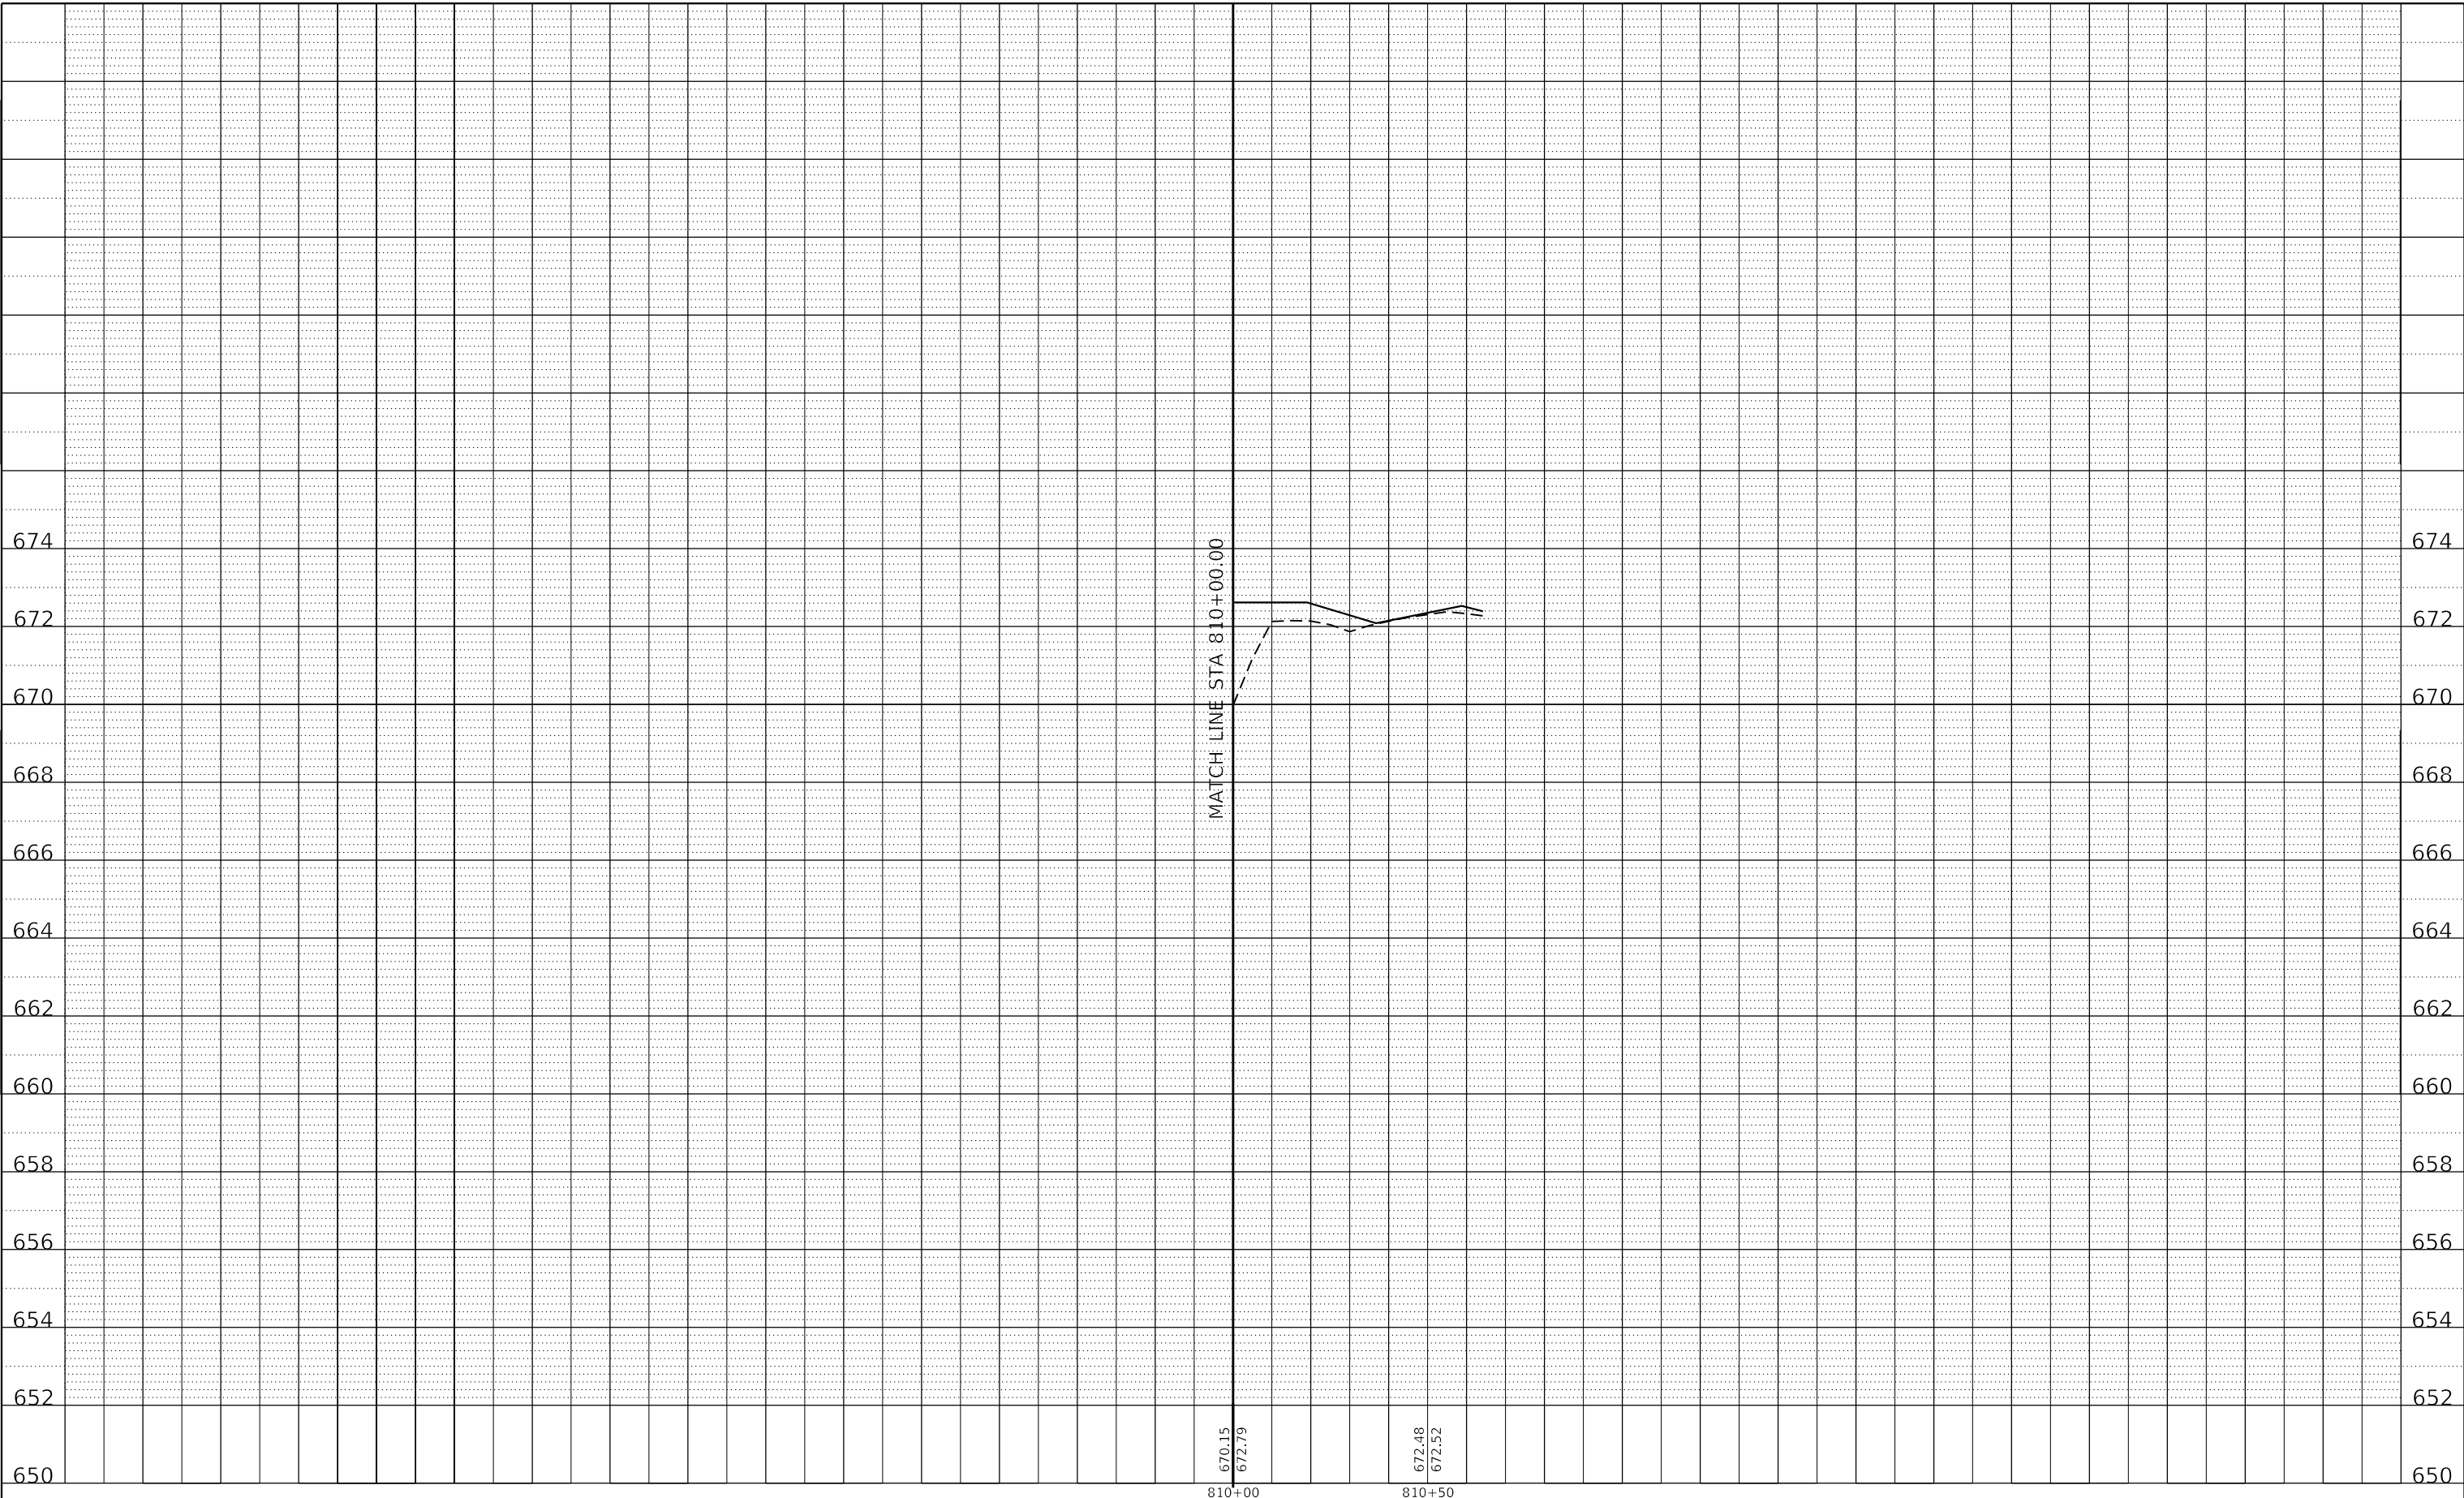


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	PLOTTED		
NOTE BOOK NO.	ALIGNMENT CHECKED		
	CAD FILE NAME		

PROFILE	SURVEYED	BY	DATE
	PLOTTED		
NOTE BOOK NO.	GRADES CHECKED		
	STRUCTURE NOTATIONS CHWD		

MODEL: Default
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USER NAME = gjameson	DESIGNED - TJB	REVISED -
PLOT SCALE = 40.0000' / in.	DRAWN - GSJ	REVISED -
PLOT DATE = 4/27/2021	CHECKED - CWC	REVISED -
	DATE - 4/30/2021	REVISED -

**STATE OF ILLINOIS
 DEPARTMENT OF TRANSPORTATION**


E HARRISON AVENUE (WEST LEG) PROPOSED DRAINAGE PROFILES RIGHTSIDE			
SCALE: 1"=10' V	SHEET 23 OF 27 SHEETS	STA. 804+50.00	TO STA. 810+20.00

F.A.U. RTE. 7448	SECTION 09-00933-01-BR	COUNTY MACON	TOTAL SHEETS 1019	SHEET NO. 501
CONTRACT NO. 95893				
ILLINOIS FED. AID PROJECT				

PLAN	SURVEYED	BY	DATE
	PLOTTED		
NOTE BOOK NO.	ALIGNMENT CHECKED		
	CAD FILE NAME		

PROFILE	SURVEYED	BY	DATE
	PLOTTED		
NOTE BOOK NO.	GRADES CHECKED		
	STRUCTURE NOTATIONS CHECKED		

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700+00 700+50 701+00

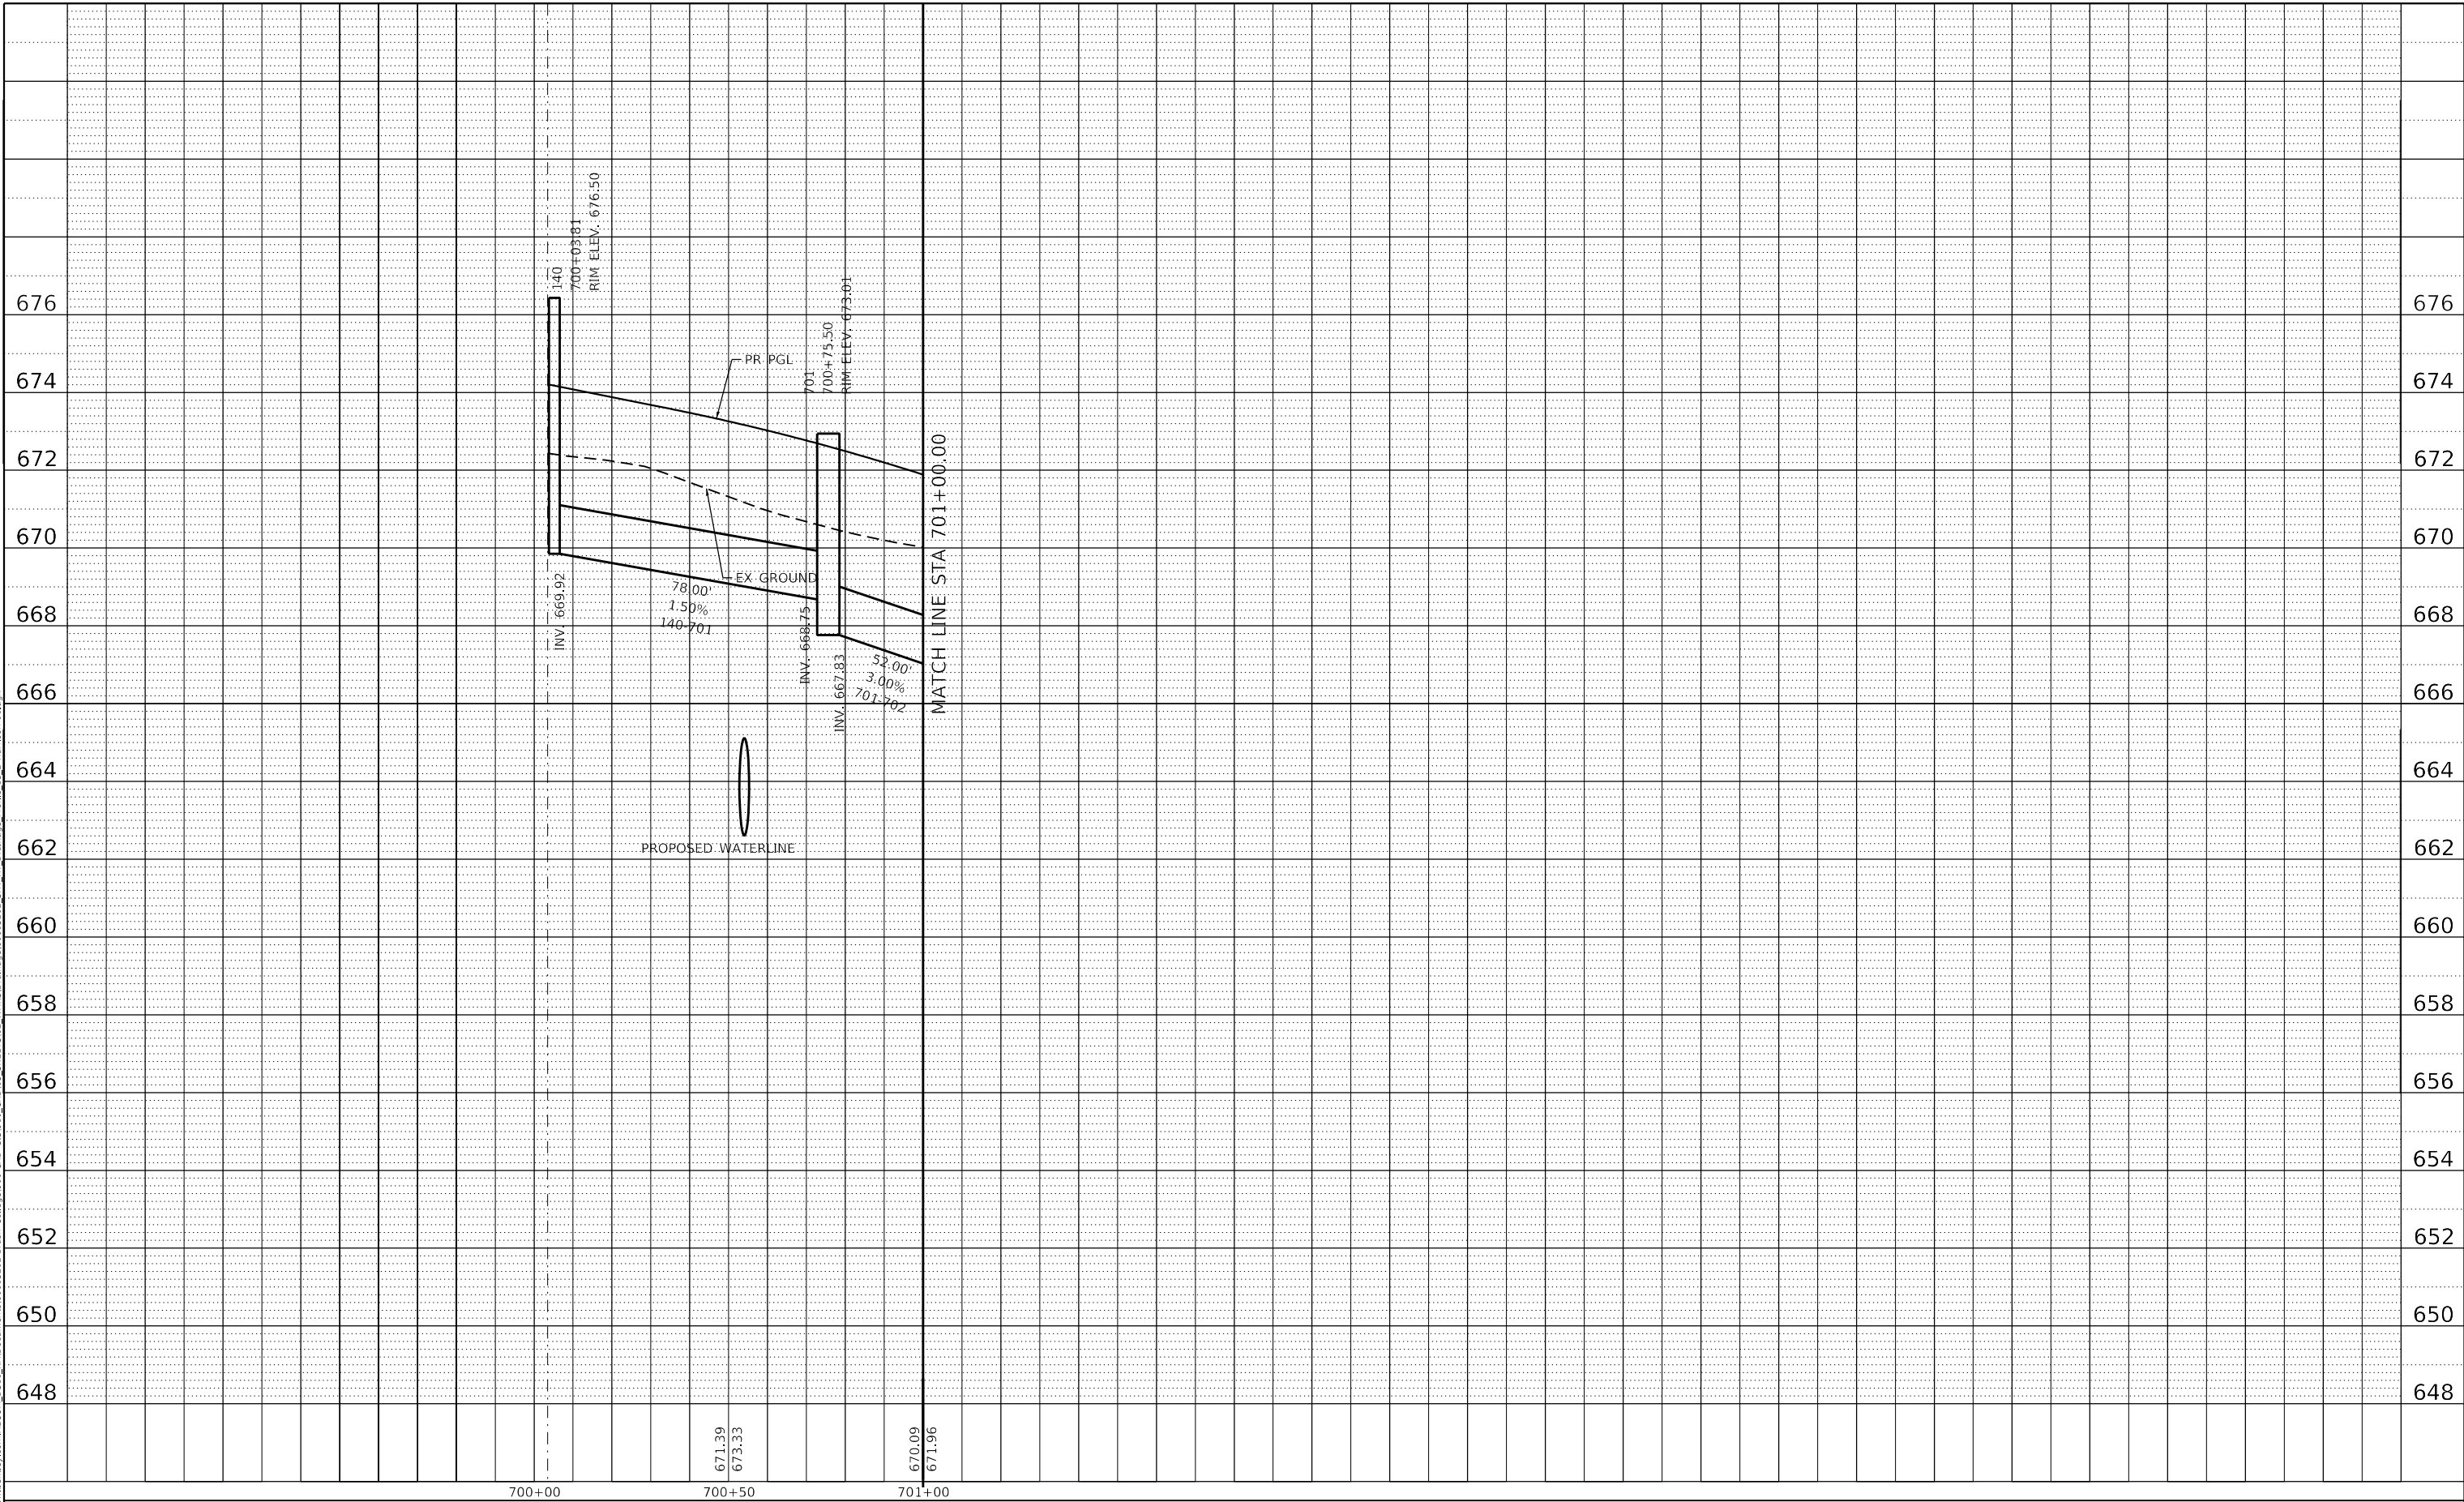671.39
673.33

670.09
671.96



USER NAME = gjameson	DESIGNED - TJB	REVISED -
PLOT SCALE = 40.0000' / in.	DRAWN - GSJ	REVISED -
PLOT DATE = 4/27/2021	CHECKED - CWC	REVISED -
	DATE - 4/30/2021	REVISED -

**STATE OF ILLINOIS
DEPARTMENT OF TRANSPORTATION**

**E HARRISON AVENUE (EAST LEG)
PROPOSED DRAINAGE PROFILES RIGHTSIDE**


SCALE: 1"=10' V SHEET 24 OF 27 SHEETS STA. 700+00.00 TO STA. 705+00.00

F.A.U. RTE.	SECTION	COUNTY	TOTAL SHEETS	SHEET NO.
7448	09-00933-01-BR	MACON	1019	502
CONTRACT NO. 95893				
ILLINOIS FED. AID PROJECT				

PLAN	SURVEYED	BY	DATE
	PLOTTED		
NOTE BOOK NO.	ALIGNMENT CHECKED		
	STRUCTURE NOTATION		
	CAD FILE NAME		

PROFILE	SURVEYED	BY	DATE
	PLOTTED		
NOTE BOOK NO.	GRADES CHECKED		
	STRUCTURE NOTATION		

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design firm
 no. 184001036
whks
 engineers + planners + land surveyors

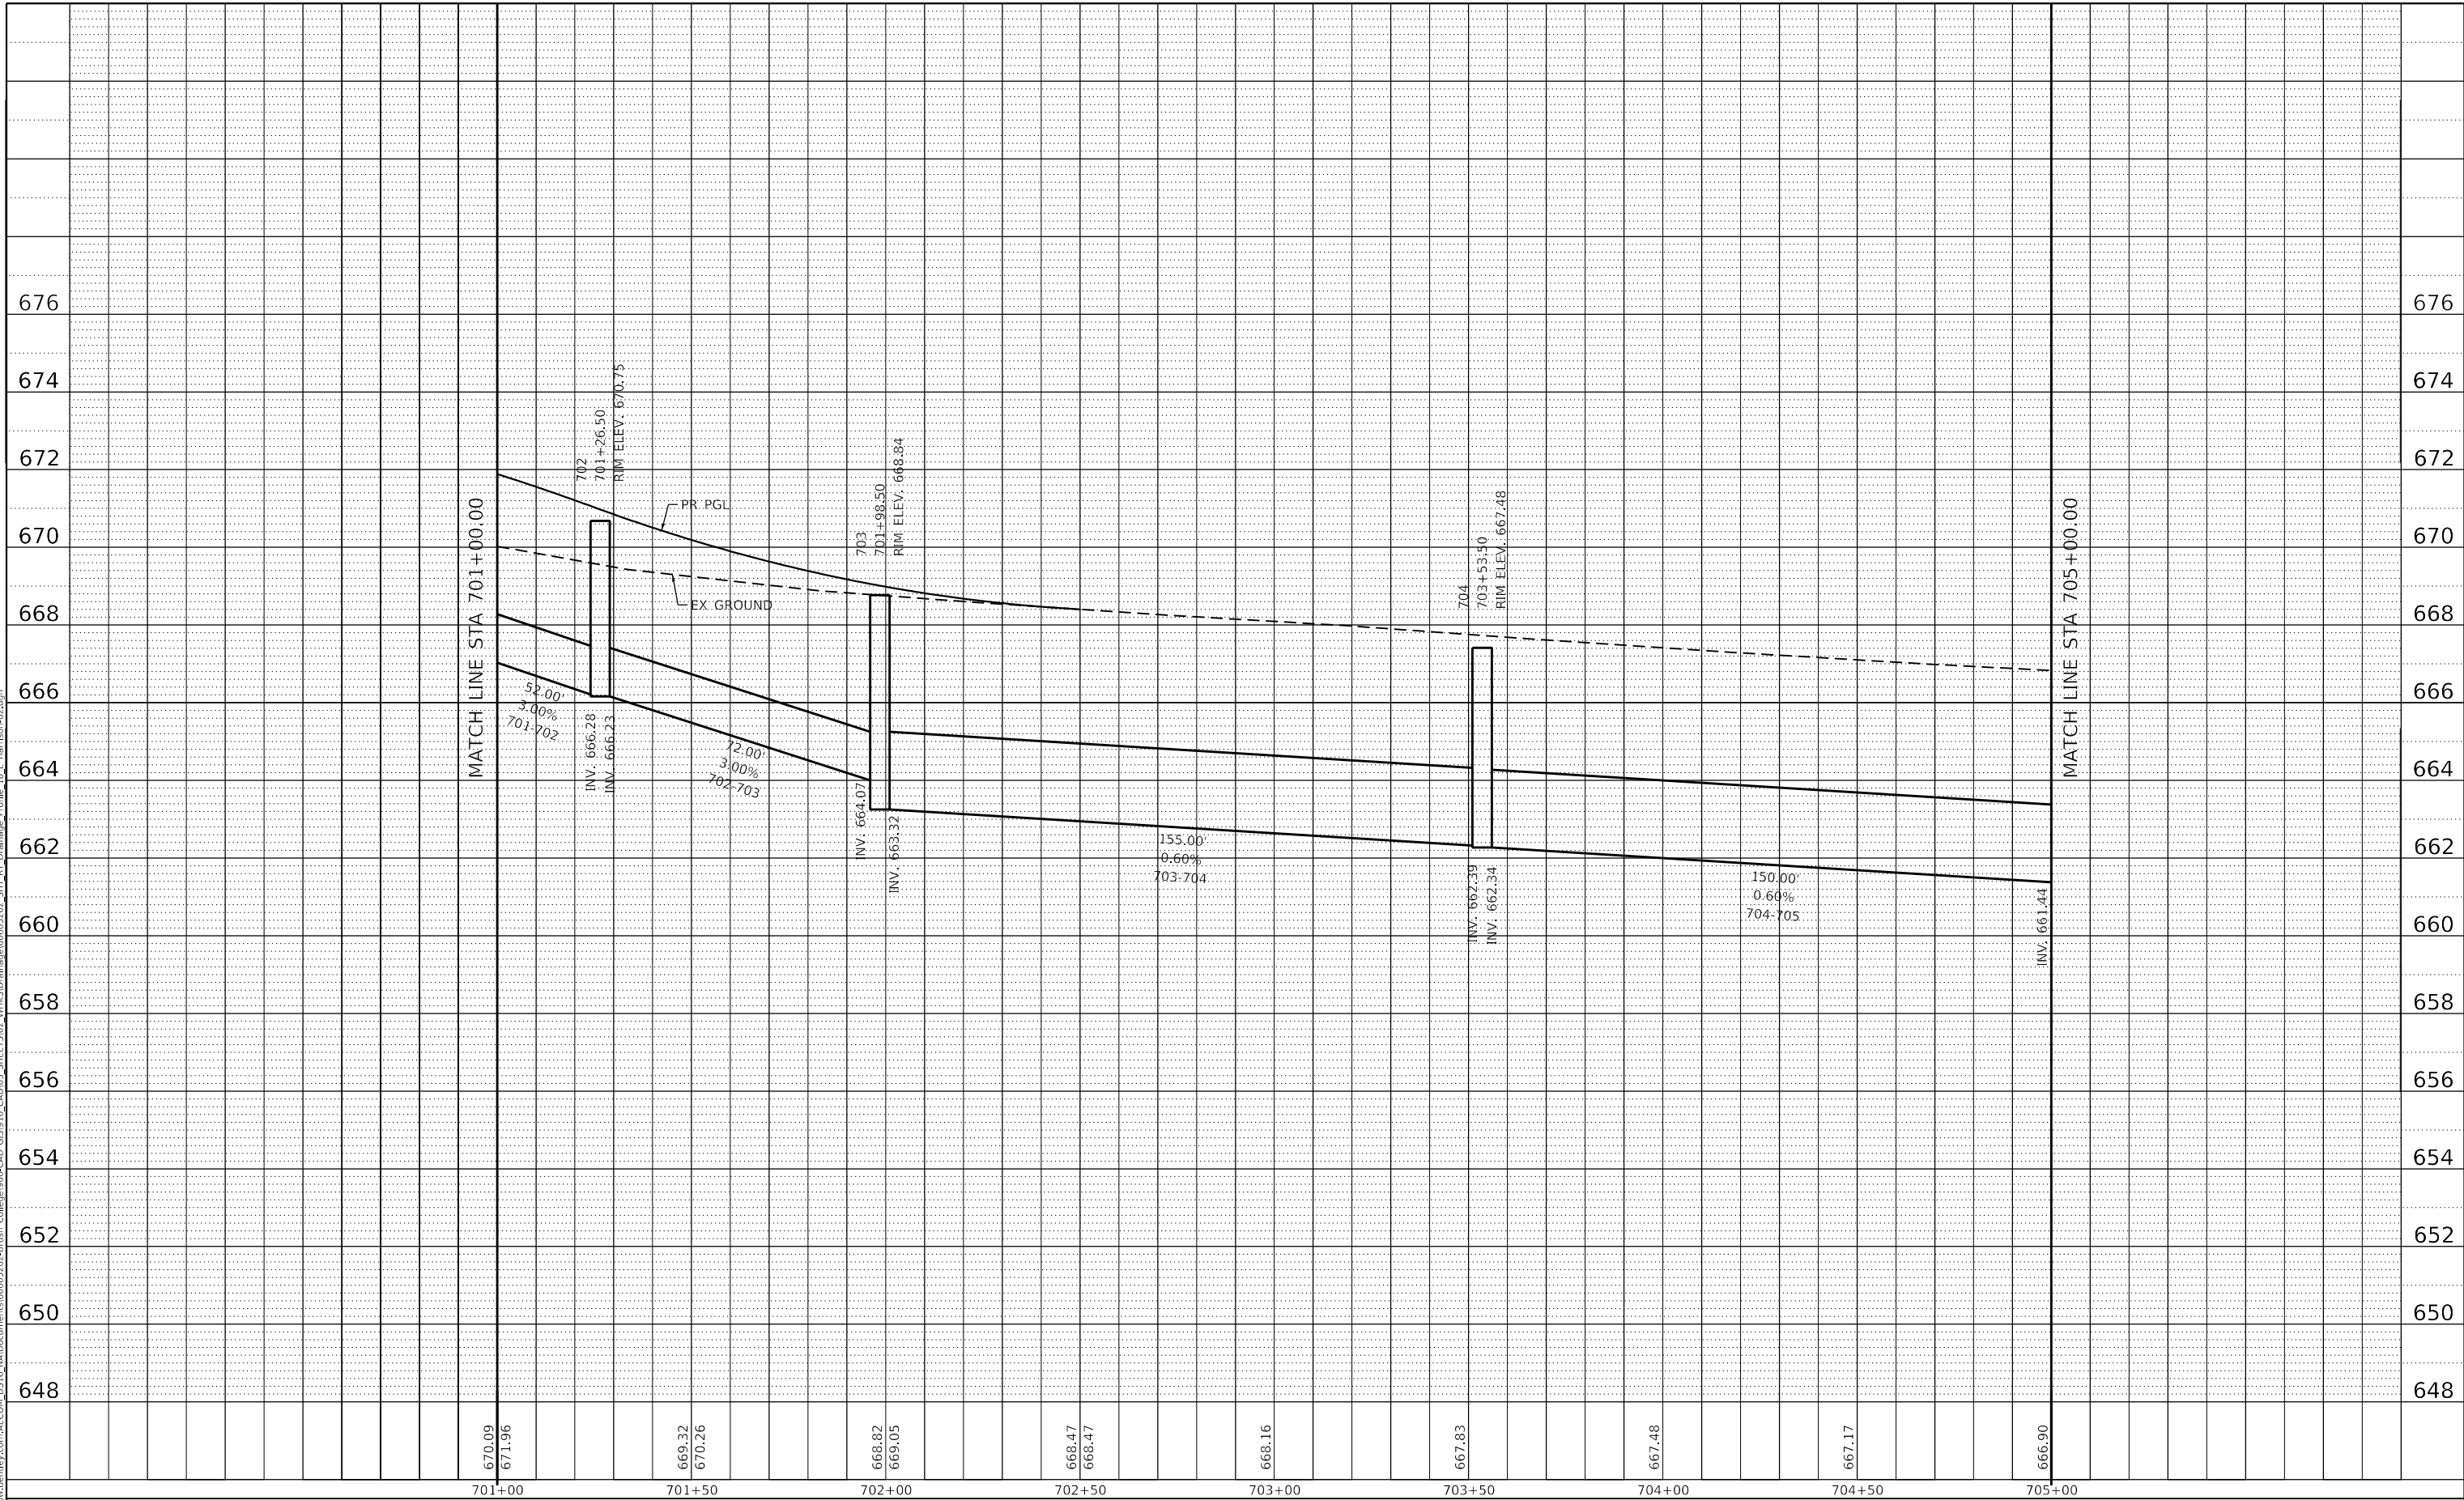USER NAME = gjameson	DESIGNED - TJB	REVISED -
PLOT SCALE = 40,0000 ' / in.	DRAWN - GSJ	REVISED -
PLOT DATE = 4/27/2021	CHECKED - CWC	REVISED -
	DATE - 4/30/2021	REVISED -

**STATE OF ILLINOIS
 DEPARTMENT OF TRANSPORTATION**

**E HARRISON AVENUE (EAST LEG)
 PROPOSED DRAINAGE PROFILES RIGHTSIDE**


SCALE: 1"=10' V SHEET 25 OF 27 SHEETS STA. 700+00.00 TO STA. 705+00.00

F.A.U. RTE.	SECTION	COUNTY	TOTAL SHEETS	SHEET NO.
7448	09-00933-01-BR	MACON	1019	503
CONTRACT NO. 95893				
ILLINOIS FED. AID PROJECT				

PLAN	SURVEYED	BY	DATE
NO.	PLOTTED		
	ALIGNED		
	CHECKED		
	CAD FILE NAME		

PROFILE	SURVEYED	BY	DATE
NO.	PLOTTED		
	GRADES CHECKED		
	STRUCTURE NOTATION		

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USER NAME = gjameson	DESIGNED - TJB	REVISED -
PLOT SCALE = 40,0000' / in.	DRAWN - GSJ	REVISED -
PLOT DATE = 4/27/2021	CHECKED - CWC	REVISED -
	DATE - 4/30/2021	REVISED -

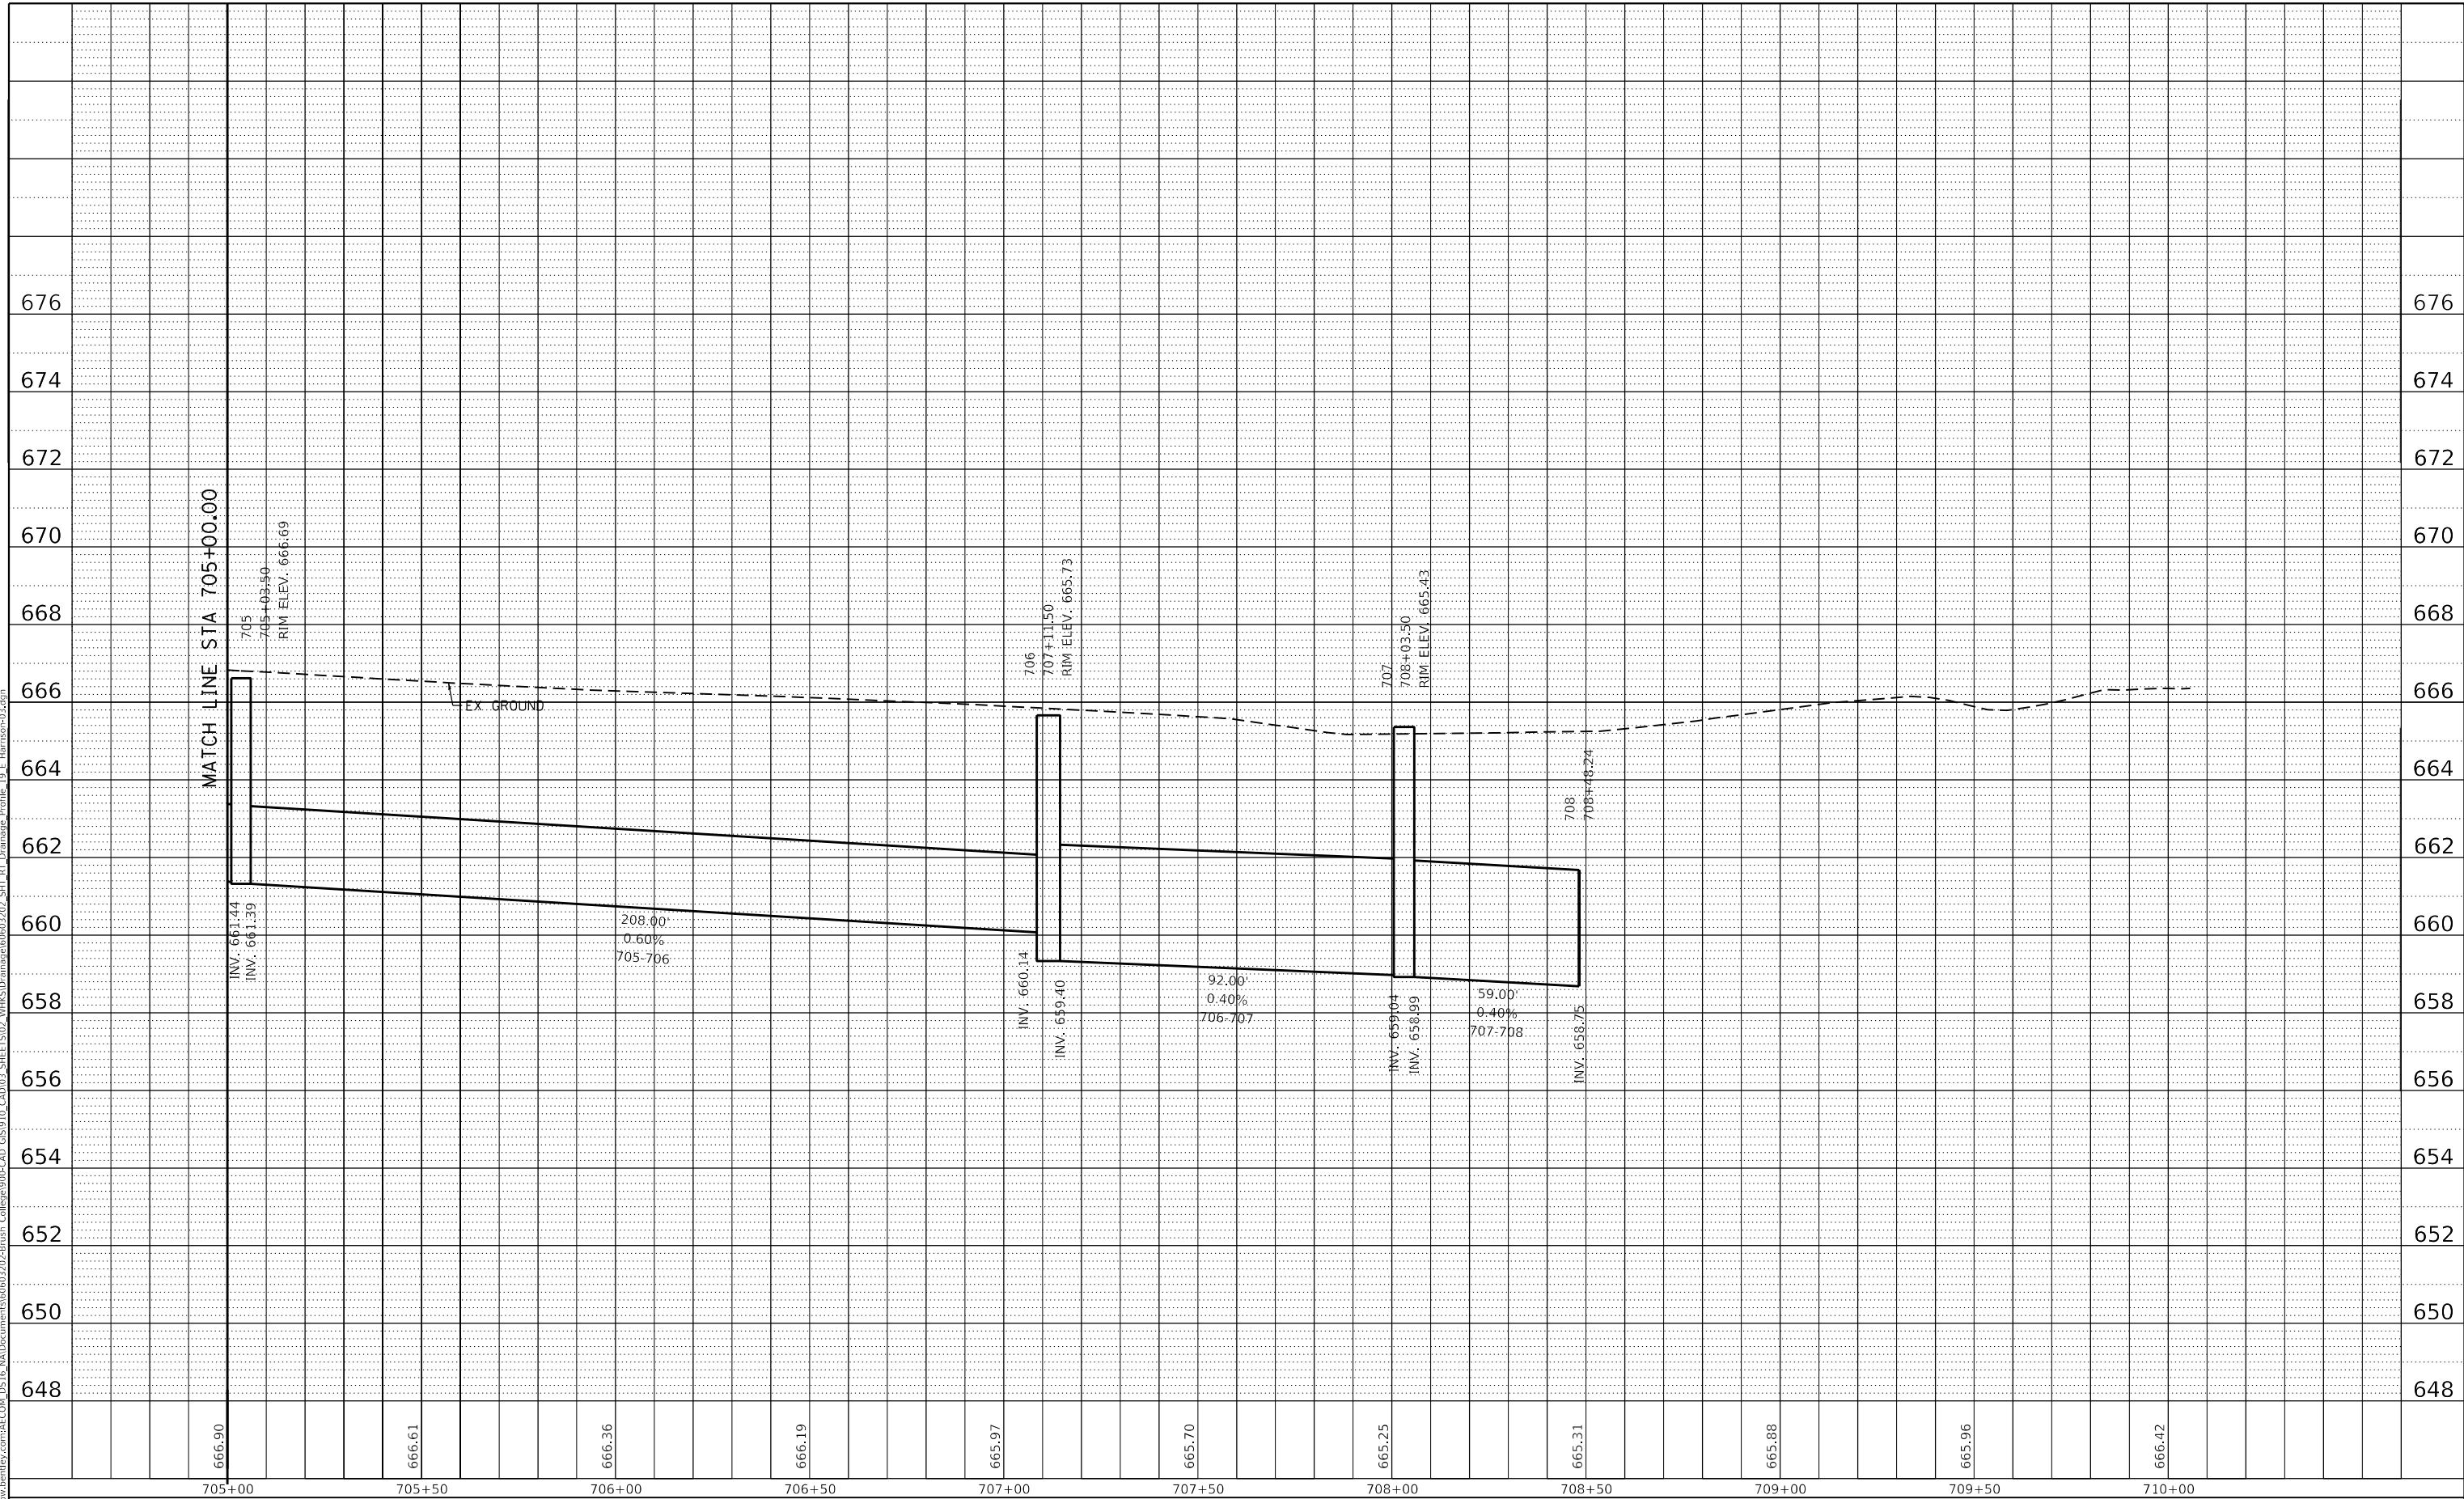
**STATE OF ILLINOIS
 DEPARTMENT OF TRANSPORTATION**

E HARRISON AVENUE (EAST LEG) PROPOSED DRAINAGE PROFILES RIGHTSIDE			
SCALE: 1"=10' V	SHEET 26	OF 27 SHEETS	STA. 705+00.00 TO STA. 710+00.00

F.A.U. RTE.	SECTION	COUNTY	TOTAL SHEETS	SHEET NO.
7448	09-00933-01-BR	MACON	1019	504
CONTRACT NO. 95893				
ILLINOIS FED. AID PROJECT				

PLAN	SURVEYED	BY	DATE
	PLOTTED		
NOTE BOOK NO.	ALIGNMENT CHECKED		
	CADD FILE NAME		

PROFILE	SURVEYED	BY	DATE
	PLOTTED		
NOTE BOOK NO.	GRADES CHECKED		
	STRUCTURE NOTATIONS		

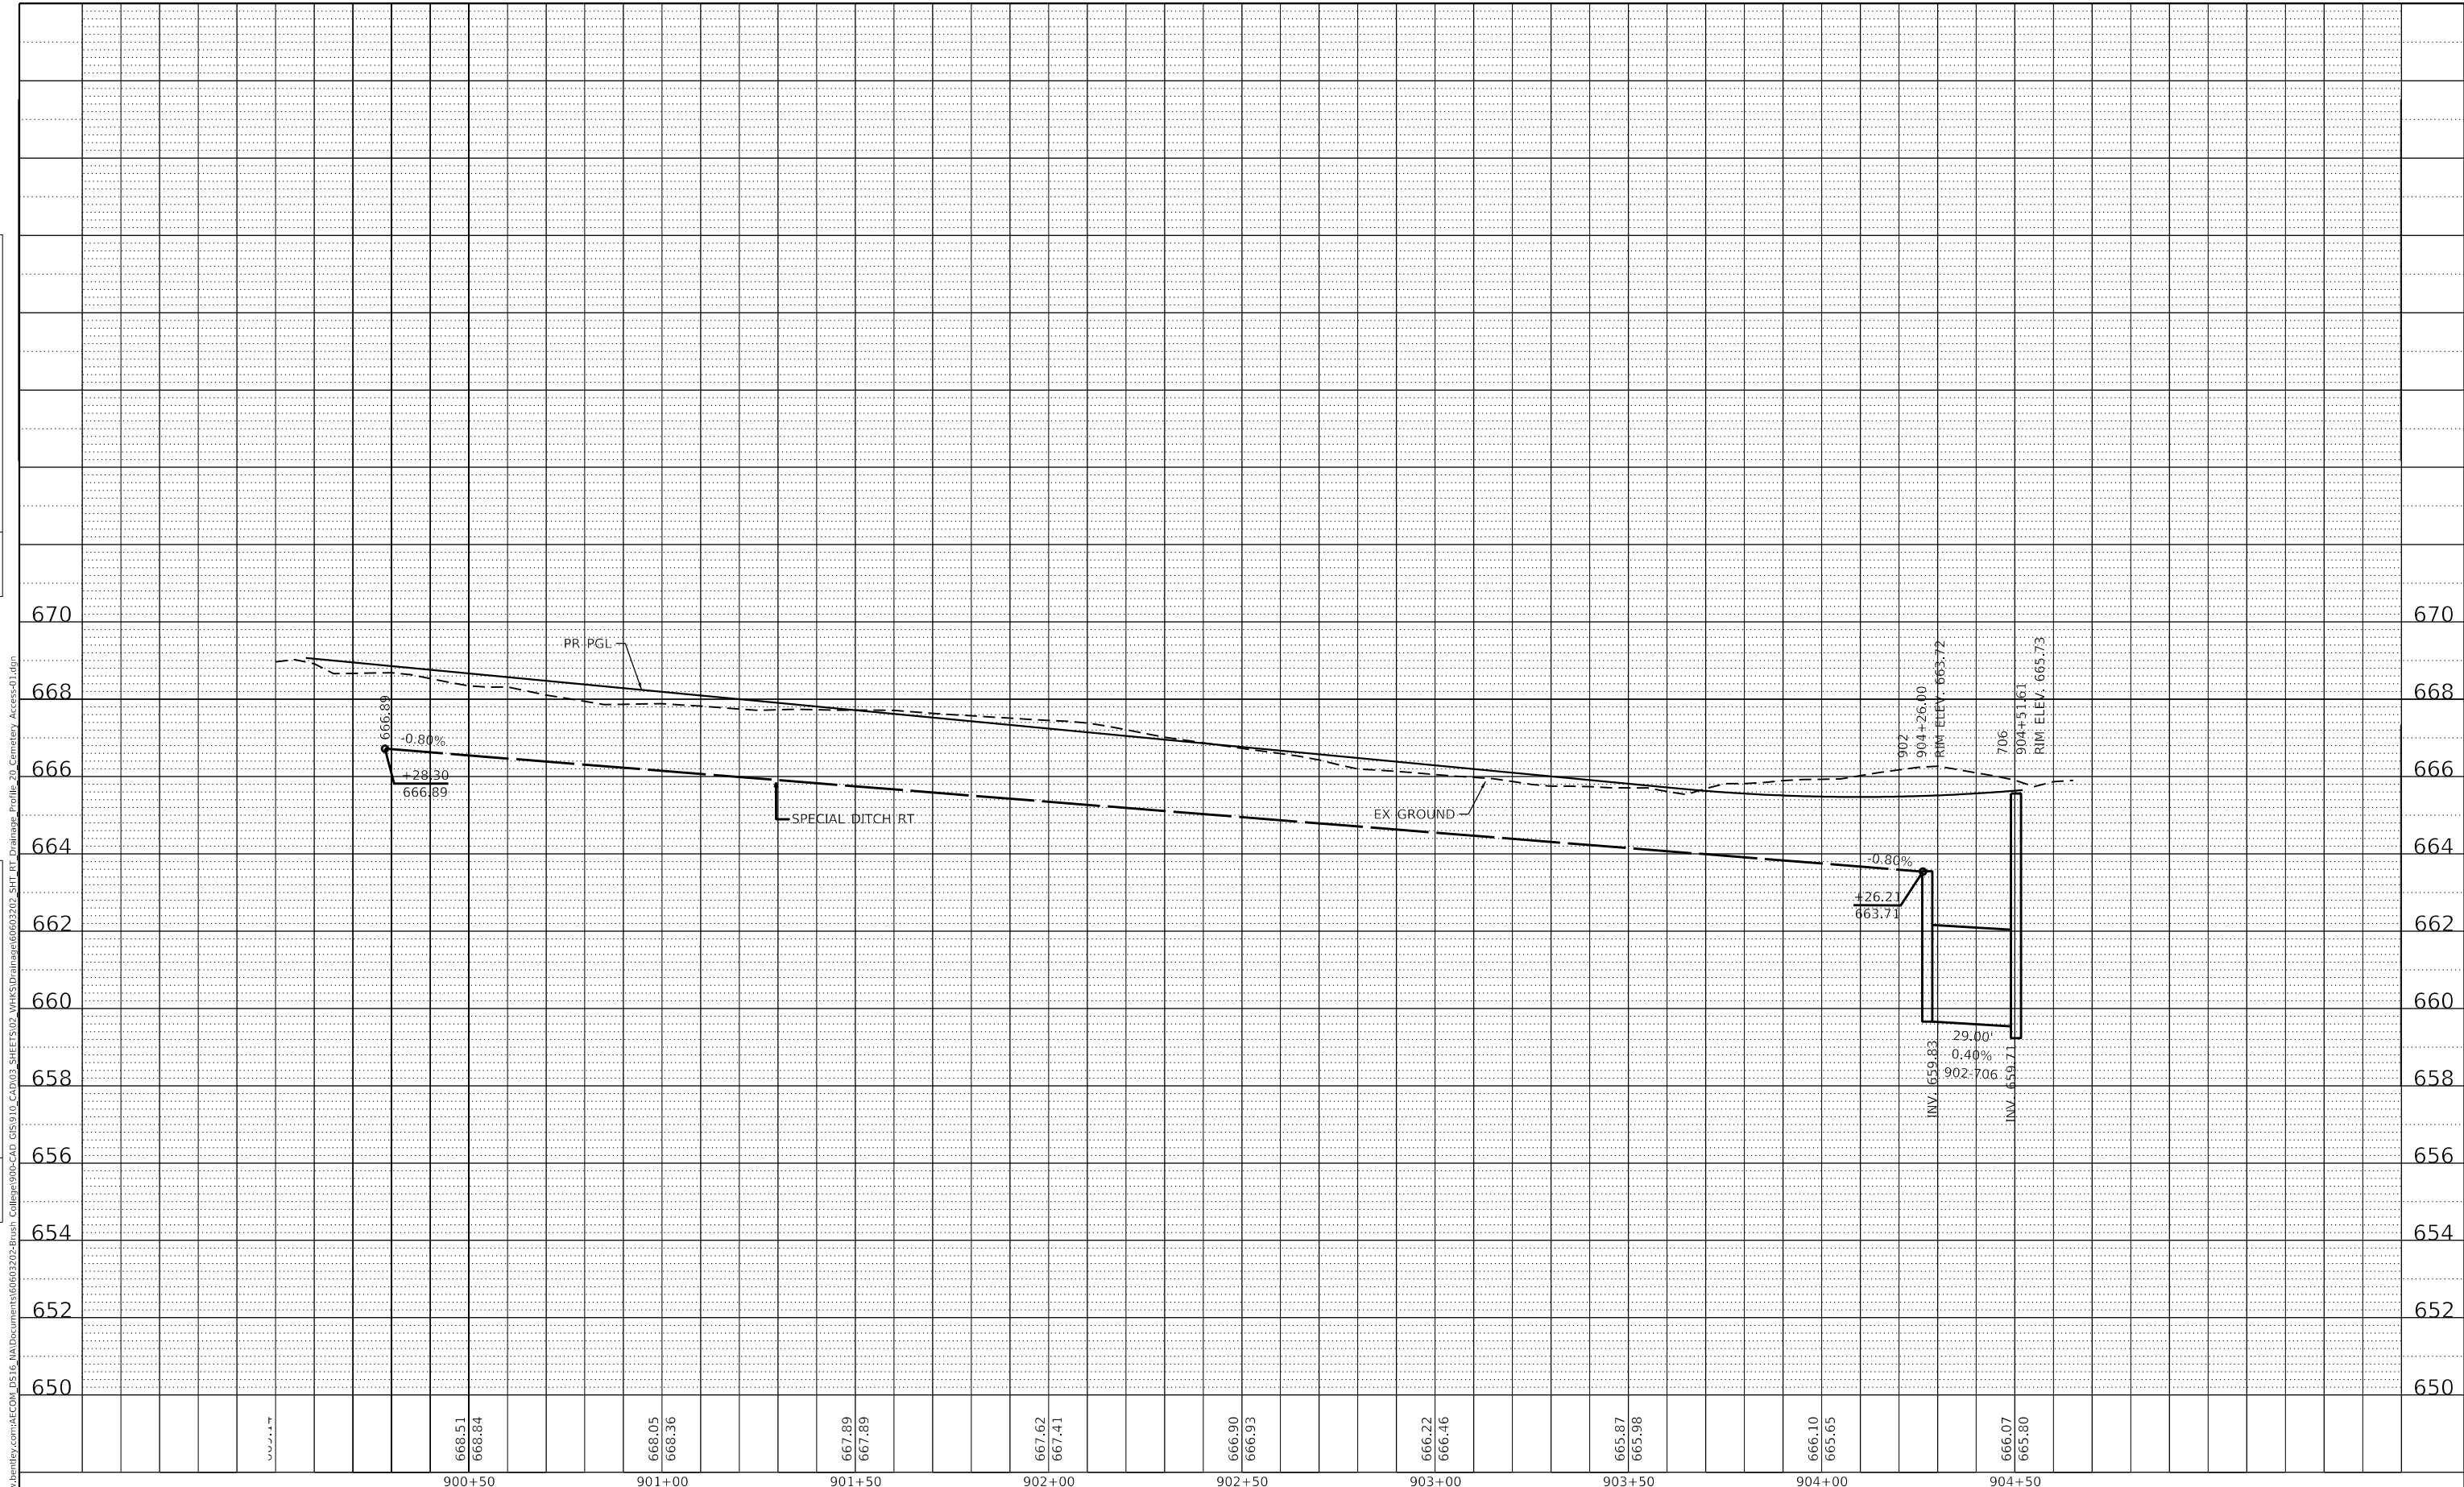

668.51	668.84	668.05	668.36	667.89	667.89	667.62	667.41	666.90	666.93	666.22	666.46	665.87	665.98	666.10	665.65	666.07	665.80
900+50		901+00		901+50		902+00		902+50		903+00		903+50		904+00		904+50	


design firm
no. 184001036
whks
engineers + planners + land surveyors

USER NAME = gjameson	DESIGNED - TJB	REVISED -
PLOT SCALE = 40.0000' / in.	DRAWN - GSJ	REVISED -
PLOT DATE = 4/27/2021	CHECKED - CWC	REVISED -
	DATE - 4/30/2021	REVISED -


**STATE OF ILLINOIS
DEPARTMENT OF TRANSPORTATION**

CEMETERY ACCESS PROPOSED DRAINAGE PROFILES RIGHTSIDE	
SCALE: 1"=10' V	SHEET 27 OF 27 SHEETS
STA. 900+00.00	TO STA. 904+66.28


F.A.U. RTE.	SECTION	COUNTY	TOTAL SHEETS	SHEET NO.
7448	09-00933-01-BR	MACON	1019	505
CONTRACT NO. 95893				
ILLINOIS FED. AID PROJECT				

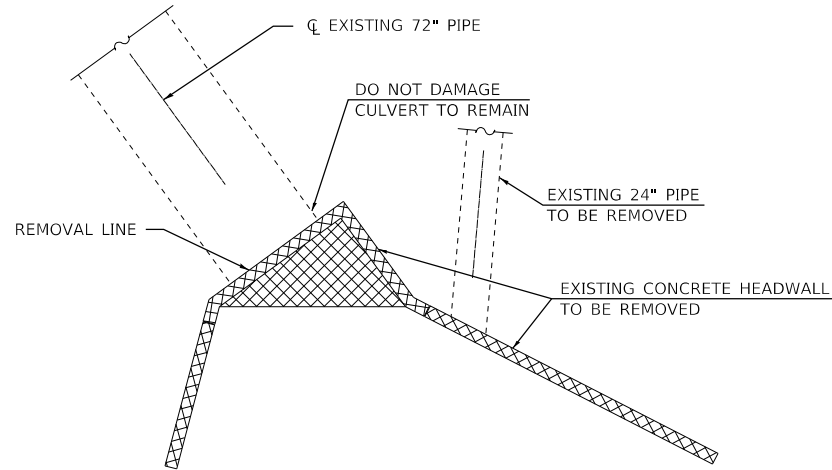


REMOVAL PLAN
FARIES ROAD (STA. 226+62)

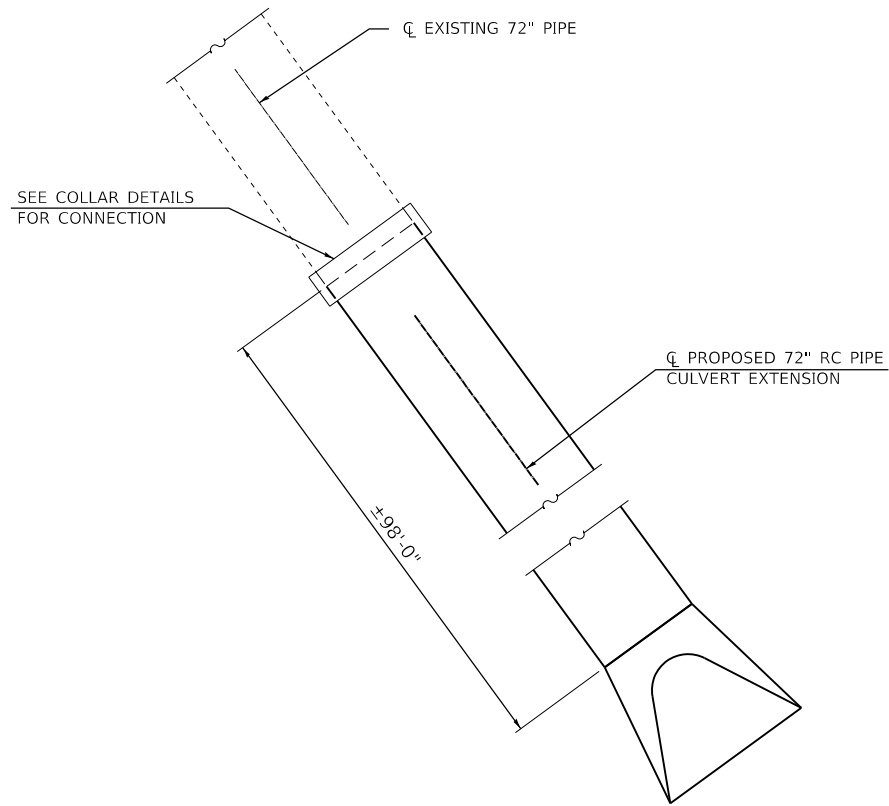

PROPOSED PLAN
FARIES ROAD (STA. 226+62)

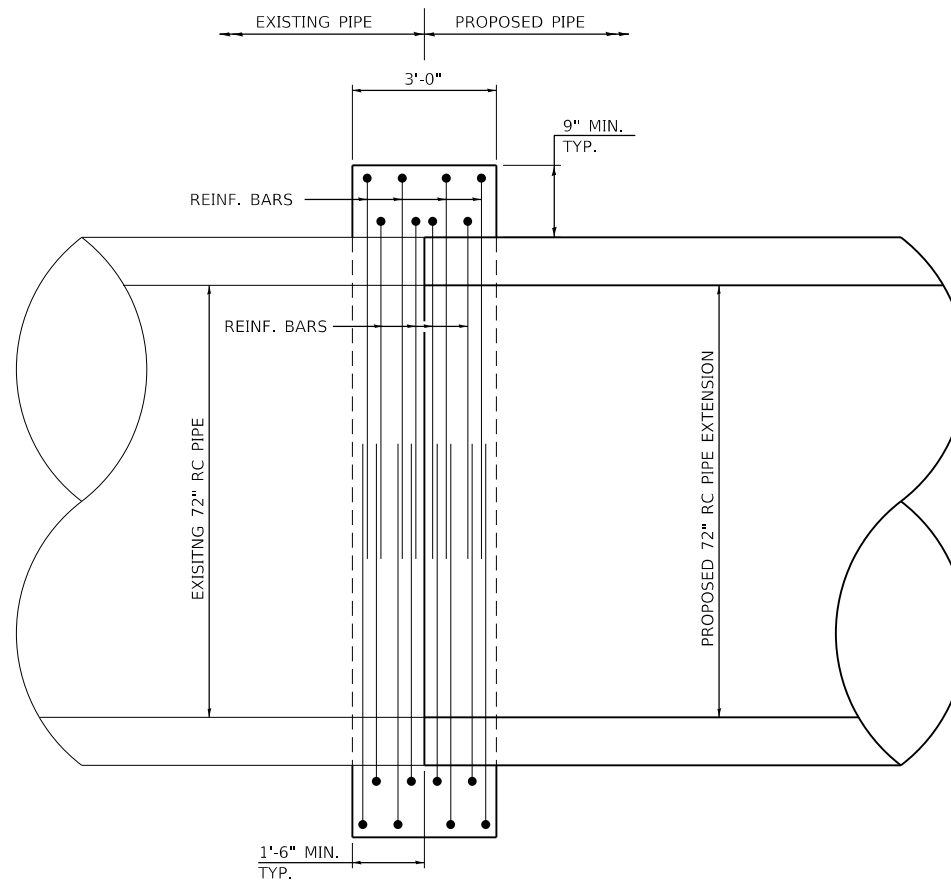


COLLAR SECTION
PIPE END TO PIPE END EXTENSION

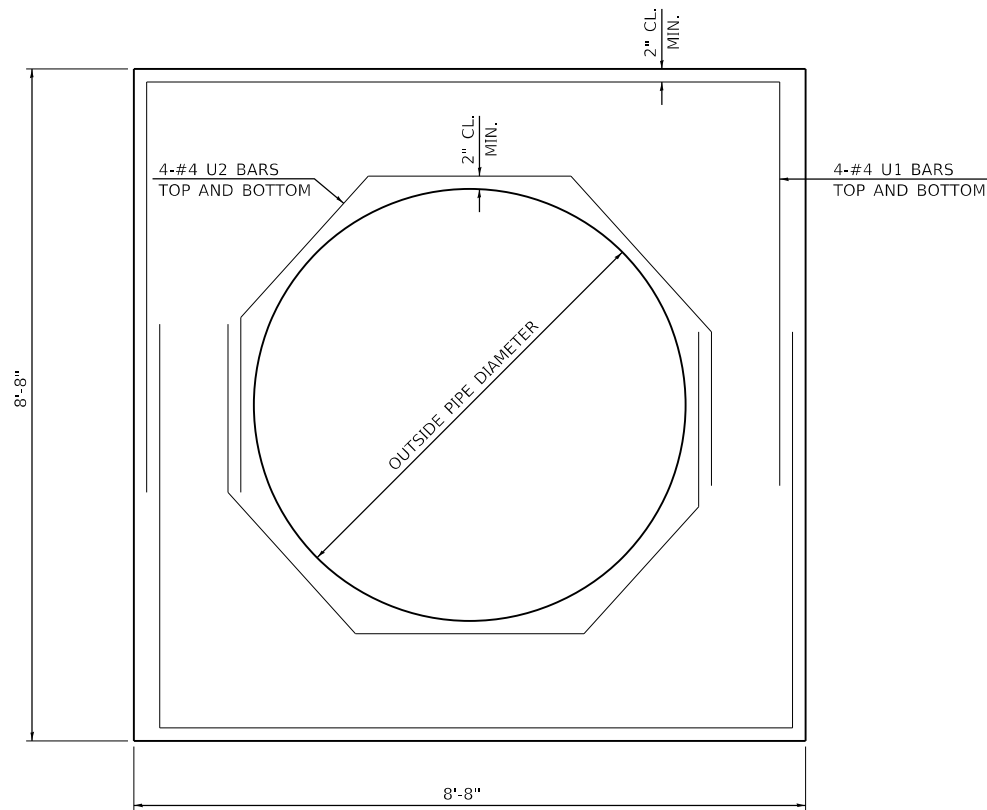

END SECTION

GENERAL NOTES

1. THE COLLAR SHALL BE CONSTRUCTED OF CLASS SI CONCRETE IN ACCORDANCE WITH THE APPLICABLE PORTIONS OF SECTION 503 OF THE STANDARD SPECIFICATIONS. REINFORCEMENT BARS SHALL CONFORM TO SECTION 508.
2. THIS WORK SHALL BE PAID FOR BY THE CUBIC YARD FOR CONCRETE COLLAR WHICH SHALL INCLUDE THE COST OF THE REINFORCEMENT SHOWN.
3. DETAILS ARE NOT TO SCALE.
4. SEE DRAINAGE PLANS FOR ADDITIONAL DETAILS.

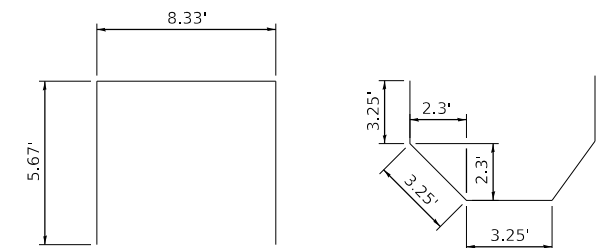

U1 BAR

U2 BAR

BILL OF MATERIAL

ITEM	UNIT	TOTAL
CONCRETE COLLAR	CU. YD.	6.2

IF NEEDED FOR CONNECTION, A COLLAR SIMILAR TO ABOVE SHALL BE USED TO CONNECT PROPOSED 36" S5 NEAR STR 809. A ESTIMATED QUANTITY OF 2.3 CU YD OF CONCRETE COLLAR HAS BEEN ADDED TO TOTAL QUANTITY.

MODEL SHEET
FILE NAME: p:\luc\com-pw\hntley.com\AECOM_0516_M\Documents\60603202\Drainage Details\60603202_Culvert_Ext_Collar_Details_Sheet 1




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PLOT SCALE = 0.167' / in.	DRAWN - DLH	REVISED -
PLOT DATE = 4/27/2021	CHECKED - CWC	REVISED -
	DATE - 4/30/2021	REVISED -

**STATE OF ILLINOIS
DEPARTMENT OF TRANSPORTATION**


**DRAINAGE DETAILS
CONCRETE PIPE EXTENSION AND COLLAR DETAILS**

SCALE: SHEET 1 OF 7 SHEETS STA. 207+98 TO STA. 209+82

F.A.U. RTE.	SECTION	COUNTY	TOTAL SHEETS	SHEET NO.
7448	09-00933-01-BR	MACON	1019	506
CONTRACT NO. 95893				
ILLINOIS FED. AID PROJECT				

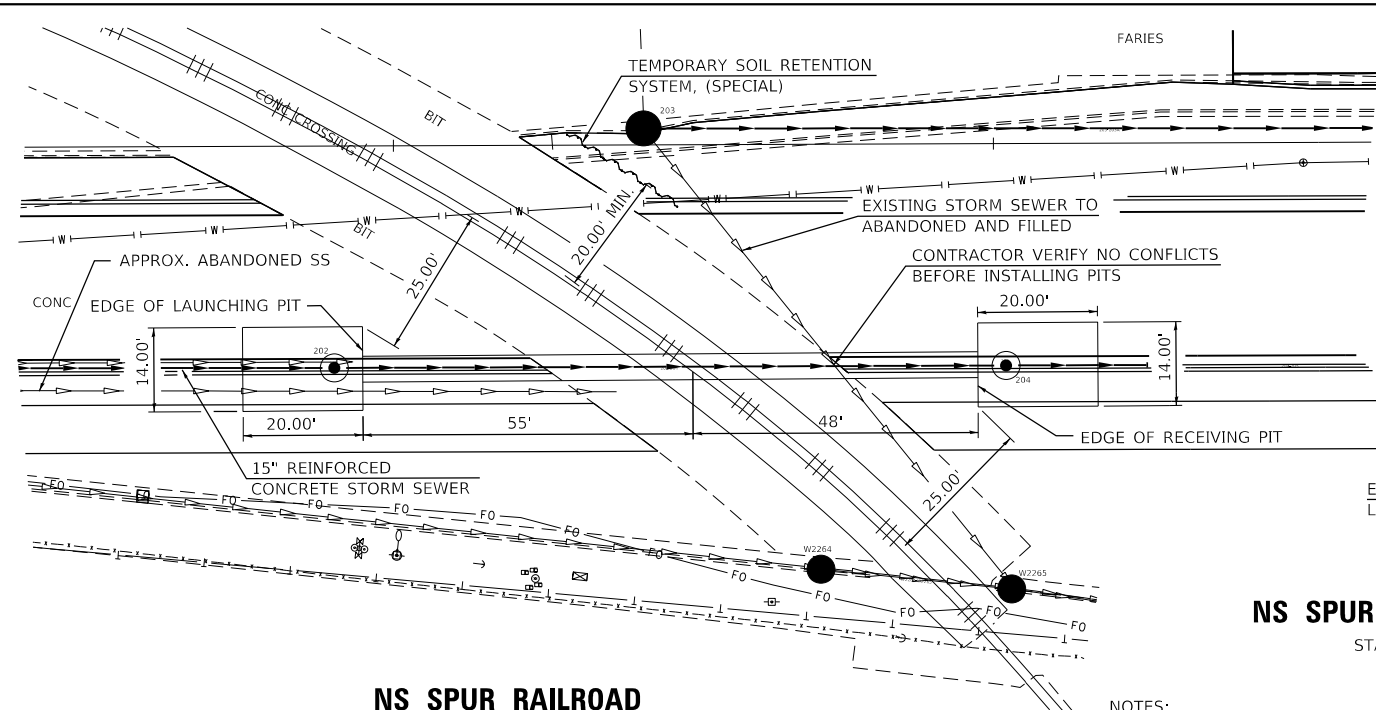

NS SPUR RAILROAD
STA. 207+98.50

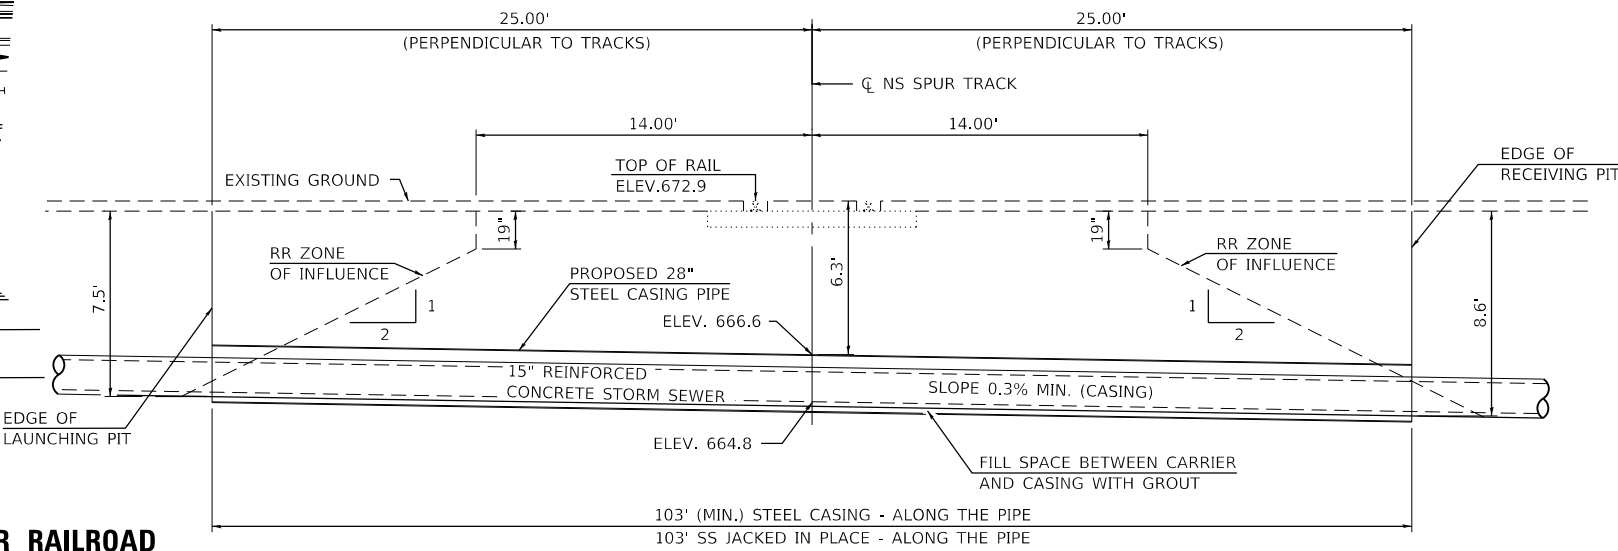


IC RAILROAD

	Carrier Pipe	Casing Pipe
Contents to Be Carried	Storm Water	---
Diameter (inches)	15	28
Wall Thickness (inches)	2.25	0.438
Material/Type of Pipe	Reinf. Concrete	Steel
Specification/Grade	ASTM C76, Class IV, Wall B	fy = 35,000 psi
Actual Working Pressure (psi)	---	---
Test Pressure (psi)	---	---
Joint Type	ASTM C443 Rubber Gasket Gouted Between Carrier and Casing	Welded
Coating	---	---
Method of Installation	Jacked/Bored	Jacked/Bored
Cathodic Protection	None	None
Dimension from Top of Rail	---	---
Protection at Ends of Casing	1/4" Steel Plate with holes for drainage	


NOTES:

- SEE DRAINAGE PLANS AND SPECIAL PROVISIONS FOR ADDITIONAL DETAILS AND REQUIREMENTS NOT SHOWN.
- SEE MOT AND STAGING DETAILS FOR SEQUENCE OF STORM SEWER CONSTRUCTION.
- CASING SLOPE TO MATCH CARRIER SLOPE BUT CANNOT BE LESS THAN 0.3%.
- CONTRACTOR IS ALERTED THERE IS AN ABANDONED 15" STORM SEWER IN THE VICINITY OF THE PROPOSED STORM SEWER TO BE JACKED IN PLACE. THE EXACT LOCATION OF THE ABANDONED STORM SEWER IS NOT KNOWN. CONTRACTOR SHALL POT HOLE TO VERIFY EXACT LOCATION OF ABANDONED UTILITY AND SUBMIT A REQUEST FOR ANY FIELD ADJUSTMENTS TO THE ENGINEER FOR APPROVAL. FIELD ADJUSTMENTS MUST BE APPROVED BY THE ENGINEER PRIOR TO ORDERING MATERIAL, INSTALLING JACKING AND RECEIVING PITS OR SUBMITTING FINAL PERMITS FOR EXCAVATIONS TO THE RAILROADS INVOLVED.
- THE CONTRACTOR IS ALERTED TO THE PRESENCE OF UNDERGROUND STORM SEWER, SANITARY SEWERS AND OTHER UTILITIES. THESE SEWERS AND UTILITIES IN THE VICINITY AND UNDER THE PROPOSED TEMPORARY SOIL RETENTION SYSTEM NEED TO BE KEPT IN SERVICE DURING CONSTRUCTION. SEE DRAINAGE AND UTILITY PLANS.

	Carrier Pipe	Casing Pipe
Contents to Be Carried	Storm Water	---
Diameter (inches)	24	38
Wall Thickness (inches)	3	0.562
Material/Type of Pipe	Reinf. Concrete	Steel
Specification/Grade	ASTM C76, Class IV, Wall B	fy = 35,000 psi
Actual Working Pressure (psi)	---	---
Test Pressure (psi)	---	---
Joint Type	ASTM C443 Rubber Gasket Gouted Between Carrier and Casing	Welded
Coating	---	---
Method of Installation	Jacked/Bored	Jacked/Bored
Cathodic Protection	None	None
Dimension from Top of Rail	---	---
Protection at Ends of Casing	1/4" Steel Plate with holes for drainage	

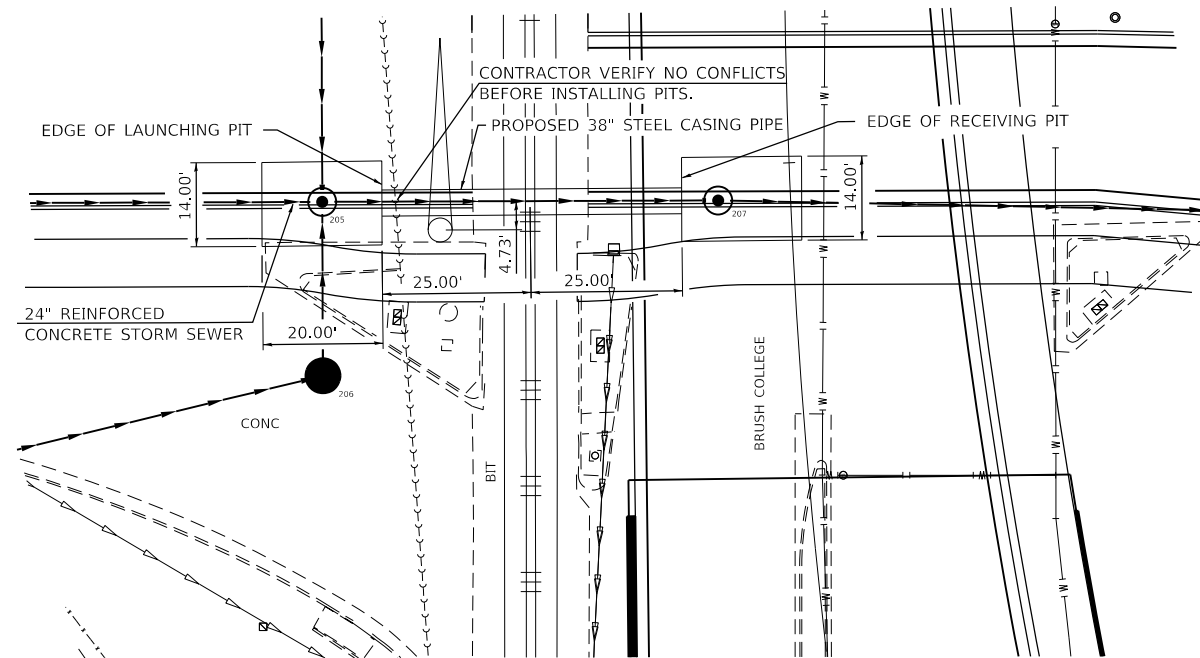

IC RAILROAD

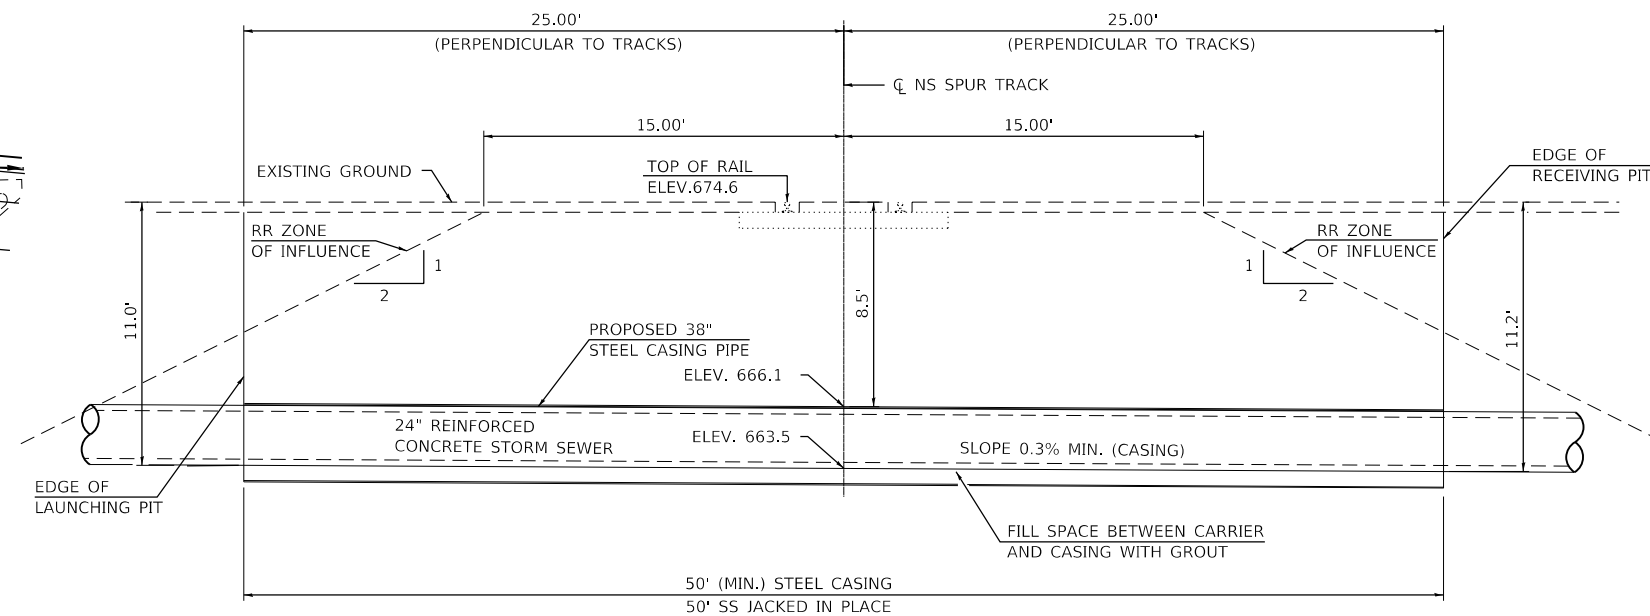

MODEL: Border
FILE NAME: p:\w\com-nw-hendley.com\AECOM_051\NA\Documents\60603202-Brush College\00-CAD GIS\910_CAD\03_SHEETS\02_VHKS\Drainage Details\Sheet_2.dgn




DESIGNED - CWC	REVISOR -
DRAWN - DLH	REVISION -
CHECKED - CWC	REVISION -
DATE - 4/30/2021	REVISION -

**STATE OF ILLINOIS
DEPARTMENT OF TRANSPORTATION**

**DRAINAGE DETAILS
STORM SEWER UNDER RAILROADS**


SCALE: SHEET 2 OF 7 SHEETS STA. 207+98 TO STA. 209+82

F.A.U. RTE.	SECTION	COUNTY	TOTAL SHEETS	SHEET NO.
7448	09-00933-01-BR	MACON	1019	507
CONTRACT NO. 95893				
ILLINOIS FED. AID PROJECT				

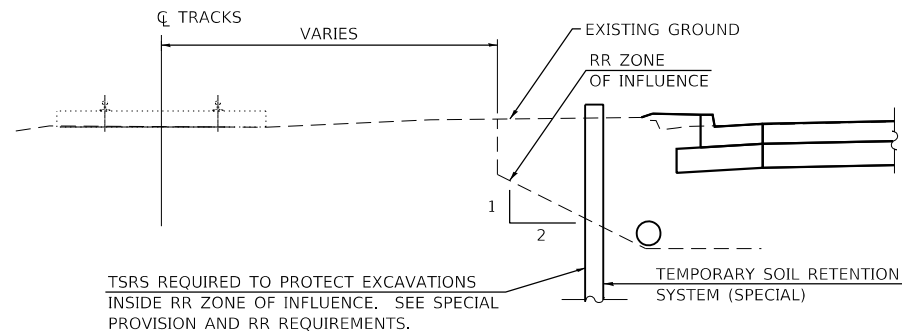


TSRS REQUIRED TO PROTECT EXCAVATIONS INSIDE RR ZONE OF INFLUENCE. SEE SPECIAL PROVISION AND RR REQUIREMENTS.

TYPICAL SECTION

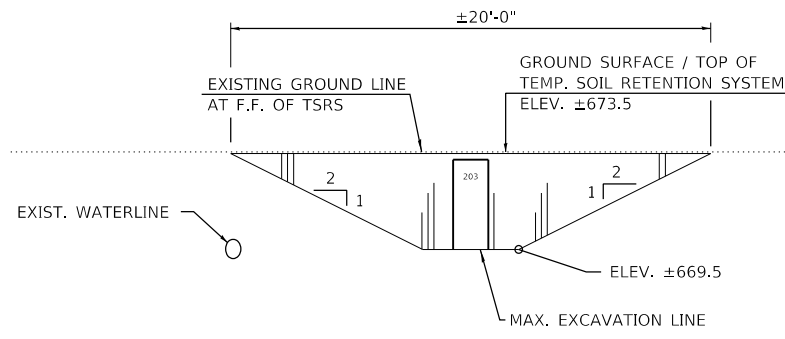


ELEVATION

STA. 207+98.50
(LOOKING WEST)

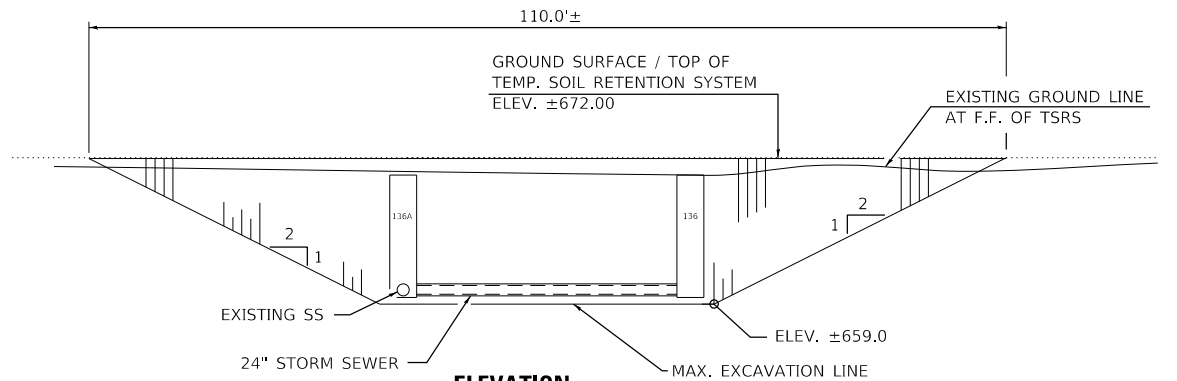


ELEVATION

STA. 67+32
(LOOKING WEST)

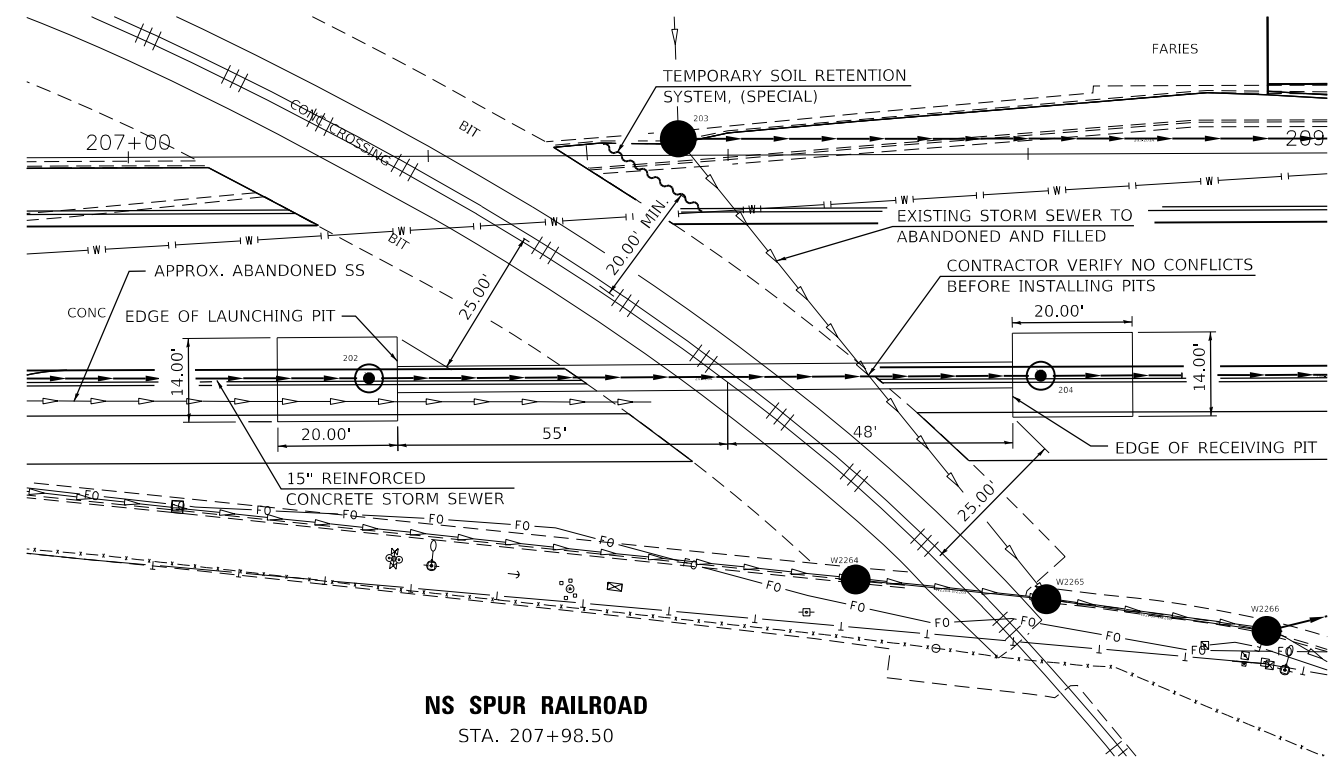

NS SPUR RAILROAD
STA. 207+98.50

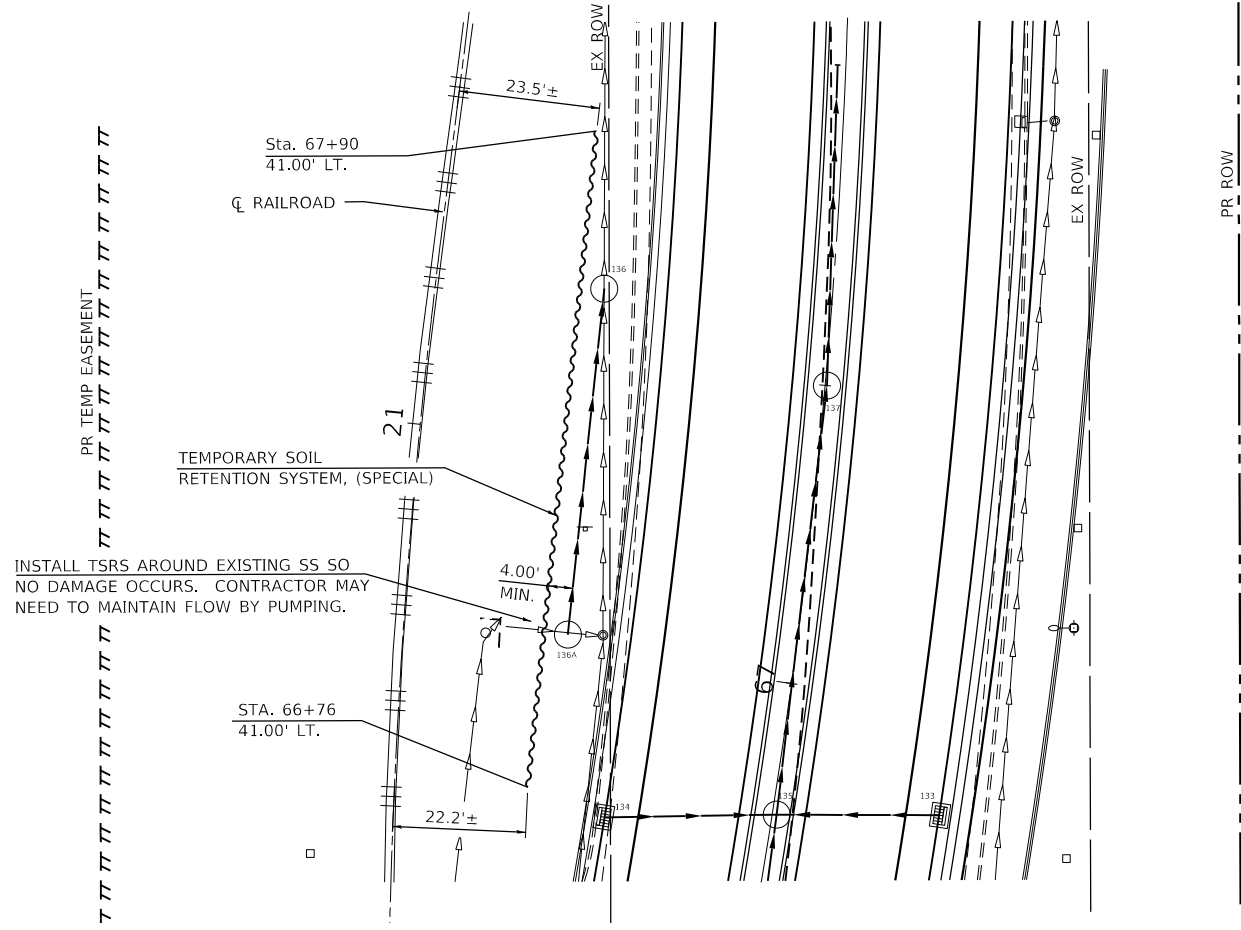

INSTALL TSRS AROUND EXISTING SS SO NO DAMAGE OCCURS. CONTRACTOR MAY NEED TO MAINTAIN FLOW BY PUMPING.

PLAN

STA. 67+32

NOTES:

1. A CANTILEVERED SHEET PILING DESIGN DOES NOT APPEAR FEASIBLE AND ADDITIONAL MEMBERS OR OTHER RETENTION SYSTEMS MAY BE NECESSARY. THE CONTRACTOR SHALL SUBMIT A TEMPORARY SOIL RETENTION SYSTEM DESIGN INCLUDING PLAN DETAILS AND CALCULATIONS FOR REVIEW AND ACCEPTANCE BY THE ENGINEER.
2. HORIZONTAL DIMENSIONS AND GROUNDS SLOPES ARE SHOWN ALONG THE TEMPORARY SOIL RETENTION SYSTEM UNLESS NOTED OTHERWISE.
3. THE CONTRACTOR IS ALERTED TO THE PRESENCE OF UNDERGROUND STORM SEWER, SANITARY SEWERS AND OTHER UTILITIES. THESE SEWERS AND UTILITIES IN THE VICINITY AND UNDER THE PROPOSED TEMPORARY SOIL RETENTION SYSTEM NEED TO BE KEPT IN SERVICE DURING CONSTRUCTION. SEE DRAINAGE AND UTILITY PLANS.
4. TEMPORARY SOIL RETENTION SYSTEM IS PAID FOR AS TEMPORARY SOIL RETENTION SYSTEM (SPECIAL). SEE SPECIAL PROVISIONS.
5. DIMENSIONS AND OFFSETS ARE APPROXIMATE AND MAY NEED TO BE ADJUSTED BASED ON ACTUAL DEPTHS OF STRUCTURES AND THE CONTRACTOR'S MEANS AND METHODS.

BILL OF MATERIAL

ITEM	UNIT	TOTAL
TEMPORARY SOIL RETENTION SYSTEM (SPECIAL)	SQ. FT.	1140

MODEL: TEMP. SOIL RETENT SYS
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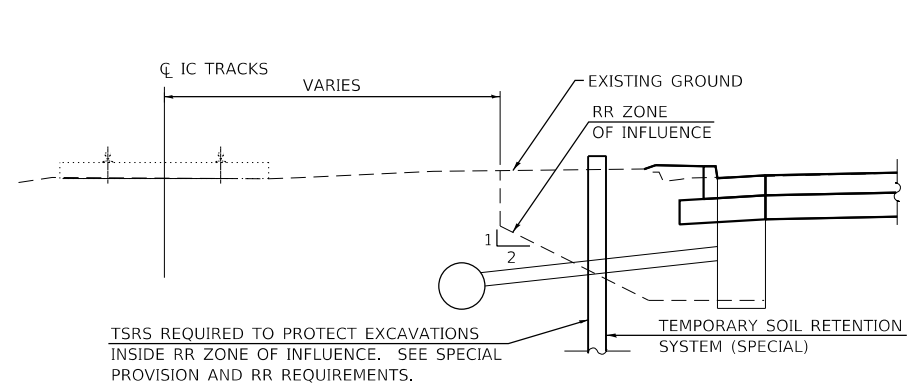


USER NAME = gjameson	DESIGNED - CWC	REVISED -
PLOT SCALE = 0.1667' / in.	DRAWN - DLH	REVISED -
PLOT DATE = 4/27/2021	CHECKED - CWC	REVISED -
	DATE - 4/30/2021	REVISED -


**STATE OF ILLINOIS
DEPARTMENT OF TRANSPORTATION**

DRAINAGE DETAILS TEMPORARY SOIL RETENTION SYSTEM	
SCALE:	SHEET 3 OF 7 SHEETS STA. TO STA.

F.A.U. RTE. 7448	SECTION 09-00933-01-BR	COUNTY MACON	TOTAL SHEETS 1019	SHEET NO. 508
CONTRACT NO. 95893				
ILLINOIS FED. AID PROJECT				




TYPICAL SECTION

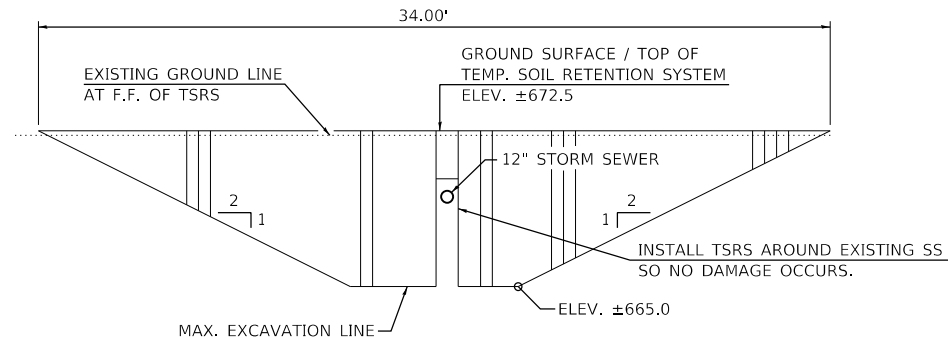

TYPICAL ELEVATION (LOCATIONS 1-5)

(LOOKING WEST)
AT 5 LOCATIONS (SEE PLAN)
ELEVATIONS VARY

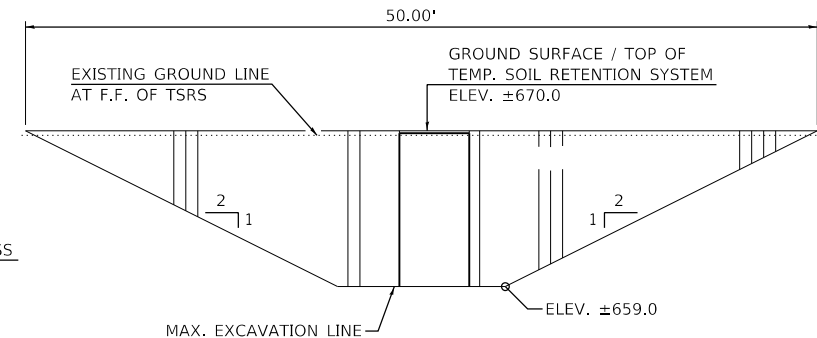

ELEVATION (LOCATION 6)


(STA. 72+40)
(LOOKING EAST)

NOTES:

1. A CANTILEVERED SHEET PILING DESIGN DOES NOT APPEAR FEASIBLE AND ADDITIONAL MEMBERS OR OTHER RETENTION SYSTEMS MAY BE NECESSARY. THE CONTRACTOR SHALL SUBMIT A TEMPORARY SOIL RETENTION SYSTEM DESIGN INCLUDING PLAN DETAILS AND CALCULATIONS FOR REVIEW AND ACCEPTANCE BY THE ENGINEER.
2. HORIZONTAL DIMENSIONS AND GROUNDS SLOPES ARE SHOWN ALONG THE TEMPORARY SOIL RETENTION SYSTEM UNLESS NOTED OTHERWISE.
3. THE CONTRACTOR IS ALERTED TO THE PRESENCE OF UNDERGROUND STORM SEWER, SANITARY SEWERS AND OTHER UTILITIES. THESE SEWERS AND UTILITIES IN THE VICINITY AND UNDER THE PROPOSED TEMPORARY SOIL RETENTION SYSTEM NEED TO BE KEPT IN SERVICE DURING CONSTRUCTION. SEE DRAINAGE AND UTILITY PLANS.
4. TEMPORARY SOIL RETENTION SYSTEM IS PAID FOR AS TEMPORARY SOIL RETENTION SYSTEM (SPECIAL). SEE SPECIAL PROVISIONS.
5. DIMENSIONS AND OFFSETS ARE APPROXIMATE AND MAY NEED TO BE ADJUSTED BASED ON ACTUAL DEPTHS OF STRUCTURES AND THE CONTRACTOR'S MEANS AND METHODS.

BILL OF MATERIAL

ITEM	UNIT	TOTAL
TEMPORARY SOIL RETENTION SYSTEM (SPECIAL)	SQ. FT.	1023

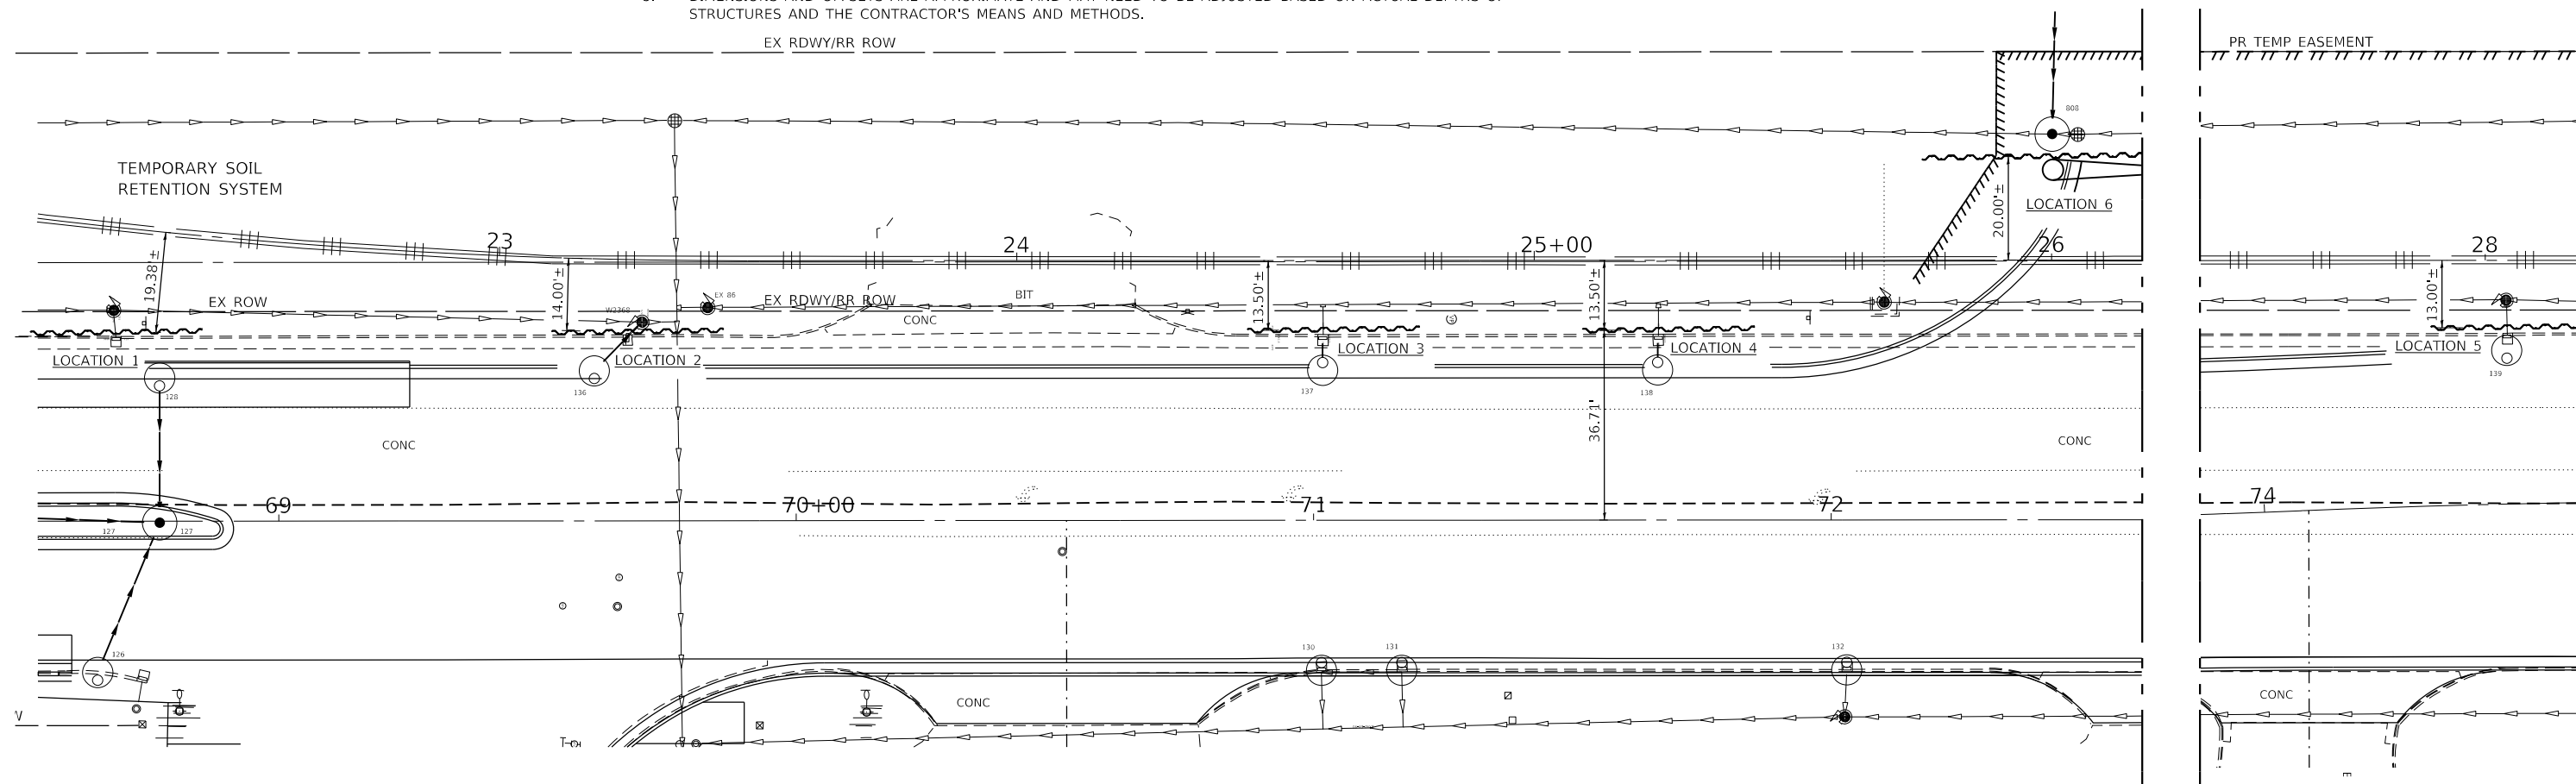

PLAN

MODEL: Drainage Details
FILE NAME: p:\w\lcom\p-w\henderly.com\AECOM_051_NA\Documents\60603202-Brush_College\006-CAD_GIS\010_CAD\03_SHEETS\02_VHKS\Drainage_Details\60603202_Drainage_Details_Sheet_4.dgn

design firm
no. 184001036
whks
engineers + planners + land surveyors


USER NAME = gjameson	DESIGNED - CWC	REVISED -
PLOT SCALE = 0.1667' / in.	DRAWN - DLH	REVISED -
PLOT DATE = 4/27/2021	CHECKED - CWC	REVISED -
	DATE - 4/30/2021	REVISED -

**STATE OF ILLINOIS
DEPARTMENT OF TRANSPORTATION**


**DRAINAGE DETAILS
TEMPORARY SOIL RETENTION SYSTEM**

SCALE: SHEET 4 OF 7 SHEETS STA. TO STA.


F.A.U. RTE.	SECTION	COUNTY	TOTAL SHEETS	SHEET NO.
7448	09-00933-01-BR	MACON	1019	509
CONTRACT NO. 95893				
ILLINOIS FED. AID PROJECT				

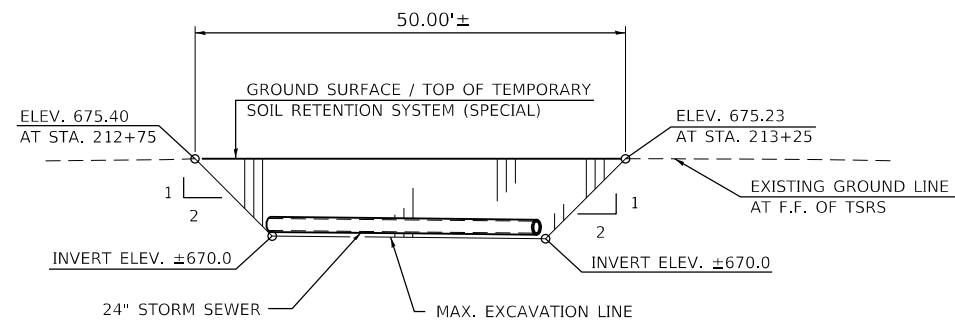

ELEVATION
(LOOKING NORTH)

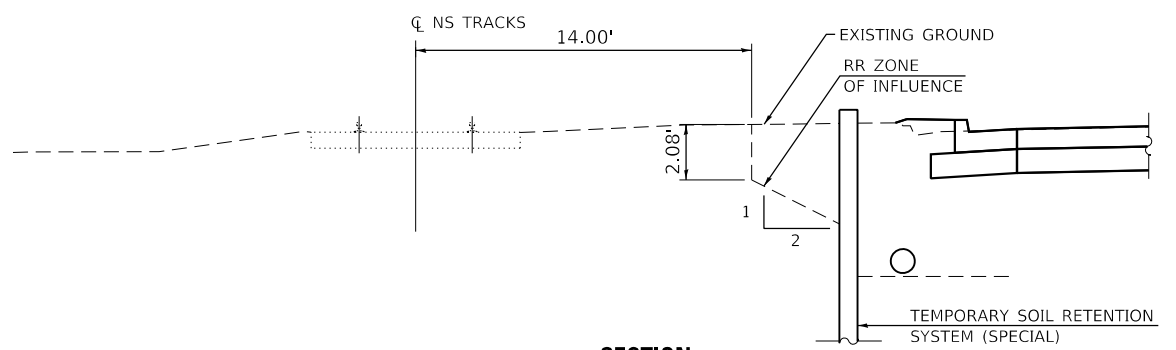

SECTION
STA. ±212+75 TO ±213+25

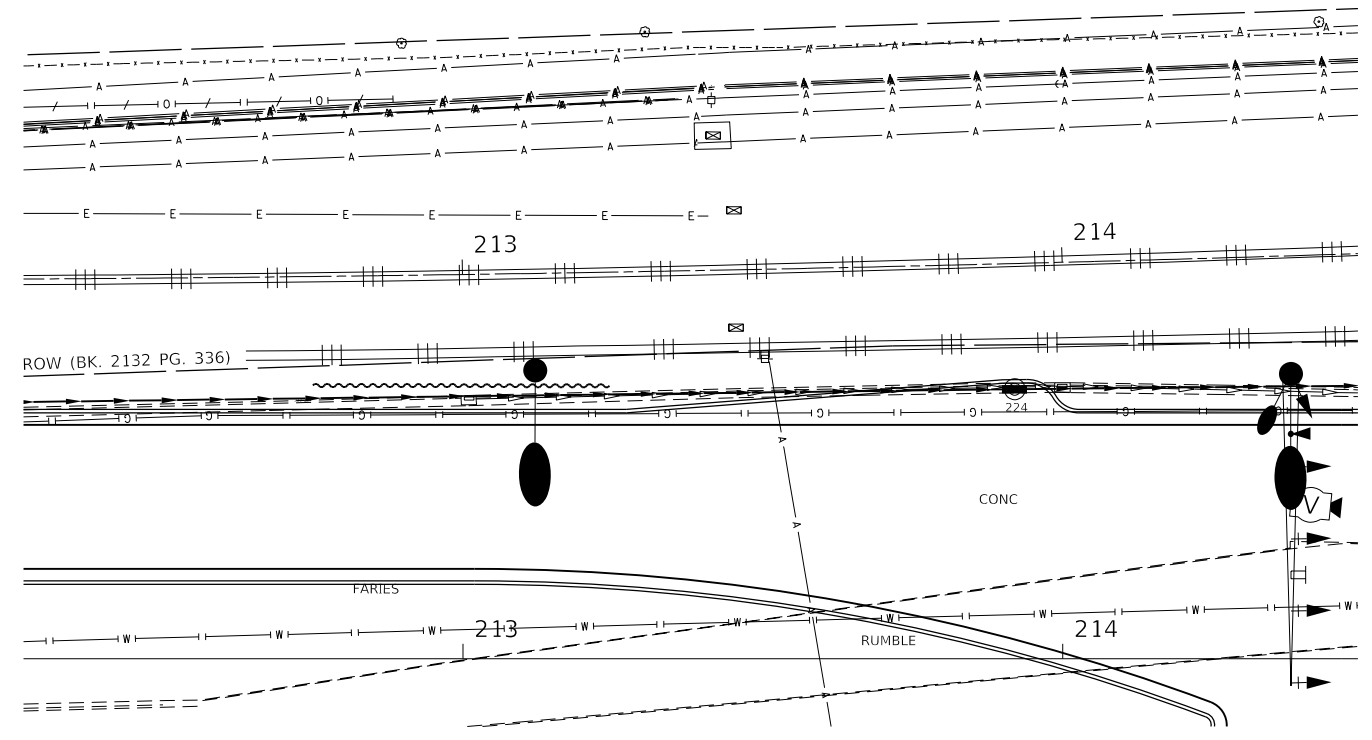

PLAN

NOTES:

1. A CANTILEVERED SHEET PILING DESIGN DOES NOT APPEAR FEASIBLE AND ADDITIONAL MEMBERS OR OTHER RETENTION SYSTEMS MAY BE NECESSARY. THE CONTRACTOR SHALL SUBMIT A TEMPORARY SOIL RETENTION SYSTEM DESIGN INCLUDING PLAN DETAILS AND CALCULATIONS FOR REVIEW AND ACCEPTANCE BY THE ENGINEER.
2. HORIZONTAL DIMENSIONS AND GROUNDS SLOPES ARE SHOWN ALONG THE TEMPORARY SOIL RETENTION SYSTEM UNLESS NOTED OTHERWISE.
3. THE CONTRACTOR IS ALERTED TO THE PRESENCE OF UNDERGROUND STORM SEWER, SANITARY SEWERS AND OTHER UTILITIES. THESE SEWERS AND UTILITIES IN THE VICINITY AND UNDER THE PROPOSED TEMPORARY SOIL RETENTION SYSTEM NEED TO BE KEPT IN SERVICE DURING CONSTRUCTION. SEE DRAINAGE AND UTILITY PLANS.
4. TEMPORARY SOIL RETENTION SYSTEM IS PAID FOR AS TEMPORARY SOIL RETENTION SYSTEM (SPECIAL). SEE SPECIAL PROVISIONS.
5. DIMENSIONS AND OFFSETS ARE APPROXIMATE AND MAY NEED TO BE ADJUSTED BASED ON ACTUAL DEPTHS OF STRUCTURES AND THE CONTRACTOR'S MEANS AND METHODS.
6. TSRS INSTALLATION SHALL BE COORDINATED WITH INSTALLATION OF TRAFFIC SIGNAL AND LIGHT FOUNDATIONS.

BILL OF MATERIAL

ITEM	UNIT	TOTAL
TEMPORARY SOIL RETENTION SYSTEM (SPECIAL)	SQ. FT.	209

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design firm
no. 184001036
whks
engineers + planners + land surveyors



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**STATE OF ILLINOIS
DEPARTMENT OF TRANSPORTATION**

**DRAINAGE DETAILS
TEMPORARY SOIL RETENTION SYSTEM**

SCALE: SHEET 5 OF 7 SHEETS STA. TO STA.

F.A.U. RTE. 7448	SECTION 09-00933-01-BR	COUNTY MACON	TOTAL SHEETS 1019	SHEET NO. 510
CONTRACT NO. 95893				
ILLINOIS FED. AID PROJECT				

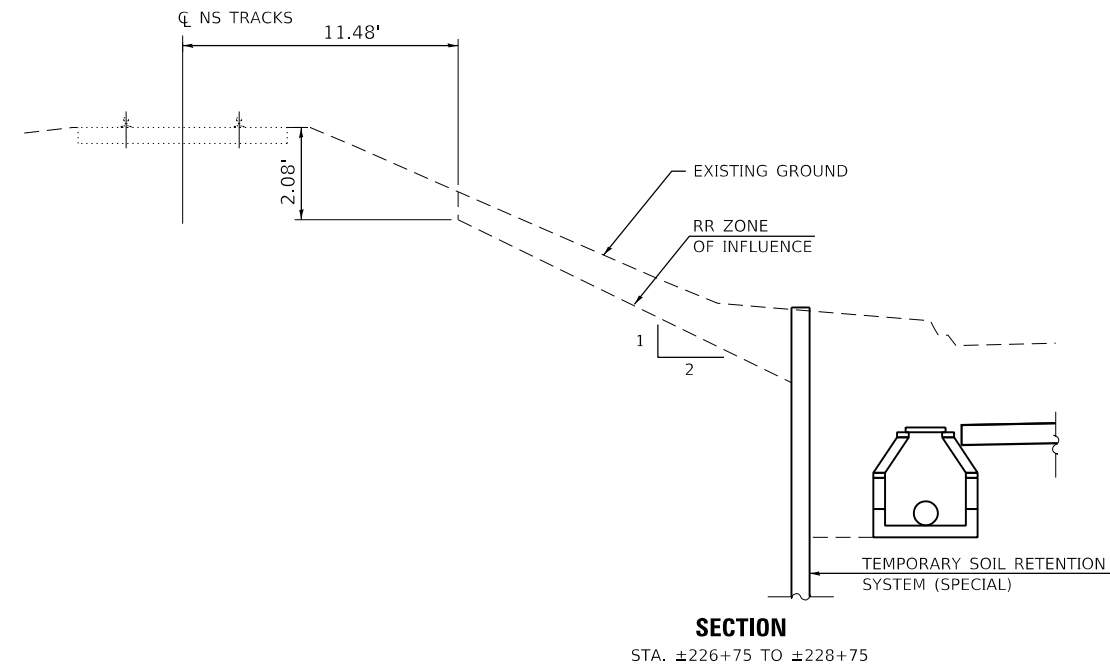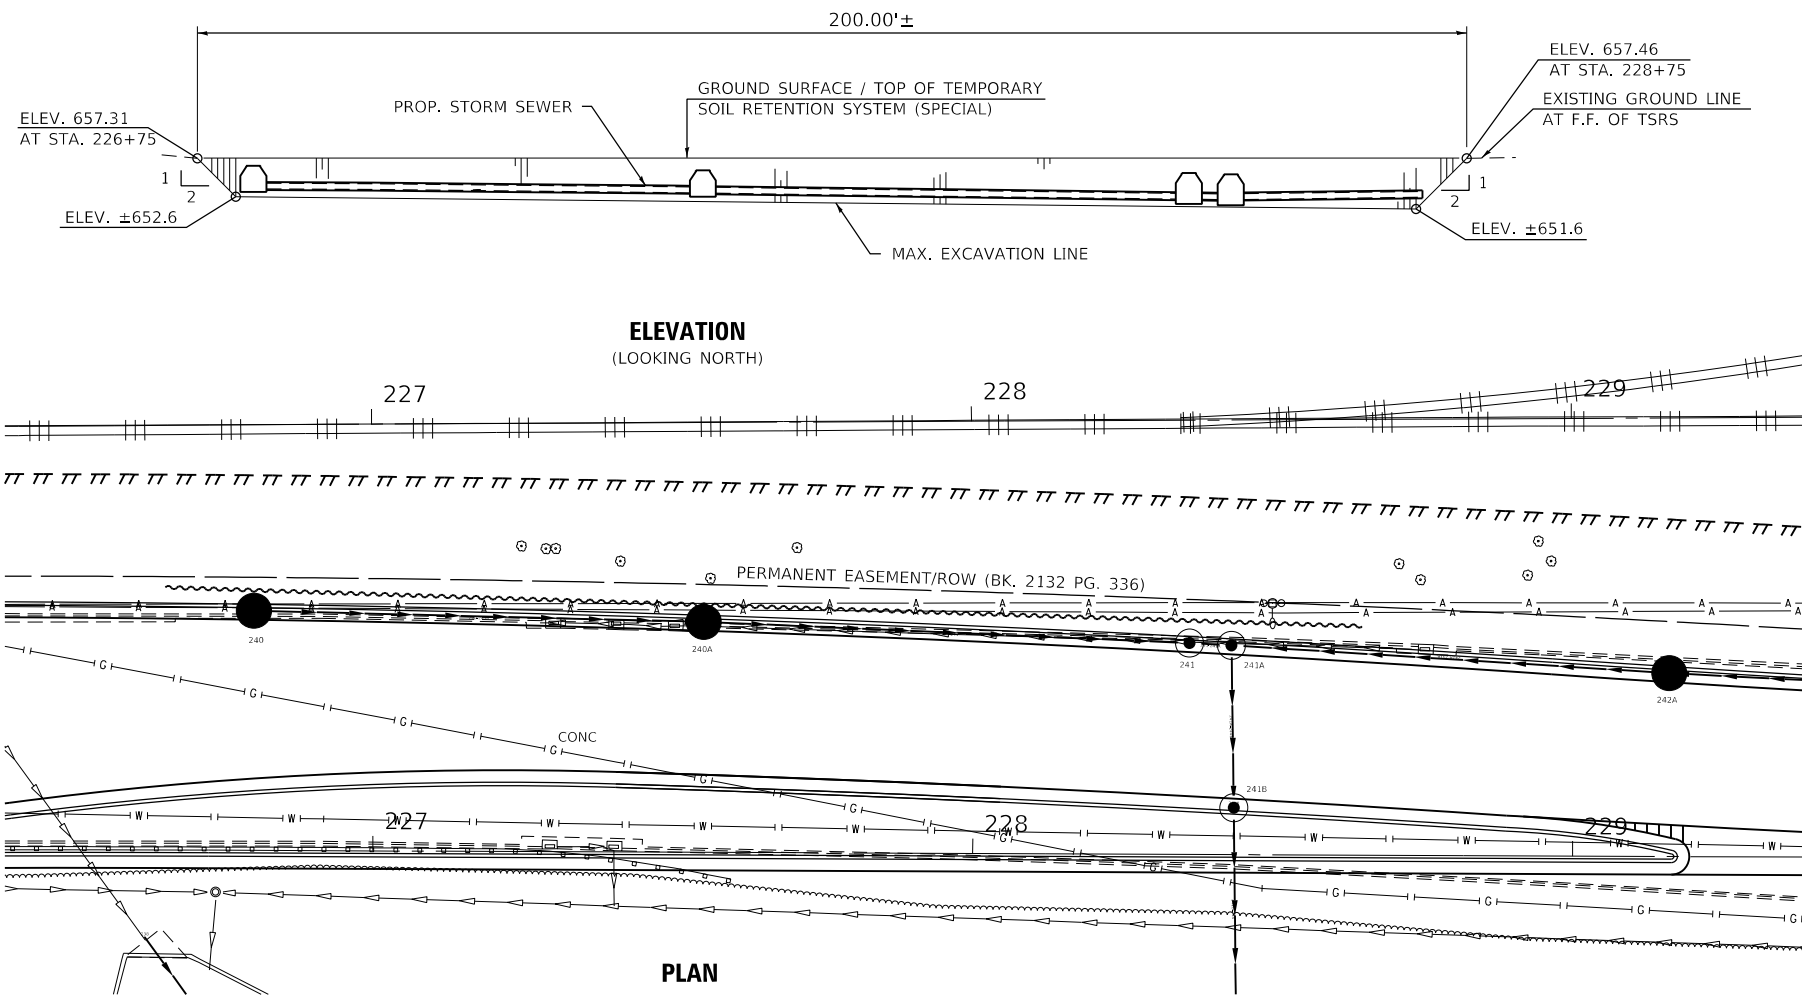

NOTES:

1. A CANTILEVERED SHEET PILING DESIGN DOES NOT APPEAR FEASIBLE AND ADDITIONAL MEMBERS OR OTHER RETENTION SYSTEMS MAY BE NECESSARY. THE CONTRACTOR SHALL SUBMIT A TEMPORARY SOIL RETENTION SYSTEM DESIGN INCLUDING PLAN DETAILS AND CALCULATIONS FOR REVIEW AND ACCEPTANCE BY THE ENGINEER.
2. HORIZONTAL DIMENSIONS AND GROUNDS SLOPES ARE SHOWN ALONG THE TEMPORARY SOIL RETENTION SYSTEM UNLESS NOTED OTHERWISE.
3. THE CONTRACTOR IS ALERTED TO THE PRESENCE OF UNDERGROUND STORM SEWER, SANITARY SEWERS AND OTHER UTILITIES. THESE SEWERS AND UTILITIES IN THE VICINITY AND UNDER THE PROPOSED TEMPORARY SOIL RETENTION SYSTEM NEED TO BE KEPT IN SERVICE DURING CONSTRUCTION. SEE DRAINAGE AND UTILITY PLANS.
4. TEMPORARY SOIL RETENTION SYSTEM IS PAID FOR AS TEMPORARY SOIL RETENTION SYSTEM (SPECIAL). SEE SPECIAL PROVISIONS.
5. DIMENSIONS AND OFFSETS ARE APPROXIMATE AND MAY NEED TO BE ADJUSTED BASED ON ACTUAL DEPTHS OF STRUCTURES AND THE CONTRACTOR'S MEANS AND METHODS.

BILL OF MATERIAL

ITEM	UNIT	TOTAL
TEMPORARY SOIL RETENTION SYSTEM (SPECIAL)	SQ. FT.	992

MODEL: Drainage Details
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design firm
no. 184001036

engineers + planners + land surveyors


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	DATE - 4/30/2021	REVISED -

**STATE OF ILLINOIS
DEPARTMENT OF TRANSPORTATION**


**DRAINAGE DETAILS
TEMPORARY SOIL RETENTION SYSTEM**

SCALE: SHEET 6 OF 7 SHEETS STA. TO STA.

F.A.U. RTE. 7448	SECTION 09-00933-01-BR	COUNTY MACON	TOTAL SHEETS 1019	SHEET NO. 511
CONTRACT NO. 95893				
ILLINOIS FED. AID PROJECT				

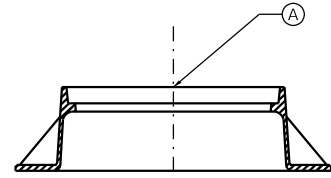


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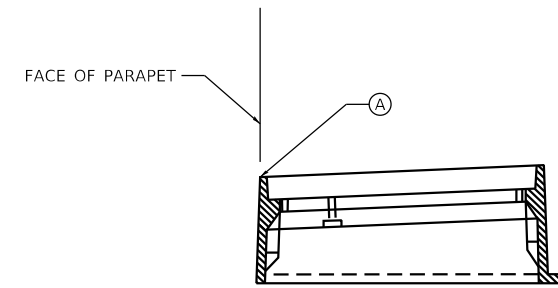
TYPE 10

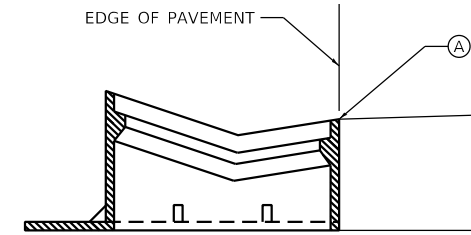NOTE: EXCEPT FOR STRUCTURES 100, 103, 105, AND 107 WHICH ARE LOCATED BEHIND RETAINING WALL AND OFFSETS ARE GIVEN TO CENTER OF STRUCTURE AND ELEVATIONS TO FLOW LINE OF GUTTER.




TYPE 3 / TYPE 11 / TYPE 6

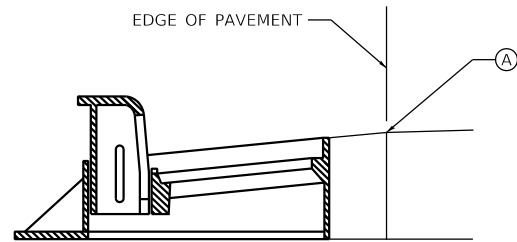
EOP TO CASTING AND STRUCTURE VARIES AT CURB FLARES.




TYPE 20

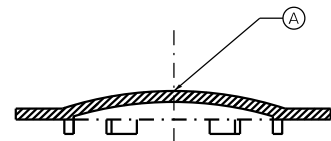

TYPE 8

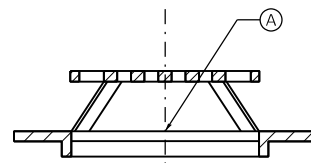

SPECIAL FRAME AND GRATE
(CITY STD. 3044)

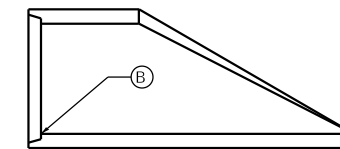

PRECAST REINFORCED CONCRETE FLARED END SECTION

DRAINAGE CASTING LOCATIONS

NOTES

CONTRACTOR TO COORDINATE WITH ROADWAY PLANS AT CURB FLARES TO DETERMINE EXACT STRUCTURE LOCATION FROM EOP OFFSETS GIVEN.

- (A) LOCATION OF STATION, OFFSET, & RIM ELEVATION OF DRAINAGE CASTING AS NOTED ON THE DRAINAGE PLANS AND SCHEDULES.
- (B) WORKING POINT STATION, OFFSET & INVERT LOCATION AS NOTED ON THE DRAINAGE PLANS AND SCHEDULES.

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design firm
no. 184001036
whks
engineers + planners + land surveyors

USER NAME = gjameson	DESIGNED - CWC	REVISED -
	DRAWN - DLH	REVISED -
PLOT SCALE = 2,000' / in.	CHECKED - CWC	REVISED -
PLOT DATE = 4/27/2021	DATE - 4/30/2021	REVISED -

**STATE OF ILLINOIS
DEPARTMENT OF TRANSPORTATION**

DRAINAGE DETAILS

SCALE: SHEET 7 OF 7 SHEETS STA. TO STA.








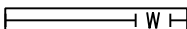

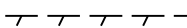
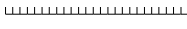
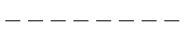




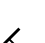




F.A.U. RTE.	SECTION	COUNTY	TOTAL SHEETS	SHEET NO.
7448	09-00933-01-BR	MACON	1019	512
CONTRACT NO. 95893				
		ILLINOIS	FED. AID PROJECT	

WATER MAIN & SANITARY SEWER GENERAL NOTES

- THE LOCATION OF EXISTING DRAINAGE STRUCTURES, STORM SEWERS, WATER MAINS, SANITARY SEWERS AND ANY OTHER PUBLIC OR PRIVATE UTILITIES AS SHOWN ON THE PLANS IS APPROXIMATE AND THEIR EXACT LOCATION IS TO BE DETERMINED IN THE FIELD BY THE CONTRACTOR. THIS WORK SHALL BE CONSIDERED INCLUDED IN THE COST OF THE CONTRACT.
- PROFILE VIEW LOCATIONS OF THE EXISTING UTILITIES ARE BASED ON ASSUMED DEPTH. ACTUAL DEPTHS OF SUCH EXISTING UTILITIES MAY BE SHALLOWER OR DEEPER THAN SHOWN.
- WATER MAIN AND SERVICE PIPES SHALL HAVE A MINIMUM COVER OF 3.5 FEET FROM GROUND SURFACE AND 6 FEET FROM TRAIN TRACKS, UNLESS OTHERWISE SHOWN IN THE PLANS.
- ANY SHEETING, SHORING OR TEMPORARY SOIL RETENTION SYSTEM USED FOR WATER MAIN AND/OR SANITARY SEWER WORK SHALL BE INCLUDED IN THE COST OF THE ITEM BEING INSTALLED, REMOVED, ADJUSTED, OR ABANDONED AND SHALL NOT BE PAID SEPARATELY.
- THE CONTRACTOR SHALL BE RESPONSIBLE FOR INSTALLING THE PROPOSED WATER MAIN AND SANITARY SEWER SO THAT THERE ARE NOT ANY CONFLICTS WITH THE REQUIRED CLEARANCES FROM EXISTING OR PROPOSED UTILITIES. SEE ROADWAY DRAINAGE AND UTILITY SHEETS FOR PROPOSED STORM SEWER INFORMATION.
- PRIOR TO STARTING ANY CONSTRUCTION A FIVE (5) WORKING DAY NOTIFICATION IS REQUIRED. NOTIFY THE CITY OF DECATUR PUBLIC WORKS AND ENGINEERING, (217) 424-2747 TO ARRANGE FOR REQUIRED INSPECTION.
- ALL MATERIAL INCORPORATED INTO THIS PUBLIC WATER MAIN IMPROVEMENT REQUIRES INSPECTION AND APPROVAL PRIOR TO ANY CONSTRUCTION.
- THE SEPARATION REQUIREMENTS BETWEEN WATER MAIN AND SEWERS SHALL BE IN ACCORDANCE WITH 35 IL ADMINISTRATIVE CODE, SUBTITLE F, SECTION 653.119.
- WATER MAIN SHUTDOWNS: COORDINATE SHUTDOWN OF EXISTING WATER MAINS WITH THE CITY OF DECATUR AND ENGINEER. CONTRACTOR SHALL NOT OPERATE EXISTING VALVES AND HYDRANTS ON THE CITY'S EXISTING WATER SYSTEM. CONTRACTOR SHALL SCHEDULE WITH THE CITY OF DECATUR A MINIMUM OF 48 HOURS PRIOR TO THE REQUIRED SHUTDOWN OF EXISTING WATER MAINS.
- WATER MAIN FITTINGS AND CONNECTIONS: INCLUDE ALL NECESSARY PIPING, FITTINGS AND ADAPTERS FOR A COMPLETE INSTALLATION, CONTRACTOR SHALL ALSO VERIFY EXACT LOCATION, DEPTH, MATERIAL, AND SIZE OF EXISTING WATER MAIN AND PIPING BEFORE ORDERING NEW MATERIALS. THE CONTRACTOR SHALL CONNECT TO EXISTING WATER MAINS, REGARDLESS OF LOCATION, DEPTH, AND MATERIAL, AT NO ADDITIONAL COST. TEES AND FITTINGS SHALL BE ROLLED AS NEEDED FOR CONSTRUCTION TO ACCOMODATE CONNECTIONS, AVOID UTILITY CONFLICTS, ETC. THE COST SHALL BE INCLUDED IN THE COST OF THE FITTING OR TEE BEING INSTALLED.
- EXISTING UTILITY LOCATIONS (JULIE REQUESTS):
 - THREE (3) WORKING DAYS PRIOR TO BEGINNING THE WORK, IT SHALL BE THE CONTRACTOR'S RESPONSIBILITY TO CONTACT JULIE TO VERIFY THE LOCATION OF ALL EXISTING UTILITIES. THE CONTRACTOR SHALL ASSUME RESPONSIBILITY FOR THE PROTECTION OF ALL EXISTING UTILITIES DURING CONSTRUCTION.
 - ALL UTILITIES ARE TO BE MAINTAINED IN SERVICE AT ALL TIMES UNLESS PRIOR WRITTEN AUTHORIZATION IS GRANTED FROM THE RESPECTIVE UTILITY FOR A PLANNED SERVICE INTERRUPTION NECESSARY FOR THE COMPLETION OF THIS WORK.
 - UTILITIES AND OBSTRUCTIONS SHOWN ON THE PLANS WERE DERIVED FROM THE BEST AVAILABLE INFORMATION THROUGH CONTACT MADE WITH VARIOUS UTILITIES AND AGENCIES KNOWN TO HAVE STRUCTURES IN THE AREA. THE LOCATION MATERIAL AND DIMENSIONS OF THE EXISTING OBSTRUCTIONS ARE BASED ON AVAILABLE RECORDS BUT MUST NOT BE CONSTRUED AS BEING ACCURATE, CORRECT OR COMPLETE. CONTRACTOR SHALL NOTIFY THE ENGINEER OF ANY DISCREPANCIES.
 - ALL STRUCTURES ABOVE OR BELOW GROUND ENCOUNTERED DURING CONSTRUCTION SHALL BE PROPERLY SUPPORTED AND MAINTAINED. THE CONTRACTOR SHALL MAKE ARRANGEMENTS WITH THE OWNER/ENGINEER OF SUCH STRUCTURES FOR SHIFTING, SUPPORT, TEMPORARY RELOCATION AND PROTECTION WHERE NECESSARY. IF DAMAGED DURING CONSTRUCTION, THE CONTRACTOR SHALL MAKE OR PAY TO HAVE MADE ALL REPAIRS TO THE STRUCTURE TO THE SATISFACTION OF THE OWNER OF THE STRUCTURE. NO EXTRA PAYMENT WILL BE MADE FOR SUCH REPAIRS.

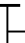- UTILITY SEPARATION: WHERE THE PROPOSED WATER MAINS CROSS OVER AND LESS THAN 18-INCHES ABOVE OR UNDER SANITARY/STORM SEWER LINES, THE SEWER SHALL BE REPLACED WITH WATER MAIN QUALITY PIPE FOR A DISTANCE OF 10 FEET ON BOTH SIDES OF THE PROPOSED WATER MAIN WHEN ORDERED IN WRITING BY THE ENGINEER. FOR NON-PARALLEL STORM SEWER CROSSINGS, CONTRACTOR IS PERMITTED TO UTILIZE REINFORCED CONCRETE PIPE WITH JOINT FLEXIBLE GASKET JOINT MEETING ASTM C361 OR ASTM C443.
- UNLESS OTHERWISE NOTED, THE CONTRACTOR SHALL MAINTAIN IN SERVICE ALL EXISTING WATER MAINS, SANITARY SEWERS, STORM SEWERS, CULVERTS, DITCHES, DRAINS, MANHOLES, AND CATCH BASINS DURING CONSTRUCTION. THIS INCLUDES, BUT IS NOT LIMITED TO, BYPASS PUMPING. REFER ALSO TO THE DRAINAGE SHEETS FOR ADDITIONAL DETAIL.
- REFER TO SPECIAL PROVISIONS FOR WATER MAIN RECORD DRAWING AND SURVEY REQUIREMENTS WHICH INCLUDES PROVIDING AS-BUILT WATER MAIN FACILITY INFORMATION TO THE CITY IN AN ELECTRONIC FORMAT COMPATIBLE WITH THE CITY'S GIS.
- ALL FRAMES, GRATES, LIDS, FIRE HYDRANTS AND BOXES SCHEDULED TO BE REMOVED FROM EXISTING STRUCTURES SHALL REMAIN THE PROPERTY OF THE CITY, AND ITEMS DAMAGED DURING REMOVAL SHALL BE REPLACED BY THE CONTRACTOR AT HIS/HER EXPENSE. THE COST OF SALVAGING EXISTING FRAMES, GRATES, LIDS, HYDRANTS OR BOXES AND/OR STOCKPILING THEM ON THE JOB SITE FOR PICK-UP BY THE CITY OR DELIVERY TO THE CITY YARD SHALL BE CONSIDERED INCLUDED IN THE COST OF THE ITEM BEING REMOVED, ABANDONED, OR FILLED. ANY REJECTED ITEMS SHALL BE DISPOSED OF BY THE CONTRACTOR AT NO ADDITIONAL COST TO THE CONTRACT.
- ALL REFERENCES IN THE DRAWINGS AND SPECIAL PROVISIONS TO STANDARDS (E.G. AWWA, ASTM, IDOT, ETC.) SHALL BE ASSUMED TO BE THE LATEST VERSION/ADDITION OF THE STANDARD BEING REFERENCED.
- UNLESS OTHERWISE SPECIFIED HEREIN, PERFORM ALL WORK IN ACCORDANCE WITH THE STANDARD SPECIFICATIONS FOR WATER MAIN CONSTRUCTION IN ILLINOIS AND THE CITY OF DECATUR STANDARD SPECIFICATIONS FOR WATER MAIN CONSTRUCTION (INCLUDING CONSTRUCTION DETAILS), LATEST EDITIONS. CITY OF DECATUR STANDARD SPECIFICATIONS FOR WATER MAIN CONSTRUCTION (INCLUDING CONSTRUCTION DETAILS) CAN BE PROVIDED UPON REQUEST.
- WHETHER TEMPORARY OR PERMANENT, ALL VALVES, PIPING, FITTINGS, SLEEVES, AND APPURTENANCES SHALL HAVE A MINIMUM RATING OF 150 PSI.
- JACKING PITS TO BE DESIGNED BY THE CONTRACTOR. LIMITS SHOWN ARE APPROXIMATE.
- THE FOLLOWING PAY ITEMS ARE INCLUDED IN THE SPECIAL PROVISIONS, BUT ARE NOT CURRENTLY SHOWN IN THE WATER MAIN RELOCATION PLANS:
 - PRESSURE CONNECTION, 16" X 16", 12" X 12", 16" X 6" (1 EACH FOR THE PAY ITEMS LISTED)
 - WATER MAIN LINE STOP, 6", 8", 12" (1 EACH FOR THE PAY ITEMS LISTED)
 - REMOVE AND RELOCATE WATER MAIN, 6", 8", 12", 16", 24", 30" (20 FT FOR EACH PAY ITEM LISTED)
 - WATER SERVICE LINE RELOCATED (20 FT)
 - FIRE HYDRANT EXTENSION (10 FT)
 - MANHOLES, SANITARY, 4'-DIAMETER, TYPE 1 FRAME, CLOSED LID (2 EACH)
 - SANITARY SEWER REMOVAL AND REPLACEMENT 8" (390 FT)
 - EARTH EXCAVATION (SPECIAL) (SHOWN IN PLANS BUT AN ADDITIONAL 10 CY IS INCLUDED IN THE SOQ)
 - SANITARY SERVICE TO BE ADJUSTED, 1 EACH
 THESE ITEMS SHALL ONLY BE USED TO ADDRESS UNFORESEEN CONDITIONS WHEN ORDERED BY THE ENGINEER IN WRITING.
- THE CONTRACTOR'S ATTENTION IS CALLED TO SECTION 106 OF IDOT'S STANDARD SPECIFICATION, SPECIFICALLY THE DOMESTIC IRON AND STEEL REQUIREMENTS. THE CONTRACTOR IS REQUIRED TO FOLLOW ALL IDOT REQUIREMENTS AND SPECIFICATIONS REGARDING DOMESTIC PRODUCTION, FABRICATION, ETC.

WATER MAIN & SANITARY SEWER SYMBOLS

-  PROPOSED WATER VALVE WITH BOX
-  PROPOSED WATER VALVE AND BYPASS WITH BOXES
-  PROPOSED LINE STOP
-  PROPOSED FIRE HYDRANT AUXILIARY VALVE
-  PROPOSED FIRE HYDRANT
-  PROPOSED COMMUNICATIONS VAULT
-  PROPOSED WATER MAIN
-  PROPOSED WATER MAIN IN STEEL CASING PIPE
-  UTILITY TO BE ABANDONED
-  UTILITY TO BE REMOVED
-  UTILITY TO BE ABANDONED
-  PROPOSED UNDERGROUND CONDUIT
-  PROPOSED WATER MAIN FITTING, REDUCER
-  PROPOSED CAP OR PLUG FOR EXISTING WATER MAIN
-  PROPOSED WATER MAIN FITTING, TEE
-  PROPOSED WATER MAIN FITTING, 90 DEGREE BEND
-  PROPOSED WATER MAIN FITTING, 45 DEGREE BEND
-  PROPOSED WATER MAIN FITTING, 22.5 DEGREE BEND
-  PROPOSED WATER MAIN FITTING, 11.25 DEGREE BEND
-  PROPOSED WATER MAIN FITTING, CAP OR PLUG
-  PROPOSED WATER MAIN FITTING, SOLID SLEEVE

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	DATE - 4/17/2023	REVISED -

**STATE OF ILLINOIS
DEPARTMENT OF TRANSPORTATION**

WATER MAIN RELOCATION PLAN AND SANITARY SEWER ADJUSTMENTS	
GENERAL NOTES AND SYMBOLS	
SCALE: NTS	SHEET 1 OF 31 SHEETS STA. N/A TO STA. N/A

F.A.U. RTE.	SECTION	COUNTY	TOTAL SHEETS	SHEET NO.
7448	09-00933-01-BR	MACON	1019	513
CONTRACT NO. 95893				
ILLINOIS FED. AID PROJECT				

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NOTES

1. FOR VALVES WITH TWO (2) BOXES (I.E. VALVES WITH A BYPASS) IN THE PROPOSED STRUCTURE SCHEDULE. THE PROPOSED GROUND ELEVATION LISTED IS FOR THE BYPASS VALVE BOX. THE CONTRACTOR IS RESPONSIBLE FOR COORDINATING AND CONFIRMING THE FINAL ELEVATION OF THE VALVE BOX FOR THE MAIN VALVE. UNLESS OTHERWISE NOTED, NO ADDITIONAL PAYMENT WILL BE MADE FOR ANY VALVE BOXES TO BE ADJUSTED.
2. FOR FIRE HYDRANT WITH AUXILIARY VALVE AND VALVE BOX IN THE PROPOSED STRUCTURE SCHEDULE, THE PROPOSED GROUND ELEVATION LISTED IS FOR THE HYDRANT. THE CONTRACTOR IS RESPONSIBLE FOR COORDINATING AND CONFIRMING THE FINAL GROUND ELEVATION FOR THE PROPOSED AUXILIARY VALVE. UNLESS OTHERWISE NOTED, NO ADDITIONAL PAYMENT WILL BE MADE FOR ANY VALVE BOXES TO BE ADJUSTED.

PROPOSED STRUCTURES							
ROAD	SHEET	STRUCTURE TYPE	WM STATION	ROADWAY STATION OFFSET	IDOT PAY ITEM NAME	EXST. GROUND EL. (FT.)	PR. GROUND EL. (FT.)
BRUSH COLLEGE	5	WATER VALVE AND BOX	10+04	47+10, RT 2.3	PRESSURE CONNECTION 24" X 24"	-	-
	5				VALVE BOX*	653.0	653.1
	5				VALVE BOXES TO BE ADJUSTED*	653.0	653.1
	5	WATER VALVE AND BOX	13+52, RT 5.1	49+68, RT 84.7	WATER VALVES 24"	-	-
	5				VALVE BOX*	673.1	-
	5				VALVE BOXES TO BE ADJUSTED*	673.1	-
	5	FIRE HYDRANT	13+45, RT 11.8	49+61, RT 77.0	FIRE HYDRANT WITH AUXILIARY VALVE AND VALVE BOX	673.0	-
	6	WATER VALVE AND BOX	16+08, RT 7.5	52+22, RT 103.1	WATER VALVES 8"	-	-
	6				VALVE BOX	674.9	674.7
	6				VALVE BOXES TO BE ADJUSTED	674.9	674.7
	6	FIRE HYDRANT	16+09, RT 49.4	52+16, RT 144.3	FIRE HYDRANT WITH AUXILIARY VALVE AND VALVE BOX	675.6	-
	7	WATER VALVE AND BOX	24+25	60+18, RT 118.8	WATER VALVES 24"	-	-
	7				VALVE BOX*	676.4	675.1
	7				VALVE BOXES TO BE ADJUSTED*	676.4	675.1
	7	FIRE HYDRANT	24+68, RT 27.9	60+76, RT 124.1	FIRE HYDRANT WITH AUXILIARY VALVE AND VALVE BOX	675.6	675.1
	7	COMMUNICATIONS VAULT	24+32, LT 4.6	60.22, RT 112.7	COMMUNICATIONS VAULT	676.4	674.9
	7	COMMUNICATIONS VAULT	26+61, LT 1.6	62+47, RT 43.0	COMMUNICATIONS VAULT	675.1	-
	9	WATER VALVE AND BOX	29+15	64+98, RT 61.6	WATER VALVES 30"	-	-
	9				VALVE BOX*	674.2	-
	9				VALVE BOXES TO BE ADJUSTED*	674.2	-
	9	FIRE HYDRANT	29+32, LT 18.0	65+24, RT 59.6	FIRE HYDRANT WITH AUXILIARY VALVE AND VALVE BOX	673.9	-
	9	WATER VALVE AND BOX	30+54, RT 3.6	66+36, RT 82.0	WATER VALVES 8"	-	-
	9				VALVE BOX	670.2	-
	9				VALVE BOXES TO BE ADJUSTED	670.2	-
	9	COMMUNICATIONS VAULT	30+53, LT 2.2	66+34, RT 76.5	COMMUNICATIONS VAULT	670.3	-
	10	WATER VALVE AND BOX	34+00, RT 3.6	69+54, 31.0	WATER VALVES 12"	-	-
	10				VALVE BOX	672.0	673.2
	10				VALVE BOXES TO BE ADJUSTED	672.0	673.2
10	FIRE HYDRANT	34+22, RT 24.6	69+76, RT 43.0	FIRE HYDRANT WITH AUXILIARY VALVE AND VALVE BOX	671.7	-	
10	WATER VALVE AND BOX	34+45, RT 5.3	69+95, RT 15.5	WATER VALVES 16"	-	-	
10				VALVE BOX	672.2	672.7	
10				VALVE BOXES TO BE ADJUSTED	672.2	672.7	
10	WATER VALVE AND BOX	34+78	69+89, LT 17.4	PRESSURE CONNECTION 24" X 24"	-	-	
10				VALVE BOX*	672.3	672.6	
10				VALVE BOXES TO BE ADJUSTED*	672.3	672.6	
JUG HANDLE	6, 18	WATER VALVE AND BOX	40+08	302+04, LT 128.8	WATER VALVES 8"	-	-
	6, 18				VALVE BOX	675.3	675.4
	6, 18				VALVE BOXES TO BE ADJUSTED	675.3	675.4
18	FIRE HYDRANT	43+44, LT 7.2	304+59, RT 112.8	FIRE HYDRANT WITH AUXILIARY VALVE AND VALVE BOX	678.1	678.2	
FARIES	7, 13	WATER VALVE AND BOX	50+41	61+33, RT 96.6	WATER VALVES 16"	-	-
	7, 13				VALVE BOX	675.2	675.8
	7, 13				VALVE BOXES TO BE ADJUSTED	675.2	675.8
	7, 13	WATER VALVE AND BOX	61+66	61+38, LT 104.3	WATER VALVES 16"	-	-
	7, 13				VALVE BOX	675.3	675.2
	7, 13				VALVE BOXES TO BE ADJUSTED	675.3	675.2
	14	FIRE HYDRANT	-	216+12, LT 43.7	FIRE HYDRANT WITH AUXILIARY VALVE AND VALVE BOX	673.6	673.2
17	FIRE HYDRANT	-	231+36, LT 24.4	FIRE HYDRANT WITH AUXILIARY VALVE AND VALVE BOX	661.3	660.6	
LOGAN	19	N/A					
JAMES	20	N/A					
HARRISON	21-25	N/A					
CEMETERY	25	N/A					

* PROPOSED STRUCTURE HAS TWO VALVE BOXES, REFER ALSO TO NOTE 1.



USER NAME = brooke.henry	DESIGNED - BNH	REVISED -
PLOT SCALE = 40.0000' / in.	DRAWN - BNH	REVISED -
PLOT DATE = 10/27/2021	CHECKED - RB	REVISED -
	DATE - 10/22/2021	REVISED -

STATE OF ILLINOIS
DEPARTMENT OF TRANSPORTATION

WATER MAIN RELOCATION PLAN AND SANITARY SEWER ADJUSTMENTS			
STRUCTURE SCHEDULE			
SCALE: NTS	SHEET 2 OF 31 SHEETS	STA. N/A TO STA. N/A	

F.A.U. RTE.	SECTION	COUNTY	TOTAL SHEETS	SHEET NO.
7448	09-00933-01-BR	MACON	1019	514
CONTRACT NO. 95893				
ILLINOIS FED. AID PROJECT				

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EXISTING STRUCTURES							
ROAD	SHEET	STRUCTURE TYPE	WM STATION	ROADWAY STATION OFFSET	IDOT PAY ITEM NAME	EXST. GROUND EL. (FT.)	PR. GROUND EL. (FT.)
BRUSH COLLEGE	6	FIRE HYDRANT	-	57+10, RT 37.8	FIRE HYDRANT TO BE REMOVED & SALVAGED	674.9	
	7	FIRE HYDRANT	-	62+38, LT 73.3	FIRE HYDRANT TO BE REMOVED & SALVAGED	673.9	
	10	VALVE BOX	-	70+63, LT 22.8	VALVE BOXES TO BE ADJUSTED	671.9	671.6
	11	VALVE BOX	-	73+64, RT 20.3	VALVE BOXES TO BE ADJUSTED	672.0	672.3
	11	VALVE BOX	-	75+41, LT 24.2	VALVE BOXES TO BE ADJUSTED	671.6	671.7
JUG HANDLE	18	N/A	-				
FARIES	14	FIRE HYDRANT	-	215+89, RT 17.5	FIRE HYDRANT TO BE REMOVED & SALVAGED	673.5	-
	15	VALVE BOX	-	221+30, LT 6.9	VALVE BOXES TO BE ADJUSTED	668.3	668.6
	15	VALVE BOX	-	221+62, LT 5.4	VALVE BOXES TO BE ADJUSTED	668.0	668.8
	15	VALVE BOX	-	221+68, LT 9.6	VALVE BOXES TO BE ADJUSTED	668.0	668.2
	15	VALVE VAULT	-	221+68, LT 4.7	VALVE VAULTS TO BE ADJUSTED	667.6	668.7
	15	MANHOLE	-	221+70, RT 3.5	SANITARY MANHOLES TO BE RECONSTRUCTED WITH NEW TYPE 1 FRAME, CLOSED LID	668.7	668.3
	15	FIRE HYDRANT	-	221+61, RT 36.2	FIRE HYDRANTS TO BE REMOVED AND REPLACED	668.8	668.2
	16	VALVE BOX	-	225+47, LT 5.8	VALVE BOXES TO BE ADJUSTED	659.5	660.7
	16	FIRE HYDRANT	-	225+46, RT 31.8	FIRE HYDRANTS TO BE REMOVED AND REPLACED	662.0	660.7
	16	MANHOLE	-	225+64, LT 0.1	SANITARY MANHOLES TO BE ADJUSTED	659.2	660.9
	16	MANHOLE	-	228+14, RT 69.1	SANITARY MANHOLES TO BE ADJUSTED	647.5	648.8
	16	MANHOLE	-	225+79, RT 34.4	SANITARY MANHOLES TO BE RECONSTRUCTED WITH NEW TYPE 1 FRAME, CLOSED LID	654.0	660.0
	16	MANHOLE	-	229+75, RT 41.2	SANITARY MANHOLES TO BE RECONSTRUCTED WITH NEW TYPE 1 FRAME, CLOSED LID	645.1	657.8
	17	VALVE BOX	-	232+22, RT 2.4	VALVE BOXES TO BE ADJUSTED	662.5	662.6
	17	VALVE VAULT	-	232+22, LT 2.8	VALVE VAULTS TO BE ADJUSTED	662.5	662.6
	17	FIRE HYDRANT	-	232+16, LT 22.7	FIRE HYDRANT TO BE REMOVED & SALVAGED	663.5	-
	17	VALVE BOX	-	234+71, LT 1.7	VALVE BOXES TO BE ADJUSTED	665.7	666.1
	LOGAN	19	N/A				
JAMES	20	N/A					
W. HARRISON	21-22	N/A					
E. HARRISON	10	FIRE HYDRANT	-	700.47, LT 43.7	FIRE HYDRANT TO BE REMOVED & SALVAGED	671.7	-
CEMETERY	25	N/A					

EXISTING STRUCTURES TO BE REMOVED OR ABANDONED					
ROAD	SHEET	STRUCTURE TYPE	ROADWAY STATION OFFSET	IDOT PAY ITEM NAME	EX. GROUND EL. (FT.)
BRUSH COLLEGE	6	VALVE VAULT	51+77, LT 35.2	VALVE VAULTS TO BE ABANDONED	671.9
	6	VALVE VAULT	54+55, LT 1.8	VALVE VAULTS TO BE ABANDONED	674.1
	6	VALVE BOX	52+22, RT 7.6	WATER VALVE BOXES TO BE ABANDONED	673.3
	6	VALVE BOX	54+55, LT 3.5	WATER VALVE BOXES TO BE ABANDONED	674.2
	6	VALVE BOX	57.14, RT 11.9	WATER VALVE BOXES TO BE ABANDONED	673.9
	7	MANHOLE	58+89, RT 45.5	SANITARY MANHOLES TO BE REMOVED	675.8
	7	VALVE BOX	60+47, RT 5.7	VALVE BOXES TO BE REMOVED	674.1
	7	VALVE BOX	62+43, RT 44.3	VALVE BOXES TO BE REMOVED	675.1
	7	VALVE VAULT	63+02, RT 43.8	VAULTS TO BE REMOVED	674.8
	7, 13	VALVE BOX	61+22, RT 45.0	WATER VALVE BOXES TO BE ABANDONED	674.8
	7, 13	VALVE BOX	61+29, RT 54.6	WATER VALVE BOXES TO BE ABANDONED	674.9
	8	VALVE BOX	65+85, RT 0.0	WATER VALVE BOXES TO BE ABANDONED	673.7
	8	VALVE BOX	66+31, RT 32.2	WATER VALVE BOXES TO BE ABANDONED	673.4
	9	VALVE VAULT	69+65, RT 20.0	VALVE VAULTS TO BE ABANDONED	672.1
9	VALVE BOX	69+54, RT 19.9	WATER VALVE BOXES TO BE ABANDONED	672.1	
9	VALVE BOX	69+65, RT 4.4	WATER VALVE BOXES TO BE ABANDONED	672.2	
JUG HANDLE	18	MANHOLE	301+66, RT 53.5	SANITARY MANHOLES TO BE REMOVED	685.1
FARIES	13	VALVE BOX	209+02, RT 3.4	VALVE BOXES TO BE REMOVED	674.4
	14	MANHOLE	215+22, RT 62.9	SANITARY MANHOLES TO BE REMOVED	677.4
LOGAN	19	N/A			
JAMES	20	N/A			
W. HARRISON	21-22	N/A			
E. HARRISON	23-24	N/A			
CEMETERY	25	N/A			





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DRAWN - BNH	REVISIONS -	
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PLOT DATE = 10/27/2021	DATE - 10/22/2021	REVISED -

STATE OF ILLINOIS
DEPARTMENT OF TRANSPORTATION

WATER MAIN RELOCATION PLAN AND SANITARY SEWER ADJUSTMENTS
STRUCTURE SCHEDULE
 SCALE: NTS SHEET 3 OF 31 SHEETS STA. N/A TO STA. N/A

F.A.U. RTE. 7448	SECTION 09-00933-01-BR	COUNTY MACON	TOTAL SHEETS 1019	SHEET NO. 515
CONTRACT NO. 95893				
ILLINOIS FED. AID PROJECT				

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NOTES
 1. ALL NUMBERING SHOWN IS FOR WATER MAIN KEY PLAN NUMBERING. REFER TO FOLLOWING SHEETS.

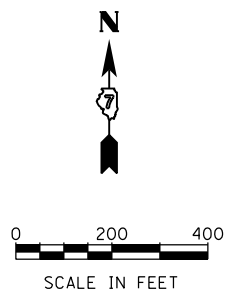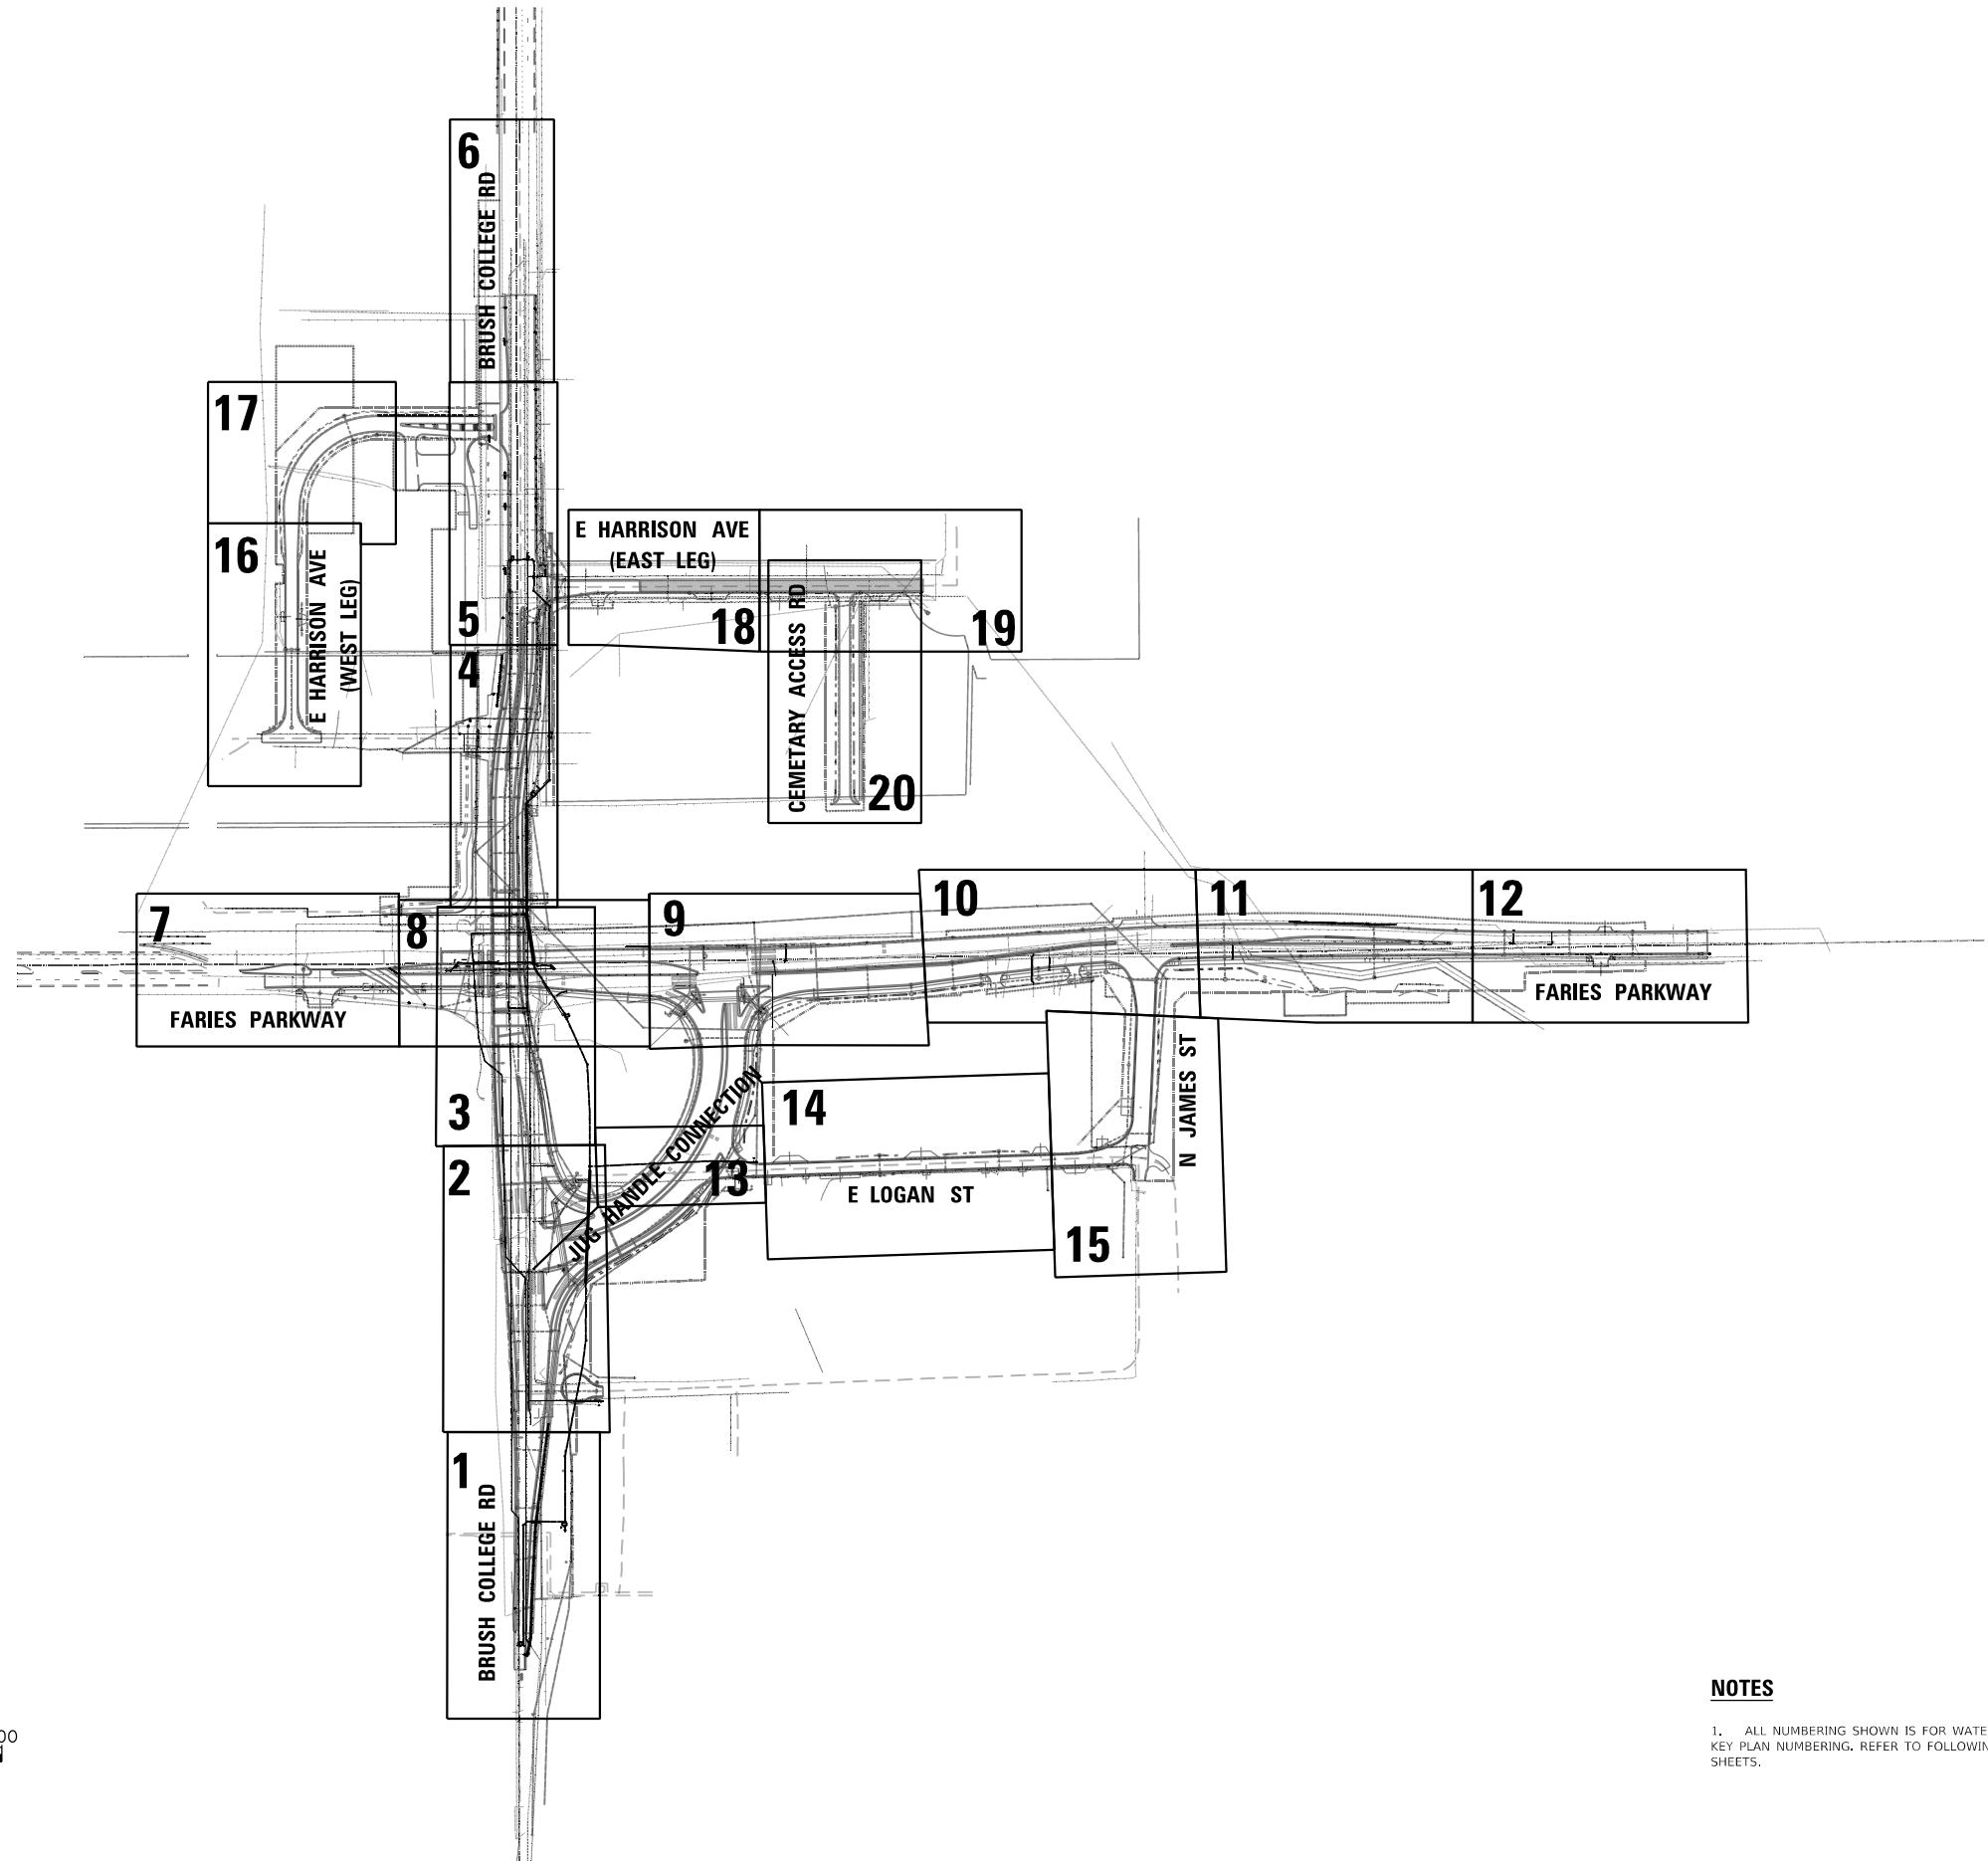

USER NAME = brooke.henry	DESIGNED - BNH	REVISED - XXX
	DRAWN - BNH	REVISED - XXX
PLOT SCALE = 400,000' / in.	CHECKED - PSA	REVISED - XXX
PLOT DATE = 10/27/2021	DATE - 10/22/2021	REVISED -

**STATE OF ILLINOIS
 DEPARTMENT OF TRANSPORTATION**


WATER MAIN RELOCATION PLAN AND SANITARY SEWER ADJUSTMENTS
WATER MAIN KEY PLAN MAP
 SCALE: 1"=200' SHEET 4 OF 31 SHEETS STA. N/A TO STA. N/A

F.A.U. RTE.	SECTION	COUNTY	TOTAL SHEETS	SHEET NO.
7448	09-00933-01-BR	MACON	1019	516
CONTRACT NO. 95893				
		ILLINOIS	FED. AID PROJECT	

PLAN	SURVEYED	DATE
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	PLOTTED	
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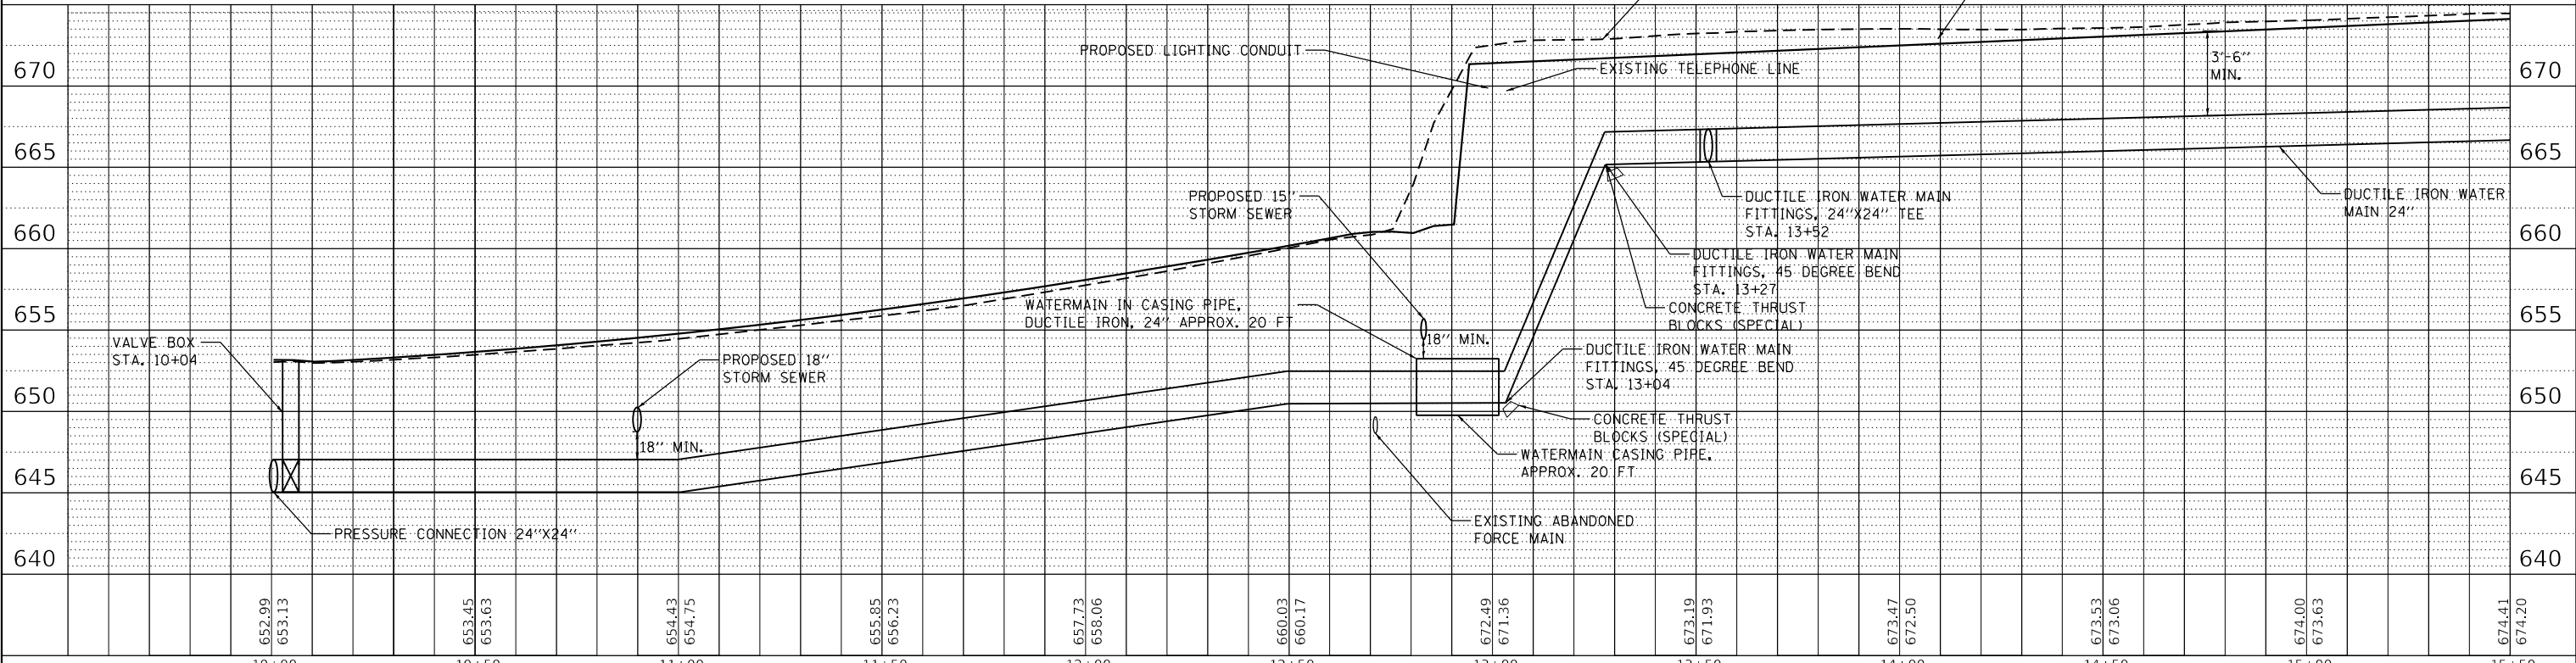


NOTES

1. BETWEEN STA. 10+00 AND 12+60, THE 24" DIAMETER WATER MAIN IS BEING RELOCATED SO THAT THE PROPOSED SOUTH ANCHORAGE SLAB WILL NOT BE CONSTRUCTED ON TOP OF THE EXISTING 24" DIAMETER WATER MAIN. A MINIMUM OF ONE (1) MONTH PRIOR TO CONSTRUCTION, THE CONTRACTOR SHALL FIELD VERIFY THE EXACT LOCATION OF THE EXISTING 24" DIAMETER WATER MAIN AND NOTIFY THE ENGINEER OF THE RESULTS. SHOULD THE EXISTING WATER MAIN LOCATION VARY FROM WHAT IS CURRENTLY SHOWN IN THE PLANS, THE ENGINEER MAY DELETE FROM THE CONTRACT SOME OR ALL OF THIS PORTION OF THE PROPOSED 24" DIAMETER WATER MAIN RELOCATION.

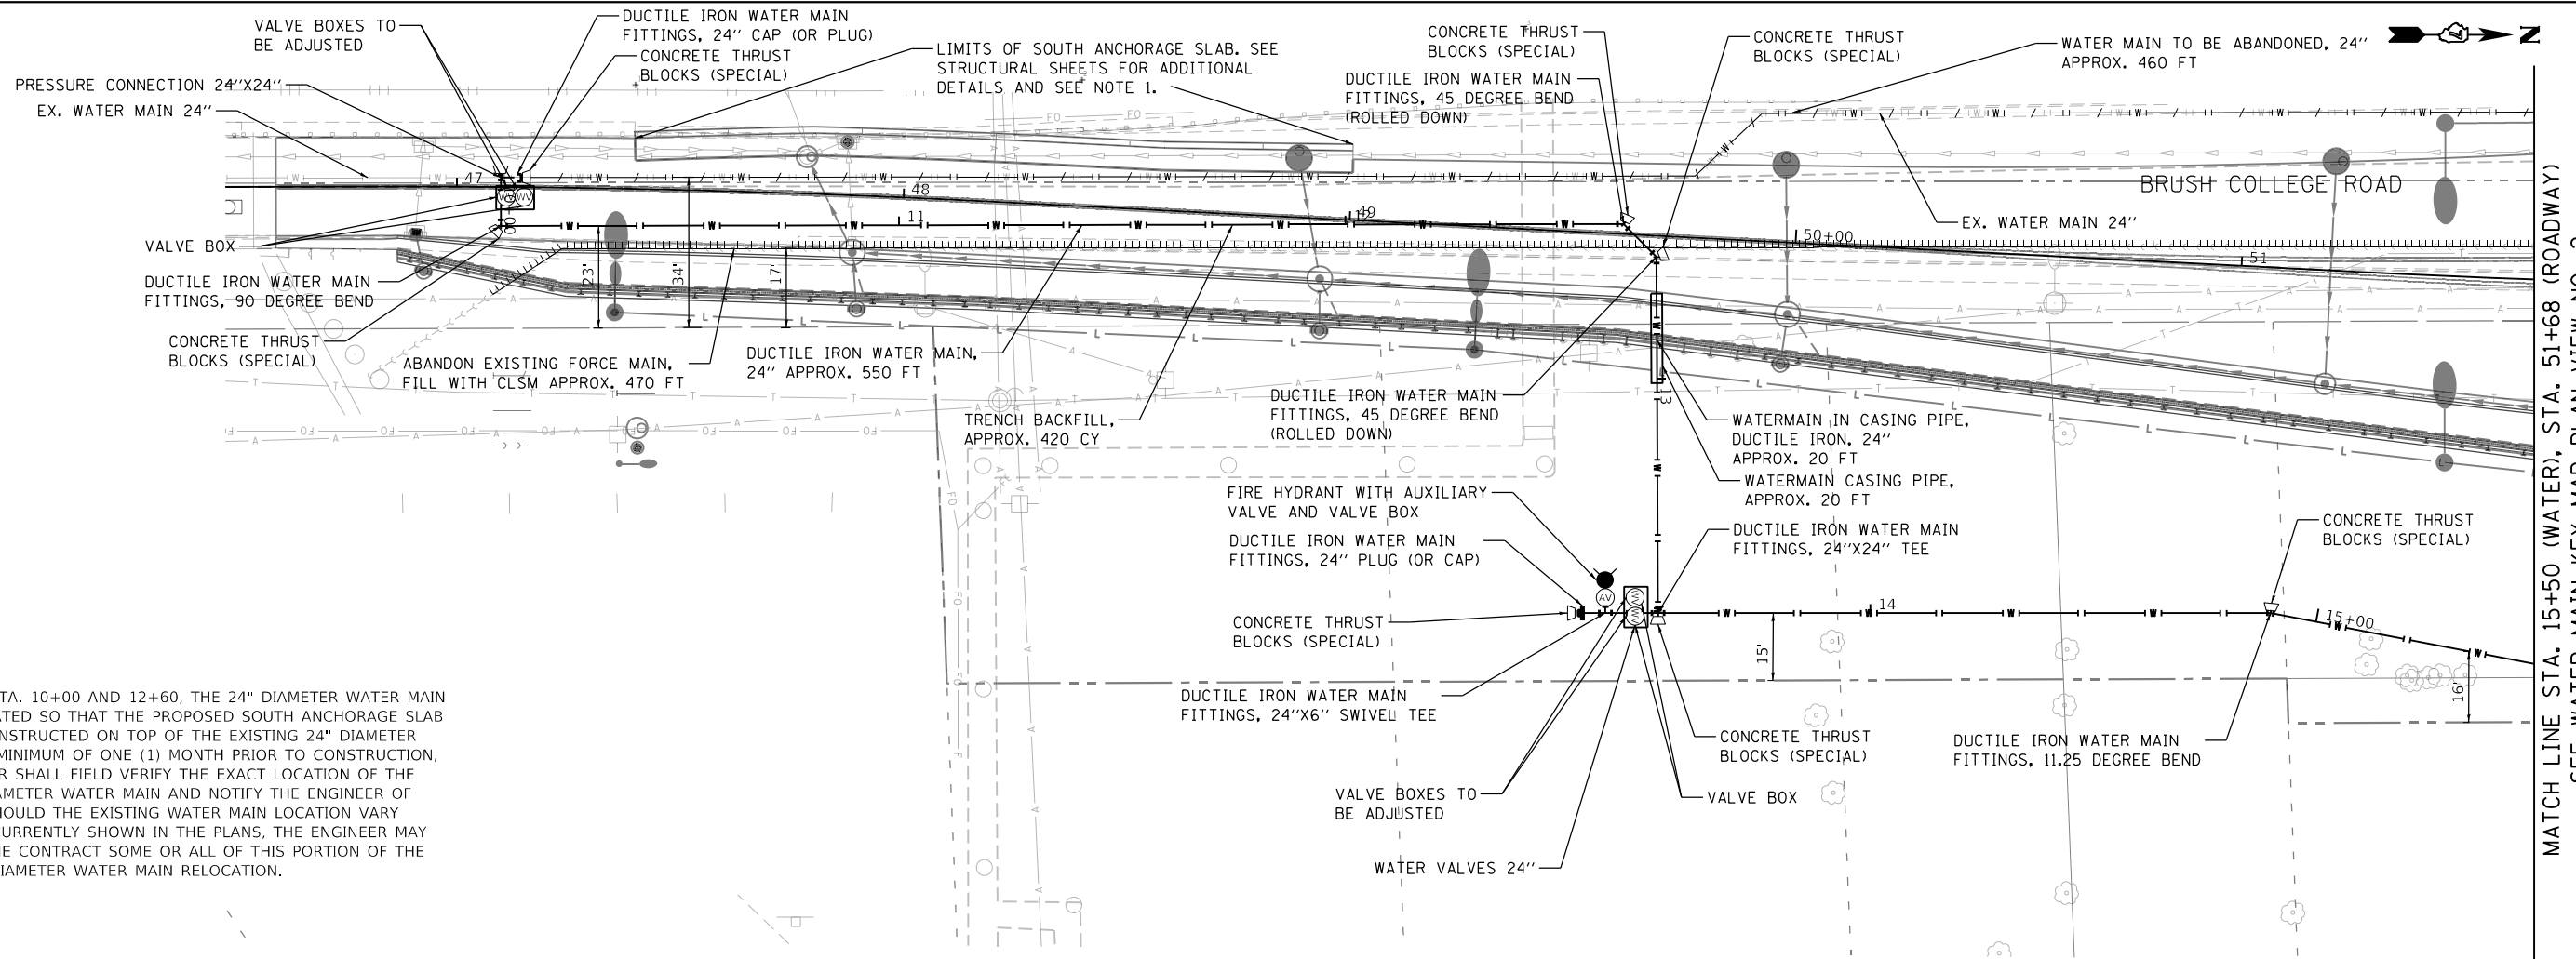

WATER MAIN KEY MAP PLAN VIEW NO. 1



USER NAME = brooke.henry
 DESIGNED - BNH
 DRAWN - BNH
 PLOT SCALE = 40,0000 ' / in.
 CHECKED - PSA
 PLOT DATE = 10/27/2021
 DATE - 10/22/2021

REVISIED -
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 REVISIED -

**STATE OF ILLINOIS
 DEPARTMENT OF TRANSPORTATION**

WATER MAIN RELOCATION PLAN AND SANITARY SEWER ADJUSTMENTS
WATER MAIN PLAN AND PROFILE
 SCALE: 1"=20'
 SHEET 5 OF 31 SHEETS
 STA. 10+00 TO STA. 15+50

F.A.U. RTE. SECTION COUNTY TOTAL SHEETS SHEET NO.
 7448 09-00933-01-BR MACON 1019 517
 CONTRACT NO. 95893
 ILLINOIS FED. AID PROJECT


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	GRADES CHECKED	
	NOTE BOOK	
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	FILE NAME	
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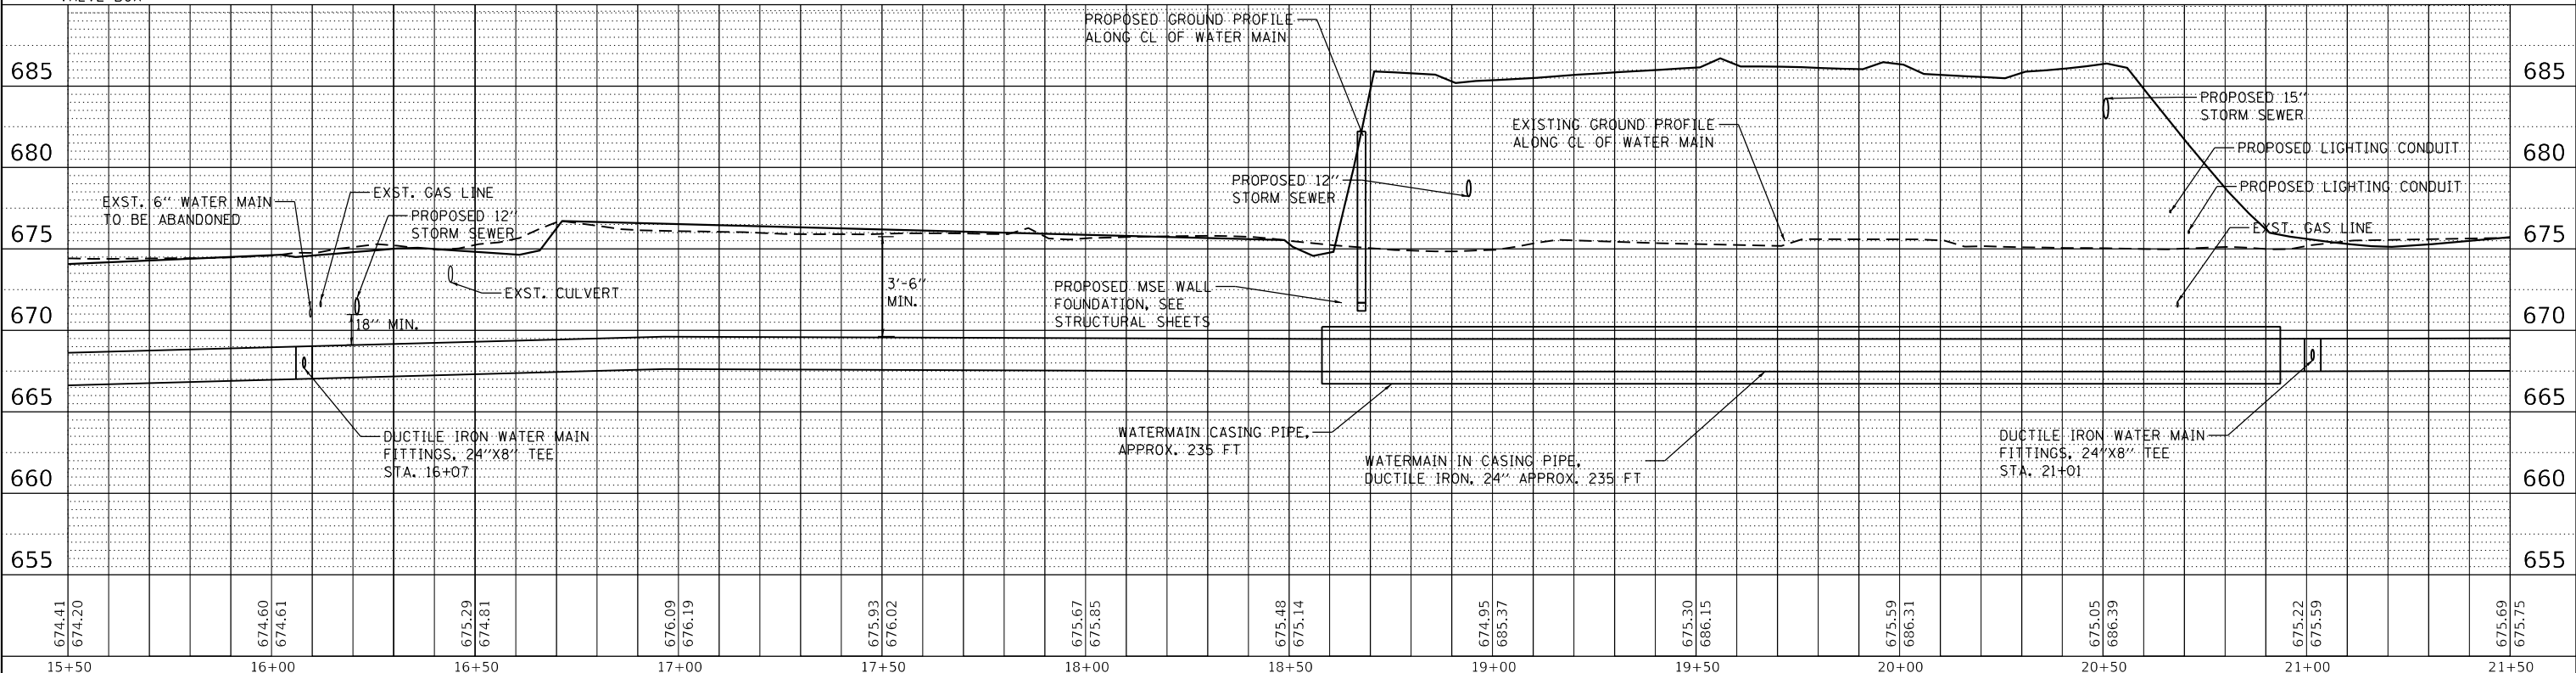
MATCH LINE STA. 15+50 (WATER) STA. 51+68 (ROADWAY)
 SEE WATER MAIN KEY MAP PLAN VIEW NO. 1

MATCH LINE STA. 21+50 (WATER) STA. 57+53 (ROADWAY)
 SEE WATER MAIN KEY MAP PLAN VIEW NO. 3



WATER MAIN KEY MAP PLAN VIEW NO. 2

SEE WATER MAIN KEY MAP PLAN VIEW NO. 13

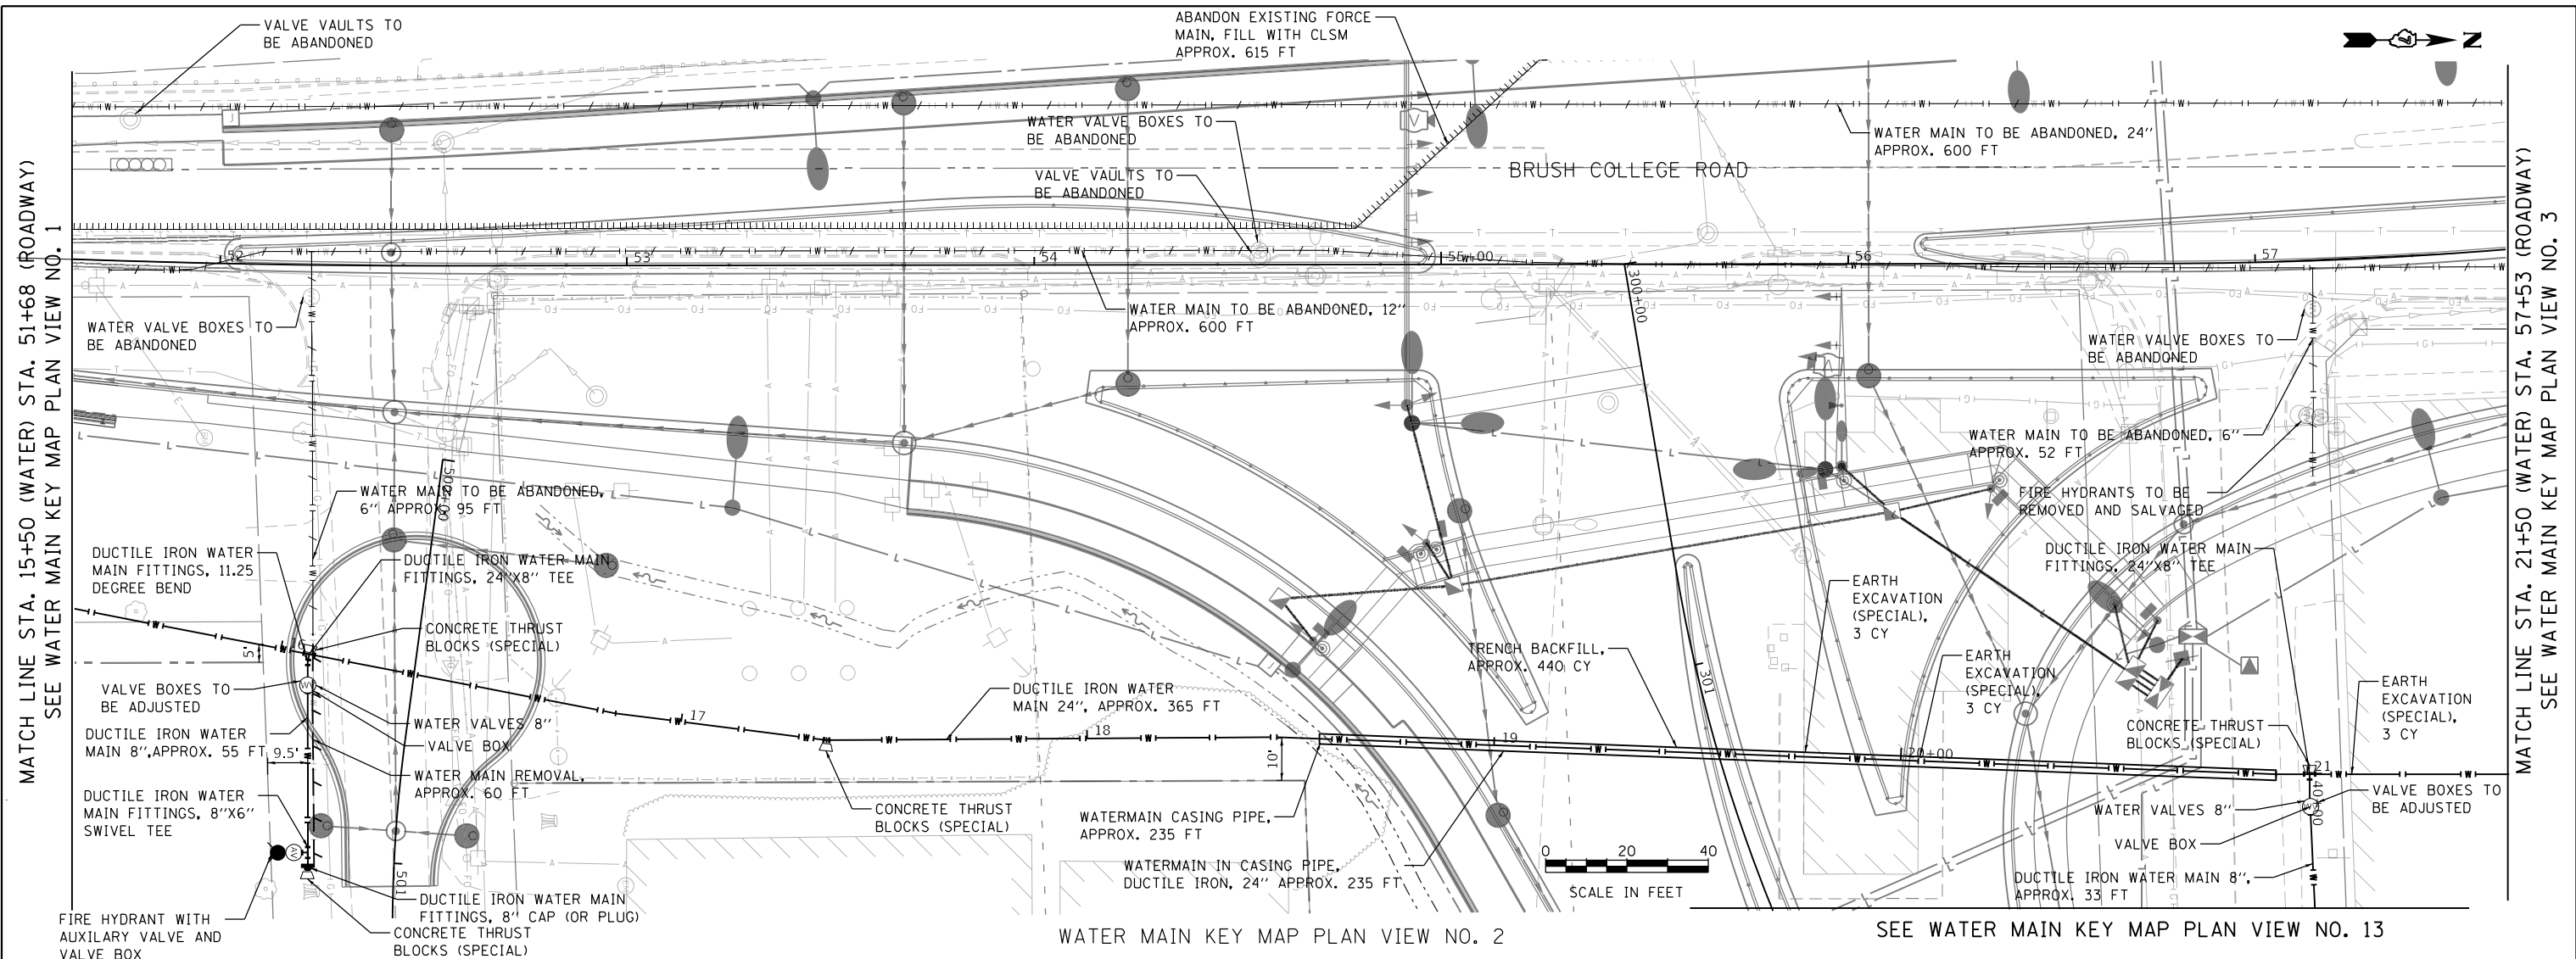

674.41	674.20	674.60	674.61	675.29	674.81	676.09	676.19	675.93	676.02	675.67	675.85	675.48	675.14	674.95	685.37	675.30	686.15	675.59	686.31	675.05	686.39	675.22	675.59	675.69	675.75	
15+50	16+00	16+50	17+00	17+50	18+00	18+50	19+00	19+50	20+00	20+50	21+00	21+50														



USER NAME = dishevaz	DESIGNED - BNH	REVISED -
	DRAWN - BNH	REVISED -
	CHECKED - PSA	REVISED -
PLOT DATE = 4/13/2023	DATE - 4/17/2023	REVISED -

STATE OF ILLINOIS
 DEPARTMENT OF TRANSPORTATION

WATER MAIN RELOCATION PLAN AND SANITARY SEWER ADJUSTMENTS
 WATER MAIN PLAN AND PROFILE
 SCALE: 1"=20' SHEET 6 OF 31 SHEETS STA. 15+50 TO STA. 21+50

F.A.U. RTE. 7448	SECTION 09-00933-01-BR	COUNTY MACON	TOTAL SHEETS 1019	SHEET NO. 518
CONTRACT NO. 95893				
ILLINOIS FED. AID PROJECT				


NOTES

1. FIBER OPTIC CONDUIT FOR FUTURE USE IS TO BE INSTALLED WITH A MINIMUM 20" BENDING RADIUS. CONDUIT TERMINATING IN COMMUNICATION VAULTS SHALL BE CAPPED FOR FUTURE USE.
2. CONDUIT UNDER FARIES PARKWAY SHALL BE HDPE SCHEDULE 80.
3. COMMUNICATIONS VAULTS AND INSTALLED CONDUIT SHALL BE STAKED IN THE FIELD AND APPROVED BY THE ENGINEER PRIOR TO INSTALLATION. SEE WATER MAIN DETAILS SHEETS FOR COMMUNICATIONS VAULT DETAIL.
4. FIBER OPTIC CONDUIT SHALL BE INSTALLED WITHIN 48" STEEL CASING.
5. COMMUNICATIONS VAULT AT WATER MAIN STA. 24+30 SHALL NOT BE INSTALLED UNTIL THE PROPOSED FINAL GRADE IS ESTABLISHED AND AS APPROVED BY THE ENGINEER.



MATCH LINE STA. 21+50 (WATER), STA. 57+53 (ROADWAY)
SEE WATER MAIN KEY MAP PLAN VIEW NO. 2

MATCH LINE STA. 27+50 (WATER), STA. 63+35 (ROADWAY)
SEE WATER MAIN KEY MAP PLAN VIEW NO. 4

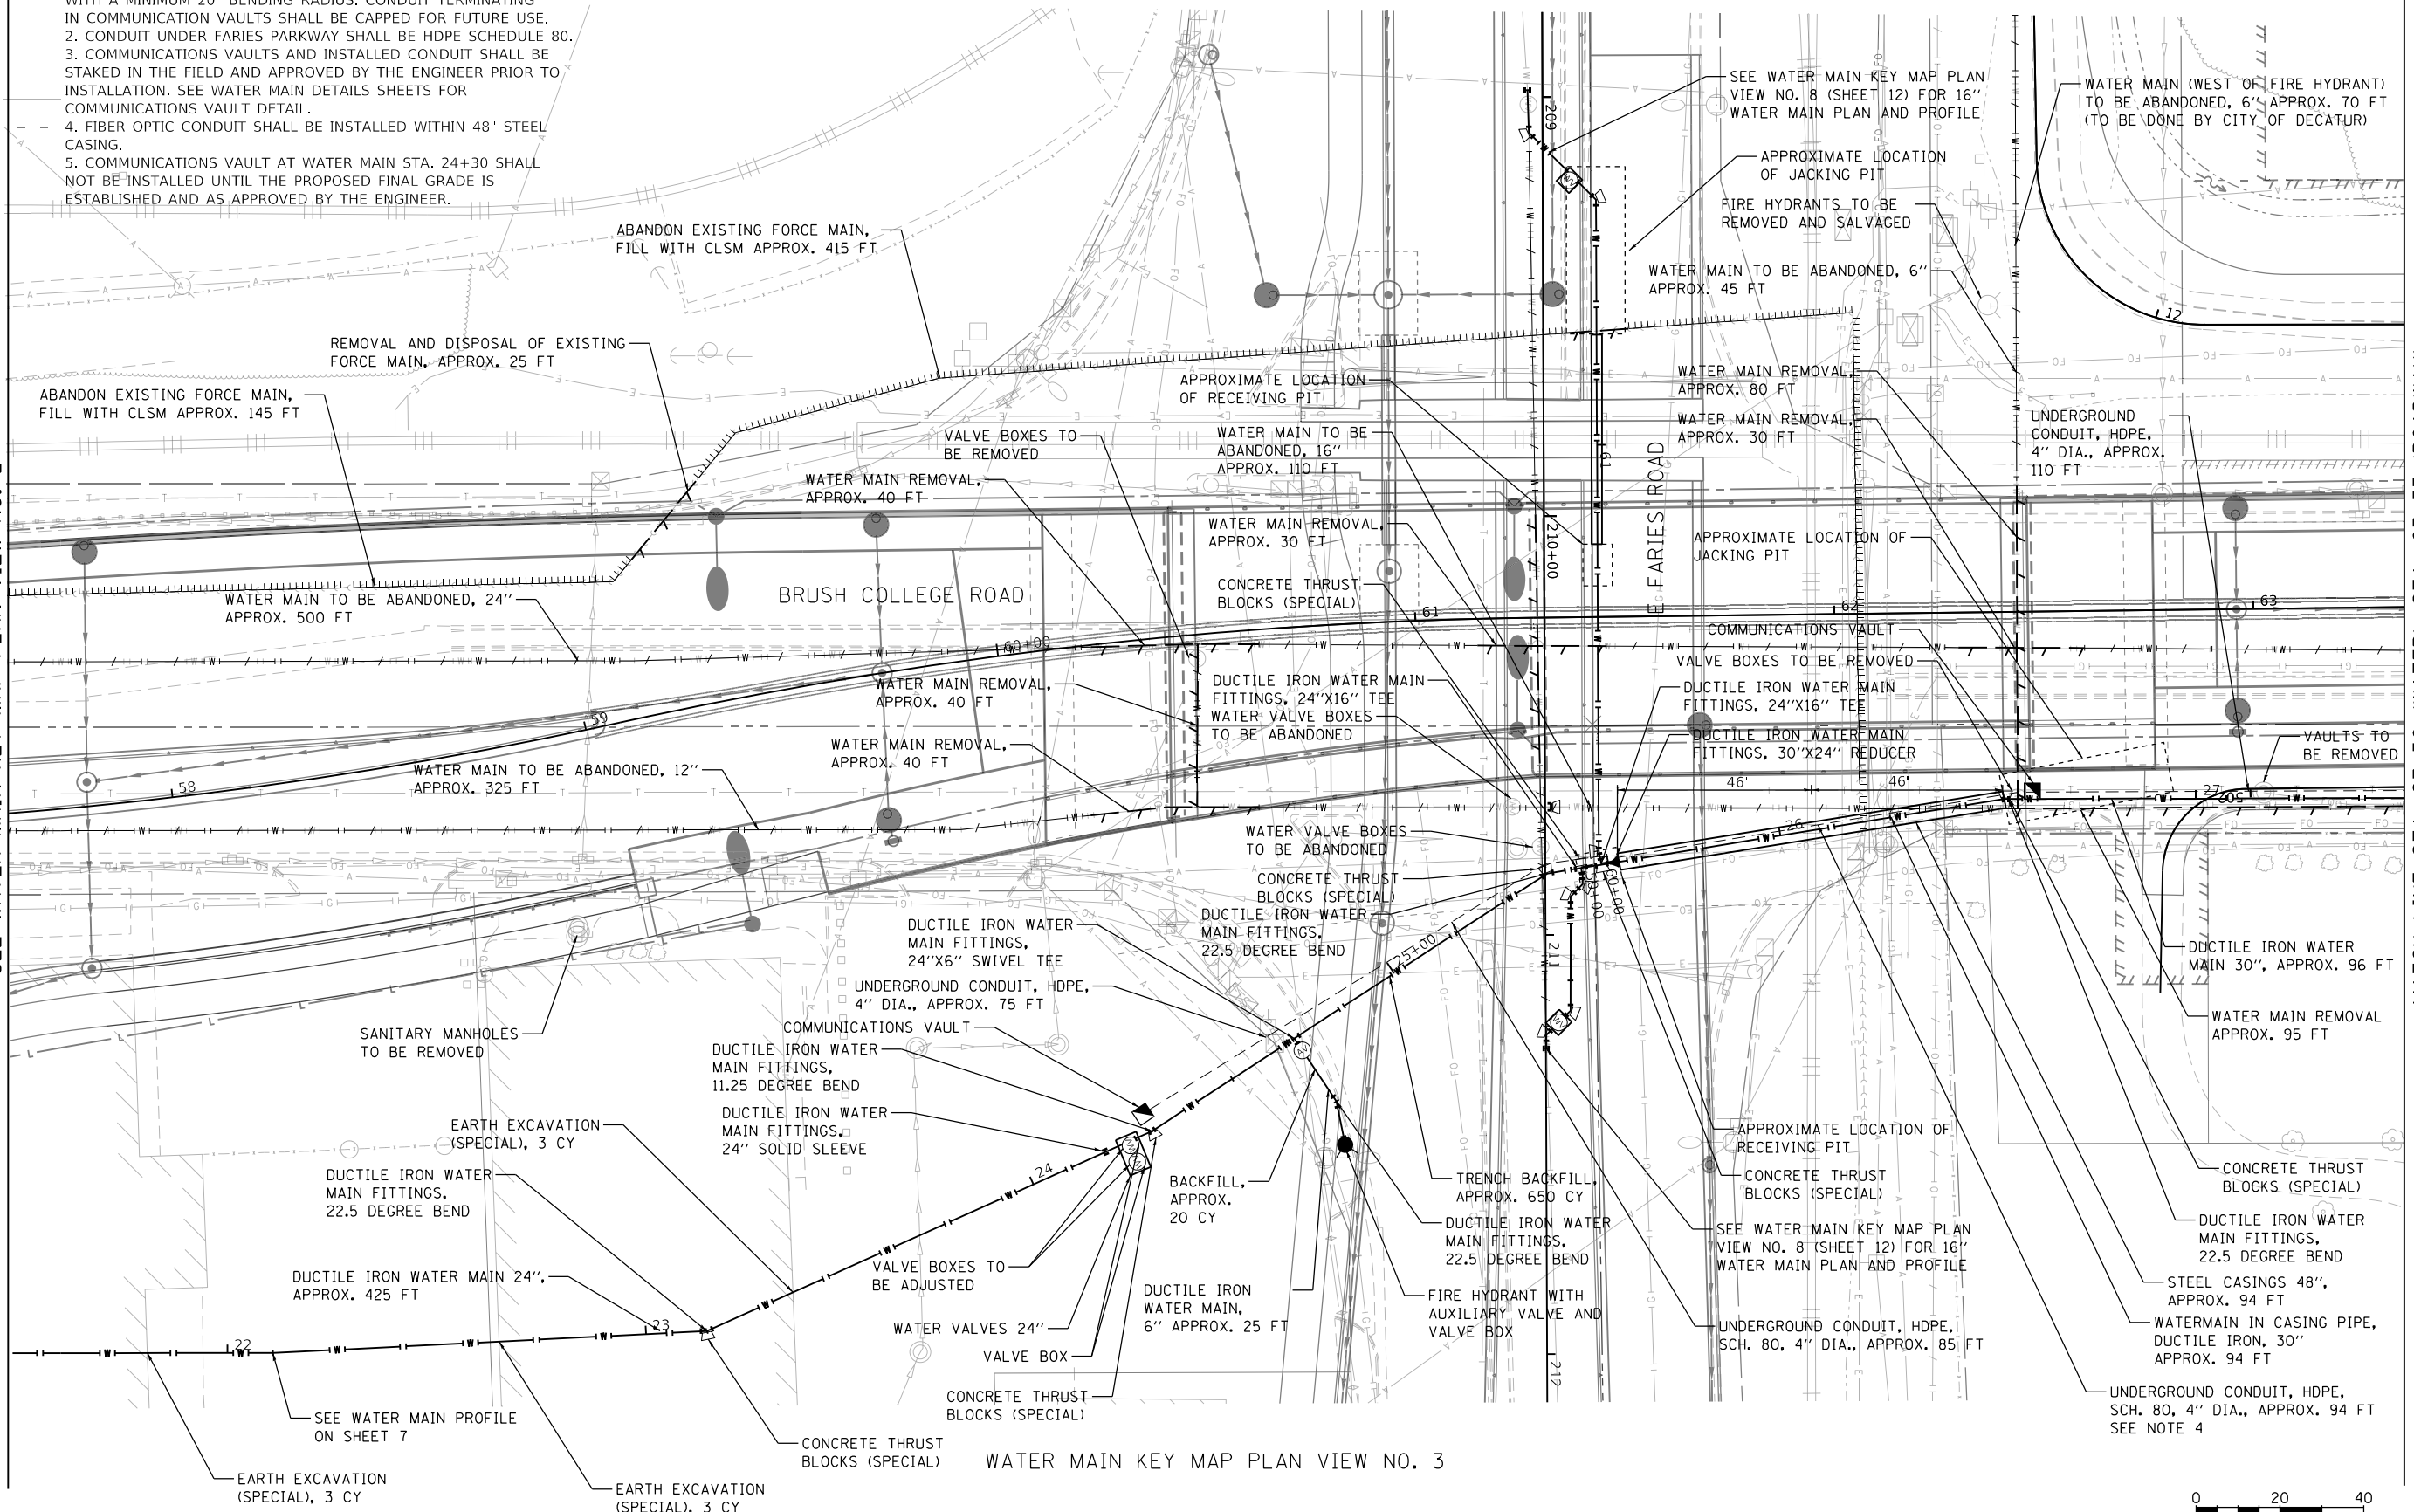

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USER NAME = dishevaz	DESIGNED - BNH	REVISED -
PLOT SCALE = 40,0000' / in.	DRAWN - BNH	REVISED -
PLOT DATE = 4/13/2023	CHECKED - PSA	REVISED -
	DATE - 4/17/2023	REVISED -

**STATE OF ILLINOIS
DEPARTMENT OF TRANSPORTATION**


**WATER MAIN RELOCATION PLAN AND SANITARY SEWER ADJUSTMENTS
WATER MAIN PLAN**

F.A.U. RTE. 7448	SECTION 09-00933-01-BR	COUNTY MACON	TOTAL SHEETS 1019	SHEET NO. 519
CONTRACT NO. 95893				
ILLINOIS FED. AID PROJECT				

SCALE: 1"=20' SHEET 7 OF 31 SHEETS STA. 21+50 TO STA. 27+50


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NOTE BOOK NO.	CHECKED	
	BY	

PROFILE	SURVEYED	DATE
	PLOTTED	
NOTE BOOK NO.	CHECKED	
	BY	

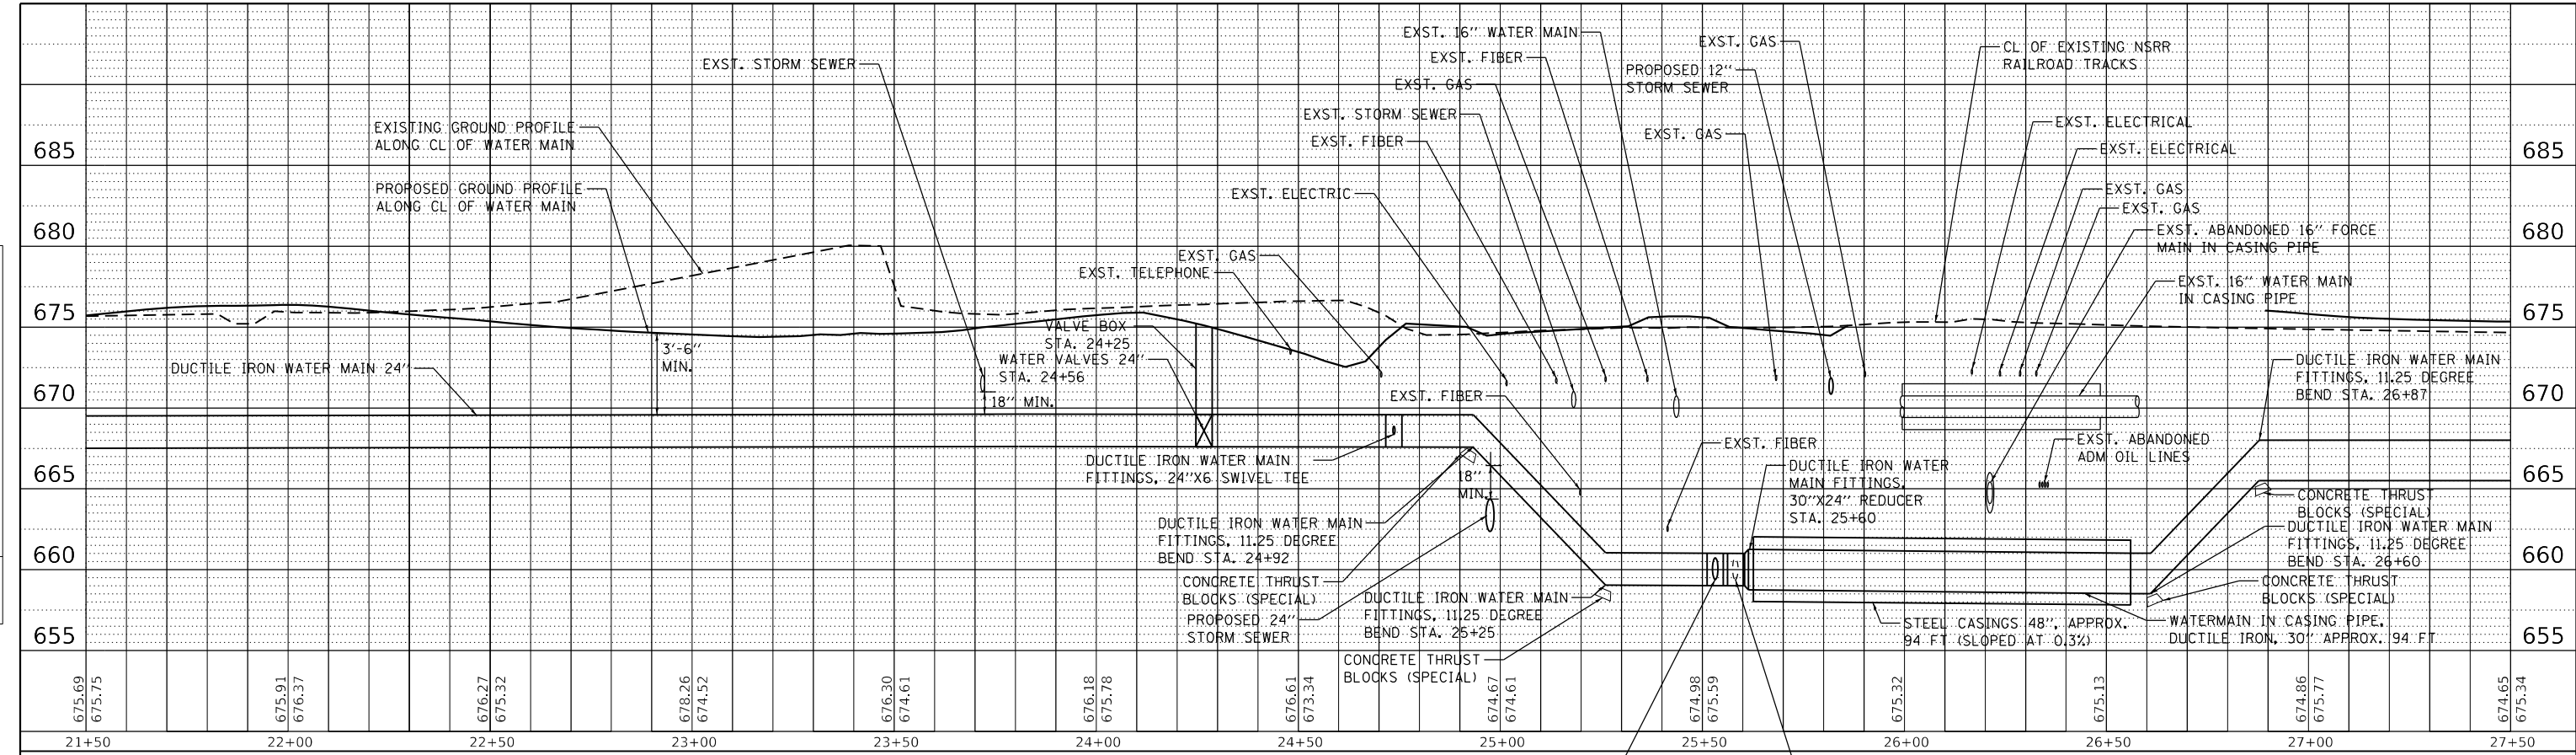

NOTES

- FOR CLARITY, PR UNDERGROUND CONDUIT, HDPE, 4" DIA. IS NOT SHOWN IN THE PROFILE. THE CONTRACTORS ATTENTION IS ESPECIALLY CALLED TO THE PROPOSED GRADING CHANGES BETWEEN STA. 24+10 AND 24+75. CONTRACTOR SHALL MAINTAIN A BURIED CONDUIT DEPTH OF 30"-36" (TO THE TOP OF THE CONDUIT) WITH THE PROPOSED GRADING IN THIS AREA.
- WHERE WATER MAIN IS PROPOSED TO HAVE LESS THAN 42" OF COVER BETWEEN APPROX. STA. 24+55 AND 24+70, CONTRACTOR SHALL INSTALL INSULATION AROUND THE ENTIRE 24-INCH DIA. WATER MAIN, FITTING, AND VALVE. INSULATION SHALL BE FOAMGLAS (WITH PITTTWRAP JACKETING) OR ENGINEER APPROVED EQUAL.

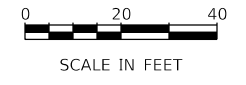

USER NAME = brooke.henry
 PLOT SCALE = 40.0000' / in.
 PLOT DATE = 10/27/2021

DESIGNED - BNH	REVISED -
DRAWN - BNH	REVISED -
CHECKED - PSA	REVISED -
DATE - 10/22/2021	REVISED -

**STATE OF ILLINOIS
DEPARTMENT OF TRANSPORTATION**

**WATER MAIN RELOCATION PLAN AND SANITARY SEWER ADJUSTMENTS
WATER MAIN PROFILE**

SCALE: 1"=20' SHEET 8 OF 31 SHEETS STA. 21+50 TO STA. 27+50


F.A.U. RTE. 7448	SECTION 09-00933-01-BR	COUNTY MACON	TOTAL SHEETS 1019	SHEET NO. 520
CONTRACT NO. 95893				
ILLINOIS FED. AID PROJECT				

PLAN	SURVEYED	DATE
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PROFILE	SURVEYED	DATE
	PLOTTED	
	GRADES	
	CHECKED	
	STRUCTURE	
	NOTATION	
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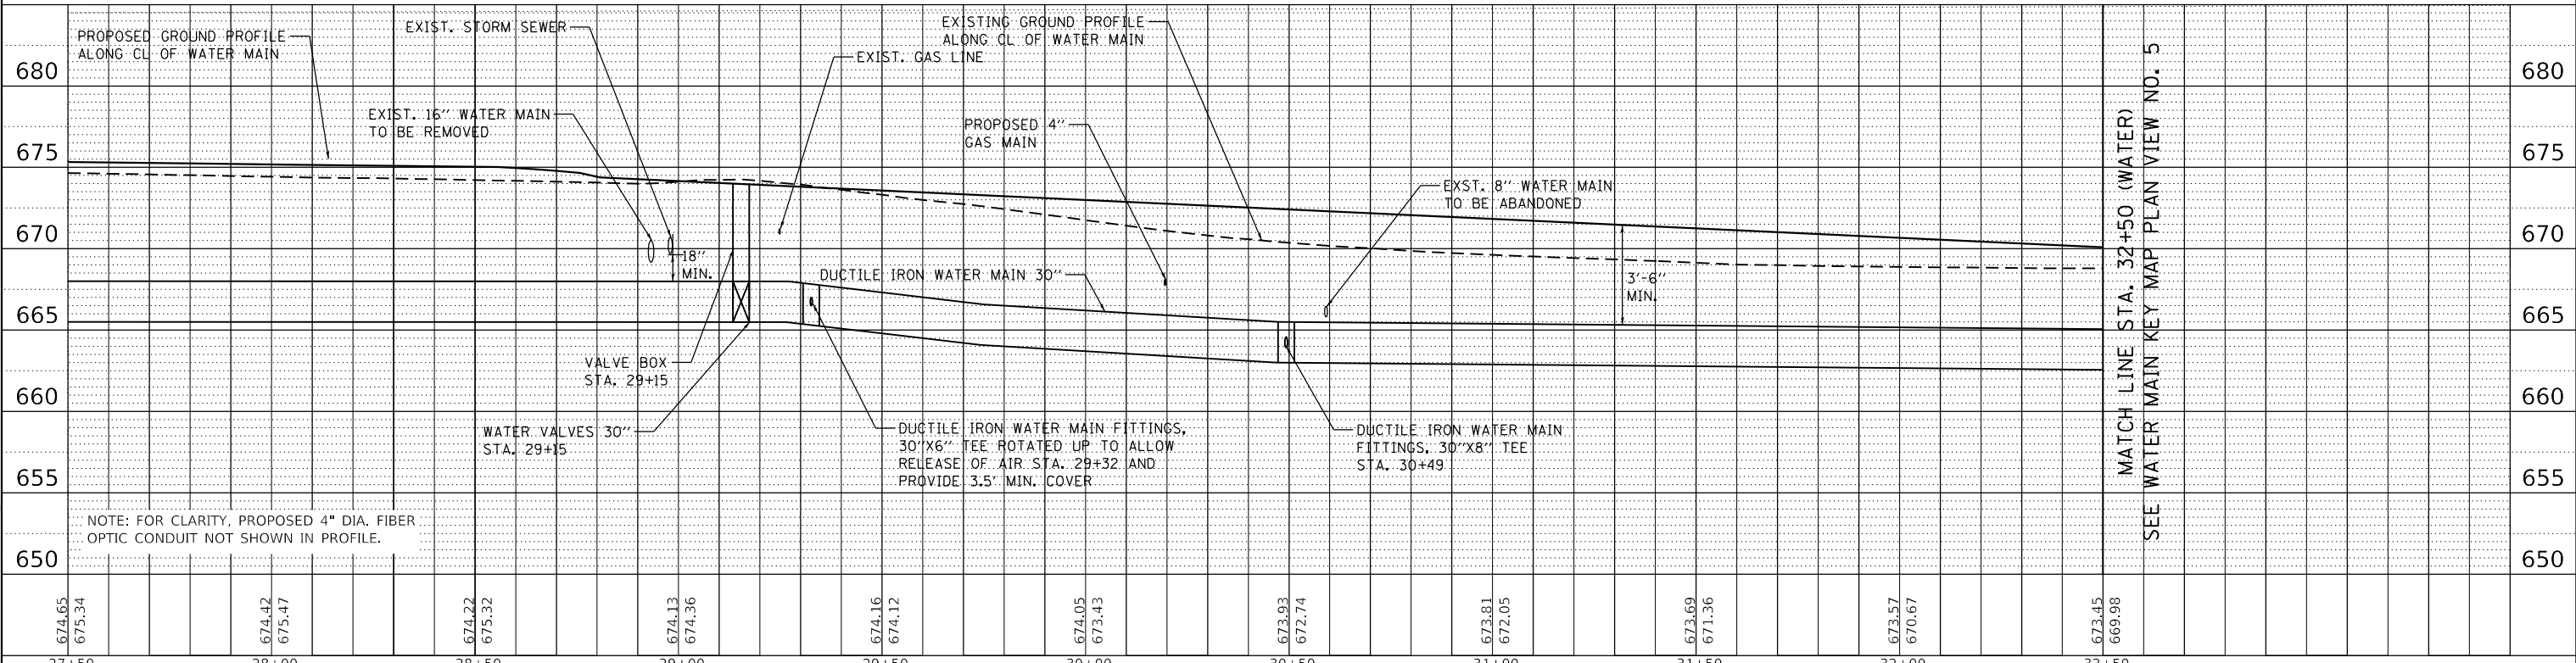
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MATCH LINE STA. 27+50 (WATER), STA. 63+35 (ROADWAY)
 SEE WATER MAIN KEY MAP PLAN VIEW NO. 3



MATCH LINE STA. 32+50 (WATER), STA. 68+17 (ROADWAY)
 SEE WATER MAIN KEY MAP PLAN VIEW NO. 5

- NOTES**
1. USE FLUOROELASTOMER (VITON) GASKETS FOR ALL WATER MAIN JOINTS FROM STA. 28+80 TO STA. 32+00.
 2. FIBER OPTIC CONDUIT FOR FUTURE USE IS TO BE INSTALLED WITH A MINIMUM 20" BENDING RADIUS. CONDUIT TERMINATING IN COMMUNICATION VAULTS SHALL BE CAPPED FOR FUTURE USE.
 3. COMMUNICATIONS VAULTS AND INSTALLED CONDUIT SHALL BE STAKED IN THE FIELD AND APPROVED BY THE ENGINEER PRIOR TO INSTALLATION. SEE WATER MAIN DETAIL SHEETS FOR COMMUNICATIONS VAULT DETAIL.
 4. REFER TO ADVANCE CUSTOMER COORDINATION NOTES ON THE WATER MAIN PHASING PLAN SHEETS.

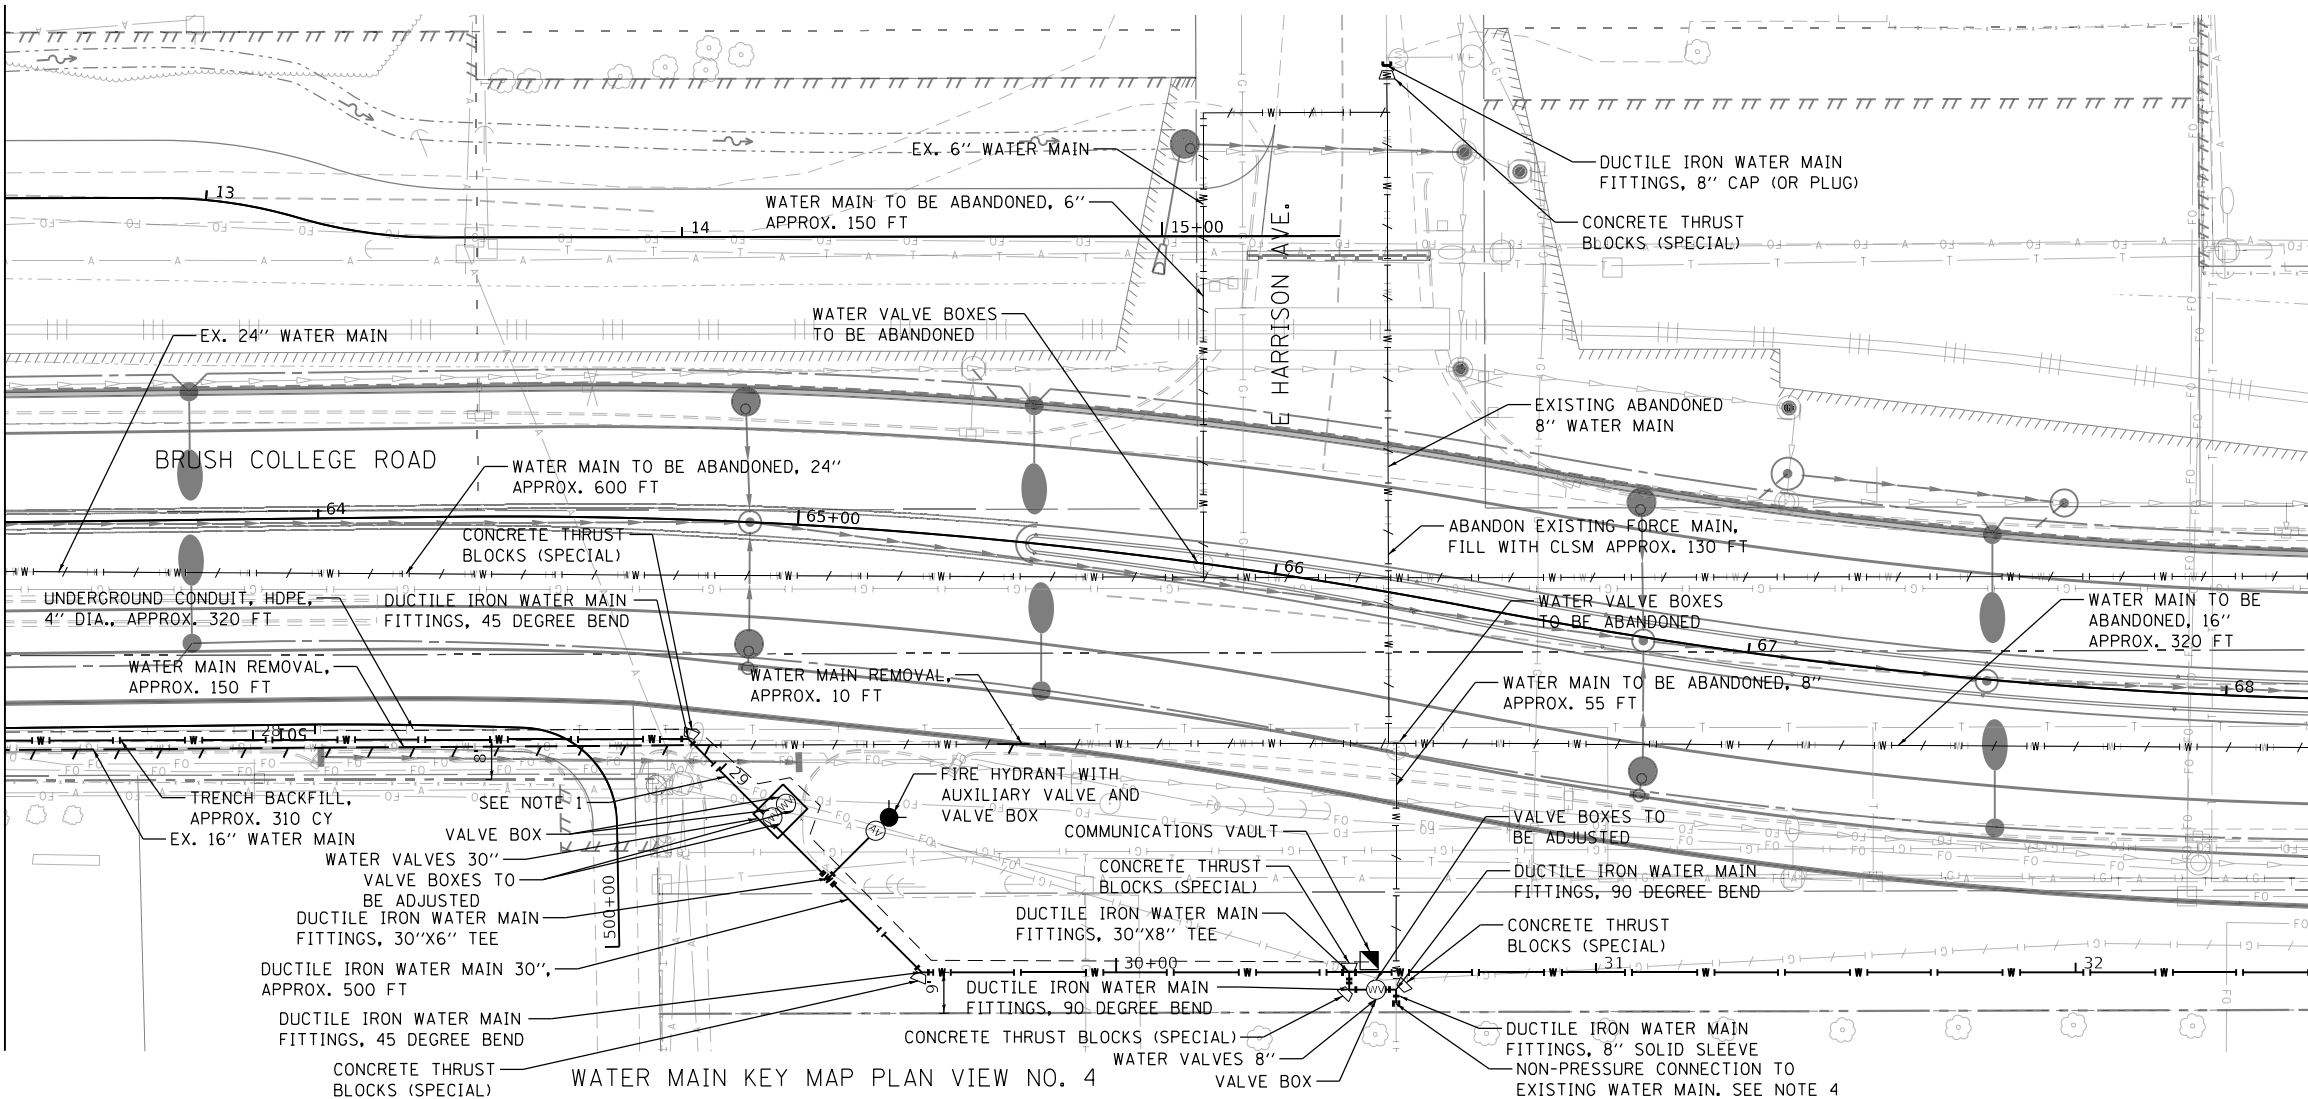

MATCH LINE STA. 32+50 (WATER)
 SEE WATER MAIN KEY MAP PLAN VIEW NO. 5



USER NAME = brooke.henry
 DESIGNED - BNH
 DRAWN - BNH
 CHECKED - PSA
 DATE - 10/22/2021

REVISIONS
 REVISED -
 REVISED -
 REVISED -
 REVISED -

STATE OF ILLINOIS
 DEPARTMENT OF TRANSPORTATION

WATER MAIN RELOCATION PLAN AND SANITARY SEWER ADJUSTMENTS
 WATER MAIN PLAN AND PROFILE
 SCALE: 1"=20'
 SHEET 9 OF 31 SHEETS
 STA. 27+50 TO STA. 32+50



F.A.U. RTE.	SECTION	COUNTY	TOTAL SHEETS	SHEET NO.
7448	09-00933-01-BR	MACON	1019	521
CONTRACT NO. 95893				
ILLINOIS FED. AID PROJECT				

PLAN	SURVEYED	DATE
	PLOTTED	
	ALIGNED	
	CHECKED	
	NO. _____	
	NOTE BOOK	
	NO. _____	
	FILE NAME	
	NO. _____	

PROFILE	SURVEYED	DATE
	PLOTTED	
	GRADES	
	CHECKED	
	NO. _____	
	NOTE BOOK	
	NO. _____	
	FILE NAME	
	NO. _____	

MATCH LINE STA. 32+50 (WATER), STA. 68+17 (ROADWAY)
SEE WATER MAIN KEY MAP PLAN VIEW NO. 4

MATCH LINE SEE WATER MAIN KEY MAP PLAN VIEW NO. 17

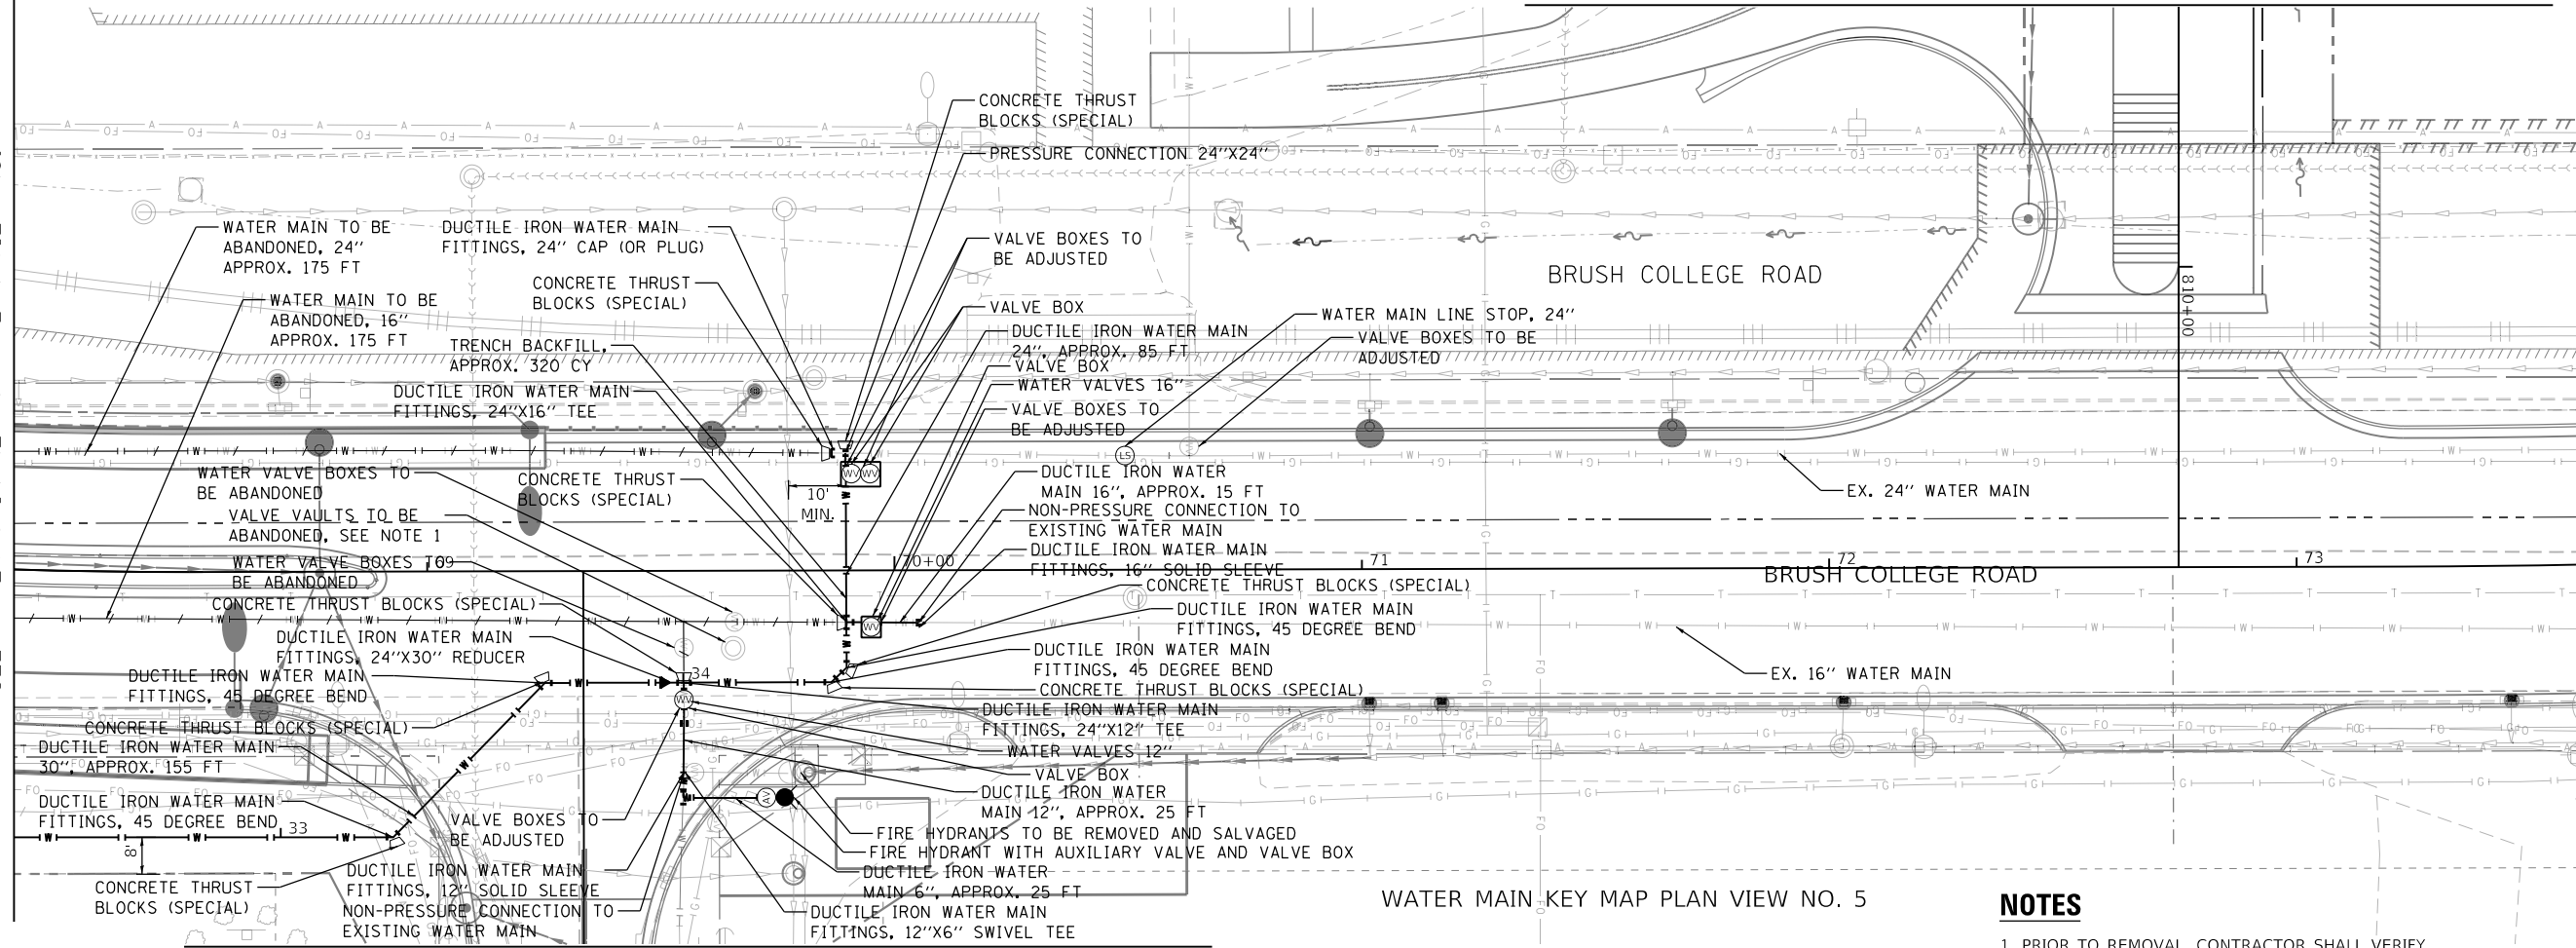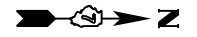



MATCH LINE STA. 73+61 (ROADWAY)
SEE WATER MAIN KEY MAP PLAN VIEW NO. 6

MATCH LINE SEE WATER MAIN KEY MAP PLAN VIEW NO. 18

WATER MAIN KEY MAP PLAN VIEW NO. 5

NOTES

1. PRIOR TO REMOVAL, CONTRACTOR SHALL VERIFY WITH THE ENGINEER THAT THIS VAULT IS CONNECTED TO THE EXISTING WATER MAIN SYSTEM THAT IS PROPOSED TO BE ABANDONED.

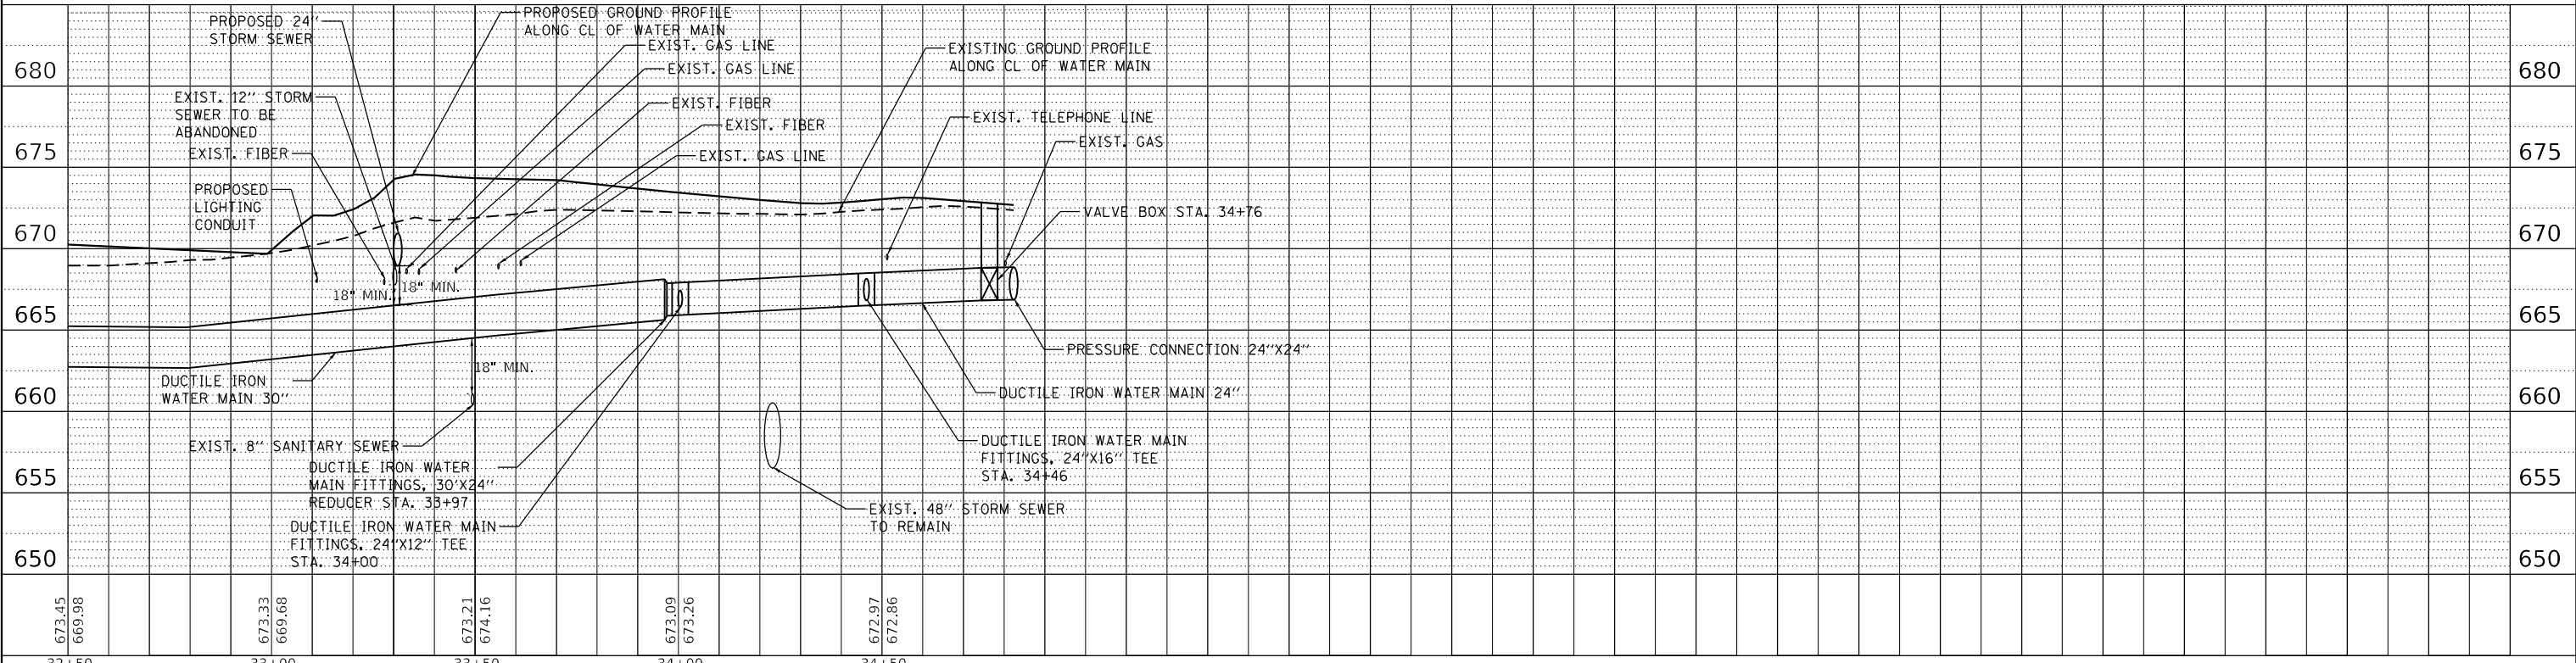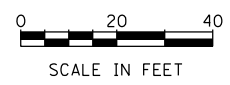

USER NAME = brooke.henry
DESIGNED - BNH
DRAWN - BNH
CHECKED - PSA
PLOT DATE = 10/22/2021

REVISIONS
REVISED -
REVISED -
REVISED -
REVISED -

DATE - 10/22/2021

STATE OF ILLINOIS
DEPARTMENT OF TRANSPORTATION

WATER MAIN RELOCATION PLAN AND SANITARY SEWER ADJUSTMENTS
WATER MAIN PLAN AND PROFILE


SCALE: 1"=20' SHEET 10 OF 31 SHEETS STA. 32+50 TO STA. 32+82

F.A.U. RTE. 7448	SECTION 09-00933-01-BR	COUNTY MACON	TOTAL SHEETS 1019	SHEET NO. 522
CONTRACT NO. 95893				
ILLINOIS FED. AID PROJECT				

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MATCH LINE STA 73+61 (ROADWAY)
SEE WATER MAIN KEY MAP PLAN VIEW NO. 5



REFER TO ADVANCE CUSTOMER
COORDINATION NOTES ON THE
WATER MAIN PHASING PLAN
SHEETS

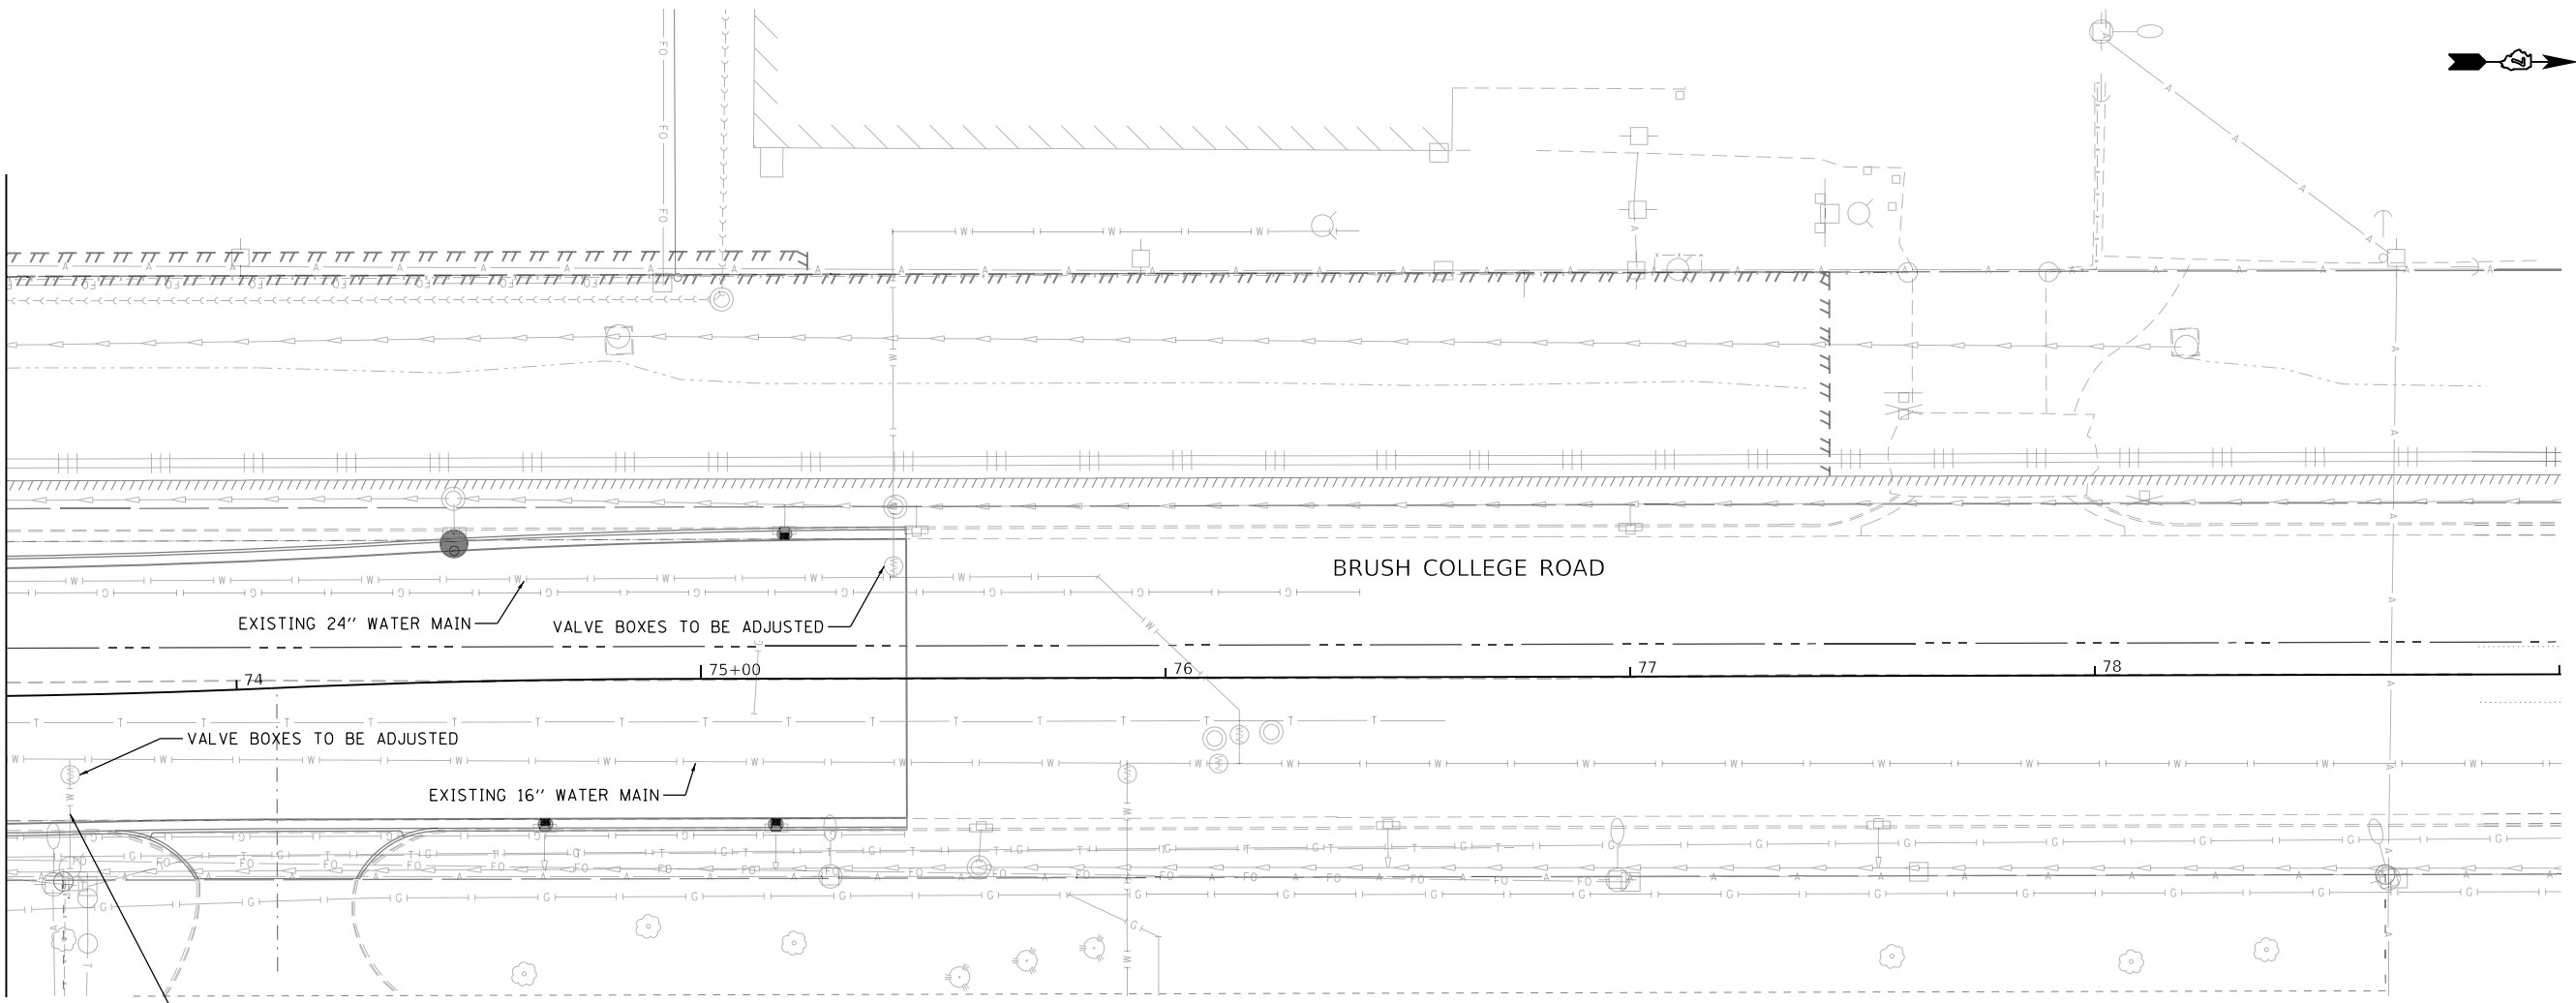WATER MAIN KEY MAP PLAN VIEW NO. 6



MODEL: Default
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USER NAME = brooke.henry
PLOT SCALE = 40.0000 ' / in.
PLOT DATE = 10/27/2021


DESIGNED - BNH
DRAWN - BNH
CHECKED - PSA
DATE - 10/22/2021

REVISED -
REVISED -
REVISED -
REVISED -

**STATE OF ILLINOIS
DEPARTMENT OF TRANSPORTATION**


WATER MAIN RELOCATION PLAN AND SANITARY SEWER ADJUSTMENTS
WATER MAIN PLAN
SCALE: 1"=20' SHEET 11 OF 31 SHEETS STA. 73+61 TO STA.

F.A.U. RTE.	SECTION	COUNTY	TOTAL SHEETS	SHEET NO.
7448	09-00933-01-BR	MACON	1019	523
CONTRACT NO. 95893				
ILLINOIS FED. AID PROJECT				

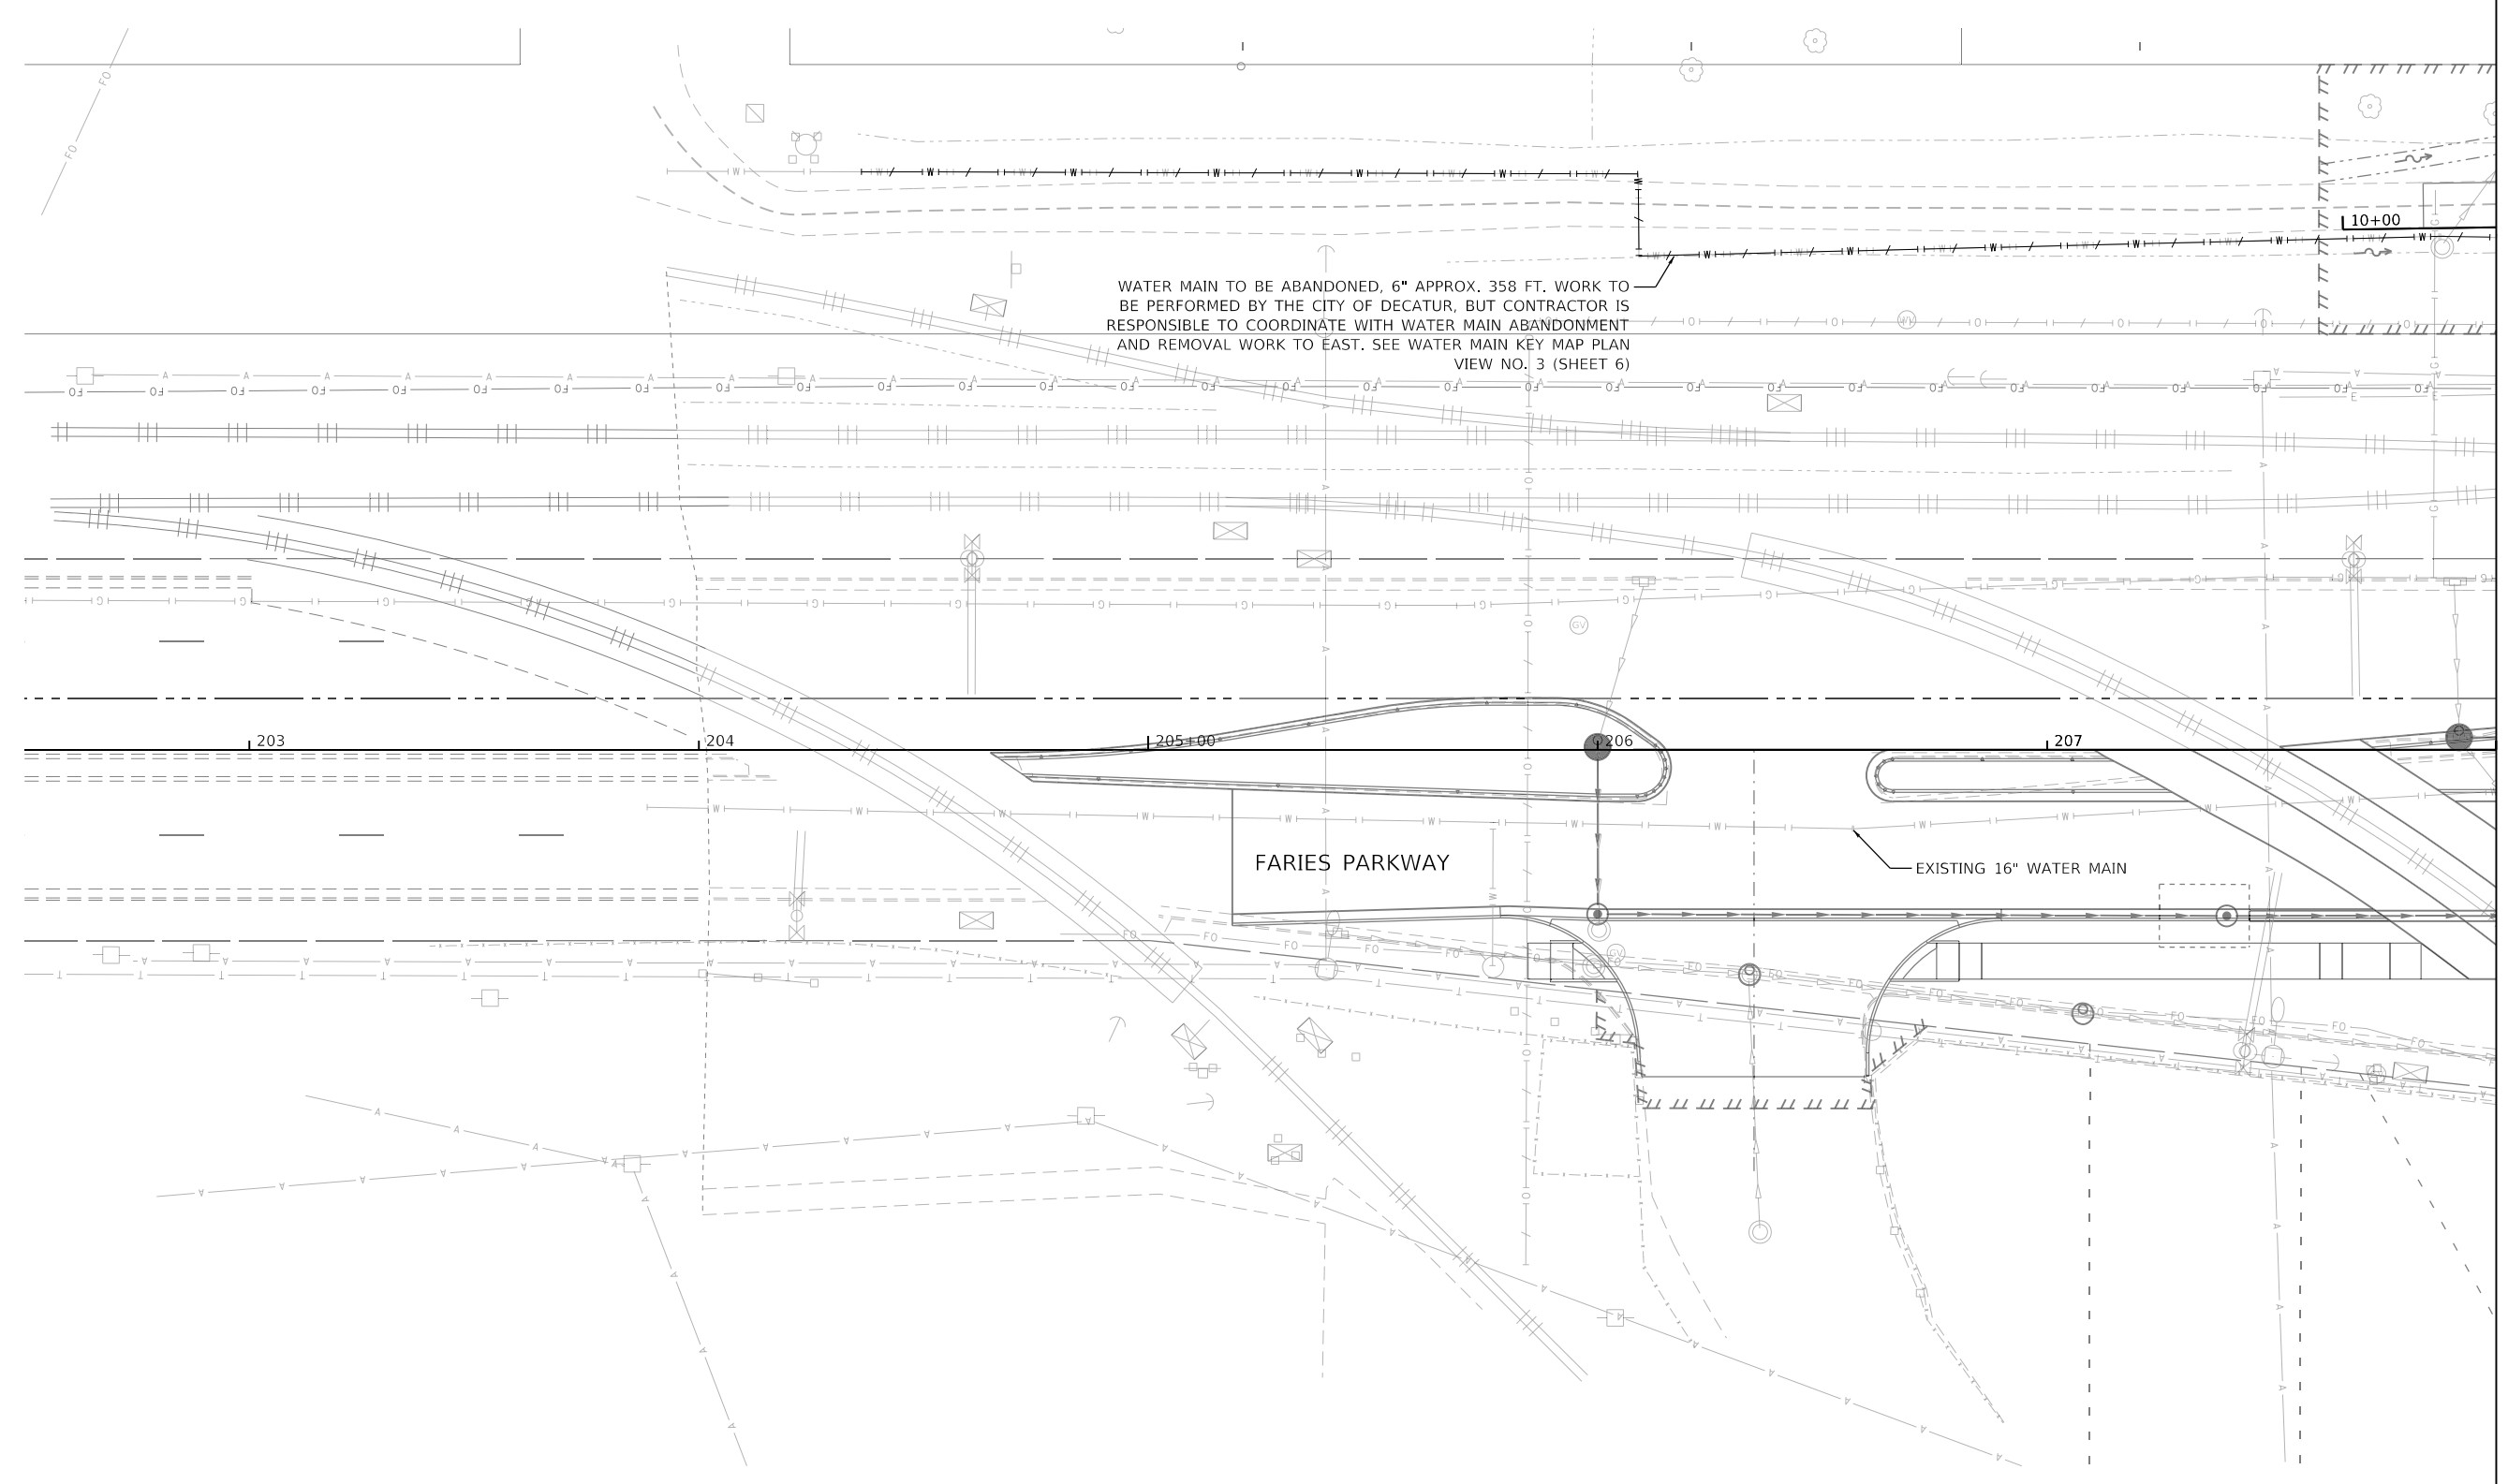

MATCH LINE STA 208+00 (ROADWAY)
SEE WATER MAIN KEY MAP PLAN VIEW NO. 8

WATER MAIN KEY MAP PLAN VIEW NO. 7

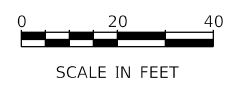

MODEL: Default
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USER NAME = brooke,henry
PLOT SCALE = 40.0000 ' / in.
PLOT DATE = 10/27/2021

DESIGNED - BNH	REVISD -
DRAWN - BNH	REVISD -
CHECKED - PSA	REVISD -
DATE - 10/22/2021	REVISD -

STATE OF ILLINOIS
DEPARTMENT OF TRANSPORTATION

WATER MAIN RELOCATION PLAN AND SANITARY SEWER ADJUSTMENTS
WATER MAIN PLAN

SCALE: 1"=20' SHEET 12 OF 31 SHEETS STA. 202+50 TO STA. 208+00


F.A.U. RTE.	SECTION	COUNTY	TOTAL SHEETS	SHEET NO.
7448	09-00933-01-BR	MACON	1019	524
CONTRACT NO. 95893				
ILLINOIS FED. AID PROJECT				

PLAN	SURVEYED	DATE
	PLOTTED	
	ALIGNED	
	CHECKED	
	FILED	
	NO.	
	BY	


PROFILE	SURVEYED	DATE
	PLOTTED	
	GRADES	
	CHECKED	
	STRUCTURE	
	NOTATION	
	NO.	
	BY	

MODEL: Default
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MATCH LINE STA 208+00 (ROADWAY)
 SEE WATER MAIN KEY MAP PLAN VIEW NO. 7

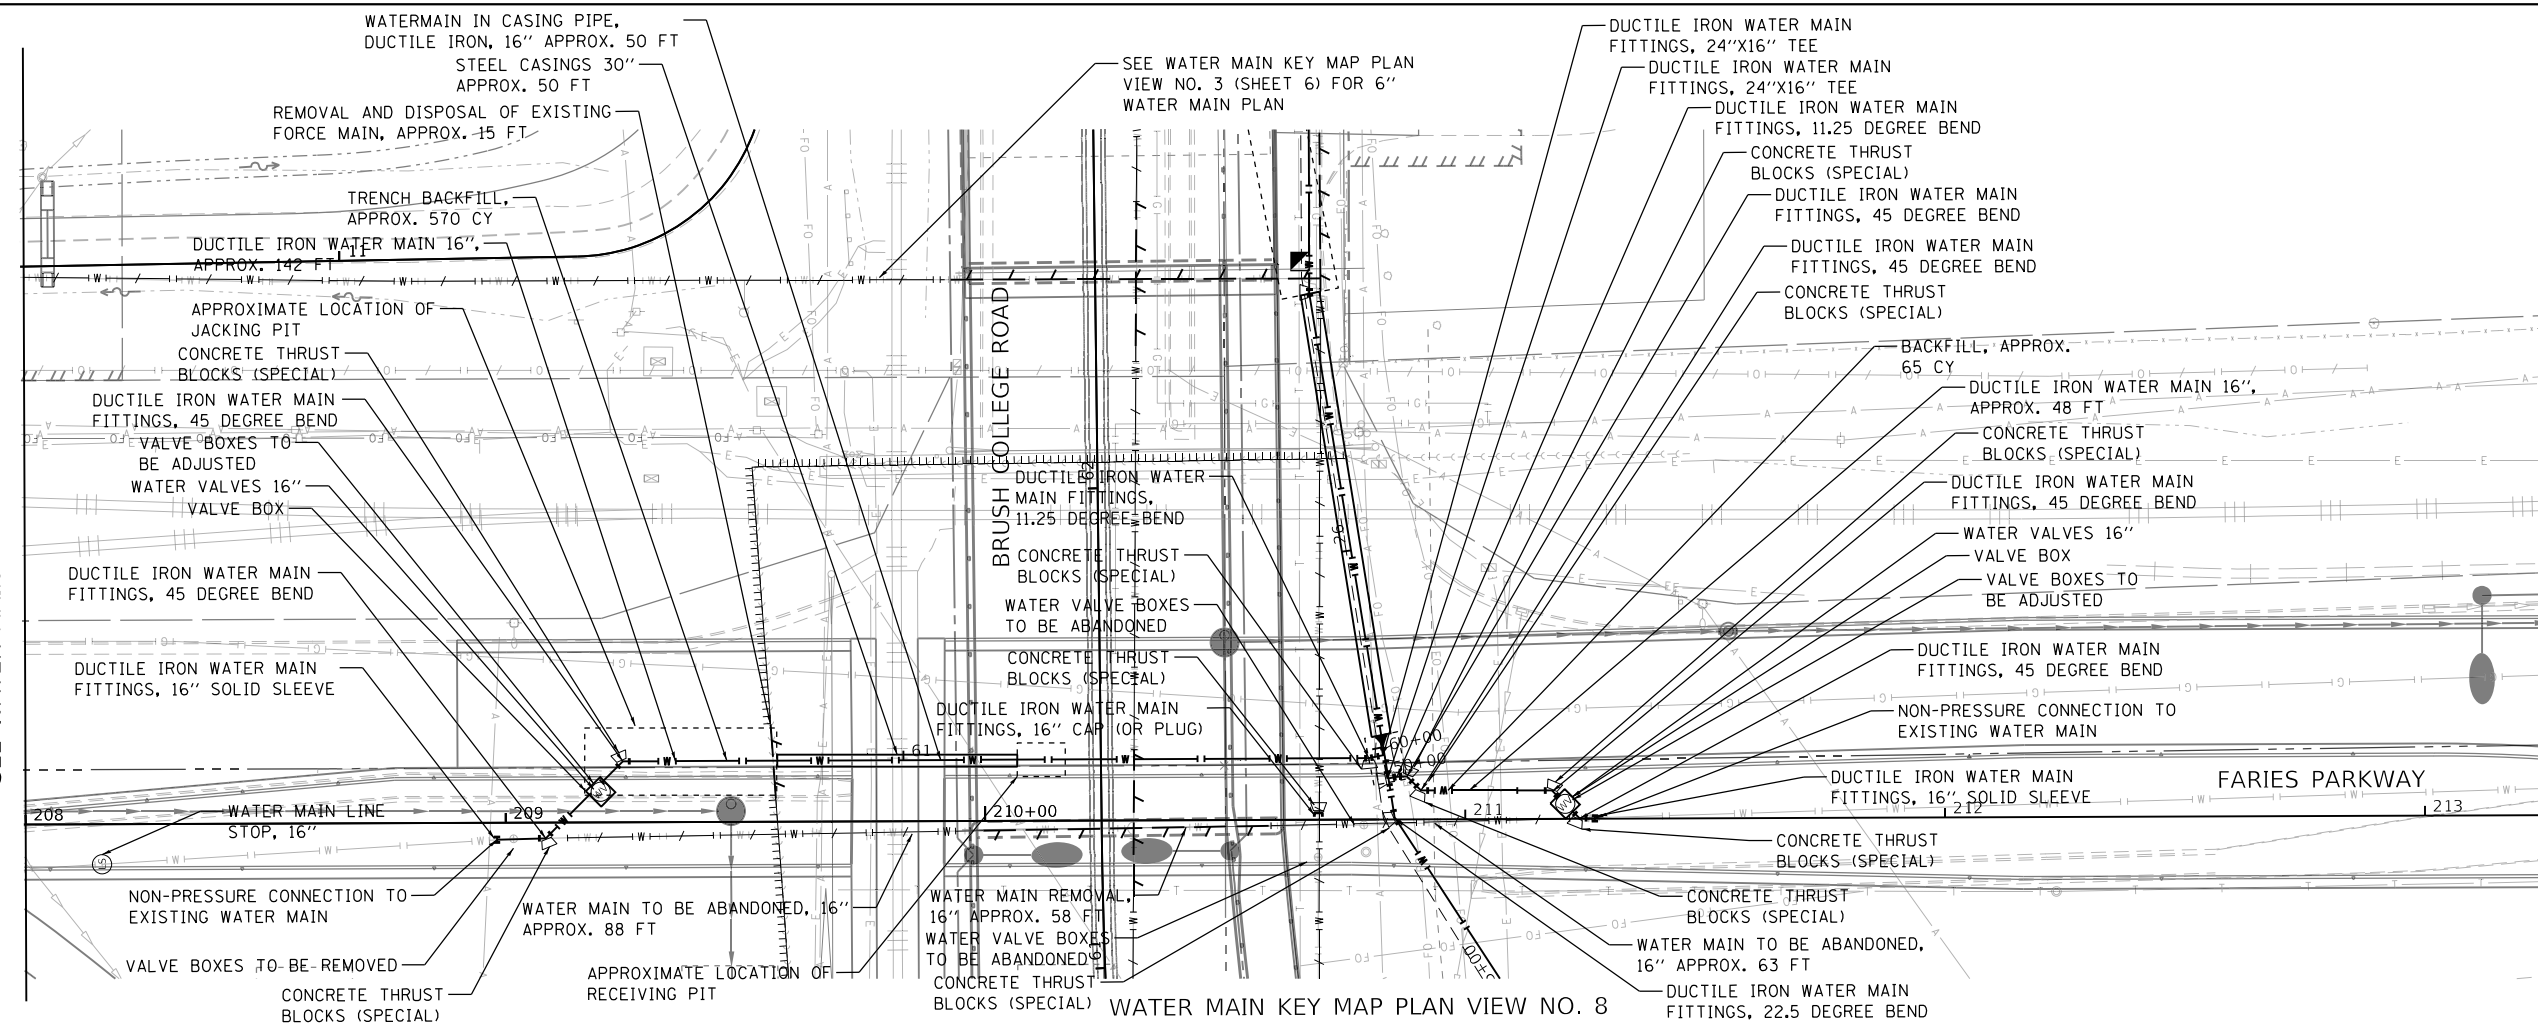

MATCH LINE STA 213+25 (ROADWAY)
 SEE WATER MAIN KEY MAP PLAN VIEW NO. 9

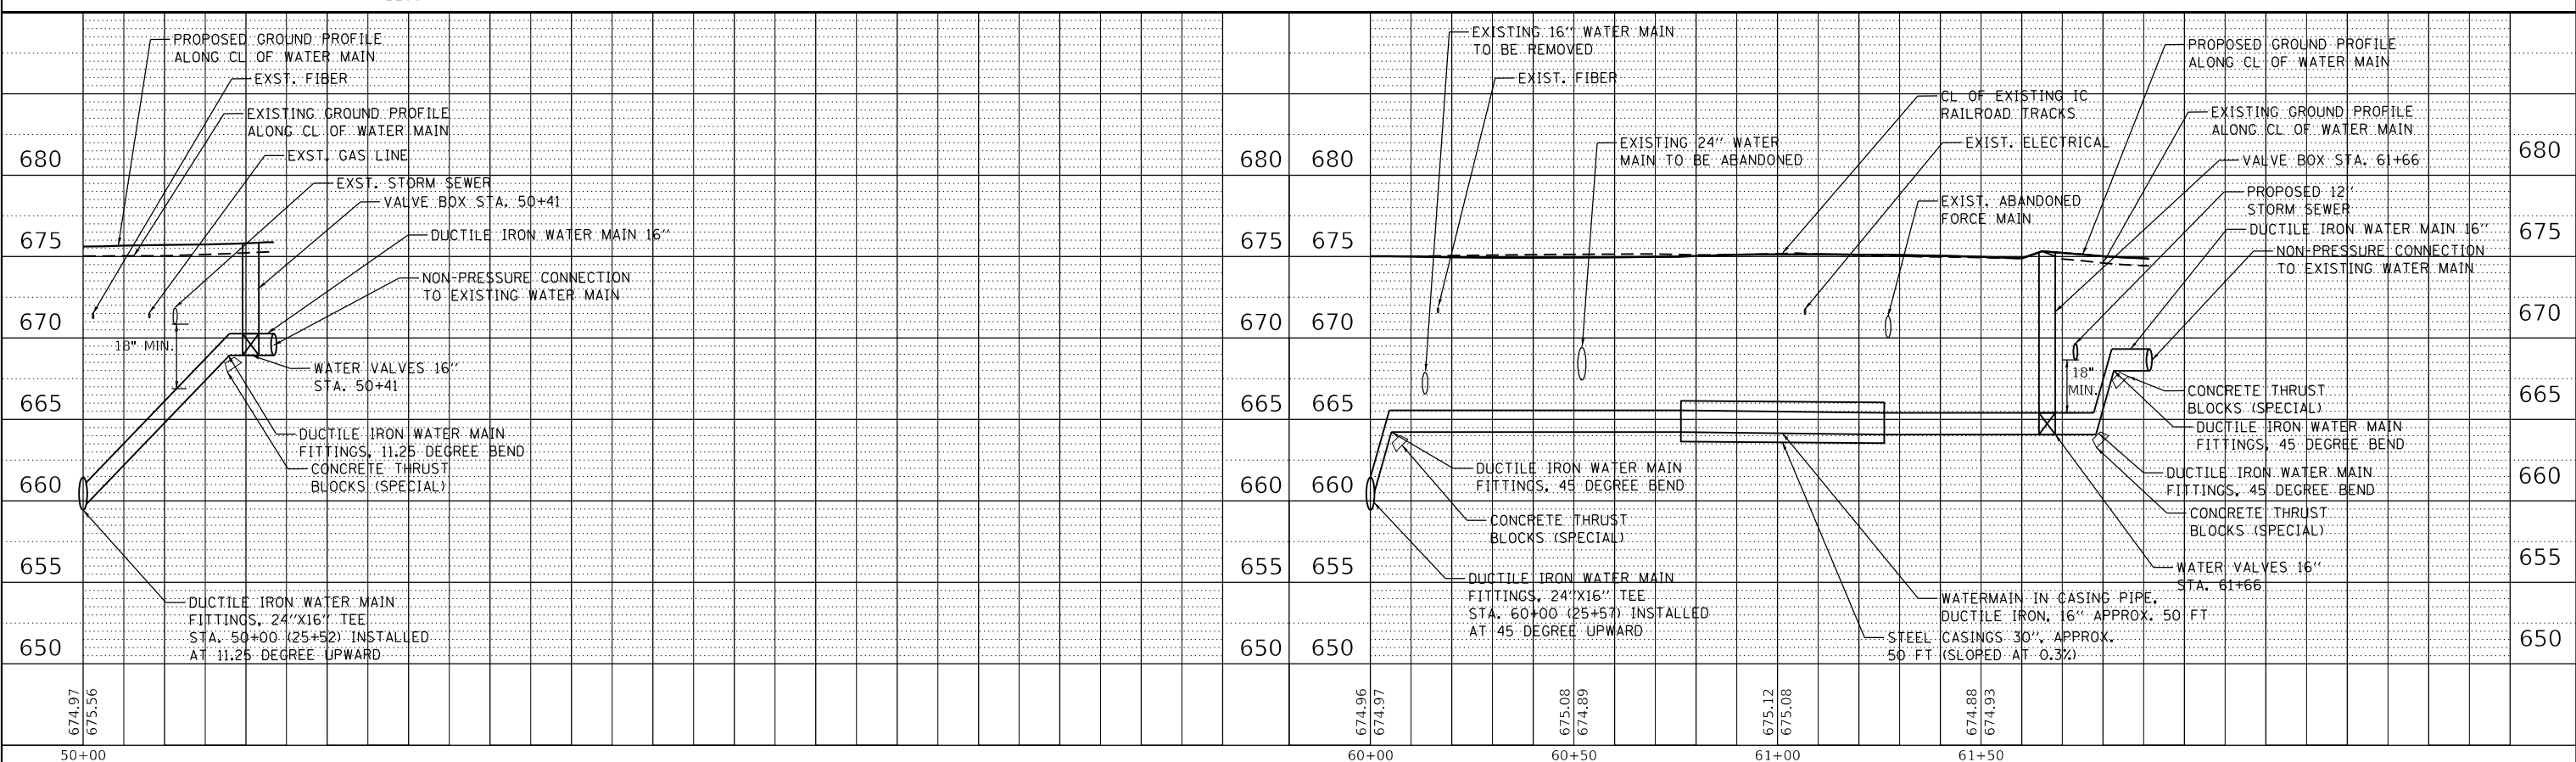


674.97 675.56	674.96 674.97	675.08 674.89	675.12 675.08	674.88 674.93	680	680	675	675	670	670	665	665	660	660	655	655	650	650						
					50+00						60+00	60+50	61+00	61+50										
AECOM 345 EAST ASH AVENUE DECATUR, IL 62526 PHONE: (217) 775-6065																				USER NAME = monica.crinion DESIGNED - BNH DRAWN - BNH CHECKED - PSA PLOT DATE = 10/29/2021	DESIGNED - BNH REVISED - DRAWN - BNH REVISED - CHECKED - PSA REVISED - DATE - 10/22/2021 REVISED -	STATE OF ILLINOIS DEPARTMENT OF TRANSPORTATION	WATER MAIN RELOCATION PLAN AND SANITARY SEWER ADJUSTMENTS WATER MAIN PLAN AND PROFILE SCALE: 1"=20' SHEET 13 OF 31 SHEETS STA. 208+00 TO STA. 213+25	F.A.U. RTE. 7448 SECTION 09-00933-01-BR COUNTY MACON TOTAL SHEETS 1019 SHEET NO. 525 CONTRACT NO. 95893 ILLINOIS FED. AID PROJECT



MATCH LINE STA 213+25 (ROADWAY)
SEE WATER MAIN KEY MAP PLAN VIEW NO. 8


MATCH LINE STA 219+00 (ROADWAY)
SEE WATER MAIN KEY MAP PLAN VIEW NO. 10

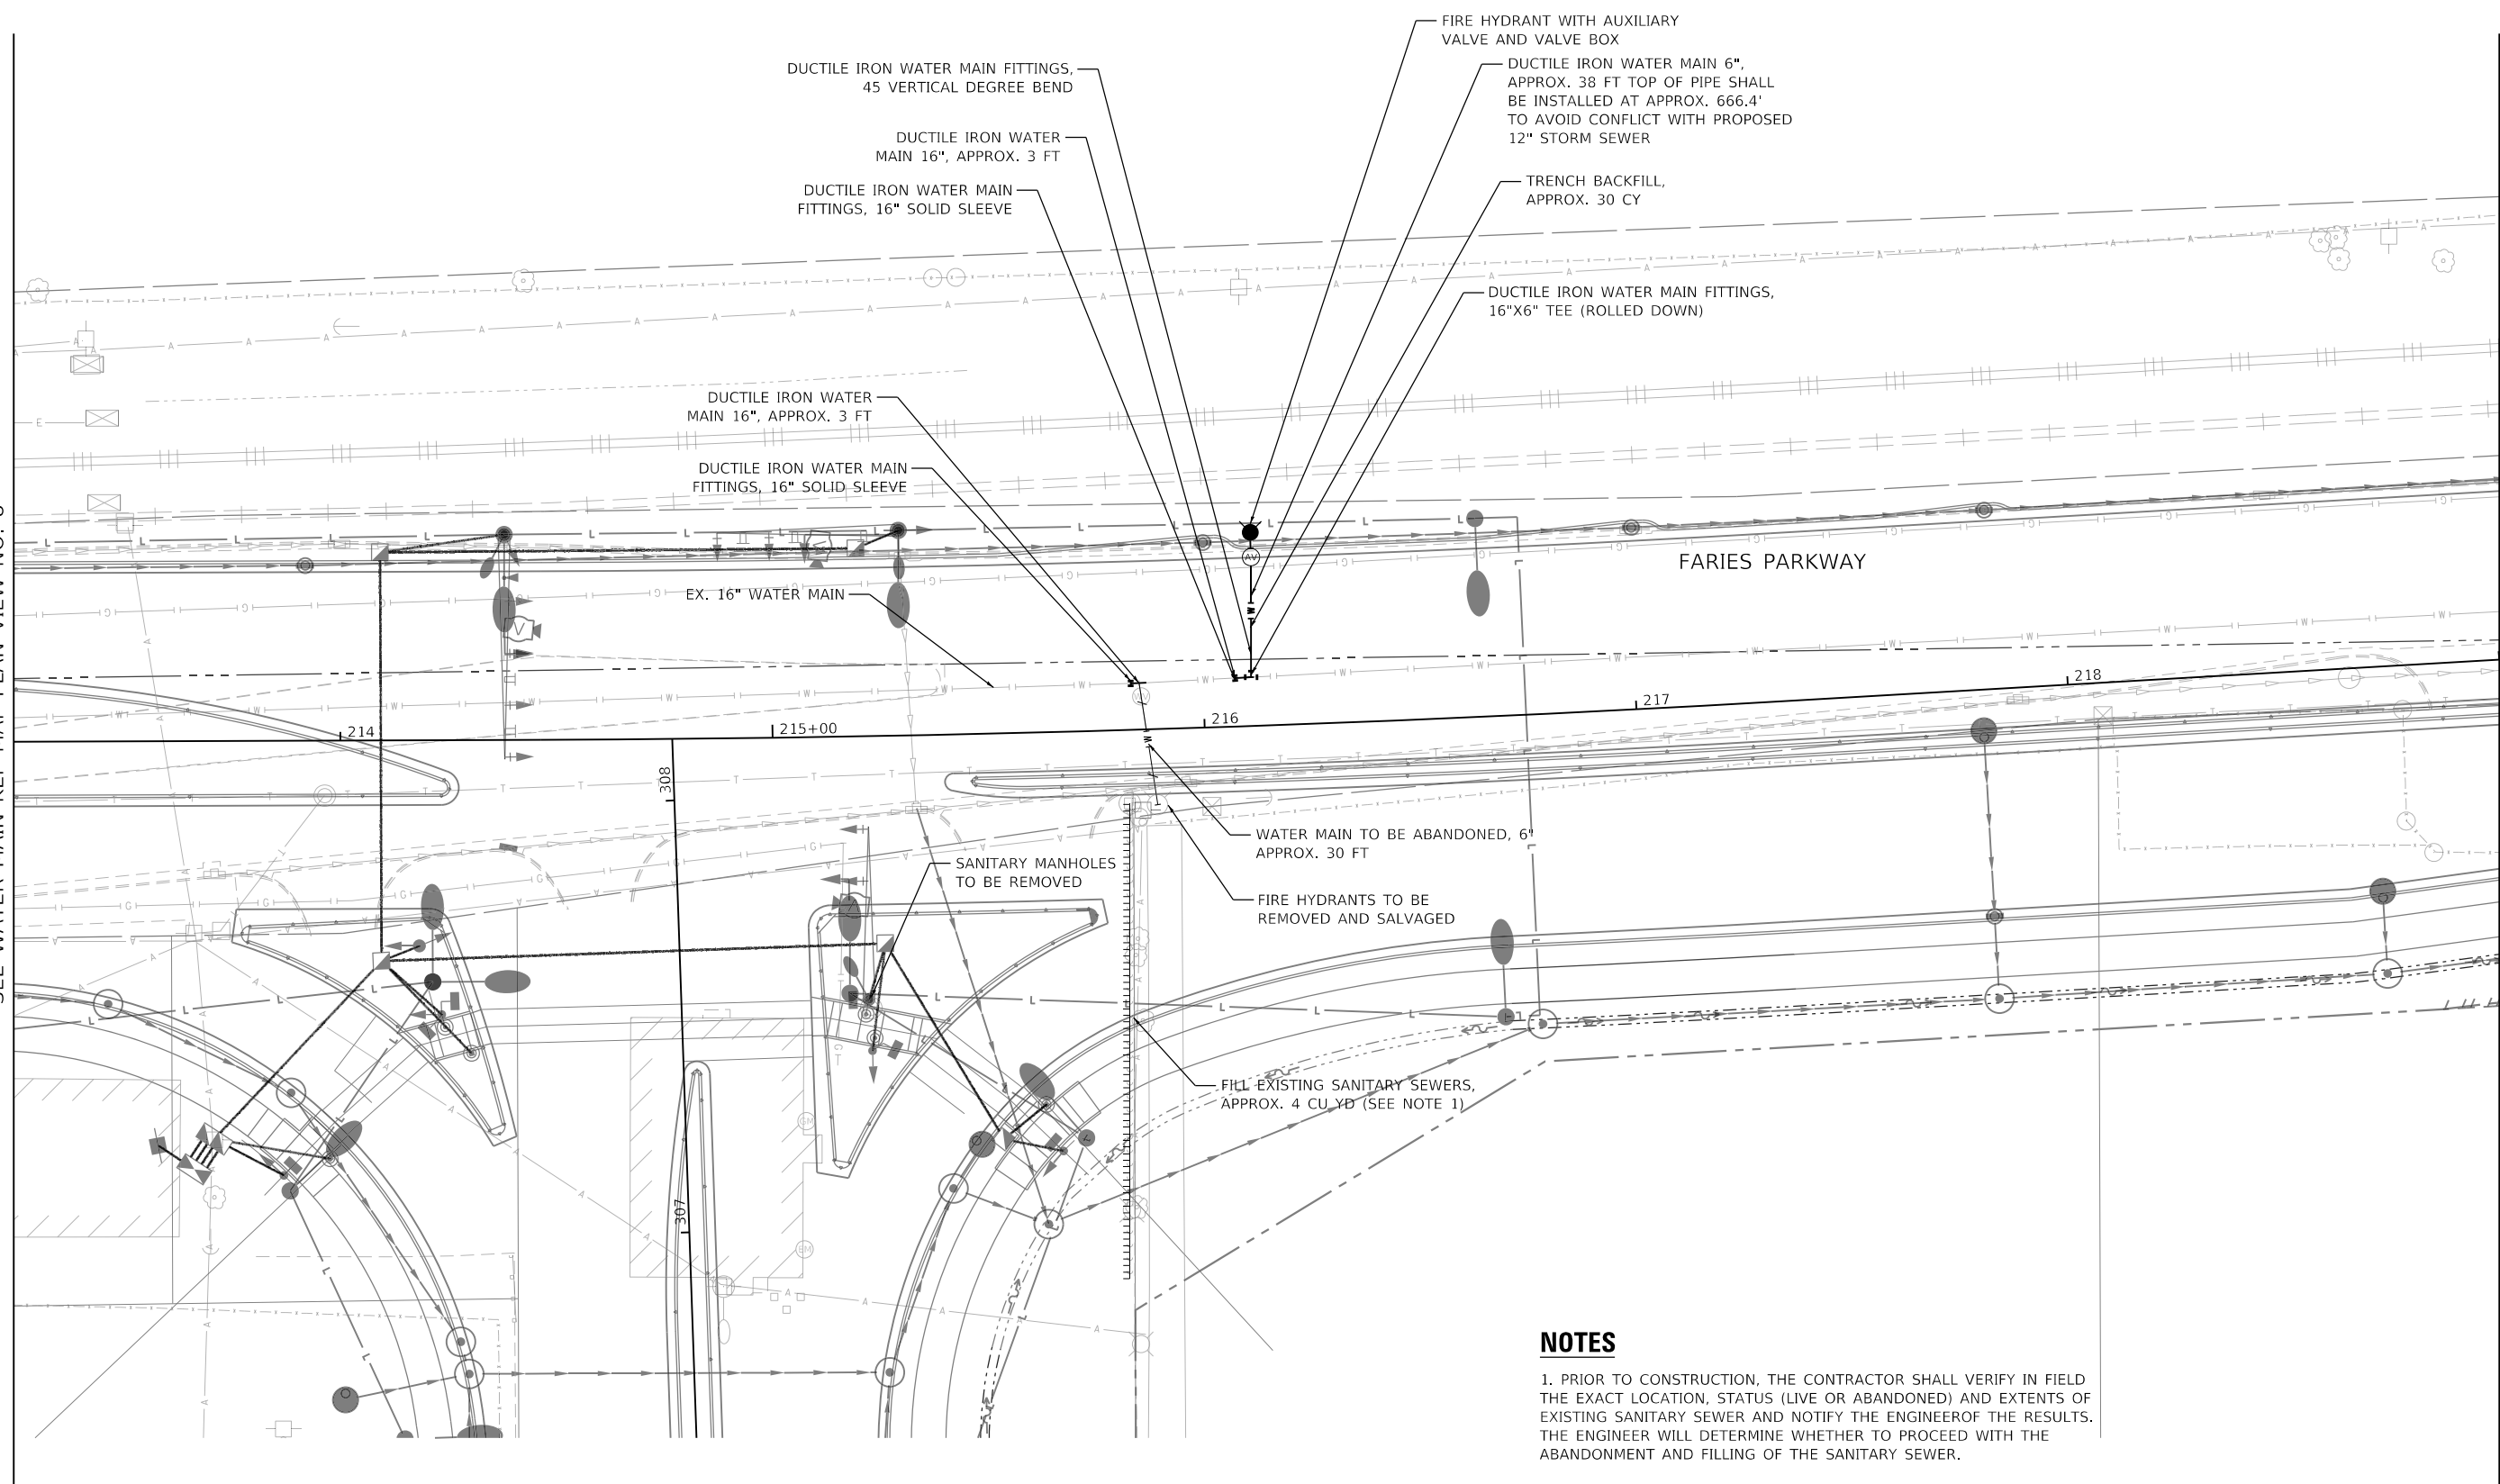

NOTES

1. PRIOR TO CONSTRUCTION, THE CONTRACTOR SHALL VERIFY IN FIELD THE EXACT LOCATION, STATUS (LIVE OR ABANDONED) AND EXTENTS OF EXISTING SANITARY SEWER AND NOTIFY THE ENGINEER OF THE RESULTS. THE ENGINEER WILL DETERMINE WHETHER TO PROCEED WITH THE ABANDONMENT AND FILLING OF THE SANITARY SEWER.

WATER MAIN KEY MAP PLAN VIEW NO. 9

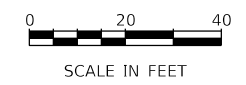

MODEL: Default
FILE NAME: p:\aecom\p-w-bentley.com\AECOM_0516_MA\Documents\60603202-Brush College\00-CAD GIS\10_CAD\03_SHEETS\10_LA\AECOM\Watermain\60603202_WW_KEYMAP_SFC_09



USER NAME = brooke.henry
PLOT SCALE = 40.0000 ' / in.
PLOT DATE = 10/27/2021

DESIGNED - BNH
DRAWN - BNH
CHECKED - PSA
DATE - 10/22/2021

REVISED -
REVISED -
REVISED -
REVISED -

**STATE OF ILLINOIS
DEPARTMENT OF TRANSPORTATION**

WATER MAIN RELOCATION PLAN AND SANITARY SEWER ADJUSTMENTS
WATER MAIN PLAN
SCALE: 1"=20' SHEET 14 OF 31 SHEETS STA. 213+25 TO STA. 219+00


F.A.U. RTE.	SECTION	COUNTY	TOTAL SHEETS	SHEET NO.
7448	09-00933-01-BR	MACON	1019	526
CONTRACT NO. 95893				
ILLINOIS FED. AID PROJECT				

NOTES


1. EXISTING SANITARY MANHOLE IS BURIED UNDER EXISTING CONCRETE SLAB. REFER TO SPECIAL PROVISION FOR ADDITIONAL DETAILS. CONTRACTOR SHALL REMOVE THE SLAB AND FIELD VERIFY EXISTING SANITARY MANHOLE INVERT ELEVATIONS.
2. CONFIRM ELEVATION OF EXISTING SANITARY SEWER SERVICE LATERAL. IF THE SEWER CROWN IS NOT LOCATED A MINIMUM OF 18" BELOW THE PROPOSED HYDRANT LEAD INVERT, THEN CONTRACTOR SHALL PERFORM SANITARY SEWER TO BE ADJUSTED WORK (1 EACH) TO MEET IEPA WATER/SEWER SEPARATION REQUIREMENTS. PAYMENT WILL BE IN ACCORDANCE WITH THE SPECIAL PROVISIONS.
3. THE EXACT ELEVATION OF THE EXISTING 4" DIAMETER WATER SERVICE MAIN IS UNKNOWN. HOWEVER, AS A RESULT OF THE PROPOSED GRADING CHANGES OVER THE EXISTING PIPE, IT IS ASSUMED THAT MINIMUM BURY DEPTH REQUIREMENTS CANNOT BE MET (I.E. 3.5' OF COVER), AND THEREFORE THE PIPE WILL NEED TO BE RELOCATED IN ORDER TO ACHIEVE THE SPECIFIED BURY DEPTH. HOWEVER, A MINIMUM OF 2 WEEKS PRIOR TO ANY PROPOSED WORK, THE CONTRACTOR SHALL CONFIRM THE NEED AND EXACT LIMITS OF CONSTRUCTION WITH THE ENGINEER. REFER ALSO TO ADVANCE CUSTOMER COORDINATION NOTES ON THE WATER MAIN PHASING PLAN SHEETS.
4. CONTRACTOR SHALL FIELD VERIFY THE ELEVATION OF EXISTING 8" DIAMETER SANITARY SEWER TO DETERMINE IF A CONFLICT EXISTS WITH THE PROPOSED STORM SEWER. THE CONTRACTOR SHALL NOTIFY THE ENGINEER OF THE RESULTS A MINIMUM OF 4 WEEKS IN ADVANCE OF CONSTRUCTION. AT THE ENGINEER'S DIRECTION AND IF REQUIRED FOR CONSTRUCTION, THE CONTRACTOR MAY BE DIRECTED TO UTILIZE THE FOLLOWING SPECIAL PROVISIONS IN ORDER TO AVOID A CONFLICT.
 -SANITARY SEWER REMOVAL AND REPLACEMENT 8"
 -MANHOLES, SANITARY, 4'-DIAMETER, TYPE 1 FRAME, CLOSED LID

MATCH LINE STA 219+00 (ROADWAY)
SEE WATER MAIN KEY MAP PLAN VIEW NO. 9

MATCH LINE STA 224+75 (ROADWAY)
SEE WATER MAIN KEY MAP PLAN VIEW NO. 11

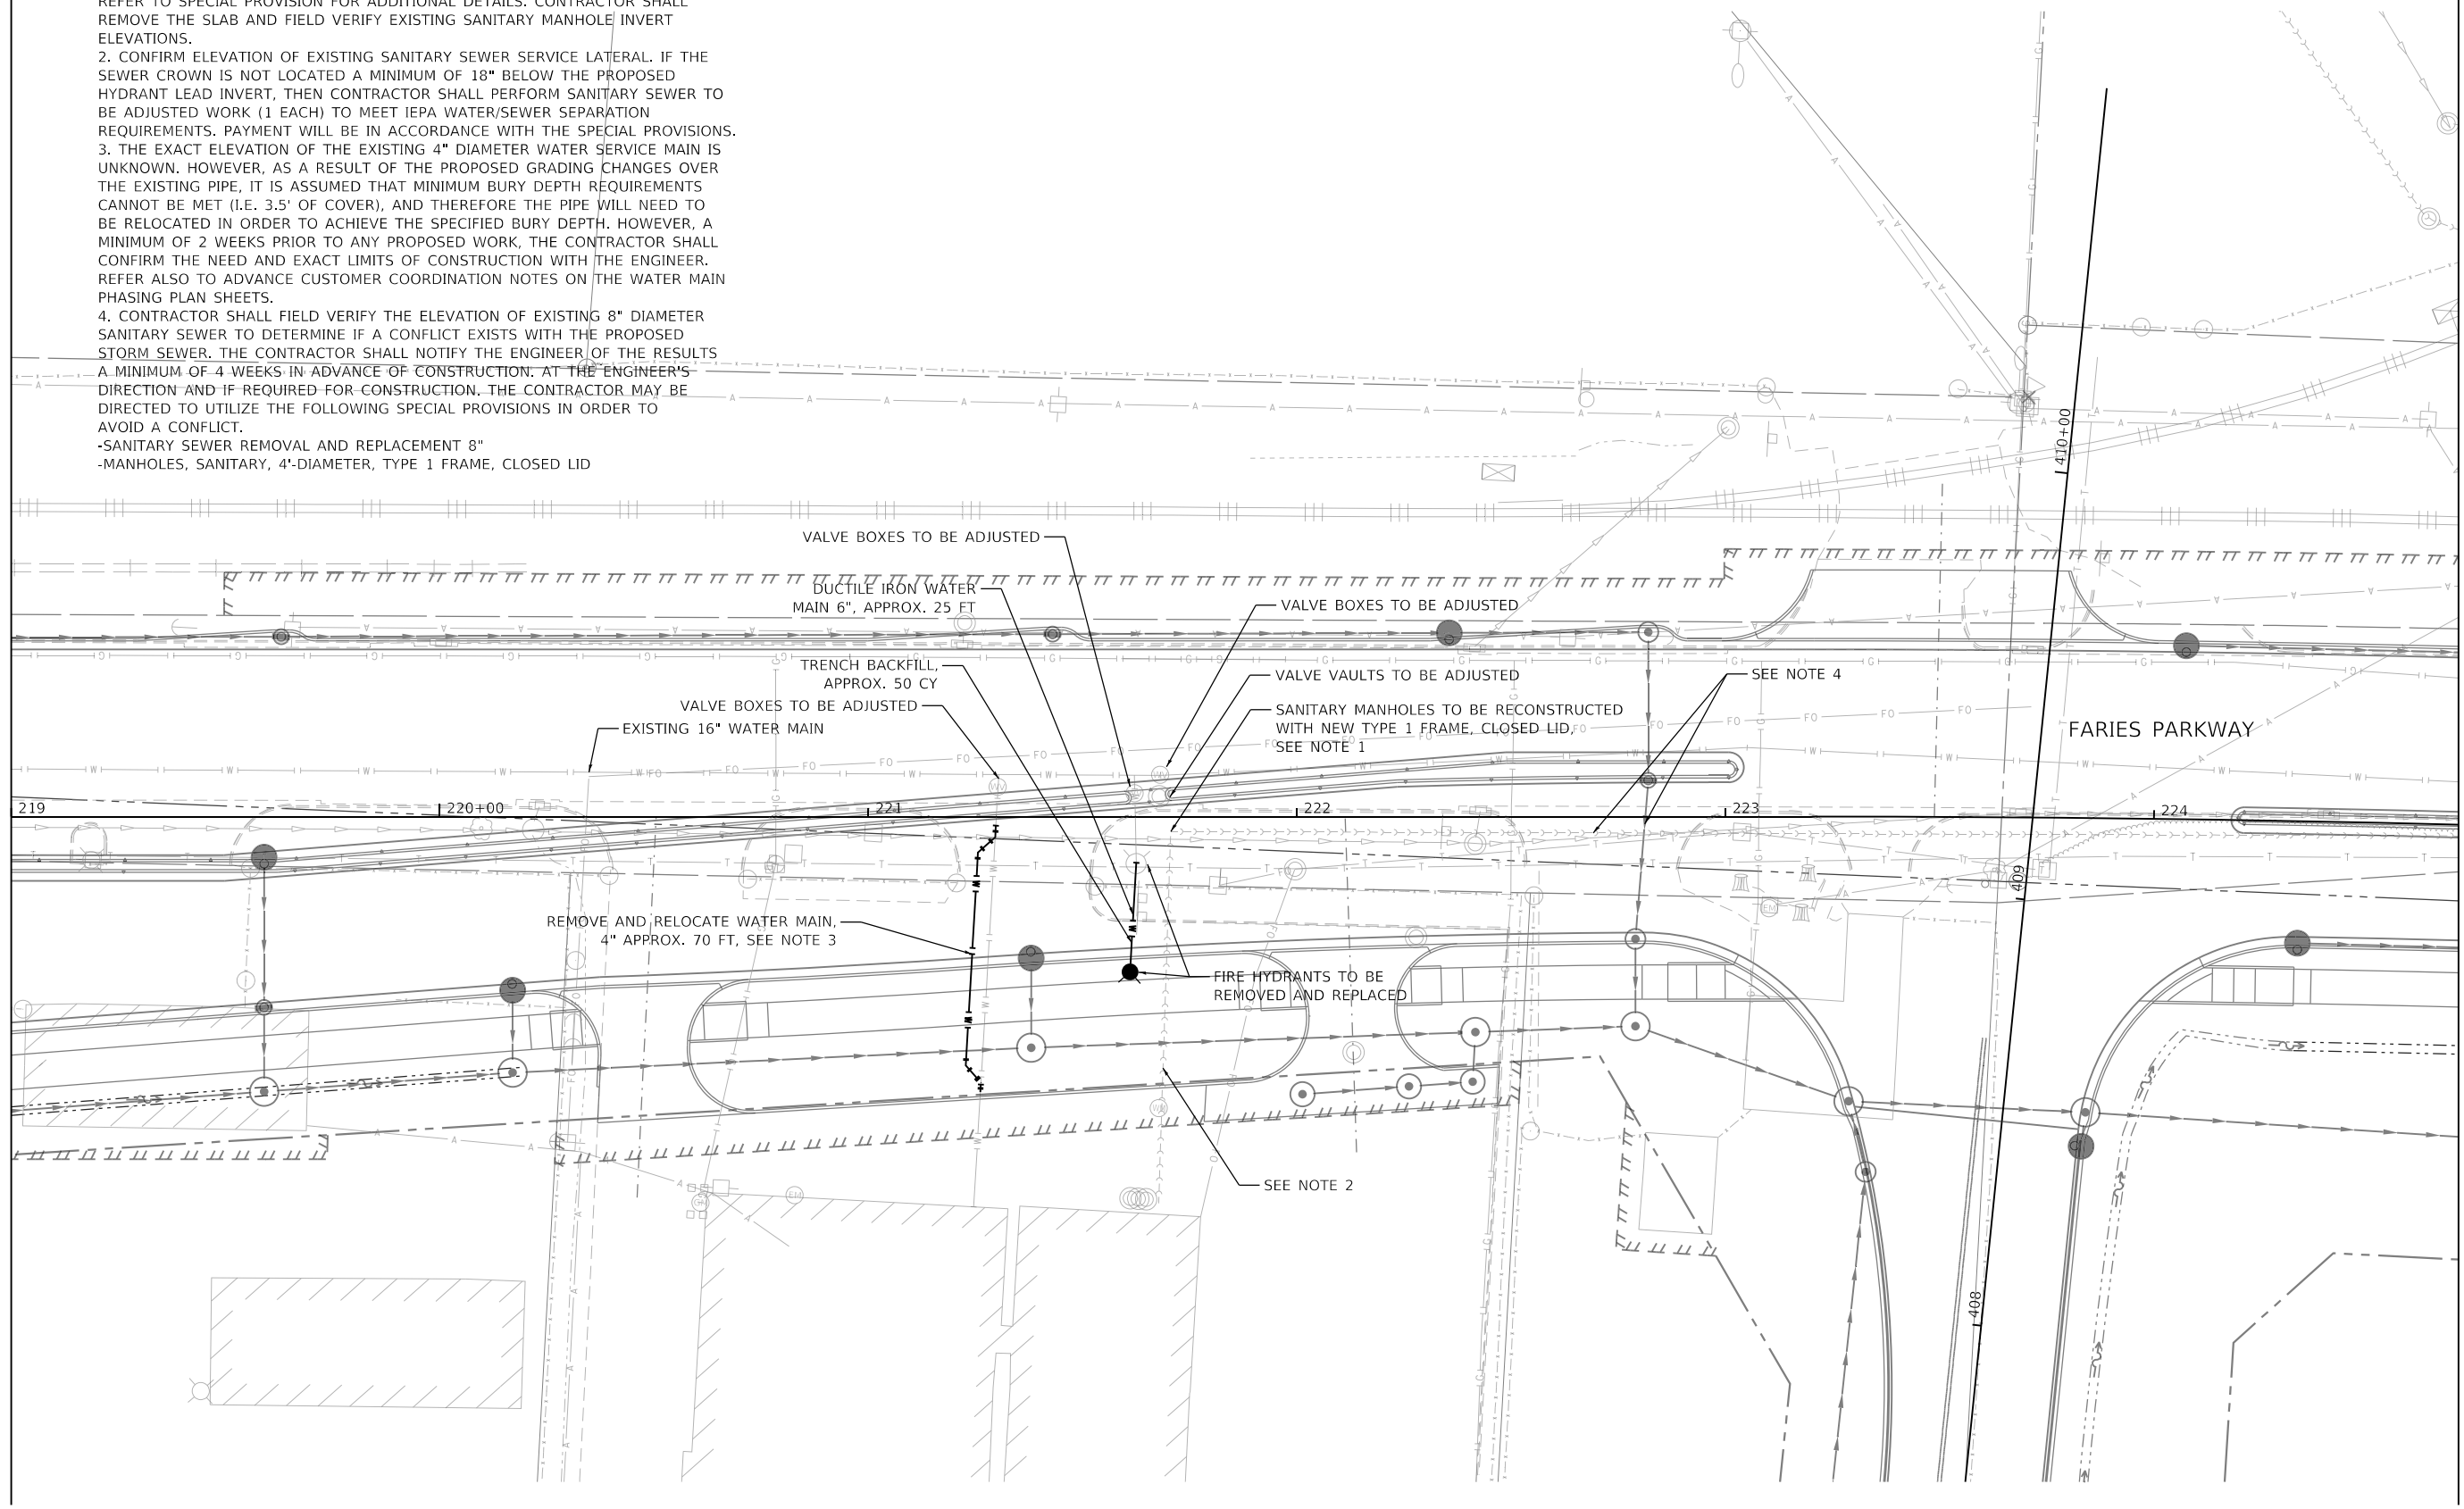

WATER MAIN KEY MAP PLAN VIEW NO. 10

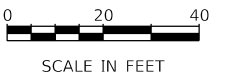

MODEL: Default
FILE NAME: p:\aecom\m-pw\henley.com\AECOM_0516_MIA\Documents\60603202-Brush_College\00-CAD_GIS\910_CAD\03_SHEETS\10_LAECOM\Watermain\60603202_WW_KEYMAP_SEC_10




USER NAME = brooke,henry	DESIGNED - BNH	REVISED -
PLOT SCALE = 40,0000 ' / in.	DRAWN - BNH	REVISED -
PLOT DATE = 10/27/2021	CHECKED - PSA	REVISED -
	DATE - 10/22/2021	REVISED -

**STATE OF ILLINOIS
DEPARTMENT OF TRANSPORTATION**

WATER MAIN RELOCATION PLAN AND SANITARY SEWER ADJUSTMENTS	
WATER MAIN PLAN	
SCALE: 1"=20'	SHEET 15 OF 31 SHEETS
STA. 219+00	TO STA. 224+75

F.A.U. RTE. 7448	SECTION 09-00933-01-BR	COUNTY MACON	TOTAL SHEETS 1019	SHEET NO. 527
CONTRACT NO. 95893				
ILLINOIS FED. AID PROJECT				

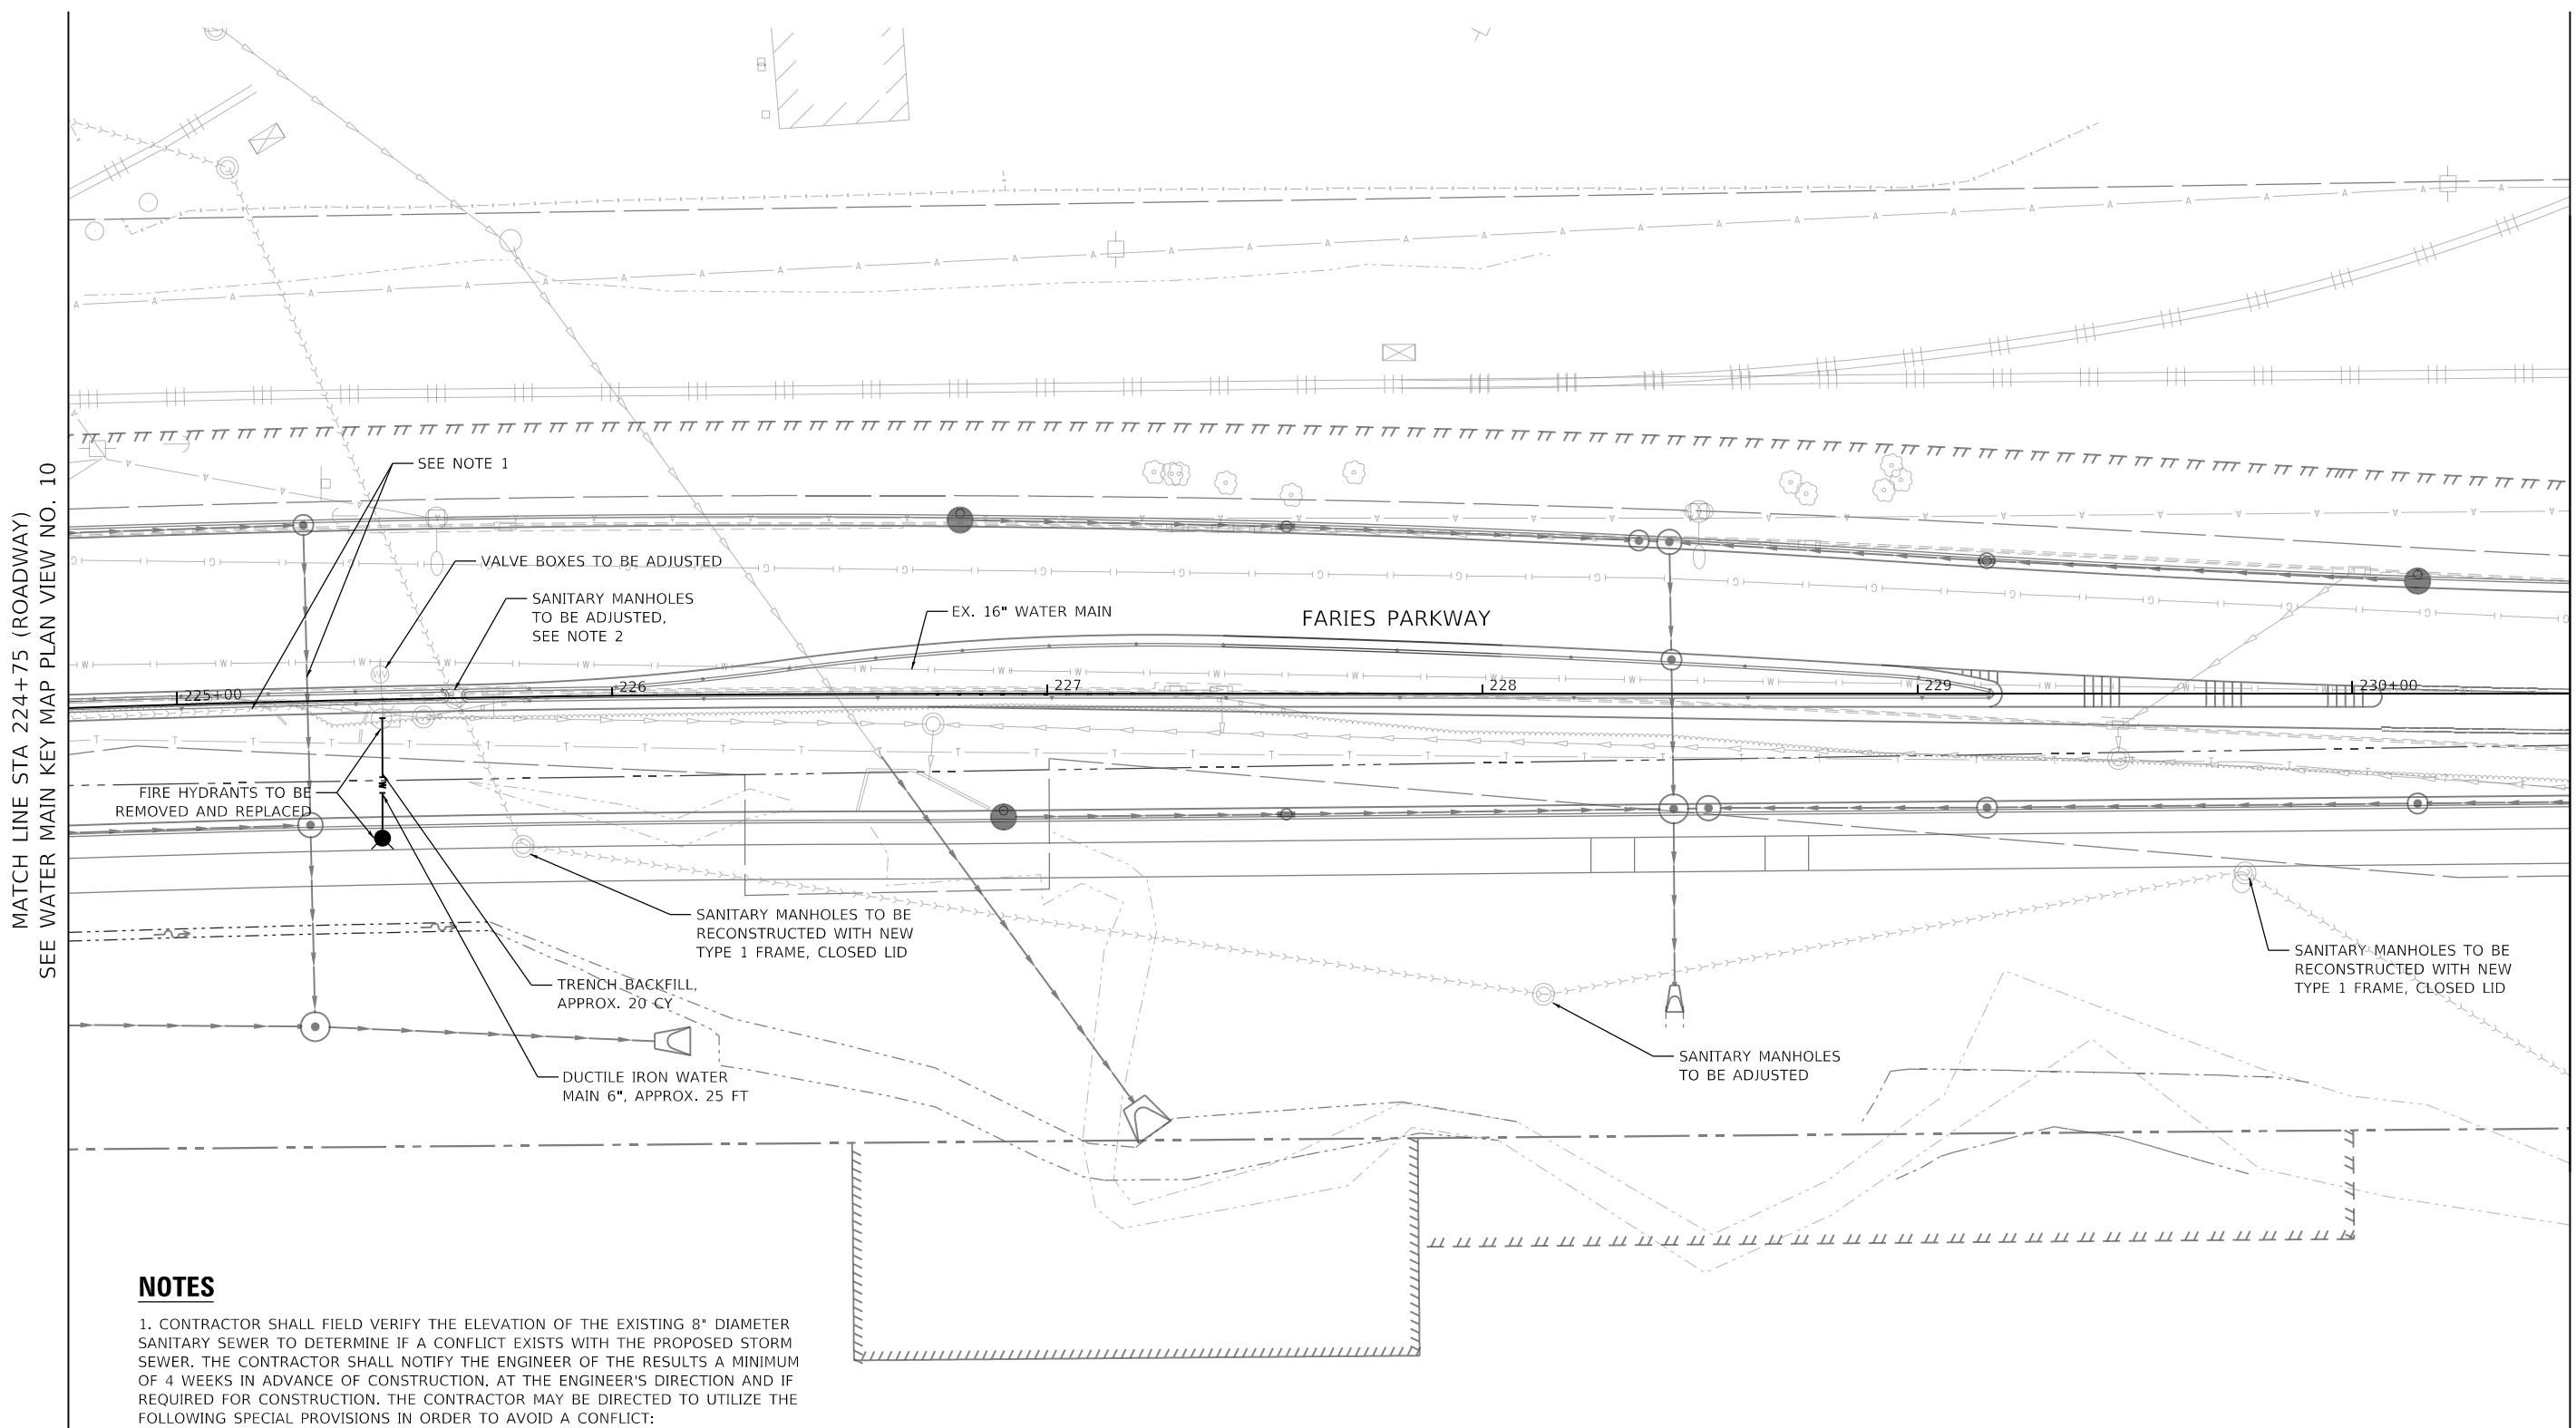

MATCH LINE STA 224+75 (ROADWAY)
SEE WATER MAIN KEY MAP PLAN VIEW NO. 10

MATCH LINE STA 230+50 (ROADWAY)
SEE WATER MAIN KEY MAP PLAN VIEW NO. 12

NOTES

1. CONTRACTOR SHALL FIELD VERIFY THE ELEVATION OF THE EXISTING 8" DIAMETER SANITARY SEWER TO DETERMINE IF A CONFLICT EXISTS WITH THE PROPOSED STORM SEWER. THE CONTRACTOR SHALL NOTIFY THE ENGINEER OF THE RESULTS A MINIMUM OF 4 WEEKS IN ADVANCE OF CONSTRUCTION. AT THE ENGINEER'S DIRECTION AND IF REQUIRED FOR CONSTRUCTION, THE CONTRACTOR MAY BE DIRECTED TO UTILIZE THE FOLLOWING SPECIAL PROVISIONS IN ORDER TO AVOID A CONFLICT:
 - SANITARY SEWER REMOVAL AND REPLACEMENT
 - MANHOLES, SANITARY, 4'-DIAMETER, TYPE 1 FRAME, CLOSED LID
2. EXISTING SANITARY MANHOLE RIM ELEVATION = 659.21' (APPROX.)
EXISTING 8" SANITARY INVERT ELEVATION TO WEST = 652.57' (APPROX.)

WATER MAIN KEY MAP PLAN VIEW NO. 11



MODEL: Default
FILE NAME: p:\aecom\m-pw\henley.com\AECOM_0516_M\Documents\60603202-Brush\College006-CAD GIS09_10_CAD\03_SHEETS\10_LAECOM\Watermain\60603202_WW_KEYMAP_SEC_11



USER NAME = brooke.henry	DESIGNED - BNH	REVISED -
PLOT SCALE = 40.0000 ' / in.	DRAWN - BNH	REVISED -
PLOT DATE = 10/27/2021	CHECKED - PSA	REVISED -
	DATE - 10/22/2021	REVISED -

**STATE OF ILLINOIS
DEPARTMENT OF TRANSPORTATION**


**WATER MAIN RELOCATION PLAN AND SANITARY SEWER ADJUSTMENTS
WATER MAIN AND SANITARY SEWER PLAN**

SCALE: 1"=20' SHEET 16 OF 31 SHEETS STA. 224+75 TO STA. 230+50

F.A.U. RTE.	SECTION	COUNTY	TOTAL SHEETS	SHEET NO.
7448	09-00933-01-BR	MACON	1019	528
CONTRACT NO. 95893				
ILLINOIS FED. AID PROJECT				



MATCH LINE STA 230+50 (ROADWAY)
SEE WATER MAIN KEY MAP PLAN VIEW NO. 11

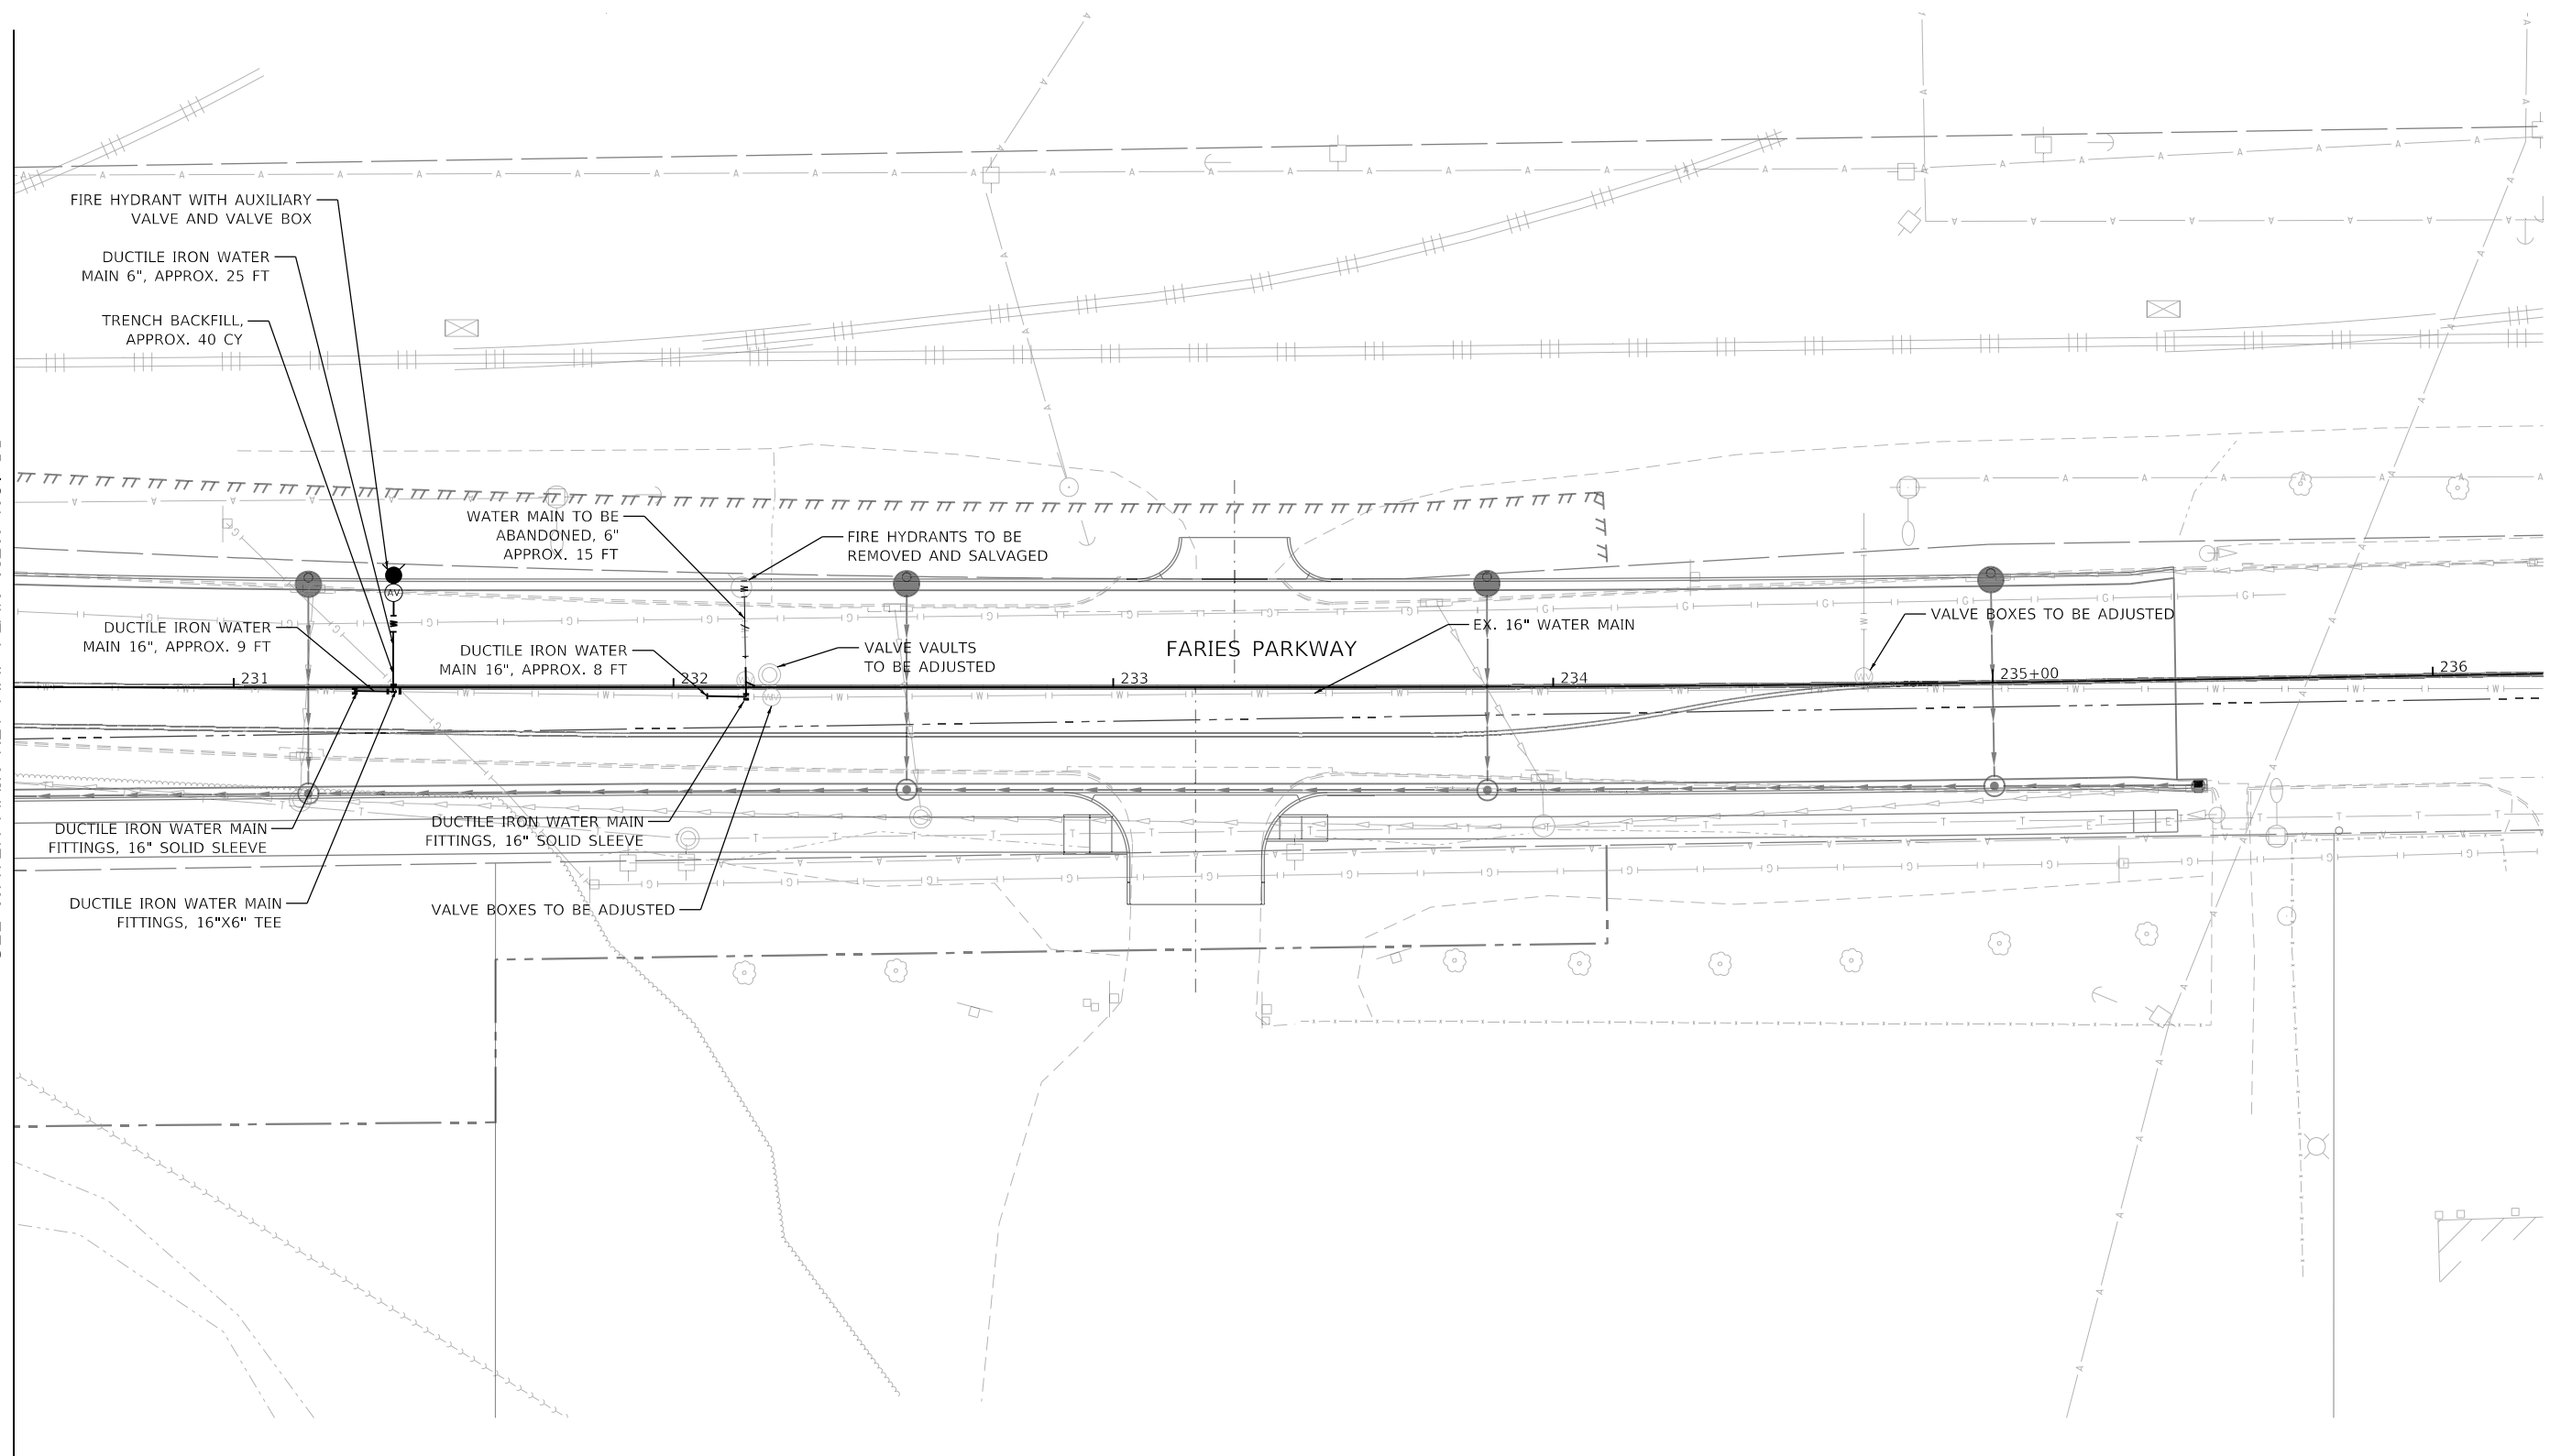

WATER MAIN KEY MAP PLAN VIEW NO. 12



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USER NAME = brooke.henry
PLOT SCALE = 40.0000 ' / in.
PLOT DATE = 10/27/2021

DESIGNED - BNH	REVISD -
DRAWN - BNH	REVISED -
CHECKED - PSA	REVISED -
DATE - 10/22/2021	REVISED -

**STATE OF ILLINOIS
DEPARTMENT OF TRANSPORTATION**


WATER MAIN RELOCATION PLAN AND SANITARY SEWER ADJUSTMENTS
WATER MAIN PLAN
SCALE: 1"=20' SHEET 17 OF 31 SHEETS STA. 230+50 TO STA. 236+25

F.A.U. RTE.	SECTION	COUNTY	TOTAL SHEETS	SHEET NO.
7448	09-00933-01-BR	MACON	1019	529
CONTRACT NO. 95893				
ILLINOIS FED. AID PROJECT				



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	PLOTTED	
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	CHECKED	
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PROFILE	SURVEYED	DATE
	PLOTTED	
	GRADES CHECKED	
	STRUCTURE NOTATIONS CHECKED	
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WATER MAIN KEY MAP PLAN VIEW NO. 13



USER NAME = brooke.henry	DESIGNED - BNH	REVISED -
	DRAWN - BNH	REVISED -
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PLOT DATE = 10/27/2021	DATE - 10/22/2021	REVISED -

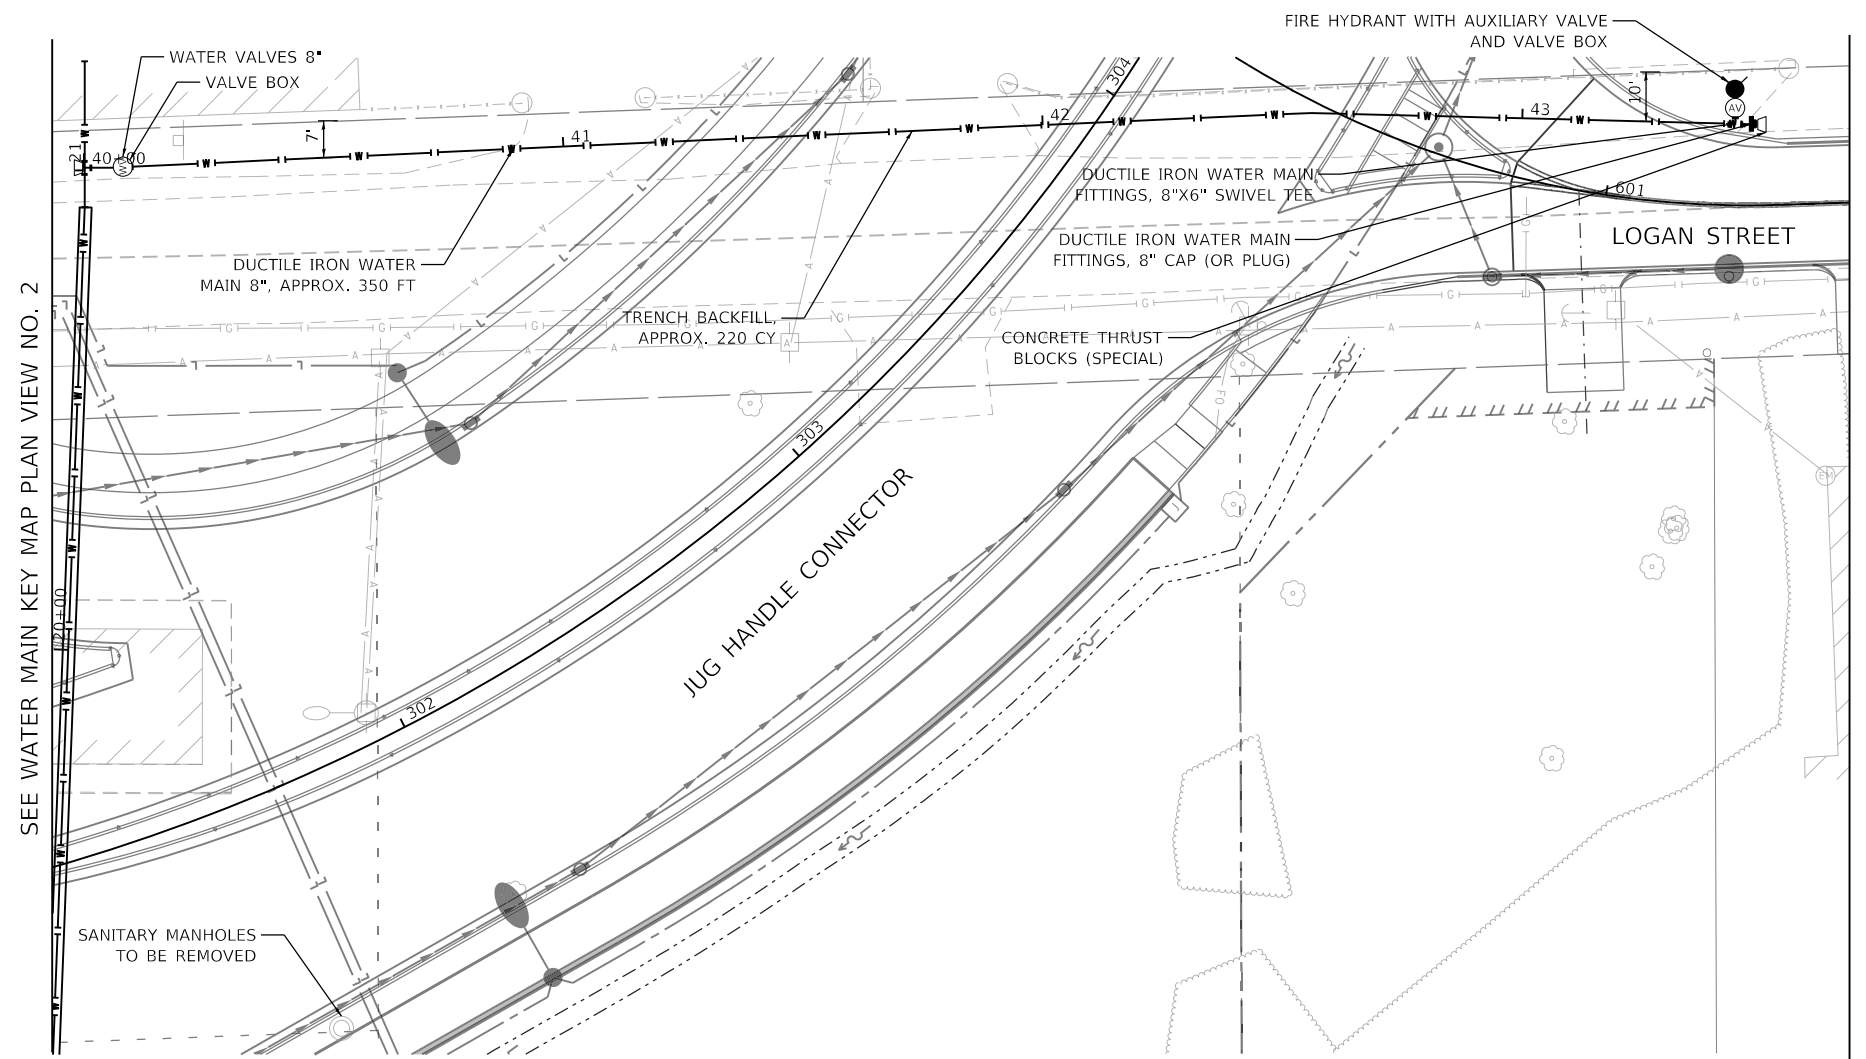
STATE OF ILLINOIS
DEPARTMENT OF TRANSPORTATION

WATER MAIN RELOCATION PLAN AND SANITARY SEWER ADJUSTMENTS
WATER MAIN PLAN AND PROFILE

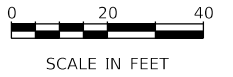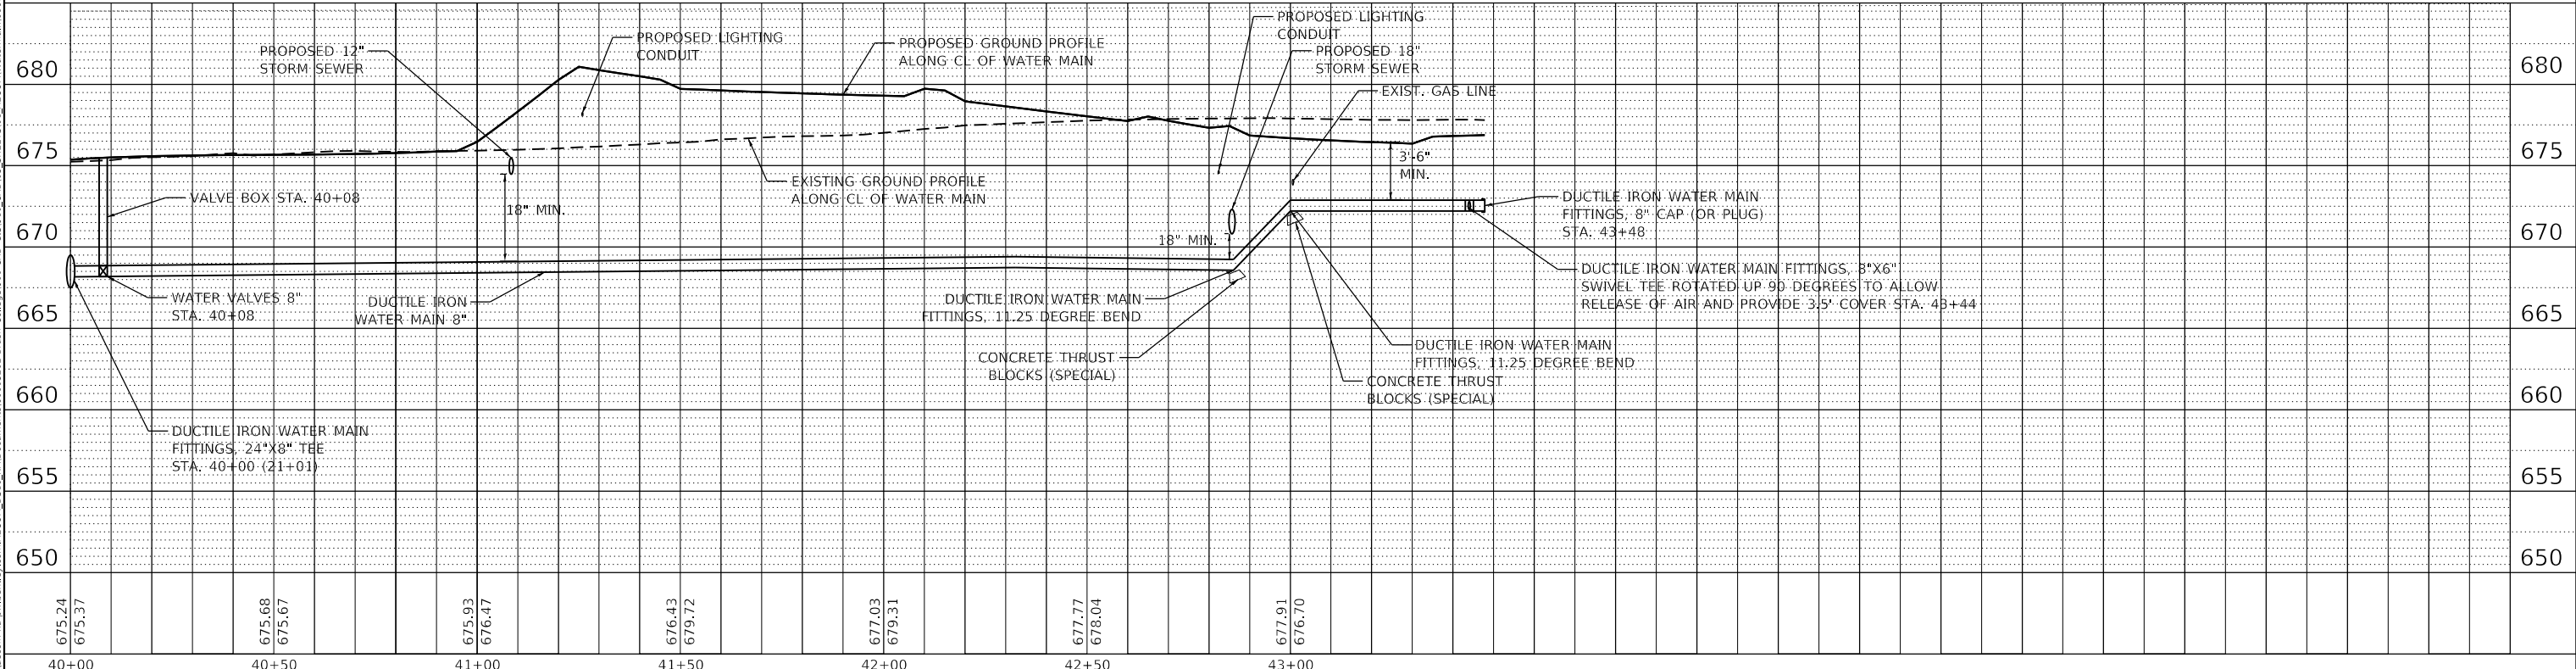SCALE: 1"=20' SHEET 18 OF 31 SHEETS STA. 40+50 TO STA.

F.A.U. RTE. 7448	SECTION 09-00933-01-BR	COUNTY MACON	TOTAL SHEETS 1019	SHEET NO. 530
CONTRACT NO. 95893				
ILLINOIS FED. AID PROJECT				

MODEL: Default
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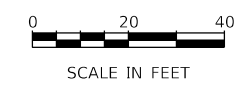
MATCH LINE STA 601+50 (ROADWAY)
 SEE WATER MAIN KEY MAP PLAN VIEW NO. 13

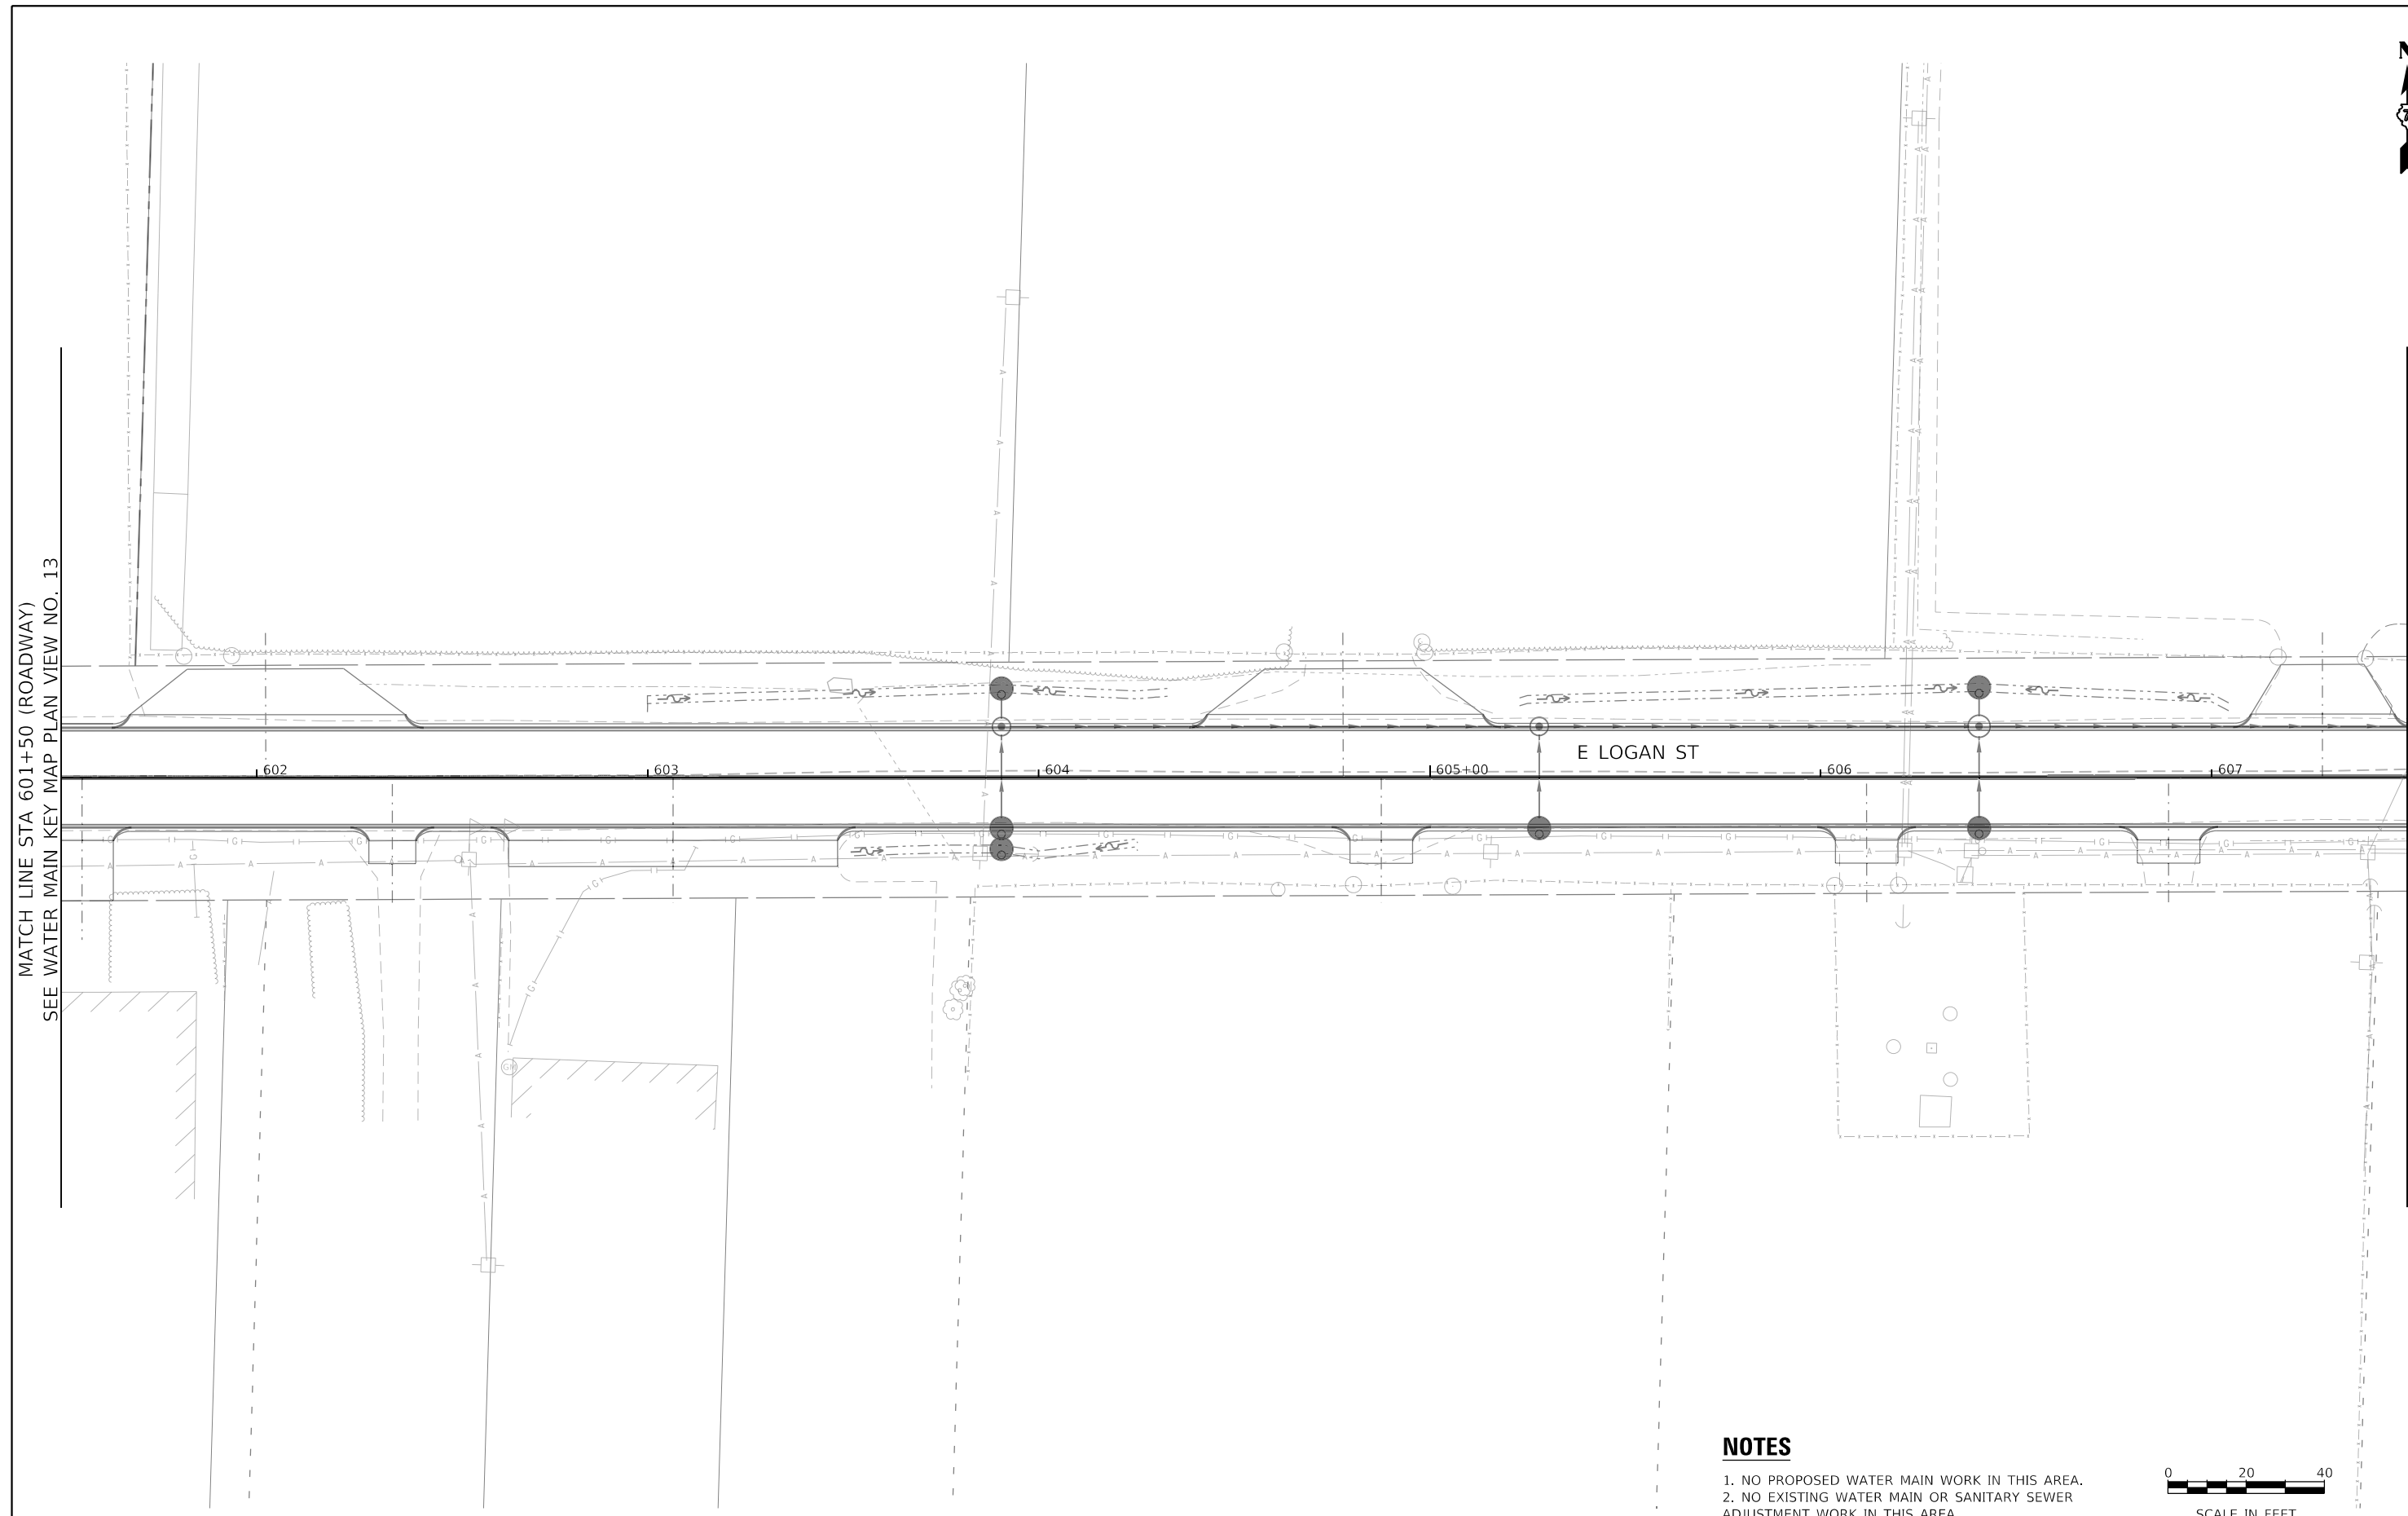MATCH LINE STA 607+50 (ROADWAY)
 SEE WATER MAIN KEY MAP PLAN VIEW NO. 15



NOTES

1. NO PROPOSED WATER MAIN WORK IN THIS AREA.
2. NO EXISTING WATER MAIN OR SANITARY SEWER ADJUSTMENT WORK IN THIS AREA.



WATER MAIN KEY MAP PLAN VIEW NO. 14



USER NAME = brooke.henry	DESIGNED - XXX	REVISED -
DRAWN - XXX	CHECKED - XXX	REVISED -
PLOT SCALE = 40.0000' / in.	DATE - 10/22/2021	REVISED -
PLOT DATE = 10/27/2021		


**STATE OF ILLINOIS
 DEPARTMENT OF TRANSPORTATION**

**WATER MAIN RELOCATION PLAN AND SANITARY SEWER ADJUSTMENTS
 EXISTING UTILITY PLAN**

SCALE: 1"=20' SHEET 19 OF 31 SHEETS STA. 601+50 TO STA. 607+50

F.A.U. RTE.	SECTION	COUNTY	TOTAL SHEETS	SHEET NO.
7448	09-00933-01-BR	MACON	1019	531
CONTRACT NO. 95893				
ILLINOIS FED. AID PROJECT				

MATCH LINE STA 607+50 (ROADWAY)
SEE WATER MAIN KEY MAP PLAN VIEW NO. 14

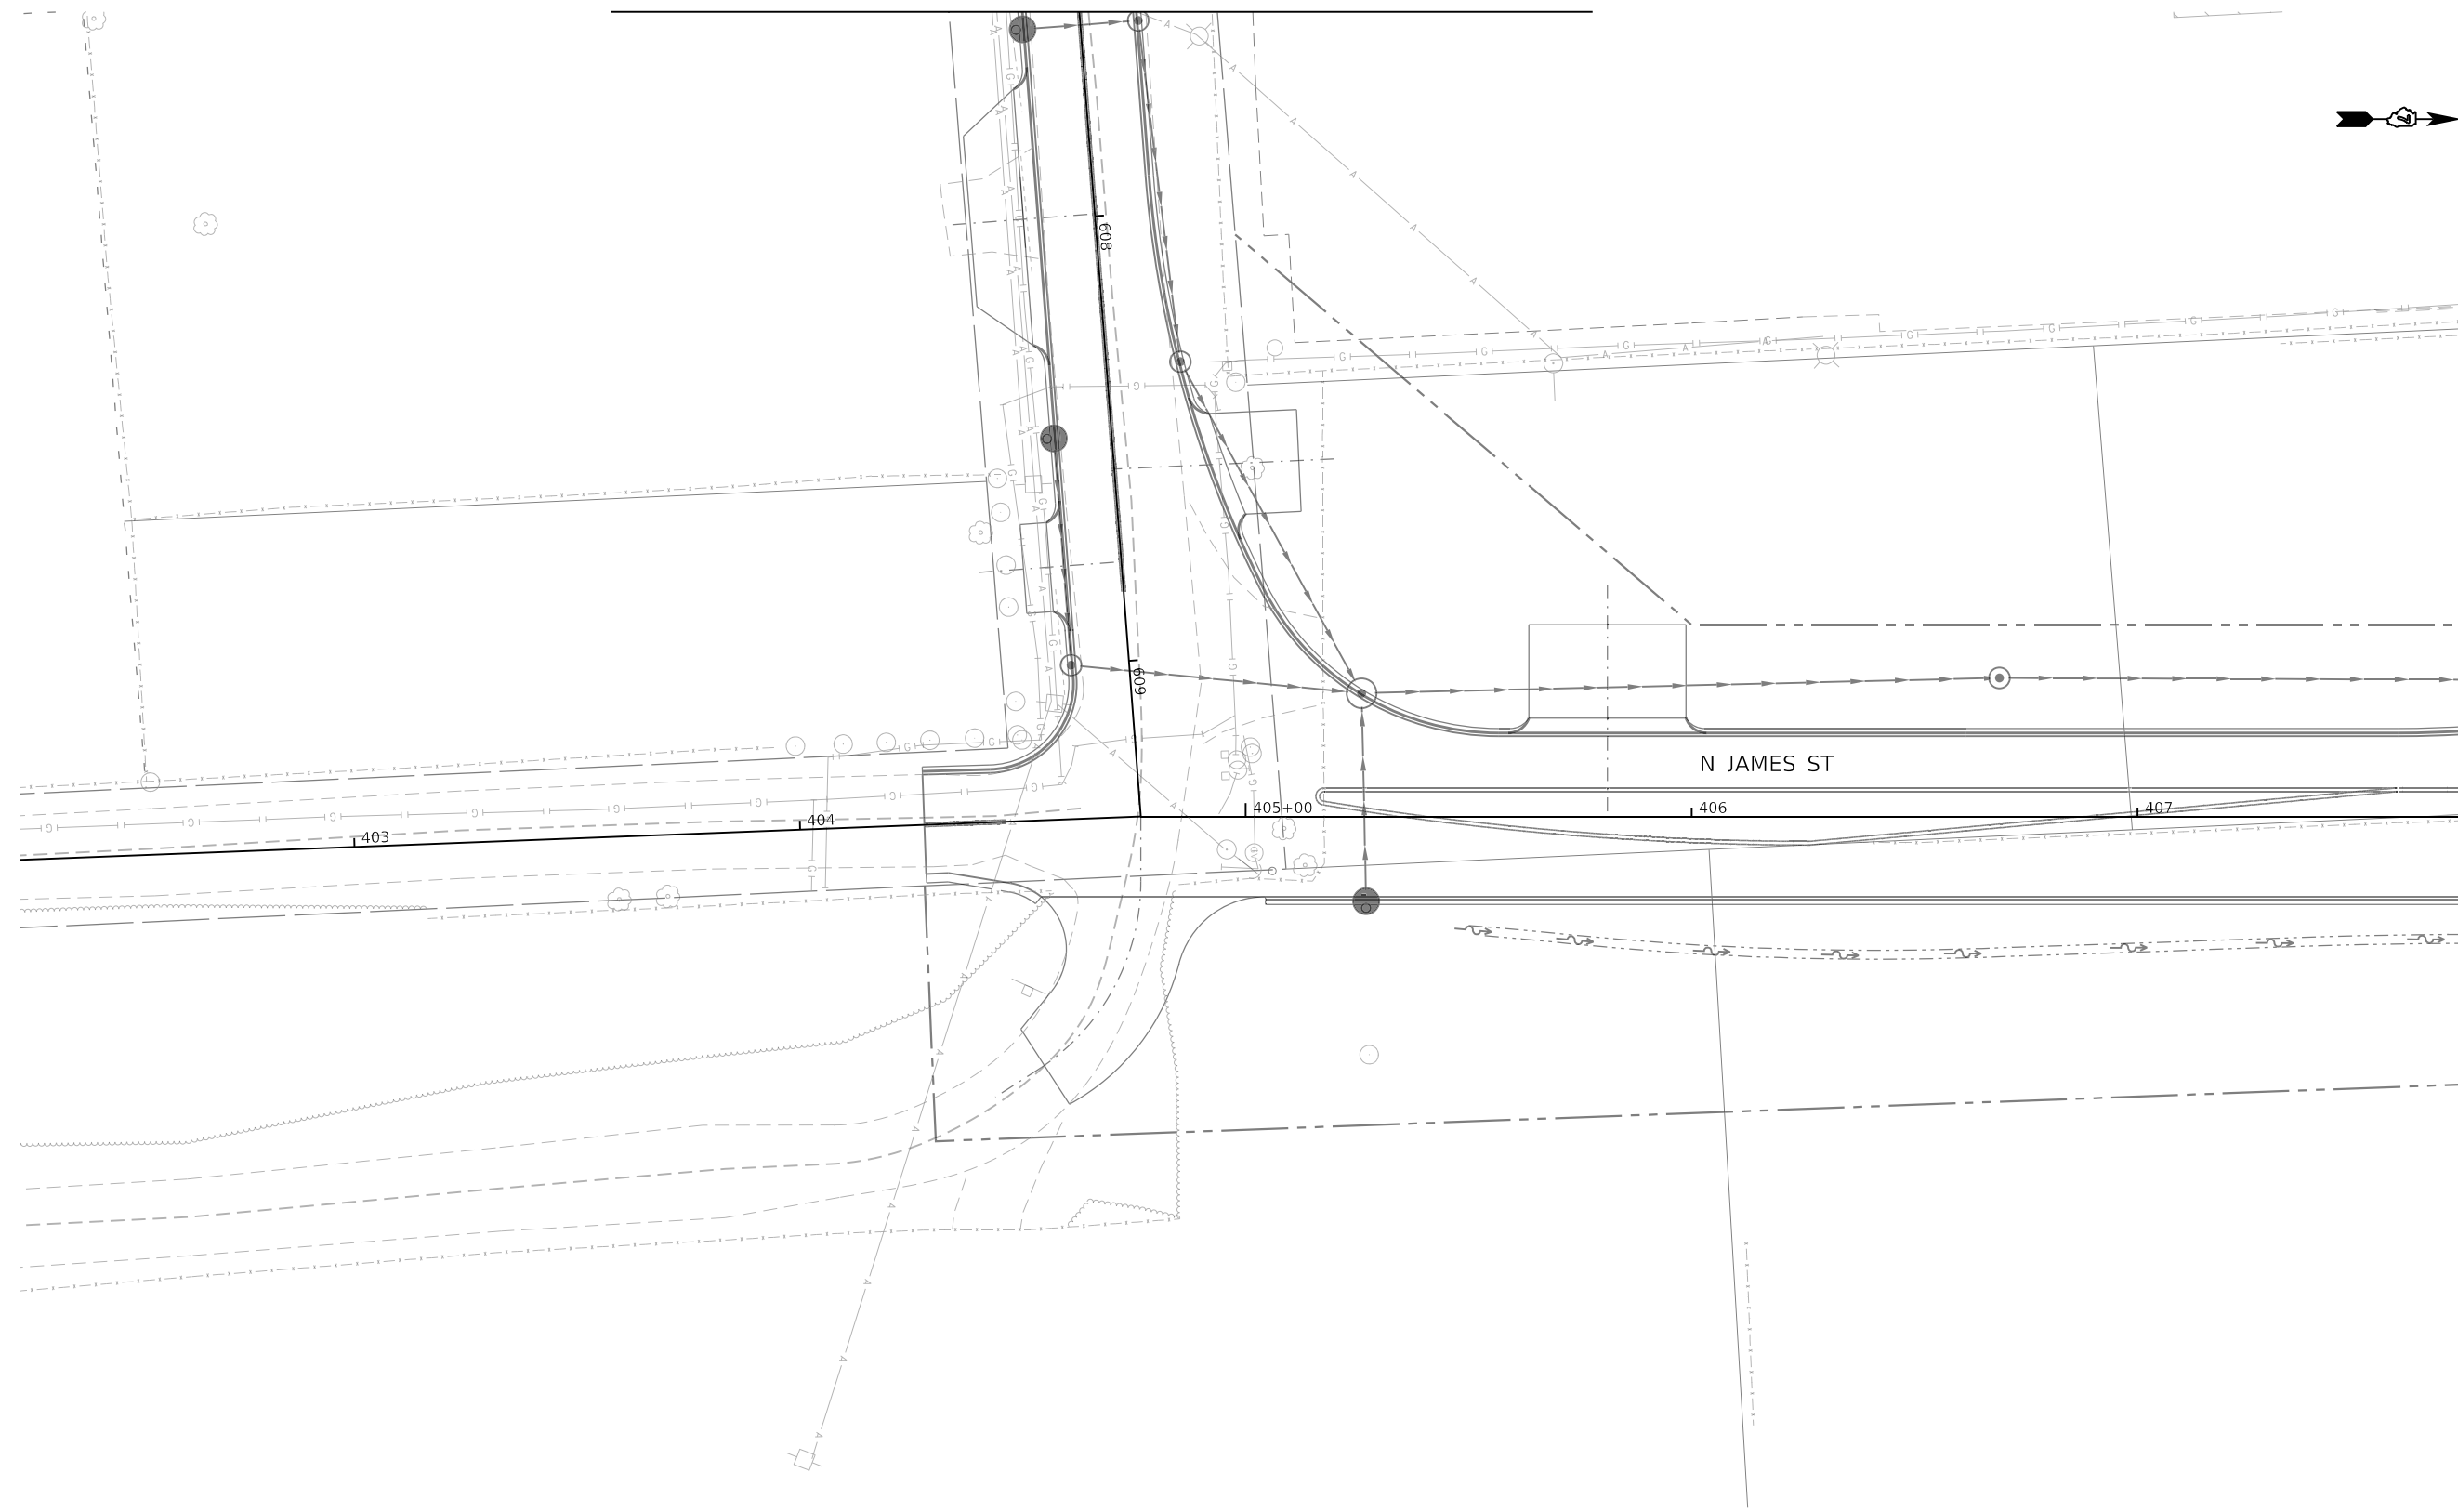

MATCH LINE STA 407+50 (ROADWAY)
SEE WATER MAIN KEY MAP PLAN VIEW NO. 10

WATER MAIN KEY MAP PLAN VIEW NO. 15

NOTES

1. NO PROPOSED WATER MAIN WORK IN THIS AREA.
2. NO EXISTING WATER MAIN OR SANITARY SEWER ADJUSTMENT WORK IN THIS AREA.



MODEL: Default
FILE NAME: p:\aecom\pw\henley.com\AECOM_0516_M\Documents\60603202-Brush_College\006-CAD_GIS\010_CAD\03_SHEETS\01_L\AECOM\Watermain\60603202_WW_KEYMAP_SEC_15




USER NAME = brooke.henry	DESIGNED - BNH	REVISED -
	DRAWN - BNH	REVISED -
PLOT SCALE = 40.0000 ' / in.	CHECKED - PSA	REVISED -
PLOT DATE = 10/27/2021	DATE - 10/22/2021	REVISED -

**STATE OF ILLINOIS
DEPARTMENT OF TRANSPORTATION**

WATER MAIN RELOCATION PLAN AND SANITARY SEWER ADJUSTMENTS
EXISTING UTILITY PLAN
SCALE: 1"=20' SHEET 20 OF 31 SHEETS STA. 402+50 TO STA. 407+75

F.A.U. RTE.	SECTION	COUNTY	TOTAL SHEETS	SHEET NO.
7448	09-00933-01-BR	MACON	1019	532
CONTRACT NO. 95893				
ILLINOIS FED. AID PROJECT				

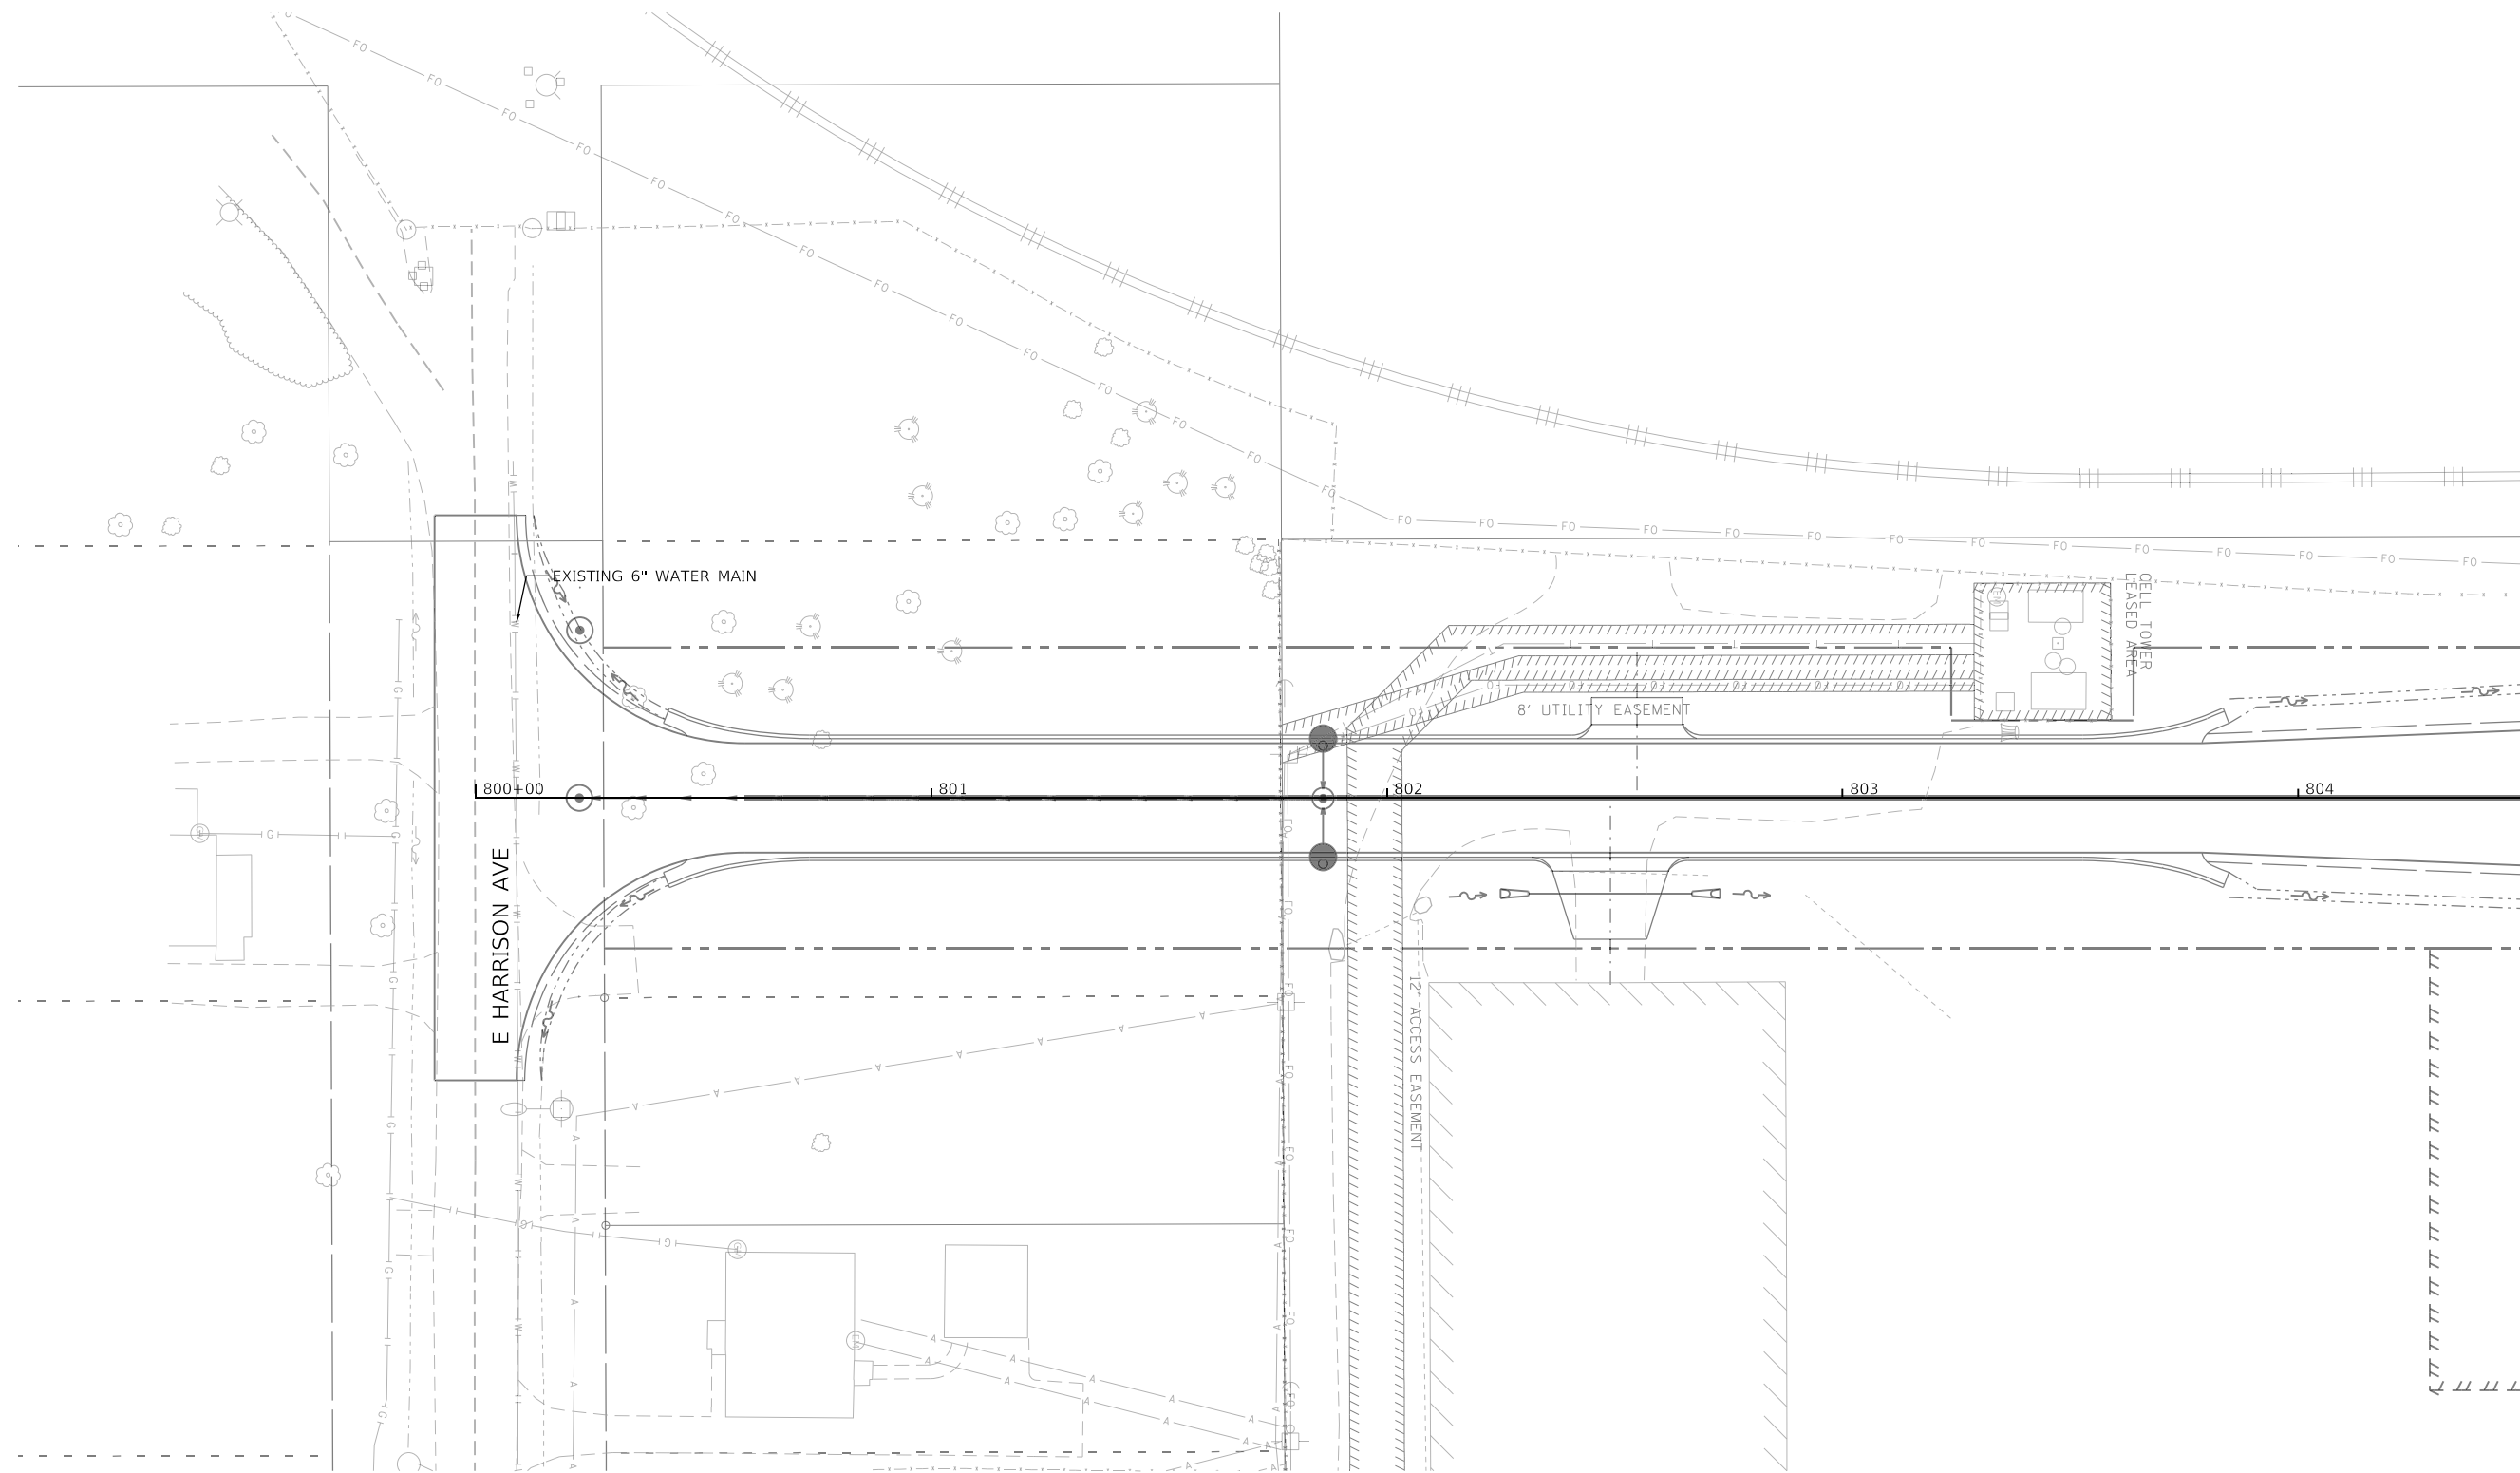


MATCH LINE STA 804+50 (ROADWAY)
SEE WATER MAIN KEY MAP PLAN VIEW NO. 17

WATER MAIN KEY MAP PLAN VIEW NO. 16

NOTES

1. NO PROPOSED WATER MAIN WORK IN THIS AREA.
2. NO EXISTING WATER MAIN OR SANITARY SEWER ADJUSTMENT WORK IN THIS AREA.

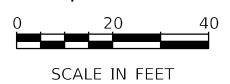

MODEL: Default
FILE NAME: p:\aecom\p-w\henley.com\AECOM_0516_NA\Documents\60603202-Brush College\06-CAD GIS\010_CAD\03_SHEETS\01_L\AECOM\Watermain\60603202_WW_KEYMAP_SEC_16




USER NAME = brooke.henry	DESIGNED - BNH	REVISED -
PLOT SCALE = 40.0000 ' / in.	DRAWN - BNH	REVISED -
PLOT DATE = 10/27/2021	CHECKED - PSA	REVISED -
	DATE - 10/22/2021	REVISED -

**STATE OF ILLINOIS
DEPARTMENT OF TRANSPORTATION**

**WATER MAIN RELOCATION PLAN AND SANITARY SEWER ADJUSTMENTS
EXISTING UTILITY PLAN**
SCALE: 1"=20' SHEET 21 OF 31 SHEETS STA. 800+00 TO STA. 804+50

F.A.U. RTE.	SECTION	COUNTY	TOTAL SHEETS	SHEET NO.
7448	09-00933-01-BR	MACON	1019	533
CONTRACT NO. 95893				
ILLINOIS FED. AID PROJECT				

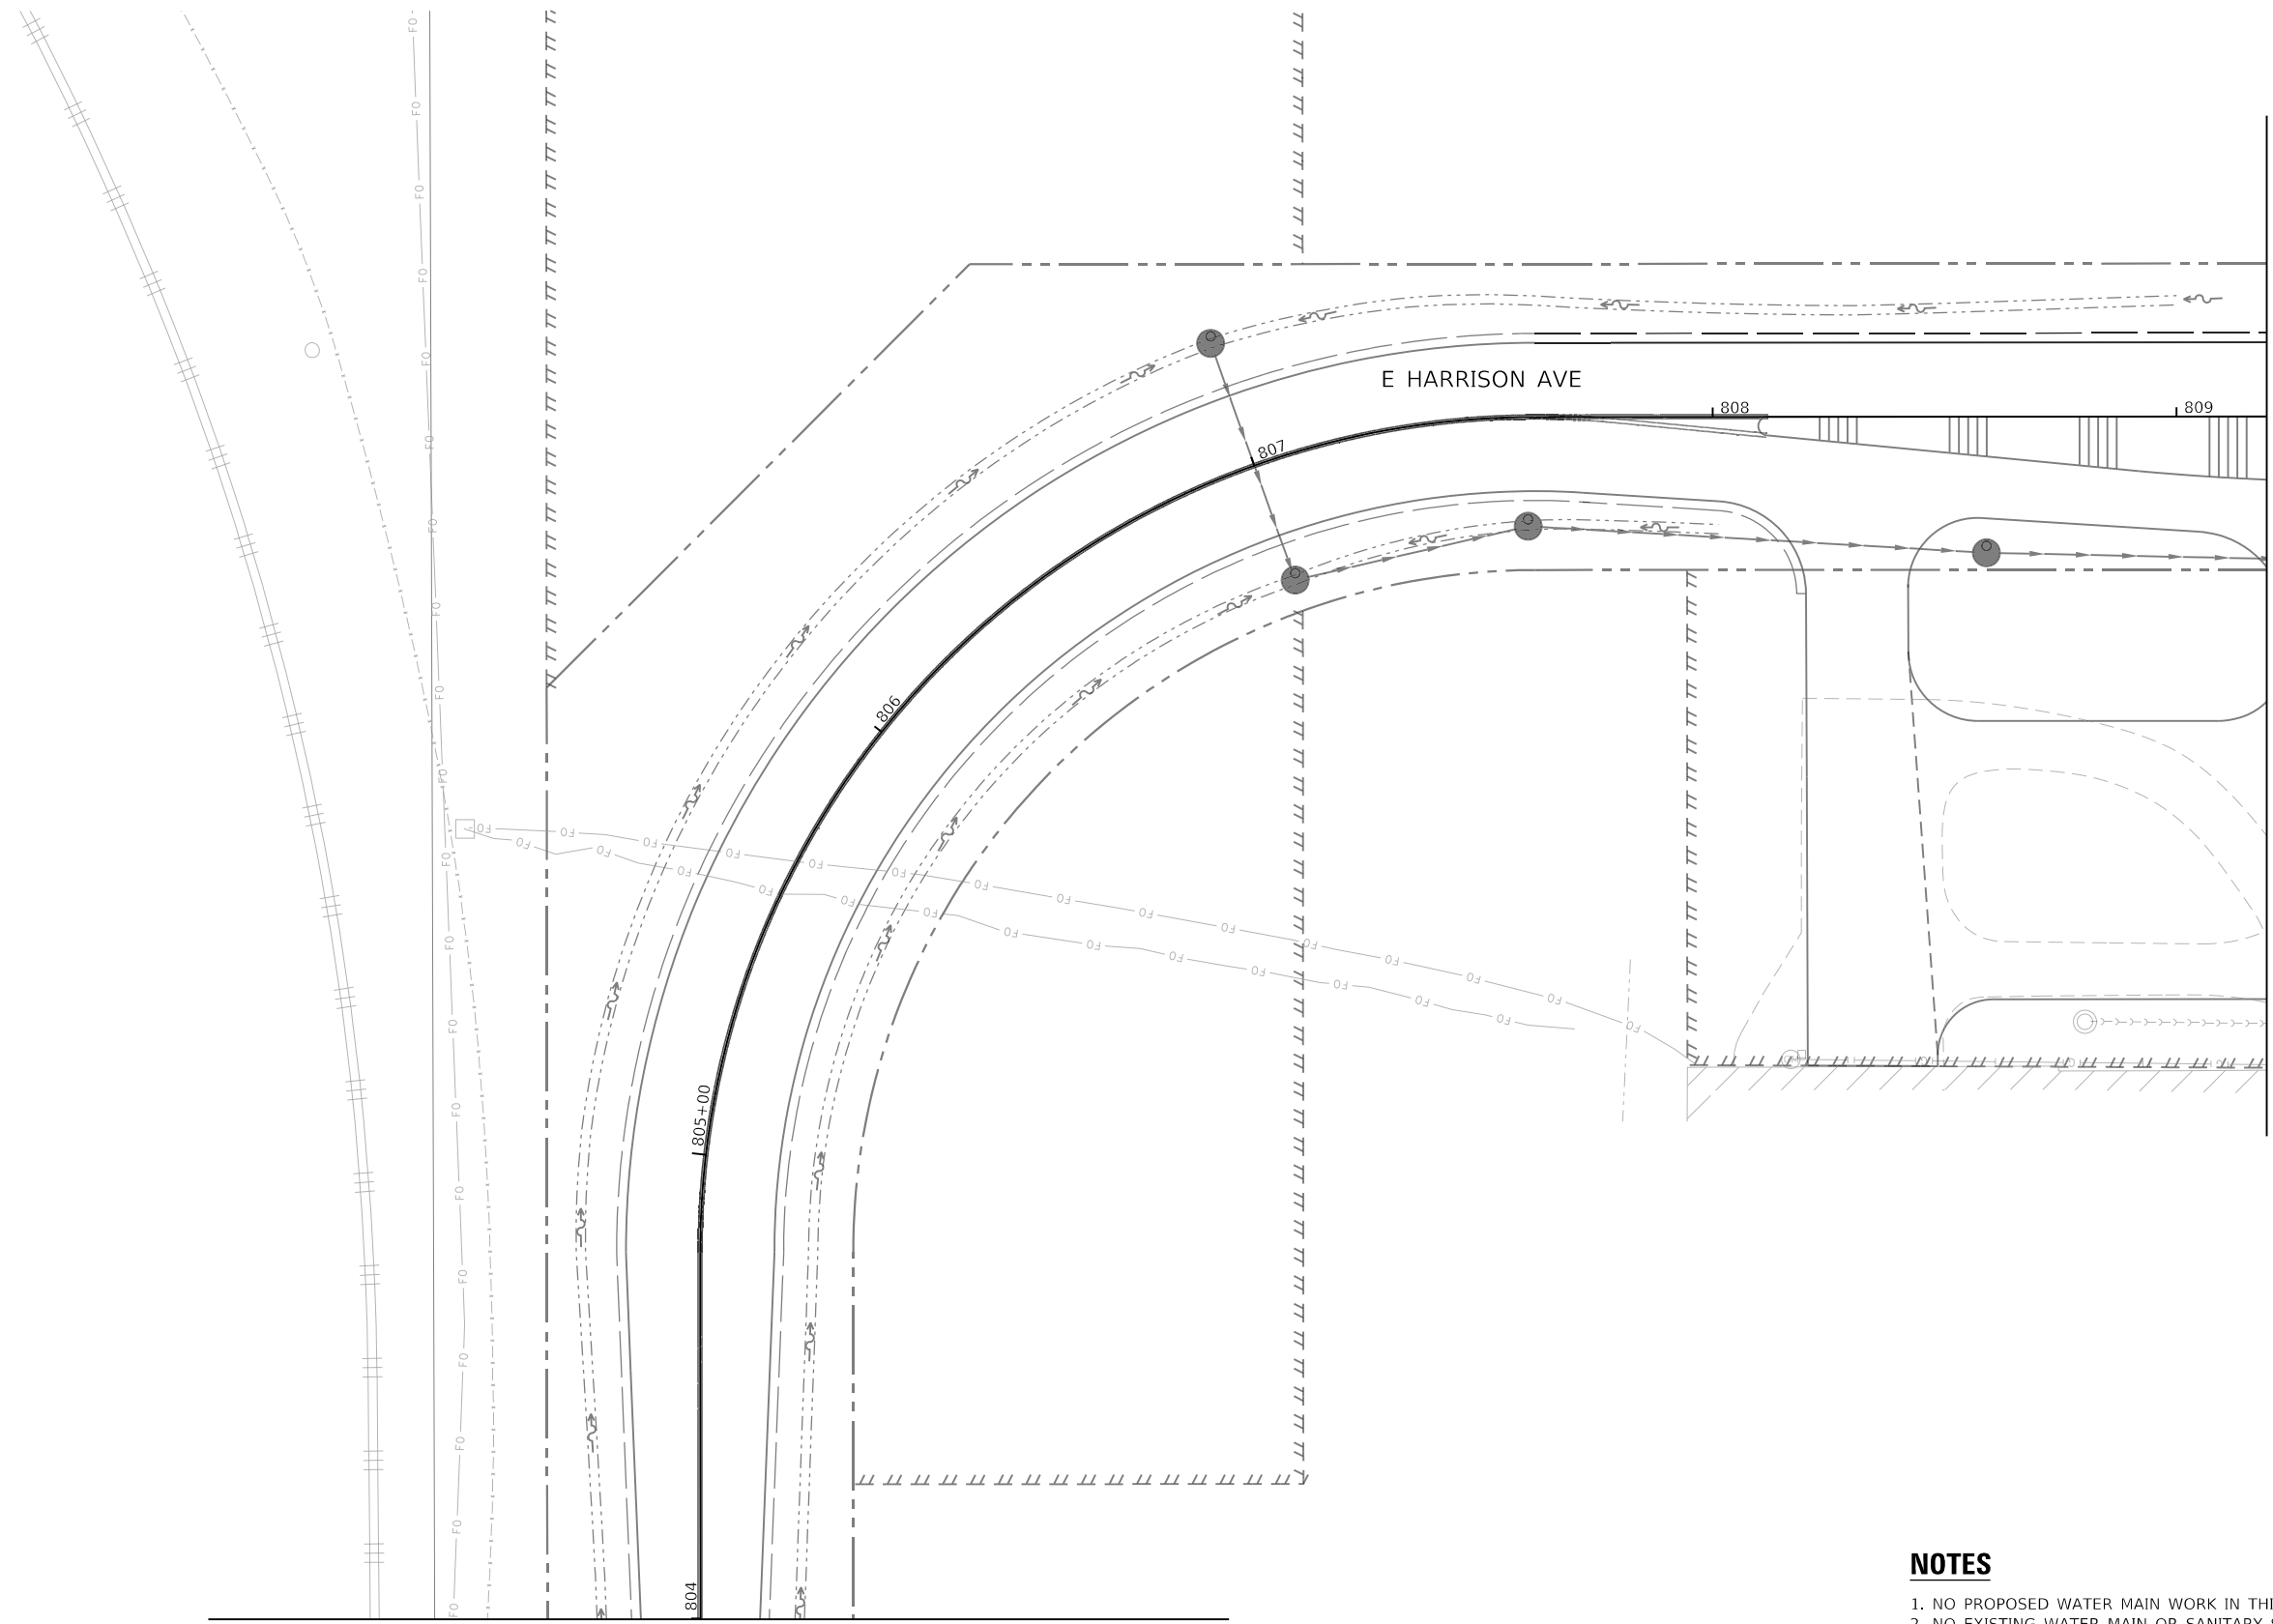

SEE WATER MAIN KEY MAP PLAN VIEW NO. 5

MATCH LINE STA 804+00 (ROADWAY)
SEE WATER MAIN KEY MAP PLAN VIEW NO. 16

WATER MAIN KEY MAP PLAN VIEW NO. 17

NOTES

1. NO PROPOSED WATER MAIN WORK IN THIS AREA.
2. NO EXISTING WATER MAIN OR SANITARY SEWER ADJUSTMENT WORK IN THIS AREA.



MODEL: Default
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USER NAME = brooke,henry	DESIGNED - BNH	REVISD -
DRAWN - BNH	CHECKED - PSA	REVISD -
PLOT SCALE = 40,0000 ' / in.	DATE - 10/22/2021	REVISD -
PLOT DATE = 10/27/2021		

DESIGNED - BNH	REVISD -
DRAWN - BNH	REVISD -
CHECKED - PSA	REVISD -
DATE - 10/22/2021	REVISD -

**STATE OF ILLINOIS
DEPARTMENT OF TRANSPORTATION**

WATER MAIN RELOCATION PLAN AND SANITARY SEWER ADJUSTMENTS
EXISTING UTILITY PLAN


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F.A.U. RTE. 7448	SECTION 09-00933-01-BR	COUNTY MACON	TOTAL SHEETS 1019	SHEET NO. 534
CONTRACT NO. 95893				
ILLINOIS FED. AID PROJECT				



MATCH LINE STA 701+00 (ROADWAY)
SEE WATER MAIN KEY MAP PLAN VIEW NO. 5


MATCH LINE STA 705+00 (ROADWAY)
SEE WATER MAIN KEY MAP PLAN VIEW NO. 19

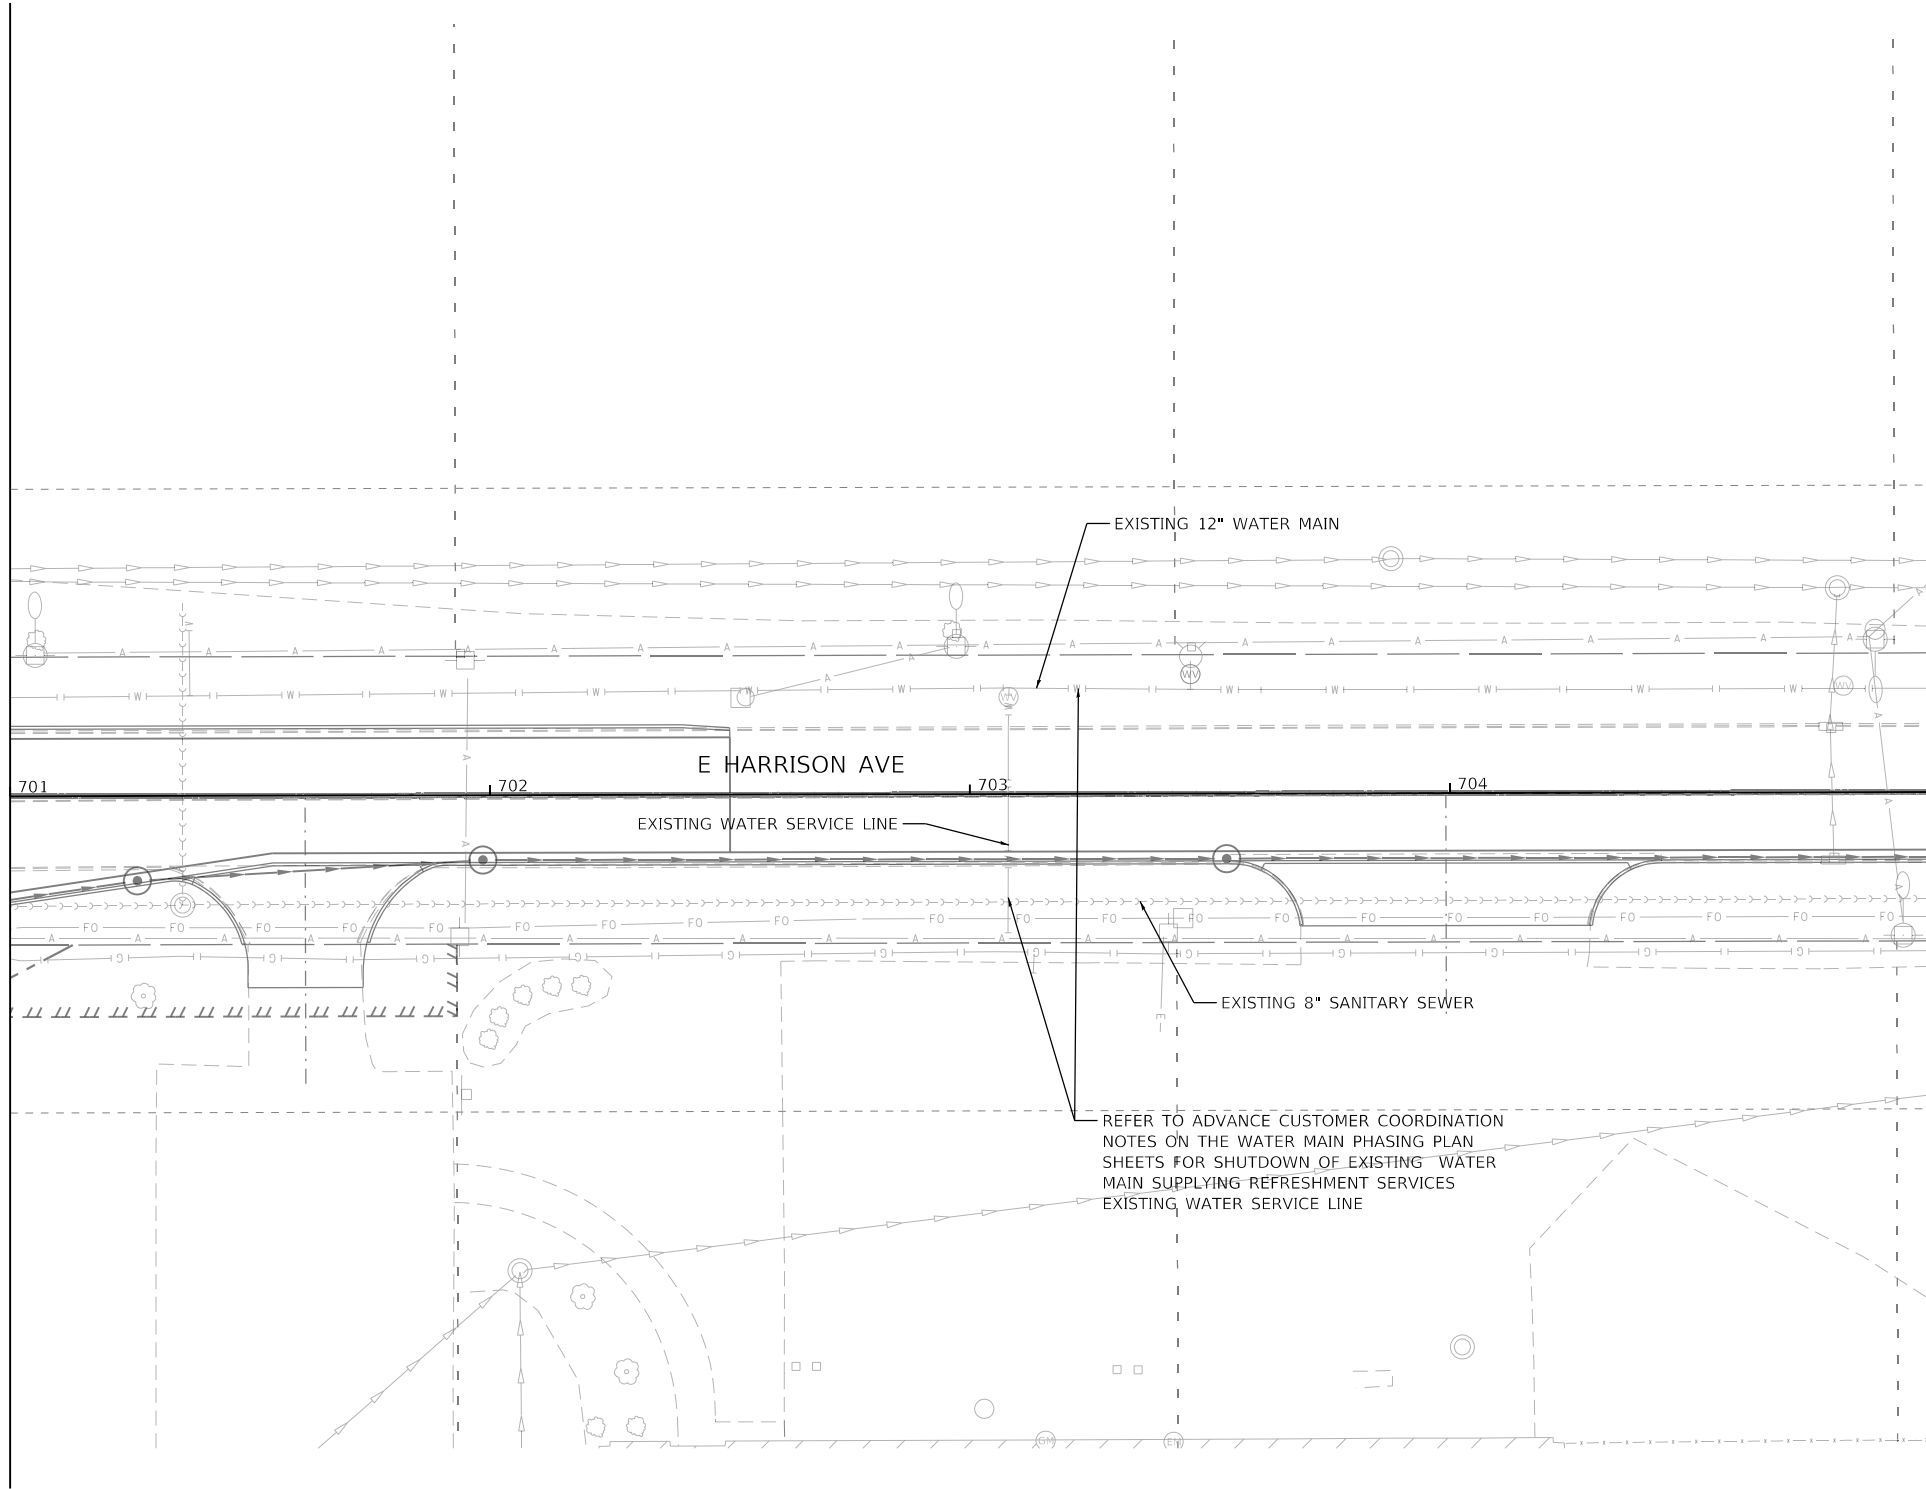

WATER MAIN KEY MAP PLAN VIEW NO. 18

NOTES

1. NO PROPOSED WATER MAIN WORK IN THIS AREA.
2. NO EXISTING WATER MAIN OR SANITARY SEWER ADJUSTMENT WORK IN THIS AREA.

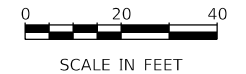

MODEL: Default
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PLOT SCALE = 40.0000 ' / in.	DRAWN - XXX	REVISED -
PLOT DATE = 10/27/2021	CHECKED - XXX	REVISED -
	DATE - 10/22/2021	REVISED -

**STATE OF ILLINOIS
DEPARTMENT OF TRANSPORTATION**


**WATER MAIN RELOCATION PLAN AND SANITARY SEWER ADJUSTMENTS
EXISTING UTILITY PLAN**

SCALE: 1"=20' SHEET 23 OF 31 SHEETS STA. 701+00 TO STA. 705+00

F.A.U. RTE.	SECTION	COUNTY	TOTAL SHEETS	SHEET NO.
7448	09-00933-01-BR	MACON	1019	535
CONTRACT NO. 95893				
ILLINOIS FED. AID PROJECT				



MATCH LINE STA 705+00 (ROADWAY)
SEE WATER MAIN KEY MAP PLAN VIEW NO. 18

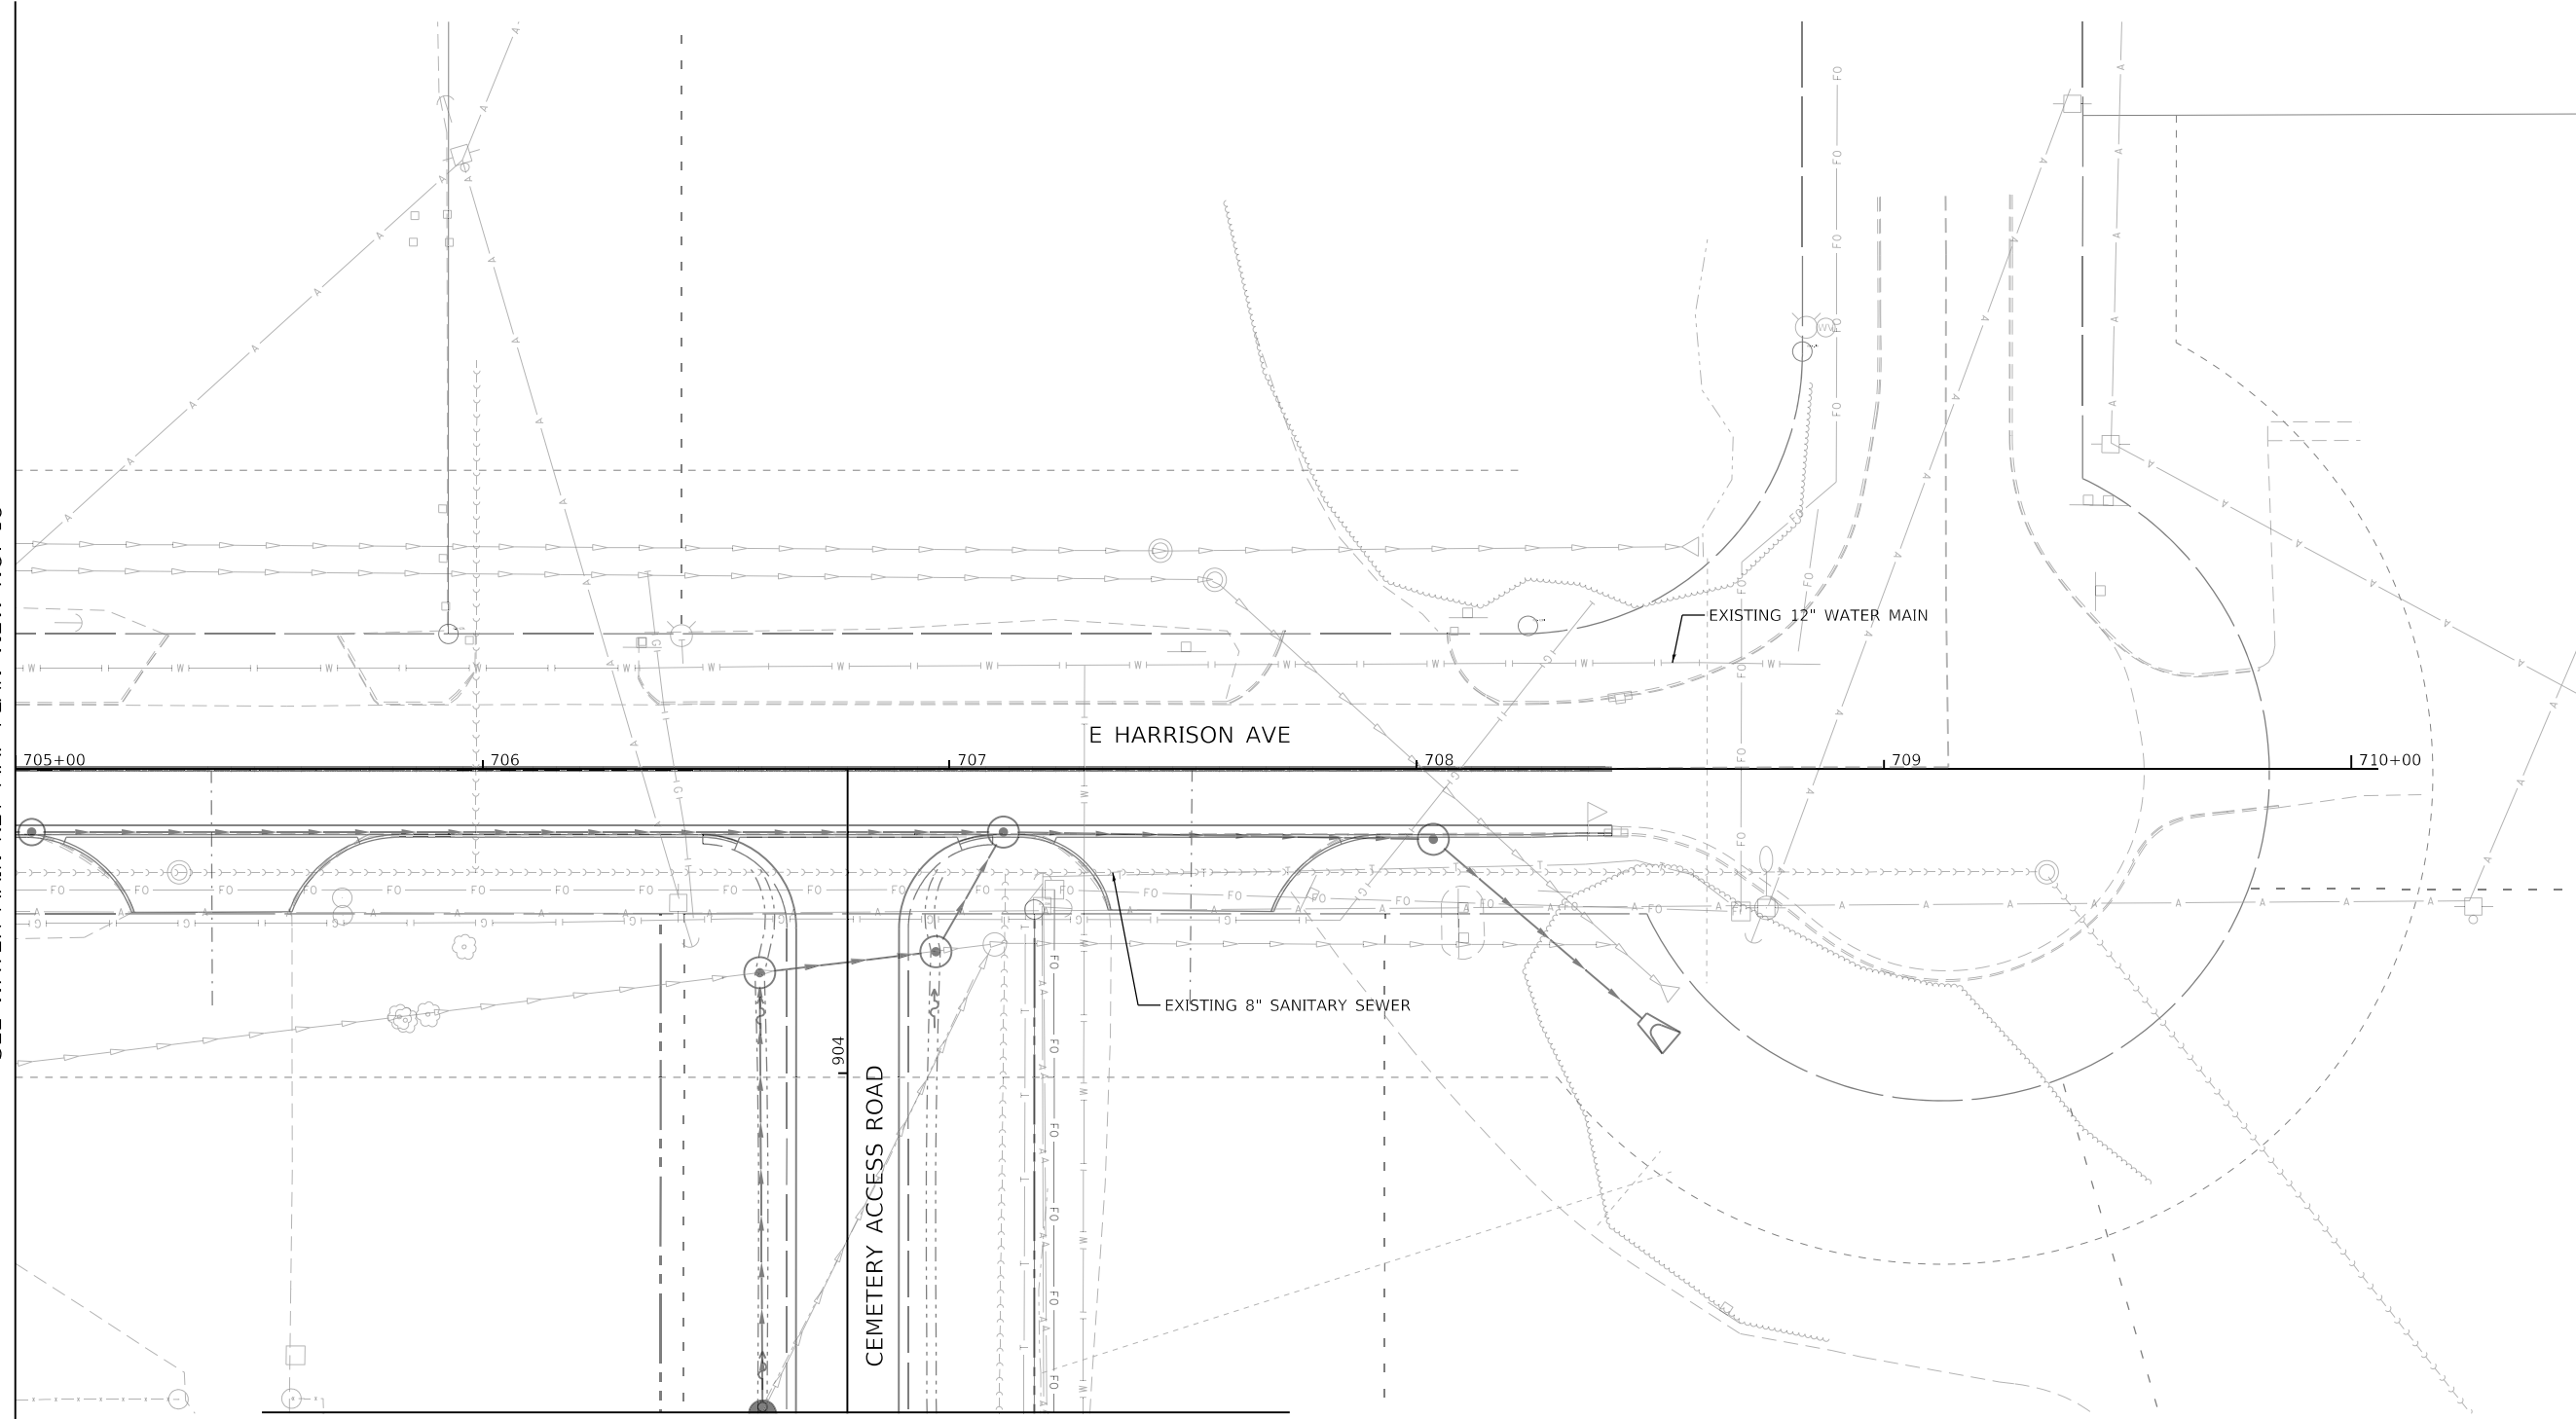


MATCH LINE STA 904+75 (ROADWAY)
SEE WATER MAIN KEY MAP PLAN VIEW NO. 20

WATER MAIN KEY MAP PLAN VIEW NO. 19

NOTES

1. NO PROPOSED WATER MAIN WORK IN THIS AREA.
2. NO EXISTING WATER MAIN OR SANITARY SEWER ADJUSTMENT WORK IN THIS AREA.

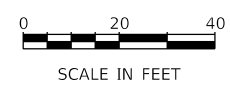

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**STATE OF ILLINOIS
DEPARTMENT OF TRANSPORTATION**


WATER MAIN RELOCATION PLAN AND SANITARY SEWER ADJUSTMENTS
EXISTING UTILITY PLAN

SCALE: 1"=20' SHEET 24 OF 31 SHEETS STA. 705+00 TO STA. 710+00

F.A.U. RTE.	SECTION	COUNTY	TOTAL SHEETS	SHEET NO.
7448	09-00933-01-BR	MACON	1019	536
CONTRACT NO. 95893				
ILLINOIS FED. AID PROJECT				




MATCH LINE STA 705+00 (ROADWAY)
SEE WATER MAIN KEY MAP PLAN VIEW NO. 18 & 19

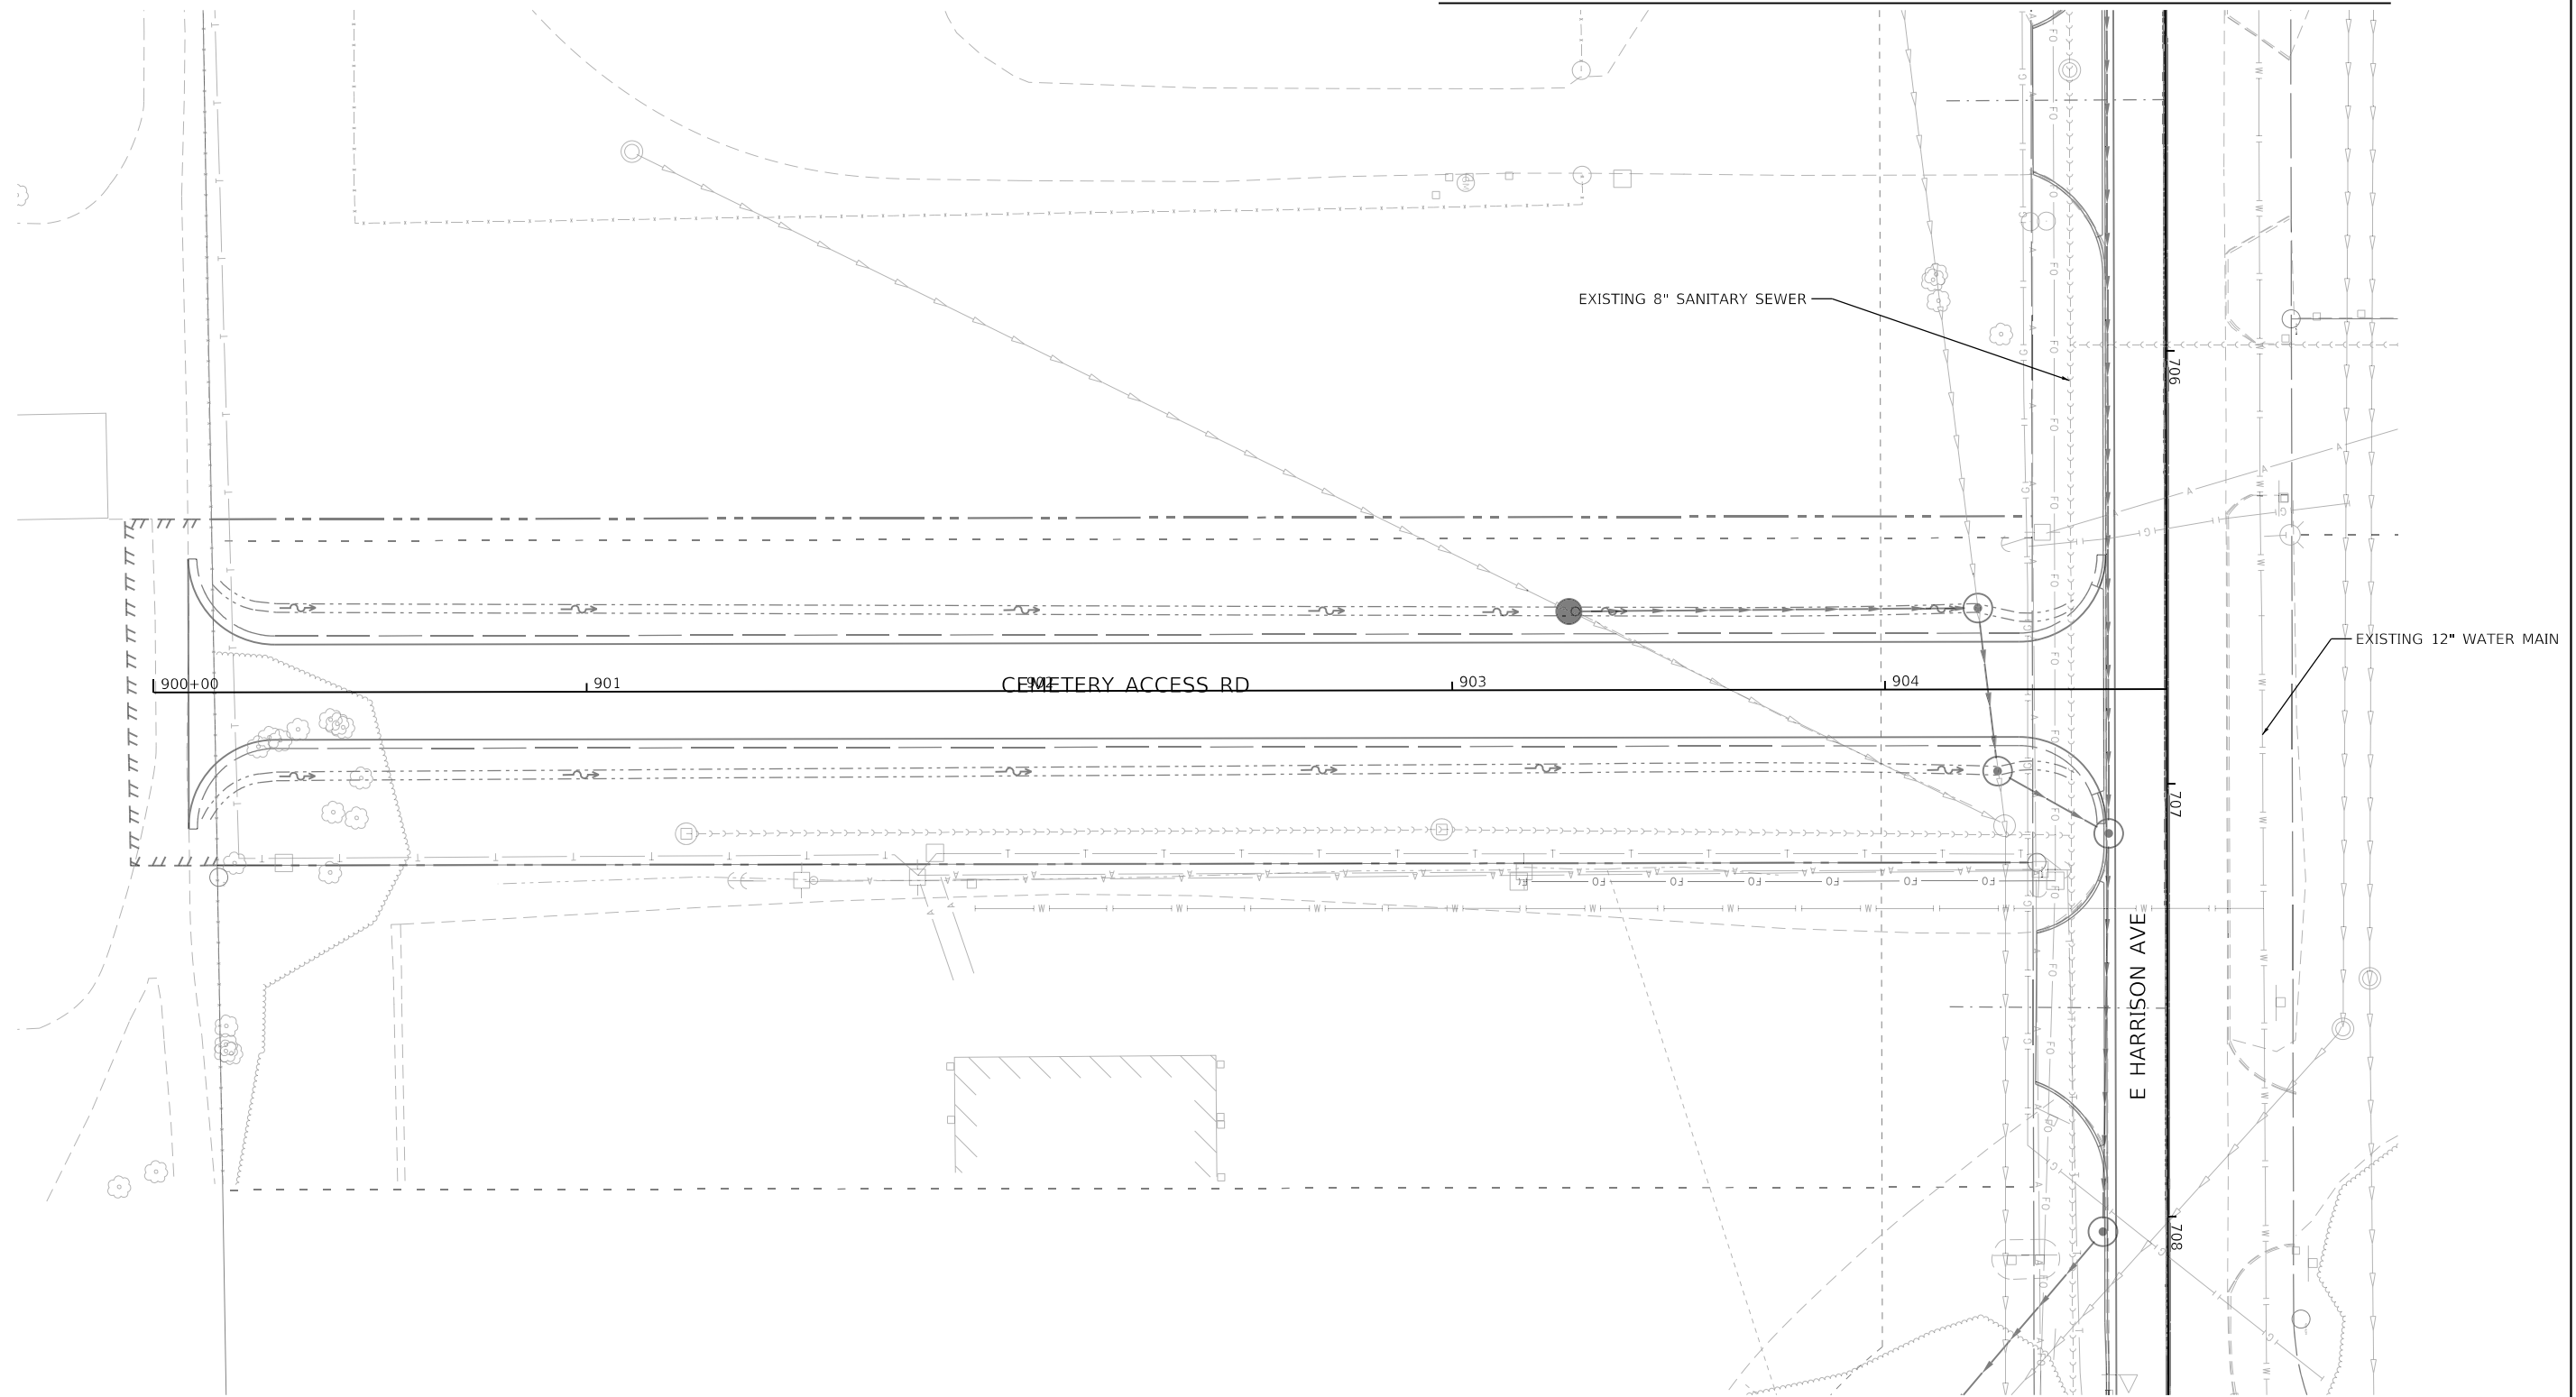

WATER MAIN KEY MAP PLAN VIEW NO. 20

NOTES

1. NO PROPOSED WATER MAIN WORK IN THIS AREA.
2. NO EXISTING WATER MAIN OR SANITARY SEWER ADJUSTMENT WORK IN THIS AREA.

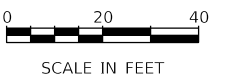

MODEL: Default
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USER NAME = brooke,henry
PLOT SCALE = 40.0000' / in.
PLOT DATE = 10/27/2021

DESIGNED - BNH	REVISED -
DRAWN - BNH	REVISED -
CHECKED - PSA	REVISED -
DATE - 10/22/2021	REVISED -

STATE OF ILLINOIS
DEPARTMENT OF TRANSPORTATION

WATER MAIN RELOCATION PLAN AND SANITARY SEWER ADJUSTMENTS
EXISTING UTILITY PLAN

SCALE: 1"=20' SHEET 25 OF 31 SHEETS STA. 900+00 TO STA. 904+60


F.A.U. RTE.	SECTION	COUNTY	TOTAL SHEETS	SHEET NO.
7448	09-00933-01-BR	MACON	1019	537
CONTRACT NO. 95893				
ILLINOIS FED. AID PROJECT				

GENERAL NOTES

- WATER MAIN CONSTRUCTION PHASES 1 THROUGH 3B SHALL BE PERFORMED DURING ROADWAY CONSTRUCTION PRE-STAGES A THROUGH H. WATER MAIN CONSTRUCTION PHASES 4 THROUGH 5 SHALL BE PERFORMED DURING ROADWAY CONSTRUCTION STAGE 1. PHASE 6 SHALL BE PERFORMED AS NEEDED FOR CONSTRUCTION.
- WATER MAIN ABANDONMENT AND REMOVAL IS NOT REQUIRED TO BE PERFORMED AT ANY SPECIFIC POINT DURING THE WATER MAIN PHASING AND SEQUENCING BUT IS THE RESPONSIBILITY OF THE CONTRACTOR AND MUST BE PERFORMED AS NEEDED FOR CONSTRUCTION. ADDITIONALLY, EXISTING WATER MAINS IN CONFLICT WITH THE PROPOSED PIER FOOTING AND/OR OTHER ROADWAY AND BRIDGE CONSTRUCTION MUST BE REMOVED AS DETAILED IN THE PLANS.
- ALL WORK REQUIRES A COORDINATION MEETING WITH THE CITY A MINIMUM OF 48 HOURS IN ADVANCE.
- MAXIMUM ALLOWABLE DURATION FOR EACH SHUT DOWN IS 6 HOURS UNLESS OTHERWISE NOTED. ALL SHUT DOWNS MUST BE COORDINATED WITH THE CITY OF DECATUR AND THE CUSTOMERS BEING AFFECTED. CONTRACTOR SHALL PERFORM SHUTDOWNS AT A TIME THAT IS APPROVED BY THE CITY AND BY THE CUSTOMER BEING AFFECTED. THIS MAY REQUIRE THAT WORK BE PERFORMED DURING NON STANDARD WORKING HOURS, SUCH AS OVERNIGHT OR ON THE WEEKEND. ALL WORK, REGARDLESS OF THE TIME AND DAY SHALL BE PERFORMED AT NO ADDITIONAL COST TO THE CONTRACT. THE ENGINEER HAS PERFORMED SOME ADVANCE COORDINATION WITH CUSTOMERS. SEE NOTES IN THE UPPER RIGHT OF THIS SHEET.
- CONTRACTOR IS NOT ALLOWED TO OPERATE EXISTING VALVES AND HYDRANTS. EXISTING VALVES AND HYDRANTS ARE ONLY TO BE OPERATED BY THE CITY OF DECATUR.
- THE SEQUENCING PLAN DETAILED HEREIN IS THE ENGINEER'S GENERAL RECOMMENDED APPROACH, WHICH MAY NEED TO BE REVISED BASED ON FIELD CONDITIONS, EXISTING VALVE OPERABILITY, ETC. CONTRACTOR REQUESTED CHANGES TO THE SEQUENCING MAY BE CONSIDERED BUT MUST BE SUBMITTED IN ADVANCE TO THE CITY AND THE ENGINEER FOR APPROVAL. ANY CHANGES TO THE SEQUENCING SHALL BE AT NO ADDITIONAL COST TO THE CONTRACT.
- ALL PREPARATION WORK, INCLUDING, BUT NOT LIMITED TO, EXCAVATION, THRUST BLOCKS, PIPE CLEANING, TEST SHUTDOWNS, ETC. SHALL BE DONE IN ADVANCE OF CONSTRUCTING THE PROPOSED CONNECTIONS TO REDUCE SHUT DOWN TIMES. ALL PROPOSED FITTINGS, VALVES, AND HYDRANTS SHALL BE LOCATED ON-SITE, IN ADVANCE OF CONSTRUCTION TO PROVIDE SUFFICIENT OPPORTUNITY FOR THE PROPOSED APPURTENANCES TO BE INSPECTED.
- PROVIDE ALL TEMPORARY AND PERMANENT BRACING/ THRUST BLOCKING REQUIRED FOR ALL PRESSURIZED PIPING AND SYSTEMS.
- THE STATION LOCATIONS IN THE PHASING NOTES REFERENCE THE PROPOSED WATER MAIN BASELINE.
- FLUSHING, DISINFECTION, AND DE CHLORINATION OF WATER MAIN SYSTEM, INCLUDING BOTH THE BRANCH CONNECTIONS (E.G. THE 12" WATER MAIN IN E. HARRISON AVENUE) AND THE MAIN LINES SHALL BE PERFORMED IN ACCORDANCE WITH AWWA REQUIREMENTS. THE CONTRACTOR SHALL SUBMIT A DETAILED PLAN AND SCHEDULE FOR THESE OPERATIONS TO THE CITY AND THE ENGINEER A MINIMUM OF 7 DAYS IN ADVANCE FOR REVIEW AND APPROVAL.
- A MINIMUM OF TWO (2) WEEKS IN ADVANCE OF BEGINNING CONSTRUCTION, CONTRACTOR SHALL FIELD VERIFY ALL EXISTING WATER MAIN ELEVATIONS. ALL STATIONING IS APPROXIMATE.

PHASE 1

- GENERALLY, INSTALL PIPE AND FITTINGS SOUTH TO NORTH FROM STA. 29+15 TO 34+82 AS SHOWN ON THE PLANS.
- INSTALL 30" VALVE AT STA. 29+15.
- SET TEE AND FIRE HYDRANT AT STA. 29+32.
- SET 30"x8" TEE, 8" VALVE, AND TEMPORARY CAP AT STA. 30+49.
 - THIS WORK IS IN PREPARATION FOR CONNECTION NO. 4, WHICH WILL BE COMPLETED AT THE END OF PHASE 1 (8" CONNECTION FOR REFRESHMENT SERVICES AT 2112 BRUSH COLLEGE ROAD).

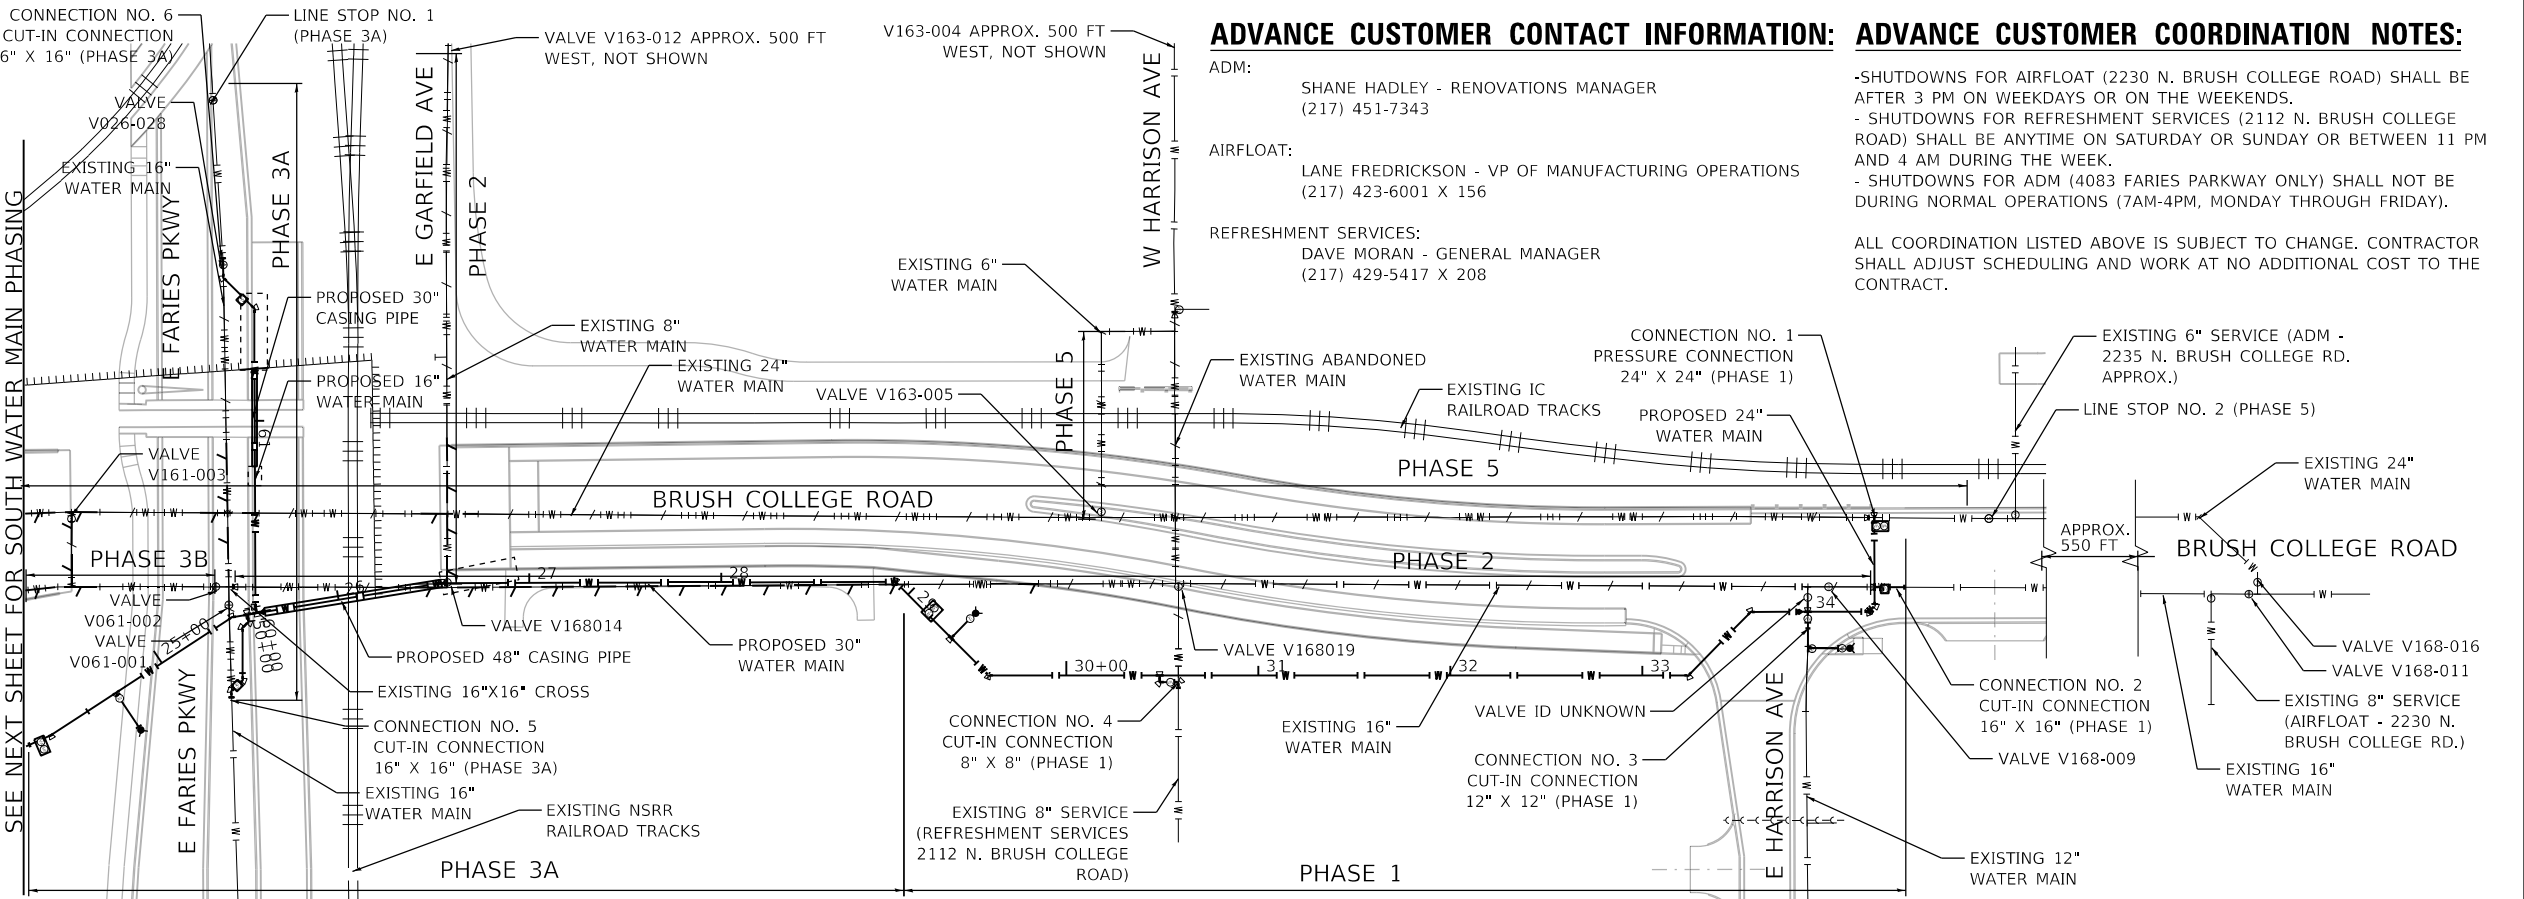

PHASE 2

- CLOSE EXISTING VALVE V168-008 AND THE EXISTING VALVE (UNKNOWN ID) AT BRUSH COLLEGE ROAD AND E. HARRISON AVENUE.
 - INSTALL PERMANENT CAP ON EXISTING 12" WATER MAIN TO WEST OF FUTURE CONNECTION POINT.
 - INSTALL TEMPORARY CAP ON EXISTING 12" WATER MAIN TO EAST OF FUTURE CONNECTION POINT.
 - OPEN VALVE V168-008 TO PLACE 12" WATER MAIN BACK INTO SERVICE.
 - INSTALL 24"x12" TEE, VALVE, PIPING AND APPURTENANCES AT STA. 34+00 INCLUDING A TEMPORARY CAP AND THE PROPOSED HYDRANT ASSEMBLY AT THE NORTHEAST CORNER OF BRUSH COLLEGE ROAD AND E. HARRISON AVENUE.
- CLOSE EXISTING VALVES V168-011, V168-009, AND THE 8" SERVICE VALVE FOR AIRFLOAT (2230 N. BRUSH COLLEGE ROAD).
 - INSTALL PERMANENT CAP ON EXISTING 16" WATER MAIN TO THE SOUTH OF FUTURE CONNECTION POINT.
 - INSTALL TEMPORARY CAP ON EXISTING 16" WATER MAIN TO THE NORTH OF FUTURE CONNECTION POINT.
 - OPEN EXISTING VALVES V168-011 AND THE 8" SERVICE VALVE FOR AIRFLOAT (2230 N. BRUSH COLLEGE ROAD) TO PLACE THE 16" WATER MAIN AND AIRFLOAT BACK INTO SERVICE.
 - INSTALL 24"x16" TEE, VALVE, PIPING, AND APPURTENANCES AT STA. 34+46, INCLUDING A TEMPORARY CAP.

PHASE 3A

- INSTALL CONNECTION NO. 1 (PRESSURE CONNECTION) ON THE EXISTING 24" WATER MAIN AT STA. 34+82.
- FLUSH, PRESSURE TEST, DISINFECT, AND PLACE THE PHASE 1 WATER MAIN INTO SERVICE.
 - WATER MAIN SHALL BE FLUSHED TO BRUSH COLLEGE ROAD OR OTHER SUITABLE LOCATION. PROVIDE TRAFFIC CONTROL ON BRUSH COLLEGE ROAD AND E. HARRISON AVENUE AS NEEDED FOR THE FLUSHING OPERATION AND TO MAINTAIN TRAFFIC OPERATIONS. PROVIDE ALL TEMPORARY PIPING, VALVES, AND APPURTENANCES NEEDED TO PERFORM THIS FLUSHING OPERATION.
 - TEMPORARY FLUSHING PIPING SHALL BE 30" DIAMETER MINIMUM.
 - THE CONTRACTOR'S ATTENTION IS CALLED TO THE CITY'S REQUIREMENT FOR UTILIZING PIGS FOR THE FLUSHING OPERATIONS. REFER TO SPECIAL PROVISIONS FOR ADDITIONAL DETAILS.
- CLOSE VALVES V168-011 AND THE EXISTING 8" SERVICE VALVE FOR AIRFLOAT (2230 N. BRUSH COLLEGE ROAD).
 - REMOVE TEMPORARY CAPS AND INSTALL CONNECTION NO. 2 (CUT-IN) AT STA. 34+46, RT 15.5 FT.
 - OPEN VALVE V168-011, 8" SERVICE VALVE FOR AIRFLOAT (2230 N. BRUSH COLLEGE ROAD), AND THE PROPOSED 16" VALVE AT STA. 34+46, RT 5.3 FT.
- CLOSE VALVE V168-008.
 - REMOVE TEMPORARY CAPS AND INSTALL CONNECTION NO. 3 (CUT-IN) AT STA. 34+00, RT. 8.6 FT.
 - OPEN VALVE V168-008 AND THE PROPOSED 12" VALVE AT STA. 31+51, RT 3.6 FT.

PHASE 3B

- CLOSE VALVE V161-003, JUST SOUTH OF FARIES PKWY IN BRUSH COLLEGE RD.
- INSTALL ALL PERMANENT CAPS AS NEEDED TO ABANDON THE EXISTING 12" WATER MAIN ALONG BRUSH COLLEGE RD., SOUTH OF FARIES PKWY. ABANDON EXISTING 8" WATER MAIN STUBS.

PHASE 3C

- INSTALL 48" CASING PIPE BY JACK AND BORE ALONG BRUSH COLLEGE ROAD UNDER NSRR TRACKS BETWEEN STA. 25+66 AND STA. 26+40.
- INSTALL 30" CASING PIPE BY JACK AND BORE ALONG FARIES PKWY UNDER IC RR TRACKS BETWEEN STA. 60+76 AND STA. 61+26.
- GENERALLY, INSTALL PIPE AND FITTINGS FROM NORTH TO SOUTH FROM STA. 29+15 TO STA. 24+25 AS SHOWN ON THE PLANS. FOR THE FOLLOWING WORK ITEMS, SEQUENCE WATER MAIN WORK AS REQUIRED FOR CONSTRUCTION IN ORDER TO MEET THE SUGGESTED STAGES OF CONSTRUCTION AND TRAFFIC CONTROL PLAN (SEE ESPECIALLY PRE STAGES A THROUGH H).
 - SET 30"x24" REDUCER AT STA. 26+60.
 - SET 24"x16" TEE AT STA. 25+57. LAY 16" PIPE AND FITTINGS TO THE WEST ALONG FARIES PKWY. INSTALL 16" VALVE AT STA. 61+66 AND TEMPORARILY CAP.
 - SET 24"x16" TEE AT STA. 25+52. LAY 16" PIPE AND FITTINGS TO THE EAST ALONG FARIES PKWY. INSTALL 16" VALVE AT STA. 50+41 AND TEMPORARILY CAP.
 - SET 24"x6" TEE AND FIRE HYDRANT AT STA. 24+72.
 - INSTALL 24" VALVE AT STA. 24+25.
 - OPEN PROPOSED 30" VALVE AT STA. 29+15.

PHASE 4

- CLOSE VALVE V168-019.
 - INSTALL PERMANENT CAP ON EXISTING 8" WATER MAIN.
 - INSTALL CONNECTION NO. 4 (CUT-IN) AT STA. 30+49, RT 3.6 FT.
 - OPEN PROPOSED 8" VALVE AT STA. 30+49, RT 3.6 FT TO PROVIDE SERVICE TO REFRESHMENT SERVICES (2112 N. BRUSH COLLEGE ROAD).

ADVANCE CUSTOMER CONTACT INFORMATION:

ADM: SHANE HADLEY - RENOVATIONS MANAGER (217) 451-7343

AIRFLOAT: LANE FREDRICKSON - VP OF MANUFACTURING OPERATIONS (217) 423-6001 X 156

REFRESHMENT SERVICES: DAVE MORAN - GENERAL MANAGER (217) 429-5417 X 208

ADVANCE CUSTOMER COORDINATION NOTES:

-SHUTDOWNS FOR AIRFLOAT (2230 N. BRUSH COLLEGE ROAD) SHALL BE AFTER 3 PM ON WEEKDAYS OR ON THE WEEKENDS.

- SHUTDOWNS FOR REFRESHMENT SERVICES (2112 N. BRUSH COLLEGE ROAD) SHALL BE ANYTIME ON SATURDAY OR SUNDAY OR BETWEEN 11 PM AND 4 AM DURING THE WEEK.

- SHUTDOWNS FOR ADM (4083 FARIES PARKWAY ONLY) SHALL NOT BE DURING NORMAL OPERATIONS (7AM-4PM, MONDAY THROUGH FRIDAY).

ALL COORDINATION LISTED ABOVE IS SUBJECT TO CHANGE. CONTRACTOR SHALL ADJUST SCHEDULING AND WORK AT NO ADDITIONAL COST TO THE CONTRACT.

PHASE 3A

- FLUSH, PRESSURE TEST, DISINFECT, AND PLACE THE PHASE 3A WATER MAIN INTO SERVICE.
 - WATER MAIN SHALL BE FLUSHED TO THE PROPOSED STORM SEWER DRAIN SYSTEM LOCATED IN FARIES PARKWAY (STRUCTURE I.D. 205, 208, 209, OR OTHER SUITABLE LOCATION). REFER TO DRAINAGE SHEETS FOR ADDITIONAL DETAIL. PROVIDE TRAFFIC CONTROL ON FARIES PARKWAY AS NEEDED FOR FLUSHING OPERATION AND TO MAINTAIN TRAFFIC OPERATIONS. PROVIDE ALL TEMPORARY PIPING, VALVES, AND APPURTENANCES NEEDED TO PERFORM THIS FLUSHING OPERATION.
 - TEMPORARY FLUSHING PIPING SHALL BE THE SAME SIZE AS THE WATER MAIN BEING FLUSHED.
 - THE CONTRACTOR'S ATTENTION IS CALLED TO THE CITY'S REQUIREMENT FOR UTILIZING PIGS FOR THE FLUSHING OPERATIONS. REFER TO SPECIAL PROVISIONS FOR ADDITIONAL DETAILS.
- CLOSE VALVES V061-001 AND UNKNOWN VALVE EAST ON FARIES (NOT SHOWN).
 - INSTALL PERMANENT CAP ON EXISTING 16" WATER MAIN AT STA. 50+25, RT 2.4 FT.
 - INSTALL CONNECTION NO. 5 (CUT-IN) AT STA. 50+47.
 - OPEN THE PROPOSED 16" VALVE JUST EAST OF THE PROPOSED 24" WATER MAIN AND THE UNKNOWN VALVE EAST ON FARIES (NOT SHOWN). THIS WILL PLACE THE EASTERN SEGMENT OF THE 16" FARIES PKWY WATER MAIN BACK INTO SERVICE.
 - VALVE V061-001 WILL REMAIN CLOSED.
- INSTALL LINE STOP NO. 1 IN FARIES PKWY, JUST WEST OF BRUSH COLLEGE RD.
 - INSTALL PERMANENT CAP ON EXISTING 16" WATER MAIN AT STA. 61+78, LT 3.1 FT.
 - INSTALL CONNECTION NO. 6 (CUT-IN) AT STA. 61+91.
 - OPEN THE PROPOSED 16" VALVE AT STA. 61+66 AND REMOVE LINE STOP NO. 1. THIS WILL PLACE THE 16" FARIES PKWY WATER MAIN SYSTEM BACK INTO SERVICE.
 - VALVE V061-002 WILL REMAIN CLOSED.
- ABANDON 16" WATER MAIN ALONG FARIES PKWY AS SHOWN ON THE PLANS.

PHASE 3B

- CLOSE VALVE V161-003, JUST SOUTH OF FARIES PKWY IN BRUSH COLLEGE RD.
- INSTALL ALL PERMANENT CAPS AS NEEDED TO ABANDON THE EXISTING 12" WATER MAIN ALONG BRUSH COLLEGE RD., SOUTH OF FARIES PKWY. ABANDON EXISTING 8" WATER MAIN STUBS.

PHASE 3C

- INSTALL 48" CASING PIPE BY JACK AND BORE ALONG BRUSH COLLEGE ROAD UNDER NSRR TRACKS BETWEEN STA. 25+66 AND STA. 26+40.
- INSTALL 30" CASING PIPE BY JACK AND BORE ALONG FARIES PKWY UNDER IC RR TRACKS BETWEEN STA. 60+76 AND STA. 61+26.
- GENERALLY, INSTALL PIPE AND FITTINGS FROM NORTH TO SOUTH FROM STA. 29+15 TO STA. 24+25 AS SHOWN ON THE PLANS. FOR THE FOLLOWING WORK ITEMS, SEQUENCE WATER MAIN WORK AS REQUIRED FOR CONSTRUCTION IN ORDER TO MEET THE SUGGESTED STAGES OF CONSTRUCTION AND TRAFFIC CONTROL PLAN (SEE ESPECIALLY PRE STAGES A THROUGH H).
 - SET 30"x24" REDUCER AT STA. 26+60.
 - SET 24"x16" TEE AT STA. 25+57. LAY 16" PIPE AND FITTINGS TO THE WEST ALONG FARIES PKWY. INSTALL 16" VALVE AT STA. 61+66 AND TEMPORARILY CAP.
 - SET 24"x16" TEE AT STA. 25+52. LAY 16" PIPE AND FITTINGS TO THE EAST ALONG FARIES PKWY. INSTALL 16" VALVE AT STA. 50+41 AND TEMPORARILY CAP.
 - SET 24"x6" TEE AND FIRE HYDRANT AT STA. 24+72.
 - INSTALL 24" VALVE AT STA. 24+25.
 - OPEN PROPOSED 30" VALVE AT STA. 29+15.

PHASE 3D

- CLOSE VALVE V161-003, JUST SOUTH OF FARIES PKWY IN BRUSH COLLEGE RD.
- INSTALL ALL PERMANENT CAPS AS NEEDED TO ABANDON THE EXISTING 12" WATER MAIN ALONG BRUSH COLLEGE RD., SOUTH OF FARIES PKWY. ABANDON EXISTING 8" WATER MAIN STUBS.




USER NAME	= brooke.henry
PLOT SCALE	= 100,000.1' / in.
PLOT DATE	= 10/27/2021

DESIGNED	- BNH	REVISED	-
DRAWN	- BNH	REVISED	-
CHECKED	- PSA	REVISED	-
DATE	- 10/22/2021	REVISED	-

**STATE OF ILLINOIS
DEPARTMENT OF TRANSPORTATION**

WATER MAIN RELOCATION PLAN AND SANITARY SEWER ADJUSTMENTS		F.A.U. RTE.	SECTION	COUNTY	TOTAL SHEETS	SHEET NO.
WATER MAIN PHASING PLAN NORTH		7448	09-00933-01-BR	MACON	1019	538
SCALE: 1"=50'		SHEET 26 OF 31 SHEETS		CONTRACT NO. 95893		
STA.	N/A	TO STA.	N/A	ILLINOIS FED. AID PROJECT		

MODEL: Default
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SEE PREVIOUS SHEET FOR NORTH WATER MAIN PHASING

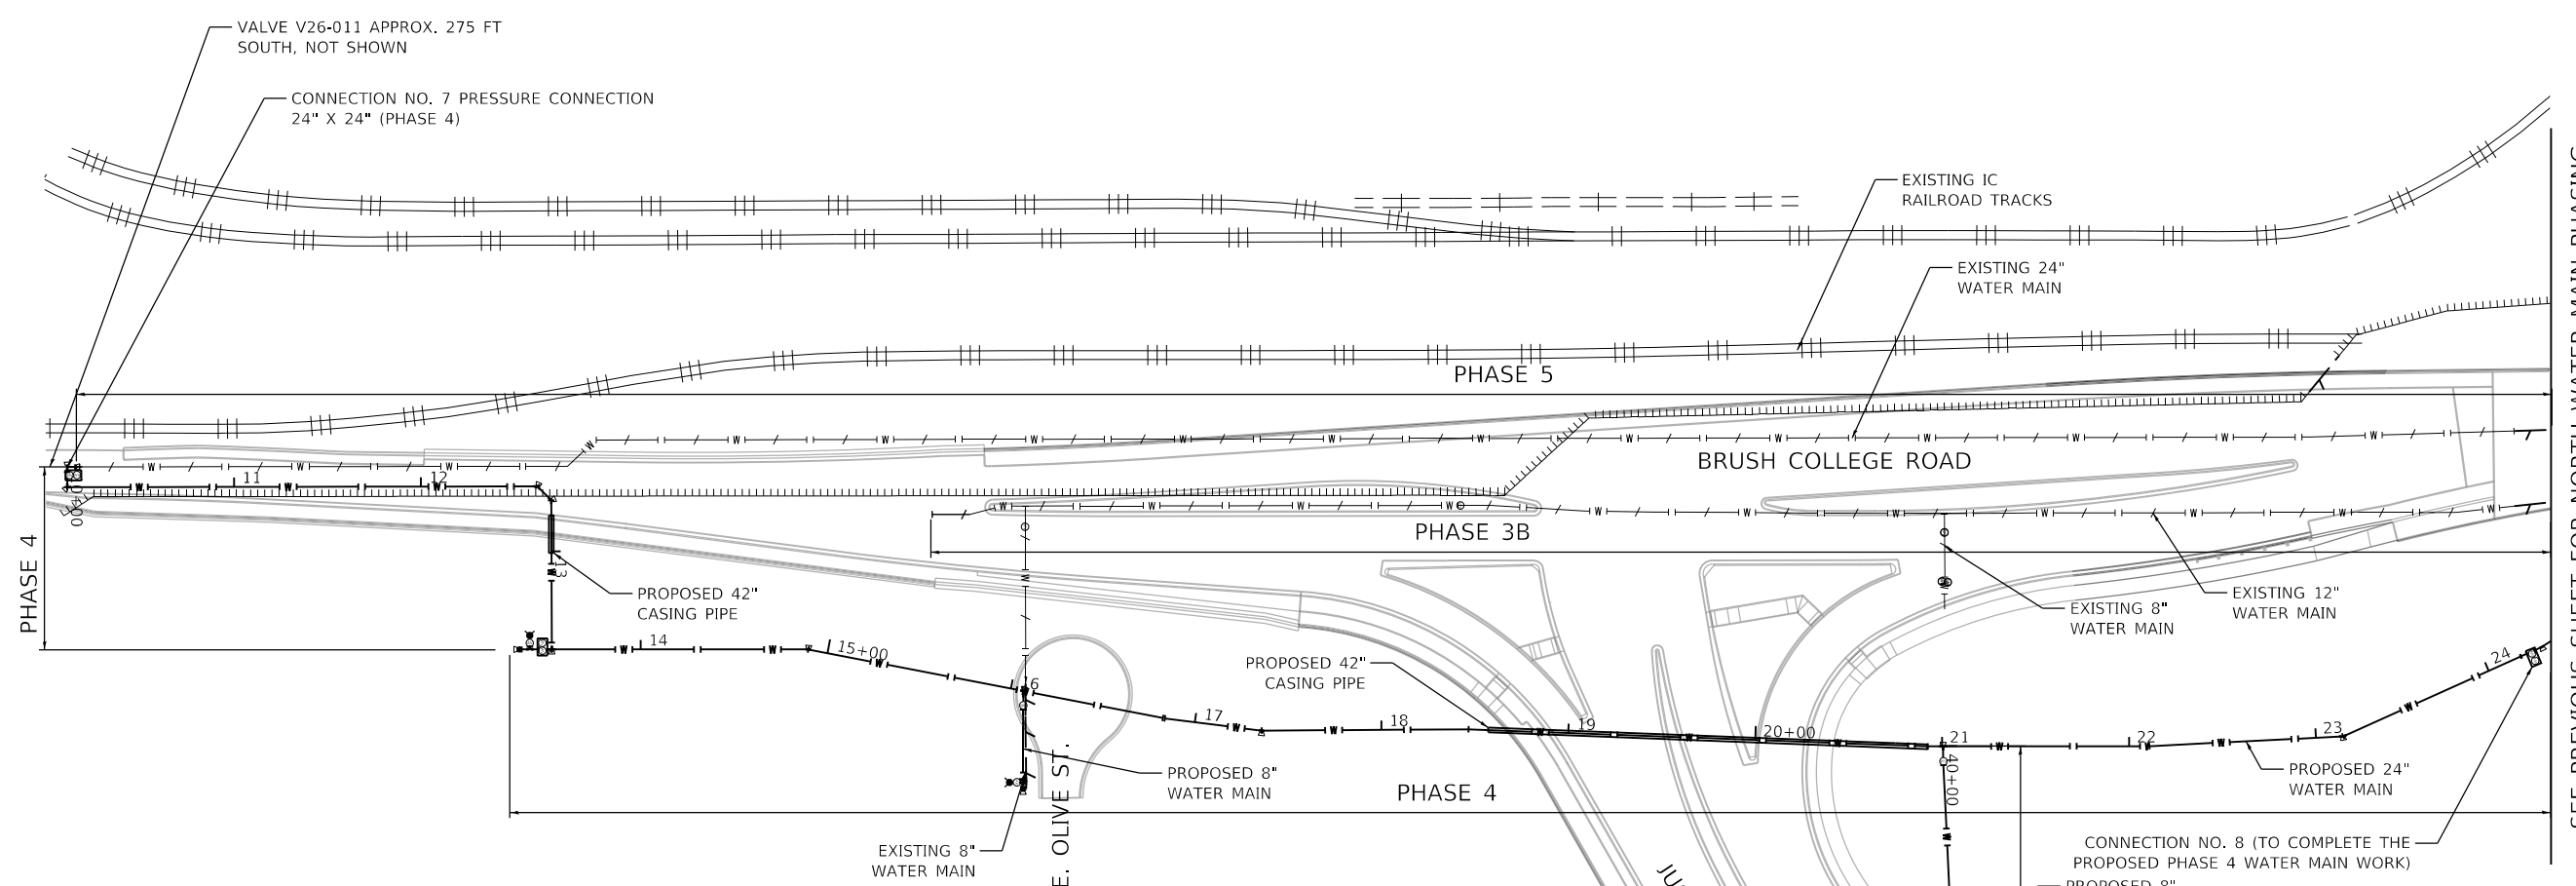PHASE 4

1. GENERALLY, INSTALL PIPE AND FITTINGS FROM NORTH TO SOUTH FROM STA. 24+25 TO STA. 10+00 AS SHOWN ON THE PLANS.
 - A. CONTRACTOR IS RECOMMENDED TO DELAY THE CONNECTION TO THE PROPOSED WATER MAIN AT STA. 24+25. UTILIZING THIS APPROACH, THE PHASE 4 WATER MAIN CAN BE USED TO FLUSH FROM SOUTH TO NORTH AND THEN USING TEMPORARY PIPING TO DISCHARGE INTO STRUCTURE I.D. 209. AFTER PRELIMINARY FLUSHING AND BEFORE DISINFECTION, CONTRACTOR CAN MAKE THE CONNECTION AT STA. 24+25.
2. SET 24"x8" TEE AT STA. 21+00 (E. LOGAN ST. EXTENDED).
 - A. INSTALL 8" VALVE, PIPING AND HYDRANT TO THE EAST FROM STA. 40+00 TO STA. 43+48.
 - B. SET 8"x6" TEE AND FIRE HYDRANT AT STA. 43+44.
 - C. INSTALL 8" PLUG IN EAST RUN OF TEE.
3. INSTALL 42" CASING PIPE BY OPEN CUT UNDER THE PROPOSED JUG HANDLE ROAD FROM STA. 18+57 TO STA. 20+92.
4. SET 24"x8" TEE AT STA. 16+07 (E. OLIVE ST.)
 - A. INSTALL 8" PIPING AND HYDRANT TO THE EAST.
 - B. SET 8"x6" TEE AND FIRE HYDRANT 40.5 FT.
 - C. INSTALL 8" PLUG IN EAST RUN OF TEE.
5. SET 24"x24" TEE AT STA. 13+52.
6. INSTALL 42" CASING PIPE BY OPEN CUT UNDER PROPOSED RETAINING WALL.
7. INSTALL 24" VALVE AT STA. 13+52, RT 5.1 FT.
8. SET 24"x6" TEE AT STA. 13+52, RT 11.8 FT AND INSTALL 6" VALVE AND FIRE HYDRANT.
9. INSTALL PERMANENT CAP AT STA. 13+52, RT 16.9 FT.
10. LAY 24" PIPE AND FITTINGS TO THE WEST.
11. INSTALL PIPING AND FITTINGS BETWEEN STA. 13+52 AND 10+00, INCLUDING INSTALLATION OF CONNECTION NO. 7 (PRESSURE CONNECTION WITH EXISTING 24" WATER MAIN)
12. FLUSH, PRESSURE TEST AND DISINFECT.
 - A. 24" WATER MAIN SHALL BE FLUSHED TO THE PROPOSED STORM SEWER DRAIN SYSTEM LOCATED ON FARIES PARKWAY (STRUCTURE I.D. 209 OR OTHER SUITABLE LOCATION). REFER TO DRAINAGE SHEETS FOR ADDITIONAL DETAIL. PROVIDE TRAFFIC CONTROL ON FARIES PARKWAY AS NEEDED FOR THE FLUSHING OPERATION AND TO MAINTAIN TRAFFIC OPERATIONS. PROVIDE ALL TEMPORARY PIPING, VALVES, AND APPURTENANCES NEEDED TO PERFORM THIS FLUSHING OPERATION. FOR FLUSHING THE 8" LOGAN STREET WATER MAIN, CONTRACTOR SHALL INSTALL TEMPORARY PIPING AND FLUSH TO THE PROPOSED E. FARIES PARKWAY DRAINAGE SYSTEM TO THE NORTH. FOR FLUSHING THE 8" OLIVE STREET WATER MAIN, CONTRACTOR SHALL UTILIZE THE EXISTING GREEN SPACE TO THE SOUTH OF OLIVE STREET, BUT SHALL PROVIDE ENERGY DISSIPATION, TEMPORARY TANKS, AND/OR SILT FENCE AS NEEDED TO PREVENT FLOODING.
 - B. TEMPORARY FLUSHING PIPING SHALL BE THE SAME SIZE AS THE WATER MAIN BEING FLUSHED.
 - C. THE CONTRACTOR'S ATTENTION IS CALLED TO THE CITY'S REQUIREMENT FOR UTILIZING PIGS FOR THE FLUSHING OPERATIONS. REFER TO THE SPECIAL PROVISIONS FOR ADDITIONAL DETAILS.


13. INSTALL CONNECTION NO. 8 (SLEEVED CONNECTION) TO THE PROPOSED VALVE AT STA. 24+25.
14. OPEN THE FOLLOWING VALVES TO PLACE THE WATER DISTRIBUTION SYSTEM BACK INTO COMPLETE SERVICE.
 - A. V026-011
 - B. PROPOSED VALVE AT STA. 24+25
 - C. PROPOSED VALVE AT STA. 34+82

PHASE 5

1. CLOSE VALVES V163-004 AND V163-005
 - A. INSTALL TWO (2) PERMANENT CAPS ON EXISTING 8" WATER MAIN IN W. HARRISON AVE. (WEST OF BRUSH COLLEGE RD.), JUST EAST OF EXISTING FIRE HYDRANT.
 - B. ABANDON EXISTING 8" WATER MAIN ALONG WEST HARRISON AVE.
 - C. OPEN VALVE V163-004.
 - D. THIS 8" WATER MAIN ABANDONMENT WORK CAN BE PERFORMED AT ANY POINT DURING THE CONSTRUCTION SEQUENCING.
2. INSTALL LINE STOP NO. 2 IN BRUSH COLLEGE RD., JUST NORTH OF E. HARRISON AVE. (SEE WATER MAIN KEY MAP PLAN VIEW NO. 5 FOR LOCATION). THE EXISTING 24" WATER MAIN SHALL NOT BE SHUT DOWN FOR LONGER THAN 12 HOURS. ALL WORK SHALL BE COORDINATED WITH THE CITY OF DECATUR AND PERFORMED ONLY AT APPROVED TIMES, WHICH MAY INCLUDE WEEKENDS AND/OR OVERNIGHT WORK.
 - A. CLOSE VALVE V026-011.
 - B. CLOSE THE PROPOSED VALVE AT STA. 34+82.
 - C. CLOSE THE PROPOSED VALVE (I.E. FOR THE PRESSURE CONNECTION) AT STA. 10+00.
 - D. WITHIN THE SAME SHUT DOWN PERIOD, INSTALL A PERMANENT CAP ON THE EXISTING 24" WATER MAIN BOTH JUST NORTH OF CONNECTION NO. 7 AND JUST SOUTH OF CONNECTION NO. 1.
 - E. ABANDON EXISTING 24" WATER MAIN ALONG BRUSH COLLEGE RD.
3. OPEN PREVIOUSLY CLOSED VALVES. REMOVE LINE STOP AND PLACE WATER DISTRIBUTION SYSTEM BACK INTO COMPLETE SERVICE.

PHASE 6

1. FIRE HYDRANT RELOCATIONS ALONG FARIES PARKWAY (NOT SHOWN IN THE WATER MAIN PHASING PLAN SHEETS) SHALL BE PERFORMED IN CONJUNCTION WITH ROADWAY CONSTRUCTION WORK OR AS NEEDED FOR CONSTRUCTION.

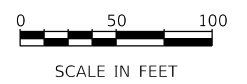

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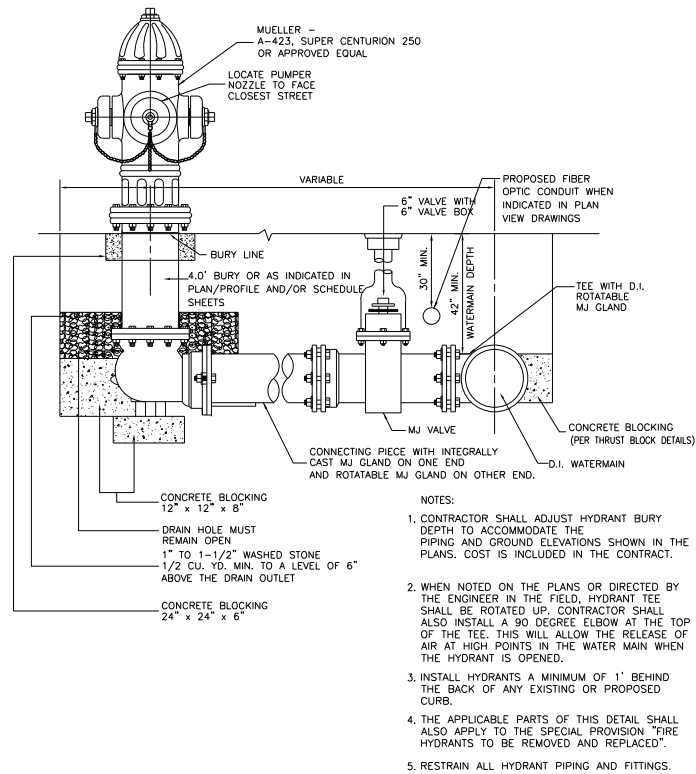
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PLOT DATE = 10/27/2021	DATE - 10/22/2021	REVISED -

**STATE OF ILLINOIS
DEPARTMENT OF TRANSPORTATION**


WATER MAIN RELOCATION PLAN AND SANITARY SEWER ADJUSTMENTS		
WATER MAIN PHASING PLAN SOUTH		
SCALE: 1"=50'	SHEET 27 OF 31 SHEETS	STA. N/A TO STA. N/A

F.A.U. RTE. 7448	SECTION 09-00933-01-BR	COUNTY MACON	TOTAL SHEETS 1019	SHEET NO. 539
CONTRACT NO. 95893				
		ILLINOIS FED. AID PROJECT		


FIRE HYDRANT WITH AUXILIARY VALVE AND VALVE BOX



CONCRETE THRUST BLOCKS (SPECIAL) - 4" TO 10"

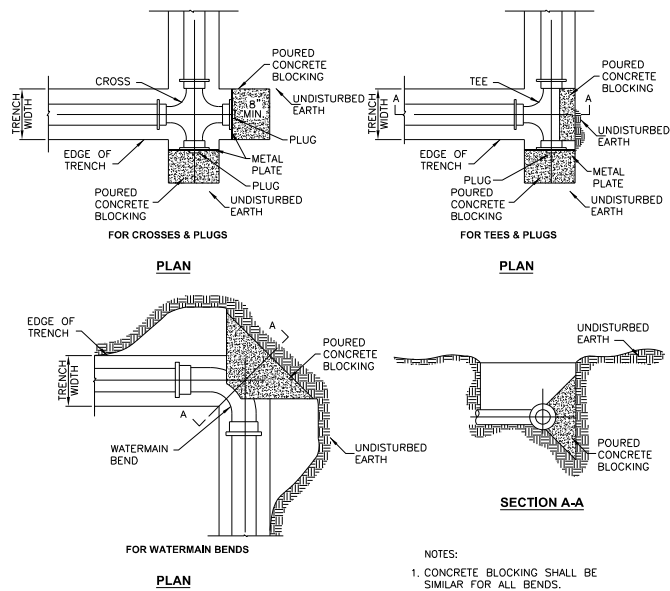

CONCRETE THRUST BLOCKS (SPECIAL) - 12" TO 42"

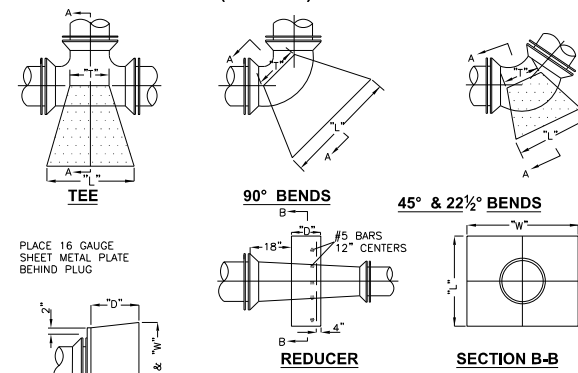


- NOTES:**
- DEPTH "D" MAY BE GREATER THAN SPECIFIED TO ALLOW WORKING SPACE. BLOCK MUST BE POURED AGAINST UNDISTURBED EARTH.
 - POURED BLOCKING NOT TO HINDER REMOVAL OR INSTALLATION OF BOLTS ON MJ FITTINGS.



		BLOCKING DIMENSION							
		12"	16"	20"	24"	30"	36"	42"	
TEE	D	6"	8"	12"	20"	30"	36"	44"	
	L	24"	32"	50"	62"	84"	96"	114"	
	W	24"	32"	40"	48"	60"	80"	120"	
	T	18"	22"	27"	32"	34"	36"	36"	
BENDS	D	10"	15"	54"	66"	*	*	*	
	L	34"	54"	108"	120"	*	*	*	
	H	36"	54"	48"	60"	*	*	*	
	C	14"	18"	60"	72"	*	*	*	
REDUCERS	D	8"	8"	12"	18"	20"	24"		
	L	26"	36"	48"	60"	63"	66"		
	W	20"	36"	36"	42"	48"	60"		
	T	8"	22"	24"	32"	32"	33"		
PLUG	D	8"	8"	12"	10"	20"	24"		
	L	26"	36"	48"	42"	63"	66"		
	H	20"	36"	36"	36"	48"	60"		
	C	8"	22"	24"	24"	32"	33"		
REDUCER	SIZE	42"x36"	36"x30"	36"x24"	30"x24"	30"x18"			
	D	12"	12"	12"	12"	12"			
	L	72"	48"	60"	42"	48"			
	W	72"	48"	60"	42"	48"			

*TO BE DESIGNED BY CONTRACTOR
**AND ALL REDUCERS SMALLER THAN 30"x16"

WATER VALVES AND VALVE BOX 12" AND SMALLER

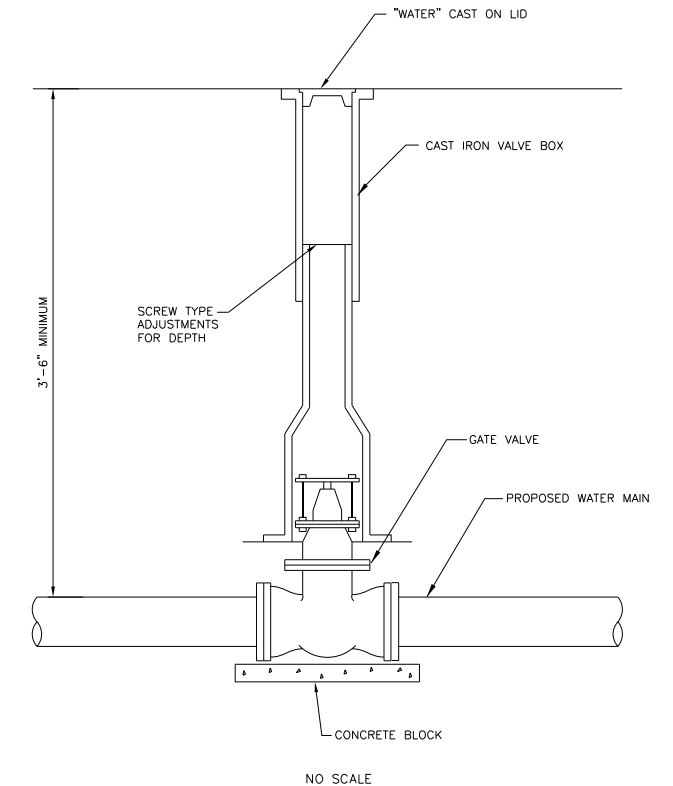

WATER VALVES AND VALVE BOX 16" AND LARGER

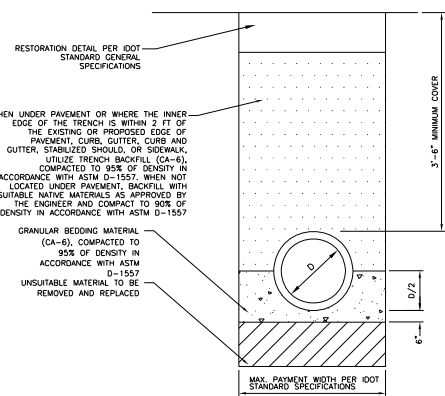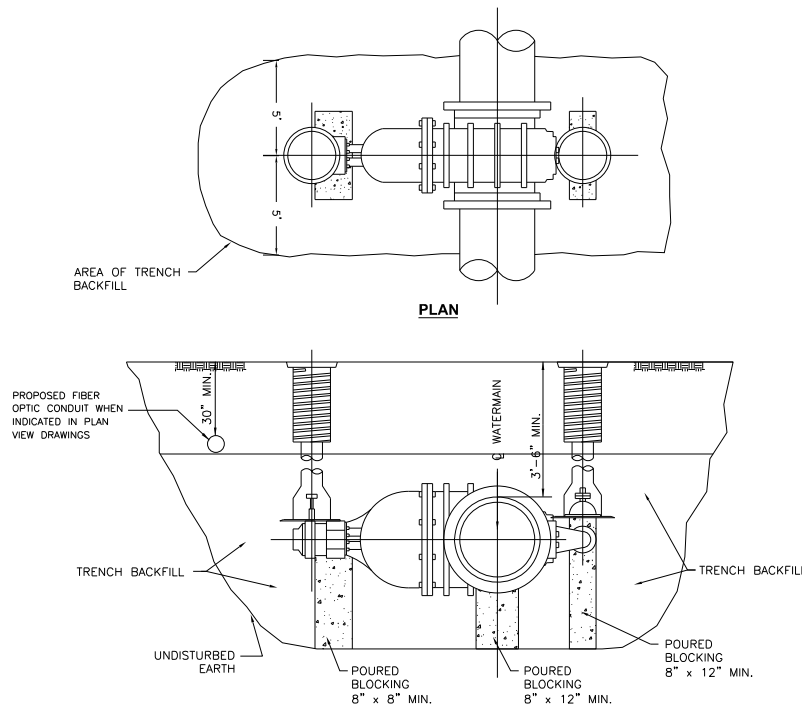


TYPICAL WATER MAIN TRENCH CROSS SECTION

NO SCALE

NOTES:

- TYPICAL WATER MAIN TRENCH CROSS SECTION SHALL APPLY TO DUCTILE IRON WATER MAIN AND OPEN CUT STEEL CASINGS.
- BETWEEN STA. 24+30 AND 30+55 (APPROX.), INSTALL FIBER OPTIC CONDUIT A MIN. HORIZONTAL DISTANCE OF 18" FROM THE PROPOSED 24" DIA. AND 30" DIA. WATER MAINS (AS MEASURED FROM OD TO OD). STANDARD BURY DEPTH SHALL BE 30"-36", AND SHALL BE A MINIMUM OF 6" ABOVE THE TOP OF THE PROPOSED 24" AND 30" DIA. WATER MAINS. THE FOLLOWING EXCEPTIONS SHALL APPLY:
A. WHEN INSTALLED INSIDE THE PROPOSED 48" DIAMETER CASING PIPE.
B. WHEN THE PROPOSED WATER MAIN HAS ONLY 36-INCHES OF BURY DEPTH (SEE WATER MAIN STATION 24+55 TO 24+70, APPROX.), IN WHICH CASE THE 4" HDPE CONDUIT IS PERMITTED TO BE INSTALLED AT APPROXIMATELY THE SAME ELEVATION AS THE PROPOSED WATER MAIN.

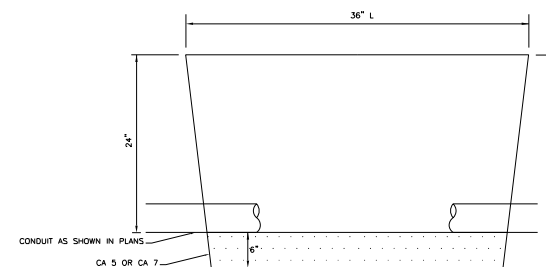

COMMUNICATIONS VAULT

NO SCALE

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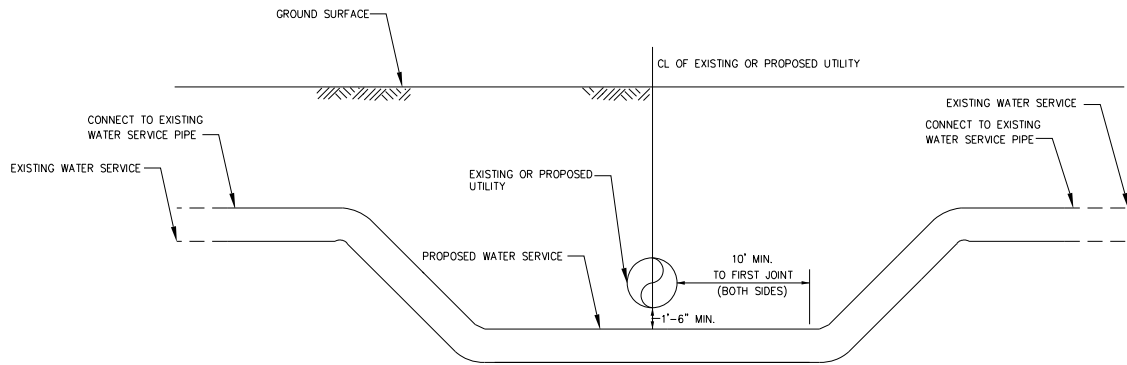
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	DATE - 10/22/2021	REVISED -

**STATE OF ILLINOIS
DEPARTMENT OF TRANSPORTATION**

WATER MAIN RELOCATION PLAN AND SANITARY SEWER ADJUSTMENTS				
DETAIL SHEET 1				
SCALE: NTS	SHEET 28	OF 31 SHEETS	STA. N/A	TO STA. N/A


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CONTRACT NO. 95893				
ILLINOIS FED. AID PROJECT				

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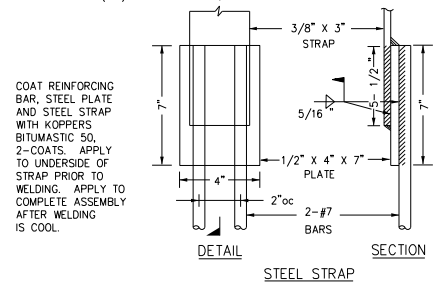
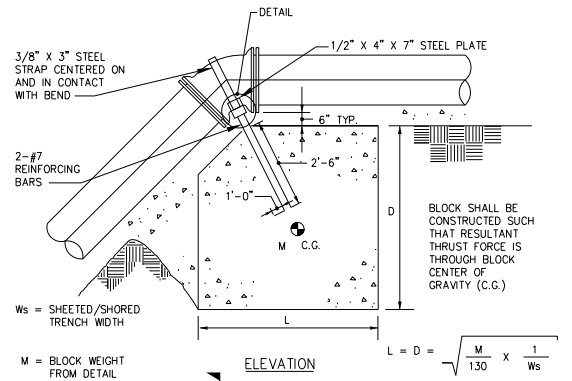
WATER SERVICE LINE RELOCATED
 NTS

NOTES:
 1. SEWER SHALL BE WATER MAIN QUALITY PIPE MATERIAL (OR RCP PIPE WITH GASKETS MEETING ASTM C361 OR C443), ALL IN ACCORDANCE WITH IEPA WATER/SEWER SEPARATION REQUIREMENTS.
 2. PROVIDE ALL REQUIRED COUPLINGS, UNIONS, BENDS, FITTINGS, REDUCERS, AND APPURTENANCES REQUIRED FOR CONSTRUCTION.





REMOVE AND RELOCATE WATER MAIN
 NTS

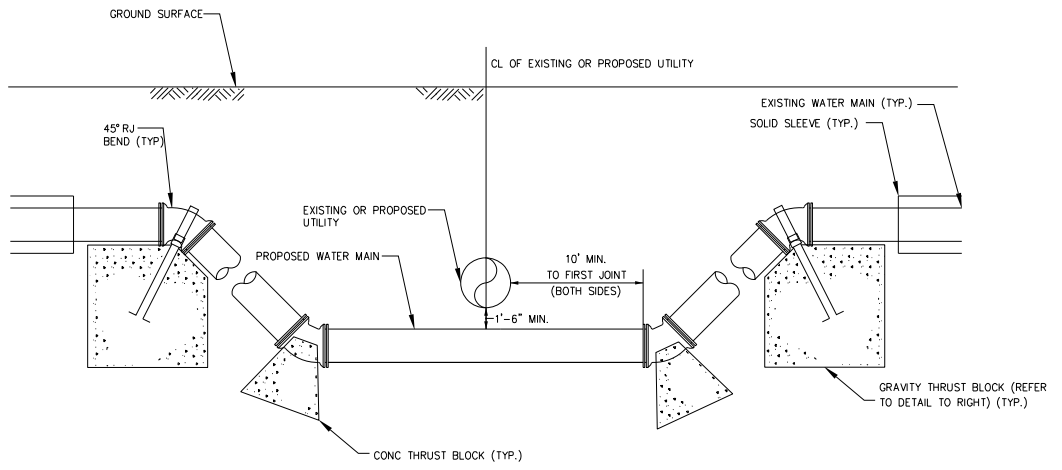NOTES:
 1. SEWER SHALL BE WATER MAIN QUALITY PIPE MATERIAL (OR RCP PIPE WITH GASKETS MEETING ASTM C361 OR C443), ALL IN ACCORDANCE WITH IEPA WATER/SEWER SEPARATION REQUIREMENTS.



CONCRETE GRAVITY THRUST BLOCK
 NTS

MANHOLES, SANITARY, 4' DIAMETER, TYPE 1 FRAME, CLOSED LID




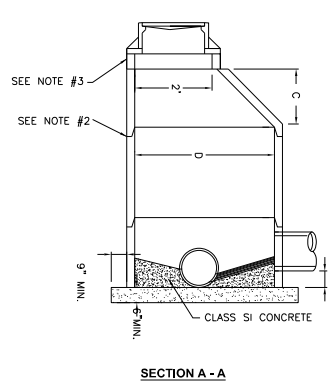
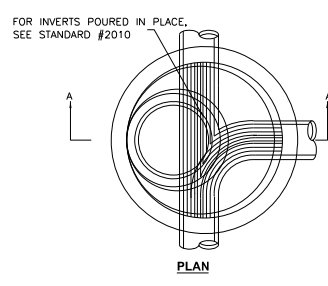


SANITARY SEWER NOTES:
 1. FOR VERTICAL SEPARATIONS GREATER THAN 2' USE DROP STACK, STANDARD 2030.
GENERAL NOTES:
 1. PRECAST MANHOLE SECTIONS ARE REQUIRED. POURED IN PLACE MANHOLES MUST BE APPROVED IN WRITING BY THE CITY ENGINEER.
 2. ALL MASONRY JOINTS IN THE STRUCTURE SHALL BE SEALED USING PERMAGUM ROPE MASTIC OR APPROVED EQUAL. ADJUSTING RINGS AND THE CASTING SHALL BE SEALED USING 2 LOOPS OF 3/4\"/>

ALTERNATE MATERIALS FOR WALLS	D	C*	T (MIN.)
PRECAST REINFORCED CONCRETE RISERS	4'-0"	2'-6"	4"
	5'-0"	3'-9"	5"
MONOLITHIC CONCRETE	4'-0"	2'-6"	6"
	5'-0"	3'-9"	6"




*WHEN USING PRECAST REINFORCED CONCRETE RISERS, DIMENSION "C" MAY VARY FROM THAT GIVEN TO PLUS 6 INCHES.

SANITARY FRAME AND LIDS TYPE 1

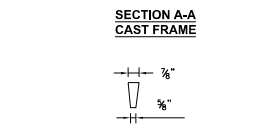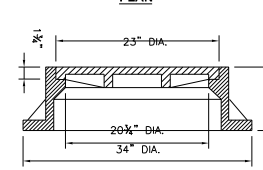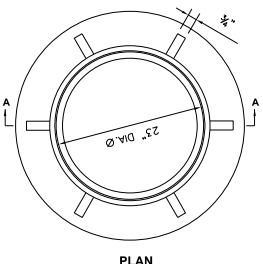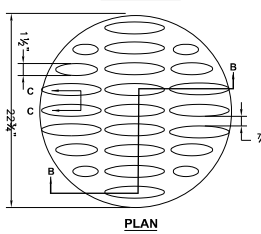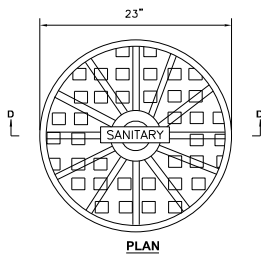

NOTES:
 1. THE OPEN AND CLOSED LIDS MAY BE MADE OF EITHER GRAY IRON OR DUCTILE IRON.
 2. CLOSED LID SHALL HAVE CONCEALED PICKHOLE.
 3. CLOSED LID SHALL BE GASKETED IF INSTALLATION IS FOR A SEPARATE SANITARY SEWER.
 4. THE LID SHALL BE CAST "STORM" IF INSTALLATION IS FOR A SEPARATE STORM SEWER.
 5. THE LID SHALL BE CAST "SANITARY" IF INSTALLATION IS FOR A SEPARATE SANITARY SEWER OR COMBINATION SEWERS, UNLESS OTHERWISE SPECIFIED OR NOTED.
 6. THE LID SHALL BE CAST "COMBINED" IF INSTALLATION IS FOR A COMBINED SEWER.

DROP STACK MANHOLE

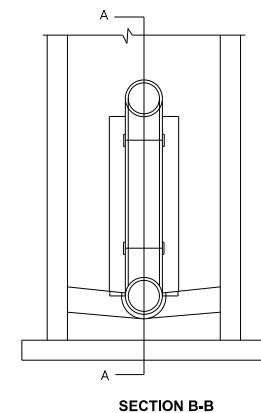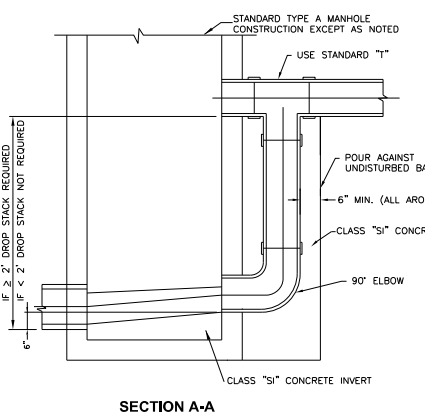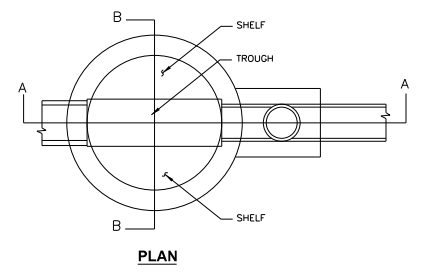

NOTES:
 1. ENTIRE EXCAVATION TO BE BACKFILLED WITH TRENCH BACKFILL MATERIAL, IF ANY EDGE OF EXCAVATION IS WITHIN 2' OF ANY PAVED SURFACE.
 2. BACKFILL AROUND PIPE SHALL BE IN ACCORDANCE IBOT STANDARDS.
 3. POURED CONCRETE AROUND DROP STACK PIPE WILL NOT BE REQUIRED IF DROP STACK IS PRECAST WITH MANHOLE.
 4. TO BE USED IN PLACE OF SANITARY MANHOLE WHERE SEWER ENTERS 2'-0" OR MORE ABOVE LOWEST INVERT, NOT TO BE USED FOR INLET OR CATCH BASIN CONNECTIONS.
 5. THIS DETAIL APPLIES TO INCOMING SEWER OF 18" DIAMETER OR LESS.
 6. FOR INCOMING SEWER SMALLER THAN 12" USE VERTICAL PIPE OF SAME DIAMETER. FOR INCOMING SEWER 12" OR GREATER, USE 12" VERTICAL PIPE.

VERTICAL BEND CONCRETE GRAVITY BLOCKS		
TABLE OF MINIMUM BLOCK WEIGHTS IN POUNDS		
PIPE SIZE	BEND	PRESSURE 150 psi
4"/6"	45°	4,300
	22 1/2°	2,300
8"	45°	7,500
	22 1/2°	3,900
12"	45°	16,300
	22 1/2°	8,600
16"	45°	28,800
	22 1/2°	15,200
20"	45°	44,800
	22 1/2°	23,700

NOTES:
 1. FOR PIPES EQUAL TO OR GREATER THAN 24", CONTRACTOR SHALL DESIGN AND INSTALL THRUST RESTRAINT AND THRUST RESTRAINT SYSTEM.
 2. BLOCK WEIGHTS ARE VALID ONLY FOR GRAVITY BLOCKS WHICH ARE ALWAYS ABOVE THE GROUND WATER LEVEL.
 3. USE BLOCK WEIGHT FOR 22 1/2° BEND FOR FITTINGS LESS THAN 22 1/2° VERTICAL.

STRUCTURAL NOTES

FOR ALL WATER MAIN AND SANITARY SEWER SPECIAL PROVISIONS, CONTRACTOR SHALL MEET OR EXCEED THE FOLLOWING REQUIREMENTS:
 1. ALL EXCAVATION FOR STRUCTURES SHALL BE KEPT Dewatered DURING CONSTRUCTION OPERATIONS UNTIL BACKFILL IS IN PLACE. PROVISIONS SHALL BE MADE TO PREVENT THE BOTTOM OF ALL EXCAVATIONS FROM FREEZING OR FLOODING AT ALL TIMES.
 2. ALL CONCRETE SLABS SUPPORTED ON SOIL SHALL BE PROTECTED AGAINST FROST ACTION AND DANGER FROM HEAVING BY INSULATING THE SLAB WITH A LAYER OF INSULATING MATERIAL THICK ENOUGH TO PREVENT FROST PENETRATION.
 3. BACKFILL MATERIAL PLACING AND COMPACTION OF BACKFILL SHALL BE IN ACCORDANCE WITH THE CONTRACT DRAWINGS AND SPECIFICATIONS. PLACE BACKFILL EQUALLY ON BOTH SIDES OF FOUNDATION WALLS AND STRUCTURES.
 4. ALL DIMENSIONS AND ELEVATIONS SHOWN TO EXISTING CONSTRUCTION AND ALL EXISTING CONDITIONS SHALL BE ASSUMED TO BE (±) AND SHALL BE VERIFIED BY THE CONTRACTOR PRIOR TO FABRICATION OF MATERIAL. THE CONTRACTOR SHALL VISIT THE SITE AND FAMILIARIZE HIMSELF WITH ALL EXISTING CONDITIONS PRIOR TO BIDDING THE WORK.
 5. CONTRACTOR SHALL BE RESPONSIBLE FOR THE DESIGN AND INSTALLATION OF ALL TEMPORARY CONSTRUCTION REQUIRED FOR, BUT NOT LIMITED TO, SHEETING, SHORING, UNDERPINNING, NEEDLING AND BRACING, FOR THE PROTECTION OF THE EXISTING STRUCTURES, UTILITIES AND ROADWAYS TO REMAIN WHETHER OR NOT SHOWN ON THE CONTRACT DRAWINGS. THE CONTRACTOR SHALL PROVIDE ALL MEASURES AND PRECAUTIONS NECESSARY TO PREVENT DAMAGE, SETTLEMENT OR MOVEMENT OF EXISTING AND NEW CONSTRUCTION INSIDE AND OUTSIDE OF THE PROJECT LIMITS DURING EXCAVATION AND CONSTRUCTION. ANY DAMAGE TO NEW OR EXISTING CONSTRUCTION INSIDE OR OUTSIDE OF THE PROJECT LIMITS, CAUSED BY CONSTRUCTION TECHNIQUES OR MOVEMENTS OF THE SOIL OR STRUCTURE RETENTION SYSTEM, IS THE RESPONSIBILITY OF THE CONTRACTOR. CONTRACTOR SHALL ALSO PROVIDE ALL NECESSARY MATERIALS, LABOR, AND EQUIPMENT TO MEET RAILROAD REQUIREMENTS FOR SHEETING AND/OR SHORING.
 6. (*) - DIMENSIONS NOTED THUS INDICATE DIMENSIONS TO BE DETERMINED BY EQUIPMENT MANUFACTURER OR DIMENSIONS TO BE VERIFIED IN FIELD BASED ON EXISTING CONSTRUCTION.





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	DATE - 10/22/2021	REVISED -

**STATE OF ILLINOIS
 DEPARTMENT OF TRANSPORTATION**

WATER MAIN RELOCATION PLAN AND SANITARY SEWER ADJUSTMENTS
DETAIL SHEET 2
 SCALE: NTS SHEET 29 OF 31 SHEETS STA. N/A TO STA. N/A

F.A.U. RTE.	SECTION	COUNTY	TOTAL SHEETS	SHEET NO.
7448	09-00933-01-BR	MACON	1019	541
CONTRACT NO. 95893				
ILLINOIS FED. AID PROJECT				

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DETAIL OF PIPE INSTALLED IN CASING PIPE UNDER RAILROAD (INSTALLED BY JACKING AND BORING)
 NTS

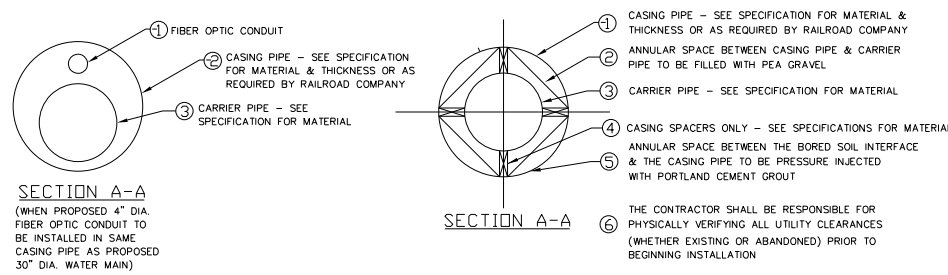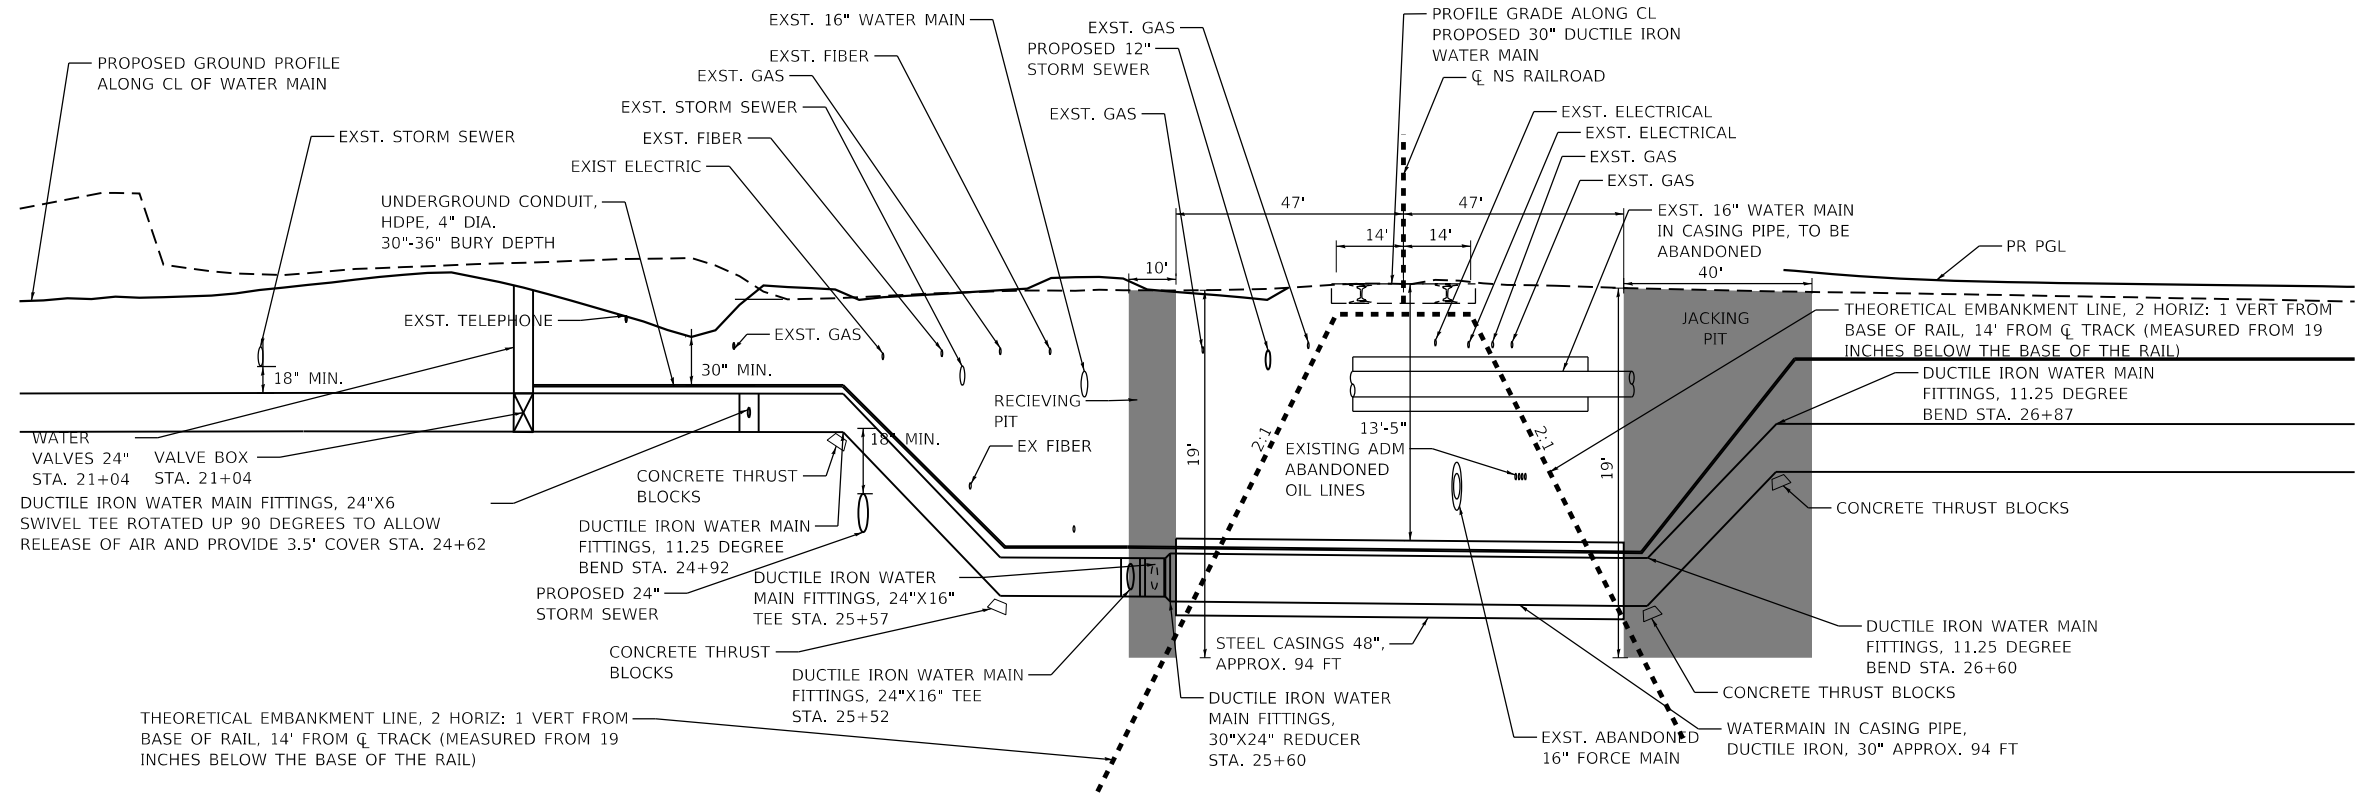

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	DRAWN - BNH	REVISED -
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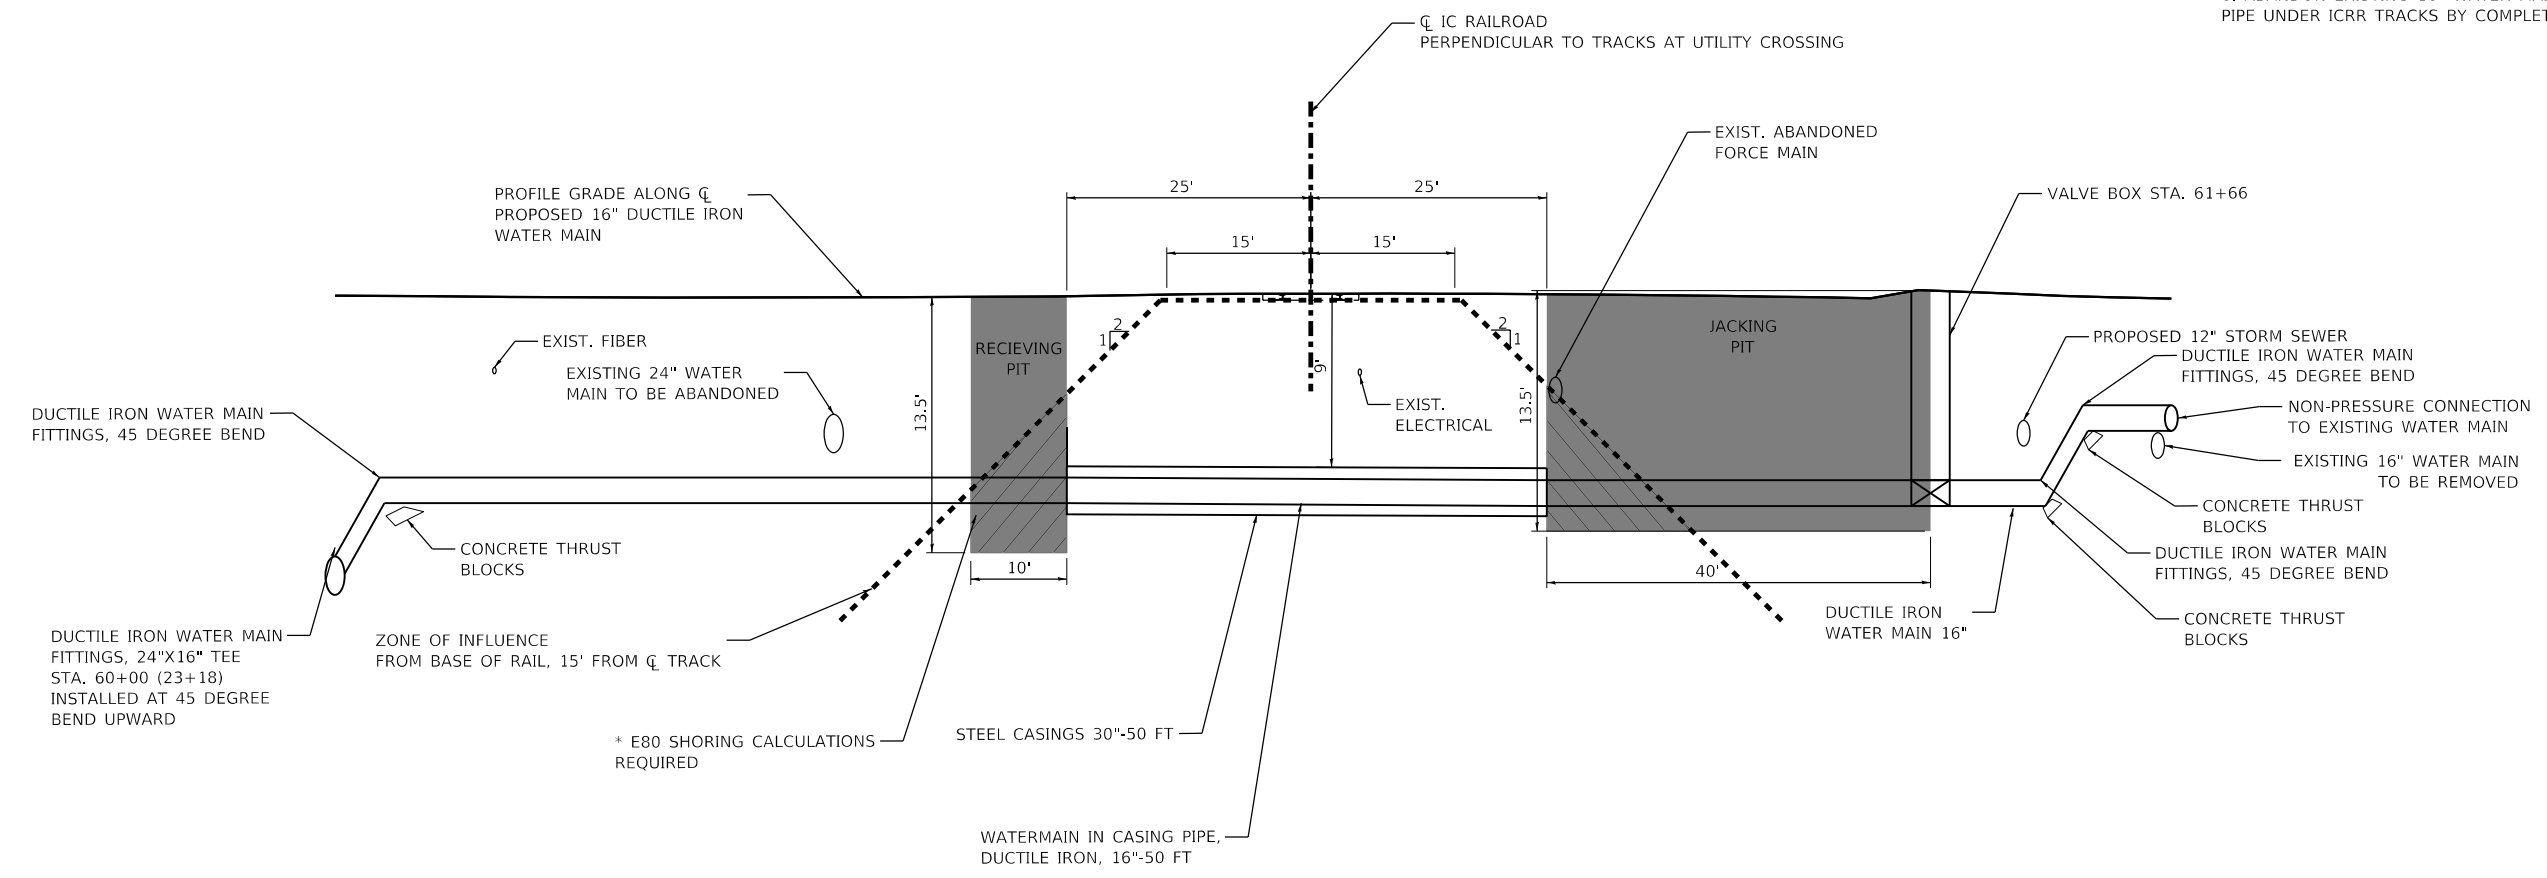
STATE OF ILLINOIS
 DEPARTMENT OF TRANSPORTATION

WATER MAIN RELOCATION PLAN AND SANITARY SEWER ADJUSTMENTS
 DETAIL SHEET 3 - NS RAILROAD CROSSING
 SCALE: NTS SHEET 30 OF 31 SHEETS STA. N/A TO STA. N/A

F.A.U. RTE.	SECTION	COUNTY	TOTAL SHEETS	SHEET NO.
7448	09-00933-01-BR	MACON	1019	542
CONTRACT NO. 95893				
ILLINOIS FED. AID PROJECT				

NOTES



1. CARRIER PIPE WILL BE HELD CLEAR OF THE CASING PIPE BY SUPPORTS (STAINLESS STEEL SPACER AS SPECIFIED IN THE SPECIAL PROVISIONS).
2. CASING WILL BE SEALED WITH CONCRETE BRICK AND MORTAR.
3. INSTALL UTILITY WARNING MARKER ON NORTH SIDE OF FARRIES IN PARKWAY (SEE DETAIL BELOW).
4. MAXIMUM TEST PRESSURE OF WATER MAIN (CARRIER PIPE) IS 110 PSI.
5. SLOPE CASING PIPE AT 0.3%.
6. ABANDON EXISTING 16" WATER MAIN IN CASING PIPE UNDER ICRR TRACKS BY COMPLETELY FILLING WITH CLSM.



SECTION A-A
LOOKING SOUTH

RAILROAD CROSSING PROFILE DETAILS

DETAIL OF CASING PIPE INSTALLED BY DRY JACK AND BORING UNDER RAILROAD TRACKS
NTS

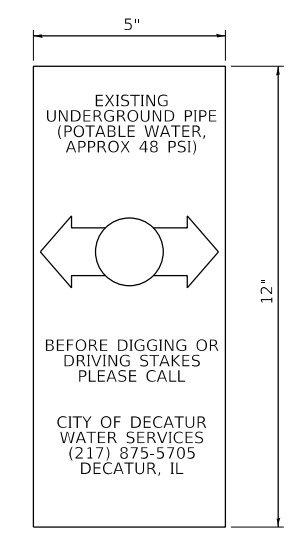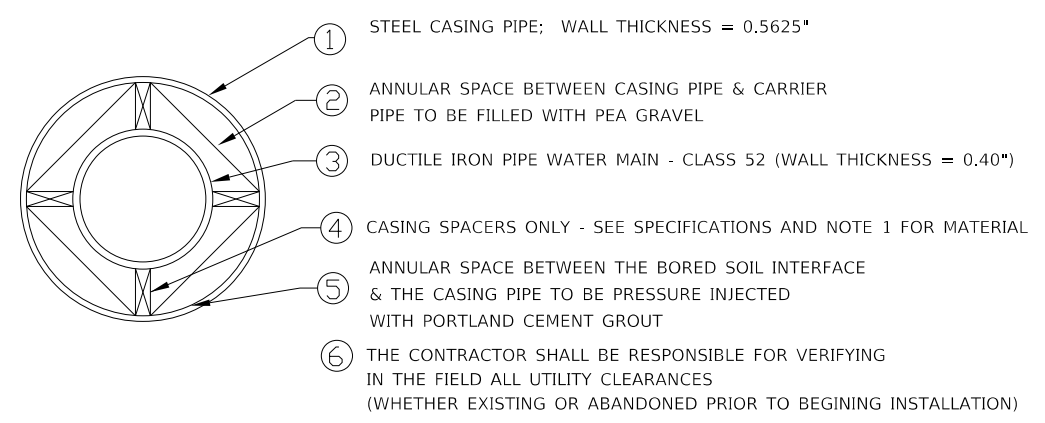

CABLE ROUTE MUST BE MARKED AT EDGE OF RIGHT OF WAY WHERE CABLE ENTERS OR LEAVES RAILROAD PROPERTY. IN CASES OF PARALLEL CABLE ROUTE, SIGNS AS INDICATED IN FIGURE 1 ON THIS EXHIBIT WILL BE PLACED APPROXIMATELY EVERY 200 FEET. SIGNS TO BE OF A PERMANENT VERTICAL TYPE, NOT SMALLER THAN 5 INCHES WIDE BE 12 INCHES HEIGHT. YELLOW BACKGROUND WITH BOLD BLACK LETTERING, SIGNS TO BE MOUNTED ON METAL POSTS OR AS OTHERWISE AGREED TO AT A HEIGHT OF 3 FEET ABOVE GROUND LEVEL.

MARKING OF UTILITIES ON RAILROAD RIGHT-OF-WAY
NTS

MODEL: Default
FILE NAME: p:\aecom\m-pw\henley.com\AECOM_051\NA\Documents\60603202-Brush_College\006-CAD_GIS\910_CAD\03_SHEETS\01_AECOM\Watermain\60603202_SHT_Detail_Sheets_ICRR.dgn

	USER NAME = brooke.henry	DESIGNED - BNH	REVISED -	STATE OF ILLINOIS DEPARTMENT OF TRANSPORTATION	WATER MAIN RELOCATION PLAN AND SANITARY SEWER ADJUSTMENTS DETAIL SHEET 4 - IC RAILROAD CROSSING	F.A.U. RTE. = 7448	SECTION = 09-00933-01-BR	COUNTY = MACON	TOTAL SHEETS = 1019	SHEET NO. = 543
	PLOT SCALE = 20.0000' / in.	CHECKED - RB	REVISED -			SCALE: 1"=10'	SHEET 31 OF 31 SHEETS	STA. N/A TO STA. N/A	CONTRACT NO. 95893	
345 EAST ASH AVENUE DECATUR, IL 62526 PHONE: (217) 775-9065	PLOT DATE = 10/27/2021	DATE = 10/22/2021	REVISED -							

PAVEMENT MARKING SCHEDULE

SHEET	ROAD	STATION	STATION	SQ FT	FOOT	FOOT	FOOT	FOOT	FOOT	SQ FT	FOOT	FOOT	FOOT	FOOT	FOOT	EACH	EACH	FOOT	COMMENTS
				MOD URETH PW LTR-SYM	MOD URETH PW LINE 4	MOD URETH PW LINE 6	MOD URETH PW LINE 8	MOD URETH PW LINE 12	MOD URETH PW LINE 24	GRV RCSD PW LTR & SYM	GRV RCSD PVT MRKG 5	GRV RCSD PVT MRKG 7	GRV RCSD PVT MRKG 9	GRV RCSD PVT MRKG 13	GRV RCSD PVT MRKG 26	RAISED REFL PAVT MKR	CURB REFLECTORS	PAINT CURB	
1	BRUSH	46+59.44	52+00.00		2,082	38		41			2,082	38		41		35			
2		52+00.00	57+75.00	110	1,504	812	206	37	72	305	1,504	812	206	37	72	19	33	287	
3		57+75.00	62+50.00	73	2,463	643		98		210	2,463	643		98		22	14	52	
4		62+50.00	68+00.00		2,800	276			101		2,800	276		101		42	15	52	
5		68+00.00	73+50.00	63	1,289	269		240		208	1,289	269		240		28	7	63	
6		73+50.00	75+44.21	32	485	97				104	485	97				16			
6		75+44.21	84+56.00	110	1,814	624				364	1,814	624				69			REPLACEMENT STRIPING FOR MOT IMPACTED AREAS
7 & 8		200+32.00	208+90.03		457	563					457	563				22			REPLACEMENT STRIPING FOR MOT IMPACTED AREAS
7	FARIES	205+18.73	208+00.00		474	59				474	59				3	30	129	205+18.73 RT & 208+90.03 LT	
8		208+00.00	213+25.00	282	1,012	284	4		144	384	1,012	284	4	144	11	30	53		
9		213+25.00	219+00.00	146	936	1,476	168	51	88	407	936	1,476	168	51	88	30	36	170	
10		219+00.00	224+75.00	146	932	688				407	932	688				17	47	95	
11		224+75.00	230+50.00	120	1,237	328		28		315	1,237	328		28		23	32	78	
12		230+50.00	235+41.47	37	1,859	177		283		102	1,859	177		283		58			
12		235+41.47	239+99.00	73	1,068	305		128		204	1,068	305		128		26			REPLACEMENT STRIPING FOR MOT IMPACTED AREAS
13		JUG	301+75.00	306+50.00	401	1,340	1,291	377	1,122	98	1,124	1,340	1,291	377	1,122	98	21	174	985
14	LOGAN	601+50.00	607+50.00		1,654	128		22	28		1,654	128		22	28		18	112	INCLUDES CONNECTOR RD & N JAMES ST INTERSECTIONS
15	JAMES	404+27.90	407+75.00	37	1,228	143		421	70	102	1,228	143		421	70				INCLUDES FARIES PKWY INTERSECTION
16	HARRISON W	800+00.00	804+50.00		782						782								
17		804+50.00	808+00.00	62	1,512				73	71	1,512				73				INCLUDES BRUSH COLLEGE RD INTERSECTION & BUSINESS DRIVES
18	HARRISON E	701+00.00	705+00.00		874						874				19				INCLUDES BRUSH COLLEGE RD INTERSECTION
19		705+00.00	708+41.73		684						684								
19	CEMETERY	900+00.00	904+52.12						25					25					
TOTAL				1,692	28,486	8,201	755	2,572	617	4,307	28,486	8,201	755	2,572	617	442	436	2,077	

TERMINAL MARKER SCHEDULE

SHEET	ROAD	STATION	STATION	STA	LOC	TYPE	DESCRIPTION	W (INCH)	H (INCH)	EACH	COMMENTS
3	BRUSH	57+75.00	62+50.00	58+43.7	RT	DIRECT APPLIED	TERMINAL MARKER	VARIABLES	VARIABLES	1.0	GUARDRAIL
5		68+00.00	73+50.00	69+87.8	LT	DIRECT APPLIED	TERMINAL MARKER	VARIABLES	VARIABLES	1.0	GUARDRAIL
TOTAL										2.0	

SIGNING SCHEDULE

SHEET	ROAD	STATION	STATION	STA	LOC	TYPE	DESCRIPTION	W (INCH)	H (INCH)	SIGN PANEL T1	SIGN PANEL T2	TELES STL SIN SUPPORT	COMMENTS		
1	BRUSH	46+59.44	52+00.00	51+95.0	RT	D3-2	ADVANCE STREET NAMES (2 LINES)	60	30	-	12.5	31.0	FARIES PKWY NEXT RIGHT - TWO POSTS		
2				52+00.00	57+75.00	54+33.6	RT	D1-1d	CIRCULAR INTERSECTION DESTINATION (1 LINE)	78	18	-	9.8	32.0	FARIES PKWY (RIGHT ARROW) - TWO POSTS
		54+94.5	LT			R3-24	ALL TURNS (RGHT ARROW)	72	18	9.0	-				
		56+24.2	LT			R4-7	KEEP RIGHT	24	30	5.0	-	16.0			
						R3-8	MODIFIED	30	30	6.3	-	16.0	DUAL LEFT TURN ONLY (BACK TO BACK)		
3		57+75.00	62+50.00	58+03.2	LT	R4-7	KEEP RIGHT	24	30	5.0	-				
				R3-8	MODIFIED	30	30	6.3	-	34.0	DUAL LEFT TURN ONLY - TWO POSTS				
				D1-1d	CIRCULAR INTERSECTION DESTINATION (1 LINE)	78	18	-	9.8		FARIES PKWY (LEFT ARROW)				
				59+00.0	RT	W4-2	LANE ENDS	36	36	9.0	-	18.0			
4		62+50.00	68+00.00	65+95.7	LT	OM4-2	OBJECT MARKER	18	18	2.3	-	16.0	AT THE END OF OLD E HARRISON AVE AND RR TRACK		
				66+03.1	LT	R11-1100	ROAD ENDS	36	30	7.5	-	16.0	AT THE END OF OLD E HARRISON AVE AND RR TRACK		
				66+10.6	LT	OM4-2	OBJECT MARKER	18	18	2.3	-	16.0	AT THE END OF OLD E HARRISON AVE AND RR TRACK		
				68+83.1	LT	R4-7	KEEP RIGHT	24	30	5.0	-	16.0			
				69+40.0	LT	W1-7	TWO-DIRECTION	48	24	8.0	-	30.0	TWO POSTS		
				71+68.9	RT	M1-6	COUNTY ROUTE SIGN	24	24	4.0	-	18.0	MACON CO 1		
				71+90.0	LT	R5-1101	BEGIN CLASS II TRUCK ROUTE	24	30	5.0	-				
				73+16.0	LT	R2-1	SPEED LIMIT	30	36	RELOC	-	16.0	RELOCATE - SPEED LIMIT, 35 MPH		
						D3-1	STREET NAME	60	9	3.8	-	15.0	N BRUSH COLLEGE RD		
						D3-1	STREET NAME	48	9	3.0	-		E HARRISON AVE		
SUB-TOTAL										81.3	32.0	290.0			



USER NAME = rjo
DESIGNED - LDC
DRAWN - RJO
CHECKED - LDC
DATE - 4/17/2023

REVISED -
REVISED -
REVISED -
REVISED -

STATE OF ILLINOIS
DEPARTMENT OF TRANSPORTATION

BRUSH COLLEGE ROAD & FARIES PARKWAY
PAVEMENT MARKING & SIGNING SCHEDULES

SCALE: SHEET 1 OF 3 SHEETS STA. TO STA.

F.A.U. RTE. SECTION COUNTY TOTAL SHEETS SHEET NO.
7448 09-00933-01-BR MACON 1019 544
CONTRACT NO. 95893
ILLINOIS FED. AID PROJECT

SIGNING SCHEDULE

SHEET	ROAD	STATION	STATION	STA	LOC	TYPE	DESCRIPTION	W (INCH)	H (NCH)	SQ FT	SQ FT	TELES STL SN SUPPORT	FOOT	COMMENTS
7		205+18.73	208+00.00	-	-	-	-	-	-	-	-	-	-	
8	FARIES	208+00.00	213+25.00	208+51.2	RT	W10-1	GRADE CROSSING ADVANCE WARNING	36 DIA.	-	7.1	-	-	16.0	RAILROAD
				209+56.0	RT	R8-10a	STOP HERE WHEN FLASHING	24	30	5.0	-	16.0		
				210+05.0	LT	R8-10a	STOP HERE WHEN FLASHING	24	30	5.0	-	16.0		
				210+75.8	RT	D3-2	ADVANCE STREET NAMES (2 LINES)	78	30	-	16.3	31.0	BRUSH COLLEGE RD NEXT RIGHT - TWO POSTS	
				211+52.9	LT	W10-1	GRADE CROSSING ADVANCE WARNING	36 DIA.	-	7.1	-	16.0	RAILROAD	
9	FARIES	213+25.00	219+00.00	213+95.6	RT	D1-1c	CIRCULAR INTERSECTION DESTINATION (1 LINE)	96	18	-	12.0	-	32.0	BRUSH COLLEGE RD (RIGHT ARROW) - TWO POSTS
				214+23.3	RT	R4-7	KEEP RIGHT	24	30	5.0	-	16.0		
				215+59.3	RT	R3-8	MODIFIED	30	30	6.3	-	16.0	DUAL LEFT TURN ONLY (BACK TO BACK)	
				218+42.4	RT	W4-2	LANE ENDS	36	36	9.0	-	18.0		
				219+74.6	LT	R3-8	MODIFIED	60	30	-	12.5	34.0	DUAL LEFT TURN ONLY & DUAL THRU LANE - TWO POSTS	
10	FARIES	219+00.00	224+75.00	222+50.0	LT	D1-1c	CIRCULAR INTERSECTION DESTINATION (1 LINE)	96	18	-	12.0	-	34.0	BRUSH COLLEGE RD (LEFT ARROW)
				223+00.0	LT	R2-1	SPEED LIMIT, 35 MPH	30	36	7.5	-	16.0		
				224+26.1	LT	R3-5L	LEFT TURN ONLY	30	36	7.5	-	16.0	BACK TO BACK	
				224+26.1	LT	R4-7	KEEP RIGHT	24	30	5.0	-	16.0	BACK TO BACK	
				224+26.1	LT	R3-5L	LEFT TURN ONLY	30	36	7.5	-	16.0	BACK TO BACK	
11		224+75.00	230+50.00	226+40.0	LT	W9-1	LEFT LANE ENDS	36	36	9.0	-	18.0		
12		230+50.00	235+41.47	234+00.0	LT	R8-3	NO PARKING	30	30	6.3	-	16.0		
13	JUG	301+75.00	306+50.00	300+84.0	LT	R4-7	KEEP RIGHT	24	30	5.0	-	-	16.0	
				302+00.0	RT	D3-2	ADVANCE STREET NAMES (2 LINES)	48	30	-	10.0	31.0	LOGAN ST NEXT RIGHT - TWO POSTS	
				303+00.0	LT	R3-7R	RIGHT LANE MUST TURN RIGHT	36	36	9.0	-	16.0		
				303+00.0	CENTER	R3-8	MODIFIED	30	30	6.3	-	16.0	DUAL LEFT TURN ONLY	
				304+25.0	RT	D1-1c	CIRCULAR INTERSECTION DESTINATION (1 LINE)	60	18	7.5	-	29.0	LOGAN ST (RIGHT ARROW) - TWO POSTS	
				304+56.7	CENTER	R6-1R	ONE WAY	54	18	6.8	-	29.0	TWC POSTS	
				305+24.2	CENTER	R3-8	MODIFIED	30	30	6.3	-	16.0	DUAL LEFT TURN ONLY	
				305+24.2	RT	R3-7R	RIGHT LANE MUST TURN RIGHT	36	36	9.0	-	16.0		
				307+26.5	RT	R3-8	MODIFIED	30	30	6.3	-	16.0	DUAL LEFT TURN ONLY (BACK TO BACK)	
				307+26.5	RT	R4-7	KEEP RIGHT	24	30	5.0	-	16.0	DUAL LEFT TURN ONLY (BACK TO BACK)	
14	LOGAN	601+50.00	607+50.00	600+48.3	LT	R3-2	NO LEFT TURN	36	36	9.0	-	16.0		
				600+90.0	LT	R1-1	STOP SIGN	36	36	7.0	-	19.0		
				601+50.0	LT	R3-5R	RIGHT TURN ONLY	30	36	7.5	-	19.0		
				601+50.0	LT	W11-2	PEDESTRIAN	36	36	9.0	-	19.0		
				608+91.9	RT	W16-9P	AHEAD	24	12	2.0	-	17.0		
15	JAMES	607+50.00	407+75.00	404+41.5	RT	R1-1	STOP SIGN	36	36	7.0	-	-	17.0	
				404+41.5	RT	R1-3P	ALL WAY	18	6	0.8	-	17.0		
				405+21.2	LT	D3-1	STREET NAME	36	9	2.3	-	19.0	N JAMES ST	
				405+21.2	LT	D3-1	STREET NAME	36	9	2.3	-	19.0	E LOGAN ST	
				405+21.2	LT	R1-1	STOP SIGN	36	36	7.0	-	19.0		
				405+21.2	LT	R1-3P	ALL WAY	18	6	0.8	-	19.0		
				408+66.2	RT	D-3	STREET NAME	36	9	2.3	-	19.0	N JAMES ST	
				408+66.2	RT	D-3	STREET NAME	42	9	2.6	-	19.0	E FARIES PKWY	
				408+66.2	RT	R1-1	STOP SIGN	36	36	7.0	-	19.0		
				408+66.2	RT	W4-4P	CROSS TRAFFIC DOES NOT STOP	24	12	2.0	-	19.0		
16		800+00.00	804+50.00	799+83.0	RT	W14-1	DEAD END	30	30	6.3	-	17.0		
17	HARRISON W	804+50.00	808+00.00	809+63.9	RT	R1-1	STOP SIGN	36	36	7.0	-	16.0		
				809+83.0	RT	R1-1	STOP SIGN	36	36	7.0	-	16.0		
18	HARRISON E	701+00.00	705+00.00	700+66.9	LT	R1-1	STOP SIGN	36	36	7.0	-	-	19.0	
				700+66.9	LT	W4-4P	CROSS TRAFFIC DOES NOT STOP	24	12	2.0	-	19.0	N BRUSH COLLEGE RD	
				700+66.9	LT	D3-1	STREET NAME	60	9	3.8	-	19.0	E HARRISON AVE	
				700+66.9	LT	D3-1	STREET NAME	48	9	3.0	-	19.0		
				702+00.0	LT	W11-2	PEDESTRIAN	36	36	9.0	-	19.0		
19		705+00.00	708+41.73	-	-	-	-	-	-	-	-	-		
20	CEMETERY	900+00.00	904+52.12	900+24.8	LT	R1-1	STOP SIGN	36	36	7.0	-	16.0		
				904+37.9	RT	R1-1	STOP SIGN	36	36	7.0	-	16.0		

SUB-TOTAL	304.5	62.8	723.0
SUB-TOTAL PAGE 1	81.3	32.0	290.0
TOTAL	386	95	1013

NOTES: 1. ALL STATIONS ARE APPROXIMATE. SIGNS SHALL BE ERECTED ACCORDING TO HIGHWAY STANDARD 720006.

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USER NAME = rjo	DESIGNED - LDC	REVISED -
PLOT SCALE = 2,000' / in.	DRAWN - RJO	REVISED -
PLOT DATE = 4/28/2021	CHECKED - LDC	REVISED -
	DATE - 4/30/2021	REVISED -

STATE OF ILLINOIS
 DEPARTMENT OF TRANSPORTATION

BRUSH COLLEGE ROAD & FARIES PARKWAY
 PAVEMENT MARKING & SIGNING SCHEDULES

SCALE: SHEET 2 OF 3 SHEETS STA. TO STA.

F.A.U. RTE.	SECTION	COUNTY	TOTAL SHEETS	SHEET NO.
7448	09-00933-01-BR	MACON	1019	545
CONTRACT NO. 95893				
ILLINOIS FED. AID PROJECT				

SIGNING REMOVAL SCHEDULE

SHEET	ROAD	STATION	STATION	STA	LOC	TYPE	DESCRIPTION	SIGN REMOVAL EACH	COMMENTS
2		52+00.00	57+75.00	52+60	RT	R1-1	STOP SIGN	1	
				52+64	RT	D3-1	STREET NAME	1	OLIVE ST
						D3-1	STREET NAME		BRUSH COLLEGE RD
				57+14	RT	R8-3	NO PARKING	1	
57+18	RT	D3-1	STREET NAME	1	LOGAN ST				
					R1-1	STOP SIGN	BRUSH COLLEGE RD		
3	BRUSH	57+75.00	62+50.00	59+12	LT	W4-2R	LANE ENDS	1	
				60+78	RT	R15-1	GRADE CROSSING (CROSS BUCK)	1	MOUNTED ON SIGNAL POST
						D3-1	STREET NAME		BRUSH COLLEGE RD - MOUNTED ON SIGNAL MAST ARM
				60+78	LT	R15-1	GRADE CROSSING (CROSS BUCK)	1	MOUNTED ON SIGNAL TRUSS POST
						R15-1	GRADE CROSSING (CROSS BUCK)		MOUNTED ON SIGNAL TRUSS
						R15-1	GRADE CROSSING (CROSS BUCK)		MOUNTED ON SIGNAL TRUSS
						R15-1	GRADE CROSSING (CROSS BUCK)		MOUNTED ON SIGNAL TRUSS
				R-SPECIAL	WATCH FOR TRAIN WHEN FLASHING	MOUNTED ON SIGNAL TRUSS			
				60+81	LT	R10-11a	NO TURN ON RED	1	MOUNTED ON SIGNAL POST
						D3-1	STREET NAME		FARIES PKWY - MOUNTED ON SIGNAL MAST ARM
				61+80	RT	R15-1	GRADE CROSSING (CROSS BUCK)	1	MOUNTED ON SIGNAL POST
						R-SPECIAL	WATCH FOR TRAIN WHEN FLASHING		MOUNTED ON SIGNAL TRUSS
				61+83	LT	R15-1	GRADE CROSSING (CROSS BUCK)	1	MOUNTED ON SIGNAL TRUSS
						R15-1	GRADE CROSSING (CROSS BUCK)		MOUNTED ON SIGNAL TRUSS
				62+08	RT	D3-1	STREET NAME	1	MOUNTED ON SIGNAL TRUSS
									EMERGENCY - CALL NUMBERS
R15-1	GRADE CROSSING (CROSS BUCK)	MOUNTED ON SIGNAL TRUSS							
R15-1	GRADE CROSSING (CROSS BUCK)	MOUNTED ON SIGNAL TRUSS							
R-SPECIAL	WATCH FOR TRAIN WHEN FLASHING	MOUNTED ON SIGNAL TRUSS							
62+08	LT	R-SPECIAL	WATCH FOR TRAIN WHEN FLASHING	1	MOUNTED ON SIGNAL POST				
					R15-1	GRADE CROSSING (CROSS BUCK)	MOUNTED ON SIGNAL TRUSS		
					R15-1	GRADE CROSSING (CROSS BUCK)	MOUNTED ON SIGNAL TRUSS		
					R15-1	GRADE CROSSING (CROSS BUCK)	MOUNTED ON SIGNAL TRUSS POST		
EMERGENCY - CALL NUMBERS	MOUNTED ON SIGNAL POST								
4		62+50.00	68+00.00	63+87	RT	R5-1101	BEGIN TRUCK ROUTE	1	
				M1-6	COUNTY ROUTE SIGN				
				64+48	LT	W10-1	GRADE CROSSING ADVANCE WARNING	1	
				64+71	RT	W10-3L	GRADE CROSSING AND INTERSECTION ADVANCE WARNING	1	
									R3-9dP
				65+44	LT	R3-9b	TWO-WAY LEFT TURN ONLY (POST MOUNTED)	1	
									R3-9b
				65+80	LT	R15-1	GRADE CROSSING (CROSS BUCK)	1	
				65+83	LT	R1-1	STOP SIGN	1	
				66+22	LT	W14-2	NO OUTLET	1	
				66+35	LT	R15-1	GRADE CROSSING (CROSS BUCK)	1	
									R1-2
66+39	LT	D3-1	STREET NAME	1	E HARRISON AV				
					D3-1	STREET NAME	NBRUSH COLLEGE RD		
66+57	RT	R3-9cP	BEGIN	1					
					R3-9b	TWO-WAY LEFT TURN ONLY (POST MOUNTED)			
67+22	LT	W10-3R	GRADE CROSSING AND INTERSECTION ADVANCE WARNING	1					
5		68+00.00	73+50.00	68+45	RT		UNKNOWN	1	
				68+74	LT	R3-9b	TWO-WAY LEFT TURN ONLY (POST MOUNTED)	1	
				69+65	RT	R1-1	STOP SIGN	1	
									D3-1
				69+69	RT	D3-1	STREET NAME	1	NBRUSH COLLEGE RD
									R15-1
				70+08	LT	R1-2	YIELD	1	
70+63	LT	R15-1	GRADE CROSSING (CROSS BUCK)	1					
71+96	LT	R2-1	SPEED LIMIT	1	35 MPH				
9	FARIES	213+25.00	219+00.00	215+83	RT	W4-2R	LANE ENDS	1	
219+00.00		224+75.00	222+34	RT	R4-1	DO NOT PASS	1		
230+50.00		235+41.47	222+63	LT	R2-1	SPEED LIMIT	1	35 MPH - MOUNTED ON UTILITY POLE	
			234+32	LT	R7-#	NO PARKING	1		
TOTAL								34	

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USER NAME = rjo
 DESIGNED - LDC
 DRAWN - RJO
 CHECKED - LDC
 DATE - 4/30/2021
 PLOT SCALE = 2,000' / in.
 PLOT DATE = 4/28/2021

REVISED -
 REVISED -
 REVISED -
 REVISED -

**STATE OF ILLINOIS
 DEPARTMENT OF TRANSPORTATION**


**BRUSH COLLEGE ROAD & FARIES PARKWAY
 PAVEMENT MARKING & SIGNING SCHEDULES**

SCALE: SHEET 3 OF 3 SHEETS STA. TO STA.

F.A.U. RTE.	SECTION	COUNTY	TOTAL SHEETS	SHEET NO.
7448	09-00933-01-BR	MACON	1019	546
CONTRACT NO. 95893				
ILLINOIS FED. AID PROJECT				

PAVEMENT MARKING & SIGNING NOTES



1. ALL PAVEMENT MARKINGS SHALL BE OF THE TYPE AND COLOR AS SPECIFIED IN THE PLANS AND SHALL BE PLACED PER DISTRICT 7 STANDARD 78000001 AND IDOT STANDARD 780001-05.
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PAVEMENT MARKING LEGEND

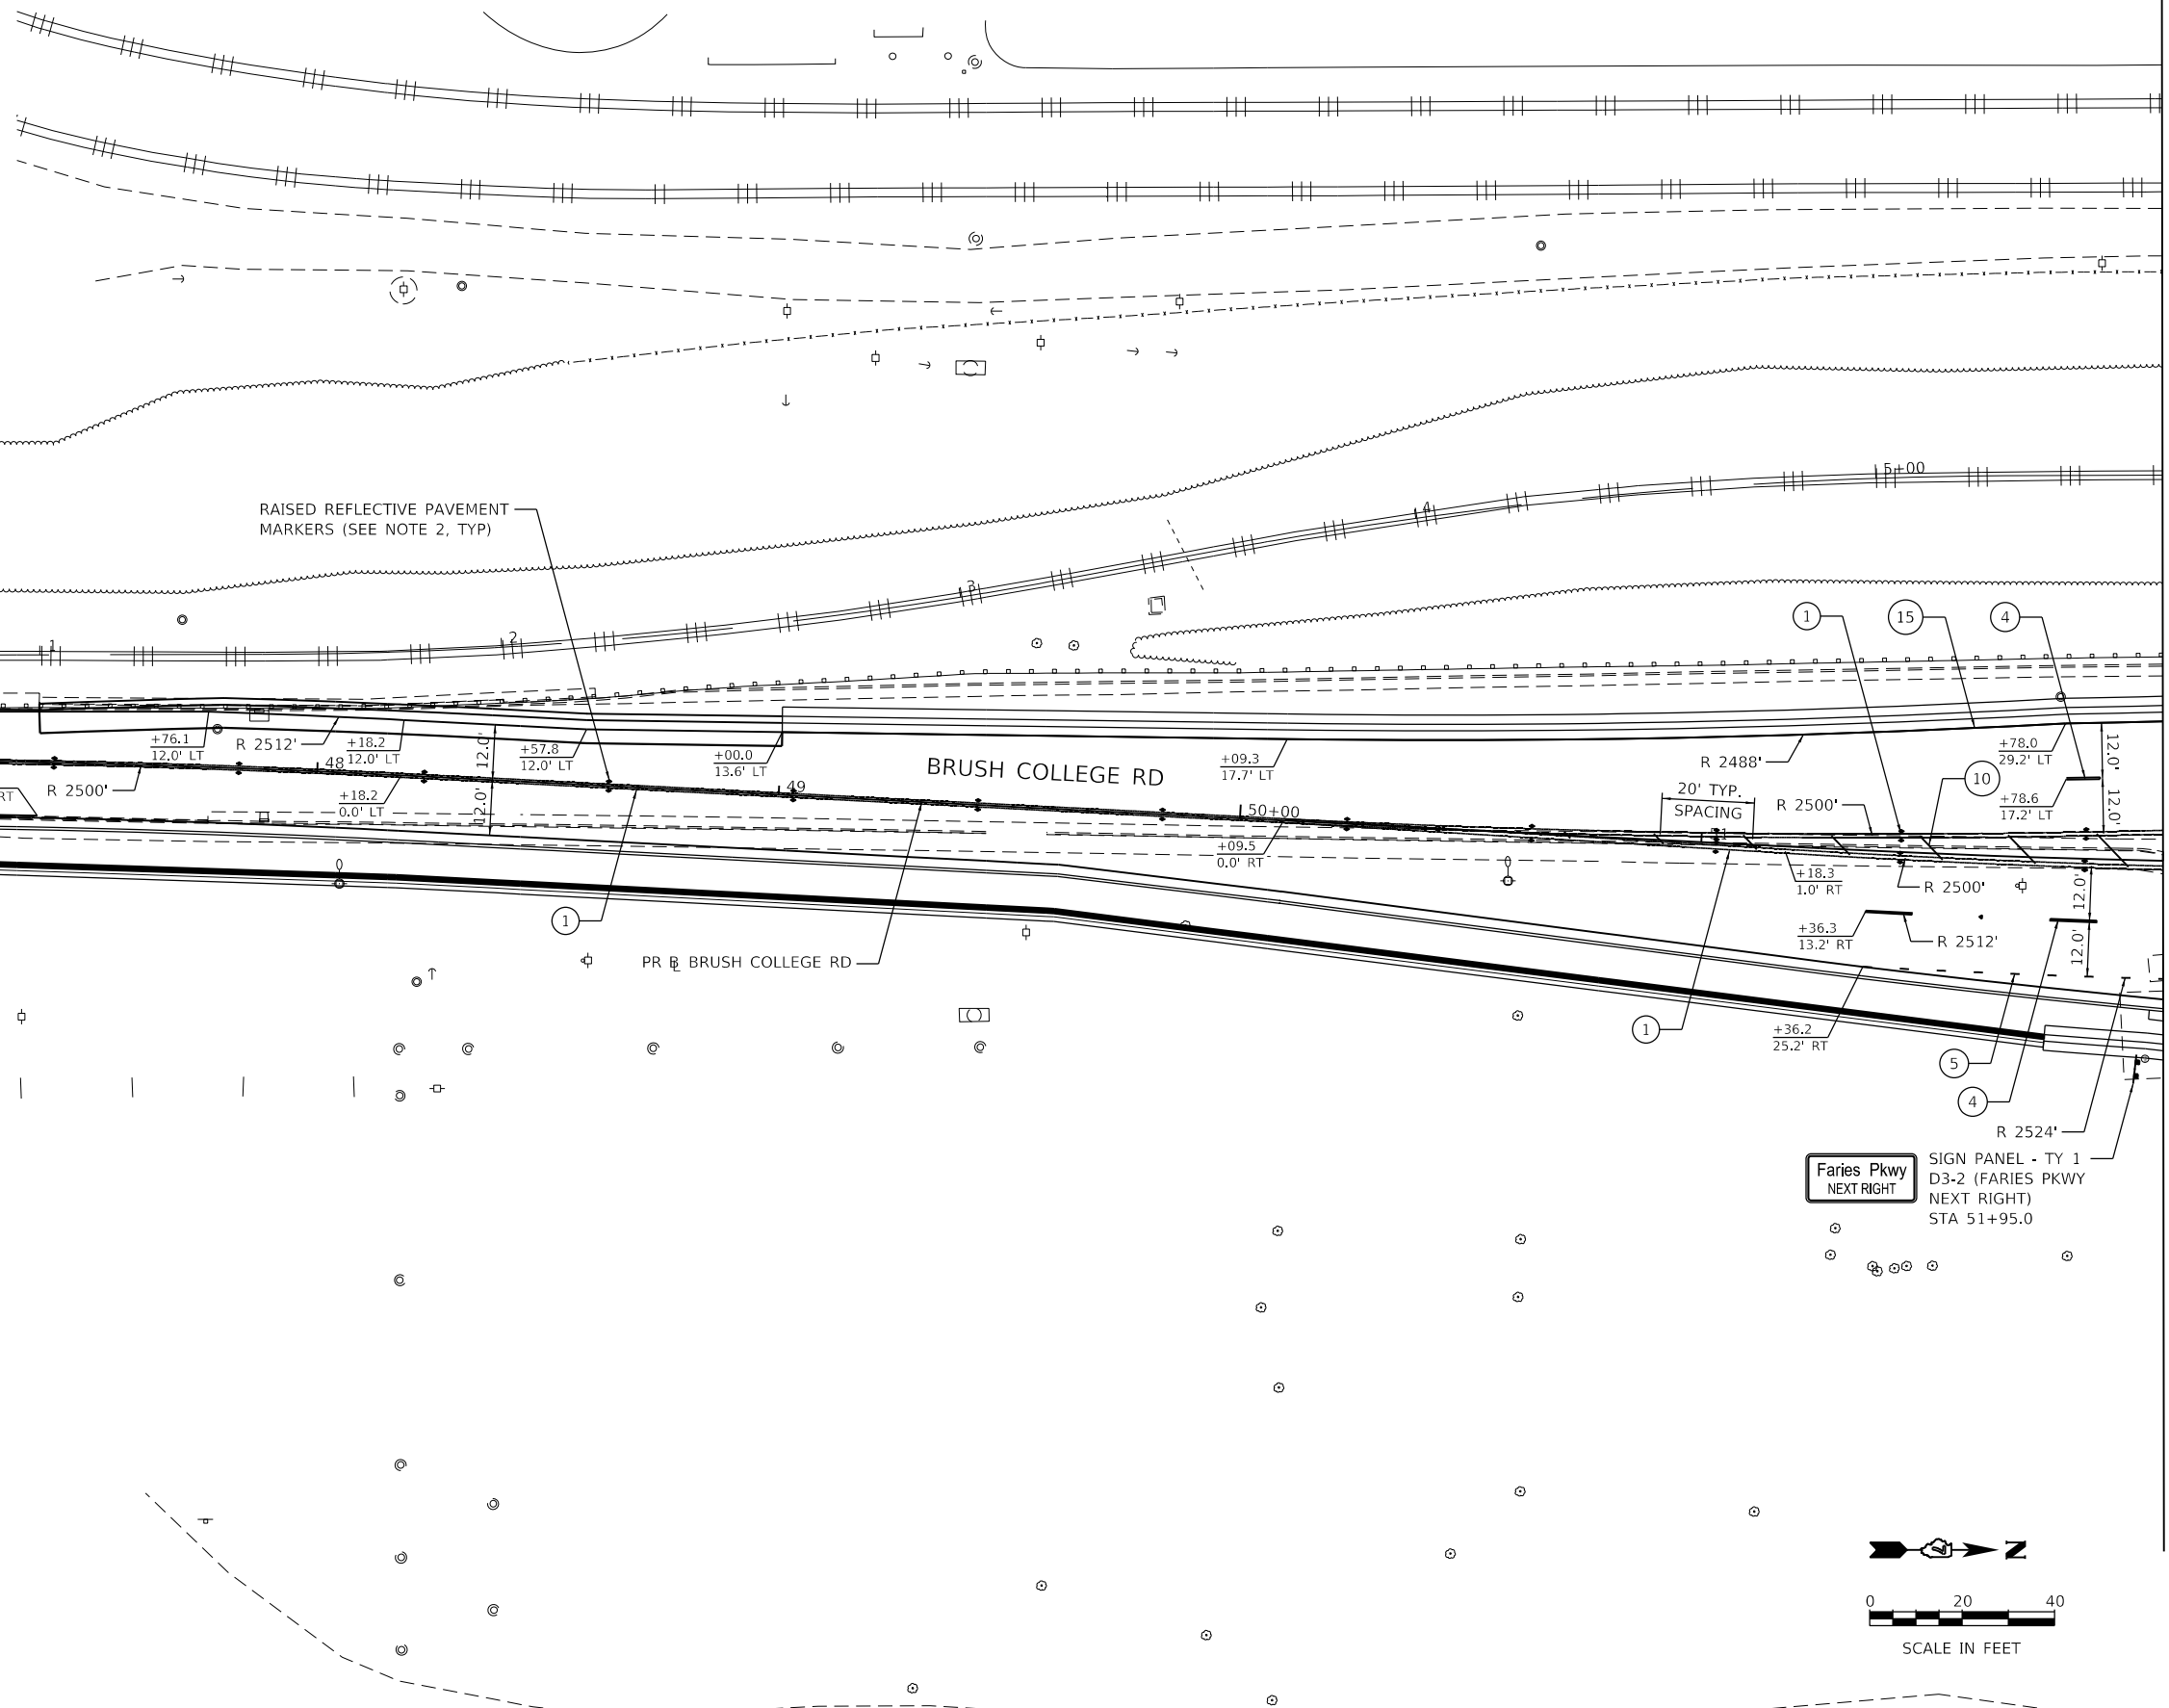- ① MOD URETH PM LINE 4 (SOLID YELLOW, DOUBLE CENTERLINE, 11" C-C)
- ④ MOD URETH PM LINE 6 (WHITE, 10' DASH - 30' SKIP)
- ⑤ MOD URETH PM LINE 6 (WHITE, 2' DASH - 6' SKIP)
- ⑩ MOD URETH PM LINE 12 (SOLID YELLOW)
- ⑮ MOD URETH PM LINE 4 (SOLID WHITE)

Faries Pkwy
NEXT RIGHT
SIGN PANEL - TY 1
D3-2 (FARIES PKWY
NEXT RIGHT)
STA 51+95.0



SCALE IN FEET

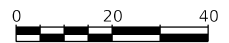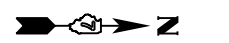MATCH LINE STA 52+00.00 (PR BRUSH)

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PLOT SCALE = 40.0000 ' / in.	DRAWN - NDP	REVISED -
PLOT DATE = 4/28/2021	CHECKED - LDC	REVISED -
	DATE - 4/30/2021	REVISED -


**STATE OF ILLINOIS
DEPARTMENT OF TRANSPORTATION**

BRUSH COLLEGE ROAD PAVEMENT MARKING & SIGNING PLAN	
SCALE: 1"=20'	SHEET 1 OF 20 SHEETS
STA. 46+59.44 TO STA. 52+00.00	

F.A.U. RTE. 7448	SECTION 09-00933-01-BR	COUNTY MACON	TOTAL SHEETS 1019	SHEET NO. 547
CONTRACT NO. 95893				
ILLINOIS FED. AID PROJECT				


PAVEMENT MARKING & SIGNING NOTES

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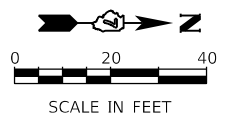
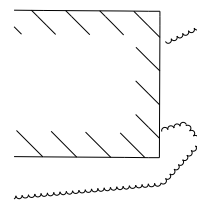
MATCH LINE STA 52+00.00 (PR BRUSH)

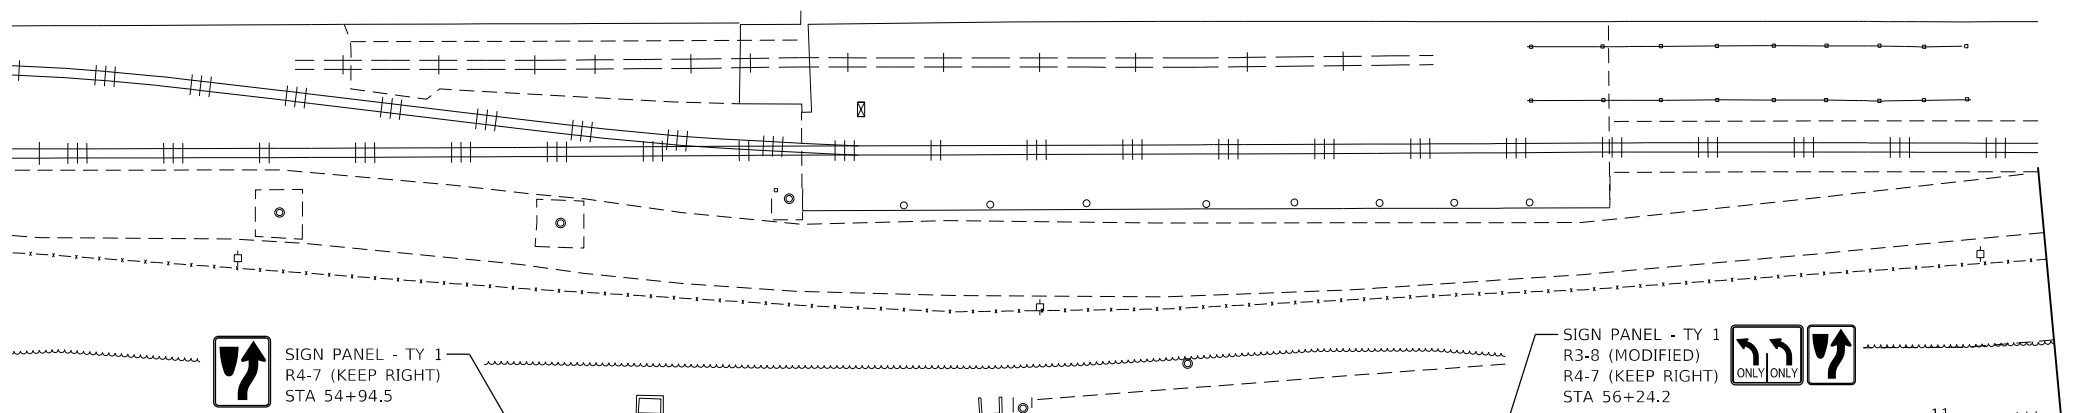MATCH LINE STA 57+75.00 (PR BRUSH)



PAVEMENT MARKING LEGEND

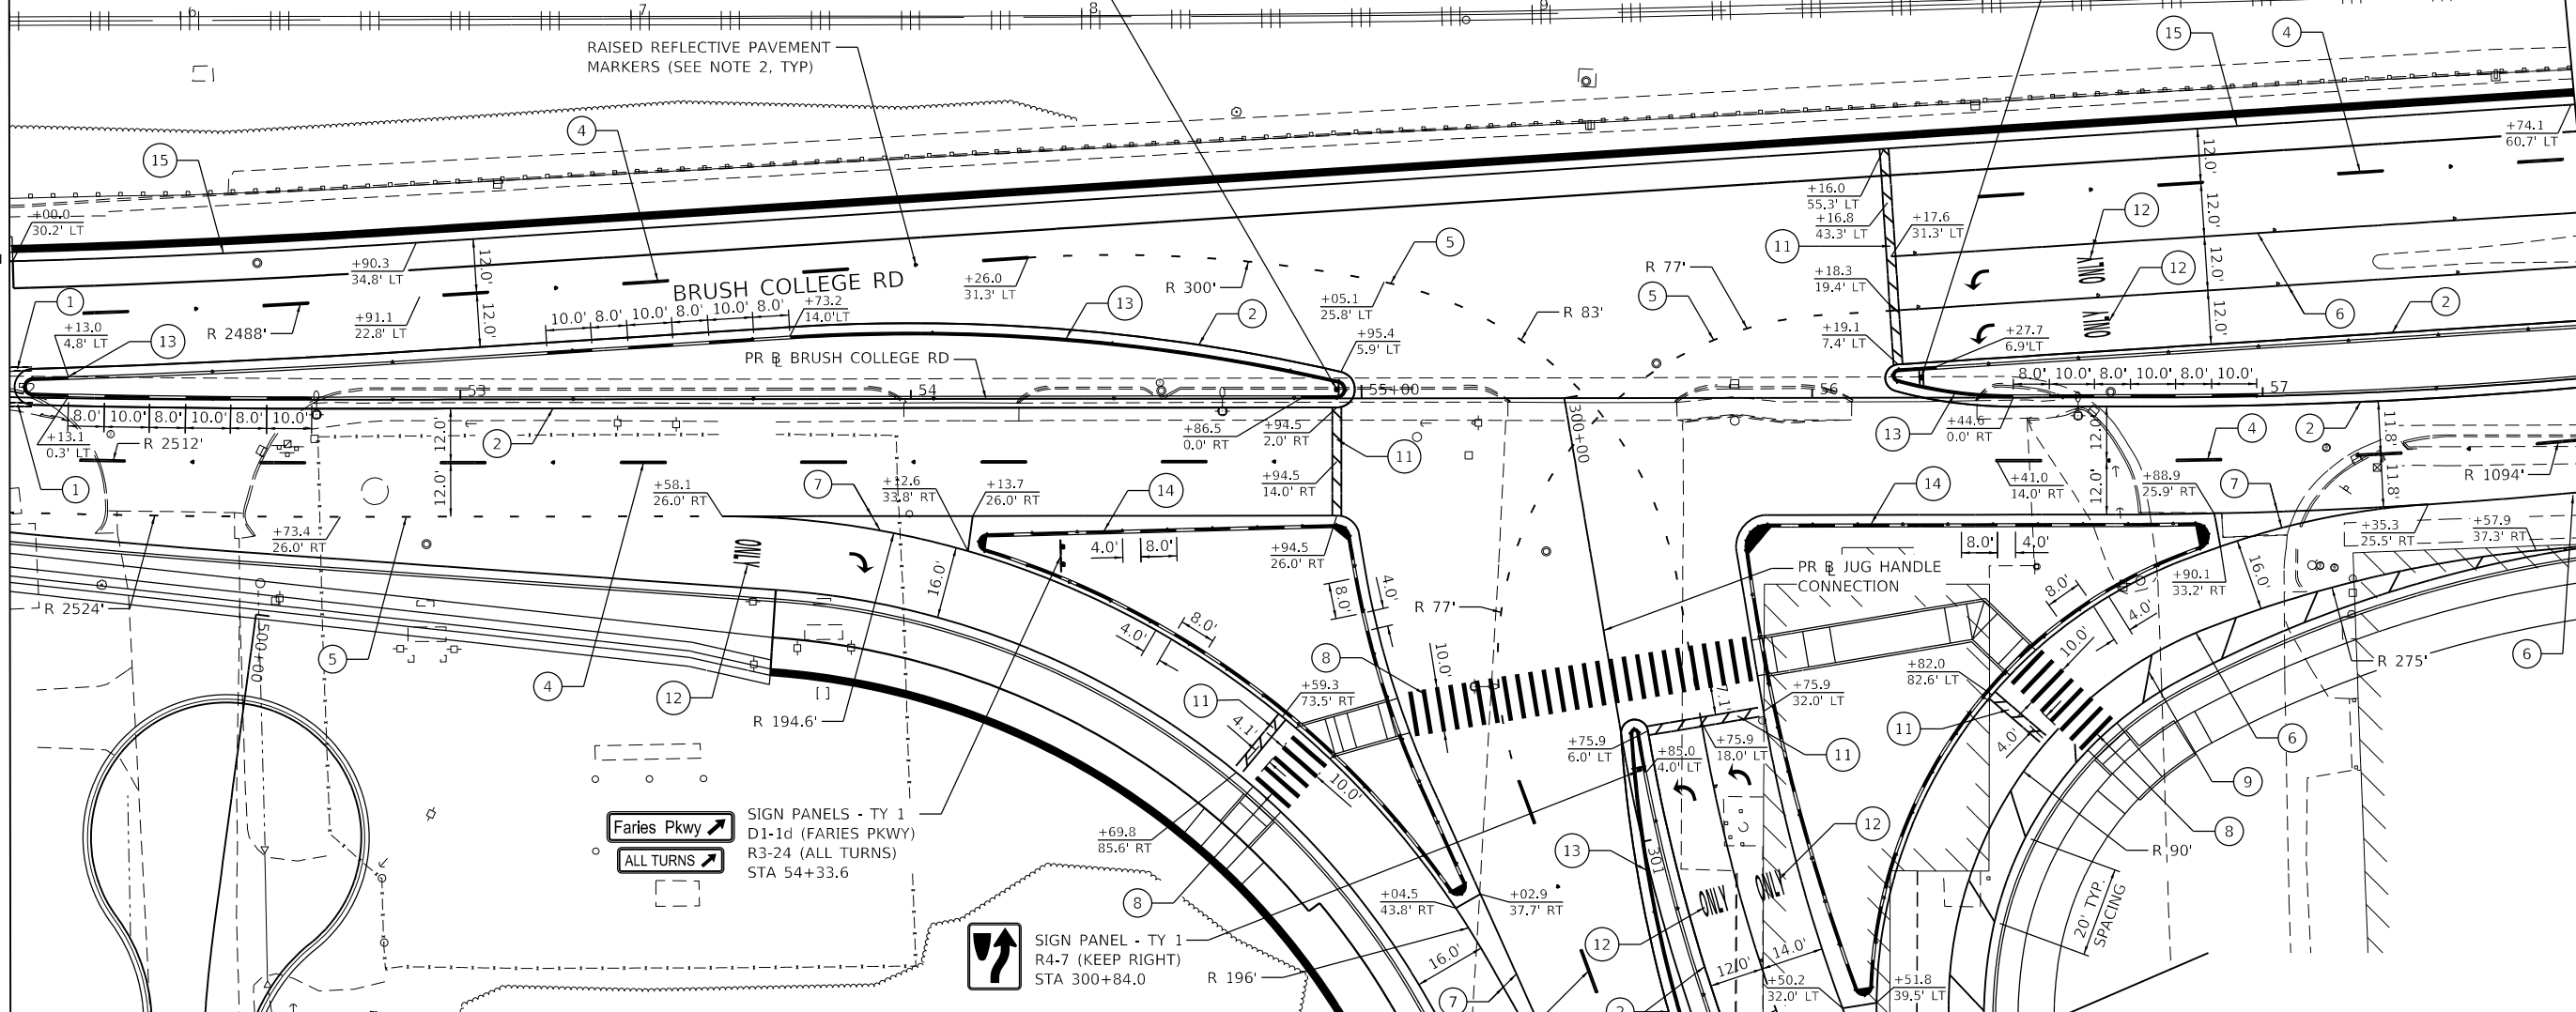- | | |
|--|--|
| ① MOD URETH PM LINE 4 (SOLID YELLOW, DOUBLE CENTERLINE, 11" C-C) | ⑧ MOD URETH PM LINE 12 (SOLID WHITE, CROSS WALK) |
| ② MOD URETH PM LINE 4 (SOLID YELLOW) | ⑨ MOD URETH PM LINE 12 (SOLID WHITE) |
| ④ MOD URETH PM LINE 6 (WHITE, 10' DASH - 30' SKIP) | ⑪ MOD URETH PM LINE 24 (SOLID WHITE, STOP BAR) |
| ⑤ MOD URETH PM LINE 6 (WHITE, 2' DASH - 6' SKIP) | ⑫ MOD URETH PM LTR-SYM |
| ⑥ MOD URETH PM LINE 6 (SOLID WHITE) | ⑬ PAINT PVT MARK CURB (YELLOW) |
| ⑦ MOD URETH PM LINE 8 (SOLID WHITE) | ⑭ PAINT PVT MARK CURB (WHITE) |
| | ⑮ MOD URETH PM LINE 4 (SOLID WHITE) |



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PLOT SCALE = 40.0000' / in.	DRAWN - NDP	REVISED -
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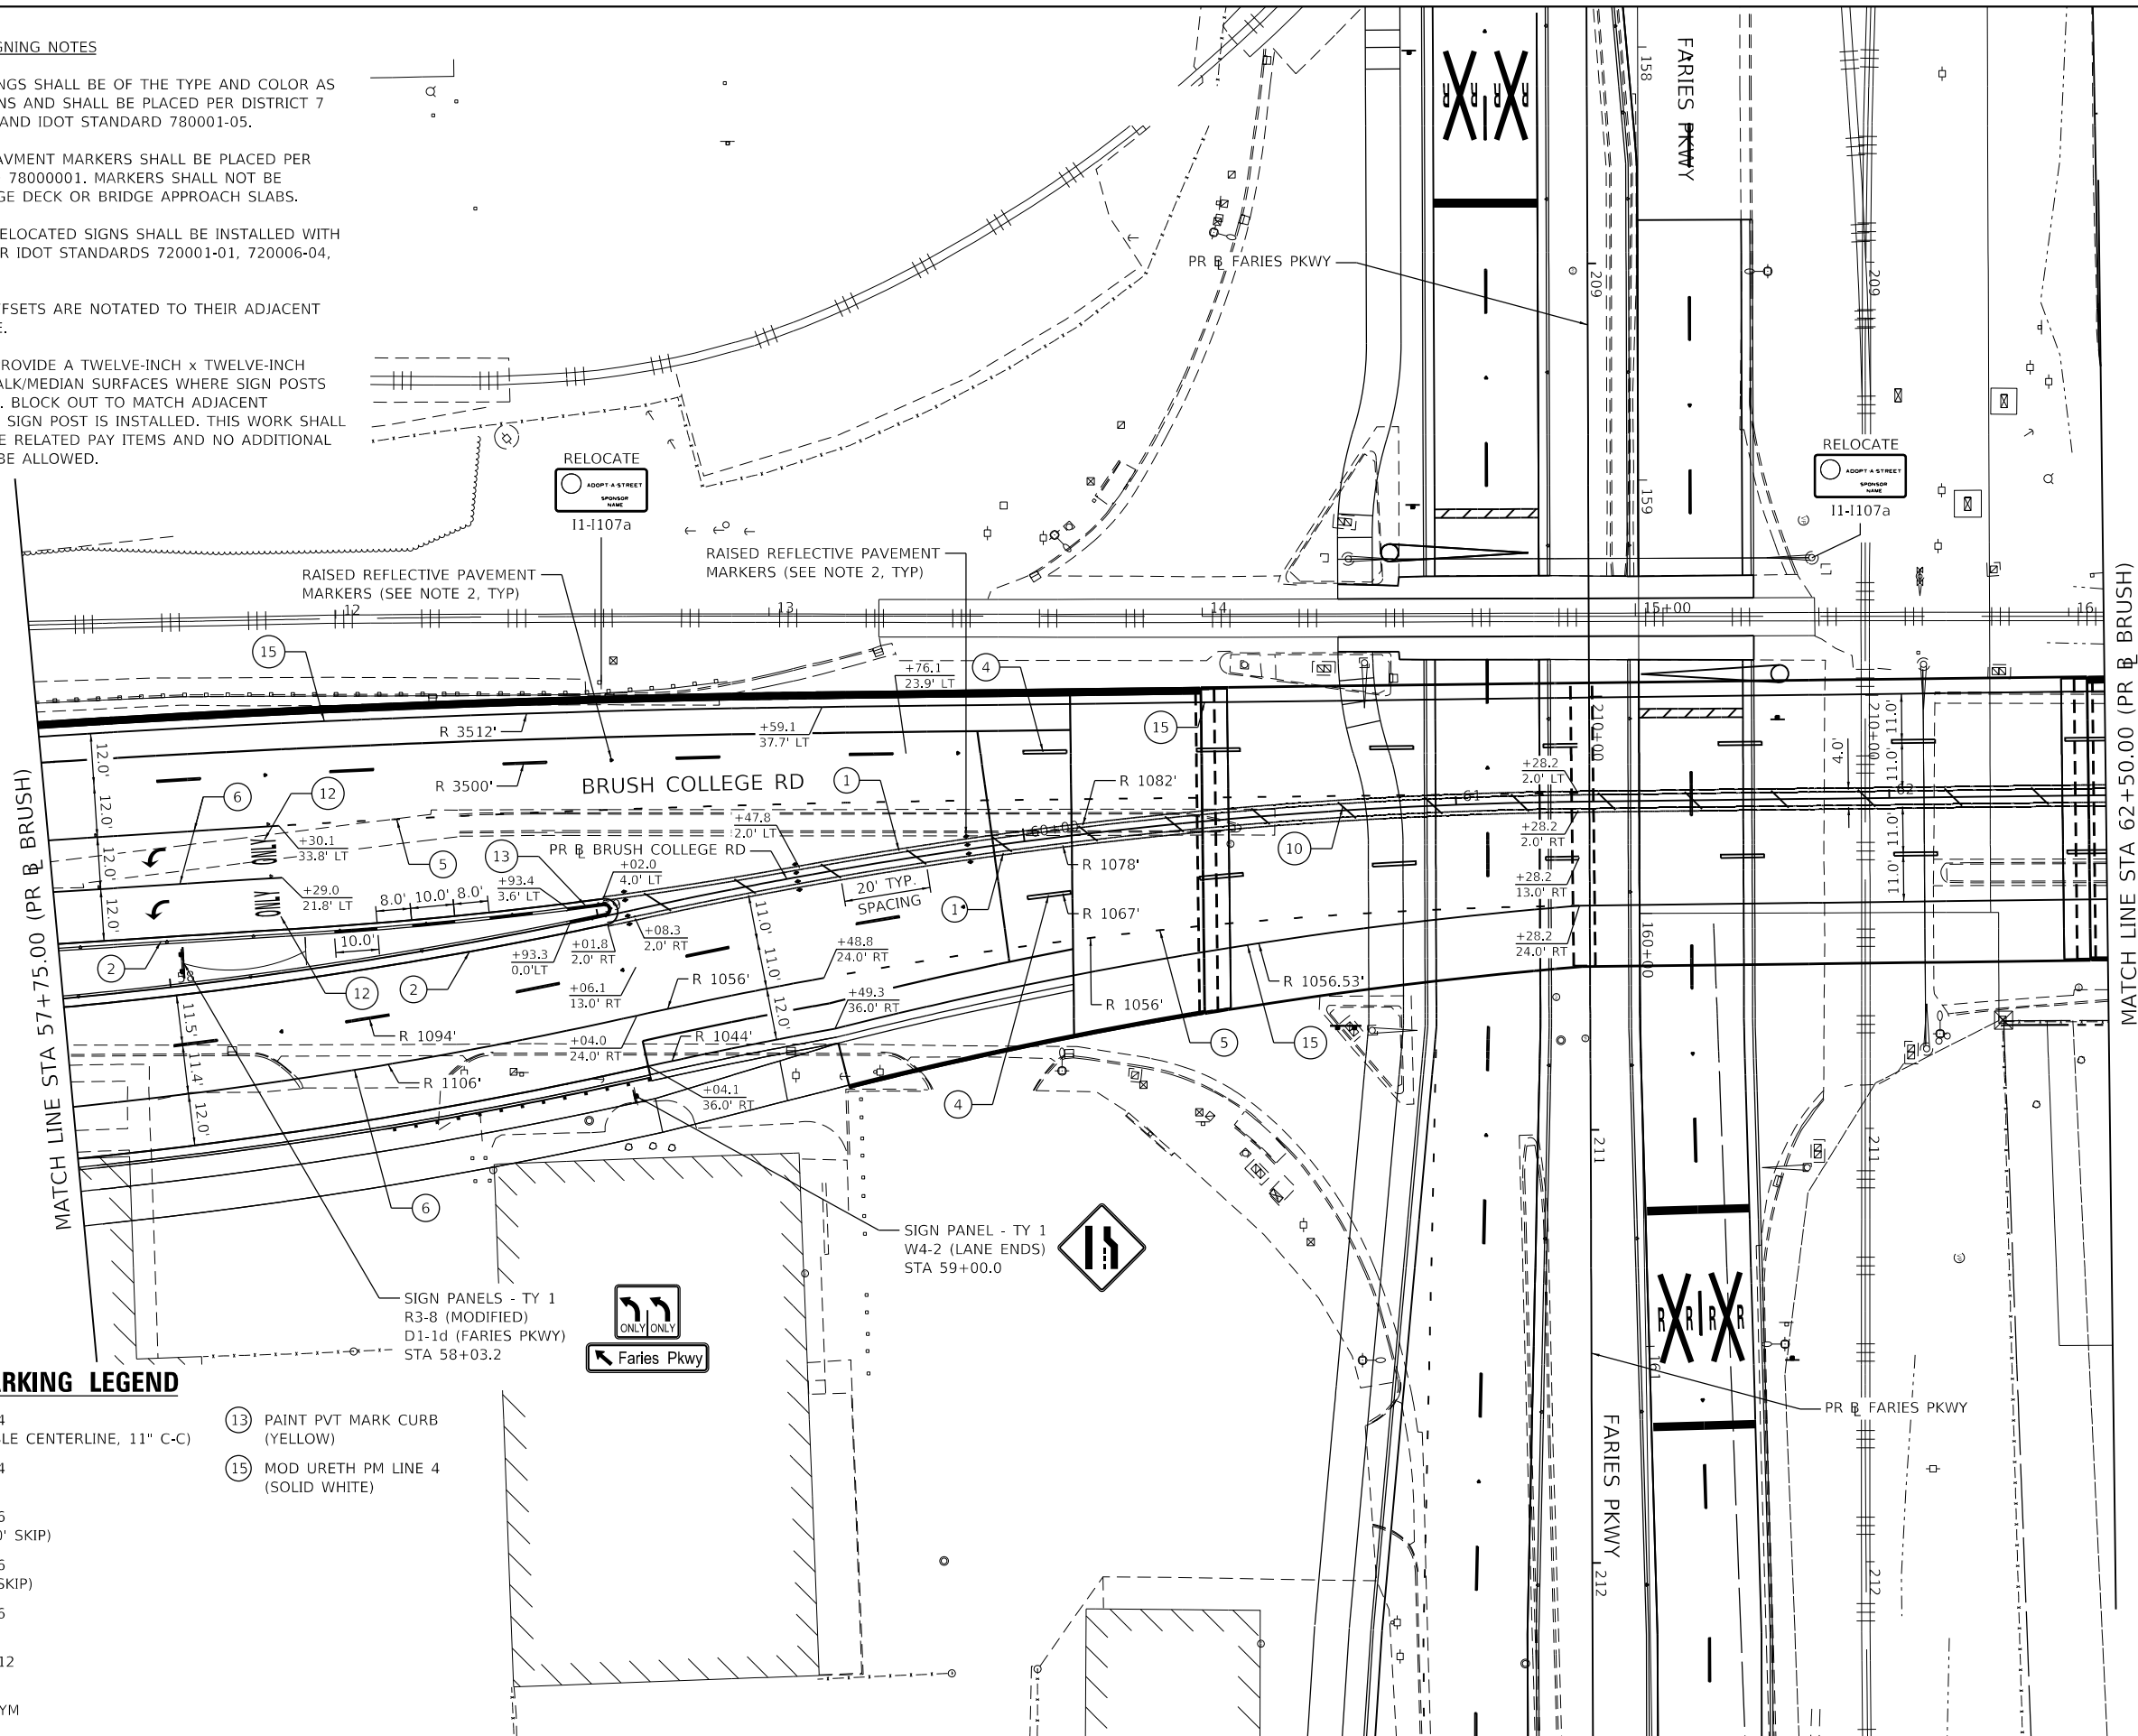
**STATE OF ILLINOIS
DEPARTMENT OF TRANSPORTATION**

BRUSH COLLEGE ROAD PAVEMENT MARKING & SIGNING PLAN	
SCALE: 1"=20'	SHEET 2 OF 20 SHEETS STA. 52+00.00 TO STA. 57+75.00

F.A.U. RTE. 7448	SECTION 09-00933-01-BR	COUNTY MACON	TOTAL SHEETS 1019	SHEET NO. 548
CONTRACT NO. 95893				
ILLINOIS FED. AID PROJECT				

PAVEMENT MARKING & SIGNING NOTES


1. ALL PAVEMENT MARKINGS SHALL BE OF THE TYPE AND COLOR AS SPECIFIED IN THE PLANS AND SHALL BE PLACED PER DISTRICT 7 STANDARD 78000001 AND IDOT STANDARD 780001-05.
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PAVEMENT MARKING LEGEND

- | | |
|--|-------------------------------------|
| ① MOD URETH PM LINE 4 (SOLID YELLOW, DOUBLE CENTERLINE, 11" C-C) | ⑬ PAINT PVT MARK CURB (YELLOW) |
| ② MOD URETH PM LINE 4 (SOLID YELLOW) | ⑮ MOD URETH PM LINE 4 (SOLID WHITE) |
| ④ MOD URETH PM LINE 6 (WHITE, 10' DASH - 30' SKIP) | |
| ⑤ MOD URETH PM LINE 6 (WHITE, 2' DASH - 6' SKIP) | |
| ⑥ MOD URETH PM LINE 6 (SOLID WHITE) | |
| ⑩ MOD URETH PM LINE 12 (SOLID YELLOW) | |
| ⑫ MOD URETH PM LTR-SYM | |

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USER NAME = rjo	DESIGNED - NDP	REVISED -
PLOT SCALE = 40.0000' / in.	DRAWN - NDP	REVISED -
PLOT DATE = 4/28/2021	CHECKED - LDC	REVISED -
	DATE - 4/30/2021	REVISED -


**STATE OF ILLINOIS
DEPARTMENT OF TRANSPORTATION**

BRUSH COLLEGE ROAD PAVEMENT MARKING & SIGNING PLAN	
SCALE: 1"=20'	SHEET 3 OF 20 SHEETS STA. 57+75.00 TO STA. 62+50.00

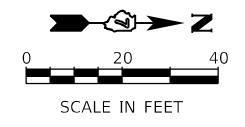F.A.U. RTE. 7448	SECTION 09-00933-01-BR	COUNTY MACON	TOTAL SHEETS 1019	SHEET NO. 549
CONTRACT NO. 95893				
ILLINOIS FED. AID PROJECT				

PAVEMENT MARKING & SIGNING NOTES

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PAVEMENT MARKING LEGEND

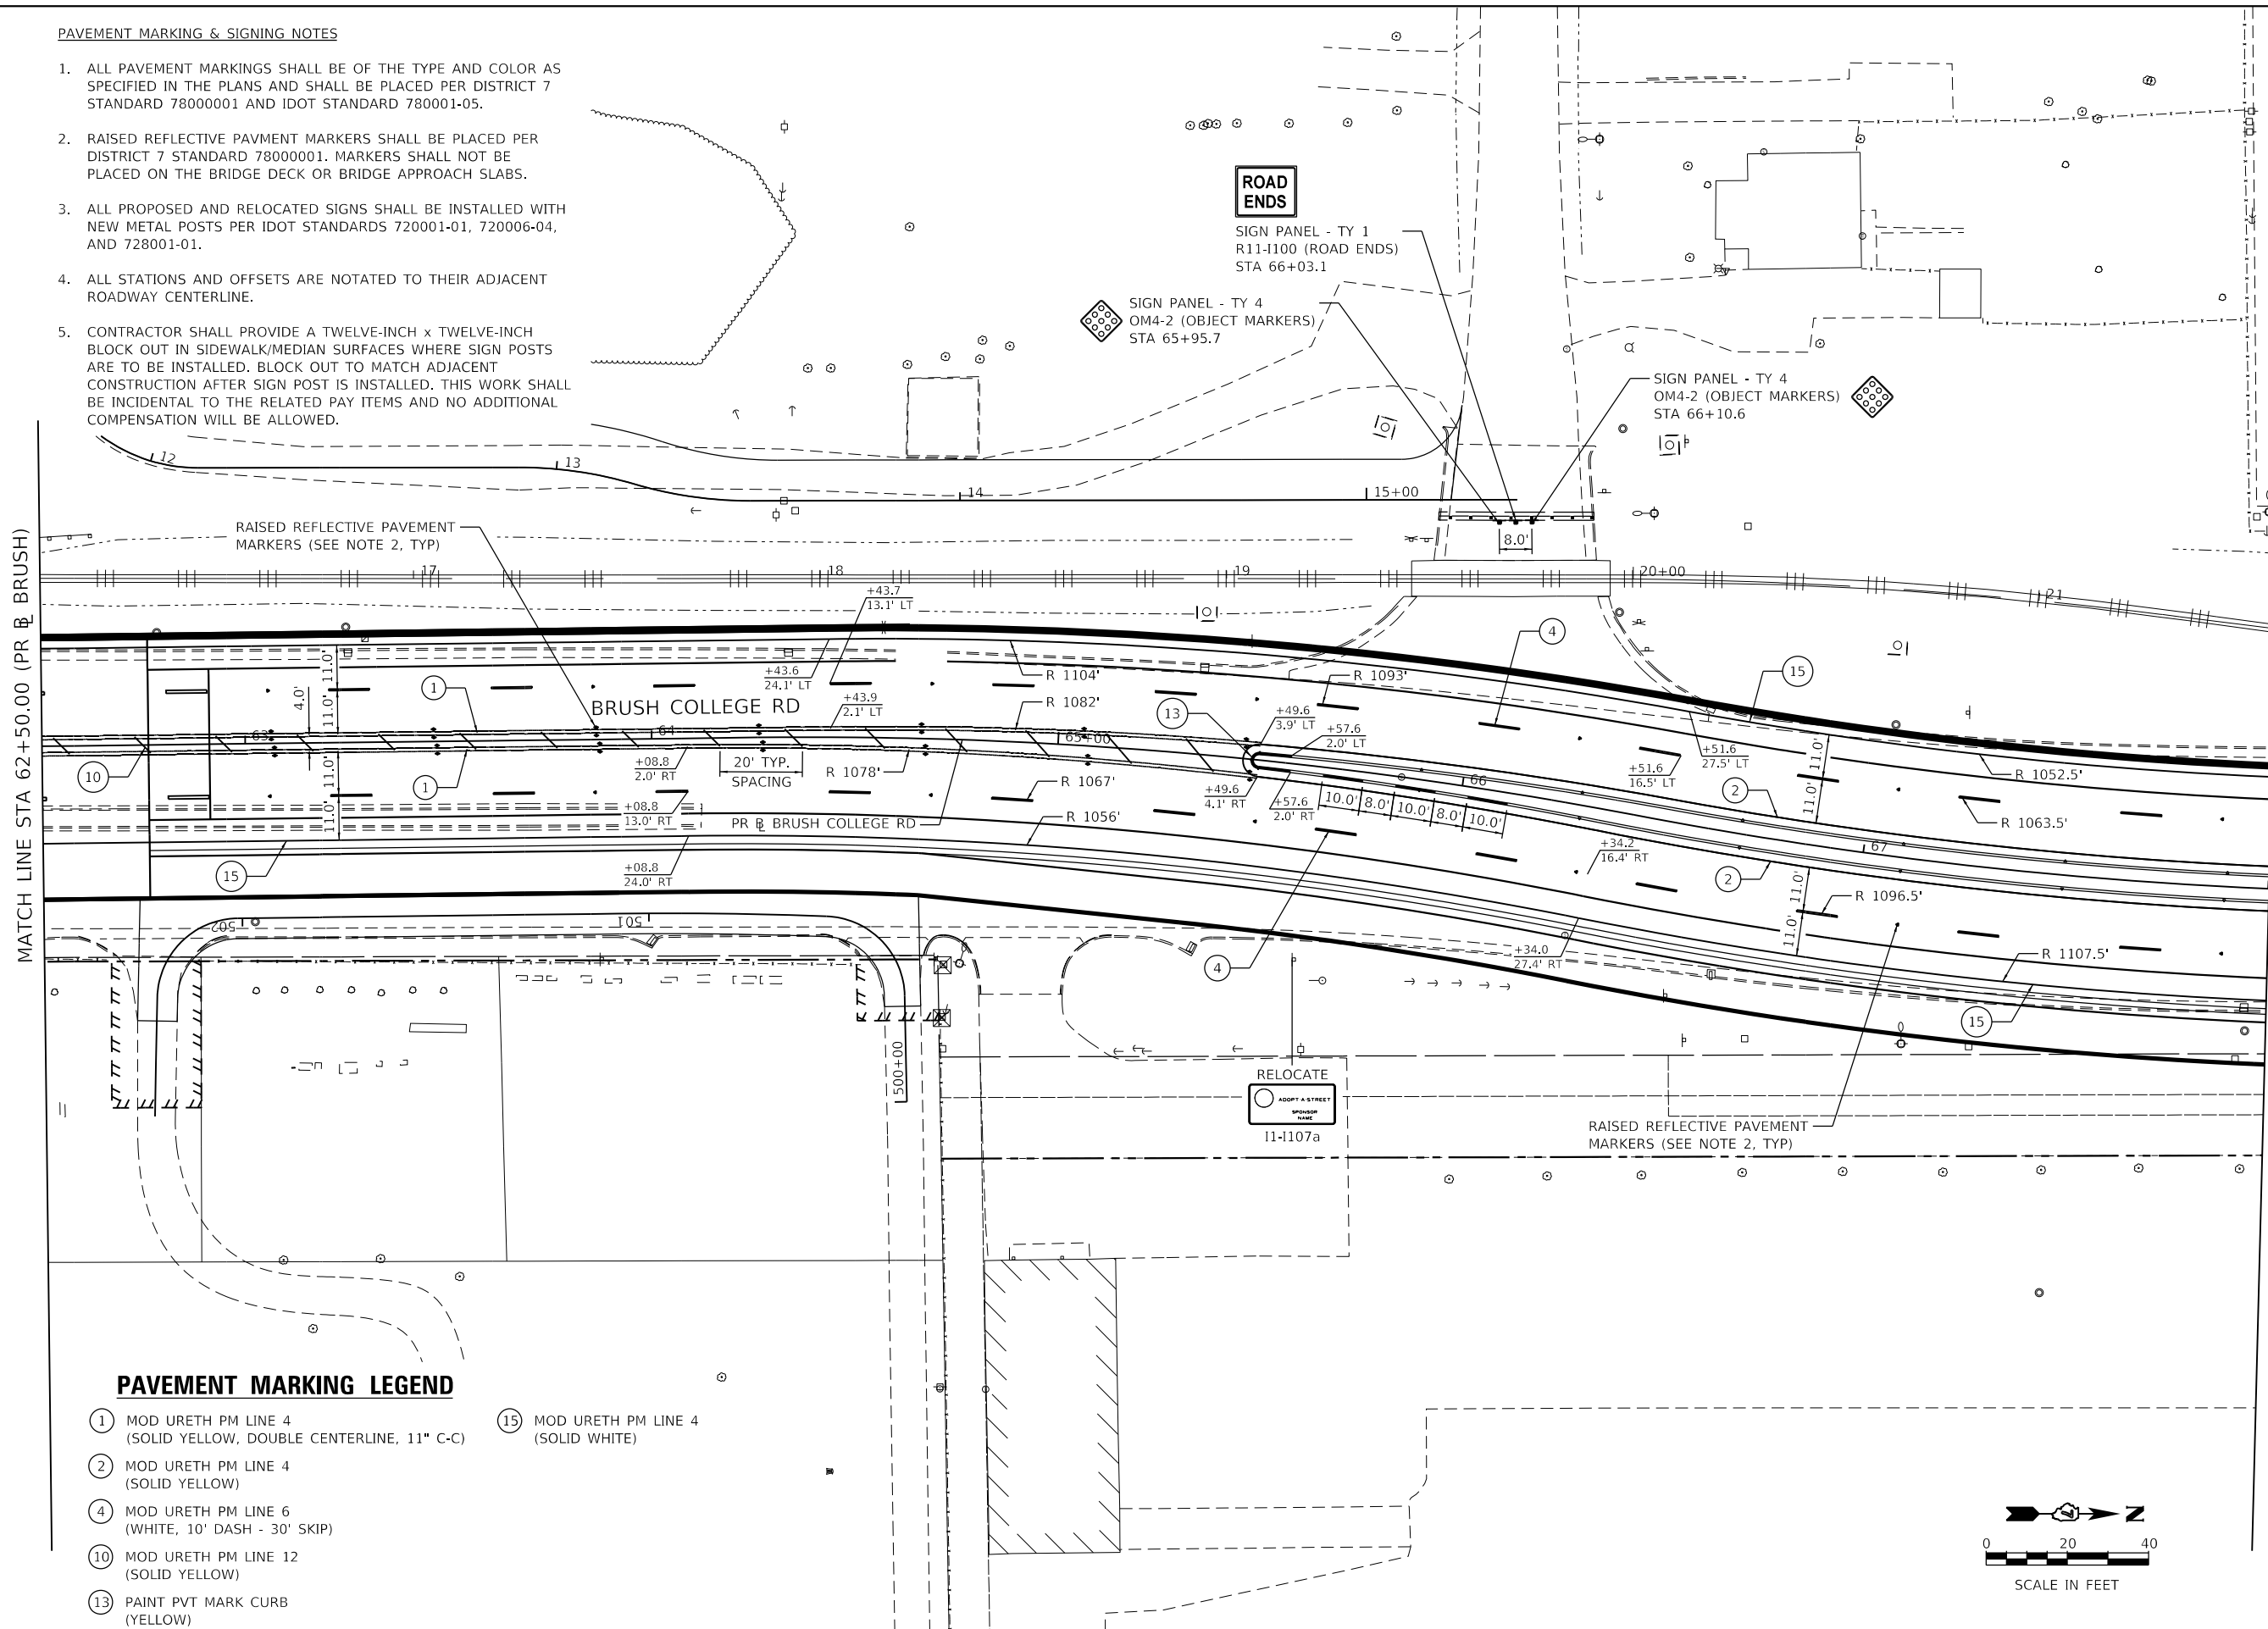- ① MOD URETH PM LINE 4 (SOLID YELLOW, DOUBLE CENTERLINE, 11" C-C)
- ② MOD URETH PM LINE 4 (SOLID YELLOW)
- ④ MOD URETH PM LINE 6 (WHITE, 10" DASH - 30" SKIP)
- ⑩ MOD URETH PM LINE 12 (SOLID YELLOW)
- ⑬ PAINT PVT MARK CURB (YELLOW)
- ⑮ MOD URETH PM LINE 4 (SOLID WHITE)

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Kaskaskia
 Engineering Group, LLC
PROFESSIONAL REGISTERED ENGINEERS
 Illinois Professional Design Firm
 Professional Engineering Group

USER NAME = rjo	DESIGNED - NDP	REVISED -
PLOT SCALE = 40.0000' / in.	DRAWN - NDP	REVISED -
PLOT DATE = 10/21/2021	CHECKED - LDC	REVISED -
	DATE - 10/22/2021	REVISED -

STATE OF ILLINOIS
DEPARTMENT OF TRANSPORTATION

BRUSH COLLEGE ROAD
PAVEMENT MARKING & SIGNING PLAN

SCALE: 1"=20'
 SHEET 4 OF 20 SHEETS
 STA. 62+50.0 TO STA. 68+00.00


F.A.U. RTE.	SECTION	COUNTY	TOTAL SHEETS	SHEET NO.
7448	09-00933-01-BR	MACON	1019	550
CONTRACT NO. 95893				
ILLINOIS FED. AID PROJECT				

PAVEMENT MARKING & SIGNING NOTES

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PAVEMENT MARKING LEGEND

- ① MOD URETH PM LINE 4 (SOLID YELLOW, DOUBLE CENTERLINE, 11" C-C)
- ② MOD URETH PM LINE 4 (SOLID YELLOW)
- ③ MOD URETH PM LINE 4 (YELLOW, 10' DASH - 30' SKIP)
- ④ MOD URETH PM LINE 6 (WHITE, 10' DASH - 30' SKIP)
- ⑤ MOD URETH PM LINE 6 (WHITE, 2' DASH - 6' SKIP)
- ⑥ MOD URETH PM LINE 6 (SOLID WHITE)
- ⑧ MOD URETH PM LINE 12 (SOLID WHITE, CROSS WALK)
- ⑪ MOD URETH PM LINE 24 (SOLID WHITE, STOP BAR)
- ⑫ MOD URETH PM LTR-SYM
- ⑬ PAINT PVT MARK CURB (YELLOW)
- ⑮ MOD URETH PM LINE 4 (SOLID WHITE)

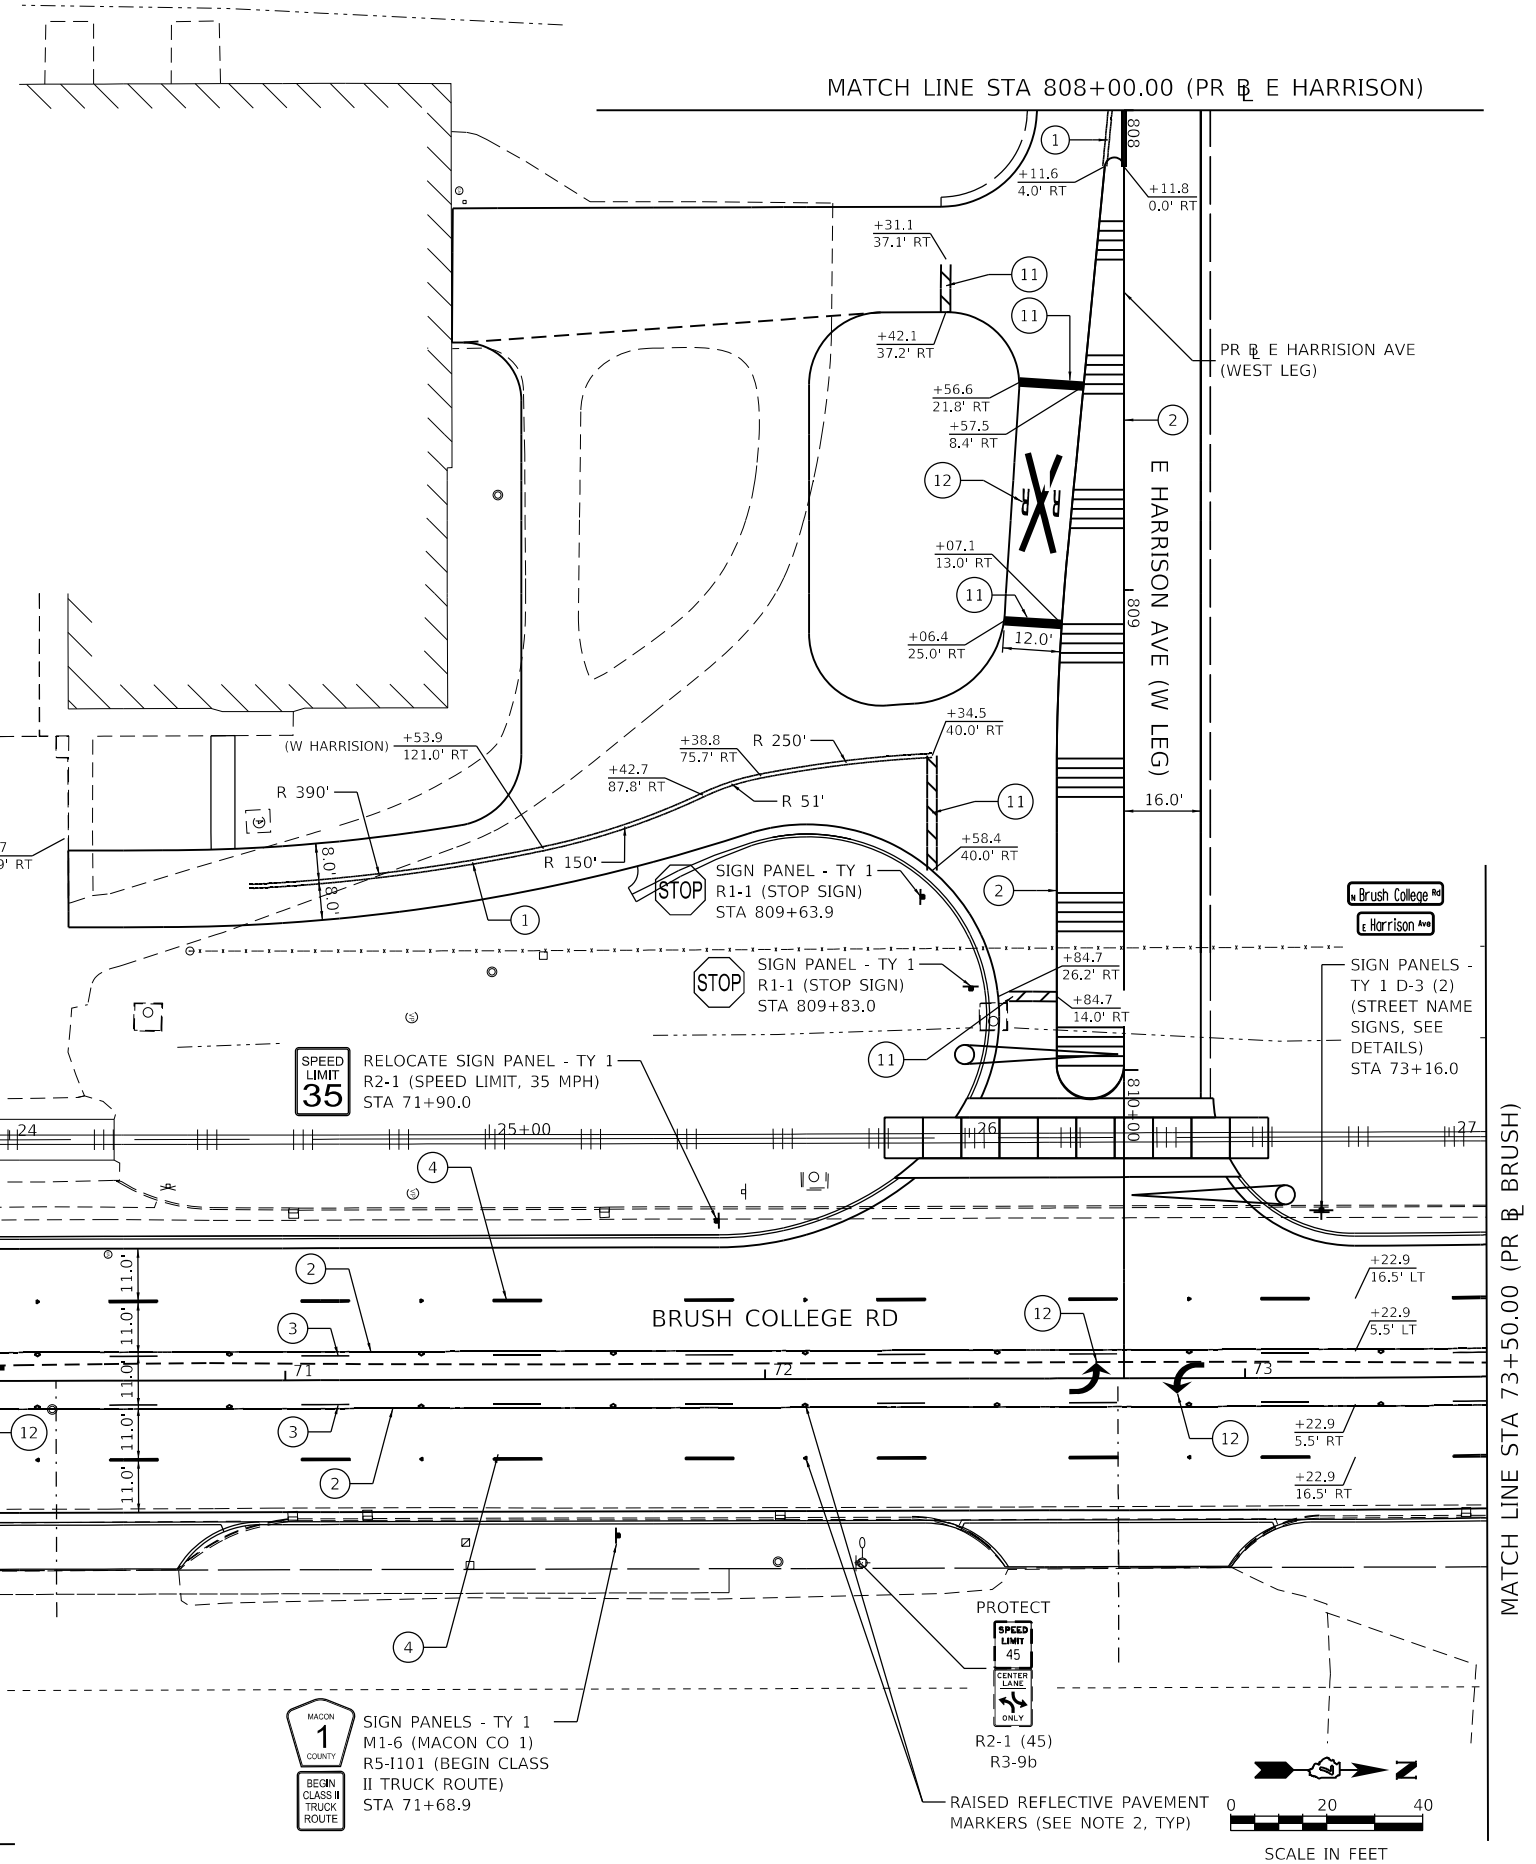

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Kaskaskia
 Engineering Group, LLC
PROFESSIONAL REGISTERED ENGINEERS
 Illinois Professional Design Firm
 Professional Engineering Group

USER NAME = rjo	DESIGNED - NDP	REVISED -
PLOT SCALE = 40.0000' / in.	DRAWN - NDP	REVISED -
PLOT DATE = 4/28/2021	CHECKED - LDC	REVISED -
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**STATE OF ILLINOIS
 DEPARTMENT OF TRANSPORTATION**


**BRUSH COLLEGE ROAD
 PAVEMENT MARKING & SIGNING PLAN**

SCALE: 1"=20' SHEET 5 OF 20 SHEETS STA. 68+00.00 TO STA. 73+50.00

F.A.U. RTE. 7448	SECTION 09-00933-01-BR	COUNTY MACON	TOTAL SHEETS 1019	SHEET NO. 551
CONTRACT NO. 95893				
ILLINOIS FED. AID PROJECT				



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PAVEMENT MARKING LEGEND

- ① MOD URETH PM LINE 4 (SOLID YELLOW, DOUBLE CENTERLINE, 11" C-C)
- ② MOD URETH PM LINE 4 (SOLID YELLOW)
- ③ MOD URETH PM LINE 4 (YELLOW, 10' DASH - 30' SKIP)
- ④ MOD URETH PM LINE 6 (WHITE, 10' DASH - 30' SKIP)
- ⑤ MOD URETH PM LINE 6 (WHITE, 2' DASH - 6' SKIP)
- ⑥ MOD URETH PM LINE 6 (SOLID WHITE)
- ⑫ MOD URETH PM LTR-SYM

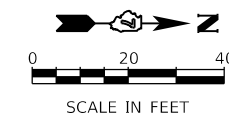

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Kaskaskia
Engineering Group, LLC
PROFESSIONAL DESIGNER
184.004773
Professional Engineering Group 20-5080586

USER NAME = rjo	DESIGNED - NDP	REVISED -
PLOT SCALE = 40.0000' / in.	DRAWN - NDP	REVISED -
PLOT DATE = 4/28/2021	CHECKED - LDC	REVISED -
	DATE - 4/30/2021	REVISED -

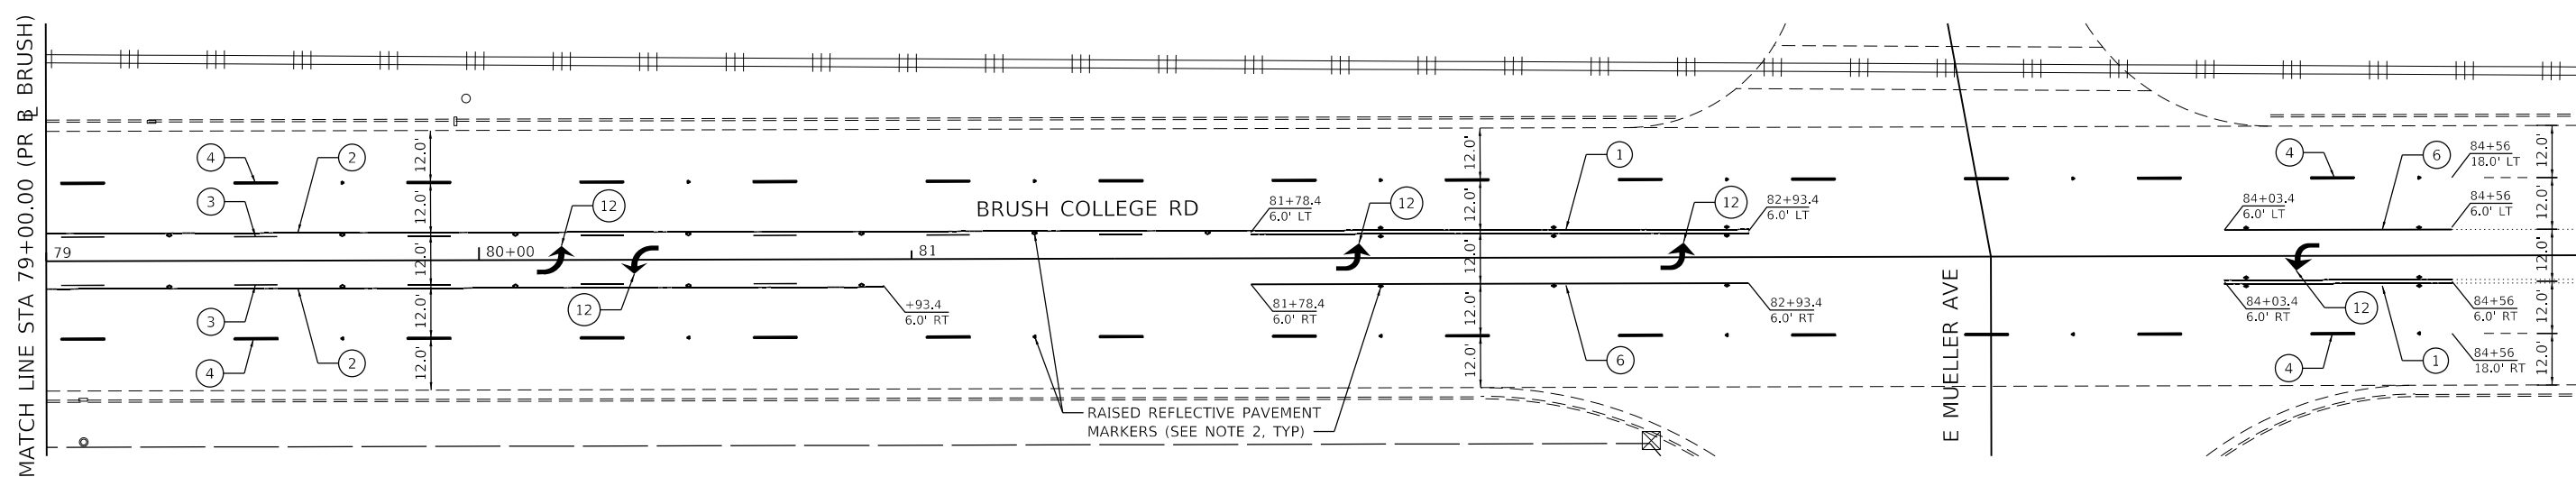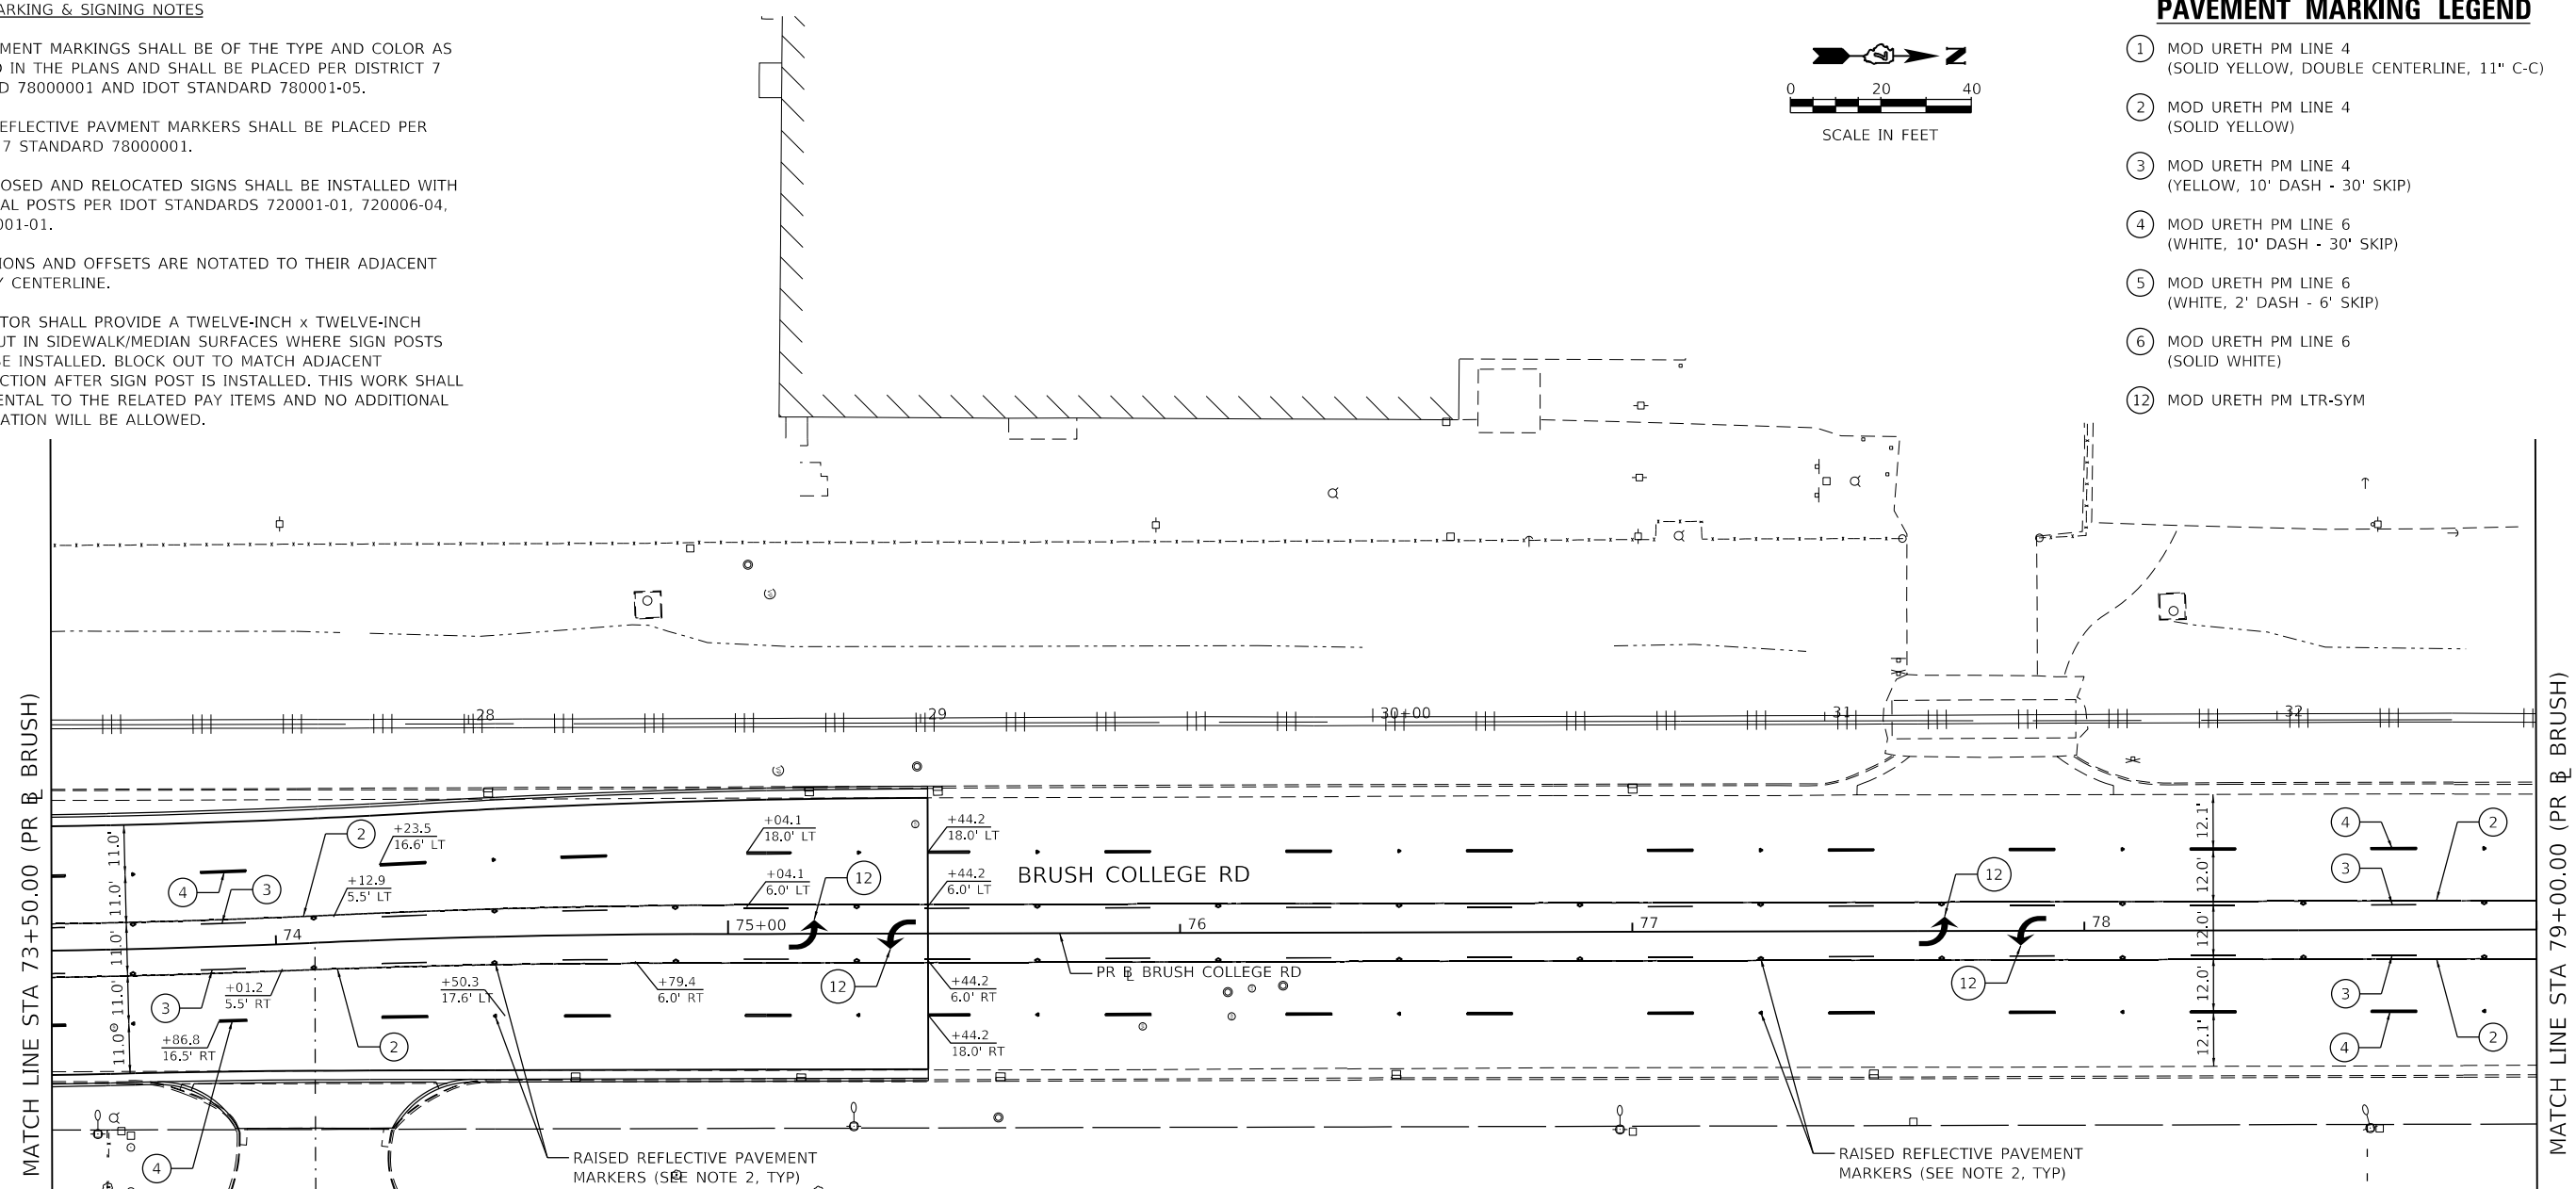**STATE OF ILLINOIS
DEPARTMENT OF TRANSPORTATION**

**BRUSH COLLEGE ROAD
PAVEMENT MARKING & SIGNING PLAN**

SCALE: 1"=20'
SHEET 6 OF 20 SHEETS
STA. 73+50.00 TO STA.



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CONTRACT NO. 95893				
ILLINOIS FED. AID PROJECT				

PAVEMENT MARKING & SIGNING NOTES

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PAVEMENT MARKING LEGEND

- (2) MOD URETH PM LINE 4 (SOLID YELLOW)
- (4) MOD URETH PM LINE 6 (WHITE, 10' DASH - 30' SKIP)
- (6) MOD URETH PM LINE 6 (SOLID WHITE)
- (13) PAINT PVT MARK CURB (YELLOW)

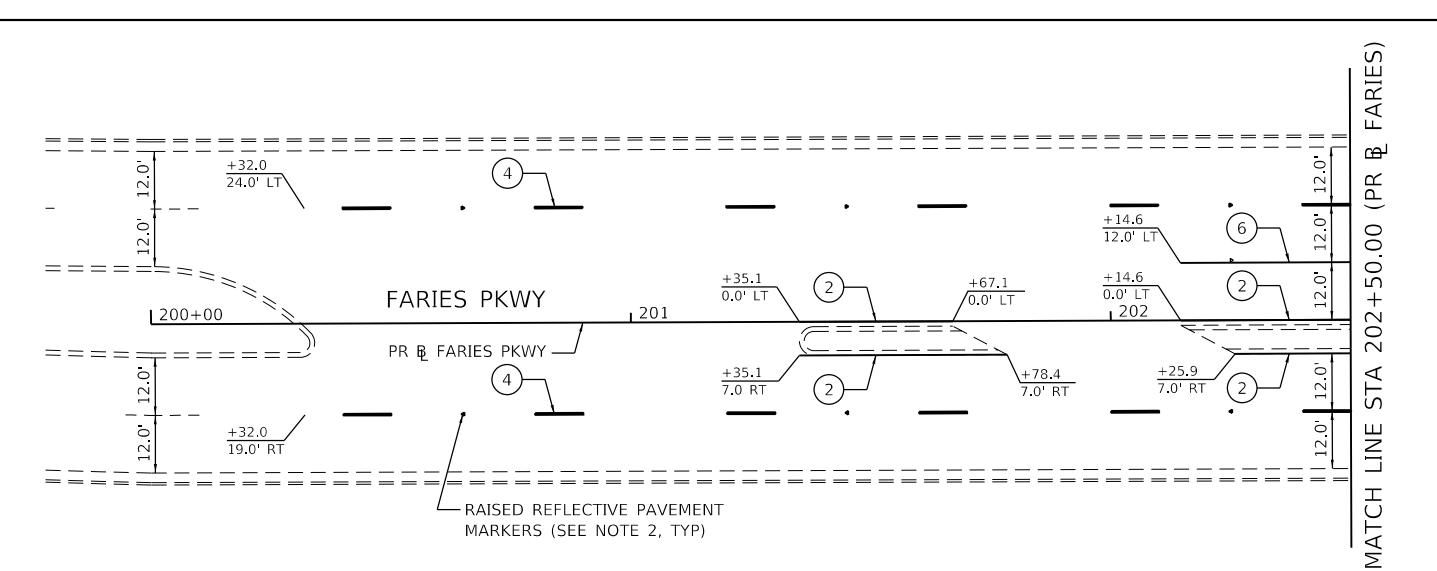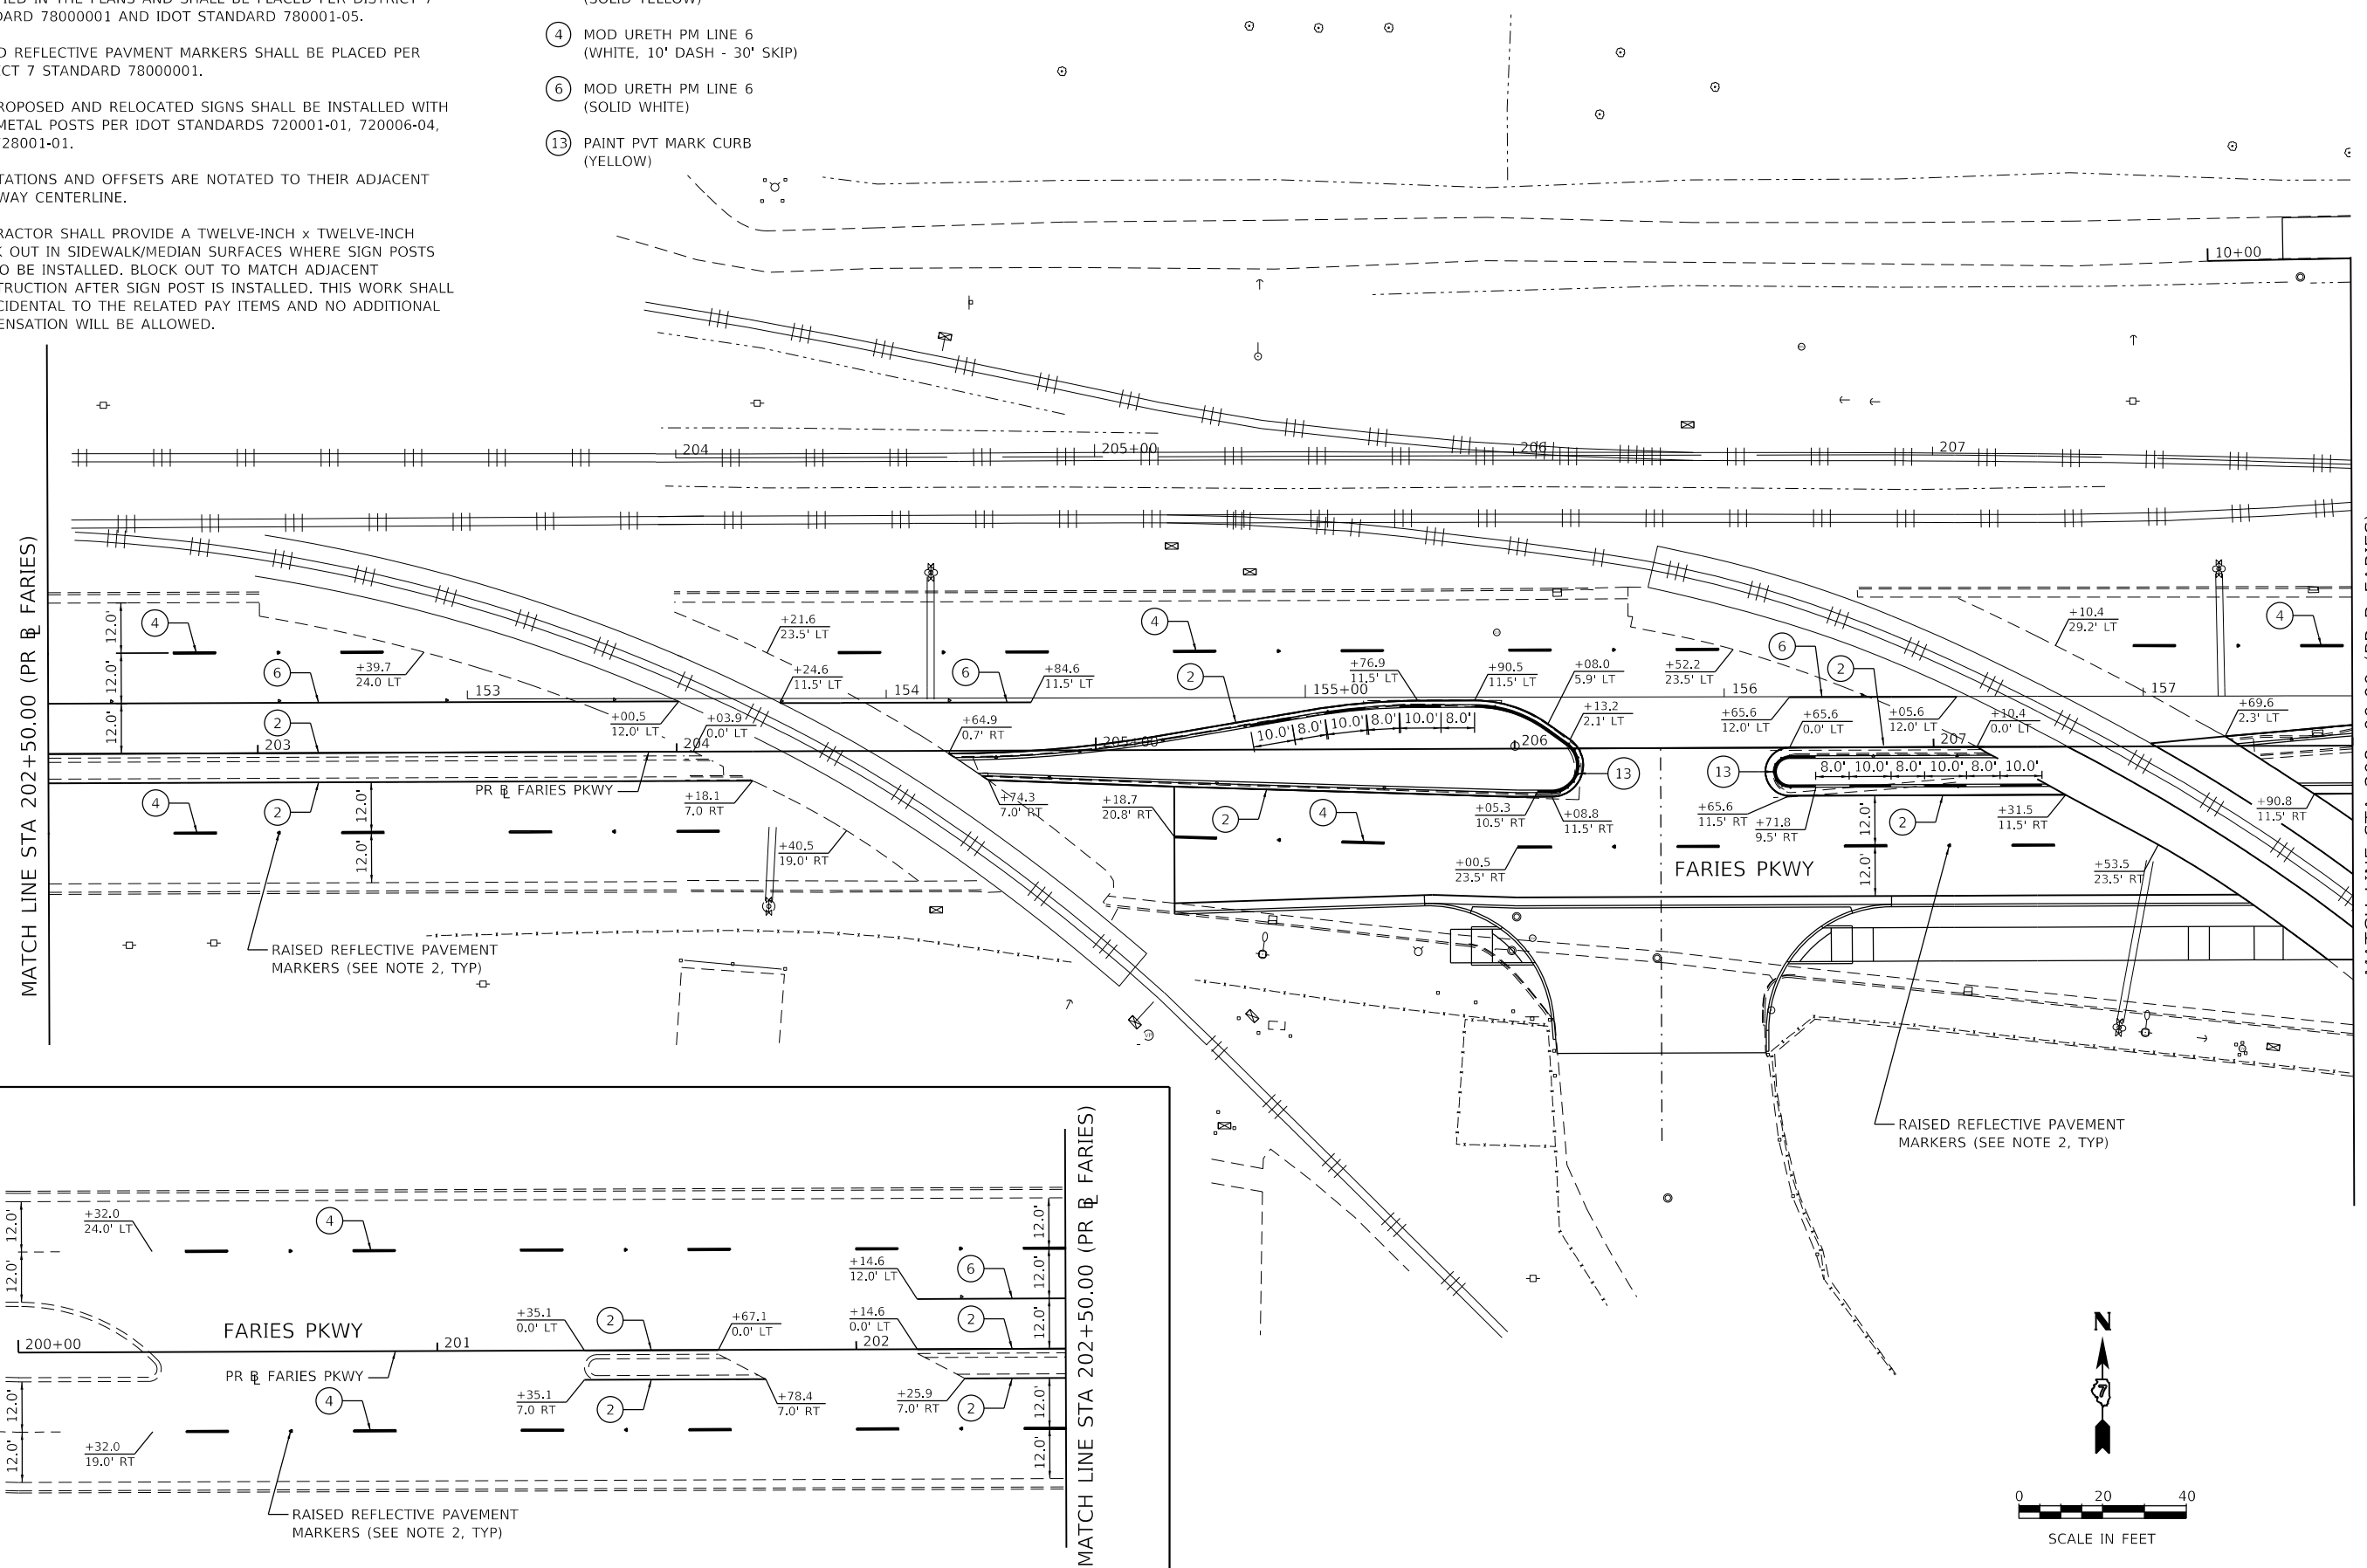

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PLOT DATE = 4/28/2021	CHECKED - LDC	REVISED -
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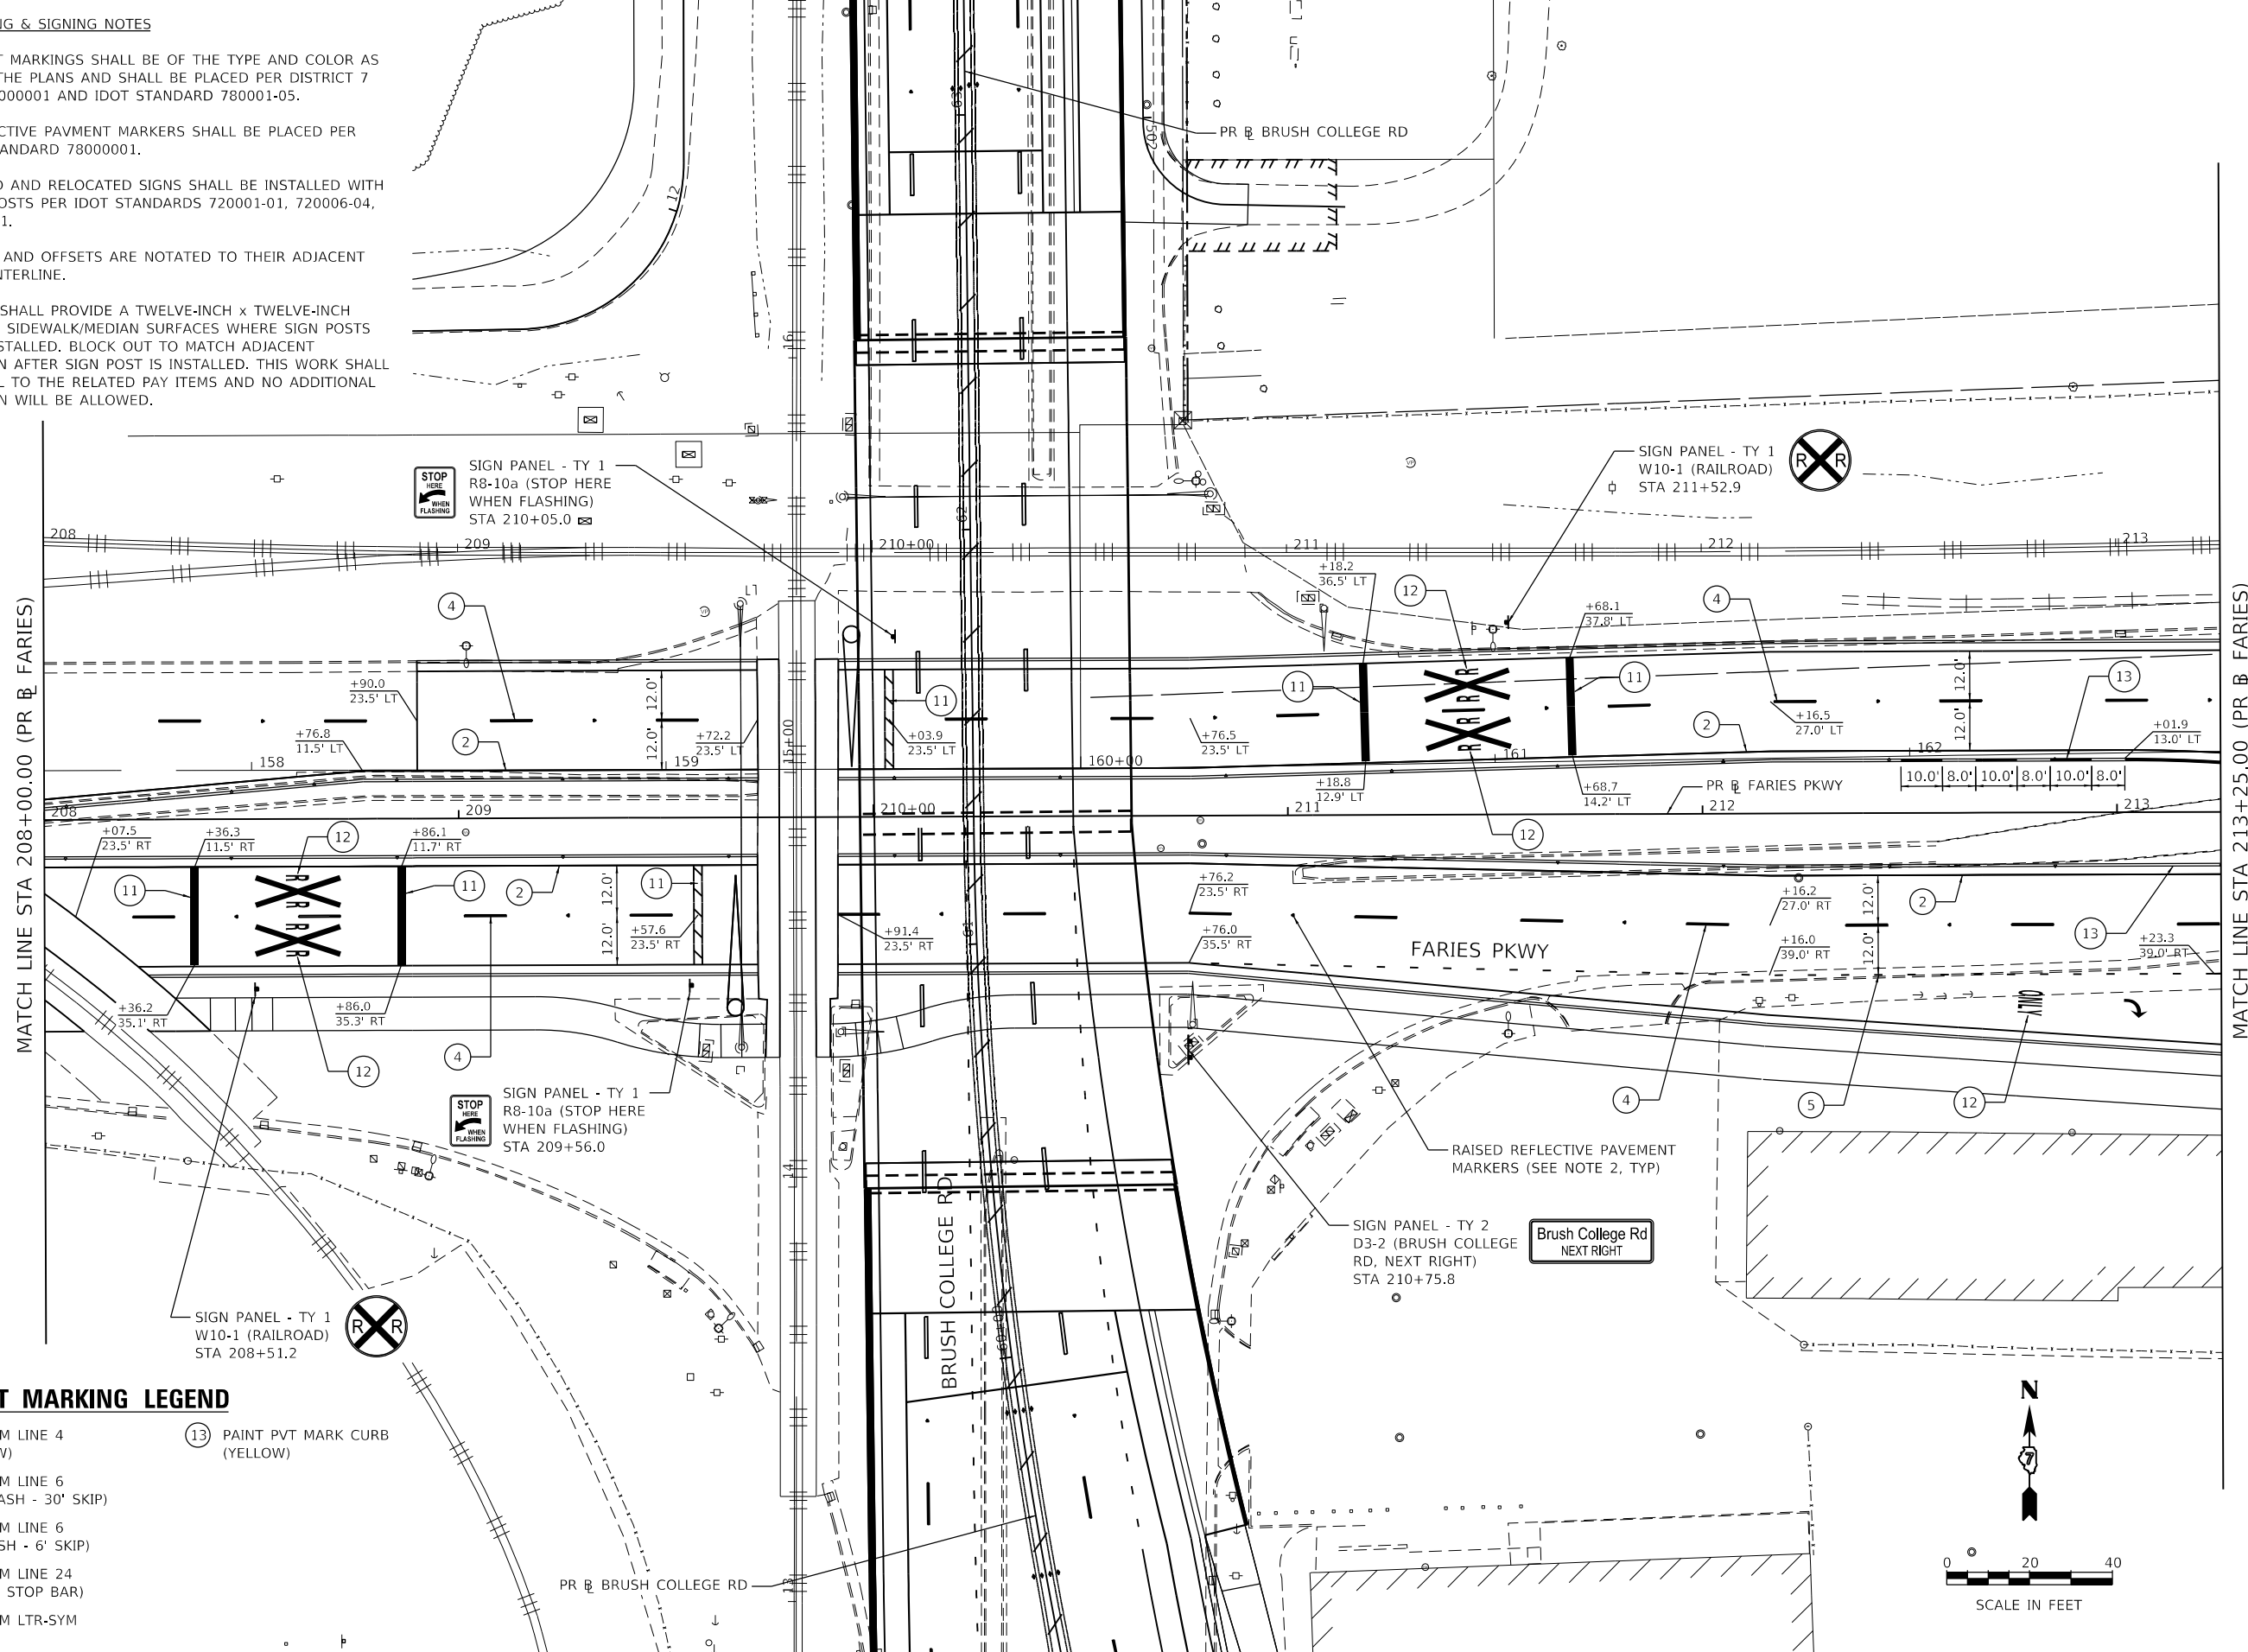
STATE OF ILLINOIS
DEPARTMENT OF TRANSPORTATION

FARIES PARKWAY PAVEMENT MARKING & SIGNING PLAN		
SCALE: 1"=20'	SHEET 7 OF 20 SHEETS	STA. 205+18.77 TO STA. 208+00.00

F.A.U. RTE. 7448	SECTION 09-00933-01-BR	COUNTY MACON	TOTAL SHEETS 1019	SHEET NO. 553
CONTRACT NO. 95893				
ILLINOIS FED. AID PROJECT				

PAVEMENT MARKING & SIGNING NOTES

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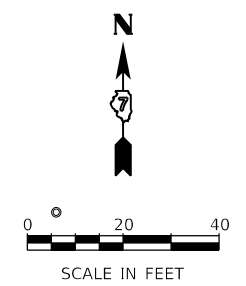


MATCH LINE STA 208+00.00 (PR BR FARIES)

MATCH LINE STA 213+25.00 (PR BR FARIES)

PAVEMENT MARKING LEGEND

- | | |
|--|--------------------------------|
| ② MOD URETH PM LINE 4 (SOLID YELLOW) | ⑬ PAINT PVT MARK CURB (YELLOW) |
| ④ MOD URETH PM LINE 6 (WHITE, 10' DASH - 30' SKIP) | |
| ⑤ MOD URETH PM LINE 6 (WHITE, 2' DASH - 6' SKIP) | |
| ⑪ MOD URETH PM LINE 24 (SOLID WHITE, STOP BAR) | |
| ⑫ MOD URETH PM LTR-SYM | |



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Kaskaskia
Engineering Group, LLC
PROFESSIONAL REGISTERED ENGINEERS
Illinois Professional Design Firm
Professional Engineering Group

USER NAME = rjo	DESIGNED - NDP	REVISED -
	DRAWN - NDP	REVISED -
PLOT SCALE = 40.0000' / in.	CHECKED - LDC	REVISED -
PLOT DATE = 10/21/2021	DATE - 10/22/2021	REVISED -

**STATE OF ILLINOIS
DEPARTMENT OF TRANSPORTATION**


**FARIES PARKWAY
PAVEMENT MARKING & SIGNING PLAN**

SCALE: 1"=20' SHEET 8 OF 20 SHEETS STA. 208+00.00 TO STA. 213+25.00

F.A.U. RTE. 7448	SECTION 09-00933-01-BR	COUNTY MACON	TOTAL SHEETS 1019	SHEET NO. 554
CONTRACT NO. 95893				
ILLINOIS FED. AID PROJECT				


PAVEMENT MARKING & SIGNING NOTES

1. ALL PAVEMENT MARKINGS SHALL BE OF THE TYPE AND COLOR AS SPECIFIED IN THE PLANS AND SHALL BE PLACED PER DISTRICT 7 STANDARD 78000001 AND IDOT STANDARD 780001-05.
2. RAISED REFLECTIVE PAVEMENT MARKERS SHALL BE PLACED PER DISTRICT 7 STANDARD 78000001.
3. ALL PROPOSED AND RELOCATED SIGNS SHALL BE INSTALLED WITH NEW METAL POSTS PER IDOT STANDARDS 720001-01, 720006-04, AND 728001-01.
4. ALL STATIONS AND OFFSETS ARE NOTATED TO THEIR ADJACENT ROADWAY CENTERLINE.
5. CONTRACTOR SHALL PROVIDE A TWELVE-INCH x TWELVE-INCH BLOCK OUT IN SIDEWALK/MEDIAN SURFACES WHERE SIGN POSTS ARE TO BE INSTALLED. BLOCK OUT TO MATCH ADJACENT CONSTRUCTION AFTER SIGN POST IS INSTALLED. THIS WORK SHALL BE INCIDENTAL TO THE RELATED PAY ITEMS AND NO ADDITIONAL COMPENSATION WILL BE ALLOWED.

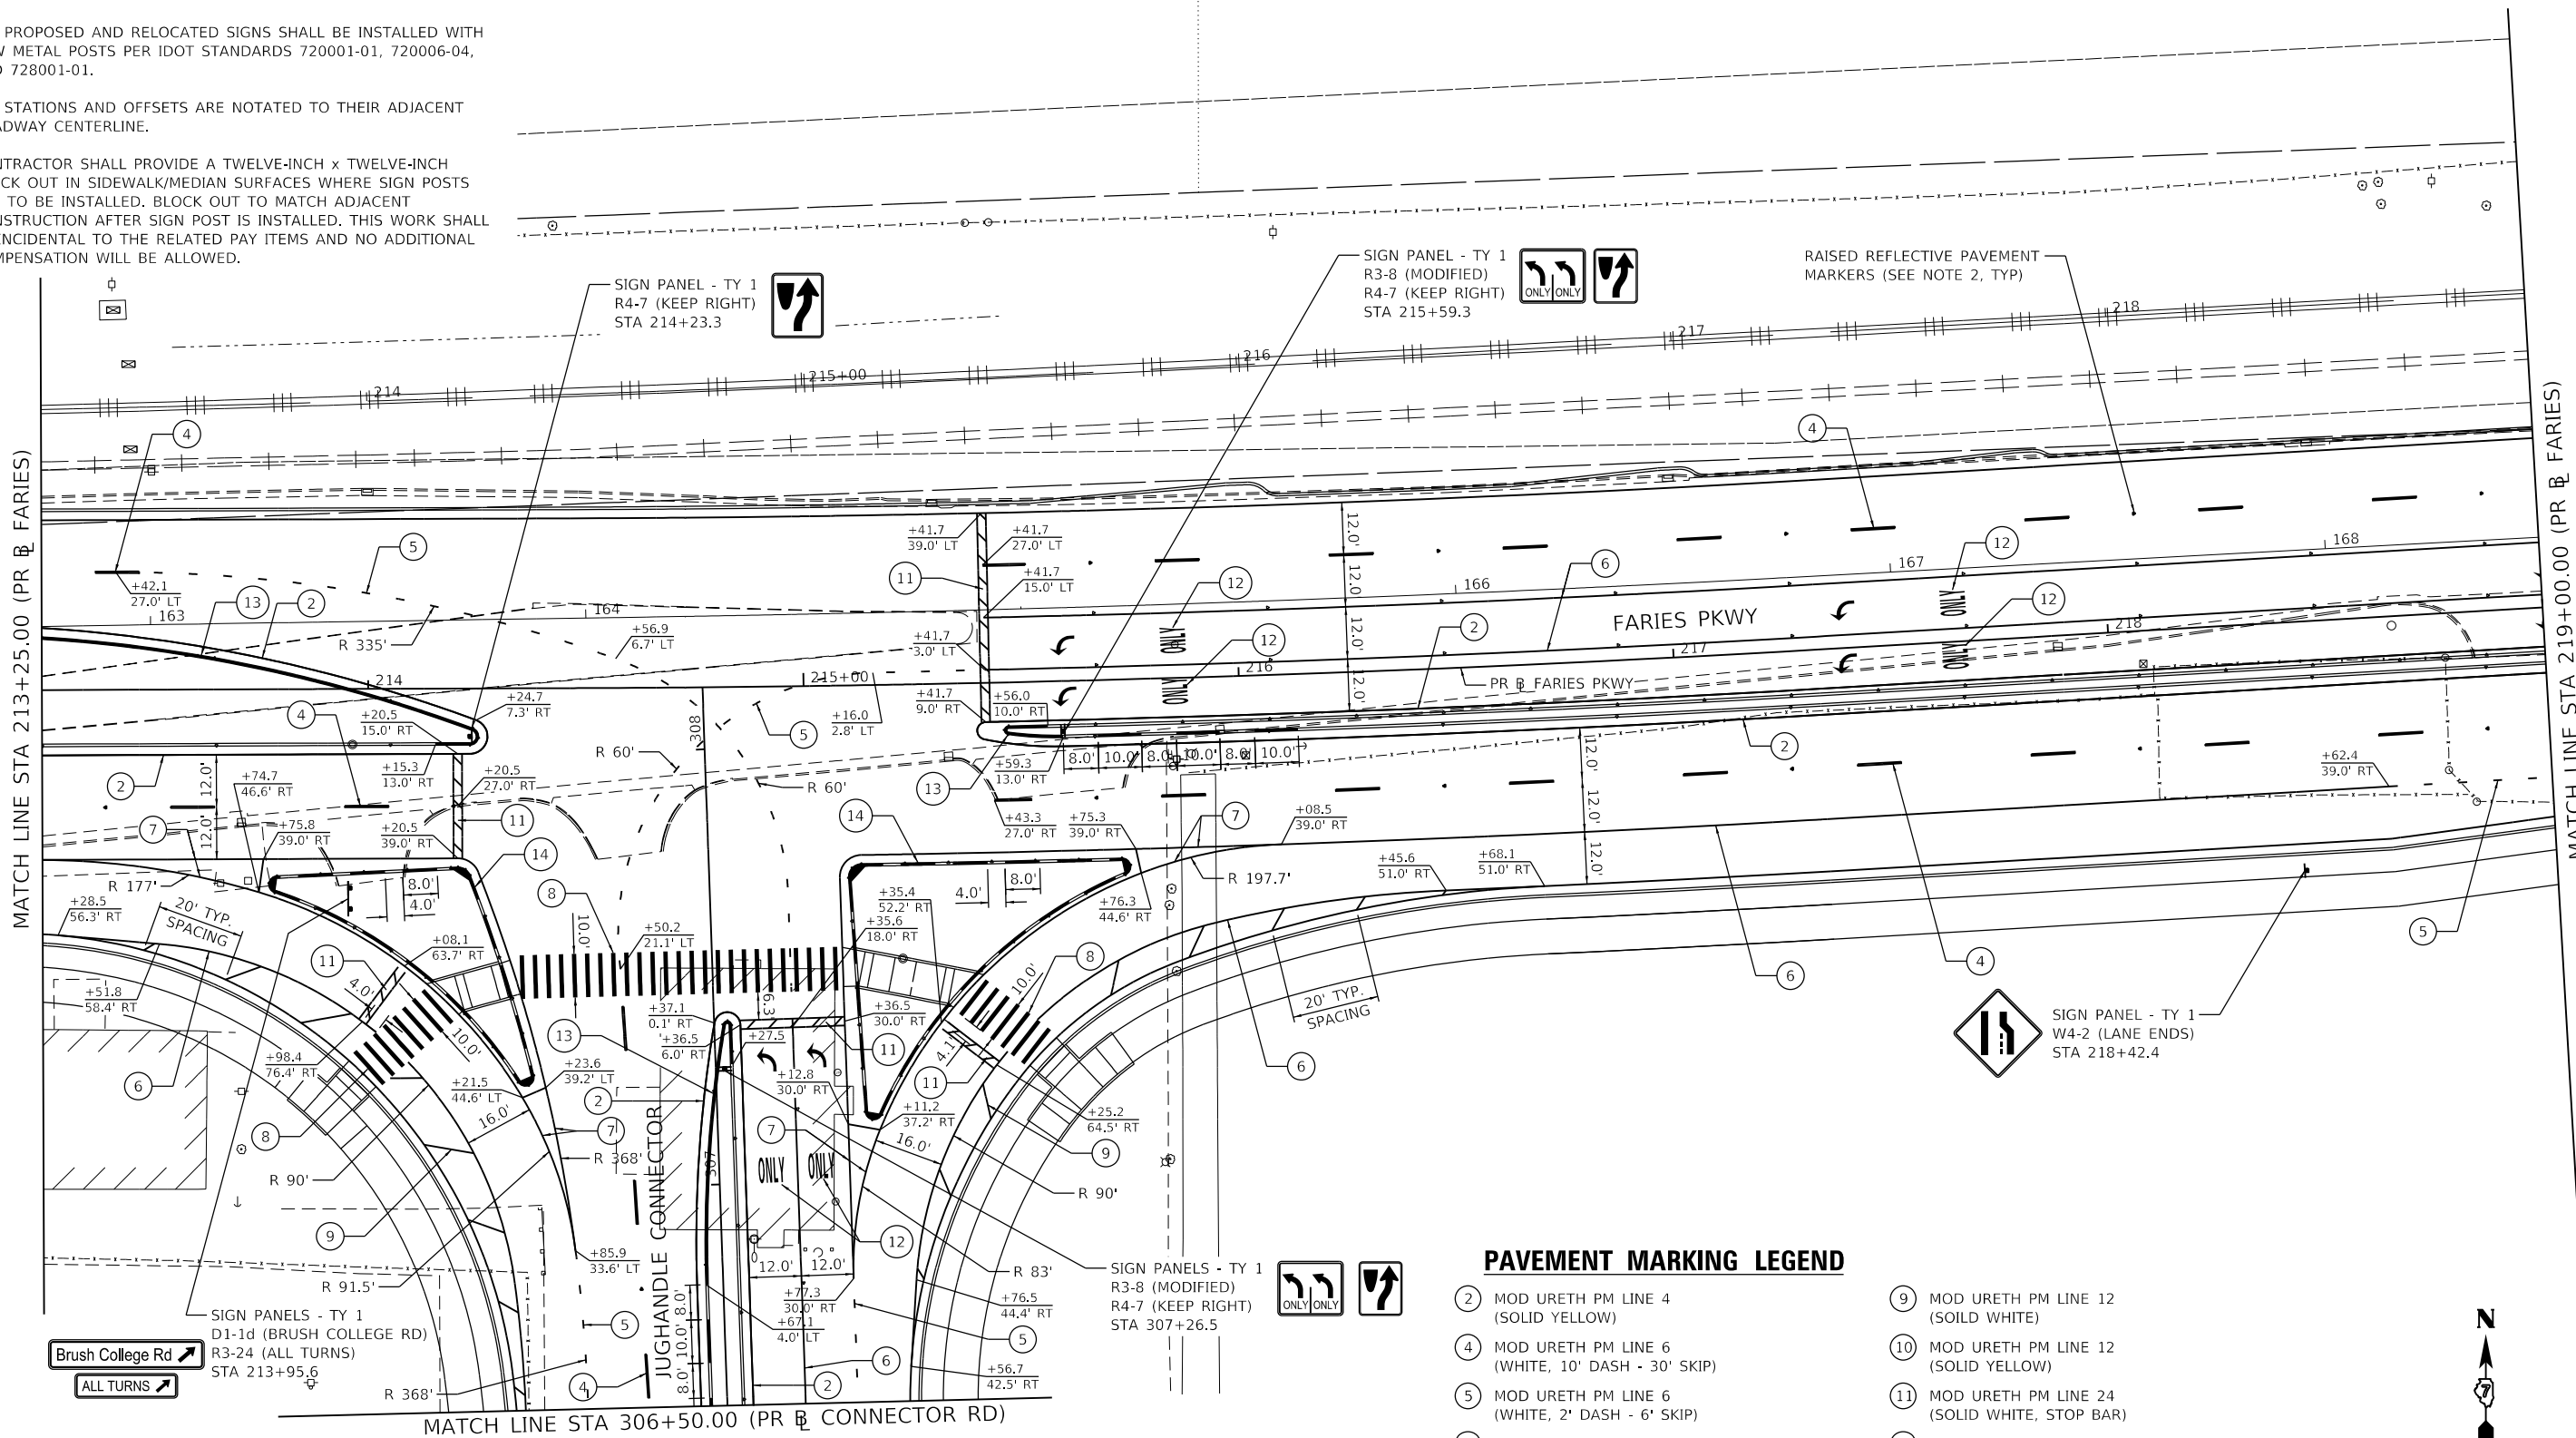

PAVEMENT MARKING LEGEND

- | | |
|--|--|
| ② MOD URETH PM LINE 4 (SOLID YELLOW) | ⑨ MOD URETH PM LINE 12 (SOLID WHITE) |
| ④ MOD URETH PM LINE 6 (WHITE, 10' DASH - 30' SKIP) | ⑩ MOD URETH PM LINE 12 (SOLID YELLOW) |
| ⑤ MOD URETH PM LINE 6 (WHITE, 2' DASH - 6' SKIP) | ⑪ MOD URETH PM LINE 24 (SOLID WHITE, STOP BAR) |
| ⑥ MOD URETH PM LINE 6 (SOLID WHITE) | ⑫ MOD URETH PM LTR-SYM |
| ⑦ MOD URETH PM LINE 8 (SOLID WHITE) | ⑬ PAINT PVT MARK CURB (YELLOW) |
| ⑧ MOD URETH PM LINE 12 (SOLID WHITE, CROSS WALK) | ⑭ PAINT PVT MARK CURB (WHITE) |

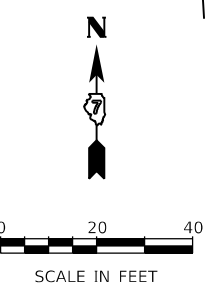

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 Kaskaskia Engineering Group, LLC
 PROFESSIONAL REGISTERED ENGINEERS
 Illinois Professional Design Firm
 184.004773
 20-5880586

Brush College Rd
ALL TURNS

SIGN PANELS - TY 1
D1-1d (BRUSH COLLEGE RD)
R3-24 (ALL TURNS)
STA 213+95.6

JUGHANDLE CONNECTOR

SIGN PANELS - TY 1
R3-8 (MODIFIED)
R4-7 (KEEP RIGHT)
STA 307+26.5



SIGN PANEL - TY 1
R3-8 (MODIFIED)
R4-7 (KEEP RIGHT)
STA 215+59.3

RAISED REFLECTIVE PAVEMENT MARKERS (SEE NOTE 2, TYP)



SIGN PANEL - TY 1
W4-2 (LANE ENDS)
STA 218+42.4

STATE OF ILLINOIS
DEPARTMENT OF TRANSPORTATION

FARIES PARKWAY
PAVEMENT MARKING & SIGNING PLAN

SCALE: 1"=20' SHEET 9 OF 20 SHEETS STA. 213+25.00 TO STA. 219+00.00


F.A.U. RTE.	SECTION	COUNTY	TOTAL SHEETS	SHEET NO.
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CONTRACT NO. 95893				
ILLINOIS FED. AID PROJECT				

PAVEMENT MARKING & SIGNING NOTES


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PAVEMENT MARKING LEGEND

- | | |
|--|--------------------------------|
| ② MOD URETH PM LINE 4 (SOLID YELLOW) | ⑫ MOD URETH PM LTR-SYM |
| ④ MOD URETH PM LINE 6 (WHITE, 10' DASH - 30' SKIP) | ⑬ PAINT PVT MARK CURB (YELLOW) |
| ⑤ MOD URETH PM LINE 6 (WHITE, 2' DASH - 6" SKIP) | |
| ⑥ MOD URETH PM LINE 6 (SOLID WHITE) | |
| ⑧ MOD URETH PM LINE 12 (SOLID WHITE, CROSS WALK) | |
| ⑪ MOD URETH PM LINE 24 (SOLID WHITE, STOP BAR) | |

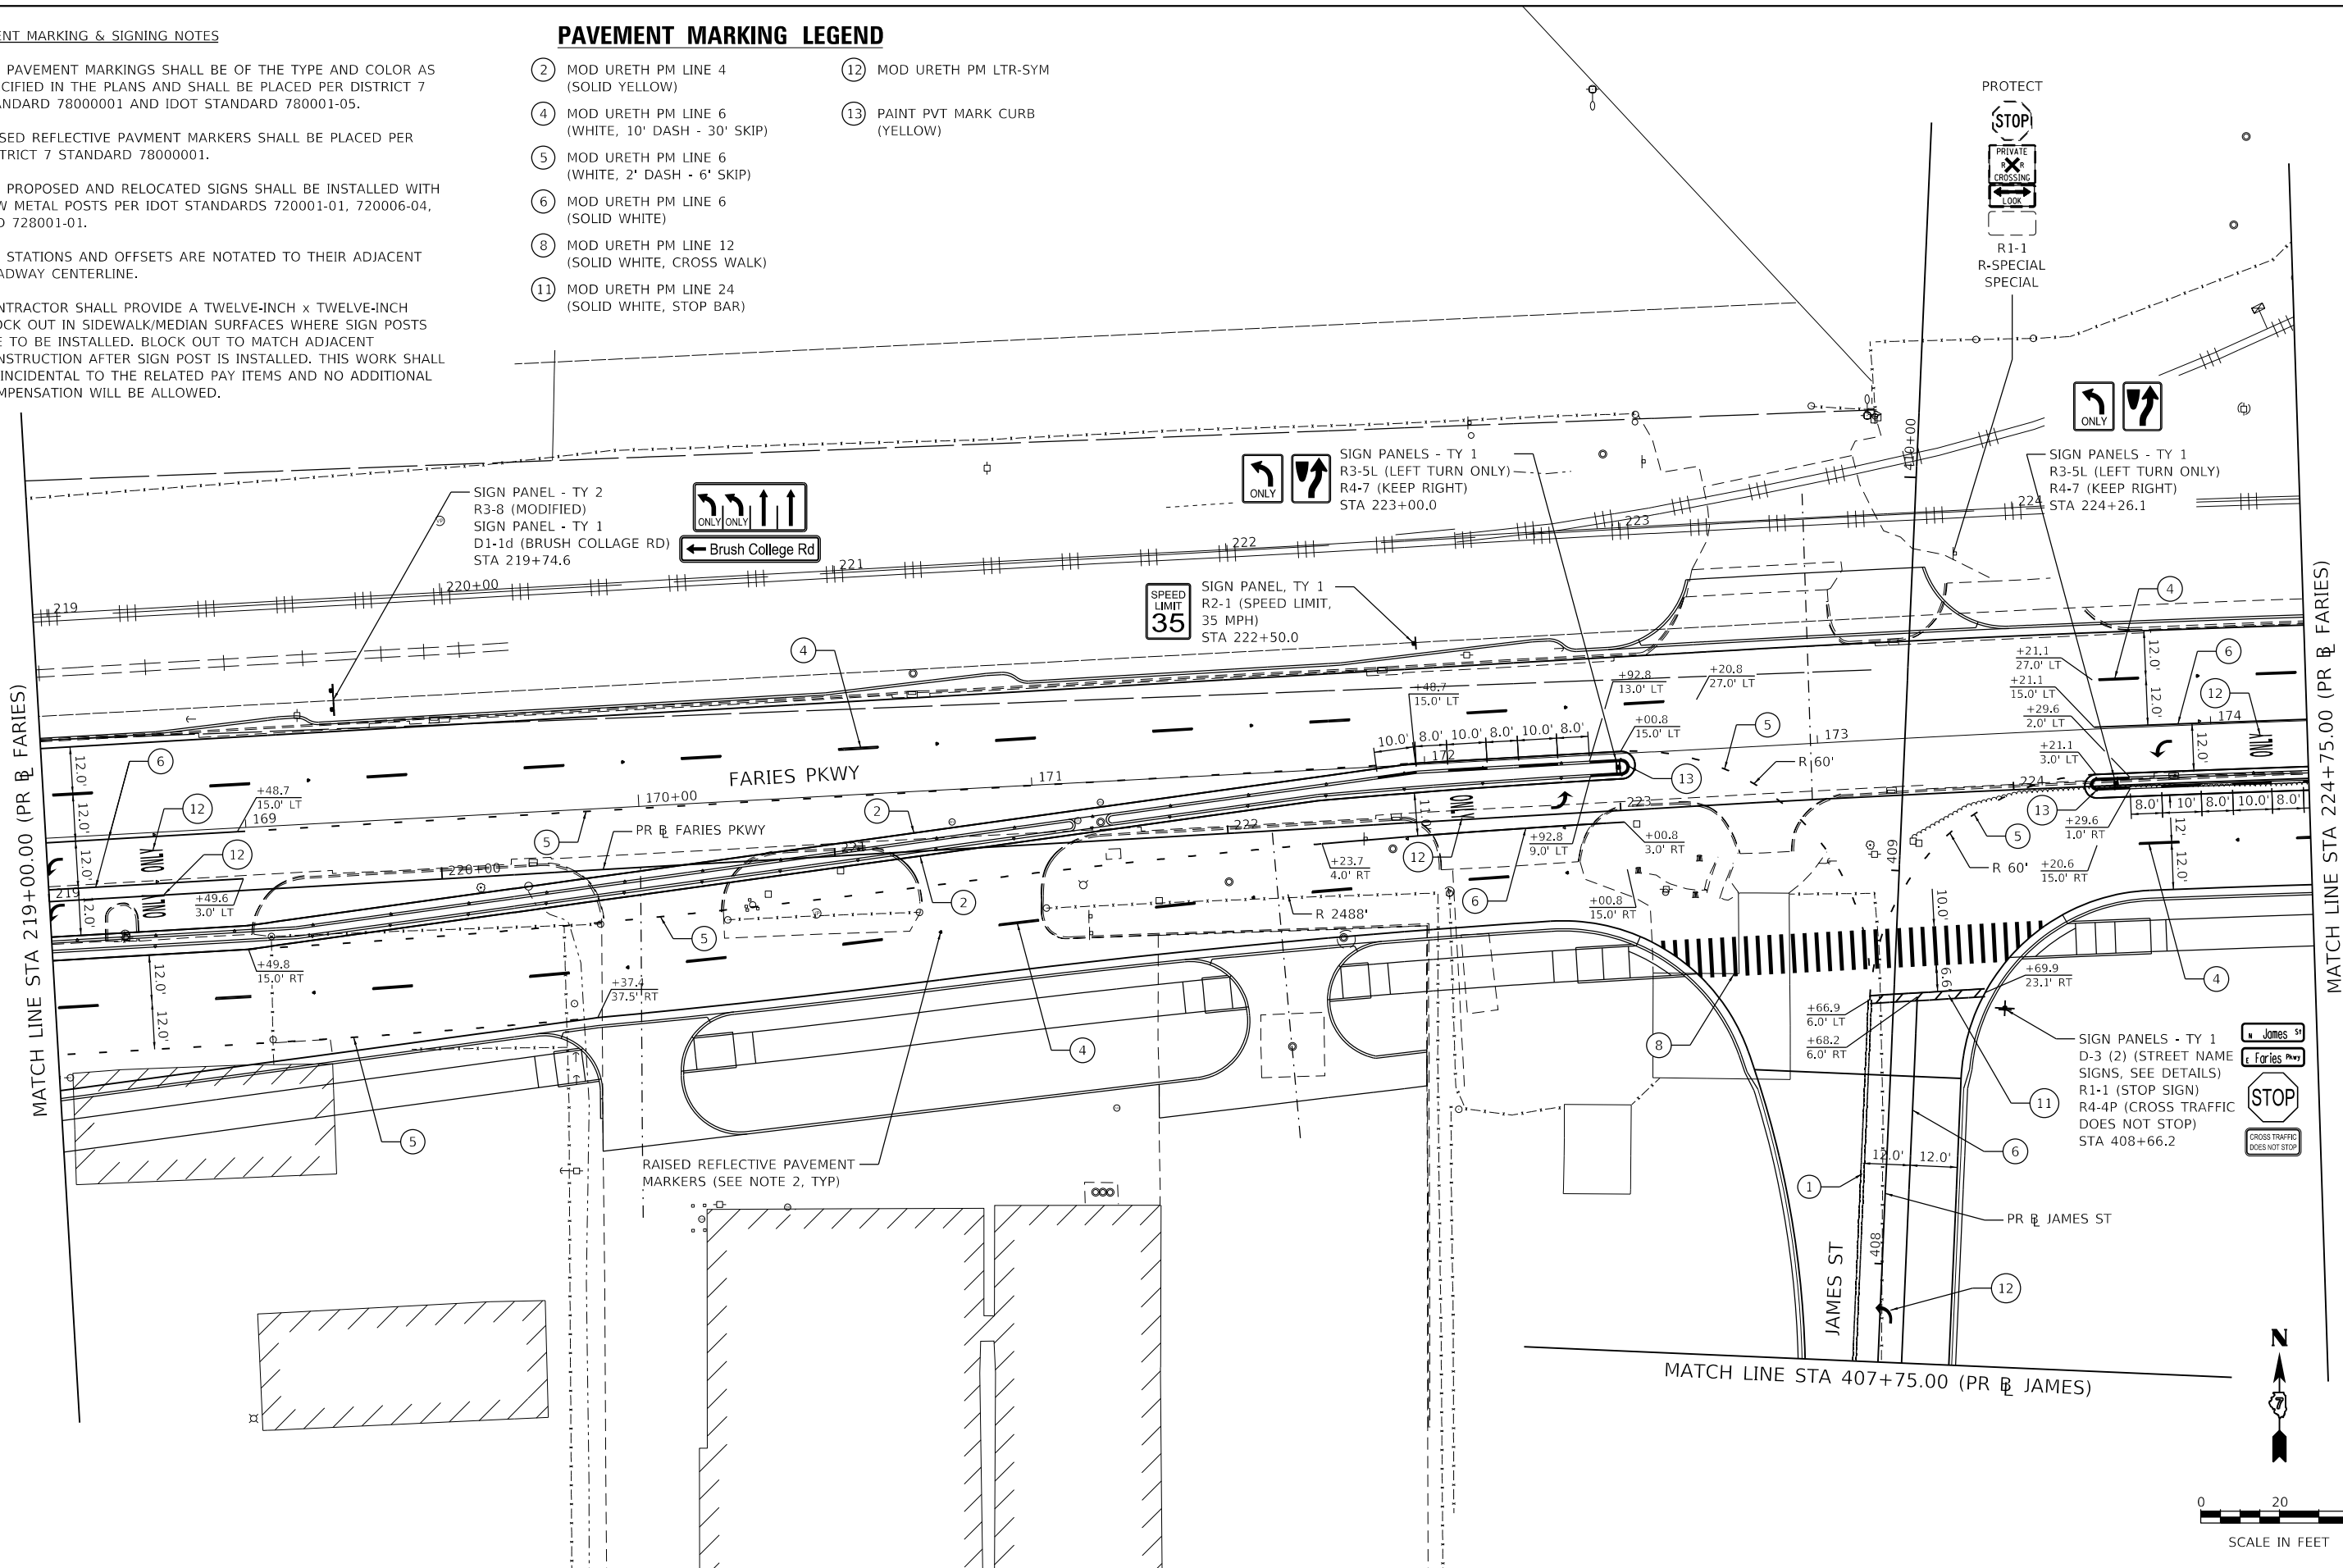

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 Kaskaskia Engineering Group, LLC
 PROFESSIONAL REGISTERED ENGINEERS & ARCHITECTS
 Illinois Professional Design Firm
 184.004773
 20-5880586

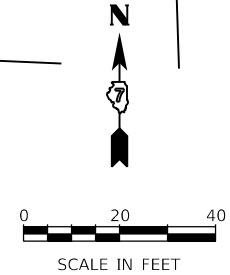

USER NAME = rjo	DESIGNED - NDP	REVISED -
PLOT SCALE = 40.0000' / in.	DRAWN - NDP	REVISED -
PLOT DATE = 4/28/2021	CHECKED - LDC	REVISED -
	DATE - 4/30/2021	REVISED -



**STATE OF ILLINOIS
DEPARTMENT OF TRANSPORTATION**

FARIES PARKWAY PAVEMENT MARKING & SIGNING PLAN		
SCALE: 1"=20'	SHEET 10 OF 20 SHEETS	STA. 219+00.0 TO STA. 224+75.00

F.A.U. RTE. 7448	SECTION 09-00933-01-BR	COUNTY MACON	TOTAL SHEETS 1019	SHEET NO. 556
CONTRACT NO. 95893				
ILLINOIS FED. AID PROJECT				


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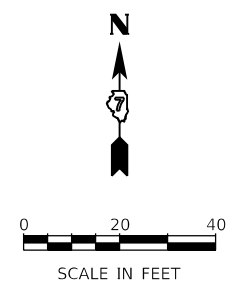


PAVEMENT MARKING LEGEND

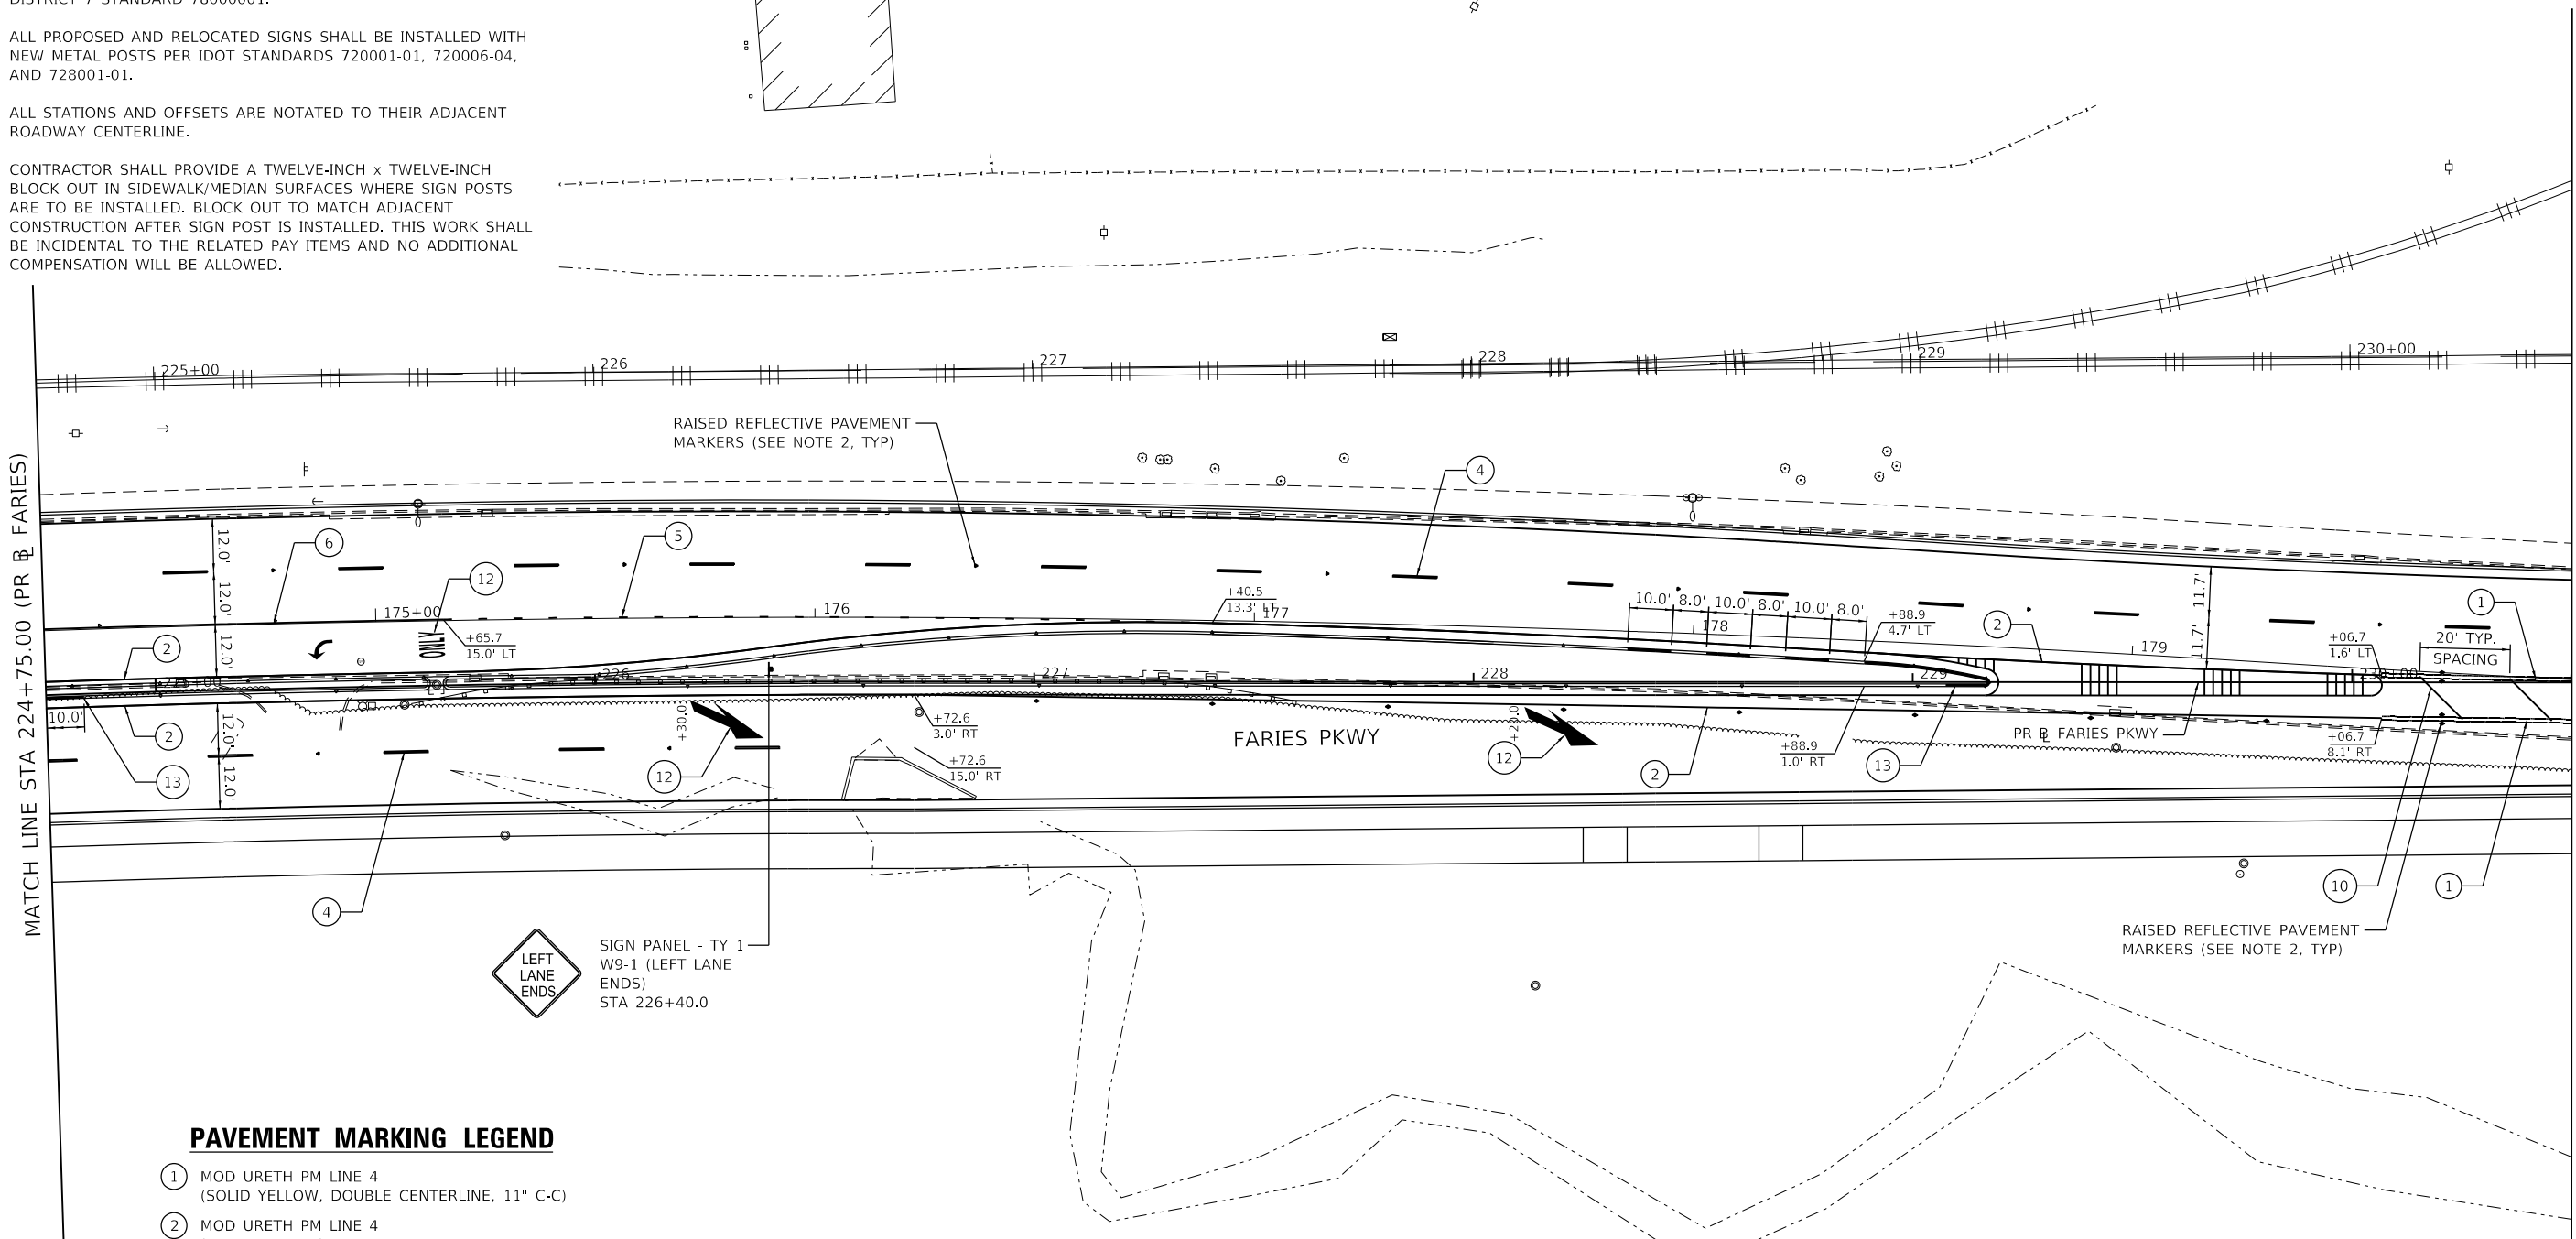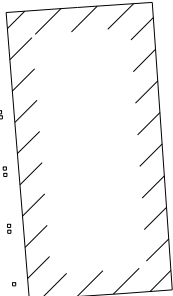- ① MOD URETH PM LINE 4 (SOLID YELLOW, DOUBLE CENTERLINE, 11" C-C)
- ② MOD URETH PM LINE 4 (SOLID YELLOW)
- ④ MOD URETH PM LINE 6 (WHITE, 10' DASH - 30' SKIP)
- ⑤ MOD URETH PM LINE 6 (WHITE, 2' DASH - 6' SKIP)
- ⑥ MOD URETH PM LINE 6 (SOLID WHITE)
- ⑩ MOD URETH PM LINE 12 (SOLID YELLOW)
- ⑫ MOD URETH PM LTR-SYM
- ⑬ PAINT PVT MARK CURB (YELLOW)



SIGN PANEL - TY 1
W9-1 (LEFT LANE ENDS)
STA 226+40.0

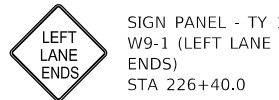

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PLOT DATE = 4/28/2021	CHECKED - LDC	REVISED -
	DATE - 4/30/2021	REVISED -

**STATE OF ILLINOIS
DEPARTMENT OF TRANSPORTATION**

FARIES PARKWAY PAVEMENT MARKING & SIGNING PLAN	
SCALE: 1"=20'	SHEET 11 OF 20 SHEETS
STA. 224+75.00 TO STA. 230+50.00	




F.A.U. RTE. 7448	SECTION 09-00933-01-BR	COUNTY MACON	TOTAL SHEETS 1019	SHEET NO. 557
CONTRACT NO. 95893				
ILLINOIS FED. AID PROJECT				

PAVEMENT MARKING & SIGNING NOTES

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PAVEMENT MARKING LEGEND

- ① MOD URETH PM LINE 4 (SOLID YELLOW, DOUBLE CENTERLINE, 11" C-C)
- ④ MOD URETH PM LINE 6 (WHITE, 10' DASH - 30' SKIP)
- ⑥ MOD URETH PM LINE 6 (SOLID WHITE)
- ⑧ MOD URETH PM LINE 12 (SOLID WHITE, CROSS WALK)
- ⑩ MOD URETH PM LINE 12 (SOLID YELLOW)
- ⑫ MOD URETH PM LTR-SYM

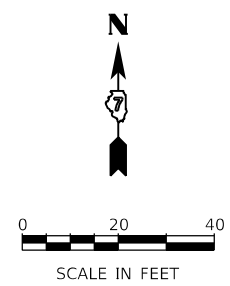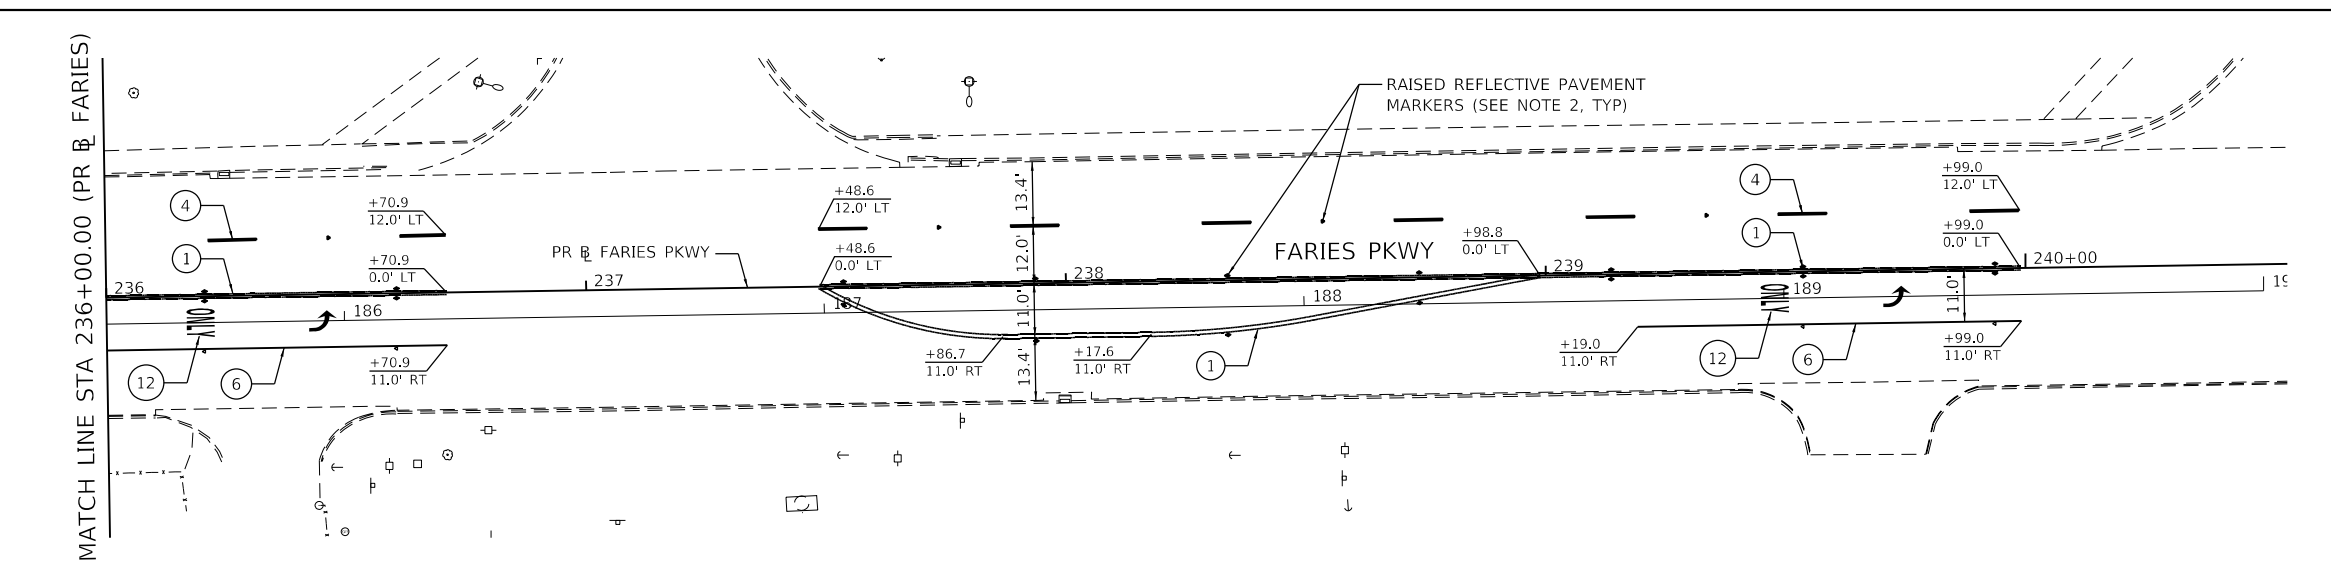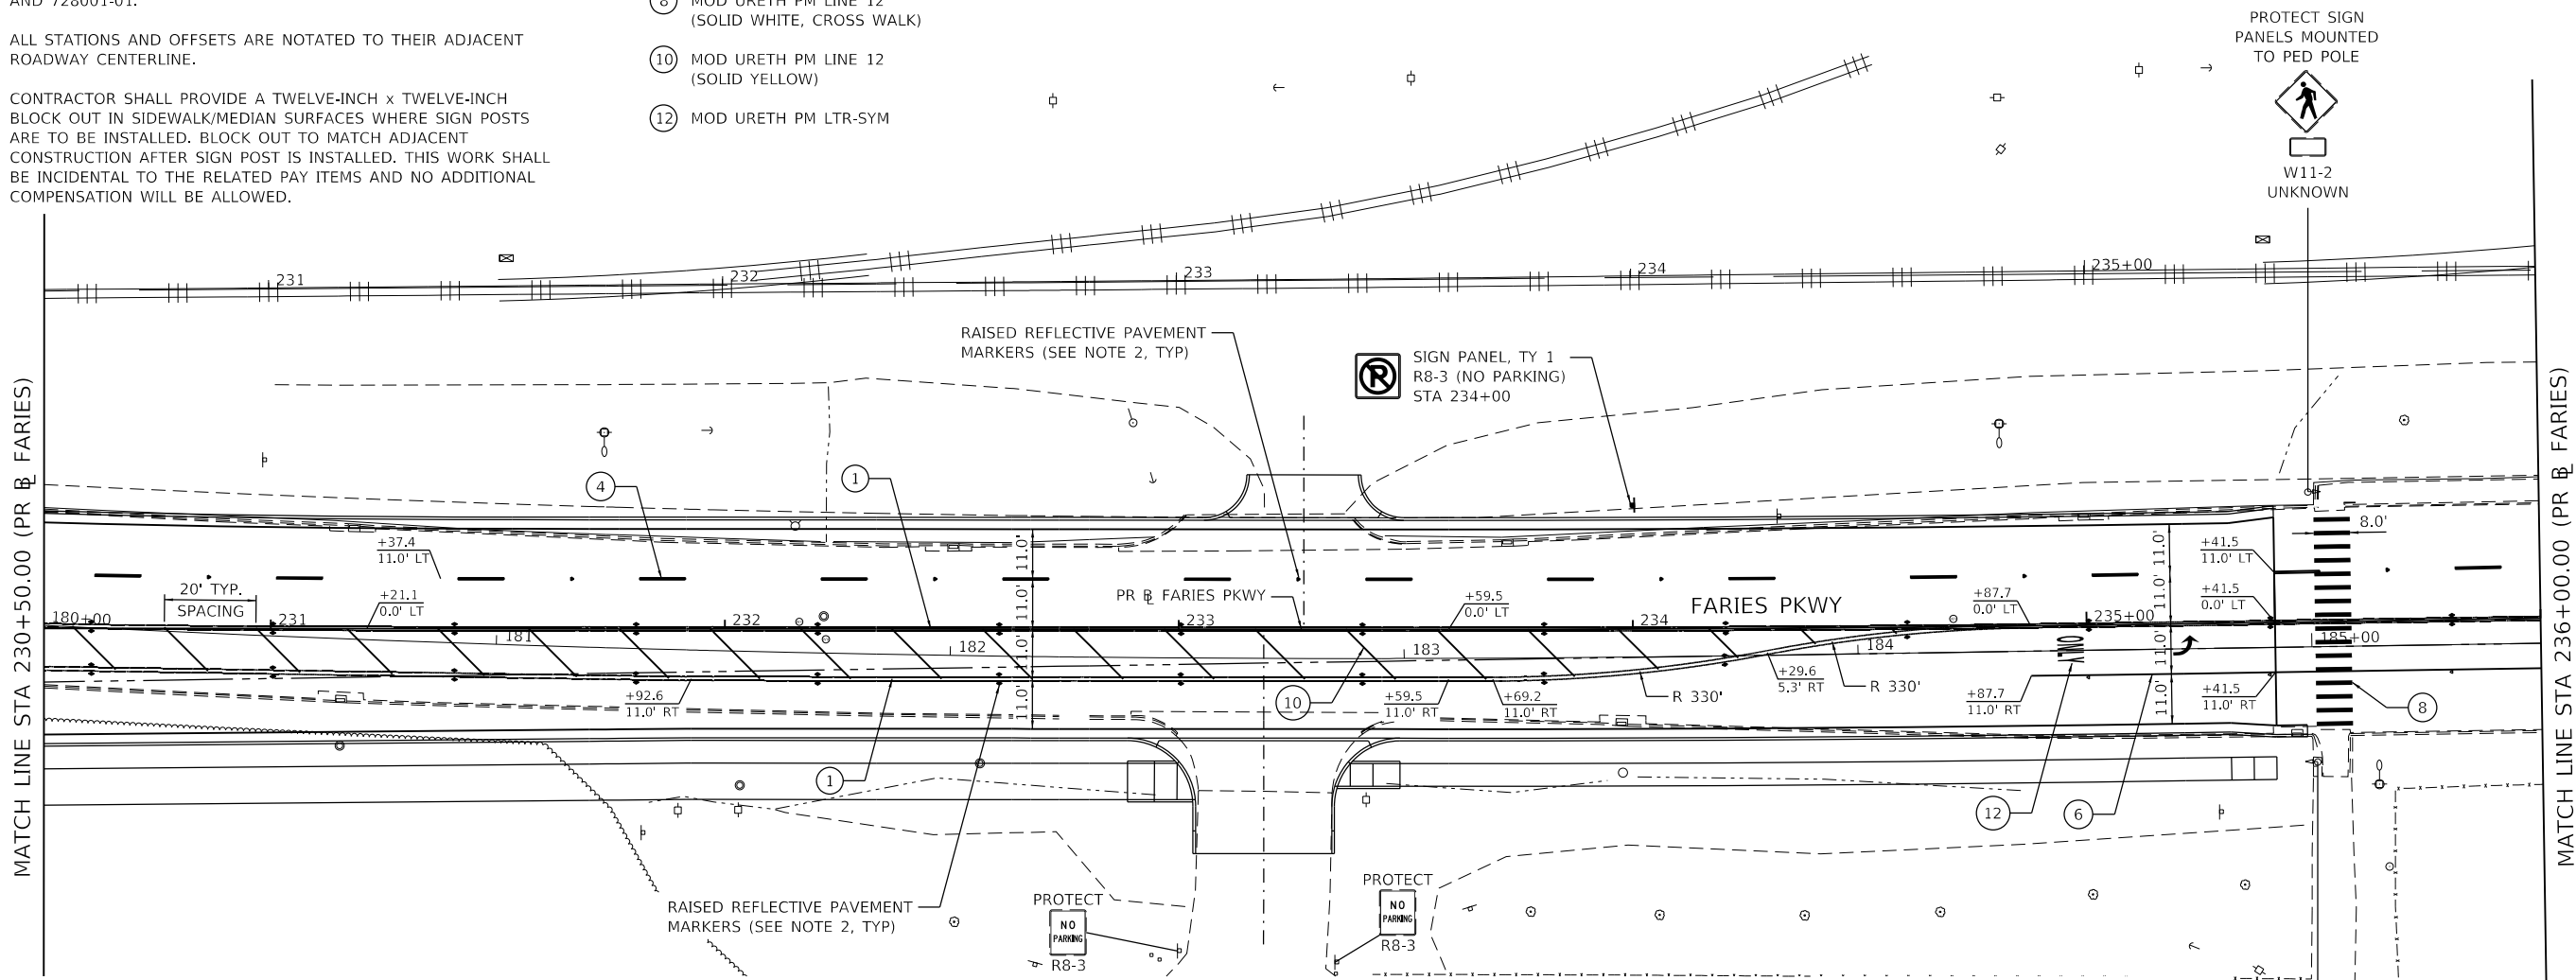

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Kaskaskia
Engineering Group, LLC
PROFESSIONAL ENGINEERS
Illinois Professional Design Firm
Professional Engineering Group

USER NAME = rjo	DESIGNED - NDP	REVISED -
PLOT SCALE = 40.0000' / in.	DRAWN - NDP	REVISED -
PLOT DATE = 4/28/2021	CHECKED - LDC	REVISED -
	DATE - 4/30/2021	REVISED -

**STATE OF ILLINOIS
DEPARTMENT OF TRANSPORTATION**


**FARIES PARKWAY
PAVEMENT MARKING & SIGNING PLAN**

SCALE: 1"=20' SHEET 12 OF 20 SHEETS STA. 230+50.00 TO STA.

F.A.U. RTE. 7448	SECTION 09-00933-01-BR	COUNTY MACON	TOTAL SHEETS 1019	SHEET NO. 558
CONTRACT NO. 95893				
ILLINOIS FED. AID PROJECT				

PAVEMENT MARKING & SIGNING NOTES

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PAVEMENT MARKING LEGEND

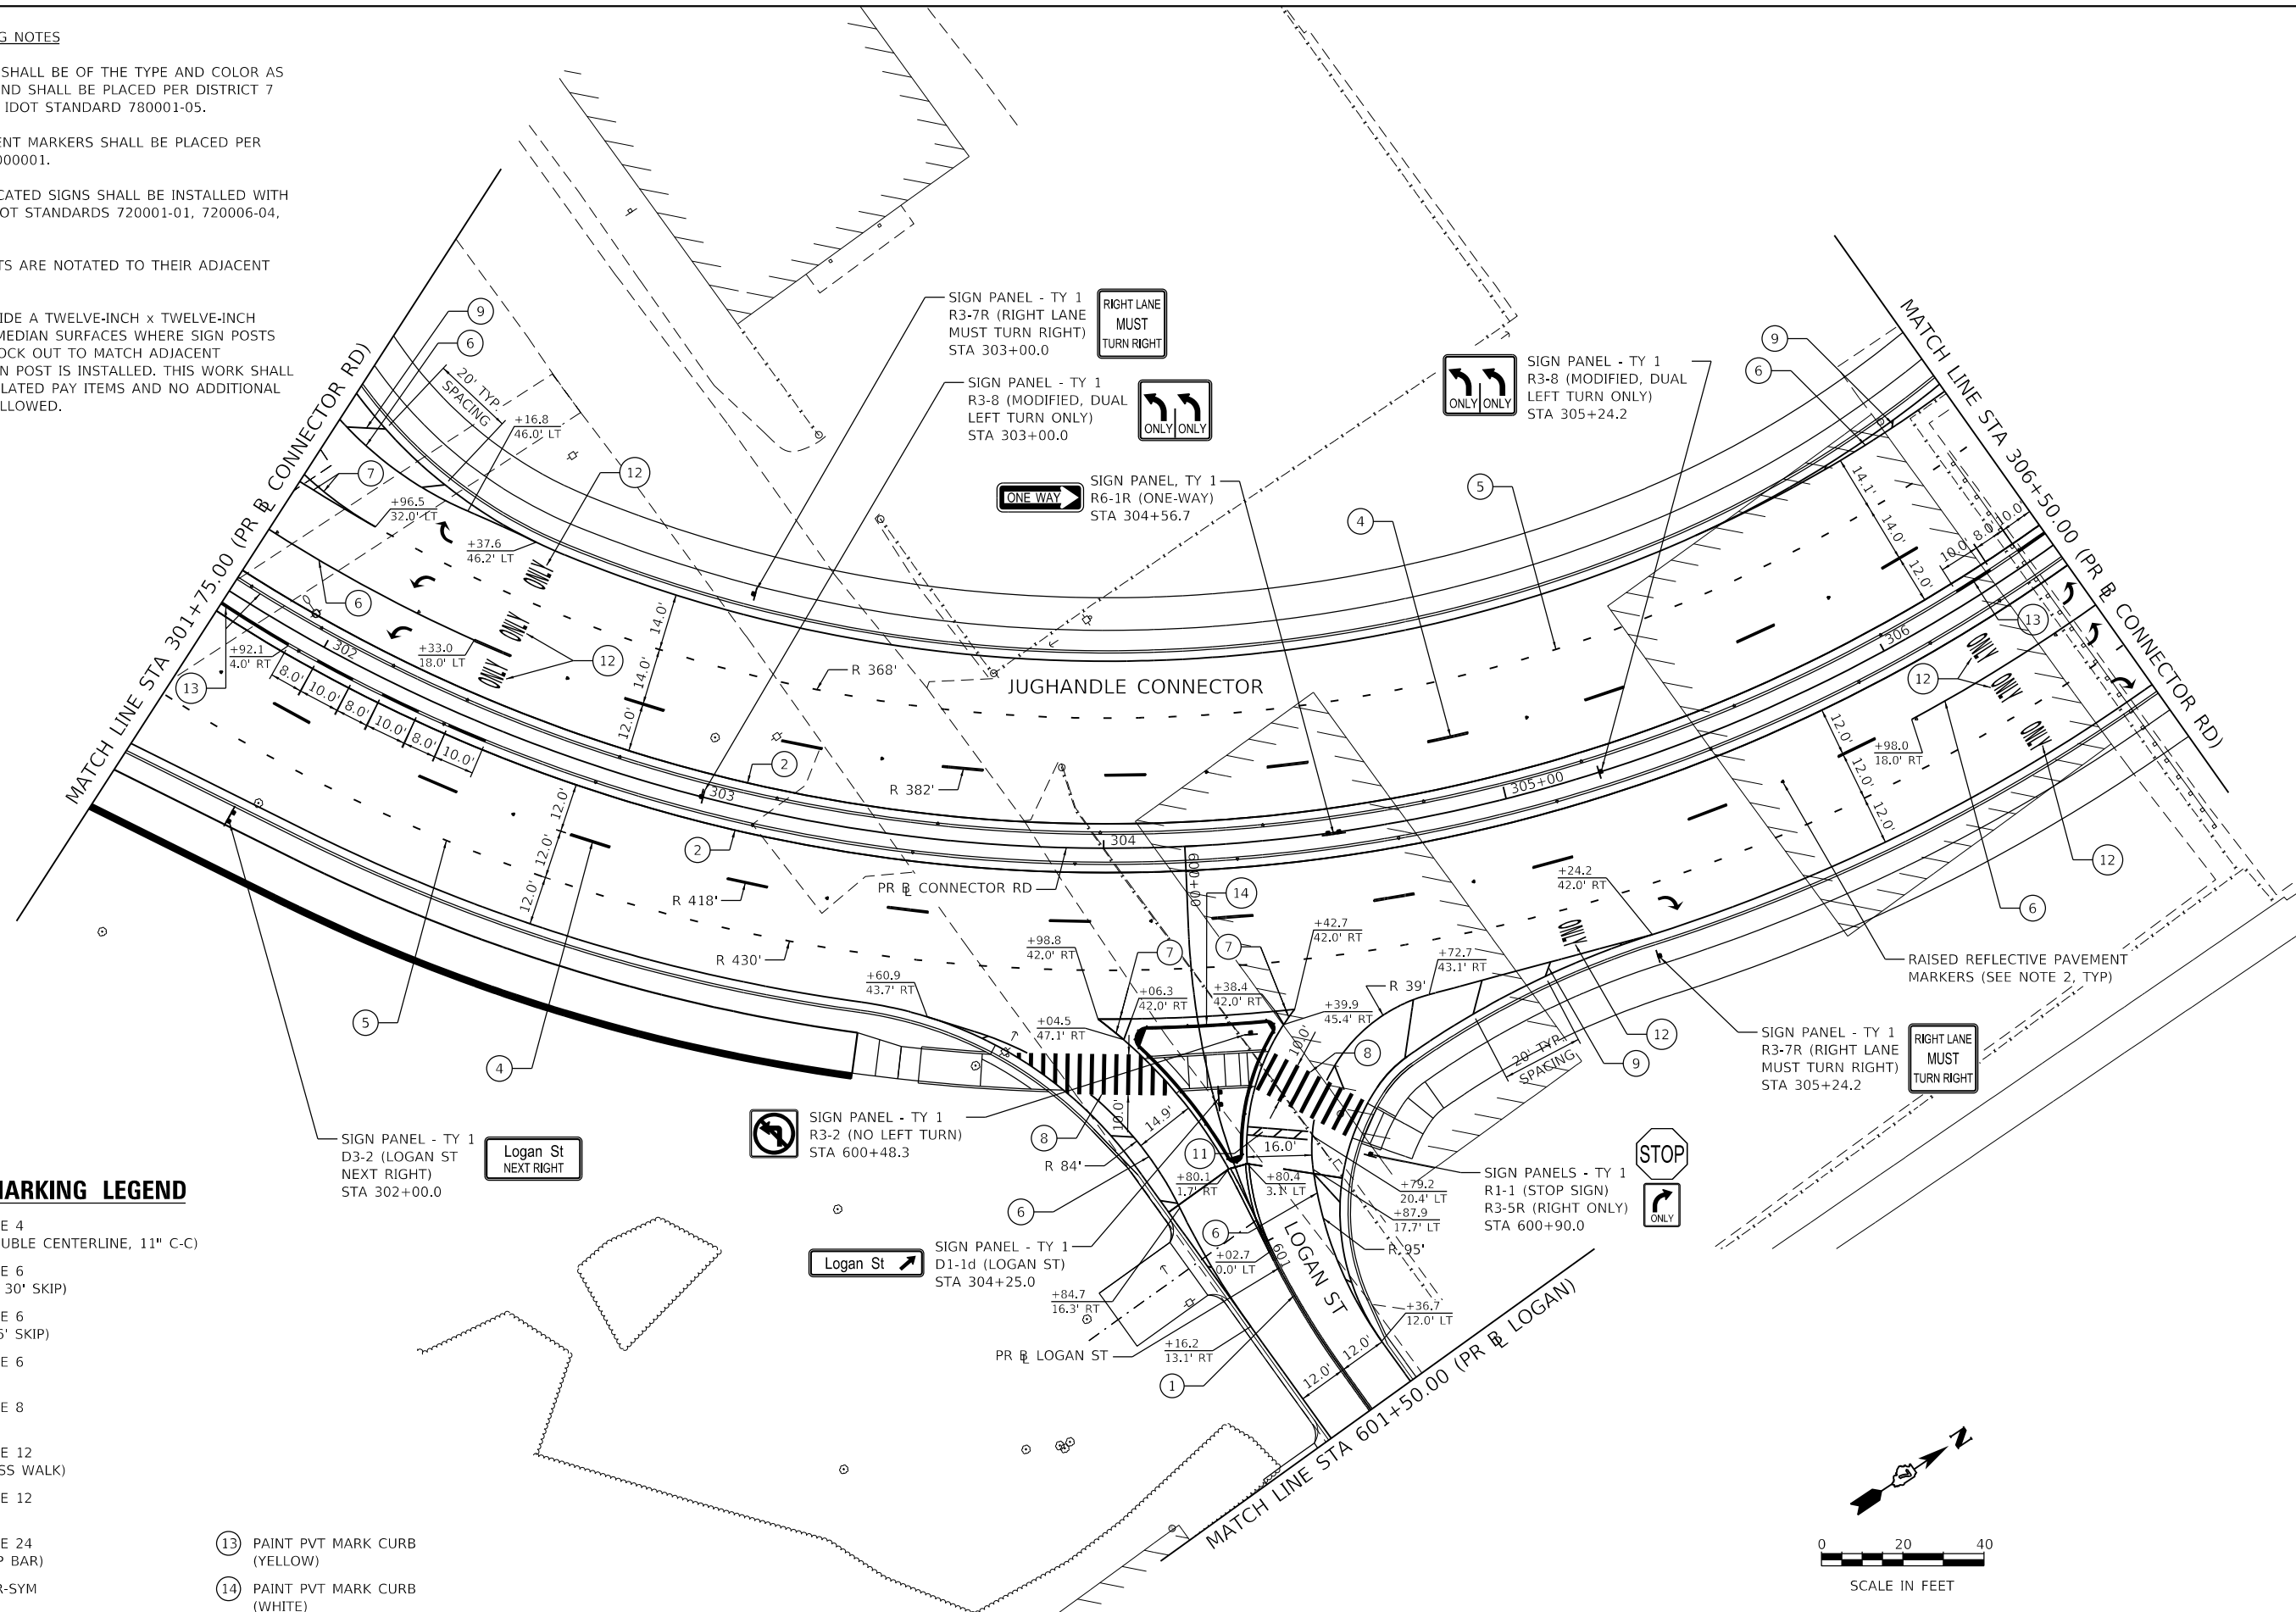- ① MOD URETH PM LINE 4 (SOLID YELLOW, DOUBLE CENTERLINE, 11" C-C)
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- ⑤ MOD URETH PM LINE 6 (WHITE, 2' DASH - 6' SKIP)
- ⑥ MOD URETH PM LINE 6 (SOLID WHITE)
- ⑦ MOD URETH PM LINE 8 (SOLID WHITE)
- ⑧ MOD URETH PM LINE 12 (SOLID WHITE, CROSS WALK)
- ⑨ MOD URETH PM LINE 12 (SOLID WHITE)
- ⑪ MOD URETH PM LINE 24 (SOLID WHITE, STOP BAR)
- ⑫ MOD URETH PM LTR-SYM
- ⑬ PAINT PVT MARK CURB (YELLOW)
- ⑭ PAINT PVT MARK CURB (WHITE)

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	DATE - 4/30/2021	REVISED -


STATE OF ILLINOIS
DEPARTMENT OF TRANSPORTATION

CONNECTOR ROAD
PAVEMENT MARKING & SIGNING PLAN

SCALE: 1"=20' SHEET 13 OF 20 SHEETS STA. 301+75.00 TO STA. 306+50.00

F.A.U. RTE.	SECTION	COUNTY	TOTAL SHEETS	SHEET NO.
7448	09-00933-01-BR	MACON	1019	559
CONTRACT NO. 95893				
ILLINOIS FED. AID PROJECT				

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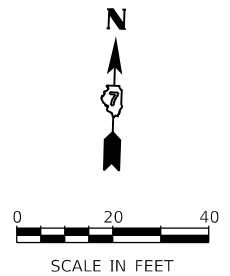


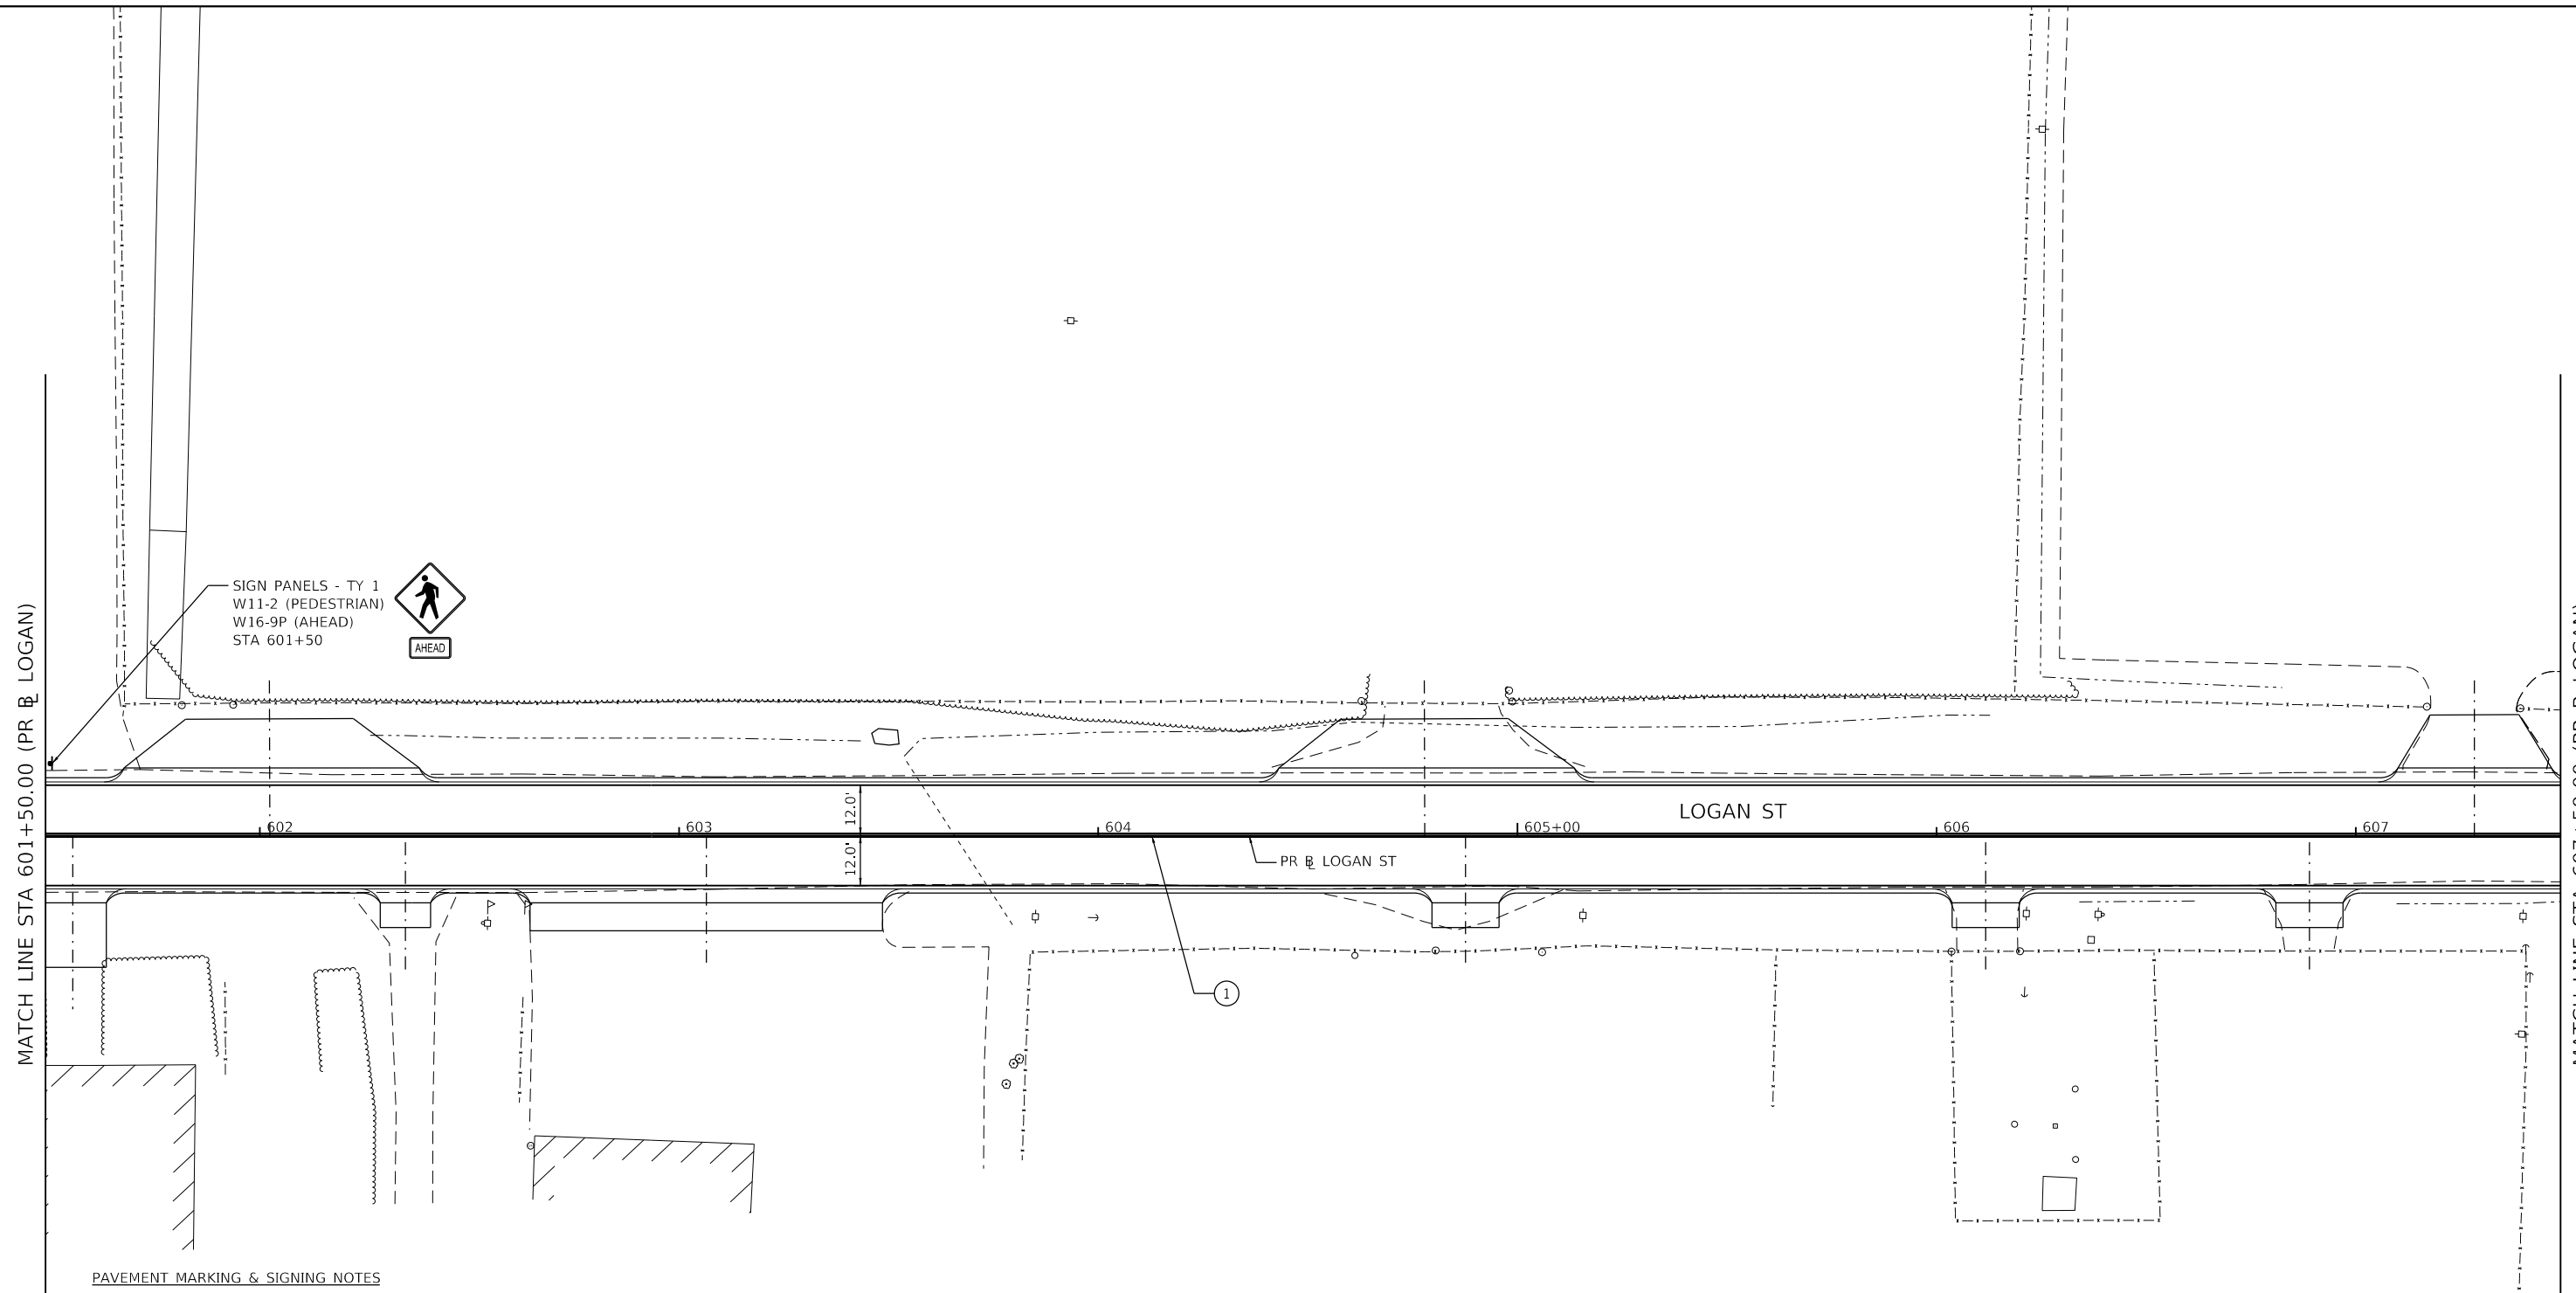PAVEMENT MARKING & SIGNING NOTES

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PAVEMENT MARKING LEGEND

- ① MOD URETH PM LINE 4 (SOLID YELLOW, DOUBLE CENTERLINE, 11" C-C)



USER NAME = rjo	DESIGNED - NDP	REVISED -
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PLOT DATE = 4/28/2021	CHECKED - LDC	REVISED -
	DATE - 4/30/2021	REVISED -

**STATE OF ILLINOIS
 DEPARTMENT OF TRANSPORTATION**


**EAST LOGAN STREET
 PAVEMENT MARKING & SIGNING PLAN**

SCALE: 1"=20' SHEET 14 OF 20 SHEETS STA. 601+50.00 TO STA. 607+50.00

F.A.U. RTE.	SECTION	COUNTY	TOTAL SHEETS	SHEET NO.
7448	09-00933-01-BR	MACON	1019	560
CONTRACT NO. 95893				
ILLINOIS FED. AID PROJECT				


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PAVEMENT MARKING LEGEND

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- ⑤ MOD URETH PM LINE 6 (WHITE, 2' DASH - 6' SKIP)
- ⑥ MOD URETH PM LINE 6 (SOLID WHITE)
- ⑩ MOD URETH PM LINE 12 (SOLID YELLOW)
- ⑪ MOD URETH PM LINE 24 (SOLID WHITE, STOP BAR)
- ⑫ MOD URETH PM LTR-SYM

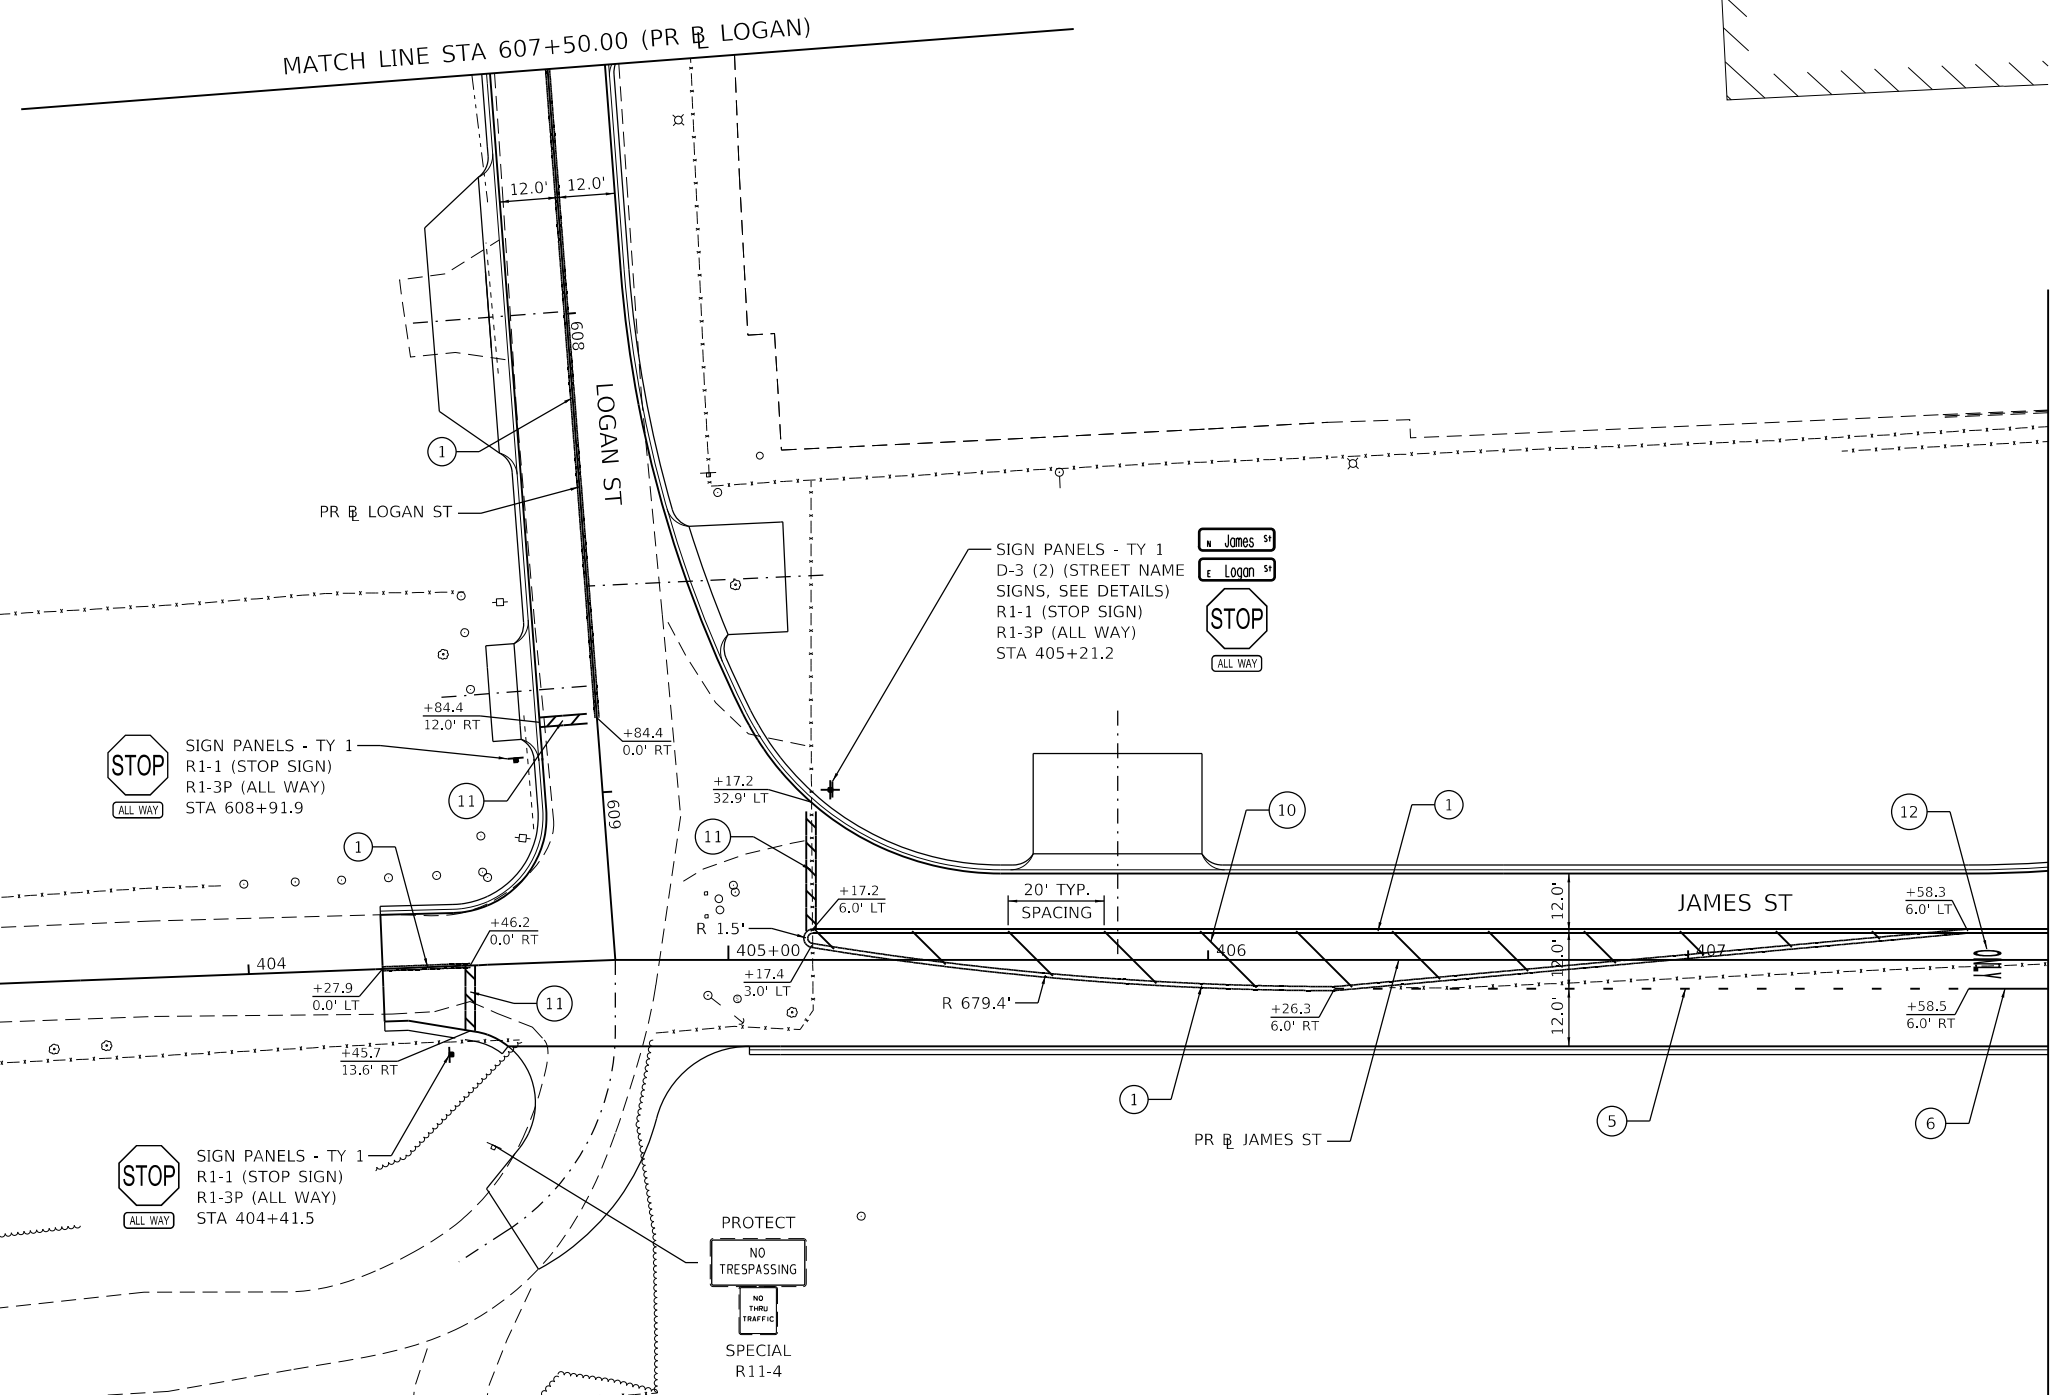

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PLOT DATE = 4/28/2021	CHECKED - LDC	REVISED -
	DATE - 4/30/2021	REVISED -

**STATE OF ILLINOIS
DEPARTMENT OF TRANSPORTATION**

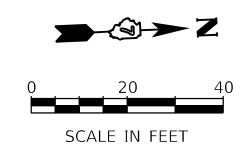NORTH JAMES STREET PAVEMENT MARKING & SIGNING PLAN	
SCALE: 1"=20'	SHEET 15 OF 20 SHEETS
STA. 607+50.00 TO STA. 407+75.00	

F.A.U. RTE.	SECTION	COUNTY	TOTAL SHEETS	SHEET NO.
7448	09-00933-01-BR	MACON	1019	561
CONTRACT NO. 95893				
ILLINOIS FED. AID PROJECT				

PAVEMENT MARKING & SIGNING NOTES


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PAVEMENT MARKING LEGEND


- ① MOD URETH PM LINE 4 (SOLID YELLOW, DOUBLE CENTERLINE, 11" C-C)



SIGN PANEL - TY 1
W14-1 (DEAD END)
STA 799+83.0

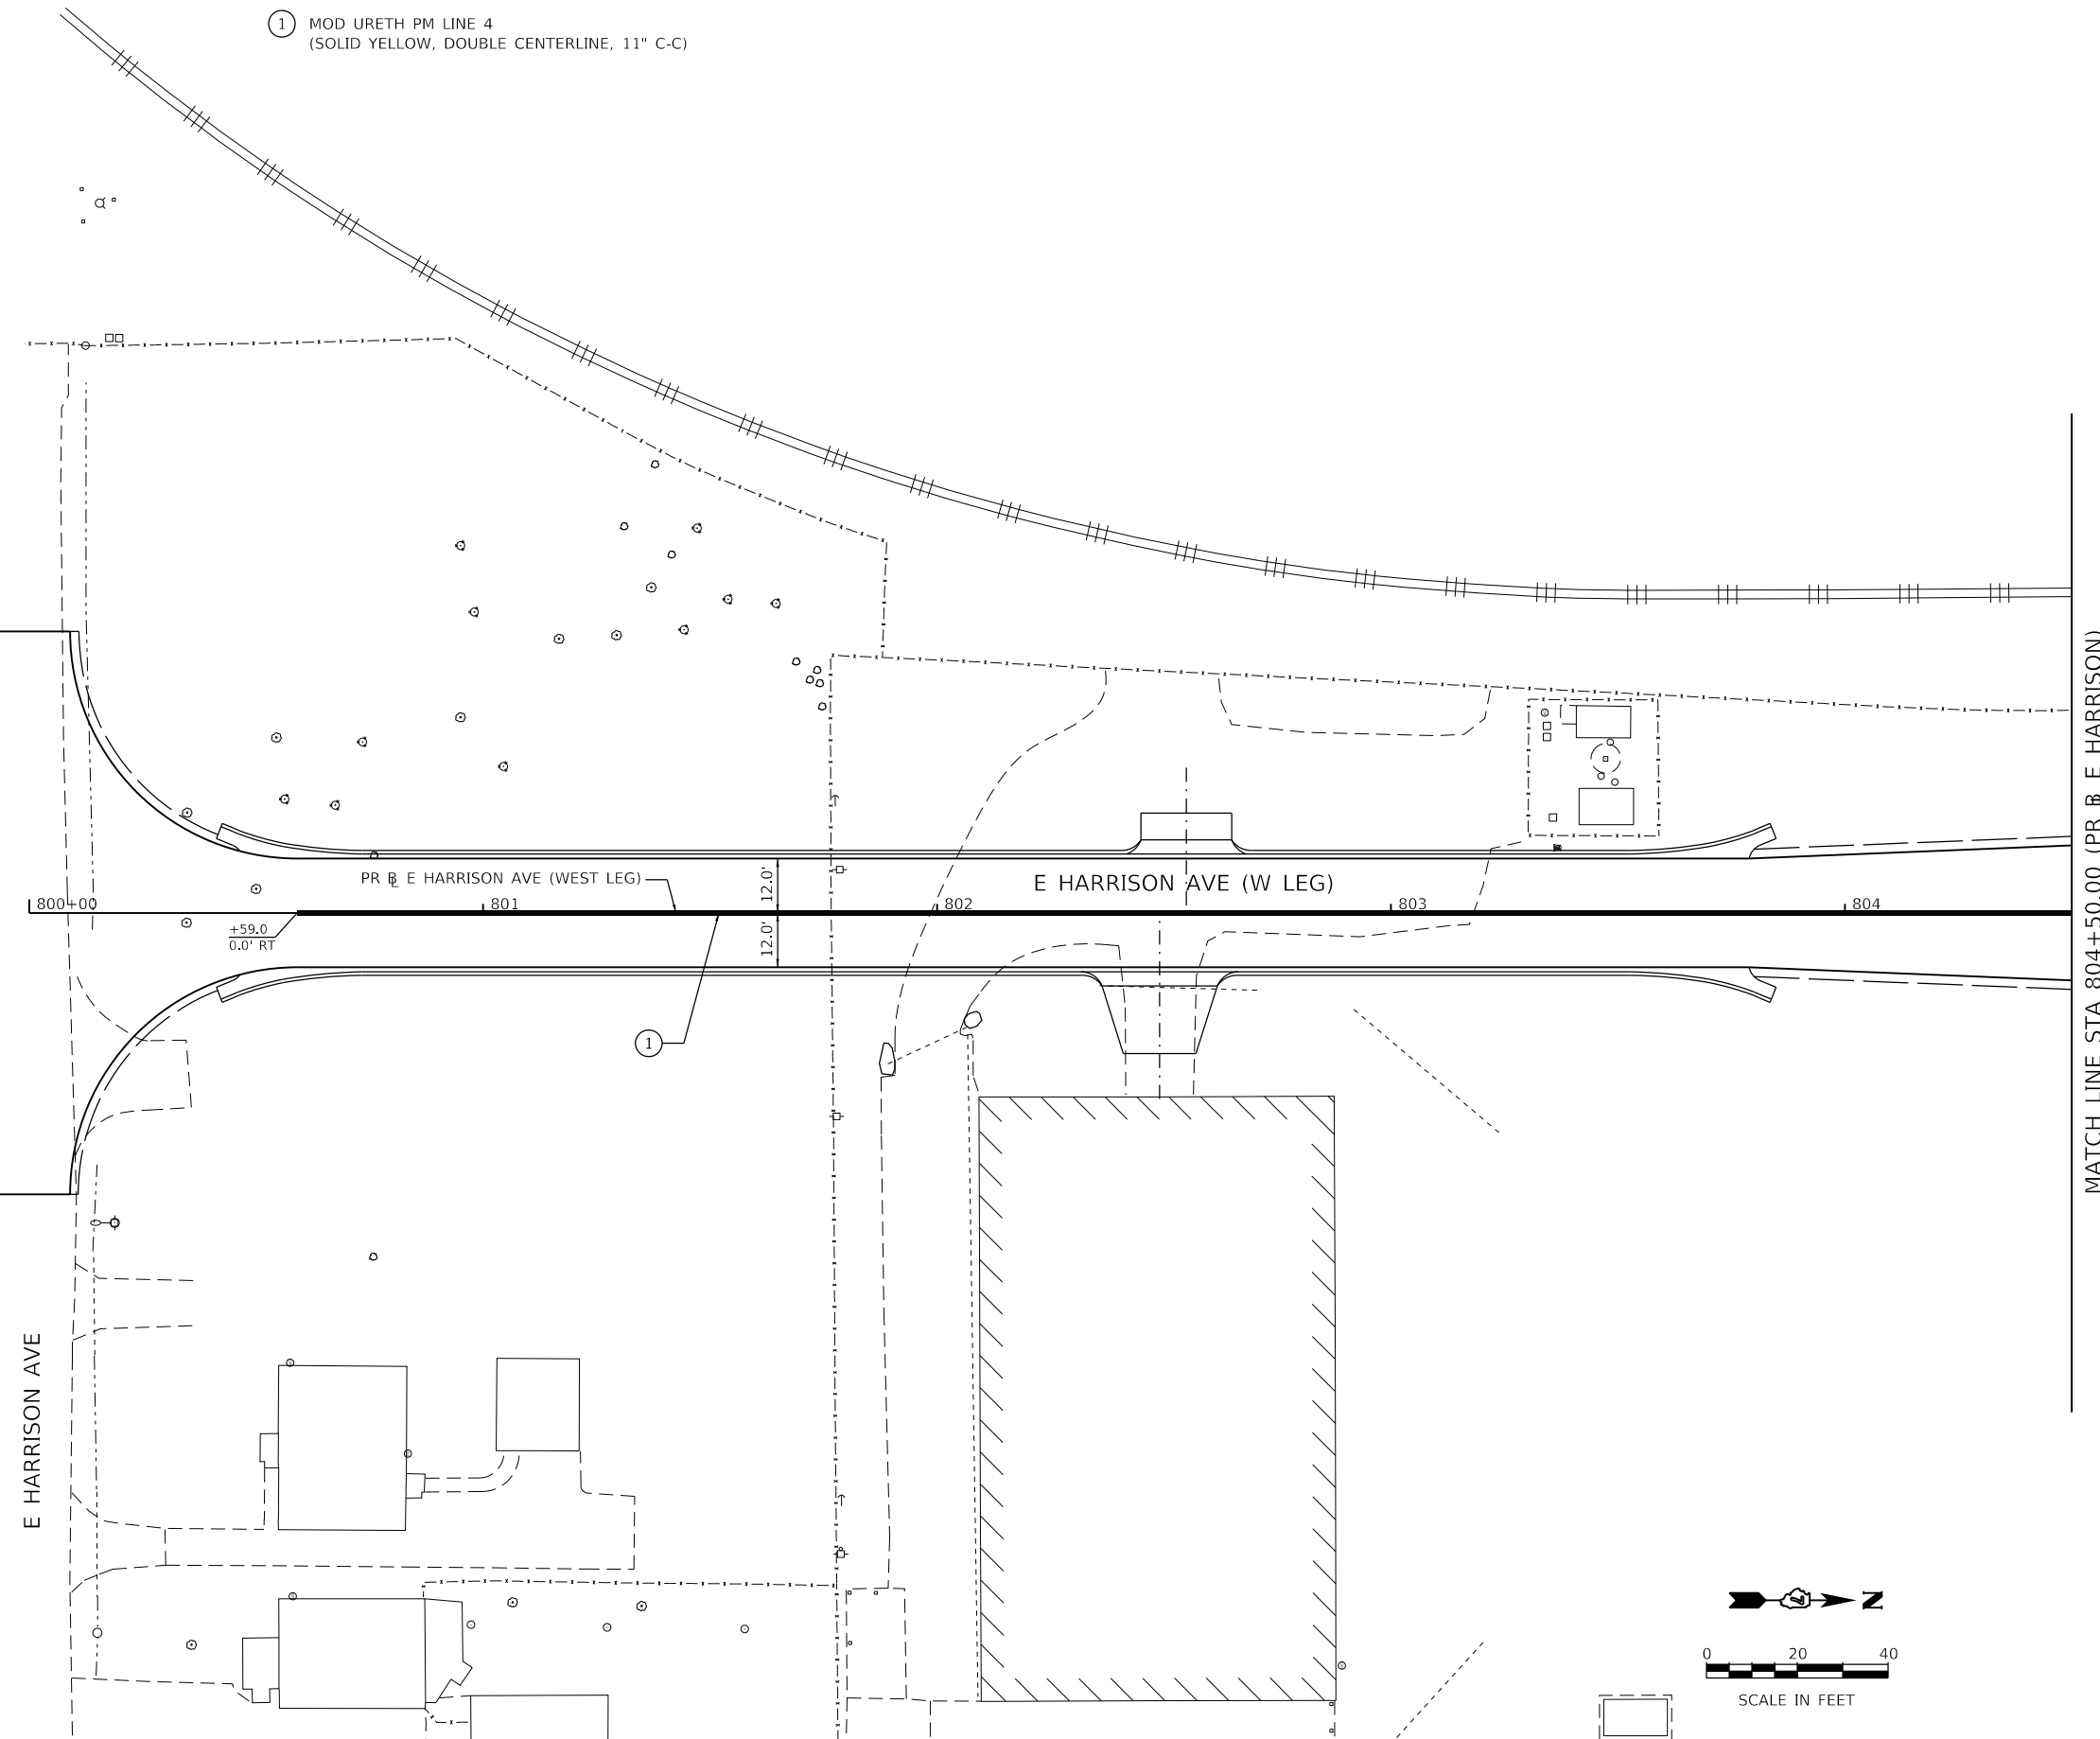

MATCH LINE STA 804+50.00 (PR E HARRISON)

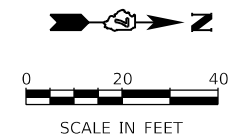

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Kaskaskia
Engineering Group, LLC
PROFESSIONAL REGISTERED ENGINEERS
Illinois Professional Design Firm
Professional Engineering Group

USER NAME = rjo	DESIGNED - NDP	REVISED -
PLOT SCALE = 40.0000' / in.	DRAWN - NDP	REVISED -
PLOT DATE = 4/28/2021	CHECKED - LDC	REVISED -
	DATE - 4/30/2021	REVISED -

DESIGNED - NDP	REVISED -
DRAWN - NDP	REVISED -
CHECKED - LDC	REVISED -
DATE - 4/30/2021	REVISED -

STATE OF ILLINOIS
DEPARTMENT OF TRANSPORTATION

E HARRISON AVENUE (WEST LEG)	
PAVEMENT MARKING & SIGNING PLAN	
SCALE: 1"=20'	SHEET 16 OF 20 SHEETS
STA. 800+00.00 TO STA. 804+50.00	

F.A.U. RTE. 7448	SECTION 09-00933-01-BR	COUNTY MACON	TOTAL SHEETS 1019	SHEET NO. 562
CONTRACT NO. 95893				
ILLINOIS FED. AID PROJECT				

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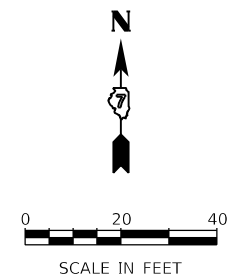


PAVEMENT MARKING & SIGNING NOTES

1. ALL PAVEMENT MARKINGS SHALL BE OF THE TYPE AND COLOR AS SPECIFIED IN THE PLANS AND SHALL BE PLACED PER DISTRICT 7 STANDARD 78000001 AND IDOT STANDARD 780001-05.
2. RAISED REFLECTIVE PAVMENT MARKERS SHALL BE PLACED PER DISTRICT 7 STANDARD 78000001.
3. ALL PROPOSED AND RELOCATED SIGNS SHALL BE INSTALLED WITH NEW METAL POSTS PER IDOT STANDARDS 720001-01, 720006-04, AND 728001-01.
4. ALL STATIONS AND OFFSETS ARE NOTATED TO THEIR ADJACENT ROADWAY CENTERLINE.
5. CONTRACTOR SHALL PROVIDE A TWELVE-INCH x TWELVE-INCH BLOCK OUT IN SIDEWALK/MEDIAN SURFACES WHERE SIGN POSTS ARE TO BE INSTALLED. BLOCK OUT TO MATCH ADJACENT CONSTRUCTION AFTER SIGN POST IS INSTALLED. THIS WORK SHALL BE INCIDENTAL TO THE RELATED PAY ITEMS AND NO ADDITIONAL COMPENSATION WILL BE ALLOWED.

PAVEMENT MARKING LEGEND

- ① MOD URETH PM LINE 4 (SOLID YELLOW, DOUBLE CENTERLINE, 11" C-C)



Kaskaskia
 Engineering Group, LLC
 PROFESSIONAL REGISTERED ENGINEERS
 Illinois Professional Design Firm
 LICENSE NO. 184,004,733
 20-5880586

USER NAME = rjo	DESIGNED - NDP	REVISED -
	DRAWN - NDP	REVISED -
PLOT SCALE = 40.0000' / in.	CHECKED - LDC	REVISED -
PLOT DATE = 4/28/2021	DATE - 4/30/2021	REVISED -

**STATE OF ILLINOIS
 DEPARTMENT OF TRANSPORTATION**


**E HARRISON AVENUE (WEST LEG)
 PAVEMENT MARKING & SIGNING PLAN**

SCALE: 1"=20' SHEET 17 OF 20 SHEETS STA. 804+50.00 TO STA. 808+00.00

F.A.U. RTE. 7448	SECTION 09-00933-01-BR	COUNTY MACON	TOTAL SHEETS 1019	SHEET NO. 563
CONTRACT NO. 95893				
ILLINOIS FED. AID PROJECT				

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MATCH LINE STA 701+00.00 (PR E HARRISON)
 SEE SHEET 550

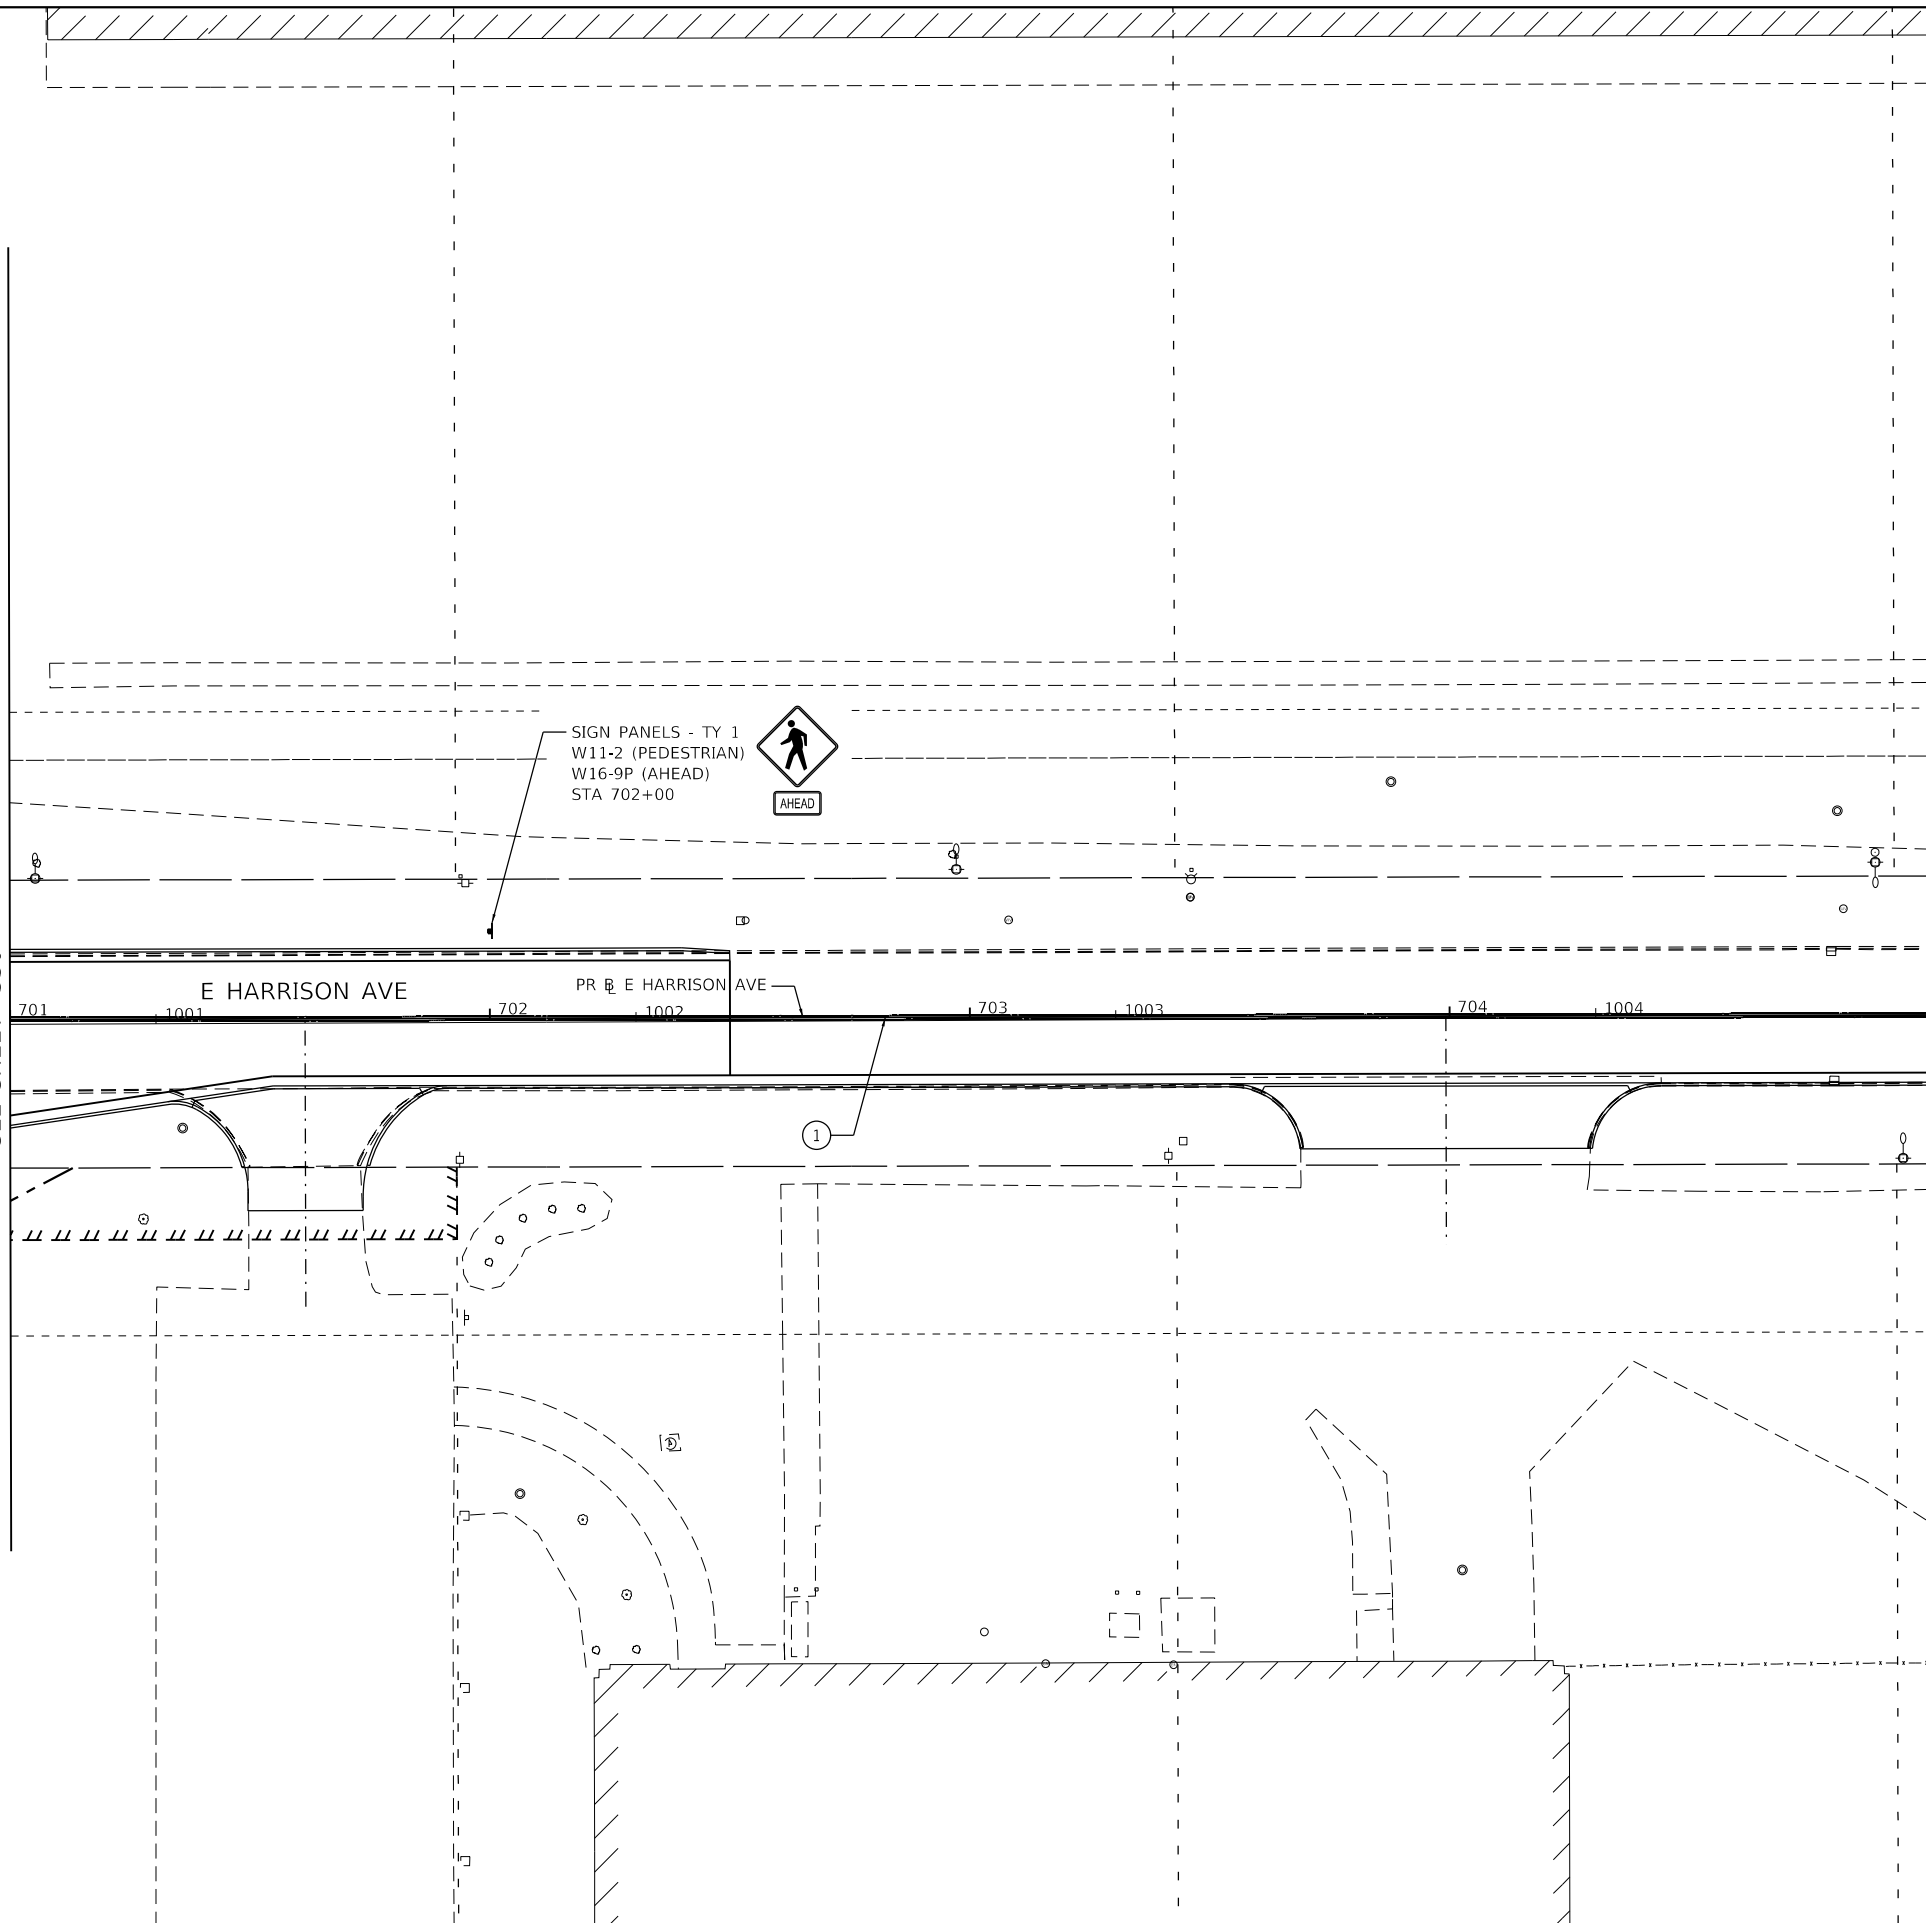


MATCH LINE STA 705+00.00 (PR E HARRISON)
 SEE SHEET 565

PAVEMENT MARKING & SIGNING NOTES

1. ALL PAVEMENT MARKINGS SHALL BE OF THE TYPE AND COLOR AS SPECIFIED IN THE PLANS AND SHALL BE PLACED PER DISTRICT 7 STANDARD 78000001 AND IDOT STANDARD 780001-05.
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PAVEMENT MARKING LEGEND

- ① MOD URETH PM LINE 4 (SOLID YELLOW, DOUBLE CENTERLINE, 11" C-C)

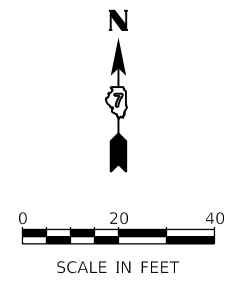

Kaskaskia
 Engineering Group, LLC
PROFESSIONAL REGISTERED ENGINEERS
 Illinois Professional Design Firm
 Professional Engineering Group

USER NAME = rjo	DESIGNED - NDP	REVISED -
PLOT SCALE = 40.0000' / in.	DRAWN - NDP	REVISED -
PLOT DATE = 4/28/2021	CHECKED - LDC	REVISED -
	DATE - 4/30/2021	REVISED -

**STATE OF ILLINOIS
 DEPARTMENT OF TRANSPORTATION**

**E HARRISON AVENUE (EAST LEG)
 PAVEMENT MARKING & SIGNING PLAN**

SCALE: 1"=20' SHEET 18 OF 20 SHEETS STA. 701+00.00 TO STA. 705+00.00


F.A.U. RTE. 7448	SECTION 09-00933-01-BR	COUNTY MACON	TOTAL SHEETS 1019	SHEET NO. 564
CONTRACT NO. 95893				
ILLINOIS FED. AID PROJECT				

PAVEMENT MARKING & SIGNING NOTES

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PAVEMENT MARKING LEGEND

- ① MOD URETH PM LINE 4
(SOLID YELLOW, DOUBLE CENTERLINE, 11" C-C)
- ⑪ MOD URETH PM LINE 24
(SOLID WHITE, STOP BAR)

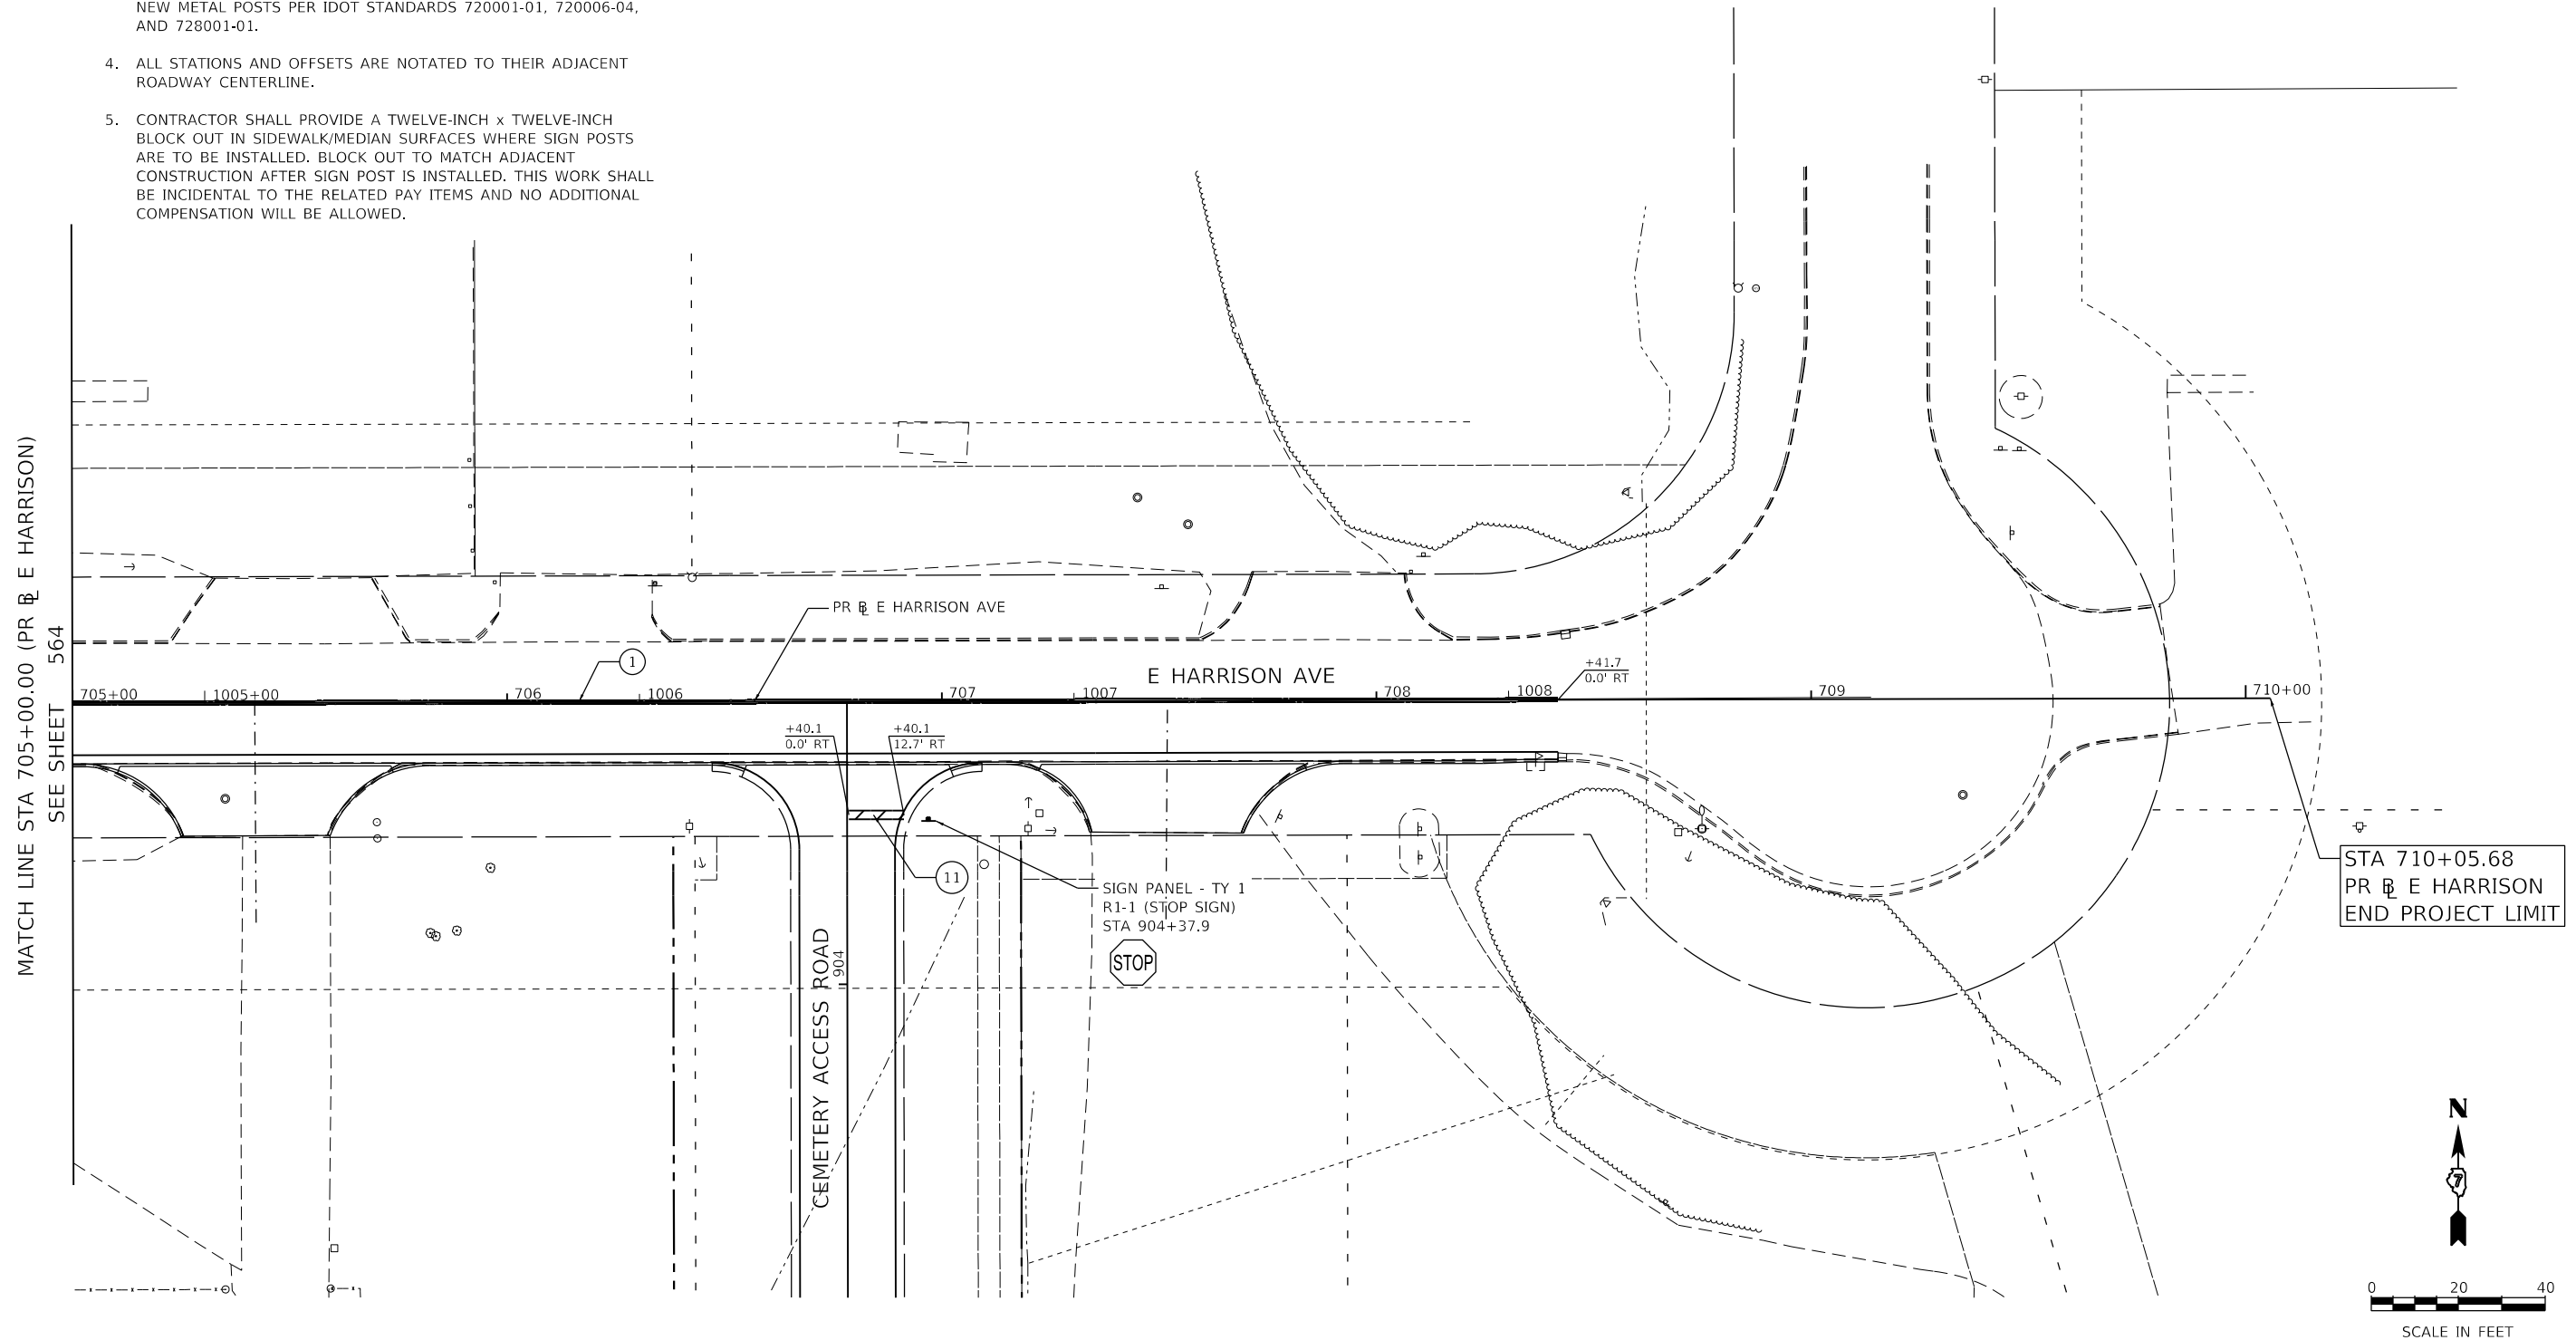

MATCH LINE STA 705+00.00 (PR E HARRISON)
SEE SHEET 564

STA 710+05.68
PR E HARRISON
END PROJECT LIMIT

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Kaskaskia
Engineering Group, LLC
PROFESSIONAL REGISTERED ENGINEERS
Illinois Professional Design Firm
Professional Engineering Group

USER NAME = rjo	DESIGNED - NDP	REVISED -
PLOT SCALE = 40.0000' / in.	DRAWN - NDP	REVISED -
PLOT DATE = 4/28/2021	CHECKED - LDC	REVISED -
	DATE - 4/30/2021	REVISED -


**STATE OF ILLINOIS
DEPARTMENT OF TRANSPORTATION**

**E HARRISON AVENUE (EAST LEG)
PAVEMENT MARKING & SIGNING PLAN**

SCALE: 1"=20' SHEET 19 OF 20 SHEETS STA. 705+00.00 TO STA. 710+05.68

F.A.U. RTE.	SECTION	COUNTY	TOTAL SHEETS	SHEET NO.
7448	09-00933-01-BR	MACON	1019	565
CONTRACT NO. 95893				
ILLINOIS FED. AID PROJECT				

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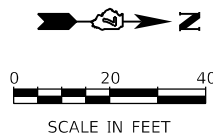


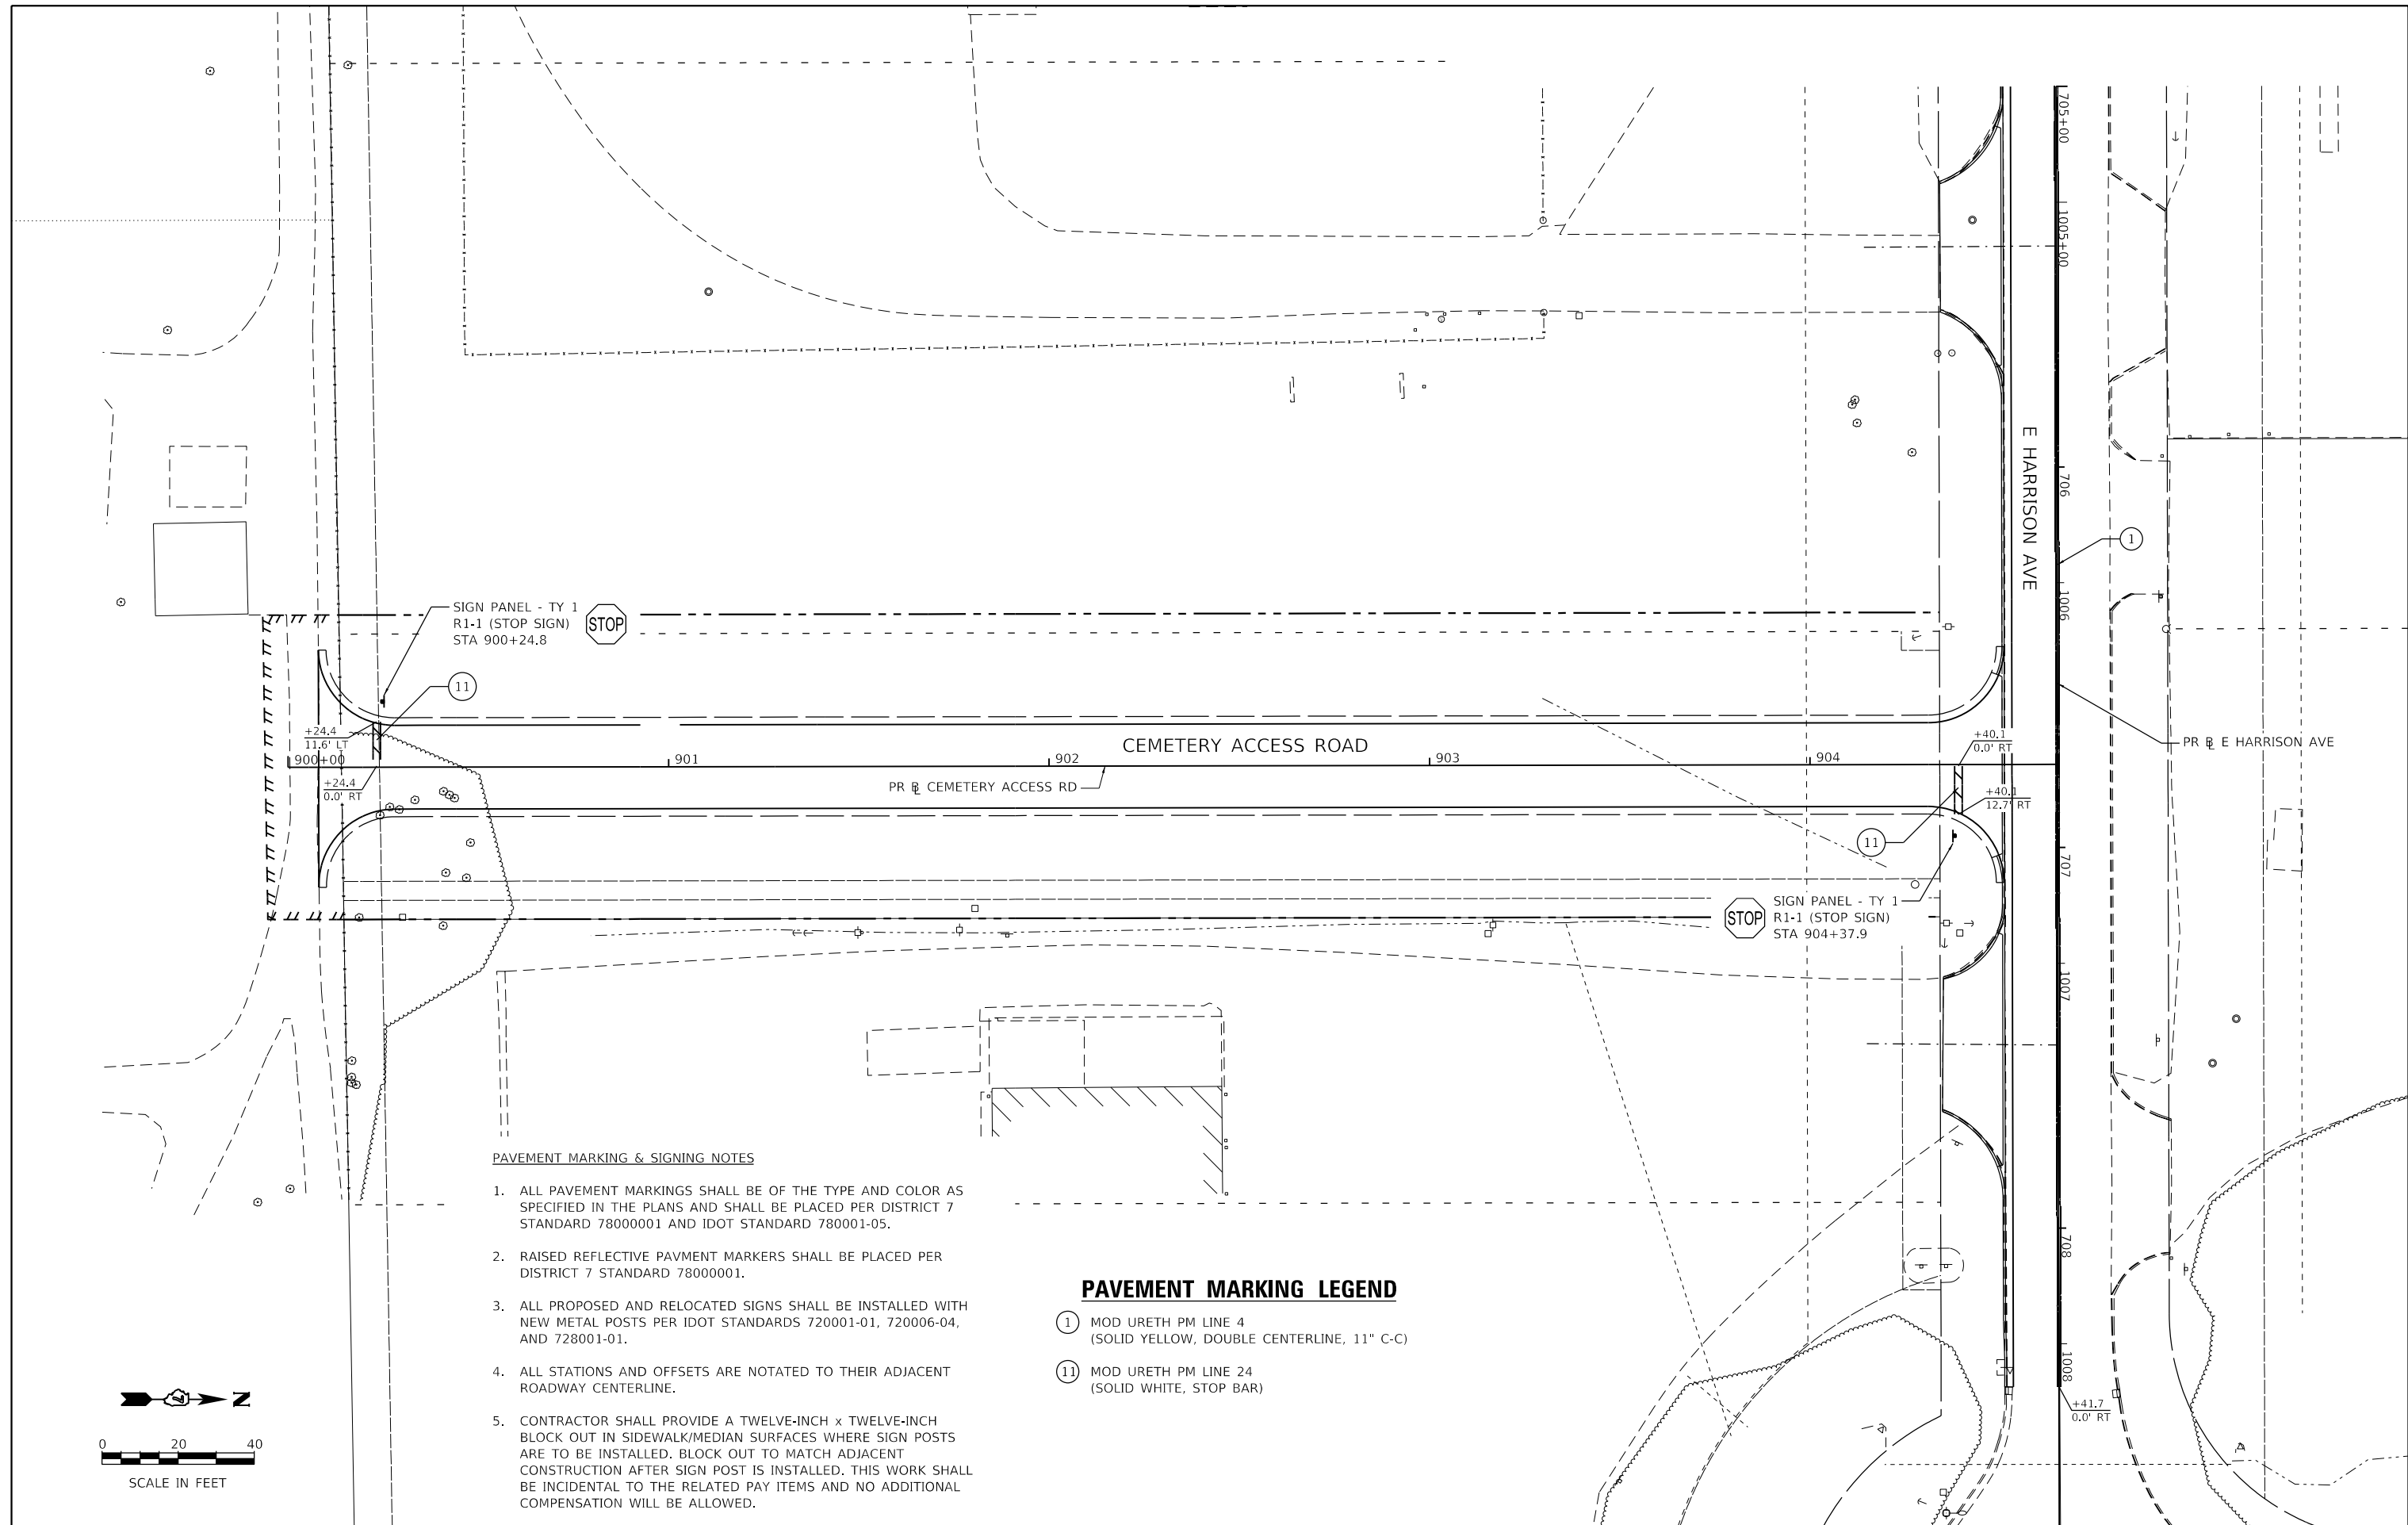PAVEMENT MARKING & SIGNING NOTES

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PAVEMENT MARKING LEGEND

- ① MOD URETH PM LINE 4
(SOLID YELLOW, DOUBLE CENTERLINE, 11" C-C)
- ⑪ MOD URETH PM LINE 24
(SOLID WHITE, STOP BAR)



Kaskaskia
 Engineering Group, LLC
PROFESSIONAL REGISTERED ENGINEERS
 Illinois Professional Design Firm
 Professional Engineering Group


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PLOT SCALE = 40.0000' / in.	DRAWN - NDP	REVISED -
PLOT DATE = 4/28/2021	CHECKED - LDC	REVISED -
	DATE - 4/30/2021	REVISED -

**STATE OF ILLINOIS
 DEPARTMENT OF TRANSPORTATION**


**E HARRISON AVENUE (EAST LEG) & CEMETERY ROAD
 PAVEMENT MARKING & SIGNING PLAN**

SCALE: 1"=20' SHEET 20 OF 20 SHEETS STA. 900+00.00 TO STA. 904+52.12


F.A.U. RTE. 7448	SECTION 09-00933-01-BR	COUNTY MACON	TOTAL SHEETS 1019	SHEET NO. 566
CONTRACT NO. 95893				
ILLINOIS FED. AID PROJECT				

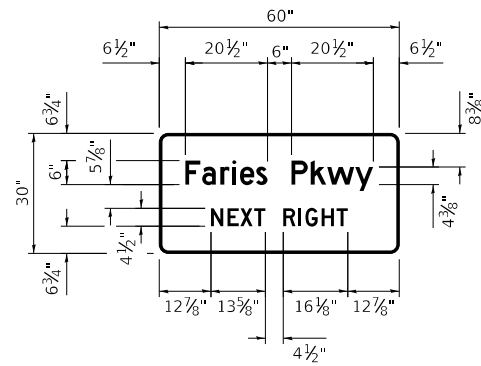


D3-2 - STA 51+95.0 RT
DETAIL OF
SIGN PANEL - TYPE 2
(NOT TO SCALE)

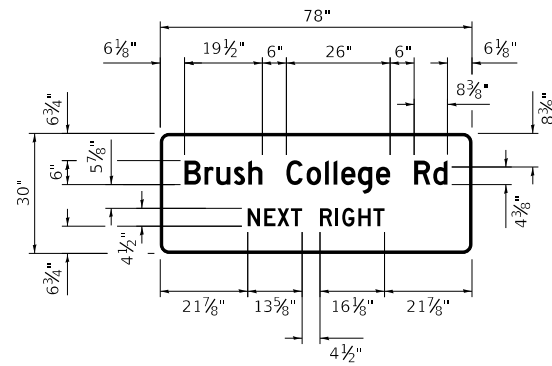


D3-2 - STA 210+75.8 RT
DETAIL OF
SIGN PANEL - TYPE 2
(NOT TO SCALE)

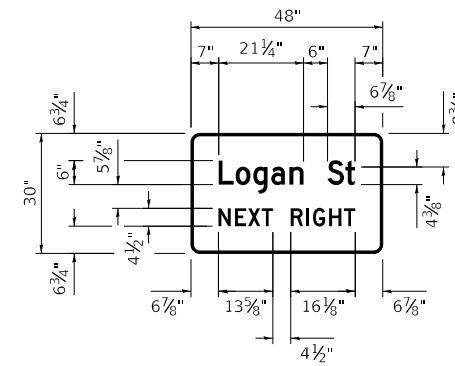


D3-2 - STA 302+00.0 RT
DETAIL OF
SIGN PANEL - TYPE 2
(NOT TO SCALE)

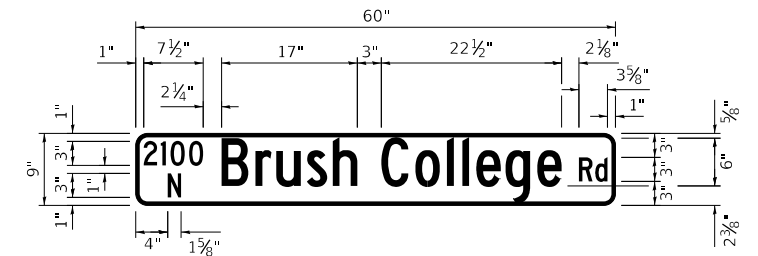


D3-1 - STA 73+16.0 LT
DETAIL OF
SIGN PANEL - TYPE 1
(NOT TO SCALE)

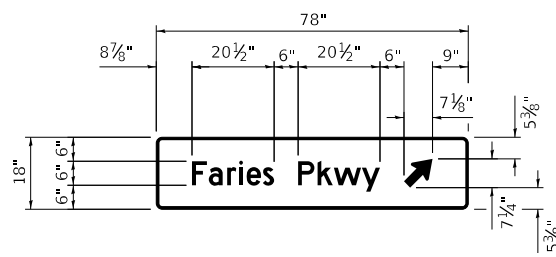


D1-1d - STA 54+33.6 RT
DETAIL OF
SIGN PANEL - TYPE 2
(NOT TO SCALE)

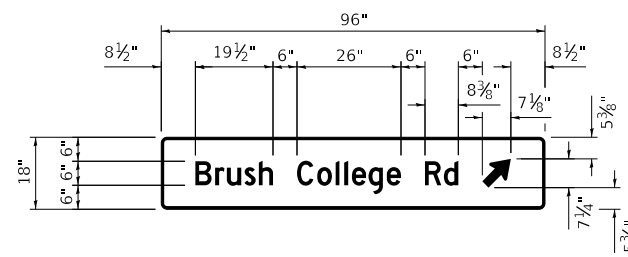


D1-1d - STA 213+95.6 RT
DETAIL OF
SIGN PANEL - TYPE 2
(NOT TO SCALE)

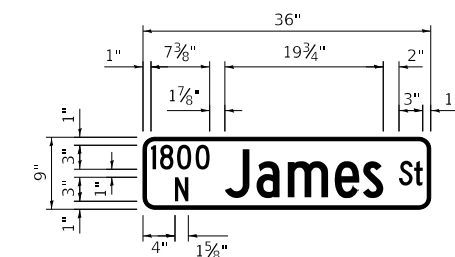


D3-1 - STA 405+21.2 LT
STA 408+66.2 RT
DETAIL OF
SIGN PANEL - TYPE 1
(NOT TO SCALE)

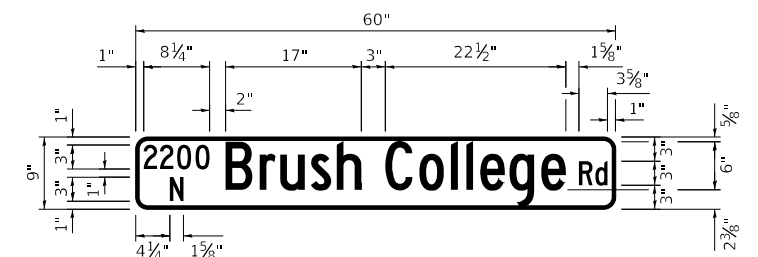


D3-1 - STA 701+66.9 RT
DETAIL OF
SIGN PANEL - TYPE 1
(NOT TO SCALE)

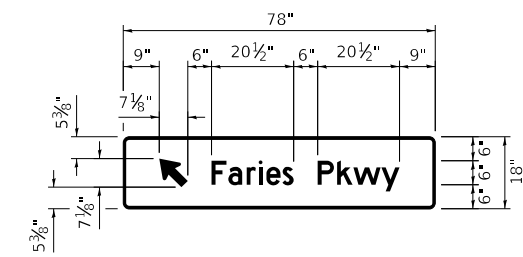


D1-1d - STA 58+03.2 LT
DETAIL OF
SIGN PANEL - TYPE 2
(NOT TO SCALE)

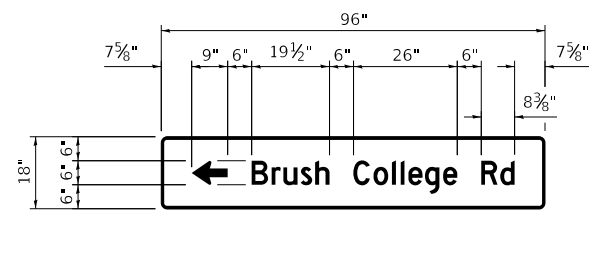


D1-1d - STA 219+74.6 LT
DETAIL OF
SIGN PANEL - TYPE 2
(NOT TO SCALE)

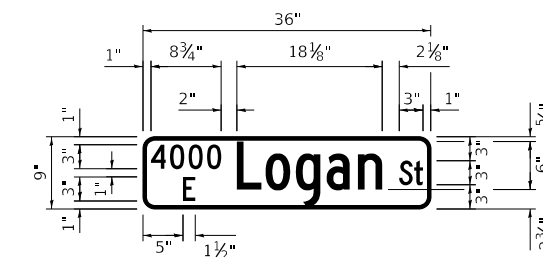


D3-1 - STA 405+21.2 LT
DETAIL OF
SIGN PANEL - TYPE 1
(NOT TO SCALE)

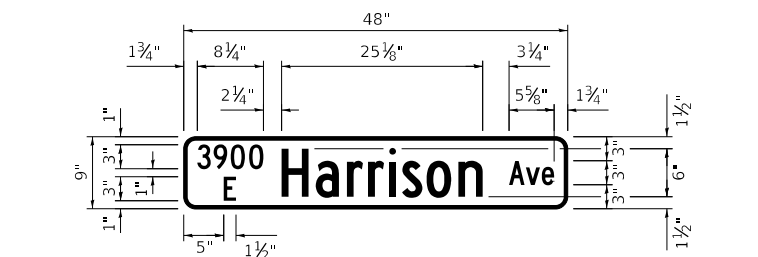


D3-1 - STA 701+66.9 RT
DETAIL OF
SIGN PANEL - TYPE 1
(NOT TO SCALE)

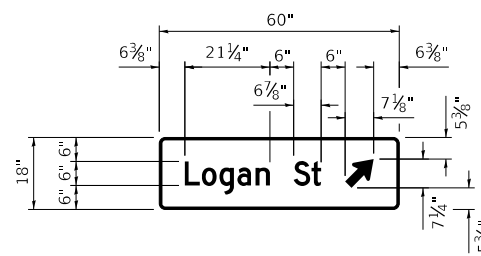

D1-1d - STA 304+25.0 RT
DETAIL OF
SIGN PANEL - TYPE 1
(NOT TO SCALE)

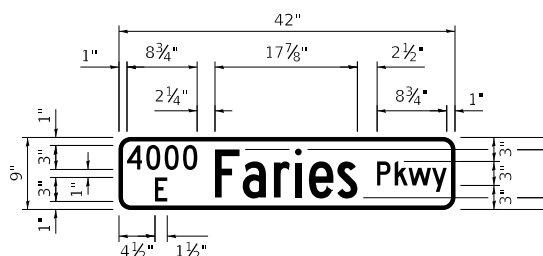

D3-1 - STA 408+66.2 RT
DETAIL OF
SIGN PANEL - TYPE 1
(NOT TO SCALE)

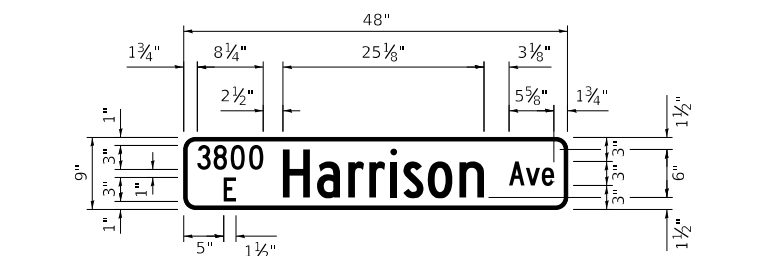

D3-1 - STA 73+16.0 LT
DETAIL OF
SIGN PANEL - TYPE 1
(NOT TO SCALE)

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DESIGNED - LDC
DRAWN - RJO
PLOT SCALE = 2,000' / in.
CHECKED - LDC
DATE = 4/28/2021

DESIGNED - LDC
DRAWN - RJO
CHECKED - LDC
DATE = 4/30/2021

REVISED -
REVISED -
REVISED -
REVISED -

STATE OF ILLINOIS
DEPARTMENT OF TRANSPORTATION

BRUSH COLLEGE ROAD & FARIES PARKWAY
PAVEMENT MARKING & SIGNING - SIGN PANELS

SCALE: SHEET 1 OF 1 SHEETS STA. TO STA.

F.A.U. RTE.	SECTION	COUNTY	TOTAL SHEETS	SHEET NO.
7448	09-00933-01-BR	MACON	1019	567
CONTRACT NO. 95893				
ILLINOIS FED. AID PROJECT				

F.A.U. RTE.	SECTION	COUNTY	TOTAL SHEETS	SHEET NO.
7448	09-00933-01-BR	MACON	1019	568
		ILLINOIS	CONTRACT NO. 95893	

FOR INDEX OF SHEETS AND STANDARDS SEE SHEET NO. 2

STATE OF ILLINOIS

VOLUME II


DEPARTMENT OF TRANSPORTATION

DESIGN DESIGNATIONS:		POSTED / DESIGN SPEEDS:
BRUSH COLLEGE ROAD (FAU 7448)	21,000 (2035) MINOR ARTERIAL	35 /40 MPH
FARIES PARKWAY (FAU 7369) (WEST LEG)	12,000 (2035) MINOR ARTERIAL	35 /40 MPH
FARIES PARKWAY (FAU 7369) (EAST LEG)	15,000 (2035) COLLECTOR	35 /40 MPH
JUG HANDLE CONNECTOR ROAD	18,000 (2035) COLLECTOR	30 /30 MPH

PLANS FOR PROPOSED LOCAL AGENCY IMPROVEMENT

FAU ROUTE 7448 (BRUSH COLLEGE ROAD)
OVER FARIES PARKWAY GRADE SEPARATION
SECTION 09-00933-01-BR

PROJECT 3ELT(222)
BRIDGE STRUCTURE, RETAINING WALLS,
ROADWAY RECONSTRUCTION,
LIGHTING, AND TRAFFIC SIGNALS
MACON COUNTY

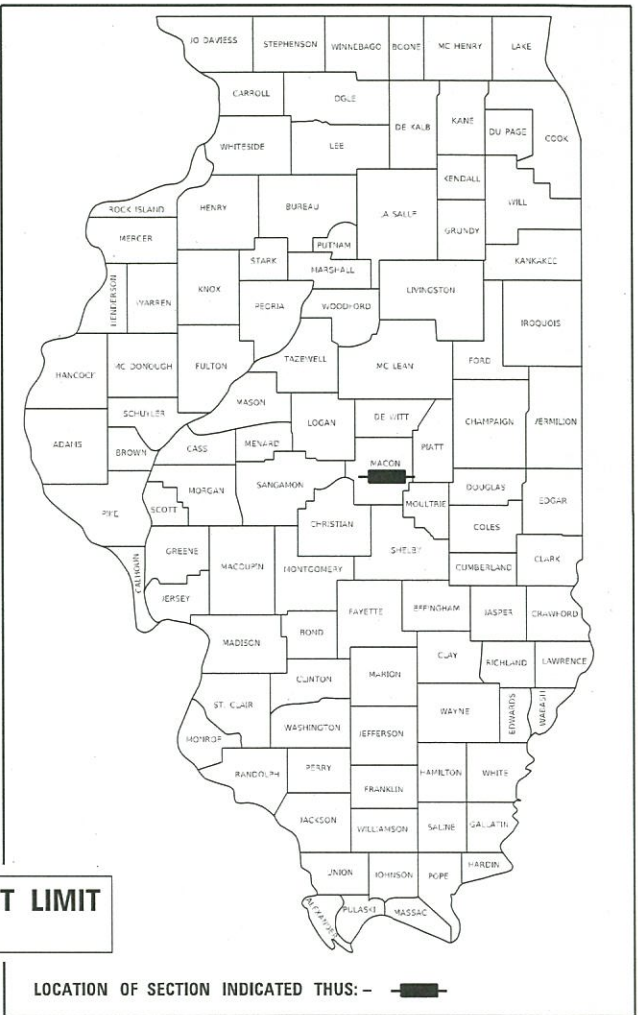

Kirsten Mawhinney
KIRSTEN MAWHINNEY, P.E. DATE 04 /17 /2023
LICENSE EXPIRES 11 /30 /2023
SHEET RANGE: 1-49, 53, 55-92, 97-98, 100-112, 117-118, 120-132, 141, 143-157, 159-175, 177, 179-302, 379-398, 568, 742-930, 987-1009



Cory W. Chamberlain
CORY W. CHAMBERLAIN, P.E. DATE 04 /17 /2023
LICENSE EXPIRES 11 /30 /2023
SHEET RANGE: 50-52, 54, 93-96, 99, 113-116, 119, 133-140, 142, 158, 176, 178, 399-512, 931-986, 1010-1019



Demir Dabezic
DEMIR DEBEZIC, S.E. DATE 04 /17 /2023
LICENSE EXPIRES 11 /30 /2024
SHEET RANGE: 665-705



Richard K. Allender III
RICHARD K. ALLENDER III, P.E. DATE 04 /17 /2023
LICENSE EXPIRES 11 /30 /2023
SHEET RANGE: 308-378



SEE SHEET 569 FOR SIGNATURE
SCOTT D. SANFORD, S.E. DATE 11 /30 /2024
LICENSE EXPIRES 11 /30 /2024
SHEET RANGE: 569-594



Matthew J. Letourneau
MATTHEW J. LETOURNEAU, P.E. DATE 04 /17 /2023
LICENSE EXPIRES 11 /30 /2023
SHEET RANGE: 303-307, 706-720



Keith W. Benting
KEITH W. BENTING, S.E. DATE 04 /17 /2023
LICENSE EXPIRES 11 /30 /2024
SHEET RANGE: 595-664




Gregory R. Reilly
GREGORY R. REILLY, P.E. DATE 04 /17 /2023
LICENSE EXPIRES 11 /30 /2023
SHEET RANGE: 731-741



Eric J. Lindemann
ERIC J. LINDEMANN, P.E. DATE 04 /17 /2023
LICENSE EXPIRES 11 /30 /2023
SHEET RANGE: 544-567, 721-730



Hsing H. Chu
HSING H. CHU, P.E. DATE 04 /17 /2023
LICENSE EXPIRES 11 /30 /2023
SHEET RANGE: 513-543

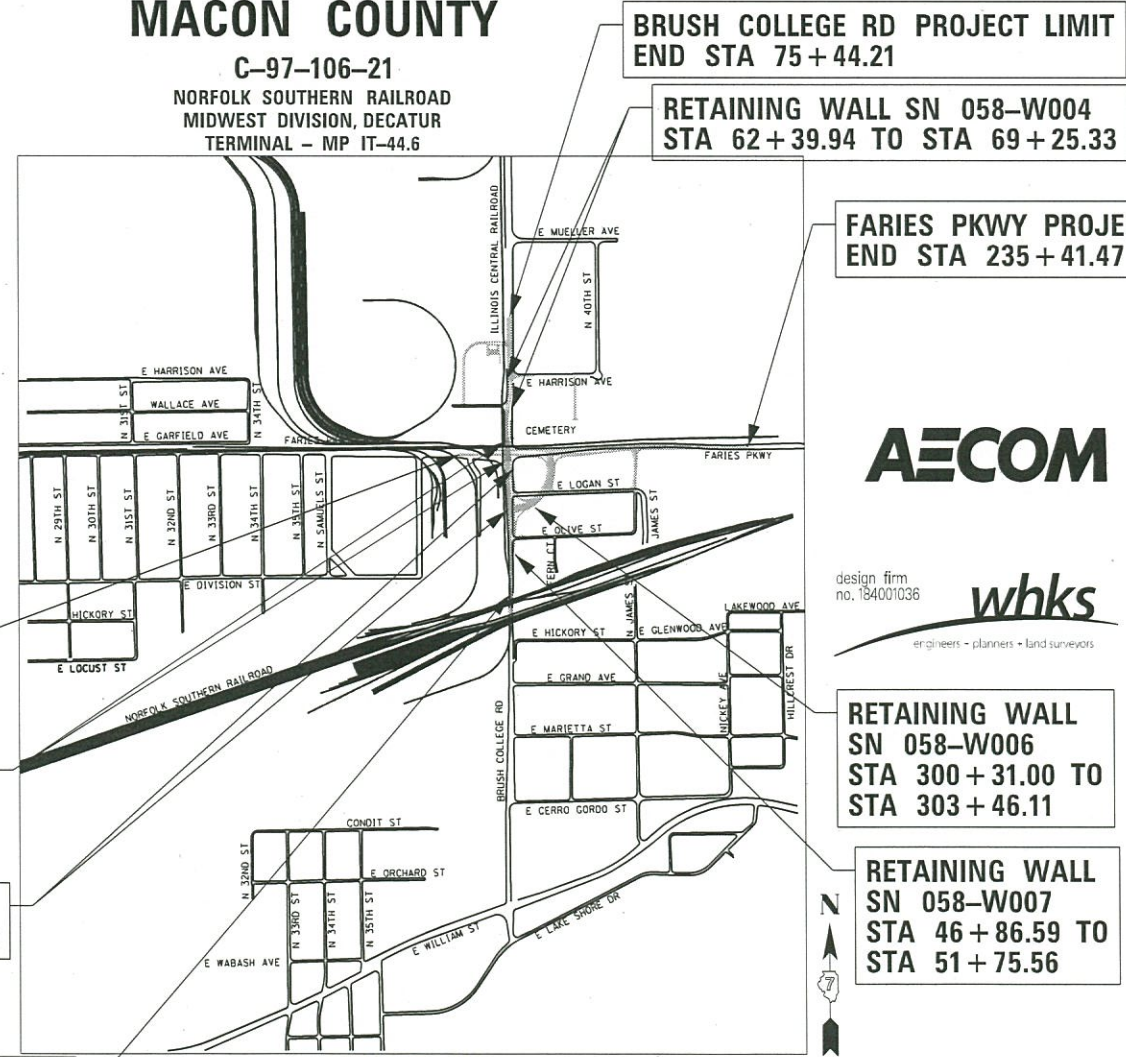

BRUSH COLLEGE RD PROJECT LIMIT
END STA 75 + 44.21

RETAINING WALL SN 058-W004
STA 62 + 39.94 TO STA 69 + 25.33

FARIES PKWY PROJECT LIMIT
END STA 235 + 41.47

FARIES PKWY PROJECT LIMIT
BEGIN STA 205 + 18.73

BRUSH COLLEGE STRUCTURE LIMIT
STA 60 + 10.96 TO STA 62 + 76.19
SN 058-9202


RETAINING WALL SN 058-W003
STA 52 + 00.00 TO STA 59 + 50.20

RETAINING WALL SN 058-W006
STA 300 + 31.00 TO STA 303 + 46.11

RETAINING WALL SN 058-W007
STA 46 + 86.59 TO STA 51 + 75.56

BRUSH COLLEGE RD PROJECT LIMIT
BEGIN STA 46 + 59.43

LOCATION MAP
NOT TO SCALE
GROSS LENGTH = 5,855.36 FT (1.11 MILES)
NET LENGTH = 5,855.36 FT (1.11 MILES)

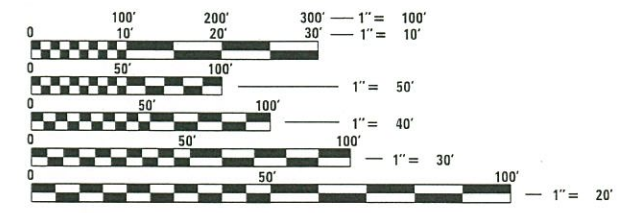

FULL SIZE PLANS HAVE BEEN PREPARED USING STANDARD ENGINEERING SCALES. REDUCED SIZED PLANS WILL NOT CONFORM TO STANDARD SCALES. IN MAKING MEASUREMENTS ON REDUCED PLANS, THE ABOVE SCALES MAY BE USED.

J.U.L.I.E.
JOINT UTILITY LOCATION INFORMATION FOR EXCAVATION
1-800-892-0123
OR 811

AECOM
345 EAST ASH AVE
DECATUR, IL 62526
PHONE: (217) 775-6065

whks
design firm
no. 184001036
engineers - planners - land surveyors

OEI
QUIGG ENGINEERING INC
2351 S. DIRKSEN PARKWAY
SPRINGFIELD, IL 62703
PHONE: (217) 670-0563

Kaskaskia
Engineering Group, LLC
208 E. MAIN STREET, SUITE 100
BELLEVILLE, IL 62220
PHONE: (618) 233-5877
FAX: (618) 233-5977

APPROVED *Paul Caswell*
PAUL CASWELL, P.E. DATE 04 /17 /2023
CITY ENGINEER

PASSED *04/29/23 Scott H. ...*
DISTRICT SEVEN ENGINEER OF LOCAL ROADS & STREETS

RELEASING FOR BID BASED ON LIMITED REVIEW *04/29/23 Jeff ...*
REGION FOUR ENGINEER


STATE OF ILLINOIS
DEPARTMENT OF TRANSPORTATION

CONTRACT NO. 95893


Benchmark: "M" in Mueller on fire hydrant at Southeast corner of Cerro Gordo St. and Brush College Rd. - Elev. 652.58.

Existing Structure: None

Traffic Control: The existing Brush College Road shall be closed and traffic will be detoured during construction.

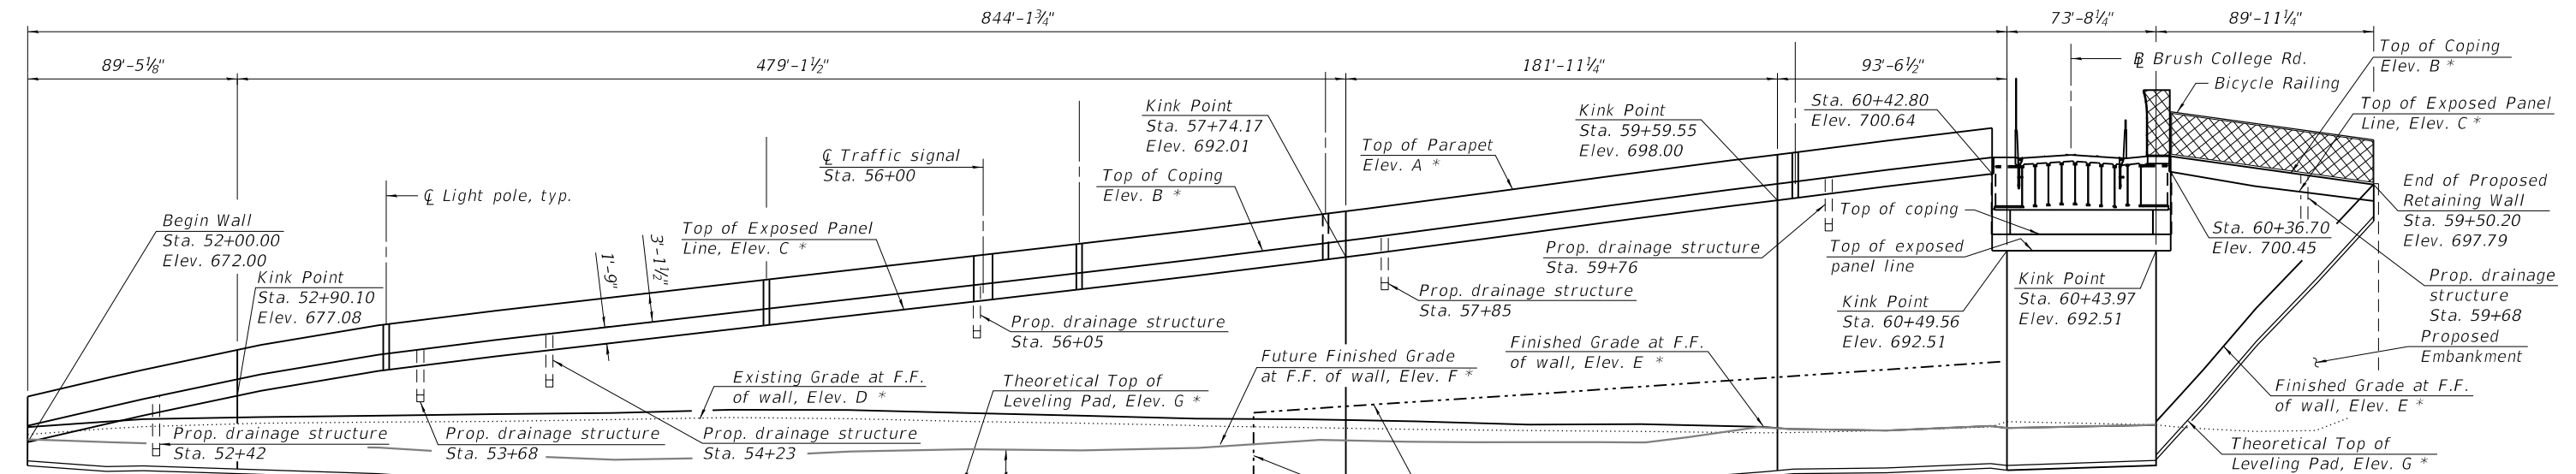

- Notes:**
- Wall offsets are measured from Brush College Road to front face of precast modular units. Horizontal dimensions are measured along F.F. of wall units.
 - For Temporary Soil Retention System (Special) details, see sheet SA-5 of SA-26.
 - F.F. denotes Front Face.
 - B.F. denotes Back Face.
- * For Elevations, see Wall Elevations Table on sheet SA-03 of SA-26.
 ** Ending station and offset of existing sheet pile retaining wall.
- Limits of Crashworthy Wall - Sta. 57+01.57 to Sta. 60+49.56
 See cross sections on sheet SA-4 of SA-26.

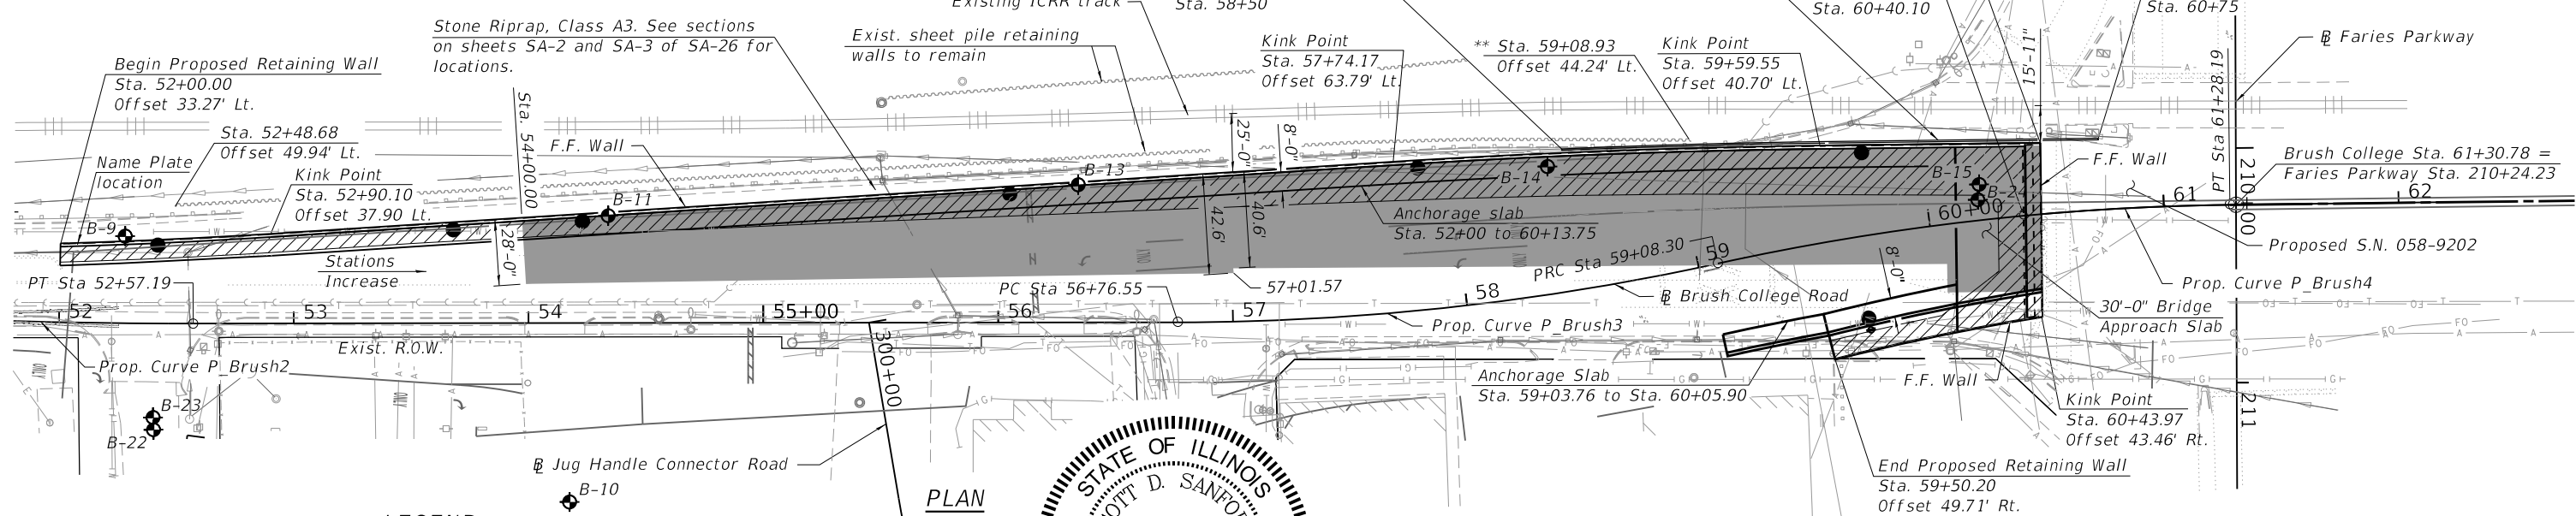

- LEGEND**
- Soil Boring Location
 - Existing Aerial
 - Existing Electric
 - Existing Fiber Optic
 - Existing Gas
 - Existing Sanitary Sewer
 - Existing Storm Sewer
 - Existing underground Telephone
 - Existing Water
 - Proposed above ground Lighting
 - Proposed above ground Inlet
 - Proposed traffic signal
 - Approximate Limits of Precast Modular Retaining Wall Mass
 - Approximate Limits of Lightweight Concrete Cellular Fill



I certify that to the best of my knowledge, information and belief, this structure design is structurally adequate for the design loading shown on the plans. The design is an economical one for the style of structure and complies with requirements of the current AASHTO Standard Specifications for Highway Bridges.


4/17/2023
Expires: 11/30/2024

DESIGN SPECIFICATIONS
2017 AASHTO LRFD Bridge Design Specifications, 8th Edition

DESIGN STRESSES

FIELD UNITS
 f'c = 3,500 psi
 fy = 60,000 psi (Reinforcement)
 f'c = 4,000 psi (Superstructure)

PRECAST UNITS
 f'c = 4,500 psi
 Allowable Bearing Pressure = 2,670 psf

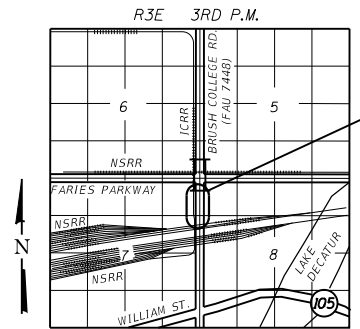

GENERAL PLAN & ELEVATION
BRUSH COLLEGE ROAD
 F.A.U. 7448 - SECTION 09-00933-01-BR
 MACON COUNTY
 STA. 52+00.00 LT TO STA. 59+50.20 RT
 STRUCTURE NO. 058-W003



DESIGNER	DESIGNED	REVISIONS
USER NAME = dtheberling	SDS	
FILE NAME = 60603202_SNO58W003.dgn	CHECKED - CEH	REVISED
PLOT SCALE = 0.167" / in.	DRAWN - DLH	REVISED
PLOT DATE = 4/13/2023	CHECKED - SDS	REVISED

STATE OF ILLINOIS
DEPARTMENT OF TRANSPORTATION

SHEET NO. SA-01 OF SA-26 SHEETS

F.A.U. RTE.	SECTION	COUNTY	TOTAL SHEETS	SHEET NO.
7448	09-00933-01-BR	MACON	1019	569
CONTRACT NO. 95893				

ILLINOIS FED. AID PROJECT

LAST SAVED DATE: SJASTSASVEDDATES

GENERAL NOTES


1. Reinforcement bars designated (E) shall be epoxy coated.
2. Protective Coat shall be applied to the top and interior surfaces of the parapets and the top exposed surface of the Anchorage Slabs.
3. The Contractor shall field verify the location of all underground utilities. The contractor shall take precautions to protect existing underground utilities that are to remain in service during construction of the wall. Any damage to underground utilities will be the responsibility of the Contractor. For locations and elevations of utilities, see Utility Plans.
4. The Contractor may encounter abandoned utilities or drainage structures that obstruct construction of the proposed wall. Removal and disposal of portions of these obstructions shall not be cause for additional payment but shall be included in the cost of "Precast Modular Retaining Wall". For locations and elevations of utilities, see Utility Plans.
5. All Lightweight Cellular Concrete Fill shall be Class II. See Special Provisions.
6. The Contractor shall coordinate the construction of the proposed wall with the construction of the proposed bridge over Faries Parkway (S.N. 058-9202). See suggested Stages of Construction and Traffic Control plan sheets and Special Provisions.
7. For details and quantity of conduits embedded in structure, see Electrical Plans.
8. Fill type retaining walls (MSE and precast modular) shall be detailed and constructed to allow for proposed roadway drainage to be placed properly and as shown in the plans. Any requests for modification to drainage structure locations to accommodate wall reinforcement or details shall be submitted to the Engineer in writing for review. Any changes approved by the Engineer in writing will be coordinated by the Contractor at no additional cost.
9. Slipforming of east parapet is not allowed.

TOTAL BILL OF MATERIAL

ITEM	UNIT	Super	Sub	TOTAL
Structure Excavation	Cu. Yd.		3,890	3,890
Concrete Structures	Cu. Yd.		250.0	250.0
Concrete Superstructure	Cu. Yd.	536.0		536.0
Protective Coat	Sq. Yd.	1,221		1,221
Reinforcement Bars, Epoxy Coated	Pound	76,840		76,840
Bicycle Railing	Foot	55		55
Parapet Railing	Foot	100		100
Name Plates	Each	1		1
Precast Modular Retaining Wall	Sq. Ft.		19,343	19,343
Lightweight Cellular Concrete Fill	Cu. Yd.		18,134	18,134
Temporary Soil Retention System (Special)	Sq. Ft.		1,200	1,200
Portland Cement Concrete Sidewalk 5 inch, Special	Sq. Ft.	532		532
Pipe Underdrains for Structures 4"	Foot		652	652


INDEX OF SHEETS

- SA-01. General Plan and Elevation
- SA-02. General Data
- SA-03. Wall Cross Sections and Details 1
- SA-04. Wall Cross Sections and Details 2
- SA-05. Temporary Soil Retention System (Special) Details
- SA-06. West Parapet and Anchorage Slab Plan and Elevation 1
- SA-07. West Parapet and Anchorage Slab Plan and Elevation 2
- SA-08. West Parapet and Anchorage Slab Plan and Elevation 3
- SA-09. West Parapet and Anchorage Slab Plan and Elevation 4
- SA-10. West Parapet and Anchorage Slab Plan and Elevation 5
- SA-11. West Parapet and Anchorage Slab Plan and Elevation 6
- SA-12. West Parapet and Anchorage Slab Plan and Elevation 7
- SA-13. West Parapet and Anchorage Slab Plan and Elevation 8
- SA-14. West Parapet and Anchorage Slab Plan and Elevation 9
- SA-15. East Parapet and Anchorage Slab Plan and Elevation
- SA-16.-SA-17. Parapet and Anchorage Slab Details
- SA-18.-SA-18A. Bicycle Railing and Parapet Railing
- SA-19. Concrete Parapet Slipforming Option
- SA-20. Existing Sheet Pile Retaining Wall Plans
- SA-21.-SA-26. Borings

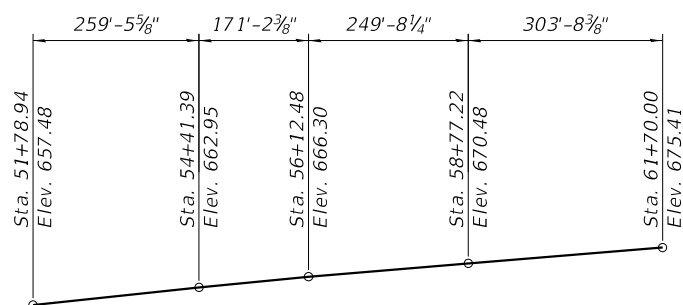


PROFILE GRADE

(Along top of existing rail ICRR)
(Stations are from Brush College Road)

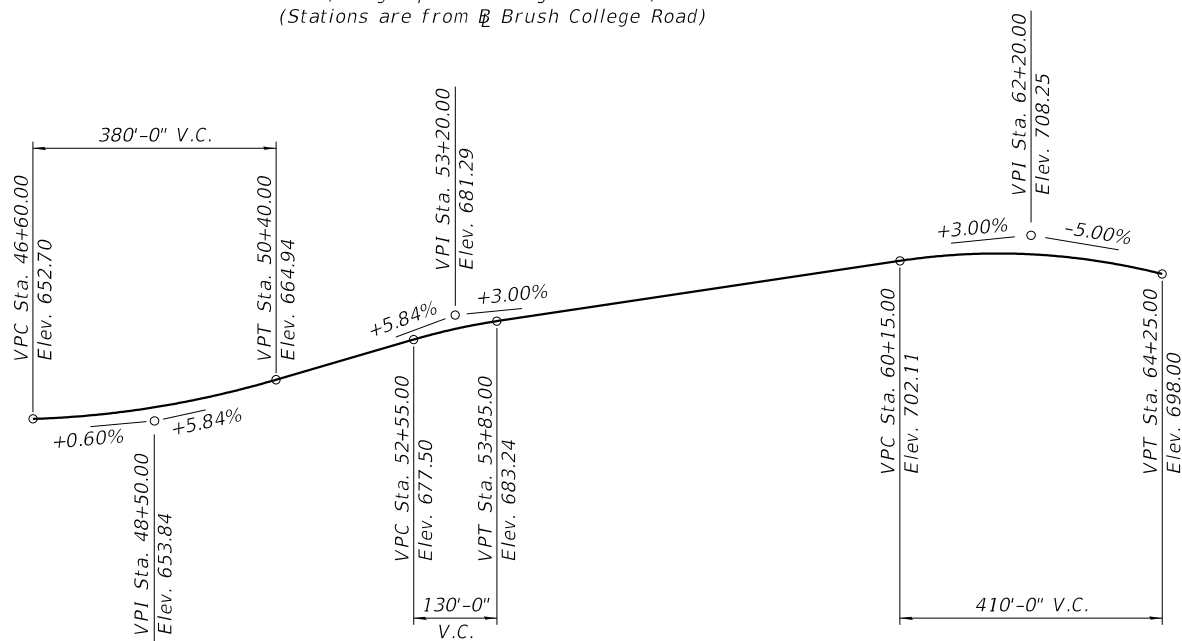

PROFILE GRADE

(Along Brush College Road)

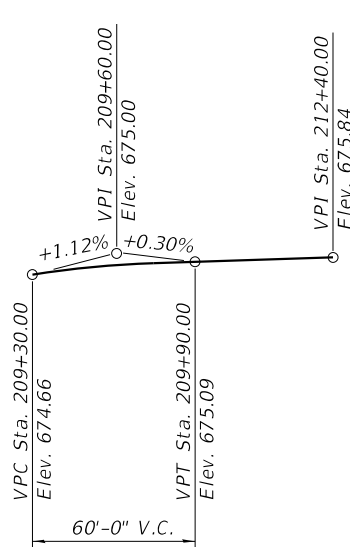

PROFILE GRADE

(Along Faries Parkway)

STA. 52+00.00 LT. TO 59+50.20 RT.
BUILT BY
CITY OF DECATUR
F.A.U. RT. 7448
SECTION 09-00933-01-BR
LOADING HL-93
STRUCTURE NO. 058-W003

NAME PLATE

See Std. 515001

PROP. CURVE P_BRUSH2

BRUSH COLLEGE RD.

PI STA. = 51+91.51
Δ = 3° 00' 41" (LT)
D = 2° 17' 31"
R = 2,500.00'
T = 65.72'
L = 131.40'
E = 0.86'
e = NC
T.R. = N/A
S.E. RUN = N/A
P.C. STA. = 51+25.79
P.T. STA. = 52+57.19

PROP. CURVE P_BRUSH3

BRUSH COLLEGE RD.

PI STA. = 57+92.87
Δ = 12° 17' 41" (LT)
D = 5° 18' 19"
R = 1,080.00'
T = 116.32'
L = 231.75'
E = 6.25'
e = NC
T.R. = N/A
S.E. RUN = N/A
P.C. STA. = 56+76.55
P.T. STA. = 59+08.30

PROP. CURVE P_BRUSH4

BRUSH COLLEGE RD.

PI STA. = 60+18.63
Δ = 11° 39' 57" (RT)
D = 5° 18' 19"
R = 1,080.00'
T = 110.33'
L = 219.89'
E = 5.62'
e = NC
T.R. = N/A
S.E. RUN = N/A
P.C. STA. = 59+08.30
P.T. STA. = 61+28.19

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design firm
no. 184001036



USER NAME = dtheberling	DESIGNED - SDS	REVISED
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STATE OF ILLINOIS
DEPARTMENT OF TRANSPORTATION

GENERAL DATA
STRUCTURE NO. 058-W003


SHEET NO. SA-02 OF SA-26 SHEETS

F.A.U. RTE. 7448	SECTION 09-00933-01-BR	COUNTY MACON	TOTAL SHEETS 1019	SHEET NO. 570
CONTRACT NO. 95893			ILLINOIS FED. AID PROJECT	


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WALL ELEVATIONS


Station	Offset		Elevation A	Elevation B	Elevation C	Elevation D	Elevation E	Elevation F	Elevation G	Elevation H
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52+50.00	35.70	LT	679.79	676.67	674.92	673.72	674.52	673.04	669.54	676.54
52+90.10	37.90	LT	681.95	678.83	677.08	674.24	674.69	672.59	669.09	678.70
53+00.00	38.52	LT	682.43	679.31	677.56	674.10	674.74	672.64	669.14	679.18
53+50.00	41.66	LT	684.51	681.39	679.64	674.21	674.89	672.23	668.73	681.26
54+00.00	44.80	LT	686.08	682.96	681.21	674.30	675.07	671.40	667.90	682.83
54+50.00	47.94	LT	687.51	684.39	682.64	674.48	675.18	670.55	667.05	684.26
55+00.00	51.08	LT	688.95	685.83	684.08	674.69	675.53	670.35	666.85	685.70
55+50.00	54.22	LT	690.38	687.26	685.51	674.58	675.51	671.19	667.69	687.13
56+00.00	57.36	LT	691.82	688.70	686.95	674.28	675.19	671.26	667.76	688.57
56+50.00	60.50	LT	693.25	690.13	688.38	674.10	674.89	671.23	667.73	690.00
57+00.00	63.32	LT	694.69	691.57	689.82	673.84	674.58	671.57	668.07	691.44
57+01.57-	63.38	LT	694.74	691.62	689.87	673.80	674.58	671.59	668.09	691.49
57.01.57+	63.38	LT	694.74	691.62	689.87	673.80	674.58	671.59	667.59	691.49
57+50.00	64.16	LT	696.16	693.04	691.29	673.63	674.51	672.32	668.32	692.91
57+74.17	63.79	LT	696.88	693.76	692.01	673.53	674.41	672.55	668.55	693.63
58+00.00	62.74	LT	697.67	694.55	692.80	673.44	674.28	672.77	668.77	694.42
58+50.00	58.55	LT	699.24	696.12	694.37	673.31	673.95	672.35	668.35	695.99
59+00.00	51.45	LT	700.86	697.74	695.99	673.23	674.00	671.92	667.92	697.61
59+50.00	42.29	LT	702.55	699.43	697.68	673.07	673.71	-	669.71	699.30
59+59.55	40.70	LT	702.87	699.75	698.00	673.10	673.49	-	669.49	699.62
60+00.00	34.92	LT	704.20	701.08	699.33	673.32	673.32	-	669.32	700.95
60+42.80	30.55	LT	705.51	702.39	700.64	673.70	673.80	-	669.80	702.26
60+49.56	30.05	LT	-	694.26	692.51	674.26	673.59	-	669.59	-
60+43.97 -	43.46	RT	-	694.26	692.51	673.92	680.24	-	676.24	-
60+43.97 +	43.46	RT	-	694.26	692.51	673.92	680.24	-	676.74	-
60+36.70	43.94	RT	-	702.20	700.45	673.70	681.74	-	678.24	-
60+25.00	44.53	RT	-	701.87	700.12	673.52	684.15	-	680.65	-
60+00.00	46.40	RT	-	701.10	699.35	673.52	689.31	-	685.81	-
59+75.00	48.07	RT	-	700.31	698.56	673.31	694.45	-	690.95	-
59+50.20	49.71	RT	-	699.54	697.79	675.64	699.54	-	696.04	-

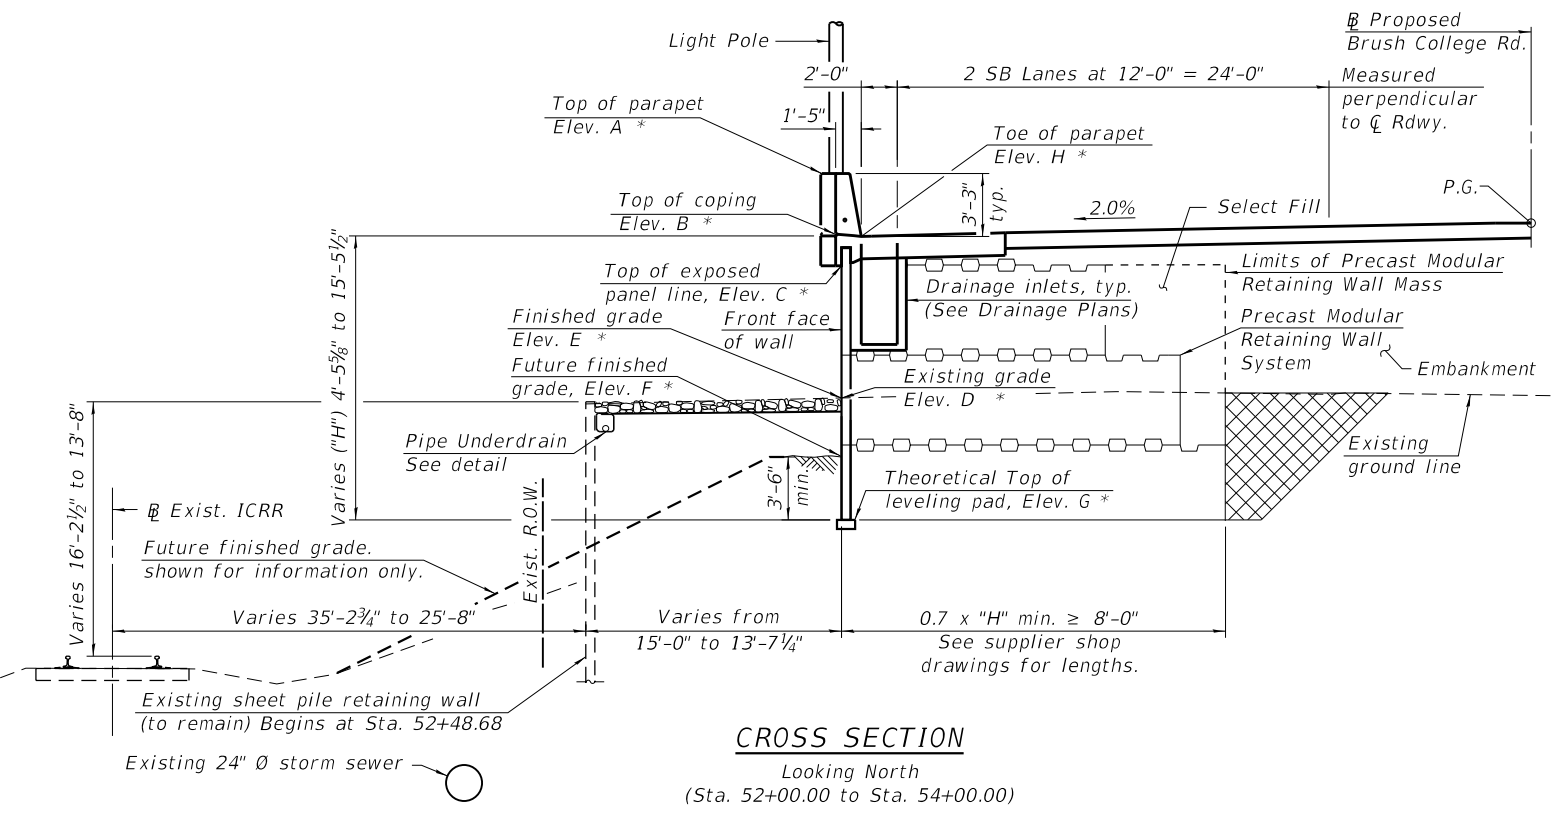

CROSS SECTION
Looking North
(Sta. 52+00.00 to Sta. 54+00.00)

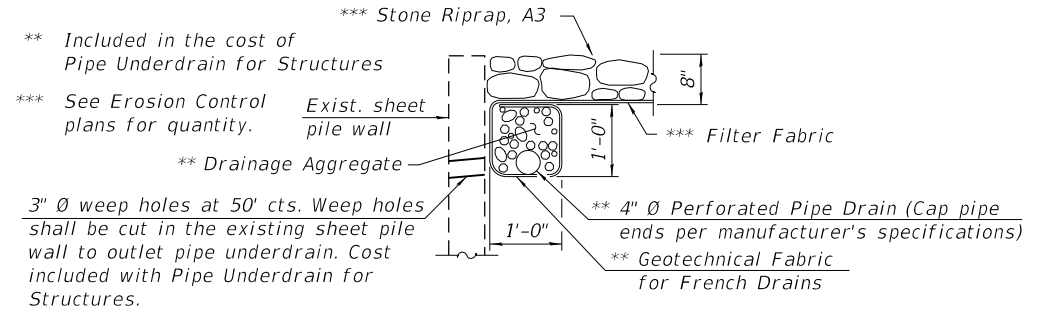

PIPE UNDERDRAIN FOR STRUCTURES DETAIL
(Install Pipe Underdrain for Structures at location shown for entire length of Existing Sheet Pile Retaining Wall.)

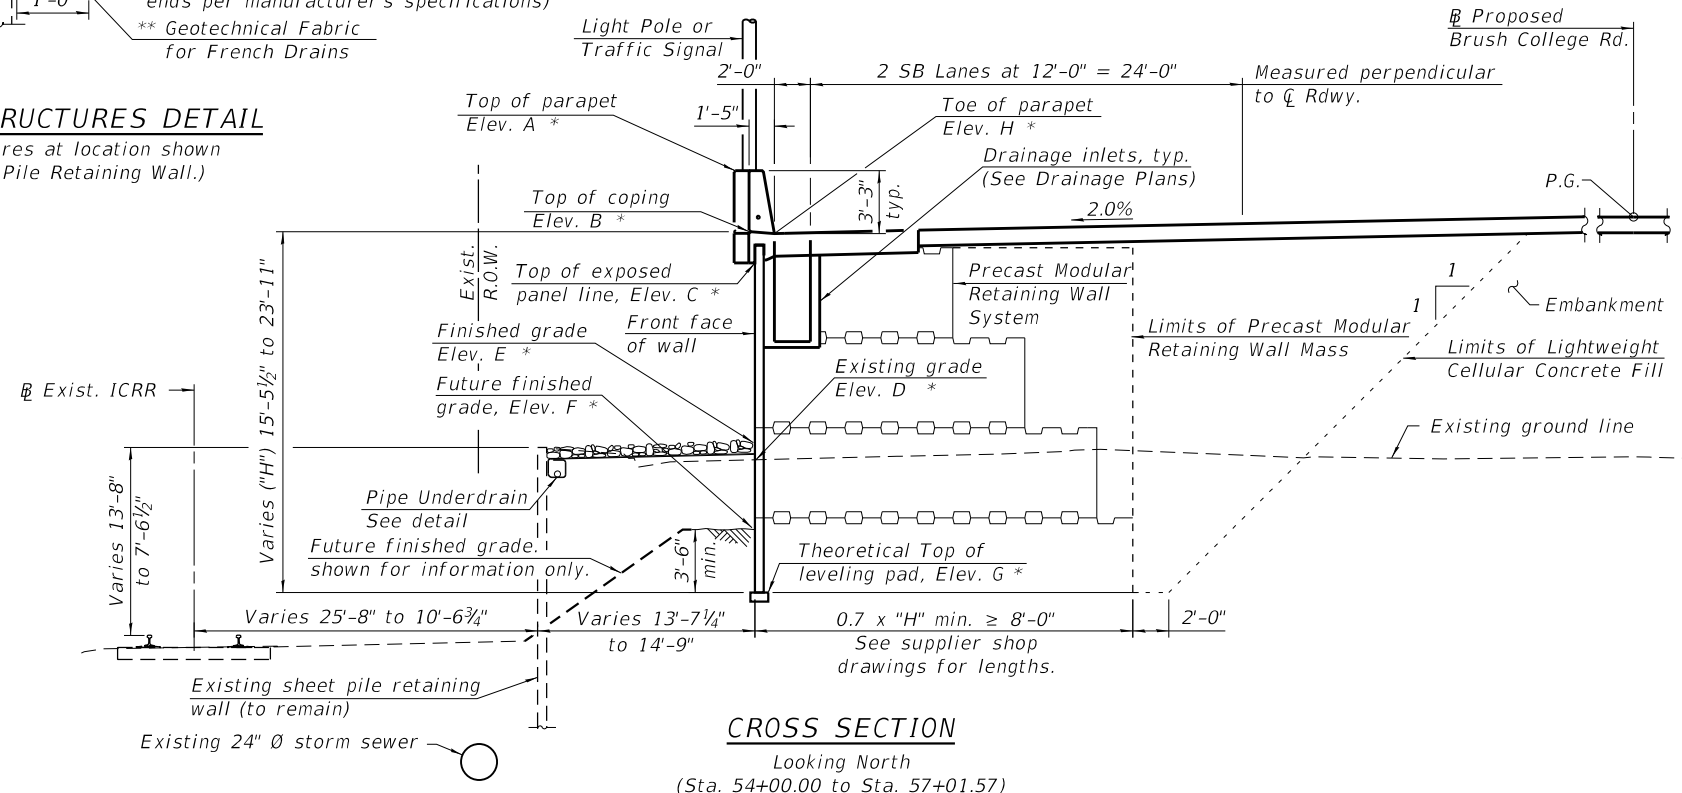

CROSS SECTION
Looking North
(Sta. 54+00.00 to Sta. 57+01.57)


- Elevation A - Top of Parapet
 Elevation B - Top of Coping
 Elevation C - Top of Exposed Panel Line
 Elevation D - Existing Grade at F.F. of wall
 Elevation E - Finished Grade at F.F. of wall
 Elevation F - Future Finished Grade at F.F. of wall (For information only)
 Elevation G - Theoretical Top of Leveling Pad
 Elevation H - Toe of Parapet

LEGEND

Over excavation beyond the limits of Structure Excavation. This area not measured for payment. Area to be back-filled with the same material as used for Select Fill or Lightweight Cellular Concrete Fill.

- Note:
- The Precast Modular Retaining Wall supplier's internal stability design shall account for anchorage slab's bearing pressure surcharge of 1.0 ksf and horizontal sliding force of 0.67 kips/ft. of wall.
 - Horizontal dimensions are measured perpendicular to the F.F. of wall unless noted otherwise.

* For Elevations, see Wall Elevations Table above.

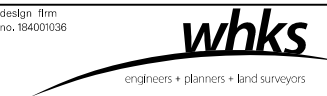

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PLOT DATE = 4/6/2023	CHECKED = SDS	REVISED


STATE OF ILLINOIS
DEPARTMENT OF TRANSPORTATION

WALL CROSS SECTIONS AND DETAILS 1
STRUCTURE NO. 058-W003


SHEET NO. SA-03 OF SA-26 SHEETS

F.A.U. RTE.	SECTION	COUNTY	TOTAL SHEETS	SHEET NO.
7448	09-00933-01-BR	MACON	1019	571
CONTRACT NO. 95893				

ILLINOIS FED. AID PROJECT

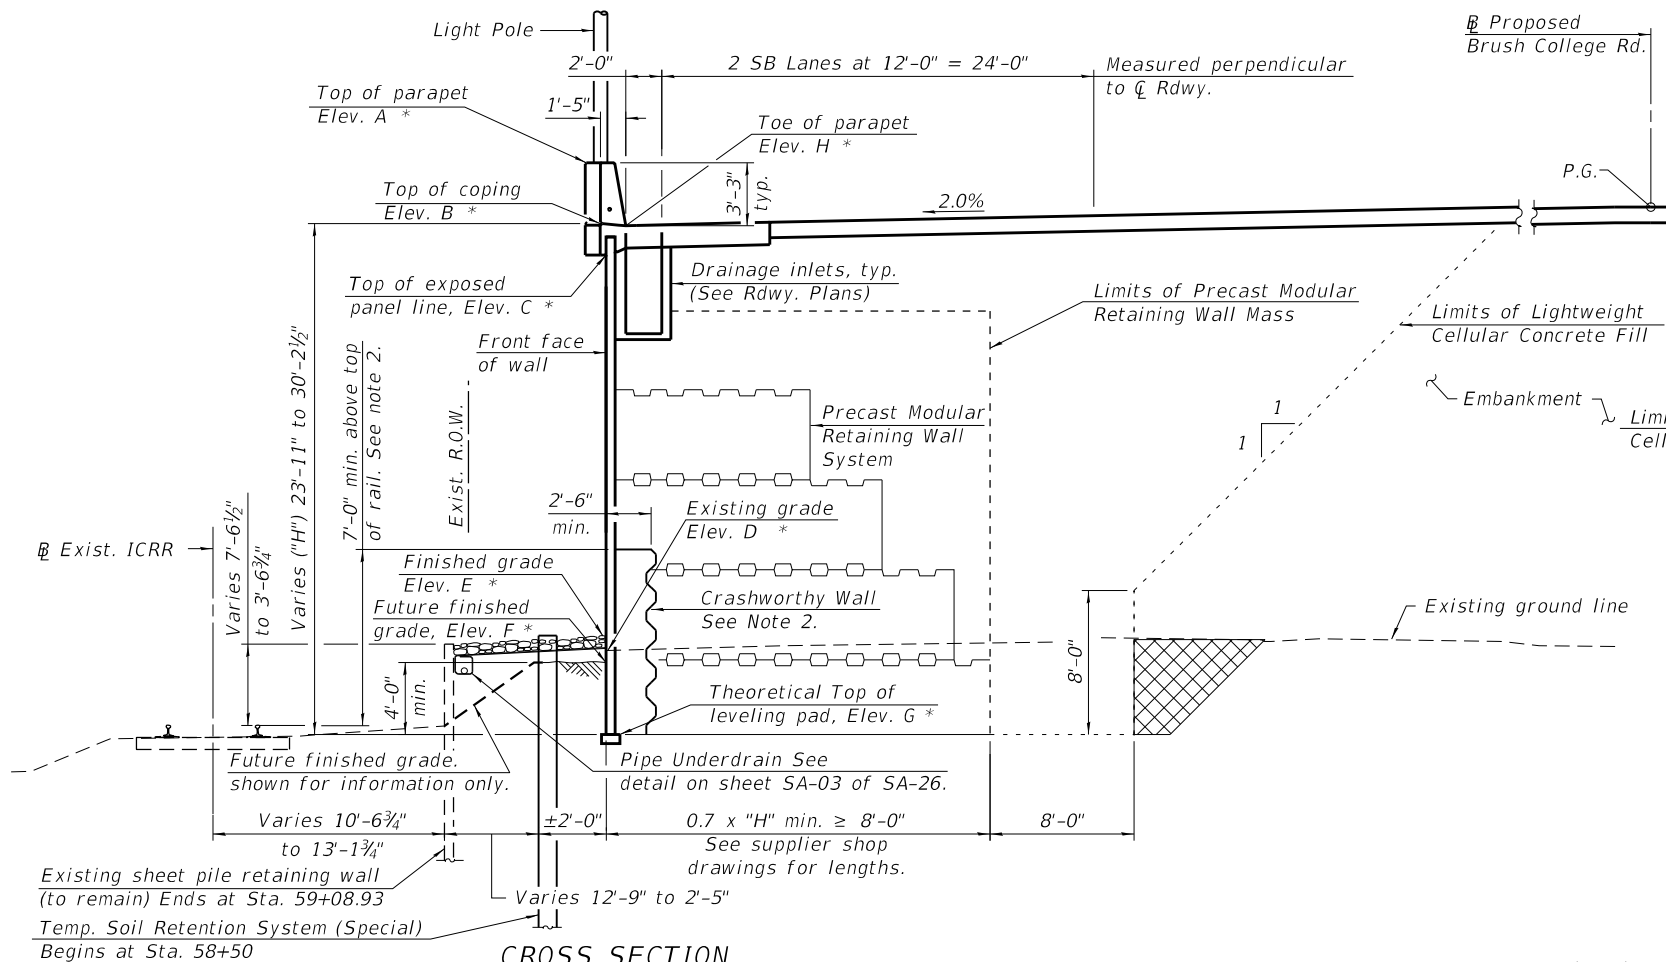


CROSS SECTION
Looking North
(Sta. 57+01.57 to Sta. 59+50.20)

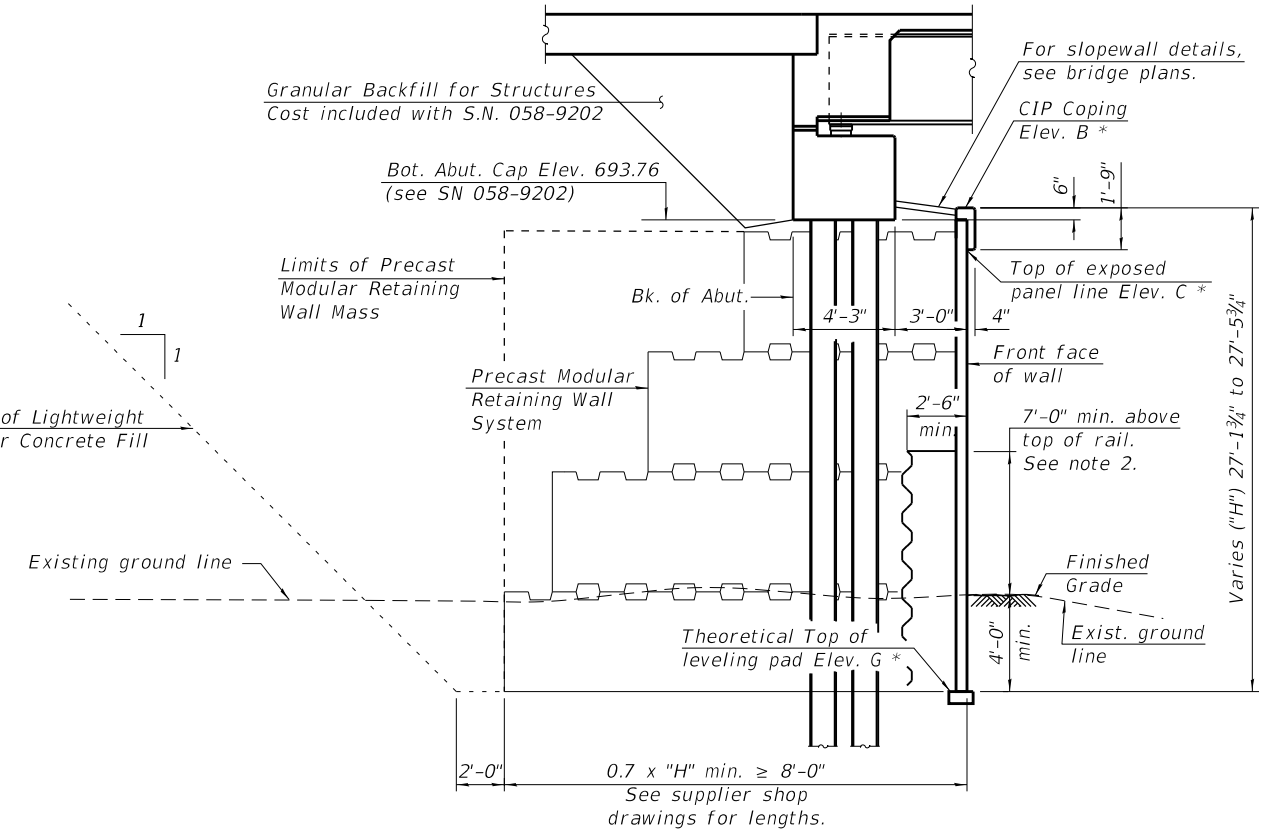

CROSS SECTION AT ABUTMENT
Looking West

* For Elevations, see Wall Elevations Table on sheet SA-03 of SA-26.

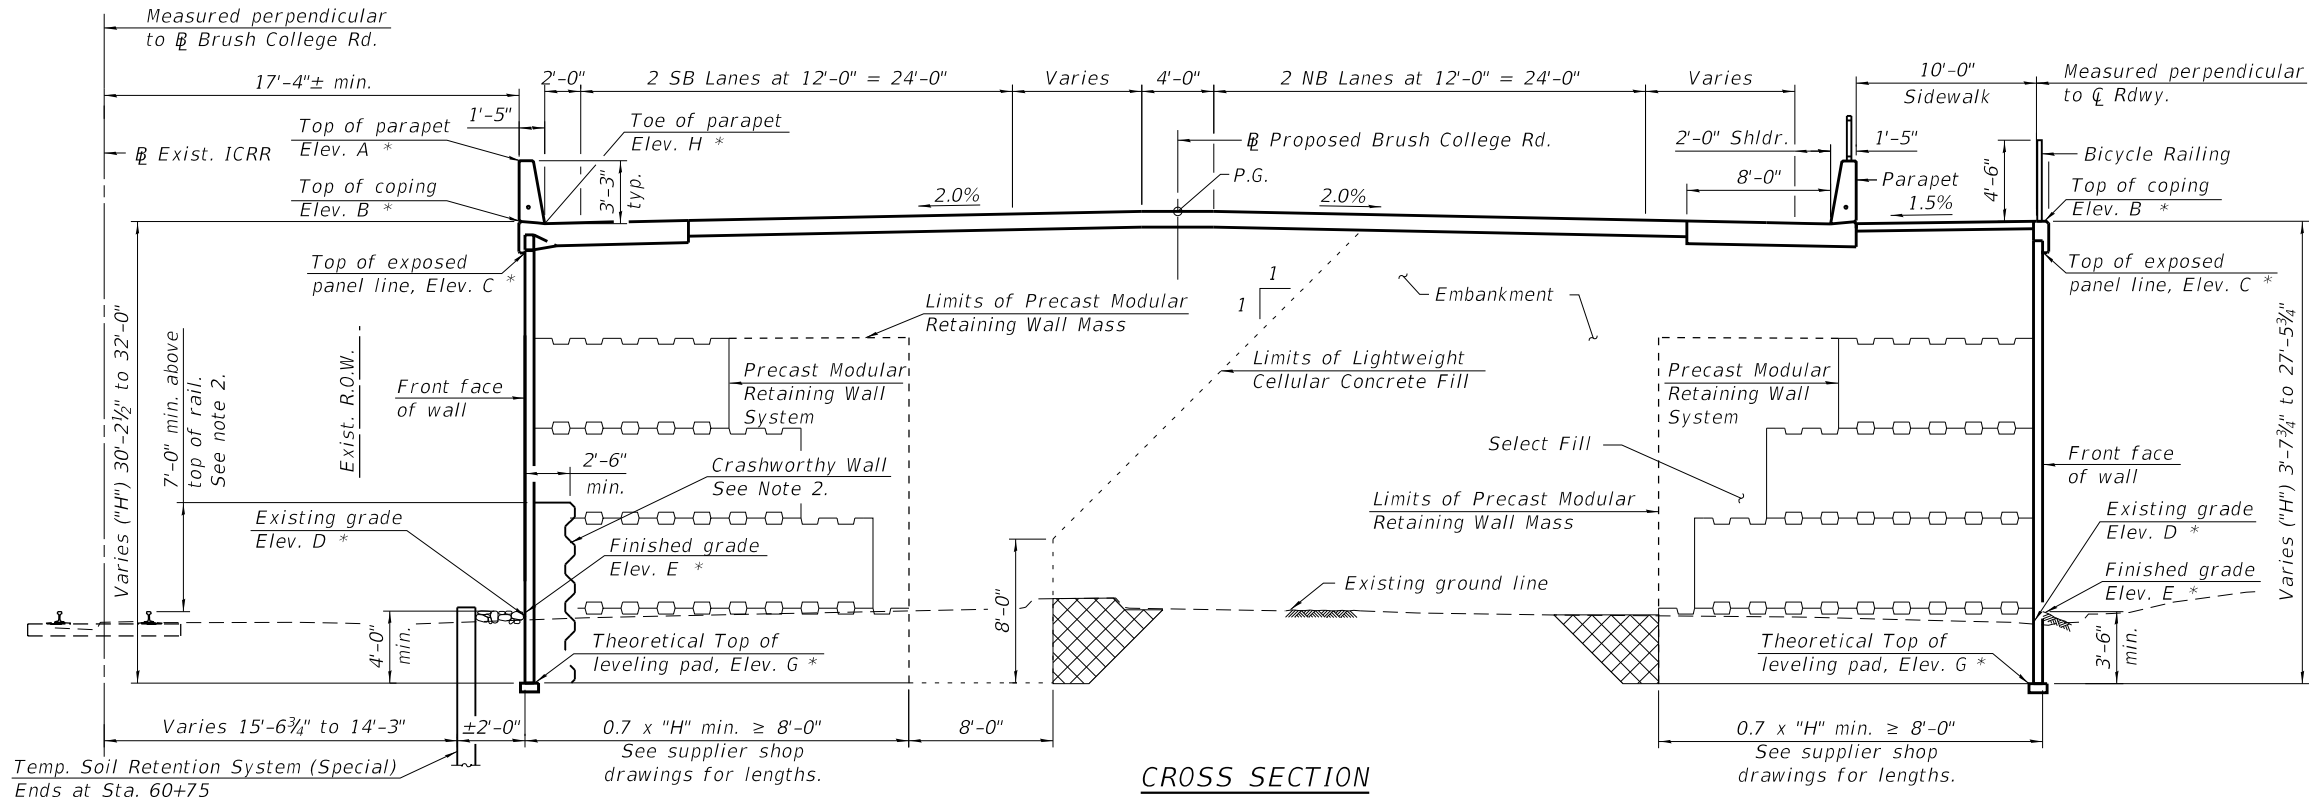


CROSS SECTION
Looking North
(Sta. 59+50.20 to Sta. 60+49.56)

LEGEND

Over excavation beyond the limits of Structure Excavation. This area not measured for payment. Area to be back-filled with the same material as used for Select Fill or Lightweight Cellular Concrete Fill.


- Note:
- The Precast Modular Retaining Wall supplier's internal stability design shall account for anchorage slab's bearing pressure surcharge of 1.0 ksf and horizontal sliding force of 0.67 kips/ft. of wall.
 - Retaining wall shall be Crashworthy per 2020 Manual for Railway Engineering from a min. of 7'-0" above top of rail down to top of leveling pad for wall within 25' of the \bar{C} existing rail from Sta. 57+01.57 Rt. to Sta. 60+49.56 Rt., see cross sections. Cost of crashworthy concrete mass paid for as Concrete Structures.
 - Horizontal dimensions are measured perpendicular to the F.F. of wall unless noted otherwise.

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ELEVATION

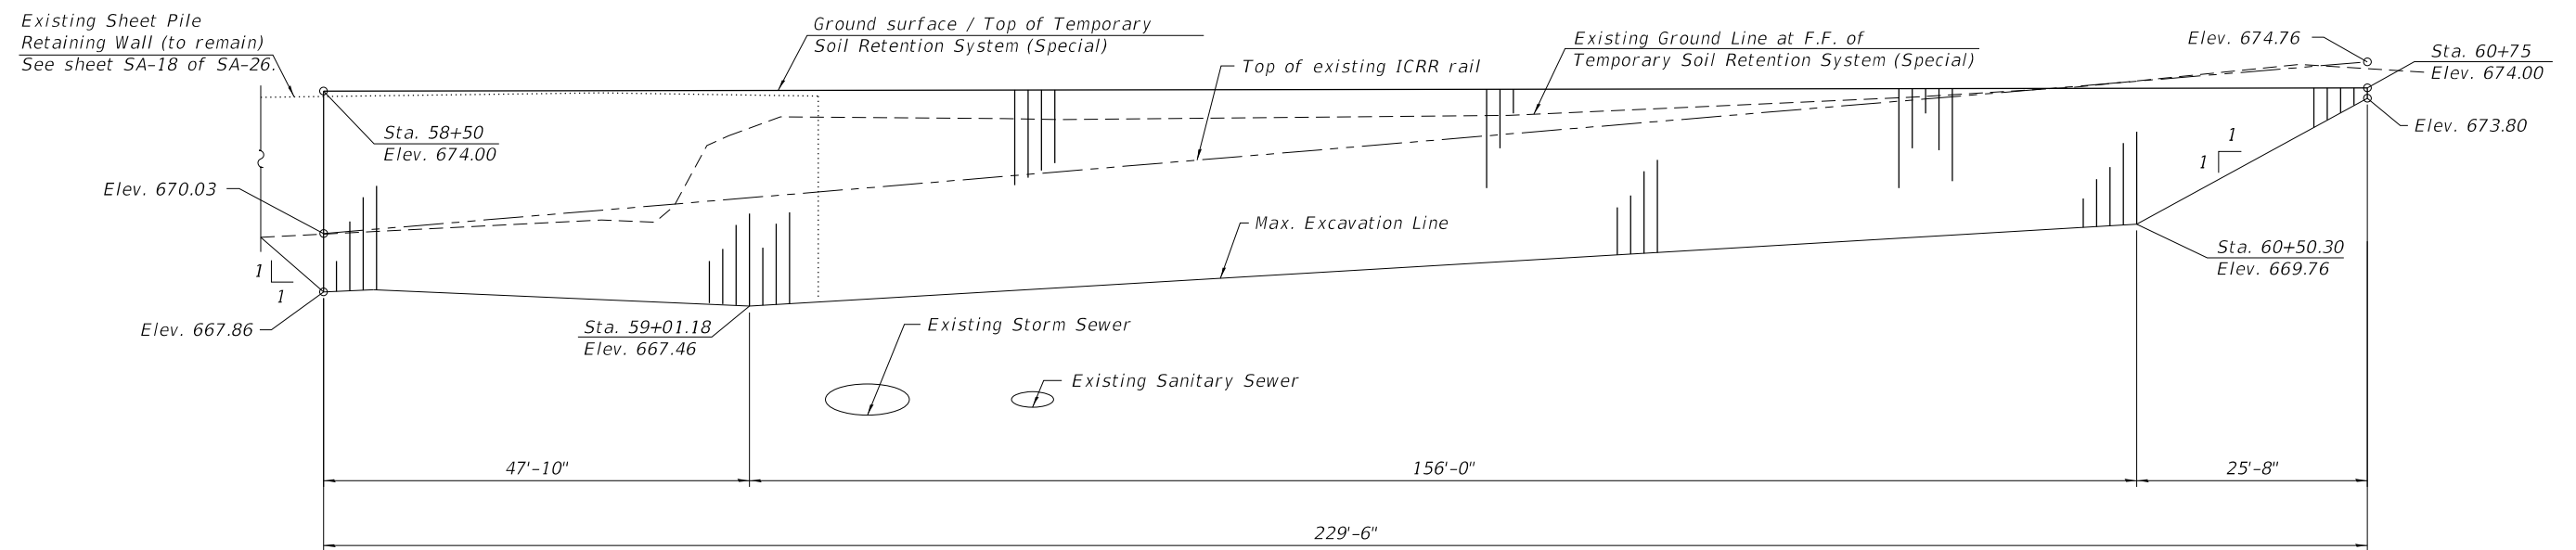* Measured perpendicular to centerline of tracks.




PLAN

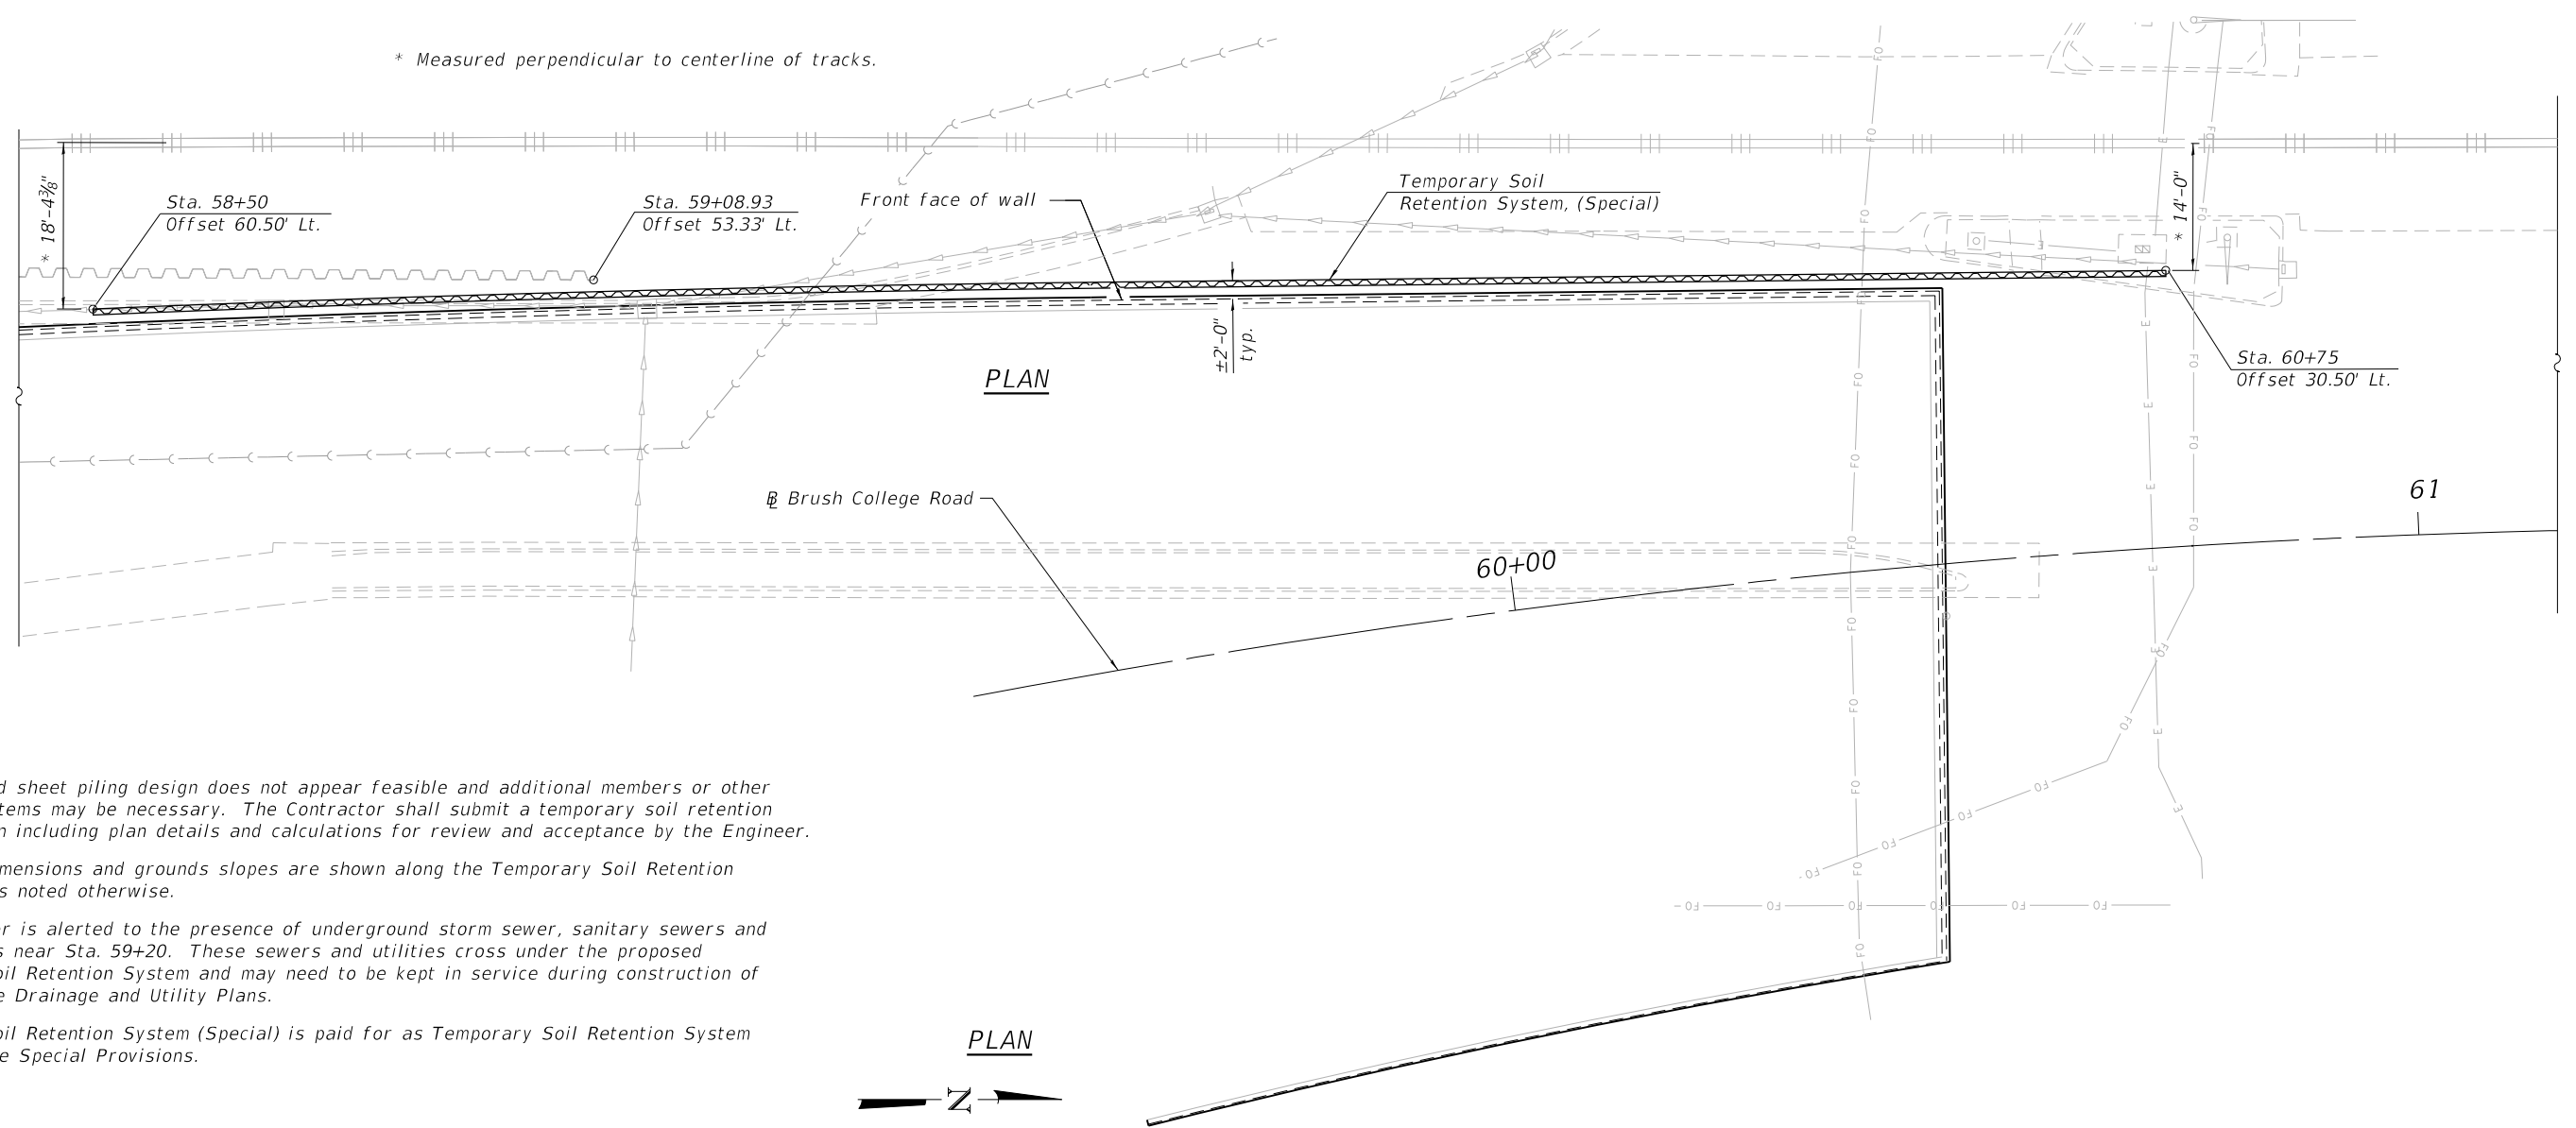PLAN

Notes:

1. A cantilevered sheet piling design does not appear feasible and additional members or other retention systems may be necessary. The Contractor shall submit a temporary soil retention system design including plan details and calculations for review and acceptance by the Engineer.
2. Horizontal dimensions and grounds slopes are shown along the Temporary Soil Retention System unless noted otherwise.
3. The contractor is alerted to the presence of underground storm sewer, sanitary sewers and other utilities near Sta. 59+20. These sewers and utilities cross under the proposed Temporary Soil Retention System and may need to be kept in service during construction of the wall. See Drainage and Utility Plans.
4. Temporary Soil Retention System (Special) is paid for as Temporary Soil Retention System (Special). See Special Provisions.

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PLOT DATE = 4/6/2023	CHECKED - SDS	REVISED

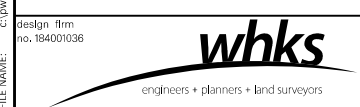**STATE OF ILLINOIS
DEPARTMENT OF TRANSPORTATION**


**TEMPORARY SOIL RETENTION SYSTEM, (SPECIAL)
STRUCTURE NO. 058-W003**

SHEET NO. SA-05 OF SA-26 SHEETS



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CONTRACT NO. 95893			ILLINOIS FED. AID PROJECT	

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 design firm no. 184001036

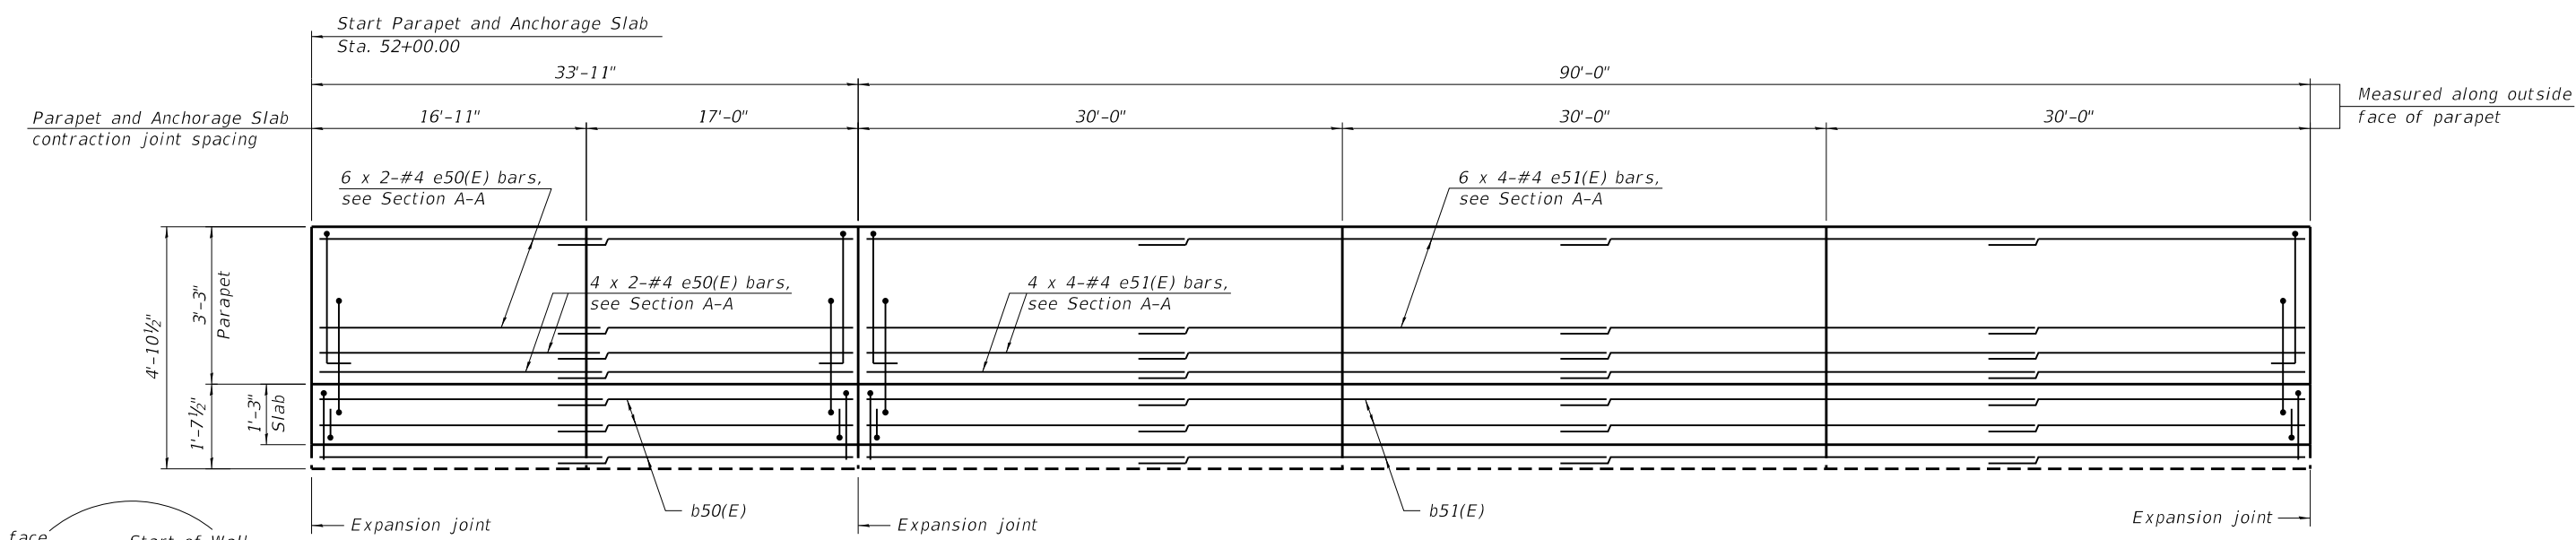


INSIDE ELEVATION OF WEST PARAPET AND ANCHORAGE SLAB

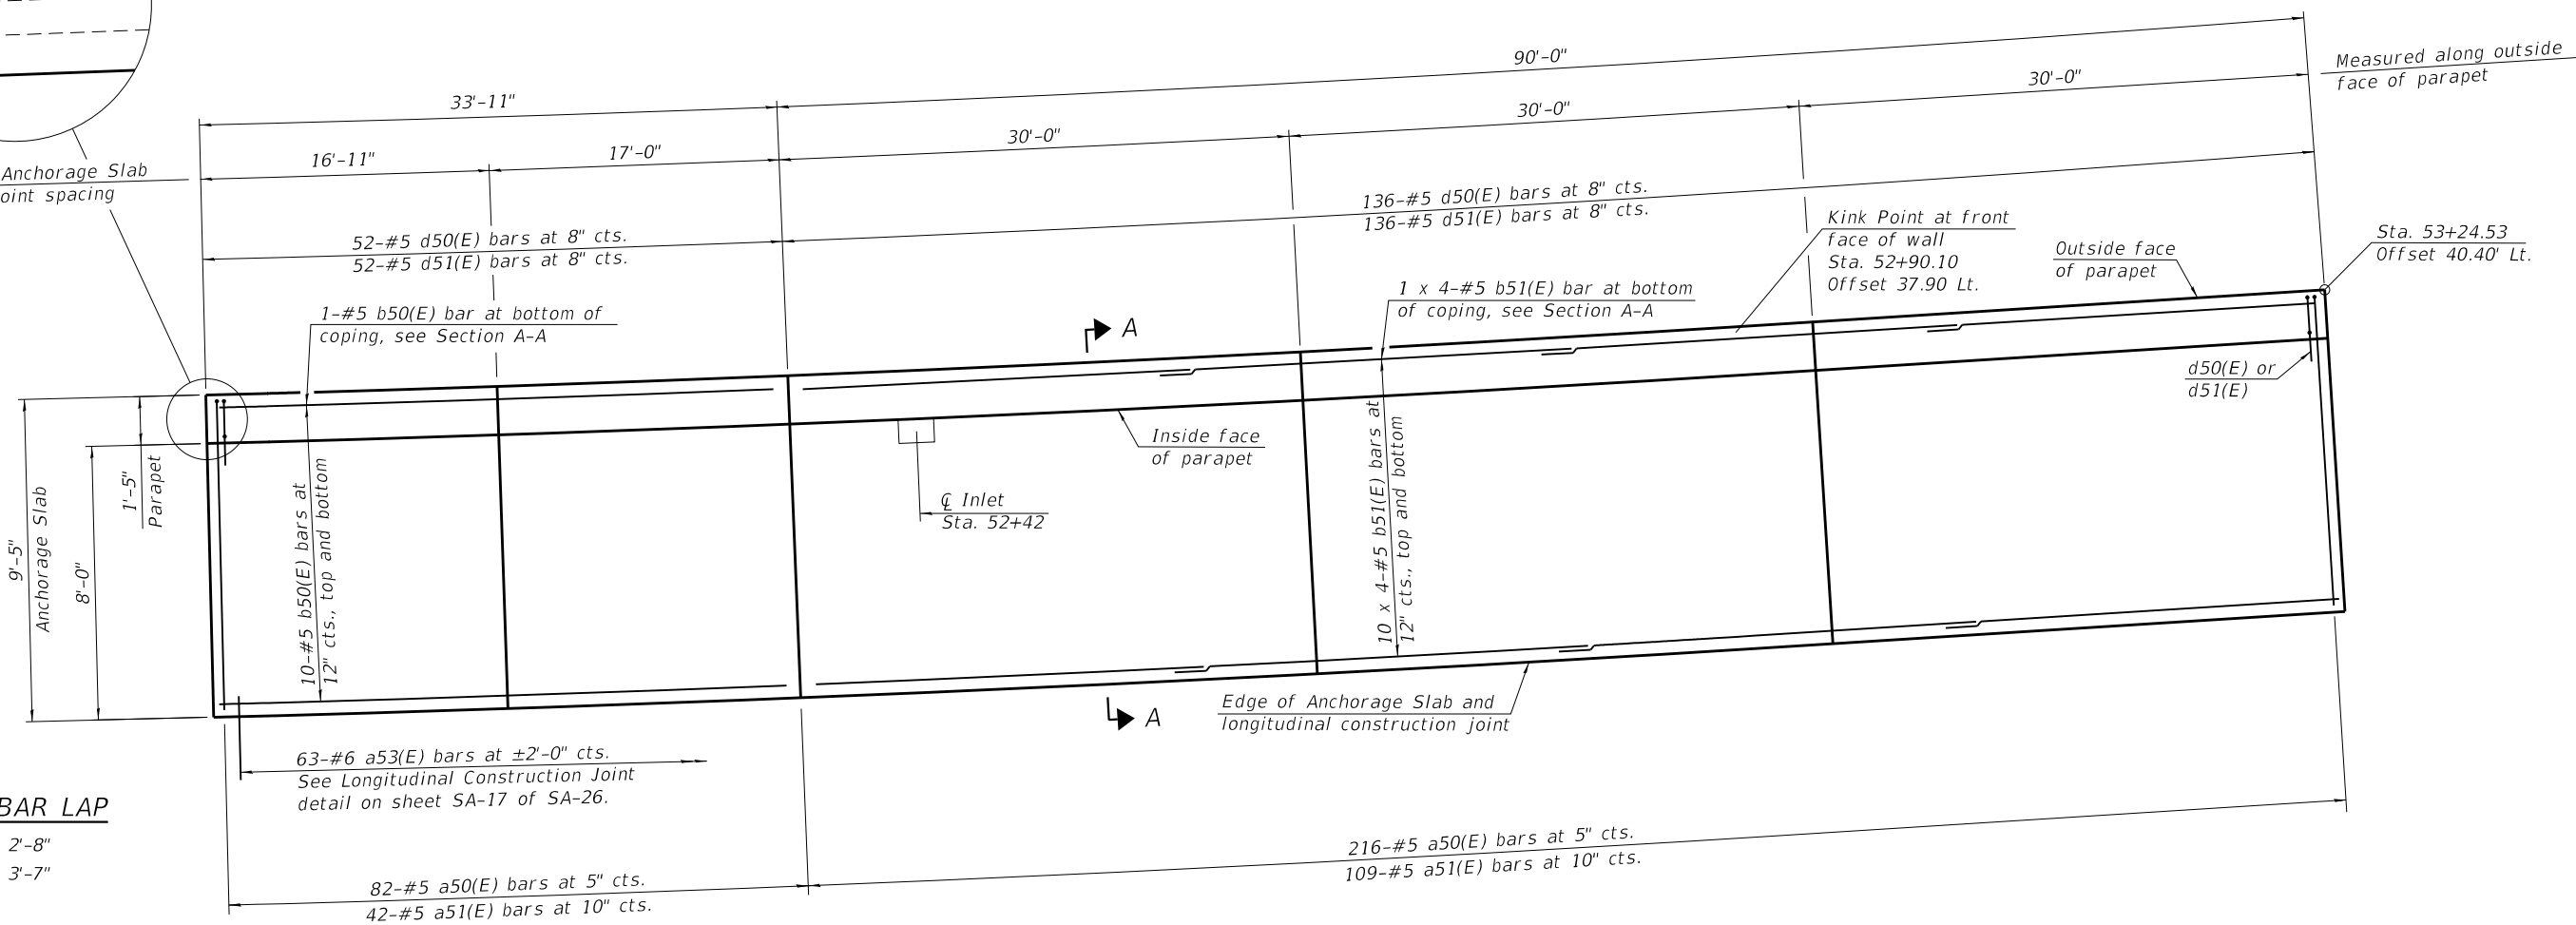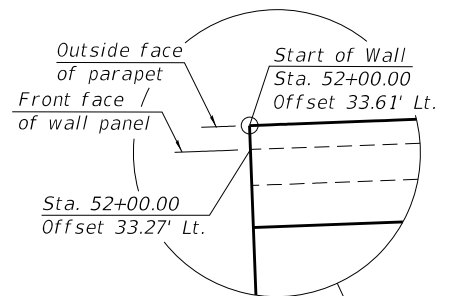

MINIMUM BAR LAP

- #4 bar = 2'-8"
- #5 bar = 3'-7"

- Notes:
1. For Section A-A see sheet SA-16 of SA-26.
 2. See sheet SA-16 of SA-26 for Anchorage Slab details, light pole details, parapet joint details, bar bend details and Bill of Material.
 3. Portion of Anchorage Slab within the traveled way shall be finished to match PPC pavement finish according to Section 420.09 of the Standard Specifications.
 4. For light pole, traffic signal and junction box details, see Electrical Plans.
 5. Stations and offsets are measured from Brush College Road.

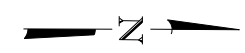

WEST PARAPET AND ANCHORAGE SLAB PLAN



USER NAME = dtheberling	DESIGNED - SDS	REVISED
FILE NAME = 60603202_SAS058W003.dgn	CHECKED - CEH	REVISED
PLOT SCALE = 2.000" / ft.	DRAWN - DLH	REVISED
PLOT DATE = 4/6/2023	CHECKED - SDS	REVISED

STATE OF ILLINOIS
DEPARTMENT OF TRANSPORTATION


WEST PARAPET AND ANCHORAGE SLAB PLAN AND ELEVATION 1
STRUCTURE NO. 058-W003

F.A.U. RTE. 7448	SECTION 09-00933-01-BR	COUNTY MACON	TOTAL SHEETS 1019	SHEET NO. 574
CONTRACT NO. 95893				


SHEET NO. SA-06 OF SA-26 SHEETS

ILLINOIS FED. AID PROJECT

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INSIDE ELEVATION OF WEST PARAPET AND ANCHORAGE SLAB

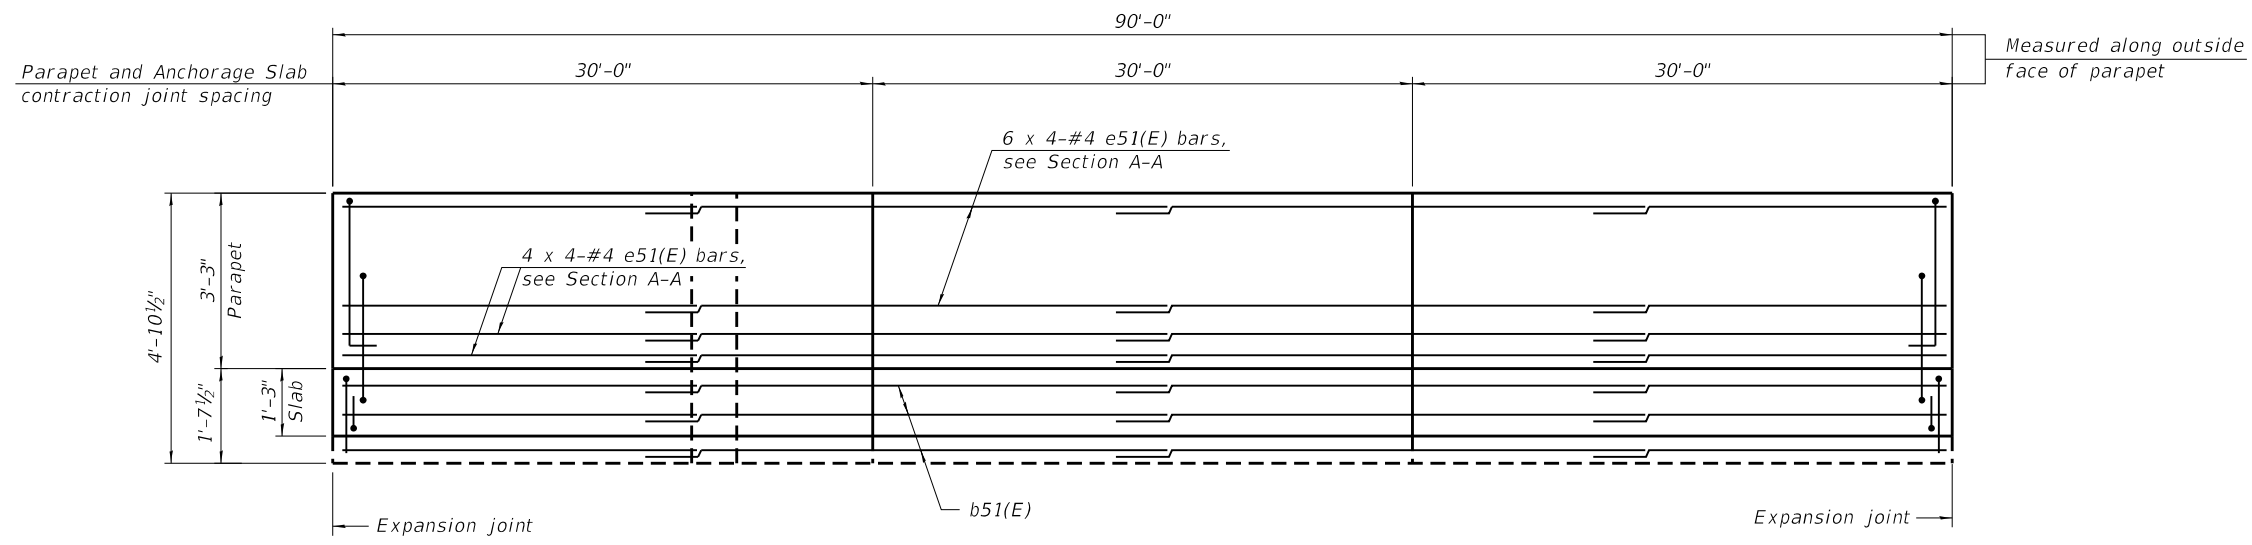


WEST PARAPET AND ANCHORAGE SLAB PLAN

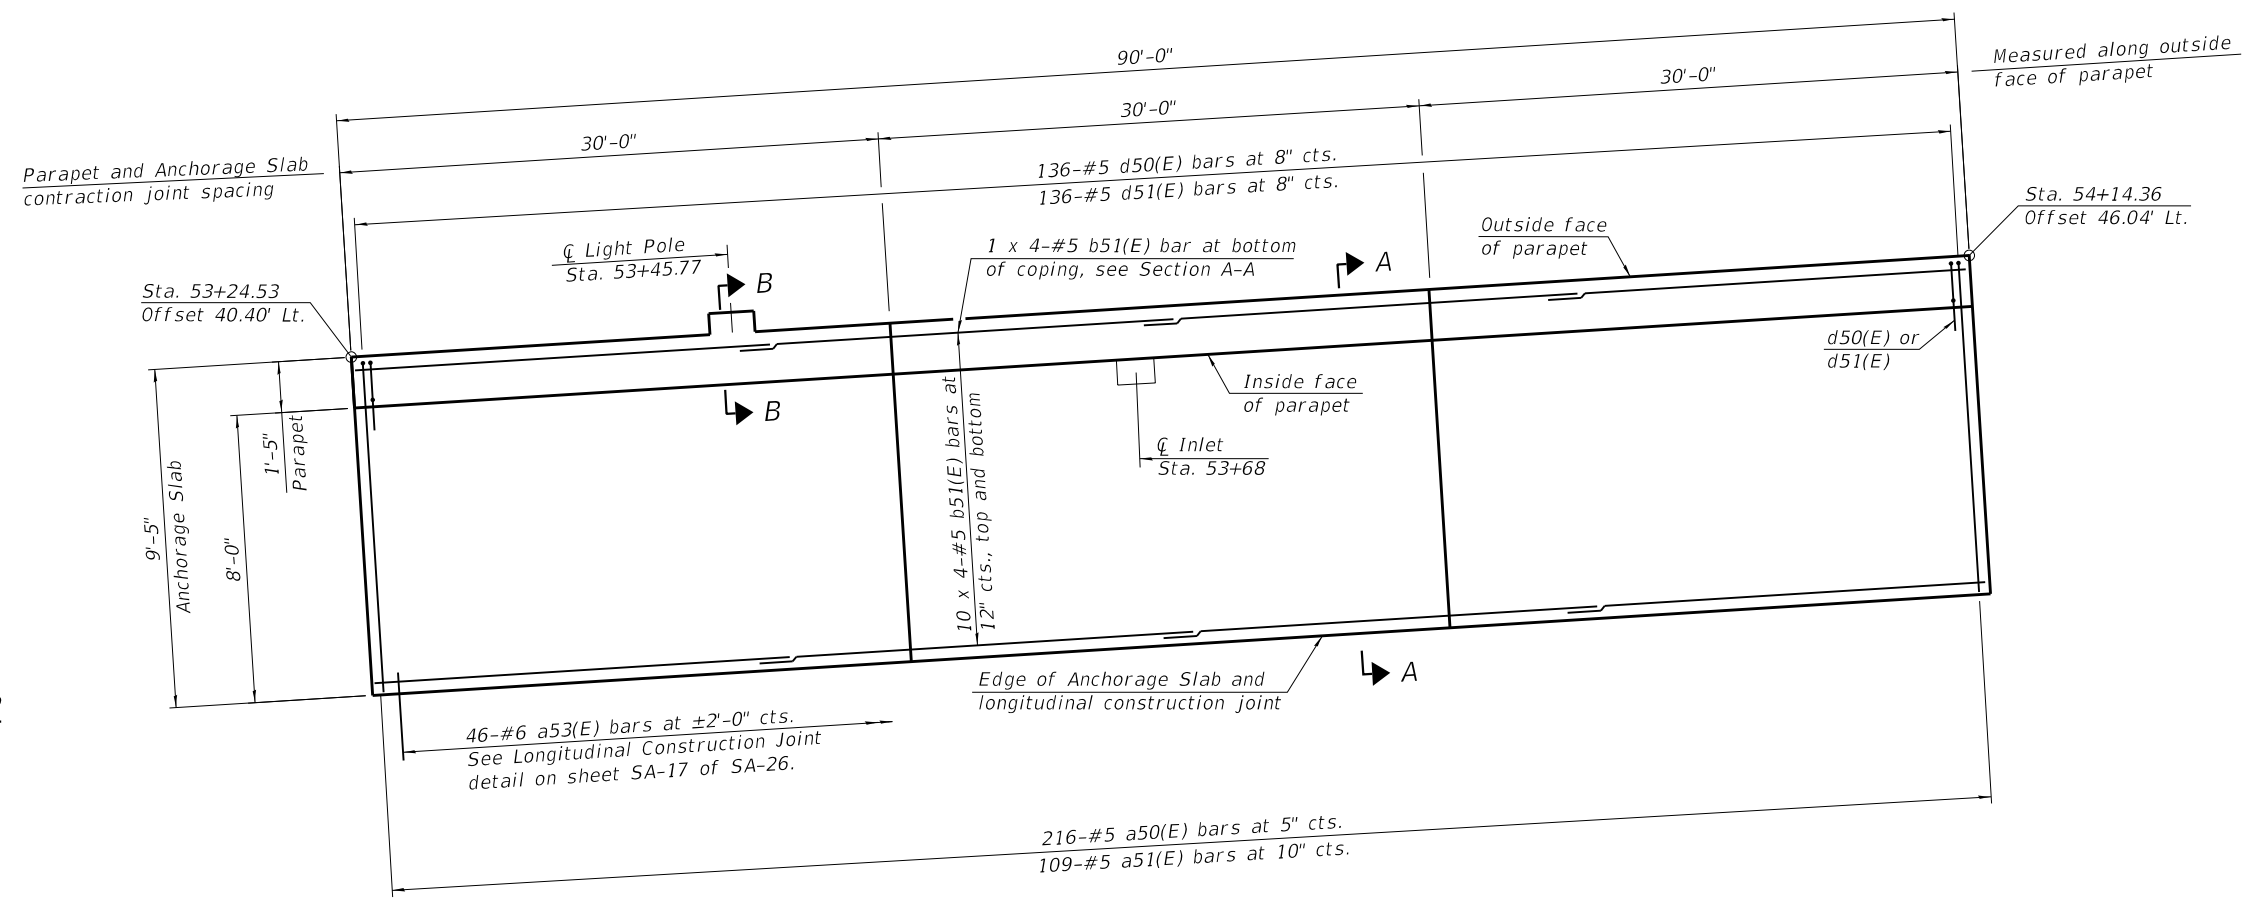MINIMUM BAR LAP

- #4 bar = 2'-8"
- #5 bar = 3'-7"

Notes:

1. For Section A-A and B-B see sheet SA-16 of SA-26.
2. See sheet SA-16 of SA-26 for Anchorage Slab details, light pole details, parapet joint details, bar bend details and Bill of Material.
3. Portion of Anchorage Slab within the traveled way shall be finished to match PPC pavement finish according to Section 420.09 of the Standard Specifications.
4. For light pole, traffic signal and junction box details, see Electrical Plans.
5. Stations and offsets are measured from Brush College Road.

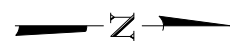

design firm
no. 184001036



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FILE NAME = 60603202_SN058W003.dgn	CHECKED - CEH	REVISED
PLOT SCALE = 2.000' / ft.	DRAWN - DLH	REVISED
PLOT DATE = 4/6/2023	CHECKED - SDS	REVISED


**STATE OF ILLINOIS
DEPARTMENT OF TRANSPORTATION**

**WEST PARAPET AND ANCHORAGE SLAB PLAN AND ELEVATION 2
STRUCTURE NO. 058-W003**


F.A.U. RTE.	SECTION	COUNTY	TOTAL SHEETS	SHEET NO.
7448	09-00933-01-BR	MACON	1019	575
CONTRACT NO. 95893				

SHEET NO. SA-07 OF SA-26 SHEETS

ILLINOIS FED. AID PROJECT

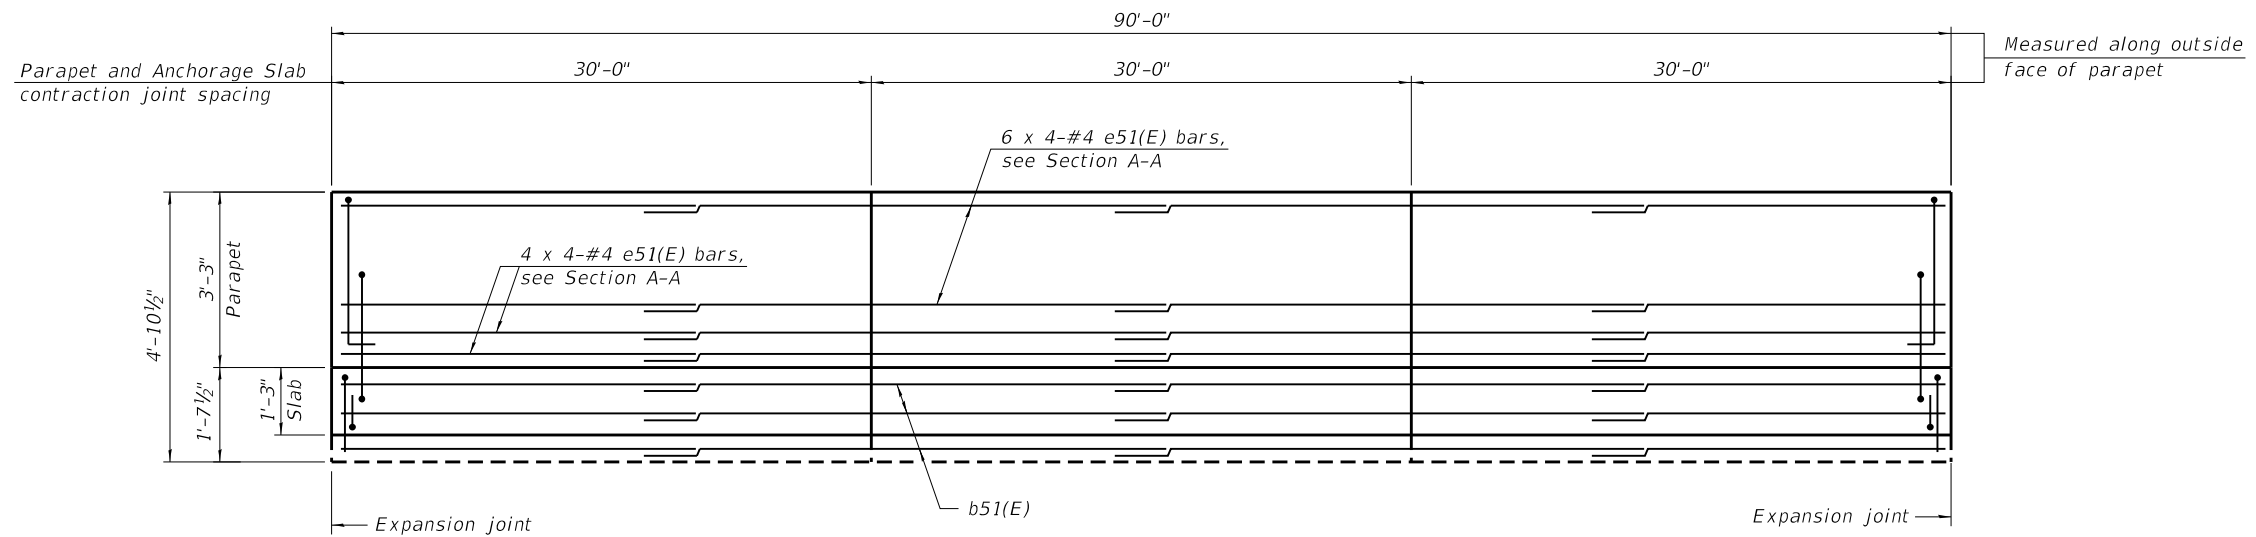

INSIDE ELEVATION OF WEST PARAPET AND ANCHORAGE SLAB

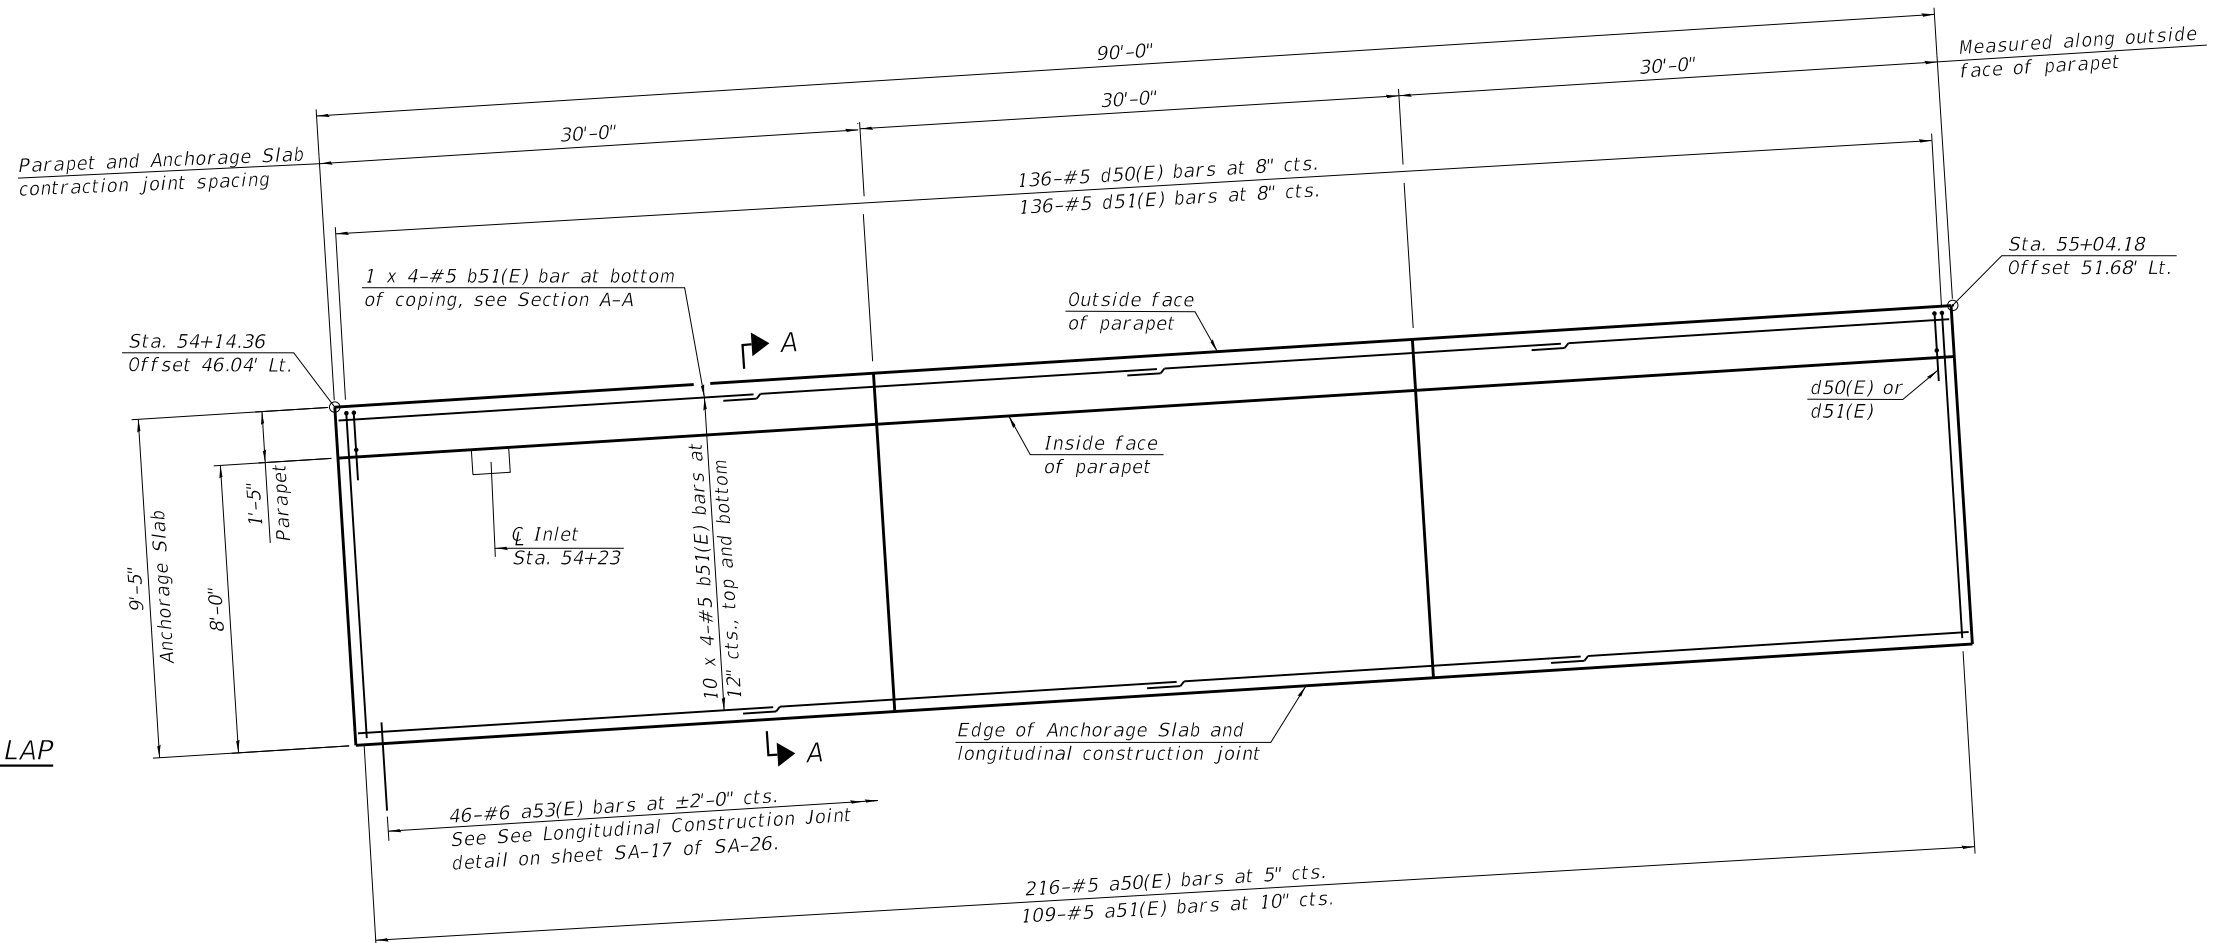


WEST PARAPET AND ANCHORAGE SLAB PLAN

MINIMUM BAR LAP


- #4 bar = 2'-8"
- #5 bar = 3'-7"

Notes:


1. For Section A-A see sheet SA-16 of SA-26.
2. See sheet SA-16 of SA-26 for Anchorage Slab details, light pole details, parapet joint details, bar bend details and Bill of Material.
3. Portion of Anchorage Slab within the traveled way shall be finished to match PPC pavement finish according to Section 420.09 of the Standard Specifications.
4. For light pole, traffic signal and junction box details, see Electrical Plans.
5. Stations and offsets are measured from Brush College Road.

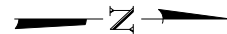

LAST SAVED DATE: 2/15/2023 10:40:00 AM

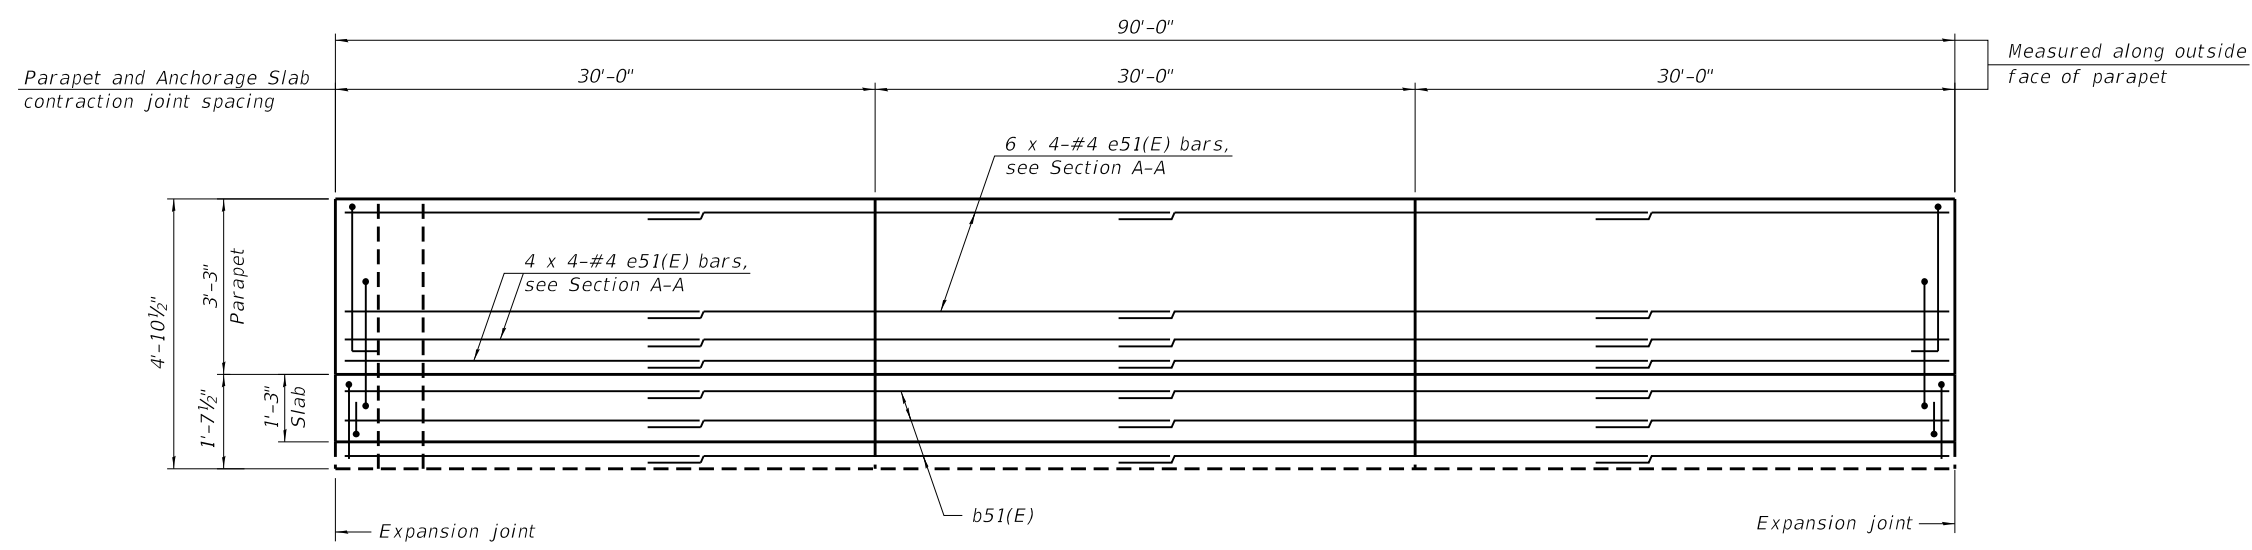

INSIDE ELEVATION OF WEST PARAPET AND ANCHORAGE SLAB

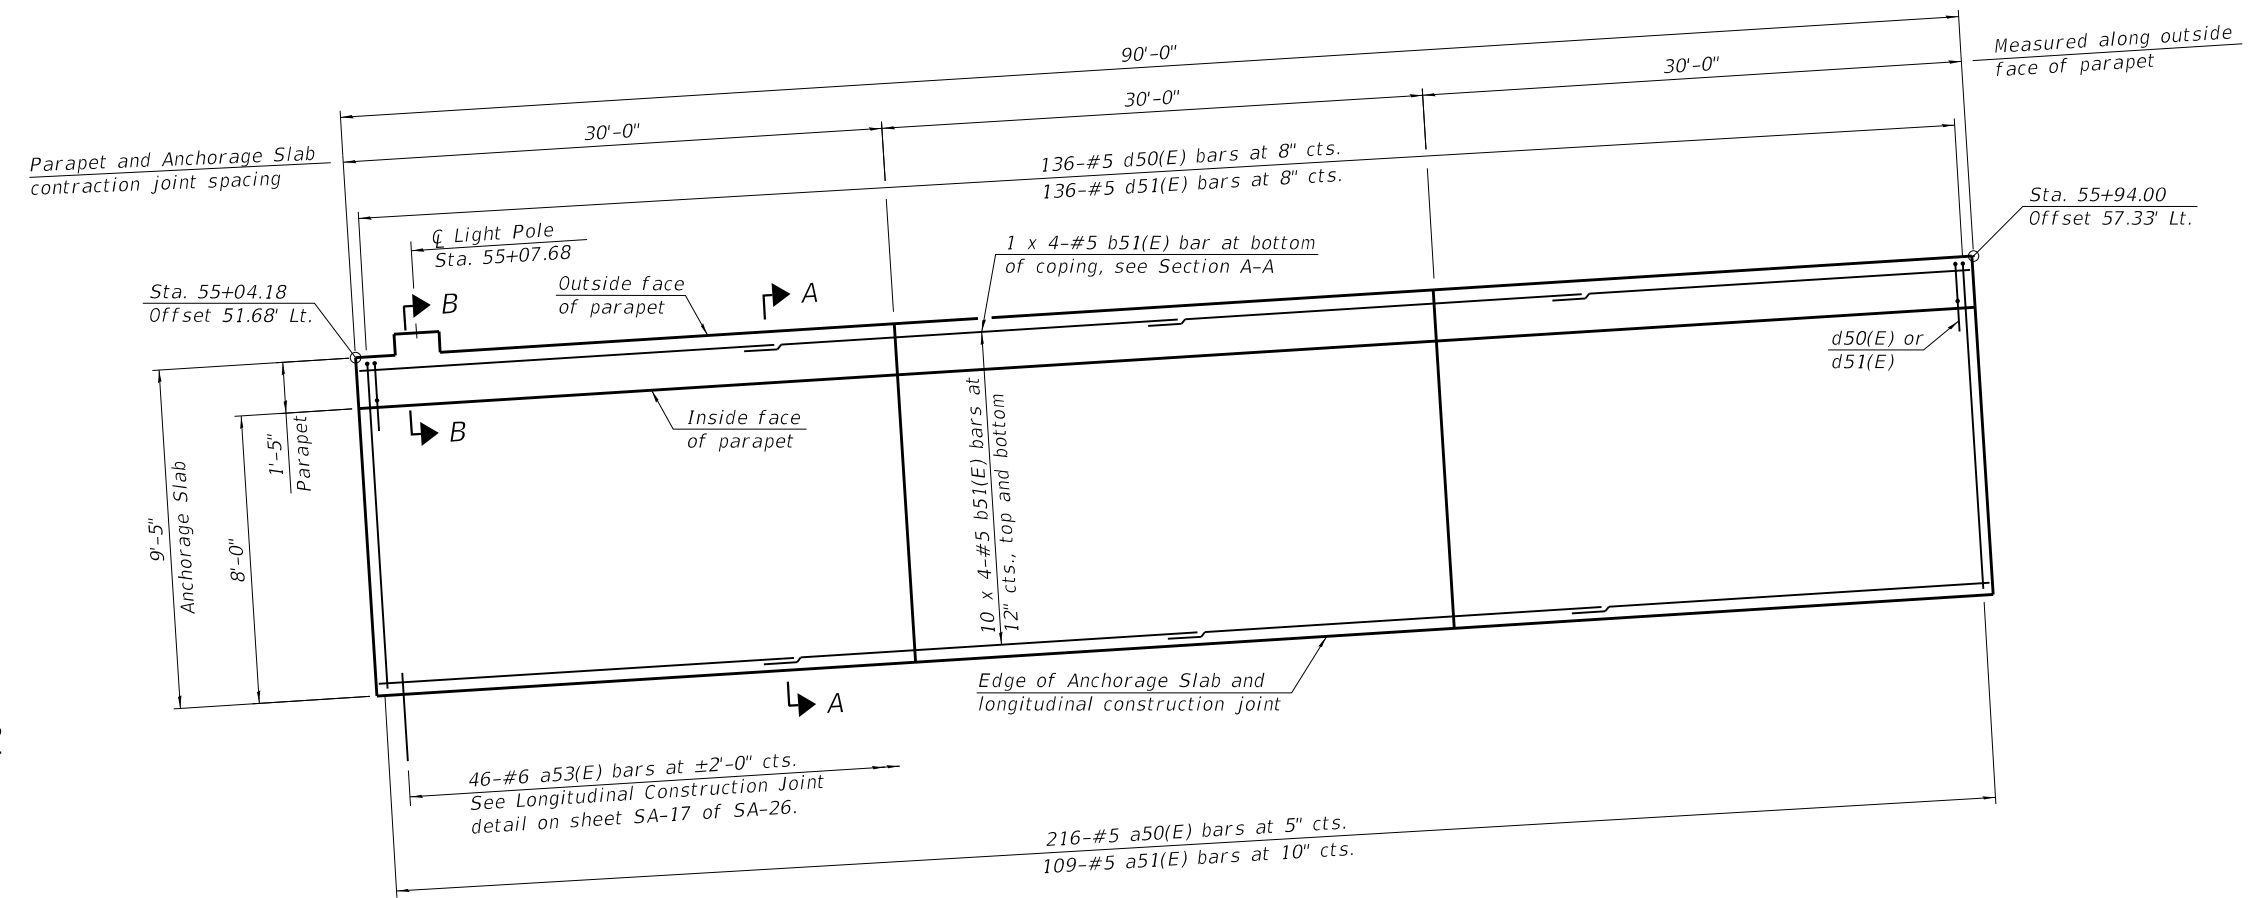


WEST PARAPET AND ANCHORAGE SLAB PLAN

MINIMUM BAR LAP

- #4 bar = 2'-8"
- #5 bar = 3'-7"

Notes:

1. For Section A-A and B-B see sheet SA-16 of SA-26.
2. See sheet SA-16 of SA-26 for Anchorage Slab details, light pole details, parapet joint details, bar bend details and Bill of Material.
3. Portion of Anchorage Slab within the traveled way shall be finished to match PPC pavement finish according to Section 420.09 of the Standard Specifications.
4. For light pole, traffic signal and junction box details, see Electrical Plans.
5. Stations and offsets are measured from \square Brush College Road.

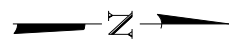

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FILE NAME = 60603202_SN058W003.dgn	CHECKED - CEH	REVISED
PLOT SCALE = 2.000' / ft.	DRAWN - DLH	REVISED
PLOT DATE = 4/6/2023	CHECKED - SDS	REVISED

**STATE OF ILLINOIS
DEPARTMENT OF TRANSPORTATION**

**WEST PARAPET AND ANCHORAGE SLAB PLAN AND ELEVATION 4
STRUCTURE NO. 058-W003**


SHEET NO. SA-09 OF SA-26 SHEETS

F.A.U. RTE.	SECTION	COUNTY	TOTAL SHEETS	SHEET NO.
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CONTRACT NO. 95893				


ILLINOIS FED. AID PROJECT

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LAST SAVED DATE: 5/15/2023 10:03:58 AM

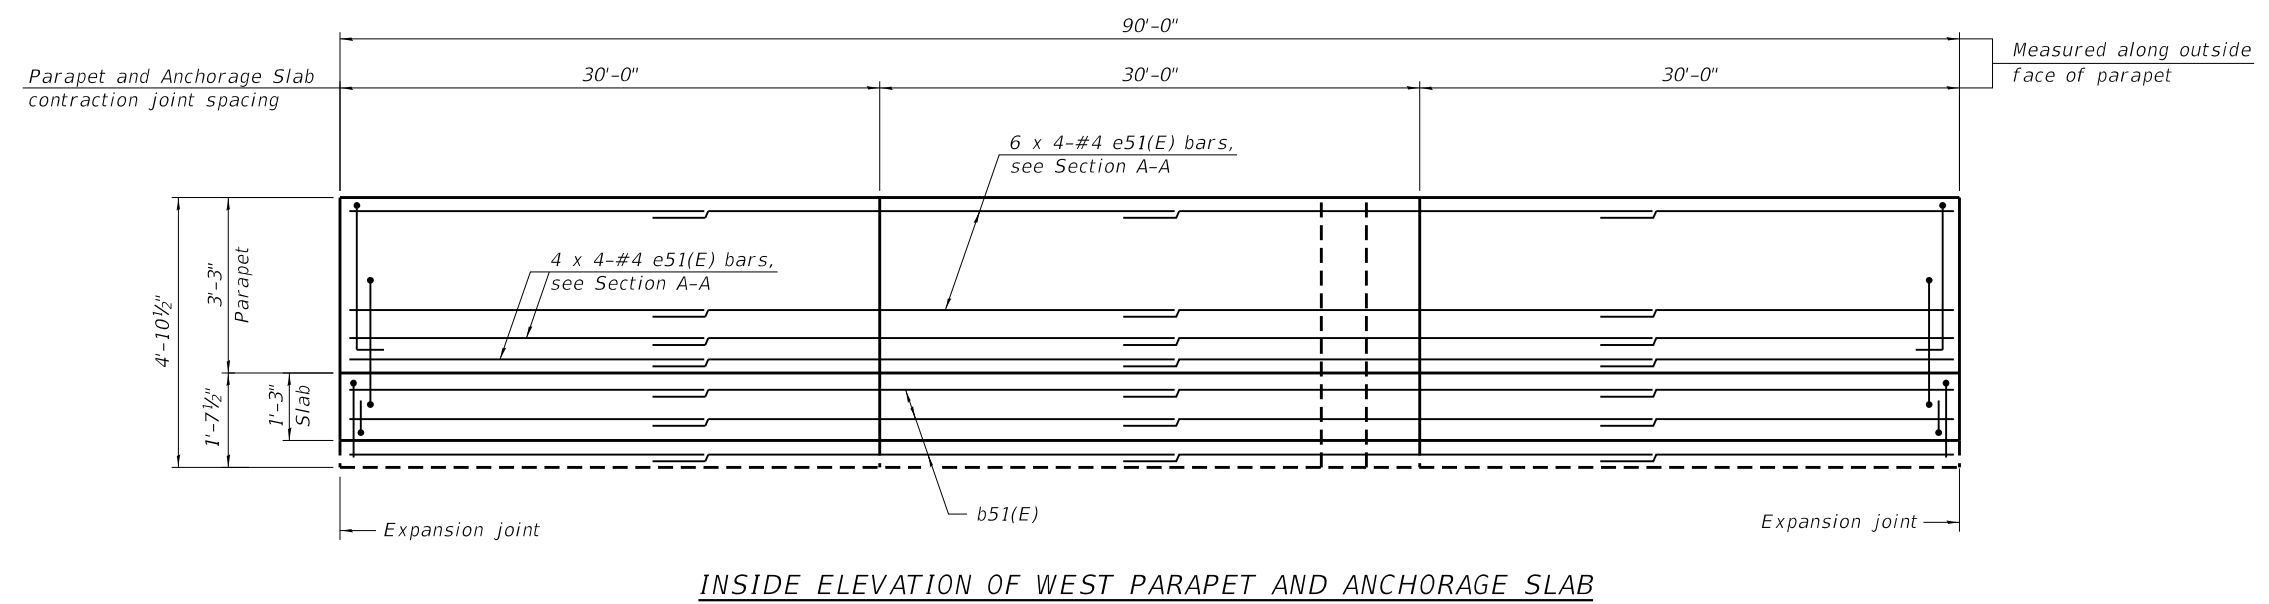

INSIDE ELEVATION OF WEST PARAPET AND ANCHORAGE SLAB


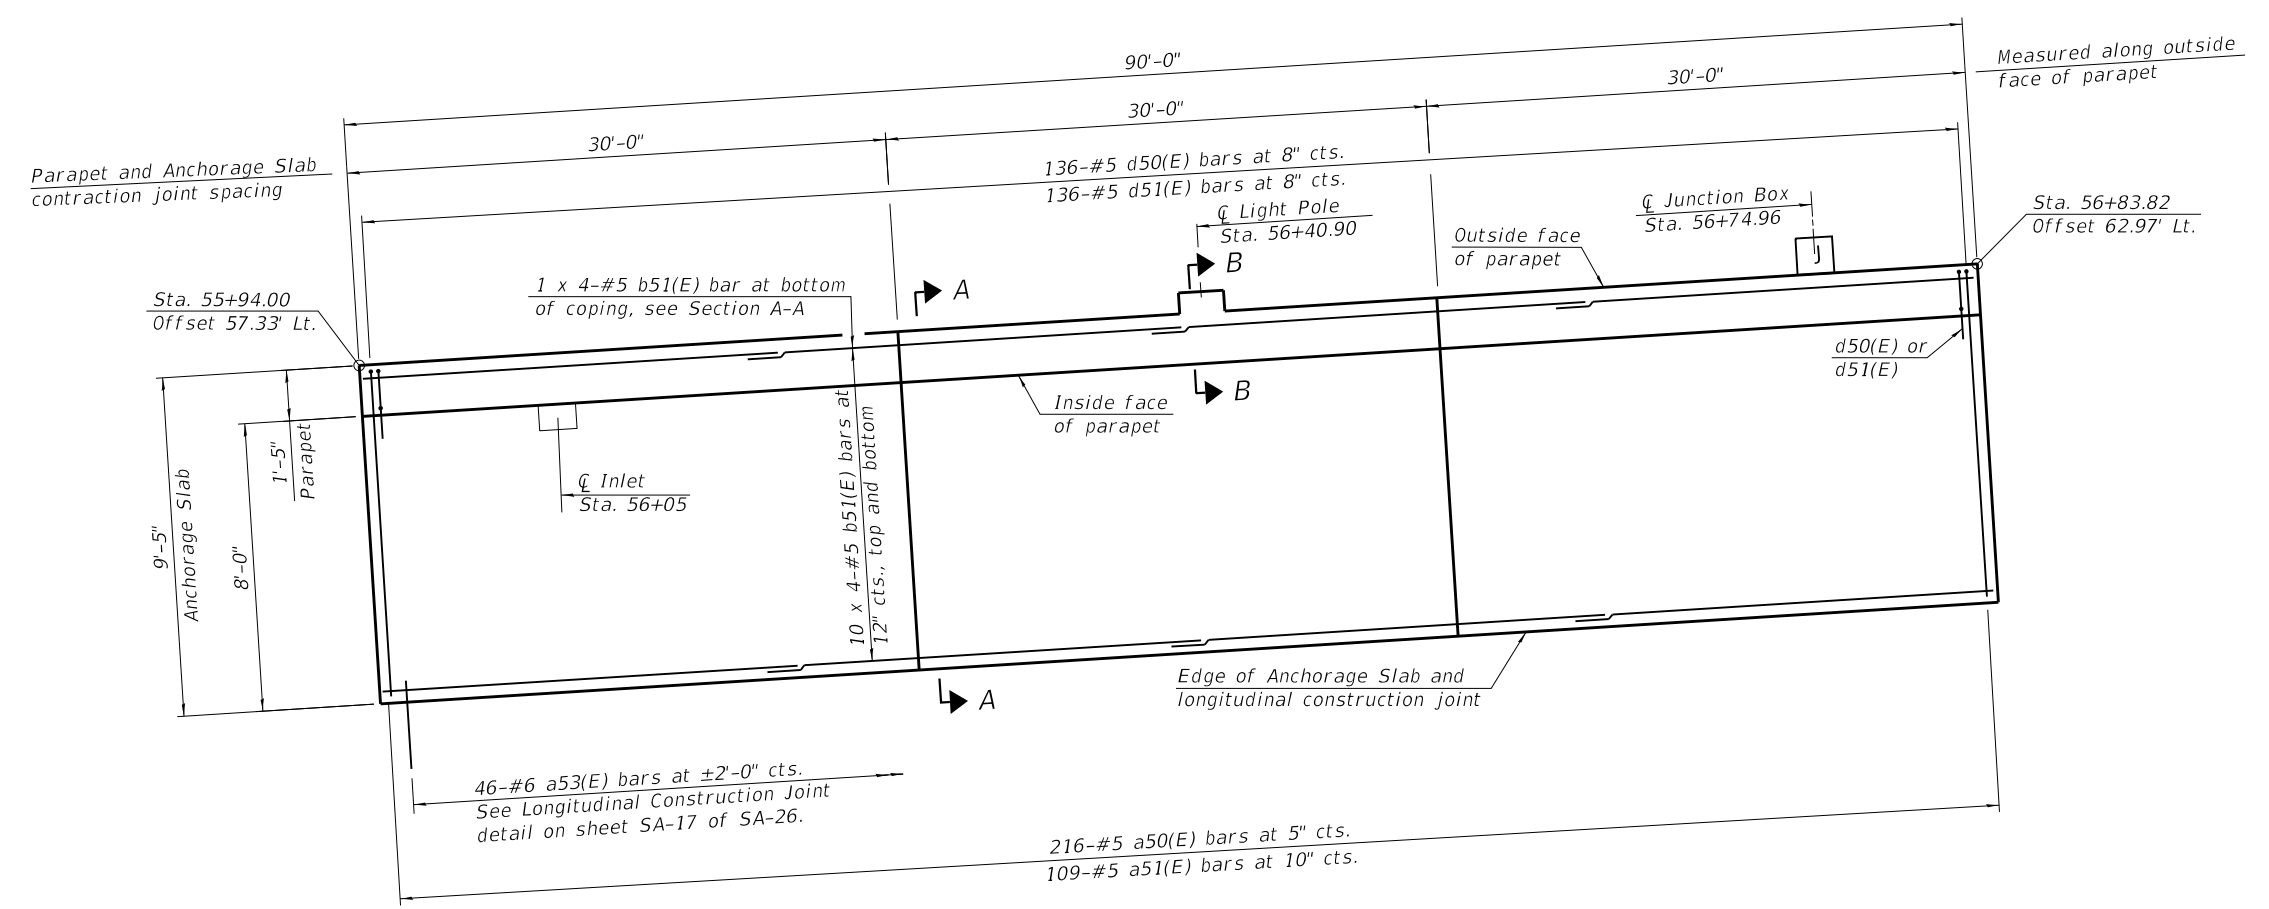


WEST PARAPET AND ANCHORAGE SLAB PLAN

MINIMUM BAR LAP

- #4 bar = 2'-8"
- #5 bar = 3'-7"

- Notes:
1. For Section A-A and B-B see sheet SA-16 of SA-26.
 2. See sheet SA-16 of SA-26 for Anchorage Slab details, light pole details, parapet joint details, bar bend details and Bill of Material.
 3. Portion of Anchorage Slab within the traveled way shall be finished to match PPC pavement finish according to Section 420.09 of the Standard Specifications.
 4. For light pole, traffic signal and junction box details, see Electrical Plans.
 5. Stations and offsets are measured from Brush College Road.

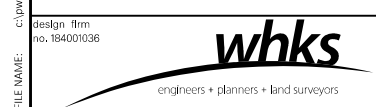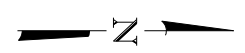

USER NAME = dtheberling	DESIGNED - SDS	REVISED
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PLOT DATE = 4/6/2023	CHECKED - SDS	REVISED


**STATE OF ILLINOIS
DEPARTMENT OF TRANSPORTATION**

**WEST PARAPET AND ANCHORAGE SLAB PLAN AND ELEVATION 5
STRUCTURE NO. 058-W003**


SHEET NO. SA-10 OF SA-26 SHEETS

F.A.U. RTE.	SECTION	COUNTY	TOTAL SHEETS	SHEET NO.
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				CONTRACT NO. 95893

ILLINOIS FED. AID PROJECT

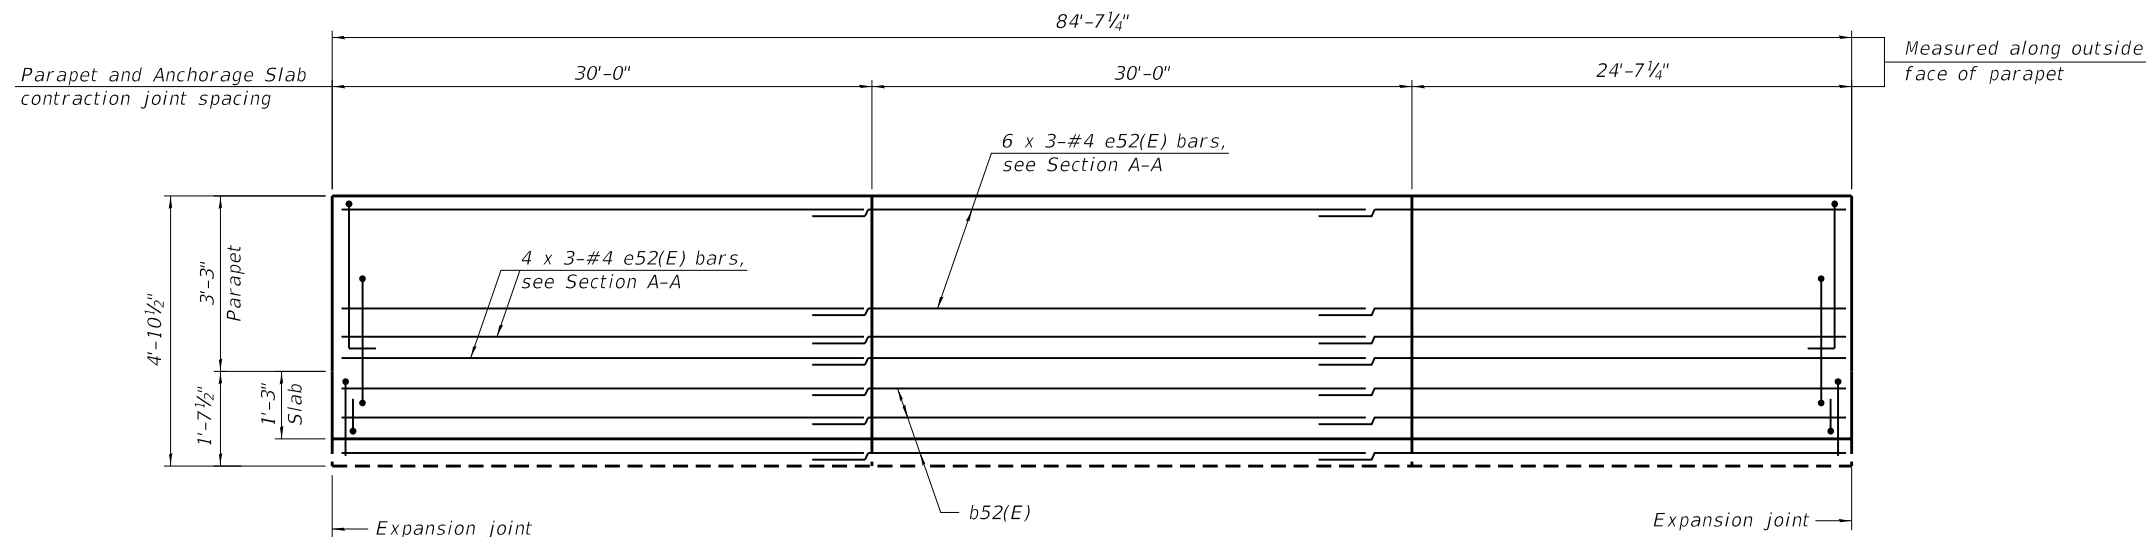

INSIDE ELEVATION OF WEST PARAPET AND ANCHORAGE SLAB

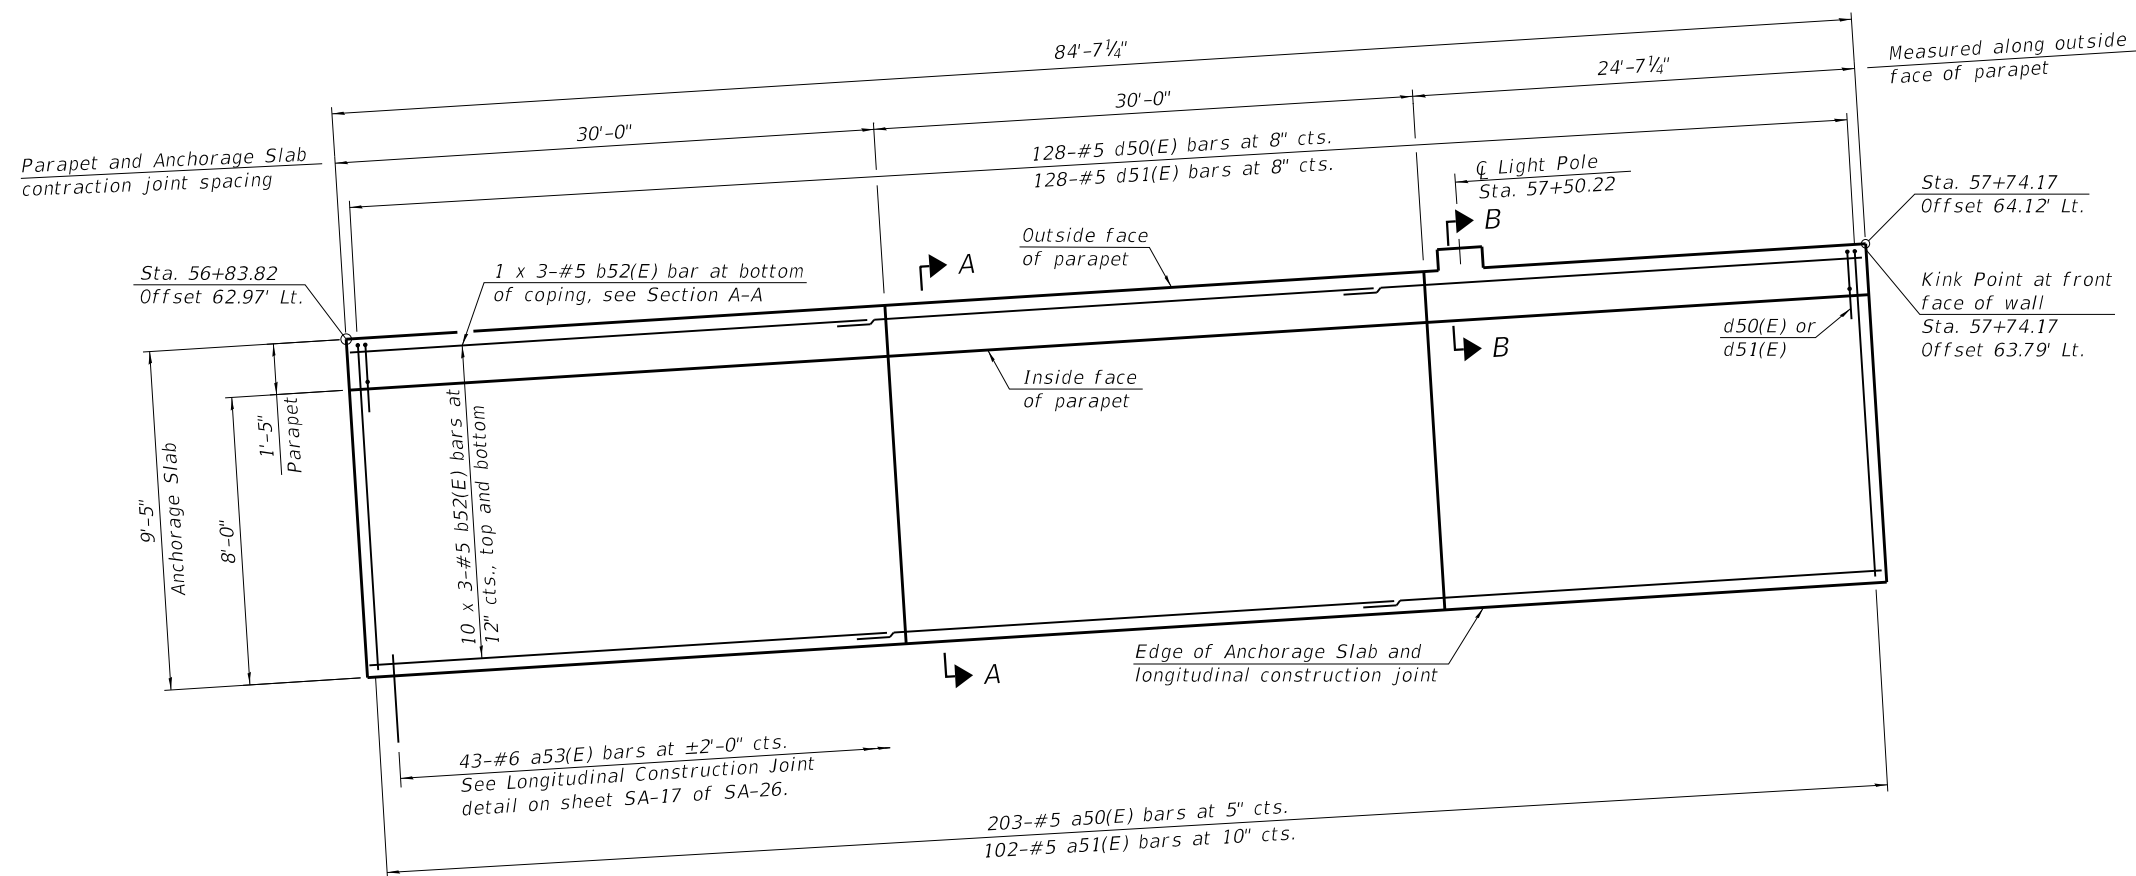


WEST PARAPET AND ANCHORAGE SLAB PLAN

MINIMUM BAR LAP

- #4 bar = 2'-8"
- #5 bar = 3'-7"


Notes:

1. For Section A-A and B-B see sheet SA-16 of SA-26.
2. See sheet SA-16 of SA-26 for Anchorage Slab details, light pole details, parapet joint details, bar bend details and Bill of Material.
3. Portion of Anchorage Slab within the traveled way shall be finished to match PPC pavement finish according to Section 420.09 of the Standard Specifications.
4. For light pole, traffic signal and junction box details, see Electrical Plans.
5. Stations and offsets are measured from \mathbb{B} Brush College Road.

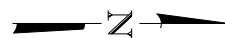


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PLOT DATE = 4/6/2023	CHECKED - SDS	REVISED

F.A.U. RTE.	SECTION	COUNTY	TOTAL SHEETS	SHEET NO.
7448	09-00933-01-BR	MACON	1019	579
CONTRACT NO. 95893				
ILLINOIS FED. AID PROJECT				

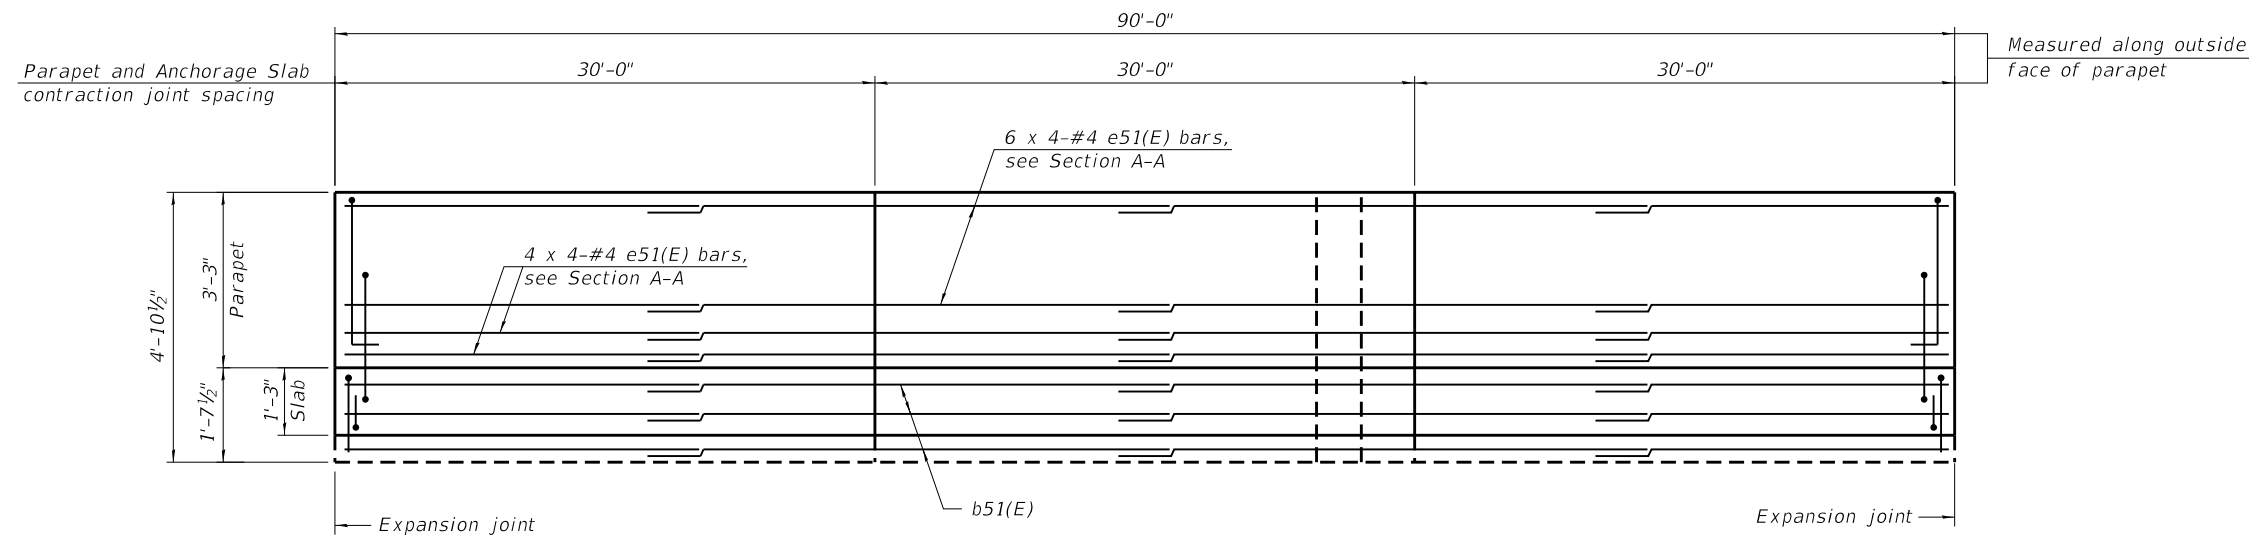

INSIDE ELEVATION OF WEST PARAPET AND ANCHORAGE SLAB

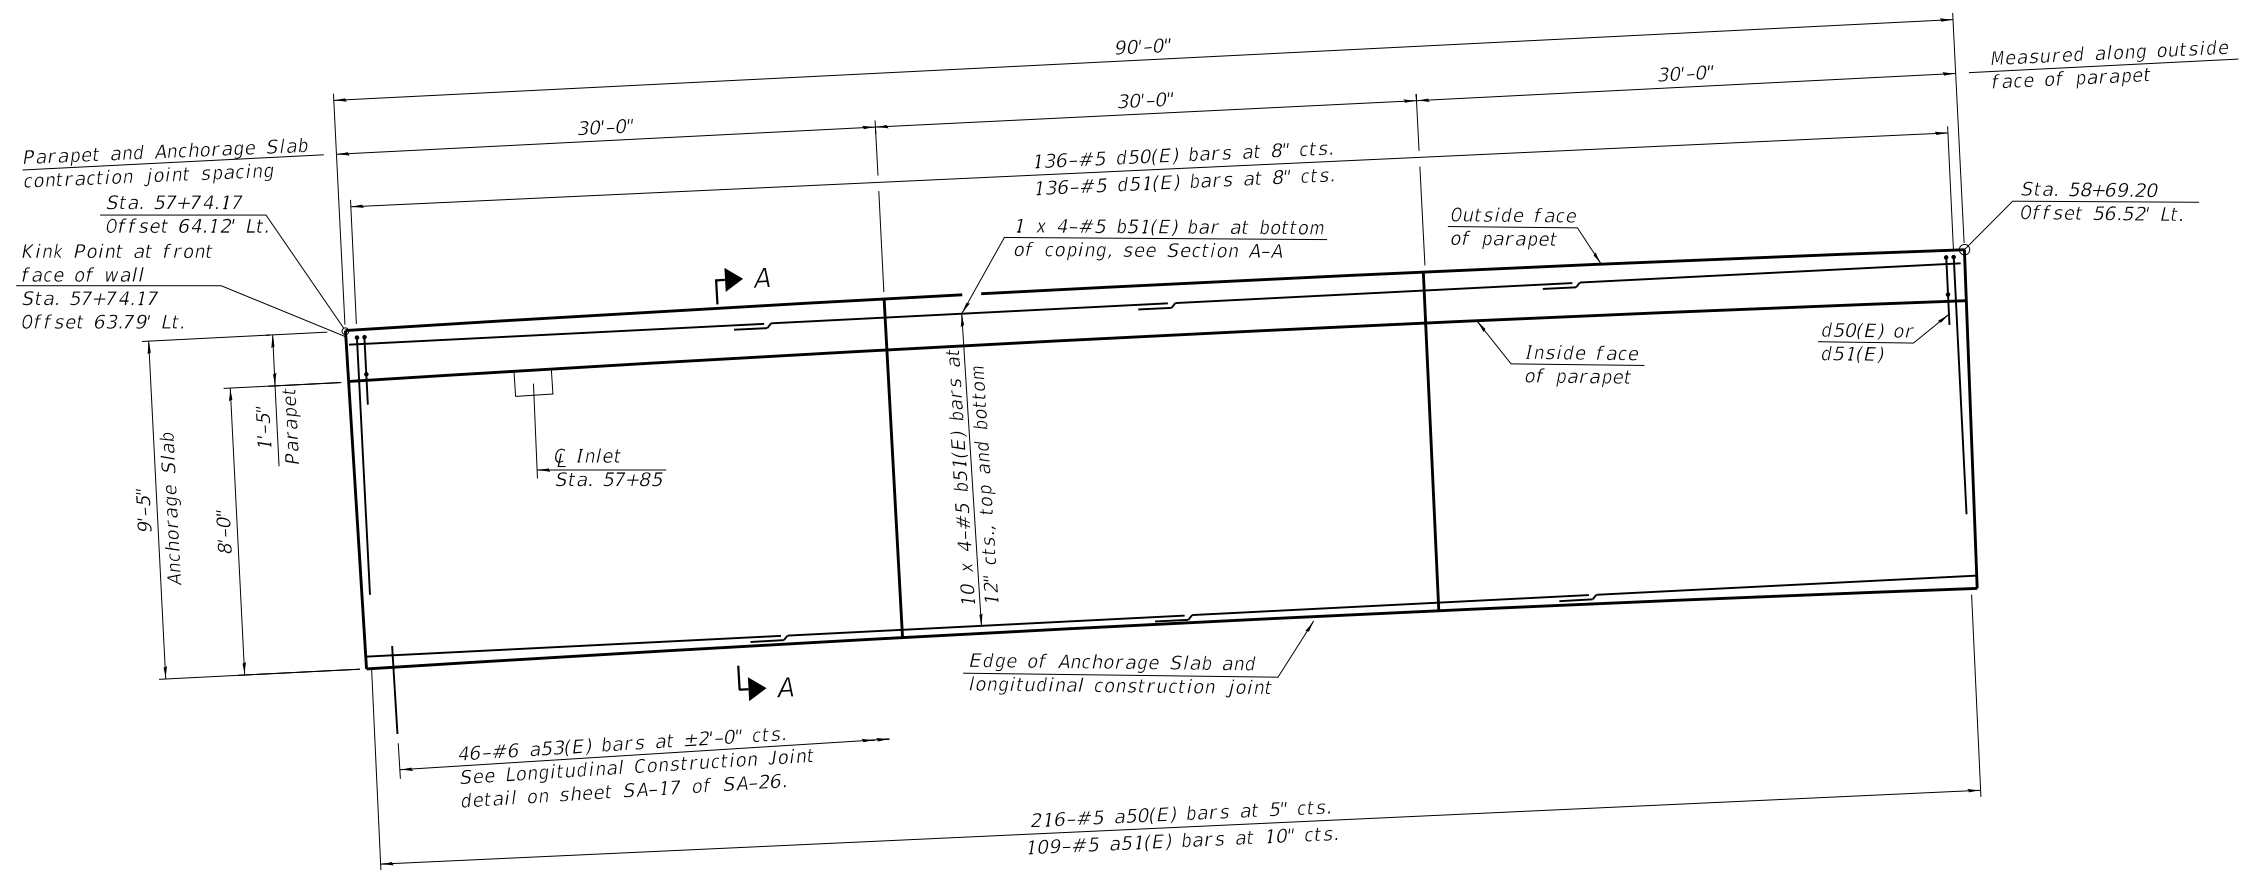

WEST PARAPET AND ANCHORAGE SLAB PLAN

MINIMUM BAR LAP



- #4 bar = 2'-8"
- #5 bar = 3'-7"

Notes:

1. For Section A-A see sheet SA-16 of SA-26.
2. See sheet SA-16 of SA-26 for Anchorage Slab details, light pole details, parapet joint details, bar bend details and Bill of Material.
3. Portion of Anchorage Slab within the traveled way shall be finished to match PPC pavement finish according to Section 420.09 of the Standard Specifications.
4. For light pole, traffic signal and junction box details, see Electrical Plans.
5. Stations and offsets are measured from \square Brush College Road.


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PLOT DATE = 4/6/2023	CHECKED - SDS	REVISED

F.A.U. RTE.	SECTION	COUNTY	TOTAL SHEETS	SHEET NO.
7448	09-00933-01-BR	MACON	1019	580
CONTRACT NO. 95893				

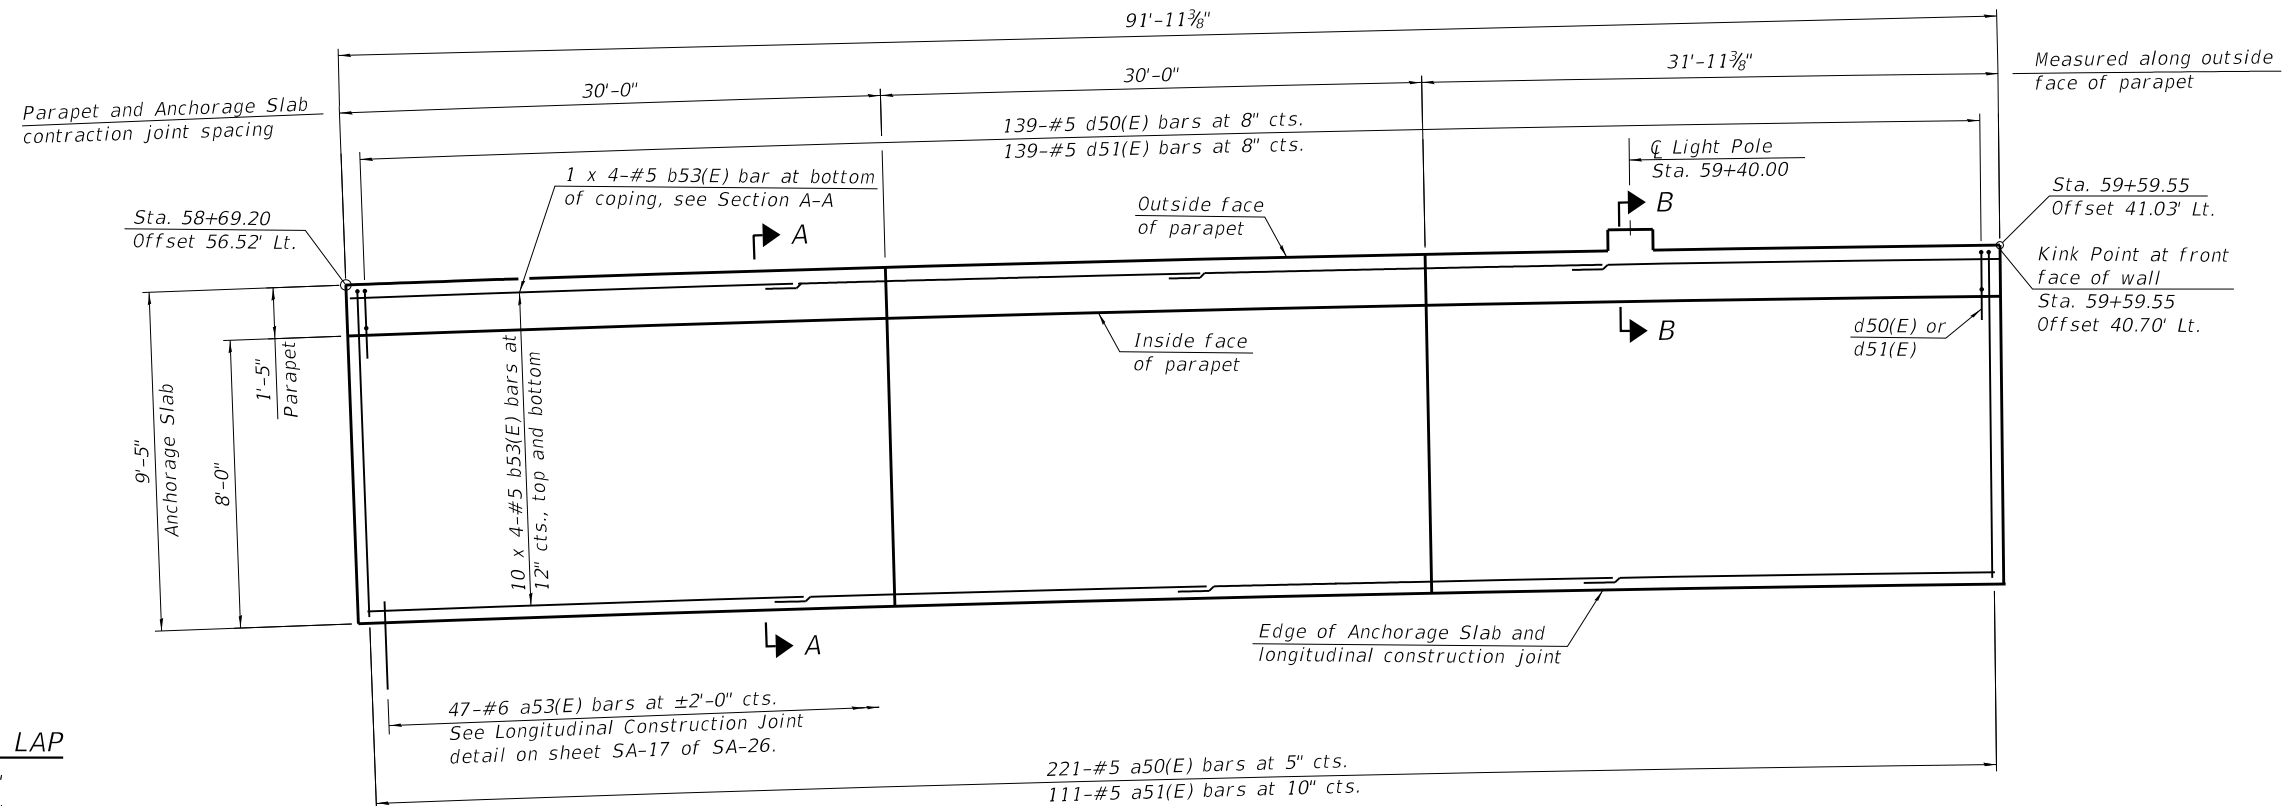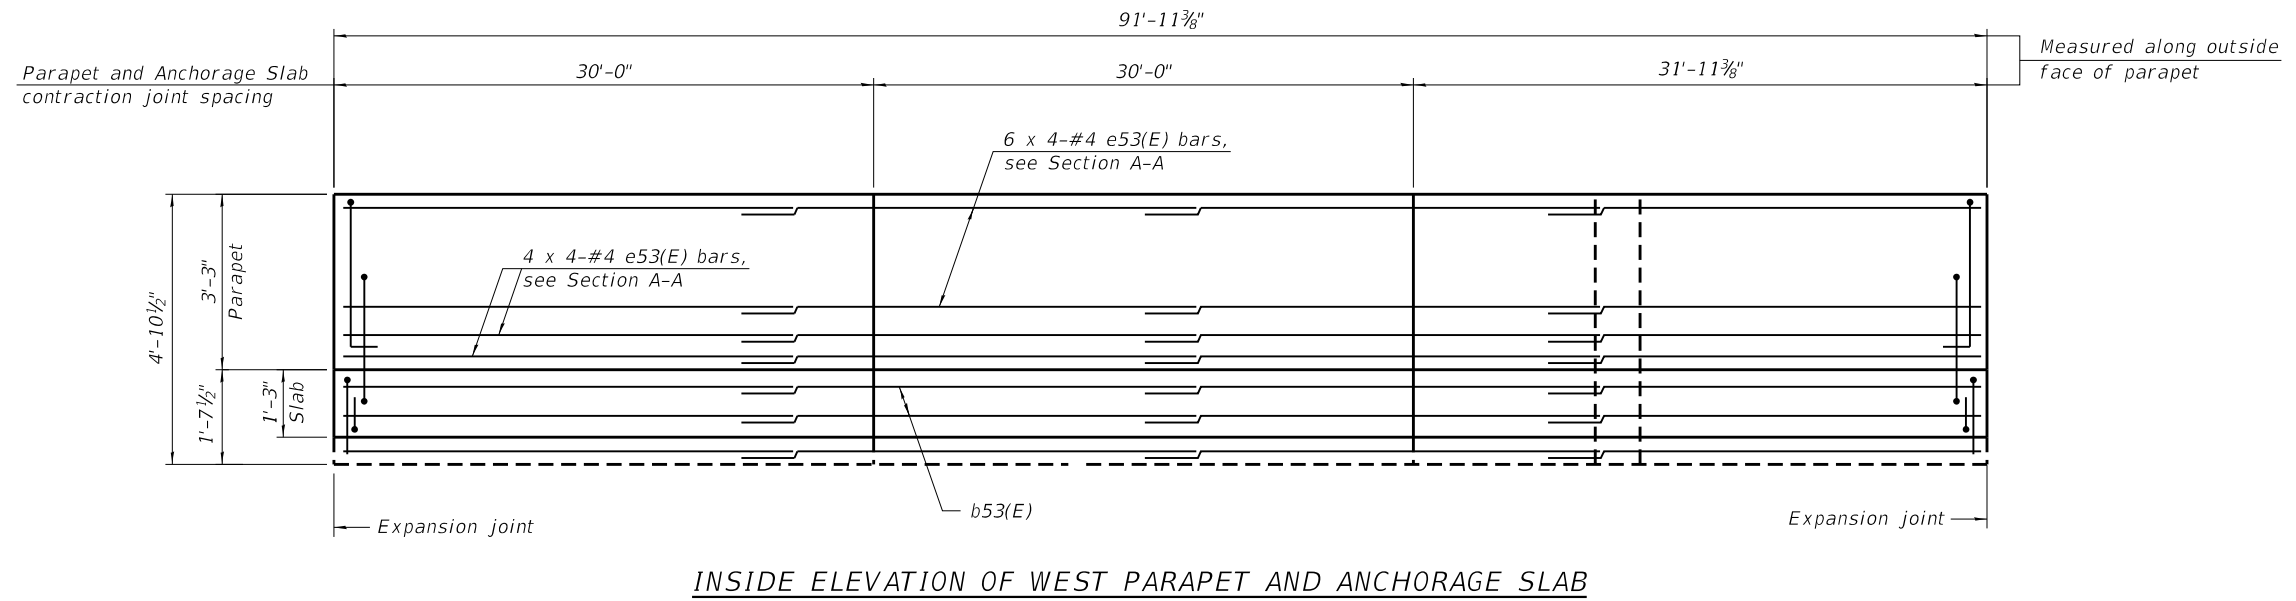

MINIMUM BAR LAP

- #4 bar = 2'-8"
- #5 bar = 3'-7"

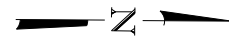


WEST PARAPET AND ANCHORAGE SLAB PLAN

Notes:


1. For Section A-A and B-B see sheet SA-16 of SA-26.
2. See sheet SA-16 of SA-26 for Anchorage Slab details, light pole details, parapet joint details, bar bend details and Bill of Material.
3. Portion of Anchorage Slab within the traveled way shall be finished to match PPC pavement finish according to Section 420.09 of the Standard Specifications.
4. For light pole, traffic signal and junction box details, see Electrical Plans.
5. Stations and offsets are measured from **B** Brush College Road.

LAST SAVED DATE: 2/15/2023 10:58:00 AM

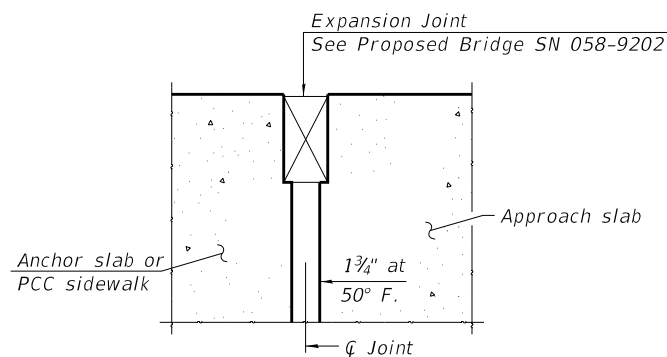

DETAIL A

* Cost included with Concrete Superstructure, see Bridge Plans.

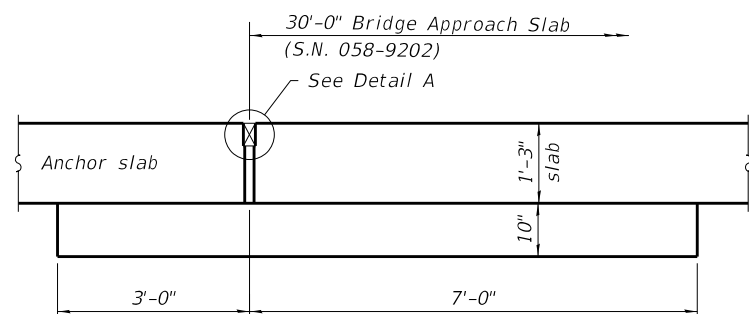


SECTION D-D

MINIMUM BAR LAP


- #4 bar = 2'-8"
- #5 bar = 3'-7"

Notes:


1. For Section A-A see sheet SA-16 of SA-26.
2. See sheet SA-16 of SA-26 for Anchorage Slab details, light pole details, parapet joint details, bar bend details and Bill of Material.
3. Portion of Anchorage Slab within the traveled way shall be finished to match PPC pavement finish according to Section 420.09 of the Standard Specifications.
4. For light pole, traffic signal and junction box details, see Electrical Plans.
5. Stations and offsets are measured from Brush College Road.

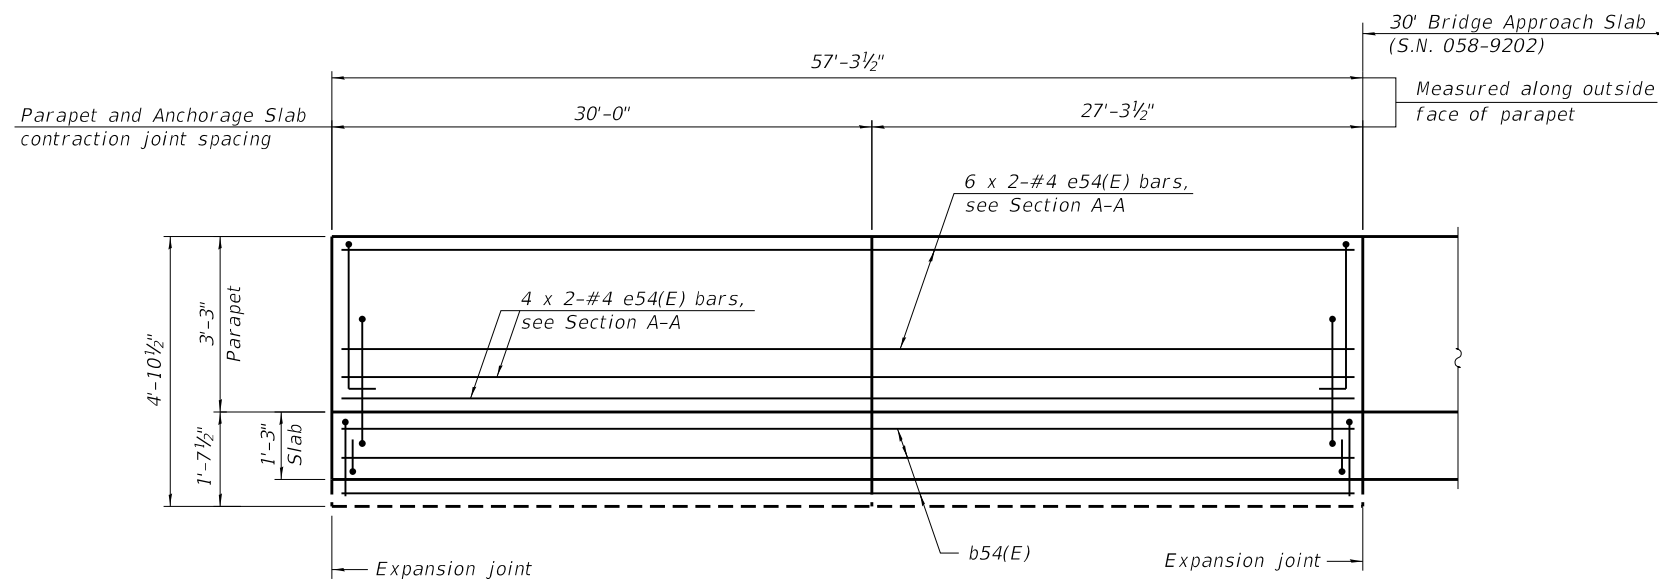

INSIDE ELEVATION OF WEST PARAPET AND ANCHORAGE SLAB

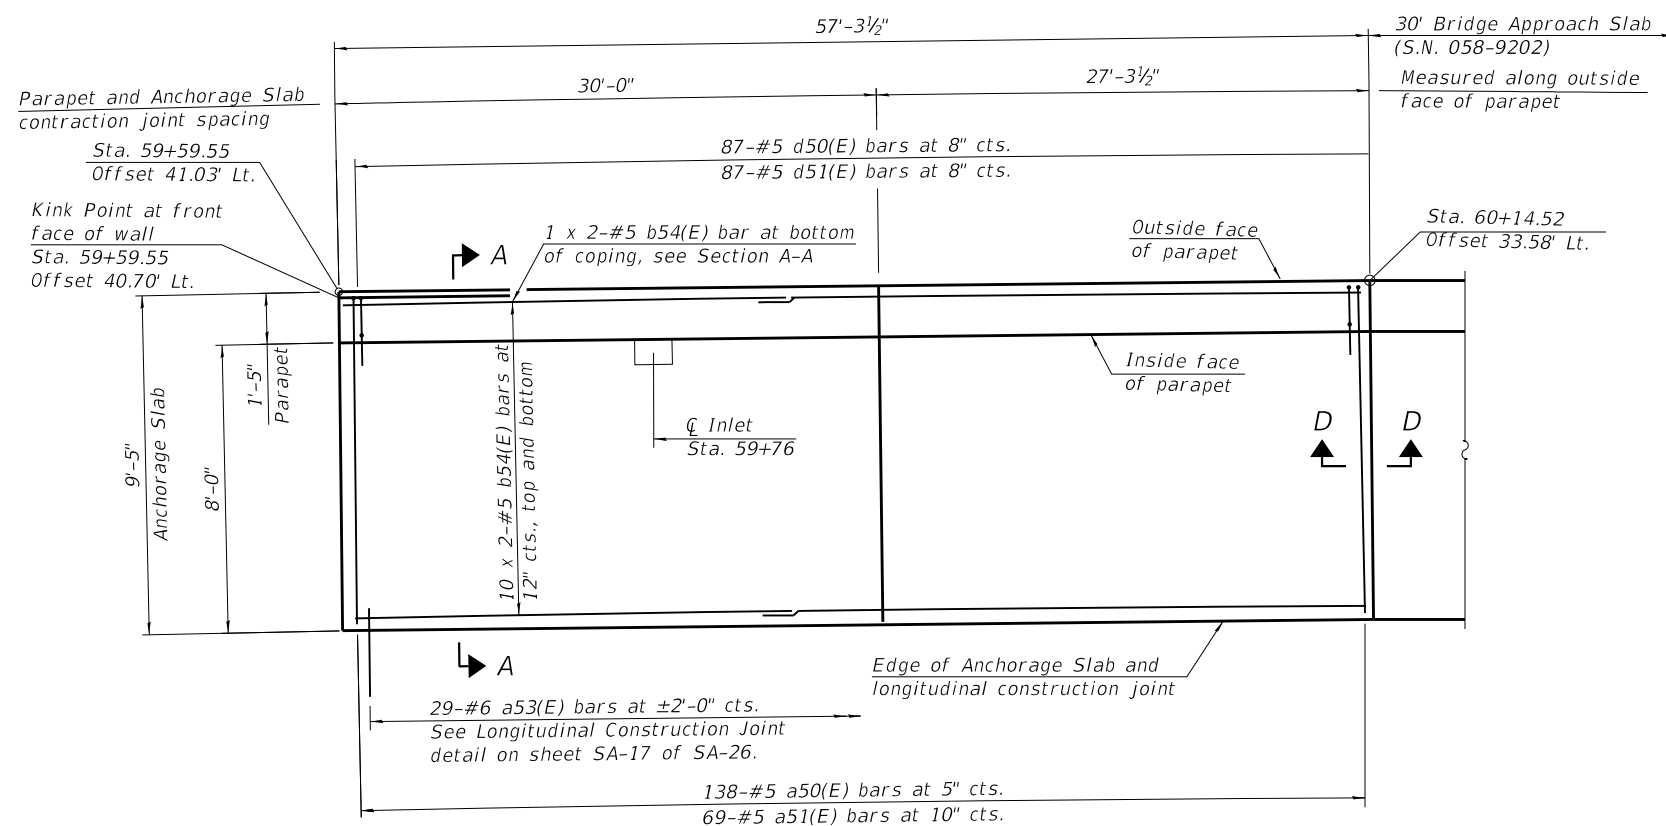

WEST PARAPET AND ANCHORAGE SLAB PLAN

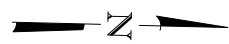

design firm
no. 184001036



USER NAME = dheberling	DESIGNED - SDS	REVISED
FILE NAME = 60603202_SN058W003.dgn	CHECKED - CEH	REVISED
PLOT SCALE = 0.167" / in.	DRAWN - DLH	REVISED
PLOT DATE = 4/14/2023	CHECKED - SDS	REVISED


**STATE OF ILLINOIS
DEPARTMENT OF TRANSPORTATION**

**WEST PARAPET AND ANCHORAGE SLAB PLAN AND ELEVATION 9
STRUCTURE NO. 058-W003**


SHEET NO. SA-14 OF SA-26 SHEETS

F.A.U. RTE. 7448	SECTION 09-00933-01-BR	COUNTY MACON	TOTAL SHEETS 1019	SHEET NO. 582
CONTRACT NO. 95893				
ILLINOIS FED. AID PROJECT				

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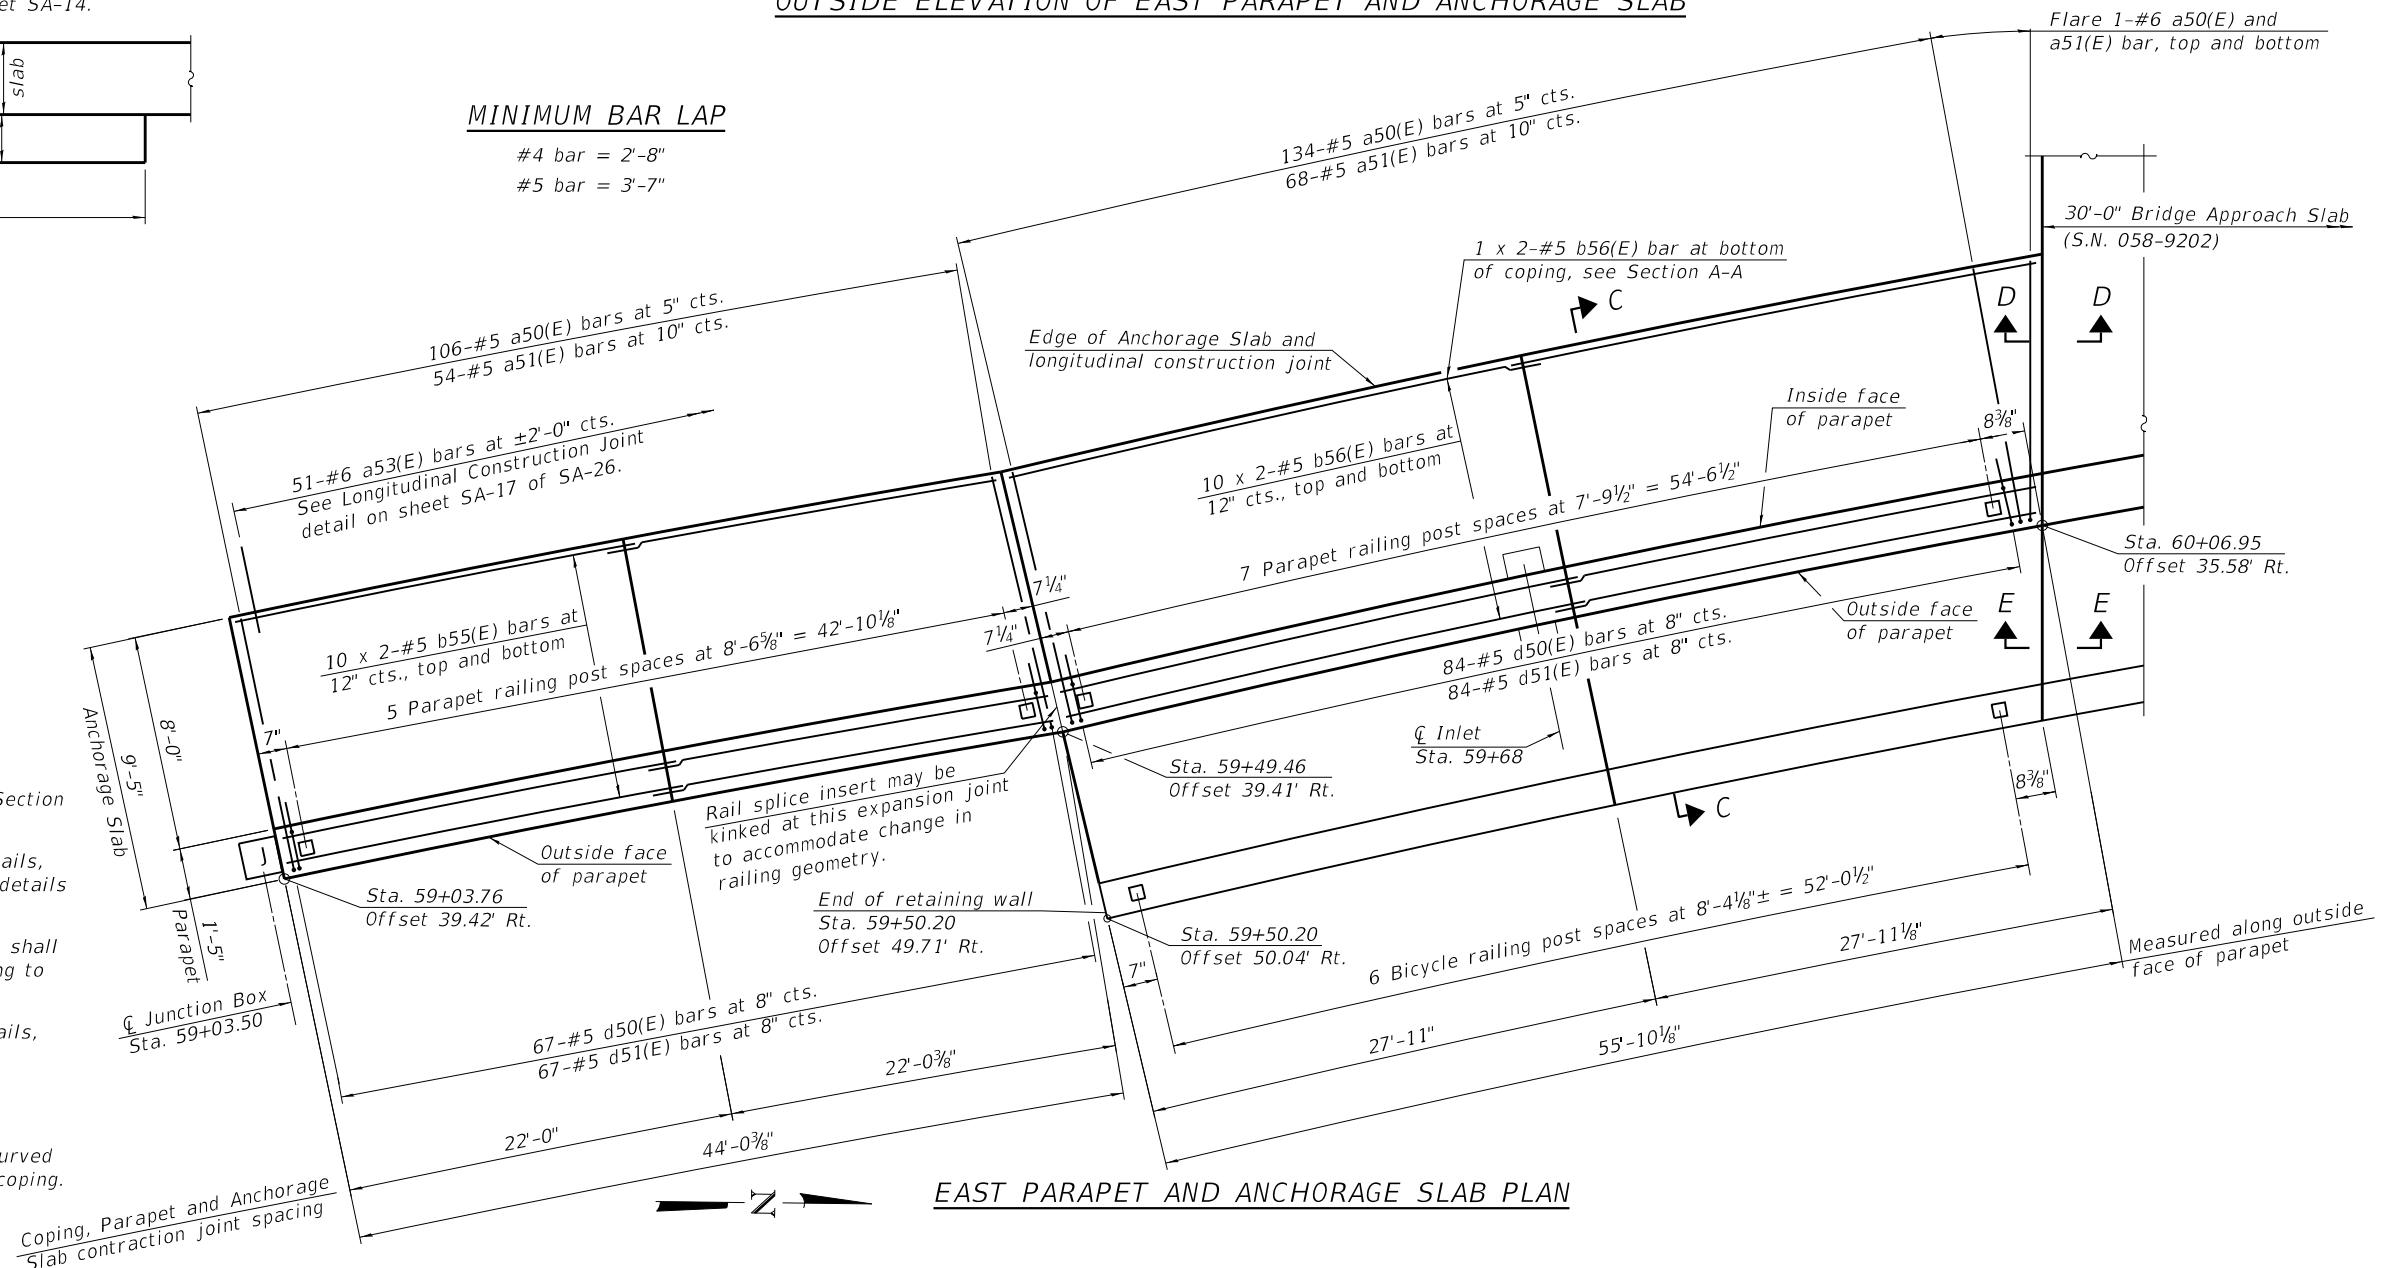


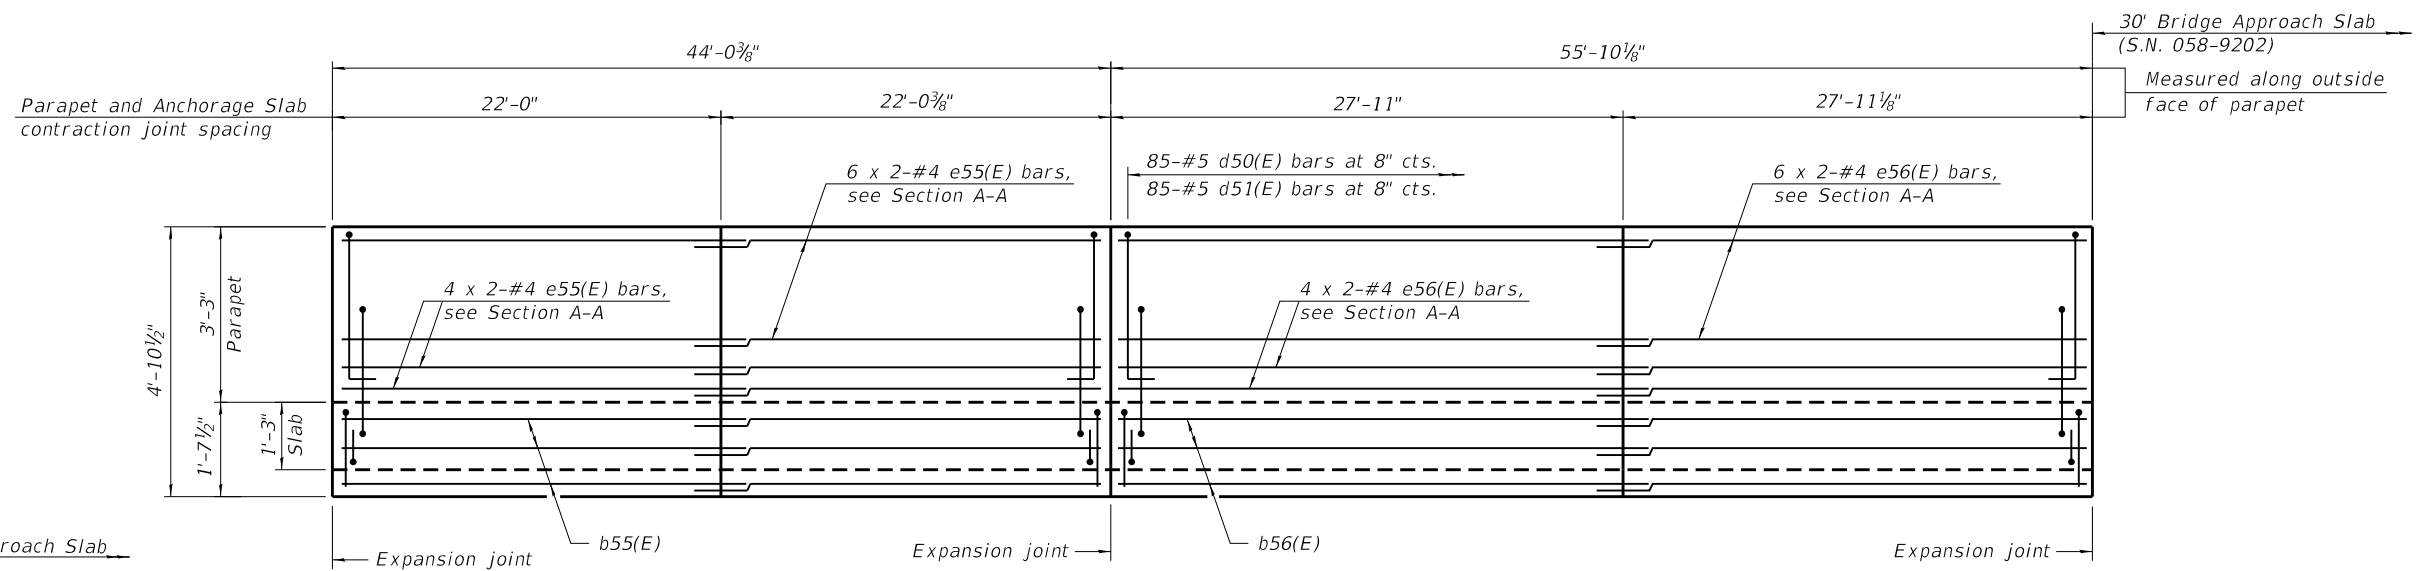OUTSIDE ELEVATION OF EAST PARAPET AND ANCHORAGE SLAB

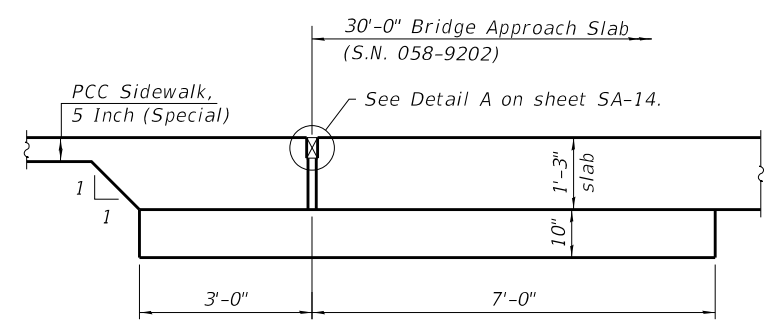

SECTION E-E


MINIMUM BAR LAP
 #4 bar = 2'-8"
 #5 bar = 3'-7"



EAST PARAPET AND ANCHORAGE SLAB PLAN

- Notes:
1. For Section C-C see sheet SA-16 of SA-26. For Section D-D, see sheet SA-14 of SA-26.
 2. See sheet SA-16 of SA-26 for Anchorage Slab details, light pole details, parapet joint details, bar bend details and Bill of Material.
 3. Portion of Anchorage Slab within the traveled way shall be finished to match PPC pavement finish according to Section 420.09 of the Standard Specifications.
 4. For light pole, traffic signal and junction box details, see Electrical Plans.
 5. Stations and offsets are measured from \square Brush College Road.
 6. Parapet and bicycle railing shall be horizontally curved to accommodate the geometry of the parapet and coping.

FILE NAME: C:\working\ecom_d516_nal\ep15528\044066\6060202_S058W003.dgn

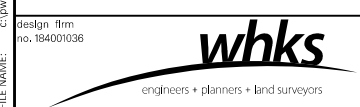

DESIGN FIRM	USER NAME = dtheberling	DESIGNED - SDS	REVISED
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STATE OF ILLINOIS
 DEPARTMENT OF TRANSPORTATION


EAST PARAPET AND ANCHORAGE SLAB PLAN AND ELEVATION
 STRUCTURE NO. 058-W003

SHEET NO. SA-15 OF SA-26 SHEETS


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7448	09-00933-01-BR	MACON	1019	583
CONTRACT NO. 95893				
ILLINOIS FED. AID PROJECT				

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SECTION A-A

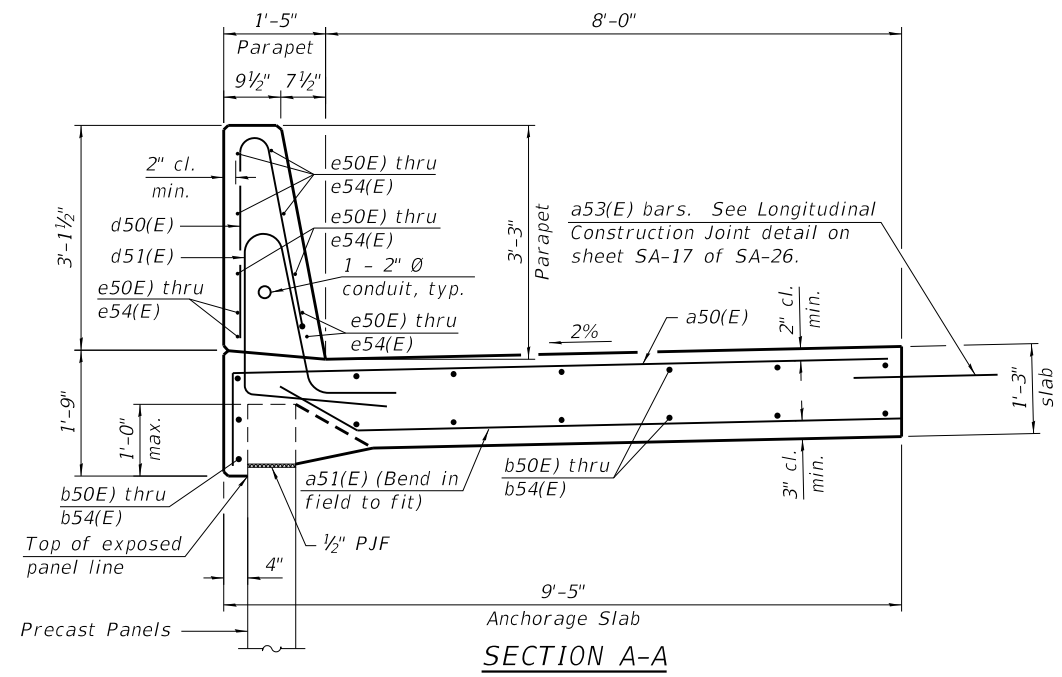


SECTION C-C


* The Precast Modular Wall supplier's design of the coping and attachment to the wall facing shall account for the following service loads applied at the base of the Bicycle Rail posts. Horizontal sliding force of 0.7 kips and overturning moment of 3.1 kip-ft. Cost of concrete and reinforcement for coping under the Bicycle Railing is included with Precast Modular Retaining Wall.

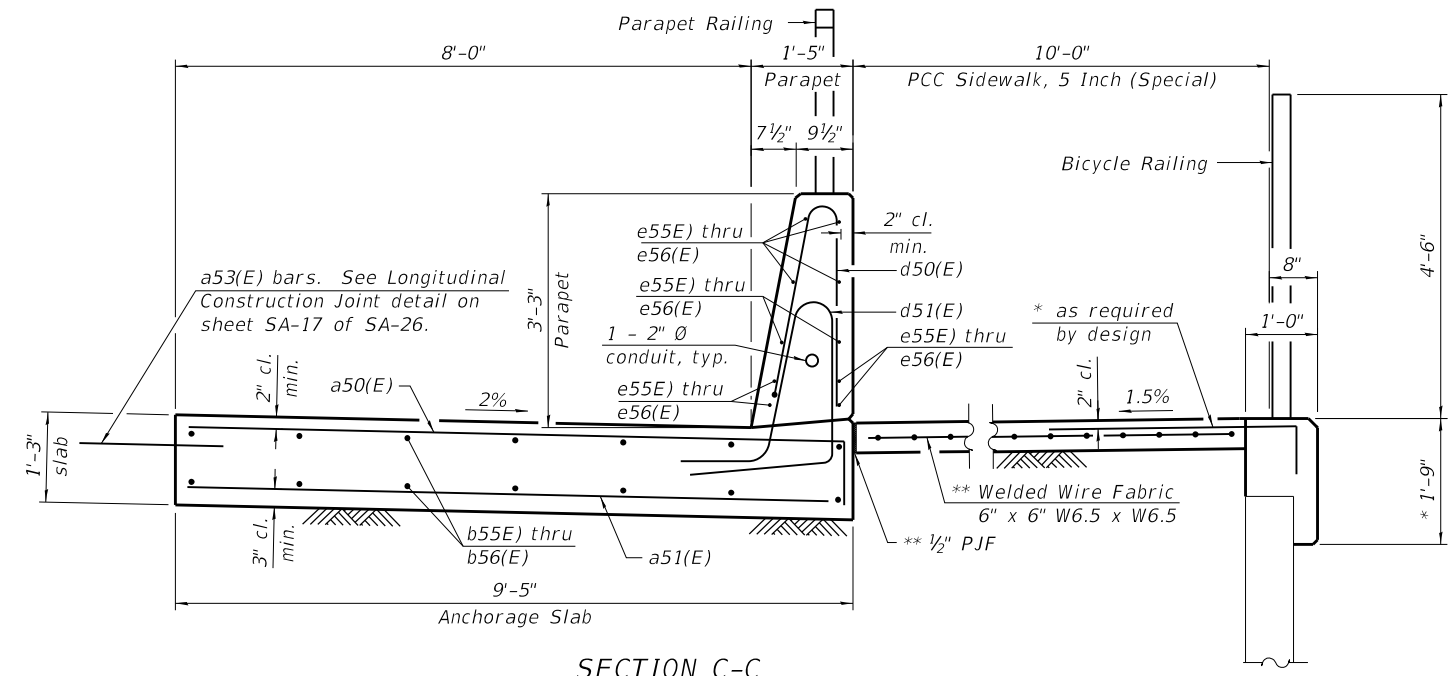** Cost of Welded Wire Fabric and PJJ is included with Portland Cement Concrete Sidewalk, 5 Inch (Special).


Note:
 The Precast Modular Retaining Wall supplier's internal stability design shall account for the sidewalk's bearing pressure surcharge of 0.16 ksf in addition to any loads imposed by the Bicycle Railing.

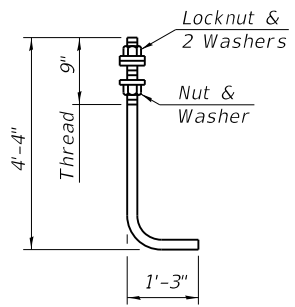

ANCHOR ROD
 Diameter as specified for light poles.
 (ASTM F 1554 Grade 105)
 Full length hot dipped galvanized.

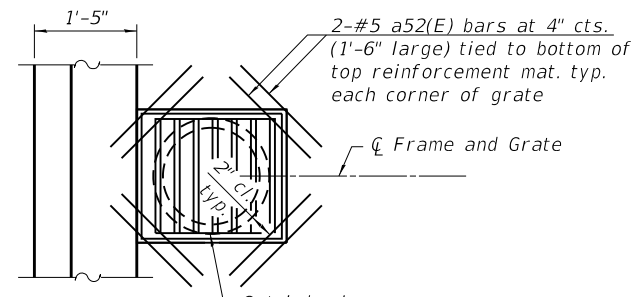


DRAINAGE INLET
 (8 locations, see Drainage Plans.)

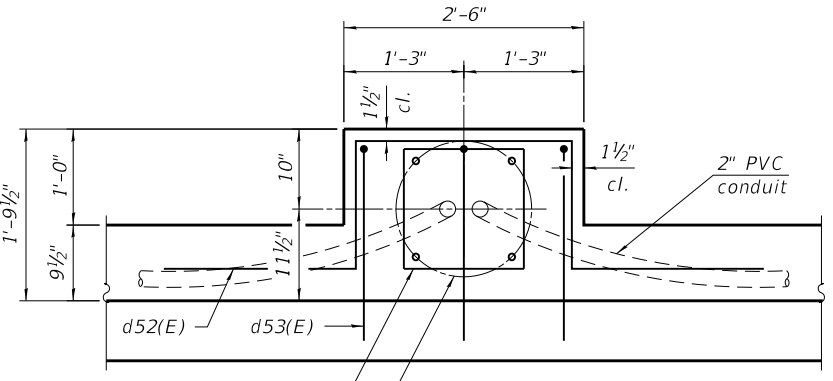


Note:
 Bolt circle to match light pole or traffic signal base.
 See Electrical Plans.

Note:
 Cost of anchor rods and conduit is included with Concrete Superstructure.


PLAN

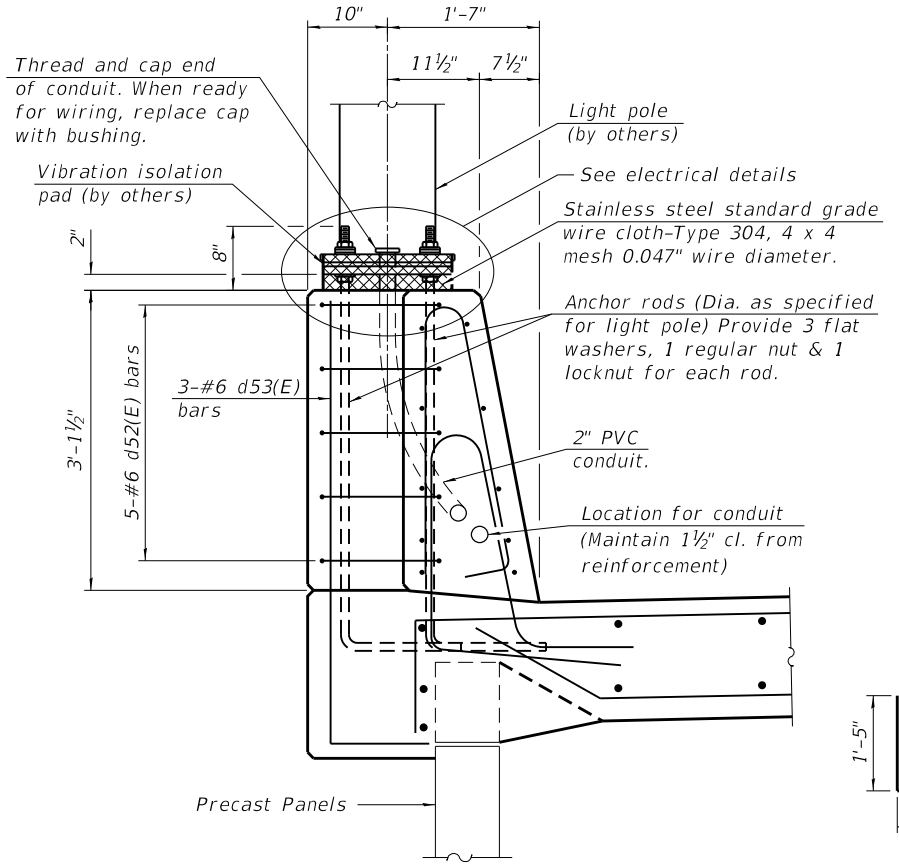


SECTION B-B

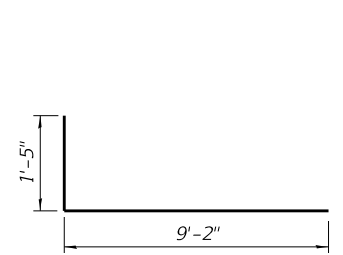


BAR a50(E)

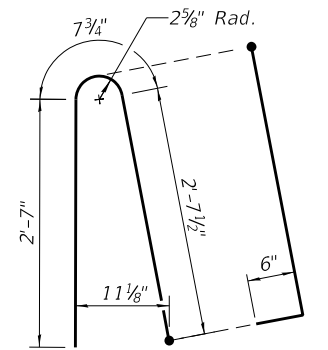


BAR d50(E)

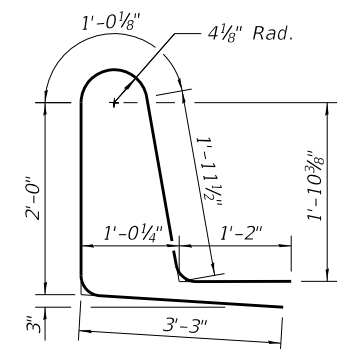

BAR d51(E)

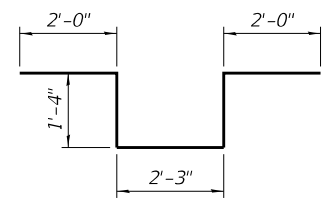

BAR d52(E)

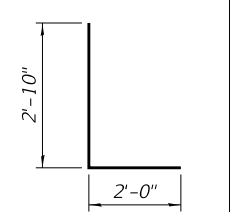


BAR d53(E)

BILL OF MATERIAL

Bar	No.	Size	Length	Shape
a50(E)	2,180	#5	10'-7"	—
a51(E)	1,100	#5	9'-3"	—
a52(E)	64	#5	1'-6"	—
a53(E)	463	#6	2'-0"	—
b50(E)	11	#5	33'-9"	—
b51(E)	264	#5	25'-2"	—
b52(E)	33	#5	30'-6"	—
b53(E)	44	#5	25'-8"	—
b54(E)	22	#5	30'-4"	—
b55(E)	20	#5	23'-8"	—
b56(E)	20	#5	30'-2"	—
d50(E)	1,373	#5	6'-5"	⌒
d51(E)	1,373	#5	9'-5"	⌒
d52(E)	24	#6	8'-11"	⌒
d53(E)	15	#6	4'-10"	⌒
e50(E)	20	#4	18'-3"	—
e51(E)	240	#4	24'-6"	—
e52(E)	30	#4	29'-11"	—
e53(E)	40	#4	25'-0"	—
e54(E)	20	#4	29'-11"	—
e55(E)	20	#4	23'-3"	—
e56(E)	20	#4	29'-3"	—
Concrete Superstructure		Cu. Yd.	536.0	
Protective Coat		Sq. Yd.	1,221	
Reinforcement Bars, Epoxy Coated		Pound	76,840	
Portland Cement Concrete Sidewalk, 5 inch (Special)		Sq. Ft.	532	

Bars indicated thus 6 x 3-#8 etc. indicates 6 line of bars with 3 lengths per line.

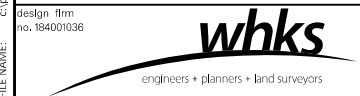

USER NAME = dtheberling	DESIGNED - SDS	REVISED
FILE NAME = 60603202_SNO58W003.dgn	CHECKED - CEH	REVISED
PLOT SCALE = 2.000' / ft.	DRAWN - DLH	REVISED
PLOT DATE = 4/6/2023	CHECKED - SDS	REVISED


STATE OF ILLINOIS
DEPARTMENT OF TRANSPORTATION

PARAPET AND ANCHORAGE SLAB DETAILS
STRUCTURE NO. 058-W003



SHEET NO. SA-16 OF SA-26 SHEETS

F.A.U. RT. = 7448	SECTION = 09-00933-01-BR	COUNTY = MACON	TOTAL SHEETS = 1019	SHEET NO. = 584
CONTRACT NO. 95893			ILLINOIS FED. AID PROJECT	


LAST SAVED DATE: 5/15/2023 10:03:58 AM

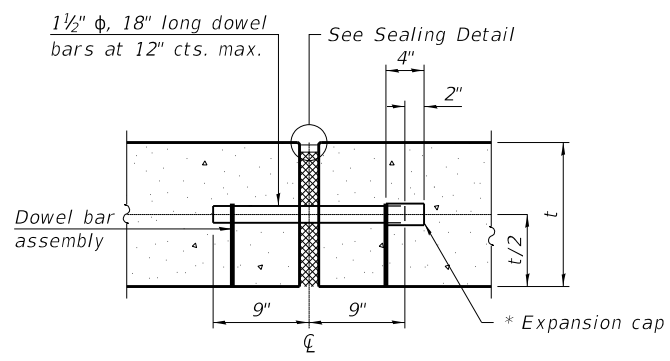

ANCHORAGE SLAB EXPANSION JOINT
Expansion joint and dowel bars included in the cost of Concrete Superstructure

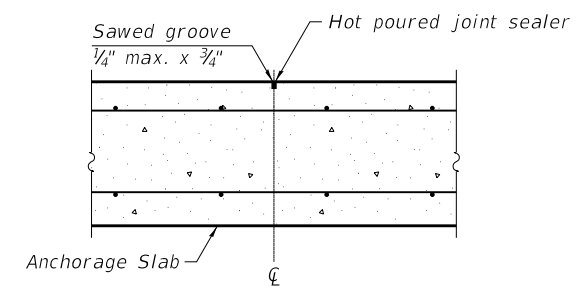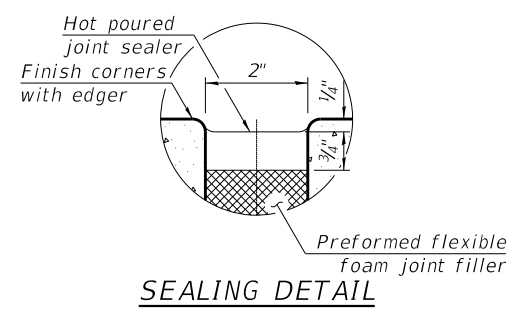


TRANSVERSE CONTRACTION JOINT

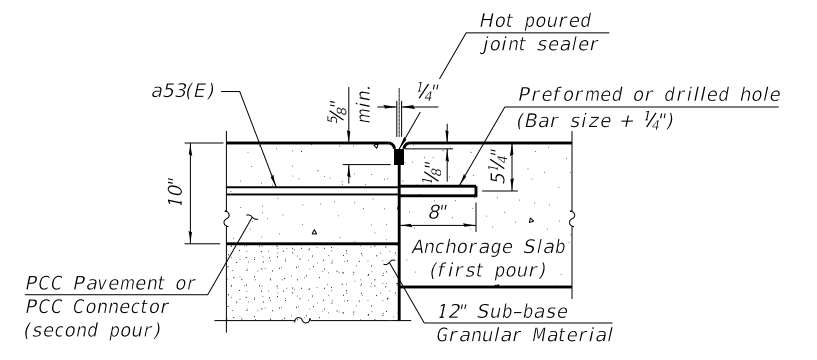


LONGITUDINAL CONSTRUCTION JOINT GROUTED-IN-PLACE TIE BAR

* Expansion caps shall be installed on the exposed end of each dowel bar once the header has been removed and the joint filler material has been installed.

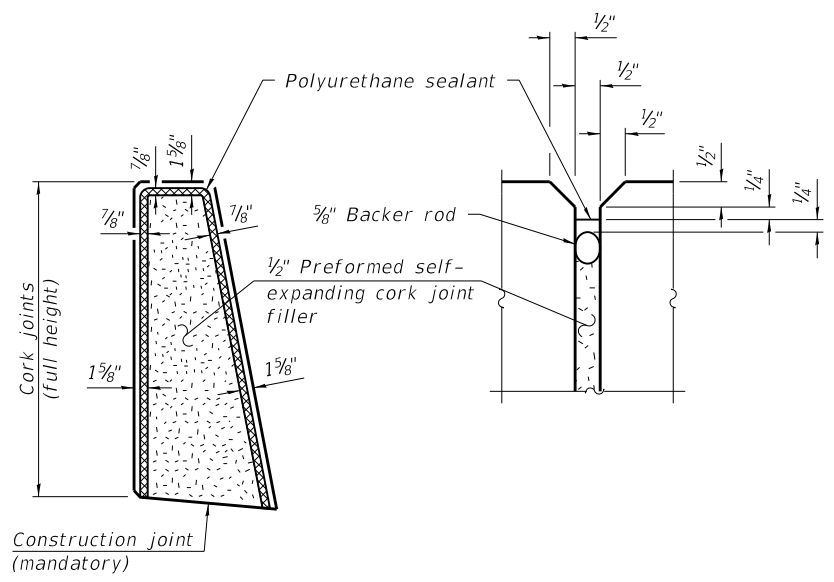


PARAPET EXPANSION JOINT DETAILS

Note:
The polyurethane sealant shall be according to Article 1050.04 of the Standard Specifications and the color shall be gray.

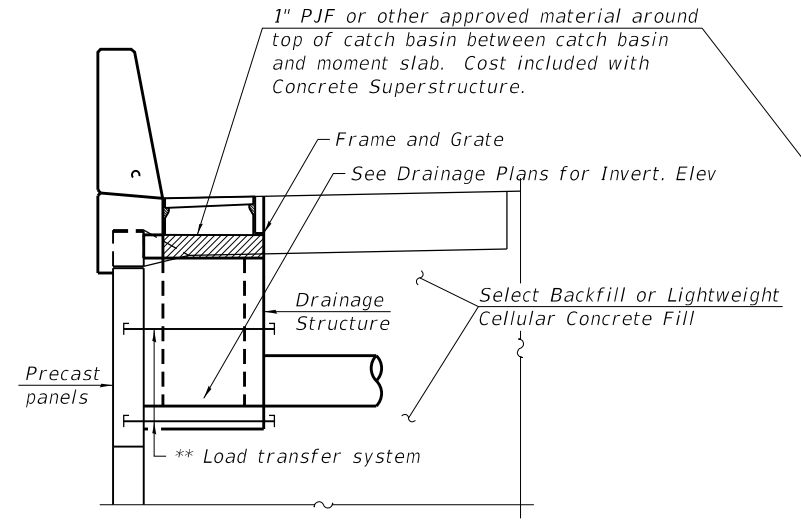


ANCHORAGE SLAB INLET SECTION


** Precast Modular Retaining Wall supplier to design load transfer system to accommodate concrete pipe and drainage structure.

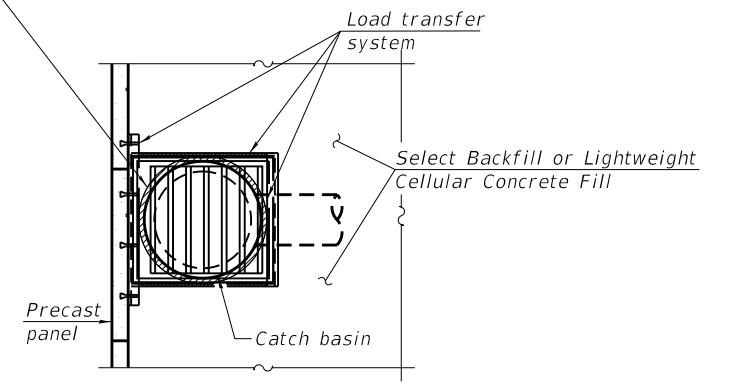

ANCHORAGE SLAB INLET SECTION

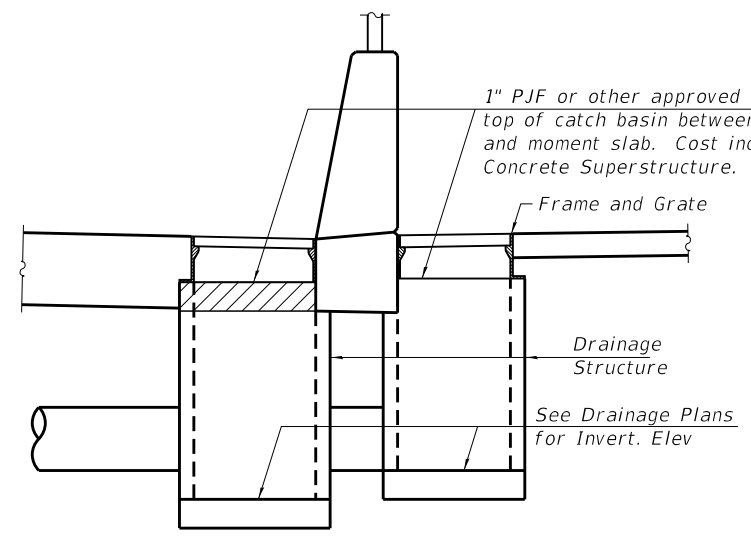


ANCHORAGE SLAB/SIDEWALK INLET SECTION

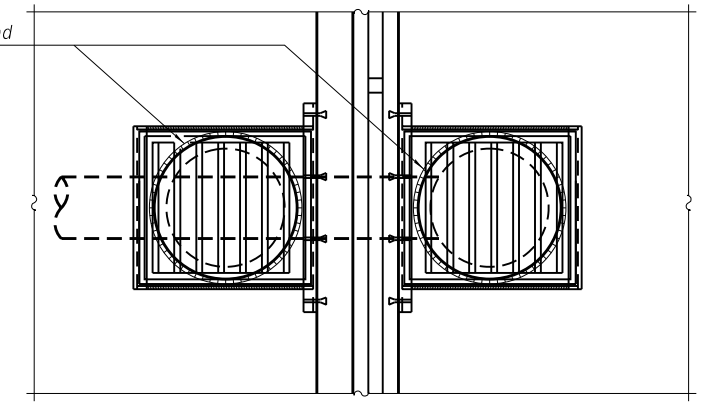

ANCHORAGE SLAB/SIDEWALK INLET

FILE NAME: c:\working\acrom_0516_nal\ep015528\0440069\60603202_S0038W003.dgn

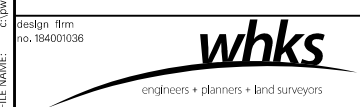

USER NAME = dheberling	DESIGNED - SDS	REVISED
FILE NAME = 60603202_S0038W003.dgn	CHECKED - CEH	REVISED
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PLOT DATE = 4/14/2023	CHECKED - SDS	REVISED


STATE OF ILLINOIS
DEPARTMENT OF TRANSPORTATION

PARAPET JOINT AND DETAILS
STRUCTURE NO. 058-W003


SHEET NO. SA-17 OF SA-26 SHEETS

F.A.U. RTE.	SECTION	COUNTY	TOTAL SHEETS	SHEET NO.
7448	09-00933-01-BR	MACON	1019	585
CONTRACT NO. 95893				
ILLINOIS FED. AID PROJECT				

LAST SAVED DATE: 5/15/2023 10:03:58 AM

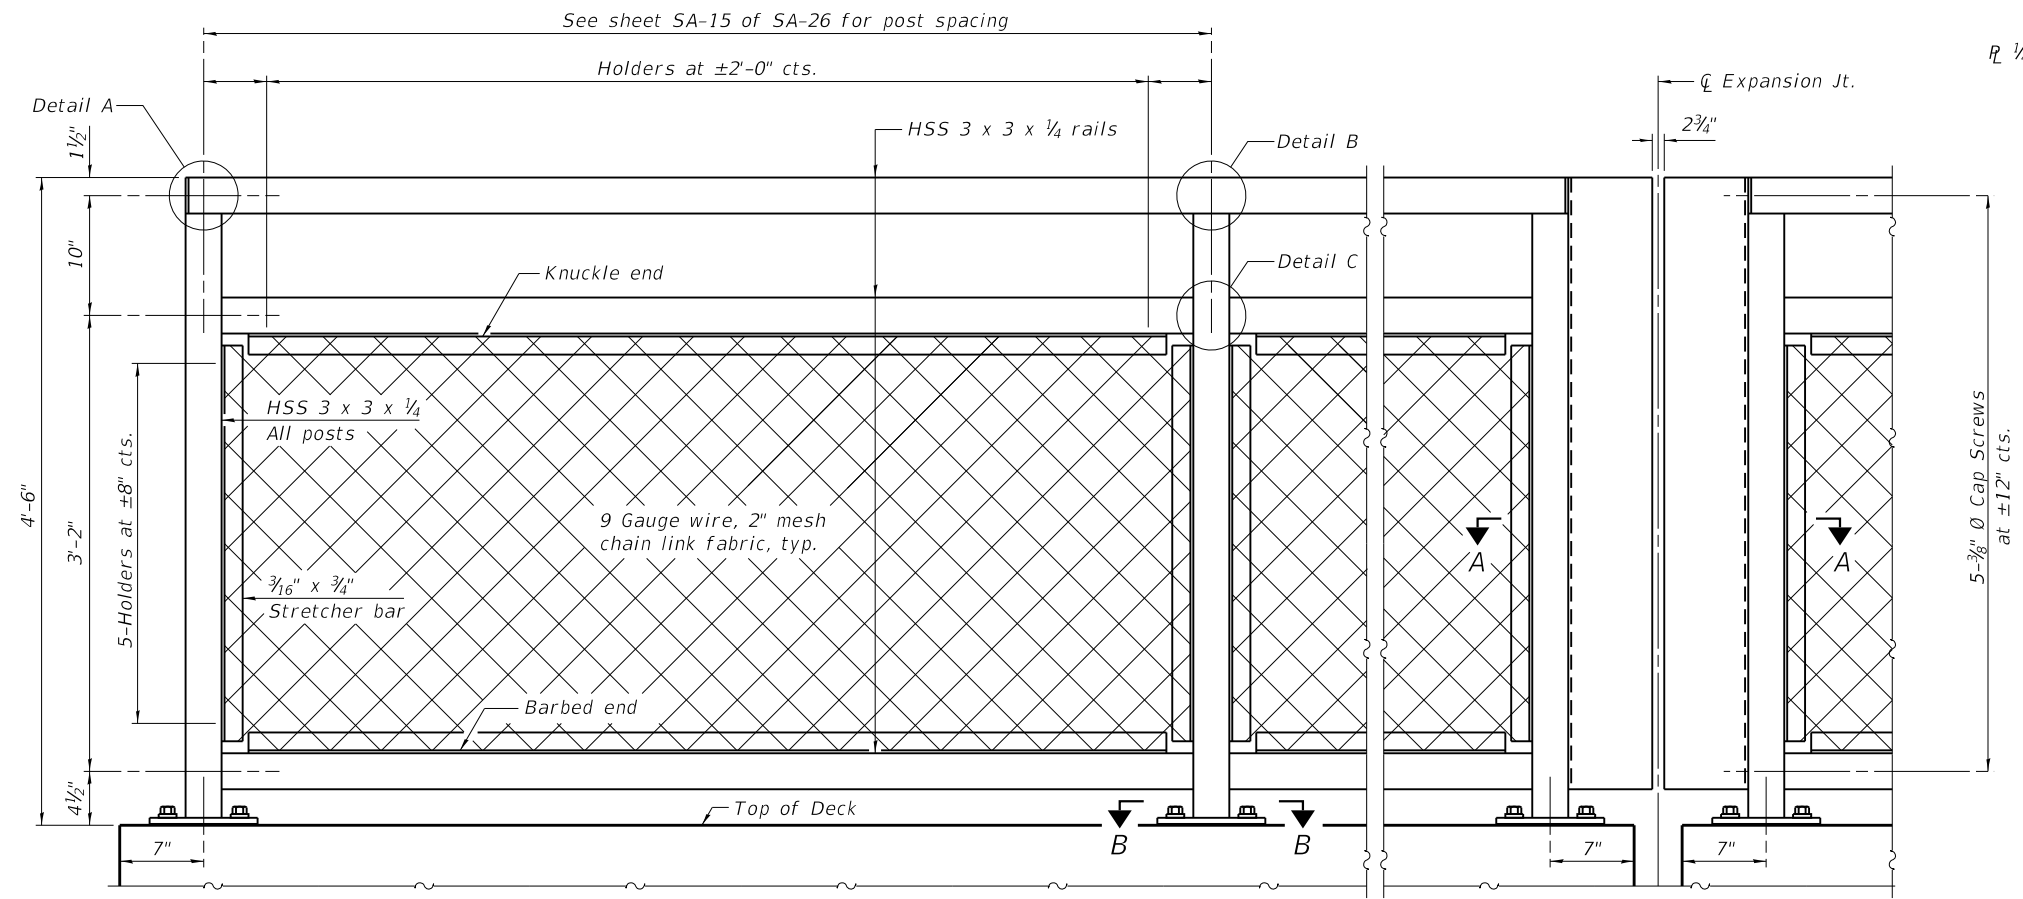


ELEVATION BICYCLE RAILING
(Inside face)

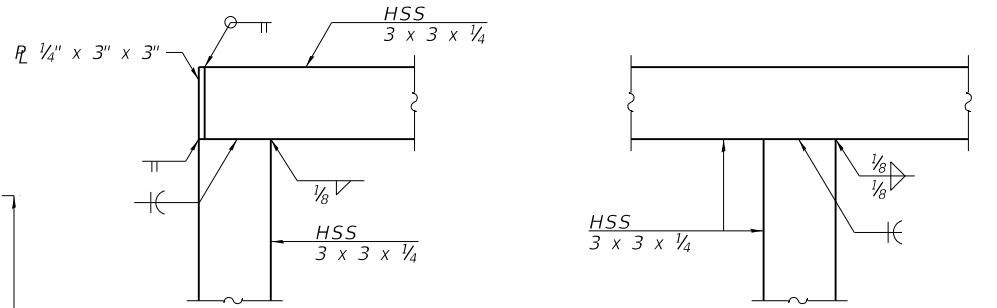


DETAIL A


DETAIL B

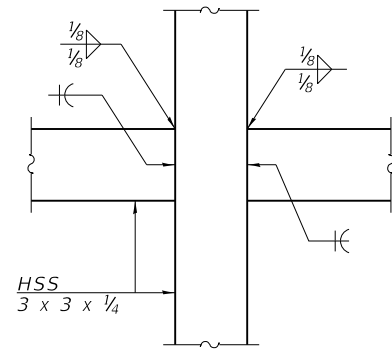


DETAIL C

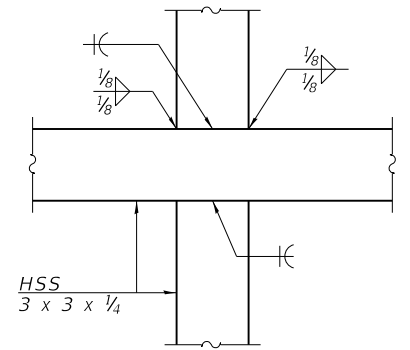

DETAIL D

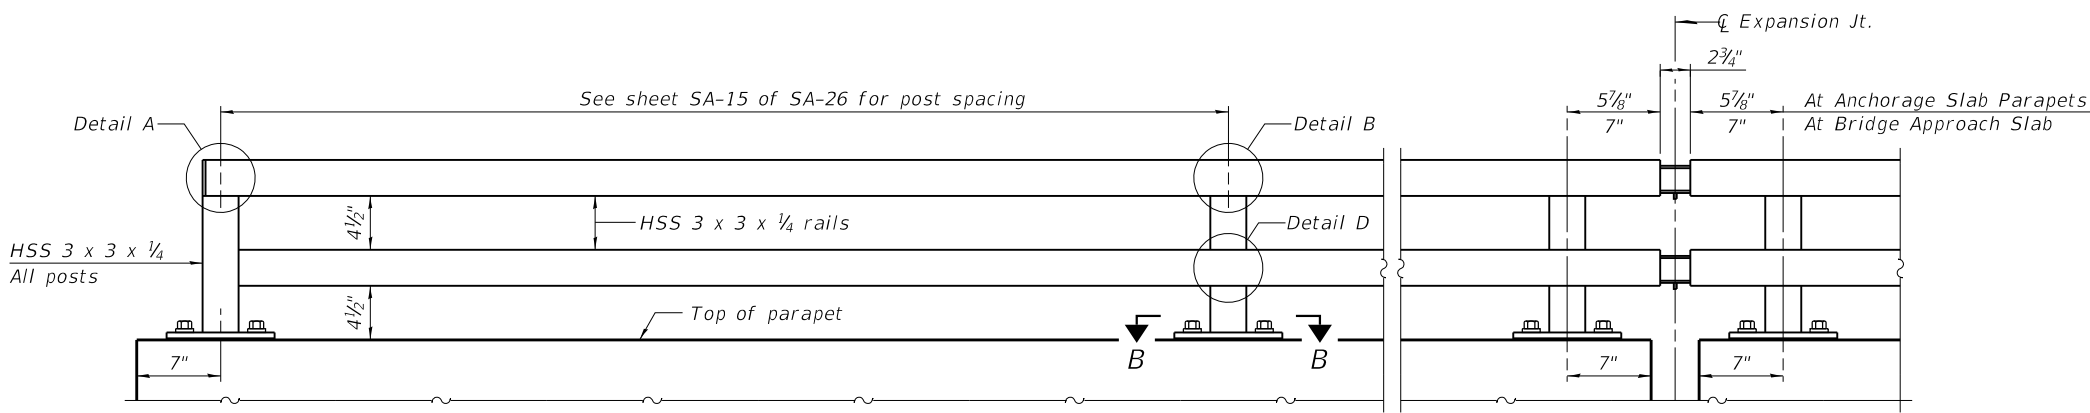

ELEVATION PARAPET RAILING
(Inside face)

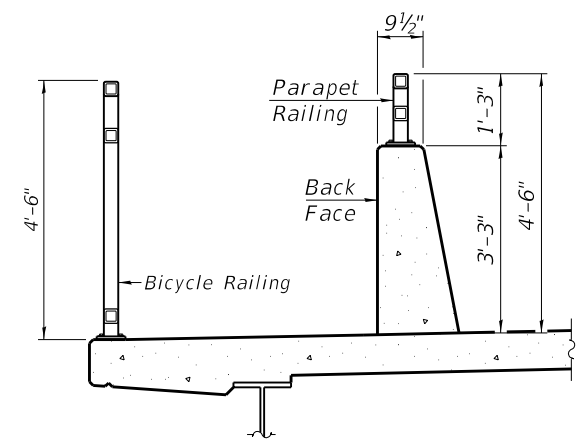

SECTION THRU DECK

RAILING CRITERIA

MASH 2016 Test Level	4
Parapet Railing Weight (plf)	25
Bicycle Railing Weight (plf)	50
Max Post Spacing	10'-0"

FILE NAME: C:\working\proj\com_d516_nal\proj15528\0440069\60603202_51038W003.dgn



USER NAME = dtheberling	DESIGNED - SDS	REVISED
FILE NAME = 60603202_51038W003.dgn	CHECKED - CEH	REVISED
PLOT SCALE = 0.167" / in.	DRAWN - DLH	REVISED
PLOT DATE = 4/14/2023	CHECKED - SDS	REVISED

**STATE OF ILLINOIS
DEPARTMENT OF TRANSPORTATION**


**BICYCLE RAILING AND PARAPET RAILING
STRUCTURE NO. 058-W003**

SHEET NO. SA-18 OF SA-26 SHEETS

F.A.U. RTE.	SECTION	COUNTY	TOTAL SHEETS	SHEET NO.
7448	09-00933-01-BR	MACON	1019	586
CONTRACT NO. 95893				


ILLINOIS FED. AID PROJECT

(Sheet 1 of 2)

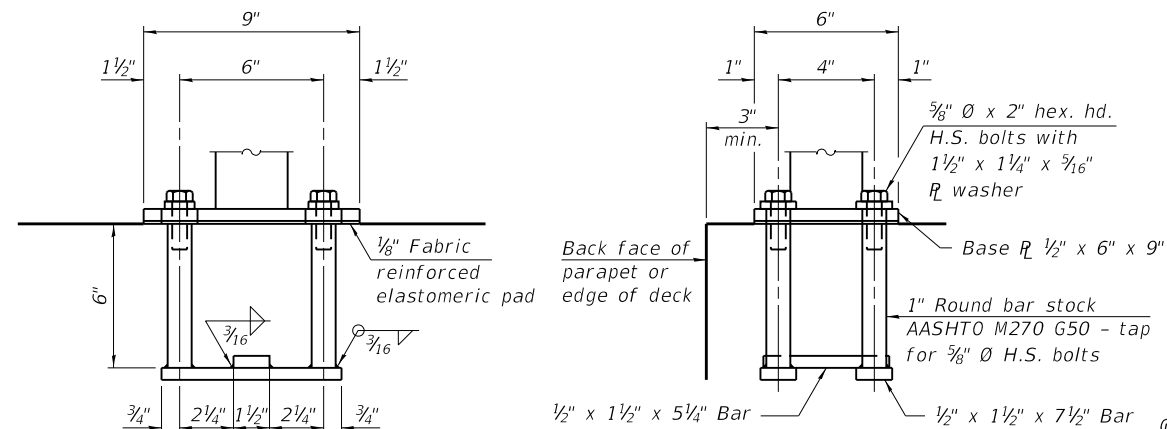


ANCHORAGE ASSEMBLY


The Bicycle Railing fasteners for end posts near expansion joints may need to be installed prior to installing the bent plates. In lieu of the cast-in-place anchor device shown, the Contractor has the option of drilling and setting 5/8" Ø fully threaded anchor rods with the same plate washers as specified above and heavy hex lock nuts according to Article 509.06 of the Standard Specifications. Embedment shall be according to the manufacturer's specifications.

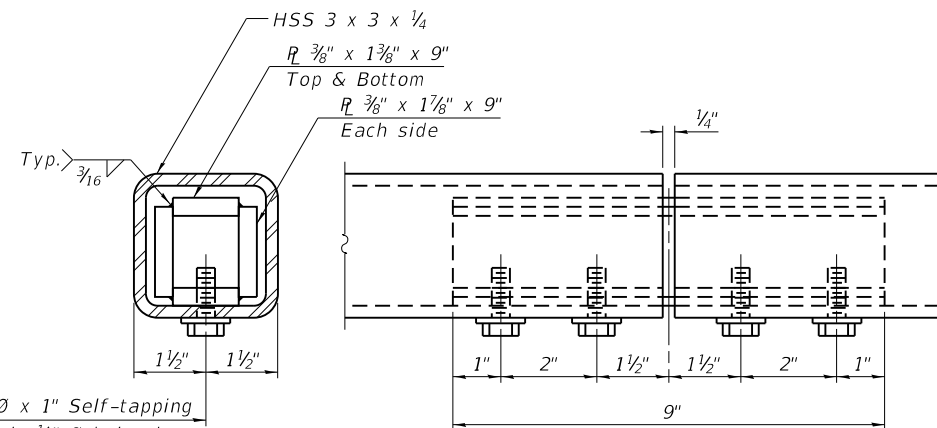


MATERIAL SPLICE

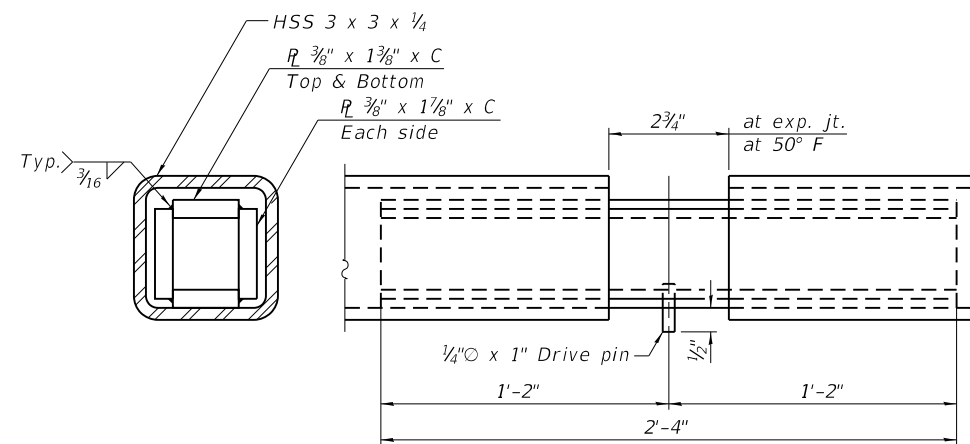

EXPANSION SPLICE

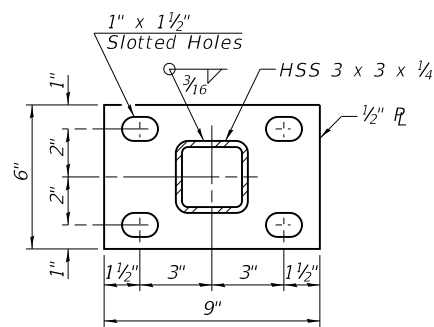

SECTION B-B

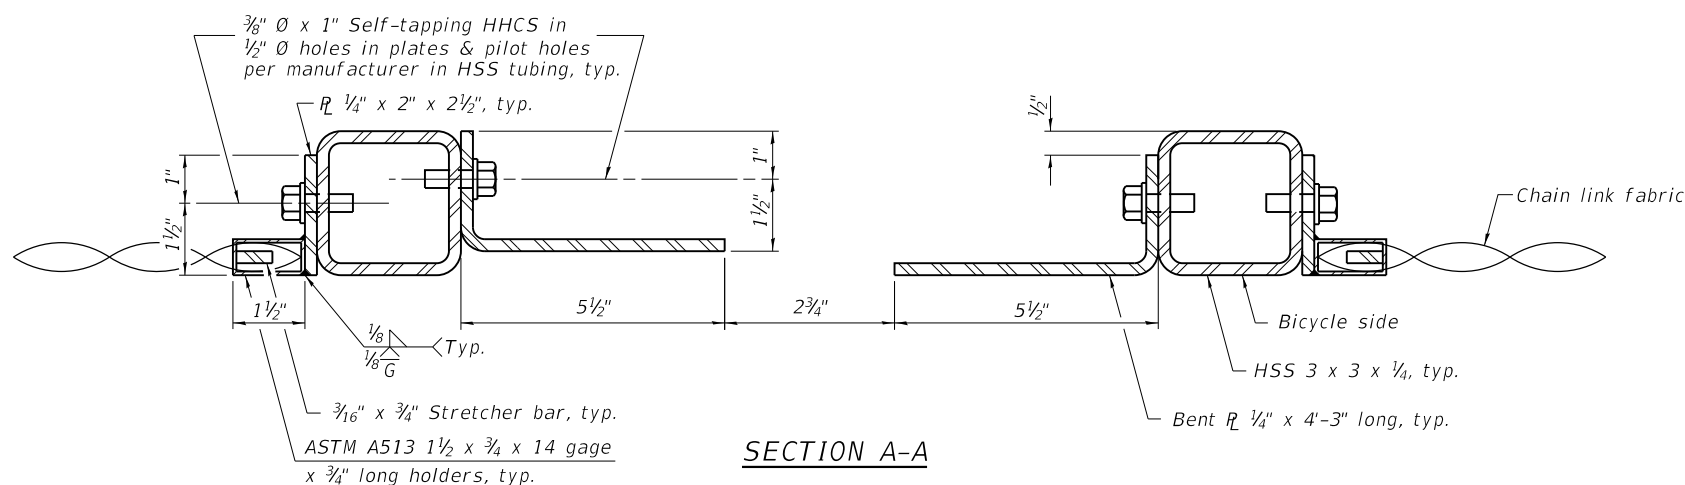

SECTION A-A

Notes:

1. Place reinforcement bars to miss anchor rod locations.
2. CVN testing is not required for the HSS tubing used in the Bicycle Railing.
3. All HSS tubing used for the Parapet Railing shall be CVN tested according to Article 1006.34(b) of the Standard Specifications.
4. All HSS tubing used for the Parapet Railing shall be ASTM A500 grade C.
5. All base plates used for the Paraper Railing shall be AASHTO M270 grade 50.
6. All heavy hex nuts shall be according to ASTM A 563 grade DH.
7. All fully threaded anchor rods shall be ASTM F1554 grade 105.
8. The post base plate shall be fastened to the curb snug tight and given an additional 1/8" turn.
9. Rail splice inserts may be built out of bent plates of the same thicknesses and outside geometry limits as the 4 plate rail splice inserts shown.
10. All steel rail elements shall be galvanized according to Article 509.05 of the Standard Specifications.
11. See sheet SA-14 and SA-17 of SA-26 for dimensions of concrete openings at expansion joints.


BILL OF MATERIAL

Item	Unit	Quantity
Bicycle Railing	Foot	55
Parapet Railing	Foot	100

(Sheet 2 of 2)

LAST SAVED DATE: 2/15/2023 10:40:06 AM



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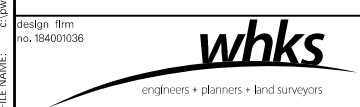
39" CONSTANT-SLOPE PARAPET SECTION
 (Showing dimensions, d50(E), d51(E) and 1/2" Ø GFRP rebar)
 (Showing reinforcement clearances for slip forming and additional reinforcement)

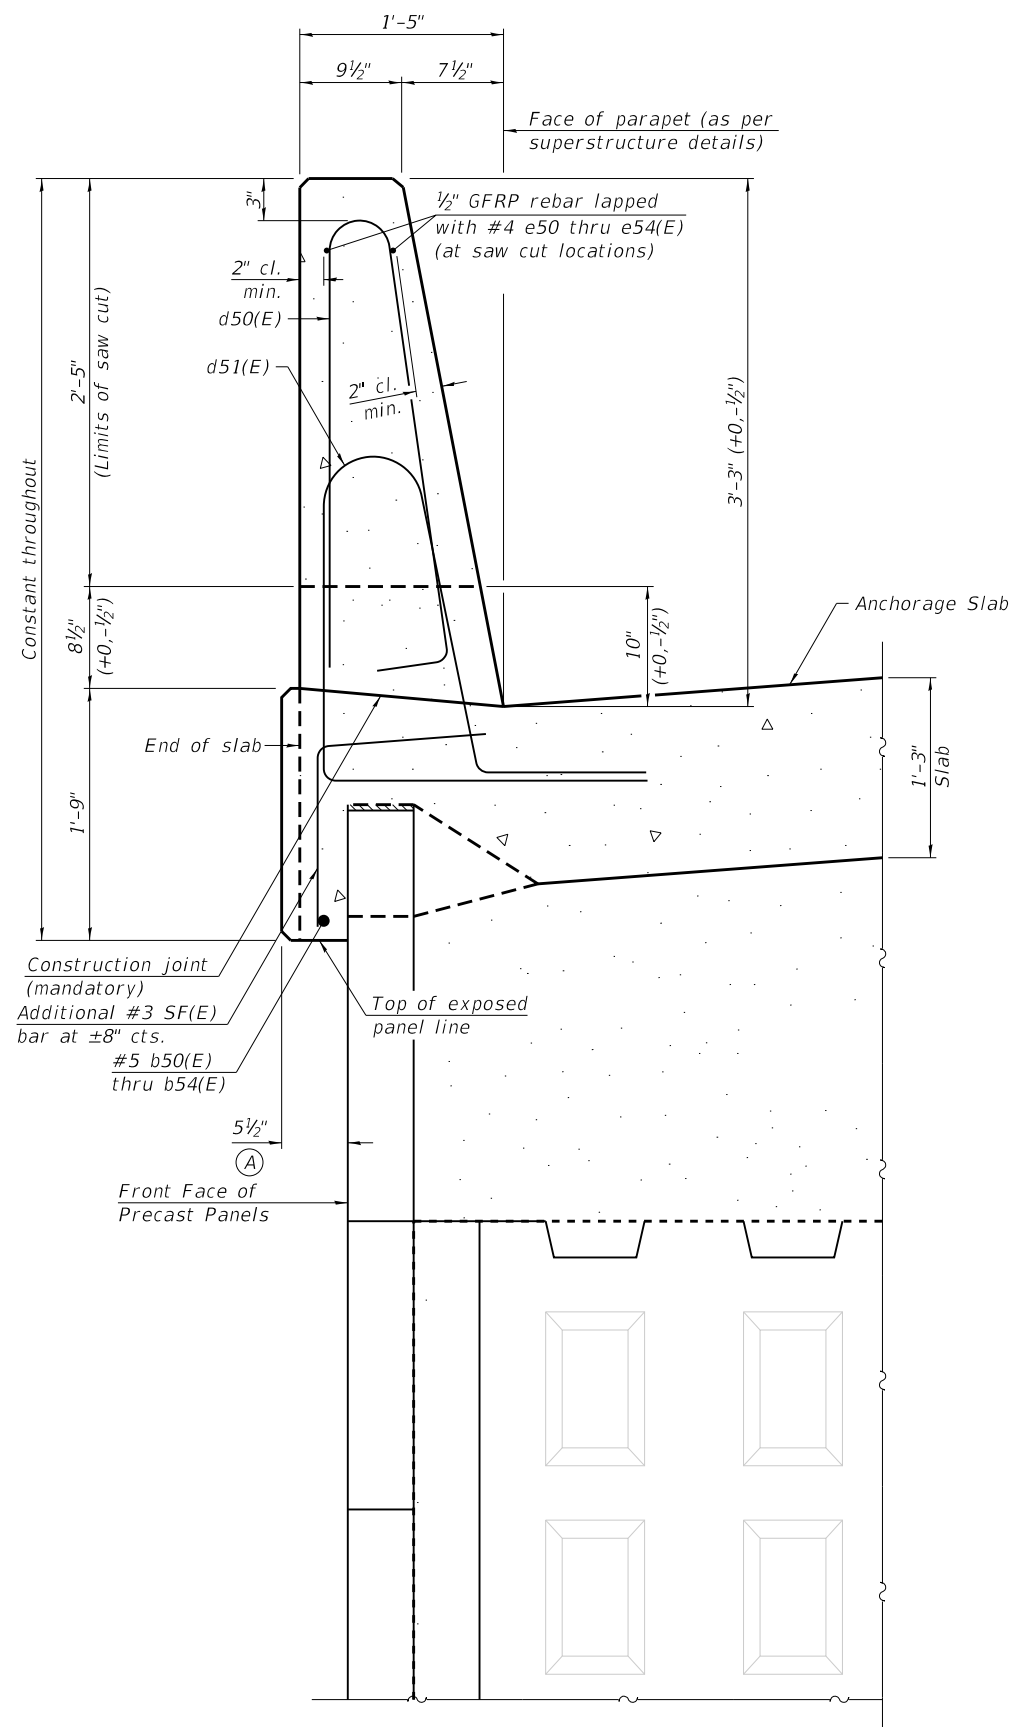GENERAL NOTES

All dimensions shall remain the same as shown on superstructure details, except dimension A which is to be revised as shown. Additional concrete needed to revise dimension A = 0.01 cu. yds./ft.
 Place full depth aluminum sheets as shown on superstructure details.
 Replace all cork joint filler locations with a full thickness saw cut.
 Slipforming of parapets along the east anchorage slab is not allowed.



GFRP REBAR STIFFENING DETAIL
 (Place as shown in parapet section at each parapet joint location.)

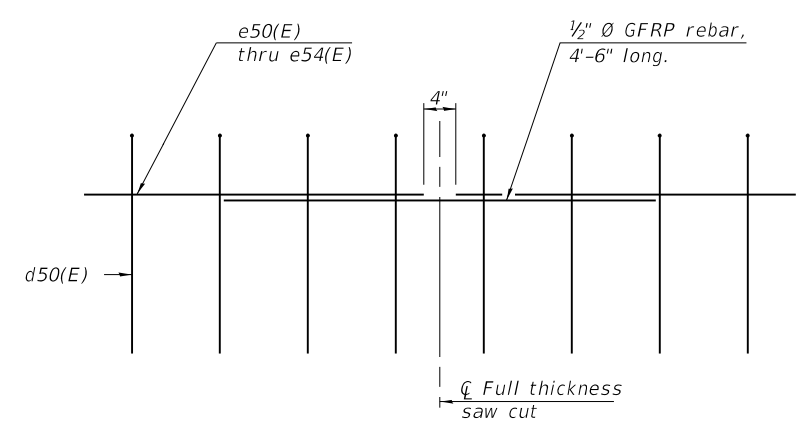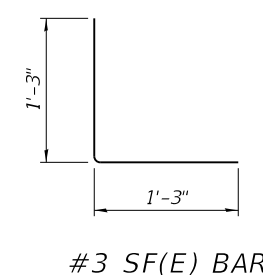

USER NAME = dheberling	DESIGNED - SDS	REVISED
FILE NAME = 60603202_51038W003.dgn	CHECKED - CEH	REVISED
PLOT SCALE = 2.000" / ft.	DRAWN - DLH	REVISED
PLOT DATE = 4/6/2023	CHECKED - SDS	REVISED

**STATE OF ILLINOIS
 DEPARTMENT OF TRANSPORTATION**

**CONCRETE PARAPET SLIPFORMING OPTION
 STRUCTURE NO. 058-W003**






SHEET NO. SA-19 OF SA-26 SHEETS

F.A.U. RTE.	SECTION	COUNTY	TOTAL SHEETS	SHEET NO.
7448	09-00933-01-BR	MACON	1019	587
CONTRACT NO. 95893				

ILLINOIS FED. AID PROJECT


B.M. "X" CHISELED "O" AT BASE OF FENCE POST AT SW CORNER OF ILLINOIS POWER SUBSTATION, 32' RT. STA. 52+00 ELEV. 674.75

B.M. "A" NW CORNER OF CONCRETE BASE FOR A/C UNIT NEAR SW CORNER OF WELDING SHOP, 51' RT. STA. 50+77 ELEV. 676.61

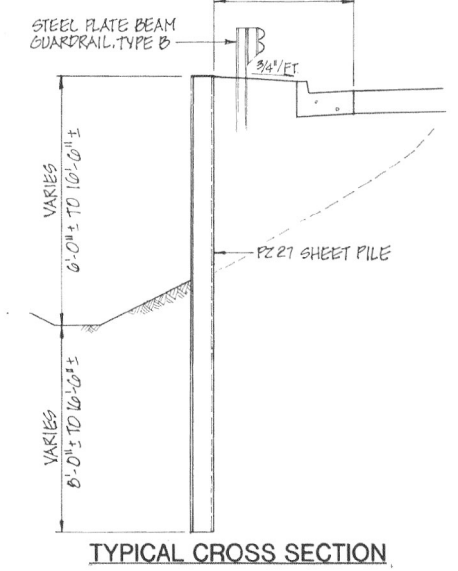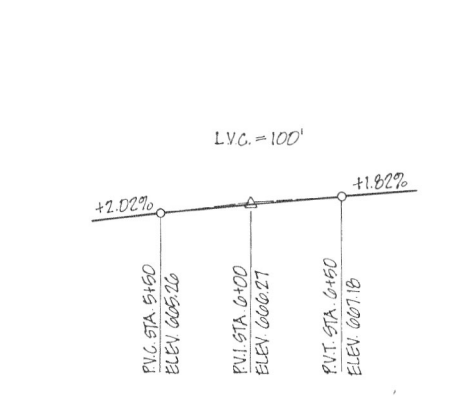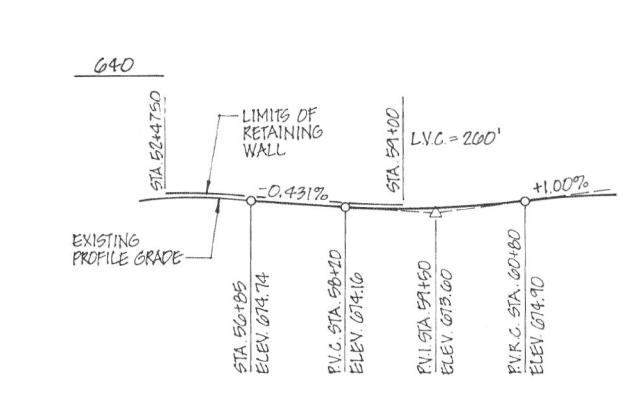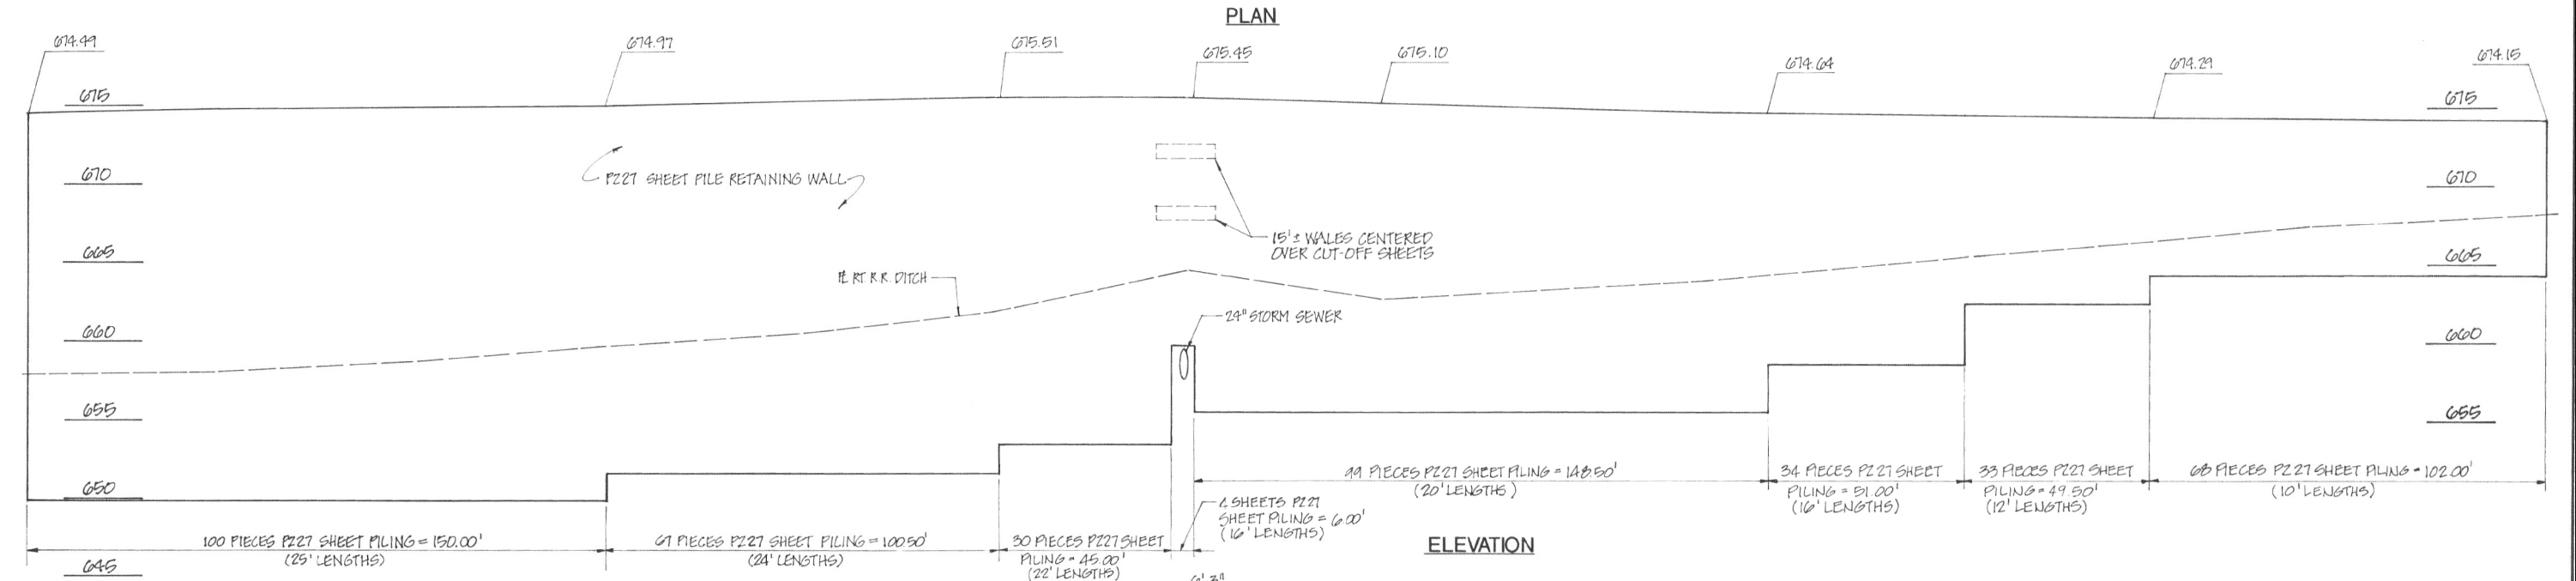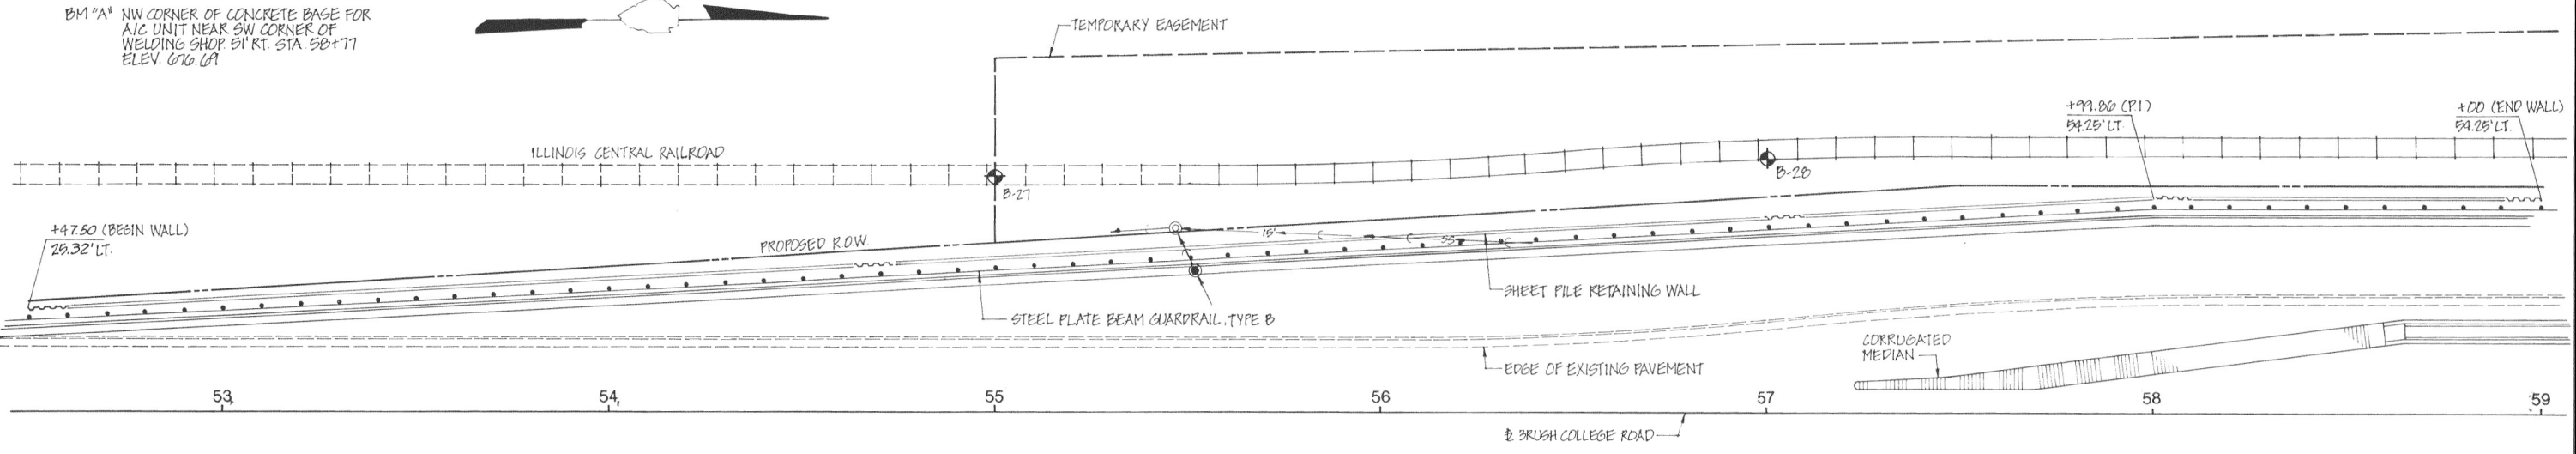

DESIGN SPECIFICATIONS
1989 AASHTO, 1990 AND 1991 INTERIM

DESIGN STRESSES
 $f_s = 32,000$ PSI (GR 50)

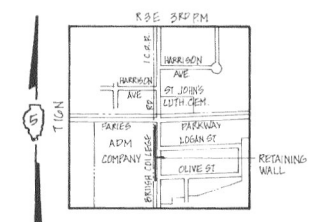

FOR INFORMATION ONLY

REVISIONS			BRUSH COLLEGE ROAD		DRAWN BY DATE	
No.	DATE	INITIALS			K. King 1-92	
1					CHECKED BY DATE	
2					BOOK NUMBER	
3			F.A.U. 7448 (CH-1)		SEC. 90-00119-00-PV	
4			MACON		COUNTY	
5					PROJECT NO.	
6					3570-9	
7					SHEET NO.	
8					HOMER L. CHASTAIN & ASSOCIATES	
9					CONSULTING ENGINEERS	
10					DECATUR, ILLINOIS	



USER NAME = dtheberling	DESIGNED - SDS	REVISED
FILE NAME = 60603202_SNO58W003.dgn	CHECKED - CEH	REVISED
PLOT SCALE = 2.000" / ft.	DRAWN - DLH	REVISED
PLOT DATE = 4/6/2023	CHECKED - SDS	REVISED

STATE OF ILLINOIS
DEPARTMENT OF TRANSPORTATION

EXISTING SHEET PILE RETAINING WALL
STRUCTURE NO. 058-W003

SHEET NO. SA-20 OF SA-26 SHEETS

F.A.U. RTE. 7448	SECTION 09-00933-01-BR	COUNTY MACON	TOTAL SHEETS 1019	SHEET NO. 588
			CONTRACT NO. 95893	
ILLINOIS FED. AID PROJECT				



SOIL BORING LOG

Page 1 of 1
Project #: 012017
Date 08/16/11

ROUTE _____ DESCRIPTION BRUSH COLLEGE RD BRIDGE (SKS #012017) LOGGED BY EK, RC

SECTION _____ LOCATION DECATUR, IL

COUNTY MACON STRUCTURE NO. _____ (Exist) _____ (Prop.)

BORING NO. B-9 DRILLING METHOD HOLLOW STEM HAMMER TYPE 140# SAFETY HAMMER

Station 52+28.27
Offset 37.19' LT.
Ground Surface Elev. 673.5 (ft.)

SOIL DESCRIPTION	(ft.)	(ft.)	/6"	(tsf)	(%)	SOIL DESCRIPTION	(ft.)	(ft.)	/6"	(tsf)	(%)
9 1/4" CONCRETE											
SILTY CLAY LOAM - A-6 Mottled Brown, moist, stiff, low-medium plasticity, trace sand, trace gravel	2	4	2.4	26.6							
	5		ST-2'								
SILTY CLAY LOAM - A-6 Brown-Gray, moist, stiff, low plasticity, trace sand, trace gravel	4	6	2.2	20.7							
- silt seam	10	5		12.5							
- sand lenses	9	12	3.0								
- very stiff	7	10	3.5	13.2							
	15	12									
- hard	6	9	2.4	13.9							
	17	16									
(*)free water @ 18.0'	55	17		10.4							
- sand lenses	5-1"	20									
END OF BORING @ 21.0 FT.	652.5	20		8.8							
	30	30-3"									
	25										
	30										

The Unconfined Compressive Strength (UCS) Failure Mode is indicated by (B-Bulge, S-Shear, P-Penetrometer).
The Standard Penetration Test (SPT) N Value is per (AASHTO T206)
BBS 137 (9/05)



SOIL BORING LOG

Page 1 of 1
Project #: 313516
Date 03/13/13

ROUTE _____ DESCRIPTION BRUSH COLLEGE ROAD LOGGED BY CH, CM

SECTION _____ LOCATION DECATUR, IL

COUNTY MACON STRUCTURE NO. _____ (Exist) _____ (Prop.)

BORING NO. B-10 DRILLING METHOD HOLLOW STEM HAMMER TYPE 140# SAFETY HAMMER

Station By URS
Offset By URS
Ground Surface Elev. 674.992 (ft.)

SOIL DESCRIPTION	(ft.)	(ft.)	/6"	(tsf)	(%)	SOIL DESCRIPTION	(ft.)	(ft.)	/6"	(tsf)	(%)
SILTY CLAY - A-6 Gray-Mottled-Brown, moist, stiff, low plasticity	6	6		31.6							
	8										
CLAY LOAM - A-4 Brown, moist, low plasticity	5		1.5	14.7							
SILTY CLAY LOAM - A-4 Brown, moist, very stiff, low plasticity, trace gravel	6	9	1.5	15.2							
	10	10									
	10	8	1.8	13.6							
	10	12									
	6	11	1.3	14.1							
	11	13									
	15	13	2.3	12.5							
-hard	23										
13" seam SAND- Brown, fine-coarse (*)free water @ 18.5'	38	22-4									
-hard	20	30	6.6	12.2							
	27	23									
SILT - A-4 Gray, moist, hard, low plasticity, trace sand, trace gravel	14	26	2.1	14.3							
	21										
CLAY - A-6 Gray, moist, very stiff, low plasticity, trace sand, trace gravel	648.992	11	2.5								
END OF BORING @ 26.0 FT.	25	8									
	30										

The Unconfined Compressive Strength (UCS) Failure Mode is indicated by (B-Bulge, S-Shear, P-Penetrometer).
The Standard Penetration Test (SPT) N Value is per (AASHTO T206)
BBS 137 (9/05)



SOIL BORING LOG

Page 1 of 1
Project #: 313516
Date 04/05/13

ROUTE _____ DESCRIPTION BRUSH COLLEGE ROAD LOGGED BY CM, JM

SECTION _____ LOCATION DECATUR, IL

COUNTY MACON STRUCTURE NO. _____ (Exist) _____ (Prop.)

BORING NO. B-11 DRILLING METHOD HOLLOW STEM HAMMER TYPE 140# SAFETY HAMMER

Station By URS
Offset By URS
Ground Surface Elev. 674.629 (ft.)

SOIL DESCRIPTION	(ft.)	(ft.)	/6"	(tsf)	(%)	SOIL DESCRIPTION	(ft.)	(ft.)	/6"	(tsf)	(%)
12" CONCRETE											
SILTY CLAY - A-6 Gray-Mottled-Brown, moist, stiff, medium plasticity	3	3	1.9	30.7							
	6										
	5	2		23.4							
	4	5									
SILTY CLAY LOAM - A-4 Brown, moist, low plasticity, little sand, trace gravel			1.3	18.0							
-stiff	10	2	1.2	15.7							
	5	7									
-very stiff	6	10	2.6	14.6							
	11										
	15	8	3.2	13.5							
	11	15									
CLAY - A-6 Gray, moist, hard, low plasticity, little sand, trace gravel	21	33	12.0	9.8							
	27										
	20	20		9.7							
	15	21									
	15	18		10.5							
	23										
	25	15	7.1	10.5							
	19	22									
END OF BORING @ 26.0 FT.	648.629										
	30										

The Unconfined Compressive Strength (UCS) Failure Mode is indicated by (B-Bulge, S-Shear, P-Penetrometer).
The Standard Penetration Test (SPT) N Value is per (AASHTO T206)
BBS 137 (9/05)



DESIGN FIRM	USER NAME = dtheberling	DESIGNED - SDS	REVISED
FILE NAME = 60603202_SNO58W003.dgn	CHECKED - CEH	CHECKED - CEH	REVISED
PLOT SCALE = 2.000" / ft.	DRAWN - DLH	DRAWN - DLH	REVISED
PLOT DATE = 4/6/2023	CHECKED - SDS	CHECKED - SDS	REVISED

STATE OF ILLINOIS
DEPARTMENT OF TRANSPORTATION

BORINGS
STRUCTURE NO. 058-W003

F.A.U. RTE.	SECTION	COUNTY	TOTAL SHEETS	SHEET NO.
7448	09-00933-01-BR	MACON	1019	589
CONTRACT NO. 95893				

SHEET NO. SA-21 OF SA-26 SHEETS

ILLINOIS FED. AID PROJECT

SOIL BORING LOG

ROUTE _____ DESCRIPTION BRUSH COLLEGE ROAD LOGGED BY CH, CM
SECTION _____ LOCATION DECATUR, IL
COUNTY MACON STRUCTURE NO. _____ (Exist) _____ (Prop.)
BORING NO. B-13 DRILLING METHOD HOLLOW STEM HAMMER TYPE 140# SAFETY HAMMER

Station	By URS	ELEV	DEPTH	BLWS	UCS	MOIST	Surface Water Elev.	ELEV	DEPTH	BLWS	UCS	MOIST
Offset	By URS	(ft.)	(ft.)	/6"	(tsf)	(%)	(ft.)	(ft.)	(ft.)	/6"	(tsf)	(%)
Ground Surface Elev.	674.506						-					
SOIL DESCRIPTION							SOIL DESCRIPTION					
15" CONCRETE												
SAND - A-1-a			12									
Brown, moist, medium dense-dense, fine-coarse			17									
			13									
		5	4									
CRUSHED LIMESTONE- A-1			4			9.7						
			4									
SILTY CLAY LOAM - A-4			5			17.6						
Gray-Mottled-Brown, moist, stiff, low plasticity, little sand, trace gravel			6		1.0							
			7									
		10	5			17.6						
			5									
SILTY CLAY LOAM - A-4			6			12.5						
Gray-Mottled-Brown, moist, stiff, low plasticity, little sand, trace gravel			7									
		15	9									
SILTY CLAY LOAM - A-4			13			13.2						
Brown, moist, very stiff, low plasticity, trace sand, trace gravel -hard			14		5.3							
			20			10.4						
			24									
			33									
(*free water @ 19.5' sand lens		20	26			42.2						
			60									
			33									
CLAY - A-6			30			10.2						
Gray, moist, hard, low plasticity, trace sand, trace gravel			30-5		6.8							
			25									
		648.506	23			11.5						
END OF BORING @ 26.0 FT.			32									
			30									

The Unconfined Compressive Strength (UCS) Failure Mode is indicated by (B-Bulge, S-Shear, P-Penetrometer).
The Standard Penetration Test (SPT) N Value is per (AASHTO T206)

BBS 137 (9/05)

SOIL BORING LOG

ROUTE _____ DESCRIPTION BRUSH COLLEGE ROAD LOGGED BY CM
SECTION _____ LOCATION DECATUR, IL
COUNTY MACON STRUCTURE NO. _____ (Exist) _____ (Prop.)
BORING NO. B-14 DRILLING METHOD HOLLOW STEM HAMMER TYPE 140# SAFETY HAMMER

Station	By URS	ELEV	DEPTH	BLWS	UCS	MOIST	Surface Water Elev.	ELEV	DEPTH	BLWS	UCS	MOIST
Offset	By URS	(ft.)	(ft.)	/6"	(tsf)	(%)	(ft.)	(ft.)	(ft.)	/6"	(tsf)	(%)
Ground Surface Elev.	673.609						-					
SOIL DESCRIPTION							SOIL DESCRIPTION					
18" CONCRETE												
SILTY CLAY - A-6						9.6						
Dark Brown, moist, stiff, low plasticity, little sand			6									
			4									
			5									
			5									
CRUSHED LIMESTONE- A-1			2			24.8						
			3									
			7									
SILTY CLAY LOAM - A-4			3			16.2						
Gray-Mottled-Brown, moist, stiff, low plasticity, little sand, trace gravel			4		1.7							
			5									
		10	2			16.9						
SILTY CLAY LOAM - A-4			3			15.9						
Brown, moist, firm-stiff, low plasticity, trace sand, trace gravel -very stiff			5									
			4			15.9						
			8			1.0						
			10									
		15										
SILTY CLAY LOAM - A-6						13.0						
Brown, moist, low plasticity, trace sand, trace gravel -hard												
			8			14.2						
			14									
			24									
(*free water @ 19.5'			20			10.8						
			15									
			31									
			29									
			11			11.6						
			17									
			21									
			25									
CLAY - A-6			8			12.6						
Gray, moist, very stiff, low plasticity, trace sand, trace gravel			13									
END OF BORING @ 26.0 FT.		647.609	16									
			30									

The Unconfined Compressive Strength (UCS) Failure Mode is indicated by (B-Bulge, S-Shear, P-Penetrometer).
The Standard Penetration Test (SPT) N Value is per (AASHTO T206)

BBS 137 (9/05)

design firm
no. 184001036



USER NAME = dtheberling	DESIGNED - SDS	REVISED
FILE NAME = 60603202_SNO58W003.dgn	CHECKED - CEH	REVISED
PLOT SCALE = 2.000" / ft.	DRAWN - DLH	REVISED
PLOT DATE = 4/6/2013	CHECKED - SDS	REVISED

STATE OF ILLINOIS
DEPARTMENT OF TRANSPORTATION

BORINGS
STRUCTURE NO. 058-W003

SHEET NO. SA-22 OF SA-26 SHEETS

F.A.U. RTE.	SECTION	COUNTY	TOTAL SHEETS	SHEET NO.
7448	09-00933-01-BR	MACON	1019	590
CONTRACT NO. 95893				

ILLINOIS FED. AID PROJECT



SOIL BORING LOG

Page 1 of 1
 Project #: 916780
 Date 2/20/20

ROUTE _____ DESCRIPTION BRUSH COLLEGE ROAD LOGGED BY GC
 SECTION _____ LOCATION DECATUR, ILLINOIS
 COUNTY MACON COUNTY STRUCTURE NO. _____ (Exist) _____ (Prop.)
 BORING NO. B-22 DRILLING METHOD HOLLOW STEM HAMMER TYPE 140# SAFETY HAMMER

Station	ELEV (ft.)	DEPTH (ft.)	BLOW COUNT	UCS (tsf)	MOISTURE (%)	Surface Water Elev. (ft.)		ELEV (ft.)	DEPTH (ft.)	BLOW COUNT	UCS (tsf)	MOISTURE (%)
						Groundwater Elev.	First Encounter					
Offset												
Ground Surface Elev. 674.665 (ft.)												
SOIL DESCRIPTION	(ft.)	(ft.)	/6"	(tsf)	(%)	SOIL DESCRIPTION	(ft.)	(ft.)	/6"	(tsf)	(%)	
7" ASPHALT												
CLAY A-6 Mottled Brown, very moist, stiff, medium plasticity, trace sand -firm		3	6		26.0							
-Shelby Tube		5	3	.45	32.4							
CLAY LOAM A-6 Brown, very moist, very stiff, low plasticity, with sand trace gravel		10	5	0.58	17.9							
			8	.78	14.8							
		15	5	.65	14.9							
			8	4.53	12.0							
CLAY LOAM A-6 Brownish Gray, moist, hard, low plasticity, with sand trace gravel		20	17	3.7	12.2							
SANDY CLAY LOAM A-2-4 Gray, moist, very dense, fine-coarse, trace gravel			60-6		9.0							
	648.665		60-5		11.3							
END OF BORING @ 26.0 FT.												
		30										

The Unconfined Compressive Strength (UCS) Failure Mode is indicated by (B-Bulge, S-Shear, P-Penetrometer).
 The Standard Penetration Test (SPT) N Value is per (AASHTO T206)

BBS 137 (9/05)



SOIL BORING LOG

Page 1 of 1
 Project #: 916780
 Date 02/12/20

ROUTE _____ DESCRIPTION BRUSH COLLEGE ROAD LOGGED BY GC/EE
 SECTION _____ LOCATION DECATUR, ILLINOIS
 COUNTY MACON COUNTY STRUCTURE NO. _____ (Exist) _____ (Prop.)
 BORING NO. B-23 DRILLING METHOD HOLLOW STEM HAMMER TYPE 140# SAFETY HAMMER

Station	ELEV (ft.)	DEPTH (ft.)	BLOW COUNT	UCS (tsf)	MOISTURE (%)	Surface Water Elev. (ft.)		ELEV (ft.)	DEPTH (ft.)	BLOW COUNT	UCS (tsf)	MOISTURE (%)
						Groundwater Elev.	First Encounter					
Offset												
Ground Surface Elev. 675.958 (ft.)												
SOIL DESCRIPTION	(ft.)	(ft.)	/6"	(tsf)	(%)	SOIL DESCRIPTION	(ft.)	(ft.)	/6"	(tsf)	(%)	
SILTY CLAY A-4 Brown, very moist, stiff, low plasticity, trace sand			4	1.1	15.9							
			2	0.6	22.5							
SILTY CLAY A-6 Brown, very moist, firm, low plasticity, trace gravel		5	1	0.6	26.8							
			2	0.4	18.3							
SILTY CLAY A-6 Mottled Brown, very moist, soft-firm, low plasticity, trace sand			2	0.99	12.9							
(*free water @ 7.5'		10	3	0.99	12.9							
CLAY LOAM A-6 Brown, moist, stiff, low plasticity, with sand trace gravel			4	0.95	23.7							
SILT A-4 Brown, very moist, stiff-very stiff, low plasticity, trace sand		15										
CLAY LOAM A-6 Gray, moist, hard, low plasticity, with sand trace gravel			60-6		13.7							
		20	46	0.44	21.5							
SILT A-4 Gray, very moist, hard, low plasticity, trace sand			36	8.66	10.3							
			40									
CLAY LOAM A-6 Gray, moist, hard, low plasticity, with sand trace gravel		25	26	6.1	10.7							
	649.958		23									
END OF BORING @ 26.0 FT.			31									
		30										

The Unconfined Compressive Strength (UCS) Failure Mode is indicated by (B-Bulge, S-Shear, P-Penetrometer).
 The Standard Penetration Test (SPT) N Value is per (AASHTO T206)

BBS 137 (9/05)



USER NAME = dheberling	DESIGNED - SDS	REVISED
FILE NAME = 60603202_5N058W003.dgn	CHECKED - CEH	REVISED
PLOT SCALE = 2.000" / ft.	DRAWN - DLH	REVISED
PLOT DATE = 4/6/2023	CHECKED - SDS	REVISED

STATE OF ILLINOIS
 DEPARTMENT OF TRANSPORTATION

BORINGS
 STRUCTURE NO. 058-W003

SHEET NO. SA-24 OF SA-26 SHEETS

F.A.U. RTE.	SECTION	COUNTY	TOTAL SHEETS	SHEET NO.
7448	09-00933-01-BR	MACON	1019	592
CONTRACT NO. 95893				

ILLINOIS FED. AID PROJECT

LAST SAVED DATE: 3/23/2023 10:45:11 AM



SOIL BORING LOG

Page 1 of 2
Project #: 916780
Date 03/2/20

ROUTE DESCRIPTION BRUSH COLLEGE ROAD LOGGED BY GC/EE
SECTION LOCATION DECATUR, ILLINOIS
COUNTY MACON COUNTY STRUCTURE NO. (Exist) (Prop.)
BORING NO. B-24 DRILLING METHOD MUD ROTARY HAMMER TYPE 140# SAFETY HAMMER

Table with columns for SOIL DESCRIPTION, ELEVATION, DEPTH, BLOW COUNT, UNCONFINED COMPRESSIVE STRENGTH (UCS), and MOISTURE CONTENT. Includes soil types like SAND A-1-a, CLAY LOAM A-6, and CONCRETE.

The Unconfined Compressive Strength (UCS) Failure Mode is indicated by (B-Bulge, S-Shear, P-Penetrometer).
The Standard Penetration Test (SPT) N Value is per (AASHTO T206)

BBS 137 (9/05)



SOIL BORING LOG

Page 2 of 2
Project #: 916780
Date 03/2/20

ROUTE DESCRIPTION BRUSH COLLEGE ROAD LOGGED BY GC/EE
SECTION LOCATION DECATUR, ILLINOIS
COUNTY MACON COUNTY STRUCTURE NO. (Exist) (Prop.)
BORING NO. B-24 DRILLING METHOD MUD ROTARY HAMMER TYPE 140# SAFETY HAMMER

Table with columns for SOIL DESCRIPTION, ELEVATION, DEPTH, BLOW COUNT, UNCONFINED COMPRESSIVE STRENGTH (UCS), and MOISTURE CONTENT. Includes soil types like CLAY LOAM A-6, SAND A-1-a, and SHALE.

The Unconfined Compressive Strength (UCS) Failure Mode is indicated by (B-Bulge, S-Shear, P-Penetrometer).
The Standard Penetration Test (SPT) N Value is per (AASHTO T206)

BBS 137 (9/05)

FILE NAME: C:\working\macom_d516_nal\proj15528\044066\60603202_S038W003.dgn

Design firm no. 184001036



Table with columns for USER NAME, FILE NAME, PLOT SCALE, PLOT DATE, DESIGNED, CHECKED, DRAWN, and CHECKED status.

STATE OF ILLINOIS DEPARTMENT OF TRANSPORTATION

BORINGS STRUCTURE NO. 058-W003

SHEET NO. SA-25 OF SA-26 SHEETS

Table with columns for F.A.U. RTE., SECTION, COUNTY, TOTAL SHEETS, SHEET NO., and CONTRACT NO.

ILLINOIS FED. AID PROJECT



SOIL BORING LOG

Page 1 of 2
Project #: 916780
Date 3/11/20

ROUTE _____ DESCRIPTION BRUSH COLLEGE ROAD LOGGED BY _____
SECTION _____ LOCATION DECATUR, ILLINOIS
COUNTY MACON COUNTY STRUCTURE NO. _____ (Exist) _____ (Prop.)
BORING NO. B-25 DRILLING METHOD _____ HAMMER TYPE 140# SAFETY HAMMER

Station	Offset	Ground Surface Elev. (ft.)	ELEV (ft.)	DEPTH (ft.)	BLOW S	UCS (tsf)	MOIST (%)	SOIL DESCRIPTION	ELEV (ft.)	DEPTH (ft.)	BLOW S	UCS (tsf)	MOIST (%)	SOIL DESCRIPTION
		674.997						16" CONCRETE			35	34		
				7				SILTY CLAY A-6			60-5		11.5	
				12	2.0	28.6		Brown, very moist, very stiff, low plasticity, trace sand -shelby tube						
				5										
				3				SAND A-1-a			60-6	4.6	10.4	
				5				Brown, very moist, loose, fine-medium, trace silt						
				10	6	1.6	14.6	CLAY LOAM A-6						
				8				Brown, moist, stiff, low plasticity, little sand, trace gravel -hard			45	7	10.5	
				9							18	28		
				16										
				35										
				15	10	4.7	15.2							
				26										
				34										
				4				(*free water @ 17.0'			50	21	12.9	
				7	1.9	12.7		CLAY LOAM A-6			25	35-6		
				12				Gray, moist, very stiff, low plasticity, with sand, trace gravel						
				20	5	2.4	10.5							
				8										
				12										
				7				SAND A-1-a			55	34		
				8	1.1	14.0		Gray, saturated, very dense, fine-coarse, trace gravel			40	20-3		
				16										
				25				-hard						
				18										
				24	1.4	11.8								
				26										
				10				-very stiff						
				12				-2 attempts no recovery						
				14										
				30				-begin mud rotary drilling						
				34				-hard						
				60-3										
				65										
				32										
				40										
				20-3										

The Unconfined Compressive Strength (UCS) Failure Mode is indicated by (B-Bulge, S-Shear, P-Penetrometer).
The Standard Penetration Test (SPT) N Value is per (AASHTO T206)

BBS 137 (9/05)



SOIL BORING LOG

Page 2 of 2
Project #: 916780
Date 3/11/20

ROUTE _____ DESCRIPTION BRUSH COLLEGE ROAD LOGGED BY _____
SECTION _____ LOCATION DECATUR, ILLINOIS
COUNTY MACON COUNTY STRUCTURE NO. _____ (Exist) _____ (Prop.)
BORING NO. B-25 DRILLING METHOD _____ HAMMER TYPE 140# SAFETY HAMMER

Station	Offset	Ground Surface Elev. (ft.)	ELEV (ft.)	DEPTH (ft.)	BLOW S	UCS (tsf)	MOIST (%)	SOIL DESCRIPTION	ELEV (ft.)	DEPTH (ft.)	BLOW S	UCS (tsf)	MOIST (%)	SOIL DESCRIPTION
		674.997						CLAY LOAM A-6			60-5		14.3	
				70				Gray, moist, hard, low plasticity, with sand, trace gravel						
				60-6										
				105										
				60-2										9.4
				75				-dense						
				27										
				20										
				23										
				110										
				60-3										14.8
				80										
				33										
				25										
				24										
				115										
				60-2										12.4
				85										
				60-6										
				120				SAND A-3						
				60-5				Gray, saturated, very dense fine						
				90										
				60-2										
				125				SHALE						
				60-5				Gray, moist, very dense, weathered						
				120										
				125										
				60-1										
				544.997				END OF BORING @ 130.0 FT.						
				60-1										

The Unconfined Compressive Strength (UCS) Failure Mode is indicated by (B-Bulge, S-Shear, P-Penetrometer).
The Standard Penetration Test (SPT) N Value is per (AASHTO T206)

BBS 137 (9/05)

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Design firm no. 184001036



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PLOT SCALE = 2.000" / ft.	DRAWN - DLH	REVISED
PLOT DATE = 4/6/2023	CHECKED - SDS	REVISED

STATE OF ILLINOIS
DEPARTMENT OF TRANSPORTATION

BORINGS
STRUCTURE NO. 058-W003

SHEET NO. SA-26 OF SA-26 SHEETS

F.A.U. RTE.	SECTION	COUNTY	TOTAL SHEETS	SHEET NO.
7448	09-00933-01-BR	MACON	1019	594
CONTRACT NO. 95893				
ILLINOIS FED. AID PROJECT				

Benchmark: "M" in Mueller on fire hydrant at Southeast corner of Cerro Gordo St. and Brush College Rd. - Elev. 652.58
 Existing Structure: None. New MSE wall and Precast Modular Wall to be constructed to support the north abutment and approach roadway to proposed SN 058-9202.
 Road to be closed during construction and traffic to be detoured.



PROP. CURVE P-BRUSH-5

P.I. Sta. = 65+34.81
 $\Delta = 11^{\circ}30'09''$ (RT)
 $D = 5^{\circ}18'19''$
 $R = 1,080.00'$
 $T = 108.77'$
 $L = 216.82'$
 $E = 5.46'$
 $e = NC$ (40 mph)
 $T.R. = N/A$
 $S.E. Run = N/A$
 $P.C. Sta. = 64+26.03$
 $P.T. Sta. = 66+42.85$

PROP. CURVE P-BRUSH-6

P.I. Sta. = 67+46.28
 $\Delta = 10^{\circ}56'28''$ (LT)
 $D = 5^{\circ}18'19''$
 $R = 1,080.00'$
 $T = 103.43'$
 $L = 206.24'$
 $E = 4.94'$
 $e = NC$ (40 mph)
 $T.R. = N/A$
 $S.E. Run = N/A$
 $P.C. Sta. = 66+42.85$
 $P.T. Sta. = 68+49.09$

Precast Modular Retaining Wall MSE Retaining Wall

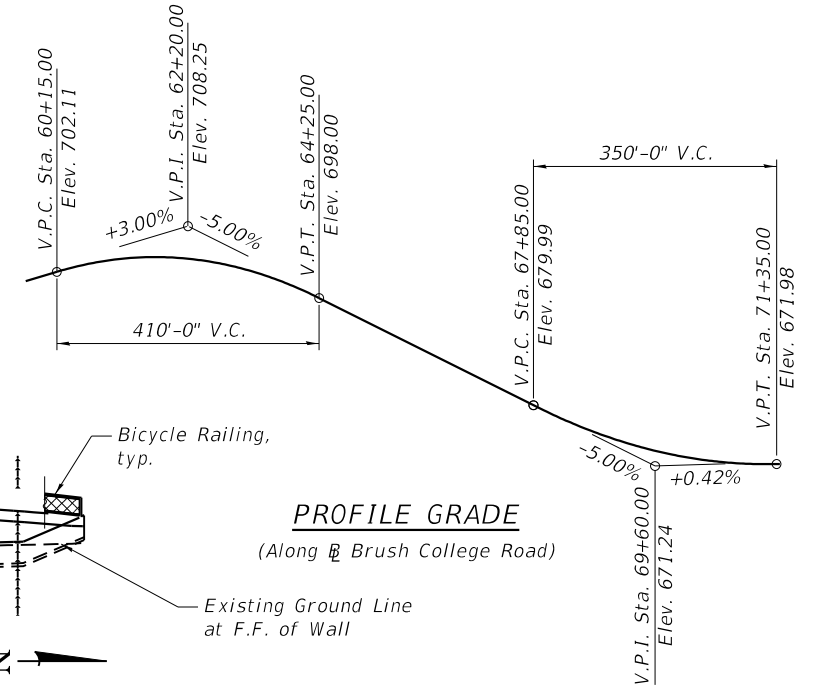
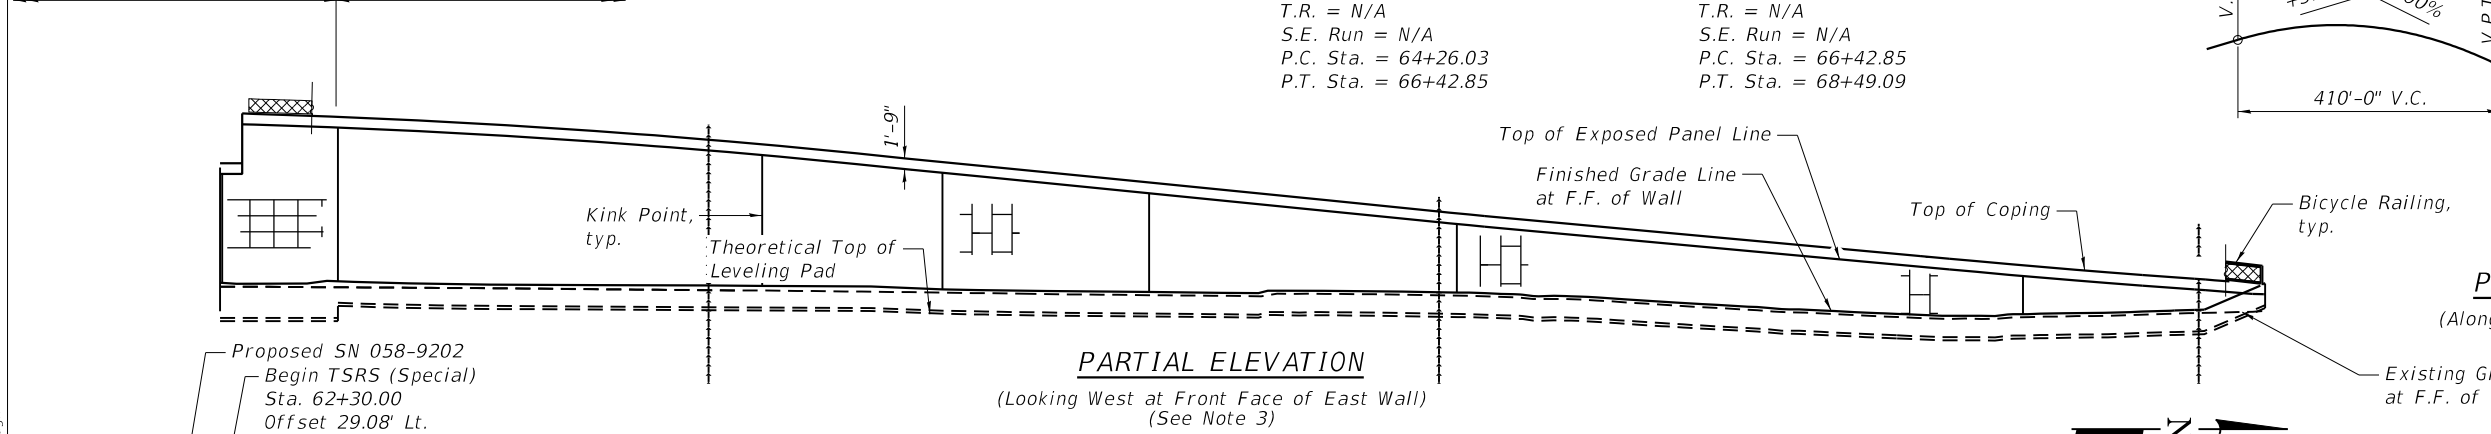


DESIGN SPECIFICATIONS
 2017 AASHTO LRFD Bridge Design Specifications, 8th Edition

DESIGN STRESSES

FIELD UNITS
 $f'_c = 4,000$ psi
 $f_y = 60,000$ psi (Reinforcement)

PRECAST UNITS
 $f'_c = 4,500$ psi

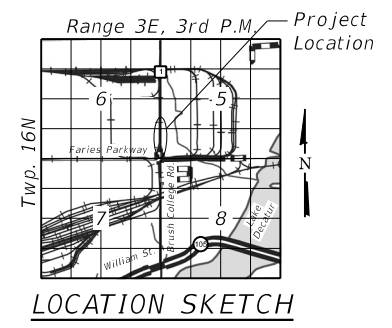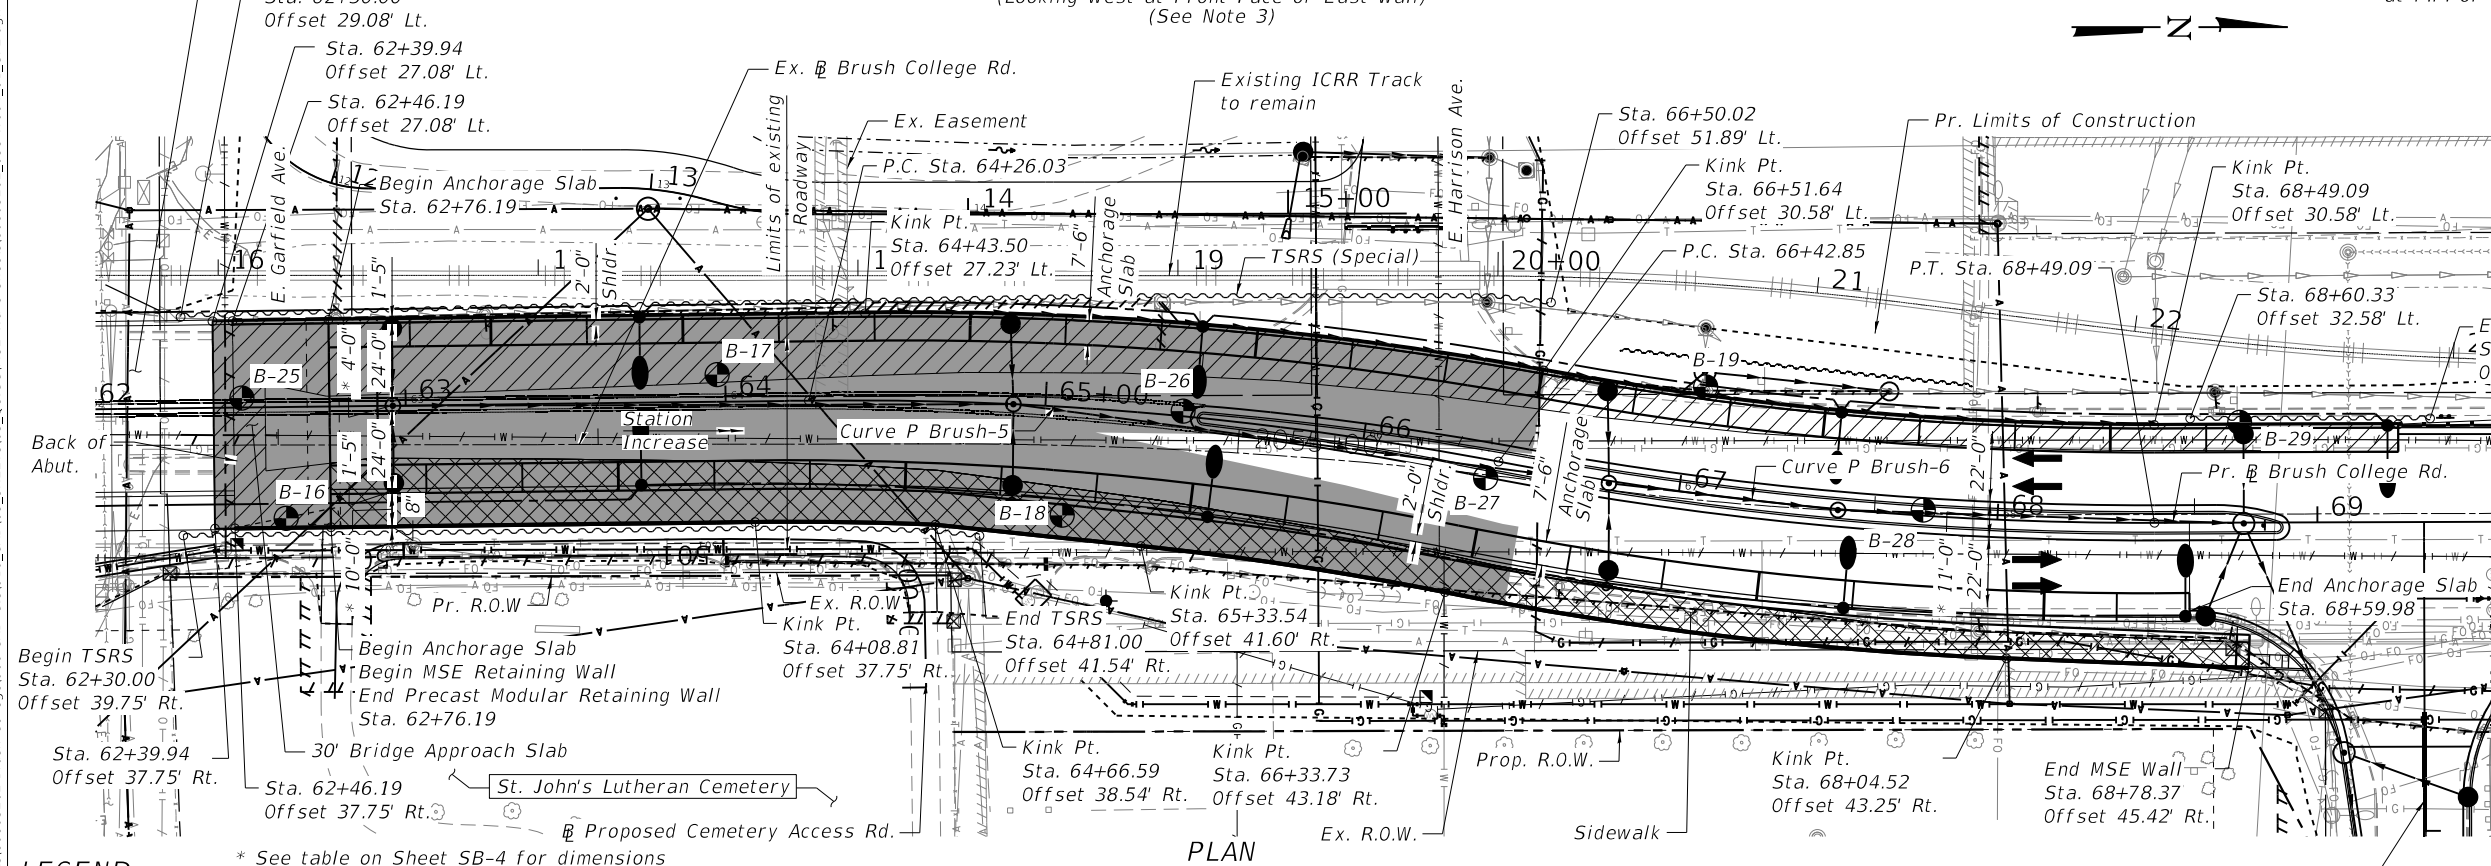


LEGEND

—G—	Ex. Gas Line	—W—	Abandoned Water Line
—W—	Ex. Water Line	—G—	Abandoned Gas Line
—T—	Ex. Underground Telephone Line	—O—	Abandoned Oil Line
—A—	Ex. Aerial Line	—L—	Pr. Buried Lighting Cable
—S—	Ex. Storm Sewer	—G—	Pr. Gas Line
—SS—	Ex. Sanitary Sewer	—W—	Pr. Water Line
—E—	Ex. Easement	—E—	Pr. Temporary Easement
—RR—	Ex. RR Track	—S—	Pr. Storm Sewer
—FO—	Ex. Underground Fiber Optic Line	—AL—	Pr. Above Ground Lighting
—M—	Approximate Precast Modular Retaining Wall Mass Limits	—BI—	Pr. Drainage Inlet
—R—	Approximate Limits of Reinforced Soil Mass	—SBL—	Soil Boring Location
—L—	Approximate Limits of Lightweight Concrete Cellular Fill	—TSRS—	Temporary Soil Retention System (TSRS)
		—WLR—	Water Line Removal

- Notes:**
1. Wall offsets are measured from Brush College Rd. to the front face of precast panels.
 2. F.F. denotes front face.
 3. See Sheet SB-3 for unfolded elevation view and wall details.
 4. Existing drainage and utilities in conflict with proposed construction will be abandoned or relocated.
 5. For TSRS details see Sheets SB-6 and SB-7.
 6. For existing ICRR track profile, see Sheet SB-2.

"I certify that to the best of knowledge, information, and belief, this structure design is structurally adequate for the design loading shown on the plans. The design is an economical one for the style of structure and complies with requirements of the current AASHTO Standard Specifications for Highway Bridges."

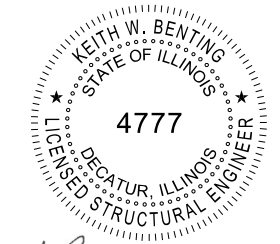

Keith W. Benting, Illinois S.E. 081-004777
 Expires 11/30/2024
 Date 4/17/2023

GENERAL PLAN & ELEVATION
BRUSH COLLEGE ROAD
 F.A.U. 7448 - SECTION 09-00933-01-BR
 MACON COUNTY
 STA. 62+39.94 TO STA. 69+25.33
 STRUCTURE NO. 058-W004



USER NAME = zdavison	DESIGNED - KWB	REVISED -
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PLOT SCALE = 60,000' / in.	DRAWN - LMC	REVISED -
PLOT DATE =	CHECKED - MDC	REVISED -

STATE OF ILLINOIS
 DEPARTMENT OF TRANSPORTATION

SHEET SB-1 OF SB-35 SHEETS

F.A.U. RTE.	SECTION	COUNTY	TOTAL SHEETS	SHEET NO.
7448	09-00933-01-BR	MACON	1019	595
CONTRACT NO. 95893				
ILLINOIS FED. AID PROJECT				

GENERAL NOTES

- Reinforcement bars designated (E) shall be epoxy coated.
- Wall stations and offsets are given to the front face (FF) of the wall and are measured from the Brush College Road baseline, except as noted.
- Protective Coat shall be applied to the top and interior surfaces of the parapets and the top exposed surface of the Anchorage Slabs and Sidewalk.
- Slipforming of parapets along east anchorage slab is not allowed.
- The Contractor shall field verify the location of all underground utilities. The contractor shall take precautions to protect existing underground utilities that are to remain in service during construction of the wall. Any damage to underground utilities will be the responsibility of the Contractor. For locations and elevations of utilities, see Utility Plans.
- The Contractor may encounter abandoned utilities or drainage structures that obstruct construction of the proposed wall. Removal and disposal of portions of these obstructions shall not be cause for additional payment but shall be included in the cost of "Precast Modular Retaining Wall". For locations and elevations of utilities, see Utility Plans.
- All Lightweight Cellular Concrete Fill shall be Class II. See Special Provisions.
- The Contractor shall coordinate the construction of the proposed wall with the construction of the proposed bridge over Faries Parkway (S.N. 058-9202). See Suggested Stages of Construction and Traffic Control Plans and special provisions.
- For details and quantity of conduits embedded in structure, see Electrical Plans.
- Fill type retaining walls (MSE and Precast Modular) shall be detailed and constructed to allow for proposed roadway drainage to be placed properly and as shown in the plans. Any requests for modification to drainage structure locations to accommodate wall reinforcing or details shall be submitted to the engineer in writing for review. Any changes approved by the engineer in writing will be coordinated by the contractor at no additional cost.

TOTAL BILL OF MATERIAL


ITEM	UNIT	TOTAL
Structure Excavation	Cu. Yd.	3,971
Concrete Structures	Cu. Yd.	424.8
Concrete Superstructure	Cu. Yd.	679.1
Protective Coat	Sq. Yd.	2,301
Reinforcement Bars, Epoxy Coated	Pound	111,340
Bicycle Railing	Foot	603
Parapet Railing	Foot	584
Name Plates	Each	1
Temporary Soil Retention System	Sq. Ft.	1,243
Mechanically Stabilized Earth Retaining Wall	Sq. Ft.	10,612
Precast Modular Retaining Wall	Sq. Ft.	16,346
Lightweight Cellular Concrete Fill	Cu. Yd.	21,687
Temporary Soil Retention System (Special)	Sq. Ft.	4,046
Portland Cement Concrete Sidewalk 5 inch, Special	Sq. Ft.	5,900
Pipe Underdrains for Structures, 4"	Foot	690

INDEX OF SHEETS

- SB-1. General Plan & Elevation
- SB-2. General Notes & Bill of Material
- SB-3. Developed Elevation
- SB-4. Typical Section
- SB-5. Typical Sections
- SB-6. Temporary Soil Retention System (Special)
- SB-7. Temporary Soil Retention System
- SB-8. West Anchorage Slab (1 of 7)
- SB-9. West Anchorage Slab (2 of 7)
- SB-10. West Anchorage Slab (3 of 7)
- SB-11. West Anchorage Slab (4 of 7)
- SB-12. West Anchorage Slab (5 of 7)
- SB-13. West Anchorage Slab (6 of 7)
- SB-14. West Anchorage Slab (7 of 7)
- SB-15. East Anchorage Slab (1 of 7)
- SB-16. East Anchorage Slab (2 of 7)
- SB-17. East Anchorage Slab (3 of 7)
- SB-18. East Anchorage Slab (4 of 7)
- SB-19. East Anchorage Slab (5 of 7)
- SB-20. East Anchorage Slab (6 of 7)
- SB-21. East Anchorage Slab (7 of 7)
- SB-22. Sidewalk (1 of 2)
- SB-23. Sidewalk (2 of 2)
- SB-24. Anchorage Slab & Wall Details (1 of 3)
- SB-25. Anchorage Slab & Wall Details (2 of 3)
- SB-26. Anchorage Slab & Wall Details (3 of 3)
- SB-27. Bicycle Railing (Sheet 1 of 2)
- SB-27A. Bicycle Railing (Sheet 2 of 2)
- SB-28. Concrete Parapet Slipforming Option
- SB-29. Soil Boring Logs (B-16)
- SB-30. Soil Boring Logs (B-17)
- SB-31. Soil Boring Logs (B-18)
- SB-32. Soil Boring Logs (B-19)
- SB-33. Soil Boring Logs (B-25)
- SB-34. Soil Boring Logs (B-26 & B-27)
- SB-35. Soil Boring Logs (B-28 & B-29)

STATION 62+39.94 TO 69+25.33
 BUILT BY
 CITY OF DECATUR
 F.A.U. 7448
 SEC. 09-00933-01-BR
 STR. NO. 058-W004

NAME PLATE
 See Std. 515001

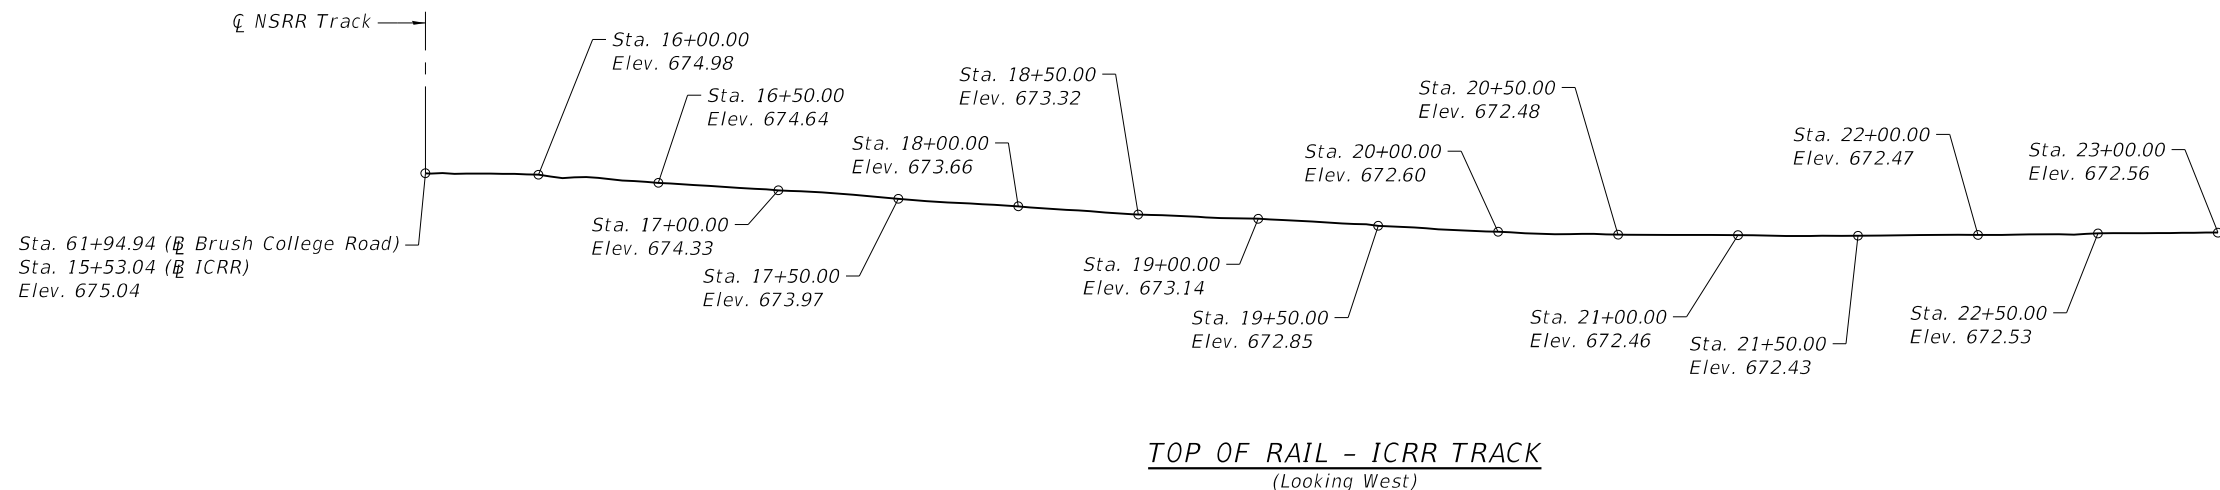

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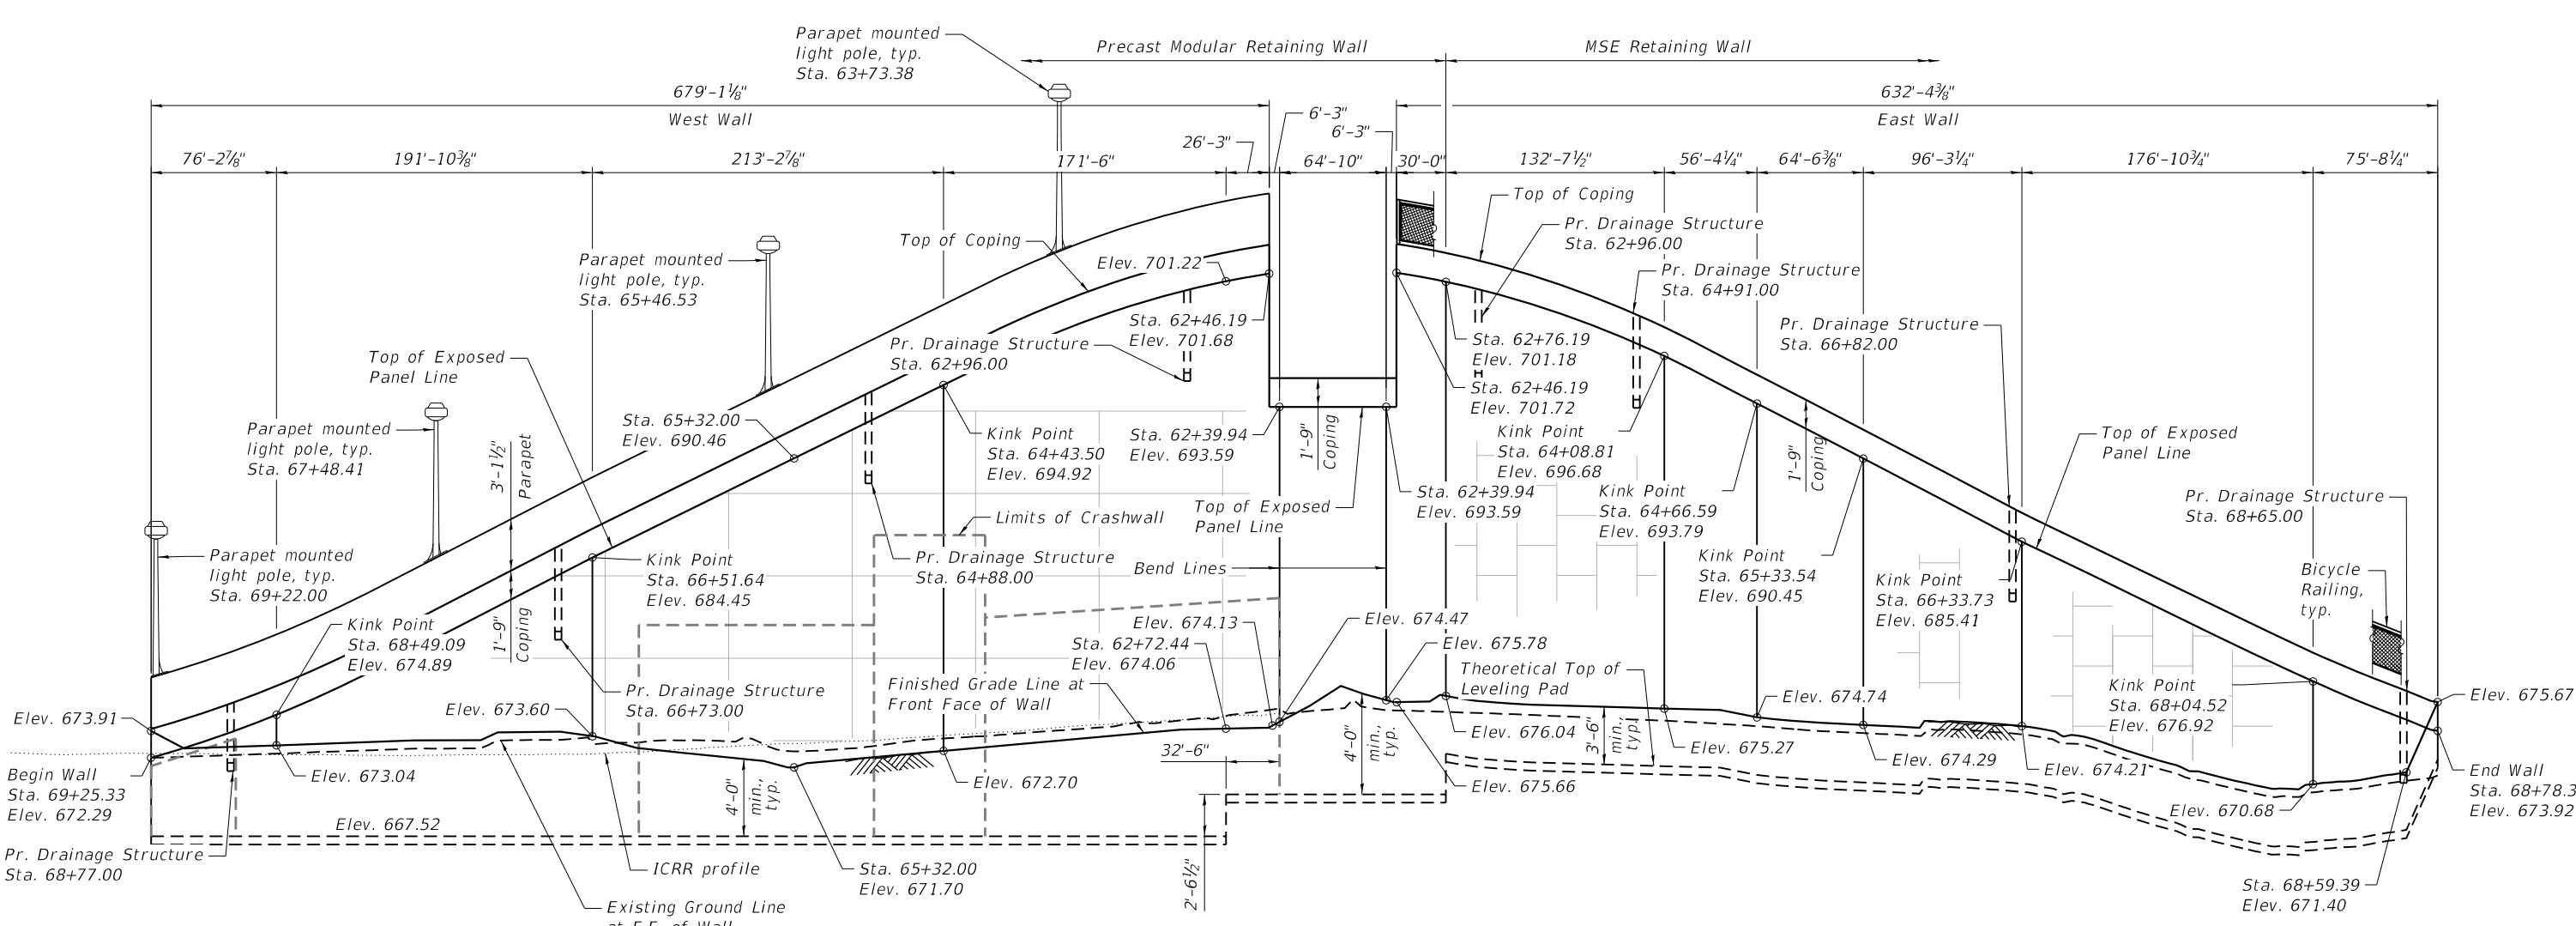
**STATE OF ILLINOIS
 DEPARTMENT OF TRANSPORTATION**

**GENERAL NOTES & BILL OF MATERIAL
 STRUCTURE NO. 058-W004**

SHEET SB-2 OF SB-35 SHEETS

F.A.U. RTE. 7448	SECTION 09-00933-01-BR	COUNTY MACON	TOTAL SHEETS 1019	SHEET NO. 596
			CONTRACT NO. 95893	
		ILLINOIS FED. AID PROJECT		

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ALLOWABLE BEARING PRESSURE

Location	Station	Static Limit State
		Allowable Bearing q_a (psf)
Abut	62+39.94	3,187
West	64+62.89	2,673
West	66+52.64	2,673
West	66+52.64	2,673
West	68+30.22	2,673
East	63+91.53	3,187
East	65+47.29	2,673
East	66+14.23	2,673
East	66+50.00	2,673
East	66+50.00	2,673
East	67+94.90	2,673

UNFOLDED ELEVATION

(Looking at Front Face of Wall)

Note:
All measurements are along the F.F. of wall.




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PLOT DATE =	CHECKED - MDC	REVISED -

**STATE OF ILLINOIS
DEPARTMENT OF TRANSPORTATION**

**DEVELOPED ELEVATION
STRUCTURE NO. 058-W004**

SHEET SB-3 OF SB-35 SHEETS

F.A.U. RTE.	SECTION	COUNTY	TOTAL SHEETS	SHEET NO.
7448	09-00933-01-BR	MACON	1019	597
CONTRACT NO. 95893				
		ILLINOIS	FED. AID PROJECT	

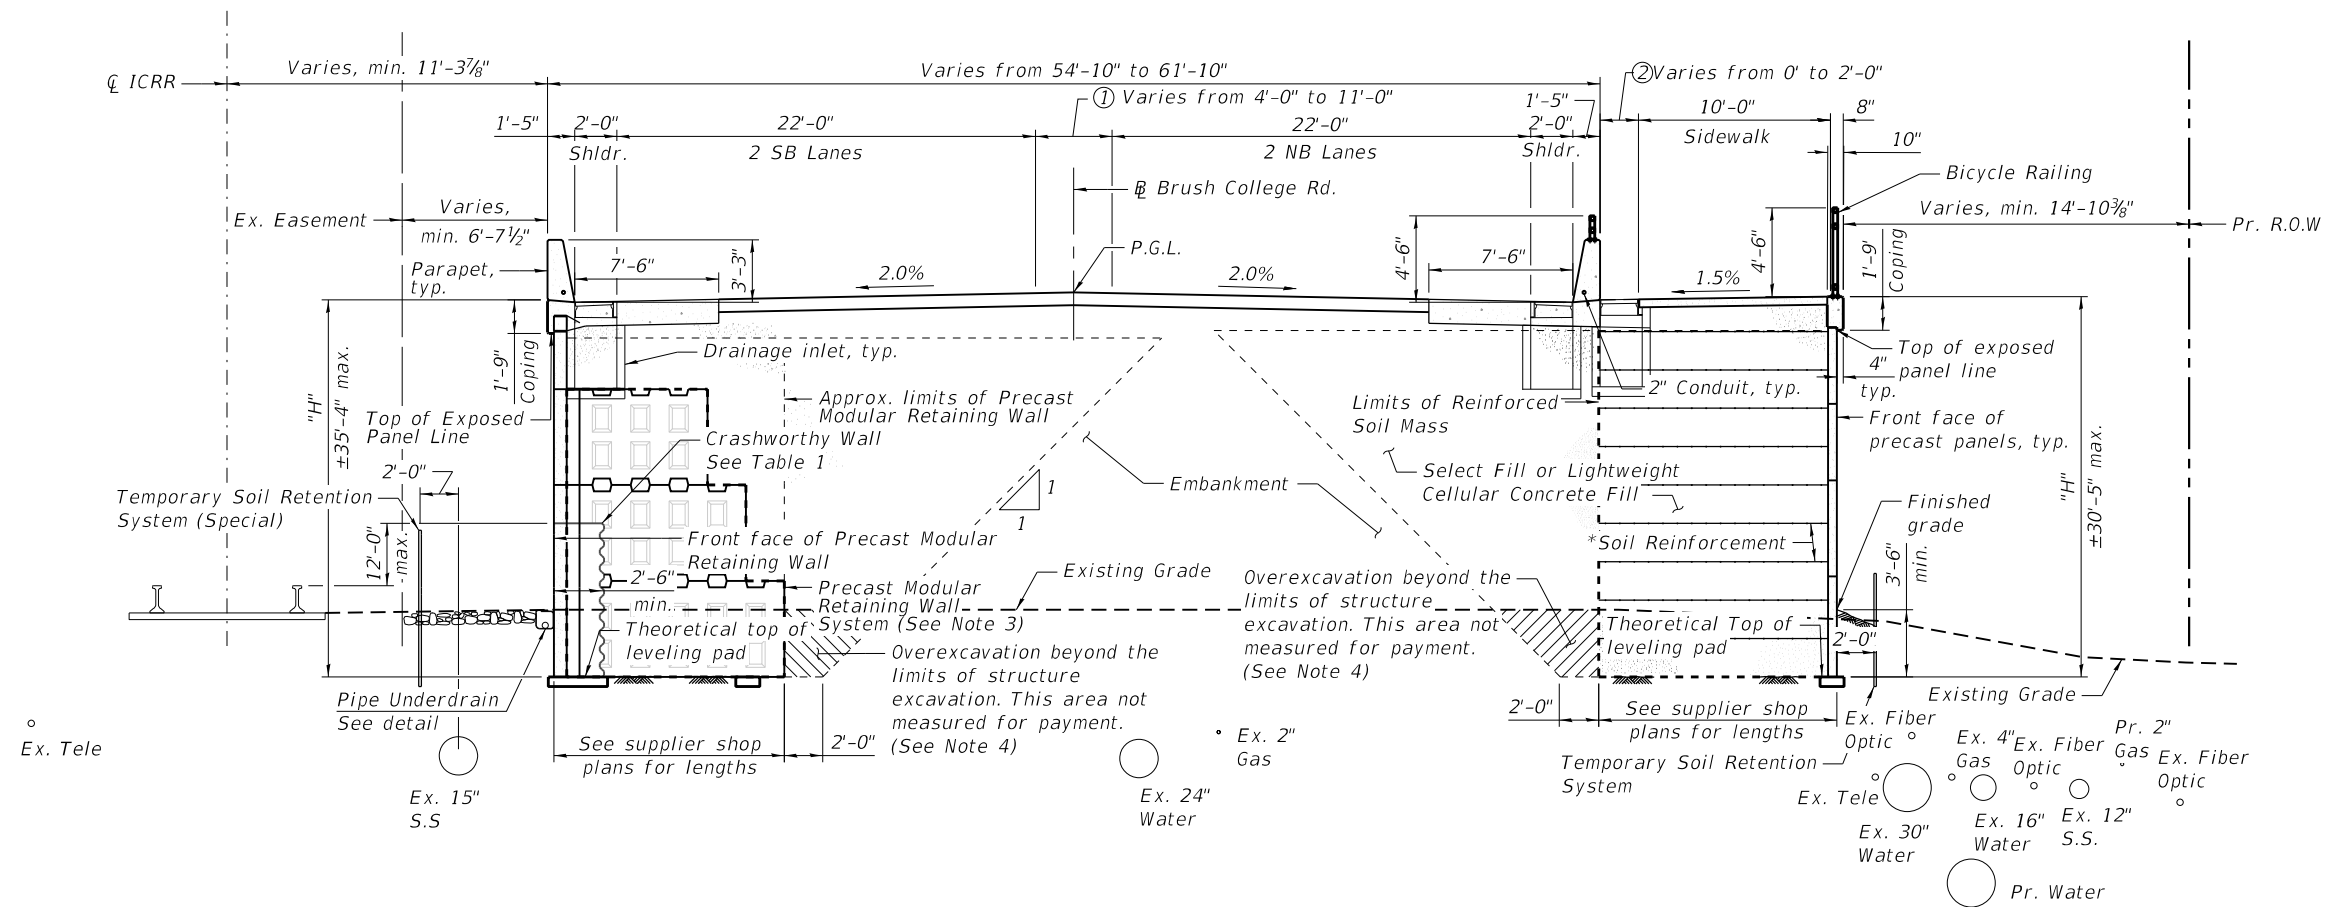

TYPICAL ROADWAY SECTION THROUGH RETAINING WALLS

(Looking North)

Notes:

1. See Sheet SB-5 of SB-35 for section through east wall beyond station 68+59.98.
2. Retaining wall shall be Crashworthy per 2020 Manual for Railway Engineering from a min. of 7'-0" above top of rail down to top of leveling pad for wall within 25' of the ϕ existing rail from Sta. 62+39.94 Lt. to Sta. 69+25.33 Lt., see cross sections. Cost of crashworthy concrete mass paid for as Concrete Structures.
3. The wall supplier's interval stability design shall account for the anchorage slab's bearing pressure surcharge of 1.0 ksf and horizontal sliding force of 0.67 kips/ft. of wall.
4. Backfill overexcavation with same material as used for select fill or lightweight cellular fill.

ROADWAY DIMENSION TABLE

Station	①	②
62+39.94	4'-0"	0
64+08.81	4'-0"	0
64+67.08	5'-3 $\frac{1}{8}$ "	0
65+33.42	7'-5 $\frac{3}{4}$ "	2'-0"
65+47.63	7'-11 $\frac{1}{4}$ "	2'-0"
66+51.64	11'-0"	2'-0"
68+04.52	11'-0"	2'-0"
68+59.98	11'-0"	3'-4 $\frac{3}{4}$ "


(Raised Median)

(Note 1)

TABLE 1 - CRASHWORTHY WALL LIMITS

Start Station	Top of CW Elev.	Height (ft.)	End Station	Top of CW Elev.	Height (ft.)	Length (ft.)
62+39.94	681.98	11.92	62+72.44	681.77	11.71	32.50
62+72.44	681.77	14.25	64+18.60	680.85	13.33	146.16
64+18.60	685.85	18.33	64+84.68	685.85	18.33	67.59
64+84.68	680.34	12.82	66+23.86	680.34	12.82	142.93
66+23.86	N/R	N/R	68+73.83	N/R	N/R	244.66
68+73.83	673.45	5.93	69+25.33	671.79	4.27	51.50

N/R - Crashworthy Wall not required

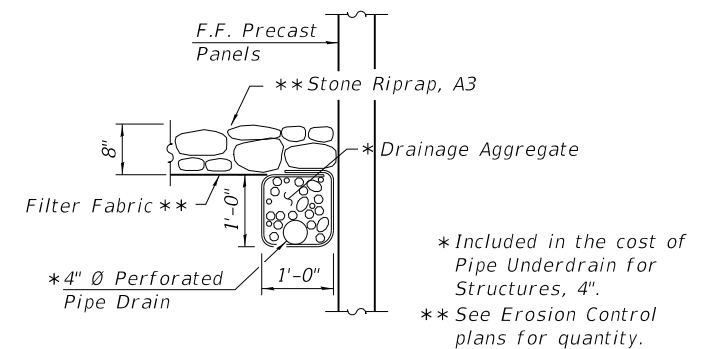

PIPE UNDERDRAIN DETAIL

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4/5/2023 12:33:02 PM



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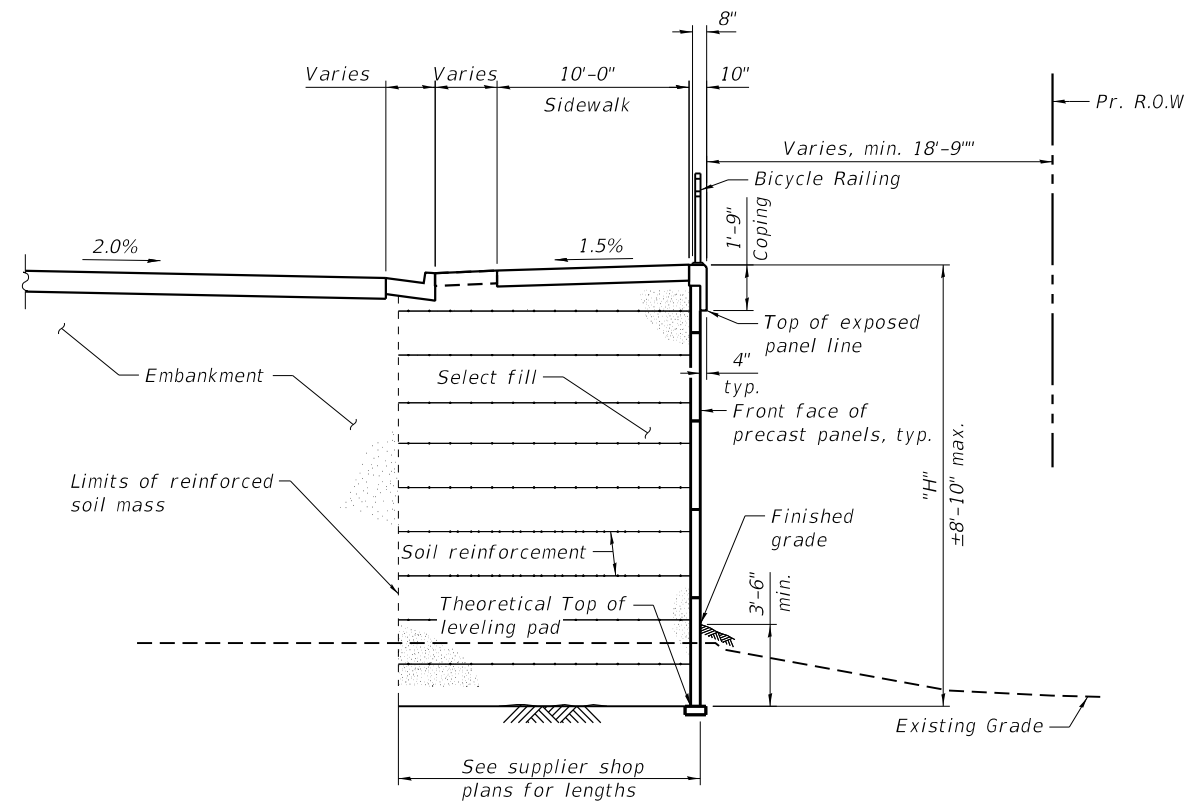
**STATE OF ILLINOIS
DEPARTMENT OF TRANSPORTATION**

**TYPICAL SECTION
STRUCTURE NO. 058-W004**

SHEET SB-4 OF SB-35 SHEETS


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7448	09-00933-01-BR	MACON	1019	598
CONTRACT NO. 95893				
ILLINOIS		FED. AID PROJECT		

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SECTION THROUGH EAST MSE WALL
 (From Sta. 68+59.98 to Sta. 68+78.37)

- Notes:
1. Section thru abutment showing IC railroad running parallel to the bridge beyond the west side of the structure. Crashworthy retaining walls shall extend 7'-0" above top of rail for wall within 25' of the ϕ existing rail.
 2. Fabric Reinforced Elastomeric Mat according to Section 1028 of the Standard Specifications. Fabric mat shall be 24" wide and attached full width and vertically at edges to the abutment cap with a $\frac{3}{8}$ " x 5" steel plate and $\frac{1}{2}$ " ϕ studs with nuts and washers at 12" cts. Cost included with Concrete Superstructure.



SECTION THROUGH SEMI-INTEGRAL ABUTMENT
 (Horiz. dim. @ Rt. L's)

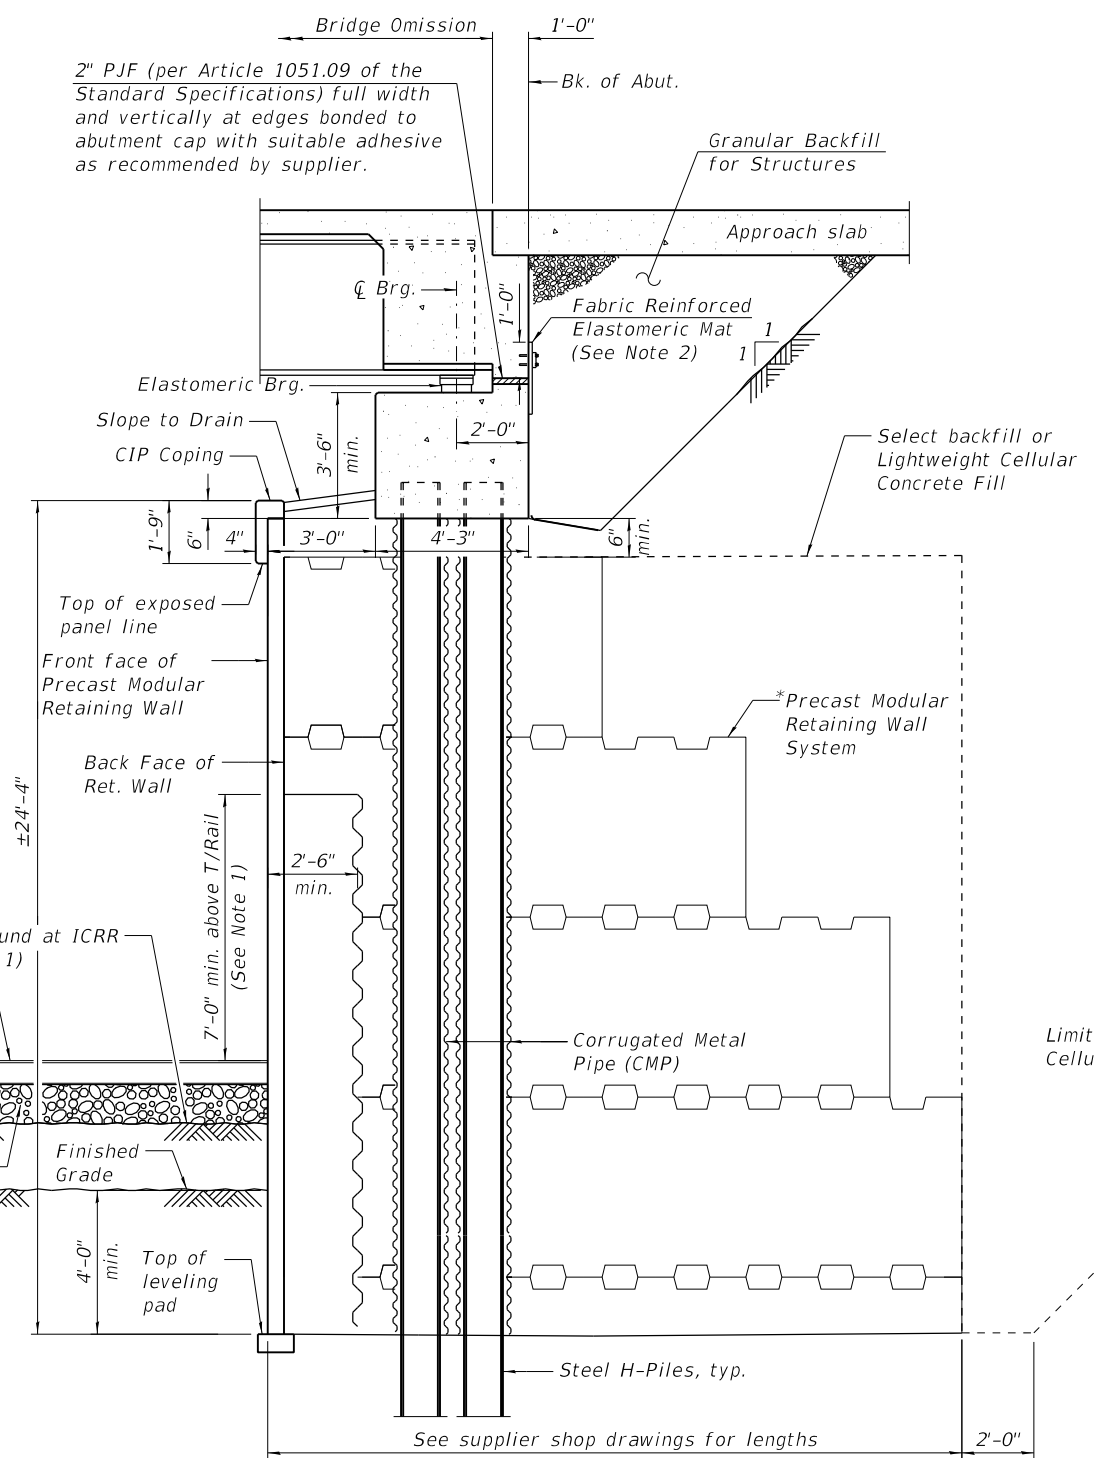* The Precast Modular Wall supplier's internal stability design shall account for the anchorage slab's bearing pressure surcharge of 1.0 ksf and horizontal sliding force of 0.67 kips/ft. of wall.







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STATE OF ILLINOIS
DEPARTMENT OF TRANSPORTATION

TYPICAL SECTIONS
STRUCTURE NO. 058-W004

SHEET SB-5 OF SB-35 SHEETS

F.A.U. RTE.	SECTION	COUNTY	TOTAL SHEETS	SHEET NO.
7448	09-00933-01-BR	MACON	1019	599
CONTRACT NO. 95893				
ILLINOIS		FED. AID PROJECT		

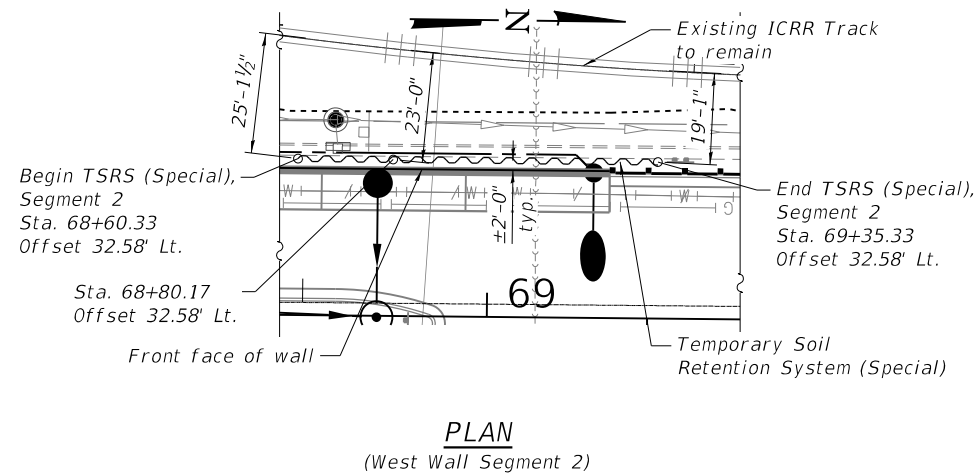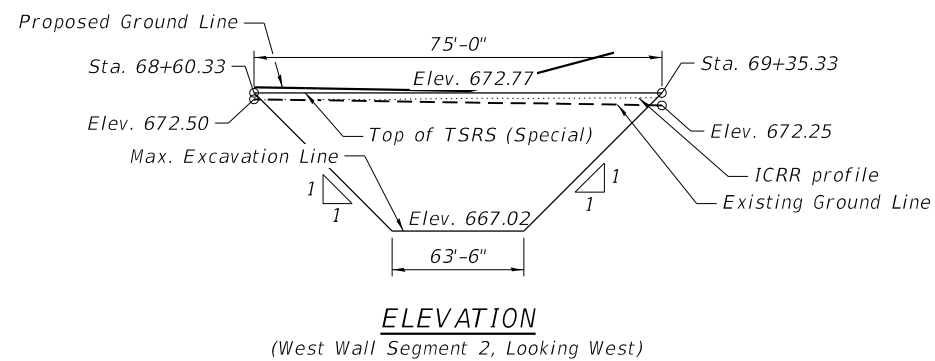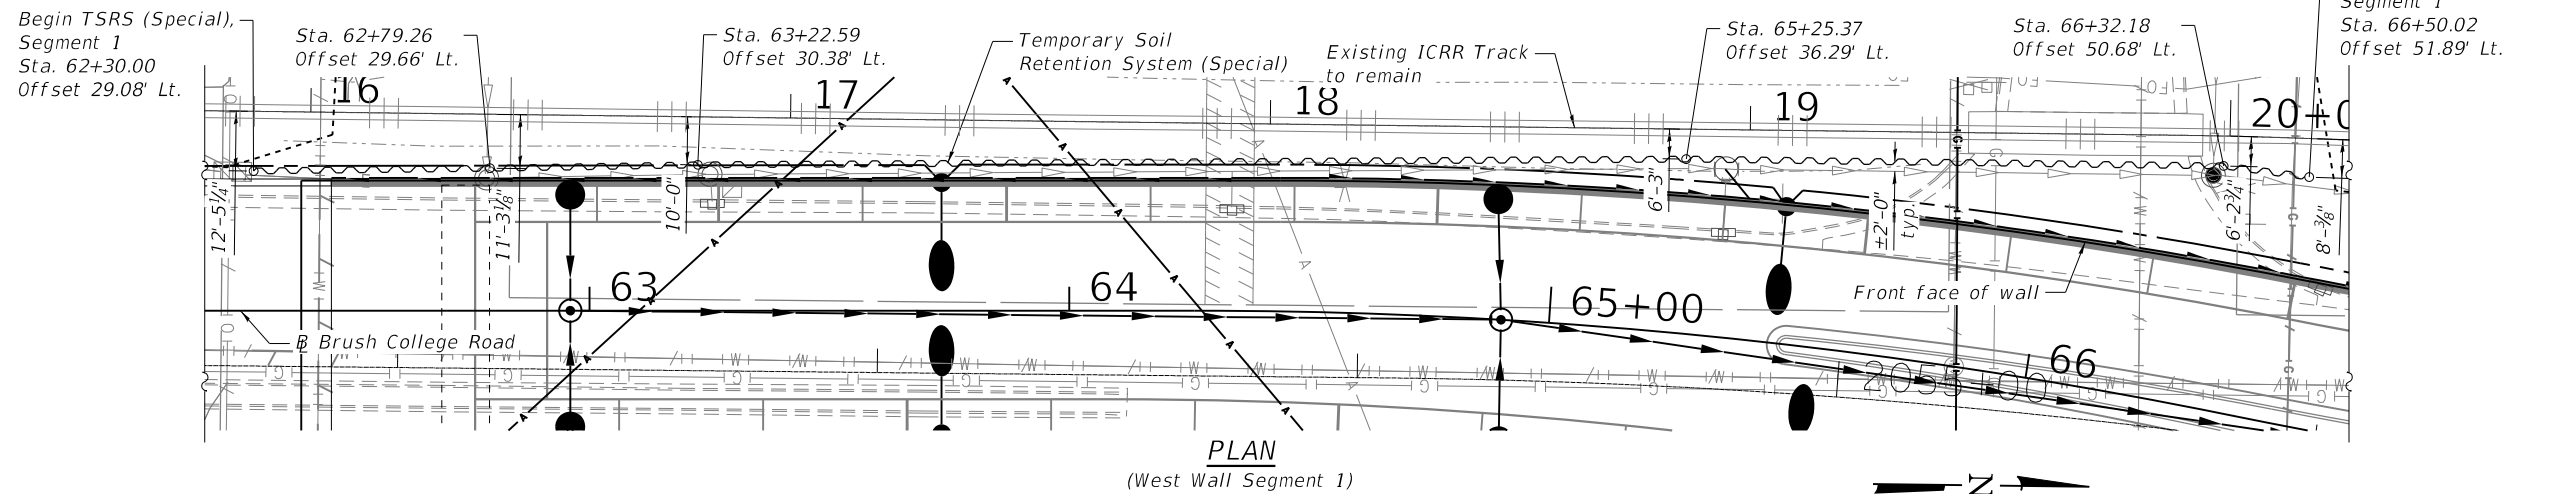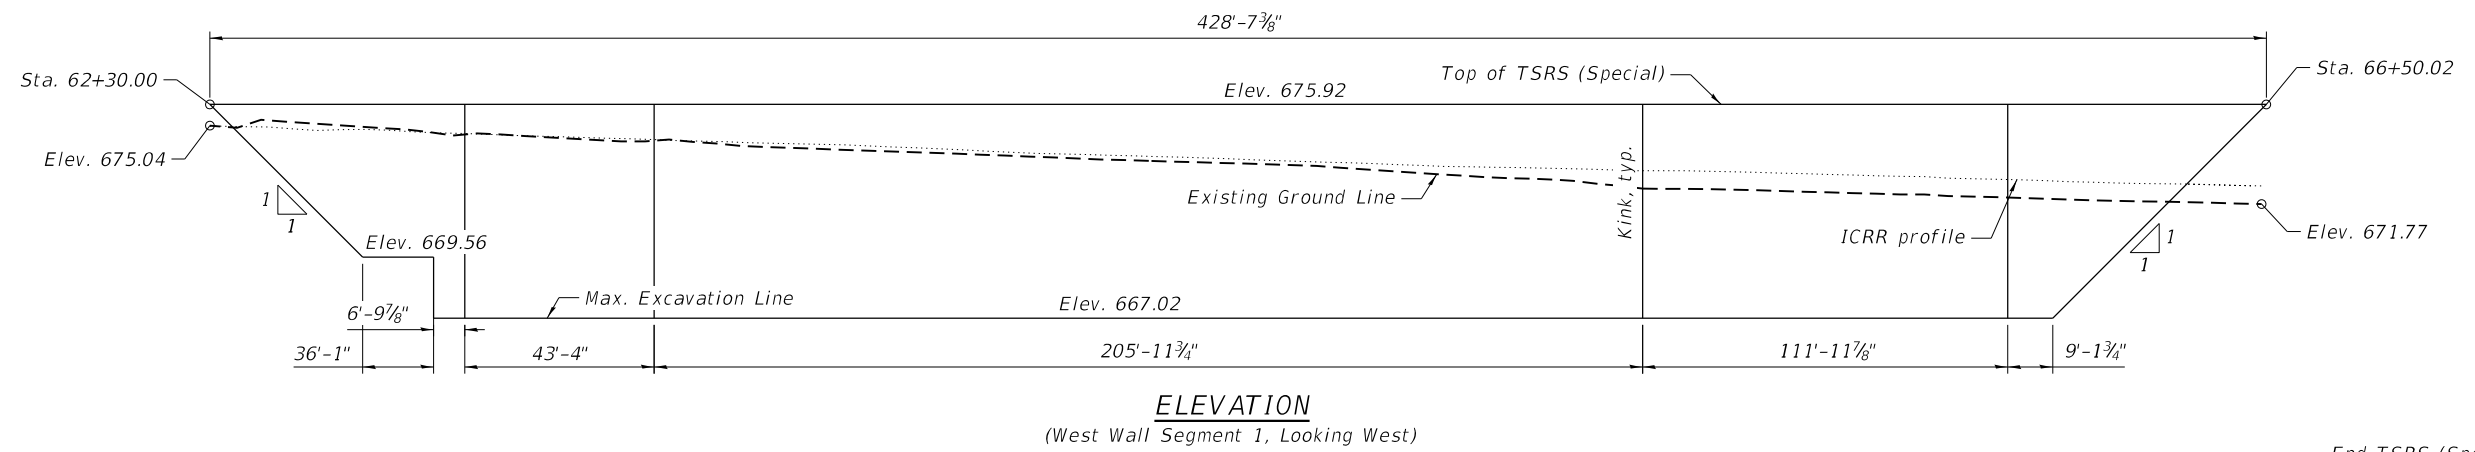

- Notes:
1. A cantilevered sheet piling design does not appear feasible and additional members or other retention systems may be necessary. The Contractor shall submit a temporary soil retention system design including plan details and calculations for review and acceptance by the Engineer.
 2. Horizontal dimensions and grounds slopes are shown along the Temporary Soil Retention System unless noted otherwise.
 3. Temporary Soil Retention System is paid for as Temporary Soil Retention System (Special). See Special Provisions.
 4. The contractor is alerted to the presence of underground utilities under the proposed Temporary Soil Retention System and may need to be kept in service during construction of the wall. See Drainage and Utility Plans.

BILL OF MATERIAL

Item	Unit	Quantity
* Temporary Soil Retention System (Special)	Sq. Ft.	4,046

* See Special Provisions

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STATE OF ILLINOIS
DEPARTMENT OF TRANSPORTATION

TEMPORARY SOIL RETENTION SYSTEM (SPECIAL)
STRUCTURE NO. 058-W004

SHEET SB-6 OF SB-35 SHEETS

F.A.U. RTE.	SECTION	COUNTY	TOTAL SHEETS	SHEET NO.
7448	09-00933-01-BR	MACON	1019	600
CONTRACT NO. 95893				
		ILLINOIS	FED. AID PROJECT	