06-17-2022 LETTING ITEM 109

FOR INDEX OF SHEETS, SEE SHEET NO. 2

FOR INDEX OF HIGHWAY STANDARDS, SEE SHEET NO. 2

BARCLAY BOULEVARD POSTED SPEED LIMIT = 30 MPH 2019 AADT = 4950FUNCTIONAL CLASSIFICATION = MAJOR COLLECTOR

STATE OF ILLINOIS **DEPARTMENT OF TRANSPORTATION**


PLANS FOR PROPOSED FEDERAL AID HIGHWAY

FAU 1677 (BARCLAY BOULEVARD) APTAKISIC ROAD TO HALF DAY ROAD RESURFACING

> **SECTION: 20-00025-00-RS PROJECT: 229J(968)**

VILLAGE OF LINCOLNSHIRE LAKE COUNTY

C-91-121-22

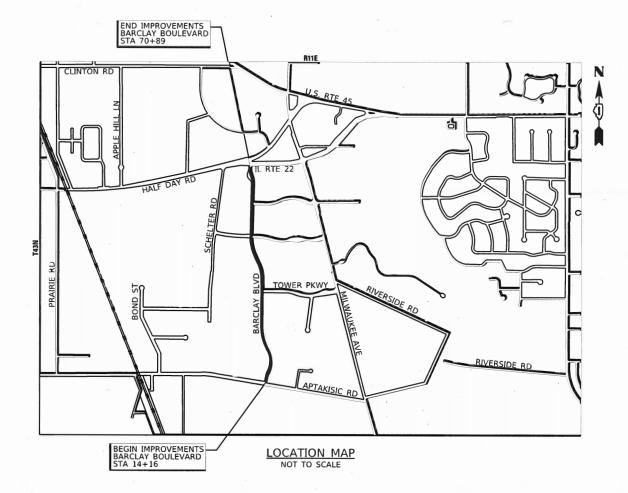

GROSS LENGTH = 5,673 FT. = 1.074 MILE NET LENGTH = 5,673 FT. = 1.074 MILE

TRAFFIC DATA

ENGINEERING SCALES. REDUCED SIZED PLANS WILL NOT CONFORM TO STANDARD SCALES. IN MAKING MEASUREMENTS ON REDUCED PLANS, THE ABOVE SCALES MAY BE USED.

J.U.L.I.E. DESIGN STAGE REQUEST

DIG. No. A2382968

CONTACT JULIE AT 811 OR 800-892-0123

CITY-TWNSHP. = <u>LINCOLNSHIRE</u>

SEC. & 1/4 SEC. NO. = <u>\$15/\$22/\$27 T43N R11E</u>

ONE CALL SYSTEM

48 HOURS (2 working days) BEFORE YOU DIG

CONTRACT NO. 61H79

20-00025-00-RS LAKE 25 1 CONTRACT NO. 61H79





PRINTED BY THE AUTHORITY OF THE STATE OF ILLINOIS

B&W PROJECT NO.: 211456

DATE: 4/4/2022

INDEX OF SHEETS

25

1,	COVER SHEET
2	INDEX OF SHEETS AND HIGHWAY STANDARDS
3	GENERAL NOTES
4 - 9	SUMMARY OF QUANTITIES
10	SCHEDULE OF QUANTITIES
11	TYPICAL SECTIONS
12 - 17	ROADWAY PLAN BARCLAY BOULEVARD
18	FRAMES AND LIDS ADJUSTMENT WITH MILLING (BD-08)
19	PAVEMENT PATCHING FOR HMA SURFACED PAVEMENT (BD-22)
20	CURB OR CURB AND GUTTER REMOVAL AND REPLACEMENT (BD-24)
21	BUTT JOINT AND HMA TAPER (BD-32)
22	TRAFFIC CONTROL & PROTECTION FOR SIDE ROADS, INTERSECTIONS, & DRIVEWAYS (TC-10
23	DISTRICT ONE TYPICAL PAVEMENT MARKINGS (TC-13)
24	SHORT-TERM PAVEMENT MARKING LETTERS AND SYMBOLS (TC-16)

ARTERIAL ROAD INFORMATION SIGN (TC-22)

HIGHWAY STANDARDS

000001-08	STANDARD SYMBOLS, ABBREVIATIONS AND PATTERNS
001001-02	AREAS OF REINFORCEMENT BARS
001006	DECIMAL OF AN INCH AND OF A FOOT
280001-07	TEMPORARY EROSION CONTROL SYSTEMS
424021-06	DEPRESSED CORNER FOR SIDEWALKS
442201-03	CLASS C AND D PATCHES
606001-08	CONCRETE CURB TYPE B AND COMBINATION CONCRETE CURB AND GUTTER
701006-05	OFF-RD OPERATIONS, 2L, 2W, 15' (4.5 m) TO 24" (600 mm) FROM PAVEMENT EDGE
701011-04	OFF-RD MOVING OPERATIONS, 2L, 2W, DAY ONLY
701301-04	LANE CLOSURE, 2L, 2W, SHORT TIME OPERATIONS
701311-03	LANE CLOSURE 2L, 2W MOVING OPERATIONS - DAY ONLY
701501-06	URBAN LANE CLOSURE, 2L, 2W, UNDIVIDED
701701-10	URBAN LANE CLOSURE, MULTILANE INTERSECTION
701311-03	TRAFFIC CONTROL DEVICES
720001-01	SIGN PANEL MOUNTING DETAILS
720006-04	SIGN PANEL ERECTION DETAILS
720011-01	METAL POSTS FOR SIGNS, MARKERS & DELINEATORS
729001-01	APPLICATIONS OF TYPES A & B METAL POSTS (FOR SIGNS & MARKERS)
780001-05	TYPICAL PAVEMENT MARKINGS

DISTRICT DETAILS

SCALE: NTS

BD-08	FRAMES AND LIDS ADJUSTMENT WITH MILLING
BD-22	PAVEMENT PATCHING FOR HMA SURFACED PAVEMENT
BD-24	CURB OR CURB AND GUTTER REMOVAL AND REPLACEMENT
TC-10	TRAFFIC CONTROL & PROTECTION FOR SIDE ROADS, INTERSECTIONS, & DRIVEWAYS
TC-13	DISTRICT ONE TYPICAL PAVEMENT MARKINGS
TC-16	SHORT-TERM PAVEMENT MARKING LETTERS AND SYMBOLS
TC-22	ARTERIAL ROAD INFORMATION SIGN

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BAXTER WOODMAN Consulting Engineers

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STATE OF ILLINOIS DEPARTMENT OF TRANSPORTATION

	. 05 .							F.A.U RTE.	SECTION	COUNTY	TOTAL SHEETS	SHEET NO.
INDEX	(UF S	SHE	-15	AN	D HIG	HWAY	STANDARDS	1677	20-00025-00-RS	LAKE	25	2
										CONTRAC	T NO. 6	1H79
ITS	SHEET	1	ΩE	1	SHEETS	STA	TO STA	3	Lauranous Lutro	10 BBOJECT 30 C	0035 00 00	10

- 1. ALL CONSTRUCTION SHALL BE DONE IN ACCORDANCE WITH THE DETAILS IN THE PLANS. THE SPECIAL PROVISIONS INCLUDED IN THE CONTRACT DOCUMENTS, AND THE EDITION ADOPTED JANUARY 1, 2022 OF THE "THE STANDARD SPECIFICATIONS FOR ROAD AND BRIDGE CONSTRUCTION" (REFERRED TO AS THE "STANDARD SPECIFICATIONS"), THE "SUPPLEMENTAL SPECIFICATIONS AND RECURRING SPECIAL PROVISIONS", THE "MANUAL ON UNIFORM TRAFFIC CONTROL DEVICES FOR STREETS AND HIGHWAYS 2009 EDITION", THE "MANUAL OF TEST PROCEDURES FOR MATERIALS, 2019 EDITION" AND THE "STANDARD SPECIFICATIONS FOR WATER AND SEWER MAIN CONSTRUCTION IN ILLINOIS, 8TH EDITION"
- 2. THE LOCATIONS OF PUBLIC AND PRIVATE UTILITIES SHOWN ON THE PLANS REPRESENTS ONLY THE OPINION OF THE VILLAGE AND IS ONLY INCLUDED FOR THE CONVENIENCE OF THE BIDDER AND THE ACCURACY IS NOT GUARANTEED. THE CONTRACTOR SHALL BE RESPONSIBLE FOR THE PROTECTION OF ALL UNDERGROUND OR SURFACE UTILITIES, INCLUDING SPRINKLER SYSTEMS, EVEN THOUGH THEY MAY NOT BE SHOWN ON THE PLANS. THE CONTRACTOR SHALL ALSO VERIFY THE DEPTHS OF THE EXISTING UTILITIES IF NECESSARY TO VERIFY THAT GRADE CONFLICTS WILL NOT OCCUR WITH ANY PROPOSED UTILITIES PRIOR TO CONSTRUCTION AND ORDERING ANY MATERIALS. ANY RELOCATION OR LOWERING OF UTILITIES SHALL BE COORDINATED BY THE CONTRACTOR.
- 3. THE CONTRACTOR SHALL NOTIFY THE VILLAGE PUBLIC WORKS ADMINISTRATOR AT LEAST 48 HOURS IN ADVANCE OF BEGINNING WORK TO OBTAIN VILLAGE UTILITY LOCATIONS
- THE CONTRACTOR MAY OBTAIN MUNICIPAL WATER IN BULK, AT NO CHARGE, AS LONG AS THERE IS NOT A "WATERING BAN" IN FEFECT. THE INDISCRIMINATE USE OF FIRE HYDRANTS IS STRICTLY PROHIBITED. WATER FOR CONSTRUCTION SHALL BE METERED OR OTHERWISE ACCOUNTED FOR AND A DAILY LOG MAINTAINED. THE CONTRACTOR SHALL PROVIDE THE WATER TRUCK AND DRIVER REQUIRED TO OBTAIN AND TRANSPORT THIS WATER. THE VILLAGE RESERVES THE RIGHT TO RESTRICT OR REFUSE THE USE OF VILLAGE WATER IF DEEMED NECESSARY.
- ACCESS TO PRIVATE DRIVEWAYS SHALL BE PROVIDED AT ALL TIMES EXCEPT DURING ACTUAL CONSTRUCTION ADJACENT THERE TO. TEMPORARY RAMPS SHALL BE CONSTRUCTED AS NEEDED TO PROVIDE SUCH ACCESS, UTILIZING CRUSHED STONE OR CRUSHED GRAVEL.
- 6. IT WILL BE THE CONTRACTOR'S RESPONSIBILITY TO NOTIFY RICHARD WILLIAM FROM PACE (847) 228-3584 AT LEAST 7 BUSINESS DAYS PRIOR TO WORK ADJACENT TO BUS STOPS
- 7. ALL COMMERCIAL PROPERTIES SHALL BE PROVIDED AT LEAST ONE INGRESS AND ONE EGRESS EITHER ON THE MAINLINE OR A SIDE STREET AT ALL TIMES. ACCESS TO LOADING DOCS SHALL BE MAINTAINED, THE CONTRACTOR SHALL COORDINATE DRIVEWAY CLOSURES/MODIFICATIONS WITH THE LOCAL BUSINESSES AND THE ENGINEER. COMMERCIAL DRIVEWAYS WHICH CANNOT BE CLOSED, AS DETERMINED BY THE ENGINEER, SHALL BE CONSTRUCTED IN STAGES ALLOWING FOR ACCESS AT ALL TIMES, HIGH EARLY STRENGTH CONCRETE MAY BE USED.
- ALL REMOVED SIGNS SHALL BE DELIVERED TO THE VILLAGE OF LINCOLNSHIRE PUBLIC WORKS, 205 SCHELTER ROAD. THE DATE AND TIME SHALL BE COORDINATED BY THE ENGINEER, ALL EXISTING SIGN POSTS SHALL BE DISCARDED IN A APPROPRIATE MANNER BY THE CONTRACTOR.
- 9. A 1/2-INCH THICK EXPANSION JOINT SHALL BE PROVIDED AT THE JUNCTION OF THE DRIVEWAY APRON AND CURB, AND AT THE JUNCTION OF THE DRIVEWAY APRON AND THE SIDEWALK.
- 10. THE CONTRACTOR SHALL CONTACT THE LOCAL AGENCY MATERIAL INSPECTOR AT LEAST 48 HOURS PRIOR TO ANY CONCRETE OR HOT-MIX ASPHALT MATERIAL DELIVERIES
- 11. ALL FRAME AND LID CASTINGS LOCATED WITHIN THE PAVEMENT WHICH REQUIRE RESETTING TO FINISH GRADE SHALL BE BACKFILLED WITH CLASS SI CONCRETE AND ALLOWED TO CURE FOR 72 HOURS PRIOR TO PLACEMENT OF SURFACE COURSE. CLASS PP CONCRETE SHALL BE USED IF PLACEMENT OF SURFACE COURSE IS PLANNED IN LESS THAN 72 HOURS. HMA MATERIALS WILL NOT BE ALLOWED AS BACKFILL AROUND AN ADJUSTED CASTING. THIS WORK SHALL APPLY TO ALL CASTINGS ADJUSTED OR RECONSTRUCTED AS PART OF THIS CONTRACT, WHETHER PAID FOR SEPARATELY OR INCLUDED IN OTHER CONTRACT WORK.
- 12. THE TOP OF ALL NEW CURB BOXES ON DRAINAGE STRUCTURES SHALL BE STAMPED "DUMP NO WASTE - DRAINS TO RIVER"
- 13. ON STREETS TO BE FULL WIDTH MILLED (2" OR MORE), THE EXISTING STRUCTURES IN THE PAVEMENT SHALL BE ADJUSTED IN ACCORDANCE WITH THE IDOT DETAIL "DETAILS FOR FRAMES AND LIDS ADJUSTMENT WITH MILLING".
- 14. WHEN MILLED PAVEMENT IS OPEN TO TRAFFIC, THE MAXIMUM GRADE DIFFERENTIAL BETWEEN PASSES OF THE MILLING MACHINE SHALL NOT EXCEED 1 ½ INCHES WHERE THE SPEED LIMIT IS 45 MPH OR LESS, AND SHALL NOT EXCEED 1 INCH WHERE THE SPEED LIMIT IS OVER 45 MPH. A MAXIMUM GRADE DIFFERENCE OF 3 INCHES MAY BE ALLOWED IF THE EDGE OF THE MILLING IS SLOPED A MINIMUM OF 1:3 (V:H), AS DETERMINED BY THE ENGINEER.
- 15. GEOTECHNICAL FABRIC AT THE LOCATIONS INDICATED FOR SOILS THAT TEND TO BE UNSTABLE AND/OR UNSUITABLE FOR GROUND STABILIZATION AND/OR AGGREGATE SUBGRADE IMPROVEMENT (CU YD) HAVE BEEN PROVIDED FOR USE. THE ACTUAL NEED FOR REMOVAL AND REPLACEMENT WITH ABOVE ITEM WILL BE DETERMINED IN THE FIELD AT THE TIME OF CONSTRUCTION BY THE GEOTECHNICAL ENGINEER. ALL POTENTIALLY UNSTABLE SOILS SHOULD BE TESTED WITH A STATIC OR DYNAMIC CONE PENETROMETER AND TREATED IN ACCORDANCE WITH ARTICLE 301.04 OF THE SSRBC AND IDOT SUBGRADE STABILITY MANUAL IF UNSTABLE AND/OR UNSUITABLE SOILS ARE NOT ENCOUNTERED, THEN THE QUANTITY SHALL BE DEDUCTED AND NO ADDITIONAL COMPENSATION WILL BE DUE TO THE CONTRACTOR.
- 16. THE CONTRACTOR SHALL DOCUMENT EXISTING PAVEMENT MARKING LOCATION PRIOR TO

COMMITMENTS

THERE ARE NO COMMITMENTS ON THIS PROJECT.

17.	THE	VILLAGE	USES	SEEDING	FOR	RESTORATION	BEHIND	CURB	AND	GUTTER	REPLACEMENT
	DIST	RICT 1 DE	ETAIL E	BD-24 SHA	LL BE	MODIFIED TO	USE SEE	DING, C	CLASS	1A	

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STATE OF ILLINOIS DEPARTMENT OF TRANSPORTATION

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GENERAL NOTES						1677	20-00025	-00-RS		LAKE	25	3		
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SUMMARY OF QUANTITIES

				80% FED 20% VILL
CODE NO.	ITEM	UNIT	TOTAL QUANTITY	ROADWAY 0005 URBAN
20101100	TREE TRUNK PROTECTION	EACH	8	8
			_	
20101200	TREE ROOT FRUNING	EACH	8	8
20101400	NTROGEN FERTILIZER NUTRIENT	POUND	23	23
20101600	POTASSIUM FERTILIZER NUTRIENT	POUND	23	23
20101700	SUPPLEMENTAL WATERING	UNIT	1	1
20200100	EARTH EXCAVATION	a y p	5	5
20201200	REMOVAL AND DISPOSAL OF UNSUITABLE MATERIAL	OJ YD	225	225
20800150	TREVCH BACKFILL	CUYD	140	140
21001000	GEOTECHNICAL FABRIC FOR GROUND STABILIZATION	SQYD	6.746	6.746
21101615	TOPSOIL FURNISH AND PLACE, 4"	SQYD	419	419
25000110	SEEDING, CLASS 1A	ACRE	0.25	0 25
25100630	EROSION CONTROL BLANKET	SQYD	419	419
28000250	TEMPORARY EROSION CONTROL SEEDING	POUND	25	25

* INDICATES SPECIALTY ITEM

28000510 INLET FILTERS

28001100 TEMPORARY BROSION CONTROL BLANKET

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STATE OF ILLINOIS DEPARTMENT OF TRANSPORTATION

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CONSTRUCTION

STATE OF ILLINOIS - PROFESSIONAL DESIGN FIRM LICENSE NO. - 184-001121 - EXPIRES 4/30/2020 4/4/2022 2:19:28 PM

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SUMMARY OF QUANTITIES

				CONSTRUCTION
				80% FED
	T			20% VILL
CODE	ITEM	UNIT	TOTAL	ROADWAY
NO.	,,,,,,,,,,,,,,,,,,,,,,,,,,,,,,,,,,,,,,,	5,117	QUANTITY	0005 URBAN
30300001	A GGREGA TE SUBGRADE IMPROVEMENT	OL AD	225	225
31101400	SUBBASE GRANULAR MATERIAL TYPE 8 6"	SQYD	409	409
35101600	AGGREGATE BASE COURSE, TYPE B 4"	SQYD	501	501
40201000	AGGREGATE FOR TEMPORARY ACCESS	TON	3	3
40600290	BITUMINOUS MATERIALS (TACK COAT)	POUND	18,257	18,257
40600370	LONGITUDINAL JOINT SEA LANT	FOOT	11,346	11,346
40600400	MXTURE FOR CRACKS, JOINTS, AND FLANGEWAYS	TON	5	5
40600982	HOT-MX ASFHALT SURFACE REMOVAL - BUTT JOINT	SQYD	137	137
40603200	POLYMERIZED HOT-MIX ASPHALT BINDER COURSE, IL-4.75, N50	TON	1,134	1.134
40604050	HOT-MIX ASPHALT SURFACE COURSE, IL-9.5, MIX "D", N50	TON	2,267	2,267
42001300	PROTECTIVE COAT	SQYD	766	766
42300400	PORTLAND CEMBNT CONCRETE DRIVEWAY PAVEMENT, 8 INCH	SQYD	409	409
42400200	PORTLAND CEMBAT CONCRETE SIDEWALK 5 INCH	SQFT	229	229
42400800	DETECTABLE WARNINGS	saft	20	20
44000157	HOT-MIX ASPHALT SURFACE REMOVAL, 2"	SQYD	27.047	27,047

* INDICATES SPECIALTY ITEM

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STATE OF ILLINOIS						
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		,	SUM	MAR	Y OF	QU	ANTITIES	
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CONSTRUCTION

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	1677	20-00025-00-RS	LAKE	25	5
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STATE OF ILLINOIS DEPARTMENT OF TRANSPORTATION

	F.A.U. RTE.	SECTION	COUNTY	TOTAL SHEETS	SHEET NO.
SUMMARY OF QUANTITIES	1677	20-00025-00-RS	LAKE	25	6
			CONTRACT	NO. 6	
CALE: NTS SHEET 3 OF 6 SHEETS STA. TO STA.		ILLINOIS FED. A	D PROJECT 20-00	025-00-RS	
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CONSTRUCTION CODE

				CODE.
				80% FED 20% VILL
				ROADWAY
CODE	ITBM	UNIT	TOTAL	0005
NO.			QUANTITY .	URBAN
44000200	DRIVEWAY PAVEMENT REMOVAL	SQYD	486	486
44000500	COMBINATION CURB AND GUTTER REMOVAL	FOOT	2,135	2,136
44000600	SIDEWALK REMOVAL	SQFT	432	432
44201713	CLASSID PATCHES, TYPE I, 6 INCH	SQ YD	1.350	1,350
44201717	CLASS D PATCHES, TYPE II, 6 INCH	SQYD	1,350	1,350
44201721	CLASSID PATCHES, TYPE III. 6 INCH	SQYD	1,350	1.350
			,	
44201723	CLASSID PATCHES, TYPE IV. 6 INCH	SQYD	1,350	1,350
44201785	CLASS D PATCHES, TYPE I, 12 INCH	SQ YD	338	338
				,,
44201789	CLASSID PATCHES TYPE II, 12 INCH	SQ YD	338	338
44201794	CLASSID FATCHES: TYPE III. 12 INCH	SQYD	338	338
44201796	CLASSID PATCHES, TYPE IV., 12 INCH	SQYD	338	338
55100400	STORM SEWER REMOVAL 10"	FOOT	50	50
55100500	STORM SEWER REMOVAL 12'	FOOT	160	160
55100700	STORM SEWER REMOVAL 15"	FOOT	70	70
55100900	STORM SEWER REMOVAL 18"	FOOT	115	115
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SUMMARY OF QUANTITIES

* INDICATES SPECIALTY ITEM

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STATE OF ILLINOIS DEPARTMENT OF TRANSPORTATION

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CALE:	NTS	SHEET	4	OF	6	SHEETS	STA.	TO STA.		

0005 NO. QUANTITY URBAN 55080040 STORM SEWERS, CLASS B, TYPE 1 10" FOOT 50 50 FOOT 160 160 550A0050 STORM SEWERS, CLASS A. TYPE 1 12" 70 550A0070 STORM SEWERS, CLASS A, TYPE 1 15° FOOT 70 550A0090 STORM SEWERS, CLASS A, TYPE 1 18" FOOT 115 115 EACH 2 CATCH BASINS TO BE RECONSTRUCTED 60256700 MANHOLES TO BE ANJUSTED WITH NEW TYPE 11 FRAME AND GRATE EACH 1 EACH 5 60261300 INLETS TO SE ADJUSTED WITH NEW TYPE 11 FRAME AND GRATE 5 60262700 INLETS TO BE RECONSTRUCTED EACH 5 5 60265700 VALVE VAULTS TO BE ABJUSTED EACH 1 60300305 FRAMES AND LIDS TO BE ADJUSTED EACH 13 13 FOOT 1,885 1,886 60603800 COMBINATION CONCRETE CURB AND GUTTER, TYPE B-6.12 60605000 COMBINATION CONCRETE CURB AND GUTTER TYPE B-6.24 FOOT 250 250 66900200 NON-SPECIAL WASTE DISPOSAL OJ YD 50 50 66900530 SOIL DISPOSAL ANALYSIS EACH 1 66901001 REGULATED SUBSTANCES PRE-CONSTRUCTION PLAN LISUM 1

SUMMARY OF QUANTITIES

ITEM

* INDICATES SPECIALTY ITEM

CODE

CONSTRUCTION ∞DE 80% FED 20% VILL ROADWAY

TOTAL

UNIT

COUNTY TOTAL SHEET NO.

LAKE 25 7 SECTION 20-00025-00-RS CONTRACT NO. 61H79 ILLINOIS | FED. AID PROJECT 20-00025-00-RS

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* INDICATES SPECIALTY ITEM

STATE OF ILLINOIS DEPARTMENT OF TRANSPORTATION

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		GOMMAN OF COARTINES			
					CONSTRUCTION
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ı			Γ		RCADWAY
	CODE NO	m B vt	UNIT	TOTAL QUANTITY	0005
	INO			QUANTIT .	URBAN
-	66901003	REGULATED SUBSTANCES FINAL CONSTRUCTION REPORT	LSUM	1	1
*	66901006	REGULA TED SUBSTANCES MONITORING	CAL DA	5	5
	67100100	MOBILIZATION	LSUM	1	1
	07 100 100	NOUGEATOR	Louve	,	'
	70102620	TRAFFIC CONTROLAND PROTECTION, STANDARD 701501	LSUM	1	1
	70102635	TRAFFIC CONTROL AND PROTECTION, STANDARD 701701	LSUM	1	1
	70000400		FOOT	4.05	4 405
	70300100	SHORT TERM PAVEMENT MARKING	FOOT	1,135	1,135
	70300150	SHORT TERM PAVEMENT MARKING REMOVAL	SQ FT	379	379
	70300221	TEMPORARY PAVEMENT MARKING - LINE 4"- PAINT	FOOT	1,135	1,135
	70300281	TEMPORARY PAVEMENT MARKING - UNE 24"-PAINT	FOOT	67	67
*	72000100	SIGN PANEL - TYPE 1	SQFT	95	95
					
٠	72400100	REMOVE SIGN PANEL ASSEMBLY - TYPE A	EACH	11	11
`	72400200	REMOVE SIGN PANEL ASSEMBLY - TYPE B	EACH	2	2
١	72900100	METAL POST - TYPE A	FOOT	208	208
	78000100	THERMOPLASTIC PAVEMENT MARKING - LETTERS AND SYMBOLS	SQ FT	110	110
	78000200	THERMOPLASTIC PAVEMENT MARKING - LINE 4"	FOOT	11 072	11,072

SUMMARY OF QUANTITIES

SUMMARY OF QUANTITIES

				80% HED 20% VILL
CODE			TOTAL	ROADWAY
NO.	ITBM	UNIT	QUANTITY	0005 URBAN
78000400	THERMOPLASTIC PAVEMENT MARKING - LINE 6"	F∞T	439	439
				1,55
78000600	THERMOPLASTIC PAVEMENT MARKING - LINE 12"	FOOT	316	316
78000650	THERMOPLASTIC PAVEMENT MARKING - LINE 24"	FOOT	67	67
78300202	PAVEMENT MARKING REMOVAL - WATER BLASTING	SQFT	513	513
X4022000	TEMPORARY ACCESS (COMMERCIAL ENTRANCE)	EACH	6	6
X6030310	FRAMES AND LIDS TO BE AGUIUSTED (SPECIAL)	EACH	3	3
Z0019600	DUST CONTROL WATERING	UNIT	2	2
Z0030850	TEMPORARY INFORMATION SIGNING	SQFT	103	103
Z0004522	HOT-MIX ASPHALT DRIVEWAY PAVEMENT, 6"	SQ YD	77	77
Z0076600	TRAINES	HOUR	500	500
Z0076604	TRAINEES TRAINING PROGRAM GRADUATE	HOUR	500	500
	ECIALITY (TEM			

BAXTER WOODMAN

USER NAME = mhigginson	DESIGNED - MH	REVISED -
	DRAWN - MJO	REVISED -
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STATE OF ILLINOIS
DEPARTMENT OF TRANSPORTATION

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INDICATES SFECIALTY ITEM
T INDICATES CONSTRUCTION CODE 0042 TRAINEES

DESIGNED - MH REVISED -BAXTER WOODMAN Consulting Engineers DRAWN - MJO REVISED -PLOT SCALE = 80.0000 ' / in. CHECKED -REVISED -FILE - 211456-SHT-Schedule_01.dgn

SIGN SCHEDULE


					REMOVE SIGN	REMOVE SIGN	
				SIGN PANEL -	PANEL	PANEL	METAL POST -
				TYPE 1	ASSEMBLY-	ASSEMBLY-	TYPE A
					TYPE A	TYPE B	
STATION	SIZE 1 (IN)	SIZE 2 (IN)	SIGN TYPE	(SF)	(EACH)	(EACH)	(FOOT)
15+18	24	30	R2-1	5		1	16
13.10	12	18	NO PARKING	1.5			10
26+50	30	30	W11-2	6.25			16
26+50	24	12	W19-9P	2			10
28+75	30	30	W11-2	6.25	1		16
	24	12	W16-7P	2			10
29+00	30	30	W11-2	6.25	1		16
	24	12	W16-7P	2			10
31+50	30	30	W11-2	6.25			16
	24	12	W19-9P	2			10
36+00	24	30	R2-1	5	1		16
35+25	24	30	R2-1	5	1		16
39+50	24	30	R2-1	5	1		16
54+10	24	30	R2-1	5	1		16
52+50	30	30	R1-1	6.25	1		
32+30	18	6	R1-3P	0.75			
54+00	30	30	R1-1	6.25	1		
54+00	18	6	R1-3P	0.75			
54+50	24	30	R2-1	5	1		16
59+25	24	30	R2-1	5	1		16
63+50	24	30	R2-1	5	1		16
70+00	24	30	R2-1	5		1	16
70+00	12	18	NOPARKING	1.5			10
		TOTAL		95	11	2	208

STATE OF ILLINOIS DEPARTMENT OF TRANSPORTATION

COUNTY TOTAL SHEETS NO.

LAKE 25 10


CONTRACT NO. 61H79 F.A.U. RTE. 1677 SECTION SCHEDULE OF QUANTITIES 20-00025-00-RS SHEET 1 OF 1 SHEETS STA.

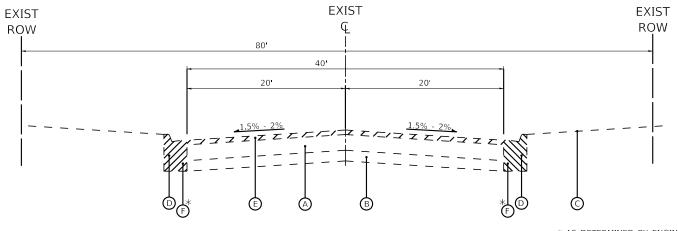

* AS DETERMINED BY ENGINEER


EXISTING TYPICAL SECTION BARCLAY BOULEVARD

STA 14+16 TO STA 70+89

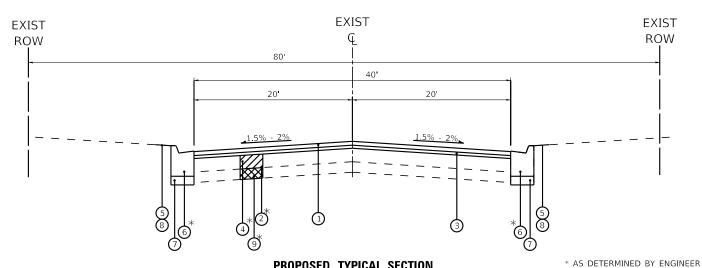

PROPOSED TYPICAL SECTION BARCLAY BOULEVARD

STA 14+16 TO STA 70+89

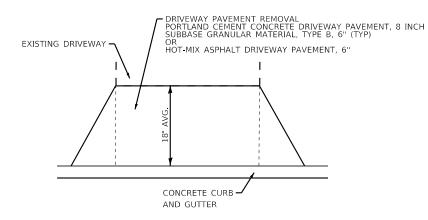

SIDEWALK DETAIL

AGGREGATE BASE COURSE, TYPE B, 4" PORTLAND CEMENT CONCRETE SIDEWALK 5 INCH

DRIVEWAY DETAIL

EXISTING LEGEND

- A EXISTING HMA BINDER & SURFACE COURSE, 5.00" 13.75"
- B EXISTING AGGREGATE BASE COURSE, 5.75" 17.00"
- © GROUND SURFACE
- D EXISTING COMBINATION CURB AND GUTTER
- E HOT-MIX ASPHALT SURFACE REMOVAL, 2"
- F COMBINATION CURB AND GUTTER REMOVAL
- REMOVAL ITEM

PROPOSED LEGEND

- 1 HOT-MIX ASPHALT SURFACE COURSE, IL-9.5, MIX "D", N50 1 1/2"
- 2 GEOTECHNICAL FABRIC FOR GROUND STABILIZATION
- 3 POLYMERIZED HOT-MIX ASPHALT BINDER COURSE, IL-4.75, N50 3/4"
- 4 CLASS D PATCHES
- 5 SEEDING, CLASS 1A
- 6 COMBINATION CONCRETE CURB AND GUTTER, TYPE B-6.12
- 7 AGGREGATE BASE COURSE, TYPE B, 4"
- (8) TOPSOIL FURNISH AND PLACE, 4"
- 9 REMOVAL AND DISPOSAL OF UNSUITABLE MATERIALS AGGREGATE SUBGRADE IMPROVEMENT

HOT-MIX ASPHALT MIXTURE REQUIREMENTS

CONTRACTOR SHALL MILL BEFORE PATCHING

CONTRACTOR SHALE MILE BEFORE PATCHING		
MIXTURE TYPE	AIR VOIDS @ Ndes	QMP
PAVEMENT RESURFACING		
HOT-MIX ASPHALT SURFACE COURSE, IL-9.5, MIX "D", N50 1 1/2"	4% @ 50 Gyr.	LR 1030-2
POLYMERIZED HOT-MIX ASPHALT BINDER COURSE, IL-4.75, N50; 3/4"	3.5% @ 50 Gyr.	LR 1030-2
HMA DRIVEWAY PAVEMENT 6"	·	
HOT-MIX ASPHALT SURFACE COURSE, IL-9.5, MIX "D", N50 2"	4% @ 50 Gyr.	LR 1030-2
HOT-MIX ASPHALT BINDER COURSE, IL-19.0, N50 4"	4% @ 50 Gyr.	LR 1030-2
PATCHING	·	
CLASS D PATCHES (HMA BINDER IL-19.0mm)	4% @ 70 Gyr.	LR 1030-2
QMP DESIGNATION: QUALITY CONTROL/QUALITY ASSURANCE (QC/QA); PER LR 1030-2	·	


- 1. THE UNIT WEIGHT USED TO CALCULATE ALL HMA SURFACE MIXTURE QUANTITIES IS 112 LBS/SQ YD/IN.
- 2. THE "AC TYPE" FOR POLYMERIZED HMA MIXES SHALL BE "SBS/SBR PG 76 -22" AND FOR NON-POLYMERIZED HMA THE
- "AC TYPE" SHALL BE "PG 64 -22" UNLESS MODIFIED BY RECLAIMED MATERIALS SPECIFICATIONS.
- 3. THE LONGITUDINAL JOINT SEALANT SHALL BE PLACED OVER THE POLYMERIZED HMA BC IL-4.75 N50


_	USER NAME = mornig	DESIGNED - MH	REVISED -
BAXTER WOODMAN		DRAWN - MJO	REVISED -
Consulting Engineers	PLOT SCALE = 40.0000 ' / in.	CHECKED -	REVISED -
~	PLOT DATE = 4/4/2022	DATE - 4/4/2022	FILE - 211456-SHT-TypSec 01.dgn


STATE OF ILLINOIS DEPARTMENT OF TRANSPORTATION

TYPICAL SECTIONS				F.A.U. RTE	SECTION	COUNTY	TOTAL SHEETS	SHEE NO.			
	D	ARCI	۸v	BOUL	EVADD	•	1677	20-00025-00-RS	LAKE	25	11
	Di	Anci	_A I	DUUL	EVAND	<u> </u>			CONTRACT	NO. 6	1H79
Т	1	OF	1	SHEETS	STA.	TO STA.		TILLINOIS FED A	ID PROJECT 20-00	025-00-RS	

1) ALL PROPOSED SIGNS SHALL BE MOUNTED ON METAL POST - TYPE A 2) TRAFFIC SIGNAL AT APTAKISC ROAD USED VIDEO DETECTION, NO DETECTOR LOOPS ARE USED VALVE VAULTS TO BE ADJUSTED + THERMOPLASTIC PAVEMENT MARKING THERMOPLASTIC PAVEMENT MARKING TO THE COMPANY (WHITE) (TYP) EX ROW EXISTING & PROPOSED THERMOPLASTIC PAVEMENT -€ BARCLAY BOULEVARD MARKING - LINE 6" (WHITE) HOT-MIX ASPHALT SURFACE REMOVAL - BUTT JOINT BEGIN CONSTRUCTION BARCLAY BOULEVARD **BARCLAY BOULEVARD** STA 14+16 THERMOPLASTIC PAVEMENT MARKING - LINE 4" (DOUBLE YELLOW, 11" C-C) EX ROW ROAD BEGIN RESURFACING SPEED POLYMERIZED HOT-MIX ASHPALT BINDER COURSE **APTAKISIC** LIMIT IL-4.75, N50; ¾" HOT-MIX ASPHALT SURFACE COURSE, IL-9.5, MIX "D", N50 1½" NO PARKING ON CORPORATI CENTER STREETS R2-1 30 MPH THERMOPLASTIC PAVEMENT -24" x 30" MARKING - LINE 4" THERMOPLASTIC PAVEMENT MARKING - -LETTERS & SYMBOLS (WHITE)(TYP) NO PARKING ON CORPORATE (DOUBLE YELLOW, 11" C-C) CENTER STREETS 12" × 18**"** THERMOPLASTIC PAVEMENT 0 THERMOPLASTIC PAVEMENT STA 15+18 MARKING - LINE 6" (WHITE) EXISTING & PROPOSED -MARKING - LINE 12" (YELLOW) \odot (2' DASH - 6' SKIP) © BARCLAY BOULEVARD (45° DIAGONALS AT 75' SPACING, 5 MIN) \odot ♠ $\langle 0 \rangle$ 4 BARCLAY BOULEVARD \odot \odot \odot 0 0 POLYMERIZED HOT-MIX ASHPALT BINDER COURSE, THERMOPLASTIC PAVEMENT - MARKING - LINE 6" (WHITE) (SP FRAMES AND LIDS TO BE ADJUSTED (SPECIAL) IL-4.75, N50;¾**"** ADJ FRAMES AND GRATES TO BE ADJUSTED HOT-MIX ASPHALT TREE TRUNK PROTECTION TREE ROOT PRUNNING THERMOPLASTIC PAVEMENT — MARKING - LINE 6" (WHITE) (2' DASH - 6' SKIP) SURFACE COURSE, IL-9.5, MIX "D", N50 1½" DESIGNED - MH REVISED **ROADWAY PLAN** SECTION STATE OF ILLINOIS DRAWN - MJO BAXTER WOODMAN REVISED 20-00025-00-RS LAKE 25 **BARCLAY BOULEVARD** LOT SCALE = 40.0000 ' / in. HECKED -REVISED DEPARTMENT OF TRANSPORTATION CONTRACT NO. 61H79 FILE - 211456-SHT-Plan 01.dgr SCALE: 1" = 20' SHEET 1 OF 6 SHEETS STA. 10+00 TO STA. 20+50

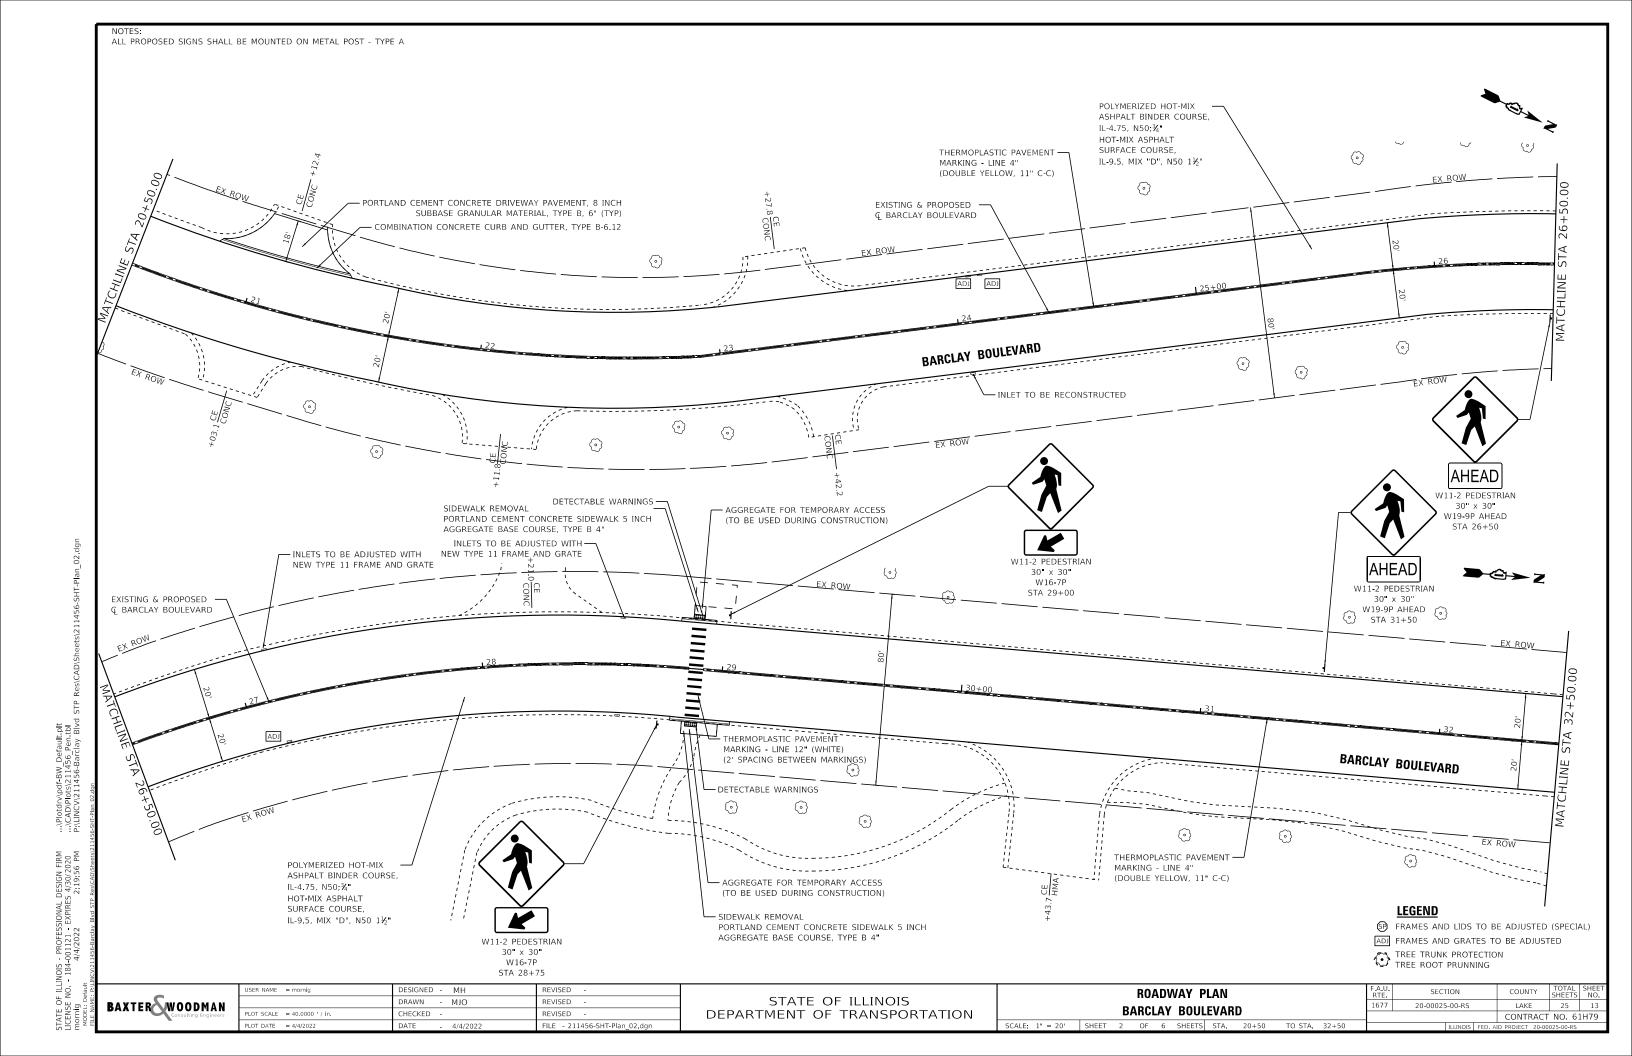

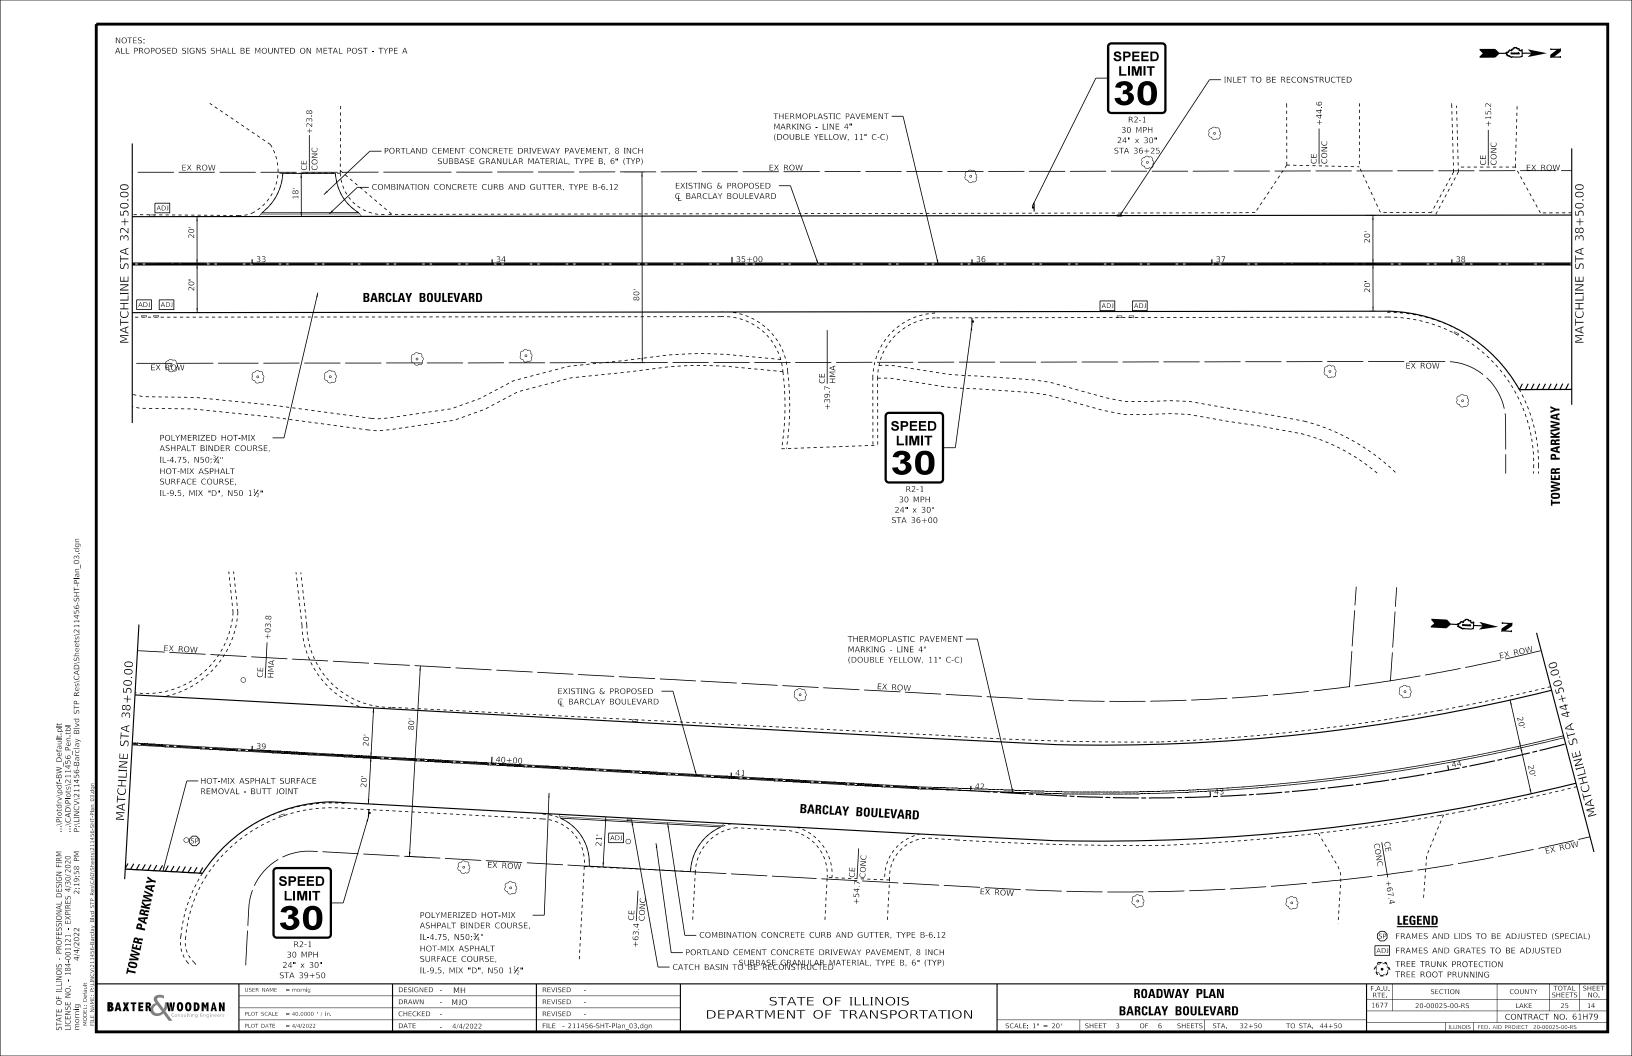

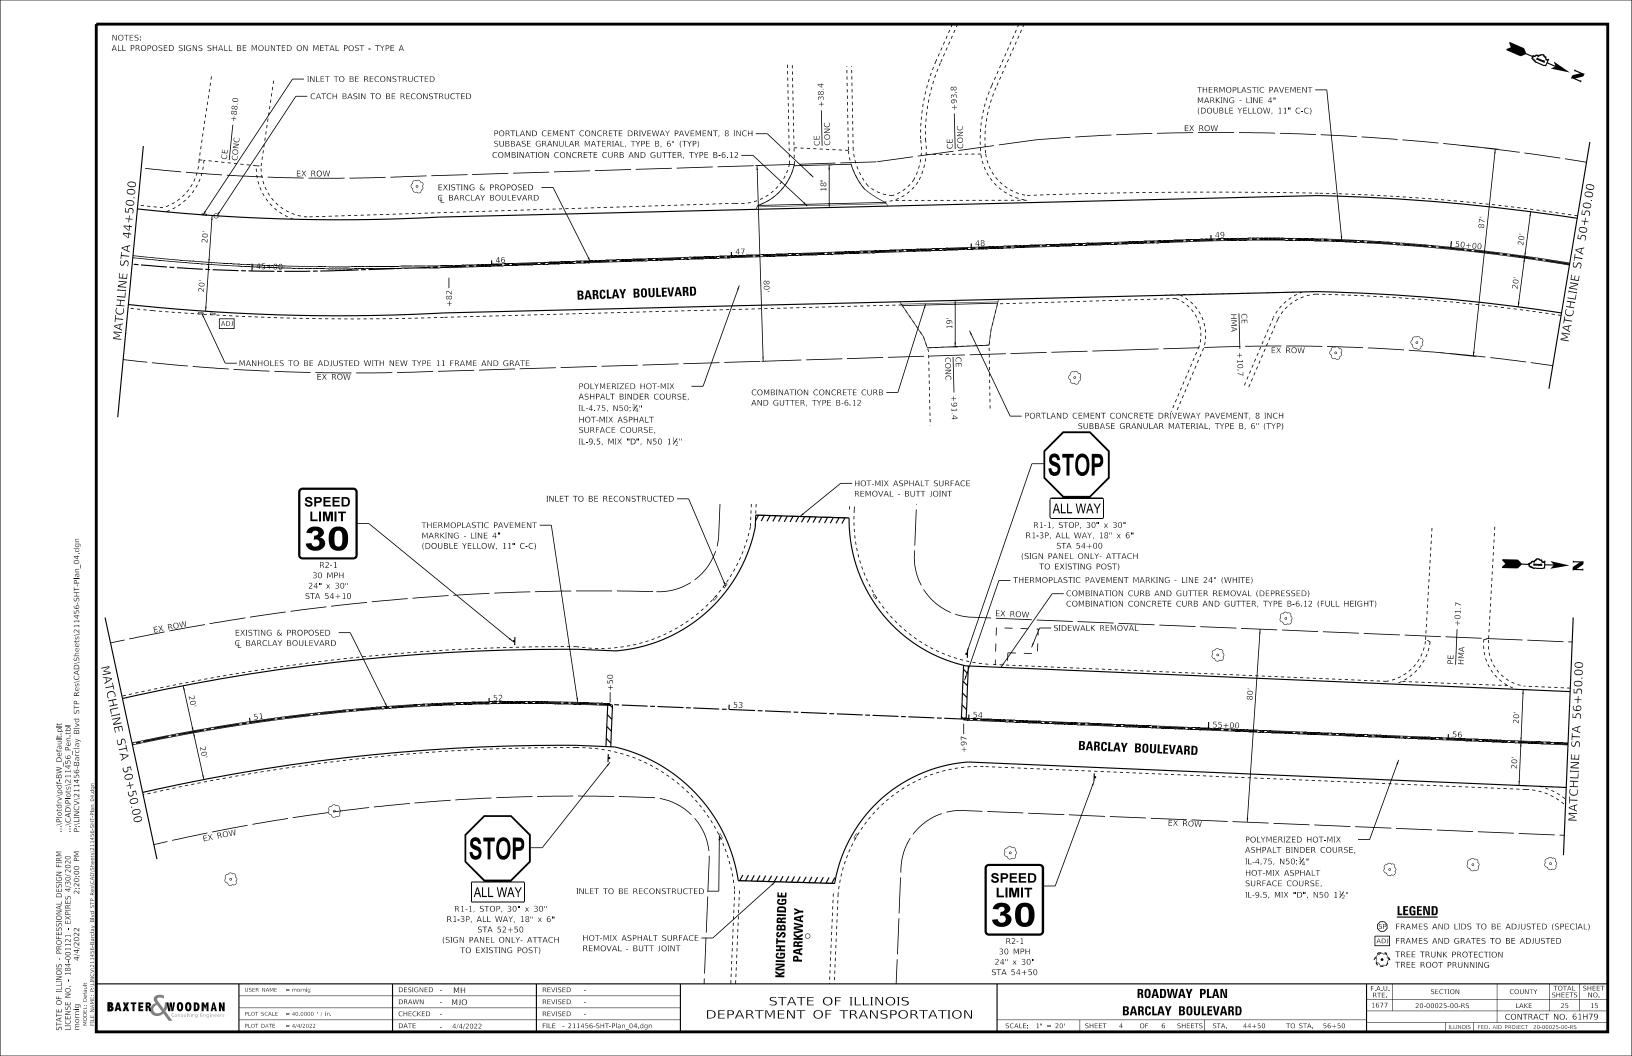

BAXTER WOODMAN Consulting Engineers LOT SCALE = 40.0000 / in.


DESIGNED - MH REVISED DRAWN - MJO REVISED CHECKED -REVISED FILE - 211456-SHT-Plan 06.dgr


STATE OF ILLINOIS DEPARTMENT OF TRANSPORTATION


ROADWAY PLAN BARCLAY BOULEVARD SCALE: 1" = 20' SHEET 6 OF 6 SHEETS STA. 68+50 TO STA.

SECTION 20-00025-00-RS

LAKE 25 17 CONTRACT NO. 61H79

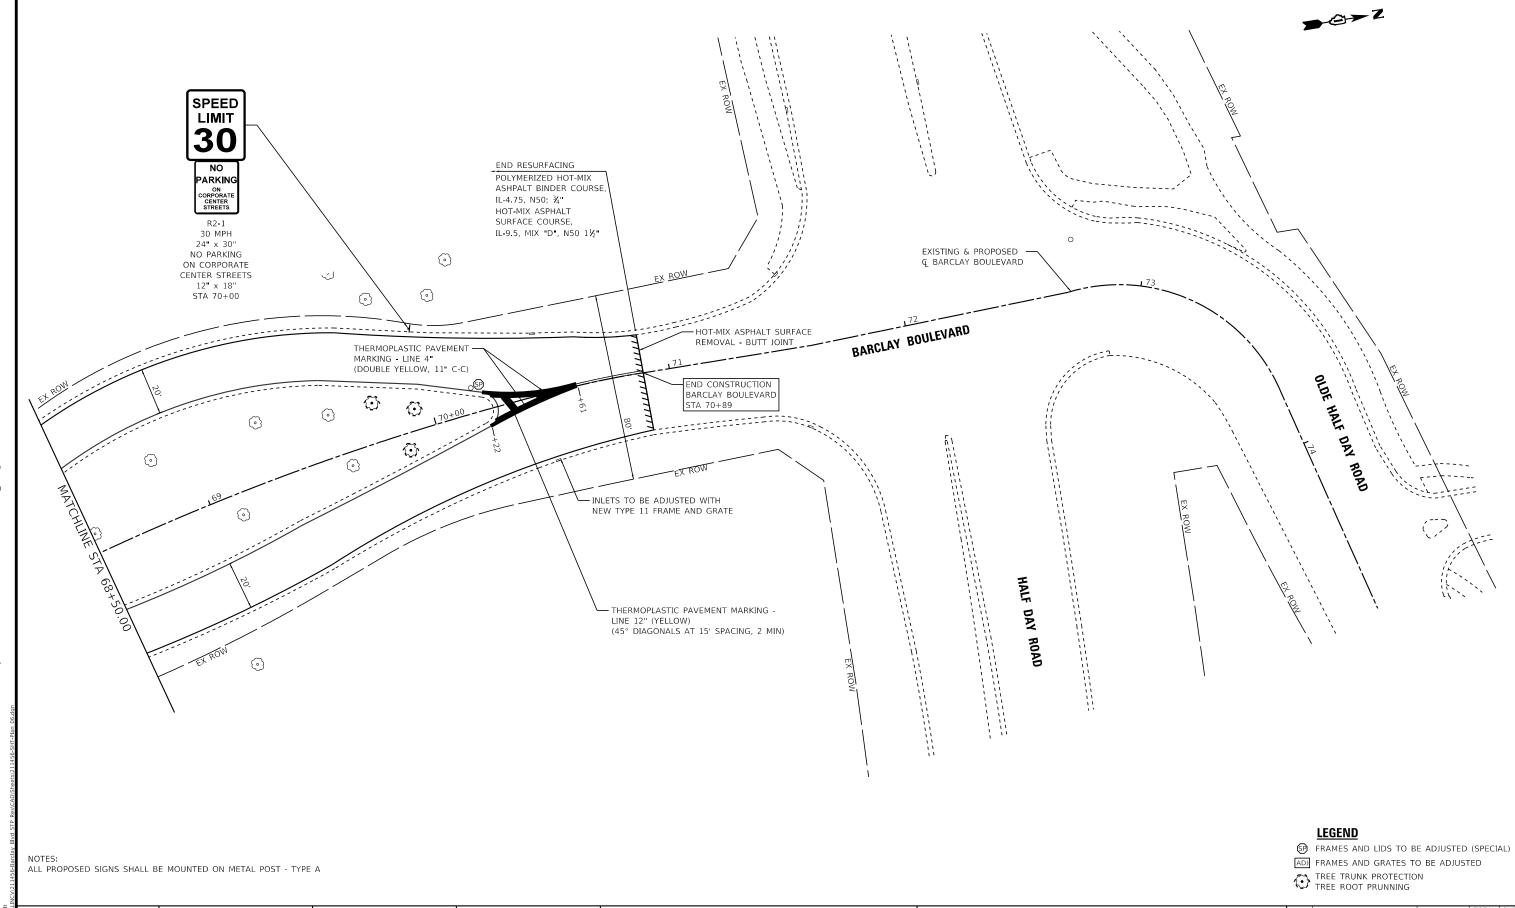

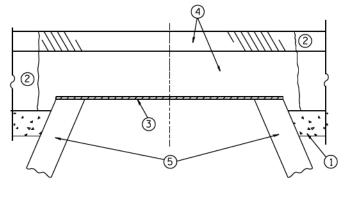

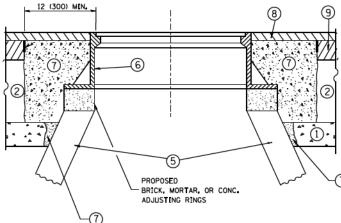

EXISTING BROKEN FRAMES AND LIDS SHALL BE REMOVED AND DISPOSED OF BY THE CONTRACTOR AND SHALL BE REPLACED AS DIRECTED BY THE ENGINEER. REPLACEMENT FRAMES AND LIDS WILL BE PAID FOR IN ACCORDANCE WITH ARTICLE 109.04 OF THE STANDARD SPECIFICATIONS UNLESS A SEPARATE PAY ITEM HAS BEEN PROVIDED.

IF THE EXISTING LIDS ARE OPEN, THE FRAME WILL BE ADJUSTED TO THE ELEVATION OF THE MILLED PAVEMENT SURFACE PRIOR TO THE MILLING OPERATION. THE FRAME WILL NOT BE REMOVED AND COVERED BY THE METAL PLATE.

CITY OF CHICAGO CASTINGS ARE THE PROPERTY OF THE CITY AND THE CONTRACTOR SHALL NOTIFY THE CITY FOR REMOVAL AND DISPOSITION OF THE CASTINGS.

THE METAL PLATE USED TO COVER THE STRUCTURE SHALL REMAIN THE PROPERTY OF THE CONTRACTOR.

WHEN STRUCTURES ARE TO BE ADJUSTED OR RECONSTRUCTED, THE LOWERING AND RAISING OF THE FRAMES AND LIDS WILL NOT BE PAID FOR SEPARATELY BUT WILL BE INCLUDED IN THE COST OF THE CORRESPONDING PAY ITEM.

CONSTRUCTION PROCEDURES

STAGE 1 (BEFORE PAVEMENT MILLING)

- A) REMOVE A MINIMUM OF 12 (300) OF THE PAVEMENT FROM AROUND THE STRUCTURE.
- B) REMOVE THE EXISTING FRAME AND LID FROM THE STRUCTURE.
- C) COVER THE STRUCTURE OPENING WITH A 36 (900) DIAMETER
- METAL PLATE.

 D) BACKFILL WITH CRUSHED STONE AND A MINIMUM 11/2 (40)
 THICK HMA SURFACE MIX APPROVED BY THE ENGINEER.

STAGE 2 (AFTER PAVEMENT MILLING)

- A) REMOVE THE HMA SURFACE MIX AND CRUSHED STONE.
- B) INSTALL THE FRAME AND LID: ADJUST THE FRAME TO ITS FINAL SURFACE ELEVATION.
- C) THE SURROUNDING SPACE SHALL BE FILLED WITH CLASS PP-1*
 CONCRETE TO THE ELEVATION OF THE SURFACE OF THE EXISTING BASE COURSE OR THE BINDER COURSE.
- * UNLESS OTHERWISE SPECIFIED IN THE PLANS.

THE PROCEDURE EXPLAINED ABOVE SHALL CONFORM TO THE APPLICABLE PORTIONS OF SECTIONS 353, 406, 602, AND 603 OF THE STANDARD SPECIFICATIONS EXCEPT THAT "THE CONTRACTOR SHALL ADJUST THE STRUCTURES TO THE FINISHED PAVEMENT ELEVATION NO MORE THAN 5 CALENDAR DAYS PRIOR TO PLACEMENT OF THE FINAL LIFT OF SURFACE UNLESS APPROVED BY THE

LEGEND

- 1 SUB-BASE GRANULAR MATERIAL
- (6) FRAME AND LID (SEE NOTES)
- 2 EXISTING PAVEMENT
- 7 CLASS PP-1* CONCRETE
- 3 36 (900) DIAMETER METAL PLATE
- (8) PROPOSED HMA SURFACE COURSE
- PROPOSED CRUSHED STONE AND HMA SURFACE MIX
- 5 EXISTING STRUCTURE
- 9 PROPOSED HMA BINDER COURSE

THE CONTRACTOR WILL BE REQUIRED TO KEEP A RECORD OF THE LOCATIONS OF THE BURIED STRUCTURES ACCORDING TO THE STATION AND DISTANCE LEFT OR RIGHT OF THE CENTERLINE OF PAVEMENT. UPON COMPLETION OF THE WORK, THE CONTRACTOR WILL DELIVER THE RECORD TO THE ENGINEER.

BASIS OF PAYMENT

REMOVING FRAMES AND LIDS ON DRAINAGE AND UTILITY STRUCTURES IN THE PAVEMENT PRIOR TO MILLING, AND ADJUSTING TO FINAL GRADE PRIOR TO PLACING THE SURFACE COURSE, WILL BE PAID FOR AT THE CONTRACT UNIT PRICE EACH FOR "FRAMES AND LIDS TO BE ADJUSTED

THIS WORK WILL NOT BE PAID FOR WHEN DRAINAGE AND UTILITY STRUCTURES ARE SPECIFIED FOR PAYMENT AS STRUCTURE RECONSTRUCTION.

NEW FRAMES AND LIDS, WHEN SPECIFIED, WILL BE PAID FOR SEPARATELY.

DETAILS FOR FRAMES AND LIDS ADJUSTMENT WITH MILLING

ALL DIMENSIONS ARE IN INCHES (MILLIMETERS) UNLESS OTHERWISE SHOWN

TOTAL SHEET NO. 25 18

LAKE

BAXTER & WOODMAN, INC. PROFESSIONAL DESIGN FIRMAR HOLD FOUND STANDARD STAND

NOTES:

1. THE WIDTH OF THE FULL DEPTH PATCH OVER A TRENCH SHALL BE 12 (300) WIDER ON EACH SIDE OF THE TRENCH.

THICKNESS AND MATERIALS

2. FOR METHOD OF MEASUREMENT AND BASIS OF PAYMENT. SEE RECURRING SPECIAL PROVISION "PATCHING WITH HOT-MIX ASPHALT OVERLAY REMOVAL".

SEQUENCE OF CONSTRUCTION (PATCHING FIRST)

- 1. REMOVE THE EXISTING HMA MATERIAL OVER THE AREA TO BE PATCHED.
- 2. REMOVE AND REPLACE WITH CLASS C OR D PATCH.
- 3. REPLACE HMA MATERIAL OVER THE AREA TO BE PATCHED.

SEQUENCE OF CONSTRUCTION (MILLING FIRST)

- 1. MILL HMA FIRST IF THERE IS AT LEAST $4\frac{1}{2}$ INCHES OR MORE OF HMA MATERIAL ON TOP OF THE EXISTING PAVEMENT OR IF THE PAVEMENT IS FULL DEPTH HMA. A MINIMUM OF 2 INCHES OF HMA MATERIAL SHALL BE IN PLACE AFTER MILLING.
- 2. REMOVE AND REPLACE WITH FULL DEPTH CLASS D PATCHES TO TOP OF MILLED SURFACE.


ALL DIMENSIONS ARE IN INCHES (MILLIMETERS) UNLESS

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USER NAME = bauerdl	DESIGNED - R. SHAH	REVISED - A. ABBAS 04-27-98
	DRAWN -	REVISED - R. BORO 01-01-07
PLOT SCALE = 50.000 '/ IN.	CHECKED -	REVISED - R. BORO 09-04-07
PLOT DATE = 10/27/2008	DATE - 10-25-94	REVISED - K. ENG 10-27-08

STATE OF ILLINOIS **DEPARTMENT OF TRANSPORTATION**

PAVEMENT PATCHING FOR HMA SURFACED PAVEMENT						SECTION		
						20-00025-00-RS	Ξ	
	TIMEA SUN		BD400-04 (BD-22)	_				
.E.: NONE	SHEET NO. 1 OF 1	SHEETS	STA.	TO STA.	FED. R	DAD DIST. NO. 1 ILLINOIS FED. AI	D	

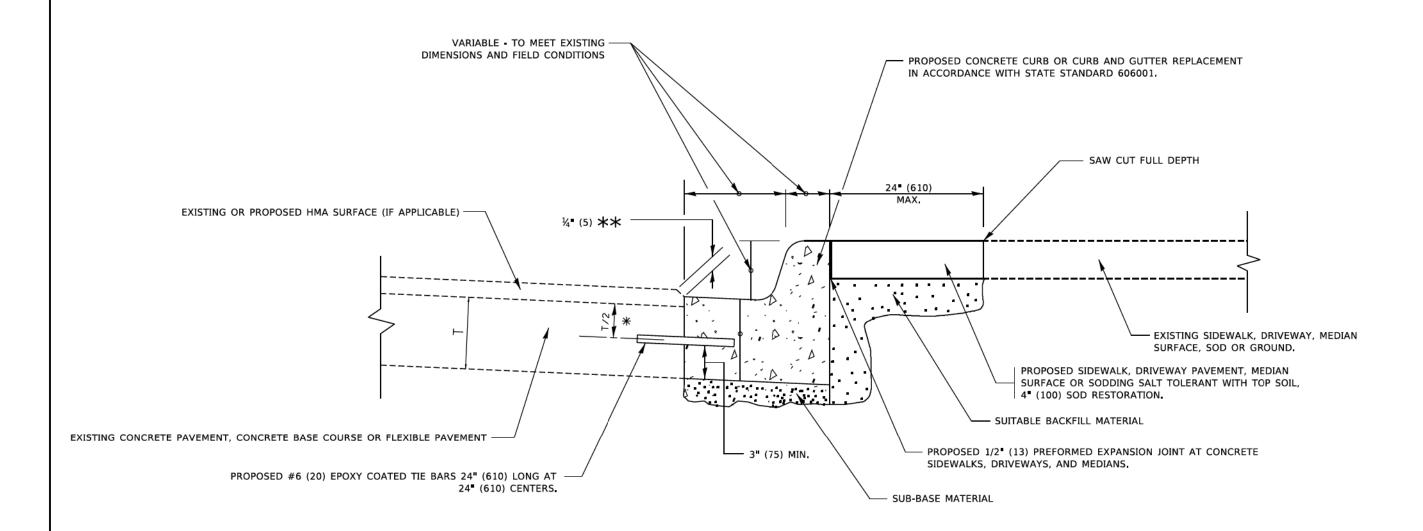

- ★ 3 (75) MINIMUM FROM TOP AND BOTTOM OF THE CONCRETE PAVEMENT OR BASE COURSE.
- $\star\star$ IF THE FINAL SURFACE OF THE PAVEMENT IS CONCRETE, THE GUTTER IS TO BE FLUSH WITH THE PAVEMENT.

CURB OR CURB AND GUTTER REMOVAL AND REPLACEMENT

ALL DIMENSIONS ARE IN INCHES (MILLIMETERS) UNLESS OTHERWISE SHOWN.

USER NA	AME = footemj	DESIGNED	-	A. HOUSEH	REVISED	-	A. ABBAS 03-21-97
		DRAWN	-		REVISED	-	M. GOMEZ 01-22-01
PLOT SC	CALE = 50,0000 / In.	CHECKED	-		REVISED	-	R. BORO 12-15-09
PLOT DA	ATE = 7/11/2019	DATE	-	03-11-94	REVISED	-	K. SMITH 07-11-19

STATE OF ILLINOIS
DEPARTMENT OF TRANSPORTATION

CURB OR CURB AND GUTTER
REMOVAL AND REPLACEMENT

SHEET 1 OF 1 SHEETS STA.


F.A. SECTION COUNTY TOTAL SHE
RTE. 1677 20-00025-00-RS LAKE 25 20

BD600-06 (BD-24) CONTRACT NO, 61H79

Illinois | FED. AID PROJEG20-00025-00-RS

OPTION 1


(FOR BUTT JOINT AND HMA TAPER SEE DETAIL BELOW)

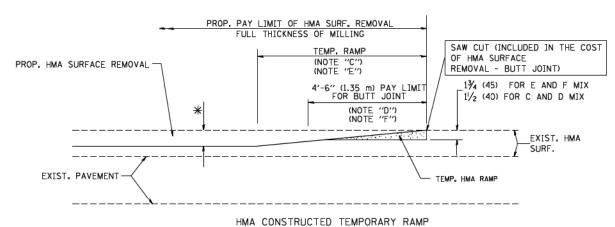

(FOR BUTT JOINT AND HMA TAPER SEE DETAIL BELOW)

OPTION 2

TYPICAL TEMPORARY RAMP

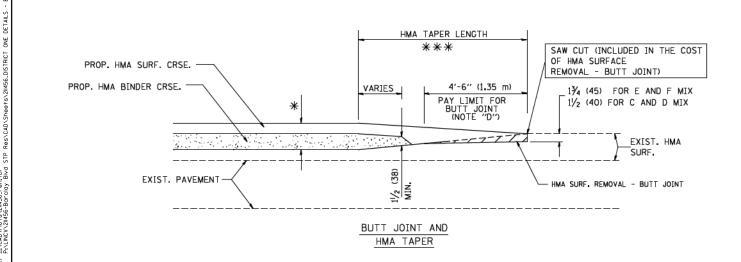

TYPICAL BUTT JOINT AND HMA TAPER FOR MILLING AND RESURFACING

USER NAME = geglenobt DESIGNED - M. DE YONG REVISED - R. SHAH 10-25-94

DRAWN - REVISED - A. ABBAS 03-21-97


PLOT SCALE = 50.0000 '/ IN. CHECKED - REVISED - M. GOMEZ 04-06-01


PLOT DATE = 1/4/2008 DATE - 06-13-90 REVISED - R. BORO 01-01-07

FILE NAME =

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STATE OF ILLINOIS
DEPARTMENT OF TRANSPORTATION



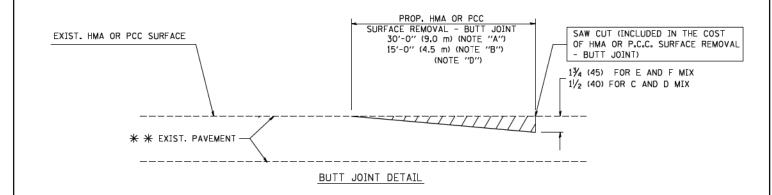

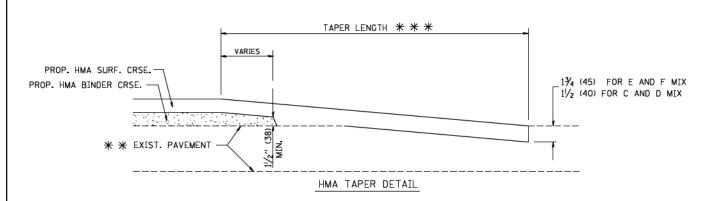TYPICAL BUTT JOINT AND HMA TAPER FOR RESURFACING ONLY

* * PC CONCRETE, HMA OR HMA RESURFACED PAVEMENT.


NOTES

- A: MAINLINE ROADWAYS AND MAJOR SIDE ROADS.
- B: MINOR SIDE ROADS.
- C: THE TEMP. RAMP SHALL BE CONSTRUCTED IMMEDIATELY UPON REMOVAL OF THE EXISTING HMA SURFACE.
- D: THE BUTT JOINT SHALL BE CONSTRUCTED IMMEDIATELY PRIOR TO PLACING THE PROPOSED HMA COURSES.
- E: TAPER THE TEMP, RAMP AT A RATE OF 3'-0" (900 mm) PER 1 INCH (25 mm) OF MILLING THICKNESS.
- F: INSTALLATION AND REMOVAL OF THE 4'-6" (1.35 m) TEMP. RAMP IS INCLUDED IN COST OF HMA SURFACE REMOVAL BUTT JOINT
- G: SEE ARTICLE 406.08 AND 406.14 OF THE STANDARD SPECIFICATIONS FOR "HMA AND/OR PCC SURFACE REMOVAL, BUTT JOINT".
- * SEE TYPICAL SECTIONS FOR MILLING THICKNESS.
- * * 20'-0" (6.1 m) PER 1 (25) RESURFACING (NOTE "A") 10'-0" (3.0 m) PER 1 (25) RESURFACING (NOTE "B")

BASIS OF PAYMENT:

THE BUTT JOINT WILL BE PAID FOR AT THE CONTRACT UNIT PRICE PER SQUARE YARD (SQUARE METER)
FOR "HOT-MIX ASPHALT SURFACE REMOVAL - BUTT JOINT" OR FOR "PORTLAND CEMENT CONCRETE SURFACE REMOVAL- BUTT JOINT".

ALL DIMENSIONS ARE IN INCHES (MILLIMETERS) UNLESS OTHERWISE SHOWN.

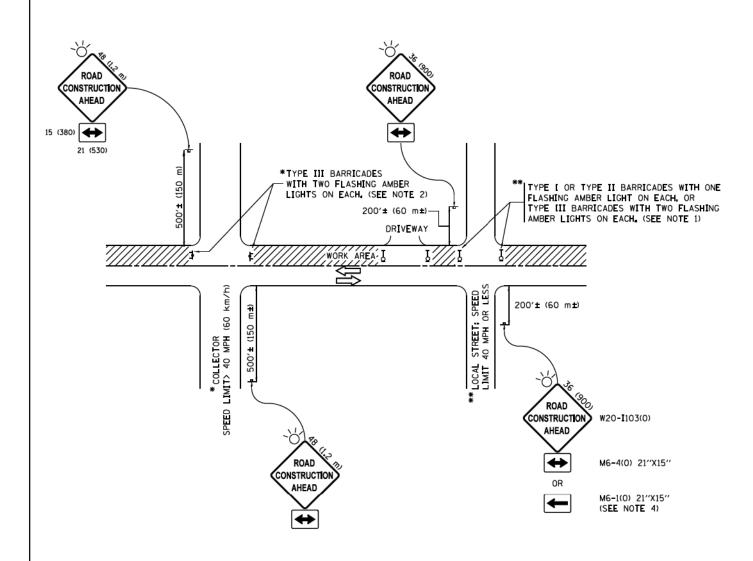

NOTES:

- 1. SIDE ROAD WITH A SPEED LIMIT OF 40 MPH (60 km/h) OR LESS AS SHOWN ON THE DRAWING AND AS DIRECTED BY THE ENGINEER:
 - d) ONE "ROAD CONSTRUCTION AHEAD" SIGN 36 x 36 (900x900) WITH A FLASHER MOUNTED ON IT APPROXIMATELY 200" (60 m) IN ADVANCE OF THE MAIN ROUTE.
 - b) THE CLOSED PORTION OF THE MAIN ROUTE SHALL BE PROTECTED BY BLOCKING WITH TYPE I, TYPE II OR TYPE III BARRICADES, 1/3 OF THE CROSS SECTION OF THE CLOSED PORTION,
- 2. SIDE ROAD WITH A SPEED LIMIT GREATER THAN 40 MPH (60 km/h) AS SHOWN ON THE DRAWING AND AS DIRECTED BY THE ENGINEER:
 - O) ONE "ROAD CONSTRUCTION AHEAD" SIGN 48 x 48 (1.2 m x 1.2 m) WITH A FLASHER MOUNTED ON IT APPROXIMATELY 500" (150 m) IN ADVANCE OF THE MAIN ROUTE.
 - b) THE CLOSED PORTION OF THE MAIN ROUTE SHALL BE PROTECTED BY BLOCKING WITH TYPE III BARRICADES, 1/2 OF THE CROSS SECTION OF THE CLOSED PORTION.
- CONES MAY BE SUBSTITUTED FOR BARRICADES OR DRUMS AT HALF THE SPACING DURING DAY OPERATIONS. CONES SHALL BE A MINIMUM OF 28 (710)
- 4. WHEN THE SIDE ROAD LIES BETWEEN THE BEGINNING OF THE MAINLINE SIGNING AND THE WORK ZONE, A SINGLE HEADED ARROW (M6-1) SHALL BE USED IN LIEU OF THE DOUBLE HEADED ARROW (M6-4).

SCALE NONE

- 5. WHEN WORK IS BEING PERFORMED ON A SIDE ROAD OR DRIVEWAY, FOLLOW THE APPLICABLE STANDARD(S). THE DIRECTIONAL ARROW (M6-1 OR M6-4) SHALL BE COVERED OR REMOVED WHEN NO LONGER CONSISTENT WITH THE TRAFFIC CONTROL SET-UP.
- 6. ADVANCE WARNING SIGNS ARE TO BE OMITTED ON DRIVEWAYS UNLESS OTHERWISE SPECIFIED IN THE PLANS OR BY THE FIGURER
- 7. THE TRAFFIC CONTROL AND PROTECTION FOR SIDE ROADS, INTERSECTIONS, AND DRIVEWAYS SHALL BE INCLUDED IN THE COST OF SPECIFIED TRAFFIC CONTROL STANDARDS OR ITEMS.


All dimensions are in inches (millimeters) unless otherwise shown.

STATE OF ILLINOIS
DEPARTMENT OF TRANSPORTATION


TRAFFIC CONTROL AND PROTECTION FOR SIDE ROADS, INTERSECTIONS, AND DRIVEWAYS

SHEET 1 OF 1 SHEETS STA. TO S

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STATE OF 11 I INNIS - PRIPESSIONA INFSIGN FIRM PRATERY NA

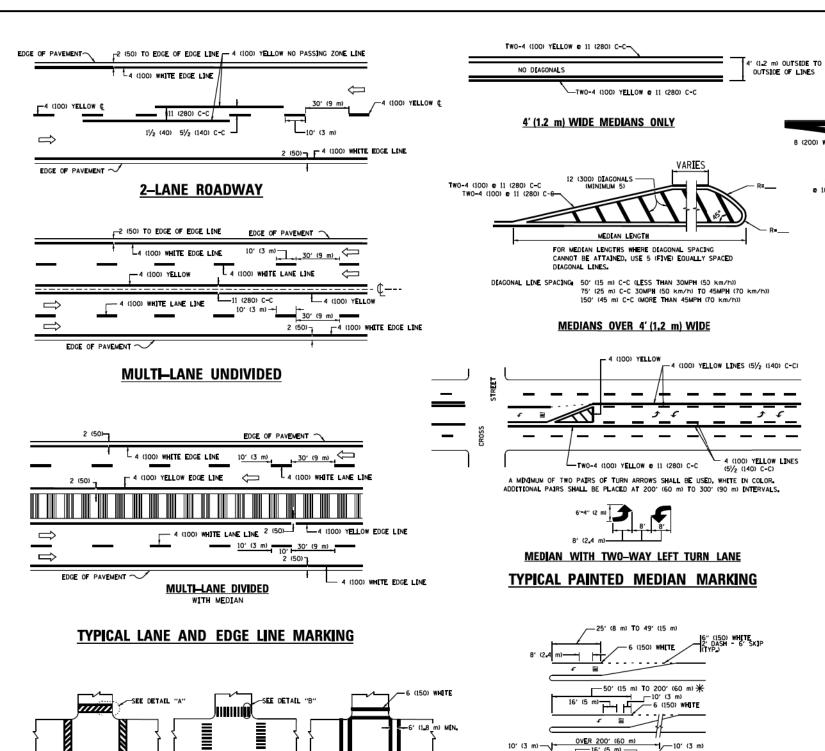

PEDESTRIAN

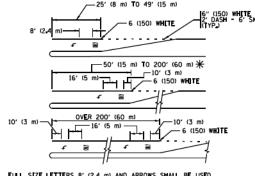

* TURN LANES IN EXCESS OF 400' (120 m) IN LENGTH MAY HAVE AN ADDITIONAL SET OF ARROW - "ONLY" [INSTALLED MIDWAY BETWEEN THE OTHER TWO SETS OF

TYPICAL LEFT (OR RIGHT) TURN LANE

TYPICAL TURN LANE MARKING

FILE NAME : USER NAME = leyso DESIGNED - EVERS REV[SED C. JUCIUS 09-09-09 \diststd\22x34\tcl3.dgn DRAWN REVISED - C. JUCIUS 07-01-13 CHECKED -REVISED - C. JUCIUS 12-21-15 PLOT SCALE = 50.000 '/ in. PLOT DATE = 6/23/2017 DATE - 03-19-90 REVISED - C. JUCIUS 04-12-16

TYPICAL CROSSWALK MARKING

* MARKINGS SHALL BE INSTALLED PARALLEL TO THE CENTERLINE OF THE ROAD WHICH IT CROSSES

(150) WHITE

DETAIL "A"

2' (600)

DETAIL "B"

STATE OF ILLINOIS **DEPARTMENT OF TRANSPORTATION**

DISTRICT ONE 20-00025-00-RS LAKE TYPICAL PAVEMENT MARKINGS CONTRACT NO. 61H79 TC-13 SHEET 1 OF 1 SHEETS STA. TO STA

SPEED LIMIT 345 30 425 35 500 40 580 45 50 **COMBINATION** LEFT AND U-TURN 5'-4" (1620) √ 32 R (810) 2 (50)

LANE REDUCTION TRANSITION * LANE REDUCTION ARROWS REQUIRED AT SPEEDS OF 45 MPH OF GREATER OR WHEN SPECIFIED IN PLANS. **U_TURN**

TYPE OF MARKING	WIDTH OF LINE	PATTERN	COLOR	SPACING /REMARKS
CENTERLINE ON 2 LANE PAVEMENT	4 (100)	SKIP-DASH	YELLOW	10' (3 m) LINE WITH 30' (9 m) SPACE
CENTERLINE ON MULTI-LANE UNDIVIDED PAVEMENT	2 2 4 (100)	SOL1D	YELLOW	11 (280) C-C
NO PASSING ZONE LINES FOR ONE DIRECTION FOR BOTH DIRECTIONS	4 (100) 2 e 4 (100)	SOLID SOLID	YBLLOW YBLLOW	5/2 (140) C-C FROM SKIP-DASH CENTERLINE 11 (280) C-C OMIT SKIP-DASH CENTERLINE BETWEEN
LANE LINES	4 (100) 5 (125) ON FREEWAYS	SKIP-DASH SKIP-DASH	WHITE WHITE	10' (3 m) LINE WITH 30' (9 m) SPACE
DOTTED LINES (EXTENSIONS OF CENTER, LANE OR TURN LANE MARKINGS)	SAME AS LINE BEING EXTENDED	SKIP-DASH	SAME AS LINE BEING EXTENDED	2' (600) LINE WITH 6' (1.8 m) SPACE
EDGE LINES	4 (100)	SOL1D	YELLOW-LEFT WHITE-RIGHT	OUTLINE MEDIANS IN YELLOW
TURN LANE MARKINGS	6 (150) LINE; FULL SIZE LETTERS & SYMBOLS (8' (2.4m))	SOL1D	WHITE	SEE TYPICAL TURN LANE MARKING DETAIL
TWO WAY LEFT TURN MARKING	2 @ 4 (100) EACH DIRECTION 8' (2.4m) LEFT ARROW	SKIP-DASH AND SOLID IN PA[RS	YELLOW WHITE	10' (3 m) LINE WITH 30' (9 m) SPACE FOR SKIP-DASH, 5½ (140) C-C BETWEEN SOLID LINE AND SKIP-DASH (140) EFT TURN MARKING DETAIL
CROSSWALK LINES (PEDESTRIAN) A. DIAGONALS (BIKE & EQUESTRIAN) B. LONGITUDINAL BARS (SCHOOL)	2 e 6 (150) 12 (300) e 45° 12 (300) e 90°	SOLID SOLID SOLID	WHITE WHITE WHITE	NOT LESS THAN 6' (1,8 m) APART 2' (600) APART 2' (600) APART 5' (500) APART SEE TYPICAL CROSSWALK MARKING DETAILS.
STOP LINES	24 (600)	SOLID	WHETE.	PLACE 4' (1.2 m) IN ADVANCE OF AND PARALLEL TO CROSSWALK, IF PRESENT, OTHERWISE, PLACE AT DESIRED STOPPING PODIT, PARALLEL TO CROSSROAD CENTERLINE, WHERE POSSELE.
PAINTED MEDIANS	2 @ 4 (100) WITH 12 (300) DIAGONALS @ 45° NO DIAGONALS USED FOR 4' (1.2 m) WIDE MEDIANS	SOLID	YELLOW: TWO WAY TRAFFIC WHITE: ONE WAY TRAFFIC	11 (280) C-C FOR THE DOUBLE LINE SEE TYPICAL PAINTED MEDIAN MARKING.
GORE MARKING AND CHANNELIZING LINES	8 (200) WITH 12 (300) DIAGONALS @ 45°	SOLID	WHETE	DEAGONALS: 15' (4,5 m) C-C (LESS THAN 30MPH (50 km/h)) 20' (6 m) C-C 30MPH (50 km/h) TO 45MPH (70 km/h)) 30' (9 m) C-C (OVER 45MPH (70 km/h))
RAILROAD CROSSING	24 (600) TRANSVERSE LINES; "RR" IS 6' (1.8 m) LETTERS; 16 (400) LINE FOR "X"	SOLID	WH[TE	SEE STATE STANDARD 780001 AREA OFI "R"=3.6 SO, FT. (0.33 m ²) EACH "X"=54.0 SO, FT. 15.0 m ²)
SHOULDER DIAGONALS (REQUIRED FOR SHOULDERS ≥ 8')	12 (300) e 45°	SOL1D	WHITE - RIGHT YELLOW - LEFT	50' (15 m) C-C (LESS THAN 30MPH (50 km/h)) 75' (25 m) C-C (30 MPH (50 km/h) TO 45MPH (70 km/h)) 150' (45 m) C-C (0VER 45MPH (70 km/h))
U TURN ARROW	SEE DETAIL	SOL1D	WHITE	16 _* 3 SF
2 ARROW COMB[NAT]ON LEFT AND U TURN	SEE DETAIL	SOL1D	WHITE	30_4 SF

FOR FURTHER DETAILS ON PAVEMENT MARKING REFER TO STANDARD SPECIFICATIONS FOR ROAD AND BRIDGE CONSTRUCTION AND STATE STANDARD 780001.

SCALE NONE

8 (200) WHITE-

12 (300) WHITE DIAGONALS

ISLAND OFFSET FROM PAVEMENT EDGE

8 (200) WH[TE ---

ISLAND AT PAVEMENT EDGE

TYPICAL ISLAND MARKING


RAISED


ISLAND

e 10' (3 m) OR LESS SPACING

unless otherwise shown.

BICYCLE & EQUESTRIAN

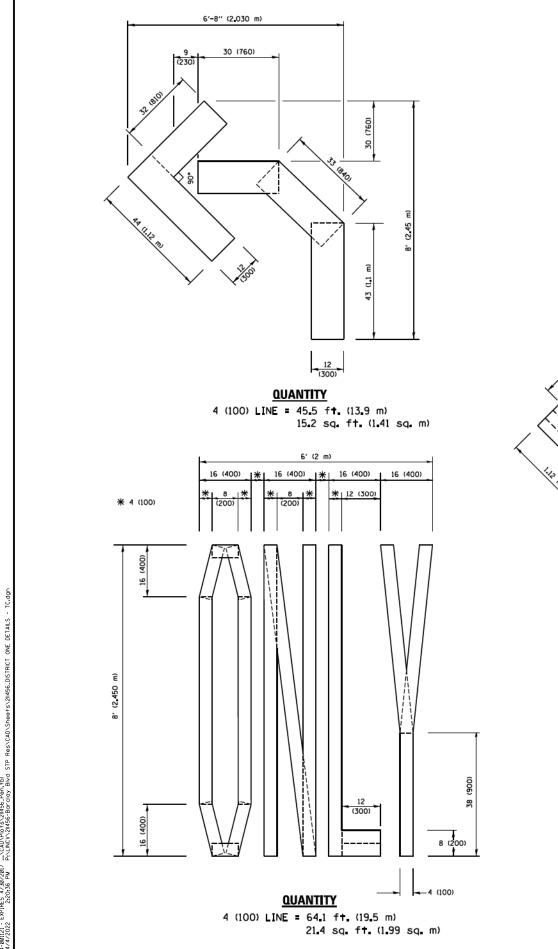

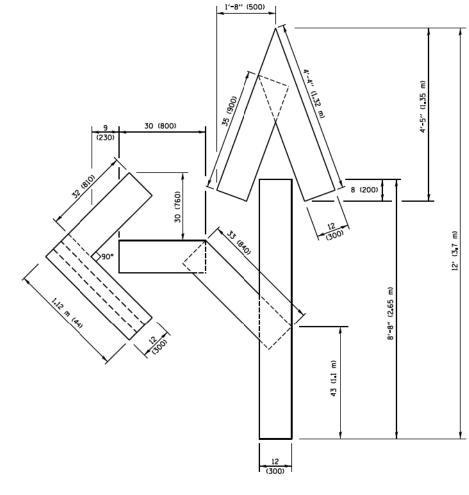


QUANTITY

4 (100) LINE = 82.5 ft. (25.1 m) 27.5 sq. ft. (2.53 sq. m)

NOTE:

ALL QUANTITIES OF PLACEMENT ARE REPRESENTED IN LINEAR FEET OF 4" LINES TO MATCH THE 4" TEMPORARY TAPE PAY ITEM AND REPRESENTS THE TOTAL QUANTITY OF 4" TAPE REQUIRED.

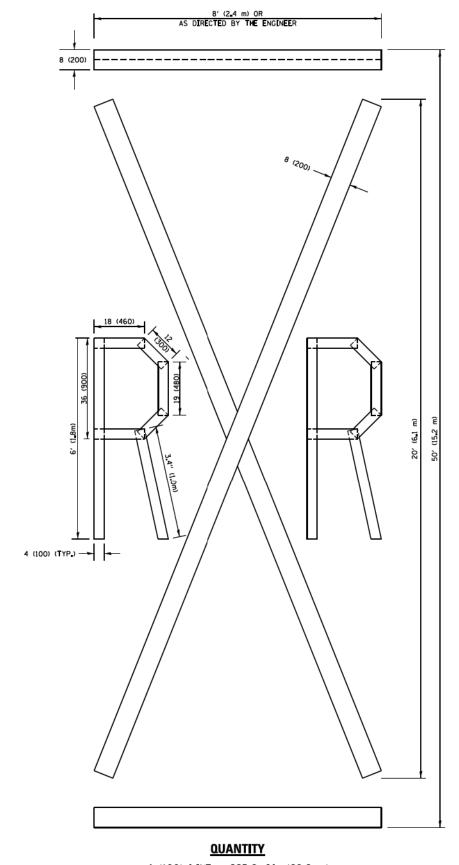

4 (100) LINE = 225.9 ft. (68.9 m) 75.3 sq. ft. (6.99 sq. m)

All dimensions are in inches (millimeters) unless otherwise shown.

SECT10N

FILE NAME : DES[GNED -USER NAME = footemj REV[SED -T_ RAMMACHER 03-02-98 ments\IDDT Offices\District 1\Projects\Dist**@R2WM**CADDete\CADsheets\tc16.dgn REVISED -E. GOMEZ 08-28-00 STATE OF ILLINOIS SHORT TERM PAVEMENT MARKING LETTERS AND SYMBOLS 20-00025-00-RS PLOT SCALE = 50.0000 '/ in-CHECKED -REVISED -E. GOMEZ 08-28-00 **DEPARTMENT OF TRANSPORTATION** TC-16 CONTRACT NO. 61H79
FED. ROAD DIST. NO. 1 ILLINOIS FED. AID PROJECTO-00025-00-RS SCALE NONE SHEET NO. 1 OF 1 SHEETS STA. DATE - 09-18-94 REVISED - A. SCHUETZE 09-15-16 PLOT DATE 9/15/2016

NOTES:

- 1. USE BLACK LETTERING ON ORANGE BACKGROUND.
- 2. ERECT SIGNS IN ADVANCE OF THE LOCATION FOR THE "ROAD CONSTRUCTION AHEAD" SIGN AT LOCATIONS AS DIRECTED BY THE ENGINEER.
- 3. ERECT SIGN (1) WITH INSTALLED PANEL (2) ONE WEEK PRIOR TO THE START OF CONSTRUCTION.
- 4. REMOVE PANEL 2 SOON AFTER THE START OF CONSTRUCTION.
- 5. SEE SPECIAL PROVISION FOR "TEMPORARY INFORMATION SIGNING" FOR ADDITIONAL INFORMATION.
- 6. ONE SIGN ASSEMBLY EQUALS 25.70 SQ. FT. (2.3 SQ. M.)
- 7. SHALL BE PAID FOR AS TEMPORARY INFORMATION SIGNING.

ALL DIMENSIONS ARE IN INCHES (MILLIMETERS) UNLESS OTHERWISE SHOWN.

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	FILE NAME =	USER NAME = gaglianobt	DESIGNED -	REVISED	 R. MIRS 09-15-97
	Wi\dastatd\22x34\to22.dgn		DRAWN -	REVISED	 R. MIRS 12-11-97
Ē		PLOT SCALE = 50.000 '/ IN.	CHECKED -	REVISED	-T. RAMMACHER 02-02-
5	1	DLOT DATE - 1/4/2000	DATE	DEVICED	C IIICTUS 01-31-0

STATE	0	: ILLINOIS
DEPARTMENT	0F	TRANSPORTATION

ARTERIAL ROAD INFORMATION SIGN					F.A RTE. 1677	SECTION 20-00025-00-RS	COUNTY	TOTAL SHEETS 25	SHEET NO. 25
						TC-22	CONTRACT		
ALE: NONE	SHEET NO. 1 OF	1 SHEETS	STA.	TO STA.	FED. ROAD DIST. NO. 1 ILLINOIS FED. AID PROJECTO-00025-00-R				