
06-17-2022 LETTING ITEM 154 **INDEX OF SHEETS** COVER SHEET GENERAL NOTES & COMMITMENTS SUMMARY OF QUANTITIES 3-8 9-15 TYPICAL SECTION 16-22 **SCHEDULES** 23 LAYOUT MAP 24-55 ADA DETAILS MISCELLANEOUS DETAILS LIST OF ILLINOIS DOT HIGHWAY STANDARDS STANDARD SYMBOLS, ABBREVIATIONS AND PATTERNS DECIMAL OF AN INCH AND OF A FOOT TEMPORARY EROSION CONTROL SYSTEMS 280001 07 406201-01 MAILBOX TURNOUT 442201-03 CLASS C AND D PATCHES 542011-02 CONCRETE END SECTIONS FOR ELLIPTICAL PIPE CULVERTS 15" (375mm) THRU 72" (1800 mm) EQUIVALENT DIAMETER 542311-07 TRAVERSABLE PIPE GRATE FOR CONCRETE END SECTIONS 701001-02

STATE OF ILLINOIS **DEPARTMENT OF TRANSPORTATION**

PROPOSED HIGHWAY PLANS

FAS 1324 (OR 45), FAS 321 (MAIN ST) SECTION (38)RS-5,SW PROJECT STP-YY9S(980) **3P MILL & RESURF & ADA IROQUOIS COUNTY**

C-93-072-21

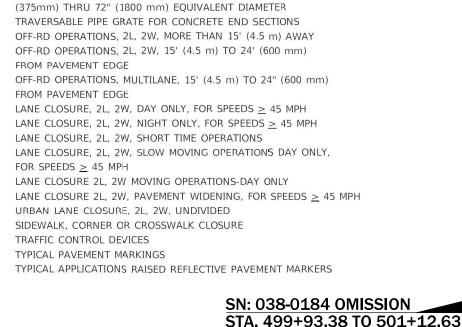

SN: 038-0185 OMISSION

STA. 558+09.92 TO 559+38.08

END PROJECT

STA. 695+10

KANKAKEE CO E 3200 North Rd **BEGIN PROJECT** STA. 417+71 IROQUOIS CO E 2900 North Rd

ON REDUCED PLANS, THE ABOVE SCALES MAY BE USED. JOINT UTILITY LOCATION INFORMATION FOR EXCAVATION 1-800-892-0123

CONFORM TO STANDARD SCALES. IN MAKING MEASUREMENTS

FULL SIZE PLANS HAVE BEEN PREPARED USING STANDARD ENGINEERING SCALES. REDUCED SIZED PLANS WILL NOT

PROJECT ENGINEER JOE KANNEL, P.E. UNIT CHIEF JORDAN LONGNECKER **DISTRICT 3 NO. (815) 434-6131** CONTRACT NO. 66K68

701006-05

701101-05

701201-05

701311-03

701326-04

701501-06

701801-06

701901-08

780001-05

 \circ

FROM PAVEMENT EDGE

FROM PAVEMENT EDGE

FOR SPEEDS > 45 MPH

GROSS LENGTH = 27403 FT. = ± 5.19 MILES NET LENGTH = 27245 FT. = ± 5.16 MILES

(38)RS-5.SW IROQUOIS ILLINOIS CONTRACT NO. 66K68



FUNCTIONAL CLASSIFICATION: OTHER MAJOR COLLECTOR RURAL

2018 ADT: 2550

PV = 100% SU = 0.0% MU = 0.0%



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THE HMA SURFACE OF ALL MAILBOX TURNOUTS, PRIVATE ENTRANCES, COMMERCIAL ENTRANCES, AND SIDE ROADS SHALL BE MADE NEATLY, IN A WORKMANLIKE MANNER, AND SHALL ACCURATELY CONFORM TO THE SHAPES AND DIMENSIONS SHOWN ON THE PLAN DETAILS. IF REQUIRED BY THE ENGINEER, THE CONTRACTOR SHALL SAW CUT THE HMA SURFACE TO CONFORM TO THE SHAPES AND DIMENSIONS SHOWN ON THE PLAN DETAILS. THIS WORK WILL BE INCLUDED IN THE COST OF THE HMA SURFACE.

EXCEPT AS NOTED ON THE PLANS, PAVEMENT GRADES SHOWN ARE AT THE TOP OF PAVEMENT SURFACES.

BEFORE ORDERING PIPE CULVERTS OR PIPE DRAINS, THE CONTRACTOR SHALL CONSULT THE ENGINEER FOR EXACT LENGTHS.

THE ENGINEER WILL BE THE SOLE JUDGE CONCERNING CURING TIME FOR THE VARIOUS HMA LIFTS.

ON EXISTING PAVEMENT WHICH MAY BE SUPERELEVATED, THE NEW HMA PAVEMENT SHALL BE BUILT WITH THE SAME SUPERELEVATION UNLESS NEW SUPERELEVATION RATES ARE GIVEN ON THE PLANS.

ALL ELEVATIONS REFERRING TO U.S.G.S. MEAN SEA LEVEL DATUM.

THE FOLLOWING RATES OF APPLICATION HAVE BEEN USED IN CALCULATING PLAN QUANTITIES:

GRANULAR MATERIALS	2.05	TONS / CU YD
HMA RESURFACING	112	LBS / SQ YD / IN
SHORT TERM PAVEMENT MARKING	10	FT /100 FT OF APPLICATION
MIX FOR CRACKS, JTS & FLGWYS	0.0003	TONS / SQ YD
LEVEL BINDER (HAND METHOD)	0.0005	TONS / SQ YD

ALL DAMAGE TO DEPARTMENT OWNED UNDERGROUND FACILITIES, CAUSED BY THE CONTRACTOR SHALL BE REPAIRED TO THE SATISFACTION OF THE ENGINEER AND AT NO EXPENSE TO THE DEPARTMENT. THIS SHALL INCLUDE ALL TEMPORARY REPAIRS REQUIRED TO KEEP THE FACILITY OPERATIONAL WHILE MATERIAL IS BEING OBTAINED TO MAKE PERMANENT REPAIRS. SPLICING OF ELECTRIC CABLE WILL NOT BE ALLOWED. ELECTRIC CABLE SHALL BE REPLACED FROM POLE TO POLE OR CONTROLLER.

MEMBERS OF JULIE KNOWN TO BE WITHIN THE LIMITS OF THE IMPROVEMENT ARE: AMEREN, COMCAST, EASTERN ILLINI ELECTRIP CO-OP. FRONTIER, METRO, NICOR, WINDSTREAM, ZAYO, CHEBANSE, AND CLIFTON.

THE CONTRACTOR SHALL CONTACT JULIE AT LEAST 48 HOURS PRIOR TO EXCAVATION TO DETERMINE WHICH ULTILITES ARE WITH THE AREA.

COMMITMENTS

HMA MIXTURE REQUIREMENT TABLE										
LOCATIONS:	ENTIRE PROJECT	ENTIRE PROJECT	ENTIRE PROJECT	ENTIRE PROJECT	ENTIRE PROJECT					
MIXTURE USE(S):	HMA	HMA	HMA SHOULDER 8"	HMA SHOULDER 8"	HMA					
	SURFACE	BINDER	BOTTOM LIFT (S)	TOP LIFT	INCIDENTAL					
BINDER GRADE (PG):	PG 64-22	PG 64-22	PG 64-22	PG 64-22	PG 64-22					
DESIGN AIR VOIDS:	4.0% @ N70	4.0% @ N70	4.0% @ N50	4.0% @ N50	4.0% @ N50					
MIXTURE COMPOSITION:	IL 9.5	I∟ 19.0	IL 19.0	IL 9.5	IL 9.5					
(MIXTURE GRADATION)										
FRICTION AGGREGATE:	MIXTURE C	·								
MIXTURE WEIGHT:	112.0 LB/SY/IN	112.0 LB/SY/IN	112.0 LB/SY/IN	112.0 LB/SY/IN	112.0 LB/SY/IN					
QUALITY MANAGEMENT PROGRAM:	QCP	QCP	QCQA	QCQA	QCQA					
SUBLOT SIZE:	1000 TONS	1000 TONS	N/A	N/A	N/A					
DENSITY TEST METHOD:	CORES	CORES	CORES	CORES	SATISFACTION OF ENGINEER					
MATERIAL TRANSFER DEVICE (REQUIRED)	YES	YES	NO	NO	NO					

STATE OF ILLINOIS
DEPARTMENT OF TRANSPORTATION
DISTRICT THREE
AS BUILT INFORMATION

SCALE:

STATE OF ILLINOIS DEPARTMENT OF TRANSPORTATION DISTRICT THREE

	SUPERVISING CONSTRUCTION FIELD ENGINEER		
		PREPARED BY:	
	RESIDENT ENGINEER / TECHNICIAN		DISTRICT STUDIES & PLANS ENGINEER
		DATE:	
TART & END DATES OF CONSTRUCTION:			
OF CONSTRUCTION.		EXAMINED BY:	
INSPECTORS:			DISTRICT CONSTRUCTION ENGINEER
			DISTRICT MATERIALS ENGINEER
			DISTRICT OPERATIONS ENGINEER

STATE OF ILLINOIS
DEPARTMENT OF TRANSPORTATION

				CONSTRUCTION CODE					
				80% FED 20% ST	80% FED 20% ST			80% FED 20% VIL	80% FED 20% VIL
				FAS 1324	FAS 321	FAS 1324	FAS 321	FAS 1324	FAS 321
				ROADWAY	ROADWAY	ROADWAY	ROADWAY	ROADWAY	ROADWAY
CODE			TOTAL	0005	0005	0005	0005	0021	0021
NO.	I TEM	UNIT	QUANTITY	RURAL	RURAL	RURAL	RURAL	RURAL	RURAL
			 						
20400800	FURNISHED EXCAVATION	CU YD	15	15					
	SOURCE MANUAL PROPERTY OF AN EXPRESSION OF	100F0 V0000	Sections	80.80					
20800150	TRENCH BACKFILL	CU YD	71	68				3	
		A-700A-000A-70	n 2 more	9 27 50000					
21400100	GRADING AND SHAPING DITCHES	FOOT	1400	1400					
25000210		1.65.5	0.5	0.5					
25000210	SEEDING, CLASS 2A	ACRE	0.5	0.5					
25000400	NITDOCEN FEBTU 1750 AUTDIENT	DOLIND	42	4.2					
25000400	NITROGEN FERTILIZER NUTRIENT	POUND	42	42					
25000500	DUOCDUODUC FEDTU 1750 AUSTRIENT	DOLIND	4.2	42				-	
25000500	PHOSPHORUS FERTILIZER NUTRIENT	POUND	42	42					
35000600	DOTACCIUM FEDTILIZED MUTDIENT	POUND	42	42					
25000600	POTASSIUM FERTILIZER NUTRIENT	POUND	42	42					
25100630	EROSION CONTROL BLANKET	SQ YD	2266	2266					
23100630	EROSTON CONTROL BLANKET	SQ TD	2200	2200					
25200100	SODDING	SQ YD	357	233	124				
23200100		30 10	337		124				
40200800	AGGREGATE SURFACE COURSE, TYPE B	TON	87	87					
	ACCURE SOME SOME COOKSE, THE B	1011		-					
40600290	BITUMINOUS MATERIALS (TACK COAT)	POUND	55331	45683	7454	203	1991		
	The first contract of the cont	1 00115	33331	13003	7.12.1	203	1331	<u> </u>	
40600370	LONGITUDINAL JOINT SEALANT	FOOT	30659	24916	5743				
					3007-3007, 3 \$3000				
				_					
40600400	MIXTURE FOR CRACKS, JOINTS, AND FLANGEWAYS	TON	24	20	3		1		
300 40 40 260		2000000		-01 #6				_	
				_					
40600901	HOT-MIX ASPHALT BINDER COURSE (HAND METHOD), N70	TON	36	32	4				
				_	-				
40600990	TEMPORARY RAMP	SQ YD	1406	981	425				
							_		

USER NAME = longneckerjh	DESIGNED -	REVISED -
	DRAWN -	REVISED -
PLOT SCALE = 100.0000 / in.	CHECKED -	REVISED -
PLOT DATE = 4/26/2022	DATE -	REVISED -

SCALE:

	CHMMADY OF CHANTITIES						F.A.S. SECTION		COUNTY	TOTAL SHEETS	SHEET NO.		
	SUMMARY OF QUANTITIES					1324	(38)RS-5,SW		IROQUOIS	61	3		
											CONTRACT	NO. 66	5K68
S	HEET :	l	OF	6	SHEETS	STA.	TO STA.		ILLINOIS	FED. A	ID PROJECT		

						CONSTRU	CTION CODE		
				80% FED 20% ST	80% FED 20% ST			80% FED 20% VIL	80% FED 20% VI
				FAS 1324	FAS 321	FAS 1324	FAS 321	FAS 1324	FAS 321
				ROADWAY	ROADWAY	ROADWAY	ROADWAY	ROADWAY	ROADWAY
CODE			TOTAL	0005	0005	0005	0005	0021	0021
NO.	ITEM	UNIT	QUANTITY	RURAL	RURAL	RURAL	RURAL	RURAL	RURAL
NO.	11EM	UNII	QUANTITY	RUKAL	RURAL	RURAL	KUKAL	RUKAL	RUKAL
40603085	HOT-MIX ASPHALT BINDER COURSE, IL-19.0, N70	TON	10748	9414	1334				
10003003		1 1011	10710	3111	133 /				
40604052	HOT-MIX ASPHALT SURFACE COURSE, IL-9.5, MIX "C", N70	TON	6686	5531	882	25	248		
40800050	INCIDENTAL HOT-MIX ASPHALT SURFACING	TON	560	443	117				
42400100	PORTLAND CEMENT CONCRETE SIDEWALK 4 INCH	SQ FT	6086	2307	3779			_	
42400800	DETECTABLE WARNINGS	SQ FT	692	283	409				
44000100	DAVENERT DEMOVAL	50. 1/0	125						
44000100	PAVEMENT REMOVAL	SQ YD	125	8	90			1,	26
44000164	HOT-MIX ASPHALT SURFACE REMOVAL, 3 3/4"	SQ YD	76344	65840	10504				
44000104	TIOT-MIX ASPITALT SURFACE REMOVAL, 3 3/4	30 10	70344	03840	10304				
44000300	CURB REMOVAL	FOOT	241					183	58
44000500	COMBINATION CURB AND GUTTER REMOVAL	FOOT	144	81	63				
·									
44000600	SIDEWALK REMOVAL	SQ FT	3308	717	1539			409	643
				-					
44201737	CLASS D PATCHES, TYPE I, 8 INCH	SQ YD	24	14	10				
44201741	CLASS D PATCHES, TYPE II, 8 INCH	SQ YD	26		26		_		
44201741	CLASS D PAICHES, TIPE II, & INCH	30 10	26	_	20	+			
44201747	CLASS D PATCHES, TYPE IV, 8 INCH	SQ YD	26			<u> </u>			26
		# 13 (NE)							,
44201789	CLASS D PATCHES, TYPE II, 12 INCH	SQ YD	318	_	69	67	182		
44201794	CLASS D PATCHES, TYPE III, 12 INCH	SQ YD	111	34			77		

*= SPECIALTY ITEM

USER NAME = longneckerjh	DESIGNED -	REVISED -
	DRAWN -	REVISED -
PLOT SCALE = 100.0000 / in.	CHECKED -	REVISED -
PLOT DATE = 4/26/2022	DATE -	REVISED -

011111111111111111111111111111111111111	F.A.S. RTE	SEC ⁻	LION		COUNTY		
SUMMARY OF O	1324 (38)RS-5,SW			IROQUOI			
							CONTRA
SHEET 2 OF 6 SHEET	S STA.	TO STA.			ILLINOIS	FED. A	ID PROJECT

				CONSTRUCTION CODE						
						50% VIL 50% ST	50% VIL 50% ST		80% FED 20% VIL	
	_	I	1	FAS 1324 ROADWAY	FAS 321 ROADWAY	FAS 1324 ROADWAY	FAS 321 ROADWAY	FAS 1324 ROADWAY	FAS 321 ROADWAY	
CODE			TOTAL	0005	0005	0005	0005	0021	0021	
NO.	ITEM	UNIT	QUANTITY		RURAL	RURAL	RURAL	RURAL	RURAL	
49102100	AGGREGATE WEDGE SHOULDER, TYPE B	TON	1773	1549	224		_			
40102100	AGGREGATE WEDGE SHOOLDER, THE B	1011	1775	1549	224					
				_						
48203029	HOT-MIX ASPHALT SHOULDERS, 8"	SQ YD	3387	2734	653					
48203100	HOT-MIX ASPHALT SHOULDERS	TON	357		357					
F0200225	CONCRETE CIPLICITIES	GIL VD	4 0	-			_	_		
30300225	CONCRETE STRUCTURES	CU YD	4.8	4.8			_	_		
							_			
50800205	REINFORCEMENT BARS, EPOXY COATED	POUND	441	441						
52100510	ANCHOR BOLTS, 3/4"	EACH	8	8						
			1							
	PIPE CULVERTS, CLASS A, TYPE 2 EQUIVALENT ROUND-SIZE							_		
542A8215	30"	FOOT	48	48						
54260315	TRAVERSABLE PIPE GRATE FOR CONCRETE END SECTION	FOOT	9.4	9.4						
			1							
E 4262220	CONCRETE FAIR CECTION CTANDARD F42011 201 1.2	FACU	1	1						
54263330	CONCRETE END SECTION, STANDARD 542011, 30", 1:3	EACH	1	1						
550A0050	STORM SEWERS, CLASS A, TYPE 1 12"	FOOT	15		15					
60238800	INLETS, TYPE A	EACH	1	-	1					
24 9000000000000000000000000000000000000	2000000	52.955 30.455 6	1							
	INLETS TO BE ADJUSTED WITH NEW TYPE 1 FRAME, CLOSED			_						
60260400	LID	EACH	1	_	1					
60600605	CONCRETE CURB, TYPE B	FOOT	492		492					
				_						
60603500	COMBINATION CONCRETE CURB AND GUTTER, TYPE B-6.06	FOOT	21	_	21					
	SOLD THE BOOK OF T	1001		_	2.1					
60604400	COMBINATION CONCRETE CURB AND GUTTER, TYPE B-6.18	FOOT	56	12	44					
60605000	COMBINATION CONCRETE CURB AND GUTTER, TYPE B-6.24	FOOT	69	69						
				_			_			
					<u> </u>	1		<u> </u>		

FILE NAME: pw://ildot-pw.

STATE OF ILLINOIS
DEPARTMENT OF TRANSPORTATION

SCALE:

 SUMMARY OF QUANTITIES
 F.A.S. RTE. 1324

 SHEET 3 OF 6 SHEETS STA. TO STA.
 TO STA.

F.A.S. RTE. SECTION COUNTY TOTAL SHEETS NO. 1324 (38)RS-5,SW IROQUOIS 61 5 CONTRACT NO. 66K68

						CONSTRU	CTION CODE		
				80% FED 20% ST	80% FED 20% ST			80% FED 20% VIL	80% FED 20% VI
				FAS 1324	FAS 321	FAS 1324	FAS 321	FAS 1324	FAS 321
				ROADWAY	ROADWAY	ROADWAY	ROADWAY	ROADWAY	ROADWAY
CODE			TOTAL	0005	0005	0005	0005	0021	0021
NO.	ITEM	UNIT	QUANTITY	RURAL	RURAL	RURAL	RURAL	RURAL	RURAL
		0.111	QUINTITY	NOTATE		Notifie			
60618300	CONCRETE MEDIAN SURFACE, 4 INCH	SQ FT	121	_	121		_		
28 502 5030		,			50,000,000				
63301210	REMOVE AND REERECT STEEL PLATE BEAM GUARDRAIL, TYPE A	FOOT	75	75					
03301210	NEIGHT AND RELIEU STEEL FEATURE SEATT GOALDINIE, THE A	1 001	, ,	, ,					
66900200	NON-SPECIAL WASTE DISPOSAL	CU YD	50	25	25				
66900530	SOIL DISPOSAL ANALYSIS	EACH	2	1	1				
66901001	REGULATED SUBSTANCES PRE-CONSTRUCTION PLAN	L SUM	1	0.5	0.5		_		
00301001	REGULATED SUBSTANCES THE CONSTRUCTION FEAR	L 30M	1		0.3				
66901003	REGULATED SUBSTANCES FINAL CONSTRUCTION REPORT	L SUM	1	0.5	0.5				
66901006	REGULATED SUBSTANCES MONITORING	CAL DA	3	1.5	1.5				
67000400	ENGINEER'S FIELD OFFICE, TYPE A	CAL MO	3	2	1				
67100100	MOBILIZATION	L SUM	1	0.8	0.2				
70100450	TRAFFIC CONTROL AND PROTECTION CTANDARD TOLOGO				0.2				
70100450	TRAFFIC CONTROL AND PROTECTION, STANDARD 701201	L SUM	1	0.8	0.2				
70100455	TRAFFIC CONTROL AND PROTECTION, STANDARD 701206	L SUM	1	0.8	0.2				
70100460	TRAFFIC CONTROL AND PROTECTION, STANDARD 701306	L SUM	1	0.8	0.2				
70100500	TOUTE OF CONTROL AND PROTECTION OF UP AND ADDRESS.								
70100500	TRAFFIC CONTROL AND PROTECTION, STANDARD 701326	L SUM	1	0.8	0.2				
70102620	TRAFFIC CONTROL AND PROTECTION, STANDARD 701501	L SUM	1	0.5	0.5				
70102640	TRAFFIC CONTROL AND PROTECTION, STANDARD 701801	L SUM	1	0.5	0.5				
70200100	NIGHTTIME WORK ZONE LIGHTING	L SUM	1	1			_		
70200100	SHORT TERM DAVEMENT MARKING	ECOT	0212	7215	000				
70300100	SHORT TERM PAVEMENT MARKING	FOOT	8313	7315	998				
		I	1			1	1	1	ĺ

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								80% FED 20% VIL	
		1	_	FAS 1324	FAS 321	FAS 1324	FAS 321	FAS 1324	FAS 321
				ROADWAY	ROADWAY	ROADWAY	ROADWAY	ROADWAY	ROADWAY
CODE			TOTAL	0005	0005	0005	0005	0021	0021
NO.	I TEM	UNIT	QUANTITY	RURAL	RURAL	RURAL	RURAL	RURAL	RURAL
70740150	CUODE TERM DAVEMENT MARKING DEMOVAL	60.57	2772	2420	222				
70300150	SHORT TERM PAVEMENT MARKING REMOVAL	SQ FT	2772	2439	333				
1000 NO.								_	
* 72400500	RELOCATE SIGN PANEL ASSEMBLY - TYPE A	EACH	1	1					
* 78000100	THERMOPLASTIC PAVEMENT MARKING - LETTERS AND SYMBOLS	SQ FT	187.2		187.2				
* 78000200	THERMOPLASTIC PAVEMENT MARKING - LINE 4"	FOOT	8380	_	8380				
* 78000500	THERMOPLASTIC PAVEMENT MARKING - LINE 8"	FOOT	206		206				
* 78000600	THERMOPLASTIC PAVEMENT MARKING - LINE 12"	FOOT	276	_	276		-		
* 78000650	THERMOPLASTIC PAVEMENT MARKING - LINE 24"	FOOT	60		60				
* 78000630	THERMOPLASTIC PAVEMENT MARKING - LINE 24	FOOT	80		60				
* 78009004	MODIFIED URETHANE PAVEMENT MARKING - LINE 4"	FOOT	106412	97816	8596				
				_					
* 78009006	MODIFIED URETHANE PAVEMENT MARKING - LINE 6"	FOOT	14021	12465	1556				
* 78011000	GROOVING FOR RECESSED PAVEMENT MARKING, LETTERS AND SYMBOLS	SQ FT	187.2		187.2				
* 78011025	GROOVING FOR RECESSED PAVEMENT MARKING 5"	FOOT	16898	8518	8380				
* 78011045	GROOVING FOR RECESSED PAVEMENT MARKING 9"	FOOT	206		206				
* 78011065	GROOVING FOR RECESSED PAVEMENT MARKING 13"	FOOT	276		276				
* 78011125	GROOVING FOR RECESSED PAVEMENT MARKING 25"	FOOT	60	_	60				
* /3011123	CHOCKING FOR RECESSED FAVERENT PLANKING 25	1 001							
* 78100100	RAISED REFLECTIVE PAVEMENT MARKER	EACH	37.5	311	64				
				_					
* 78200020	CURB REFLECTORS	EACH	35		35				

*= SPECIALTY ITEM

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PLOT DATE = 4/26/2022	DATE -	REVISED -

STATE OF ILLINOIS
DEPARTMENT OF TRANSPORTATION

SCALE:

OUNTAIN OF QUANTITIES							SEC.	ΠΟΝ		COUNTY
SUMMARY OF QUANTITIES						1324	(38)RS	6-5,SW		IROQUOIS
										CONTRA
	SHEET 5	OF 6	SHEETS	STA.	TO STA.			ILLINOIS	FED. AI	D PROJECT

CONSTRUCTION CODE

						CONSTRU	CTION CODE		
								80% FED 20% VIL	
		1	ı	FAS 1324	FAS 321	FAS 1324	FAS 321	FAS 1324	FAS 321
CODE			TOTAL	ROADWAY 0005	ROADWAY 0005	ROADWAY 0005	ROADWAY 0005	ROADWAY 0021	ROADWAY 0021
NO.	ITEM	UNIT	QUANTITY	RURAL	RURAL	RURAL	RURAL	RURAL	RURAL
		5.1.1	Q0/		HORRE	NOTIFIE .			
78300200	RAISED REFLECTIVE PAVEMENT MARKER REMOVAL	EACH	339	280	59				
70300200	TOTAL BUILDING TOTAL PROPERTY OF THE PROPERTY	EXCIT	333	200					
V0230050	CONCERNICATION LANGUE (CRECIAL)	I CUM	1	0.5	0.5				
XU32UU5U	CONSTRUCTION LAYOUT (SPECIAL)	L SUM	1	0.5	0.5				
				_					
X0326998	FURNISH AND INSTALL HANDRAIL	FOOT	282		282				
				_					
X0327809	LINEAR DELINEATOR PANELS, 4 INCH	EACH	100	100					
X0800001	SHOULDER REMOVAL (SPECIAL)	SQ YD	7861	7170	691				
X1200050	BOX CULVERT REMOVAL	FOOT	45	45					
X4401198	HOT-MIX ASPHALT SURFACE REMOVAL, VARIABLE DEPTH	SQ YD	6817	3061	3756				
X4402805	ISLAND REMOVAL	SQ FT	443		443			-	
X5012502	CONCRETE REMOVAL (SPECIAL)	CU YD	12	4	5				3
X6030310	FRAMES AND LIDS TO BE ADJUSTED (SPECIAL)	EACH	4	4					
X6061055	CONCRETE ISLAND (SPECIAL)	SQ FT	226		226				
0 600 × 2000 0000 0000		22.00	0.601/0.0000		,,,,,,,,,,,,,,,,,,,,,,,,,,,,,,,,,,,,,,,				
Z0007126	HANDRAIL REMOVAL	FOOT	64		64				
				_	12.0				
Z0030850	TEMPORARY INFORMATION SIGNING	SQ FT	42	42					
7003/105	MATERIAL TRANSFER DEVICE	TON	17434	14970	2464				
	TRAINEES	HOUR	1,000	_	2704				
				1,000					
-	RAILROAD PROTECTIVE LIABILITY INSURANCE	L SUM	1	1 1 000					
· · · · · · · · · · · · · · · · · · ·	TRAINEES - TRAINING PROGRAM GRADUATE	HOUR	1,000	1,000				101	
Z0050100	REMOVE AND RE-ERECT EXISTING HANDRAIL	FOOT	17		17				


Ø 0042


USER NAME = longneckerjh	DESIGNED -	REVISED -
	DRAWN -	REVISED -
PLOT SCALE = 100.0000 / in.	CHECKED -	REVISED -
PLOT DATE = 4/26/2022	DATE -	REVISED -


STATE OF ILLINOIS
DEPARTMENT OF TRANSPORTATION


SCALE:

			25 211			F.A.S. RTE	SEC ⁻	TION		COUNTY	TOTAL SHEETS
SUMMARY OF QUANTITIES							324 (38)RS-5,SW I			IROQUOIS	61
										CONTRACT	NO. 6
	SHEET 6	OF 6	SHEETS	STA.	TO STA.			ILLINOIS	FED. A	D PROJECT	

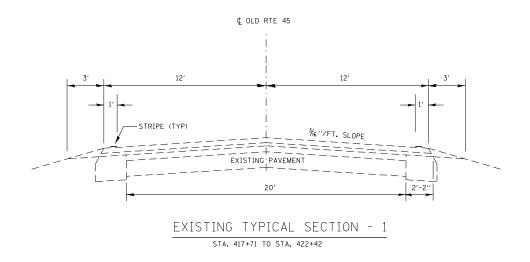

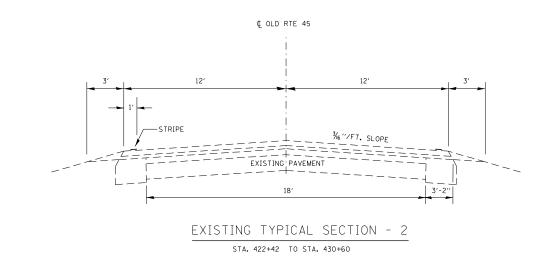

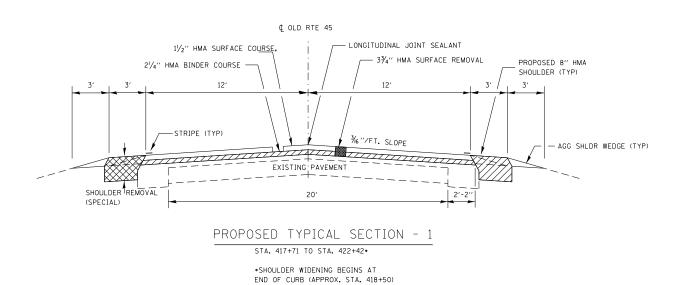

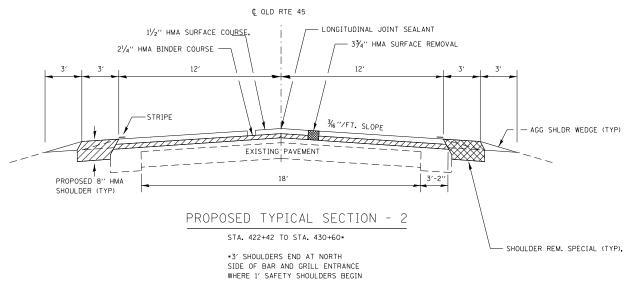


USER NAME = mariniej	DESIGNED	-	CJ	KEVISED -	
	DRAWN	-	CJ	REVISED -	
PLOT SCALE = 3.9371 / mm	CHECKED	-	JL	REVISED -	
PLOT DATE = 3/29/2022	DATE	-	3/29/2022	REVISED -	


STATE OF ILLINOIS DEPARTMENT OF TRANSPORTATION


EXISTING TYPICAL SECTION - 3

STA. 430+60 TO STA. 499+93.38 (BRIDGE DECK STA. 499+93.38 TO STA. 501+12.63) STA. 501+12.63 TO STA. 558+09.92 (BRIDGE DECK STA. 558+09.92 TO STA. 559+38.08) STA. 559+38.08 TO STA. 583+46

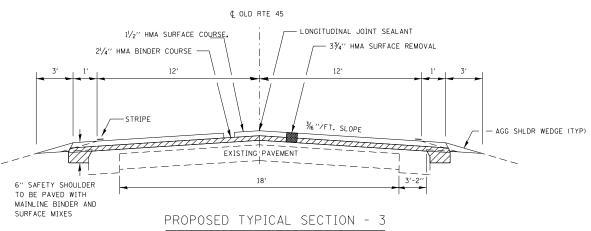

STA. 430+60 TO STA. 499+93.38 OMISSION STA. 499+93.38 TO STA. 501+12.63 STA. 501+12.63 TO STA. 558+09.92 OMISSION STA. 558+09.92 TO STA. 559+38.08 STA. 559+38.08 TO STA. 583+46

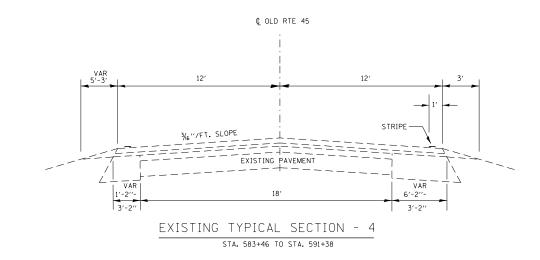


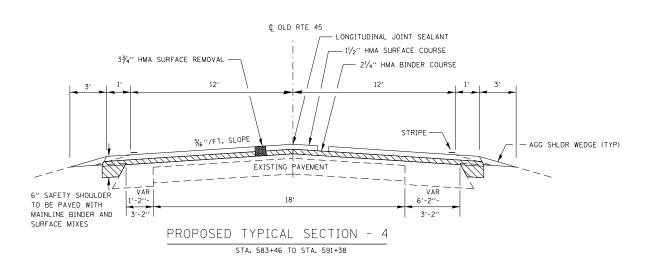



USER NAME = mariniej	DESIGNED	-	CJ	REVISED -	
	DRAWN	-	CJ	REVISED -	
PLOT SCALE = 3.9380 ' / mm	CHECKED	-	JL	REVISED -	
PLOT DATE = 3/29/2022	DATE	-	3/29/2022	REVISED -	


STATI	E OF	ILLINOIS
DEPARTMENT	OF	TRANSPORTATION

	TYPICAL SECTIONS						F.A.S. SECTION		TOTAL SHEETS	SHEET NO.
							(38)RS-5,SW	IROQUOIS	61	10
								CONTRAC	NO. 6	5K68
	SHEET 2	OF 7	SHEETS	STA.	TO STA.		ILLINOIS FE	D. AID PROJECT		

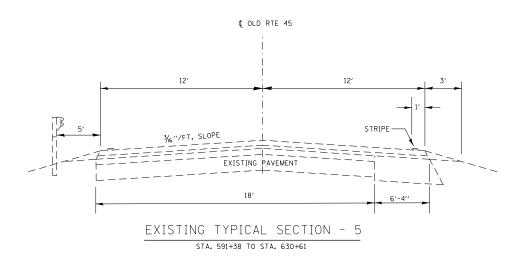

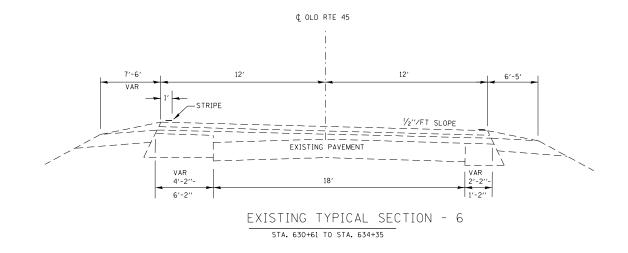

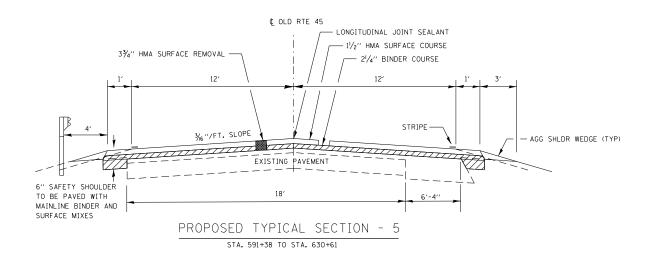

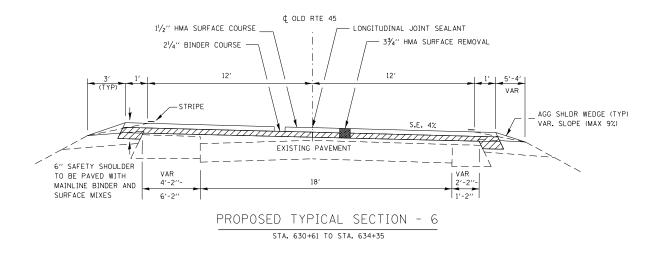

COUNTY SHEETS NO.

IROQUOIS 61 11


CONTRACT NO. 66K68


SECTION


(38)RS-5,SW


1324

USER NAME = mariniej	DESIGNED - CJ	REVISED -						
	DRAWN - CJ	REVISED -	STATE OF ILLINOIS			TYPICAL SECTI		
PLOT SCALE = 3.9380 / mm	CHECKED - JL	REVISED -	DEPARTMENT OF TRANSPORTATION					
PLOT DATE = 3/29/2022	DATE - 3/29/2022	REVISED -		SCALE:	SHEET 3	OF 7 SHEETS	STA.	TO STA.

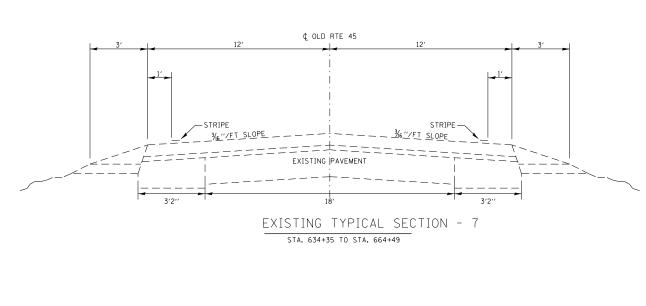


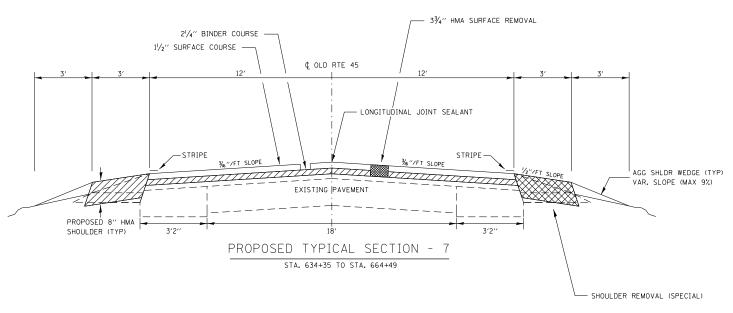

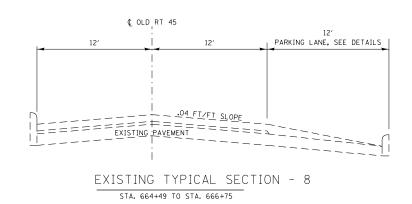

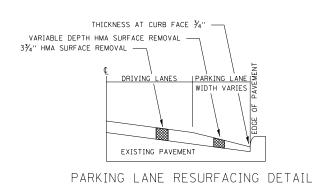



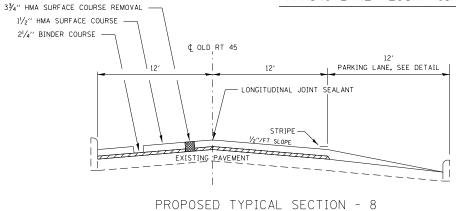


STA. 664+49 TO STA. 666+75


USER NAME = mariniej	DESIGNED	-	CJ	REVISED -
	DRAWN	-	CJ	REVISED -
PLOT SCALE = 3.9395 / mm	CHECKED	-	JL	REVISED -
PLOT DATE = 3/29/2022	DATE	-	3/29/2022	REVISED -


STATE OF I	ILLINOIS
DEPARTMENT OF TR	RANSPORTATION


						F.A.S. RTE	SECT	TION		COUNTY	TOTAL SHEETS	SHEET NO.
		TYP	ICAL SECT	IONS		1324	(38)RS	5-5,SW		IROQUOIS	61	12
										CONTRACT	NO. 66	6K68
SCALE:	SHEET 4	OF	7 SHEETS	STA.	TO STA.			ILLINOIS	FED. AI	D PROJECT		

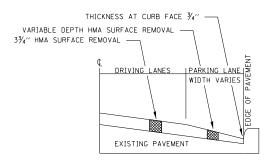

PARKING LANE RESURFACING DETAIL

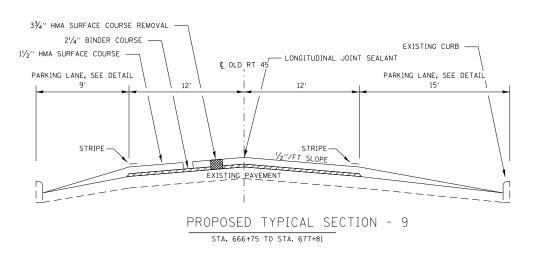

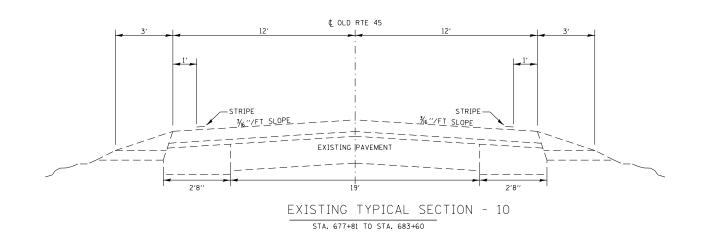


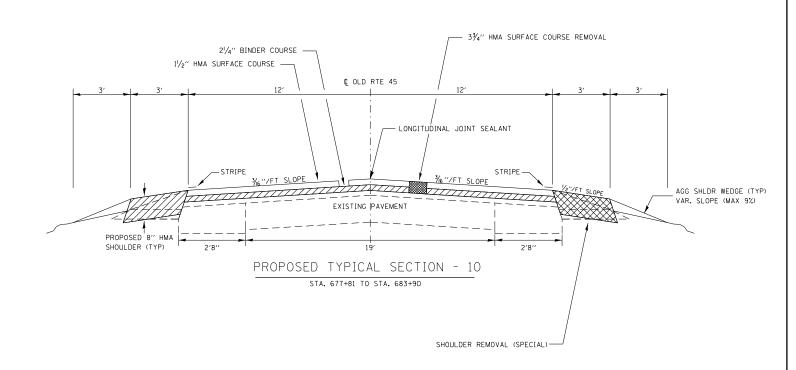



USER NAME = mariniej	DESIGNED -	CJ	REVISED -
	DRAWN -	CJ	REVISED -
PLOT SCALE = 3.9395 / mm	CHECKED -	JL	REVISED -
PLOT DATE = 3/29/2022	DATE -	3/29/2022	REVISED -


STATE OF ILLINOIS DEPARTMENT OF TRANSPORTATION

| F.A.S. | SECTION | COUNTY | SHEET | SHEET | SHEET | SHEET | SHEET | STA. | TO STA. | SHEET | SHEET | SHEET | STA. | TO STA. | SHEET | SHEET | SHEET | STA. | TO STA. | SHEET | SHEET

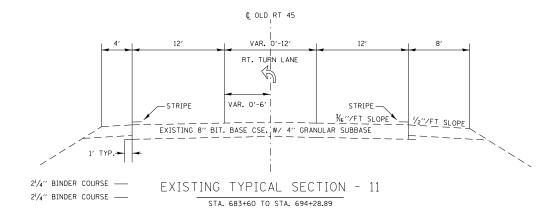

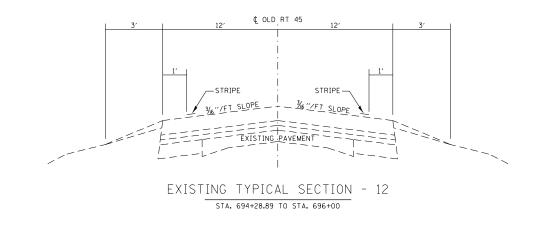

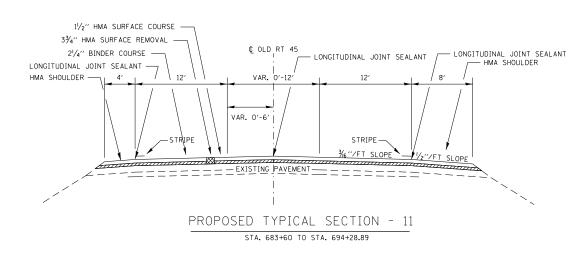


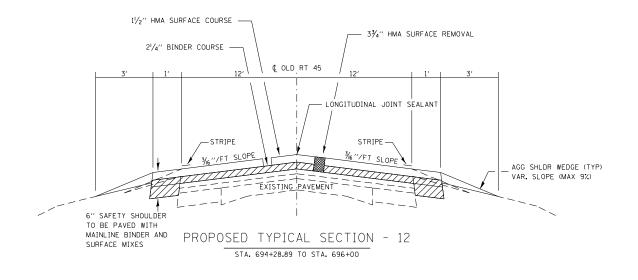


USER NAME = Harifile)	DESIGNED	-	CJ	KENIZED -	
	DRAWN	-	CJ	REVISED -	i
PLOT SCALE = 3.9395 / mm	CHECKED	-	JL	REVISED -	i
PLOT DATE = 3/29/2022	DATE	-	3/29/2022	REVISED -	

STATI	E OF	- ILLINOIS
DEPARTMENT	0F	TRANSPORTATION

					F.A.S. RTE	SECTION		COUNTY	TOTAL SHEETS	SHEET NO.
TYPICAL SECTIONS					1324	(38)RS-5,SW		IROQUOIS	61	14
								CONTRACT	NO. 66	K68
SHEET 6	OF 7	SHEETS	STA.	TO STA.		ILLINOIS	FED. A	ID PROJECT		

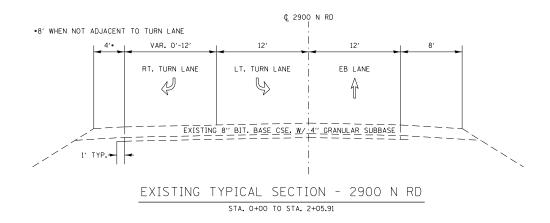

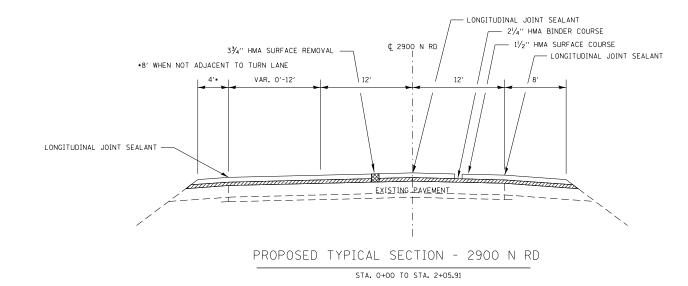

USER NAME = mariniej	DESIGNED	-	CJ	REVISED -	
	DRAWN	-	CI	REVISED -	
PLOT SCALE = 3.9395 / mm	CHECKED	-	JL	REVISED -	
PLOT DATE = 3/29/2022	DATE	-	3/29/2022	REVISED -	

						F.A.S. RTE	SECTION		COUNTY	TOTAL SHEETS	SHEET NO.
		TYPICA	L SECT	IONS		1324	(38)RS-5,SW		IROQUOIS	61	15
						·			CONTRACT	NO. 66	5K68
SCALE:	SHEET 7	OF 7	SHEETS	STA.	TO STA.		ILLINOIS	FED. AID	PROJECT		

MAINLINE SCHEDULE

			HMA	НМА	НМА	НМА					AGG		ВІТ	MIX FOR	
		AVG	SURF	SURF	SURF	BINDER	LONG	SHOULDER	8 "	HMA	WEDGE	TEMP	MAT	CRACKS,	НМА
	LENGTH	PVMT	REM	REM	CSE	COURSE	JOINT	REMOVAL	НМА	SHOULDERS	SHLD	RAMP	(TACK	JOINTS &	BIND.
LOCATION		WIDTH	3 3/4"	VAR DEPTH			SEAL	(SPECIAL)	SHLDR		TYPE B		COAT)	FLGWYS	(H.M)
	FOOT	FOOT	SQ YD	SQ YD	TON	TON	FOOT	SQ YD	SQ YD	TON	TON	SQ YD	POUND	TON	TON
417+71 TO 422+42	471	24	1256		106	158	471	194	194		18	33	848	0	1
422+22 TO 430+99	877	24	2339		196	295	877	493	493		55		1579	1	1
430+99 TO 500+00.39	6901	26	18403		1546	2701	6901	1515			437	36	12422	6	9
500+00.39 TO 501+05.61 (SN 038-0184 OMISSION)	105	26													
501+05.61 TO 558+09.92	5704	26	15211		1278	2236	5704	1268			361	72	10267	5	8
558+09.92 TO 559+38.08 (SN 038-0185 OMISSION)	128	26													
559+38.08 TO 583+46	2408	26	6421		539	944	2408	535			152	36	4334	2	3
583+46 TO 591+38	792	26	2112		177	310	792	176			50		1426	1	1
591+38 TO 630+61	3923	26	10461		879	1538	3923	872			248		7061	3	5
630+61 TO 633+78	317	26	845		71	124	317	70			20		570	0	0
633+78 TO 664+49	3071	24	8189		688	1032	3071	2047	2047		194		5528	2	4
664+49 TO 666+75	226	24	603		51	76	226				14		407	0	0
666+75 TO 677+81	1106	24	2949		248	372	1106				70		1991	1	1
677+81 TO 683+60	979	24	2611		219	329	979	653	653		62		1762	1	1
683+60 TO 694+28.89	1069	32	3801		319	479	1069			299	68		2566	1	2
694+28.89 TO 695+10	171	26	456		38	67	171	38			11	36	308	0	0
2900 N SEGMENT															
0+00 TO 2+05.91	206	30	687		58	87	206			58	13	42	464	0	0
CLIFTON PARKING LANES															<u> </u>
664+49 TO 666+75	226	12		301	25		226				14		0	0	1
666+75 TO 677+81	1106	24		2949	248		1106				70		0	0	
0007/3 10 0//701	1100	24		2343			1100				70		0		1
MAINLINE SUBTOTAL			76344	0	6413	10748	28221	7861	3387	357	1773	255	51533	23	36
CLIFTON PARKING SUBTOTAL			0	3250	273	0	1332	0	0	0	84	0	0	0	0
TOTAL	29786	476	76344	3250	6686	10748	29553	7861	3387	357	1857	255	51533	23	36

MONUMENT NUMBER	DESCRIPTION	APPROXIMATE LOCATION	EXISTING MONUMENT TYPE	PROPOSED MONUMENT TYPE	MONUMENT RECORD TO BE RECORDED	RESPONSIBILITY
OLDRTE4501	CENTER OF INTERSECTION 1ST S ST AND OR 45 IN CHEBANSE	CENTER OF INTERSECTION	NAIL AND WASHER	MAG NAIL	NO	2
_						

ONLY THE ORIGINAL SCOPE OF THIS JOB HAS BEEN SEARCHED FOR MONUMENTS. R.E. MUST INFORM PLATS AND PLANS TO SEARCH FOR ADDITIONAL MONUMENTS PRIOR TO MILLING IF AN ADDENDUM(S) HAS BEEN ADDED TO THIS JOB.

UNKNOWN MONUMENTS SET BY OTHERS MAY EXIST. IF AN UNLISTED MONUMENT IS FOUND, R.E. IS REQUIRED TO PROTECT THE MONUMENT FROM DAMAGE UNTIL A PLATS AND PLANS LAND SURVEYOR CAN DOCUMENT THE MONUMENT. PLATS AND PLANS WILL RESET SUCH MONUMENTS IN KIND FOLLOWING CONSTRUCTION.

UPON PAVING COMPLETION, R.E. WILL DIRECT PLATS AND PLANS TO RESET THE LISTED MONUMENT. NOTE: FOR BIDDING PURPOSES NO CONTRACTED LAND SURVEYING SERVICES WILL BE REQUIRED. NO MONUMENT RECORDS WILL BE REQUIRED.

RESPONSIBILITY:

- 1) RESIDENT TO RE-ESTABLISH MONUMENT (PAY ITEM REQUIRED. PERMANENT SURVEY MARKER, TYPE 1)
- 2) PLATS AND PLANS TO RE-ESTABLISH MONUMENT

USER NAME = mariniej	DESIGNED	REVISED
	DRAWN	REVISED
PLOT SCALE = 3.9369 / mm	CHECKED	REVISED
PLOT DATE = 3/29/2022	DATE	REVISED

							F.A.S. RTE.	SECTION	COUNTY	TOTAL SHEETS	SHEET NO.
			SCF	IEDULES	5		1324	(38)RS-5,SW	IROQUOIS	61	16
									CONTRACT	NO. 66	5K68
:	SHEET 1	OF	7	SHEETS	STA	TO STA		ILLINOIS FED. AI	ID PROJECT		

									SIDE	WALK								
LOCATION	QUADRANT	TRENCH BACKFILL	SODDING	PORTLAND CEMENT CONCRETE SIDEWALK 4 INCH	DETECTABLE WARNINGS	REM	MENT OVAL VILLAGE	CURB RE		COMBINATION CURB AND GUTTER REMOVAL	SIDEV REMO	DVAL	CLASS D PATCHES, TYPE I, 8 INCH	CLASS D PATCHES, TYPE II, 8 INCH	CLASS D PATCHES, TYPE IV, 8 INCH VILLAGE	STORM SEWERS, CLASS A, TYPE 1 12"	INLETS, TYPE A	INLETS TO BE ADJUS WITH NEW TYPE FRAME, CLOSED L
		CU YD	SQ YD	SQ FT	SQ FT		SQ YD		FOOT	FOOT	SQ FT		SQ YD	SQ YD	SQYD	FOOT	EACH	EACH
TON								_										
TON	NW	1	9.3	166.5	16.0						146.5			Ī				
	NE NE		4.0	35.5	8.0	1.5					15.9							
2900 NORTH ROAD	NE ISLAND			138.0	35.8	1.0				18.4	10.0							
	SE		7.3	73.7	8.0	1.2					52.4							
	SE ISLAND			79.3	20.0					33.3								
	NE OW/		3.3	30.5	8.0		0.8				50.0	18.0						
	SW SE (N-S		6.8	122.9	16.0			_			50.0					<u> </u>		
E 7TH AVE	CROSSING)		1.7	20.8	8.0						20.2							
	SE (E-W		11.7	180.3	10.0						56.3							
	CROSSING)																	
	NW		5.8	124.9	16.0			12.4			49.9	100.0						
E 6TH AVE	NE SW		15.2 6.1	235.9 132.5	20.0 16.0			12.4	-		47.4	109.0						
	SE		2.3	317.1	20.0						66.6							
	NW		19.7	314.3	20.0			25.3			80.6							
	NE			130.7	29.2			6.9			98.4							
E 5TH AVE	SW (N-S		4.0	60.2	14.7				11.7			53.3						
ESINAVE	CROSSING) SW (E-W															_		
	CROSSING)		5.1	89.6	15.6			14.8			79.4							
	SE			358.2	22.7	35.8		46.4			154.4			12.4				
	NE			132.9	11.6		8.5		21.7			67.0						
E 4TH AVE	SW	2.0	7.1	100.7	10.0	F4 4		40.0			86.8		2.7	12.2		45.0		
	SE NW (N-S	3.0		212.0	20.6	51.4		48.8			207.7		3.7	13.3		15.0	1	1
	CROSSING)		5.6	93.8	15.4				2.5			74.6						
E 3RD AVE	NW (E-W		4.2	71.8	16.1			8.9			59.1							
ESRUAVE	CROSSING)			50 AMESON	16.1			0.9										
	NE .		4.4	288.5	20.0			19.6		11.6	267.5		6.7					
	SE NE		3.4	268.2 34.5	11.0 8.0		17.0		22.3			321.0 27.2	3.2		26.3			
E 2ND AVE	SE		9.7	88.0	8.0							15.7	3.8					
	NW		4.4	65.6	10.0						35.7	10.1	0.0					
	NE (N-S		4.6	40.8	8.0							24.2						
E 40T A)/E	CROSSING)		7.0	40.0	0.0													
E 1ST AVE	NE (E-W CROSSING)		6.5	65.9	8.0						45.6							
	SW SW		2.3	40.4	10.1							-						
	SE		25.4	226.2	18.1							114.6						
	NW		3.4	55.6	11.0						28.6							
SPAULDING ST	NE		20.8	318.8	20.0						49.0	54.1	3.3					
	SW		3.4	60.1	11.1						32.6	50.0				_		
	SE NW		27.0 2.2	277.5 23.0	20.0 11.0						63.3	59.6		+		 		+
	NE (N-S			1			0.4					27.0				 		
	CROSSING)		4.8	39.3	8.0		0.4					27.0				<u> </u>		
PORTER AVE	NE (E-W		3.3	26.9	8.0						18.4							
	CROSSING)										arest .	-		-		_		
	SW SE		2.4 24.7	23.8 212.8	10.4 18.0						37.0	67.2		+		 		
	NW		2.3	25.0	11.2						37.0	51.2				-		
JENSEN AVE	SW		2.3	24.6	11.1													
	SE		3.1	25.2	8.1							19.6						
DANCE								_										
BANSE	NE NE	1	5.3	48.1	8.0				Ι		18.7	-				T		
2ND SOUTH ST	SE		11.8	83.6	8.0						97.0		3.9					
	NE NE		3.6	55.9	15.1					16.8	42.7							
1ST SOUTH ST	SW		5.8	53.7	8.0					12.0	41.3							
	SE		50.4	391.8	25.4	8.3				52.0	207.1							
80% FEDERAL / 20%	STATE SUBTOTAL	3	357	6086	691	98		183	Г	144	2256		25	26	1	15	1	1
80% FEDERAL / 20% V	ILLAGE SUBTOTAL	3	33/	0000	1 80	90	27	103	58	144	2206	1052	25	26	26	15	1	1 1
	TOTAL	3	357	6086	691	1	25	24		144	330		25	26	26	15	1	17

MODEL: Derault
FILE NAME: pw:\/\idot-pw.\

STATE OF ILLINOIS
DEPARTMENT OF TRANSPORTATION

SCALE: _

					F.A.S. RTE.	SEC ⁻	TION		COUNTY	TOTAL SHEETS	SHEET NO.
		SCHEDUL	ES		1324	(38)RS	5-5,SW		IROQUOIS	61	17
									CONTRACT	NO. 66	5K68
 SHEET 2	OF '	7 SHEET:	STA	TO STA			ILLINOIS	FED. AI	D PROJECT		

						SIDEWAL	K (CONT)						
LOCATION	QUADRANT	CONCRETE CURB, TYPE B	COMBINATION CONCRETE CURB AND GUTTER, TYPE B-6.06 FOOT	COMBINATION CONCRETE CURB AND GUTTER, TYPE B-6.18 FOOT	COMBINATION CONCRETE CURB AND GUTTER, TYPE B-6.24 FOOT	CONCRETE MEDIAN	DELOCATE SICN	FURNISH AND INSTALL HANDRAIL FOOT	ISLAND REMOVAL	CONCRETE REMOVAL (SPECIAL) STATE VILLAGE CU YD CU YD	CONCRETE ISLAND (SPECIAL)	HANDRAIL REMOVAL FOOT	REMOVE AND RE- ERECT EXISTING HANDRAIL FOOT
										33.12			
CLIFTON	- NIA/	ı		<u> </u>	Ī					1			1
	NW NE												
2900 NORTH ROAD	NE ISLAND		6.1	12.3					259.8		121.7		
	SE												
	SE ISLAND NE		15.1	18.2					182.9		104.6		
	SW												
E 7TH AVE	SE (N-S CROSSING)												
	SE (E-W												
	CROSSING)												
	NW												
E 6TH AVE	NE SW												
	SE												
	NW NE	29.3				2.1							
	SW (N-S	44.7		-		2.1							
E 5TH AVE	CROSSING)	11.7											
	SW (E-W CROSSING)	14.8											
	SE SE	171.6				41.3		88.7		1.5			
E 471 AVE	NE	25.6				9.8		37.8		1.4			
E 4TH AVE	SW SE	170.6				53.9		102.8		3.5		21.0	
	NW (N-S	170.0				55.5		102.0		0.0		21.0	
	CROSSING)												
E 3RD AVE	NW (E-W CROSSING)	8.9											
	NE			13.8									17.4
	SE NE	59.5				13.8		53.0		1.3		42.9	
E 2ND AVE	SE								_				
	NW												
	NE (N-S CROSSING)												
E 1ST AVE	NE (E-W												
	CROSSING)				3								
	SW SE												
	NW												
SPAULDING ST	NE SW												
	SE												
	NW								_				
	NE (N-S CROSSING)												
PORTER AVE	NE (E-W												
	CROSSING) SW												
	SE												
(F1/6-11-1-)	NW												
JENSEN AVE	SW SE												
					<u> </u>		1						<u> </u>
CHEBANSE	NE												T
2ND SOUTH ST	NE SE												
	NE				16.8				_				
1ST SOUTH ST	SW SE			12.0	52.0		1			4.0			
	-	I								T.∪			<u></u>
S	TATE SUBTOTAL	492	21	56	69	121	1	282	443	9	226	64	17
VIL	LAGE SUBTOTAL TOTAL	492	21	56	69	121	1	282	443	12	226	64	17
<u> </u>	101/12				1 00	323						<u>.</u>	1 "

STATE OF ILLINOIS
DEPARTMENT OF TRANSPORTATION

v:\\ildot-pw.bentley.com:PWIDOT\Documents\IDOT_Offic

			SIDE	ROAD	AND	ENTRANCE	S			
SIDEROAD OR				OFFSET		HMA SURF	INC	BIT		AGG
ENTRANCE	TYPE	SIDE	STATION	FROM	AREA	REM	HMA	MATL	TEMP	SURF
				EOP		VAR DEPTH	SURF	(TACK CT)	RAMP	CSE
				FOOT	SQ YD	SQ YD	TON	POUND	SQ YD	TON
							are some some some			
E FIRST ST	HMA	LT	417+71	60	340	340	50	153	97	
E FIRST ST	HMA	RT	417+71	60	297	297	44	134	78	
МВТО	AGG	RT	419+64	8	41	MODELLO 19	2			4.1
PE	HMA	LT	419+78	10	23	23	3	10		20 - 47 - 500
MBTO	AGG	LT	420+53	8	41	75-72-75	2		-	4.1
E 2ND S ST	HMA	LT	421+96	20	58	58	9	26	39	
PE	НМА	LT	423+42	7	14	14	2	6		
MBTO	AGG	LT	423+68	8	32		2			3.2
PE	HMA	LT	424+08	10	16	16	2	7		9881 00 100.000
МВТО	AGG	LT	424+82	8	32	1000000	2	*		3.2
PE	HMA	LT	424+89	10	21	21	 3	9	-	
MBTO	AGG	LT	426+80	8	32		2			3.2
E 3RD S ST	HMA	LT	427+06	30	87	87	13	39	39	3.2
CE	HMA	LT	427+67	10	61	61	9	27		
CE	HMA	LT	430+67	30	109	109	16	49		
FE	AGG	LT	436+59	10	19	103		13		1.9
FE	AGG	LT	457+77	10	31					3.1
FE	AGG	LT	460+46	10	15					1.5
FE	AGG	LT	464+60	10	13					1.3
FE	AGG	LT	492+89	10	17					1.7
3200 NORTH RD	HMA	LT	520+72	30	125	125	18	56	78	4.7
PE PE	HMA	LT	561+65	10	47	47	7	21	7.0	
MBTO	AGG	LT	568+37	8	32	-17	2		-	3.2
PE	HMA	LT	568+56	10	26	26	4	12		3.2
PE	HMA	LT	571+56	10	21	21	3	9		
MBTO	AGG	LT	571+74	8	32	21	2	9		3.2
MBTO	AGG	LT	575+45	8	32		2			3.2
PE	HMA	LT	575+71	10	32	32	5	14		5.2
3100 N RD	HMA	LT	577+39	64	253	253	37	114	62	
3100 N RD	HMA	RT	577+39	30	114	114	17	51	46	
FE	AGG	LT	609+20	10	28	114	17	51	40	2.8
FE	AGG	LT	627+21	10	20					2.6
3000 NORTH RD	HMA	RT	632+70	30	86	86	13	39	35	
3000 NORTH RD	HMA	LT	634+35	70	285	285	42	128	58	
PE	HMA	LT	642+29	19 100	27	27	42	120	30	
MBTO	AGG	LT	642+29	10 8	41	۷.	2	12		4.1
MBTO	AGG	LT	644+57	8	41		2	-		4.1
PL	HMA	RT	645+19	10	41	40	6	18		4.1
	0.00.000.000.000	700000			V	37.560			30	
HENDRON AVE	HMA	LT	645+29	10	39 56	39 56	6	18	38	
PE	HMA	LT	646+64	10	56	56	8	25		
PL	HMA	RT	646+79	20	69	69	10	31		
SUBTOTAL						2246	351	1008	570	49.9
JOBIOTAL			L		<u> </u>	2240	221	1008	370	49.9

			SIDE	ROAD	AND E	NTRANCE	S			
SIDEROAD OR				OFFSET		HMA SURF	INC	BIT		AGG
ENTRANCE	TYPE	SIDE	STATION	FROM	AREA	REM	НМА	MATL	ТЕМР	SURF
TYPE				EOP		VAR DEPTH	SURF	(TACK CT)	RAMP	CSE
				FOOT	SQ YD	SQ YD	TON	POUND	SQ YD	TON
_					34 .5	54 .5				
JENSEN AVE	HMA	LT	648+49	20	65	65	10	29	39	
PE	HMA	LT	648+96	10	20	20	3	9		
MBTO	AGG	LT	649+82	8	41		2		-	4 . 1
МВТО	AGG	LT	651+53	8	41		2			4.1
E PORTER AVE	HMA	LT	652+05	20	90	90	13	41	51	
МВТО	AGG	LT	652+45	8	41		2			4.1
МВТО	AGG	LT	653+71	8	41		2			4.1
PE	HMA	LT	654+04	20	30	30	4	14		
MBTO	AGG	LT	654+22	8	41		2			4.1
PE	HMA	LT	654+69	10	10	10	1	5		
SPAULDING ST	HMA	LT	655+99	27	90	90	13	41	45	
MBTO	AGG	LT	656+81	8	41		2			4.1
MBTO	AGG	LT	657+35	8	41		2			4.1
МВТО	AGG	LT	658+22	8	41		2			4.1
MBTO	AGG	LT	658+75	8	41		2			4.1
E 1ST AVE	HMA	LT	659+45	30	125	125	18	56	47	
E 2ND AVE	HMA	LT	663+06	20	84	84	12	38	52	
E 3RD AVE	HMA	LT	666+75	30	204	204	30	92	66	
E 3RD AVE	HMA	RT	666+75	10	59	59	9	27	50	
E 4TH AVE	HMA	LT	670+36	30	118	118	17	53	45	
PL	HMA	RT	671+42	5	16.1	16	2	7		
PL	HMA	RT	673+02	5	16.7	17	2	8		
5TH AVE	HMA	LT	674+02	15	85	85	12	38	40	
5TH AVE	HMA	RT	674+02	20	81	81	12	36	40	
PE	HMA	LT	676+07	10	16	16	2	7		
E 6TH AVE	HMA	LT	678+31	20	77	77	11	35	52	
E 7TH AVE	HMA	LT	682+57	19	81	81	12	36	54	
PE	HMA	LT	684+78	10	27.8	28	4	13		
PE	HMA	LT	685+88	10	25	25	4	11		
SUBTOTAL						1321	209	596	581	36.9
TOTAL						3567	560	1604	1151	86.8

USER NAME = mariniej	DESIGNED	REVISED
	DRAWN	REVISED
PLOT SCALE = 3.9388 / mm	CHECKED	REVISED
PLOT DATE = 3/29/2022	DATE -	REVISED -

1								F.A.S. RTE	SEC	TION		COUNTY	TOTAL SHEETS	SHEET NO.
ı				SCHE	EDULES	5		1324	(38)R9	5-5,SW		IROQUOIS	61	19
١												CONTRACT	NO. 6	6K68
ı	SCALE:	SHEET 4	OF	7 9	SHEETS	STA	TO STA			ILLINOIS	FED. AI	D PROJECT		

NOTE: PROPOSED NO PASSING ZONES SHALL BE STRIPED AS EXISTING.

TOTAL

ADDITIONAL QUANTITY HAS BEEN INCLUDED TO ALLOW FOR TWO SEPARATE APPLICATIONS OF MODIFIED URETHANE LINES. APPLICATIONS ARE TO BE INSTALLED A MINIMUM OF 14 DAYS BETWEEN APPLICATIONS.

USER NAME = mariniej	DESIGNED	REVISED
	DRAWN	REVISED
PLOT SCALE = 3.9388 / mm	CHECKED	REVISED
PLOT DATE = 3/29/2022	DATE	REVISED

187.2

187.2

						F.A.S. RTE	SECTION		COUNTY	TOTAL SHEETS	SHEET NO.
		SCI	HEDULES	5		1324	(38)RS-5,SW		IROQUOIS	61	20
									CONTRACT	NO. 66	5K68
LE:	SHEET 5	OF 7	SHEETS	STA	TO STA		ILLINOIS	FED. Al	ID PROJECT		

8380 204 206

	SEEDING SCHEDULE										
LOCATION		SIDE	LENGTH	WIDTH	DEPTH		FURNISHED EX.	NITRO FERT NUT	PHOSP FERT NUT	POT FERT NUT	EROSION CONTROL BLANKET
STA TO STA			FOOT	FOOT	INCH	ACRE	CU YD	LB	LB	LB	SQ YD
417+71	E FIRST ST	ALL QUADS	160	5	1	0.018	2.5	1.62	1.62	1.62	89
421+96	E 2ND S ST	ALL QUADS	160	5	1	0.018	2.5	1.62	1.62	1.62	89
427+06	E 3RD S ST	ALL QUADS	160	5	1	0.018	2.5	1.62	1.62	1.62	89
458+00	459+00	EAST	100	12	6	0.028		2.52	2.52	2.52	133
464+00	465+00	WEST	100	12	6	0.028		2.52	2.52	2.52	133
520+72	3200 N RD	ALL QUADS	160	5	1	0.018	2.5	1.62	1.62	1.62	89
532+80	534+00	WEST	120	12	6	0.033		2.97	2.97	2.97	160
538+50	541+00	WEST	250	12	6	0.069		6.21	6.21	6.21	333
577+39	3100 N RD	ALL QUADS	160	5	1	0.018	2.5	1.62	1.62	1.62	89
592+20	595+00	EAST	280	12	6	0.077		6.93	6.93	6.93	373
627+00	629+50	EAST	250	12	6	0.069		6.21	6.21	6.21	333
629+50	631+50	EAST	200	12	6	0.055		4.95	4.95	4.95	267
633+78	3000 N RD	ALL QUADS	160	5	1	0.018	2.5	1.62	1.62	1.62	89
TOTAL						0.5	15	42	42	42	2266

FRAMES AND LIDS TO BE ADJUSTED										
LOCATION	SIDE	STATION	FRAMES AND LIDS							
			TO BE ADJUSTED							
			EACH							
EOP AT 1ST ST	12' LT	659+54	1							
EOP AT SPAULDING ST	12' LT	656+08	1							
EOP AT PORTER ST	12' LT	652+17	1							
EOP AT JENSEN ST	12' LT	648+61	1							
TOTALS			4							

SIDEROAD QUANTITES ARE 40 FEET PER QUADRANT

USER NAME = mariniej	DESIGNED	REVISED -
	DRAWN	REVISED -
PLOT SCALE = 3.9388 / mm	CHECKED	REVISED
PLOT DATE = 3/29/2022	DATE -	REVISED

	F.A.S. RTE	SECTION	COUNTY	TOTAL SHEETS	SHEET NO.
SCHEDULES	1324	(38)RS-5,SW	IROQUOIS	61	21
			CONTRACT	NO. 66	5K68
SCALE: SHEET 6 OF 7 SHEETS STA TO STA		ILLINOIS FED. A	ID PROJECT		

CLASS D PATCHING								
LANE & DIRECTION	STATION	STATION L		AREA	TYPE II	TYPE III		
				SQ YD	SQ YD	SQ YD		
NB PARKING LANE	661+05	6	12	8	8			
NB PARKING LANE	661+69	6	12	8	8			
NB PARKING LANE	661+81	8	12	10.7	10.7			
NB PARKING LANE	662+87	6	12	8	8			
NB PARKING LANE	663+39	6	12	8	8			
NB PARKING LANE	663+86	6	12	8	8			
NB PARKING LANE	664+20	6	12	8	8			
NB PARKING LANE	666+49	6	12	8	8			
NB PARKING LANE	666+81	6	15	10	10			
SB PARKING LANE		6	9	6	6			
NB PARKING LANE	667+15	6	15	10	10			
SB PARKING LANE		6	9	6	6			
NB PARKING LANE	667+46	12	15	20		20		
SB PARKING LANE	007 - 10	12	9	12		12		
NB PARKING LANE	667+83	6	15	10	10			
SB PARKING LANE	007+03	6	9	6	6			
NB PARKING LANE	669+22	6	15	10	10			
SB PARKING LANE	009+22	6	9	6	6			
NB DRIVING LANE		10	12	13.3	13.3			
SB DRIVING LANE	670 15	10	12	13.3	13.3			
NB PARKING LANE	670+15	10	15	16.7	16.7			
SB PARKING LANE		10	9	10	10			
NB PARKING LANE	670+82	6	15	10	10			
SB PARKING LANE	670+82	6	9	6	6			
NB PARKING LANE		6	15	10	10			
SB PARKING LANE	671+16	6	9	6	6			
NB PARKING LANE		6	15	10	10			
SB PARKING LANE	671+64	6	9	6	6			
NB PARKING LANE	e 1927/2020 - 1927/2020	6	15	10	10			
SB PARKING LANE	672+55	6	9	6	6			
NB PARKING LANE		6	15	10	10			
SB PARKING LANE	675+75	6	9	6	6			
NB PARKING LANE	0000000	6	15	10	10			
SB PARKING LANE	676+08	6	9	6	6			
		15	15	25	<u> </u>	25		
NB PARKING LANE SB PARKING LANE	677+03	15	9	15		25 15		
NB DRIVING LANE	1	8	12	10.7	10.7	13		
SB DRIVING LANE	685+19	8	12	10.7	10.7			
We do become		2000	12					
NB DRIVING LANE	690+07	8		10.7	10.7			
SB DRIVING LANE		8	12	10.7	10.7			
TOTALS				394.8	322.8	72		

	SIDEROAD AND ENTRANCES								
SIDEROAD OR			OFFSET		HMA SURF	INC	BIT		AGG
ENTRANCE	SIDE	STATION		AREA	REM	HMA	MATL	TEMP	SURF
	SIDE	STATION		AKEA			W. M. S. W. S. W.	V61 MCV60 (1988)	Section and the second
TYPE			EOP		VAR DEPTH	SURF	(TACK CT)	RAMP	CSE
			FOOT	SQ YD	SQ YD	TON	POUND	SQ YD	TON
E 4TH AVE	LT	670+36	30	118	118	17	53	45	
PL	RT	671+42	5	16.1	16	2	7		
PL	RT	673+02	5	16.7	17	2	8		
5TH AVE	LT	674+02	15	85	85	12	38	40	
5TH AVE	RT	674+02	20	81	81	12	36	40	
PE	LT	676+07	10	16	16	2	7		
E 6TH AVE	LT	678+31	20	77	77	11	35	52	
E 7TH AVE	LT	682+57	19	81	81	12	36	54	
PE	LT	684+78	10	27.8	28	4	13		
PE	LT	685+88	10	25	25	4	11		
SUBTOTAL					544	78	244	231	0
TOTAL					3567	522	1604	1151	14

USER NAME = mariniej	DESIGNED -	REVISED
	DRAWN	REVISED
PLOT SCALE = 3.9388 / mm	CHECKED -	REVISED
PLOT DATE = 3/29/2022	DATE	REVISED


STATE OF ILLINOIS
DEPARTMENT OF TRANSPORTATION

SCALE:

	SCHEDULES				F.A.S. RTE.	SECT	TION	COUNTY	TOTAL SHEETS	SHEET NO.		
					1324	(38)RS	5-5,SW	IROQUOIS	61	22		
										CONTRACT	NO. 6	6K68
	SHEET 7	OF	7	SHEETS	STA.	TO STA.			ILLINOIS FED.	AID PROJECT		

3\Projects\D366K68\CADData\D366K68-sht-schedule.d

MUDEL: Default FILE NAME: pw:\\ildot.pw.

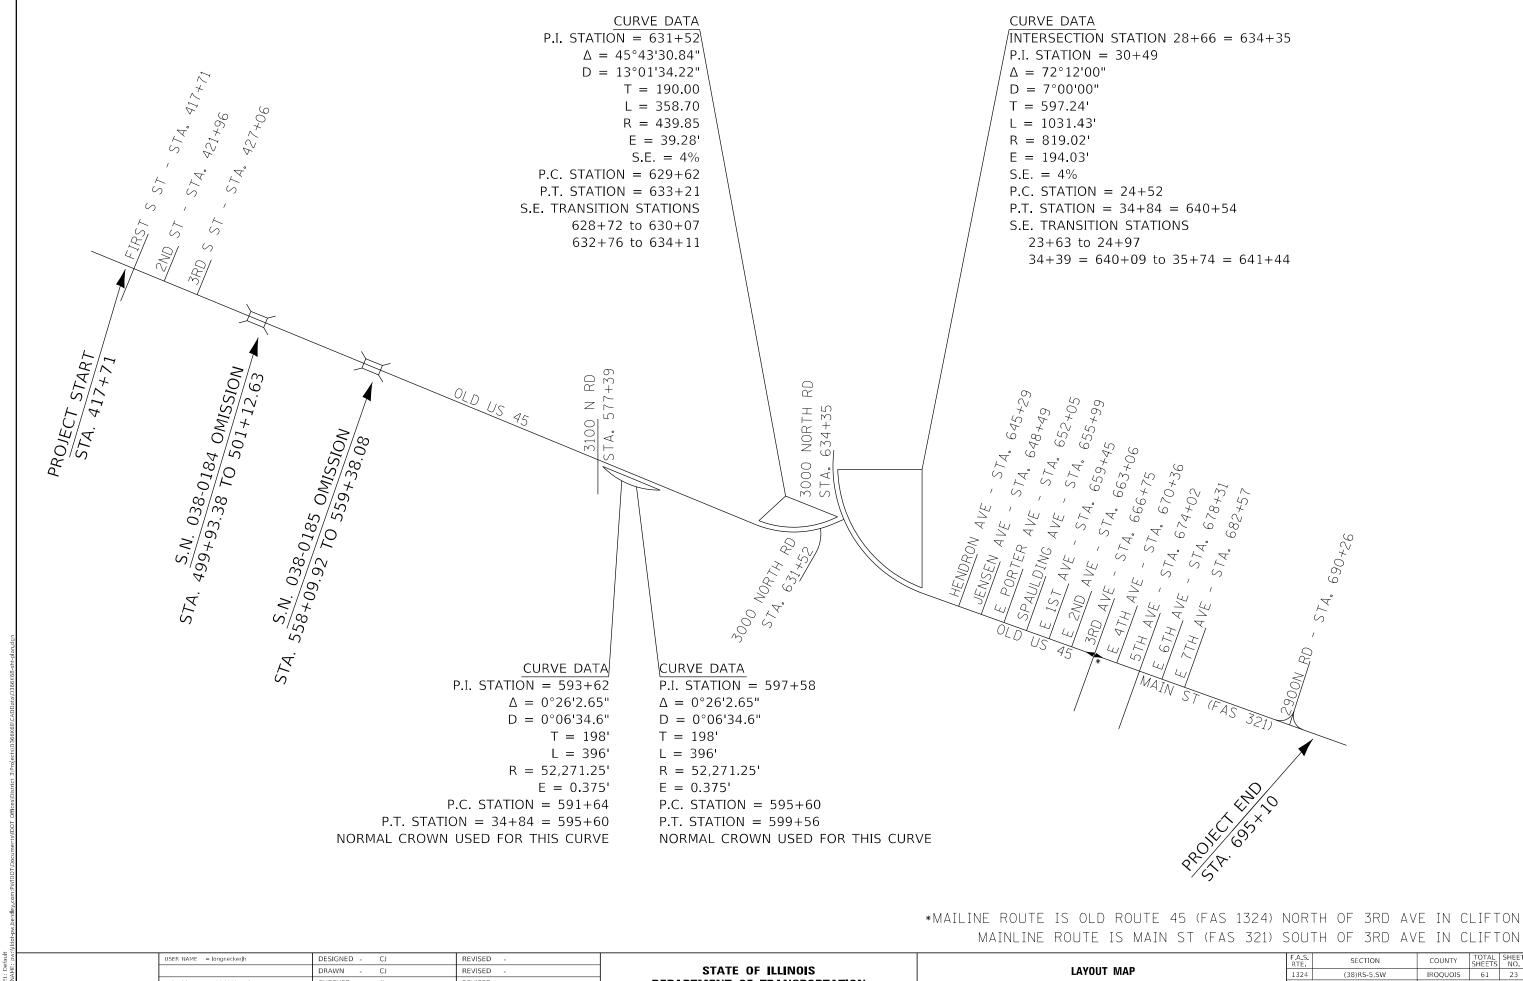

DEPARTMENT OF TRANSPORTATION

SHEET 1

OF 1 SHEETS STA.

TO STA.

CONTRACT NO. 66K68

MODEL: Defau

HECKED

4/26/2022


PLOT DATE = 4/26/2022

REVISED

REVISED

2900N RD

NW QUAD

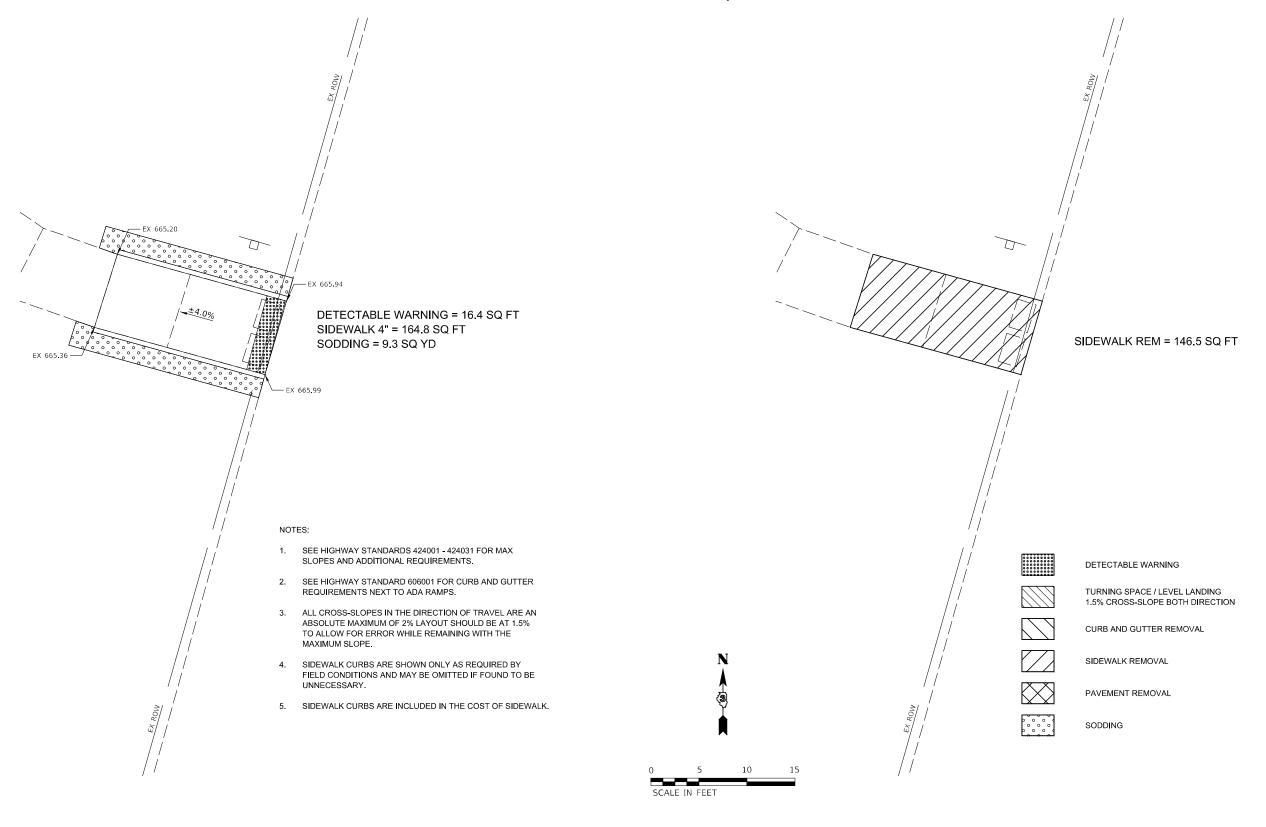

MODEL: Default

JSER NAME = BWedemeier

PLOT DATE = 3/9/2022

DESIGNED -

CHECKED

DRAWN

DATE

REVISED

REVISED

REVISED

REVISED


STATE OF ILLINOIS
DEPARTMENT OF TRANSPORTATION

SCALE: 1"=5'

2900N RD

NE QUAD & NE ISLAND

DETECTABLE WARNING = 8.0 SQ FT SIDEWALK 4" = 34.7 SQ FT SODDING = 4.0 SQ YD

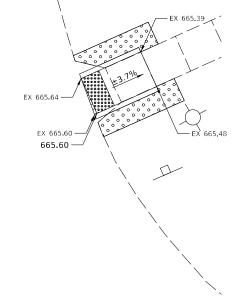

CCC & G TYPE B-6.06 = 6.1 FT CCC & G TYPE B-6.18 = 12.3 FT DETECTABLE WARNING = 35.8 SQ FT SIDEWALK 4" = 138.0 SQ FT CONCRETE ISLAND = 121.7 SQ FT

NOTES:

666.41 EX 666.34 ---

> 666.38 EX 666.28 ---

666.46

EX 666.45 -

666.47 -

EX 666.46 -

666.33 -666.30

> SEE HIGHWAY STANDARDS 424001 - 424031 FOR MAX SLOPES AND ADDITIONAL REQUIREMENTS.

5' (TYP)

2. SEE HIGHWAY STANDARD 606001 FOR CURB AND GUTTER REQUIREMENTS NEXT TO ADA RAMPS.

- 666.26

- 666.22


— EX 666.17

- 666,20


— EX 666.15

666.23

- ALL CROSS-SLOPES IN THE DIRECTION OF TRAVEL ARE AN ABSOLUTE MAXIMUM OF 2% LAYOUT SHOULD BE AT 1.5%
 TO ALLOW FOR ERROR WHILE REMAINING WITH THE MAXIMUM SLOPE.
- 4. SIDEWALK CURBS ARE SHOWN ONLY AS REQUIRED BY FIELD CONDITIONS AND MAY BE OMITTED IF FOUND TO BE
- 5. SIDEWALK CURBS ARE INCLUDED IN THE COST OF SIDEWALK.

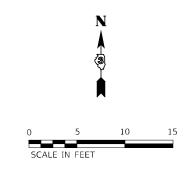

PAVEMENT REM = 1.5 SQ YD SIDEWALK REM = 15.9 SQ FT

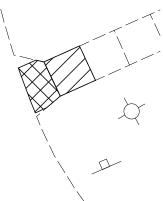

ISLAND REM = 259.8 SQ FT CCC & G REM = 18.4 SQ YD



DETECTABLE WARNING



TURNING SPACE / LEVEL LANDING 1.5% CROSS-SLOPE BOTH DIRECTION



ISLAND REMOVAL



CURB REMOVAL



SIDEWALK REMOVAL PAVEMENT REMOVAL



CONCRETE ISLAND



SODDING

0		٥		٥	
	0		0		0
ю		0		0	
	0		0		0

USER NAME = BWedemeier	DESIGNED -	REVISED -
	DRAWN -	REVISED -
PLOT SCALE = 10.0000 / in.	CHECKED -	REVISED -
PLOT DATE = 3/9/2022	DATE -	REVISED -

STATE OF ILLINOIS **DEPARTMENT OF TRANSPORTATION**


SCALE: 1"=5"

SECTION ADA DETAILS 2900N RD IROOUOIS CONTRACT NO. 66K68 SHEET 2 OF 3 SHEETS STA. TO STA.

USER NAME = BWedemeier	DESIGNED -	REVISED -
	DRAWN -	REVISED -
PLOT SCALE = 10.0000 / in.	CHECKED -	REVISED -
BLOT BATE 2/0/2022	DATE	DEVICED

2900N RD

SE QUAD & SE ISLAND

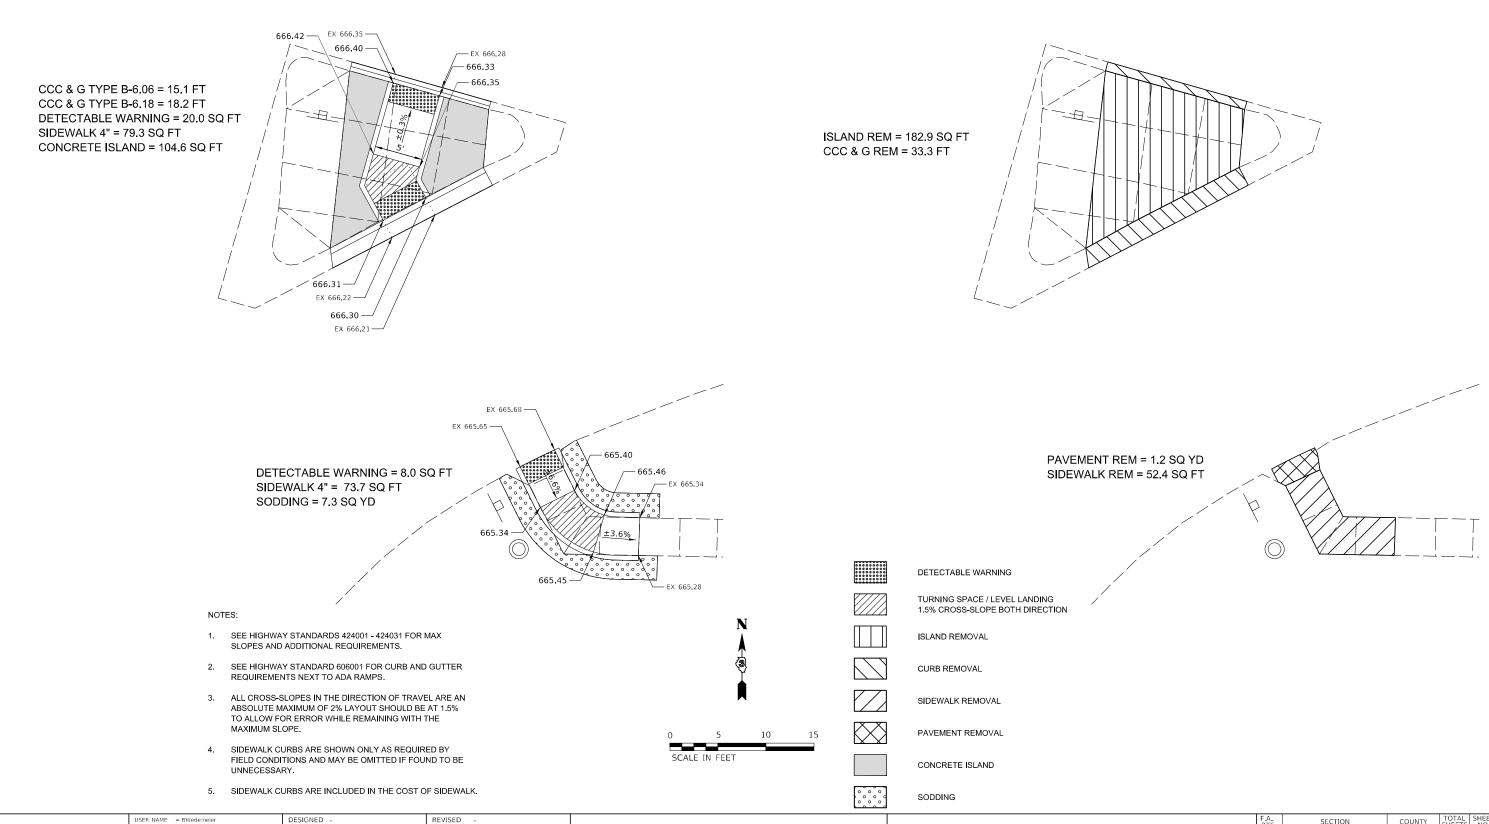

MODEL: Default

STATE OF ILLINOIS
DEPARTMENT OF TRANSPORTATION

SCALE: 1"=5"


ADA DETAILO COCON DD			F.A. RTE	SECTION	COUNTY	TOTAL SHEETS				
ADA DETAILS 2900N RD						IROQUOIS				
							CONTRACT	NO. 66	5K68	
SHEET 3	OF 3	SHEETS	STA.	TO STA.		ILLINOIS FED. A	ID PROJECT			1

E 7th AVE

NE & SE QUADS

NOTES:

- SEE HIGHWAY STANDARDS 424001 424031 FOR MAX SLOPES AND ADDITIONAL REQUIREMENTS.
- 2. SEE HIGHWAY STANDARD 606001 FOR CURB AND GUTTER REQUIREMENTS NEXT TO ADA RAMPS.
- ALL CROSS-SLOPES IN THE DIRECTION OF TRAVEL ARE AN ABSOLUTE MAXIMUM OF 2% LAYOUT SHOULD BE AT 1.5% TO ALLOW FOR ERROR WHILE REMAINING WITH THE MAXIMUM SLOPE
- 4. SIDEWALK CURBS ARE SHOWN ONLY AS REQUIRED BY FIELD CONDITIONS AND MAY BE OMITTED IF FOUND TO BE UNNECESSARY.
- 5. SIDEWALK CURBS ARE INCLUDED IN THE COST OF SIDEWALK.

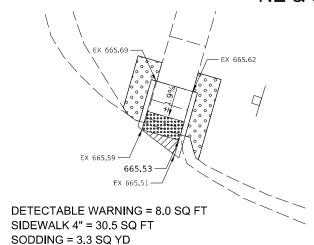

DETECTABLE WARNING


TURNING SPACE / LEVEL LANDING 1.5% CROSS-SLOPE BOTH DIRECTION


CURB AND GUTTER REMOVAL


SIDEWALK REMOVAL

PAVEMENT REMOVAL

sodding

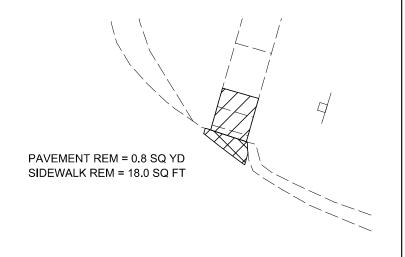

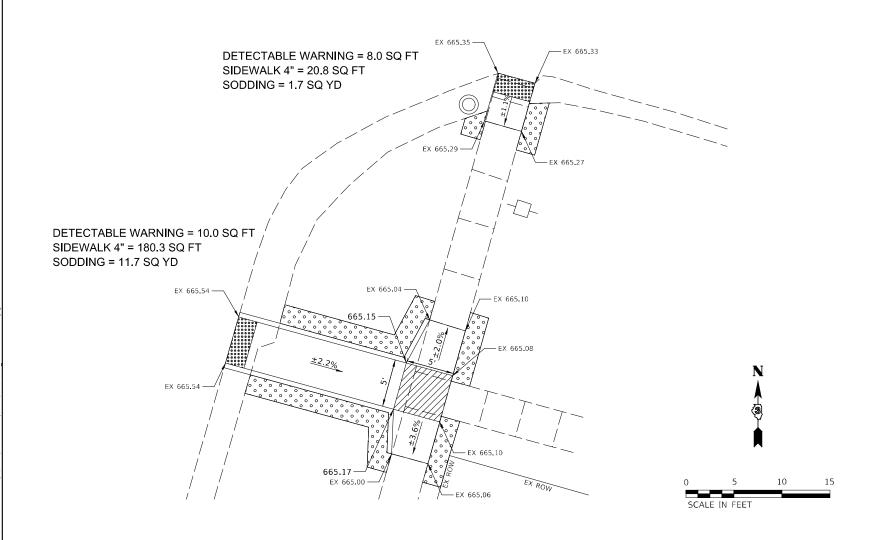

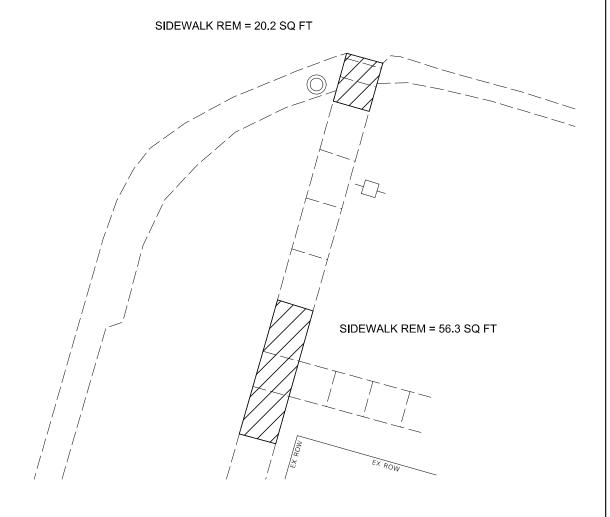


USER NAME = BWedemeier	DESIGNED -	REVISED -
	DRAWN -	REVISED -
PLOT SCALE = 10.0000 / in.	CHECKED -	REVISED -
PLOT DATE = 3/9/2022	DATE -	REVISED -

						F.A. RTE	SEC ⁻	TION	COUNTY	TOTAL SHEETS	SHEET NO.
	ADA DETAILS E 7th AVE								IROQUOIS		
									CONTRACT	NO. 66	5K68
SCALE: 1"=5'	SHEET 1	OF 2	SHEETS	STA.	TO STA.			ILLINOIS FED. AI	D PROJECT		

E 7th AVE

SW QUAD

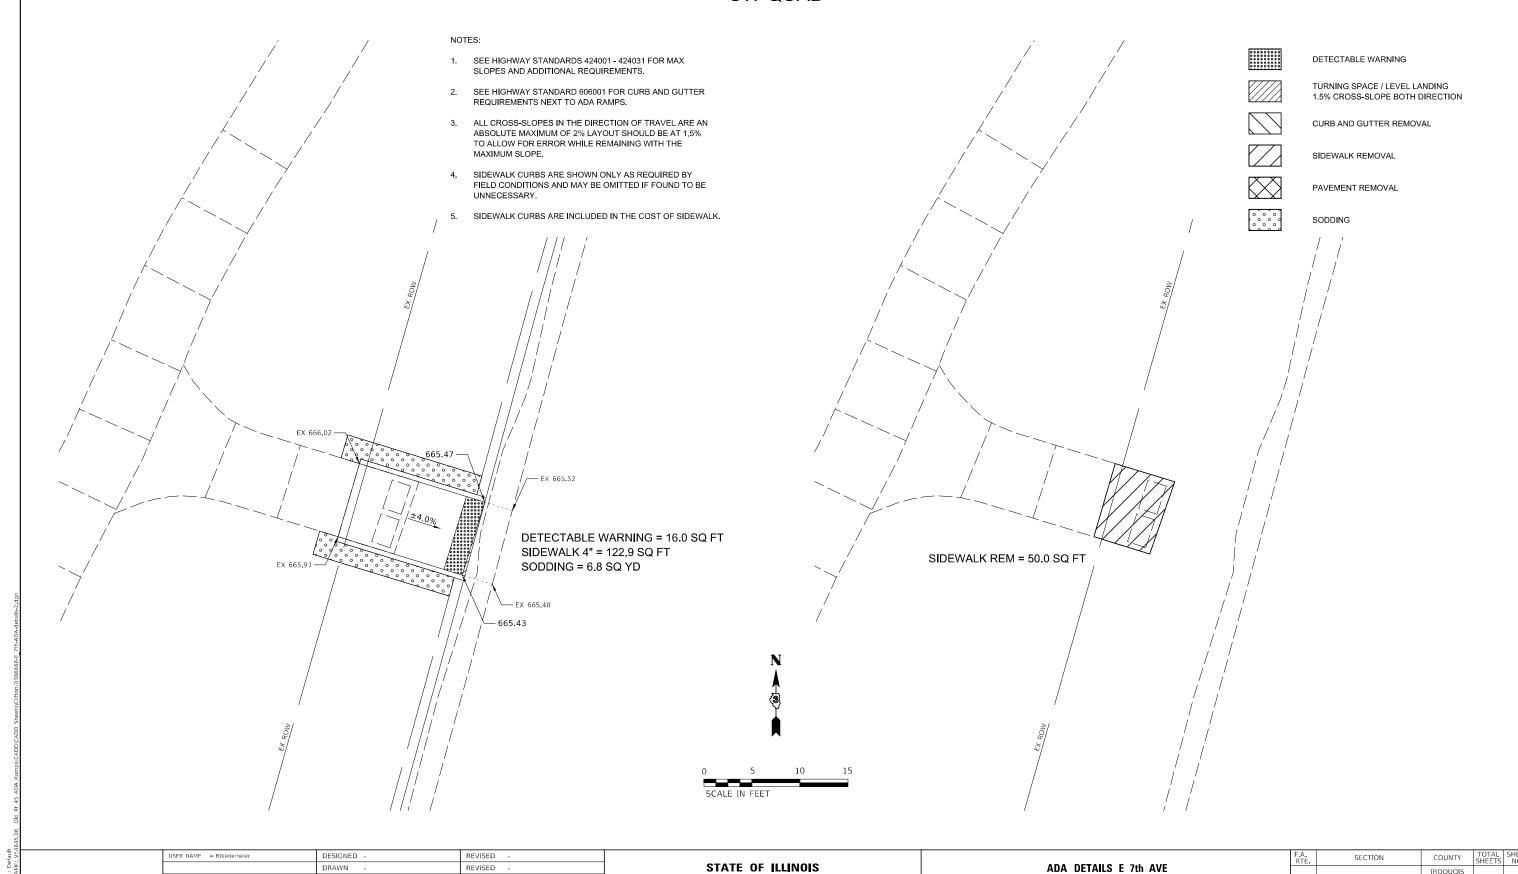

DEPARTMENT OF TRANSPORTATION

SCALE: 1"=5'

SHEET 2 OF 2 SHEETS STA.

TO STA.

PLOT SCALE = 10.0000 ' / in.

PLOT DATE = 3/9/2022

CHECKED

DATE


REVISED

REVISED

IROOUOIS

CONTRACT NO. 66K68

NW QUAD

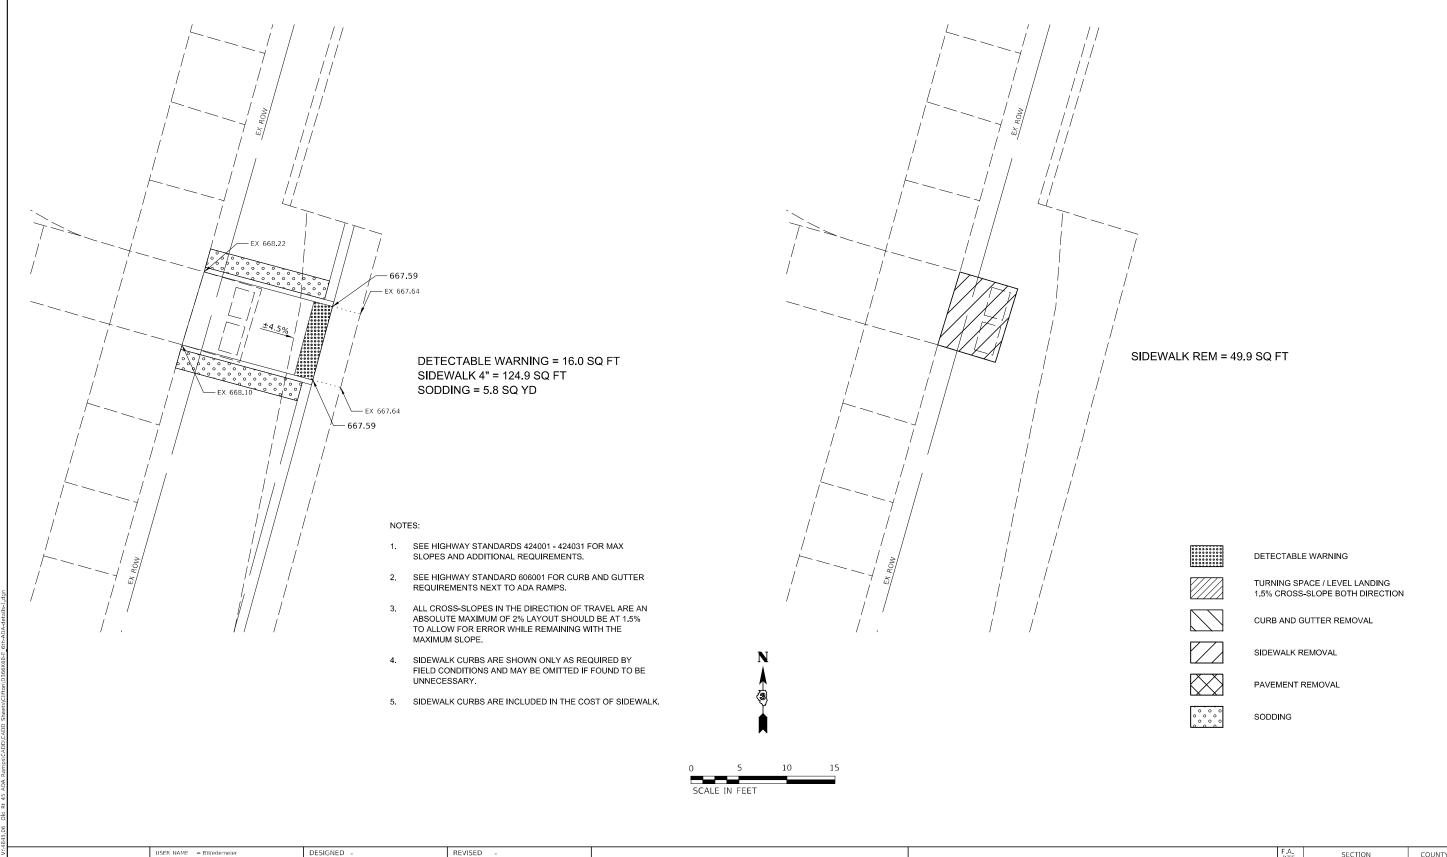

MODEL: Default

DRAWN

DATE

PLOT DATE = 3/9/2022

CHECKED


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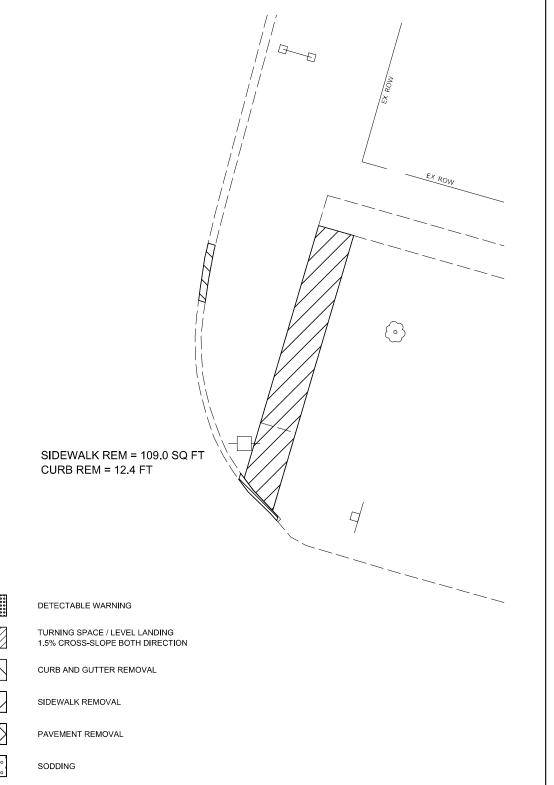
REVISED

REVISED

STATE OF ILLINOIS DEPARTMENT OF TRANSPORTATION

NE QUAD



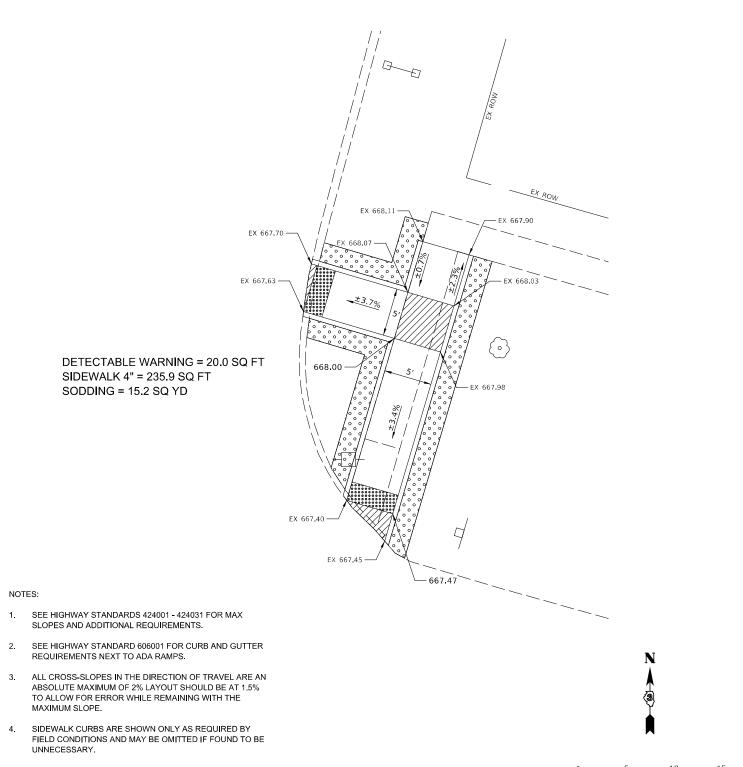

5.	SIDEWALK CURBS ARE INCLUDED IN THE COST OF SIDEWALK.


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	DRAWN -	REVISED -
PLOT SCALE = 10.0000 / in.	CHECKED -	REVISED -
PLOT DATE = 3/9/2022	DATE -	REVISED -

STATE OF ILLINOIS
DEPARTMENT OF TRANSPORTATION

	ADA DETAILO E CAL AVE										ПОИ		COUNTY	TOTAL SHEETS	SHEET NO.
	ADA DETAILS E 6th AVE												IROQUOIS		
													CONTRACT	NO. 66	5K68
SCALE: 1"=	:5'	SHEET	2	OF	4 9	SHEETS	STA.	TO STA.			ILLINOIS	FED. AI	D PROJECT		

FILE NAME: V:\4845.06 Old Rt 45 ADA Ramps\CADD\CADD Sheets\Clifton\D366K68-E_


SW QUAD

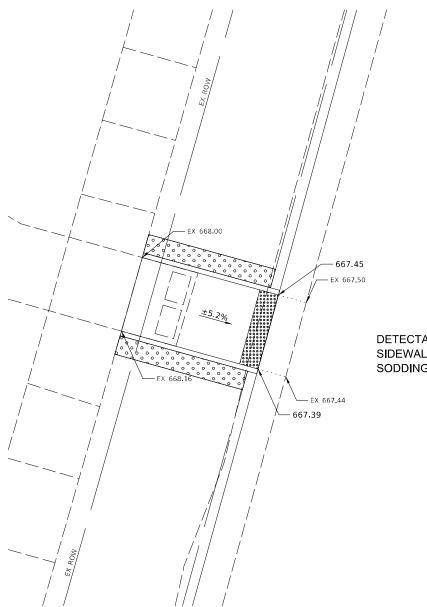


DETECTABLE WARNING = 16.0 SQ FT SIDEWALK 4" = 132.5 SQ FT SODDING = 6.1 SQ YD

NOTES:

- SEE HIGHWAY STANDARDS 424001 424031 FOR MAX SLOPES AND ADDITIONAL REQUIREMENTS.
- 2. SEE HIGHWAY STANDARD 606001 FOR CURB AND GUTTER REQUIREMENTS NEXT TO ADA RAMPS.
- 3. ALL CROSS-SLOPES IN THE DIRECTION OF TRAVEL ARE AN ABSOLUTE MAXIMUM OF 2% LAYOUT SHOULD BE AT 1.5% TO ALLOW FOR ERROR WHILE REMAINING WITH THE MAXIMUM SLOPE.
- 4. SIDEWALK CURBS ARE SHOWN ONLY AS REQUIRED BY FIELD CONDITIONS AND MAY BE OMITTED IF FOUND TO BE UNINFOESSARY
- 5. SIDEWALK CURBS ARE INCLUDED IN THE COST OF SIDEWALK.

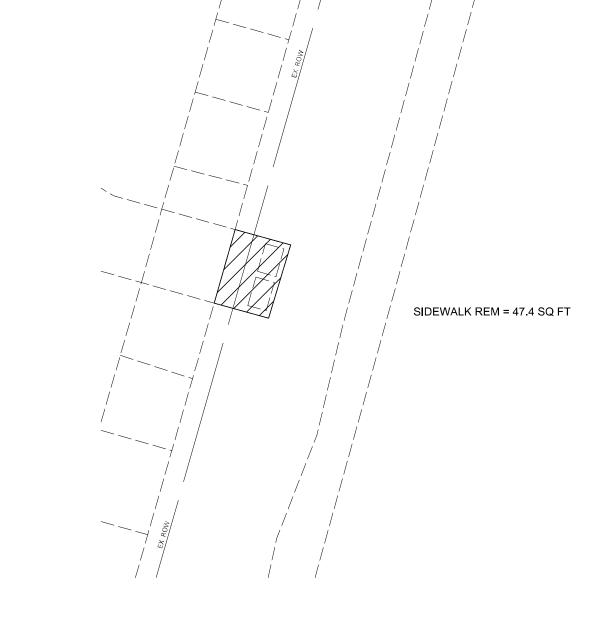

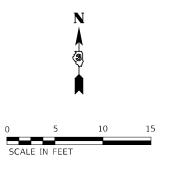



DETECTABLE WARNING



TURNING SPACE / LEVEL LANDING 1.5% CROSS-SLOPE BOTH DIRECTION



CURB AND GUTTER REMOVAL



SIDEWALK REMOVAL



PAVEMENT REMOVAL



SCALE: 1"=5'

SODDI	NC


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	DRAWN -	REVISED -
PLOT SCALE = 10.0000 / in.	CHECKED -	REVISED -
PLOT DATE = 3/9/2022	DATE -	REVISED -

STATE OF ILLINOIS DEPARTMENT OF TRANSPORTATION


					a.i. 41/5		F.A. RTE	SEC.	ΓΙΟΝ		COUNTY	TOTAL SHEETS	SHEET NO.
ADA DETAILS E 6th AVE										IROQUOIS			
											CONTRACT	NO. 66	5K68
SHEET	3	OF	4	SHEETS	STA.	TO STA.			ILLINOIS	FED. AI	D PROJECT		


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SE QUAD

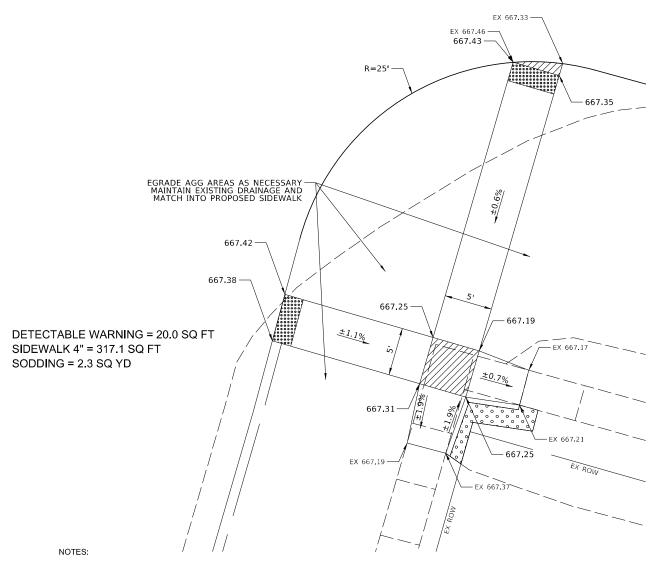

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DETECTABLE WARNING

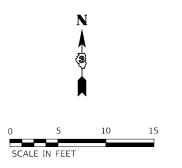

TURNING SPACE / LEVEL LANDING 1.5% CROSS-SLOPE BOTH DIRECTION

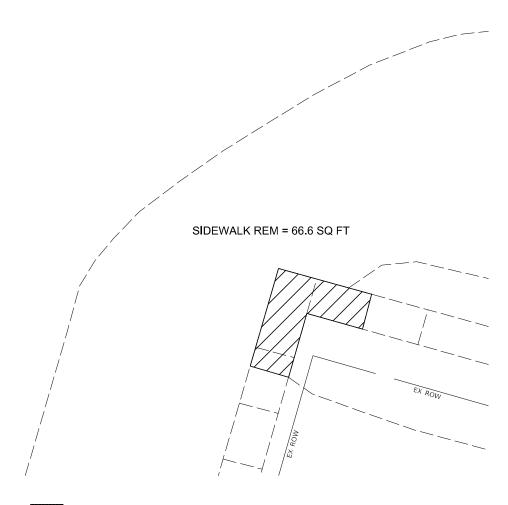

CURB AND GUTTER REMOVAL



SIDEWALK REMOVAL



PAVEMENT REMOVAL




SODDING

USER NAME = BWedemeier	DESIGNED -	REVISED -
	DRAWN -	REVISED -
PLOT SCALE = 10.0000 / in.	CHECKED -	REVISED -
PLOT DATE = 3/9/2022	DATE -	REVISED -


		_			F.A. RTE	SECT	ION		COUNTY	TOTAL SHEETS	SHEET NO.		
l		ADA DETAILS E 6th AVE									IROQUOIS		
ļ											CONTRACT	NO. 60	5K68
	SCALE: 1"=5'	SHEET 4	OF 4	SHEETS	STA.	TO STA.			ILLINOIS	FED. AI	D PROJECT		


NW QUAD

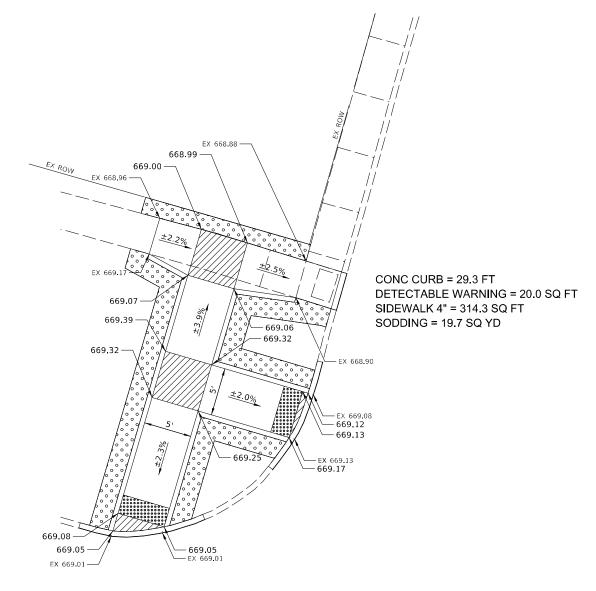



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DETECTABLE WARNING

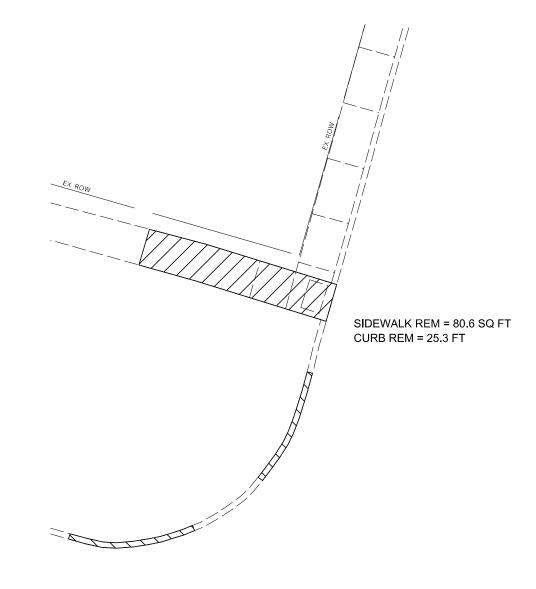

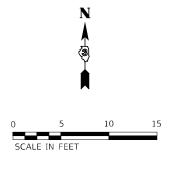TURNING SPACE / LEVEL LANDING 1.5% CROSS-SLOPE BOTH DIRECTION



CURB AND GUTTER REMOVAL



SIDEWALK REMOVAL



PAVEMENT REMOVAL



SCALE: 1"=5'


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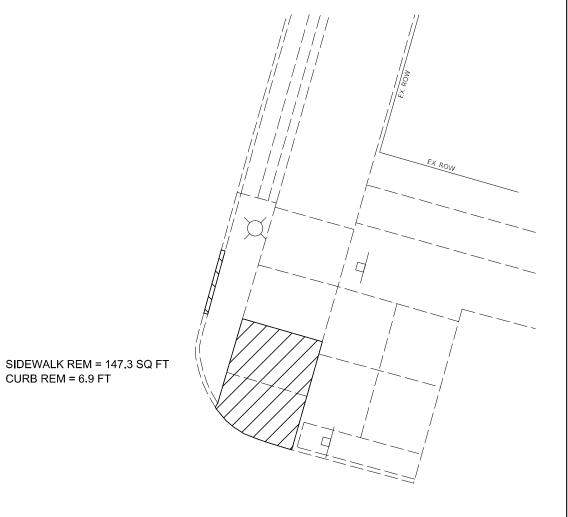
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PLOT SCALE = 10.0000 / in.	CHECKED -	REVISED -
PLOT DATE = 3/9/2022	DATE -	REVISED -

STATE OF	: ILLINOIS
DEPARTMENT OF	TRANSPORTATION

						F.A. RTE	SECT	'ION		COUNTY	TOTAL SHEETS	SHEET NO.
	ADA DETAILS E 5th AVE									IROQUOIS		
										CONTRACT	NO. 66	5K68
EET	1	OF 4	SHEETS	STA.	TO STA.			ILLINOIS	FED ΔI	D PROJECT		


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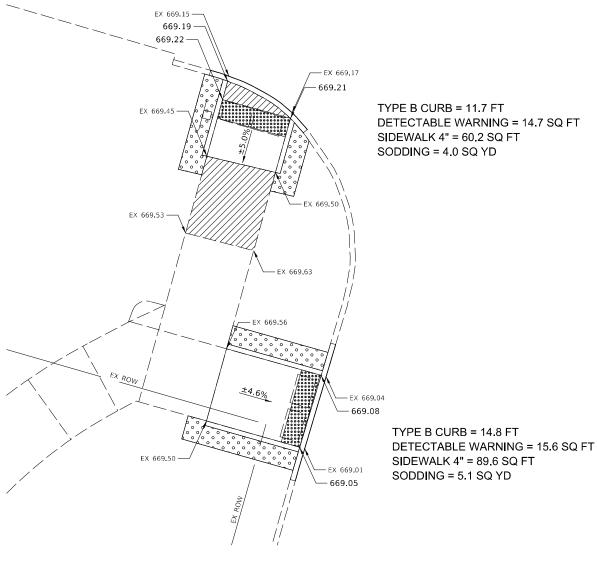



0000000	DETECTABLE WARNING
	TURNING SPACE / LEVEL LANDING 1.5% CROSS-SLOPE BOTH DIRECTION
	CURB AND GUTTER REMOVAL
	SIDEWALK REMOVAL
	PAVEMENT REMOVAL
	CONCRETE MEDIAN SURFACE

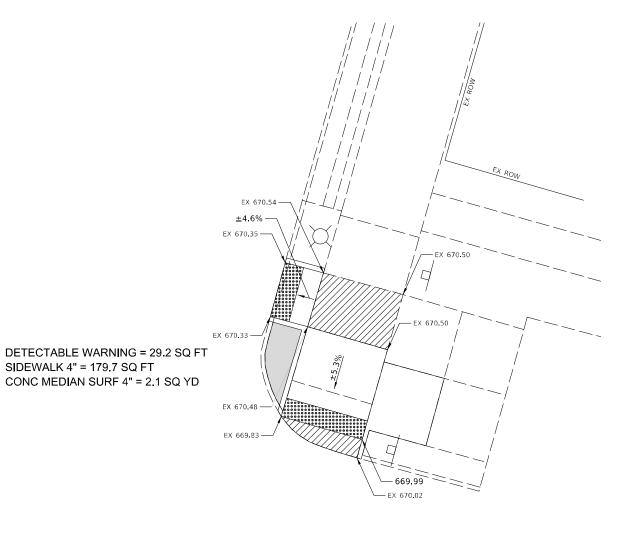USER NAME = BWedemeler	DESIGNED -	KENIZED -
	DRAWN -	REVISED -
PLOT SCALE = 10.0000 / in.	CHECKED -	REVISED -
PLOT DATE = 3/9/2022	DATE -	REVISED -

F R					SEC.	TION		COUNTY	TOTAL SHEETS	SHEET NO.
	ADA DETAILS E 5th AVE							IROQUOIS		
								CONTRACT	NO. 66	5K68
SCALE: 1"=5'	SHEET 2 OF 4 SHEETS	STA.	TO STA.			ILLINOIS	FED. AI	D PROJECT		


SW QUAD

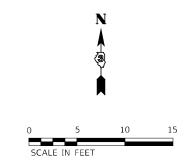

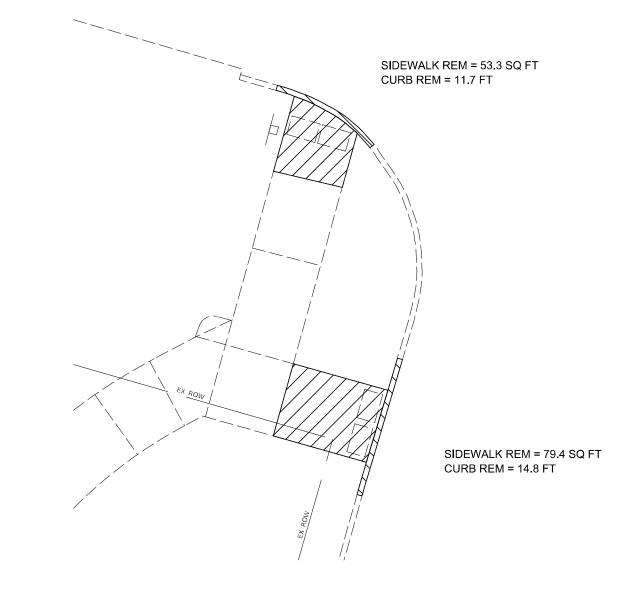

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DETECTABLE WARNING

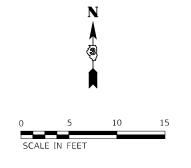

TURNING SPACE / LEVEL LANDING 1.5% CROSS-SLOPE BOTH DIRECTION



CURB AND GUTTER REMOVAL



SIDEWALK REMOVAL



PAVEMENT REMOVAL



SCALE: 1"=5"

SODDING


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PLOT DATE = 3/9/2022	DATE -	REVISED -

STATE OF ILLINOIS
DEPARTMENT OF TRANSPORTATION

	_						F.A. RTE	SEC.	TION		COUNTY	TOTAL SHEETS	SHEET NO.
ADA DETAILS E 5th AVE								IROQUOIS					
											CONTRACT	NO. 66	5K68
SHEET	3	OF	4	SHEETS	STA.	TO STA.			ILLINOIS	FED. A	ID PROJECT		


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SE QUAD

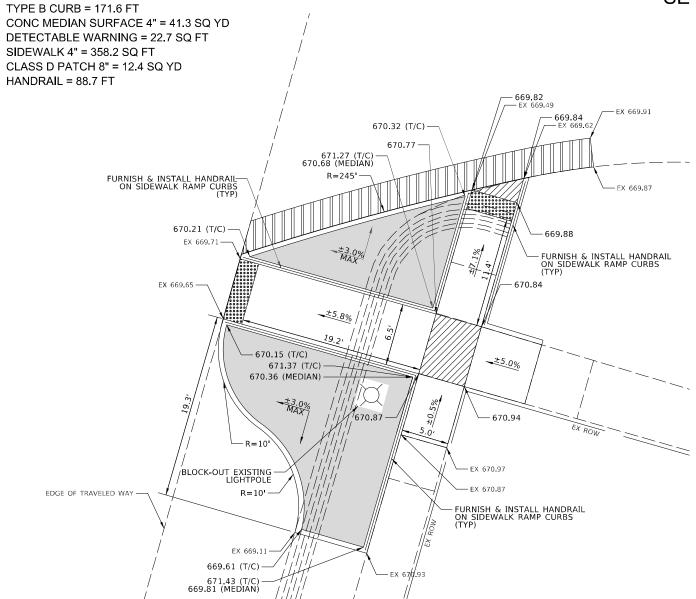

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- SIDEWALK CURBS ARE INCLUDED IN THE COST OF SIDEWALK.
- 6. FELT EXPANSION IS INCIDENTAL TO CONCRETE MEDIAN SURFACE.



SIDI	/EMENT REM = 35.8 SQ FT EWALK REM = 154.4 SQ FT RB REM = 46.4 FT NCRETE REM = 1.5 CU YD		EX ROV		
	///////////////////////////////////////	00000000	DETECTABLE WARNIN	٧G	
			TURNING SPACE / LEV 1.5% CROSS-SLOPE E		
			CURB AND GUTTER R	REMOVAL	
			CONCRETE REMOVAL	_	
			SIDEWALK REMOVAL		
			PAVEMENT REMOVAL	-	
			CLASS D PATCH		
			CONCRETE MEDIAN S	SURFACE	Learne
	ADA DETAILS E 546 AVE	F.A. RTE	SECTION	COUNTY	TOTAL SHEET NO.

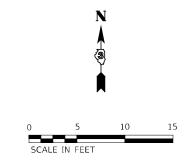
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	DRAWN -	REVISED -
PLOT SCALE = 10.0000 / in.	CHECKED -	REVISED -
PLOT DATE = 3/23/2022	DATE -	REVISED -

STATE OF ILLINOIS **DEPARTMENT OF TRANSPORTATION**

ADA DETAILS E 5th AVE SCALE: 1"=5' SHEET 4 OF 4 SHEETS STA.

TO STA.


IROQUOIS CONTRACT NO. 66K68

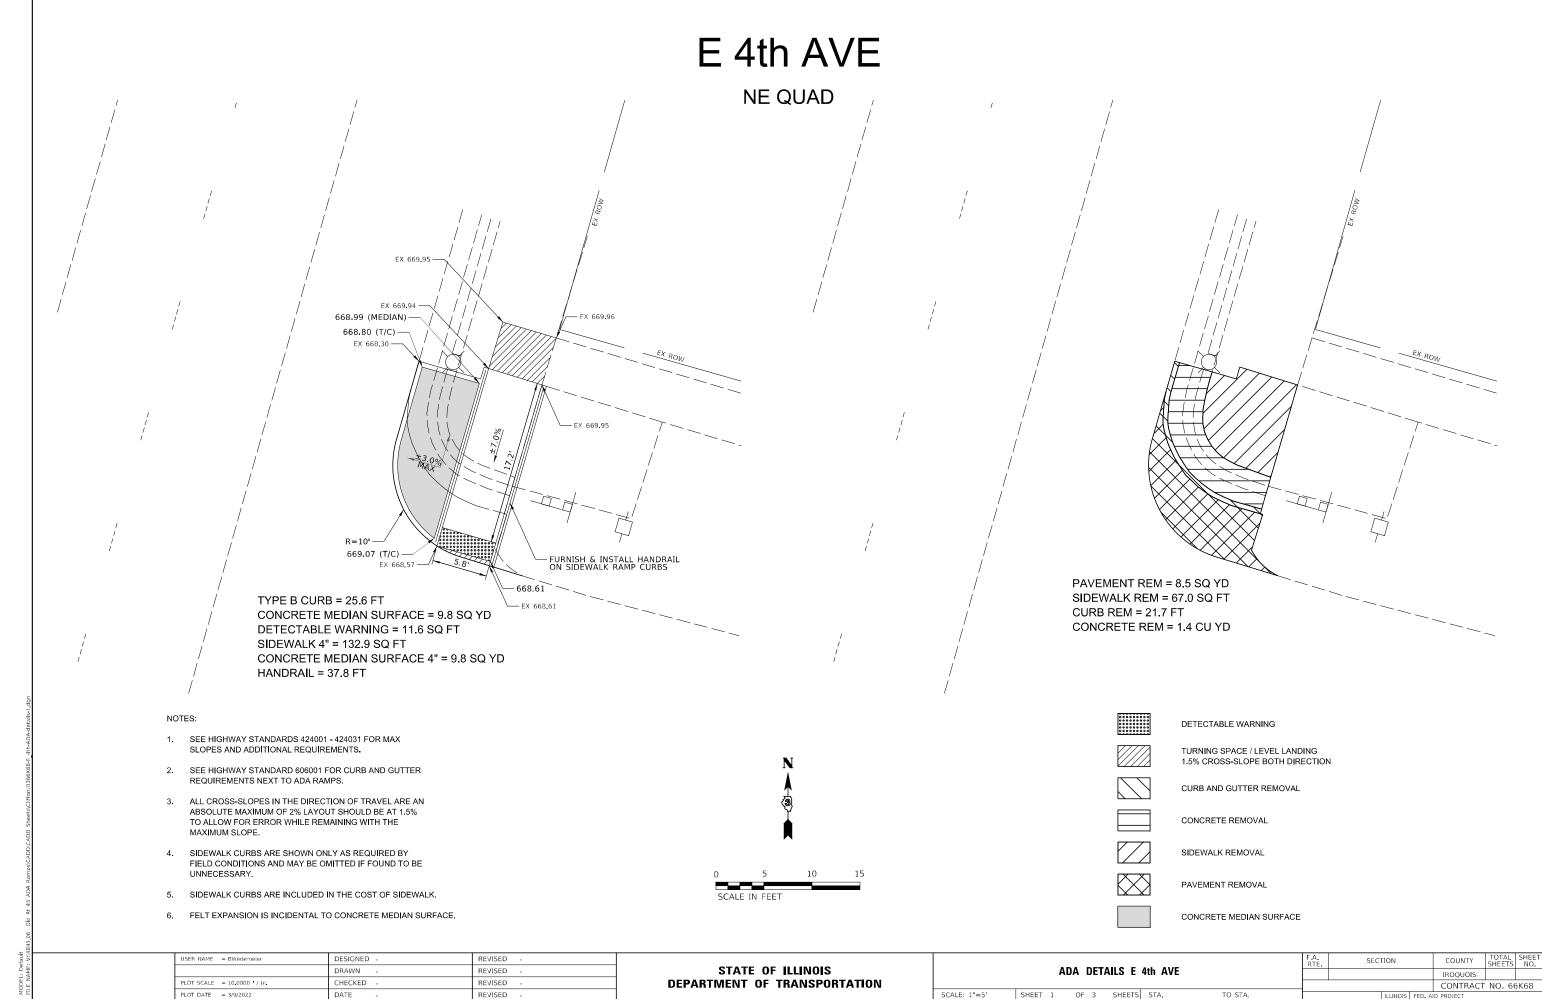


SCALE: 1"=5"

E 4th AVE

SW QUAD

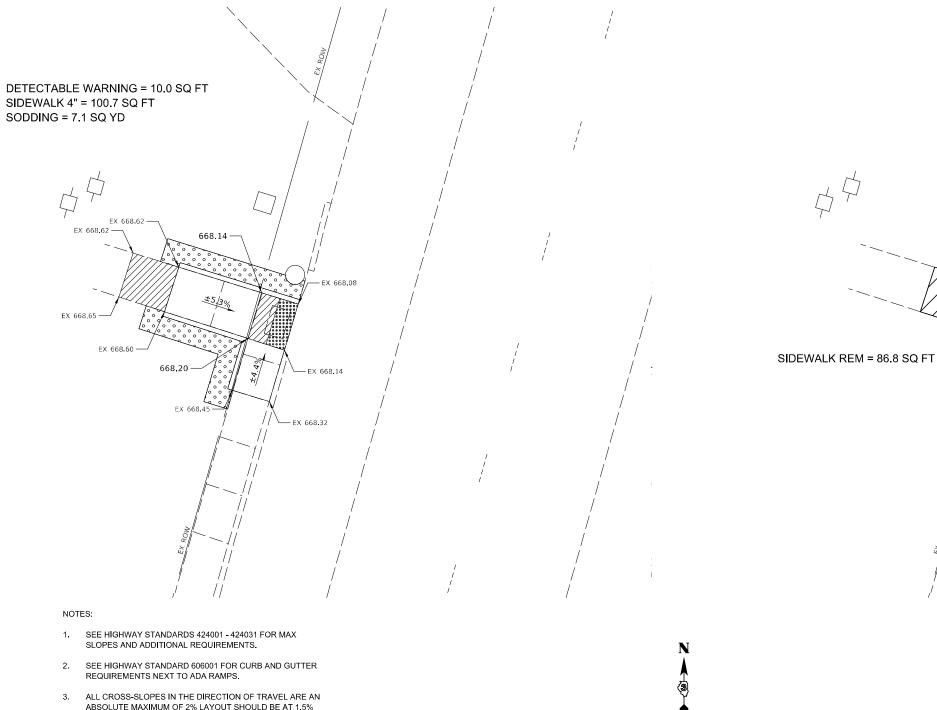

- ALL CROSS-SLOPES IN THE DIRECTION OF TRAVEL ARE AN ABSOLUTE MAXIMUM OF 2% LAYOUT SHOULD BE AT 1.5% TO ALLOW FOR ERROR WHILE REMAINING WITH THE
- 4. SIDEWALK CURBS ARE SHOWN ONLY AS REQUIRED BY FIELD CONDITIONS AND MAY BE OMITTED IF FOUND TO BE
- 5. SIDEWALK CURBS ARE INCLUDED IN THE COST OF SIDEWALK.

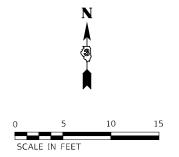

N (3)				
5	10	15		

DETECTABLE WARNING

TURNING SPACE / LEVEL LANDING 1.5% CROSS-SLOPE BOTH DIRECTION

CURB AND GUTTER REMOVAL

CONCRETE REMOVAL


SIDEWALK REMOVAL

PAVEMENT REMOVAL

SODDING


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	DRAWN -	REVISED -
PLOT SCALE = 10.0000 / in.	CHECKED -	REVISED -
PLOT DATE = 3/9/2022	DATE -	REVISED -

	F.A. RTE							TION		COUNTY	TOTAL SHEETS	SHEET NO.
	ADA DETAILS E 4th AVE									IROQUOIS		
										CONTRACT	NO. 60	5K68
SCALE: 1"=5'	SHEET 2	OF	3 SHEETS	STA.	TO STA.			ILLINOIS	FED. A	D PROJECT		

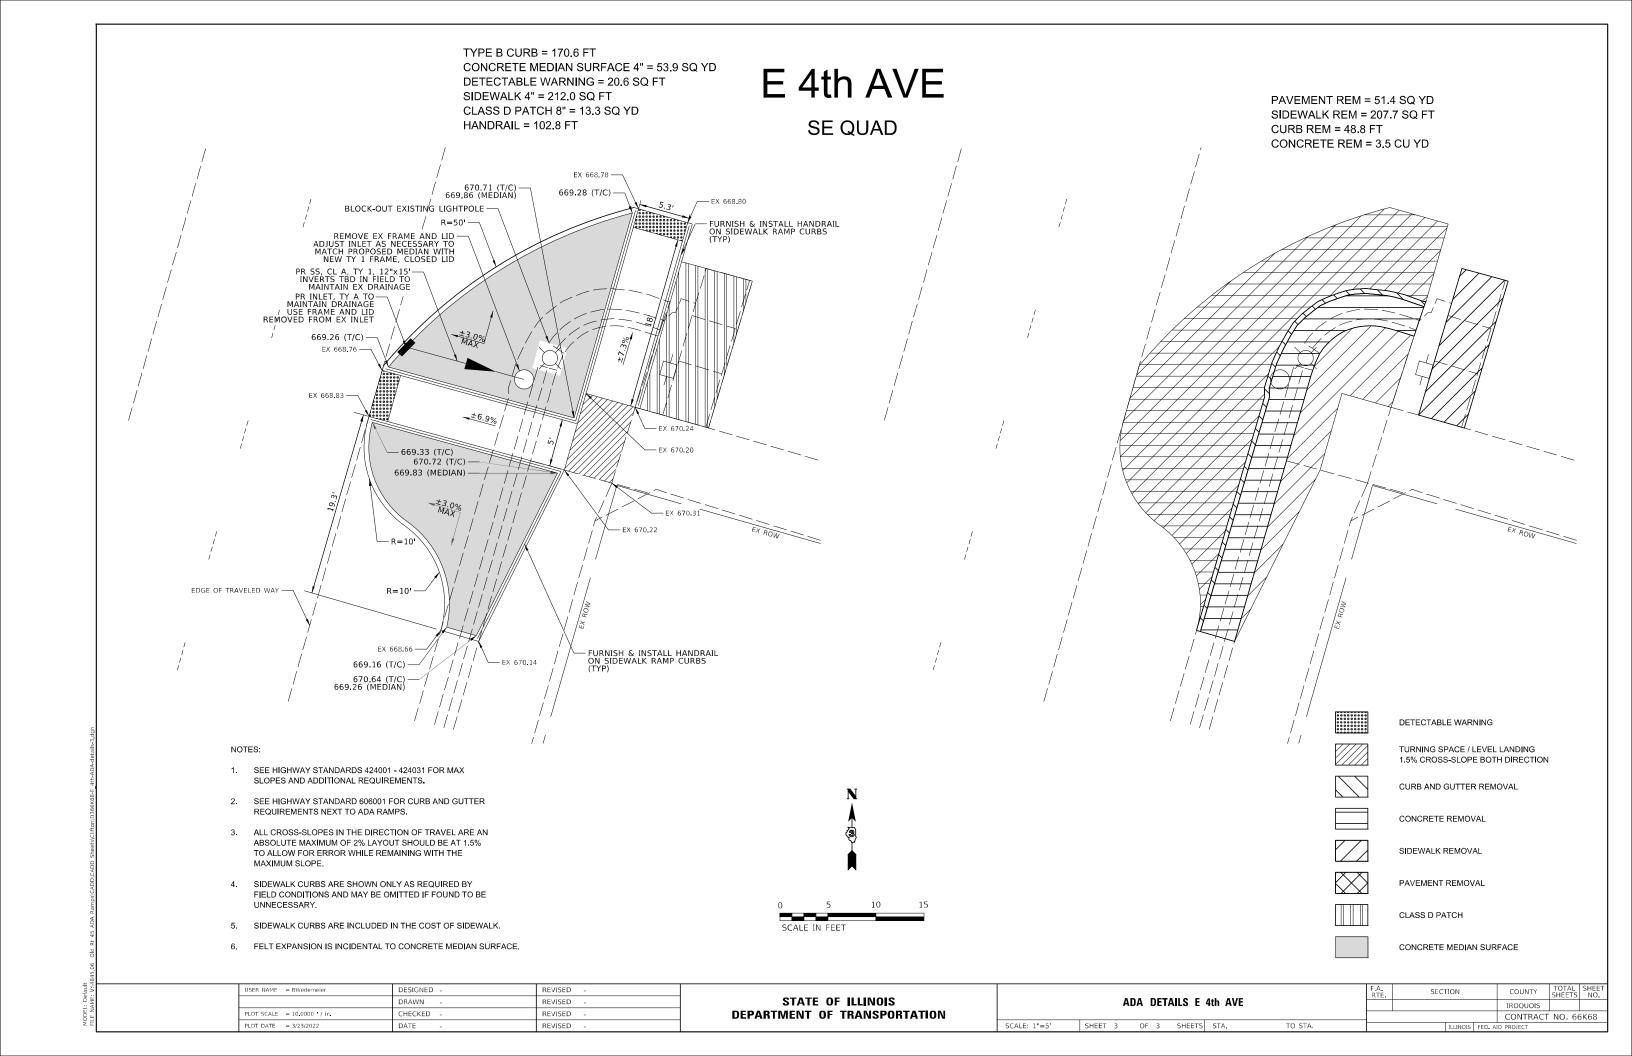

E 3rd AVE

NW QUAD

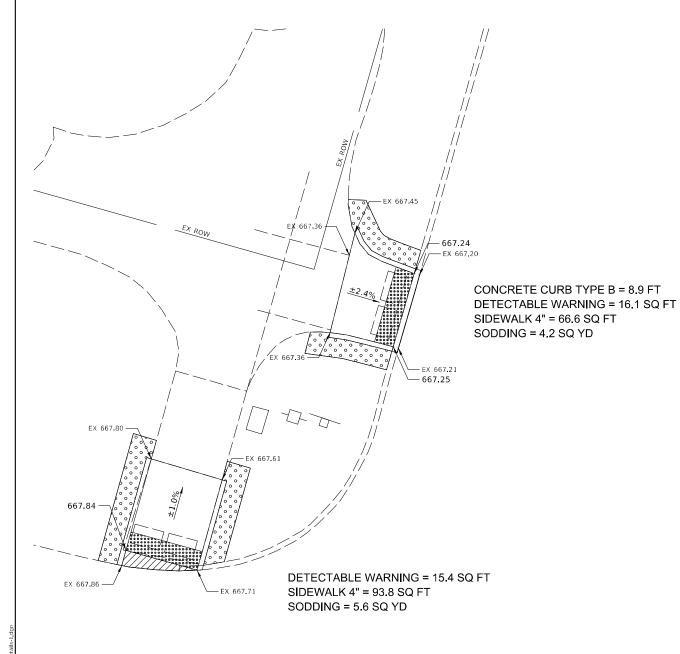


SIDEWALK REM = 59.1 SQ FT CURB REM = 8.9 FT

> SIDEWALK REM = 74.6 SQ FT CURB REM = 2.5 FT

> > SCALE: 1"=5'

NOTES:

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DETECTABLE WARNING

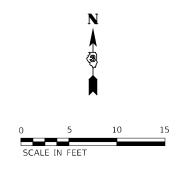

TURNING SPACE / LEVEL LANDING 1.5% CROSS-SLOPE BOTH DIRECTION



CURB AND GUTTER REMOVAL



SIDEWALK REMOVAL



PAVEMENT REMOVAL




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	DRAWN -	REVISED -
PLOT SCALE = 10.0000 / in.	CHECKED -	REVISED -
PLOT DATE = 3/9/2022	DATE -	REVISED -

							F.A. RTE	SECT	ION		COUNTY	TOTAL SHEETS	SHEET NO.
ADA DETAILS E 3rd AVE								IROQUOIS					
											CONTRACT	NO. 66	5K68
	SHEET	1	OF 3	SHEETS	STA.	TO STA.			ILLINOIS	FED. AI	D PROJECT		

E 3rd AVE

NE QUAD

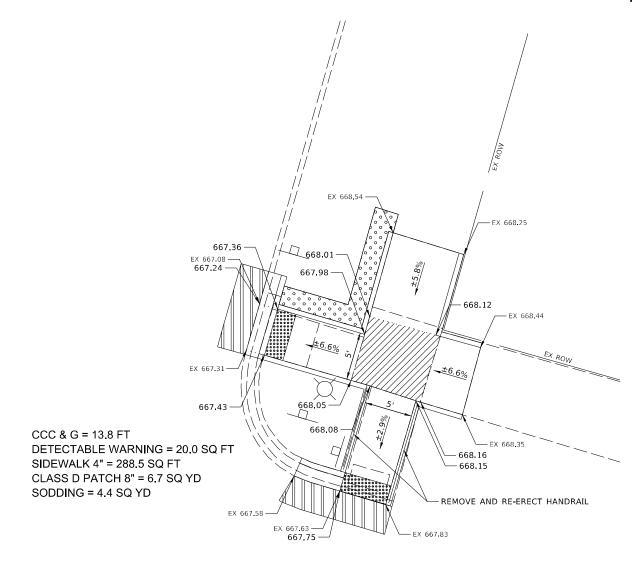


EX ROW

SIDEWALK REM = 267.5 SQ FT CCC & G REM = 11.6 FT CURB REM = 19.6 FT

NOTES:

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00000000	DETECTABLE WARNING
	TURNING SPACE / LEVEL LANDING 1.5% CROSS-SLOPE BOTH DIRECTION
	CURB AND GUTTER REMOVAL
	SIDEWALK REMOVAL
	DAVEMENT BEMOVAL

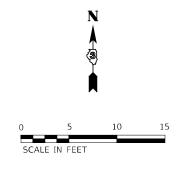CLASS D PATCH
SODDING


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USER NAME = BWedemeier	DESIGNED -	REVISED -
	DRAWN -	REVISED -
PLOT SCALE = 10.0000 / in.	CHECKED -	REVISED -
BLOT DATE - 2/0/2022	DATE	DEVICED

I B							F.A. RTE	SEC	TION		COUNTY	TOTAL SHEETS			
	ADA DETAILS E 3rd AVE										IROQUOIS				
												CONTRACT	NO. 66	5K68	
SCALE: 1"=	5'	SHEET	2	OF	3	SHEETS	STA.	TO STA.			ILLINOIS	FED. A	ID PROJECT		


E 3rd AVE

SE QUAD

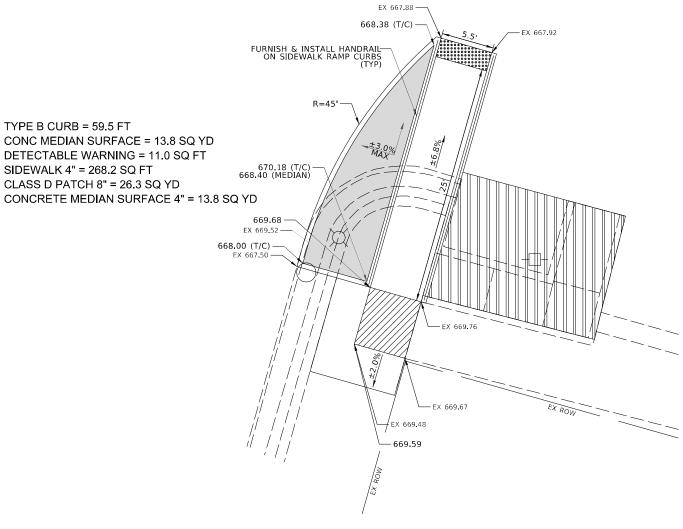

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PAVEMENT REM = 17.0 SQ FT SIDEWALK REM = 322.1 SQ FT CURB REM = 22.3 FT CONCRETE REM = 1.3 CU YD	
	DETECTABLE WARNING
	TURNING SPACE / LEVEL LANDING 1.5% CROSS-SLOPE BOTH DIRECTION
	CURB AND GUTTER REMOVAL
	CONCRETE REMOVAL
	SIDEWALK REMOVAL
	PAVEMENT REMOVAL
	CLASS D PATCH
	CONCRETE MEDIAN SURFACE


USER NAME = BWedemeier	DESIGNED -	REVISED -
	DRAWN -	REVISED -
PLOT SCALE = 10.0000 / in.	CHECKED -	REVISED -
PLOT DATE = 3/9/2022	DATE -	REVISED -

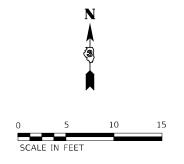STATE OF ILLINOIS
DEPARTMENT OF TRANSPORTATION

SCALE: 1"=5"


E 2nd AVE NE & SE QUADS


DETECTABLE WARNING = 8.0 SQ FT SIDEWALK 4" = 34.5 SQ FT CLASS D PATCH 8" = 3.2 SQ YD SODDING = 3.4 SQ YD

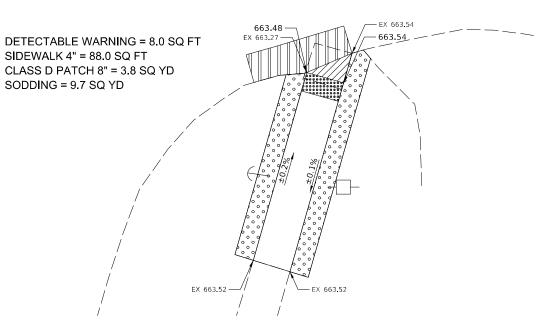

NOTES:


- 1. SEE HIGHWAY STANDARDS 424001 424031 FOR MAX SLOPES AND ADDITIONAL REQUIREMENTS.
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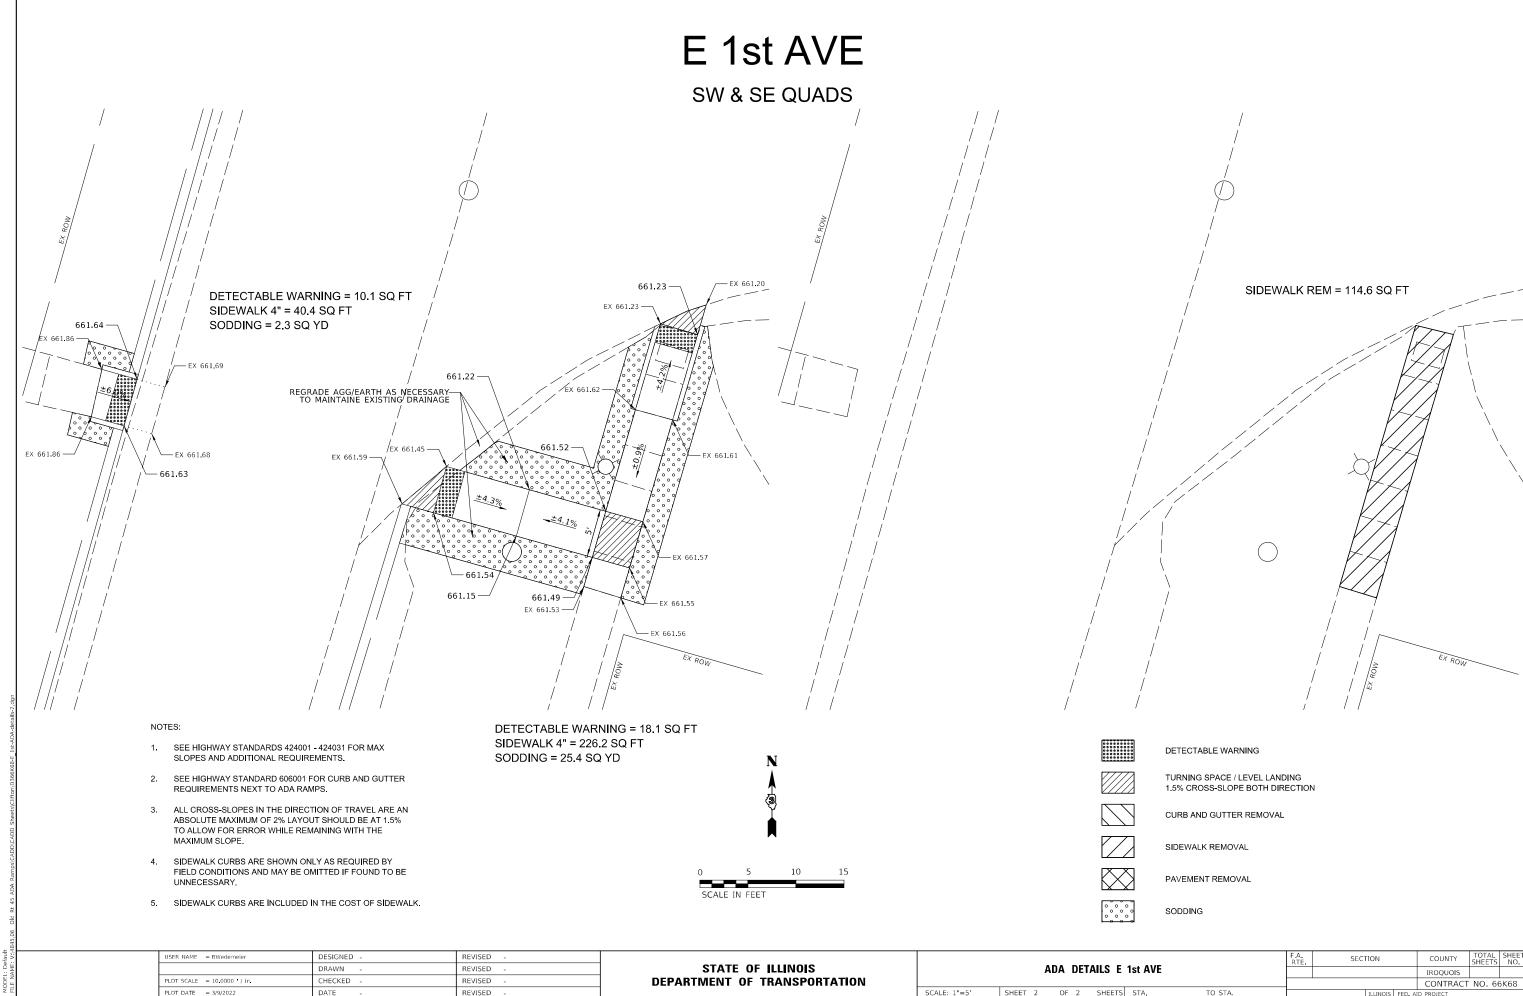


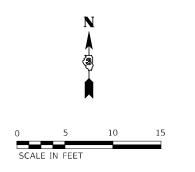

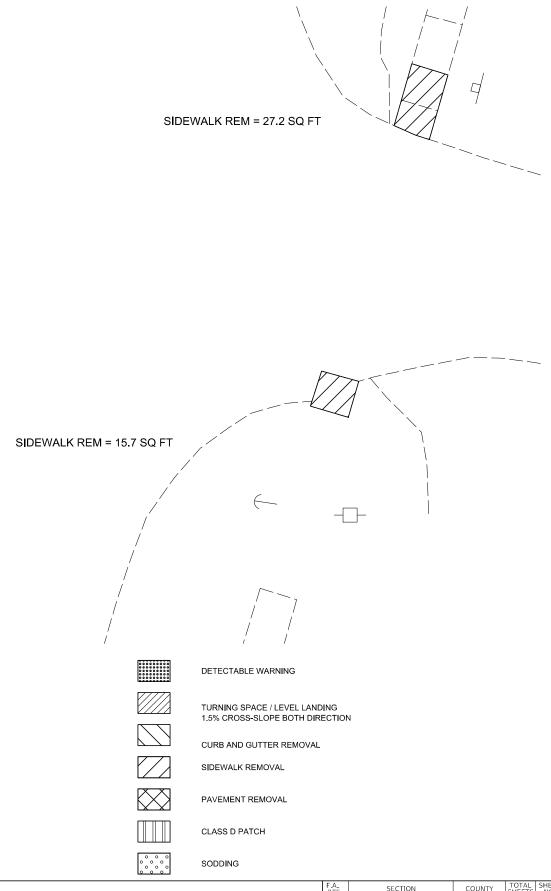USER NAME = BWedemeier	DESIGNED -	REVISED -
	DRAWN -	REVISED -
PLOT SCALE = 10.0000 / in.	CHECKED -	REVISED -
PLOT DATE = 3/9/2022	DATE -	REVISED -

ADA DETAILS E 2nd AVE							SEC	TION		COUNTY	TOTAL SHEETS	SHEET NO.
										IROQUOIS		
										CONTRACT	NO. 6	6K68
SCALE: 1"=5'	SHEET 1	OF 1	SHEETS	STA.	TO STA.			ILLINOIS	FED. A	ID PROJECT		




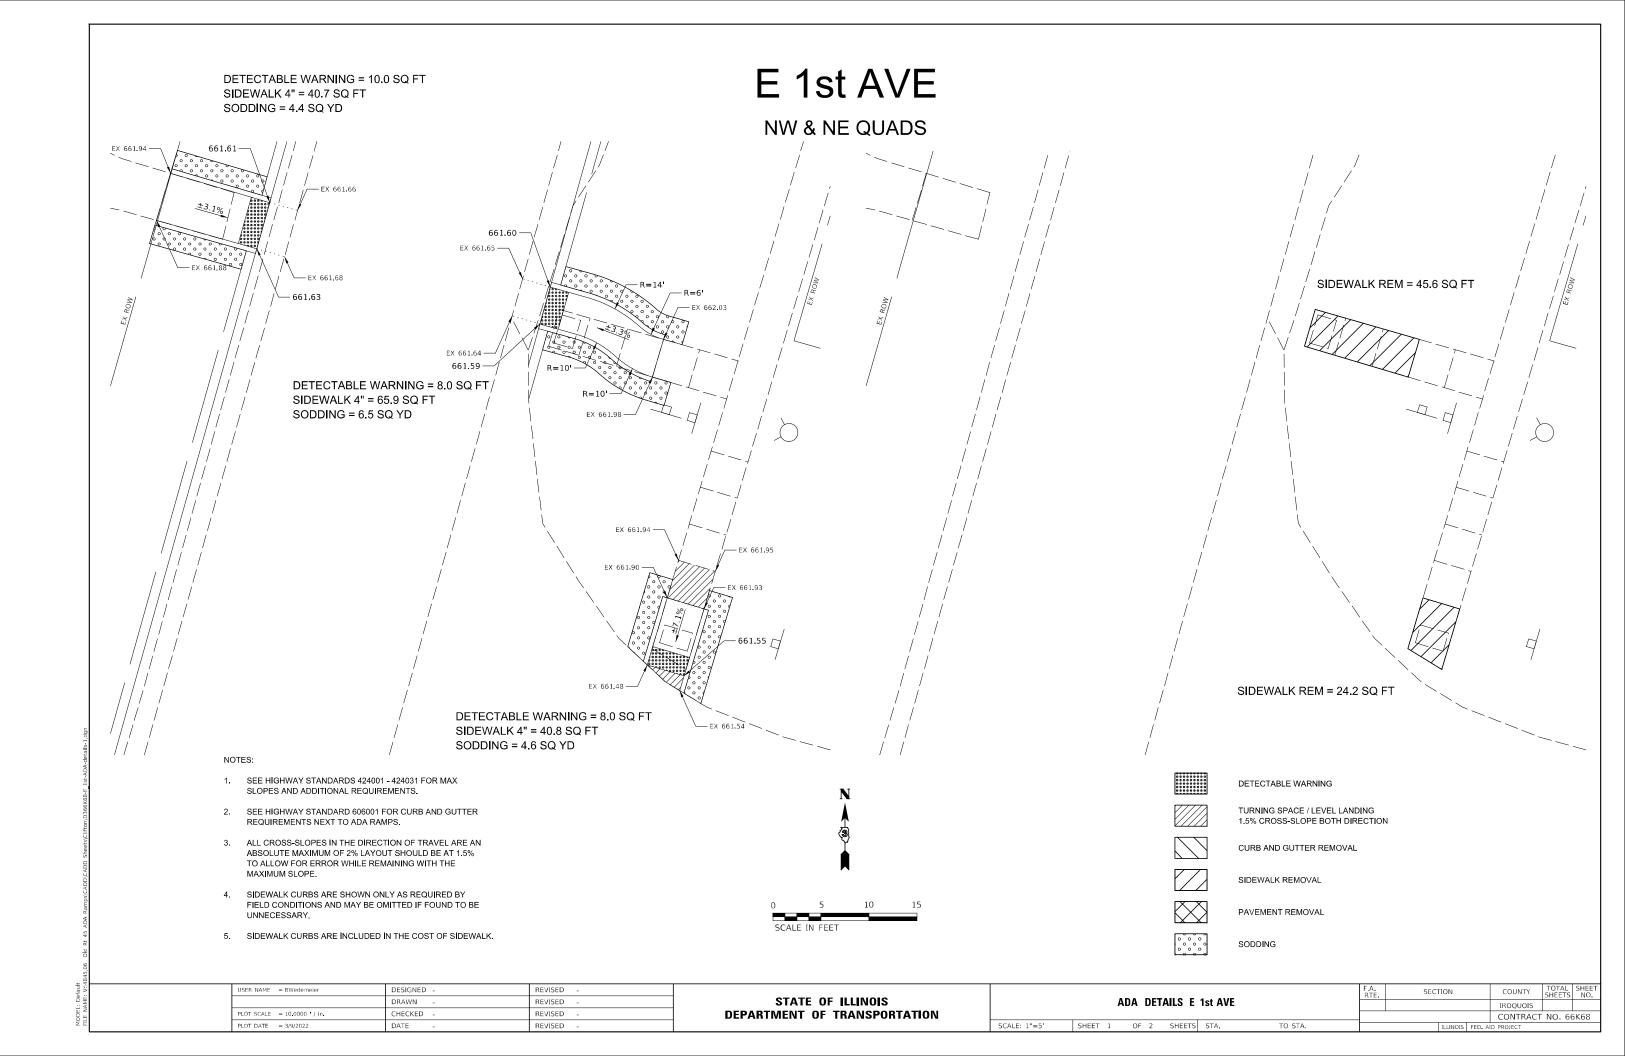

DATE

SCALE: 1"=5' SHEET 2 OF 2 SHEETS STA.


CONTRACT NO. 66K68

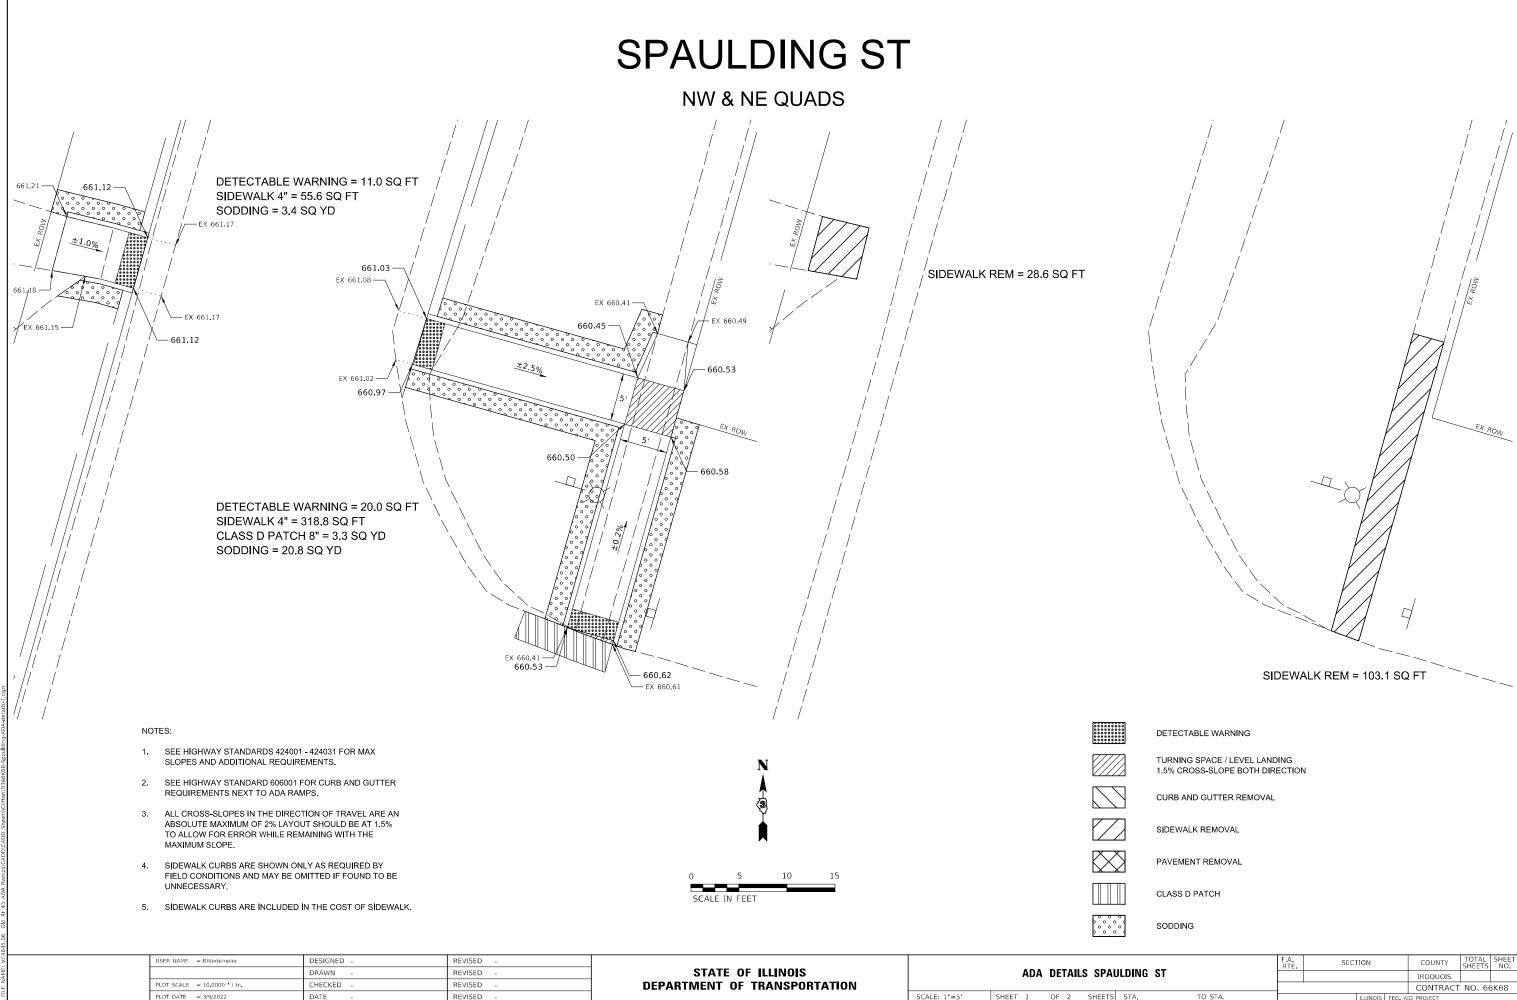

SHEET 1 OF 2 SHEETS STA.

SPAULDING ST

SW & SE QUADS

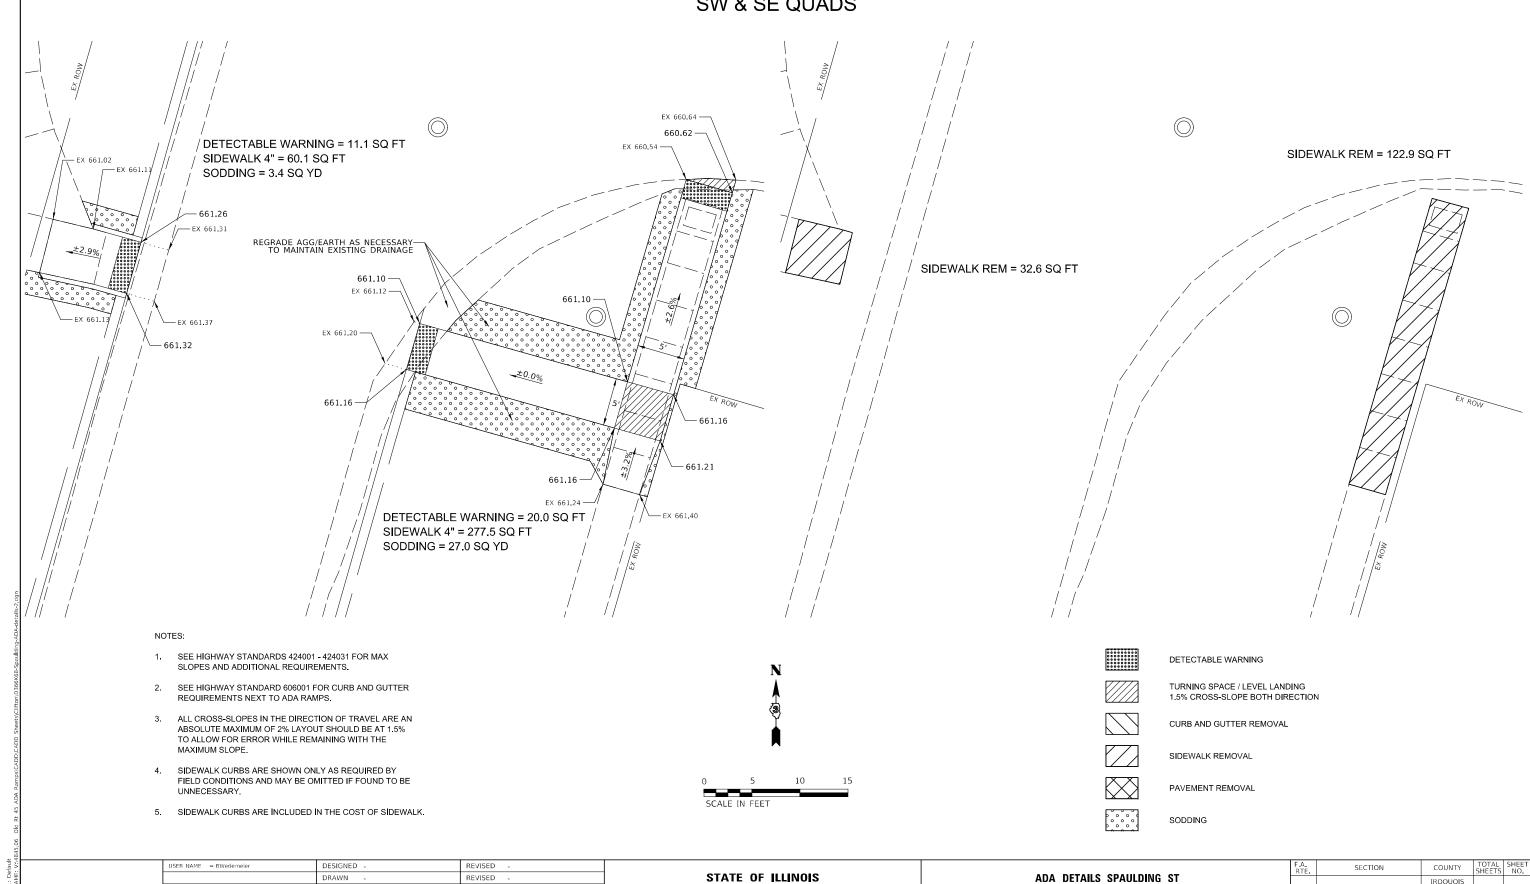

DEPARTMENT OF TRANSPORTATION

CHECKED

DATE

REVISED

SCALE: 1"=5'


ADA DETAILS SPAULDING ST


SHEET 2 OF 2 SHEETS STA.

IROOUOIS CONTRACT NO. 66K68

PORTER AVE

NW & NE QUADS

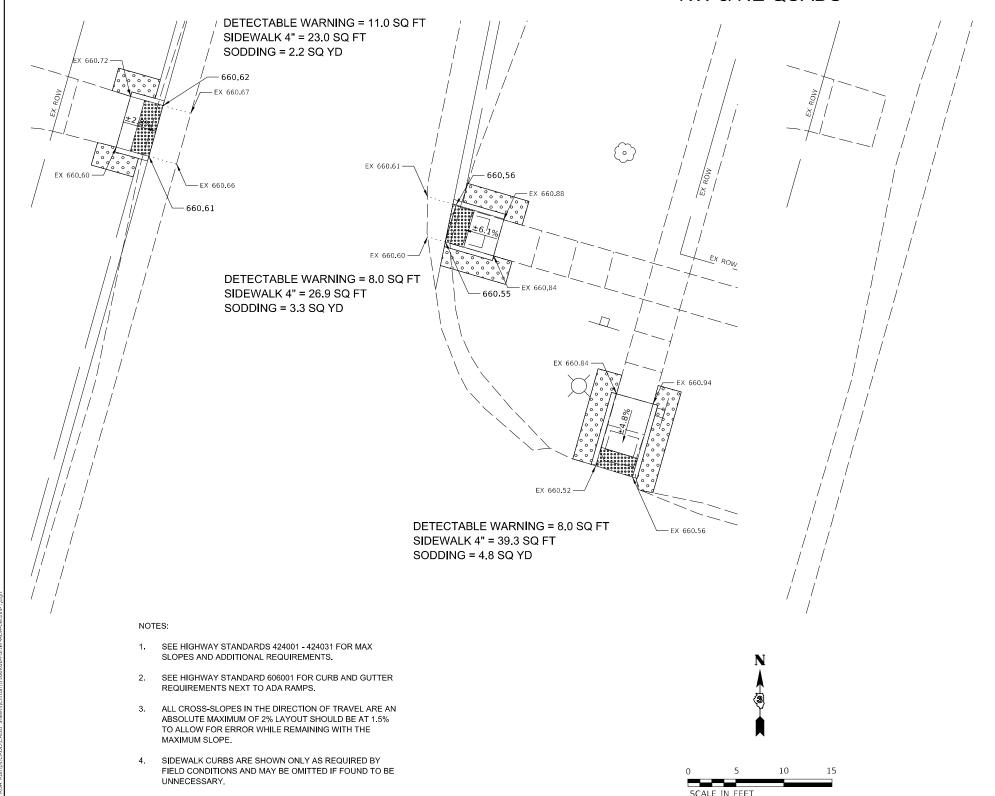

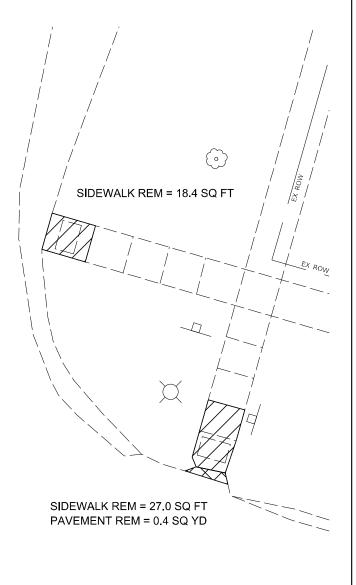

5. SIDEWALK CURBS ARE INCLUDED IN THE COST OF SIDEWALK.

DETECTABLE WARNING

TI.

TURNING SPACE / LEVEL LANDING 1.5% CROSS-SLOPE BOTH DIRECTION



CURB AND GUTTER REMOVAL



PAVEMENT REMOVAL

SIDEWALK REMOVAL



SCALE: 1"=5"

SODDING

USER NAME = BWedemeier	DESIGNED -	REVISED -
	DRAWN -	REVISED -
PLOT SCALE = 10.0000 / in.	CHECKED -	REVISED -
PLOT DATE = 3/9/2022	DATE -	REVISED -


STATE OF ILLINOIS
DEPARTMENT OF TRANSPORTATION


							_						
							F.A. RTE	SECT	ПОИ		COUNTY	TOTAL SHEETS	SHEET NO.
											IROQUOIS		
											CONTRACT	NO. 60	5K68
	CHEET	1	OE 2	CHEETC	CTA	TO CTA			THEMPORE	550 A	D. DDOJECT		

TLE NAME: V:\4845.06 Old Rt 45 ADA Ramps\CADI

PORTER AVE

SW & SE QUADS

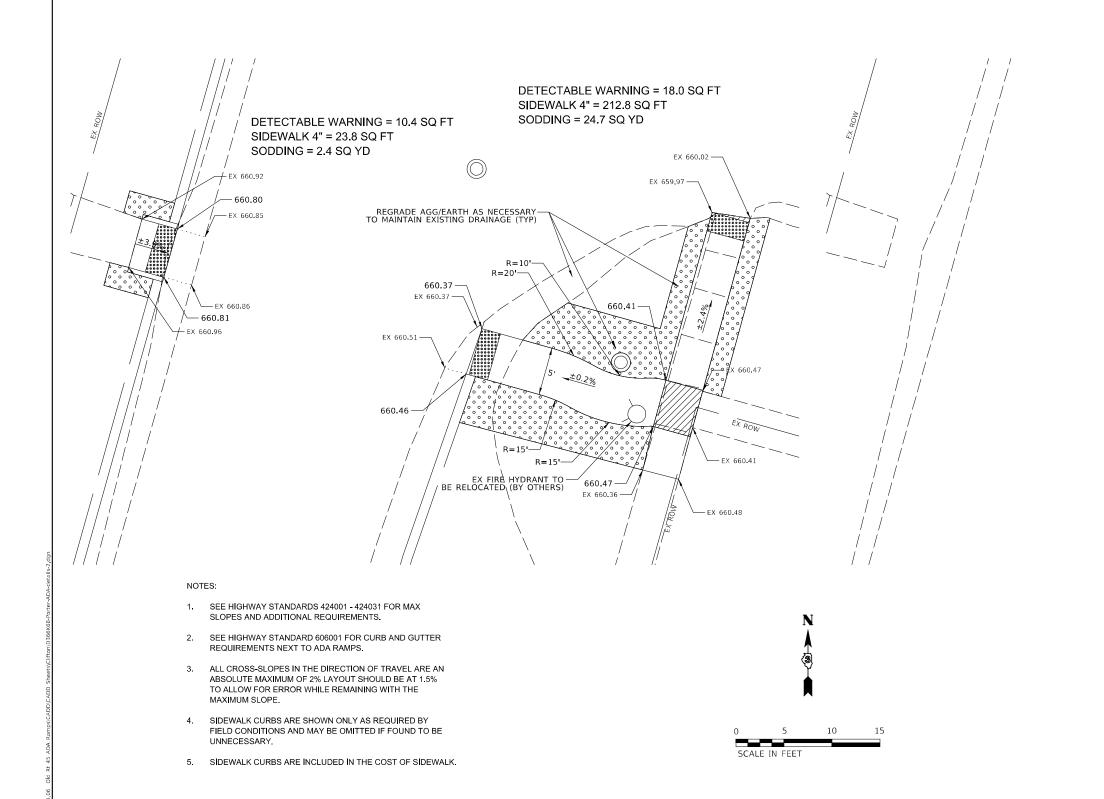

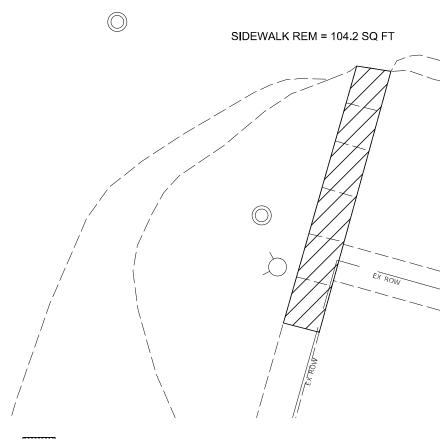



DETECTABLE WARNING



TURNING SPACE / LEVEL LANDING 1.5% CROSS-SLOPE BOTH DIRECTION



CURB AND GUTTER REMOVAL



SIDEWALK REMOVAL



PAVEMENT REMOVAL



SODDING

USER NAME = BWedemeier	DESIGNED -	REVISED -
	DRAWN -	REVISED -
PLOT SCALE = 10.0000 / in.	CHECKED -	REVISED -
PLOT DATE = 3/9/2022	DATE -	REVISED -

	F.A. RTE	SEC	TION		COUNTY	TOTAL SHEETS				
ADA					IROQUOIS					
									NO. 66	5K68
SCALE: 1"=5' SHEET 2 C	OF 2 SHEETS	STA.	TO STA.			ILLINOIS	FED. AI	D PROJECT		

JENSEN AVE NW & NE QUADS DETECTABLE WARNING = 11.2 SQ FT SIDEWALK 4" = 25.0 SQ FT SODDING = 2.3 SQ YD -659.63 1. SEE HIGHWAY STANDARDS 424001 - 424031 FOR MAX DETECTABLE WARNING SLOPES AND ADDITIONAL REQUIREMENTS. SEE HIGHWAY STANDARD 606001 FOR CURB AND GUTTER REQUIREMENTS NEXT TO ADA RAMPS. TURNING SPACE / LEVEL LANDING 1.5% CROSS-SLOPE BOTH DIRECTION ALL CROSS-SLOPES IN THE DIRECTION OF TRAVEL ARE AN ABSOLUTE MAXIMUM OF 2% LAYOUT SHOULD BE AT 1.5% CURB AND GUTTER REMOVAL TO ALLOW FOR ERROR WHILE REMAINING WITH THE SIDEWALK REMOVAL 4. SIDEWALK CURBS ARE SHOWN ONLY AS REQUIRED BY FIELD CONDITIONS AND MAY BE OMITTED IF FOUND TO BE PAVEMENT REMOVAL


USER NAME = BWedemeier	DESIGNED -	REVISED -
	DRAWN -	REVISED -
PLOT SCALE = 10.0000 / in.	CHECKED -	REVISED -
BLOT DATE - 2/0/2022	DATE	DEVICED

5. SIDEWALK CURBS ARE INCLUDED IN THE COST OF SIDEWALK.

STATE OF ILLINOIS
DEPARTMENT OF TRANSPORTATION

SCALE: 1"=5'

SODDING

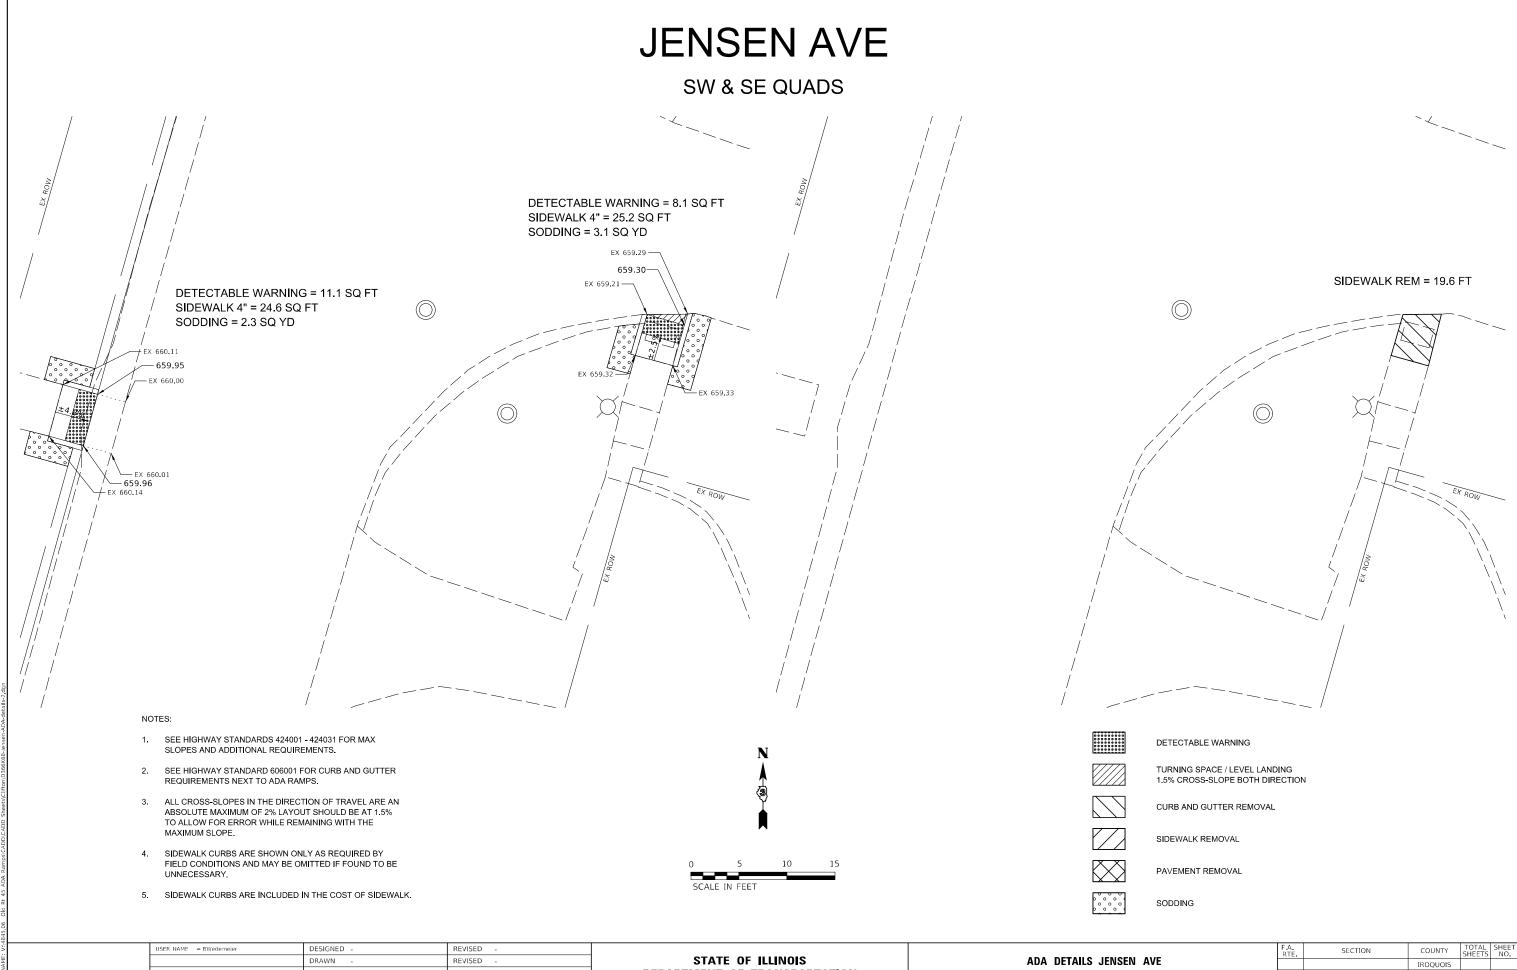


CHECKED REVISED PLOT DATE = 3/9/2022 DATE

DEPARTMENT OF TRANSPORTATION


SCALE: 1"=5"


CONTRACT NO. 66K68 SHEET 2 OF 2 SHEETS STA.

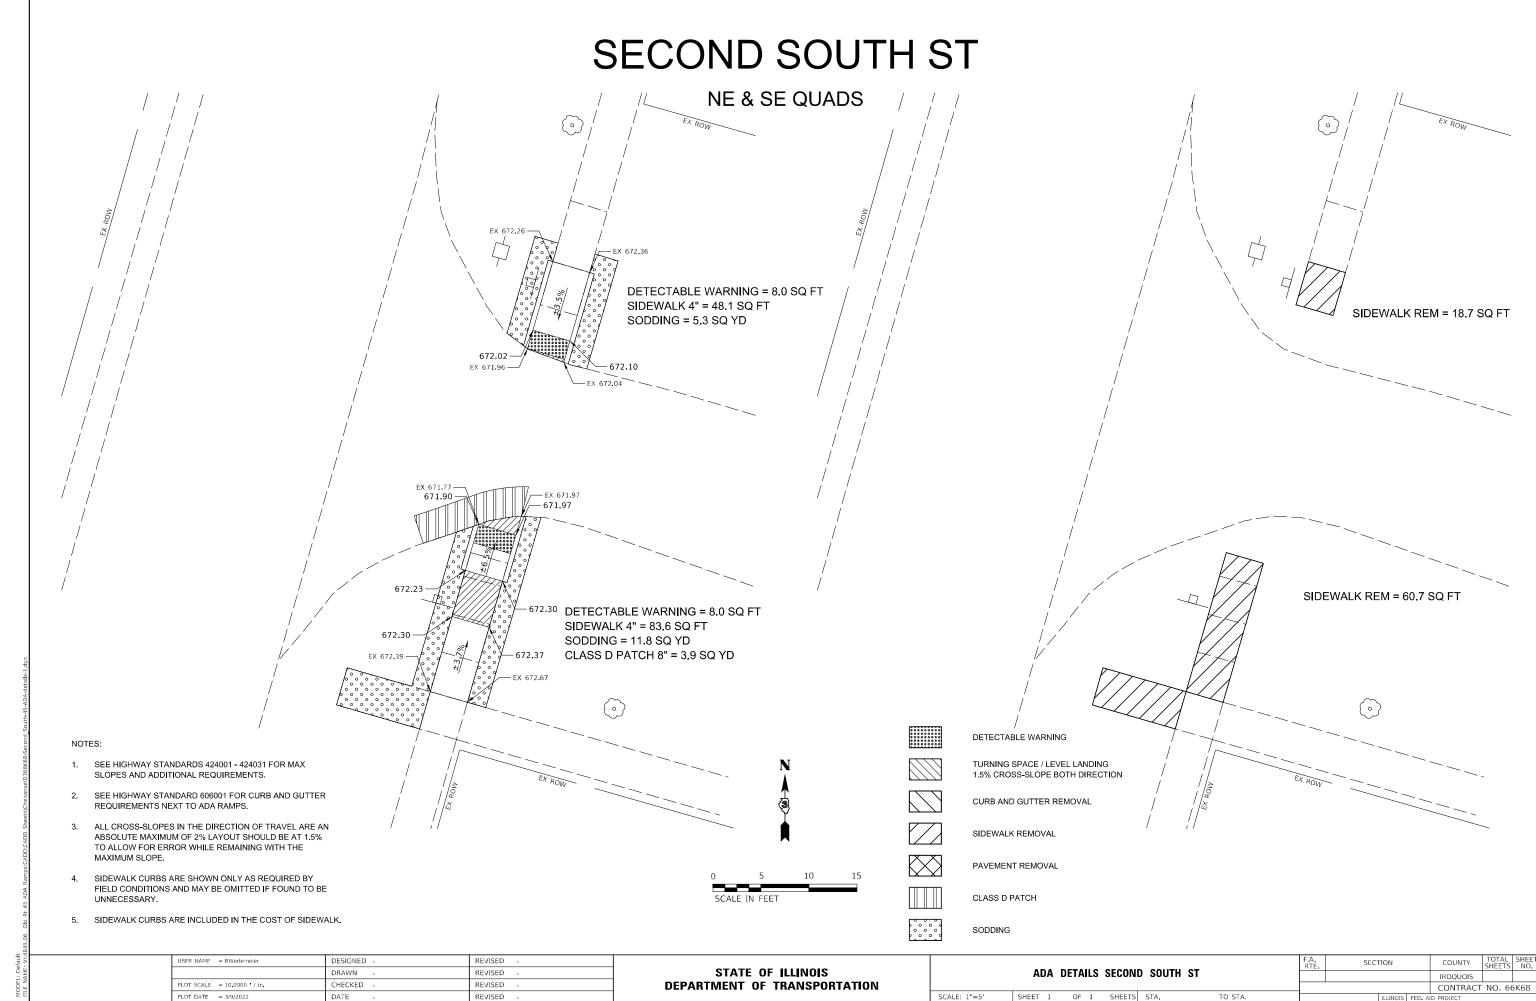


FIRST SOUTH ST

NE QUAD

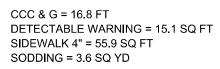

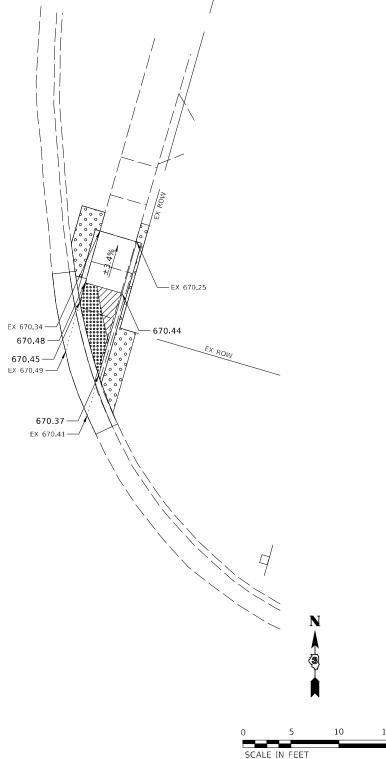

CURB REM = 16.8 FT SIDEWALK REM = 42.7 SQ FT

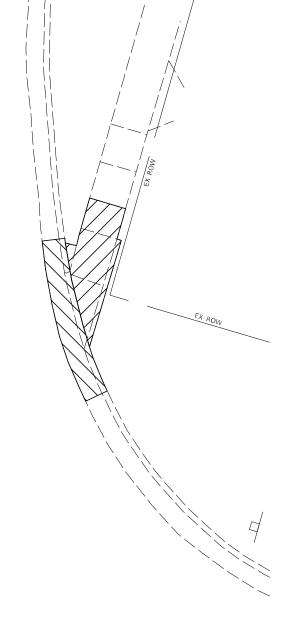

NOTES:

- SEE HIGHWAY STANDARDS 424001 424031 FOR MAX SLOPES AND ADDITIONAL REQUIREMENTS.
- SEE HIGHWAY STANDARD 606001 FOR CURB AND GUTTER REQUIREMENTS NEXT TO ADA RAMPS.
- 3. ALL CROSS-SLOPES IN THE DIRECTION OF TRAVEL ARE AN ABSOLUTE MAXIMUM OF 2% LAYOUT SHOULD BE AT 1,5% TO ALLOW FOR ERROR WHILE REMAINING WITH THE MAXIMUM SLOPE.
- 4. SIDEWALK CURBS ARE SHOWN ONLY AS REQUIRED BY FIELD CONDITIONS AND MAY BE OMITTED IF FOUND TO BE UNINFOESSARY
- 5. SIDEWALK CURBS ARE INCLUDED IN THE COST OF SIDEWALK.



DETECTABLE WARNING



TURNING SPACE / LEVEL LANDING 1.5% CROSS-SLOPE BOTH DIRECTION



CURB AND GUTTER REMOVAL



SIDEWALK REMOVAL
PAVEMENT REMOVAL



SCALE: 1"=5"


SODDING

USER NAME = BWedemeier	DESIGNED -	REVISED -
	DRAWN -	REVISED -
PLOT SCALE = 10.0000 / in.	CHECKED -	REVISED -
PLOT DATE = 3/9/2022	DATE -	REVISED -

	ADA DETAILS FIRST SOUTH ST						SECTION		COUNTY	TOTAL SHEETS	SHEET NO.	
										IROQUOIS		
										CONTRACT	NO. 66	5K68
	SHEET 1	OF 3	SHEETS	STA.	TO STA.			ILLINOIS	FED. AI	D PROJECT		

FIRST SOUTH ST

SW QUAD

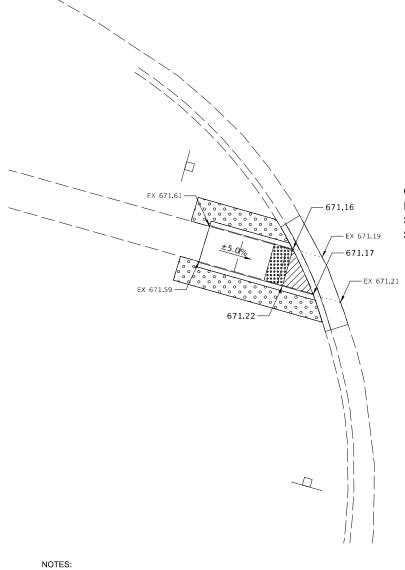


CCC & G = 12.0 FT

DETECTABLE WARNING = 8.0 SQ FT

SIDEWALK 4" = 53.7 SQ FT

SODDING = 5.8 SQ YD

- SEE HIGHWAY STANDARDS 424001 424031 FOR MAX SLOPES AND ADDITIONAL REQUIREMENTS.
- SEE HIGHWAY STANDARD 606001 FOR CURB AND GUTTER REQUIREMENTS NEXT TO ADA RAMPS.
- ALL CROSS-SLOPES IN THE DIRECTION OF TRAVEL ARE AN ABSOLUTE MAXIMUM OF 2% LAYOUT SHOULD BE AT 1.5% TO ALLOW FOR ERROR WHILE REMAINING WITH THE MAXIMUM SLOPE.
- 4. SIDEWALK CURBS ARE SHOWN ONLY AS REQUIRED BY FIELD CONDITIONS AND MAY BE OMITTED IF FOUND TO BE LINNECESSARY
- 5. SIDEWALK CURBS ARE INCLUDED IN THE COST OF SIDEWALK.

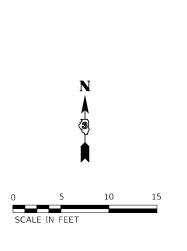

DETECTABLE WARNING

TURNING SPACE / LEVEL LANDING 1.5% CROSS-SLOPE BOTH DIRECTION

CURB AND GUTTER REMOVAL



PAVEMENT REMOVAL

SIDEWALK REMOVAL



SODDING

USER NAME = BWedemeier	DESIGNED -	REVISED -
	DRAWN -	REVISED -
PLOT SCALE = 10.0000 / in.	CHECKED -	REVISED -
PLOT DATE = 3/9/2022	DATE -	REVISED -

STATE OF ILLINOIS
DEPARTMENT OF TRANSPORTATION

ADA DETAILS FIRST SOUTH ST					F.A. RTE	SEC ⁻	ΓΙΟΝ		COUNTY	TOTAL SHEETS	SHEET NO.
									IROQUOIS		
									CONTRACT	NO. 66	5K68
SHEET 2	OF 3	SHEETS	STA.	TO STA.			TELINOIS	FED. AI	D PROJECT		

CURB REM = 12.0 FT

SIDEWALK REM = 41.3 SQ FT


\Chebanse\D366K68-First_South-45-ADA-details

Rt 45 ADA Ramps\CADD\CADD Sheets\Chebans

DEL: Default NAME: V:\4845.06

FIRST SOUTH ST

SE QUAD

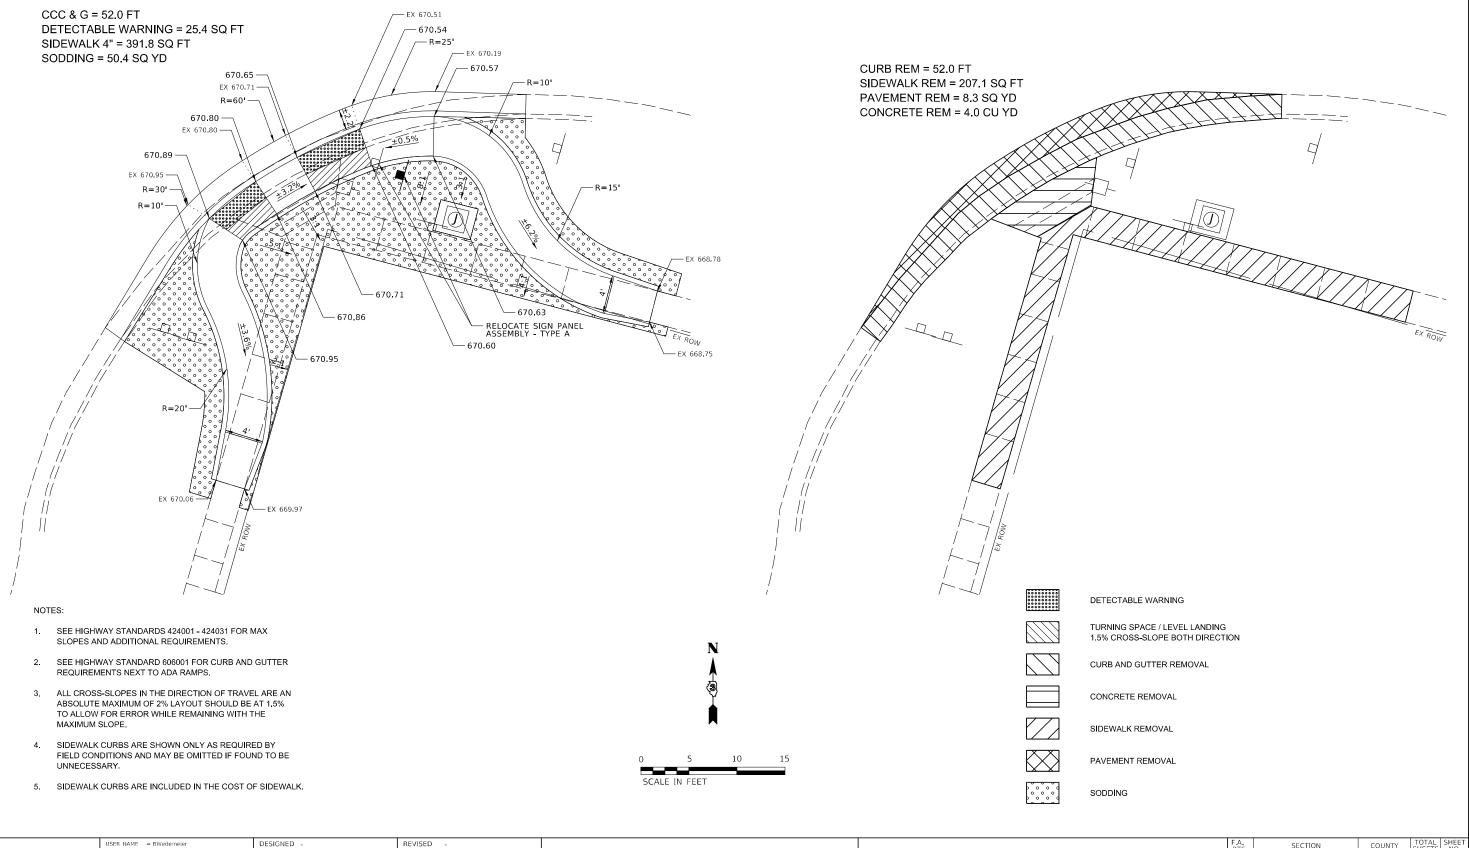


MODEL: Default

| DRAWN - REVISED - | PLOT SCALE = 10.0000 ' / in | CHECKED - REVISED - | PLOT DATE = 3/9/2022 | DATE - REVISED - | |


STATE OF ILLINOIS
DEPARTMENT OF TRANSPORTATION

SCALE: 1"=5"

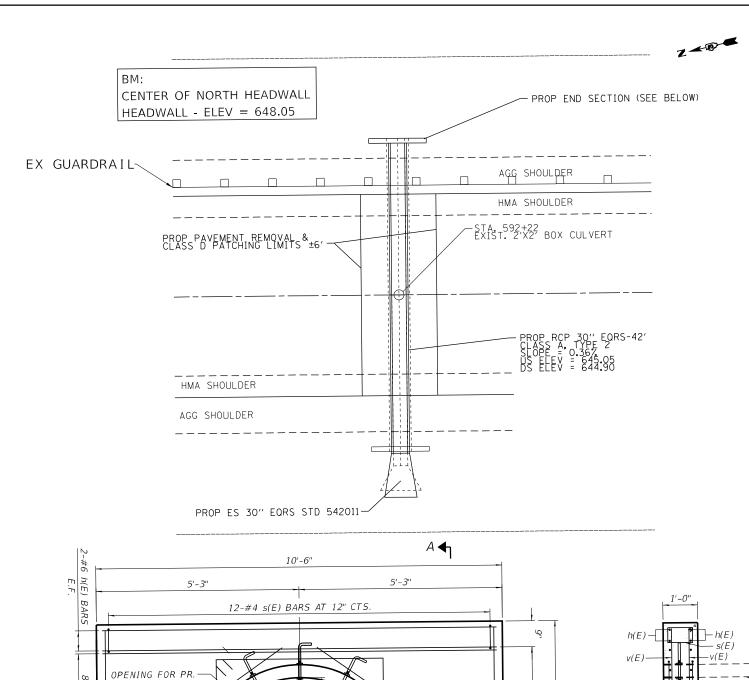


TOTAL BILL OF MATERIAL

ITEM	UNIT	TOTAL
Box Culvert Removal	Foot	45
Traversable Pipe Grate For Concrete End Section	Foot	9.4
Pipe Culverts, Class A, Type 2 EQRS 30"	Foot	42
*Class D Patches, Type III, 12 inch	Sq Yd	34
Trench Backfill	Cu Yd	68
Remove and Reerect Steel Plate Beam Guardrail, Type A	Foot	75

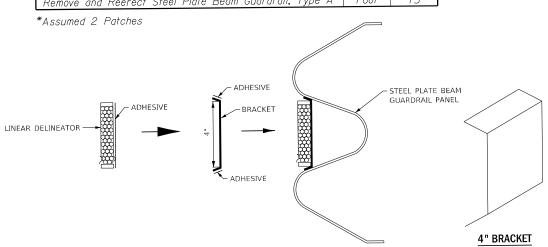

LINEAR DELINEATOR APPLICATION TO STANDARD GALVANIZED GUARDRAIL

LINEATOR DELINEATOR SHALL BE APLLIED ACCORDING TO THE MANUFACTURER'S RECOMMENDATIONS

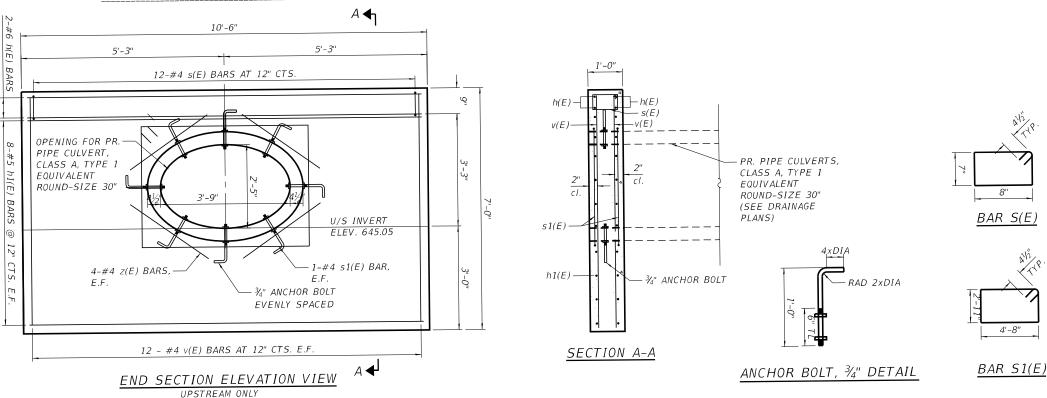

BILL OF MATERIAL END SECTION ONLY

Bar	No.	Size	Length	Shape			
h(E)	4	#6	10'-2"				
h1(E)	16	#5	10'-2"				
s(E)	12	#4	3'-3"				
s1(E)	2	#4	15'-11"				
v(E)	24	#4	6'-7"				
z(E)	8	#4	4'-6"				
CONCR	ETE ST	CU. YD.	4.8				
REINF	ORCEME	POUND	441				
	COATE	TOUND					
ANCHOR BOLTS 3/4" EACH 8							
		·					

- 1. CUT h1(E) AND v(E) BARS AS REQUIRED FOR THE PIPE OPENING.
- 2. PIPE OUTSIDE SURFACE WITHIN END
 SECTION SHALL BE CLEAN AND FREE OF LAITANCE
 WITH SURFACE INTENTIONALLY ROUGHENED TO AN
 AMPLITUDE OF 1/4".
- 3. REINFORCEMENT BARS SHALL CONFORM TO THE REQUIREMENTS OF ASTM A 706 GRADE 60.

 4. REINFORCEMENT BARS DESIGNATED (E)

 SHALL BE EPOXY COATED.


 5. ANCHOR BOLTS SHALL CONFORM TO THE
- REQUIREMENTS ASTM F1554 Grade 36 OR AN ENGINEER-APPROVED ALTERNATE MATERIAL.

USER NAME = longneckerjh	DESIGNED	-	CJ	REVISED -	
	DRAWN	-	CJ	REVISED -	
PLOT SCALE = 100.0000 / in.	CHECKED	-	JL	REVISED -	
PLOT DATE = 4/26/2022	DATE	-	4/26/2022	REVISED -	

UPSTREAM ONLY

STATE OF ILLINOIS
DEPARTMENT OF TRANSPORTATION

									F.A.S. RTE	SEC	TION		COUNTY	TOTAL SHEETS	SHEET NO.
MISCELLANEOUS DETAILS							1324	(38)R	S-5,SW		IROQUOIS	61	56		
													CONTRACT	NO. 66	5K68
S	HEET	1		OF	6	SHEETS	STA.	TO STA.			ILLINOIS	FED. AI	D PROJECT		

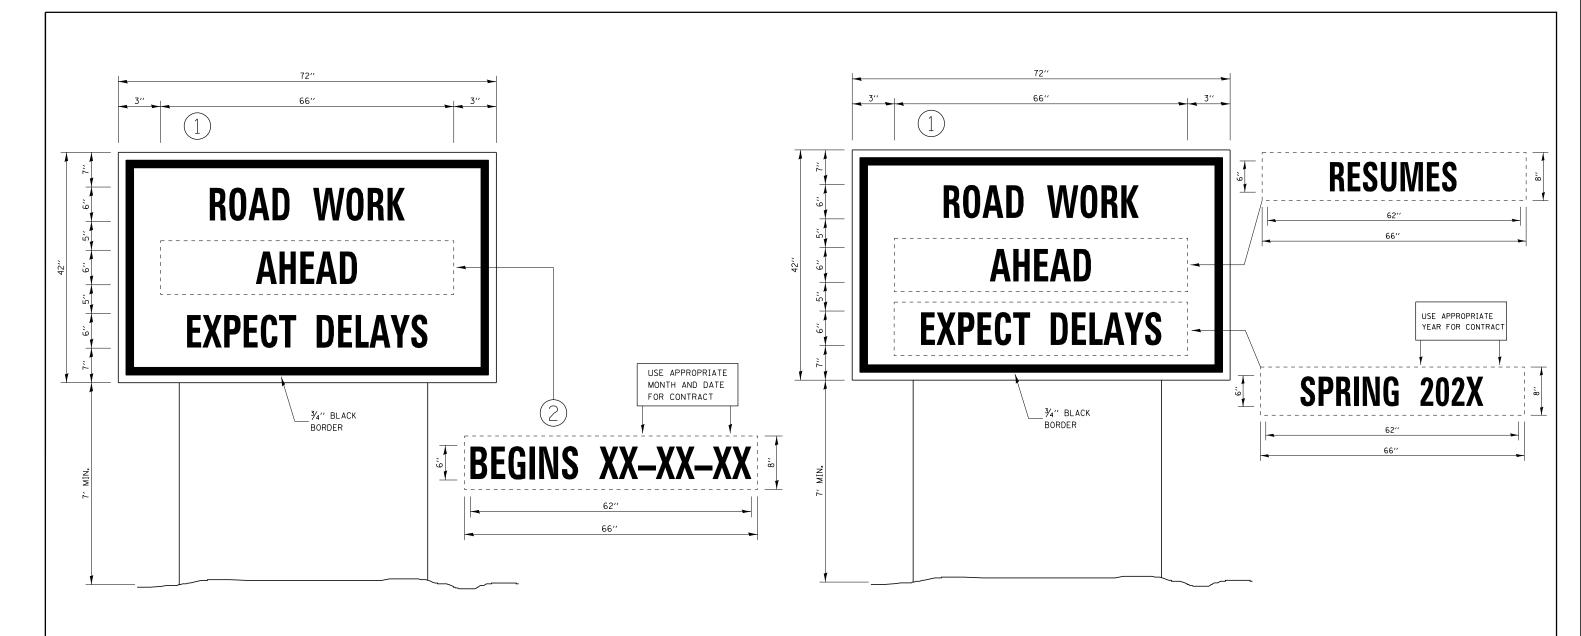

TEMPORARY INFORMATION SIGNING

WINTER SHUT DOWN SIGNING


NOTES:


- 1. USE 6" D BLACK LETTERING ON FLOURESENT ORANGE BACKGROUND.
- ERECT SIGNS AT LOCATIONS IN ADVANCE OF THE "ROAD CONSTRUCTION AHEAD" SIGNS AS DIRECTED BY THE ENGINEER.
- 3. ERECT SIGN() WITH INSTALLED PANEL (2) A MINIMUM OF ONE WEEK PRIOR TO THE START OF THE LANE CLOSURE.
- 4. REMOVE PANEL 2 ON THAT DATE.
- 5. SEE SPECIAL PROVISION "TEMPORARY INFORMATION SIGNING" FOR ADDITIONAL INFORMATION.
- 6. WILL BE PAID FOR PER SO FT AS "TEMPORARY INFORMATION SIGNING". EACH SIGN = 21 SO FT AND THE DATE PANEL ② WILL NOT BE MEASURED SEPARATELY FOR PAYMENT.


USER NAME = mariniej	DESIGNED -	-	Cl	REVISED	-
	DRAWN	-	CJ	REVISED	-
PLOT SCALE = 3.9383 / mm	CHECKED	-	JL	REVISED	-
PLOT DATE = 3/29/2022	DATE .	_	3/29/2022	REVISED	_

STATE OF ILLINOIS
DEPARTMENT OF TRANSPORTATION


						F.A.S. RTE	SECTION	COUNTY	TOTAL SHEETS	SHEET NO.
MISCELLANEOUS DETAILS						1324	(38)RS-5,SW	IROQUOIS	61	57
								CONTRACT	NO. 6	6K68
	SHEET 2	OF 6	SHEETS	STA.	TO STA.		ILLINOIS FED.	AID PROJECT		

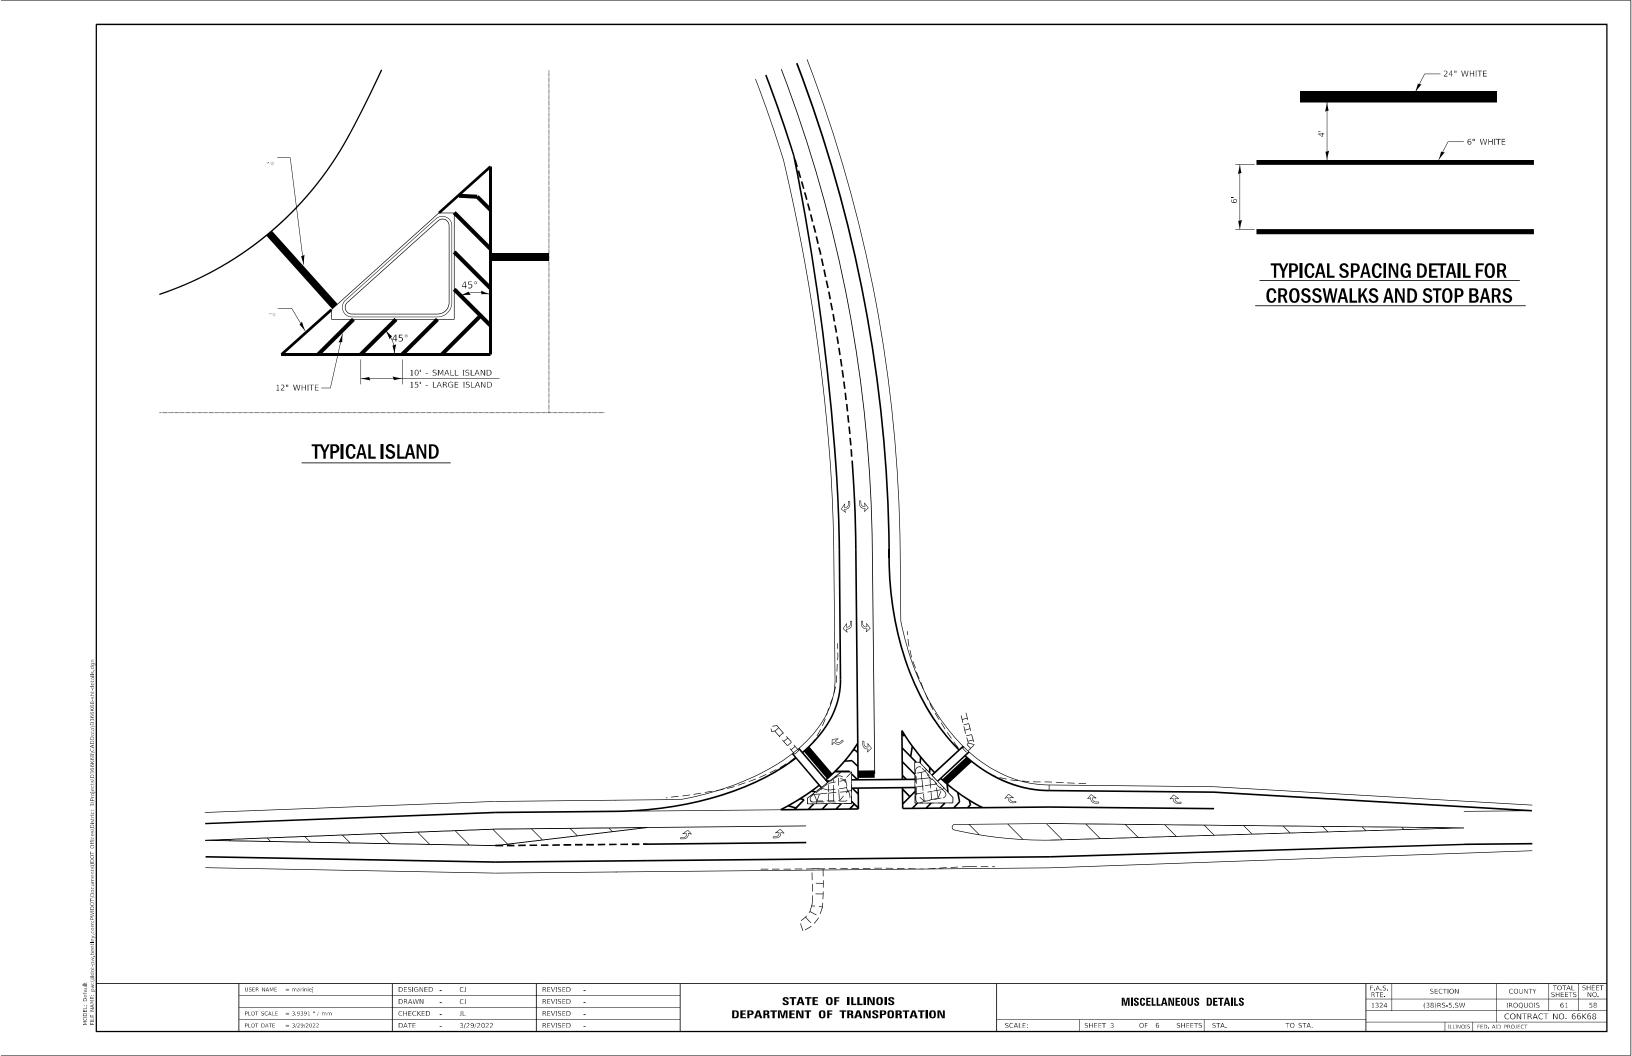

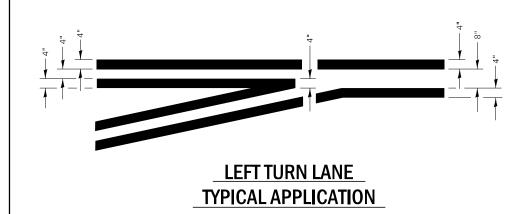


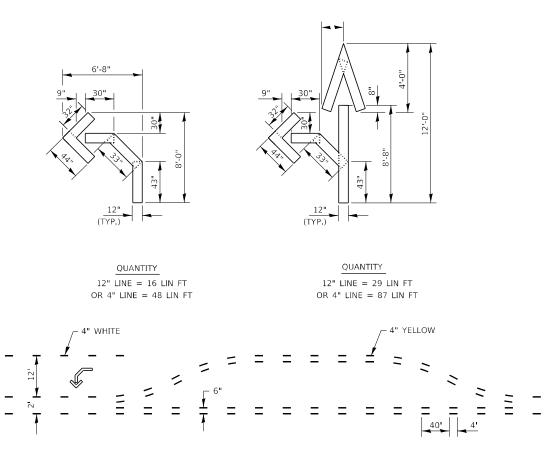


SHORT-TERM PAVEMENT MARKING FOR MEDIANS AND ARROWS

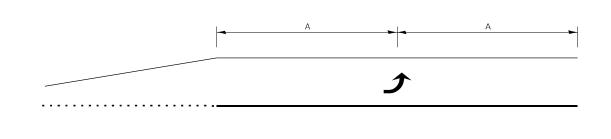

99' AND UNDER

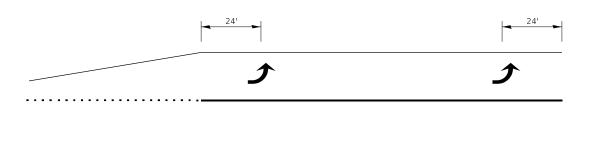

100' TO 149'

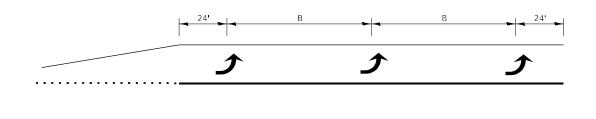


150' AND LONGER

TYPICAL PLACEMENT OF ARROWS IN TURN LANES

USER NAME = mariniej	DESIGNED	-	CJ	REVISED	-
	DRAWN	-	CJ	REVISED	-
PLOT SCALE = 3.9391 / mm	CHECKED	-	JL	REVISED	-
PLOT DATE = 3/29/2022	DATE	-	3/29/2022	REVISED	-

						F.A.S. RTE	SECT	ION		COUNTY	TOTAL SHEETS	SHEET NO.
MISCELLANEOUS DETAILS					LS	1324	(38)RS	-5,SW		IROQUOIS	61	59
										CONTRACT	NO. 6	5K68
T 4	OF	6	SHEETS	STA.	TO STA.			ILLINOIS	FED Δ1	D PROJECT		

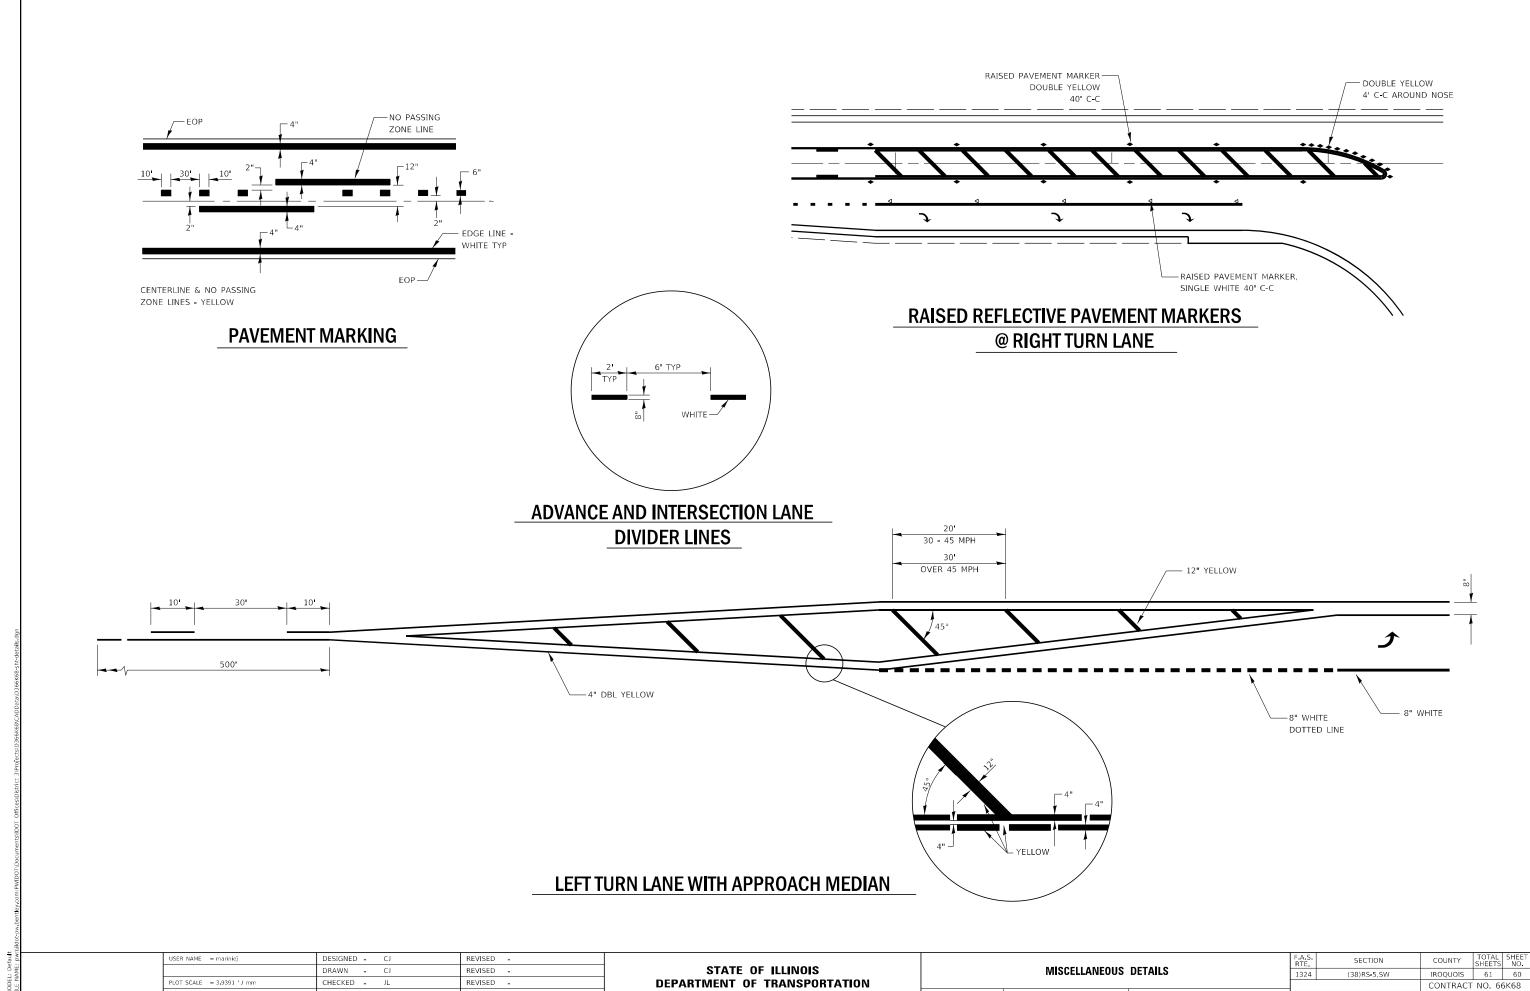

PLOT DATE = 3/29/2022

DATE - 3/29/2022

REVISED -


DEPARTMENT OF TRANSPORTATION

SHEET 5 OF 6 SHEETS STA.


NOTE:

WHEN MILLING OPERATIONS PRODUCE A ROUNDED EDGE, THEN A SAW CUT SHALL BE USED TO MANUFACTURE A PERPENDICULAR EDGE AS SHOWN IN THE DETAIL. THE ENGINEER SHALL BE THE SOLE JUDGE CONCERNING THE USE OF THIS DETAIL

HMA DETAIL AT BUTT JOINTS

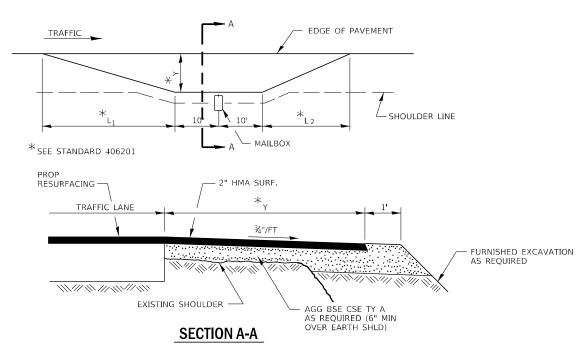


RURAL MAILBOX TURNOUT DETAILS

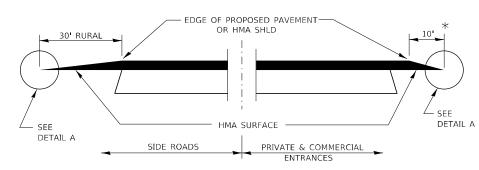

SECTION A-A

EDGE OF AGG SHOULDER

DETAILS AT ENTRANCES & SIDE ROADS

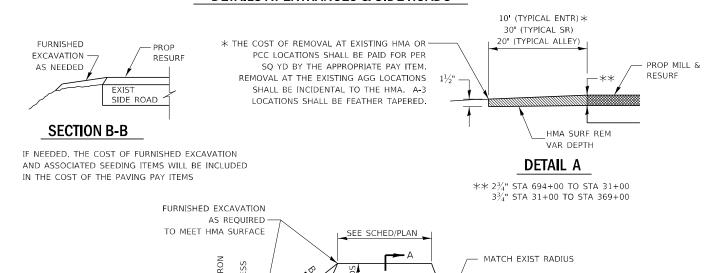

PLAN AT SIDE ROADS AND ALLEYS

AGG SHOULDER IS NOT TO BE PLACED AROUND SIDE ROAD RADII

EDGE OF PVMT

OR HMA SHLD

SECTION


(38)RS-5.SW

1324

COUNTY TOTAL SHEETS NO.
IROQUOIS 61 61

CONTRACT NO. 66K68

PROP HMA SHLD SHALL NOT BE CONSTRUCTED THRU

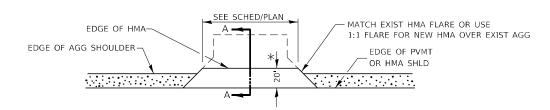

PLAN AT PRIVATE & COMMERCIAL ENTRANCES

(DO NOT RESURFACE FIELD ENTRANCES)

* PROPOSED HMA RESURFACING AT PUBLIC EDUCATIONAL FACILITY ENTRANCES SHALL BE EXTENDED TO THE RIGHT-OF-WAY LIMITS.

TO STA.

USER NAME = mariniej	DESIGNED - CJ	REVISED -			
	DRAWN - CJ	REVISED -	STATE OF ILLINOIS		MISCELLANEOUS DETAILS
PLOT SCALE = 3.9391 / mm	CHECKED - JL	REVISED -	DEPARTMENT OF TRANSPORTATION		
PLOT DATE = 3/29/2022	DATE - 3/29/2022	REVISED -		SCALE:	SHEET 6 OF 6 SHEETS STA.