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CODE NUMBER	PAY ITEM	UNIT	TOTAL QUANTITY	LANDSCAPING	
				90% FED	10% STATE
				0031	URBAN
20100110	TREE REMOVAL (6 TO 15 UNITS DIAMETER)	UNIT	1,100	1,100	
20100210	TREE REMOVAL (OVER 15 UNITS DIAMETER)	UNIT	128	128	
20101300	TREE PRUNING (1 TO 10 INCH DIAMETER)	EACH	20	20	
20101350	TREE PRUNING (OVER 10 INCH DIAMETER)	EACH	35	35	
20101700	SUPPLEMENTAL WATERING	UNIT	5,000 325	5,000 325	①
20200100	EARTH EXCAVATION	CU YD	2,950	2,950	
20201200	REMOVAL AND DISPOSAL OF UNSUITABLE MATERIAL	CU YD	660	660	
21101505	TOPSOIL EXCAVATION AND PLACEMENT	CU YD	1,975	1,975	
21101805	COMPOST FURNISH AND PLACE, 2"	SQ YD	1,115	1,115	
25000210	SEEDING, CLASS 2A	ACRE	2.25 2.50	2.25 2.50	
25000400	NITROGEN FERTILIZER NUTRIENT	POUND	293 149	293 149	
25000500	PHOSPHORUS FERTILIZER NUTRIENT	POUND	293 149	293 149	①
25000600	POTASSIUM FERTILIZER NUTRIENT	POUND	293 149	293 149	
25000750	MOWING	ACRE	50 15.00	50 15.00	

* DENOTES SPECIALTY ITEM ** DENOTES NON-PARTICIPATING ITEM % 0042



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 USER NAME = dwhojjer
 PLOT SCALE = 20.0000' / in.
 PLOT DATE = 3/21/2022

DESIGNED - VLJ
 DRAWN - KM
 CHECKED - JMG
 DATE - 3/18/2022

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**STATE OF ILLINOIS
 DEPARTMENT OF TRANSPORTATION**

SUMMARY OF QUANTITIES

SCALE: NONE SHEET 1 OF 10 SHEETS STA. TO STA.

F.A.I. RTE. 90/94/290	SECTION 2014-012LS	COUNTY COOK	TOTAL SHEETS 220	SHEET NO. 5
CONTRACT NO. 60X98				
ILLINOIS FED. AID PROJECT				

① REVISED SHEET 5/27/2022

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CODE NUMBER	PAY ITEM		TOTAL QUANTITY	LANDSCAPING	
				90% FED	10% STATE
				0031	URBAN
25003210	INTERSEEDING, CLASS 2A	ACRE	1.00	1.00	
25100115	MULCH, METHOD 2	ACRE	11.75	11.75	
25100125	MULCH, METHOD 3	ACRE	1.75 2.75	1.75 2.75	
25100630	EROSION CONTROL BLANKET	SQ YD	24,167 26,620	24,167 26,620	
25200110	SODDING, SALT TOLERANT	SQ YD	24,587	24,587	
28000250	TEMPORARY EROSION CONTROL SEEDING	POUND	1,056	1,056	
28000400	PERIMETER EROSION BARRIER	FOOT	9,514	9,514	
28000510	INLET FILTERS	EACH	58	58	
28100107	STONE RIPRAP, CLASS A4	SQ YD	4,899	4,899	
35101500	AGGREGATE BASE COURSE, TYPE B	CU YD	1,397	1,397	
40200200	AGGREGATE SURFACE COURSE, TYPE A	CU YD	38	38	
42001300	PROTECTIVE COAT	SQ YD	3	3	
42400200	PORTLAND CEMENT CONCRETE SIDEWALK 5 INCH	SQ FT	25	25	
66400305	CHAIN LINK FENCE, 6'	FOOT	120	120	



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**STATE OF ILLINOIS
DEPARTMENT OF TRANSPORTATION**


SUMMARY OF QUANTITIES	
SCALE: NONE	SHEET 2 OF 10 SHEETS STA. TO STA.

F.A.I. RTE.	SECTION	COUNTY	TOTAL SHEETS	SHEET NO.
90/94/290	2014-012LS	COOK	220	6
CONTRACT NO. 60X98				
ILLINOIS FED. AID PROJECT				

REVISED SHEET 5/27/2022

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CODE NUMBER	PAY ITEM		TOTAL QUANTITY	LANDSCAPING	
				90% FED	10% STATE
				0031	URBAN
A2005420	TREE, LIRIODENDRON TULIPIFERA (TULIP TREE), 2-1/2" CALIPER, BALLED AND BURLAPPED	EACH	8	8	
A2005616	TREE, OSTRYA VIRGINIANA (AMERICAN HOPHORNBEAM), 2" CALIPER, BALLED AND BURLAPPED	EACH	11	11	
A2006520	TREE, QUERCUS BICOLOR (SWAMP WHITE OAK), 2-1/2" CALIPER, BALLED AND BURLAPPED	EACH	14	14	
A2006618	TREE, QUERCUS IMBRICARIA (SHINGLE OAK), 2-1/2" CALIPER, BALLED AND BURLAPPED	EACH	8	8	
A2006720	TREE, QUERCUS MACROCARPA (BUR OAK), 2-1/2" CALIPER, BALLED AND BURLAPPED	EACH	5	5	
A2006820	TREE, QUERCUS MUEHLENBERGII (CHINKAPIN OAK), 2-1/2" CALIPER, BALLED AND BURLAPPED	EACH	13	13	
A2007208	TREE, QUERCUS X WAREI 'NADLER', (KINDRED SPIRIT HYBRID OAK), 2-1/2" CALIPER, BALLED AND BURLAPPED	EACH	10	10	
A2007616	TREE, TAXODIUM DISTICHUM (COMMON BALD CYPRESS), 2" CALIPER, BALLED AND BURLAPPED	EACH	8	8	
A2007818	TREE, TILIA AMERICANA MCKSENTRY (SENTRY AMERICAN LINDEN/BASSWOOD), 2" CALIPER, BALLED AND BURLAPPED	EACH	3	3	
A2008470	TREE, ULMUS AMERICANA PRINCETON (PRINCETON AMERICAN ELM), 2-1/2" CALIPER, BALLED AND BURLAPPED	EACH	5	5	
B2001668	TREE, CRATAEGUS CRUSGALLI INERMIS (THORN LESS COCKSPUR HAWTHORN), 7' HEIGHT, SHRUB FORM, BALLED AND BURLAPPED	EACH	15	15	
B2001920	TREE, CRATAEGUS PHAENOPYRUM (WASHINGTON HAWTHORN), 2-1/2" CALIPER, TREE FORM, BALLED AND BURLAPPED	EACH	6	6	
B2002616	TREE, MALUS ADAMS (ADAMS CRABAPPLE), 2" CALIPER, TREE FORM, BALLED AND BURLAPPED	EACH	2	2	
B2005385	TREE, METASEQUOIA GLYPTOSTROBOIDES (DAWN REDWOOD), 2" CALIPER, BALLED AND BURLAPPED	EACH	6	6	

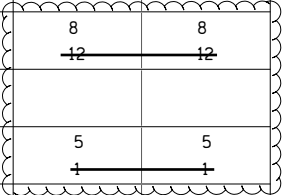

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1 REVISED SHEET 5/27/2022



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**STATE OF ILLINOIS
DEPARTMENT OF TRANSPORTATION**

SUMMARY OF QUANTITIES	
SCALE: NONE	SHEET 4 OF 10 SHEETS STA. TO STA.

F.A.I. RTE.	SECTION	COUNTY	TOTAL SHEETS	SHEET NO.
90/94/290	2014-012LS	COOK	220	8
CONTRACT NO. 60X98				
ILLINOIS FED. AID PROJECT				

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CODE NUMBER	PAY ITEM		TOTAL QUANTITY	LANDSCAPING	
				90% FED	10% STATE
				0031	URBAN
					
B2005421	TREE, PRUNUS VIRGINIANA CANADA RED (CANADA RED CHOKECHERRY), 2" CALIPER, TREE FORM, BALLED AND BURLAPPED TREE, PRUNUS VIRGINIANA SCHUBERT (SCHUBERT CHOKEBERRY), 2" CALIPER, TREE FORM, BALLED AND BURLAPPED	EACH	8	8	
B2006116	TREE, SYRINGA PEKINENSIS MORTON (CHINA SNOW PEKING LILAC), 2" CALIPER, TREE FORM, BALLED AND BURLAPPED	EACH	8	8	
B2006370	TREE, SYRINGA RETICULATA IVORY SILK (IVORY SILK JAPANESE TREE LILAC), 8' HEIGHT, CLUMP FORM, BALLED AND BURLAPPED	EACH	10	10	
C20059G5	SHRUB, RHUS GLABRA (SMOOTH SUMAC), 5-GALLON	EACH	119	119	
C2011036	SHRUB, SYRINGA PATULA MISS KIM (MISS KIM MANCHURIAN LILAC), 3' HEIGHT, BALLED AND BURLAPPED	EACH	24	24	
C2012472	SHRUB, VIBURNUM LENTAGO (NANNYBERRY VIBURNUM), 6' HEIGHT, BALLED AND BURLAPPED	EACH	4	4	
C20132G3	SHRUB, WEIGELA MINUET (MINUET OLD FASHIONED WEIGELA), 3-GALLON CONTAINER	EACH	55	55	
C2C03724	SHRUB, HYPERICUM KALMIANUM (KALM ST. JOHNSWORT), 2' HEIGHT, CONTAINER	EACH	82	82	
D2001788	EVERGREEN, PICEA ABIES (NORWAY SPRUCE), 8' HEIGHT, BALLED AND BURLAPPED	EACH	11	11	
D2001988	EVERGREEN, PICEA GLAUCA DENSATA (BLACK HILLS SPRUCE), 8' HEIGHT, BALLED AND BURLAPPED	EACH	3	3	
E20020G6	VINE-CAMPSIS RADICANS (TRUMPET VINE), 1-GALLON POT	EACH	64	64	
E20150G1	VINE-HYDRANGEA ANOMALA SUBSP. PETIOLARIS (CLIMBING HYDRANGEA), 1-GALLON POT	EACH	9	9	
E20210G1	VINE-PARTHENOCISSUS QUINQUEFOLIA ENGEL MANNII (ENGLMANNII VIRGINIA CREEPER), 1-GALLON POT	EACH	2,309 2,209	2,309 2,209	
E20220G1	VINE-PARTHENOCISSUS TRICUSPIDATA (BOSTON IVY), 1-GALLON POT	EACH	2,477	2,477	

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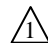
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**STATE OF ILLINOIS
DEPARTMENT OF TRANSPORTATION**

SUMMARY OF QUANTITIES

SCALE: NONE SHEET 5 OF 10 SHEETS STA. TO STA.

F.A.I. RTE.	SECTION	COUNTY	TOTAL SHEETS	SHEET NO.
90/94/290	2014-012LS	COOK	220	9
CONTRACT NO. 60X98				
ILLINOIS FED. AID PROJECT				

 REVISED SHEET 5/27/2022

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CODE NUMBER	PAY ITEM		TOTAL QUANTITY	LANDSCAPING	
				90% FED	10% STATE
				0031	URBAN
K0012970	PERENNIAL PLANTS, BULB TYPE	UNIT	472 340	472 340	⚠
K0012990	PERENNIAL PLANTS, ORNAMENTAL TYPE, GALLON POT	UNIT	19	19	
K0026700	TREE CARE	EACH	600 321	600 321	⚠
K0026810	SHRUB CARE	EACH	700 388	700 388	⚠
K0026820	VINE CARE	EACH	5,000 4,822	5,000 4,822	
K0026850	PERENNIAL PLANT CARE	SQ YD	7,000 200	7,000 200	
K0029629	WEED CONTROL, BROADLEAF IN TURF	POUND	3	3	
K0029632	WEED CONTROL, NON-SELECTIVE AND NON-RESIDUAL	GALLON	15	15	
K0029634	WEED CONTROL, PRE-EMERGENT GRANULAR HERBICIDE	POUND	719	719	
K0036120	MULCH PLACEMENT 4"	SQ YD	1,055	1,055	
X0100018	TREE REMOVAL (UNDER 6 UNITS DIAMETER)	UNIT	100	100	
X0321501	WEED BARRIER FABRIC	SQ YD	4,899	4,899	
X0325222	WEED CONTROL, BASAL TREATMENT	GALLON	3	3	
X0327120	WEED CONTROL, NATIVE LANDSCAPE ENHANCEMENT	ACRE	10 5	10 5	⚠

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**STATE OF ILLINOIS
DEPARTMENT OF TRANSPORTATION**

SUMMARY OF QUANTITIES	
SCALE: NONE	SHEET 6 OF 10 SHEETS STA. TO STA.

F.A.I. RTE.	SECTION	COUNTY	TOTAL SHEETS	SHEET NO.
90/94/290	2014-012LS	COOK	220	10
CONTRACT NO. 60X98				
ILLINOIS FED. AID PROJECT				

⚠ REVISED SHEET 5/27/2022

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CODE NUMBER	PAY ITEM		TOTAL QUANTITY	LANDSCAPING	
				90% FED	10% STATE
				0031	URBAN
X2010400	STUMP REMOVAL ONLY	UNIT	120	120	
X2110100	TOPSOIL FURNISH AND PLACE, SPECIAL	CU YD	2,515	2,515	
X2501820	SEEDING, CLASS 5 (MODIFIED)	ACRE	0.25	0.25	
X2502014	SEEDING, CLASS 4A (MODIFIED)	ACRE	2.50 2.75	2.50 2.75	
X2503315	INTERSEEDING, CLASS 4A (MODIFIED)	ACRE	1.75 0.75	1.75 0.75	
X2503321	INTERSEEDING, CLASS 5 (MODIFIED)	ACRE	1.50 1.00	1.50 1.00	
X2810108	STONE RIPRAP, CLASS A4 (SPECIAL)	SQ YD	4,899	4,899	
X6640300	CHAIN LINK FENCE REMOVAL	FOOT	452	452	
X6700410	ENGINEER'S FIELD OFFICE, TYPE A (SPECIAL)	CAL MO	30	30	
X7010216	TRAFFIC CONTROL AND PROTECTION, (SPECIAL)	L SUM	1	1	
X7011015	TRAFFIC CONTROL AND PROTECTION (EXPRESSWAYS)	L SUM	1	1	
Z0013798	CONSTRUCTION LAYOUT	L SUM	1	1	
Z0019600	DUST CONTROL WATERING	UNIT	125	125	
Z0048665	RAILROAD PROTECTIVE LIABILITY INSURANCE	L SUM	1	1	



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STATE OF ILLINOIS
 DEPARTMENT OF TRANSPORTATION

SUMMARY OF QUANTITIES

SCALE: NONE SHEET 7 OF 10 SHEETS STA. TO STA.

F.A.I. RTE. SECTION COUNTY TOTAL SHEETS SHEET NO.

90/94/290 2014-012LS COOK 220 11

CONTRACT NO. 60X98

ILLINOIS FED. AID PROJECT

REVISOR SHEET 5/27/2022

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CODE NUMBER	PAY ITEM		TOTAL QUANTITY	LANDSCAPING	
				90% FED	10% STATE
				0031	
				URBAN	
Z0064800	SELECTIVE CLEARING	UNIT	33	33	
A2008756	TREE, ULMUS AMERICANA LEWIS AND CLARK (LEWIS AND CLARK ELM), 2 1/2", CALIPER, BALLED AND BURLAPPED	EACH	5	5	
X1900011	NATIVE SODDING, SPECIAL	SQ YD	8,205	8,205	
C2002437	SHRUB, DIERVILLA G2X88544 (KODIAK ORANGE BUSH HONEYSUCKLE), CONTAINER GROWN, 3-GALLON	EACH	243	243	
A3005012	TREE, GYMNOCLADUS DIOICUS 'MORTON' SKINNY LATTE KENTUCKY COFFEE TREE, 2 1/2" CAL, BALLED AND BURLAPPED	EACH	9	9	
X2503114	MOWING (SELECTIVE)	UNIT	45	45	
X0327999	ANTI-GRAFFITI COATING	SQ FT	31,632	31,632	
X1800026	STONE OUTCROPPING	EACH	380 274	380 274	⚠
E20332GP	VINE-WISTERIA MACROSTACHYA BETTY MATHEWS (FIRST EDITIONS SUMMER CASCADE KENTUCKY WISTERIA), 2-GALLON POT	EACH	6	6	
E20342GP	VINE-LONICERA SAMPERVIRENS MAJOR WHEELER (MAJOR WHEELER HONEYSUCKLE VINE), 2-GALLON POT	EACH	22	22	
C2C10930	SHRUB, SYRINGA MEYERI PALIBIN (DWARF KOREAN LILAC), CONTAINER GROWN, 5-GALLON	EACH	40	40	
A2002504	TREE, CARPINUS BETULUS, (EUROPEAN HORNBEAM), 2" CALIPER, BALLED AND BURLAPPED	EACH	5	5	
B2010072	TREE, CLADRASTIS KENTUCKEA PERKINS PINK, (PERKINS PINK AMERICAN YELLOWWOOD), 2" CALIPER, BALLED AND BURLAPPED	EACH	2 +	2 +	⚠
A2005466	TREE, MACLURA POMIFERA WHITE SHIELD OSAGE ORANGE, 2" CALIPER, BALLED AND BURLAPPED	EACH	8	8	

* DENOTES SPECIALTY ITEM ** DENOTES NON-PARTICIPATING ITEM % 0042



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**STATE OF ILLINOIS
DEPARTMENT OF TRANSPORTATION**

SUMMARY OF QUANTITIES
 SCALE: NONE SHEET 8 OF 10 SHEETS STA. TO STA.

F.A.I. RTE.	SECTION	COUNTY	TOTAL SHEETS	SHEET NO.
90/94/290	2014-012LS	COOK	220	12
CONTRACT NO. 60X98				
ILLINOIS FED. AID PROJECT				

⚠ REVISED SHEET 5/27/2022

ITEM	2022						2023											
	JUL	AUG	SEP	OCT	NOV	DEC	JAN	FEB	MAR	APR	MAY	JUN	JULY	AUG	SEPT	OCT	NOV	DEC
	PHASE I						PHASE II						PHASE III					

NATIVE SODDING (SPECIAL) & ESTABLISHMENT WORK

<p>SUBMITTALS & INSPECTIONS PLACE ORDER FOR NATIVE SODDING (SPECIAL) WHICH THE ROADSIDE DEVELOPMENT UNIT WILL PERIODICALLY INSPECT AT THE NURSERY</p> <p>PREPARATION WEED CONTROL, NON-SELECTIVE AND NON-RESIDUAL: TO KILL TURF AREAS WHERE NATIVE SODDING (SPECIAL) IS TO BE PLACED AND AS DIRECTED BY THE ENGINEER</p> <p>GROUND PREPARATION AS PER SPECIAL PROVISION</p> <p>INSTALLATION NATIVE SODDING (SPECIAL) (SEPTEMBER 1 TO NOVEMBER 15) AS PER SPECIAL PROVISION</p> <p>INITIAL WATERING AS PER SPECIAL PROVISION</p> <p>ESTABLISHMENT SUPPLEMENTAL WATERING: AFTER COMPLETION OF PERIOD OF ESTABLISHMENT (ONCE A WEEK OR AS DIRECTED BY THE ENGINEER)</p> <p>WEED CONTROL, NATIVE LANDSCAPE ENHANCEMENT AS DIRECTED BY THE ENGINEER</p>			<p>SUBMIT COMPLETED PLANT INSPECTION SHEETS TO IDOT FOR NATIVE SODDING (SPECIAL)</p>																

NATIVE SEEDING AND ESTABLISHMENT WORK

<p>PREPARATION WEED CONTROL, NON-SELECTIVE AND NON-RESIDUAL: TO KILL TURF AREAS TO BE INTERSEEDED WITH NATIVE SEEDING (CLASS 4A (MODIFIED) & CLASS 5 (MODIFIED) AND AS DIRECTED BY THE ENGINEER</p> <p>MOWING (ACRE) AND/OR MOWING (SPECIAL): MOW TURF AREAS TO BE INTERSEEDED WITH NATIVE SEEDING (CLASS 4A (MODIFIED) & CLASS 5 (MODIFIED) TO A HEIGHT OF NO MORE THAN 3" AND AS DIRECTED BY THE ENGINEER</p> <p>INSTALLATION INTERSEEDING, CLASS 4A (MODIFIED) & 5 (MODIFIED) FALL SEEDING: OCTOBER 15 TO NOVEMBER 30 PER SPECIAL PROVISION</p> <p>MULCH METHOD 3</p> <p>SEEDING, CLASS 4A (MODIFIED) & 5 (MODIFIED) FALL SEEDING: OCTOBER 15 TO NOVEMBER 1 (PER SPECIAL PROVISION)</p> <p>EROSION CONTROL BLANKET</p> <p>ESTABLISHMENT/WEED CONTROL MOWING (ACRE) IF NEEDED, TO A HEIGHT OF 5" WHEN REACHES A HEIGHT OF 10" OR AS DIRECTED BY THE ENGINEER</p> <p>MOWING (UNIT) SELECTIVE, SPOT MOWING AS DIRECTED BY THE ENGINEER</p>																				

WEED CONTROL, NATIVE LANDSCAPE ENHANCEMENT
SELECTIVE, SPOT SPRAYING AS DIRECTED BY THE ENGINEER

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PLOT DATE = 03/16/2022	DATE — 03/16/2022

**STATE OF ILLINOIS
DEPARTMENT OF TRANSPORTATION**

CALENDAR OF CONSTRUCTION AND ESTABLISHMENT WORK

SHEET NO. 7 OF 8 SHEETS

F.A.I. RTE.	SECTION	COUNTY	TOTAL SHEETS	SHEET NO.
90/94/290	2014-012LS	COOK	220	21
CONTRACT NO. 60X98			ILLINOIS FED. AID PROJECT	

REVISED SHEET 5/27/2022

ITEM	2024												2025							
	JAN	FEB	MAR	APR	MAY	JUN	JULY	AUG	SEPT	OCT	NOV	DEC	JAN	FEB	MAR	APR	MAY	JUNE		
	PHASE IV					PHASE V							PHASE VI							
SUBMITTALS & INSPECTIONS PLACE ORDER FOR NATIVE SODDING (SPECIAL) WHICH THE ROADSIDE DEVELOPMENT UNIT WILL REGULARLY INSPECT AT THE NURSERY PREPARATION WEED CONTROL, NON-SELECTIVE AND NON-RESIDUAL: TO KILL TURF AREAS WHERE NATIVE SODDING (SPECIAL) IS TO BE PLACED AND AS DIRECTED BY THE ENGINEER GROUND PREPARATION AS PER SPECIAL PROVISION INSTALLATION NATIVE SODDING (SPECIAL) (SEPTEMBER 1 TO NOVEMBER 15) AS PER SPECIAL PROVISION AS PER SPECIAL PROVISION ESTABLISHMENT SUPPLEMENTAL WATERING: AFTER COMPLETION OF PERIOD OF ESTABLISHMENT (ONCE A WEEK OR AS DIRECTED BY THE ENGINEER) WEED CONTROL, NATIVE LANDSCAPE ENHANCEMENT AS DIRECTED BY THE ENGINEER						PROPAGATION OF NATIVE SOD MAT	RDU INSPECTS AT NURSERY	RDU INSPECTS AT NURSERY												
						INSPECTION OF NATIVE SOD				FALL INSTALLATION OF NATIVE SODDING (SPECIAL) IF REQUIRED										
						SUPPLEMENTAL WATERING AS NEEDED														
											INITIAL WATERING									

NATIVE SEEDING AND ESTABLISHMENT WORK

PREPARATION WEED CONTROL, NON-SELECTIVE AND NON-RESIDUAL: TO KILL TURF AREAS TO BE INTERSEEDED WITH NATIVE SEEDING (CLASS 4A (MODIFIED) & CLASS 5 (MODIFIED) AND AS DIRECTED BY THE ENGINEER MOWING (ACRE) AND/OR MOWING (SPECIAL): MOW TURF AREAS TO BE INTERSEEDED WITH NATIVE SEEDING (CLASS 4A(MODIFIED) & CLASS 5 (MODIFIED) TO A HEIGHT OF NO MORE THAN 3" AND AS DIRECTED BY THE ENGINEER INSTALLATION INTERSEEDING, CLASS 4A (MODIFIED) & 5 (MODIFIED) FALL SEEDING: OCTOBER 15 TO NOVEMBER 30 PER SPECIAL PROVISION MULCH METHOD 3 <div style="border: 1px dashed black; padding: 2px;"> SEEDING, CLASS 4A (MODIFIED) & 5 (MODIFIED) FALL SEEDING: OCTOBER 15 TO NOVEMBER 30 (PER SPECIAL PROVISION) </div> EROSION CONTROL BLANKET ESTABLISHMENT/WEED CONTROL MOWING (ACRE) IF NEEDED, TO A HEIGHT OF 5" WHEN REACHES A HEIGHT OF 10" OR AS DIRECTED BY THE ENGINEER MOWING (UNIT) SELECTIVE, SPOT MOWING AS DIRECTED BY THE ENGINEER <div style="border: 1px dashed black; padding: 2px;"> WEED CONTROL, NATIVE LANDSCAPE ENHANCEMENT SELECTIVE, SPOT SPRAYING AS DIRECTED BY THE ENGINEER </div>																		

1 REVISOR SHEET 5/27/2022

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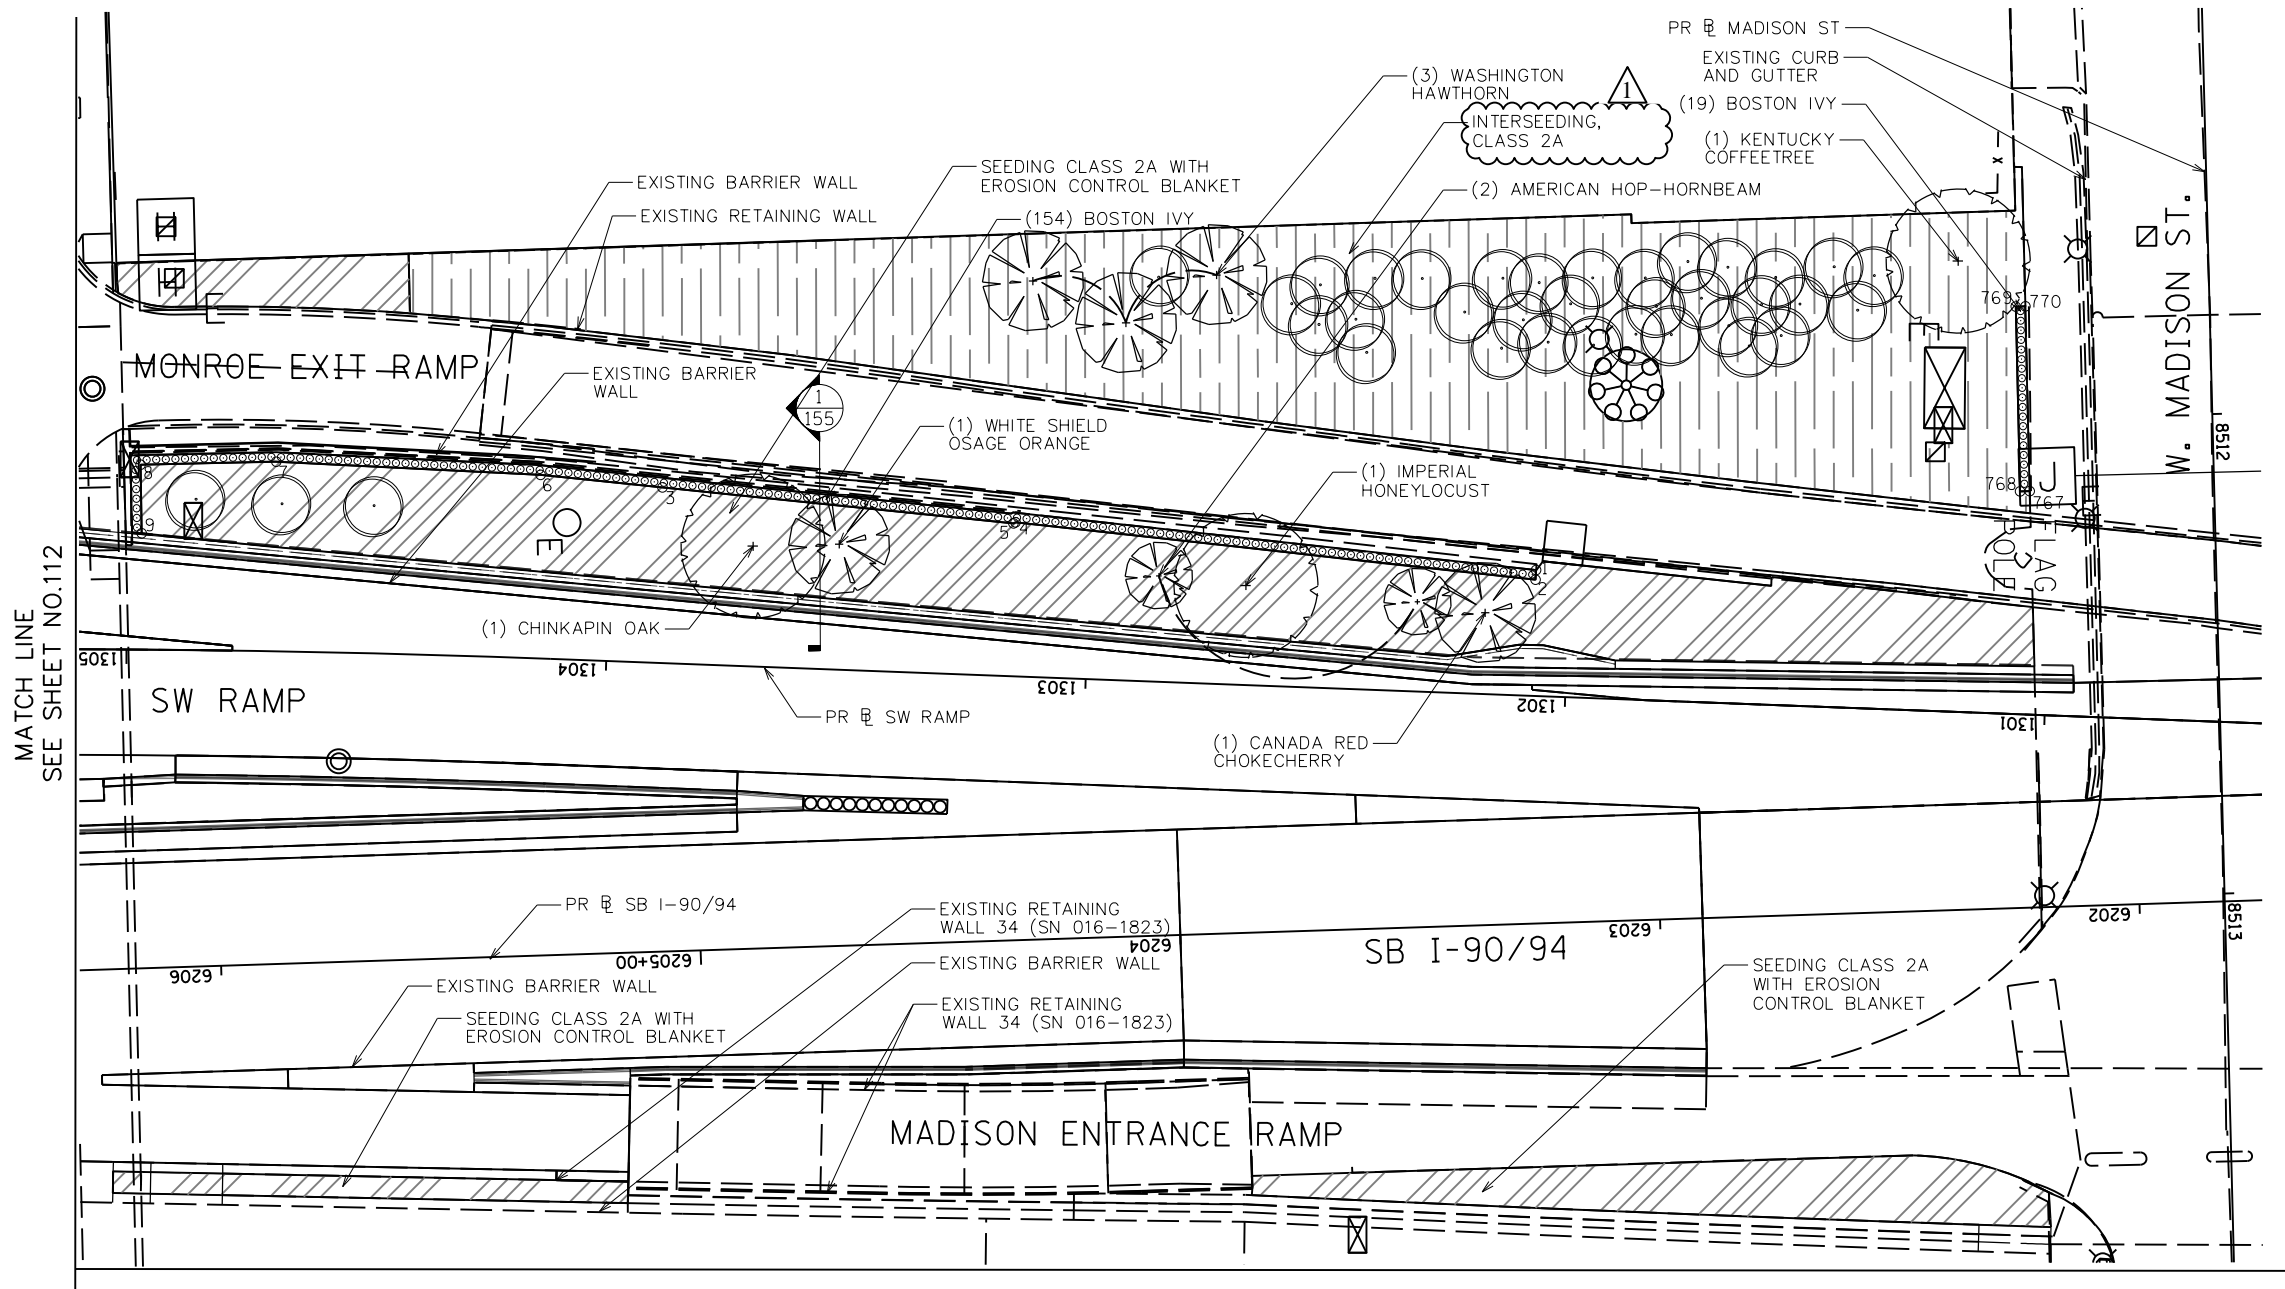
DESIGNED — BK	REVISED — 5/20/2022
CHECKED — BM	REVISED
DRAWN — JT	REVISED
DATE — 03/16/2022	REVISED

STATE OF ILLINOIS
DEPARTMENT OF TRANSPORTATION

CALENDAR OF CONSTRUCTION AND ESTABLISHMENT WORK


SHEET NO. 8 OF 8 SHEETS

F.A.I. RTE.	SECTION	COUNTY	TOTAL SHEETS	SHEET NO.
90/94/290	2014-012LS	COOK	220	22
ILLINOIS FED. AID PROJECT			CONTRACT NO. 60X98	



- LEGEND**
- SHADE TREE
 - EVERGREEN TREE
 - UNDERSTORY TREE
 - EXISTING TREE WITH MULCH PLACEMENT AND TREE CARE
 - PERENNIAL/SHRUBS
 - VINE, 1 GALLON POT
 - STONE OUTCROPPING
 - CHAIN LINK FENCE, 6'
 - NATIVE SODDING, SPECIAL
 - SEEDING, CLASS 4A (MODIFIED) WITH EROSION CONTROL BLANKET
 - SEEDING, CLASS 4A (MODIFIED) AND SEEDING, CLASS 5 (MODIFIED) WITH EROSION CONTROL BLANKET
 - SODDING, SALT TOLERANT
 - AGGREGATE SURFACE COURSE
 - STONE RIPRAP, CLASS A4 (SPECIAL)
 - STONE RIPRAP, CLASS A4
 - SEEDING CLASS 2A WITH EROSION CONTROL BLANKET
 - INTERSEEDING, CLASS 4A (MODIFIED) AND INTERSEEDING, CLASS 5 (MODIFIED) WITH MULCH, METHOD 3
 - INTERSEEDING, CLASS 2A
 - PERENNIAL PLANTS, BULB TYPE
 - COORDINATE POINT

- NOTES:**
1. SEE SHEET 70 FOR REMOVAL AND EXCAVATION PLAN.
 2. ENSURE STONE RIPRAP DOES NOT OBSTRUCT ACCESS TO UTILITY COVERS.

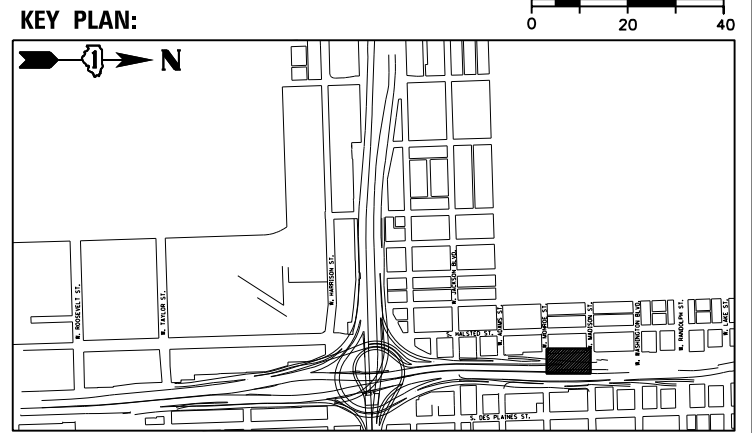

QUANTITY	BOTANIC NAME	COMMON NAME	SIZE	ROOT	REMARKS
SHADE TREES:					
1	<i>Gymnocladus dioica</i>	Kentucky Coffeetree	2.5" cal	B&B	
1	<i>Quercus muehlenbergii</i>	Chinkapin Oak	2.5" cal	B&B	
1	<i>Gleditsia triacanthos</i> va. <i>inermis</i>	Imperial Honeylocust	3" cal	B&B	
UNDERSTORY TREES:					
3	<i>Crataegus phaenopyrum</i>	Washington Hawthorn	2.5" cal	B&B	
1	<i>Maclura pomifera</i> 'White Shield'	White Shield Osage Orange	2" cal	B&B	
1	<i>Prunus virginiana</i> 'Canada Red'	Canada Red Chokecherry	2" cal	B&B	
2	<i>Ostrya virginiana</i>	American Hop-Hornbeam	2" cal	B&B	
10	TOTAL				
VINES:					
173	<i>Parthenocissus tricuspidata</i>	Boston Ivy	1 gal		24" oc, mulch bed

REVISOR: [Symbol] REVISED SHEET 5/27/2022



DESIGNED -- BK	REVISOR -- [Symbol] 5/20/2022
CHECKED -- BM	REVISOR
DRAWN -- JT	REVISOR
DATE -- 12/04/2020	REVISOR

STATE OF ILLINOIS
DEPARTMENT OF TRANSPORTATION

LANDSCAPE PLANS

SHEET NO. 1 OF 43 SHEETS


F.A.I. RTE.	SECTION	COUNTY	TOTAL SHEETS	SHEET NO.
90/94/290	2014-012L5	COOK	220	111
CONTRACT NO. 60X98				

ILLINOIS FED. AID PROJECT

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- LEGEND**
- SHADE TREE
 - EVERGREEN TREE
 - UNDERSTORY TREE
 - EXISTING TREE WITH MULCH PLACEMENT AND TREE CARE
 - PERENNIAL /SHRUBS
 - VINE, 1 GALLON POT
 - STONE OUTCROPPING
 - CHAIN LINK FENCE, 6'
 - NATIVE SODDING, SPECIAL
 - SEEDING, CLASS 4A (MODIFIED) WITH EROSION CONTROL BLANKET
 - SEEDING, CLASS 4A (MODIFIED) AND SEEDING, CLASS 5 (MODIFIED) WITH EROSION CONTROL BLANKET
 - SODDING, SALT TOLERANT
 - AGGREGATE SURFACE COURSE
 - STONE RIPRAP, CLASS A4 (SPECIAL)
 - STONE RIPRAP, CLASS A4
 - SEEDING CLASS 2A WITH EROSION CONTROL BLANKET
 - INTERSEEDING, CLASS 4A (MODIFIED) AND INTERSEEDING, CLASS 5 (MODIFIED) WITH MULCH, METHOD 3
 - INTERSEEDING, CLASS 2A
 - PERENNIAL PLANTS, BULB TYPE
 - COORDINATE POINT

- NOTES:**
- SEE SHEET 74 FOR REMOVAL AND EXCAVATION PLAN.
 - ENSURE STONE RIPRAP DOES NOT OBSTRUCT ACCESS TO UTILITY COVERS.

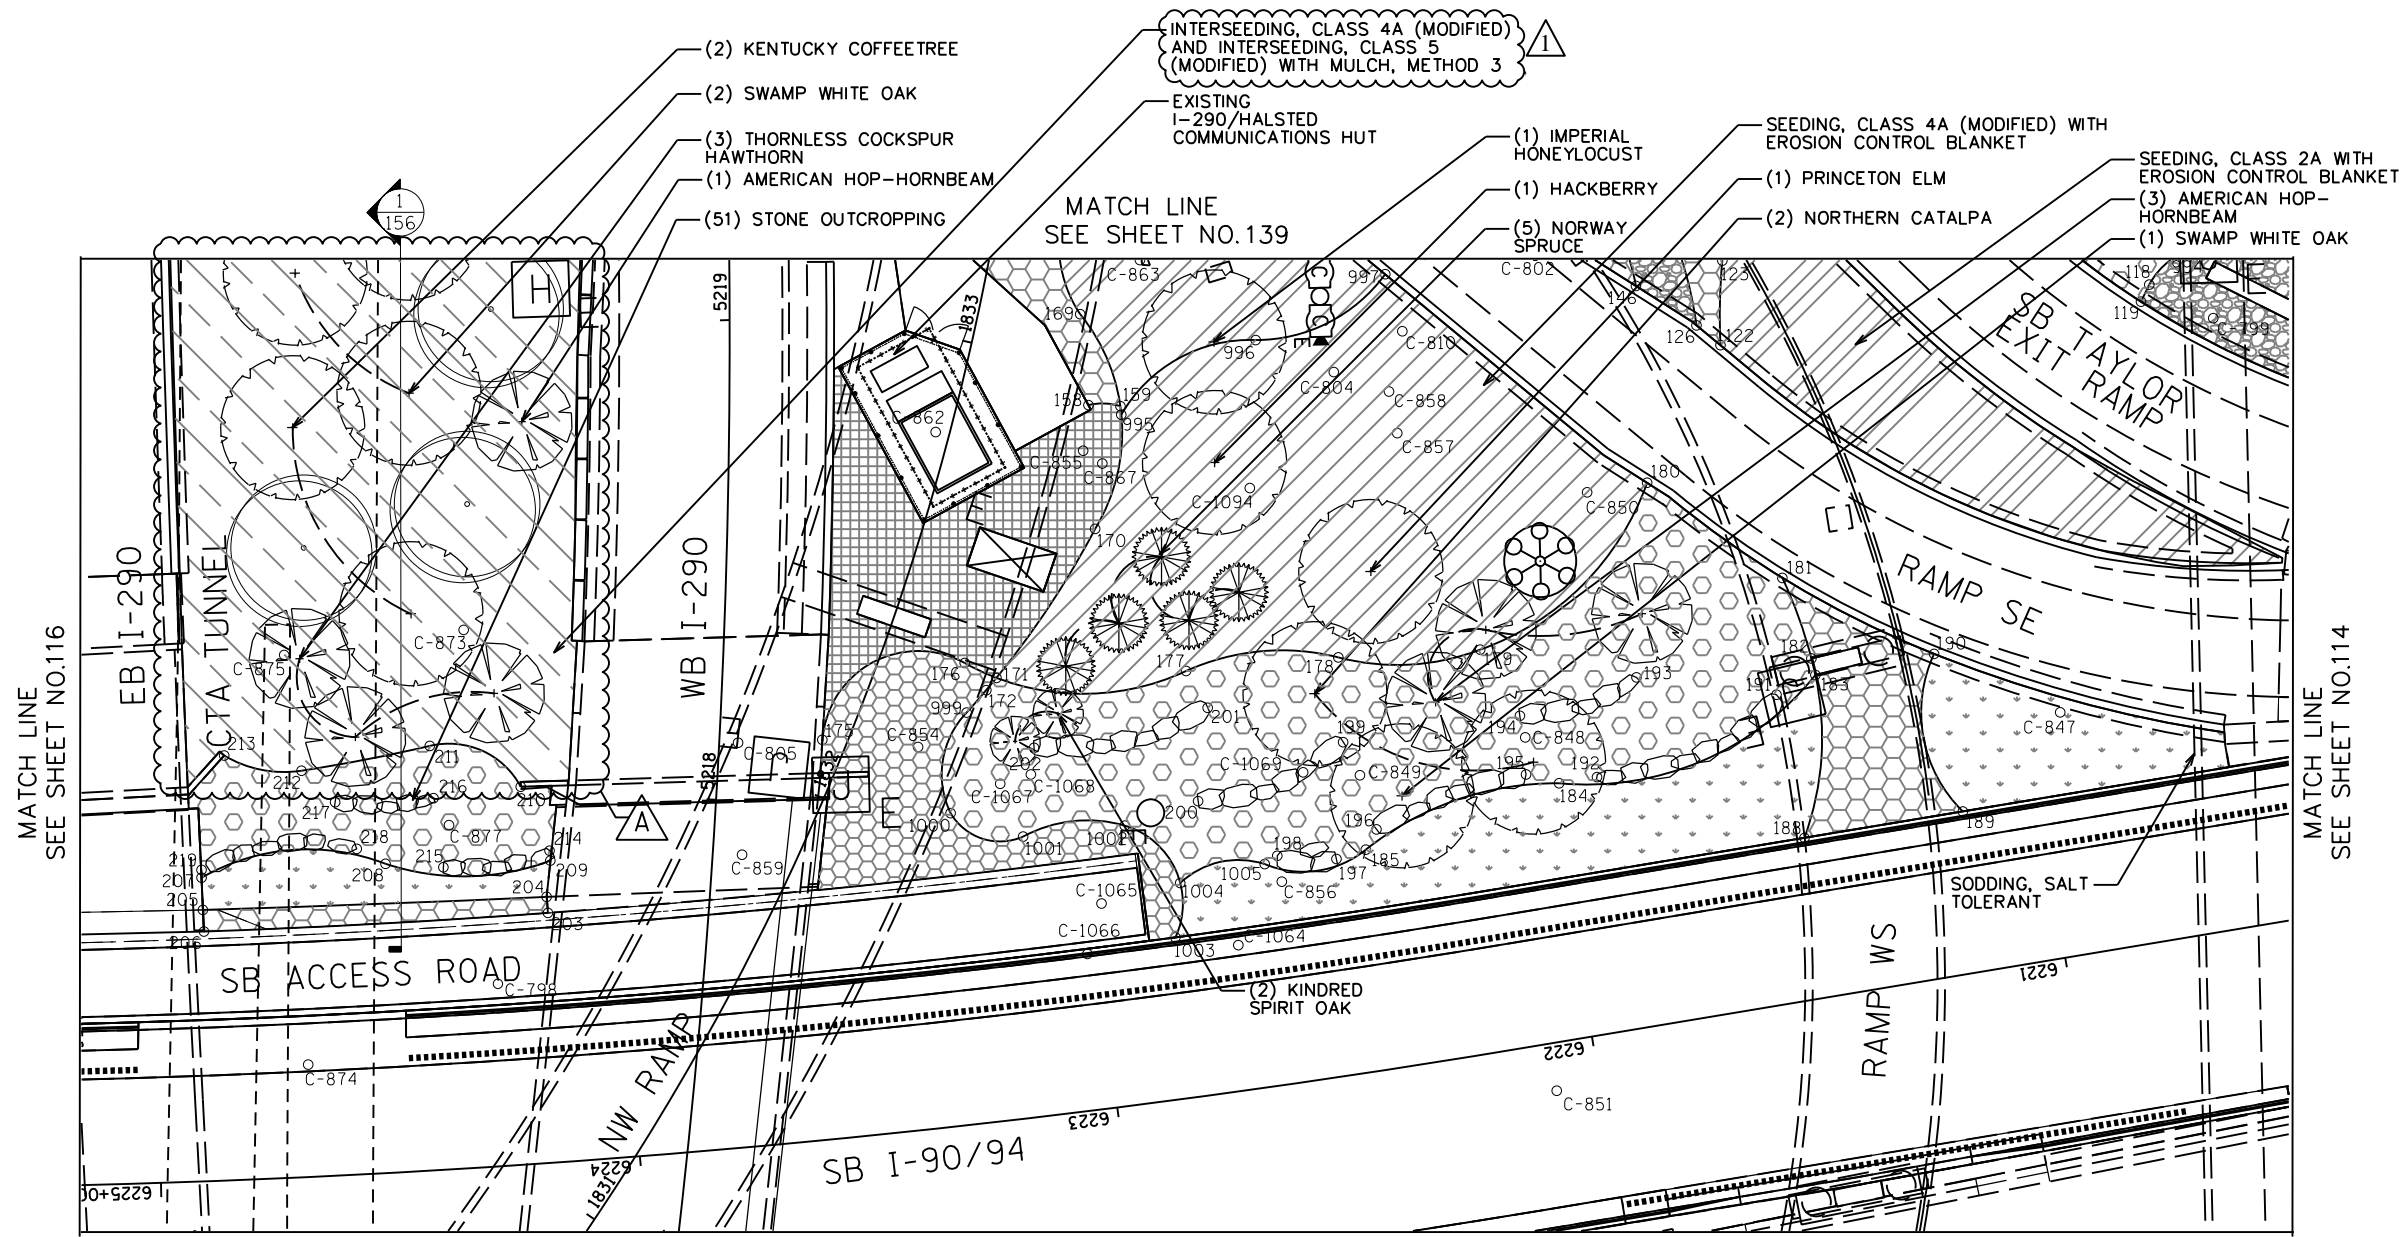


MATCH LINE SEE SHEET NO.116

MATCH LINE SEE SHEET NO.114

MATCH LINE SEE SHEET NO.131

QUANTITY	BOTANIC NAME	COMMON NAME	SIZE	ROOT	REMARKS
SHADE TREES:					
1	<i>Celtis occidentalis</i>	Hackberry	2.5" cal	B&B	
2	<i>Catalpa speciosa</i>	Northern Catalpa	2.5" cal	B&B	
1	<i>Gleditsia triacanthos</i> var. <i>inermis</i> Imperial	Imperial Honeylocust	3" cal	B&B	
2	<i>Gymnocladus dioica</i>	Kentucky Coffeetree	2.5" cal	B&B	
3	<i>Quercus bicolor</i>	Swamp White Oak	2.5" cal	B&B	
2	<i>Quercus x vareii</i> 'Nadler'	Kindred Spirit Columnar Oak	2.5" cal	B&B	15' oc
1	<i>Ulmus americana</i> 'Princeton'	Princeton Elm	2.5" cal	B&B	
EVERGREEN TREES:					
5	<i>Picea abies</i>	Norway Spruce	8' Ht	B&B	
UNDERSTORY TREES:					
3	<i>Crataegus crus-galli</i> var. <i>inermis</i>	Thornless Cockspur Hawthorn	7' Ht	B&B	
4	<i>Ostrya virginiana</i>	American Hop-Hornbeam	2" cal	B&B	
24	TOTAL				

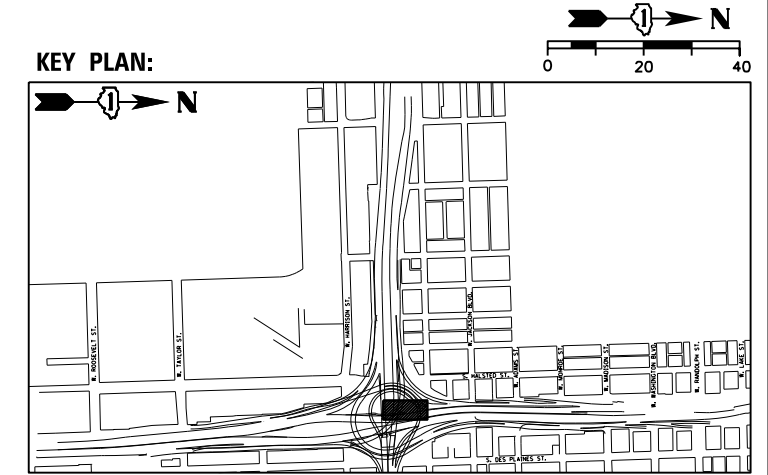

REVISOR: [Symbol] REVISED SHEET 5/27/2022



DESIGNED - BK	REVISOR [Symbol] 5/20/2022
CHECKED - BM	REVISOR
DRAWN - JT	REVISOR
DATE - 12/04/2020	REVISOR

STATE OF ILLINOIS
DEPARTMENT OF TRANSPORTATION


LANDSCAPE PLANS

SHEET NO. 5 OF 43 SHEETS

F.A.I. RTE.	SECTION	COUNTY	TOTAL SHEETS	SHEET NO.
90/94/290	2014-012L5	COOK	220	115
CONTRACT NO. 60X98				

ILLINOIS FED. AID PROJECT


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- LEGEND**
- SHADE TREE
 - EVERGREEN TREE
 - UNDERSTORY TREE
 - EXISTING TREE WITH MULCH PLACEMENT AND TREE CARE
 - PERENNIAL/SHRUBS
 - VINE, 1 GALLON POT
 - STONE OUTCROPPING
 - CHAIN LINK FENCE, 6'
 - NATIVE SODDING, SPECIAL
 - SEEDING, CLASS 4A (MODIFIED) WITH EROSION CONTROL BLANKET
 - SEEDING, CLASS 4A (MODIFIED) AND SEEDING, CLASS 5 (MODIFIED) WITH EROSION CONTROL BLANKET
 - SODDING, SALT TOLERANT
 - AGGREGATE SURFACE COURSE
 - STONE RIPRAP, CLASS A4 (SPECIAL)
 - STONE RIPRAP, CLASS A4
 - SEEDING CLASS 2A WITH EROSION CONTROL BLANKET
 - INTERSEEDING, CLASS 4A (MODIFIED) AND INTERSEEDING, CLASS 5 (MODIFIED) WITH MULCH, METHOD 3
 - INTERSEEDING, CLASS 2A
 - PERENNIAL PLANTS, BULB TYPE
 - COORDINATE POINT

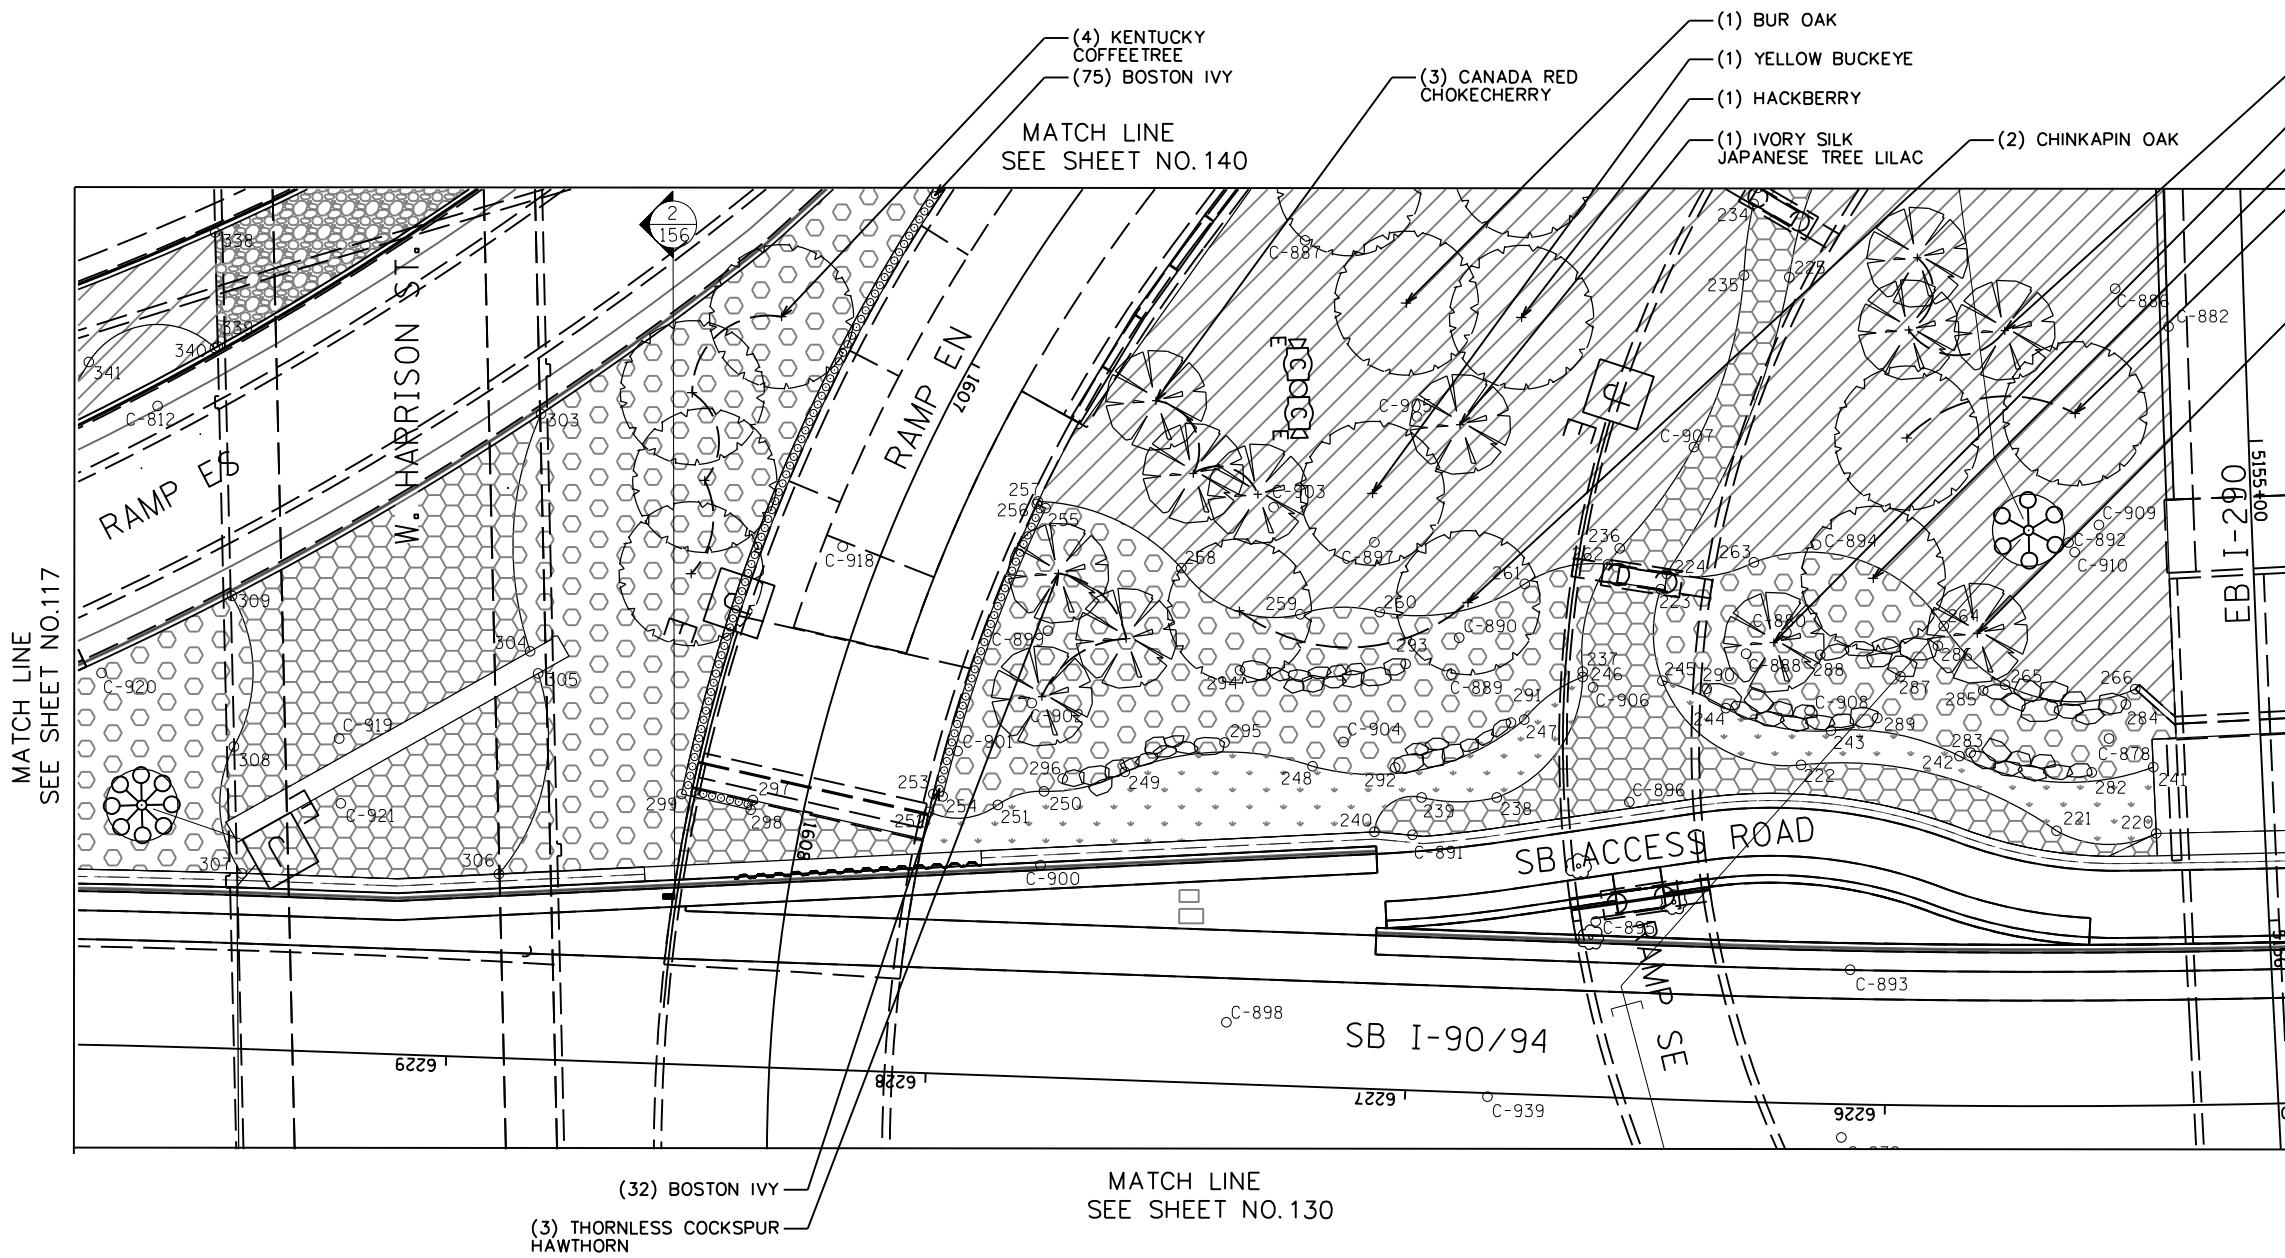- NOTES:**
- SEE SHEET 75 FOR REMOVAL AND EXCAVATION PLAN.
 - ENSURE STONE RIPRAP DOES NOT OBSTRUCT ACCESS TO UTILITY COVERS.

QUANTITY	BOTANIC NAME	COMMON NAME	SIZE	ROOT	REMARKS
SHADE TREES:					
1	<i>Aesculus flava</i>	Yellow Buckeye	3" cal	B&B	
3	<i>Betula nigra 'Heritage'</i>	Heritage River Birch	8' Ht	B&B	
1	<i>Celtis occidentalis</i>	Hackberry	2.5" cal	B&B	
4	<i>Gymnocladus dioica</i>	Kentucky Coffeetree	2.5" cal	B&B	
2	<i>Quercus bicolor</i>	Swamp White Oak	2.5" cal	B&B	
1	<i>Quercus macrocarpa</i>	Bur Oak	2.5" cal	B&B	
3	<i>Quercus muehlenbergii</i>	Chinkapin Oak	2.5" cal	B&B	
UNDERS TORY TREES:					
3	<i>Crataegus crus-galli var. inermis</i>	Thornless Cockspur Hawthorn	7' Ht	B&B	
1	<i>Maclura pomifera 'White Shield'</i>	White Shield Osage Orange	2" cal	B&B	
3	<i>Prunus virginiana 'Canada Red'</i>	Canada Red Chokecherry	2" cal	B&B	
2	<i>Syringa reticulata 'Ivory Silk'</i>	Ivory Silk Japanese Tree Lilac	8' Ht	B&B	
24	TOTAL				
VINES:					
107	<i>Parthenocissus tricuspidata</i>	Boston Ivy	1 gal		24" oc, mulch bed



REVISD SHEET 5/27/2022

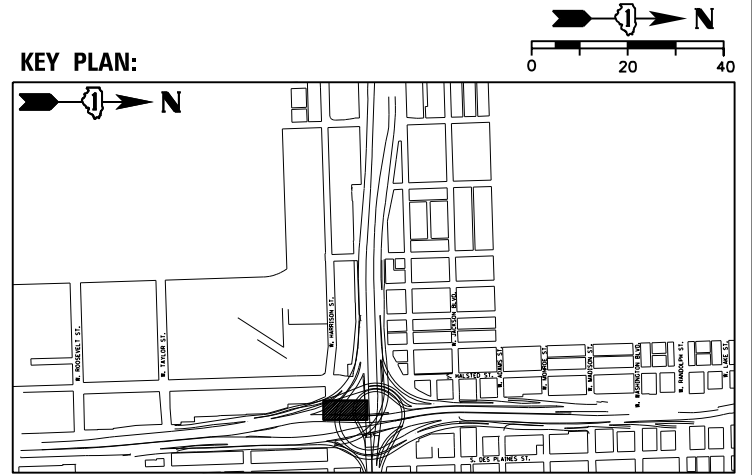

DESIGNED - BK	REVISD 5/20/2022
CHECKED - BM	REVISD
DRAWN - JT	REVISD
DATE - 12/04/2020	REVISD


STATE OF ILLINOIS
DEPARTMENT OF TRANSPORTATION

LANDSCAPE PLANS

SHEET NO. 6 OF 43 SHEETS

F.A.I. RTE.	SECTION	COUNTY	TOTAL SHEETS	SHEET NO.
90/94/290	2014-012L5	COOK	220	116
CONTRACT NO. 60X98				

ILLINOIS FED. AID PROJECT

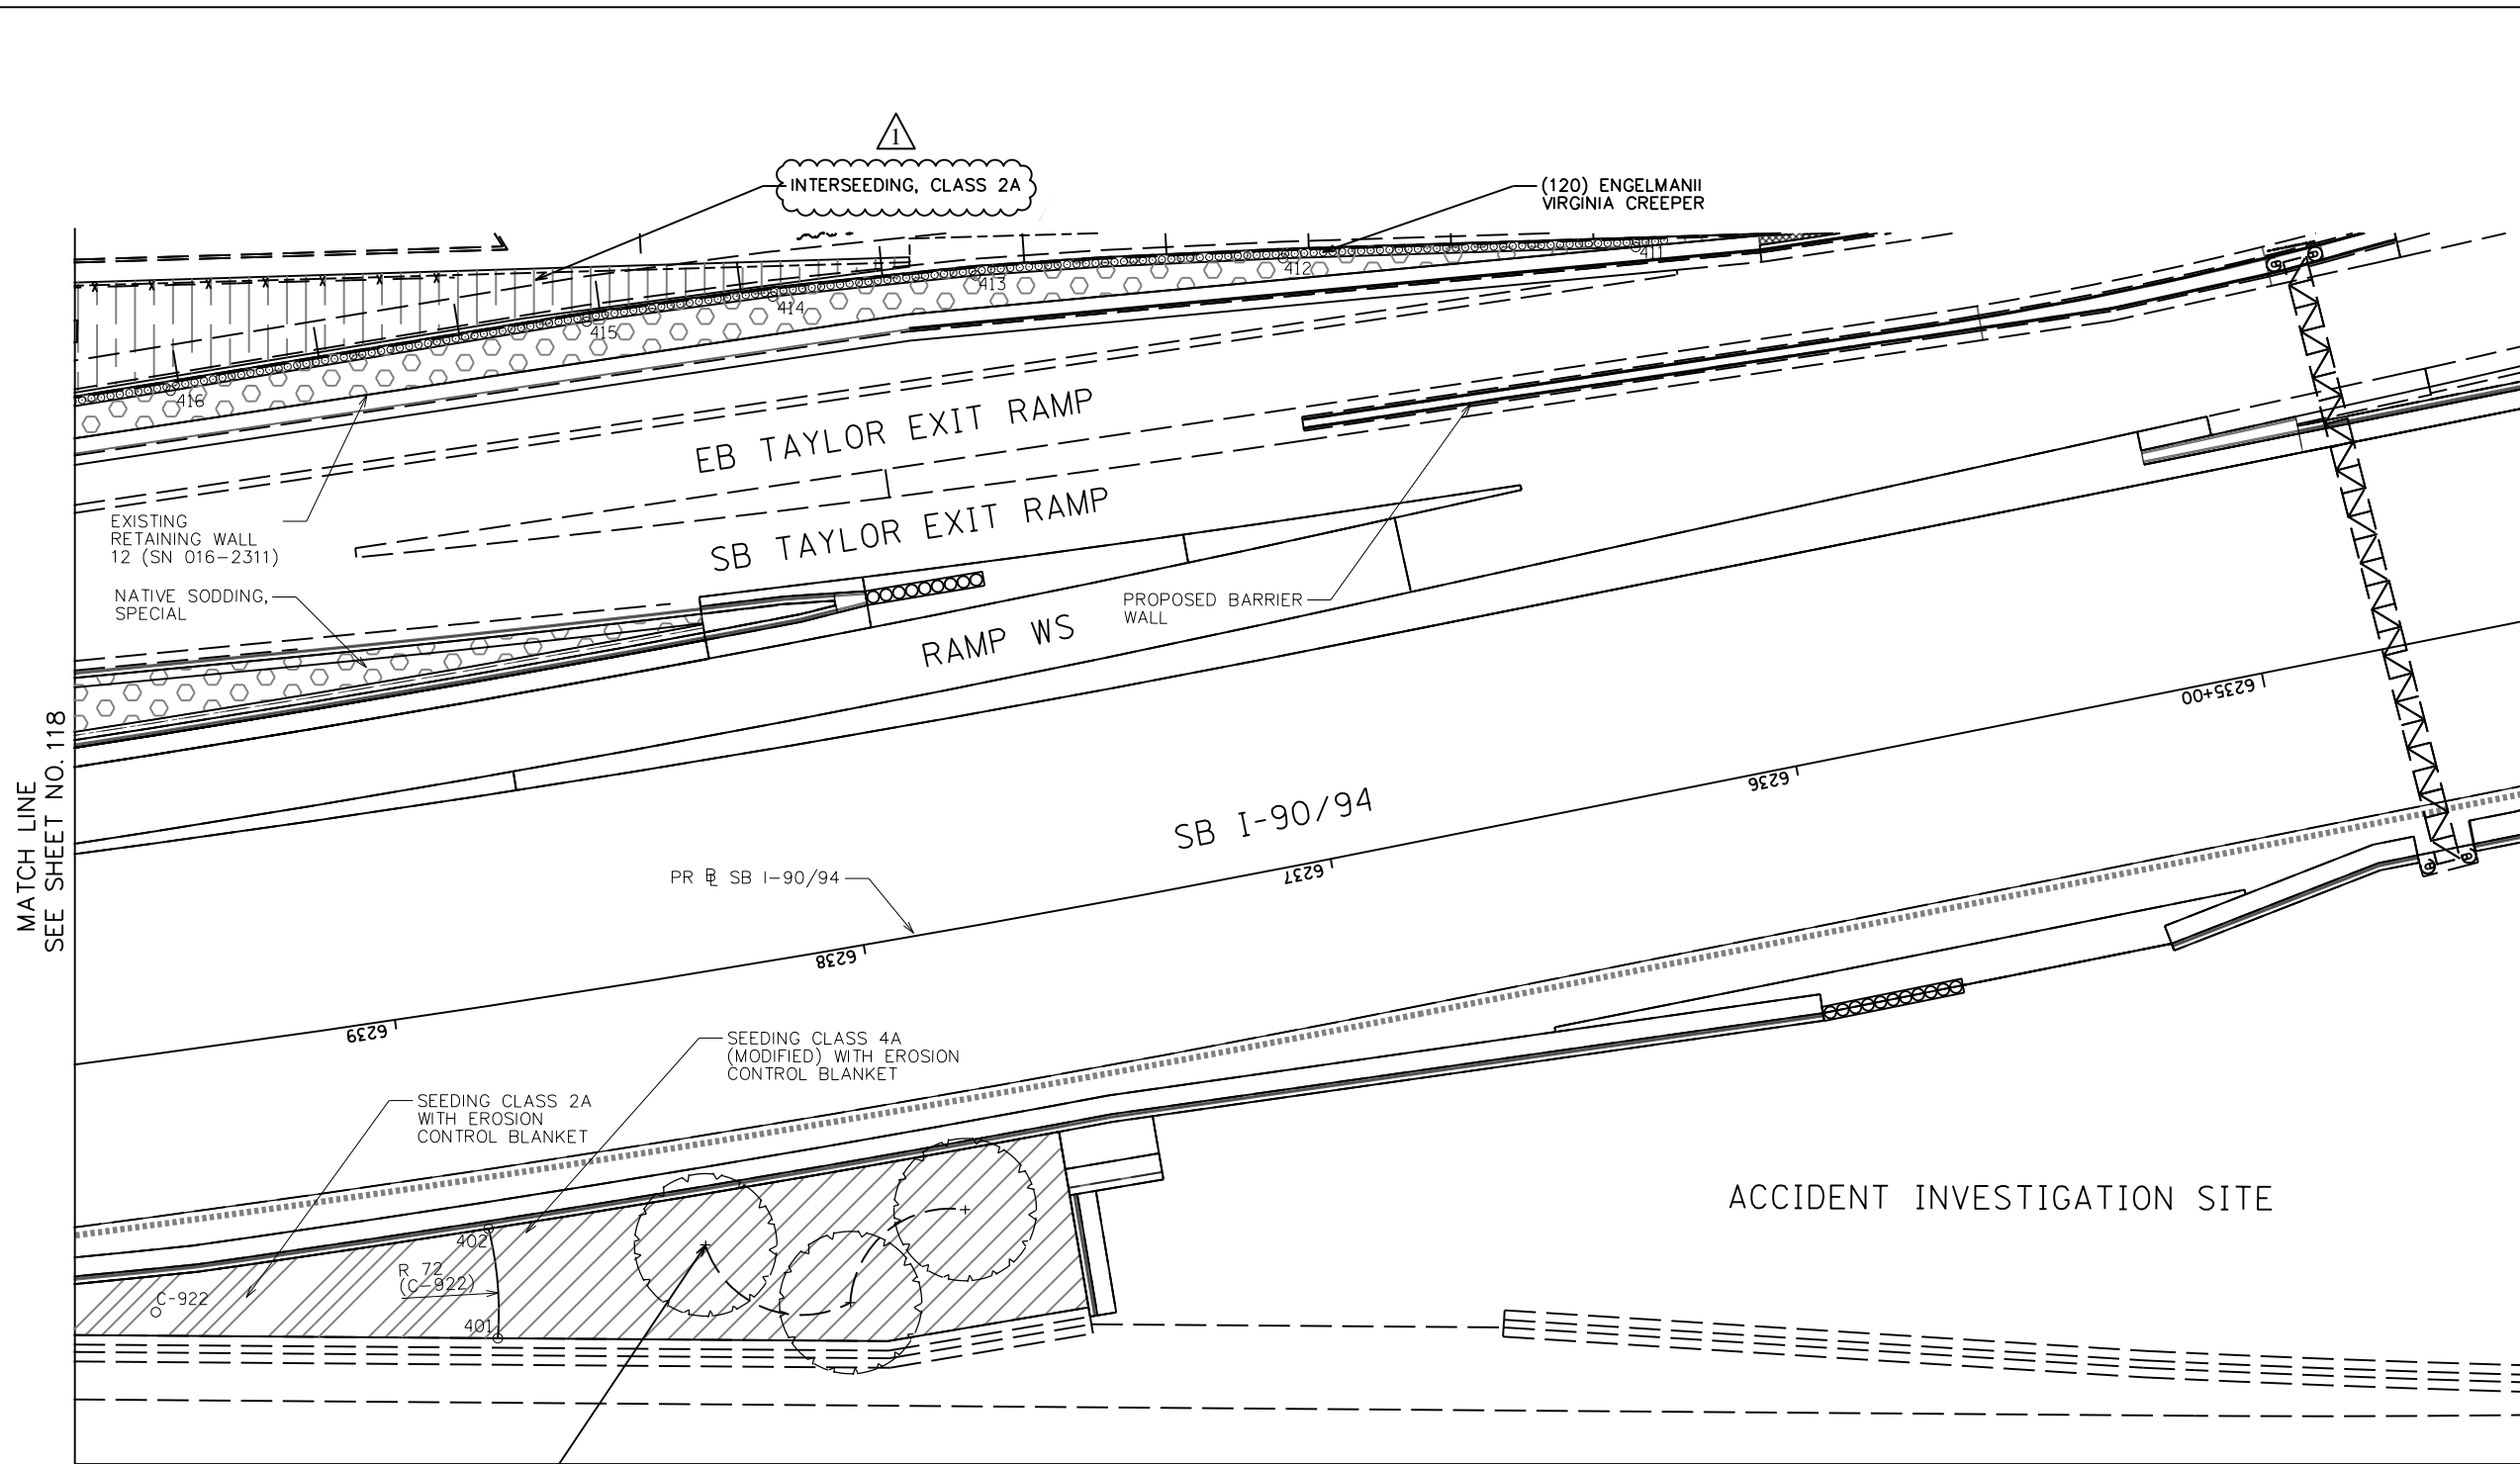

LEGEND

- SHADE TREE
- EVERGREEN TREE
- UNDERSTORY TREE
- EXISTING TREE WITH MULCH PLACEMENT AND TREE CARE
- PERENNIAL/SHRUBS
- VINE, 1 GALLON POT
- STONE OUTCROPPING
- CHAIN LINK FENCE, 6'
- NATIVE SODDING, SPECIAL
- SEEDING, CLASS 4A (MODIFIED) WITH EROSION CONTROL BLANKET
- SEEDING, CLASS 4A (MODIFIED) AND SEEDING, CLASS 5 (MODIFIED) WITH EROSION CONTROL BLANKET
- SODDING, SALT TOLERANT
- AGGREGATE SURFACE COURSE
- STONE RIPRAP, CLASS A4 (SPECIAL)
- STONE RIPRAP, CLASS A4
- SEEDING CLASS 2A WITH EROSION CONTROL BLANKET
- INTERSEEDING, CLASS 4A (MODIFIED) AND INTERSEEDING, CLASS 5 (MODIFIED) WITH MULCH, METHOD 3
- INTERSEEDING, CLASS 2A
- PERENNIAL PLANTS, BULB TYPE
- COORDINATE POINT

NOTES:

- SEE SHEET 77 FOR REMOVAL AND EXCAVATION PLAN.
- ENSURE STONE RIPRAP DOES NOT OBSTRUCT ACCESS TO UTILITY COVERS.

MATCH LINE SEE SHEET NO. 118

MATCH LINE SEE SHEET NO. 117

MATCH LINE SEE SHEET NO. 129

MATCH LINE SEE SHEET NO. 127


ACCIDENT INVESTIGATION SITE

(3) BALD CYPRESS

NOTE: CONTRACTOR TO PROVIDE THE FOLLOWING TREES WHICH WILL BE PLANTED BETWEEN THE RETAINING WALL AND UIC PARKING LOT. TREES WILL BE LOCATED IN THE FIELD BY THE ROADSIDE DEVELOPMENT UNIT AND UIC.

QUANTITY	BOTANIC NAME	COMMON NAME	SIZE	ROOT	REMARKS
SHADE TREES:					
3	<i>Taxodium distichum</i>	Common Bald Cypress	2"	B&B	
VINES:					
120	<i>Parthenocissus quinquefolia</i> 'Engelmannii'	Engelmann's Virginia Creeper	1 gal		24" oc, mulch bed

QUANTITY	BOTANIC NAME	COMMON NAME	SIZE	ROOT	REMARKS
SHADE TREES:					
2	<i>Celtis occidentalis</i>	Hackberry	2.5" cal	B&B	
2	<i>Gymnocladus dioica</i>	Kentucky Coffeetree	2.5" cal	B&B	
4	<i>Metasequoia glyptostroboides</i>	Dawn Redwood	2.5" cal	B&B	
2	<i>Quercus imbricaria</i>	Shingle Oak	2.5" cal	B&B	
2	<i>Taxodium distichum</i>	Common Bald Cypress	2"	B&B	
12	TOTAL				

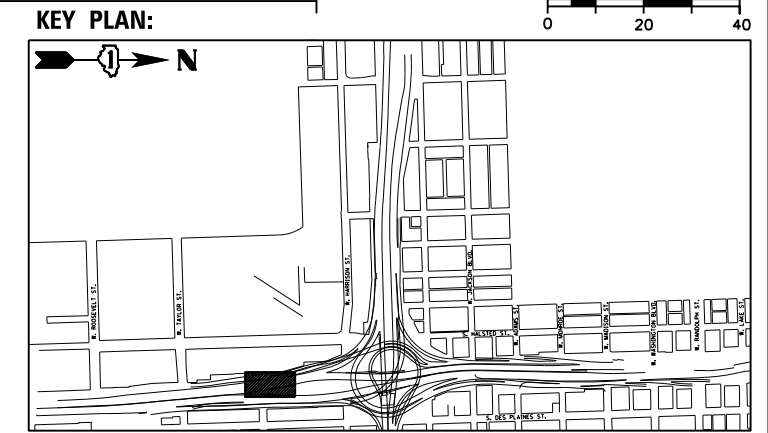

REVISED SHEET 5/27/2022



DESIGNED	- BK	REVISED	5/20/2022
CHECKED	- BM	REVISED	
DRAWN	- JT	REVISED	
DATE	- 12/04/2020	REVISED	


STATE OF ILLINOIS
DEPARTMENT OF TRANSPORTATION

LANDSCAPE PLANS

SHEET NO. 8 OF 43 SHEETS

F.A.I. R.T.E.	SECTION	COUNTY	TOTAL SHEETS	SHEET NO.
90/94/290	2014-012L5	COOK	220	118
CONTRACT NO. 60X98				


ILLINOIS FED. AID PROJECT

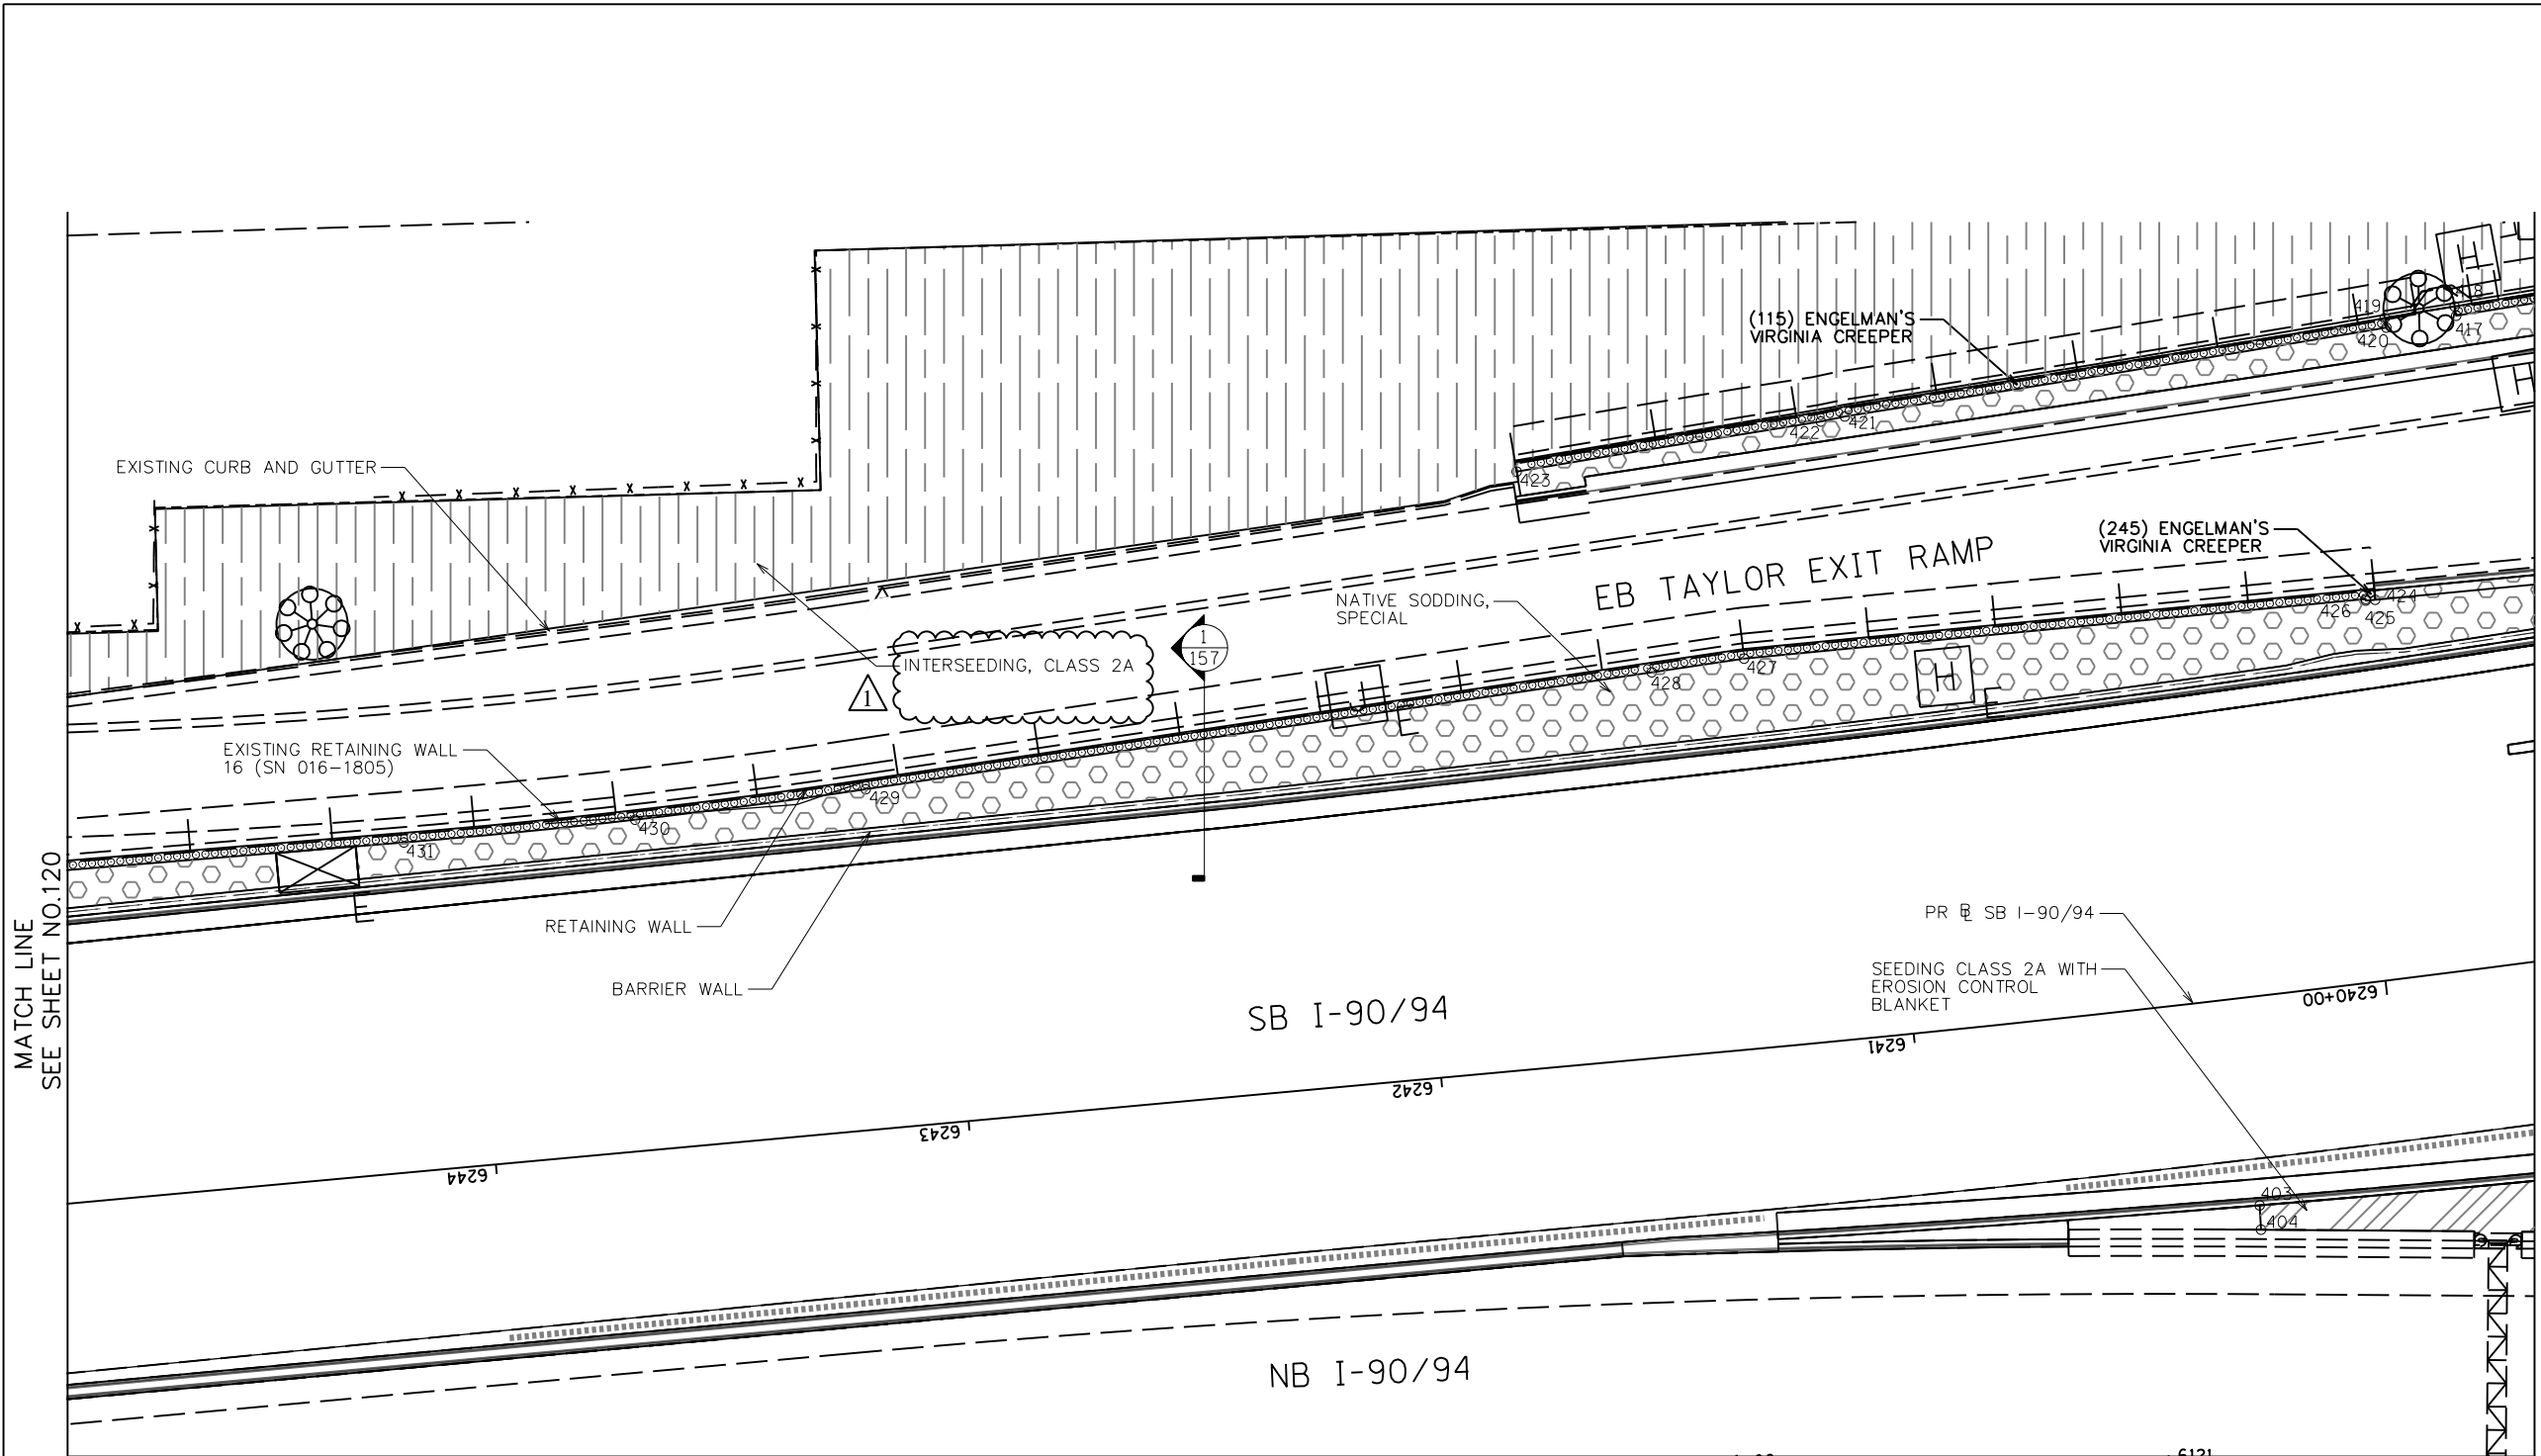

- LEGEND**
- SHADE TREE
 - EVERGREEN TREE
 - UNDERSTORY TREE
 - EXISTING TREE WITH MULCH PLACEMENT AND TREE CARE
 - PERENNIAL/SHRUBS
 - VINE, 1 GALLON POT
 - STONE OUTCROPPING
 - CHAIN LINK FENCE, 6'
 - NATIVE SODDING, SPECIAL
 - SEEDING, CLASS 4A (MODIFIED) WITH EROSION CONTROL BLANKET
 - SEEDING, CLASS 4A (MODIFIED) AND SEEDING, CLASS 5 (MODIFIED) WITH EROSION CONTROL BLANKET
 - SODDING, SALT TOLERANT
 - AGGREGATE SURFACE COURSE
 - STONE RIPRAP, CLASS A4 (SPECIAL)
 - STONE RIPRAP, CLASS A4
 - SEEDING CLASS 2A WITH EROSION CONTROL BLANKET
 - INTERSEEDING, CLASS 4A (MODIFIED) AND INTERSEEDING, CLASS 5 (MODIFIED) WITH MULCH, METHOD 3
 - INTERSEEDING, CLASS 2A
 - PERENNIAL PLANTS, BULB TYPE
 - COORDINATE POINT

NOTES:

- SEE SHEET 78 FOR REMOVAL AND EXCAVATION PLAN.
- ENSURE STONE RIPRAP DOES NOT OBSTRUCT ACCESS TO UTILITY COVERS.

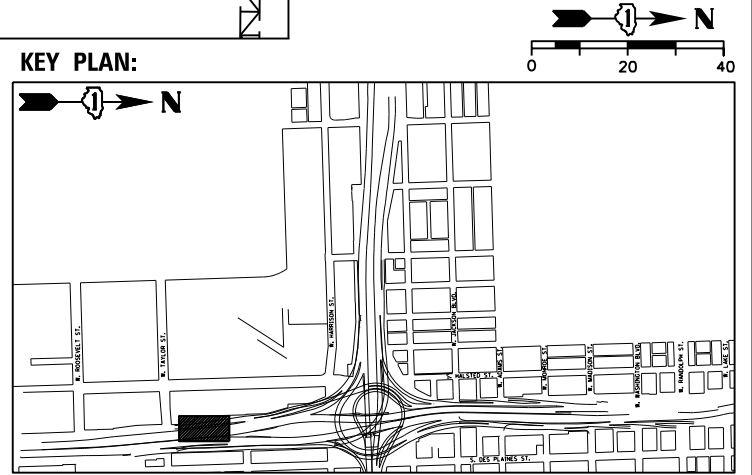

QUANTITY	BOTANIC NAME	COMMON NAME	SIZE	ROOT	REMARKS
VINES:					
360	<i>Parthenocissus quinquefolia 'Engelmannii'</i>	Engelman's Virginia Creeper	1 gal		24" oc, mulch bed

REVISD SHEET 5/27/2022



USER NAME = SG	DESIGNED -- BK	REVISED A 5/20/2022
PLOT SCALE = 1:20	CHECKED -- BM	REVISED
PLOT DATE = 12/04/2020	DRAWN -- JT	REVISED
	DATE -- 12/04/2020	REVISED

STATE OF ILLINOIS
DEPARTMENT OF TRANSPORTATION

LANDSCAPE PLANS

SHEET NO. 9 OF 43 SHEETS


F.A.I. RTE.	SECTION	COUNTY	TOTAL SHEETS	SHEET NO.
90/94/290	2014-012L5	COOK	220	119
CONTRACT NO. 60X98				

ILLINOIS FED. AID PROJECT

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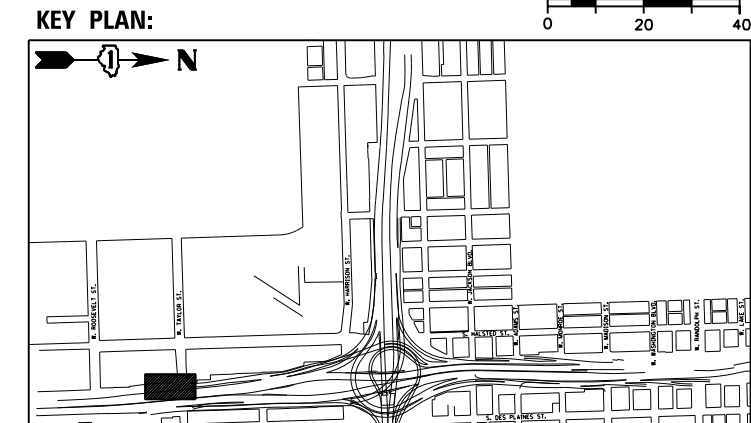
- LEGEND**
- SHADE TREE
 - EVERGREEN TREE
 - UNDERSTORY TREE
 - EXISTING TREE WITH MULCH PLACEMENT AND TREE CARE
 - PERENNIAL/SHRUBS
 - VINE, 1 GALLON POT
 - STONE OUTCROPPING
 - CHAIN LINK FENCE, 6'
 - NATIVE SODDING, SPECIAL
 - SEEDING, CLASS 4A (MODIFIED) WITH EROSION CONTROL BLANKET
 - SEEDING, CLASS 4A (MODIFIED) AND SEEDING, CLASS 5 (MODIFIED) WITH EROSION CONTROL BLANKET
 - SODDING, SALT TOLERANT
 - AGGREGATE SURFACE COURSE
 - STONE RIPRAP, CLASS A4 (SPECIAL)
 - STONE RIPRAP, CLASS A4
 - SEEDING CLASS 2A WITH EROSION CONTROL BLANKET
 - INTERSEEDING, CLASS 4A (MODIFIED) AND INTERSEEDING, CLASS 5 (MODIFIED) WITH MULCH, METHOD 3
 - INTERSEEDING, CLASS 2A
 - PERENNIAL PLANTS, BULB TYPE
 - COORDINATE POINT

- NOTES:**
- SEE SHEET 79 FOR REMOVAL AND EXCAVATION PLAN.
 - ENSURE STONE RIPRAP DOES NOT OBSTRUCT ACCESS TO UTILITY COVERS.

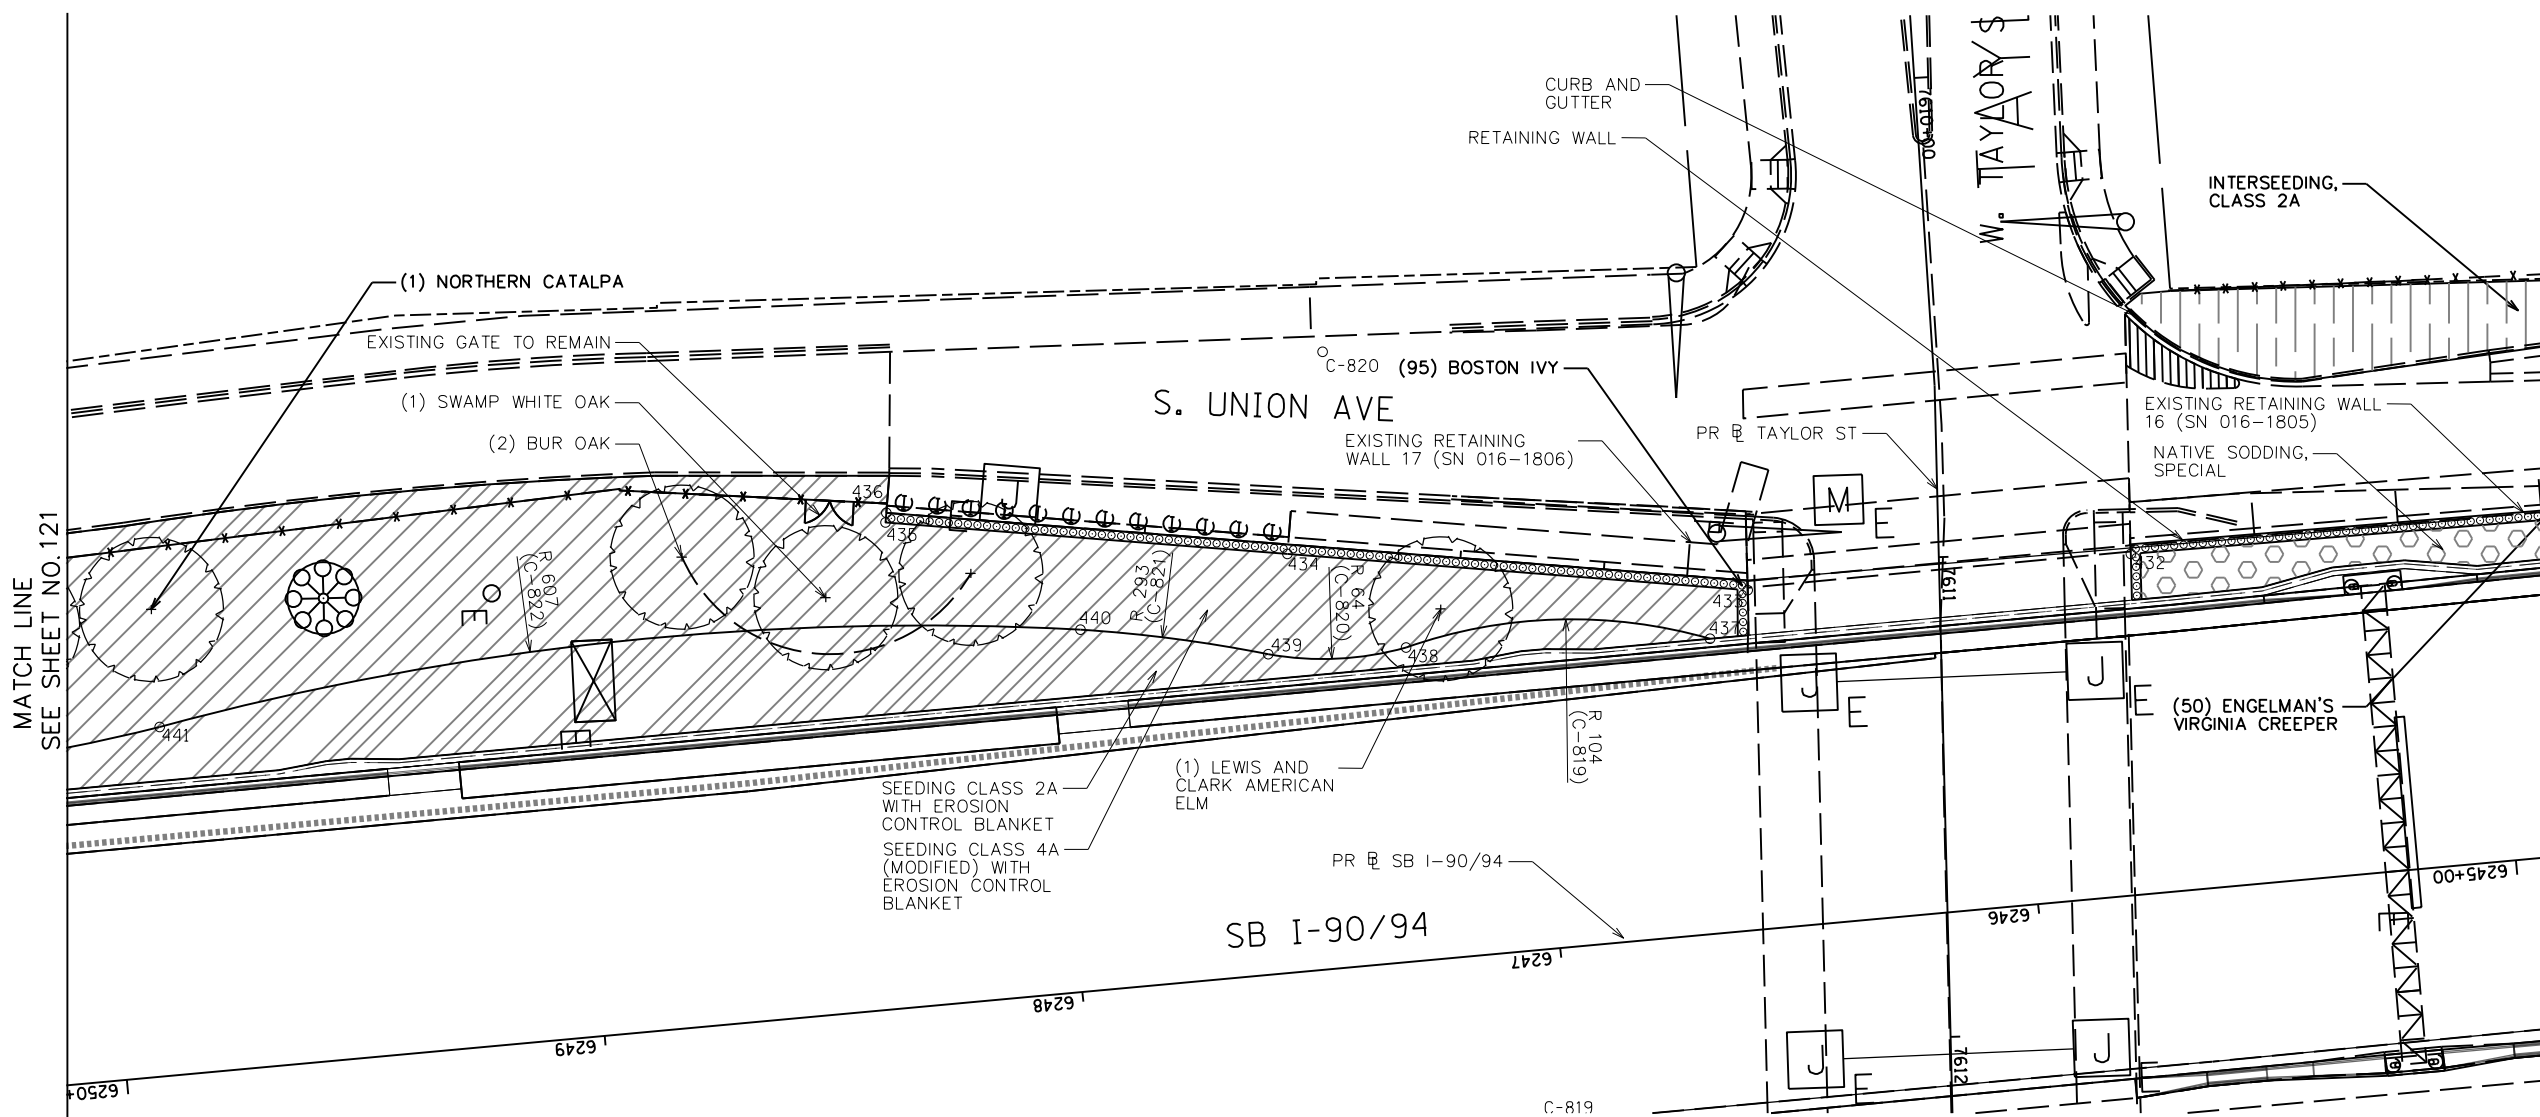

MATCH LINE
SEE SHEET NO. 125

QUANTITY	BOTANIC NAME	COMMON NAME	SIZE	ROOT	REMARKS
SHADE TREES:					
1	<i>Catalpa speciosa</i>	Northern Catalpa	2.5" cal	B&B	
1	<i>Quercus hypoleuca</i>	Swamp White Oak	2.5" cal	B&B	
2	<i>Quercus macrocarpa</i>	Bur Oak	2.5" cal	B&B	
1	<i>Ulmus americana</i> Lewis and Clark	Lewis and Clark American Elm	2 cal	B&B	
5	TOTAL				
VINES:					
95	<i>Parthenocissus tricuspidata</i>	Boston Ivy	1 gal		24" oc, mulch bed
50	<i>Parthenocissus quinquefolia</i> 'Engelmannii'	Engelman's Virginia Creeper	1 gal		24" oc, mulch bed
145	TOTAL				



REVISED SHEET 5/27/2022



DESIGNED -- BK	REVISION 5/20/2022
CHECKED -- BM	REVISION
DRAWN -- JT	REVISION
DATE -- 12/04/2020	REVISION


STATE OF ILLINOIS
DEPARTMENT OF TRANSPORTATION


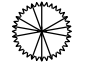





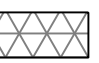
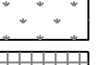
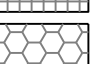
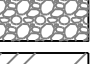
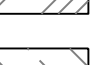
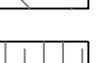

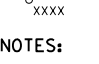
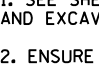
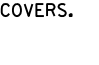



LANDSCAPE PLANS

SHEET NO. 10 OF 43 SHEETS

F.A.I. R.T.E.	SECTION	COUNTY	TOTAL SHEETS	SHEET NO.
90/94/290	2014-012L5	COOK	220	120
CONTRACT NO. 60X98				


ILLINOIS FED. AID PROJECT

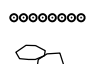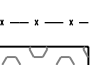LEGEND (CONT.)
 INTERSEEDING, CLASS 4A (MODIFIED), WITH MULCH, METHOD 3


- LEGEND**
-  SHADE TREE
 -  EVERGREEN TREE
 -  UNDERSTORY TREE
 -  EXISTING TREE WITH MULCH PLACEMENT AND TREE CARE
 -  PERENNIAL/SHRUBS
 -  VINE, 1 GALLON POT
 -  STONE OUTCROPPING
 -  CHAIN LINK FENCE, 6'
 -  NATIVE SODDING, SPECIAL
 -  SEEDING, CLASS 4A (MODIFIED) WITH EROSION CONTROL BLANKET
 -  SEEDING, CLASS 4A (MODIFIED) AND SEEDING, CLASS 5 (MODIFIED) WITH EROSION CONTROL BLANKET
 -  SODDING, SALT TOLERANT
 -  AGGREGATE SURFACE COURSE
 -  STONE RIPRAP, CLASS 4A (SPECIAL)
 -  STONE RIPRAP, CLASS 4A
 -  SEEDING CLASS 2A WITH EROSION CONTROL BLANKET
 -  INTERSEEDING, CLASS 4A (MODIFIED) AND INTERSEEDING, CLASS 5 (MODIFIED) WITH MULCH, METHOD 3
 -  INTERSEEDING, CLASS 2A
 -  PERENNIAL PLANTS, BULB TYPE
 -  COORDINATE POINT

NOTES:

- SEE SHEET 80 FOR REMOVAL AND EXCAVATION PLAN.
- ENSURE STONE RIPRAP DOES NOT OBSTRUCT ACCESS TO UTILITY COVERS.

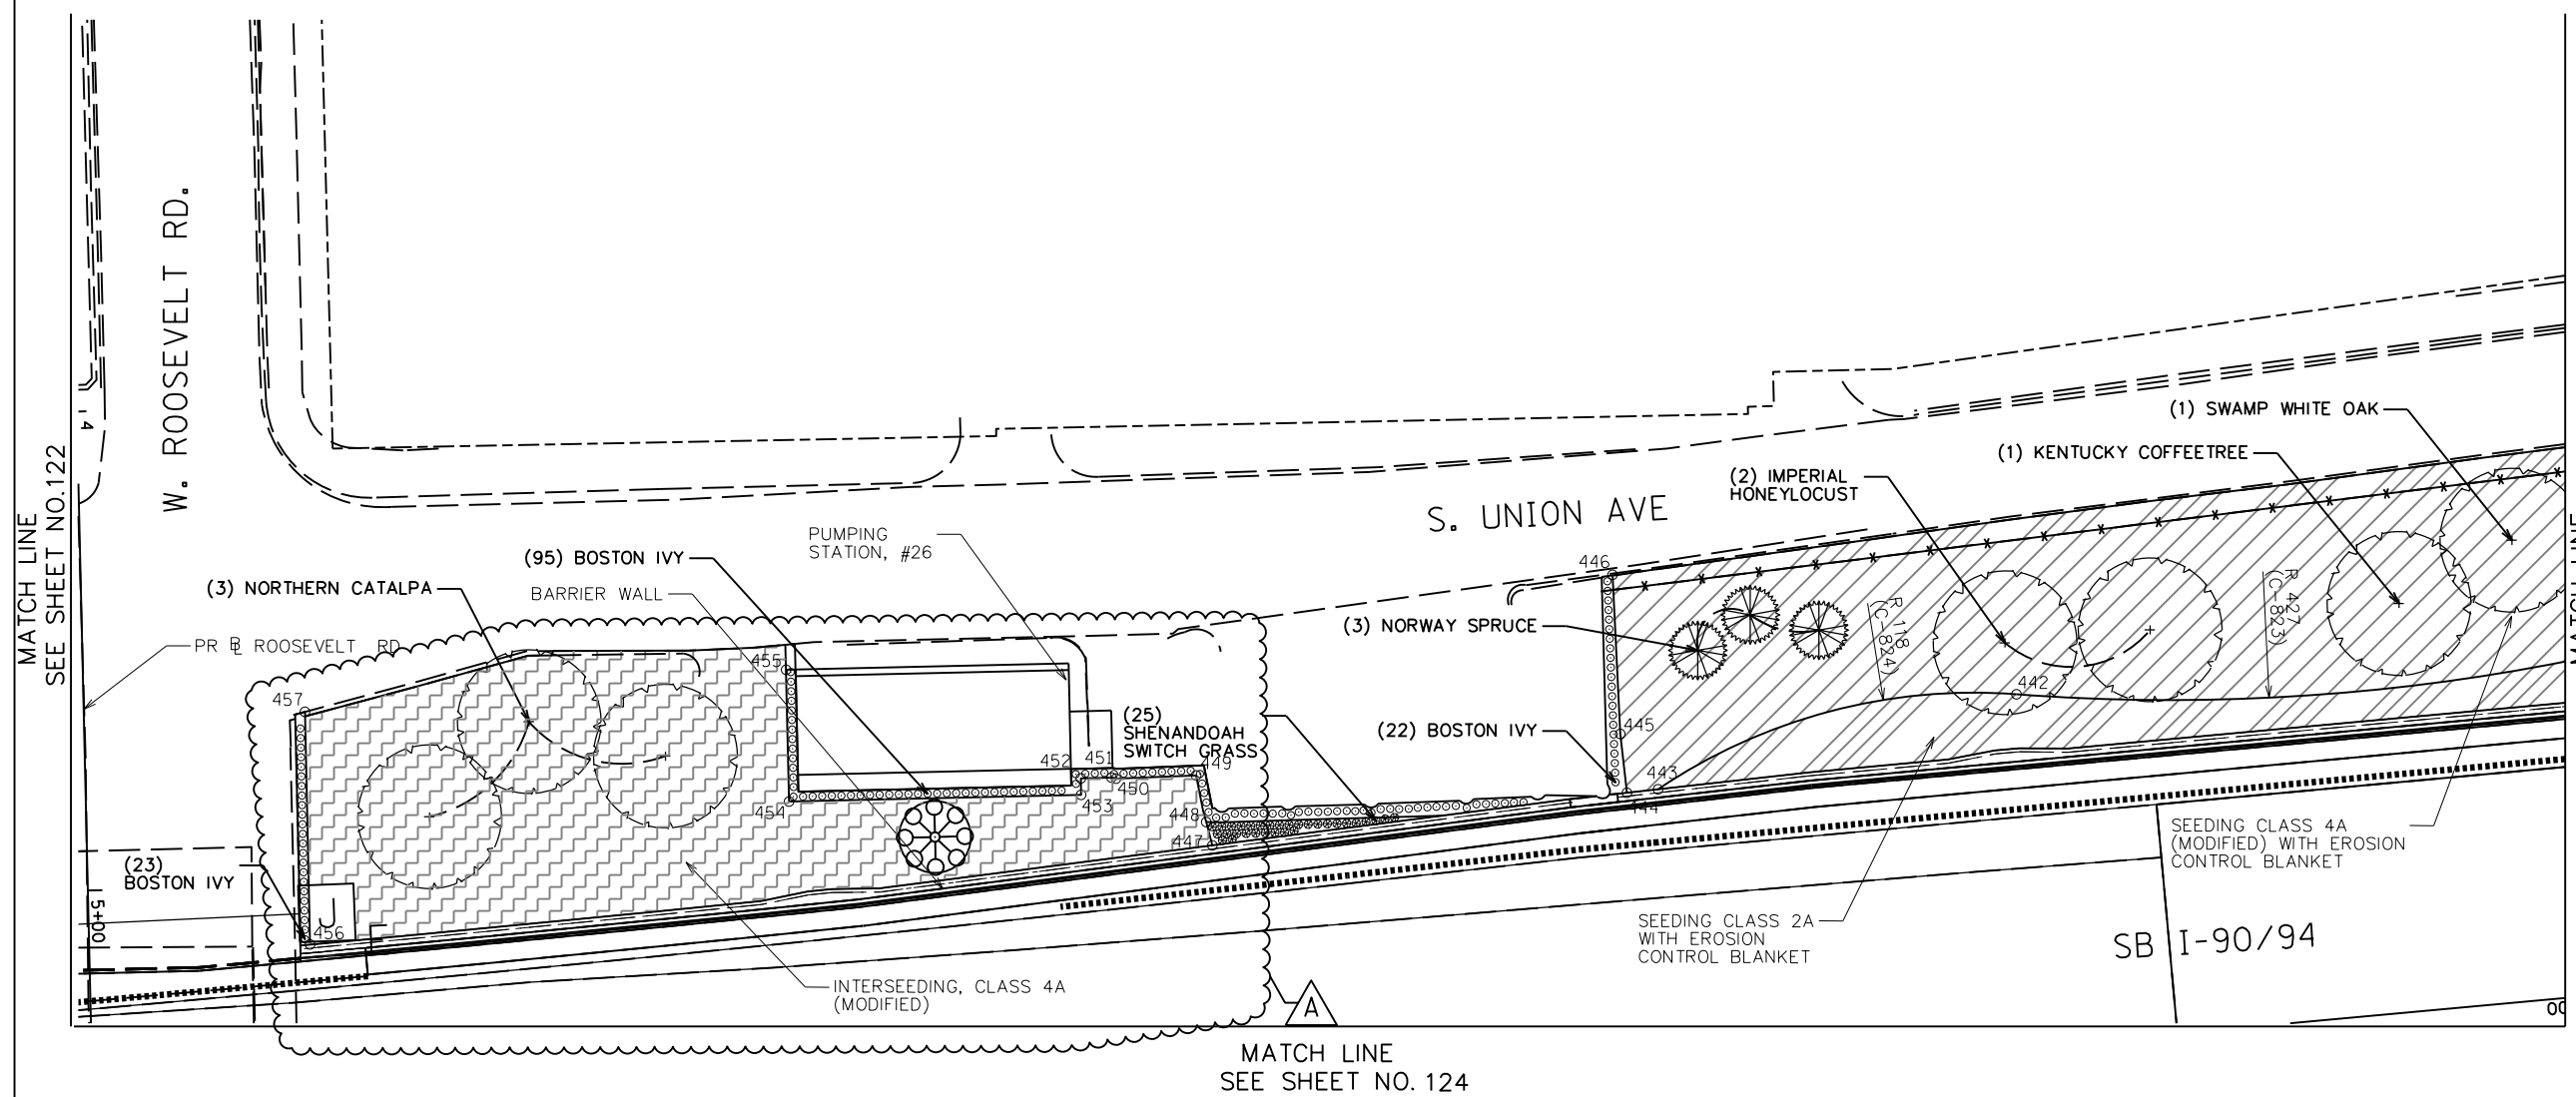

QUANTITY	BOTANIC NAME	COMMON NAME	SIZE	ROOT	REMARKS
SHADE TREES:					
2	<i>Gleditsia triacanthos va. inermis 'Imperial'</i>	Imperial Honeylocust	3" cal	B&B	
1	<i>Gymnocladus dioicus</i>	Kentucky Coffeetree	2.5" cal	B&B	
3	<i>Catalpa speciosa</i>	Northern Catalpa	2.5" cal	B&B	
1	<i>Quercus bicolor</i>	Swamp White Oak	2.5" cal	B&B	
EVERGREEN TREES:					
3	<i>Picea abies</i>	Norway Spruce	8' Ht	B&B	
10	TOTAL				
PERENNIALS:					
**25	<i>Panicum virgatum 'Shenandoah'</i>	Shenandoah Switch Grass	1 gal		24" oc, mulch bed
**PAID FOR AS PERENNIAL, UNIT = 100					
VINES:					
140	<i>Parthenocissus tricuspidata</i>	Boston Ivy	1 gal		24" oc, mulch bed
140	TOTAL				

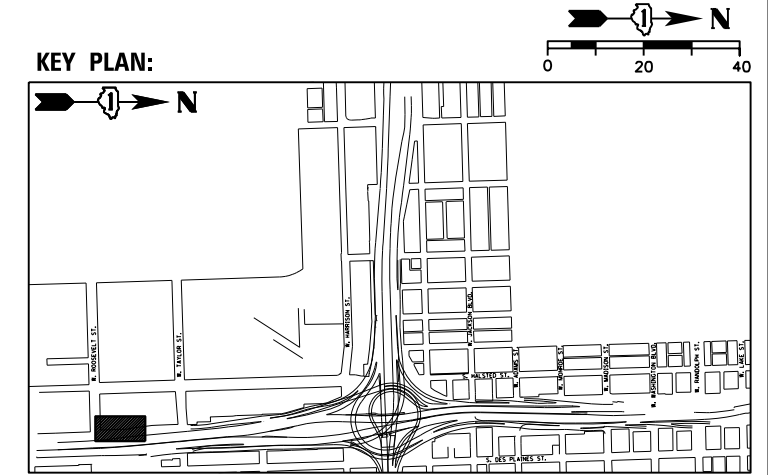

REVISION 1 REVISED SHEET 5/27/2022



DESIGNED - BK	REVISION 1	5/20/2022
CHECKED - BM	REVISION 2	
DRAWN - JT	REVISION 3	
DATE - 12/04/2020	REVISION 4	

STATE OF ILLINOIS
DEPARTMENT OF TRANSPORTATION


LANDSCAPE PLANS

SHEET NO. 11 OF 43 SHEETS

F.A.I. RTE.	SECTION	COUNTY	TOTAL SHEETS	SHEET NO.
90/94/290	2014-012L5	COOK	220	121
CONTRACT NO. 60X98				

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MATCH LINE
SEE SHEET NO. 117

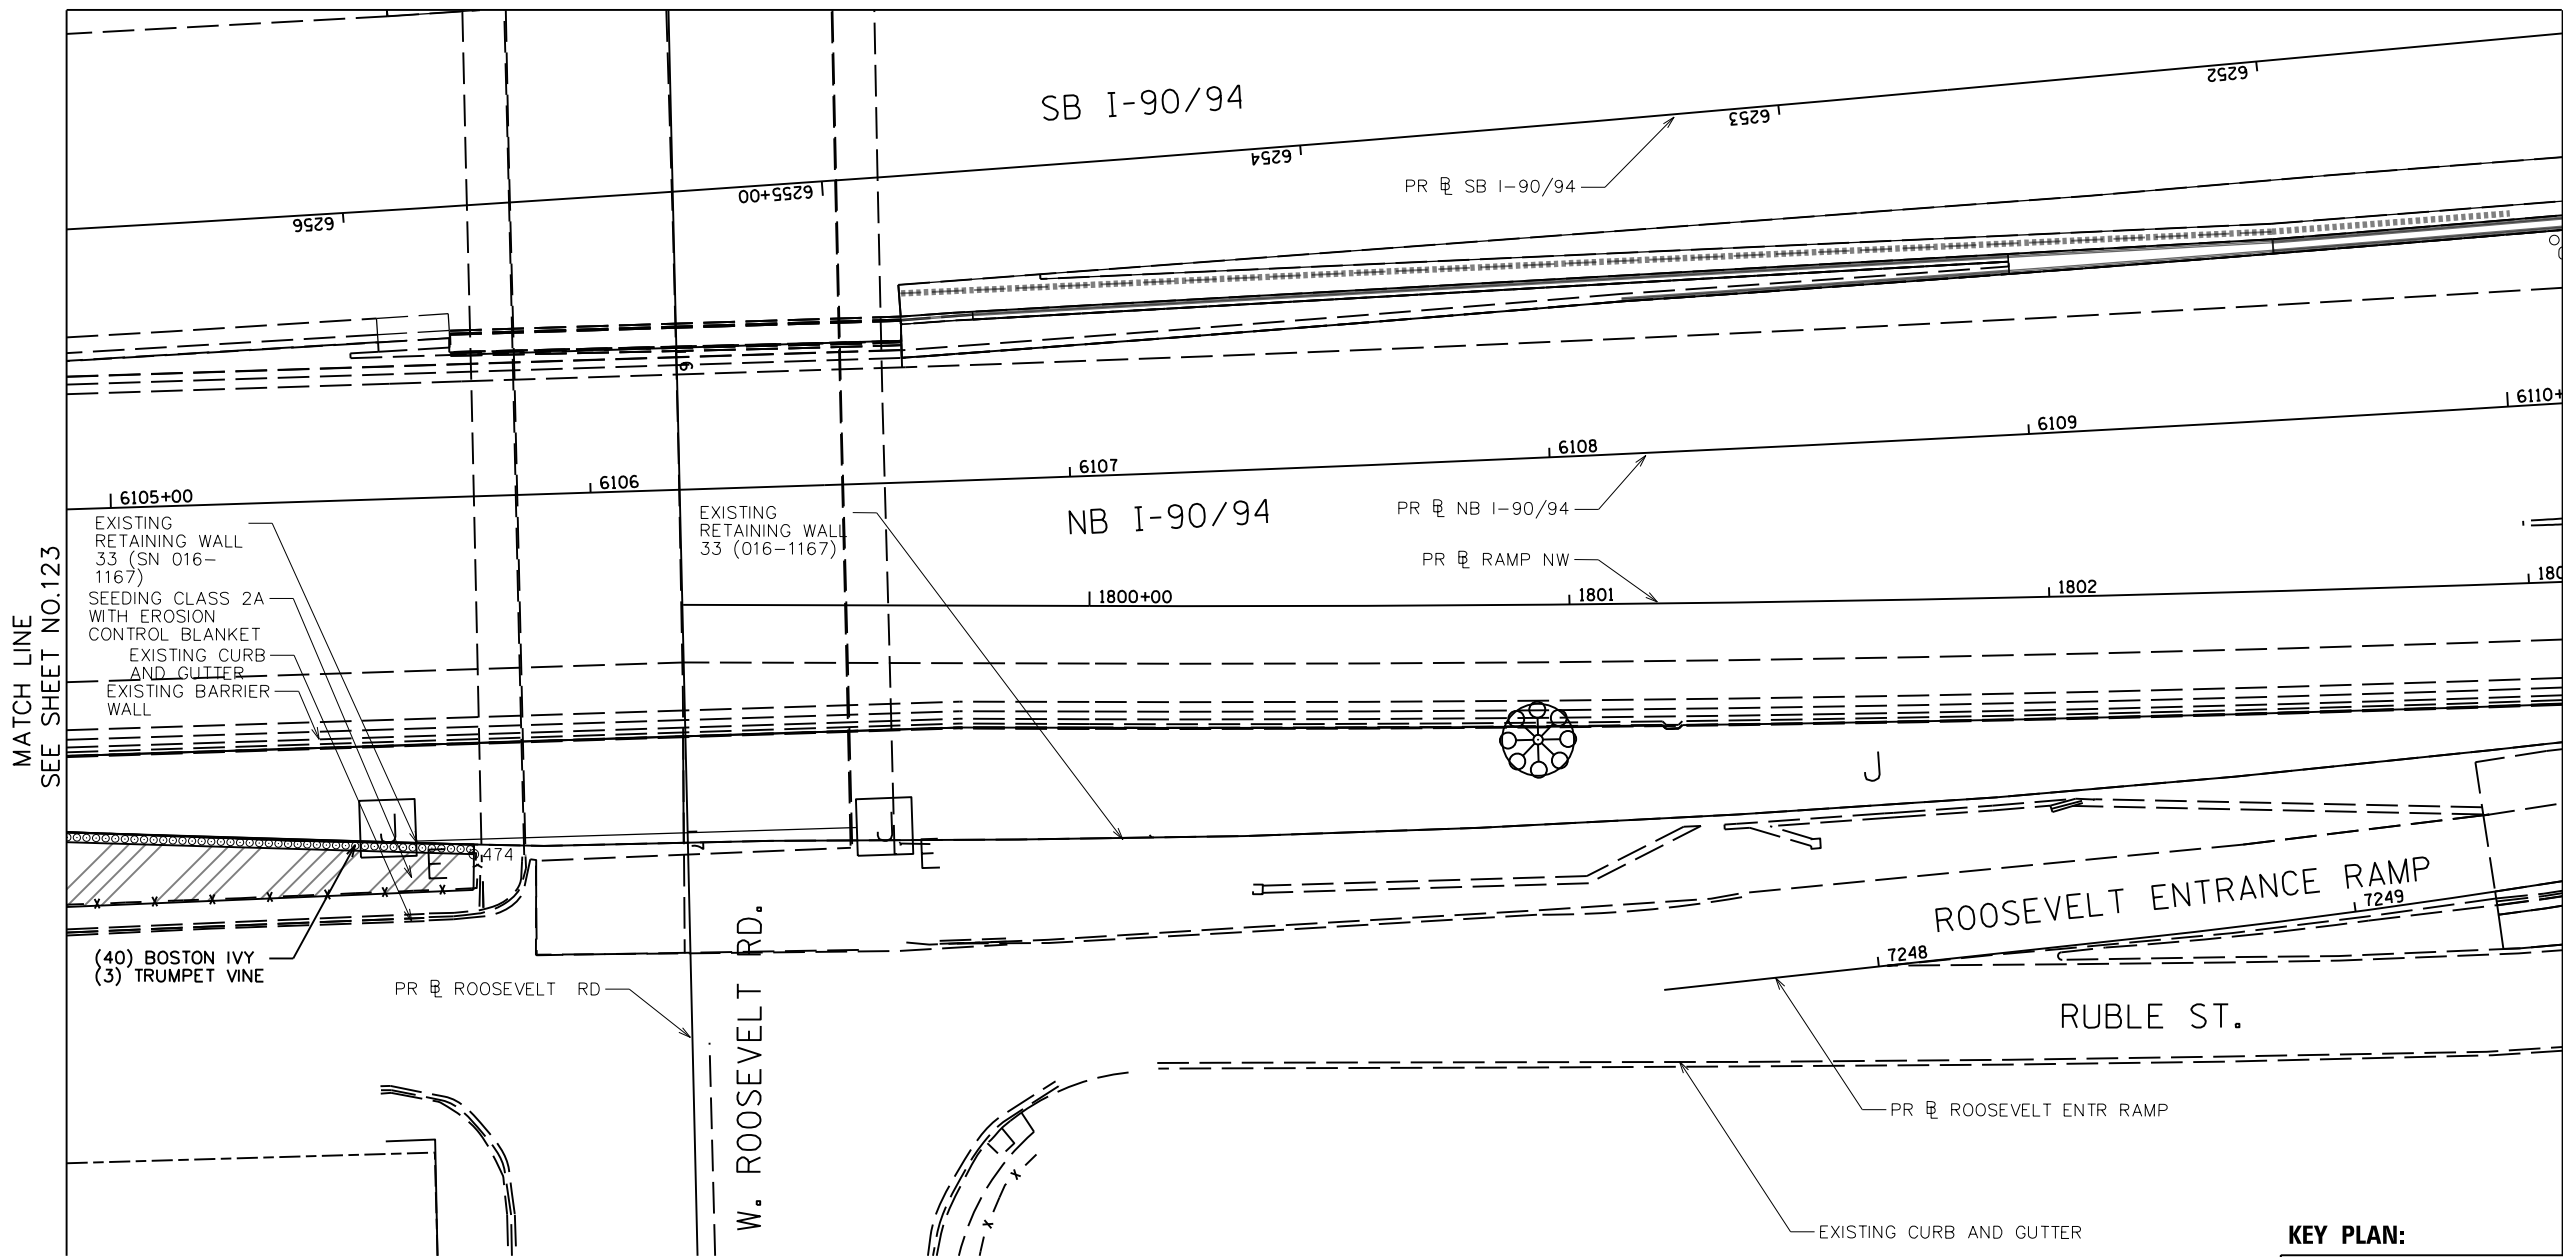


- LEGEND**
- SHADE TREE
 - EVERGREEN TREE
 - UNDERSTORY TREE
 - EXISTING TREE WITH MULCH PLACEMENT AND TREE CARE
 - PERENNIAL/SHRUBS
 - VINE, 1 GALLON POT
 - STONE OUTCROPPING
 - CHAIN LINK FENCE, 6'
 - NATIVE SODDING, SPECIAL
 - SEEDING, CLASS 4A (MODIFIED) WITH EROSION CONTROL BLANKET
 - SEEDING, CLASS 4A (MODIFIED) AND SEEDING, CLASS 5 (MODIFIED) WITH EROSION CONTROL BLANKET
 - SODDING, SALT TOLERANT
 - AGGREGATE SURFACE COURSE
 - STONE RIPRAP, CLASS A4 (SPECIAL)
 - STONE RIPRAP, CLASS A4
 - SEEDING CLASS 2A WITH EROSION CONTROL BLANKET
 - INTERSEEDING, CLASS 4A (MODIFIED) AND INTERSEEDING, CLASS 5 (MODIFIED) WITH MULCH, METHOD 3
 - INTERSEEDING, CLASS 2A
 - PERENNIAL PLANTS, BULB TYPE
 - COORDINATE POINT

- NOTES:**
- SEE SHEET 83 FOR REMOVAL AND EXCAVATION PLAN.
 - ENSURE STONE RIPRAP DOES NOT OBSTRUCT ACCESS TO UTILITY COVERS.

MATCH LINE
SEE SHEET NO. 123

MATCH LINE
SEE SHEET NO. 114

QUANTITY	BOTANIC NAME	COMMON NAME	SIZE	ROOT	REMARKS
VINES:					
3	<i>Campsis radicans</i>	Trumpet Vine	1 gal		25' oc, mulch bed
40	<i>Parthenocissus tricuspidata</i>	Boston Ivy	1 gal		24" oc, mulch bed
43	TOTAL				

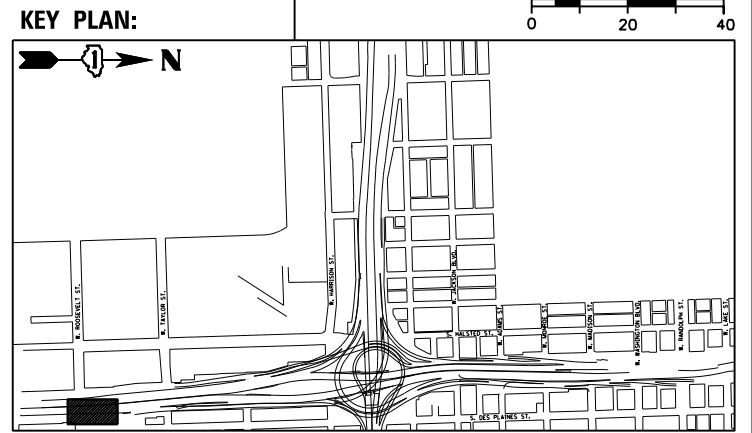

REVISOR: [Symbol] REVISED SHEET 5/27/2022



DESIGNED - BK	REVISOR - [Symbol] 5/20/2022
CHECKED - BM	REVISOR
DRAWN - JT	REVISOR
DATE - 12/04/2020	REVISOR

STATE OF ILLINOIS
DEPARTMENT OF TRANSPORTATION

LANDSCAPE PLANS

SHEET NO. 14 OF 43 SHEETS


F.A.I. RTE.	SECTION	COUNTY	TOTAL SHEETS	SHEET NO.
90/94/290	2014-012L5	COOK	220	124
CONTRACT NO. 60X98				

ILLINOIS FED. AID PROJECT

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- PERENNIAL MIX B, MIXTURE II:
 (700) HARMONEY DWARF IRIS
 (525) JACK SNIPE DAFFODIL
 (500) JET FIRE DAFFODIL
 (500) MINNOW DAFFODIL
 (525) TETE A TETE DAFFODIL
 (500) CYNTHIA TULIP
 (500) HELENE WILDFLOWER TULIP
 (500) FUSILIER TULIP
 (500) FLORENTINE TULIP
 (500) TARDA TULIP

MATCH LINE
 SEE SHEET NO. 117

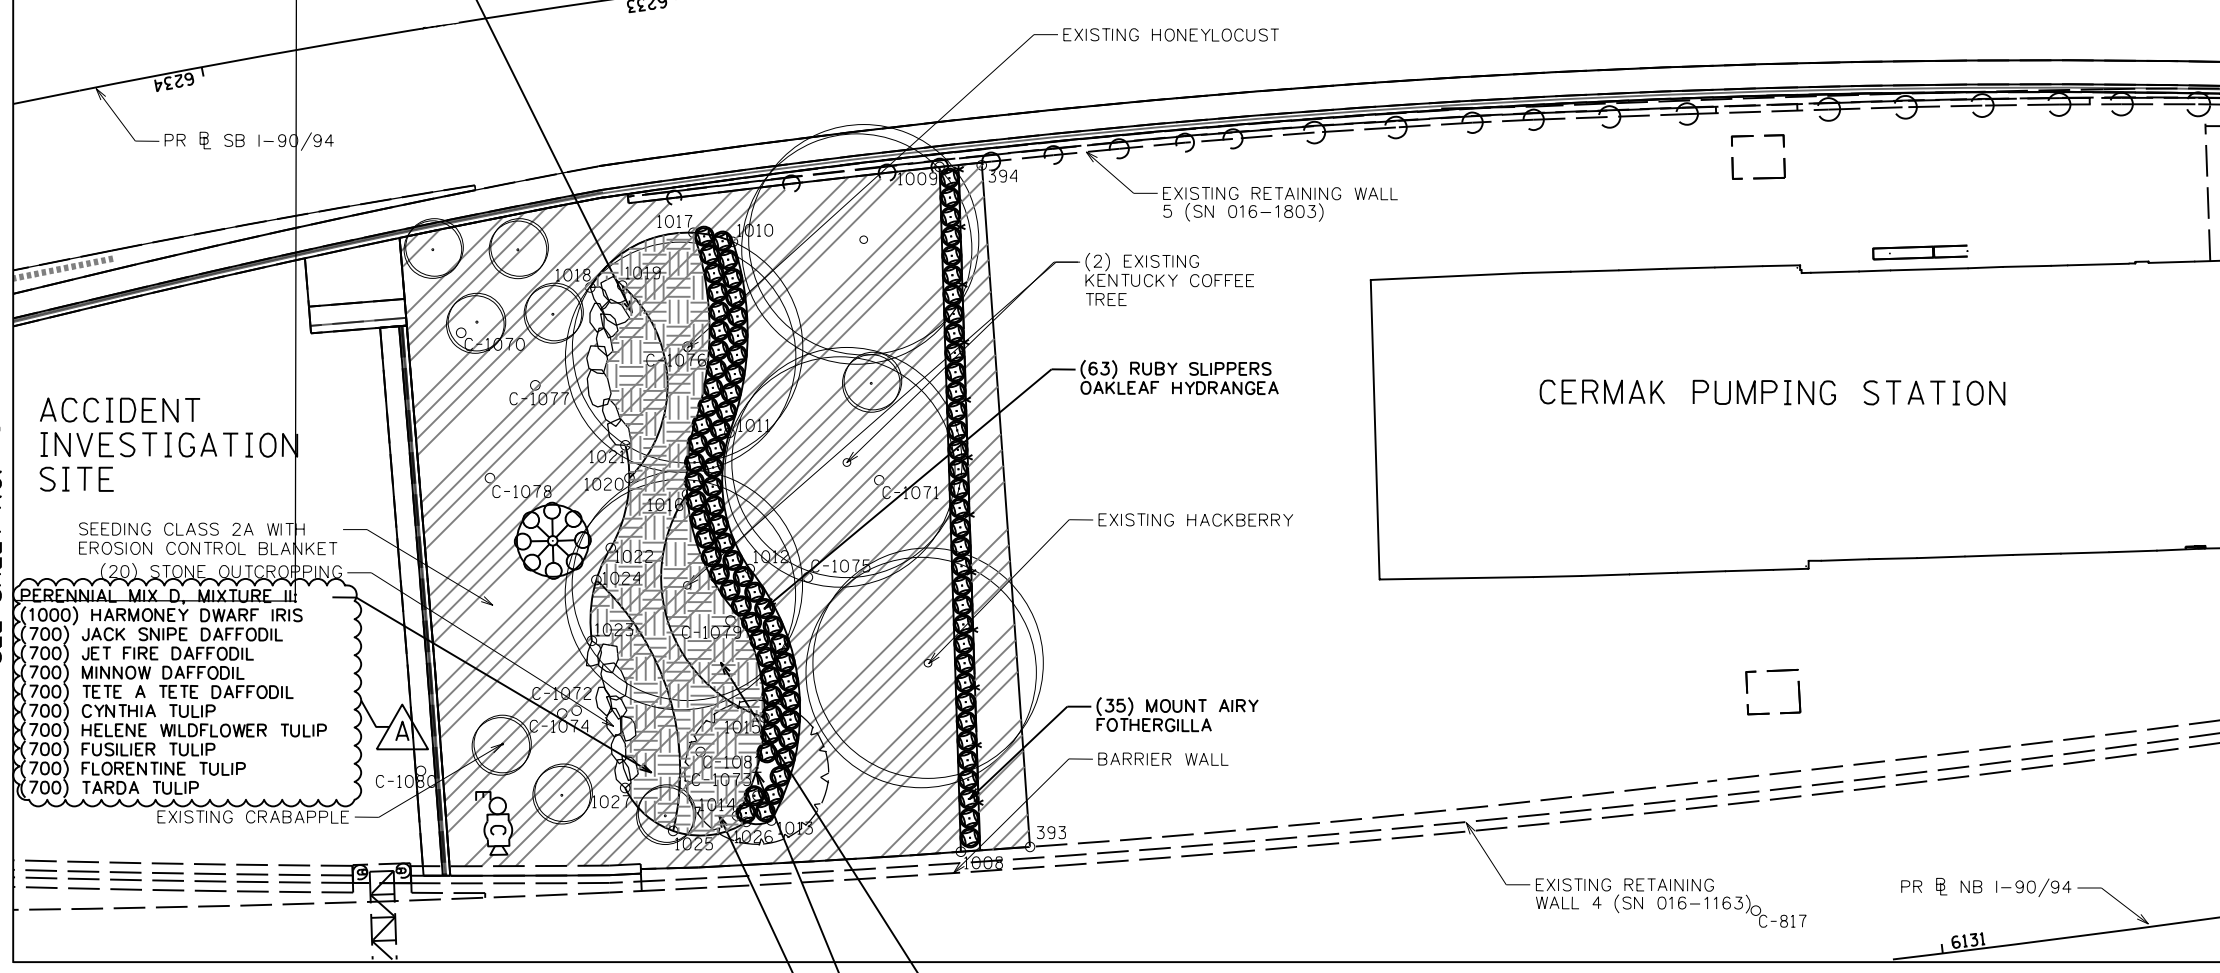

- LEGEND**
- SHADE TREE
 - EVERGREEN TREE
 - UNDERSTORY TREE
 - EXISTING TREE WITH MULCH PLACEMENT AND TREE CARE
 - PERENNIAL/SHRUBS
 - VINE, 1 GALLON POT
 - STONE OUTCROPPING
 - CHAIN LINK FENCE, 6'
 - NATIVE SODDING, SPECIAL
 - SEEDING, CLASS 4A (MODIFIED) WITH EROSION CONTROL BLANKET
 - SEEDING, CLASS 4A (MODIFIED) AND SEEDING, CLASS 5 (MODIFIED) WITH EROSION CONTROL BLANKET
 - SODDING, SALT TOLERANT
 - AGGREGATE SURFACE COURSE
 - STONE RIPRAP, CLASS A4 (SPECIAL)
 - STONE RIPRAP, CLASS A4
 - SEEDING CLASS 2A WITH EROSION CONTROL BLANKET
 - INTERSEEDING, CLASS 4A (MODIFIED) AND INTERSEEDING, CLASS 5 (MODIFIED) WITH MULCH, METHOD 3
 - INTERSEEDING, CLASS 2A
 - PERENNIAL PLANTS, BULB TYPE
 - COORDINATE POINT

- NOTES:**
- SEE SHEET 88 FOR REMOVAL AND EXCAVATION PLAN.
 - ENSURE STONE RIPRAP DOES NOT OBSTRUCT ACCESS TO UTILITY COVERS.

MATCH LINE
 SEE SHEET NO. 118

ACCIDENT INVESTIGATION SITE

- PERENNIAL MIX D, MIXTURE III:
 (1000) HARMONEY DWARF IRIS
 (700) JACK SNIPE DAFFODIL
 (700) JET FIRE DAFFODIL
 (700) MINNOW DAFFODIL
 (700) TETE A TETE DAFFODIL
 (700) CYNTHIA TULIP
 (700) HELENE WILDFLOWER TULIP
 (700) FUSILIER TULIP
 (700) FLORENTINE TULIP
 (700) TARDA TULIP


MATCH LINE
 SEE SHEET NO. 128

- PERENNIAL MIX C, MIXTURE II:
 (1175) HARMONEY DWARF IRIS
 (800) JACK SNIPE DAFFODIL
 (750) JET FIRE DAFFODIL
 (750) MINNOW DAFFODIL
 (800) TETE A TETE DAFFODIL
 (750) CYNTHIA TULIP
 (750) HELENE WILDFLOWER TULIP
 (750) FUSILIER TULIP
 (750) FLORENTINE TULIP
 (750) TARDA TULIP

- PERENNIAL MIX A, MIXTURE I:
 (2650) ROMANCE CROCUS
 (2650) RUBY GIANT CROCUS
 (2650) JEANNE D'ARC CROCUS
 (2650) PICKWICK CROCUS
 (2650) REMEMBRANCE CROCUS
 (2475) BLUE GIANT GLORY OF THE SNOW
 (2475) PINK GIANT GLORY OF THE SNOW
 (4175) GRAPE HYACINTH
 (4175) BLUE SQUILL

QUANTITY	BOTANIC NAME	COMMON NAME	SIZE	ROOT	REMARKS
SHADE TREES:					
1	<i>Quercus muehlenbergii</i>	Chinkapin Oak	2.5" cal	B&B	
SHRUBS:					
35	<i>Fothergilla major 'Mount Airy'</i>	Mount Airy Fothergilla	3 gal	B&B	48" oc, mulch bed
63	<i>Hydrangea quercifolia 'Ruby Slippers'</i>	Ruby Slippers Oakleaf Hydrangea	5 gal		48" oc, mulch bed
98	TOTAL				
BULBS:					
2650	<i>Crocus tommasinianus 'Romance'</i>	Romance Crocus			
2650	<i>Crocus tommasinianus 'Ruby Giant'</i>	Ruby Giant Crocus			
2650	<i>Crocus vernus 'Jeanne D'Arc'</i>	Jeanne D'Arc Crocus			
2650	<i>Crocus vernus 'Pickwick'</i>	Pickwick Crocus			
2650	<i>Crocus vernus 'Remembrance'</i>	Remembrance Crocus			
2475	<i>Chionodoxa forbesii 'Blue Giant'</i>	Blue Giant Glory of the Snow			3" oc, intermixed and planted at a depth of 4"
2475	<i>Chionodoxa forbesii 'Pink Giant'</i>	Pink Giant Glory of the Snow			
4175	<i>Muscari armeniacum</i>	Grape Hyacinth			
4175	<i>Scilla siberica</i>	Blue Squill			
2875	<i>Iris reticulata 'Harmony'</i>	Harmony Dwarf Iris			
2025	<i>Narcissus 'Jack Snipe'</i>	Jack Snipe Daffodil			
1950	<i>Narcissus 'Jet Fire'</i>	Jet Fire Daffodil			
1950	<i>Narcissus 'Minnow'</i>	Minnow Daffodil			
2025	<i>Narcissus 'Tete a Tete'</i>	Tete A Tete Daffodil			
1950	<i>Tulipa clusiana 'Cynthia'</i>	Cynthia Tulip			
1950	<i>Tulipa humilis 'Helene'</i>	Helene Wildflower Tulip			
1950	<i>Tulipa praestans 'Fusilier'</i>	Fusilier Tulip			
1950	<i>Tulipa sylvestris</i>	Florentine Tulip			
1950	<i>Tulipa tarda</i>	Tarda Tulip			
47125	TOTAL				

**PAID FOR AS PERENNIAL PLANTS BULB TYPE, UNIT = 100

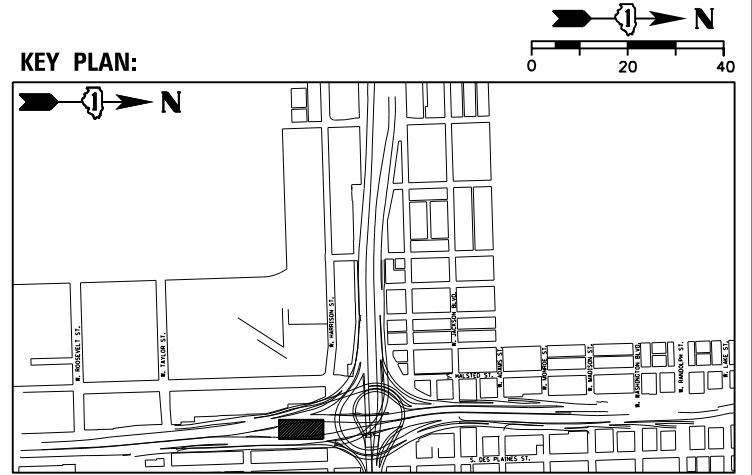

NOTE: MOW TURF WHERE BULBS ARE TO BE INSTALLED AS LOW AS POSSIBLE PRIOR TO INSTALLATION. DO NOT MOW IN THE SPRING UNTIL 6 WEEKS AFTER ALL BULBS HAVE DIED. APPROXIMATELY MID-JUNE AS DIRECTED BY ENGINEER.

REVISOR 5/27/2022



DESIGNED -- BK	REVISOR 5/20/2022
CHECKED -- BM	REVISOR
DRAWN -- JT	REVISOR
DATE -- 12/04/2020	REVISOR

STATE OF ILLINOIS
 DEPARTMENT OF TRANSPORTATION

LANDSCAPE PLANS


SHEET NO. 19 OF 43 SHEETS

F.A.I. RTE. 90/94/290	SECTION 2014-012L5	COUNTY COOK	TOTAL SHEETS 220	SHEET NO. 129
CONTRACT NO. 60X98				


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






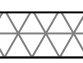
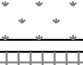
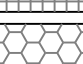
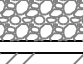
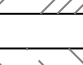
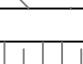

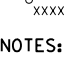
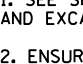
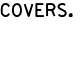


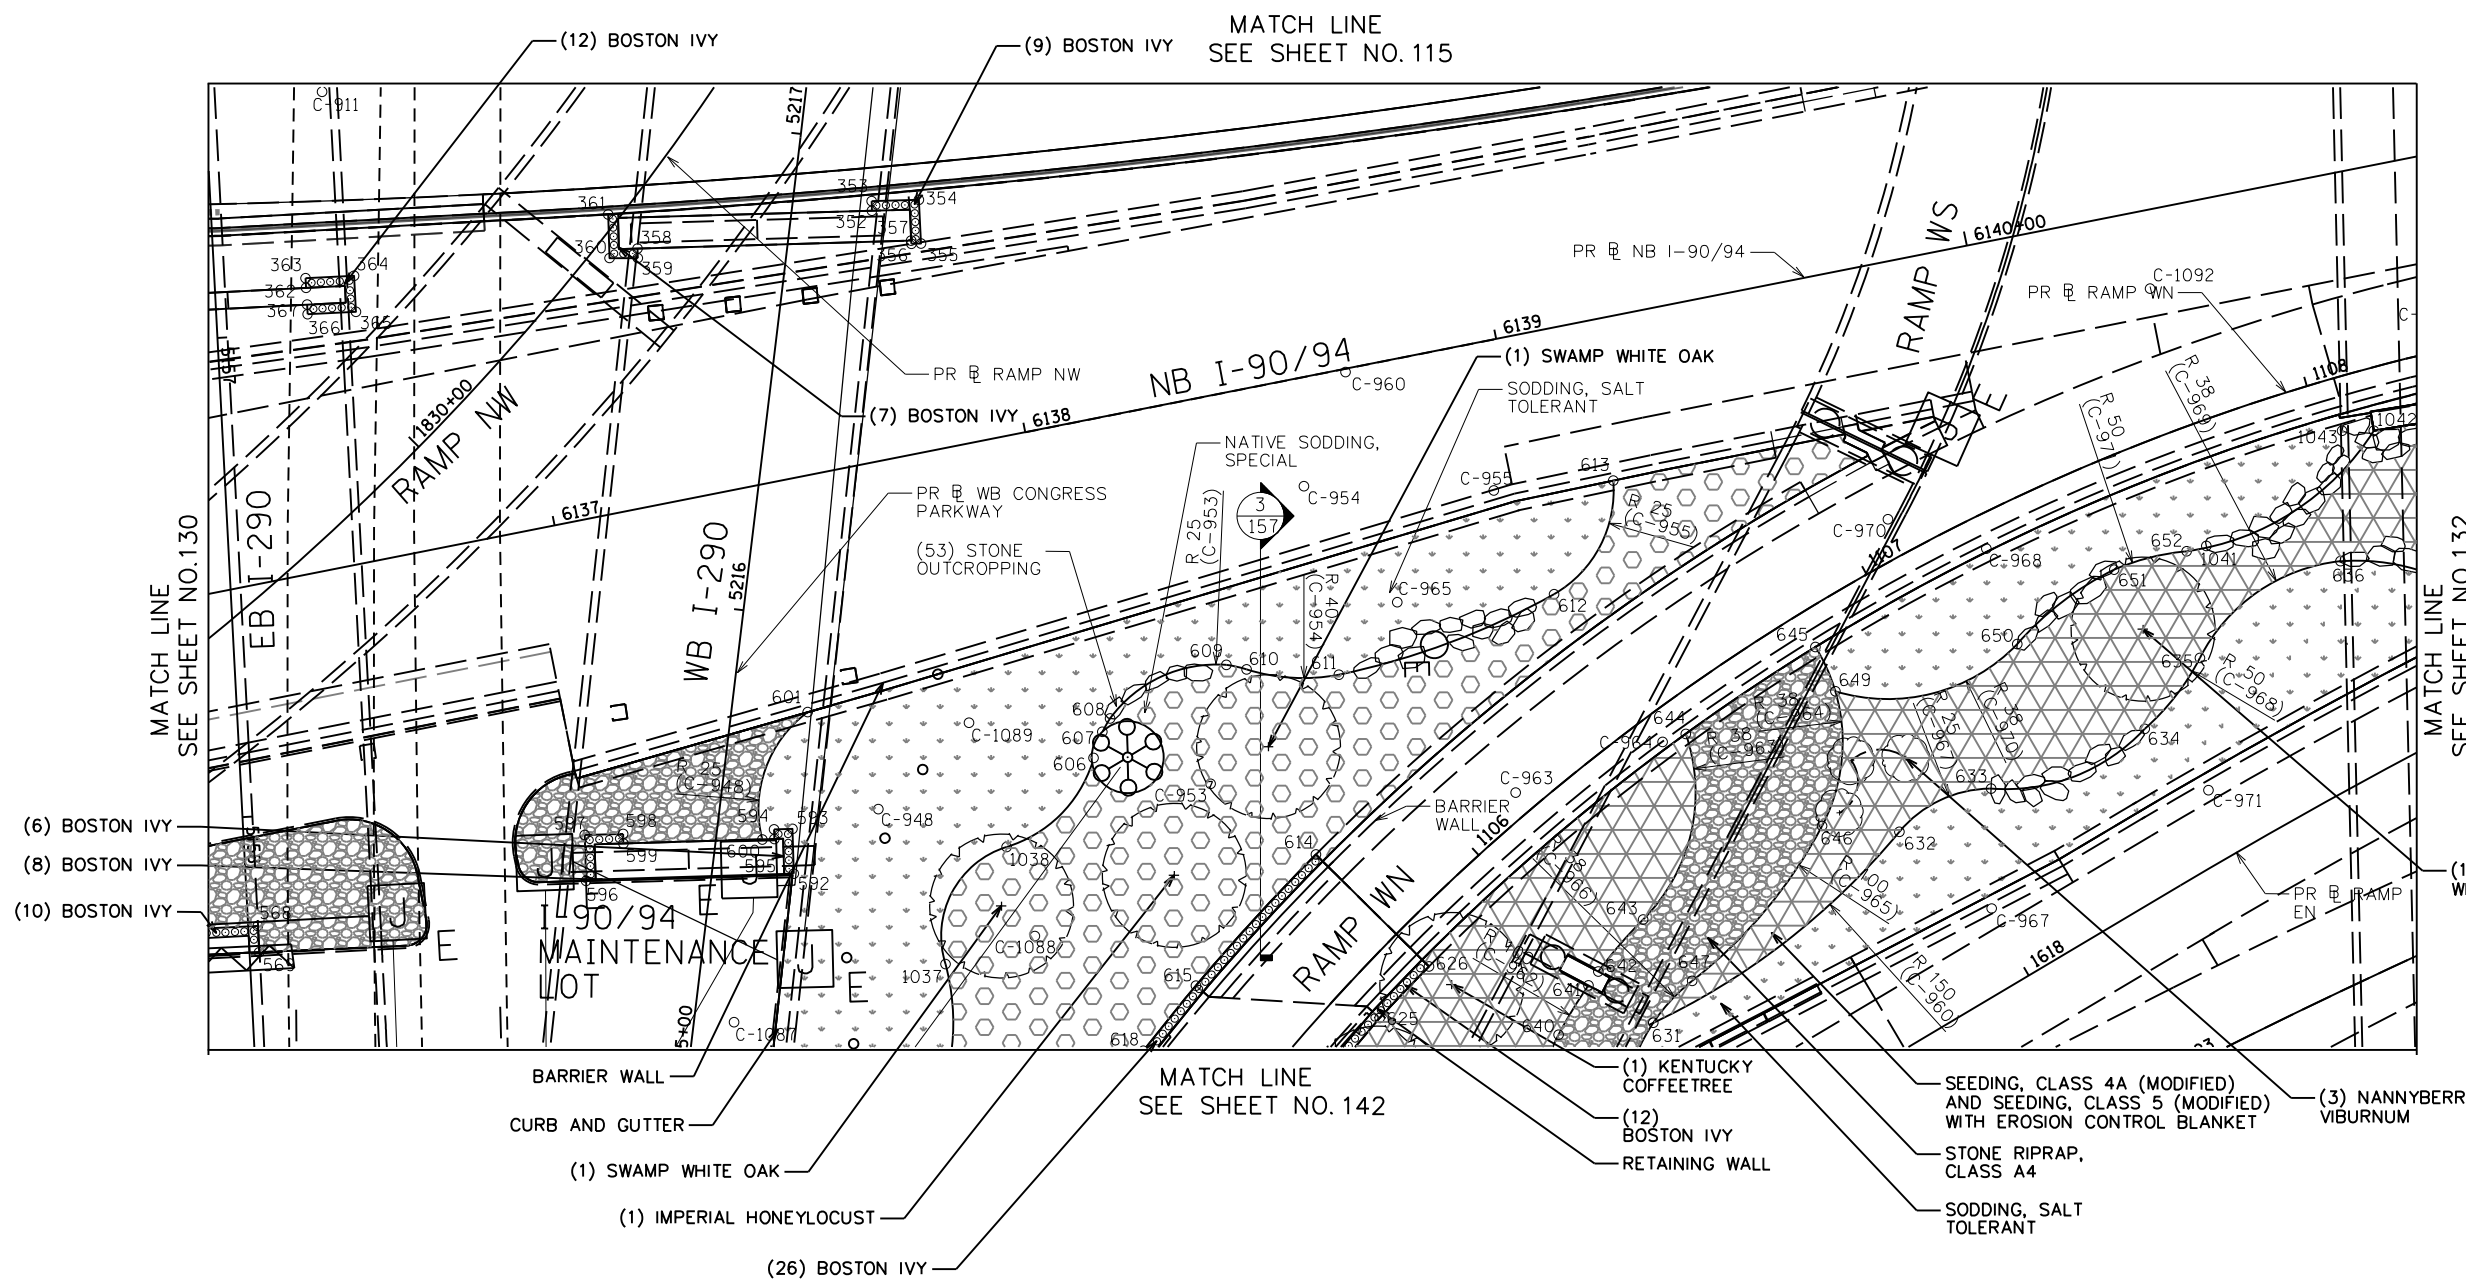
- LEGEND**
- SHADE TREE
 - EVERGREEN TREE
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 - EXISTING TREE WITH MULCH PLACEMENT AND TREE CARE
 - PERENNIAL/SHRUBS
 - VINE, 1 GALLON POT
 - STONE OUTCROPPING
 - CHAIN LINK FENCE, 6'
 - NATIVE SODDING, SPECIAL
 - SEEDING, CLASS 4A (MODIFIED) WITH EROSION CONTROL BLANKET
 - SEEDING, CLASS 4A (MODIFIED) AND SEEDING, CLASS 5 (MODIFIED) WITH EROSION CONTROL BLANKET
 - SODDING, SALT TOLERANT
 - AGGREGATE SURFACE COURSE
 - STONE RIPRAP, CLASS A4 (SPECIAL)
 - STONE RIPRAP, CLASS A4
 - SEEDING CLASS 2A WITH EROSION CONTROL BLANKET
 - INTERSEEDING, CLASS 4A (MODIFIED) AND INTERSEEDING, CLASS 5 (MODIFIED) WITH MULCH, METHOD 3
 - INTERSEEDING, CLASS 2A
 - PERENNIAL PLANTS, BULB TYPE
 - COORDINATE POINT

- NOTES:**
- SEE SHEET 90 FOR REMOVAL AND EXCAVATION PLAN.
 - ENSURE STONE RIPRAP DOES NOT OBSTRUCT ACCESS TO UTILITY COVERS.


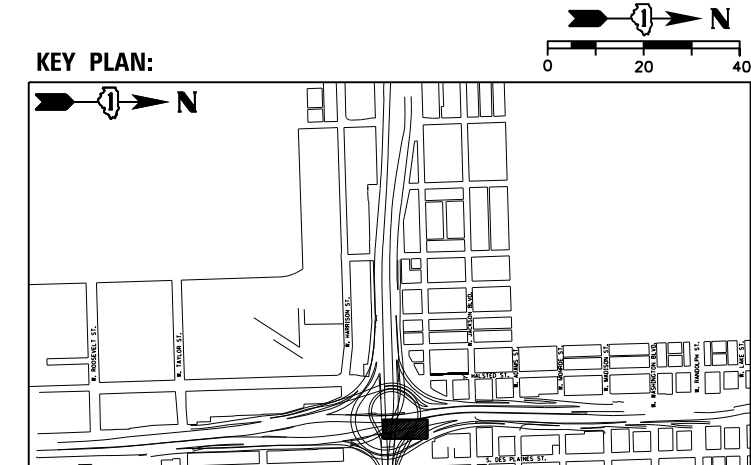


QUANTITY	BOTANIC NAME	COMMON NAME	SIZE	ROOT	REMARKS
SHADE TREES:					
1	<i>Gleditsia triacanthos</i> va. <i>inermis</i> 'Imperial'	Imperial Honeylocust	3" cal	B&B	
1	<i>Gymnocladus dioica</i>	Kentucky Coffeetree	2.5" cal	B&B	
3	<i>Quercus bicolor</i>	Swamp White Oak	2.5" cal	B&B	
5	TOTAL				
SHRUBS:					
3	<i>Viburnum lentago</i>	Nannyberry Viburnum	6' Ht	B&B	
VINES:					
90	<i>Parthenocissus tricuspidata</i>	Boston Ivy	1 gal		24" oc, mulch bed

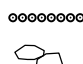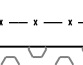

- LEGEND**
-  SHADE TREE
 -  EVERGREEN TREE
 -  UNDERSTORY TREE
 -  EXISTING TREE WITH MULCH PLACEMENT AND TREE CARE
 -  PERENNIAL/SHRUBS
 -  VINE, 1 GALLON POT
 -  STONE OUTCROPPING
 -  CHAIN LINK FENCE, 6'
 -  NATIVE SODDING, SPECIAL
 -  SEEDING, CLASS 4A (MODIFIED) WITH EROSION CONTROL BLANKET
 -  SEEDING, CLASS 4A (MODIFIED) AND SEEDING, CLASS 5 (MODIFIED) WITH EROSION CONTROL BLANKET
 -  SODDING, SALT TOLERANT
 -  AGGREGATE SURFACE COURSE
 -  STONE RIPRAP, CLASS A4 (SPECIAL)
 -  STONE RIPRAP, CLASS A4
 -  SEEDING CLASS 2A WITH EROSION CONTROL BLANKET
 -  INTERSEEDING, CLASS 4A (MODIFIED) AND INTERSEEDING, CLASS 5 (MODIFIED) WITH MULCH, METHOD 3
 -  INTERSEEDING, CLASS 2A
 -  PERENNIAL PLANTS, BULB TYPE
 -  COORDINATE POINT

- NOTES:**
1. SEE SHEET 96 FOR REMOVAL AND EXCAVATION PLAN.
 2. ENSURE STONE RIPRAP DOES NOT OBSTRUCT ACCESS TO UTILITY COVERS.

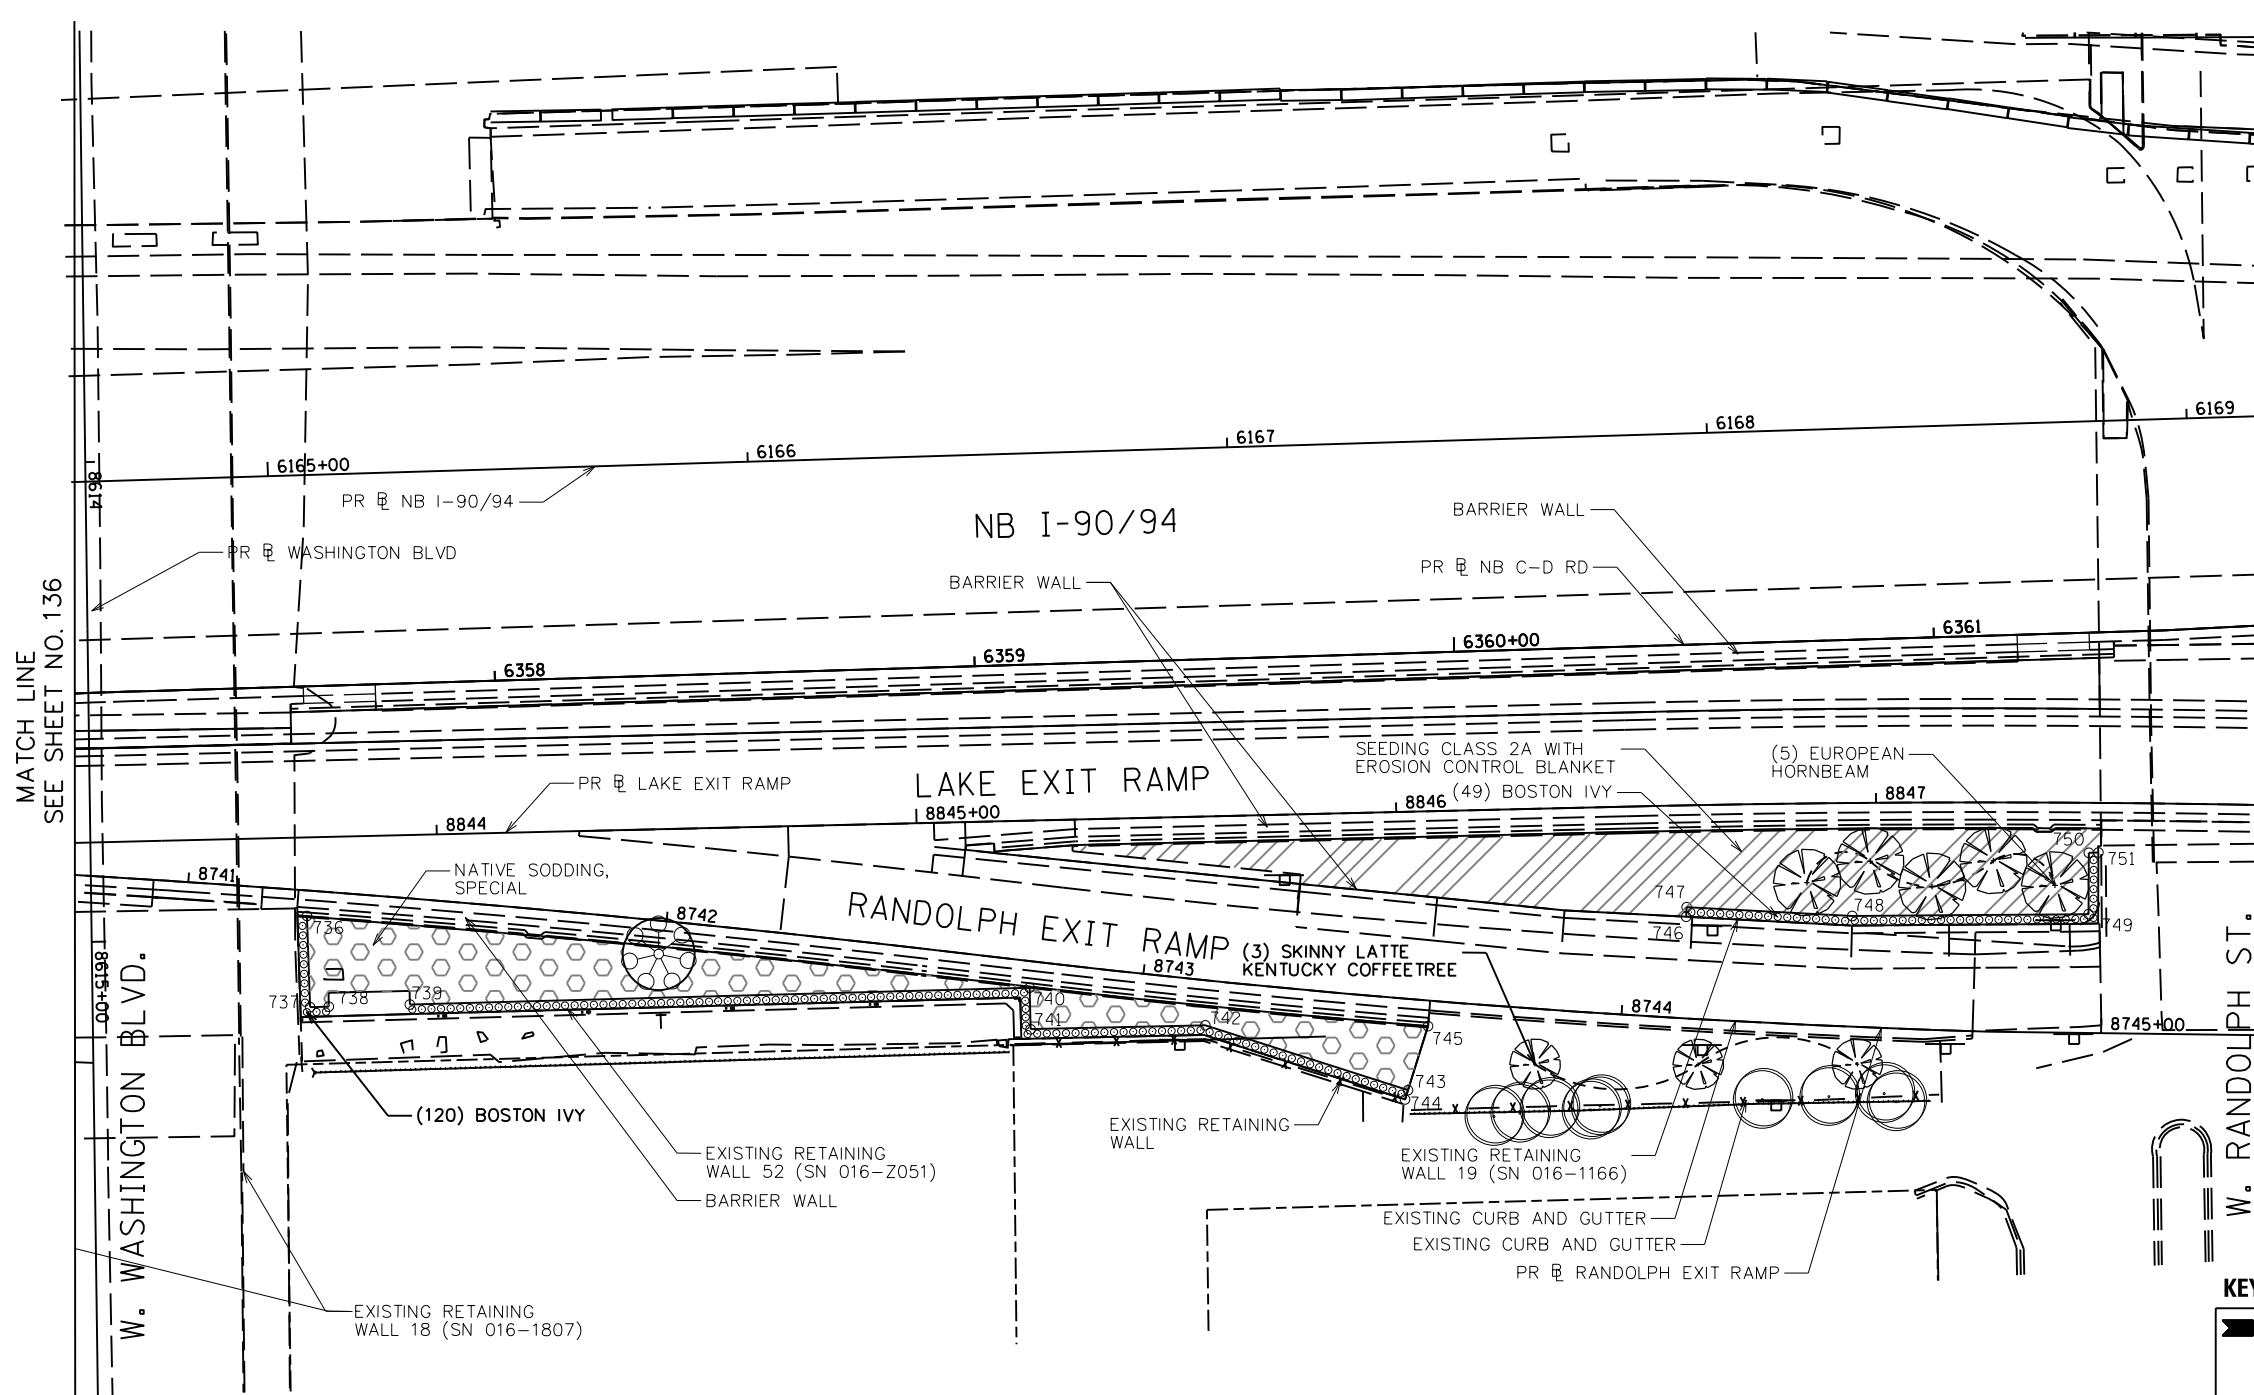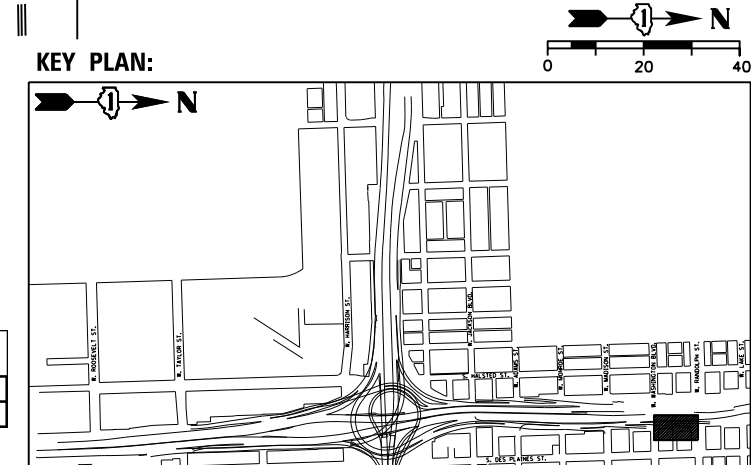

QUANTITY	BOTANIC NAME	COMMON NAME	SIZE	ROOT	REMARKS
UNDERSTORY TREES:					
3	<i>Gymnocladus dioica</i> 'Skinny Latte'	Skinny Latte Kentucky Coffeetree	2.5" cal	B&B	
5	<i>Carpinus betulus</i>	European Hornbeam	2" cal	B&B	
8	TOTAL				
VINES:					
169	<i>Parthenocissus tricuspidata</i>	Boston Ivy	1 gal		24" oc, mulch bed

NOTE: CONTRACTOR TO PROVIDE THE FOLLOWING PLANTS. PLANTS TO BE LOCATED IN THE FIELD BY ROADSIDE DEVELOPMENT UNIT.

QUANTITY	BOTANIC NAME	COMMON NAME	SIZE	ROOT	REMARKS
VINES:					
100	<i>Parthenocissus quinquefolia</i> 'Engelmannii'	Engelman's Virginia Creeper	1 gal		24" oc, mulch bed

Site

USER NAME = SG	DESIGNED -- BK	REVISED A 5/20/2022
PLOT SCALE = 1:20	CHECKED -- BM	REVISED
PLOT DATE = 12/04/2020	DRAWN -- JT	REVISED
	DATE -- 12/04/2020	REVISED

STATE OF ILLINOIS
DEPARTMENT OF TRANSPORTATION


LANDSCAPE PLANS

REVISION: REVISED SHEET 5/27/2022

SHEET NO. 27 OF 43 SHEETS

F.A.I. RTE.	SECTION	COUNTY	TOTAL SHEETS	SHEET NO.
90/94/290	2014-012L5	COOK	220	137
CONTRACT NO. 60X98				
ILLINOIS FED. AID PROJECT				

MATCH LINE SEE SHEET NO. 149

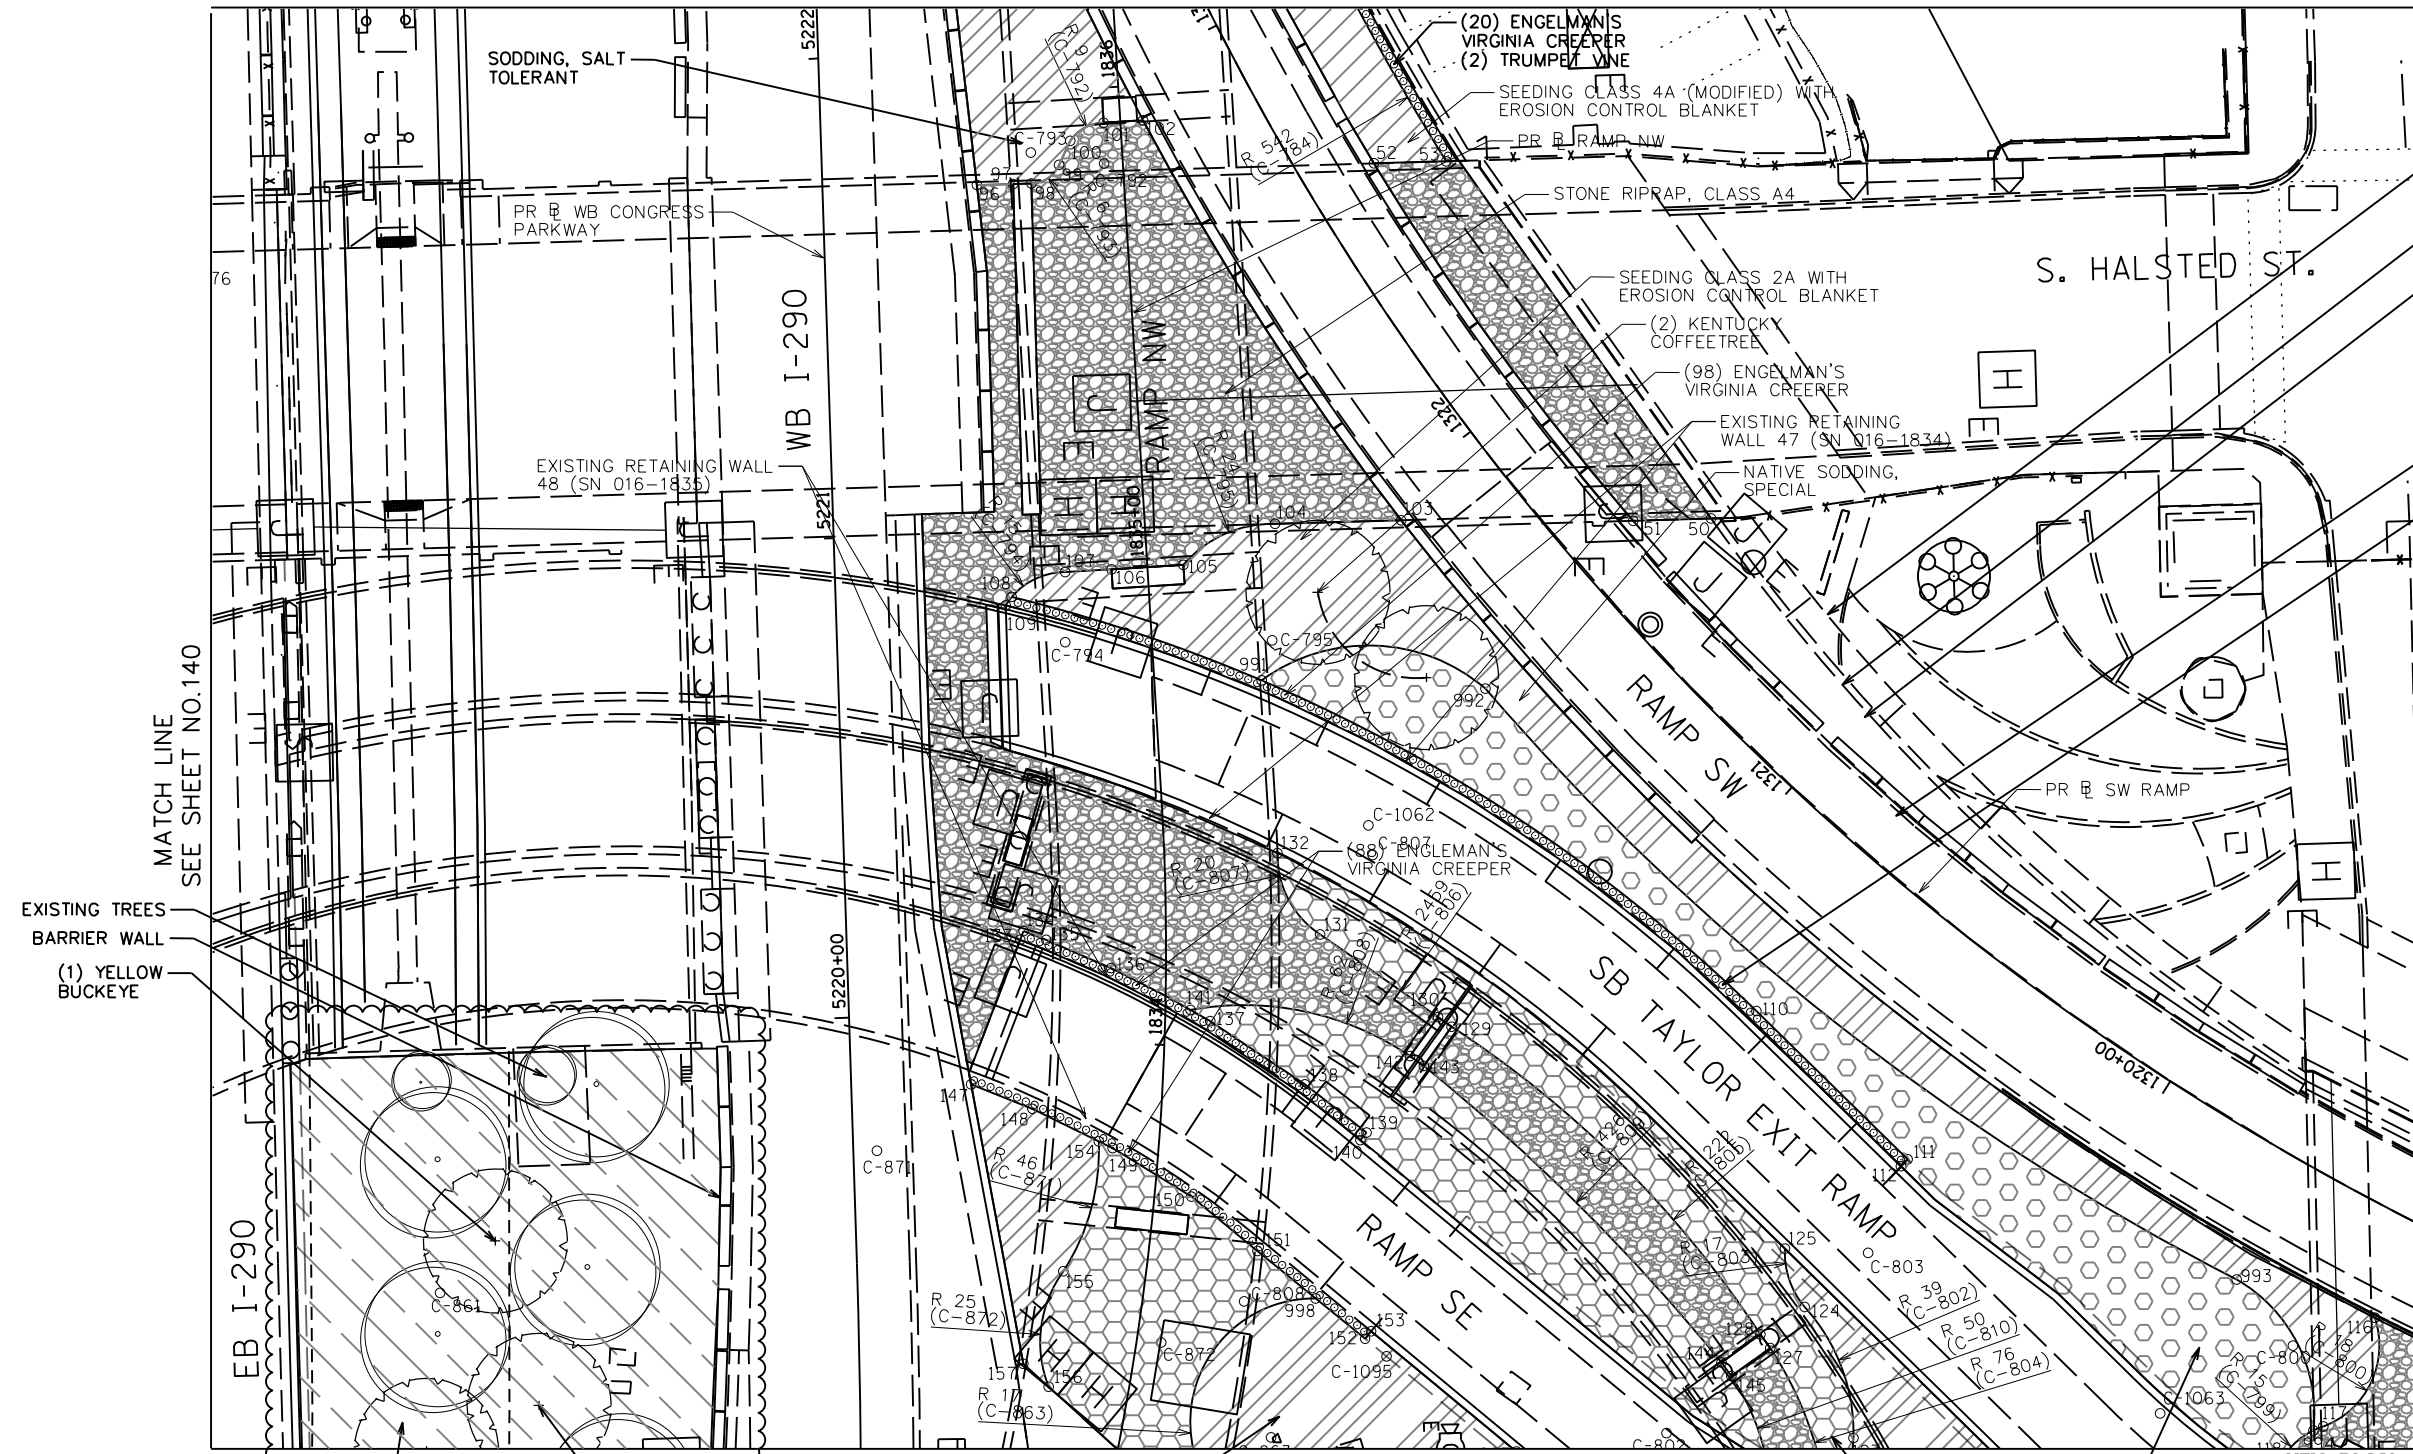


LEGEND

- SHADE TREE
- EVERGREEN TREE
- UNDERSTORY TREE
- EXISTING TREE WITH MULCH PLACEMENT AND TREE CARE
- PERENNIAL/SHRUBS
- VINE, 1 GALLON POT
- STONE OUTCROPPING
- CHAIN LINK FENCE, 6'
- NATIVE SODDING, SPECIAL
- SEEDING, CLASS 4A (MODIFIED) WITH EROSION CONTROL BLANKET
- SEEDING, CLASS 4A (MODIFIED) AND SEEDING, CLASS 5 (MODIFIED) WITH EROSION CONTROL BLANKET
- SODDING, SALT TOLERANT
- AGGREGATE SURFACE COURSE
- STONE RIPRAP, CLASS A4 (SPECIAL)
- STONE RIPRAP, CLASS A4
- SEEDING CLASS 2A WITH EROSION CONTROL BLANKET
- INTERSEEDING, CLASS 4A (MODIFIED) AND INTERSEEDING, CLASS 5 (MODIFIED) WITH MULCH, METHOD 3
- INTERSEEDING, CLASS 2A
- PERENNIAL PLANTS, BULB TYPE
- COORDINATE POINT

NOTES:

1. SEE SHEET 98 FOR REMOVAL AND EXCAVATION PLAN.
2. ENSURE STONE RIPRAP DOES NOT OBSTRUCT ACCESS TO UTILITY COVERS.

KEY PLAN:

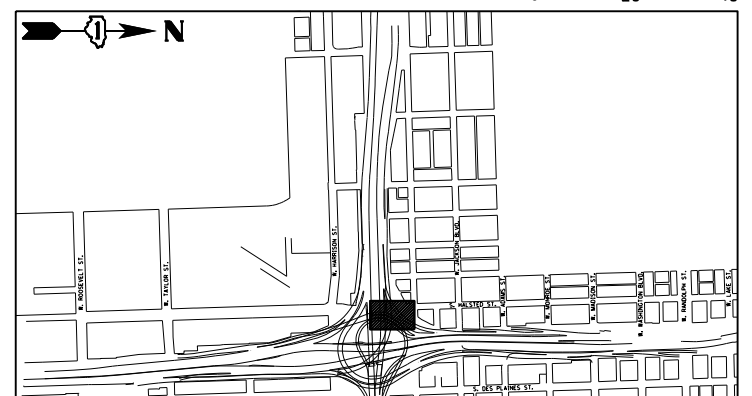

INTERSEEDING, CLASS 4A (MODIFIED) AND INTERSEEDING, CLASS 5 (MODIFIED) WITH MULCH, METHOD 3

(1) WHITE SHIELD OSAGE ORANGE

SEEDING, CLASS 2A WITH EROSION CONTROL BLANKET

MATCH LINE SEE SHEET NO. 115

NATIVE SODDING, SPECIAL
STONE RIPRAP, CLASS A4 (SPECIAL)

QUANTITY	BOTANIC NAME	COMMON NAME	SIZE	ROOT	REMARKS
SHADE TREES:					
1	<i>Aesculus flava</i>	Yellow Buckeye	3" cal	B&B	
2	<i>Gymnocladus dioica</i>	Kentucky Coffeetree	2.5" cal	B&B	
UNDERSTORY TREES:					
1	<i>Maclura pomifera 'White Shield'</i>	White Shield Osage Orange	2" cal	B&B	
4	TOTAL				
VINES:					
2	<i>Campsis radicans</i>	Trumpet Vine	1 gal		25' oc, mulch bed
85	<i>Parthenocissus tricuspidata</i>	Boston Ivy	1 gal		24" oc, mulch bed
206	<i>Parthenocissus quinquefolia 'Engelmanni'</i>	Engelman's Virginia Creeper	1 gal		24" oc, mulch bed
6	<i>Wisteria macrostachya 'Betty Mathews'</i>	First Editions Summer Cascade Wisteria	2 gal		field located, mulch bed
299	TOTAL				

REVISD SHEET 5/27/2022



DESIGNED	- BK	REVISED	5/20/2022
CHECKED	- BM	REVISED	
DRAWN	- JT	REVISED	
DATE	- 12/04/2020	REVISED	

STATE OF ILLINOIS
DEPARTMENT OF TRANSPORTATION


LANDSCAPE PLANS

SHEET NO. 29 OF 43 SHEETS

F.A.I. RTE.	SECTION	COUNTY	TOTAL SHEETS	SHEET NO.
90/94/290	2014-012L5	COOK	220	139
CONTRACT NO. 60X98				

ILLINOIS FED. AID PROJECT


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- LEGEND**
- SHADE TREE
 - EVERGREEN TREE
 - UNDERSTORY TREE
 - EXISTING TREE WITH MULCH PLACEMENT AND TREE CARE
 - PERENNIAL/SHRUBS
 - VINE, 1 GALLON POT
 - STONE OUTCROPPING
 - CHAIN LINK FENCE, 6'
 - NATIVE SODDING, SPECIAL
 - SEEDING, CLASS 4A (MODIFIED) WITH EROSION CONTROL BLANKET
 - SEEDING, CLASS 4A (MODIFIED) AND SEEDING, CLASS 5 (MODIFIED) WITH EROSION CONTROL BLANKET
 - SODDING, SALT TOLERANT
 - AGGREGATE SURFACE COURSE
 - STONE RIPRAP, CLASS A4 (SPECIAL)
 - STONE RIPRAP, CLASS A4
 - SEEDING CLASS 2A WITH EROSION CONTROL BLANKET
 - INTERSEEDING, CLASS 4A (MODIFIED) AND INTERSEEDING, CLASS 5 (MODIFIED) WITH MULCH, METHOD 3
 - INTERSEEDING, CLASS 2A
 - PERENNIAL PLANTS, BULB TYPE
 - COORDINATE POINT

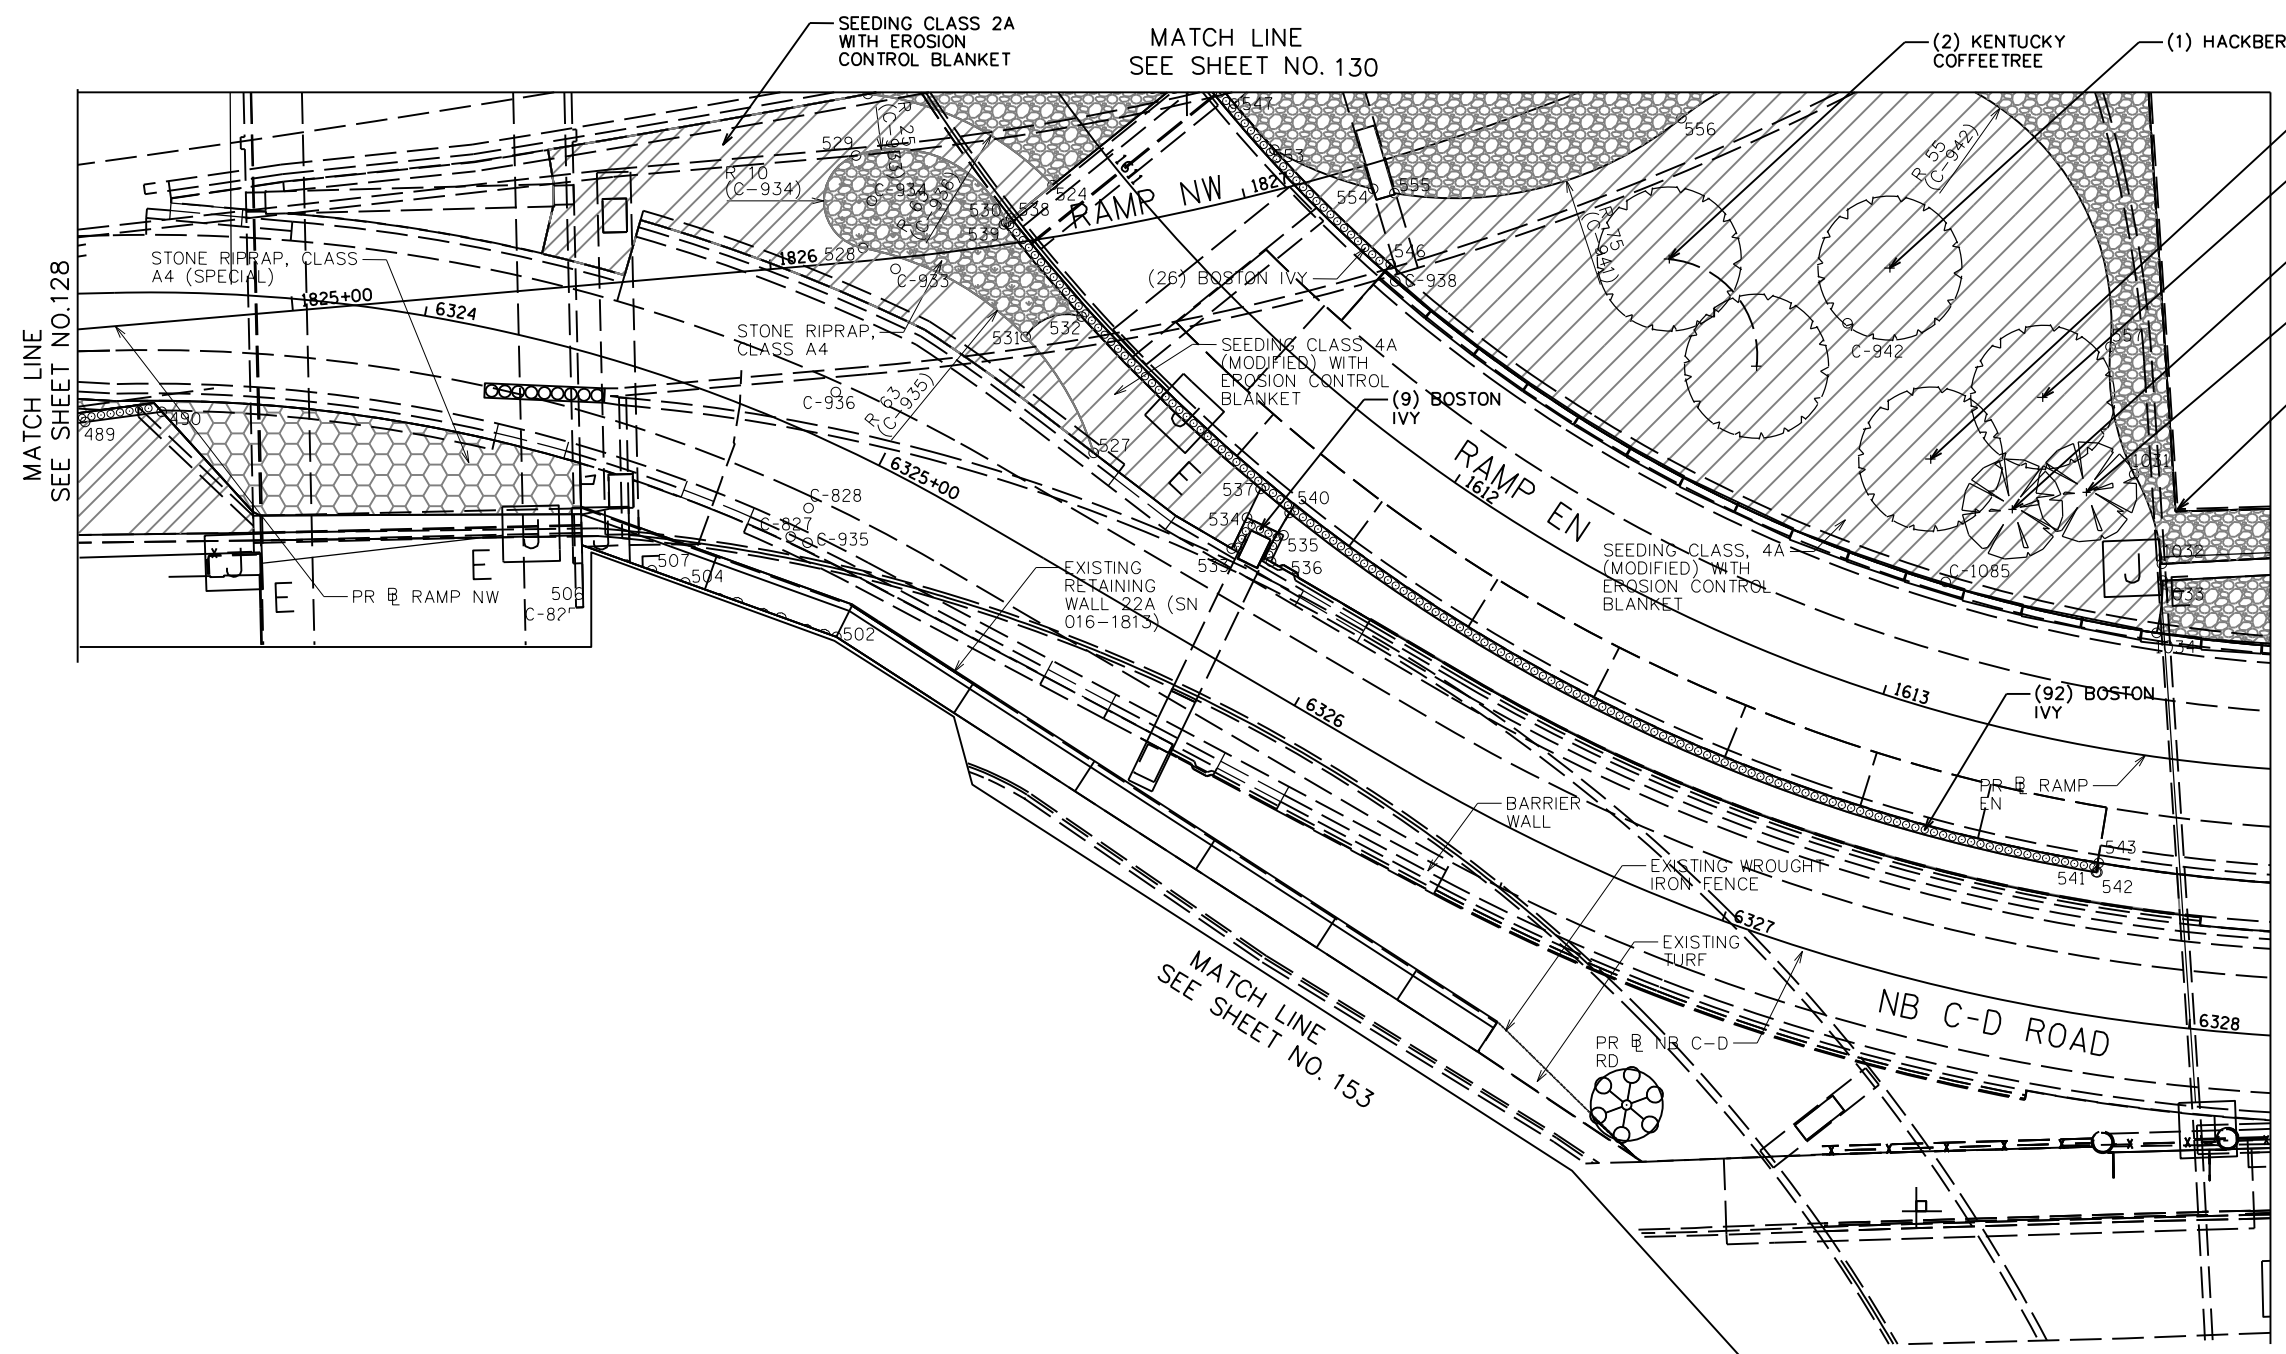NOTES:

- SEE SHEET 100 FOR REMOVAL AND EXCAVATION PLAN.
- ENSURE STONE RIPRAP DOES NOT OBSTRUCT ACCESS TO UTILITY COVERS.



QUANTITY	BOTANIC NAME	COMMON NAME	SIZE	ROOT	REMARKS
SHADE TREES:					
1	<i>Celtis occidentalis</i>	Hackberry	2.5" cal	B&B	
2	<i>Gymnocladus dioica</i>	Kentucky Coffeetree	2.5" cal	B&B	
1	<i>Quercus macrocarpa</i>	Bur Oak	2.5" cal	B&B	
1	<i>Ulmus americana</i>	Princeton Elm	2.5" cal	B&B	
UNDERSTORY TREES:					
1	<i>Prunus virginiana</i> 'Canada Red'	Canada Red Chokecherry	2" cal	B&B	
1	<i>Syringa reticulata</i> 'Ivory Silk'	Ivory Silk Japanese Tree Lilac	8" HT	B&B	
7	TOTAL				
VINES:					
127	<i>Parthenocissus tricuspidata</i>	Boston Ivy	1 gal		24" oc. mulch bed

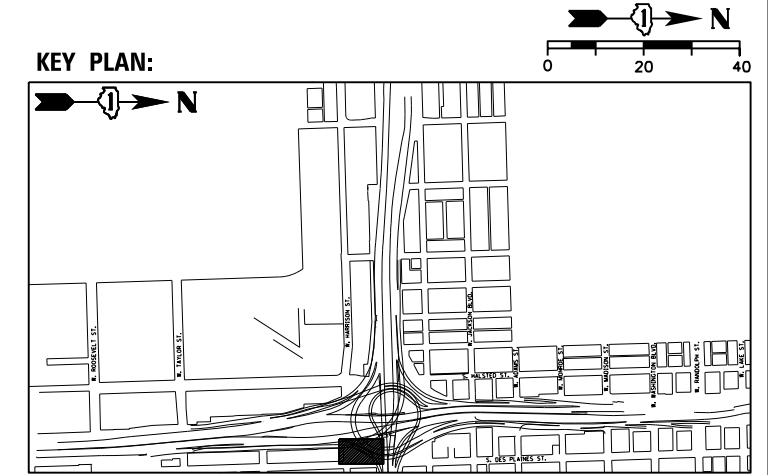REVISD SHEET 5/27/2022



USER NAME = SG	DESIGNED -- BK	REVISED A 5/20/2022
PLOT SCALE = 1:20	CHECKED -- BM	REVISED
PLOT DATE = 12/04/2020	DRAWN -- JT	REVISED
	DATE -- 12/04/2020	REVISED

STATE OF ILLINOIS
DEPARTMENT OF TRANSPORTATION


LANDSCAPE PLANS

SHEET NO. 31 OF 43 SHEETS

F.A.I. RTE.	SECTION	COUNTY	TOTAL SHEETS	SHEET NO.
90/94/290	2014-012L5	COOK	220	141
CONTRACT NO. 60X98				

ILLINOIS FED. AID PROJECT

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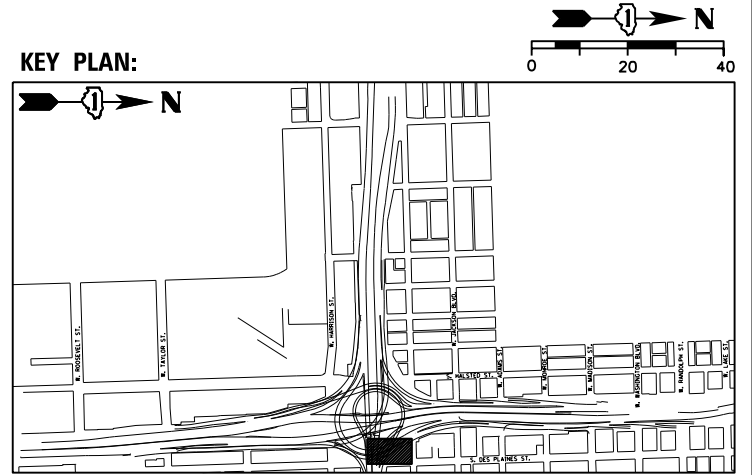


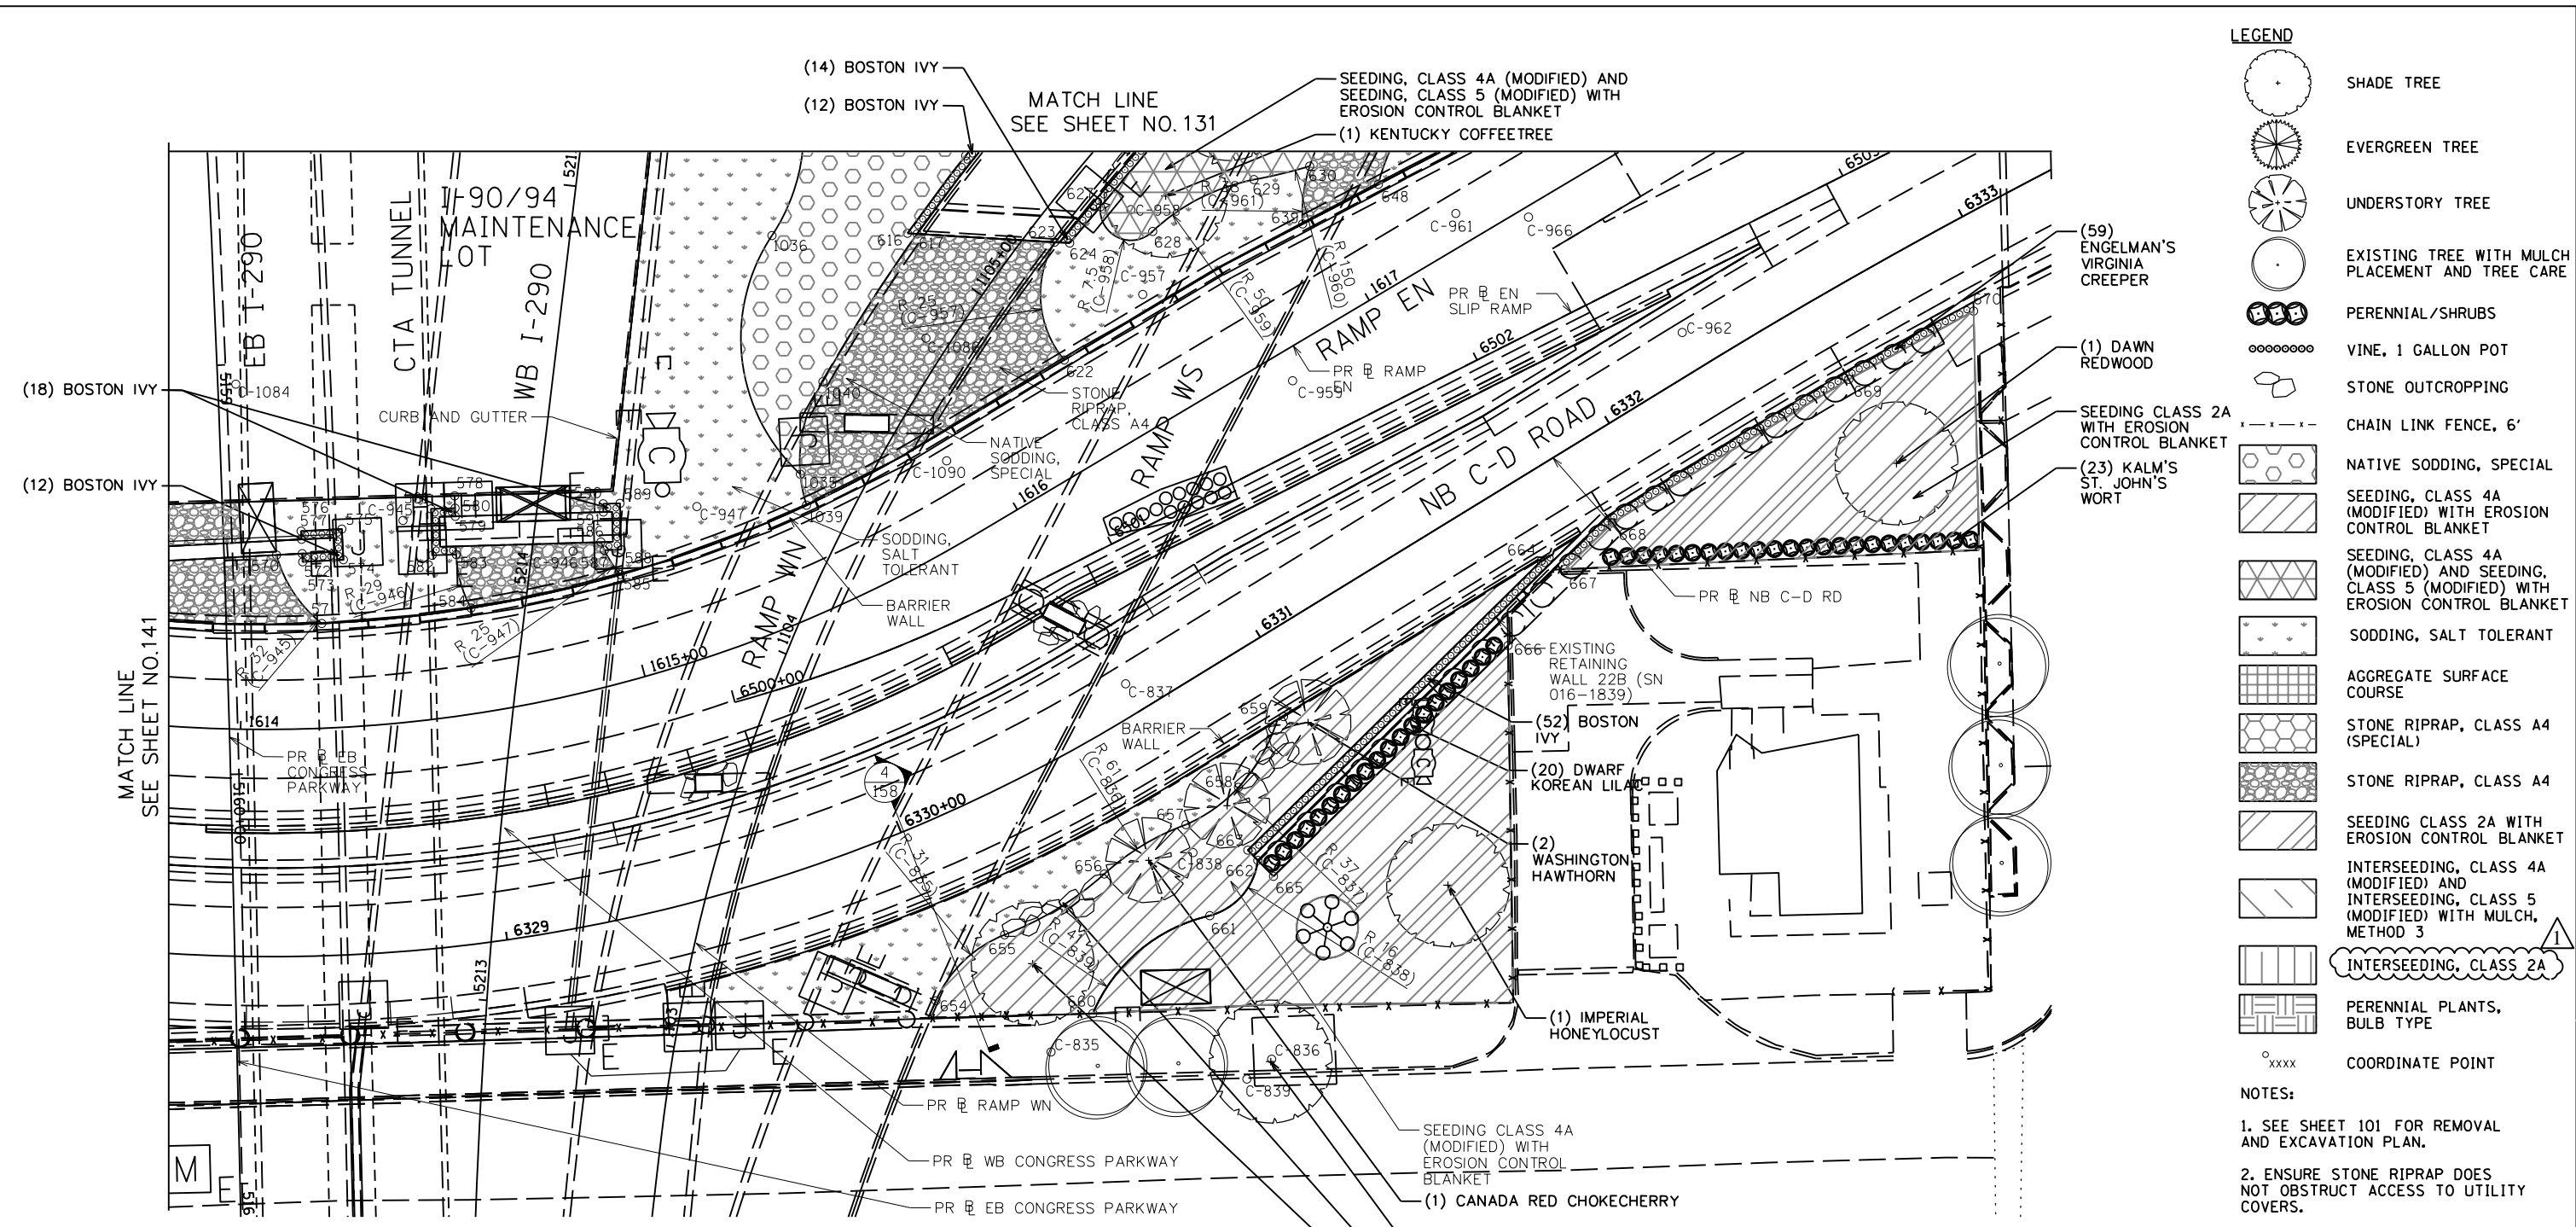- LEGEND**
- SHADE TREE
 - EVERGREEN TREE
 - UNDERSTORY TREE
 - EXISTING TREE WITH MULCH PLACEMENT AND TREE CARE
 - PERENNIAL/SHRUBS
 - VINE, 1 GALLON POT
 - STONE OUTCROPPING
 - CHAIN LINK FENCE, 6'
 - NATIVE SOODING, SPECIAL
 - SEEDING, CLASS 4A (MODIFIED) WITH EROSION CONTROL BLANKET
 - SEEDING, CLASS 4A (MODIFIED) AND SEEDING, CLASS 5 (MODIFIED) WITH EROSION CONTROL BLANKET
 - SODDING, SALT TOLERANT
 - AGGREGATE SURFACE COURSE
 - STONE RIPRAP, CLASS A4 (SPECIAL)
 - STONE RIPRAP, CLASS A4
 - SEEDING CLASS 2A WITH EROSION CONTROL BLANKET
 - INTERSEEDING, CLASS 4A (MODIFIED) AND INTERSEEDING, CLASS 5 (MODIFIED) WITH MULCH, METHOD 3
 - INTERSEEDING, CLASS 2A
 - PERENNIAL PLANTS, BULB TYPE
 - COORDINATE POINT

NOTES:

- SEE SHEET 101 FOR REMOVAL AND EXCAVATION PLAN.
- ENSURE STONE RIPRAP DOES NOT OBSTRUCT ACCESS TO UTILITY COVERS.

QUANTITY	BOTANIC NAME	COMMON NAME	SIZE	ROOT	REMARKS
SHADE TREES:					
1	<i>Aesculus flava</i>	Yellow Buckeye	3" cal	B&B	
1	<i>Gleditsia triacanthos va. inermis 'Imperial'</i>	Imperial Honeylocust	3" cal	B&B	
2	<i>Gymnocladus dioicus</i>	Kentucky Coffeetree	2.5" cal	B&B	
1	<i>Metasequoia glyptostroboides</i>	Dawn Redwood	2.5" cal	B&B	
UNDERSTORY TREES:					
2	<i>Crataegus phaenopyrum</i>	Washington Hawthorn	2.5" cal	B&B	
1	<i>Prunus virginiana 'Canada Red'</i>	Canada Red Chokecherry	2" cal	B&B	
8	TOTAL				
SHRUBS:					
23	<i>Hypericum kalmianum</i>	Kalm's St. John's Wort	3 gal		36" oc, mulch bed
20	<i>Syringa meyeri 'Palibin'</i>	Dwarf Korean Lilac	5 gal		48" oc, mulch bed
43	TOTAL				
VINES:					
108	<i>Parthenocissus tricuspidata</i>	Boston Ivy	1 gal		24" oc, mulch bed
59	<i>Parthenocissus quinquefolia 'Engelmannii'</i>	Engelman's Virginia Creeper	1 gal		24" oc, mulch bed
167	TOTAL				



REVISD SHEET 5/27/2022




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PLOT SCALE = 1:20	CHECKED - BM	REVISED
PLOT DATE = 12/04/2020	DRAWN - JT	REVISED
	DATE - 12/04/2020	REVISED

STATE OF ILLINOIS
 DEPARTMENT OF TRANSPORTATION

LANDSCAPE PLANS

SHEET NO. 32 OF 43 SHEETS

F.A.I. R.T.E.	SECTION	COUNTY	TOTAL SHEETS	SHEET NO.
90/94/290	2014-012L5	COOK	220	142
CONTRACT NO. 60X98				
ILLINOIS FED. AID PROJECT				

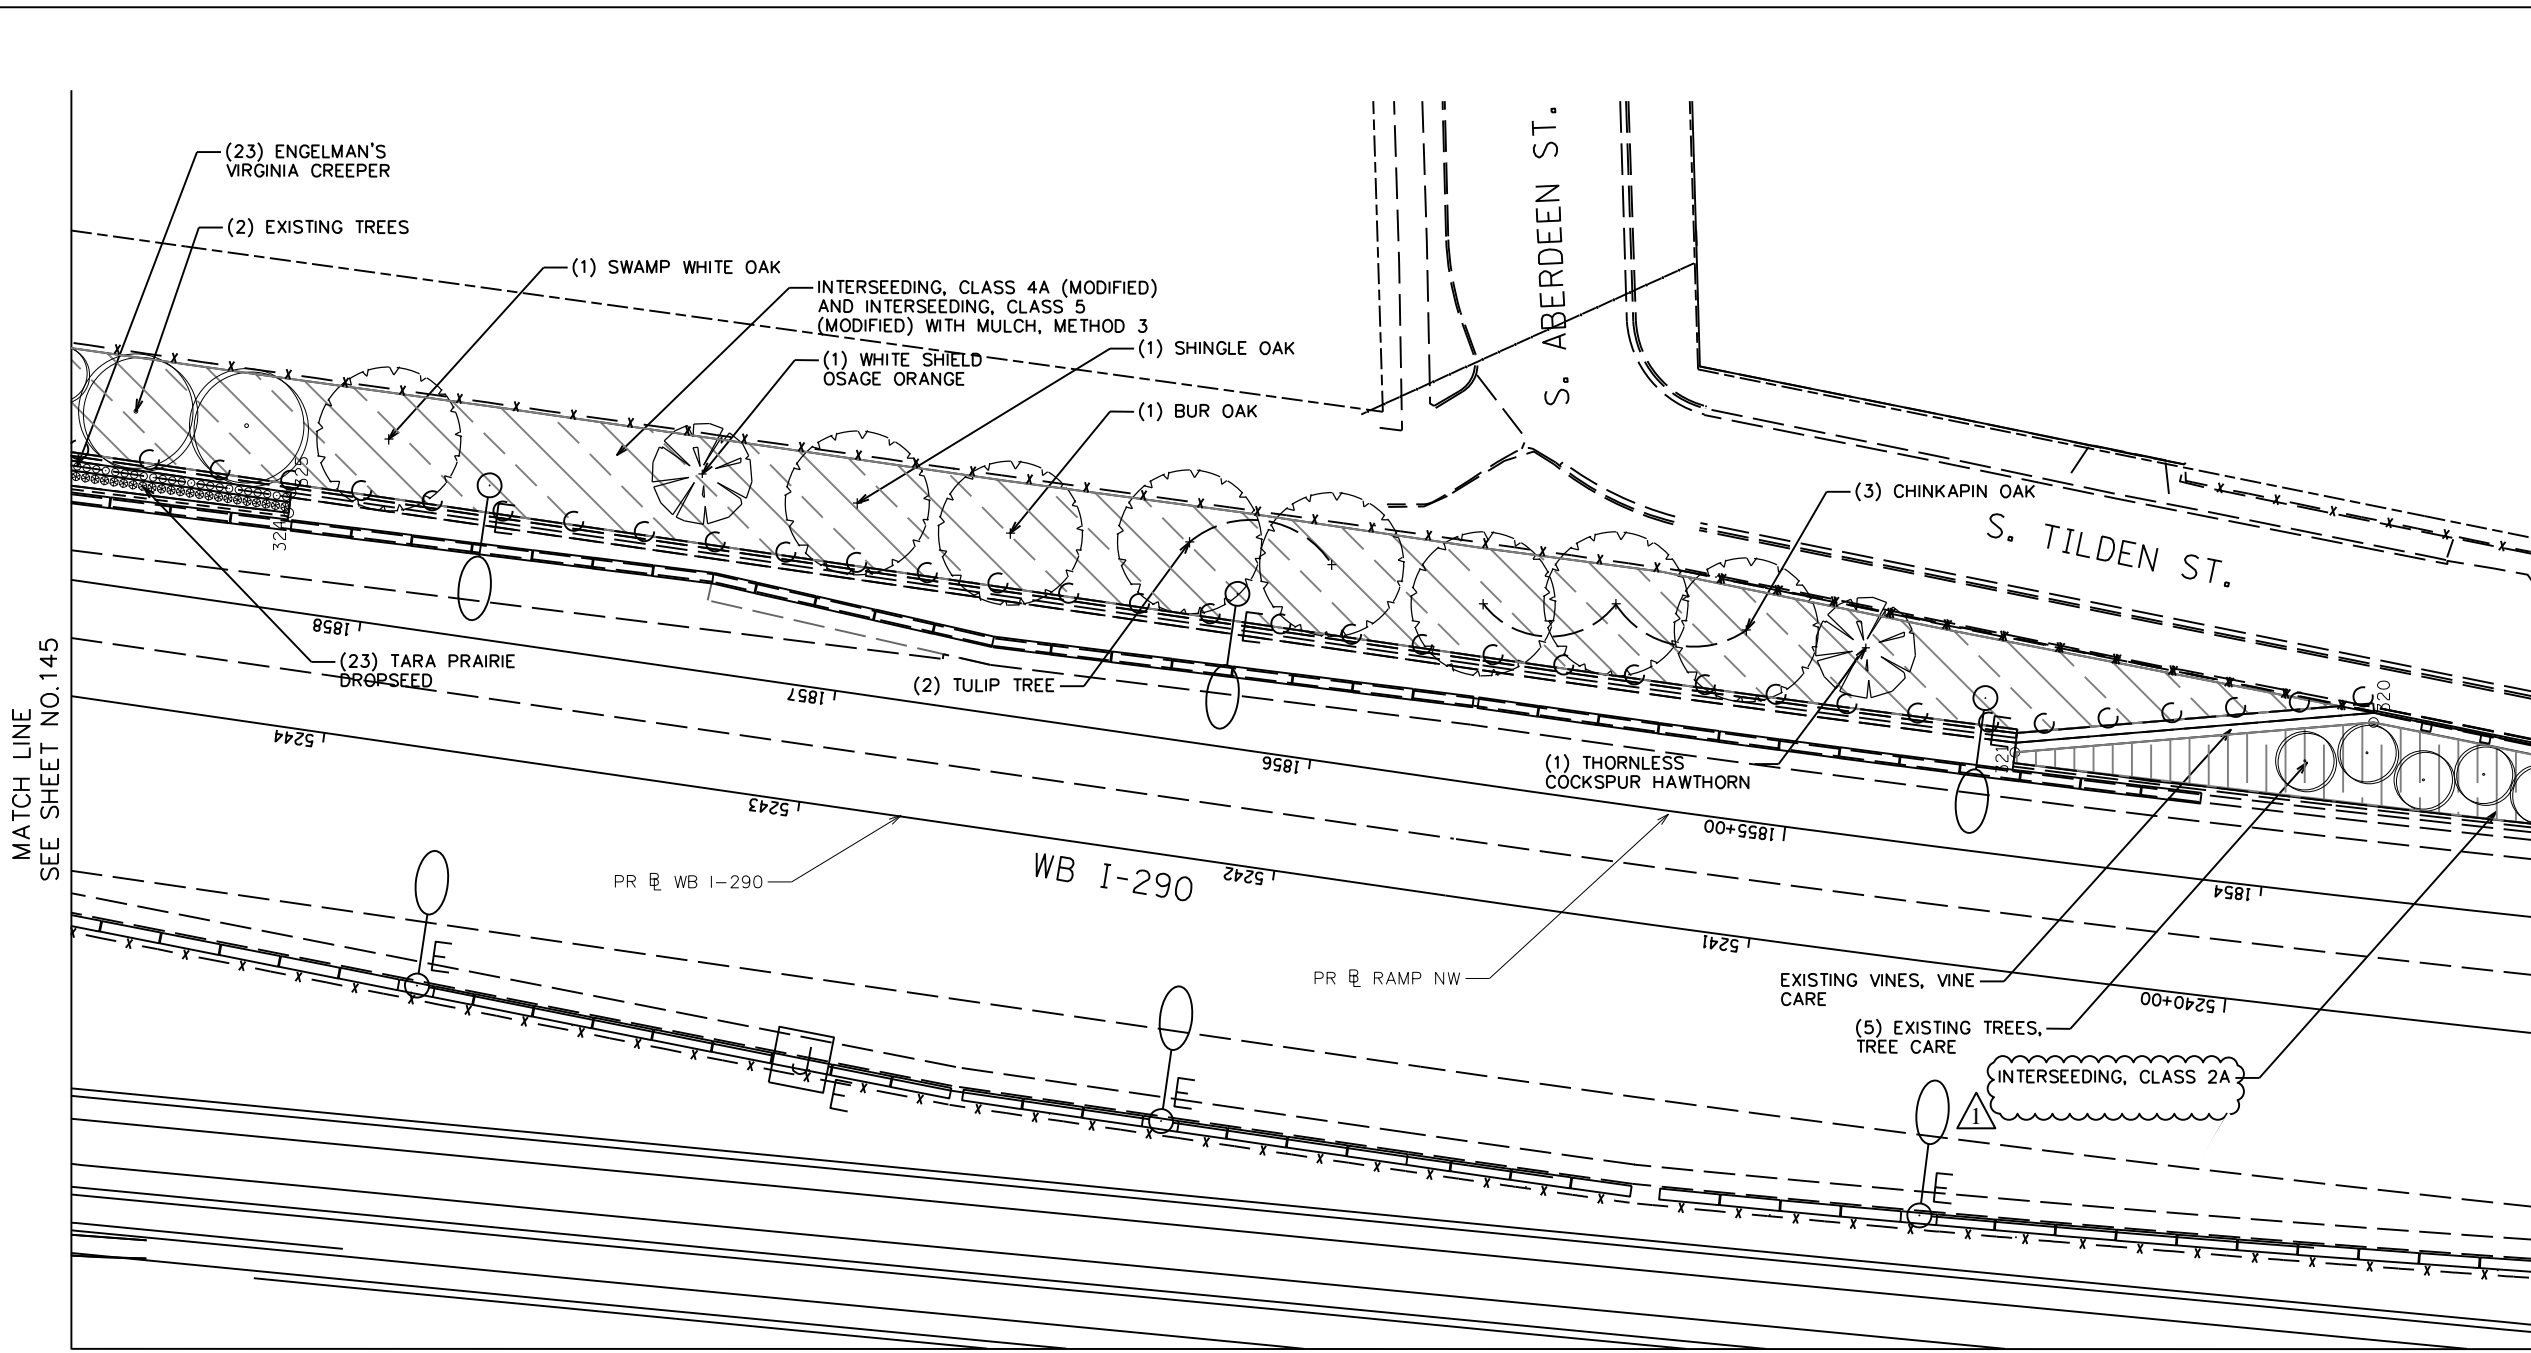

- LEGEND**
- SHADE TREE
 - EVERGREEN TREE
 - UNDERSTORY TREE
 - EXISTING TREE WITH MULCH PLACEMENT AND TREE CARE
 - PERENNIAL/SHRUBS
 - VINE, 1 GALLON POT
 - STONE OUTCROPPING
 - CHAIN LINK FENCE, 6'
 - NATIVE SODDING, SPECIAL
 - SEEDING, CLASS 4A (MODIFIED) WITH EROSION CONTROL BLANKET
 - SEEDING, CLASS 4A (MODIFIED) AND SEEDING, CLASS 5 (MODIFIED) WITH EROSION CONTROL BLANKET
 - SODDING, SALT TOLERANT
 - AGGREGATE SURFACE COURSE
 - STONE RIPRAP, CLASS A4 (SPECIAL)
 - STONE RIPRAP, CLASS A4
 - SEEDING CLASS 2A WITH EROSION CONTROL BLANKET
 - INTERSEEDING, CLASS 4A (MODIFIED) AND INTERSEEDING, CLASS 5 (MODIFIED) WITH MULCH, METHOD 3
 - INTERSEEDING, CLASS 2A
 - PERENNIAL PLANTS, BULB TYPE
 - COORDINATE POINT

NOTES:


- SEE SHEET 103 FOR REMOVAL AND EXCAVATION PLAN.
- ENSURE STONE RIPRAP DOES NOT OBSTRUCT ACCESS TO UTILITY COVERS.

MATCH LINE
SEE SHEET NO.145

MATCH LINE
SEE SHEET NO.143

MATCH LINE
SEE SHEET NO.147

QUANTITY	BOTANIC NAME	COMMON NAME	SIZE	ROOT	REMARKS
SHADE TREES:					
2	<i>Liriodendron tulipifera</i>	Tulip Tree	2.5" cal	B&B	
1	<i>Quercus bicolor</i>	Swamp White Oak	2.5" cal	B&B	
1	<i>Quercus imbricaria</i>	Shingle Oak	2.5" cal	B&B	
1	<i>Quercus macrocarpa</i>	Bur Oak	2.5" cal	B&B	
3	<i>Quercus muehlenbergii</i>	Chinkapin Oak	2.5" cal	B&B	
UNDERSTORY TREES:					
1	<i>Crataegus crus-galli</i> var. <i>inermis</i>	Thornless Cockspur Hawthorn	7' Ht	B&B	
1	<i>Maclura pomifera</i> 'White Shield'	White Shield Osage Orange	2" cal	B&B	
10	TOTAL				
PERENNIALS:					
**23	<i>Sporobolus heterolepis</i> 'Tara'	Tara Prairie Dropseed	1 gal		24" oc, mulch bed
**PAID FOR AS PERENNIAL, UNIT = 100					
VINES:					
23	<i>Parthenocissus quinquefolia</i> 'Engelmannii'	Engelman's Virginia Creeper	1 gal		24" oc, mulch bed

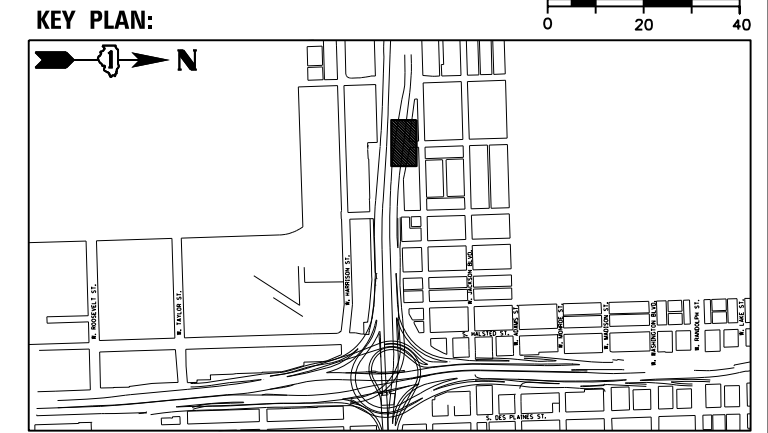

REVISOR: [Symbol] REVISED SHEET 5/27/2022



DESIGNED - BK	REVISOR [Symbol] 5/20/2022
CHECKED - BM	REVISOR
DRAWN - JT	REVISOR
DATE - 12/04/2020	REVISOR

STATE OF ILLINOIS
DEPARTMENT OF TRANSPORTATION

LANDSCAPE PLANS


SHEET NO. 34 OF 43 SHEETS

F.A.I. R.T.E.	SECTION	COUNTY	TOTAL SHEETS	SHEET NO.
90/94/290	2014-012L5	COOK	220	144
CONTRACT NO. 60X98				
ILLINOIS FED. AID PROJECT				

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- LEGEND**
- SHADE TREE
 - EVERGREEN TREE
 - UNDERSTORY TREE
 - EXISTING TREE WITH MULCH PLACEMENT AND TREE CARE
 - PERENNIAL/SHRUBS
 - VINE, 1 GALLON POT
 - STONE OUTCROPPING
 - CHAIN LINK FENCE, 6'
 - NATIVE SODDING, SPECIAL
 - SEEDING, CLASS 4A (MODIFIED) WITH EROSION CONTROL BLANKET
 - SEEDING, CLASS 4A (MODIFIED) AND SEEDING, CLASS 5 (MODIFIED) WITH EROSION CONTROL BLANKET
 - SODDING, SALT TOLERANT
 - AGGREGATE SURFACE COURSE
 - STONE RIPRAP, CLASS A4 (SPECIAL)
 - STONE RIPRAP, CLASS A4
 - SEEDING CLASS 2A WITH EROSION CONTROL BLANKET
 - INTERSEEDING, CLASS 4A (MODIFIED) AND INTERSEEDING, CLASS 5 (MODIFIED) WITH MULCH, METHOD 3
 - INTERSEEDING, CLASS 2A
 - PERENNIAL PLANTS, BULB TYPE
 - COORDINATE POINT

- NOTES:**
- SEE SHEET 109 FOR REMOVAL AND EXCAVATION PLAN.
 - ENSURE STONE RIPRAP DOES NOT OBSTRUCT ACCESS TO UTILITY COVERS.

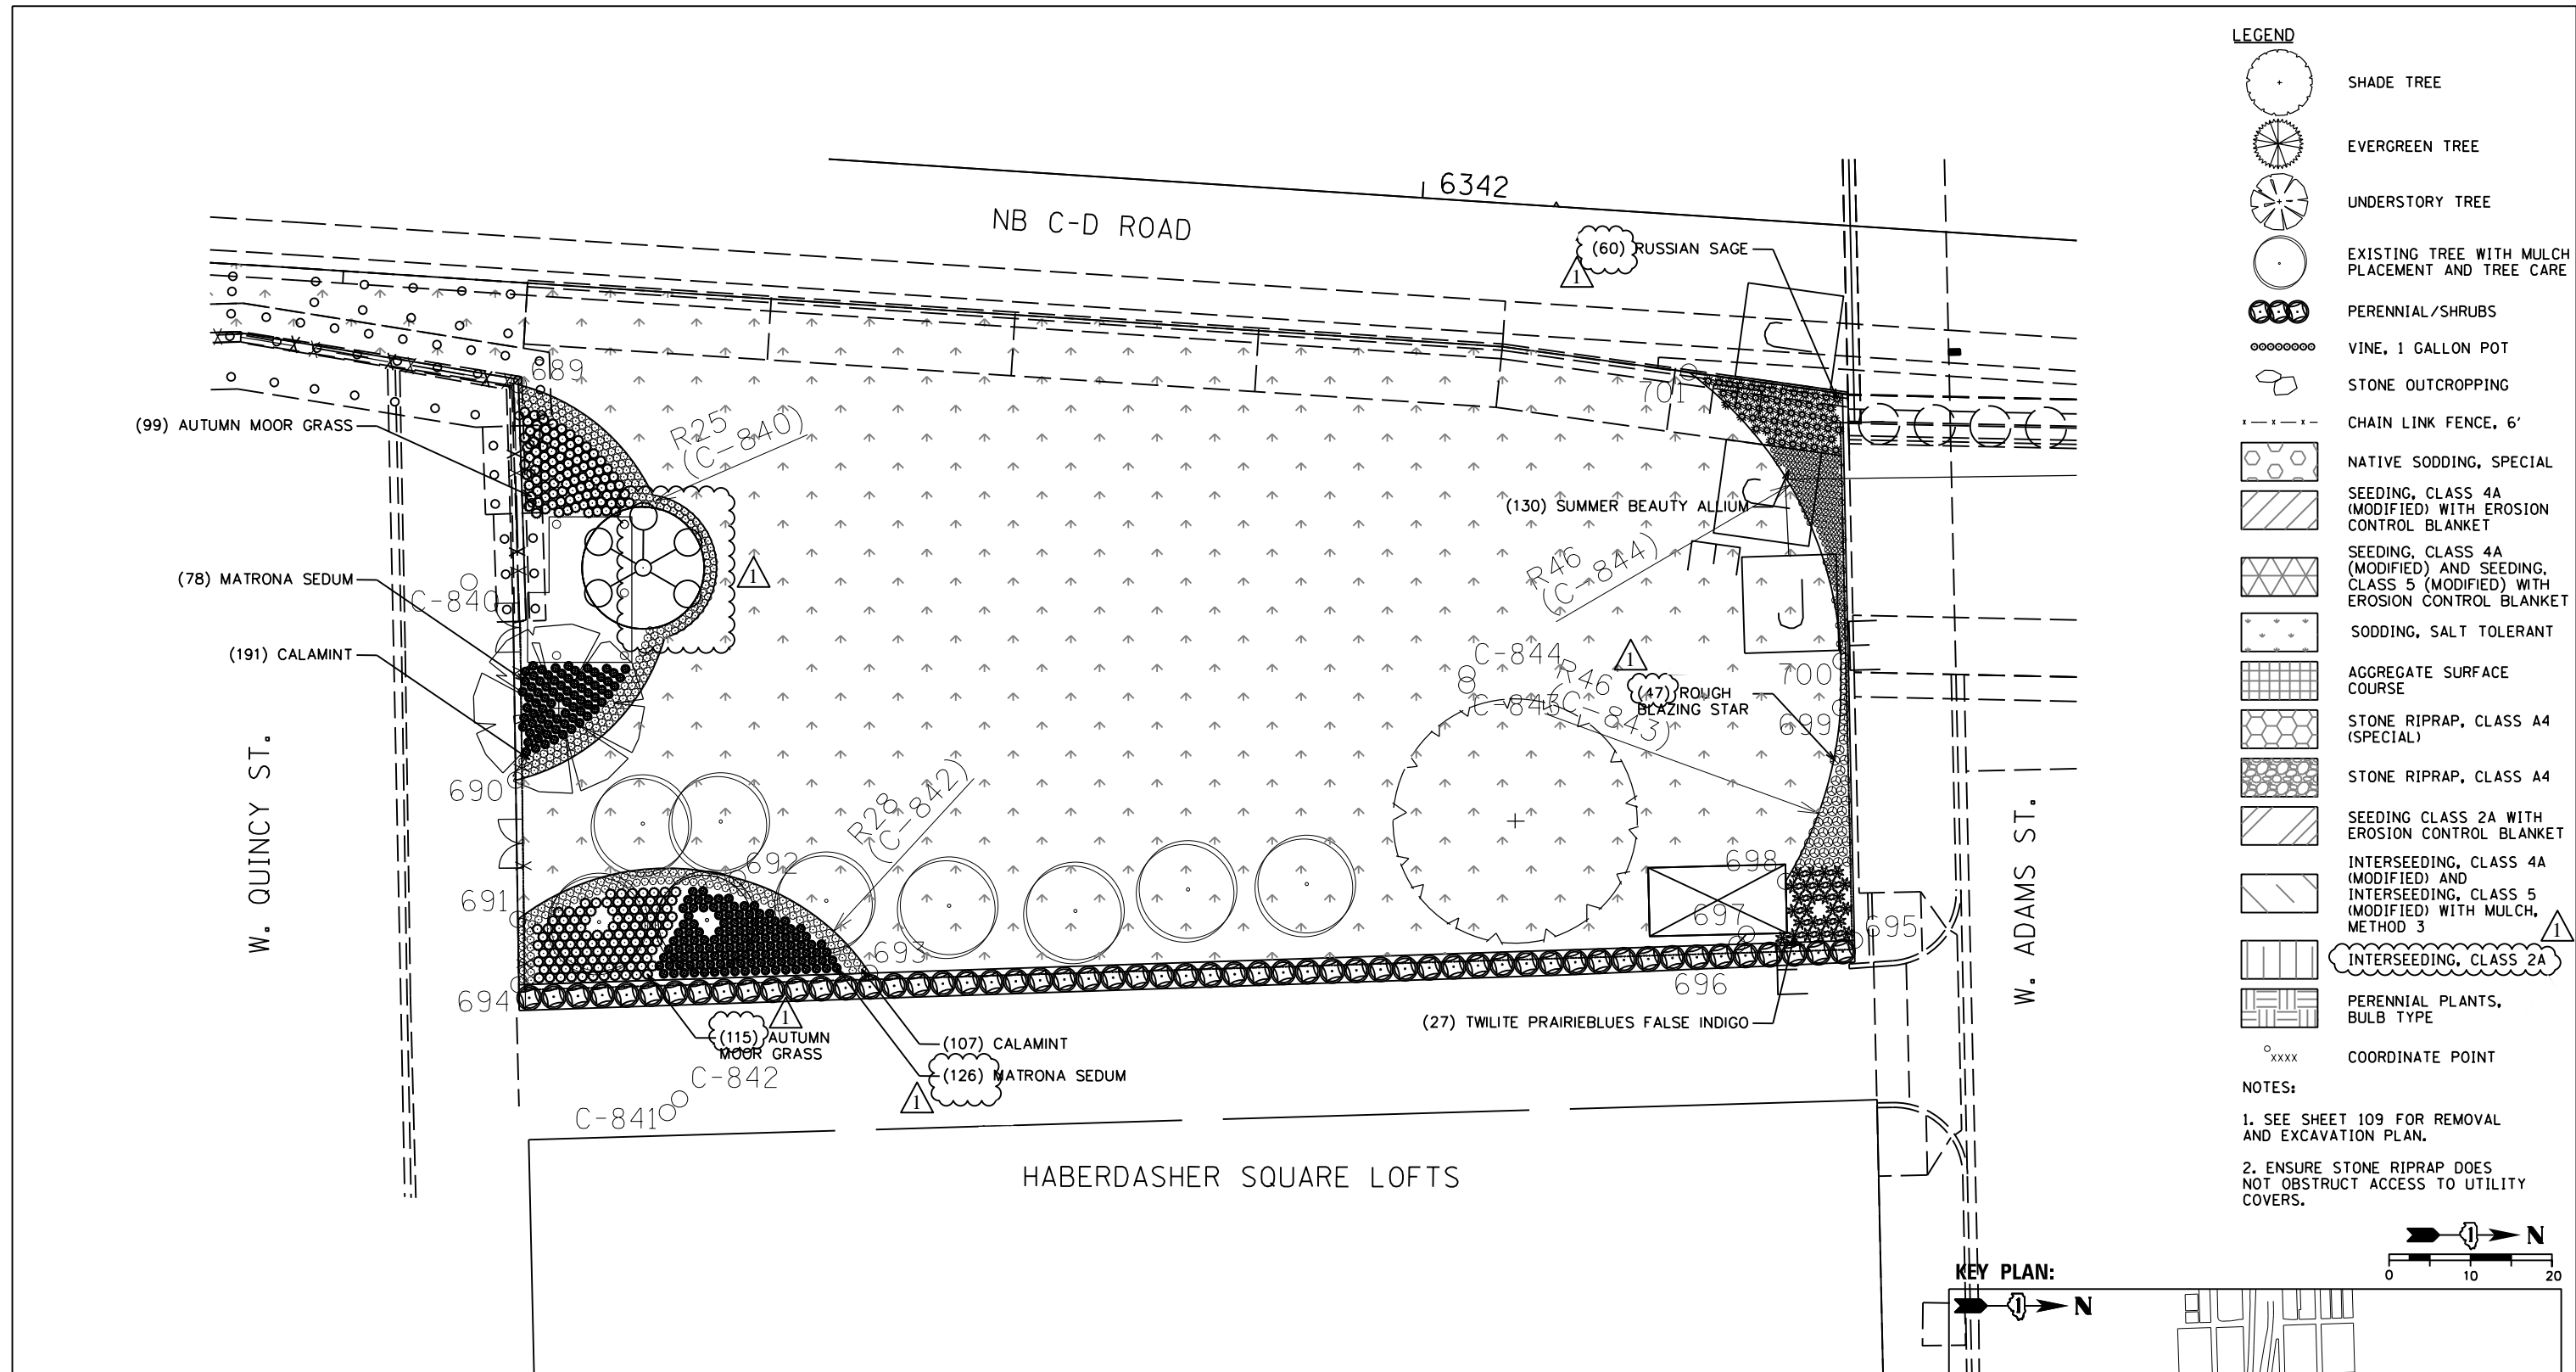

QUANTITY	BOTANIC NAME	COMMON NAME	SIZE	ROOT	REMARKS
PERENNIALS:					
**130	<i>Allium 'Summer Beauty'</i>	Summer Beauty Allium	1 gal	18" oc	
**27	<i>Baptisia x varicolor 'Twilite'</i>	Twilite Prairieblues False Indigo	1 gal	30" oc	
**298	<i>Calamintha nepeta subsp. Nepeta</i>	Calamint	1 gal	18" oc	
**47	<i>Liatris aspera</i>	Rough Blazing Star	1 gal	15" oc	
**60	<i>Perovskia atriplicifolia</i>	Russian Sage	1 gal	24" oc	
**204	<i>Sedum 'Matrona'</i>	Matrona Sedum	1 gal	18" oc	
**214	<i>Sesleria autumnalis</i>	Autumn Moor Grass	1 gal	15" oc	
980	Total				

**PAID FOR AS PERENNIAL, UNIT = 100

REVISD SHEET 5/27/2022



DESIGNED - BK	REVISD 5/20/2022
CHECKED - BM	REVISD
DRAWN - JT	REVISD
DATE - 12/04/2020	REVISD








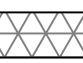
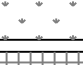
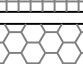
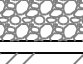
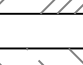
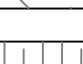

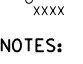
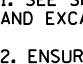
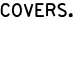



STATE OF ILLINOIS
DEPARTMENT OF TRANSPORTATION

LANDSCAPE PLANS


SHEET NO. 42 OF 43 SHEETS

F.A.I. RTE.	SECTION	COUNTY	TOTAL SHEETS	SHEET NO.
90/94/290	2014-012L5	COOK	220	152
CONTRACT NO. 60X98				

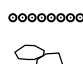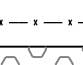ILLINOIS FED. AID PROJECT


- LEGEND**
-  SHADE TREE
 -  EVERGREEN TREE
 -  UNDERSTORY TREE
 -  EXISTING TREE WITH MULCH PLACEMENT AND TREE CARE
 -  PERENNIAL/SHRUBS
 -  VINE, 1 GALLON POT
 -  STONE OUTCROPPING
 -  CHAIN LINK FENCE, 6'
 -  NATIVE SODDING, SPECIAL
 -  SEEDING, CLASS 4A (MODIFIED) WITH EROSION CONTROL BLANKET
 -  SEEDING, CLASS 4A (MODIFIED) AND SEEDING, CLASS 5 (MODIFIED) WITH EROSION CONTROL BLANKET
 -  SODDING, SALT TOLERANT
 -  AGGREGATE SURFACE COURSE
 -  STONE RIPRAP, CLASS A4 (SPECIAL)
 -  STONE RIPRAP, CLASS A4
 -  SEEDING CLASS 2A WITH EROSION CONTROL BLANKET
 -  INTERSEEDING, CLASS 4A (MODIFIED) AND INTERSEEDING, CLASS 5 (MODIFIED) WITH MULCH, METHOD 3
 -  INTERSEEDING, CLASS 2A
 -  PERENNIAL PLANTS, BULB TYPE
 -  COORDINATE POINT

- NOTES:**
1. SEE SHEET 110 FOR REMOVAL AND EXCAVATION PLAN.
 2. ENSURE STONE RIPRAP DOES NOT OBSTRUCT ACCESS TO UTILITY COVERS.

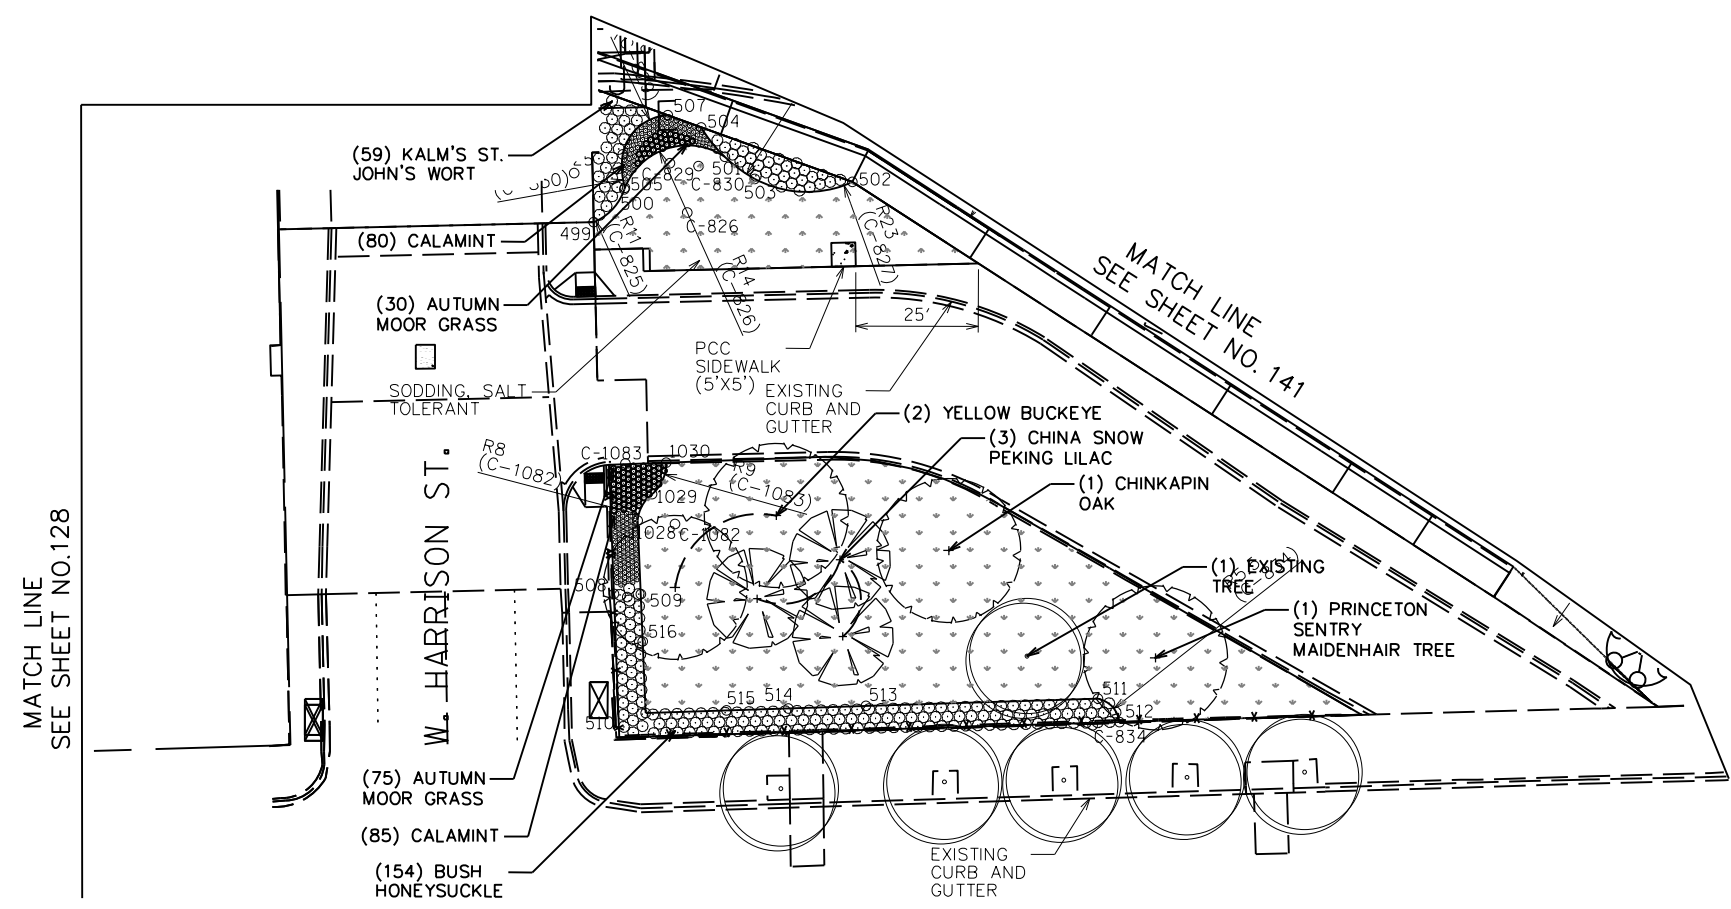

QUANTITY	BOTANIC NAME	COMMON NAME	SIZE	ROOT	REMARKS
SHADE TREES:					
2	<i>Aesculus flava</i>	Yellow Buckeye	3" cal	B&B	
1	<i>Ginkgo biloba</i> 'Princeton Sentry'	Princeton Sentry Maidenhair Tree	2.5" cal	B&B	
1	<i>Quercus muehlenbergii</i>	Chinkapin Oak	2.5" cal	B&B	
UNDERSTORY TREES:					
3	<i>Syringa pekinensis</i> 'Morton'	China Snow Peking Lilac	2" cal	B&B	
7	TOTAL				
SHRUBS:					
154	<i>Diervilla lonicera</i>	Kodiak Orange Bush Honeysuckle	3 gal	30" oc	
59	<i>Hypericum kalmianum</i>	Kalm's St. John's Wort	3 gal	36" oc, mulch bed	
213	TOTAL				
PERENNIALS:					
**165	<i>Calamintha nepeta</i> subsp. <i>Nepeta</i>	Calamint	1 gal	18" oc	
**105	<i>Sesleria autumnalis</i>	Autumn Moor Grass	1 gal	15" oc	
**270	TOTAL				

*PAID FOR AS PERENNIAL UNIT = 100

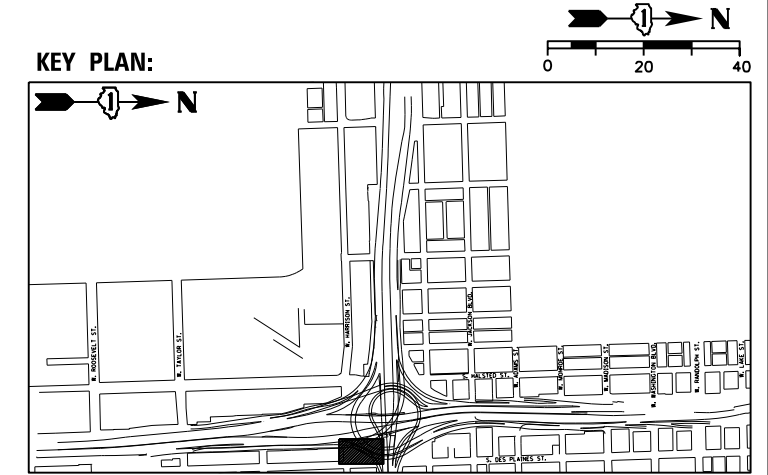

REVISED SHEET 5/27/2022



DESIGNED -- BK	REVISED A 5/20/2022
CHECKED -- BM	REVISED
DRAWN -- JT	REVISED
DATE -- 12/04/2020	REVISED

STATE OF ILLINOIS
DEPARTMENT OF TRANSPORTATION


LANDSCAPE PLANS

SHEET NO. 43 OF 43 SHEETS

F.A.I. RTE.	SECTION	COUNTY	TOTAL SHEETS	SHEET NO.
90/94/290	2014-012L5	COOK	220	153
CONTRACT NO. 60X98				


ILLINOIS FED. AID PROJECT

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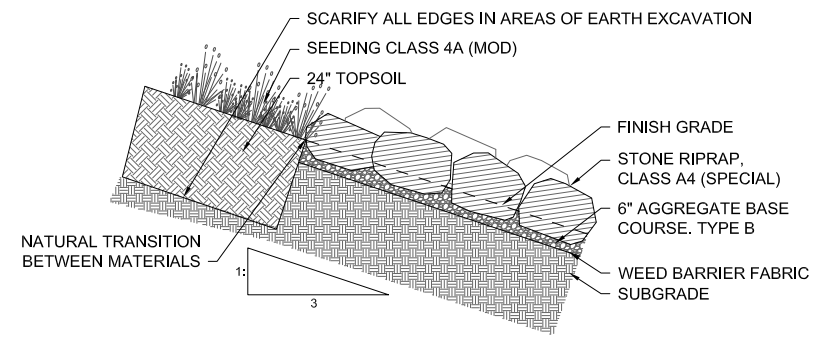


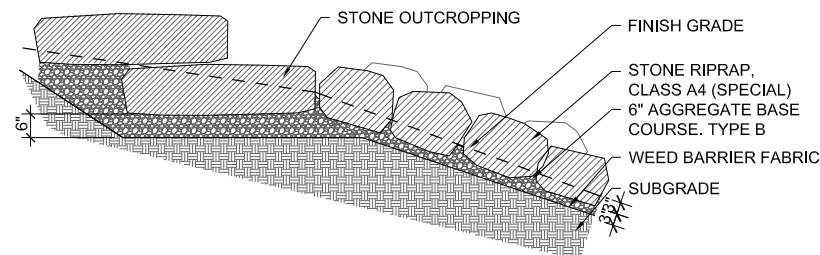PLACE RIPRAP ON 3" COMPACTED AGGREGATE BASE COURSE, FILL REMAINING 3" OF RIPRAP TO LOCK RIPRAP IN PLACE. WHEN PLACING RIPRAP, ENSURE NO BARE SPOTS ARE SEEN

1 STONE OUTCROPPING - STONE RIPRAP CLASS A4 (SPECIAL) TRANSITION DETAIL
1/2" = 1'-0"

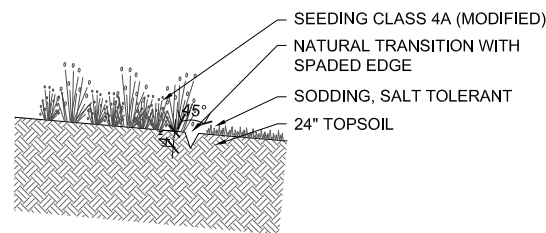


2 LANDSCAPE TRANSITION DETAIL
1/2" = 1'-0"




NOTE: SCARIFICATION OF SUBGRADE ONLY NECESSARY WHEN EXCAVATION IS SPECIFIED, INCLUDED IN THE COST OF TOPSOIL EXCAVATION AND PLACEMENT


3 LANDSCAPE TRANSITION DETAIL
1/2" = 1'-0"

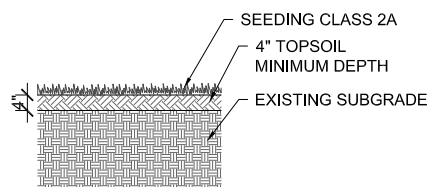


4 SEEDING 2A DETAIL
1/2" = 1'-0"

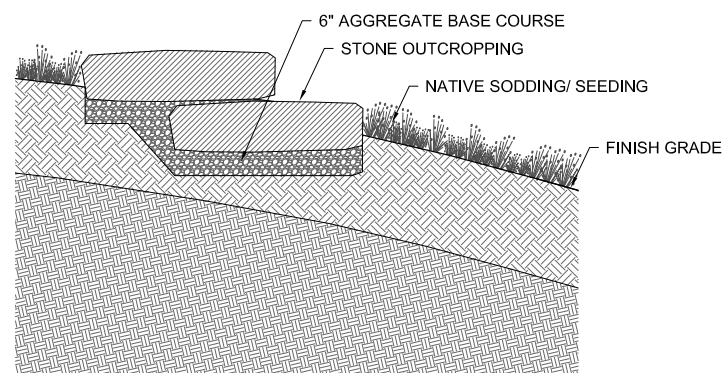

5 LANDSCAPE TRANSITION DETAIL
1/2" = 1'-0"

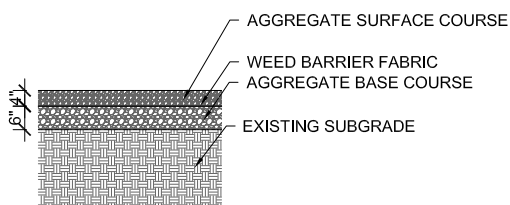

6 AGGREGATE SURFACE COURSE DETAIL
1/2" = 1'-0"

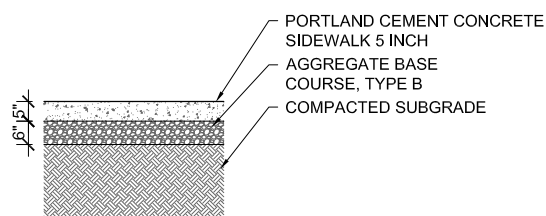

7 PORTLAND CEMENT CONCRETE SIDEWALK 5 INCH
1" = 1'-0"

7191_60096_DET_PAVE.DWG




DESIGNED — BK	REVISION 5/20/2022
CHECKED — BM	REVISION
DRAWN — JT	REVISION
DATE — 03/16/2022	REVISION

STATE OF ILLINOIS
DEPARTMENT OF TRANSPORTATION


HARDSCAPE DETAILS

SHEET NO. 7 OF 13 SHEETS


REVISION 5/27/2022				
F.A.I. RTE.	SECTION	COUNTY	TOTAL SHEETS	SHEET NO.
90/94/290	2014-012LS	COOK	220	160
CONTRACT NO. 60X98			ILLINOIS FED. AID PROJECT	

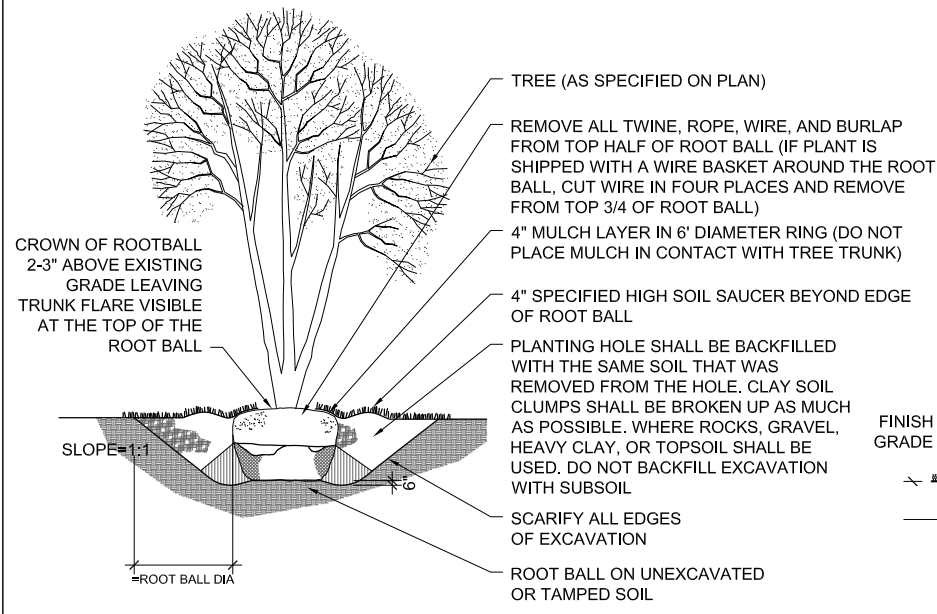


1 ORNAMENTAL TREE PLANTING SECTION
NOT TO SCALE

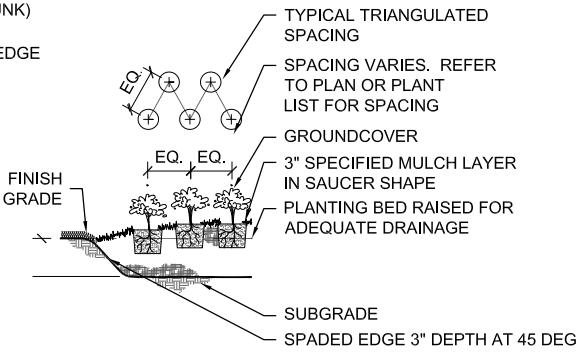


2 PERENNIAL PLANTING DETAIL
NOT TO SCALE

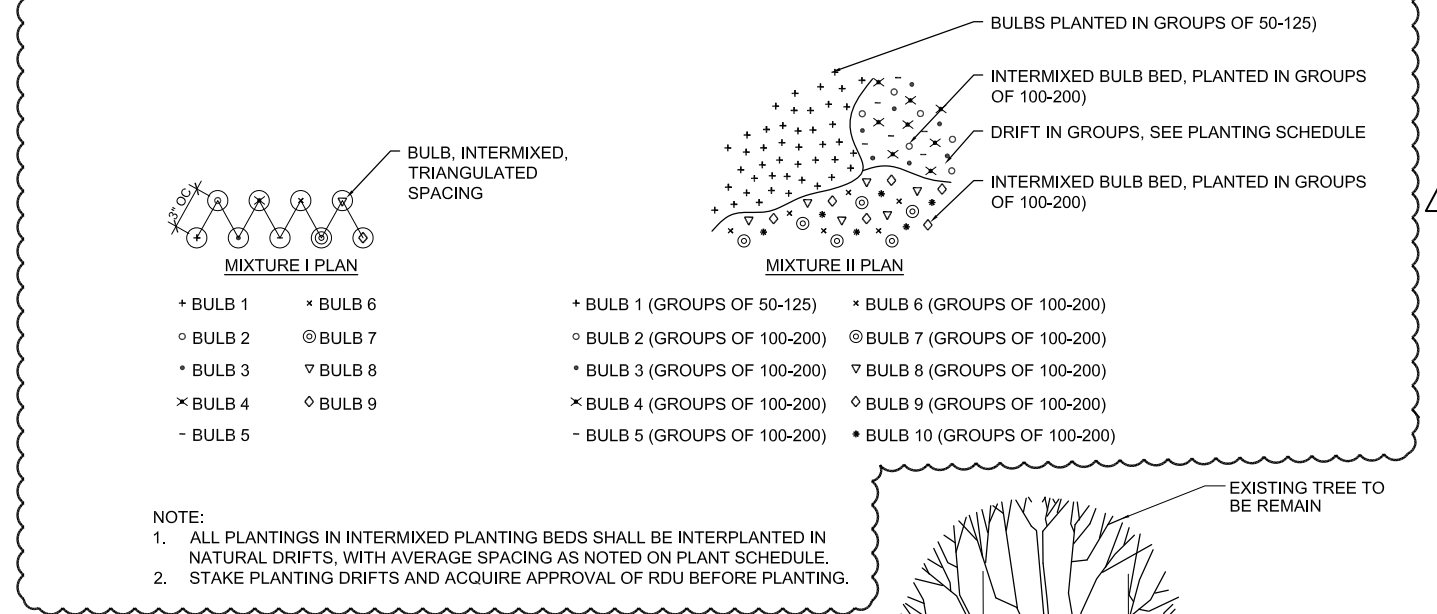


3 BULB PLANTING DETAIL
NOT TO SCALE

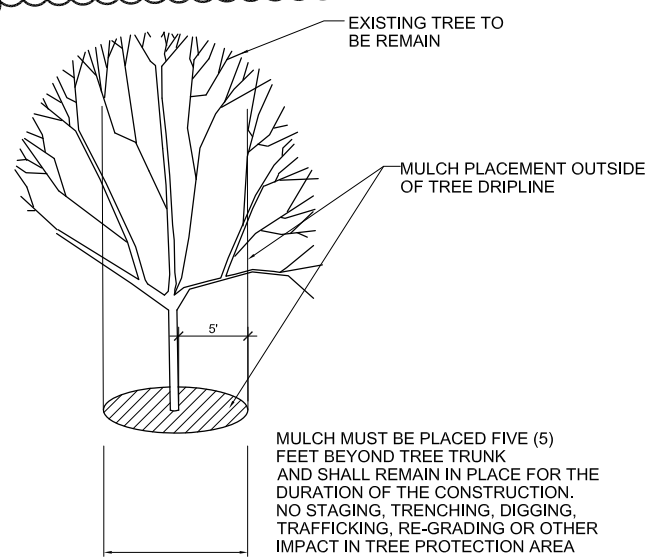

5 MULCH PLACEMENT AROUND EXISTING TREES
NOT TO SCALE

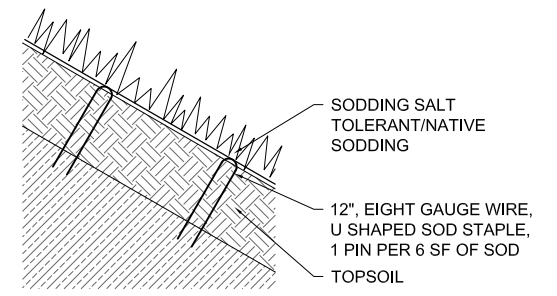

4 SOD ON SLOPE DETAIL
NOT TO SCALE

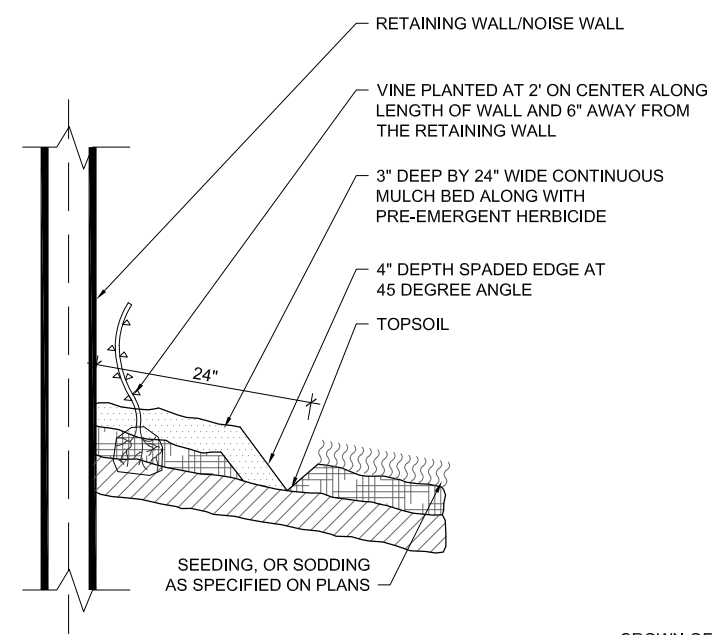


NOTES:
1. SEE LANDSCAPE PLANS FOR SPECIFIC LOCATIONS OF VINES.
2. THE CONTRACTOR SHALL ORDER MATERIAL FOR VINES IMMEDIATELY FOLLOWING EXECUTION OF THE CONTRACT TO ASSURE AVAILABILITY OF THE PLANT MATERIAL FOR SPRING PLANTING.
3. MULCH BED SHALL BE PLACED AS SHOWN IN VINE PLANTING DETAIL AND ACCORDING TO IDOT STANDARD SPECIFICATION 253.11 EXCEPT THAT NO WEED BARRIER FABRIC IS REQUIRED. COST OF MULCH COVER IS INCLUDED WITH PAYMENT UNDER THE RESPECTIVE VINE PAY ITEM.
4. PRE-EMERGENT HERBICIDE SHALL BE PLACED ON MULCHED BEDS ACCORDING TO THE SPECIAL PROVISION.


6 VINE PLANTING DETAIL
NOT TO SCALE

WHEN INSTALLING PLANTING SOIL, INSTALL IN EQ LIFTS, LIFT MAX 6" IN DEPTH, TAMP EACH LIFT AND FULLY SATURATE WITH WATER PRIOR TO PROCEEDING TO SUBSEQUENT LIFTS

7 SHRUB PLANTING DETAIL SECTION
NOT TO SCALE

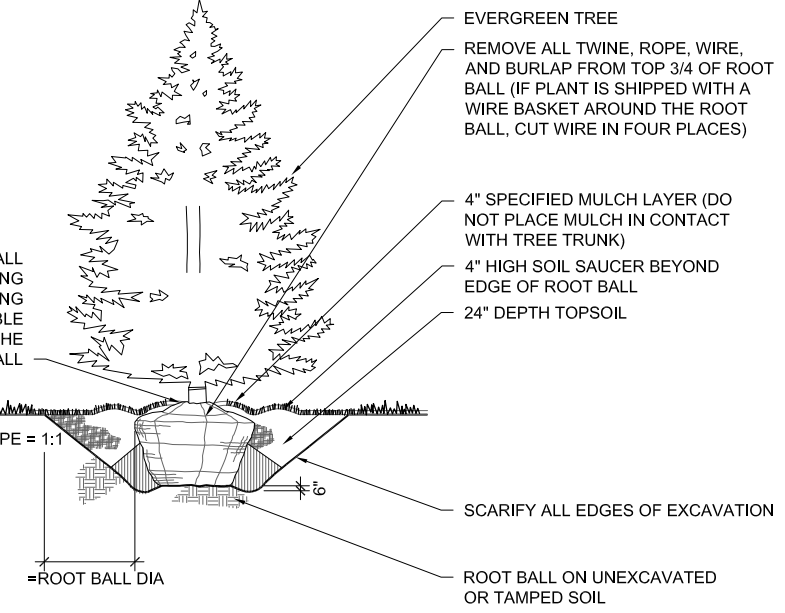

8 EVERGREEN TREE PLANTING DETAIL
NOT TO SCALE

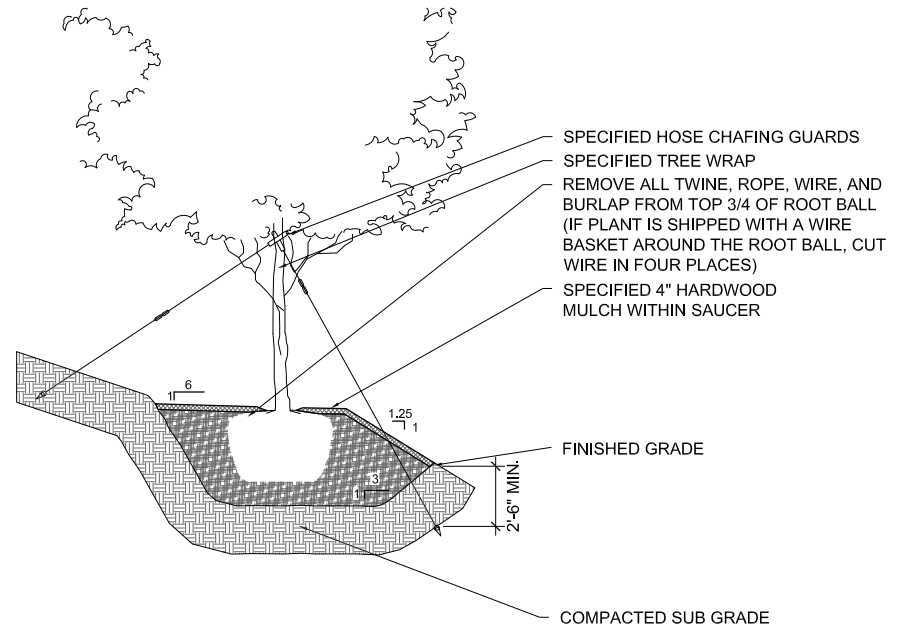

9 SHADE TREE PLANTING ON SLOPE DETAIL
NOT TO SCALE

7191_00108_DET_LAND.DWG



DESIGNED — BK	REVISED — 5/20/2022
CHECKED — BM	REVISED
DRAWN — JT	REVISED
DATE — 03/16/2022	REVISED

**STATE OF ILLINOIS
DEPARTMENT OF TRANSPORTATION**

LANDSCAPE DETAILS

SHEET NO. 9 OF 13 SHEETS

REVISION 5/27/2022

F.A.I. RTE.	SECTION	COUNTY	TOTAL SHEETS	SHEET NO.
90/94/290	2014-012LS	COOK	220	162
CONTRACT NO. 60X98			ILLINOIS FED. AID PROJECT	

MASTER PLANT SCHEDULE

Series Sheet Number

TOTAL QUANTITY	1	2	3	4	5	6	7	8	9	10	11	12	13	14	15	16	17	18	19	20	21	22	23	24	25	26	27	28	29	30	31	32	33	34	35	36	37	38	39	40	41	42	43	BOTANIC NAME	COMMON NAME	SIZE	ROOT	REMARKS								
SHADE TREES:																																																								
8					1																								1	1		1											2	<i>Aesculus flava</i>	Yellow Buckeye	3" cal	B&B									
3					3																																										<i>Betula nigra</i> 'Heritage'	Heritage River Birch	8" Ht	B&B						
6					1	1		2							1																																	<i>Celtis occidentalis</i>	Hackberry	2.5" cal	B&B					
9				1	2	1					1	3																																				<i>Catalpa speciosa</i>	Northern Catalpa	2.5" cal	B&B					
2																																																<i>Cladrastis kentuckea</i> 'Perkins Pink'	Perkins Pink Yellowwood	2" cal	B&B					
1																																																	<i>Fagus sylvatica</i> 'Roseomarginata'	Tricolor European Beech	2" cal	B&B				
2																																																		<i>Ginkgo biloba</i> 'Princeton Sentry'	Princeton Sentry Maidenhair Tree	2.5" cal	B&B			
9					1						2																																							<i>Gleditsia triacanthos</i> va. <i>inermis</i> 'Imperial'	Imperial Honeylocust	3" cal	B&B			
26	1				2	2	4		2			1	1																																					<i>Gymnocladus dioica</i>	Kentucky Coffeetree	2.5" cal	B&B			
8																																																		<i>Liriodendron tulipifera</i>	Tulip Tree	2.5" cal	B&B			
6					1																																													<i>Metasequoia glyptostroboides</i>	Dawn Redwood	2.5" cal	B&B			
14					3	2																																													<i>Quercus bicolor</i>	Swamp White Oak	2.5" cal	B&B		
8					1																																														<i>Quercus imbricaria</i>	Shingle Oak	2.5" cal	B&B		
5																																																			<i>Quercus macrocarpa</i>	Bur Oak	2.5" cal	B&B		
13																																																			<i>Quercus muehlenbergii</i>	Chinkapin Oak	2.5" cal	B&B		
10																																																			<i>Quercus x warei</i> 'Nadler'	Kindred Spirit Columnar Oak	2.5" cal	B&B	15' oc	
8																																																			<i>Taxodium distichum</i>	Common Bald Cypress	2"	B&B		
3																																																			<i>Tilia americana</i> 'McKsentry'	American Sentry Linden	2" cal	B&B		
5																																																				<i>Ulmus americana</i> 'Lewis and Clark'	Lewis and Clark American Elm	2" cal	B&B	
5						1																																													<i>Ulmus americana</i> 'Princeton'	Princeton Elm	2.5" cal	B&B		

TOTAL QUANTITY	1	2	3	4	5	6	7	8	9	10	11	12	13	14	15	16	17	18	19	20	21	22	23	24	25	26	27	28	29	30	31	32	33	34	35	36	37	38	39	40	41	42	43	BOTANIC NAME	COMMON NAME	SIZE	ROOT	REMARKS																																													
EVERGREEN TREES:																																																																																													
11					5							3																																								<i>Picea abies</i>	Norway Spruce	8" Ht	B&B																																						
3																																																				<i>Picea glauca</i> 'Densata'	Black Hills Spruce	8" Ht	B&B																																						
UNDERSTORY TREES:																																																																																													
5																																																				<i>Carpinus betulus</i>	European Hornbeam	2" cal	B&B																																						
15																																																				<i>Crataegus crus-galli</i> var. <i>inermis</i>	Thornless Cockspur Hawthorn	7" Ht	B&B																																						
6																																																				<i>Crataegus phaenopyrum</i>	Washington Hawthorn	2.5" cal	B&B																																						
9																																																				<i>Gymnocladus dioica</i> 'Skinny Latte'	Skinny Latte Kentucky Coffeetree	2.5" cal	B&B																																						
8																																																				<i>Maclura pomifera</i> 'White Shield'	White Shield Osage Orange	2" cal	B&B																																						
2																																																				<i>Malus</i> 'Adams'	Adams Crabapple	2" cal	B&B																																						
3																																																				<i>Malus</i> 'Ruby Dayze'	Ruby Dayze Crabapple	2" cal	B&B	18" oc																																					
11																																																				<i>Ostrya virginiana</i>	American Hop-Hornbeam	2" cal	B&B																																						
8																																																				<i>Prunus virginiana</i> 'Canada Red'	Canada Red Chokecherry	2" cal	B&B																																						
8																																																				<i>Syringa pekinensis</i> 'Morton'	China Snow Peking Lilac	2" cal	B&B																																						
10																																																				<i>Syringa reticulata</i> 'Ivory Silk'	Ivory Silk Japanese Tree Lilac	8" Ht	B&B																																						
250	TOTAL																																																																																												

TOTAL QUANTITY	1	2	3	4	5	6	7	8	9	10	11	12	13	14	15	16	17	18	19	20	21	22	23	24	25	26	27	28	29	30	31	32	33	34	35	36	37	38	39	40	41	42	43	BOTANIC NAME	COMMON NAME	SIZE	ROOT	REMARKS									
SHRUBS:																																																									
243																																																					<i>Diervilla lonicera</i>	Kodiak Orange Bush Honeysuckle	3 gal		30" oc
35																																																				<i>Fothergilla major</i> 'Mount Airy'	Mount Airy Fothergilla	3 gal	B&B	48" oc, mulch bed	
63																																																				<i>Hydrangea quercifolia</i> 'Ruby Slippers'	Ruby Slippers Oakleaf Hydrangea	5 gal		48" oc, mulch bed	
82																																																				<i>Hypericum kalmianum</i>	Kalm's St. John's Wort	3 gal		36" oc, mulch bed	
119																																																				<i>Rhus glabra</i>	Smooth Sumac	5 gal	B&B	36" oc, mulch bed	
40																																																				<i>Syringa meyeri</i> 'Palibin'	Dwarf Korean Lilac	5 gal		48" oc, mulch bed	
24																																																				<i>Syringa patula</i> 'Miss Kim'	Miss Kim Manchurian Lilac	3" Ht	B&B	48" oc, mulch bed	