

06/17/2022 LETTING ITEM 202

STATE OF ILLINOIS
 DEPARTMENT OF TRANSPORTATION
 ILLINOIS TRANSPORTATION ENHANCEMENT PROGRAM

F.A. RTE.	SECTION	COUNTY	TOTAL SHEETS	SHEET NO.
	17-00136-00-BT	JACKSON	51	1
		ILLINOIS	CONTRACT NO. 99632	


INDEX OF SHEETS

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PROPOSED PLANS
 NORTHWEST PEDESTRIAN AND BICYCLE PATH
 CITY OF CARBONDALE
 SECTION 17-00136-00-BT
 PROJECT VI1N(801)
 JACKSON COUNTY
 C-99-023-18



EX. BRIDGE TO BE REHABILITATED @ STA. 17+82.45
 BEGIN IMPROVEMENT STA. 1+12.70
 PR. PEDESTRIAN TRUSS BRIDGE @ STA. 28+15.66
 END IMPROVEMENT STA. 58+16.73

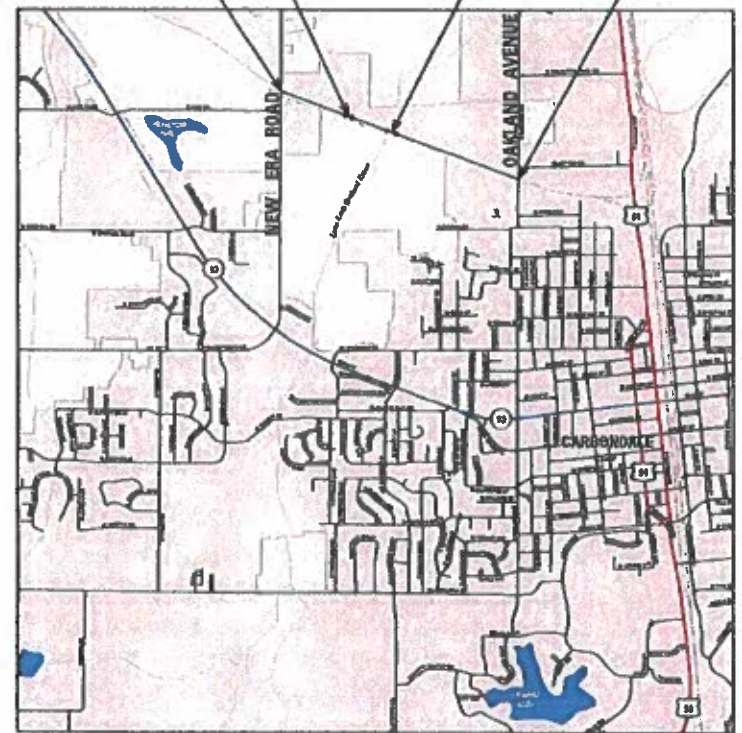

NOT TO SCALE

GROSS LENGTH = 5,704.03 FT. = 1.080 MILE
 NET LENGTH = 5,704.03 FT. = 1.080 MILE




FULL SIZE PLANS HAVE BEEN PREPARED USING STANDARD ENGINEERING SCALES. REDUCED SIZED PLANS WILL NOT CONFORM TO STANDARD SCALES. IN MAKING MEASUREMENTS ON REDUCED PLANS, THE ABOVE SCALES MAY BE USED.

J.U.L.I.E.
 JOINT UTILITY LOCATION INFORMATION FOR EXCAVATORS
 1-800-892-0123
 OR 811

PROJECT MANAGER: ROBERT HARDIN

CONTRACT NO. 99632

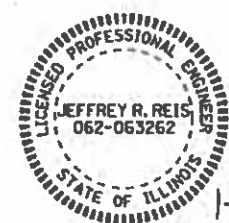

Jeffrey R. Reis, P.E.
 EXPIRATION DATE 11-30-2023
 LICENSE NO. 062-063262
 COVERS SHEETS 1-15 AND 28-51

CITY OF CARBONDALE	
APPROVED	January 28 th 2022 <i>Robert Hardin</i> PE CITY OF CARBONDALE
PASSED	3/29 th 2022 <i>Jeffrey R. Reis</i> DISTRICT ENGINEER OF LOCAL ROADS & STREETS
RELEASING FOR BID BASED ON LIMITED REVIEW	3/29 th 2022 <i>Stephen Trainor</i> ACTING DEPUTY DIRECTOR OF HIGHWAYS, REGION 5 ENGINEER

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GENERAL

FOR CODED PAY ITEM DESCRIPTIONS, INCLUDED ITEMS, AND ALL MATERIAL SPECIFICATIONS, PLEASE REFER TO THE LATEST EDITION OF THE IDOT STANDARD SPECIFICATIONS FOR ROAD AND BRIDGE CONSTRUCTION.

WHERE SECTION OR SUBSECTION MONUMENTS ARE ENCOUNTERED, THE ENGINEER SHALL BE NOTIFIED BEFORE SUCH MONUMENTS ARE REMOVED. THE CONTRACTOR SHALL PROTECT AND CAREFULLY PRESERVE ALL PROPERTY MARKERS AND MONUMENTS UNTIL THE OWNER AND AN AUTHORIZED SURVEYOR OR AGENT, HAVE WITNESSED OR OTHERWISE REFERENCED THEIR LOCATION.

THE CONTRACTOR IS RESPONSIBLE FOR CONTACTING THE ENGINEER AT LEAST FORTY-EIGHT (48) HOURS IN ADVANCE PRIOR TO COMMENCEMENT OF ANY CONSTRUCTION ACTIVITIES OR WORK REQUIRING INSPECTION OR APPROVAL BY THE AFFECTED UNITS OF GOVERNMENT.

ANY REFERENCE TO AN IDOT HIGHWAY STANDARD IN THESE PLANS SHALL BE INTERPRETED TO MEAN THE EDITION, AS INDICATED BY THE SUB-NUMBER LISTED IN THE INDEX OF SHEETS, OR THE COPY OF THE STANDARD INCLUDED IN THESE PLANS.

ALL SIDEWALK CONSTRUCTION SHALL MEET THE AMERICANS WITH DISABILITIES ACT (ADA) STANDARDS.

ALL EARTH SURFACES DISTURBED BY CONSTRUCTION SHALL BE SEEDED AS SPECIFIED AND AS DIRECTED BY THE ENGINEER.

TREE REMOVAL

EVERY TREE SHALL BE SAVED, IF POSSIBLE. THE ENGINEER IN THE FIELD WILL VERIFY AND MARK ALL TREES REQUIRED TO BE REMOVED. SHOULD THE ENGINEER'S DECISION INCREASE OR DECREASE THE QUANTITIES OF WORK TO BE PROFORMED FROM THE PLANS, THE CONTRACTOR SHALL ACCEPT PAYMENT AS STATED IN ARTICLE 104.03 OF THE STANDARD SPECIFICATIONS. TREES OUTSIDE THE LIMITS OF CONSTRUCTION SHALL NOT BE DISTURBED UNLESS DESIGNATED BY THE ENGINEER. THE ENGINEER SHOULD BE CONTACTED AND PRIOR APPROVAL OBTAINED FOR ANY TREE REMOVAL BEYOND THE LIMITS/LOCATIONS INCLUDED IN THE PLANS.

NO TREE REMOVAL SHALL OCCUR BETWEEN APRIL 1ST AND OCTOBER 14TH OF ANY CONSTRUCTION YEAR TO AVOID IMPACTS TO INDIANA BAT HABITATS.

ALL CLEARING OF LOGS, SHRUBS, BUSHES, SAPLINGS, GRASS, WEEDS, OTHER VEGETATION AND STUMPS OF LESS THAN 6 INCHES IN DIAMETER WILL NOT BE MEASURED FOR PAYMENT.

ANY TREE ROOTS ENCOUNTERED DURING CONSTRUCTION SHALL BE EXCAVATED AND REMOVED TO A MINIMUM OF 6" BELOW THE SUB-GRADE OF THE PROPOSED SIDEWALK, OR AS DIRECTED BY THE ENGINEER. THE COST OF ROOT REMOVAL SHALL BE INCLUDED IN THE COST FOR PORTLAND CEMENT CONCRETE SIDEWALK OF THE THICKNESS SPECIFIED.

UTILITIES – LOCATIONS/INFORMATION ON PLANS

THE OWNER AND ENGINEER HAVE NOT UNDERTAKEN SUBSURFACE EXPLORATORY INVESTIGATIONS TO CONFIRM OR VERIFY THE UTILITIES SHOWN ON THESE DOCUMENTS; THEREFORE, THEIR EXACT LOCATION, SIZE AND FUNCTION MUST BE CONSIDERED APPROXIMATE AND MUST BE FIELD CONFIRMED BY THE CONTRACTOR.

THE ENGINEER AND OWNER FURTHER DO NOT WARRANT THAT ALL UTILITIES HAVE BEEN ILLUSTRATED ON THESE DOCUMENTS. THE CONTRACTOR IS SOLELY RESPONSIBLE FOR CONTACTING J.U.L.I.E. FOR FIELD VERIFICATION OF ALL UTILITIES AT THIS LOCATION PRIOR TO COMMENCEMENT OF CONSTRUCTION. IF THE CONTRACTOR DETERMINES THAT SUBSTANTIAL DISCREPANCY EXISTS BETWEEN FIELD VERIFIED UTILITIES AND THESE PLANS, WHICH WOULD SIGNIFICANTLY AFFECT THE FUNCTION, COST, OR PERFORMANCE OF THE PROJECT, THE CONTRACTOR SHALL IMMEDIATELY CONTACT THE ENGINEER FOR CLARIFICATION AND PROJECT DIRECTION.

DRAINAGE

PROPOSED DITCHES OR SWALES SHALL BE CONSTRUCTED ACCORDING TO THE PLANS AND AS NEEDED, PER THE DIRECTION OF THE ENGINEER. COST SHALL BE INCLUDED IN COST OF EARTH EXCAVATION.

ALL EARTH AREAS SHALL BE SLOPED TO DRAIN TO PREVENT PONDING OF ANY WATERS, MAXIMUM SLOPE SHALL BE 4:1 UNLESS OTHERWISE APPROVED BY THE ENGINEER.

IT SHOULD BE THE RESPONSIBILITY OF THE CONTRACTOR TO MAINTAIN POSITIVE DRAINAGE DURING VARIOUS STAGES OF CONSTRUCTION. THIS INCLUDES ALL LABOR MATERIALS USED BEYOND WHAT IS SPECIFIED IN THE PLANS. ITEMS SUCH AS TEMPORARY DITCHES AND PIPES DEEMED NECESSARY FOR MAINTAINING DRAINAGE ARE CONSIDERED TO BE THE RESPONSIBILITY OF THE CONTRACTOR AND WILL NOT BE PAID SEPARATELY.

EROSION CONTROL

ALL TEMPORARY AND PERMANENT EROSION CONTROL DEVICES SHALL BE IMPLEMENTED AS SHOWN ON THE PLAN SHEETS. IT IS THE CONTRACTOR'S RESPONSIBILITY TO INSURE THAT ALL EROSION AND DISPLACED SEDIMENT DOES NOT MIGRATE OFF SITE. IF UNEXPECTED EROSION OR SEDIMENTATION OCCURS, OR IF THE EROSION PLAN STRUCTURES BECOME DAMAGED, THE CONTRACTOR SHALL PROVIDE SUFFICIENT MEASURES TO REPAIR, REPLACE, OR INSTALL EROSION CONTROL STRUCTURES TO INSURE OFF-SITE DAMAGE DOES NOT OCCUR. ANY SEDIMENT OR EROSION DAMAGE WHICH OCCURS OFF-SITE SHALL BE REPAIRED BY THE CONTRACTOR AT HIS OR HER EXPENSE.

EROSION AND SEDIMENT CONTROL SHALL BE PERFORMED IN ACCORDANCE WITH SECTION 280 OF THE IDOT STANDARD SPECIFICATIONS AND THE PROJECT PLANS SHOWING EROSION CONTROL ITEMS. EROSION AND SEDIMENT CONTROL DEVICES SHALL BE INSTALLED EARLY IN THE CONSTRUCTION STAGES AND BE MAINTAINED FOR THE DURATION OF THE PROJECT AS INDICATED ON THE PLANS AND AS DIRECTED BY THE ENGINEER.

HIGHWAY STANDARDS

000001 - 08	STANDARD SYMBOLS, ABBREVIATIONS AND PATTERNS
001006	DECIMAL OF AN INCH AND OF A FOOT
280001 - 07	TEMPORARY EROSION CONTROL SYSTEMS
424001 - 11	PERPENDICULAR CURB RAMPS FOR SIDEWALKS
542401 - 04	METAL FLARED END SECTION FOR PIPE CULVERTS
606001 - 08	CONCRETE CURB TYPE B AND COMBINATION CONCRETE CURB AND GUTTER
701001 - 02	OFF-RD OPERATIONS, 2L, 2W, MORE THAN 15' AWAY
701006 - 05	OFF-RD OPERATIONS, 2L, 2W, 15' TO 24" FROM PAVEMENT EDGE
701201 - 05	LANE CLOSURE, 2L, 2W, DAY ONLY, FOR SPEEDS ≥ 45 MPH
701301 - 04	LANE CLOSURE, 2L, 2W, SHORT TIME OPERATIONS
701501 - 06	URBAN LANE CLOSURE, 2L, 2W, UNDIVIDED
701801 - 06	SIDEWALK, CORNER OR CROSSWALK CLOSURE
701901 - 08	TRAFFIC CONTROL DEVICES
720001 - 01	SIGN PANEL MOUNTING DETAILS
720006 - 04	SIGN PANEL ERECTION DETAILS

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CITY OF CARBONDALE
NORTHWEST PEDESTRIAN
AND BICYCLE PATH

GENERAL NOTES

SCALE: N.T.S. SHEET 1 OF 1 SHEETS STA. TO STA.

F.A. RTE.	SECTION	COUNTY	TOTAL SHEETS	SHEET NO.
	17-00136-00-BT	JACKSON	51	2
CONTRACT NO. 99632				
			ILLINOIS	FED. AID PROJECT

CODE NO.	PAY ITEM	UNIT	TOTAL QUANTITY
20100110	TREE REMOVAL (6 TO 15 UNITS DIAMETER)	UNIT	783
20100210	TREE REMOVAL (OVER 15 UNITS DIAMETER)	UNIT	426
20200100	EARTH EXCAVATION	CU YD	675
20201200	REMOVAL AND DISPOSAL OF UNSUITABLE MATERIAL	CU YD	100
20300100	CHANNEL EXCAVATION	CU YD	162
20400800	FURNISHED EXCAVATION	CU YD	750
20800150	TRENCH BACKFILL	CU YD	22
21400100	GRADING AND SHAPING DITCHES	FOOT	310
25000305	SEEDING, CLASS 3A	ACRE	1.5
25000400	NITROGEN FERTILIZER NUTRIENT	POUND	140
25000500	PHOSPHORUS FERTILIZER NUTRIENT	POUND	140
25000600	POTASSIUM FERTILIZER NUTRIENT	POUND	140
28000305	TEMPORARY DITCH CHECKS	FOOT	27
28000400	PERIMETER EROSION BARRIER	FOOT	8203
28000500	INLET AND PIPE PROTECTION	EACH	5
28100707	STONE DUMPED RIPRAP, CLASS A4	SQ YD	219
28200200	FILTER FABRIC	SQ YD	219
30300011	AGGREGATE SUBGRADE IMPROVEMENT	TON	1335
35101400	AGGREGATE BASE COURSE, TYPE B	TON	722
42400300	PORTLAND CEMENT CONCRETE SIDEWALK 6 INCH	SQ FT	44920
42400800	DETECTABLE WARNINGS	SQ FT	32
44000500	COMBINATION CURB AND GUTTER REMOVAL	FOOT	18
50200100	STRUCTURE EXCAVATION	CU YD	30
50300225	CONCRETE STRUCTURES	CU YD	16.4
50800105	REINFORCEMENT BARS	POUND	1940
51200957	FURNISHING METAL SHELL PILES 12" X 0.250"	FOOT	81
51202305	DRIVING PILES	FOOT	81
51203200	TEST PILE METAL SHELLS	EACH	1
54262712	METAL FLARED END SECTIONS 12"	EACH	1
54262715	METAL FLARED END SECTIONS 15"	EACH	2
54262718	METAL FLARED END SECTIONS 18"	EACH	2

CODE NO.	PAY ITEM	UNIT	TOTAL QUANTITY
54262724	METAL FLARED END SECTIONS 24"	EACH	2
54262748	METAL FLARED END SECTIONS 48"	EACH	2
542D0217	PIPE CULVERTS, CLASS D, TYPE 1 12"	FOOT	22
542D0220	PIPE CULVERTS, CLASS D, TYPE 1 15"	FOOT	19
542D0223	PIPE CULVERTS, CLASS D, TYPE 1 18"	FOOT	28
542D0229	PIPE CULVERTS, CLASS D, TYPE 1 24"	FOOT	24
542D0253	PIPE CULVERTS, CLASS D, TYPE 1 48"	FOOT	125
59000200	EPOXY CRACK INJECTION	FOOT	10.8
59200101	BRIDGE WASHING NO. 1	EACH	1
60236200	INLETS, TYPE A, TYPE 8 GRATE	EACH	1
60604400	COMBINATION CONCRETE CURB AND GUTTER, TYPE B-6.18	FOOT	18
67100100	MOBILIZATION	L SUM	1
72000100	SIGN PANEL - TYPE 1	SQ FT	23
73000100	WOOD SIGN SUPPORT	FOOT	98
78001110	PAINT PAVEMENT MARKING - LINE 4"	FOOT	81
78001150	PAINT PAVEMENT MARKING - LINE 12"	FOOT	8
Z0013798	CONSTRUCTION LAYOUT	L SUM	1
Z0015500	DEBRIS REMOVAL	L SUM	1
Z0078000	WOOD RAIL	FOOT	96
Z0078002	WOOD RAIL (SPECIAL)	FOOT	60
X0322194	POLYMER MODIFIED PORTLAND CEMENT MORTAR	SQ FT	1.2
X0322508	PEDESTRIAN TRUSS SUPERSTRUCTURE	SQ FT	622
X0350805	FOLD DOWN BOLLARDS	EACH	2
X0800003	COARSE AGGREGATE BACKFILL (SPECIAL)	CU YD	36
X5030301	CONCRETE WEARING SURFACE (VARIABLE DEPTH)	SQ YD	38.1
X7010216	TRAFFIC CONTROL AND PROTECTION, (SPECIAL)	L SUM	1

Δ SPECIALTY ITEMS

Δ SPECIALTY ITEMS

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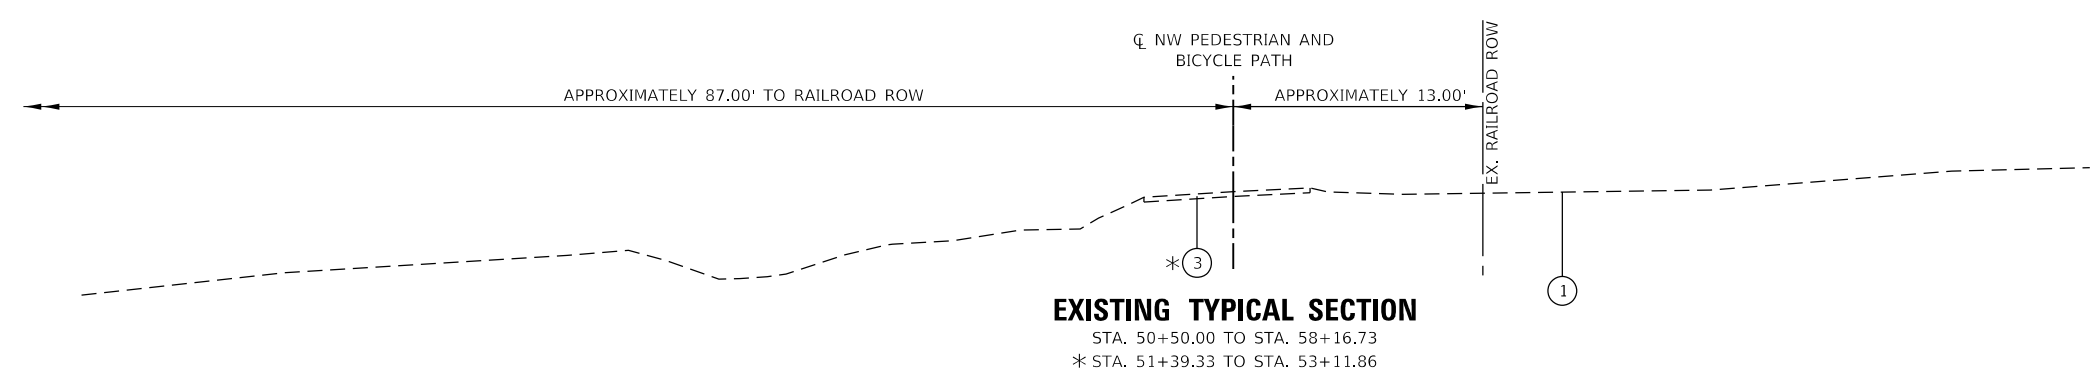
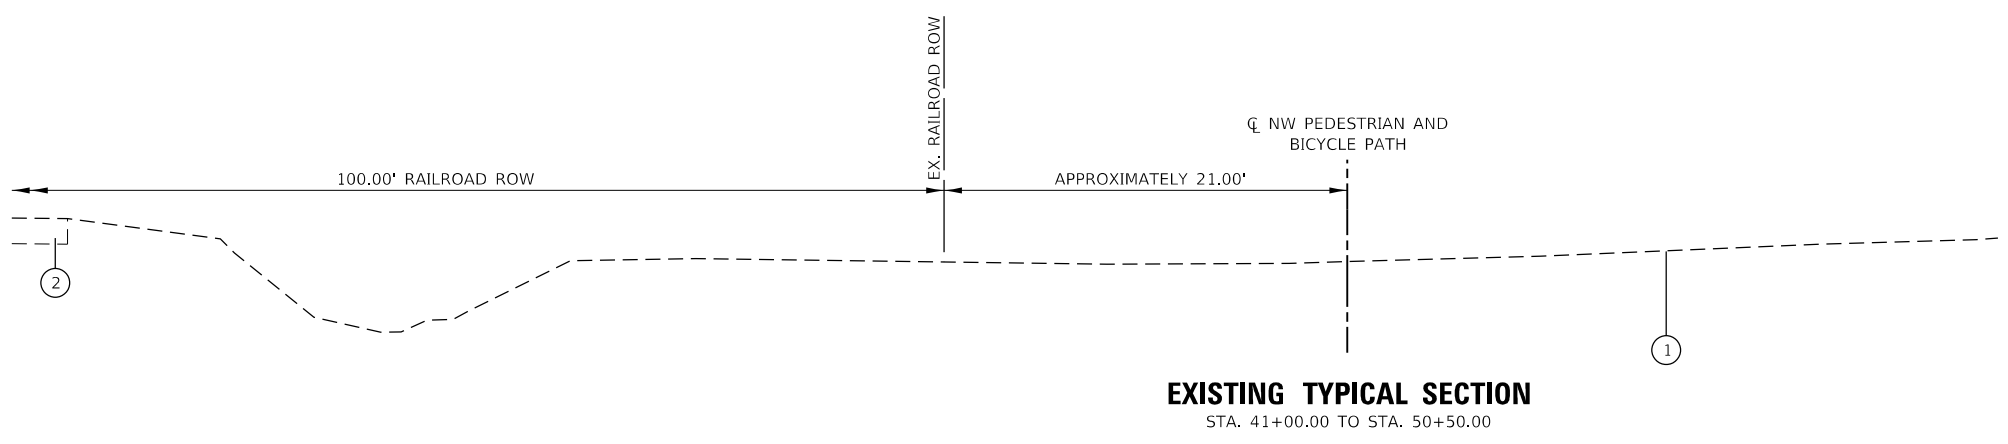
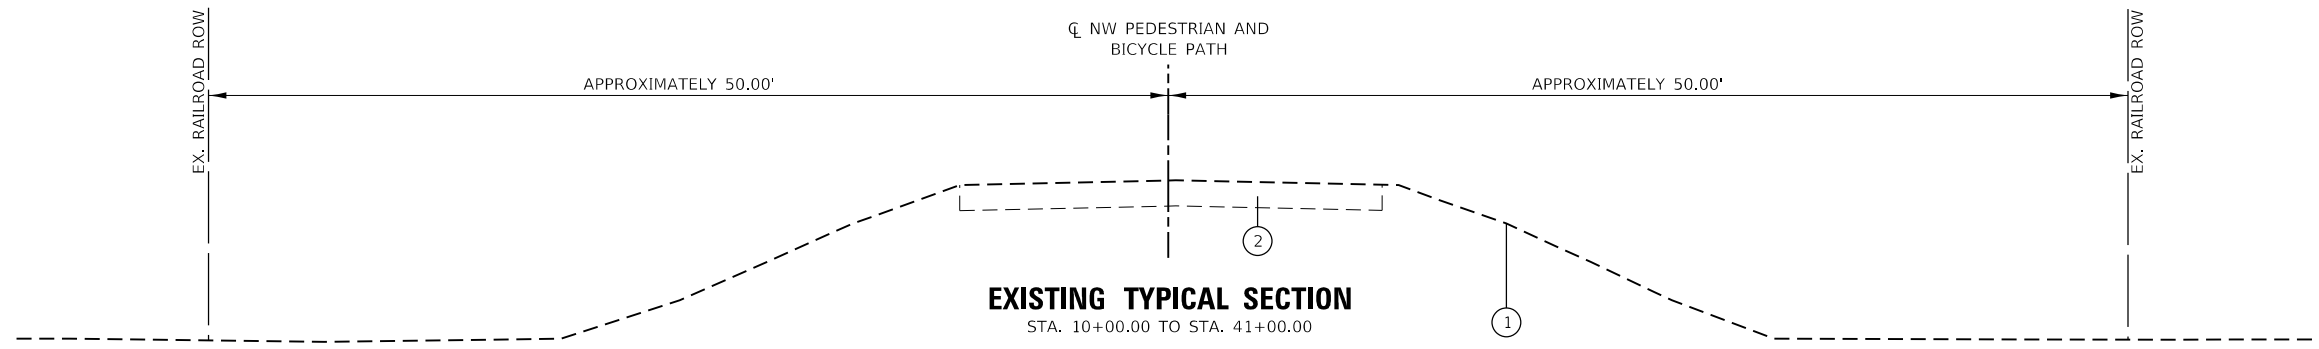
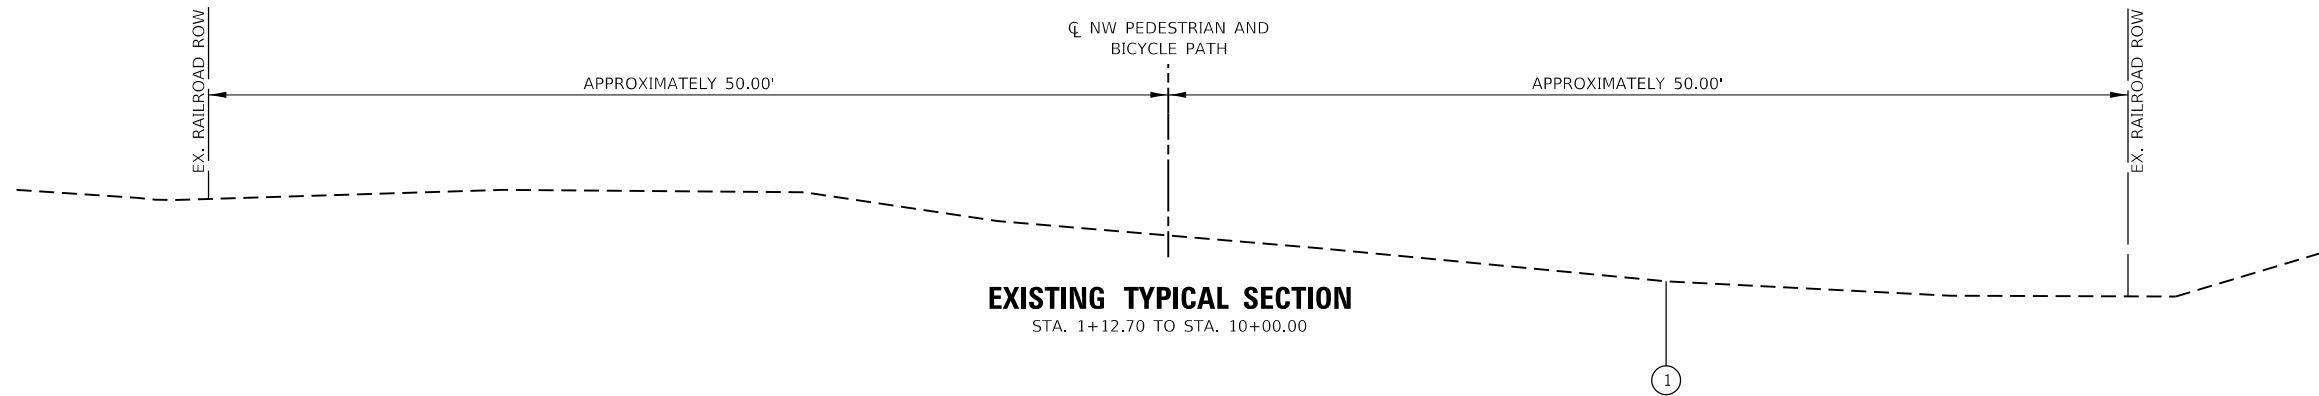


CITY OF CARBONDALE
 NORTHWEST PEDESTRIAN
 AND BICYCLE PATH

SUMMARY OF QUANTITIES

SCALE: N.T.S. SHEET 1 OF 1 SHEETS STA. TO STA.

F.A. RTE.	SECTION	COUNTY	TOTAL SHEETS	SHEET NO.
	17-00136-00-BT	JACKSON	51	3
CONTRACT NO. 99632				
ILLINOIS FED. AID PROJECT				



- LEGEND**
- ① EX. GROUND
 - ② EX. RAILROAD BALLAST
 - ③ EX. CEMETERY ROAD (OIL & CHIP)
 - ④ PR. PORTLAND CEMENT CONCRETE SIDEWALK, 6"
 - ⑤ PR. AGGREGATE BASE COURSE, TYPE B, 3"
 - ⑥ PR. AGGREGATE SUBGRADE IMPROVEMENT, VAR. DEPTH
 - ⑦ PR. EARTH SHOULDER
 - ⑧ PR. AGGREGATE BASE COURSE, TYPE B, 2" (SEE NOTE 1)

NOTES:
 1. INCORPORATE WITH EXISTING AGGREGATE RAIL BED MATERIAL AND GRADE TO PROVIDE LEVEL, UNIFORM BASE FOR CONCRETE SIDEWALK. ENGINEER TO DETERMINE LOCATION AND THICKNESS IN FIELD.

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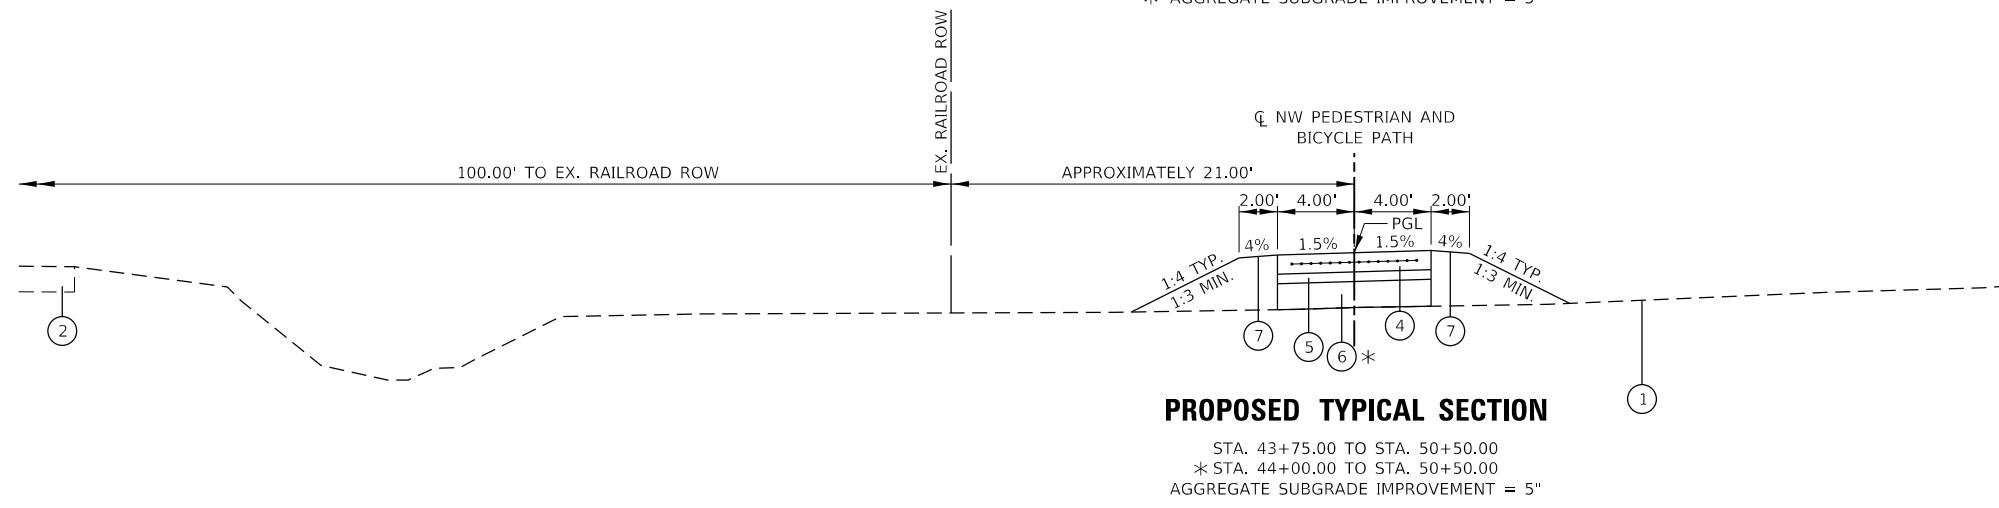
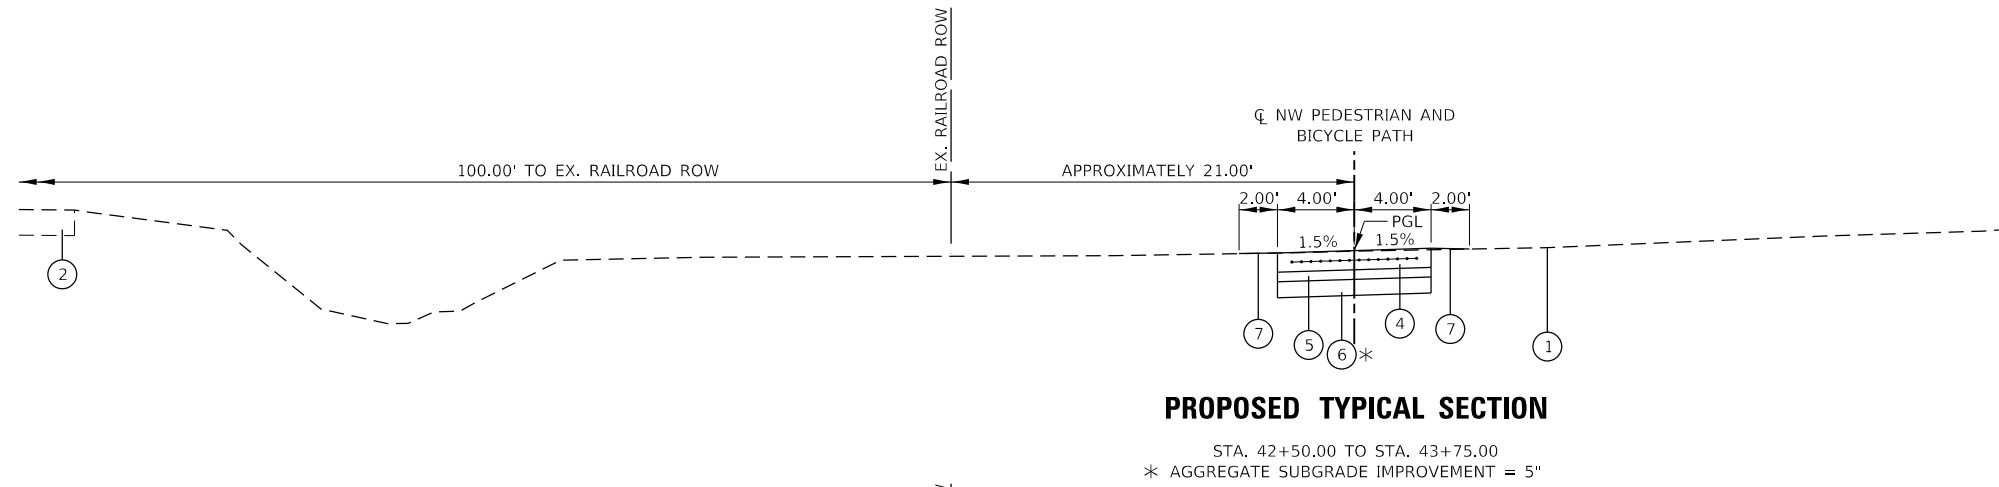
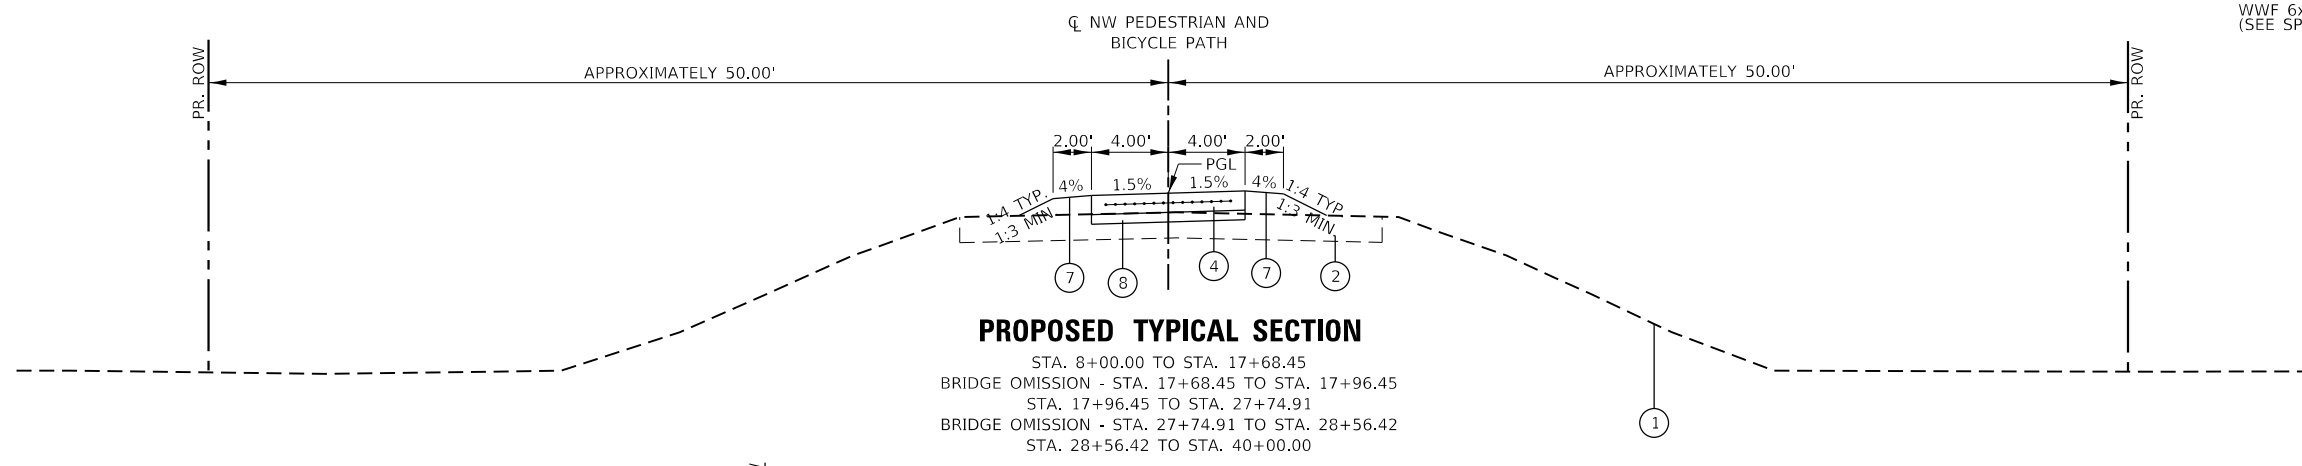
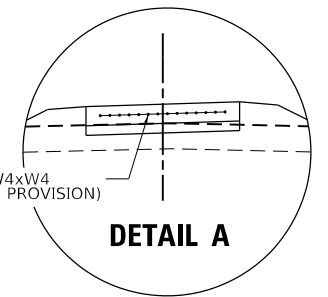
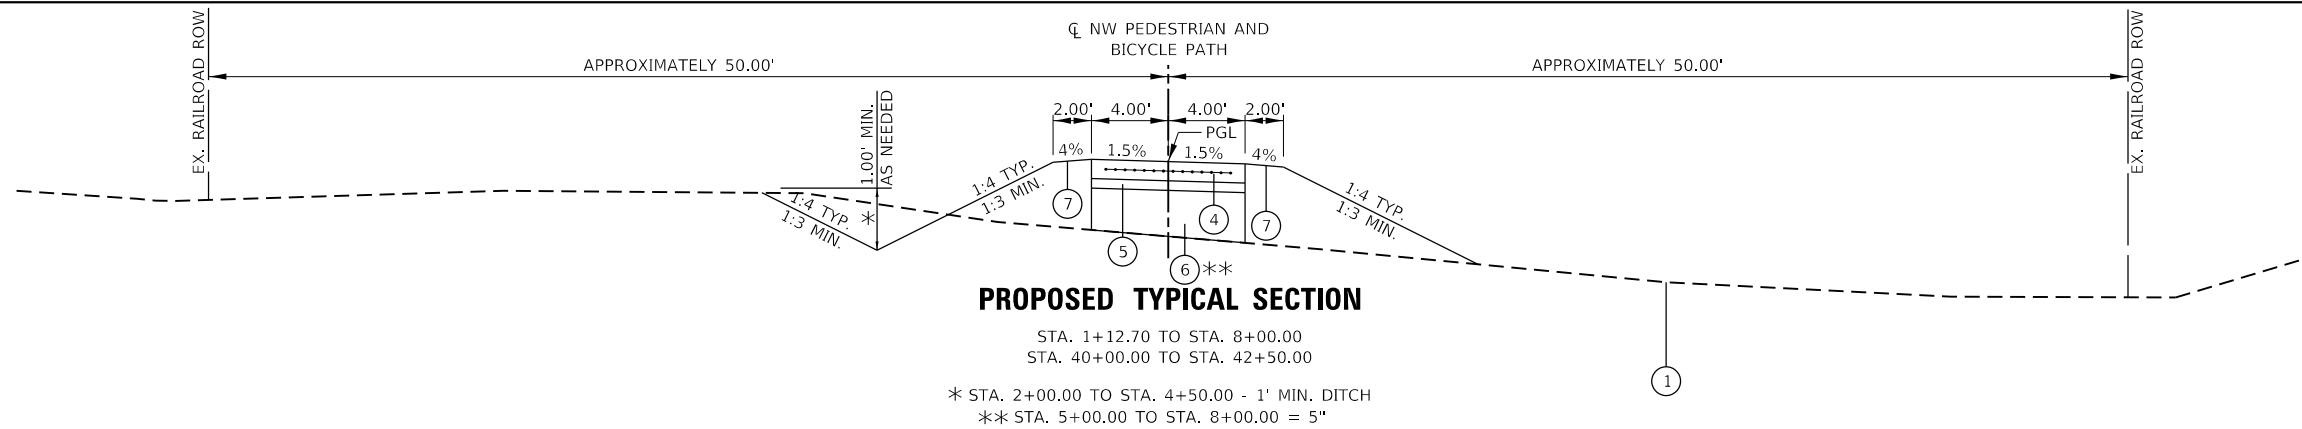
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CITY OF CARBONDALE
 NORTHWEST PEDESTRIAN
 AND BICYCLE PATH

TYPICAL SECTIONS			
SCALE: N.T.S.	SHEET 1	OF 3 SHEETS	STA. TO STA.

F.A. RTE.	SECTION	COUNTY	TOTAL SHEETS	SHEET NO.
	17-00136-00-BT	JACKSON	51	4
ILLINOIS FED. AID PROJECT			CONTRACT NO. 99632	



- LEGEND**
- ① EX. GROUND
 - ② EX. RAILROAD BALLAST
 - ③ EX. CEMETERY ROAD (OIL & CHIP)
 - ④ PR. PORTLAND CEMENT CONCRETE SIDEWALK, 6"
 - ⑤ PR. AGGREGATE BASE COURSE, TYPE B, 3"
 - ⑥ PR. AGGREGATE SUBGRADE IMPROVEMENT, VAR. DEPTH
 - ⑦ PR. EARTH SHOULDER
 - ⑧ PR. AGGREGATE BASE COURSE, TYPE B, 2" (SEE NOTE 1)

NOTES:
 1. INCORPORATE WITH EXISTING AGGREGATE RAIL BED MATERIAL AND GRADE TO PROVIDE LEVEL, UNIFORM BASE FOR CONCRETE SIDEWALK. ENGINEER TO DETERMINE LOCATION AND THICKNESS IN FIELD.
 2. PGL SHALL BE APPROXIMATELY 6" ABOVE EX. GROUND UNLESS NOTED OTHERWISE ON THE PLAN AND PROFILE SHEETS.

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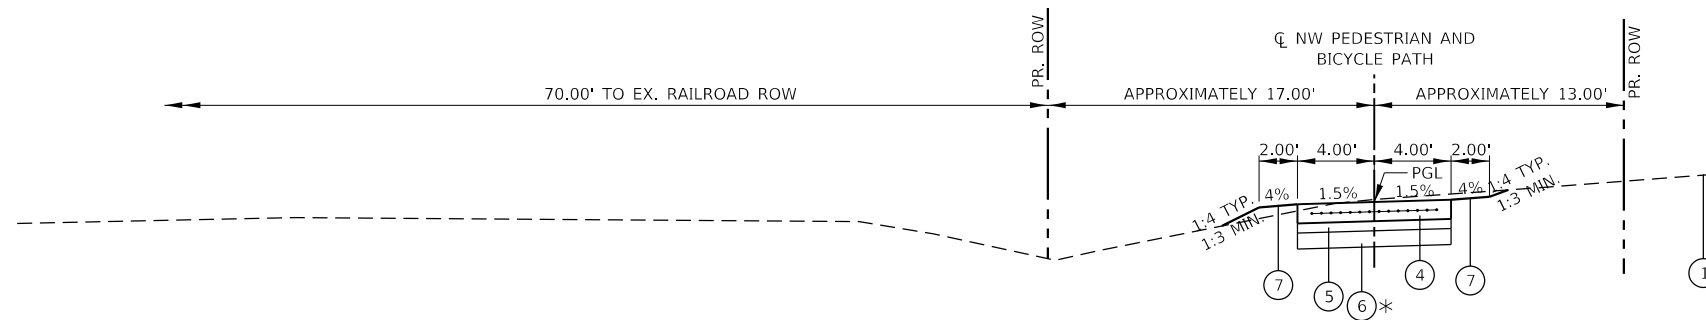
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CITY OF CARBONDALE
 NORTHWEST PEDESTRIAN
 AND BICYCLE PATH



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SCALE: N.T.S.	SHEET 2 OF 3 SHEETS
STA.	TO STA.

F.A. RTE.	SECTION	COUNTY	TOTAL SHEETS	SHEET NO.
	17-00136-00-BT	JACKSON	51	5
ILLINOIS FED. AID PROJECT			CONTRACT NO. 99632	



PROPOSED TYPICAL SECTION

STA. 54+00.00 TO STA. 58+00.00
 * AGGREGATE SUBGRADE IMPROVEMENT = 5"

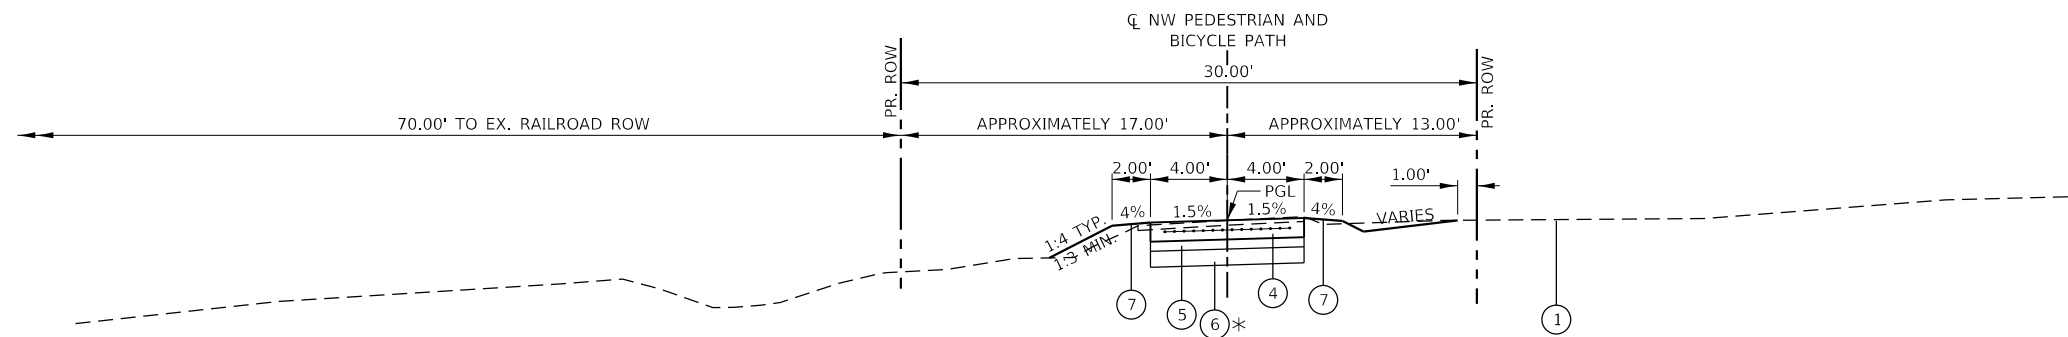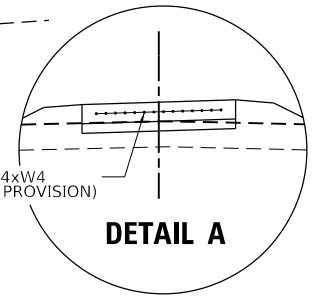

PROPOSED TYPICAL SECTION

STA. 50+50.00 TO STA. 54+00.00
 STA. 58+00.00 TO STA. 58+16.73
 * AGGREGATE SUBGRADE IMPROVEMENT = 5"

LEGEND

- ① EX. GROUND
- ② EX. RAILROAD BALLAST
- ③ EX. CEMETERY ROAD (OIL & CHIP)
- ④ PR. PORTLAND CEMENT CONCRETE SIDEWALK, 6"
PR. AGGREGATE BASE COURSE, TYPE B, 3"
- ⑤ PR. AGGREGATE SUBGRADE IMPROVEMENT, VAR. DEPTH
- ⑥ PR. EARTH SHOULDER
- ⑦ PR. AGGREGATE BASE COURSE, TYPE B, 2"
(SEE NOTE 1)
- ⑧

NOTES:
 1. INCORPORATE WITH EXISTING AGGREGATE RAIL BED MATERIAL AND GRADE TO PROVIDE LEVEL, UNIFORM BASE FOR CONCRETE SIDEWALK. ENGINEER TO DETERMINE LOCATION AND THICKNESS IN FIELD.
 2. PGL SHALL BE APPROXIMATELY 6" ABOVE EX. GROUND UNLESS NOTED OTHERWISE ON THE PLAN AND PROFILE SHEETS.

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CITY OF CARBONDALE
 NORTHWEST PEDESTRIAN
 AND BICYCLE PATH

TYPICAL SECTIONS		F.A. RTE.	SECTION	COUNTY	TOTAL SHEETS	SHEET NO.
SCALE: N.T.S.	SHEET 3 OF 3 SHEETS	STA.	17-00136-00-BT	JACKSON	51	6
				CONTRACT NO. 99632		
				ILLINOIS FED. AID PROJECT		

EARTHWORK SCHEDULE								
LOCATION				EARTH EXCAVATION	FOR INFORMATION ONLY			FURNISHED EXCAVATION
					EARTH EXCAVATION ADJUSTED FOR 25% SHRINKAGE	EMBANKMENT	BALANCE WASTE (+) SHORTAGE (-)	
ROUTE	STATION	TO	STATION	CU YD	CU YD	CU YD	CU YD	CU YD
NW PATH	1+14.78	TO	58+16.73	674	505.5	1254	-748.5	748.5
SUB-TOTAL:				674	506	1254	-748	749
PAY TOTAL:				675	505	1255	-750	750

EROSION CONTROL SCHEDULE							
LOCATION				TEMPORARY DITCH CHECKS	INLET AND PIPE PROTECTION	PERIMETER EROSION BARRIER	
STATION	TO	STATION	LT/RT	EACH	FOOT	EACH	FOOT
NORTHWEST PEDESTRIAN AND BICYCLE PATH							
1+12.70	TO	5+00.00	LT	2	18	1	
1+12.70	TO	5+00.00	RT				50.0
5+00.00	TO	17+00.00	LT				985.0
5+00.00	TO	17+00.00	RT				680.0
17+00.00	TO	29+00.00	LT				1114.0
17+00.00	TO	29+00.00	RT				1116.0
29+00.00	TO	40+00.00	LT				1100.0
29+00.00	TO	40+00.00	RT				1100.0
40+00.00	TO	46+00.00	LT			1	573.0
40+00.00	TO	46+00.00	RT			1	285.0
46+00.00	TO	52+00.00	LT				600.0
46+00.00	TO	52+00.00	RT				600.0
52+00.00	TO	58+16.73	LT	1	9		600.0
52+00.00	TO	58+16.73	RT			2	
TOTAL:				27		5	8,203

TREE REMOVAL SCHEDULE					
LOCATION				TREE REMOVAL (6 TO 15 UNITS DIAMETER)	TREE REMOVAL (OVER 15 UNITS DIAMETER)
STATION	TO	STATION	LT/RT	UNIT	UNIT
NORTHWEST PEDESTRIAN AND BICYCLE PATH					
1+12.70	TO	5+00.00	LT		
1+12.70	TO	5+00.00	RT		
5+00.00	TO	17+00.00	LT	22.0	20.0
5+00.00	TO	17+00.00	RT	30.0	21.0
17+00.00	TO	29+00.00	LT	88.0	
17+00.00	TO	29+00.00	RT	28.0	50.0
29+00.00	TO	40+00.00	LT	162.0	
29+00.00	TO	40+00.00	RT	116.0	
40+00.00	TO	46+00.00	LT	101.0	79.0
40+00.00	TO	46+00.00	RT	152.0	82.0
46+00.00	TO	52+00.00	LT	73.0	136.0
46+00.00	TO	52+00.00	RT	11.0	38.0
52+00.00	TO	58+16.73	LT		
52+00.00	TO	58+16.73	RT		
TOTAL:				783	426

*SEE PLAN SHEETS FOR ADDITIONAL INFORMATION

SEEDING SCHEDULE									
LOCATION				SEEDING CLASS 3A	NITROGEN FERTILIZER NUTRIENT	PHOSPHORUS FERTILIZER NUTRIENT	POTASSIUM FERTILIZER NUTRIENT	FOR INFORMATION ONLY	
								MULCH METHOD 1	TEMP. EROSION CONTROL SEEDING (POUND) (2 APPL.)
STATION	TO	STATION	ACRE	POUND	POUND	POUND	ACRE	POUND	
NORTHWEST PEDESTRIAN AND BICYCLE PATH									
1+12.70	TO	58+16.73	1.518	136.6	136.6	136.6	1.518	303.6	
TOTAL:				1.518	136.6	136.6	1.50	300	
PAY TOTAL:				1.50	140	140	140		

DRAINAGE SCHEDULE																		
LOCATION							INLETS, TYPE A, TYPE 8 GRATE	METAL FLARED END SECTIONS					PIPE CULVERTS, CLASS D, TYPE 1					TRENCH BACKFILL
								12 INCH	15 INCH	18 INCH	24 INCH	48 INCH	12 INCH	15 INCH	18 INCH	24 INCH	48 INCH	
STATION	TO	STATION	LT/RT	STATION	TO	STATION	EACH	EACH	EACH	EACH	EACH	FOOT	FOOT	FOOT	FOOT	FOOT		
NORTHWEST PEDESTRIAN AND BICYCLE PATH																		
3+00.00	13.08	LT	TO	3+00.00	14.41	RT									27.5	3.4		
40+90.02	20.56	RT	TO	42+09.55	24.76	LT					2					124.9		
43+88.62	11.34	RT	TO	43+93.54	12.21	LT					2			24.0		2.8		
53+60.27	7.74	LT	TO	53+77.85	7.73	RT	1	1				22.4				2.4		
58+04.97	9.24	LT	TO	58+07.72	9.16	RT					2			18.6		1.5		
TOTAL:							1	1	2	2	2	22	19	28	24	125	22	

SIDEWALK SCHEDULE							
LOCATION		AGGREGATE BASE COURSE, TYPE B	AGGREGATE SUBGRADE IMPROVEMENT	REMOVAL AND DISPOSAL OF UNSUITABLE MATERIAL	PORTLAND CEMENT CONCRETE SIDEWALK 6 INCH	DETECTABLE WARNINGS	FOLD DOWN BOLLARDS
STATION	TON	TON	CU YD	SQ FT	SQ FT	EACH	EACH
NORTHWEST PEDESTRIAN AND BICYCLE PATH							
1+12.70	TO	5+00.00		304.3		16.0	
1+35.78			106.9				1
5+00.00	TO	8+00.00		77.8			
8+00.00	TO	40+00.00	331.8				
40+00.00	TO	42+50.00		337.9	44871.8		
42+50.00	TO	43+75.00		32.4			
43+75.00	TO	44+00.00	282.6				
44+00.00	TO	58+16.73		367.3		16.0	
57+65.00	TO	57+73.00	0.9		48.0		
57+95.73							1
SUB-TOTAL:		722	1135	0	44920	32	2
CONTINGENCY:			200	100			
TOTAL:		722	1335	100	44920	32	2

CURB AND GUTTER SCHEDULE			
LOCATION		COMBINATION CONCRETE CURB AND GUTTER, TYPE B-6.18	COMBINATION CURB AND GUTTER REMOVAL
STATION	NOTES	FOOT	FOOT
NORTHWEST PEDESTRIAN AND BICYCLE PATH			
1+12.70	TO 1+14.78	CURB RAMP	18.0
TOTAL:			18

GRADING AND SHAPING DITCHES SCHEDULE				
LOCATION				GRADING AND SHAPING DITCHES
STATION	TO	STATION	LT/RT	FOOT
NORTHWEST PEDESTRIAN AND BICYCLE PATH				
2+00.00	TO	4+00.00	LT	200.0
52+50.00	TO	53+60.00	LT	110.0
TOTAL:				310

PAVEMENT MARKING SCHEDULE						
LOCATION				PAINT PAVEMENT MARKING - LINE 4"	PAINT PAVEMENT MARKING - LINE 12"	
						YELLOW
STATION	TO	STATION	LOCATION	TYPE	FOOT	FOOT
NORTHWEST PEDESTRIAN AND BICYCLE PATH						
1+20.78	TO	1+50.78	Center	Solid Yellow Line	40.4	
1+21.28			Stop bar	Solid White Line		4.0
57+80.73	TO	58+10.73	Center	Solid Yellow Line	40.4	
58+10.21			Stop bar	Solid White Line		4.0
TOTAL:					81	8

FENCE SCHEDULE	
LOCATION	WOOD RAIL
STATION	FOOT
NORTHWEST PEDESTRIAN AND BICYCLE PATH	
EX. BRIDGE (4 QUADS)	48.0
PR. TRUSS BRIDGE (3 QUADS)	48.0
TOTAL:	
	96

SIGNAGE SCHEDULE						
LOCATION		DESCRIPTION			SIGN PANEL - TYPE 1	WOOD SIGN SUPPORT
STATION	SIGN	SHAPE	SIZE	SQ FT	FOOT	
NORTHWEST PEDESTRIAN AND BICYCLE PATH						
1+20.80	8.00	RT	R5-3 (NO MOTOR VEHICLES)	RECTANGLE	24.0 X 24.0	4.00
1+20.80	8.00	LT	R1-1 (STOP)	OCTAGON	18.0 X 18.0	2.25
2+70.80	8.00	LT	W3-1 (STOP AHEAD)	RECTANGLE	18.0 X 18.0	2.25
56+60.72	8.00	RT	W3-1 (STOP AHEAD)	RECTANGLE	18.0 X 18.0	2.25
58+10.72	8.00	RT	R1-1 (STOP)	OCTAGON	18.0 X 18.0	2.25
58+10.72	8.00	LT	R5-3 (NO MOTOR VEHICLES)	RECTANGLE	24.0 X 24.0	4.00
OAKLAND AVE.	LT		W16-1 (SHARE THE ROAD)	RECTANGLE	18.0 X 24.0	3.00
OAKLAND AVE.	LT		W16-1 (SHARE THE ROAD)	RECTANGLE	18.0 X 24.0	3.00
TOTAL:					23	98

NOTES:
1. FOR BRIDGE QUANTITIES, SEE STRUCTURAL PLANS AND DETAILS.

MODEL: I:\P\NAME\170528\170528.dwg
FILE NAME: 170528.dwg
DRAWN: EKF
CHECKED: JRR
DATE: 3/4/2022



USER NAME = efisher	DESIGNED - EKF	REVISED -
	DRAWN - EKF	REVISED -
PLOT SCALE = 2,000' / in.	CHECKED - JRR	REVISED -
PLOT DATE = 3/4/2022	DATE -	REVISED -



CITY OF CARBONDALE
NORTHWEST PEDESTRIAN AND BICYCLE PATH

SCHEDULE OF QUANTITIES				F.A. RTE.	SECTION	COUNTY	TOTAL SHEETS	SHEET NO.
SCALE: N.T.S.	SHEET 1	OF 1	SHEETS	STA.	TO STA.	JACKSON	51	7
						CONTRACT NO. 99632		
						ILLINOIS FED. AID PROJECT		

PROP. CURVE P_FINAL1
 PI STA. = 1+35.59
 $\Delta = 29^\circ 11' 15''$ (RT)
 $D = 163^\circ 42' 08''$
 $R = 35.00'$
 $T = 9.11'$
 $L = 17.83'$
 $E = 1.17'$
 $e = N/A$
 $T.R. = N/A$
 $S.E. RUN = N/A$
 $P.C. STA. = 1+26.47$
 $P.T. STA. = 1+44.30$


PROP. CURVE P_FINAL2
 PI STA. = 2+15.45
 $\Delta = 9^\circ 53' 18''$ (LT)
 $D = 28^\circ 38' 52''$
 $R = 200.00'$
 $T = 17.30'$
 $L = 34.52'$
 $E = 0.75'$
 $e = N/A$
 $T.R. = N/A$
 $S.E. RUN = N/A$
 $P.C. STA. = 1+98.15$
 $P.T. STA. = 2+32.67$

**CARBONDALE NORTHWEST
 WASTEWATER TREATMENT PLANT**

PROP. CURVE P_FINAL3
 PI STA. = 10+94.34
 $\Delta = 0^\circ 26' 09''$ (RT)
 $D = 0^\circ 22' 55''$
 $R = 15,000.00'$
 $T = 57.05'$
 $L = 114.10'$
 $E = 0.11'$
 $e = N/A$
 $T.R. = N/A$
 $S.E. RUN = N/A$
 $P.C. STA. = 10+37.29$
 $P.T. STA. = 11+51.39$

PROP. CURVE P_FINAL4
 PI STA. = 16+02.49
 $\Delta = 0^\circ 58' 29''$ (LT)
 $D = 0^\circ 45' 50''$
 $R = 7,500.00'$
 $T = 63.80'$
 $L = 127.59'$
 $E = 0.27'$
 $e = N/A$
 $T.R. = N/A$
 $S.E. RUN = N/A$
 $P.C. STA. = 15+38.69$
 $P.T. STA. = 16+66.28$

PROP. CURVE P_FINAL5
 PI STA. = 20+13.42
 $\Delta = 0^\circ 32' 21''$ (RT)
 $D = 0^\circ 22' 55''$
 $R = 15,000.00'$
 $T = 70.56'$
 $L = 141.12'$
 $E = 0.17'$
 $e = N/A$
 $T.R. = N/A$
 $S.E. RUN = N/A$
 $P.C. STA. = 19+42.86$
 $P.T. STA. = 20+83.98$

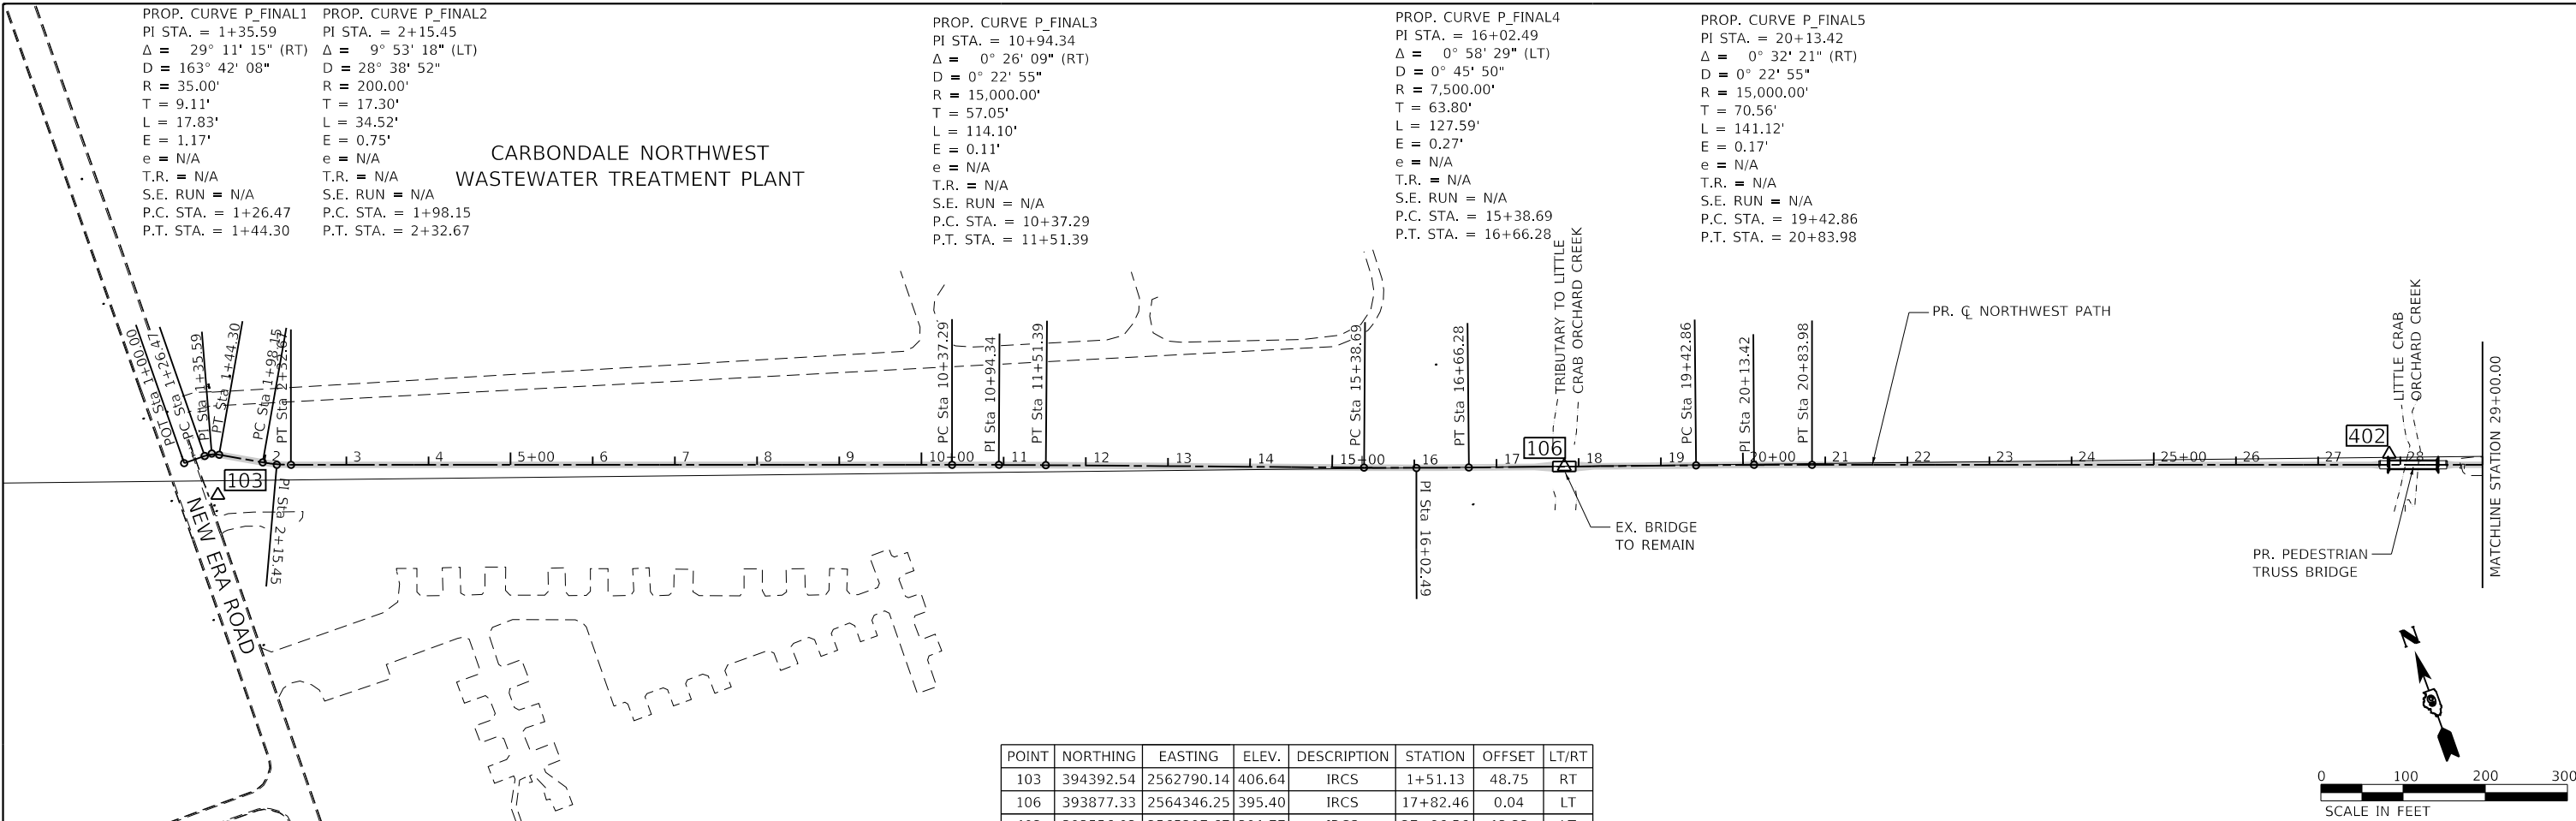



POINT	NORTHING	EASTING	ELEV.	DESCRIPTION	STATION	OFFSET	LT/RT
103	394392.54	2562790.14	406.64	IRCS	1+51.13	48.75	RT
106	393877.33	2564346.25	395.40	IRCS	17+82.46	0.04	LT
402	393556.02	2565297.67	391.77	IRCS	27+86.56	13.23	LT
400	393448.45	2565556.30	396.72	IRCS	30+66.26	1.66	RT
100	392697.02	2567754.97	406.58	IRCS	54+10.39	62.48	LT
101	392596.82	2568105.07	405.64	IRCS	57+73.84	85.14	LT



PROP. CURVE P_FINAL8
 PI STA. = 50+45.58
 $\Delta = 29^\circ 59' 54''$ (LT)
 $D = 57^\circ 17' 45''$
 $R = 100.00'$
 $T = 26.79'$
 $L = 52.36'$
 $E = 3.53'$
 $e = N/A$
 $T.R. = N/A$
 $S.E. RUN = N/A$
 $P.C. STA. = 50+18.79$
 $P.T. STA. = 50+71.15$

PROP. CURVE P_FINAL9
 PI STA. = 51+12.36
 $\Delta = 29^\circ 59' 54''$ (RT)
 $D = 57^\circ 17' 45''$
 $R = 100.00'$
 $T = 26.79'$
 $L = 52.36'$
 $E = 3.53'$
 $e = N/A$
 $T.R. = N/A$
 $S.E. RUN = N/A$
 $P.C. STA. = 50+85.57$
 $P.T. STA. = 51+37.92$

PROP. CURVE P_FINAL10
 PI STA. = 58+04.72
 $\Delta = 18^\circ 42' 33''$ (LT)
 $D = 163^\circ 42' 08''$
 $R = 35.00'$
 $T = 5.77'$
 $L = 11.43'$
 $E = 0.47'$
 $e = N/A$
 $T.R. = N/A$
 $S.E. RUN = N/A$
 $P.C. STA. = 57+98.96$
 $P.T. STA. = 58+10.38$

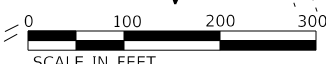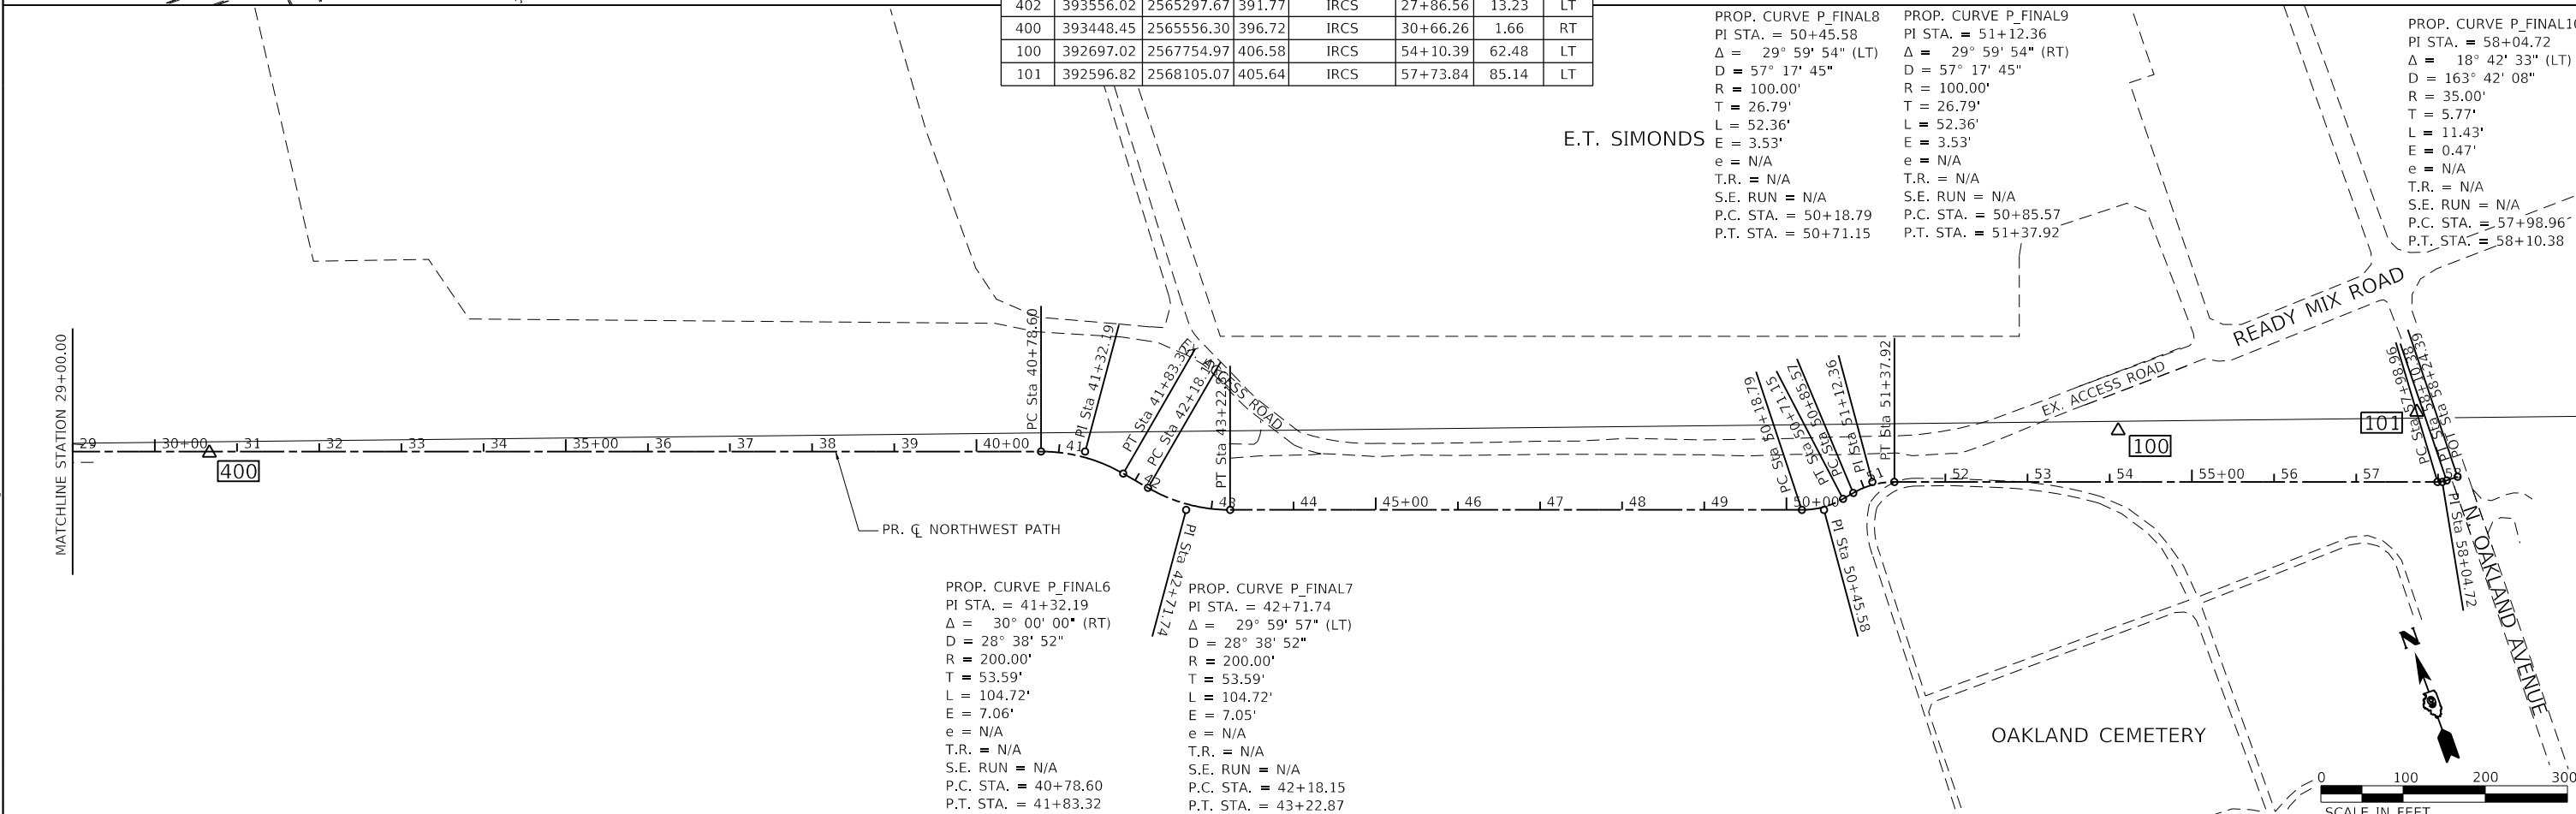

PROP. CURVE P_FINAL6
 PI STA. = 41+32.19
 $\Delta = 30^\circ 00' 00''$ (RT)
 $D = 28^\circ 38' 52''$
 $R = 200.00'$
 $T = 53.59'$
 $L = 104.72'$
 $E = 7.06'$
 $e = N/A$
 $T.R. = N/A$
 $S.E. RUN = N/A$
 $P.C. STA. = 40+78.60$
 $P.T. STA. = 41+83.32$

PROP. CURVE P_FINAL7
 PI STA. = 42+71.74
 $\Delta = 29^\circ 59' 57''$ (LT)
 $D = 28^\circ 38' 52''$
 $R = 200.00'$
 $T = 53.59'$
 $L = 104.72'$
 $E = 7.05'$
 $e = N/A$
 $T.R. = N/A$
 $S.E. RUN = N/A$
 $P.C. STA. = 42+18.15$
 $P.T. STA. = 43+22.87$



USER NAME = efisher
 PLOT SCALE = 200.0000' / in.
 PLOT DATE = 1/24/2022

DESIGNED - EKF
 DRAWN - EKF
 CHECKED - JRR
 DATE -

REVISED -
 REVISED -
 REVISED -
 REVISED -



**CITY OF CARBONDALE
 NORTHWEST PEDESTRIAN
 AND BICYCLE PATH**

ALIGNMENT, TIES AND BENCHMARKS

SCALE: 1" = 100' SHEET 1 OF 1 SHEETS STA. TO STA.


F.A. RTE.	SECTION	COUNTY	TOTAL SHEETS	SHEET NO.
	17-00136-00-BT	JACKSON	51	8
CONTRACT NO. 99632				
ILLINOIS FED. AID PROJECT				

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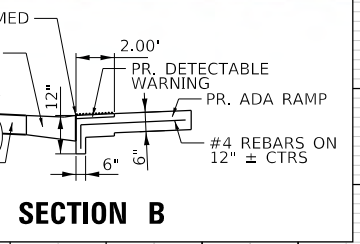
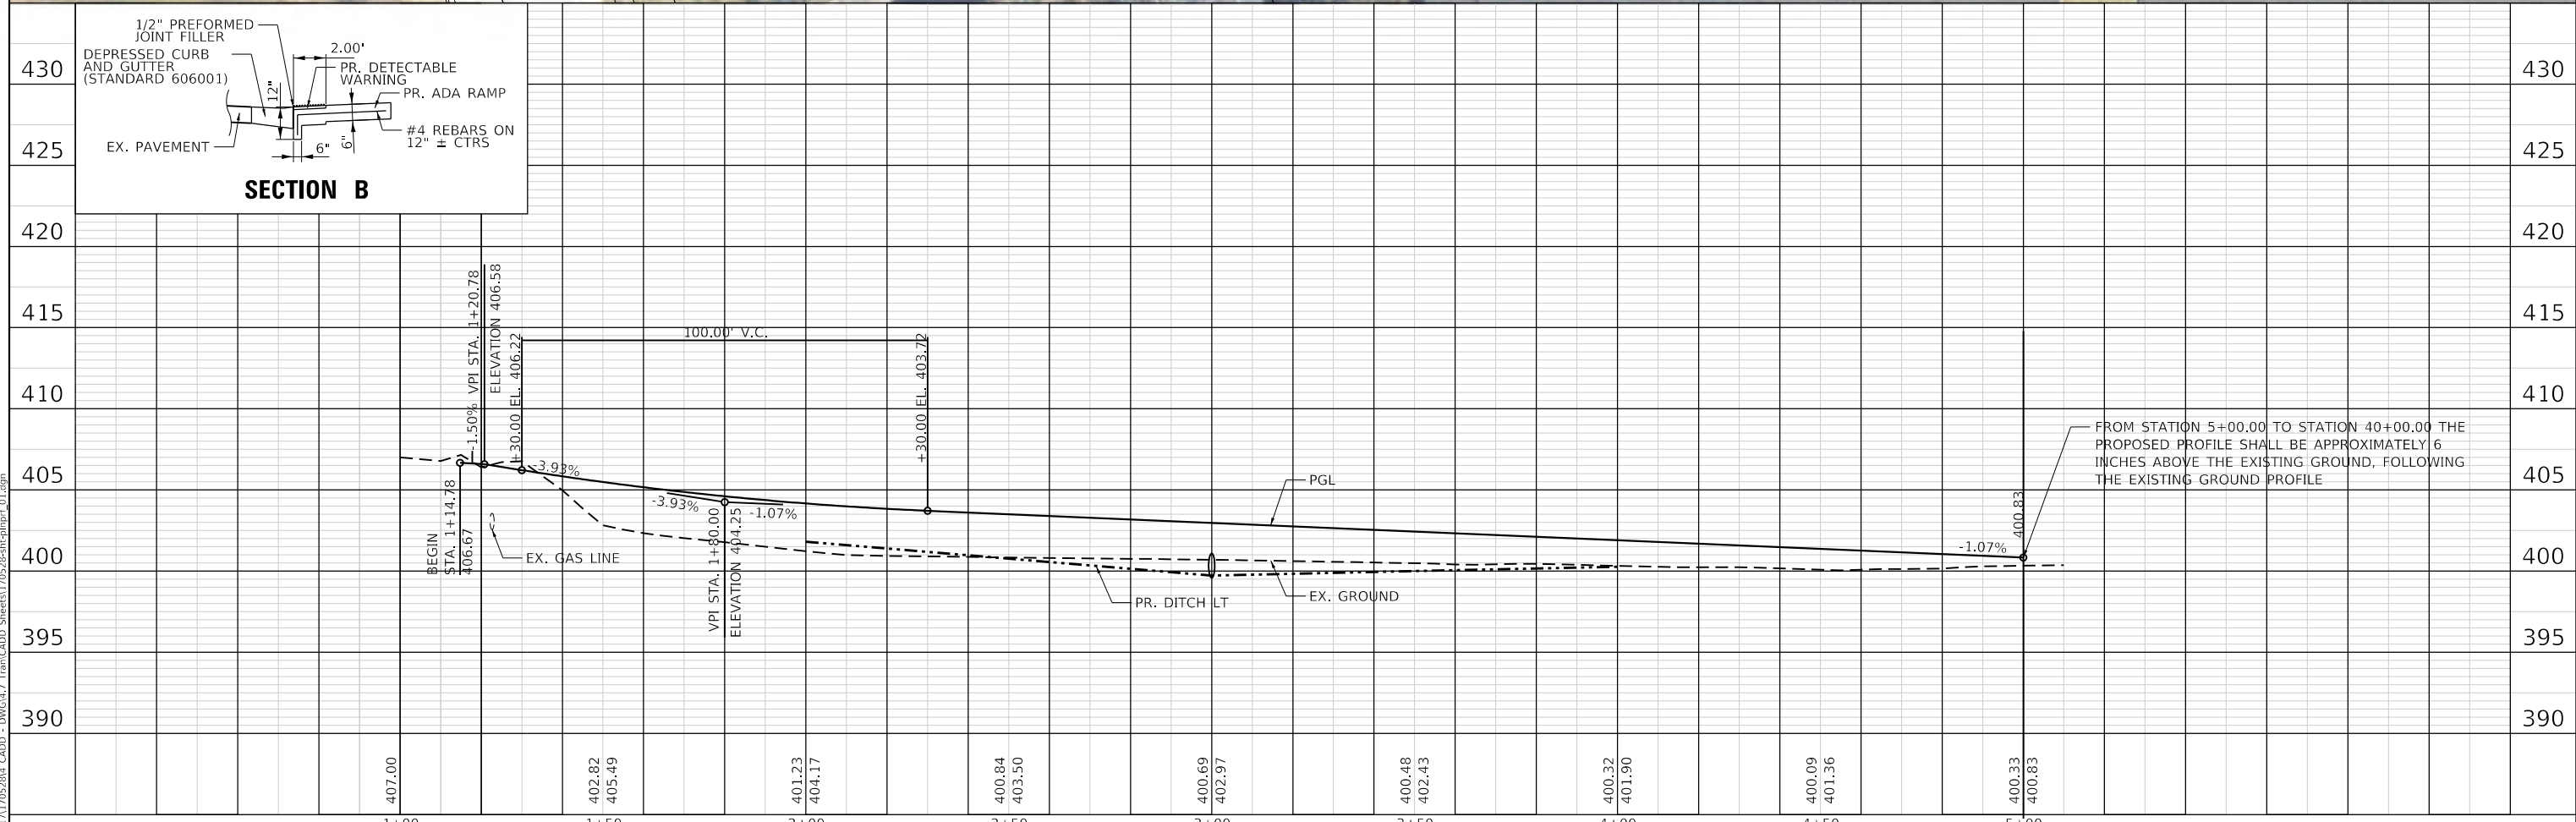
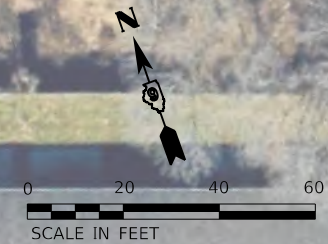
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PLAN	
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- TEMPORARY DITCH CHECK
 - INLET AND PIPE PROTECTION
 - PERIMETER EROSION BARRIER
- NOTES:
 1. SEE SCHEDULES FOR ADDITIONAL INFORMATION.
 2. SEE TREE REMOVAL GENERAL NOTES FOR ADDITIONAL INFORMATION.



USER NAME = efisher	DESIGNED - EKF	REVISED -
PLOT SCALE = 40.0000' / in.	DRAWN - EKF	REVISED -
PLOT DATE = 3/4/2022	CHECKED - JRR	REVISED -
	DATE -	REVISED -

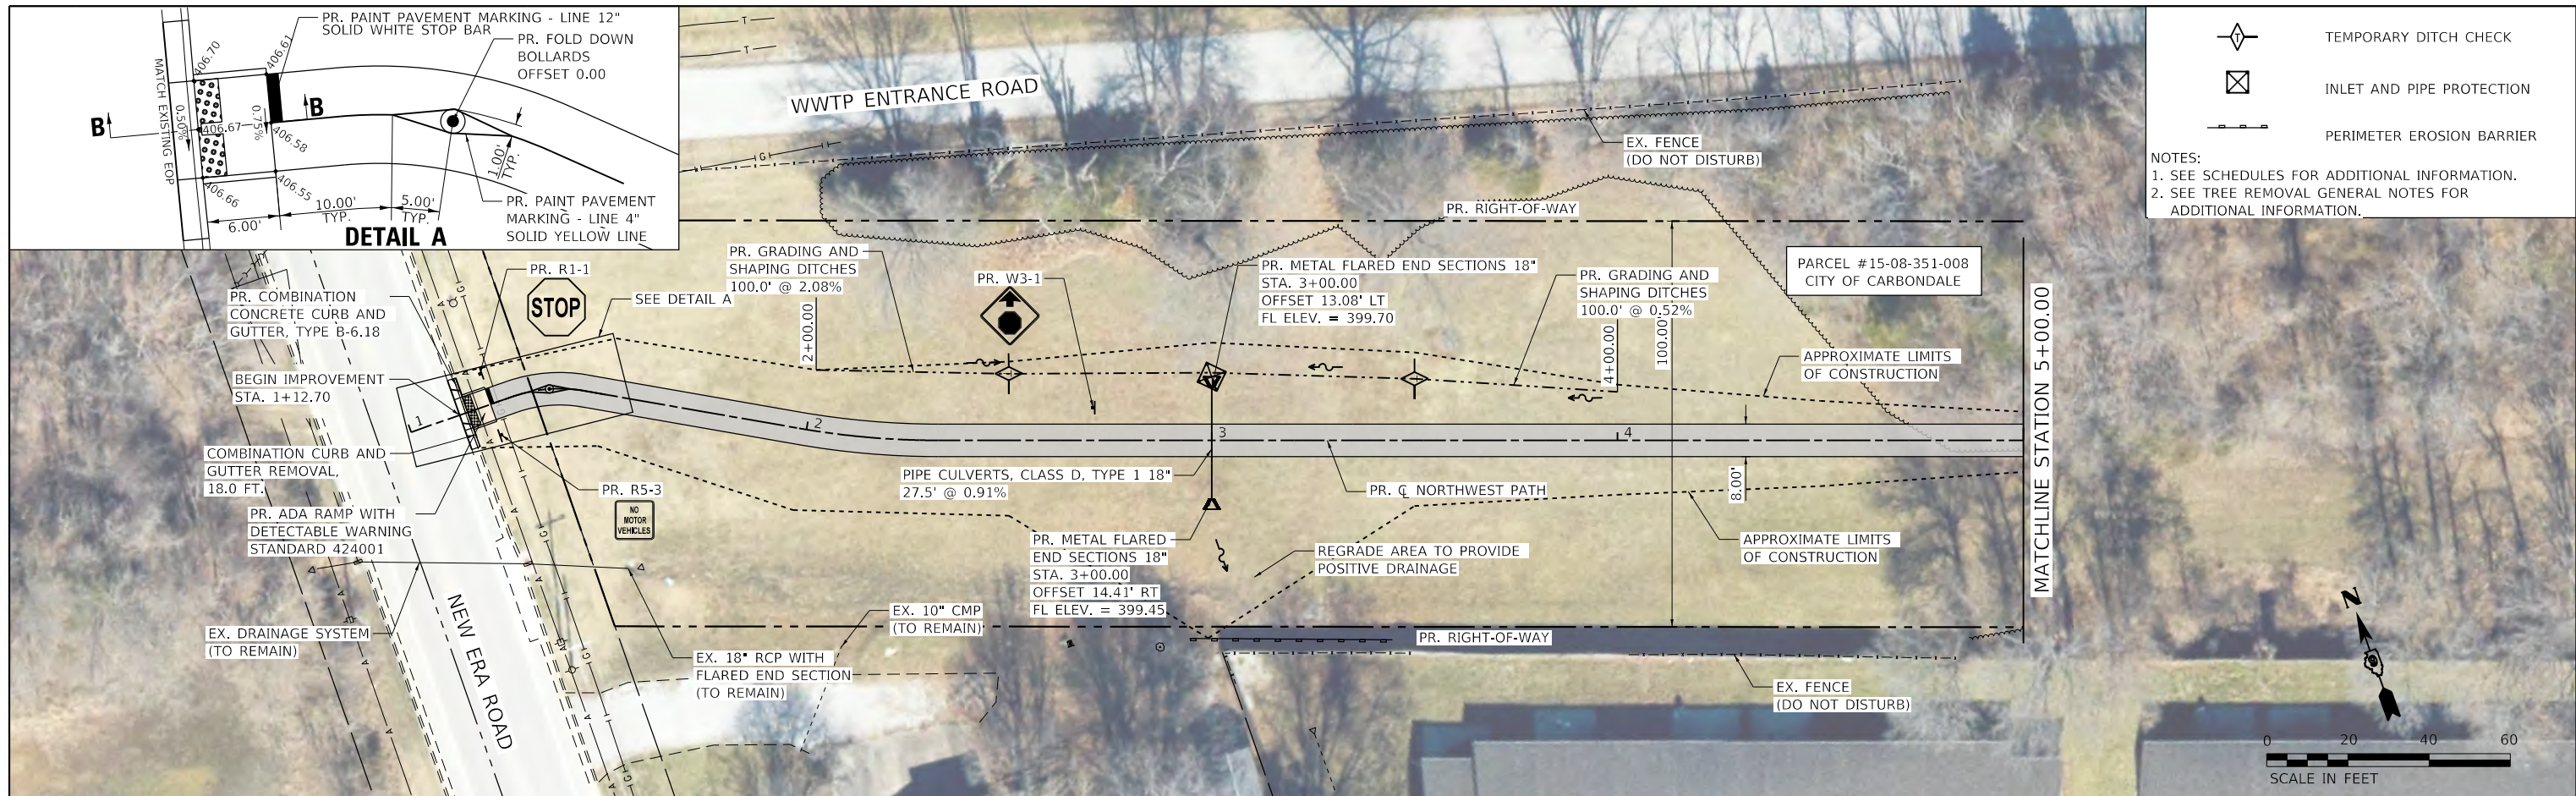

CITY OF CARBONDALE
 NORTHWEST PEDESTRIAN
 AND BICYCLE PATH

PLAN, EROSION CONTROL, PAVEMENT MARKING AND SIGNAGE
 SCALE: 1" = 20' SHEET 1 OF 7 SHEETS STA. 1+12.70 TO STA. 5+00.00




F.A. RTE.	SECTION	COUNTY	TOTAL SHEETS	SHEET NO.
	17-00136-00-BT	JACKSON	51	9
CONTRACT NO. 99632			ILLINOIS FED. AID PROJECT	

MATCHLINE STATION 5+00.00

MATCHLINE STATION 11+00.00

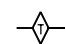

TREE REMOVAL SCHEDULE					
LOCATION			TREE REMOVAL (6 TO 15 UNITS DIAMETER)	TREE REMOVAL (OVER 15 UNITS DIAMETER)	
STATION	TO	STATION	LT/RT	UNIT	UNIT
NORTHWEST PEDESTRIAN AND BICYCLE PATH					
1+12.70	TO	18+00.00	LT	7, 8, 7	20
1+12.70	TO	18+00.00	RT	8, 7, 7, 8	21

 TEMPORARY DITCH CHECK
 INLET AND PIPE PROTECTION
 PERIMETER EROSION BARRIER

NOTES:
 1. SEE SCHEDULES FOR ADDITIONAL INFORMATION.
 2. SEE TREE REMOVAL GENERAL NOTES FOR ADDITIONAL INFORMATION.

MATCHLINE STATION 11+00.00

MATCHLINE STATION 17+00.00



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USER NAME = efisher
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 PLOT DATE = 3/4/2022

DESIGNED - EKF
 DRAWN - EKF
 CHECKED - JRR
 DATE -

REVISED -
 REVISED -
 REVISED -
 REVISED -



CITY OF CARBONDALE
 NORTHWEST PEDESTRIAN
 AND BICYCLE PATH

PLAN, EROSION CONTROL, PAVEMENT MARKING AND SIGNAGE
 SCALE: 1" = 20' SHEET 2 OF 7 SHEETS STA. 5+00.00 TO STA. 17+00.00

F.A. RTE.	SECTION	COUNTY	TOTAL SHEETS	SHEET NO.
	17-00136-00-BT	JACKSON	51	10
CONTRACT NO. 99632				
ILLINOIS FED. AID PROJECT				




TREE REMOVAL SCHEDULE

LOCATION				TREE REMOVAL (6 TO 15 UNITS DIAMETER)	TREE REMOVAL (OVER 15 UNITS DIAMETER)
STATION	TO	STATION	LT/RT	UNIT	UNIT
NORTHWEST PEDESTRIAN AND BICYCLE PATH					
18+00.00	TO	28+00.00	LT	8, 10, 11	
18+00.00	TO	28+00.00	RT	8, 8, 12	
28+00.00	TO	29+00.00	LT	8, 8, 9, 10, 8, 8, 8	

LEGEND

- TEMPORARY DITCH CHECK
- INLET AND PIPE PROTECTION
- PERIMETER EROSION BARRIER

NOTES:
 1. SEE SCHEDULES FOR ADDITIONAL INFORMATION.
 2. SEE TREE REMOVAL GENERAL NOTES FOR ADDITIONAL INFORMATION.

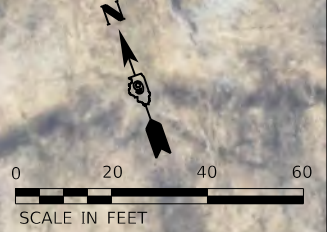

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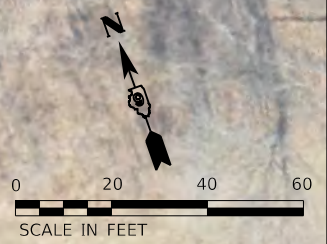
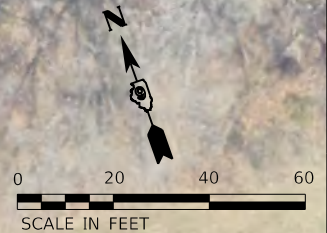
	USER NAME = efisher	DESIGNED - EKF	REVISED -		CITY OF CARBONDALE NORTHWEST PEDESTRIAN AND BICYCLE PATH	PLAN, EROSION CONTROL, PAVEMENT MARKING AND SIGNAGE		F.A. RTE.	SECTION	COUNTY	TOTAL SHEETS	SHEET NO.
	PLOT SCALE = 40,0000 ' / in.	CHECKED - JRR	REVISED -			17-00136-00-BT	JACKSON	51	11			
	PLOT DATE = 3/4/2022	DATE -	REVISED -			SCALE: 1" = 20'	SHEET 3 OF 7 SHEETS	STA. 17+00.00 TO STA. 29+00.00	CONTRACT NO. 99632		ILLINOIS	FED. AID PROJECT



TREE REMOVAL SCHEDULE					
LOCATION				TREE REMOVAL (6 TO 15 UNITS DIAMETER)	TREE REMOVAL (OVER 15 UNITS DIAMETER)
STATION	TO	STATION	LT/RT	UNIT	UNIT
NORTHWEST PEDESTRIAN AND BICYCLE PATH					
30+00.00	TO	31+00.00	RT		32
31+00.00	TO	32+00.00	RT	15, 10, 12	18
32+00.00	TO	33+00.00	LT	9, 10	
32+00.00	TO	33+00.00	RT	12	
33+00.00	TO	34+00.00	LT	11, 8	
34+00.00	TO	35+00.00	LT	13, 13, 10, 12	
34+00.00	TO	35+00.00	RT	8, 12	
35+00.00	TO	36+00.00	LT	8	
36+00.00	TO	37+00.00	LT	10	
37+00.00	TO	38+00.00	LT	13	
37+00.00	TO	38+00.00	RT	13, 13	
39+00.00	TO	40+00.00	LT	8, 9, 9, 11, 8	
39+00.00	TO	40+00.00	RT	10, 11	

TEMPORARY DITCH CHECK
 INLET AND PIPE PROTECTION
 PERIMETER EROSION BARRIER

NOTES:
 1. SEE SCHEDULES FOR ADDITIONAL INFORMATION.
 2. SEE TREE REMOVAL GENERAL NOTES FOR ADDITIONAL INFORMATION.



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USER NAME = efisher
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 PLOT DATE = 3/4/2022

DESIGNED - EKF
 DRAWN - EKF
 CHECKED - JRR
 DATE -

REVISED -
 REVISED -
 REVISED -
 REVISED -



CITY OF CARBONDALE
NORTHWEST PEDESTRIAN AND BICYCLE PATH

PLAN, EROSION CONTROL, PAVEMENT MARKING AND SIGNAGE


SCALE: 1" = 20' SHEET 4 OF 7 SHEETS STA. 29+00.00 TO STA. 40+00.00

F.A. RTE.	SECTION	COUNTY	TOTAL SHEETS	SHEET NO.
	17-00136-00-BT	JACKSON	51	12
CONTRACT NO. 99632				
ILLINOIS FED. AID PROJECT				


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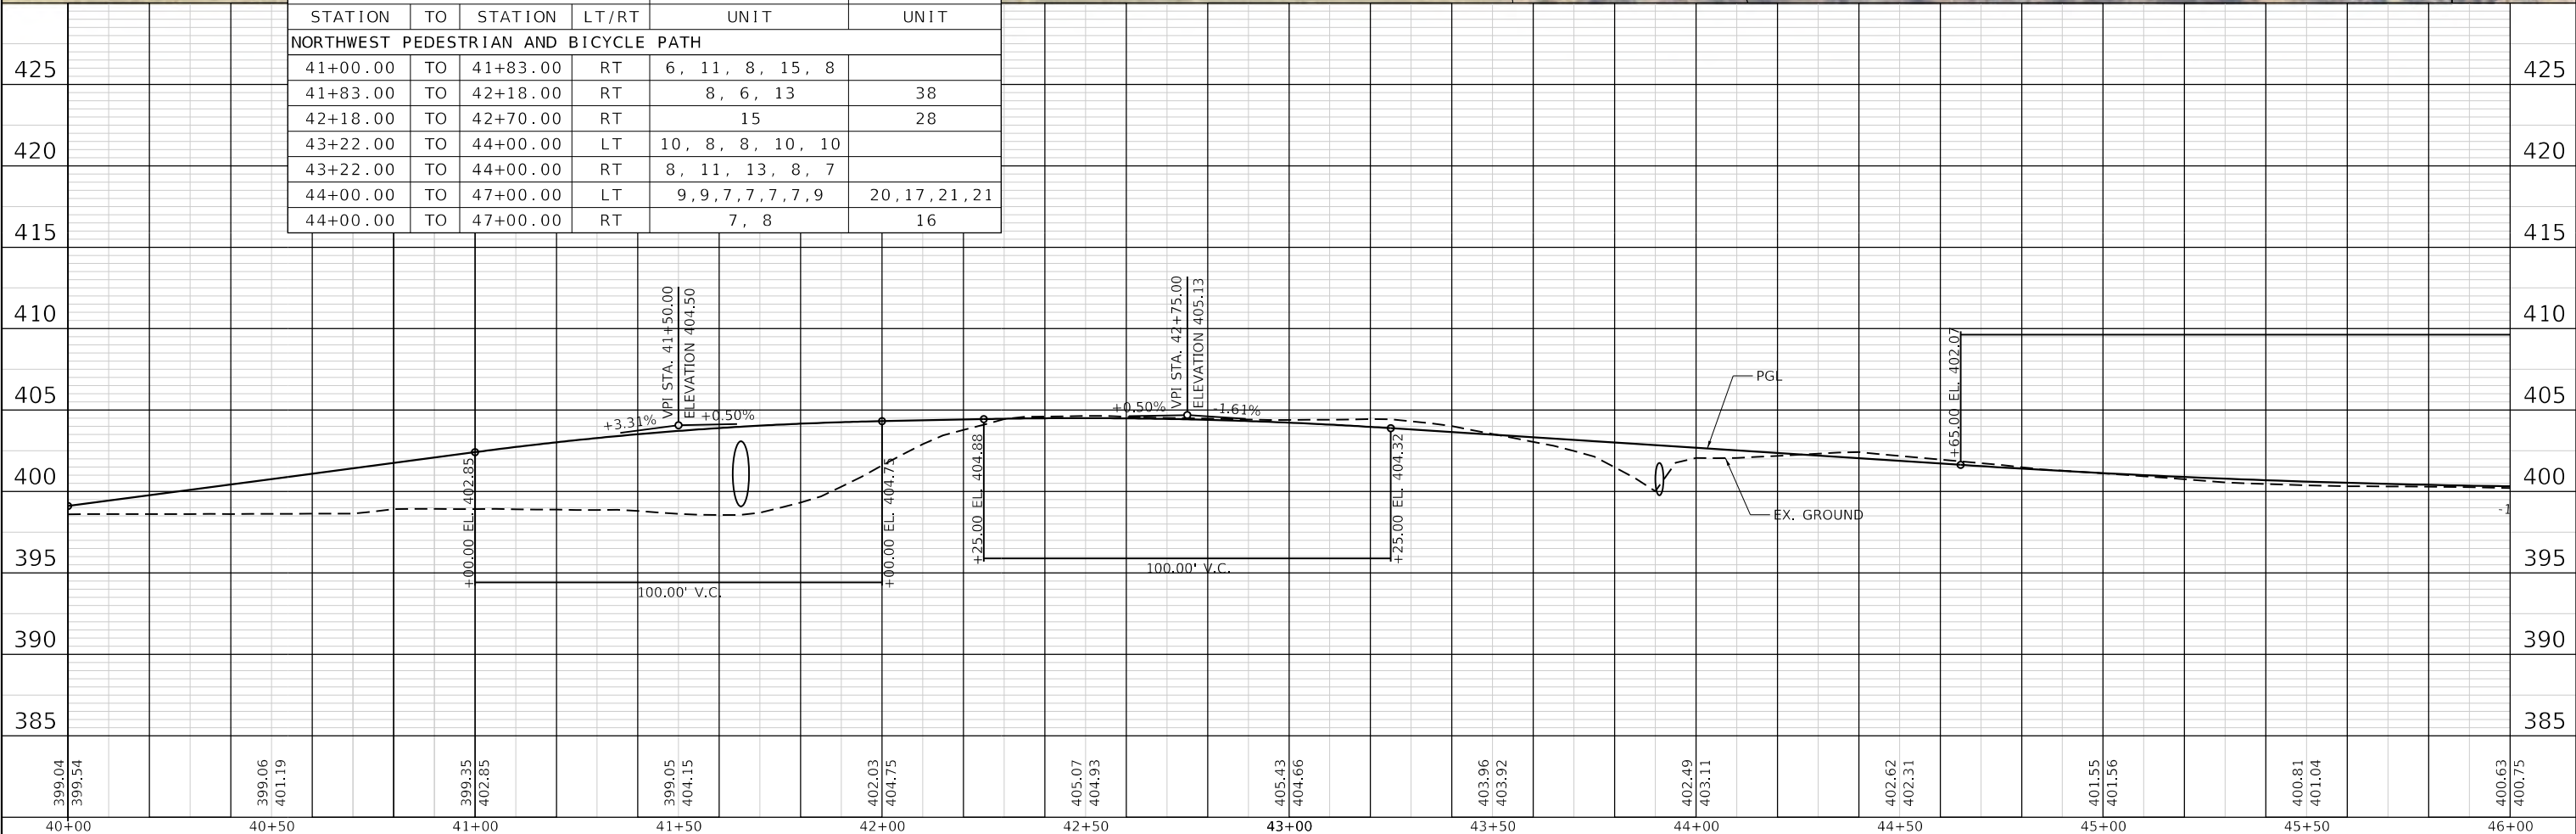
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- NOTES:
1. SEE SCHEDULES FOR ADDITIONAL INFORMATION.
2. SEE TREE REMOVAL GENERAL NOTES FOR ADDITIONAL INFORMATION.
- TEMPORARY DITCH CHECK
 - INLET AND PIPE PROTECTION
 - PERIMETER EROSION BARRIER



TREE REMOVAL SCHEDULE						
LOCATION				TREE REMOVAL (6 TO 15 UNITS DIAMETER)	TREE REMOVAL (OVER 15 UNITS DIAMETER)	
STATION	TO	STATION	LT/RT	UNIT	UNIT	
NORTHWEST PEDESTRIAN AND BICYCLE PATH						
41+00.00	TO	41+83.00	RT	6, 11, 8, 15, 8		425
41+83.00	TO	42+18.00	RT	8, 6, 13	38	
42+18.00	TO	42+70.00	RT	15	28	
43+22.00	TO	44+00.00	LT	10, 8, 8, 10, 10		420
43+22.00	TO	44+00.00	RT	8, 11, 13, 8, 7		
44+00.00	TO	47+00.00	LT	9, 9, 7, 7, 7, 9	20, 17, 21, 21	
44+00.00	TO	47+00.00	RT	7, 8	16	415

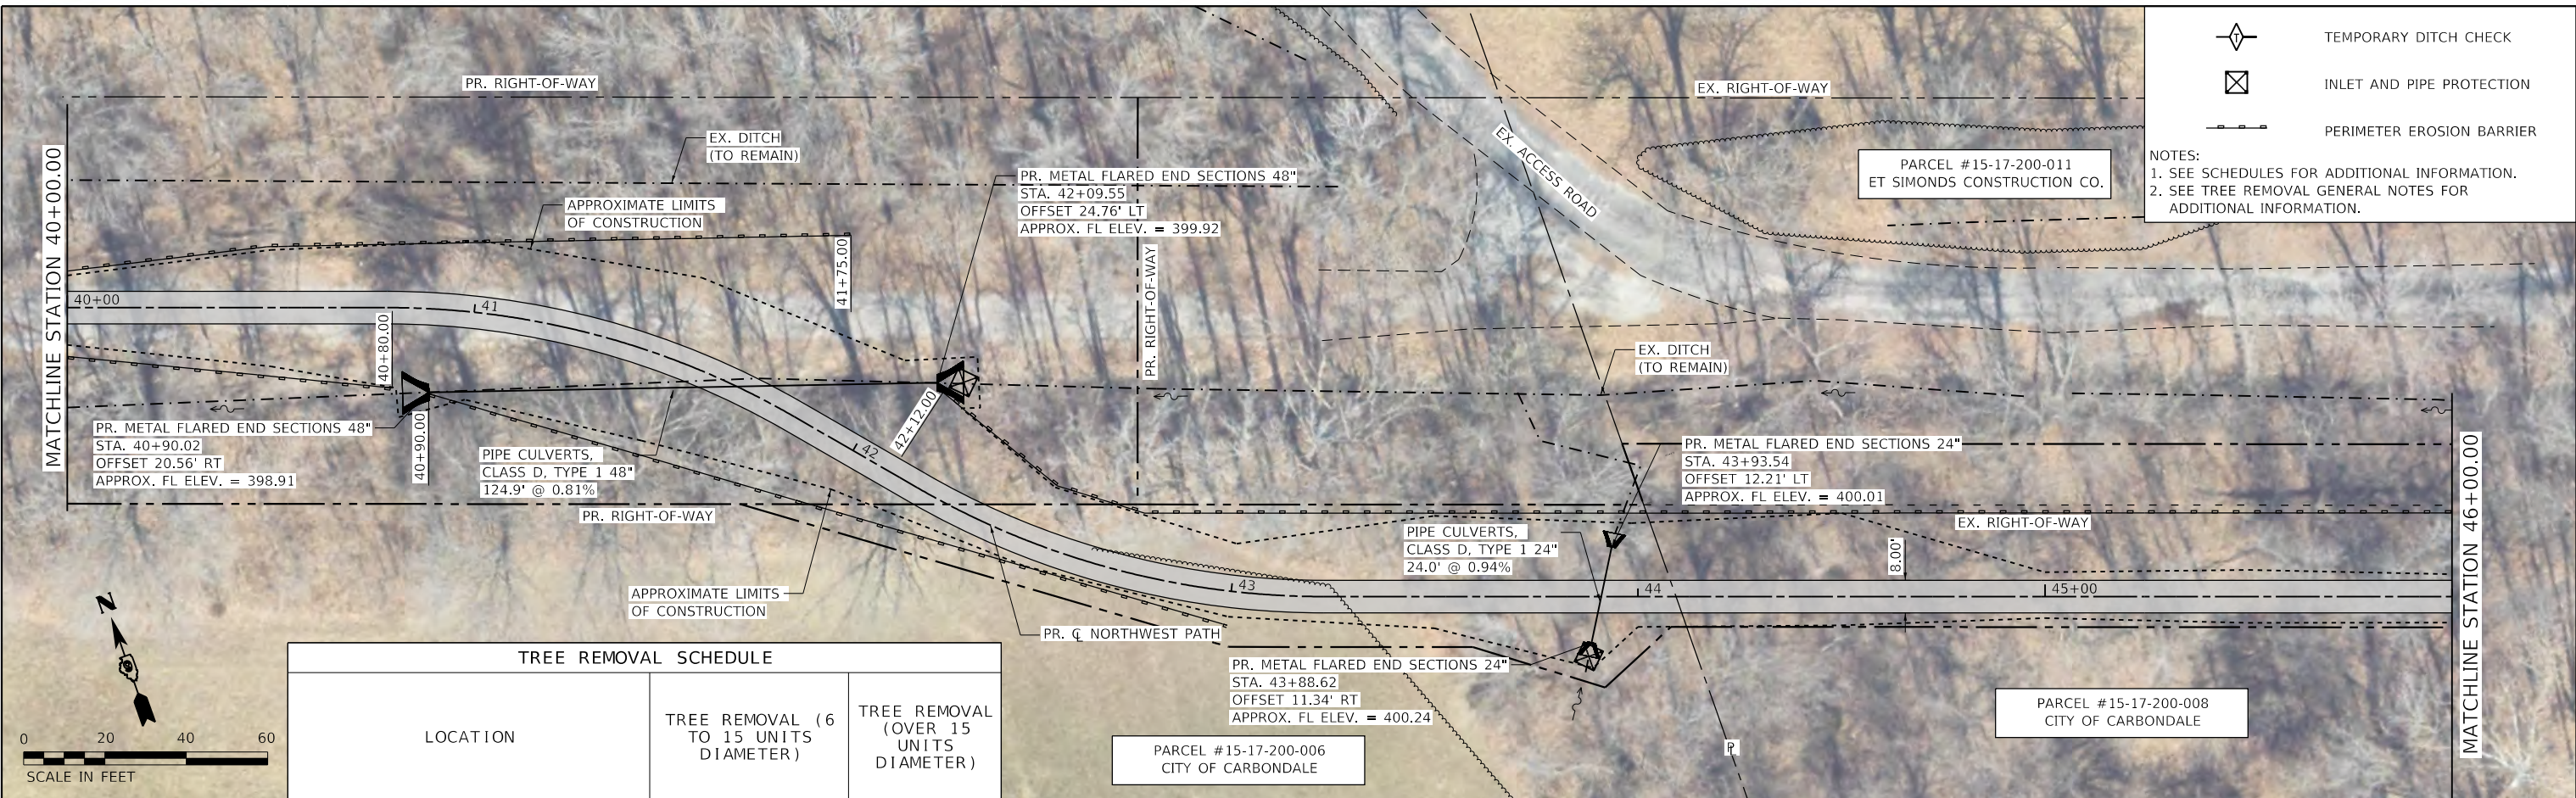

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	DATE -	REVISED -

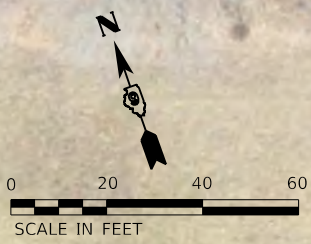

CITY OF CARBONDALE
NORTHWEST PEDESTRIAN AND BICYCLE PATH

PLAN, EROSION CONTROL, PAVEMENT MARKING AND SIGNAGE
SCALE: 1" = 20' SHEET 5 OF 7 SHEETS STA. 40+00.00 TO STA. 46+00.00


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CONTRACT NO. 99632			ILLINOIS FED. AID PROJECT	

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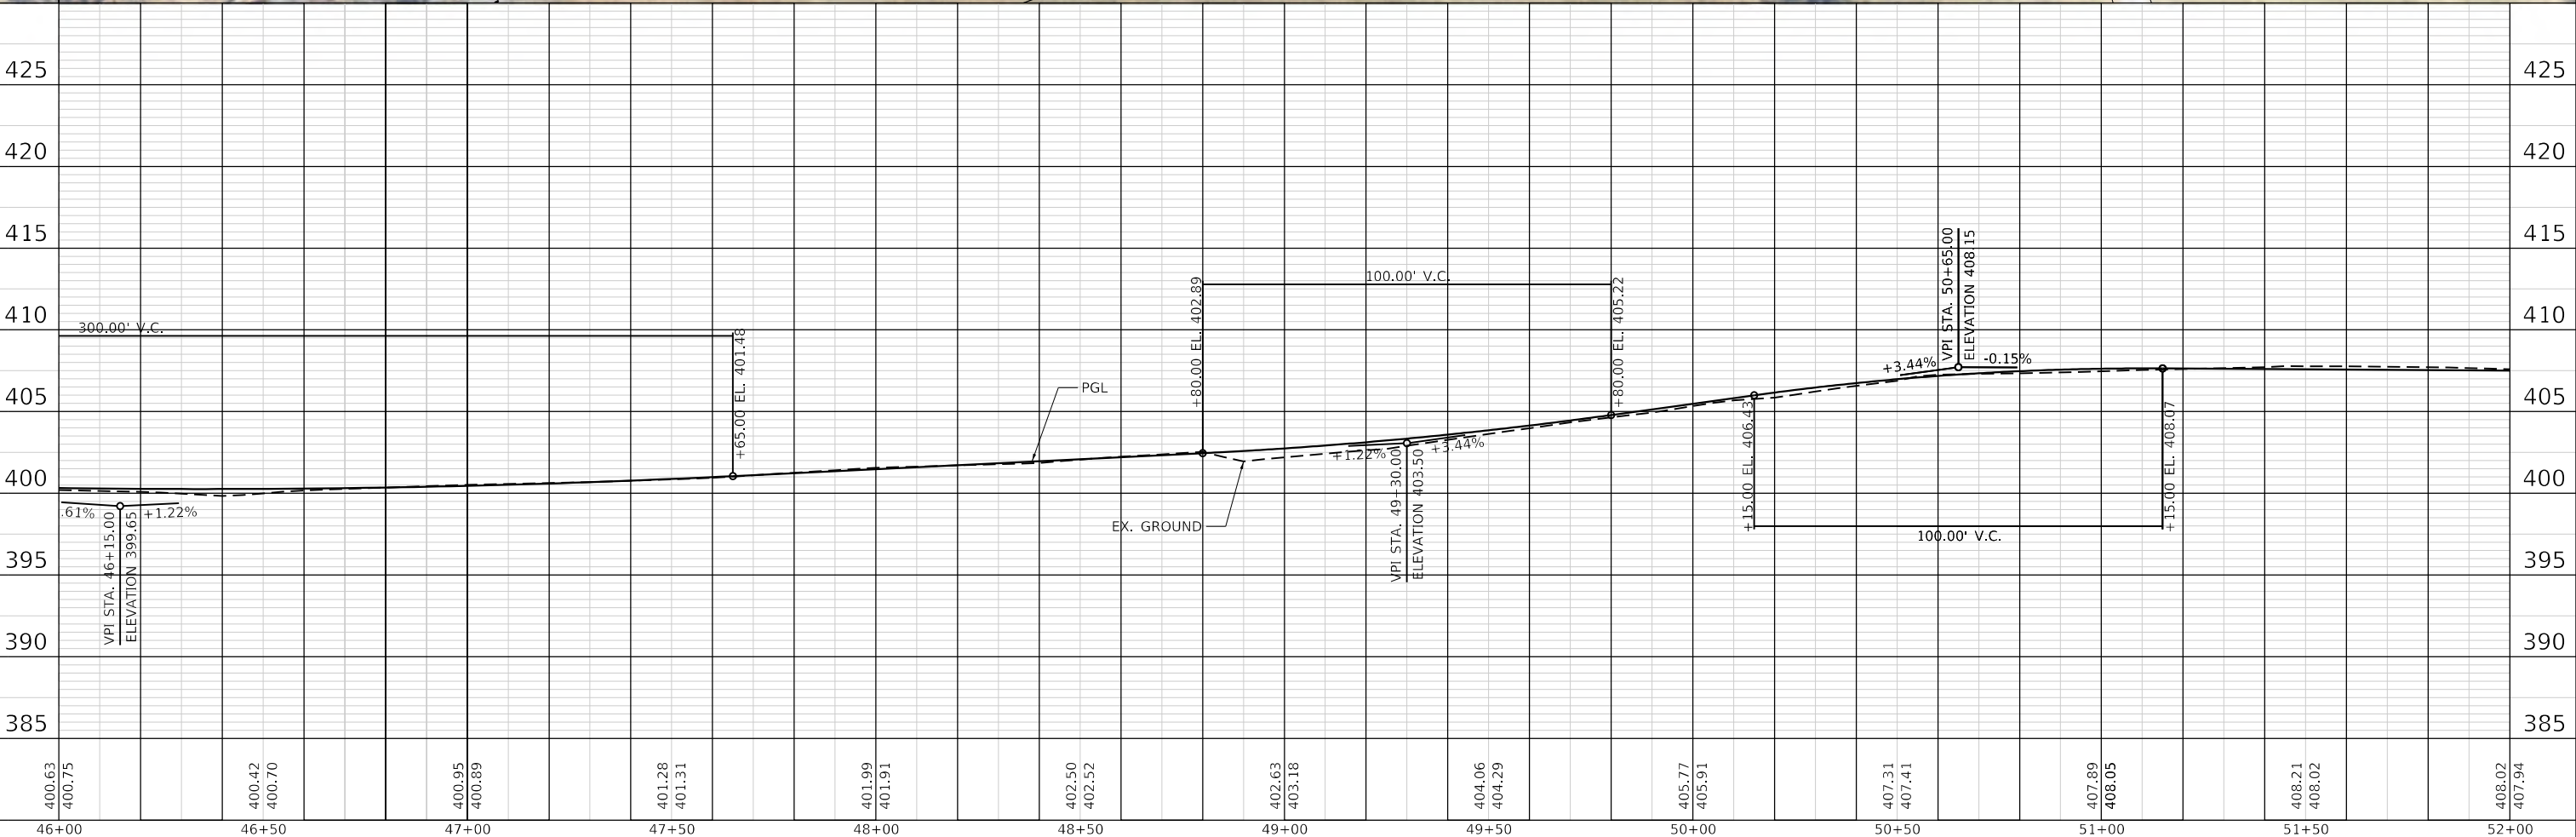
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STATION	TO	STATION	LT/RT	UNIT	UNIT	
NORTHWEST PEDESTRIAN AND BICYCLE PATH						
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47+00.00	TO	48+00.00	RT	11	16, 22	
50+00.00	TO	51+00.00	LT	12, 15	44, 33	



- NOTES:
1. SEE SCHEDULES FOR ADDITIONAL INFORMATION.
2. SEE TREE REMOVAL GENERAL NOTES FOR ADDITIONAL INFORMATION.

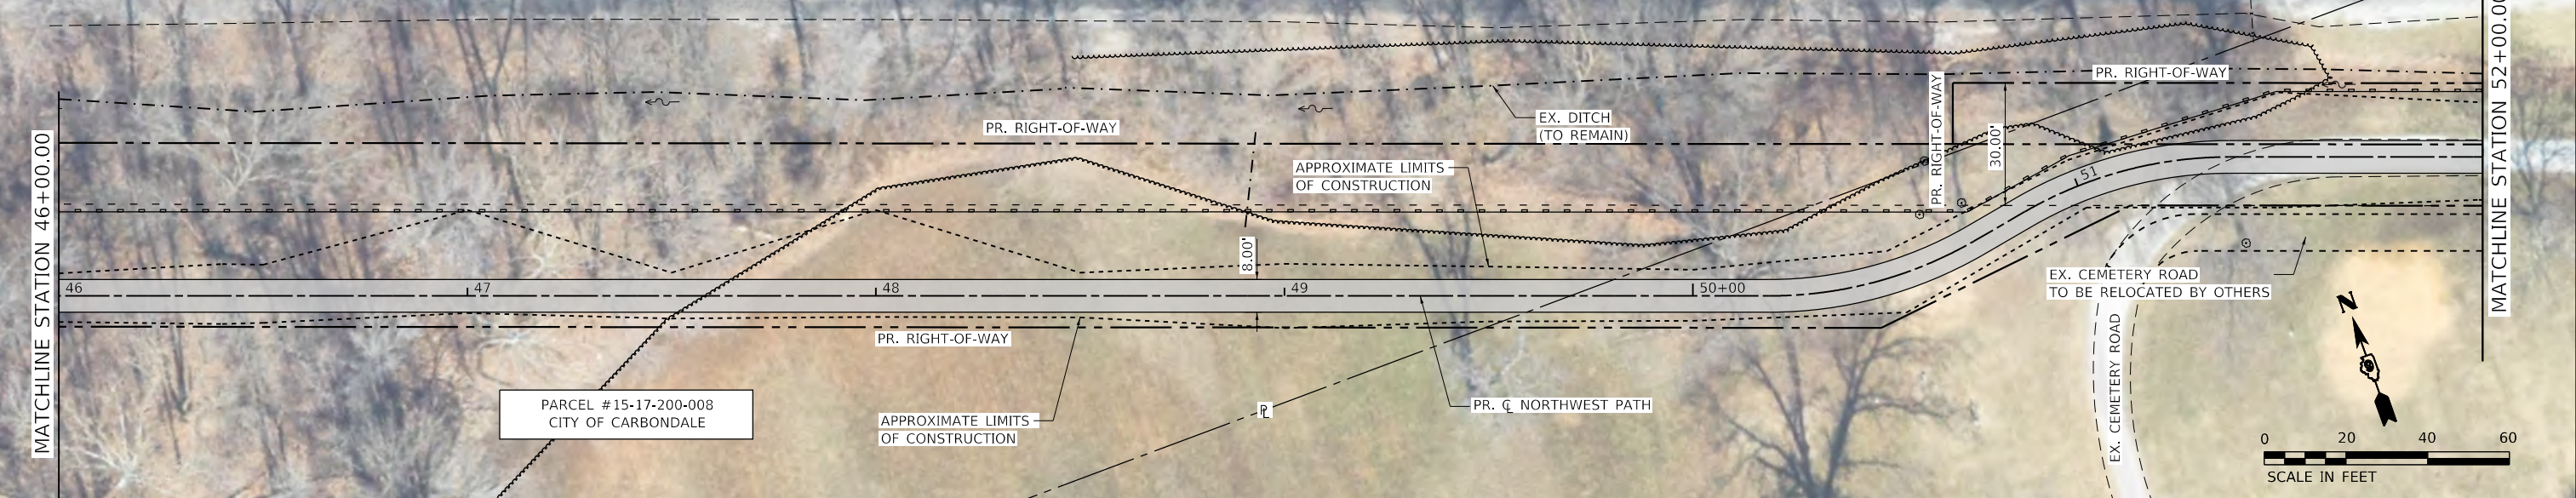

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	DATE -	REVISED -



CITY OF CARBONDALE
NORTHWEST PEDESTRIAN
AND BICYCLE PATH




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CONTRACT NO. 99632			ILLINOIS FED. AID PROJECT	

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PROFILE	SURVEYED	DATE
	PLOTTED	
	GRADES CHECKED	
	NOTE BOOK	
	NO.	
	STRUCTURE NOTATIONS CHECKED	
	NO.	



408.02 407.94	407.79 407.86	407.24 407.54	406.77 407.43	407.70 407.78	407.94 408.03	408.17 408.27	408.68 408.51	408.82 408.75	409.04 408.99	409.10 409.08	408.15 408.80	407.54 408.31	408.15
52+00	52+50	53+00	53+50	54+00	54+50	55+00	55+50	56+00	56+50	57+00	57+50	58+00	

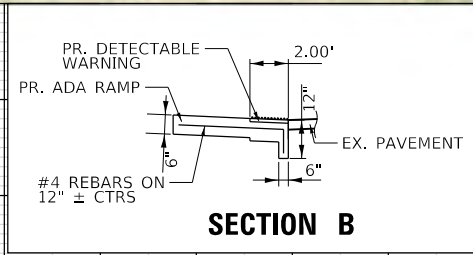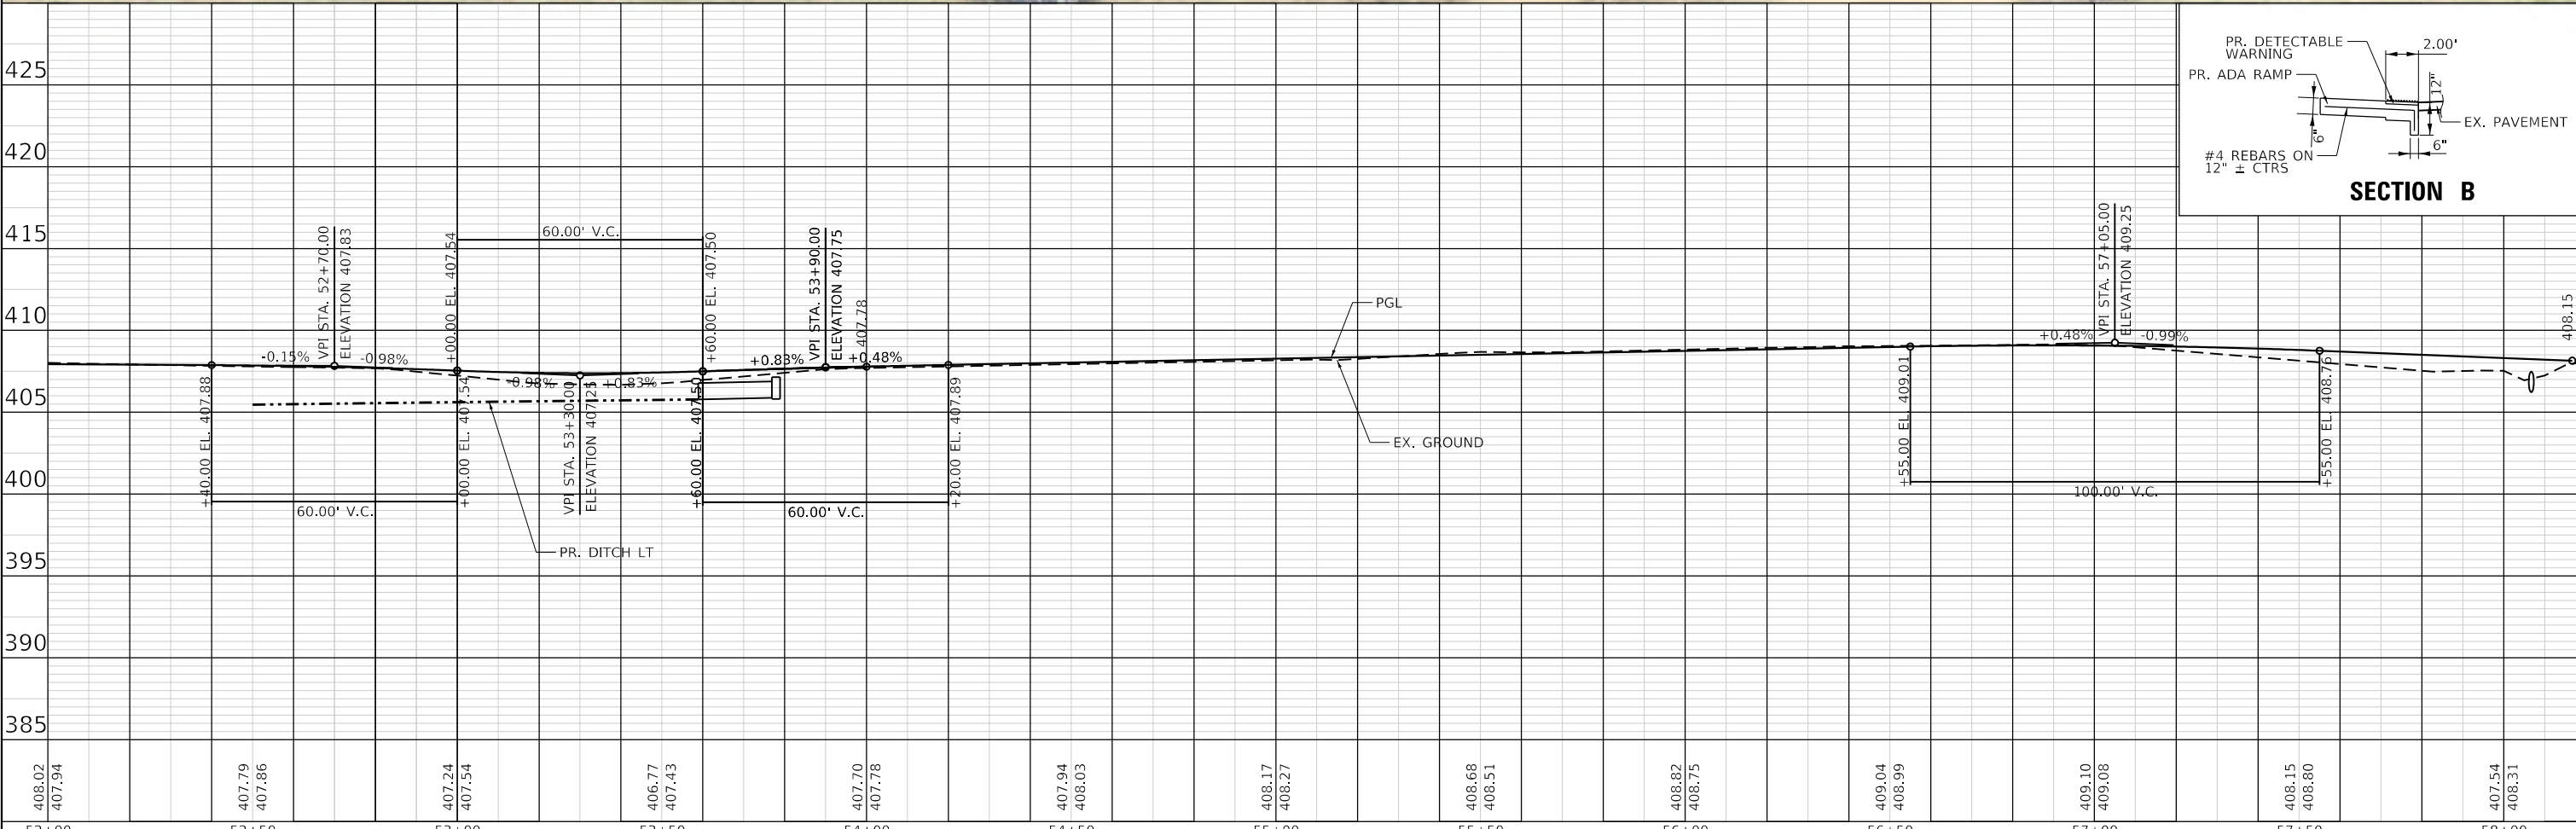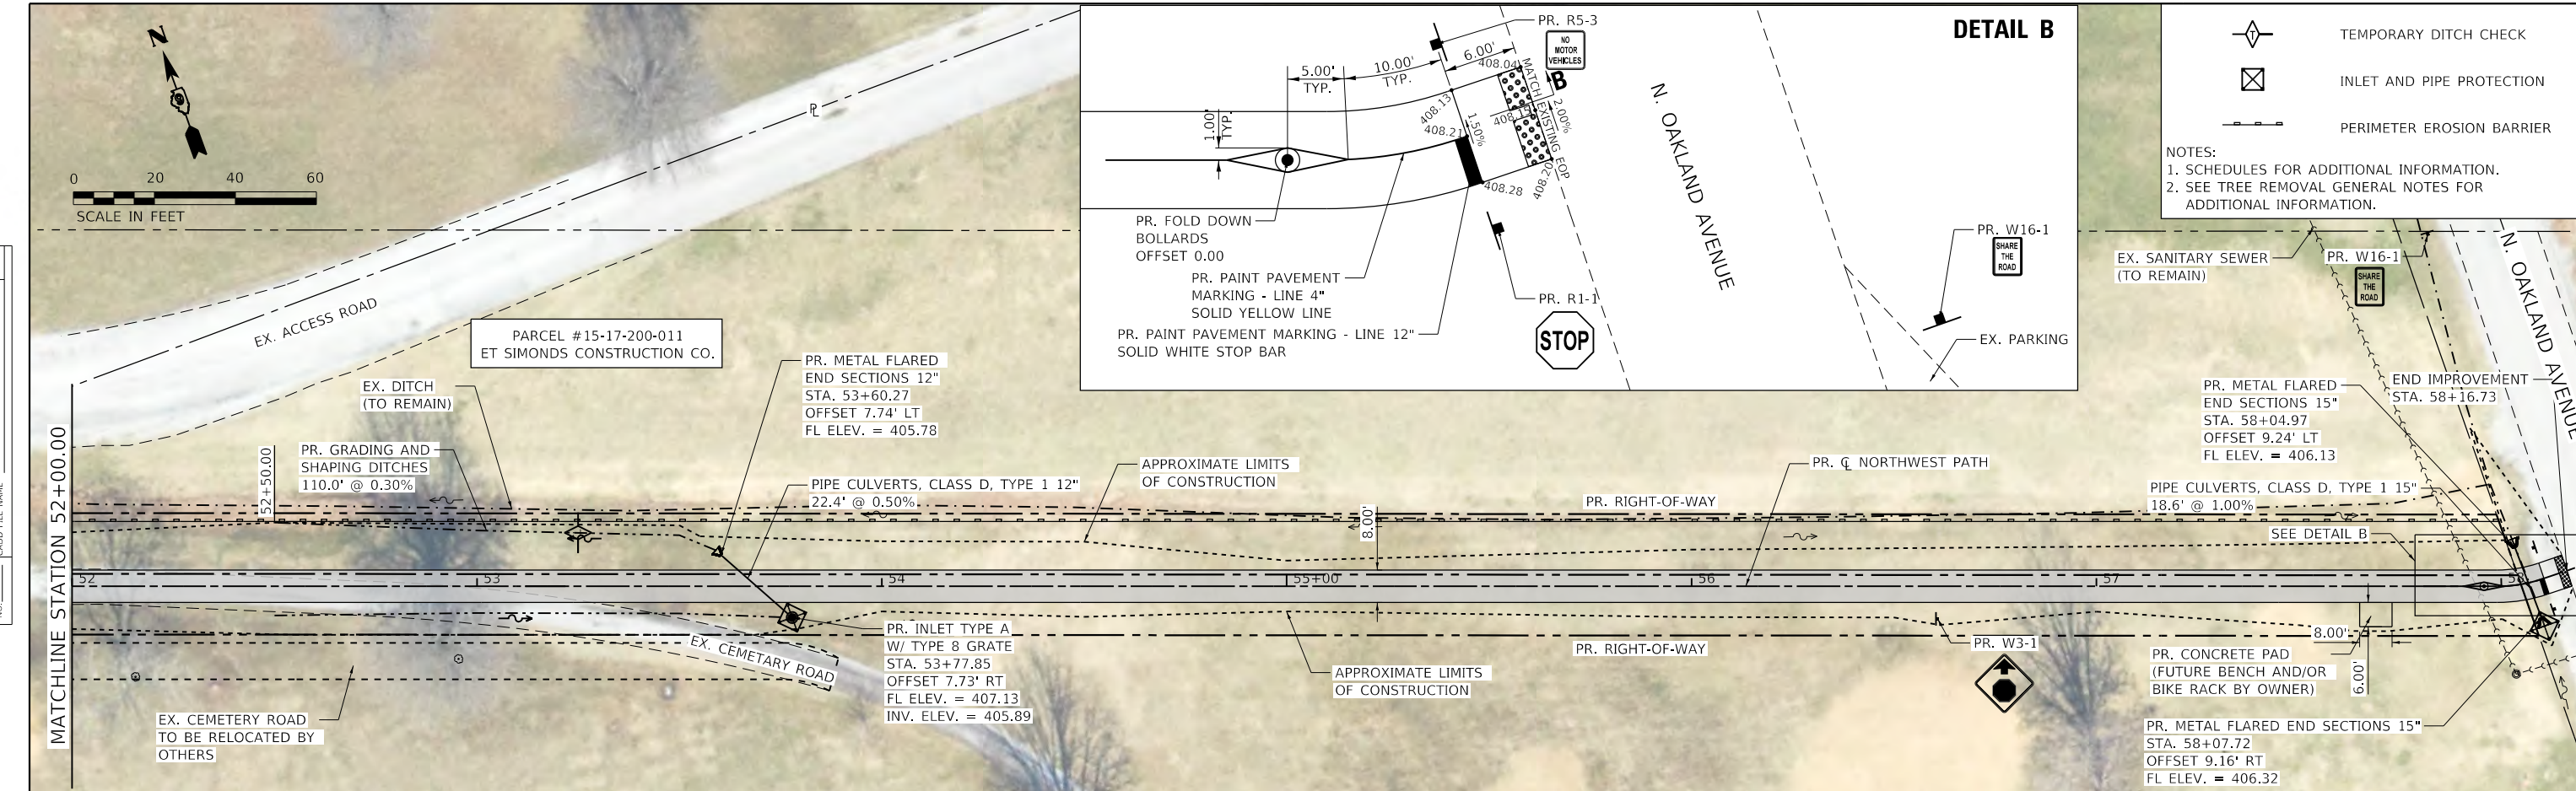

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CITY OF CARBONDALE
NORTHWEST PEDESTRIAN
AND BICYCLE PATH


PLAN, EROSION CONTROL, PAVEMENT MARKING AND SIGNAGE

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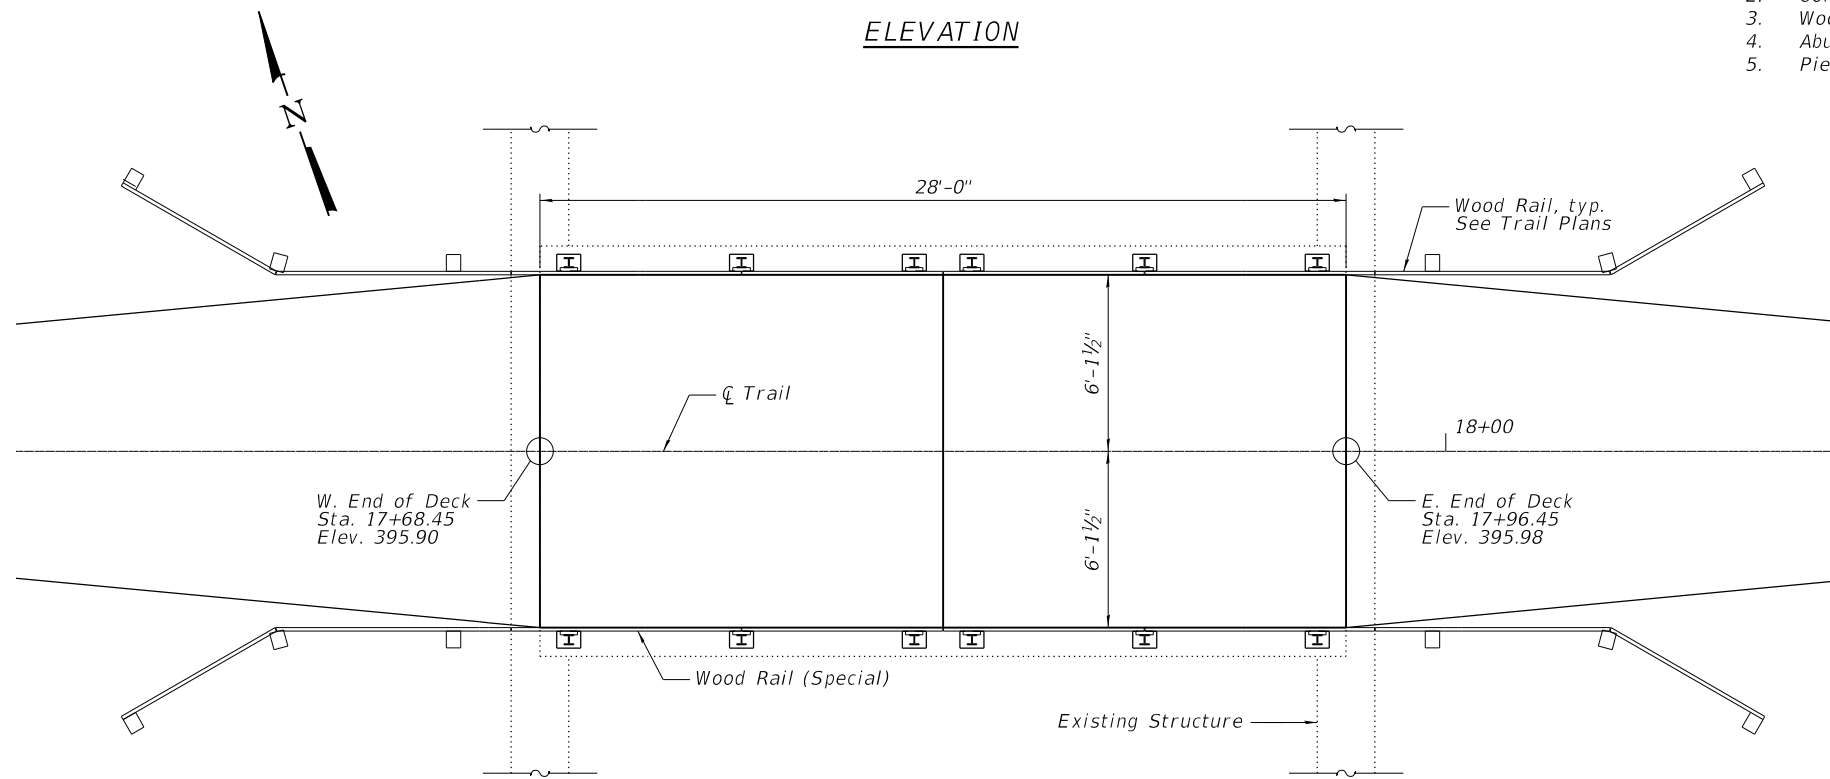
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	17-00136-00-BT	JACKSON	51	15
CONTRACT NO. 99632			ILLINOIS FED. AID PROJECT	

Benchmark: Control Point #106 - Iron Rod with Control Cap. Station 17+82.46, Offset 0.04 ft. Lt, Elevation NAVD '88 = 395.40

Existing Structure: Two simple span, reinforced concrete slabs with a longitudinal joint along the centerline of the structure on closed concrete abutments and concrete wall pier.

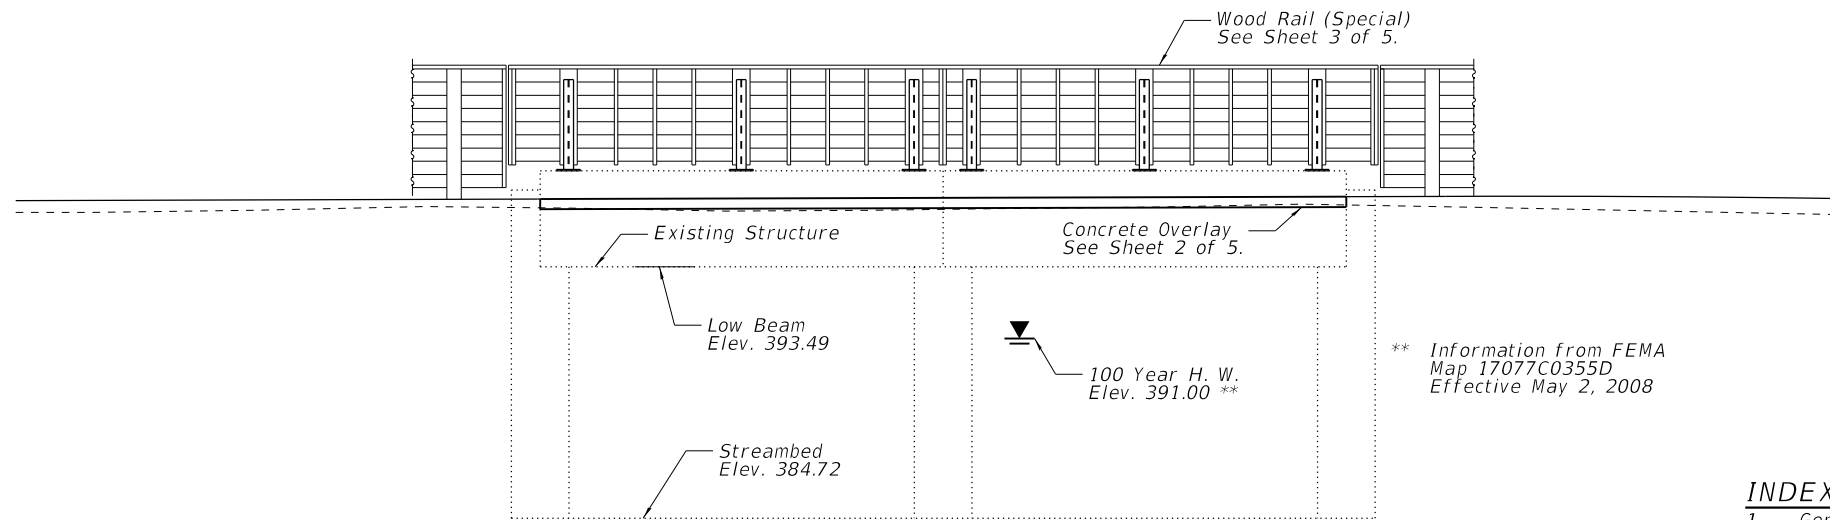

ELEVATION



PLAN

WATERWAY INFORMATION **

Drainage Area = 8.91 sq mi Low Grade Elev. 395.00 @ Sta. 18+40.00									
Flood	Freq. Yr.	Q C.F.S.	Opening Ft ²		Nat. H.W.E.	Head - Ft.			Headwater El.
			Exist.	Prop.		Exist.	Prop.	Exist.	
Design	10								
Base	100	4640	---	151	391.00				
Overtopping									
Max. Calc.	500			175	392.00				


DESIGN SCOUR ELEVATION TABLE

Design Scour Elev. (ft.)	W. Abut.	E. Abut.
	384.72	384.72



PROFILE GRADE

(along CL Northwest Pedestrian and Bicycle Path)

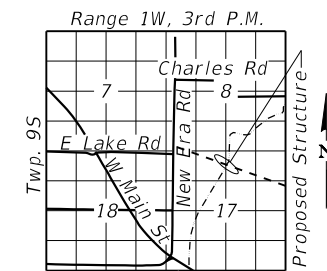

LOCATION SKETCH

GENERAL NOTES

- Plan dimensions and details relative to the existing structure are subject to nominal construction variations. The Contractor shall field verify existing dimensions and details affecting new construction and make necessary approved adjustments prior to construction or ordering of materials. Such variations shall not be cause for additional compensation for a change in scope of the work, however, the Contractor will be paid for the quantity actually furnished at the unit price bid for the work.

TOTAL BILL OF MATERIAL

ITEM	UNIT	SUPER	SUB	TOTAL
Concrete Wearing Surface (Variable Depth)	Sq. Yd.	38.1		38.1
Wood Rail (Special)	Foot	60		60
Polymer Modified Portland Cement Mortar	Sq. Ft.		1.2	1.2
Bridge Washing No. 1	Each	0.5	0.5	1
Debris Removal	L. Sum	1		1
Epoxy Crack Injection	Foot		10.8	10.8

INDEX OF SHEETS

- General Plan & Elevation
- Concrete Overlay
- Wood Rail (Special) Details
- Abutment Repairs
- Pier Repairs

DESIGN SPECIFICATIONS

2009 AASHTO LRFD Guide Specifications for the Design of Pedestrian Bridges 2015 Interims

2017 AASHTO LRFD Bridge Design Specifications, 8th Edition

DESIGN STRESSES

FIELD UNITS

f'c = 4,000 psi
fy = 65,000 psi (min.) (WW Reinforcement)

LOADING

Pedestrian Live Load = 90 psf
Vehicle Live Load = AASHTO H5

I certify that to the best of knowledge, information and belief, this bridge design is structurally adequate for the design loading shown on the plans. The design is an economical one for the style of structure and complies with requirements of the AASHTO Design Specifications shown on the plans.



Angela L. Nemsky

1/27/2022

EXPIRES 11/30/2022

**GENERAL PLAN & ELEVATION
NORTHWEST PEDESTRIAN AND
BICYCLE PATH OVER TRIB. TO
LITTLE CRAB ORCHARD CREEK
SECTION 17-00136-00-BT
JACKSON COUNTY
STA. 17+82.45**

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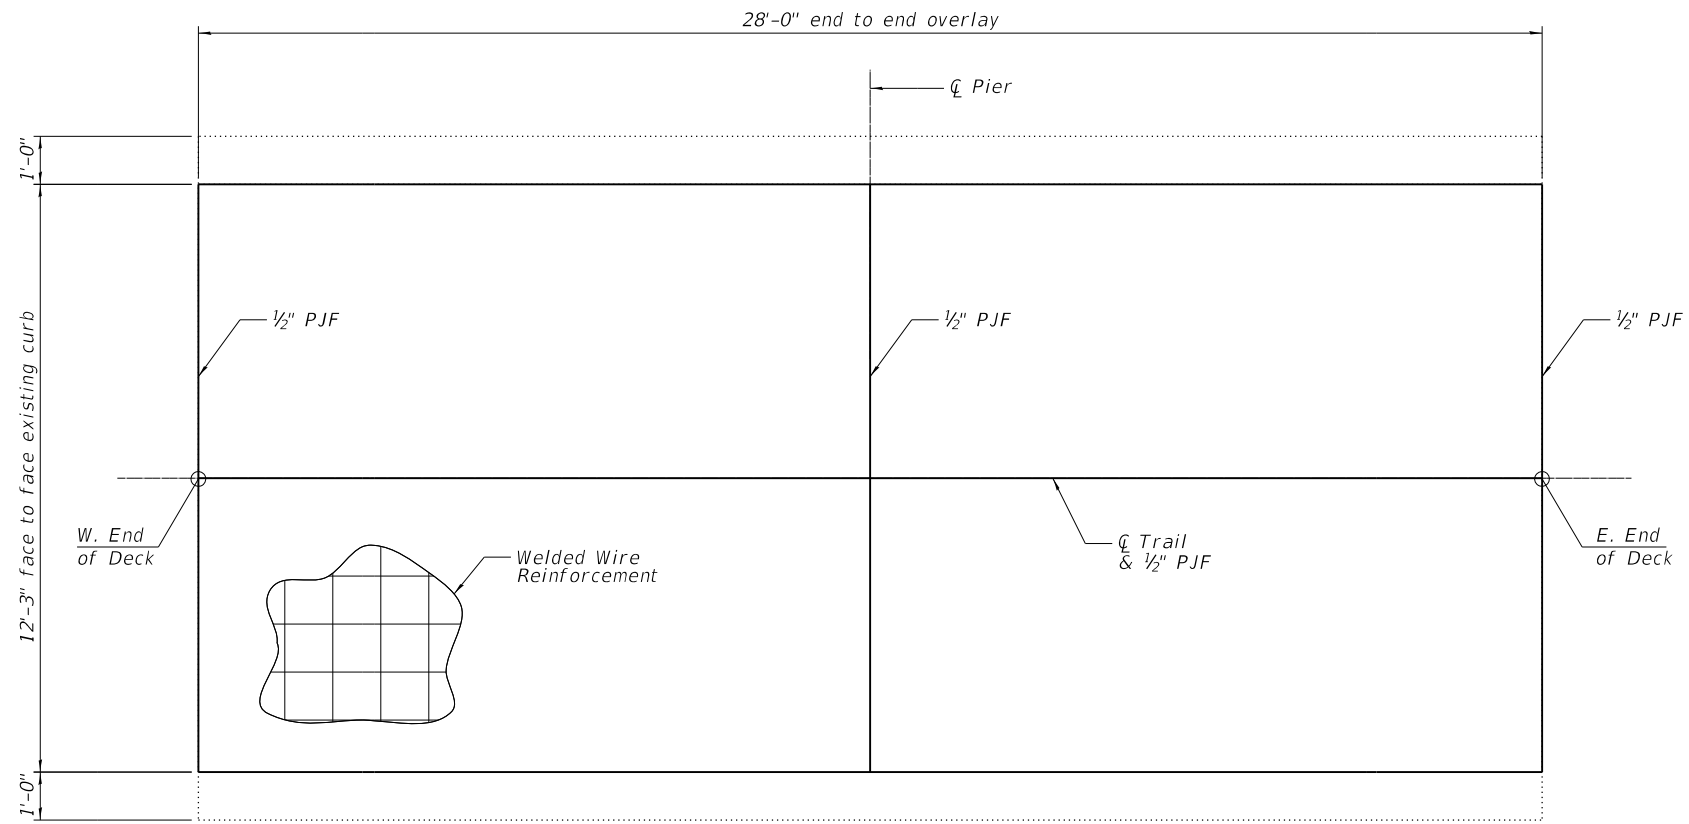


CITY OF CARBONDALE

GENERAL PLAN & ELEVATION


SHEET 1 OF 5 SHEETS

F.A. RTE.	SECTION	COUNTY	TOTAL SHEETS	SHEET NO.
	17-00136-00-BT	JACKSON	51	16
CONTRACT NO. 99632				
ILLINOIS FED. AID PROJECT				



PLAN

Note:
 Cost of PJF and Welded Wire Reinforcement shall be included in the price bid for Concrete Wearing Surface (Variable Depth).
 If a lap is required in the Welded Wire Reinforcement, it shall be a min. of the cross wire spacing plus 2".

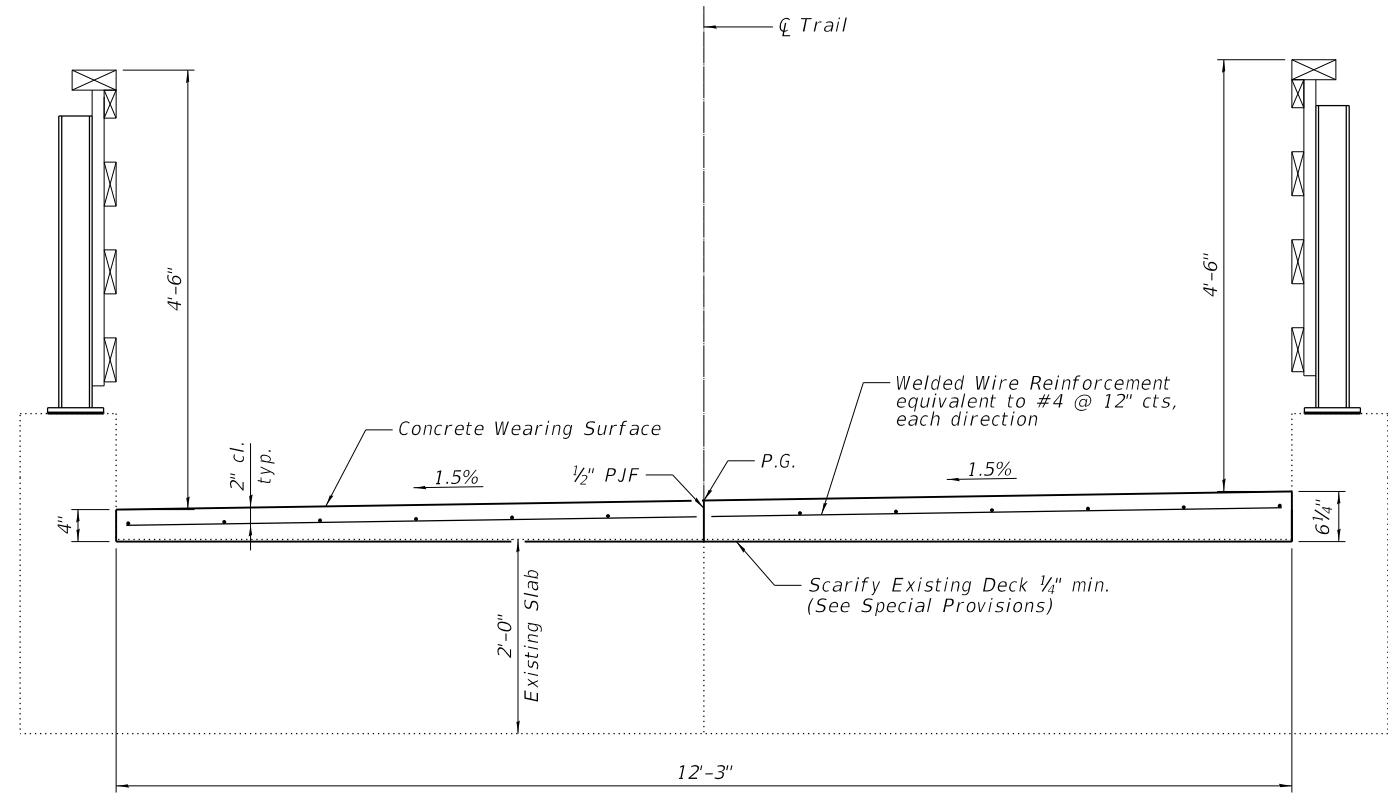

CROSS SECTION
 (Looking East)

TOTAL BILL OF MATERIAL

ITEM	UNIT	QTY.
Concrete Wearing Surface (Variable Depth)	Sq. Yd.	38.1

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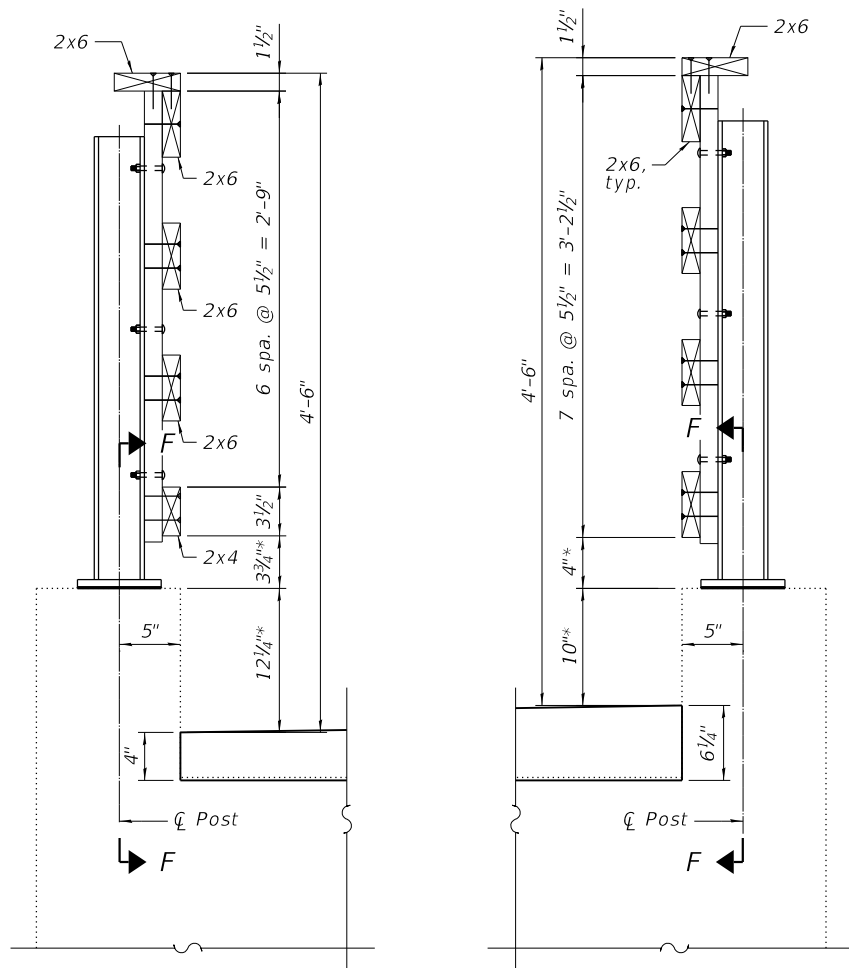


CITY OF CARBONDALE

CONCRETE OVERLAY


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CONTRACT NO. 99632				
ILLINOIS FED. AID PROJECT				





SECTION THRU RAILING

* Dimensions based on 1/4" min. scarification. May be adjusted in the field as directed by the Engineer if actual amount varies.

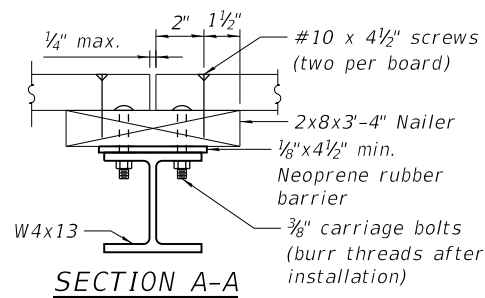


SECTION A-A


SECTION D-D

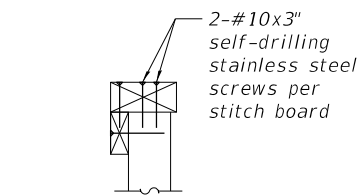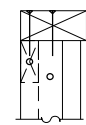


SECTION B-B

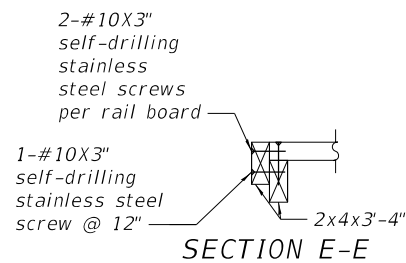


SECTION E-E

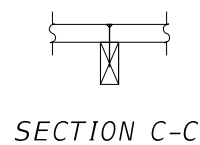


SECTION C-C

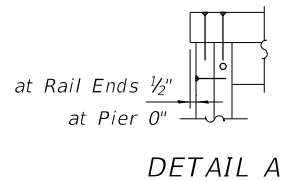

DETAIL A

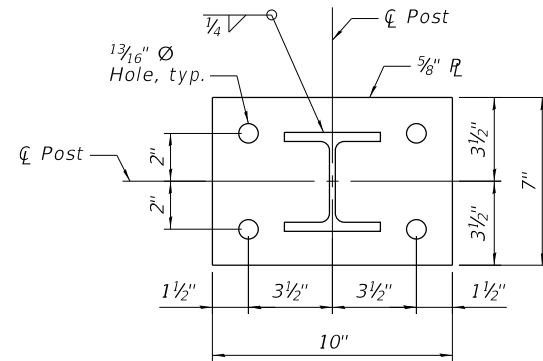

BASE PLATE

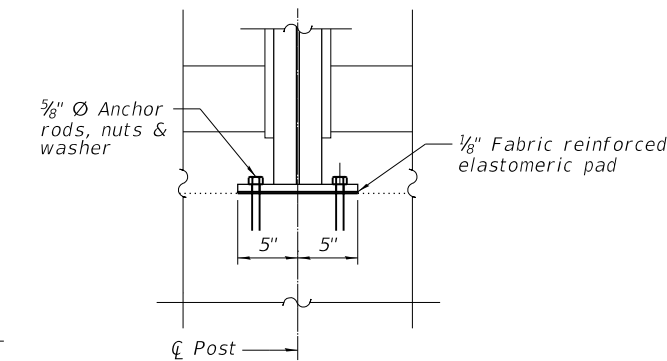


SECTION F-F

Drill and set 5/8" diameter anchor rods according to Article 509.06 of the Standard Specifications. Embedment (6" min.) shall be according to the manufacturer's specifications.


NOTES:

- Carriage bolts and screws shall be Stainless Steel according to Article 1006.29(d) of the Standard Specifications.
- Neoprene rubber barrier shall meet the material requirements of Article 1052.02 (a) of the Standard Specifications.
- Anchor bolts, nuts and washers shall be hot dipped galvanized in accordance with ASTM F 2329.
- Wood Rail construction shall be in accordance with Section 507 of the Standard Specification except as modified by these plans.
- Submit pressure treatment type and retention level prior to ordering timber. Pressure treatment shall be one of the following:
 - MCA with a minimum retention level of 0.23
 - ACQ with a minimum retention level of 0.60
- Pressure treated lumber shall not contact any metal except stainless steel fasteners.
- Screws shall be driven such that boards are tightly clamped. Where screw threads in the top board push the boards apart screws shall be backed out and re-driven until the boards are tightly clamped. If re-driving does not tightly clamp boards other methods such as pre-drilling top boards shall be used.
- Rail boards shall only terminate at Posts as shown in Section A-A. Rail boards shall be continuous over the end posts and posts on either side of Pier. Terminate as shown in the Railing Elevation.
- Holes for anchor bolts may be drilled through existing reinforcement.
- Cost of furnishing and installing anchor bolts, fabricating and installing posts, and furnishing and installing timber, including all fasteners and neoprene barrier shall be included in the cost of Wood Rail (Special). This work will be measured for payment in place in feet. The length measured will be the overall length along the top longitudinal railing member through all posts and gaps.

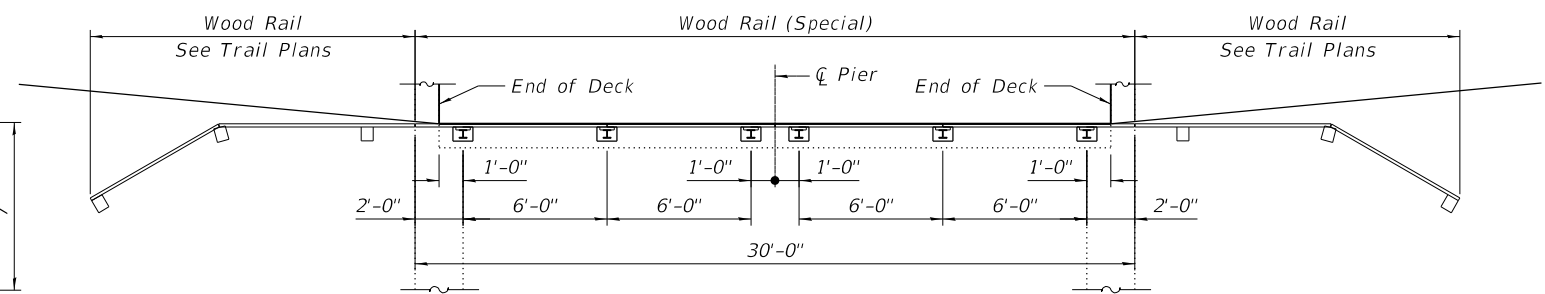

PLAN

South Curb Shown
North Curb Similar

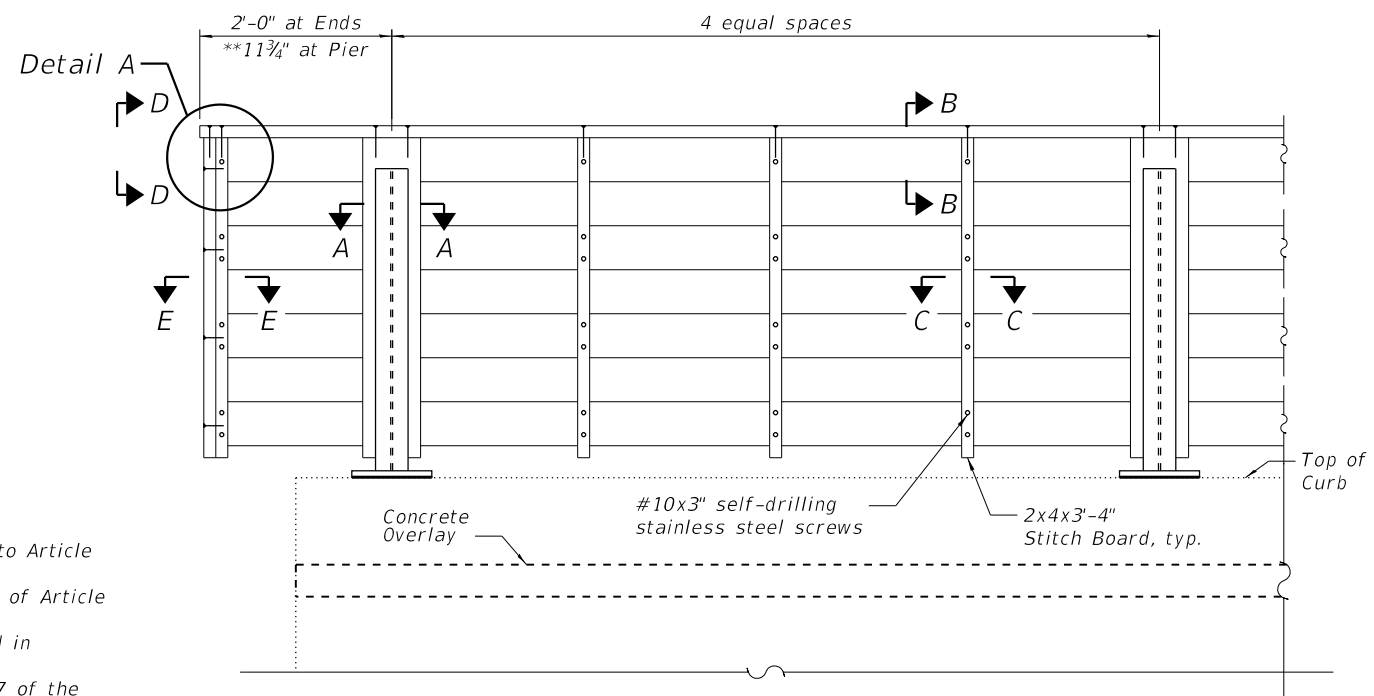

RAILING ELEVATION

** 1/2" Gap in rails at Pier

MATERIALS

- W Shapes - AASHTO M270 Grade 50W
- Plates - AASHTO M270 Grade 50W
- Anchor Bolts - F1554 Grade 36
- Welds - E70XX Electrodes
- Timber - No. 1 Southern Pine (Pressure Treated)

TOTAL BILL OF MATERIAL

ITEM	UNIT	QTY.
Wood Rail (Special)	Foot	60

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CITY OF CARBONDALE

WOOD RAIL (SPECIAL) DETAILS


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F.A. RTE.	SECTION	COUNTY	TOTAL SHEETS	SHEET NO.
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CONTRACT NO. 99632				
ILLINOIS FED. AID PROJECT				


KEY

— Crack

▨ Polymer Modified Portland Cement Mortar

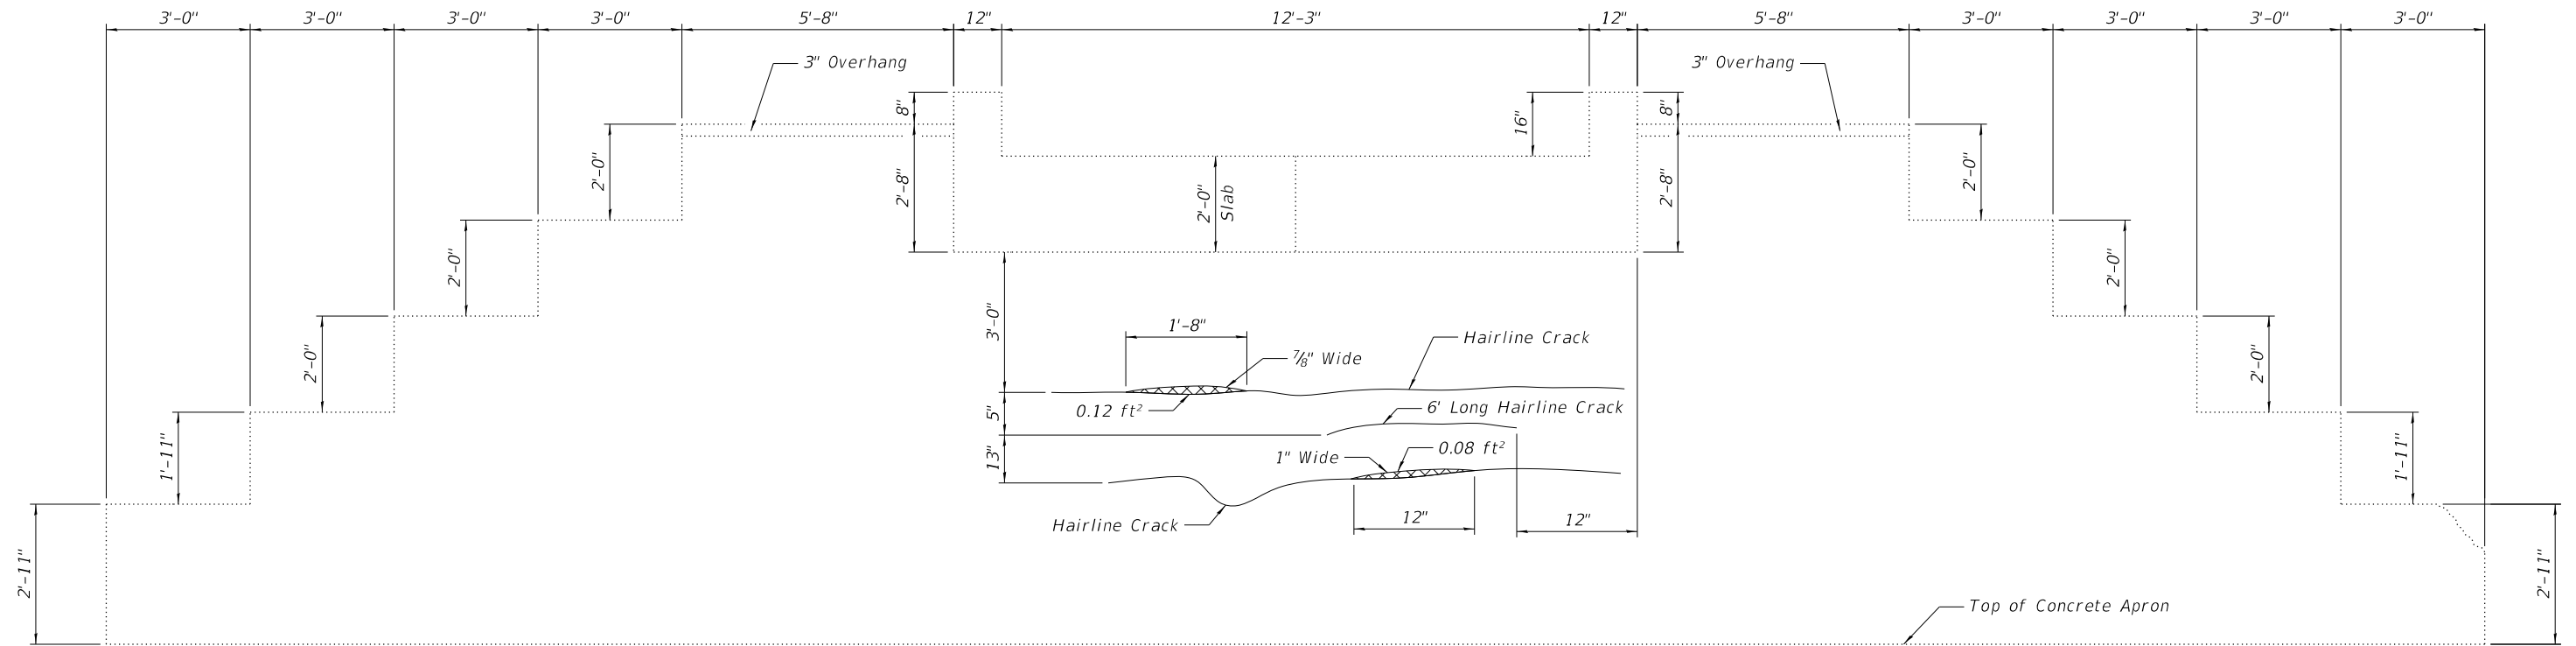

ELEVATION - EAST ABUTMENT

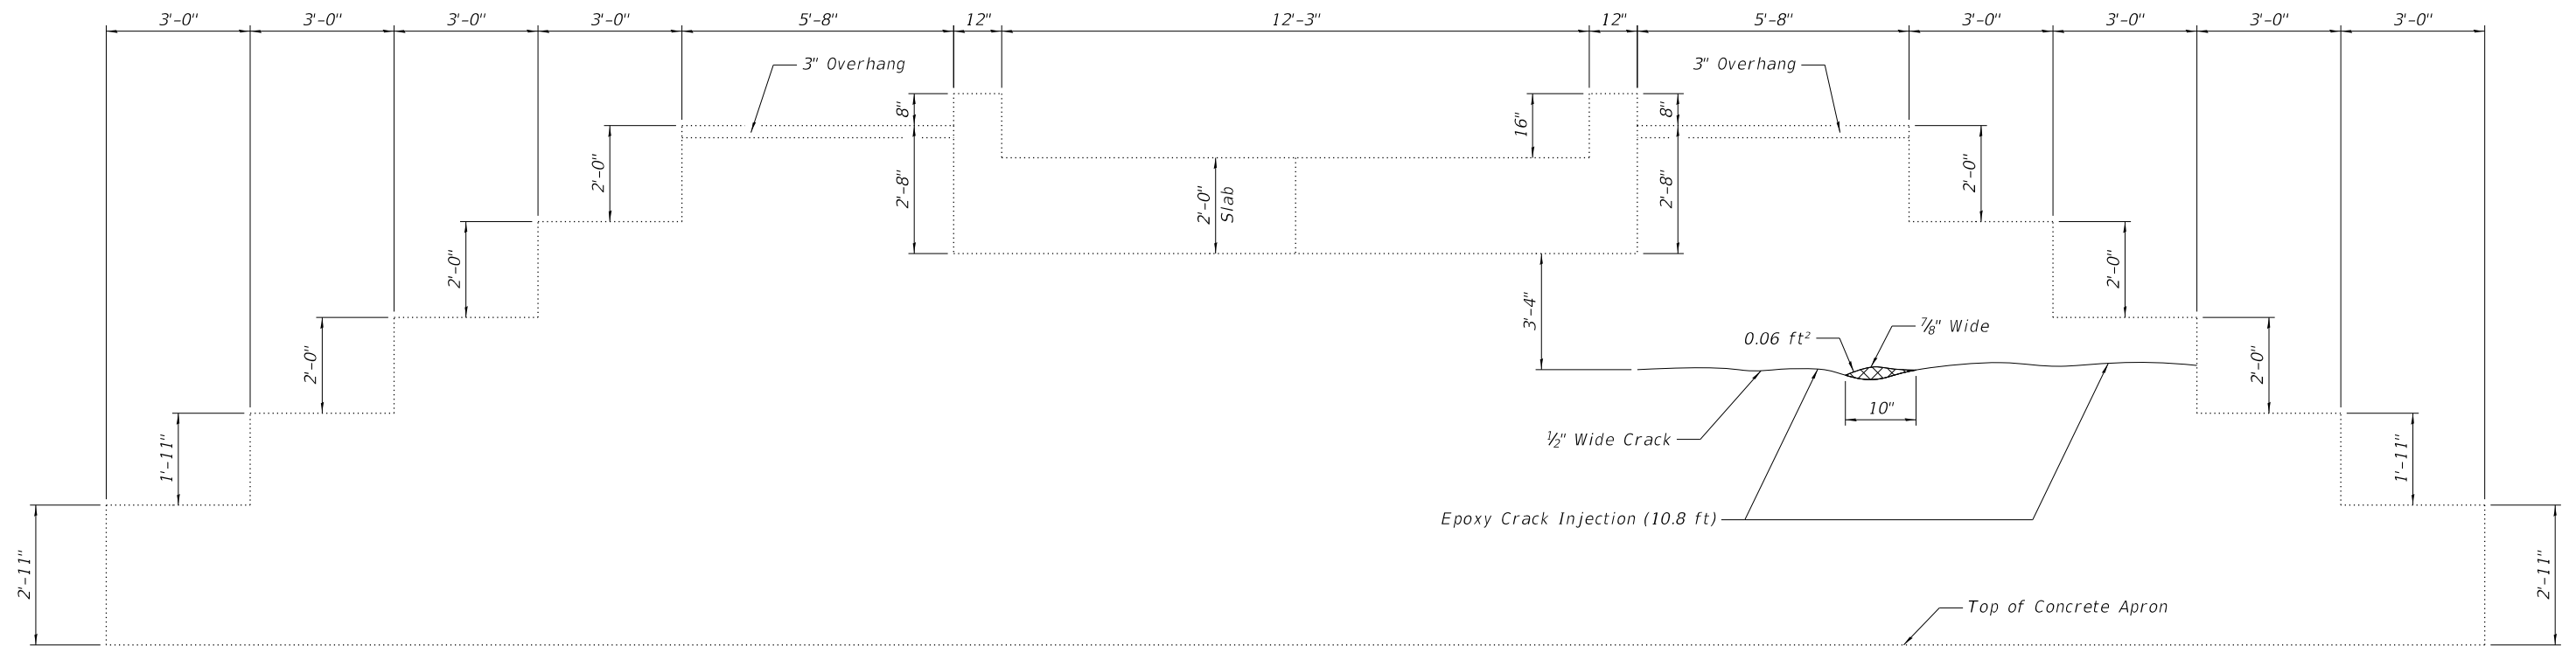

ELEVATION - WEST ABUTMENT

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CITY OF CARBONDALE

ABUTMENT REPAIRS

SHEET 4 OF 5 SHEETS


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ILLINOIS FED. AID PROJECT


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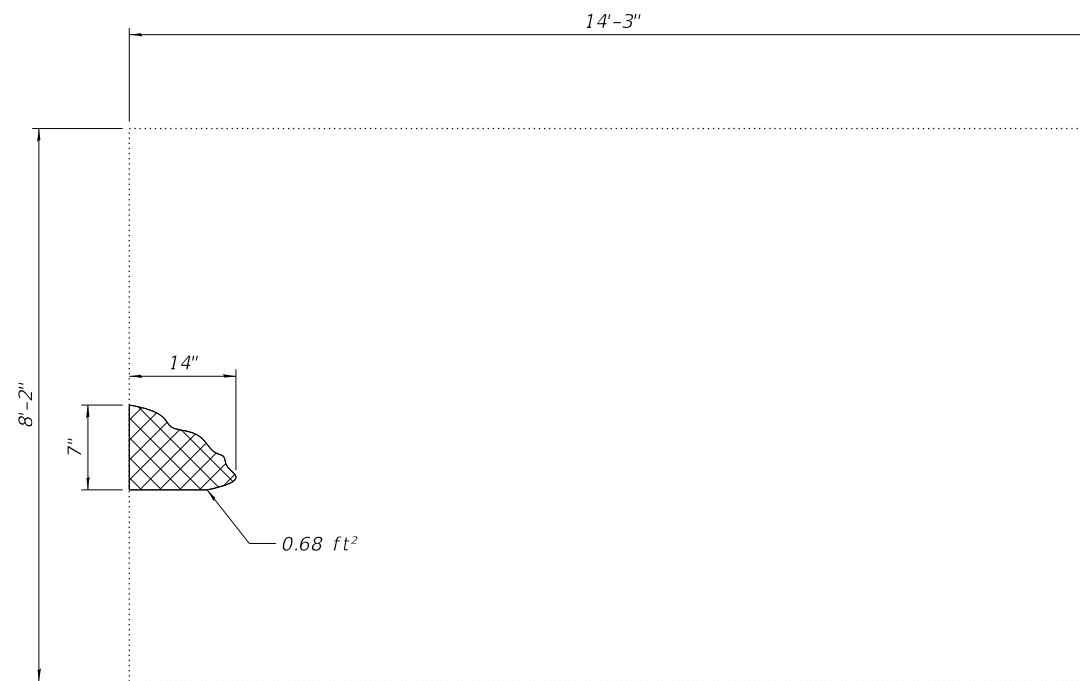
Polymer Modified Portland Cement Mortar




ELEVATION - EAST PIER FACE

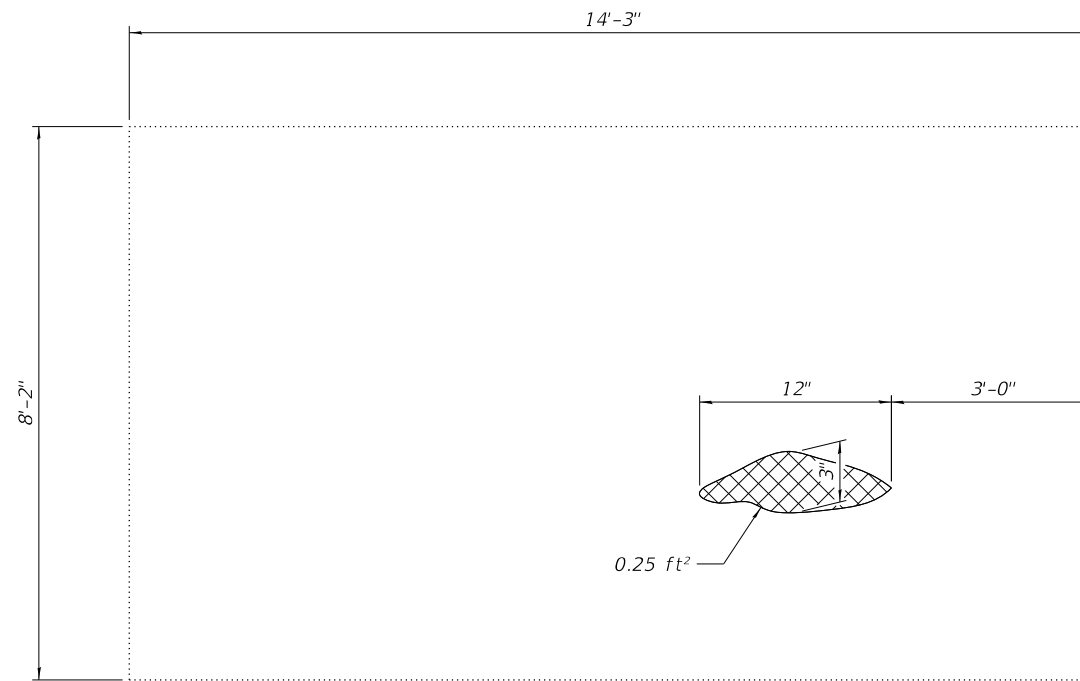

ELEVATION - NORTH PIER FACE

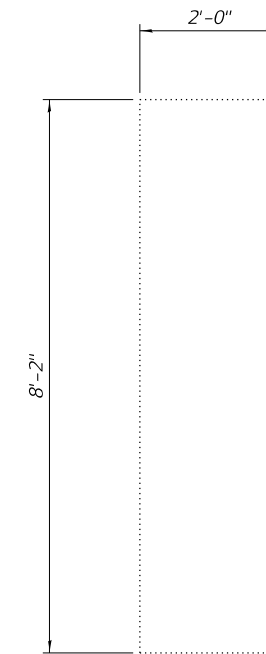

ELEVATION - WEST PIER FACE

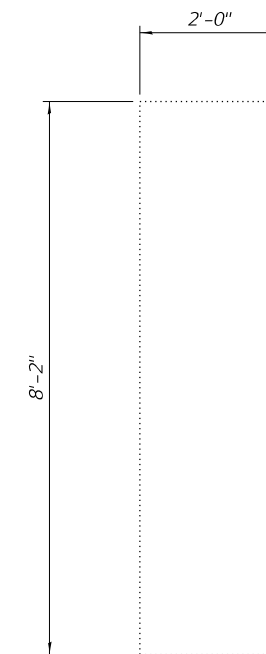

ELEVATION - SOUTH PIER FACE

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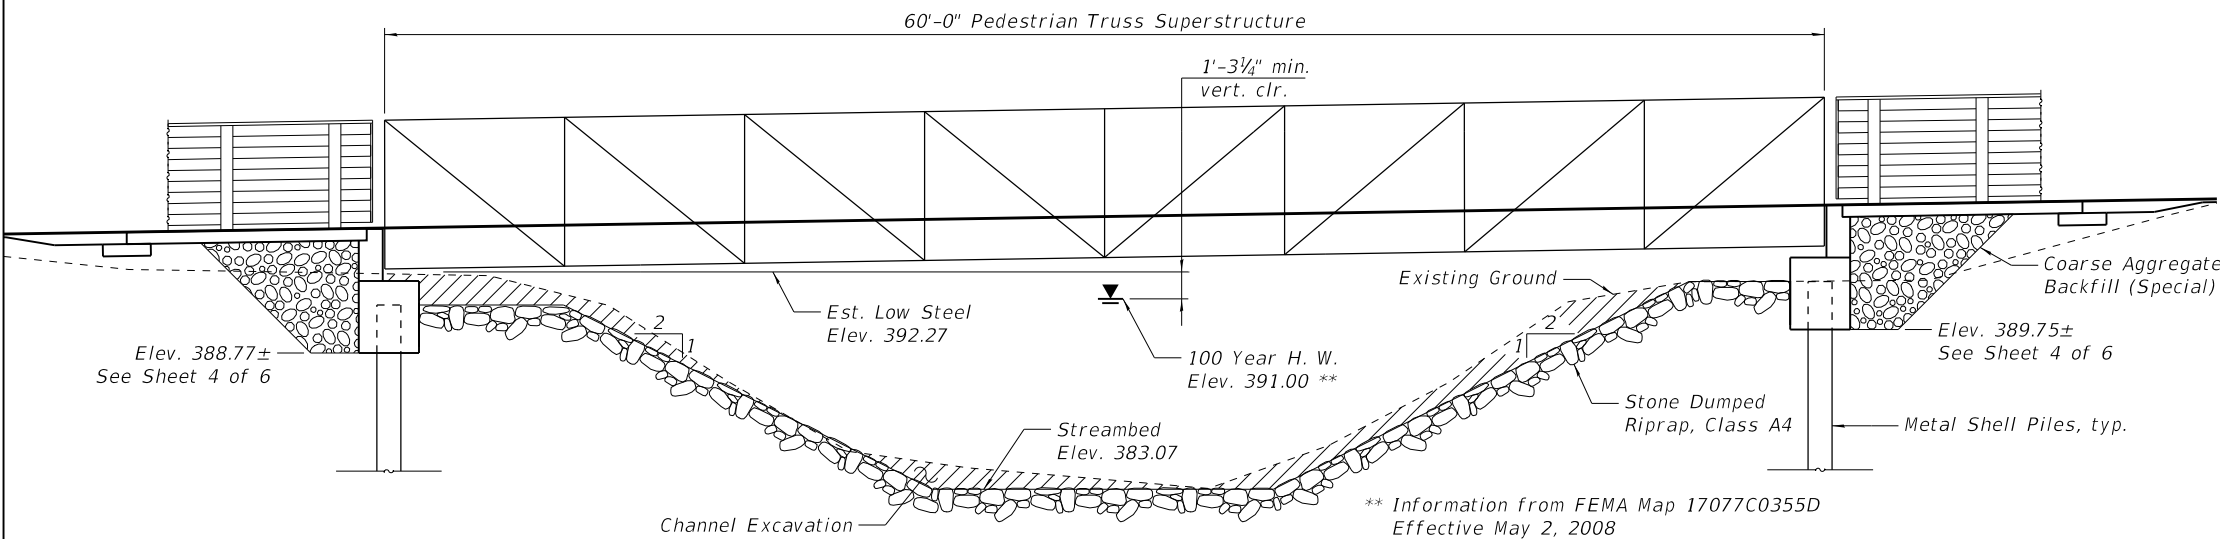
CITY OF CARBONDALE

PIER REPAIRS

SHEET 5 OF 5 SHEETS

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CONTRACT NO. 99632				
ILLINOIS FED. AID PROJECT				

Benchmark: Control Point #402 - Iron Rod with Control Cap. Station 27+86.56, Offset 13.23 ft. Lt., Elevation NAVD '88 = 391.77
 Existing Structure: Existing Railroad Bridge Superstructure has been removed. Remnants of the existing substructure may be present below grade.



INDEX OF SHEETS

1. General Plan & Elevation
2. General Data
3. Bridge Approach Slab Details
4. Abutment Details
5. Metal Shell Pile Details
6. Boring Log

DESIGN SPECIFICATIONS

2009 AASHTO LRFD Guide Specifications for the Design of Pedestrian Bridges 2015 Interims

2017 AASHTO LRFD Bridge Design Specifications, 8th Edition

DESIGN STRESSES

FIELD UNITS

$f'_c = 4,000$ psi (Superstructure)
 $f'_c = 3,500$ psi (Substructure)
 $f_y = 60,000$ psi (Reinforcement)


LOADING

Pedestrian Live Load = 90 psf
 Vehicle Live Load = AASHTO H5

SEISMIC DATA

Seismic Performance Zone (SPZ) = 3
 Design Spectral Acceleration at 1.0 sec. (SD1) = 0.357
 Design Spectral Acceleration at 0.2 sec. (SDS) = 0.837
 Soil Site Class = D

ELEVATION

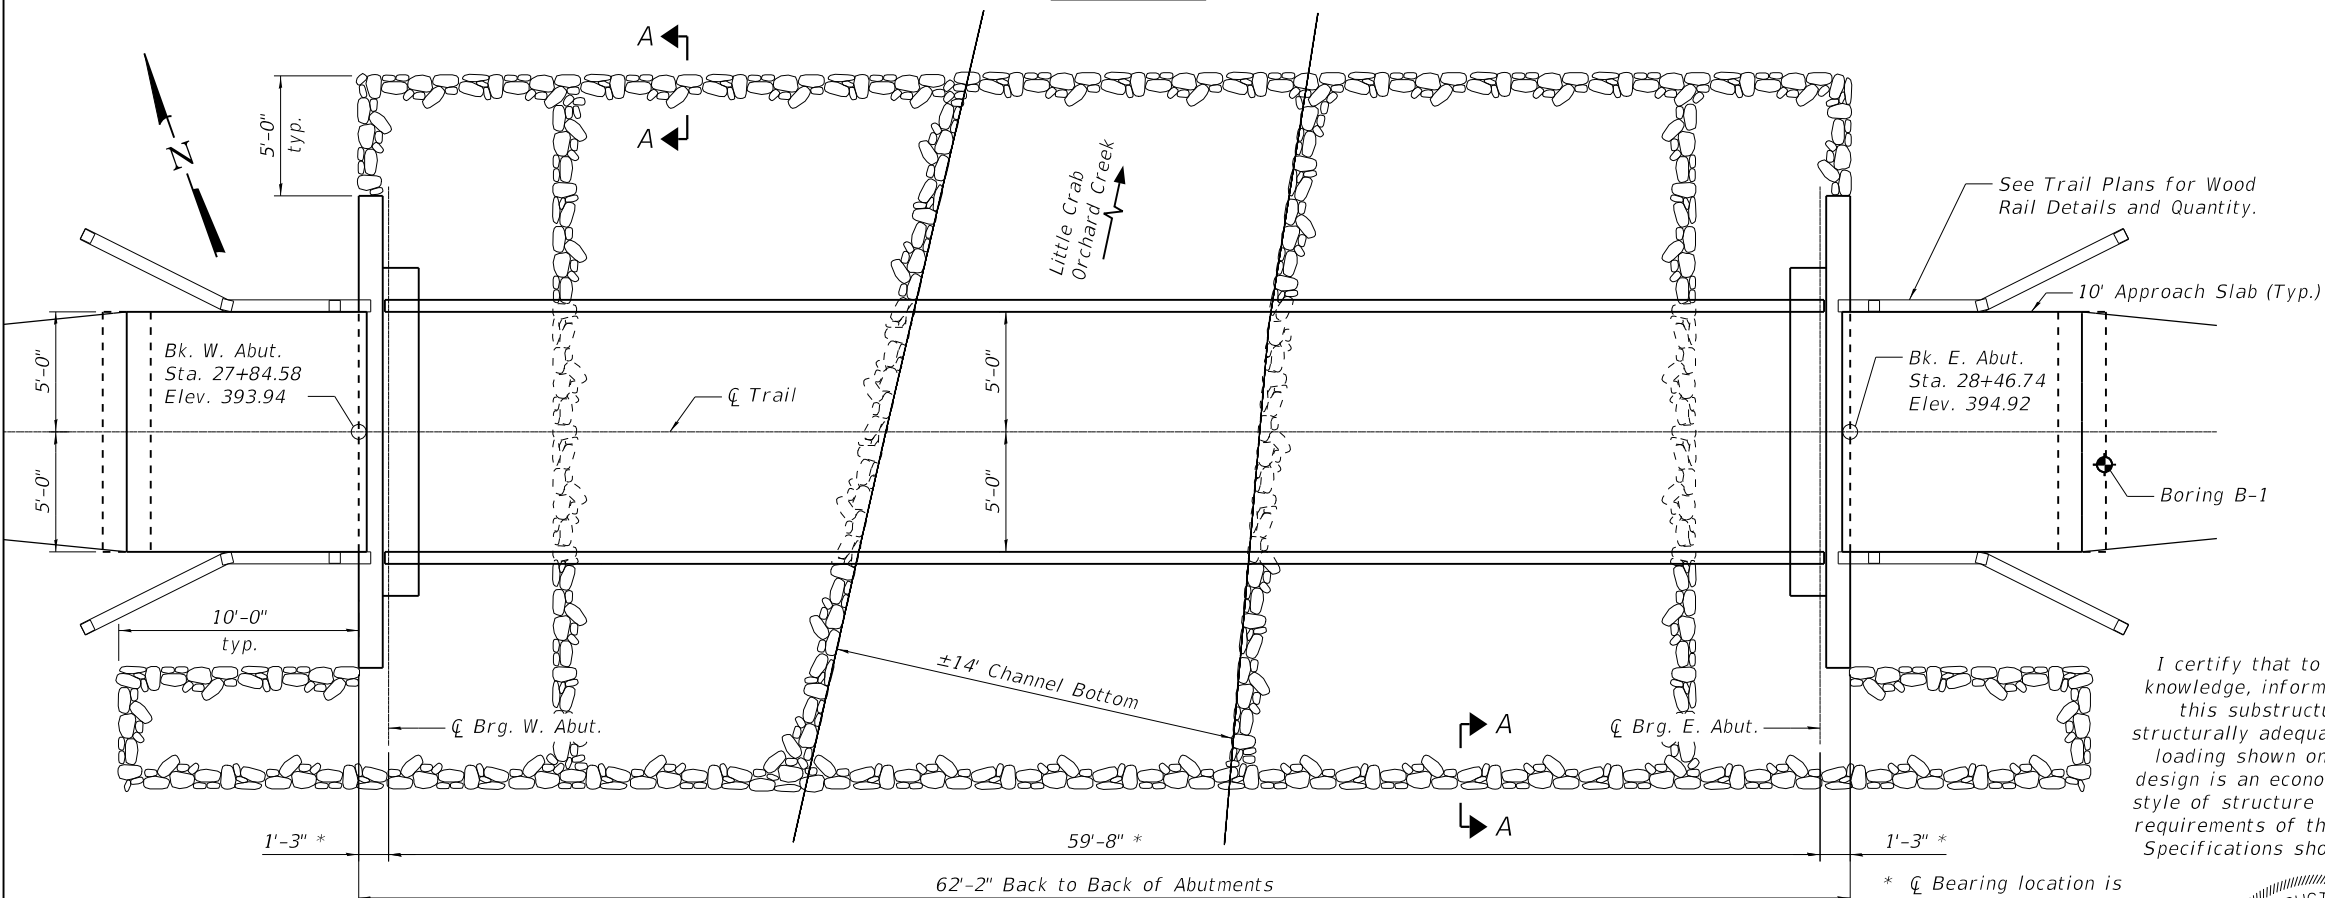

PLAN

(See Sheet 2 of 6 for Section A-A)

WATERWAY INFORMATION **

Drainage Area = 8.91 sq mi Low Grade Elev. 393.12 @ Sta. 27+33.26									
Flood	Freq. Yr.	Q C.F.S.	Opening Ft ²		Nat. H.W.E.	Head - Ft.		Headwater El.	
			Exist.	Prop.		Exist.	Prop.	Exist.	Prop.
Design	10								
Base	100	4640	---	238	391.00				
Overtopping									
Max. Calc.	500			284	392.00				


DESIGN SCOUR ELEVATION TABLE

Design Scour Elev. (ft.)	W. Abut.	E. Abut.
	388.77	389.75

I certify that to the best of my knowledge, information and belief, this substructure design is structurally adequate for the design loading shown on the plans. The design is an economical one for the style of structure and complies with requirements of the AASHTO Design Specifications shown on the plans.




Angela L. Nemsky
 1/27/2022
 EXPIRES 11/30/2022

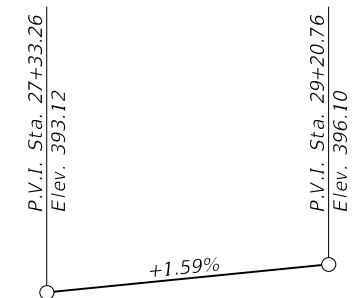

PROFILE GRADE

(along ϕ Northwest Pedestrian and Bicycle Path)

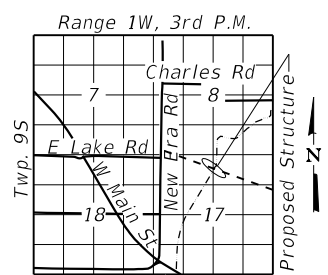

LOCATION SKETCH

**GENERAL PLAN & ELEVATION
 NORTHWEST PEDESTRIAN AND
 BICYCLE PATH OVER LITTLE
 CRAB ORCHARD CREEK
 SECTION 17-00136-00-BT
 JACKSON COUNTY
 STA. 28+15.66**

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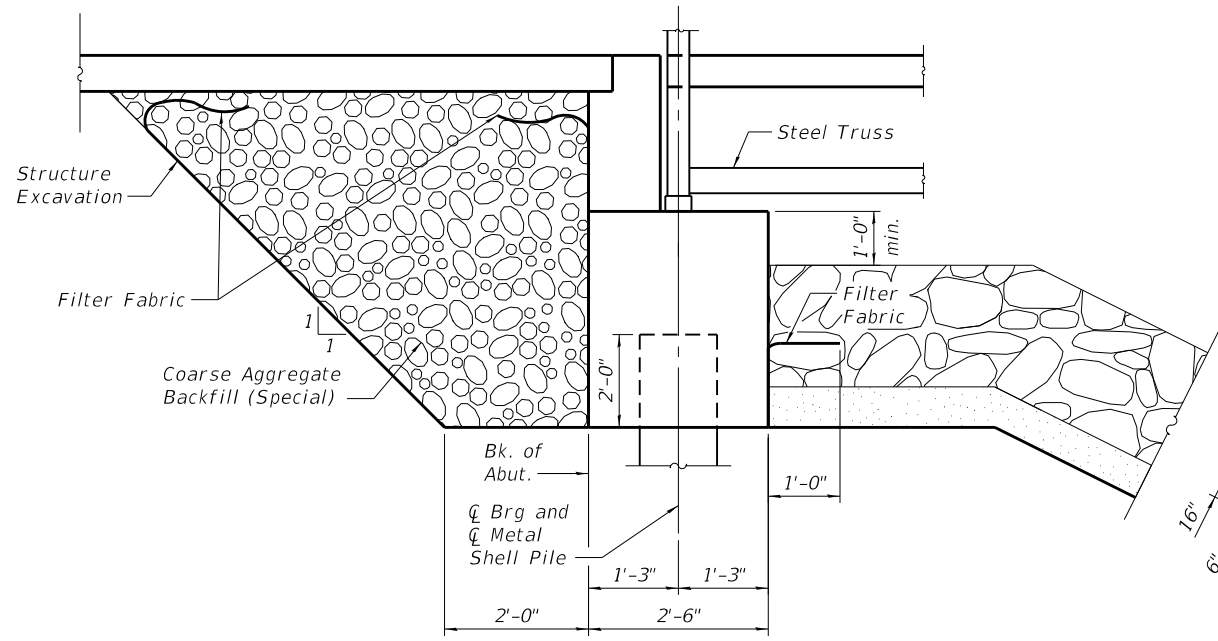


CITY OF CARBONDALE

GENERAL PLAN & ELEVATION

SHEET 1 OF 6 SHEETS



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	17-00136-00-BT	JACKSON	51	21
CONTRACT NO. 99632				
ILLINOIS FED. AID PROJECT				




SECTION THROUGH ABUTMENT

NOTE

1. Coarse Aggregate Backfill (Special) shall be placed in lifts of 6" maximum thickness. Each lift shall be compacted by two complete passes with walk behind vibrating compactors or with an excavator plate mounted compactor.
2. Wrap all sides of backfill to eliminate intermixing of adjacent soils.

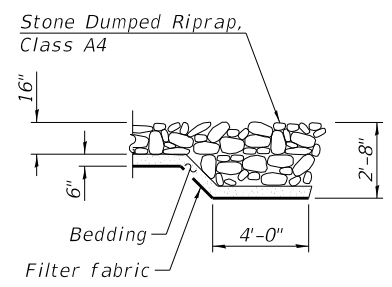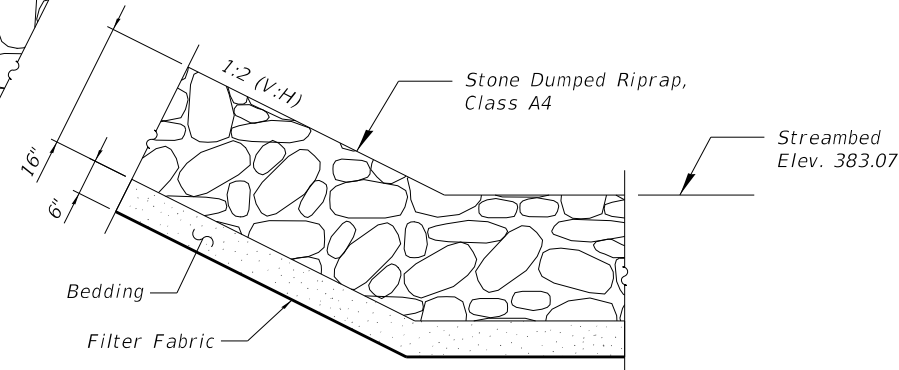

SECTION A-A

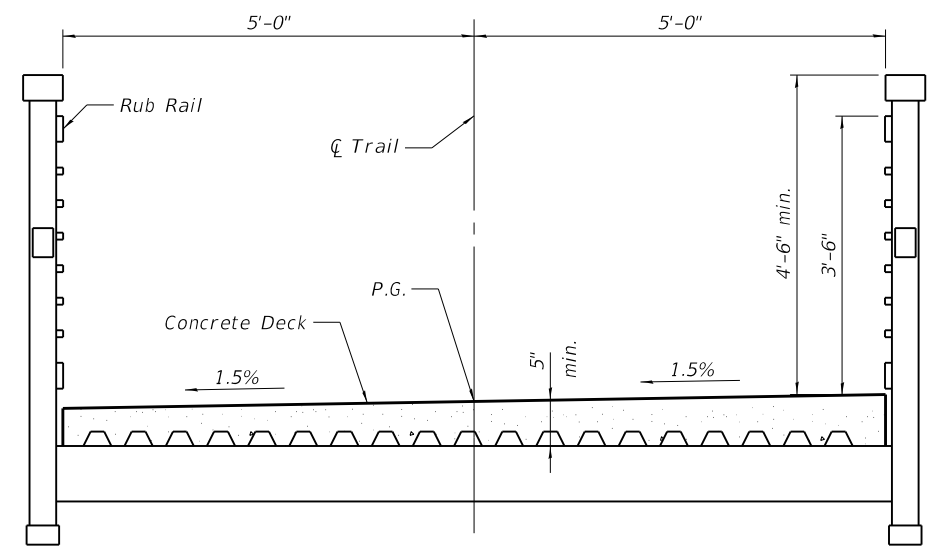

SECTION THROUGH BRIDGE
(Looking East)

GENERAL NOTES

1. Layout of the slope protection system may be varied to suit ground conditions in the field as directed by the Engineer.
2. For approach details, see Bridge Approach Slab Details, sheet 3.
3. The Pedestrian Truss Superstructure shall meet the requirements of the Special Provisions and the design plans.
Bearings: The bearings shall be specified by the bridge manufacturer. Camber: The truss shall be cambered for Dead Load only.
4. The truss manufacturer shall provide the reinforced concrete deck design. The concrete deck shall utilize stay-in-place galvanized forms. Reinforcement shall be epoxy coated. Contractor shall place the concrete deck after the truss is set. Cost included with Pedestrian Truss Superstructure.

TOTAL BILL OF MATERIAL

ITEM	UNIT	SUPER	SUB	TOTAL
Pedestrian Truss Superstructure	Sq. Ft.	622		622
Structure Excavation	Cu. Yd.		30	30
Concrete Structures	Cu. Yd.	3.7	12.7	16.4
Reinforcement Bars	Pound	800	1140	1940
Furnishing Metal Shell Piles, 12"x0.250"	Foot		81	81
Test Pile Metal Shells	Each		1	1
Driving Piles	Foot		81	81
Coarse Aggregate Backfill (Special)	Cu. Yd.		36	36
Stone Dumped Riprap, Class A4	Sq. Yd.		219	219
Filter Fabric	Sq. Yd.		219	219
Channel Excavation	Cu. Yd.		162	162

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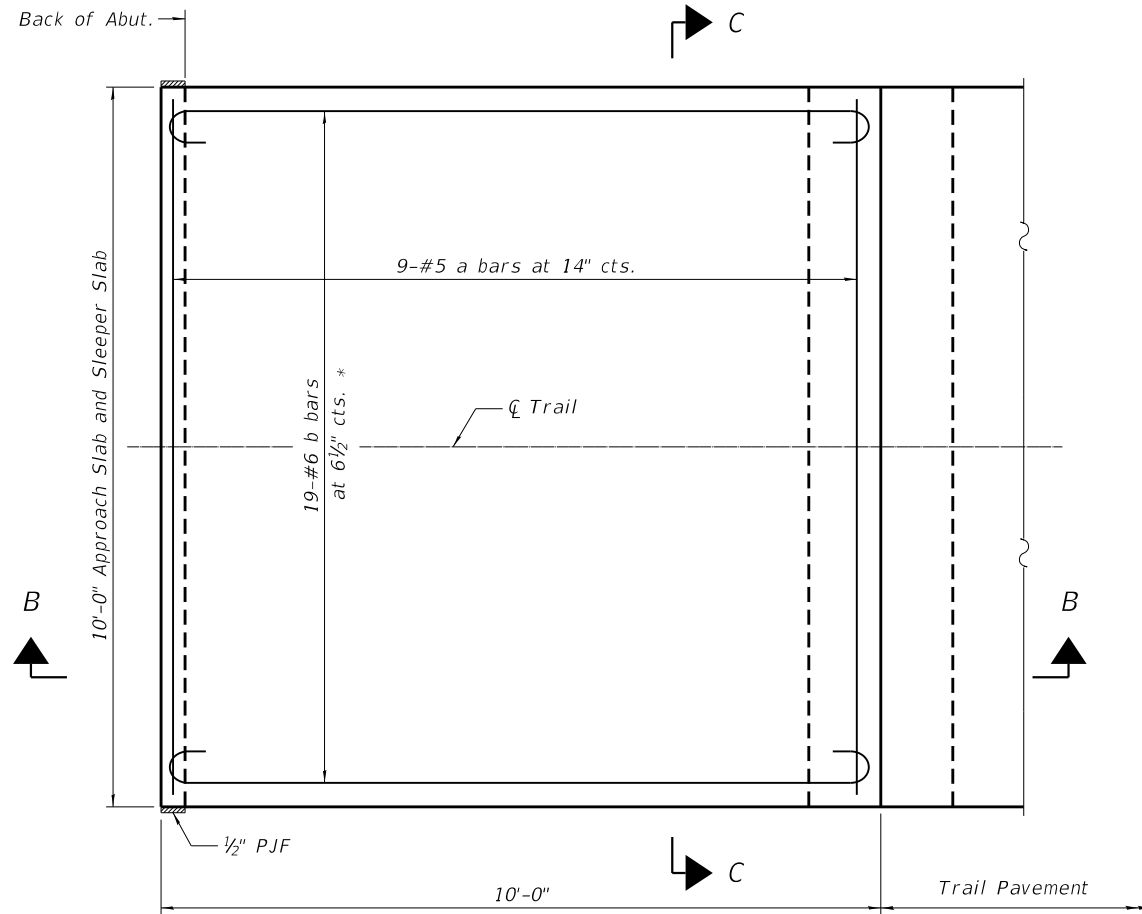


CITY OF CARBONDALE

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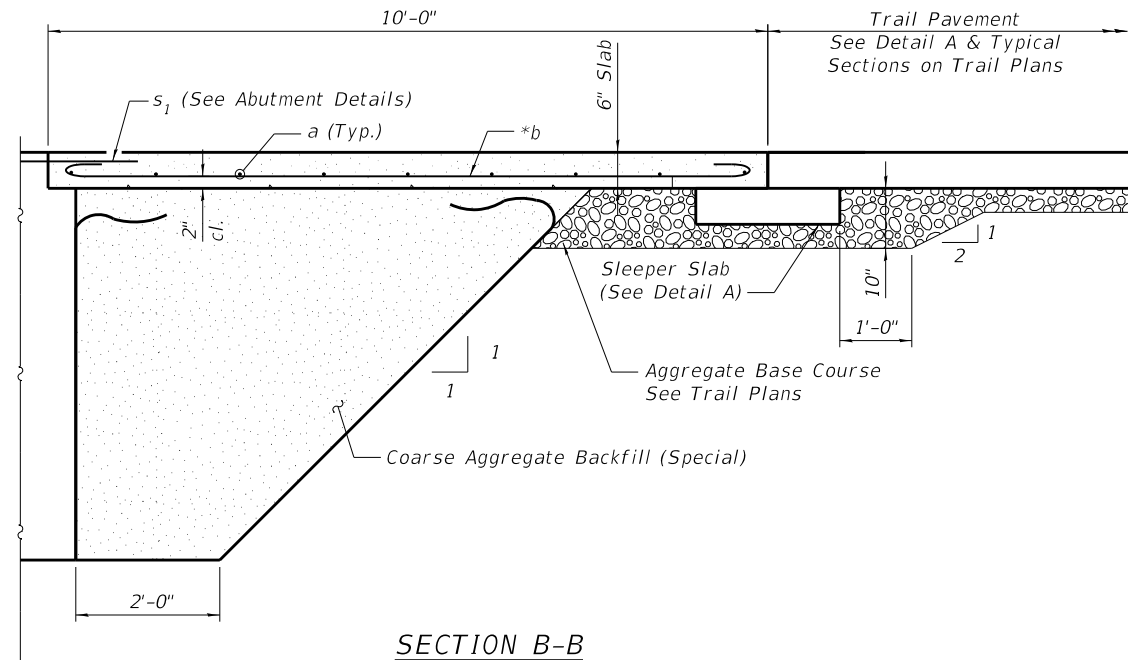
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CONTRACT NO. 99632				
ILLINOIS FED. AID PROJECT				




PLAN


(East Appr. Slab Shown; West Similar)
* Tilt #6 b bars as required to maintain clearance.



SECTION B-B

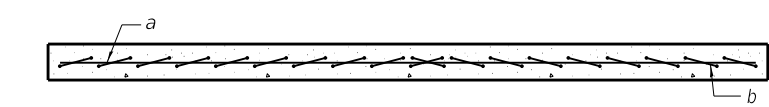

SECTION C-C

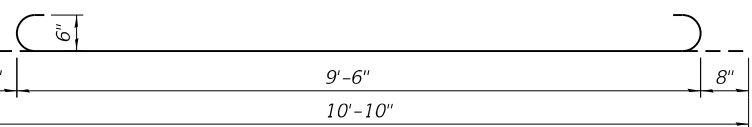

BAR b

WEST SLEEPER SLAB - NORTH EDGE


Location	Station	Offset	Top of Slab Elevations
W. End of W. Sleeper Slab	27+73.91	-5.00	393.19
E. End of W. Sleeper Slab	27+75.91	-5.00	393.22

WEST SLEEPER SLAB - CL TRAIL & P.G.

Location	Station	Offset	Top of Slab Elevations
W. End of W. Sleeper Slab	27+73.91	0.00	393.27
E. End of W. Sleeper Slab	27+75.91	0.00	393.30

WEST SLEEPER SLAB - SOUTH EDGE

Location	Station	Offset	Top of Slab Elevations
W. End of W. Sleeper Slab	27+73.91	5.00	393.34
E. End of W. Sleeper Slab	27+75.91	5.00	393.37

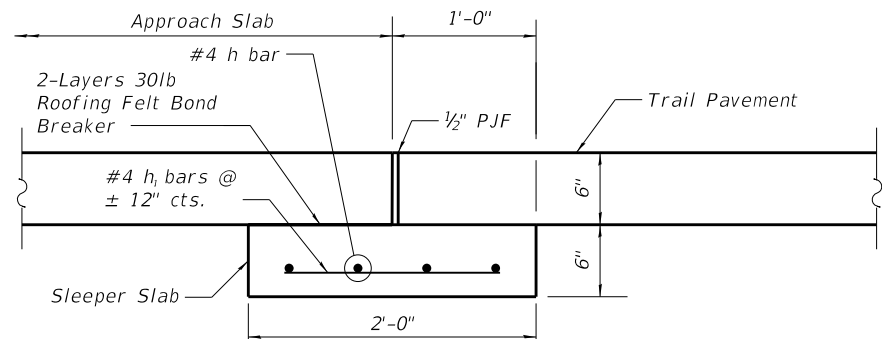

DETAIL A

WEST APPROACH SLAB - NORTH EDGE

Location	Station	Offset	Top of Slab Elevations
W. End of W. Appr. Slab	27+74.91	-5.00	393.71
E. End of W. Appr. Slab	27+84.91	-5.00	393.87

WEST APPROACH SLAB - CL TRAIL & P.G.

Location	Station	Offset	Top of Slab Elevations
W. End of W. Appr. Slab	27+74.91	0.00	393.78
E. End of W. Appr. Slab	27+84.91	0.00	393.94

WEST APPROACH SLAB - SOUTH EDGE

Location	Station	Offset	Top of Slab Elevations
W. End of W. Appr. Slab	27+74.91	5.00	393.86
E. End of W. Appr. Slab	27+84.91	5.00	394.02

EAST SLEEPER SLAB - NORTH EDGE

Location	Station	Offset	Top of Slab Elevations
W. End of E. Sleeper Slab	28+55.41	-5.00	394.49
E. End of E. Sleeper Slab	28+57.41	-5.00	394.52

EAST SLEEPER SLAB - CL TRAIL & P.G.

Location	Station	Offset	Top of Slab Elevations
W. End of E. Sleeper Slab	28+55.41	0.00	394.56
E. End of E. Sleeper Slab	28+57.41	0.00	394.59

EAST SLEEPER SLAB - SOUTH EDGE

Location	Station	Offset	Top of Slab Elevations
W. End of E. Sleeper Slab	28+55.41	5.00	394.64
E. End of E. Sleeper Slab	28+57.41	5.00	394.67

**BILL OF MATERIAL
(2 SLEEPER SLABS)**

Bar	No.	Size	Length	Shape
h	8	#4	9'-8"	—
h ₁	22	#4	1'-8"	—
Concrete Structures			Cu. Yd.	0.7
Reinforcement Bars			Pound	80

EAST APPROACH SLAB - NORTH EDGE

Location	Station	Offset	Top of Slab Elevations
W. End of E. Appr. Slab	28+46.41	-5.00	394.84
E. End of E. Appr. Slab	28+56.41	-5.00	395.00

EAST APPROACH SLAB - CL TRAIL & P.G.

Location	Station	Offset	Top of Slab Elevations
W. End of E. Appr. Slab	28+46.41	0.00	394.92
E. End of E. Appr. Slab	28+56.41	0.00	395.08

EAST APPROACH SLAB - SOUTH EDGE

Location	Station	Offset	Top of Slab Elevations
W. End of E. Appr. Slab	28+46.41	5.00	394.99
E. End of E. Appr. Slab	28+56.41	5.00	395.15

**BILL OF MATERIAL
(2 APPROACH SLABS)**

Bar	No.	Size	Length	Shape
a	18	#5	9'-8"	—
b	38	#6	10'-10"	U
Concrete Structures			Cu. Yd.	3.7
Reinforcement Bars			Pound	800

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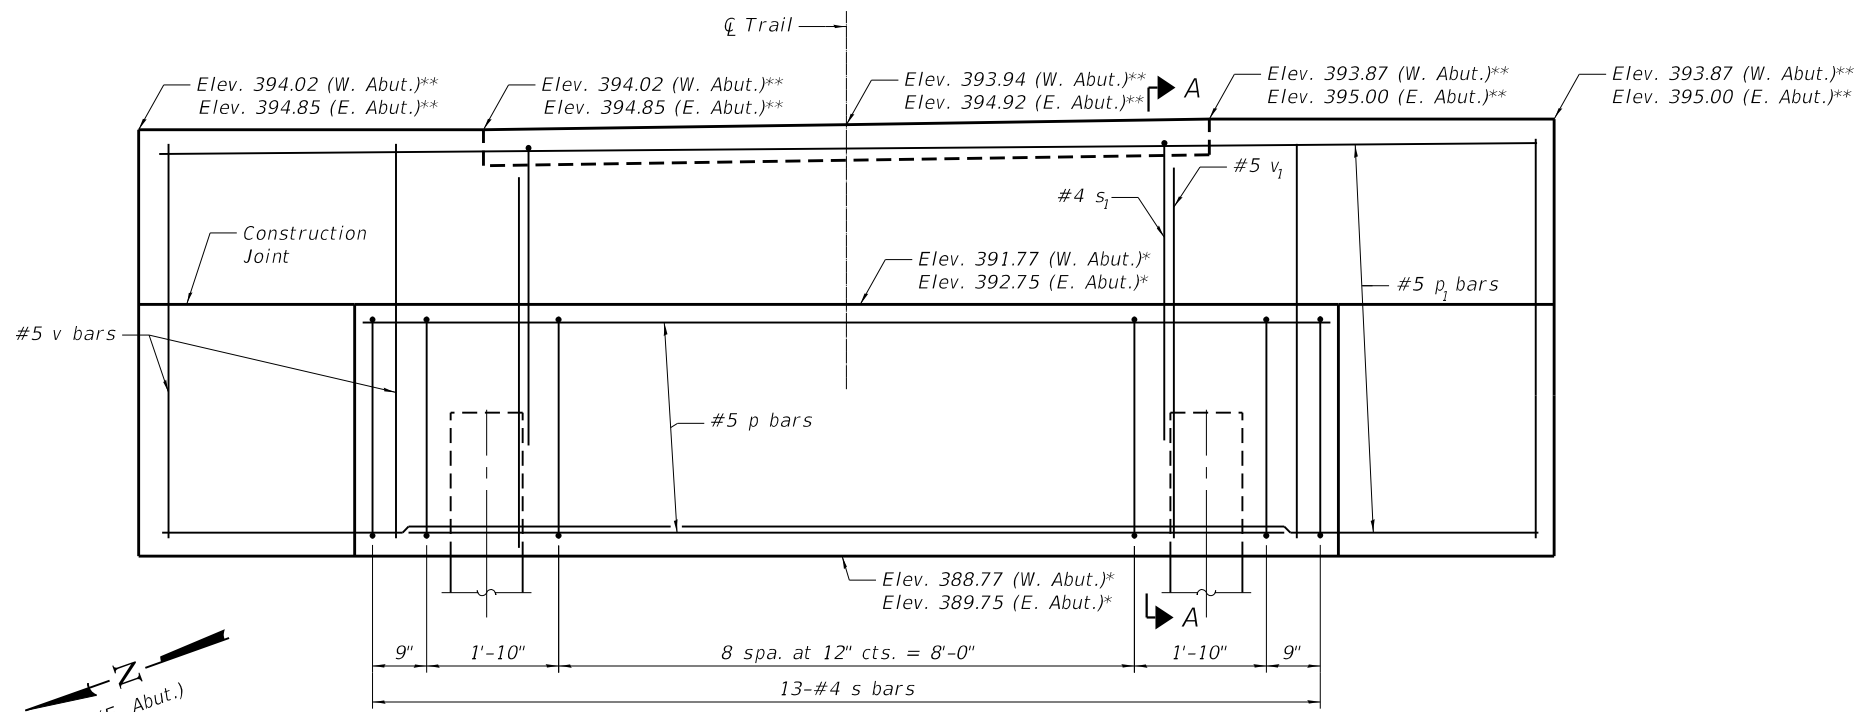
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CITY OF CARBONDALE


BRIDGE APPROACH SLAB DETAILS

SHEET 3 OF 6 SHEETS

F.A. RTE.	SECTION	COUNTY	TOTAL SHEETS	SHEET NO.
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CONTRACT NO. 99632				
ILLINOIS FED. AID PROJECT				




ABUTMENT ELEVATION
East Abutment shown. West Abutment similar.

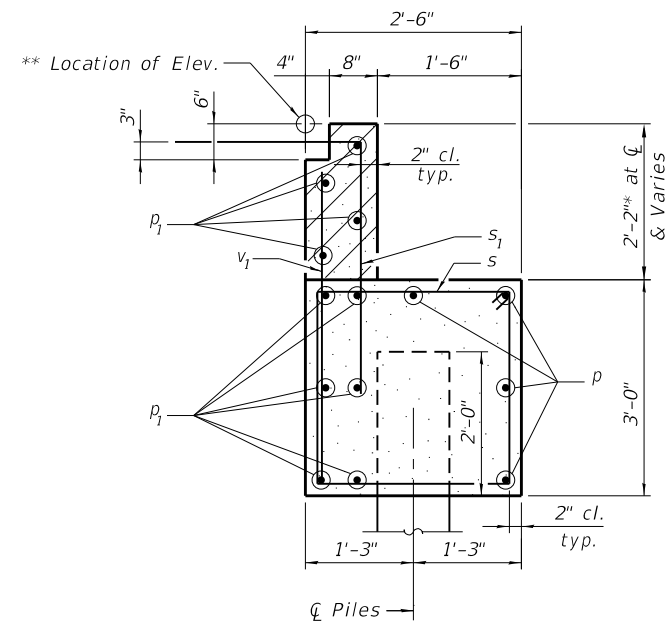

SECTION A-A

** Location of Elev. 4" 8" 1'-6"
3" 6" 2" cl. typ.
2'-2" at $\bar{\bar{c}}$ & Varies
3'-0" 2" cl. typ.
1'-3" 1'-3"
 $\bar{\bar{c}}$ Piles

* Indicated dimensions and elevations shall be coordinated with requirements of bridge fabricator. Estimated Quantities and bar dimensions based on dimensions shown.

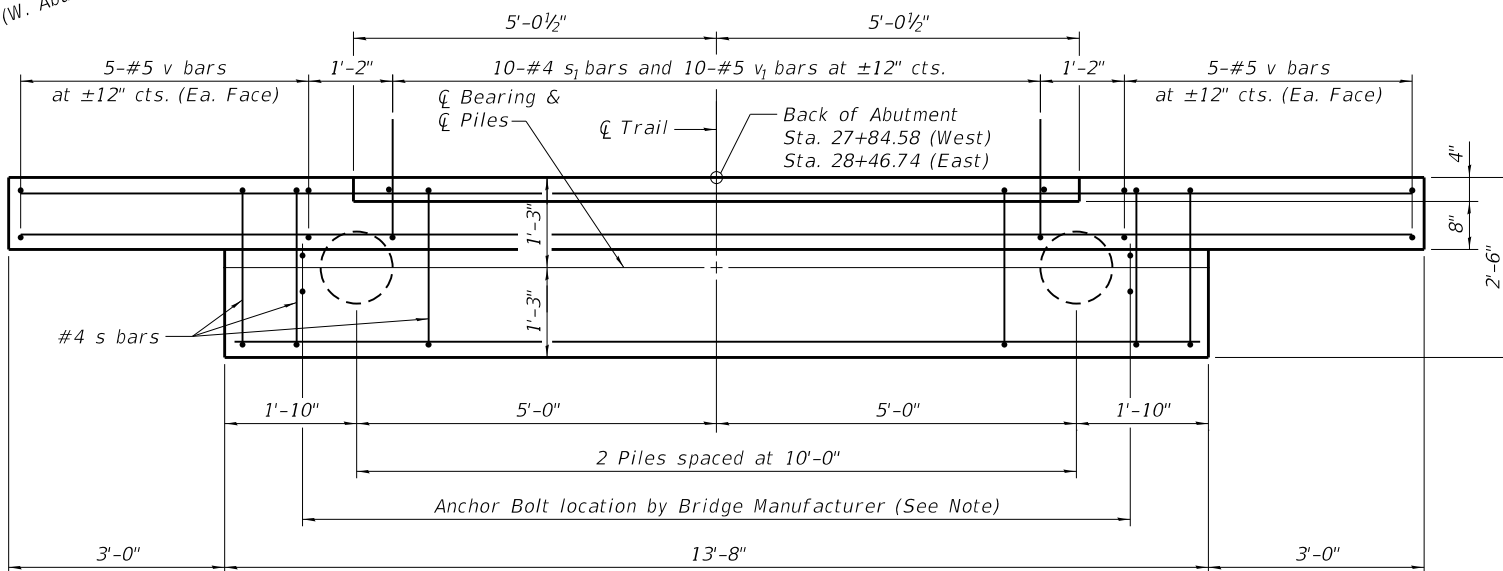

ABUTMENT PLAN

ASSUMED TRUSS LOADS

	P (lbs)	H (lbs)	L (lbs)
Dead Load	12,525		
Uniform Live Load	13,500		
Vehicle Load	5,000		
Wind Uplift	Windward -4,875		
20_psf	Leeward -1,625		
Wind	$\pm 1,925$	5,995	
Thermal			1,880


"+" - Downward Load
 "-" - Upward Load
 "P" - Vertical Load Each Base Plate (4 per Truss)
 "H" - Horizontal Load Each Abutment (2 per Truss)
 "L" - Longitudinal Load Each Base Plate (4 per Truss)
 Loads are unfactored

BILL OF MATERIAL
2 ABUTMENTS


Bar	No.	Size	Length	Shape
p	8	#5	13'-4"	—
p _l	20	#5	19'-4"	—
s	26	#4	10'-5"	□
s ₁	20	#4	6'-2"	┌
v	40	#5	4'-9"	—
v ₁	20	#5	4'-3"	—
Structure Excavation			Cu. Yd.	30
Concrete Structures			Cu. Yd.	12.0
Reinforcement Bars			Pound	1060
Furnishing Metal Shell Piles, 12"x0.250"			Foot	81
Driving Piles			Foot	81
Test Pile, Metal Shells			Each	1

Notes:
Hatched area above construction joint to be poured after truss has been erected.


Spacing of s Bars at each end of pile cap should be modified to avoid anchor bolts. Size, number, and location of anchor bolts are to be based on the approved shop drawings for the Pedestrian Truss Superstructure.

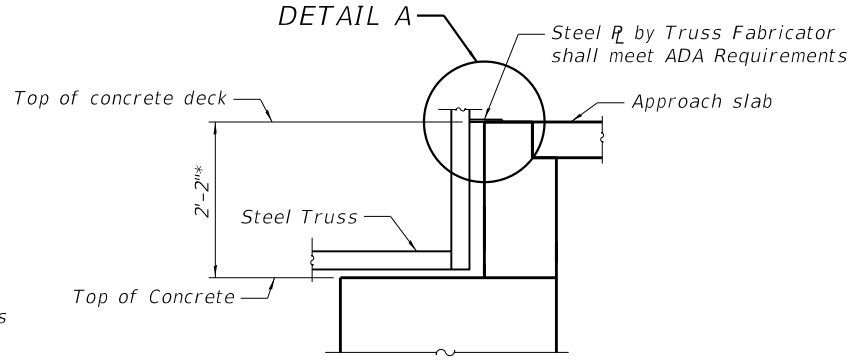

APPROACH DETAIL

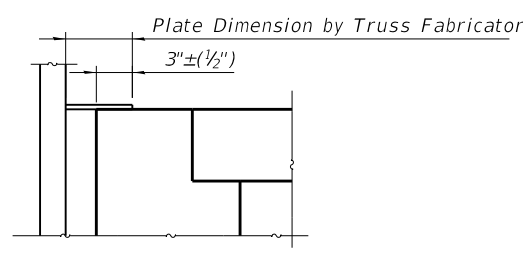

DETAIL A

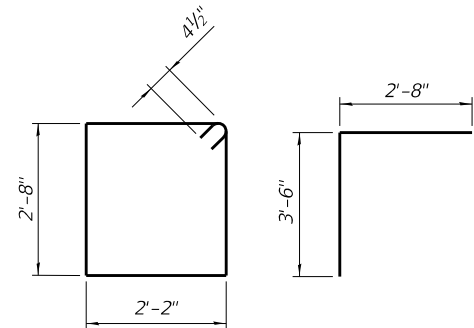

BAR S

BAR S1

PILE DATA

Type: Metal Shell
 Nominal Required Bearing: 119 kips
 Factored Resistance Available: 65 kips
 Est. Length: 27'
 No. Test Piles: 1 at West Abutment
 No. Production Piles: 1 at West Abutment
 2 at East Abutment

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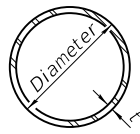


CITY OF CARBONDALE

ABUTMENT DETAILS


SHEET 4 OF 6 SHEETS

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CONTRACT NO. 99632				
ILLINOIS FED. AID PROJECT				




METAL SHELL PILE TABLE


Designation and outside diameter	Wall thickness t	Weight per foot (Lbs./ft.)	Inside volume (yd. ³ /ft.)
PP12	0.250"	31.37	0.0267
PP14	0.250"	36.71	0.0368
PP14	0.312"	45.61	0.0361
PP16	0.312"	52.32	0.0478
PP16	0.375"	62.64	0.0470

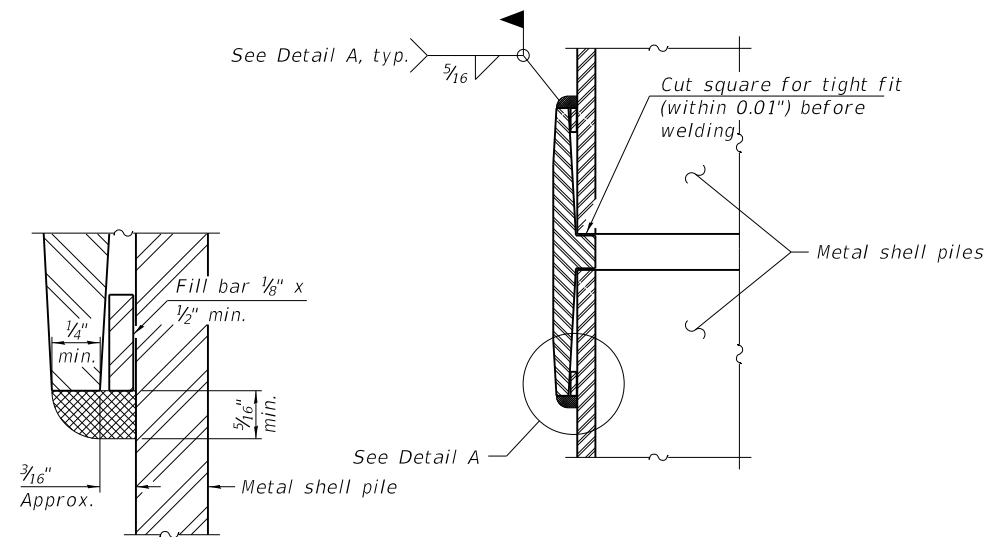

DETAIL A

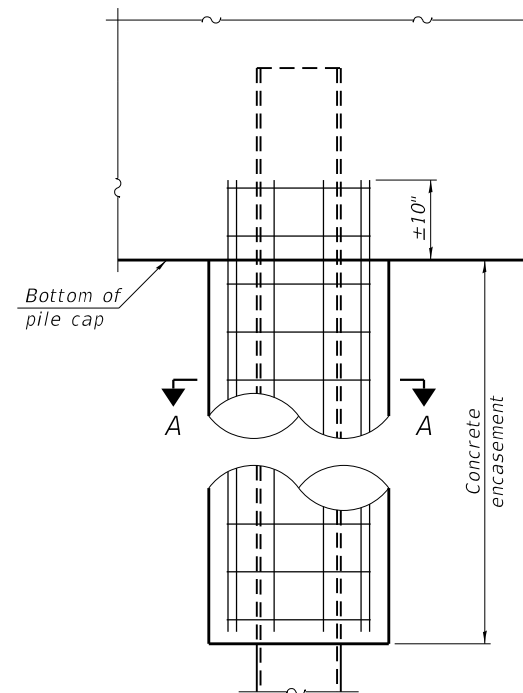


ELEVATION

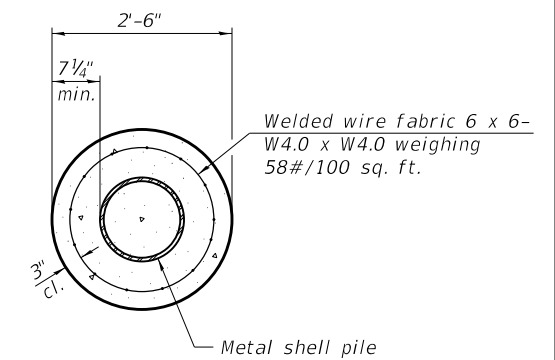


SECTION A-A

INDIVIDUAL PILE CONCRETE ENCASEMENT AT PIERS

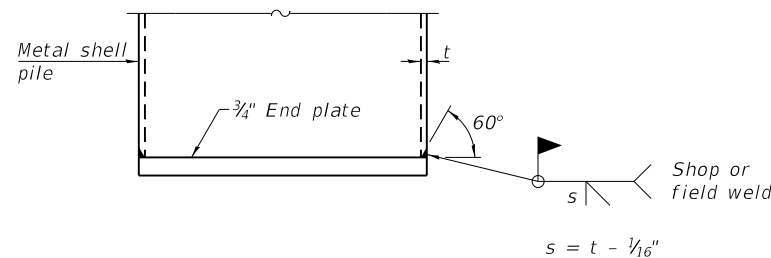


END PLATE ATTACHMENT

WELDED COMMERCIAL SPLICE
 Notes:
 The 1/8" x 1/2" min. fill bar may be constructed of 2 bars with a 1/8" max. gap between them.
 Pile segments shall be driven to solid contact with splicer before welding.

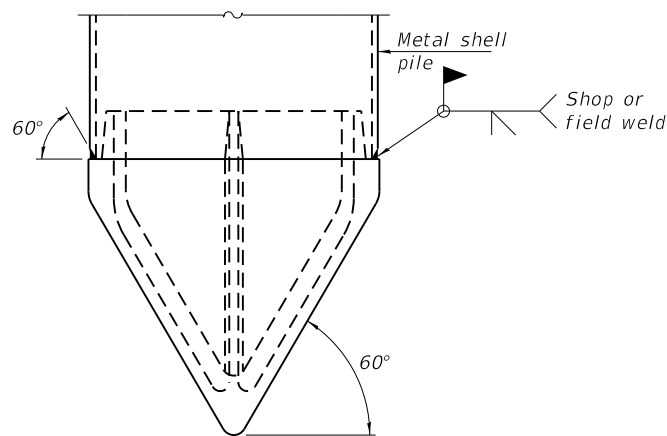


PILE SHOE ATTACHMENT

(When called for on the plans, the Contractor shall furnish metal shell pile shoes consisting of a single piece conical pile point as shown. The pile shoes shall be cast in one piece steel according to either ASTM A 148 Grade 90-60 or AASHTO M 103 Grade 65-35 and shall provide full bearing over the full circumference of the metal shell pile. The pile shoe shall have tapered leads to assure proper alignment and fitting and shall be secured to the pile with a circumferential weld).

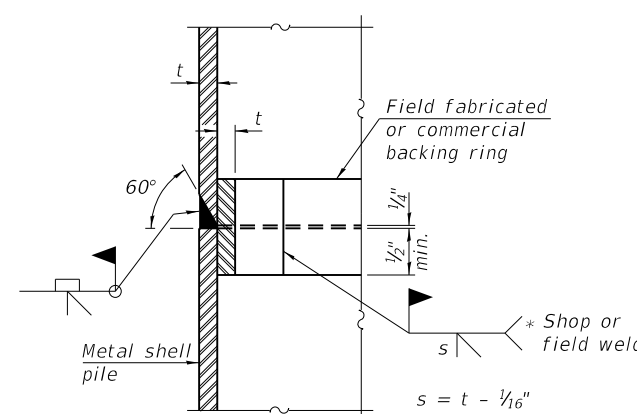


COMPLETE PENETRATION WELD SPLICE

* Field fabricated backing ring may be made from pile shell by removing segment to allow reducing circumference and vertically rejoin with partial joint penetration weld.

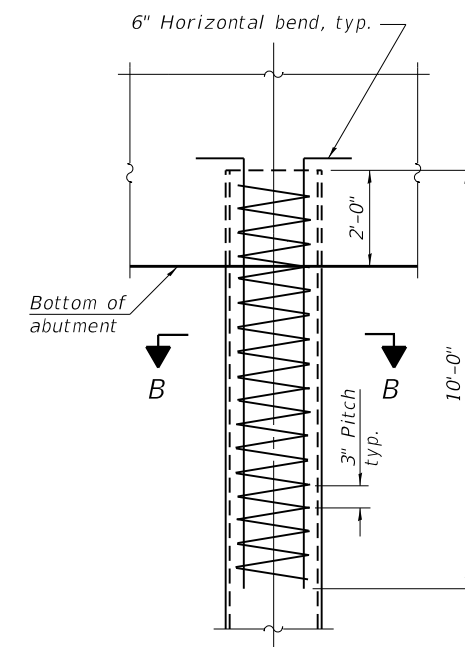

ELEVATION

REINFORCEMENT AT ABUTMENTS

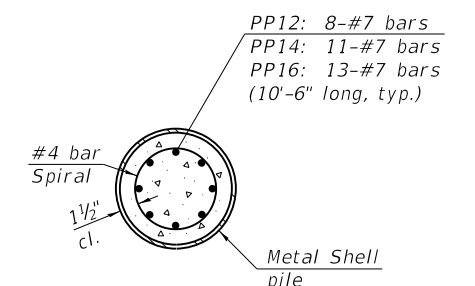

SECTION B-B

Note:
 The metal shell piles shall be according to Article 1006.05 of the Standard Specifications.

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CITY OF CARBONDALE

METAL SHELL PILE DETAILS

SHEET 5 OF 6 SHEETS

F.A. RTE.	SECTION	COUNTY	TOTAL SHEETS	SHEET NO.
	17-00136-00-BT	JACKSON	51	25
CONTRACT NO. 99632				
ILLINOIS FED. AID PROJECT				

Bridge Foundation Boring Log

Project: H-19010 Bridge Northwest Trail Bridge Date: 2/4/2019
 Section: _____ Station _____
 Structure: _____ Bored by: D. Plucker
 County: Jackson Checked By: T. Holcomb

Boring No. _____ Station: _____ Offset: _____	Elevation	N	Qu	tsf	w %	Surface Water Elev. _____	Elevation	N	Qu	tsf	w %	Ground Water Elev.	
												During Drilling	Upon Completion
Ground Surface 396.5 0						silty clay to clay (continued)						376.5'	
4" Crushed Stone												Plugged @	
Gray Mottled Brown Silty CLAY (A-6)												381.5'	
26 -- 32												9 2.0S 28	
7 -- 23												8 2.1S 40	
368.0													
Brown Mottled Gray Silty CLAY to CLAY (A-6)												9 2.0S 36	
387.5													
Gray Clayey SILT (A-4)												3 0.7S 30	
3 0.4S 30												8 2.1S 31	
3 1.1S 28													
379.5													
Gray Silty CLAY (A-6)												7 1.9S 34	
4 2.1S 26													
375.5													
Gray Silty CLAY to CLAY (A-6)												8 1.2S 36	

N = Standard Penetration Test Blows per foot to drive 2" O.D. Split Spoon Sampler 12" with a 140 lbs. hammer falling 30"
 Qu—Unconfined Compressive Strength in tons/sq.ft.
 w—Water Content—percentage of oven dry weight—%
 B = Bulge Failure
 S = Shear Failure
 E = Estimated Value
 P = Penetrometer

Bridge Foundation Boring Log

Project: H-19010 Bridge Northwest Trail Bridge Date: 2/4/2019
 Section: _____ Station _____
 Structure: _____ Bored by: D. Plucker
 County: Jackson Checked By: T. Holcomb

Boring No. _____ Station: _____ Offset: _____	Elevation	N	Qu	tsf	w %	Surface Water Elev. _____	Elevation	N	Qu	tsf	w %	Ground Water Elev.	
												During Drilling	Upon Completion
silty clay to clay (continued)												376.5'	
45												Plugged @	
347.5												381.5'	
End of Boring @ -49.0'												9 1.0B 30	
-70													
-75													
-80													
-85													
-65													

N = Standard Penetration Test Blows per foot to drive 2" O.D. Split Spoon Sampler 12" with a 140 lbs. hammer falling 30"
 Qu—Unconfined Compressive Strength in tons/sq.ft.
 w—Water Content—percentage of oven dry weight—%
 B = Bulge Failure
 S = Shear Failure
 E = Estimated Value
 P = Penetrometer

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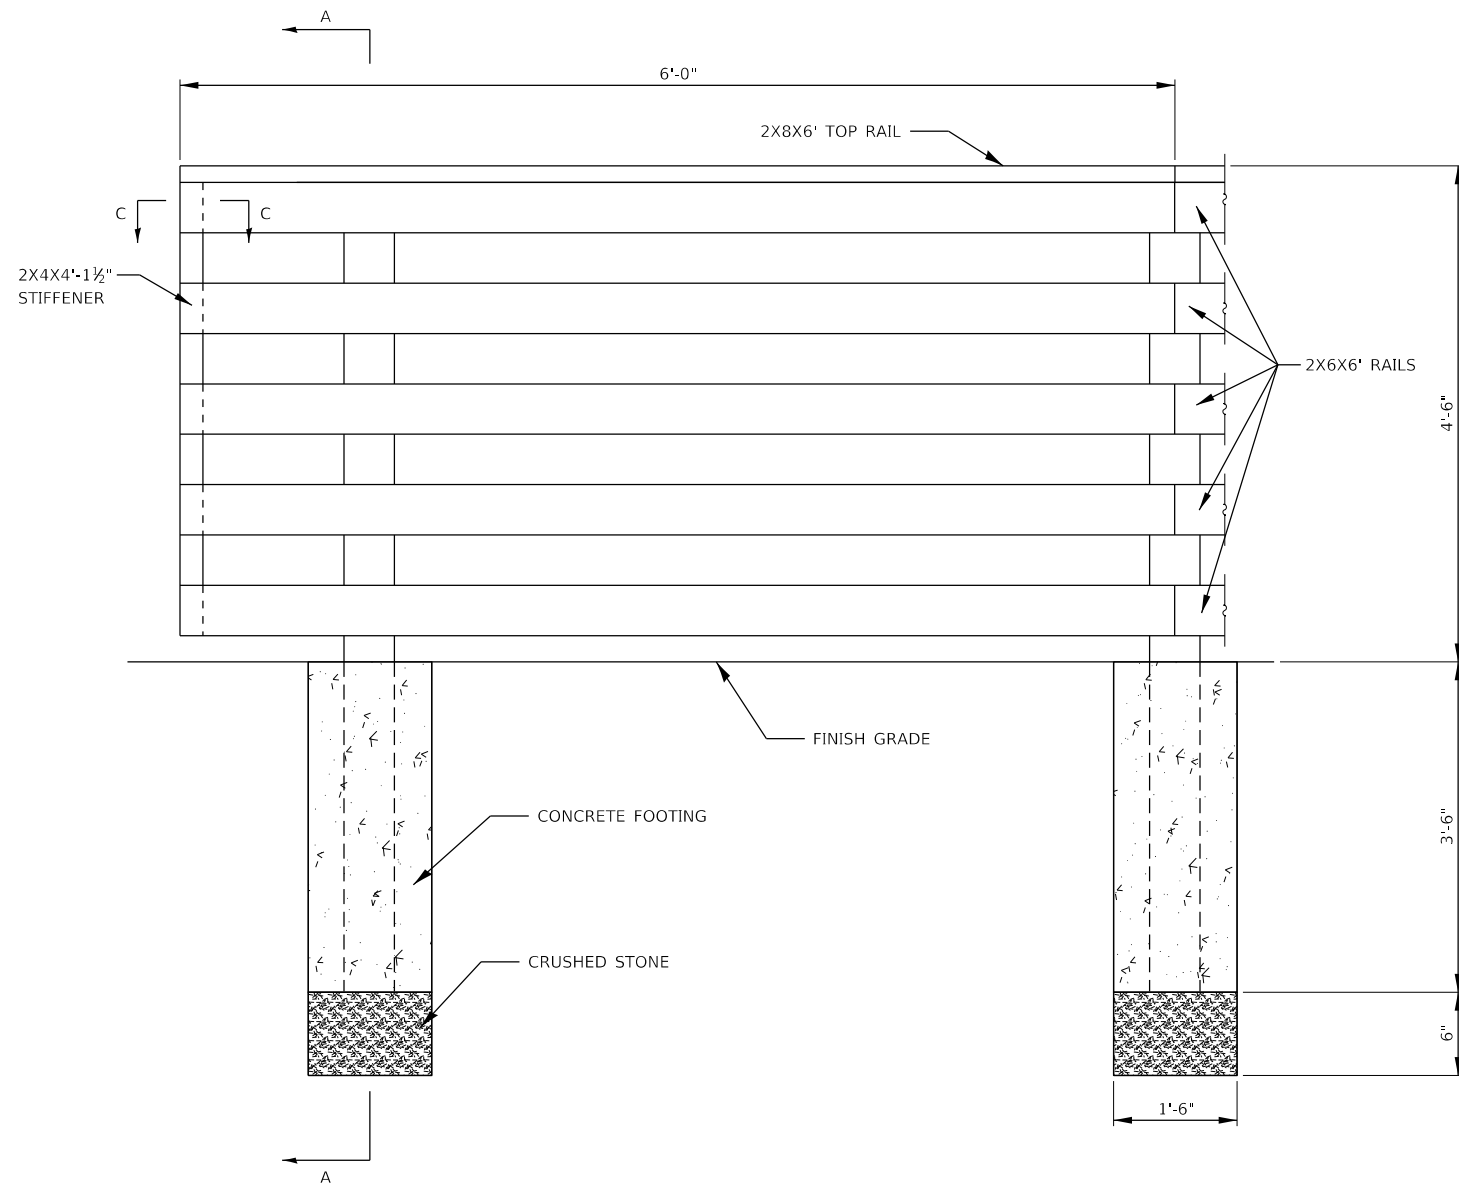


CITY OF CARBONDALE

BORING B-1





SHEET 6 OF 6 SHEETS

F.A. RTE.	SECTION	COUNTY	TOTAL SHEETS	SHEET NO.
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CONTRACT NO. 99632				
ILLINOIS FED. AID PROJECT				




VIEW B-B

WOOD RAIL DETAIL

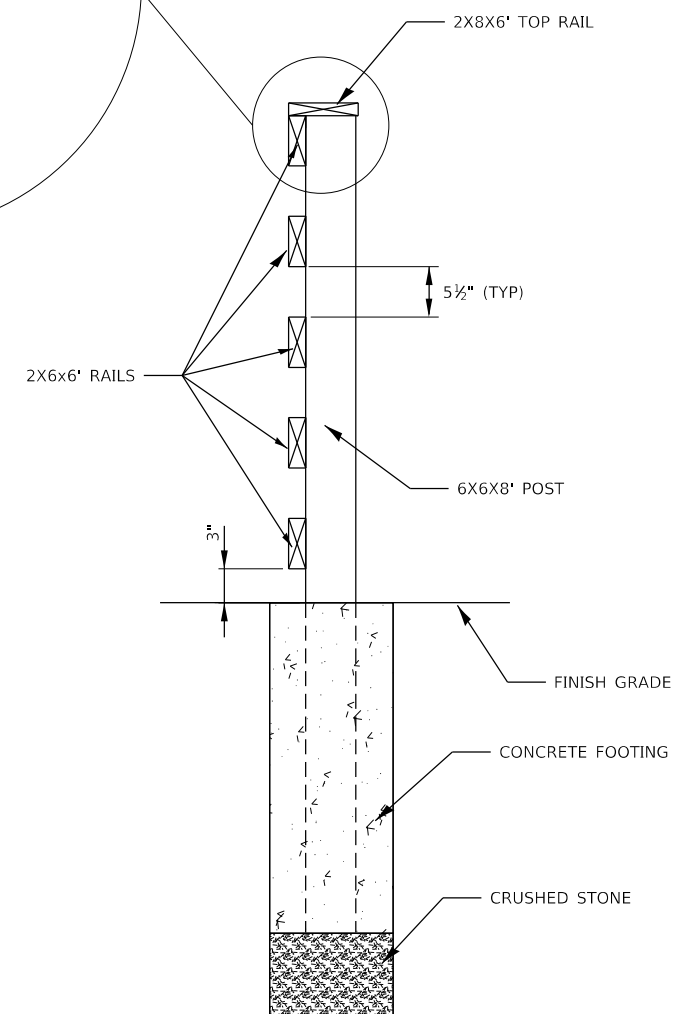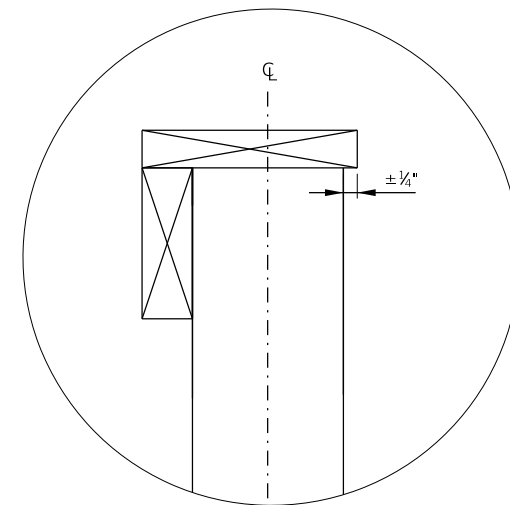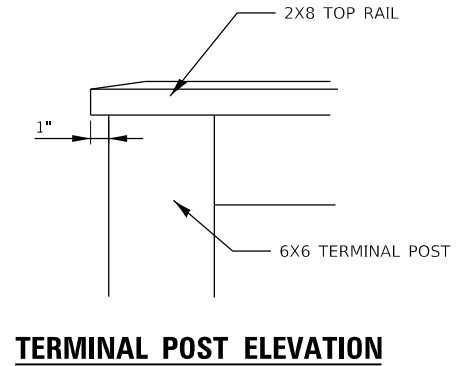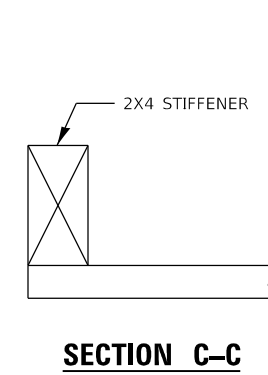

SECTION A-A

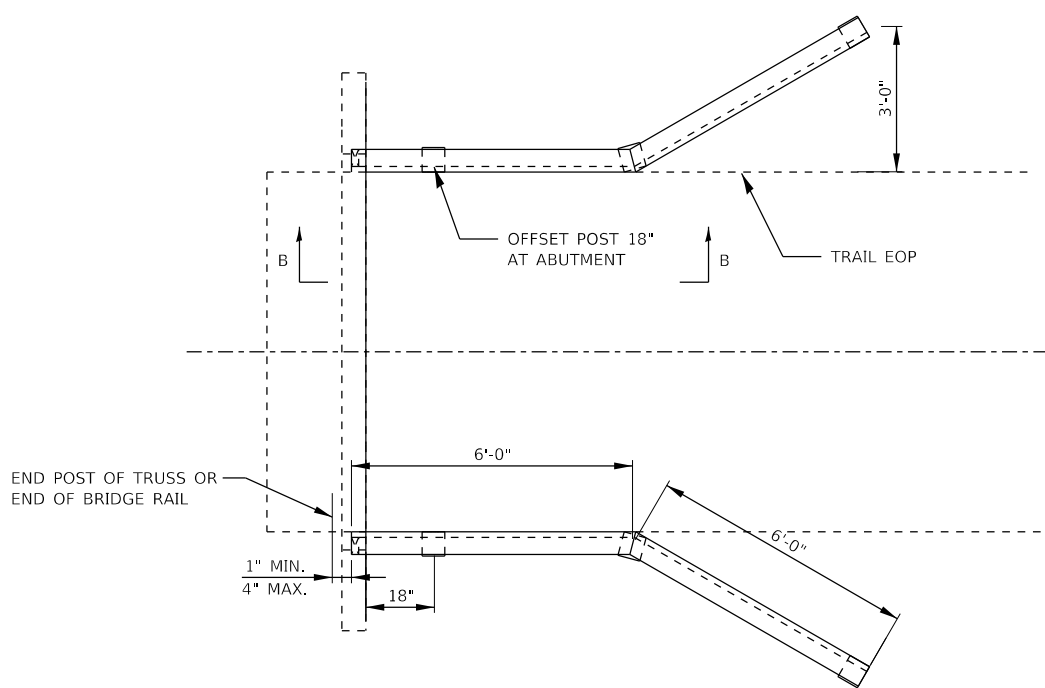

LAYOUT AT TRAIL BRIDGE

GENERAL NOTES

1. CONTRACTOR SHALL COORDINATE LAYOUT WITH ENGINEER PRIOR TO INSTALLATION.
2. ALL LUMBER SHALL BE PRESSURE TREATED NO. 1 SOUTHERN PINE.
3. ALL SCREWS SHALL BE #10 X 3".
4. ATTACH RAILS WITH 3 STAINLESS STEEL SCREWS AT EACH POST OR STIFFENER.

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CITY OF CARBONDALE
 NORTHWEST PEDESTRIAN
 AND BICYCLE PATH


WOOD RAIL DETAILS			
SCALE: N.T.S.	SHEET 1	OF 1 SHEETS	STA. TO STA.

F.A. RTE.	SECTION	COUNTY	TOTAL SHEETS	SHEET NO.
	17-00136-00-BT	JACKSON	51	27
CONTRACT NO. 99632				
ILLINOIS FED. AID PROJECT				

FINAL SURVEY NO.	SURVEYED PLOTTED AREAS CHECKED	BY	DATE
NOTE BOOK	TEMPLATE		
	AREAS CHECKED		

ORIGINAL SURVEY NO.	SURVEYED PLOTTED AREAS CHECKED	BY	DATE
NOTE BOOK	TEMPLATE		
	AREAS CHECKED		

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CITY OF CARBONDALE
 NORTHWEST PEDESTRIAN
 AND BICYCLE PATH

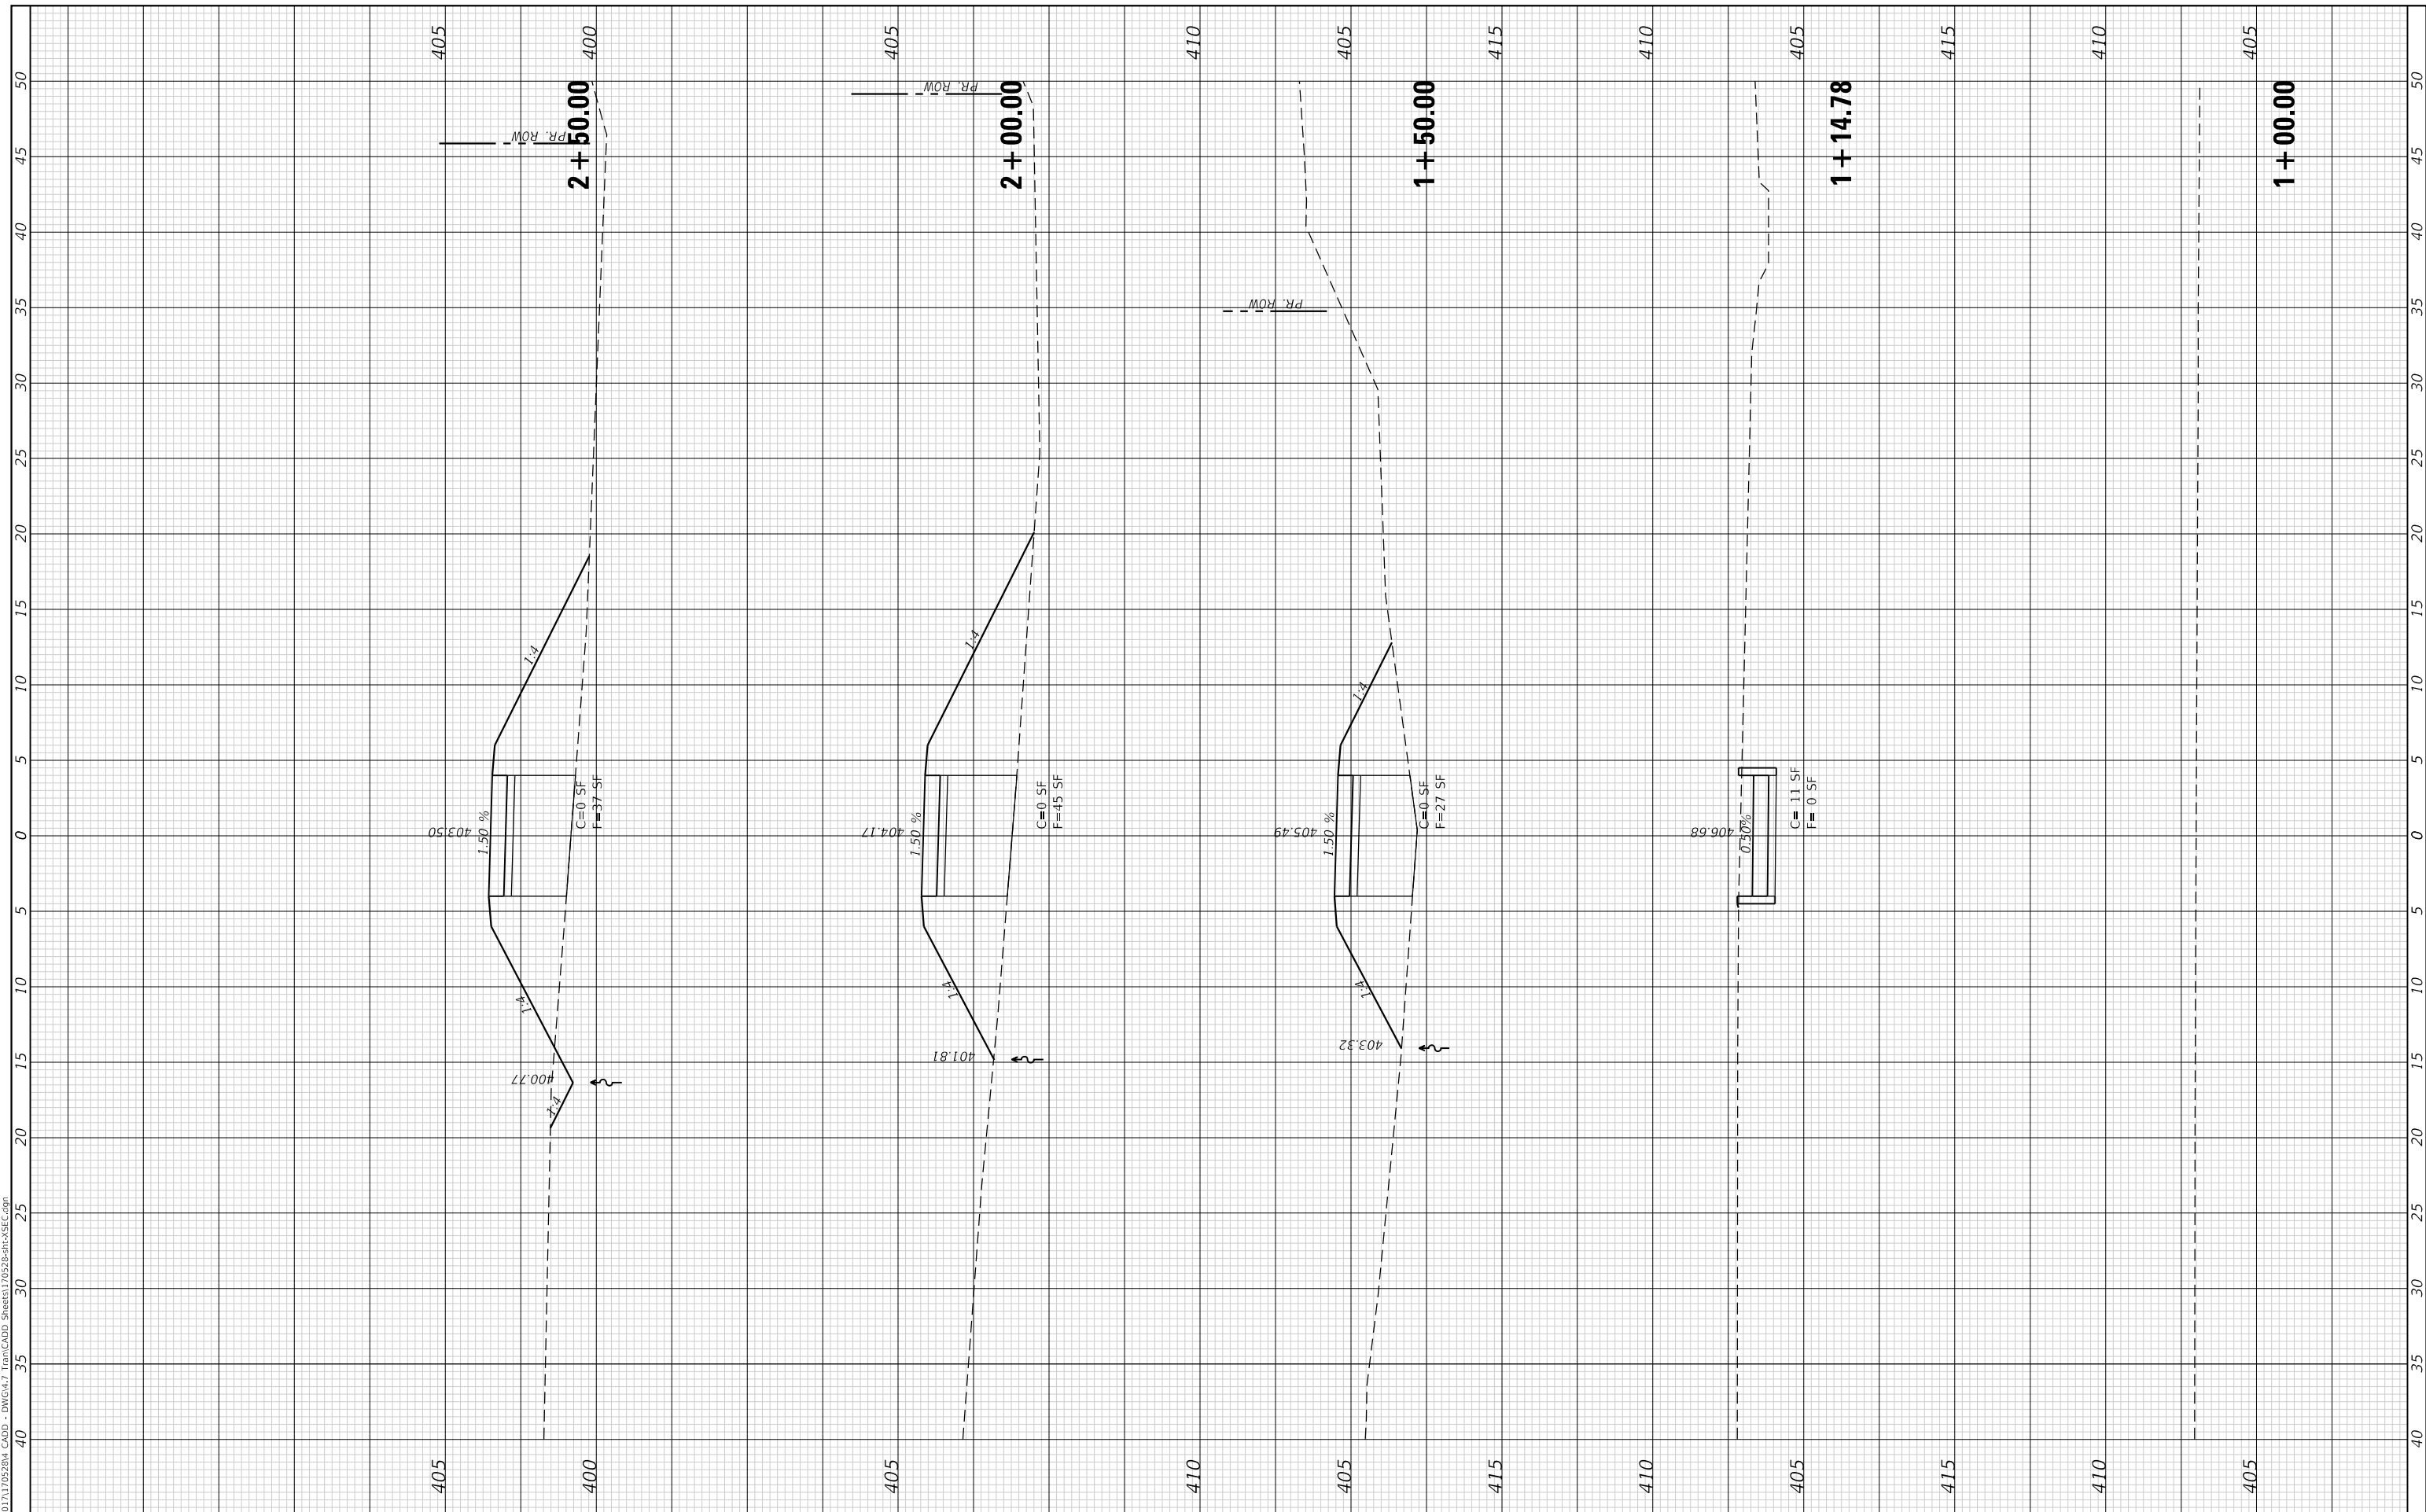CROSS SECTIONS


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F.A. RTE.	SECTION	COUNTY	TOTAL SHEETS	SHEET NO.
	17-00136-00-BT	JACKSON	51	28
CONTRACT NO. 99632			ILLINOIS FED. AID PROJECT	

FINAL SURVEY NO.	SURVEYED PLOTTED AREAS CHECKED	BY	DATE

ORIGINAL SURVEY NO.	SURVEYED PLOTTED AREAS CHECKED	BY	DATE

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CITY OF CARBONDALE
NORTHWEST PEDESTRIAN AND BICYCLE PATH

CROSS SECTIONS

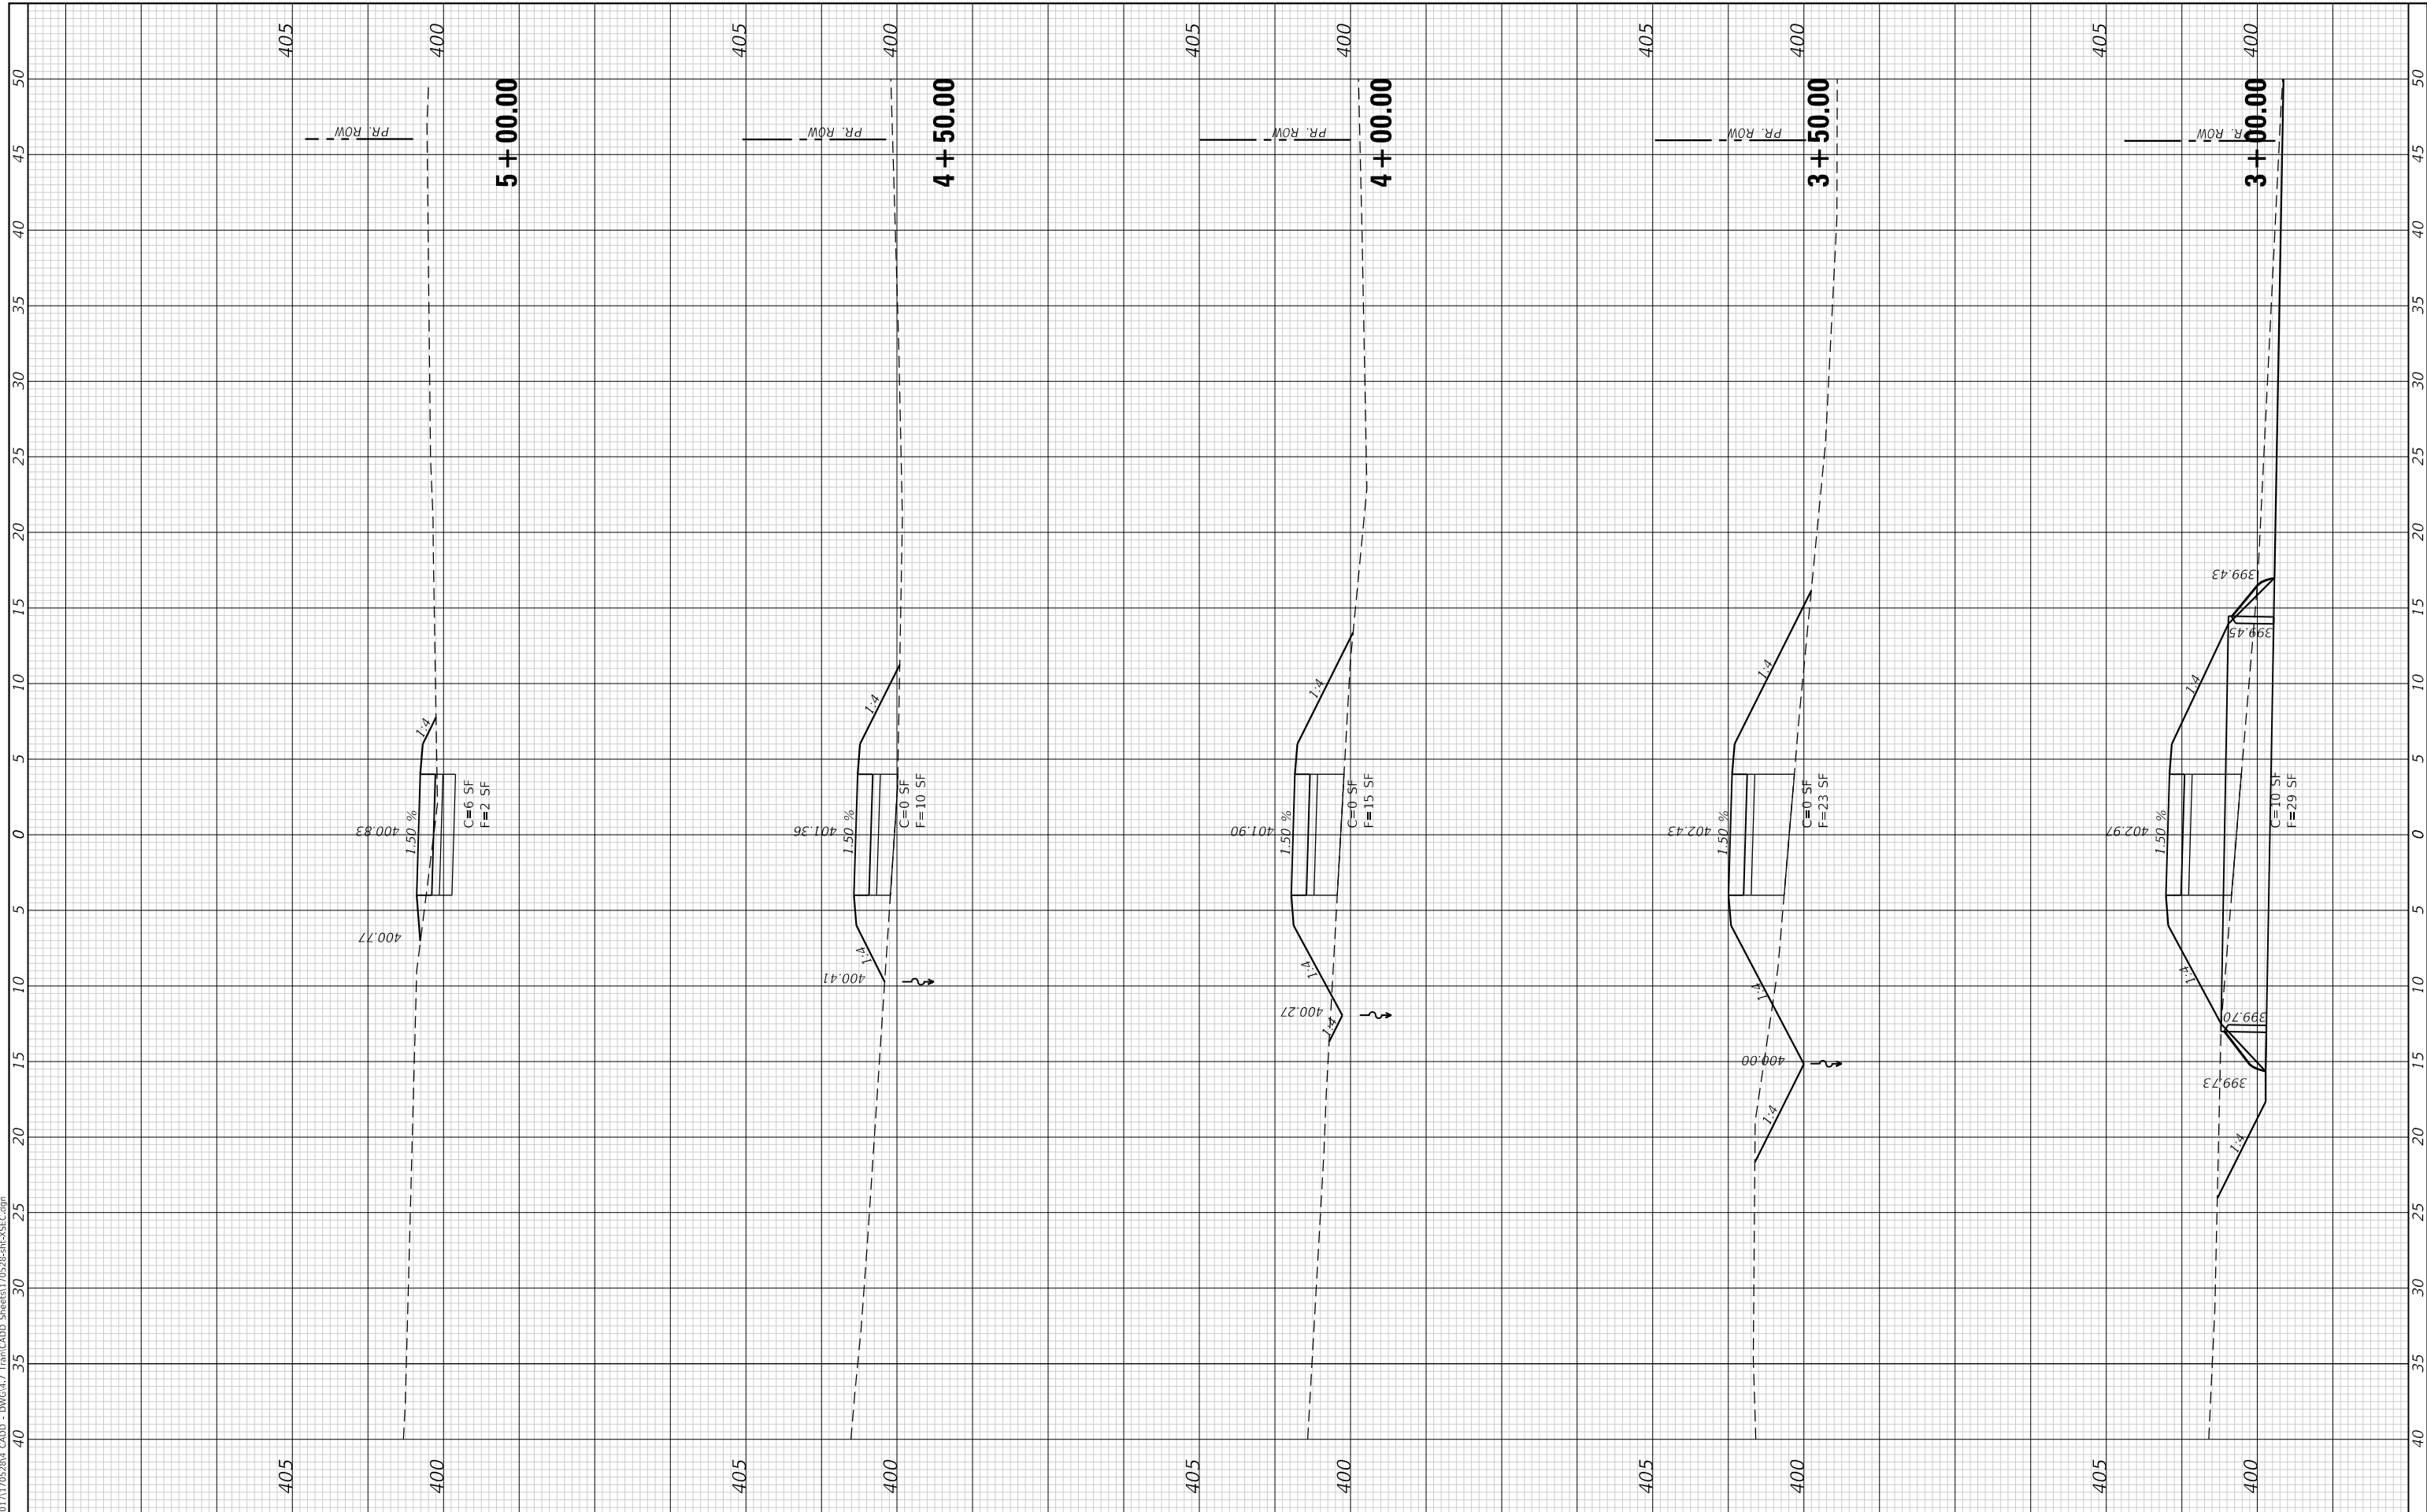
SCALE: 1" = 5' SHEET 2 OF 24 SHEETS STA. 3+00.00 TO STA. 5+00.00

F.A. RTE.	SECTION	COUNTY	TOTAL SHEETS	SHEET NO.
	17-00136-00-BT	JACKSON	51	29
CONTRACT NO. 99632				
ILLINOIS FED. AID PROJECT				

FINAL SURVEY NO.	SURVEYED PLOTTED AREAS CHECKED	BY	DATE

ORIGINAL SURVEY NO.	SURVEYED PLOTTED AREAS CHECKED	BY	DATE

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CITY OF CARBONDALE
NORTHWEST PEDESTRIAN AND BICYCLE PATH

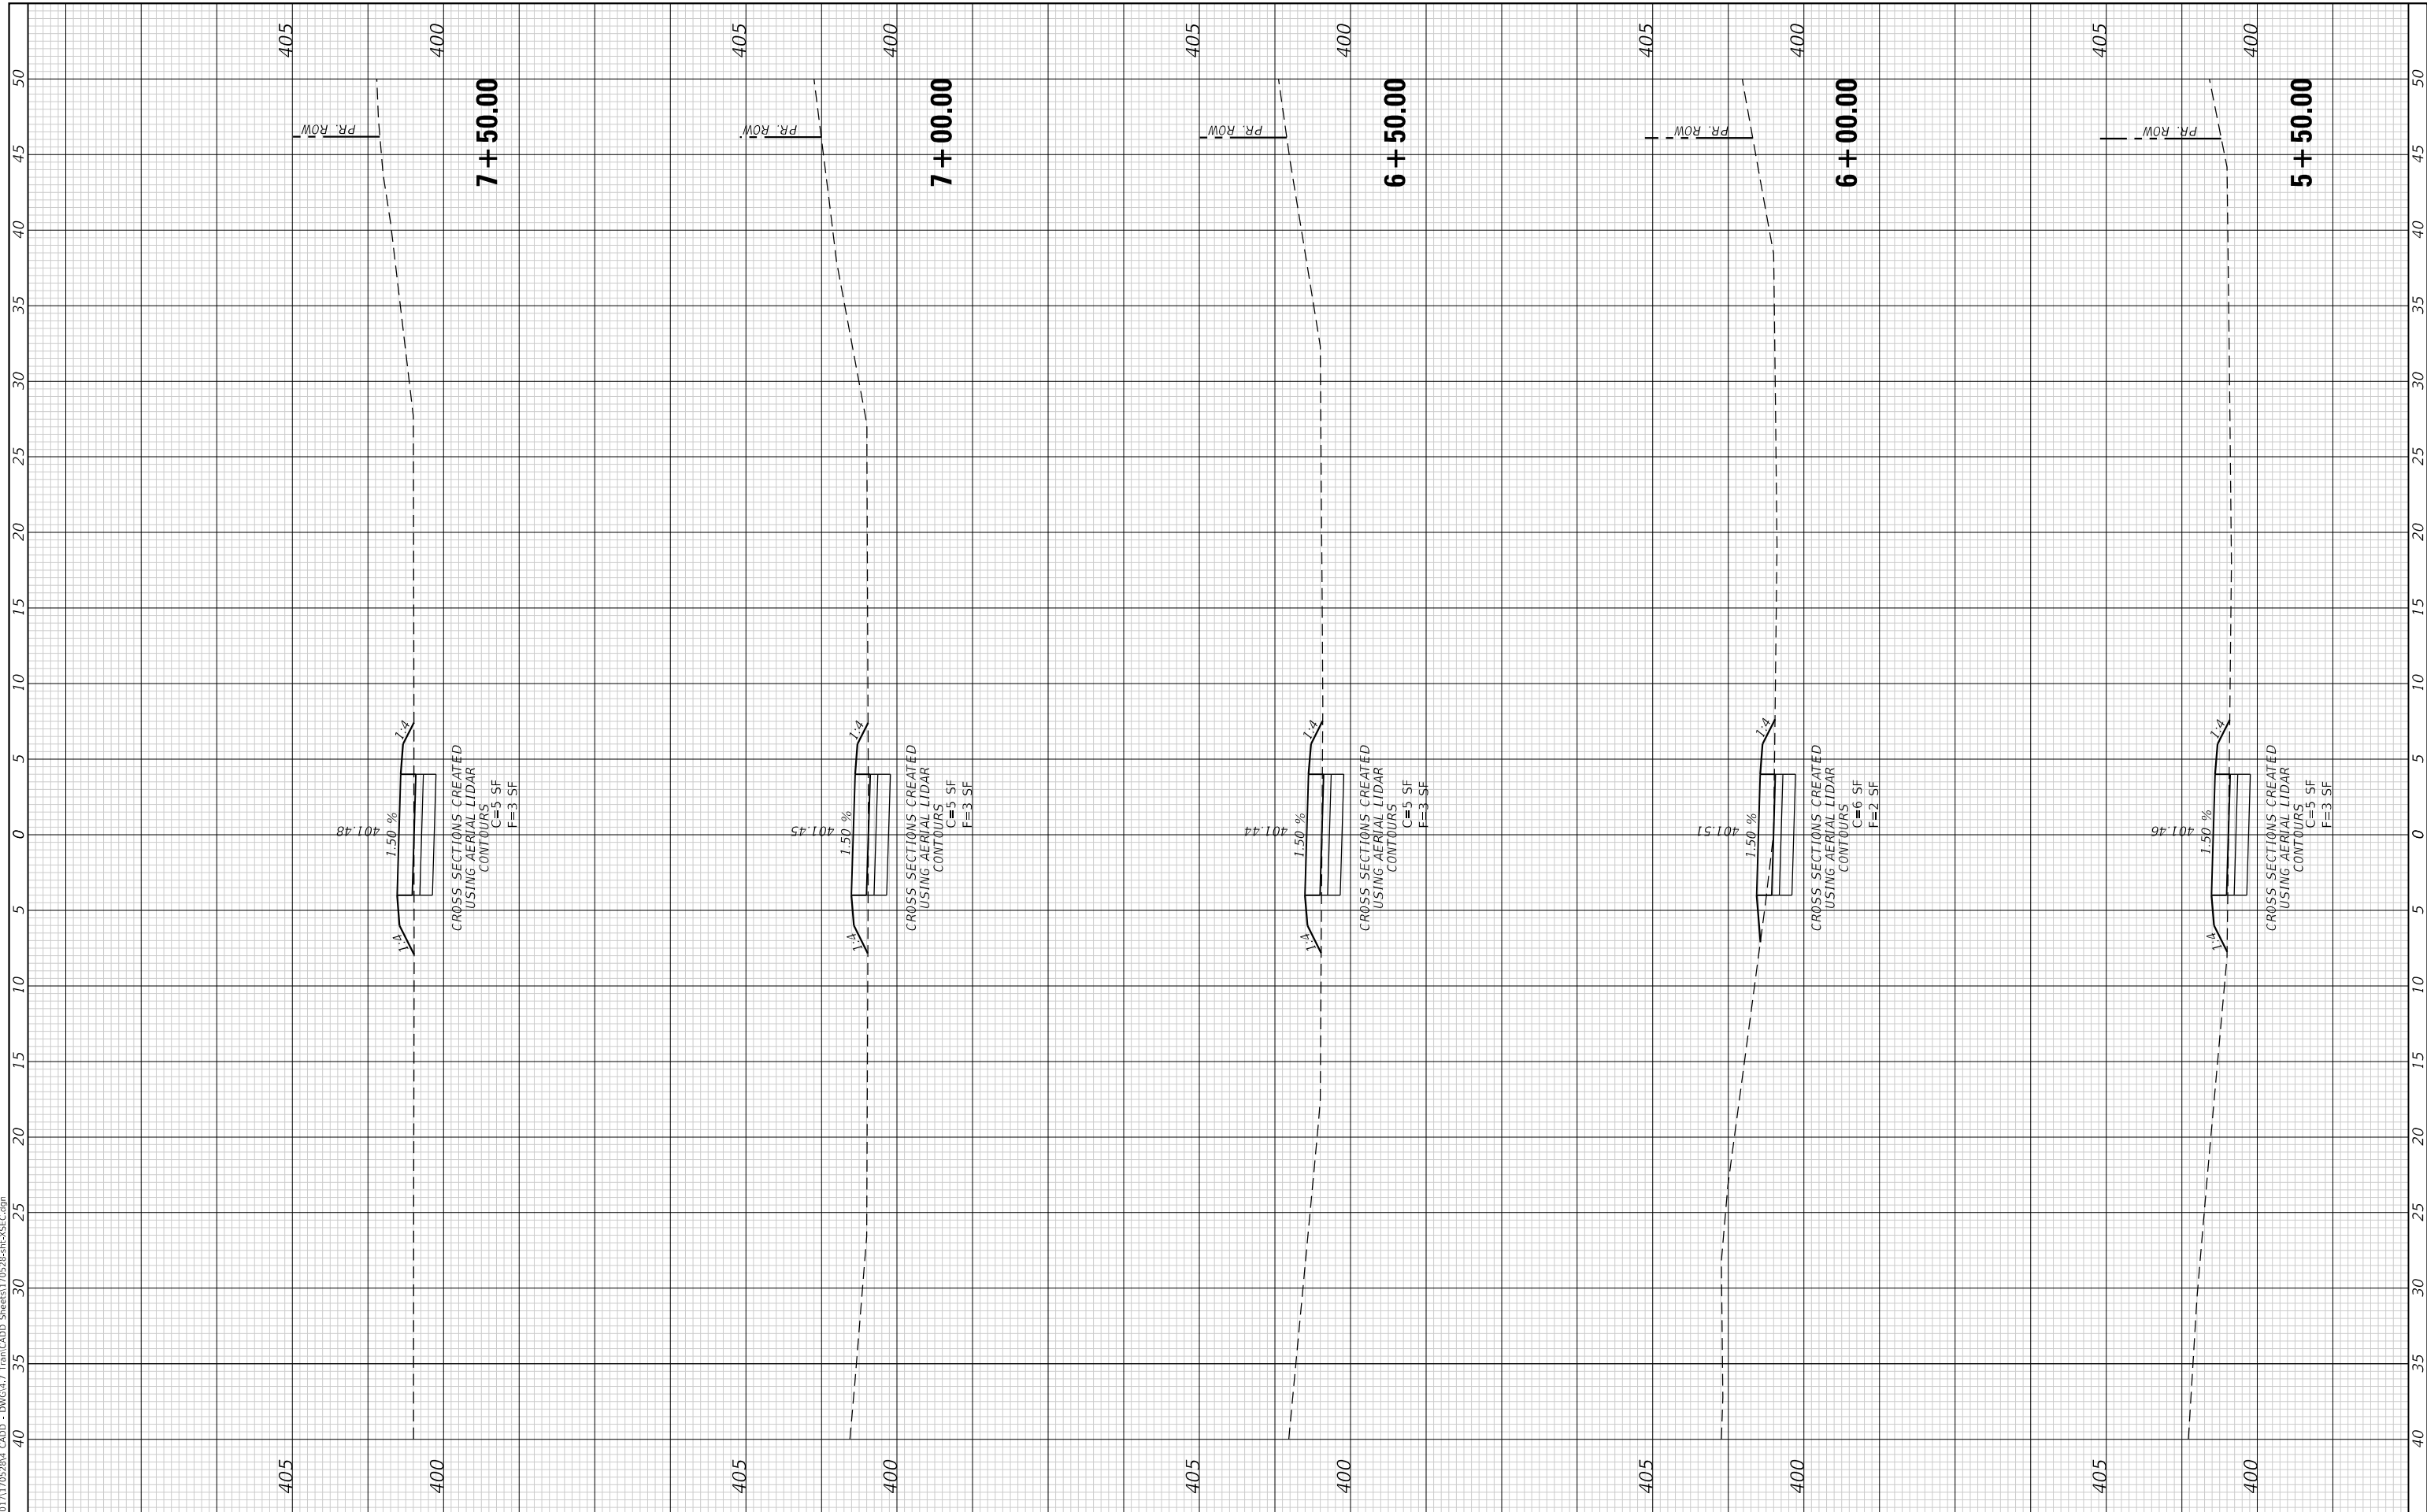CROSS SECTIONS


SCALE: 1" = 5' SHEET 3 OF 24 SHEETS STA. 5+50.00 TO STA. 7+50.00

F.A. RTE.	SECTION	COUNTY	TOTAL SHEETS	SHEET NO.
	17-00136-00-BT	JACKSON	51	30
CONTRACT NO. 99632				
ILLINOIS FED. AID PROJECT				

FINAL SURVEY NO.	SURVEYED PLOTTED AREAS CHECKED	BY	DATE
	NOTE BOOK		
	TEMPLATE		
	AREAS CHECKED		

ORIGINAL SURVEY NO.	SURVEYED PLOTTED AREAS CHECKED	BY	DATE
	NOTE BOOK		
	TEMPLATE		
	AREAS CHECKED		

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CITY OF CARBONDALE
NORTHWEST PEDESTRIAN
AND BICYCLE PATH

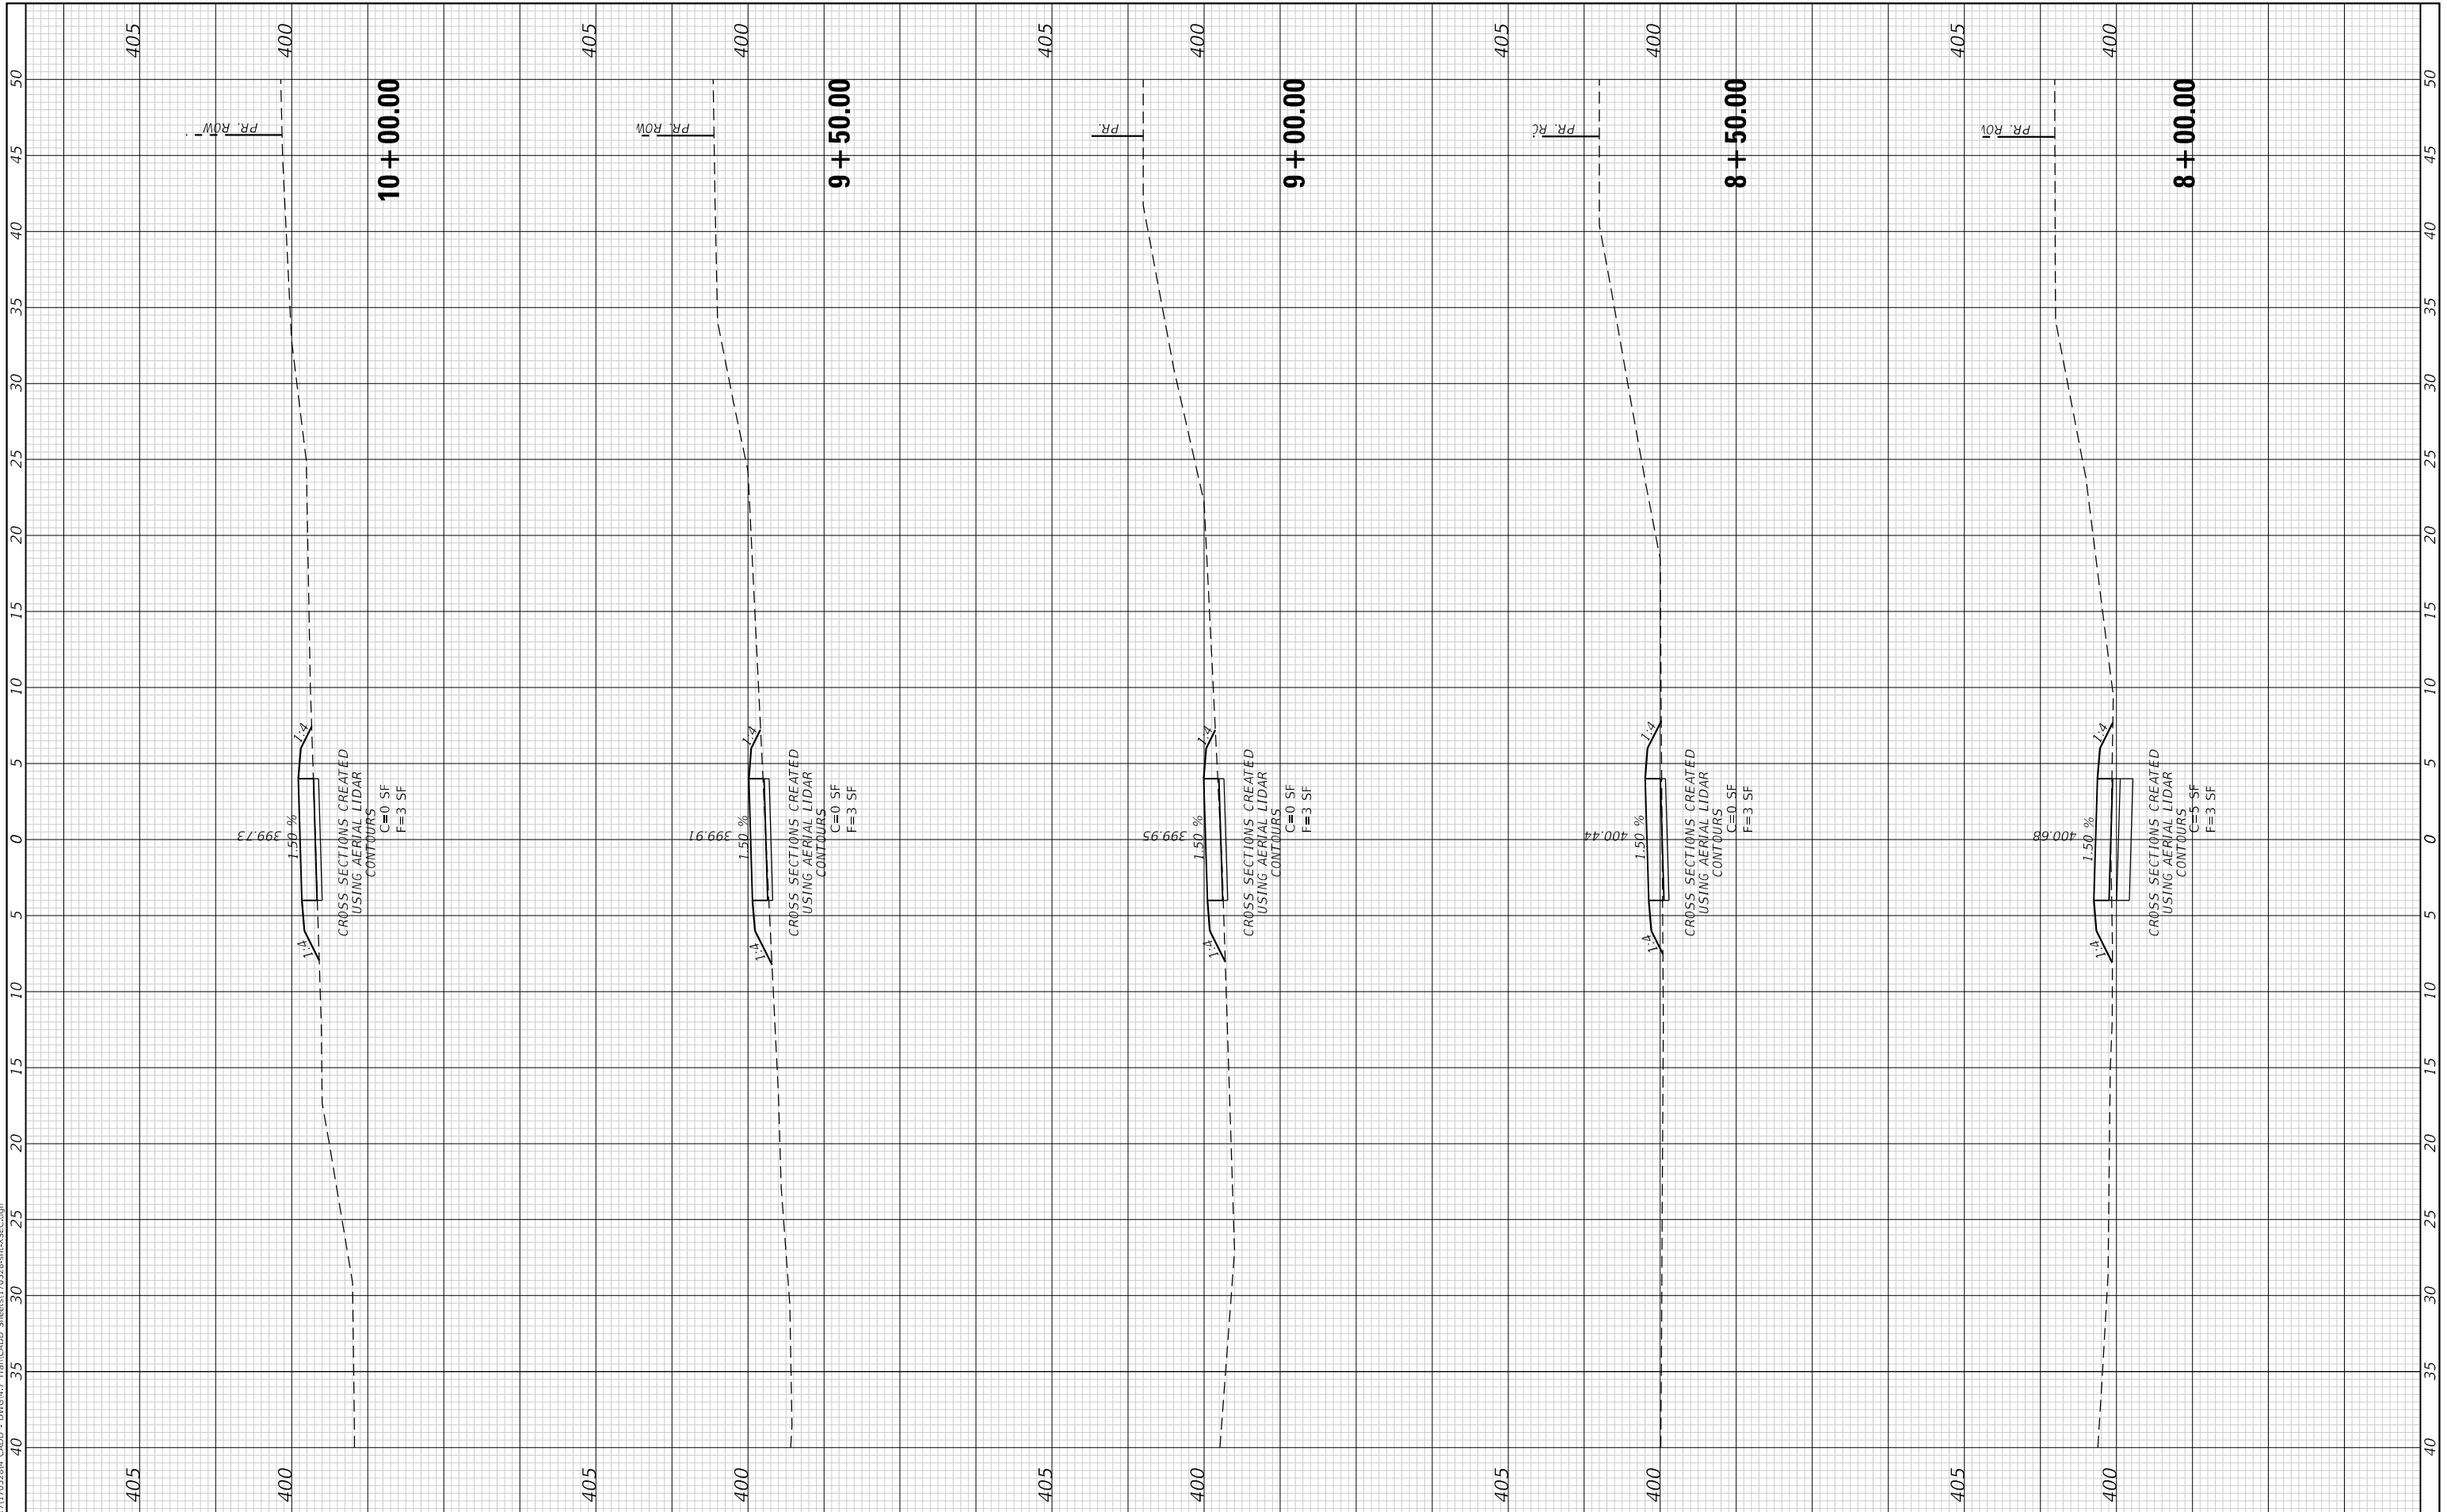CROSS SECTIONS


SCALE: 1" = 5' SHEET 4 OF 24 SHEETS STA. 8+00.00 TO STA. 10+00.00

F.A. RTE.	SECTION	COUNTY	TOTAL SHEETS	SHEET NO.
	17-00136-00-BT	JACKSON	51	31
CONTRACT NO. 99632				
ILLINOIS FED. AID PROJECT				

FINAL SURVEY NO.	SURVEYED PLOTTED AREAS CHECKED	BY	DATE

ORIGINAL SURVEY NO.	SURVEYED PLOTTED AREAS CHECKED	BY	DATE

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 CHECKED - JRR
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CITY OF CARBONDALE
NORTHWEST PEDESTRIAN AND BICYCLE PATH

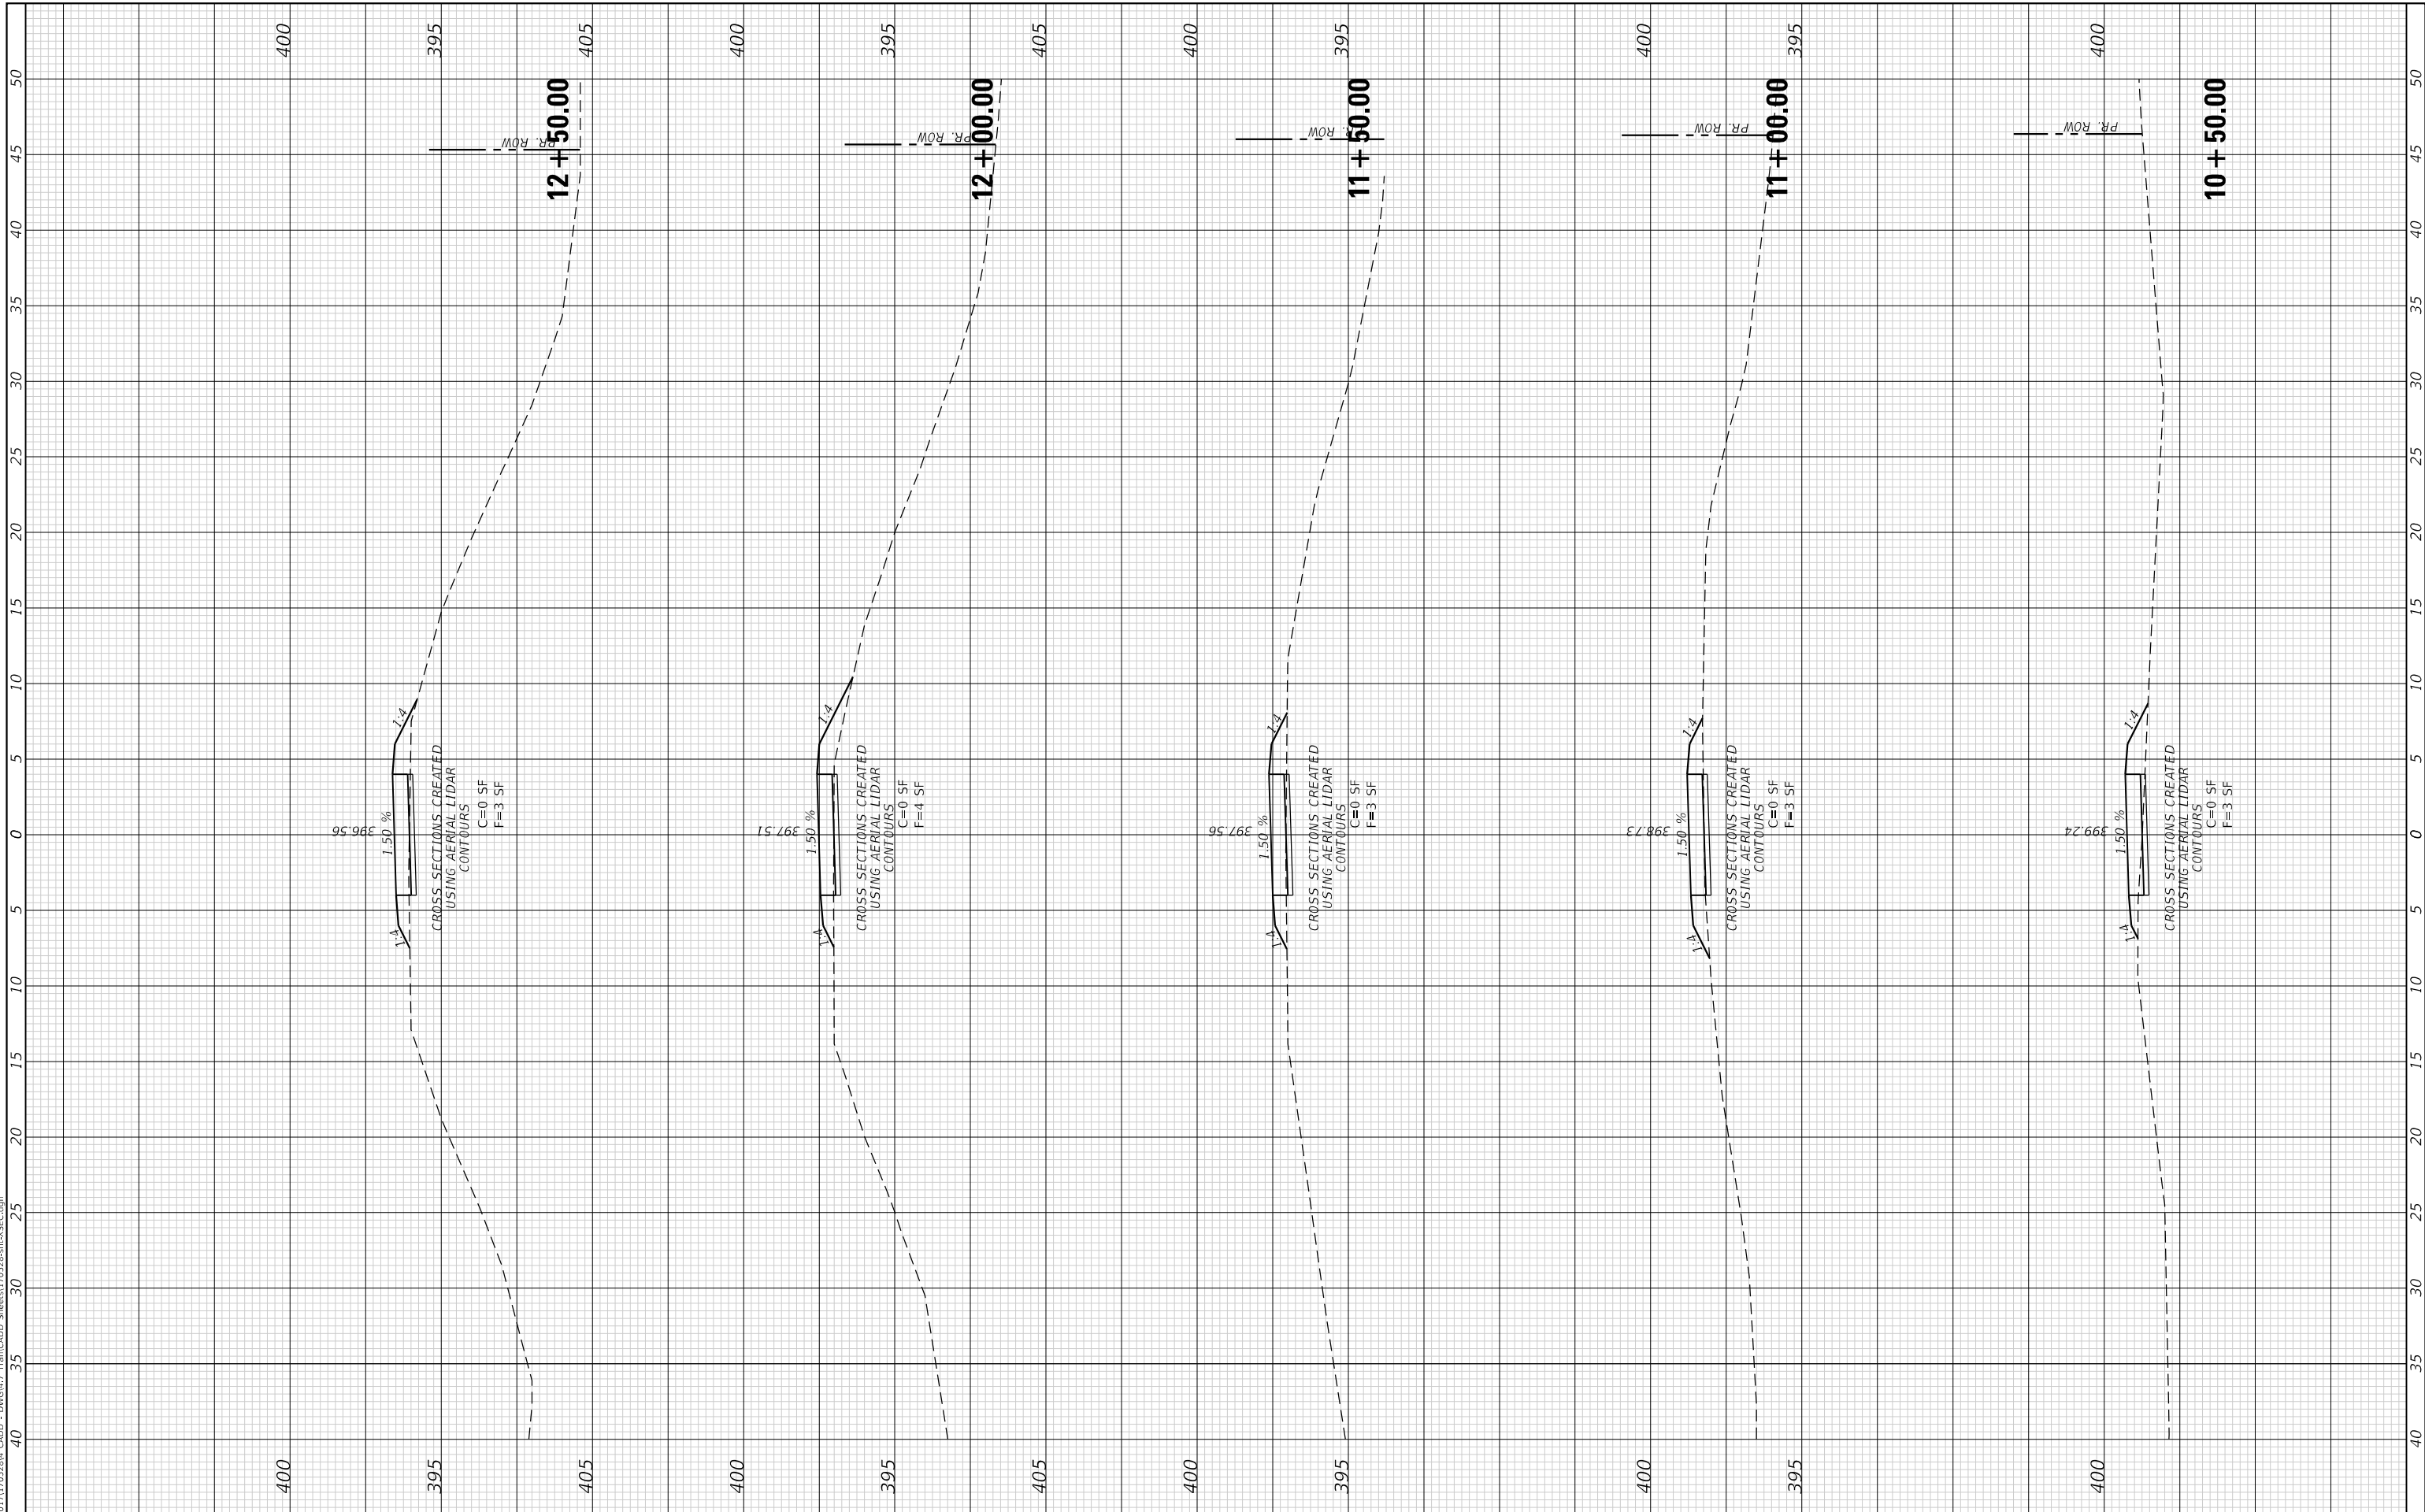SCALE: 1" = 5' SHEET 5 OF 24 SHEETS STA. 10+50.00 TO STA. 12+50.00


CROSS SECTIONS

F.A. RTE.	SECTION	COUNTY	TOTAL SHEETS	SHEET NO.
	17-00136-00-BT	JACKSON	51	32
CONTRACT NO. 99632				
ILLINOIS FED. AID PROJECT				

FINAL SURVEY NO.	SURVEYED PLOTTED TEMPLATE AREAS CHECKED	BY	DATE

ORIGINAL SURVEY NO.	SURVEYED PLOTTED TEMPLATE AREAS CHECKED	BY	DATE

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 PLOT DATE = 1/24/2022

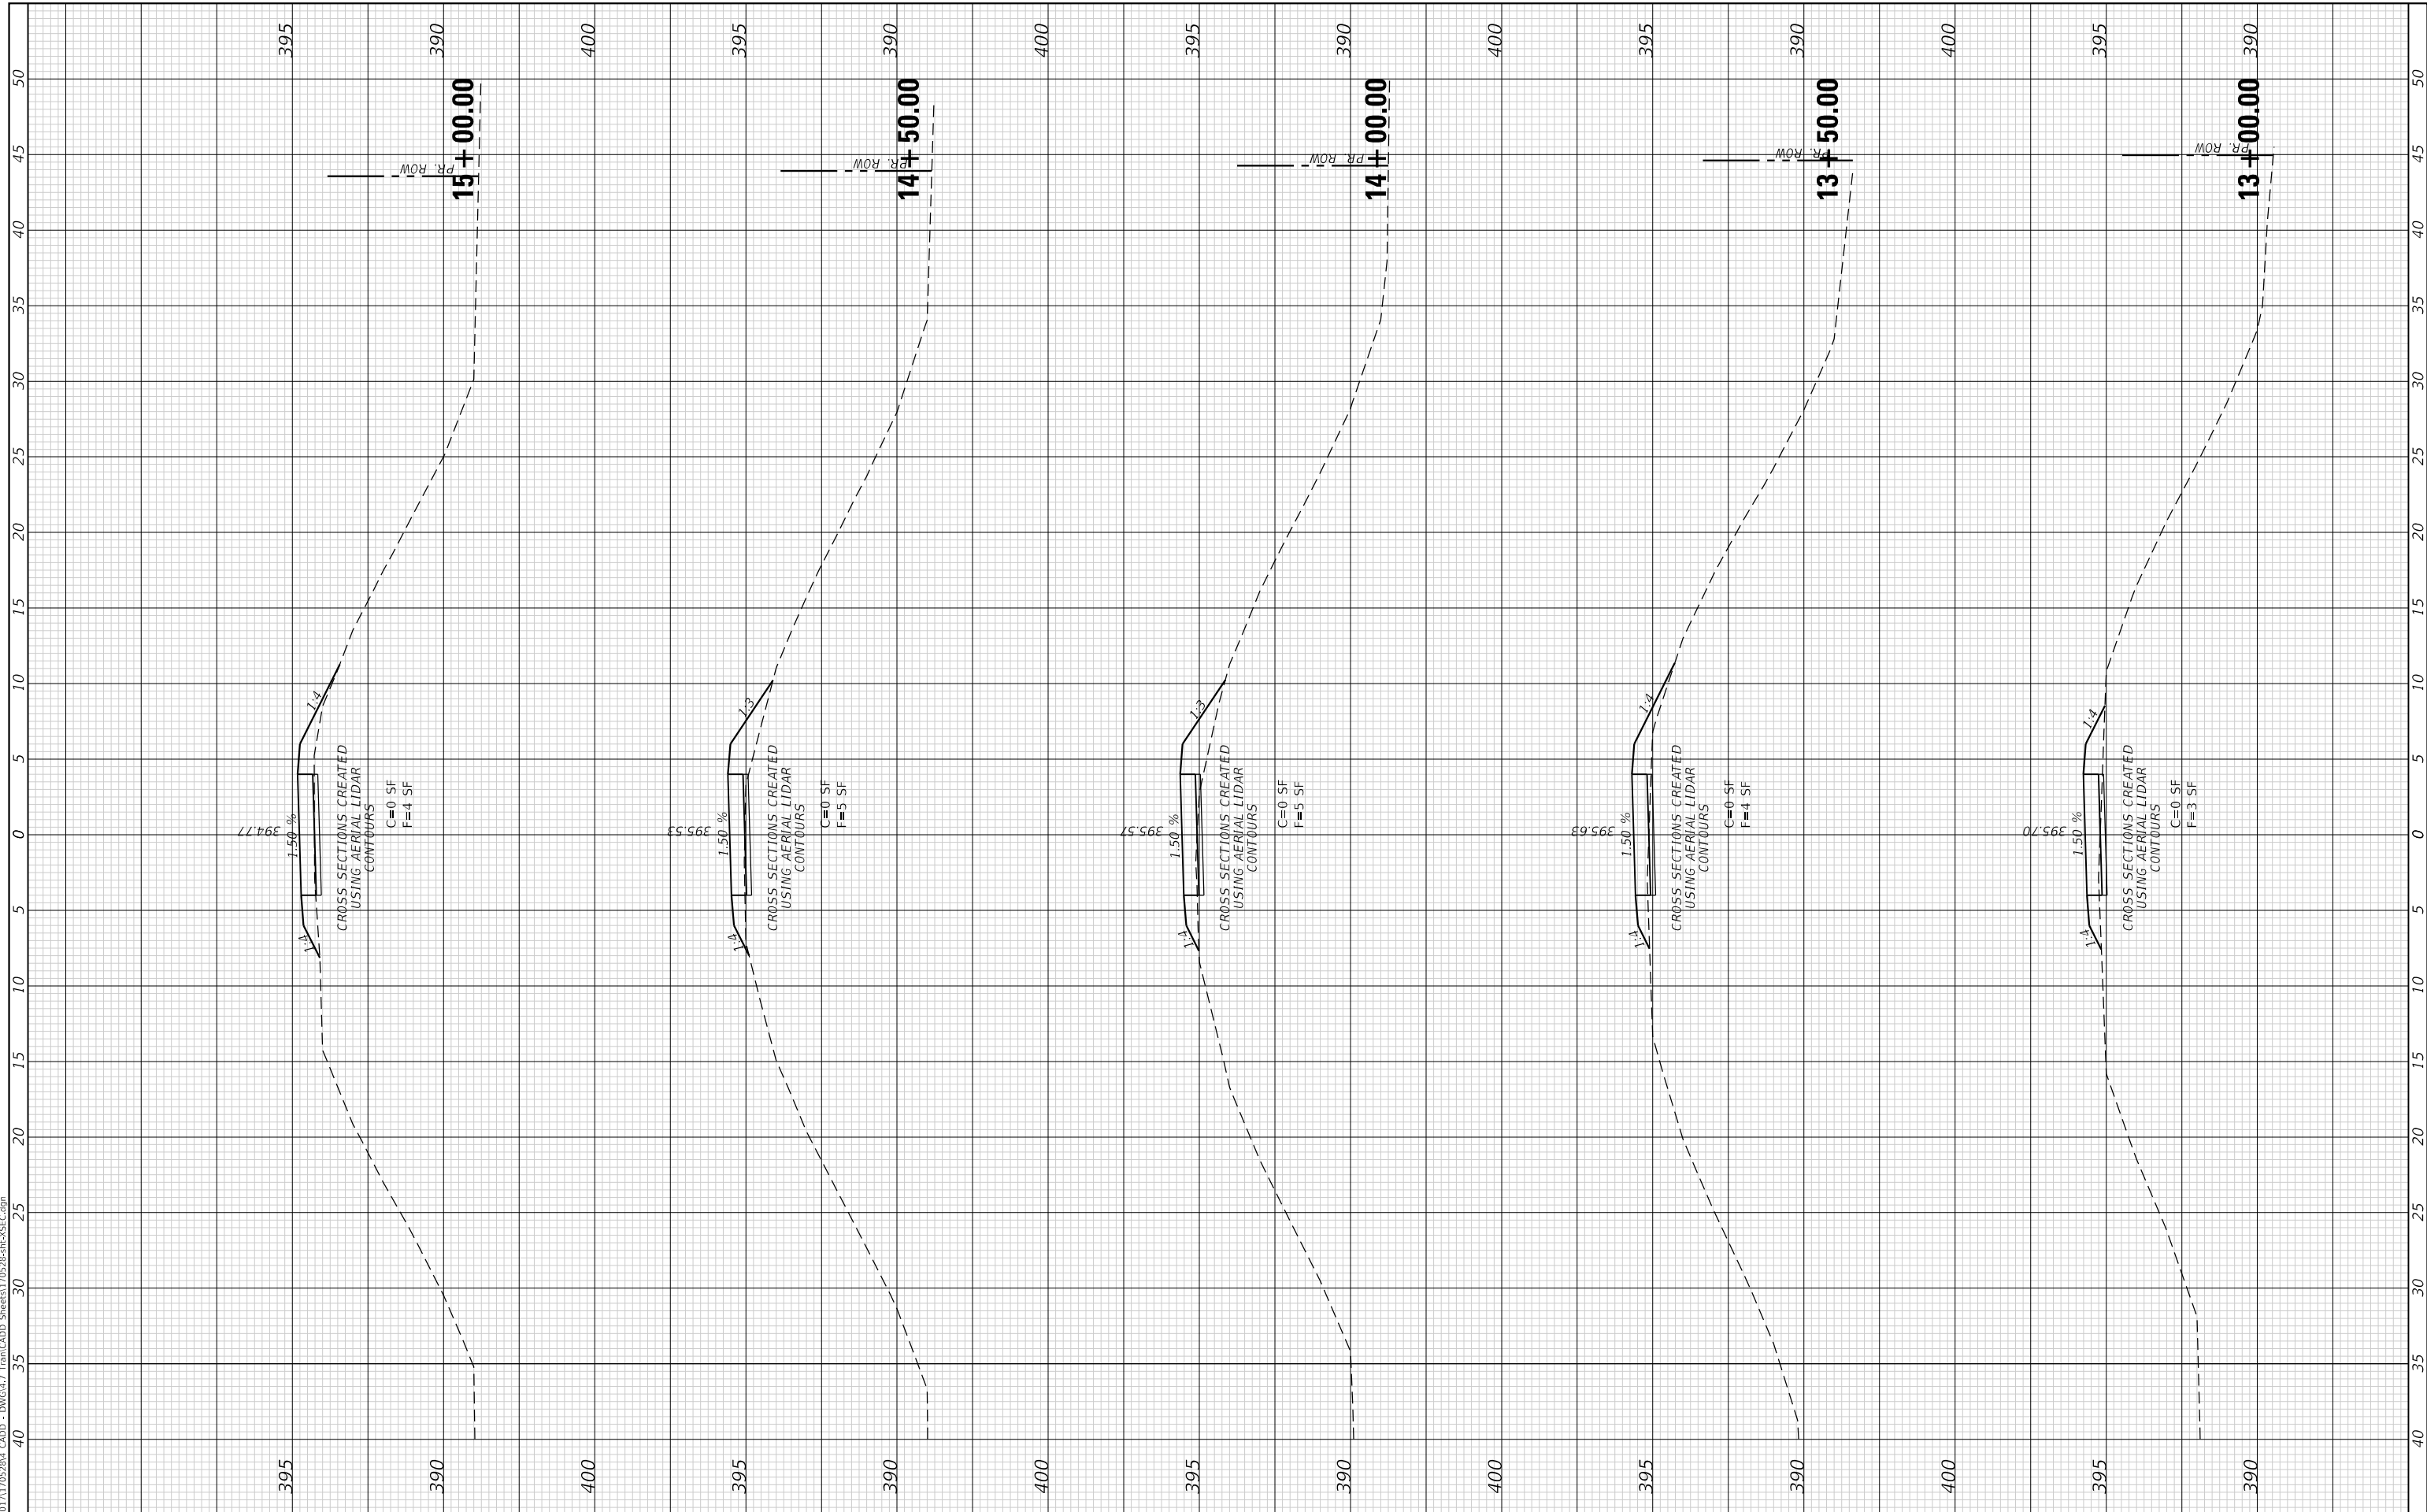DESIGNED - EKF
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CITY OF CARBONDALE
NORTHWEST PEDESTRIAN AND BICYCLE PATH

SCALE: 1" = 5' SHEET 6 OF 24 SHEETS STA. 13+00.00 TO STA. 15+00.00


CROSS SECTIONS

F.A. RTE.	SECTION	COUNTY	TOTAL SHEETS	SHEET NO.
	17-00136-00-BT	JACKSON	51	33
CONTRACT NO. 99632				
ILLINOIS FED. AID PROJECT				

FINAL SURVEY NO.	SURVEYED	BY	DATE
NOTE BOOK	PLOTTED		
AREAS CHECKED	TEMPLATE		
	AREAS CHECKED		

ORIGINAL SURVEY NO.	SURVEYED	BY	DATE
NOTE BOOK	PLOTTED		
AREAS CHECKED	TEMPLATE		
	AREAS CHECKED		

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CITY OF CARBONDALE
NORTHWEST PEDESTRIAN AND BICYCLE PATH

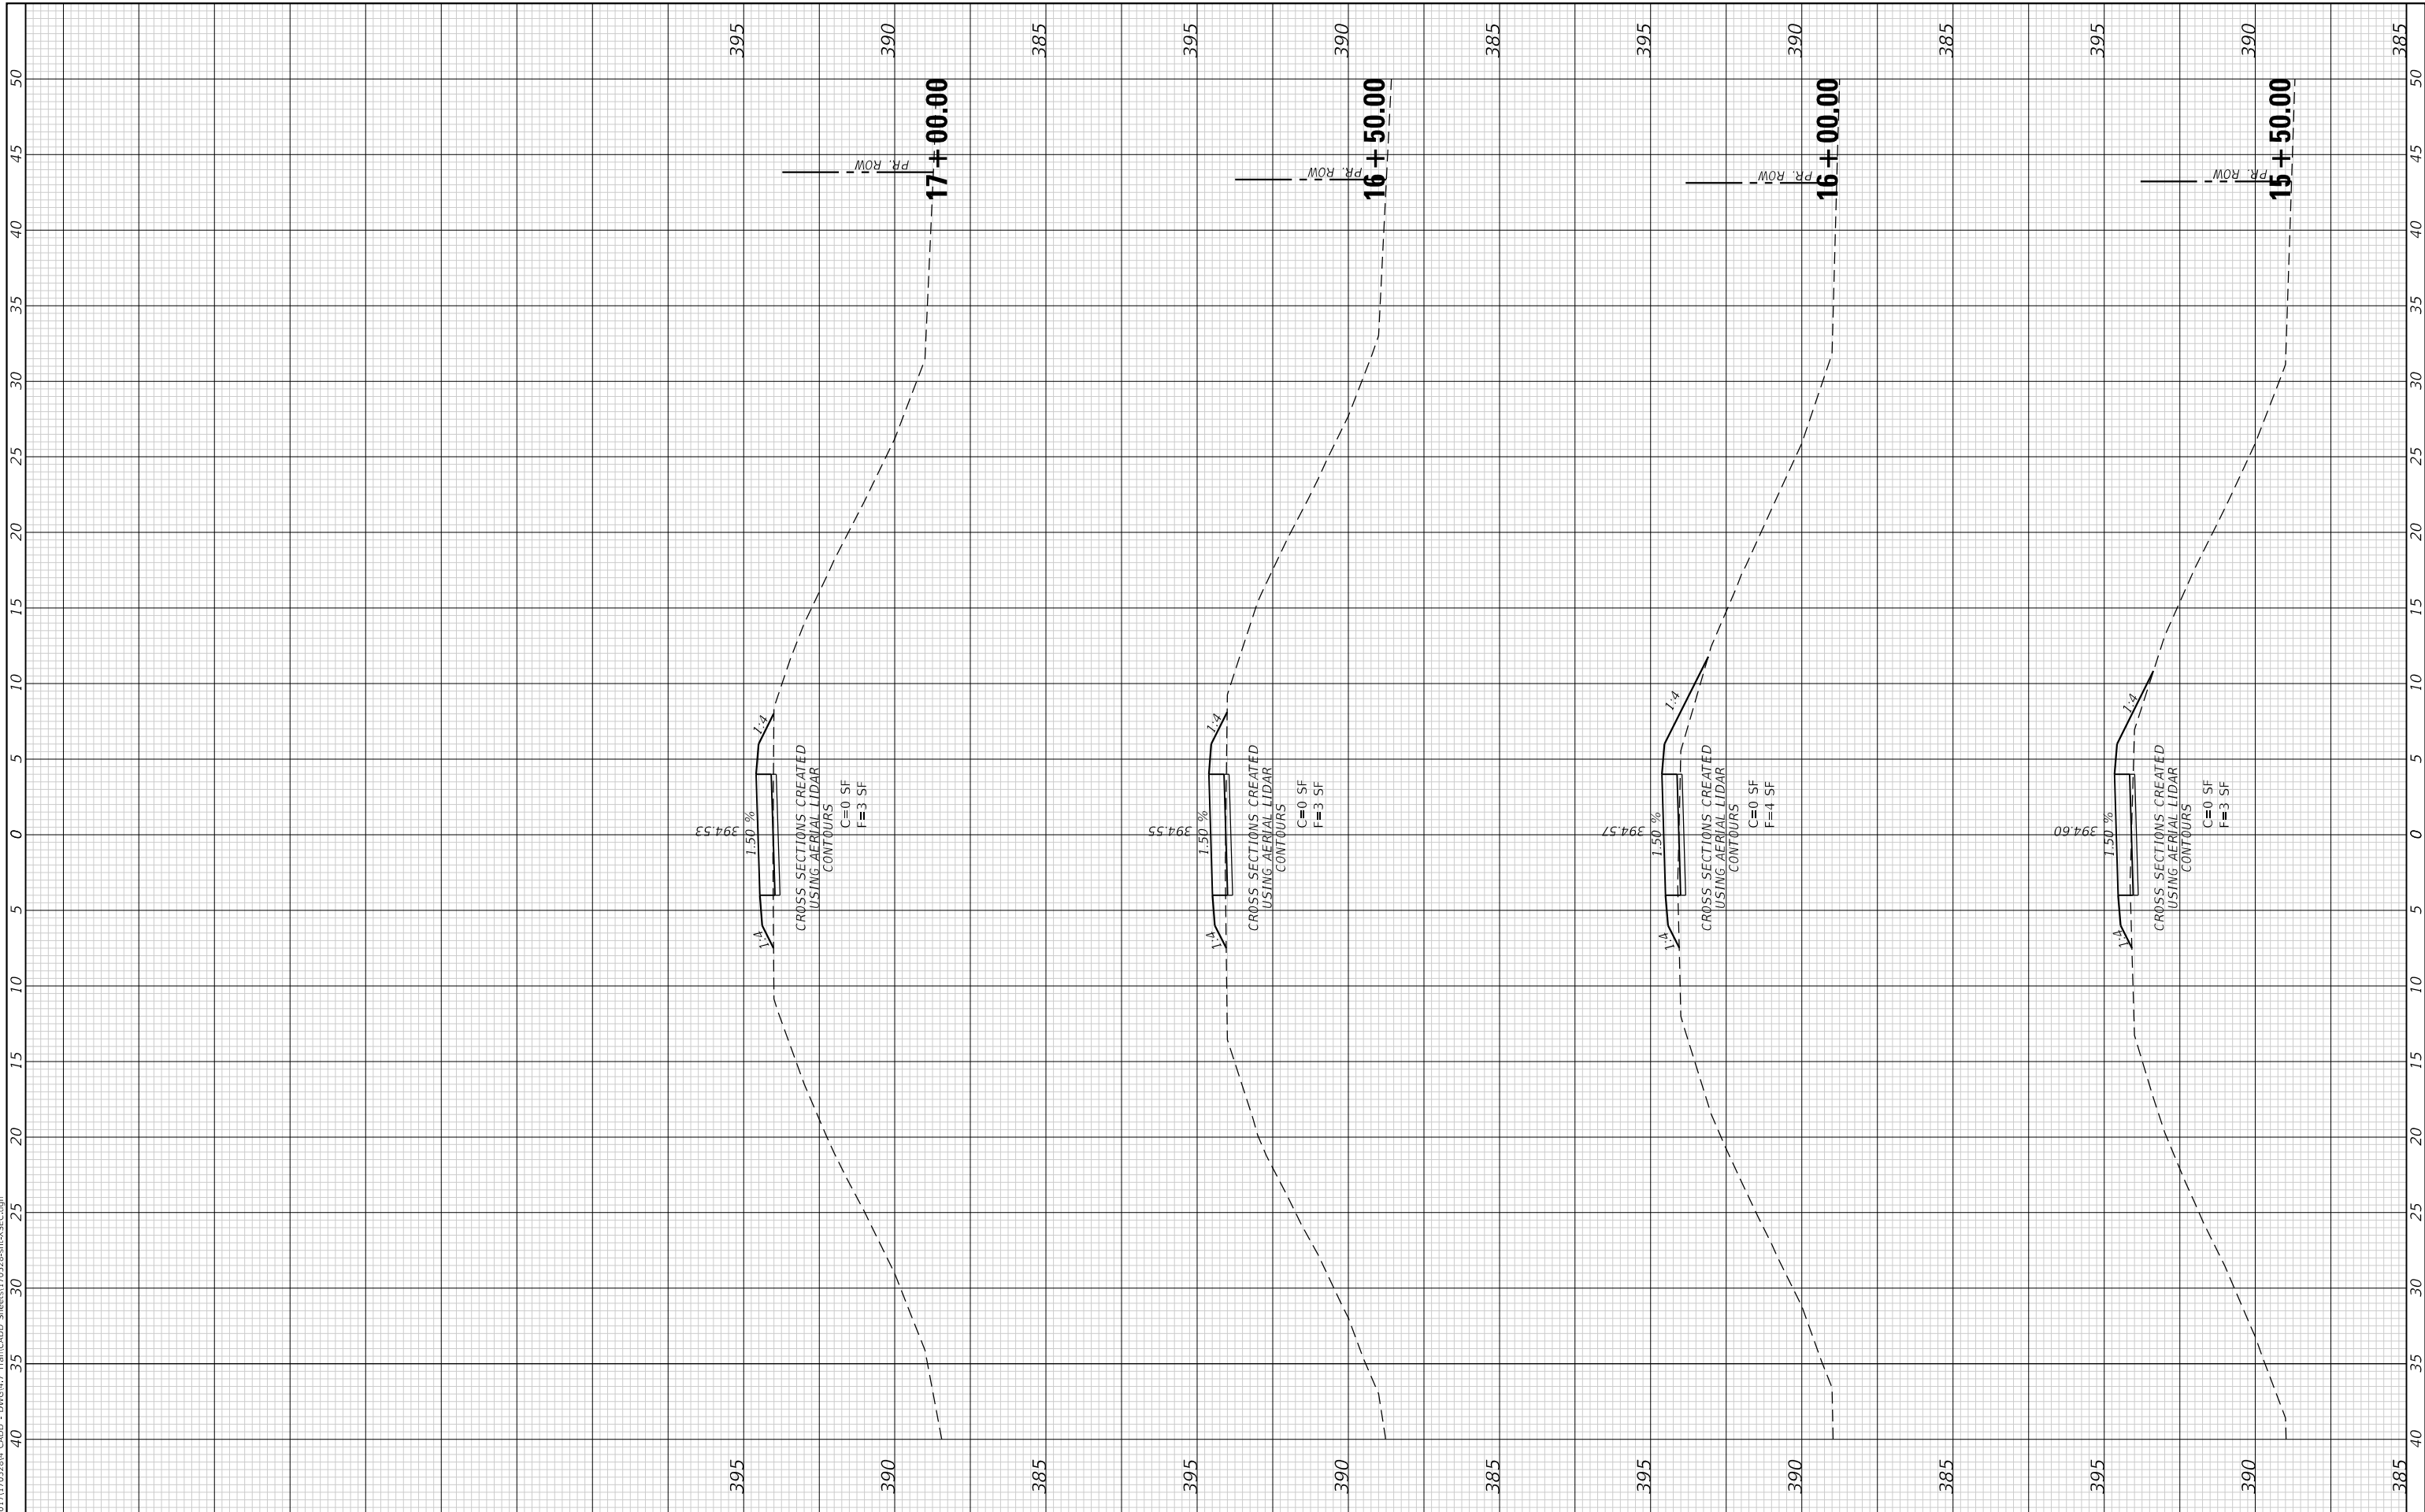CROSS SECTIONS


SCALE: 1" = 5' SHEET 7 OF 24 SHEETS STA. 15+50.00 TO STA. 17+00.00

F.A. RTE.	SECTION	COUNTY	TOTAL SHEETS	SHEET NO.
	17-00136-00-BT	JACKSON	51	34
CONTRACT NO. 99632				
ILLINOIS FED. AID PROJECT				

FINAL SURVEY NO.	SURVEYED PLOTTED AREAS CHECKED	BY	DATE

ORIGINAL SURVEY NO.	SURVEYED PLOTTED AREAS CHECKED	BY	DATE


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CITY OF CARBONDALE
NORTHWEST PEDESTRIAN AND BICYCLE PATH

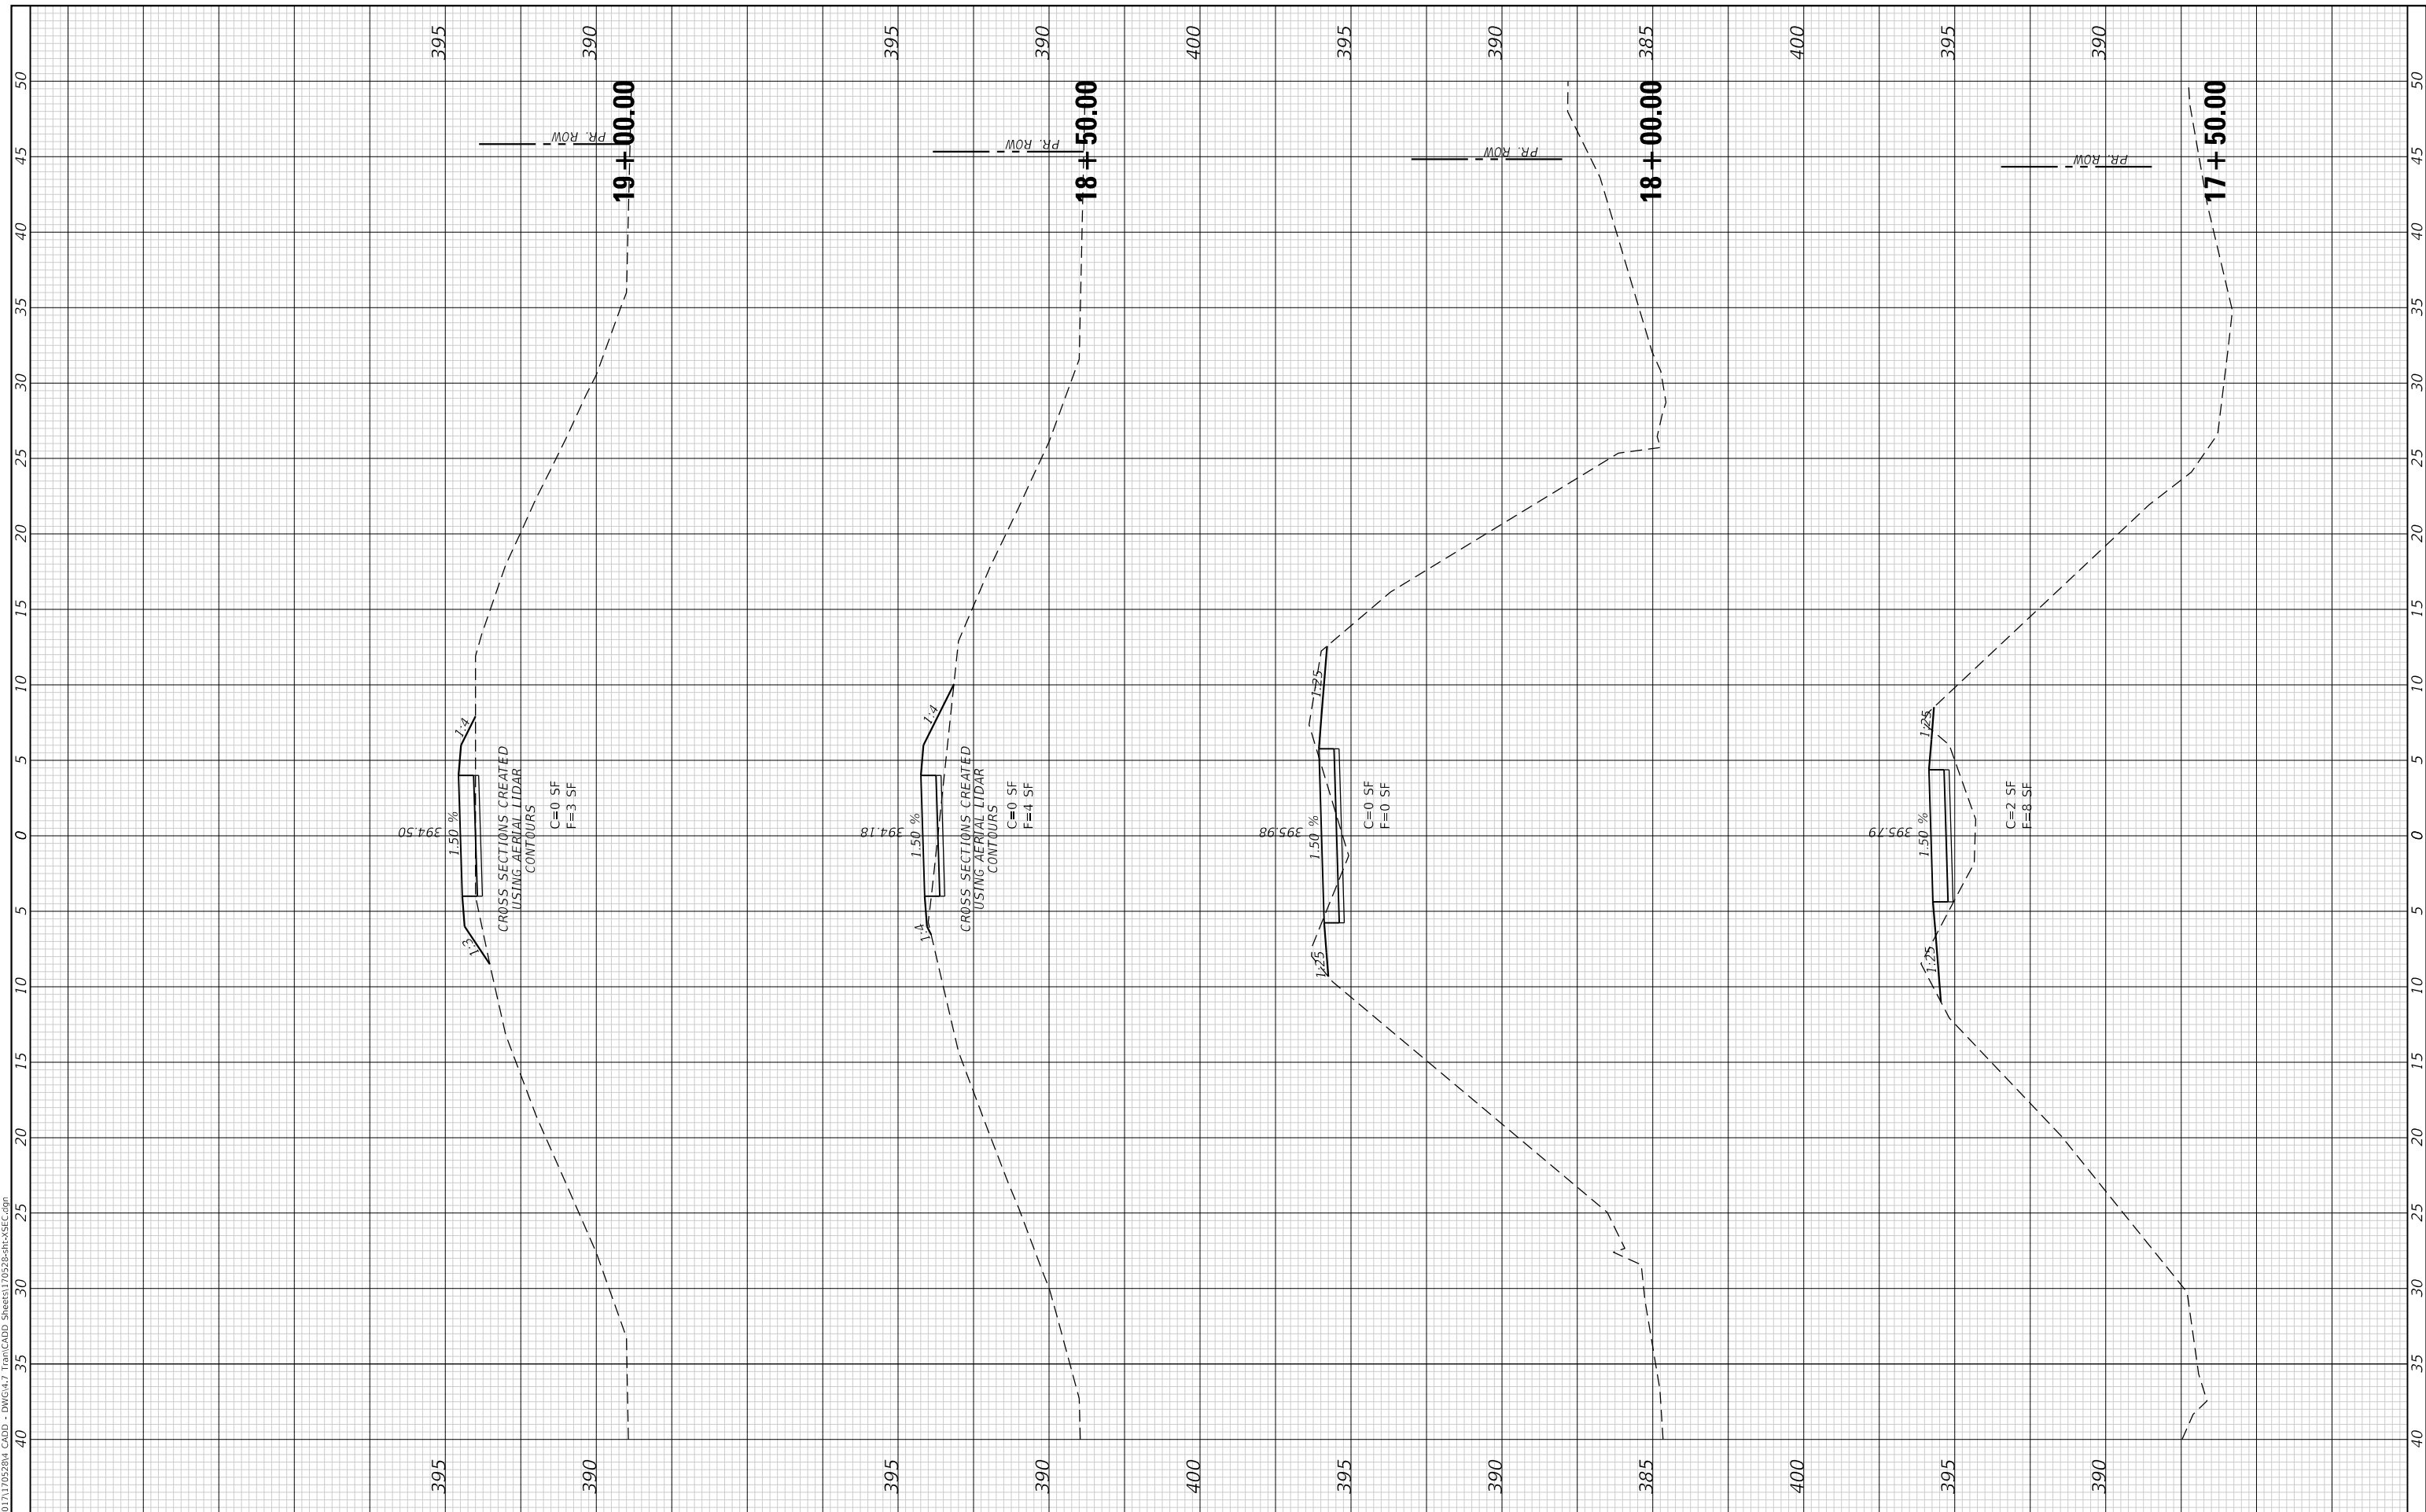CROSS SECTIONS


SCALE: 1" = 5' SHEET 8 OF 24 SHEETS STA. 17+50.00 TO STA. 19+00.00

F.A. RTE.	SECTION	COUNTY	TOTAL SHEETS	SHEET NO.
	17-00136-00-BT	JACKSON	51	35
CONTRACT NO. 99632				
ILLINOIS FED. AID PROJECT				

FINAL SURVEY NO.	SURVEYED PLOTTED TEMPLATE AREAS CHECKED	BY	DATE

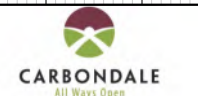ORIGINAL SURVEY NO.	SURVEYED PLOTTED TEMPLATE AREAS CHECKED	BY	DATE

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USER NAME = efisher
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CITY OF CARBONDALE
NORTHWEST PEDESTRIAN AND BICYCLE PATH

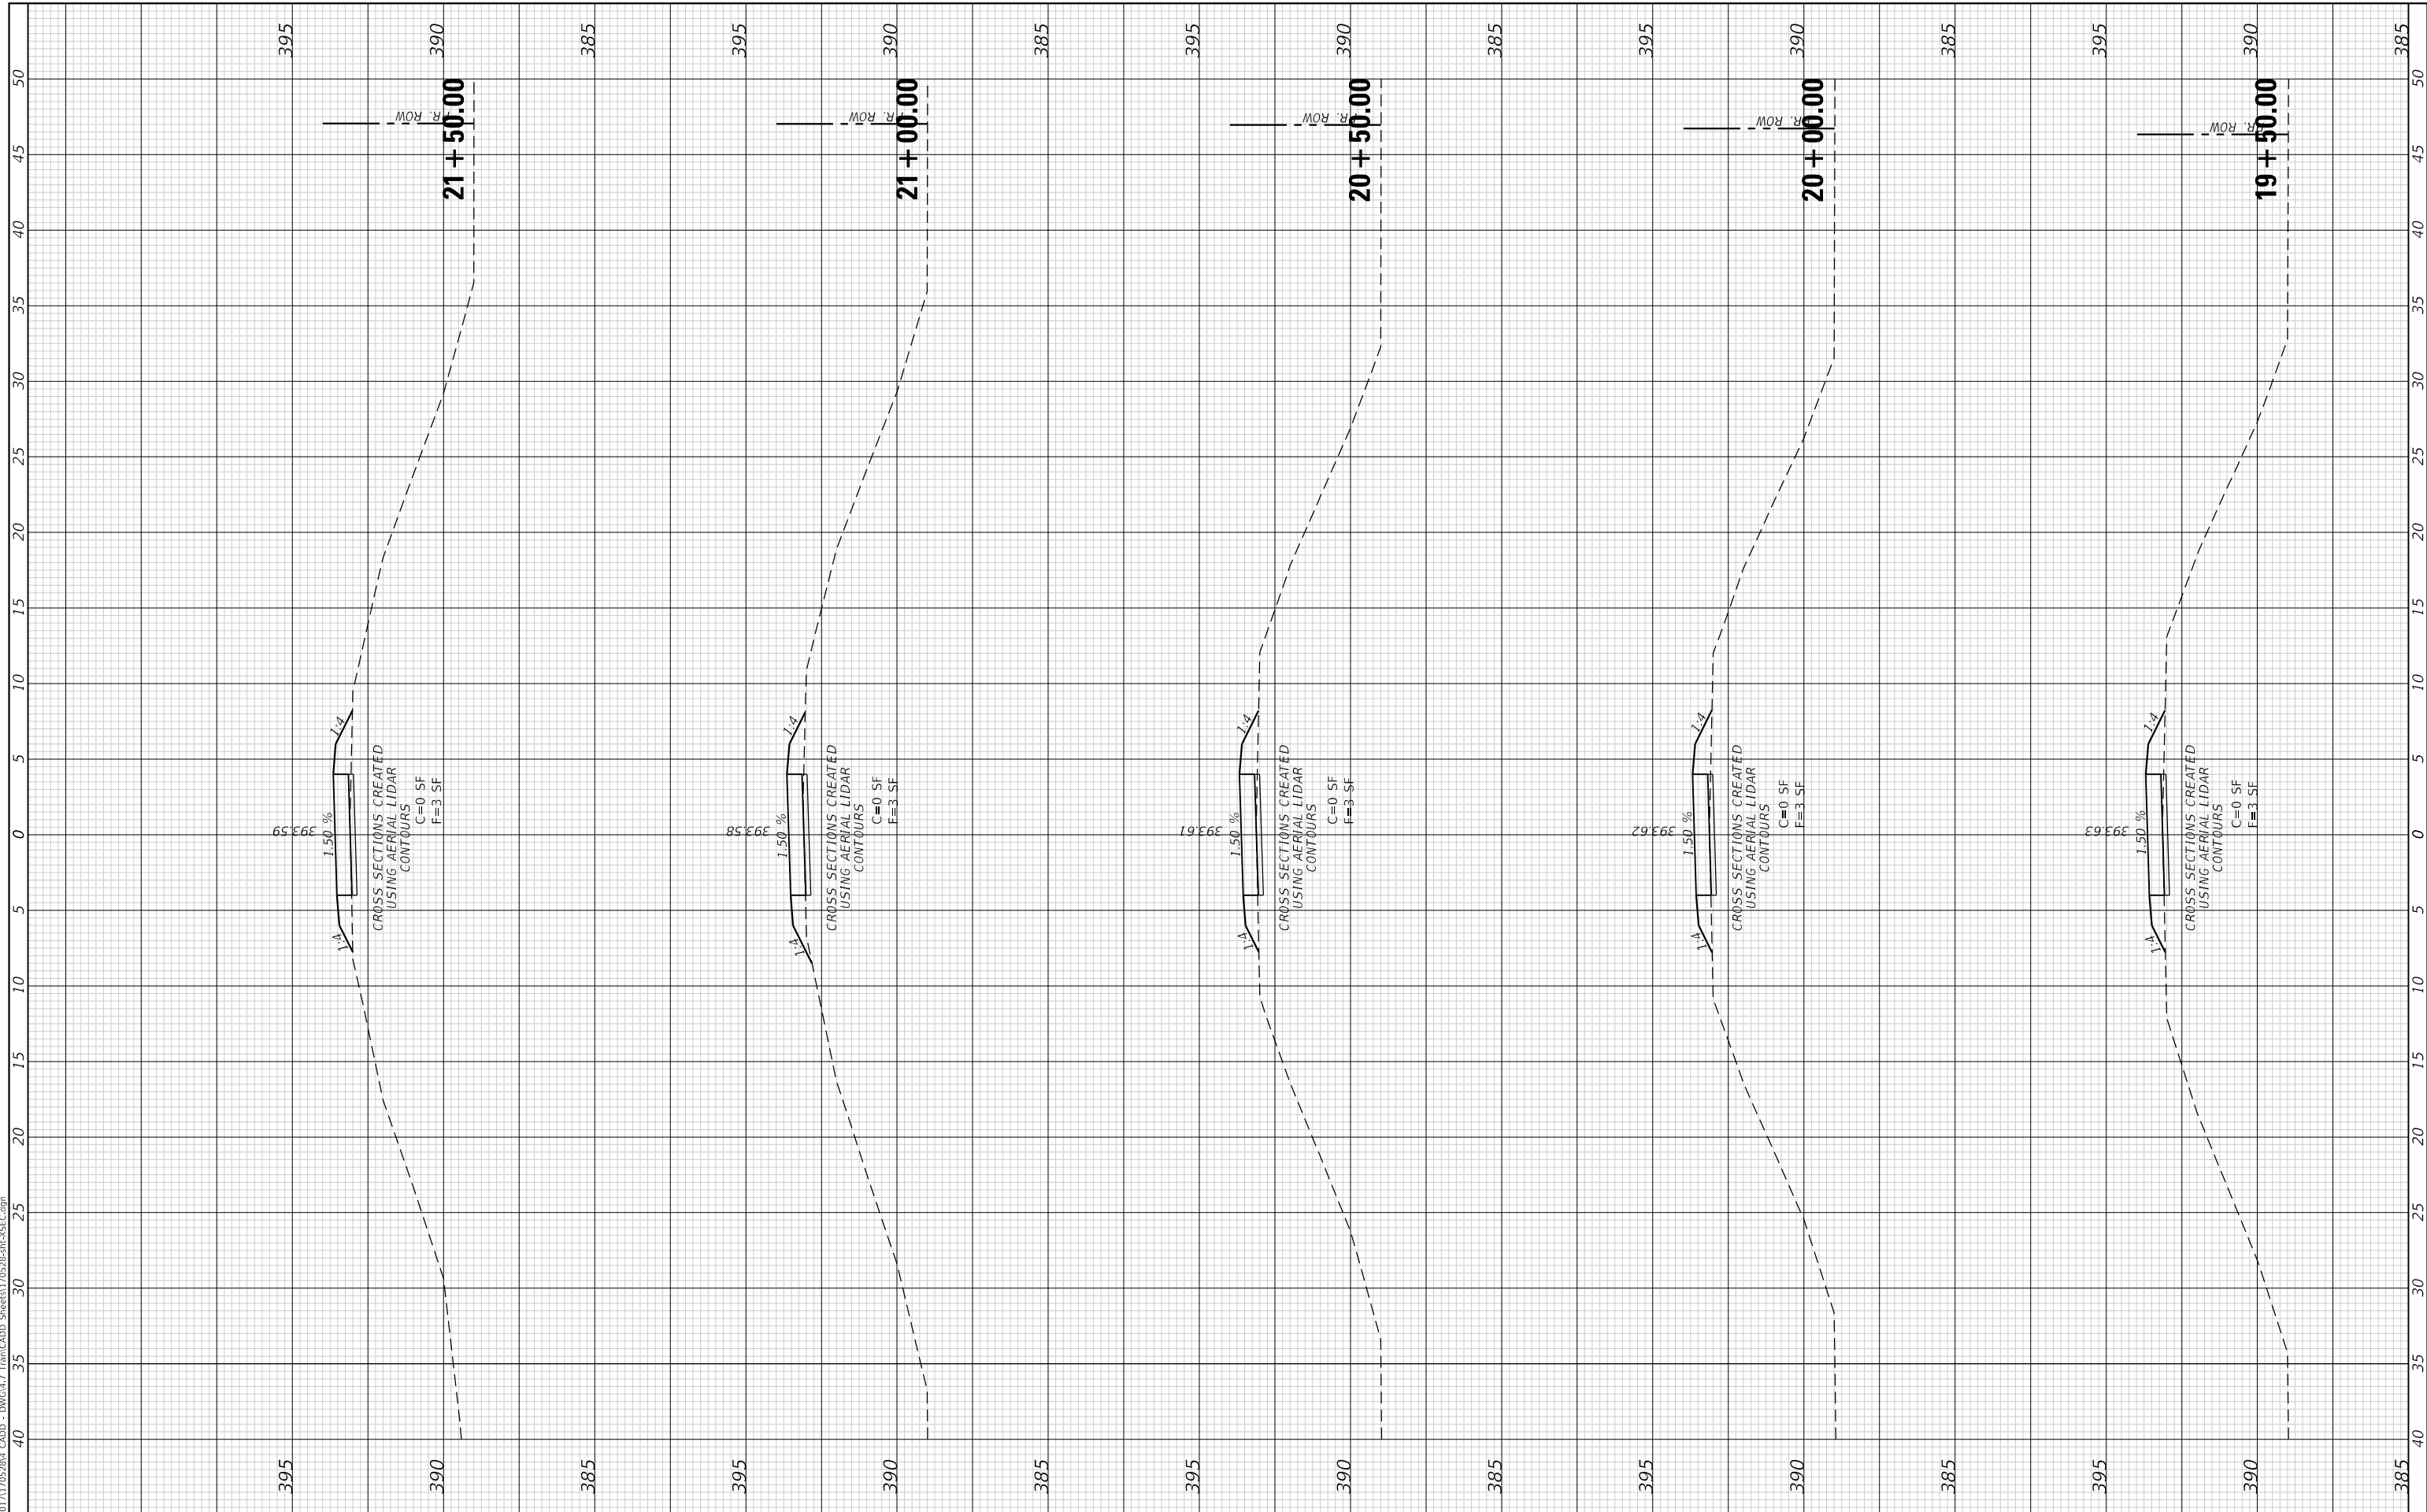CROSS SECTIONS


SCALE: 1" = 5' SHEET 9 OF 24 SHEETS STA. 19+50.00 TO STA. 21+50.00

F.A. RTE.	SECTION	COUNTY	TOTAL SHEETS	SHEET NO.
	17-00136-00-BT	JACKSON	51	36
CONTRACT NO. 99632				
ILLINOIS FED. AID PROJECT				

FINAL SURVEY NO.	SURVEYED PLOTTED AREAS CHECKED	BY	DATE
NOTE BOOK	TEMPLATE		
	AREAS CHECKED		

ORIGINAL SURVEY NO.	SURVEYED PLOTTED AREAS CHECKED	BY	DATE
	TEMPLATE		
	AREAS CHECKED		

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CITY OF CARBONDALE
NORTHWEST PEDESTRIAN AND BICYCLE PATH

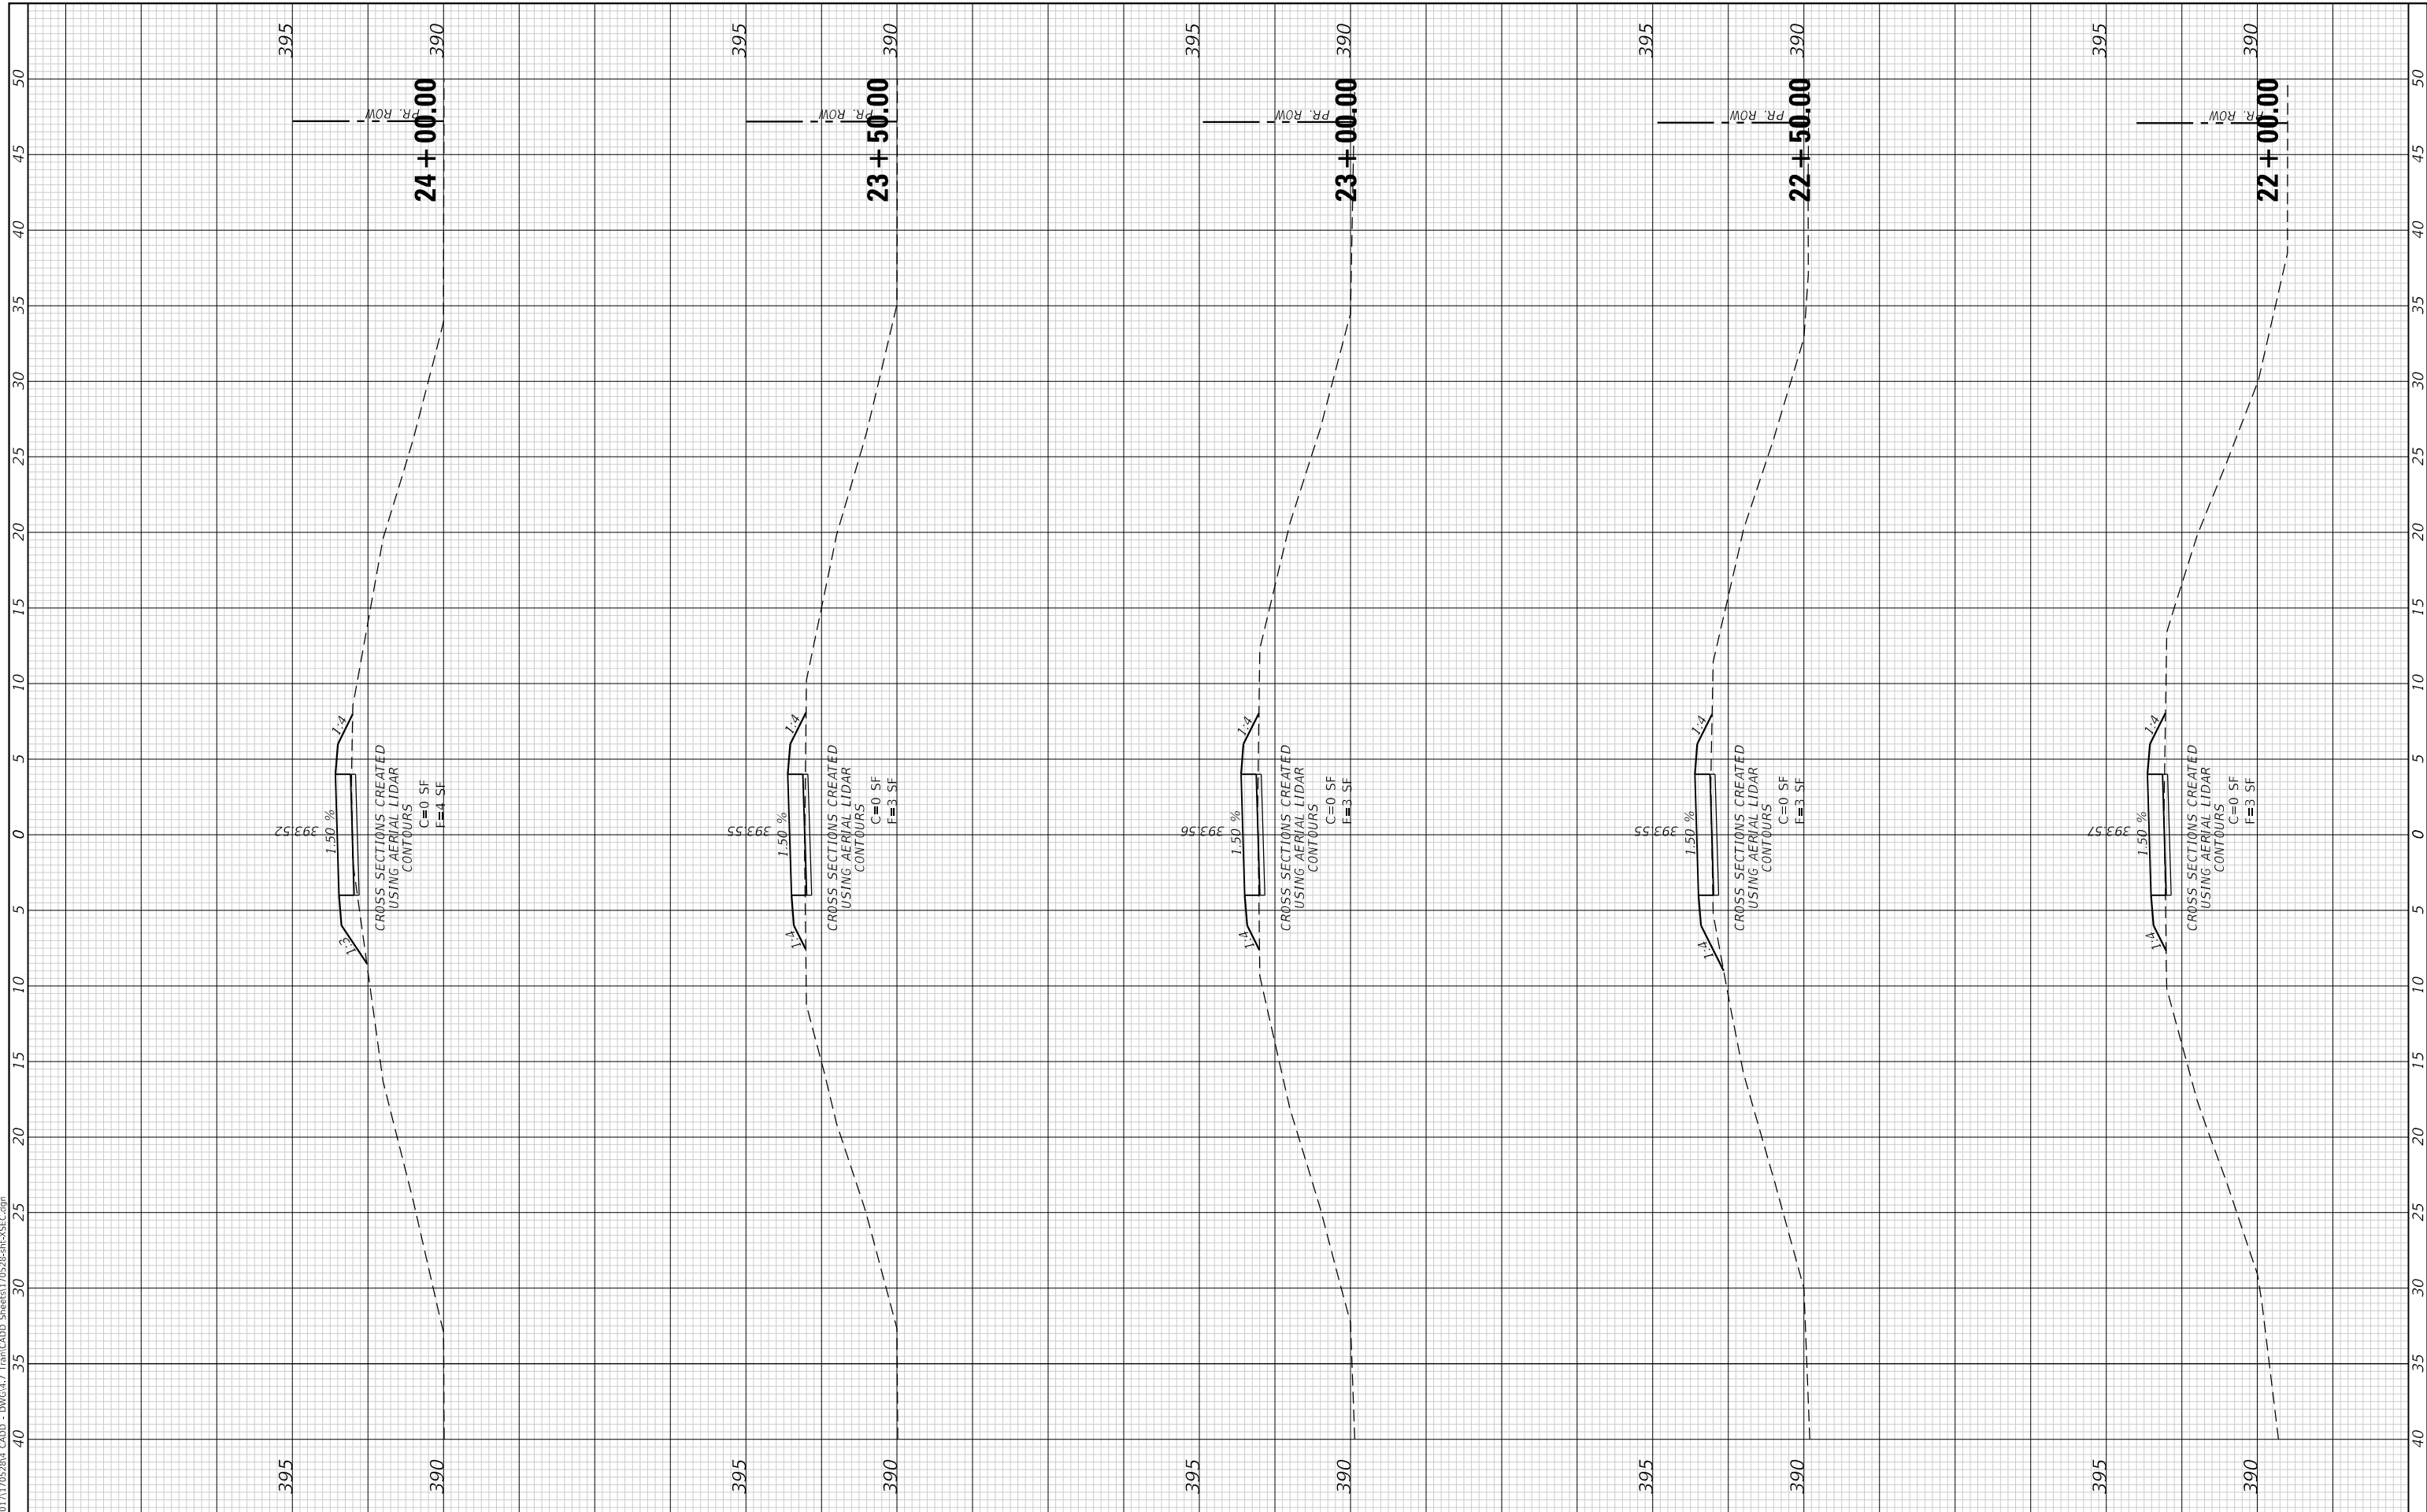CROSS SECTIONS


SCALE: 1" = 5' SHEET 10 OF 24 SHEETS STA. 22+00.00 TO STA. 24+00.00

F.A. RTE.	SECTION	COUNTY	TOTAL SHEETS	SHEET NO.
	17-00136-00-BT	JACKSON	51	37
CONTRACT NO. 99632				
ILLINOIS FED. AID PROJECT				

FINAL SURVEY NO.	SURVEYED PLOTTED AREAS CHECKED	BY	DATE

ORIGINAL SURVEY NO.	SURVEYED PLOTTED AREAS CHECKED	BY	DATE

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CITY OF CARBONDALE
NORTHWEST PEDESTRIAN AND BICYCLE PATH

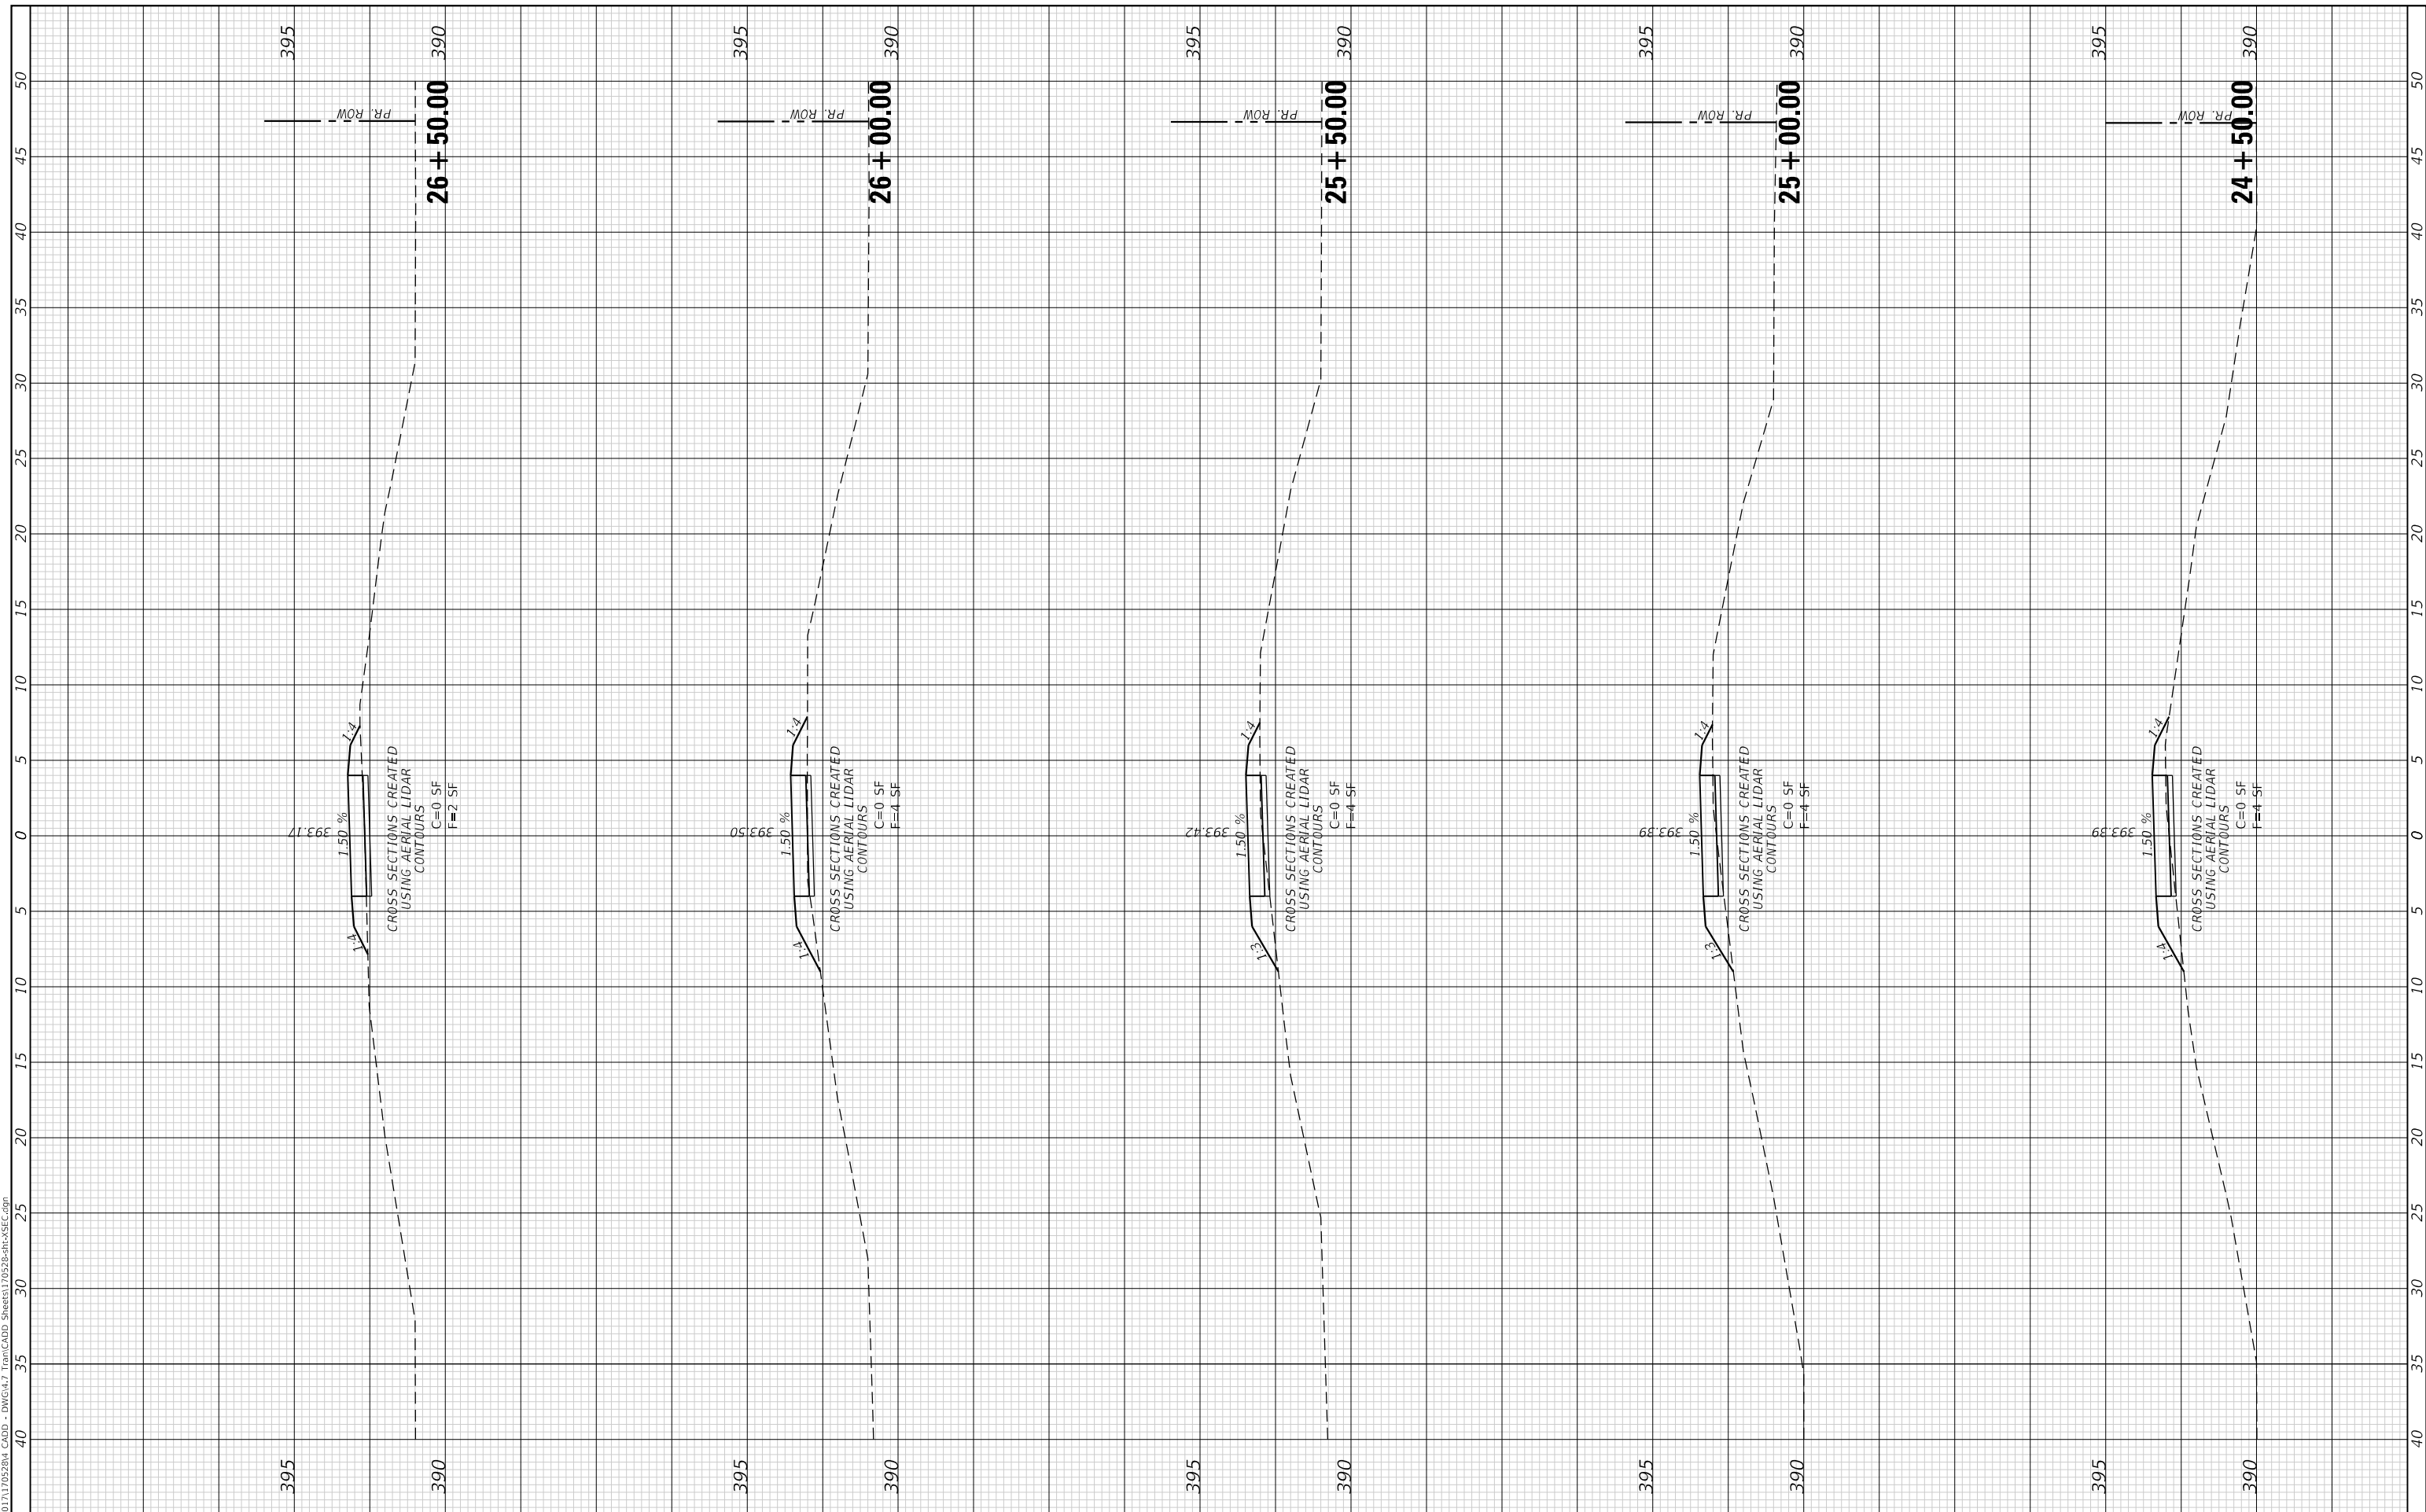
CROSS SECTIONS
 SCALE: 1" = 5' SHEET 11 OF 24 SHEETS STA. 24+50.00 TO STA. 26+50.00

F.A. RTE.	SECTION	COUNTY	TOTAL SHEETS	SHEET NO.
	17-00136-00-BT	JACKSON	51	38
CONTRACT NO. 99632				
ILLINOIS FED. AID PROJECT				

FINAL SURVEY NO.	SURVEYED PLOTTED AREAS CHECKED	BY	DATE

ORIGINAL SURVEY NO.	SURVEYED PLOTTED AREAS CHECKED	BY	DATE

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CITY OF CARBONDALE
NORTHWEST PEDESTRIAN AND BICYCLE PATH

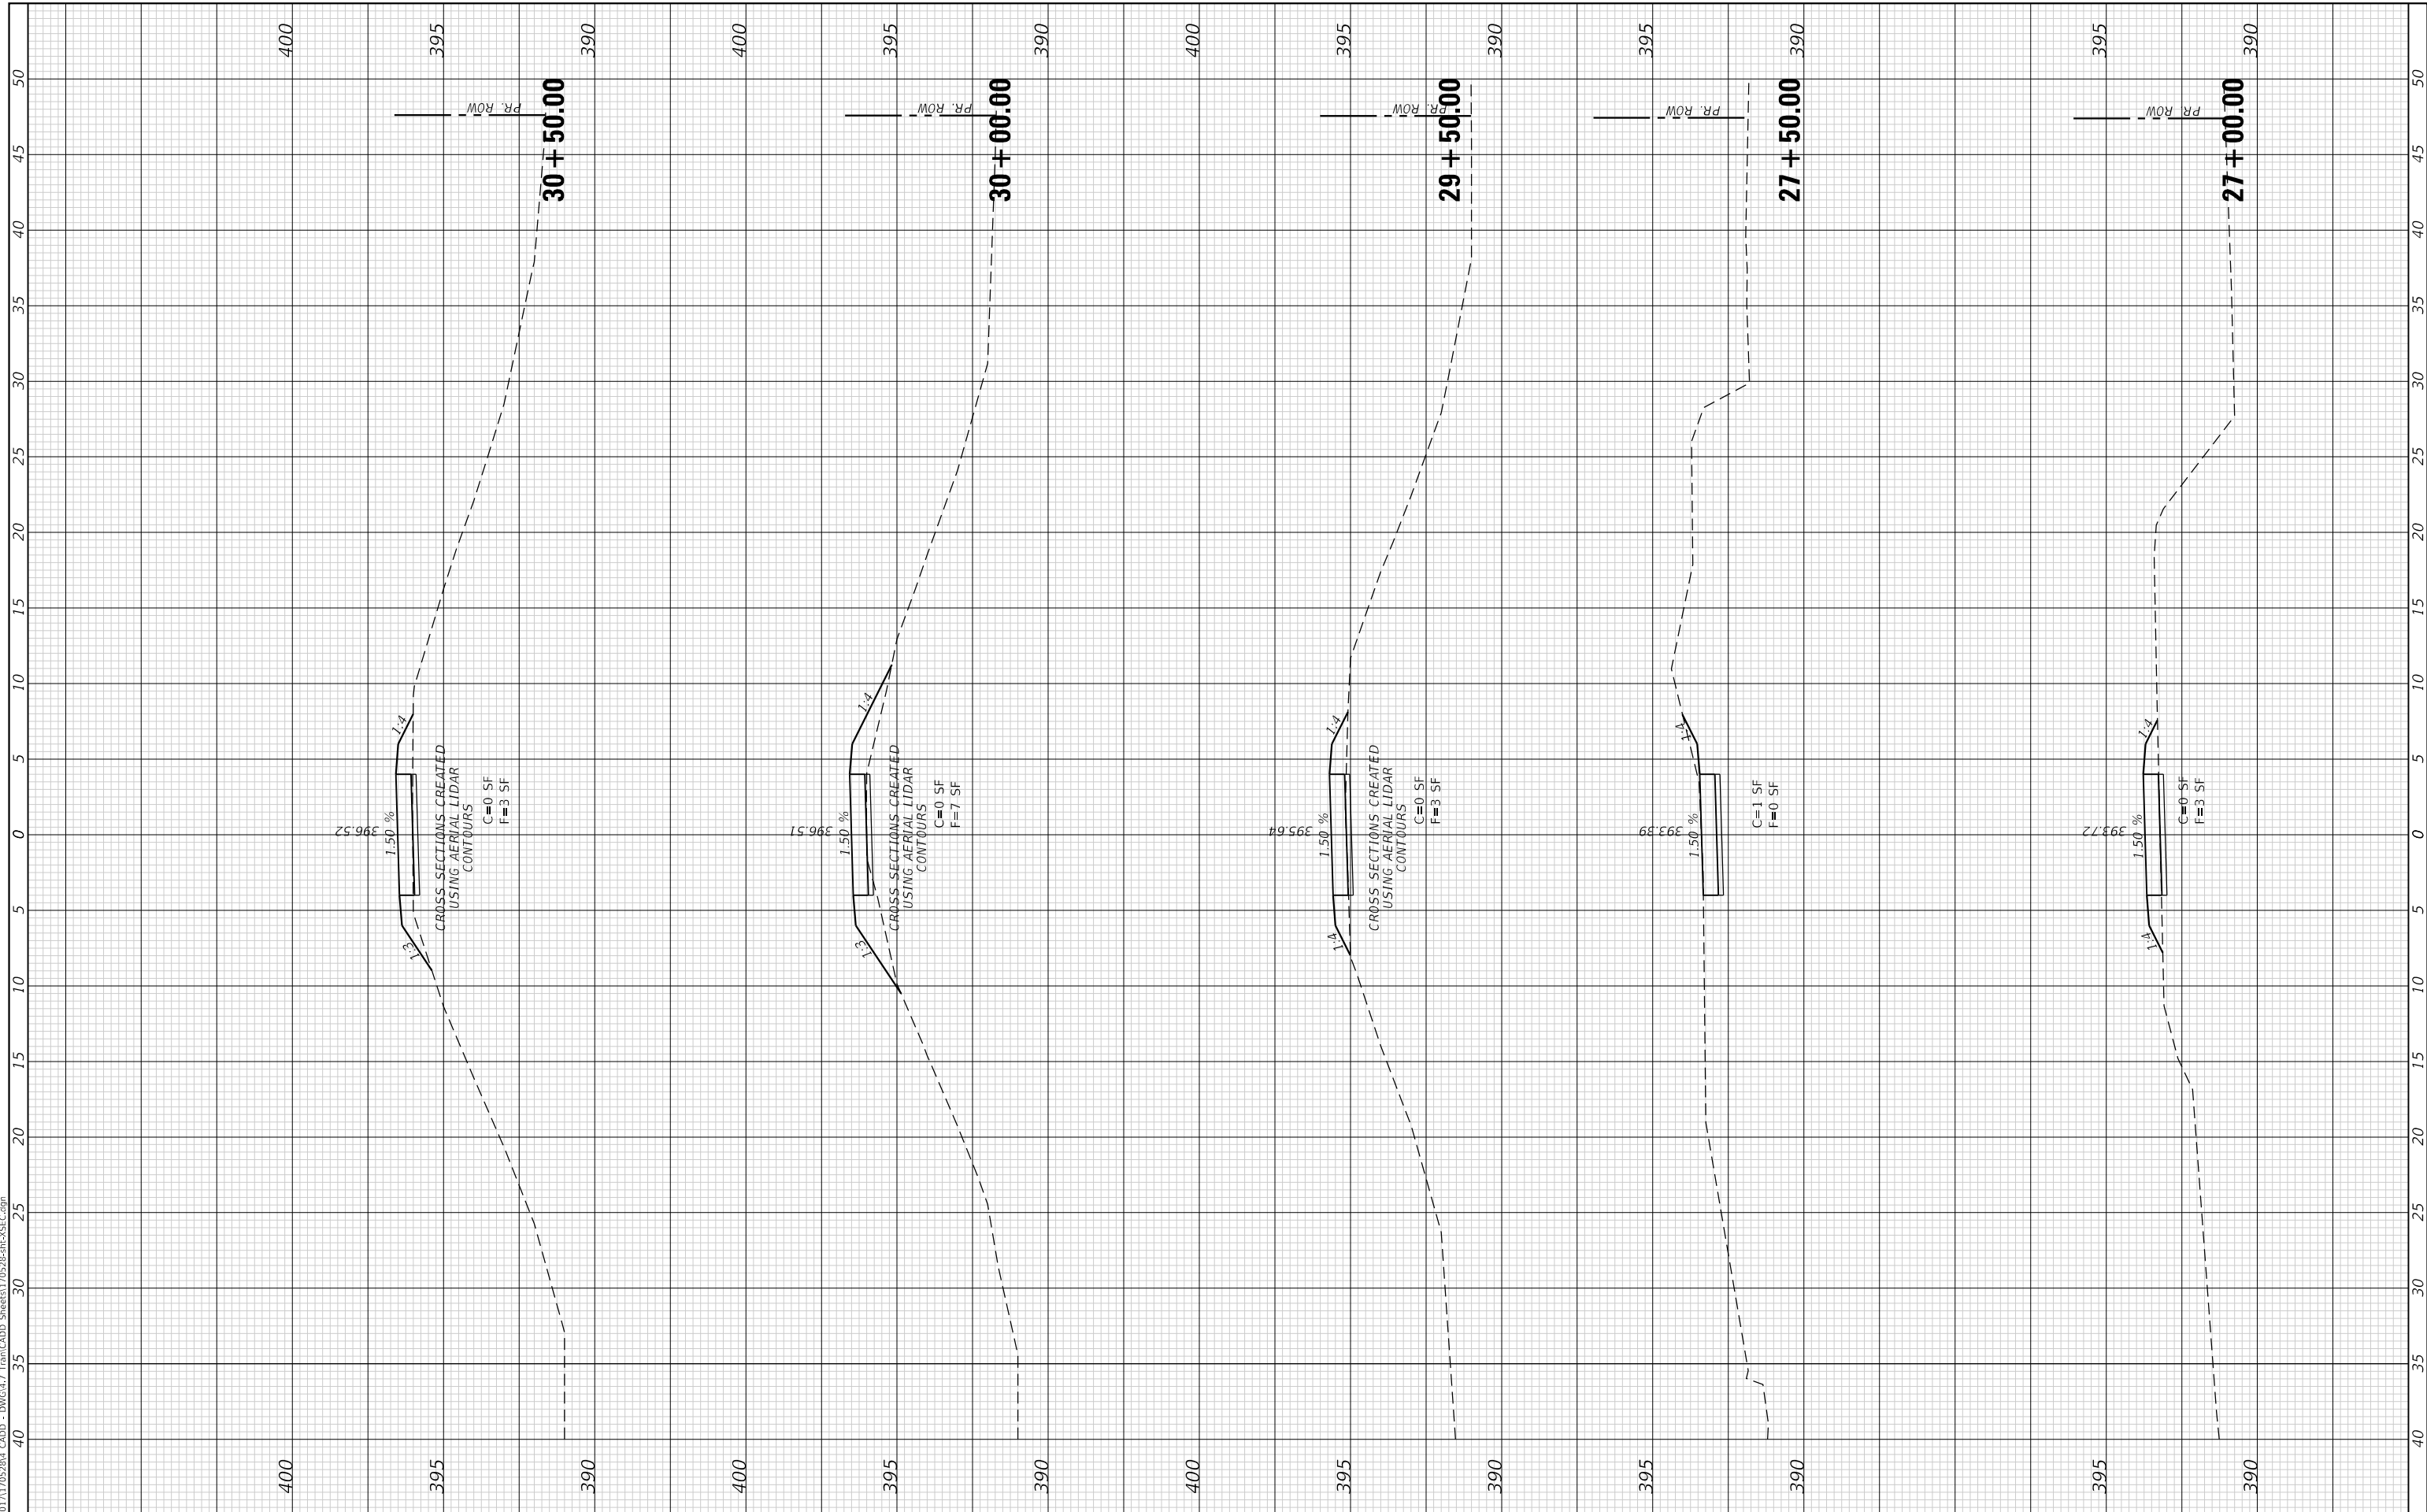CROSS SECTIONS


SCALE: 1" = 5' SHEET 12 OF 24 SHEETS STA. 27+00.00 TO STA. 30+50.00

F.A. RTE.	SECTION	COUNTY	TOTAL SHEETS	SHEET NO.
	17-00136-00-BT	JACKSON	51	39
CONTRACT NO. 99632				
ILLINOIS FED. AID PROJECT				

FINAL SURVEY NO.	SURVEYED PLOTTED TEMPLATE AREAS CHECKED	BY	DATE

ORIGINAL SURVEY NO.	SURVEYED PLOTTED TEMPLATE AREAS CHECKED	BY	DATE

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CITY OF CARBONDALE
NORTHWEST PEDESTRIAN AND BICYCLE PATH

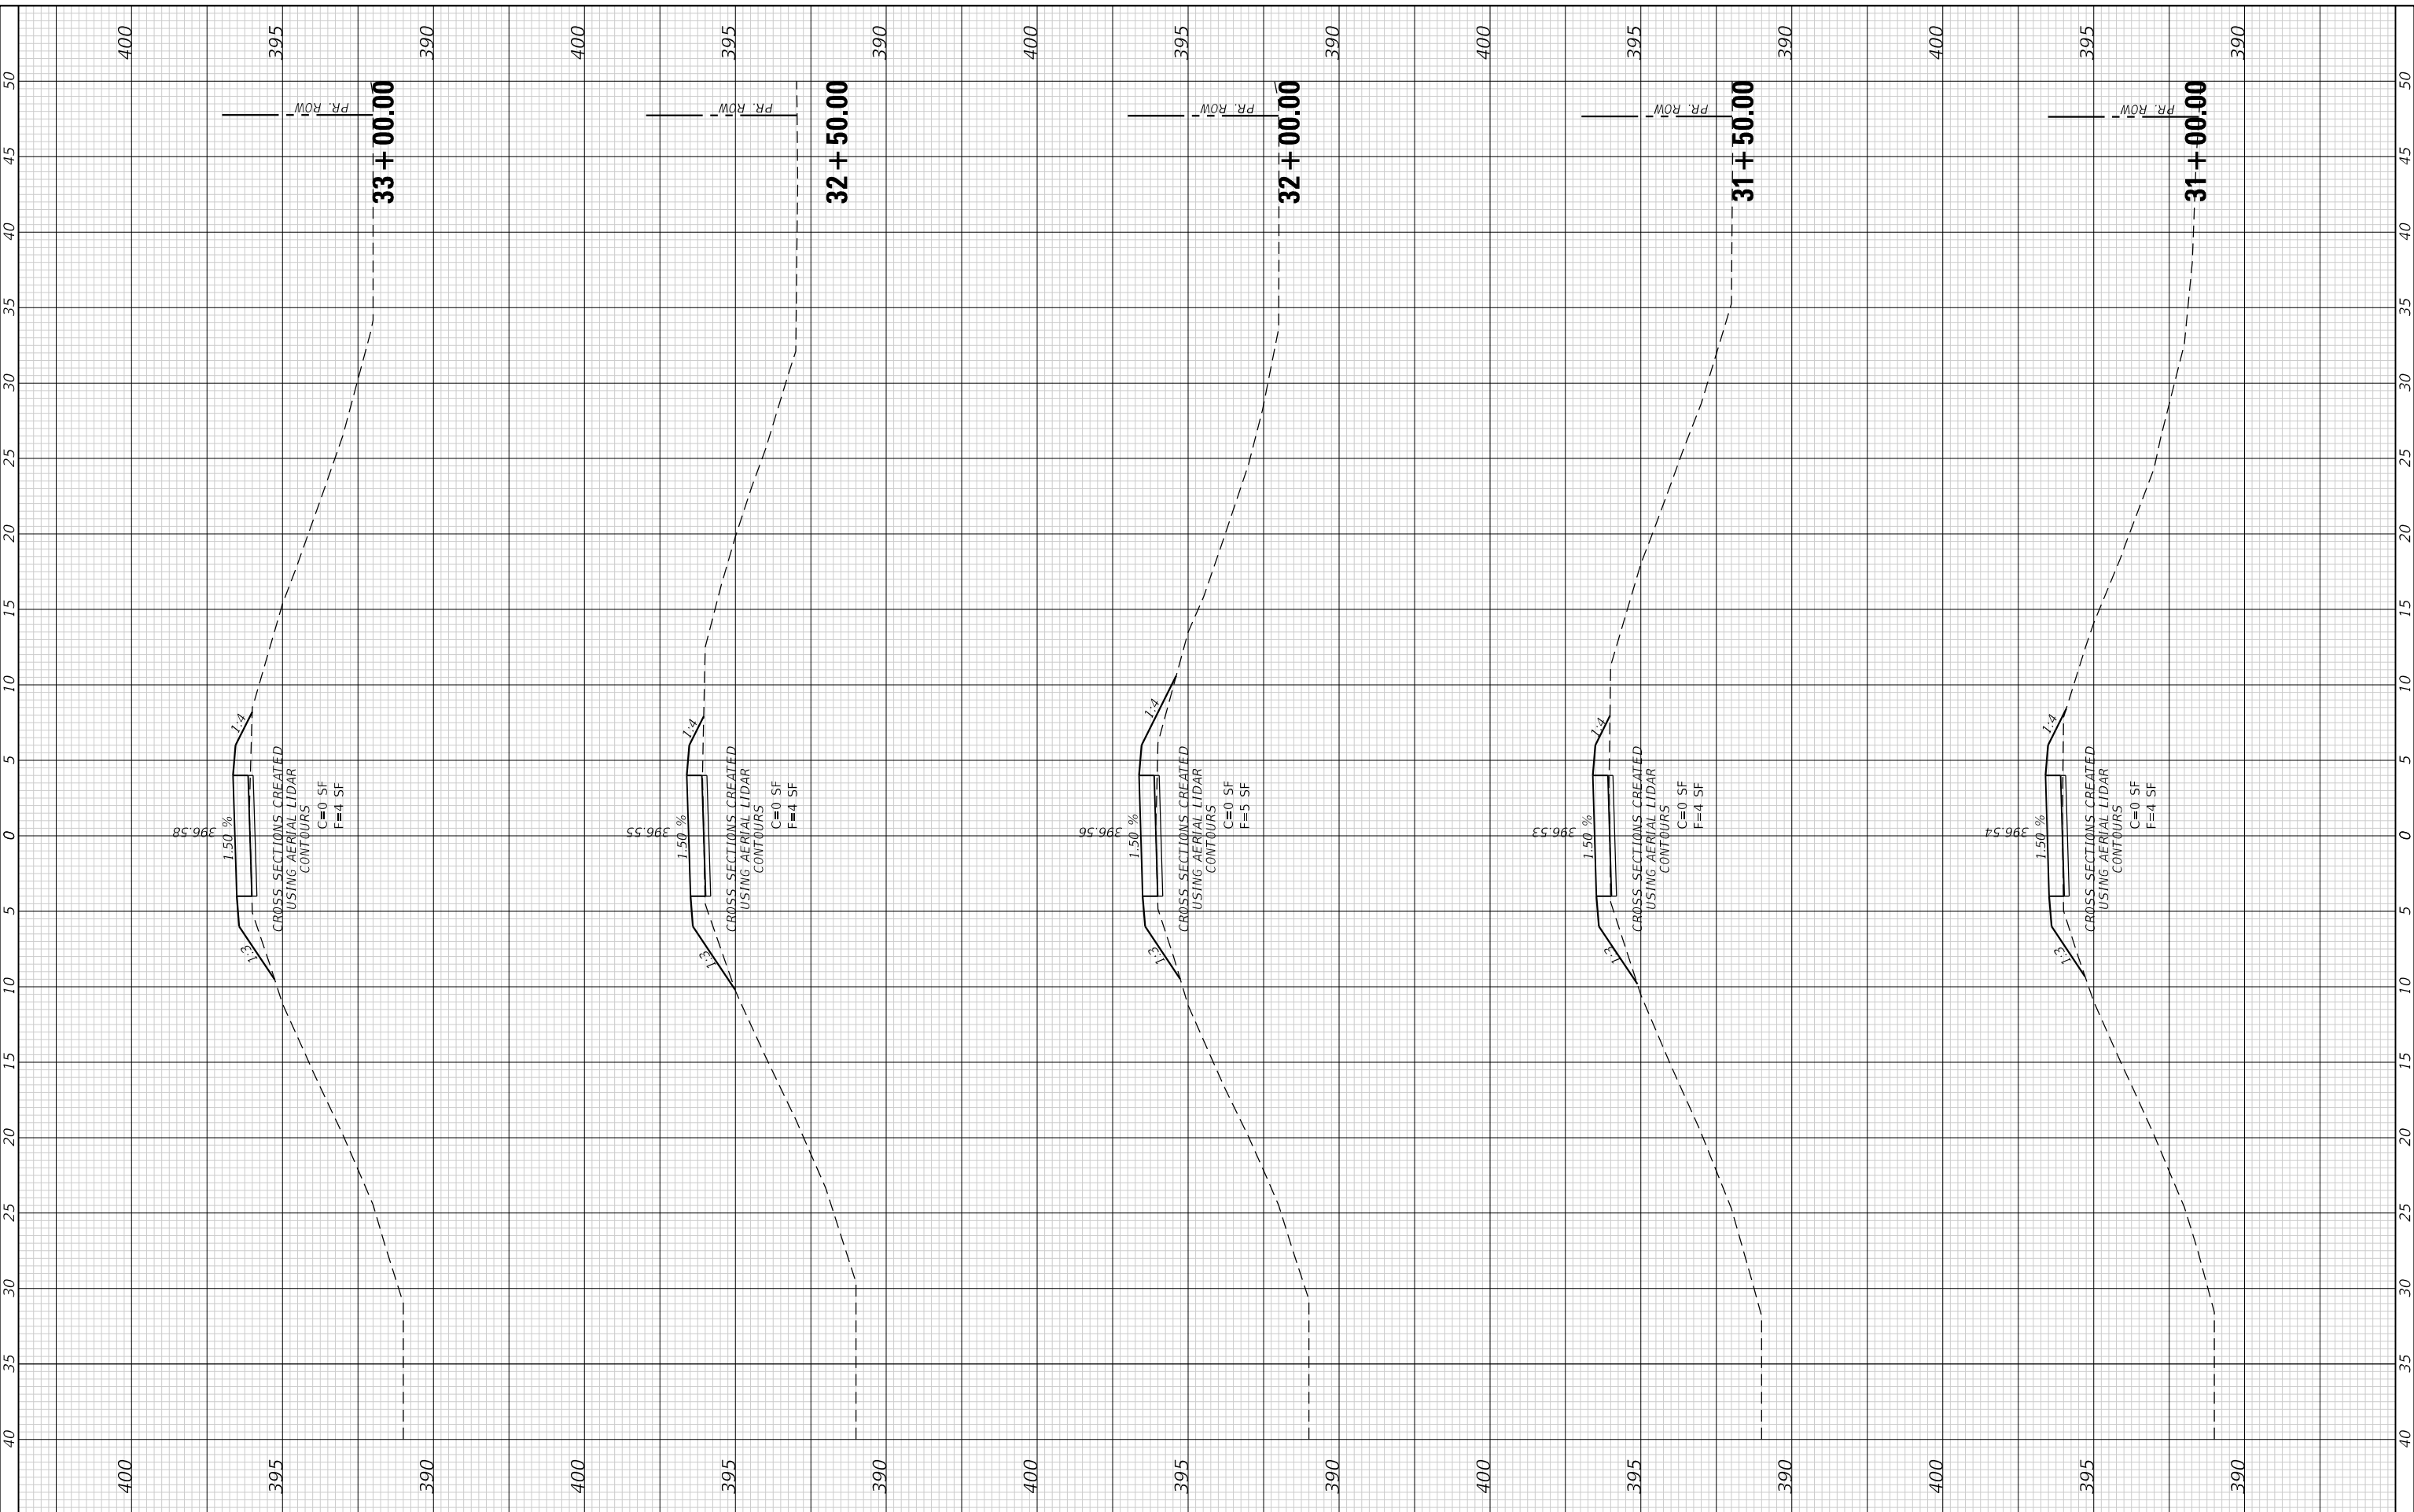CROSS SECTIONS


SCALE: 1" = 5' SHEET 13 OF 24 SHEETS STA. 31+00.00 TO STA. 33+00.00

F.A. RTE.	SECTION	COUNTY	TOTAL SHEETS	SHEET NO.
	17-00136-00-BT	JACKSON	51	40
CONTRACT NO. 99632				
ILLINOIS FED. AID PROJECT				

FINAL SURVEY NO.	SURVEYED PLOTTED TEMPLATE AREAS CHECKED	BY	DATE

ORIGINAL SURVEY NO.	SURVEYED PLOTTED TEMPLATE AREAS CHECKED	BY	DATE

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CITY OF CARBONDALE
NORTHWEST PEDESTRIAN AND BICYCLE PATH

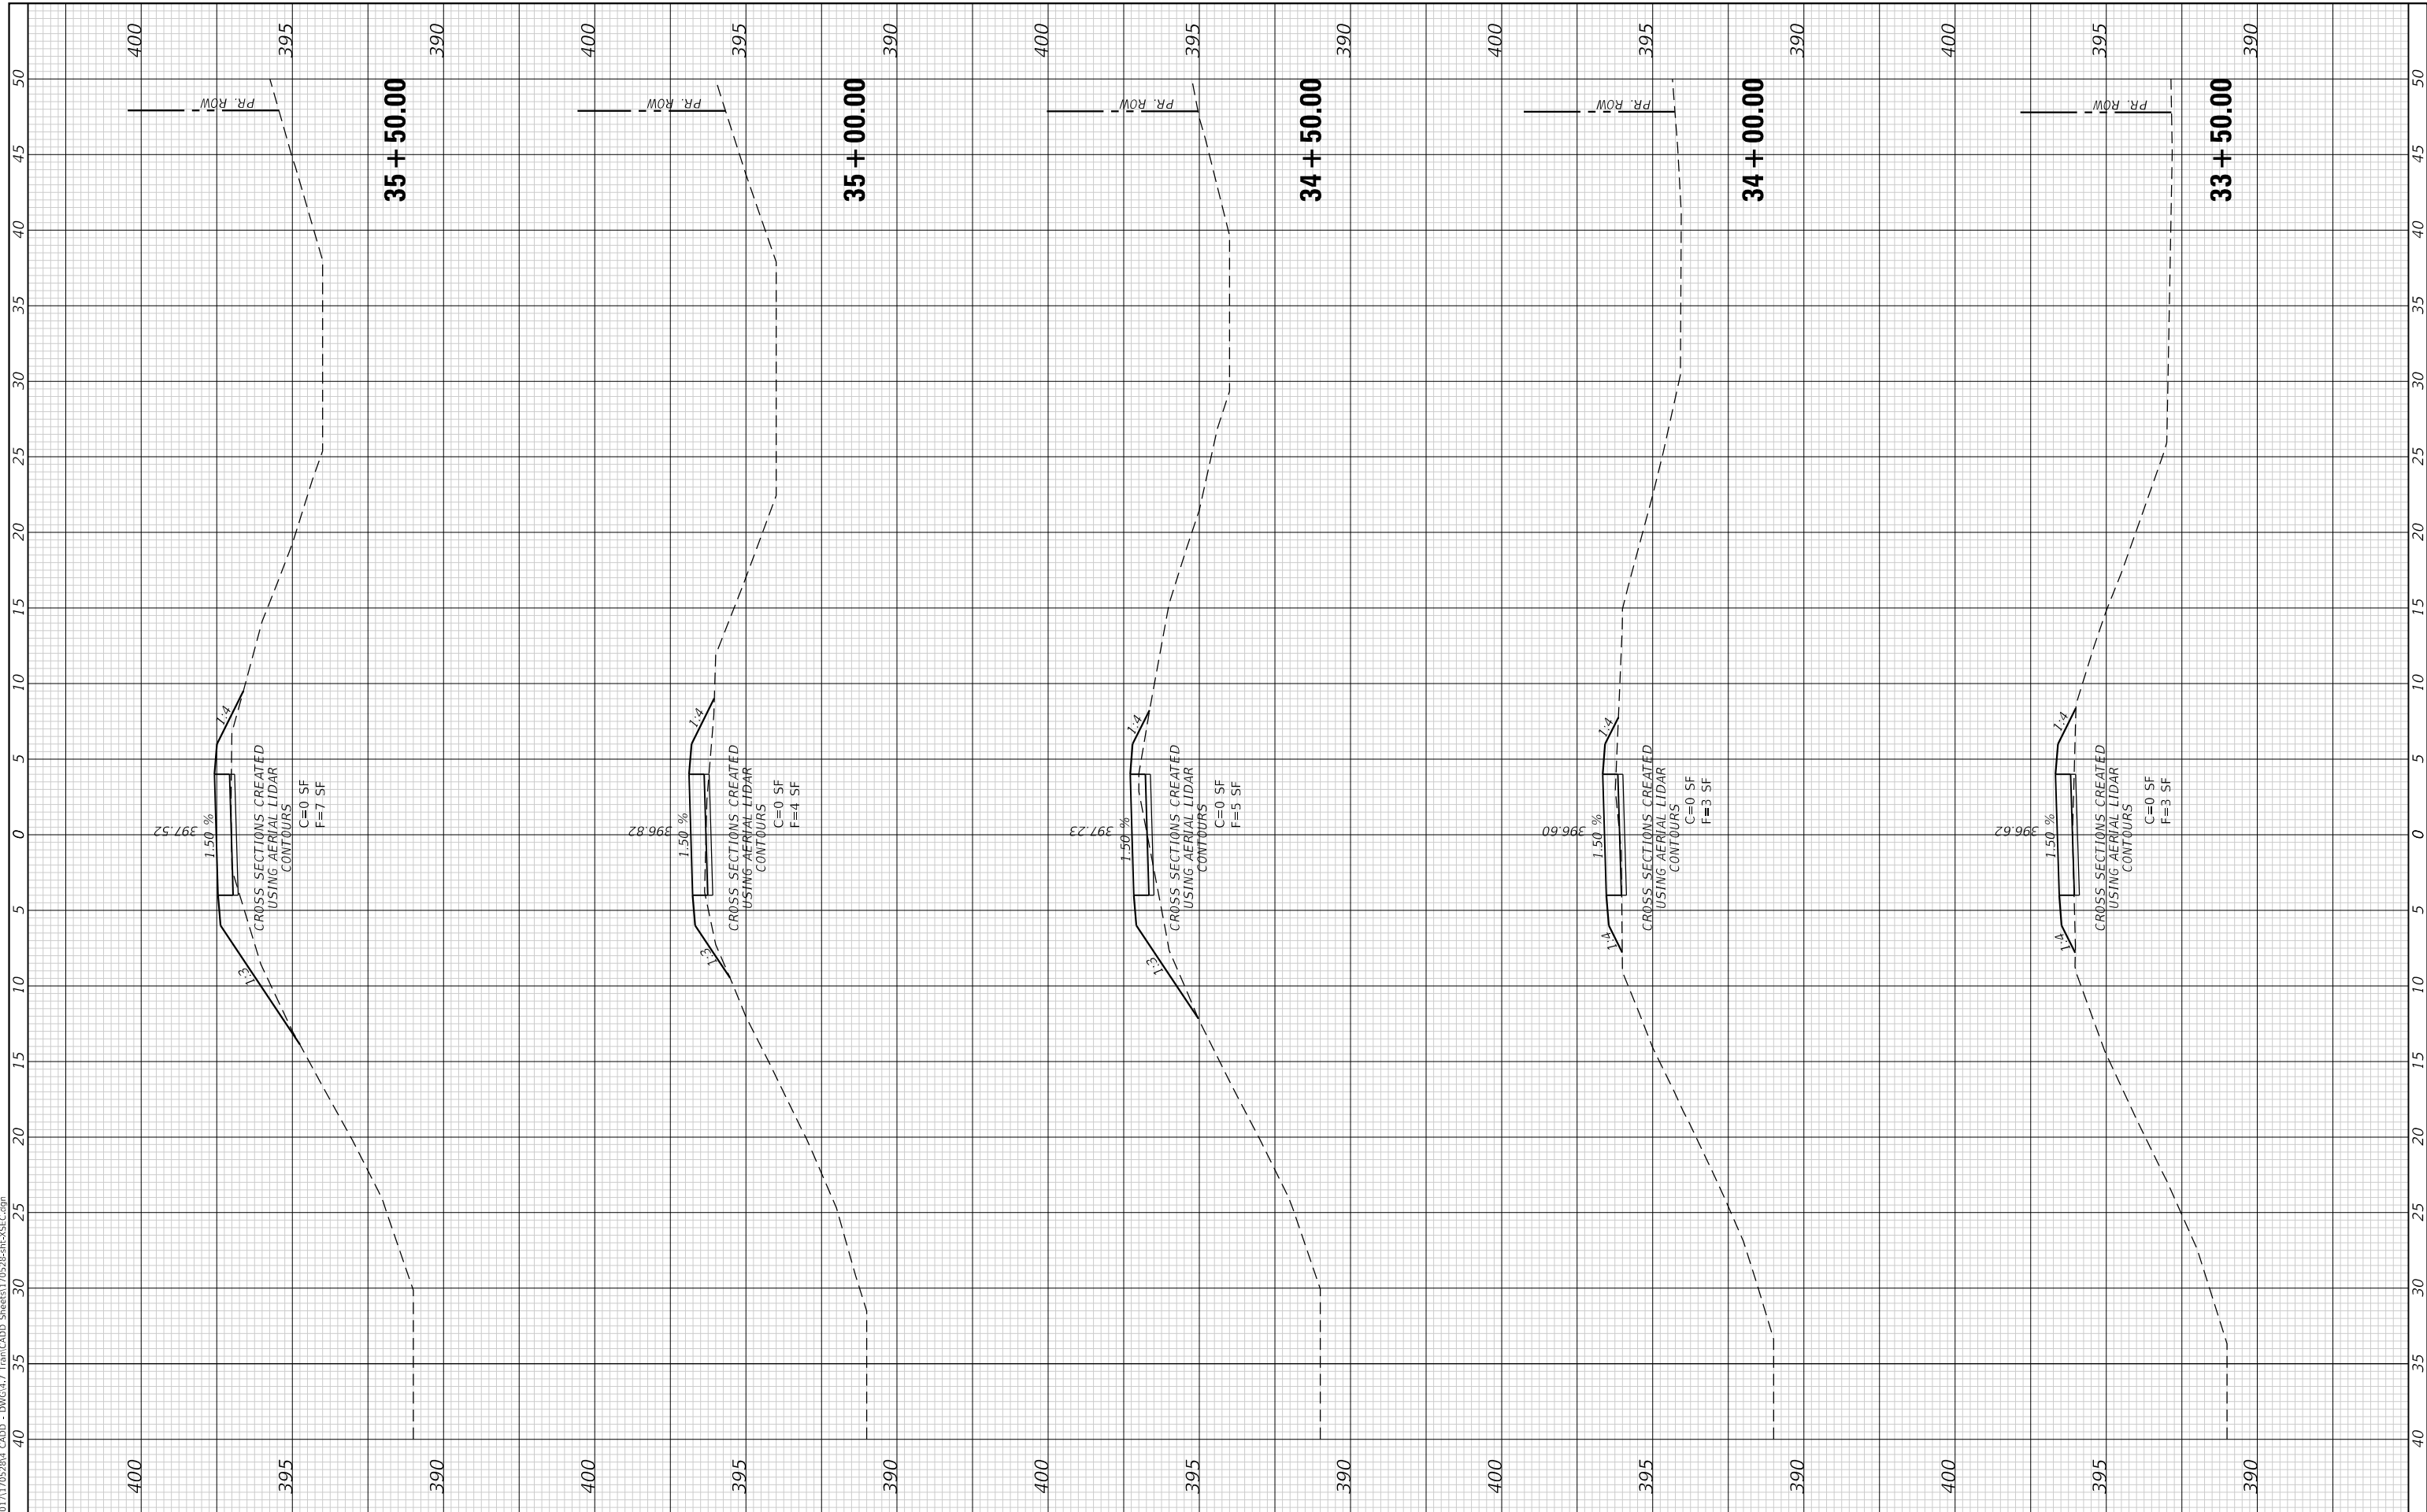CROSS SECTIONS


SCALE: 1" = 5' SHEET 14 OF 24 SHEETS STA. 33+50.00 TO STA. 35+50.00

F.A. RTE.	SECTION	COUNTY	TOTAL SHEETS	SHEET NO.
	17-00136-00-BT	JACKSON	51	41
CONTRACT NO. 99632				
ILLINOIS		FED. AID PROJECT		

FINAL SURVEY NO.	SURVEYED PLOTTED AREAS CHECKED	BY	DATE
NOTE BOOK	TEMPLATE		
	AREAS CHECKED		

ORIGINAL SURVEY NO.	SURVEYED PLOTTED AREAS CHECKED	BY	DATE
NOTE BOOK	TEMPLATE		
	AREAS CHECKED		

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CITY OF CARBONDALE
 NORTHWEST PEDESTRIAN
 AND BICYCLE PATH

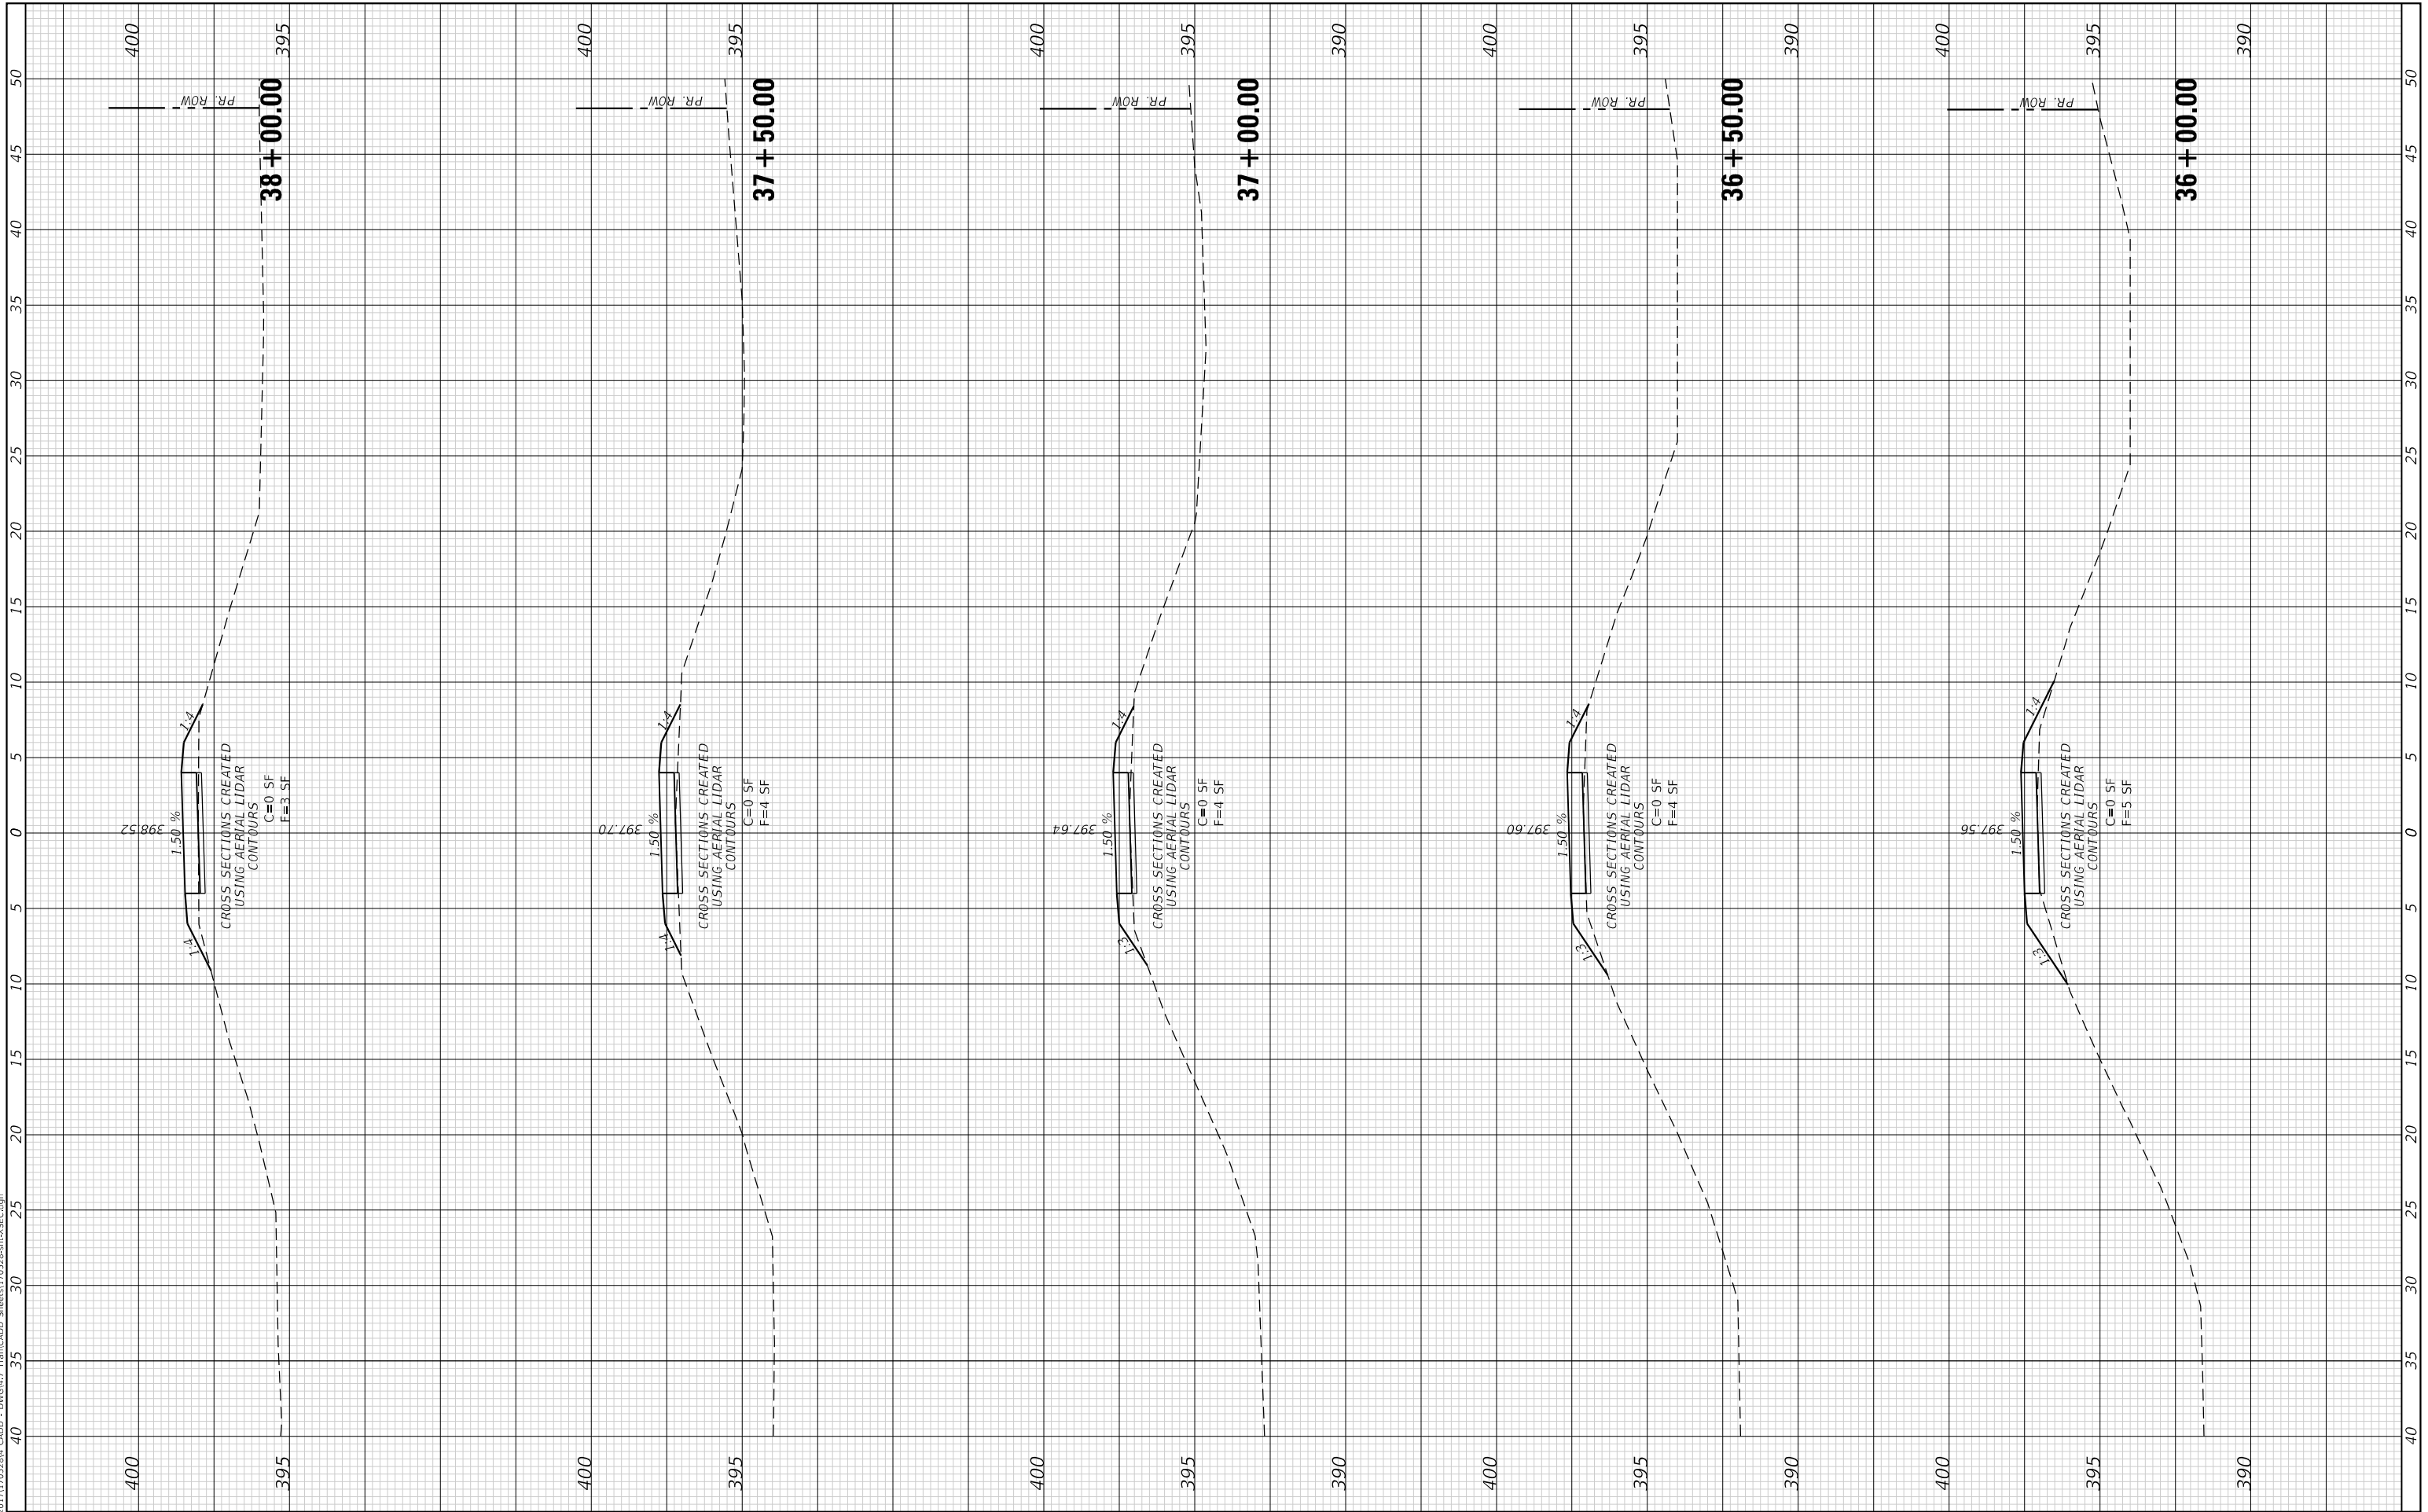CROSS SECTIONS


SCALE: 1" = 5' SHEET 15 OF 24 SHEETS STA. 36+00.00 TO STA. 38+00.00

F.A. RTE.	SECTION	COUNTY	TOTAL SHEETS	SHEET NO.
	17-00136-00-BT	JACKSON	51	42
CONTRACT NO. 99632				
ILLINOIS		FED. AID PROJECT		

FINAL SURVEY NO.	SURVEYED PLOTTED TEMPLATE AREAS CHECKED	BY	DATE

ORIGINAL SURVEY NO.	SURVEYED PLOTTED TEMPLATE AREAS CHECKED	BY	DATE

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CITY OF CARBONDALE
NORTHWEST PEDESTRIAN AND BICYCLE PATH

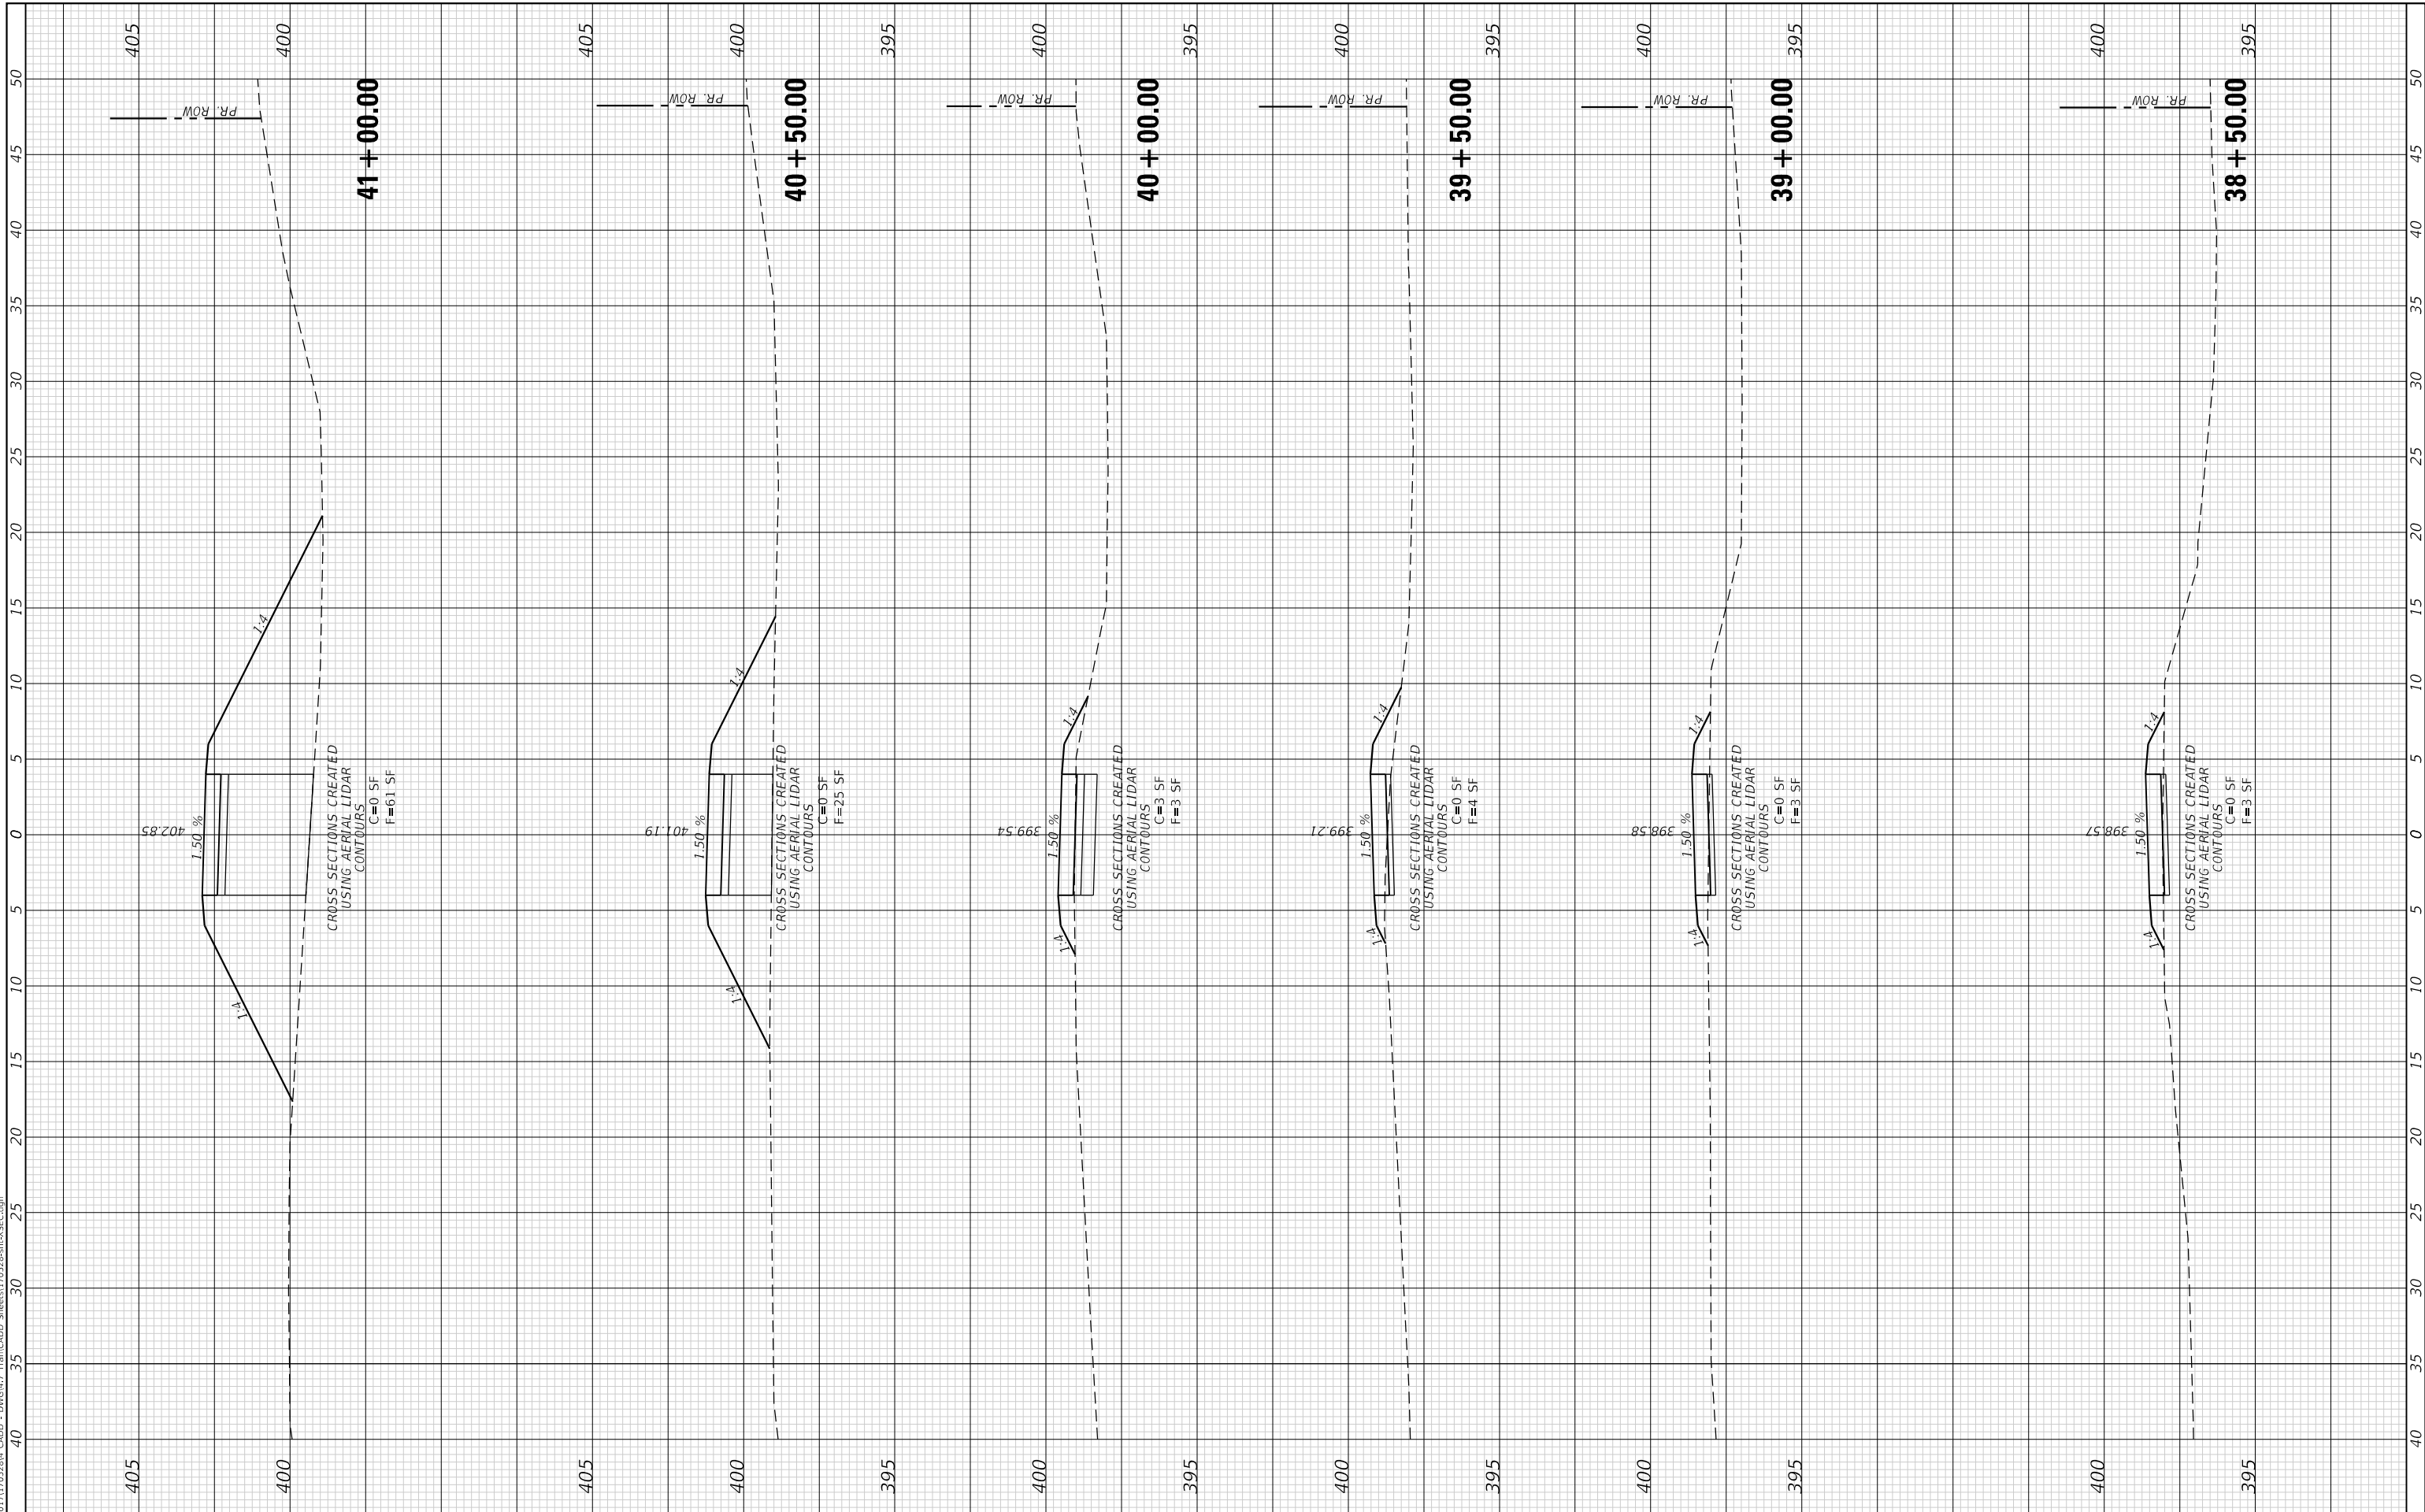CROSS SECTIONS


SCALE: 1" = 5' SHEET 16 OF 24 SHEETS STA. 38+50.00 TO STA. 41+00.00

F.A. RTE.	SECTION	COUNTY	TOTAL SHEETS	SHEET NO.
	17-00136-00-BT	JACKSON	51	43
CONTRACT NO. 99632				
ILLINOIS FED. AID PROJECT				

FINAL SURVEY NO.	SURVEYED PLOTTED AREAS CHECKED	BY	DATE
NOTE BOOK NO.	TEMPLATE AREAS CHECKED		

ORIGINAL SURVEY NO.	SURVEYED PLOTTED AREAS CHECKED	BY	DATE

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CITY OF CARBONDALE
 NORTHWEST PEDESTRIAN
 AND BICYCLE PATH

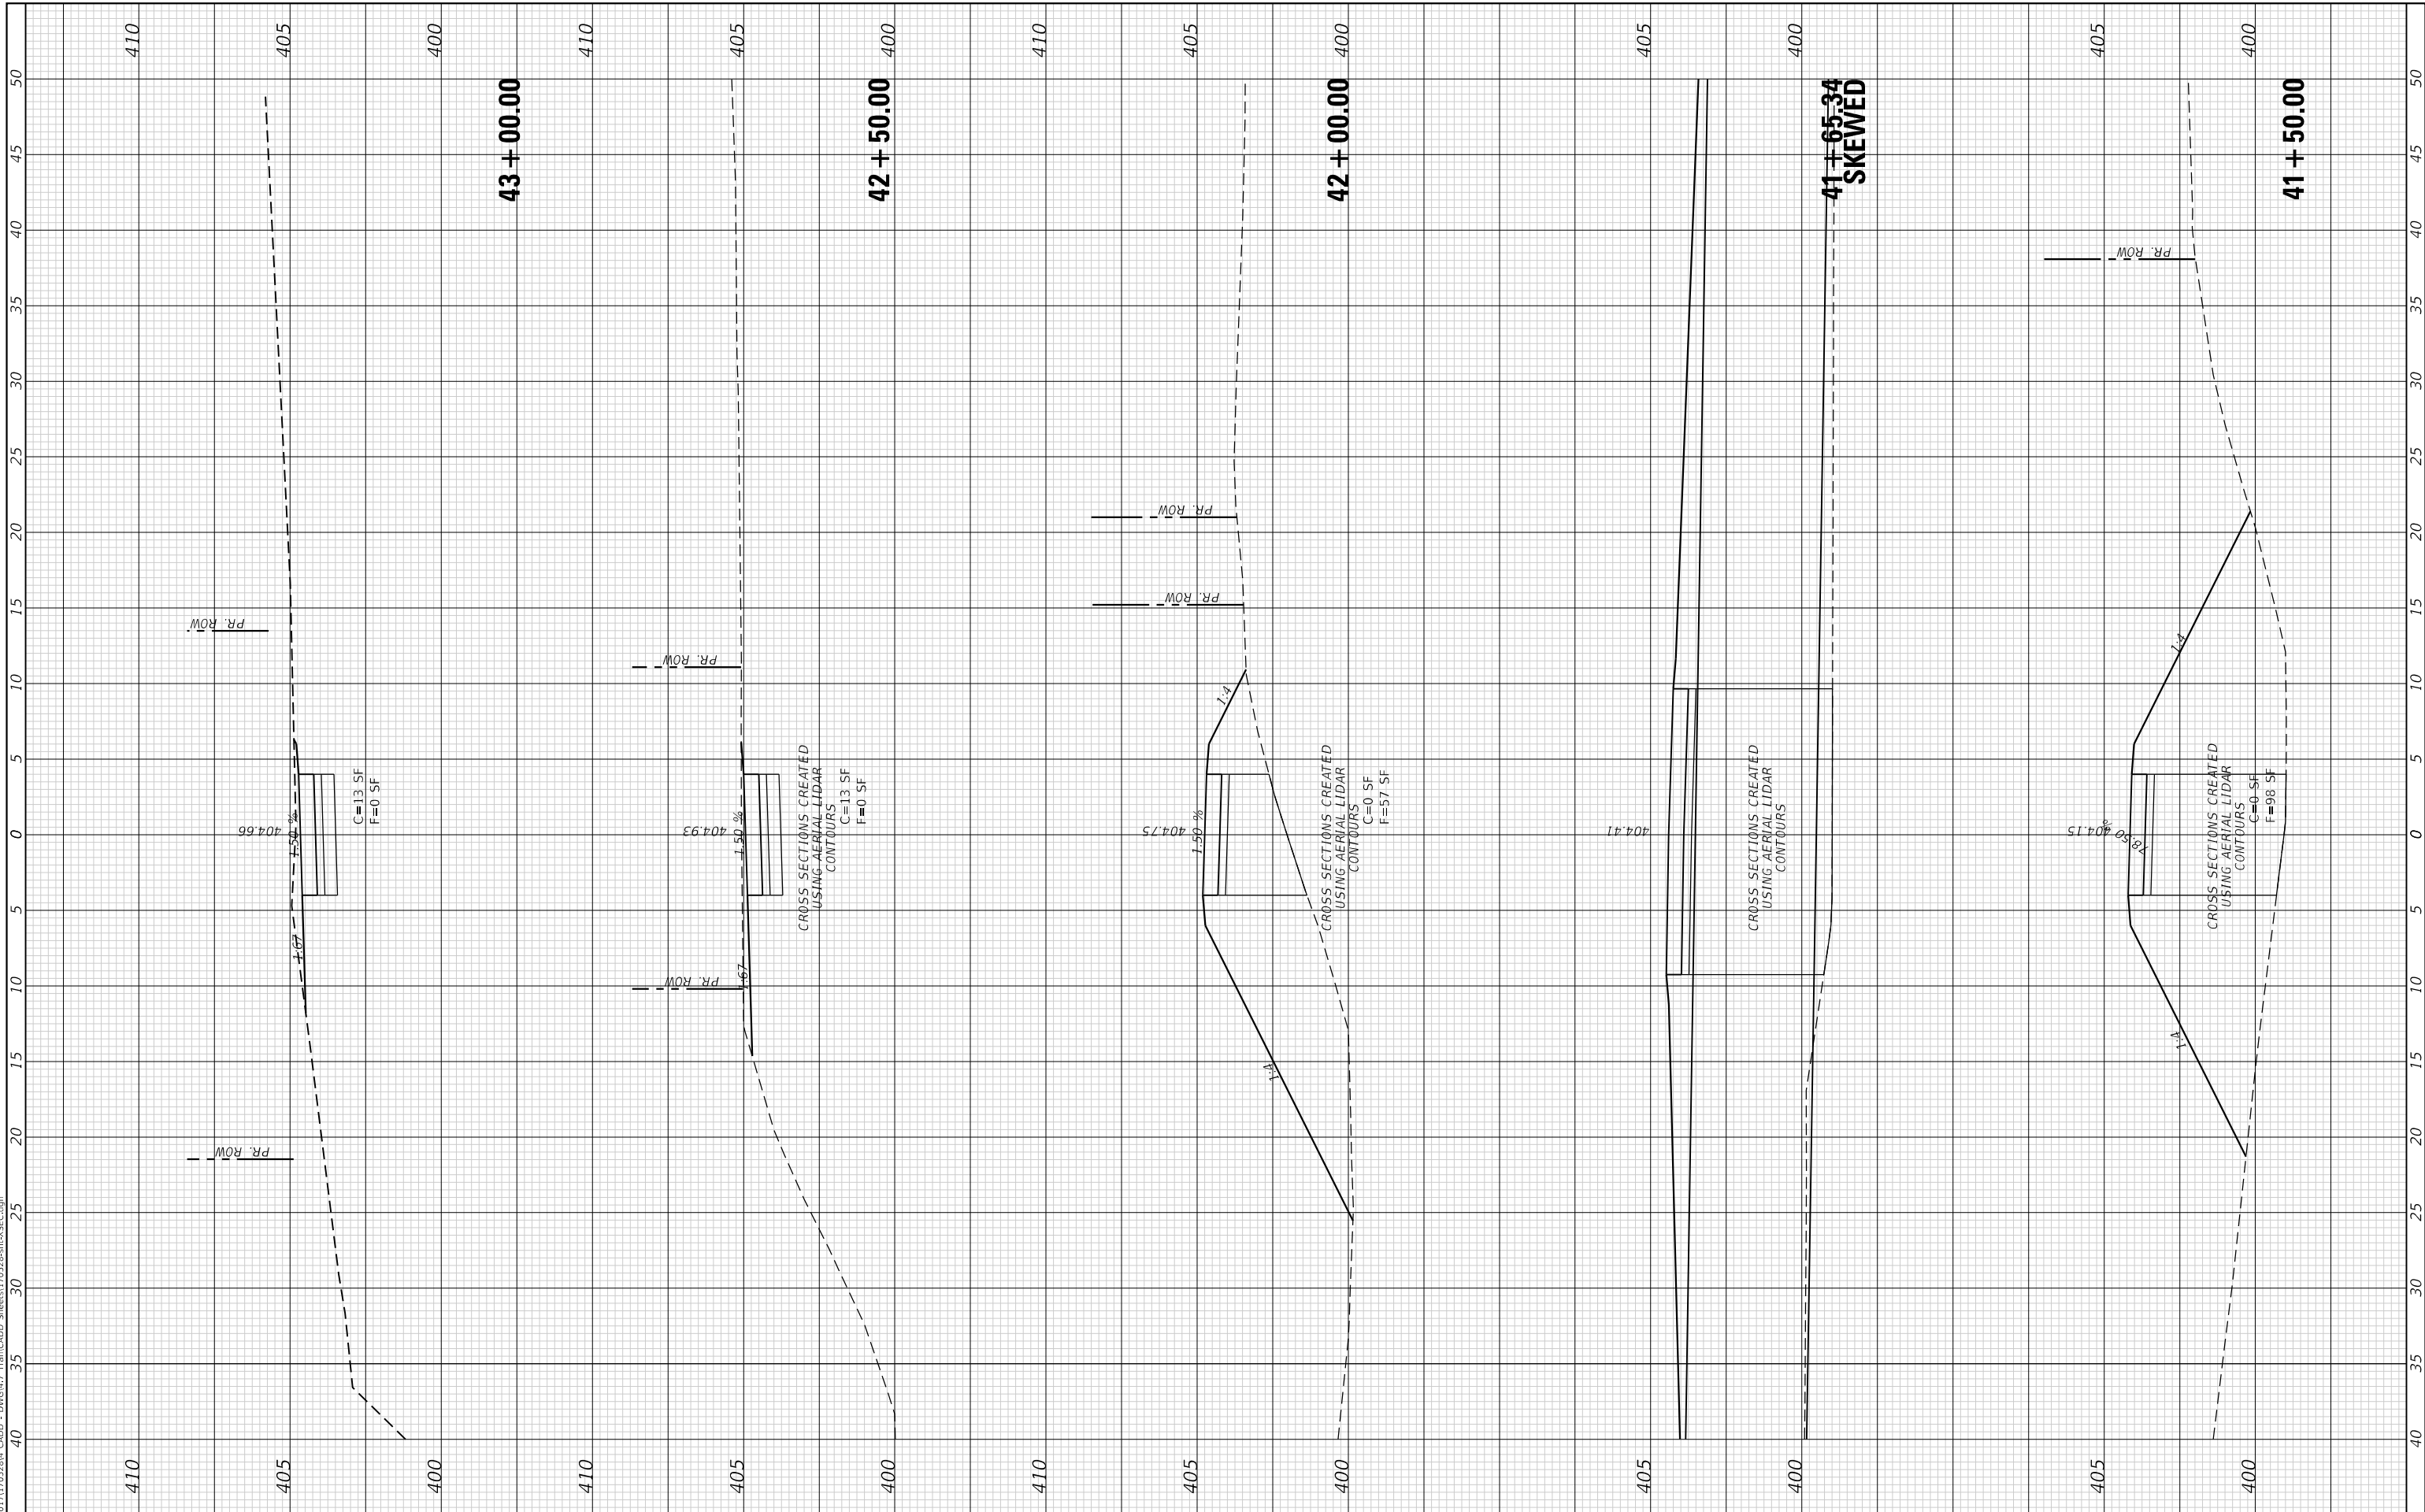CROSS SECTIONS


SCALE: 1" = 5' SHEET 17 OF 24 SHEETS STA. 41+50.00 TO STA. 43+00.00

F.A. RTE.	SECTION	COUNTY	TOTAL SHEETS	SHEET NO.
	17-00136-00-BT	JACKSON	51	44
CONTRACT NO. 99632				
ILLINOIS FED. AID PROJECT				

FINAL SURVEY NO.	SURVEYED PLOTTED AREAS CHECKED	BY	DATE
NOTE BOOK	TEMPLATE		
	AREAS CHECKED		

ORIGINAL SURVEY NO.	SURVEYED PLOTTED AREAS CHECKED	BY	DATE
NOTE BOOK	TEMPLATE		
	AREAS CHECKED		

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PLOT DATE = 1/24/2022
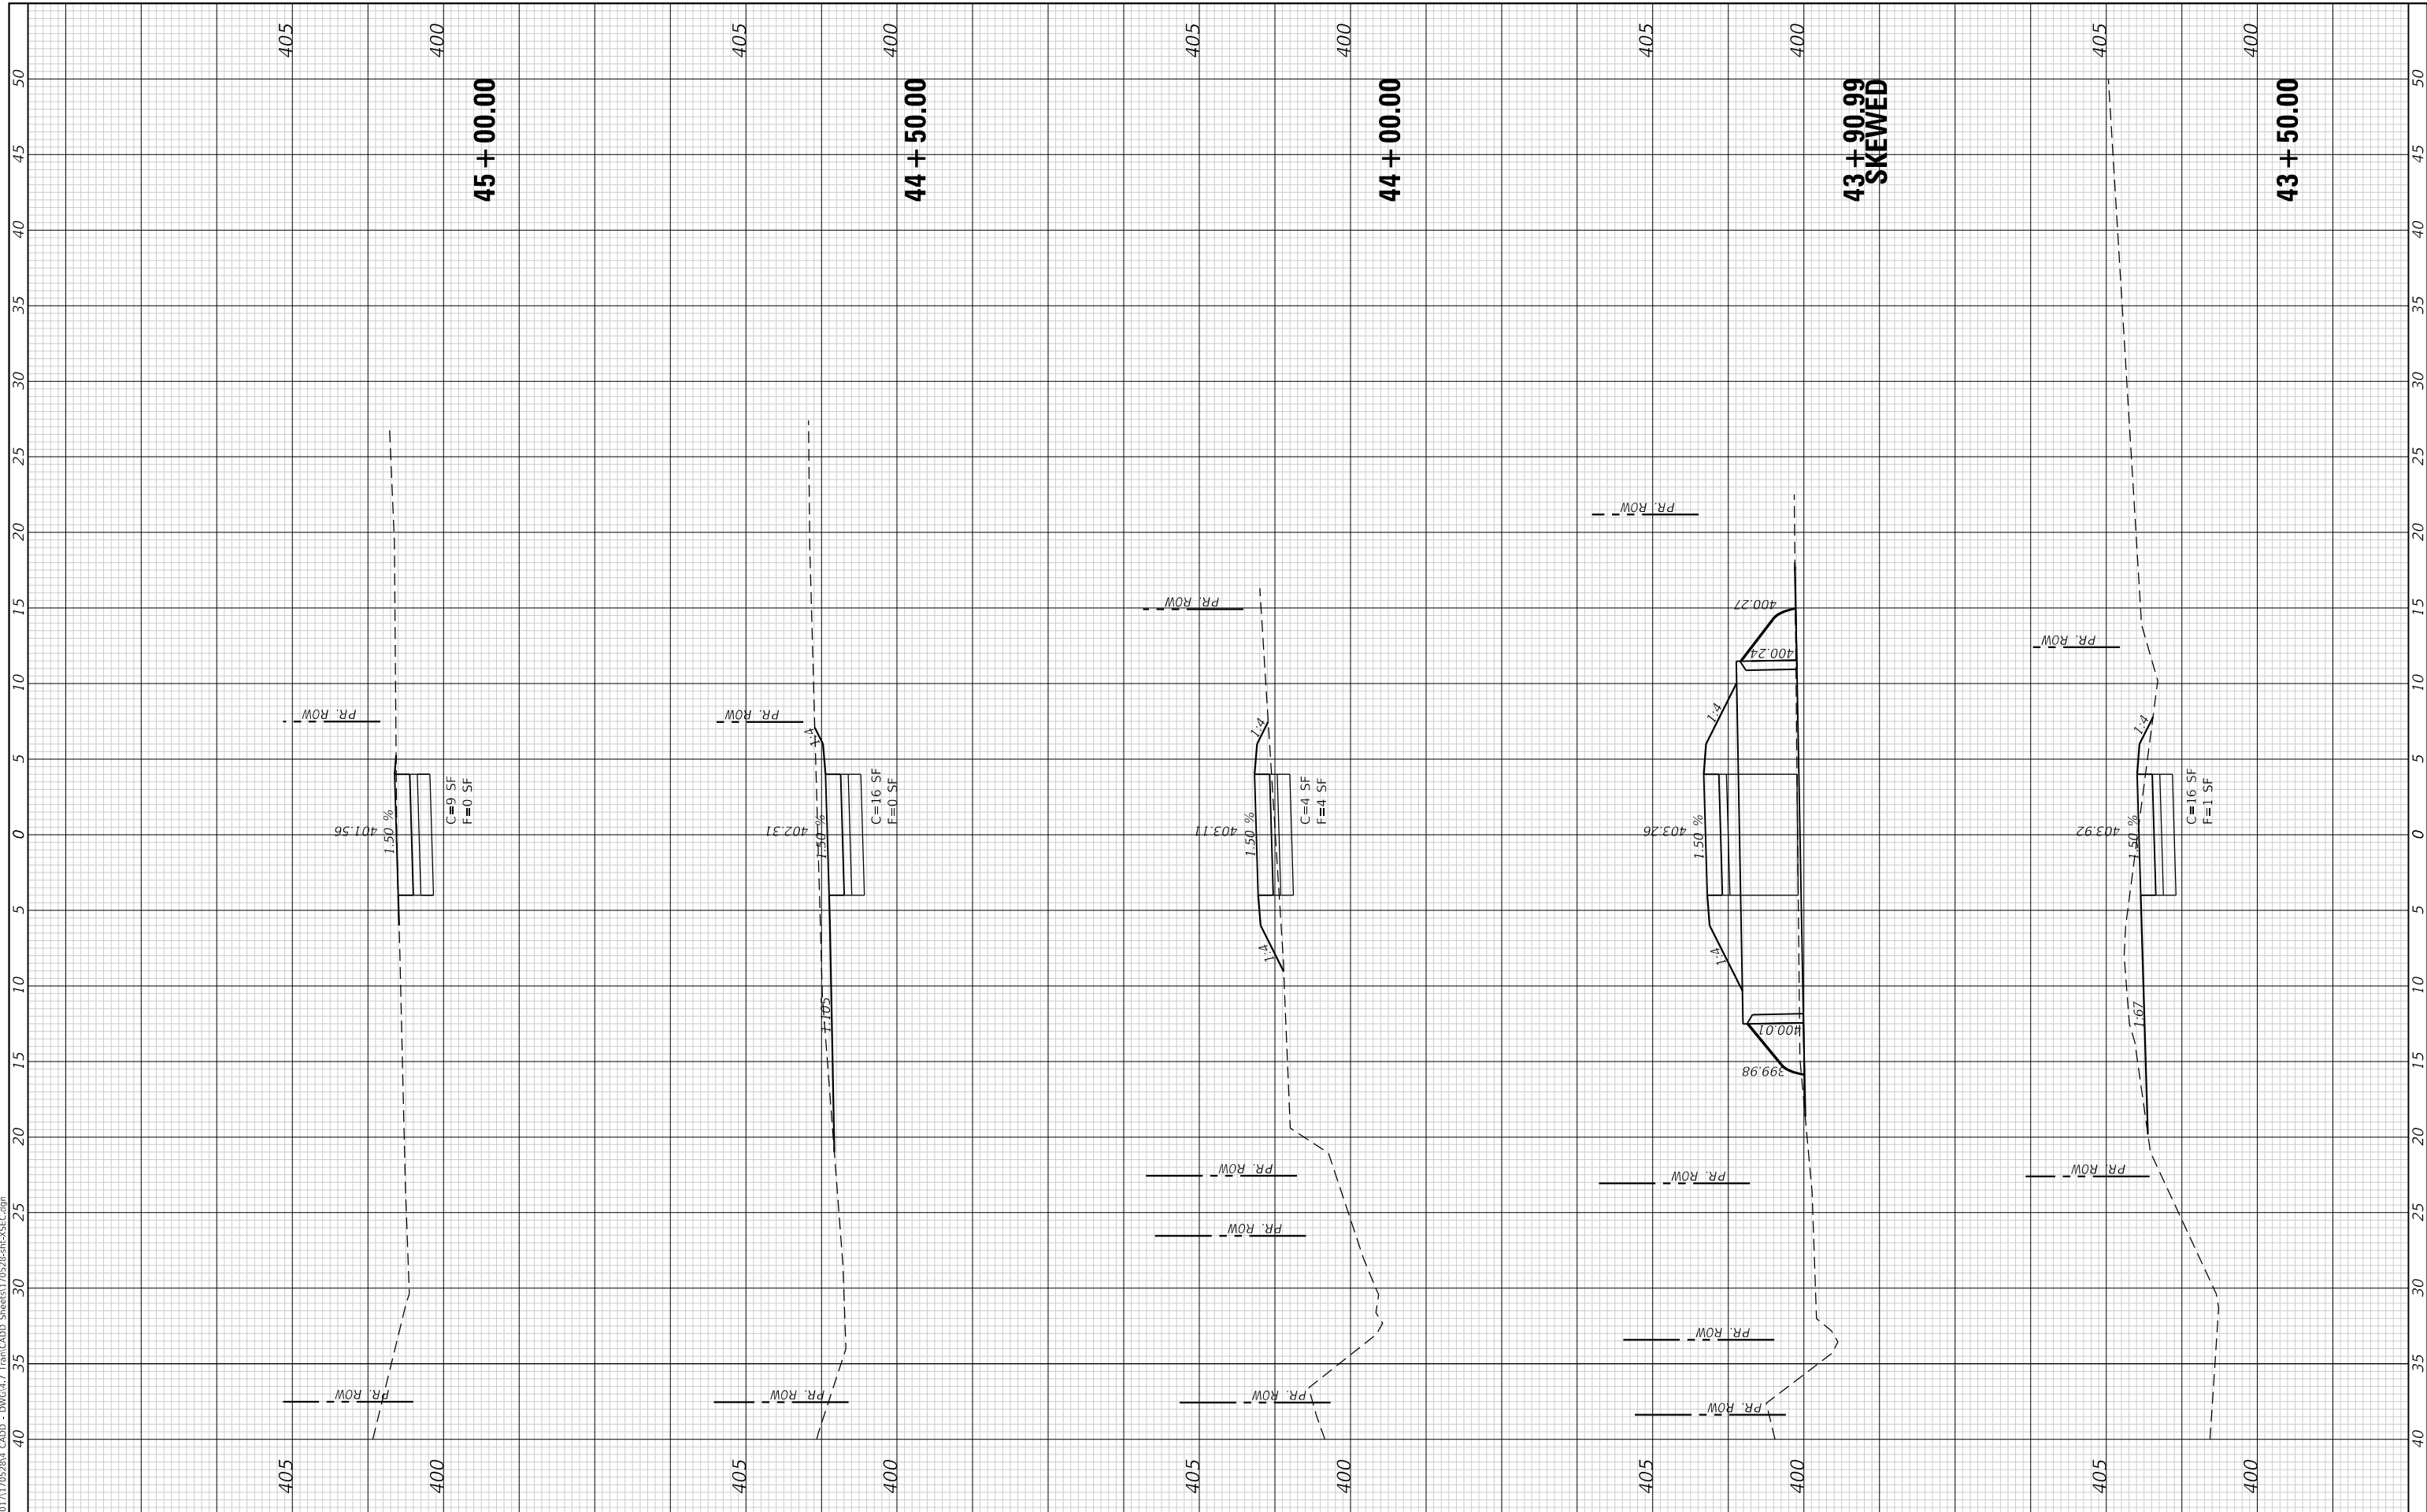
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 3. REVISION
 4. REVISION



CITY OF CARBONDALE
NORTHWEST PEDESTRIAN AND BICYCLE PATH

CROSS SECTIONS


SCALE: 1" = 5' SHEET 18 OF 24 SHEETS STA. 43+50.00 TO STA. 45+00.00

F.A. RTE.	SECTION	COUNTY	TOTAL SHEETS	SHEET NO.
	17-00136-00-BT	JACKSON	51	45
CONTRACT NO. 99632				
ILLINOIS		FED. AID PROJECT		

FINAL SURVEY NO.	SURVEYED PLOTTED AREAS CHECKED	BY	DATE

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CITY OF CARBONDALE
 NORTHWEST PEDESTRIAN
 AND BICYCLE PATH

CROSS SECTIONS

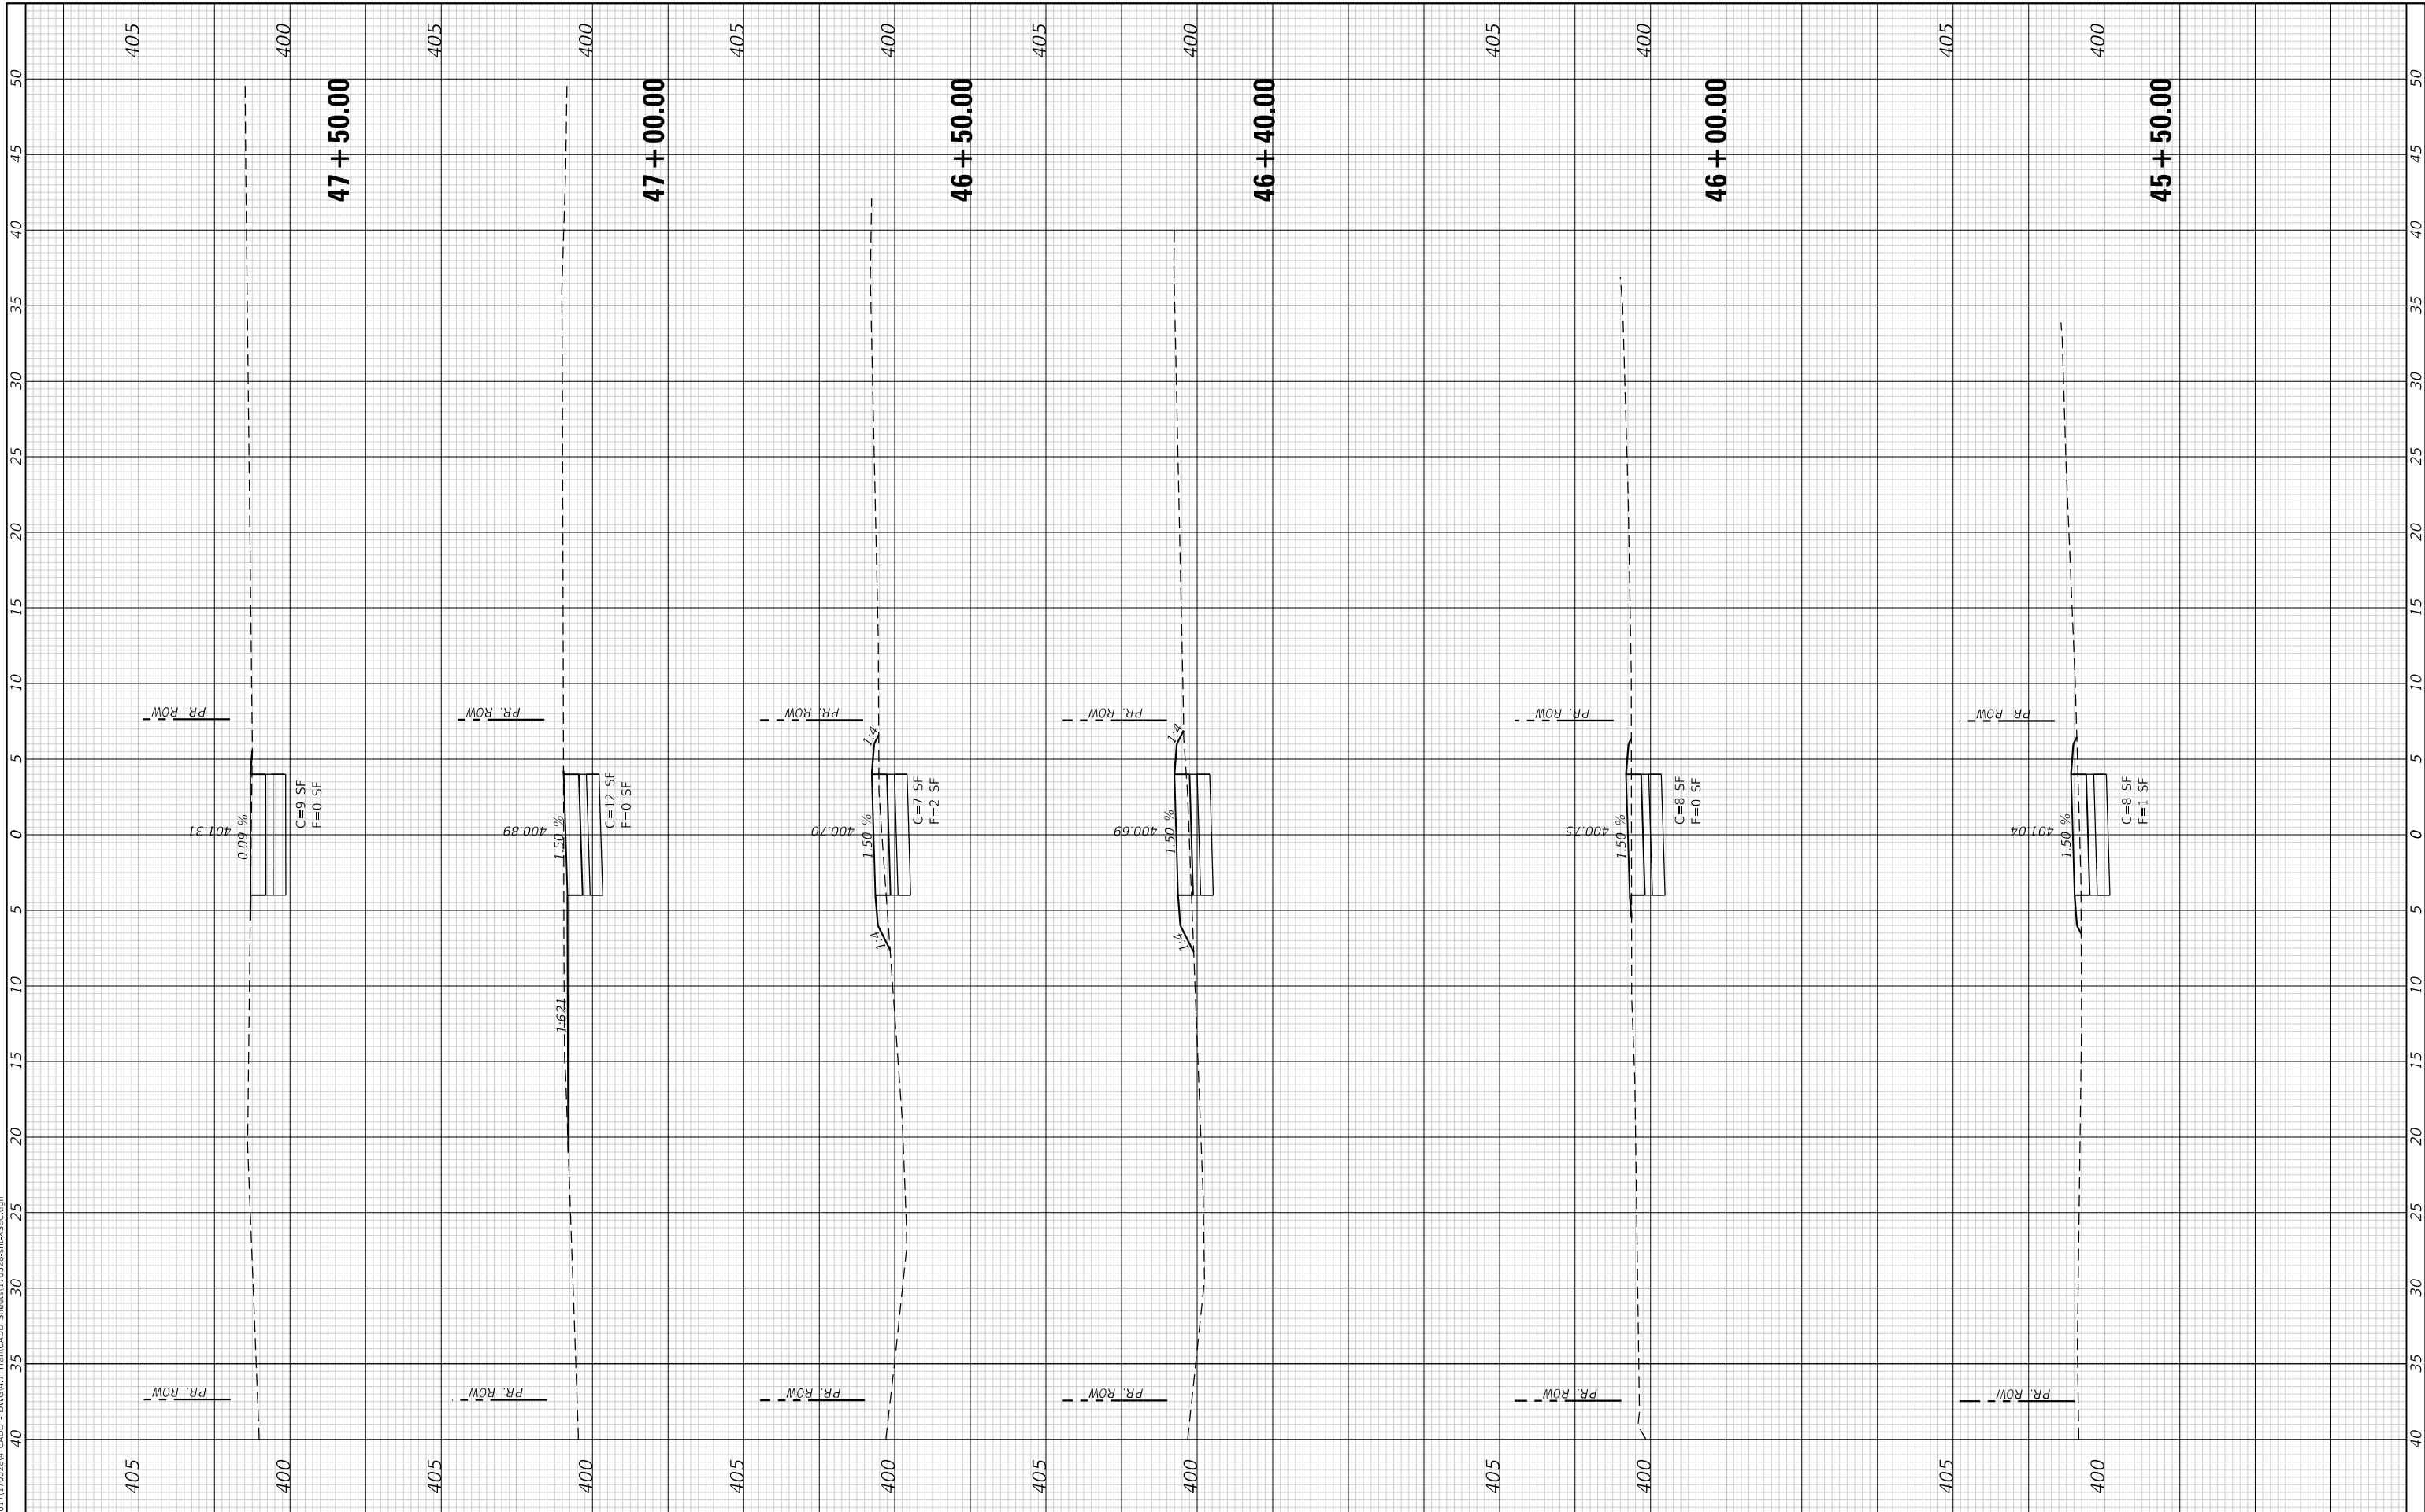
SCALE: 1" = 5' SHEET 19 OF 24 SHEETS STA. 45+50.00 TO STA. 47+50.00

F.A. RTE.	SECTION	COUNTY	TOTAL SHEETS	SHEET NO.
	17-00136-00-BT	JACKSON	51	46
CONTRACT NO. 99632				
ILLINOIS FED. AID PROJECT				

FINAL SURVEY NO.	SURVEYED PLOTTED AREAS CHECKED	BY	DATE

ORIGINAL SURVEY NO.	SURVEYED PLOTTED AREAS CHECKED	BY	DATE

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USER NAME = efisher
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 PLOT DATE = 1/24/2022

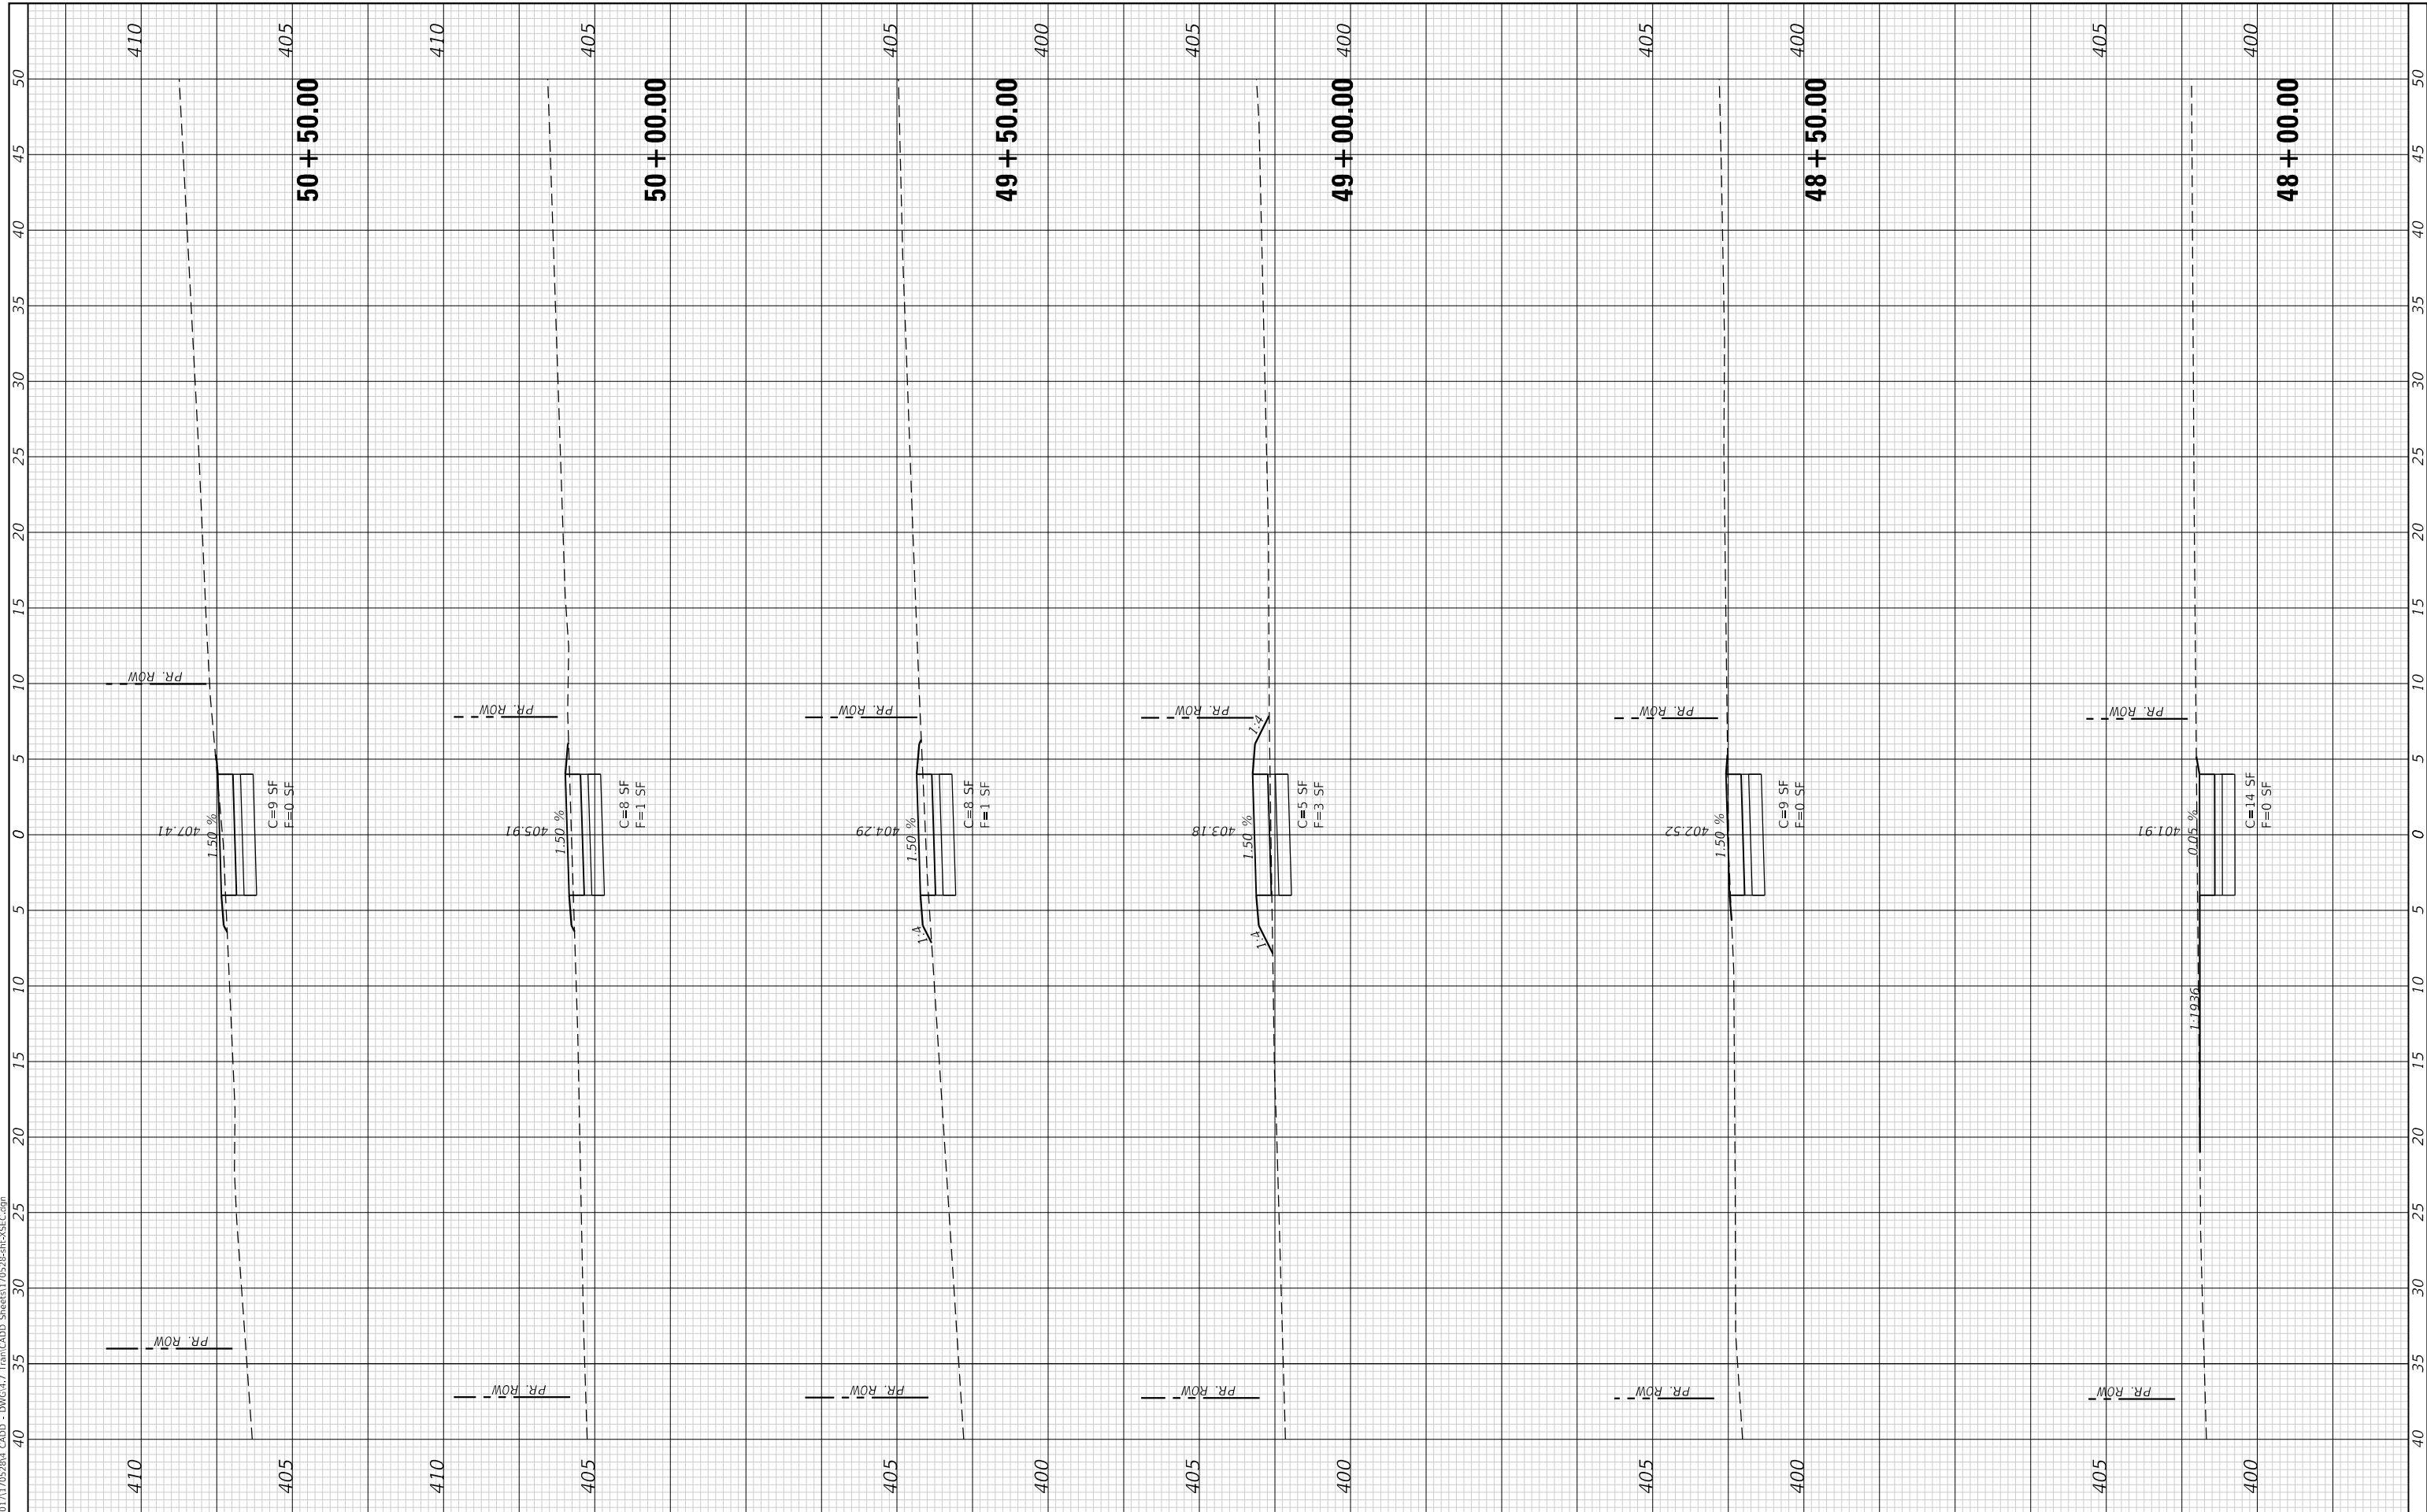DESIGNED - EKF
 DRAWN - EKF
 CHECKED - JRR
 DATE -

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CITY OF CARBONDALE
NORTHWEST PEDESTRIAN
AND BICYCLE PATH

CROSS SECTIONS


SCALE: 1" = 5' SHEET 20 OF 24 SHEETS STA. 48+00.00 TO STA. 50+50.00

F.A. RTE.	SECTION	COUNTY	TOTAL SHEETS	SHEET NO.
	17-00136-00-BT	JACKSON	51	47
CONTRACT NO. 99632				
ILLINOIS		FED. AID PROJECT		

FINAL SURVEY NO.	SURVEYED	DATE
NOTE BOOK	PLOTTED	
AREAS CHECKED	TEMPLATE	
	AREAS CHECKED	

ORIGINAL SURVEY NO.	SURVEYED	DATE
NOTE BOOK	PLOTTED	
AREAS CHECKED	TEMPLATE	
	AREAS CHECKED	

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PLOT DATE	= 1/24/2022

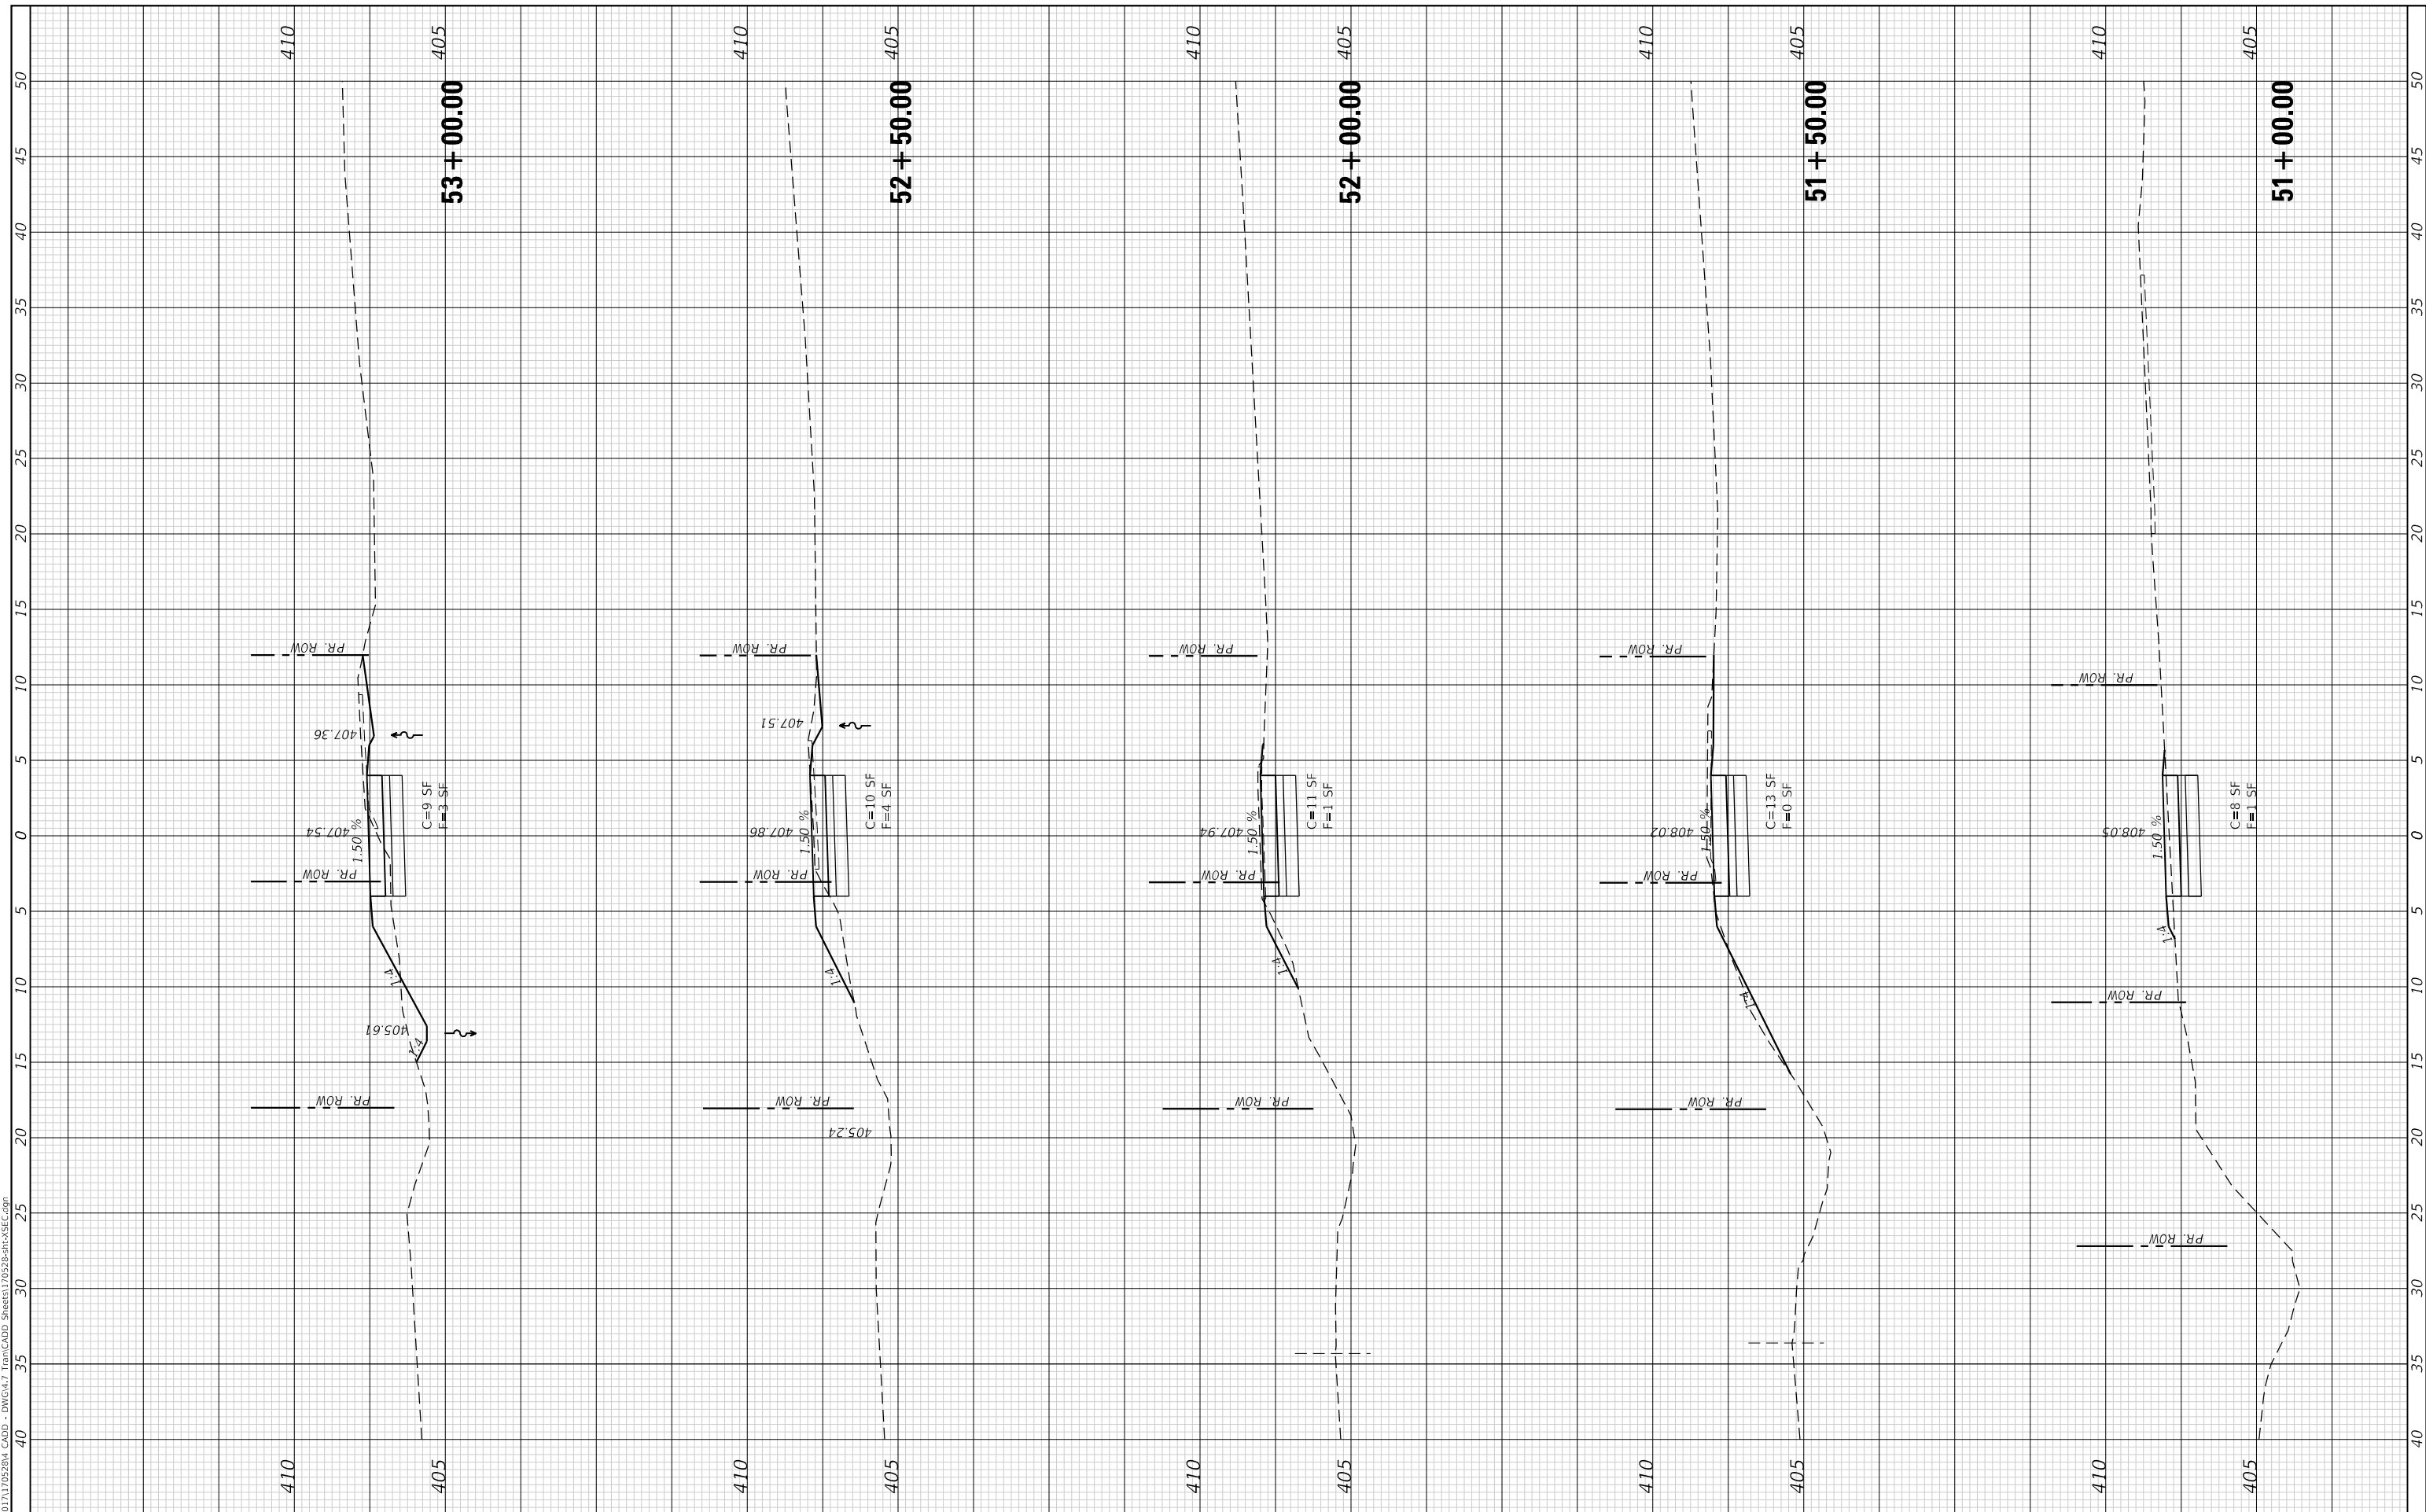DESIGNED	- EKF
DRAWN	- EKF
CHECKED	- JRR
DATE	-

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CITY OF CARBONDALE
NORTHWEST PEDESTRIAN AND BICYCLE PATH

CROSS SECTIONS


SCALE: 1" = 5' SHEET 21 OF 24 SHEETS STA. 51+00.00 TO STA. 53+00.00

F.A. RTE.	SECTION	COUNTY	TOTAL SHEETS	SHEET NO.
	17-00136-00-BT	JACKSON	51	48
ILLINOIS FED. AID PROJECT			CONTRACT NO. 99632	

FINAL SURVEY NO.	SURVEYED	BY	DATE
NOTE BOOK	PLOTTED		
AREAS CHECKED	TEMPLATE		
	AREAS CHECKED		

ORIGINAL SURVEY NO.	SURVEYED	BY	DATE
NOTE BOOK	PLOTTED		
AREAS CHECKED	TEMPLATE		
	AREAS CHECKED		

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PLOT DATE	= 1/24/2022

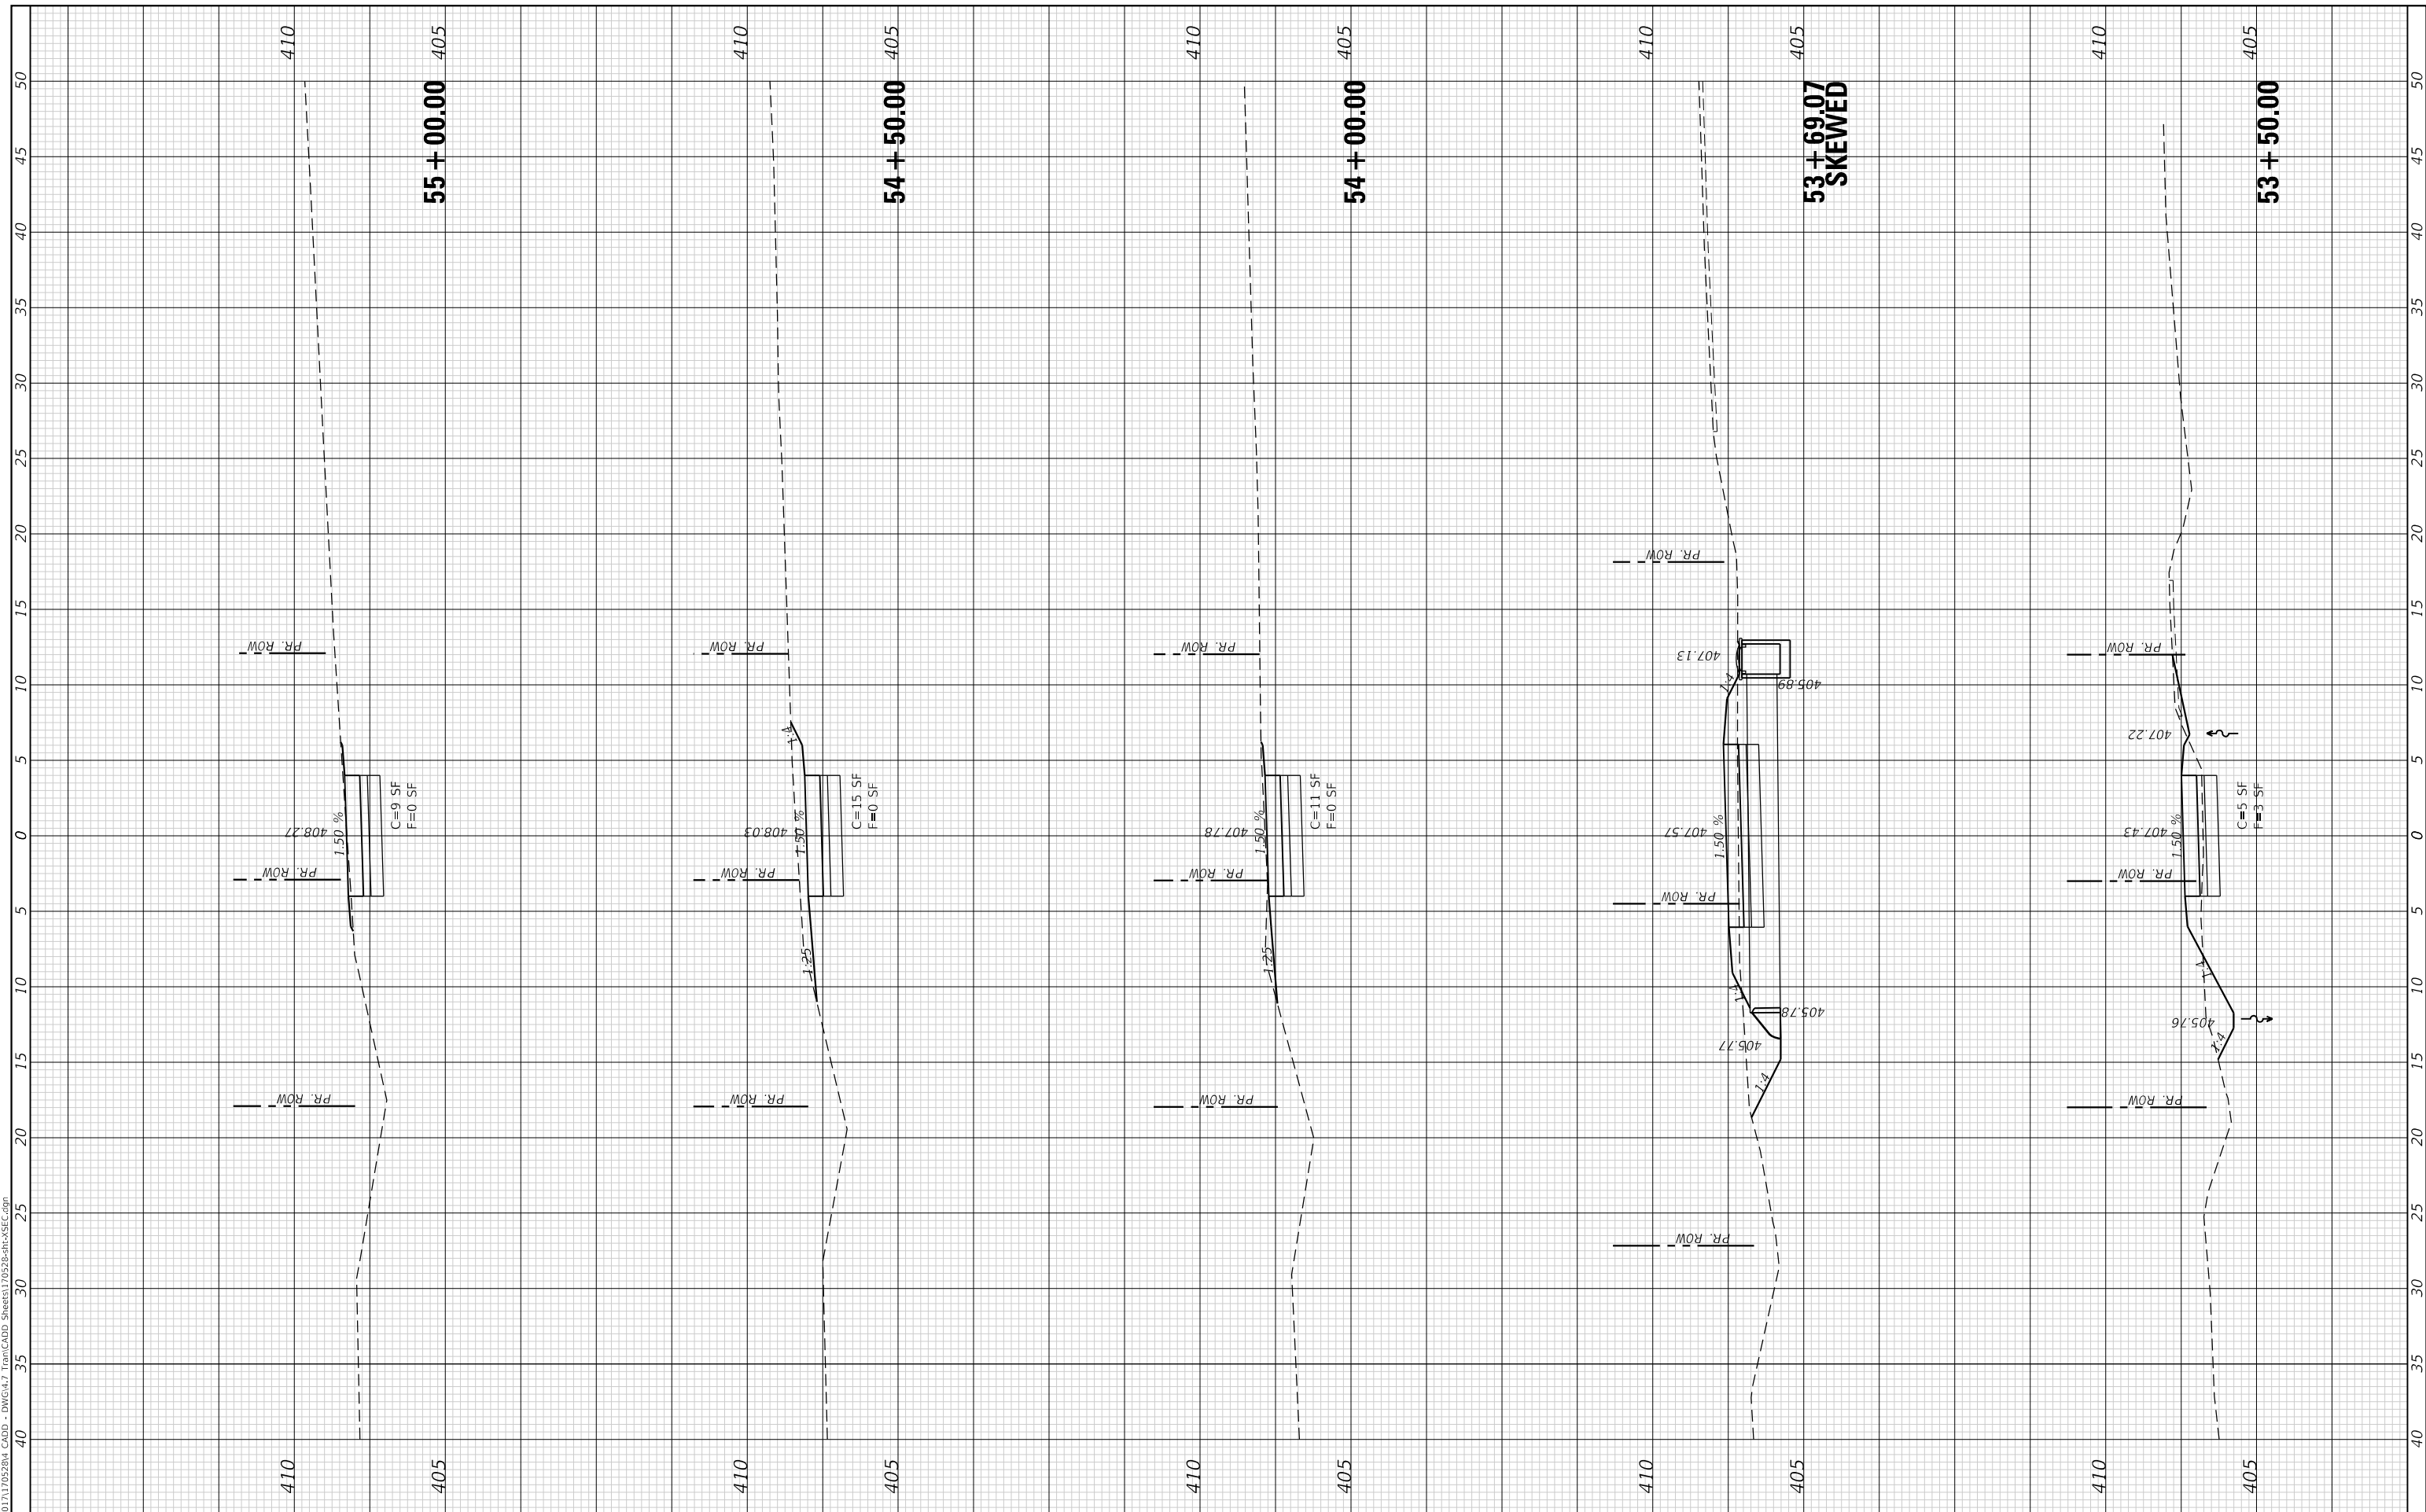DESIGNED	- EKF
DRAWN	- EKF
CHECKED	- JRR
DATE	-

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CITY OF CARBONDALE
NORTHWEST PEDESTRIAN
AND BICYCLE PATH

SCALE: 1" = 5' SHEET 22 OF 24 SHEETS STA. 53+50.00 TO STA. 55+00.00


CROSS SECTIONS

F.A. RTE.	SECTION	COUNTY	TOTAL SHEETS	SHEET NO.
	17-00136-00-BT	JACKSON	51	49
CONTRACT NO. 99632				
ILLINOIS FED. AID PROJECT				

FINAL SURVEY NO.	SURVEYED PLOTTED AREAS CHECKED	BY	DATE
NOTE BOOK	TEMPLATE		

ORIGINAL SURVEY NO.	SURVEYED PLOTTED AREAS CHECKED	BY	DATE
NOTE BOOK	TEMPLATE		

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 PLOT SCALE = 10.0000 ' / in.
 PLOT DATE = 1/24/2022

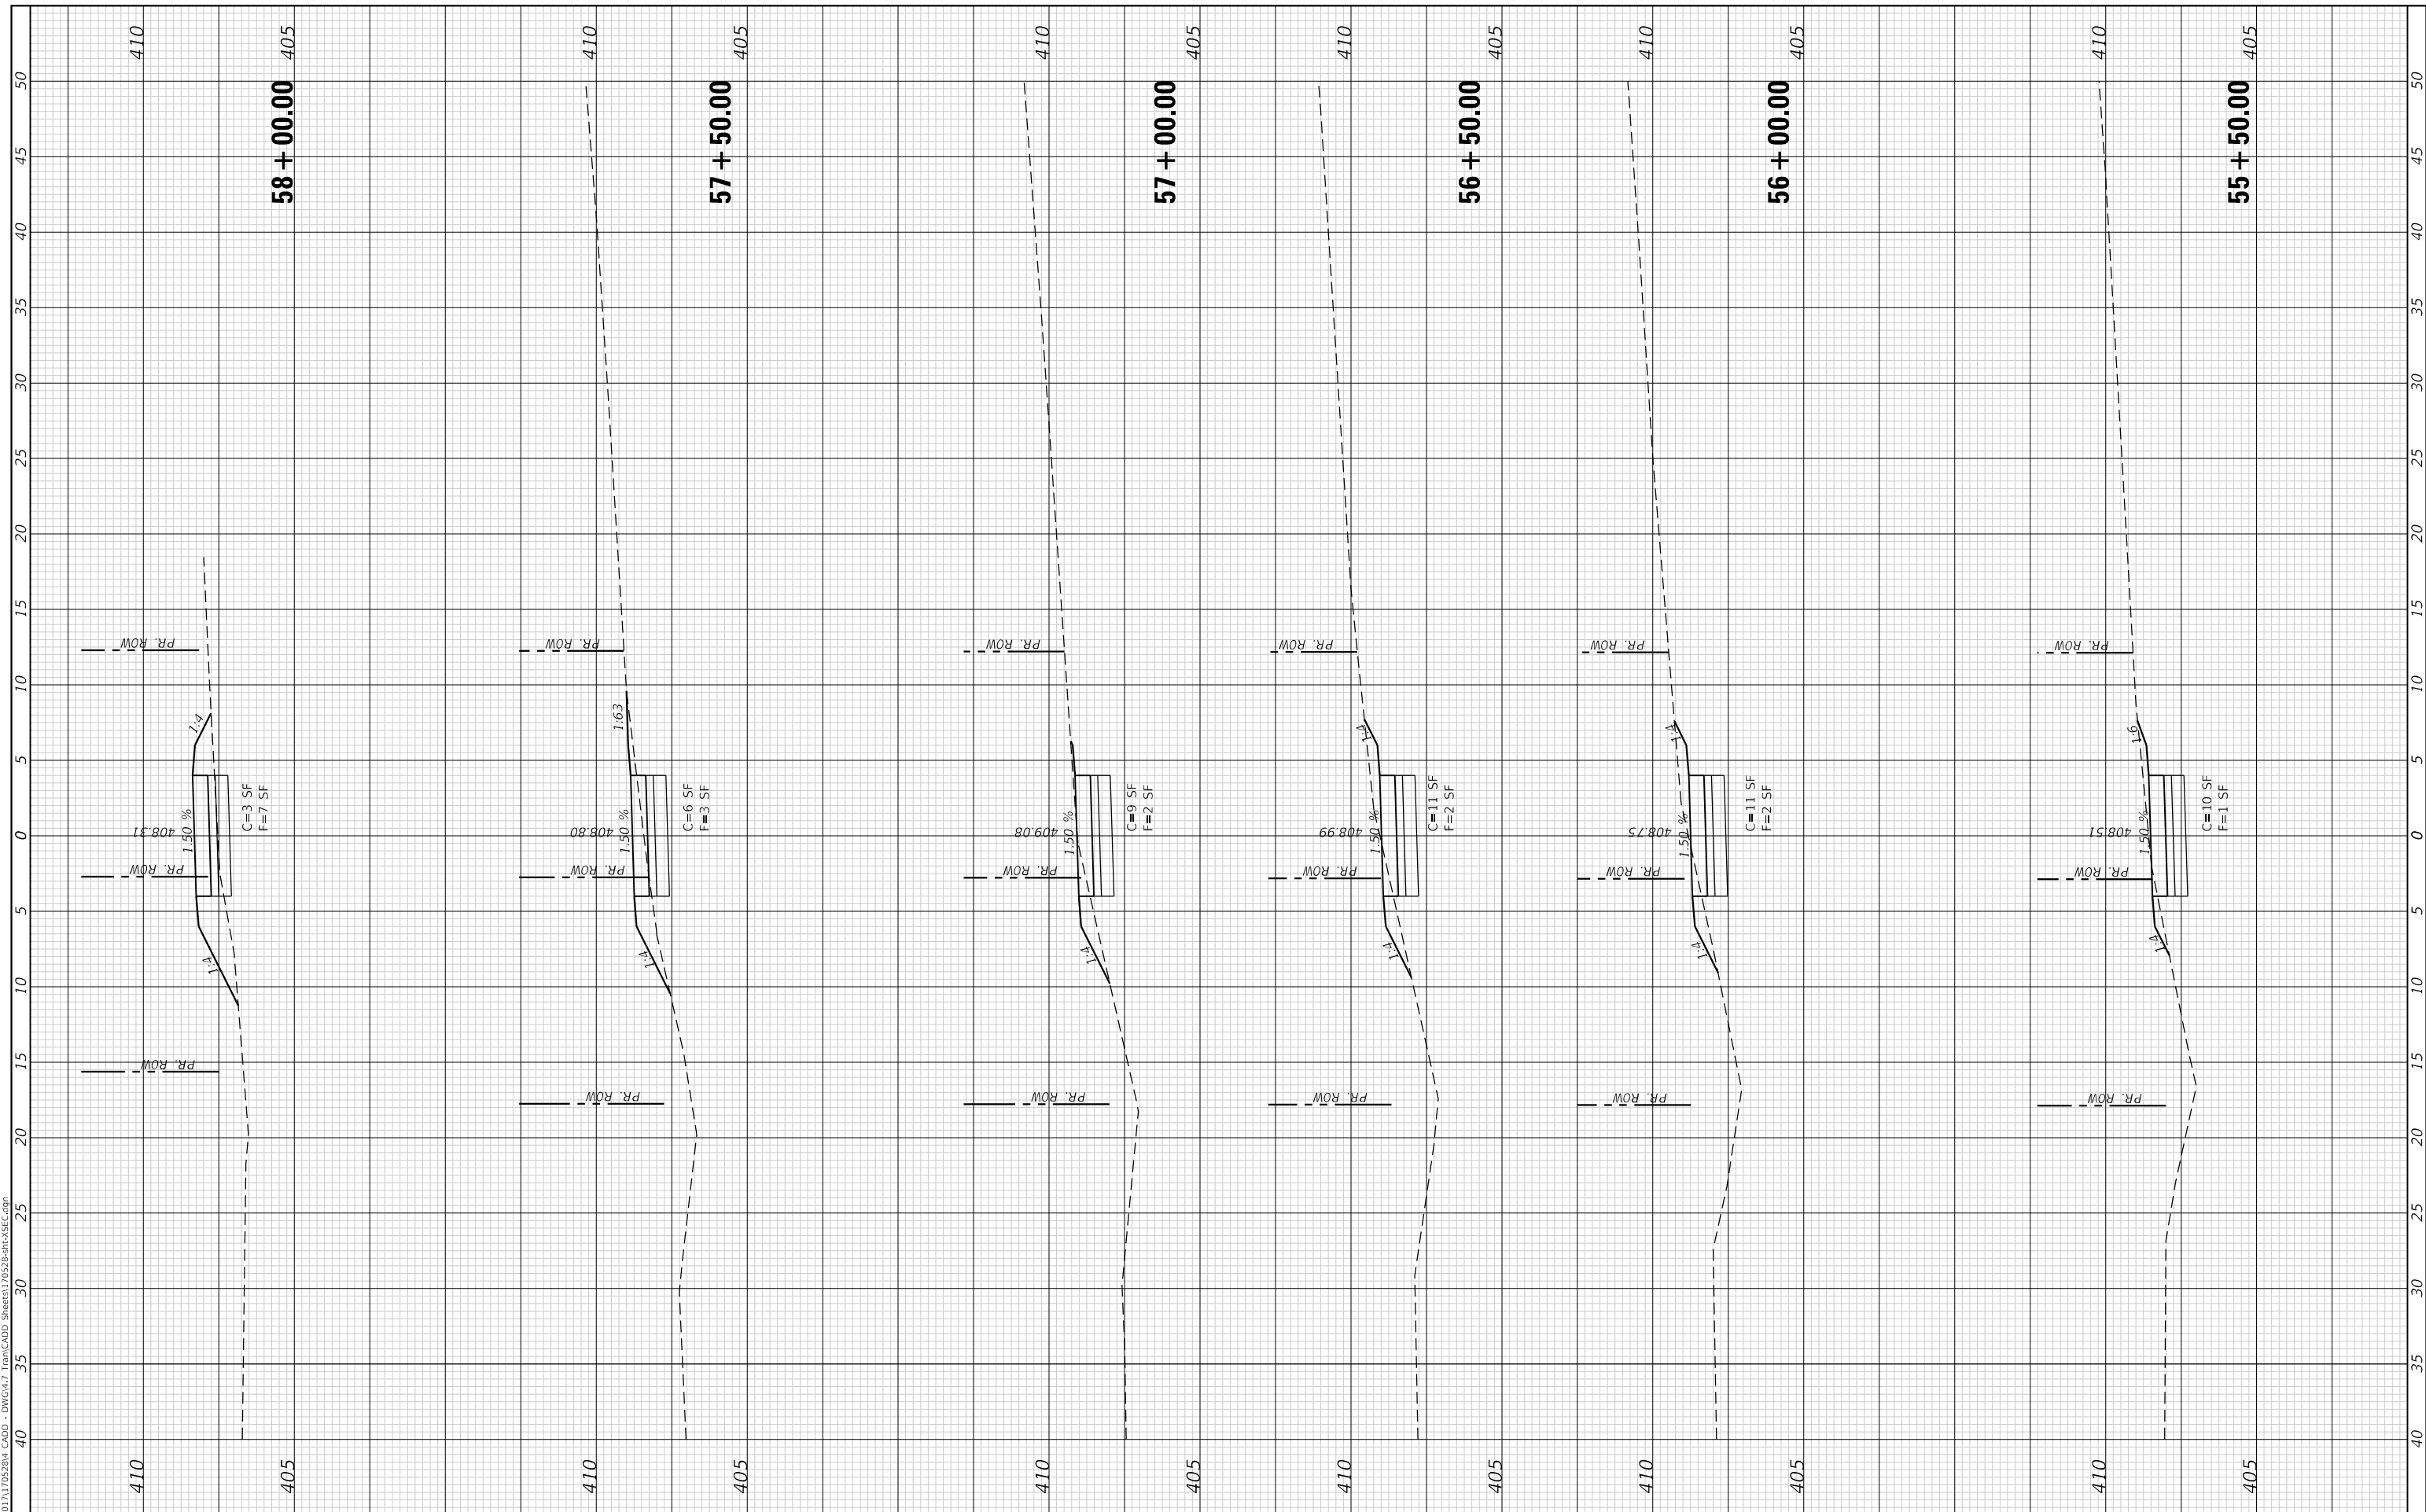DESIGNED - EKF
 DRAWN - EKF
 CHECKED - JRR
 DATE -

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CITY OF CARBONDALE
NORTHWEST PEDESTRIAN AND BICYCLE PATH

CROSS SECTIONS


SCALE: 1" = 5' SHEET 23 OF 24 SHEETS STA. 55+50.00 TO STA. 58+00.00

F.A. RTE.	SECTION	COUNTY	TOTAL SHEETS	SHEET NO.
	17-00136-00-BT	JACKSON	51	50
CONTRACT NO. 99632				
ILLINOIS FED. AID PROJECT				

FINAL SURVEY NO.	SURVEYED PLOTTED AREAS CHECKED	BY	DATE
NOTE BOOK	TEMPLATE		

ORIGINAL SURVEY NO.	SURVEYED PLOTTED AREAS CHECKED	BY	DATE
NOTE BOOK	TEMPLATE		

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USER NAME =	efisher
PLOT SCALE =	10.0000 ' / in.
PLOT DATE =	1/24/2022

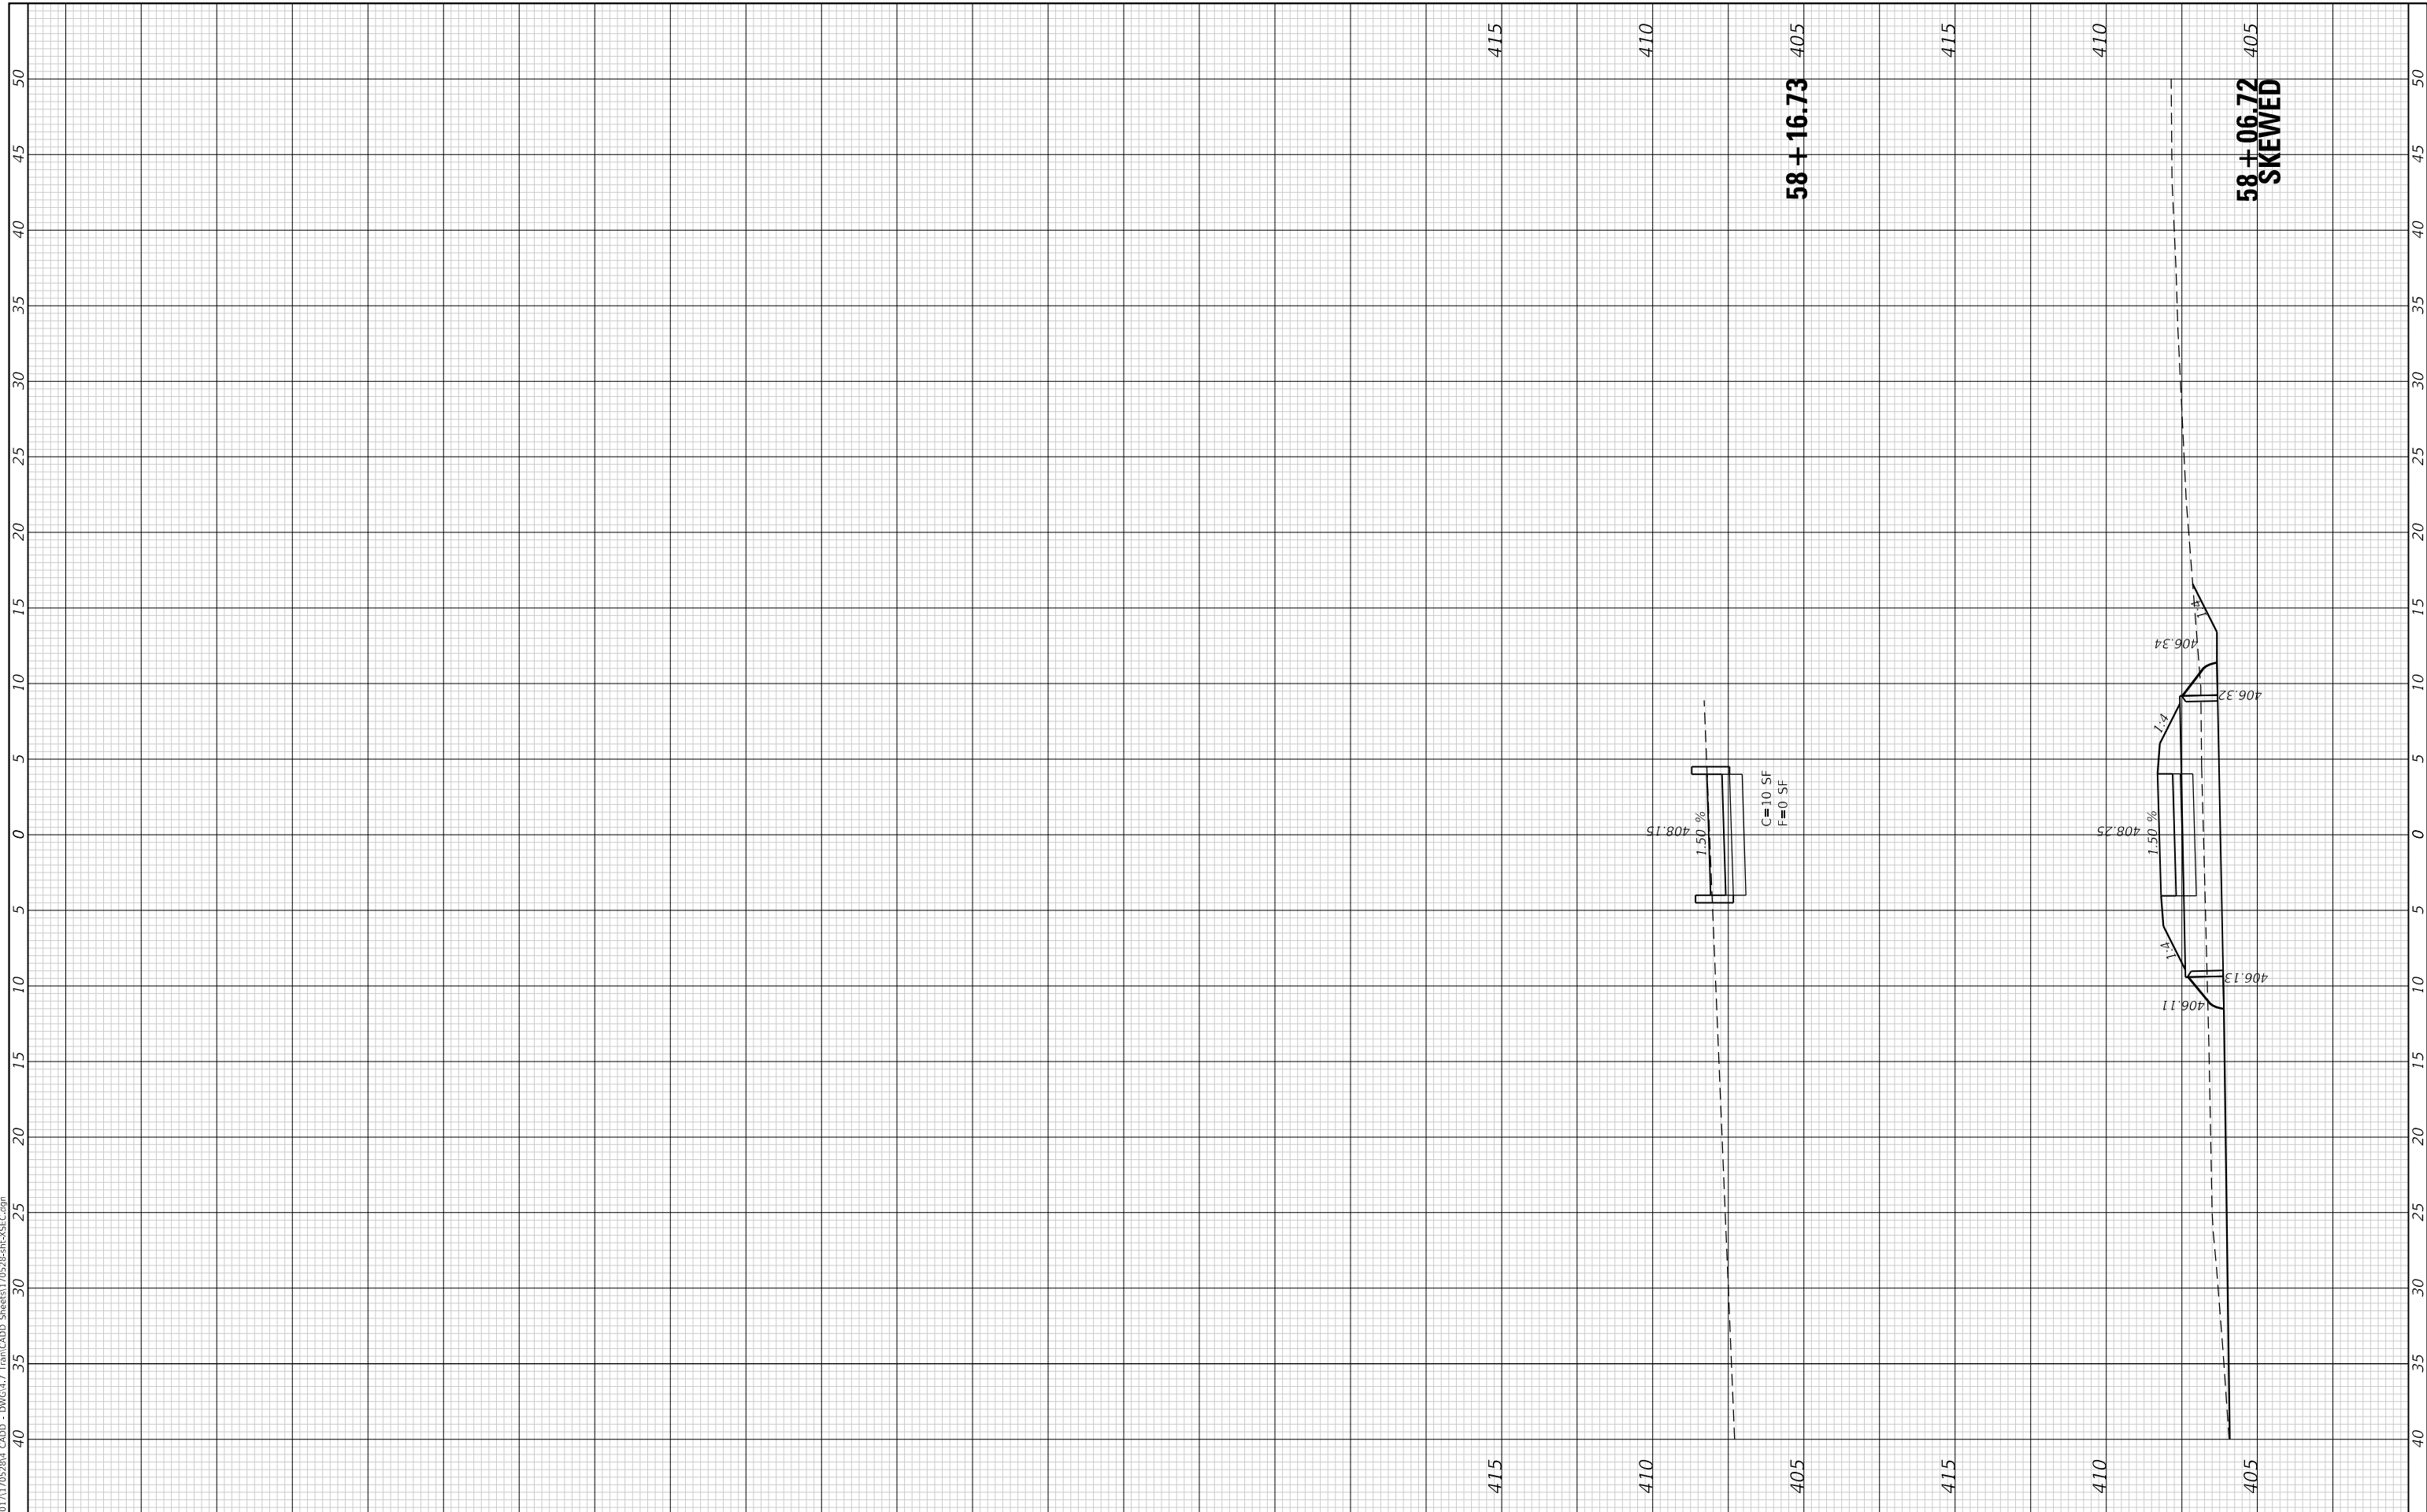DESIGNED -	EKF
DRAWN -	EKF
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CITY OF CARBONDALE
 NORTHWEST PEDESTRIAN
 AND BICYCLE PATH

CROSS SECTIONS

SCALE: 1" = 5' SHEET 24 OF 24 SHEETS STA. 58+06.72 TO STA. 58+16.73

F.A. RTE.	SECTION	COUNTY	TOTAL SHEETS	SHEET NO.
	17-00136-00-BT	JACKSON	51	51
CONTRACT NO. 99632				
ILLINOIS FED. AID PROJECT				