INDEX OF SHEETS

FOR INDEX OF SHEETS, SEE SHEET NO. 2

STATE OF LINOIS **DEPARTMENT OF TRANSPORTATION DIVISION OF HIGHWAYS**

DAN YAN EXPRESSWAY: ADT (2010) DESIGN SPEED POSTED SPEED SB I-94 JAN RYAN) 140,500 65.800 60 MPH 55 MPH SB I-57 SB 95Th REET EXIT RAMP 11,900 45 MPH 40 MPH 40 MPH SB WEN RTH AVE EXIT RAMP 4 800 45 MPH

PROPOSED HIGHWAY PLANS

MAJOR CROSS STREETS AND FRONTAGE ROADS:

95TH STREET

S. LAF. LIVE STREET

ADT POSTED SPEED 23 800 30 MPH 6.800 30 MPH

58.000

60 MPH

F.A.I. ROUTE 94 (DAN RYAN EXPRESSWAY) **SECTION** (1516.1 I-9)


FLUTED KNEE WALL CONSTRUCTION ALONG LAFAYETTE AVENUE FROM S. LASALLE STREET TO 95TH STREET

> **COOK COUNTY** C-91-235-05

PROJECT: ESP-094-3(445)063


DESCRIPTION OF PROJECT


CONSTRUCTION OF FLUTED KNEE WALLS AN. HREE HIGH MAST LIGHT TOWER SERME PADS WITH MINI RETAINING WALLS ALONG NB AND SB 1-57.

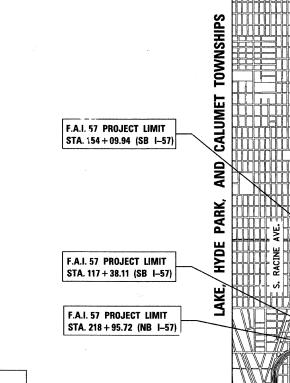

R. 14 E. 79TH ST. I-57 I-94 (BISHOP FORO)

COUNTY SECTION 94 1516 2-9 COOK 59 FED. ROAD DIST. No ILLINOIS FED. AID PROJECT D-91-235-05

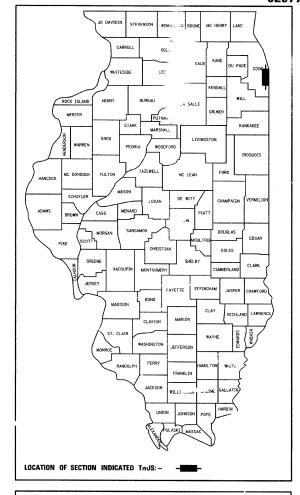

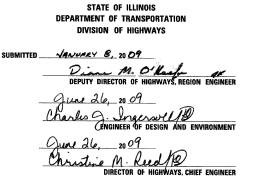


CONTRACT 26A



TY:LIN INTERNATIONAL

PROJECT LOCATED IN THE CITY OF CHICAGO

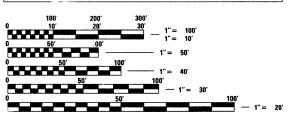

FULL SIZE PLANS HAVE BEEN PREPARED USING STANDARD ENGINEERING SCALES: REDUCED SIZED PLANS WILL NOT CONFORM TO STANDARD SCALES. IN MAKING MEASUREMENTS ON REDUCED PLANS, THE ABOVE SCALES MAY BE USED

CHICAGO UTILITY ALERT NETWORK (312) 744-7000

CTA CONTACT: DAVID HEARD, MANAGER, CONSTRUCTION **MANAGEMENT OVERSIGHT** (312) 681-3862

CONTRACT Nº 62977

1/2 MILE 1 MILE GROSS LENGTH OF PROJECT = 4355.2 FT. = 0.82 MI. MAP SCALE: 1' = 1/2 MILE NET LENGTH OF PROJECT = 4355.2 FT. = 0.82 MI.

F.A., 57 PROJECT LIMIT STA. 225 + 79.12 (NB I-57)

LOCATION MAP

PRINTED BY THE AUTHORITY OF THE STATE OF ILLINOIS

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2	INDEX OF SHEETS, INDEX OF STATE STANDARDS, GENERAL NOTES, AND CONTRACTOR ACCESS ASSUMPTIONS
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4	EXISTING AND PROPOSED TYPICAL SECTIONS
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16-21	HMLT PROPOSED, EROSION CONTROL, AND LANDSCAPING PLANS
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30	CONCRETE MEDIAN SURFACE, 5" (MODIFIED) WITH CALIFORNIA FINISH DETAIL
31-32	HIGH MAST LIGHT TOWER SERVICE PAD, SPECIAL AND RETAINING WALL DETAILS
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54-55	DIST 1 BE-501, HIGH MAST LIGHT TOWER - 90 FT TO 120 FT (27 m TO 26 m) FOUNDATION DETAILS - FOR INFORMATION ONLY
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57	TC-17 DIST 1, TRAFFIC CONTROL DETAILS FOR FREEWAY SHOULDER CLOSURES AND PARTIAL RAMP CLOSURES
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001006	DECIMAL OF AN INCH AND OF A FOOT
280001- 0 4	TEMPORARY EROSION CONTROL SYSTEM
606001- 0 4	CONCRETE CURB TYPE B AND COMBINATION CONCRETE CURB AND GUTTER
664001-02	CHAIN LINK FENCE
701456	PARTIAL EXIT RAMP CLOSURE FREEWAY/EXPRESSWAY
701601-03	URBAN LANE CLOSURE, MULTILANE 1W OR 2W WITH NONTRAVERSABLE MEDIAN
701701- 06	URBAN LANE CLOSURE MULTILANE INTERSECTION
701801- 04	LANE CLOSURE MULTILANE IW OR 2W CROSSWALK OR SIDEWALK CLOSURE
701901 - 01	TRAFFIC CONTROL DEVICES

GENERAL NOTES:

- 1. UTILITY LOCATIONS SHOWN ON THESE PLANS MAY NOT BE CORRECT OR COMPLETE. THE CONTRACTOR SHALL COORDINATE CONSTRUCTION ACTIVITIES WITH THE RESPECTIVE UTILITIES OF THE CITY OF CHICAGO AND THOSE PRIVATELY OWNED. BEFORE STARTING ANY EXCAVATION, THE CONTRACTOR SHALL CALL THE CHICAGO UTILITY ALERT NETWORK AT (312) 744-7000 FOR FIELD LOCATIONS OF BURIED ELECTRIC, TELEPHONE, CABLE, AND GAS FACILITIES (48 HOURS NOTIFICATION IS REQUIRED). CONTACT THE CHICAGO DEPARTMENT OF WATER MANAGEMENT PERMIT SECTION AT (312) 747-7893 FOR WATER AND SEWER LOCATIONS.
- 2. WHERE SECTION OR SUBSECTION MONUMENTS ARE ENCOUNTERED, THE ENGINEER SHALL BE NOTIFIED BEFORE SUCH MONUMENTS ARE REMOVED. THE CONTRACTOR SHALL PROTECT AND CAREFULLY PRESERVE ALL PROPERTY MARKERS AND MONUMENTS. THE ENGINEER OR AN AUTHORIZED SURVEYOR AGENT WILL WITNESS OR OTHERWISE REFERENCE AND RESET MONUMENTS AS NECESSARY. ALL PROPERTY CORNERS EXCEPT THOSE WITHIN AREAS WHERE THE SCHEDULE, IF PROVIDED, SHOWS PLACEMENT OF R.O.W. MARKERS SHALL REMAIN UNDISTURBED.
- THE CONTRACTOR SHALL NOT SET UP A YARD OR FIELD OFFICE ON IDOT PROPERTY WITHOUT WRITTEN PERMISSION FROM IDOT.
- 4. THE CONTRACTOR SHALL TAKE ALL NECESSARY SAFETY PRECAUTIONS TO PROTECT AND PROVIDE ACCESS TO ABUTTING PROPERTY, UTILITIES, PEDESTRIANS, AND VEHICUL AR TRAFFIC.
- 5. ALL ELEVATIONS SHOWN ARE BASED ON THE CHICAGO CITY DATUM OF 0.00, WHICH IS 579.19 FEET ABOVE MEAN TIDE NEW YORK. (NAVD 88)
- 6. THE CONTRACTOR SHALL USE CARE IN GRADING OR EXCAVATING NEAR ANY AND ALL EXISTING ITEMS THAT WILL NOT BE REMOVED. ANY DAMAGE DONE TO EXISTING ITEMS BY THE CONTRACTOR SHALL BE REPAIRED BY THE CONTRACTOR AT THE CONTRACTOR'S OWN EXPENSE.
- 7. IT SHALL BE THE CONTRACTOR'S RESPONSIBILITY TO ENSURE THAT NO GAP REMAINS BETWEEN PROPOSED RELOCATED FENCING OR WHERE PROPOSED RELOCATED FENCING TERMINATES AND EXISTING FENCE REMAINS IN PLACE.
- 8. ALL EXISTING FENCE THAT IS REQUIRED TO BE REMOVED AND RE-ERECTED SHALL BE RELOCATED PRIOR TO THE START OF INSTALLATION OF THE PROPOSED KNEE WALL OR AS DIRECTED BY THE ENGINEER.
- 9. THE LOCATIONS OF VARIOUS ITEMS SUCH AS PAVEMENT, RETAINING WALLS, AND DRAINAGE STRUCTURES BUILT IN CONTRACTS UNDER CONSTRUCTION ARE BASED ON THE PUBLISHED CONTRACT PLAN DRAWINGS AVAILABLE DURING DESIGN. THE CONTRACTOR SHALL VERIFY AS-BUILT CONDITIONS.
- 10. THE CONTRACTOR SHALL TAKE ALL NECESSARY PRECAUTIONS FOR THE PROTECTION OF EXISTING PLANT MATERIAL FOR WHICH THE CONTRACT DOES NOT PROVIDE REMOVAL. THE PROTECTION OF EXISTING PLANT MATERIAL SHALL BE DONE IN ACCORDANCE WITH THE REQUIREMENTS OF SECTION 201 OF THE STANDARD SPECIFICATIONS.
- 1. THE INTENT OF THE CONTRACT DOCUMENTS IS TO CONSTRUCT THE FLUTED KNEE WALL BEHIND THE EXISTING CURB AND GUTTER. ANY DAMAGE TO THE EXISTING CURB AND GUTTER SHALL BE REPAIRED TO THE ORIGINAL CONDITION OF THE CURB AND GUTTER OR REPLACED AT THE CONTRACTOR'S OWN EXPENSE.
- 12. THE ENGINEER SHALL BE ALLOWED ACCESS TO THE FIELD OFFICE IN USE FOR CONTRACT *62981 (26E).
- 13. THE CONTRACTOR SHALL PROVIDE ALL NECESSARY TRAFFIC CONTROL DEVICES NEEDED TO COMPLETE THE WORK. THIS WORK SHALL BE INCLUDED IN THE COST OF TRAFFIC CONTROL AND PROTECTION (SPECIAL).
- 14. THE CONTRACTOR SHALL NOT MAINTAIN A PERMANENT PARTIAL RAMP OR SHOULDER CLOSURE ALONG MAINLINE I-57 OR I-94 (DAN RYAN) FOR THE DURATION OF THIS PROJECT. ONLY TEMPORARY PARTIAL RAMP AND SHOULDER CLOSURES SHALL BE PERMITTED.
- 15. ALL CATCH BASINS IN THE CITY OF CHICAGO SHALL MEET THE CHICAGO DEPARTMENT OF WATER MANAGEMENT'S STANDARDS.
- 16. PERMITS FROM THE DEPARTMENT OF WATER MANAGEMENT ARE REQUIRED FOR ALL UNDERGROUND STORM, SANITARY AND COMBINED SEWER SYSTEM CONSTRUCTION, AND FOR ALL WORK INVOLVING ADJUSTMENT OF SEWER STRUCTURES. THE DEPARTMENT OF WATER MANAGEMENT'S PERMIT SHALL E OBTAINED BY A LICENSED SEWER DRAIN LAYER PRIOR TO START OF CONSTRUCTION. THE LICENSED SEWER CONTRACTOR/SUBCONTRACTOR SHALL SUBMIT TWO SETS OF PLANS APPROVED BY THE DEPARTMENT OF WATER MANAGEMENT FOR THE ISSUANCE OF THE SEWER PERMIT TO BUREAU OF FORDIRERING SERVICES-SEWER SECTION, JARDINE PURIFICATION PLANT, EL+51, ROOM 313, 1000 E. OHIO ST., CHICAGO, IL 60611. INSPECTION WILL BE PROVIDED B? THE DEPARTMENT OF WATER MANAGEMENT.
- 17. THE RESIDENT ENGINEER AND THE CONTRACTOR SHALL FIELD VERIFY THE CITY'S EXISTING SEWER FACILITIES IN THE LIMITS OF THE REFERENCED PROJECT FOR ANY CONFLICTS DUE TO THE PROPOSED IMPROVEMENT. ANY CONFLICT SHALL BE RESOLVED WITH THE DEPARTMENT OF WATER MANAGEMENT PRIOR TO START OF CONSTRUCTION.
- 18. IN CASE OF DAMAGE TO CITY OF CHICAGO SEWERS, PRIVATE AND PUBLIC DRAINS, SEWER STRUCTURES AND/OR BENCH MONUMENTS, THE CONTRACTOR SHALL IMMEDIATELY CONTACT THE DEPARTMENT OF WATER MANAGEMENT AT (312) 744-0409 0R (312) 744-0408.
- 19. PERFORATED LIDS SHALL BE PLACED ON ALL SEWER MANHOLES AND CATCH BASINS.
- 20. NIGHT OPERATIONS SHALL NOT BE ALLOWED
- 21. LOCATION OF THE ELECTRICAL EQUIPMENT, INSTALLED BY CONTRACT 62583, IS APPROXIMATE.
 THE RESIDENT ENGINEER AND THE CONTRACTOR SHALL FIELD VERIFY THE EXACT LOCATION OF
 ALL ELECTRICAL ITEMS WITHIN THE PROJECT LIMITS WITH THE IDOT ELECTRICAL REPRESENTATIVE
 PRIOR TO THE START OF CONSTRUCTION. THE COST SHALL BE INCLUDED IN THE COST OF MOBILIZATION.

| FA.L | SECTION | COUNTY | STALL | SHEET | SH

GENERAL NOTES (CONT.):

6297

- 22. CITY OF CHICAGO WATER VALVE VAULTS AND SEWER STRUCTURES SHALL NOT BE CLOSED, COVERED OR OTHERWISE OBSTRUCTED DURING CONSTRUCTION WITHOUT PRIOR WRITTEN PERMISSION FROM THE CITY OF CHICAGO DEPARTMENT OF WATER MANAGEMENT.
- 23. IN LOCATIONS WHERE THE MAIN SEWER IS NOT BEING REPLACED AND THE EXISTING DRAINAGE FACILITIES ARE DISTURBED OR DAMAGED DURING CONSTRUCTION BY THE CONTRACTOR, IT SHALL BE THE CONTRACTOR'S RESPONSIBILITY TO RESTORE AND REPLACE THE DAMAGED FACILITIES AT HIS/HER OWN EXPENSE TO THE SATISFACTION OF THE ENGINEER.
- 24. IT IS CALLED TO THE CONTRACTOR'S ATTENTION THAT HE/SHE SHALL BE REQUIRED TO OBTAIN AND PAY FOR ANY INSPECTION OR PERMIT FEES TO THE VARIOUS DEPARTMENTS OF THE CITY OF CHICAGO AND THE STATE OF ILLINOIS. THE COST FOR THESE FEES SHALL NOT BE PAID FOR SEPARAFELY BUT SHALL BE CONSIDERED INCLUDED IN THE COST OF MOBILIZATION. PERMIT FEES SHALL BE PAID PRIOR TO COMMENCING CONSTRUCTION.
- 25. A PERMIT SHALL BE SECURED FROM THE BUREAU OF TRAFFIC PERMIT DIVISION, ROOM 804, CITY HALL AND BE INCLUDED IN THE COST OF MOBILIZATION. ADDITIONALLY, SEVEN (7) DAYS NOTICE SHALL BE GIVEN TO THE BUREAU OF TRAFFIC (3:22-744-0330) PRIOR TO STARTING ANY WORK OR MAKING ANY CHANGES IN THE TRAFFIC PATTERNS. ANY LANE OR ROADWAY CLOSURE INCLUDING DETOUR SHALL BE REVIEWED AND APPROVED BY THE BUREAU OF TRAFFIC.
- 26. A "BOXED" NOTE INDICATES AN ITEM OF WORK THAT IS NOT PAID FOR SEPARATELY, BUT IS PAID FOR AS PART OF ANOTHER ITEM LISTED IN THE SUMMARY OF QUANTITIES.
- 27. THE REMOVED AND RE-ERECTED CHAIN LINK FENCE SHALL REMAIN IN ITS RELOCATED POSITION, AS SHOWN ON PLANS, AT THE END OF THIS CONTRACT. FUTURE CONTRACT *60A07 SHALL INSTALL THE PERMANENT FENCING ON THE KNEE WALL AND THEN REMOVE THE FENCE LEFT IN PLACE BY THIS CONTRACT.
- 28. THE CONTRACTOR SHALL PROTECT ALL BLUNT ENDS OF THE KNEE WALL FOR TRAFFIC SAFETY. ALL TEMPORARY PROTECTION DEVICES USED FOR THIS PURPOSE SHALL BE NOHRP 350 COMPLIANT AND AS DIRECTED BY THE ENCINEER. THIS WORK SHALL BE INCLUDED IN THE COST OF TRAFFIC CONTROL AND PROTECTION (SPECIAL).

CONTRACTOR ACCESS ASSUMPTIONS:

- 1. FOR HMLT 6AIJ2, ACCESS IS ASSUMED TO BE FROM THE FRONTAGE ROAD (W. 98TH PL.).
- 2. FOR HMLT 6AMN2, ACCESS IS ASSUMED TO BE PROVIDED FROM HMLT 6AMN1.
- 3. FOR HMLT 6AMN1, ACCESS IS ASSUMED TO BE PROVIDED FROM THE EXPRESSWAY (NB I-57).
- FOR FLUTED KNEE WALL AND FLUTED KNEE WALL, SPECIAL CONSTRUCTION, ACCESS IS ASSUMED TO BE FROM THE FRONTAGE ROAD.

REVISIONS
NAME DATE

F.A.I. 94 (DAN RYAN EXPRESSWAY)

INDEX OF SHEETS, INDEX OF STATE
STANDARDS, GENERAL NOTES,
AND ACCESS ASSUMPTIONS

SCALE: NONE
DATE: JANUARY 16, 2009

DRAWN BY: AMB, MAF
CHECKED BY: TGB,MI

PROJECT: KNEE WALLS ALONG LAFAYETTE AVENUE FROM S. LASALLE STREET TO 95TH STREET COOK COUNTY/CITY OF CHICAGO

F.A.I. SECTION COUNTY TOTAL SHEET NO. 94 1516.1 I-9 COOK 59 3 STA. 117+38.11 (SB 1-57) TO STA. 154+09.94 (SB 1-57) FED. ROAD DIST. NO. 1LLINOIS FED. AID PROJECT

SUMMARY OF QUANTITIES

CODE NUMBER	ITEM DESCRIPTION	UNIT	QUANTITY	100% STATE SFTY-4A URBAN
20100110	TREE REMOVAL (6 TO 15 UNITS DIAMETER)	UNIT	78	78
20200100	EARTH EXCAVATION	CU YD	200	200
20201200	REMOVAL AND DISPOSAL OF UNSUITABLE MATERIAL	CU YD	280	280
21101615	TOPSOIL FURNISH AND PLACE, 4"	SQ YD	225	225
21101645	TOPSOIL FURNISH AND PLACE, 12"	SQ YD	1368	1368
21101825	COMPOST FURNISH AND PLACE, 6"	SQ YD	1368	1368
25000210	SEEDING, CLASS 2A	ACRE	1.00	1.00
25000400	NITROGEN FERTILIZER NUTRIENT	POUND	14	14
25000500	PHOSPHORUS FERTILIZER NUTRIENT	POUND	14	14
25000600	POTASSIUM FERTILIZER NUTRIENT	POUND	14	14
25001800	SEEDING, CLASS 4 (MODIFIED)	ACRE	0.25	0.25
25100630	EROSION CONTROL BLANKET	SQ YD	3453	3453
25200200	SUPPLEMENTAL WATERING	UNIT	198	198
28000250	TEMPORARY EROSION CONTROL SEEDING	POUND	53	53
28000510	INLET FILTERS	EACH	17	17
42001300	PROTECTIVE COAT	SQ YD	25	25
44000500	COMBINATION CURB AND GUTTER REMOVAL	FOOT	48	48
44004250	PAVED SHOULDER REMOVAL	SQ YD	288	288
60255500	MANHOLES TO BE ADJUSTED	EACH	1	1
63200310	GUARDRAIL REMOVAL	F00T	90	90
66410300	CHAIN LINK FENCE REMOVAL	FOOT	566	566
66410400	CHAIN LINK FENCE TO BE REMOVED AND RE-ERECTED	FOOT	723	723
67100100	MOBILIZATION	L SUM	1	1
70101800	TRAFFIC CONTROL AND PROTECTION, (SPECIAL)	L SUM	1	1
X0326143	FLUTED KNEE WALL (SPECIAL)	FOOT	30	30
X0326311	RELOCATE EXISTING SIGN PANEL (SPECIAL)	EACH	3	3

SUMMARY OF QUANTITIES

CODE NUMBER	ITEM DESCRIPTION	UNIT	QUANTITY	100% STATE SFTY-4A URBAN
X0321750	REMOVE TEMPORARY CONCRETE BARRIER, STATE OWNED	FOOT	80	80
X0322256	TEMPORARY INFORMATION SIGNING	SQ FT	52	52
X0322434	LIGHT TOWER, SERVICE PAD, SPECIAL	EACH	3	3
X0323973	SEDIMENT CONTROL, SILT FENCE	FOOT	222	222
X0324640	FLUTED KNEE WALL	FOOT	1654	1654
X0325132	SHAPING AND GRADING AT HIGH MAST LIGHT TOWER	SQ YD	64	64
X2500322	SEEDING, CLASS 5A, (MODIFIED)	ACRE	0.25	0.25
X6065740	CONCRETE MEDIAN SURFACE, 5" (MODIFIED)	-SQ FT	130	130
XX104800	COMBINATION CONCRETE CURB AND GUTTER, TYPE B-V.12	FOOT	48.0	48.0
Z0013798	CONSTRUCTION LAYOUT	L SUM	1	1

^{*} SPECIALTY ITEM

TREE REMOVAL (6 TO 15 UNITS)


	LOCATION		TREE REMOV
ALIGNMENT	STATION	OFFSET	(UNIT)
SB I-57	136+79	150.6′ LT	6
SB I-57	137+08	147.9' LT	6
SB I-57	137+38	144.8' LT	7
SB I-57	137+58	142.3′ LT	7
SB I-57	138+10	136.2′ LT	8
SB I-57	138+22	133.3′ LT	12
SB I-57	138+29	129.2′ LT	12
SB I-57	138+40	134.2' LT	6
SB I-57	138+52	132.9′ LT	6
SB I-57	149+76	128.2′ LT	8
		TOTAL	78


EARTHWORK SCHEDULE


LOC	EARTH	REM. & DISP.		
ALIGNMENT	STATION	TO STATION	(CU YD)	UNSUITABLE (CU YD)
SB I-57	136+09.5	154+09.9	200.0	280.0
r				
		TOTAL =	200.0	280.0


ILLINOIS DEPARTMENT OF TRANSPORTATION F.A.I. 94 (DAN RYAN EXPRESSWAY) SUMMARY OF QUANTITIES AND SCHEDULE OF QUANTITIES DRAWN BY: AMB,MAF DATE: JANUARY 16, 2009

CHECKED BY: TGB,MI

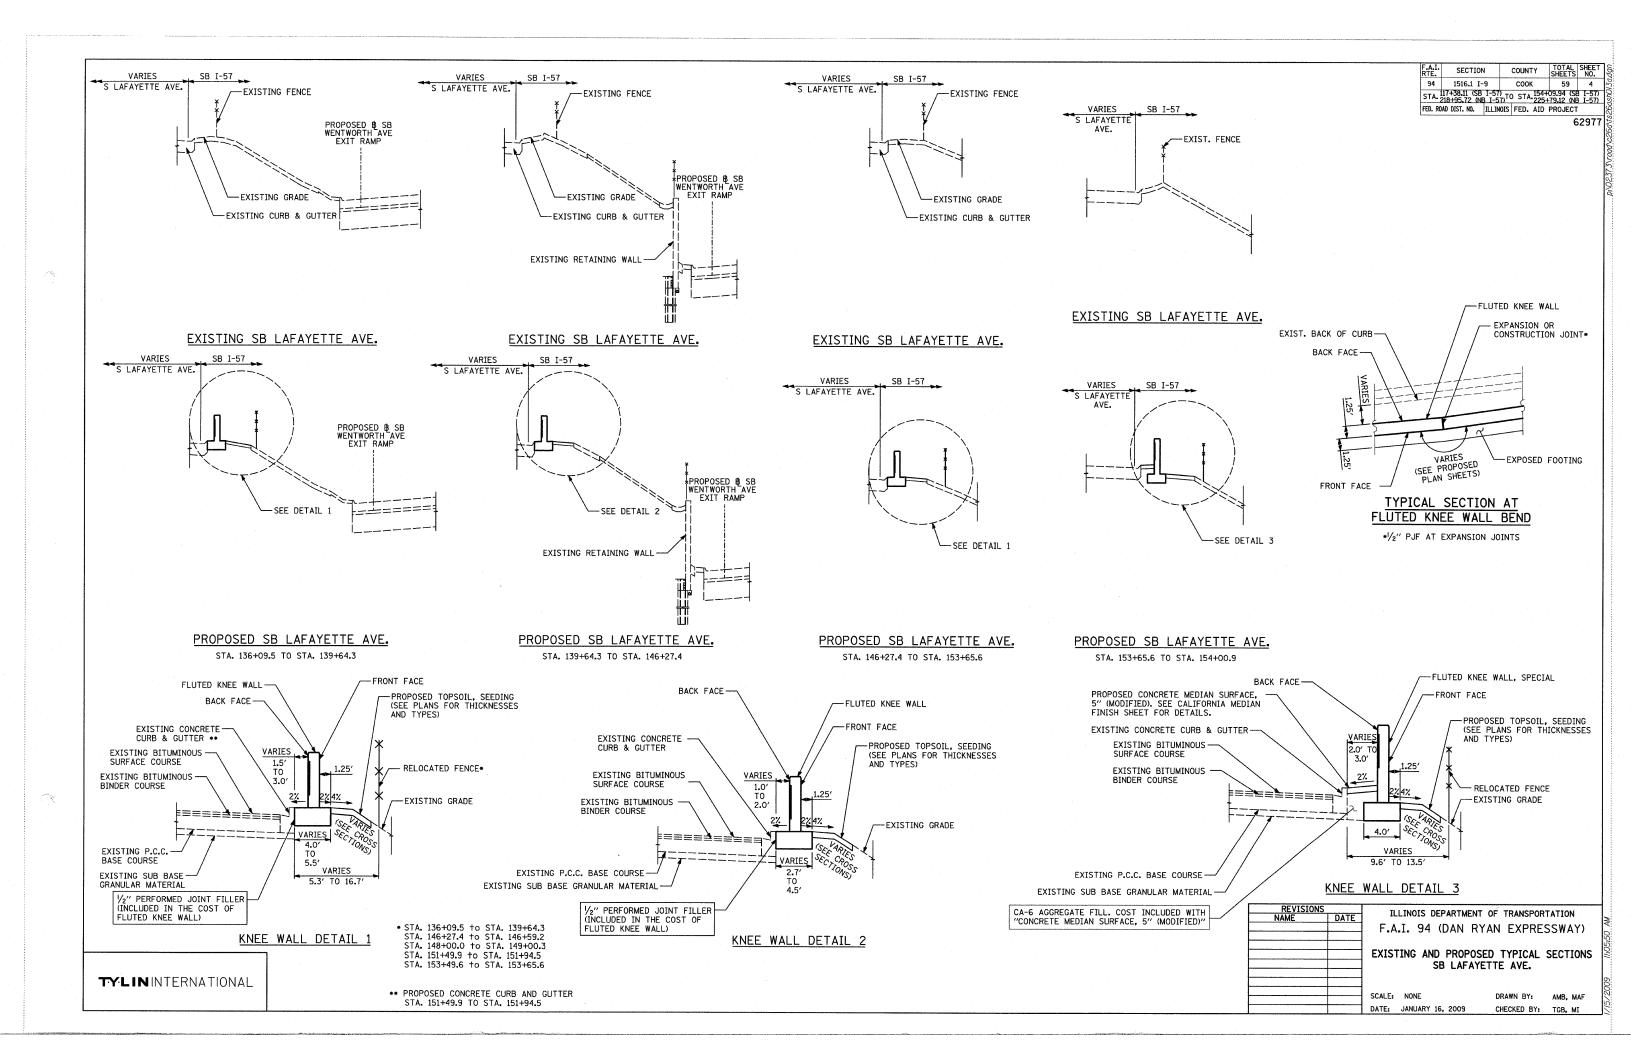

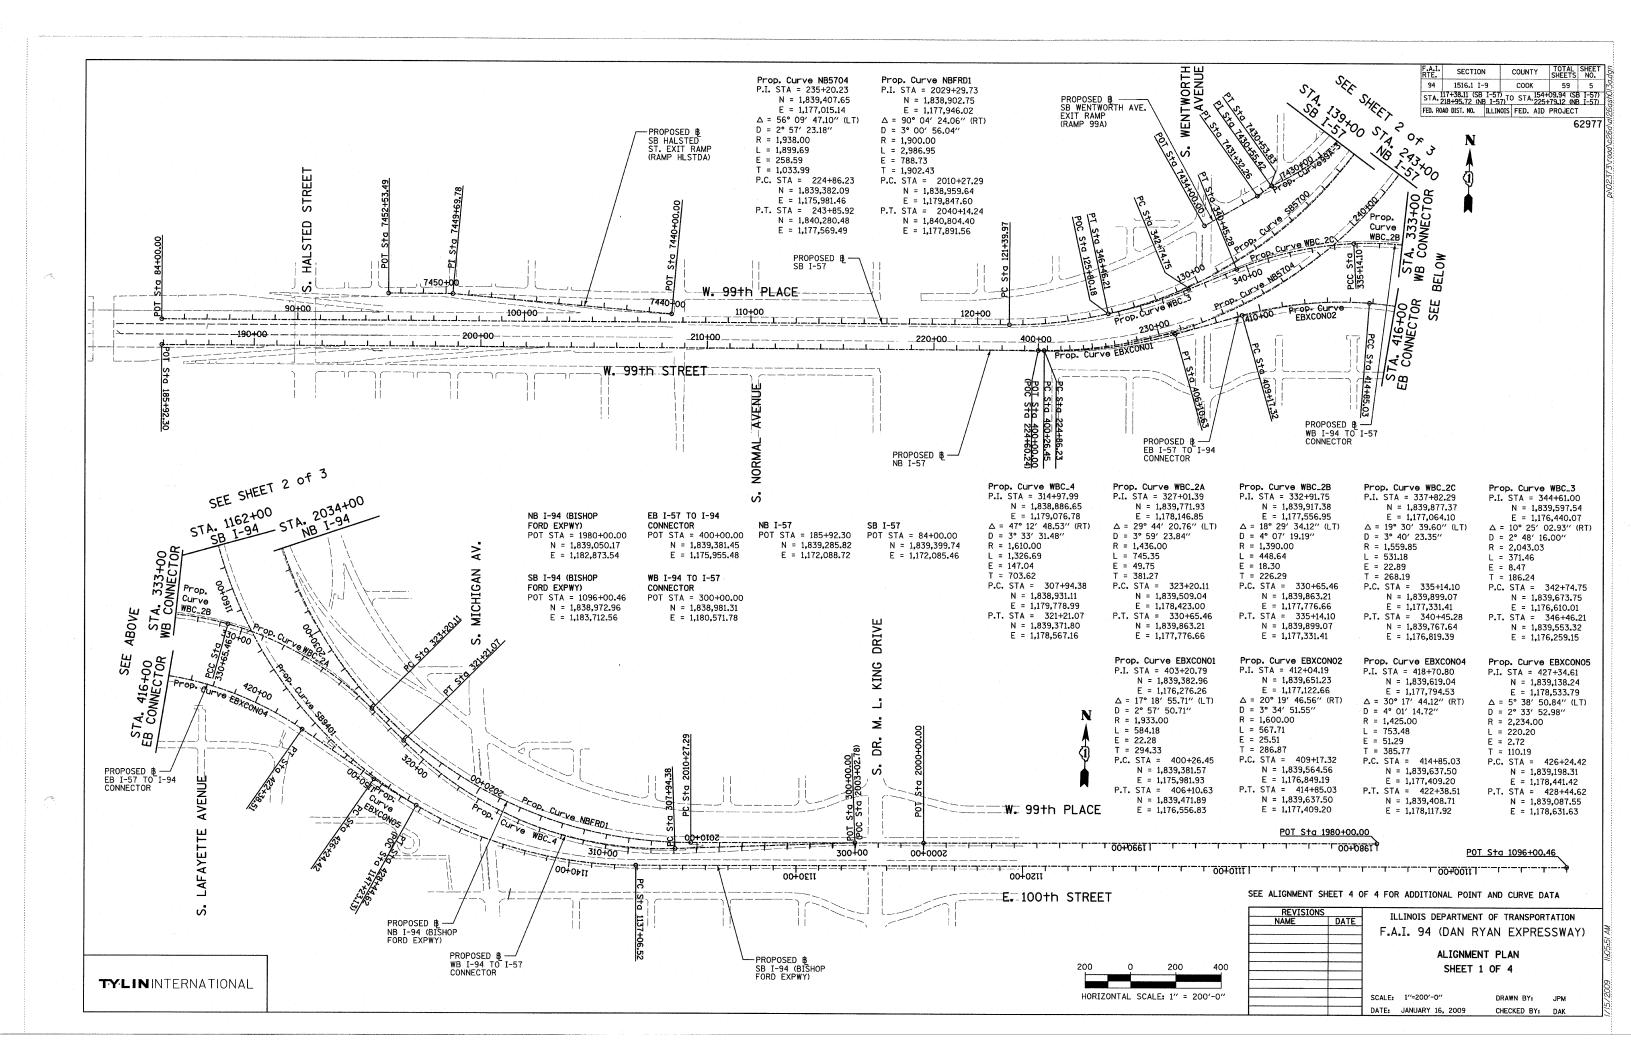

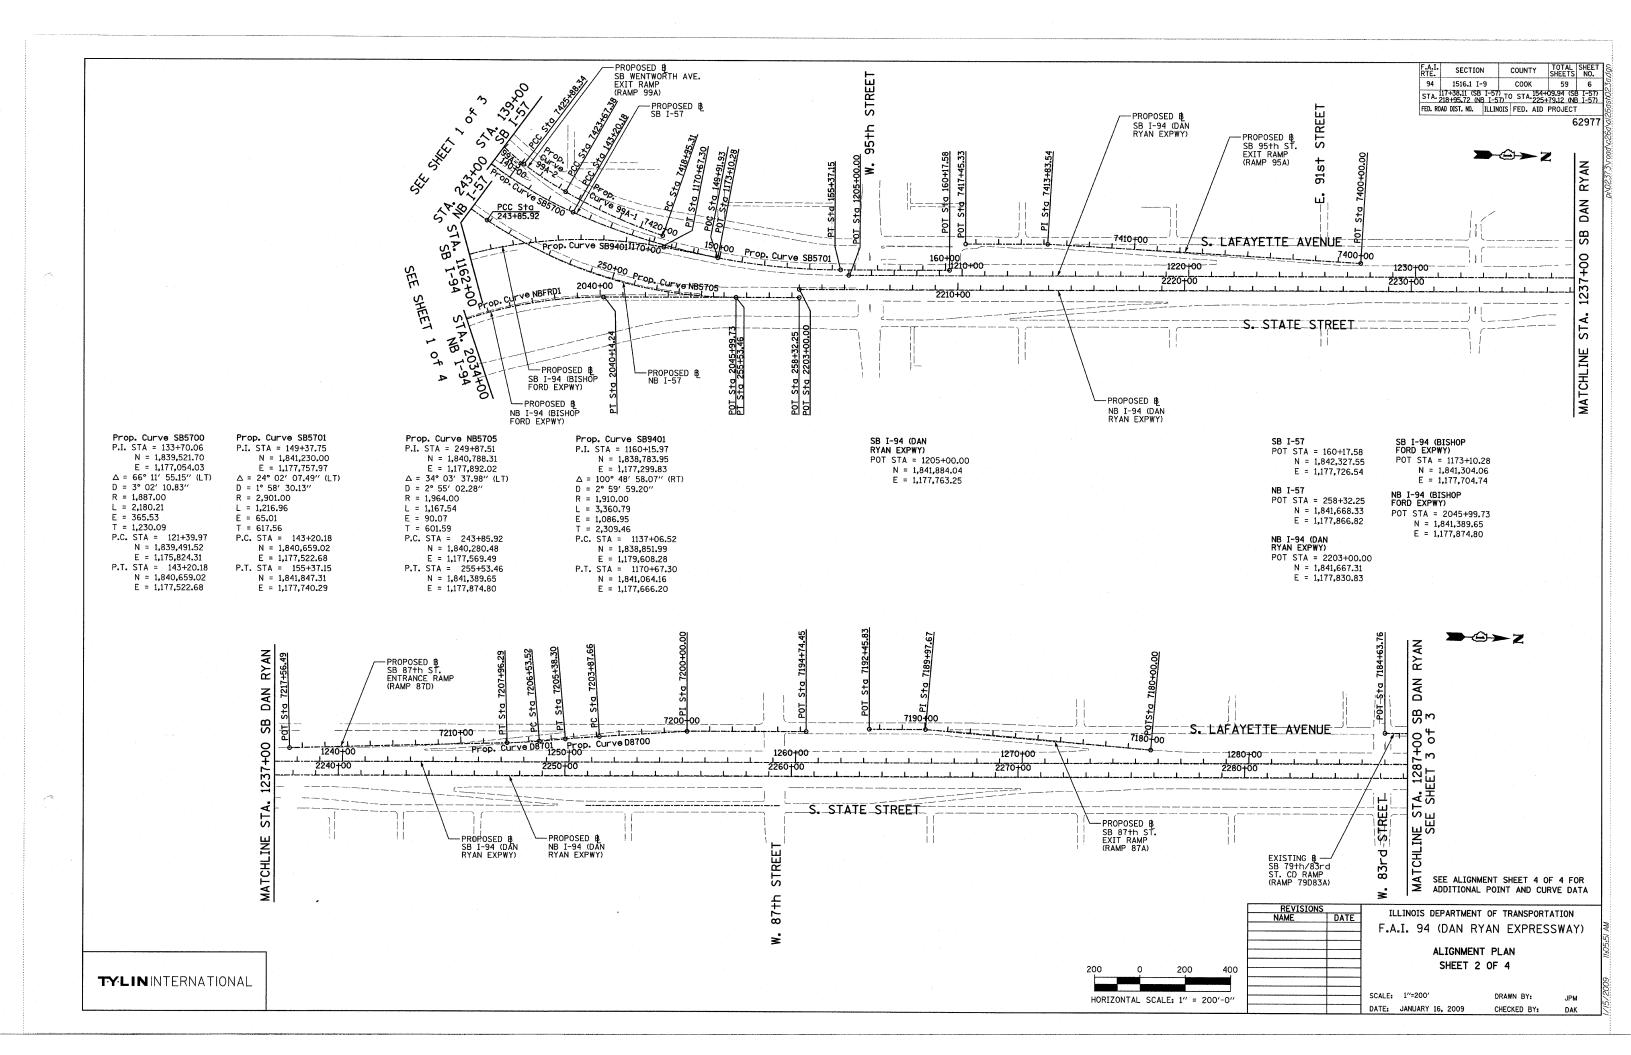

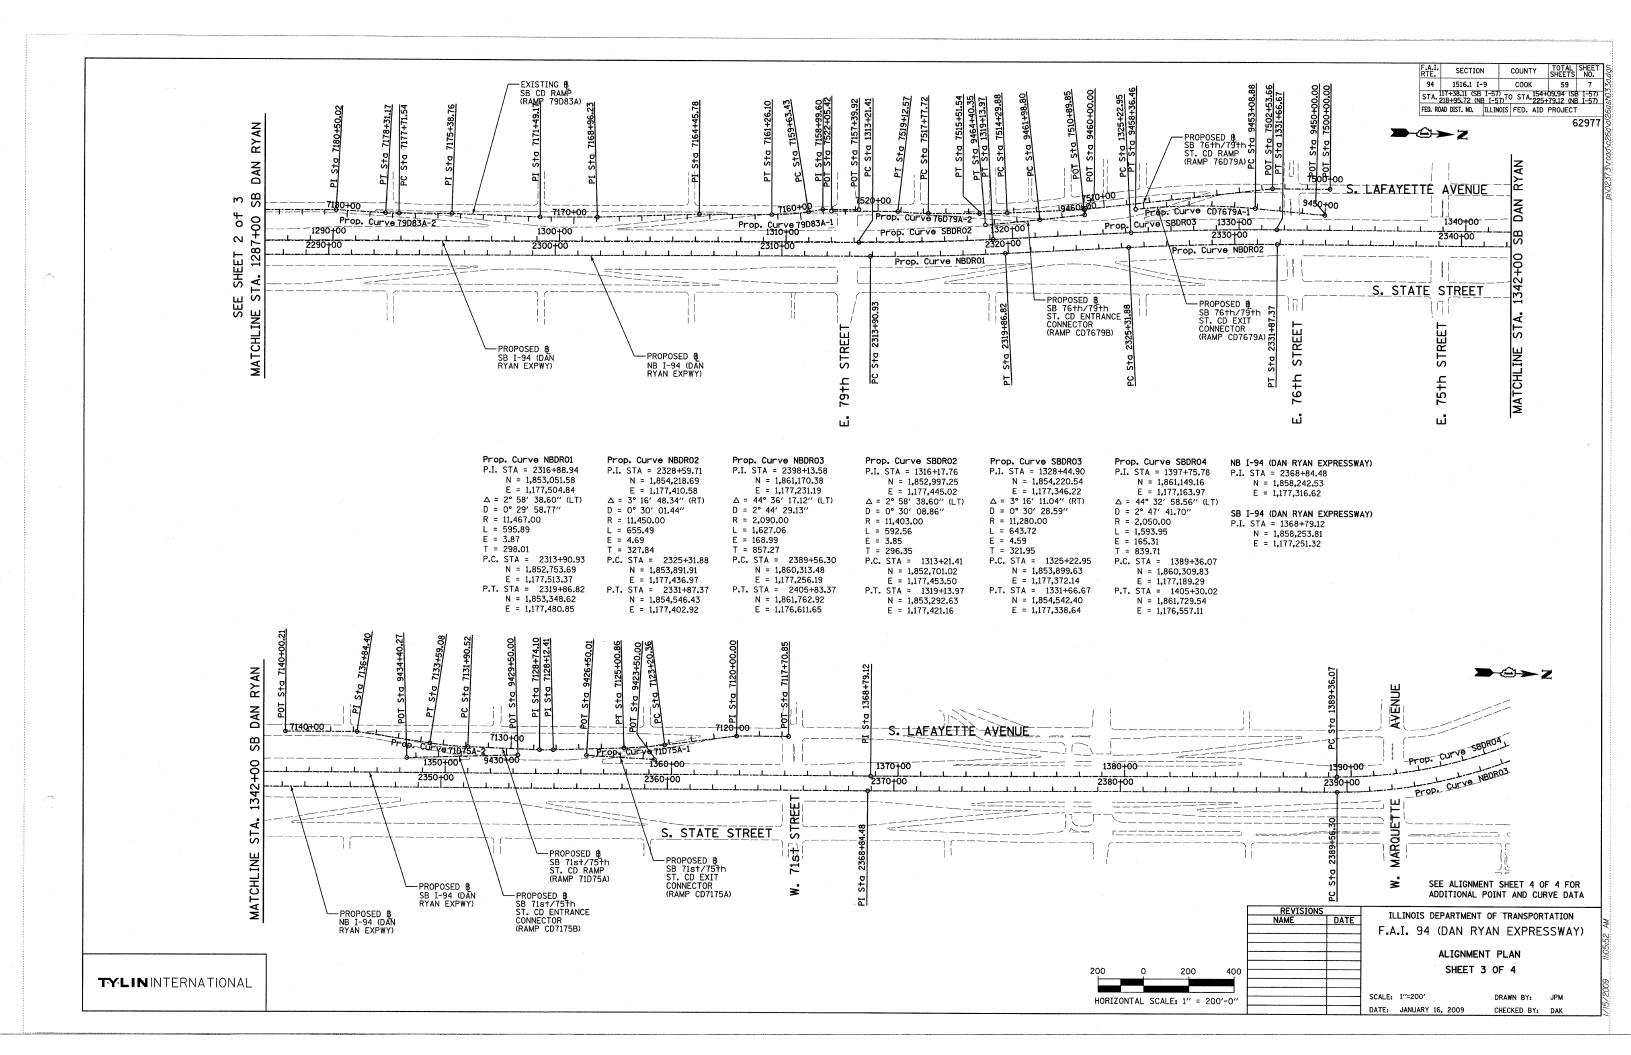

(RAMP HLSTDA) POT STA = 7440+00.00 N = 1,839,490.94E = 1,174,333.70P.I. STA = 7449+69.78 N = 1.839.551.73E = 1.173.365.83 POT STA = 7452+53.49 N = 1,839,544.76E = 1,173,082.20

SB HALSTED ST.

SB WENTWORTH AVE. EXIT RAMP (RAMP 99A)

POT STA = 7430+55.42 N = 1,840,141.17E = 1,176,961.02 POT STA = 7431+32.26 N = 1.840.094.48 E = 1.176.899.99 POT STA = 7434+00.00 N = 1,839,955.89E = 1,176,670.92

Prop. Curve 99A-1 P.I. STA = 7421+32.05 N = 1.840.832.05E = 1,177,544.75 $\Delta = 10^{\circ} 49' 08.53'' (RT)$ D = 2° 17′ 30.59″ R = 2,500.001 = 472.07E = 11.18T = 236.74P.C. STA = 7418+95.31 N = 1,841,058.12

R = 1,700.001 = 220.96F = 3.60T = 110.64P.C. STA = 7423+67.38 N = 1,840,623.20E = 1,177,615.03E = 1,177,433.29P.T. STA = 7423+67.38P.T. STA = 7425+88.34 N = 1,840,623.20N = 1.840.435.56E = 1,177,433.29E = 1.177.316.90

Prop. Curve 99A-2

P.I. STA = 7424+78.02

N = 1.840.525.59

E = 1,177,381.20

 $\Delta = 7^{\circ} 26' 49.68'' (RT)$

D = 3° 22′ 13.22″

SB 95th ST. EXIT RAMP (RAMP 95A)

POT STA = 7400+00.00 N = 1.844.139.73E = 1,177,638.63 P.I. STA = 7413+83.54 N = 1842 756 77 E = 1,177,598.60POT STA = 7417+45.33 N = 1,842,395.13E = 1,177,608.95

SB 87th ST. ENTRANCE RAMP (RAMP 87D) POT STA = 7194+74.45

N = 1,847,424.06E = 1,177,468.58P.I. STA = 7200+00.00 N = 1.846.898.74E = 1.177.484.09 POT STA = 7217+56.49 N = 1,845,147.17E = 1,177,609.78

Prop. Curve D8700 P.I. STA = 7204+62.99 N = 1,846,437.54E = 1,177,524.69 $\Delta = 1^{\circ} 30' 03.72'' (LT)$ D = 0° 59′ 47.21″ R = 5,750.00

L = 150.64E = 0.49T = 75.32P.C. STA = 7203+87.66 N = 1,846,512.58E = 1,177,518.09P.T. STA = 7205+38.30 N = 1,846,362.71

N = 1,846,177.29E = 1,177,554.49 $\Delta = 3^{\circ} 27' 36.43'' (RT)$ D = 2° 25' 25.25" R = 2,364.00L = 142.76 F = 1.08T = 71.40P.C. STA = 7206+53.52N = 1,846,248.23E = 1,177,546.37P.T. STA = 7207+96.29

Prop. Curve D8701

P.I. STA = 7207+24.93

SB 87th ST. EXIT RAMP (RAMP 87A) POT STA = 7180+00-00

N = 1.848.946.30E = 1,177,501.00P.I. STA = 7189+97.67 N = 1.847.950.35F = 1.177.442.53POT STA = 7192+45.83 N = 1,847,702.29E = 1,177,449.63

N = 1,846,105.99E = 1,177,533.26E = 1.177.558.32

D = 6° 21′ 58.31″ R = 900.00L = 465.49E = 30.96T = 238.08P.C. STA = 7425+88.34 N = 1,840,435.56 E = 1,177,316.90P.T. STA = 7430+53.83 N = 1.840.141.84 E = 1.176.962.46

Prop. Curve 99A-3

P.I. STA = 7428+26.42

N = 1.840.241.82

E = 1.177.178.53

 $\Delta = 29^{\circ} 38' 02.27'' (RT)$

SB 71st/75th ST. CD RAMP (RAMP 71D75A)

(RAMP 76D79A)

N = 1.854.771.42

E = 1,177,153.21

N = 1.854.517.84

E = 1.177.159.17

N = 1,853,689.73

E = 1,177,275.17

N = 1.852.575.71

E = 1.177.319.03

POT STA = 7522+05.42

P.I. STA = 7510+89.85

P.I. STA = 7502+53.66

R = 1,000.00

L = 162.67

F = 3.32

T = 81.51

POT STA = 7117+70.85 N = 1.857.886.40 F = 1.177.086.26 P.I. STA = 7120+00.00 N = 1,857,657.31E = 1,177,091.65P.I. STA = 7128+12.41 N = 1.856.850.29E = 1,177,177.64 P.I. STA = 7128+74.10 N = 1,856,788.62E = 1,177,179.10P.I. STA = 7136+84.40 N = 1.855.981.27E = 1.177.124.75

POT = 7140+00.21 N = 1.855.665.56

E = 1,177,132.18

R = 1,850.00L = 180.49E = 2.20T = 90.32P.C. STA = 7123+20.36 N = 1,857,340.76E = 1,177,140.92P.T. STA = 7125+00.86 N = 1.857.161.34E = 1.177.159.94

 $\Delta = 2^{\circ} 48' 22.72'' (RT)$

P.C. STA = 7514+29.88

P.T. STA = 7515+51.54

Prop. Curve 71D75A-1

N = 1.857.251.52

E = 1.177.154.81

 $\Delta = 5^{\circ} 35' 23.99'' (RT)$

D = 3° 05′ 49.45″

P.I. STA = 7124+10.68

N = 1,853,350.72

E = 1.177.301.54

N = 1,853,229.24

E = 1,177,307.99

 $D = 2^{\circ} 18' 23.74''$

R = 2.484.00

L = 121.66

T = 60.84

E = 0.75

Prop. Curve 71D75A-2 P.I. STA = 7132+74.89N = 1.856.387.85E = 1.177.175.17 $\Delta = 6^{\circ} 30' 28.18'' (RT)$ D = 3° 51′ 39.25″ R = 1,484.00L = 168.56E = 2.40T = 84.37P.C. STA = 7131+90.52 N = 1,856,472.22E = 1,177,176.00P.T. STA = 7133+59.08 N = 1.856.304.13E = 1.177.164.79

 $\Delta = 6^{\circ} 31' 33.29'' (RT)$

P.C. STA = 7517+77.72

P.T. STA = 7519+12.57

N = 1.853.003.16

E = 1.177.314.47

N = 1,852,868.44

E = 1,177,310.65

D = 4° 50′ 21.01″

R = 1.184.00

= 67.50

L = 134.86

E = 1.92

E = 1,177,267.55SB 71st/75th ST. CD EXIT CONNECTOR (RAMP CD7175A) POT STA = 9423+50.00 N = 1,857,297.2866 E = 1,177,207.4713POT STA = 9426+50.01 N = 1.856.997.4225

N = 1.854.751.70

E = 1,177,267.37

N = 1,854,179.28

E = 1,177,230.83

Prop. Curve CD7679A-1

P.I. STA = 9455+73.58

 $\Delta = 11^{\circ} 37' 34.33'' \text{ (LT)}$

P.C. STA = 9453+08.88

P.T. STA = 9458+36.46

N = 1.854.443.44

 $\Xi = 1,177,247.69$

N = 1,853,917.14

D = 2° 12′ 13.26″

R = 2,600.00

L = 527.58

T = 264.70

E = 13.44

E = 1,177,198.1891 CD ENTRANCE CONNECTOR (RAMP CD7175B)
POT STA = 9429+50.00 N = 1,856,694.2083E = 1,177,205.3235POT STA = 9434+40.27N = 1,856,204.7281E = 1,177,233.1786

> REVISIONS NAME ILLINOIS DEPARTMENT OF TRANSPORTATION DATE F.A.I. 94 (DAN RYAN EXPRESSWAY)

> > ALIGNMENT PLAN SHEET 4 OF 4

SCALE: NO SCALE DATE: JANUARY 16, 2009

CHECKED BY: JPM

TYLIN INTERNATIONAL

N = 1.853.693.06

TOTAL SHEET SHEETS NO.

59 8

62977


E = 1,177,298.94 Prop. Curve CD7679B-1 P.I. STA = 9463+19.58

N = 1,853,376.57E = 1,177,343.27 $\Delta = 1^{\circ} 13' 13.54'' (RT)$ $D = 0^{\circ} 30' 18.91''$ R = 11,340.00L = 241.55E = 0.64


T = 120.78P.C. STA = 9461+98.80 N = 1.853.496.18E = 1,177,326.52P.T. STA = 9464+40.35

N = 1,853,256.63 E = 1,177,357.48

DRAWN BY: JPA

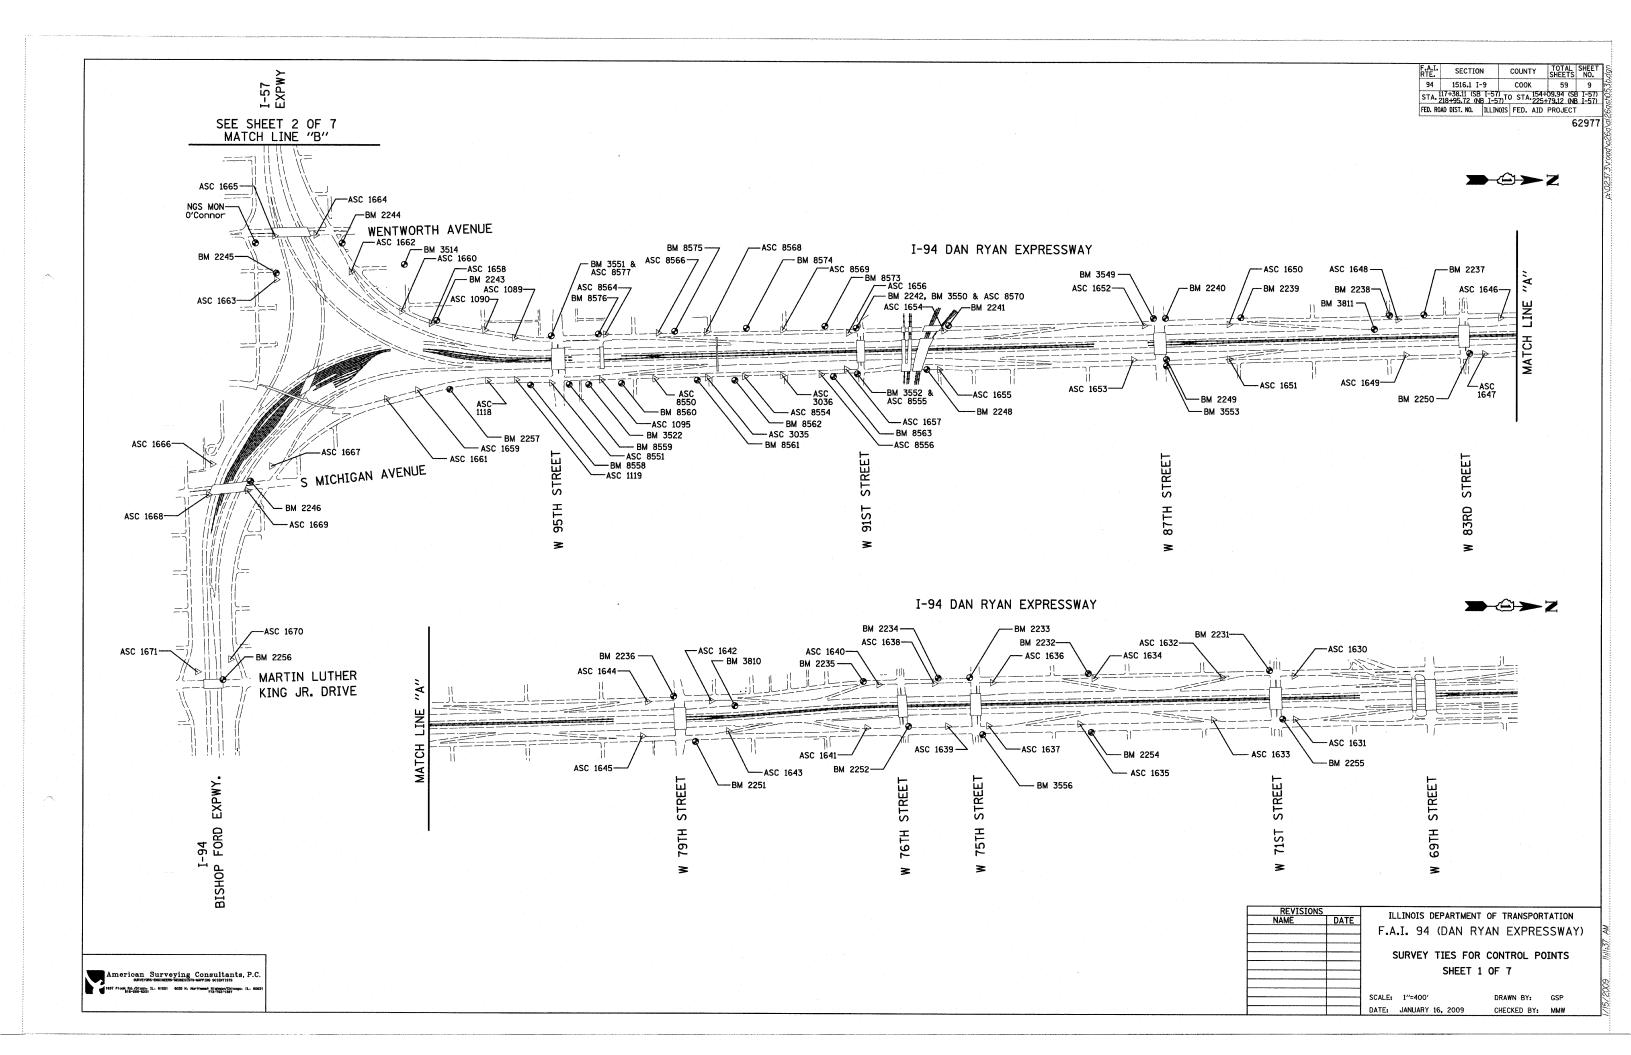

F.A.I. RTE.	SECTION	COUN	TY SH	TAL EETS	SHEET NO.
94	1516.1 I-			59	10
STA.	17+38.11 (SB 18+95.72 (NB	I-57) I-57) TO STA	154+09.9 225+79.1	4 (SB 2 (NB	I-57) I-57)
FED. RO.	AD DIST. NO.	ILLINOIS FED.	AID PRO	JECT	

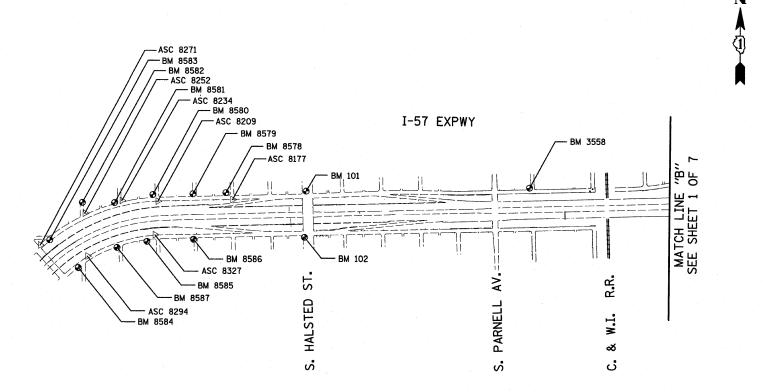



REVISIONS	5	ILLINOIS DEPARTMENT OF TRANSPORTATION
NAME	DATE	ILLINOIS DEPARTMENT OF TRANSPORTATION
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		SURVEY TIES FOR CONTROL POINTS


SURVEY TIES FOR CONTROL POINTS
SHEET 2 OF 7


SCALE: 1"=400' DATE: JANUARY 16, 2009 DRAWN BY: GSP
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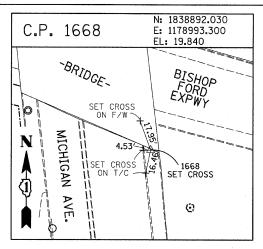
ı		
I	American Surveying Consultants, I	P.C.
ı	1637 Plock Rd. /Dixon- IL. 61021 6035 N- Northwest Highesy/Chicogo: IL 773-763-1387	. 6063




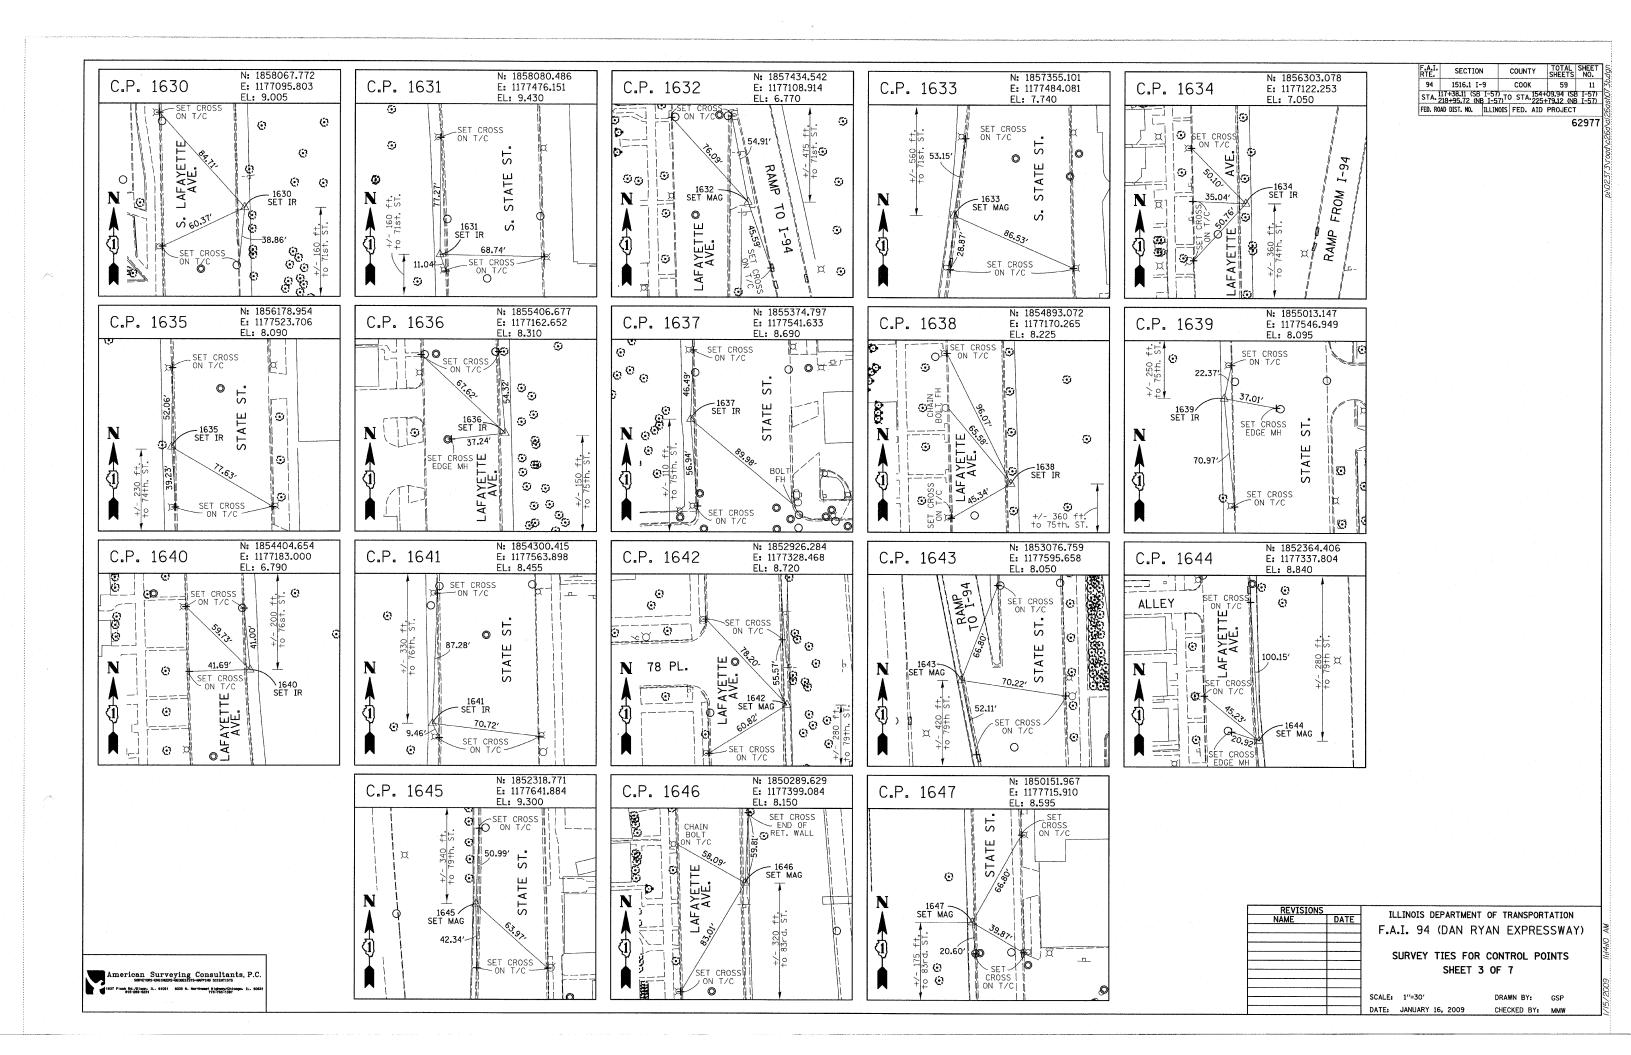


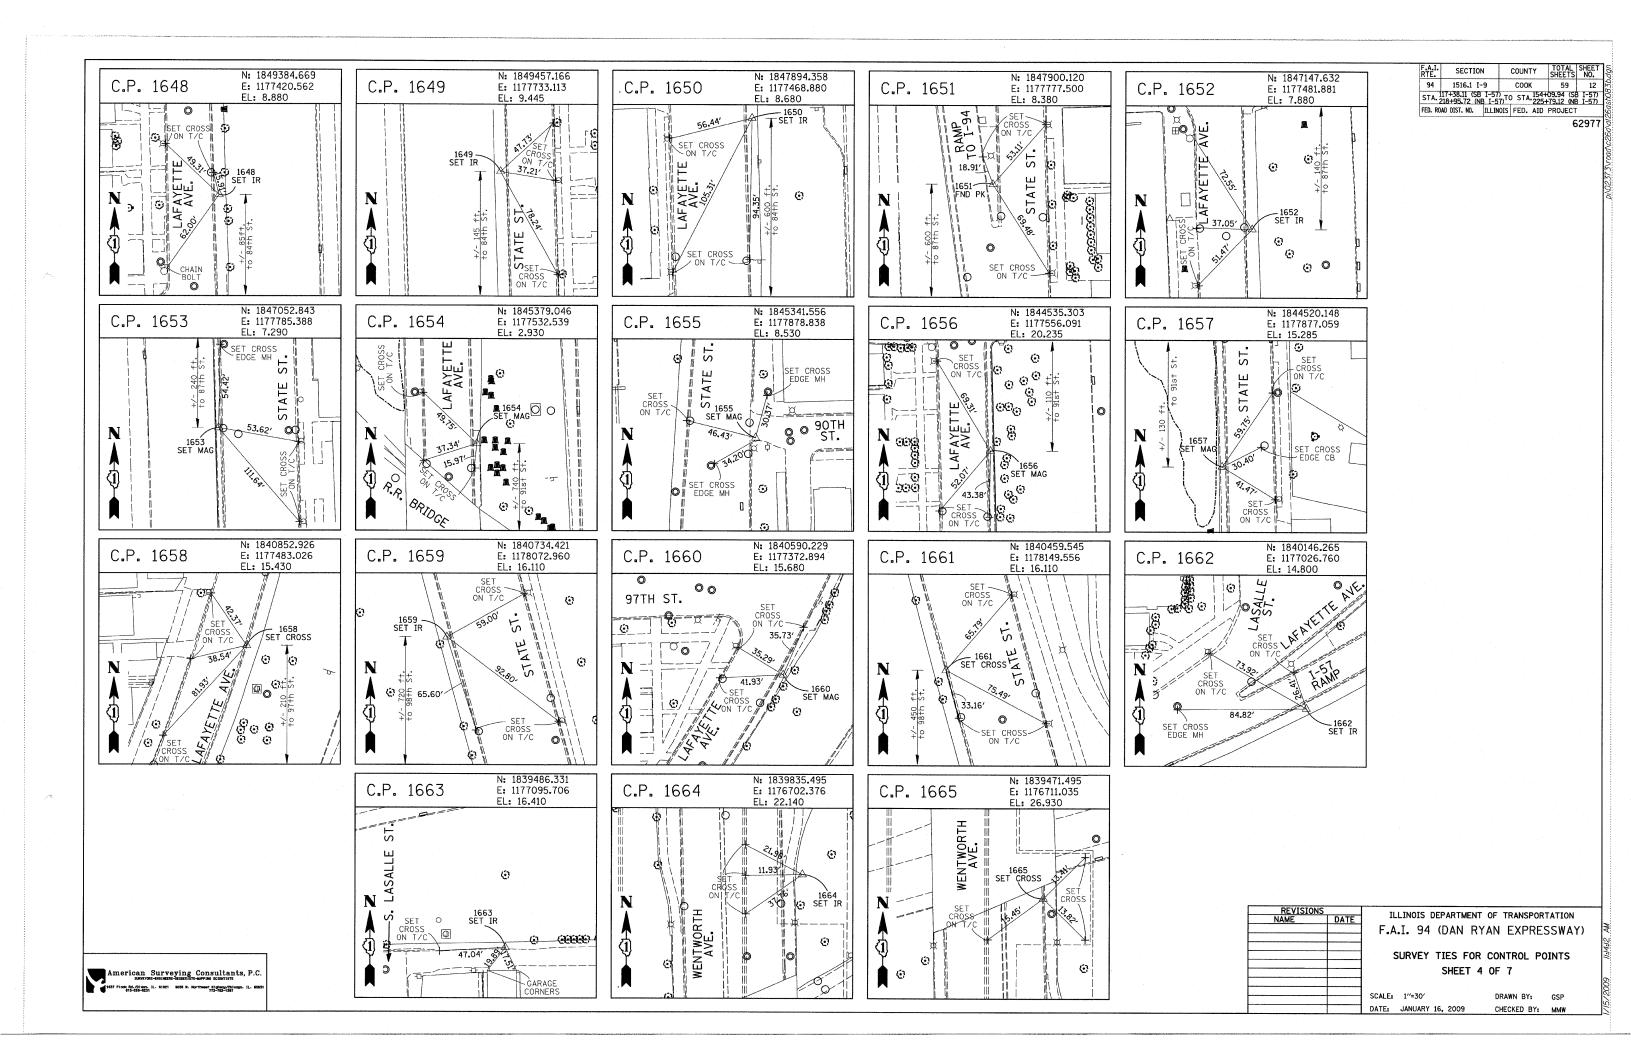

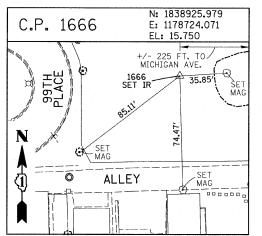


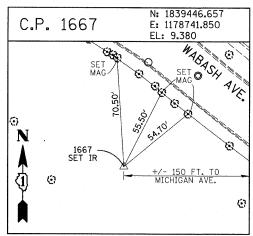

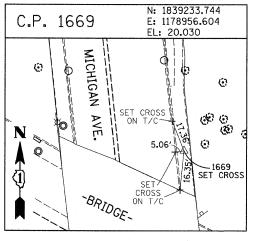

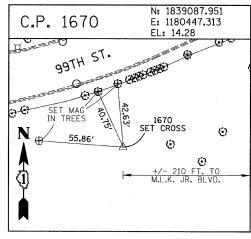

 F.A.I. RTE.	SECTION		COUNT	Ý	TOTAL	SHEET NO.
94	1516.1 I-	- 1	СООК		59	13
STA.	17+38.11 (SB 218+95.72 (NE	I-57) I I-57)	STA.	154+ 225+	09.94 (SI 79.12 (NI	3 I-57) 3 I-57)
FED. RO	AD DIST. NO.	ILLINOIS	FED.	AID	PROJECT	

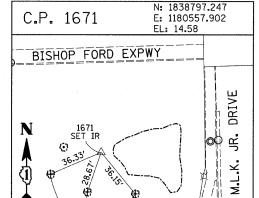

PROJECT BENCHMARKS

BM 2231 ELEVATION= 10.24 FEET SET CROSS ON CHAIN BOLT OF FIRE HYDRANT ON THE SOUTHWEST CORNER OF 71ST STREET AND LAFAYETTE AVENUE.

BM 2232 ELEVATION= 8.46 FEET SET CROSS ON CHAIN BOLT OF FIRST FIRE HYDRANT SOUTH OF 73RD STREET ON THE WEST SIDE OF LAFAYETTE AVENUE, APPROXIMATELY 330 FEET SOUTH OF 73RD STREET.

BM 2233 ELEVATION= 9.90 FEET SET CROSS ON NORTHWEST BOLT OF FIRE HYDRANT ON THE NORTHWEST CORNER OF 75TH STREET AND LAFAYETTE AVENUE.

BM 2234 ELEVATION= 9.56 FEET SET CROSS ON CHAIN BOLT OF FIRST FIRE HYDRANT SOUTH OF 75TH STREET ON THE WEST SIDE OF LAFAYETTE AVENUE. APPROXIMATELY 320 FEET SOUTH OF 75TH STREET.

BM 2235 ELEVATION= 7.50 FEET SET CROSS ON CHAIN BOLT OF FIRST FIRE HYDRANT SOUTH OF 76TH STREET ON THE WEST SIDE OF LAFAYETTE. APPROXIMATELY 330 FEET SOUTH OF 76TH STREET.

BM 2236 ELEVATION= 10.41 FEET SET CROSS ON WEST BOLT OF FIRE HYDRANT ON THE SOUTHWEST CORNER OF 79TH STREET AND LAFAYETTE AVENUE.

BM 2237 ELEVATION= 9.20 FEET SET CROSS ON CHAIN BOLT OF FIRST FIRE HYDRANT NORTH OF 83RD STREET ON THE WEST SIDE OF LAFAYETTE AVENUE. APPROXIMATELY 350 FEET NORTH OF 83RD STREET.

BM 2238 ELEVATION= 10.04 FEET SET CROSS ON CHAIN BOLT OF FIRE HYDRANT OF THE NORTHWEST CORNER OF 4TH STREET AND LAFAYETTE AVENUE.

BM 2239 ELEVATION= 9.59 FEET SET CROSS ON CHAIN BOLT OF SECOND FIRE HYDRANT NORTH OF 87TH STREET ON THE WEST SIDE OF LAFAYETTE AVENUE. APPROXIMATELY 720 FEET OF NORTH OF 87TH STREET.

BM 2240 ELEVATION= 9.49 FEET
SET CROSS ON THE NORTHWEST BOLT OF FIRE HYDRANT ON THE SOUTHWEST
CORNER OF 78TH STREET AND LAFAYETTE AVENUE.

BM 2241 ELEVATION= 3.63 FEET
SET SQUARE CUT ON TOP OF CURB NEXT TO LIGHT POLE ON THE NORTHWEST
CORNER OF LAFAYETTE AVENUE AND RAILROAD BRIDGE. APPROXIMATELY 770
FEET NORTH OF 91ST STREET.

BM 2242 ELEVATION= 22.82 FEET SET CROSS ON CHAIN BOLT OF FIRE HYDRANT ON THE SOUTHWEST CORNER OF 91ST STREET AND LAFAYETTE AVENUE.

BM 2243 ELEVATION= 15.68 FEET SQUARE CUT ON THE TOP OF CURB NEXT TO THIRD LIGHT POLE NORTH OF 97TH STREET ON THE WEST SIDE OF LAFAYETTE AVENUE, APPROXIMATELY 260 FEET NORTH OF 97TH STREET.

BM 2244 ELEVATION= 15.94 FEET
SET SQUARE CUT ON TOP OF CURB NEXT TO LIGHT POLE ON THE NORTH SIDE
OF 98TH STREET. APPROXIMATELY 120 FEET EAST OF WENTWORTH AVENUE.

BM 2245 ELEVATION= 16.35 FEET
SET SOUARE CUT ON THE EAST END OF CURB AT THE NORTHEAST CORNER OF
FIRST ALLEY NORTH OF 99TH STREET. APPROXIMATELY 35 FEET EAST OF LASALLE
STREET.

BM 2246 ELEVATION= 20.00 FEET SQUARE CUT WITH CROSS ON TOP OF ABUTMENT WALL ON THE NORTHWEST CORNER OF STATE STREET BRIDGE OVER THE BISHOP FORD EXPRESSWAY. APPROXIMATELY 20 FEET NORTH OF THE NORTH EDGE OF THE BRIDGE.

BM 2248 ELEVATION= 9.77 FEET SET CROSS ON CHAIN BOLT OF FIRST FIRE HYDRANT NORTH OF RAILROAD BRIDGE ON THE EAST SIDE OF STATE STREET. APPROXIMATELY 110 FEET SOUTH OF 90TH STREET.

BM 2249 ELEVATION= 9.67 FEET SET CROSS ON CHAIN BOLT OF FIRE HYDRANT ON THE NORTHWEST CORNER OF 87TH AND STATE STREET.

BM 2250 ELEVATION= 10.03 FEET SET CROSS ON CHAIN BOLT OF FIRE HYDRANT ON THE NORTHWEST CORNER OF 83RD ST. AND STATE STREET.

BM 2251 ELEVATION= 10.95 FEET
FOUND CROSS ON EAST BOLT OF FIRE HYDRANT ON THE EAST SIDE OF STATE
STREET. APPROXIMATELY 135 FEET NORTH OF 79TH STREET.

BM 2252 ELEVATION= 10.02 FEET SET CROSS ON WEST BOLT OF FIRE HYDRANT ON THE NORTHWEST CORNER OF STATE STREET AND 76TH STREET.

BM 2254 ELEVATION= 9.17 FEET SET CROSS ON CHAIN BOLT OF FIRST FIRE HYDRANT SOUTH OF 73RD STREET ON THE EAST SIDE OF STATE STREET. APPROXIMATELY 330 FEET SOUTH OF 73RD STREET.

BM 2255 ELEVATION= 11.25 FEET SET CROSS ON CHAIN BOLT OF FIRE HYDRANT ON THE NORTHWEST CORNER OF 71ST STREET AND STATE STREET.

BM 2256 ELEVATION= 16.36 FEET SUARE CUT ON TOP OF ABUTMENT WALL ON THE NORTHWEST CORNER OF MARTIN LUTHER KING DRIVE BRIDGE OVER THE BISHOP FORD EXPRESSWAY. APPROXIMATELY 1 FOOT NORTH OF THE NORTH END OF THE BRIDGE.

BM 2257 ELEVATION= 18.25 FEET SET CROSS ON NORTHEAST BOLT OF LIGHT POLE BASE ON THE EAST SIDE OF STATE STREET. APPROXIMATELY 970 FEET SOUTH OF 95TH STREET.


BM 2258 ELEVATION= 10.53 FEET SET CROSS ON NORTHWEST BOLT OF LIGHT BASE ON NORTHWEST CORNER OF 71ST STREET AND LAFAYETTE AVENUE.

REVISIONS NAME	DATE	ILLINOIS DEPARTMENT OF TRANSPORTATION F.A.I. 94 (DAN RYAN EXPRESSWAY)
		SURVEY TIES FOR CONTROL POINTS

SCALE: 1"=30" DRAWN BY: GSP
DATE: JANUARY 16, 2009 CHECKED BY: MMW

SHEET 5 OF 7

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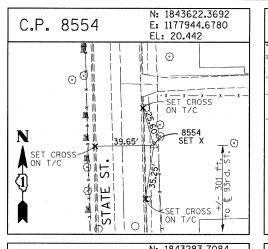
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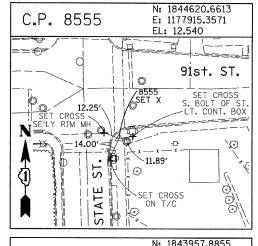
ILLINOIS DEPARTMENT OF TRANSPORTATION
F.A.I. 94 (DAN RYAN EXPRESSWAY)

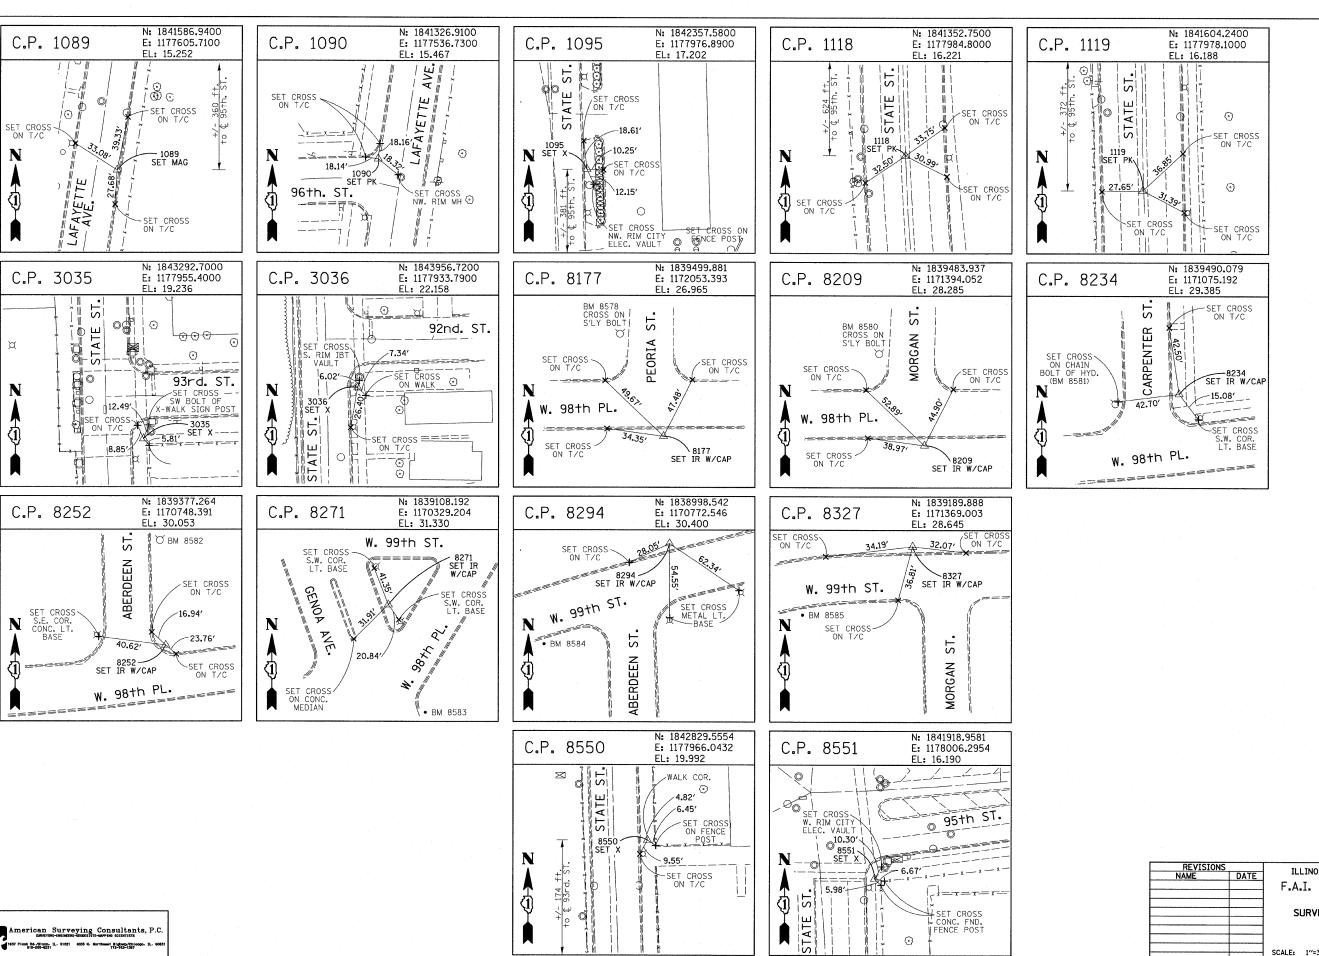
SURVEY TIES FOR CONTROL POINTS
SHEET 6 OF 7


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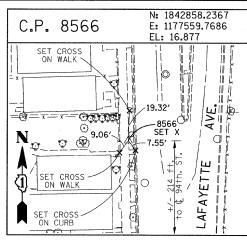
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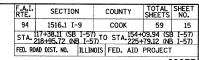











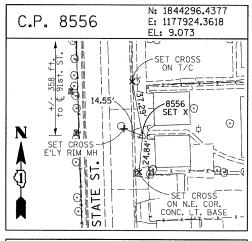


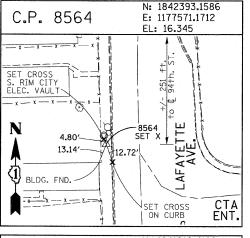

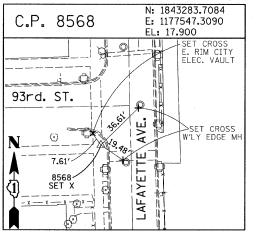

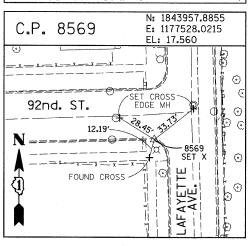

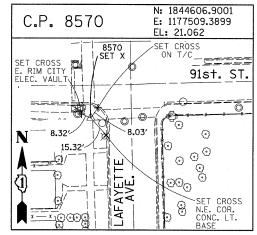

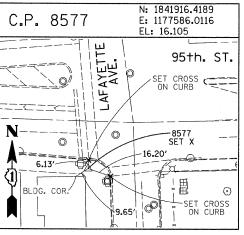

PROJECT BENCHMARKS

BM 101 ELEVATION= 24.89 FEET
SET SQUARE CUT ON SOUTHERLY CURB OF WEST 98TH PLACE. APPROXIMATELY
70 FEET EAST OF THE CENTERLINE OF GREEN STREET.

BM 102 ELEVATION= 27.36 FEET SET CROSS ON SOUTHERLY FLANGE BOLT OF FIRE HYDRANT AT THE SOUTHWEST CORNER OF WEST 99TH STREET AND GREEN STREET.

BM 8558 ELEVATION= 17.73 FEET
SET SQUARE CUT ON SOUTHEAST CORNER OF FOURTH LIGHT BASE SOUTH OF
95TH STREET, ON THE EAST SIDE OF STATE STREET.

BM 8559 ELEVATION= 17.10 FEET
SET SQUARE CUT ON SOUTHWEST CORNER OF CONCRETE SIGN BASE AT THE
NORTHWEST CORNER OF THE MOBIL GAS STATION PROPERTY AT THE NORTHEAST
CORNER OF 95TH STREET AND STATE STREET.

BM 8560 ELEVATION= 17.50 FEET
SET SQUARE CUT ON SOUTHEAST CORNER OF CONCRETE BUS SLAB ON THE EAST
SIDE OF STATE STREET. APPROXIMATELY 50 FEET SOUTH OF THE CENTERLINE OF
94TH STREET.

BM 8561 ELEVATION= 19.77 FEET
SET CROSS ON SOUTHEASTERLY FLANGE BOLT OF FIRST FIRE HYDRANT SOUTH OF
93RD STREET, ON THE EAST SIDE OF STATE STREET.

BM 8562 ELEVATION= 22.29 FEET SET CROSS ON SOUTHEASTERLY FLANGE BOLT OF FIRST FIRE HYDRANT NORTH OF 93RD STREET, ON THE EAST SIDE OF STATE STREET.

BM 8563 ELEVATION= 20.47 FEET SET CROSS ON SOUTHEASTERLY FLANGE BOLT OF FIRST FIRE HYDRANT SOUTH OF 91ST STREET, ON THE EAST SIDE OF STATE STREET.

BM 8573 ELEVATION= 19.89 FEET SQUARE CUT ON EAST SIDE OF SIDEWALK OPPOSITE TO THE SECOND FIRE HYDRANT SOUTH OF 91ST STREET, ON THE WEST SIDE OF LAFAYETTE AVENUE.

BM 8574 ELEVATION= 18.90 FEET
SET CROSS ON THE WESTERLY FLANGE BOLT OF FIRE HYDRANT APPROXIMATELY
AT 9224 S. LAFAYETTE AVENUE, ON THE WEST SIDE OF LAFAYETTE AVENUE.

BM 8575 ELEVATION= 17.77 FEET
SET CROSS ON THE WESTERLY FLANGE BOLT OF FIRE HYDRANT APPROXIMATELY
AT 9326 S. LAFAYETTE AVENUE, ON THE WEST SIDE OF LAFAYETTE AVENUE.

BM 8576 ELEVATION= 17.43 FEET
SET CROSS ON THE WESTERLY FLANCE BOLT OF FIRE HYDRANT AT THE VACANT
LOT BETWEEN 9416 AND 9422 S. LAFAYETTE AVENUE, ON THE WEST SIDE OF
LAFAYETTE AVENUE.

BM 8578 ELEVATION= 27.92 FEET SET CROSS ON SOUTHERLY FLANGE BOLT OF FIRE HYDRANT AT THE NORTHWEST CORNER OF WEST 98TH PLACE AND PEORIA STREET.

BM 8579 ELEVATION= 28.59 FEET
SET CROSS ON SOUTHERLY FLANGE BOLT OF FIRE HYDRANT AT THE NORTHWEST
CORNER OF WEST 98TH PLACE AND SANGAMON STREET.

BM 8580 ELEVATION= 29.24 FEET SET CROSS ON SOUTHERLY FLANGE BOLT OF FIRE HYDRANT AT THE NORTHWEST CORNER OF WEST 98TH PLACE AND MORGAN STREET.

BM 8581 ELEVATION= 30.82 FEET SET CROSS ON CHAIN BOLT OF FIRE HYDRANT ON THE NORTHWEST CORNER OF CARPENTER STREET AND WEST 98TH PLACE.

BM 8582 ELEVATION= 30.69 FEET SET CROSS ON CHAIN BOLT OF FIRST FIRE HYDRANT NORTH OF WEST 98TH PLACE, ON THE EAST SIDE OF ABERDEEN STREET.

BM 8583 ELEVATION= 33.14 FEET SET SQUARE CUT ON CONCRETE BRIDGE WALL AT THE SOUTHEASTERLY CORNER OF GENOA AVENUE AND 99TH STREET.

BM 8584 ELEVATION= 32.36 FEET SET CROSS ON CHAIN BOLT OF FIRST FIRE HYDRANT WEST OF ABERDEEN STREET, ON THE SOUTHERLY SIDE OF 99TH STREET.

BM 8585 ELEVATION= 30.28 FEET SET CROSS ON SOUTHERLY FLANGE BOLT OF FIRST FIRE HYDRANT WEST OF MORGAN STREET, ON THE SOUTH SIDE OF 99TH STREET.

BM 8586 ELEVATION= 28.75 FEET
SET CROSS ON NORTHERLY FLANGE BOLT OF FIRE HYDRANT AT THE SOUTHWEST
CORNER OF 99TH STREET AND SANGAMON STREET.

BM 8587 ELEVATION= 31.19 FEET
SET CROSS ON SOUTHERLY FLANGE BOLT OF FIRE HYDRANT AT THE SOUTHWEST CORNER OF 99TH STREET AND CARPENTER STREET.

BM 3514 ELEVATION= 17.56 FEET SET CROSS ON CHAIN BOLT OF HYDRANT AT SOUTHTHWEST INTERSECTION OF LASALLE ST. AND 97TH ST.

BM 3522 ELEVATION= 18.06 FEET
SET CROSS ON SOUTH SOUTHEAST FLANGE BOLT OF HYDRANT ± HALFWAY
BETWEEN NORTH AND SOUTH ENTRANCE TO CITGO, EAST SIDE OF STATE
ST. AND NORTH OF 95TH ST.

BM 3549 ELEVATION= 9.49 FEET SET CROSS WESTERLY FLANGE BOLT OF HYDRANT AT SOUTHWEST INTERSECTION OF 87TH ST. AND LAFAYETTE AVE.

BM 3550 ELEVATION= 22.88 FEET SET CROSS WESTERLY FLANGE BOLT OF HYDRANT AT SOUTHWEST INTERSECTION OF 91ST ST. AND LAFAYETTE AVE.

BM 3551 ELEVATION= 17.50 FEET SET CROSS NORTHERLY FLANGE BOLT OF HYDRANT AT SOUTHWEST INTERSECTION OF 95TH ST. AND LAFAYETTE AVE.

BM 3552 ELEVATION= 14.81 FEET SET CROSS NORTHEAST BOLT OF TRAFFIC SIGNAL/LIGHT BASE AT SOUTHEAST INTERSECTION OF 91ST ST. AND STATE ST.

BM 3553 ELEVATION= 8.47 FEET SET CROSS NORTHWEST BOLT OF TRAFFIC SIGNAL/LIGHT BASE AT NORTHEAST INTERSECTION OF 87TH ST. AND STATE ST.

BM 3556 ELEVATION= 9.06 FEET SET CROSS EASTERLY FLANGE BOLT OF HYDRANT AT NORTHEAST CORNER OF 75TH ST. AND STATE ST.


BM 3558 ELEVATION= 18.15 FEET SET CROSS SOUTHWESTERLY FLANGE BOLT OF HYDRANT AT NORTHWEST INTERSECTION OF NORMAL ST. AND 98TH PLACE.


BM 3810 ELEVATION= 0.29 FEET
CUT SQUARE ON SQUTHERLY CORNER OF METAL BASE FOR OVERHEAD
SIGN, ON THE WESTERLY SIDE OF SQUTHBOUND DAN RYAN, OPPOSITE
OF WEST 77TH PLACE, APPROXIMATELY 1000 FEET NORTH OF 79TH
STREET BRIDGE.


BM 3811 ELEVATION= 1.95 FEET CUT SQUARE ON SOUTHEASTERLY CORNER OF METAL BASE FOR OVERHEAD SIGN, ON THE WESTERLY SIDE OF SOUTHBOUND DAN RYAN APPROXIMATELY 840 FEET SOUTHERLY OF 83RD STREET.


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	1	DATE: JANUARY 16, 2009	CHECKED BY: MMW	


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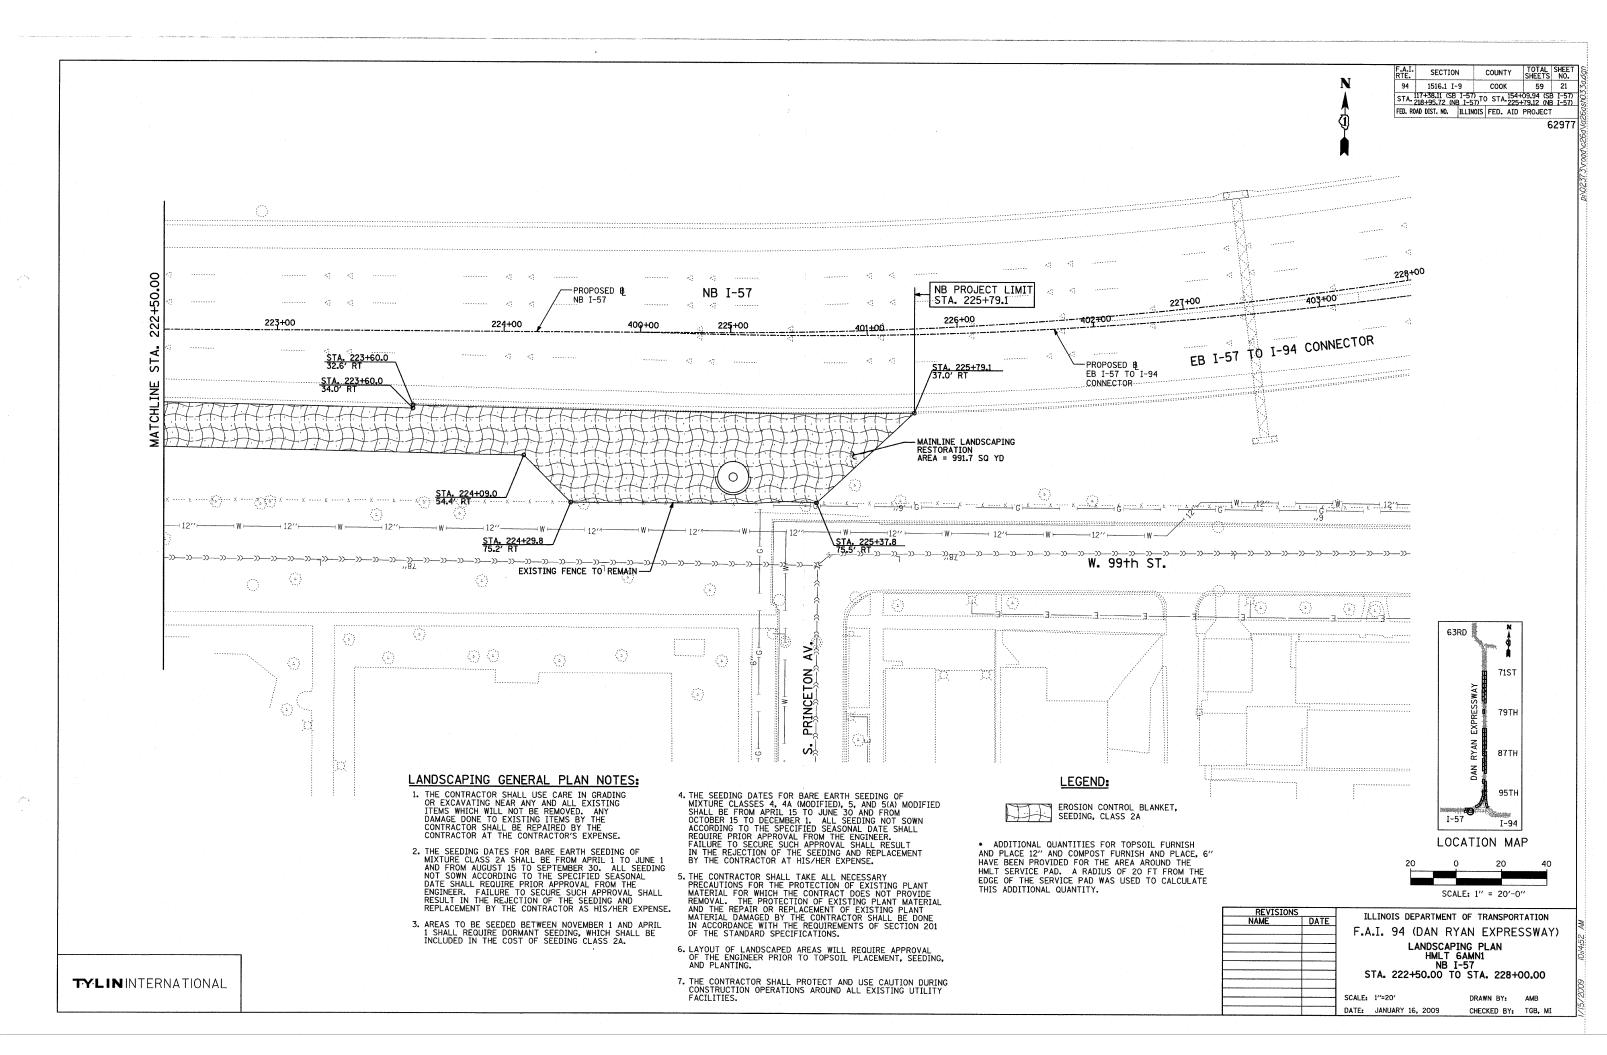


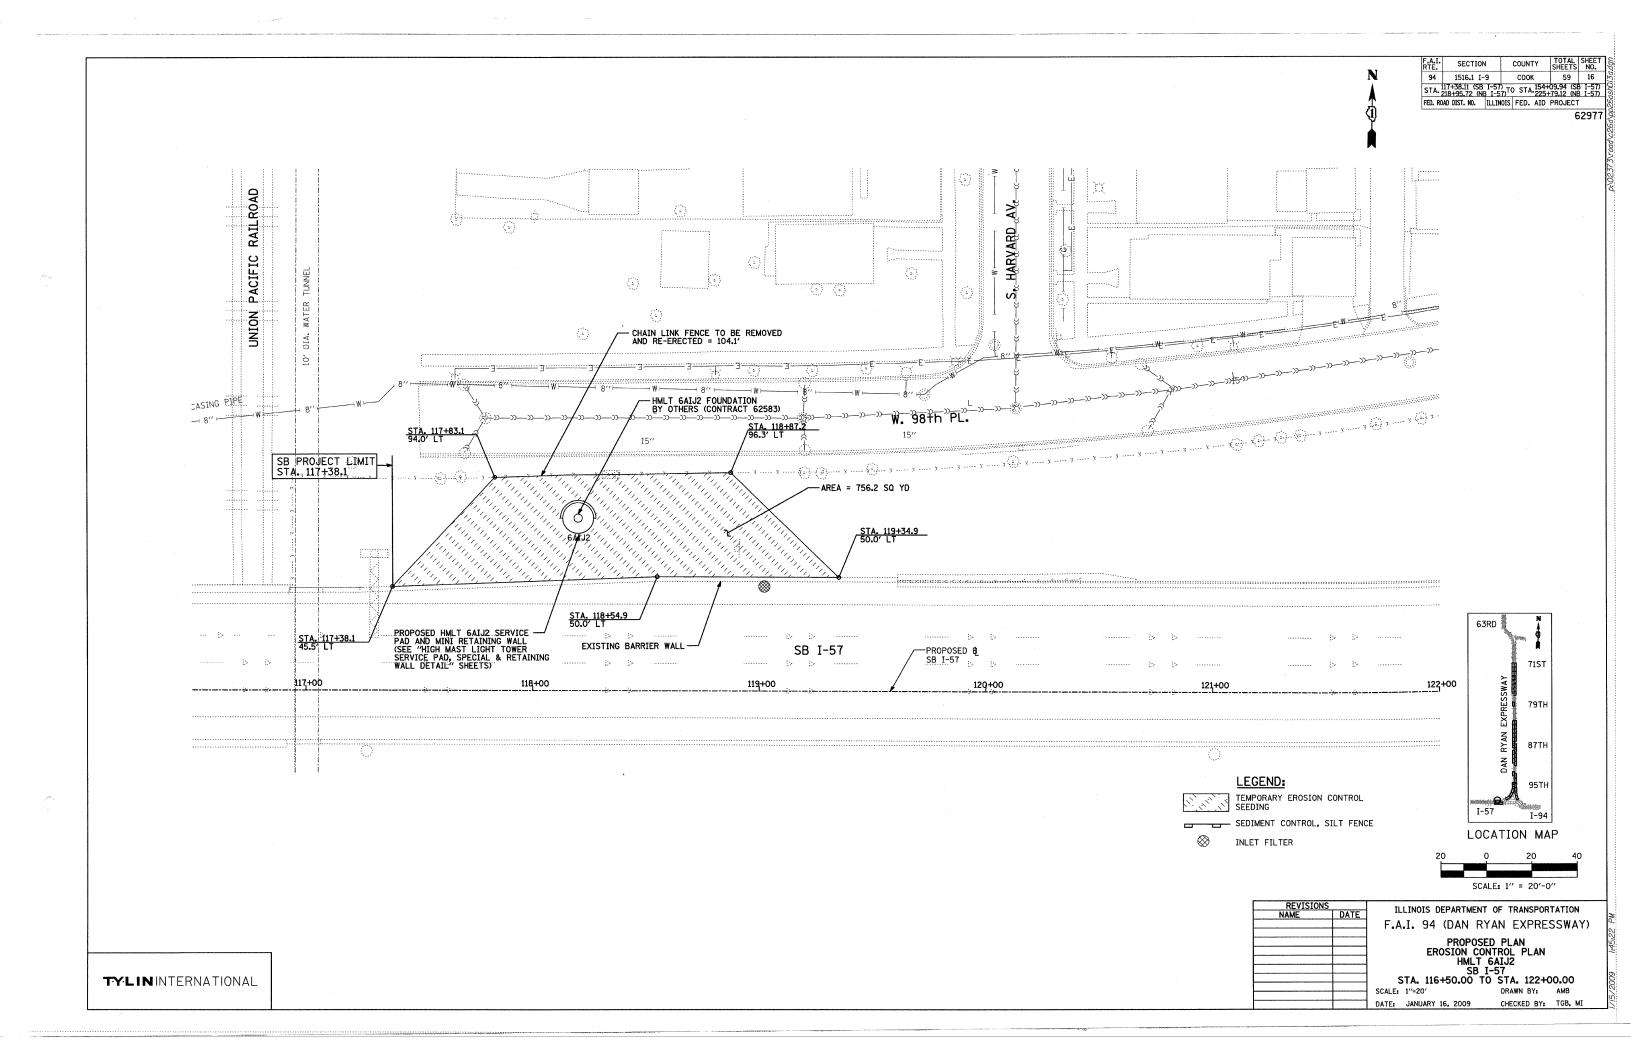


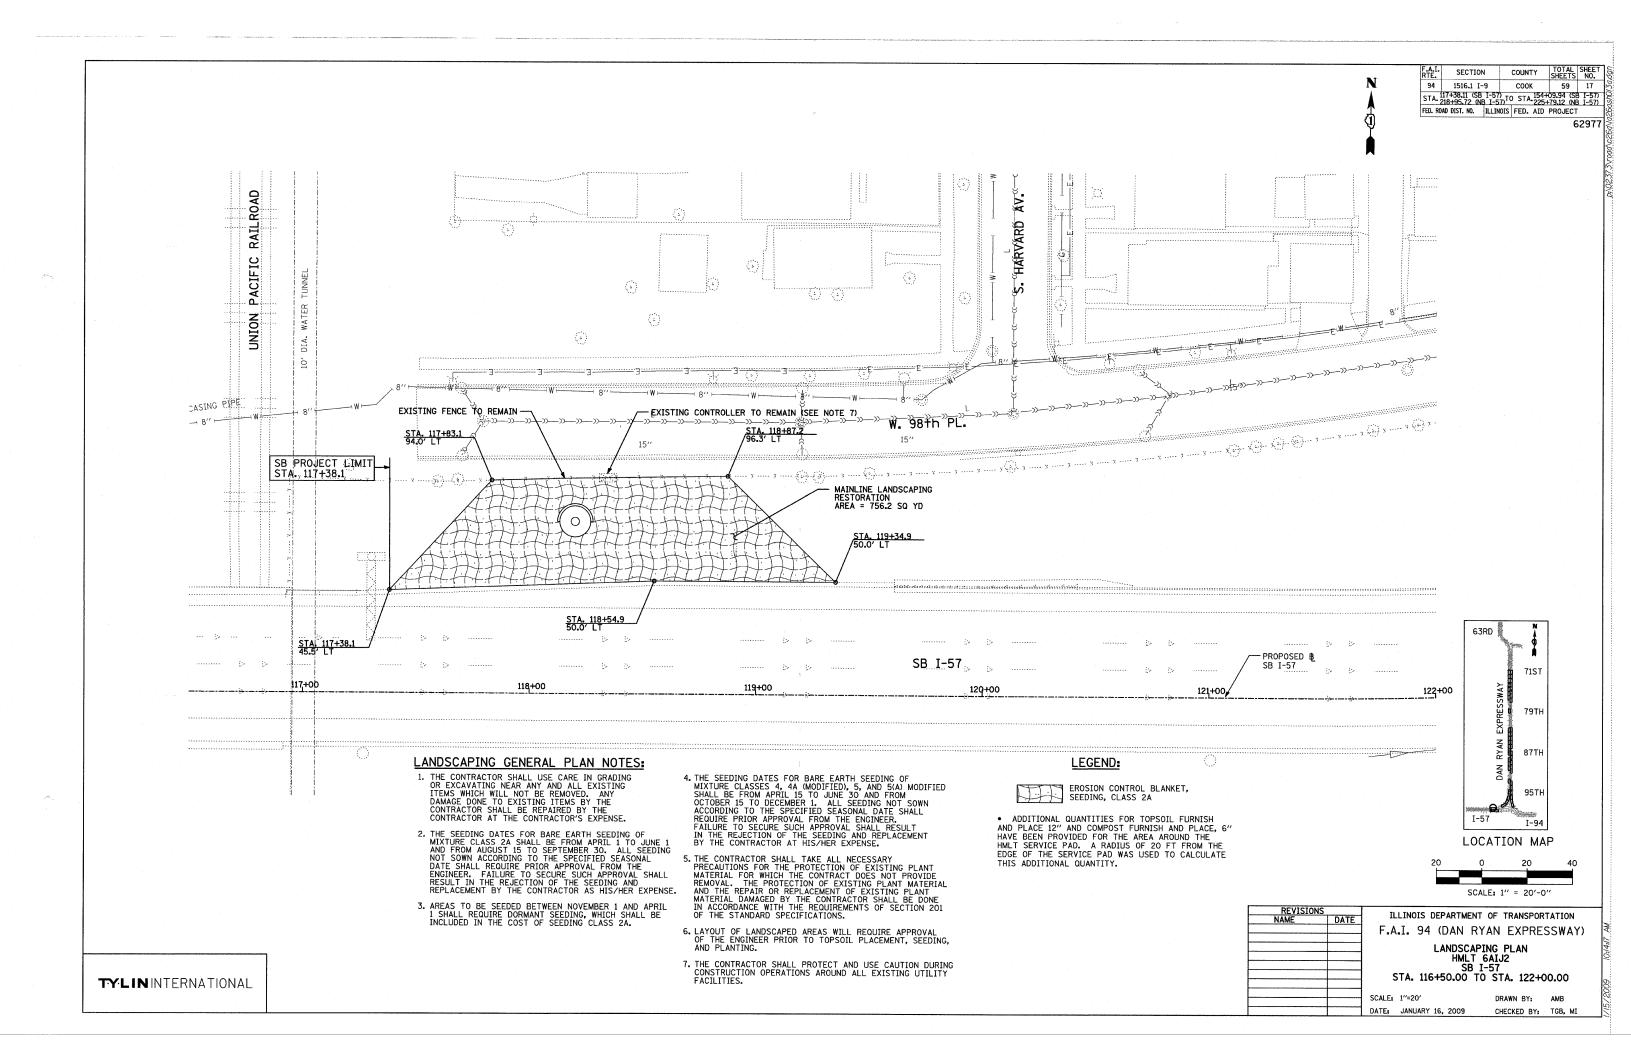


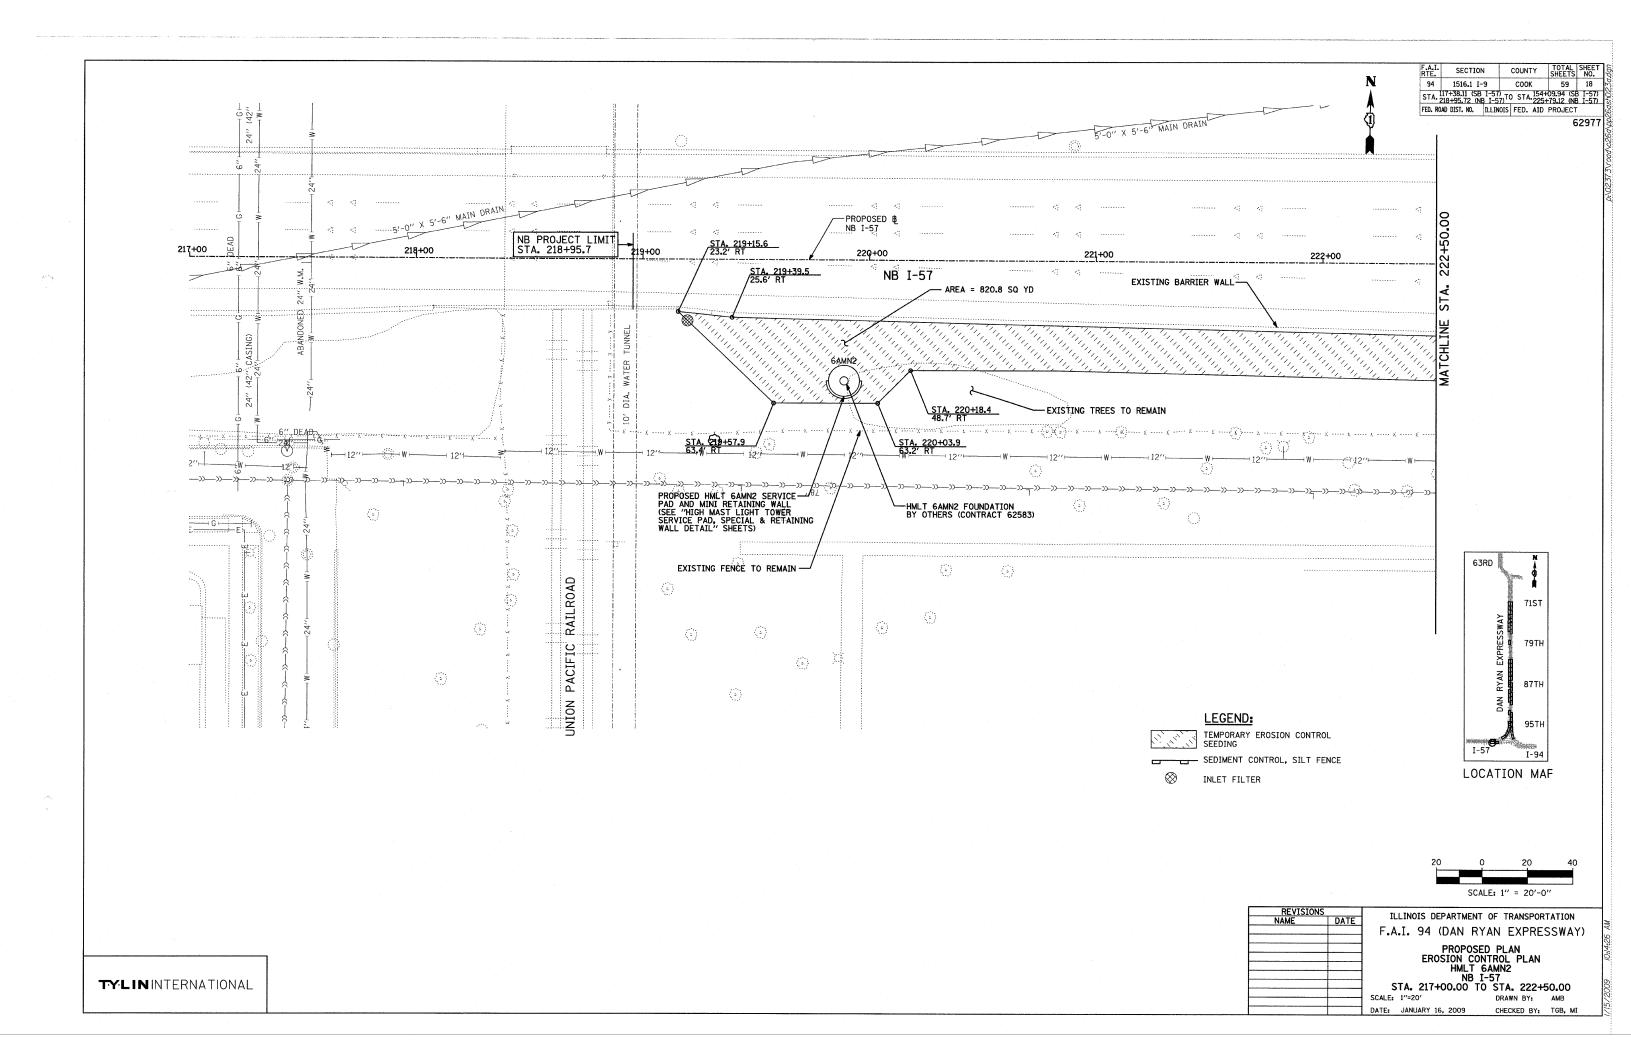


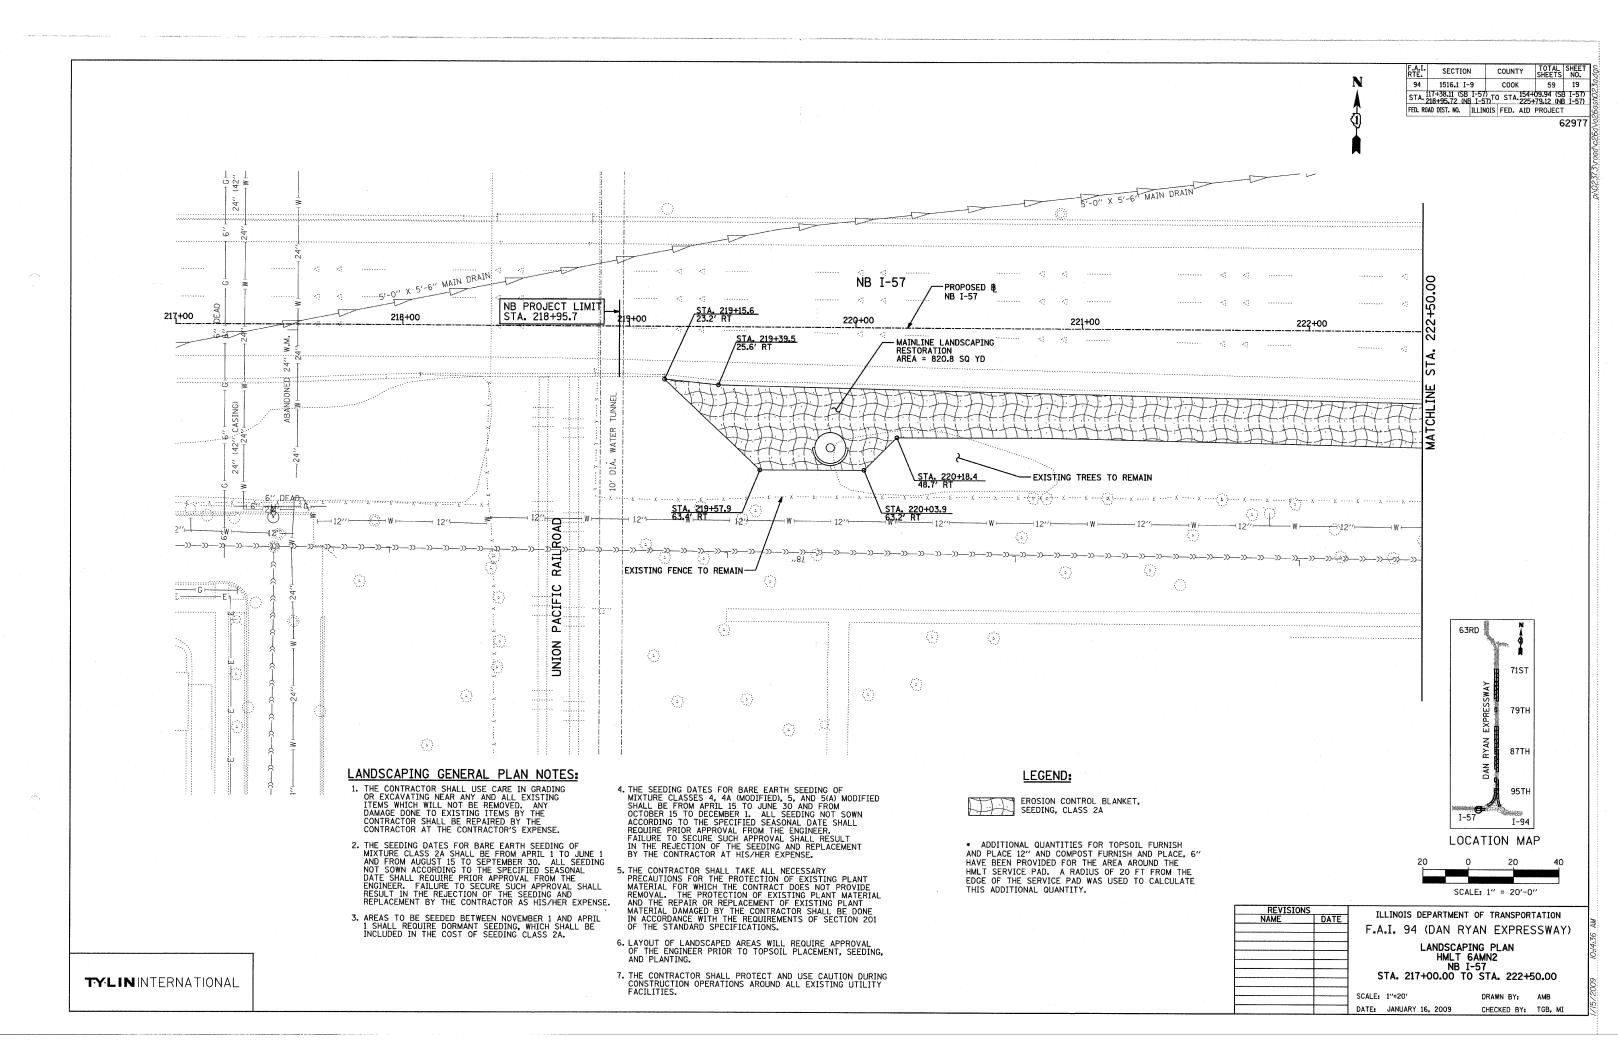


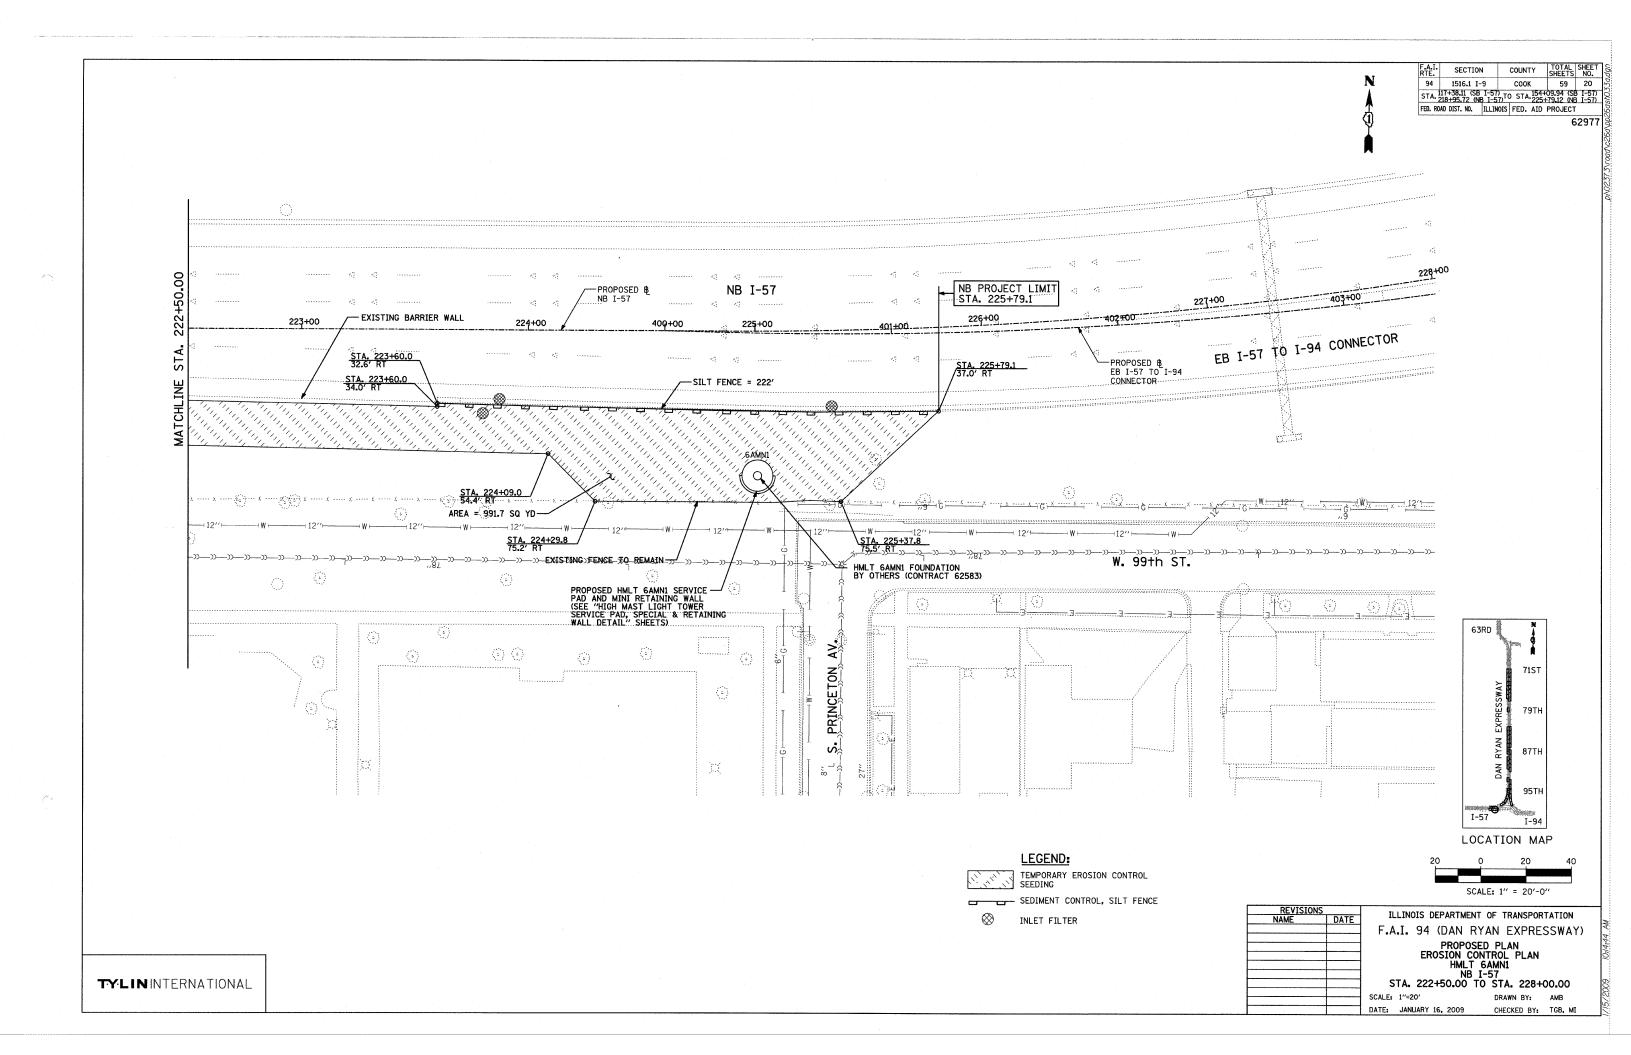


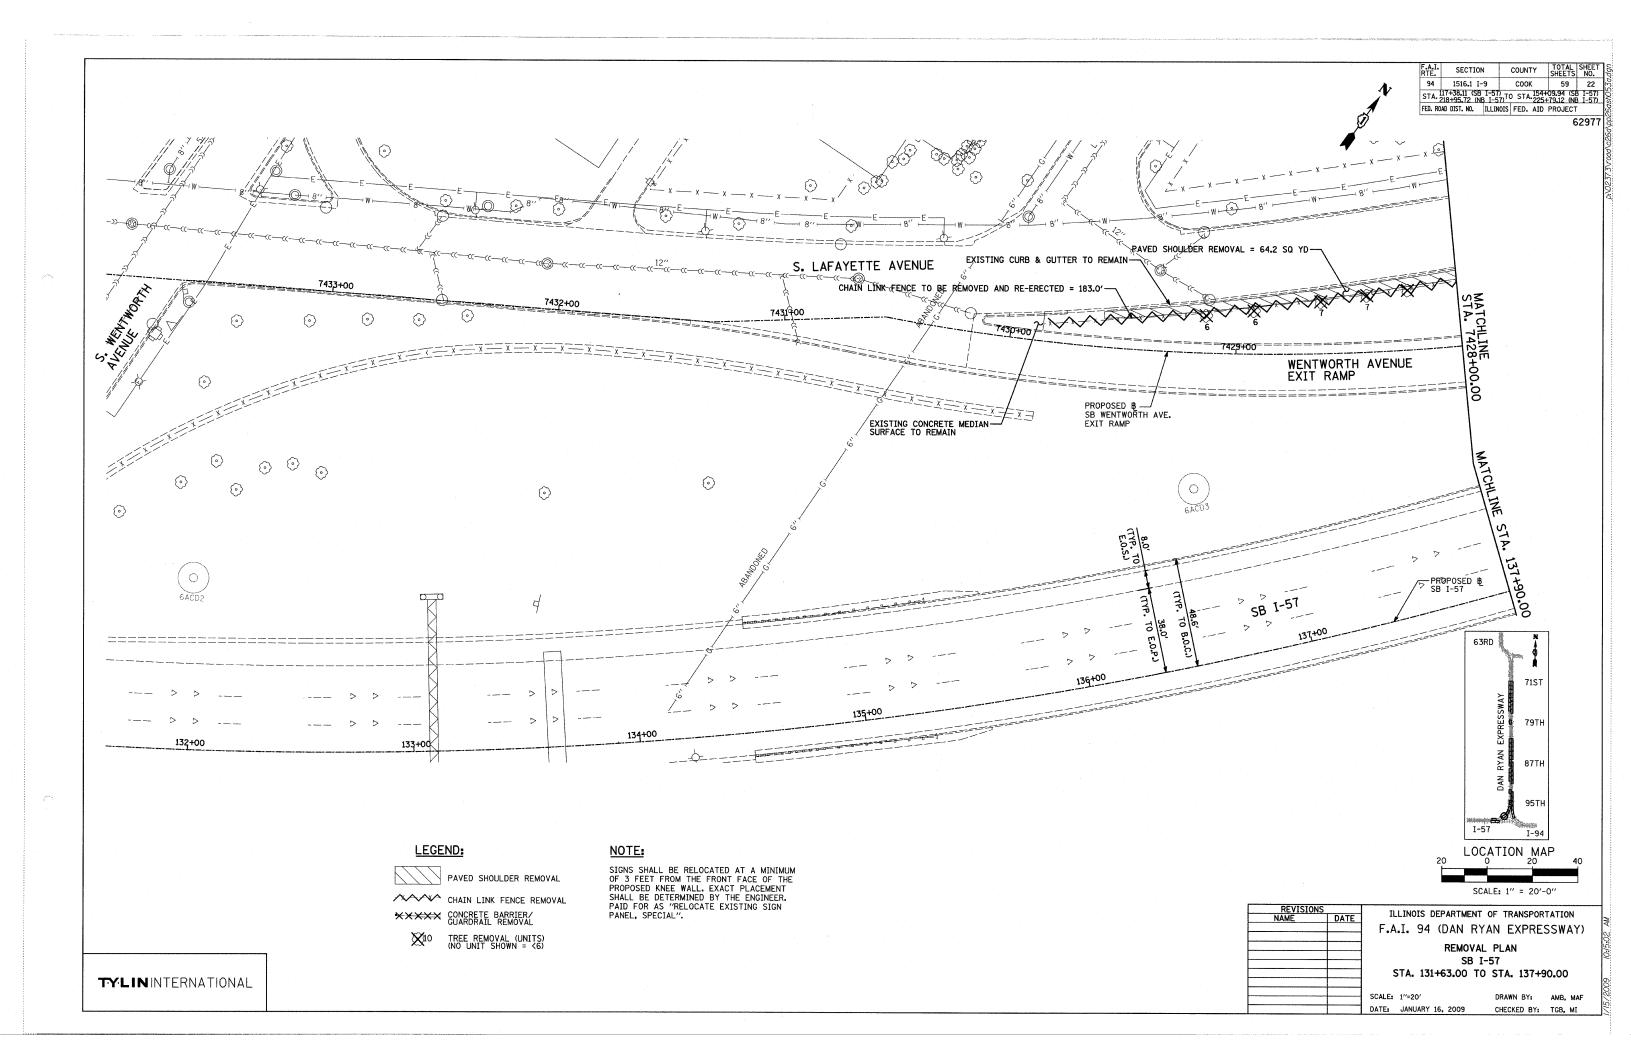


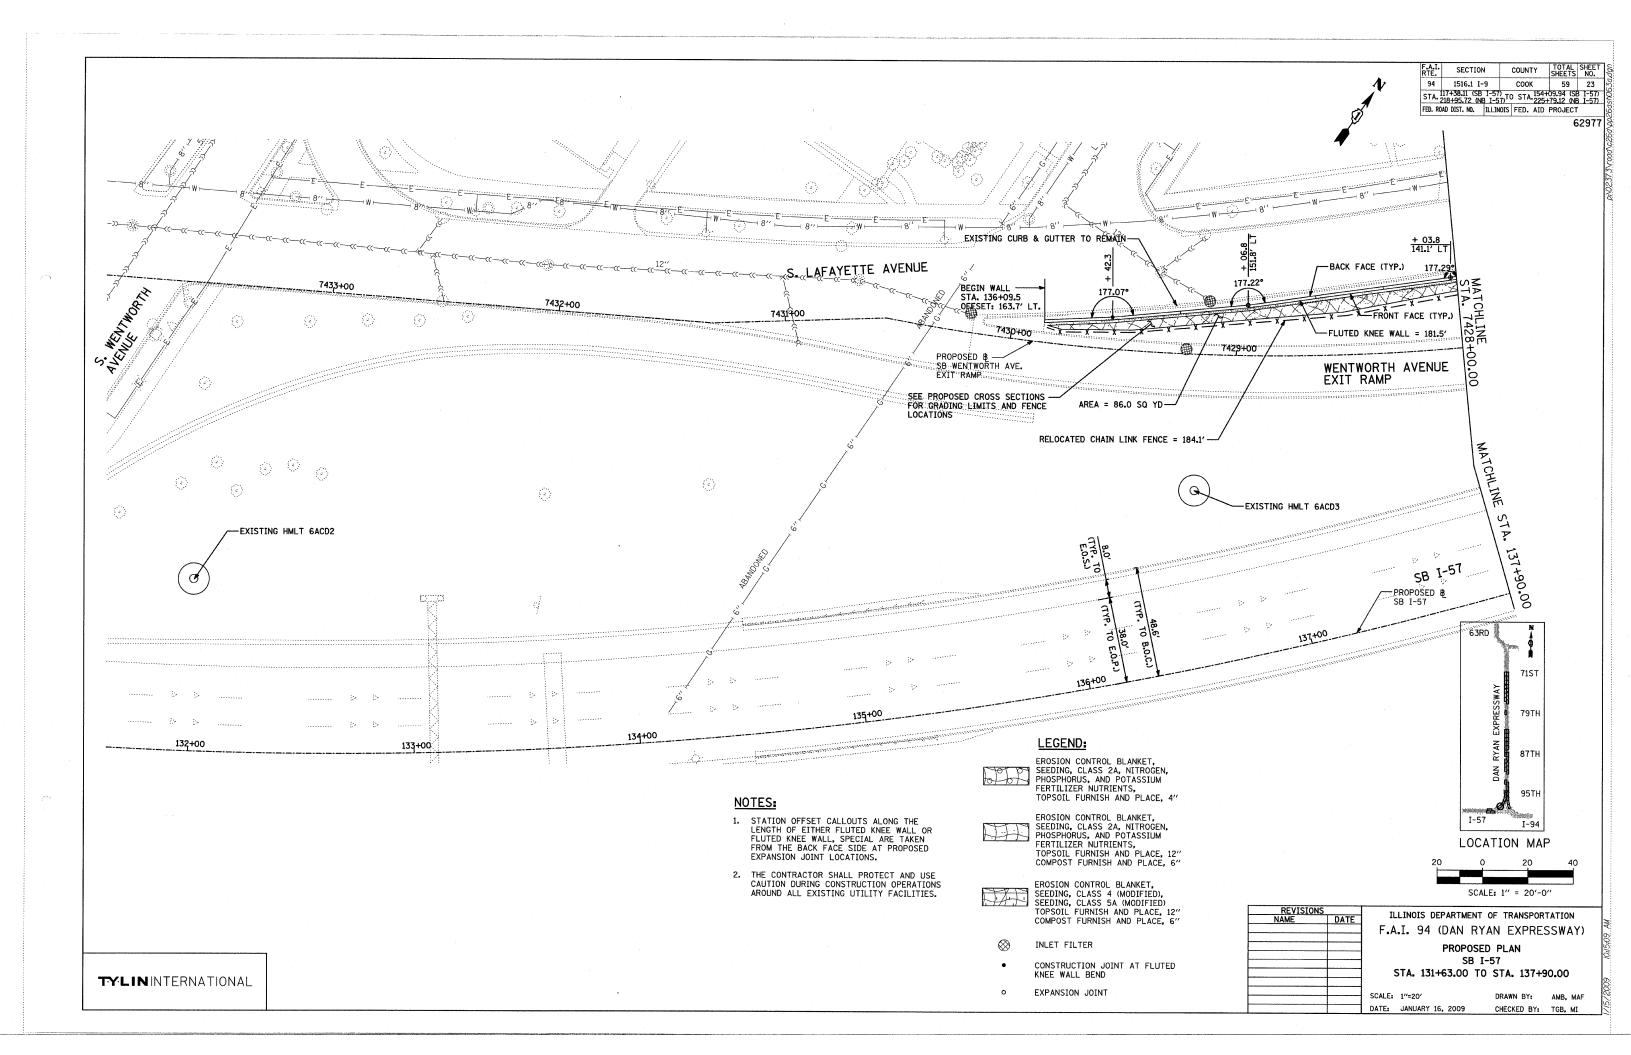


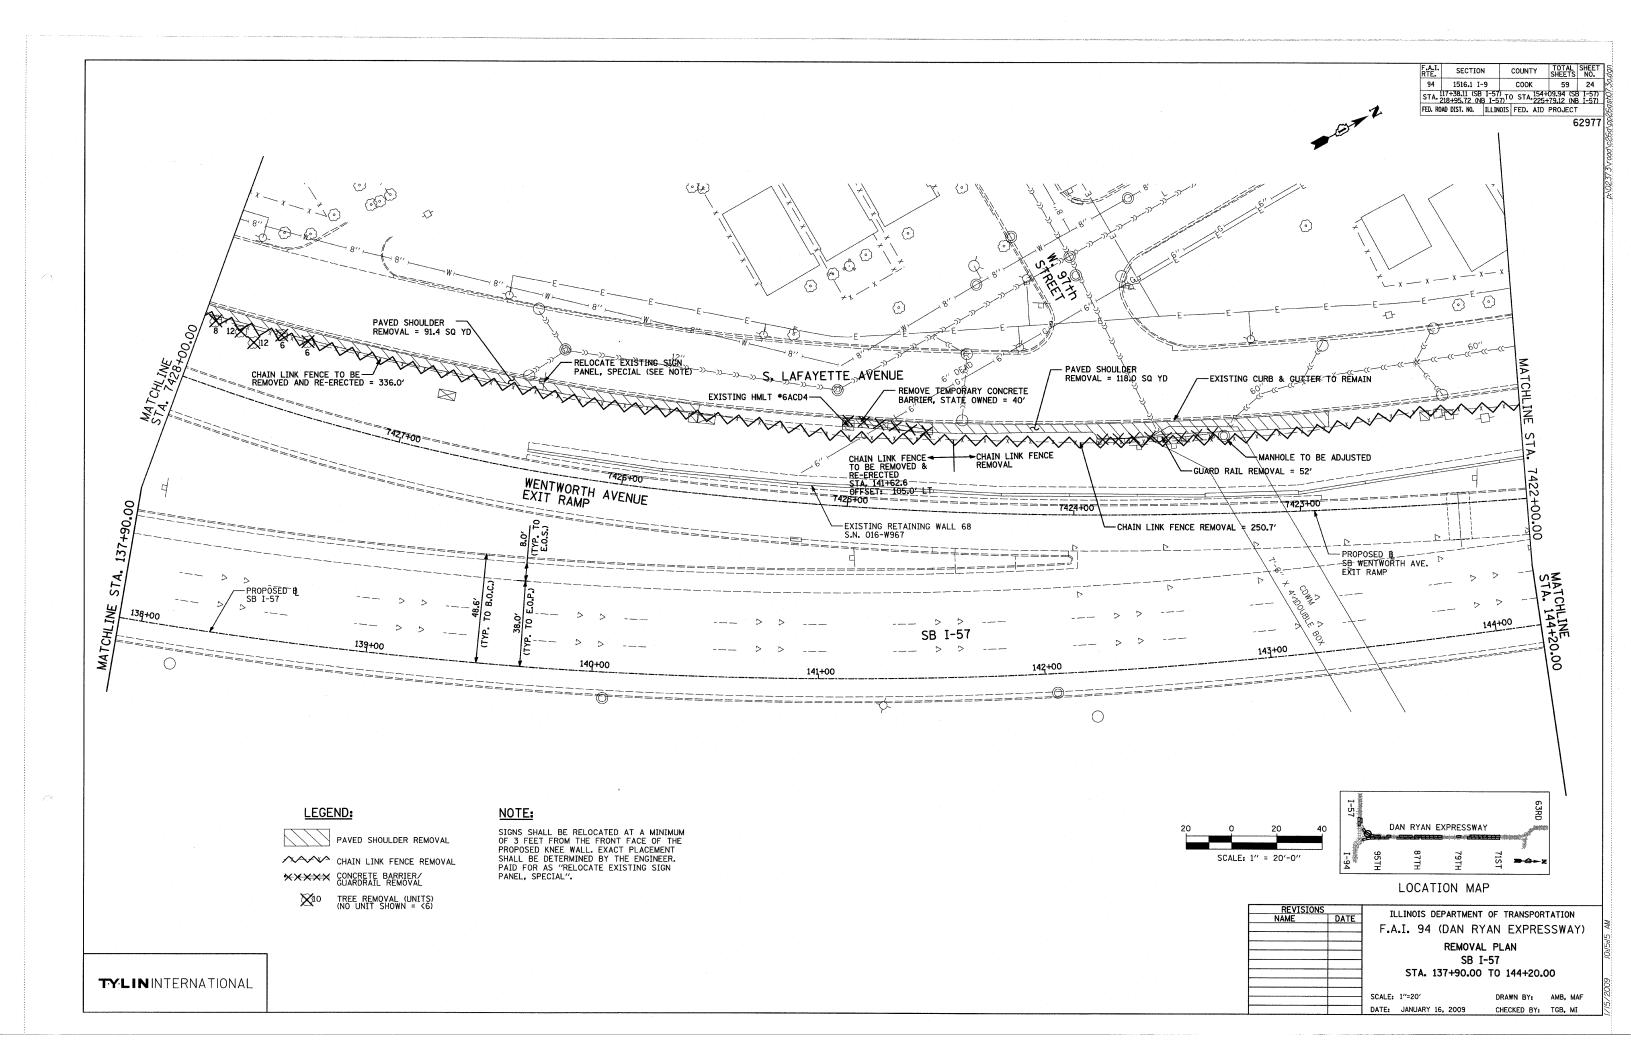


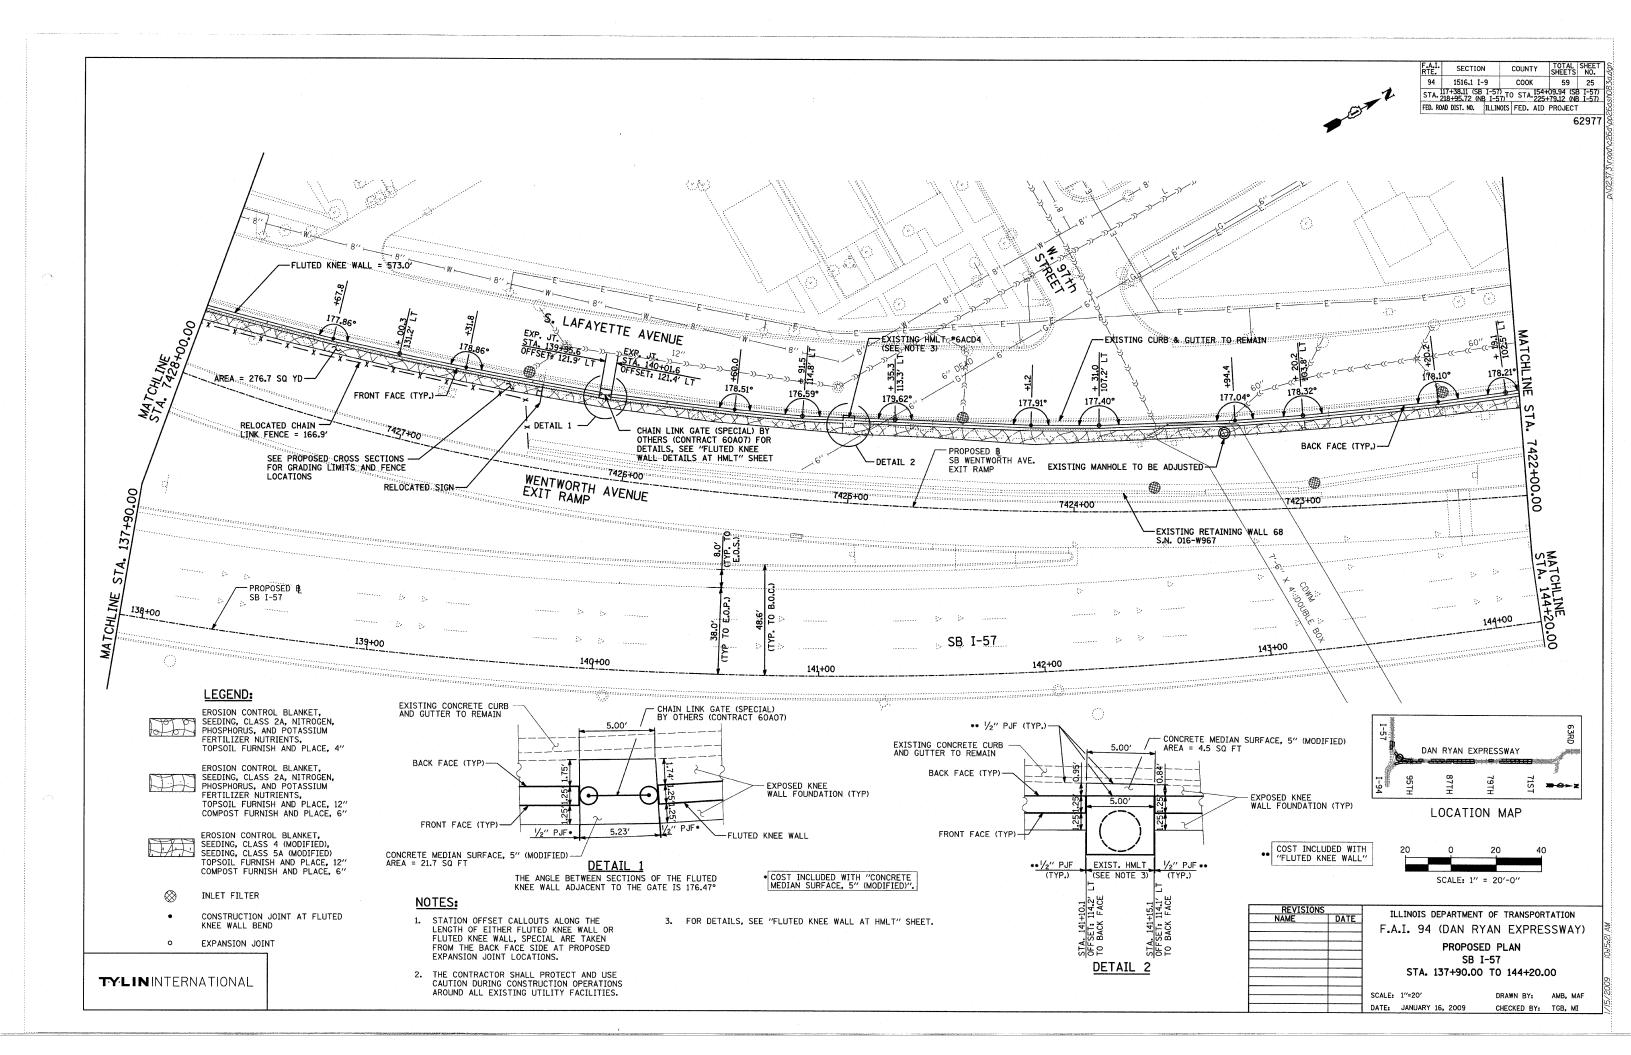


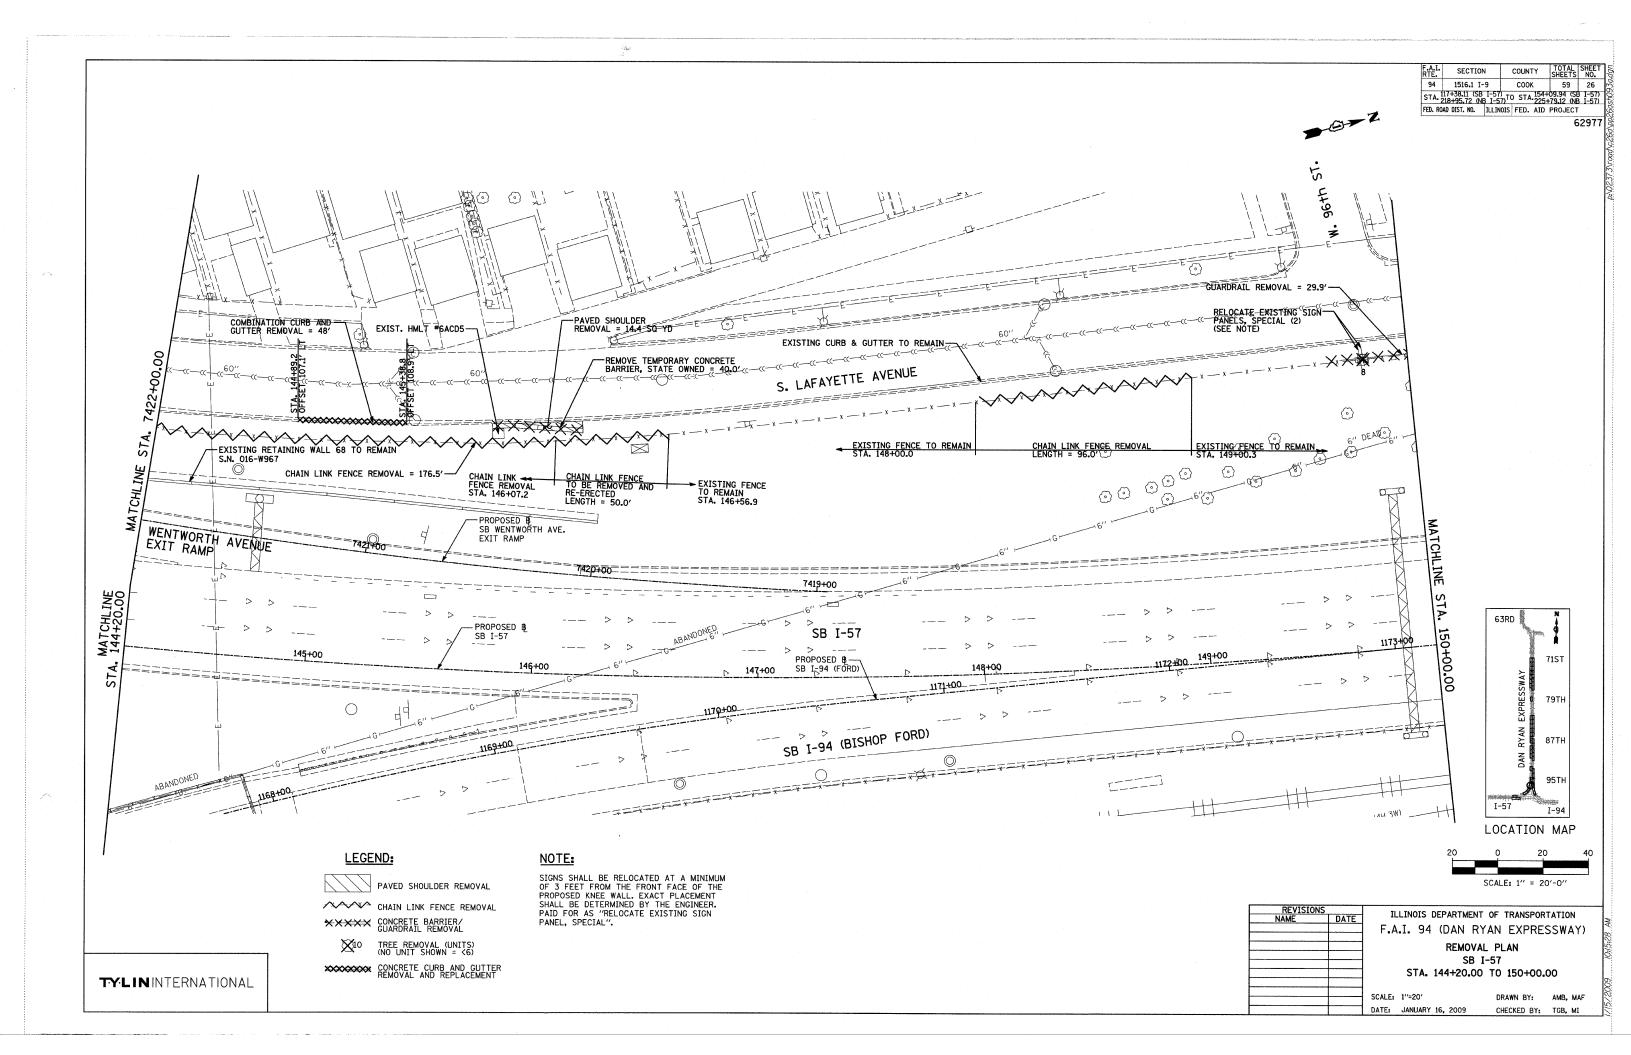

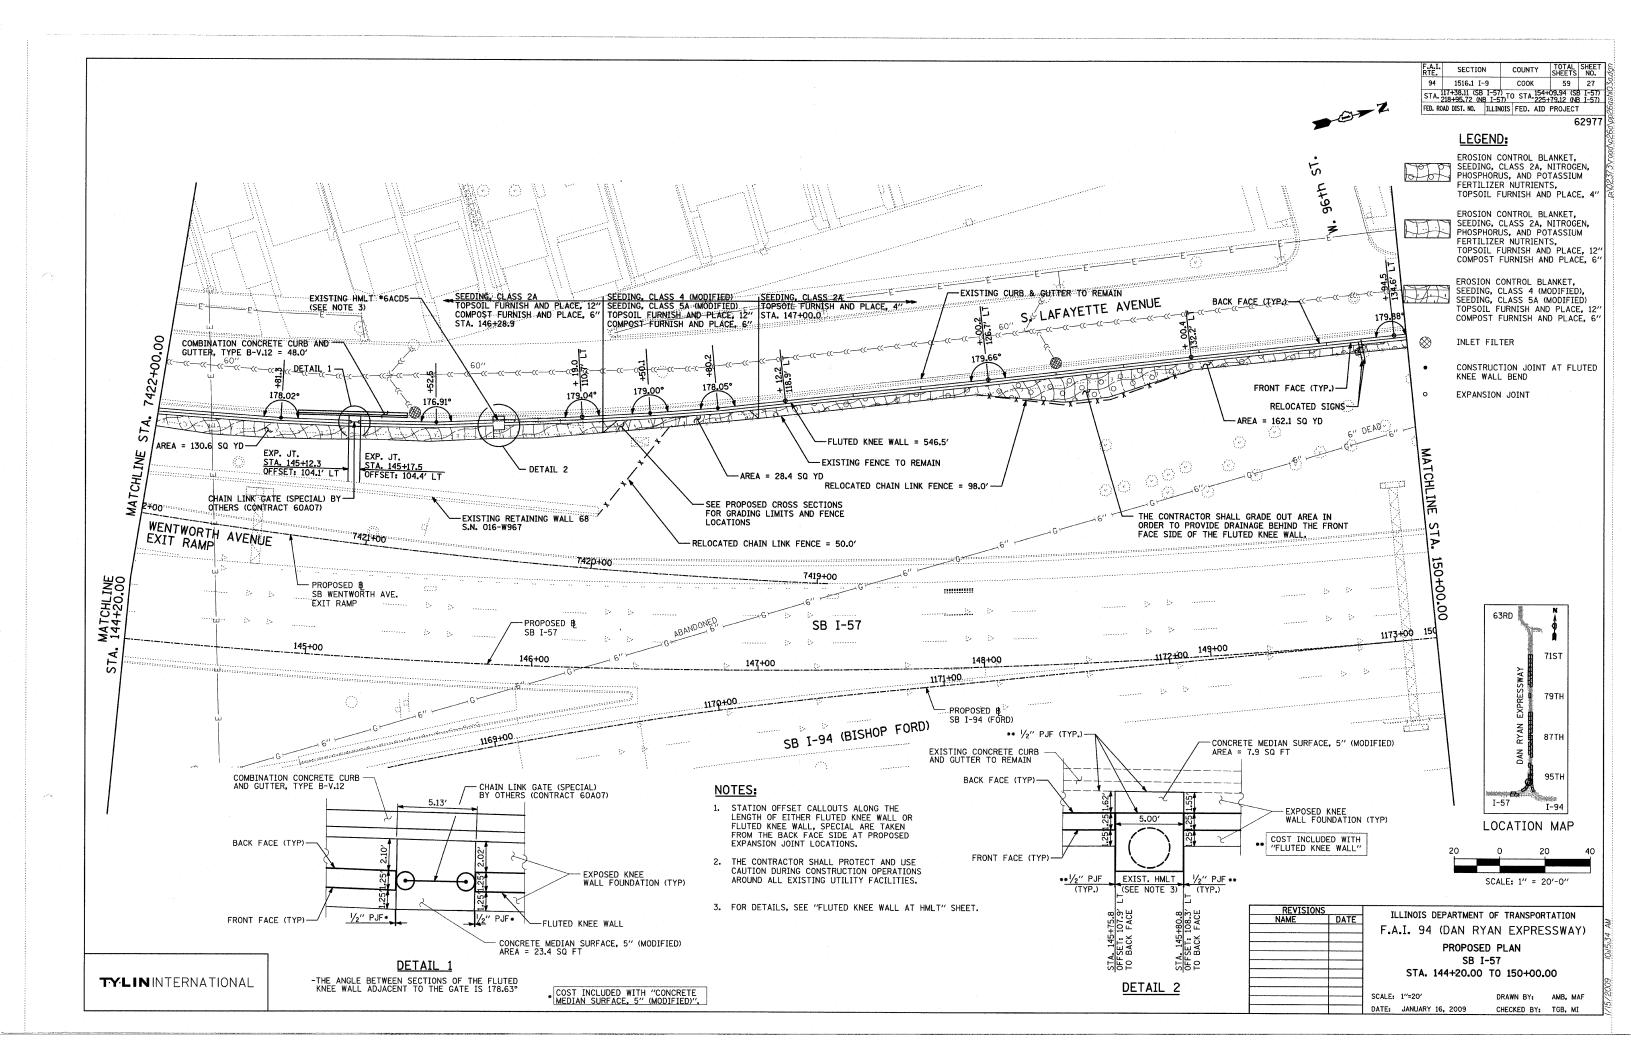


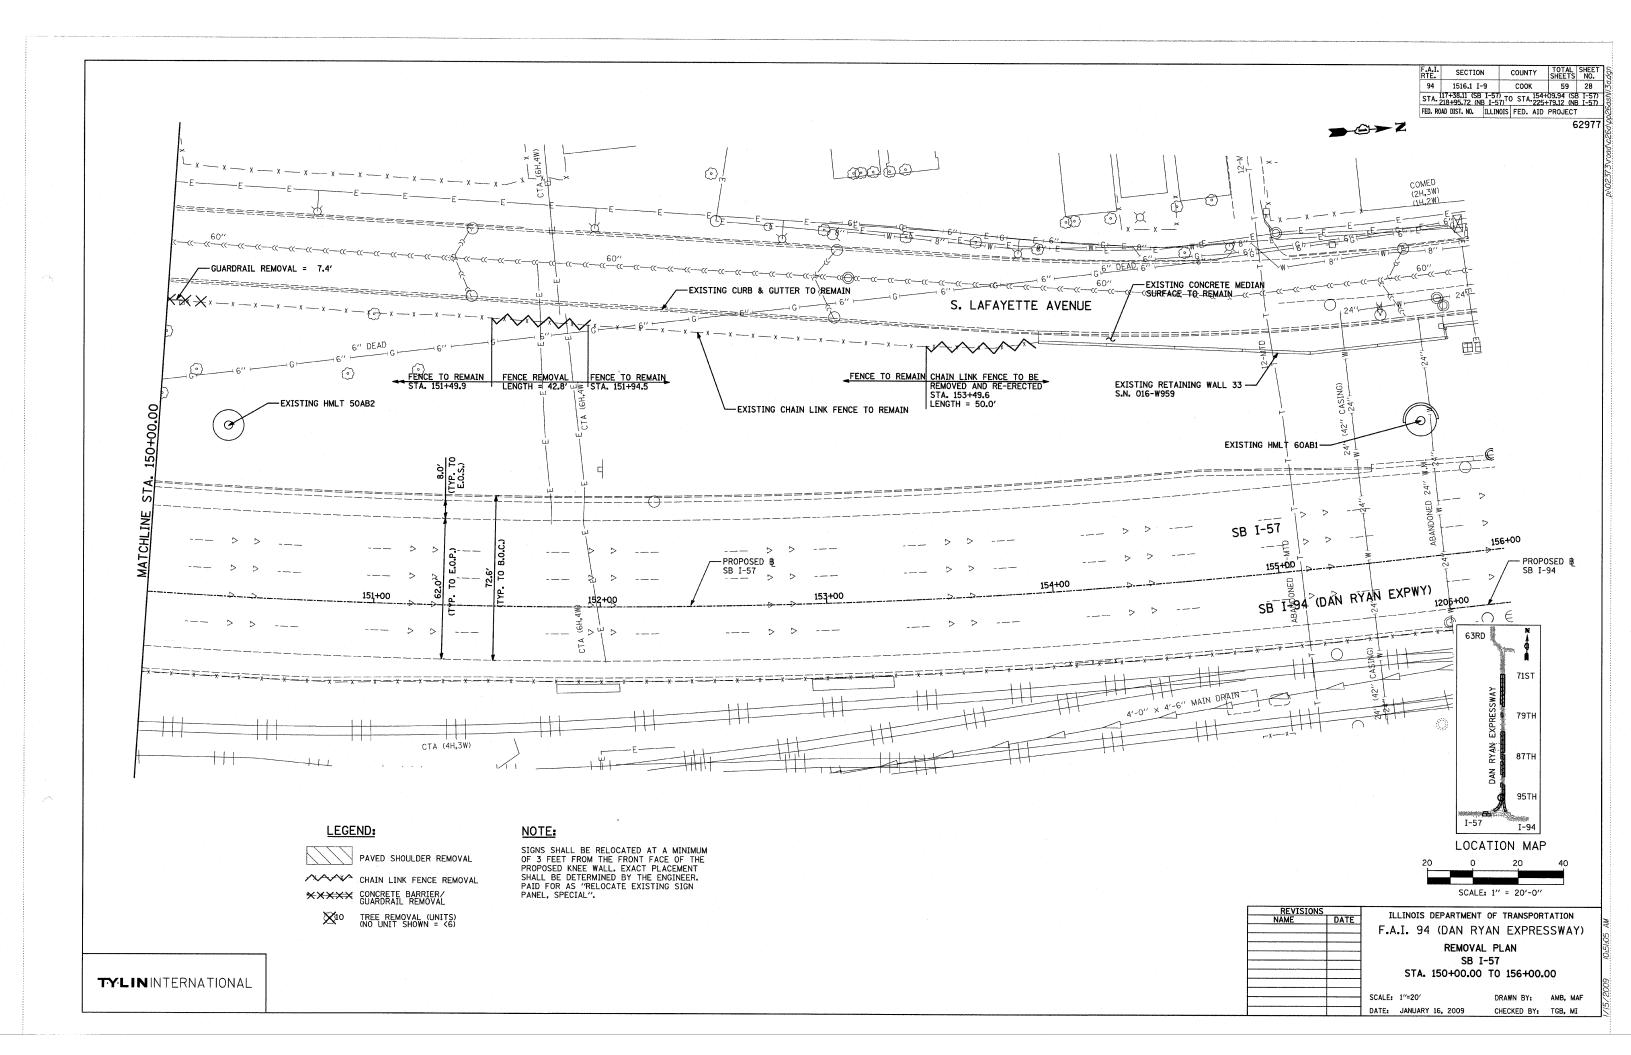

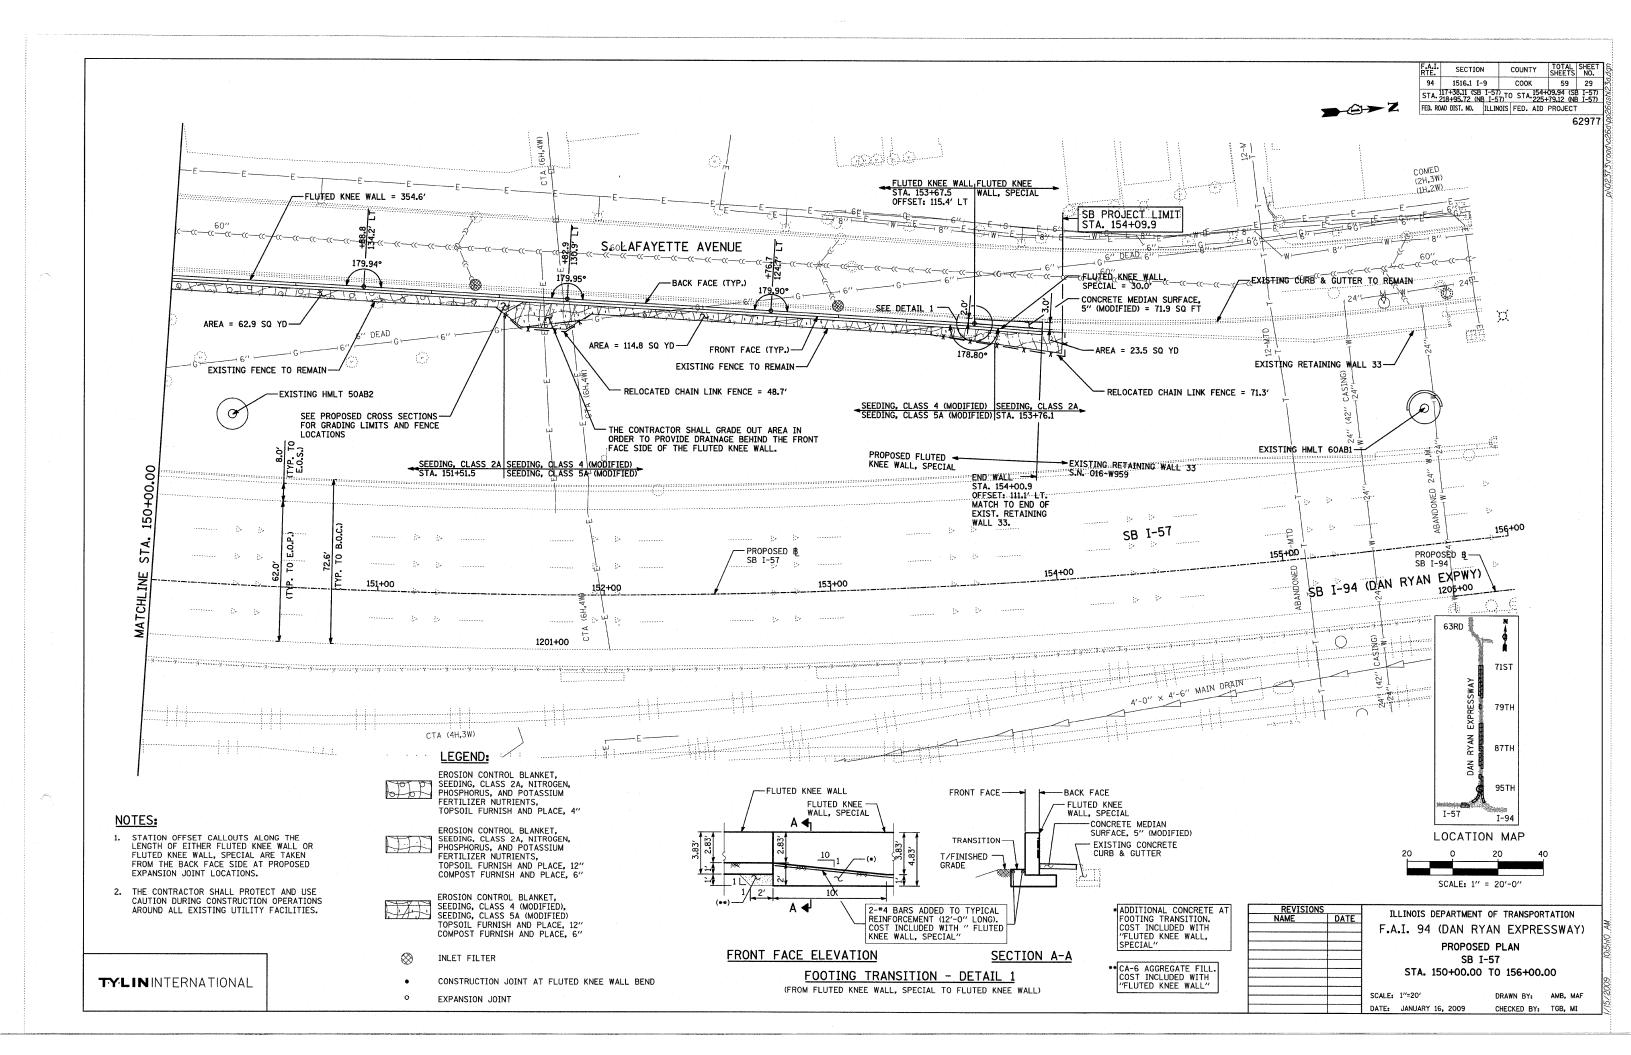


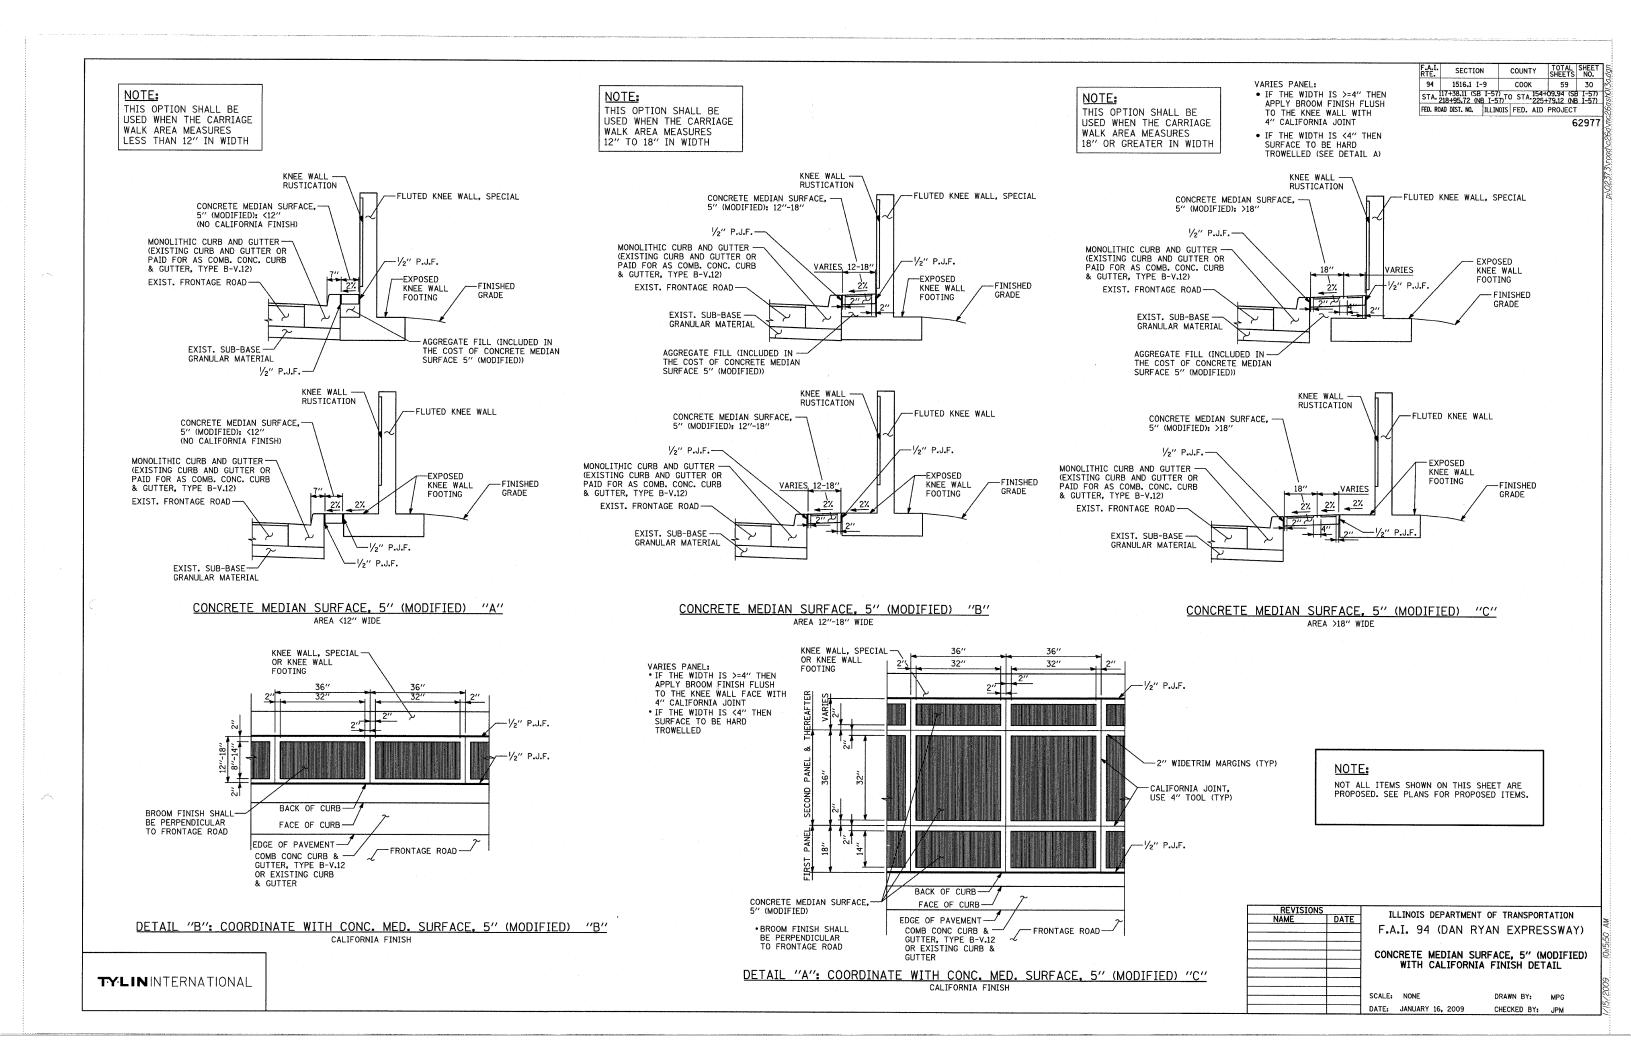

62977

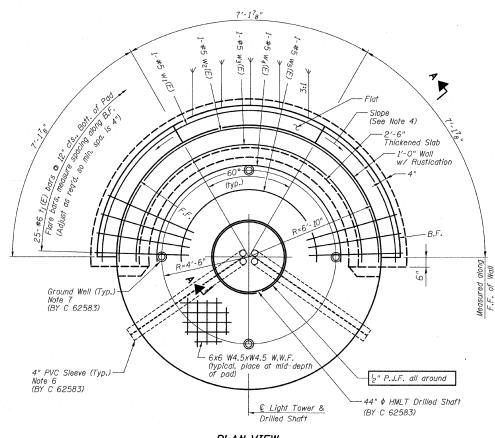


Place Bars $w_1(E)$ thru $w_5(E)$ © 12" cts., Bott. of Pad

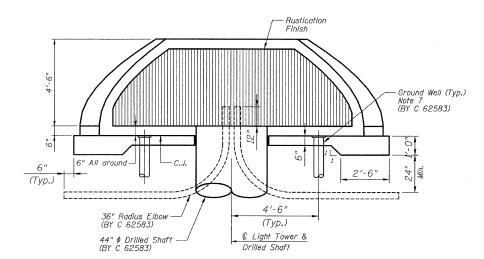

ELEVATION VIEW

(HMI T not shown for clarity

TYLIN INTERNATIONAL

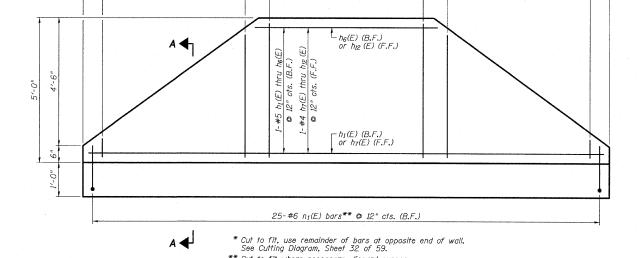

** Cut to fit where necessary, discard excess.

5'-O" RETAINING WALL ELEVATION (PROJECTED)
(Looking at F.F.)

12", 7-#4 v_I(E) bars* © 12" cts. (F.F.), 12", 8-#4 v_Z(E) bars © 12" cts. (F.F.), 12", #4 v_I(E) bars* © 12" cts. (F.F.)

NOTES


- 1. F.F. and B.F. denote Front Face and Back Face, respectively.
- 2. HMLT denotes High Mast Light Tower.
- 3. Refer to HMLT Service Pad, Special & Retaining Wall Details 2 for Bar Bending Diagrams, Bill of Material, Bar Sections and Details.
- 4. T/Wall slope is constant along the arc of any given radius.
- 5. Place horizontal tails of n_1 (E) bars radially.
- 6. PVC sleeves must be extended 6 inches by Contract 62583 beyond the edge of the concrete pad.
- 7. Ground wells 4'-6" as measured from centerline of the HMLT to centerline of the well to be installed by Contract 62583. Adjust service pad reinforcement to miss wells. Any necessary vertical adjustments will be performed by the contractor who installed the ground wells at the specific location.

REVISIONS
NAME DATE

F.A.I. 94 (DAN RYAN EXPRESSWAY)

HIGH MAST LIGHT TOWER SERVICE PAD, SPECIAL & RETAINING WALL DETAILS 1

S.N. SCALE: N.T.S. DATE: JANUARY 16, 2009 DESIGNED BY: MAF
DRAWN BY: MAF
CHECKED BY: MI

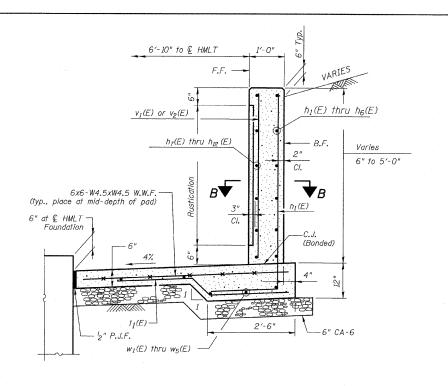

SECTION A-A


HMLT not shown for clarity

– h (E) bars n (E) bars See Detail C-C SECTION B-B

7" Module

not be overlapped

DETAIL C-C

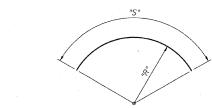

Bar	"R"	"5"
h1(E)	7'-7"	23'-6"
h ₂ (E)	7′-7"	20'-10"
h3(E)	7′-7"	17'-8"
h4(E)	7′-7"	14'-6"
h5(E)	7′-7"	11'-4"
h ₆ (E)	7′-7"	8'-2"
h ₇ (E)	7'-12"	22'-1"
$h_8(E)$	7'-12"	19'-7"
$h_9(E)$	7'-1'2"	16'-7"
h10 (E)	7'-12"	13'-7"
h_{II} (E)	7'-12"	10'-8"
h12 (E)	7'-12"	7′-8"
w ₁ (E)	7′-7"	24'-4"
w2(E)	6'-8"	21'-7"
w3(E)	5'-10"	18'-10"
W4(E)	4'-9"	<i>15′-5</i> "
w ₅ (E)	3′-6"	11'-6"

Note: "R" and "S" measured along bar €

BARS w1(E) thru w5(E) & h1(E) thru h12(E)


F.A.I. RTE.	SECTION		COUNTY	TOTAL SHEETS	SHEET NO.
94	1516.1 I-9		COOK	59	32
STA.	17+38.11 (SB) 218+95.72 (NB	I-57) I-57) ^{TC}	STA-154+	09.94 (SE +79.12 (NE	3 I-57) 3 I-57)
			FED. AID		


62977

BILL OF MATERIAL


Light Tower Service Pad, Special with 5'-0" Wall (Note 4)

Bar	No.	Size	Length	Shape
h ₁ (E)	1	#5	23′-6"	
h ₂ (E)	1	#5	20′-10″	
h3(E)	1	#5	17'-8"	
h ₄ (E)	1	#5	14'-6"	
h ₅ (E)	1	#5	11'-4"	
h ₆ (Ε)	1	#5	8'-2"	
h ₇ (E)	1	#4	22'-1"	
h ₈ (E)	1	#4	19'-7"	
hg(E)	1	#4	16'-7"	
h ₁₀ (E)	1	#4	13'-7"	
h _{II} (E)	1	#4	10′-8"	
h ₁₂ (E)	1	#4	7′-8"	
n ₁ (E)	25	#6	7′-4"	
† ₁ (E)	25	#6	5′-1"	
v ₁ (E)	7	#4	5′-0"	
v ₂ (E)	8	#4	4'-8"	
w ₁ (E)	1	#5	24'-4"	
w ₂ (E)	1	#5	21'-7"	
w₃(E)	1	#5	18'-10"	
w ₄ (E)	1	#5	15'-5"	
w ₅ (E)	1	#5	11'-6"	

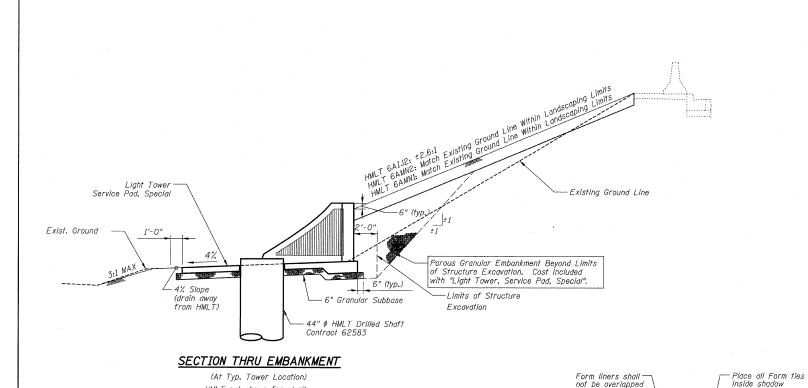

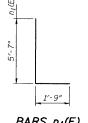


BARS n₁(E)

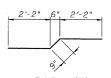

BAR t1(E)

Adjust as required

SUGGESTED FORMWORK DETAIL

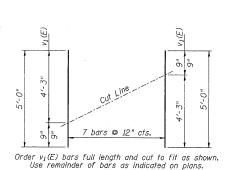

* CUTTING DIAGRAM Bars $v_1(E)$

(Per HMLT)

Item	. Unit	Total
Welded Wire Fabric	Sq. Yd.	18
Structure Excavation	Cu. Yd.	11
Concrete Structures	Cu. Yd.	7.2
Reinforcement Bars, Epoxy Coated	Pound	775
Rustication Finish	Sq. Ft.	55
Protective Coat	Sq. Yd.	29
Sub-Base Granular Material, Type B 6"	Sq. Yd.	22
Porous Granular Embankment	Cu. Yd.	48

OF	MATERIAL		

Item	Unit	Total
Welded Wire Fabric	Sq. Yd.	18
Structure Excavation	Cu. Yd.	11
Concrete Structures	Cu. Yd.	7.2
Reinforcement Bars, Epoxy Coated	Pound	775
Rustication Finish	Sq. Ft.	55
Protective Coat	Sq. Yd.	29
Sub-Base Granular Material, Type B 6"	Sq. Yd.	22

<u>NOTES</u>

- 1. F.F. and B.F. denote Front Face and Back Face, respectively.
- 2. HMLT denotes High Mast Light Tower.
- 3. See IDOT Standard Drawing BE501 for additional High Mast Light Tower foundation and ground well details.
- 4. Reinforcement Bars designated (E) shall be epoxy coated.
- Refer to High Mast Light Tower Service Pad, Special & Retaining Wall Details I for location and orientation of conduit sleeves and grounding wells.
- Contractor shall maintain integrity of Frontage Roads as may be required in excavating for HMLT service pad walls.
- Provide Protective Coat to top, front face, exposed portion of back face, and ends of walls, and top and edges of pad.


TOTAL BILL OF MATERIAL


Item	Unit	Total
Light Tower, Service Pad, Special	Each	3


REVISIONS		ILLINOIS DEPARTMENT OF TRANSPORTATION
NAME	DATE	ILLINOIS DEPARTMENT OF TRANSPORTATION
		F.A.I. 94 (DAN RYAN EXPRESSWAY)
		HIGH MAST LIGHT TOWER SERVICE PAD
	ļ	HIGH MAST LIGHT TOWER SERVICE PAD, SPECIAL & RETAINING WALL DETAILS 2
	1	

DESIGNED BY: MAF SCALE: N.T.S. DRAWN BY: MAF, TB DATE: JANUARY 16, 2009 CHECKED BY: MI

TYLININTERNATIONAL

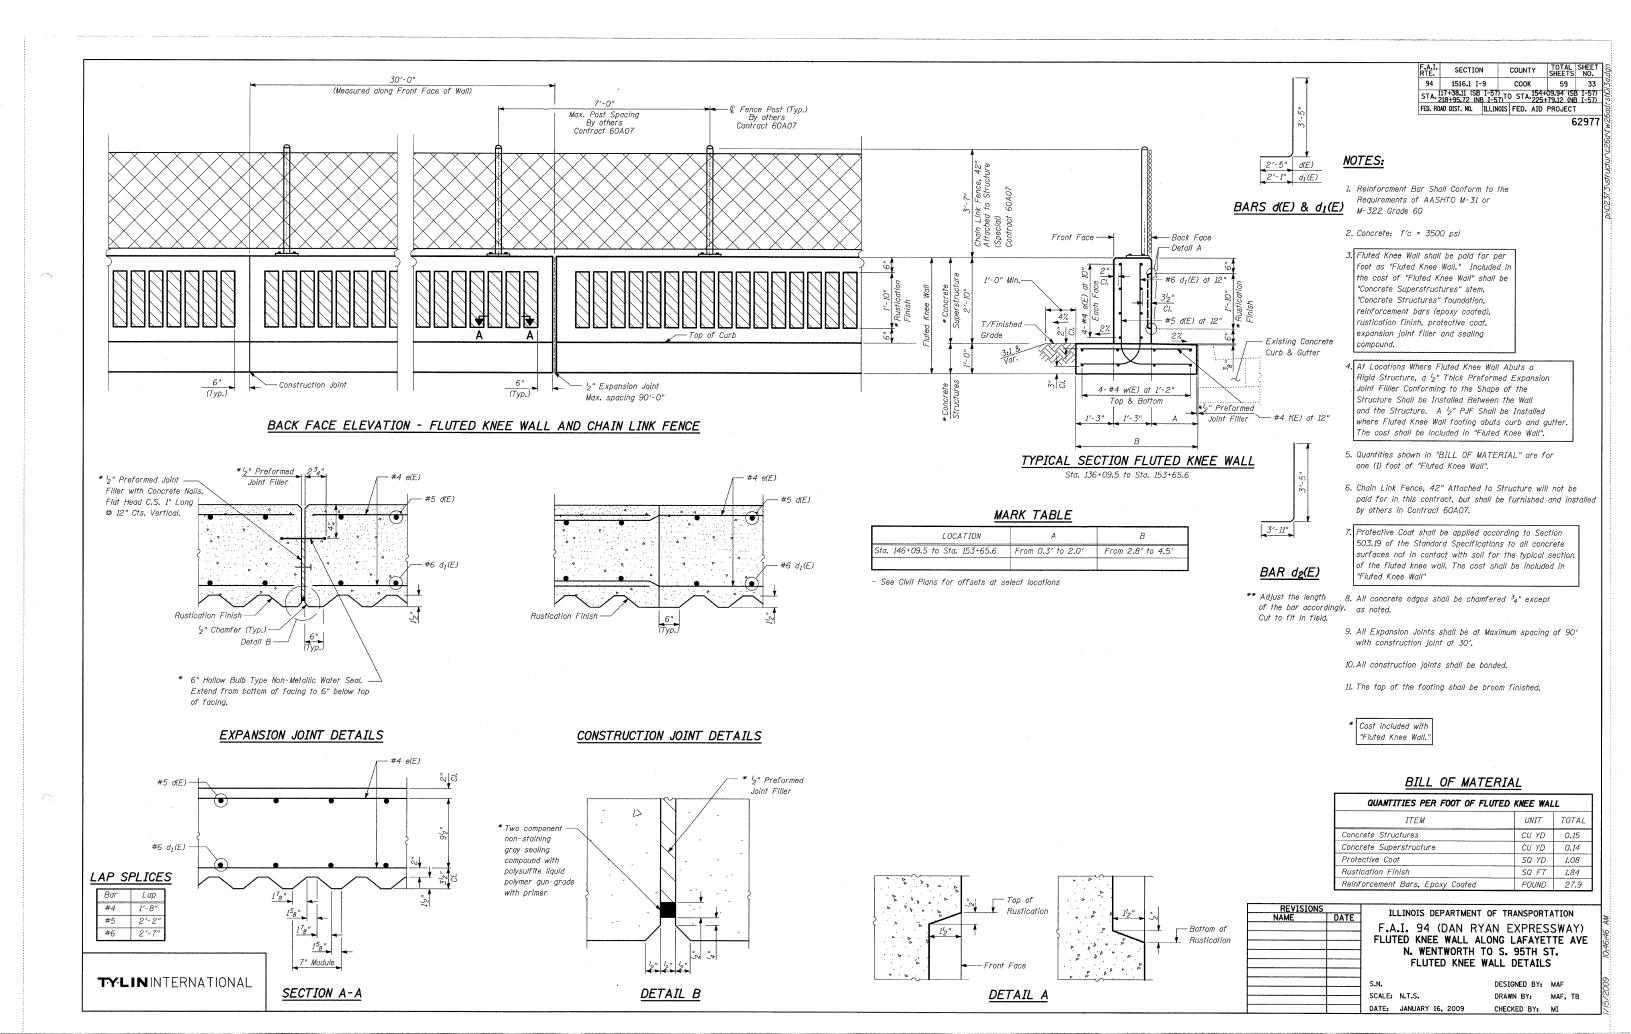

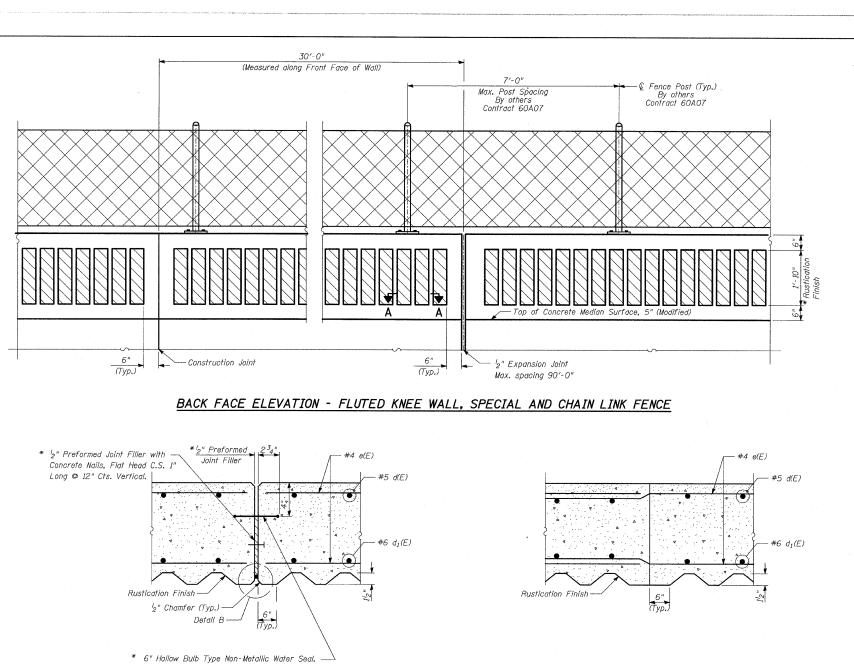


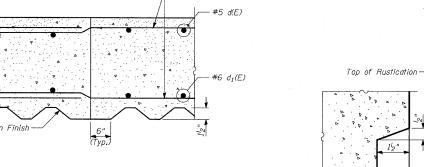


EXPANSION JOINT DETAILS

Extend from bottom of facing to 6" below top


of facing.

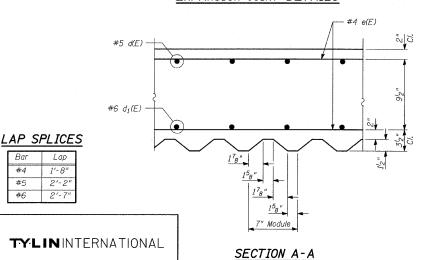

CONSTRUCTION JOINT DETAILS

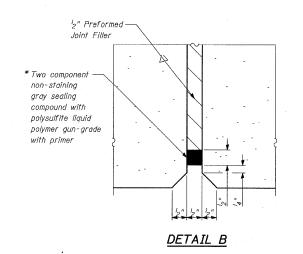

SECTION COUNTY 94 1516.1 I-9 COOK 59 34 STA. 117438.11 (SB I-57) TO STA. 1544-09.94 (SB I-57) STA. 2184-95.72 (NB I-57) STA. 1254-79.12 (FED. ROAD DIST. NO. ILLINOIS FED. AID PROJECT

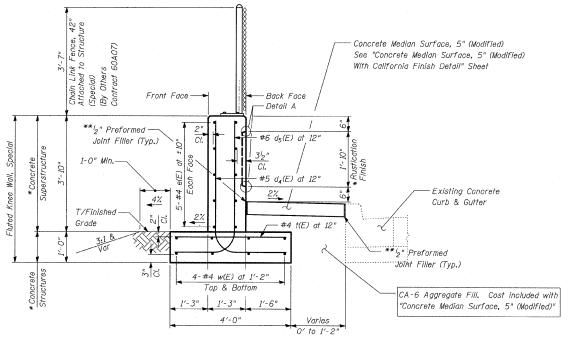

TYPICAL SECTION FLUTED KNEE WALL, SPECIAL

Sta. 153+65.6 to Sta. 154+00.9

Bottom of Rustication

DETAIL A

BILL OF MATERIAL QUANTITIES PER FOOT OF FLUTED KNEE WALL, SPECIAL Concrete Structures

UNIT TOTAL CU YD 0.15 Concrete Superstructure CU YD 0.18 Protective Coat SQ YD 1.01 Rustication Finish SQ FT 1.84 Reinforcement Bars, Epoxy Coated POUND

NOTES:

1. For notes, see "Fluted Knee Wall Standard Details" sheet,








D 4 D 0		_	
BARS	04(L)	ŏ	d5(L)

REVISION	IS .	THE THOSE DEPLOTMENT OF TOURSDOOM TOUR
NAME	DATE	ILLINOIS DEPARTMENT OF TRANSPORTATION
		F.A.I. 94 (DAN RYAN EXPRESSWAY)
		FLUTED KNEE WALL ALONG LAFAYETTE AVE
		N. WENTWORTH TO S. 95TH ST.
		FLUTED KNEE WALL, SPECIAL
		STANDARD DETAILS
		S.N. DESIGNED BY: MAF
	1 1	

SCALE: N.T.S. DRAWN BY: DATE: JANUARY 16, 2009 CHECKED BY: MAF

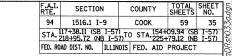

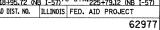


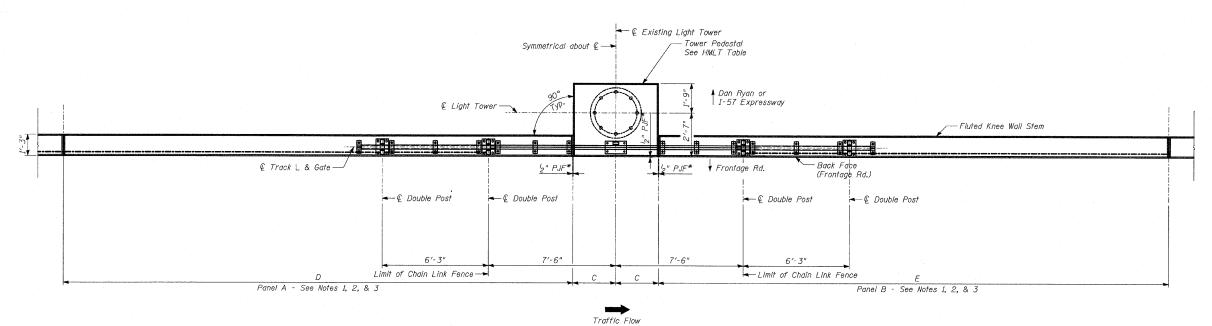

PLAN - CHAIN LINK GATE ASSEMBLY IN OPEN POSITION

HMLT TABLE

HMLT	С	D	E
6ACD4	2.5	17.9	18.0
6ACD5	2.5	34.4	25.0

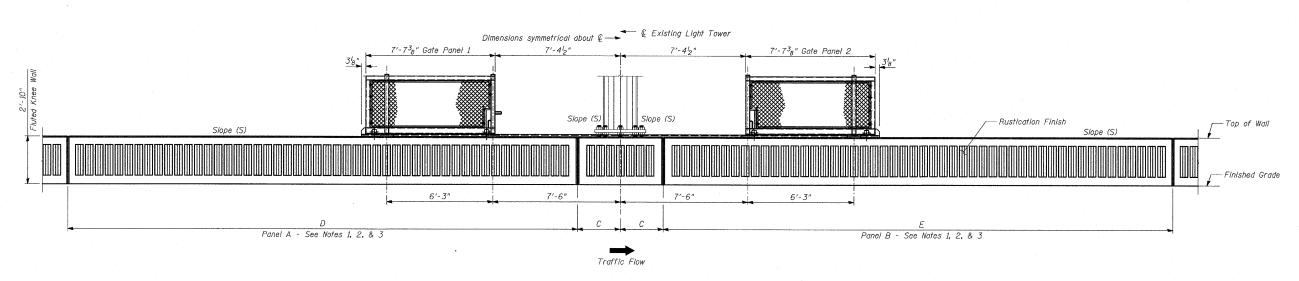

BACK FACE ELEVATION - LIMITS OF CHAIN LINK GATE ASSEMBLY IN OPEN POSITION

NOTES:

- The Chain Link Gate Assembly (Special) is not included in this contract, but shall be furnished and installed by others in Contract 60A07.
- Panels A & B shall be constructed to be aligned with the Back Face of existing High Mast Light Tower (HMLT).
- 3. The Slope (S) at the top of panels A & B and the HMLT foundation shall be the same.


REVISIONS		ILLINOIS DEPARTMENT OF TRANSPORTATION		
NAME	DATE			
		F.A.I. 94 (DAN RYAN EXPRESSWAY)		
·		FLUTED KNEE WALL ALONG LAFAYETTE AVE		
		N. WENTWORTH TO S. 95TH ST.		
		N. MENIMONIU 10 2. 2210 21.		
		FLUTED KNEE WALL DETAILS AT HMLT		
		S.N. DESIGNED BY: MAF		


* Cost included with "Fluted Knee Wall".


SCALE: N.T.S. DATE: JANUARY 16, 2009


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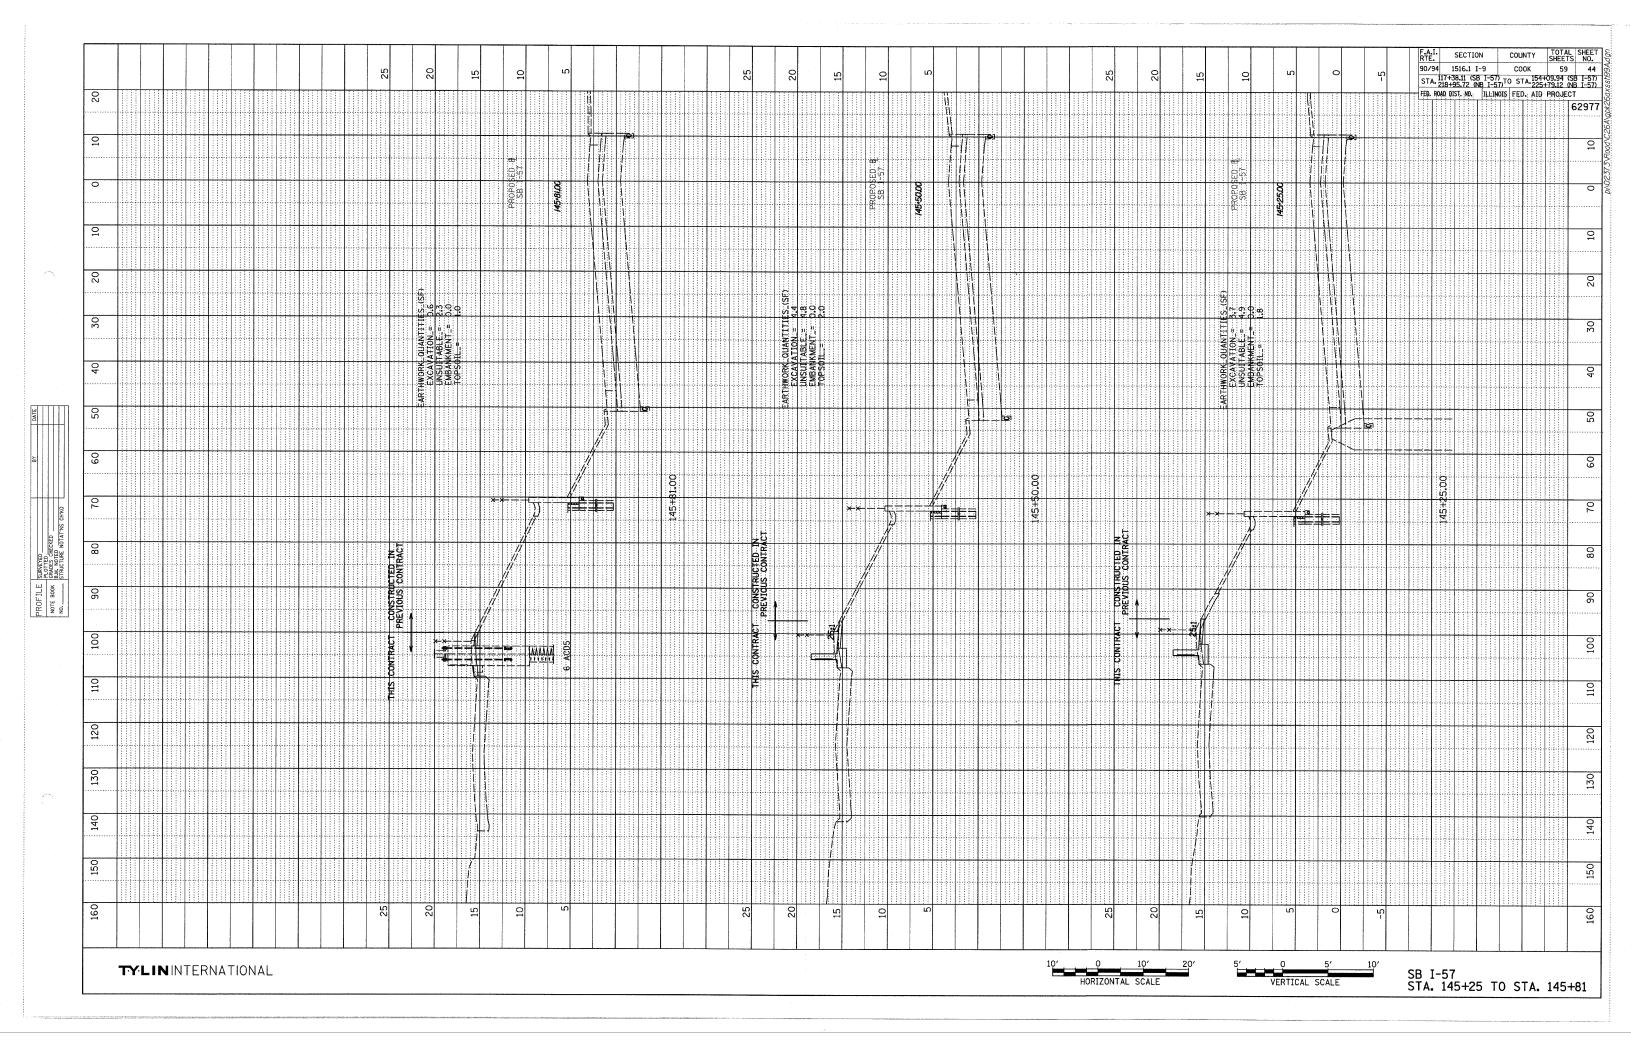
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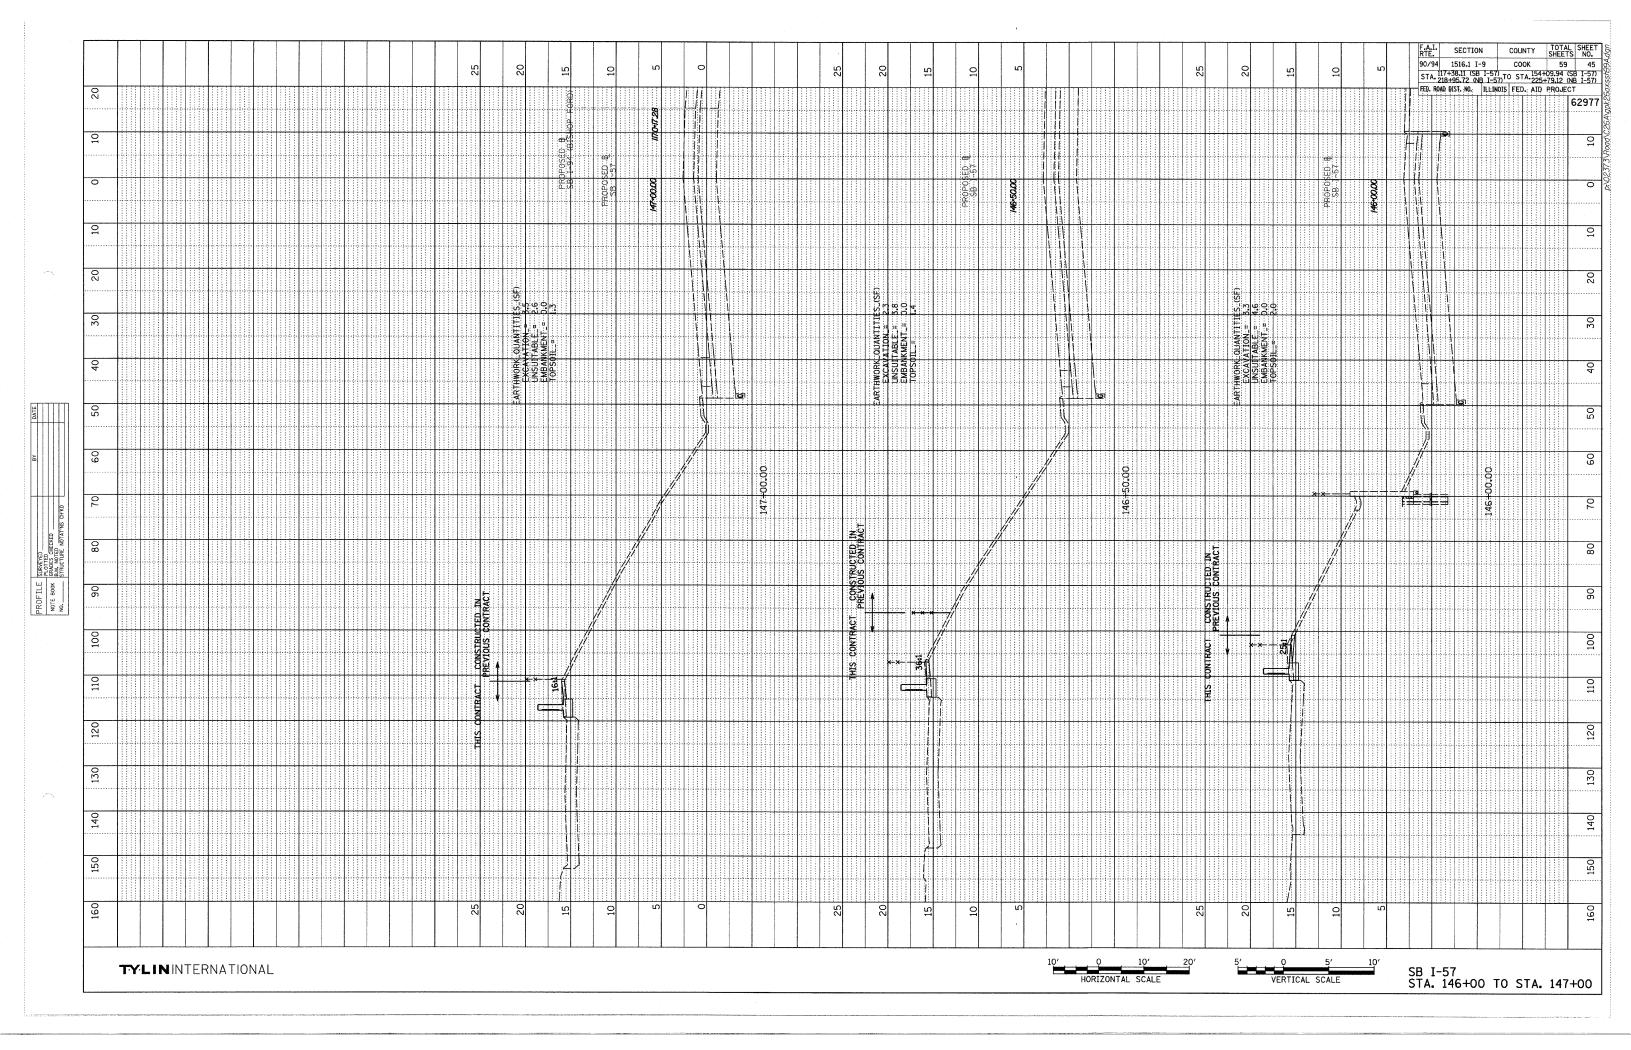





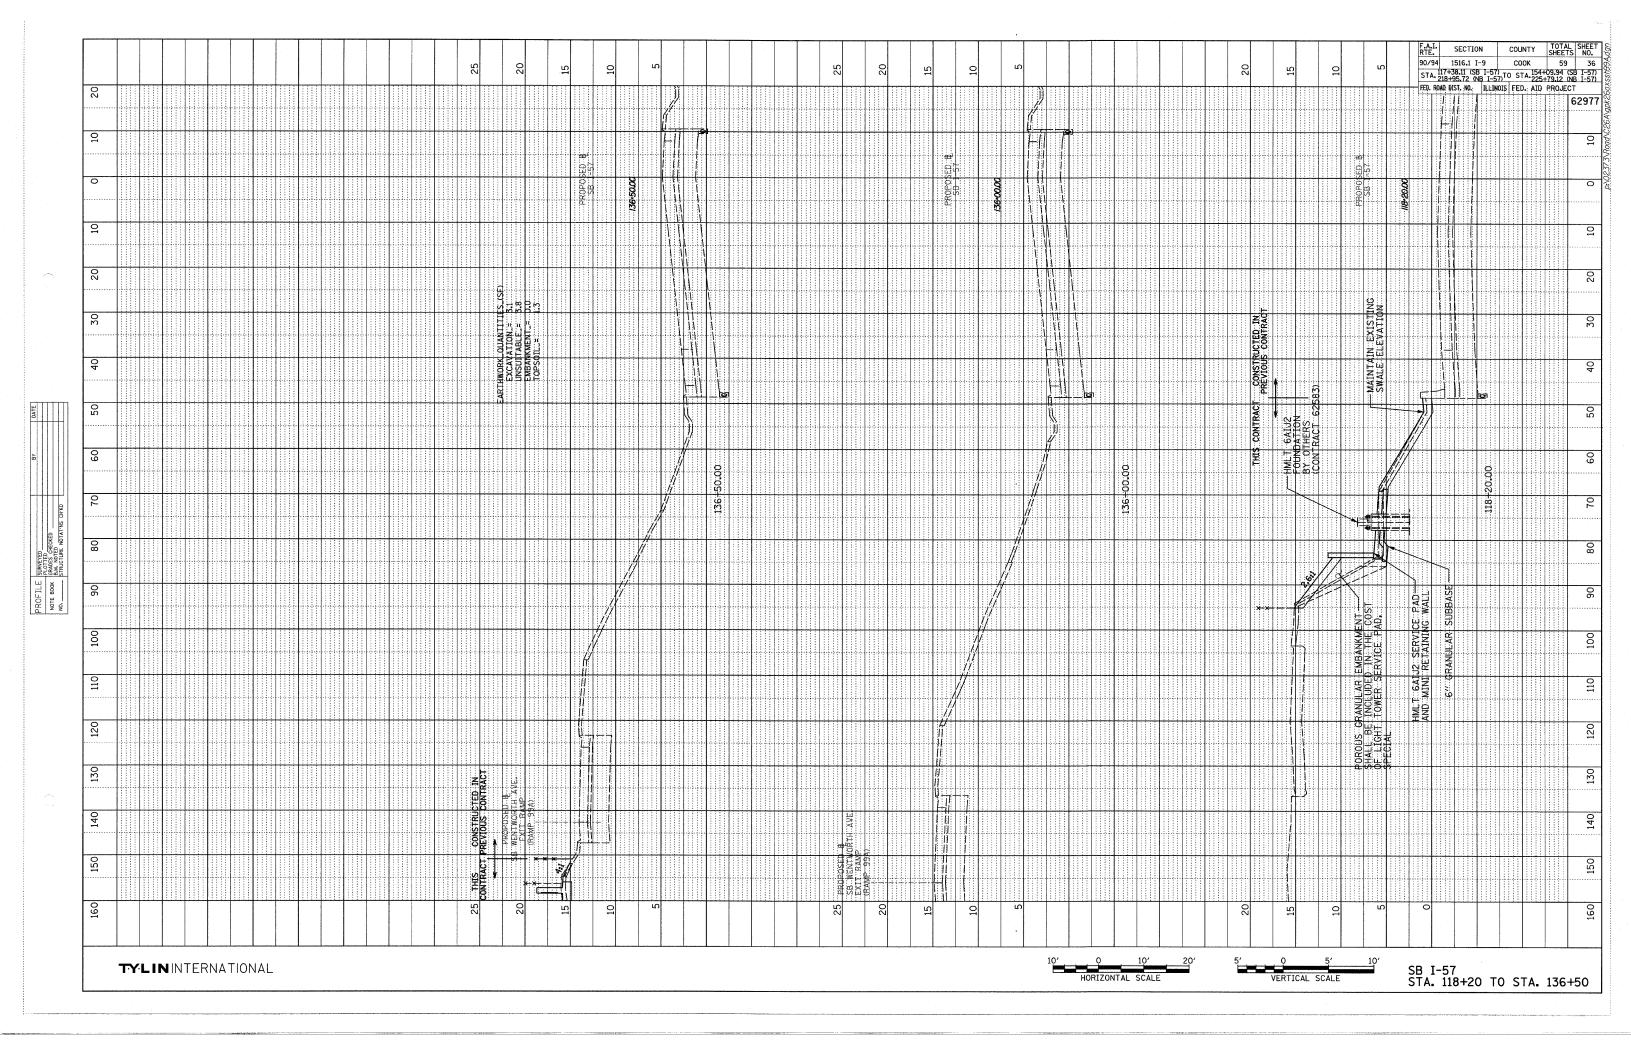


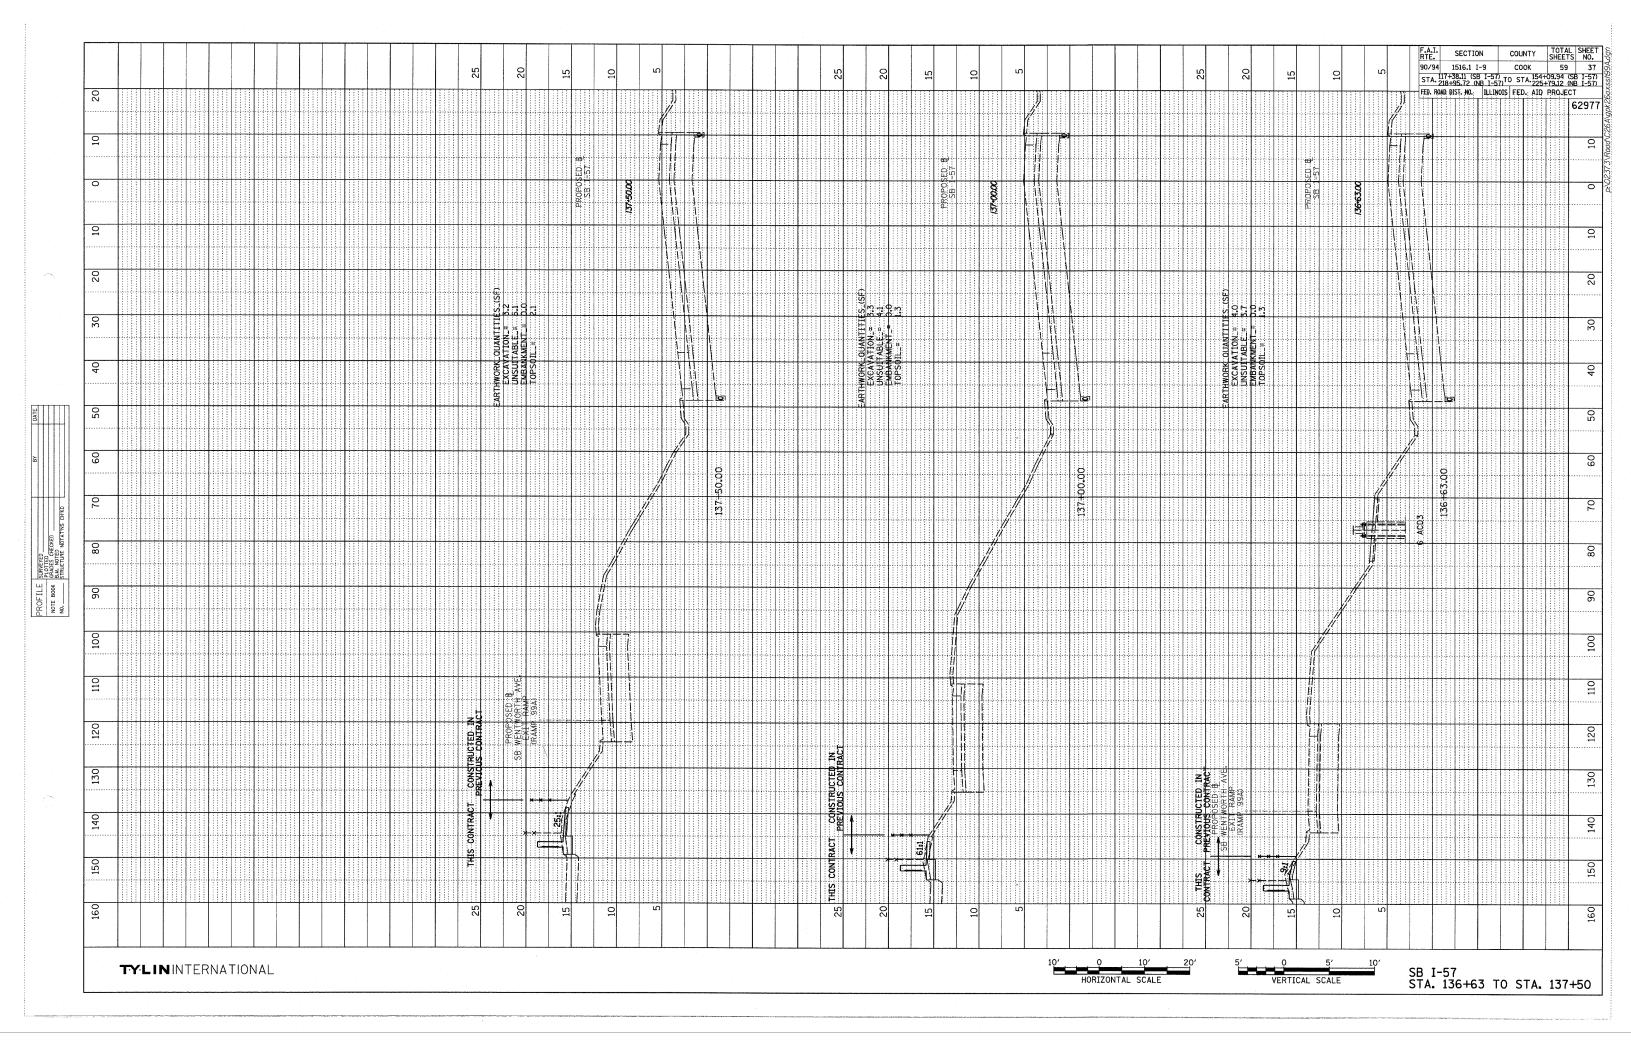


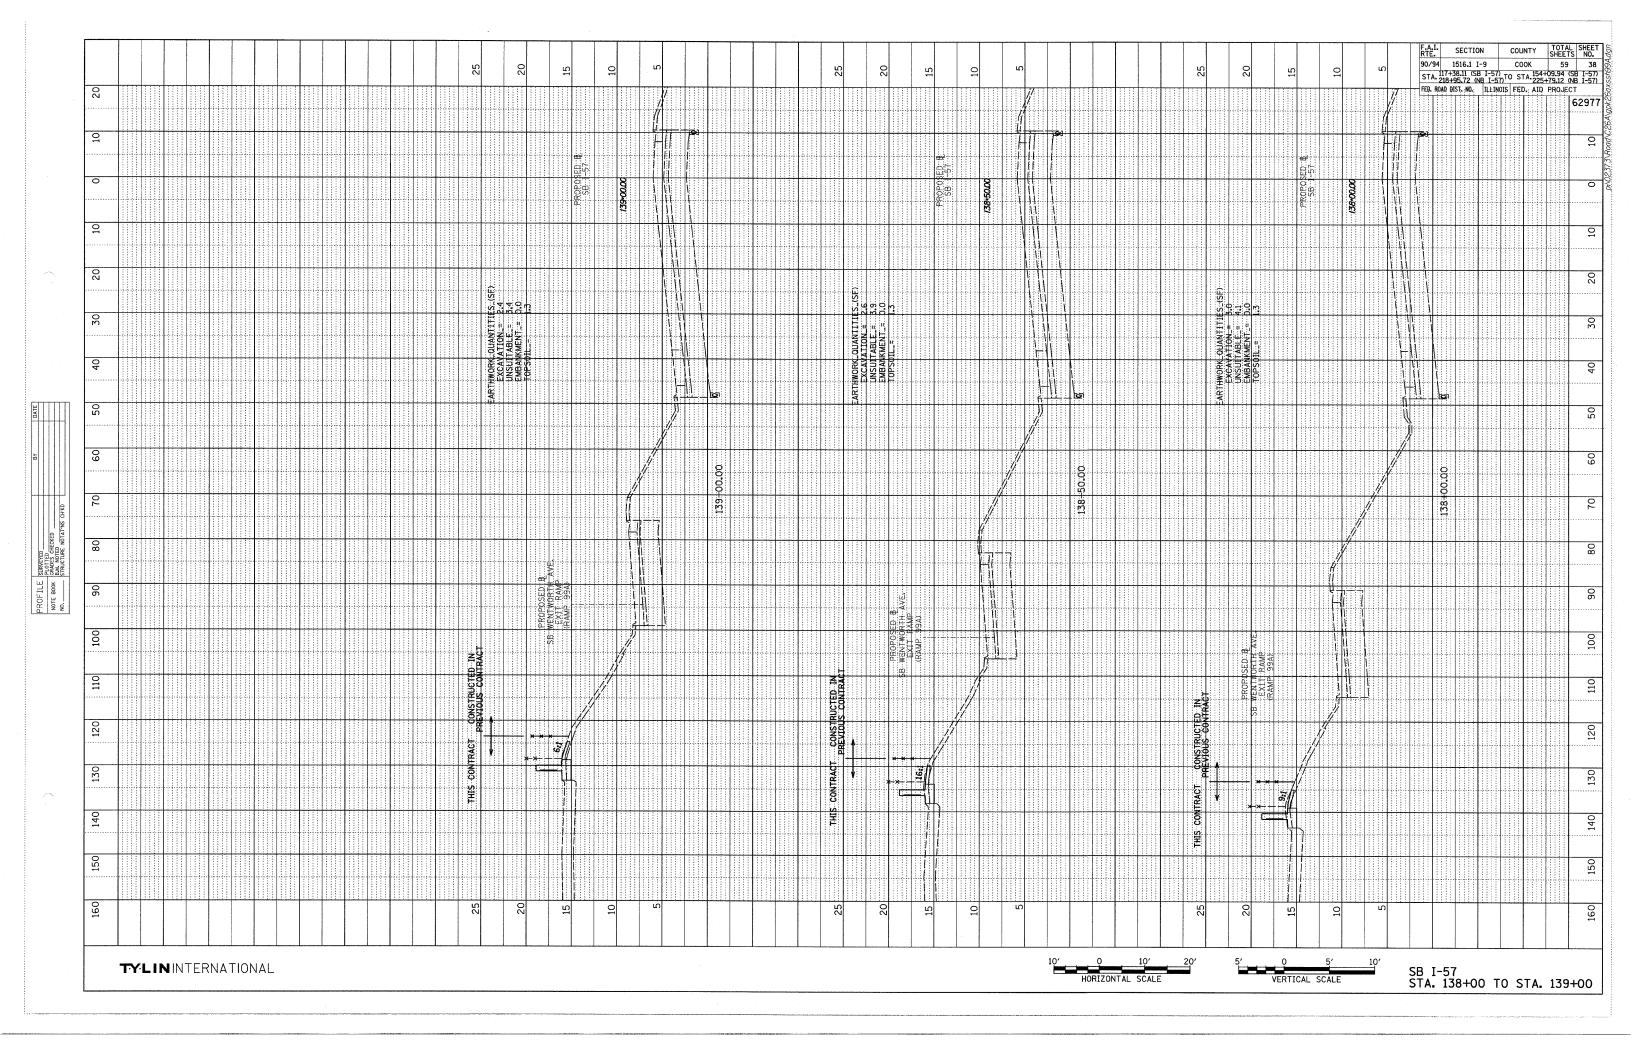


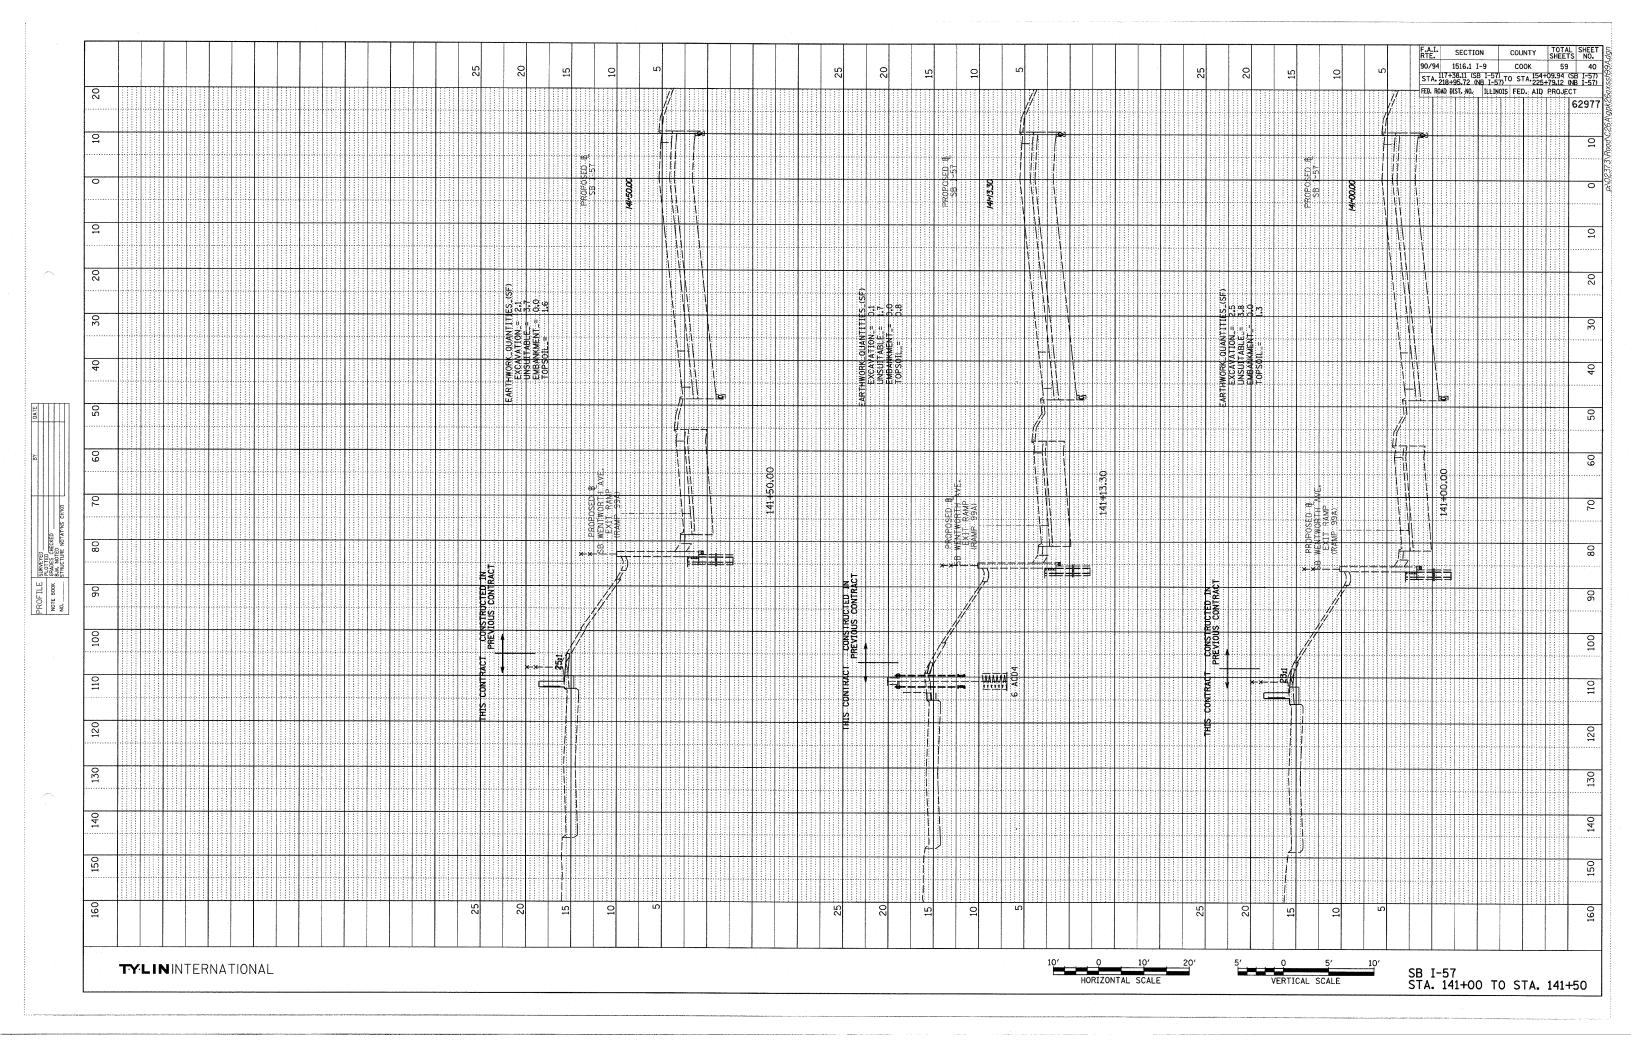

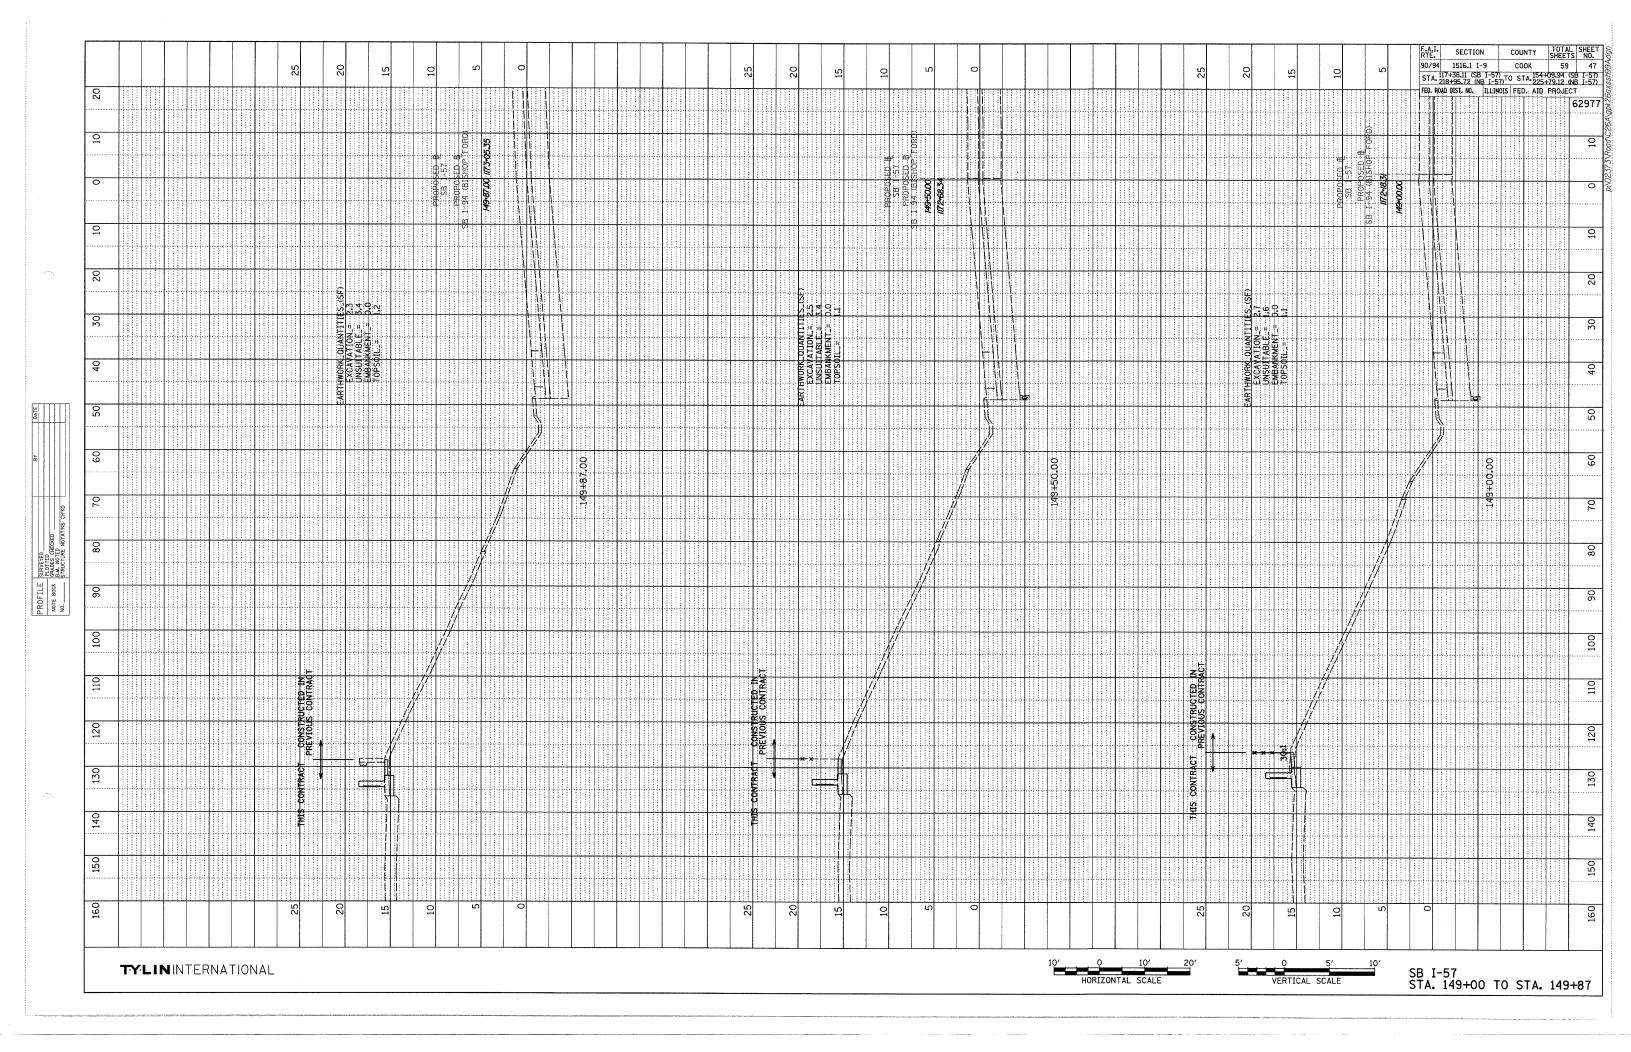

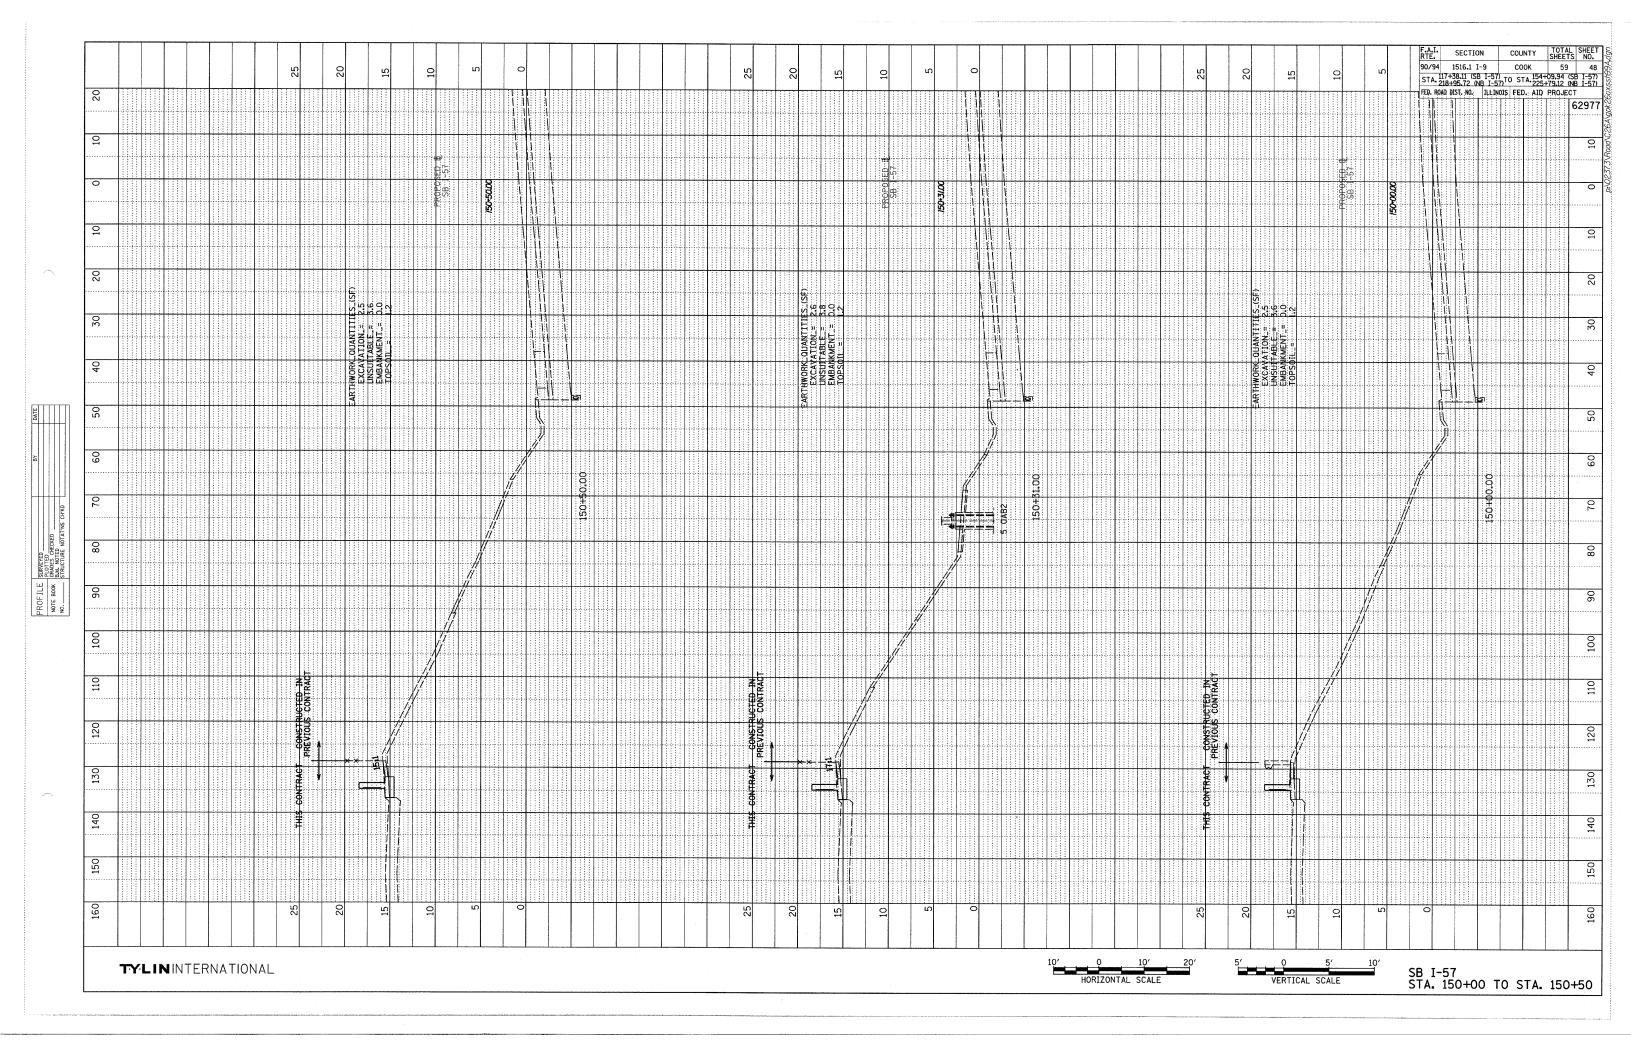


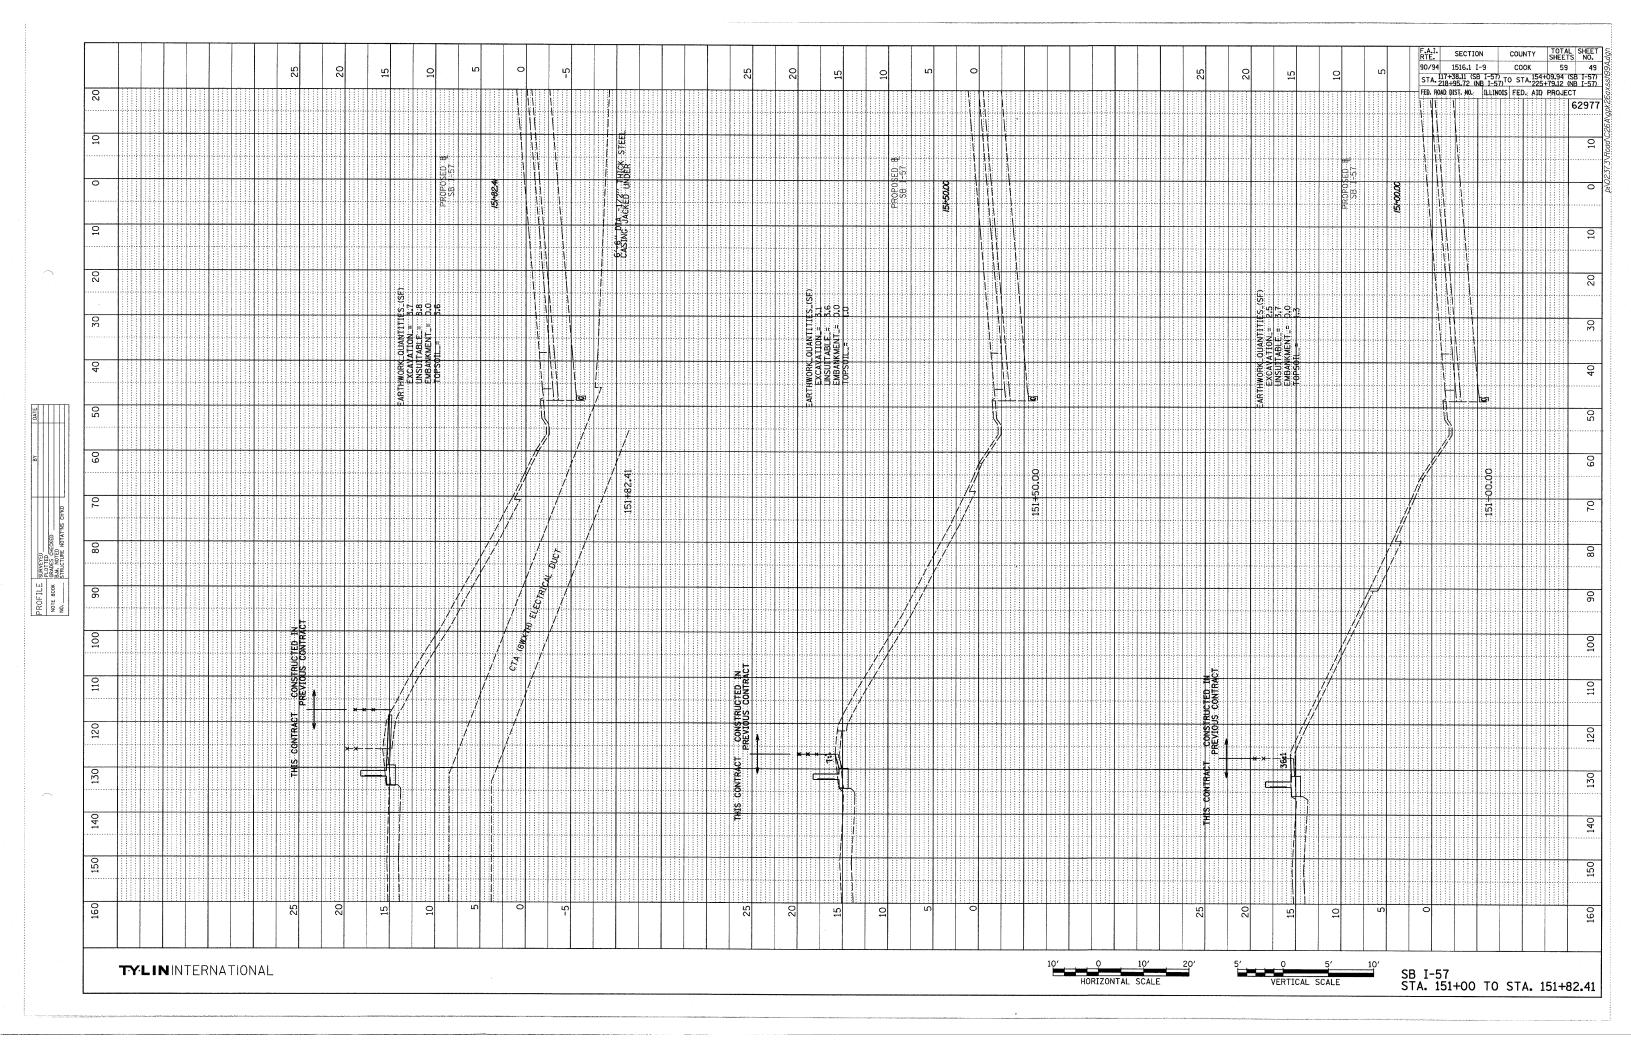

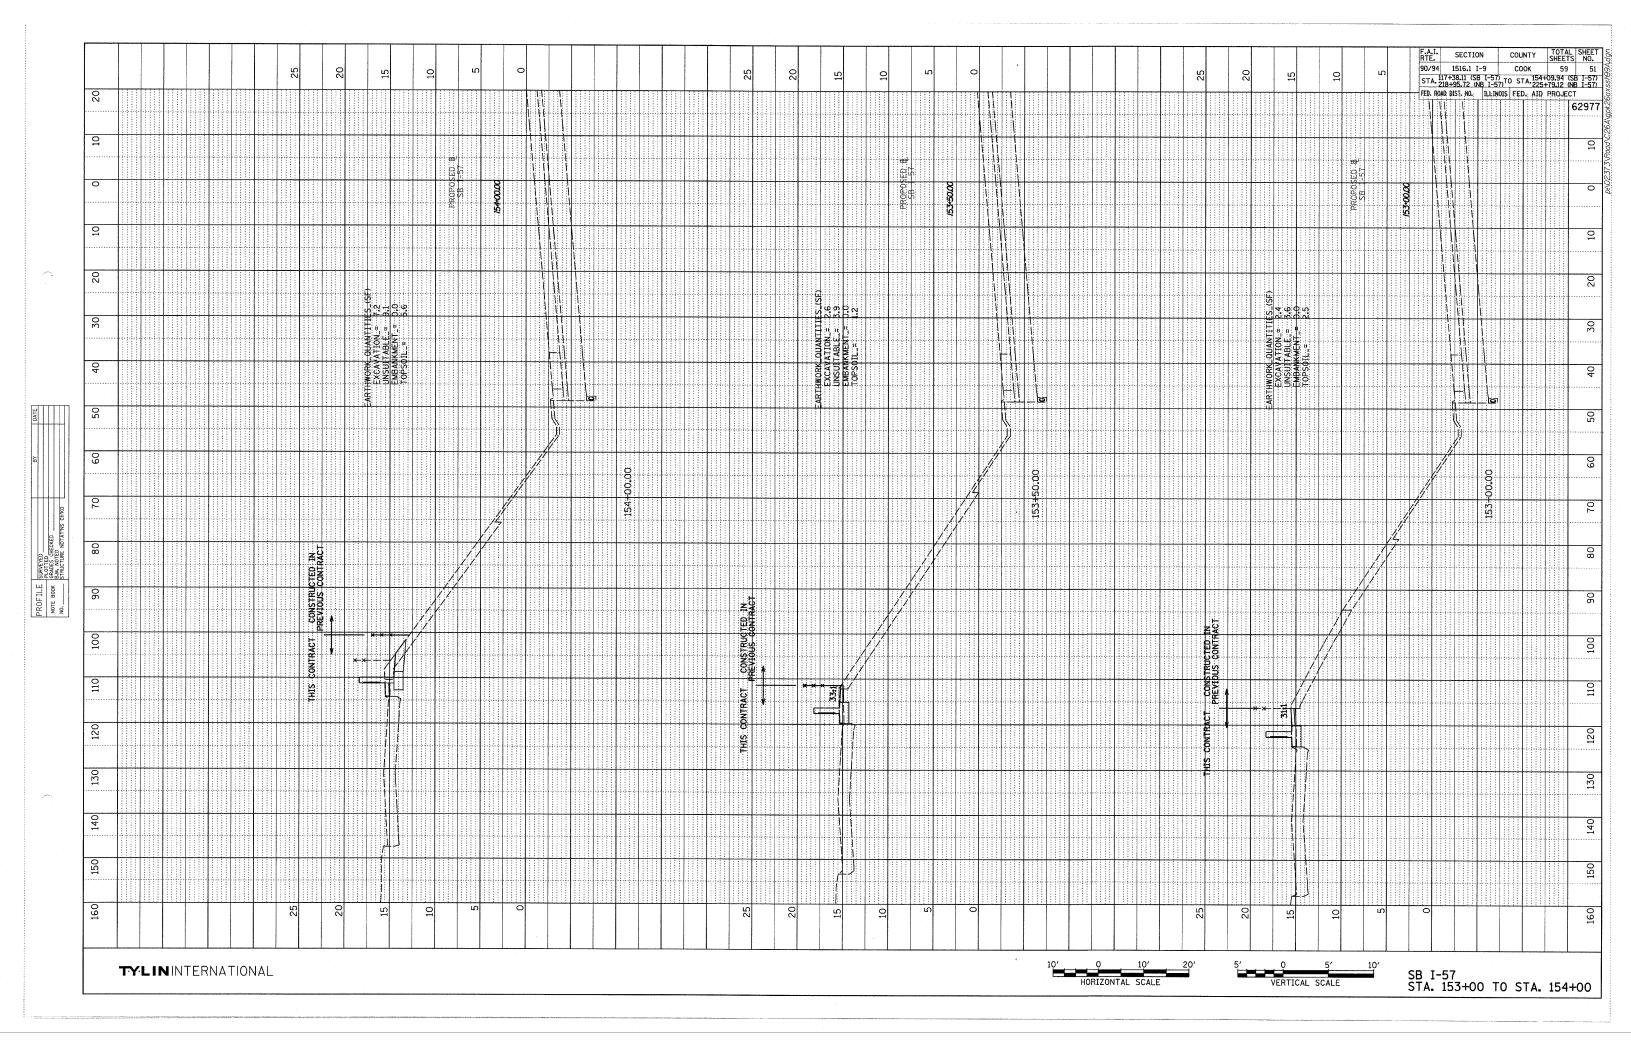


LIGHT TOWER FOUNDATION DEPTH "D"

		S	OIL CONDITIONS		· ·	
MOUNTING HEIGHT	SOFT CLAY Qu = 0.375 TON/SQ. FT	MEDIUM CLAY Qu = 0.75 TON/SQ. FT	STIFF CLAY Qu = 1.50 TON/SQ. FT	LOOSE SAND Ø = 34°	MEDIUM SAND Ø = 37.5°	DENSE SANI Ø = 40°
90 FT	29 FT	20 FT	15 FT	15 FT	13 FT	12 FT
(27 m)	(8.779 m)	(6.035 m)	(4.389 m)	(4.389 m)	(3 ₄ 840 m)	(3.429 m)
100 FT	32 FT	22 FT	16 FT	16 FT	14 FT	13 FT
(30 m)	(9.754 m)	(6.706 m)	(4.877 m)	(4.877 m)	(4.267 m)	(3.81 m)
110 FT	35 FT	24 FT	18 FT	18 FT	15 FT	14 FT
(33 m)	(10.719 m)	(7.377 m)	(5.365 m)	(5.365 m)	(4.694 m)	(4.191 m)
120 FT	38 FT	26 FT	19 FT	19 FT	17 FT	16 FT
(36 m)	(11.705 m)	(8.046 m)	(5.652 m)	(5.652 m)	(5.120 m)	(4.572 m)

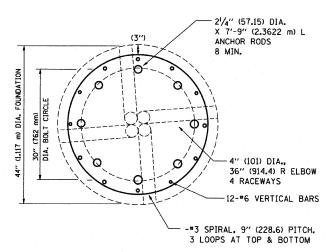


SECTION-B-B

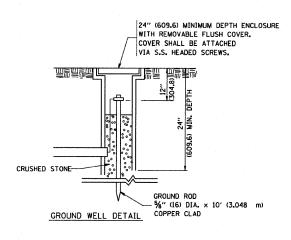

DESIGN NOTES

- (1) ALL DIMENSIONS IN INCHES (MILLIMETERS) UNLESS OTHERWISE SHOWN
- (2) THE ANCHOR RODS SHALL BE VERTICAL NO ADJUSTMENT SHALL BE ALLOWED AFTER THE FOUNDATION IS PLACED.
- (3) THE GAP BETWEEN THE FOUNDATION AND THE BASE PLATE SHALL BE ENCLOSED WITH A STAINLESS STEEL SCREEN FASTENED WITH A STAINLESS STEEL BAND.
- (4) THE TOP OF THE FOUNDATION TO 18" (450) BELOW GRADE SHALL BE FORMED.
- (5) SURFACE WATER WILL NOT BE PERMITTED TO ENTER THE HOLE AND ALL WATER WHICH MAY HAVE INFILTRATED INTO THE HOLE SHALL BE REMOVED BEFORE PLACING CONCRETE.
- (6) THE LIGHT TOWER SHALL NOT BE ERECTED UNTIL AFTER THE CONCRETE HAS BEEN CURED ACCORDING TO ARTICLE 1020.13.
- (7) ANCHOR RODS SHALL BE STRAIGHT AND SHALL BE ACCORDING TO AASHTO M 314 OR ASTM F1554, GRADE 725(GRADE 105) AND GALVANIZED ACCORDING TO ARTICLE 1006.9.
- (8) ANCHOR ROD INFORMATION SHALL BE SUBMITTED FOR APPROVAL AND SHALL BE FULLY COORDINATED FOR APPROVAL WITH TOWER MANUFACTURER REQUIREMENTS.
- (9) REINFORCEMENT BARS SHALL BE ACCORDING TO ARTICLE 1006.10
- (IO) TWO ANCHOR RODS OPPOSITE EACH OTHER SHALL

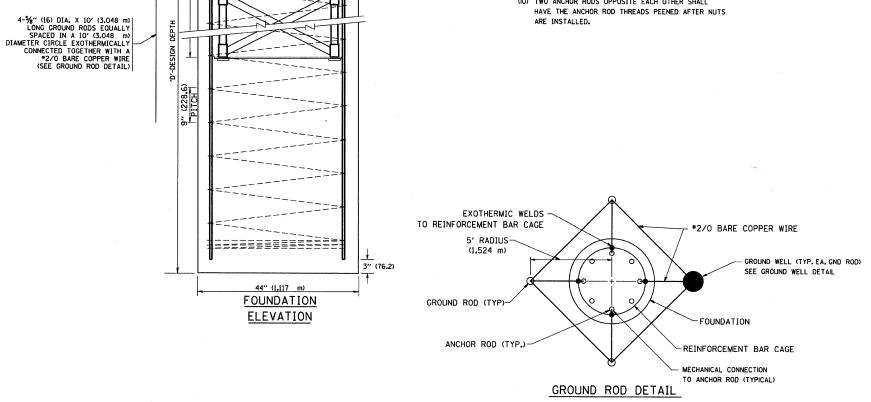

SEE ANCHOR BOLT CAGE WELDMENT DETAIL SHEET 2

12" (304.8) RACEWAY PROJECTION

BASE PLATE


MECHANICAL CONNECTION -TO ANCHOR RODS


EXOTHERMIC WELD -


EXOTHERMIC WELD CONNECTION TO REINFORCING STEEL

FOR INFORMATION ONLY


FILE NAME =	USER NAME = gaglianobt	DESIGNED -	REVISED - R. TOMSONS 04-22-02			F.A. SECTION	COUNTY TOTAL SHEET
Wi\diststd\22x34\be501.dgn	'	DRAWN -	REVISED -	STATE OF ILLINOIS	HIGH MAST LIGHT TOWER	NIE.	SHEETS NO.
	PLOT SCALE = 50.000 '/ IN.	CHECKED -	REVISED -	DEPARTMENT OF TRANSPORTATION	90 FT TO 120 FT (27 mTO 36 m) FOUNDATION DETAIL	94 1516.1 T-9	CONTRACT NO 1 2027
	PLOT DATE = 1/4/2008	DATE -	REVISED -		SCALE: NONE SHEET NO. 1 OF 2 SHEETS STA. TO STA.	BE-501 FED. ROAD DIST. NO. 1 ILLINOIS FED. A)	CONTRACT NO. GOLTET

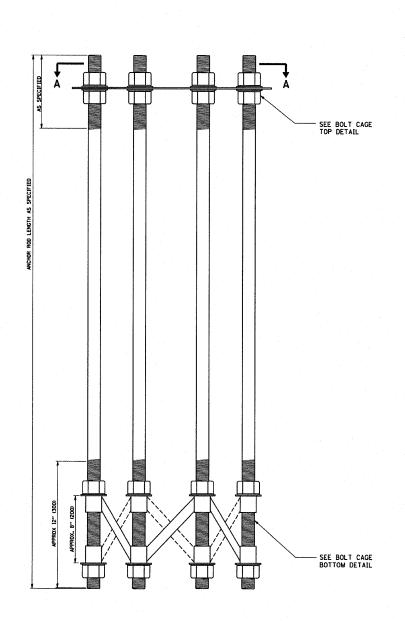

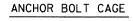


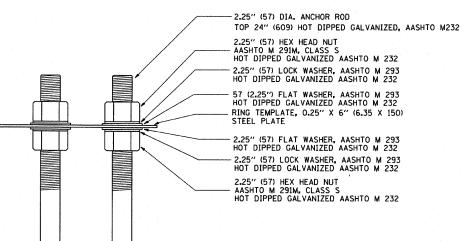

BOLT CAGE TOP

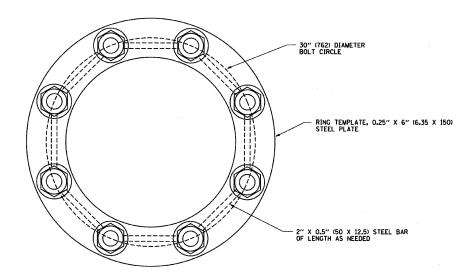

SECTION A-A

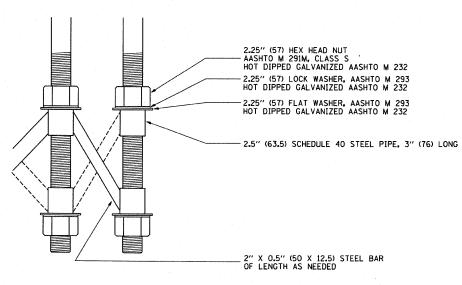


BOLT CAGE BOTTOM

NOTES

- 1. ALL DIMENSIONS IN INCHES (MILLIMETERS) UNLESS OTHERWISE SHOWN
- ANCHOR RODS SHALL BE STRAIGHT AND SHALL BE ACCORDING TO AASHTO M 314 OR ASTM F1554, GRADE 725 (GRADE 105) AND GALVANIZED ACCORDING TO ARTICLE 1006.09.
- 3. ANCHOR ROD INFORMATION SHALL BE SUBMITTED FOR APPROVAL AND SHALL BE FULLY COORDINATED WITH TOWER MANUFACTURERS REQUIREMENTS.

FOR INFORMATION ONLY

FILE NAME = USER NAME = gaglianobt DESIGNED -REVISED - R. TOMSONS 04-22-02 COUNTY TOTAL SHEET NO. HIGH MAST LIGHT TOWER i\diststd\22x34\be5Øl.dgn DRAWN REVISED STATE OF ILLINOIS COOK 59 55 CONTRACT NO.62977 94 1516.1 I-9 PLOT SCALE = 50.000 '/ IN. CHECKED 90 FT TO 120 FT (27 mTO 36 m) FOUNDATION DETAIL REVISED **DEPARTMENT OF TRANSPORTATION** PLOT DATE = 1/4/2008 DATE REVISED SHEET NO. 2 OF 2 SHEETS STA.

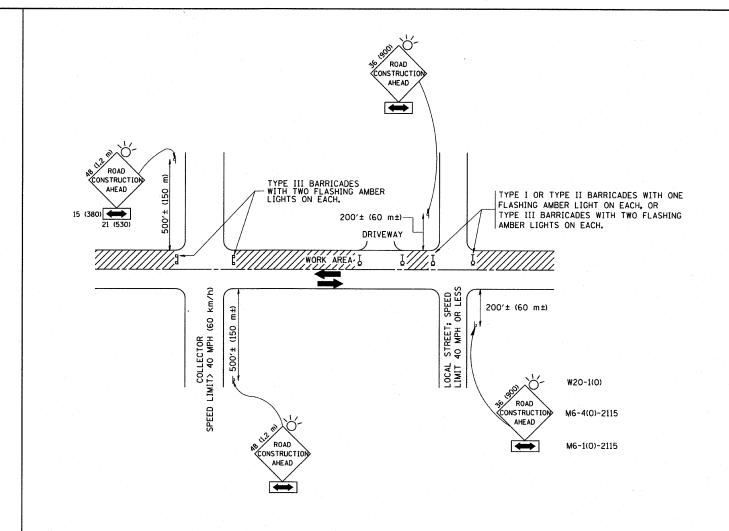

TRAFFIC CONTROL AND PROTECTION FOR SIDE ROADS, INTERSECTIONS, AND DRIVEWAYS

NOTES:

- A. FOR NO LANE RESTRICTION ON THE SIDE ROAD OR DRIVEWAYS
- 1. SIDE ROAD WITH A SPEED LIMIT OF 40 MPH (60 km/h) OR LESS AS SHOWN ON THE DRAWING AND AS DIRECTED BY THE ENGINEER:
- O) ONE ROAD CONSTRUCTION AHEAD SIGN 36 x 36 (900x900) WITH A FLASHER AND FLAG MOUNTED ON IT APPROXIMATELY 200' (60 m) IN ADVANCE OF THE MAIN POLITY
- b) THE CLOSED PORTION OF THE MAIN ROUTE SHALL BE PROTECTED BY BLOCKING WITH TYPE I, TYPE II OR TYPE III BARRICADES, 1/3 OF THE CROSS SECTION OF THE CLOSED PORTION.
- 2. SIDE ROAD WITH A SPEED LIMIT GREATER THAN 40 MPH (60 km/h) AS SHOWN ON THE DRAWING AND AS DIRECTED BY THE ENGINEER:
- O) ONE ROAD CONSTRUCTION AHEAD SIGN 48 x 48 (1.2 m x 1.2 m) WITH A FLASHER MOUNTED ON IT APPROXIMATELY 500' (150 m) IN ADVANCE OF THE MAIN ROUTE.
- b) THE CLOSED PORTION OF THE MAIN ROUTE SHALL BE PROTECTED BY BLOCKING WITH TYPE III BARRICADES, 1/2 OF THE CROSS SECTION OF THE CLOSED PORTION.
- 3. WHEN THE SIDE ROAD LIES BETWEEN THE BEGINNING OF THE MAINLINE SIGNING AND THE WORK ZONE, A SINGLE HEADED ARROW (MG-1) SHALL BE USED IN LIEU OF THE DOUBLE HEADED ARROW (MG-4).

B. FOR A LANE CLOSURE ON A SIDE ROAD OR DRIVEWAY:


- USE APPLICABLE PORTIONS OF THE TYPICAL APPLICATION OF TRAFFIC CONTROL DEVICES (STD. 701501, STD. 701606 OR THE APPROPRIATE STANDARD). THE SPACING OF SIGNS AND BARRICADES SHALL BE ADJUSTED FOR FIELD CONDITIONS AS DIRECTED BY THE ENGINEER. THE DIRECTIONAL ARROW SHALL BE COVERED OR REMOVED WHEN NO LONGER CONSISTENT WITH THE SIDE ROAD LANE CLOSURE.
- C. ADVANCE WARNING SIGNS ARE TO BE OMITTED ON DRIVEWAY UNLESS
- D. THE TRAFFIC CONTROL AND PROTECTION FOR SIDE ROADS, INTERSECTIONS, AND DRIVEWAYS SHALL BE INCIDENTAL TO THE COST OF SPECIFIED TRAFFIC CONTROL STANDARDS OR ITEMS.

All dimensions are in millimeters (inches) unless otherwise shown.

FILE NAME =	USER NAME = gaglianobt	DESIGNED - LHA	REVISED	- J. OBERLE 10-18-95
W:\diststd\22x34\tc10.dgn		DRAWN -	REVISED	- A. HOUSEH 03-06-96
	PLOT SCALE = 50.000 '/ IN.	CHECKED -	REVISED	- A. HOUSEH 10-15-96
	PLOT DATE = 1/4/2008	DATE - 06-89	REVISED	-T. RAMMACHER 01-06-0


STATE OF ILLINOIS DEPARTMENT OF TRANSPORTATION


TRAFFIC CONTROL AND PROTECTION FOR					SECTION	COUNTY	TOTAL SHEETS	SHEE NO.
SIDE ROADS, INTERSECTIONS, AND DRIVEWAYS				94	1516.1 I-9	Cook	59	56
	T				TC-10	CONTRACT	NO. 6	2977
SCALE: NONE	SHEET NO. 1 OF 1 SHEET	S STA.	TO STA.	FED. RO	AD DIST. NO. 1 ILLINOIS FED. AL	D PROJECT		

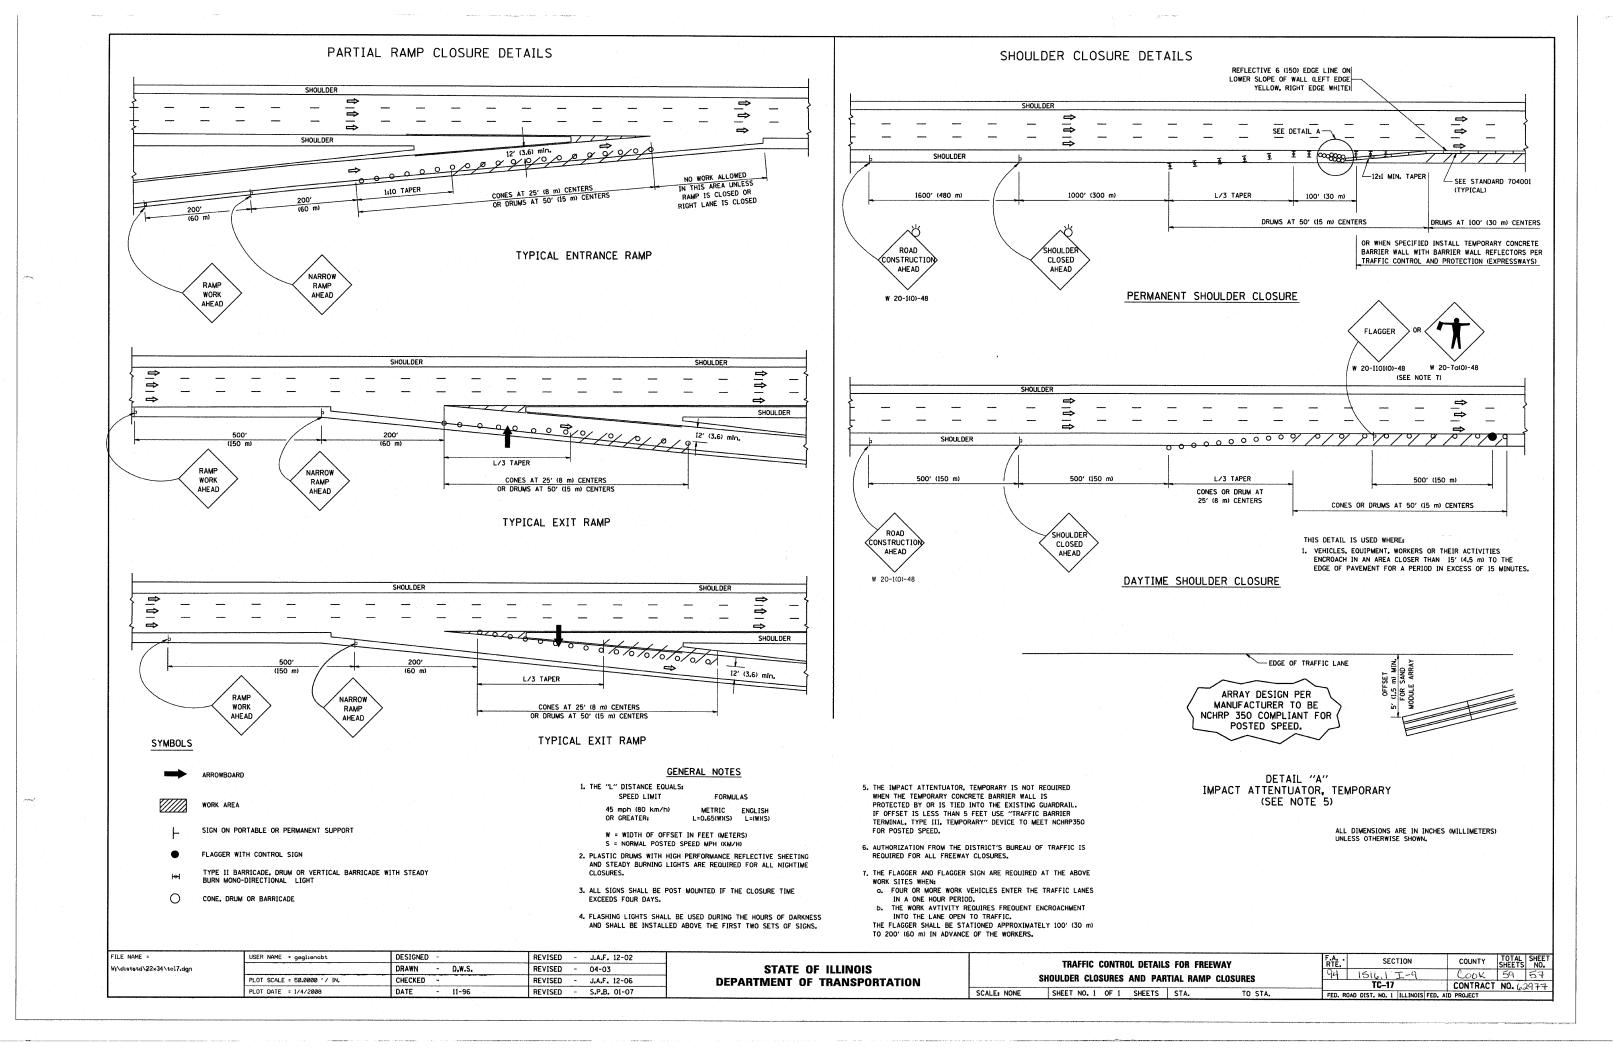

SIGNING FOR FLAGGING OPERATIONS AT WORK ZONE OPENINGS

WORK ZONE EXIT OPENING

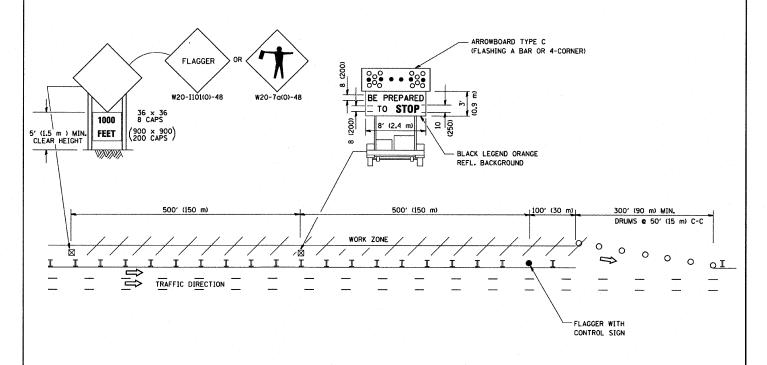

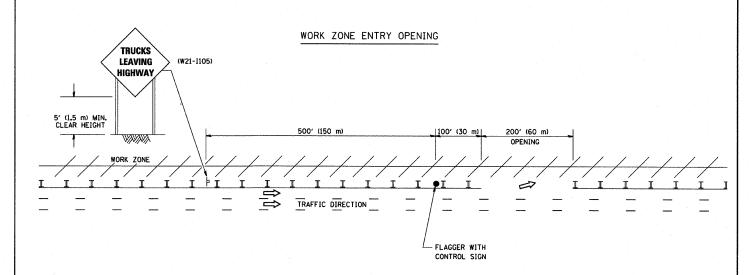

NOTES

- The Arrowboard, the Flagger Ahead trailer mounted sign, and the Trucks Leaving Highway sign shall be removed or turned away from traffic and the exit and entry openings shall be closed when the flagging operation ceases.
- 2. Work Zone Exit Openings should be a minimum of one half mile apart.

SCALE: NONE


- Exiting the work zone at any place other than at a Work Zone Exit Opening will be prohibited.
- 4. All vehicles shall enter the work zone at entry openings, using their turn signals to warn motorists

ALL DIMENSIONS ARE IN INCHES (MILLIMETERS)
UNLESS OTHERWISE SHOWN

FILE NAME =	USER NAME = gaglianobt	DESIGNED -	REVISED - D.W.S. 08-98
Wi\diststd\22x34\to18.dgn		DRAWN -	REVISED - J.A.F. 04-03
	PLOT SCALE = 50.000 '/ IN.	CHECKED -	REVISED - J.A.F. 02-06
	PLOT DATE = 1/4/2008	DATE -	REVISED ~ S.P.B. 01-07

STATI	E OF	ILLINOIS
DEPARTMENT	OF	TRANSPORTATION

SIGNING FOR FLAGGING OPERATIONS	F.A RTE.	SECTION	COUNTY	TOTAL SHEETS	SHEET NO.	
AT WORK ZONE OPENINGS			1516.1 I-9	Cook	59	58
			TC-18	CONTRACT	NO. 6	2977
SHEET NO. 1 OF 1 SHEETS STA.	TO STA.	FED. RO	DAD DIST. NO. 1 ILLINOIS FED. A	D PROJECT		

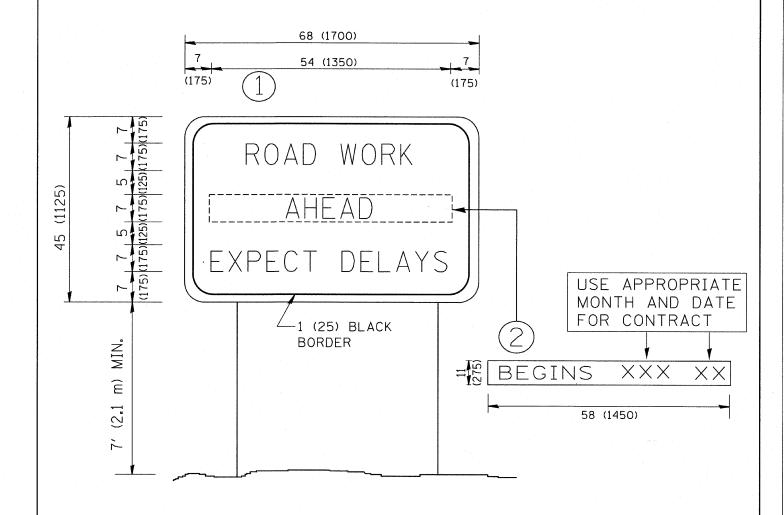

NOTES:

1. USE BLACK LETTERING ON ORANGE BACKGROUND.

SCALE: NONE

- 2. ERECT SIGNS IN ADVANCE OF THE LOCATION FOR THE "ROAD CONSTRUCTION AHEAD" SIGN AT LOCATIONS AS DIRECTED BY THE ENGINEER.
- 3. ERECT SIGN (1) WITH INSTALLED PANEL (2) ONE WEEK PRIOR TO THE START OF CONSTRUCTION.
- 4. REMOVE PANEL 2 SOON AFTER THE START OF CONSTRUCTION.
- 5. SEE SPECIAL PROVISION FOR "TEMPORARY INFORMATION SIGNING" FOR ADDITIONAL INFORMATION.
- 6. ONE SIGN ASSEMBLY EQUALS 25.70 SQ. FT. (2.3 SQ. M.)
- 7. SHALL BE PAID FOR AS TEMPORARY INFORMATION SIGNING.

ALL DIMENSIONS ARE IN INCHES (MILLIMETERS) UNLESS OTHERWISE SHOWN.

FILE NAME =	USER NAME = gaglianobt	DESIGNED ~	REVISED	- R. MIRS 09-15-97
Wi\distatd\22×34\tc22.dgn		DRAWN ~	REVISED	- R. MIRS 12-11-97
	PLOT SCALE = 50.000 ' / IN.	CHECKED -	REVISED	-T. RAMMACHER 02-02-99
	PLOT DATE = 1/4/2008	DATE -	REVISED	- C. JUCIUS 01-31-07

STATE	OF	ILLINOIS
DEPARTMENT	0F	TRANSPORTATION

	INFORMATION SIGN				F.A RTE.	SECTION	COUNTY	TOTAL SHEETS	SHEET NO.	
					ļ	94 Sibil I-9		Cook	59 59	
-							TC-22	CONTRACT	NO. 62	977
	SHEET NO. 1	OF 1	SHEETS	STA.	TO STA.	FED. RC	AD DIST. NO. 1 ILLINOIS FED. A	D PROJECT		