08-01-14 LETTING ITEM 038

STATE OF ILLINOIS

DEPARTMENT OF TRANSPORTATION

DIVISION OF HIGHWAYS

FOR INDEX OF SHEETS, SEE SHEET NO. 2

PROPOSED HIGHWAY PLANS

VARIOUS LOCATIONS IN CENTRAL COOK COUNTY #5 LIGHT EMITTING DIODE (LED) INSTALLATION **SECTION 2012-032TS COOK COUNTY**

C-91-309-14

HIGHWAY STANDARDS

720006-04

0

0

0

701006-05 OFF-ROAD OPERATIONS, 2L, 2W, 15' (4.5m) TO 24" (600mm) FROM PAVEMENT EDGE 701101-04 OFF-ROAD OPERATIONS MULTILANE. 15' (4.5m) TO 24" (600mm) FROM PAVEMENT EDGE

701701-09 URBAN LANE CLOSURE MULTILANE INTERSECTION

SIGN PANEL ERECTION DETAILS

701901-03 TRAFFIC CONTROL DEVICES 720001-01 SIGN PANEL MOUNTING DEVICES


857001-01 STANDARD PHASE DESIGNATION DIAGRAMS AND PHASE SEQUENCES

862001-01 UNINTERRUPTIBLE POWER SUPPLY (UPS)

880006-01 TRAFFIC SIGNAL MOUNTING DETAILS

> **COOK COUNTY LOCATION MAP** SEE SHEET NO. 3

ISAAC YUN, P.E. 062-062257 EXP. 11-30-2015

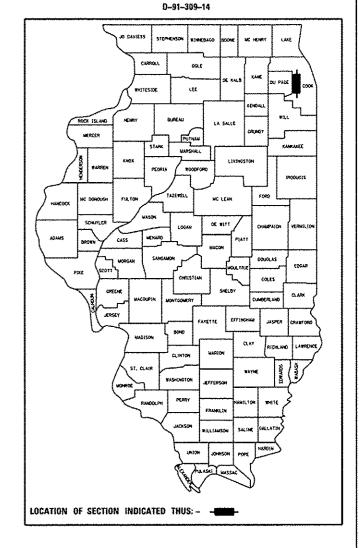

2014-032TS

COOK ILLINOIS CONTRACT NO. 60Y18

CONFORM TO STANDARD SCALES. IN MAKING MEASUREMENTS

PROJECT ENGINEER: SHAR-DAY SMITH PROJECT MANAGER: SUDUD MAHMOUD

FULL SIZE PLANS HAVE BEEN PREPARED USING STANDARD ENGINEERING SCALES. REDUCED SIZED PLANS WILL NOT

ON REDUCED PLANS, THE ABOVE SCALES MAY BE USED.

JOINT UTILITY LOCATION INFORMATION FOR EXCAVATION

CONTRACT NO. 60Y18

1-800-892-0123 OR 811

STATE OF ILLINOIS DEPARTMENT OF TRANSPORTATION

PRINTED BY THE AUTHORITY OF THE STATE OF ILLINOIS



INDEX OF SHEETS

```
COVER SHEET
INDEX OF SHEETS
       LOCATION MAP
       SUMMARY OF QUANTITIES
10-16
      DISTRICT 1 STANDARD TRAFFIC SIGNAL DESIGN DETAILS
```

TRAFFIC SIGNAL PLANS:

SHEE	<u> </u>	INTERSECTION NAME
17	11086	55TH STREET AT SERGO/TRU-YUE
18	3850	55TH STREET AT JOLIET ROAD
19	11805	IL ROUTE 171 (IST AVENUE) FRONTAGE ROAD AT 47TH ST WEST RAMP
20	11810	IL ROUTE 171 (IST AVENUE) FRONTAGE ROAD AT RAMP B AND BI
21	5360	JOLIET ROAD AT LAWNDALE AVENUE
22	5375	JOLIET ROAD AT UNIVERSAL OIL PRODUCTS
23	5070	PLAINFIELD ROAD AT EAST AVENUE
24	3780	39TH STREET (PERSHING ROAD) AT CENTRAL AVENUE
25	3785	39TH STREET (PERSHING ROAD) AT LARAMIE AVENUE
26	3790	39TH STREET (PERSHING ROAD) AT OAK PARK AVENUE
27	3795	39TH STREET (PERSHING ROAD) AT RIDGELAND AVENUE
28	3800	39TH STREET (PERSHING ROAD) AT AUSTIN BLVD
29	4845	22ND STREET (CERMAK ROAD) AT WOLF ROAD
30	21175	31ST STREET AT MAYFAIR DRIVE
31	3775	31ST STREET AT WOLF ROAD
32	135	1-294 TRI-STATE TOLLWAY WEST RAMP AT 22ND STREET (CERMAK ROAD)
33	4851	22ND STREET (CERMAK ROAD) AT ENTERPRISE DRIVE
34	15115	22ND STREET (CERMAK ROAD) AT MAYFAIR DRIVE
35	4850	22ND STREET (CERMAK ROAD) AT WESTBROOK DRIVE
36 37	130	I-294 TRI-STATE TOLLWAY EAST RAMP AT 22ND STREET (CERMAK RD)
38	15110 3865	ROOSEVELT ROAD AT WESTCHESTER BOULEVARD 55TH STREET AT WOLF ROAD
39	1480	US ROUTE 34 AT WOLF ROAD
40	3825	47TH STREET AT WOLF ROAD
41	22175	47TH STREET AT CENTRAL AVENUE
42	22035	75TH STREET AT WILLOW SPRINGS ROAD
43	3893	79TH STREET AT WILLOW SPRINGS ROAD
44	3572	IL ROUTE 171 (ARCHER AVENUE) AT NOLTON AVENUE
45	3570	IL ROUTE 171 (ARCHER AVENUE) AT WILLOW SPRINGS ROAD
46	3573	WILLOW SPRINGS ROAD AT GERMAN CHURCH ROAD
47	3735	26TH STREET AT DES PLAINES AVENUE
48	3760	31ST STREET AT DES PLAINES AVENUE
49	3585	IL ROUTE 171 (1ST AVENUE) AT 26TH STREET
50	22121	17TH AVENUE (MAPLE AVENUE) AT 23RD STREET
51	3701	22ND STREET (CERMAK ROAD) AT 12TH AVENUE
52	22065	22ND STREET (CERMAK ROAD) AT 14TH AVENUE
53	4800	22ND STREET (CERMAK ROAD) AT DES PLAINES RIVER ROAD
54	4825	22ND STREET (CERMAK ROAD) AT NORTH RIVERSIDE PLAZA EAST
55	4820	22ND STREET (CERMAK ROAD) AT NORTH RIVERSIDE PLAZA WEST
56	9360	22ND STREET (CERMAK ROAD) AT NORTH RIVERSIDE EAST PLAZA/MID CITY BANK
57	3750	26TH STREET AT NORTH RIVERSIDE PLAZA/VETERANS PARKWAY
58	7943	26TH STREET AT WESTOVER AVENUE
59	3590	IL ROUTE 171 (IST AVENUE) AT 31ST STREET IL ROUTE 43 (HARLEM AVENUE) AT 23RD STREET
60	2115	
61 62	3020	IL ROUTE 64 (NORTH AVENUE) AT 25TH AVENUE IL ROUTE 64 (NORTH AVENUE) AT NORTHWEST AVENUE
63	3065 3075	IL ROUTE 64 (NORTH AVENUE) AT RAILROAD AVENUE
64	3067	US ROUTE 20 AT RAILROAD AVENUE
65	3083	IL ROUTE 64 (NORTH AVENUE) AT ROY STREET
66	3090	IL ROUTE 64 (NORTH AVENUE) AT WOLF ROAD
67	21850	IL ROUTE 64 (NORTH AVENUE) AT WAL-MART ENTRANCE/HILLSIDE AVENUE
68	1338	US ROUTE 20 (LAKE STREET) AT 1-294 RAMP
50	• • • • •	The court of the section of the sect

GENERAL NOTES:

ALL CONSTRUCTION SHALL CONFORM TO THE STANDARD SPECIFICATIONS FOR ROAD AND BRIDGE CONSTRUCTION (SSRBC), AND SUPPLEMENTAL SPECIFICATIONS AND RECURRING SPECIAL PROVISIONS: ADOPTED JANUARY 1. 2014 BY THE ILLINOIS DEPARTMENT OF TRANSPORTATION AND ALL AMENDMENTS THERETO: IN CASE OF CONFLICT, THE MORE RESTRICTIVE PROVISIONS SHALL APPLY. ANY REFERENCE TO STANDARDS IN THE PLANS OR SPECIAL PROVISIONS SHALL BE INTERPRETED TO BE THE LATEST STANDARDS OF THE DEPARTMENT.

THE CONTRACTOR SHALL CHECK THE PROPOSED TRAFFIC SIGNAL EQUIPMENT LOCATIONS FOR OVERHEAD UTILITY CONFLICTS. THE CONTRACTOR SHALL COORDINATE ANY CONFLICTS WITH THE UTILITY COMPANIES AND THE RESIDENT ENGINEER BEFORE ORDERING MATERIALS.

THE CONTRACTOR SHALL COORDINATE CONSTRUCTION ACTIVITIES WITH UTILITY COMPANIES, LOCAL GOVERNMENT AGENCIES, AND IDOT.

THE CONTRACTOR WILL NOT BE ALLOWED TO SET UP A YARD OR FIELD OFFICE ON STATE PROPERTY WITHOUT WRITTEN PERMISSION FROM THE

WHENEVER, DURING CONSTRUCTION OPERATIONS, ANY LOOSE MATERIAL IS DEPOSITED IN THE FLOW LINE OF GUTTERS, DRAINAGE STRUCTURES, DITCHES, ETC., SUCH THAT THE NATURAL FLOW LINE OF WATER IS OBSTRUCTED, THE LOOSE MATERIAL WILL BE REMOVED AT THE CLOSE OF EACH WORKING DAY, AT THE CONCLUSION OF CONSTRUCTION OPERATIONS. ALL DRAINAGE STRUCTURES AND FLOW LINES SHALL BE FREE FROM DIRT AND DEBRIS. THIS WORK SHALL BE CONSIDERED INCIDENTAL TO THE CONTRACT. THE CONTRACTOR'S FAILURE TO PROVIDE THE ABOVE WILL PRECLUDE ANY POSSIBLE ADDED COMPENSATION REQUESTED DUE TO DELAYS OF UNSUITABLE MATERIALS CREATED AS A RESULT THEREOF.

THE CONTRACTOR SHALL NOTIFY THE IDOT ARTERIAL TRAFFIC CONTROL SUPERVISOR AT (847) 705-4470 A MINIMUM OF 72 HOURS IN ADVANCE OF REGINNING WORK.

THE CONTRACTOR SHALL SOLELY BE RESPONSIBLE FOR THE INSTALLATION AND MAINTENANCE OF ADEQUATE SIGNS, TRAFFIC CONTROL DEVICES, AND WARNING DEVICES TO INFORM AND PROTECT THE PUBLIC DURING ALL PHASES OF CONSTRUCTION.

THE CONTRACTOR SHALL BE REQUIRED TO PROVIDE ACCESS TO ABUTTING PROPERTY AT ALL TIMES DURING THE CONSTRUCTION OF THIS PROJECT OR THE DIRECTION OF THE ENGINEER,

THE CONTRACTOR IS RESPONSIBLE FOR RETURNING ALL AREAS AFFECTED BY EQUIPMENT OR LABORERS TO EXISTING CONDITIONS. THE CONTRACTOR IS ALSO RESPONSIBLE FOR PROTECTING ALL NEW WORK UNTIL COMPLETION OF THIS CONTRACT.

RESTORATION OF WORK AREA: RESTORATION OF THE TRAFFIC SIGNAL WORK AREA SHALL BE INCIDENTAL TO THE RELATED PAY ITEM SUCH AS SIGNAL POST, UNINTERRUPTIBLE POWER SUPPLY, ETC., AND NO EXTRA COMPENSATION SHALL BE ALLOWED. ALL ROADWAY SURFACES SUCH AS SHOULDERS, MEDIANS, SIDEWALKS, PAVEMENT, ETC., SHALL BE REPLACED IN KIND. ALL DAMAGE TO MOWED LAWNS SHALL BE REPLACED WITH AN APPROVED SOD IN ACCORDANCE TO STANDARD SPECIFICATIONS ARTICLE
252 WHICH SHALL INCLUDE THE REQUIRED WATERING PER ARTICLE 252.08 ALL DAMAGE TO UNMOWED FIELDS SHALL BE SEEDED IN ACCORDANCE WITH STANDARD SPECIFICATIONS ARTICLE 250 AND 251, RESPECTIVELY.

IT SHALL BE THE CONTRACTOR'S RESPONSIBILITY TO VERIFY ALL DIMENSIONS AND CONDITIONS EXISTING IN THE FIELD PRIOR TO ORDERING MATERIALS AND BEGINNING CONSTRUCTION.

THE EXACT LOCATION OF ALL UTILITIES SHALL BE FIELD VERIFIED BY THE CONTRACTOR BEFORE ORDERING ANY MATERIALS AND STARTING ANY WORK. FOR LOCATIONS OF UTILITIES, LOCALLY OWNED EQUIPMENT, LEASED ENFORCEMENT CAMERA SYSTEM FACILITIES, AND IDOT UNDERGROUND FACILITIES. CONTACT THE LOCAL COUNTIES. MUNICIPALITIES, AND IDOT FOR LOCATES. THE CONTRACTOR SHALL CALL "JULIE" AT (800) 892-0123 OR 811. IN THE CITY OF CHICAGO, CALL DIGGER AT (312) 744-7000 FOR FIELD LOCATIONS OF BURIED UTILITIES (48 HOURS NOTIFICATION REQUIRED).

AT LOCATIONS ON THE PLANS WHERE TRAFFIC SIGNAL POST REMOVAL AND NEW TRAFFIC SIGNAL POST INSTALLATIONS ARE SPECIFIED, THE CONTRACTOR SHALL INSPECT THE EXISTING POST FOUNDATION. PRIOR TO REMOVING THE EXISTING TRAFFIC SIGNAL POST TO BE REPLACED, THE CONTRACTOR SHALL VERIFY THAT THE PATTERN, SPACING, AND CONDITION OF THE EXISTING ANCHOR BOLT IS ACCEPTABLE FOR REUSE WITH A NEW POST. IF THE EXISTING ANCHOR BOLT CONDITION IS NOT ACCEPTABLE. THE CONTRACTOR SHALL REPLACE ANCHOR BOLTS AS DIRECTED BY THE ENGINEER. ANCHOR BOLT REPLACEMENT WILL BE PAID FOR AS "REMOVE AND REPLACE ANCHOR BOLTS." "REMOVE AND REPLACE ANCHOR BOLTS" PAY ITEMS QUANTITIES SHOWN ARE NOMINAL AND ONLY TO BE UTILIZED AS APPROVED BY THE ENGINEER.

SCALE: NTS

THE CONTRACTOR SHALL RELOCATE ANY EXISTING SIGN PANELS, INCLUDING BLANK OUT SIGNS, FROM PAINTED POSTS THAT ARE INDICATED FOR REPLACEMENT TO A NEW POST AS SHOWN ON THE PLANS OR AS DIRECTED BY THE ENGINEER. THE COST OF REMOVAL, RELOCATION, AND ANY NEW MOUNTING HARDWARE NECESSARY TO COMPLETE THIS WORK SHALL BE INCLUDED IN THE PAY ITEM OF THE LENGTH AS SPECIFIED IN THE PLANS.

CONTRACTOR SHALL REPLACE METAL MOUNTING BRACKETS AT ALL RETROFIT SIGNAL HEADS WITH NEW POLYCARBONATE BRACKETS OR AS DIRECTED BY THE ENGINEER. THE COST OF THIS WORK SHALL BE INCLUDED IN THE CORRESPONDING SIGNAL HEAD, LED, RETROFIT PAY ITEM OF THE TYPE AND NUMBER OF SIGNAL HEADS, FACES, AND SECTIONS AS SPECIFIED IN THE PLANS.

PARTIAL PAYMENT AS DESCRIBED IN ARTICLE 109.07(b) OF THE STANDARD SPECIFICATIONS WILL NOT BE ALLOWED FOR ITEMS INCLUDED IN THIS CONTRACT.

A CONCRETE APRON SHALL NOT BE REQUIRED FOR NEW UPS INSTALLATIONS ADJACENT TO EXISTING IMPERVIOUS SURFACES THAT SATISFY THE NEED OF THE CONCRETE APRON, AS DIRECTED BY THE

FOR THE FOLLOWING TS LOCATIONS, DUE TO THE PRESENCE OF RED LIGHT RUNNING (RLR) CAMERA COMPANY WITHIN THE PROJECT LIMITS. THE CONTRACTOR SHALL NOTIFY THE MUNICIPALITIES AND RLR CAMERA COMPANIES LISTED BELOW PRIOR TO THE START OF CONTRUCTION, THE MUNICIPALITIES AND RLR CAMERA COMPANIES SHALL MAKE THE CAMERA INOPERATIVE FOR THE TIME OF CONSTRUCTION, ANY RER CAMERA EQUIPMENT THAT IS IN CONFLICT WITH THE PROPOSED CONSTRUCTION SHALL BE REMOVED BY ITS RESPECTIVE OWNERS PRIOR TO THE START OF CONSTRUCTION.

RLR CAMERA LOCATIONS: 3865 55TH ST AT WOLF RD, WESTERN SPRINGS, IL

1480 US ROUTE 34 AT WOLF RD, WESTERN SPRINGS, IL VILLAGE OF WESTERN SPRINGS REDSPEED ILLINOIS 400 EISENHOWER LN N 740 HILLGROVE AVE. WESTERN SPRINGS, IL 60558-1409 LOMBARD, IL 60148 (630) 317-5700

(708) 246-1800

RLR CAMERA LOCATIONS: 3585 IL ROUTE 171 AT 26TH ST. NORTH RIVERSIDE. IL

VILLAGE OF NORTH RIVERSIDE REDFLEX TRAFFIC SYSTEMS 23751 N, 23RD AVE, STE 150 PHOENIX, AZ 85085 2401 S. DES PLAINES AVE. NORTH RIVERSIDE, IL 60546 (708) 447-4211 (866) 703-8097

RLR CAMERA LOCATIONS: 3075 IL ROUTE 64 AT RAILROAD AVE. NORTHLAKE. IL 3067 US ROUTE 20 AT RAILROAD AVE. NORTHLAKE, IL

CITY OF NORTHLAKE CITY HALL 55 E. NORTH AVE. NORTHLAKE, IL 60164 (708) 343-8700

REDFLEX TRAFFIC SYSTEMS 23751 N. 23RD AVE, STE 150 PHOENIX, AZ 85085 (866) 703-8097

RLR CAMERA LOCATIONS: 4845 22ND ST AT WOLF RD. WESTCHESTER, IL

VILLAGE WESTCHESTER SAFESPEED, LLC 10300 W. ROOSEVELT RD. 155 N. WACKER DRIVE WESTCHESTER, IL 60154 CHICAGO, IL 60606 (708) 345-0020 (312) 924-7244

RLR CAMERA LOCATIONS: 3020 IL ROUTE 64 AT 25TH AVE, MELROSE PARK, IL


VILLAGE OF MELROSE PARK 1000 N. 25TH AVE. MELROSE PARK, IL 60160 (708) 343-4000

SAFESPEED, LLC 155 N. WACKER DRIVE CHICAGO, IL 60606 (312) 924-7244

FILE NAME =	USER NAME = LUSER.	DESIGNED -	M.A./V.O.	REVISED	
Ji/13155/Work Order 2/BGN/CAGO Sheete/C	68Yl&-sht-gennote,dgn	DRAWN -	Y,J./E.C.	REVISED	-
	PLOT SCALE = 1.8808 '/ im.	CHECKED -	I.Y.	REVISED	•
	PLOT DATE + 5/14/2014	DATE -	5/16/2014	REVISED	-

STATI	E 01	: ILLINOIS
DEPARTMENT	OF	TRANSPORTATION

11125 OF 011550	·	F.A.P.	SECTION	COUNTY	TOTAL	SHEET NO.
INDEX OF SHEETS			2014-032TS	соок	68	2
				CONTRACT	NO. E	50Y18
SHEFT NO. 1 OF 1 SHEFTS (STA. N/A	TO STA NIZA		ill a thotel eta a	to poor ear		

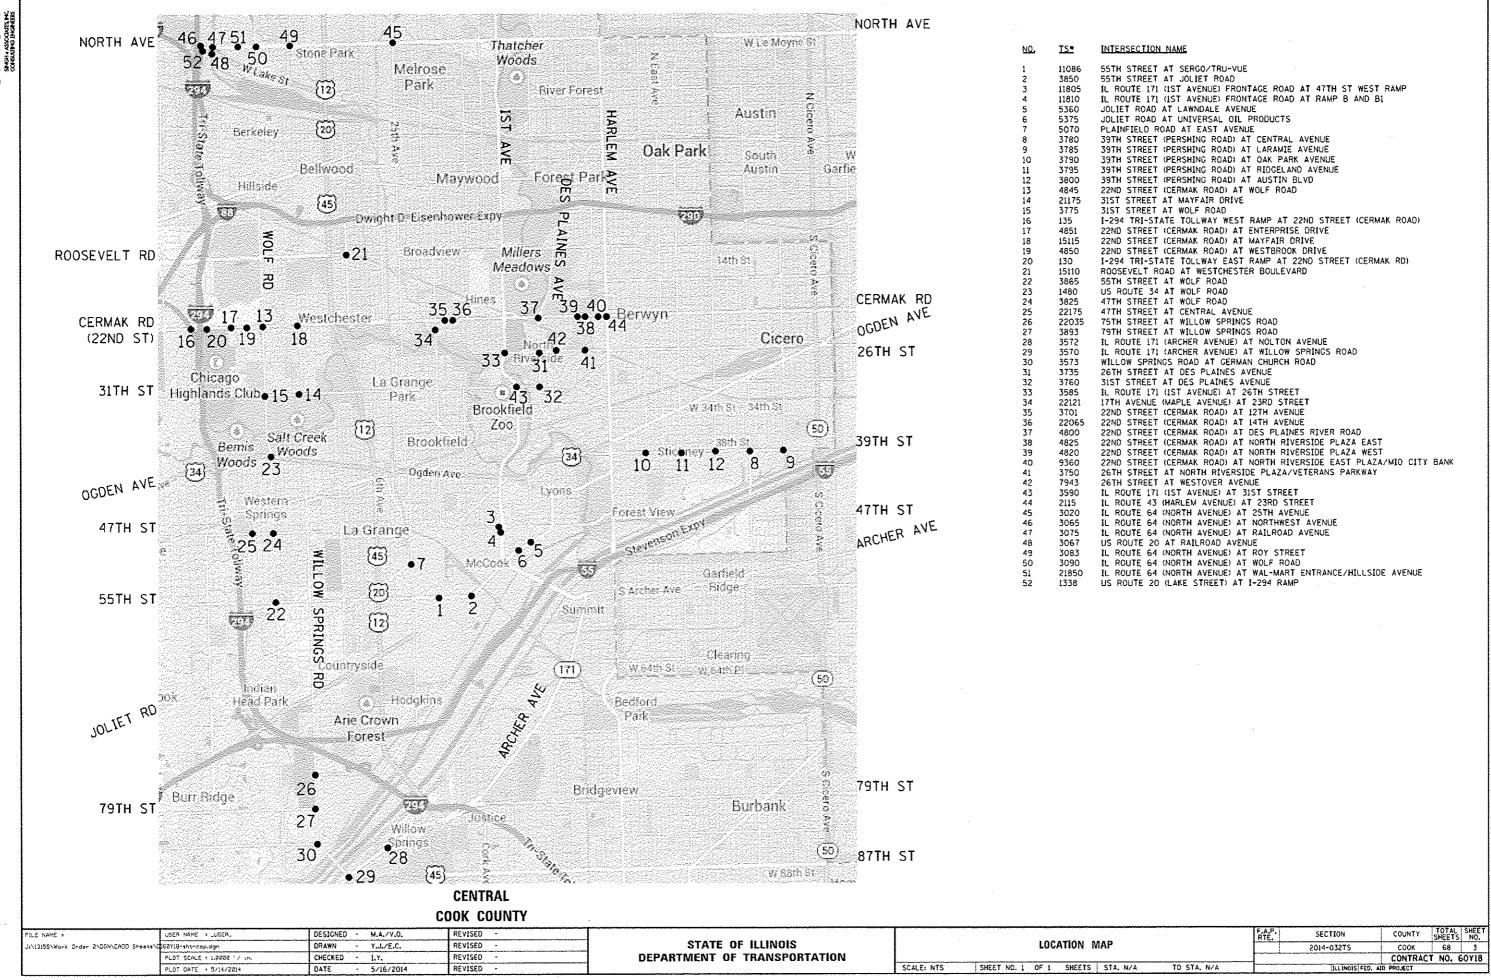

					SUMMA	RT UF	UUAN	HILL	HEADI	ING LE	GENU	FI	UNDINO	PART	TCIPAT	TION	***************************************	÷*		·····		
				<i></i>	7	/ 8	5. /	7	/,&	7	7.	y	SND INC	7	/			7	7	/	-> /	
OLUMN	TS#	INTERSECTION NAME		/ w /	, coo, coo,	193	0430/	STICKNEY	PLANT WATER	A COMPANY	ESCORESTER	\ \ \ \ \ \ \ \ \ \ \ \ \ \ \ \ \ \ \		SPACEON SPACEON	CONTA VERSION	#14EAS1OE	TOROVIEW SOLE SOLE	11.040 MT 10.040 MT 10.041 EW 10.041 EW 10.040 MT 10.040 MT		2 4 5 7 5 1 5 1 5 1 5 1 5 1 5 1 5 1 5 1 5 1	C. C	MORTH AKE
JMBER	1,3"	INTERSECTION NAME			`/\$,	٤/		15	£ 63/	/			r/	٦/	<u>~/</u>	`/_`	/_~	~ ~ ~ ~ ~ ~ ~ ~ ~ ~ ~ ~ ~ ~ ~ ~ ~ ~ ~	/ ~	/ 5	/ <u>Q</u>	
2	11086	55TH STREET AT SERGO/TRU-VUE	96. 7%	3. 3	z l				2									- Commence			Total Control of the	
3	3850	55TH STREET AT JOLIET ROAD	97.5%	2. 5	<i>y.</i>	The second		***				\mathbf{I}										
1	11805	IL ROUTE 171 (1ST AVENUE) FRONTAGE ROAD AT 47TH ST WEST RAMP	100.0%							1									1			
Į.	11810	IL ROUTE 171 (1ST AVENUE) FRONTAGE ROAD AT RAMP B AND BI	100.0%								NAME OF THE PERSON OF THE PERS	П						VALUE AND A STATE OF THE STATE		1		
4	5360	JOLIET ROAD AT LAWNDALE AVENUE	95.0%	5.0	<i>y.</i>													7 to 100				
5	5375	JOLIET ROAD AT UNIVERSAL OIL PRODUCTS	95.0%		5.0	4	Western											- Constant		Arran		
1	5070	PLAINFIELD ROAD AT EAST AVENUE	100.0%																	-		
6	3780	39TH STREET (PERSHING ROAD) AT CENTRAL AVENUE	97.5%			2. 57			1								-					
7	3785	39TH STREET (PERSHING ROAD) AT LARAMIE AVENUE	95.0%				5.0	1%	-													
8	3790	39TH STREET (PERSHING ROAD) AT OAK PARK AVENUE	95.0%				2.5	у.	2. 5%		1	T										
9	3795	39TH STREET (PERSHING ROAD) AT RIDGELAND AVENUE	97.5%				2.5	7.		1	-						1					
10	3800	39TH STREET (PERSHING ROAD) AT AUSTIN BLVD	95. 0%			2.5%		2.	Z.							<u> </u>						
Į	4845	22ND STREET (CERMAK ROAD) AT WOLF ROAD	100.0%								***************************************	11	TT									
11	21175	31ST STREET AT MAYFAIR DRIVE	96. 7%							3. 3/	:	11	11				 					
11	3775	31ST STREET AT WOLF ROAD	96. 7%				<u> </u>			3. 3%		11		<u> </u>	\neg			1				
1	135	1-294 TRI-STATE TOLLWAY WEST RAMP AT 22ND STREET (CERMAK ROAD)	100.0%				1	_		1				1	_							
11	4851	22ND STREET (CERMAK ROAD) AT ENTERPRISE DRIVE	96. 7%				1			3. 3%					-			1		<u>-</u>		
12	15115	22ND STREET (CERMAK ROAD) AT MAYFAIR DRIVE	95.0%					1	- 	5, 0%							-	1				
13	4850	22ND STREET (CERMAK ROAD) AT WESTBROOK DRIVE	95.0%			1	1			-	2.5%				_	_	<u> </u>	1				
1	130	I-294 TRI-STATE TOLLWAY EAST RAMP AT 22ND STREET (CERMAK RD)	100, 0%		-	1		_		1	1	11		_	_		-	 	<u>-</u>			
12	15110	ROOSEVELT ROAD AT WESTCHESTER BOULEVARD	95.0%				1	_	<u> </u>	5.0%								1				
1	3865	55TH STREET AT WOLF ROAD	100.0%		+	1	1		-		1						 -	1	——i			
1	1480	US ROUTE 34 AT WOLF ROAD	100.0%	 		1	1		_	1	-	†			1		1	1				
1	3825	47TH STREET AT WOLF ROAD	100.0%	 		_			1	1	-	+					1					
14	22175	47TH STREET AT CENTRAL AVENUE	96. 7%					-i	_	1	1		3.	7.		 						
14	22035	75TH STREET AT WILLOW SPRINGS ROAD	96. 7%				Ì	1	1	1	1	7	3.				1	1		 -		
16	3893	79TH STREET AT WILLOW SPRINGS ROAD	97.5%				1	+	1				2.5	-	-		 	1				
17	3572	IL ROUTE 171 (ARCHER AVENUE) AT NOLTON AVENUE	95.0%				1	_		1	1	11	5.0			_	<u> </u>	1				
1	3570	IL ROUTE 171 (ARCHER AVENUE) AT WILLOW SPRINGS ROAD	100, 0%				1	1		1	1	11			_		<u> </u>	1				
1	3573	WILLOW SPRINGS ROAD AT GERMAN CHURCH ROAD	100, 0%		1		1		***************************************	1	1	11	1		1		1	1	-			
18	3735	26TH STREET AT DES PLAINES AVENUE	95.0%			1	1	1	www.	1	1	\top	1	5. 0	1/2		1	1				
19		31ST STREET AT DES PLAINES AVENUE	96. 7%		<u> </u>	1	1	1		1		$\forall f$	1		3. 3	3%	1	1 1				
18		IL ROUTE 171 (1ST AVENUE) AT 26TH STREET	95.0%				1	<u> </u>		1	-	1	1	5.0			1	1				
18		17TH AVENUE (MAPLE AVENUE) AT 23RD STREET	95.0%			-	1	_		_				5.0		***************************************	1		-			
		22ND STREET (CERMAK ROAD) AT 12TH AVENUE	95. 0%		- 	1	†	 	1	1	L. Land	11	1	2, 5		2. 5%	1	1		***	***	1
21		22ND STREET (CERMAK ROAD) AT 14TH AVENUE	95, 0%		1	-	-	1	- 	+			1		1		5.0%	-				
22		22ND STREET (CERMAK ROAD) AT DES PLAINES RIVER ROAD	97.5%		-	-	1		-	1	1	#	1	2, 5	z		1	 				
23	! 	22ND STREET (CERMAK ROAD) AT NORTH RIVERSIDE PLAZA EAST	96. 7%							-	1	1		5,00			3	3. 3%				
23		22NO STREET (CERMAK ROAD) AT NORTH RIVERSIDE PLAZA WEST	96. 7%		-	1				*	 	1			-			3. 3%				
		22NO STREET (CERMAK ROAD) AT NORTH RIVERSIDE EAST PLAZA/MID CITY BANK	95. 0%				-	+-		*	1	+		-			+		5 m			
	, , , , , ,	A THE STATE OF THE PARTY OF THE	1 33. 0%						i			 						1 1	5.0%			i

							Kev. I
FILE NAME =	USER NAME = _USER_	DESIGNED - M.A./V.O.	REVISED -			F.A.P. SECTION	COUNTY TOTAL SHEET
J:\13155\Work Order Z\DGN\CAOD Sheets\C	168718-sht-50081.dgn	DRAWN - Y.J./E.C.	REVISED -	STATE OF ILLINOIS	SUMMARY OF QUANTITIES	2014-032TS	COOK 68 4
	PLOT SCALE = 1,0000 1/ in,	CHECKED - 1.Y.	REVISED -	DEPARTMENT OF TRANSPORTATION		2014-03215	CONTRACT NO. 60Y18
	PLOT DATE = 5/14/2914	DATE - 5/16/2014	REVISEO -		SCALE: NTS SHEET NO. 1 OF 6 SHEETS STA. N/A TO STA, N/A	[LLINOIS]	FED. AID PROJECT

				5	SUMMAR	Y OF Q	UANTI	TIES H	EADING	LEGE	END												
														F	UNDIN	G PART	ICIPAT	ION	,,,		,	,,	
COLUMN			57475		, 600°, 100°	CICEC CO	our /25	STICKNEY STICKNEY SECONEY	SERVINATION CON	West.	COLCE COLCE			Solves A	NERS IDE	VERSIOE BRO.	SOLE WILL	(c. 20V. c.) 0. 1/C (c.) 0. 1/C (c.) 0. 1/C (c.)	30/18/25/27/25/25/25/25/25/25/25/25/25/25/25/25/25/	\$ 50,55 50 50,55 50 50,55 50 50 50 50 50 50 50 50 50 50 50 50 5	CE 104 CE 104 P. L. S. W. W. S. T. O. S. C. S. C	MON 14550C.	Comises Comises
NUMBER	13"	INTERSECTION NAME	/		12.4	/		15 80	<u> </u>	, 					/		/	7		-7			
		26TH STREET AT NORTH RIVERSIDE PLAZA/VETERANS PARKWAY	95.0%			 							•	2 57	2, 5%			3, 0%					
		26TH STREET AT WESTOVER AVENUE	95.0%			-						-	1	1 2. 3"	1. 7"	1							
		IL ROUTE 171 (1ST AVENUE) AT 31ST STREET	100.0%			-		-				 	 	1	 	-				2. 5%	2. 5%		
		IL ROUTE 43 (HARLEM AVENUE) AT 23RD STREET	95.0%									 	H	 	 	1							
		IL ROUTE 64 (NORTH AVENUE) AT 25TH AVENUE	96. 7%		-	1		-				1	 		1	 						3. 3%	
		IL ROUTE 64 (NORTH AVENUE) AT NORTHWEST AVENUE	95.0%		┪	 						-		1	1	<u> </u>						5.0%	
		IL ROUTE 64 (NORTH AVENUE) AT RAILROAD AVENUE	96. 7%		-	+		And a				\top			-	1	<u> </u>					3. 3%	
		US ROUTE 20 AT RAILROAD AVENUE	95. 0%					The state of the s				1-1	1			1						2. 5%	2. 5%
		IL ROUTE 64 (NORTH AVENUE) AT ROY STREET	95.0%		+			1				+ +	1	-	The contract of the contract o	1						5. 0%	
29	3090	IL ROUTE 64 (NORTH AVENUE) AT WOLF ROAD IL ROUTE 64 (NORTH AVENUE) AT WAL-MART ENTRANCE/HILLSIDE AVENUE	95.0%		+			†				$\top \top$					1					5.0%	
		US ROUTE 20 (LAKE STREET) AT 1-294 RAMP	100.0%		+							++		1	1	T							
1	1338	US ROUTE SO CLARE STREET, AT 1-234 RAME	100.00		-	 								1	1								
						+		-						1									
					1	1		1															
					1	-																	
						1		1															
						1								1									
						1																	
					1	·	1							- Annual Control									
					1			-						A-10-1		_							
															<u> </u>		<u> </u>						
							Control of the second							1			WA PERSON AND						
															<u> </u>								
														ļ	<u> </u>		1	<u> </u>					
																	ļ	<u> </u>					
	-					- Common	1											ļ	ļ				
							Annan v							<u> </u>	<u> </u>		<u> </u>		<u> </u>				
								Anna Anna Anna Anna Anna Anna Anna Anna			ļ			ļ			<u> </u>	-	 				
	į.				1		ļ							-			<u> </u>	<u> </u>				-	
											-			ļ	- 		 	 					
						***************************************	-						 	-	-		 	ļ	-				
							-					H	 		-		-	<u> </u>	 				
							<u> </u>				ļ	4-	1	-	-		-		 -				
2											ļ	!			-		-	<u> </u>	 				
							ļ	<u> </u>			ļ	 	 				 		 -				
					_						<u> </u>	 		 	-		 	 			·····		
	-				***************************************		-				ļ	-	-	 			***	-	+ +				
							-				ļ	 		1	-		 		-				
						-	1					<u> </u>					<u> </u>	<u> </u>	<u> </u>				

Onl	
Kev	

						F.A.P. COUNTY TOTAL SHEET
FILE NAME :	USER NAME + LUSER_	DESIGNED - M.A./Y.O.	REVISED -		Average of Average Transport	RTE. SECTION COUNTY SHEETS NO.
3013155\Work Grder 2\D6N\CASD Sheets\U	58Y18-aht-90082.dqn	DRAWN - Y.J./E.C.	REVISED -	STATE OF ILLINOIS	SUMMARY OF QUANTITIES	2014-032TS COOK 68 5
V	PLOT SCALE = 1.0205 ' / 101	CHECKED - I.Y.	REVISED -	DEPARTMENT OF TRANSPORTATION		CONTRACT NO. 60Y18
	91 OT DATE = 5/14/2814	DATE - 5/16/2014	REVISED -		SCALE: NTS SHEET NO. 2 OF 6 SHEETS STA. N/A TO STA. N/A	[LL]NOIS FED. AID PROJECT



						- A	Z1 Z	<u> </u>			T . T .			CONS					T _a , I					.	
CODE				TOTAL		#/	3 4	5	6	8] 3] 1	111	12 [1		FFIC	SIGN		13 50	21	22 2	24	25	26 2	1 28	29 30
NO.	ITEM		UNIT	QUANTIT	Y										00 URE										
				***************************************											COLUMB NAME OF THE PARTY OF THE	***************************************				**************************************					
67000400	ENGINEER'S FIELD OFFICE. TYPE A		CAL MO	3	3		enimente A Antonia na Ballanda								-					- Constitution of the Cons	and an analysis of the same of				
		,					-									-									
67100100	MOBILIZATION		r shw	1	1																				

70102635	TRAFFIC CONTROL AND PROTECTION, STANDARD 7	701701	L SUM	1	1																				
							- Continues of the Cont														-				
85000200	MAINTENANCE OF EXISTING TRAFFIC SIGNAL INS	STALLATION	EACH	52	14	1	1 1	1	1	1	1 1	3	2 1	2		1	3	1 1	1	1	2 1	1	1 1	2	3 1
~~~~~~~~~~~~~~~~~~~~~~~~~~~~~~~~~~~~~~																									
85700200	FULL-ACTUATED CONTROLLER AND TYPE IV CABIN	NET	EACH	2										ı				***************************************				1			
87502440	TRAFFIC SIGNAL POST, GALVANIZED STEEL 10 F	· T.	EACH	1													1								
										***************************************															
87502480	TRAFFIC SIGNAL POST, GALVANIZED STEEL 14 F	FT.	EACH	20	4		1 1	3		***************************************				3			1				2		3 1		
87502490	TRAFFIC SIGNAL POST. GALVANIZED STEEL 15 F	₹Т,	EACH	1			-			***												1			
			20.0020.20mm avven				-			***************************************							***************************************								
87502500	TRAFFIC SIGNAL POST, GALVANIZED STEEL 16 F	FT.	EACH	43	15		2		3	***************************************	4 3	4	2				3				4 2		1		
			11 U.V.				***************************************																		
87502520	TRAFFIC SIGNAL POST, GALVANIZED STEEL 18 F	FT.	EACH	2			· · · · · · · · · · · · · · · · · · ·									***************************************	***************************************			***************************************		1	1		
							A																		
88030010	SIGNAL HEAD, LED. 1-FACE, 1-SECTION, MAST-	-ARM MOUNTED	EACH	2	2		***************************************									***************************************				***************************************					
																				***************************************					
88030012	SIGNAL HEAD, LED. 1-FACE. 1-SECTION, BRACK	KET MOUNTED	EACH	2	2										***************************************	***************************************				***************************************					
					***************************************																				
88030020	SIGNAL HEAD, LED. 1-FACE, 3-SECTION, MAST-	-ARM MOUNTED	EACH	64	13		1 4	2		6	2 5		4 1	3			4				4		2 2		5 6
			100		***************************************																		***************************************		
88030050	SIGNAL HEAD, LED. 1-FACE, 3-SECTION, BRACK	KET MOUNTED	EACH	30	4		2	2	2	2	1		2 1	2			3				3		2 2		2
			usern version of the second se													and the second decrease of the second decreas		-							
														,											1
NYCABO Sheete/Cas	SSR NAME = LUSER. DESIGNED - M.A./V.O. 9719-sht-50000.dgn	REVISED -	STATE OF	ILLINOIS				T				SUMM	IARY O	F QUAN	ITITIES	:				F.A.P. RTÉ,		SECTIO 2014-03			OUNTY S
T _F	LOT SCALE = 1,0008 '/ in CHECKED - 1.Y.  LOT DATE - 5/16/2014  DATE - 5/16/2014	REVISED - REVISED -	DEPARTMENT OF		TATIO	NC		501	E: NTS		SHEET NO						TO ST	A N/A					LINOIS FEO	CO	NTRACT

M

	FILE NAME >	USER NAME = _USER_	DESIGNED - M,A./V.O.	REVISED -		
	J:\13155\Work Drder 2\88N\CABO Sheets\8	63718-sht-50003,dgn	DRAWN - Y.J./E.C.	REVISED -	STATE OF ILLINOIS	
-		PLOT SCALE = 1,9988 1/ in.	CHECKED - 1.Y.	REVISED -	DEPARTMENT OF TRANSPORTATION	
1		PLOT DATE + 5/14/2814	DATE - 5/16/2014	REVISED -		SCALE: NTS

	F.A.P.	SECTION
SUMMARY OF QUANTITIES		2014-032TS
THE NIC CHEST NO 3 OF 6 SHEETS STANDA TO STANDA	1	TO I THINK!

				1	2 3	3 4	5	6	7	8 9	10	11	12	13 1	4 -1	5 10	5 17	18	19 2	20 21	22	23 2	24 25	26	27 2	28 2	9 30
CODE	ITEM	UNIT	TOTAL												TRAF	00:	SIG	1AL									
NO.			QUANTIT'	Y								<del></del>				URB			·····						<del></del>		<del></del>
				***************************************		***************************************																					
88030070	SIGNAL HEAD, LED, 1-FACE, 4-SECTION, BRACKET MOUNTED	EACH	5	**************************************	2	2				***************************************				2					ekonolisebessionisek				1	**************************************			
88030080	SIGNAL HEAD, LED, 1-FACE, 4-SECTION, MAST ARM MOUNTED	EACH	4			1								2	$\parallel$		1								1	2	2
					$\top$				十		$\top$	$l^-$			1		1					1	$\top$				
88030100	SIGNAL HEAD, LED, 1-FACE, 5-SECTION, BRACKET MOUNTED	EACH	34	5	$\top$			4	$\top$	2 4	1 3		2	1			1	3	T	+		2	+		2	+	4 2
					-				-	1															+		
88030110	SIGNAL HEAD, LED, 1-FACE, 5-SECTION, MAST-ARM MOUNTED	EACH	36	8		2		4		2 2	2 3	<del> </del>	2	3		$\parallel$	-	3	1		+	2	2		+		2
		_		$\dagger \dagger$	-	1			$\dashv$			-										-			+		+
88030210	SIGNAL HEAD, LED, 2-FACE, 3-SECTION, BRACKET MOUNTED	EACH	21	+++	_	2	1			-		-			2			4		-	+	2	2 1	4	+		2
00000210	STOTAL HEAD, CED, 2 TAGE, 3 SECTION, BROWNED	-		+-	+	+	<del>  •</del>			-											+			+	-	-	+
99070330	SIGNAL HEAD. LED. 2-FACE, 5-SECTION, BRACKET MOUNTED	EACH	2	+-+	_	-	-					-		2	-				_		$\ \cdot\ $	-		+-			+
	STOTIAL HEAD, CED, ZTIACE, S SCOTTON, BRACKET MOUNTED	Laci			_	+						_					***************************************		+			-	-		_		+
00030075		F.100		+	+	+				-	-			_				$\vdash$	_			-		+	-		+
88030230	SIGNAL HEAD, LED. 2-FACE, 1-3 SECTION, 1-4 SECTION, BRACKET MOUNTED	EACH	4	1		-	-		-	+	-	-		-	+		***************************************				$\blacksquare$	_	- -	+			-
				-		-	-			- -		-			-				_		$\bot$	-			_		-
88030240	SIGNAL HEAD. LED, 2-FACE, 1-3 SECTION, 1-5 SECTION, BRACKET MOUNTED	EACH	14	5	$ \frac{1}{1}$	2	-		-	_	2	-		_				$\vdash$			-	2	1 1	+	_	-	-
		_		-	_	_				_					_					_		_		$\perp \downarrow$	_	_	
88030310	SIGNAL HEAD, LED, 3-FACE, 3-SECTION, BRACKET MOUNTED	EACH	4	1			1										-								2		
									***************************************	_																	
88030320	SIGNAL HEAD, LED. 3-FACE, 1-3 SECTION, 2-5 SECTION BRACKET MOUNTED	EACH	ŧ					1	***************************************																		
									***************************************										-	***************************************	***************************************						
88030330	SIGNAL HEAD, LED. 3-FACE, 2-3 SECTION, 1-5 SECTION BRACKET MOUNTED	EACH	5						***************************************												-	2	1		2		
									***************************************																		
88055150	OPTICALLY PROGRAMMED SIGNAL HEAD, LED, 1-FACE, 3-SECTION, BRACKET MOUNTED	EACH	12			<del> </del>					1				$\parallel$	$\parallel$					****			$\prod$		4	4 8
						-			***************************************	$\dagger$	1				$\parallel$	$\parallel$			1								
88055160	OPTICALLY PROGRAMMED SIGNAL HEAD, LED. 1-FACE, 3-SECTION, MAST ARM MOUNTED	EACH	4	$\dagger \dagger$						1				***************************************	┪	$\parallel$	-		1		The state of the s					$\dashv$	
		-		+	$\dashv$	-				+	1	-				-	-		$\dashv$	1		+	_			-	+
88102717	PEDESTRIAN SIGNAL HEAD, LED, 1-FACE, BRACKET MOUNTED WITH COUNTDOWN TIMER	EACH	104	12	1 2	+				+,	}	6	16		4		4	8	4	8 6	++		2	18	2 2	2 1	0 8
30.02.11			ļ	+	-	-	1					ļ			$\bot$	₩-		$\vdash$		- -				$+\dot{+}$		-	+

FILE NAME =	USER NAME + _USER_	DESIGNED -		M.A./V.O.	REVISEO	•
Jill3155/Work Order 2/DGN/CAGB Sheete/C	62Y18-sht-\$C084.dgn	DRAWN -		Y.J./E.C.	REVISED	
	PLOT SCALE = 1,8208 '/ in.	CHECKED ~	-	1.Y.	REVISED	-
	PLOY GATE = 5/14/2214	DATE -		5/16/2014	REVISED	*

STATE OF ILLINOIS
DEPARTMENT OF TRANSPORTATION

	SUMMARY OF QUANTITIES	RTE. SECTION 2014-032
1	SCALE: NTS SHEET NO. 4 OF 6 SHEETS STA, N/A TO STA, N/A	įit.

CONSTRUCTION CODE

					2	3 4	<b>5</b>	6	7	8	9 1	0 1	1 1:	<del></del>	<del></del>	15				19 2	20 2	1 22	2 23	24	25	26 2	27 28	8 29	30
CODE	ITEM	UNIT	TOTAL									l			. 1	RAFF	IC S	IGN						<u></u>	 				<u> </u>
NO.	1 1 C W	UNII	QUANTITY														DO21												
		-Proposition to the Commission of the Commission		***************************************			***************************************	-			***************************************								***************************************	and the factor of the factor o							***************************************	***************************************	
88102747	PEDESTRIAN SIGNAL HEAD. LED, 2-FACE, BRACKET MOUNTED WITH COUNTDOWN TIMER	EACH	11	2	1					4		1	ı						***************************************									3	
												1											1						
88200210	TRAFFIC SIGNAL BACKPLATE, LOUVERED, ALUMINUM	EACH	113	28		3 6	2			8	4	В	6	6	4	+			7		1		6	2	3	2 :	2	7	8
entellen Melandland and soll followed a resident								-											***************************************										
88500100	INDUCTIVE LOOP DETECTOR	EACH	7										-		3										4				
						-	-					-		-	ļ						_							-	<u> </u>
88800100	PEDESTRIAN PUSH-BUTTON	EACH	65	2	- 13	3		-			2	1	1		4			4	8	4	8		_	2		8 2	2 2	+	12
89500100	RELOCATE EXISTING SIGNAL HEAD	EACH	34	17		-		2				8	-				***************************************	_		-		-	-				3	-	-
	RECORTE EXISTING STORME READ	LACI	77					-				+		-	-				_	-			-		$\blacksquare$	*	1	+	-
89500200	RELOCATE EXISTING PEDESTRIAN SIGNAL HEAD	EACH	9	1													***************************************		8										
					_	***************************************						_	-				***************************************	_	_	_	_	-	-			-	-	-	<u> </u>
89500400	RELOCATE EXISTING PEDESTRIAN PUSH-BUTTON	EACH	6	2								-	-	-	-				4	_	_		-					-	+
89502210	MODIFY EXISTING CONTROLLER CABINET	EACH	50	13	1 1	. 2	1	1	1	1		1 3	3 2	1	1	-	**************************************	1	3	1	1	1 1	2	1		1	1 2	3	1
89502375	REMOVE EXISTING TRAFFIC SIGNAL EQUIPMENT	EACH	46	10		6	1	1		1	***************************************	1 3	3 2	1	2		***	1	2	1	1		2	1	1	1 1	1 1	3	1
					_							_			-											_			<u> </u>
Z0050400	REMOVE AND REPLACE ANCHOR BOLTS	EACH	37	12	+	1	2	2			2 3	2 2	2	1	2				3				2	2	1	2 1	1		-
X8620200	UNINTERRUPTABLE POWER SUPPLY. SPECIAL	EACH	50	13	1	1	1	1	1	1	-	1 3	3 2	1	2	*	1	1	3	1	1	1 1	2	1	i	1	1 2	3	1
ramente continue de servicio de la manda de la mentra de la continue de la continue de la continue de la conti					1															1									
X8803038	SIGNAL HEAD, LED, 2-FACE, 1-3 SECTION, 1-4 SECTION, BRACKET MOUNTED, RETROFIT	EACH	2	2																									
													-																
X8803040	SIGNAL HEAD, LED, 2-FACE, 1-3 SECTION, 1-5 SECTION, BRACKET MOUNTED, RETROFIT	EACH	8	4					1													2			$\bot$			1	ļ
							_							_									And the same of th		$\perp$	***************************************		_	_
X8803042	SIGNAL HEAD, LED. 2-FACE, 1-4 SECTION, 1-5 SECTION, BRACKET MOUNTED, RETROFIT	EACH	1																			1				hallower and the same of the s			
		National Parketing Street											-	1					***************************************				***************************************			41444			

FILE NAME = USER NAME = USER L DESIGNED - M.A./V.O. REVISED 
JONISISSINGOR Order 2100N1CADO Sheets/1688/18-sht-5005.dgn DRAWN - Y.J./E.C. REVISED 
PLOT SCALE = 1.0000 / In. CHECKED - LY. REVISED 
PLOT DATE = 5/14/2014 DATE - 5/16/2014 REVISED -

STATE OF ILLINOIS
DEPARTMENT OF TRANSPORTATION

SUMMARY OF QUANTITIES

SCALE: NTS | SHEET NO. 5 OF 6 | SHEETS | STA. N/A | TO STA. N/A

CONSTRUCTION CODE



				1	2	3 4	5	6	7	8 9	10	11	12 1						20 2	1 22	23	24 25	26 2	7 28	29
CODE	ITEM	UNIT	TOTAL QUANTITY	<u></u>										TR	0	021	IGNAL								
NO.		**************************************	QUARTET 1			<del></del>	1	П	T			****	$\overline{}$		UF	RBAN			T	T	ТТ				
						-				_		-		-		-	***************************************			-	+		+-	-	
X8803051	SIGNAL HEAD, LED. 3-FACE, 2-3 SECTION, 1-5 SECTION, BRACKET MOUNTED, RETROFIT	EACH	1	_	_		-		_			1								-					
										-			_				_						+-	-	-
X8803060	SIGNAL HEAD, LED. 3-FACE, 3-SECTION, BRACKET MOUNTED, RETROFIT	EACH	1	1			-		-			_								-			++	_	-
						***************************************			-							-			_	-		_		-	-
X8803082	SIGNAL HEAD, LED. 1-FACE, 3-SECTION, BRACKET MOUNTED. RETROFIT	EACH	29	10	5				2	-		2	3	3	+6	- 4	2		2	-	+			-	-
					_								_	3		_	_		2 2	<del> </del>	+		++	-	5
X8803084	SIGNAL HEAD. LED. 1-FACE. 3-SECTION, MAST ARM MOUNTED, RETROFIT	EACH	51	16	3	-			4			2	3	2	3	4			4			_	+-		"
			ļ	-		***************************************			2	_		2	_	٠,		4	2		2 .	1 5					7
X8803088	SIGNAL HEAD, LED. 1-FACE. 5-SECTION, MAST ARM MOUNTED, RETROFIT	EACH	36	4	1				+	-		-	-			-	-		-		-				<u> </u>
		FACU	15	7					-		+		2		-	$\dashv$	2	-	2		+-		-		+
X8803090	SIGNAL HEAD. LED. 2-FACE. 3-SECTION, BRACKET MOUNTED. RETROFIT	EACH	13				-													-					-
	SIGNAL HEAD. LED. 1-FACE, 4-SECTION, BRACKET MOUNTED. RETROFIT	EACH	1				-		+	_				-		_									-
X8803110	SIGNAL HEAD, LED, 1-FACE, 4-SECTION, BRACKET WOUNTED, RETROLL		1				-		***************************************	-							-	-		-	+				-
V880312	SIGNAL HEAD, LED. 1-FACE, 4-SECTION, MAST ARM MOUNTED, RETROFIT	EACH	4	2			+		-	+				-						2	+-1				+
V0003150	STOTAL MEAN, SED, A PROCE OF SECURITION AND SECURIT	-		-					$\dashv$								***************************************							1	
X880321	SIGNAL HEAD, LED. 1-FACE, 5-SECTION, BRACKET MOUNTED, RETROFIT	EACH	18	2	1				1			1	2	(		4	2		2	1 1					
				<del> </del>		_			***************************************	1															
X880391	SIGNAL HEAD, LED, 2-FACE, 5-SECTION, BRACKET MOUNTED RETROFIT	EACH	6	1								1								1 1					3
						***************************************																			
X888001	5 PEDESTRIAN PUSH-BUTTON, NON-LATCHING	EACH	51	***************************************						4		3	16							5			***************************************		12
7.007666	4 TRAINEES - TRAINING PROGRAM GRADUATE	HOUR	500	500		***************************************								***************************************		,									
<u> </u>				and the second																					
,,,,,,,,,,,,,,,,,,,,,,,,,,,,,,,,,,,,,,,		***							****												-				<u> </u>
											***************************************												11		
				A CONTRACTOR OF THE CONTRACTOR					***************************************									**************************************							

REVISED -DESIGNED - M.A./V.O. FILE NAME & STATE OF ILLINOIS
DEPARTMENT OF TRANSPORTATION SUMMARY OF QUANTITIES DRAWN - Y.J./E.C.

CHECKED - 1.Y.

DATE - 5/16/2014 REVISED -CEG8Y18->ht-50086.dgn Jill3155/Work Order 2/DGN/CADD Sheets PLOT DATE : 5/14/2814 REVISED -SHEET NO. 6 OF 6 SHEETS STA. N/A REVISED -

SECTION COUNTY SHEETS NO.

114-032TS COOK 68 9

CONTRACT NO. GOY18

[ILLIMOIS] FED. AID PROJECT SECTION 2014-032TS

TO STA. N/A

CONSTRUCTION CODE


### TRAFFIC SIGNAL LEGEND

ITEM	REMOVAL	EXISTING	PROPOSED	ITEM	REMOVAL	EXISTING	PROPOSED	ITEM	REMOVAL	EXISTING	PROPOSED
CONTROLLER CABINET	R			EMERGENCY VEHICLE LIGHT DETECTOR	R≪	$\otimes$	•	ELECTRIC CABLE IN CONDUIT, TRACER, NO. 14 1/C, UNLESS NOTED OTHERWISE			
RAILROAD CONTROL CABINET				CONFIRMATION BEACON	$R_{o-0}$	<b>○</b> —(]		No. 17 176, GREESS NOTES OTHERWISE		,	
DMMUNICATIONS CABINET	C C	ECC	СС	HANDHOLE	R □			COAXIAL CABLE		<u> </u>	<u> </u>
STER CONTROLLER		EMC	MC	HANDIOLE	_			W50000 0005 500 00050		$\sim$	_
ASTER MASTER CONTROLLER	R	EMMC	MMC	HEAVY DUTY HANDHOLE	R _H	H	Н	VENDOR CABLE FOR CAMERA			
NINTERRUPTABLE POWER SUPPLY	UPS	EUPS	UPS	DOUBLE HANDHOLE	K N R □			COPPER INTERCONNECT CABLE, NO. 18 3 PAIR TWISTED, SHIELDED		<u></u>	<u>—6</u> —
RVICE INSTALLATION, POLE OR (G) GROUND MOUNT	-□ ^R	- <u></u> -	<b>-</b> ■ <u>P</u>	JUNCTION BOX UNDERGROUND CONDUIT,	R 🔘	<u> </u>	<b>0</b>	FIBER OPTIC CABLE NO. 62.5/125, MM12F		— <u>(12</u> F)—	
LEPHONE CONNECTION POLE OR (G) GROUND MOUNT	R T	P	P	GALVANIZED STEEL (UC) TEMPORARY SPAN WIRE, TETHER WIRE,	_R			FIBER OPTIC CABLE NO. 62.5/125, MM12F SM12F		<u> </u>	—(24F)—
EEL MAST ARM ASSEMBLY AND POLE UMINUM MAST ARM ASSEMBLY AND POLE	D	0		AND CABLE				FIBER OPTIC CABLE		_/	
EEL COMBINATION MAST ARM SEMBLY AND POLE WITH LUMINAIRE	R _{O-X}	0- <del>x</del>	•*	COMMON TRENCH  COILABLE NONMETALLIC CONDUIT (EMPTY)			CT CNC	NO. 62.5/125, MM12F SM24F  GROUND ROD AT (C) CONTROLLER,		<u> </u>	—36F—
EEL COMBINATION MAST ARM SEMBLY AND POLE WITH PTZ CAMERA	R PTZ[]	Q——— PīZļj	PīZ	SYSTEM ITEM  INTERSECTION ITEM		I	S IP	(H) HANDHOLE, (P) POST, (M) MAST ARM, OR (S) SERVICE		с (  —•	^c ∥ <del> </del> →
GNAL POST	R	0	•	REMOVE ITEM	R			CONTROLLER CABINET AND FOUNDATION TO BE REMOVED	RCF ◯◯		
MPORARY WOOD POLE (CLASS 5 OR TTER) 45 FOOT (13.7m) MINIMUM	R⊗	$\otimes$	•	RELOCATE ITEM ABANDON ITEM	RL A			STEEL MAST ARM POLE AND	RMF		
Y WIRE	>R	>	>	12" (300mm) TRAFFIC SIGNAL SECTION		R	R	FOUNDATION TO BE REMOVED  ALUMINUM MAST ARM POLE AND	DUE		
NAL HEAD	R →	$\rightarrow$	-	12" (300mm) RED WITH 8" (200mm)		R		FOUNDATION TO BE REMOVED	RMF		
NAL HEAD CONSTRUCTION STAGES MBERS INDICATE THE CONSTRUCTION STAGE)			<b>→</b> ²	YELLOW AND GREEN TRAFFIC SIGNAL FACE				STEEL COMBINATION MAST ARM ASSEMBLY AND POLE WITH LUMINAIRE AND	RMF O-⊅		
NAL HEAD WITH BACKPLATE	+CR	+->	+-			R	R	FOUNDATION TO BE REMOVED			
NAL HEAD OPTICALLY PROGRAMMED		—[>′′p′′	— <b>&gt;</b> "P"	SIGNAL FACE			G	SIGNAL POST AND FOUNDATION TO BE REMOVED	RPF O		
ASHER INSTALLATION DENOTES SOLAR POWER)	R O- <b>⊳</b> ″F″	O-t>"F"	<b>←►</b> ″F″			(+ Y)	<b>←</b> Y <b>←</b> G	INTERSECTION & SAMPLING (SYSTEM) DETECTOR		[IS]	IS
DESTRIAN SIGNAL HEAD	R -∏	-0	-8			R	R	SAMPLING (SYSTEM) DETECTOR		[s]	S
ESTRIAN PUSHBUTTON DETECTOR	R (2)	<b>©</b>	<b>©</b>	SIGNAL FACE WITH BACKPLATE. "P" INDICATES PROGRAMMED HEAD		Y	Y	QUEUE DETECTOR			0
CESSIBLE PEDESTRIAN PUSHBUTTON DETECTOR	R APS	@APS	APS	"RB" INDICATES REFLECTIVE BACKPLATE		, , b	<b>←</b> Y <b>←</b> G	PREFORMED QUEUE DETECTOR		ţPOţ	 [PQ]
LUMINATED SIGN O LEFT TURN''	R S		lacktriangle	12" (300mm) PEDESTRIAN SIGNAL HEAD WALK/DON'T WALK SYMBOL		(DW) (W)		PREFORMED INTERSECTION AND SAMPLING		PIS	PIS
_UMINATED SIGN O RIGHT TURN''	R			12" (300mm) PEDESTRIAN SIGNAL HEAD				(SYSTEM) DETECTOR			
TECTOR LOOP, TYPE I				INTERNATIONAL SYMBOL, OUTLINED				PREFORMED SAMPLING (SYSTEM) DETECTOR		ÎPSÎ	[PS]
EFORMED DETECTOR LOOP		} }    	P	12" (300mm) PEDESTRIAN SIGNAL HEAD INTERNATIONAL SYMBOL, SOLID		<b>(*)</b>	*	RAILROA	D SYMBO	OLS	
CROWAVE VEHICLE SENSOR	R M)	[M]	M	PEDESTRIAN SIGNAL HEAD, INTERNATIONAL SYMBOL, WITH COUNTDOWN TIMER		<b>●</b> C <b>※</b> D	<b>₽</b> C <b>★</b> D			EXISTING	PROPOSED
DEO DETECTION CAMERA	R [√]3	(V)	$\bigcirc$	RADIO INTERCONNECT	<del>    R</del>	##+0	<del>    •</del>	RAILROAD CONTROL CABINET			$\mathbb{R}$
DEO DETECTION ZONE					1.	,		RAILROAD CANTILEVER MAST ARM	,	X <del>OX X</del> X	X <del>QX X</del>
	R			RADIO REPEATER	RERR	ERR	RR	FLASHING SIGNAL	•	X <del>0</del> X	<b>X</b> ⊖ <b>X</b>
N, TILT, ZOOM CAMERA	PTZ)	PTZ	PTZ <b>■</b>	DENOTES NUMBER OF CONDUCTORS, ELECTRIC CABLE NO. 14, UNLESS NOTED OTHERWISE,		<u>(5)</u>					
RELESS DETECTOR SENSOR	RW	W	W	ALL DETECTOR LOOP CABLE TO BE SHIELDED		~		CROSSING GATE		<del>\\\\\\\\\\\\\\\\\\\\\\\\\\\\\\\\\\\\\</del>	<del>**</del>
RELESS ACCESS POINT	R			GROUND CABLE IN CONDUIT NO. 6 SOLID COPPER (GREEN)		1	(1)	CROSSBUCK		<b>&gt;</b> ≤	*
NAME = USER NAME = footemj w_work\pwidot\footemj\d0108315\ts05.pgn		SIGNED - DAG/BCK AWN - BCK	REVISED REVISED	- DAG 1-1-14 - STATE	OF ILLINOIS	 S		DISTRICT ONE	F.A RTE.	SECTION	COUNTY TOTAL SHEETS
PLOT SCALE = 50.0000 //		ECKED - DAD	REVISED	- DEPARTMENT				STANDARD TRAFFIC SIGNAL DESIGN DETAILS		2014-032TS <b>TS-05</b>	COOK 68


### **LOOP DETECTOR NOTES**

- 1. EACH PAIR OF LOOP WIRES SHALL BE PLACED IN A SEPARATE EMPTY COILABLE NONMETALLIC CONDUIT FROM THE EDGE OF PAVEMENT TO THE HANDHOLE. SPACING BETWEEN THE HOLES DRILLED IN THE PAVEMENT SHALL NOT BE LESS THAN 6" (150 mm). EMPTY COILABLE NONMETALLIC CONDUIT SHALL BE INCLUDED IN THE COST OF THE LOOP WIRE.
- 2. THE NUMBER OF LOOP TURNS SHALL BE AS RECOMMENDED BY THE AMPLIFIER MANUFACTURER. ALL ADJACENT SIDES OF THE LOOPS SHALL BE INSTALLED IN SUCH A WAY THAT THE CURRENT FLOW IS IN THE SAME DIRECTION TO REINFORCE ITS MAGNETIC FIELDS FOR SMALL VEHICLE DETECTION.
- 3. EACH LOOP LEAD-IN SHALL BE IDENTIFIED AND PERMANENTLY TAGGED IN THE HANDHOLE. EACH LEAD-IN CABLE TAG SHALL INDICATE THE LOCATION OF THE LOOP, LOOP ROTATION (CLOCKWISE/COUNTERCLOCKWISE), LOOP LEAD-IN DIRECTION (IN OR OUT), LOOP CABLE NUMBER AND LOCATION IN CABINET, AND NUMBER OF TURNS IN THE DETECTOR LOOPS IN WATER PROOF INK AS INDICATED ON THE DISTRICT 1 STANDARD TRAFFIC SIGNAL DESIGN DETAIL. THE CONTRACTOR SHALL MARK LOOP LOCATIONS ON RECORD DRAWINGS AND PRESENT TO THE ENGINEER AFTER FINAL INSPECTION. LOOPS SHALL BE MARKED BY LANE AND LOOP NUMBER. SEE DETAIL BELOW.
- 4. ALL LOOP CABLE SHALL BE FASTENED WITH PLASTIC TIE WRAP TO THE HANDHOLE HOOKS.
- 5. IN ASPHALT PAVEMENT, LOOPS SHOULD BE PLACED IN THE BINDER AND DIVEHOLES MARKED AT THE CURB WITH A SAW-CUT. THE SAW-CUT SHALL BE CUT IN ACCORDANCE WITH LOCAL AND E.P.A. DUST CONTROL REQUIREMENTS. DETECTOR LOOP(S) SHALL NOT BE INSTALLED IN WET CONDITIONS AND THE SAW-CUTS MUST BE FREE OF DEBRIS AND RESIDUE SUCH AS DUST AND WATER WHICH IS TO BE ACHIEVED BY THE USE OF COMPRESSED AIR, WIRE BRUSHING AND HEAT DRYING ACCORDING TO SEALANT MANUFACTURER REQUIREMENTS. THE DETECTOR WIRE SHALL BE HELD IN PLACE BY THE USE OF FORM WEDGES. WEDGES SHALL BE SPACED NO MORE THAN 18" (450 mm) APART.
- 6. LOOP SPLICES SHALL BE SOLDERED USING A SOLDERING IRON. BLOW TORCHES OR OTHER DEVICES WHICH OXIDIZE COPPER CABLE SHALL NOT BE ALLOWED FOR SOLDERING OPERATIONS. SEE DETAIL BELOW RIGHT.
- 7. PREFORMED DETECTOR LOOPS SHALL BE USED, AS SHOWN ON THE PLANS, WHERE NEW CONCRETE PAVEMENT IS PROPOSED. THE INSTALLATION OF PREFORMED LOOPS SHALL BE IN ACCORDANCE WITH THE DISTRICT 1 SPECIFICATIONS OR AS DIRECTED BY THE ENGINEER.

### LOOP LEAD-IN CABLE TAG

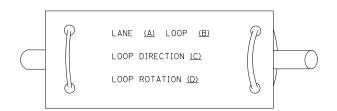



- A. LANE 1 IS THE LANE CLOSEST TO THE CENTERLINE OF THE ROADWAY
- B. LOOP \$1 IS THE LOOP IN THE LANE CLOSEST TO THE INTERSECTION.
- C. LABEL LOOP CABLE "IN" OR LOOP CABLE "OUT".
- D. LABEL LOOP CABLE CLOCKWISE OR LOOP CABLE COUNTERCLOCKWISE.

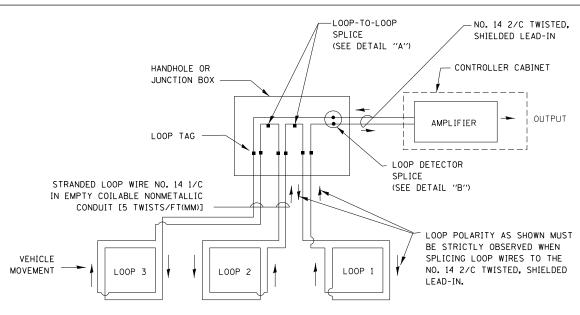

### **DETECTOR LOOP WIRING SCHEMATIC**

- LOOPS SHALL BE SPLICED IN SERIES.
- SAW-CUTS SHALL BE A MINIMUM WIDTH OF 5/16" (8 mm).
- SAW-CUT DEPTHS SHALL BE 3" (75 mm). IF IN CONCRETE,
   THE SAW-CUT DEPTH SHALL BE TO THE TOP OF THE REINFORCEMENT.
- LOOP CORNERS SHALL BE DRILLED WITH A 2" (50 mm) DIAMETER CORE.

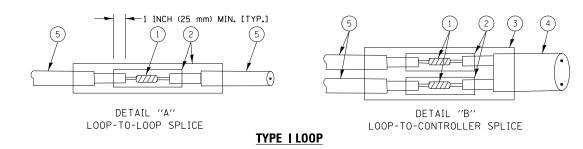

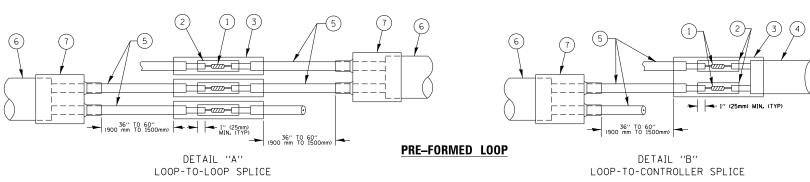

### LOOP DETECTOR SPLICE

- 1 WESTERN UNION SPLICE SOLDERED WITH ROSIN CORE FLUX. ALL EXPOSED SURFACES OF THE SOLDER SHALL BE SMOOTH. THE WESTERN UNION SPLICES SHALL BE STAGGERED.
- (2) WCSMW 30/100 HEAT SHRINK TUBE, MINIMUM LENGTH 3" (75 mm), UNDERWATER GRADE.
- (3) WCS 200/750 HEAT SHRINK TUBE, MINIMUM LENGHT 6" (150 mm), UNDERWATER GRADE.

SCALE: NONE

(4) NO. 14 2/C TWISTED, SHIELDED CABLE.


- 5 LOOP CONDUCTOR WITH FLEXIBLE PLASTIC TUBE.
- 6 PRE-FORMED LOOP
- 7 XL POLYOLEFIN 2 CONDUCTOR BREAKOUT SEALS. TYCO CBR-2 OR APPROVED EQUAL

FILE NAME =	USER NAME = footemj	DESIGNED	-	DAD	REVISED	-	DAG 1-1-14
c:\pw_work\pwidot\footemj\d0108315\ts05.	dgn	DRAWN	-	BCK	REVISED	-	
	PLOT SCALE = 50.0000 '/ in.	CHECKED	-	DAD	REVISED	-	
	PLOT DATE = 1/13/2014	DATE	-	10-28-09	REVISED	-	

STATE OF ILLINOIS
DEPARTMENT OF TRANSPORTATION


	DI	STRICT OF	JE		F.A RTE.	SECTION	COUNTY	TOTAL SHEETS	SHEE NO.
	STANDARD TRAFF	IC SIGNAL	DECICN	DETAILS		2014-032TS	COOK	68	11
	STANDAND THAT	IC SIGNAL	DESIGN	DETAILS		TS-05	CONTRACT	NO. 6	60Y18
7	SHEET NO. 2 OF 7	SHEETS	STA.	TO STA.	EEU D	OAD DIST NO 1 THE INDIS EED	ATD DROIECT		

### TRAFFIC SIGNAL MAST ARM AND SIGNAL POST MAST ARM MOUNTED SIGNALS IN EXISTING, PROPOSED OR FUTURE SIDEWALKBICYCLE PATH AREA. INTERSECTION SHOWN WITH PEDESTRIAN SIGNALS AND PEDESTRIAN PUSHBUTTON DETECTORS.

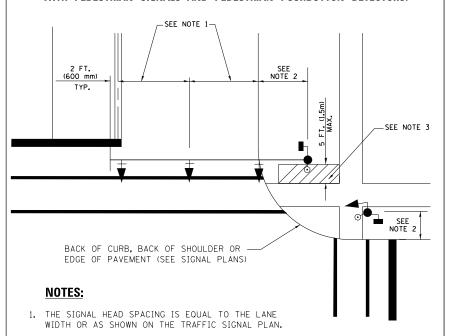


- 2. REFER TO THE TRAFFIC SIGNAL EQUIPMENT OFFSET TABLE.
- 3. PROVIDE A LEVEL ALL-WEATHER SURFACE (CONCRETE SIDEWALK, ASPHALT BICYCLE PATH SURFACE OR MATCHING MATERIAL TO THE ADJACENT SURFACE) UP TO THE MAST ARM SHAFT OR THE SIGNAL POST
- 4. THE FACE OF THE PEDESTRIAN PUSHBUTTON SHALL BE PARALLEL TO THE CROSSWALK TO BE USED.
- 5. THE LOCATIONS AND INSTALLATION OF PEDESTRIAN SIGNAL HEADS AND PEDESTRIAN PUSHBUTTONS SHALL MEET THE REQUIREMENTS OF THE MUTCD AND INFORMATION FOUND IN THE "AMERICANS WITH DISABILITIES ACT ACCESSIBILITY GUIDELINES FOR BUILDINGS AND FACILITIES."

### <u>Pedestrian Signal Post</u> <u>and</u> Pedestrian Push Button Post

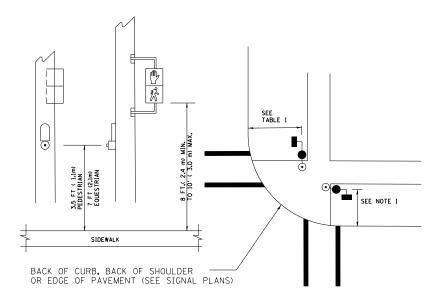

### NOTES:

- 1. REFER TO THE TRAFFIC SIGNAL EQUIPMENT OFFSET TABLE.
- 2. PROVIDE A LEVEL ALL-WEATHER SURFACE (CONCRETE SIDEWALK, ASPHALT BICYCLE PATH SURFACE OR MATCHING MATERIAL TO THE ADJACENT SURFACE) UP TO THE PEDESTRIAN SIGNAL POST OR THE PEDESTRIAN PUSH BUTTON POST.
- 3. THE FACE OF THE PEDESTRIAN PUSHBUTTON SHALL BE PARALLEL TO THE CROSSWALK TO BE USED.
- 4. THE LOCATIONS AND INSTALLATION OF PEDESTRIAN SIGNAL HEADS AND PEDESTRIAN PUSHBUTTONS SHALL MEET THE REQUIREMENTS OF THE MUTCD AND INFORMATION FOUND IN THE "AMERICANS WITH DISABILITIES ACT ACCESSIBILITY GUIDELINES FOR

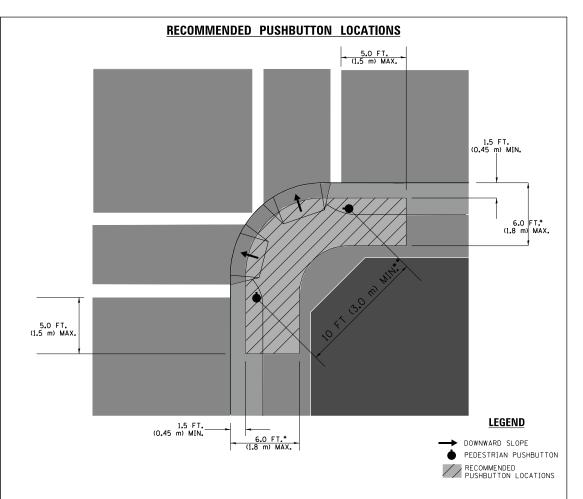

- WHERE THERE ARE CONSTRAINTS THAT MAKE IT IMPRACTICAL TO PLACE THE PEDESTRIAN PUSHBUTTON BETWEEN 1.5 FT (0.45 m) AND 6 FT (1.8 m) FROM THE EDGE OF THE CURB, SHOULDER, OR PAVEMENT, IT SHOULD NOT BE FURTHER THAN 10 FT (3 m) FROM THE EDGE OF CURB, SHOULDER, OR PAVEMENT.
- ** WHERE THERE ARE CONSTRAINTS ON A PARTICULAR CORNER THAT MAKE IT IMPRACTICAL TO PROVIDE THE 10 FT (3 m) SEPERATION BETWEEN THE TWO PEDESTRIAN PUSHBUTTONS, THE PUSHBUTTONS MAY BE PLACED CLOSER TOGETHER OR ON THE SAME POLE.

### NOTES:

- PEDESTRIAN SIGNAL HEADS SHALL BE MOUNTED WITH THE BOTTOM OF THE SIGNAL HOUSING INCLUDING BRACKETS NOT LESS THAN 8 FT (2.4 m) OR MORE THAN 10 FT (3 m) ABOVE SIDEWALK LEVEL, AND SHALL BE POSITIONED AND ADJUSTED TO PROVIDE MAXIMUM VISIBILITY AT THE BEGINNING OF THE CONTROLLED CROSSWALK.
- 2. THE BOTTOM OF THE SIGNAL HOUSING (INCLUDING BRACKETS) OF A VEHICULAR SIGNAL FACE THAT IS NOT LOCATED OVER A HIGHWAY SHALL BE AT LEAST 8 FT (2.4 m) BUT NOT MORE THAN 19 FT (5.8 m) ABOVE THE SIDEWALK OR, IF THERE IS NO SIDEWALK, ABOVE THE PAVEMENT GRADE AT THE CENTER OF THE ROADWAY.
- 3. THE BOTTOM OF THE SIGNAL HOUSING AND ANY RELATED ATTACHMENTS TO A SIGNAL FACE LOCATED OVER ANY PORTION OF A HIGHWAY SHALL BE ACCORDING TO CURRENT STATE STANDARDS 877001, 877002, 877006, 877011 AND 877012 WITH A MINIMUM OF 16 FT (5.0 m) AND A MAXIMUM OF 18 FT. (5.5 m) FROM THE HIGHEST POINT OF PAVEMENT.
- 4. THE BOTTOM OF THE TEMPORARY SPAN WIRE MOUNTED SIGNAL HOUSING AND ANY RELATED ATTACHMENTS TO A SIGNAL FACE LOCATED OVER ANY PORTION OF A HIGHWAY SHALL BE ACCORDING TO CURRENT STATE STANDARD 880001 WITH A MINIMUM OF 17 FT (5.18 m) FROM THE HIGHEST POINT OF PAVEMENT.
- 5. THE TOP OF THE SIGNAL HOUSING OF A SIGNAL FACE LOCATED OVER ANY PORTION OF A HIGHWAY SHALL NOT BE MORE THAN 25.6 FT (7.8 m) ABOVE THE PAVEMENT.

### TRAFFIC SIGNAL EQUIPMENT OFFSET

TRAFFIC SIGNAL EQUIPMENT	COMBINATION CONCRETE CURB AND GUTTER (MINIMUM DISTANCE FROM BACK OF CURB TO CENTERLINE OF FOUNDATION)	SHOULDER/NON-CURBED AREA (MINIMUM DISTANCE FROM EDGE OF PAVEMENT TO CENTERLINE OF FOUNDATION)
TRAFFIC SIGNAL MAST ARM POLE	6 FT (1.8m)	SHOULDER WIDTH + 2 FT (0.6m), MINIMUM 10 FT (3.0m)
TRAFFIC SIGNAL POST	4 FT (1.2m)	SHOULDER WIDTH + 2 FT (0.6m), MINIMUM 10 FT (3.0m)
PEDESTRIAN SIGNAL POST	4 FT (1.2m)	SHOULDER WIDTH + 2 FT (0.6m), MINIMUM 10 FT (3.0m)
PEDESTRIAN PUSHBUTTON POST	4 FT (1.2m)	SHOULDER WIDTH + 2 FT (0.6m), MINIMUM 10 FT (3.0m)
TEMPORARY WOOD POLE	6 FT (1.8m)	SHOULDER WIDTH + 2 FT (0.6m), MINIMUM 10 FT (3.0m)
CONTROLLER CABINET	6 FT (1.8m) MINIMUM DISTANCE SEE NOTE 2	SHOULDER WIDTH + 6 FT (1.8m), MINIMUM 16 FT (4.9m) SEE NOTE 3.
SERVICE INSTALLATION, GROUND MOUNT	6 FT (1.8m) MINIMUM DISTANCE SEE NOTE 2	SHOULDER WIDTH + 6 FT (1.8m), MINIMUM 16 FT (4.9m) SEE NOTE 3.

### NOTES:


- 1. CONTACT THE "AREA TRAFFIC SIGNAL MAINTENANCE AND OPERATIONS ENGINEER" FOR ASSISTANCE IN LOCATING THE TRAFFIC SIGNAL EQUIPMENT WHEN THERE ARE CONFLICTS WITH DITCHES OR THE MINIMUM OFFSET DISTANCES CANNOT BE MET.
- 2. MINIMUM DISTANCE FROM THE BACK OF CURB TO THE ROADWAY SIDE OF THE FOUNDATION.
- 3. MINIMUM DISTANCE FROM THE EDGE OF PAVEMENT TOTHE ROADWAY SIDE OF THE FOUNDATION.
- 4. ANY CHANGES TO THE OFFSETS OF THE FOUNDATIONS, FROM THE MINIMUM DISTANCES LISTED IN THE "TRAFFIC SIGNAL EQUIPMENT OFFSET" CHART AND THE TRAFFIC SIGNAL INSTALLATION PLAN, COULD EFFECT THE PLACEMENT OF THE SIGNAL HEADS, PEDESTRIAN SIGNAL HEADS AND THE PEDESTRIAN PUSHBUTTONS. THE SIGNAL HEAD PLACEMENT ON THE MAST ARMS SHALL REMAIN AS PER THE TRAFFIC SIGNAL INSTALLATION PLAN AND THE "TRAFFIC SIGNAL MAST ARM AND SIGNAL POST" DETAIL ABOVE. THE PROPOSED MAST ARM LENGTHS MAY NEED TO BE REVISED TO MEET THE ABOVE REQUIREMENTS. THE PEDESTRIAN SIGNAL HEADS AND PEDESTRIAN PUSHBUTTONS MUST MEET THE REQUIREMENTS UNDER THE DETAILS ON THIS SHEET.


SCALE: NO


FILE NAME =	USER NAME = footemj	DESIGNED	-	DAD	KEAIZED	- DAG 1-1-14	
c:\pw_work\pwidot\footemj\d0108315\ts05.	dgn	DRAWN	-	BCK	REVISED	-	
	PLOT SCALE = 50.0000 '/ in.	CHECKED	-	DAD	REVISED	-	
	PLOT DATE = 1/13/2014	DATE	-	10-28-09	REVISED	-	

STATE OF ILLINOIS
DEPARTMENT OF TRANSPORTATION

		DIS	TRICT OF	IE			F.A RTE.	SECTION	COUNTY	TOTAL SHEETS	SHEET NO.
	STANDARD	TRAFFI	C CICNIAI	DESIGN	DETAILS			2014-032TS	COOK	68	12
	STANDARD	INALL	C SIGNAL	DESIGN	DETAILS			TS-05	CONTRACT	NO. 6	50Y18
NONE	SHEET NO. 3	OF 7	SHEETS	STA.	1	TO STA.	FED. R	OAD DIST. NO. 1   ILLINOIS FED. A	ID PROJECT		

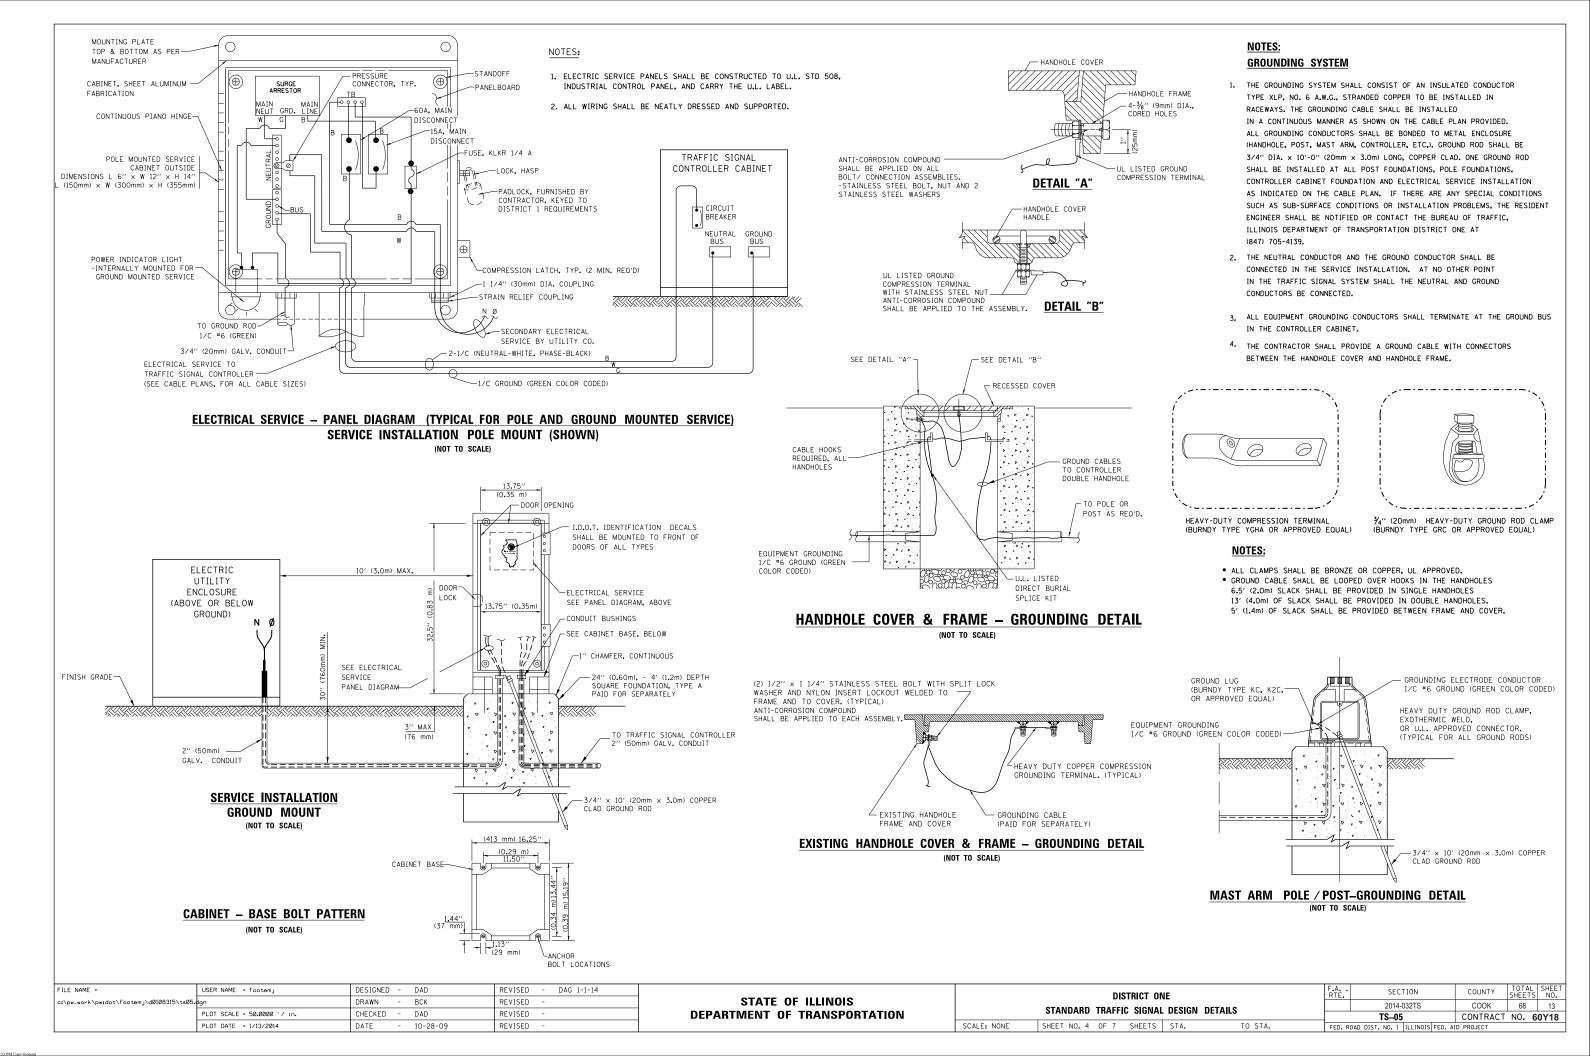

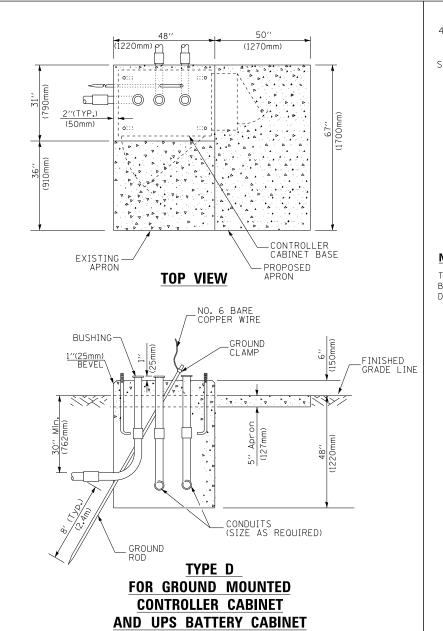

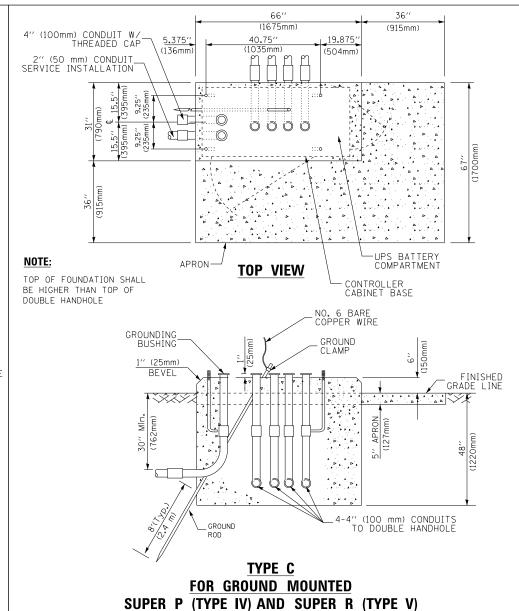

**CONTROLLER CABINETS** 

SEE NOTE 5- 49'	(SEE NOTE 3)
(51mm)	(1245mm) 44" (1118mm) (406mm)
e e e	(64 mm) (32 mm) (1 mm)
(imm 1/25) 1/25 1/25 1/25 1/25 1/25 1/25 1/25 1/25	(mm) (mg) (mg) (mg) (mg) (mg) (mg) (mg)
© 10 T (25r	
, E	2" × 6"
2,'' (5,1mm)	WOOD FRAMING (TYP.)
	====
TRAFFIC SIGNAL	<u> </u>
CONTROLLER CABINET	
	H UPS CABINET
¾′′ (19mm) TREATED	
PHYWOOD DECK	<u> </u> i_
2"x 6" (51mm x 152mm)	•  -    -
<del></del> \ <del></del>	
2" MIN 305mm)	
305	
Ž E I . I	
48" MIN (1219mm)	<del></del>
(12)	
	i i ''
NOTES: 6" (152mm × 152mm)/ TREATED WOOD POSTS	LJ
BASED ON CONTROLLER CABINET TYPE IV WITH BASE I     ADJUST PLATFORM SIZE TO FIT CABINET BASE DIMENS	DIMENSIONS OF 26" × 44" (660mm × 1118mm).
ADJUST PLATFORM SIZE TO FIT CABINET BASE DIMENS  2. BASED ON UNINTERRUPTIBLE POWER SUPPLY CABINET N	

- 2. BASED ON UNINTERRUPTIBLE POWER SUPPLY CABINET WITH BASE DIMENSIONS ADJUST PLATFORM SIZE TO FIT CABINET BASE DIMENSIONS BEING SUPPLIED.
- 3. PLATFORM SIZE FOR CONTROLLER CABINET TYPE IV.
- 4. PLATFORM SIZE FOR CONTROLLER CABINET TYPE IV AND UNINTERRUPTIBLE POWER SUPPLY CABINET.
- 5. DRILLED HOLES THROUGH THE PLATFORM BASE TO MATCH THE CONTROLLER CABINET BOLT TEMPLATE. FASTEN THE CONTROLLER CABINET TO THE PLATFORM WITH CARRIAGE BOLTS, WASHERS AND NUTS.
- 6. FASTEN ALL SUPPORT WOOD FRAMING TO THE WOOD POSTS WITH 2 LAG SCREWS FOR EACH CONNECTION.

### TEMPORARY SIGNAL CONTROLLER WOOD SUPPORT PLATFORM

CABLE SLACK LENGTH	FEET	METER
HANDHOLE	6.5	2.0
DOUBLE HANDHOLE	13.0	4.0
SIGNAL POST	2.0	0.6
MAST ARM	2.0	0.6
CONTROLLER CABINET	1.5	0.5
FIBER OPTIC AT CABINET	13.0	4.0
ELECTRIC SERVICE AT (CABINET OR SERVICE LOCATION)	1.5	0.5
GROUND CABLE (SIGNAL POST, MAST ARM, CABINET)	1.5	0.5
GROUND CABLE (BETWEEN FRAME AND COVER)	5.0	1.6

**CABLE SLACK** 

VERTICAL CABLE LENGTH	FEET	METER
MAST ARM POLE ( MAST ARM MOUNTED SIGNAL HEAD)		
(L = MAST ARM LENGTH - DISTANCE TO SIGNAL HEAD FROM END OF ARM)	20.0+L	6.0+L
BRACKET MOUNTED (MAST ARM POLE OR SIGNAL POLE)	13.0	4.0
PEDESTRIAN PUSH BUTTON	6.0	2.0
SERVICE INSTALLATION POLE MOUNT TO SERVICE DROP	13.5	4.1
SERVICE INSTALLATION POLE MOUNT TO GROUND	13.5	4.1
SERVICE INSTALLATION GROUND MOUNT	6.0	2.0
FOUNDATION (SIGNAL POST, MAST ARM POLE, CONTROLLER CABINET, SERVICE-GROUND MOUNT)	3.0	1.0

VEKI	HCAL	CARLE	LEN

FOUNDATION	DEPTH		
TYPE A - Signal Post	4'-0" (1.2m)		
TYPE C - CONTROLLER W/ UPS	4'-0" (1.2m)		
TYPE D - CONTROLLER	4'-0'' (1.2m)		
SERVICE INSTALLATION, GROUND MOUNT, TYPE A - SOUARE	4'-0'' (1.2m)		

### **DEPTH OF FOUNDATION**


Mast Arm Length	① Foundation Depth	Foundation Diameter	Spiral Diameter	Quantity of Rebars	Size of Rebars
Less than 30′ (9.1 m)	10'-0'' (3.0 m)	30" (750mm)	24" (600mm)	8	6(19)
Greater than or equal to	13'-6'' (4.1 m)	30'' (750mm)	24" (600mm)	8	6(19)
30' (9.1 m) and less than 40' (12.2 m)	11'-0'' (3.4 m)	36'' (900mm)	30" (750mm)	12	7(22)
Greater than or equal to 40' (12.2 m) and less than 50' (15.2 m)	13'-0'' (4.0 m)	36'' (900mm)	30'' (750mm)	12	7(22)
Greater than or equal to 50' (15.2 m) and up to 55' (16.8 m)	15'-0'' (4.6 m)	36'' (900mm)	30'' (750mm)	12	7(22)
Greater than or equal to 56' (16.8 m) and less than 65' (19.8 m)	21'-0'' (6.4 m)	42'' (1060mm)	36" (900mm)	16	8(25)
Greater than or equal to 65' (19.8 m) and up to 75' (22.9 m)	25'-0'' (7.6 m)	42'' (1060mm)	36'' (900mm)	16	8(25)

### NOTES:

- 1. These foundation depths are for sites which have cohesive soils (clayey silt, sandy clay, etc.) along the length of the shaft, with an average Unconfined Compressive Strength (Ou) > 1.0 tsf (100 kpa). This strength shall be verified by boring data prior to construction or with testing by the Engineer during foundation drilling. The Bureau of Bridges & structures should be contacted for a revised design if other conditions are encountered.
- 2. Combination mast arm assemblies under 55 feet (16.8 m) shall use 36" (900 mm) diameter foundations.
- 3. Combination mast arm assemblies under 56 feet (16.8 m) through 75 feet (22.9 m) shall use 42" (1060 mm) diameter foundations
- 4. For mast arm assemblies with dual arms refer to state standard 878001.

### DEPTH OF MAST ARM FOUNDATIONS, TYPE E


FILE NAME =	USER NAME = footemj	DESIGNED - DAG	REVISED - DAG 1-1-14			DISTRICT ONE	F.A	SECTION	COUNTY TOTAL SHEET SHEETS NO.
c:\pw_work\pwidot\footemj\d0108315\ts05.	dgn	DRAWN - BCK	REVISED -	STATE OF ILLINOIS				2014-032TS	COOK 68 14
	PLOT SCALE = 50.0000 '/ in.	CHECKED - DAD	REVISED -	DEPARTMENT OF TRANSPORTATION	STANDARD TRAFFIC SIGNAL DESIGN DETAILS  TS-05				CONTRACT NO. 60Y18
	PLOT DATE = 1/13/2014	DATE - 10-28-09	REVISED -		SCALE: NONE	SHEET NO. 5 OF 7 SHEETS STA. TO STA.	FED. ROA	AD DIST. NO. 1 ILLINOIS FED. AI	D PROJECT

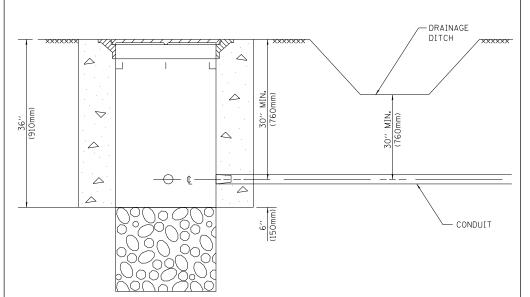

### NOTES:

- 1. CONDUIT DEPTH SHALL BE A MINIMUM OF 30" (760mm) BELOW THE BOTTOM OF THE DRAINAGE DITCH OR ANY SLOPING GROUND
- 2. THE MINIMUM CONDUIT DEPTH APPLIES TO ALL CONDUIT PLACED UNDER ROADWAY PAVEMENT, MULTI-USE PATHS, SIDEWALKS AND SOIL SURFACES.
- 3. THE MINIMUM CONDUIT DEPTH APPLIES TO ALL HANDHOLES, HEAVY DUTY HANDHOLES AND DOUBLE HANDHOLES.

### HANDHOLE WITH MINIMUM CONDUIT DEPTH (NOT TO SCALE)

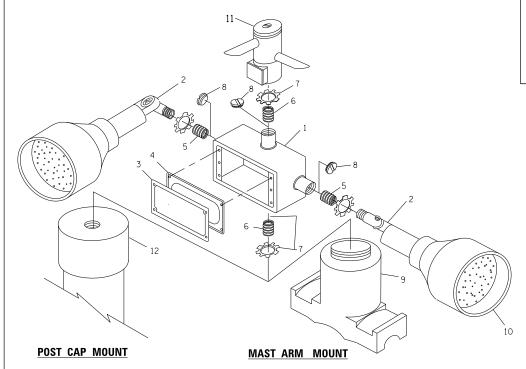

### 19.875" 5.375" 40.75" (136mm) (1035mm) (504mm) PROPOSED -APRON -CONTROLLER CABINET BASE **TOP VIEW** NO. 3 DOWEL 18" (450mm) LONG (8 REQ.) BUSHING -_GROUND CLAMP / EXISTING ANCHOR BOLTS 1''(25mm) BEVEL GRADE LINE (300mm) (ŽOOmm) (300mm) -EXISTING CONDUITS EXISTING GROUND ROD

(1675mm)

(915mm)

### MODIFY EXISTING TYPE "D" FOUNDATION TO TYPE "C" FOUNDATION


(NOT TO SCALE

## ITEM NO. IDENTIFICATION 1 OUTLET BOX- GALV. 21 CU,IN. (0.000344 CU-M) 2 LAMP HOLDER AND COVER 3 OUTLET BOX COVER 4 RUBBER COVER GASKET 5 REDUCING BUSHING 6 ¾''(19 mm) CLOSE NIPPLE 7 ¾''(19 mm) LOCKNUT 8 ¾''(19 mm) HOLE PLUG 9 SADDLE BRACKET - GALV. 10 6 WATT PAR 38 LED FLOOD LAMP 11 DETECTOR UNIT 12 POST CAP [18 FT. (5.4 m) POST MIN.]

### NOTES:

- 1. ALL ELECTRICAL ITEMS, EXCEPT ITEMS #2 AND #11 SHALL BE ALUMINUM OR GALVANIZED
- 2. ITEM #1- OZ/GEDNEY FSX-1-50 OR EQUIVALENT ITEM #2- MULBERRY CON-O-SHADE LAMP SHIELD OR EQUIVALENT ITEM #9- "BAND-IT" SADDLE BRACKET OR EQUIVALENT
- POST CAP MOUNT

  MAST ARM MOUNT

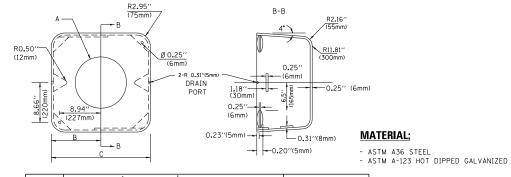



Α	В	С	HEIGHT	WEIGHT
VARIES	9.5′′(241mm)	19''(483mm)	7" (178mm) - 12" (300mm)	53 lbs (24kg)
VARIES	10.75"(273mm)	21.5"(546mm)	7" (178mm) - 12" (300mm)	68 lbs (31 kg)
VARIES	13.0"(330mm)	26''(660mm)	7" (178mm) - 12" (300mm)	81 lbs (37 kg)
VARIES	18.5''(470mm)	37''(940mm)	7" (178mm) - 12" (300mm)	126 lbs (57 kg)

### **SHROUD**

### NOTES:

- DIMENSION "A" IS EQUAL TO THE DIAMETER OF THE MAST ARM POLE AT THE TOP OF THE SHROUD.
  THE SHROUD SHALL BE TIGHT TO THE MAST ARM POLE.
- 2. THE SUPPLIER SHALL VERIFIED THE ABOVE DIMENSIONS BASED ON MAST ARM REQUIREMENTS.
- 3. THE HEIGHT OF THE SHROUD SHALL COVER THE ANCHOR BOLTS, NUTS AND MAST ARM POLE BASE.

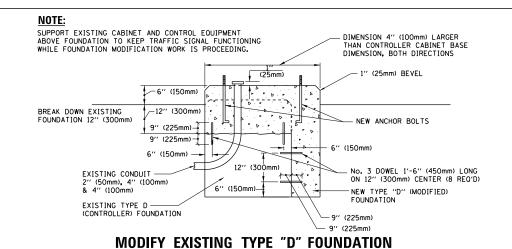

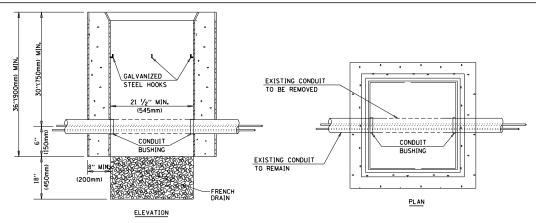

### NOTES:

SCALE: NONE


- 1. HANDHOLE CONSTRUCTED PER STATE STANDARD 814001.
- 2. REMOVAL OF THE EXISTING CONDUIT FROM THE HANDHOLE AND THE INSTALLATION OF THE CONDUIT BUSHINGS SHALL BE INCLUDED WITH THE COST OF THE HANDHOLE.

### HANDHOLE TO INTERCEPT EXISTING CONDUIT


### 

### STATE OF ILLINOIS DEPARTMENT OF TRANSPORTATION

	DI	STRICT OF	IE		F.A RTE.	SECTION	COUNTY	TOTAL SHEETS	SHEET NO.
	STANDARD TRAFF	IC SIGNAI	DESIGN	DETAILS		2014-032TS	COOK	68	15
STANDARD TRAFFIC SIGNAL DESIGN DETAILS						TS-05	CONTRACT	NO. 6	0Y18
ΙE	SHEET NO. 6 OF 7	SHEETS	STA.	TO STA.	FED. RO	DAD DIST. NO. 1 ILLINOIS FED. A	ID PROJECT		
_	311EE1 110. 0 01 1	JIILLIJ	J 1 M.	10 51A.	FED. R	DAD DIST. NO. 1   ILLINOIS FED. A.	ID FRUJEUI		

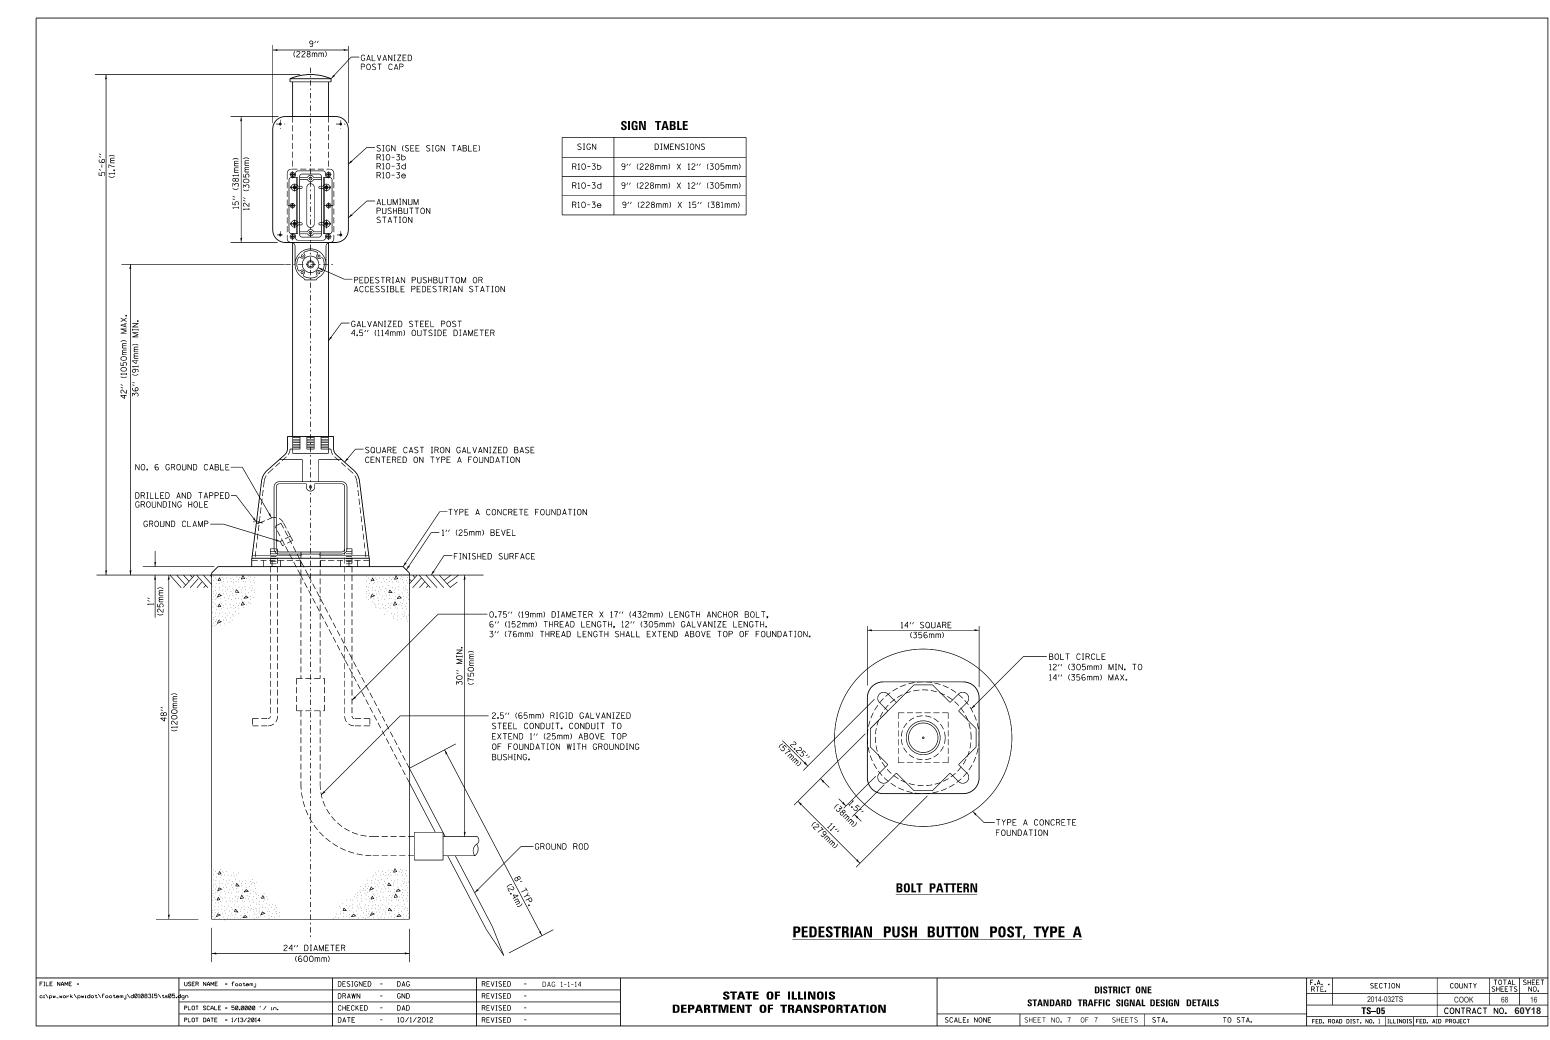



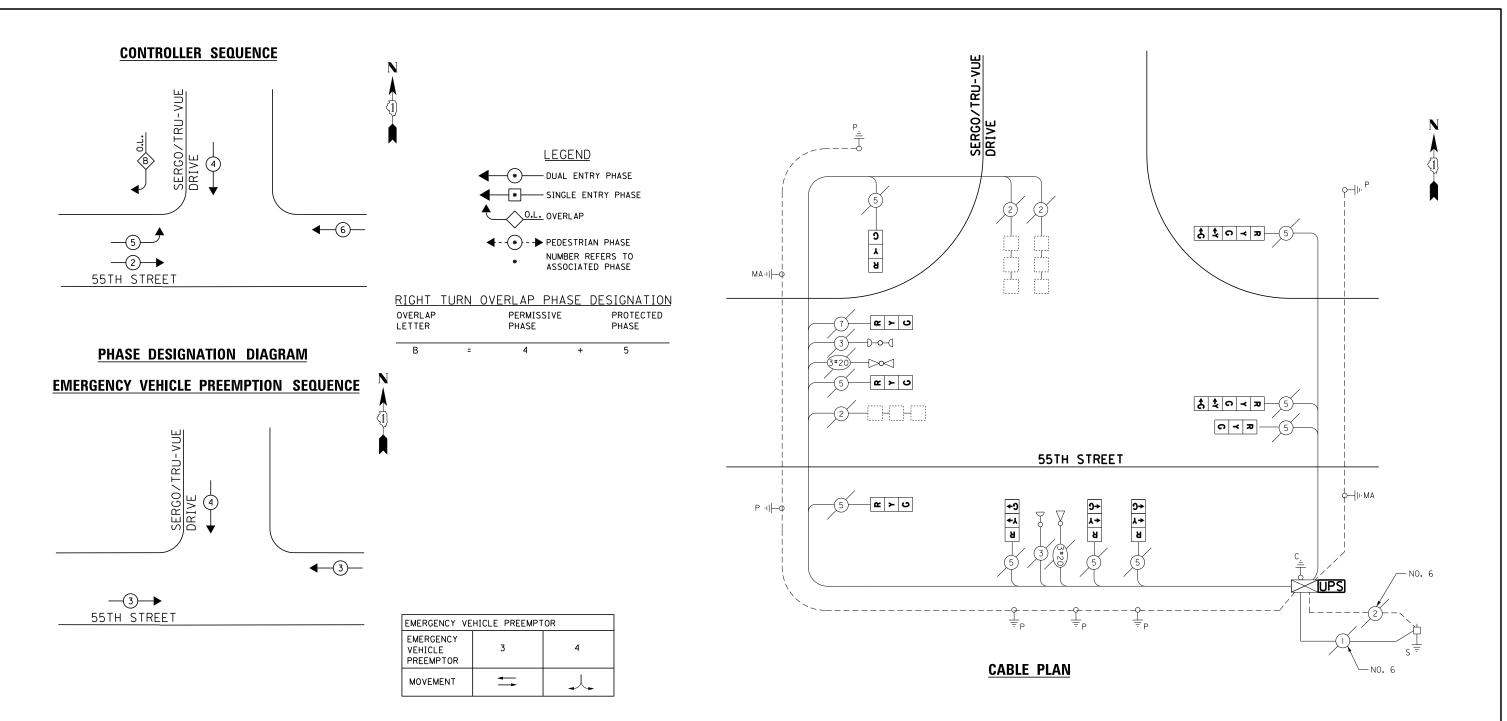

TRAF ELECTR	TOTAL								
TYPE	NO LAMPS	WATT		%OPERATION	WATTAGE				
		INCAND.	LED						
SIGNAL (RED)	10		17	0.5	85				
(YELLOW)	10		25	0.25	62.5				
(GREEN)	10		15	0.25	37 <b>.</b> 5				
ARROW	4		12	0.10	4.8				
PED. SIGNAL	-		25	1.00	-				
CONTROLLER	1		100	1.00	100				
ILLUM. SIGN			25	0.05	-				
VIDEO SYSTEM			ı	1.00	1				
FLASHER				-					
ENERGY COSTS T	0:			TOTAL =	289.8				
ILLINOIS DEPARTMENT OF TRANSPORTATION 201 WEST CENTER COURT SCHAUMBURG, ILLINOIS 60196-1096									

ENERGY SUPPLY CONTACT: ILYAS MOHIUDDUN

### **SCHEDULE OF QUANTITIES**

QUANTITY	UNIT	ITEM
1	EACH	MAINTENANCE OF EXISTING TRAFFIC SIGNAL INSTALLATION
1	EACH	MODIFY EXISTING CONTROLLER CABINET
1	EACH	UNINTERRUPTABLE POWER SUPPLY, SPECIAL
5	EACH	SIGNAL HEAD, LED, 1-FACE, 3-SECTION, BRACKET MOUNTED, RETROFIT
3	EACH	SIGNAL HEAD, LED, 1-FACE, 3-SECTION, MAST ARM MOUNTED, RETROFIT
1	EACH	SIGNAL HEAD, LED, 1-FACE, 5-SECTION, MAST ARM MOUNTED, RETROFIT
1	EACH	SIGNAL HEAD, LED, 1-FACE, 5-SECTION, BRACKET MOUNTED, RETROFIT

RETROFIT ALL EXISTING SIGNAL HEADS TO L.E.D.


EAGLE EPAC 300 CONTROLLER ON-SITE

TRAFFIC SIGNAL EQUIPMENT
SHALL BE EAGLE TO
MATCH THE ADJACENT
EXISTING SYSTEM

TS# 11086 MC COOK

PHONE: (7	08) 235-2692							N	MC COOK
COMPANY: COM	MMONWEALTH EDISON								
FILE NAME =	USER NAME = _USER_	DESIGNED - M.A./V.O.	REVISED -		SCHEDULE OF	QUANTITIES, CABLE PLAN, PHASE DESIGNATION DIAGRAM, AND	F.A.P.	SECTION	COUNTY TOTAL SHEET
J:\13155\Work Order 2\DGN\CADD Sheets\D	160Y18-sht-ts-01_11086.dgn	DRAWN - Y.J./E.C.	REVISED -	STATE OF ILLINOIS		EMERGENCY VEHICLE PREEMPTION SEQUENCE	1,1,2,	2014-032TS	COOK 68 17
	PLOT SCALE = 20.0000 ' / in.	CHECKED - I.Y.	REVISED -	DEPARTMENT OF TRANSPORTATION		55TH STREET AT SERGO/TRU-VUE DRIVE			CONTRACT NO. 60Y18
	PLOT DATE = 5/14/2014	DATE - 5/16/2014	REVISED -		SCALE: NTS	SHEET NO. 1 OF 1 SHEETS STA. N/A TO STA. N/A		ILLINOIS FED. A	1



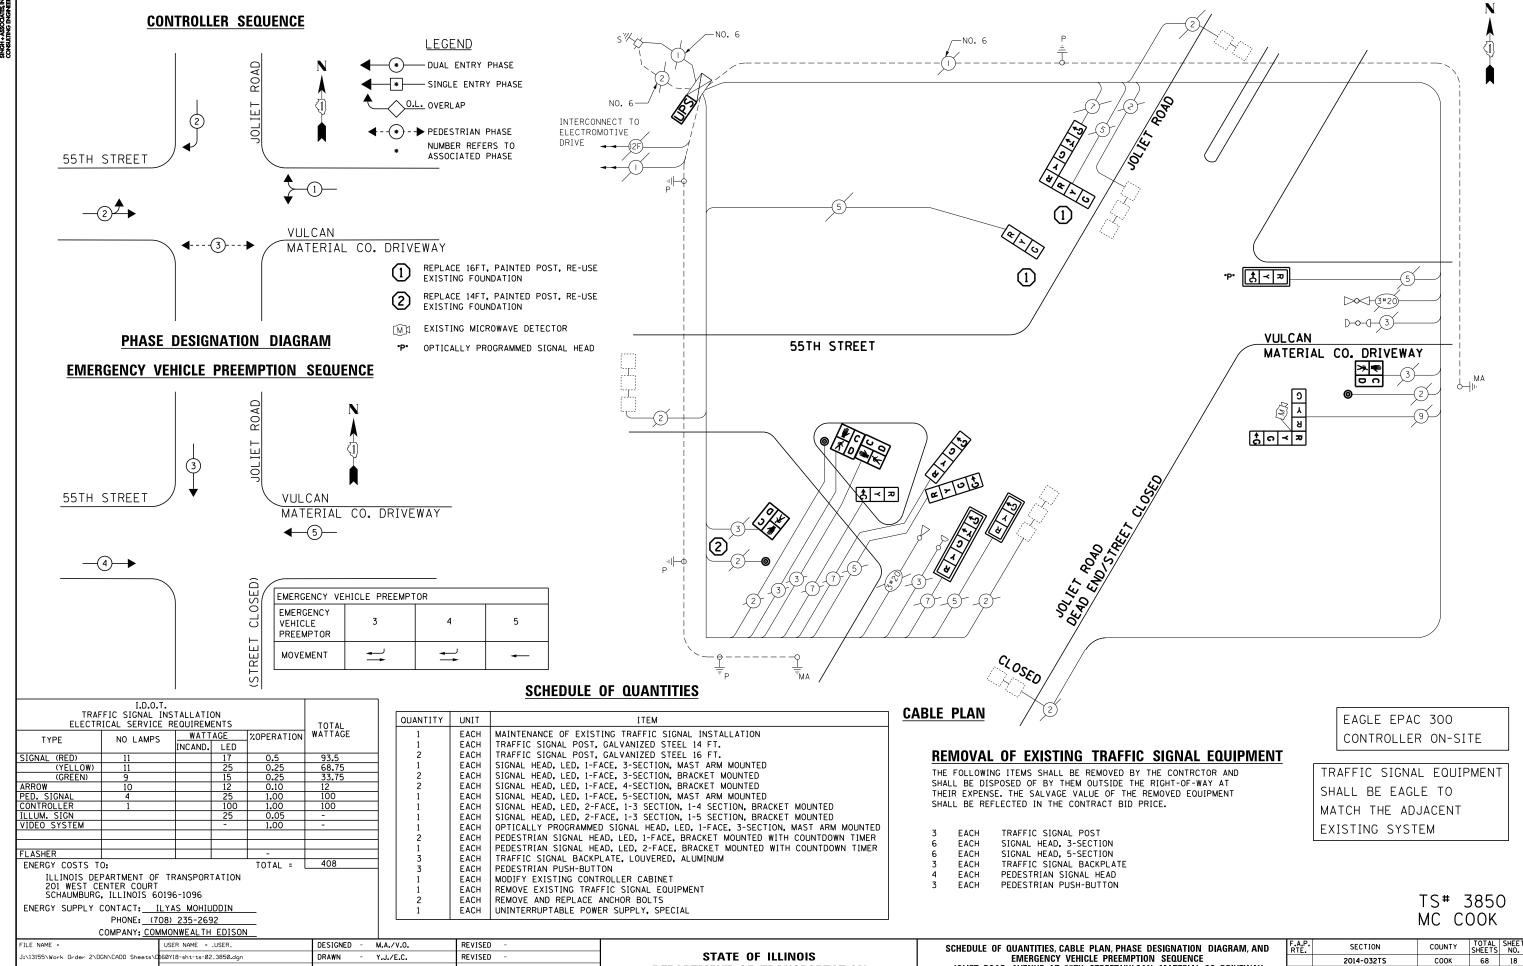

**DEPARTMENT OF TRANSPORTATION** 

JOLIET ROAD AVENUE AT 55TH STREET/VULCAN MATERIAL CO. DRIVEWAY

SHEET NO. 1 OF 1 SHEETS STA. N/A

SCALE: NTS

CONTRACT NO. 60Y18

CHECKED

DATE


PLOT DATE = 5/14/2014


I.Y.


5/16/2014

REVISED

REVISED

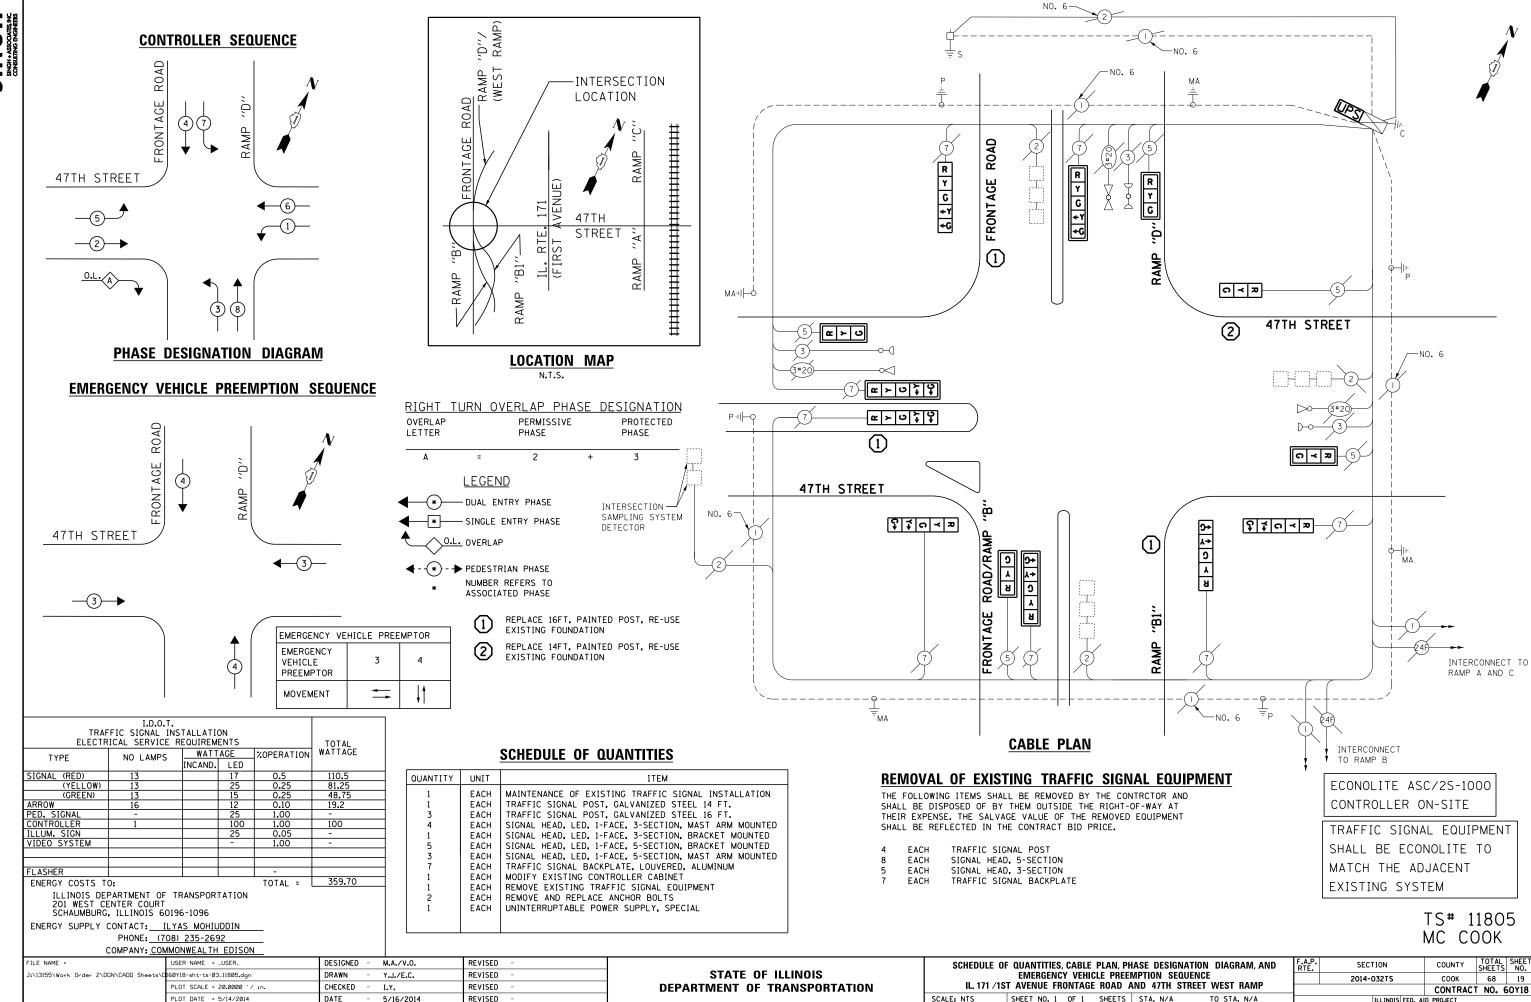

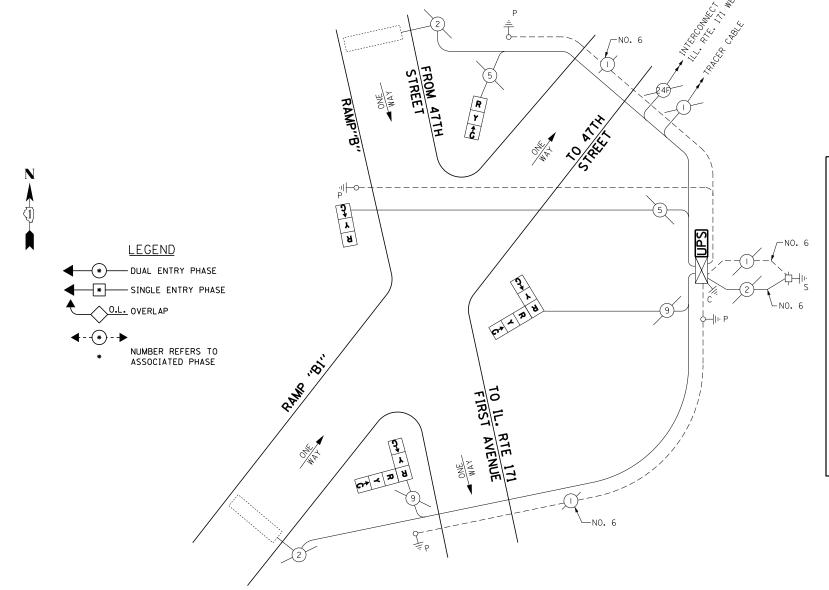

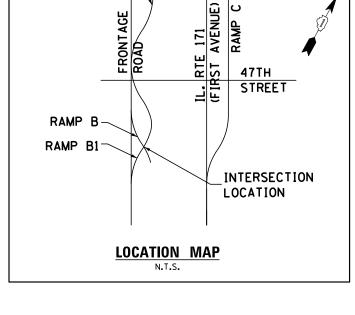

**▽RAMP** D

### **CABLE PLAN**

TRAF ELECTR	TOTAL				
TYPE	NO LAMPS			%OPERATION	WATTAGE
SIGNAL (RED)	6		17	0.5	51
(YELLOW)	6		25	0.25	37 <b>.</b> 5
(GREEN)	6		15	0.25	22.5
ARROW	•		12	0.10	-
PED. SIGNAL	•		25	1.00	-
CONTROLLER	1		100	1.00	100
ILLUM. SIGN	•		25	0.05	-
VIDEO SYSTEM	•		-	1.00	-
FLASHER				-	
ENERGY COSTS TO	0:			TOTAL =	211

PHASE DESIGNATION DIAGRAM

ILLINOIS DEPARTMENT OF TRANSPORTATION 201 WEST CENTER COURT SCHAUMBURG, ILLINOIS 60196-1096

ENERGY SUPPLY CONTACT: ILYAS MOHIUNDDIN

PHONE: (708) 235-2692
COMPANY: COMMONWEALTH EDISON

### SCHEDULE OF QUANTITIES

QUANTITY	UNIT	ITEM
1 1 1 2 2	EACH EACH EACH EACH EACH	MAINTENANCE OF EXISTING TRAFFIC SIGNAL INSTALLATION MODIFY EXISTING CONTROLLER CABINET UNINTERRUPTABLE POWER SUPPLY, SPECIAL SIGNAL HEAD, LED, 1-FACE, 3-SECTION, BRACKET MOUNTED, RETROFIT SIGNAL HEAD, LED, 2-FACE, 3-SECTION, BRACKET MOUNTED, RETROFIT

ECONOLITE ASC/2S-1000 CONTROLLER ON-SITE


RETROFIT ALL EXISTING SIGNAL HEADS TO L.E.D.

TRAFFIC SIGNAL EQUIPMENT SHALL BE ECONOLITE TO MATCH THE ADJACENT EXISTING SYSTEM

> TS# 11810 MC COOK

	<u> </u>	<u>,                                      </u>	, , , , , , , , , , , , , , , , , , , ,							
FILE NAME =	USER NAME = _USER_	DESIGNED - M.A./V.O.	REVISED -				F.A.P.	SECTION	LUUNII CUE	TAL SHEET
J:\13155\Work Order 2\DGN\CADD Sheets\0	160Y18-sht-ts-04_11810.dgn	DRAWN - Y.J./E.C.	REVISED -	STATE OF ILLINOIS	SCHEDULE OF QUANTITIES, CABLE PLAN AND PHASE DESIGNATION DIAGRAM IL 171 / 1ST AVENUE FRONTAGE ROAD AT RAMPS B, AND B1		1,,,,,	2014-032TS		68 20
	PLOT SCALE = 20.0000 '/ in.	CHECKED - I.Y.	REVISED -	DEPARTMENT OF TRANSPORTATION					CONTRACT NO	10. 60Y18
	PLOT DATE = 5/14/2014	DATE - 5/16/2014	REVISED -		SCALE: NTS	SHEET NO. 1 OF 1 SHEETS STA. N/A TO STA. N/A		ILLINOIS FED. AII		



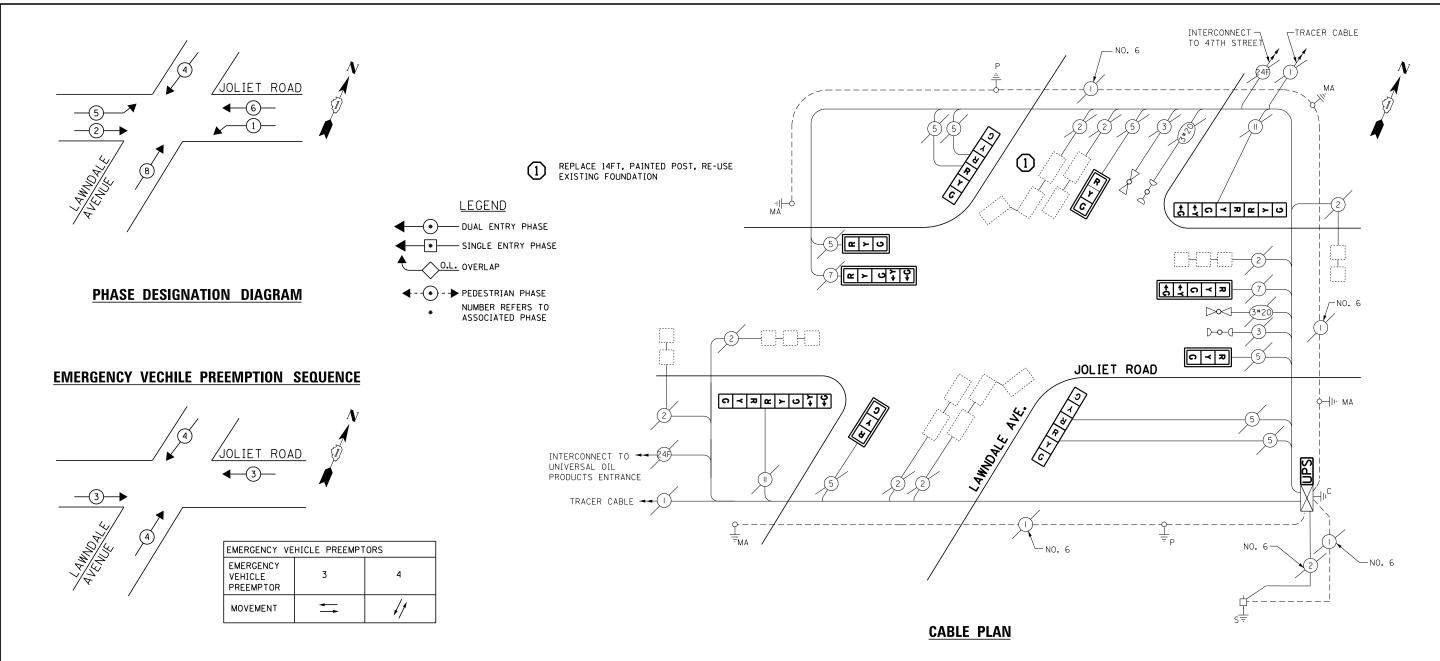

	I.D.O.T.  TRAFFIC SIGNAL INSTALLATION ELECTRICAL SERVICE REQUIREMENTS							
TYPE	NO LAMPS	NO LAMPS WATTAGE COPERATION WATT		WATTAGE				
1111	I NO LAWI S	INCAND.	LED					
SIGNAL (RED)	14		17	0.5	119			
(YELLOW)	14		25	0.25	87.5			
(GREEN)	14		15	0.25	52.5			
ARROW	8		12	0.10	9.6			
PED. SIGNAL	-		25	1.00	-			
CONTROLLER	1		100	1.00	100			
ILLUM. SIGN	-		25	0.05	-			
VIDEO SYSTEM	-		ı	1.00	-			
FLASHER				-	368.6			
ENERGY COSTS T	ENERGY COSTS TO: TOTAL =							
ILLINOIS DEPARTMENT OF TRANSPORTATION 201 WEST CENTER COURT SCHAUMBURG, ILLINOIS 60196-1096								

ENERGY SUPPLY CONTACT: ILYAS MOHIUDDIN

PHONE: (708) 235-2692

### **SCHEDULE OF QUANTITIES**

QUANTITY	UNIT	ITEM
1	EACH	MAINTENANCE OF EXISTING TRAFFIC SIGNAL INSTALLATION
1	EACH	TRAFFIC SIGNAL POST, GALVANIZED STEEL 14 FT.
4	EACH	SIGNAL HEAD, LED, 1-FACE, 3-SECTION, MAST-ARM MOUNTED
2	EACH	SIGNAL HEAD, LED, 1-FACE, 5-SECTION, MAST-ARM MOUNTED
2	EACH	SIGNAL HEAD, LED, 2-FACE, 3-SECTION, BRACKET MOUNTED
2	EACH	SIGNAL HEAD, LED, 2-FACE, 1-3 SECTION, 1-5 SECTION, BRACKET MOUNTED
6	EACH	TRAFFIC SIGNAL BACKPLATE, LOUVERED, ALUMINUM
2	EACH	MODIFY EXISTING CONTROLLER CABINET
6	EACH	REMOVE EXISTING TRAFFIC SIGNAL EQUIPMENT
1	EACH	REMOVE AND REPLACE ANCHOR BOLTS
1	EACH	UNINTERRUPTABLE POWER SUPPLY, SPECIAL

### REMOVAL OF EXISTING TRAFFIC SIGNAL EQUIPMENT

THE FOLLOWING ITEMS SHALL BE REMOVED BY THE CONTRCTOR AND SHALL BE DISPOSED OF BY THEM OUTSIDE THE RIGHT-OF-WAY AT THEIR EXPENSE. THE SALVAGE VALUE OF THE REMOVED EQUIPMENT SHALL BE REFLECTED IN THE CONTRACT BID PRICE.


6 EACH TRAFFIC SIGNAL BACKPLATE 1 EACH TRAFFIC SIGNAL POST 10 EACH SIGNAL HEAD, 3-SECTION 4 EACH SIGNAL HEAD, 5 SECTION ECONOLITE ASC/2-2100 CONTROLLER ON-SITE


TRAFFIC SIGNAL EQUIPMENT
SHALL BE ECONOLITE TO
MATCH THE ADJACENT
EXISTING SYSTEM

TS# 5360 MC COOK

COMPANY: COM	MONWEALTH EDISON								IVIC C	JUUN	
FILE NAME =	USER NAME = _USER_	DESIGNED - M.A./\	V.O. REVISED -		SCHEDULE OF	F QUANTITIES, CABLE PLAN, PHASE DESIGNATION DIAGRAM, AND	F.A.P. RTE.	SECTION	COUNTY	TOTAL S SHEETS	HEET NO.
J:\13155\Work Order 2\DGN\CADD Sheets\C	160Y18-sht-ts-05_5360.dgn	DRAWN - Y.J./E	E.C. REVISED -	STATE OF ILLINOIS	EMERGENCY VEHICLE PREEMPTION SEQUENCE			2014-032TS	соок	68	21
	PLOT SCALE = 20.0000 ' / in.	CHECKED - I.Y.	REVISED -	DEPARTMENT OF TRANSPORTATION		JOLIET ROAD AT LAWNDALE AVENUE			CONTRAC	T NO. 60	Y18
	PLOT DATE = 5/14/2014	DATE - 5/16/	2014 REVISED -		SCALE: NTS	SHEET NO. 1 OF 1 SHEETS STA. N/A TO STA. N/A		ILLINOIS FED. A			



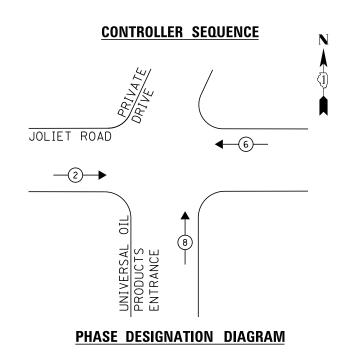

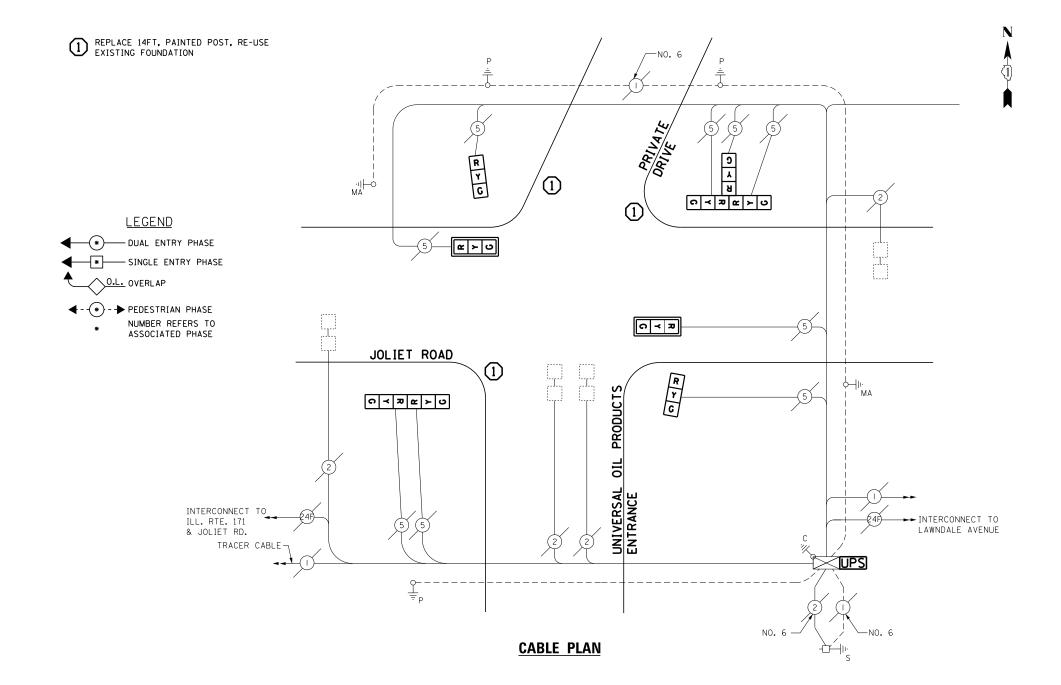

	I.D.O.T. TRAFFIC SIGNAL INSTALLATION ELECTRICAL SERVICE REQUIREMENTS							
TYPE	NO LAMPS	WATTAGE %OPE		%OPERATION	WATTAGE			
SIGNAL (RED)	9		17	0.5	76.5			
(YELLOW)	9		25	0.25	56.2			
(GREEN)	9		15	0.25	33.75			
ARROW	•		12	0.10	-			
PED. SIGNAL	-		25	1.00	-			
CONTROLLER	1		100	1.00	100			
ILLUM. SIGN	-		25	0.05	-			
VIDEO SYSTEM	-		-	1.00	-			
FLASHER				-				
	ENERGY COSTS TO: TOTAL =							
ILLINOIS DEPARTMENT OF TRANSPORTATION 201 WEST CENTER COURT SCHAUMBURG, ILLINOIS 60196-1096								

ENERGY SUPPLY CONTACT: ILYAS MOHIUDDIN

PHONE: (708) 235-2692

### **SCHEDULE OF QUANTITIES**

QUANTITY	UNIT	ITEM
1	EACH	MAINTENANCE OF EXISTING TRAFFIC SIGNAL INSTALLATION
3	EACH	TRAFFIC SIGNAL POST, GALVANIZED STEEL 14 FT.
2	EACH	SIGNAL HEAD, LED, 1-FACE, 3-SECTION, MAST ARM MOUNTED
2	EACH	SIGNAL HEAD, LED, 1-FACE, 3-SECTION, BRACKET MOUNTED
1	EACH	SIGNAL HEAD, LED, 2-FACE, 3-SECTION, BRACKET MOUNTED
1	EACH	SIGNAL HEAD, LED, 3-FACE, 3-SECTION, BRACKET MOUNTED
2	EACH	TRAFFIC SIGNAL BACKPLATE, LOUVERED, ALUMINUM
4	EACH	RELOCATE EXISTING SIGNAL HEAD
1	EACH	MODIFY EXISTING CONTROLLER CABINET
1	EACH	REMOVE EXISTING TRAFFIC SIGNAL EQUIPMENT
2	EACH	REMOVE AND REPLACE ANCHOR BOLTS
1	EACH	UNINTERRUPTABLE POWER SUPPLY, SPECIAL

### REMOVAL OF EXISTING TRAFFIC SIGNAL EQUIPMENT

THE FOLLOWING ITEMS SHALL BE REMOVED BY THE CONTRCTOR AND SHALL BE DISPOSED OF BY THEM OUTSIDE THE RIGHT-OF-WAY AT THEIR EXPENSE. THE SALVAGE VALUE OF THE REMOVED EQUIPMENT SHALL BE REFLECTED IN THE CONTRACT BID PRICE.


PACH TRAFFIC SIGNAL BACKPLATE
TRAFFIC SIGNAL POST
EACH SIGNAL HEAD, 1 FACE, 3-SECTION
EACH SIGNAL HEAD, 2 FACE, 3-SECTION
SIGNAL HEAD, 3 FACE, 3-SECTION

ECONOLITE ASC/2S-1000 CONTROLLER ON-SITE


TRAFFIC SIGNAL EQUIPMENT SHALL BE ECONOLITE TO MATCH THE ADJACENT EXISTING SYSTEM

> TS# 5375 MC COOK

COMPANY: COM	MMONWEALTH EDISON	1	EACH UNINTERROFTABLE	FOWER SUFFLI, SPECIAL						IVIC	COOK	
FILE NAME =	USER NAME = _USER_	DESIGNED - M.A./V.O.	REVISED -		0011501115 05	CHANTITIES CARLE DIAM AND DI	HACE DECIONATION DIAGRAM	F.A.P.	SECTION	COUNTY	TOTAL S	HEET
J:\13155\Work Order 2\DGN\CADD Sheets\0	160Y18-sht-ts-06_5375.dgn	DRAWN - Y.J./E.C.	REVISED -	STATE OF ILLINOIS		QUANTITIES, CABLE PLAN AND PH LIET ROAD AT UNIVERSAL OIL PRO			2014-032TS	соок	68	22
	PLOT SCALE = 20.0000 '/ in.	CHECKED - I.Y.	REVISED -	DEPARTMENT OF TRANSPORTATION	] 30	LIET NOAD AT UNIVERSAL OIL FRO	DDUCIS ENTRANCE			CONTRAC	T NO. 60	)Y18
	PLOT DATE = 5/14/2014	DATE - 5/16/2014	REVISED -		SCALE: NTS	SHEET NO. 1 OF 1 SHEETS STA	A. N/A TO STA. N/A		ILLINOIS FED.			

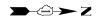

### **CONTROLLER SEQUENCE**

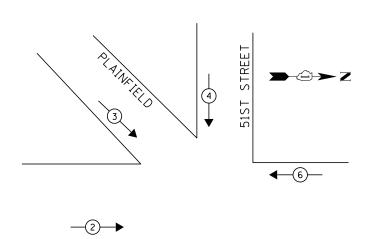

EAST AVENUE

WATTAGE CAND. LED COPERATION WATTAGE

TOTAL =

100

322

NCAND. LED

I.D.O.T. TRAFFIC SIGNAL INSTALLATION ELECTRICAL SERVICE REOUIREMENTS

NO LAMPS

ILLINOIS DEPARTMENT OF TRANSPORTATION 201 WEST CENTER COURT SCHAUMBURG, ILLINOIS 60196-1096

PHONE: (708) 235-2692

ENERGY SUPPLY CONTACT: ILYAS MOHIUDDIN


TYPE

SIGNAL (RED)


ILLUM. SIGN VIDEO SYSTEM

ENERGY COSTS TO:

(YELLOW) (GREEN)

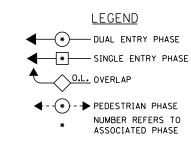

REPLACE 14FT, PAINTED POST, RE-USE EXISTING FOUNDATION

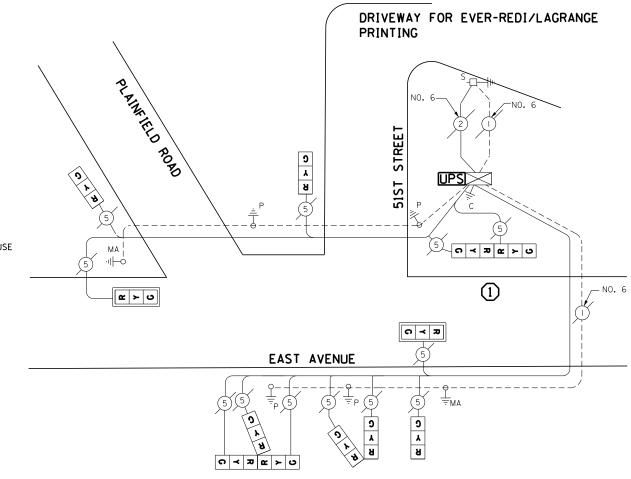

### **CABLE PLAN**

### NOTE:

51ST STREET IS A DEAD END STREET AND SERVES ONLY AS A DRIVEWAY FOR EVER-REDI/LAGRANGE PRINTING

### **SCHEDULE OF QUANTITIES**

QUANTITY	UNIT	ITEM
1	EACH	MAINTENANCE OF EXISTING TRAFFIC SIGNAL INSTALLATION
1	EACH	TRAFFIC SIGNAL POST, GALVANIZED STEEL 14 FT.
2	EACH	RELOCATE EXISTING SIGNAL HEAD
1	EACH	MODIFY EXISTING CONTROLLER CABINET
1	EACH	REMOVE EXISTING TRAFFIC SIGNAL EQUIPMENT
1	EACH	REMOVE AND REPLACE ANCHOR BOLTS
1	EACH	UNINTERRUPTABLE POWER SUPPLY, SPECIAL
1	EACH	SIGNAL HEAD, LED, 3-FACE, 3-SECTION, BRACKET MOUNTED, RETROFIT
3	EACH	SIGNAL HEAD, LED, 1-FACE, 3-SECTION, BRACKET MOUNTED, RETROFIT
2	EACH	SIGNAL HEAD, LED, 1-FACE, 3-SECTION, MAST ARM MOUNTED, RETROFIT
2	EACH	SIGNAL HEAD, LED, 2-FACE, 3-SECTION, BRACKET MOUNTED, RETROFIT

REMOVAL OF EXISTING TRAFFIC SIGNAL EQUIPMENT

THE FOLLOWING ITEMS SHALL BE REMOVED BY THE CONTRCTOR AND SHALL BE DISPOSED OF BY THEM OUTSIDE THE RIGHT-OF-WAY AT THEIR EXPENSE. THE SALVAGE VALUE OF THE REMOVED EQUIPMENT SHALL BE REFLECTED IN THE CONTRACT BID PRICE.

1 EACH TRAFFIC SIGNAL POST

EAGLE EPAC 300 CONTROLLER ON-SITE


RETROFIT ALL EXISTING SIGNAL HEADS TO L.E.D.

TRAFFIC SIGNAL EQUIPMENT SHALL BE EAGLE TO MATCH THE ADJACENT EXISTING SYSTEM

> TS# 5070 MC COOK

COMPANY: COM	MMONWEALTH EDISON_											
FILE NAME =	USER NAME = _USER_	DESIGNED - M.A./V.O.	REVISED -					F.A.P.	SECTION	COUNTY	TOTAL S	SHEET NO.
J:\13155\Work Order 2\DGN\CADD Sheets\D	160Y18-sht-ts-07_5070.dgn	DRAWN - Y.J./E.C.	REVISED -	STATE OF ILLINOIS			SE DESIGNATION DIAGRAM, AND		2014-032TS	соок	68	23
	PLOT SCALE = 20.0000 ' / in.	CHECKED - I.Y.	REVISED -	DEPARTMENT OF TRANSPORTATION	EASI	T AVENUE/PLAINFIELD ROAD	J AND 5151 SIREEI			CONTRAC	T NO. 60	
	PLOT DATE = 5/14/2014	DATE - 5/16/2014	REVISED -		SCALE: NTS SHEET	ET NO. 1 OF 1 SHEETS	STA. N/A TO STA. N/A		ILL INOIS FED. AT			



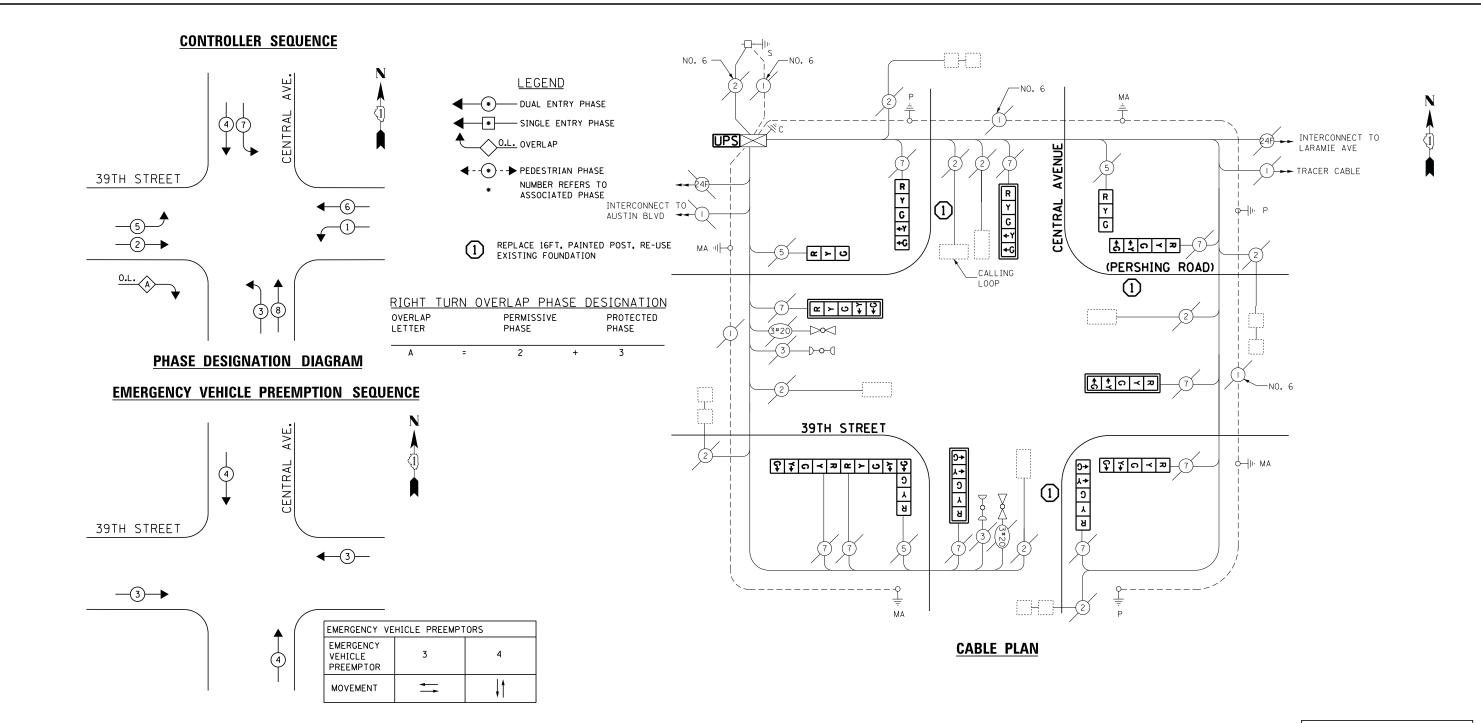

	I.D.O.T. TRAFFIC SIGNAL INSTALLATION ELECTRICAL SERVICE REQUIREMENTS								
TYPE	NO LAMPS	WATT	AGE	%OPERATION	WATTAGE				
I '''-	l No Emilio	INCAND.	LED						
SIGNAL (RED)	13		17	0.5	110.5				
(YELLOW)	13		25	0.25	81.5				
(GREEN)	13		15	0.25	48.75				
ARROW	20		12	0.10	24				
PED. SIGNAL	-		25	1.00	-				
CONTROLLER	1		100	1.00	100				
ILLUM. SIGN			25	0.05	-				
VIDEO SYSTEM			-	1.00	-				
FLASHER				-					
ENERGY COSTS T	ENERGY COSTS TO: TOTAL =								
ILLINOIS DEI 201 WEST CE SCHAUMBURG									

ENERGY SUPPLY CONTACT: JOE STACHO

PHONE: (630) 424-5704

### **SCHEDULE OF QUANTITIES**

QUANTITY	UNIT	ITEM
1	EACH	MAINTENANCE OF EXISTING TRAFFIC SIGNAL INSTALLATION
3	EACH	TRAFFIC SIGNAL POST, GALVANIZED STEEL, 16FT.
2	EACH	SIGNAL HEAD, LED, 1-FACE, 3-SECTION, BRACKET MOUNTED
4	EACH	SIGNAL HEAD, LED, 1-FACE, 5-SECTION, BRACKET MOUNTED
4	EACH	SIGNAL HEAD, LED, 1-FACE, 5-SECTION, MAST ARM MOUNTED
1	EACH	SIGNAL HEAD, LED, 3-FACE, 1-3 SECTION, 2-5 SECTION, BRACKET MOUNTED
2	EACH	RELOCATE EXISTING SIGNAL HEAD
1	EACH	MODIFY EXISTING CONTROLLER CABINET
1	EACH	REMOVE EXISTING TRAFFIC SIGNAL EQUIPMENT
2	EACH	REMOVE AND REPLACE ANCHOR BOLTS
1	EACH	UNINTERRUPTABLE POWER SUPPLY, SPECIAL

### REMOVAL OF EXISTING TRAFFIC SIGNAL EQUIPMENT

THE FOLLOWING ITEMS SHALL BE REMOVED BY THE CONTRCTOR AND SHALL BE DISPOSED OF BY THEM OUTSIDE THE RIGHT-OF-WAY AT THEIR EXPENSE. THE SALVAGE VALUE OF THE REMOVED EQUIPMENT SHALL BE REFLECTED IN THE CONTRACT BID PRICE.

1 EACH SIGNAL HEAD 5-SECTION 3 EACH TRAFFIC SIGNAL POST EAGLE EPAC 300 CONTROLLER ON-SITE


TRAFFIC SIGNAL EQUIPMENT SHALL BE EAGLE TO MATCH THE ADJACENT EXISTING SYSTEM

> TS# 3780 STICKNEY

COMPANY: COM	MMONWEALTH EDISON					3110	CKINE	ı
FILE NAME =	USER NAME = _USER_	DESIGNED - M.A./	V.O. REVISED -		SCHEDULE OF QUANTITIES, CABLE PLAN, PHASE DESIGNATION DIAGRAM, AND F.A.P. SECTION	COUNTY	TOTAL S	SHEET NO.
J:\13155\Work Order 2\DGN\CADD Sheets\C	160Y18-sht-ts-08_3780.dgn	DRAWN - Y.J./	E.C. REVISED -	STATE OF ILLINOIS	EMERGENCY VEHICLE PREEMPTION SEQUENCE 2014-032T	соок с	68	24
	PLOT SCALE = 20.0000 ' / in.	CHECKED - I.Y.	REVISED -	DEPARTMENT OF TRANSPORTATION	39TH STREET (PERSHING ROAD) AT CENTRAL AVENUE		ACT NO. 60	OY18
	PLOT DATE = 5/14/2014	DATE - 5/16/	/2014 REVISED -		SCALE: NTS SHEET NO. 1 OF 1 SHEETS STA. N/A TO STA. N/A IILLIN	OIS FED. AID PROJECT		



### CONTROLLER SEQUENCE

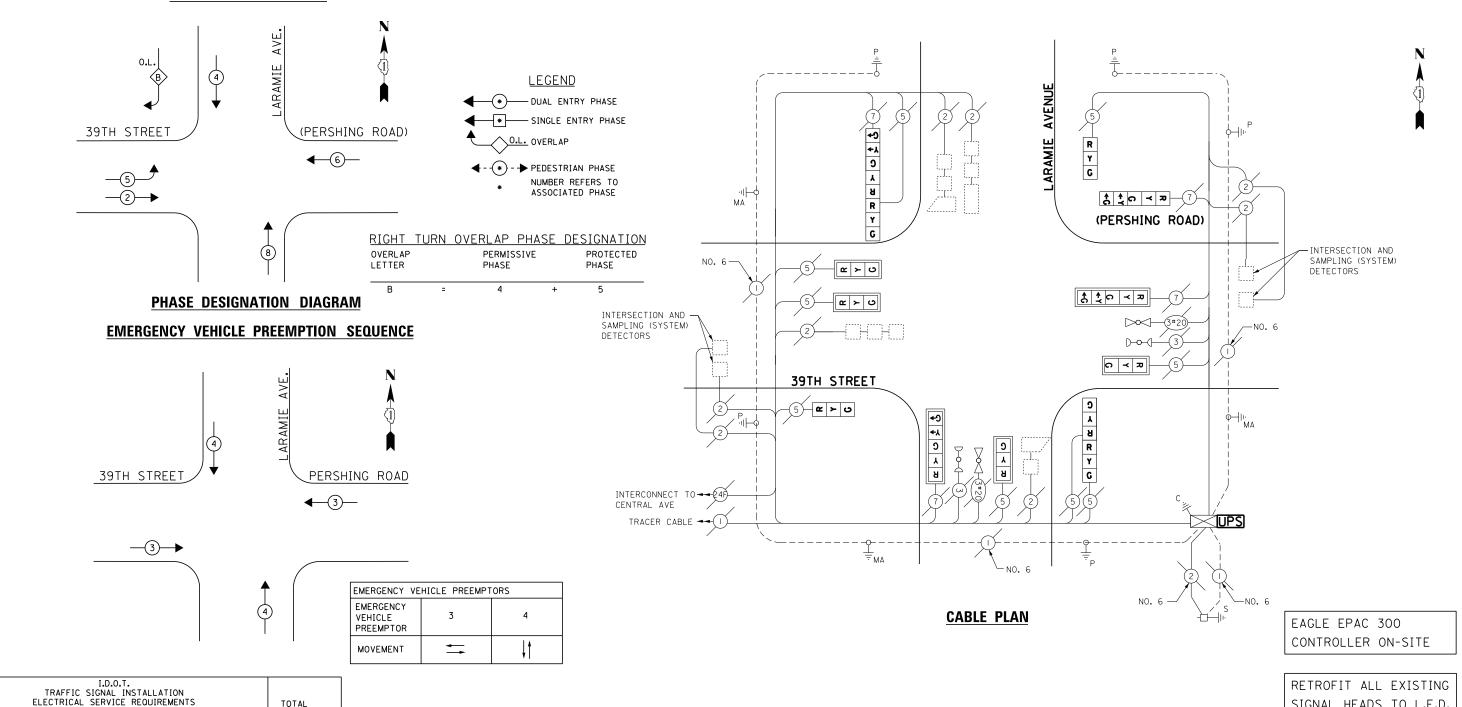

QL

### **SCHEDULE OF QUANTITIES**

ELECTR	TOTAL								
TYPE	NO LAMPS	WATT	AGE	%OPERATION	WATTAGE				
1176	NO LAWI 3	INCAND.	LED	]					
SIGNAL (RED)	13		17	0.5	110.5				
(YELLOW)	13		25	0.25	81.25				
(GREEN)	13		15	0.25	48.75				
ARROW	8		12	0.10	9.6				
PED. SIGNAL	-		25	1.00	-				
CONTROLLER	1		100	1.00	100				
ILLUM. SIGN			25	0.05	-				
VIDEO SYSTEM			-	1.00	-				
FLASHER				-					
ENERGY COSTS T	0:			TOTAL =	350.1				
ILLINOIS DEPARTMENT OF TRANSPORTATION 201 WEST CENTER COURT									

SCHAUMBURG, ILLINOIS 60196-1096

ENERGY SUPPLY CONTACT: JOE STACHO PHONE: (630) 424-5704 COMPANY: COMMONWEALTH EDISON

QUANTITY	UNIT	ITEM
1 1 1 1 2 4 2 1	EACH EACH EACH EACH EACH EACH EACH EACH	MAINTENANCE OF EXISTING TRAFFIC SIGNAL INSTALLATION MODIFY EXISTING CONTROLLER CABINET UNINTERRUPTABLE POWER SUPPLY, SPECIAL SIGNAL HEAD, LED, 2-FACE, 1-3 SECTION, 1-5 SECTION, BRACKET MOUNTED, RETROFIT SIGNAL HEAD, LED, 1-FACE, 3-SECTION, BRACKET MOUNTED, RETROFIT SIGNAL HEAD, LED, 1-FACE, 3-SECTION, MAST ARM MOUNTED, RETROFIT SIGNAL HEAD, LED, 1-FACE, 3-SECTION, MAST ARM MOUNTED, RETROFIT SIGNAL HEAD, LED, 2-FACE, 3-SECTION, BRACKET MOUNTED, RETROFIT SIGNAL HEAD, LED, 1-FACE, 5-SECTION, BRACKET MOUNTED, RETROFIT
	2.1011	5.50 (1.2.5)

SHALL BE EAGLE TO MATCH THE ADJACENT EXISTING SYSTEM

SIGNAL HEADS TO L.E.D.


TRAFFIC SIGNAL EQUIPMENT

TS# 3785 STICKNEY

FILE NAME =	USER NAME = _USER_	DESIGNED - M.A./V.O.	REVISED -		SCHEDULE OF QUANTITIES, CABLE PLAN, PHASE DESIGNATION DIAGRAM, AND	F.A.P.	SECTION	COUNTY TOTAL SHEET
J:\13155\Work Order 2\DGN\CADD Sheets\D	160Y18-sht-ts-09_3785.dgn	DRAWN - Y.J./E.C.	REVISED -	STATE OF ILLINOIS	EMERGENCY VEHICLE PREEMPTION SEQUENCE		2014-032TS	COOK 68 25
	PLOT SCALE = 20.0000 '/ in.	CHECKED - I.Y.	REVISED -	DEPARTMENT OF TRANSPORTATION	39TH STREET (PERSHING ROAD) AT LARAMIE AVENUE	_		CONTRACT NO. 60Y18
	PLOT DATE = 5/14/2014	DATE - 5/16/2014	REVISED -		SCALE: NTS SHEET NO. 1 OF 1 SHEETS STA. N/A TO STA. N/A		ILLINOIS FED. AI	ID PROJECT





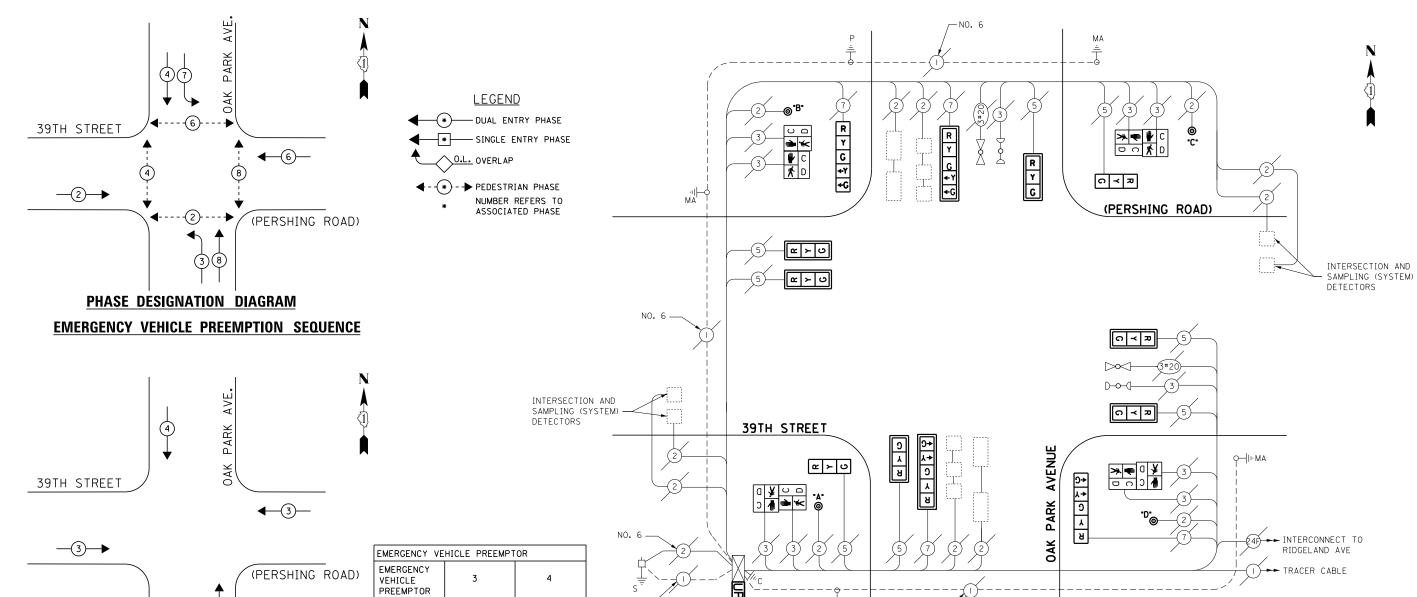

### 

201 WEST CENTER COURT SCHAUMBURG, ILLINOIS 60196-1096

PHONE: (630) 424-5704

ENERGY SUPPLY CONTACT: <u>JOE STACHO</u>

### SCHEDULE OF QUANTITIES

MOVEMENT

1 EACH 6 EACH C SIGNAL HEAD, LED, 1-FACE, 3-SECTION, MAST-ARM MOUNTED 2 EACH 2 EACH 2 EACH 2 EACH 3 IGNAL HEAD, LED, 1-FACE, 3-SECTION, BRACKET MOUNTED 3 IGNAL HEAD, LED, 1-FACE, 5-SECTION, BRACKET MOUNTED 4 EACH 5 IGNAL HEAD, LED, 1-FACE, 5-SECTION, MAST-ARM MOUNTED 6 EACH 7 FACE, 5-SECTION, MAST-ARM MOUNTED 7 FOR SIGNAL HEAD, LED, 2-FACE, BRACKET MOUNTED 8 EACH 1 EACH 1 EACH 1 EACH 1 EACH 1 EACH 1 EACH 2 IGNAL BACKPLATE, LOUVERED, ALUMINUM 1 EACH 1 EACH 2 IGNAL BACKPLATE, COUVERED, ALUMINUM 2 IGNAL BACKPLATE, LOUVERED, ALUMINUM 3 IGNAL BACKPLATE, LOUVERED, ALUMINUM 4 EACH 4 EACH 6 EACH 7 FOR SIGNAL BACKPLATE, LOUVERED, ALUMINUM 8 IGNAL BACKPLATE, LOUVERED, ALUMINUM 9 IGNAL BACKPLATE, ALUMI	N TIMER

### NOTE:

PUSH BUTTON "A" PLACES A CALL IN PHASE 2 & 4
PUSH BUTTON "B" PLACES A CALL IN PHASE 4 & 6
PUSH BUTTON "C" PLACES A CALL IN PHASE 6 & 8
PUSH BUTTON "D" PLACES A CALL IN PHASE 2 & 8

**CABLE PLAN** 

### REMOVAL OF EXISTING TRAFFIC SIGNAL EQUIPMENT

THE FOLLOWING ITEMS SHALL BE REMOVED BY THE CONTRCTOR AND SHALL BE DISPOSED OF BY THEM OUTSIDE THE RIGHT-OF-WAY AT THEIR EXPENSE. THE SALVAGE VALUE OF THE REMOVED EQUIPMENT SHALL BE REFLECTED IN THE CONTRACT BID PRICE.

8 EACH PEDESTRIAN SIGNAL HEAD
4 EACH PEDESTRIAN PUSH-BUTTON
8 EACH TRAFFIC SIGNAL BACKPLATE
8 EACH TRAFFIC SIGNAL HEAD, 3-SECTION
4 EACH TRAFFIC SIGNAL HEAD, 5-SECTION


EAGLE EPAC 300 CONTROLLER ON-SITE

TRAFFIC SIGNAL EQUIPMENT SHALL BE EAGLE TO MATCH THE ADJACENT EXISTING SYSTEM


> TS# 3790 STICKNEY


COMPANY: COMMONWEALTH EDISON										3110	KINE	<u>'</u>
FILE NAME =	USER NAME = _USER_	DESIGNED -	M.A./V.O.	REVISED -		SCHEDULE (	OF QUANTITIES, CABLE PLAN, PHASE DESIGNATION DIAGRAM, AND	F.A.P.	SECTION	COUNTY	TOTAL S	HEET NO.
J:\13155\Work Order 2\DGN\CADD Sheets\D	160Y18-sht-ts-10_3790.dgn	DRAWN -	Y.J./E.C.	REVISED -	STATE OF ILLINOIS	EMERGENCY VEHICLE PREEMPTION SEQUENCE			2014-032TS	соок	68	26
	PLOT SCALE = 20.0000 ' / in.	CHECKED -	I.Y.	REVISED -	DEPARTMENT OF TRANSPORTATION	39TH STREET (PERSHING ROAD) AT OAK PARK AVENUE				CONTRACT		JY18
	PLOT DATE = 5/14/2014	DATE -	5/16/2014	REVISED -		SCALE: NTS	SHEET NO. 1 OF 1 SHEETS STA. N/A TO STA. N/A		ILLINOIS FED.			



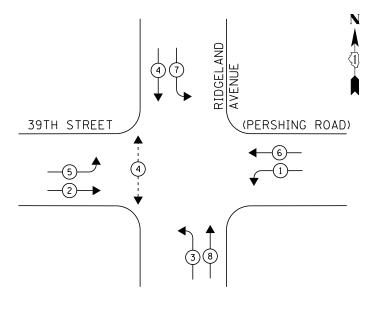

### **EMERGENCY VEHICLE PREEMPTION SEQUENCE**

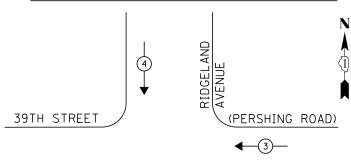

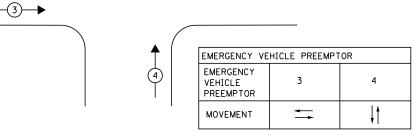

### **LEGEND**

- DUAL ENTRY PHASE - SINGLE ENTRY PHASE

--> PEDESTRIAN PHASE NUMBER REFERS TO

OVERLAP

REPLACE 16FT, PAINTED POST, RE-USE EXISTING FOUNDATION

MAINTENANCE OF EXISTING TRAFFIC SIGNAL INSTALLATION TRAFFIC SIGNAL POST, GALVANIZED STEEL 16 FT. SIGNAL HEAD, LED, 1-FACE, 3-SECTION, MAST-ARM MOUNTED

MODIFY EXISTING CONTROLLER CABINET

REMOVE AND REPLACE ANCHOR BOLTS


REMOVE EXISTING TRAFFIC SIGNAL EQUIPMENT

UNINTERRUPTABLE POWER SUPPLY SPECIAL PEDESTRIAN PUSH-BUTTON, (NON-LATCHING)

SIGNAL HEAD, LED, 1-FACE, 5-SECTION, BRACKET MOUNTED
SIGNAL HEAD, LED, 1-FACE, 5-SECTION, MAST-ARM MOUNTED
SIGNAL HEAD, LED, 1-FACE, 5-SECTION, MAST-ARM MOUNTED
SIGNAL HEAD, LED, 2-FACE, 1-3 SECTION, 1-5 SECTION, BRACKET MOUNTED
PEDESTRIAN SIGNAL HEAD, LED, 1-FACE, BRACKET MOUNTED WITH COUNTDOWN TIMER
TRAFFIC SIGNAL BACKPLATE, LOUVERED, ALUMINUM

ASSOCIATED PHASE

UPS TO BE INSTALLED ON THE LEFT SIDE OF CONTROLLER TO PROVIDE REQUIRED LATERAL

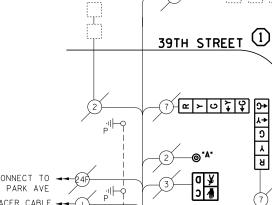

1 INTERCONNECT TO - (4) OAK PARK AVE TRACER CABLE -

**CABLE PLAN** 

\ 0

Y G **+**Y **+**C

<u>අ</u> ≻ ∪

**~** ≻ ∪ ↓ ♀

PUSH BUTTON "A" & "B" PLACE A CALL IN PHASE 4

### REMOVAL OF EXISTING TRAFFIC SIGNAL EQUIPMENT

\$ \$ 0 < ₽

(1)

(PERSHING ROAD)

ਨ ≺ ਸ

Э А В Р

THE FOLLOWING SHALL BE DISP THEIR EXPENSE SHALL BE REF

FACH PEDESTRIAN SIGNAL HEAD PEDESTRIAN PUSH-BUTTON EACH EACH TRAFFIC SIGNAL BACKPLATE EACH TRAFFIC SIGNAL POST EACH SIGNAL HEAD, 5-SECTION SIGNAL HEAD, 3-SECTION

EAGLE EPAC 300-INTERSECTION. AND MARC 300 MASTER CONTROLLER ON-SITE

► INTERCONNECT TO AUSTIN BLVD. TRACER CABLE

-LOCAL AND MASTER CONTROLLER

TRAFFIC SIGNAL EQUIPMENT

NG ITEMS SHALL BE REMOVED BY THE CONTRCTOR AND	SHALL BE EAGLE TO
SPOSED OF BY THEM OUTSIDE THE RIGHT-OF-WAY AT SE. THE SALVAGE VALUE OF THE REMOVED EQUIPMENT	MATCH THE ADJACENT
FLECTED IN THE CONTRACT BID PRICE.	FXISTING SYSTEM

### TS# 3795 STICKNEY

DESIGNED - M.A./V.O. REVISED -/1\I.Y. 6/2/2014 USER NAME = _USER_ SCHEDULE OF QUANTITIES, CABLE PLAN, PHASE DESIGNATION DIAGRAM, AND COUNTY SECTION STATE OF ILLINOIS :\13155\Work Order 2\DGN\CADD Sheet sion 1\D160Y18-sht-ts-11_3795_rev1.dor DRAWN Y.J./E.C. REVISED **EMERGENCY VEHICLE PREEMPTION SEQUENCE** соок 2014-032TS 68 27 CHECKED I.Y. REVISED **DEPARTMENT OF TRANSPORTATION** 39TH STREET (PERSHING ROAD) AT RIDGELAND AVENUE CONTRACT NO. 60Y18 SHEET NO. 1 OF 1 SHEETS STA. N/A DATE REVISED PLOT DATE = 6/3/2014 5/16/2014

### **SCHEDULE OF QUANTITIES** I.D.O.T. TRAFFIC SIGNAL INSTALLATION QUANTITY UNIT

EACH

EACH

EACH FACH EACH EACH EACH

EACH

EACH

EACH

EACH


ELECTR	TOTAL							
TYPE	NO LAMPS	WATT	AGE	%OPERATION	WATTAGE			
'''-	NO LAWI 5	INCAND.	LED					
SIGNAL (RED)	12		17	0.5	102	]		
(YELLOW)	12		25	0.25	75	]		
(GREEN)	12		15	0.25	45			
ARROW	16		12	0.10	19 <b>.</b> 2	]		
PED. SIGNAL	2		25	1.00	50			
CONTROLLER	1		100	1.00	100			
ILLUM. SIGN			25	0.05	-	]		
VIDEO SYSTEM			-	1.00	-	]		
FLASHER				-	391.2			
ENERGY COSTS T	ENERGY COSTS TO: TOTAL =							

ILLINOIS DEPARTMENT OF TRANSPORTATION 201 WEST CENTER COURT SCHAUMBURG, ILLINOIS 60196-1096

ENERGY SUPPLY CONTACT: JOE STACHO

PHONE: (630) 424-5704 COMPANY: COMMONWEALTH EDISON



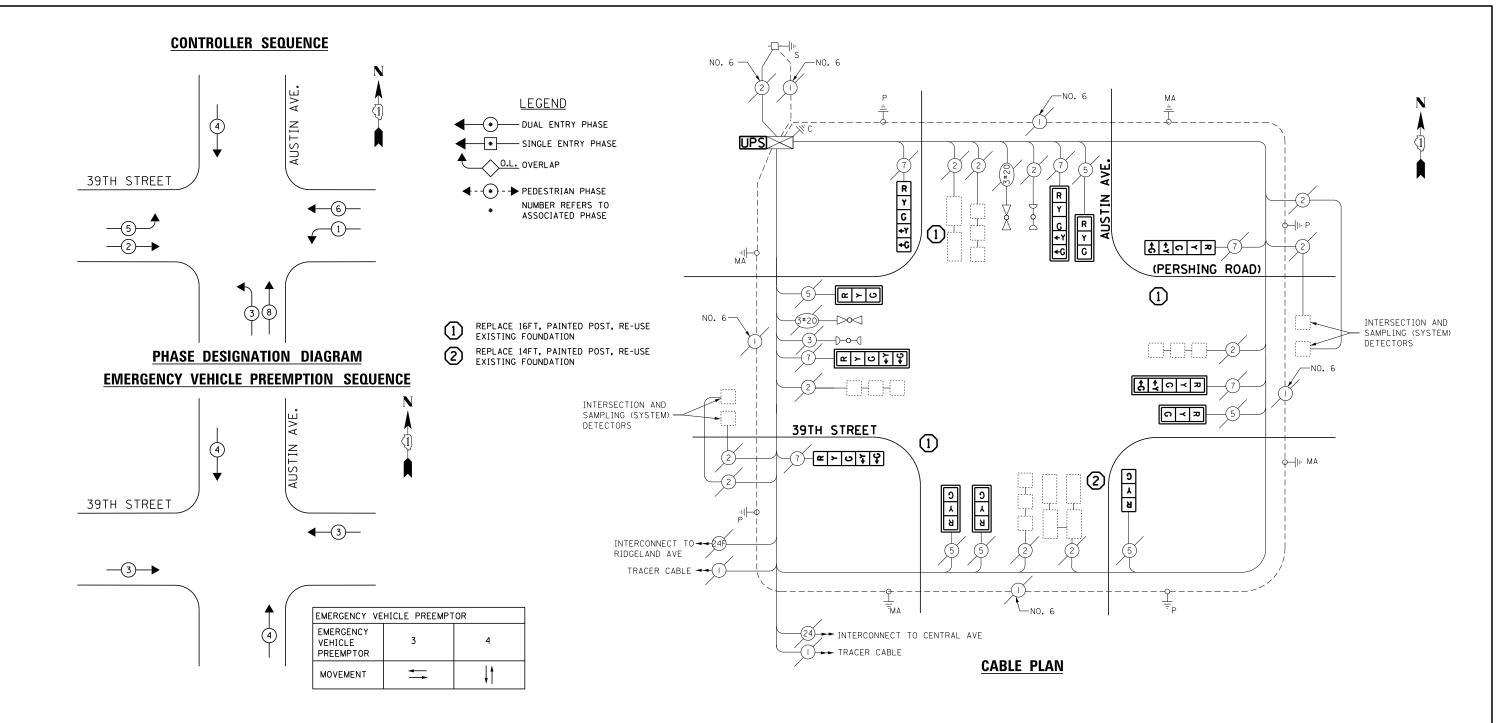

TRAF ELECTR	TOTAL							
TYPE	NO LAMPS	WATT	AGE	%OPERATION	WATTAGE			
'''-	NO LAWI 5	INCAND.	LED					
SIGNAL (RED)	12		17	0.5	102			
(YELLOW)	12		25	0.25	75			
(GREEN)	12		15	0.25	45			
ARROW	12		12	0.10	14.4			
PED. SIGNAL	-		25	1.00	-			
CONTROLLER	1		100	1.00	100			
ILLUM. SIGN			25	0.05	-			
VIDEO SYSTEM			-	1.00	-			
FLASHER				-				
ENERGY COSTS T	0:			TOTAL =	336.4			
ILLINOIS DEPARTMENT OF TRANSPORTATION 201 WEST CENTER COURT SCHAUMBURG, ILLINOIS 60196-1096								

ENERGY SUPPLY CONTACT: ILYAS MOHIUDDIN

PHONE: (708) 235-2692

### **SCHEDULE OF QUANTITIES**

QUANTITY	UNIT	ITEM
1	EACH	MAINTENANCE OF EXISTING TRAFFIC SIGNAL INSTALLATION
1	EACH	TRAFFIC SIGNAL POST, GALVANIZED STEEL 14 FT.
3	EACH	TRAFFIC SIGNAL POST, GALVANIZED STEEL 16 FT.
5	EACH	SIGNAL HEAD, LED, 1-FACE, 3-SECTION, MAST-ARM MOUNTED
1	EACH	SIGNAL HEAD, LED, 1-FACE, 3-SECTION, BRACKET MOUNTED
3	EACH	SIGNAL HEAD, LED, 1-FACE, 5-SECTION, BRACKET MOUNTED
3	EACH	SIGNAL HEAD, LED, 1-FACE, 5-SECTION, MAST-ARM MOUNTED
8	EACH	TRAFFIC SIGNAL BACKPLATE, LOUVERED, ALUMINUM
1	EACH	MODIFY EXISTING CONTROLLER CABINET
1	EACH	REMOVE EXISTING TRAFFIC SIGNAL EQUIPMENT
2	EACH	REMOVE AND REPLACE ANCHOR BOLTS
1	EACH	UNINTERRUPTABLE POWER SUPPLY, SPECIAL

### REMOVAL OF EXISTING TRAFFIC SIGNAL EQUIPMENT

THE FOLLOWING ITEMS SHALL BE REMOVED BY THE CONTRCTOR AND SHALL BE DISPOSED OF BY THEM OUTSIDE THE RIGHT-OF-WAY AT THEIR EXPENSE. THE SALVAGE VALUE OF THE REMOVED EQUIPMENT SHALL BE REFLECTED IN THE CONTRACT BID PRICE.

4 EACH TRAFFIC SIGNAL POST
6 EACH SIGNAL HEAD, 3-SECTION
6 EACH SIGNAL HEAD, 5-SECTION
8 EACH TRAFFIC SIGNAL BACKPLATE


EAGLE EPAC 300 CONTROLLER ON-SITE

TRAFFIC SIGNAL EQUIPMENT SHALL BE EAGLE TO MATCH THE ADJACENT EXISTING SYSTEM


> TS# 3800 STICKNEY

COMPANY: COM	MMONWEALTH EDISON										3110	'VINE	ı
FILE NAME =	USER NAME = LUSER_	DESIGNED - M.A	A./V.O.	REVISED -		SCHEDULE C	OF QUANTITIES, CABLE PLAN, PI	HASE DESIGNATION DIAGRAM, AND	F.A.P. RTE.	SECTION	COUNTY	TOTAL SI SHEETS	HEET NO.
J:\13155\Work Order 2\DGN\CADD Sheets\C	160Y18-sht-ts-12_3800.dgn	DRAWN - Y.J.	J./E.C.	REVISED -	STATE OF ILLINOIS	EMERGENCY VEHICLE PREEMPTION SEQUENCE 39TH STREET (PERSHING ROAD) AT AUSTIN AVENUE			2014-032TS	соок	68	28	
	PLOT SCALE = 20.0000 ' / in.	CHECKED - I.Y.	·.	REVISED -	DEPARTMENT OF TRANSPORTATION					CONTRAC	T NO. 60	Y18	
	PLOT DATE = 5/14/2014	DATE - 5/1	16/2014	REVISED -		SCALE: NTS	SHEET NO. 1 OF 1 SHEETS	STA. N/A TO STA. N/A		ILLINOIS FED. A			



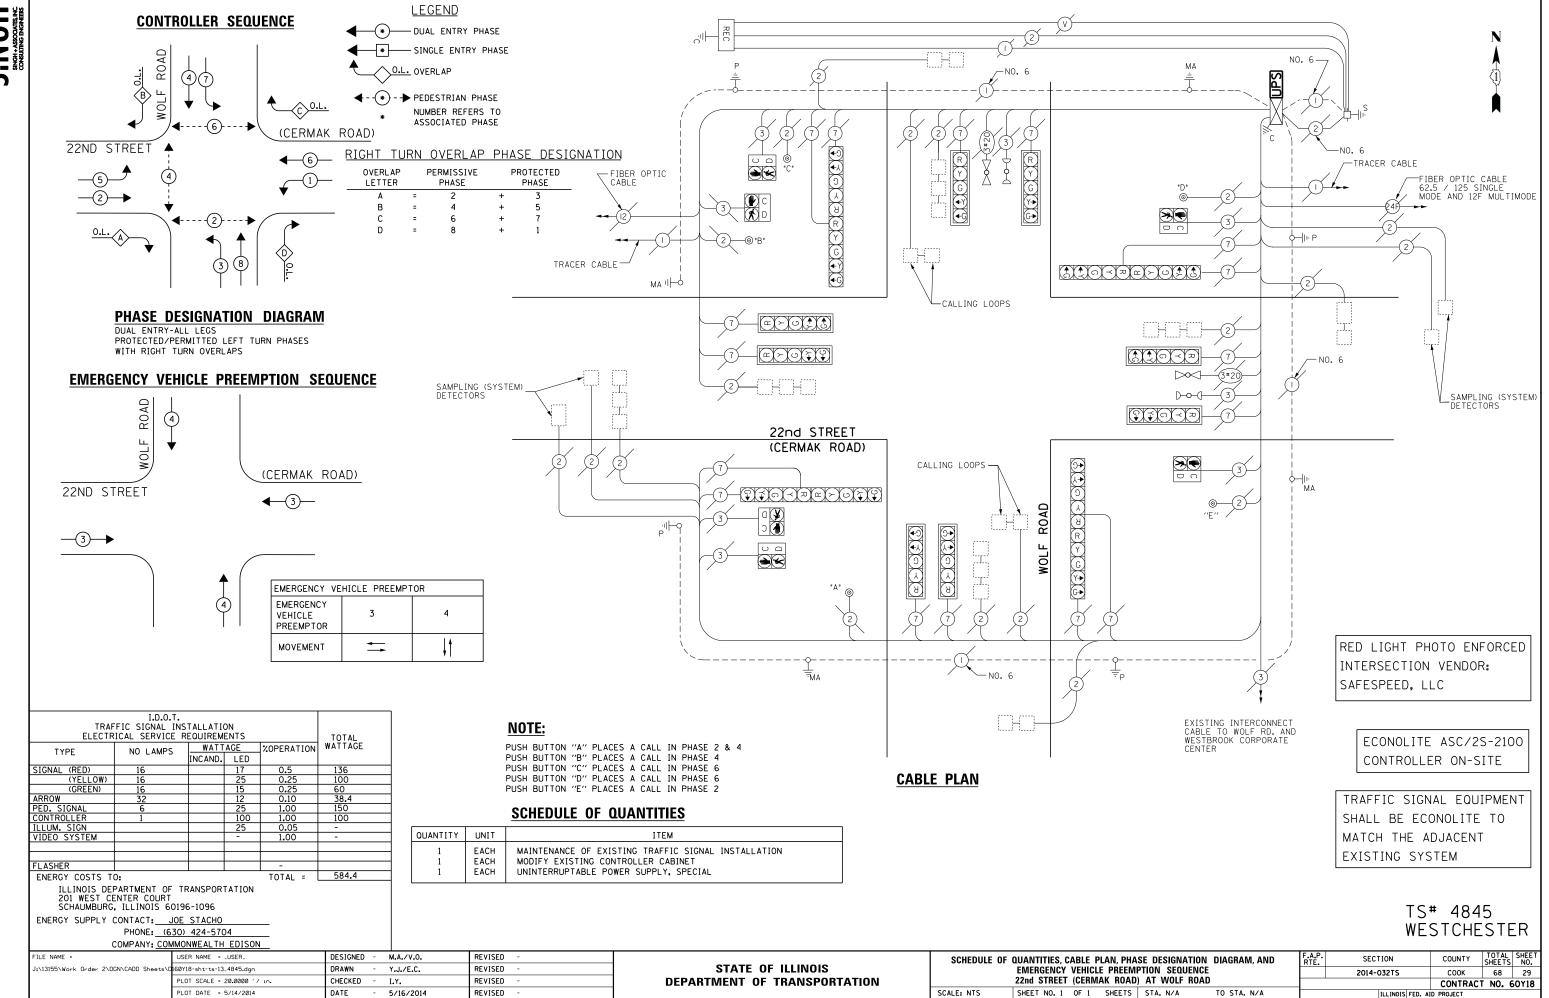

### CONTROLLER SEQUENCE

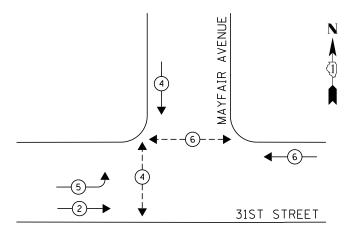


### DUAL ENTRY PHASE SINGLE ENTRY PHASE O.L. OVERLAP PEDESTRIAN PHASE NUMBER REFERS TO ASSOCIATED PHASE

## NO. 6 P T NO. 6 NO. 6 P T NO. 6 NO. 6 NO. 6 P T NO. 6 NO. 6 NO. 6 P T NO. 6 NO.

### **PHASE DESIGNATION DIAGRAM**

### **EMERGENCY VEHICLE PREEMPTION SEQUENCE**

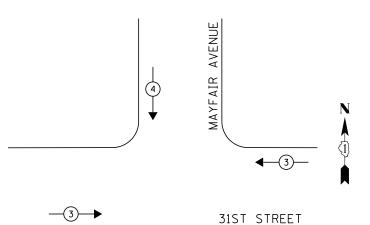

PROPOSED EMERGENCY VEHCILE PREEMPTOR								
EMERGENCY VEHICLE PREEMPTOR	3	4						
MOVEMENT	<b>=</b>	<b>↓</b>						

# TRACER CABLE TRACER CABLE TO WOLF ROAD TO WOLF ROAD

TRAF ELECTR	TOTAL				
TYPE	NO LAMPS	WATT	AGE	%OPERATION	WATTAGE
'''-	NO LAWI 5	INCAND.	LED		
SIGNAL (RED)	9		17	0.5	76.50
(YELLOW)	9		25	0.25	56.25
(GREEN)	9		15	0.25	33.75
ARROW	4		12	0.10	4.80
PED. SIGNAL	4		25	1.00	100
CONTROLLER	100		100	1.00	100
ILLUM. SIGN			-	-	-
VIDEO SYSTEM			-	-	-
FLASHER				-	
ENERGY COCTO T				TOTAL -	371 3∩

ENERGY COSTS TO: ILLINOIS DEPARTMENT OF TRANSPORTATION 201 WEST CENTER COURT SCHAUMBURG, ILLINOIS 60196-1096

ENERGY SUPPLY CONTACT: <u>JOE STACHO</u>
PHONE: <u>(630) 424-5704</u>
COMPANY: <u>COMMONWEALTH EDISON</u>

NOTE:

PUSH BUTTON "A & B" PLACES A CALL IN PHASE 4 PUSH BUTTON "C & D" PLACES A CALL IN PHASE 6

QUANTITY	UNIT	ITEM
1	EACH	MAINTENANCE OF EXISTING TRAFFIC SIGNAL INSTALLATION
4	EACH	PEDESTRIAN SIGNAL HEAD, LED, 1-FACE, BRACKET MOUNTED WITH COUNTDOWN TIMER
1	EACH	MODIFY EXISTING CONTROLLER CABINET
1	EACH	REMOVE EXISTING TRAFFIC SIGNAL EQUIPMENT
1	EACH	UNINTERRUPTABLE POWER SUPPLY SPECIAL
4	EACH	PEDESTRIAN PUSH-BUTTON,( <del>NON LATCHING</del> ) /

### **CABLE PLAN**

ECONOLITE ASC/2S-1000 CONTROLLER ON-SITE

TRAFFIC SIGNAL EQUIPMENT
SHALL BE ECONOLITE TO
MATCH THE ADJACENT
EXISTING SYSTEM


### REMOVAL OF EXISTING TRAFFIC SIGNAL EQUIPMENT

THE FOLLOWING ITEMS SHALL BE REMOVED BY THE CONTRCTOR AND SHALL BE DISPOSED OF BY THEM OUTSIDE THE RIGHT-OF-WAY AT THEIR EXPENSE. THE SALVAGE VALUE OF THE REMOVED EQUIPMENT SHALL BE REFLECTED IN THE CONTRACT BID PRICE.

4 EACH PEDESTRIAN SIGNAL HEAD 4 EACH PEDESTRIAN PUSH-BUTTON

> TS# 21175 WESTCHESTER

FILE NAME =	USER NAME = _USER_	DESIGNED - M.A./V.O.	REVISED -/1\I.Y. 6/2/2014		SCHEDULE OF QUANTITIES, CABLE PLAN, PHASE DESIGNATION DIAGRAM, AND	F.A.P.	SECTION	COUNTY	TOTAL SHEETS	SHEET NO.
J:\13155\Work Order 2\DGN\CADD Sheets\R	evision 1\D160Y18-sht-ts-14_21175_rev1.dgn	DRAWN - Y.J./E.C.	REVISED -	STATE OF ILLINOIS	EMERGENCY VEHICLE PREEMPTION SEQUENCE		2014-032TS	СООК	68	30
	PLOT SCALE = 20.0000 '/ in.	CHECKED - I.Y.	REVISED -	DEPARTMENT OF TRANSPORTATION	31ST STREET AT MAYFAIR AVENUE			CONTRACT	T NO. 6	JY18
	PLOT DATE = 6/3/2014	DATE - 5/16/2014	REVISED -		SCALE: NTS SHEET NO. 1 OF 1 SHEETS STA. N/A TO STA. N/A		ILLINOIS FED. AI	D PROJECT		

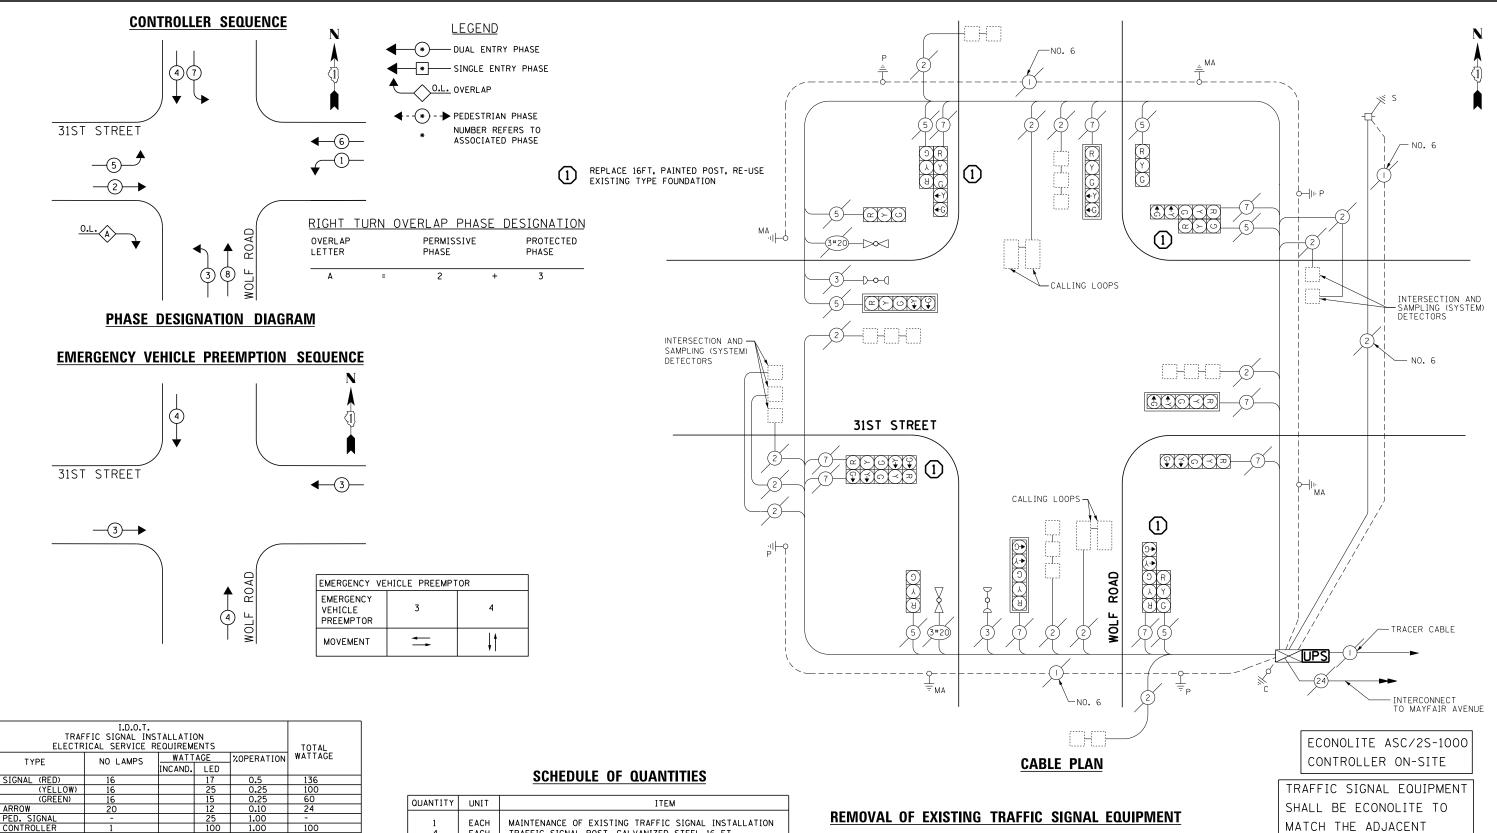

ILLUM. SIGN VIDEO SYSTEM 420 ENERGY COSTS TO: TOTAL =

ILLINOIS DEPARTMENT OF TRANSPORTATION 201 WEST CENTER COURT SCHAUMBURG, ILLINOIS 60196-1096

ENERGY SUPPLY CONTACT: JOE STACHO PHONE: (630) 424-5704 COMPANY: COMMONWEALTH EDISON


QUANTITY	UNIT	ITEM
1 4 8 1 1 2 1	EACH EACH EACH EACH EACH EACH	MAINTENANCE OF EXISTING TRAFFIC SIGNAL INSTALLATION TRAFFIC SIGNAL POST, GALVANIZED STEEL 16 FT. RELOCATE EXISTING SIGNAL HEAD MODIFY EXISTING CONTROLLER CABINET REMOVE EXISTING TRAFFIC SIGNAL EQUIPMENT REMOVE AND REPLACE ANCHOR BOLTS UNINTERRUPTABLE POWER SUPPLY, SPECIAL

THE FOLLOWING ITEMS SHALL BE REMOVED BY THE CONTRCTOR AND SHALL BE DISPOSED OF BY THEM OUTSIDE THE RIGHT-OF-WAY AT THEIR EXPENSE. THE SALVAGE VALUE OF THE REMOVED EQUIPMENT SHALL BE REFLECTED IN THE CONTRACT BID PRICE.

EACH TRAFFIC SIGNAL POST EXISTING SYSTEM

TS# 3775 WESTCHESTER

FILE NAME =	USER NAME = _USER_	DESIGNED - M.A./V.O.	REVISED -		SCHEDULE	OF QUANTITIES, CABLE PLAN, PHASE DESIGNATION DIAGRAM, AND	F.A.P.	SECTION	COUNTY	TOTAL SHEET
J:\13155\Work Order 2\DGN\CADD Sheets\0	160Y18-sht-ts-15_3775 <b>.</b> dgn	DRAWN - Y.J./E.C.	REVISED -	STATE OF ILLINOIS		EMERGENCY VEHICLE PREEMPTION SEQUENCE		2014-032TS	СООК	68 31
	PLOT SCALE = 20.0000 '/ in.	CHECKED - I.Y.	REVISED -	DEPARTMENT OF TRANSPORTATION		31ST STREET AT WOLF ROAD				T NO. 60Y18
	PLOT DATE = 5/14/2014	DATE - 5/16/2014	REVISED -		SCALE: NTS	SHEET NO. 1 OF 1 SHEETS STA. N/A TO STA. N/A		ILLINOIS FED. AI		

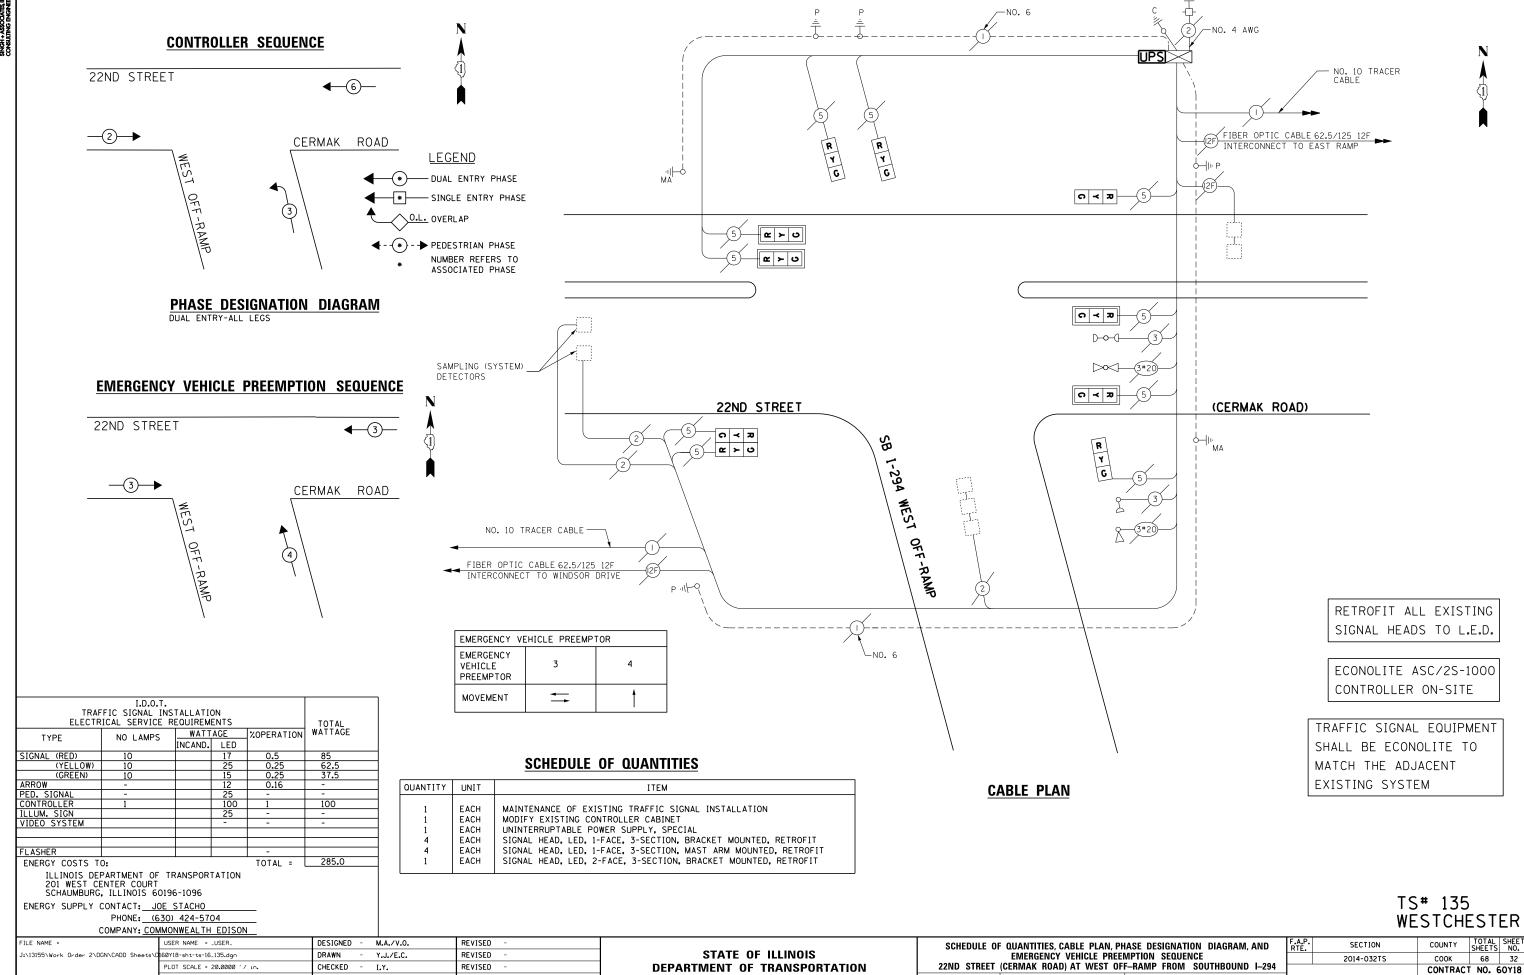

DATE


5/16/2014

PLOT DATE = 5/14/2014

REVISED

SHEET NO. 1 OF 1 SHEETS STA. N/A



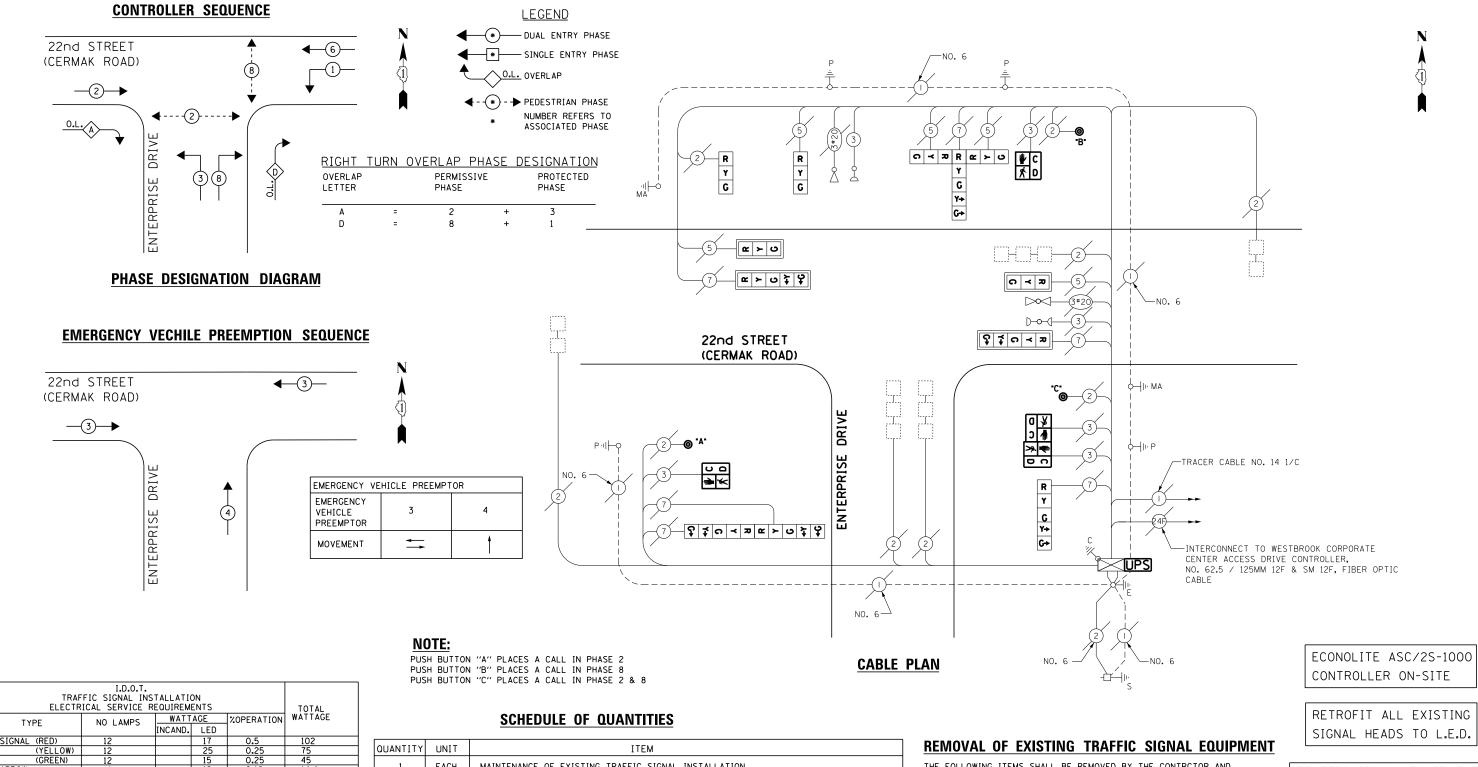

### LYTITHAUD

EACH

EACH

EACH

FACH

REVISED

REVISED

REVISED

REVISED

436.4

DRAWN

DATE

CHECKED

DESIGNED - M.A./V.O.

Y.J./E.C.

5/16/2014

I.Y.

TOTAL =

EACH MAINTENANCE OF EXISTING TRAFFIC SIGNAL INSTALLATION PEDESTRIAN SIGNAL HEAD, LED, 1-FACE, BRACKET MOUNTED WITH COUNTDOWN TIMER EACH EACH PEDESTRIAN SIGNAL HEAD, LED, 2-FACE, BRACKET MOUNTED WITH COUNTDOWN TIMER EACH MODIFY EXISTING CONTROLLER CABINET EACH REMOVE EXISTING TRAFFIC SIGNAL EQUIPMENT EACH UNINTERRUPTABLE POWER SUPPLY, SPECIAL EACH SIGNAL HEAD, LED, 3-FACE, 2-3 SECTION, 1-5 SECTION, BRACKET MOUNTED, RETROFIT EACH SIGNAL HEAD, LED, 1-FACE, 3-SECTION, BRACKET MOUNTED, RETROFIT EACH SIGNAL HEAD, LED, 1-FACE, 3-SECTION, MAST ARM MOUNTED, RETROFIT

SIGNAL HEAD, LED, 1-FACE, 5-SECTION, MAST ARM MOUNTED, RETROFIT

SIGNAL HEAD, LED, 1-FACE, 5-SECTION, BRACKET MOUNTED, RETROFIT

SIGNAL HEAD, LED, 2-FACE, 5-SECTION, BRACKET MOUNTED RETROFIT

PEDESTRIAN PUSH-BUTTON, NON-LATCHING

ENERGY COSTS TO: ILLINOIS DEPARTMENT OF TRANSPORTATION 201 WEST CENTER COURT SCHAUMBURG, ILLINOIS 60196-1096

LLUM. SIGN /IDEO SYSTEM

FILE NAME

:\13155\Work Order 2\DGN\CADD Sheet:

ENERGY SUPPLY CONTACT: JOE STACHO PHONE: (630) 424-5704

COMPANY: COMMONWEALTH EDISON

USER NAME = _USER.

60Y18-sht-ts-17_4851.don

PLOT DATE = 5/14/2014

### STATE OF ILLINOIS **DEPARTMENT OF TRANSPORTATION**

### REMOVAL OF EXISTING TRAFFIC SIGNAL EQUIPMENT

THE FOLLOWING ITEMS SHALL BE REMOVED BY THE CONTRCTOR AND SHALL BE DISPOSED OF BY THEM OUTSIDE THE RIGHT-OF-WAY AT THEIR EXPENSE. THE SALVAGE VALUE OF THE REMOVED EQUIPMENT SHALL BE REFLECTED IN THE CONTRACT BID PRICE.

PEDESTRIAN SIGNAL HEAD PEDESTRIAN PUSH-BUTTON EACH

TRAFFIC SIGNAL EQUIPMENT SHALL BE ECONOLITE TO MATCH THE ADJACENT EXISTING SYSTEM

### TS# 4851 WESTCHESTER

					RTE.	SECTION	COUNTY	SHEETS	NO.
EMERGENCY VEHICLE PREEMPTION SEQUENCE						2014-032TS	соок	68	33
2	2nd STREET (CERM	AK ROAD) A	AT ENTERPRIS	SE DRIVE			CONTRAC	T NO. (	60Y18
SCALE: NTS SHEET NO. 1 OF 1 SHEETS STA. N/A TO STA. N/A						ILLINOIS FED. AI	D PROJECT		




201 WEST CENTER COURT SCHAUMBURG, ILLINOIS 60196-1096

PHONE: (630) 424-5704

COMPANY: COMMONWEALTH EDISON

ENERGY SUPPLY CONTACT: JOE STACHO

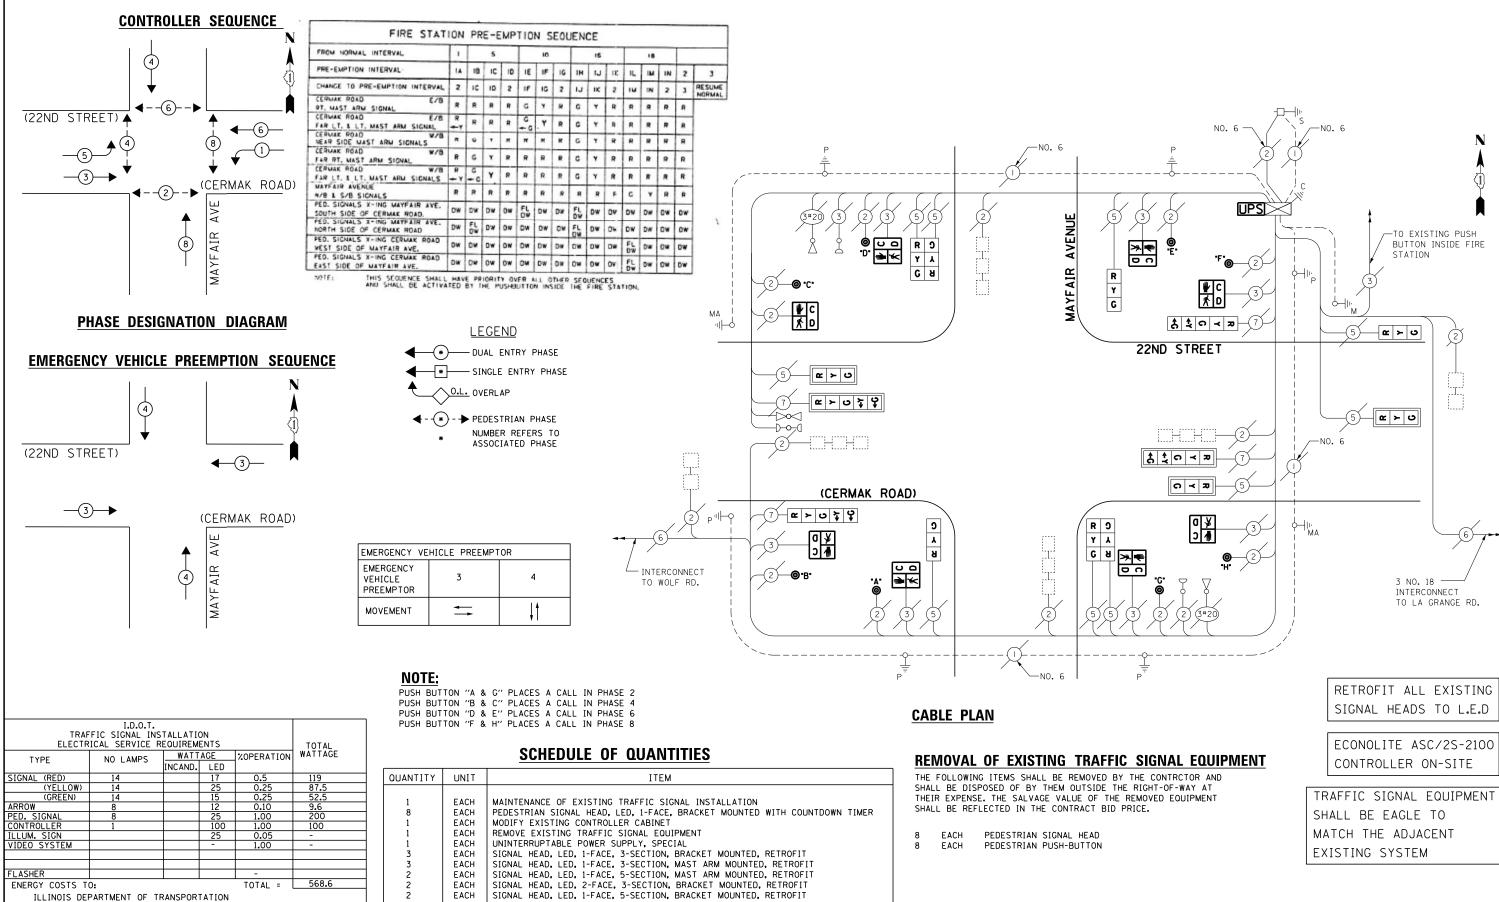

TS# 15115 WESTCHESTER

DESIGNED - M.A./V.O. REVISED FILE NAME USER NAME = _USER. SCHEDULE OF QUANTITIES, CABLE PLAN, PHASE DESIGNATION DIAGRAM, AND SECTION COUNTY STATE OF ILLINOIS J:\13155\Work Order 2\DGN\CADD Sheet 0Y18-sht-ts-18_15115.dar DRAWN Y.J./E.C. REVISED EMERGENCY VEHICLE PREEMPTION SEQUENCE 2014-032TS COOK 68 34 CHECKED I.Y. REVISED **DEPARTMENT OF TRANSPORTATION** 22nd STREET (CERMAK ROAD) AT MAYFAIR AVENUE CONTRACT NO. 60Y18 SHEET NO. 1 OF 1 SHEETS STA. N/A TO STA. N/A PLOT DATE = 5/14/2014 DATE REVISED 5/16/2014

EACH

PEDESTRIAN PUSH-BUTTON, NON-LATCHING



J:\13155\Work Order 2\DGN\CADD Sheet

60Y18-sht-ts-19_4850.dar

PLOT DATE = 5/14/2014

DRAWN

DATE

CHECKED

Y.J./E.C.


5/16/2014

I.Y.

REVISED

REVISED

REVISED

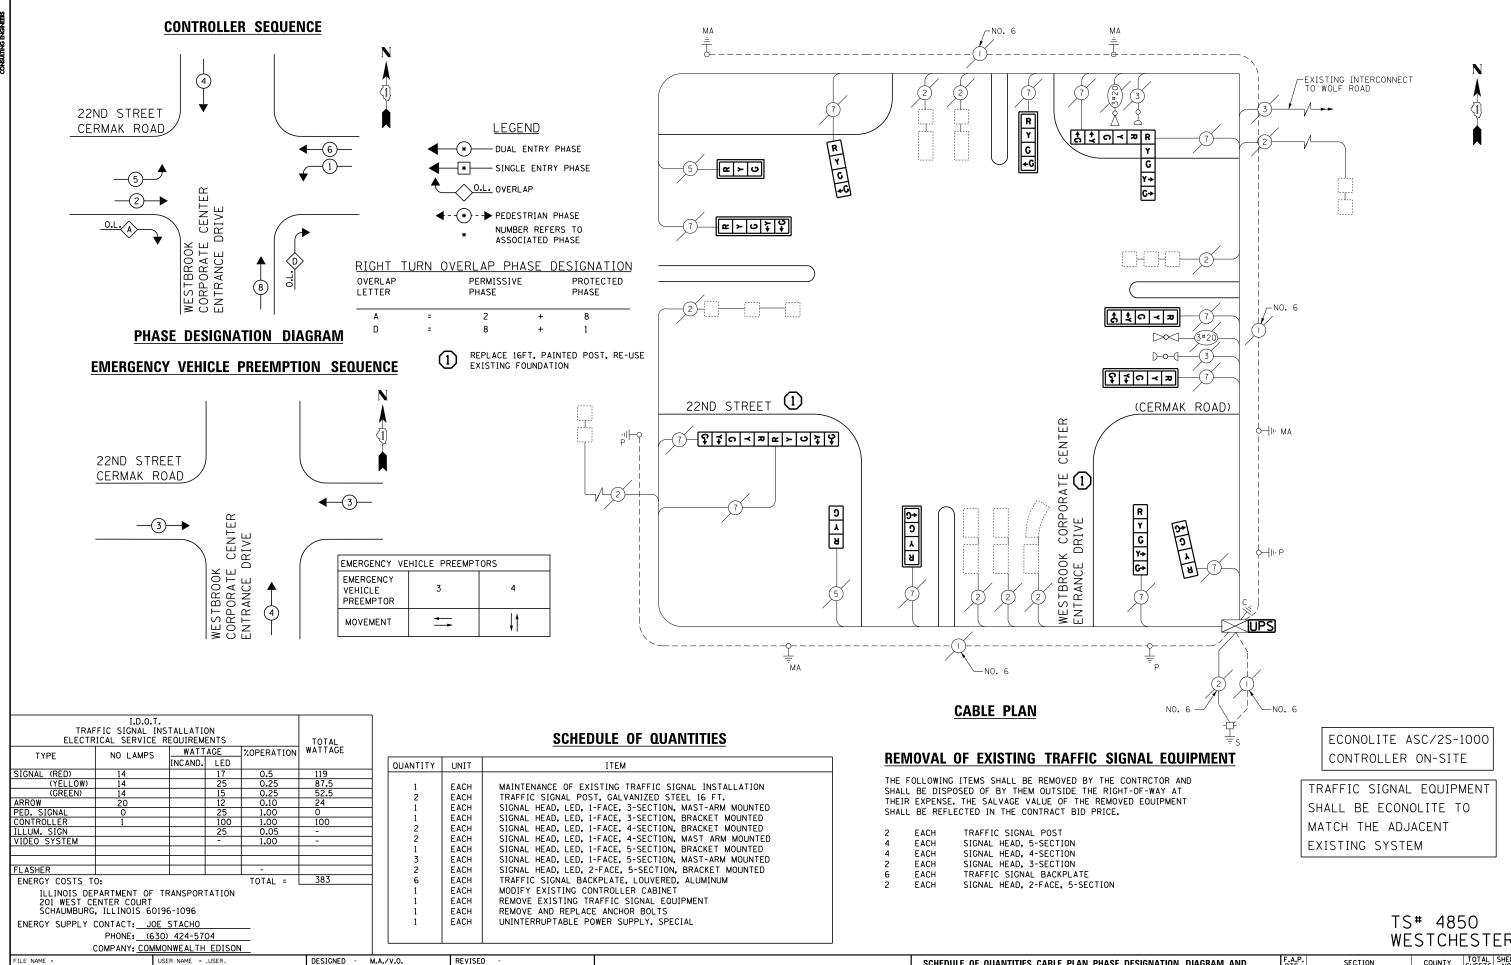

STATE OF ILLINOIS

**DEPARTMENT OF TRANSPORTATION** 

WESTCHESTER SECTION COUNTY

68 35

CONTRACT NO. 60Y18

COOK


2014-032TS

SCHEDULE OF QUANTITIES, CABLE PLAN, PHASE DESIGNATION DIAGRAM, AND

**EMERGENCY VEHICLE PREEMPTION SEQUENCE** 

22ND STREET (CERMAK ROAD) AT WESTBROOK ENTRANCE DRIVE

SHEET NO. 1 OF 1 SHEETS STA. N/A

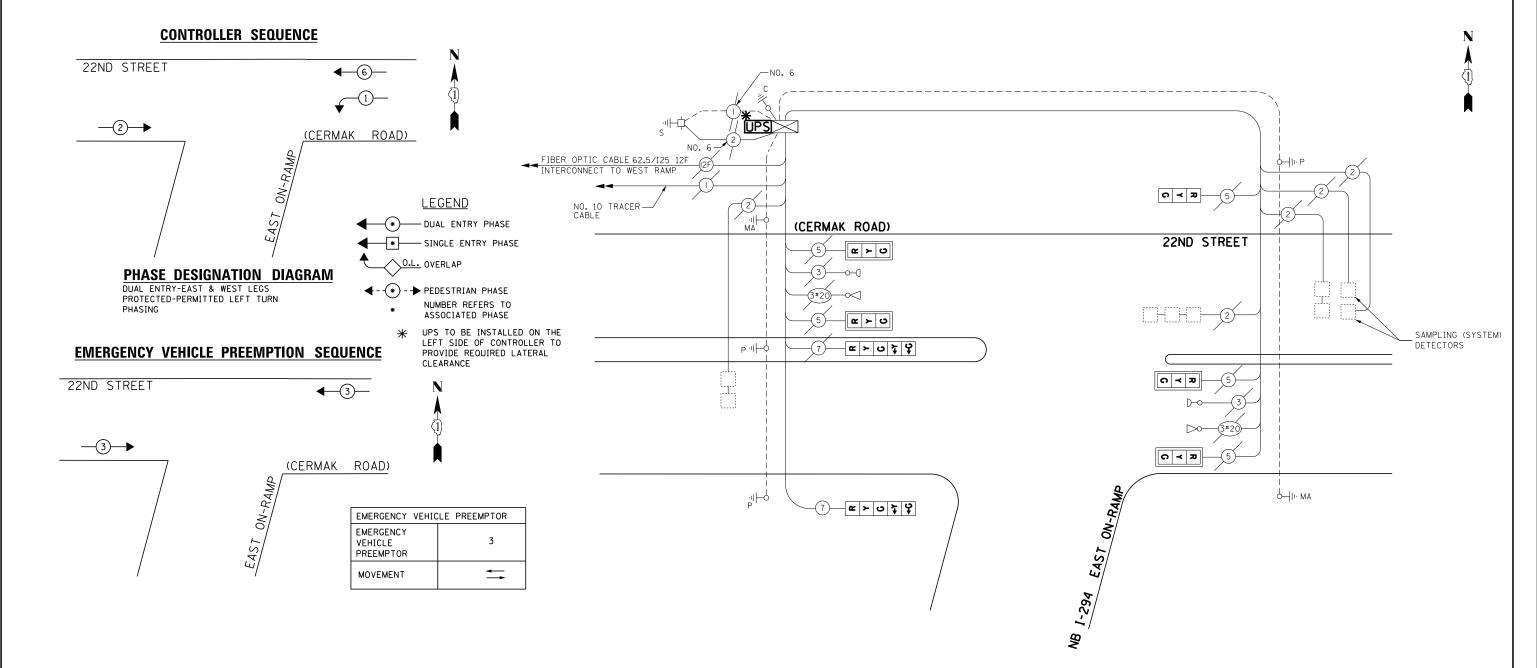

TRAF ELECTR	TOTAL							
TYPE	NO LAMPS	WATT		%OPERATION	WATTAGE			
		INCAND.	LED					
SIGNAL (RED)	7		17	0.5	59 <b>.</b> 5			
(YELLOW)	7		25	0.25	43.75			
(GREEN)	7		15	0.25	26.25			
ARROW	4		12	0.1	4.8			
PED. SIGNAL	0		25	-	-			
CONTROLLER	1		100	1	100			
ILLUM. SIGN			25	-	-			
VIDEO SYSTEM			-	-	1			
FLASHER				-				
ENERGY COSTS TO	TOTAL =	234.3						
ILLINOIS DEPARTMENT OF TRANSPORTATION 201 WEST CENTER COURT SCHAUMBURG, ILLINOIS 60196-1096								

ENERGY SUPPLY CONTACT: JOE STACHO

PHONE: (630) 424-5704

SCHEDULE OF QUANTITIES

QUANTITY	UNIT	ITEM
1	EACH	MAINTENANCE OF EXISTING TRAFFIC SIGNAL INSTALLATION
4	EACH	TRAFFIC SIGNAL BACKPLATE, LOUVERED, ALUMINUM
1	EACH	MODIFY EXISTING CONTROLLER CABINET
1	EACH	REMOVE EXISTING TRAFFIC SIGNAL EQUIPMENT
1	EACH	UNINTERRUPTABLE POWER SUPPLY, SPECIAL
4	EACH	SIGNAL HEAD, LED, 1-FACE, 3-SECTION, MAST ARM MOUNTED, RETROFIT
1	EACH	SIGNAL HEAD, LED, 1-FACE, 3-SECTION, BRACKET MOUNTED, RETROFIT
2	EACH	SIGNAL HEAD, LED, 1-FACE, 5-SECTION, BRACKET MOUNTED, RETROFIT

### REMOVAL OF EXISTING TRAFFIC SIGNAL EQUIPMENT

THE FOLLOWING ITEMS SHALL BE REMOVED BY THE CONTRCTOR AND SHALL BE DISPOSED OF BY THEM OUTSIDE THE RIGHT-OF-WAY AT THEIR EXPENSE. THE SALVAGE VALUE OF THE REMOVED EQUIPMENT SHALL BE REFLECTED IN THE CONTRACT BID PRICE.

**CABLE PLAN** 

4 EACH TRAFFIC SIGNAL BACKPLATE


ECONOLITE ASC/2S-1000 CONTROLLER ON-SITE

TRAFFIC SIGNAL EQUIPMENT SHALL BE ECONOLITE TO MATCH THE ADJACENT EXISTING SYSTEM

> TS# 130 WESTCHESTER

COMPANY: COM	MMONWEALTH EDISON						WESTCHESTEN
FILE NAME =	USER NAME = _USER_	DESIGNED - M.A./V.O.	REVISED -		SCHEDULE OF QUANTITIES, CABLE PLAN, PHASE DESIGNATION DIAGRAM, AND	F.A.P. SE	COUNTY TOTAL SHEET SHEETS NO.
J:\13155\Work Order 2\DGN\CADD Sheets\[	160Y18-sht-ts-20_130.dgn	DRAWN - Y.J./E.C.	REVISED -	STATE OF ILLINOIS	EMERGENCY VEHICLE PREEMPTION SEQUENCE	201-	4-032TS COOK 68 36
	PLOT SCALE = 20.0000 ' / in.	CHECKED - I.Y.	REVISED -	DEPARTMENT OF TRANSPORTATION	22ND STREET (CERMAK ROAD) AT EAST ON-RAMP TO NORTH BOUND I-294		CONTRACT NO. 60Y18
	PLOT DATE = 5/14/2014	DATE - 5/16/2014	REVISED -		SCALE: NTS SHEET NO. 1 OF 1 SHEETS STA. N/A TO STA. N/A		ILLINOIS FED. AID PROJECT



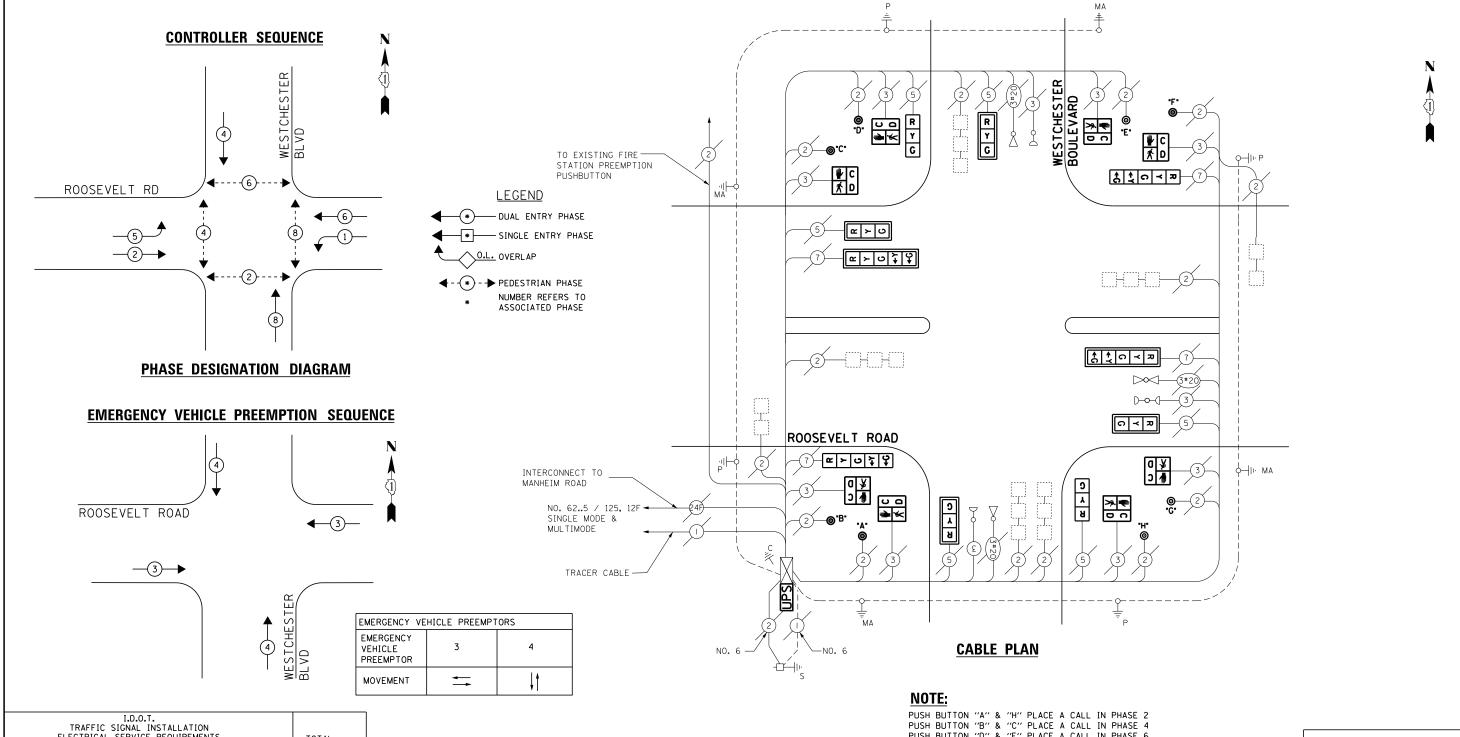

TRAF ELECTR	TOTAL							
TYPE	NO LAMPS	WATT	AGE	%OPERATION	WATTAGE			
'''-		INCAND.	LED					
SIGNAL (RED)	10		17	0.5	85			
(YELLOW)	10		25	0.25	62.5			
(GREEN)	10		15	0.25	37.5			
ARROW	8		12	0.10	9.6			
PED. SIGNAL	8		25	1.00	200			
CONTROLLER	1		100	1.00	100			
ILLUM. SIGN			25	0.05	-			
VIDEO SYSTEM			-	1.00	-			
FLASHER				-				
ENERGY COSTS T	494.6							
201 WEST CE	ENERGY COSTS TO: TOTAL = 494.6  ILLINOIS DEPARTMENT OF TRANSPORTATION 201 WEST CENTER COURT SCHAUMBURG, ILLINOIS 60196-1096							

PHONE: (630) 424-5704

ENERGY SUPPLY CONTACT: JOE STACHO

### **SCHEDULE OF QUANTITIES**

QUANTITY	UNIT	ITEM
1	EACH	MAINTENANCE OF EXISTING TRAFFIC SIGNAL INSTALLATION
4	EACH	SIGNAL HEAD, LED, 1-FACE, 3-SECTION, MAST-ARM MOUNTED
2	EACH	SIGNAL HEAD, LED, 1-FACE, 3-SECTION, BRACKET MOUNTED
2	EACH	SIGNAL HEAD, LED, 1-FACE, 5-SECTION, BRACKET MOUNTED
2	EACH	SIGNAL HEAD, LED, 1-FACE, 5-SECTION, MAST-ARM MOUNTED
8	EACH	PEDESTRIAN SIGNAL HEAD, LED, 1-FACE, BRACKET MOUNTED WITH COUNTDOWN TIMER
6	EACH	TRAFFIC SIGNAL BACKPLATE, LOUVERED, ALUMINUM
1	EACH	MODIFY EXISTING CONTROLLER CABINET
1	EACH	REMOVE EXISTING TRAFFIC SIGNAL EQUIPMENT
1	EACH	UNINTERRUPTABLE POWER SUPPLY, SPECIAL
8	EACH	PEDESTRIAN PUSH-BUTTON, NON-LATCHING

PUSH BUTTON "D" & "E" PLACE A CALL IN PHASE 6 PUSH BUTTON "F" & "G" PLACE A CALL IN PHASE 8

### REMOVAL OF EXISTING TRAFFIC SIGNAL EQUIPMENT

THE FOLLOWING ITEMS SHALL BE REMOVED BY THE CONTRCTOR AND SHALL BE DISPOSED OF BY THEM OUTSIDE THE RIGHT-OF-WAY AT THEIR EXPENSE. THE SALVAGE VALUE OF THE REMOVED EQUIPMENT SHALL BE REFLECTED IN THE CONTRACT BID PRICE.

PEDESTRIAN SIGNAL HEAD PEDESTRIAN PUSH-BUTTON EACH FACH TRAFFIC SIGNAL BACKPLATE **EACH** SIGNAL HEAD, 1-FACE, 3-SECTION EACH SIGNAL HEAD, 1-FACE, 5-SECTION EACH


ECONOLITE ASC/2S-2100 CONTROLLER ON-SITE

TRAFFIC SIGNAL EQUIPMENT SHALL BE ECONOLITE TO MATCH THE ADJACENT EXISTING SYSTEM

> TS# 15110 WESTCHESTER

COMPANY: CO	MMONWEALTH EDISON							VV C	3160	-216	'
FILE NAME =	USER NAME = _USER_	DESIGNED - M.A./V.	.O. REVISED -		SCHEDULE OF	QUANTITIES, CABLE PLAN, PHASE DESIGNATION DIAGRAM, AND	F.A.P.	SECTION	COUNTY	TOTAL SH	IEET NO.
J:\13155\Work Order 2\DGN\CADD Sheets	D160Y18-sht-ts-21_15110.dgn	DRAWN - Y.J./E.C	C. REVISED -	STATE OF ILLINOIS		EMERGENCY VEHICLE PREEMPTION SEQUENCE		2014-032TS	СООК	68	37
	PLOT SCALE = 20.0000 '/ in.	CHECKED - I.Y.	REVISED -	DEPARTMENT OF TRANSPORTATION		ROOSEVELT ROAD AT WESTCHESTER BOULEVARD				T NO. 60Y	Y18
	PLOT DATE = 5/14/2014	DATE - 5/16/20	PO14 REVISED -		SCALE: NTS	SHEET NO. 1 OF 1 SHEETS STA. N/A TO STA. N/A		ILLINOIS FED. A	ID PROJECT		



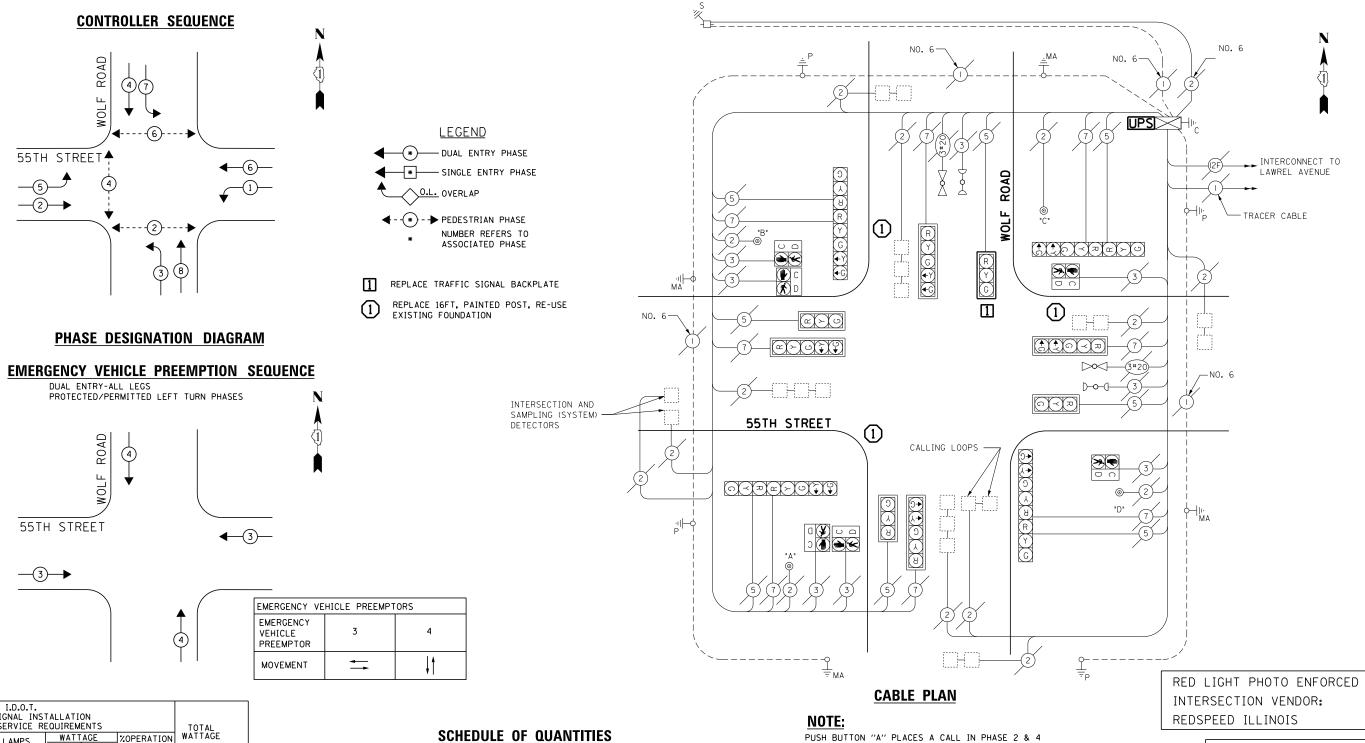

TRAF ELECTR	TOTAL						
TYPE	NO LAMPS	WATT	AGE LED	%OPERATION	WATTACE		
SIGNAL (RED)	16		17	0.5	136		
(YELLOW)	16		25	0.25	100		
(GREEN)	16		15	0.25	60		
ARROW	16		12	0.10	19.2		
PED. SIGNAL	6		25	1.00	150		
CONTROLLER	1		100	1.00	100		
ILLUM. SIGN			25	0.05	-		
VIDEO SYSTEM			-	1.00	-		
FLASHER				-			
ENERGY COSTS T	0:			TOTAL =	565.2		
ILLINOIS DEPARTMENT OF TRANSPORTATION 201 WEST CENTER COURT SCHAUMBURG, ILLINOIS 60196-1096							

ENERGY SUPPLY CONTACT: ILYAS MOHIUNDDIN

PHONE: (708) 235-2692

QUANTITY	UNIT	ITEM
1	EACH	MAINTENANCE OF EXISTING TRAFFIC SIGNAL INSTALLATION
3	EACH	TRAFFIC SIGNAL POST, GALVANIZED STEEL 16 FT.
1	EACH	TRAFFIC SIGNAL BACKPLATE, LOUVERED, ALUMINUM
6	EACH	RELOCATE EXISTING SIGNAL HEAD
1	EACH	RELOCATE EXISTING PEDESTRIAN SIGNAL HEAD
2	EACH	RELOCATE EXISTING PEDESTRIAN PUSH-BUTTON
1	EACH	MODIFY EXISTING CONTROLLER CABINET
1	EACH	REMOVE EXISTING TRAFFIC SIGNAL EQUIPMENT
2	EACH	REMOVE AND REPLACE ANCHOR BOLTS
1	EACH	UNINTERRUPTABLE POWER SUPPLY, SPECIAL

PUSH BUTTON "A" PLACES A CALL IN PHASE 2 & 4
PUSH BUTTON "B" PLACES A CALL IN PHASE 4 & 6
PUSH BUTTON "C" PLACES A CALL IN PHASE 6
PUSH BUTTON "D" PLACES A CALL IN PHASE 2

### REMOVAL OF EXISTING TRAFFIC SIGNAL EQUIPMENT


THE FOLLOWING ITEMS SHALL BE REMOVED BY THE CONTRCTOR AND SHALL BE DISPOSED OF BY THEM OUTSIDE THE RIGHT-OF-WAY AT THEIR EXPENSE. THE SALVAGE VALUE OF THE REMOVED EQUIPMENT SHALL BE REFLECTED IN THE CONTRACT BID PRICE.


3 EACH TRAFFIC SIGNAL POST 1 EACH TRAFFIC SIGNAL BACKPLATE EAGLE EPAC 300 CONTROLLER ON-SITE

TRAFFIC SIGNAL EQUIPMENT SHALL BE EAGLE TO MATCH THE ADJACENT EXISTING SYSTEM

TS# 3865 WESTERN SPRINGS


	COMPANY: COM	MONWEALTH EDISON					WESTERN	SENTINGS
ſ	FILE NAME =	USER NAME = _USER_	DESIGNED - M.A./V.O.	REVISED -		SCHEDULE OF QUANTITIES, CABLE PLAN, PHASE DESIGNATION DIAGRAM, AND	F.A.P. SECTION	COUNTY TOTAL SHEETS NO.
	J:\13155\Work Order 2\DGN\CADD Sheets\D	60Y18-sht-ts-22_3865.dgn	DRAWN - Y.J./E.C.	. REVISED -	STATE OF ILLINOIS	EMERGENCY VEHICLE PREEMPTION SEQUENCE	2014-032TS	СООК 68 38
		PLOT SCALE = 20.0000 ' / 10.	CHECKED - I.Y.	REVISED -	DEPARTMENT OF TRANSPORTATION	55TH STREET AT WOLF ROAD		CONTRACT NO. 60Y18
L		PLOT DATE = 5/14/2014	DATE - 5/16/20:	014 REVISED -		SCALE: NTS SHEET NO. 1 OF 1 SHEETS STA. N/A TO STA. N/A	ILLINOIS FED. A	ID PROJECT

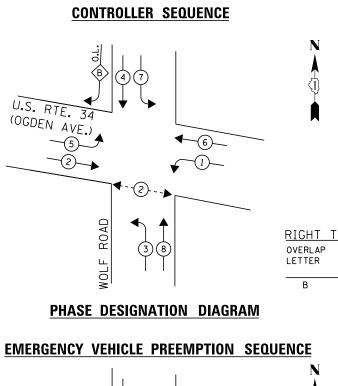

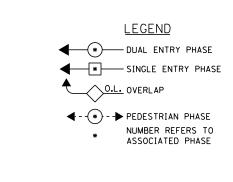

RIGHT TURN OVERLAP PHASE DESIGNATION PERMISSIVE PROTECTED

PHASE PHASE

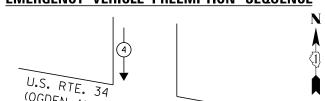

WATTAGE COPERATION WATTAGE

TOTAL =

414.5

**4**—(3)—

(OGDEN AVE.)

I.D.O.T. TRAFFIC SIGNAL INSTALLATION ELECTRICAL SERVICE REQUIREMENTS

ILLINOIS DEPARTMENT OF TRANSPORTATION 201 WEST CENTER COURT SCHAUMBURG, ILLINOIS 60196-1096

PHONE: (708)-235-2692

COMPANY: COMMONWEALTH EDISON

ENERGY SUPPLY CONTACT: ILYAS MOHIUDDIN

TYPE

SIGNAL (RED)

LLUM. SIGN /IDEO SYSTEM

ENERGY COSTS TO:

(YELLOW) (GREEN)

-(3)-**** 

NCAND. LED

ROAD EMERGENCY VEHICLE PREEMPTORS WOLF **EMERGENCY** VEHICLE PREEMPTOR MOVEMENT

REPLACE 16FT, PAINTED POST, RE-USE EXISTING FOUNDATION

US. RTE. 34 

MA

NO. 6

NO. 20

INTERSECTION AND -SAMPLING DETECTORS

**CABLE PLAN** 

RED LIGHT PHOTO ENFORCED INTERSECTION VENDOR: REDSPEED ILLINOIS

TRACER CABLE

(4F)→→ INTERCONNECT TO GILBERT

AVENUE/NAZARETH ACADEMY

## NOTE:

PUSH BUTTON "A" & "B" PLACE A CALL IN PHASE 2

### REMOVAL OF EXISTING TRAFFIC SIGNAL EQUIPMENT

ROAD

WOLF

(OGDEN AVENUE)

THE FOLLOWING ITEMS SHALL BE REMOVED BY THE CONTRCTOR AND SHALL BE DISPOSED OF BY THEM OUTSIDE THE RIGHT-OF-WAY AT THEIR EXPENSE. THE SALVAGE VALUE OF THE REMOVED EQUIPMENT SHALL BE REFLECTED IN THE CONTRACT BID PRICE.

3 EACH TRAFFIC SIGNAL POST

EAGLE EPAC 300 CONTROLLER ON-SITE

TRAFFIC SIGNAL EQUIPMENT SHALL BE EAGLE TO MATCH THE ADJACENT EXISTING SYSTEM


### TS# 1480 WESTERN SPRINGS

	FILE NAME =	USER NAME = _USER_	DESIGNED - M.A./V.O.	REVISED -		SCHEDULE O	OF QUANTITIES, CABLE PLAN, PHASE I	DESIGNATION DIAGRAM, AND	F.A.P.	SECTION	COUNTY	SHEETS	SHEET
	J:\13155\Work Order 2\DGN\CADD Sheets\D	60Y18-sht-ts-23_1480.dgn	DRAWN - Y.J./E.C.	REVISED -	STATE OF ILLINOIS		EMERGENCY VEHICLE PREEMPTIO			2014-032TS	соок	68	39
		PLOT SCALE = 20.0000 ' / in.	CHECKED - I.Y.	REVISED -	DEPARTMENT OF TRANSPORTATION		U.S. RTE. 34 (OGDEN AVENUE) AT	T WOLF ROAD			CONTRACT		0Y18
L		PLOT DATE = 5/14/2014	DATE - 5/16/2014	REVISED -		SCALE: NTS	SHEET NO. 1 OF 1 SHEETS STA.	. N/A TO STA. N/A		ILLINOIS FED.			

## **SCHEDULE OF QUANTITIES**


QUANTITY	UNIT	ITEM
1	EACH	MAINTENANCE OF EXISTING TRAFFIC SIGNAL INSTALLATION
3	EACH	TRAFFIC SIGNAL POST, GALVANIZED STEEL 16 FT.
4	EACH FACH	RELOCATE EXISTING SIGNAL HEAD MODIFY EXISTING CONTROLLER CABINET
2	EACH	REMOVE AND REPLACE ANCHOR BOLTS
1	EACH	UNINTERRUPTABLE POWER SUPPLY, SPECIAL


### CONTROLLER SEQUENCE

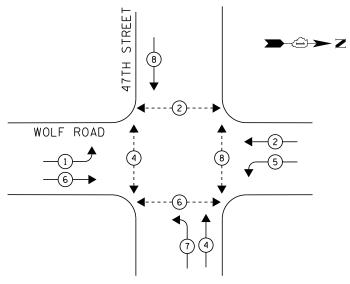

### PHASE DESIGNATION DIAGRAM

### **EMERGENCY VEHICLE PREEMPTION SEQUENCE**

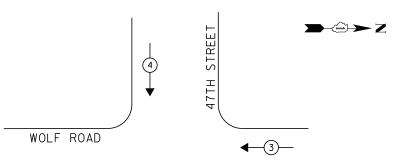

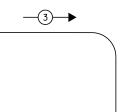

NCAND. LED

I.D.O.T.
TRAFFIC SIGNAL INSTALLATION
ELECTRICAL SERVICE REQUIREMENTS

NO LAMPS

ILLINOIS DEPARTMENT OF TRANSPORTATION 201 WEST CENTER COURT SCHAUMBURG, ILLINOIS 60196-1096

PHONE: (708) 2354-2692

ENERGY SUPPLY CONTACT: ILYAS MOHIUNDDIN

TYPE

SIGNAL (RED)

ILLUM. SIGN VIDEO SYSTEM

ENERGY COSTS TO:

(YELLOW) (GREEN)



536.4

WATTAGE CAND. LED COPERATION WATTAGE

TOTAL =

EMERGENCY VE	HICLE PREEMPT	ORS
EMERGENCY VEHICLE PREEMPTOR	3	4
MOVEMENT	<b>+</b>	<b>↓</b> ↑

### **SCHEDULE OF QUANTITIES**

QUANTITY	UNIT	ITEM
1	EACH	MAINTENANCE OF EXISTING TRAFFIC SIGNAL INSTALLATION
1	EACH	TRAFFIC SIGNAL POST, GALVANIZED STEEL 16 FT.
8	EACH	PEDESTRIAN SIGNAL HEAD, LED, 1-FACE, BRACKET MOUNTED WITH COUNTDOWN TIMER
1	EACH	RELOCATE EXISTING SIGNAL HEAD
1	EACH	MODIFY EXISTING CONTROLLER CABINET
1	EACH	REMOVE EXISTING TRAFFIC SIGNAL EQUIPMENT
1	EACH	REMOVE AND REPLACE ANCHOR BOLTS
1	EACH	UNINTERRUPTABLE POWER SUPPLY, SPECIAL
3	EACH	SIGNAL HEAD, LED, 2-FACE, 1-3 SECTION, 1-5 SECTION, BRACKET MOUNTED, RETROFIT
1	EACH	SIGNAL HEAD, LED, 1-FACE, 3-SECTION, MAST ARM MOUNTED, RETROFIT
3	EACH	SIGNAL HEAD, LED, 1-FACE, 5-SECTION, MAST ARM MOUNTED, RETROFIT
1	EACH	SIGNAL HEAD, LED, 2-FACE, 3-SECTION, BRACKET MOUNTED, RETROFIT
7	EACH	PEDESTRIAN PUSH-BUTTON, NON-LATCHING

LEGEND * DUAL ENTRY PHASE

* SINGLE ENTRY PHASE

NUMBER REFERS TO ASSOCIATED PHASE

O.L. OVERLAP

← - · * · - PEDESTRIAN PHASE

REPLACE 16FT, PAINTED POST, RE-USE EXISTING TYPE FOUNDATION

**CABLE PLAN** 

### NOTE:

R N

G ←Y ←G

WOLF ROAD

0 × 2 × 0 × 2

**∌** ≮

,₁I├─ MA

NO. 6

**∌**≮

1)--0-(1

2 7 0 7 P

-<u>A</u>. □ ¥ ⊚ ⊃ ∰

R Y G +Y +G

47TH STREE

PUSH BUTTON "A & G" PLACES A CALL IN PHASE 6 PUSH BUTTON "B & C" PLACES A CALL IN PHASE 4 PUSH BUTTON "D" PLACES A CALL IN PHASE PUSH BUTTON "E & F" PLACES A CALL IN PHASE 8

### REMOVAL OF EXISTING TRAFFIC SIGNAL EQUIPMENT

THE FOLLOWING ITEMS SHALL BE REMOVED BY THE CONTRCTOR AND SHALL BE DISPOSED OF BY THEM OUTSIDE THE RIGHT-OF-WAY AT THEIR EXPENSE. THE SALVAGE VALUE OF THE REMOVED EQUIPMENT SHALL BE REFLECTED IN THE CONTRACT BID PRICE.

NO. 6

PEDESTRIAN SIGNAL HEAD EACH EACH PEDESTRIAN PUSH-BUTTON EACH TRAFFIC SIGNAL POST

EAGLE EPAC 300 CONTROLLER ON-SITE

→II· MA

**→ ○ → Z** 

MΑ

\$ \$ G ≺ ₽ Œ ≻ ∪

<u>ಕ್ಷ</u> ಕ್ಷ ೧ ≺ ೩

≫€

≫**₹** 


RETROFIT ALL EXISTING SIGNAL HEADS TO L.E.D.

TRAFFIC SIGNAL EQUIPMENT SHALL BE EAGLE TO MATCH THE ADJACENT EXISTING SYSTEM

TS# 3825 WESTERN SPRINGS

	COMPANY: COM	MMONWEALTH EDISON								MESIEUM	SEN.	ING.	٥
FILE NAM	E =	USER NAME = _USER_	DESIGNED -	M.A./V.O.	REVISED -		SCHEDULE O	F QUANTITIES, CABLE PLAN, PHASE DESIGNATION DIAGRAM, AND	F.A.P.	SECTION	COUNTY	TOTAL	SHEET
J:\13155\	Work Order 2\DGN\CADD Sheets\D	160Y18-sht-ts-24_3825.dgn	DRAWN -	Y.J./E.C.	REVISED -	STATE OF ILLINOIS		EMERGENCY VEHICLE PREEMPTION SEQUENCE		2014-032TS	соок	68	40
		PLOT SCALE = 20.0000 ' / in.	CHECKED -	I.Y.	REVISED -	DEPARTMENT OF TRANSPORTATION		WOLF ROAD AT 47TH STREET			CONTRAC	T NO.	60Y18
		PLOT DATE = 5/14/2014	DATE -	5/16/2014	REVISED -		SCALE: NTS	SHEET NO. 1 OF 1 SHEETS STA. N/A TO STA. N/A		ILLINOIS FED. AID			



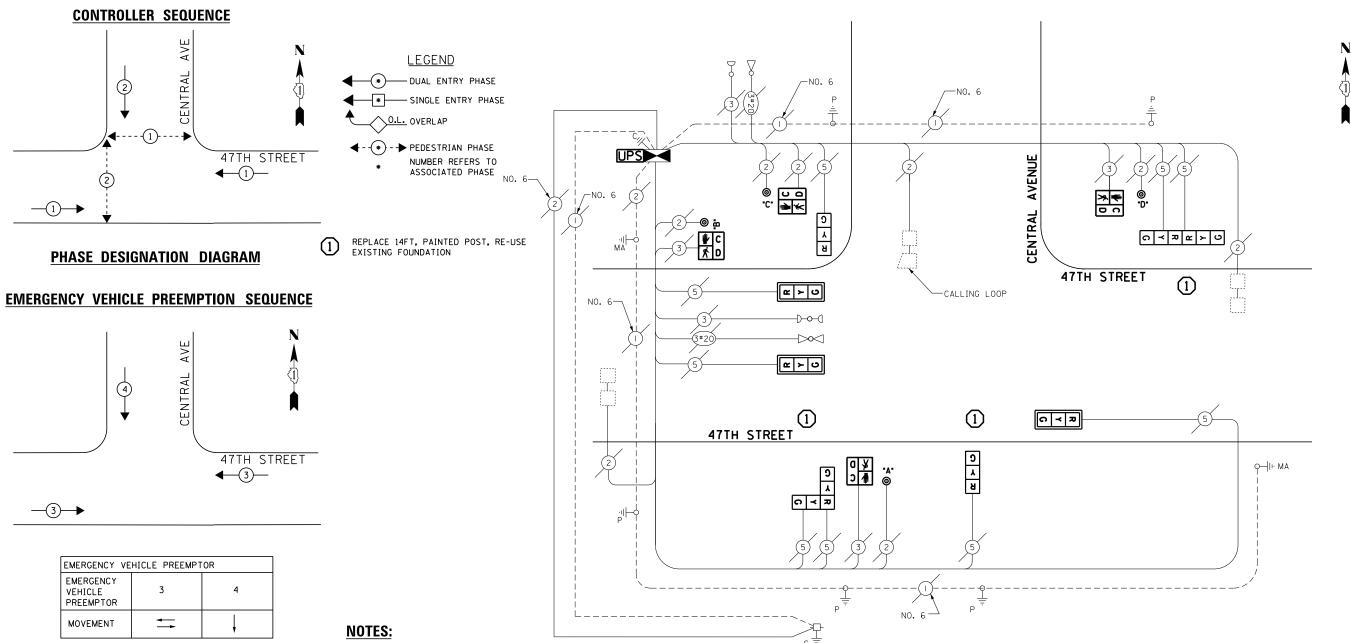

I.D.O.T.
TRAFFIC SIGNAL INSTALLATION
ELECTRICAL SERVICE REQUIREMENTS WATTAGE COPERATION WATTAGE TYPE NO LAMPS NCAND. LED SIGNAL (RED) (YELLOW) (GREEN) ILLUM. SIGN VIDEO SYSTEM 366.5 ENERGY COSTS TO: TOTAL =

ILLINOIS DEPARTMENT OF TRANSPORTATION 201 WEST CENTER COURT SCHAUMBURG, ILLINOIS 60196-1096

ENERGY SUPPLY CONTACT: ILYAS MOHIUDDIN PHONE: (708) 235-2692

COMPANY: COMMONWEALTH EDISON

PUSH BUTTON "A & B" PLACES A CALL IN PHASE 2 PUSH BUTTON "C & D" PLACES A CALL IN PHASE 1

RELOCATION OF EMERGENCY VEHICLE PREEMPTION INCLUDED IN COST OF REPLACING SIGNAL POSTS

### **SCHEDULE OF QUANTITIES**

QUANTITY	UNIT	ITEM
1	EACH	MAINTENANCE OF EXISTING TRAFFIC SIGNAL INSTALLATION
1	EACH	FULL-ACTUATED CONTROLLER AND TYPE IV CABINET
3	EACH	TRAFFIC SIGNAL POST, GALVANIZED STEEL 14 FT.
3	EACH	SIGNAL HEAD, LED, 1-FACE, 3-SECTION, MAST-ARM MOUNTED
2	EACH	SIGNAL HEAD, LED, 1-FACE, 3-SECTION, BRACKET MOUNTED
2	EACH	SIGNAL HEAD, LED, 2-FACE, 3-SECTION, BRACKET MOUNTED
4	EACH	PEDESTRIAN SIGNAL HEAD, LED, 1-FACE, BRACKET MOUNTED WITH COUNTDOWN TIMER
3	EACH	TRAFFIC SIGNAL BACKPLATE, LOUVERED, ALUMINUM
3	EACH	INDUCTIVE LOOP DETECTOR
1	EACH	REMOVE EXISTING TRAFFIC SIGNAL EQUIPMENT
2	EACH	REMOVE AND REPLACE ANCHOR BOLTS
1	EACH	UNINTERRUPTABLE POWER SURRLY SPECIAL .
4	EACH	PEDESTRIAN PUSH-BUTTON, (NON-LATCHING) /1
	•	

### REMOVAL OF EXISTING TRAFFIC SIGNAL EQUIPMENT

THE FOLLOWING ITEMS SHALL BE REMOVED BY THE CONTRCTOR AND SHALL BE DISPOSED OF BY THEM OUTSIDE THE RIGHT-OF-WAY AT THEIR EXPENSE. THE SALVAGE VALUE OF THE REMOVED EQUIPMENT SHALL BE REFLECTED IN THE CONTRACT BID PRICE.

PEDESTRIAN SIGNAL HEAD EACH PEDESTRIAN PUSH-BUTTON EACH TRAFFIC SIGNAL POST EACH TRAFFIC SIGNAL HEAD, 3-SECTION

**CABLE PLAN** 


EACH SIGNAL BACKPLATE TRAFFIC CONTROLLER AND CABINET (COMPLETE) EACH

ECONOLITE ASC-8000 CONTROLLER ON-SITE

TRAFFIC SIGNAL EQUIPMENT SHALL BE ECONOLITE TO MATCH THE ADJACENT EXISTING SYSTEM

TS# 22175 WILLOW SPRINGS

FILE NAME =	USER NAME = _USER_	DESIGNED - M.A./V.O.	REVISED -/1\I.Y. 6/2/2014		SCHEDULE (	OF QUANTITIES, CABLE PLAN, PHASE DESIGNATION DIAGRAM, AND	F.A.P. SECTION	COUNTY	TOTAL S	HEET NO.
J:\13155\Work Order 2\DGN\CADD Shee	ts\Revision 1\D160Y18-sht-ts-25_22175_revl.dgn	DRAWN - Y.J./E.C.	REVISED -	STATE OF ILLINOIS		EMERGENCY VEHICLE PREEMPTION SEQUENCE	2014-032TS	соок	68	41
	PLOT SCALE = 20.0000 '/ in.	CHECKED - I.Y.	REVISED -	DEPARTMENT OF TRANSPORTATION		47TH STREET AT CENTRAL AVENUE		CONTRAC	T NO. 60	Y18
	PLOT DATE = 6/3/2014	DATE - 5/16/2014	REVISED -		SCALE: NTS	SHEET NO. 1 OF 1 SHEETS STA. N/A TO STA. N/A	ILLINOIS FED.	AID PROJECT		

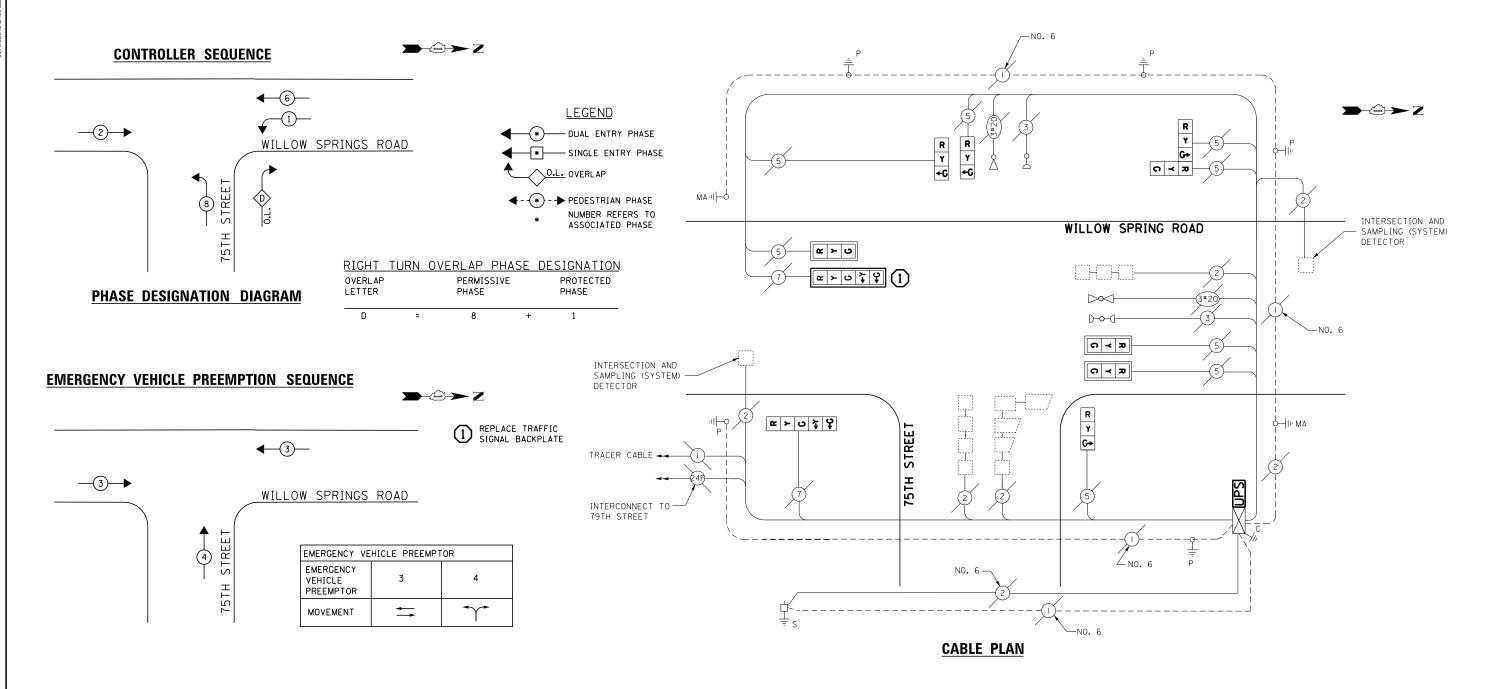

TRAF ELECTR	TOTAL				
TYPE	NO LAMPS	WATT	AGE	%OPERATION	WATTAGE
'''-	.,,,,,,,,,,,,,,,,,,,,,,,,,,,,,,,,,,,,,,	INCAND. LED			
SIGNAL (RED)	10		17	0.5	85
(YELLOW)	10		25	0.25	62.5
(GREEN)	10		15	0.25	37 <b>.</b> 5
ARROW	4		12	0.10	4.8
PED. SIGNAL			25	1.00	-
CONTROLLER	1		100	1.00	100
ILLUM. SIGN			25	0.05	-
VIDEO SYSTEM			-	1.00	-
FLASHER				_	
	ENERGY COSTS TO: TOTAL =				
ILLINOIS DEPARTMENT OF TRANSPORTATION 201 WEST CENTER COURT SCHAUMBURG, ILLINOIS 60196-1096					

ENERGY SUPPLY CONTACT: ILYAS MOHIUDDIN

PHONE: (708) 235-2692

### **SCHEDULE OF QUANTITIES**

QUANTITY	UNIT	ITEM
1	EACH	MAINTENANCE OF EXISTING TRAFFIC SIGNAL INSTALLATION
1	EACH	TRAFFIC SIGNAL BACKPLATE, LOUVERED, ALUMINUM
1	EACH	MODIFY EXISTING CONTROLLER CABINET
1	EACH	REMOVE EXISTING TRAFFIC SIGNAL EQUIPMENT
1	EACH	UNINTERRUPTABLE POWER SUPPLY, SPECIAL
3	EACH	SIGNAL HEAD, LED, 1-FACE, 3-SECTION, BRACKET MOUNTED, RETROFIT
3	EACH	SIGNAL HEAD, LED, 1-FACE, 3-SECTION, MAST ARM MOUNTED, RETROFIT
1	EACH	SIGNAL HEAD, LED, 1-FACE, 5-SECTION, MAST ARM MOUNTED, RETROFIT
1	EACH	SIGNAL HEAD, LED, 2-FACE, 3-SECTION, BRACKET MOUNTED, RETROFIT
1	EACH	SIGNAL HEAD, LED, 1-FACE, 5-SECTION, BRACKET MOUNTED, RETROFIT

### REMOVAL OF EXISTING TRAFFIC SIGNAL EQUIPMENT

THE FOLLOWING ITEMS SHALL BE REMOVED BY THE CONTRACTOR AND SHALL BE DISPOSED OF BY THEM OUTSIDE THE RIGHT-OF-WAY AT THEIR EXPENSE. THE SALVAGE VALUE OF THE REMOVED EQUIPMENT SHALL BE REFLECTED IN THE CONTACT BID PRICE.

1 EACH TRAFFIC SIGNAL BACKPLATE

RETROFIT ALL EXISTING SIGNAL HEADS TO L.E.D

ECONOLITE ASC/2-2000 CONTROLLER ON-SITE

TRAFFIC SIGNAL EQUIPMENT
SHALL BE ECONOLITE TO
MATCH THE ADJACENT
EXISTING SYSTEM

TS# 22035 WILLOW SPRINGS


<u> </u>	MMONWEALTH EDISON								WILLOW	J1 111	1105
FILE NAME =	USER NAME = _USER_	DESIGNED -	M.A./V.O.	REVISED -		SCHEDULE OF	QUANTITIES, CABLE PLAN, PHASE DESIGNATION DIAGRAM, AND	F.A.P.	SECTION		TOTAL SHEET SHEETS NO.
J:\13155\Work Order 2\DGN\CADD Sheets\0	160Y18-sht-ts-26_22035.dgn	DRAWN -	Y.J./E.C.	REVISED -	STATE OF ILLINOIS		EMERGENCY VEHICLE PREEMPTION SEQUENCE		2014-032TS	соок	68 42
	PLOT SCALE = 20.0000 '/ in.	CHECKED -	I.Y.	REVISED -	DEPARTMENT OF TRANSPORTATION		75TH STREET AT WILLOW SPRINGS ROAD				NO. 60Y18
	PLOT DATE = 5/14/2014	DATE -	5/16/2014	REVISED -		SCALE: NTS	SHEET NO. 1 OF 1 SHEETS STA. N/A TO STA. N/A		ILLINOIS FED. AII		

ENERGY COSTS TO:

ILLINOIS DEPARTMENT OF TRANSPORTATION 201 WEST CENTER COURT SCHAUMBURG, ILLINOIS 60196-1096

PHONE: (708) 235-2692

ENERGY SUPPLY CONTACT: ILYAS MOHIUDDIN

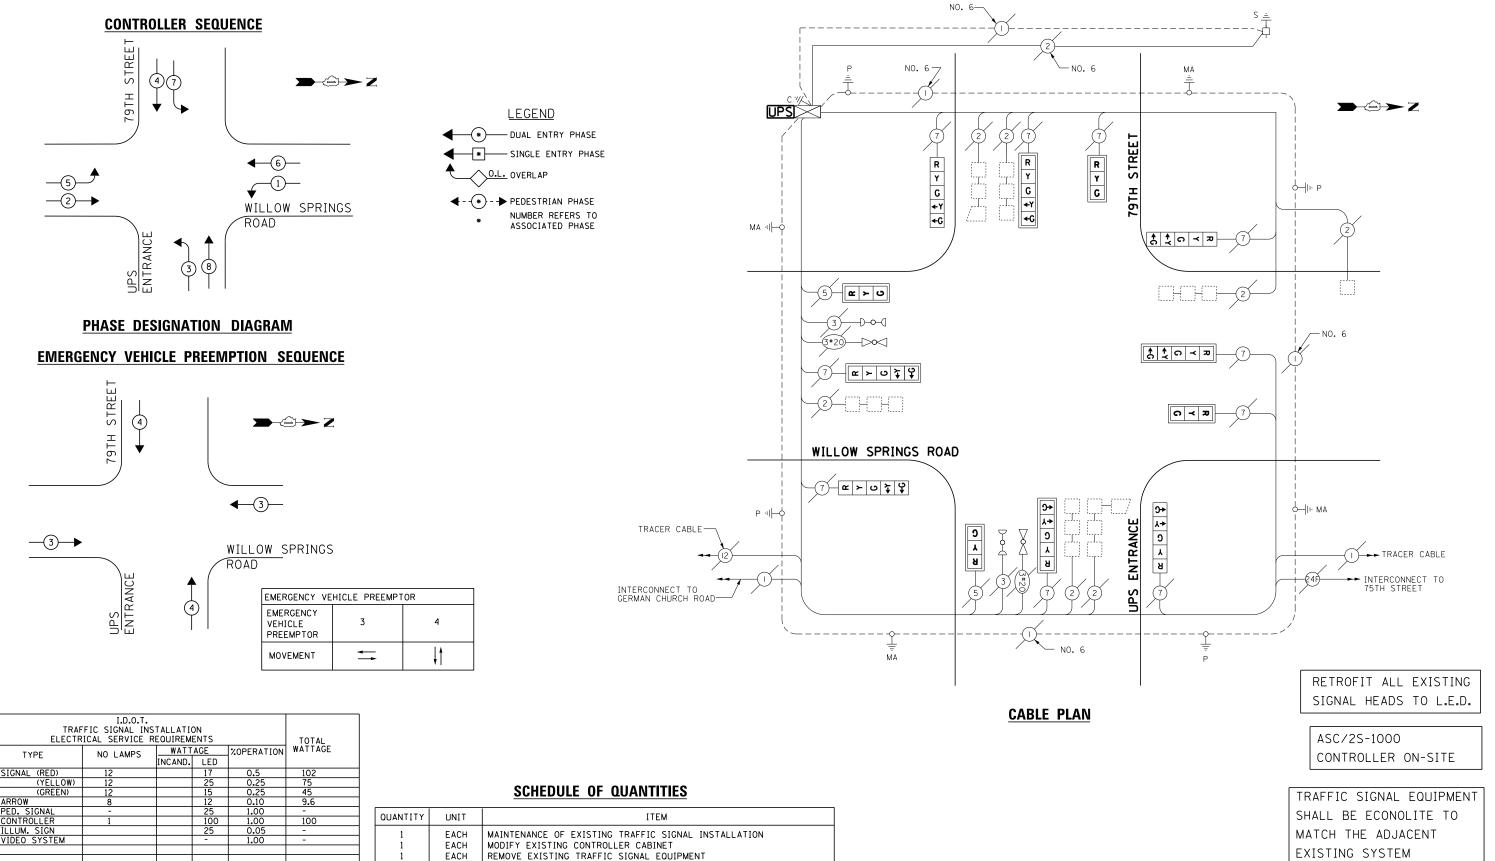

REMOVE EXISTING TRAFFIC SIGNAL EQUIPMENT UNINTERRUPTABLE POWER SUPPLY, SPECIAL EACH EACH SIGNAL HEAD, LED, 1-FACE, 3-SECTION, MAST ARM MOUNTED, RETROFIT SIGNAL HEAD, LED, 1-FACE, 5-SECTION, MAST ARM MOUNTED, RETROFIT SIGNAL HEAD, LED, 1-FACE, 5-SECTION, BRACKET MOUNTED, RETROFIT EACH


331.6

TOTAL =

TS# 3893 WILLOW SPRINGS

	MONWEALTH EDISON						WILLOW	7 51 111	1103
FILE NAME =	USER NAME = _USER_	DESIGNED - M.A./V.O.	REVISED -		SCHEDULE OF QUANTITIES, CABLE PLAN, PHASE DESIGNATION DIAGRAM, AND	F.A.P.	SECTION	COUNTY	TOTAL SHEET NO.
J:\13155\Work Order 2\DGN\CADD Sheets\D	160Y18-sht-ts-27_3893.dgn	DRAWN - Y.J./E.C.	REVISED -	STATE OF ILLINOIS	EMERGENCY VEHICLE PREEMPTION SEQUENCE		2014-032TS	соок	68 43
	PLOT SCALE = 20.0000 ' / in.	CHECKED - I.Y.	REVISED -	DEPARTMENT OF TRANSPORTATION	79TH STREET AT WILLOW SPRINGS ROAD				T NO. 60Y18
	PLOT DATE = 5/14/2014	DATE - 5/16/2014	REVISED -		SCALE: NTS SHEET NO. 1 OF 1 SHEETS STA. N/A TO STA. N/A		ILLINOIS FED.		



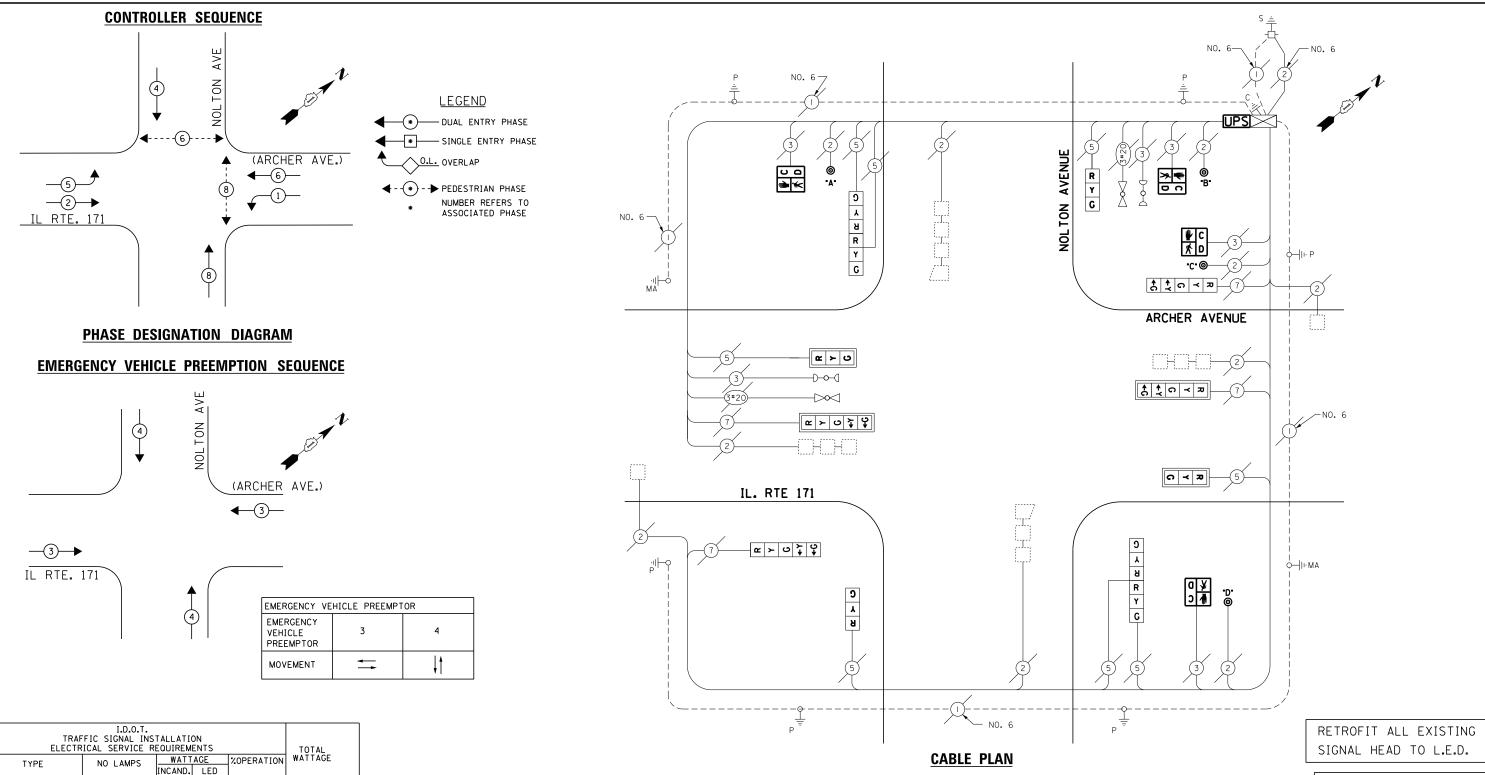

## NCAND. LED SIGNAL (RED) (YELLOW) (GREEN) LLUM. SIGN /IDEO SYSTEM 431.6 ENERGY COSTS TO: TOTAL = ILLINOIS DEPARTMENT OF TRANSPORTATION 201 WEST CENTER COURT SCHAUMBURG, ILLINOIS 60196-1096

ENERGY SUPPLY CONTACT: ILYAS MOHIUDDIN

PHONE: (708) 235-2692

### **SCHEDULE OF QUANTITIES**

QUANTITY	UNIT	ITEM
1	EACH	MAINTENANCE OF EXISTING TRAFFIC SIGNAL INSTALLATION
4	EACH	PEDESTRIAN SIGNAL HEAD, LED, 1-FACE, BRACKET MOUNTED WITH COUNTDOWN TIMER
4	EACH	PEDESTRIAN PUSH-BUTTON
1	EACH	MODIFY EXISTING CONTROLLER CABINET
1	EACH	REMOVE EXISTING TRAFFIC SIGNAL EQUIPMENT
1	EACH	UNINTERRUPTABLE POWER SUPPLY, SPECIAL
2	EACH	SIGNAL HEAD, LED, 1-FACE, 3-SECTION, BRACKET MOUNTED, RETROFIT
2	EACH	SIGNAL HEAD, LED, 1-FACE, 3-SECTION, MAST ARM MOUNTED, RETROFIT
2	EACH	SIGNAL HEAD, LED, 1-FACE, 5-SECTION, MAST ARM MOUNTED, RETROFIT
2	EACH	SIGNAL HEAD, LED, 2-FACE, 3-SECTION, BRACKET MOUNTED, RETROFIT
2	FACH	SIGNAL HEAD, LED. 1-FACE, 5-SECTION, BRACKET MOUNTED, RETROETT

## REMOVAL OF EXISTING TRAFFIC SIGNAL EQUIPMENT

THE FOLLOWING ITEMS SHALL BE REMOVED BY THE CONTRACTOR AND SHALL BE DISPOSED OF BY THEM OUTSIDE THE RIGHT-OF-WAY AT THEIR EXPENSE. THE SALVAGE VALUE OF THE REMOVED EQUIPMENT SHALL BE REFLECTED IN THE CONTACT BID PRICE.


4 EACH PEDESTRIAN SIGNAL HEAD 4 EACH PEDESTRIAN PUSH-BUTTON


ECONOLITE ASC/2S-1000 CONTROLLER ON-SITE

TRAFFIC SIGNAL EQUIPMENT SHALL BE ECONOLITE TO MATCH THE ADJACENT EXISTING SYSTEM

TS# 3572 WILLOW SPRINGS

COMPANY: COM	MONWEALTH EDISON				-			<u> </u>		
FILE NAME =	USER NAME = _USER_	DESIGNED - M.A./V.O.	REVISED -		SCHEDULE OF QUANTITIES, CABLE PLAN, PHASE DESIGNATION DIAGRAM, AND	F.A.P. S	SECTION	COUNTY	TOTAL S	SHEET NO.
J:\13155\Work Order 2\DGN\CADD Sheets\D	160Y18-sht-ts-28_3572.dgn	DRAWN - Y.J./E.C.	REVISED -	STATE OF ILLINOIS	EMERGENCY VEHICLE PREEMPTION SEQUENCE	20	14-032TS	соок	68	44
	PLOT SCALE = 20.0000 ' / in.	CHECKED - I.Y.	REVISED -	DEPARTMENT OF TRANSPORTATION	IL. RTE 171 (ARCHER AVENUE) AT NOLTON AVENUE			CONTRAC	T NO. 6	0Y18
	PLOT DATE = 5/14/2014	DATE - 5/16/2014	REVISED -		SCALE: NTS SHEET NO. 1 OF 1 SHEETS STA. N/A TO STA. N/A		ILLINOIS FED.			

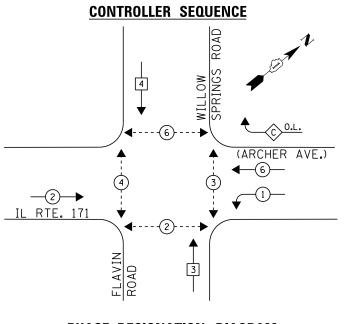

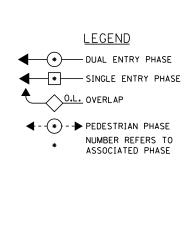

### PHASE DESIGNATION DIAGRAM

С

NOTE: PHASES 3 & 4 SHALL BE SINGLE ENTRY. SPLIT PHASING SHALL BE UTILIZED FOR WILLOW SPRINGS RD. AND FLAVIN RD.

RIGHT TURN OVERLAP PHASE DESIGNATION PROTECTED OVERLAP PERMISSIVE LETTER PHASE

PUSH BUTTON "D" PLACES A CALL IN PHASE 3

PHASE DESIGNATION DIAGRAM

PHASE		PHASE	
6	+	4	
			ļīII.
			i.,j
			-

			0 4 3	
<del>''</del>	IL. RTE 171		(ARCHER AVENUE)	
2 1 P	5	FLAVIN ROAD  (5)  (2)  (2)  (3)  (4)  (4)  (5)  (7)  (7)  (7)  (8)  (9)  (9)  (10)  (10)  3→ 3 8 R Y G	
NOTE:  PUSH BUTTON "A" PLACES A CALL IN PHASE 4  PUSH BUTTON "B" PLACES A CALL IN PHASE 4 & 6	`—————— <del>—</del> —————————————————————————————	NO. 6	<del>-</del>	
PUSH BUTTON "C" PLACES A CALL IN PHASE 6 & 3	· MA	140. 0		

NO. 6 7

R Y G

Y

**←**G

В В Р С С

œ ≻ ७ <del>१</del> ₺

ROAD

SPRINGS

WILLOW

I.D.O.T. TRAFFIC SIGNAL INSTALLATION	

	ICAL SERVICE R				TOTAL
TYPE	NO LAMPS	WATT	AGE	%OPERATION	WATTAGE
1112	NO LAWI 5	INCAND. LED			
SIGNAL (RED)	16		17	0.5	136
(YELLOW)	16		25	0.25	100
(GREEN)	16		15	0.25	60
ARROW	8		12	0.10	9.6
PED. SIGNAL	6		25	1.00	150
CONTROLLER	1		100	1.00	100
ILLUM. SIGN			25	0.05	-
VIDEO SYSTEM			-	1.00	ı
FLASHER				-	
ENERGY COSTS TO	0:			TOTAL =	555 <b>.</b> 6

ILLINOIS DEPARTMENT OF TRANSPORTATION 201 WEST CENTER COURT SCHAUMBURG, ILLINOIS 60196-1096

ENERGY SUPPLY CONTACT: ILYAS MOHIUDDIN

PHONE: (708) 235-2692 COMPANY: COMMONWEALTH EDISON

## **SCHEDULE OF QUANTITIES**

**UPS** 

.ı|⊢¢

QUANTITY	UNIT	ITEM
1	EACH	MAINTENANCE OF EXISTING TRAFFIC SIGNAL INSTALLATION
2	EACH	PEDESTRIAN SIGNAL HEAD, LED, 1-FACE, BRACKET MOUNTED WITH COUNTDOWN TIMER
2	EACH	PEDESTRIAN SIGNAL HEAD, LED, 2-FACE, BRACKET MOUNTED WITH COUNTDOWN TIMER
1	EACH	MODIFY EXISTING CONTROLLER CABINET
1	EACH	REMOVE EXISTING TRAFFIC SIGNAL EQUIPMENT
1	EACH	UNINTERRUPTABLE POWER SUPPLY, SPECIAL
2	EACH	SIGNAL HEAD, LED, 2-FACE, 1-3 SECTION, 1-4 SECTION, BRACKET MOUNTED, RETROFIT
1	EACH	SIGNAL HEAD, LED, 2-FACE, 1-3 SECTION, 1-5 SECTION, BRACKET MOUNTED, RETROFIT
5	EACH	SIGNAL HEAD, LED, 1-FACE, 3-SECTION, MAST ARM MOUNTED, RETROFIT
1	EACH	SIGNAL HEAD, LED, 1-FACE, 5-SECTION, MAST ARM MOUNTED, RETROFIT
1	EACH	SIGNAL HEAD, LED, 2-FACE, 3-SECTION, BRACKET MOUNTED, RETROFIT
2	EACH	SIGNAL HEAD, LED, 1-FACE, 4-SECTION, MAST ARM MOUNTED, RETROFIT
4	EACH	PEDESTRIAN PUSH-BUTTON, NON-LATCHING

### **CABLE PLAN**

### REMOVAL OF EXISTING TRAFFIC SIGNAL EQUIPMENT

THE FOLLOWING ITEMS SHALL BE REMOVED BY THE CONTRCTOR AND SHALL BE DISPOSED OF BY THEM OUTSIDE THE RIGHT-OF-WAY AT THEIR EXPENSE. THE SALVAGE VALUE OF THE REMOVED EQUIPMENT SHALL BE REFLECTED IN THE CONTRACT BID PRICE.

PEDESTRIAN SIGNAL HEAD EACH PEDESTRIAN PUSH-BUTTON RETROFIT ALL EXISTING SIGNAL HEADS TO L.E.D.


ECONOLITE ASC/2000 CONTROLLER ON-SITE

TRAFFIC SIGNAL EQUIPMENT SHALL BE ECONOLITE TO MATCH THE ADJACENT EXISTING SYSTEM

> TS# 3570 WILLOW SPRINGS

FILE NAME =	USER NAME = _USER_	DESIGNED - M.A./V.O.	REVISED -		SCHEDULE C	OF QUANTITIES, CABLE PLAN, PHAS	SE DESIGNATION DIAGRAM, AND	F.A.P.	SECTION	COUNTY	TOTAL	SHEET NO.
J:\13155\Work Order 2\DGN\CADD Sheets\	0160Y18-sht-ts-29_3570.dgn	DRAWN - Y.J./E.C.	REVISED -	STATE OF ILLINOIS		EMERGENCY VEHICLE PREEMP			2014-032TS	СООК	68	45
	PLOT SCALE = 20.0000 '/ in.	CHECKED - I.Y.	REVISED -	DEPARTMENT OF TRANSPORTATION	IL. RTE 171 (ARCHER AVENUE) AT WILLOW SPRINGS ROAD/FLAVIN		SPRINGS ROAD/FLAVIN ROAD			CONTRAC	T NO. F	0Y18
	PLOT DATE = 5/14/2014	DATE - 5/16/2014	REVISED -		SCALE: NTS	SHEET NO. 1 OF 1 SHEETS S	STA. N/A TO STA. N/A		ILLINOIS FED. AII	PROJECT		

### **CONTROLLER SEQUENCE**

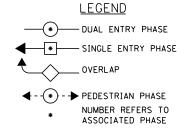

## (B) 4 **←**6 **-2** WILLOW SPRINGS ROAD

PHASE DESIGNATION DIAGRAM


**EMERGENCY VEHICLE PREEMPTION SEQUENCE** 

### RIGHT TURN OVERLAP PHASE DESIGNATION OVERLAP PERMISSIVE PROTECTED LETTER PHASE PHASE

### FIRE PREEMPTION SEQUENCE OF OPERATION

INTERVAL FROM NORMAL SEQUENCE OF OPERATION	1	-	4		5	EMERGENC VEHICLE INTERVAL
PIRE PREEMPTION INTERVAL	IA	18	10	10	IE	2
ОНДМЕЕ ТО	2	ıc	2	IE	2	0
WILLOW SPRINGS RD. NORTHBOUND FAR LEFT AND SUPPLEMENTARY FAR LEFT SIGNALS	-6-	r	R	R	R	G -G−
WILLOW SPRINGS RO. NORTHBOUND FAR RIGHT SIGNAL	6	Y	R	R	R	G
WILLOW SPRINGS RD. SOUTHBOUND SIGNALS	R	Y	R	R	R	R
GERMAN CHURCH RO EASTBOUND NEAR RIGHT AND FAR RIGHT SIGNALS	P -Y-	R	R	r	R	R
GERMAN CHURCH RD. EASTBOUND FAR LEFT SIGNAL	R	R	R	r	R	R
TIME - SECONDS-ADJUSTABLE	1.30	1-30	1-30	1-30	1-30	1-120


FIRE PREEMPTION SEQUENCE SHALL PROVIDE FOR THE PROPER CLEARANCE INTERVAL TO RESUME THE NORMAL SEQUENCE OF OPERATION (PHASE 2)

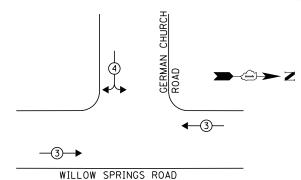

REPLACE 14FT, PAINTED POST, RE-USE EXISTING FOUNDATION

REPLACE 16FT, PAINTED POST, RE-USE EXISTING FOUNDATION

EMERGENCY VE	HICLE PREEMPT	OR
EMERGENCY VEHICLE PREEMPTOR	3	4
MOVEMENT	+	

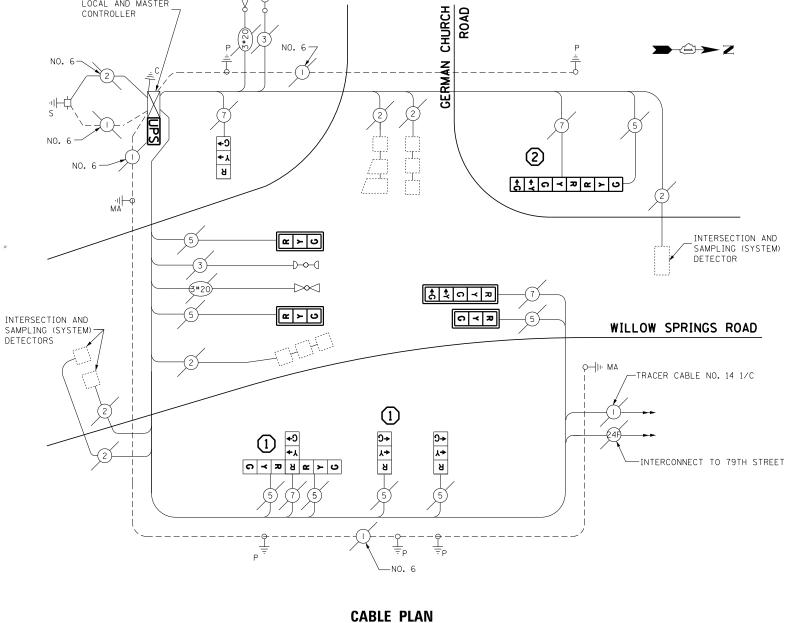

	TRAFFIC SIGNAL INSTALLATION ELECTRICAL SERVICE REQUIREMENTS											
TYPE	NO LAMPS	WATT	AGE	%OPERATION	WATTAGE							
1 '''-	THE EAST S	INCAND.	LED									
SIGNAL (RED)	12		17	0.5	102							
(YELLOW)	12		25	0.25	75							
(GREEN)	12		15	0.25	45							
ARROW	4		12	0.10	4.8							
PED. SIGNAL	-		25	1.00	-							
CONTROLLER	1		100	1.00	100							
ILLUM. SIGN			25	0.05	-							
VIDEO SYSTEM				1.00	1							

326.8

ENERGY COSTS TO: ILLINOIS DEPARTMENT OF TRANSPORTATION 201 WEST CENTER COURT SCHAUMBURG, ILLINOIS 60196-1096

ENERGY SUPPLY CONTACT: ILYAS MOHIUDDIN

PHONE: (708) 235-2692 COMPANY: COMMONWEALTH EDISON

### SCHEDULE OF QUANTITIES

QUANTITY	UNIT	ITEM
1	EACH	MAINTENANCE OF EXISTING TRAFFIC SIGNAL INSTALLATION
2	EACH	TRAFFIC SIGNAL POST, GALVANIZED STEEL 14 FT.
1	EACH	TRAFFIC SIGNAL POST, GALVANIZED STEEL 16 FT.
3	EACH	SIGNAL HEAD, LED, 1-FACE, 3-SECTION, BRACKET MOUNTED
3	EACH	SIGNAL HEAD, LED, 1-FACE, 3-SECTION, MAST-ARM MOUNTED
1	EACH	SIGNAL HEAD, LED, 1-FACE, 5-SECTION, MAST-ARM MOUNTED
1	EACH	SIGNAL HEAD, LED, 2-FACE, 1-3 SECTION, 1-5 SECTION, BRACKET MOUNTED
1	EACH	SIGNAL HEAD, LED, 3-FACE, 3-SECTION, BRACKET MOUNTED
4	EACH	TRAFFIC SIGNAL BACKPLATE, LOUVERED, ALUMINUM
4	EACH	RELOCATE EXISTING SIGNAL HEAD
1	EACH	MODIFY EXISTING CONTROLLER CABINET
1	EACH	REMOVE EXISTING TRAFFIC SIGNAL EQUIPMENT
2	EACH	REMOVE AND REPLACE ANCHOR BOLTS
1	EACH	UNINTERRUPTABLE POWER SUPPLY, SPECIAL

### REMOVAL OF EXISTING TRAFFIC SIGNAL EQUIPMENT

THE FOLLOWING ITEMS SHALL BE REMOVED BY THE CONTRCTOR AND SHALL BE DISPOSED OF BY THEM OUTSIDE THE RIGHT-OF-WAY AT THEIR EXPENSE. THE SALVAGE VALUE OF THE REMOVED EQUIPMENT SHALL BE REFLECTED IN THE CONTRACT BID PRICE.

SIGNAL HEAD, 3-SECTION SIGNAL HEAD, 5-SECTION EACH EACH TRAFFIC SIGNAL POST EACH TRAFFIC SIGNAL BACKPLATE ECONOLITE ASC/2S-1000 & ASC/2M-1000 CONTROLLERS ON-SITE


TRAFFIC SIGNAL EQUIPMENT SHALL BE ECONOLITE TO MATCH THE ADJACENT EXISTING SYSTEM

> TS# 3573 WILLOW SPRINGS

FILE NAME =	USER NAME = _USER_	DESIGNED - M.A./V.O.	REVISED -		SCHEDULE OF QUANTITIES, CABLE PLAN, PHASE DESIGNATION DIAGRAM, AND EMERGENCY VEHICLE PREEMPTION SEQUENCE WILLOW SPRINGS ROAD AT GERMAN CHURCH ROAD		SECTION C	OUNTY TOTA	AL SHEET
J:\13155\Work Order 2\DGN\CADD Sheets\D	160Y18-sht-ts-30_3573.dgn	DRAWN - Y.J./E.C.	REVISED -	STATE OF ILLINOIS			2014-032TS	СООК 68	46
	PLOT SCALE = 20.00000 '/ 10.	CHECKED - I.Y.	REVISED -	DEPARTMENT OF TRANSPORTATION			CONTRACT NO. 60Y18		
	PLOT DATE = 5/14/2014	DATE - 5/16/2014	REVISED -		SCALE: NTS SHEET NO. 1 OF 1 SHEETS STA. N/A TO STA. N/A		ILLINOIS FED. AID PR	OJECT	

LOCAL AND MASTER



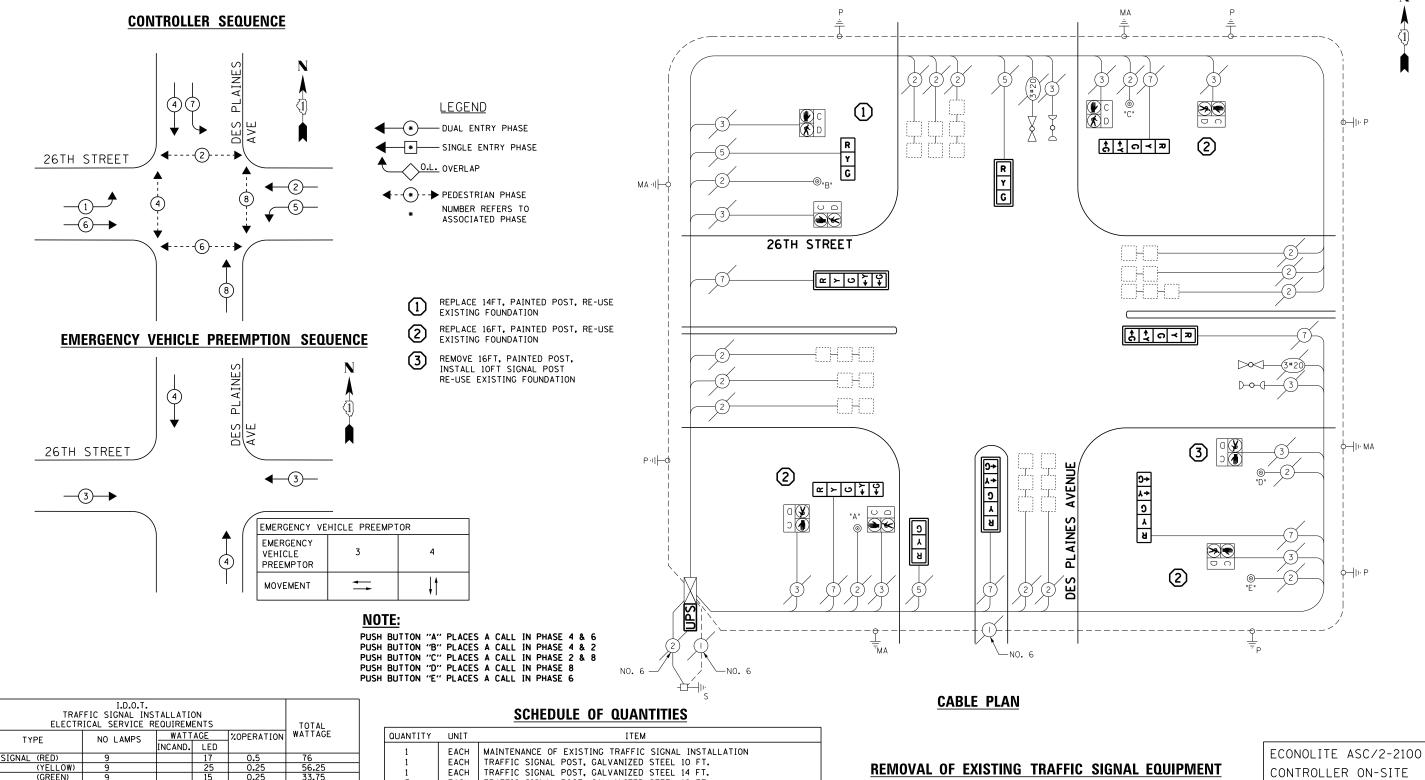

	FFIC SIGNAL INS RICAL SERVICE R				TOTAL		
TYPE	NO LAMPS	WATT	WATTAGE %		WATTAGE		
11112	NO EANS	INCAND.	LED				
SIGNAL (RED)	9		17	0.5	76		
(YELLOW)	9		25	0.25	56.25		
(GREEN)	9		15	0.25	33.75		
ARROW	12		12	0.10	14.4		
PED. SIGNAL	8		25	1.00	200		
CONTROLLER	1		100	1.00	100		
ILLUM. SIGN			25	0.05	-		
VIDEO SYSTEM			1	1.00	1		
FLASHER				-			
ENERGY COSTS T	0:			TOTAL =	480.9		
I THE THOUSE DE	DADTMENT OF TE	VICTOD.	TATION				

ILLINOIS DEPARTMENT OF TRANSPORTATION 201 WEST CENTER COURT SCHAUMBURG, ILLINOIS 60196-1096

ENERGY SUPPLY CONTACT: JOE STACHO

CONTACT: JOE STACHO
PHONE: (630) 424-5704
COMPANY: COMMONWEALTH EDISON

QUANTITY	UNIT	ITEM
1	EACH	MAINTENANCE OF EXISTING TRAFFIC SIGNAL INSTALLATION
1	EACH	TRAFFIC SIGNAL POST, GALVANIZED STEEL 10 FT.
1	EACH	TRAFFIC SIGNAL POST, GALVANIZED STEEL 14 FT.
3	EACH	TRAFFIC SIGNAL POST, GALVANIZED STEEL 16 FT.
2	EACH	SIGNAL HEAD, LED, 1-FACE, 3-SECTION, MAST-ARM MOUNTED
1	EACH	SIGNAL HEAD, LED, 1-FACE, 3-SECTION, BRACKET MOUNTED
3	EACH	SIGNAL HEAD, LED, 1-FACE, 5-SECTION, BRACKET MOUNTED
3	EACH	SIGNAL HEAD, LED, 1-FACE, 5-SECTION, MAST-ARM MOUNTED
5	EACH	TRAFFIC SIGNAL BACKPLATE, LOUVERED, ALUMINUM
8	EACH	RELOCATE EXISTING PEDESTRIAN SIGNAL HEAD
4	EACH	RELOCATE EXISTING PEDESTRIAN PUSH-BUTTON
1	EACH	MODIFY EXISTING CONTROLLER CABINET
1	EACH	REMOVE EXISTING TRAFFIC SIGNAL EQUIPMENT
3	EACH	REMOVE AND REPLACE ANCHOR BOLTS
1	EACH	UNINTERRUPTABLE POWER SUPPLY, SPECIAL

THE FOLLOWING ITEMS SHALL BE REMOVED BY THE CONTRCTOR AND SHALL BE DISPOSED OF BY THEM OUTSIDE THE RIGHT-OF-WAY AT THEIR EXPENSE. THE SALVAGE VALUE OF THE REMOVED EQUIPMENT SHALL BE REFLECTED IN THE CONTRACT BID PRICE.

5 EACH TRAFFIC SIGNAL POST
3 EACH SIGNAL HEAD, 3-SECTION
6 EACH SIGNAL HEAD, 5-SECTION
5 EACH TRAFFIC SIGNAL BACKPLATE

TRAFFIC SIGNAL EQUIPMENT
SHALL BE ECONOLITE TO
MATCH THE ADJACENT
EXISTING SYSTEM

TS# 3735 NORTH RIVERSIDE

	COM ANT CON	INIOITILAL III EDISOIT									
FILE NAME =		USER NAME = _USER_	DESIGNED - M.A./V.O.	REVISED -		SCHEDULE OF QUANTITIES, CABLE PLAN, PHASE DESIGNATION DIAGRAM, AND	F.A.P.	SECTION COUN	NTY TOTA	AL SHE	ĒΕΤ
J:\13155\Work Ord	rder 2\DGN\CADD Sheets\D	160Y18-sht-ts-31_3735.dgn	DRAWN - Y.J./E.C.	REVISED -	STATE OF ILLINOIS	EMERGENCY VECHILE PREEMPTION SEQUENCE		2014-032TS COC		3 4	<del>5.</del> 47
		PLOT SCALE = 20.0000 '/ in.	CHECKED - I.Y.	REVISED -	DEPARTMENT OF TRANSPORTATION	DES PLAINES AVENUE AT 26TH STREET			TRACT NO.	. 60Y	18
		PLOT DATE = 5/14/2014	DATE - 5/16/2014	REVISED -		SCALE: NTS SHEET NO. 1 OF 1 SHEETS STA. N/A TO STA. N/A		ILLINOIS FED. AID PROJEC	;T		



LOT SCALE = 20.0000 '/ in.

PLOT DATE = 5/14/2014

CHECKED


DATE

I.Y.

5/16/2014

REVISED

REVISED

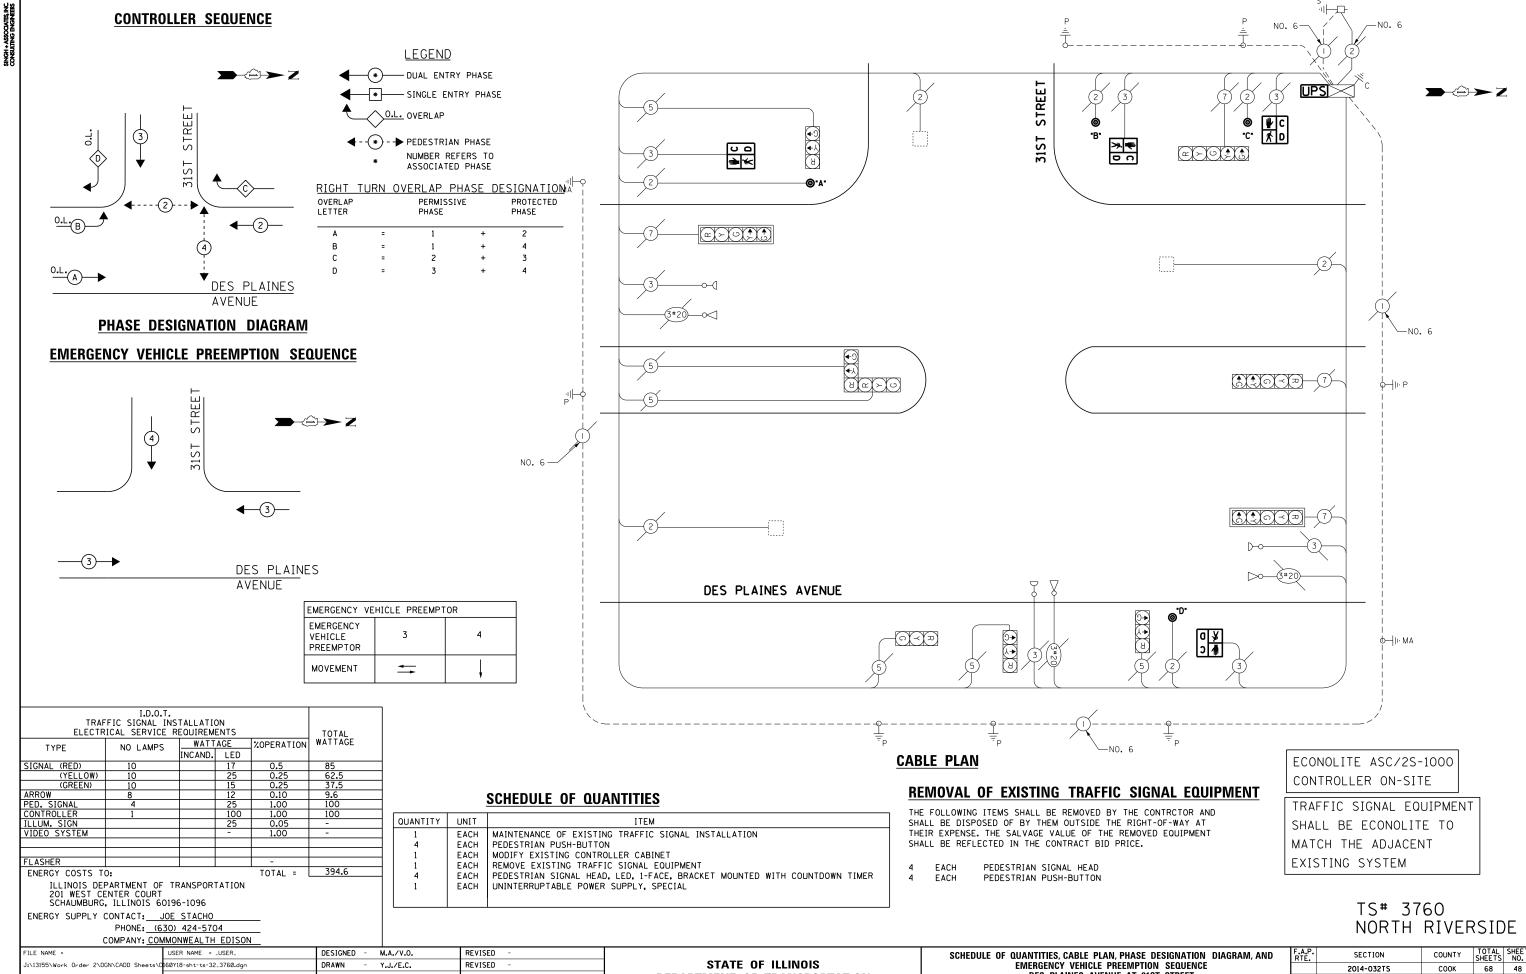

**DEPARTMENT OF TRANSPORTATION** 


DES PLAINES AVENUE AT 31ST STREET


SHEET NO. 1 OF 1 SHEETS STA. N/A

SCALE: NTS

CONTRACT NO. 60Y18



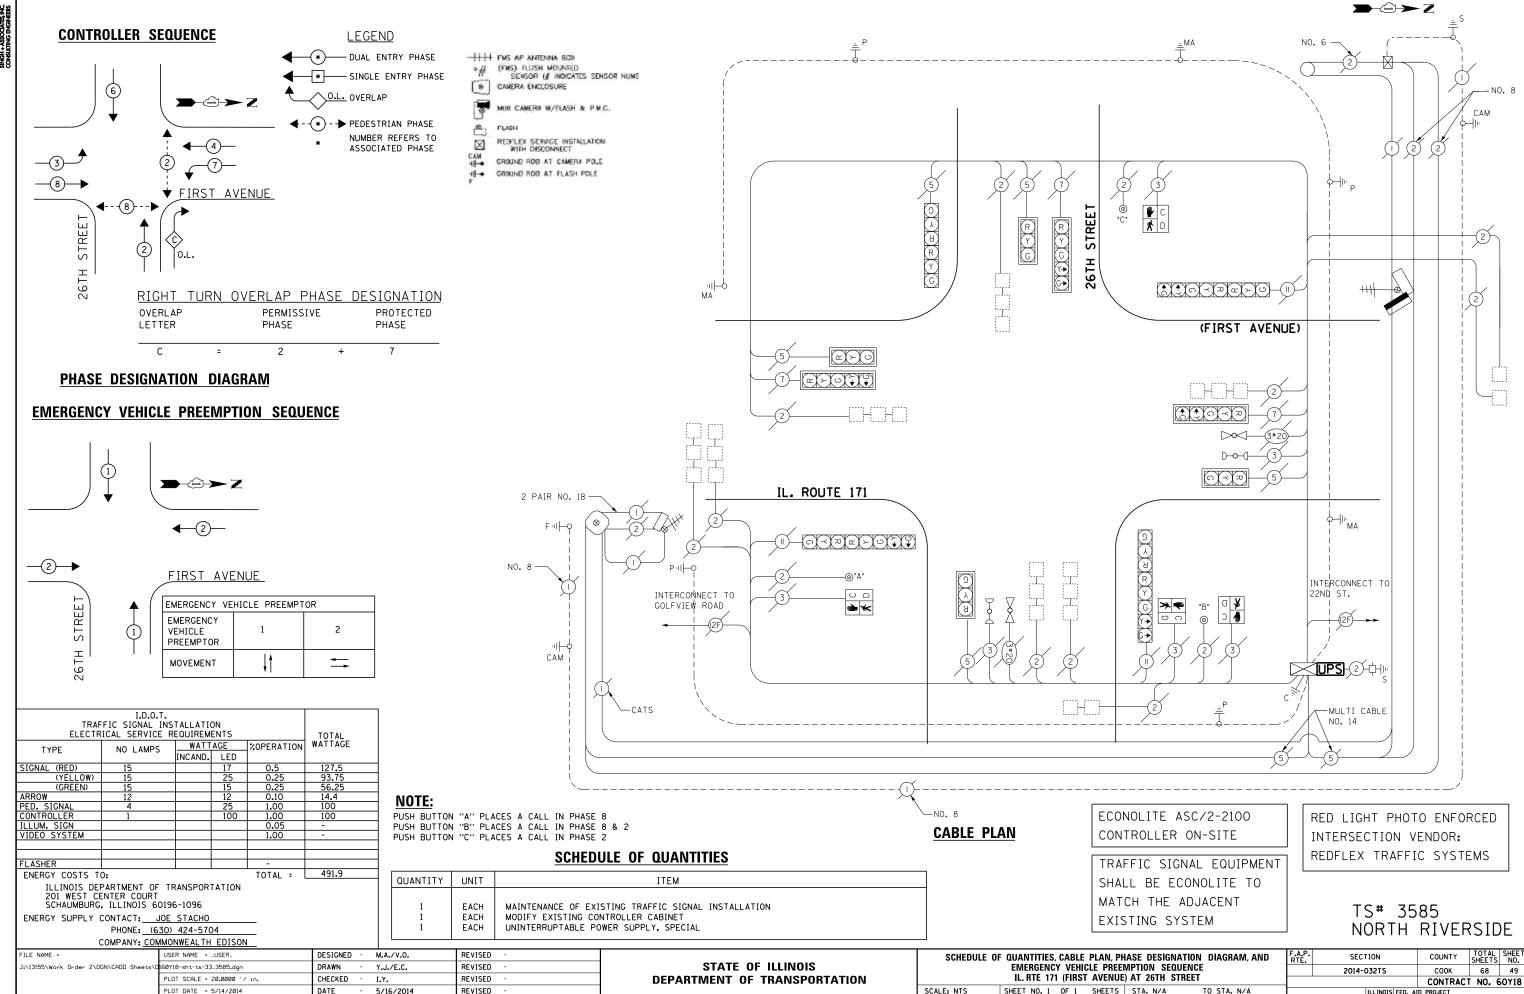

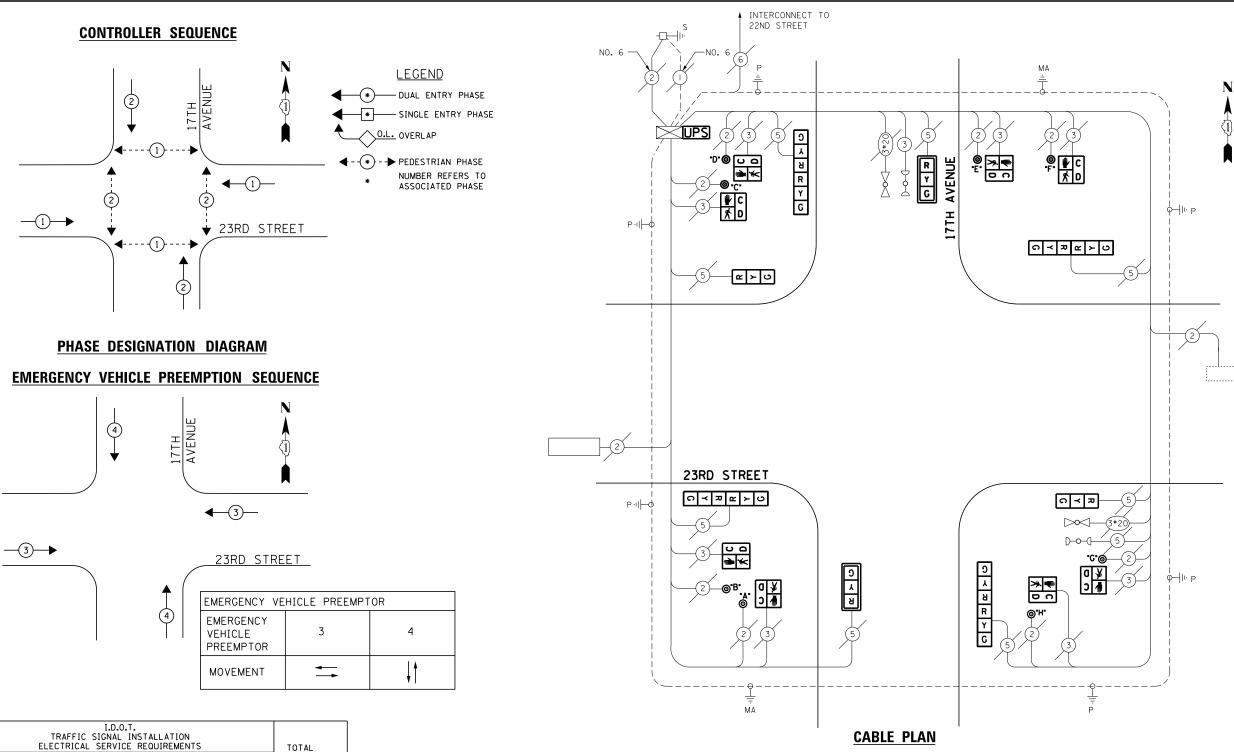

## WATTAGE CAND. LED COPERATION WATTAGE TYPE NCAND. LED SIGNAL (RED) (YELLOW) (GREEN) LLUM. SIGN /IDEO SYSTEM

522

TOTAL =

ENERGY COSTS TO: ILLINOIS DEPARTMENT OF TRANSPORTATION 201 WEST CENTER COURT SCHAUMBURG, ILLINOIS 60196-1096

ENERGY SUPPLY CONTACT: <u>JOE STACHO</u> PHONE: (630) 424-5704 **SCHEDULE OF QUANTITIES** 

QUANTITY	UNIT	ITEM
1	EACH	MAINTENANCE OF EXISTING TRAFFIC SIGNAL INSTALLATION
2	EACH	SIGNAL HEAD, LED, 1-FACE, 3-SECTION, MAST ARM MOUNTED
2	EACH	SIGNAL HEAD, LED, 1-FACE, 3-SECTION, BRACKET MOUNTED
4	EACH	SIGNAL HEAD, LED, 2-FACE, 3-SECTION, BRACKET MOUNTED
8	EACH	PEDESTRIAN SIGNAL HEAD, LED, 1-FACE, BRACKET MOUNTED WITH COUNTDOWN TIMER
2	EACH	TRAFFIC SIGNAL BACKPLATE, LOUVERED, ALUMINUM
8	EACH	PEDESTRIAN PUSH-BUTTON
1	EACH	MODIFY EXISTING CONTROLLER CABINET
1	EACH	REMOVE EXISTING TRAFFIC SIGNAL EQUIPMENT
1	EACH	UNINTERRUPTABLE POWER SUPPLY, SPECIAL

### REMOVAL OF EXISTING TRAFFIC SIGNAL EQUIPMENT

THE FOLLOWING ITEMS SHALL BE REMOVED BY THE CONTRACTOR AND SHALL BE DISPOSED OF BY THEM OUTSIDE THE RIGHT-OF-WAY AT THEIR EXPENSE. THE SALVAGE VALUE OF THE REMOVED EQUIPMENT SHALL BE REFLECTED IN THE CONTACT BID PRICE.

- PEDESTRIAN SIGNAL HEAD FACH PEDESTRIAN PUSH-BUTTON FACH
- EACH SIGNAL HEAD, 1-FACE, 3-SECTION EACH SIGNAL HEAD, 2-FACE, 3-SECTION
- TRAFFIC SIGNAL BACKPLATE

ECONOLITE ASC/2-2000 CONTROLLER ON-SITE

TRAFFIC SIGNAL EQUIPMENT SHALL BE ECONOLITE TO MATCH THE ADJACENT EXISTING SYSTEM

> TS# 22121 NORTH RIVERSIDE

COMPANY: COM	MONWEALTH EDISON							.,,,,,,,,,,,,,,,,,,,,,,,,,,,,,,,,,,,,,,		.010_	
FILE NAME =	USER NAME = _USER_	DESIGNED - M.A./V.O.	REVISED -		SCHEDULE OF	F QUANTITIES, CABLE PLAN, PHASE DESIGNATION DIAGRAM, AND	F.A.P.	SECTION	COUNTY	TOTAL SHEE	ĒΠ
J:\13155\Work Order 2\DGN\CADD Sheets\C	160Y18-sht-ts-34_22121.dgn	DRAWN - Y.J./E.C.	REVISED -	STATE OF ILLINOIS		EMERGENCY VEHICLE PREEMPTION SEQUENCE		2014-032TS	соок	68 50	<u>;</u>
	PLOT SCALE = 20.0000 ' / in.	CHECKED - I.Y.	REVISED -	DEPARTMENT OF TRANSPORTATION		17TH AVENUE AT 23RD STREET				T NO. 60Y18	8
	PLOT DATE = 5/14/2014	DATE - 5/16/2014	REVISED -		SCALE: NTS	SHEET NO. 1 OF 1 SHEETS STA. N/A TO STA. N/A		ILLINOIS FED. A			



LOT SCALE = 20.0000 '/ in.

PLOT DATE = 5/14/2014

CHECKED


DATE

I.Y.

5/16/2014

REVISED

REVISED

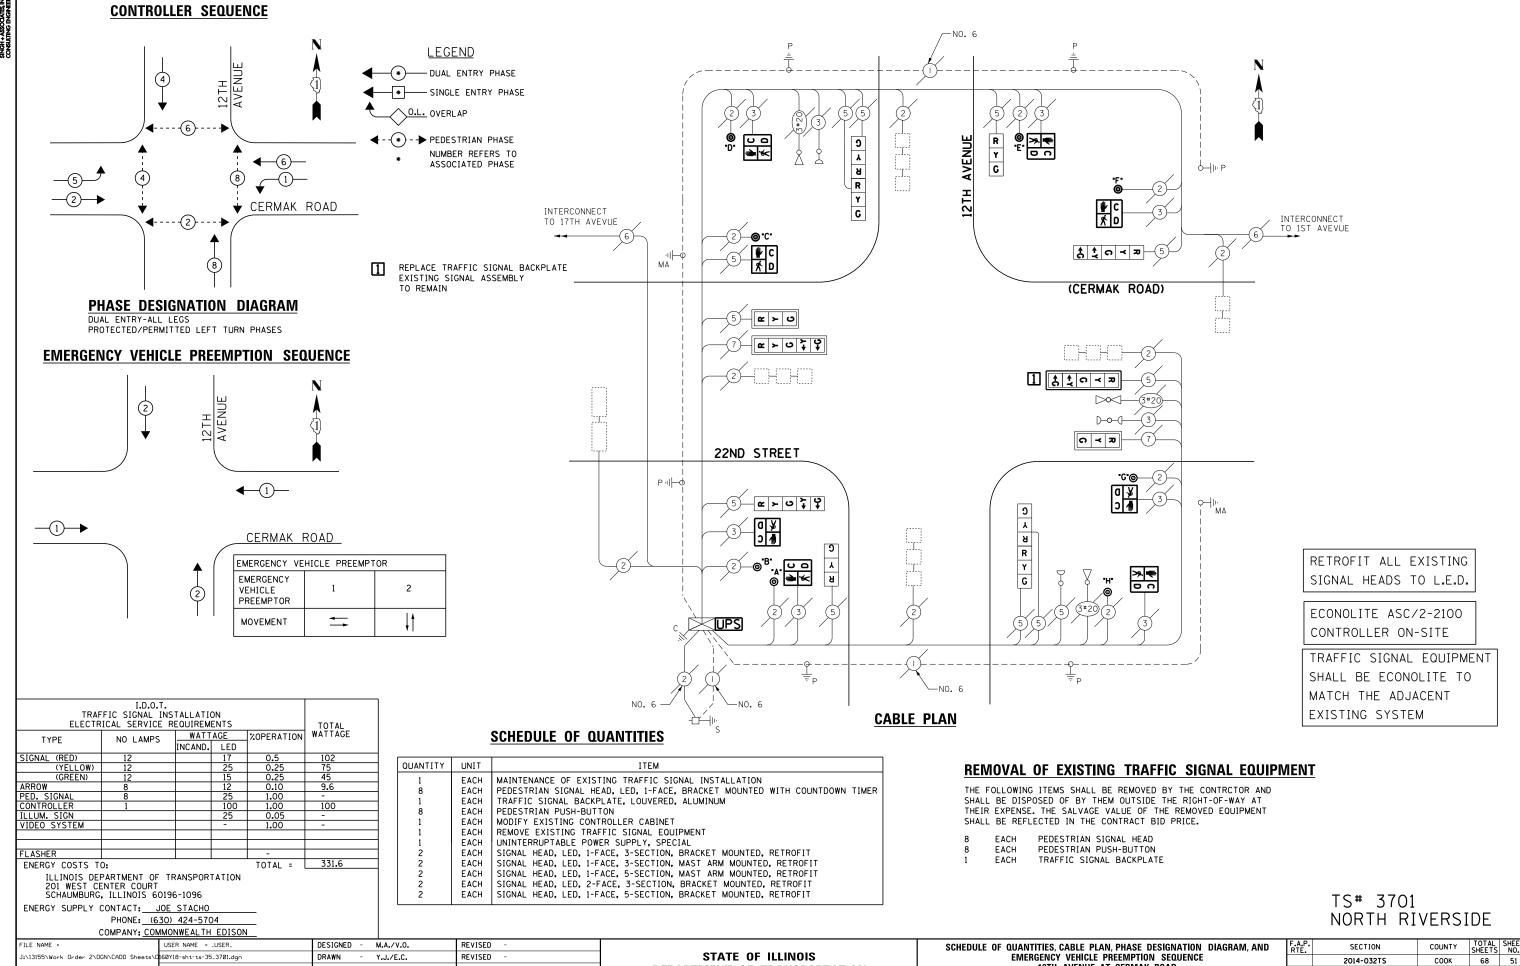

**DEPARTMENT OF TRANSPORTATION** 

12TH AVENUE AT CERMAK ROAD

TO STA. N/A

SHEET NO. 1 OF 1 SHEETS STA. N/A

SCALE: NTS

CONTRACT NO. 60Y18




DATE


5/16/2014

PLOT DATE = 5/14/2014

REVISED

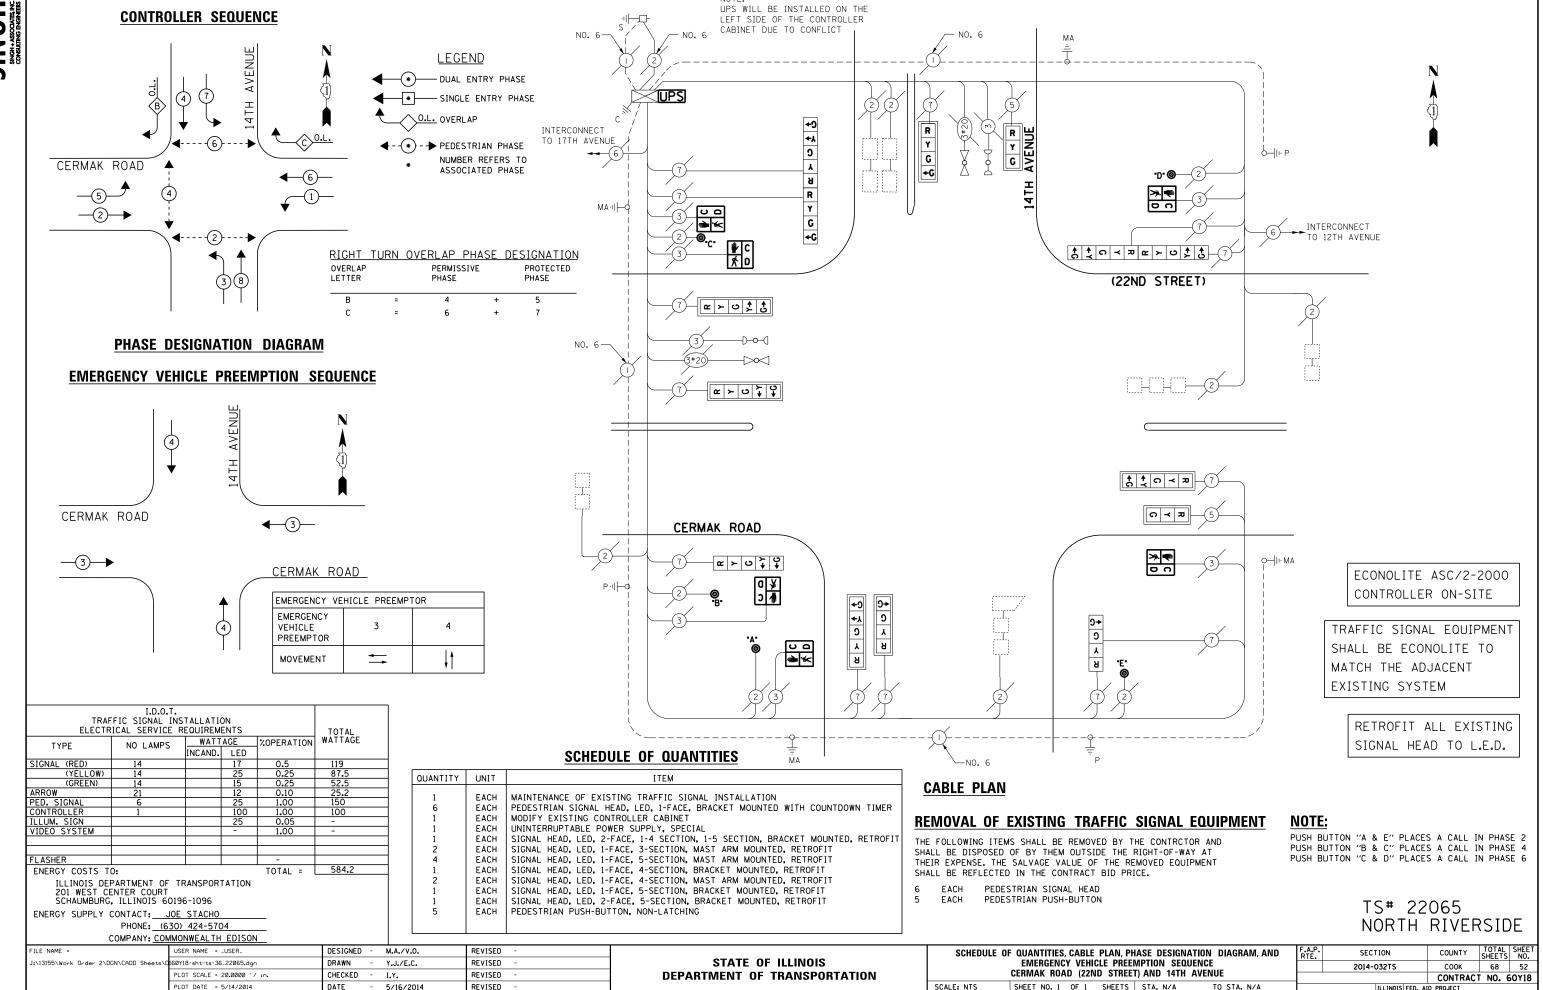



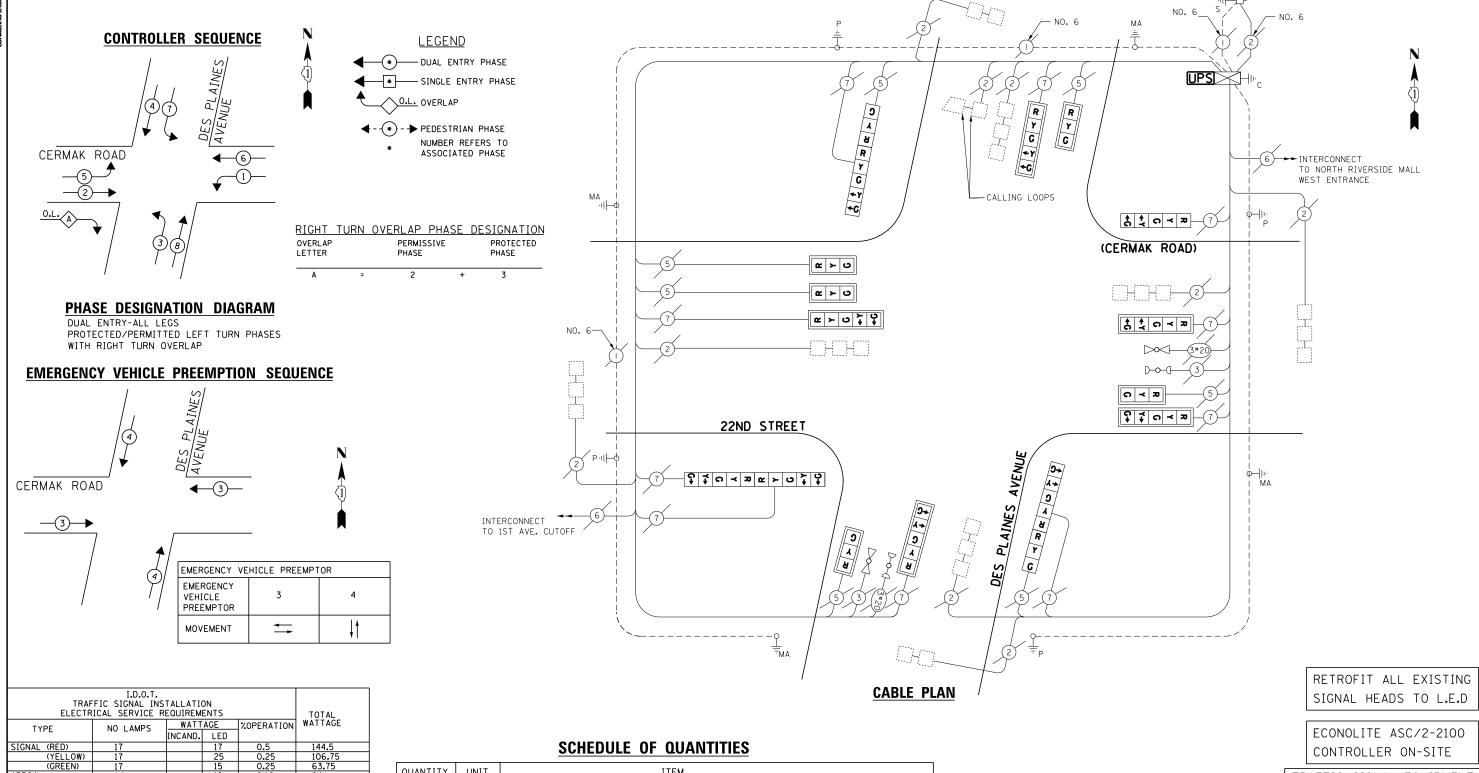

438.5 ENERGY COSTS TO: TOTAL =

ILLINOIS DEPARTMENT OF TRANSPORTATION 201 WEST CENTER COURT SCHAUMBURG, ILLINOIS 60196-1096


ENERGY SUPPLY CONTACT: <u>JOE STACHO</u> PHONE: (630) 424-5704 QUANTITY UNIT MAINTENANCE OF EXISTING TRAFFIC SIGNAL INSTALLATION EACH MODIFY EXISTING CONTROLLER CABINET UNINTERRUPTABLE POWER SUPPLY, SPECIAL EACH SIGNAL HEAD, LED, 2-FACE, 1-3 SECTION, 1-5 SECTION, BRACKET MOUNTED, RETROFIT EACH SIGNAL HEAD, LED, 1-FACE, 3-SECTION, MAST ARM MOUNTED, RETROFIT SIGNAL HEAD, LED, 1-FACE, 5-SECTION, MAST ARM MOUNTED, RETROFIT SIGNAL HEAD, LED, 1-FACE, 5-SECTION, BRACKET MOUNTED, RETROFIT SIGNAL HEAD, LED, 2-FACE, 5-SECTION, BRACKET MOUNTED, RETROFIT

TRAFFIC SIGNAL EQUIPMENT SHALL BE ECONOLITE TO MATCH THE ADJACENT EXISTING SYSTEM


> TS# 4800 NORTH RIVERSIDE

COMPANY: COI	MMONWEALTH EDISON					. , ,			
FILE NAME =	USER NAME = _USER_	DESIGNED - M.A./V.O.	REVISED -		SCHEDULE OF QUANTITIES, CABLE PLAN, PHASE DESIGNATION DIAGRAM, AND	F.A.P. SE	CTION COUNTY	TOTAL SHEET NO.	
J:\13155\Work Order 2\DGN\CADD Sheets\0	160Y18-sht-ts-37_4800.dgn	DRAWN - Y.J./E.C.	REVISED -	STATE OF ILLINOIS	EMERGENCY VEHICLE PREEMPTION SEQUENCE	2014	-032TS COOK	68 53	
	PLOT SCALE = 20.0000 ' / in.	CHECKED - I.Y.	REVISED -	DEPARTMENT OF TRANSPORTATION	CERMAK ROAD AT DES PLAINES RIVER ROAD		CONTRACT NO. 60		
	PLOT DATE = 5/14/2014	DATE - 5/16/2014	REVISED -		SCALE: NTS SHEET NO. 1 OF 1 SHEETS STA. N/A TO STA. N/A		ILLINOIS FED. AID PROJECT		



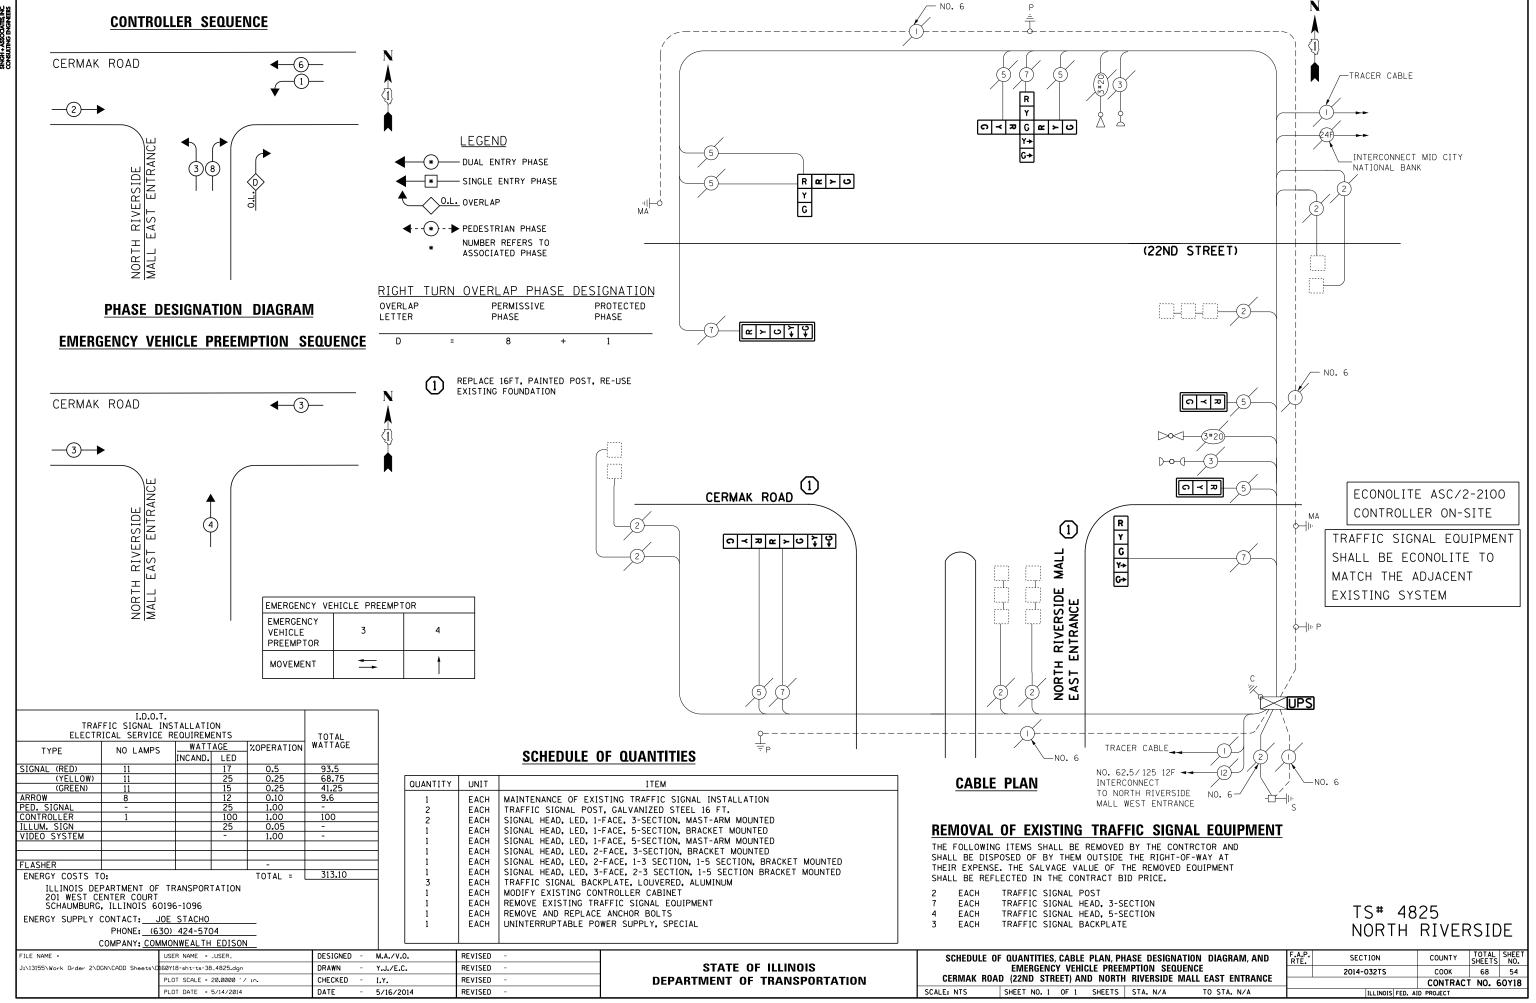



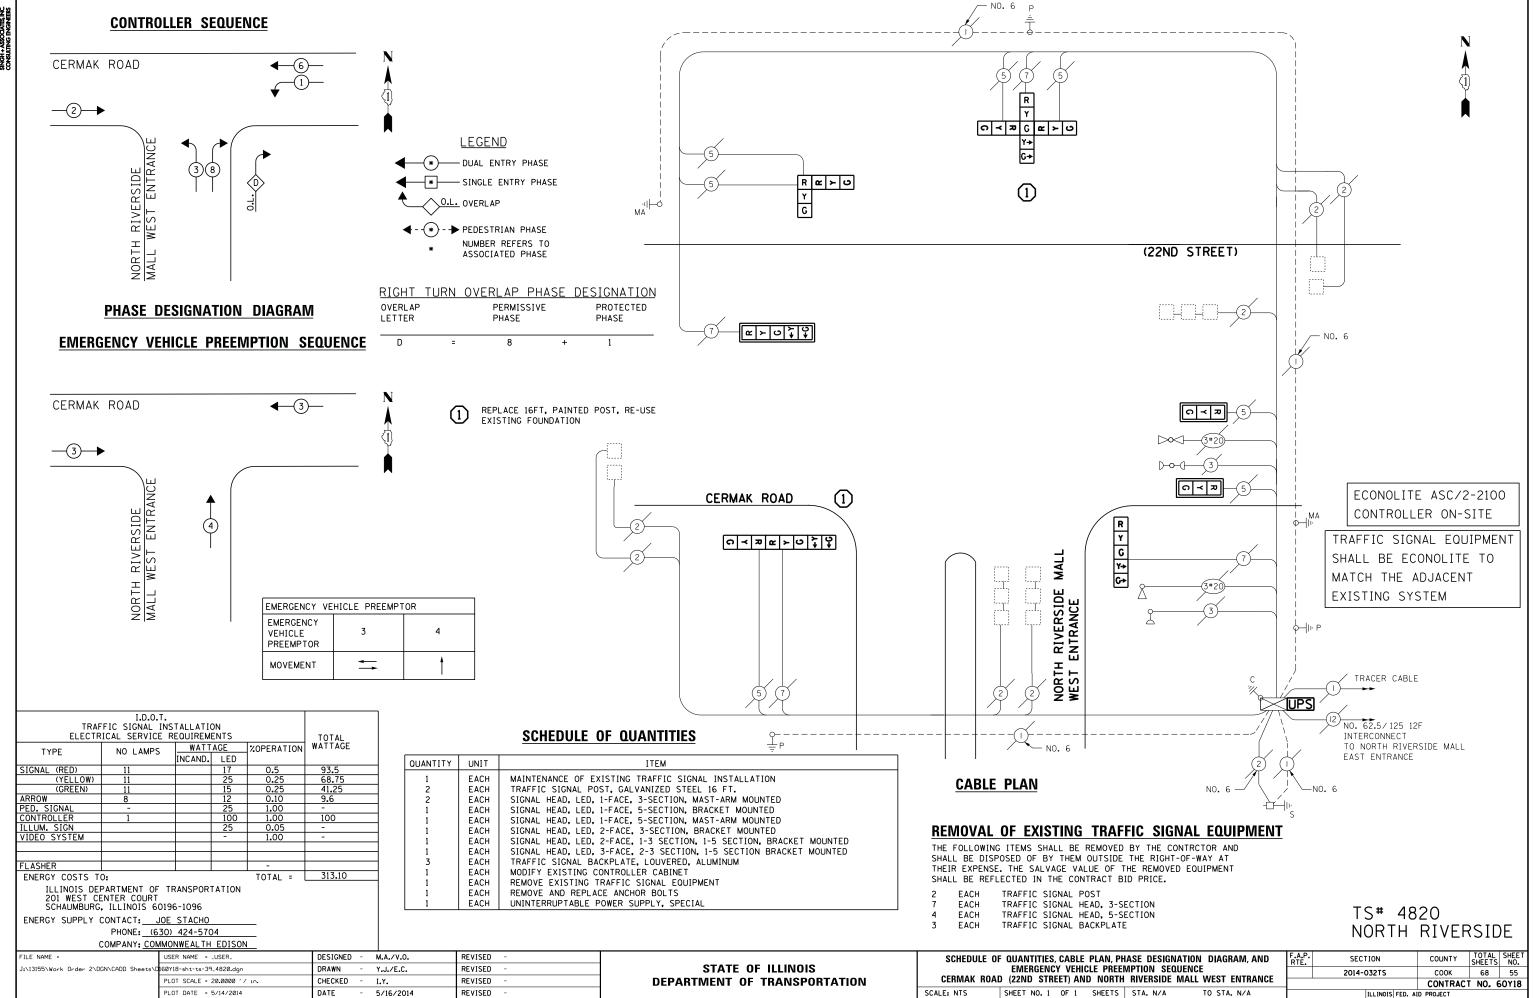



ENERGY COSTS TO:

J:\13155\Work Order 2\DGN\CADD Sheet

ILLINOIS DEPARTMENT OF TRANSPORTATION

PHONE: (630) 424-5704

COMPANY: COMMONWEALTH EDISON

USER NAME = _USER.

PLOT DATE = 6/3/2014

sion 1\D160Y18-sht-ts-40_9360_rev1.dar

201 WEST CENTER COURT SCHAUMBURG, ILLINOIS 60196-1096

ENERGY SUPPLY CONTACT: <u>JOE STACHO</u>

TOTAL =


DESIGNED -

I.Y.

DRAWN

DATE

CHECKED

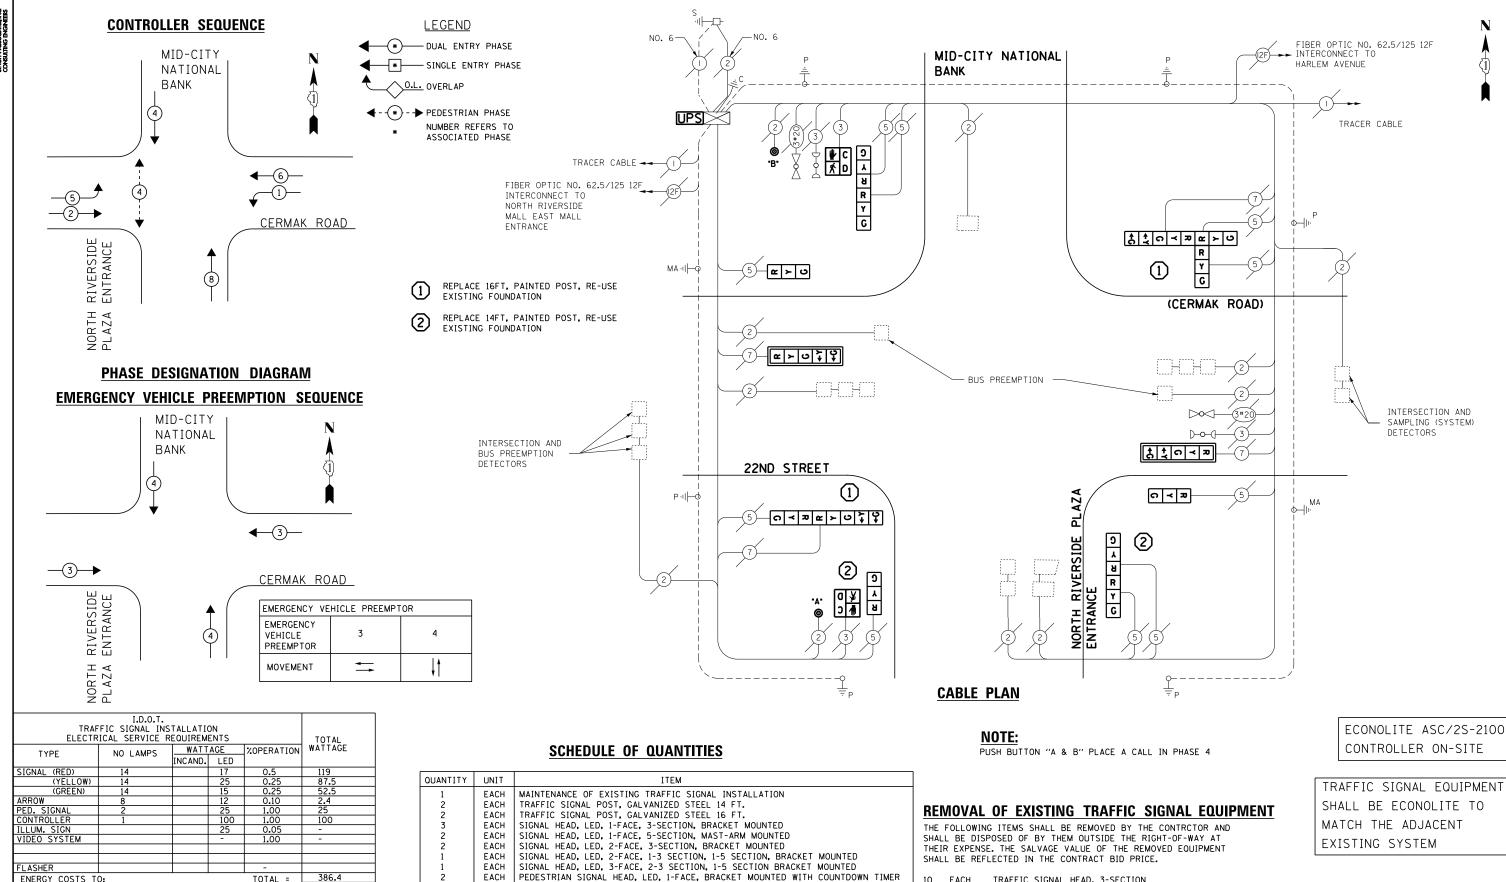

TS# 9360 NORTH RIVERSIDE

M.A./V.O. REVISED -/1\I.Y. 6/2/2014 Y.J./E.C. REVISED REVISED REVISED 5/16/2014

TRAFFIC SIGNAL BACKPLATE, LOUVERED, ALUMINUM

REMOVE EXISTING TRAFFIC SIGNAL EQUIPMENT

MODIFY EXISTING CONTROLLER CABINET

UNINTERRUPTABLE POWER SUPPLY, SPECIA

PEDESTRIAN PUSH-BUTTON, (NON-LATCHING)

REMOVE AND REPLACE ANCHOR BOLTS

EACH

EACH

EACH

EACH

FACH

EACH

STATE OF ILLINOIS **DEPARTMENT OF TRANSPORTATION** 

SCHEDULE OF QUANTITIES, CABLE PLAN, PHASE DESIGNATION DIAGRAM, AND **EMERGENCY VEHICLE PREEMPTION SEQUENCE** MID-CITY NATIONAL BANK / NORTH RIVERSIDE PLAZA EAST ENT. SCALE: NTS SHEET NO. 1 OF 1 SHEETS STA. N/A TO STA. N/A

TRAFFIC SIGNAL HEAD, 3-SECTION

TRAFFIC SIGNAL HEAD, 5-SECTION

PEDESTRIAN SIGNAL HEAD

PEDESTRIAN PUSH-BUTTON

TRAFFIC SIGNAL POSTS

10

2


EACH

FACH

EACH

EACH

SECTION COUNTY 2014-032TS COOK 68 56 CONTRACT NO. 60Y18

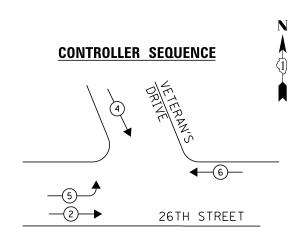

### **LEGEND** * DUAL ENTRY PHASE -SINGLE ENTRY PHASE

← - (*) - → PEDESTRIAN PHASE

NUMBER REFERS TO ASSOCIATED PHASE

REPLACE 15FT, PAINTED POST, RE-USE EXISTING FOUNDATION

REPLACE 18FT, PAINTED POST, RE-USE EXISTING FOUNDATION


ма⊣⊢

(1)

**∠** ≻ ∪ **(** | **∠** | **(** )

## PHASE DESIGNATION DIAGRAM

### **EMERGENCY VEHICLE PREEMPTION SEQUENCE**

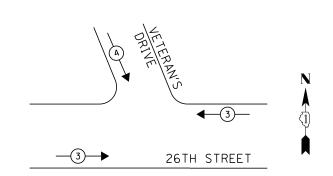

INCAND. LED

I.D.O.T.
TRAFFIC SIGNAL INSTALLATION
ELECTRICAL SERVICE REQUIREMENTS

NO LAMPS

ILLINOIS DEPARTMENT OF TRANSPORTATION 201 WEST CENTER COURT SCHAUMBURG, ILLINOIS 60196-1096

PHONE: (630) 424-5704

ENERGY SUPPLY CONTACT: <u>JOE STACHO</u>

TYPE

SIGNAL (RED)

ILLUM. SIGN VIDEO SYSTEM

ENERGY COSTS TO:

(YELLOW) (GREEN)

EMERGENCY VE	HICLE PREEMPT	OR
EMERGENCY VEHICLE PREEMPTOR	3	4
MOVEMENT	<b>+</b>	<b>↓</b>

WATTAGE XOPERATION WATTAGE

TOTAL =

292.2

### **NOTES:**

. RELOCATION OF EMERGENCY VEHICLE PREEMPTION SYSTEM, DETECTOR UNIT, IS INCLUDED IN COST OF REPLACING SIGNAL POSTS.

CONTROLLER CABINET.

2. RELOCATION OF EMERGENCY VEHICLE PREEMPTION SYSTEM, PHASING UNIT, IS INCLUDED IN COST OF

QUANTITY	UNIT	ITEM
1 1 1 1 1 1 1 1 1 3 4 1 1	EACH EACH EACH EACH EACH EACH EACH EACH	MAINTENANCE OF EXISTING TRAFFIC SIGNAL INSTALLATION FULL-ACTUATED CONTROLLER AND TYPE IV CABINET TRAFFIC SIGNAL POST, GALVANIZED STEEL 15 FT. TRAFFIC SIGNAL POST, GALVANIZED STEEL 18 FT. SIGNAL HEAD, LED, 1-FACE, 4-SECTION, BRACKET MOUNTED SIGNAL HEAD, LED, 2-FACE, 3-SECTION, BRACKET MOUNTED SIGNAL HEAD, LED, 2-FACE, 1-3 SECTION, 1-4 SECTION, BRACKET MOUNTED SIGNAL HEAD, LED, 2-FACE, 1-3 SECTION, 1-5 SECTION, BRACKET MOUNTED TRAFFIC SIGNAL BACKPLATE, LOUVERED, ALUMINUM INDUCTIVE LOOP DETECTOR REMOVE EXISTING TRAFFIC SIGNAL EQUIPMENT REMOVE AND REPLACE ANCHOR BOLTS UNINTERRUPTABLE POWER SUPPLY, SPECIAL

### REMOVAL OF EXISTING TRAFFIC SIGNAL EQUIPMENT

ე <del>+</del>ე

ର ≺ **ଅ** ଧ

DRIVE

**೧** ≺ ਸ਼

\$ \$ 0 < 2 € > 0

26TH STREET

\$ **\$** ○ ≺ ₹

THE FOLLOWING ITEMS SHALL BE REMOVED BY THE CONTRCTOR AND SHALL BE DISPOSED OF BY THEM OUTSIDE THE RIGHT-OF-WAY AT THEIR EXPENSE. THE SALVAGE VALUE OF THE REMOVED EQUIPMENT SHALL BE REFLECTED IN THE CONTRACT BID PRICE.

EACH SIGNAL HEAD, 5-SECTION TRAFFIC SIGNAL POST TRAFFIC SIGNAL BACKPLATE EACH EACH FACH SIGNAL HEAD, 3-SECTION SIGNAL HEAD, 4-SECTION FACH

CONTROLLER AND CABINET (COMPLETE) EACH

**CABLE PLAN** 

TRAFFIC SIGNAL EQUIPMENT SHALL BE ECONOLITE TO MATCH THE ADJACENT EXISTING SYSTEM


**Ç**—|I∙MA

TS# 3750 NORTH RIVERSIDE

COMPANY: COM	MONWEALTH EDISON							
FILE NAME =	USER NAME = _USER_	DESIGNED - M.A./V.	.o. REVISED -		SCHEDULE OF QUANTITIES, CABLE PLAIN, PHASE DESIGNATION DIAGRAM, AND	F.A.P. RTE.	SECTION	COUNTY TOTAL SHEE
J:\13155\Work Order 2\DGN\CADD Sheets\D	160Y18-sht-ts-41_3750.dgn	DRAWN - Y.J./E.	.c. REVISED -	STATE OF ILLINOIS	EMERGENCY VEHICLE PREEMPTION SEQUENCE		2014-032TS	COOK 68 57
	PLOT SCALE = 20.0000 '/ in.	CHECKED - I.Y.	REVISED -	DEPARTMENT OF TRANSPORTATION	26TH AVENUE AT VETERAN'S DRIVE			CONTRACT NO. 60YI
	PLOT DATE = 5/14/2014	DATE - 5/16/2	2014 REVISED -		SCALE: NTS SHEET NO. 1 OF 1 SHEETS STA. N/A TO STA. N/A		ILLINOIS FED. A	

**UPS** 



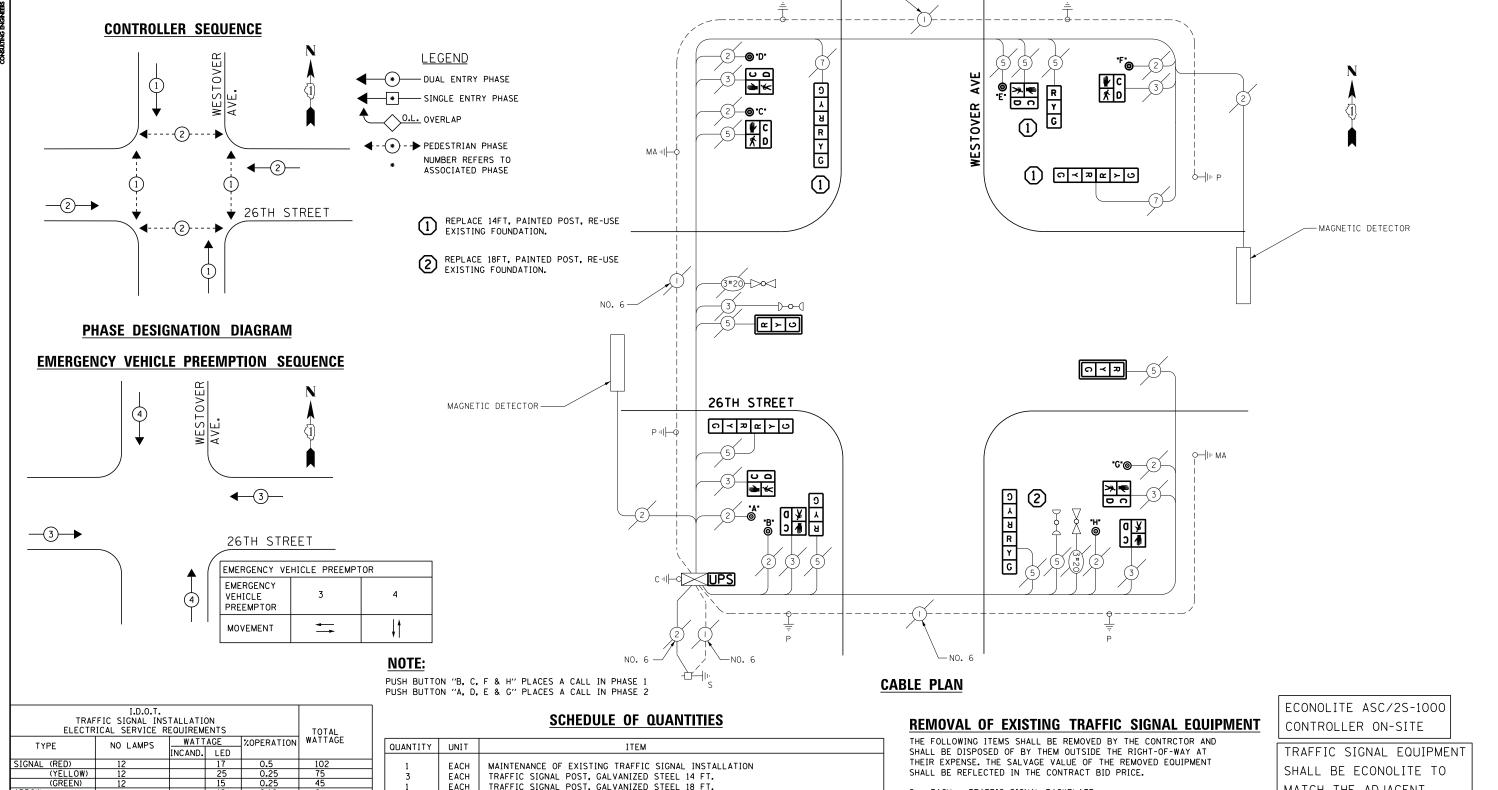

NO. 6

LLUM. SIGN /IDEO SYSTEM 522 ENERGY COSTS TO: TOTAL = ILLINOIS DEPARTMENT OF TRANSPORTATION

201 WEST CENTER COURT SCHAUMBURG, ILLINOIS 60196-1096 ENERGY SUPPLY CONTACT: JOE STACHO

PHONE: (630) 424-5704 COMPANY: COMMONWEALTH EDISON

QUANTITY	UNIT	ITEM
1 3 1 2	EACH EACH EACH EACH	MAINTENANCE OF EXISTING TRAFFIC SIGNAL INSTALLATION TRAFFIC SIGNAL POST, GALVANIZED STEEL 14 FT. TRAFFIC SIGNAL POST, GALVANIZED STEEL 18 FT. SIGNAL HEAD, LED, 1-FACE, 3-SECTION, MAST-ARM MOUNTED
4 8	EACH EACH EACH	SIGNAL HEAD, LED, 1-FACE, 3-SECTION, BRACKET MOUNTED SIGNAL HEAD, LED, 2-FACE, 3-SECTION, BRACKET MOUNTED PEDESTRIAN SIGNAL HEAD, LED, 1-FACE, BRACKET MOUNTED WITH COUNTDOWN TIMER
2 1 1	EACH EACH EACH	TRAFFIC SIGNAL BACKPLATE, LOUVERED, ALUMINUM MODIFY EXISTING CONTROLLER CABINET REMOVE EXISTING TRAFFIC SIGNAL EQUIPMENT
2 1 8	EACH EACH EACH	REMOVE AND REPLACE ANCHOR BOLTS UNINTERRUPTABLE POWER SUPPLY SRECIAL PEDESTRIAN PUSH-BUTTON, NON-LATCHING
		5555555

TRAFFIC SIGNAL BACKPLATE PEDESTRIAN SIGNAL HEAD

PEDESTRIAN PUSH-BUTTON

SIGNAL HEAD, 2-FACE, 3-SECTION EACH SIGNAL HEAD, 1-FACE, 3-SECTION

TRAFFIC SIGNAL POST


RELOCATION OF EMERGENCY VEHICLE PREEMPTION SYSTEM, DETECTOR UNIT, IS INCLUDED IN COST OF REPLACING SIGNAL POSTS.

MATCH THE ADJACENT EXISTING SYSTEM


> TS# 7943 NORTH RIVERSIDE


FILE NAME =	USER NAME = _USER_	DESIGNED - M.A./V.O.	REVISED -/1\I.Y. 6/2/2014		SCHEDULE (	OF QUANTITIES, CABLE PLAN, PHASE DESIGNATION DIAGRAM, AND	F.A.P. SECTION	COUNTY	TOTAL	SHEET NO.
J:\13155\Work Order 2\DGN\CADD Sheets\	Revision 1\D160Y18-sht-ts-42_7943_rev1.dgn	DRAWN - Y.J./E.C.	REVISED -	STATE OF ILLINOIS		EMERGENCY VEHICLE PREEMPTION SEQUENCE	2014-032TS	соок	68	58
	PLOT SCALE = 20.0000 ' / in.	CHECKED - I.Y.	REVISED -	DEPARTMENT OF TRANSPORTATION		26TH STREET AT WESTOVER AVENUE		CONTRAC	CT NO. F	0Y18
	PLOT DATE = 6/3/2014	DATE - 5/16/2014	REVISED -		SCALE: NTS	SHEET NO. 1 OF 1 SHEETS STA. N/A TO STA. N/A	ILLINOIS FED.	AID PROJECT		



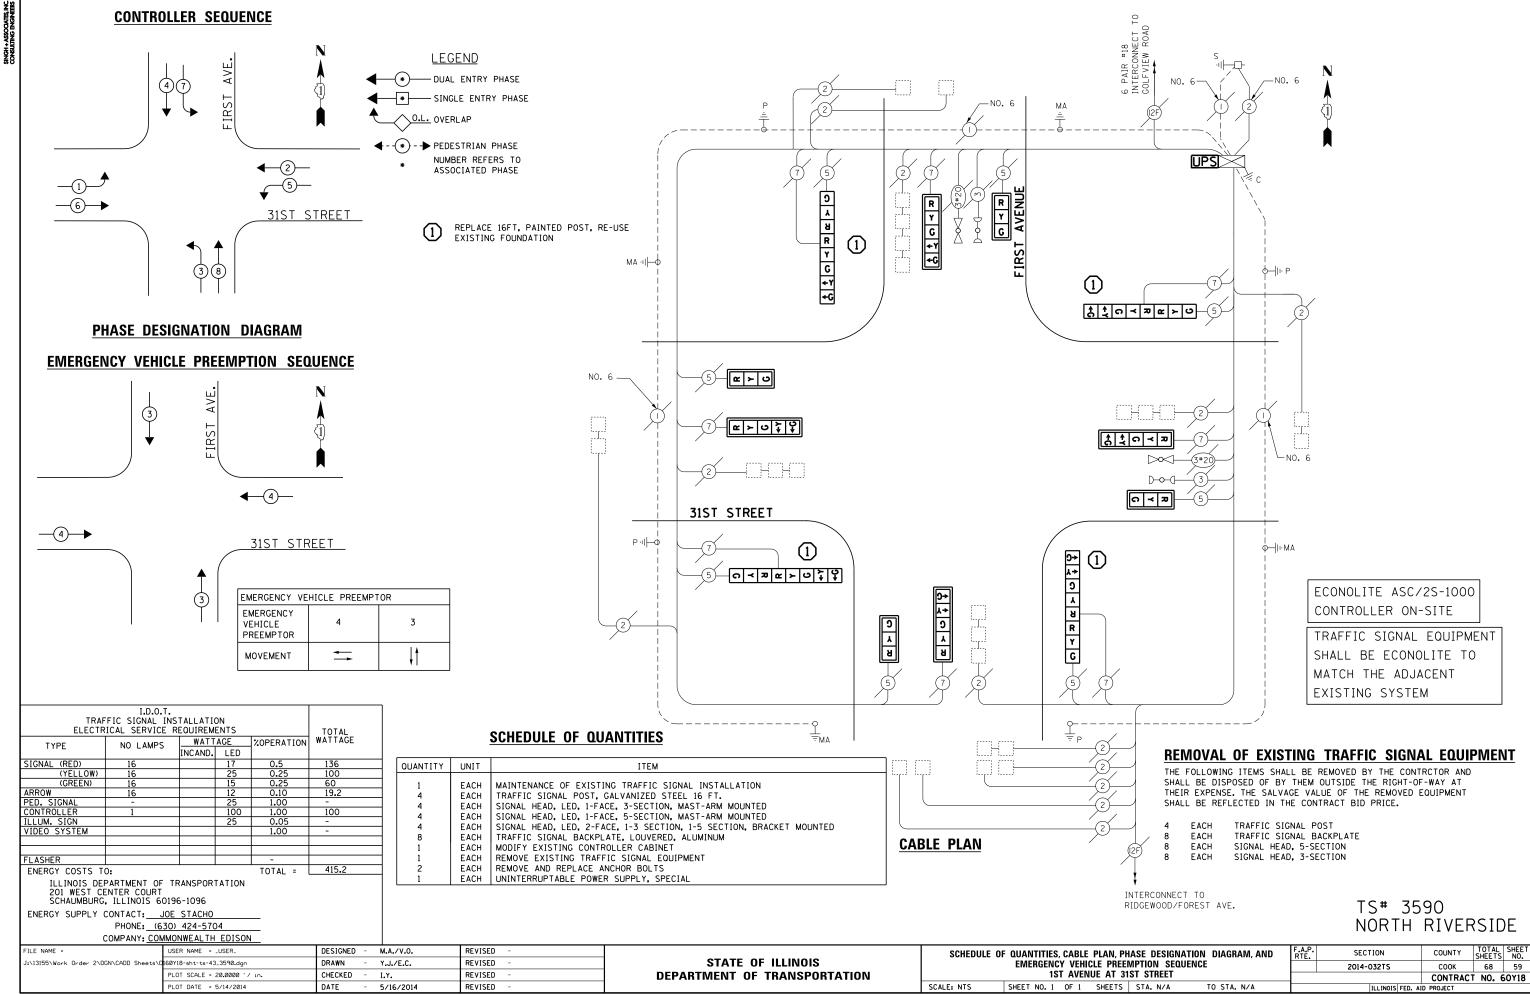



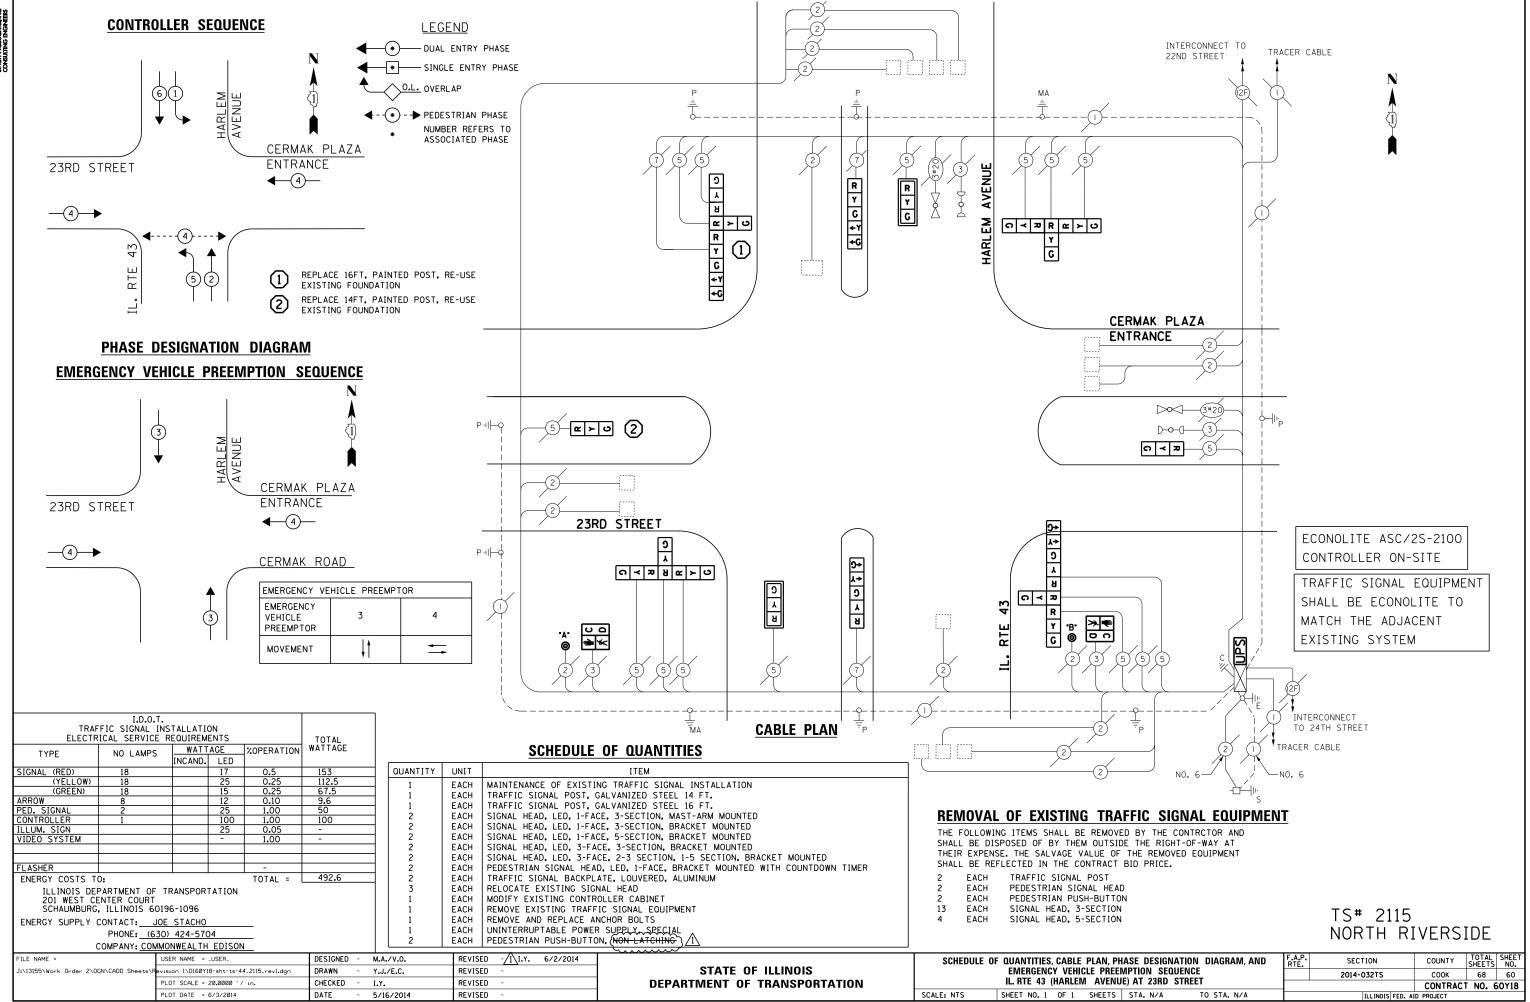


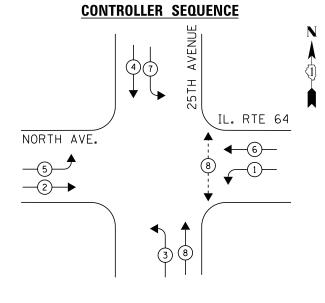


# ← - (*) - → PEDESTRIAN PHASE

NUMBER REFERS TO ASSOCIATED PHASE

мач⊩Ь

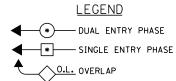


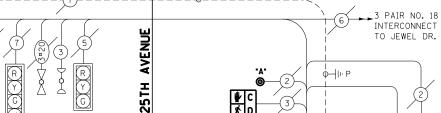

INTERCONNECT

### PHASE DESIGNATION DIAGRAM

### **EMERGENCY VEHICLE PREEMPTION SEQUENCE**

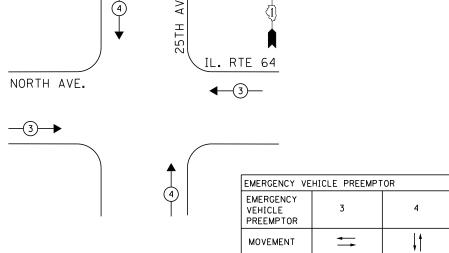

WATTAGE XOPERATION WATTAGE

TOTAL =

502.2

NCAND. LED

	P111-0 2 2
4	INTERCONNECT 1

5		(NORTH AVENUE)
INTERCONNECT TO	(a) (b) (c) (c) (c) (c) (c) (c) (c) (c) (c) (c	(a) (b) (c) (c) (c) (c) (c) (c) (c) (c) (c) (c
3 PAIR NO. 18	NO. 6	No. 6 No. 6

SAFESPEED, LLC

ECONOLITE ASC/2S-1000 CONTROLLER ON-SITE

RED LIGHT PHOTO ENFORCED INTERSECTION VENDOR:

TRAFFIC SIGNAL EQUIPMENT SHALL BE ECONOLITE TO MATCH THE ADJACENT EXISTING SYSTEM

REMOVAL OF EXISTING TRAFFIC SIGNAL EQUIPMENT

THE FOLLOWING ITEMS SHALL BE REMOVED BY THE CONTRCTOR AND SHALL BE DISPOSED OF BY THEM OUTSIDE THE RIGHT-OF-WAY AT THEIR EXPENSE. THE SALVAGE VALUE OF THE REMOVED EQUIPMENT SHALL BE REFLECTED IN THE CONTRACT BID PRICE.

PEDESTRIAN SIGNAL HEAD FACH PEDESTRIAN PUSH-BUTTON EACH

ENERGY COSTS TO: ILLINOIS DEPARTMENT OF TRANSPORTATION 201 WEST CENTER COURT SCHAUMBURG, ILLINOIS 60196-1096

I.D.O.T.
TRAFFIC SIGNAL INSTALLATION
ELECTRICAL SERVICE REQUIREMENTS

NO LAMPS

TYPE

SIGNAL (RED)

ILLUM. SIGN VIDEO SYSTEM

(YELLOW) (GREEN)

ENERGY SUPPLY CONTACT: <u>JOE STACHO</u> PHONE: (630) 424-5704


COMPANY: COMMONWEALTH EDISON

<b>SCHEDULE</b>	0F	QUANTITIES

QUANTITY	UNIT	ITEM
1	EACH	MAINTENANCE OF EXISTING TRAFFIC SIGNAL INSTALLATION
2	EACH	PEDESTRIAN SIGNAL HEAD, LED, 1-FACE, BRACKET MOUNTED WITH COUNTDOWN TIMER
2	EACH	PEDESTRIAN PUSH-BUTTON
1	EACH	REMOVE EXISTING TRAFFIC SIGNAL EQUIPMENT

TS# 3020 NORTHLAKE

FILE NAME =	USER NAME = _USER_	DESIGNED - M.A./V.O.	REVISED -		SCHEDULE OF QUANTITIES, CABLE PLAN, PHASE DESIGNATION DIAGRAM, AND	F.A.P.	SECTION	COUNTY TOTAL SHEET
J:\13155\Work Order 2\DGN\CADD Sheets\C	160Y18-sht-ts-45_3020.dgn	DRAWN - Y.J./E.C.	REVISED -	STATE OF ILLINOIS	EMERGENCY VEHICLE PREEMPTION SEQUENCE		2014-032TS	COOK 68 61
	PLOT SCALE = 20.0000 '/ in.	CHECKED - I.Y.	REVISED -	DEPARTMENT OF TRANSPORTATION	IL. ROUTE 64 /NORTH AVENUE AT 25TH AVENUE			CONTRACT NO. 60Y18
	PLOT DATE = 5/14/2014	DATE - 5/16/2014	REVISED -		SCALE: NTS SHEET NO. 1 OF 1 SHEETS STA. N/A TO STA. N/A		ILLINOIS FED. A	AID PROJECT

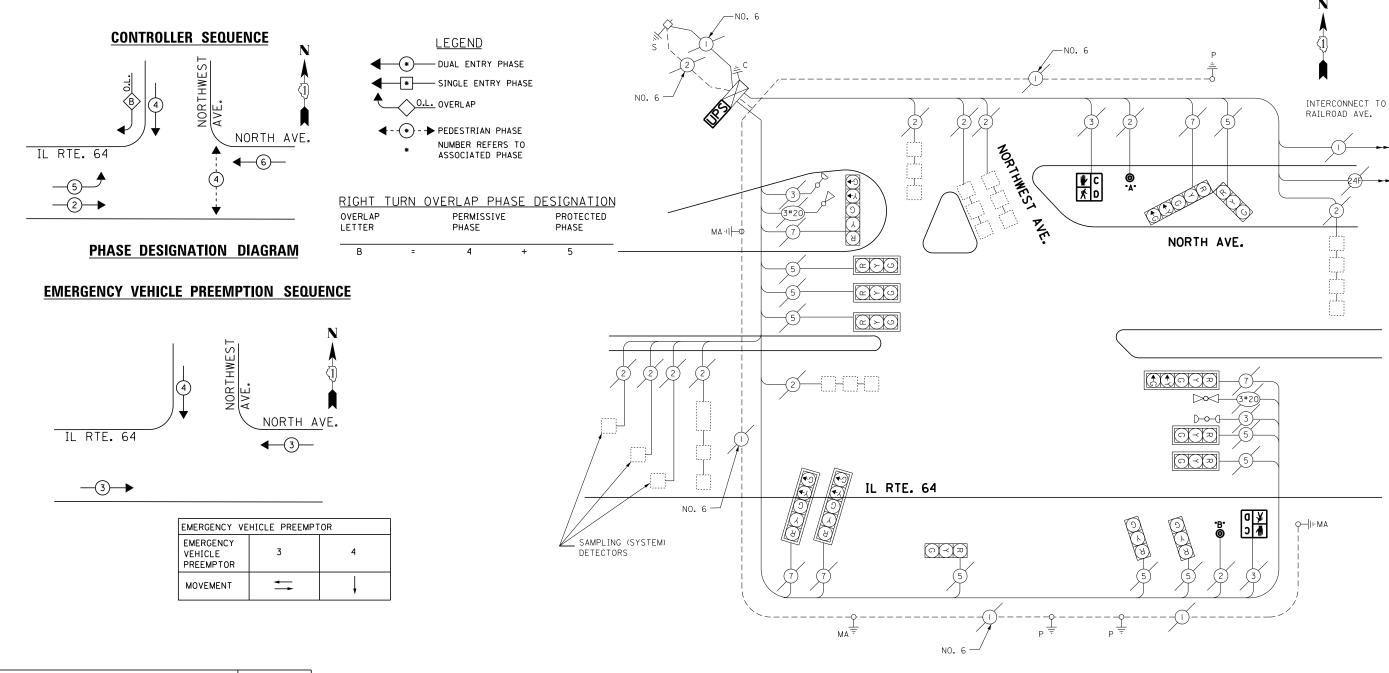

TRAF ELECTR	TOTAL				
TYPE	NO LAMPS	WATT	WATTAGE		
SIGNAL (RED)	14		17	0.5	119
(YELLOW)	14		25	0.25	87.5
(GREEN)	14		15	0.25	52.5
ARROW	10		12	0.10	12
PED. SIGNAL	2		25	1.00	50
CONTROLLER	1		100	1.00	100
ILLUM. SIGN			25	0.05	ı
VIDEO SYSTEM			-	1.00	•
FLASHER				-	
ENERGY COSTS TO	0:			TOTAL =	421

ILLINOIS DEPARTMENT OF TRANSPORTATION
201 WEST CENTER COURT
SCHAUMBURG, ILLINOIS 60196-1096

ENERGY SUPPLY CONTACT: <u>JOE STACHO</u>
PHONE: (630) 424-5704

### SCHEDULE OF QUANTITIES

QUANTITY	UNIT	ITEM
1	EACH	MAINTENANCE OF EXISTING TRAFFIC SIGNAL INSTALLATION
2	EACH	PEDESTRIAN SIGNAL HEAD, LED, 1-FACE, BRACKET MOUNTED WITH COUNTDOWN TIMER
2	EACH	PEDESTRIAN PUSH-BUTTON
1	EACH	MODIFY EXISTING CONTROLLER CABINET
1	EACH	REMOVE EXISTING TRAFFIC SIGNAL EQUIPMENT
1	EACH	UNINTERRUPTABLE POWER SUPPLY, SPECIAL

### REMOVAL OF EXISTING TRAFFIC SIGNAL EQUIPMENT

THE FOLLOWING ITEMS SHALL BE REMOVED BY THE CONTRACTOR AND SHALL BE DISPOSED OF BY THEM OUTSIDE THE RIGHT-OF-WAY AT THEIR EXPENSE. THE SALVAGE VALUE OF THE REMOVED EQUIPMENT SHALL BE REFLECTED IN THE CONTACT BID PRICE.

2 EACH PEDESTRIAN SIGNAL HEAD 2 EACH PEDESTRIAN PUSH-BUTTON

**CABLE PLAN** 

ECONOLITE ASC/2S-1000 CONTROLLER ON-SITE

TRAFFIC SIGNAL EQUIPMENT SHALL BE ECONOLITE TO MATCH THE ADJACENT EXISTING SYSTEM

> TS# 3065 NORTHLAKE

	COMPANY: COM	MMONWEALTH EDISON										• •	0		
FILE NAME =		USER NAME = _USER_	DESIGNED - M.	.A./V.O.	REVISED -		SCHEDULE (	OF QUANTITIES, CABLE PLAN, F			F.A.P. RTE.	SECTION	COUNTY	TOTAL S SHEETS	SHEET NO.
J:\13155\Work Ord	der 2\DGN\CADD Sheets\D	160Y18-sht-ts-46_3065.dgn	DRAWN - Y.	J./E.C.	REVISED -	STATE OF ILLINOIS		EMERGENCY VEHICLE PRE				2014-032TS	соок	68	62
		PLOT SCALE = 20.0000 ' / in.	CHECKED - I.	Υ.	REVISED -	DEPARTMENT OF TRANSPORTATION		IL. RTE 64 (NORTH AVENUE)	AT NORTHWEST	AVENUE			CONTRAC	T NO. 60	0Y18
		PLOT DATE = 5/14/2014	DATE - 5	/16/2014	REVISED -		SCALE: NTS	SHEET NO. 1 OF 1 SHEETS	STA. N/A	TO STA. N/A		ILLINOIS FED.			


FILE NAME

:\13155\Work Order 2\DGN\CADD Sheets

USER NAME = _USER.

160Y18-sht-ts-47_3075.dan

PLOT DATE = 5/14/2014

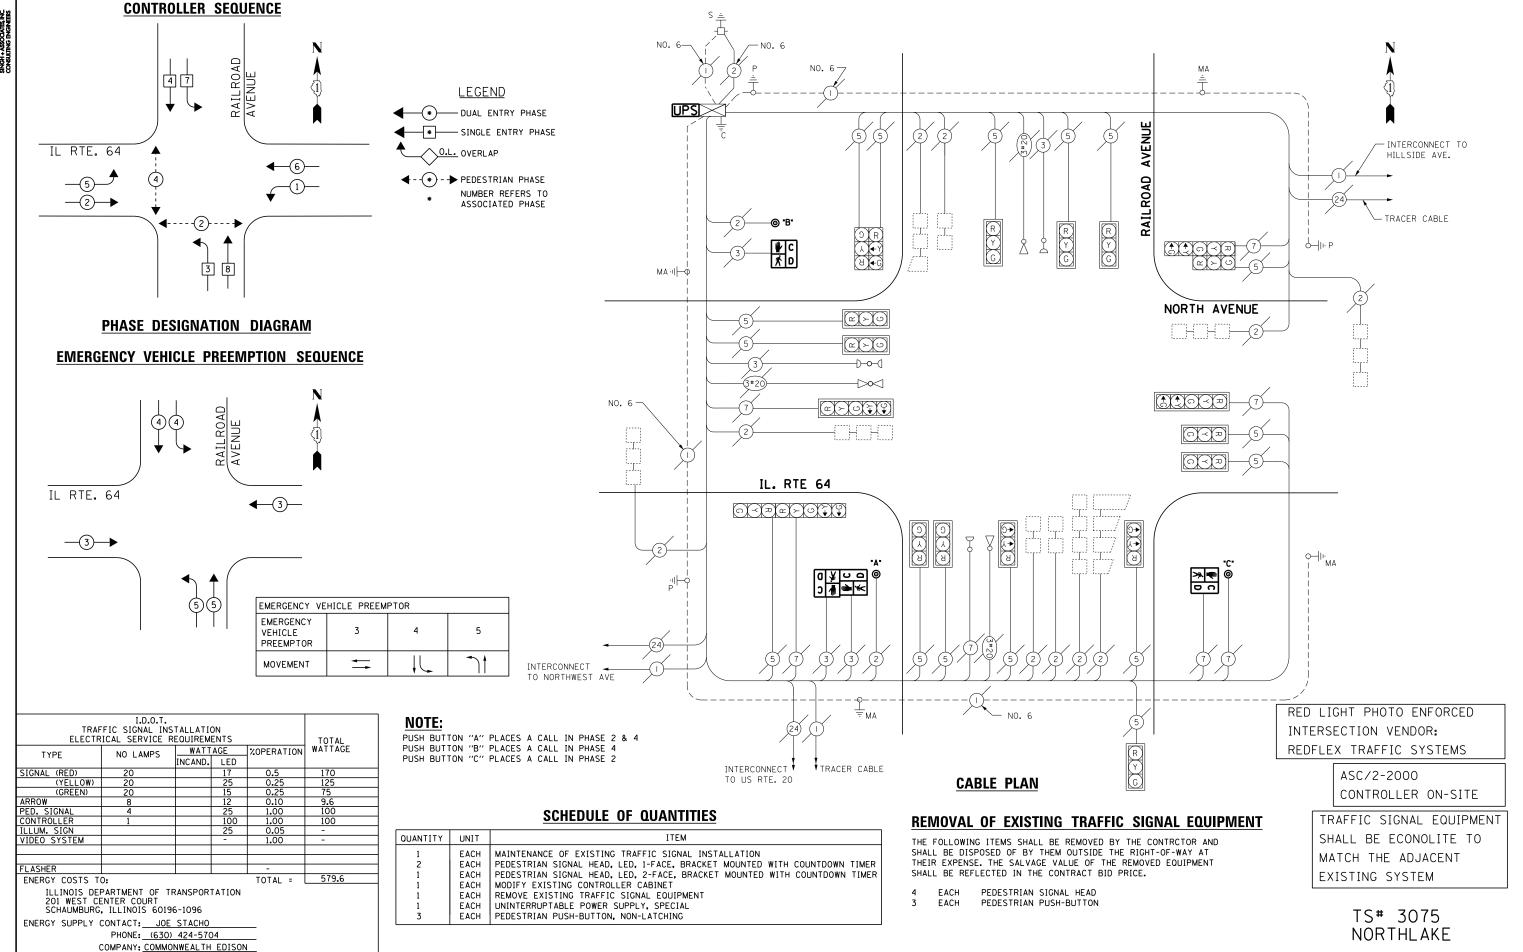

STATE OF ILLINOIS

**DEPARTMENT OF TRANSPORTATION** 

SCHEDULE OF QUANTITIES, CABLE PLAN, PHASE DESIGNATION DIAGRAM, AND

EMERGENCY VEHICLE PREEMPTION SEQUENCE

IL. RTE 64 (NORTH AVENUE) AT RAILROAD AVENUE

TO STA. N/A

SHEET NO. 1 OF 1 SHEETS STA. N/A

SCALE: NTS

SECTION

2014-032TS

COUNTY

COOK

68 63

CONTRACT NO. 60Y18

DESIGNED - M.A./V.O.

Y.J./E.C.

5/16/2014

I.Y.

DRAWN

DATE

CHECKED

REVISED

REVISED

REVISED

REVISED




DATE

5/16/2014

PLOT DATE = 5/14/2014


REVISED

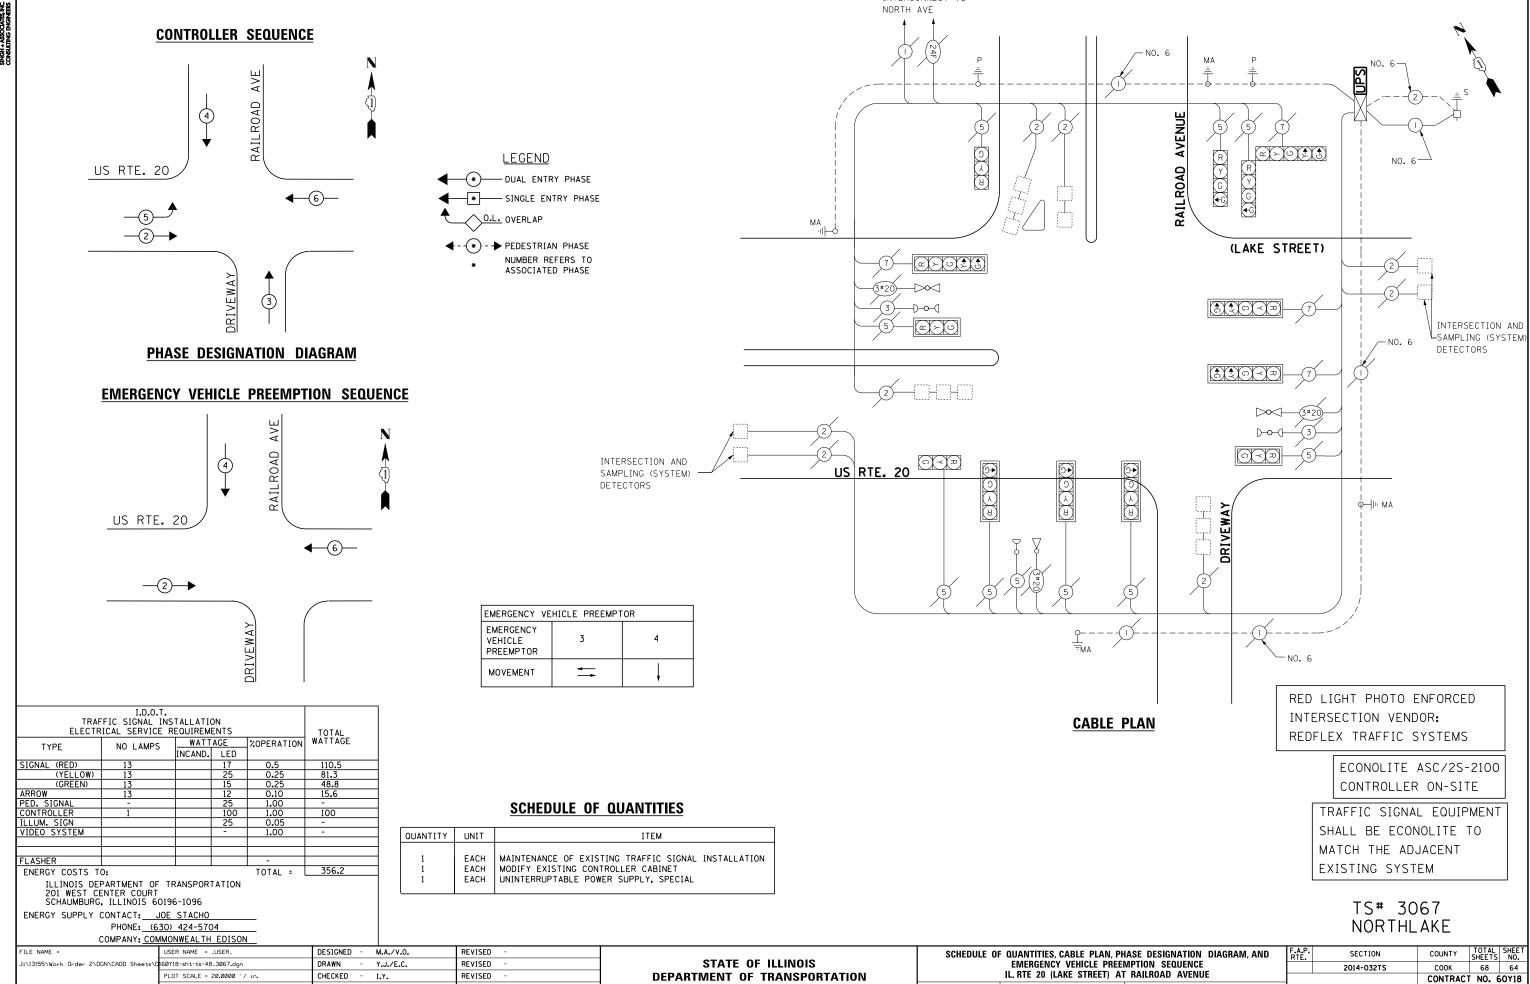

INTERCONNECT TO

SHEET NO. 1 OF 1 SHEETS STA. N/A



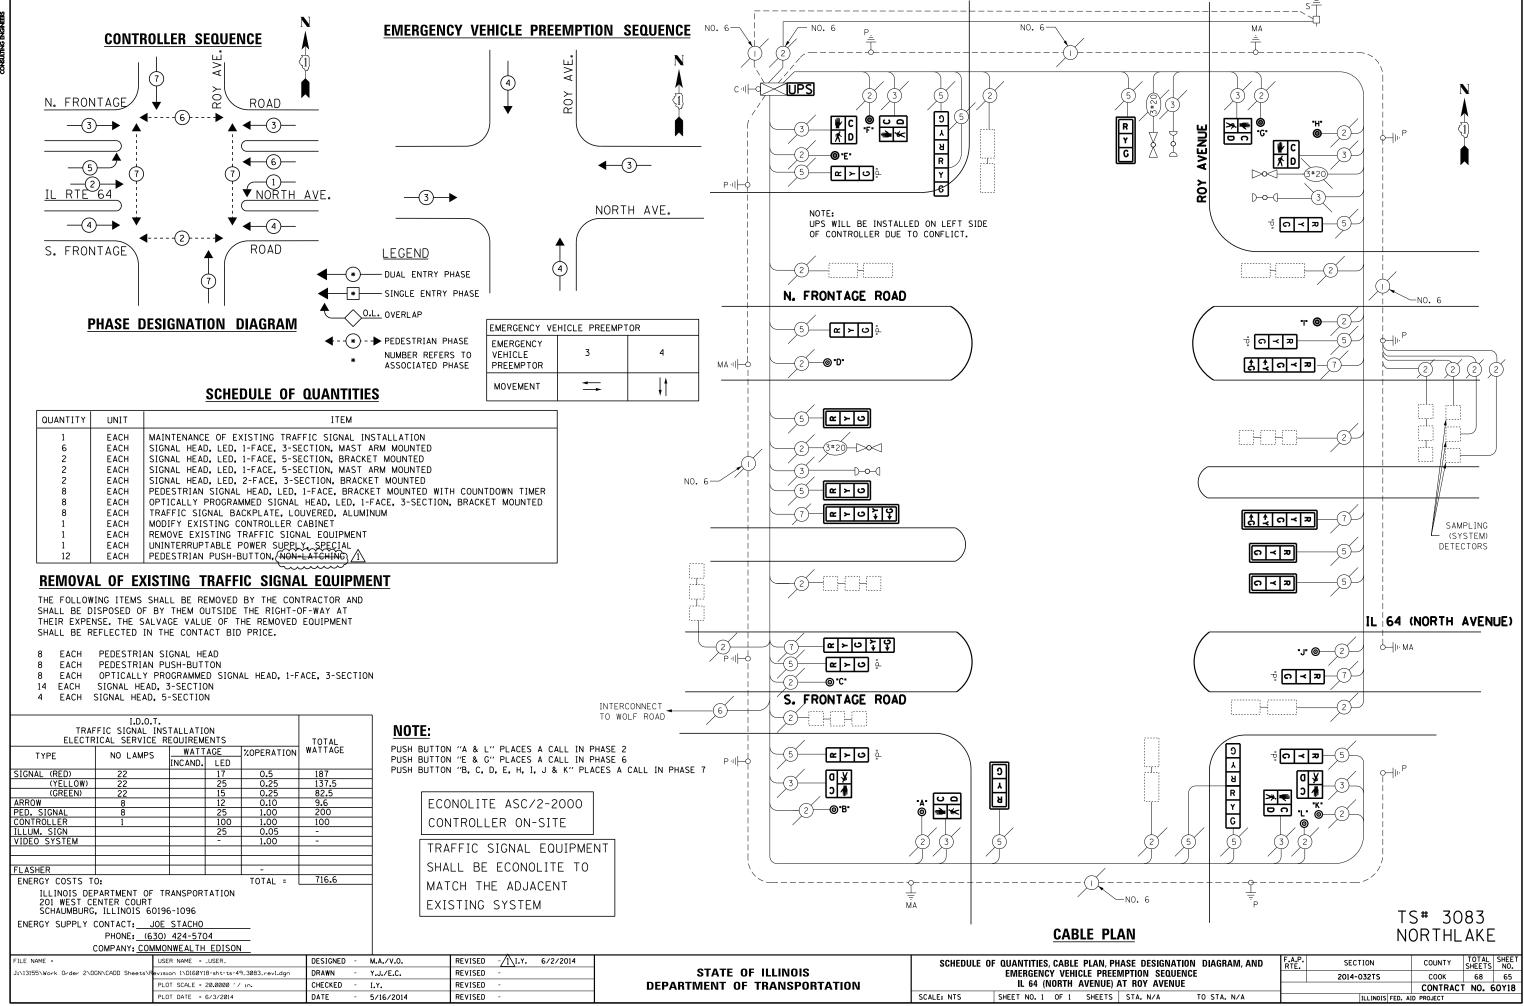



ENERGY COSTS TO:


ILLINOIS DEPARTMENT OF TRANSPORTATION

PHONE: (630) 424-5704

COMPANY: COMMONWEALTH EDISON

201 WEST CENTER COURT SCHAUMBURG, ILLINOIS 60196-1096

ENERGY SUPPLY CONTACT: <u>JOE STACHO</u>

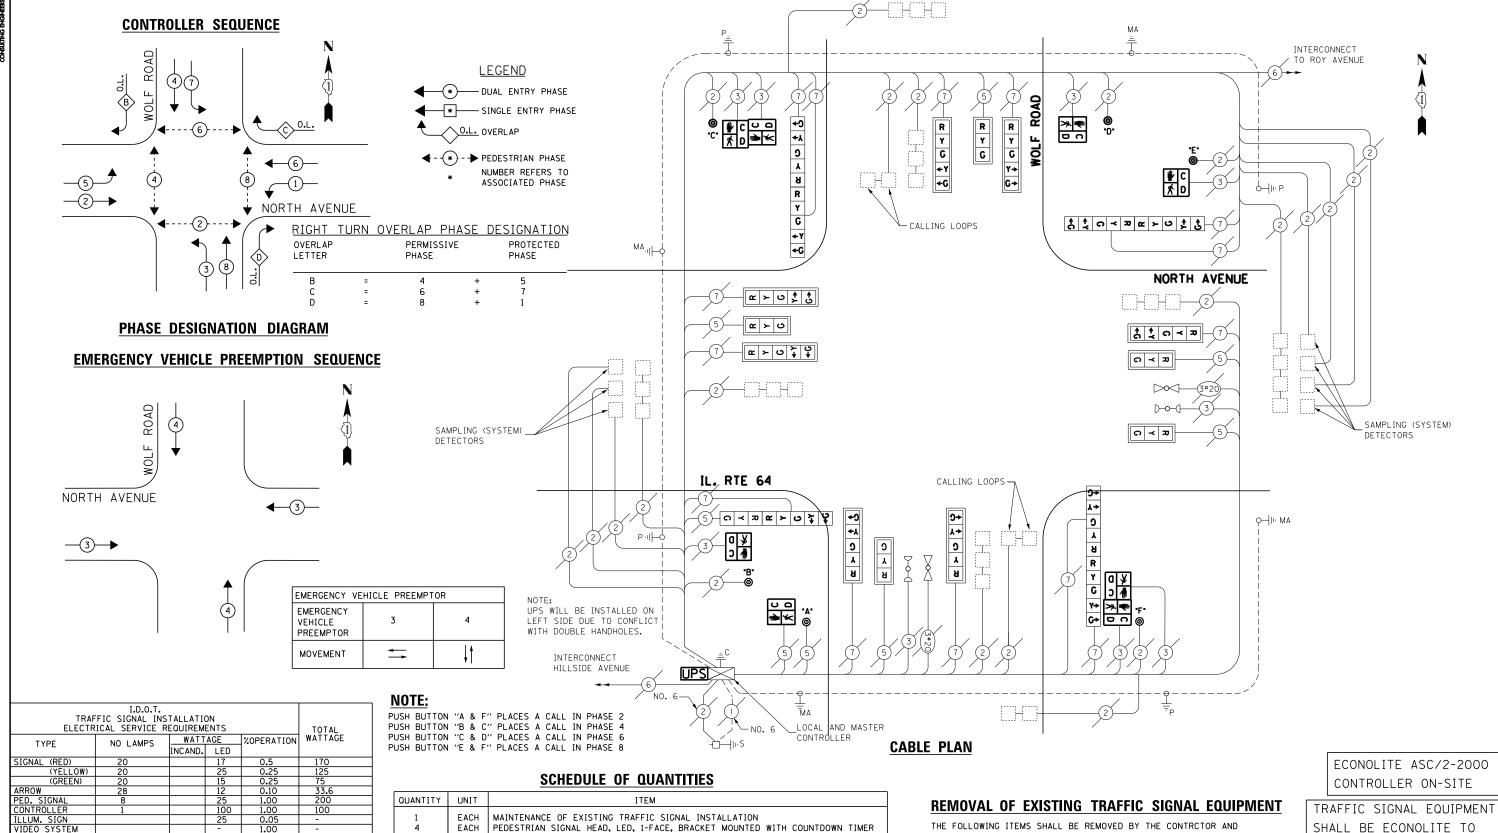

COMMITTEE	01111	11 200
1	EACH	MAINTENANCE OF EXISTING TRAFFIC SIGNAL INSTALLATION
4	EACH	PEDESTRIAN SIGNAL HEAD, LED, 1-FACE, BRACKET MOUNTED WITH COUNTDOWN TIMER
2	EACH	PEDESTRIAN SIGNAL HEAD, LED, 2-FACE, BRACKET MOUNTED WITH COUNTDOWN TIMER
1	EACH	MODIFY EXISTING CONTROLLER CABINET
1	EACH	REMOVE EXISTING TRAFFIC SIGNAL EQUIPMENT
1	EACH	UNINTERRUPTABLE POWER SUPPLY, SPECIAL
1	EACH	SIGNAL HEAD, LED, 2-FACE, 1-3 SECTION, 1-5 SECTION, BRACKET MOUNTED, RETROFIT
5	EACH	SIGNAL HEAD, LED, 1-FACE, 3-SECTION, MAST ARM MOUNTED, RETROFIT
7	EACH	SIGNAL HEAD, LED, 1-FACE, 5-SECTION, MAST ARM MOUNTED, RETROFIT
3	EACH	SIGNAL HEAD, LED, 2-FACE, 5-SECTION, BRACKET MOUNTED, RETROFIT
6	EACH	PEDESTRIAN PUSH-BUTTON, NON-LATCHING
	1	

THE FOLLOWING ITEMS SHALL BE REMOVED BY THE CONTRCTOR AND SHALL BE DISPOSED OF BY THEM OUTSIDE THE RIGHT-OF-WAY AT THEIR EXPENSE. THE SALVAGE VALUE OF THE REMOVED EQUIPMENT SHALL BE REFLECTED IN THE CONTRACT BID PRICE.

8 EACH PEDESTRIAN SIGNAL HEAD 6 EACH PEDESTRIAN PUSH-BUTTON TRAFFIC SIGNAL EQUIPMEN'
SHALL BE ECONOLITE TO
MATCH THE ADJACENT
EXISTING SYSTEM

TS# 3090 NORTHLAKE

FILE NAME =	USER NAME = _USER_	DESIGNED -	M.A./V.O.	,	REVISED	-
J:\13155\Work Order 2\DGN\CADD Sheets\C	160Y18-sht-ts-50_3090.dgn	DRAWN -	Y.J./E.C.		REVISED	-
	PLOT SCALE = 20.0000 '/ in.	CHECKED -	I.Y.		REVISED	-
	PLOT DATE = 5/14/2014	DATE -	5/16/20	4	REVISED	-


703.6


TOTAL =

STATE OF ILLINOIS
DEPARTMENT OF TRANSPORTATION

SCHEDULE O	F QUANTITIES, CABLE PLAN,			F.A.P. RTE.	SECTION	COUNTY	TOTAL SHEETS	SHEET NO.
	EMERGENCY VEHICLE PR				2014-032TS	соок	68	66
	IL 64 (NORTH AVENU	E) AT WULF KU	AD .			CONTRAC	T NO. 6	50Y18
SCALE: NTS	SHEET NO. 1 OF 1 SHEET	S STA. N/A	TO STA. N/A		ILLINOIS FED. A	ID PROJECT		



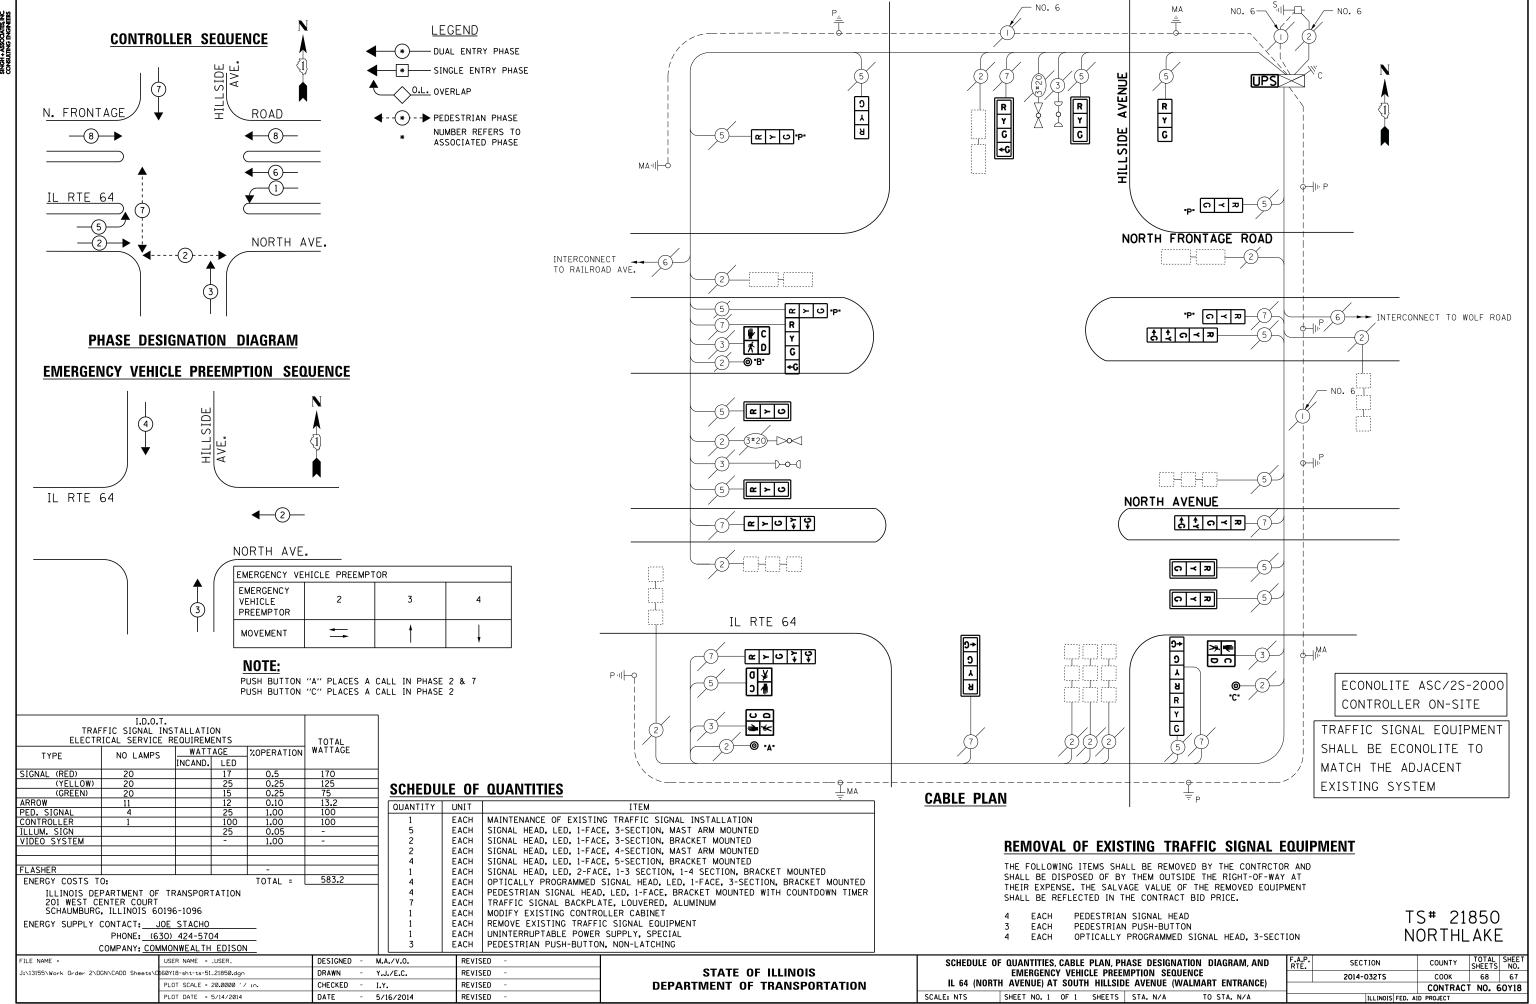

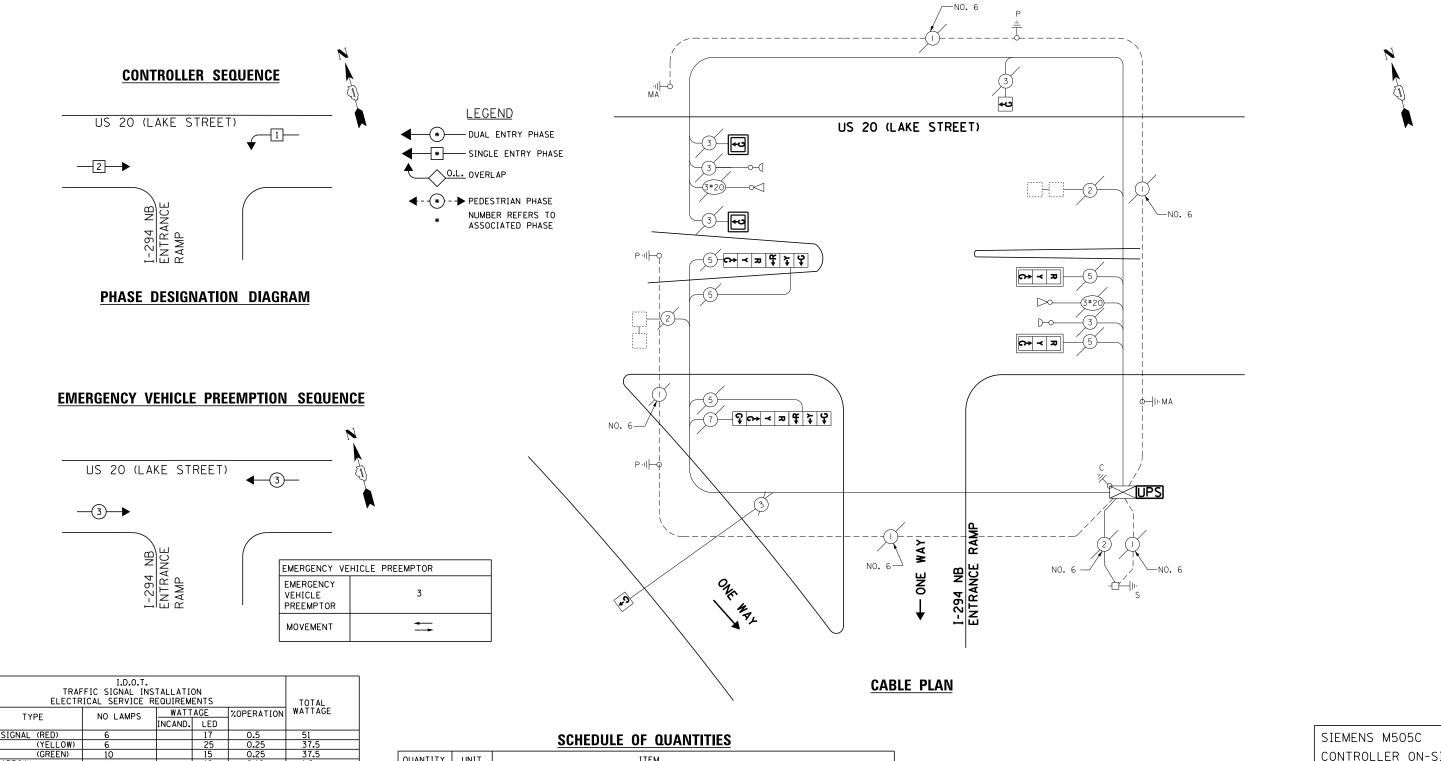

PED. SIGNAL CONTROLLER ILLUM. SIGN VIDEO SYSTEM ENERGY COSTS TO: 227.2 TOTAL =

ILLINOIS DEPARTMENT OF TRANSPORTATION 201 WEST CENTER COURT SCHAUMBURG, ILLINOIS 60196-1096

ENERGY SUPPLY CONTACT: <u>JOE STACHO</u> PHONE: (630) 424-5704

QUANTITY	UNIT	ITEM
1	EACH	MAINTENANCE OF EXISTING TRAFFIC SIGNAL INSTALLATION
2	EACH	SIGNAL HEAD, LED, 1-FACE, 1-SECTION, BRACKET MOUNTED
2	EACH	SIGNAL HEAD, LED, 1-FACE, 1-SECTION, MAST ARM MOUNTED
2	EACH	SIGNAL HEAD, LED, 1-FACE, 3-SECTION, MAST ARM MOUNTED
1	EACH	SIGNAL HEAD, LED, 2-FACE, 3-SECTION, BRACKET MOUNTED
1	EACH	SIGNAL HEAD, LED, 2-FACE, 1-3 SECTION, 1-4 SECTION, BRACKET MOUNTED
4	EACH	TRAFFIC SIGNAL BACKPLATE, LOUVERED, ALUMINUM
1	EACH	MODIFY EXISTING CONTROLLER CABINET
1	EACH	REMOVE EXISTING TRAFFIC SIGNAL EQUIPMENT
1	EACH	UNINTERRUPTABLE POWER SUPPLY, SPECIAL

### REMOVAL OF EXISTING TRAFFIC SIGNAL EQUIPMENT

THE FOLLOWING ITEMS SHALL BE REMOVED BY THE CONTRCTOR AND SHALL BE DISPOSED OF BY THEM OUTSIDE THE RIGHT-OF-WAY AT THEIR EXPENSE. THE SALVAGE VALUE OF THE REMOVED EQUIPMENT SHALL BE REFLECTED IN THE CONTRACT BID PRICE.

TRAFFIC SIGNAL BACKPLATE EACH SIGNAL HEAD, 1-SECTION EACH SIGNAL HEAD, 3-SECTION SIGNAL HEAD, 4-SECTION

CONTROLLER ON-SITE

TS# 1338 NORTHLAKE

COMPANY: COMMONWEALTH EDISON										
FILE NAME =	USER NAME = _USER_	DESIGNED - M.A./V.O.	REVISED -		SCHEDULE OF QUANTITIES, CABLE PLAN, PHASE DESIGNATION DIAGRAM, AND	F.A.P.	SECTION	COUNTY TOTAL SHEET		
J:\13155\Work Order 2\DGN\CADD Sheets\C	160Y18-sht-ts-52_1338.dgn	DRAWN - Y.J./E.C.	REVISED -	STATE OF ILLINOIS	EMERGENCY VEHICLE PREEMPTION SEQUENCE	2	2014-032TS	СООК 68 68		
	PLOT SCALE = 20.0000 '/ in. CHECKED		REVISED -	DEPARTMENT OF TRANSPORTATION	US 20 LAKE STREET AT NB 1-294 ON-RAMP			CONTRACT NO. 60Y18		
	PLOT DATE = 5/14/2014	DATE - 5/16/2014	REVISED -		SCALE: NTS SHEET NO. 1 OF 1 SHEETS STA. N/A TO STA. N/A		ILLINOIS FED.			