

STATE OF ILLINOIS  
DEPARTMENT OF TRANSPORTATION  
DIVISION OF HIGHWAYS

F.A.U. RTE. 3784	SECTION 12-F3000-23-PK	COUNTY COOK	TOTAL SHEETS 131	SHEET NO. 1
FED. ROAD DIST. NO. 1		ILLINOIS CONTRACT NO. 63764		

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# PLANS FOR PROPOSED FEDERAL AID HIGHWAY

F.A.U. ROUTE 3784 (GOLFVIEW AVENUE)  
31ST STREET INTERSECTION TO 1ST AVENUE  
SECTION: 12-F3000-23-PK  
PROJECT NO.: HPP-3576(002)  
FOREST PRESERVE DISTRICT OF COOK COUNTY  
COOK COUNTY



C-91-569-10

**TRAFFIC DATA**

	ADT (2030)	DESIGN SPEED	POSTED SPEED
GOLFVIEW AVENUE	8,000	35 MPH	30 MPH
31 ST STREET	13,000	40 MPH	35 MPH
1ST AVENUE (IL RTE 171)	28,000	35 MPH	35 MPH

**DESIGN DESIGNATION**

GOLFVIEW AVENUE (FAU 3784): MAJOR COLLECTOR  
31 ST STREET (FAU 1467): MINOR ARTERIAL  
1ST AVENUE (IL RTE 171) (FAP 0372): OTHER ARTERIAL


PROJECT BEGINS  
STA. 10 + 00.00  
GOLFVIEW AVENUE

PROJECT ENDS  
STA. 26 + 14.88  
GOLFVIEW AVENUE

PROJECT ENDS  
STA. 216 + 00.00  
31ST STREET

PROJECT BEGINS  
STA. 207 + 06.00  
31ST STREET


PROJECT LOCATION

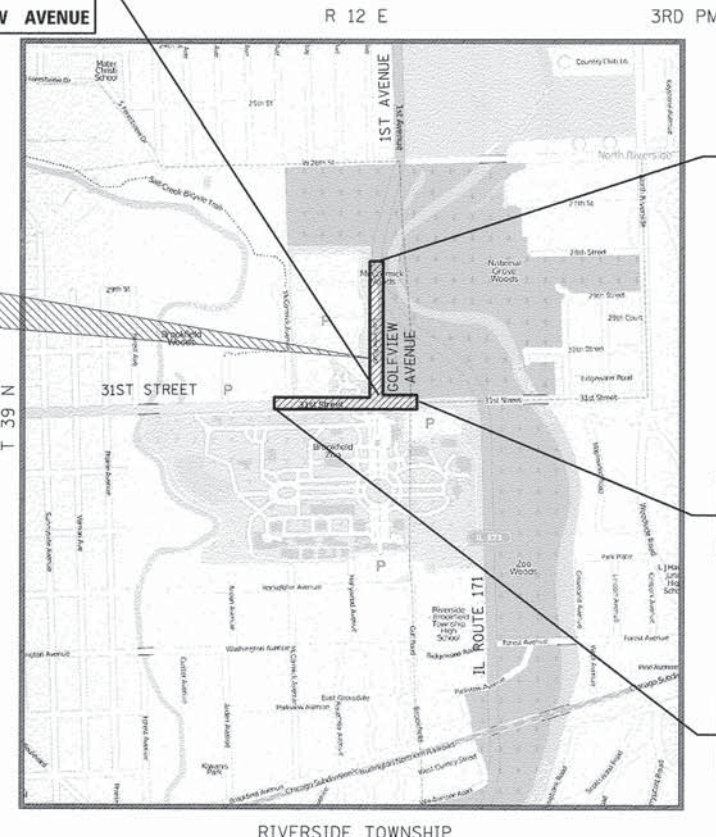

GROSS AND NET LENGTH:  
GOLFVIEW AVENUE - 1,614.88 FT. (0.306 MILE)  
31ST STREET - 894.00 FT. (0.169 MILES)  
TOTAL - 2508.88 FT. (0.475 MILES)

**STATEMENT OF COMPLIANCE**  
I have prepared, or caused to be prepared under my direct supervision, the attached plans and specification and state that, to the best of my knowledge and belief and to the extent of my contractual obligation, they are in compliance with the Environmental Barriers Act [410 ILCS 25] and the Illinois Accessibility Code (71 IL. Adm. Code 400)

Signed: \_\_\_\_\_ ARCHITECT/ENGINEER  
ILLINOIS REGISTRATION NO.: \_\_\_\_\_  
Date: \_\_\_\_\_

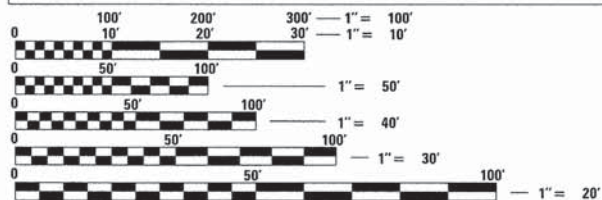

FULL SIZE PLANS HAVE BEEN PREPARED USING STANDARD ENGINEERING SCALES. REDUCED SIZED PLANS WILL NOT CONFORM TO STANDARD SCALES. IN MAKING MEASUREMENTS ON REDUCED PLANS, THE ABOVE SCALES MAY BE USED.

J.U.L.I.E.  
JOINT UTILITY LOCATION INFORMATION FOR EXCAVATION  
1-800-892-0123  
OR 811

*John Blachut* 11/30/2013  
REGISTERED P.E., STATE OF ILLINOIS  
SHEETS 99-107 EXPIRES

*David J. Olsen* 11/30/2014  
REGISTERED ARCHITECT, STATE OF ILLINOIS  
SHEETS 108-109 EXPIRES

*Gary A. Blazek* 11/30/2013  
REGISTERED P.E., STATE OF ILLINOIS  
SHEETS 108-109 EXPIRES

STATE OF ILLINOIS DEPARTMENT OF TRANSPORTATION DIVISION OF HIGHWAYS		
APPROVED	<i>Chris Statten</i> April 22	20 13
FOREST PRESERVE DISTRICT OF COOK COUNTY		
PASSED	<i>CHARTER</i> MAY 30	20 13
DISTRICT ONE ENGINEER OF LOCAL ROADS & STREETS		
RELEASING FOR BID BASED ON LIMITED REVIEW	<i>John Fertmann</i> May 30	20 13
DEPUTY DIRECTOR OF HIGHWAYS, REGION ONE ENGINEER		

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OF THE STATE OF ILLINOIS

PLANS PREPARED BY:  
**CIVILTECH**  
450 E. Devon Ave, Suite 300 - Itasca, Illinois 60143  
Tel: 630.773.3900 - Fax: 630.773.3975  
www.civiltechinc.com

PROGRAM AND OFFICE ENGINEER: CHARLES F. RIDDLE, P.E., (847)-705-4406 SCHAUMBURG, IL



SPECIFICATIONS, STANDARDS AND SPECIAL PROVISIONS

- ALL REFERENCES TO "STANDARD SPECIFICATIONS" IN THESE GENERAL NOTES SHALL BE INTERPRETED TO MEAN THE "STANDARD SPECIFICATIONS FOR ROAD AND BRIDGE CONSTRUCTION" ADOPTED BY THE ILLINOIS DEPARTMENT OF TRANSPORTATION, JANUARY 1, 2012 AND THE "SUPPLEMENTAL SPECIFICATIONS AND RECURRING SPECIAL PROVISION", ADOPTED JANUARY 1, 2013.
- ALL CONSTRUCTION SHALL BE IN ACCORDANCE WITH THE "STANDARD SPECIFICATIONS FOR ROAD AND BRIDGE CONSTRUCTION" ("STANDARD SPECIFICATIONS"), ADOPTED JANUARY 1, 2012; THE "SUPPLEMENTAL SPECIFICATIONS AND RECURRING SPECIAL PROVISIONS", ADOPTED JANUARY 1, 2013; THE LATEST EDITION OF THE "ILLINOIS MANUAL ON UNIFORM TRAFFIC CONTROL DEVICES FOR STREETS AND HIGHWAYS", (MUTCD); "THE STANDARD SPECIFICATIONS FOR WATER AND SEWER MAIN CONSTRUCTION IN ILLINOIS" JULY 2009 EDITION, THE DETAILS IN THE PLANS, AND THE SPECIAL PROVISIONS AND IDOT STANDARD DRAWINGS INCLUDED IN THE CONTRACT DOCUMENTS.
- BEFORE STARTING ANY EXCAVATION, THE CONTRACTOR SHALL CALL "JULIE" AT (800) 892-0123 OR 811.
- THE CONTRACTOR SHALL COORDINATE CONSTRUCTION ACTIVITIES WITH UTILITY COMPANIES AND GOVERNMENT AGENCIES.
- WHEN ARTIFICIAL LIGHTING IS UTILIZED IN NIGHT OPERATIONS, THE CONTRACTOR SHALL EXERCISE THE UTMOST PRECAUTIONS PREVENTING ADVERSE VISIBILITY TO THE MOTORING PUBLIC AND ADJOINING RESIDENTIAL AREA.
- NO ADDITIONAL COMPENSATION WILL BE MADE FOR REMOVAL OF STUMPS OR TREE ROOTS THAT ARE IN CONFLICT WITH THE PROPOSED IMPROVEMENTS.
- ALL DIMENSIONS, INCLUDING RADII, ARE GIVEN TO THE EDGE OF PAVEMENT UNLESS OTHERWISE NOTED.
- IT SHALL BE THE CONTRACTOR'S RESPONSIBILITY TO VERIFY ALL DIMENSIONS AND CONDITIONS EXISTING IN THE FIELD PRIOR TO ORDERING MATERIALS AND BEGINNING CONSTRUCTION.
- ALL TRAFFIC CONTROL, DETOUR, AND OTHER ADVISORY SIGNS NEEDED FOR CONSTRUCTION ARE TO BE FURNISHED BY THE CONTRACTOR IN ACCORDANCE WITH SECTION 701 OF THE STANDARD SPECIFICATIONS FOR ROAD AND BRIDGE CONSTRUCTION AND SHALL BE INCLUDED IN THE PAY ITEM "TRAFFIC CONTROL AND PROTECTION (SPECIAL)".

PAVING, SHOULDERS AND CURB & GUTTER

- THE CONTRACTOR SHALL SAW CUT PAVEMENT, CURB & GUTTER & SHOULDER AS INDICATED ON THE PLANS TO SEPARATE THE EXISTING MATERIAL TO BE REMOVED BY MEANS OF AN APPROVED CONCRETE SAW TO A DEPTH AS SHOWN ON THE PLANS OR AS DIRECTED BY THE ENGINEER. THIS WORK SHALL BE CONSIDERED INCLUDED IN THE COST OF THE ITEM BEING REMOVED.
- THE CONTRACTOR SHALL BE REQUIRED TO SAW VERTICAL CUTS SO AS TO FORM CLEAN VERTICAL JOINTS. SHOULD THE CONTRACTOR DEFACE ANY EDGE, A NEW SAWED JOINT SHALL BE PROVIDED AND ANY ADDITIONAL WORK, INCLUDING REMOVAL AND REPLACEMENT, SHALL BE DONE AT THE CONTRACTOR'S EXPENSE.
- IT IS THE CONTRACTOR'S RESPONSIBILITY TO DETERMINE THE THICKNESS OF THE EXISTING PAVEMENT AND WHETHER OR NOT IT CONTAINS REINFORCEMENT.
- HOT-MIX ASPHALT BASE COURSE AND BINDER COURSE SHALL NOT BE PLACED ADJACENT TO CURB AND GUTTER UNTIL THE CURB AND GUTTER HAS BEEN PROPERLY BACKFILLED TO THE SATISFACTION OF THE ENGINEER.
- PRIOR TO PLACING HOT-MIX ASPHALT ADJACENT TO EXISTING PAVEMENT TO REMAIN, THE EXPOSED EDGE SHALL BE CLEANED OF LOOSE MATERIAL TO THE SATISFACTION OF THE ENGINEER. THIS WORK SHALL BE CONSIDERED INCLUDED IN THE COST OF THE HMA BEING PLACED.
- THE THICKNESS OF HOT-MIX ASPHALT SHOWN ON THE PLANS IS THE NOMINAL THICKNESS. DEVIATIONS FROM THE NOMINAL THICKNESS WILL BE PERMITTED WHEN SUCH DEVIATIONS OCCUR DUE TO IRREGULARITIES IN THE EXISTING SURFACE OR BASE ON WHICH THE HOT-MIX ASPHALT IS PLACED.
- REMOVAL OF EXISTING COMBINATION CURB AND GUTTER SHALL BE PAID FOR AS "COMBINATION CURB AND GUTTER REMOVAL" REGARDLESS OF THE CURB AND GUTTER TYPE.
- PROTECTIVE COAT SHALL BE APPLIED IN ACCORDANCE WITH SECTION 420 OF THE STANDARD SPECIFICATIONS TO CONCRETE MEDIAN SURFACES, ALL EXPOSED SURFACES OF CURBS AND GUTTERS, PCC DRIVEWAYS, PCC PAVEMENT, AND PCC SIDEWALK. ANY PART OF THIS ITEM CAN BE DELETED OR ANOTHER ADDED AT THE DISCRETION OF THE ENGINEER.
- HOT-MIX ASPHALT SURFACE COURSE SHALL NOT BE PLACED UNTIL ALL EARTH EXCAVATION, TOPSOIL PLACEMENT, AND HOT-MIX ASPHALT BINDER COURSE HAVE BEEN COMPLETED TO THE SATISFACTION OF THE ENGINEER.
- PAVEMENT GRADES: THE ELEVATIONS INDICATED ON THE PLANS ARE FINISHED GRADES OF PROPOSED PAVEMENT, UNLESS OTHERWISE INDICATED.
- FOR WORK OUTSIDE THE LIMITS OF BRIDGE APPROACH PAVEMENT, ALL REFERENCES IN THE HIGHWAY STANDARDS AND STANDARD SPECIFICATIONS FOR REINFORCEMENT, DOWEL BARS AND TIE BARS IN PAVEMENT SHOULDERS, CURB, GUTTER, COMBINATION CURB AND GUTTER, MEDIAN, AND CHAIR SUPPORTS FOR CRC PAVEMENT, SHALL BE EPOXY COATED, UNLESS NOTED ON THE PLAN.

MISCELLANEOUS

- SITE OBJECTS: REMOVAL OF MISCELLANEOUS PARKWAY IMPROVEMENTS INCLUDING, BUT NOT LIMITED TO, BLOCK RETAINING WALL, CONCRETE FOOTINGS, LANDSCAPE TIMBERS, LANDSCAPE ROCKS, PLANTERS, VEGETATION, BRICK OR BRICK PAVEMENT WALKWAYS WITHIN R.O.W. LIMITS SHALL BE INCLUDED IN THE COST OF THE PAY ITEM FOR "EARTH EXCAVATION" UNLESS QUANTIFIED SEPERATELY.
- THE CONTRACTOR SHALL NOT CROSS COMPLETED BINDER COURSE, OR EXISTING PAVEMENT NOT SCHEDULED TO BE REMOVED, WITH CONSTRUCTION EQUIPMENT WHICH MAY DAMAGE THE PAVEMENT. ANY DAMAGED PAVEMENT SHALL BE REPAIRED AT THE CONTRACTORS EXPENSE.
- ALL EXCESS MATERIAL (BROKEN CONCRETE, SEWER PIPE, WASTE ROADWAY EXCAVATION AND SURPLUS MATERIAL FROM SEWER TRENCHES) SHALL BE LEGALLY DISPOSED OF OUTSIDE THE LIMITS OF THE RIGHT-OF-WAY. IT SHALL BE THE CONTRACTOR'S RESPONSIBILITY TO SELECT DUMP SITES AND OBTAIN PERMISSION AND ALL NECESSARY PERMITS TO USE SUCH DUMP SITES. PAYMENT FOR THIS WORK SHALL BE INCLUDED IN "EARTH EXCAVATION".
- THE CONTRACTOR IS PROHIBITED FROM BURNING ANY MATERIAL WITHIN OR ADJACENT TO THE PROJECT LIMITS. ALL EXCESS OR WASTE MATERIAL SHALL BE HAULED AWAY FROM THE PROJECT SITE BY THE CONTRACTOR AND DEPOSITED AT LOCATIONS PROVIDED BY HIM, OR DISPOSED OF WITHIN THE RIGHT-OF-WAY IN A MANNER OTHER THAN BURNING, SUBJECT TO THE APPROVAL OF THE ENGINEER. NO EXTRA COMPENSATION WILL BE ALLOWED THE CONTRACTOR FOR ANY EXPENSE INCURRED BY COMPLYING WITH THE REQUIREMENTS OF THIS NOTE.
- ALL EMBANKMENTS AND SUB-GRADE SHALL BE COMPACTED TO THE SATISFACTION OF THE ENGINEER PRIOR TO THE PLACEMENT OF GRANULAR SUB-BASE OR EMBANKMENT.
- AGGREGATE SUBGRADE IMPROVEMENT AND FILTER FABRIC HAVE BEEN PROVIDED TO REPLACE SOILS WHICH TEND TO BE UNSTABLE WHEN WET. THE ACTUAL NEED FOR REMOVAL AND REPLACEMENT WILL BE DETERMINED IN THE FIELD AT THE TIME OF CONSTRUCTION BY THE ENGINEER. IF UNSUITABLE SOILS ARE ENCOUNTERED THE SOILS SHALL BE REMOVED AND REPLACED. THESE LIMITS MAY BE ALTERED BY THE ENGINEER IF FIELD CONDITIONS SO WARRANT. REMOVAL OF THESE UNSUITABLE SOILS SHALL BE PAID FOR AS "REMOVAL AND DISPOSAL OF UNSUITABLE MATERIAL".
- THE GENERAL CONTRACTOR IS REQUIRED TO HIRE AN ENVIRONMENTAL FIRM WITH AT LEAST FIVE (5) DOCUMENTED LEAKING UNDERGROUND STORAGE TANK CLEANUPS OR THAT IS PRE-QUALIFIED IN HAZARDOUS WASTE BY THE DEPARTMENT TO REMEDIATE THE SOIL CONTAMINATION AND MONITOR FOR WORKER PROTECTION.
- THE GENERAL CONTRACTOR IS REQUIRED TO BE REGISTERED WITH COOK COUNTY BUILDING AND ZONING DEPARTMENT AND SHALL MEET ALL REQUIREMENTS SET FORTH BY THE DEPARTMENT.
- THE GENERAL CONTRACTOR SHALL OBTAIN ALL NECESSARY PERMITS REQUIRED BY COOK COUNTY BUILDING AND ZONING DEPARTMENT.
- THE SOILS REPORT AND GEOTECHNICAL ANALYSIS IS AVAILABLE FROM MIDLAND STANDARD ENGINEERING & TESTING, INC. (847) 844-1895

UTILITIES

- THE LOCATION OF PUBLIC OR PRIVATE UTILITIES SHOWN ON THE PLANS ARE APPROXIMATE AND THE ENGINEER DOES NOT GUARANTEE THEIR ACCURACY. THE CONTRACTOR WILL BE REQUIRED TO ASCERTAIN THE EXACT LOCATION OF SUCH UTILITIES AND EXERCISE CARE DURING HIS CONSTRUCTION OPERATIONS SO AS NOT TO DAMAGE THEM IN ACCORDANCE WITH THE SPECIAL PROVISIONS AND ARTICLE 107.31 OF THE "STANDARD SPECIFICATIONS". THE CONTRACTOR SHALL BE RESPONSIBLE FOR CONTACTING THE OWNERS OF ALL EXISTING UTILITIES SO THAT THEIR FACILITIES MAY BE LOCATED AND ADJUSTED OR MOVED, IF NECESSARY, PRIOR TO THE START OF THE CONSTRUCTION OPERATIONS.
- THE CONTRACTOR SHALL BE RESPONSIBLE FOR THE PROTECTION OF ALL ABOVE AND BELOW GROUND UTILITIES EVEN THOUGH THEY MAY NOT BE SHOWN ON THE PLANS. ANY UTILITY THAT IS DAMAGED DURING CONSTRUCTION SHALL BE REPAIRED OR REPLACED TO THE SATISFACTION OF THE ENGINEER. THIS WORK SHALL BE AT THE CONTRACTOR'S EXPENSE. THE CONTRACTOR SHALL NOTIFY ALL UTILITY OWNERS OF HIS CONSTRUCTION SCHEDULE AND SHALL COORDINATE CONSTRUCTION OPERATIONS WITH THE UTILITY OWNERS SO THAT RELOCATION OF UTILITY LINES AND STRUCTURES MAY PROCEED IN AN ORDERLY MANNER. NOTIFICATION SHALL BE IN WRITING, WITH COPIES TRANSMITTED TO THE ENGINEER.
- ANY EXISTING OR PROPOSED SEWER DAMAGED BY THE CONTRACTOR DURING CONSTRUCTION SHALL BE REPLACED BY THE CONTRACTOR TO THE SATISFACTION OF THE ENGINEER AT THE CONTRACTORS EXPENSE.
- WHERE TRENCH BACKFILL IS REQUIRED, THE MATERIAL USED SHALL BE COMPACTED AS SPECIFIED IN ARTICLE 550.07 OF THE "STANDARD SPECIFICATIONS" USING METHOD ONE.
- COORDINATION OF ANY UTILITY WORK INVOLVED IN THE CONSTRUCTION AREA WILL BE DISCUSSED AT THE PRECONSTRUCTION CONFERENCE.
- THE CONTRACTOR SHALL RECEIVE NO ADDITIONAL COMPENSATION FOR CONSTRUCTION STAGING NECESSARY TO ACCOMMODATE UTILITY RELOCATION OR ADJUSTMENT AND/OR FOR DELAYS CAUSED BY UTILITY RELOCATON OR ADJUSTMENT.

DRAINAGE

- THE STATION/OFFSET/ELEVATIONS NOTED FOR ALL DRAINAGE STRUCTURES ARE DIMENSIONED TO THE CENTER OF STRUCTURE UNLESS OTHERWISE NOTED.
- THE COST OF MAKING SEWER CONNECTIONS TO EXISTING OR PROPOSED SEWER OR DRAINAGE STRUCTURES SHALL BE INCLUDED IN THE COST OF THE SEWER OR STRUCTURE BEING CONSTRUCTED.
- UNLESS OTHERWISE NOTED ON THE PLANS, THE EXISTING DRAINAGE FACILITIES SHALL REMAIN IN USE DURING THE PERIOD OF CONSTRUCTION. LOCATIONS OF EXISTING DRAINAGE STRUCTURES AND SEWERS AS SHOWN ON THE PLANS ARE APPROXIMATE. PRIOR TO COMMENCING WORK, THE CONTRACTOR, AT HIS OWN EXPENSE, SHALL DETERMINE THE EXACT LOCATIONS OF EXISTING STRUCTURES WHICH ARE WITHIN THE PROPOSED CONSTRUCTION LIMITS.
- DURING CONSTRUCTION, IF THE CONTRACTOR ENCOUNTERS OR OTHERWISE BECOMES AWARE OF ANY SEWER, UNDERDRAINS OR FIELD DRAINS WITHIN THE RIGHT-OF-WAY OTHER THAN THOSE SHOWN ON THE PLANS, HE SHALL SO INFORM THE ENGINEER, WHO SHALL DIRECT THE WORK NECESSARY TO MAINTAIN OR REPLACE THE FACILITIES IN SERVICE AND TO PROTECT THEM FROM DAMAGE DURING CONSTRUCTION IF MAINTAINED. EXISTING FACILITIES TO BE MAINTAINED THAT ARE DAMAGED BECAUSE OF THE NON-COMPLIANCE WITH THIS PROVISION SHALL BE REPLACED AT THE CONTRACTOR'S OWN EXPENSE. SHOULD THE ENGINEER HAVE DIRECTED THE REPLACEMENT OF A FACILITY, THE NECESSARY WORK AND PAYMENT SHALL BE IN ACCORDANCE WITH SECTIONS 550 AND 601, AND ARTICLE 104.02 OF THE STANDARD SPECIFICATIONS.
- THE CONTRACTOR SHALL DETERMINE WHEN FLAT SLAB TOPS ARE REQUIRED ON MANHOLES OR CATCH BASINS. NO ADDITIONAL COMPENSATION SHALL BE ALLOWED FOR THE USE OF FLAT SLAB TOPS.
- TOP OF FRAME ("RIM") ELEVATIONS GIVEN ON THE PLANS ARE ONLY TO ASSIST THE CONTRACTOR IN DETERMINING THE APPROXIMATE OVERALL HEIGHT OF EACH STRUCTURE. FRAMES ON ALL NEW STRUCTURES SHALL BE ADJUSTED TO THE FINAL ELEVATIONS OF THE AREAS IN WHICH THEY ARE LOCATED, AS A PART OF THE STRUCTURE COST.
- ALL SEWER AND WATER SERVICES CROSSED BY NEW STORM SEWERS SHALL BE PROPERLY LOCATED AND PROTECTED DURING CONSTRUCTION. ANY DAMAGE TO SAID SERVICES NOT CONSIDERED TO BE IN CONFLICT WITH THE PROPOSED STORM SEWER SHALL BE REPAIRED BY THE CONTRACTOR AT HIS OWN EXPENSE.
- ANY TEMPORARY DAMMING OR PUMPING REQUIRED FOR THE EXCAVATIONS FOR THE STORM SEWER OR CULVERT CONNECTIONS SHALL BE INCLUDED IN THE COST OF THE STORM SEWER OR CULVERT BEING CONSTRUCTED.
- WHEN EXISTING DRAINAGE FACILITIES ARE DISTURBED, THE CONTRACTOR SHALL PROVIDE AND MAINTAIN TEMPORARY OUTLETS AND CONNECTIONS FOR ALL PRIVATE OR PUBLIC DRAINS, SEWERS OR CATCH BASINS. THE CONTRACTOR SHALL PROVIDE FACILITIES TO TAKE IN ALL STORM WATER WHICH WILL BE RECEIVED BY THESE DRAINS AND SEWERS AND DISCHARGE THE SAME. HE SHALL PROVIDE AND MAINTAIN AN EFFICIENT PUMPING PLAN, IF NECESSARY, AND A TEMPORARY OUTLET. HE SHALL BE PREPARED AT ALL TIMES TO DISPOSE OF THE WATER RECEIVED FROM TEMPORARY CONNECTIONS UNTIL SUCH TIME AS THE PERMANENT CONNECTIONS WITH SEWER ARE BUILT AND IN SERVICE. THIS WORK WILL NOT BE PAID FOR SEPARATELY, BUT SHALL BE INCLUDED IN THE CONTRACT.
- DRAINAGE STRUCTURE FLAT-TOPS AND CONES SHALL BE TURNED SO THAT THE FRAMES ARE CLOSEST TO THE CENTERLINE OF THE ROAD. ALL FLAT-TOPS AND CONES ARE ASSUMED TO BE ECCENTRIC.
- ALL EXISTING DRAINAGE STRUCTURES ARE TO BE KEPT FREE OF ANY DEBRIS RESULTING FROM THE CONTRACTOR'S CONSTRUCTION OPERATIONS. ALL WORK AND MATERIAL NECESSARY TO PREVENT ACCUMULATION OF DEBRIS IN THE DRAINAGE STRUCTURES WILL BE CONSIDERED AS INCIDENTAL TO THE CONTRACT. ANY DEBRIS IN THE DRAINAGE STRUCTURES RESULTING FROM CONSTRUCTION OPERATIONS SHALL BE REMOVED AT THE CONTRACTOR'S EXPENSE, AND NO EXTRA COMPENSATION WILL BE ALLOWED.
- THE CONTRACTOR SHALL TAKE THE NECESSARY PRECAUTIONS WHEN WORKING NEAR OR ABOVE EXISTING SEWERS IN ORDER TO PROTECT THESE PIPES DURING CONSTRUCTION FROM ANY DAMAGE RESULTING FROM HIS OPERATIONS. ALL WORK AND MATERIAL NECESSARY TO REPLACE EXISTING SEWERS DAMAGED BECAUSE OF NONCOMPLIANCE WITH THIS PROVISION SHALL BE AS DIRECTED BY THE ENGINEER IN ACCORDANCE WITH SECTION 550 OF THE "STANDARD SPECIFICATIONS" AND AT THE CONTRACTOR'S OWN EXPENSE, AND NO ADDITIONAL COMPENSATION WILL BE ALLOWED.
- THE COST OF REMOVING EXISTING PAVEMENT TO INSTALL NEW STORM SEWER OR DRAINAGE STRUCTURES SHALL BE INCLUDED IN THE COST OF THE SEWER OR STRUCTURE BEING CONSTRUCTED.

FILE NAME = ...\\2563_GEN.NOTE_01.dgn	USER NAME = dte	DESIGNED - DTE	REVISED -	<b>STATE OF ILLINOIS DEPARTMENT OF TRANSPORTATION</b>	<b>GENERAL NOTES</b>			F.A.U. RTE.	SECTION	COUNTY	TOTAL SHEETS	SHEET NO.	
		DRAWN - DTE	REVISED -		SCALE: NONE	SHEET NO. 1 OF 2 SHEETS	STA.	TO STA.	3784	12-F3000-23-PK	COOK	131	2
		CHECKED - GAB	REVISED -		<b>CONTRACT NO. 63764</b>								
		DATE - 05/13/2013	REVISED -		FED. ROAD DIST. NO. 1 ILLINOIS FED. AID PROJECT								



SIGNING, STRIPING & LANDSCAPING

- WHEN DIRECTED BY THE ENGINEER, SUPPLEMENTAL WATERING SHALL BE APPLIED TO ALL SEEDED AREAS PRIOR TO FINAL ACCEPTANCE AT A RATE SPECIFIED BY THE ENGINEER.
- THE CONTRACTOR SHALL ADHERE TO LIMITS OF RESTORATION SHOWN. AREAS OUTSIDE THESE LIMITS THAT ARE DAMAGED OR DISTURBED BY THE CONTRACTOR SHALL BE RESTORED BY THE CONTRACTOR AT HIS EXPENSE, AND NO ADDITIONAL COMPENSATION WILL BE ALLOWED.
- ALL EXISTING TRAFFIC SIGNS WHICH INTERFERE WITH THE CONTRACTOR'S WORK SHALL BE REMOVED, A RECORD MADE OF THEIR CONDITION, AND SAFELY STORED AND SAFEGUARDED BY THE CONTRACTOR UNTIL THE ENGINEER DETERMINES THAT THEY BE REINSTALLED IN THE PERMANENT LOCATIONS.
- IMMEDIATELY AFTER EACH SIGN IS REMOVED, A TEMPORARY SIGN OF THE SAME TYPE SHALL BE INSTALLED ON A SIGN SUPPORT APPROVED BY, AND AT A LOCATION DETERMINED BY, THE ENGINEER. THESE SIGNS SHALL BE MAINTAINED STRAIGHT AND CLEAN UNTIL THE PERMANENT SIGNS ARE REINSTALLED.
- ANY SIGN WHICH IS DAMAGED DURING THE TIME IT IS STORED SHALL BE REPAIRED OR REPLACED IN KIND BY THE CONTRACTOR AT HIS OWN EXPENSE PRIOR TO PERMANENT REINSTALLATION.
- ALL UNUSED SIGNS AND POSTS SHALL BE RETURNED TO THE OWNER OF SIGN THAT WAS REMOVED.
- THE COST OF STORING AND SAFEGUARDING THE PERMANENT SIGNS AND POSTS, AND REINSTALLING THE PERMANENT SIGNS SHALL BE INCLUDED IN THE CONTRACT UNIT PRICE FOR "RELOCATE SIGN PANEL ASSEMBLY" OF THE TYPE SPECIFIED. NEW SIGN SUPPORTS AND HARDWARE SHALL BE USED FOR REINSTALLED SIGNS UNLESS OTHERWISE NOTED. FURNISHING, INSTALLING, MAINTAINING AND REMOVING THE TEMPORARY SIGNS SHALL BE INCLUDED IN THE COST OF THE VARIOUS TRAFFIC CONTROL AND PROTECTION ITEMS. THE NEW SUPPORTS SHALL BE PAID FOR AS "TELESCOPING STEEL SIGN SUPPORT".
- PAVEMENT MARKINGS REMOVED OUTSIDE THE LIMITS OF THE IMPROVEMENT DUE TO TRAFFIC CONTROL AND SHIFTING TRAFFIC SHALL BE REPLACED AT THE END OF CONSTRUCTION. THIS WORK SHALL BE PAID FOR PER LINEAR FOOT OF THE LINE TYPE INSTALLED.
- THE RESIDENT ENGINEER MUST CONTACT PATRICE HARRIS, IDOT DISTRICT ONE AREA TRAFFIC FIELD TECHNICIAN AT (708)-597-9800 TWO WEEKS PRIOR TO INSTALLING PERMANENT PAVEMENT MARKINGS.

EROSION CONTROL

- THE CONTRACTOR SHALL INSPECT ALL EROSION CONTROL MEASURES PERIODICALLY AND AFTER EACH RUNOFF-PRODUCING RAINFALL EVENT. ANY NECESSARY REPAIRS OR CLEANUP TO MAINTAIN THE EFFECTIVENESS OF SAID MEASURES SHALL BE MADE IMMEDIATELY.
- THE MAINTENANCE AND REPAIR OR REPLACEMENT OF EROSION CONTROL ITEMS, WHEN DIRECTED BY THE ENGINEER, WILL NOT BE PAID FOR SEPARATELY, BUT SHALL BE INCLUDED IN THE COST OF THE ASSOCIATED PAY ITEMS.
- ALL STORM SEWER FACILITIES THAT ARE OR WILL BE FUNCTIONING DURING CONSTRUCTION SHALL BE PROTECTED, FILTERED OR OTHERWISE TREATED TO REMOVE SEDIMENT. MUD AND SEDIMENT DEPOSITS SHALL BE REMOVED FROM THE ROADWAY AT THE END OF EACH WORK DAY BY SHOVELING AND/OR SWEEPING.
- ALL DISTURBED AREAS SHALL BE SEEDED AS SHOWN ON THE LANDSCAPING PLANS AND/OR THE EROSION AND SEDIMENT CONTROL PLANS WITHIN SEVEN (7) DAYS AFTER CONSTRUCTION ACTIVITIES IN THAT AREA HAVE CONCLUDED.
- ALL SLOPES 3:1 OR STEEPER SHALL BE SEEDED IMMEDIATELY AND COVERED WITH EROSION CONTROL BLANKET. ALL FLATTER AREAS THAT DO NOT HAVE A COVER OF VEGETATION AND WHERE NO FURTHER WORK IS TO OCCUR FOR ONE (1) WEEK OR MORE SHALL BE SEEDED WITH TEMPORARY EROSION CONTROL SEEDING AND COVERED WITH MULCH METHOD 2 WITHIN SEVEN (7) CALENDAR DAYS, UNLESS OTHERWISE DIRECTED BY THE ENGINEER.
- INLET FILTERS SHALL BE PLACED ON ALL CATCH BASINS, INLETS, AND MANHOLES WITH OPEN GRATES.
- THE EROSION CONTROL MEASURES INDICATED ON THE PLANS ARE THE MINIMUM REQUIREMENTS. ADDITIONAL MEASURES MAY BE REQUIRED, AS DIRECTED BY THE ENGINEER.
- THE CONTRACTOR SHALL TAKE ALL PRECAUTIONS TO PREVENT POLLUTION OF STORM WATER AND SHALL FOLLOW IEPA & IDOT CONSTRUCTION MEMORANDUM NO. 06-60.
- SEE STANDARD 280001-05 FOR ADDITIONAL SOIL EROSION AND SEDIMENT CONTROL DETAILS AND REQUIREMENTS.
- ALL VEGETATIVE AND STRUCTURAL EROSION CONTROL PRACTICES SHALL BE CONSTRUCTED AND MAINTAINED IN ACCORDANCE WITH THE MINIMUM STANDARDS AND SPECIFICATIONS OF THE "ILLINOIS PROCEDURES AND STANDARDS FOR URBAN SOIL EROSION AND SEDIMENTATION CONTROL" AND THE "STANDARDS AND SPECIFICATIONS FOR SOIL EROSION AND SEDIMENT CONTROL" OF THE ILLINOIS ENVIRONMENTAL PROTECTION AGENCY.
- SOIL DISTURBANCE SHALL BE CONDUCTED IN SUCH A MANNER AS TO MINIMIZE EROSION. SOIL STABILIZATION MEASURES SHALL CONSIDER THE TIME OF YEAR, SITE CONDITIONS AND THE USE OF TEMPORARY OR PERMANENT MEASURES.

MAINTENANCE OF TRAFFIC

- TRAFFIC CONTROL DEPICTED IN THESE PLANS AND THE APPLICABLE IDOT DETAILS AND STANDARDS ARE THE MINIMUM REQUIREMENTS. OTHER WORK OR SIGNING MAY BE REQUIRED BY THE ENGINEER. TRAFFIC CONTROL AND PROTECTION SHALL BE PERFORMED IN ACCORDANCE WITH THE STANDARD SPECIFICATIONS, DIVISION 700; APPLICABLE GUIDELINES IN THE ILLINOIS MANUAL ON UNIFORM TRAFFIC CONTROL DEVICES FOR STREETS AND HIGHWAYS; AND APPLICABLE HIGHWAY STANDARDS FOR TRAFFIC CONTROL, UNLESS HEREIN REVISED.
- THE EXACT NUMBER, LOCATION AND SPACING OF ALL SIGNS AND TRAFFIC CONTROL DEVICES SHALL FIT FIELD CONDITIONS AS DIRECTED BY THE ENGINEER.
- ALL CONSTRUCTION SIGNS SHALL HAVE FLUORESCENT ORANGE BACKGROUNDS.
- ALL SIGNS SHALL BE MOUNTED ON METAL POSTS, 7 FEET ABOVE THE EXISTING GROUND AND DRIVEN A MINIMUM OF 3 FEET INTO THE GROUND. A J.U.L.I.E. LOCATE SHALL BE PERFORMED PRIOR TO THE INSTALLATION OF THE POSTS.
- THE CONTRACTOR SHALL MAINTAIN 10-FOOT (MIN) DRIVING LANES ON ALL ROADS UNLESS DIRECTED BY THE ENGINEER OR OTHERWISE SHOWN ON THE PLANS.
- THE CONTRACTOR SHALL MAINTAIN ACCESS TO ALL PROPERTIES AND SIDE ROADS DURING CONSTRUCTION OPERATIONS. A QUANTITY OF "AGGREGATE FOR TEMPORARY ACCESS" HAS BEEN INCLUDED IN THE CONTRACT FOR THIS PURPOSE.
- BARRICADES WILL BE REQUIRED ADJACENT TO PAVEMENT EDGES WHERE WIDENING, CURB AND GUTTER OR OVERLAYING WORK IS BEING DONE, AS SPECIFIED IN SECTION 701 OF THE STANDARD SPECIFICATIONS. SPACING SHALL BE AS SHOWN ON THE STANDARDS UNLESS OTHERWISE DIRECTED BY THE ENGINEER. BARRICADES THAT MUST BE PLACED IN EXCAVATED AREAS SHALL HAVE LEG EXTENSIONS INSTALLED SUCH THAT THE TOPS OF THE BARRICADES ARE IN COMPLIANCE WITH THE HEIGHT REQUIREMENTS OF STANDARD 701901-02.
- ALL BARRICADES AT LANE DIVERSIONS WITHIN TAPER SECTIONS SHALL HAVE DIRECTION INDICATOR PANELS.
- DRUMS SHALL HAVE ALTERNATING REFLECTORIZED TYPE AA OR TYPE AP FLUORESCENT ORANGE AND REFLECTORIZED WHITE HORIZONTAL, CIRCUMFERENTIAL STRIPES.
- DRUMS AND BARRICADES SHALL MEET THE REQUIREMENTS OF THE NATIONAL COOPERATIVE HIGHWAY RESEARCH PROGRAM (NCHRP) REPORT 350 AND THE SPECIAL PROVISION "WORK ZONE TRAFFIC CONTROL DEVICES".
- TYPE III BARRICADES ARE TO BE PLACED IN ACCORDANCE WITH STANDARD 701901-02 UNLESS AUTHORIZED BY THE ENGINEER TO USE AN ALTERNATE ARRANGEMENT.
- THE CONTRACTOR SHALL NOTIFY EMERGENCY SERVICES AT (708) 485-8131, SCHOOL DISTRICT 208 AT (708) 442-7500 AND SCHOOL DISTRICT 96 AT (708) 447-5007 REGARDING ANY ROAD CLOSURES OR DETOURS 72 HOURS PRIOR TO IMPLEMENTATION.
- THE CONTRACTOR SHALL REMOVE ALL EXISTING PAVEMENT MARKINGS WHICH CONFLICT WITH THE DESIGNATED TRAFFIC CONTROL PLAN. THIS WORK SHALL BE PAID FOR AS "PAVEMENT MARKING REMOVAL" PER SQUARE FOOT.
- PORTABLE CHANGEABLE MESSAGE SIGNS SHALL BE PLACED AS DIRECTED BY THE ENGINEER. THE MESSAGES SHOWN SHALL BE AS DIRECTED BY THE ENGINEER. THIS WORK SHALL BE PAID FOR AS "CHANGEABLE MESSAGE SIGN" PER CALENDAR MONTH.
- THE CONTRACTOR SHALL INFORM THE ENGINEER OF ANY STAGE CHANGE AT LEAST TWO WEEKS IN ADVANCE OF THE CHANGE.
- EXISTING TRAFFIC CONTROL DEVICES ARE TO BE PROTECTED FROM DAMAGE BY THE CONTRACTOR. ANY DAMAGE CAUSED BY HIS WORK SHALL BE REPAIRED TO THE SATISFACTION OF THE ENGINEER AT THE EXPENSE OF THE CONTRACTOR.
- EXISTING TRAFFIC CONTROL SIGNS AND DEVICES SHALL BE REMOVED OR RELOCATED BY THE CONTRACTOR AFTER THE TRAFFIC CONTROL REQUIREMENTS ARE MET OR AS AUTHORIZED BY THE ENGINEER; ANY SIGNS OR DEVICES LEFT IN PLACE ARE TO BE PROTECTED FROM DAMAGE AND MAINTAINED.
- TEMPORARY LANE CLOSURES WILL BE ALLOWED ONLY BETWEEN THE HOURS OF 9:00 A.M. AND 3:00 P.M. UNLESS OTHERWISE DIRECTED BY THE ENGINEER. THE CONTRACTOR SHALL NOTIFY THE ENGINEER PRIOR TO CLOSING ANY LANES. ALL CLOSURES SHALL BE COORDINATED CLOSELY WITH THE CHICAGO ZOOLOGICAL SOCIETY AND MAY NEED TO BE ADJUSTED THROUGHOUT THE PROJECT DURATION.
- "WORKERS" SIGNS SHALL ONLY BE ERECTED WHEN WORKERS ARE PRESENT. SIGN MUST BE COVERED OR REMOVED WHEN NO WORKERS ARE PRESENT.
- "FRESH OIL" SIGNS (W21-2-4848) WITH DATE. SIGNS SHALL BE ERECTED 48 HOURS PRIOR TO PRIMING. THE COST OF THESE SIGNS SHALL BE INCLUDED IN THE COST OF "TRAFFIC CONTROL AND PROTECTION (SPECIAL)".
- THE CONTRACTOR SHALL CONTACT THE TRAFFIC CONTROL SUPERVISOR AT (847) 705-4470 A MINIMUM OF 72 HOURS IN ADVANCE OF BEGINNING WORK.
- EXISTING KIOSKS SHALL REMAIN IN USE WITH POWER AND DATA UNTIL NEW KIOSKS ARE IN PLACE AND SUPPLIED WITH POWER AND DATA AT WHICH TIME THE EXISTING KIOSKS SHALL BE DEMOLISHED.

LIST OF ILLINOIS DOT HIGHWAY STANDARDS

000001-06	STANDARD SYMBOLS, ABBREVIATIONS & PATTERNS
001001-02	AREAS OF REINFORCEMENT BARS
001006	DECIMAL OF AN INCH AND A FOOT
280001-07	TEMPORARY EROSION CONTROL SYSTEMS
420001-07	PAVEMENT JOINTS
424001-07	PERPENDICULAR CURB RAMPS FOR SIDEWALKS
424011-01	CORNER PARALLEL CURB RAMPS FOR SIDEWALKS
442201-03	CLASS C AND D PATCHES
542301-03	PRECAST REINFORCED CONCRETE FLARED END SECTION
602001-02	CATCH BASIN TYPE A
602011-02	CATCH BASIN TYPE C
602401-03	MANHOLE TYPE A
602601-02	PRECAST REINFORCED CONCRETE FLAT SLAB TOP
602701-02	MANHOLE STEPS
604001-03	FRAMES AND LIDS TYPE 1
604036-02	GRATE TYPE 8
604091-02	FRAME AND GRATE, TYPE 24
606001-05	CONCRETE CURB TYPE B AND COMBINATION CONCRETE CURB & GUTTER
606201-02	TYPE B GUTTER (INLET, OUTLET & ENTRANCE)
606301-04	PC CONCRETE ISLANDS AND MEDIANS
701101-03	OFF-RD OPERATIONS, MULTILANE, 15' TO 24" FROM PAVEMENT EDGE
701301-04	LANE CLOSURE, 2L, 2W, SHORT TIME OPERATIONS
701427-01	LANE CLOSURE, MULTILANE, INTERMITTENT OR MOVING OPER., FOR SPEEDS < 40 MPH
701501-06	URBAN LANE CLOSURE, 2L, 2W, UNDIVIDED
701601-08	URBAN LANE CLOSURE, MULTILANE, 1W OR 2W WITH NONTRAVERSABLE MEDIAN
701606-08	URBAN LANE CLOSURE, MULTILANE, 2W WITH MOUNTABLE MEDIAN
701701-08	URBAN LANE CLOSURE, MULTILANE INTERSECTION
701901-02	TRAFFIC CONTROL DEVICES
720001-01	SIGN PANEL MOUNTING DETAILS
720006-03	SIGN PANEL ERECTION DETAILS
720011-01	METAL POSTS FOR SIGNS, MARKERS AND DELINEATORS
728001-01	TELESCOPING STEEL SIGN SUPPORT
729001-01	APPLICATION OF TYPES A & B METAL POSTS (FOR SIGNS AND MARKERS)
780001-03	TYPICAL PAVEMENT MARKINGS
781001-03	TYPICAL APPLICATIONS RAISED REFLECTIVE PAVEMENT MARKERS
814001-02	HANDHOLES
814006-02	DOUBLE HANDHOLES
857001-01	STANDARD PHASE DESIGNATION DIAGRAMS & PHASE SEQUENCES
862001-01	UNINTERRUPTABLE POWER SUPPLY
873001-02	TRAFFIC SIGNAL GROUNDING & BONDING
877001-05	STEEL MAST ARM ASSEMBLY & POLE
878001-09	CONCRETE FOUNDATION DETAILS
880001-01	SPAN WIRE MOUNTED SIGNALS & FLASH BEACON INSTALL
880006-01	TRAFFIC SIGNAL MOUNTING DETAILS WITH POST & BRACKET MOUNT
886001-01	DETECTOR LOOP INSTALLATIONS

MWRD GENERAL NOTES

- THE MWRD LOCAL SEWER SYSTEMS SECTION FIELD OFFICE MUST BE NOTIFIED AT LEAST TWO (2) WORKING DAYS PRIOR TO THE COMMENCEMENT OF ANY WORK (CALL 708-588-4055).
- ELEVATION DATUM IS USGS.
- THERE ARE NO FLOOR DRAINS IN THESE PLANS.
- THERE ARE NO FOOTING DRAINS AND DOWNSPOUTS IN THESE PLANS.
- "BAND SEAL" OR SIMILAR FLEXIBLE-TYPE COUPLINGS SHALL BE USED IN THE CONNECTION OF SEWER PIPES OF DISSIMILAR MATERIALS.
- WHEN CONNECTING TO AN EXISTING SEWER MAIN BY MEANS OTHER THAN AN EXISTING WYE, TEE, OR AN EXISTING MANHOLE, ONE OF THE FOLLOWING METHODS SHALL BE USED:
  - CIRCULAR SAW-CUT OF SEWER MAIN BY PROPER TOOLS ("SEWER-TAP" MACHINE OR SIMILAR) AND PROPER INSTALLATION OF HUB-WYE SADDLE OR HUB-TEE SADDLE.
  - REMOVE AN ENTIRE SECTION OF PIPE (BREAKING ONLY THE TOP OF ONE BELL) AND REPLACE WITH A WYE OR TEE BRANCH SECTION.
  - WITH PIPE CUTTER, NEATLY AND ACCURATELY CUT OUT DESIRED LENGTH OF PIPE FOR INSERTION OF PROPER FITTING, USING "BAND SEAL" OR SIMILAR COUPLINGS TO HOLD IT FIRMLY IN PLACE.

FILE NAME = ... \2563_GEN_NOTE_02.dgn	USER NAME = dte	DESIGNED - DTE	REVISED -	<b>STATE OF ILLINOIS DEPARTMENT OF TRANSPORTATION</b>	<b>GENERAL NOTES</b>			F.A.U. RTE. 3784	SECTION 12-F3000-23-PK	COUNTY COOK	TOTAL SHEETS 131	SHEET NO. 3
	PLOT SCALE = 1.0000' / in.	DRAWN - DTE	REVISED -		SCALE: NONE	SHEET NO. 2 OF 2 SHEETS	STA.	TO STA.	CONTRACT NO. 63764			
	PLOT DATE = 5/23/2013	CHECKED - GAB	REVISED -									
		DATE - 05/13/2013	REVISED -									



CODED PAY ITEM NO.	ITEM	UNIT	TOTAL QUANTITY	0004	0021	0031	0042	0044	0021			
				ROADWAY	SAFETY	LANDSCAPING	TRAINEES	OTHER	TRAFFIC SIGNALS			
									31ST STREET AT GOLFVIEW ROAD	IL ROUTE 171 AT GOLFVIEW ROAD	INTERCONNECT	
20100110	TREE REMOVAL (6 TO 15 UNITS DIAMETER)	UNIT	300			300						
20100210	TREE REMOVAL (OVER 15 UNITS DIAMETER)	UNIT	102			102						
20101700	SUPPLEMENTAL WATERING	UNIT	5			5						
20200100	EARTH EXCAVATION	CU YD	8268	8268								
20201200	REMOVAL AND DISPOSAL OF UNSUITABLE MATERIAL	CU YD	55	55								
20400800	FURNISHED EXCAVATION	CU YD	100	100								
20800150	TRENCH BACKFILL	CU YD	824	824								
21101505	TOPSOIL EXCAVATION AND PLACEMENT	CU YD	922	922								
Δ 21101615	TOPSOIL FURNISH AND PLACE, 4"	SQ YD	50	50								
Δ 21101685	TOPSOIL FURNISH AND PLACE, 24"	SQ YD	180			180						
Δ 25000210	SEEDING, CLASS 2A	ACRE	1.5			1.5						
Δ 25000400	NITROGEN FERTILIZER NUTRIENT	POUND	88			88						
Δ 25000600	POTASSIUM FERTILIZER NUTRIENT	POUND	88			88						
25100630	EROSION CONTROL BLANKET	SQ YD	6599	6599								
Δ 25200110	SODDING, SALT TOLERANT	SQ YD	506			506						
Δ 25200200	SUPPLEMENTAL WATERING	UNIT	10	10								
28000250	TEMPORARY EROSION CONTROL SEEDING	POUND	136	136								
28000400	PERIMETER EROSION BARRIER	FOOT	2583	2583								
28000510	INLET FILTERS	EACH	53	53								
28100107	STONE RIPRAP CLASS A4	SQ YD	4	4								
• 30300001	AGGREGATE SUBGRADE IMPROVEMENT	CU YD	55	55								
• 30300112	AGGREGATE SUBGRADE IMPROVEMENT 12"	SQ YD	4864	4864								
31101800	SUBBASE GRANULAR MATERIAL, TYPE B 10"	SQ YD	8173	8173								
35501287	HOT-MIX ASPHALT BASE COURSE, 2 1/4"	SQ YD	14726	14726								
40201000	AGGREGATE FOR TEMPORARY ACCESS	TON	91	91								
40600100	BITUMINOUS MATERIALS (PRIME COAT)	GALLON	7059	7059								

• REQUIRES SPECIAL PROVISION  
Δ INDICATES SPECIALTY ITEM

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STATE OF ILLINOIS  
DEPARTMENT OF TRANSPORTATION

SUMMARY OF QUANTITIES

SCALE: NONE SHEET NO. 1 OF 11 SHEETS STA. TO STA.

F.A.U. RTE.	SECTION	COUNTY	TOTAL SHEETS	SHEET NO.
3784	12-F3000-23-PK	COOK	131	4
FED. ROAD DIST. NO. 1 ILLINOIS FED. AID PROJECT			CONTRACT NO. 63764	



CODED PAY ITEM NO.	ITEM	UNIT	TOTAL QUANTITY	0004	0021	0031	0042	0044	0021			
				ROADWAY	SAFETY	LANDSCAPING	TRAINEES	OTHER	TRAFFIC SIGNALS			
									31ST STREET AT GOLFVIEW ROAD	IL ROUTE 171 AT GOLFVIEW ROAD	INTERCONNECT	
40600625	LEVELING BINDER (MACHINE METHOD), N50	TON	55	55								
40600635	LEVELING BINDER (MACHINE METHOD), N70	TON	117	117								
40600982	HOT-MIX ASPHALT SURFACE REMOVAL - BUTT JOINT	SQ YD	108	108								
40603335	HOT-MIX ASPHALT SURFACE COURSE, MIX "D", N50	TON	1796	1796								
40603340	HOT-MIX ASPHALT SURFACE COURSE, MIX "D", N70	TON	312	312								
40701816	HOT-MIX ASPHALT PAVEMENT (FULL-DEPTH), 6 3/4"	SQ YD	1174	1174								
40701861	HOT-MIX ASPHALT PAVEMENT (FULL-DEPTH), 9"	SQ YD	2488	2488								
42000401	PORTLAND CEMENT CONCRETE PAVEMENT 9" (JOINTED)	SQ YD	208	208								
42001300	PROTECTIVE COAT	SQ YD	2334	2334								
42400200	PORTLAND CEMENT CONCRETE SIDEWALK 5 INCH	SQ FT	4511	4511								
44000100	PAVEMENT REMOVAL	SQ YD	8634	8634								
44000160	HOT-MIX ASPHALT SURFACE REMOVAL, 2 3/4"	SQ YD	4105	4105								
44000166	HOT-MIX ASPHALT SURFACE REMOVAL, 4 1/4"	SQ YD	7674	7674								
44000200	DRIVEWAY PAVEMENT REMOVAL	SQ YD	733	733								
44000300	CURB REMOVAL	FOOT	2070	2070								
44000500	COMBINATION CURB AND GUTTER REMOVAL	FOOT	3775	3775								
44001980	CONCRETE BARRIER REMOVAL	FOOT	329	329								
44201771	CLASS D PATCHES, TYPE IV, 10 INCH	SQ YD	201	201								
54213660	PRECAST REINFORCED CONCRETE FLARED END SECTIONS 15"	EACH	1	1								
550A0050	STORM SEWERS, CLASS A, TYPE 1 12"	FOOT	462	462								
550A0070	STORM SEWERS, CLASS A, TYPE 1 15"	FOOT	214	214								
550A0120	STORM SEWERS, CLASS A, TYPE 1 24"	FOOT	270	270								
550A0160	STORM SEWERS, CLASS A, TYPE 1 36"	FOOT	88	88								
550A0340	STORM SEWERS, CLASS A, TYPE 2 12"	FOOT	38	38								
550A0360	STORM SEWERS, CLASS A, TYPE 2 15"	FOOT	28	28								
550A0410	STORM SEWERS, CLASS A, TYPE 2 24"	FOOT	17	17								

\* REQUIRES SPECIAL PROVISION  
 Δ INDICATES SPECIALTY ITEM

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 PLOT SCALE = 1,0000' / 1in.  
 PLOT DATE = 5/6/2013

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 DATE - 05/13/2013

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STATE OF ILLINOIS  
 DEPARTMENT OF TRANSPORTATION

SUMMARY OF QUANTITIES

SCALE: NONE SHEET NO. 2 OF 11 SHEETS STA. TO STA.

F.A.U. RTE.	SECTION	COUNTY	TOTAL SHEETS	SHEET NO.
3784	12-F3000-23-PK	COOK	131	5
FED. ROAD DIST. NO. 1 ILLINOIS			CONTRACT NO. 63764	
FED. AID PROJECT				



CODED PAY ITEM NO.	ITEM	UNIT	TOTAL QUANTITY	0004	0021	0031	0042	0044	0021			
				ROADWAY	SAFETY	LANDSCAPING	TRAINEES	OTHER	TRAFFIC SIGNALS			
									31ST STREET AT GOLFVIEW ROAD	IL ROUTE 171 AT GOLFVIEW ROAD	INTERCONNECT	
550A0450	STORM SEWERS, CLASS A, TYPE 2 36"	FOOT	280	280								
550B0070	STORM SEWERS, CLASS B, TYPE 1 15"	FOOT	16	16								
55100300	STORM SEWER REMOVAL 8"	FOOT	195	195								
55100500	STORM SEWER REMOVAL 12"	FOOT	233	233								
55100700	STORM SEWER REMOVAL 15"	FOOT	136	136								
55101200	STORM SEWER REMOVAL 24"	FOOT	12	12								
60200105	CATCH BASINS, TYPE A, 4'-DIAMETER, TYPE 1 FRAME, OPEN LID	EACH	1	1								
60201205	CATCH BASINS, TYPE A, 4'-DIAMETER, TYPE 12 FRAME AND GRATE	EACH	9	9								
60201340	CATCH BASINS, TYPE A, 4'-DIAMETER, TYPE 24 FRAME AND GRATE	EACH	1	1								
60204505	CATCH BASINS, TYPE A, 5'-DIAMETER, TYPE 8 GRATE	EACH	1	1								
60208105	CATCH BASIN, TYPE C, TYPE 12 FRAME AND GRATE	EACH	14	14								
60208240	CATCH BASIN, TYPE C, TYPE 24 FRAME AND GRATE	EACH	1	1								
60218400	MANHOLES, TYPE A, 4'-DIAMETER, TYPE 1 FRAME, CLOSED LID	EACH	11	11								
60221000	MANHOLES, TYPE A, 5'-DIAMETER, TYPE 1 FRAME, OPEN LID	EACH	2	2								
60221100	MANHOLES, TYPE A, 5'-DIAMETER, TYPE 1 FRAME, CLOSED LID	EACH	1	1								
60250200	CATCH BASINS TO BE ADJUSTED	EACH	1	1								
60251200	CATCH BASINS TO BE ADJUSTED WITH NEW TYPE 8 GRATE	EACH	1	1								
60255410	CATCH BASINS TO BE CLEANED	EACH	4	4								
60255500	MANHOLES TO BE ADJUSTED	EACH	3	3								
60255800	MANHOLES TO BE ADJUSTED WITH NEW TYPE 1 FRAME, CLOSED LID	EACH	1	1								
60500040	REMOVING MANHOLES	EACH	4	4								
60500050	REMOVING CATCH BASINS	EACH	11	11								
60600605	CONCRETE CURB, TYPE B	FOOT	46	46								
60603800	COMBINATION CONCRETE CURB AND GUTTER, TYPE B-6.12	FOOT	4706	4706								
60605000	COMBINATION CONCRETE CURB AND GUTTER, TYPE B-6.24	FOOT	872	872								
60619200	CONCRETE MEDIAN, TYPE SB-6.06	SQ FT	406	406								

• REQUIRES SPECIAL PROVISION  
 Δ INDICATES SPECIALTY ITEM

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STATE OF ILLINOIS  
 DEPARTMENT OF TRANSPORTATION

SUMMARY OF QUANTITIES

SCALE: NONE SHEET NO. 3 OF 11 SHEETS STA. TO STA.

F.A.U. RTE. 3784	SECTION 12-F3000-23-PK	COUNTY COOK	TOTAL SHEETS 131	SHEET NO. 6
FED. ROAD DIST. NO. 1 [ILLINOIS]			FED. AID PROJECT	
CONTRACT NO. 63764				



CODED PAY ITEM NO.	ITEM	UNIT	TOTAL QUANTITY	0004	0021	0031	0042	0044	0021			
				ROADWAY	SAFETY	LANDSCAPING	TRAINEES	OTHER	TRAFFIC SIGNALS			
									31ST STREET AT GOLFVIEW ROAD	IL ROUTE 171 AT GOLFVIEW ROAD	INTERCONNECT	
60619600	CONCRETE MEDIAN, TYPE SB-6.12	SQ FT	2373	2373								
64300750	IMPACT ATTENUATORS (SEVERE USE, NARROW), TEST LEVEL 2	EACH	4		4							
66400105	CHAIN LINK FENCE, 4'	FOOT	141	141								
66400505	CHAIN LINK FENCE, 8'	FOOT	43	43								
66900200	NON-SPECIAL WASTE DISPOSAL	CU YD	750	750								
66900450	SPECIAL WASTE PLANS AND REPORTS	L SUM	1	1								
66900530	SOIL DISPOSAL ANALYSIS	EACH	2	2								
67000400	ENGINEER'S FIELD OFFICE, TYPE A	CAL MO	9	9								
67100100	MOBILIZATION	L SUM	1	1								
70106800	CHANGEABLE MESSAGE SIGN	CAL MO	16	16								
70300510	PAVEMENT MARKING TAPE, TYPE III - LETTERS AND SYMBOLS	SQ FT	36.4		36.4							
70300520	PAVEMENT MARKING TAPE, TYPE III 4"	FOOT	19922		19922							
70300540	PAVEMENT MARKING TAPE, TYPE III 6"	FOOT	52		52							
70300570	PAVEMENT MARKING TAPE, TYPE III 24"	FOOT	78		78							
70400100	TEMPORARY CONCRETE BARRIER	FOOT	900		900							
70400200	RELOCATE TEMPORARY CONCRETE BARRIER	FOOT	450		450							
72000100	SIGN PANEL - TYPE 1	SQ FT	119		79				23	17		
72400100	REMOVE SIGN PANEL ASSEMBLY - TYPE A	EACH	1		1							
72400500	RELOCATE SIGN PANEL ASSEMBLY - TYPE A	EACH	2		2							
72400600	RELOCATE SIGN PANEL ASSEMBLY - TYPE B	EACH	4		4							
72400710	RELOCATE SIGN PANEL - TYPE 1	SQ FT	16		16							
72800100	TELESCOPING STEEL SIGN SUPPORT	FOOT	283		283							
Δ 78000100	THERMOPLASTIC PAVEMENT MARKING - LETTERS AND SYMBOLS	SQ FT	400		400							
Δ 78000200	THERMOPLASTIC PAVEMENT MARKING - LINE 4"	FOOT	7925		7925							
Δ 78000400	THERMOPLASTIC PAVEMENT MARKING - LINE 6"	FOOT	1799		1799							
Δ 78000600	THERMOPLASTIC PAVEMENT MARKING - LINE 12"	FOOT	265		265							

\* REQUIRES SPECIAL PROVISION  
Δ INDICATES SPECIALTY ITEM

FILE NAME = ...\\B2-Sum quant\2563_500_04.dgn	USER NAME = dte	DESIGNED - DTE	REVISED -	<b>STATE OF ILLINOIS DEPARTMENT OF TRANSPORTATION</b>	<b>SUMMARY OF QUANTITIES</b>			F.A.U. RTE. 3784	SECTION 12-F3000-23-PK	COUNTY COOK	TOTAL SHEETS 131	SHEET NO. 7
PLOT SCALE = 1.0000' / in.	CHECKED - GAB	REVISIED -	SCALE: NONE					SHEET NO. 4 OF 11 SHEETS	STA.	TO STA.	CONTRACT NO. 63764	
PLOT DATE = 5/23/2013	DATE - 05/13/2013	REVISIED -	FED. ROAD DIST. NO. 1   ILLINOIS   FED. AID PROJECT									







CODED PAY ITEM NO.	ITEM	UNIT	TOTAL QUANTITY	0004	0021	0031	0042	0044	0021		
				ROADWAY	SAFETY	LANDSCAPING	TRAINEES	OTHER	TRAFFIC SIGNALS		
									31ST STREET AT GOLFVIEW ROAD	IL ROUTE 171 AT GOLFVIEW ROAD	INTERCONNECT
Δ 81400200	HEAVY-DUTY HANDHOLE	EACH	2						2		
Δ 81400300	DOUBLE HANDHOLE	EACH	3						2	1	
Δ 81702100	ELECTRIC CABLE IN CONDUIT, 600V (XLP-TYPE USE) 1/C NO. 12	FOOT	1800		1800						
Δ 81702110	ELECTRIC CABLE IN CONDUIT, 600V (XLP-TYPE USE) 1/C NO. 10	FOOT	2100		2100						
Δ 81702120	ELECTRIC CABLE IN CONDUIT, 600V (XLP-TYPE USE) 1/C NO. 8	FOOT	8150		8150						
Δ 81702130	ELECTRIC CABLE IN CONDUIT, 600V (XLP-TYPE USE) 1/C NO. 6	FOOT	15550		15550						
Δ 81702140	ELECTRIC CABLE IN CONDUIT, 600V (XLP-TYPE USE) 1/C NO. 4	FOOT	3600		3600						
Δ 81702160	ELECTRIC CABLE IN CONDUIT, 600V (XLP-TYPE USE) 1/C NO. 1/0	FOOT	1000		1000						
Δ 81702230	ELECTRIC CABLE IN CONDUIT, 600V (XLP-TYPE USE) 1/C 500MCM	FOOT	3000		3000						
Δ 81702441	ELECTRIC CABLE IN CONDUIT, 600V (XLP-TYPE USE) 2-12/C, 1-12/C GROUND	FOOT	600		600						
84200600	REMOVAL OF LIGHTING UNIT, NO SALVAGE	EACH	4		4						
84200804	REMOVAL OF POLE FOUNDATION	EACH	4		4						
Δ 84400105	RELOCATE EXISTING LIGHTING UNIT	EACH	2	2							
Δ * 85000200	MAINTENANCE OF EXISTING TRAFFIC SIGNAL INSTALLATION	EACH	2								2
Δ 85700200	FULL-ACTUATED CONTROLLER AND TYPE IV CABINET	EACH	1						1		
Δ 86400100	TRANSCEIVER - FIBER OPTIC	EACH	1							1	
Δ 87100140	FIBER OPTIC CABLE IN CONDUIT, NO. 62.5/125, 12F	FOOT	1200		1200						
Δ 87300925	ELECTRIC CABLE IN CONDUIT, TRACER, NO. 14 1C	FOOT	3529								3529
Δ 87301215	ELECTRIC CABLE IN CONDUIT, SIGNAL NO. 14 2C	FOOT	394						394		
Δ 87301225	ELECTRIC CABLE IN CONDUIT, SIGNAL NO. 14 3C	FOOT	1207						840	367	
Δ 87301245	ELECTRIC CABLE IN CONDUIT, SIGNAL NO. 14 5C	FOOT	3673						1424	2249	
Δ 87301255	ELECTRIC CABLE IN CONDUIT, SIGNAL NO. 14 7C	FOOT	682						682		
Δ 87301305	ELECTRIC CABLE IN CONDUIT, LEAD-IN, NO. 14 1 PAIR	FOOT	2830						1062	1768	
Δ 87301800	ELECTRIC CABLE IN CONDUIT, SERVICE, NO. 4 2C	FOOT	1411							1411	
Δ 87301805	ELECTRIC CABLE IN CONDUIT, SERVICE, NO. 6 2C	FOOT	154						154		
Δ 87301900	ELECTRIC CABLE IN CONDUIT, EQUIPMENT GROUNDING CONDUCTOR, NO. 6 1C	FOOT	2812						730	2082	

\* REQUIRES SPECIAL PROVISION  
Δ INDICATES SPECIALTY ITEM







CODED PAY ITEM NO.	ITEM	UNIT	TOTAL QUANTITY	0004	0021	0031	0042	0044	0021		
				ROADWAY	SAFETY	LANDSCAPING	TRAINEES	OTHER	TRAFFIC SIGNALS		
									31ST STREET AT GOLFVIEW ROAD	IL ROUTE 171 AT GOLFVIEW ROAD	INTERCONNECT
△ 88700200	LIGHT DETECTOR	EACH	6						2	4	
△ 88700300	LIGHT DETECTOR AMPLIFIER	EACH	2						1	1	
△ 88800100	PEDESTRIAN PUSH-BUTTON	EACH	2						2		
△ 89000100	TEMPORARY TRAFFIC SIGNAL INSTALLATION	EACH	2						1	1	
△ 89502300	REMOVE ELECTRIC CABLE FROM CONDUIT	FOOT	4479		2000						2479
△ 89502350	REMOVE AND REINSTALL ELECTRIC CABLE FROM CONDUIT	FOOT	250		250						
△ 89502375	REMOVE EXISTING TRAFFIC SIGNAL EQUIPMENT	EACH	2						1	1	
89502380	REMOVE EXISTING HANDHOLE	EACH	17						5	12	
89502382	REMOVE EXISTING DOUBLE HANDHOLE	EACH	2						1	1	
89502385	REMOVE EXISTING CONCRETE FOUNDATION	EACH	12						6	6	
△ B2000566	TREE, AMELANCHIER CANADENSIS (SHADBLow SERVICEBERRY), 6' HEIGHT, SHRUB FORM, BALLED AND BURLAPPED	EACH	5			5					
△ B2001166	TREE, CERCIS CANADENSIS (EASTERN REDBUD), 6' HEIGHT, CLUMP FORM, BALLED AND BURLAPPED	EACH	1			1					
△ C2C05818	SHRUB, RHUS AROMATICA GRO•LOW (GRO•LOW FRAGRANT SUMAC), 18" WIDTH, CONTAINER	EACH	26			26					
△ C2011024	SHRUB, SYRINGA PATULA MISS KIM (MISS KIM MANCHURIAN LILAC), 2' HEIGHT, BALLED AND BURLAPPED	EACH	19			19					
△ C2011600	SHRUB, VIBURNUM DENTATUM BLUE MUFFIN (BLUE MUFFIN ARROWHEAD), 3' HEIGHT, BALLED AND BURLAPPED	EACH	10			10					
△ D2C01018	EVERGREEN, JUNIPERUS HORIZONTALIS WILTONII (BLUE RUG JUNIPER), 18" WIDTH, CONTAINER	EACH	43			43					
△ D2C03524	EVERGREEN, TAXUS X MEDIA DENSIFORMIS (DENSE ANGLOJAPANESE YEW), 2' WIDTH, CONTAINER	EACH	14			14					
△ D2C03624	EVERGREEN, TAXUS X MEDIA HICKSII (HICKS ANGLOJAPANESE YEW), 2' WIDTH, CONTAINER	EACH	10			10					
△ D2001572	EVERGREEN, JUNIPERUS VIRGINIANA (EASTERN RED CEDAR), 6' HEIGHT, BALLED AND BURLAPPED	EACH	14			14					
△ D2002172	EVERGREEN, PICEA PUNGENS (COLORADO SPRUCE), 6' HEIGHT, BALLED AND BURLAPPED	EACH	3			3					
△ K0012990	PERENNIAL PLANTS, ORNAMENTAL TYPE, GALLON POT	UNIT	1.56			1.56					
△ K0012993	PERENNIAL PLANTS, ORNAMENTAL TYPE, 3-GALLON POT	UNIT	0.59			0.59					
△ • K1003679	MULCH	CU YD	59			59					
• Z0004002	BOLLARDS	EACH	7	7							
• Z0004522	HOT-MIX ASPHALT DRIVEWAY PAVEMENT, 6"	SQ YD	269	269							
△ • Z0007601	BUILDING REMOVAL NO. 1	L SUM	1	1							

• REQUIRES SPECIAL PROVISION  
△ INDICATES SPECIALTY ITEM



CODED PAY ITEM NO.	ITEM	UNIT	TOTAL QUANTITY	0004	0021	0031	0042	0044	0021			
				ROADWAY	SAFETY	LANDSCAPING	TRAINEES	OTHER	TRAFFIC SIGNALS			
									31ST STREET AT GOLFVIEW ROAD	IL ROUTE 171 AT GOLFVIEW ROAD	INTERCONNECT	
Δ • Z0007602	BUILDING REMOVAL NO. 2	L SUM	1	1								
Δ • Z0007603	BUILDING REMOVAL NO. 3	L SUM	1	1								
Δ • Z0007604	BUILDING REMOVAL NO. 4	L SUM	1	1								
Δ • Z0007605	BUILDING REMOVAL NO. 5	L SUM	1	1								
Δ • Z0007606	BUILDING REMOVAL NO. 6	L SUM	1	1								
• Z0013798	CONSTRUCTION LAYOUT	L SUM	1	1								
• Z0018500	DRAINAGE STRUCTURES TO BE CLEANED	EACH	2	2								
• Z0019600	DUST CONTROL WATERING	UNIT	432	432								
Δ • Z0030850	TEMPORARY INFORMATION SIGNING	SQ FT	155		155							
Δ • Z0033046	RE-OPTIMIZE TRAFFIC SIGNAL SYSTEM LEVEL 2	EACH	1									1
Δ • Z0073510	TEMPORARY TRAFFIC SIGNAL TIMING	EACH	2						1	1		
• Z0075496	CONCRETE RETAINING WALL REMOVAL	FOOT	7	7								
• Z0076600	TRAINEES	HOUR	500				500					
• Z0076604	TRAINEES TRAINING PROGRAM GRADUATE	HOUR	500				500					
• LR420010	PORTLAND CEMENT CONCRETE PAVEMENT (SPECIAL)	SQ YD	90	90								
• X0301797	GATE REMOVAL	EACH	2	2								
Δ • X0322708	REMOVE EXISTING STREET LIGHTING EQUIPMENT	EACH	5	5								
Δ • X0324085	EMERGENCY VEHICLE PRIORITY SYSTEM LINE SENSOR CABLE, NO. 20 3/C	FOOT	1134						432	702		
Δ • X0326696	SIGN AND POST	EACH	20		20							
• X0327070	REMOVE EXISTING FLAGPOLE	EACH	6	6								
• X0327412	RAILROAD TIES TO BE REMOVED	FOOT	703	703								
Δ • X0327502	ACCESS GATE, DOUBLE, 40 FOOT	EACH	2	2								
Δ • X0327503	ACCESS GATE, DOUBLE, 50 FOOT	EACH	1	1								
• X2130010	EXPLORATION TRENCH, SPECIAL	FOOT	100	100								
• X4402020	CONCRETE MEDIAN SURFACE REMOVAL	SQ FT	1610	1610								
• X5537600	STORM SEWERS TO BE CLEANED 8"	FOOT	181	181								
• X5537900	STORM SEWERS TO BE CLEANED 15"	FOOT	236	236								

• REQUIRES SPECIAL PROVISION  
Δ INDICATES SPECIALTY ITEM

FILE NAME = ...\\02-Sum quant\2563.500.0%.dgn	USER NAME = dte	DESIGNED - DTE	REVISED -	<b>STATE OF ILLINOIS DEPARTMENT OF TRANSPORTATION</b>	<b>SUMMARY OF QUANTITIES</b>			F.A.U. RTE.	SECTION	COUNTY	TOTAL SHEETS	SHEET NO.
		DRAWN - DTE	REVISED -					3784	12-F3000-23-PK	COOK	131	12
		CHECKED - GAB	REVISED -		SCALE: NONE SHEET NO. 9 OF 11 SHEETS STA. TO STA.			CONTRACT NO. 63764				
		DATE - 05/13/2013	REVISED -		FED. ROAD DIST. NO. 1 ILLINOIS FED. AID PROJECT							



CODED PAY ITEM NO.	ITEM	UNIT	TOTAL QUANTITY	0004	0021	0031	0042	0044	0021			
				ROADWAY	SAFETY	LANDSCAPING	TRAINEES	OTHER	TRAFFIC SIGNALS			
									31ST STREET AT GOLFVIEW ROAD	IL ROUTE 171 AT GOLFVIEW ROAD	INTERCONNECT	
• X5538200	STORM SEWERS TO BE CLEANED 24"	FOOT	114	114								
• X6020094	MANHOLES, TYPE A, 6'-DIAMETER, TYPE 1 FRAME, CLOSED LID, RESTRICTOR PLATE	EACH	1	1								
• X6640300	CHAIN LINK FENCE REMOVAL	FOOT	133	133								
• X6640310	CHAIN LINK GATES REMOVAL	EACH	3	3								
• X7010216	TRAFFIC CONTROL AND PROTECTION (SPECIAL)	L SUM	1	1								
Δ • X8211285	LUMINAIRE LED, HORIZONTAL MOUNT 285 WATT	EACH	34		34							
Δ • X8300001	LIGHT POLE, SPECIAL	EACH	19		19							
Δ • X8570015	CONTROLLER (SPECIAL)	EACH	1		1							
Δ • X8570226	FULL-ACTUATED CONTROLLER AND TYPE IV CABINET, SPECIAL	EACH	1							1		
Δ • X8620200	UNINTERRUPTIBLE POWER SUPPLY, SPECIAL	EACH	2						1	1		
Δ • X8710024	FIBER OPTIC CABLE IN CONDUIT, NO. 62.5/125, MM12F SM24F	FOOT	3575									3575
Δ • X8780107	CONCRETE FOUNDATION (SPECIAL)	FOOT	180		180							
Δ • XX004913	REMOVE FIBER OPTIC CABLE FROM CONDUIT	FOOT	2502									2502
• XX006457	WHEEL STOP REMOVAL AND REPLACEMENT	EACH	45	45								
• XX007461	OUTCROPPING	FOOT	206			206						
Δ • XX008608	CABLE, SPECIAL	FOOT	1400		1400							
• XX008743	STORM SEWERS, CLASS B, TYPE 1 8"	FOOT	90	90								
Δ • XX008774	FABRICATED CONTROL BOOTH, TYPE 1	EACH	4						4			
Δ • XX008775	FABRICATED CONTROL BOOTH, TYPE 2	EACH	2						2			
Δ • XX008778	LUMINAIRE, LED VERTICAL FLOOD LIGHT 30 WATT	EACH	10		10							
Δ • XX008779	LUMINAIRE, LED BOLLARD 30 WATT	EACH	22		22							
Δ • XX008780	GFCI RECEPTACLES, 20AMP 125VOLT	EACH	14		14							
Δ • XX008781	RECEPTACLE IN USE COVERS	EACH	14		14							
Δ • XX008782	DATA SURGE PROTECTORS 1GB	EACH	6		6							
Δ • XX008784	FIBERGLASS 4X ENCLOSURE 24 X 24 X 12 DEEP	EACH	1		1							
Δ • XX008785	CLOSED CIRCUIT TV CAMERAS PAN ZOOM TILT	EACH	13		13							

• REQUIRES SPECIAL PROVISION  
Δ INDICATES SPECIALTY ITEM

FILE NAME =  
...\\02-Sum quant\2563.S00.10.dgn

USER NAME = dte  
DESIGNED - DTE  
DRAWN - DTE  
PLOT SCALE = 1:8000' / in.  
PLOT DATE = 5/23/2013

CHECKED - GAB  
DATE - 05/13/2013

REVISED -  
REVISED -  
REVISED -  
REVISED -

STATE OF ILLINOIS  
DEPARTMENT OF TRANSPORTATION

SUMMARY OF QUANTITIES

SCALE: NONE SHEET NO. 10 OF 11 SHEETS STA. TO STA.

F.A.U. RTE.	SECTION	COUNTY	TOTAL SHEETS	SHEET NO.
3784	12-F3000-23-PK	COOK	131	13
FED. ROAD DIST. NO. 1 ILLINOIS			CONTRACT NO. 63764	
FED. AID PROJECT				













LEGEND

- ① EXISTING BITUMINOUS CONCRETE SURFACE COURSE
- ② EXISTING BITUMINOUS CONCRETE BINDER COURSE
- ③ EXISTING PCC PAVEMENT STRUCTURE
- ④ EXISTING SUB-BASE GRANULAR MATERIAL
- ⑤ EXISTING CONCRETE CURB & GUTTER
- ⑥ EXISTING GRANULAR BASE

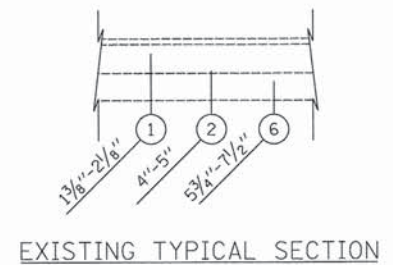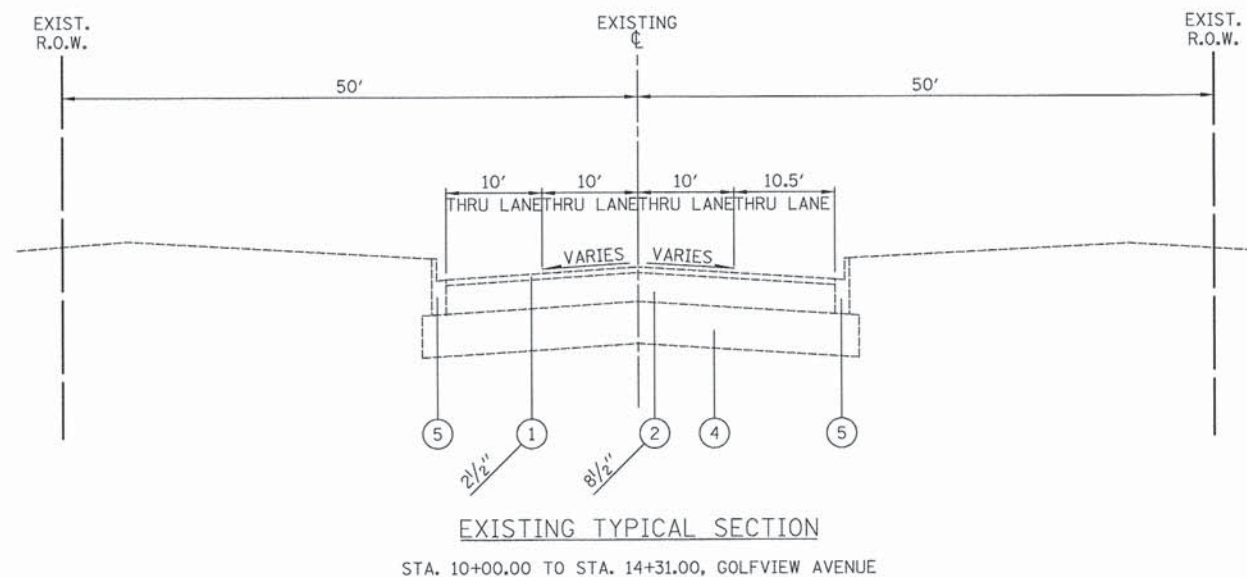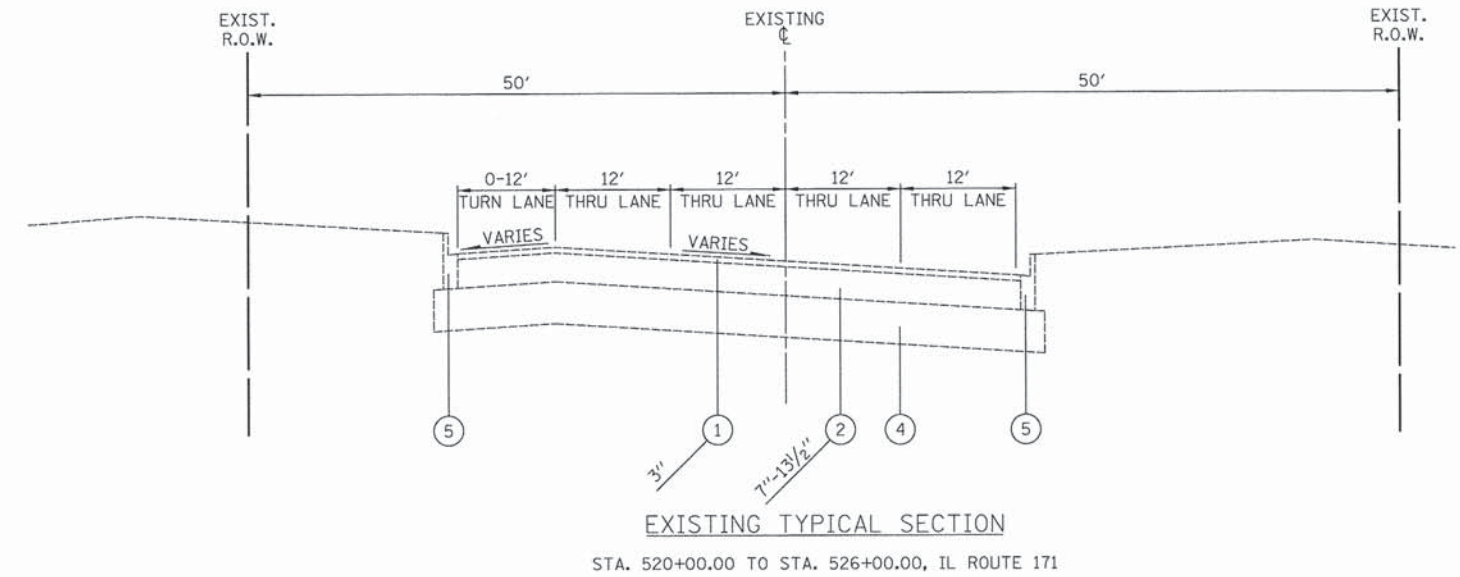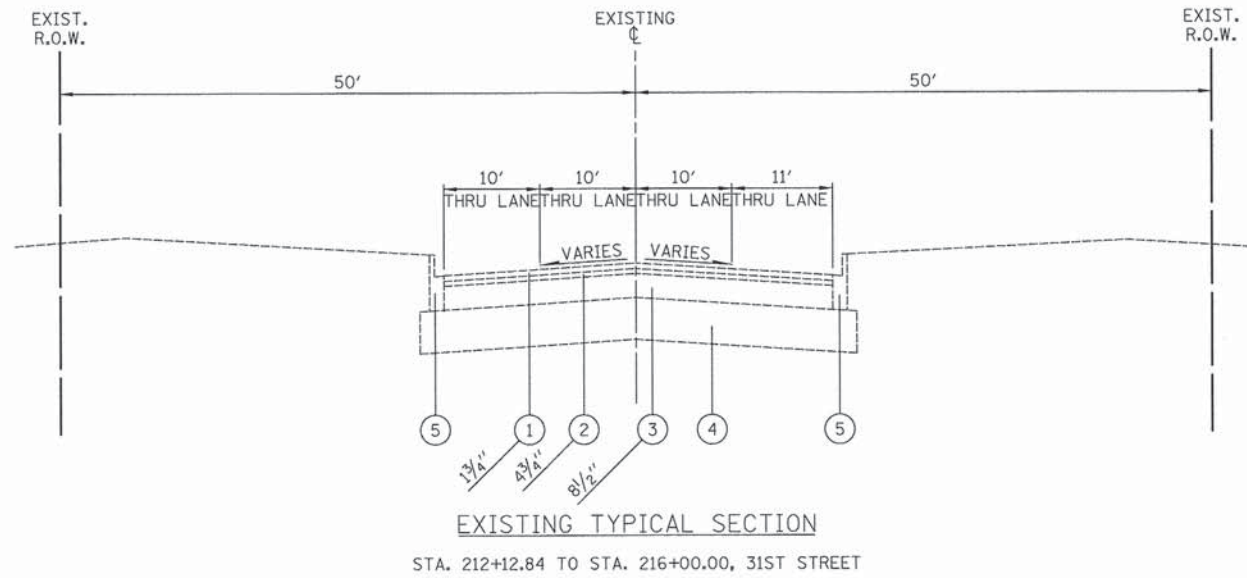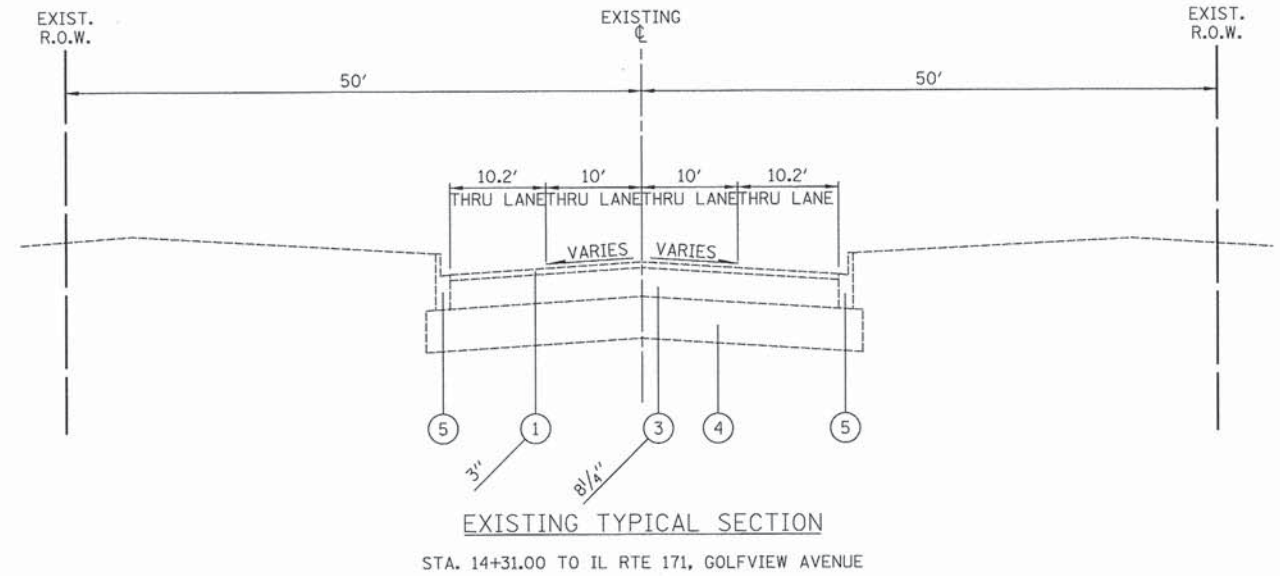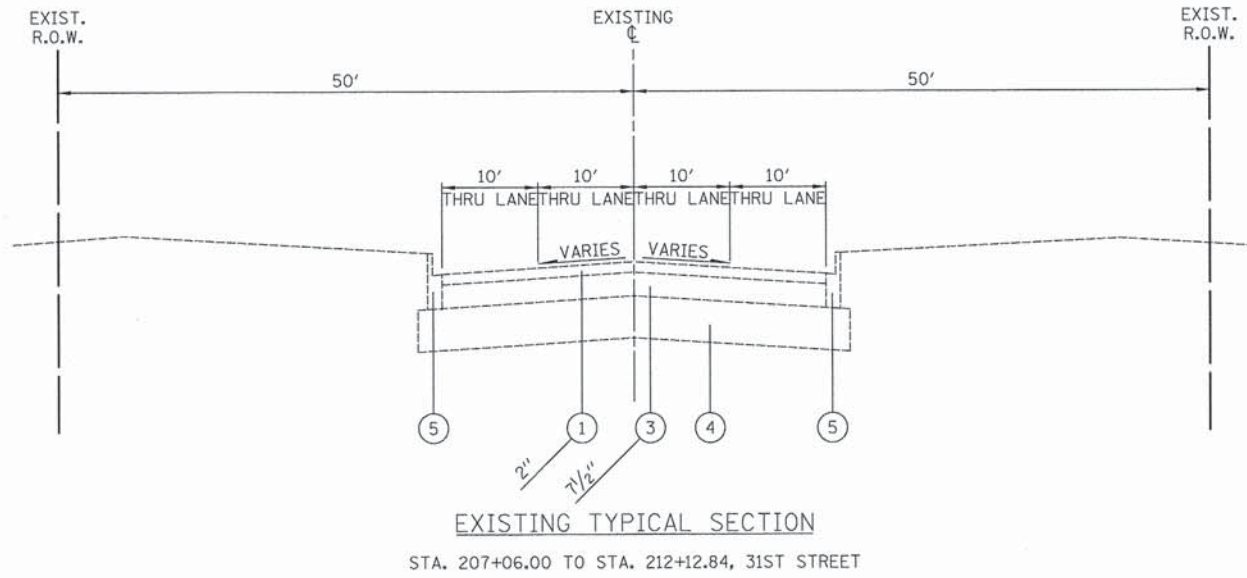

FILE NAME = ...\\03-Typicals\2563_TYP_01.dgn	USER NAME = dte	DESIGNED - DTE	REVISED -
		DRAWN - DTE	REVISED -
		CHECKED - GAB	REVISED -
		DATE - 05/13/2013	REVISED -

**STATE OF ILLINOIS  
DEPARTMENT OF TRANSPORTATION**

<b>EXISTING TYPICAL SECTIONS</b>		
SCALE: NONE	SHEET NO. 1 OF 1 SHEETS	STA. TO STA.

F.A.U. RTE. 3784	SECTION 12-F3000-23-PK	COUNTY COOK	TOTAL SHEETS 131	SHEET NO. 15
CONTRACT NO. 63764				
FED. ROAD DIST. NO. 1   ILLINOIS FED. AID PROJECT				







MIXTURE REQUIREMENT

PAY ITEM	AIR VOIDS @ Ndes
HOT-MIX ASPHALT PAVEMENT RESURFACING - 31ST STREET	
HOT-MIX ASPHALT SURFACE COURSE, MIX "D", N70 (IL-9.5 mm) (2")	4% @ 70 GYR.
LEVELING BINDER (MACHINE METHOD), N70 (IL-9.5 mm) (0.75")	4% @ 70 GYR.
HOT-MIX ASPHALT PAVEMENT RESURFACING - GOLFVIEW AVENUE	
HOT-MIX ASPHALT SURFACE COURSE, MIX "D", N50 (IL-9.5 mm) (2")	4% @ 50 GYR.
LEVELING BINDER (MACHINE METHOD), N50 (IL-9.5 mm) (0.75")	4% @ 50 GYR.
HOT-MIX ASPHALT PAVEMENT (FULL-DEPTH), 6 3/4" - GOLFVIEW AVENUE	
HOT-MIX ASPHALT SURFACE COURSE, MIX "D", N70 (IL-9.5 mm) (2")	4% @ 50 GYR.
HOT-MIX ASPHALT BINDER COURSE, IL-19.0, N70 (4.75") (2 LIFTS MIN)	4% @ 50 GYR.
HOT-MIX ASPHALT PAVEMENT (FULL-DEPTH), 9" - 31ST STREET	
HOT-MIX ASPHALT SURFACE COURSE, MIX "D", N70 (IL-9.5 mm) (2")	4% @ 70 GYR.
HOT-MIX ASPHALT BINDER COURSE, IL-19.0, N70 (7") (2 LIFTS MIN)	4% @ 70 GYR.
HOT-MIX ASPHALT PAVEMENT - BROOKFIELD ZOO NORTH PARKING LOT	
HOT-MIX ASPHALT SURFACE COURSE, MIX "D", N50 (IL-9.5 mm) (2")	4% @ 50 GYR.
HOT-MIX ASPHALT BASE COURSE, IL-19.0, N50 (2.25")	4% @ 50 GYR.
HOT-MIX ASPHALT DRIVEWAY PAVEMENT, 6"	
HOT-MIX ASPHALT SURFACE COURSE, MIX "D", N50 (IL 9.5mm) (2")	4% @ 50 GYR.
HOT-MIX ASPHALT BASE COURSE, IL-19.0, N50 (4") (2 LIFTS MIN)	4% @ 50 GYR.
CLASS D PATCHES, TYPE II, III, AND IV, 10"	
CLASS D PATCH (HMA BINDER IL-19mm) (10") (3 LIFTS MIN)	4% @ 70 GYR.

NOTES:

1. THE UNIT WEIGHT TO CALCULATE ALL HOT-MIX ASPHALT MIXTURES IS 112 LB/SY-IN.
2. FOR PERCENT OF RAP, SEE DISTRICT ONE SPECIAL PROVISIONS.
3. THE "AC TYPE" SHALL BE "PG 64-22" UNLESS MODIFIED BY DISTRICT ONE SPECIAL PROVISIONS.

REMEDIAL TREATMENT AREAS

ALIGNMENT	STATION	DEPTH	WIDTH	DESCRIPTION
GOLFVIEW AVE.	12+10 TO 15+70	12"	WIDENING	NOTE 2
31ST STREET	213+50 TO 216+00	12"	WIDENING	NOTE 2

NOTES:

1. DEPTH REFERS TO THE DEPTH BELOW DESIGN SUBGRADE ELEVATION
2. UNDERCUT AND REPLACE WITH AGGREGATE SUBGRADE, UNDERDRAIN.

STRUCTURAL PAVEMENT DESIGN INFORMATION BLOCK FOR 31ST STREET

STRUCTURAL TRAFFIC: YEAR 2030
PV = 12740 SU = 130 MU = 130
ROAD/STREET CLASSIFICATION: CLASS II
P = 98% S = 1% M = 1%
TRAFFIC FACTOR: 0.71 ACTUAL TF = 0.91
MINIMUM TF = 0.50
AC GRADE: BINDER = PG 58-22 SURFACE = PG 64-28
SUBGRADE SUPPORT RATING: SSR = POOR

STRUCTURAL PAVEMENT DESIGN INFORMATION BLOCK FOR GOLFVIEW AVENUE

STRUCTURAL TRAFFIC: YEAR 2030
PV = 7648 SU = 176 MU = 176
ROAD/STREET CLASSIFICATION: CLASS II
P = 95.6% S = 2.2% M = 2.2%
TRAFFIC FACTOR: 0.45 ACTUAL TF = 0.57
MINIMUM TF = 0.50
AC GRADE: BINDER = PG 58-22 SURFACE = PG 64-28
SUBGRADE SUPPORT RATING: SSR = POOR



STATION	HOT-MIX ASPHALT BASE COURSE, 2 1/4"	BITUMINOUS MATERIALS (PRIME COAT)	LEVELING BINDER (MACHINE METHOD), N50	LEVELING BINDER (MACHINE METHOD), N70	HOT-MIX ASPHALT SURFACE CSE, MIX "D", N50	HOT-MIX ASPHALT SURFACE CSE, MIX "D", N70	HOT-MIX ASPHALT PAVEMENT, (FULL-DEPTH), 6 3/4"	HOT-MIX ASPHALT PAVEMENT, (FULL-DEPTH), 9"	PORTLAND CEMENT CONCRETE PAVEMENT 9" (JOINTED)	AGGREGATE SUBGRADE IMPROVEMENT 12"	SUB-BASE GRANULAR MATERIAL TYPE B 10 INCH	AGGREGATE SUBGRADE IMPROVEMENT
	35501287	40600100	40600625	40600635	40603335	40603340	40701816	40701861	42000401	30300112	31101800	30300001
	(SQ YD)	(GALLON)	(TON)	(TON)	(TON)	(TON)	(SQYD)	(SQYD)	(SQYD)	(SQYD)	(SQYD)	(CUYD)
31ST STREET 207+06 TO 211+00	0	0	0	0	0	0	0	2041	0	2267	0	0
211+00 TO 216+00	0	1046	0	117	0	312	0	448	208	1063	0	55
GOLFVIEW ROAD 11+25 TO 16+00	19	7	0	0	2	0	54	0	0	121	42	0
16+00 TO 21+50	0	319	36	0	95	0	219	0	0	248	0	0
21+50 TO 26+14.88	0	172	19	0	52	0	901	0	0	1165	0	0
ZOO NORTH LOT 100+70 TO 105+00	1554	582	0	0	174	0	0	0	0	0	595	0
105+00 TO 110+50	8774	3290	0	0	983	0	0	0	0	0	3695	0
110+50 TO 113+70.87	4379	1643	0	0	490	0	0	0	0	0	3841	0
TOTALS	14726	7059	55	117	1796	312	1174	2489	208	4864	8173	55

STATION	CONCRETE CURB, TYPE B	COMB. CONC. C&G,TYPE B-6.12	COMB. CONC. C&G,TYPE B-6.24	CONC. MEDIAN TYPE SB-6.06	CONC. MEDIAN TYPE SB-6.12	PCC SIDEWALK, 5 INCH	HMA DRIVEWAY PAVEMENT 6 INCH
	60600605	60603800	60605000	60619200	60619600	42400200	Z0004522
	(FOOT)	(FOOT)	(FOOT)	(SQFT)	(SQFT)	(SQFT)	(SQYD)
31ST STREET 207+06 TO 211+00	0	930	0	0	0	64	210
211+00 TO 216+00	32	926	428	0	0	4447	59
GOLFVIEW ROAD 11+25 TO 16+00	0	237	0	0	212	0	0
16+00 TO 21+50	0	340	0	0	0	0	0
21+50 TO 26+14.88	0	519	444	0	0	0	0
ZOO NORTH LOT 100+70 TO 105+00	14	339	0	0	937	0	0
105+00 TO 110+50	0	1017	0	0	1224	0	0
110+50 TO 113+70.87	0	398	0	406	0	0	0
TOTALS	46	4706	872	406	2373	4511	269

STATION	THERMOPLASTIC PAVT. MARKING- LETTERS & SYMBOLS	THERMOPLASTIC PAVT. MARKING- LINE 4"	THERMOPLASTIC PAVT. MARKING- LINE 6"	THERMOPLASTIC PAVT. MARKING- LINE 12"	THERMOPLASTIC PAVT. MARKING- LINE 24"	PAINT PAVEMENT MARKING- LETTERS & SYMBOLS	PAINT PAVEMENT MARKING- LINE 4"	PAINT PAVEMENT MARKING- LINE 6"	PAINT PAVEMENT MARKING- LINE 12"	PAINT PAVEMENT MARKING- LINE 24"	RAISED REFELCTIVE PAVEMENT MARKING
	78000100	78000200	78000400	78000600	78000650	78001100	78001110	78001130	78001150	78001180	78100100
	(SQFT)	(FOOT)	(FOOT)	(FOOT)	(FOOT)	(SQFT)	(FOOT)	(FOOT)	(FOOT)	(FOOT)	(EACH)
31ST STREET 207+26 TO 216+00	36	3177	330	151	81	0	0	0	0	0	90
GOLFVIEW ROAD 10+58 TO 26+14.88	364	2896	1469	114	72	0	0	0	0	0	90
ZOO NORTH LOT 100+70 TO 113+70.87	0	0	0	0	0	146	6804	2621	1005	24	0
*EXISTING MARKINGS REPLACEMENT	0	1852	0	0	0	0	0	0	0	0	62
TOTALS	400	7925	1799	265	153	146	6804	2621	1005	24	242



STATION TO STATION		EARTH EXCAVATION															TOTALS BY STATION		
		STAGE I			STAGE II			STAGE III			STAGE IV			STAGE V					
		CUT	REMOVAL AND DISPOSAL OF UNSUITABLE MATERIAL	EARTH EXCAVATION	CUT	REMOVAL AND DISPOSAL OF UNSUITABLE MATERIAL	EARTH EXCAVATION	CUT	REMOVAL AND DISPOSAL OF UNSUITABLE MATERIAL	EARTH EXCAVATION	CUT	REMOVAL AND DISPOSAL OF UNSUITABLE MATERIAL	EARTH EXCAVATION	CUT	REMOVAL AND DISPOSAL OF UNSUITABLE MATERIAL	EARTH EXCAVATION	CUT	REMOVAL AND DISPOSAL OF UNSUITABLE MATERIAL	EARTH EXCAVATION
		(CUYD)	(CUYD)	(CUYD)	(CUYD)	(CUYD)	(CUYD)	(CUYD)	(CUYD)	(CUYD)	(CUYD)	(CUYD)	(CUYD)	(CUYD)	(CUYD)	(CUYD)	(CUYD)	(CUYD)	
31ST STREET	207+06 TO 211+00	202.8	0.0	202.8	97.7	0.0	97.7	226.9	0.0	226.9	---	---	---	---	---	---	527.4	0.0	527.4
	211+00 TO 216+00	212.1	0.0	212.1	0.0	0.0	0.0	252.7	51.0	201.7	---	---	---	---	---	---	464.8	51.0	413.8
GOLVIEW AVENUE	10+50 TO 16+00	---	---	---	151.9	0.0	0.0	85.6	0.0	85.6	0.0	0.0	0.0	0.0	0.0	0.0	237.5	0.0	85.6
	16+00 TO 26+14.88	---	---	---	0.0	0.0	0.0	0.0	0.0	0.0	0.0	0.0	0.0	539.6	0.0	539.6	539.6	0.0	539.6
ZOO NORTH LOT	100+70 TO 107+00	0.0	0.0	0.0	144.8	0.0	144.8	155.6	0.0	155.6	12.4	0.0	12.4	---	---	---	312.8	0.0	312.8
	107+00 TO 113+70.87	6173.4	0.0	6173.4	0.0	0.0	0.0	0.0	0.0	0.0	0.0	0.0	0.0	---	---	---	6173.4	0.0	6173.4
TOTALS		6588.3	0.0	6588.3	394.4	0.0	242.5	720.8	51.0	669.8	12.4	0.0	12.4	539.6	0.0	539.6	8255.5	51.0	8052.6
ADJUSTED QUANTITY																		55	8055

31ST STREET	414.9	0.0	414.9	97.7	0.0	97.7	479.6	51.0	428.6	0.0	0.0	0.0	0.0	0.0	0.0	992.2	51.0	941.2
GOLFVIEW AVENUE	0.0	0.0	0.0	151.9	0.0	0.0	85.6	0.0	85.6	0.0	0.0	0.0	539.6	0.0	539.6	777.1	0.0	625.2
ZOO NORTH LOT	6173.4	0.0	6173.4	144.8	0.0	144.8	155.6	0.0	155.6	12.4	0.0	12.4	0.0	0.0	0.0	6486.2	0.0	6486.2

STATION TO STATION		STAGE I		STAGE II		STAGE III		STAGE IV		STAGE V		TOTALS BY STATION	
		EMBANKMENT	FURNISHED EXCAVATION	EMBANKMENT	FURNISHED EXCAVATION	EMBANKMENT	FURNISHED EXCAVATION	EMBANKMENT	FURNISHED EXCAVATION	EMBANKMENT	FURNISHED EXCAVATION	EMBANKMENT	FURNISHED EXCAVATION
		(CUYD)	(CUYD)	(CUYD)	(CUYD)	(CUYD)	(CUYD)	(CUYD)	(CUYD)	(CUYD)	(CUYD)	(CUYD)	(CUYD)
31ST STREET	207+06 TO 211+00	353.7	236.1	0.0	-83.0	40.4	-132.3	---	---	---	---	394.1	20.7
	211+00 TO 216+00	60.5	-102.4	0.0	0.0	23.3	-83.4	---	---	---	---	83.8	-185.7
GOLVIEW AVENUE	10+50 TO 16+00	0.0	0.0	0.0	0.0	85.5	40.7	22.9	22.9	0.0	0.0	108.4	63.6
	16+00 TO 26+14.88	0.0	0.0	0.0	0.0	0.0	0.0	0.0	0.0	164.0	-194.5	164.0	-194.5
ZOO NORTH LOT	100+70 TO 107+00	0.0	0.0	171.2	100.6	0.0	-111.5	13.3	11.4	---	---	184.5	0.5
	107+00 TO 113+70.87	325.9	-4324.4	0.0	0.0	0.0	0.0	0.0	0.0	---	---	325.9	-4324.4
TOTALS BY STAGE		740.1	-4190.7	171.2	17.5	149.2	-286.5	36.2	34.3	164.0	-194.5	1260.7	-4619.9
CUMULATIVE TOTALS		740.1	-4190.7	911.3	-4173.2	1060.5	-4459.7	1096.7	-4425.4	1260.7	-4619.9		
ADJUSTED QUANTITY												1265	-4620

31ST STREET	414.2	133.7	0.0	-83.0	63.7	-215.7	0.0	0.0	0.0	0.0
GOLFVIEW AVENUE	0.0	0.0	0.0	0.0	85.5	40.7	22.9	22.9	164.0	-194.5
ZOO NORTH LOT	325.9	-4324.4	171.2	100.6	0.0	-111.5	13.3	11.4	0.0	0.0
	EMBANKMENT	FURN EX	EMBANKMENT	FURN EX	EMBANKMENT	FURN EX	EMBANKMENT	FURN EX	EMBANKMENT	FURN EX
	STAGE 1A		STAGE 1B		STAGE 2A		STAGE 2B		STAGE 2C	

FURNISHED EXCAVATION = EMBANKMENT - ((1 - SHRINKAGE FACTOR (0.15)) x (EARTH EXCAVATION - TOPSOIL EXCAVATION))

A POSITIVE QUANTITY IMPLIES THAT FURNISHED EXCAVATION WILL BE REQUIRED.

A NEGATIVE QUANTITY IMPLIES THAT THERE IS EXCESS EXCAVATED MATERIAL THAT CAN BE USED ELSEWHERE IN THE PROJECT LIMITS.

FILE NAME = ...\\04-Schedules\2563_SCH_02.dgn	USER NAME = dte	DESIGNED - DTE	REVISED -	<b>STATE OF ILLINOIS DEPARTMENT OF TRANSPORTATION</b>	<b>SCHEDULE OF QUANTITIES</b>	F.A.U. RTE.	SECTION	COUNTY	TOTAL SHEETS	SHEET NO.	
		DRAWN - DTE	REVISED -			3784	12-F3000-23-PK	COOK	131	19	
	PLOT SCALE = 1/8" = 1' / in.	CHECKED - GAB	REVISED -			CONTRACT NO. 63764					
	PLOT DATE = 5/6/2013	DATE - 05/13/2013	REVISED -			SCALE: NONE	SHEET NO. 2 OF 3 SHEETS	STA.	TO STA.	FED. ROAD DIST. NO. 1 [ILLINOIS] FED. AID PROJECT	



STATION	CLASS D PATCHES, TYPE IV, 10"	PAVEMENT MARKING TAPE, TYPE III - LETTERS & SYMBOLS	PAVEMENT MARKING TAPE, TYPE III - 4"	PAVEMENT MARKING TAPE, TYPE III - 6"	PAVEMENT MARKING TAPE, TYPE III - 24"	PERIMETER EROSION BARRIER	INLET FILTERS
	44201771	70300510	70300520	70300540	70300570	28000400	28000510
	(SQYD)	(SQFT)	(FOOT)	(FOOT)	(FOOT)	(FOOT)	(EACH)
STAGE I 207+06 TO 216+00	135	0	5426	0	46	648	15
106+75 TO 113+70.87	66	0	0	0	0	901	14
STAGE II 207+06 TO 216+00	0	0	3637	0	10	467	4
10+58 TO 26+14.88	0	36.4	0	52	0	0	2
100+00 TO 110+00	0	0	1688	0	12	0	6
STAGE III 207+06 TO 216+00	0	0	6773	0	10	0	0
10+58 TO 26+14.88	0	0	698	0	0	0	0
100+00 TO 110+00	0	0	626	0	0	0	0
STAGE IV 10+58 TO 26+14.88	0	0	0	0	0	0	0
100+00 TO 106+75	0	0	1074	0	0	0	5
STAGE V 19+10 TO 26+14.88	0	0	0	0	0	567	7
TOTALS	201	36.4	19922	52	78	2583	53

STATION	SIGN PANEL - TYPE 1	REMOVE SIGN PANEL ASSY - TYPE A	RELOCATE SIGN PANEL ASSY - TYPE A	RELOCATE SIGN PANEL ASSY - TYPE B	RELOCATE SIGN PANEL - TYPE 1	TELESCOPING STEEL SIGN SUPPORT	SIGN AND POST
	72000100	72400100	72400500	72400600	72400710	72800100	X0326696
	(SQFT)	(EACH)	(EACH)	(EACH)	(SQFT)	(FOOT)	(EACH)
31ST STREET 207+26 TO 216+00	9	0	2	3	0	138	0
GOLFVIEW AVENUE 10+58 TO 26+14.88	54.68	1	0	1	16	145	0
ZOO NORTH LOT 100+70 TO 105+00	0.00	0	0	0	0	0	2
105+00 TO 110+50	10.36	0	0	0	0	0	13
110+50 TO 113+70.87	5.18	0	0	0	0	0	5
TOTALS	79.22	1	2	4	16	283	20

STATION	SEEDING, CLASS 2A	NITROGEN FERTILIZER NUTRIENT	POTASSIUM FERTILIZER NUTRIENT	SODDING, SALT TOLERANT	EROSION CONTROL BLANKET	TEMPORARY EROSION CONTROL SEEDING	TOPSOIL FURNISH AND PLACE, 24"
	25000210	25000400	25000600	25200110	25100630	28000250	21101685
	(ACRE)	(POUND)	(POUND)	(SQYD)	(SQYD)	(POUND)	(SQYD)
31ST STREET 207+26 TO 216+00	0.40	30.00	30.00	506	1944	40.00	180
GOLFVIEW AVENUE 10+58 TO 26+14.88	0.30	17.76	17.76	0	1431	29.60	0
ZOO NORTH LOT 100+70 TO 113+70.87	0.66	39.60	39.60	0	3224	66.00	0
TOTALS	1.36	87.36	87.36	506	6599	135.60	180
ADJUSTED QUANTITY	1.50	88	88			136	

STATION TO STATION		TOPSOIL EXCAVATION					TOTALS BY STATION
		STAGE I	STAGE II	STAGE III	STAGE IV	STAGE V	
		(CUYD)	(CUYD)	(CUYD)	(CUYD)	(CUYD)	(CUYD)
31ST STREET	207+06 TO 211+00	64.4	0.0	23.7	0.0	0	88.1
	211+00 TO 216+00	20.5	0.0	76.2	0.0	0	96.7
GOLFVIEW AVENUE	10+50 TO 16+00	0.0	0.0	32.9	0.0	0.0	32.9
	16+00 TO 26+14.88	0.0	0.0	0.0	0.0	117.8	117.8
ZOO NORTH LOT	100+70 TO 107+00	0.0	61.7	24.4	10.2	0.0	96.3
	107+00 TO 113+70.87	702.5	0.0	0.0	0.0	0.0	702.5
TOTALS		787.4	61.7	157.2	10.2	117.8	*1134.3

STATION TO STATION		TOPSOIL PLACEMENT					TOTALS BY STATION
		STAGE I	STAGE II	STAGE III	STAGE IV	STAGE V	
		(CUYD)	(CUYD)	(CUYD)	(CUYD)	(CUYD)	(CUYD)
31ST STREET	207+06 TO 211+00	89.0	---	29.1	---	---	118.1
	211+00 TO 216+00	213.1	---	44.0	---	---	257.1
GOLFVIEW AVENUE	10+50 TO 16+00	---	---	75.3	---	---	75.3
	16+00 TO 26+14.88	---	---	0.0	---	123.6	123.6
ZOO NORTH LOT	100+70 TO 107+00	---	79.1	---	6.6	---	85.7
	107+00 TO 113+70.87	261.5	---	---	---	---	261.5
TOTALS		563.6	79.1	148.4	6.6	123.6	*921.3





\* EXCESS TOPSOIL EXCAVATION WILL BE PAID FOR AS EARTH EXCAVATION








**REMOVAL LEGEND**

-  HMA SURFACE REMOVAL
-  REMOVAL LIMITS
-  PIPE TO BE REMOVED
-  TREE REMOVAL


IMPROVEMENT BEGINS  
STA. 207+06.00

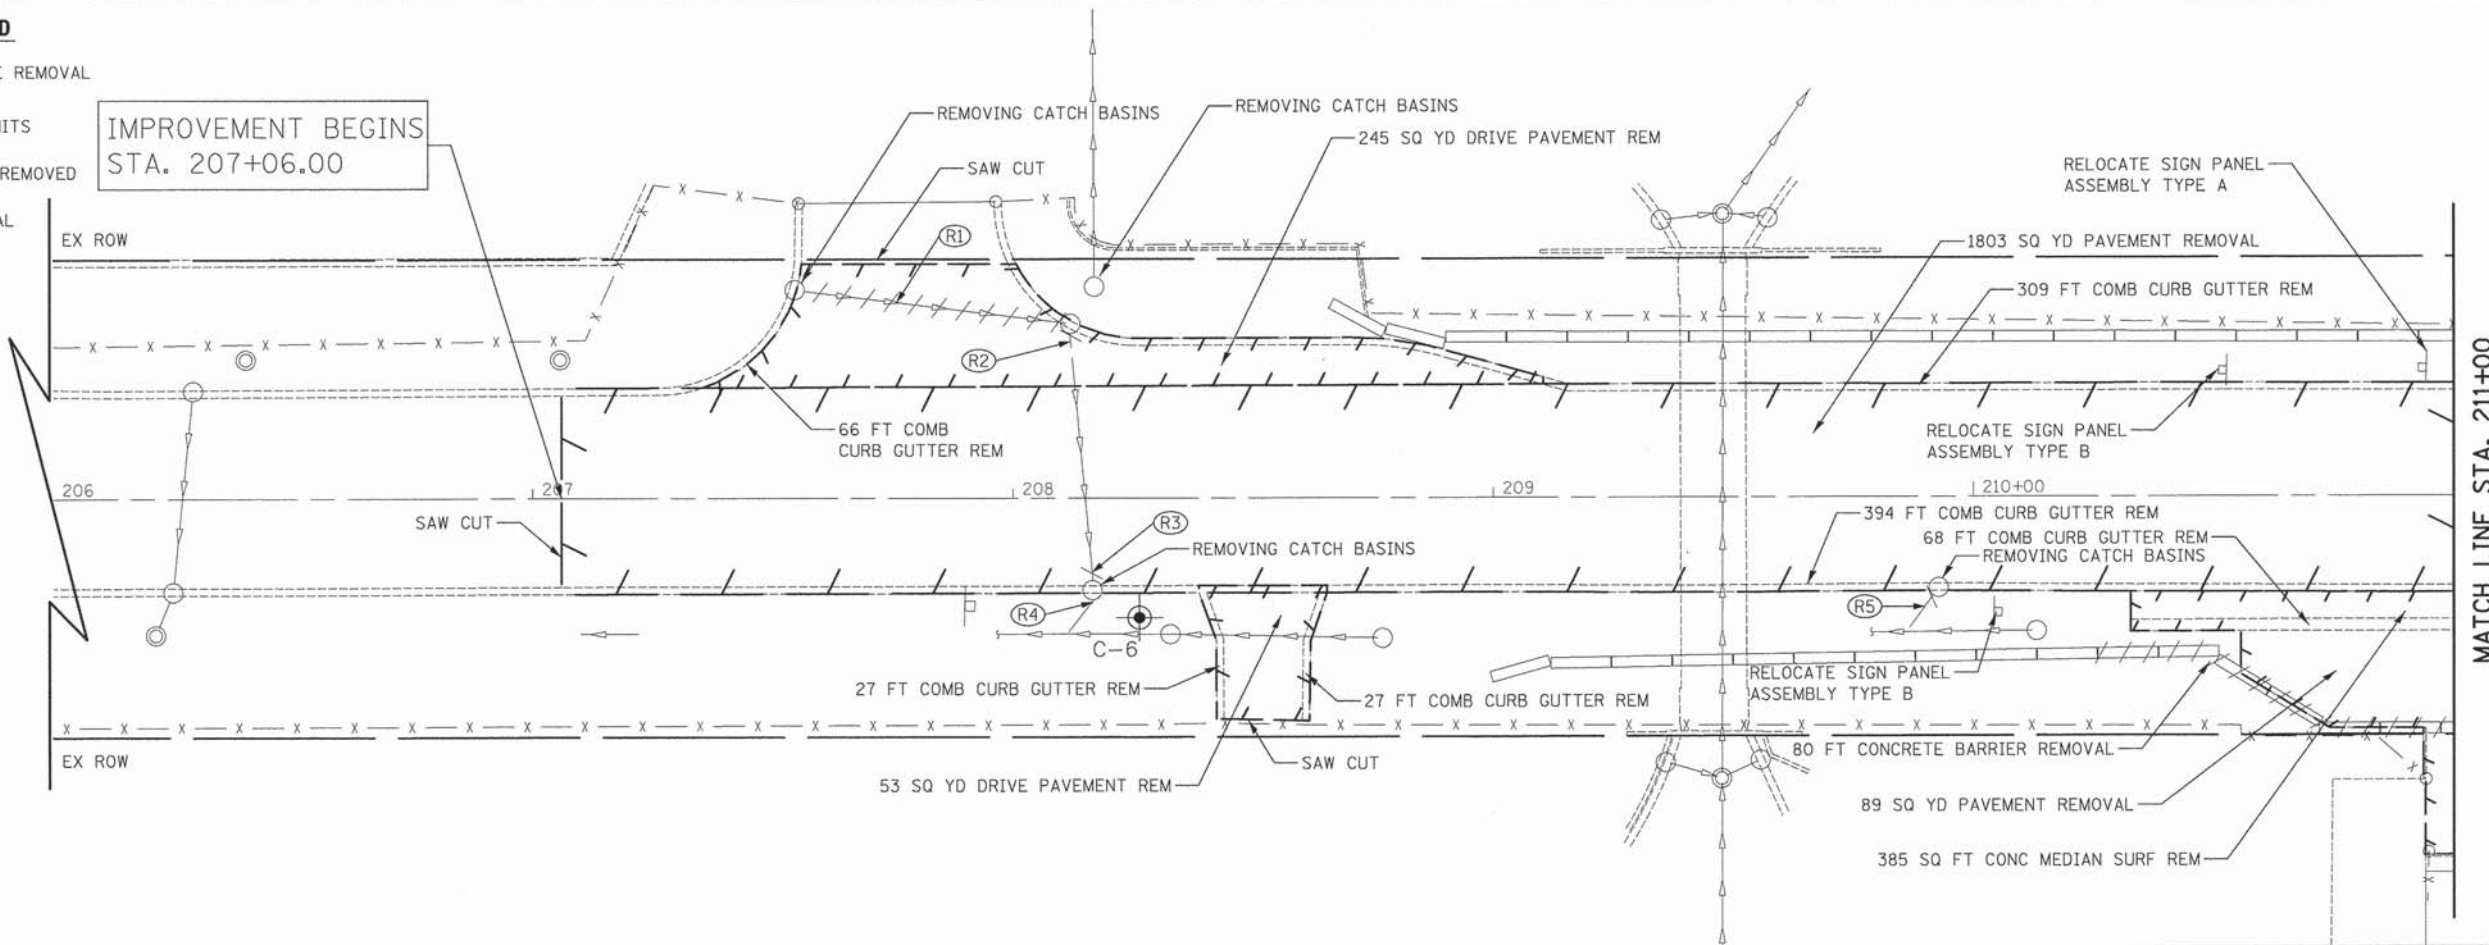

31ST STREET

GOLFVIEW AVENUE  
MATCH LINE STA. 10+75  
SEE SHEET NO. 23

IMPROVEMENT ENDS  
STA. 216+00.00

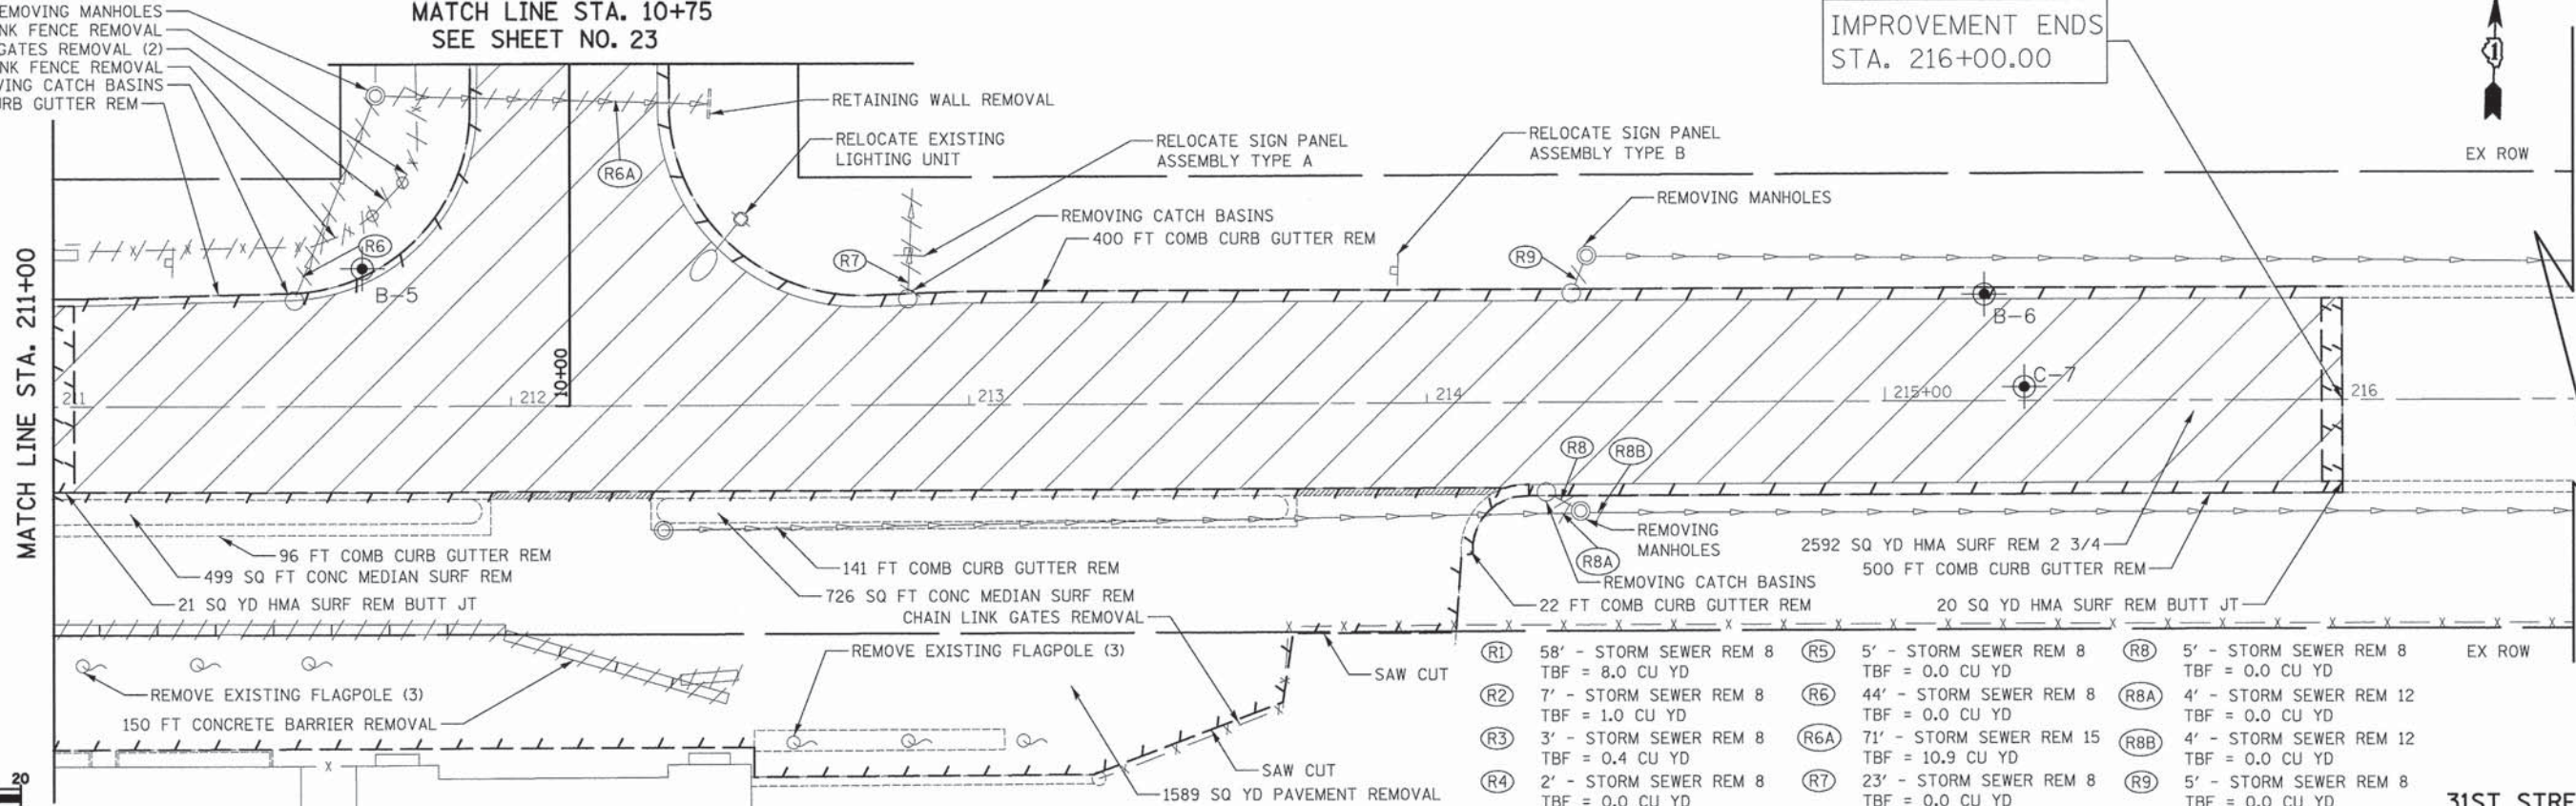

31ST STREET



FILE NAME = ...\\07-Removals\2563\_REM\_01.dgn  
USER NAME = dte  
DESIGNED - DTE  
DRAWN - DTE  
CHECKED - GAB  
DATE - 05/13/2013  
REVISOR -  
REVISOR -  
REVISOR -  
REVISOR -

**STATE OF ILLINOIS  
DEPARTMENT OF TRANSPORTATION**

**REMOVAL PLAN**





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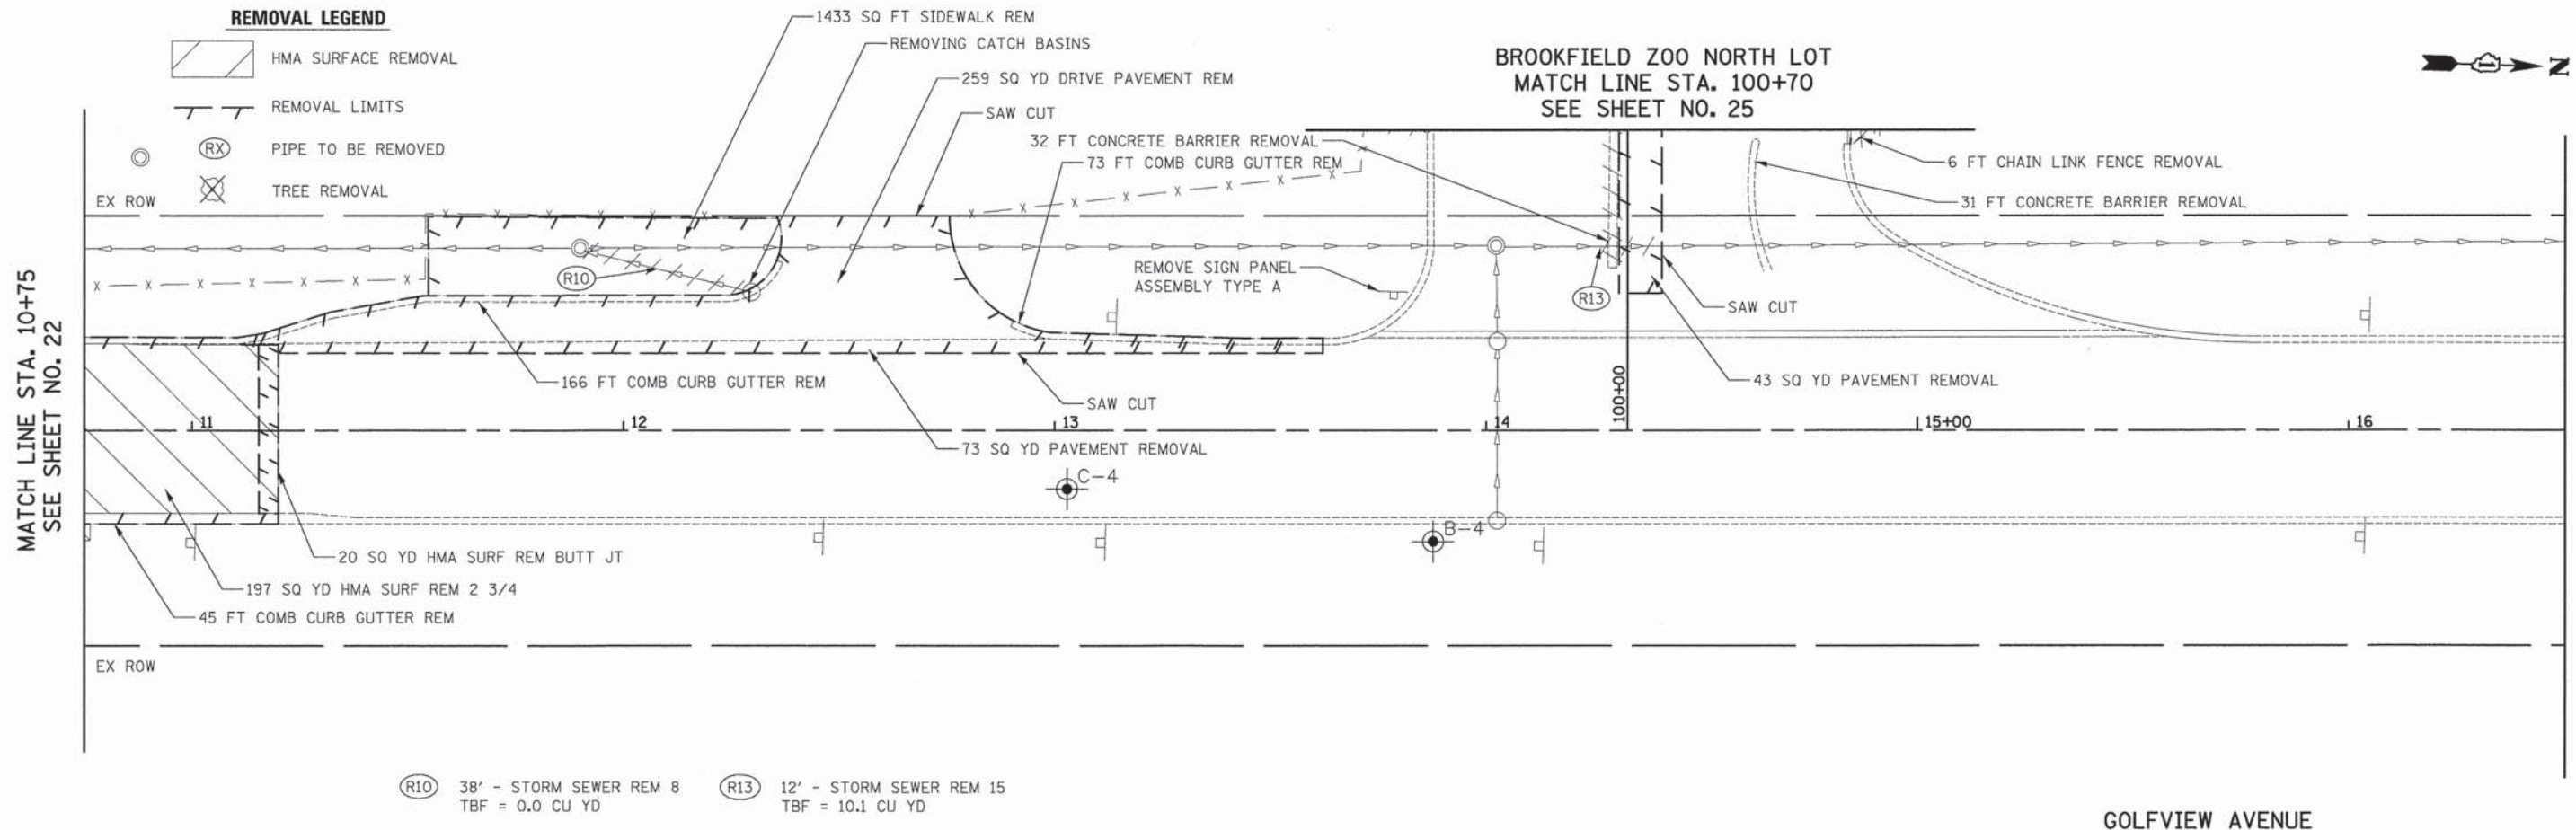
F.A.U. RTE.	SECTION	COUNTY	TOTAL SHEETS	SHEET NO.
3784	12-F3000-23-PK	COOK	131	22
CONTRACT NO. 63764				
ILLINOIS FED. AID PROJECT				

- (R1) 58' - STORM SEWER REM 8 TBF = 8.0 CU YD
- (R2) 7' - STORM SEWER REM 8 TBF = 1.0 CU YD
- (R3) 3' - STORM SEWER REM 8 TBF = 0.4 CU YD
- (R4) 2' - STORM SEWER REM 8 TBF = 0.0 CU YD
- (R5) 5' - STORM SEWER REM 8 TBF = 0.0 CU YD
- (R6) 44' - STORM SEWER REM 8 TBF = 0.0 CU YD
- (R6A) 71' - STORM SEWER REM 15 TBF = 10.9 CU YD
- (R7) 23' - STORM SEWER REM 8 TBF = 0.0 CU YD
- (R8) 5' - STORM SEWER REM 8 TBF = 0.0 CU YD
- (R8A) 4' - STORM SEWER REM 12 TBF = 0.0 CU YD
- (R8B) 4' - STORM SEWER REM 12 TBF = 0.0 CU YD
- (R9) 5' - STORM SEWER REM 8 TBF = 0.0 CU YD



**REMOVAL LEGEND**

-  HMA SURFACE REMOVAL
-  REMOVAL LIMITS
-  PIPE TO BE REMOVED
-  TREE REMOVAL




**BROOKFIELD ZOO NORTH LOT**  
**MATCH LINE STA. 100+70**  
**SEE SHEET NO. 25**

MATCH LINE STA. 10+75  
SEE SHEET NO. 22

MATCH LINE STA. 16+50

- (R10) 38' - STORM SEWER REM 8  
TBF = 0.0 CU YD
- (R13) 12' - STORM SEWER REM 15  
TBF = 10.1 CU YD

GOLFVIEW AVENUE

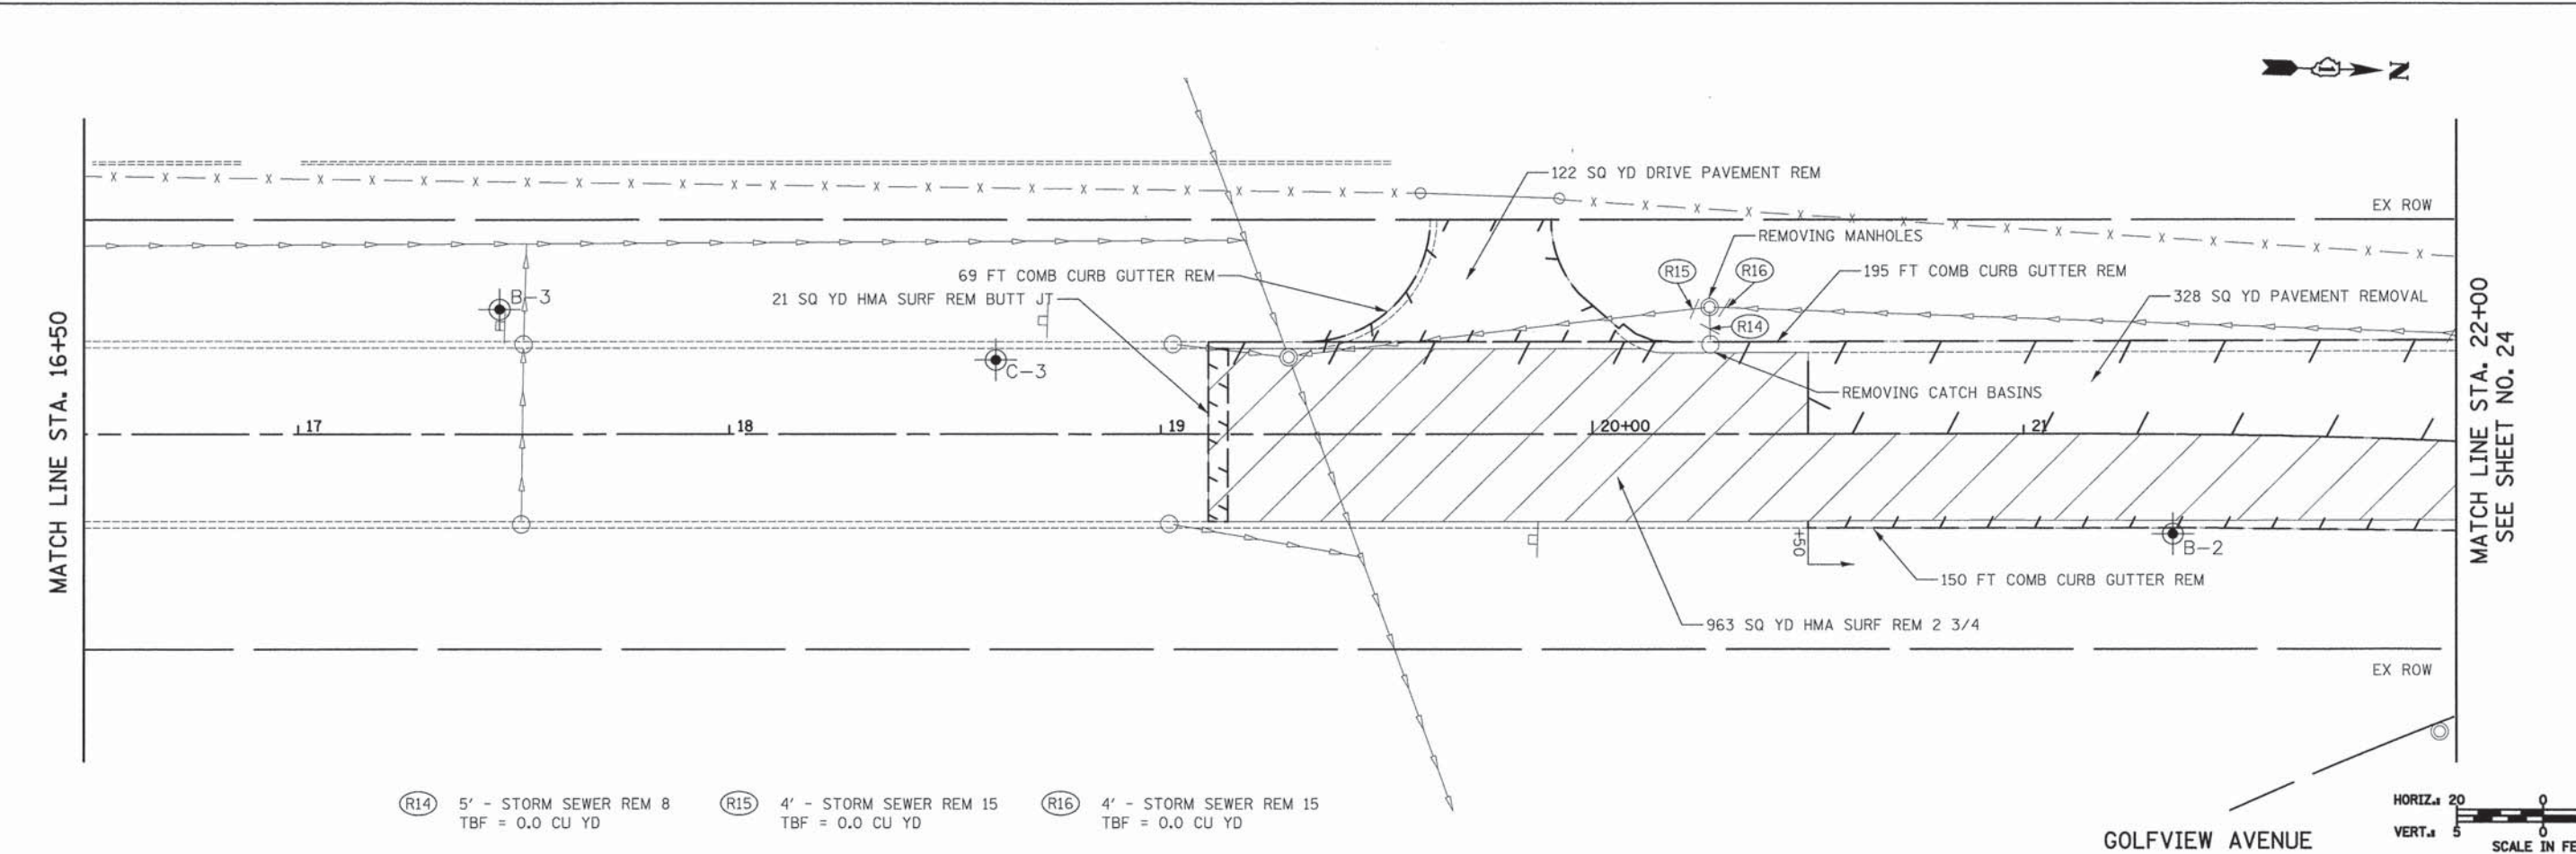

- (R14) 5' - STORM SEWER REM 8  
TBF = 0.0 CU YD
- (R15) 4' - STORM SEWER REM 15  
TBF = 0.0 CU YD
- (R16) 4' - STORM SEWER REM 15  
TBF = 0.0 CU YD







GOLFVIEW AVENUE

MATCH LINE STA. 22+00  
SEE SHEET NO. 24

FILE NAME = ...\\07-Removals\2563_REM_02.dgn	USER NAME = dte	DESIGNED - DTE	REVISED -	<b>STATE OF ILLINOIS</b> <b>DEPARTMENT OF TRANSPORTATION</b>	<b>REMOVAL PLAN</b>	F.A.U. RTE. 3784	SECTION 12-F3000-23-PK	COUNTY COOK	TOTAL SHEETS 131	SHEET NO. 23		
PLDT SCALE = 20.0000' / 1" =	CHECKED - GAB	DATE - 05/13/2013	REVISED -			SCALE: 1" = 20'	SHEET NO. 2 OF 6 SHEETS	STA. 10+75 TO STA. 23+00	CONTRACT NO. 63764			
PLDT DATE = 5/6/2013	DATE - 05/13/2013	REVISED -	REVISED -			ILLINOIS FED. AID PROJECT						




**REMOVAL LEGEND**

-  HMA SURFACE REMOVAL
-  REMOVAL LIMITS
-  PIPE TO BE REMOVED
-  TREE REMOVAL



IMPROVEMENT ENDS  
STA. 26+14.88

MATCH LINE STA. 22+00  
SEE SHEET NO. 24

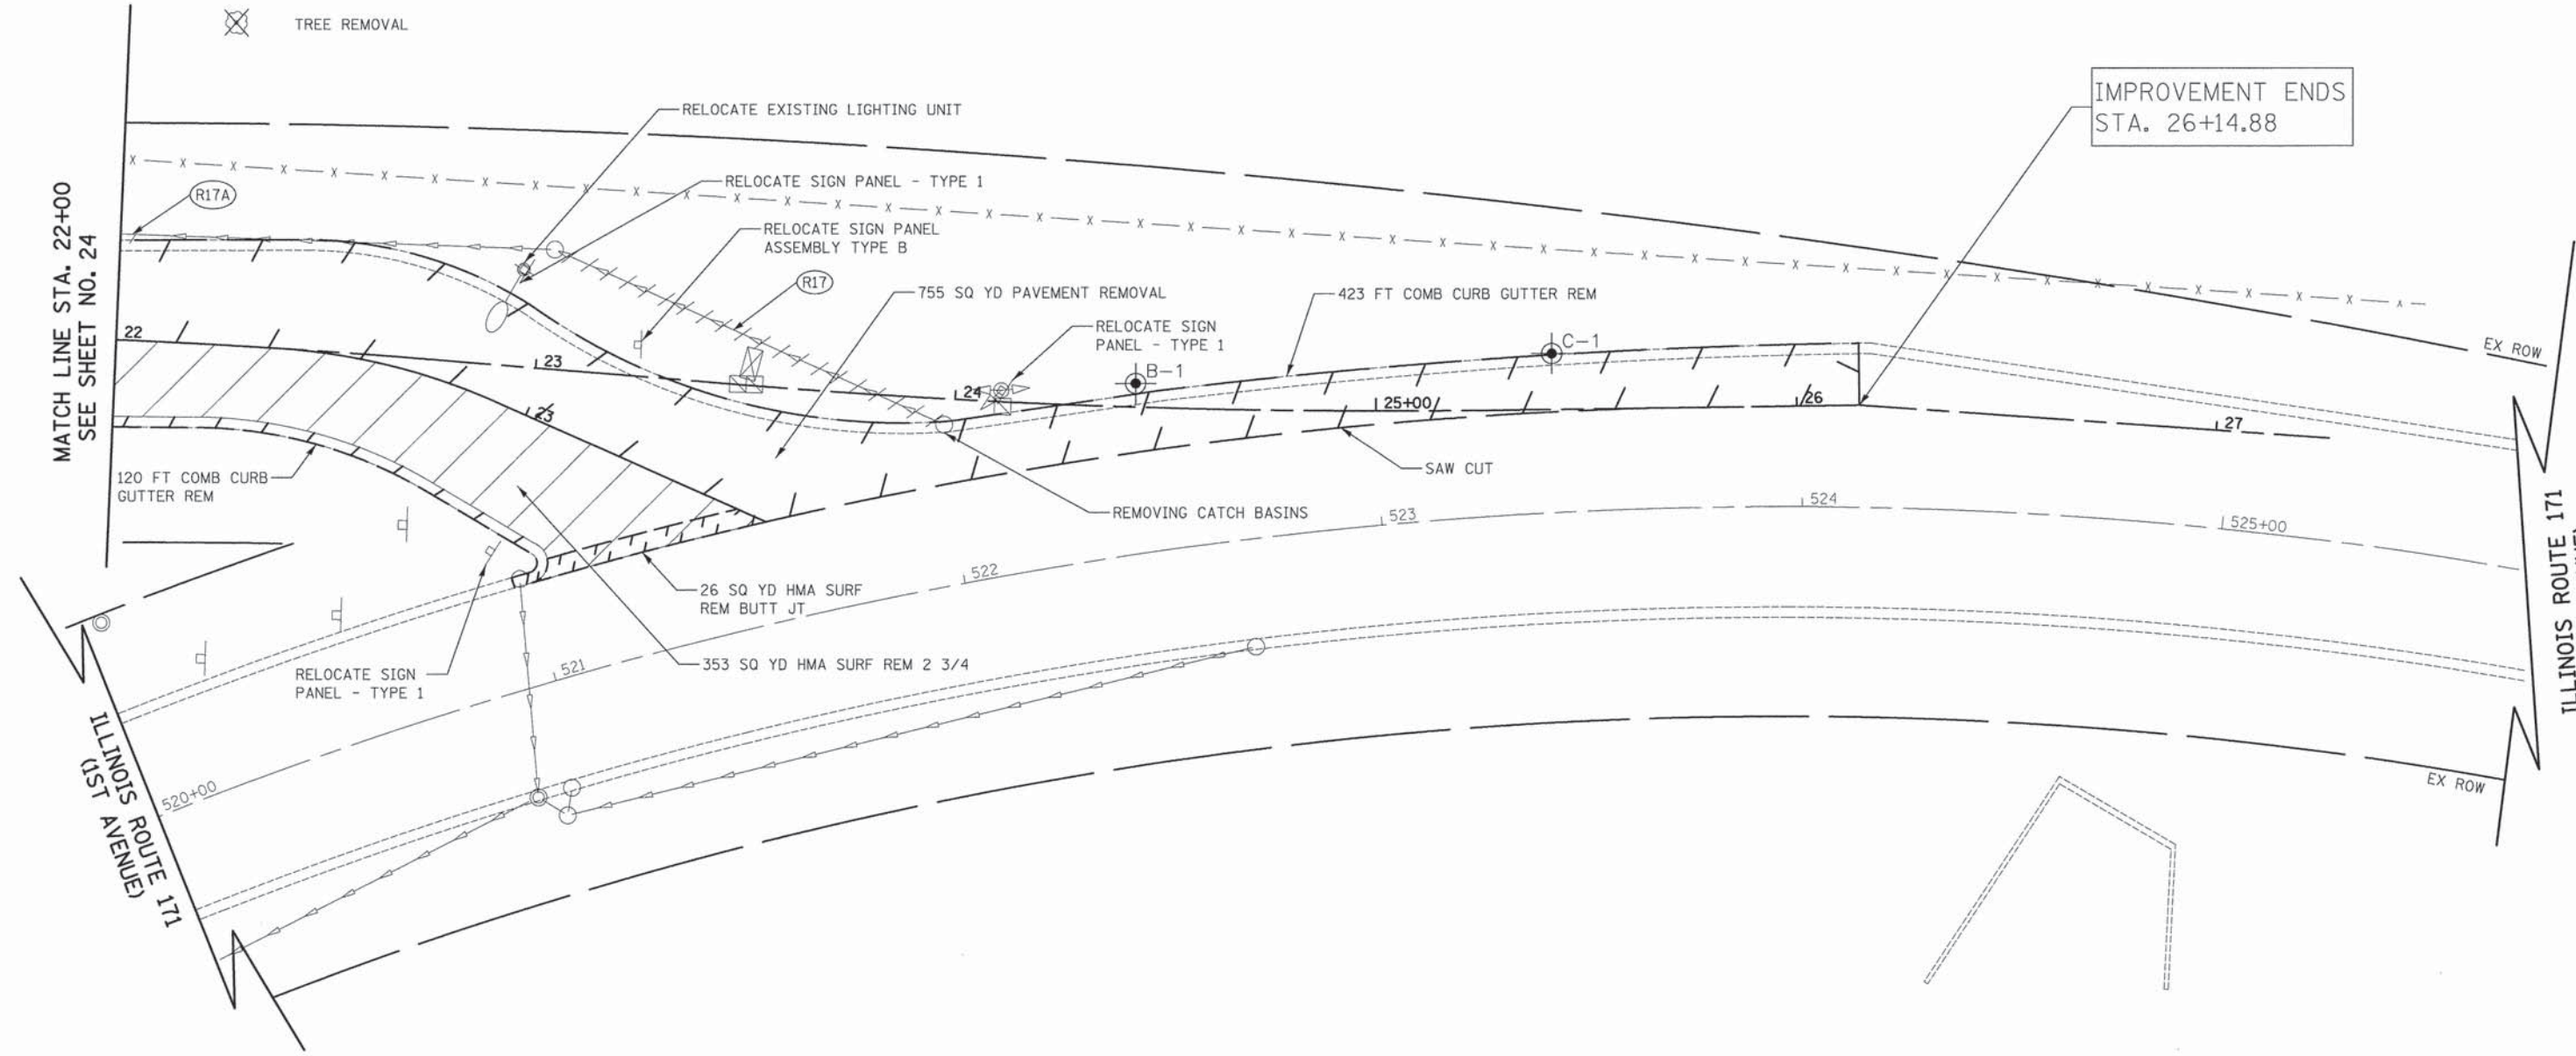

- (R17) 98' - STORM SEWER REM 12  
TBF = 0.0 CU YD
- (R17A) 12' - STORM SEWER REM 15  
TBF = 0.0 CU YD





GOLFVIEW AVENUE  
IL RTE 171




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	PLOT SCALE = 20.0000' / 1" =	CHECKED - GAB	REVISED -			SCALE: 1" = 20'	SHEET NO. 3 OF 6 SHEETS	STA. 22+00 TO STA. 26+15	CONTRACT NO. 63764 ILLINOIS FED. AID PROJECT	
PLOT DATE = 5/6/2013	DATE - 05/13/2013	REVISED -	REVISED -							




**REMOVAL LEGEND**

-  HMA SURFACE REMOVAL
-  REMOVAL LIMITS
-  PIPE TO BE REMOVED
-  TREE REMOVAL

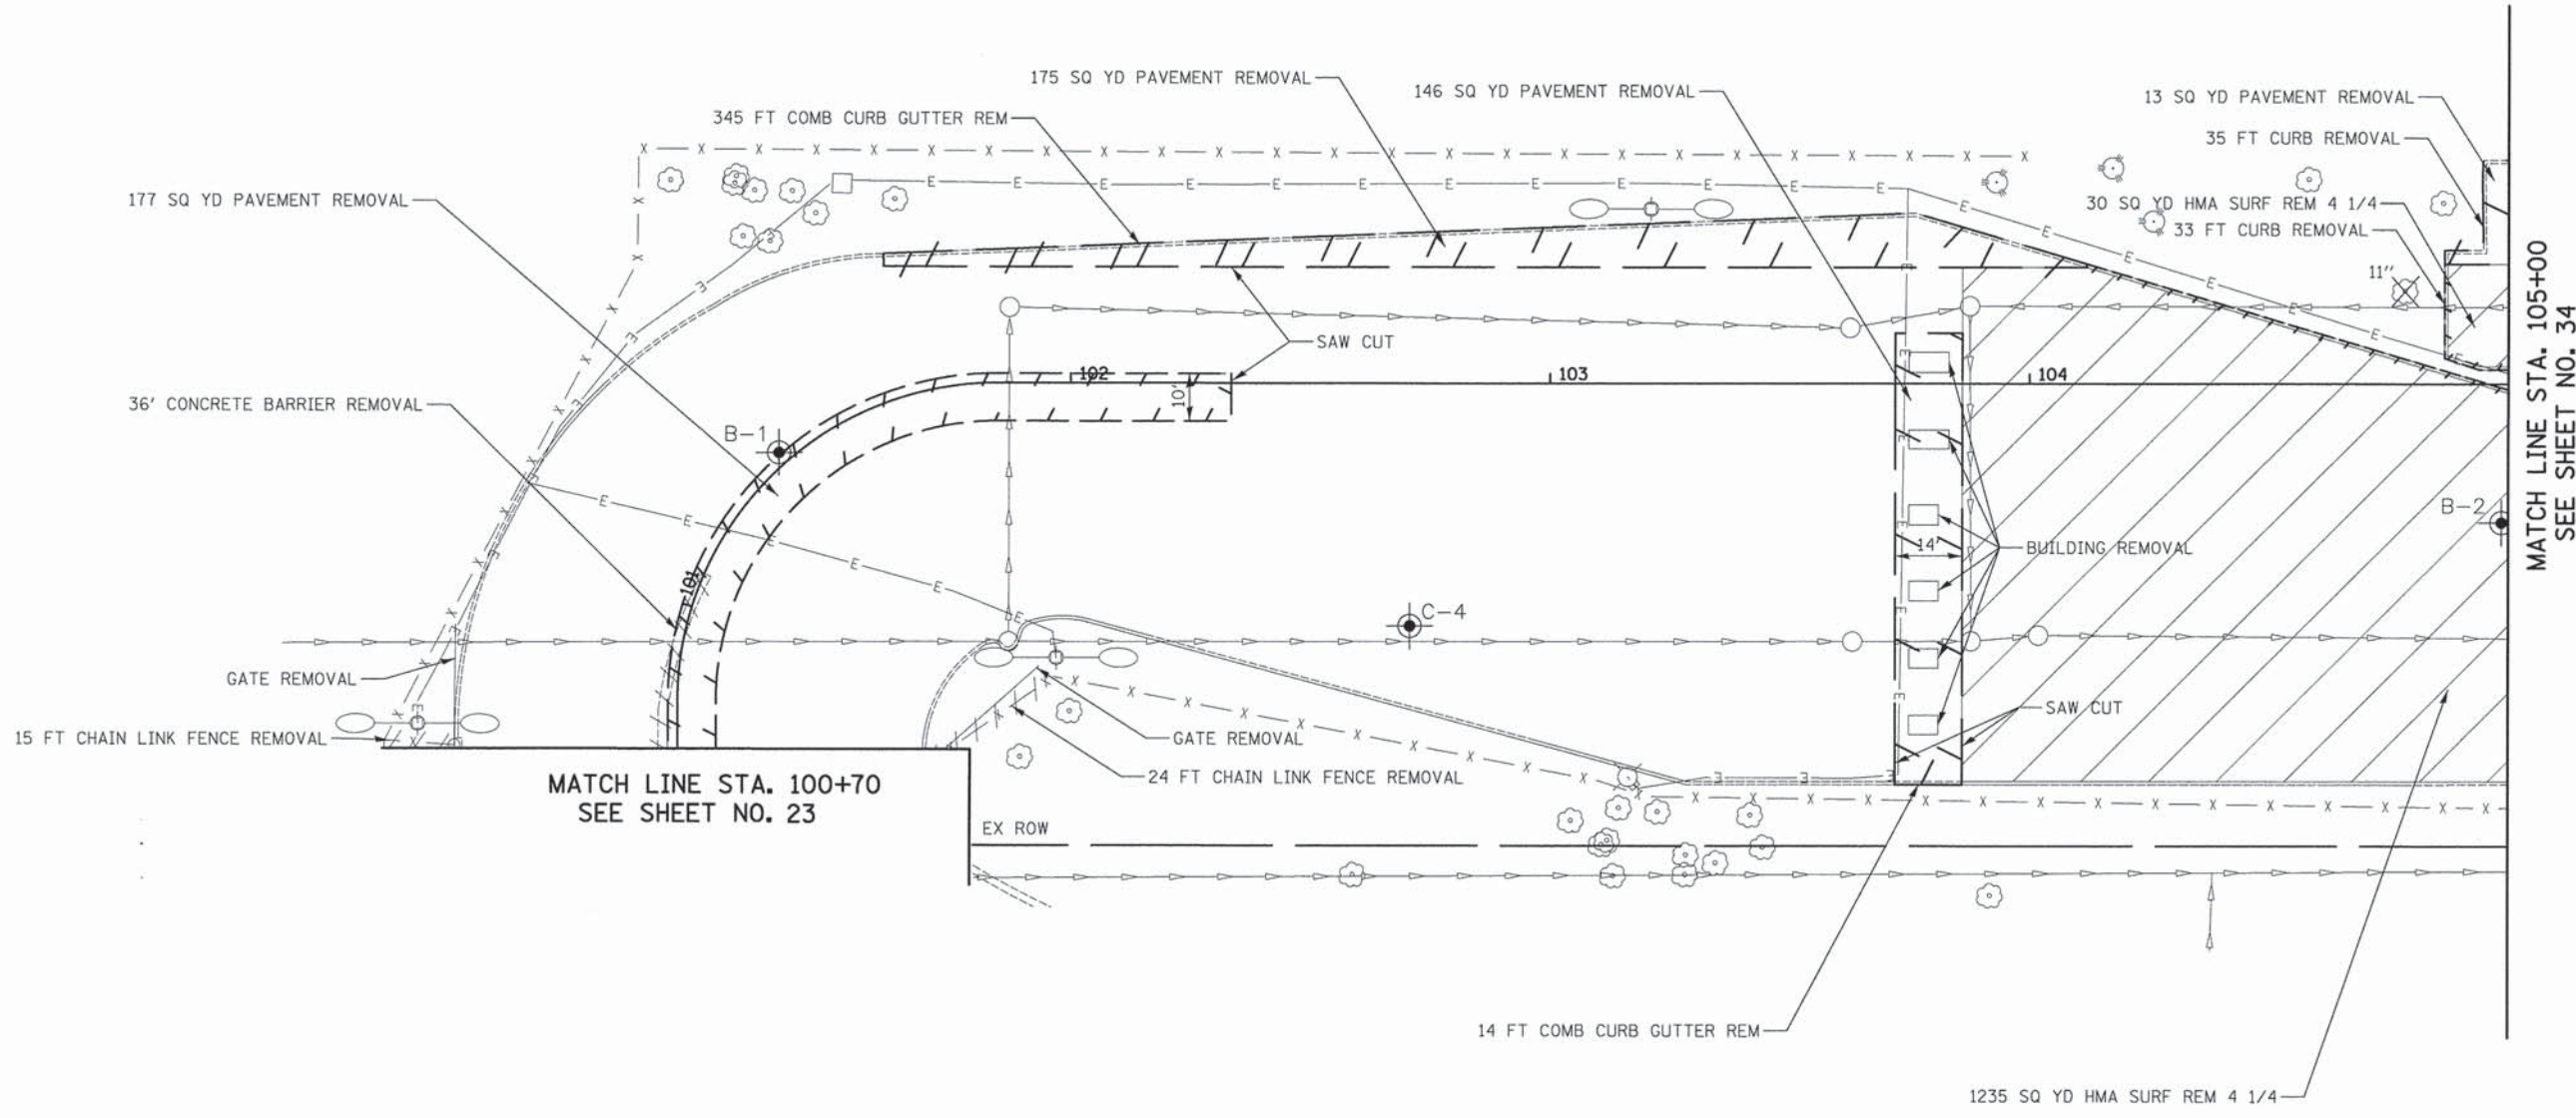

- NOTES**
1. SEE SHEET 98 FOR LIGHTING REMOVALS

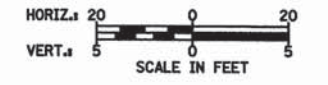







**BROOKFIELD ZOO NORTH PARKING LOT**

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PLOT SCALE = 20.0000' / 1" /				SCALE: 1" = 20'		SHEET NO. 4 OF 6 SHEETS		CONTRACT NO. 63764		
PLOT DATE = 5/6/2013				DATE = 05/13/2013		STA. 100+75 TO STA. 105+00		FED. ROAD DIST. NO. 1   ILLINOIS FED. AID PROJECT		



**REMOVAL LEGEND**

-  HMA SURFACE REMOVAL
-  REMOVAL LIMITS
-  PIPE TO BE REMOVED
-  TREE REMOVAL

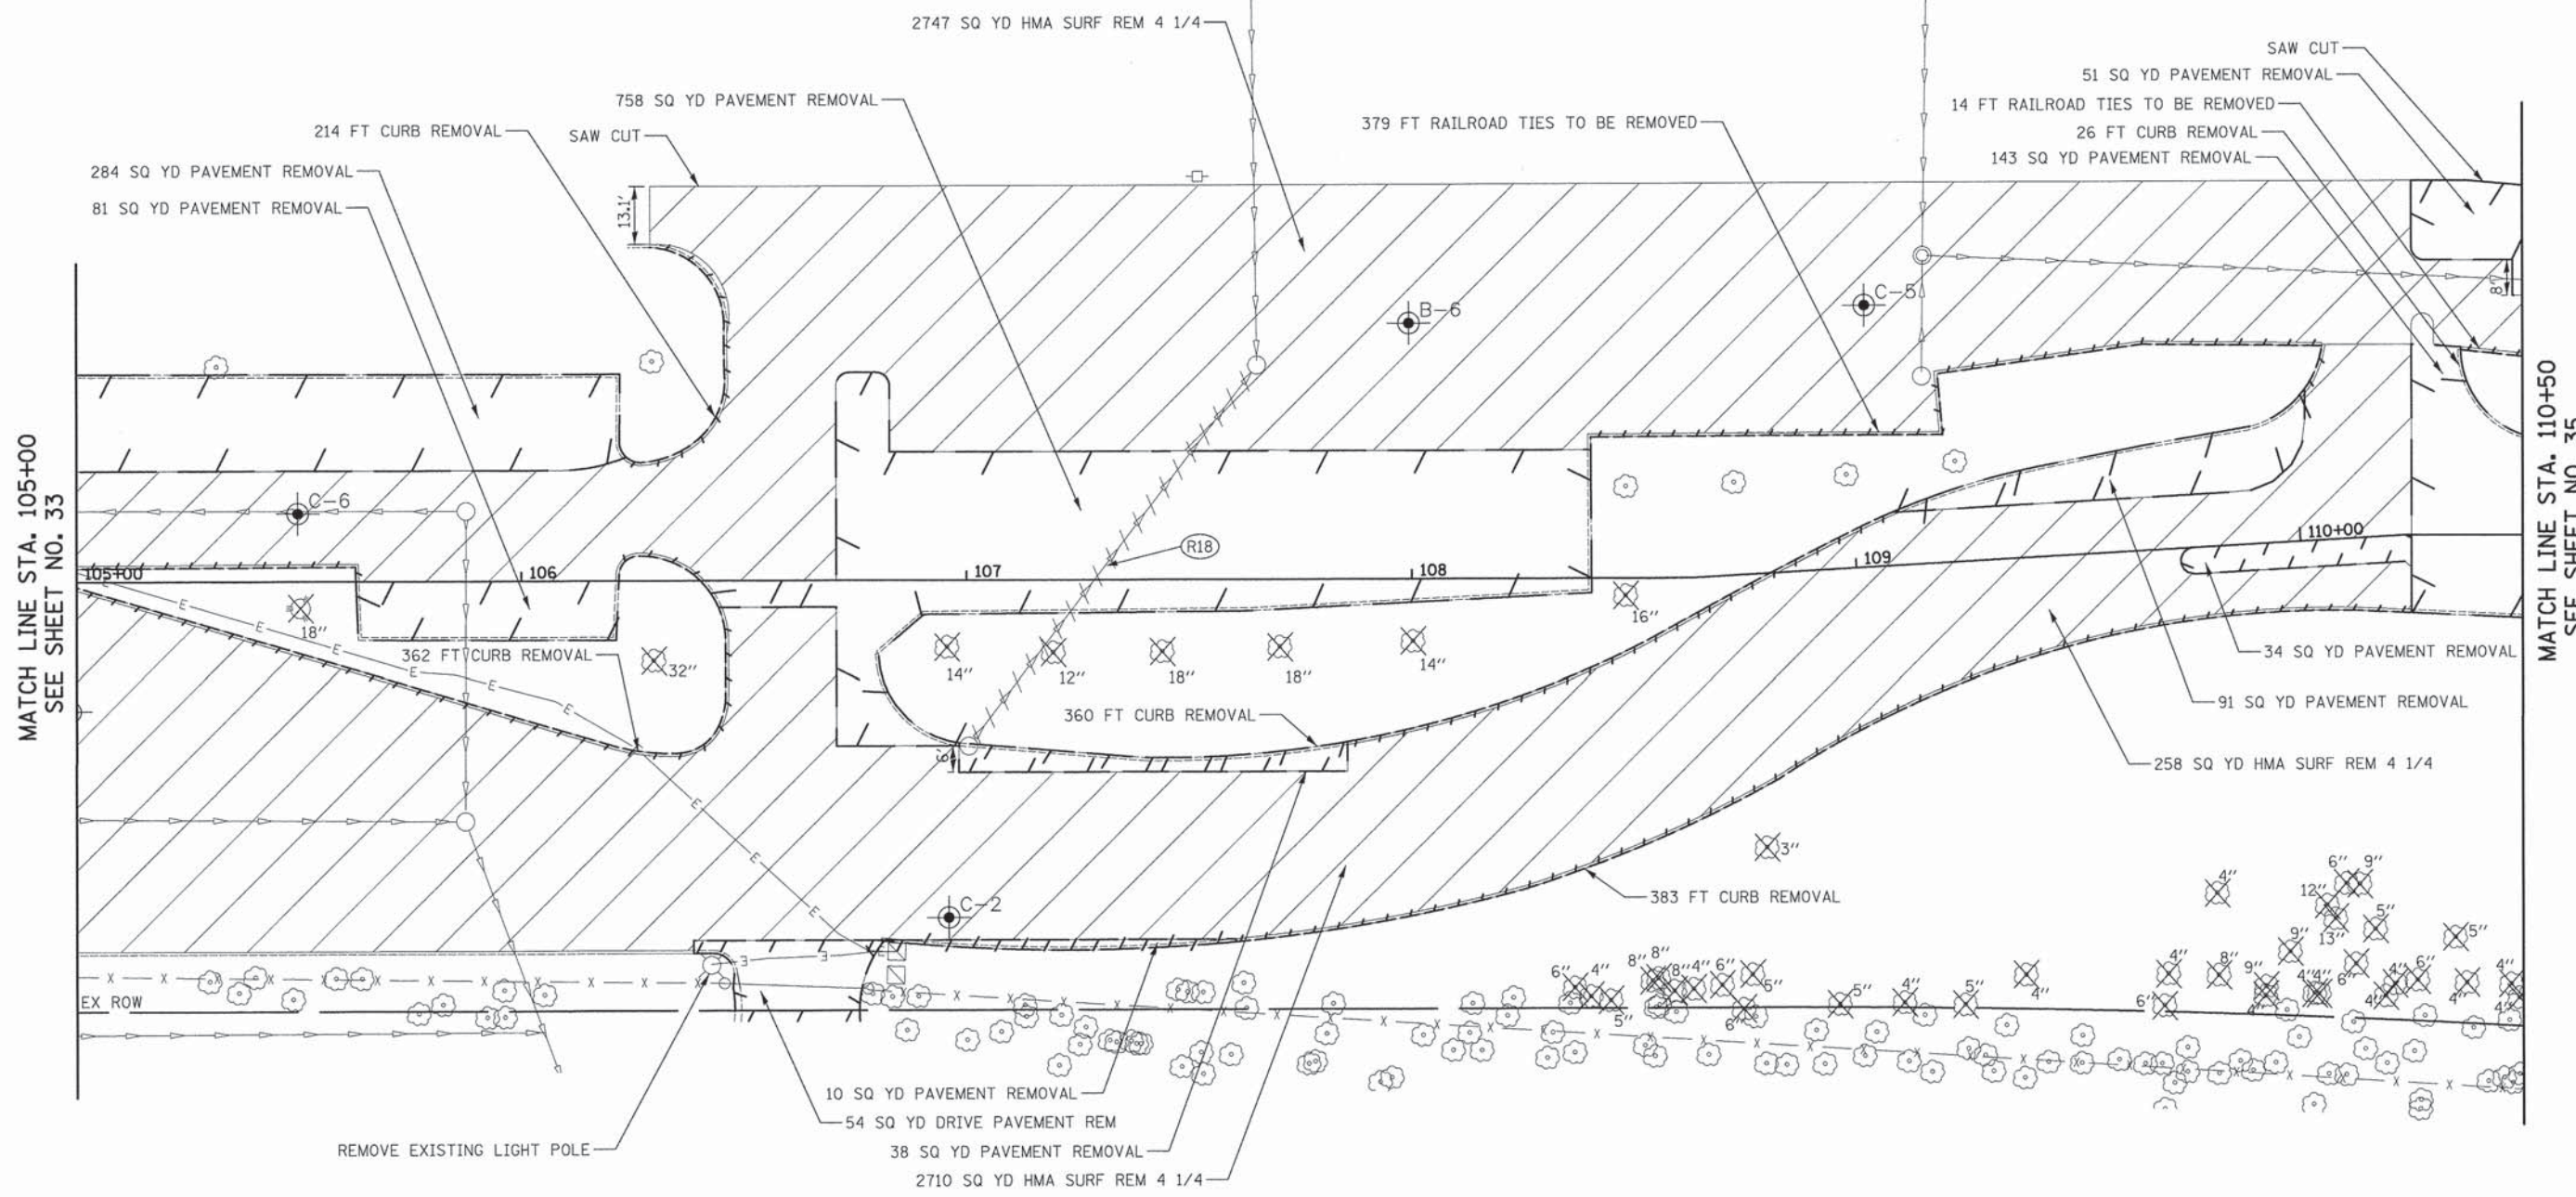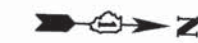

MATCH LINE STA. 105+00  
SEE SHEET NO. 33

MATCH LINE STA. 110+50  
SEE SHEET NO. 35

(R18) 104' - STORM SEWER REM 12  
TBF = 52.8 CU YD

- NOTES**
- SEE SHEET 98 FOR LIGHTING REMOVALS





**BROOKFIELD ZOO NORTH PARKING LOT**




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PLOT SCALE = 28,0000' / 1"		CHECKED - GAB	REVISED -		SCALE: 1" = 20'	SHEET NO. 5 OF 6 SHEETS	STA. 105+00 TO STA. 110+50	CONTRACT NO. 63764				
PLOT DATE = 5/6/2013		DATE - 05/13/2013	REVISED -		FED. ROAD DIST. NO. - [ILLINOIS] FED. AID PROJECT							




**REMOVAL LEGEND**

-  HMA SURFACE REMOVAL
-  REMOVAL LIMITS
-  PIPE TO BE REMOVED
-  TREE REMOVAL

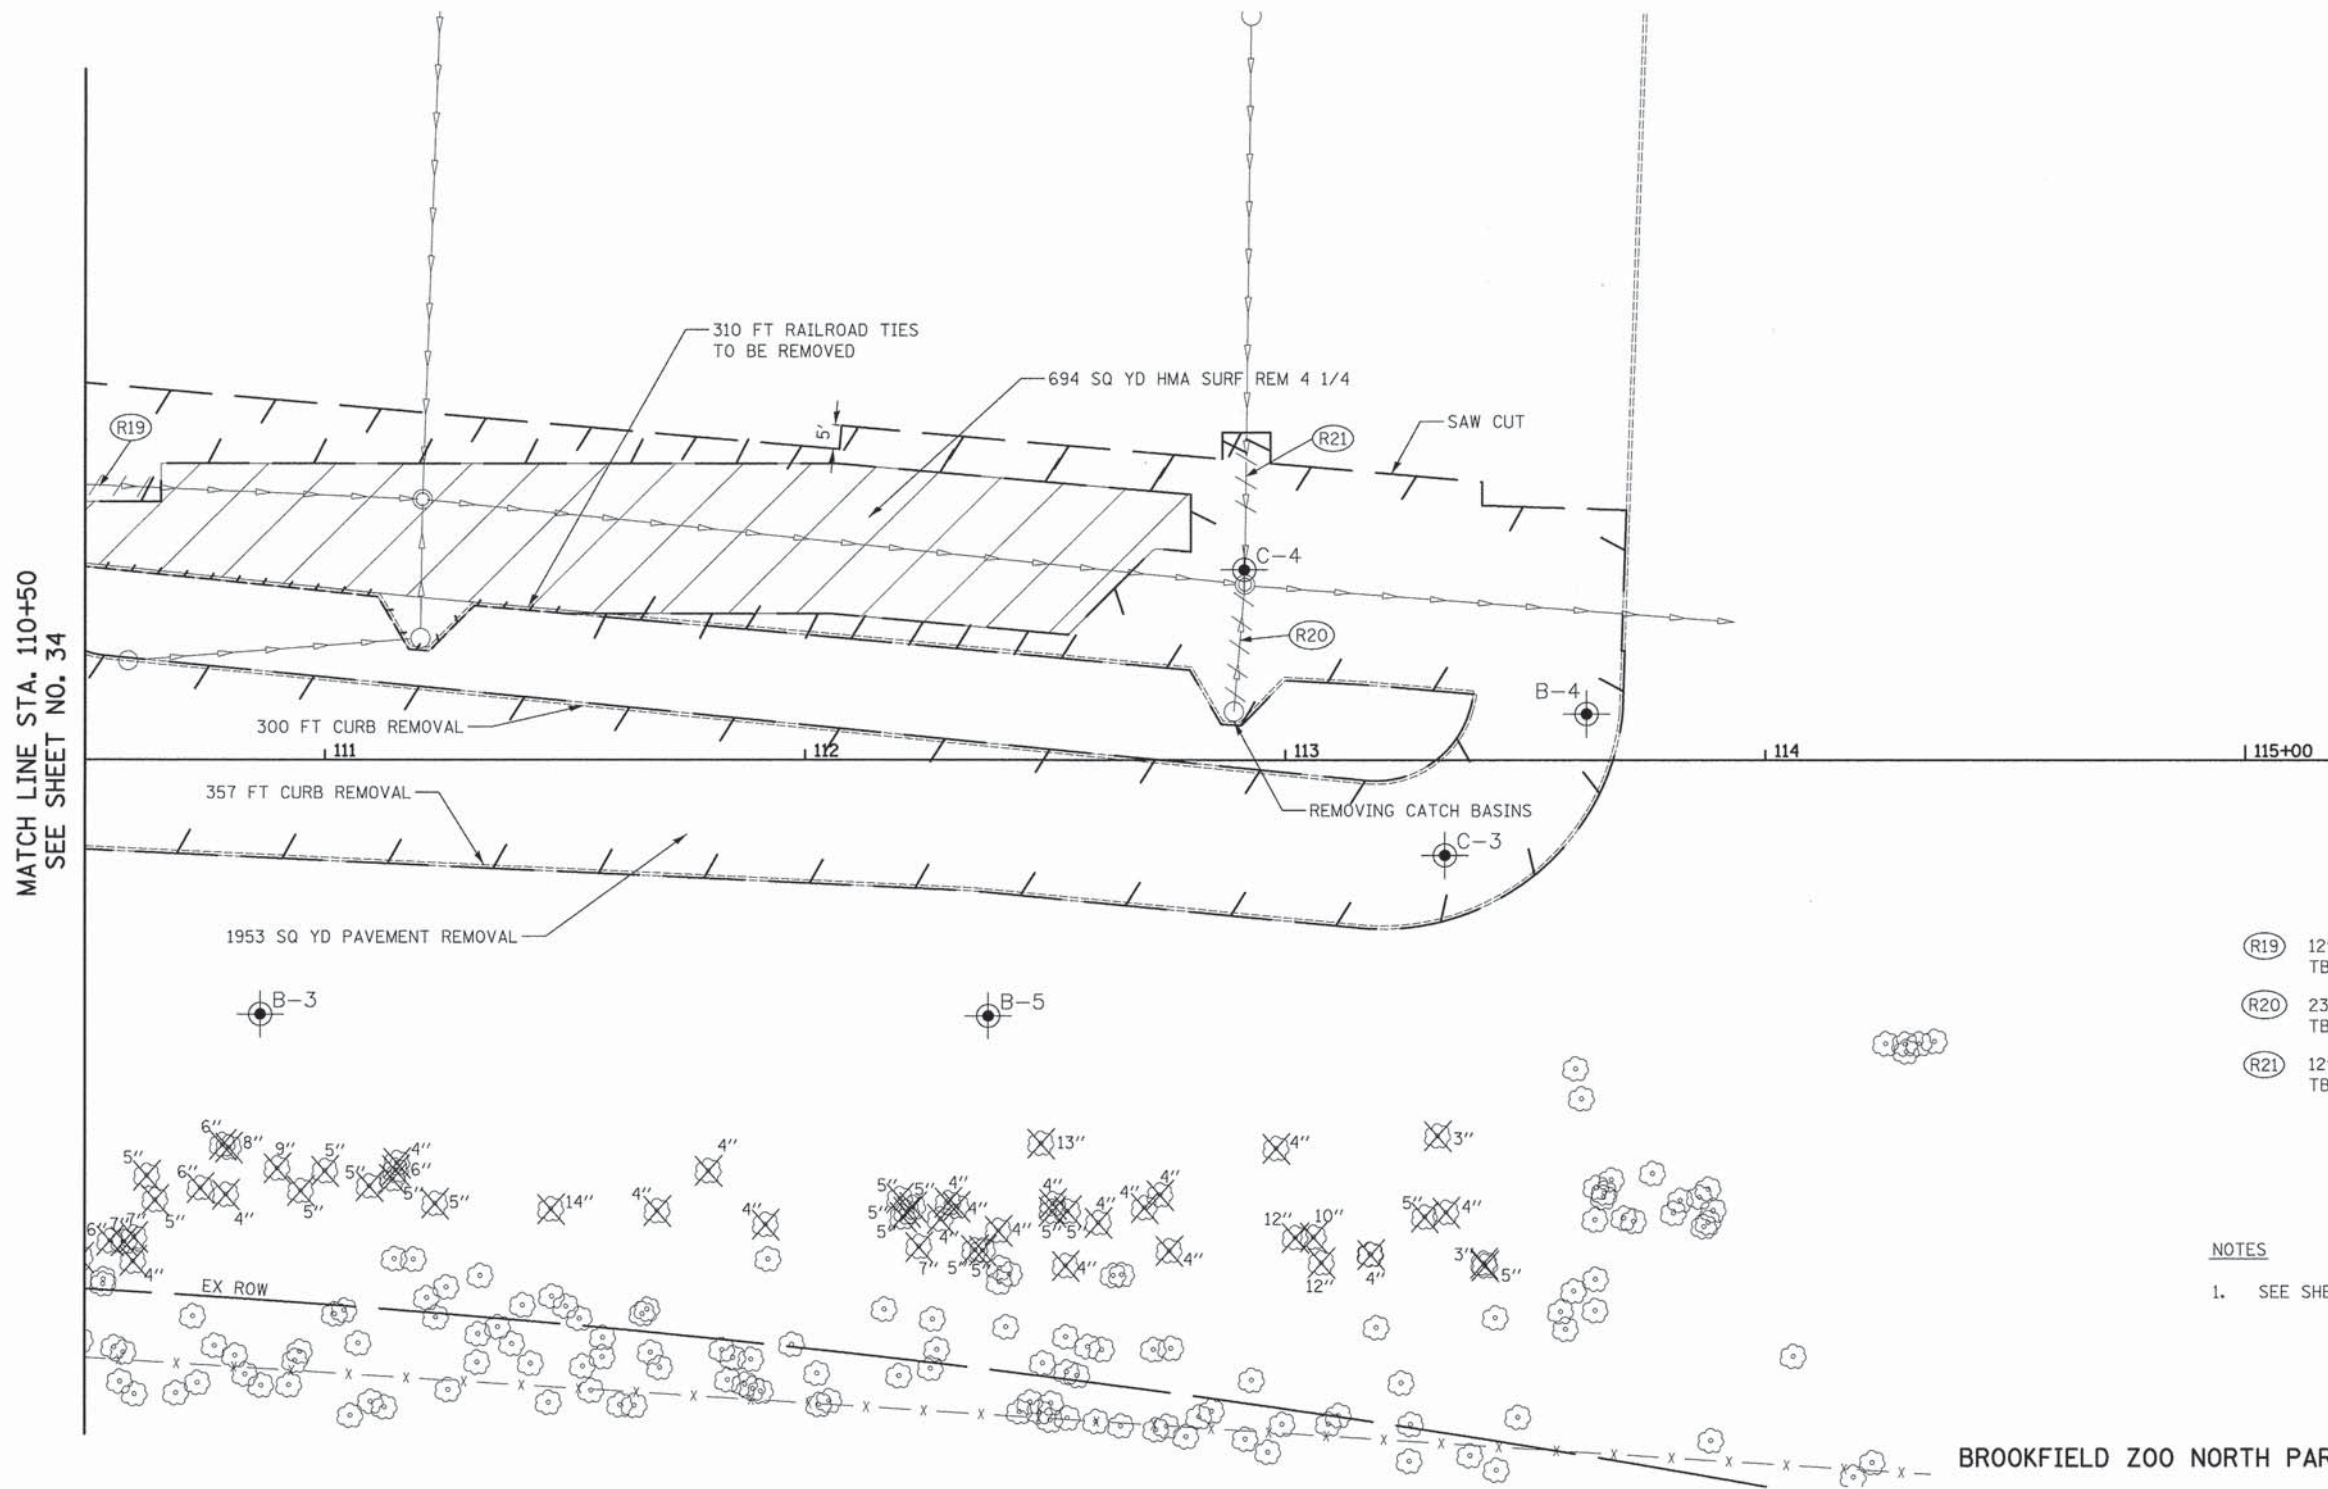

- (R19) 12' - STORM SEWER REM 24  
TBF = 16.7 CU YD
- (R20) 23' - STORM SEWER REM 12  
TBF = 16.0 CU YD
- (R21) 12' - STORM SEWER REM 15  
TBF = 8.5 CU YD

**NOTES**  
1. SEE SHEET 98 FOR LIGHTING REMOVALS

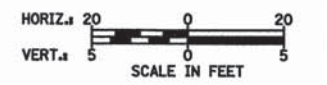

BROOKFIELD ZOO NORTH PARKING LOT

FILE NAME = ...\\07-Removals\2563_REM_06.dgn	USER NAME = dte	DESIGNED - DTE	REVISED -	<b>STATE OF ILLINOIS DEPARTMENT OF TRANSPORTATION</b>	<b>REMOVAL PLAN</b>	F.A.U. RTE. 3784	SECTION 12-F3000-23-PK	COUNTY COOK	TOTAL SHEETS 131	SHEET NO. 27
PLOT SCALE = 20,0000' / 1" / 1" / 1"				SCALE: 1" = 20'		SHEET NO. 6 OF 6 SHEETS		STA. 110+50 TO STA. 113+71		CONTRACT NO. 63764
PLOT DATE = 5/6/2013				DATE - 05/13/2013		FED. ROAD DIST. NO. 1		ILLINOIS FED. AID PROJECT		
















PLAN	DESIGNED	DATE
	PLOTTED	
	ALIGNED	
	CHECKED	
	FILE NAME	
	NO.	

PROFILE	DESIGNED	DATE
	PLOTTED	
	GRADES	
	CHECKED	
	FILE NAME	
	NO.	

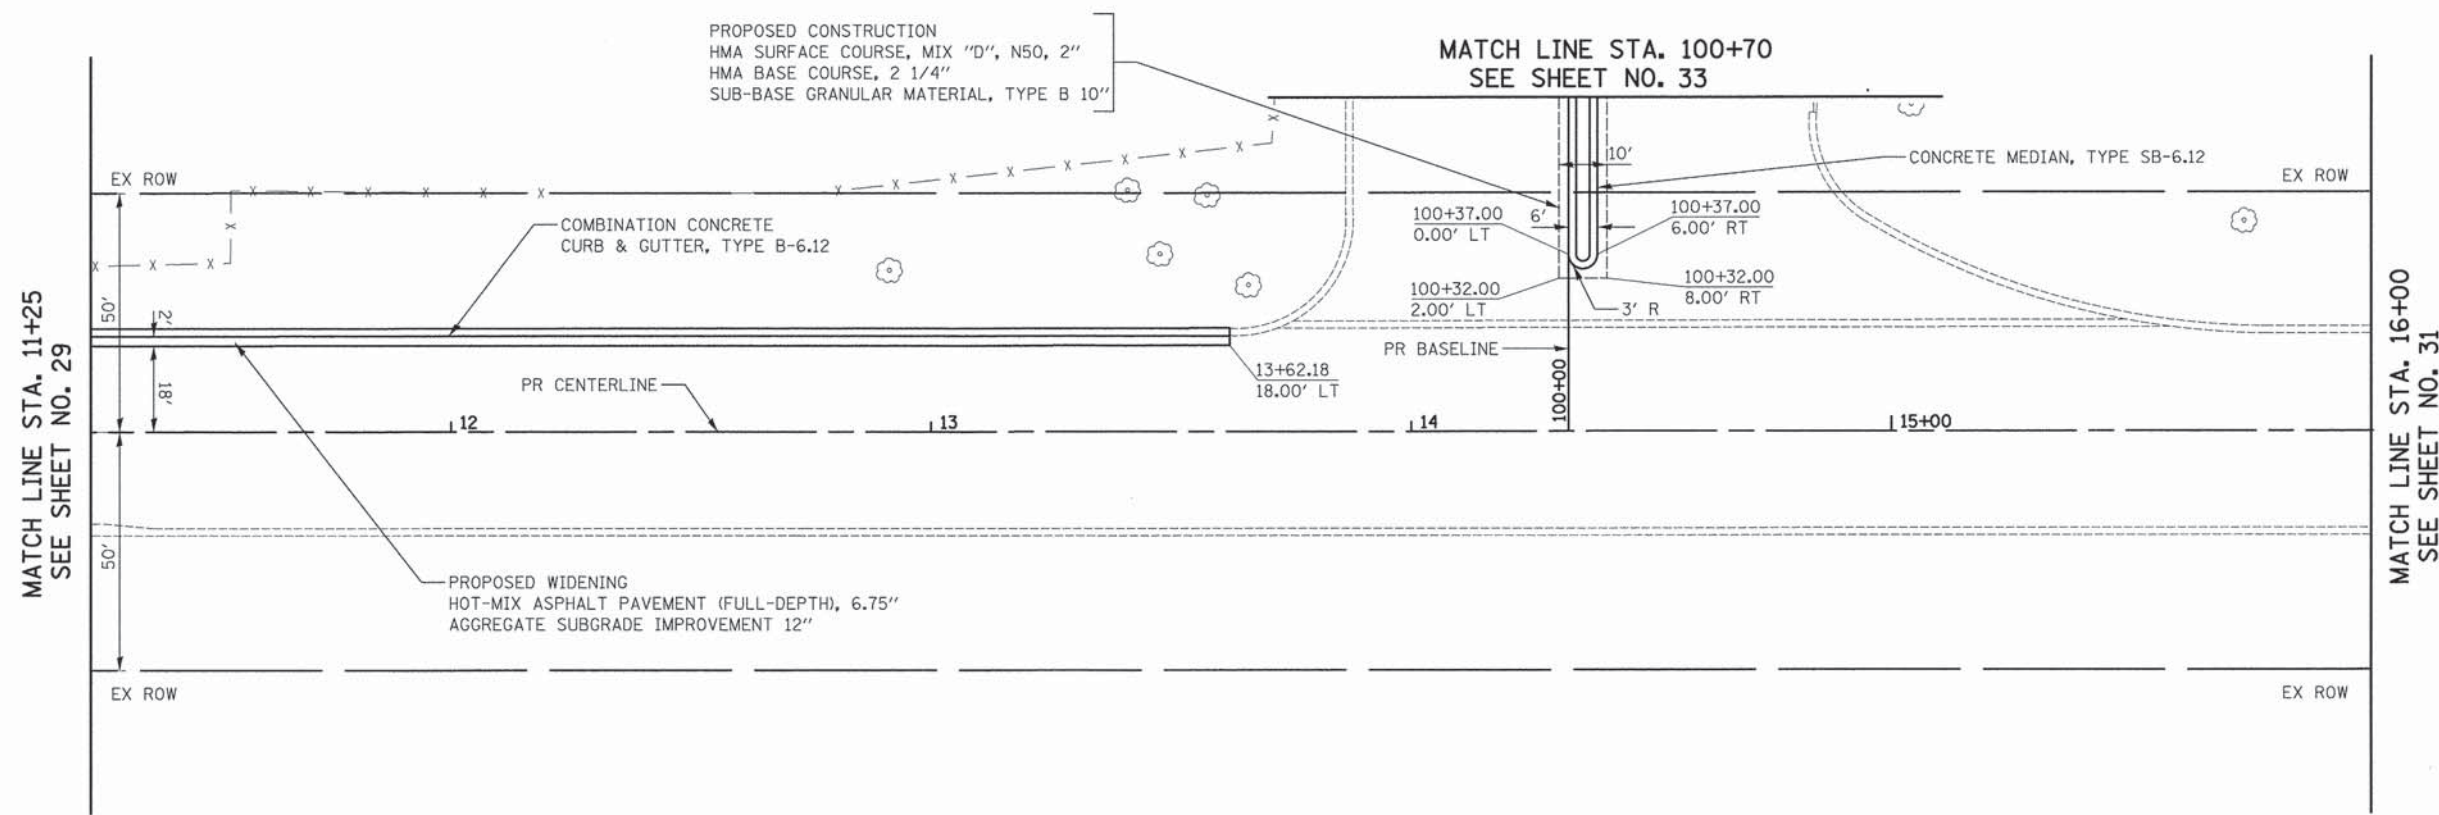

GOLFVIEW AVENUE

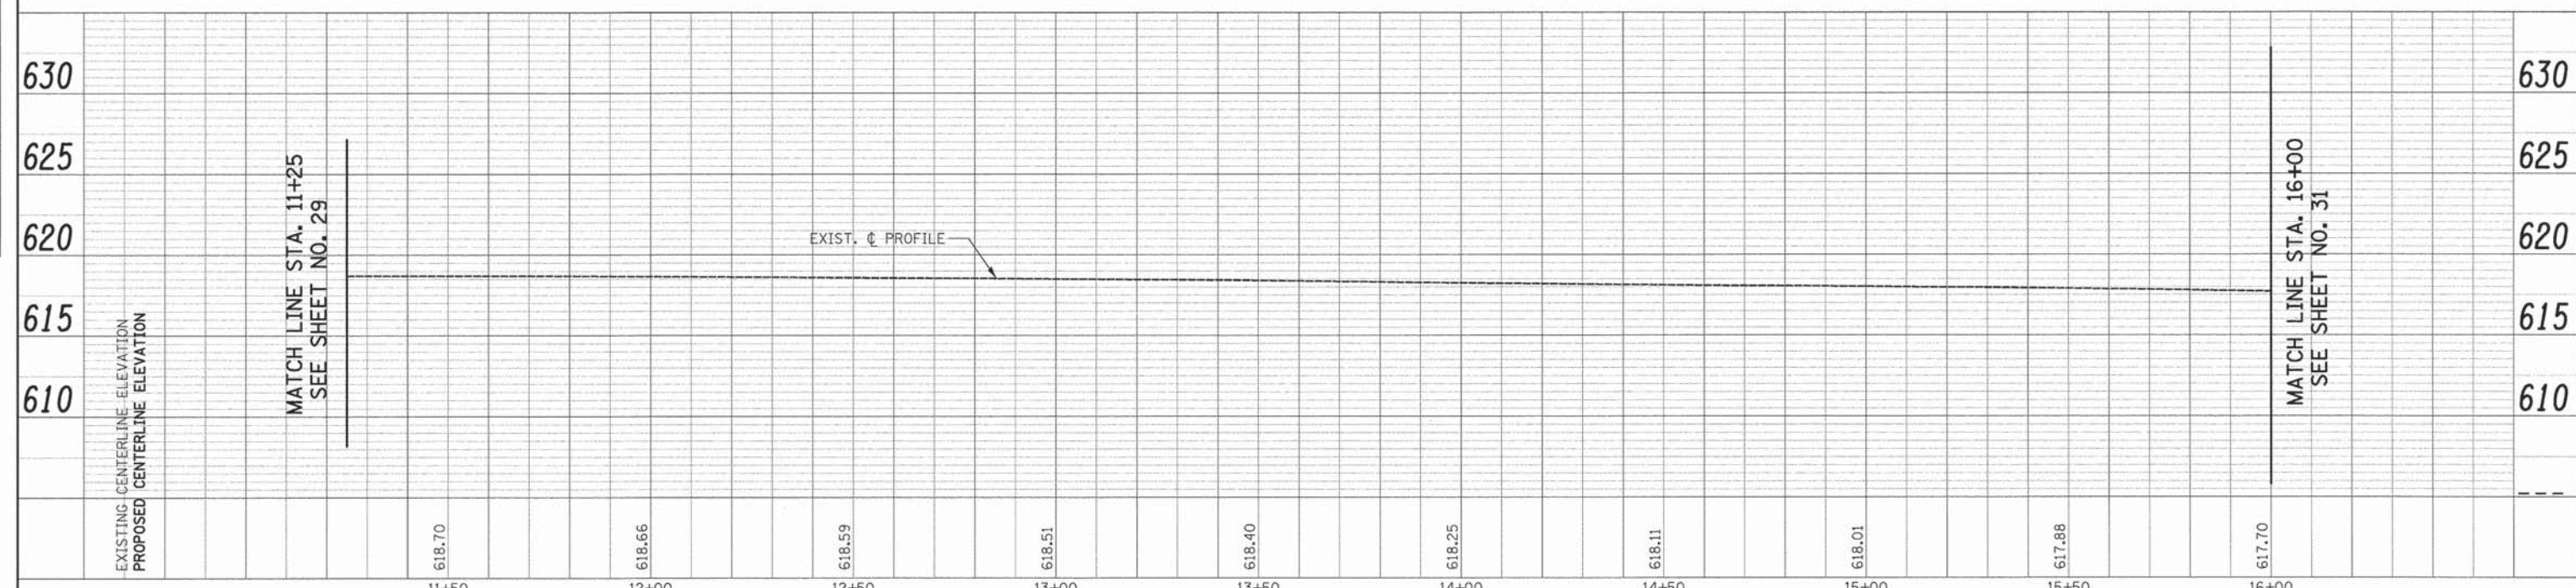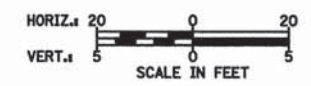

FILE NAME =	USER NAME = dte	DESIGNED - DTE	REVISED -	<b>STATE OF ILLINOIS DEPARTMENT OF TRANSPORTATION</b>	<b>PLAN AND PROFILE</b>		F.A.U. RTE.	SECTION	COUNTY	TOTAL SHEETS	SHEET NO.	
...2563_P&P_03.dgn		DRAWN - DTE	REVISED -		SCALE: 1" = 20'	SHEET NO. 3 OF 5 SHEETS	STA. 11+25 TO STA. 16+00	3784	12-F3000-23-PK	COOK	131	30
		CHECKED - GAB	REVISED -					<b>CONTRACT NO. 63764</b>				
		DATE - 05/13/2013	REVISED -					FED. ROAD DIST. NO. 1 ILLINOIS				






PROP. CURVE GOLFVIEW-1  
 PI STA. = 21+97.56  
 $\Delta = 4^\circ 42' 58''$  (RT)  
 $D = 3^\circ 00' 56''$   
 $R = 1,900.00'$   
 $T = 78.24'$   
 $L = 156.39'$   
 $E = 1.61'$   
 $e = \text{-----}$   
 $T.R. = \text{-----}$   
 $S.E. \text{ RUN} = \text{-----}$   
 $P.C. \text{ STA} = 21+19.32$   
 $P.T. \text{ STA} = 22+75.71$



DATE	
BY	
PLAN	SURVEYED
	PLOTTED
	ALIGNED
	CHECKED
	NO. _____
	FILE NAME

DATE	
BY	
PROFILE	SURVEYED
	GRADES CHECKED
	STRUCTURE NOTATIONS CHECKED
	NO. _____

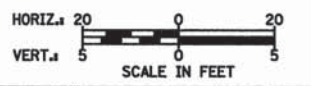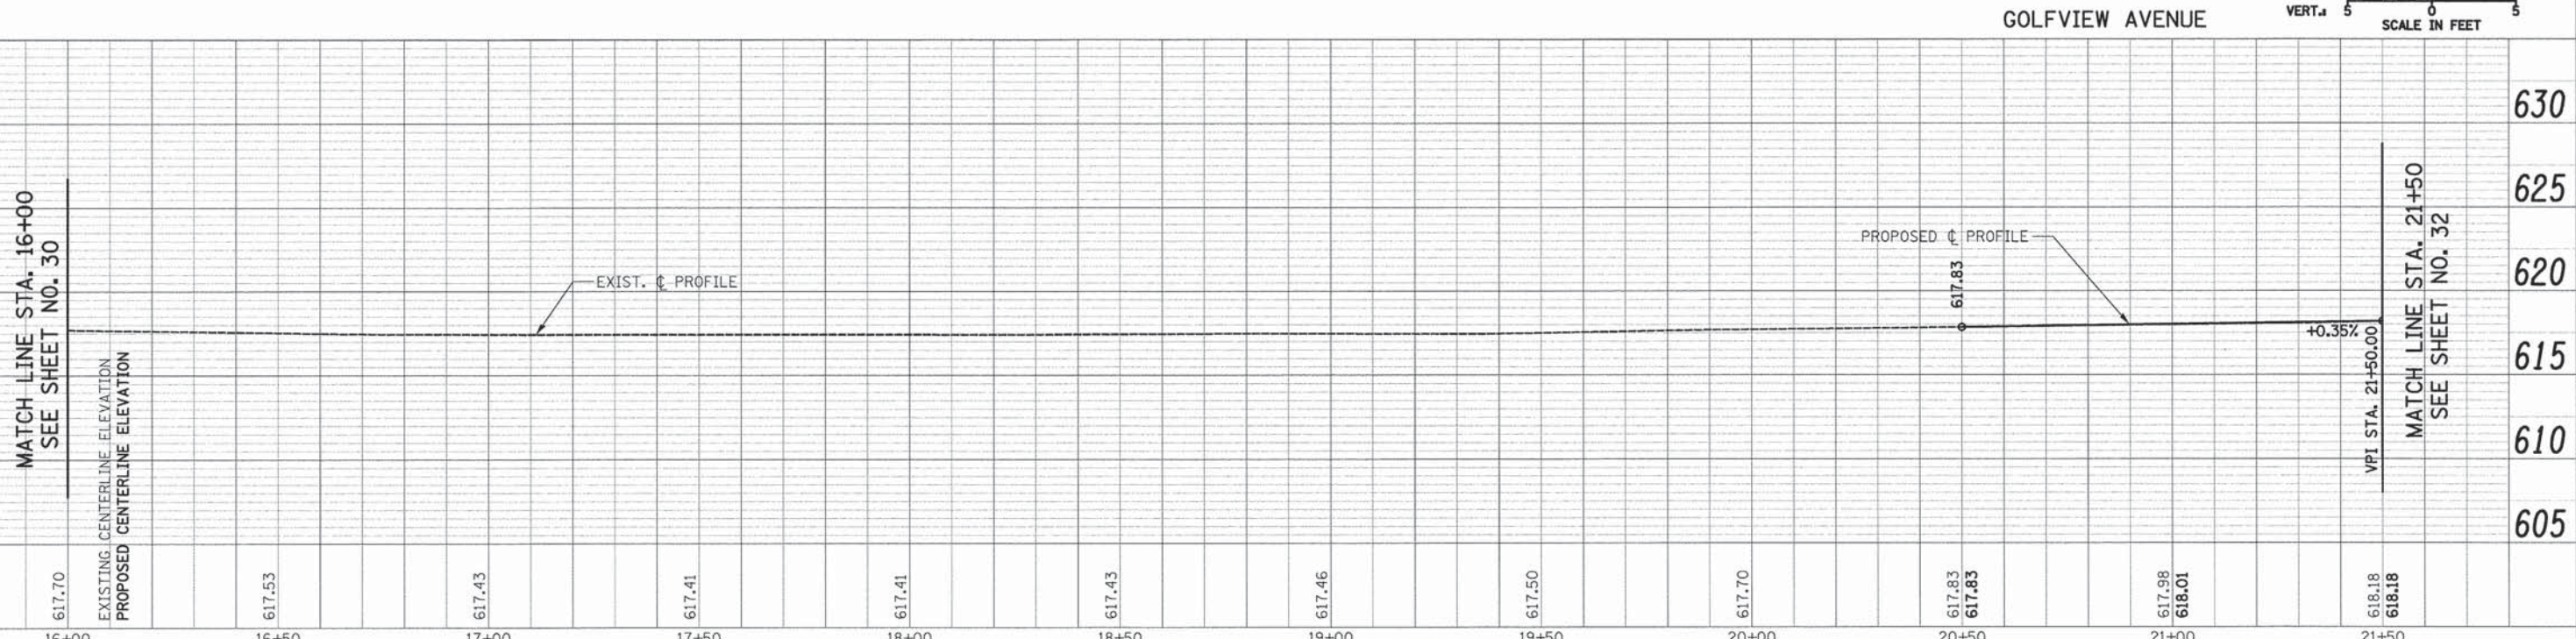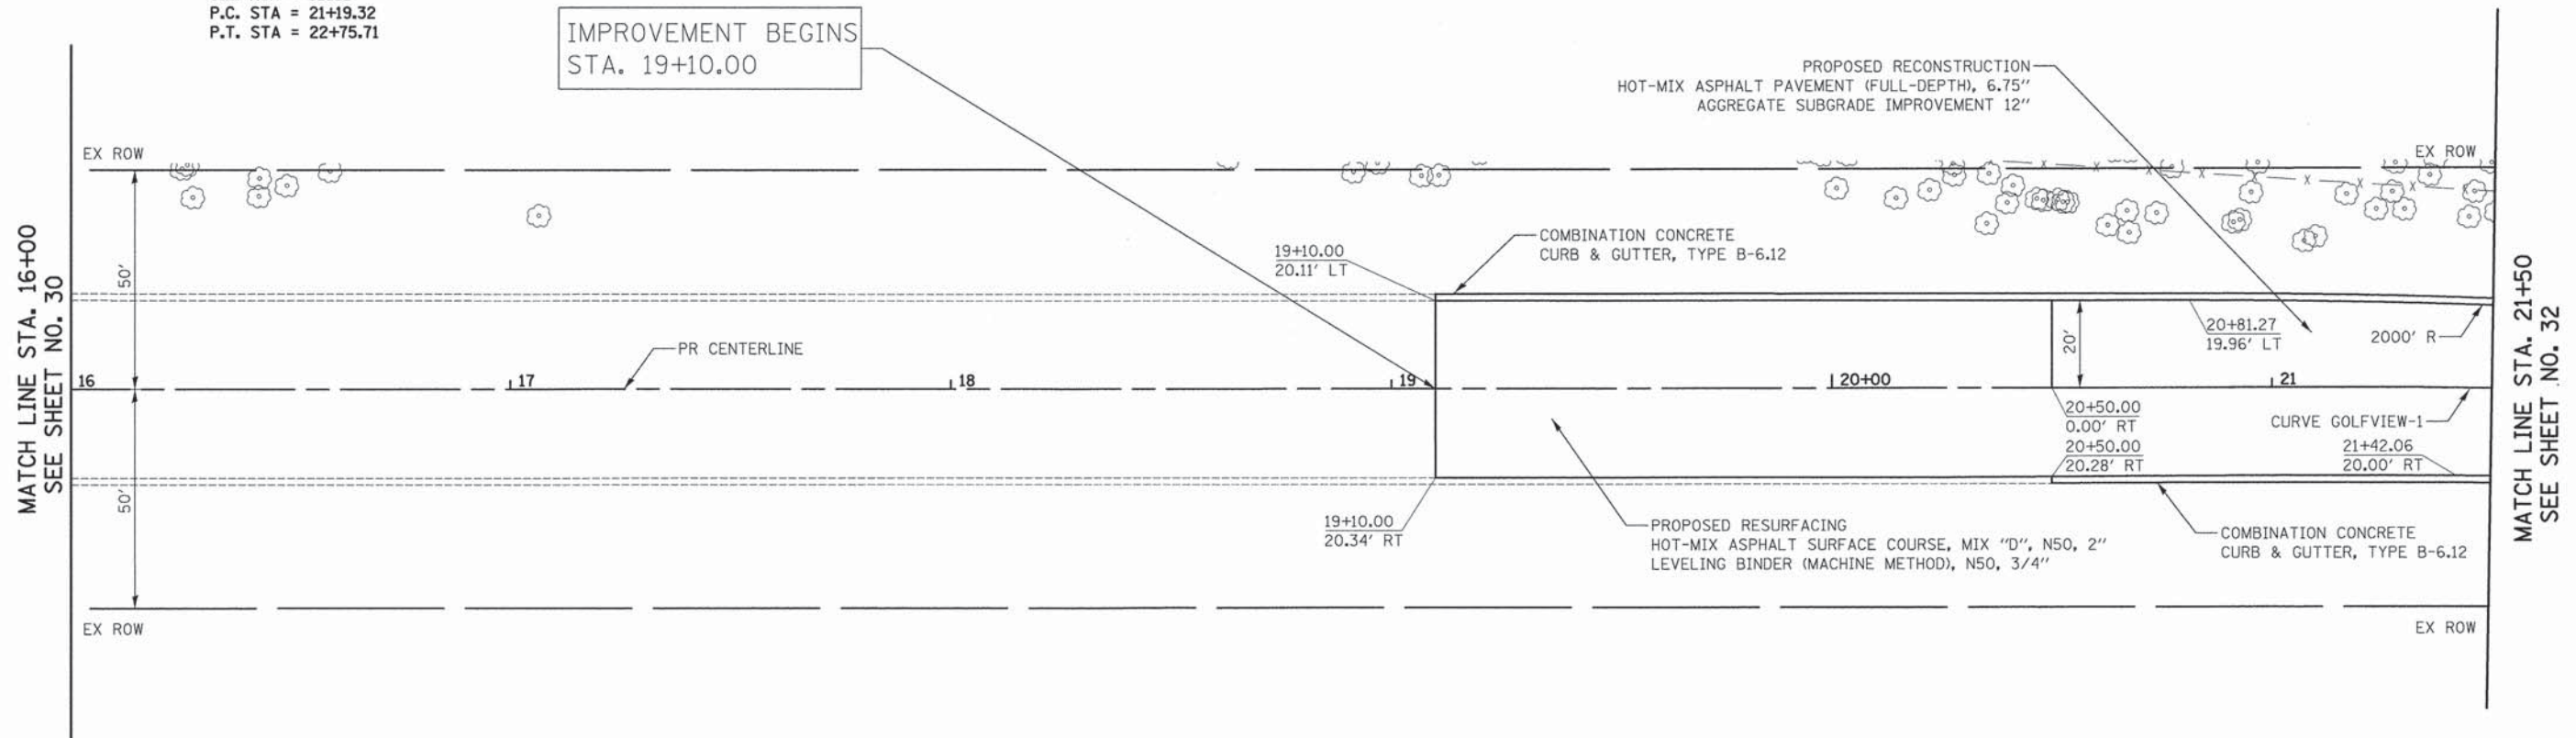


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PLOT SCALE = 20.0000' / 1"	CHECKED - GAB	REVISIED -			SCALE: 1" = 20'	SHEET NO. 4 OF 5 SHEETS	STA. 16+00 TO STA. 21+50	CONTRACT NO. 63764		FED. ROAD DIST. NO. 1 [ILLINOIS]	
PLOT DATE = 5/6/2013	DATE - 05/13/2013	REVISIED -					FED. AID PROJECT				







PROP. CURVE Z00-1  
 PI STA. = 101+46.85  
 $\Delta = 90^\circ 00' 00''$  (RT)  
 $D = 85^\circ 30' 58''$   
 $R = 67.00'$   
 $T = 67.00'$   
 $L = 105.24'$   
 $E = 27.75'$   
 $\theta = \text{-----}$   
 $T.R. = \text{-----}$   
 $S.E. \text{ RUN} = \text{-----}$   
 $P.C. \text{ STA} = 100+79.85$   
 $P.T. \text{ STA} = 101+85.09$

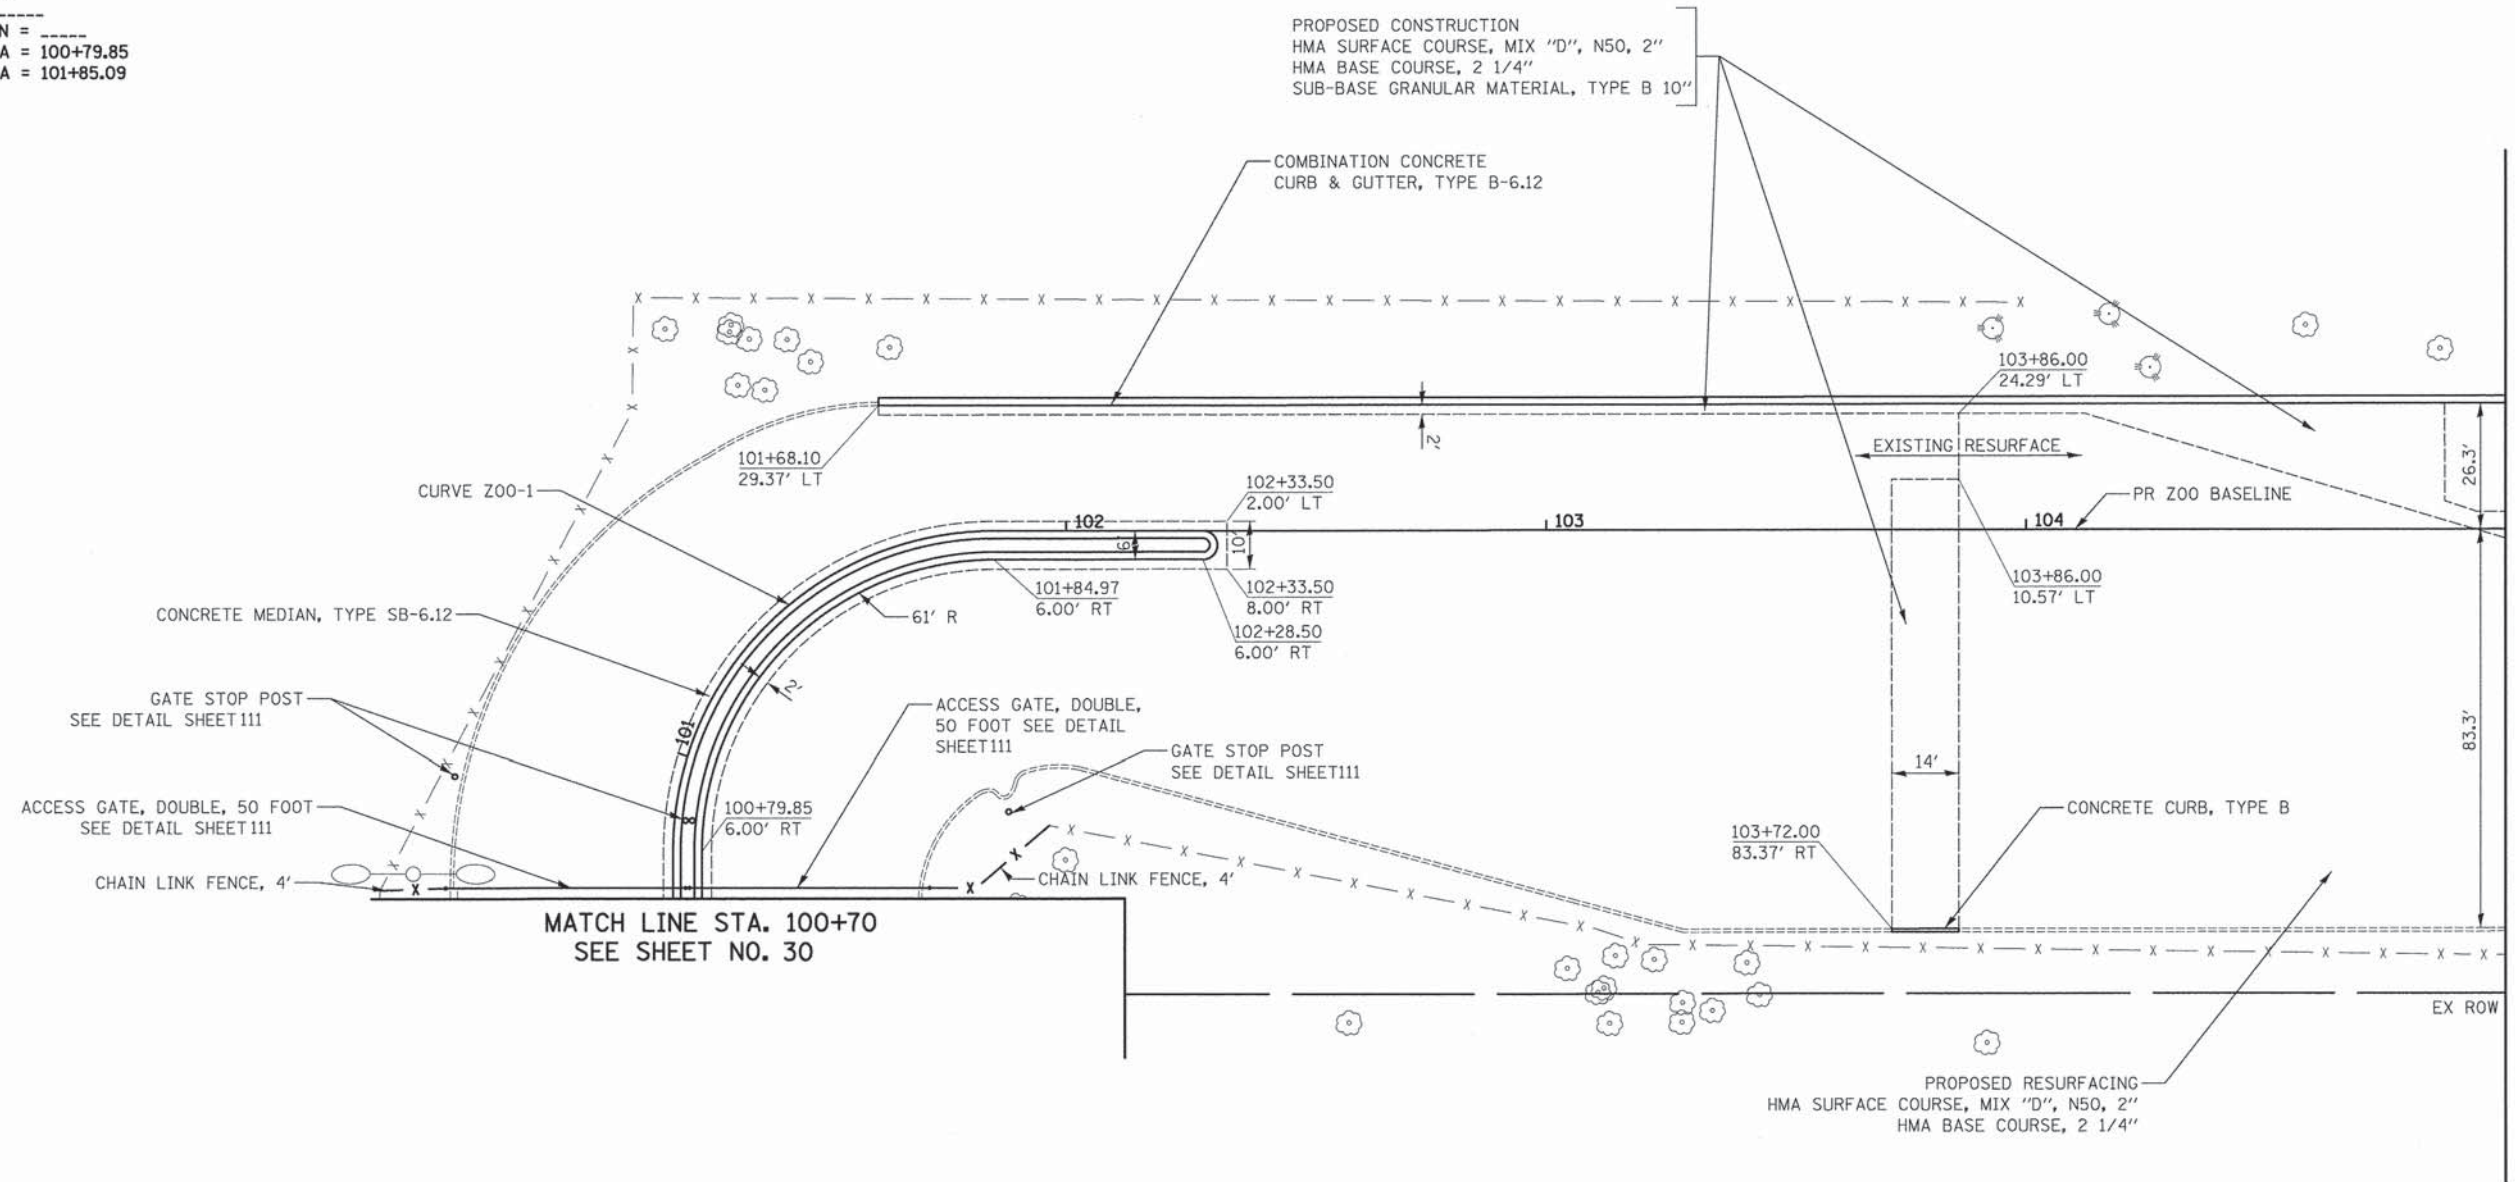


BROOKFIELD ZOO NORTH PARKING LOT



FILE NAME = ... \2563.L0T_01.dgn	USER NAME = dte	DESIGNED - DTE	REVISED -	<b>STATE OF ILLINOIS DEPARTMENT OF TRANSPORTATION</b>	<b>BROOKFIELD ZOO NORTH PARKING LOT PLANS</b>			F.A.U. RTE. 3784	SECTION 12-F3000-23-PK	COUNTY COOK	TOTAL SHEETS 131	SHEET NO. 33
	PLOT SCALE = 20.0000' / 1" =	DRAWN - DTE	REVISED -		SCALE: 1" = 20'	SHEET NO. 1 OF 6 SHEETS	STA. 100+75 TO STA. 105+00	CONTRACT NO. 63764				
	PLOT DATE = 5/6/2013	CHECKED - GAB	REVISED -		FED. ROAD DIST. NO. 1 (ILLINOIS) FED. AID PROJECT							
		DATE - 05/13/2013	REVISED -									



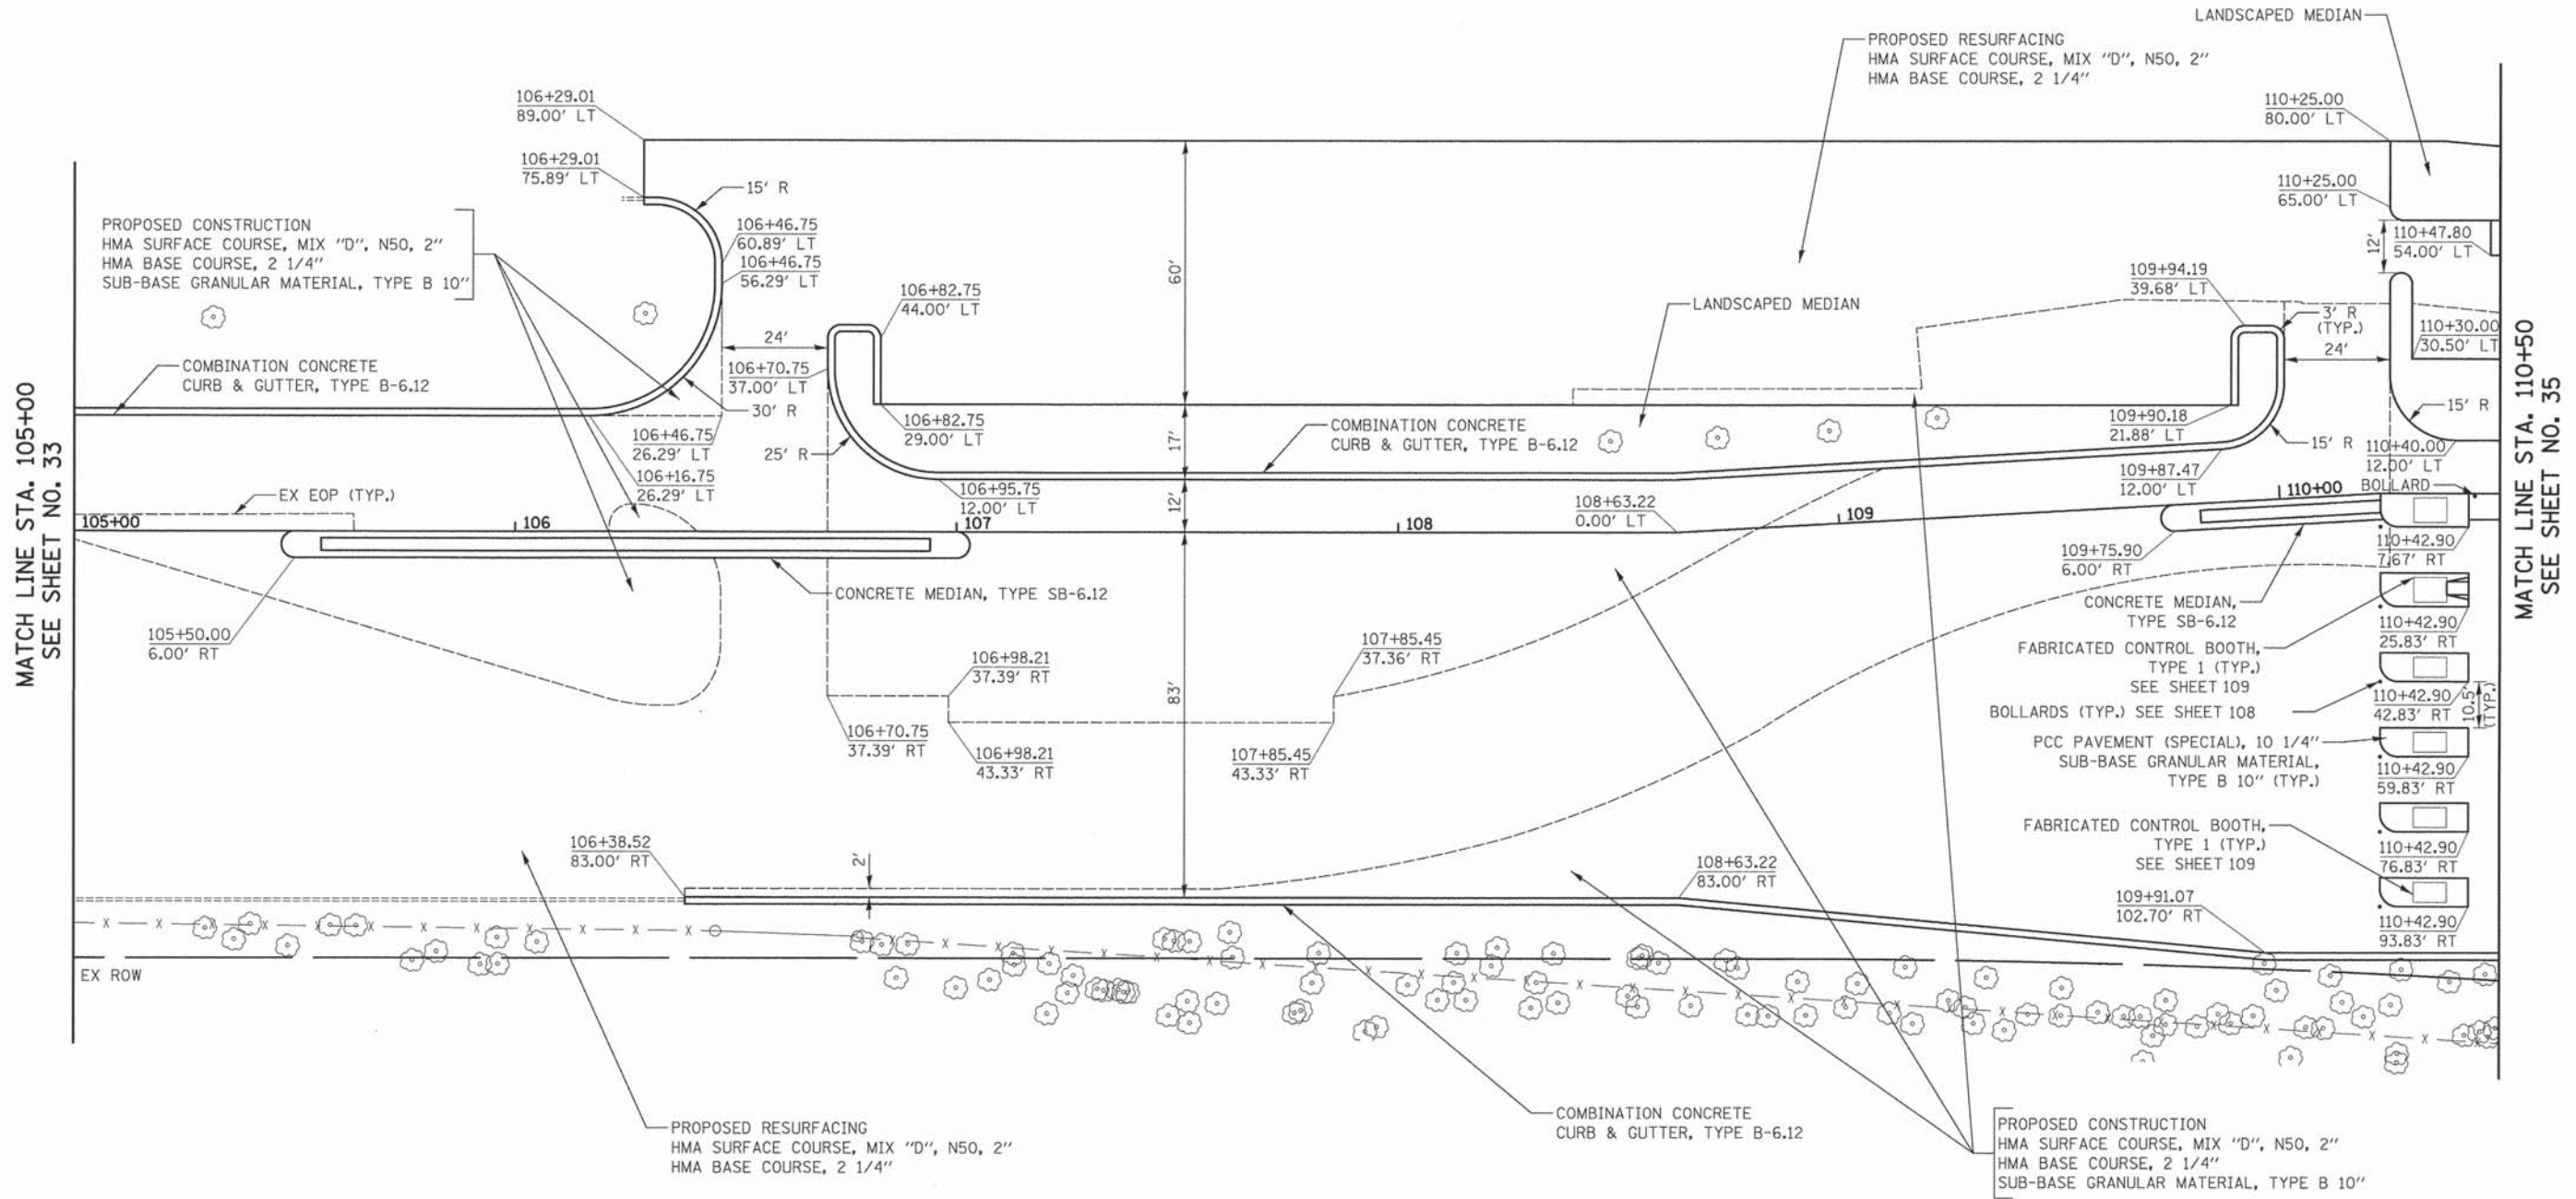

MATCH LINE STA. 105+00  
SEE SHEET NO. 33


MATCH LINE STA. 110+50  
SEE SHEET NO. 35

BROOKFIELD ZOO NORTH PARKING LOT



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	PLOT SCALE = 28,00000' / 1" =	CHECKED - GAB	REVISED -			SCALE: 1" = 20'	SHEET NO. 2 OF 6 SHEETS	STA. 105+00 TO STA. 110+50	CONTRACT NO. 63764		
	PLOT DATE = 5/23/2013	DATE - 05/13/2013	REVISED -			FED. ROAD DIST. NO. - ILLINOIS FED. AID PROJECT					



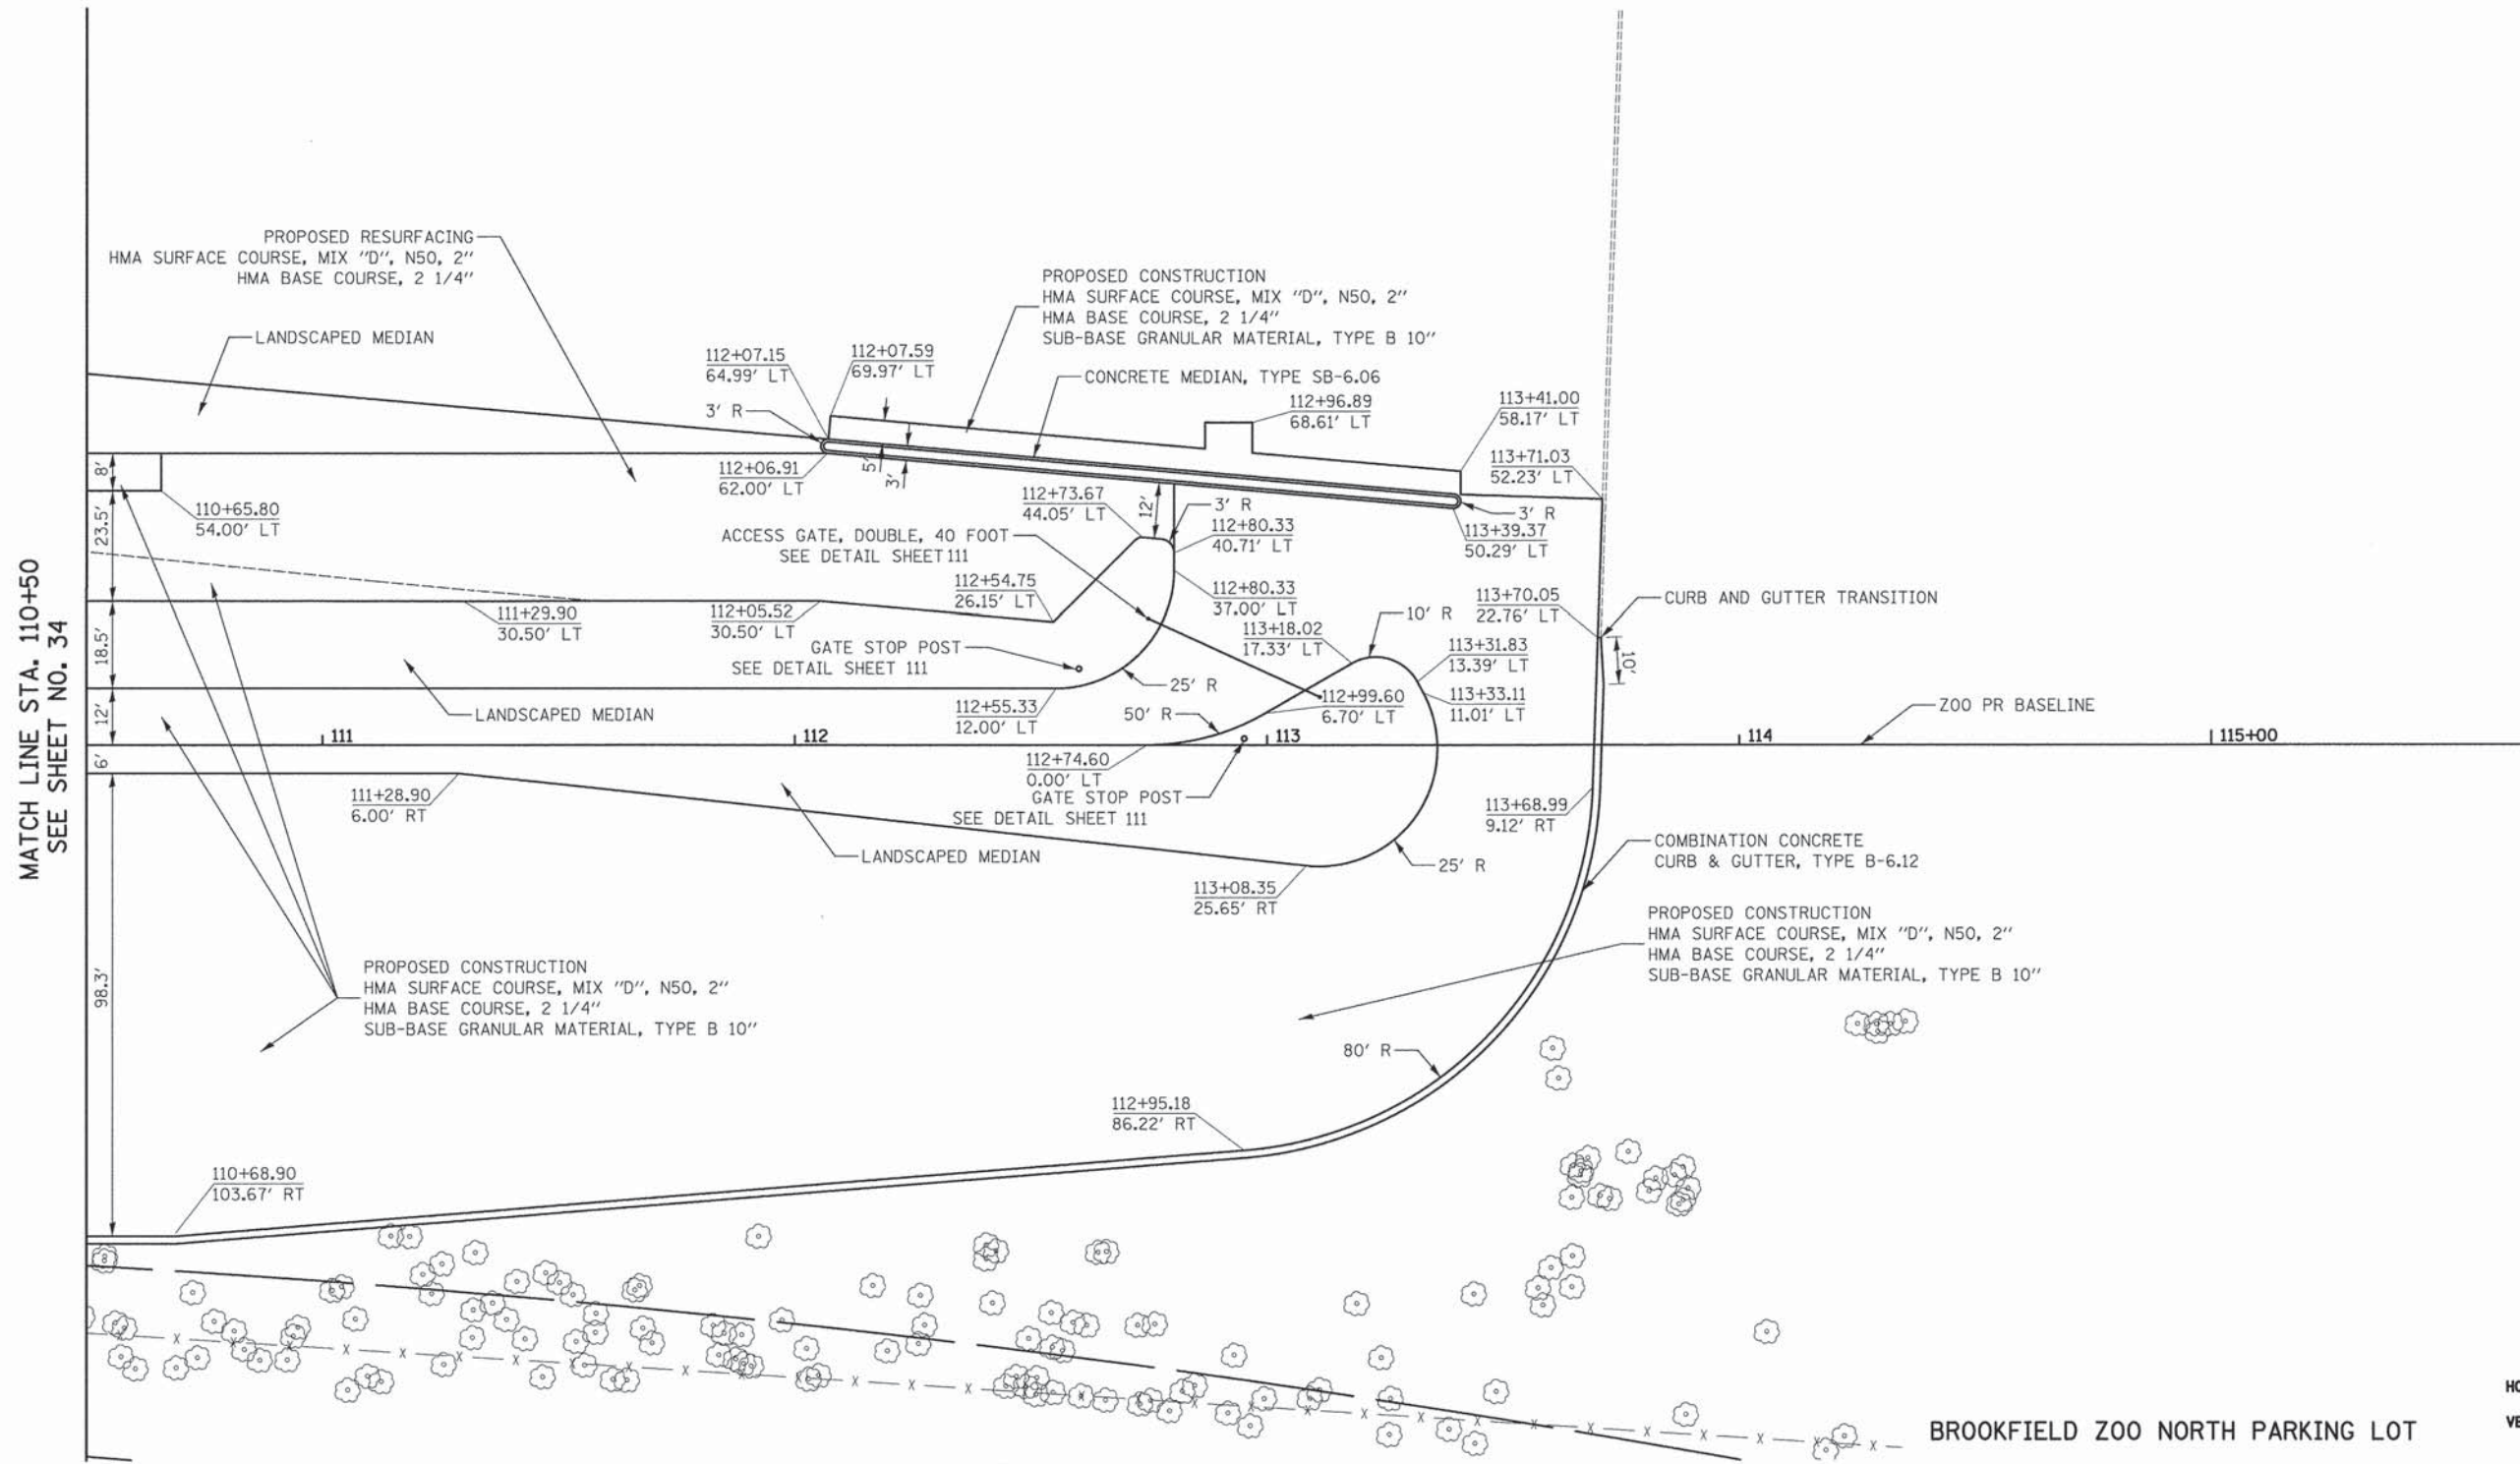


MATCH LINE STA. 110+50  
SEE SHEET NO. 34

BROOKFIELD ZOO NORTH PARKING LOT




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	PLOT SCALE = 28.0000' / in.	CHECKED - GAB	REVISED -					3784	12-F3000-23-PK	COOK	131	35
	PLOT DATE = 5/6/2013	DATE - 05/13/2013	REVISED -		SCALE: 1" = 20'    SHEET NO. 3 OF 6 SHEETS    STA. 110+50 TO STA. 113+71			CONTRACT NO. 63764				
								FED. ROAD DIST. NO. 1 [ILLINOIS] FED. AID PROJECT				




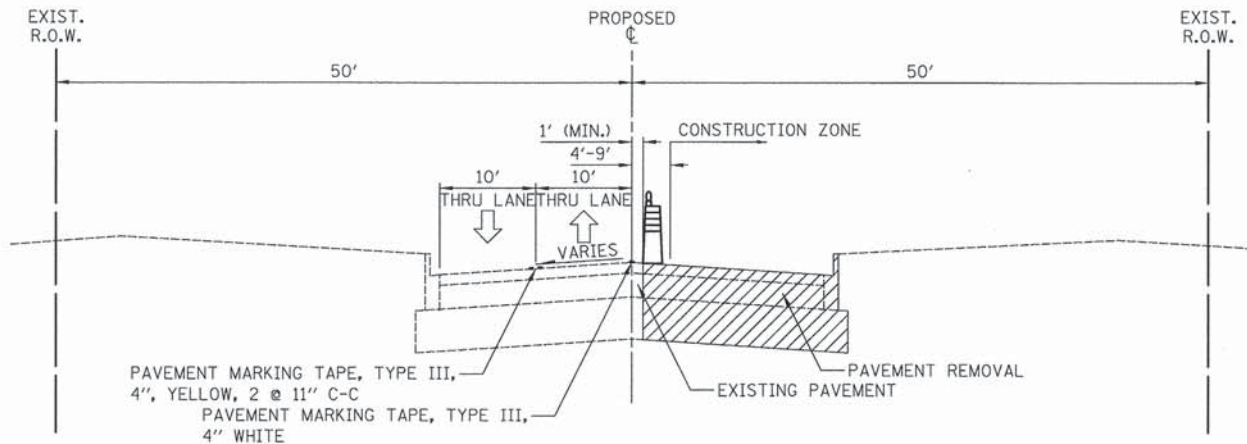


STAGE I  
31ST STREET  
STA. 207+06.00 TO STA. 211+00.00

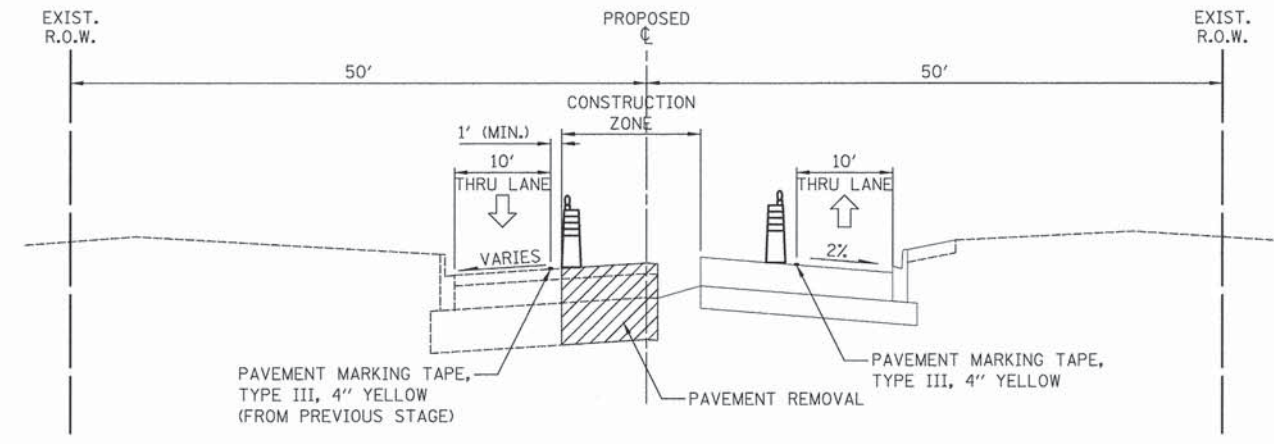


STAGE II  
31ST STREET  
STA. 207+06.00 TO STA. 211+00.00

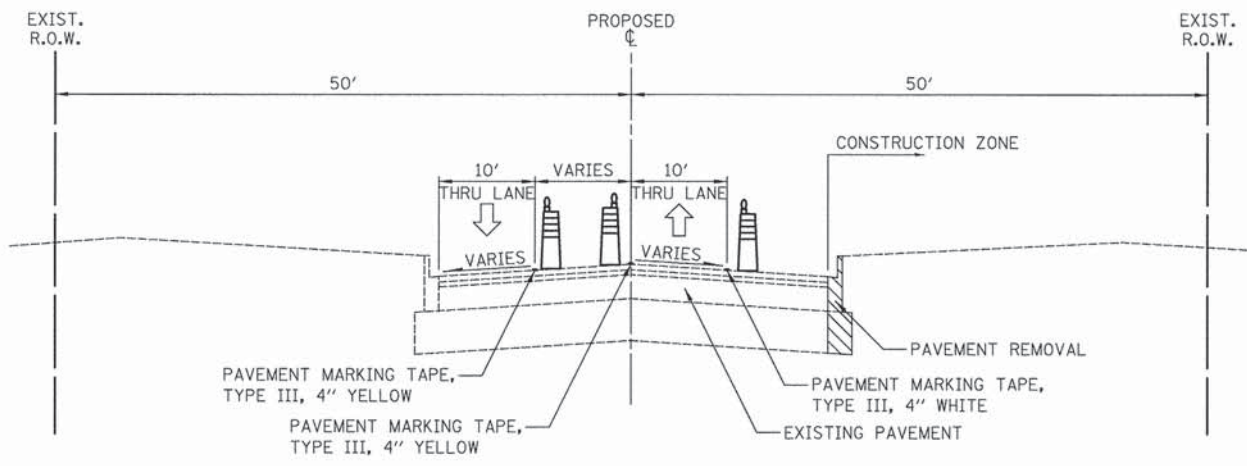

STAGE I  
31ST STREET  
STA. 211+00.00 TO STA. 216+00.00

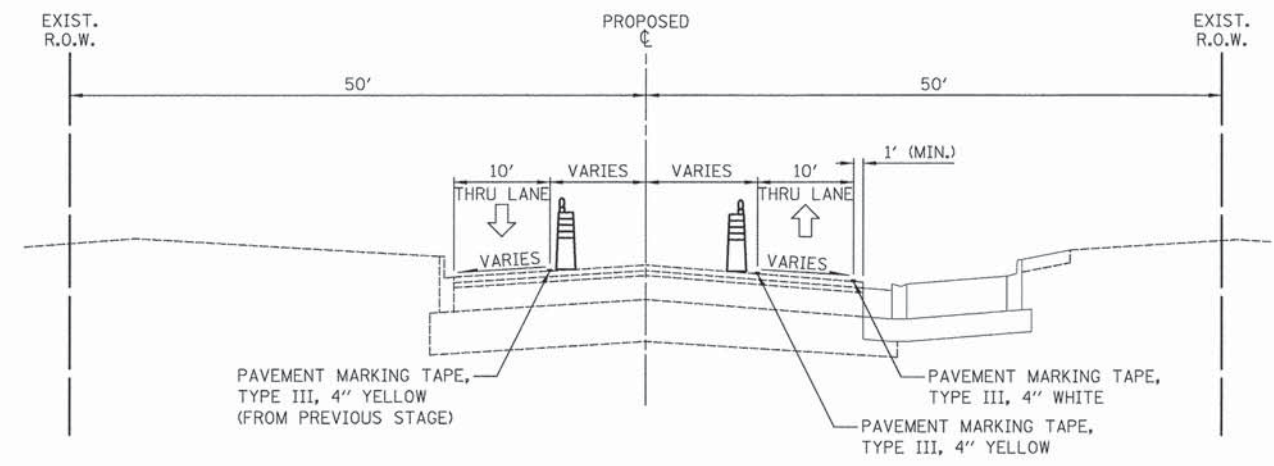


STAGE II  
31ST STREET  
STA. 211+00.00 TO STA. 216+00.00

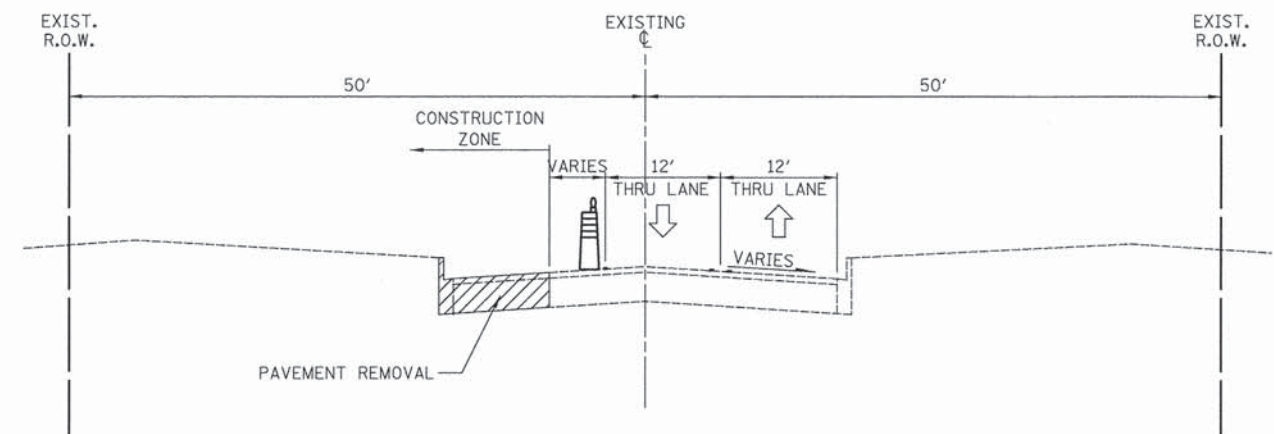


STAGE II, III, IV  
GOLFVIEW AVENUE  
STA. 11+20.01 TO STA. 13+62.18

FILE NAME = ...sheet\06-MOT\2563_MOT_01a.dgn	USER NAME = dta	DESIGNED - KWH	REVISED -	<b>STATE OF ILLINOIS DEPARTMENT OF TRANSPORTATION</b>	<b>MAINTENANCE OF TRAFFIC – TYPICAL SECTIONS</b>			F.A.U. RTE. 3784	SECTION 12-F3000-23-PK	COUNTY COOK	TOTAL SHEETS 131	SHEET NO. 36
	PLOT SCALE = 50.0000' / 1" =	DRAWN - KWH	REVISED -		SCALE: N.T.S.	SHEET NO. 1 OF 12 SHEETS	STA. 207+06.00 TO STA. 216+00.00	<b>CONTRACT NO. 63764</b>				
	PLOT DATE = 5/6/2013	CHECKED - GAB	REVISED -		FED. ROAD DIST. NO. 1 ILLINOIS							
		DATE - 05/13/2013	REVISED -		FED. AID PROJECT							



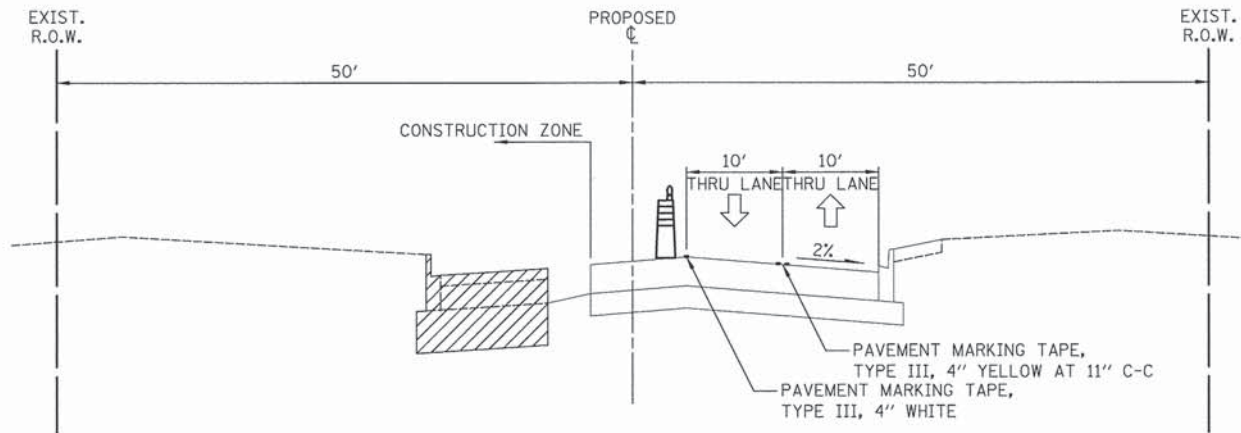

**STAGE III**  
31ST STREET  
STA. 207+06.00 TO STA. 211+00.00

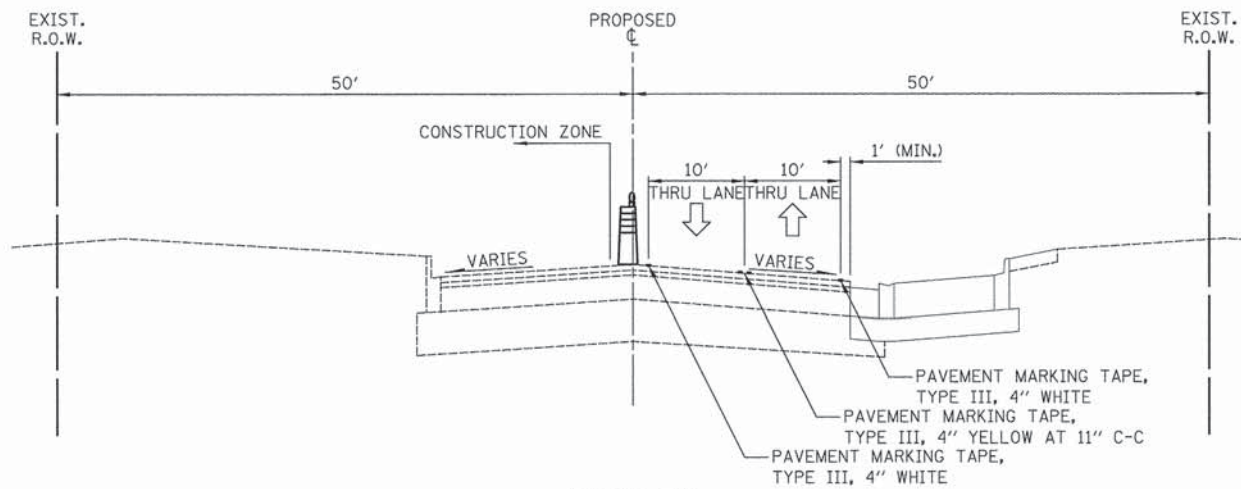

**STAGE III**  
31ST STREET  
STA. 211+00.00 TO STA. 216+00.00

**STAGE I**

- INSTALL EROSION CONTROL MEASURES.
- CONSTRUCT STORM SEWER CROSSING AND ADJACENT STRUCTURES AT STATION 207+16 AND PATCH PAVEMENT USING DAILY LANE CLOSURES.
- INSTALL TEMPORARY TRAFFIC SIGNALS AT THE 31ST STREET AND GOLFPVIEW AVENUE INTERSECTION.

- REMOVE CONFLICTING PAVEMENT MARKINGS AND INSTALL TEMPORARY TRAFFIC CONTROL MEASURES. ON 31ST STREET, CLOSE EASTBOUND LANES AND SHIFT TRAFFIC TO THE NORTH SIDE OF 31ST STREET. IN NORTH PARKING LOT, CLOSE NORTH ACCESS AND ROUTE TRAFFIC TO SOUTHERN DRIVE.

- SAWCUT THE TEMPORARY EDGE OF PAVEMENT. REMOVE EXISTING PAVEMENT, SIDEWALKS, TREES, AND OTHER ITEMS WITHIN THE WORK ZONE.

- CONSTRUCT STORM SEWER ON 31ST STREET AND STORM SEWER AND IN NORTH PARKING LOT WITHIN THE WORK ZONE. CONSTRUCT PROPOSED PAVEMENT BINDER COURSE TO THE LIMITS SHOWN ON 31ST STREET AND IN THE NORTH PARKING LOT. CONSTRUCT PROPOSED PAVEMENT BINDER COURSE WIDENING ON SOUTH SIDE OF 31ST STREET. CONSTRUCT PROPOSED SIDEWALK ALONG SOUTH SIDE OF 31ST STREET.

**STAGE II**

- INSTALL EROSION CONTROL MEASURES.

- REMOVE CONFLICTING PAVEMENT MARKINGS AND INSTALL TEMPORARY TRAFFIC CONTROL MEASURES. ON 31ST STREET, CLOSE EASTBOUND LANE AND SHIFT TRAFFIC TO THE PROPOSED PAVEMENT INSTALLED IN THE PREVIOUS STAGE. ON GOLFPVIEW AVENUE, CLOSE SOUTHBOUND LANES AND SHIFT TRAFFIC TO EAST SIDE OF THE ROADWAY. IN NORTH PARKING LOT, OPEN PROPOSED PAVEMENT CONSTRUCTED IN PREVIOUS STAGE AND SHIFT TRAFFIC. CLOSE WESTERN KIOSK FOR USE AS EXIT LANE. CLOSE SOUTHERN PARKING LOT DRIVE.

- ADJUST TEMPORARY TRAFFIC SIGNALS TO NEW TRAFFIC PATTERN.

- SAWCUT THE TEMPORARY EDGE OF PAVEMENT. REMOVE EXISTING PAVEMENT, TREES, AND OTHER ITEMS WITHIN THE WORK ZONE.

- CONSTRUCT STORM SEWER IN NORTH PARKING LOT. CONSTRUCT PROPOSED PAVEMENT BINDER COURSE TO THE LIMITS SHOWN.

**STAGE III**

- INSTALL EROSION CONTROL MEASURES.

- REMOVE CONFLICTING PAVEMENT MARKINGS AND INSTALL TEMPORARY TRAFFIC CONTROL MEASURES. ON 31ST STREET, CLOSE WESTBOUND LANE AND SHIFT TRAFFIC TO THE PROPOSED PAVEMENT INSTALLED IN THE PREVIOUS STAGE. IN NORTHERN PARKING LOT, SHIFT EXIT TRAFFIC TO THE PROPOSED PAVEMENT CONSTRUCTED IN THE PREVIOUS STAGE. INSTALL KIOSKS IN NEW LOCATION TO THE NORTH AND PLACE INTO SERVICE PRIOR TO CLOSING SOUTHERN KIOSK LOCATIONS.

- ADJUST TEMPORARY TRAFFIC SIGNALS TO NEW TRAFFIC PATTERN.

- SAWCUT THE TEMPORARY EDGE OF PAVEMENT. REMOVE EXISTING PAVEMENT, TREES, AND OTHER ITEMS WITHIN THE WORK ZONE.

- CONSTRUCT STORM SEWER ON 31ST STREET AND IN NORTH PARKING LOT. CONSTRUCT PROPOSED PAVEMENT BINDER COURSE TO THE LIMITS SHOWN.

**STAGE IV**

- INSTALL EROSION CONTROL MEASURES.

- REMOVE CONFLICTING PAVEMENT MARKINGS AND INSTALL TEMPORARY TRAFFIC CONTROL MEASURES. ON 31ST STREET, USE DAILY LANE CLOSURES TO INSTALL PERMANENT PAVEMENT MARKINGS. ON GOLFPVIEW AVENUE, CLOSE SOUTHBOUND RIGHT TURN LANE. IN NORTH PARKING LOT, SHIFT ENTRANCE TRAFFIC TO THE PROPOSED PAVEMENT CONSTRUCTED IN THE PREVIOUS STAGE. INSTALL PERMANENT PAVEMENT MARKINGS IN THE PARKING LOT AND EXIT LANES, AS SHOWN.

- REMOVE EXISTING PAVEMENT, TREES, AND OTHER ITEMS WITHIN THE WORK ZONE.

- CONSTRUCT PROPOSED PAVEMENT TO THE LIMITS SHOWN.

**STAGE V**

- INSTALL EROSION CONTROL MEASURES.

- INSTALL DETOUR TEMPORARY TRAFFIC CONTROL MEASURES. ON GOLFPVIEW AVENUE, CLOSE NORTHBOUND AND SOUTHBOUND LANES NORTH OF THE NORTH PARKING LOT ENTRANCE.

- REMOVE EXISTING PAVEMENT, TREES, AND OTHER ITEMS WITHIN THE WORK ZONE.

- CONSTRUCT PROPOSED PAVEMENT TO THE LIMITS SHOWN.

- INSTALL REMAINDER OF PERMANENT PAVEMENT MARKINGS.

FILE NAME = ...sheet\06-MOT\2563_MOT_01b.dgn	USER NAME = dte	DESIGNED - KWH	REVISED -
		DRAWN - KWH	REVISED -
		CHECKED - GAB	REVISED -
		DATE - 05/13/2013	REVISED -

**STATE OF ILLINOIS  
DEPARTMENT OF TRANSPORTATION**







**MAINTENANCE OF TRAFFIC**

SCALE: 1" = 50'    SHEET NO. 2 OF 12 SHEETS    STA. 207+06.00 TO STA. 216+00.00

F.A.U. RTE. 3784	SECTION 12-F3000-23-PK	COUNTY COOK	TOTAL SHEETS 131	SHEET NO. 37
<b>CONTRACT NO. 63764</b>				FED. AID PROJECT




**LEGEND**

-  TEMPORARY PAVEMENT
-  CONSTRUCTION WORK ZONE
-  DIRECTION OF TRAFFIC FLOW
-  TYPE I OR II BARRICADE WITH FLASHING LIGHT
-  VERTICAL PANEL
-  TYPE III BARRICADE WITH FLASHING LIGHTS


**NOTE 1**

-USE DAILY LANE CLOSURES IN ACCORDANCE WITH STANDARD 701606 TO INSTALL STORM SEWER PIPE CROSSING AND STRUCTURES, THIS LOCATION ONLY, PRIOR TO COMMENCEMENT OF CONSTRUCTION OF REMAINING ITEMS IN STAGE I.  
25 SQ YD PAVEMENT PATCHING, CLASS D, TYPE IV, 10"  
• ONLY WHEN WORKERS ARE PRESENT

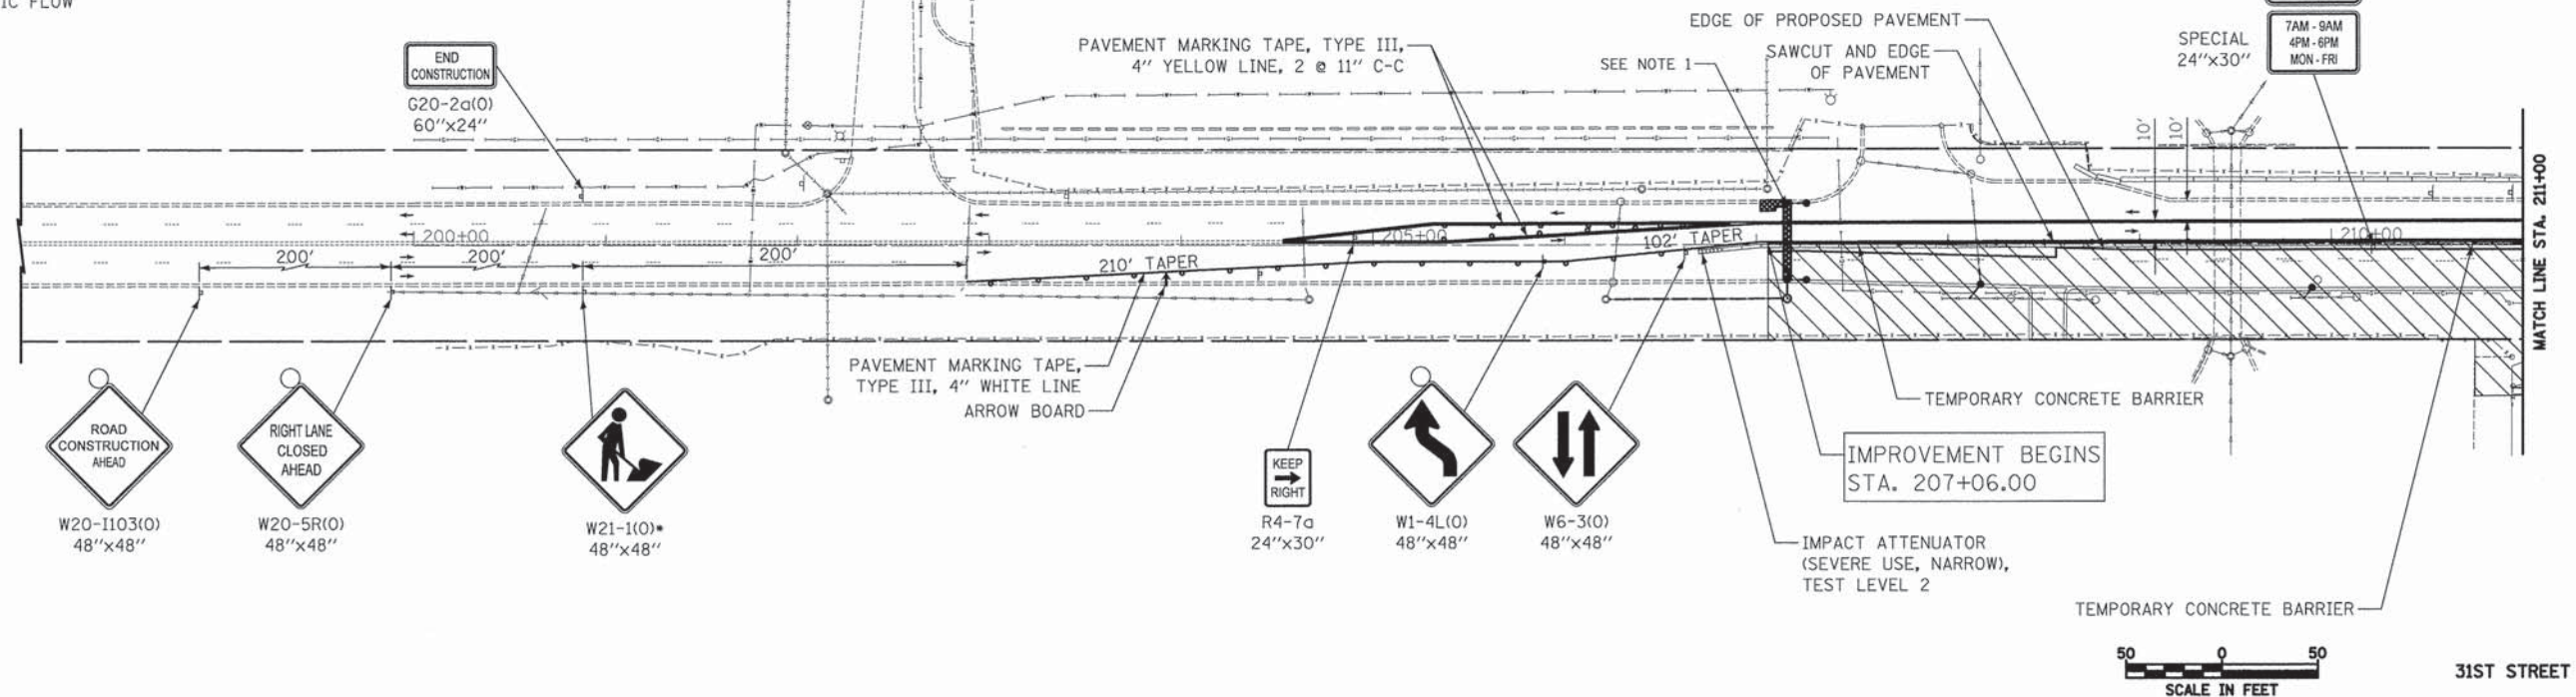

**NOTE 2**

-USE DAILY LANE CLOSURES IN ACCORDANCE WITH STANDARD 701606 TO REMOVE EXISTING STORM SEWER PIPE CROSSING, INSTALL STORM SEWER PIPE AND STRUCTURES, THIS LOCATION ONLY, PRIOR TO COMMENCEMENT OF CONSTRUCTION OF REMAINING ITEMS IN STAGE I.  
110 SQ YD PAVEMENT PATCHING, CLASS D, TYPE IV, 10"  
• ONLY WHEN WORKERS ARE PRESENT

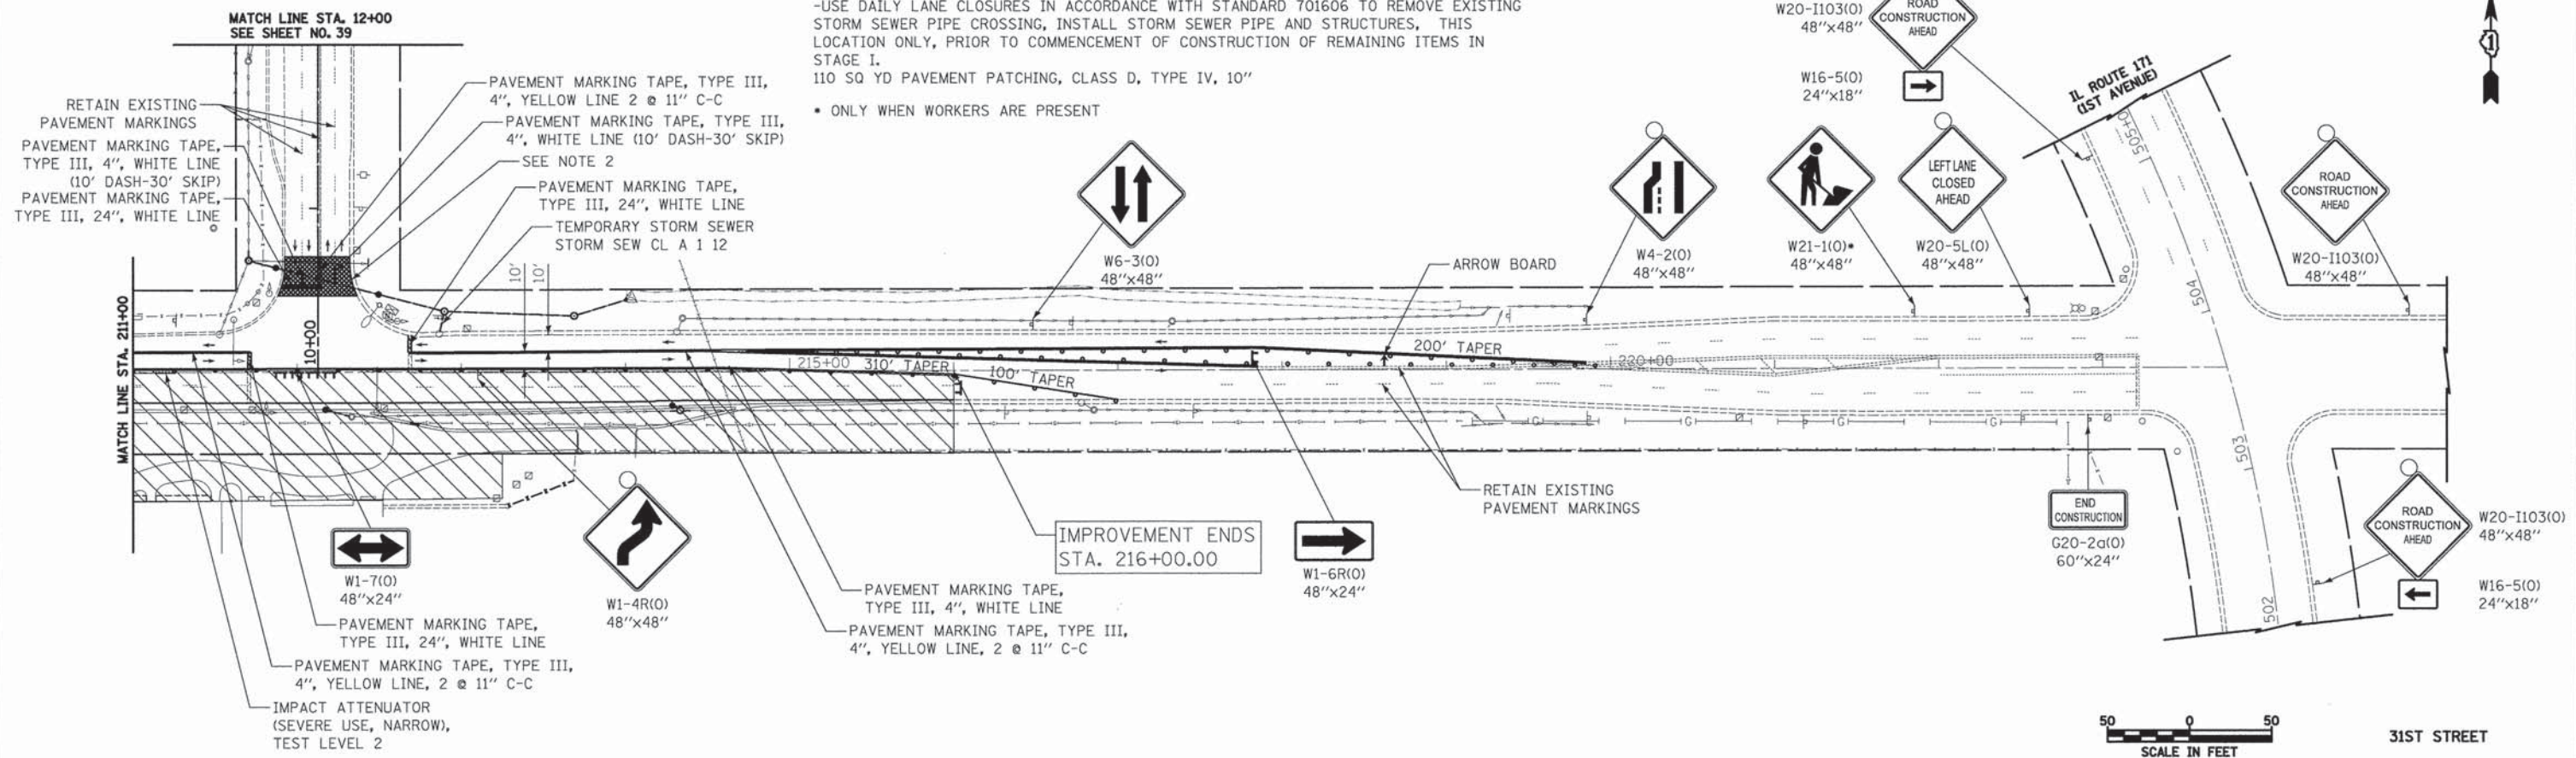

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PLOT SCALE = 50.0000' / 1"	CHECKED - GAB	DATE - 05/13/2013	REVISED -		SCALE: 1" = 50'	SHEET NO. 3 OF 12 SHEETS	STA. 207+06.00 TO STA. 216+00.00	CONTRACT NO. 63764				
PLOT DATE = 5/23/2013					FED. ROAD DIST. NO. 1 [ILLINOIS]							
					FED. AID PROJECT							






MATCH LINE STA. 211+00  
SEE SHEET NO. 38

**LEGEND**

- TEMPORARY PAVEMENT
- CONSTRUCTION WORK ZONE
- DIRECTION OF TRAFFIC FLOW
- TYPE I OR II BARRICADE WITH FLASHING LIGHT
- VERTICAL PANEL
- TYPE III BARRICADE WITH FLASHING LIGHTS

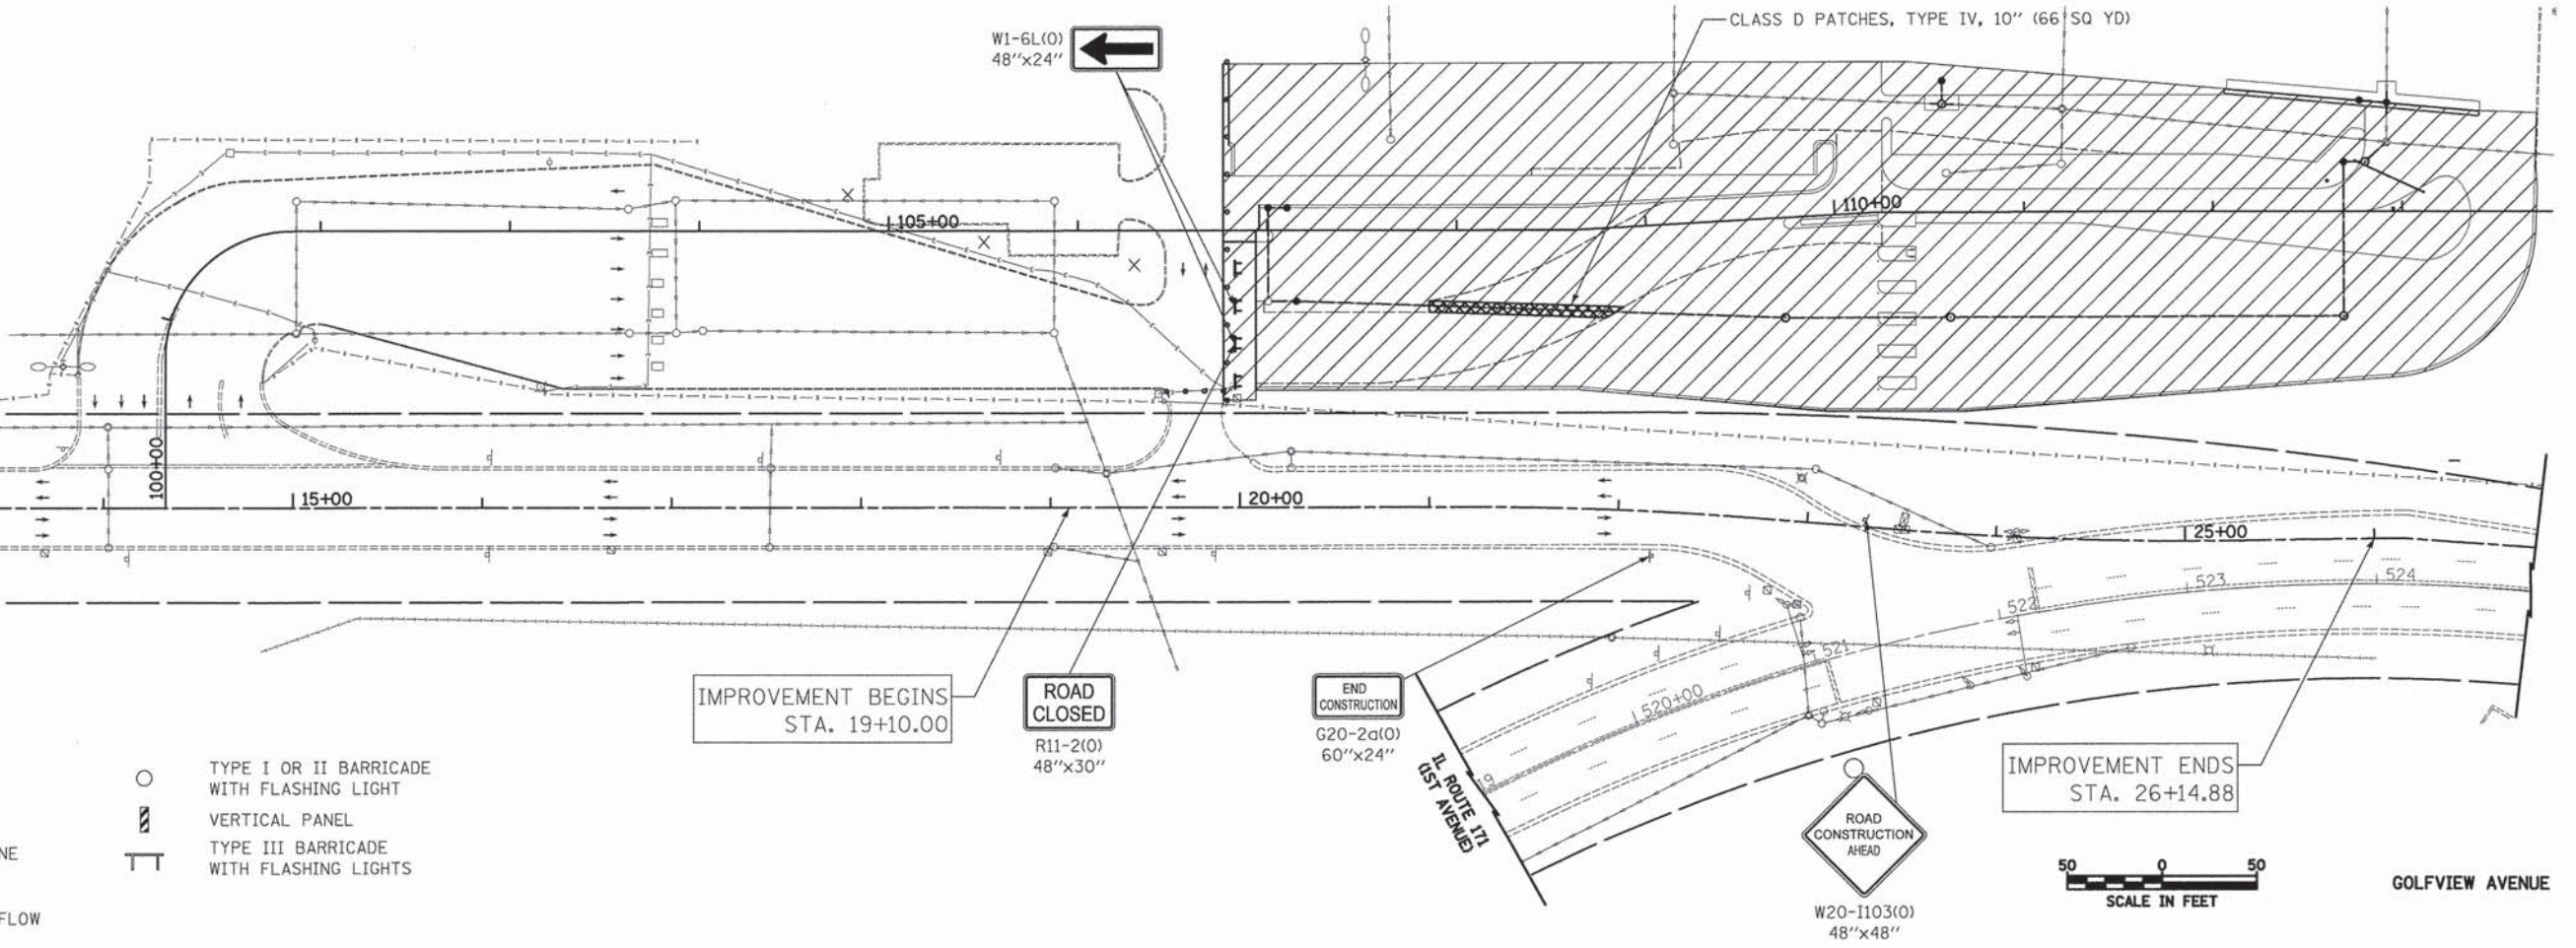

GOLFVIEW AVENUE







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PLDT SCALE = 50.0000' / 1" = 50'	CHECKED - GAB	REVISIED -	REVISIED -			SCALE: 1" = 50'	SHEET NO. 4 OF 12 SHEETS	STA. 12+00.00	TO STA. 26+14.88	CONTRACT NO. 63764		
PLDT DATE = 5/6/2013	DATE - 05/13/2013	REVISIED -	REVISIED -			FED. ROAD DIST. NO. 1 ILLINOIS						
						FED. AID PROJECT						








LEGEND

-  TEMPORARY PAVEMENT
-  CONSTRUCTION WORK ZONE
-  DIRECTION OF TRAFFIC FLOW
-  TYPE I OR II BARRICADE WITH FLASHING LIGHT
-  VERTICAL PANEL
-  TYPE III BARRICADE WITH FLASHING LIGHTS

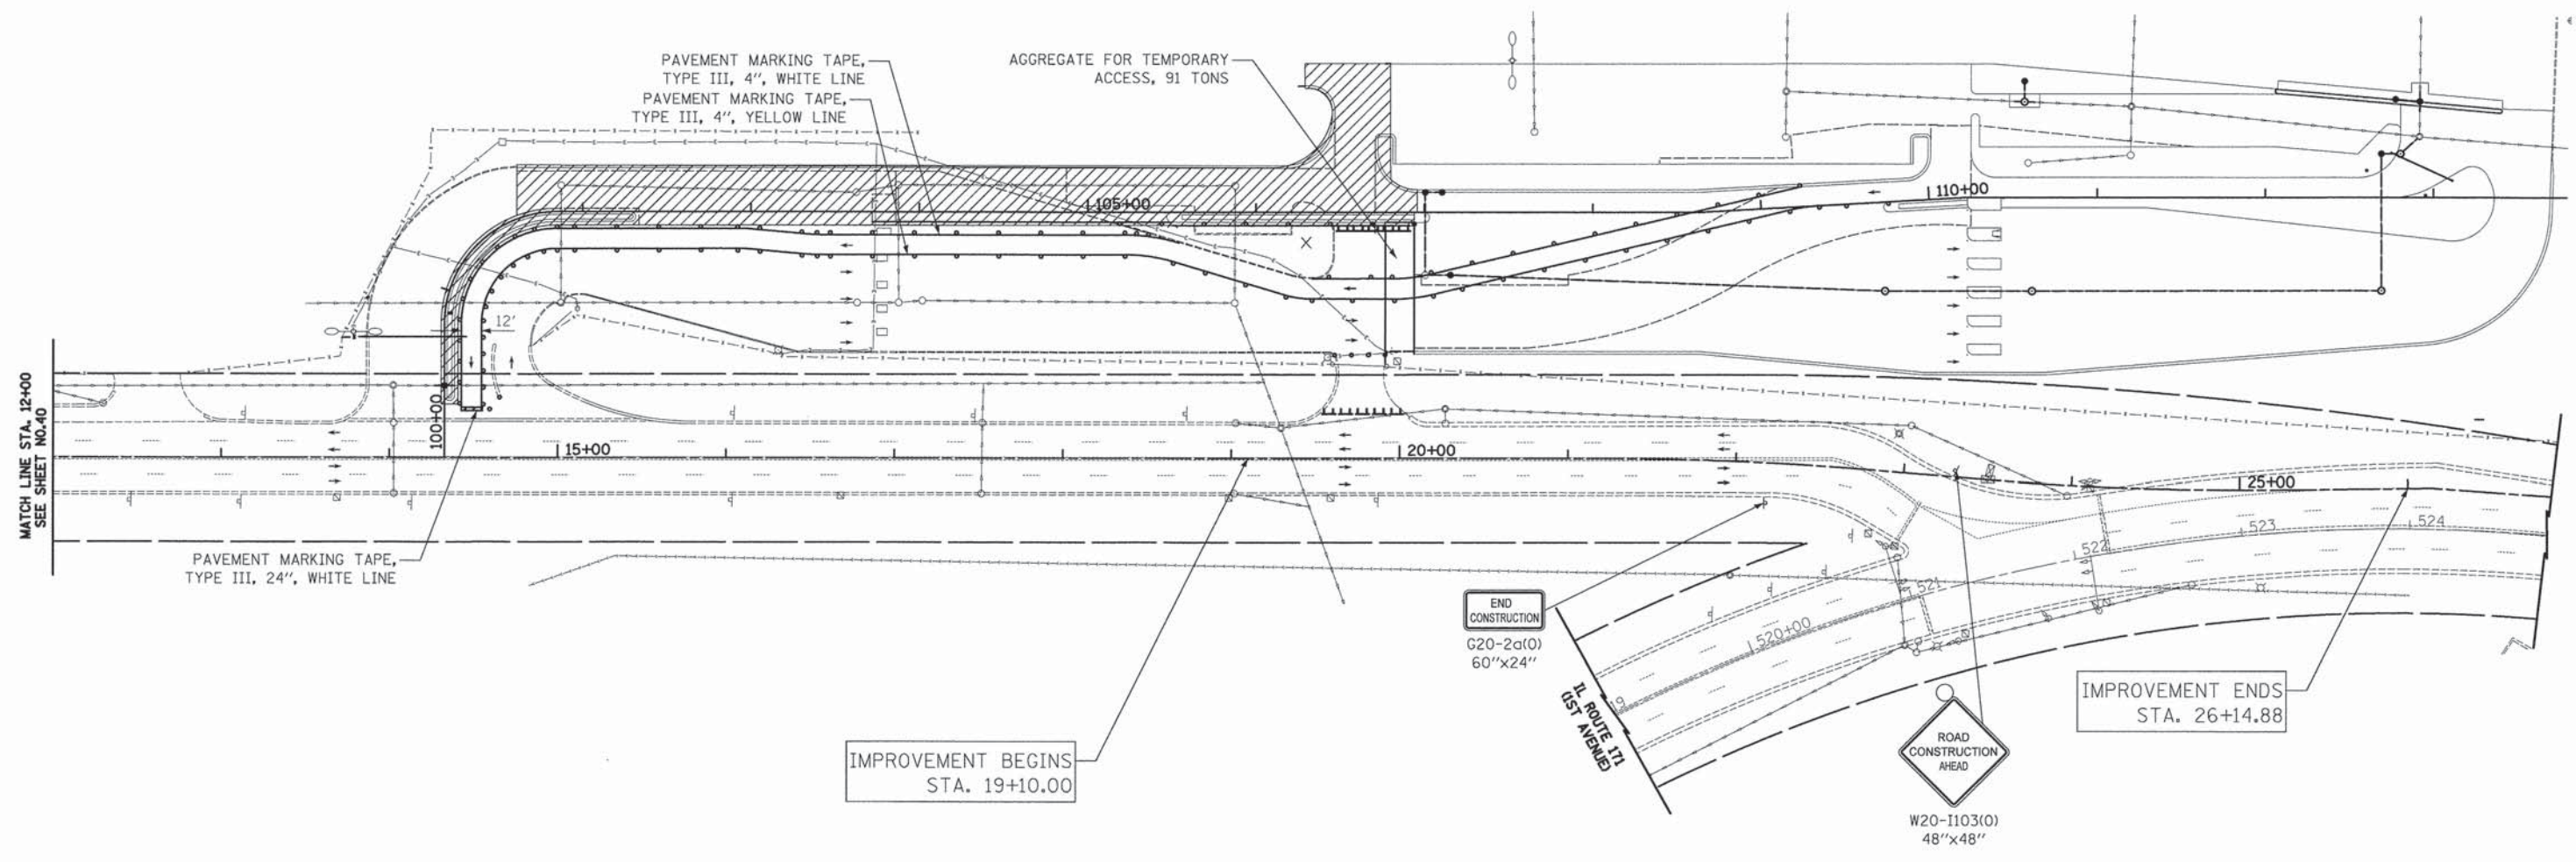








GOLFVIEW AVENUE






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PLOT SCALE = 50.0000' / 1" = 50'						SCALE: 1" = 50'		SHEET NO. 6 OF 12 SHEETS		STA. 12+00.00 TO STA. 26+14.88		CONTRACT NO. 63764
PLOT DATE = 5/6/2013						DATE - 05/13/2013		FED. ROAD DIST. NO. 1 ILLINOIS		FED. AID PROJECT		

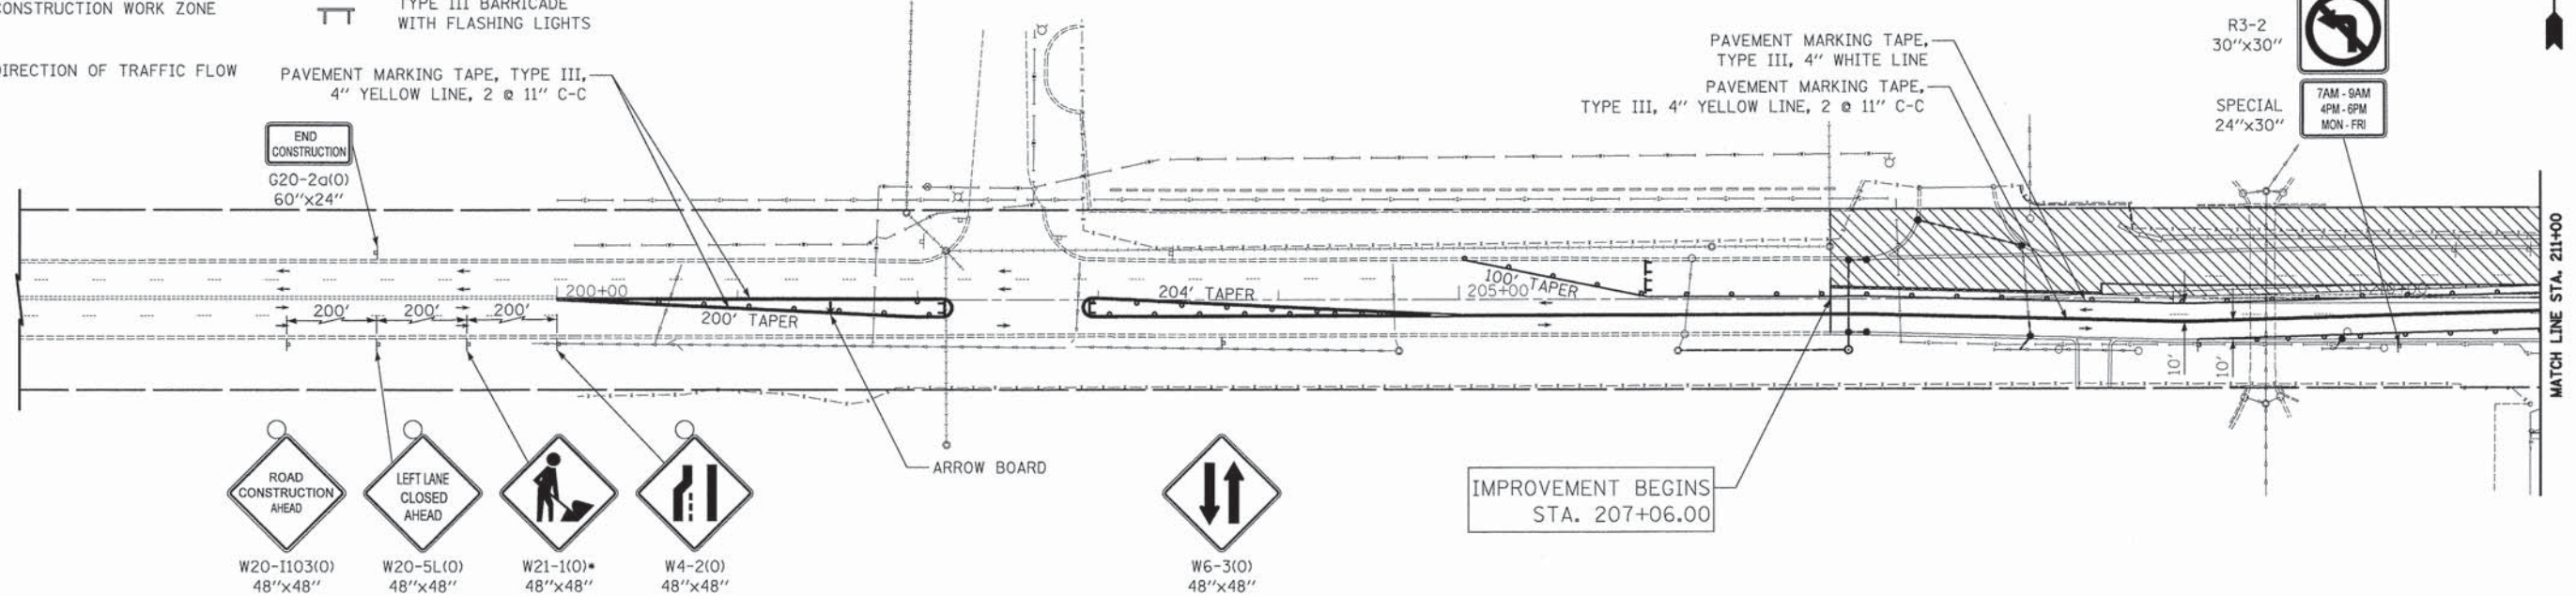

**LEGEND**


-  TEMPORARY PAVEMENT
-  CONSTRUCTION WORK ZONE
-  DIRECTION OF TRAFFIC FLOW
-  TYPE I OR II BARRICADE WITH FLASHING LIGHT
-  VERTICAL PANEL
-  TYPE III BARRICADE WITH FLASHING LIGHTS









-  W20-1103(0) 48"x48"
-  W20-5L(0) 48"x48"
-  W21-1(0)\* 48"x48"
-  W4-2(0) 48"x48"
-  W6-3(0) 48"x48"

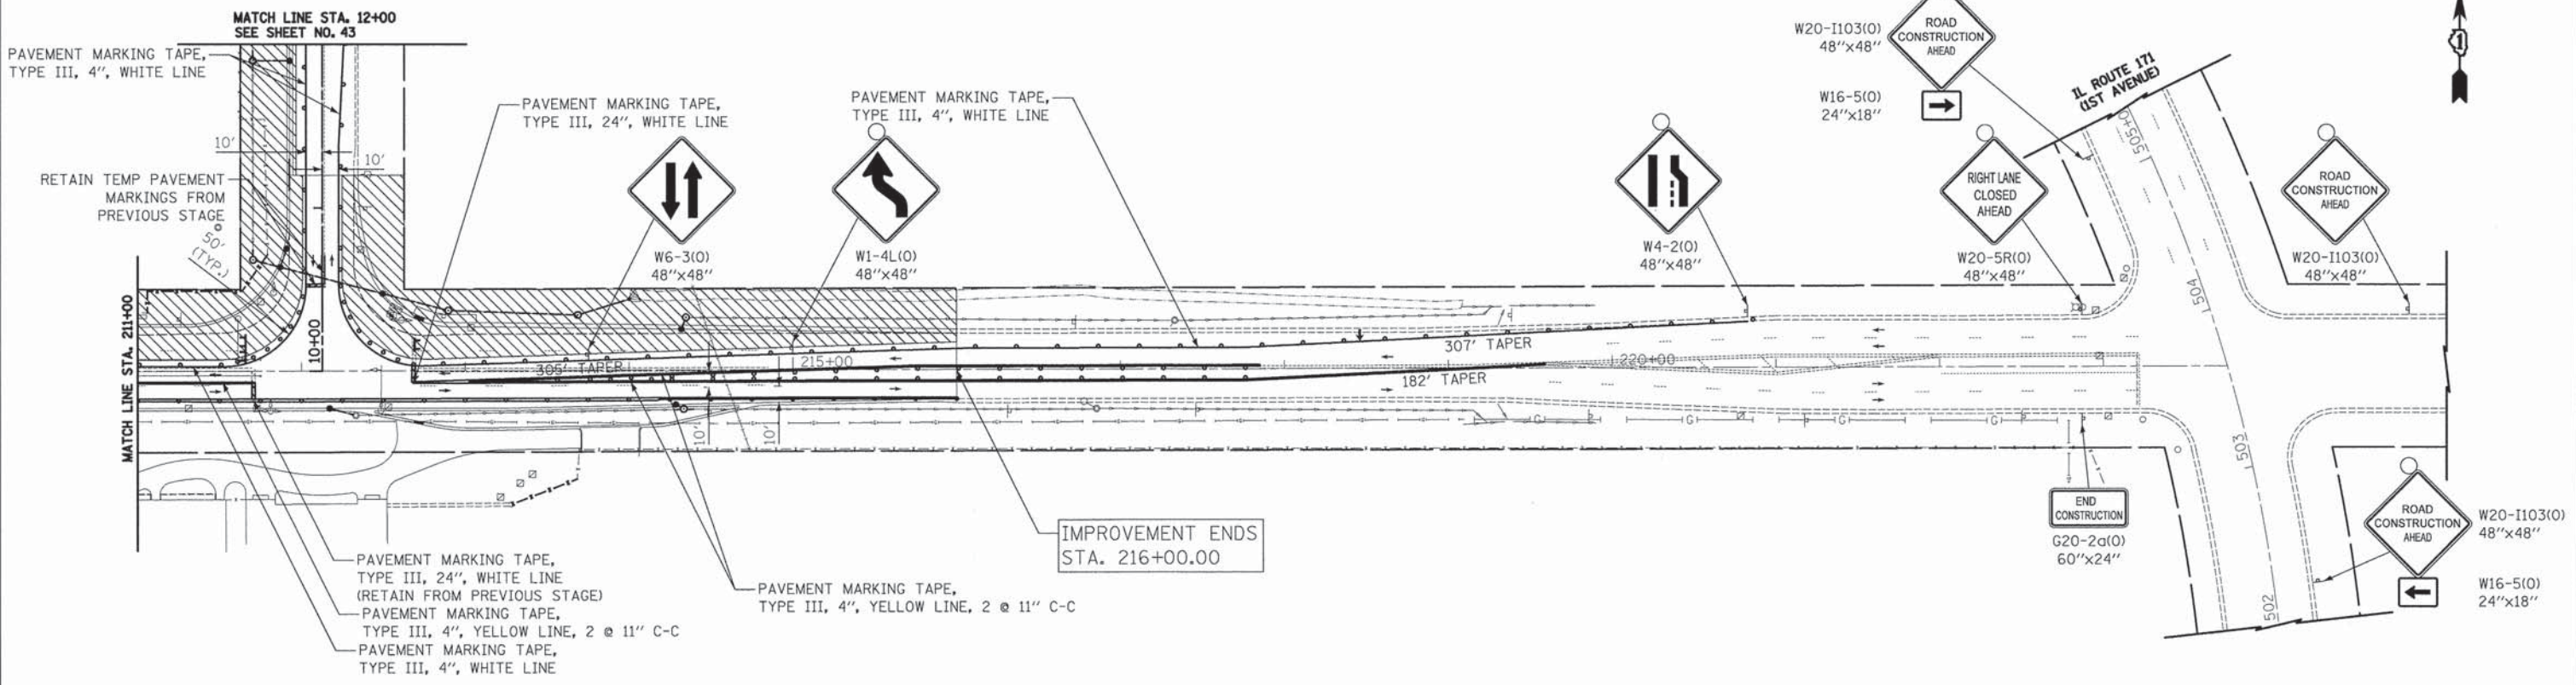

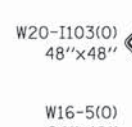31ST STREET

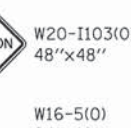

-  W20-1103(0) 48"x48"
-  W20-5R(0) 48"x48"
-  W20-1103(0) 48"x48"
-  W20-1103(0) 48"x48"
-  W20-1103(0) 48"x48"
-  W16-5(0) 24"x18"




31ST STREET

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PLLOT SCALE = 50.0000' / 1" =	CHECKED - GAB	DATE - 05/13/2013	REVISED -		SCALE: 1" = 50'	SHEET NO. 7 OF 12 SHEETS	STA. 207+06.00 TO STA. 216+00.00	FED. ROAD DIST. NO. 1 ILLINOIS	CONTRACT NO. 63764			
PLLOT DATE = 5/23/2013	DATE - 05/13/2013	REVISED -	REVISED -		FED. AID PROJECT							





MATCH LINE STA. 12+00  
SEE SHEET NO. 42

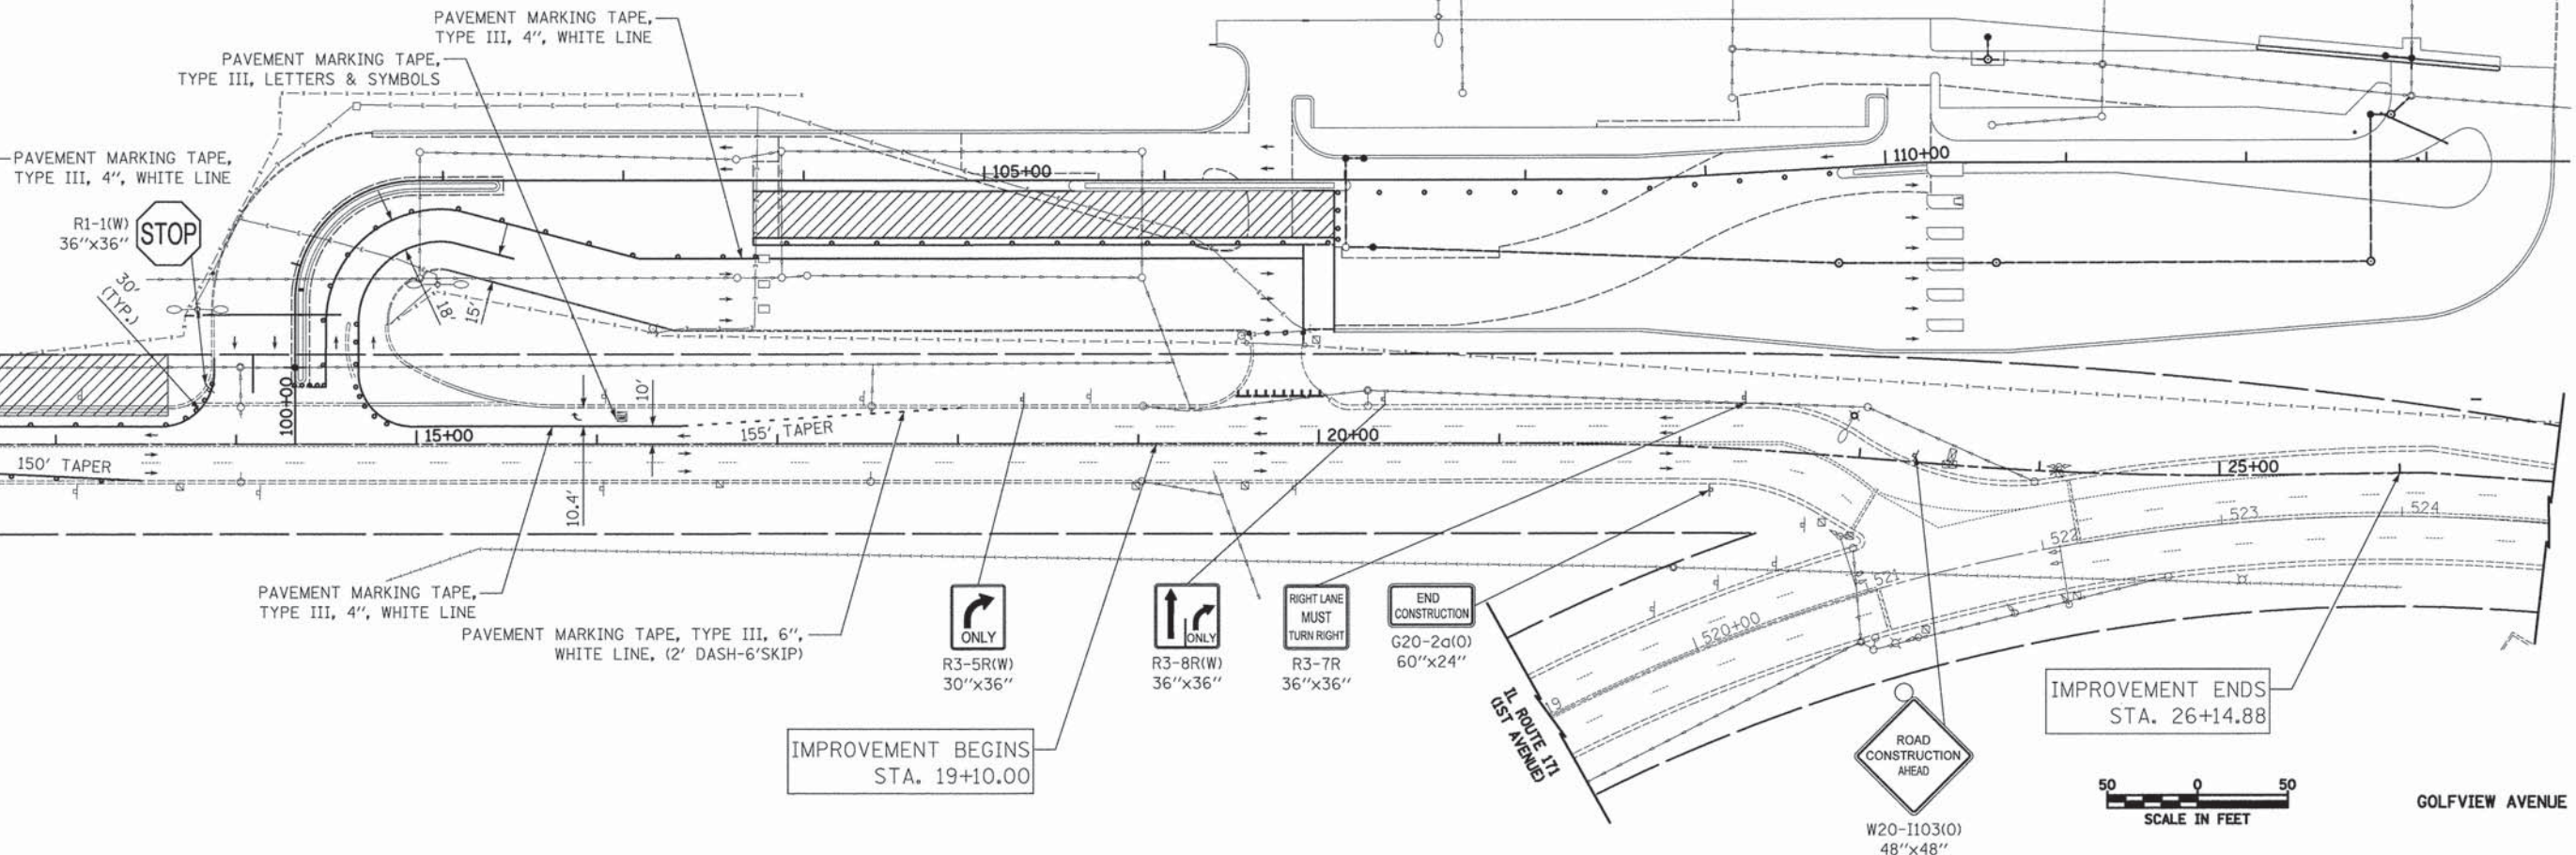

IMPROVEMENT BEGINS  
STA. 19+10.00

IMPROVEMENT ENDS  
STA. 26+14.88



GOLFVIEW AVENUE

**LEGEND**

- TEMPORARY PAVEMENT
- CONSTRUCTION WORK ZONE
- DIRECTION OF TRAFFIC FLOW
- TYPE I OR II BARRICADE WITH FLASHING LIGHT
- VERTICAL PANEL
- TYPE III BARRICADE WITH FLASHING LIGHTS

FILE NAME = ...sheet\06-MOT\2563.MOT_06.dgn	USER NAME = dte	DESIGNED - KWH	REVISED -
		DRAWN - KWH	REVISED -
		CHECKED - GAB	REVISED -
		DATE - 05/13/2013	REVISED -

**STATE OF ILLINOIS  
DEPARTMENT OF TRANSPORTATION**







**MAINTENANCE OF TRAFFIC - STAGE III**


SCALE: 1" = 50'    SHEET NO. 8 OF 12 SHEETS    STA. 12+00.00 TO STA. 26+14.88

F.A.U. RTE.	SECTION	COUNTY	TOTAL SHEETS	SHEET NO.
3784	12-F3000-23-PK	COOK	131	43
<b>CONTRACT NO. 63764</b>				
FED. ROAD DIST. NO. 1 ILLINOIS    FED. AID PROJECT				



**LEGEND**


-  TEMPORARY PAVEMENT
-  CONSTRUCTION WORK ZONE
-  DIRECTION OF TRAFFIC FLOW
-  TYPE I OR II BARRICADE WITH FLASHING LIGHT
-  VERTICAL PANEL
-  TYPE III BARRICADE WITH FLASHING LIGHTS

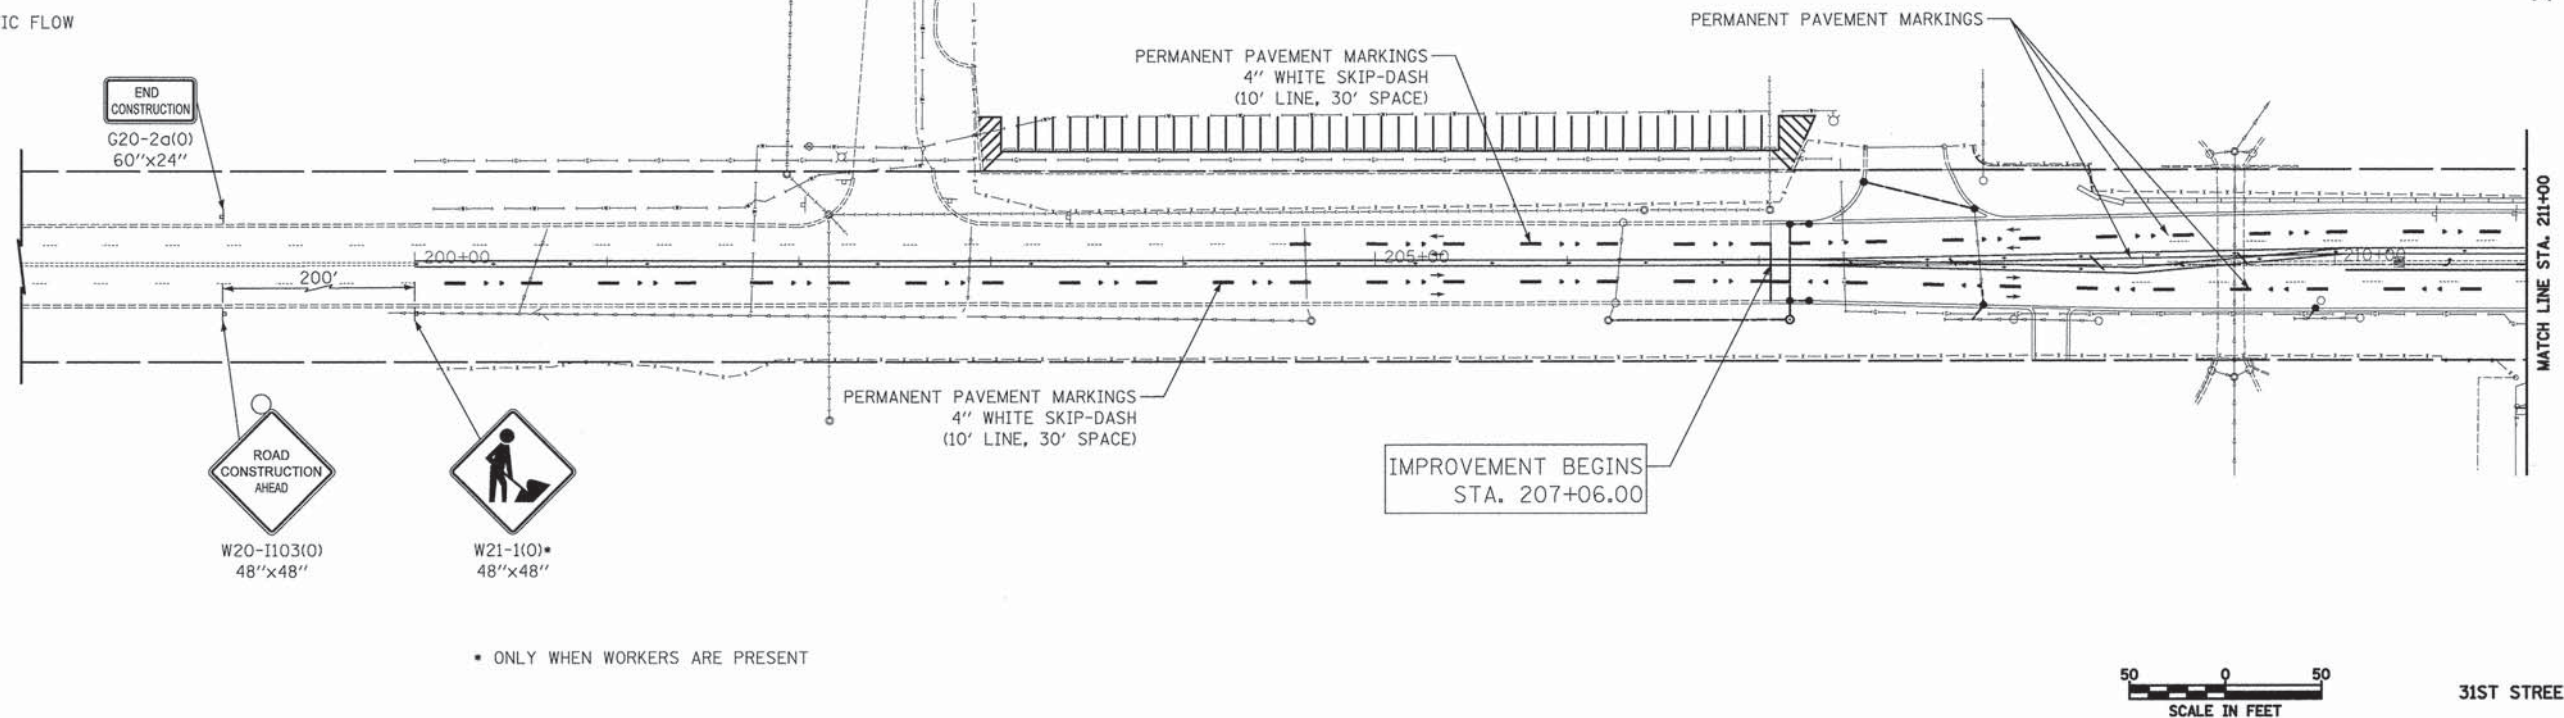

• ONLY WHEN WORKERS ARE PRESENT



31ST STREET

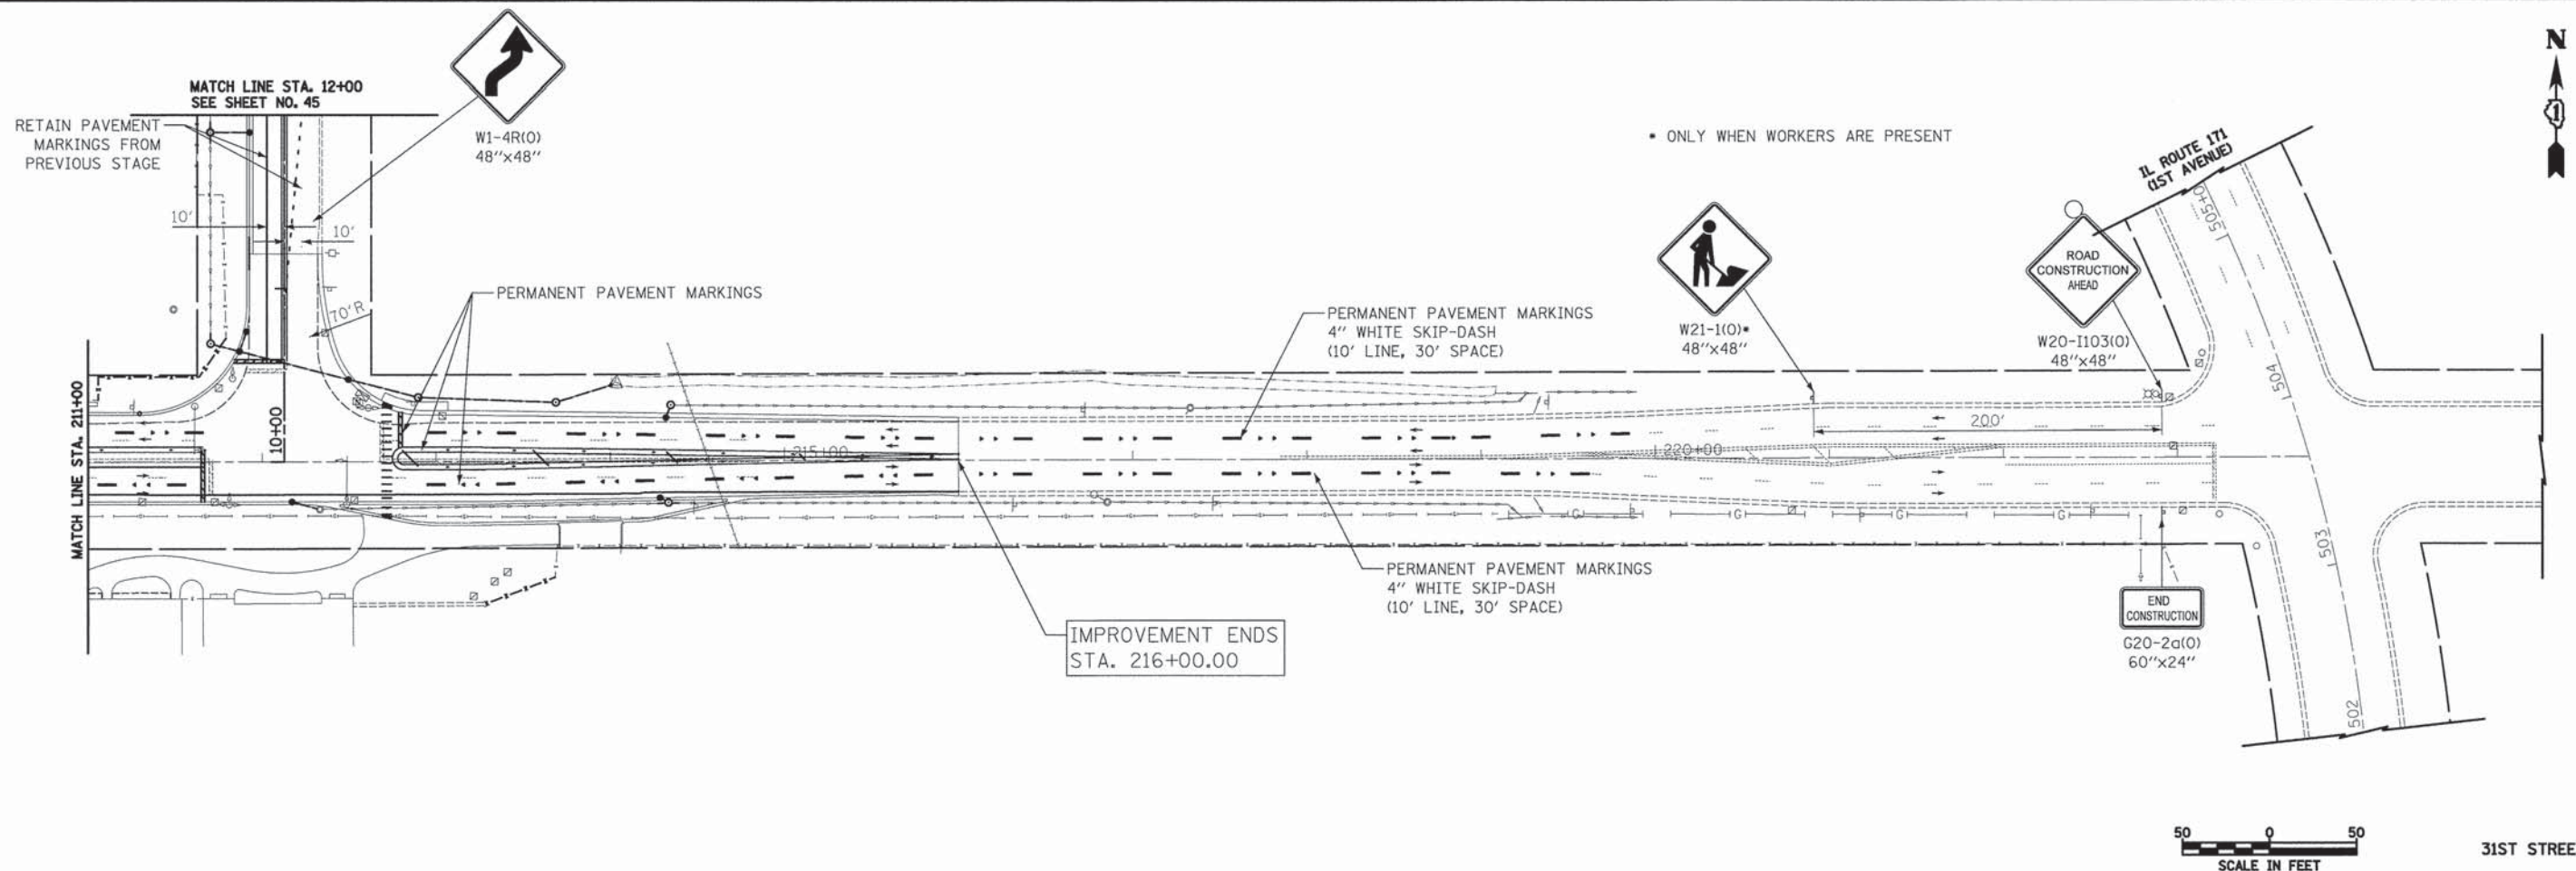

• ONLY WHEN WORKERS ARE PRESENT



31ST STREET

FILE NAME = ...sheet\06-MOT\2563\_MOT\_07.dgn  
 USER NAME = dtw  
 PLOT SCALE = 50.0000' / 1 in.  
 PLOT DATE = 5/8/2013

DESIGNED - KWH  
 DRAWN - KWH  
 CHECKED - GAB  
 DATE - 05/13/2013

REVISED -  
 REVISED -  
 REVISED -  
 REVISED -


**STATE OF ILLINOIS  
 DEPARTMENT OF TRANSPORTATION**

**MAINTENANCE OF TRAFFIC - STAGE IV**

SCALE: 1" = 50' SHEET NO. 9 OF 12 SHEETS STA. 207+06.00 TO STA. 216+00.00

F.A.U. RTE.	SECTION	COUNTY	TOTAL SHEETS	SHEET NO.
3784	12-F3000-23-PK	COOK	131	44
CONTRACT NO. 63764				
FED. ROAD DIST. NO. 1 [ILLINOIS]				FED. AID PROJECT



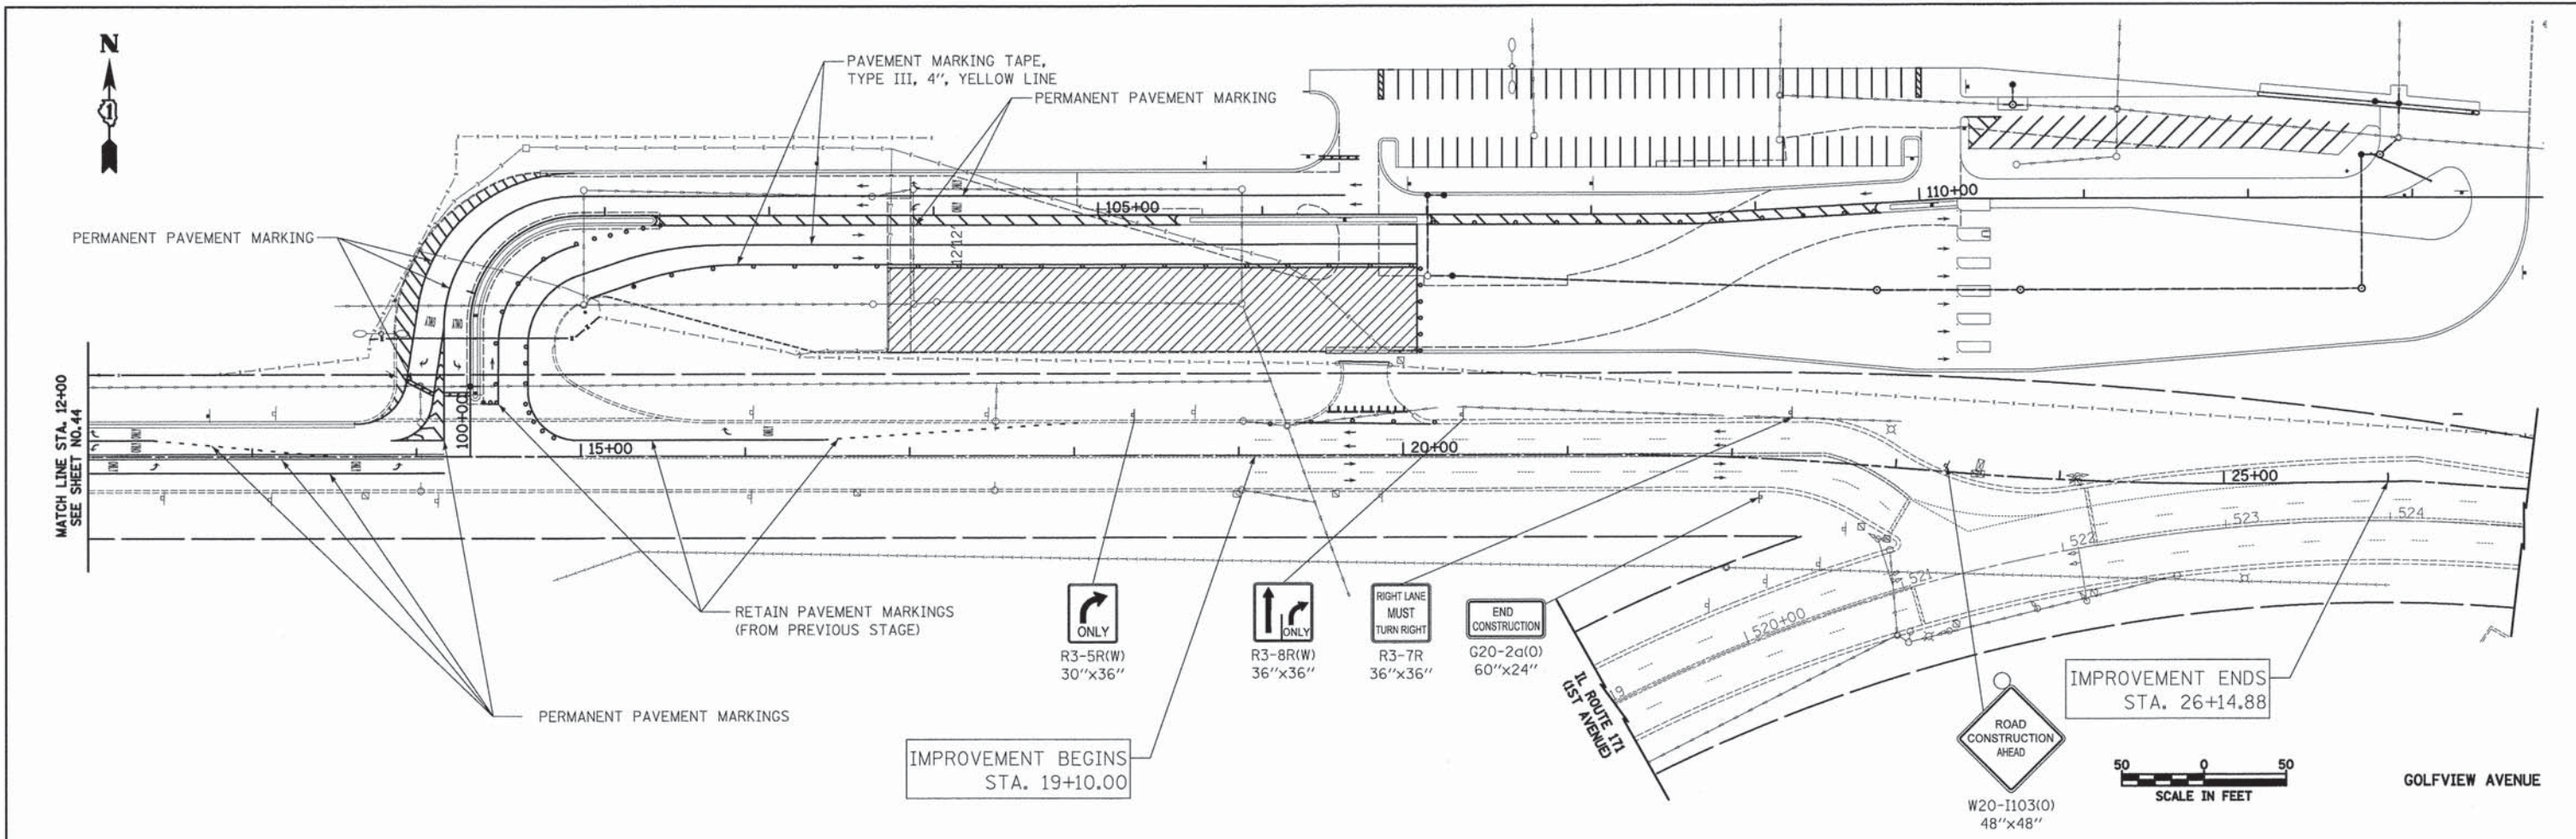

**LEGEND**



- TEMPORARY PAVEMENT
- CONSTRUCTION WORK ZONE
- DIRECTION OF TRAFFIC FLOW
- TYPE I OR II BARRICADE WITH FLASHING LIGHT
- VERTICAL PANEL
- TYPE III BARRICADE WITH FLASHING LIGHTS

FILE NAME = ...sheet\06-MOT\2563_MOT_08.dgn	USER NAME = dtw	DESIGNED - KWH	REVISED -	<b>STATE OF ILLINOIS DEPARTMENT OF TRANSPORTATION</b>	<b>MAINTENANCE OF TRAFFIC - STAGE IV</b>	F.A.U. RTE. 3784	SECTION 12-F3000-23-PK	COUNTY COOK	TOTAL SHEETS 131	SHEET NO. 45	
PLOT SCALE = 50.0000' / 1" =						SCALE: 1" = 50'		SHEET NO. 10 OF 12 SHEETS		STA. 12+00.00 TO STA. 26+14.88	
PLOT DATE = 5/6/2013						DATE = 05/13/2013		FED. ROAD DIST. NO. 1 ILLINOIS		CONTRACT NO. 63764	
						REVISED -		FED. AID PROJECT			






**LEGEND**

-  TEMPORARY PAVEMENT
-  CONSTRUCTION WORK ZONE
-  DIRECTION OF TRAFFIC FLOW
-  TYPE I OR II BARRICADE WITH FLASHING LIGHT
-  VERTICAL PANEL
-  TYPE III BARRICADE WITH FLASHING LIGHTS

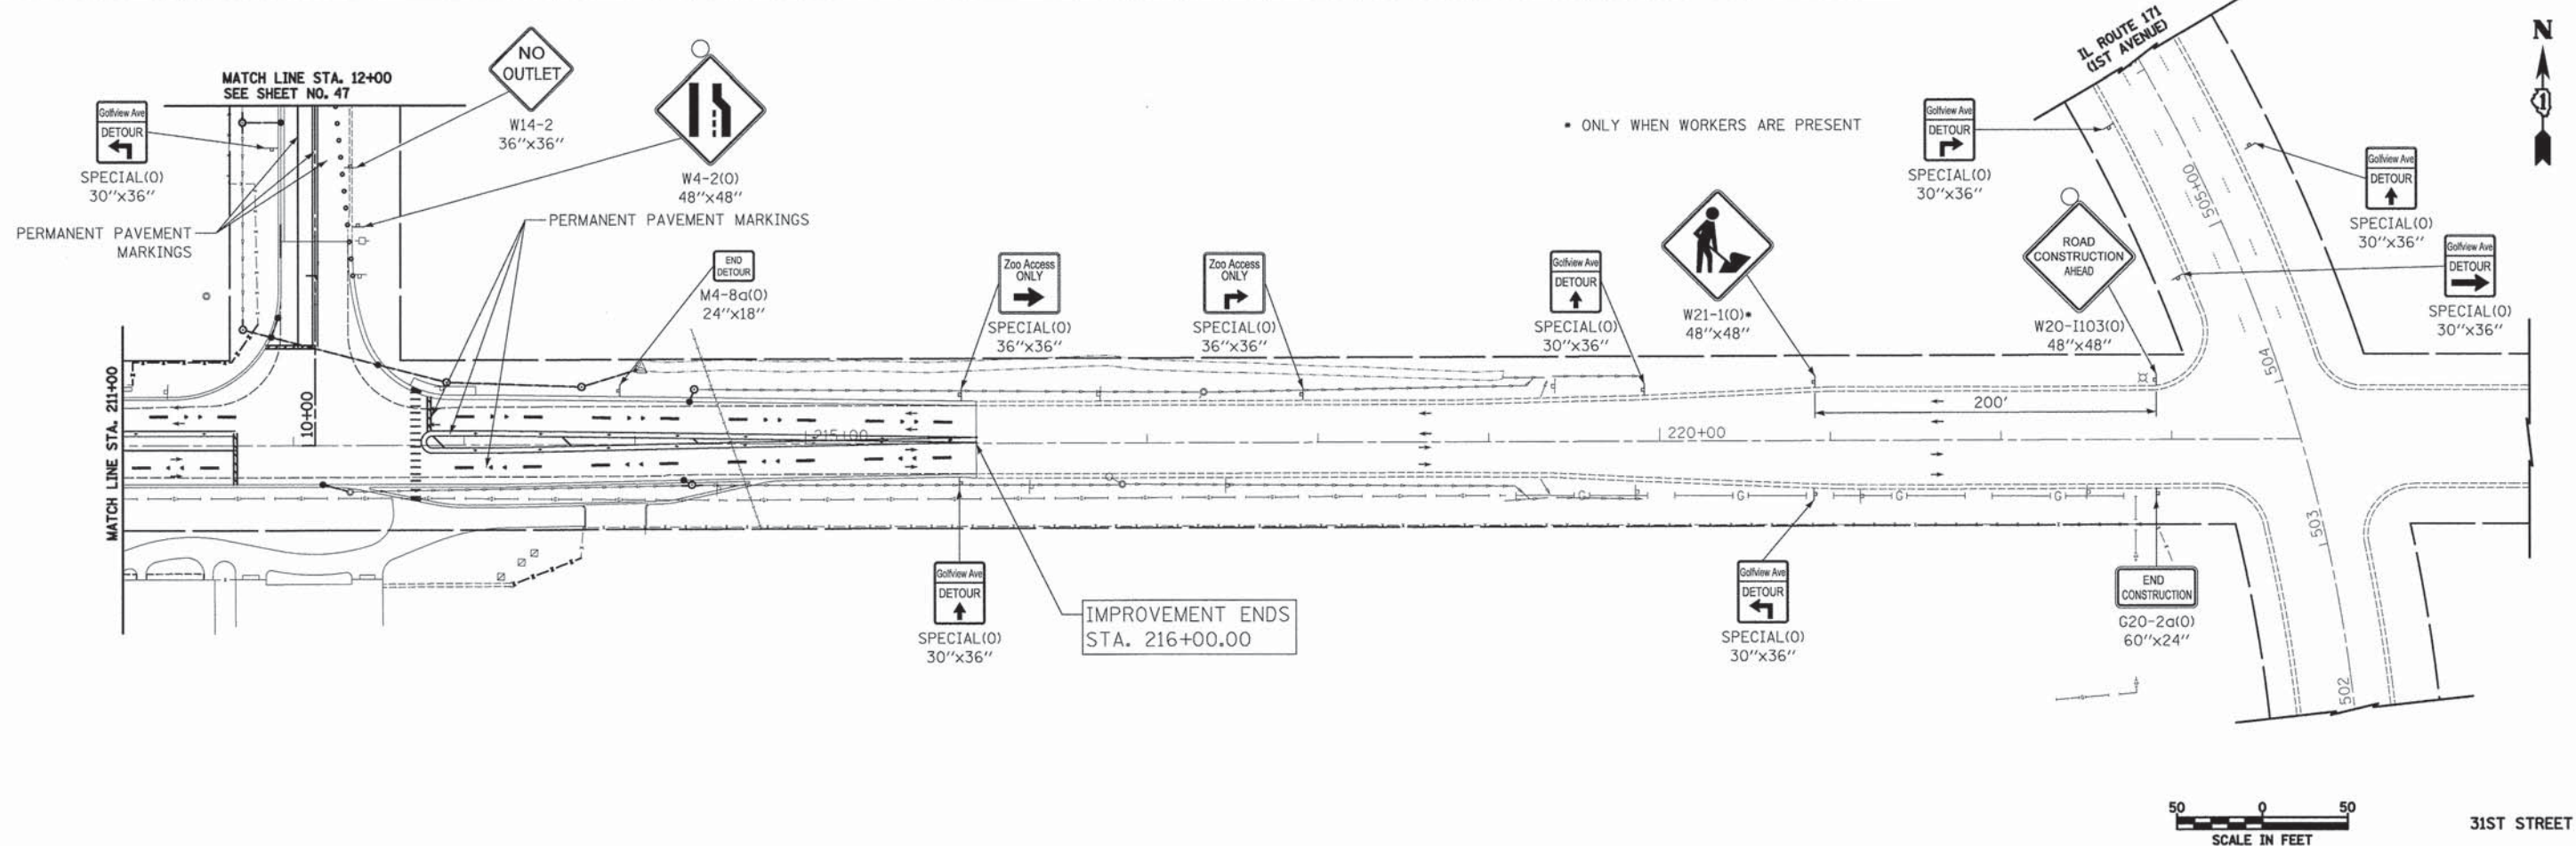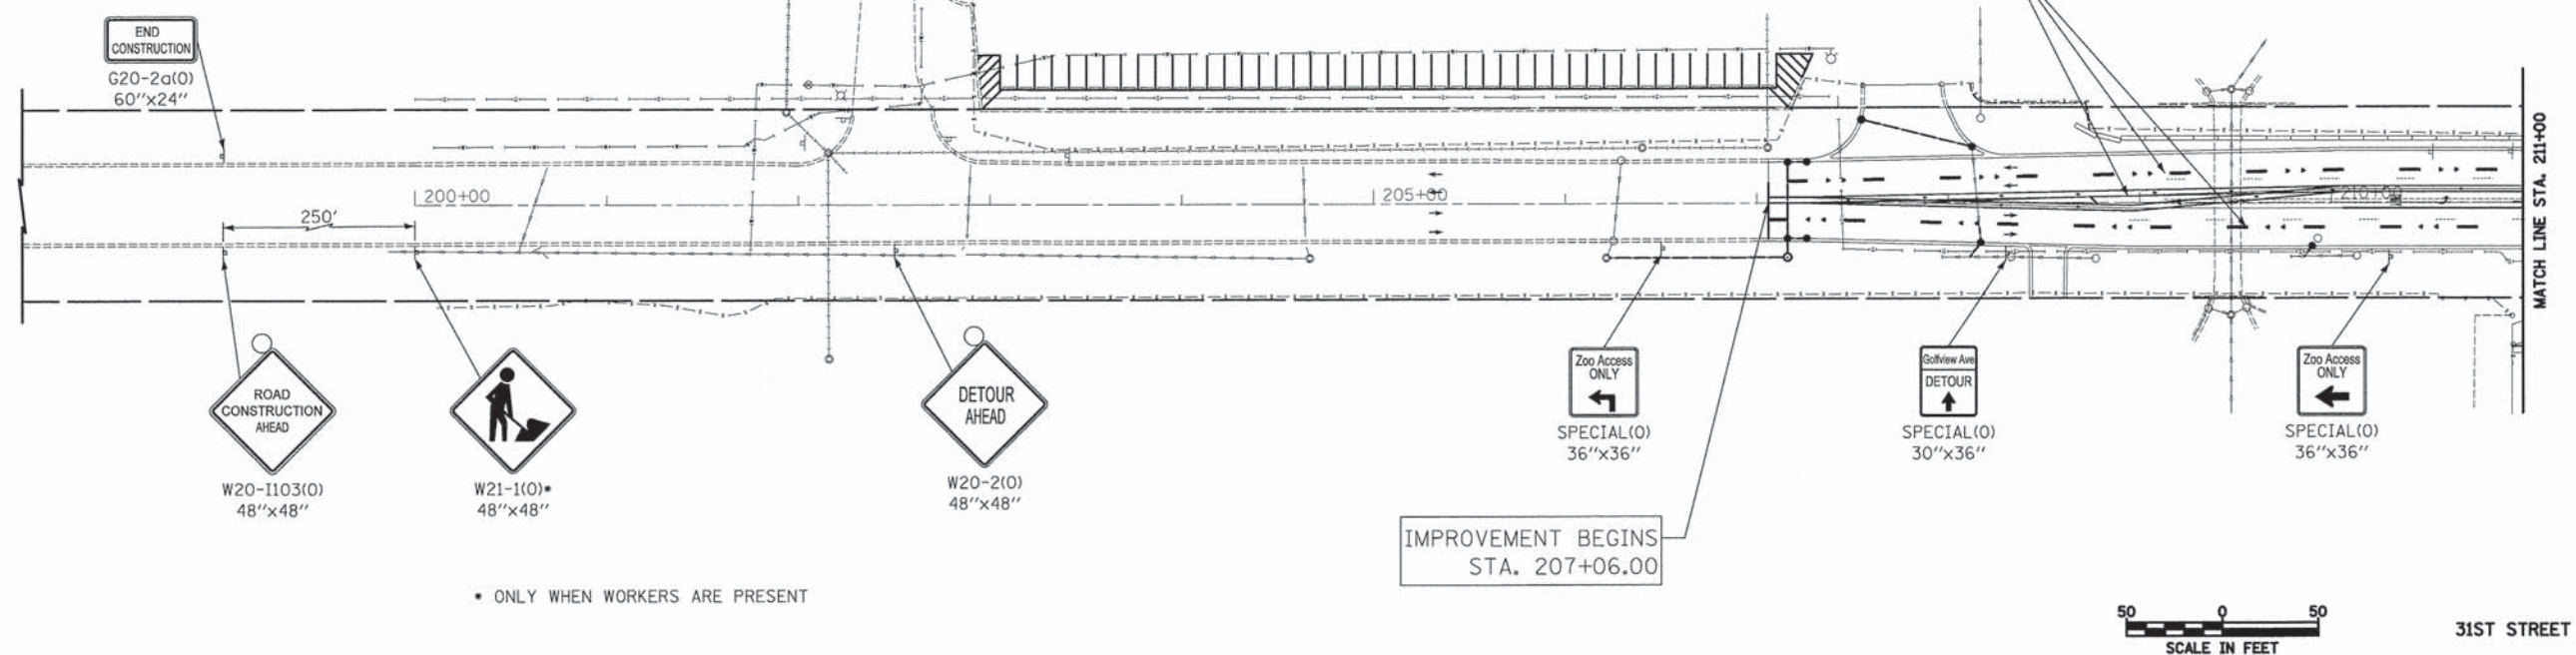

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PLOT SCALE = 50.0000' / 1" =		CHECKED - GAB	REVISED -		SCALE: 1" = 50'			SHEET NO. 11 OF 12 SHEETS			STA. 207+06.00 TO STA. 216+00.00		
PLOT DATE = 5/23/2013		DATE - 05/13/2013	REVISED -		FED. ROAD DIST. NO. 1 (ILLINOIS)			CONTRACT NO. 63764			FED. AID PROJECT		
					FED. AID PROJECT								



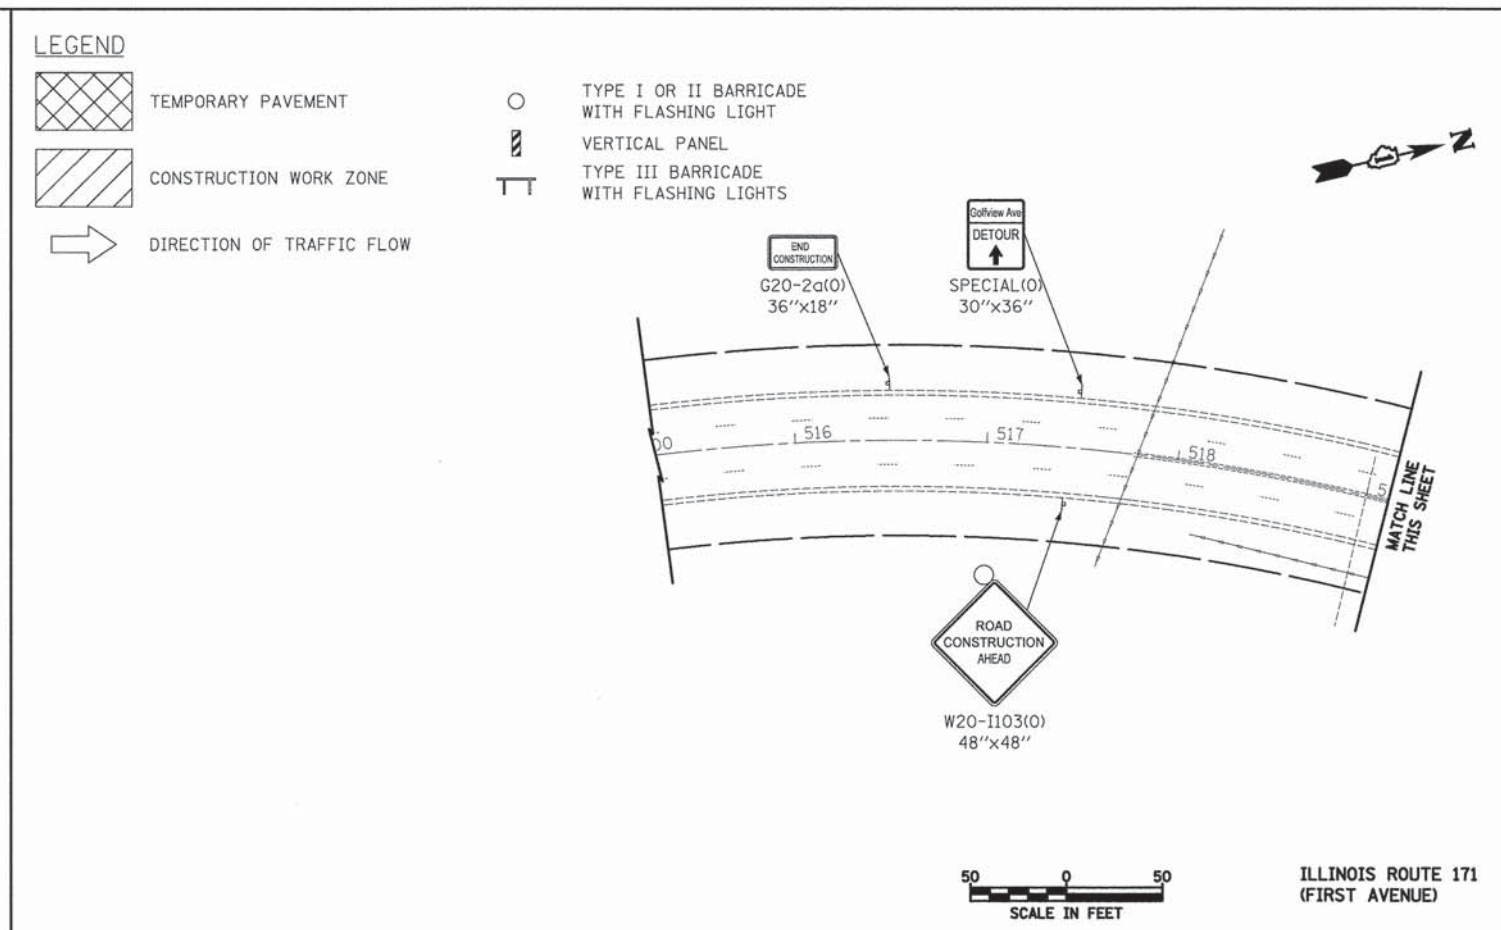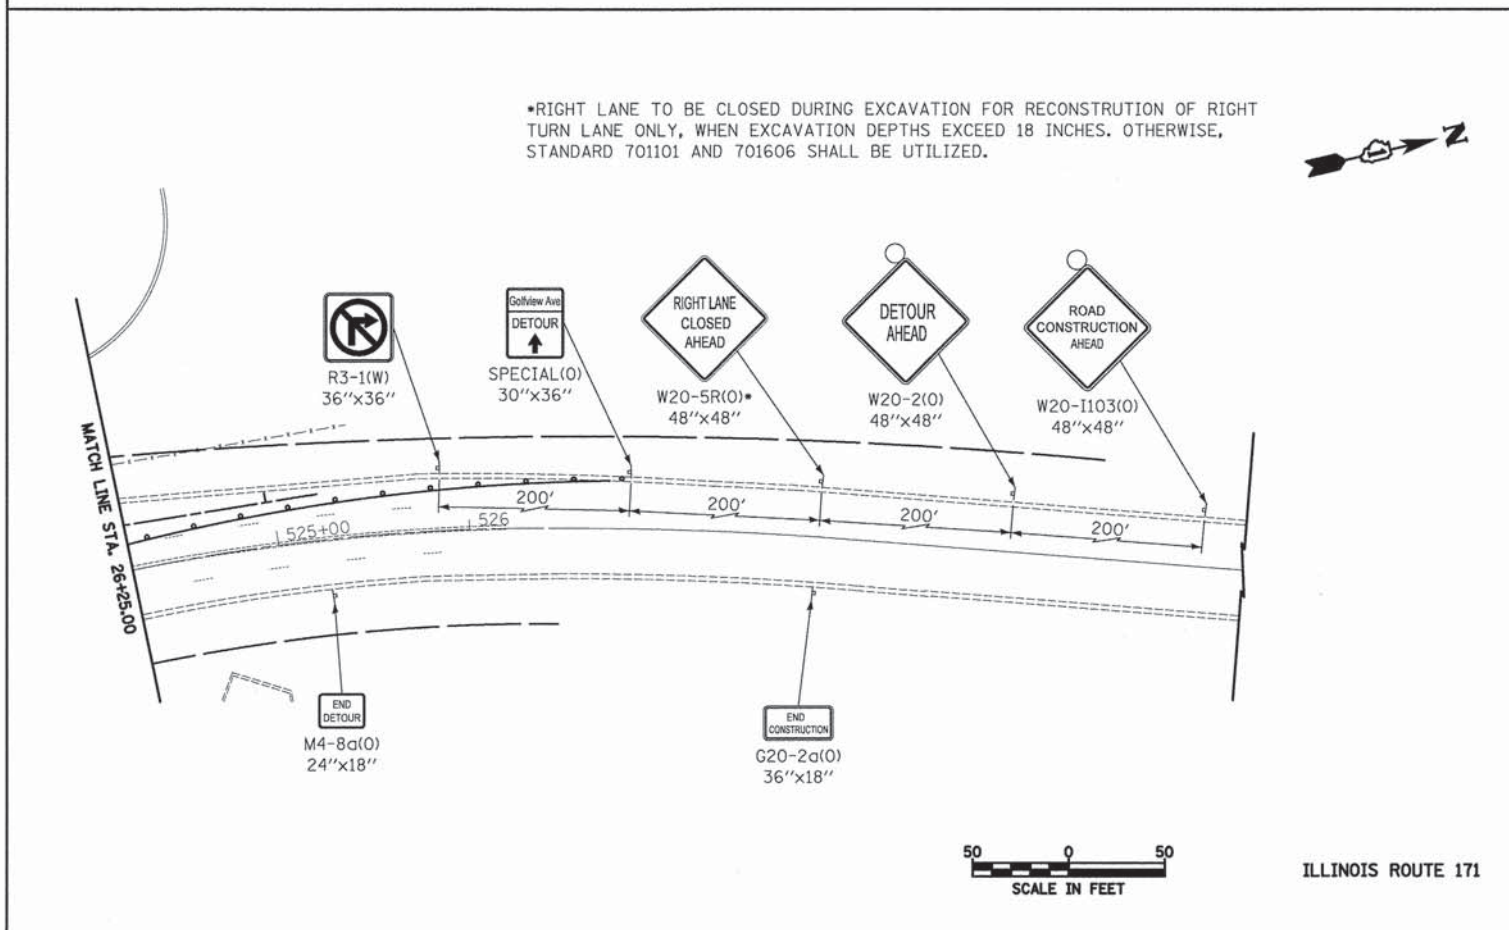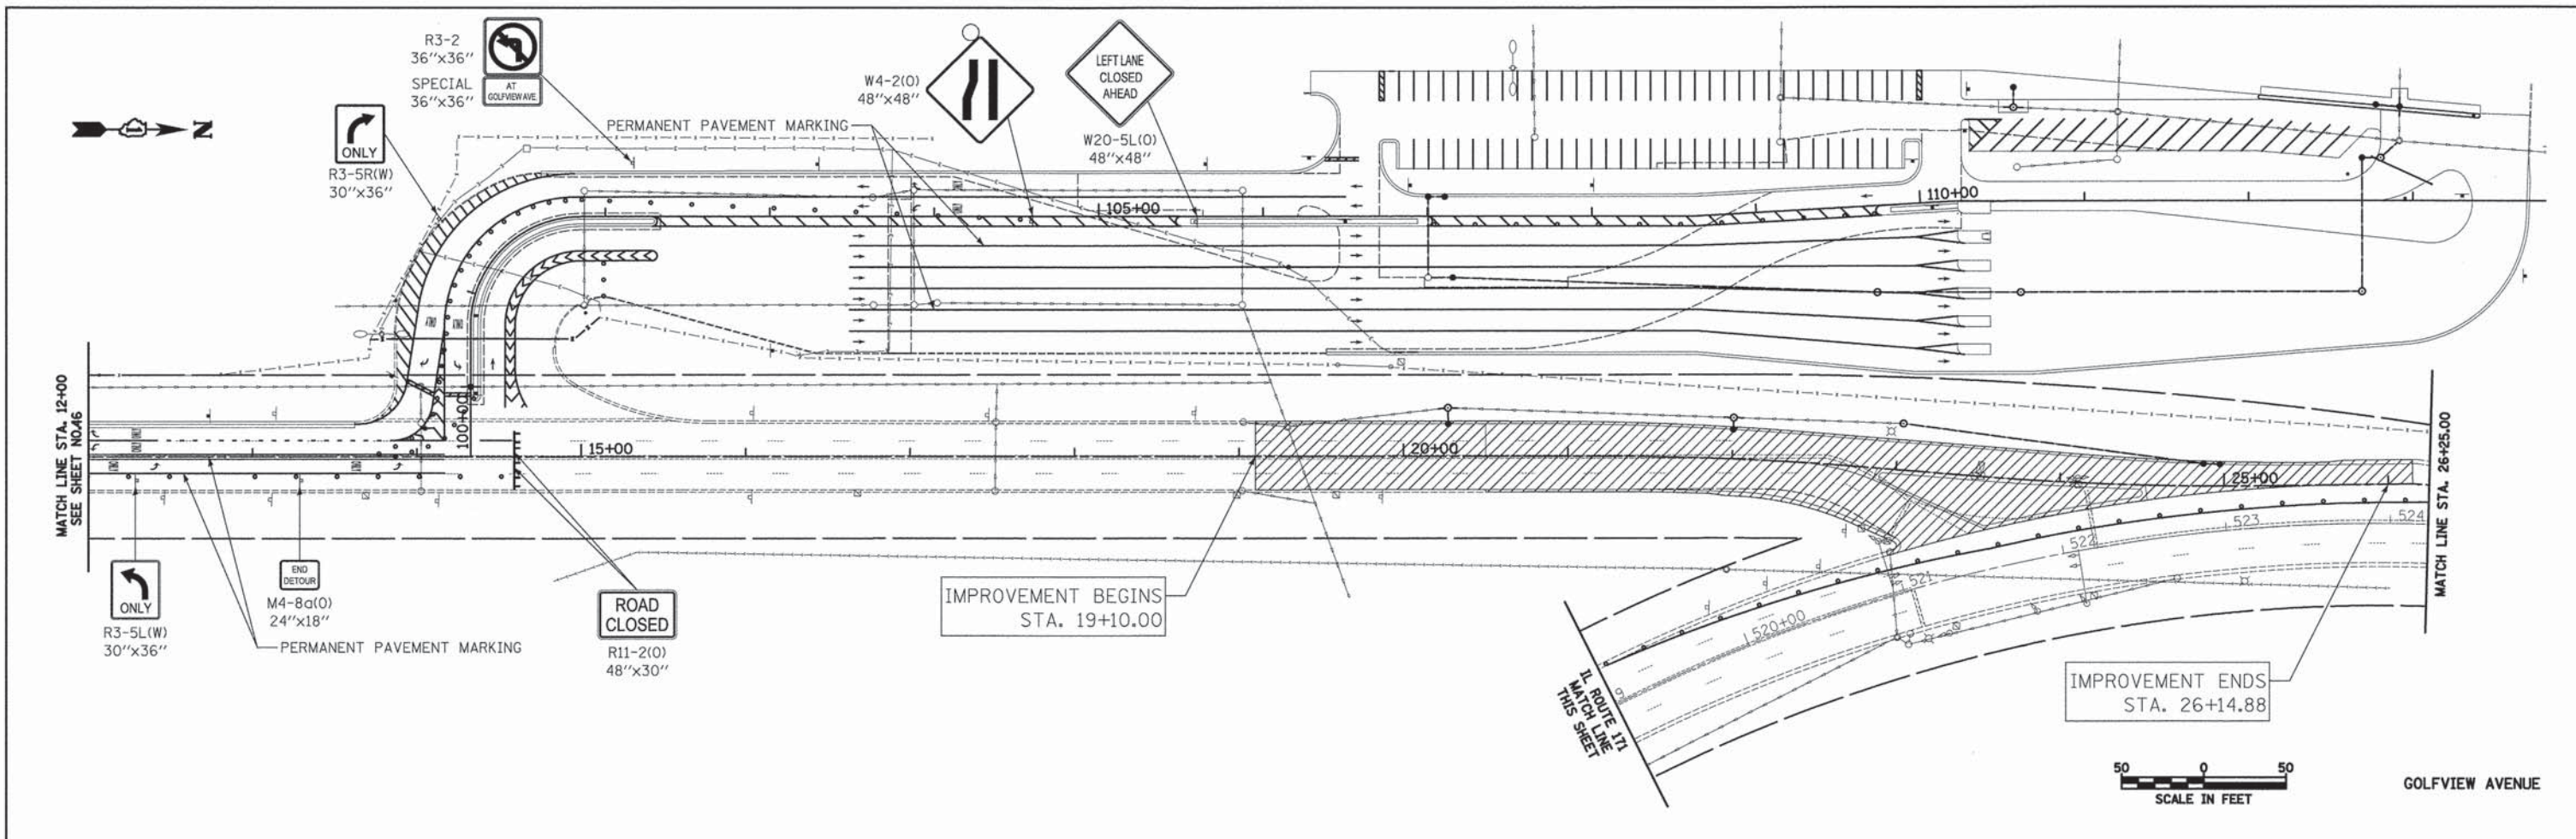


- LEGEND**
- TEMPORARY PAVEMENT
  - CONSTRUCTION WORK ZONE
  - DIRECTION OF TRAFFIC FLOW
  - TYPE I OR II BARRICADE WITH FLASHING LIGHT
  - VERTICAL PANEL
  - TYPE III BARRICADE WITH FLASHING LIGHTS

\*RIGHT LANE TO BE CLOSED DURING EXCAVATION FOR RECONSTRUCTION OF RIGHT TURN LANE ONLY, WHEN EXCAVATION DEPTHS EXCEED 18 INCHES. OTHERWISE, STANDARD 701101 AND 701606 SHALL BE UTILIZED.


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PLDT DATE = 5/23/2013	DATE - 05/13/2013	REVISED -	SCALE: 1" = 50'			SHEET NO. 12 OF 12 SHEETS		STA. 12+00.00 TO STA. 26+14.88		CONTRACT NO. 63764		
						FED. ROAD DIST. NO. 1 ILLINOIS		FED. AID PROJECT				



- LEGEND**
-  PAVEMENT PATCHING
  -  EROSION CONTROL BLANKET AND TEMPORARY EROSION CONTROL SEEDING
  -  INLET FILTER AND PERIMETER EROSION BARRIER PLACED AROUND OPEN GRATE STRUCTURE IN ACCORDANCE WITH 280001-05
  -  INLET FILTERS

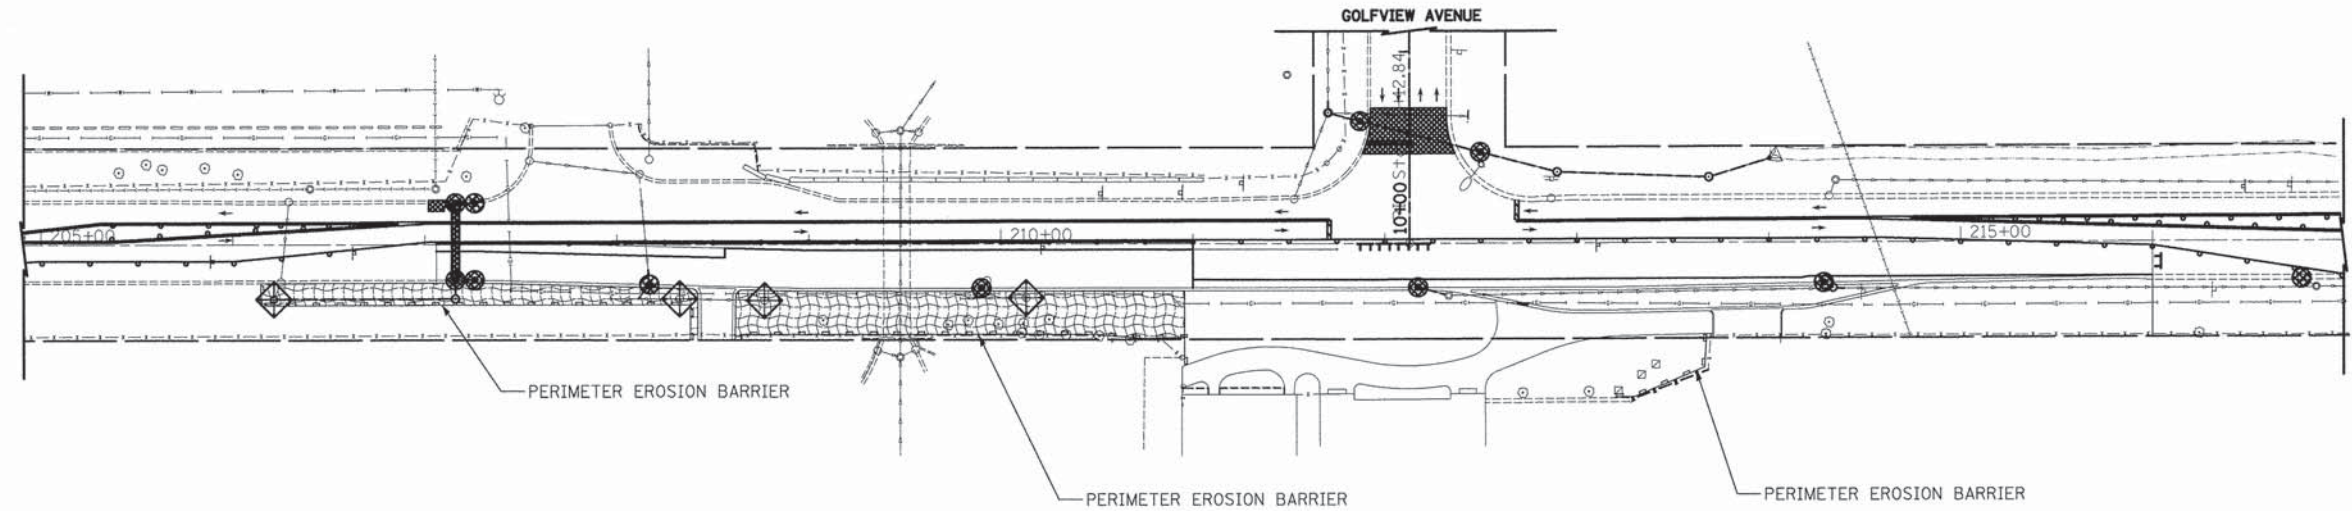

31ST STREET

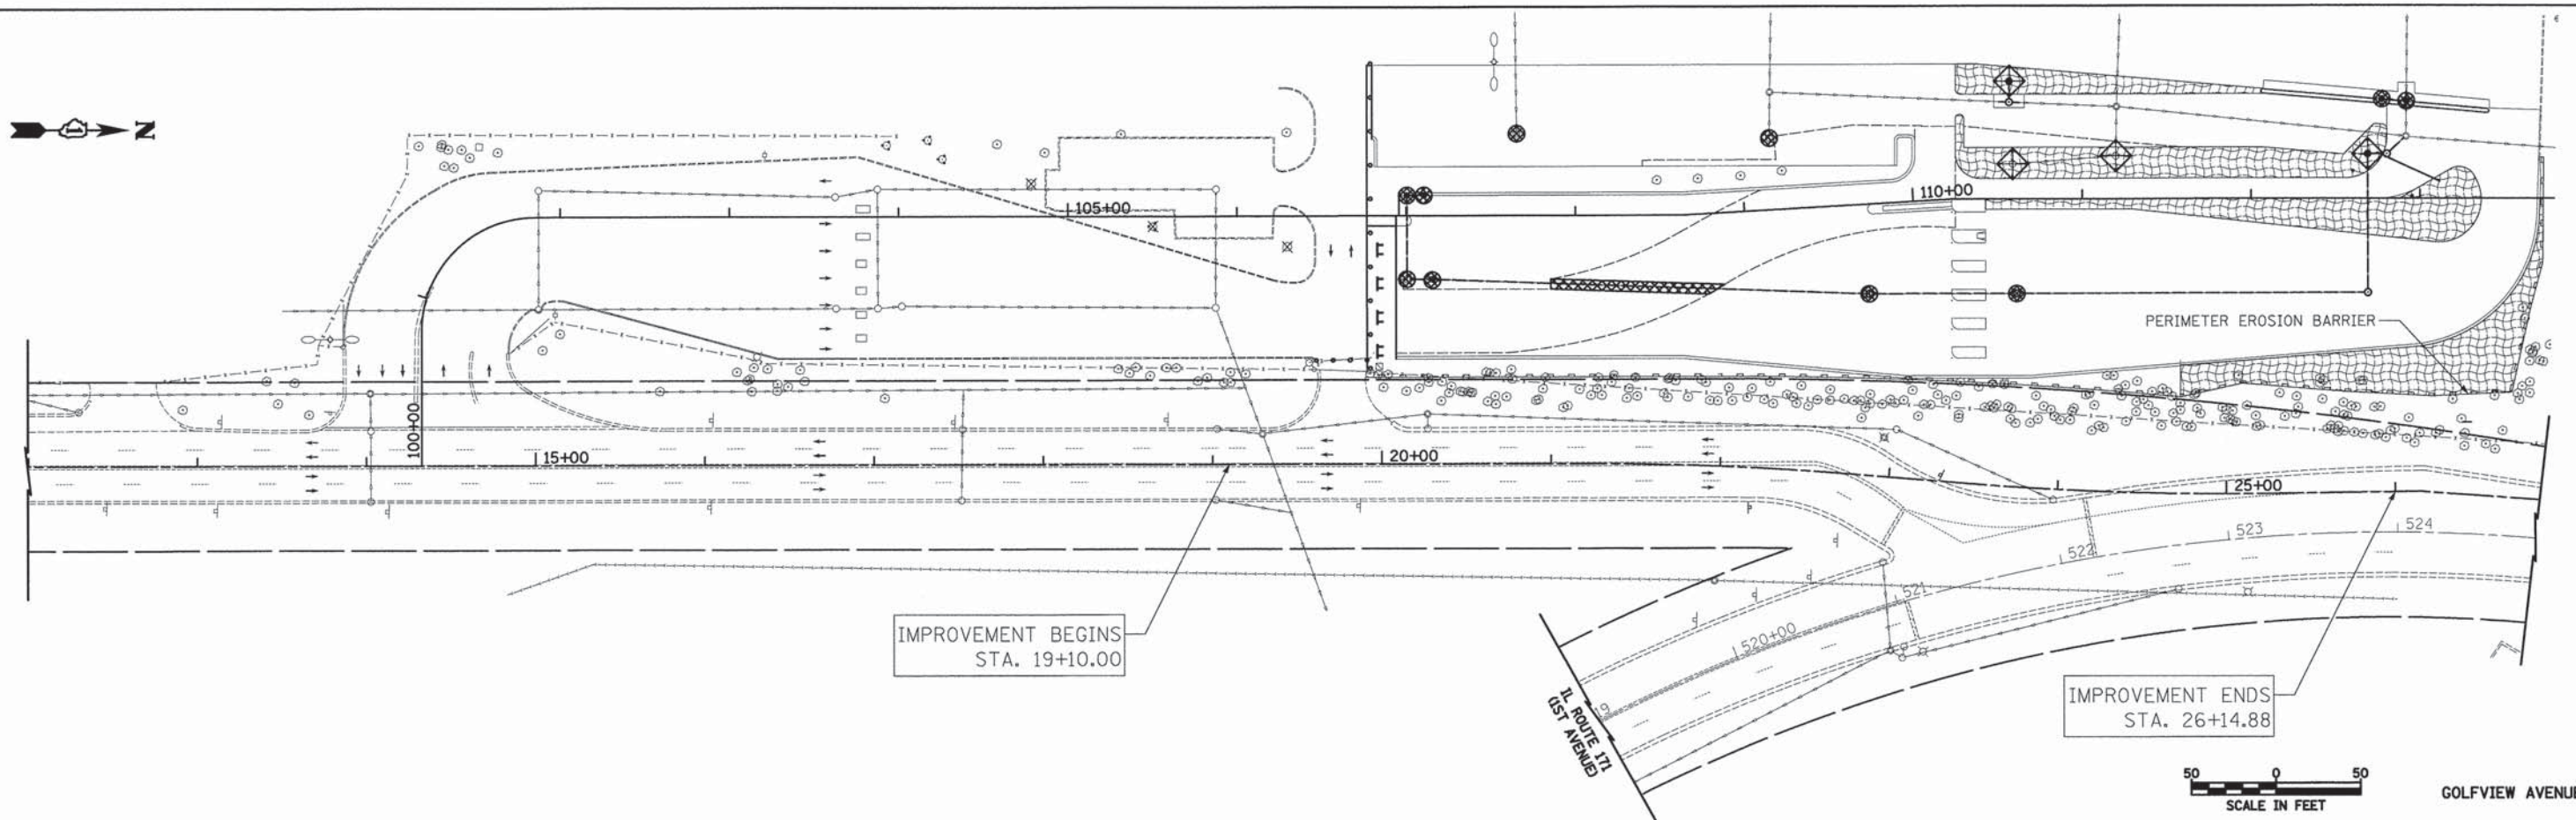


50 0 50  
SCALE IN FEET

GOLFVIEW AVENUE


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PLOT SCALE = 50.0000' / 1" =		CHECKED - GAB	REVISED -		SCALE: 1" = 50'	SHEET NO. 1 OF 3 SHEETS	STA.	TO STA.	CONTRACT NO. 63764			
PLOT DATE = 5/6/2013		DATE - 05/13/2013	REVISED -		FED. ROAD DIST. NO. 1 ILLINOIS							
FED. AID PROJECT												



- LEGEND**
-  PAVEMENT PATCHING
  -  EROSION CONTROL BLANKET AND TEMPORARY EROSION CONTROL SEEDING
  -  INLET FILTER AND PERIMETER EROSION BARRIER PLACED AROUND OPEN GRATE STRUCTURE IN ACCORDANCE WITH 280001-05
  -  INLET FILTERS

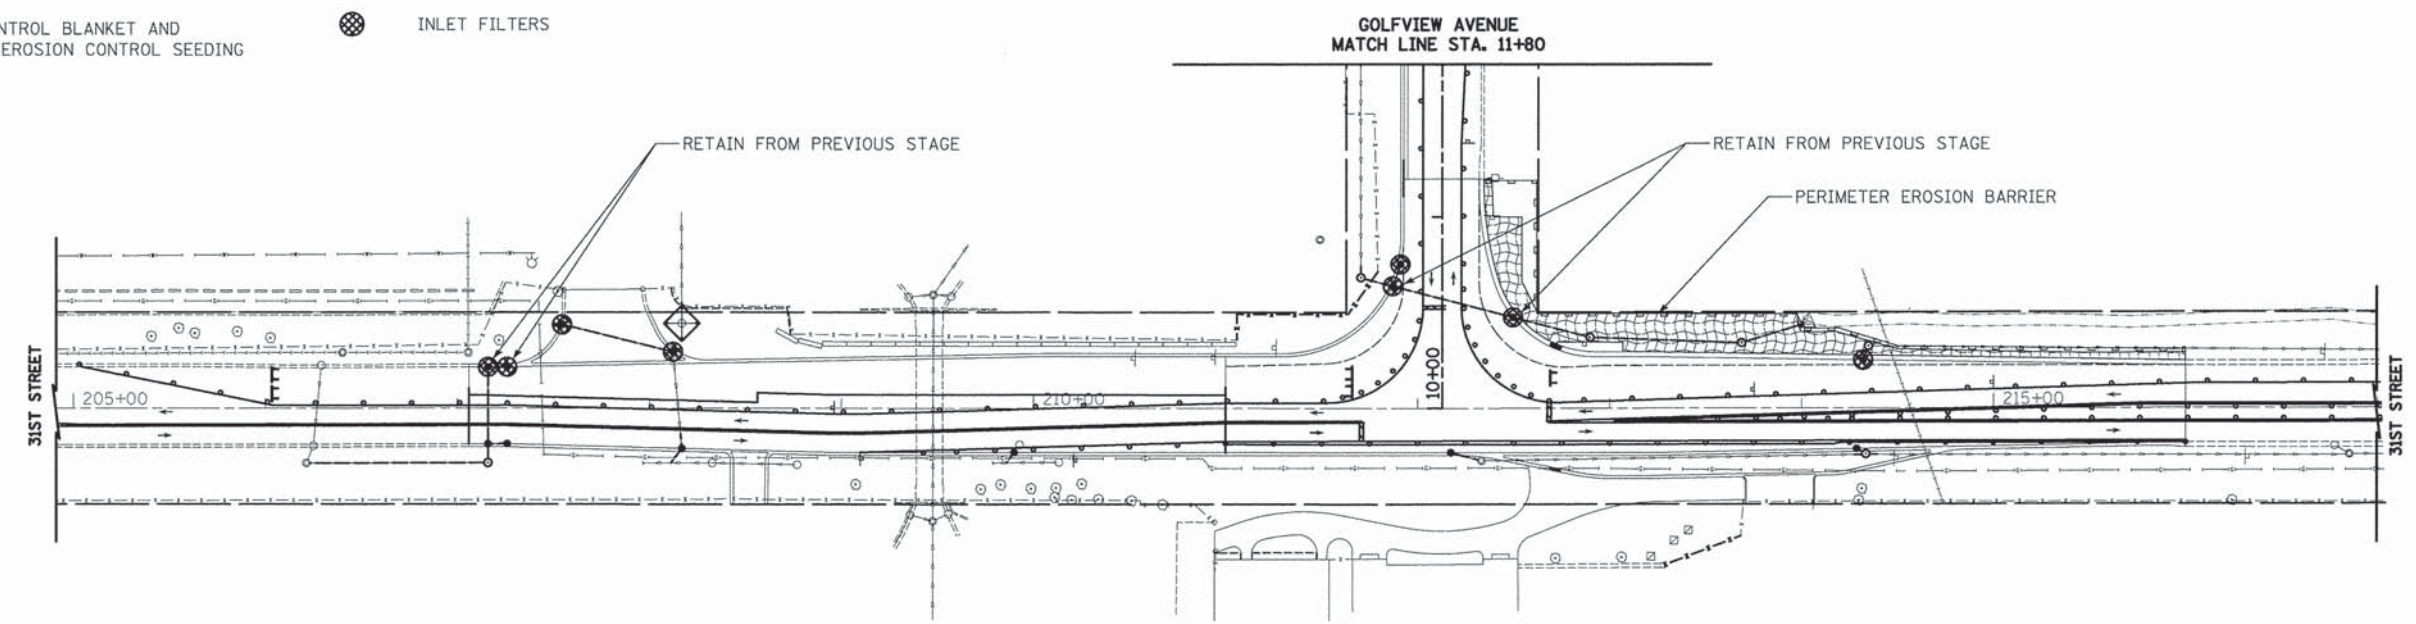

31ST STREET

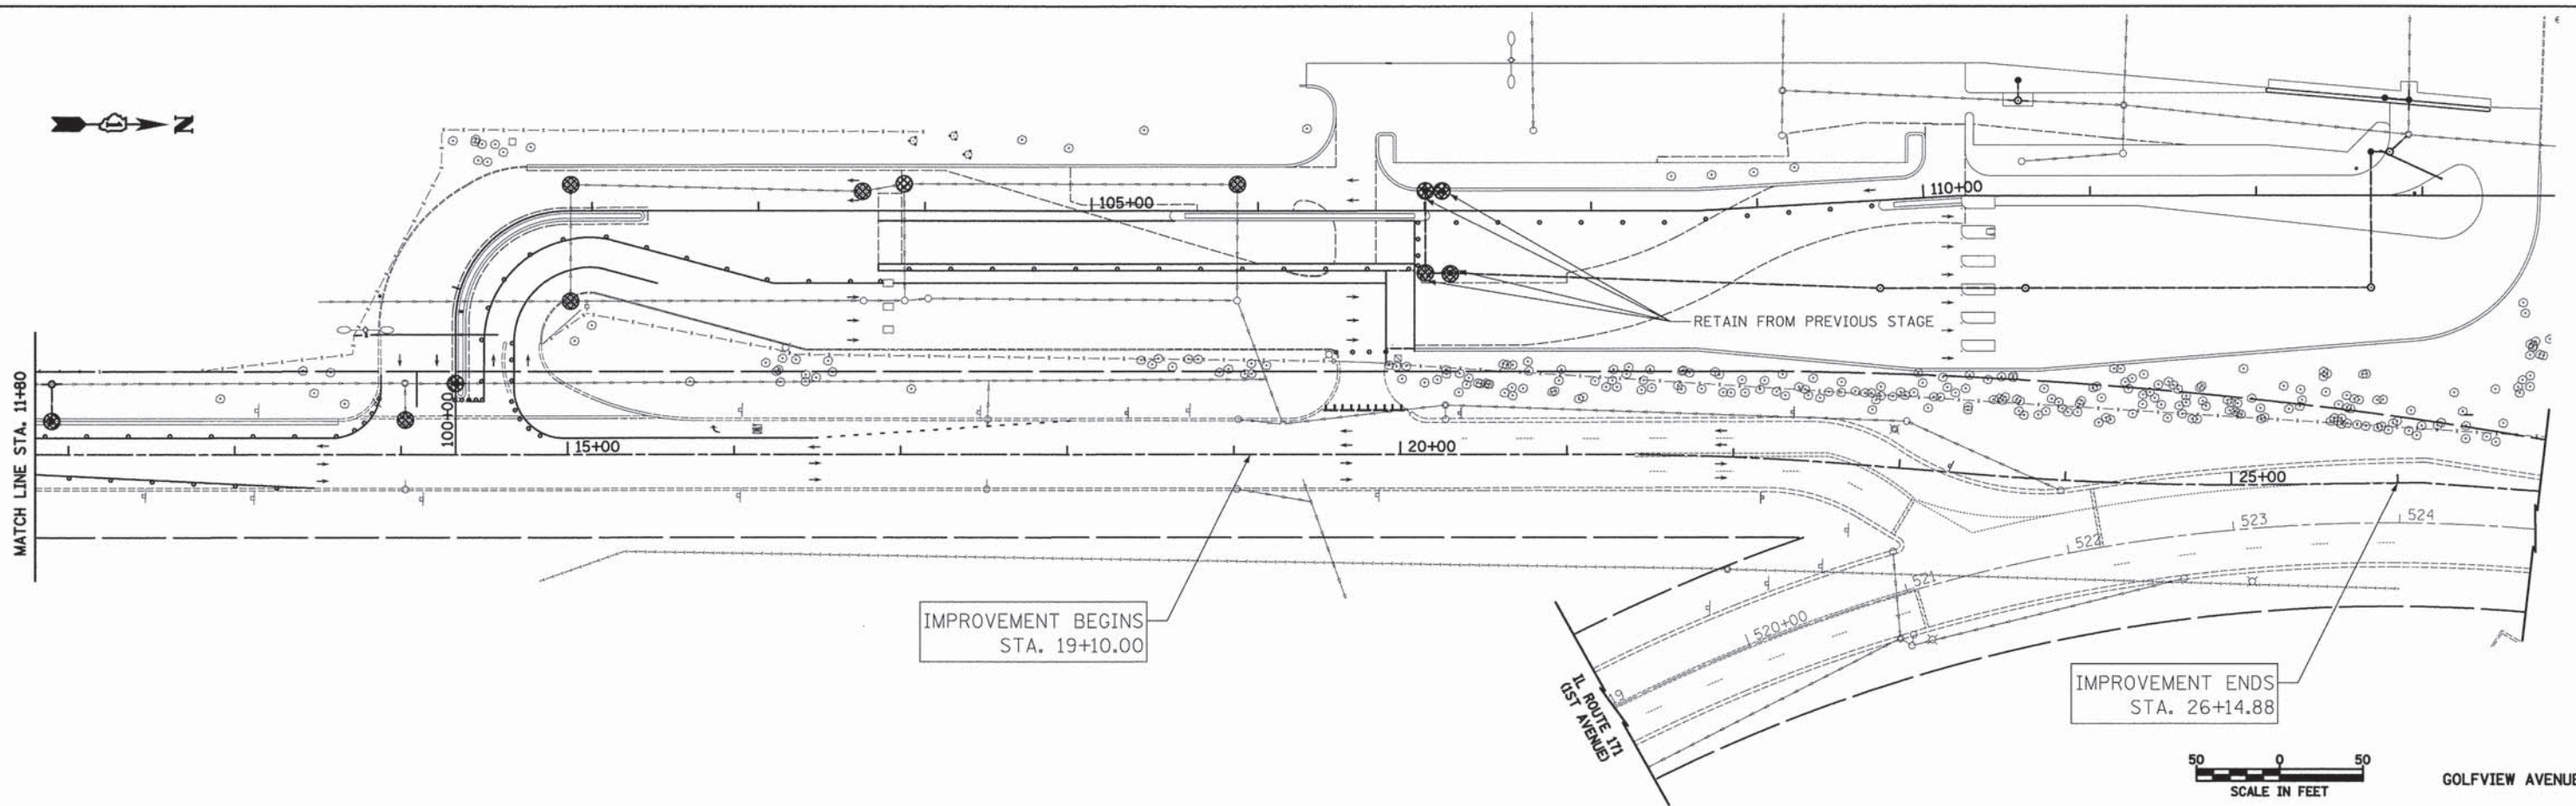

GOLFVIEW AVENUE

FILE NAME = ... \2563_ER0_02.dgn	USER NAME = dte	DESIGNED - DTE	REVISED -	<b>STATE OF ILLINOIS DEPARTMENT OF TRANSPORTATION</b>	<b>EROSION AND SEDIMENT CONTROL - STAGE II &amp; III</b>			F.A.U. RTE. 3784	SECTION 12-F3000-23-PK	COUNTY COOK	TOTAL SHEETS 131	SHEET NO. 49
	PLDT SCALE = 50.0000' / 1" =	DRAWN - DTE	REVISED -		SCALE: 1" = 50'	SHEET NO. 2 OF 3 SHEETS	STA.	TO STA.	CONTRACT NO. 63764			
	PLDT DATE = 5/6/2013	CHECKED - GAB	REVISED -		FED. ROAD DIST. NO. 1 [ILLINOIS] FED. AID PROJECT							
		DATE - 05/13/2013	REVISED -									





LEGEND



PAVEMENT PATCHING




EROSION CONTROL BLANKET AND  
TEMPORARY EROSION CONTROL SEEDING




INLET FILTER AND PERIMETER EROSION  
BARRIER PLACED AROUND OPEN GRATE  
STRUCTURE IN ACCORDANCE WITH 280001-05



INLET FILTERS

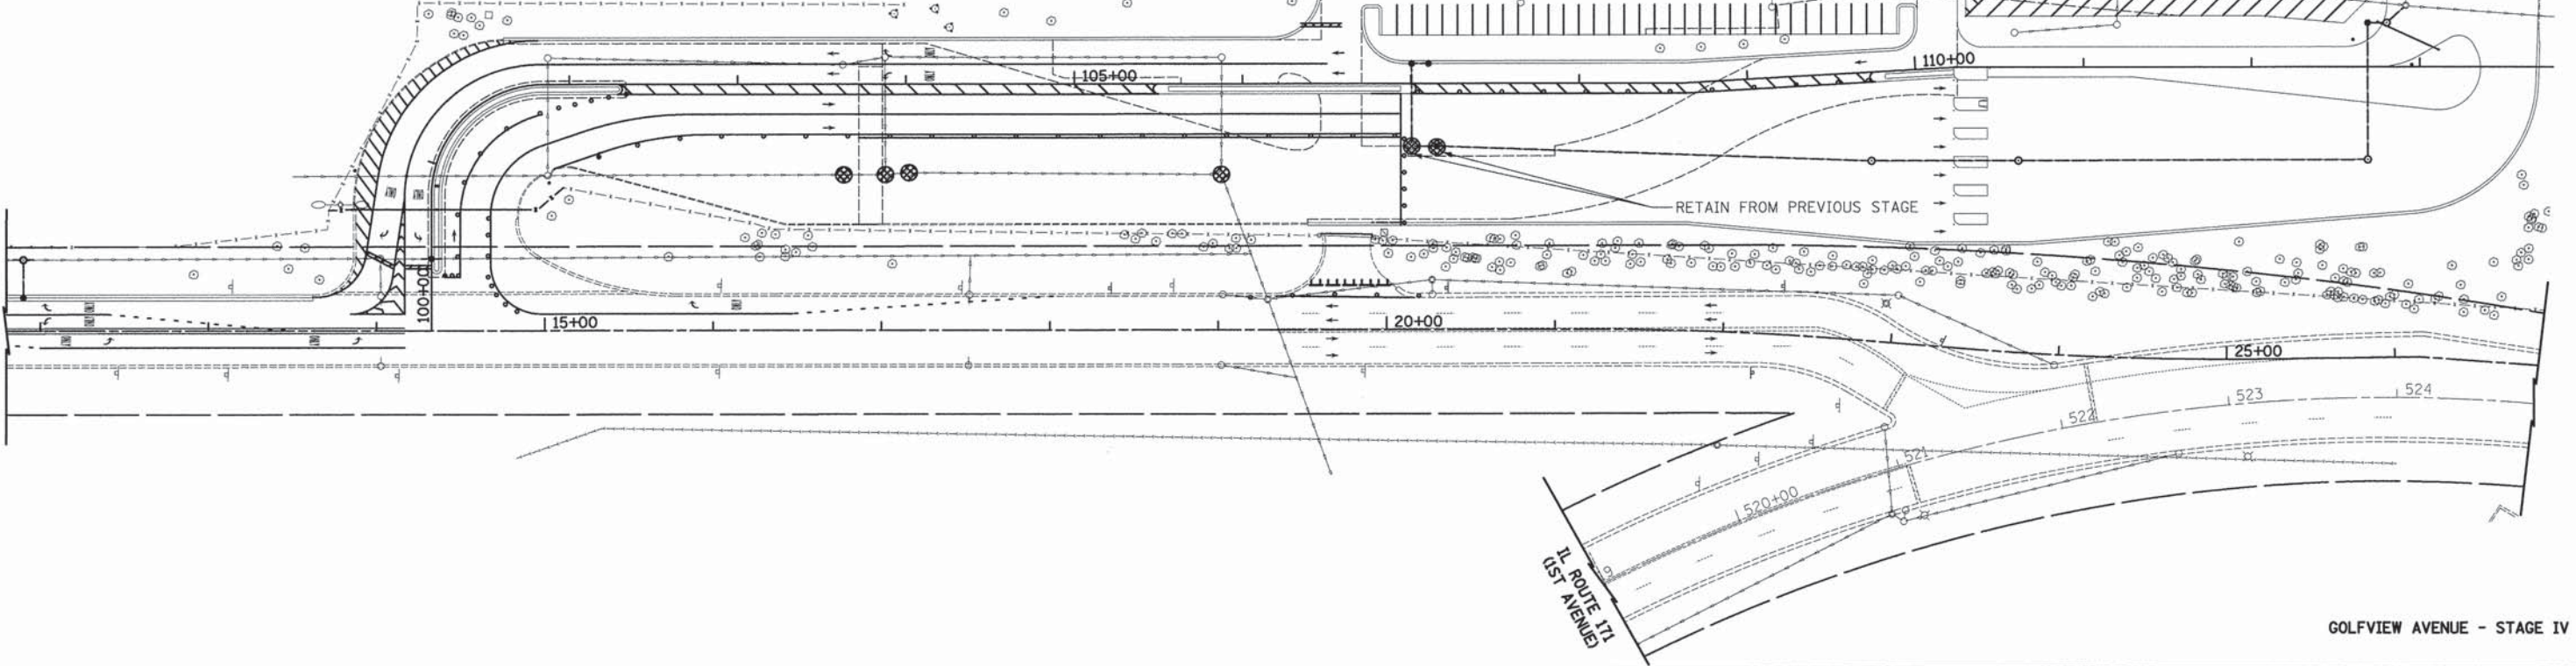

GOLFVIEW AVENUE - STAGE IV

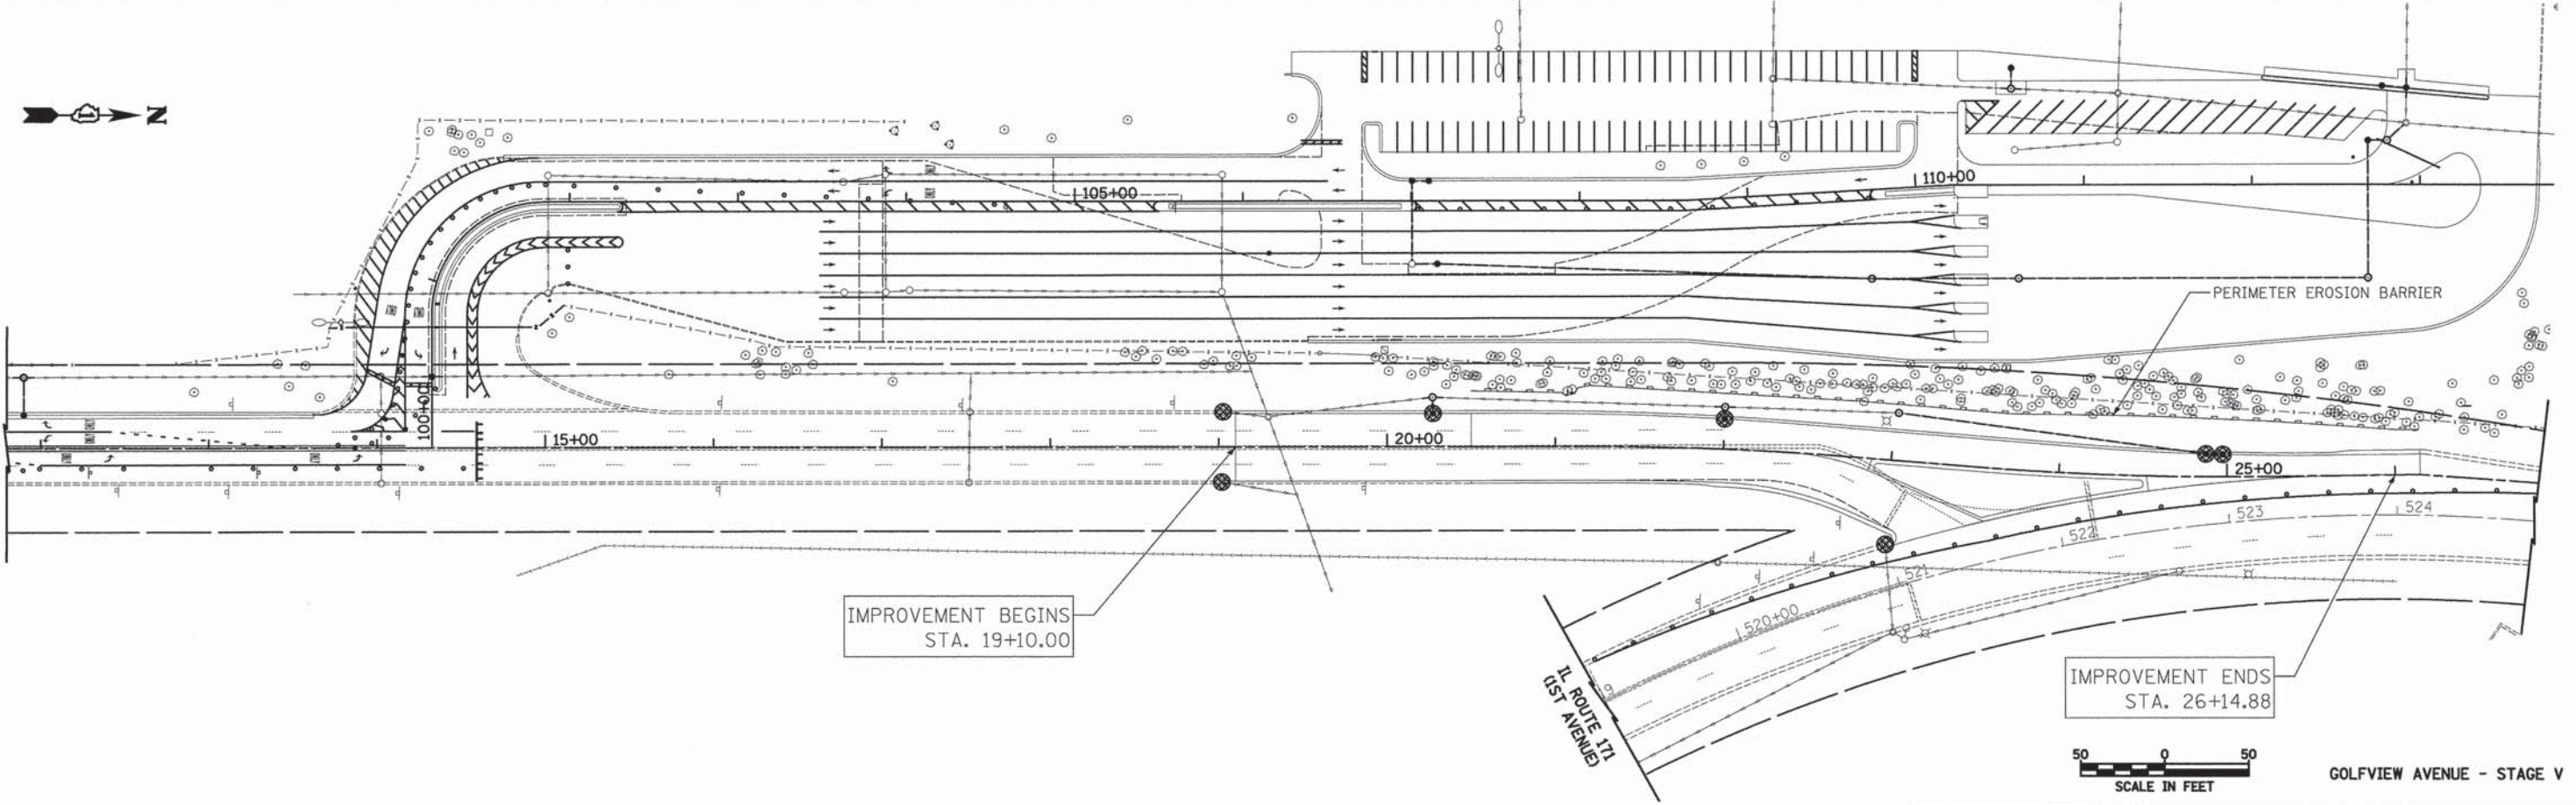

GOLFVIEW AVENUE - STAGE V



FILE NAME = ...2563_ER0_03.dgn	USER NAME = dte	DESIGNED - DTE	REVISED -
		DRAWN - DTE	REVISED -
		CHECKED - GAB	REVISED -
		DATE - 05/13/2013	REVISED -

STATE OF ILLINOIS  
DEPARTMENT OF TRANSPORTATION

EROSION AND SEDIMENT CONTROL - STAGE IV & V


SCALE: 1" = 50' SHEET NO. 3 OF 3 SHEETS STA. 11+80.00 TO STA. 26+14.88

F.A.U. RTE. 3784	SECTION 12-F3000-23-PK	COUNTY COOK	TOTAL SHEETS 131	SHEET NO. 50
FED. ROAD DIST. NO. 1 (ILLINOIS)				FED. AID PROJECT
CONTRACT NO. 63764				





PLAN	SURVEYED	DATE
	ALIGNED	
	NOTED	
	BY	
	NO.	

PROFILE	SURVEYED	DATE
	ALIGNED	
	NOTED	
	BY	
	NO.	

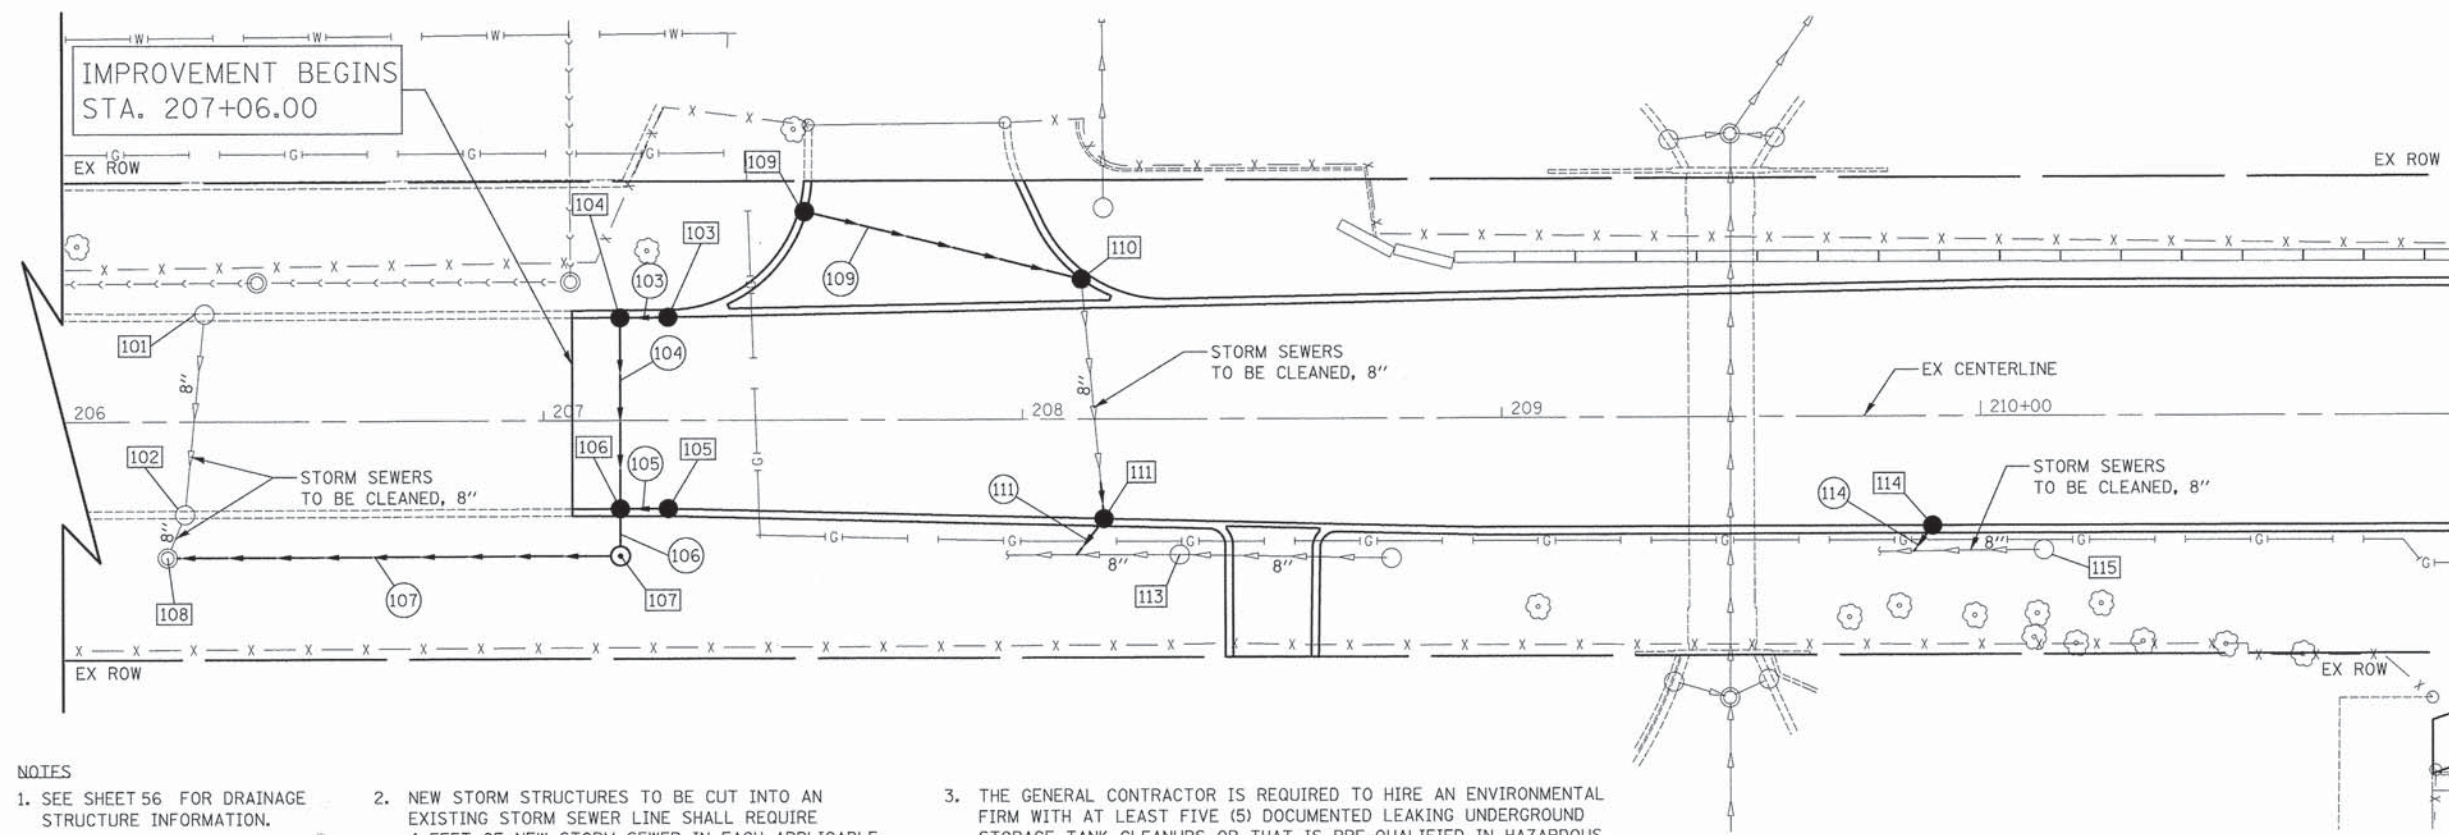

- NOTES**
- SEE SHEET 56 FOR DRAINAGE STRUCTURE INFORMATION.
  - NEW STORM STRUCTURES TO BE CUT INTO AN EXISTING STORM SEWER LINE SHALL REQUIRE 4 FEET OF NEW STORM SEWER IN EACH APPLICABLE DIRECTION. THIS WORK SHALL BE PAID FOR AS THE SAME TYPE AND SIZE OF THE EXISTING SEWER BEING TIED IN TO.
  - THE GENERAL CONTRACTOR IS REQUIRED TO HIRE AN ENVIRONMENTAL FIRM WITH AT LEAST FIVE (5) DOCUMENTED LEAKING UNDERGROUND STORAGE TANK CLEANUPS OR THAT IS PRE-QUALIFIED IN HAZARDOUS WASTE BY THE DEPARTMENT TO REMEDIATE THE SOIL CONTAMINATION AND MONITOR FOR WORKER PROTECTION.

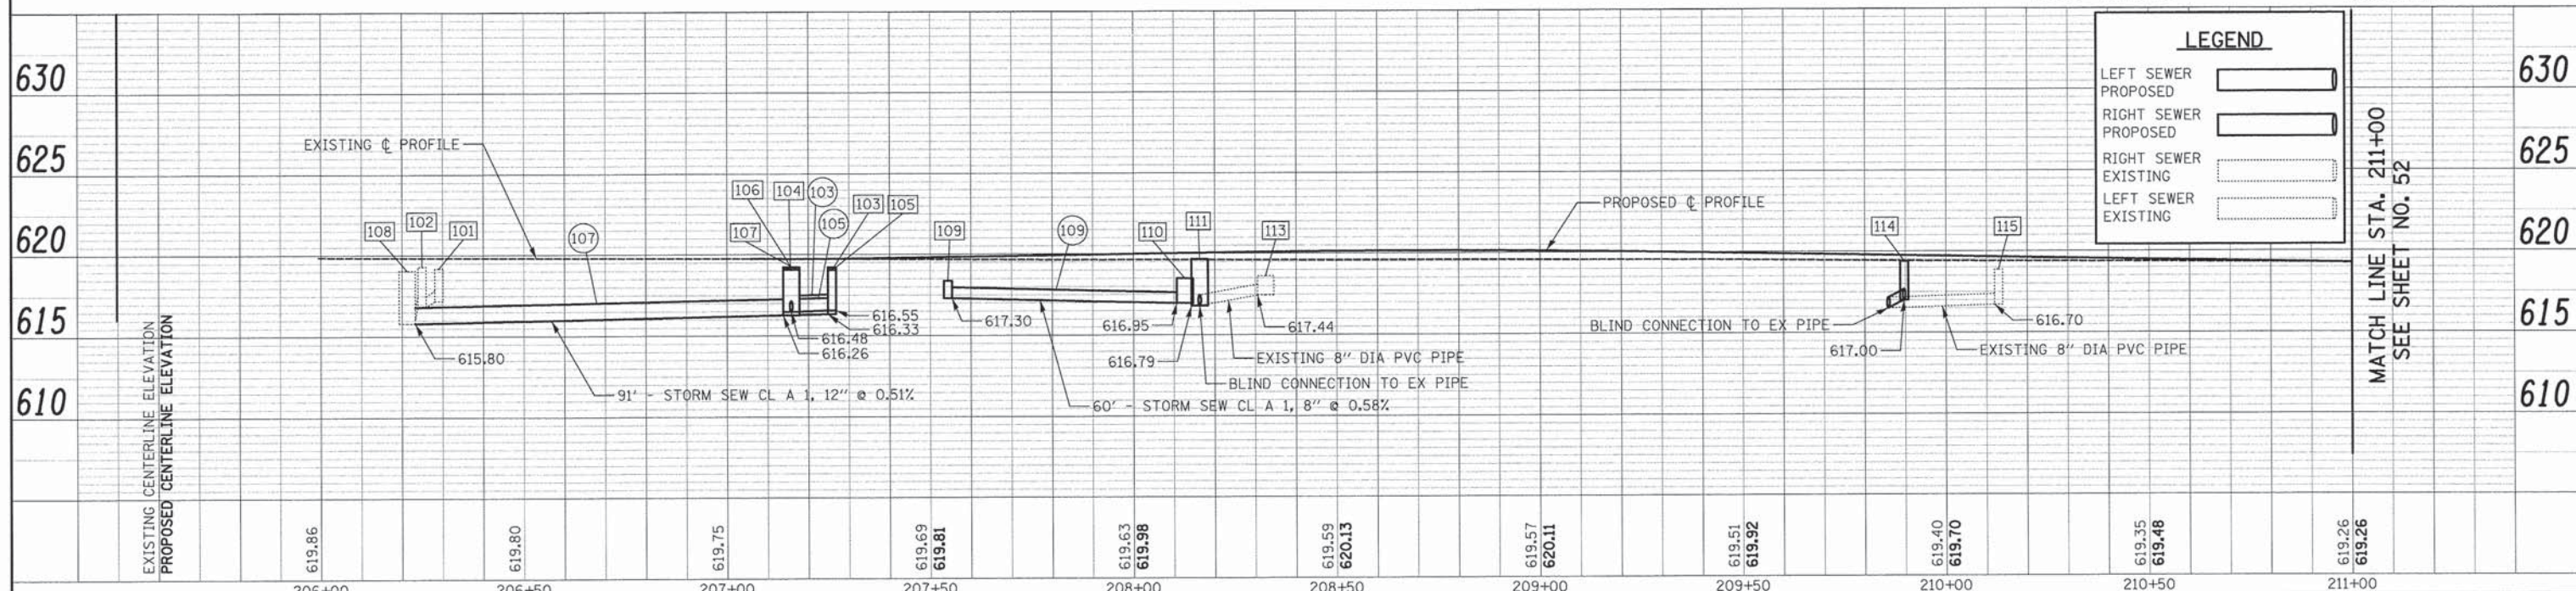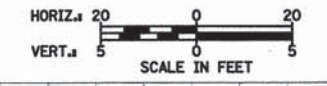

LEGEND	
LEFT SEWER PROPOSED	[Solid line]
RIGHT SEWER PROPOSED	[Solid line]
RIGHT SEWER EXISTING	[Dashed line]
LEFT SEWER EXISTING	[Dashed line]

FILE NAME = ... \2563.D&U.01.dgn	USER NAME = dte	DESIGNED - JES	REVISED -	<b>STATE OF ILLINOIS DEPARTMENT OF TRANSPORTATION</b>	<b>DRAINAGE AND UTILITIES</b>	F.A.U. RTE. 3784	SECTION 12-F3000-23-PK	COUNTY COOK	TOTAL SHEETS 131	SHEET NO. 51	
PLOT SCALE = 20,0000' / in.	CHECKED - GAB	DATE - 05/13/2013	REVISED -			SCALE: 1" = 20'	SHEET NO. 1 OF 6 SHEETS	STA. 206+00 TO STA. 211+00	FED. ROAD DIST. NO. 1 [ILLINOIS]	CONTRACT NO. 63764	
PLOT DATE = 5/23/2013	DATE - 05/13/2013	REVISED -	REVISED -			FED. AID PROJECT					














PLAN	DESIGNED	DATE
	PLOTTED	
	ALIGNED	
	CHECKED	
	BY FILE NAME	
	NO.	


PROFILE	DESIGNED	DATE
	PLOTTED	
	GRADES CHECKED	
	S.M. NOTED	
	STRUCTURE NOTATIONS CHK'D	
	NO.	

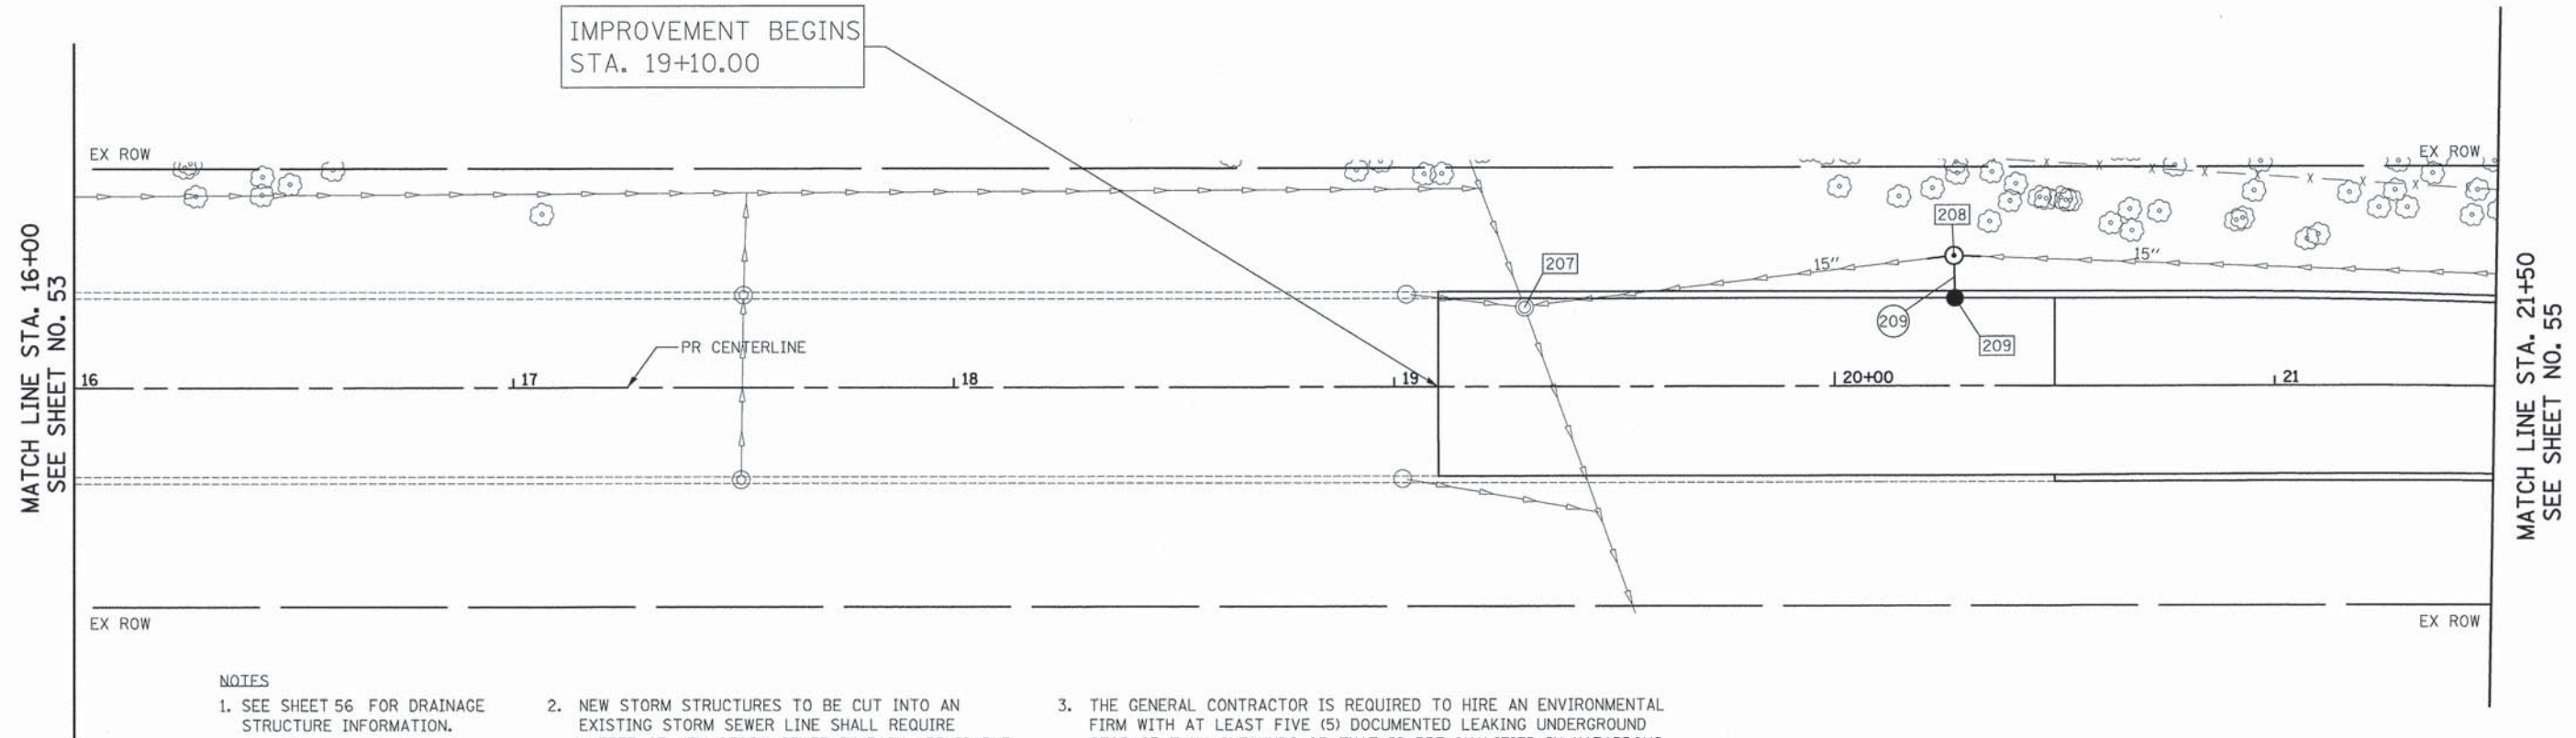

- NOTES
1. SEE SHEET 56 FOR DRAINAGE STRUCTURE INFORMATION.
  2. NEW STORM STRUCTURES TO BE CUT INTO AN EXISTING STORM SEWER LINE SHALL REQUIRE 4 FEET OF NEW STORM SEWER IN EACH APPLICABLE DIRECTION. THIS WORK SHALL BE PAID FOR AS THE SAME TYPE AND SIZE OF THE EXISTING SEWER BEING TIED IN TO.
  3. THE GENERAL CONTRACTOR IS REQUIRED TO HIRE AN ENVIRONMENTAL FIRM WITH AT LEAST FIVE (5) DOCUMENTED LEAKING UNDERGROUND STORAGE TANK CLEANUPS OR THAT IS PRE-QUALIFIED IN HAZARDOUS WASTE BY THE DEPARTMENT TO REMEDIATE THE SOIL CONTAMINATION AND MONITOR FOR WORKER PROTECTION.



GOLFVIEW AVENUE

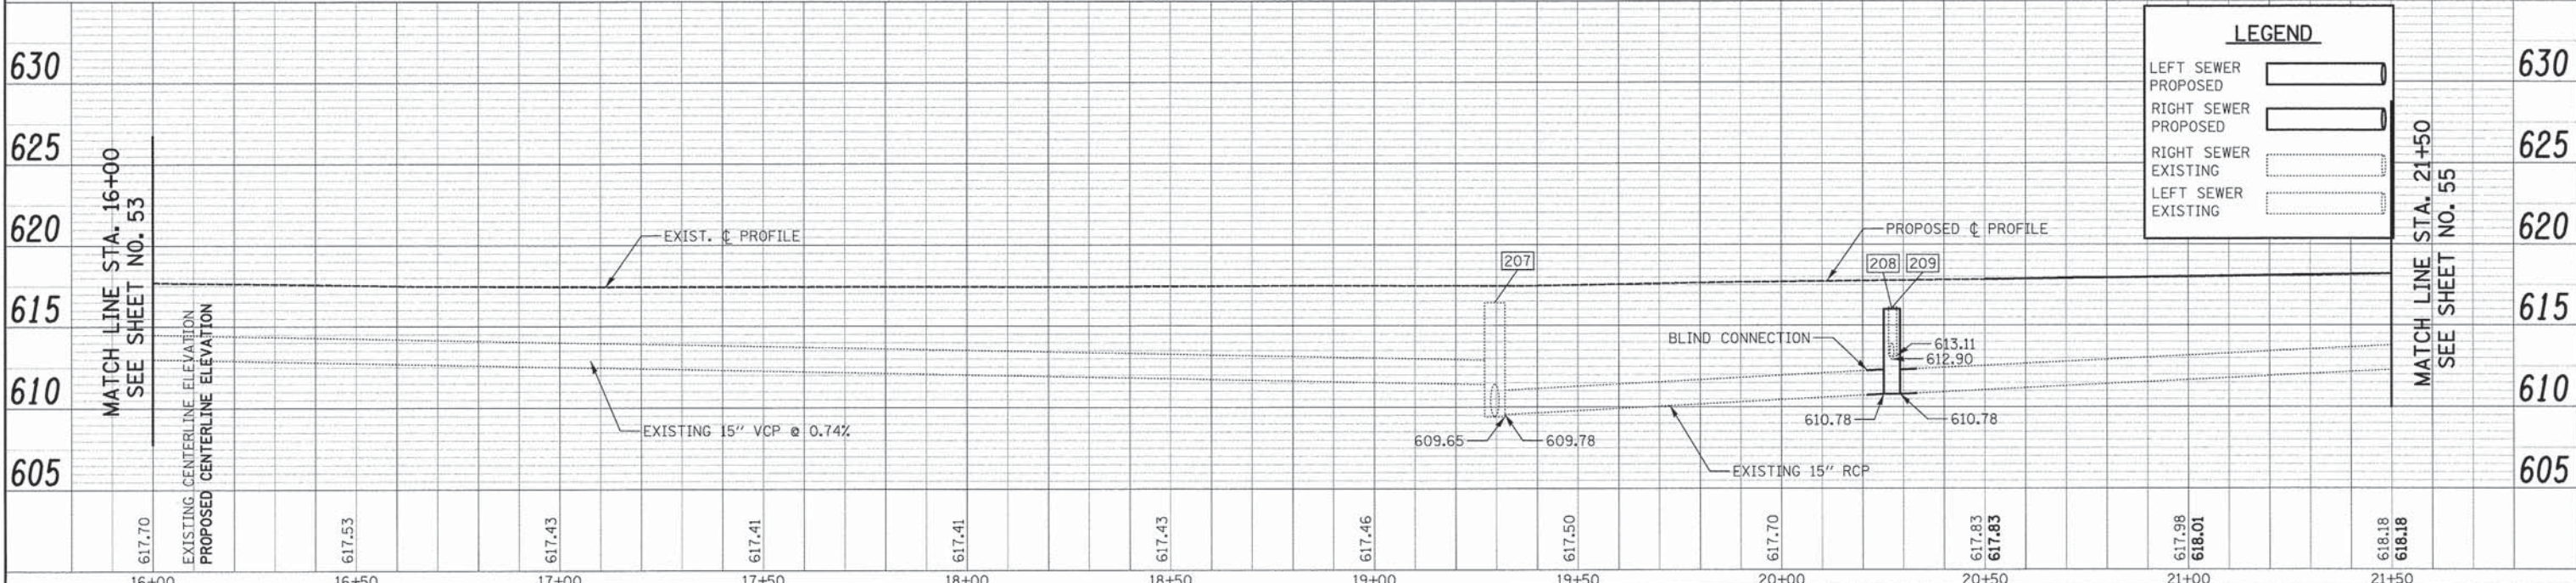


LEGEND	
LEFT SEWER PROPOSED	
RIGHT SEWER PROPOSED	
RIGHT SEWER EXISTING	
LEFT SEWER EXISTING	

FILE NAME = ...\\2563.D&U.84.dgn	USER NAME = dte	DESIGNED - DTE	REVISED -	<b>STATE OF ILLINOIS DEPARTMENT OF TRANSPORTATION</b>	<b>DRAINAGE AND UTILITIES</b>	F.A.U. RTE. 3784	SECTION 12-F3000-23-PK	COUNTY COOK	TOTAL SHEETS 131	SHEET NO. 54		
PLDT SCALE = 20.0000' / 1"	CHECKED - GAB	REVISED -	SCALE: 1" = 20'			SHEET NO. 4 OF 6 SHEETS	STA. 16+00 TO STA. 21+50	FED. ROAD DIST. NO. 1 [ILLINOIS]	FED. AID PROJECT	CONTRACT NO. 63764		
PLDT DATE = 5/23/2013	DATE - 05/13/2013	REVISED -										




PLAN	SURVEYED	BY	DATE
NOTE BOOK	ALIGNED		
NO.	RT. OF WAY CHECKED		
	POD FILE NAME		

PROFILE	SURVEYED	BY	DATE
NOTE BOOK	GRADES CHECKED		
NO.	S.M. NOTED		
	STRUCTURE NOTATIONS CHKD		

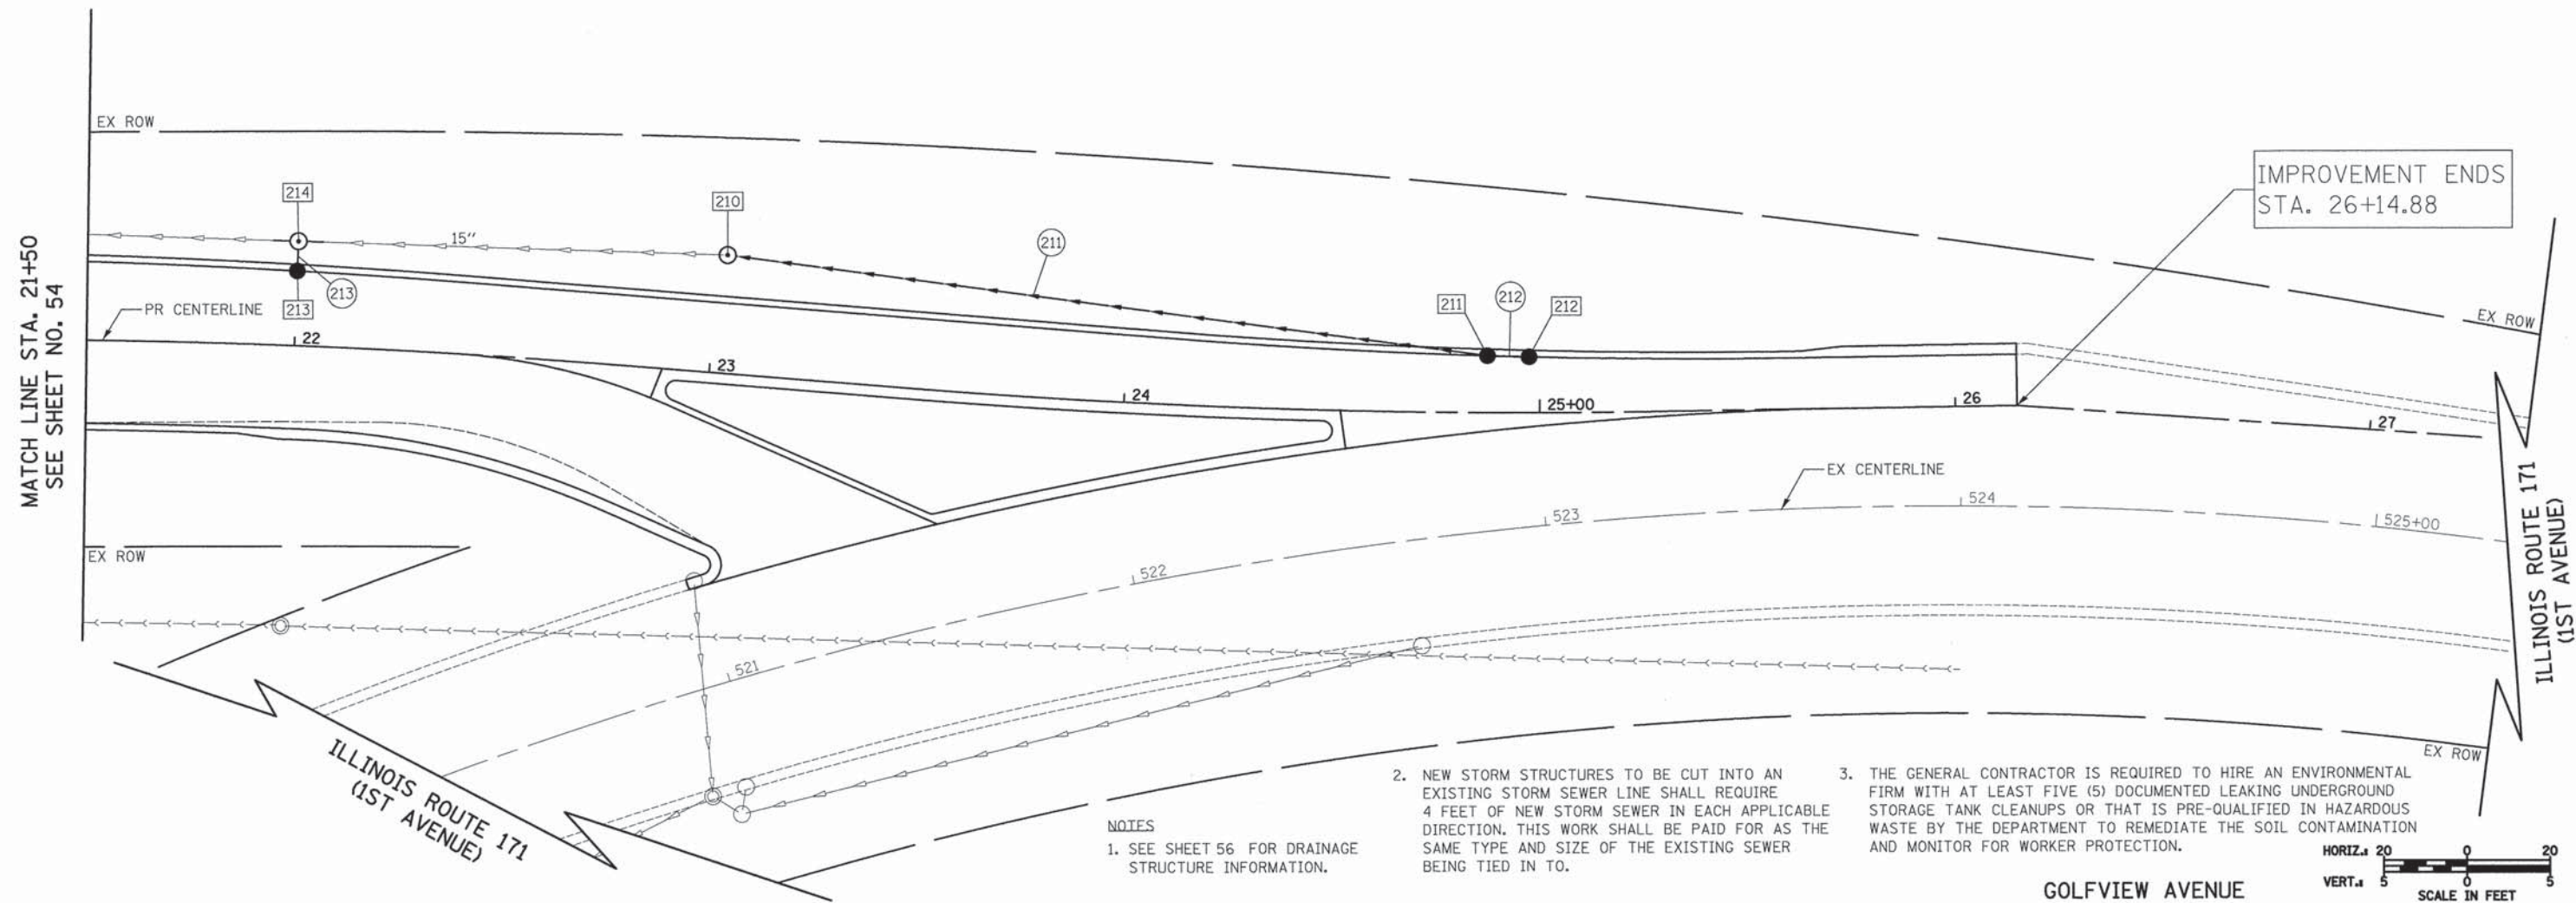

**NOTES**

1. SEE SHEET 56 FOR DRAINAGE STRUCTURE INFORMATION.
2. NEW STORM STRUCTURES TO BE CUT INTO AN EXISTING STORM SEWER LINE SHALL REQUIRE 4 FEET OF NEW STORM SEWER IN EACH APPLICABLE DIRECTION. THIS WORK SHALL BE PAID FOR AS THE SAME TYPE AND SIZE OF THE EXISTING SEWER BEING TIED IN TO.
3. THE GENERAL CONTRACTOR IS REQUIRED TO HIRE AN ENVIRONMENTAL FIRM WITH AT LEAST FIVE (5) DOCUMENTED LEAKING UNDERGROUND STORAGE TANK CLEANUPS OR THAT IS PRE-QUALIFIED IN HAZARDOUS WASTE BY THE DEPARTMENT TO REMEDIATE THE SOIL CONTAMINATION AND MONITOR FOR WORKER PROTECTION.

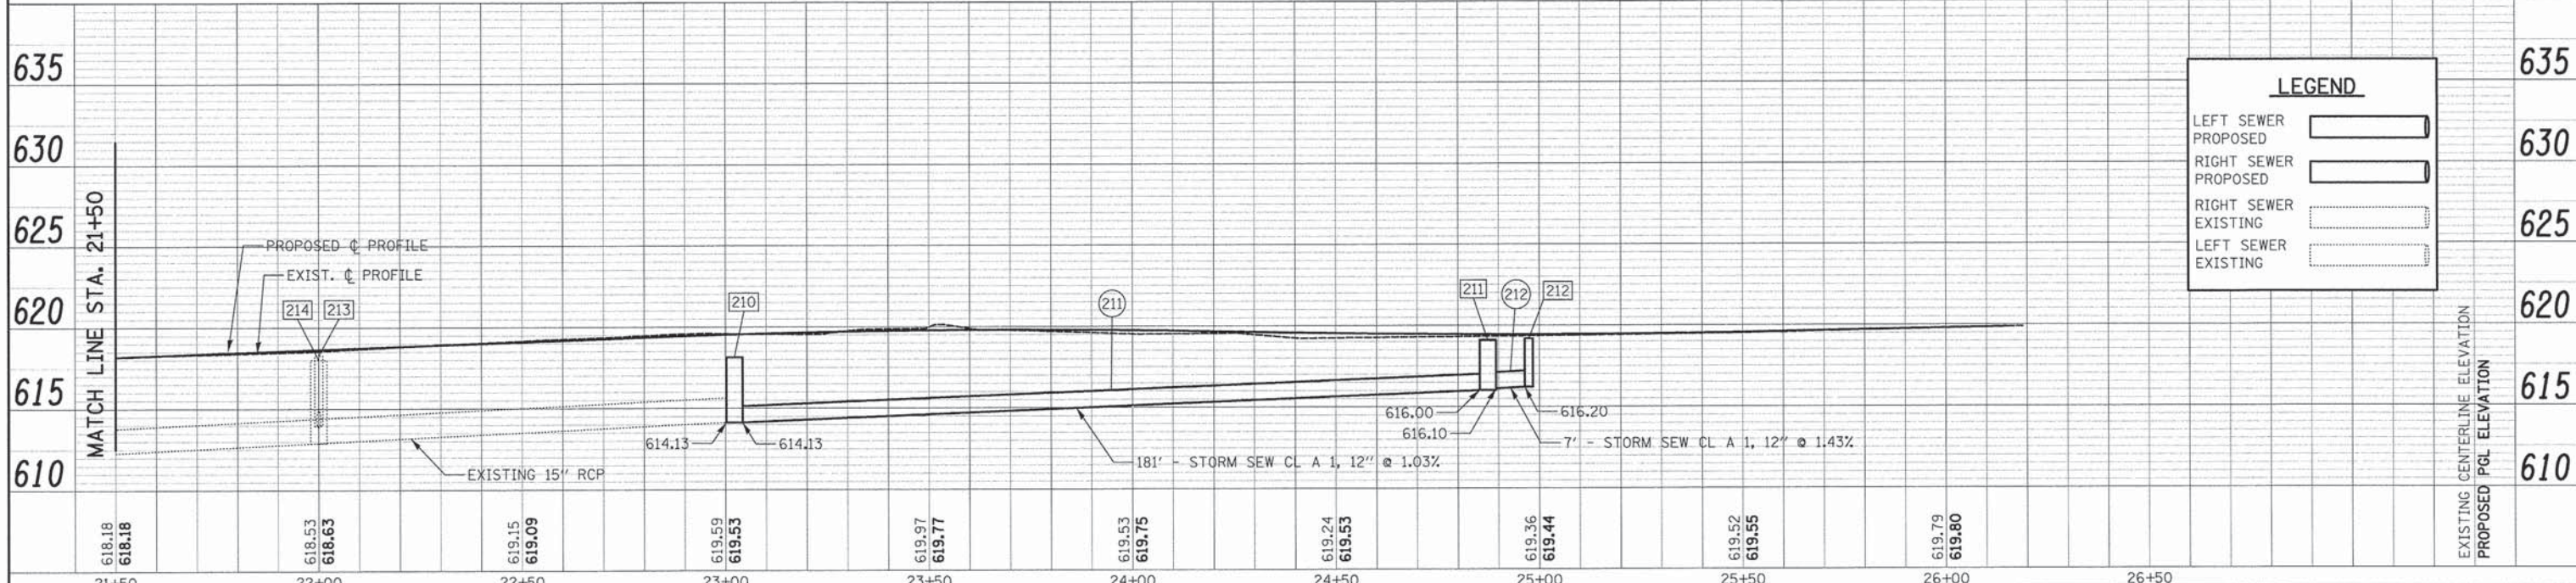

LEGEND	
LEFT SEWER PROPOSED	
RIGHT SEWER PROPOSED	
RIGHT SEWER EXISTING	
LEFT SEWER EXISTING	

FILE NAME = ...2563.D&U.05.dgn	USER NAME = dte	DESIGNED - JES	REVISED -	<b>STATE OF ILLINOIS DEPARTMENT OF TRANSPORTATION</b>	<b>DRAINAGE AND UTILITIES</b>	F.A.U. RTE. 3784	SECTION 12-F3000-23-PK	COUNTY COOK	TOTAL SHEETS 131	SHEET NO. 55	
PLT SCALE = 20.0000' / in.	CHECKED - GAB	REVISIONS	SCALE: 1" = 20'			SHEET NO. 5 OF 6 SHEETS	STA. 21+50 TO STA. 26+15	FED. ROAD DIST. NO. 1 [ILLINOIS]	CONTRACT NO. 63764		
PLT DATE = 5/23/2013	DATE - 05/13/2013	REVISIONS	FED. AID PROJECT								



PLAN	SURVEYED	DATE
NOTE BOOK	ALIGNED	
	CHECKED	
	P.T. OF WAY CHECKED	
	ROAD FILE NAME	

PROFILE	SURVEYED	DATE
NOTE BOOK	GRADES CHECKED	
	S.M. NOTED	
	STRUCTURE NOTATIONS CHECKED	

101 STA. 206+29.23, 22.5 LT  
EXISTING CB  
CB CLEANED  
RIM = 619.18

102 STA. 206+25.09, 19.6 RT  
EXISTING CB  
CB CLEANED  
RIM = 619.29

103 STA. 207+26.00, 21.5' LT  
CB TC T12F&G  
RIM = 619.05  
INV = 616.55 (W)

104 STA. 207+16.00, 21.6' LT  
CB TA 4 DIA T12F&G  
RIM = 619.06  
INV = 616.48 (E)  
INV = 616.48 (S)

105 STA. 207+26.00, 18.6' RT  
CB TC T12F&G  
RIM = 619.21  
INV = 616.33 (W)

106 STA. 207+16.00, 18.6' RT  
CB TA 4 DIA T12F&G  
RIM = 619.22  
INV = 616.29 (N)  
INV = 616.29 (E)  
INV = 616.29 (S)

107 STA. 207+16.00, 28.4' RT  
MAN TA 4 DIA T1F CL  
RIM = 619.20  
INV = 616.26 (N)  
INV = 616.26 (W)

108 STA. 206+21.45, 28.6 RT  
EXISTING CB  
RIM = 619.05  
INV = 616.05 EX (N)  
INV = 615.80 (E)

109 STA. 207+54.57, 43.6' LT  
CB TC T12F&G  
RIM = 618.95  
INV = 617.30 (SE)

110 STA. 208+12.31, 29.4' LT  
CB TA 4 DIA T12F&G  
RIM = 619.45  
INV = 616.95 (NW)  
INV = 616.95 EX (S)

111 STA. 208+16.51, 19.3' RT  
CB TA 4 DIA T12F&G  
RIM = 619.65  
INV = 616.79 (NW)  
INV = 616.79 (SE)

113 STA. 208+32.73, 28.5 RT  
EXISTING CB  
RIM = 618.61  
INV = 617.44 (E)  
INV = 617.44 (W)

114 STA. 209+89.90, 23.0 RT  
CB TC T12F&G  
RIM = 619.39  
INV = 617.00 (SW)

115 STA. 210+13.17, 28.1 RT  
EXISTING MANHOLE  
DRAINAGE STR CLEANED  
RIM = 618.87

116 STA. 211+87.05, 25.8' LT  
CB TA 4 DIA T12 F&G  
RIM = 617.99  
INV = 615.04 (N)  
INV = 615.04 (SE)  
INV = 615.04 (NW)

116A STA. 211+91.71, 74.2' LT  
CB TC T12 F&G  
RIM = 618.00  
INV = 615.20 (S)

117 STA. 211+70.49, 68.2' LT  
MAN TA 4 DIA T1F CL  
RIM = 618.85  
INV = 615.10 EX (N)  
INV = 615.10 (E)

118 STA. 212+49.74, 47.4' LT  
CB TA 4 DIA T24F&G  
RIM = 617.95  
INV = 614.80 (NW)

119 STA. 212+89.83, 36.9 LT  
MAN TA 4 DIA T1F CL  
RIM = 617.00  
INV = 614.66 (NW)  
INV = 614.66 (E)

120 STA. 213+68.87, 34.0 LT  
MAN TA 4 DIA T1F CL  
RIM = 617.00  
INV = 614.39 (W)  
INV = 614.39 (E)

121 STA. 214+01.05, 43.8 LT  
PRC FLAR END SEC 15  
RIM = 615.71  
INV = 614.27 (SW)

122 STA. 214+32.06, 25.0' LT  
CB TC T24F&G  
RIM = 617.87  
INV = 615.09 (NE)

123 STA. 214+34.88, 32.3 LT  
MAN TA 4 DIA T1F CL  
RIM = 617.81  
INV = 614.81 (E)  
PR INV = 614.91 (SW)

124 STA. 212+17.24, 23.0' RT  
CB TC T12F&G  
RIM = 618.50  
INV = 616.20 (SE)

125 STA. 212+33.23, 27.3' RT  
MAN ADJUST  
RIM = 618.35  
INV = 616.01 EX (E)  
PR INV = 616.01 (NW)

126 STA. 214+28.63, 21.2 RT  
CB TC T12F&G  
RIM = 617.96  
INV = 615.35 (SE)

127 STA. 214+33.43, 23.9 RT  
MAN TA 4 DIA T1F CL  
RIM = 618.26  
INV = 615.28 (W)  
INV = 615.21 (E)  
INV = 615.28 (NW)

200 STA. 11+90.00, 20.0' LT  
CB TC T12F&G  
RIM = 618.06  
INV = 616.20 (W)

201 STA. 11+90.01, 42.5' LT  
MAN TA 4 DIA T1 CL  
RIM = 618.05  
INV = 616.00 (E)  
INV = 615.43 EX (S)  
INV = 615.43 EX (N)

202 STA. 14+02.55, 21.0 RT  
EXISTING CB  
CB CLEANED  
EX RIM = 617.08

203 STA. 14+02.59, 20.8 LT  
EXISTING CB  
CB CLEANED  
EX RIM = 616.98

204 STA. 14+12.30, 43.1 LT  
EXISTING MH  
DRAINAGE STR CLEANED  
EX RIM = 617.96  
INV = 614.03 EX (N)  
INV = 614.03 EX (S)  
INV = 614.03 EX (E)

205 STA. 14+32.75, 42.9' LT  
CB TA 4 DIA T12F&G  
RIM = 618.00  
INV = 613.83 EX (N)  
INV = 613.83 EX (S)

207 STA. 19+29.60, 18.07 LT  
MAN ADJUST  
EX RIM = 616.65  
PR RIM = 616.65  
INV = 609.78 EX (N)  
INV = 609.65 EX (NE)  
INV = 609.65 EX (SW)  
INV = 611.64 EX (SW)  
INV = 613.00 EX (S)

208 STA. 20+27.13, 29.7 LT  
MAN TA 4 DIA T1F CL  
RIM = 616.61  
INV = 612.90 (E)  
INV = 610.78 EX (N)  
INV = 610.78 EX (S)

209 STA. 20+27.33, 21.0 LT  
CB TC T12F&G  
RIM = 617.11  
INV = 613.11 (W)

210 STA. 23+02.21, 28.5' LT  
MAN TA 4 DIA T1F CL  
RIM = 618.13  
INV = 614.13 EX (S)  
INV = 614.13 (N)

211 STA. 24+87.36, 13.6' LT  
CB TA 4 DIA T12F&G  
RIM = 619.18  
INV = 616.10 (N)  
INV = 616.00 (S)

212 STA. 24+97.44, 13.4' LT  
CB TC T12F&G  
RIM = 619.18  
INV = 616.20 (S)

213 STA. 22+00, 18.0' LT  
CB TC T12F&G  
RIM = 618.27  
INV = 613.96 (W)

214 STA. 22+00, 25.2' LT  
MAN TA 4 DIA T1F CL  
RIM = 618.38  
INV = 613.88 (E)  
INV = 612.88 EX (N)  
INV = 612.88 EX (S)

103 7' - STORM SEWERS, CL A, TYPE 1 12" @ 1.00%  
TBF = 1.1 CU YD

104 37' - STORM SEWERS, CL A, TYPE 1 12" @ 0.51%  
TBF = 6.8 CU YD

105 7' - STORM SEWERS, CL A, TYPE 1 12" @ 0.57%  
TBF = 1.4 CU YD

106 6' - STORM SEWERS, CL A, TYPE 1 12" @ 0.50%  
TBF = 0.6 CU YD

107 91' - STORM SEWERS, CL A, TYPE 1 12" @ 0.51%  
TBF = 0.0 CU YD

109 60' - STORM SEWERS, CL B, TYPE 1 8" @ 0.58%  
TBF = 8.3 CU YD

111 8' - STORM SEWERS, CL B, TYPE 1 8" @ 0.50%  
TBF = 0.0 CU YD

114 6' - STORM SEWERS, CL B, TYPE 1 8" @ 0.50%  
TBF = 0.0 CU YD

116 65' - STORM SEWERS, CL A, TYPE 1 15" @ 0.37%  
TBF = 18.3 CU YD

116A 10' - STORM SEWERS, CL A, TYPE 1 12" @ 1.60%  
TBF = 1.9 CU YD

117 12' - STORM SEWERS, CL A, TYPE 1 15" @ 0.50%  
TBF = 0.7 CU YD

118 39' - STORM SEWERS, CL A, TYPE 1 15" @ 0.36%  
TBF = 0.8 CU YD

119 76' - STORM SEWERS, CL A, TYPE 1 15" @ 0.36%  
TBF = 4.2 CU YD

120 26' - STORM SEWERS, CL A, TYPE 1 15" @ 0.38%  
TBF = 0.0 CU YD

122 5' - STORM SEWERS, CL A, TYPE 1 12" @ 3.60%  
TBF = 0.8 CU YD

124 13' - STORM SEWERS, CL A, TYPE 1 12" @ 1.46%  
TBF = 1.7 CU YD

126 3' - STORM SEWERS, CL A, TYPE 1 12" @ 2.33%  
TBF = 0.5 CU YD

200 19' - STORM SEWERS, CL A, TYPE 1 12" @ 1.05%  
TBF = 0.3 CU YD

209 6' - STORM SEWERS, CL A, TYPE 2 12" @ 3.50%  
TBF = 1.5 CU YD

211 181' - STORM SEWERS, CL A, TYPE 1 12" @ 1.03%  
TBF = 16.7 CU YD

212 7' - STORM SEWERS, CL A, TYPE 1 12" @ 1.43%  
TBF = 1.6 CU YD

213 4' - STORM SEWERS, CL A, TYPE 2 12" @ 2.00%  
TBF = 0.7 CU YD

NOTES:

- STATIONS AND OFFSETS ARE TO THE CENTER OF THE STRUCTURE.
- CURB STRUCTURE RIM ELEVATIONS ARE LOCATED AT THE EDGE OF PAVEMENT.

FILE NAME = ...2563.D&U.06.dgn	USER NAME = dte	DESIGNED - JES	REVISED -	<b>STATE OF ILLINOIS DEPARTMENT OF TRANSPORTATION</b>	<b>DRAINAGE AND UTILITY PLAN</b>	F.A.U. RTE. 3784	SECTION 12-F3000-23-PK	COUNTY COOK	TOTAL SHEETS 131	SHEET NO. 56	
PLOT SCALE = 28.0000' / 1" =	CHECKED - GAB	REVISED -	SCALE:			SHEET NO. 6 OF 6 SHEETS	STA TO STA	CONTRACT NO. 63764			
PLOT DATE = 5/6/2013	DATE - 05/13/2013	REVISED -				FED. ROAD DIST. NO. 1 ILLINOIS					
						FED. AID PROJECT					




STORM STRUCTURES

- [N6] STA. 109+70.92, 52.9' RT  
MAN TA 5 DIA TIF OL  
RIM = 618.80  
INV = 613.38 (N)  
INV = 613.38 (S)
- [N7] STA. 107+00.44, 37.4' RT  
EXISTING CB  
RIM = 617.52  
EX INV = 613.17 (NW)  
INV = 614.18 (N)  
INV = 614.18 (W)
- [N7A] STA. 107+15.43, 37.9' LT  
CB TA 4 DIA TIF OL  
RIM = 617.65  
INV = 614.15 (N)  
INV = 614.15 (S)
- [N8] STA. 107+00.44, 12.0' LT  
CB TA 4 DIA T12F&G  
RIM = 617.85  
INV = 614.63 (N)  
INV = 614.63 (E)
- [N9] STA. 107+10.44, 12.0' LT  
CB TC T12F&G  
RIM = 617.70  
INV = 614.70 (S)

STORM SEWER PIPES

- (164) 7' - STORM SEWERS, CL A, TYPE 1 12" @ 1.00%  
TBF = 1.4 CU YD
- (165) 45' - STORM SEWERS, CL A, TYPE 1 12" @ 1.00%  
TBF = 9.2 CU YD
- (166) 11' - STORM SEWERS, CL A, TYPE 1 24" @ 0.27%  
TBF = 4.4 CU YD
- (167) 255' - STORM SEWERS, CL A, TYPE 1 24" @ 0.30%  
TBF = 105.1 CU YD
- (168) 82' - STORM SEWERS, CL A, TYPE 1 36" @ 0.20%  
TBF = 87.2 CU YD

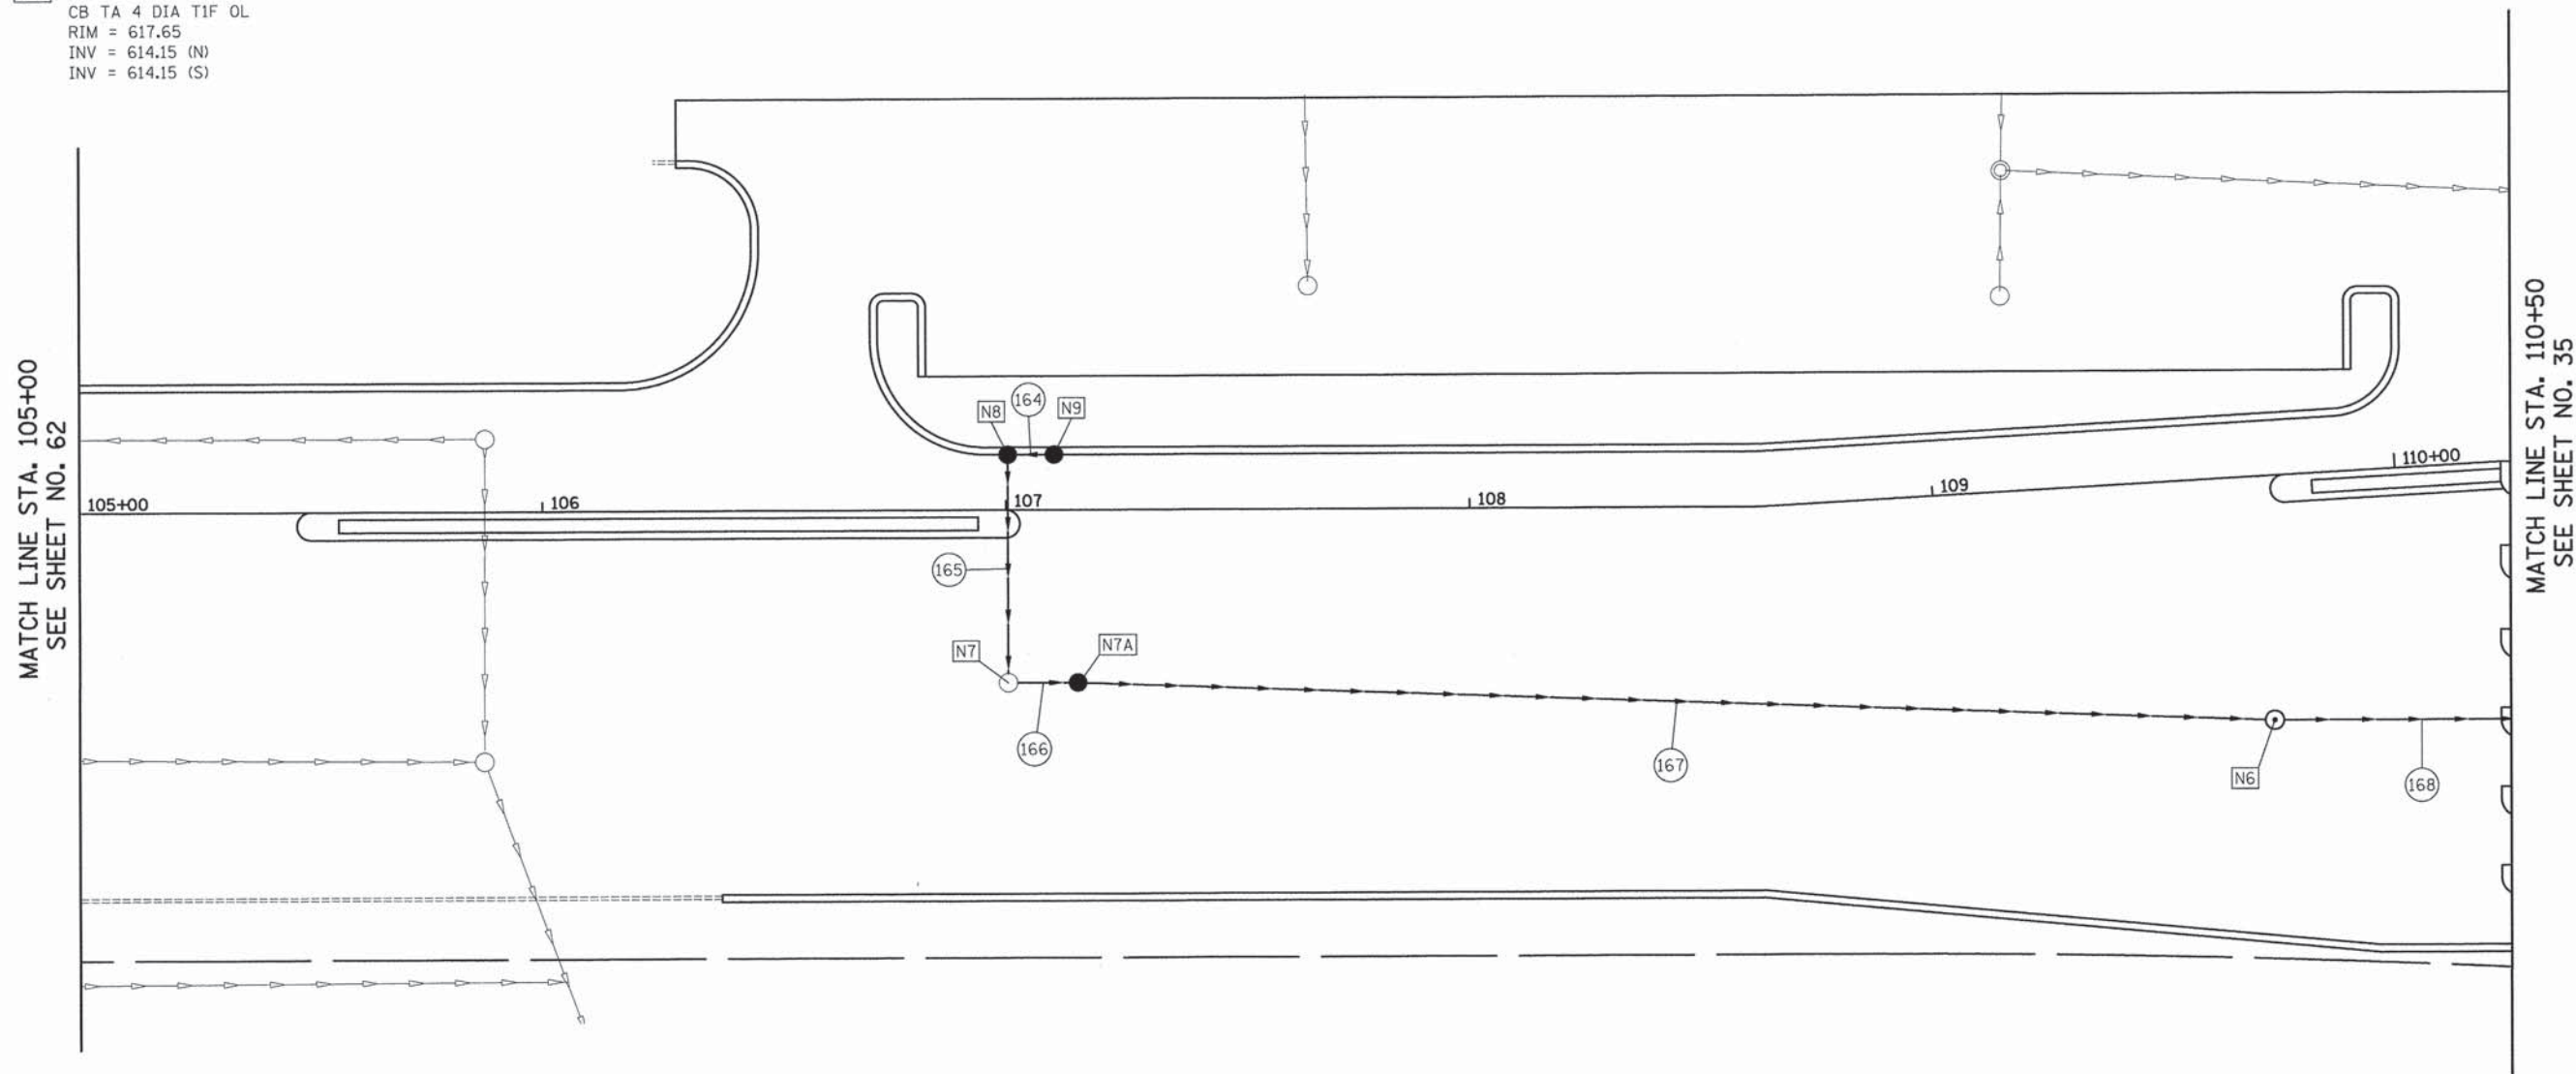

NOTES:

1. STATIONS AND OFFSETS ARE TO THE CENTER OF THE STRUCTURE.
2. RIM ELEVATIONS FOR CURB INLETS ARE AT THE FLOW LINE.

BROOKFIELD ZOO NORTH PARKING LOT



FILE NAME = ...2563_L0T_04_NoDET.dgn	USER NAME = dte	DESIGNED - DTE	REVISED -	<b>STATE OF ILLINOIS DEPARTMENT OF TRANSPORTATION</b>	<b>BROOKFIELD ZOO NORTH PARKING LOT PLAN</b>	F.A.U. RTE. 3784	SECTION 12-F3000-23-PK	COUNTY COOK	TOTAL SHEETS 131	SHEET NO. 57
PLOT SCALE = 20,0000 ' / in.				SCALE: 1" = 20'		SHEET NO. 4 OF 6 SHEETS		CONTRACT NO. 63764		
PLOT DATE = 5/6/2013				DATE - 05/13/2013		STA. 105+00 TO STA. 110+50		FED. ROAD DIST. NO. - [ILLINOIS] FED. AID PROJECT		



STORM STRUCTURES



- [3] STA. 112+91.59, 36.6' LT  
MAN ADJ NEW TIF CL  
EX RIM = 618.15  
PR RIM = 618.15  
INV = UNKNOWN (W,S,N)  
INV = 612.56 (SE)
- [8] STA. 111+19.90, 25.4' LT  
CB ADJUST  
EX RIM = 617.18  
PR RIM = 617.50
- [9] STA. 112+91.59, 36.6' LT  
CB ADJ NEW T8G  
EX RIM = 618.94  
PR RIM = 618.94
- [N1] STA. 112+77.31, 58.8' LT  
CB TC T12F&G  
RIM = 618.85  
INV = 613.80 (N)
- [N2] STA. 112+91.80, 57.5' LT  
CB TA 4 DIA T12 F&G  
RIM = 618.95  
INV = 610.00 EX (E)  
INV = 610.00 EX (W)  
INV = 613.56 (S)
- [N3] STA. 112+68.91, 26.3' LT  
CB TA 5 DIA T8G  
RIM = 618.00  
INV = 612.66 (N)  
INV = 612.66 (E)
- [N5] STA. 110+61.32, 55.8' RT  
MAN TA 5 DIA T1F OL  
RIM = 619.75  
INV = 613.22 (N)  
INV = 613.22 (S)
- [N11] STA. 110+57.72, 78.2' LT  
CB TC T12F&G  
RIM = 617.85  
INV = 611.85 (E)
- [N12] STA. 110+56.80, 57.3' LT  
MAN TA 4 DIA T1F CL  
RIM = 618.44  
INV = 609.70 EX (S)  
INV = 609.70 EX (N)  
INV = 609.70 (E)  
INV = 611.70 (W)
- [N13] STA. 112+69.03, 55.4' RT  
MAN TA 5 DIA T1F CL  
RIM = 622.33  
INV = 612.81 (N)  
INV = 612.81 (W)  
INV = 612.81 (S)
- [N14] STA. 112+93.26, 26.3' RT  
MAN TA 6D T1F CL R-P  
RIM = 618.42  
INV = 612.65 (NW)  
INV = 612.65 (S)

STORM SEWER PIPES

- (160) 12' - STORM SEWERS, CL A, TYPE 2 12" @ 2.00%  
TBF = 7.8 CU YD
- (161) 77' - STORM SEWERS, CL A, TYPE 2 36" @ 0.19%  
TBF = 81.5 CU YD
- (163) 10' - STORM SEWERS, CL A, TYPE 2 12" @ 1.50%  
TBF = 4.1 CU YD
- (169) 203' - STORM SEWERS, CL A, TYPE 2 36" @ 0.20%  
TBF = 316.1 CU YD
- (170) 6' - STORM SEWERS, CL A, TYPE 1 36" @ 0.17%  
TBF = 15.6 CU YD
- (171) 9' - STORM SEWERS, CL A, TYPE 2 24" @ 1.00%  
TBF = 7.6 CU YD



MATCH LINE STA. 110+25  
SEE SHEET NO. 34

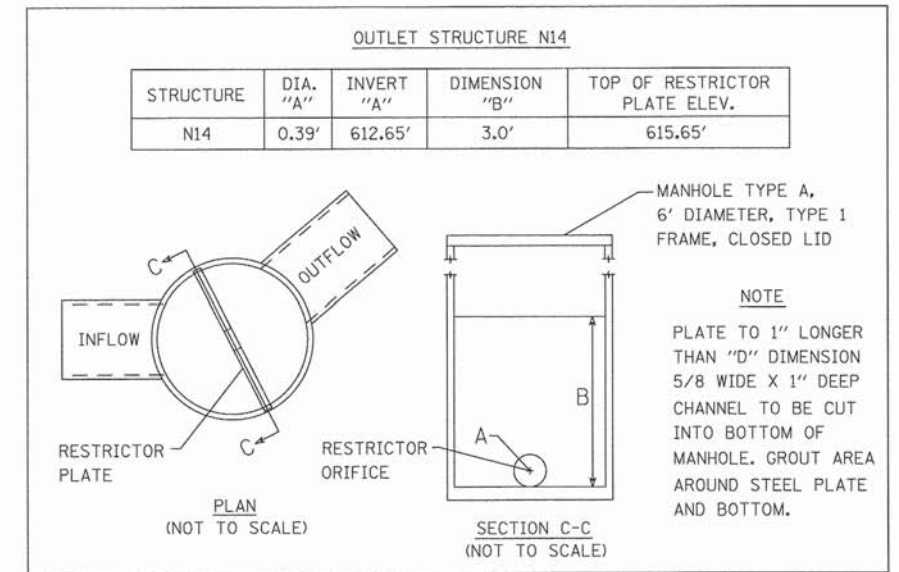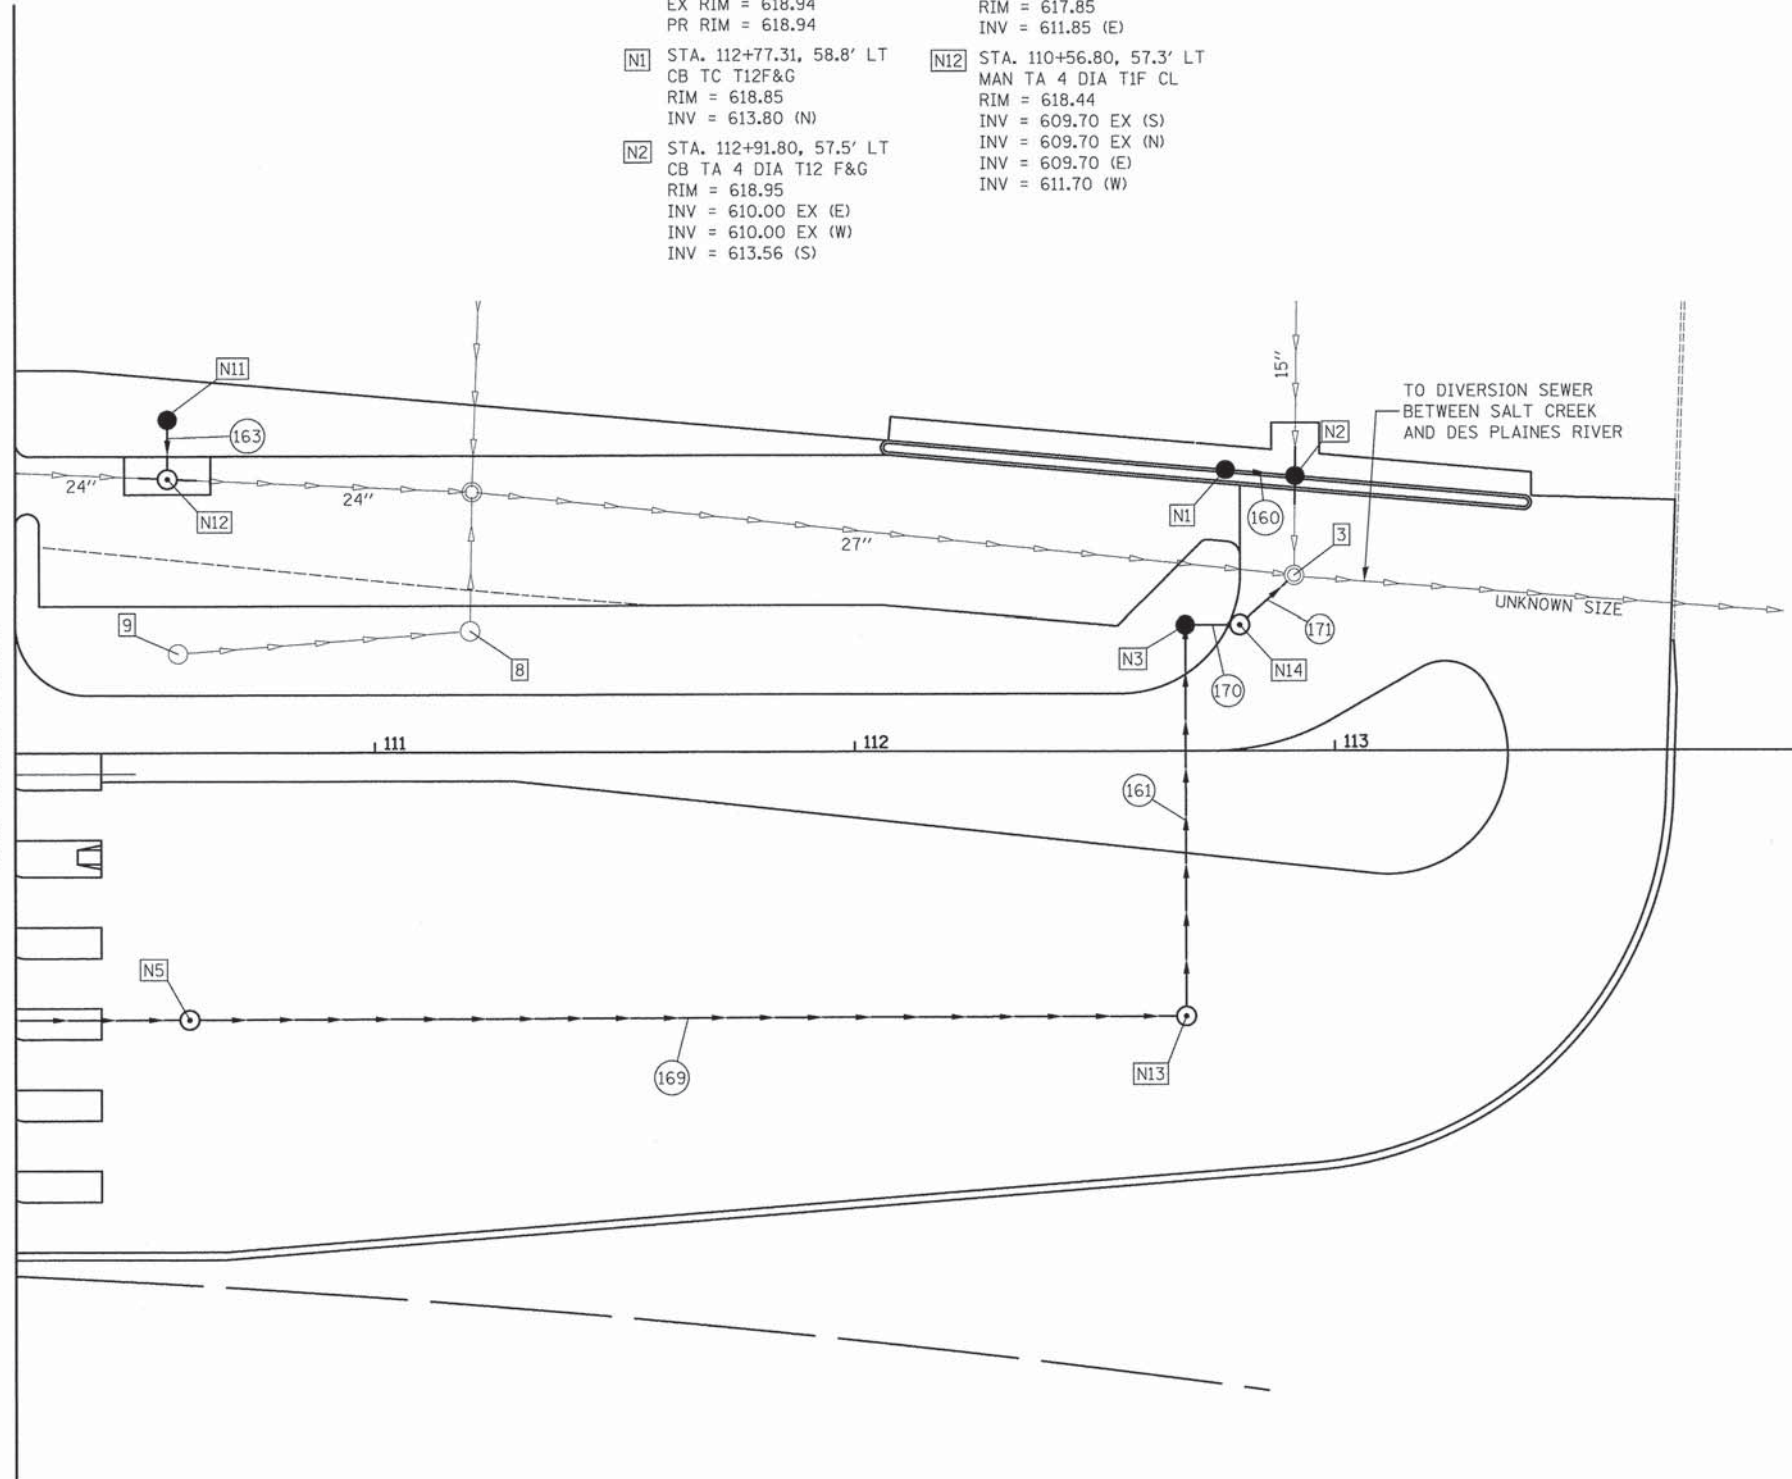

NOTES:

1. STATIONS AND OFFSETS ARE TO THE CENTER OF THE STRUCTURE.
2. RIM ELEVATIONS FOR CURB INLETS ARE AT THE FLOW LINE.
3. NEW STORM STRUCTURES TO BE CUT INTO AN EXISTING STORM SEWER LINE SHALL REQUIRE 4 FEET OF NEW STORM SEWER IN EACH APPLICABLE DIRECTION. THIS WORK SHALL BE PAID FOR AS THE SAME TYPE AND SIZE OF THE EXISTING SEWER BEING TIED IN TO.



BROOKFIELD ZOO NORTH PARKING LOT


FILE NAME = ...2563_LOT_05_NoDET.dgn	USER NAME = dte	DESIGNED - JES	REVISED -	<b>STATE OF ILLINOIS DEPARTMENT OF TRANSPORTATION</b>	<b>BROOKFIELD ZOO NORTH PARKING LOT PLAN</b>	F.A.U. RTE. 3784	SECTION 12-F3000-23-PK	COUNTY COOK	TOTAL SHEETS 131	SHEET NO. 58		
PLOT SCALE = 20,000' / 1" =						SCALE: 1" = 20'	SHEET NO. 5 OF 6 SHEETS	STA. 110+50 TO STA. 113+71	CONTRACT NO. 63764			
PLOT DATE = 5/6/2013						DATE - 05/13/2013	FED. ROAD DIST. NO. 1 [ILLINOIS] FED. AID PROJECT					



**LEGEND**

- (XXX.XX) EXISTING PAVEMENT ELEVATION
- XXX.XX PROPOSED PAVEMENT ELEVATION
- EXISTING CONTOUR
- PROPOSED CONTOUR

IN THE RESURFACING AREA, ALL EXISTING ELEVATIONS WILL ALSO BE THE FINAL PROPOSED SURFACE ELEVATION.

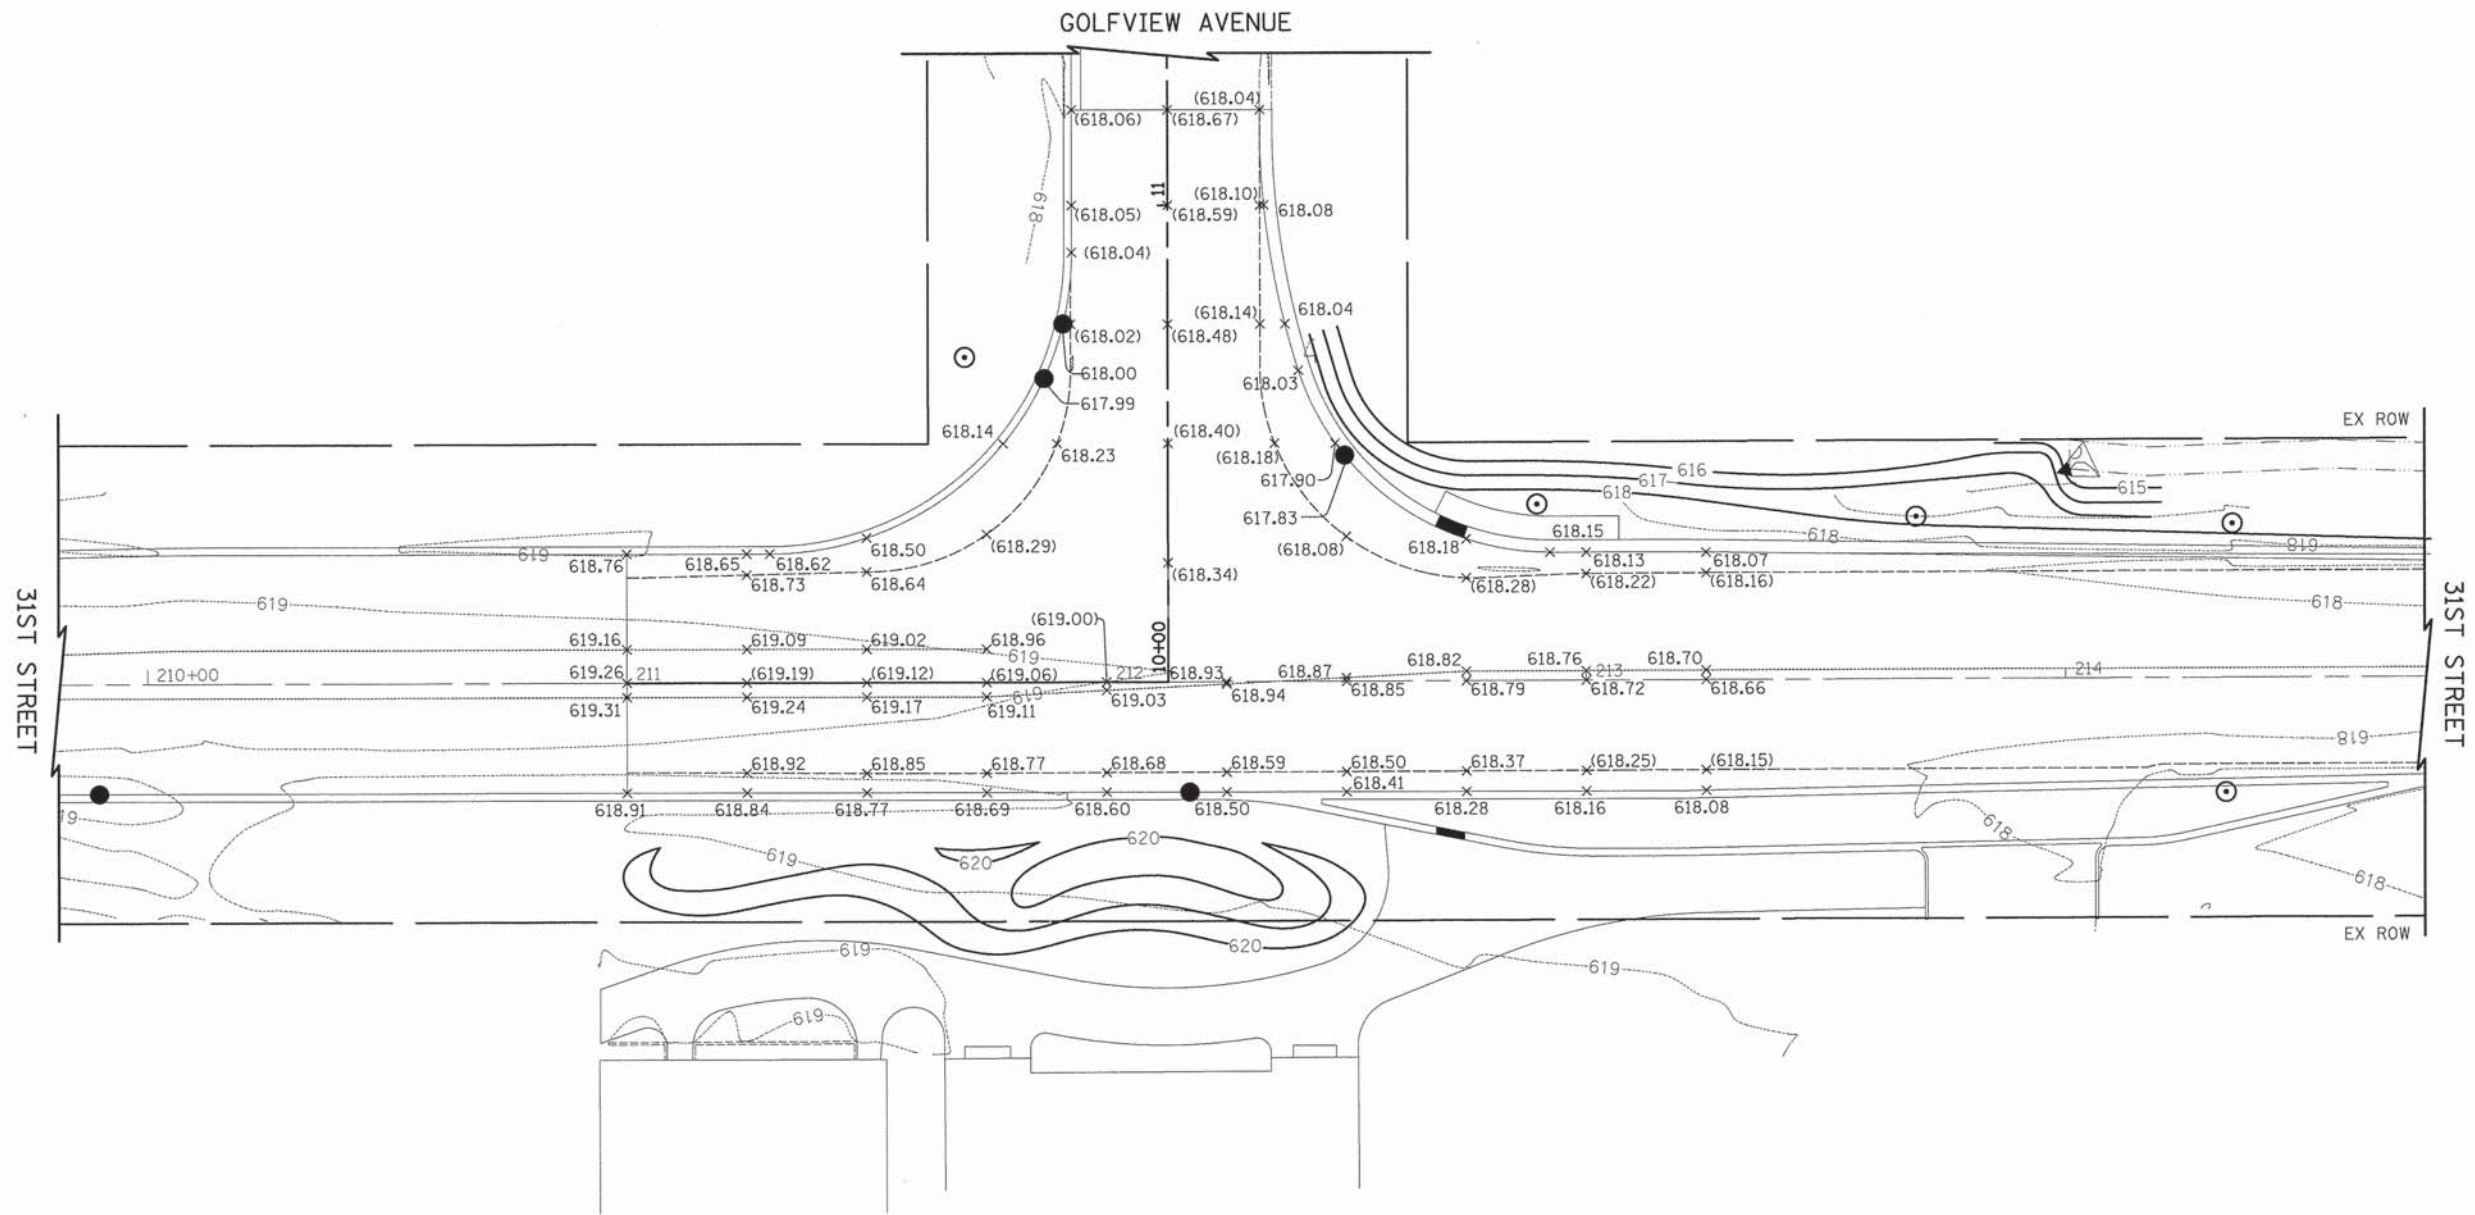

31ST STREET  
GOLFVIEW AVENUE




FILE NAME = ...\\12-Grading\2563_INT_01.dgn	USER NAME = dte	DESIGNED DTE	REVISED -	<b>STATE OF ILLINOIS DEPARTMENT OF TRANSPORTATION</b>	<b>INTERSECTION DETAILS</b>	F.A.U. RTE. 3784	SECTION 12-F3000-23-PK	COUNTY COOK	TOTAL SHEETS 131	SHEET NO. 59		
PLOT SCALE = 20.0000' / 1" =	CHECKED GAB	REVISIED -	REVISIED -			SCALE: 1" = 20'	SHEET NO. 1 OF 3 SHEETS	STA.	TO STA.	CONTRACT NO. 63764		
PLOT DATE = 5/6/2013	DATE - 05/13/2013	REVISIED -	REVISIED -			FED. ROAD DIST. NO. 1 [ILLINOIS] FED. AID PROJECT						



**LEGEND**

(XXX.XX) EXISTING PAVEMENT ELEVATION  
 XXX.XX PROPOSED PAVEMENT ELEVATION

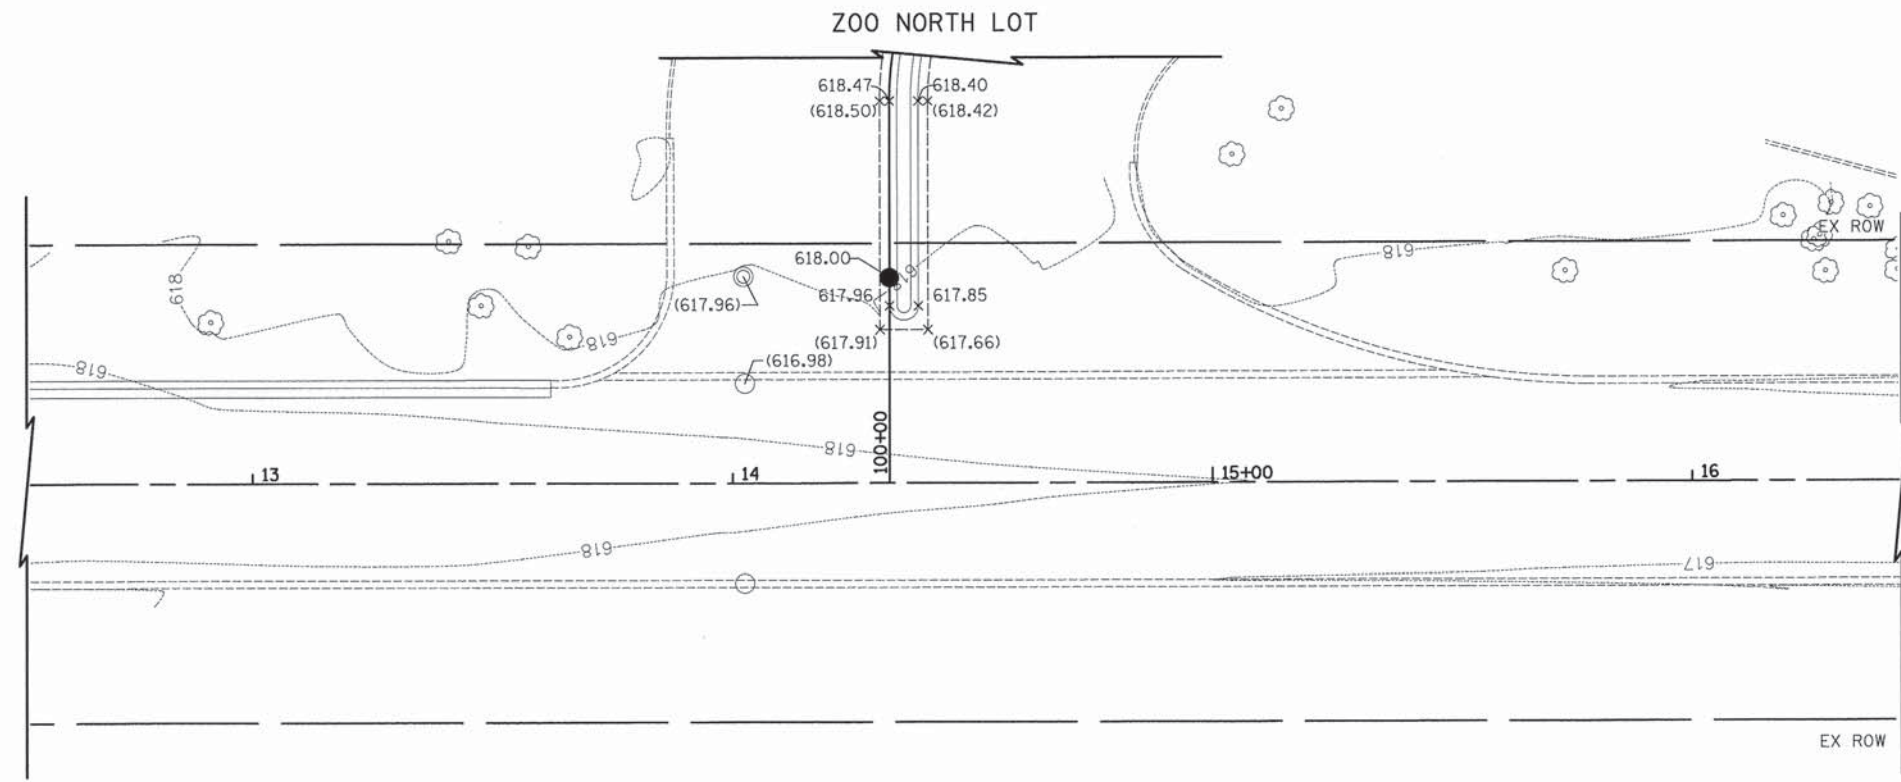

GOLFVIEW AVENUE



FILE NAME = ...\12-Grading\2563.INT.02.dgn	USER NAME = dte	DESIGNED DTE	REVISED -	<b>STATE OF ILLINOIS          DEPARTMENT OF TRANSPORTATION</b>	<b>INTERSECTION DETAILS</b>	F.A.U. RTE. 3784	SECTION 12-F3000-23-PK	COUNTY COOK	TOTAL SHEETS 131	SHEET NO. 60			
	PLOT SCALE = 20.0000' / 1"	CHECKED GAB	REVISED -			SCALE: 1" = 20'	SHEET NO. 2 OF 3 SHEETS	STA.	TO STA.	FED. ROAD DIST. NO. 1   ILLINOIS FED. AID PROJECT			
	PLOT DATE = 5/6/2013	DATE = 05/13/2013	REVISED -			CONTRACT NO. 63764							








**LEGEND**


- 618.00 TOP OF CURB ELEVATION
- 617.50 FLOW LINE ELEVATION
- (617.50) EXISTING ELEVATION
- DRAINAGE DIVIDE
- - - GRADING LIMITS
- EXISTING MAJOR CONTOUR
- EXISTING MINOR CONTOUR
- ← OVERLAND FLOW ROUTE

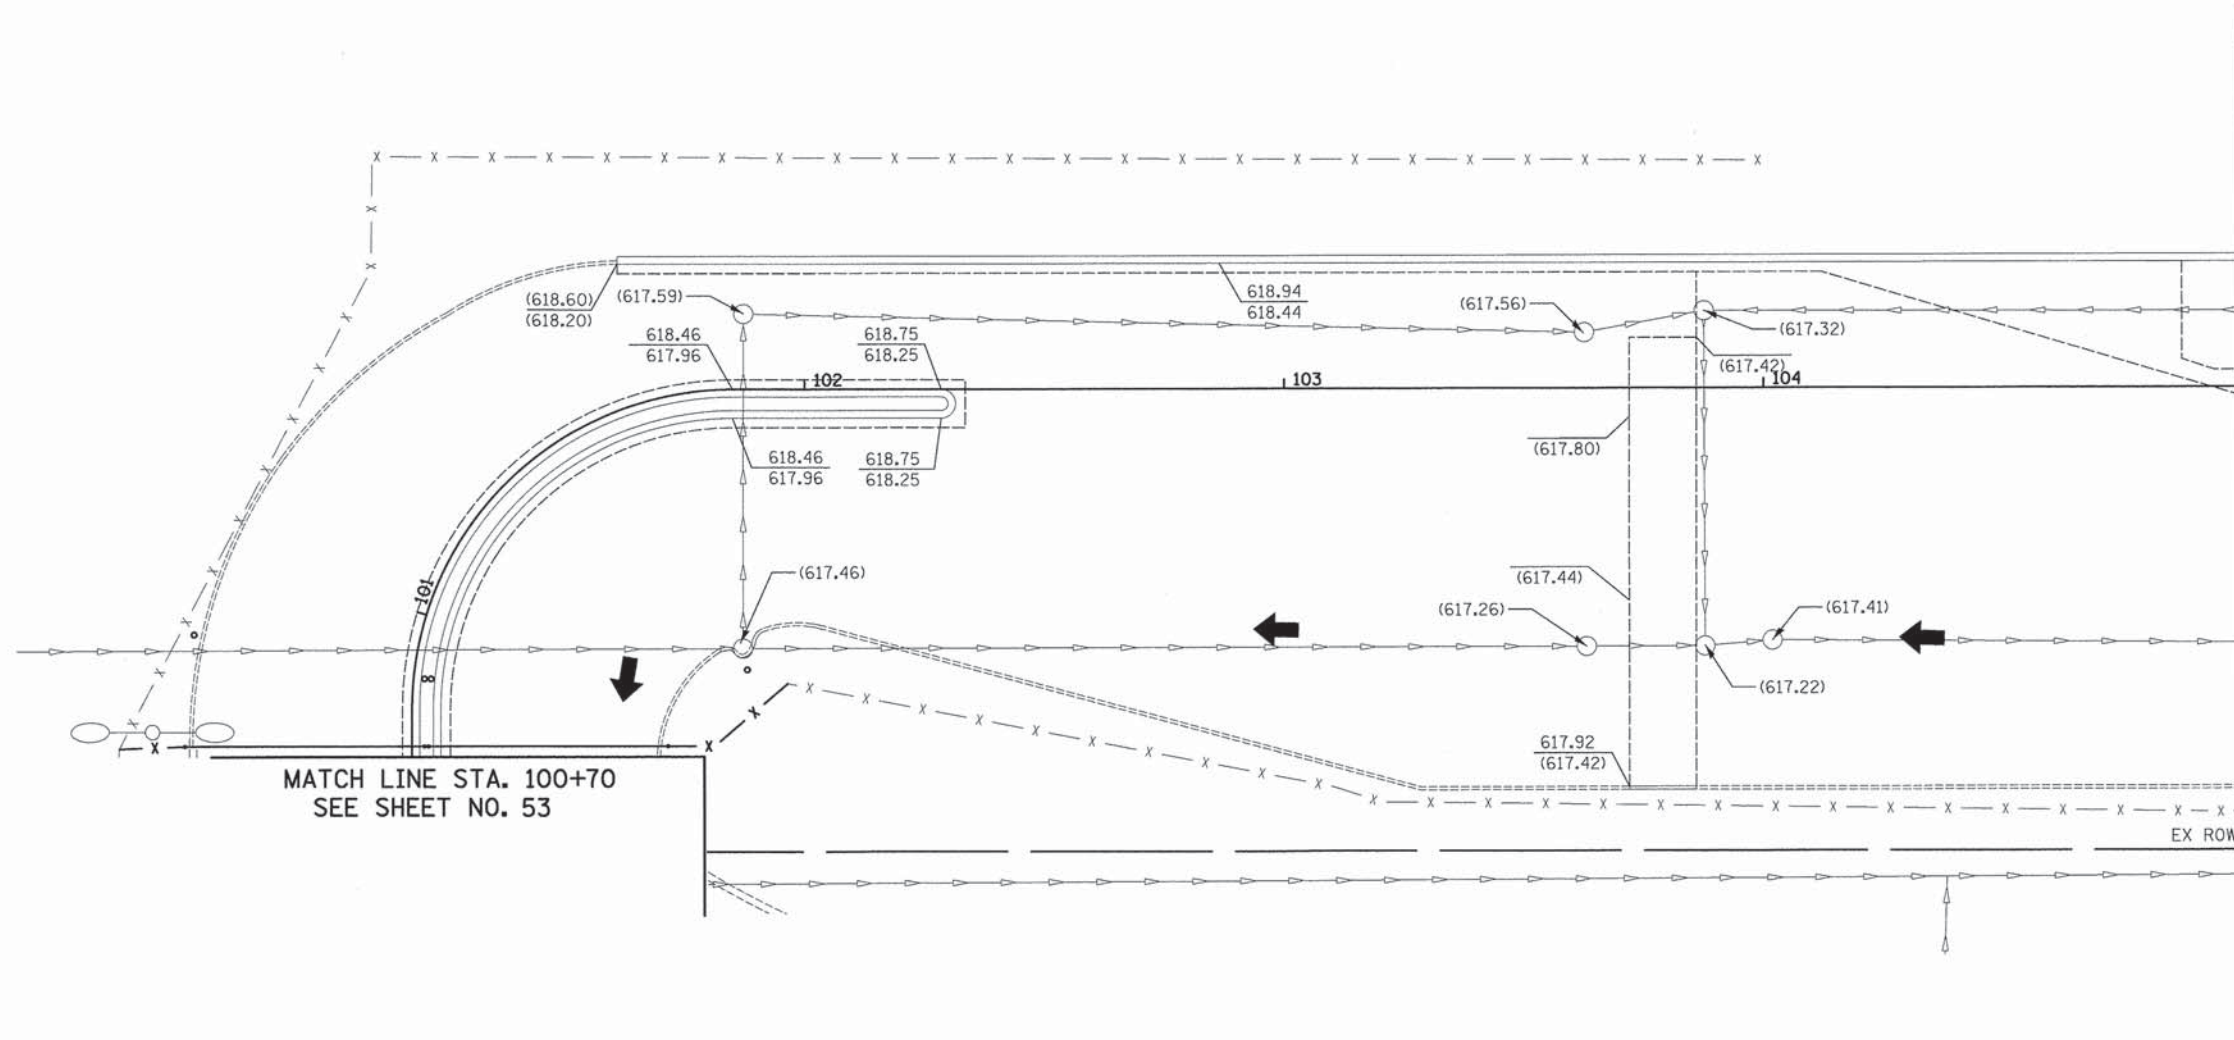

MATCH LINE STA. 105+00  
SEE SHEET NO. 63

MATCH LINE STA. 100+70  
SEE SHEET NO. 53

BROOKFIELD ZOO NORTH PARKING LOT

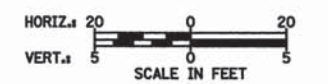


FILE NAME = ...\\12-Grading\2563.000.01.dgn	USER NAME = dte	DESIGNED - DTE	REVISED -	<b>STATE OF ILLINOIS DEPARTMENT OF TRANSPORTATION</b>	<b>GRADING PLAN</b>			F.A.U. RTE. 3784	SECTION 12-F3000-23-PK	COUNTY COOK	TOTAL SHEETS 131	SHEET NO. 62
		DRAWN - DTE	REVISED -		SCALE: 1" = 20'	SHEET NO. 1 OF 3 SHEETS	STA. 100+75 TO STA. 105+00	CONTRACT NO. 63764				
		CHECKED - GAB	REVISED -		FED. ROAD DIST. NO. 1 (ILLINOIS) FED. AID PROJECT							
		DATE - 05/13/2013	REVISED -									



**LEGEND**

- 618.00 TOP OF CURB ELEVATION
- 617.50 FLOW LINE ELEVATION
- (617.50) EXISTING ELEVATION
- DRAINAGE DIVIDE
- - - GRADING LIMITS
- EXISTING MAJOR CONTOUR
- EXISTING MINOR CONTOUR
- ← OVERLAND FLOW ROUTE

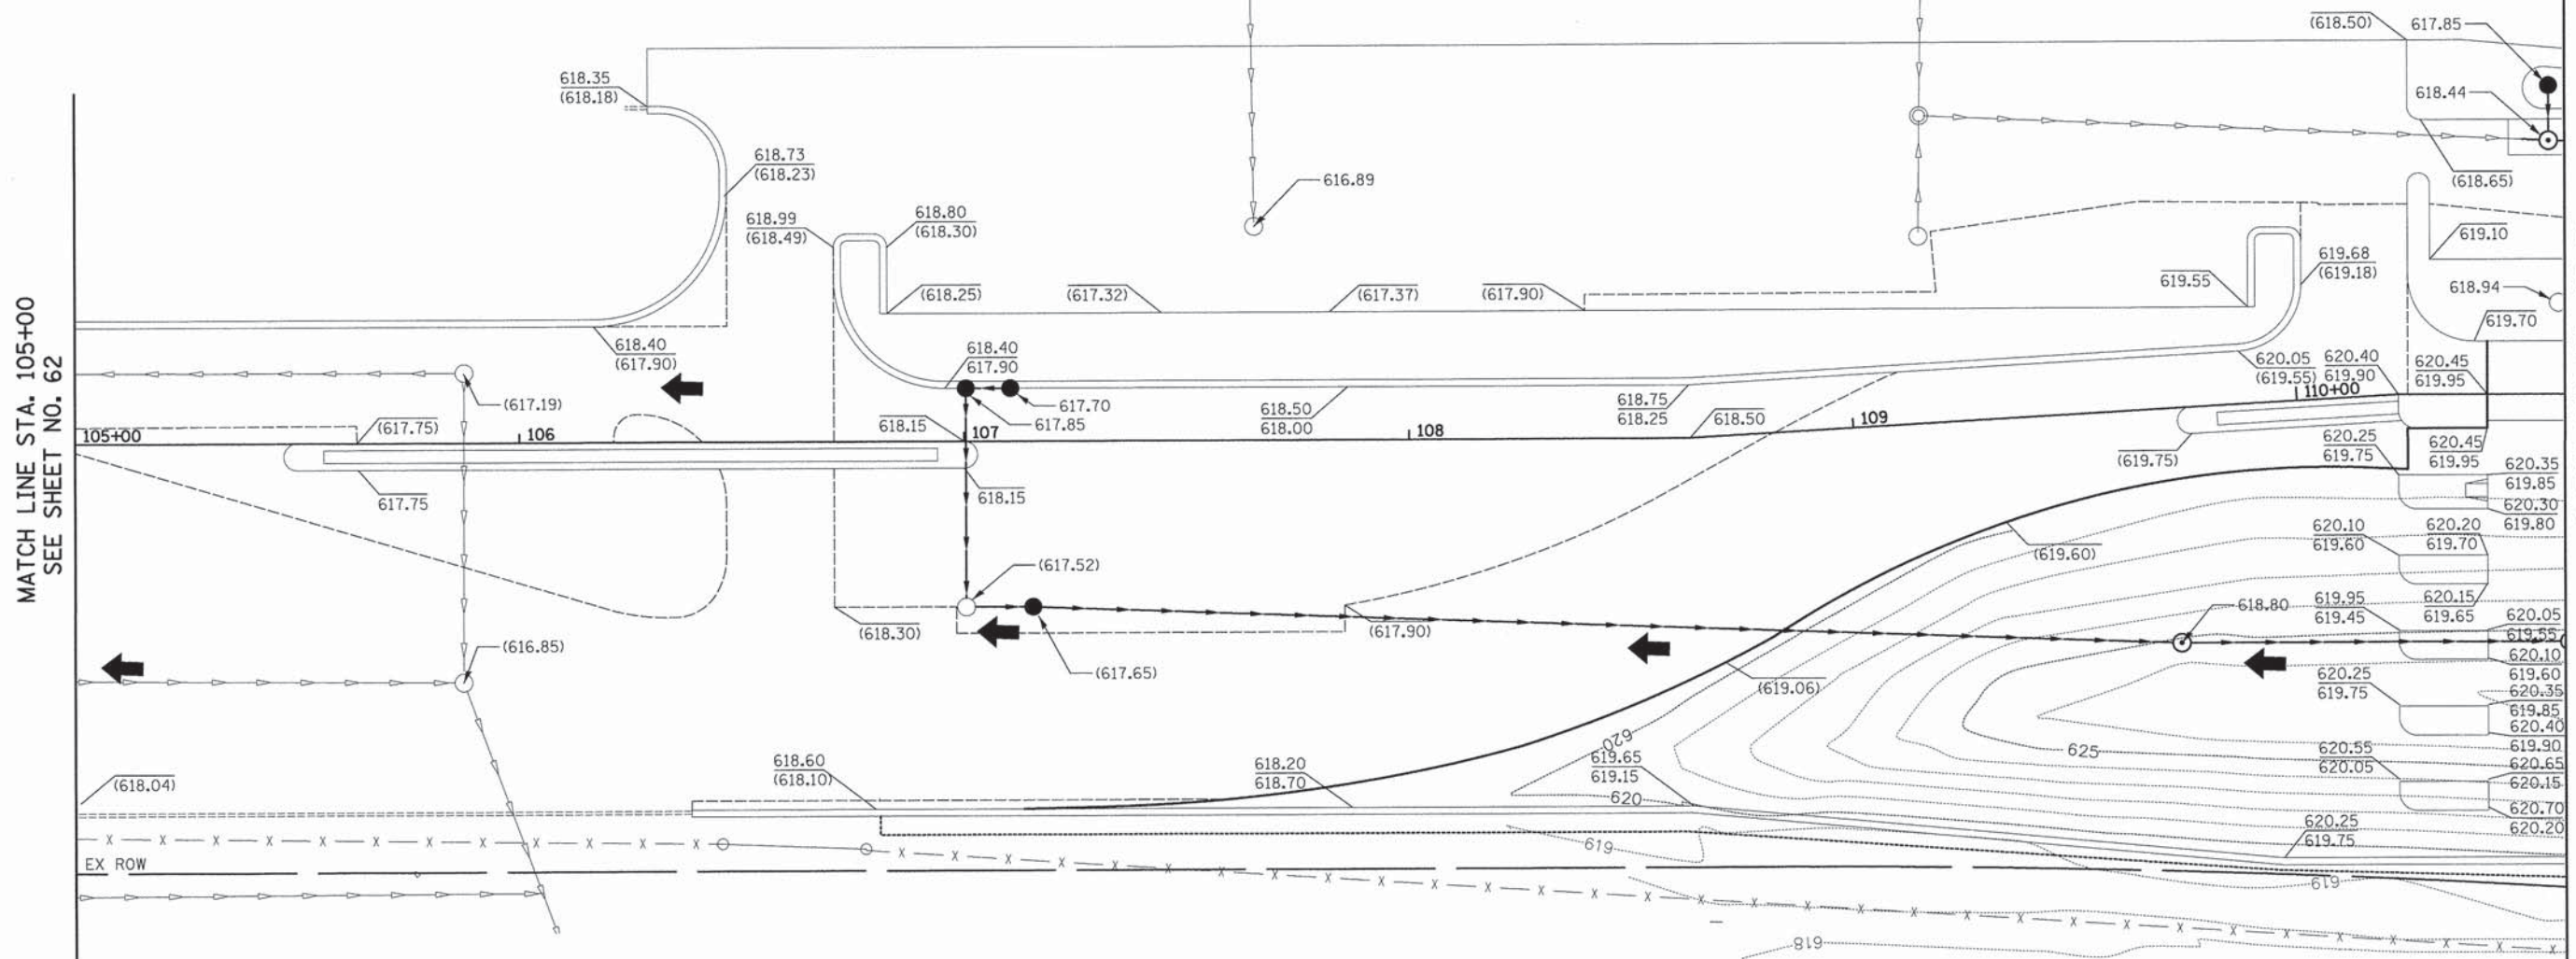

MATCH LINE STA. 105+00  
SEE SHEET NO. 62

MATCH LINE STA. 110+60  
SEE SHEET NO. 63

**BROOKFIELD ZOO NORTH PARKING LOT**



FILE NAME = ...12-Grading\2563_000_02.dgn	USER NAME = dte	DESIGNED - DTE	REVISED -	<b>STATE OF ILLINOIS DEPARTMENT OF TRANSPORTATION</b>	<b>GRADING PLAN</b>	F.A.U. RTE. 3784	SECTION 12-F3000-23-PK	COUNTY COOK	TOTAL SHEETS 131	SHEET NO. 63	
	PLOT SCALE = 20.0000' / 1" =	CHECKED - GAB	REVISED -			CONTRACT NO. 63764					
	PLOT DATE = 5/6/2013	DATE - 05/13/2013	REVISED -			FED. ROAD DIST. NO. - [ILLINOIS] FED. AID PROJECT					
						SCALE: 1" = 20'		SHEET NO. 2 OF 3 SHEETS		STA. 105+00 TO STA. 110+60	




**LEGEND**

- 618.00 TOP OF CURB ELEVATION
- 617.50 FLOW LINE ELEVATION
- (617.50) EXISTING ELEVATION
- DRAINAGE DIVIDE
- - - GRADING LIMITS
- EXISTING MAJOR CONTOUR
- EXISTING MINOR CONTOUR
- ← OVERLAND FLOW ROUTE



MATCH LINE STA. 110+60  
SEE SHEET NO. 63

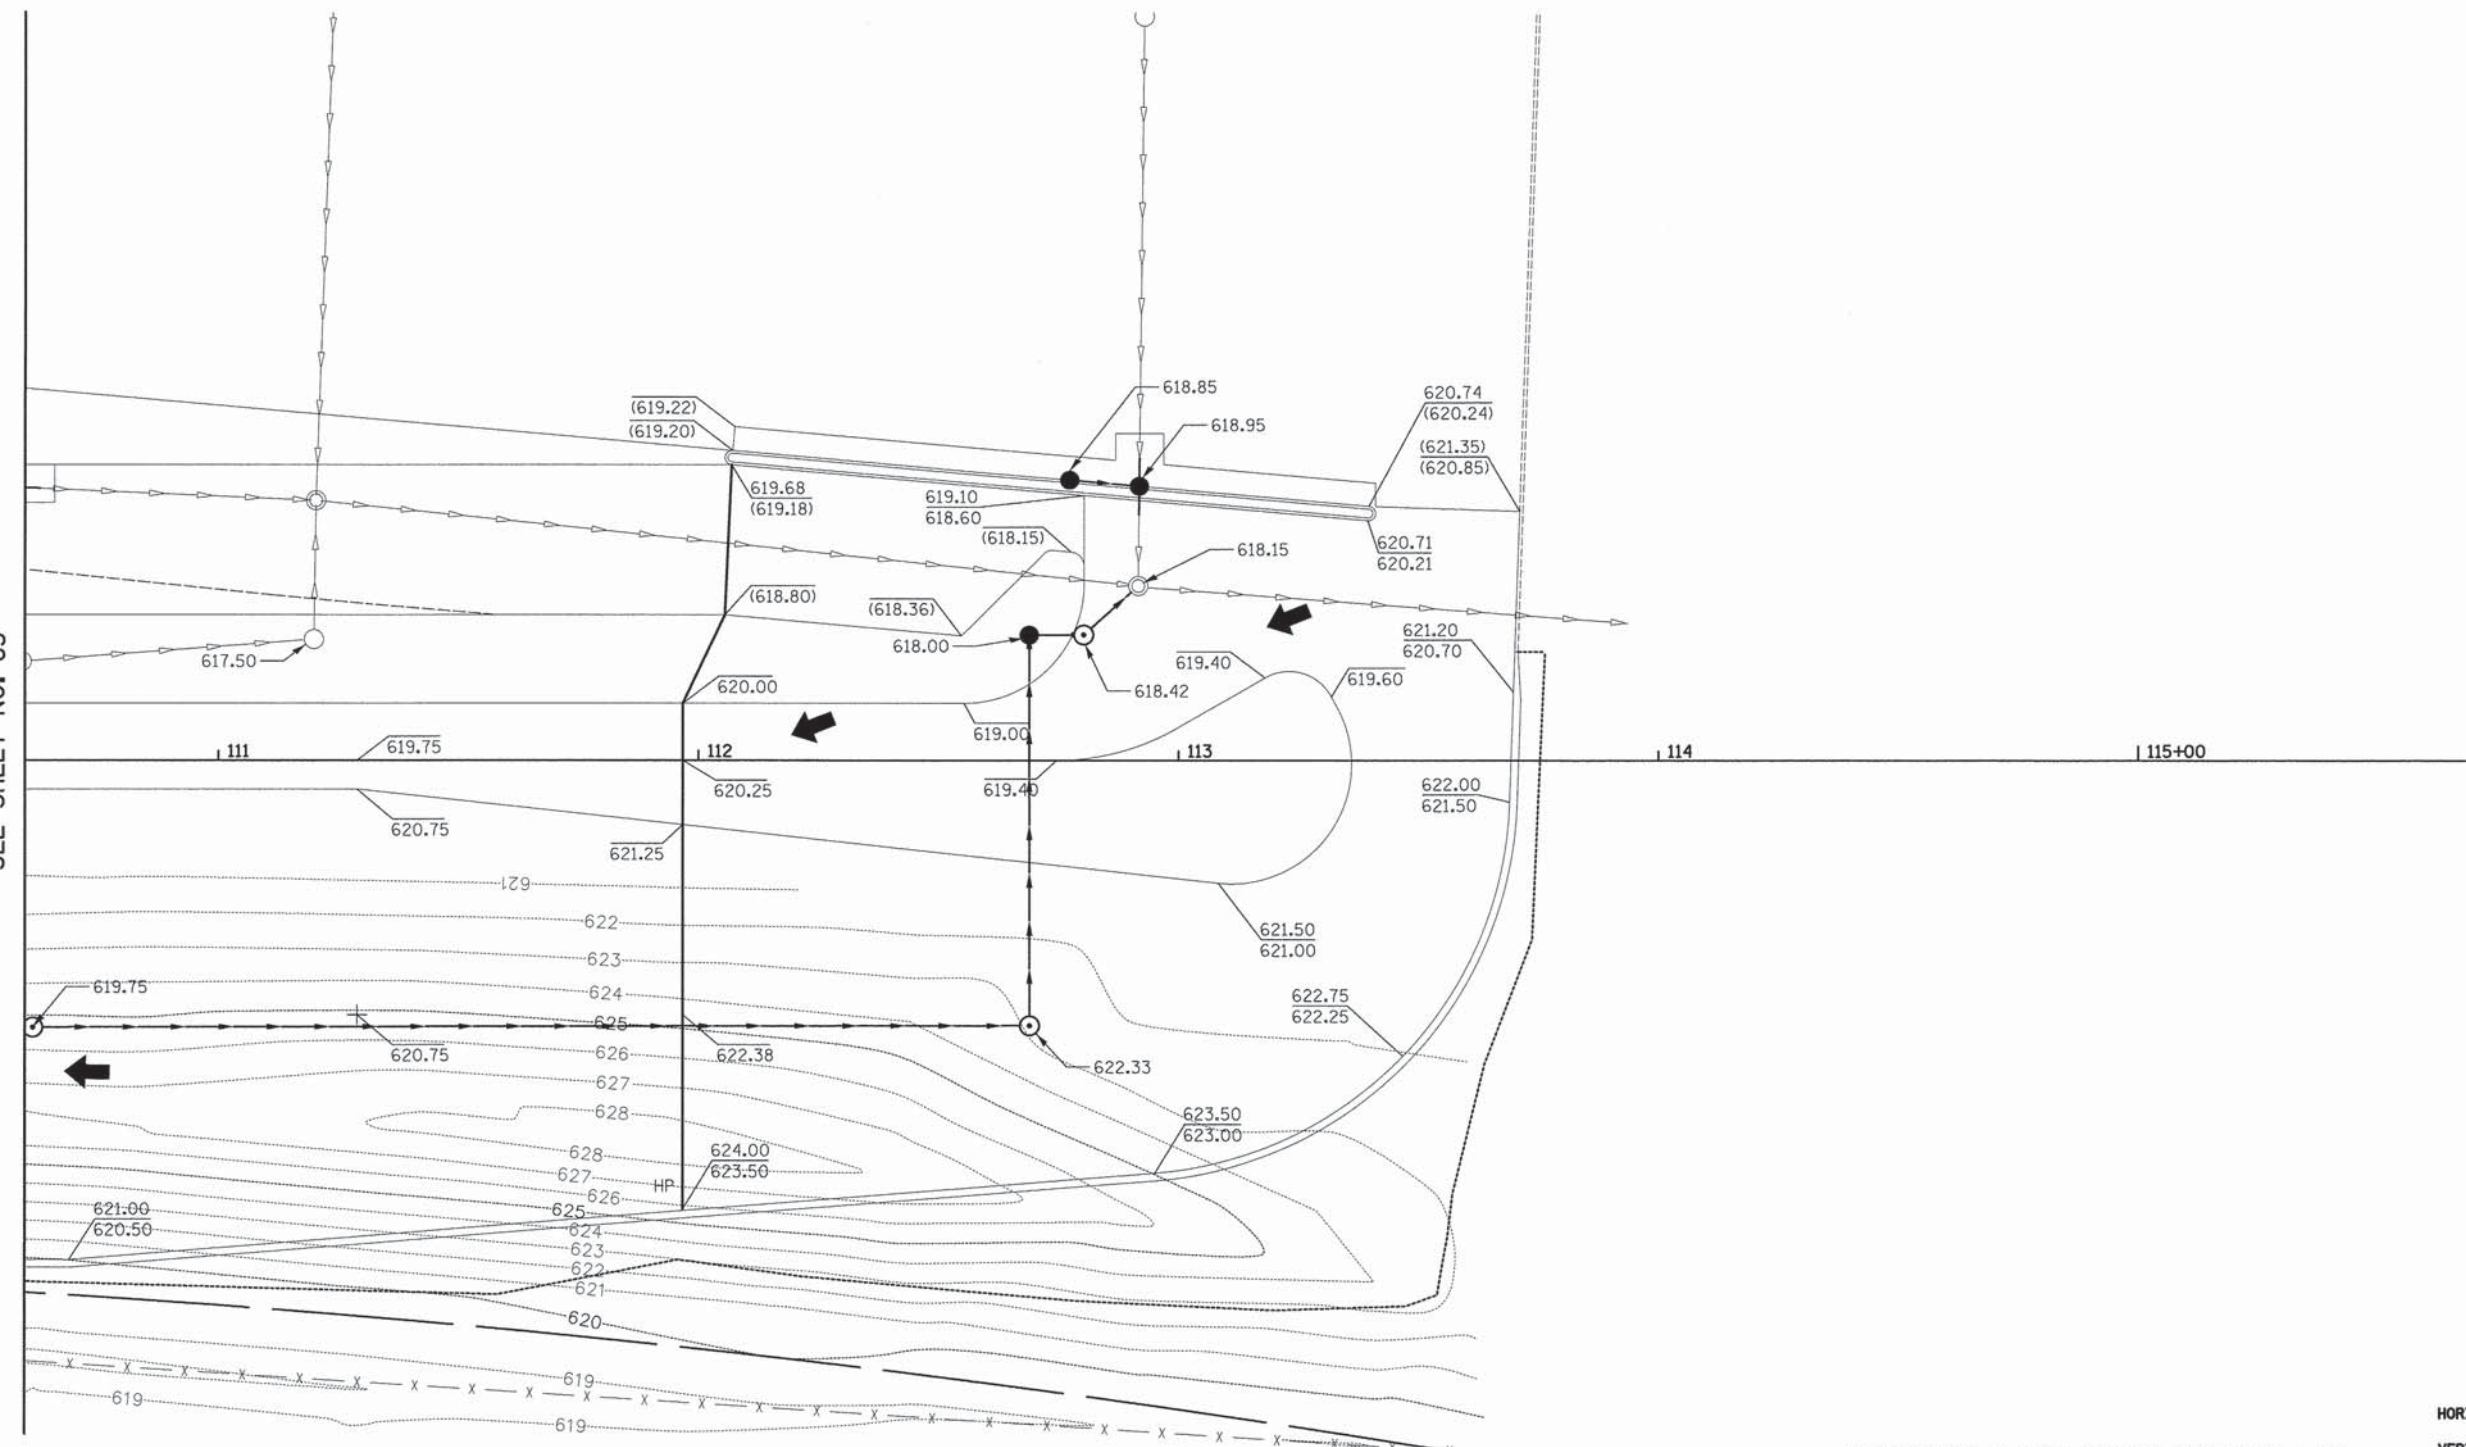

BROOKFIELD ZOO NORTH PARKING LOT

FILE NAME = ...12-Grading\2563_000_03.dgn	USER NAME = dte	DESIGNED - DTE	REVISED -	<b>STATE OF ILLINOIS DEPARTMENT OF TRANSPORTATION</b>	<b>GRADING PLAN</b>	F.A.U. RTE. 3784	SECTION 12-F3000-23-PK	COUNTY COOK	TOTAL SHEETS 131	SHEET NO. 64
PLDT SCALE = 20,0000' / 1"				SCALE: 1" = 20'		SHEET NO. 3 OF 3 SHEETS		STA. 110+50 TO STA. 113+71		
PLDT DATE = 5/6/2013				DATE - 05/13/2013		CONTRACT NO. 63764		FED. ROAD DIST. NO. 1   ILLINOIS FED. AID PROJECT		



**RELOCATED EXISTING TRAFFIC SIGNS**

- 1 SPEED LIMIT 35 R2-1, 30"x36"
- 2 NO LEFT TURN R3-2, 30"x30"
- 3 NO PARKING ANY TIME R7-1, 12"x18"
- 4 NO PARKING SPECIAL, 24"x18"
- 5 PARKING SPECIAL, 24"x18"
- 6 WELCOME TO BROOKFIELD POPULATION 19,000 INTER-CITY TRAVEL SPECIAL, 36"x30"
- 7 GIRLS SOFTBALL GIRLS STATE CHAMPIONS BOYS STATE CHAMPIONS SPECIAL, 48"x24"
- 8 TREE CITY U.S.A. SPECIAL, 24"x30"
- 9 BROOKFIELD JAYCEES WELCOME YOU SPECIAL, 18"x24"
- 10 ZOO SPECIAL, 36" DIA
- 11 PACE BUS STOP 331 SPECIAL, 18"x18"

**PROPOSED TRAFFIC SIGNS**

- 12 STOP R1-1, 30"x30"
- 13 ONLY R3-5R, 30"x36"
- 14 KEEP RIGHT R4-7, 24"x30"
- 15 KEEP RIGHT R4-7a, 24"x30"
- 16 ONLY ONLY R3-SPECIAL, 36"x36"
- 17 ONLY ONLY R3-SPECIAL, 36"x36"
- 18 ONLY ONLY R3-SPECIAL, 36"x36"
- 19 ONLY ONLY R3-SPECIAL, 36"x36"

**PROPOSED PARKING LOT SIGNS**


- 20 ONLY TO 1ST AVENUE ONLY TO 31ST STREET SPECIAL, SEE DETAIL SHEET 110
- 21 MAIN GATE TICKET PLAZA LION SPECIAL, SEE DETAIL SHEET 110
- 22 MAIN GATE TICKET PLAZA GORILLA SPECIAL, SEE DETAIL SHEET 110
- 23 10 MPH WATCH FOR CHILDREN SPECIAL, SEE DETAIL SHEET 110
- 24 MORE PARKING LION LOT SPECIAL, SEE DETAIL SHEET 110
- 25 EXIT PARKING SPECIAL, SEE DETAIL SHEET 110
- 26 ONE WAY SPECIAL, SEE DETAIL SHEET 110
- 27 DO NOT ENTER SPECIAL, SEE DETAIL SHEET 110

**RAISED PAVEMENT MARKINGS LEGEND**

- ◄ ONE-WAY CRYSTAL
- ◄ ONE-WAY AMBER
- ◆ TWO-WAY AMBER

**NOTES:**

1. ALL PERMANENT PAVEMENT MARKINGS SHALL BE THERMOPLASTIC UNLESS OTHERWISE NOTED.
2. RAISED REFLECTIVE PAVEMENT MARKERS SHALL BE INSTALLED IN ACCORDANCE WITH IDOT DISTRICT ONE STANDARD TC-11
3. ALL PAVEMENT MARKINGS SHALL BE INSTALLED IN ACCORDANCE WITH IDOT DISTRICT ONE STANDARD TC-13

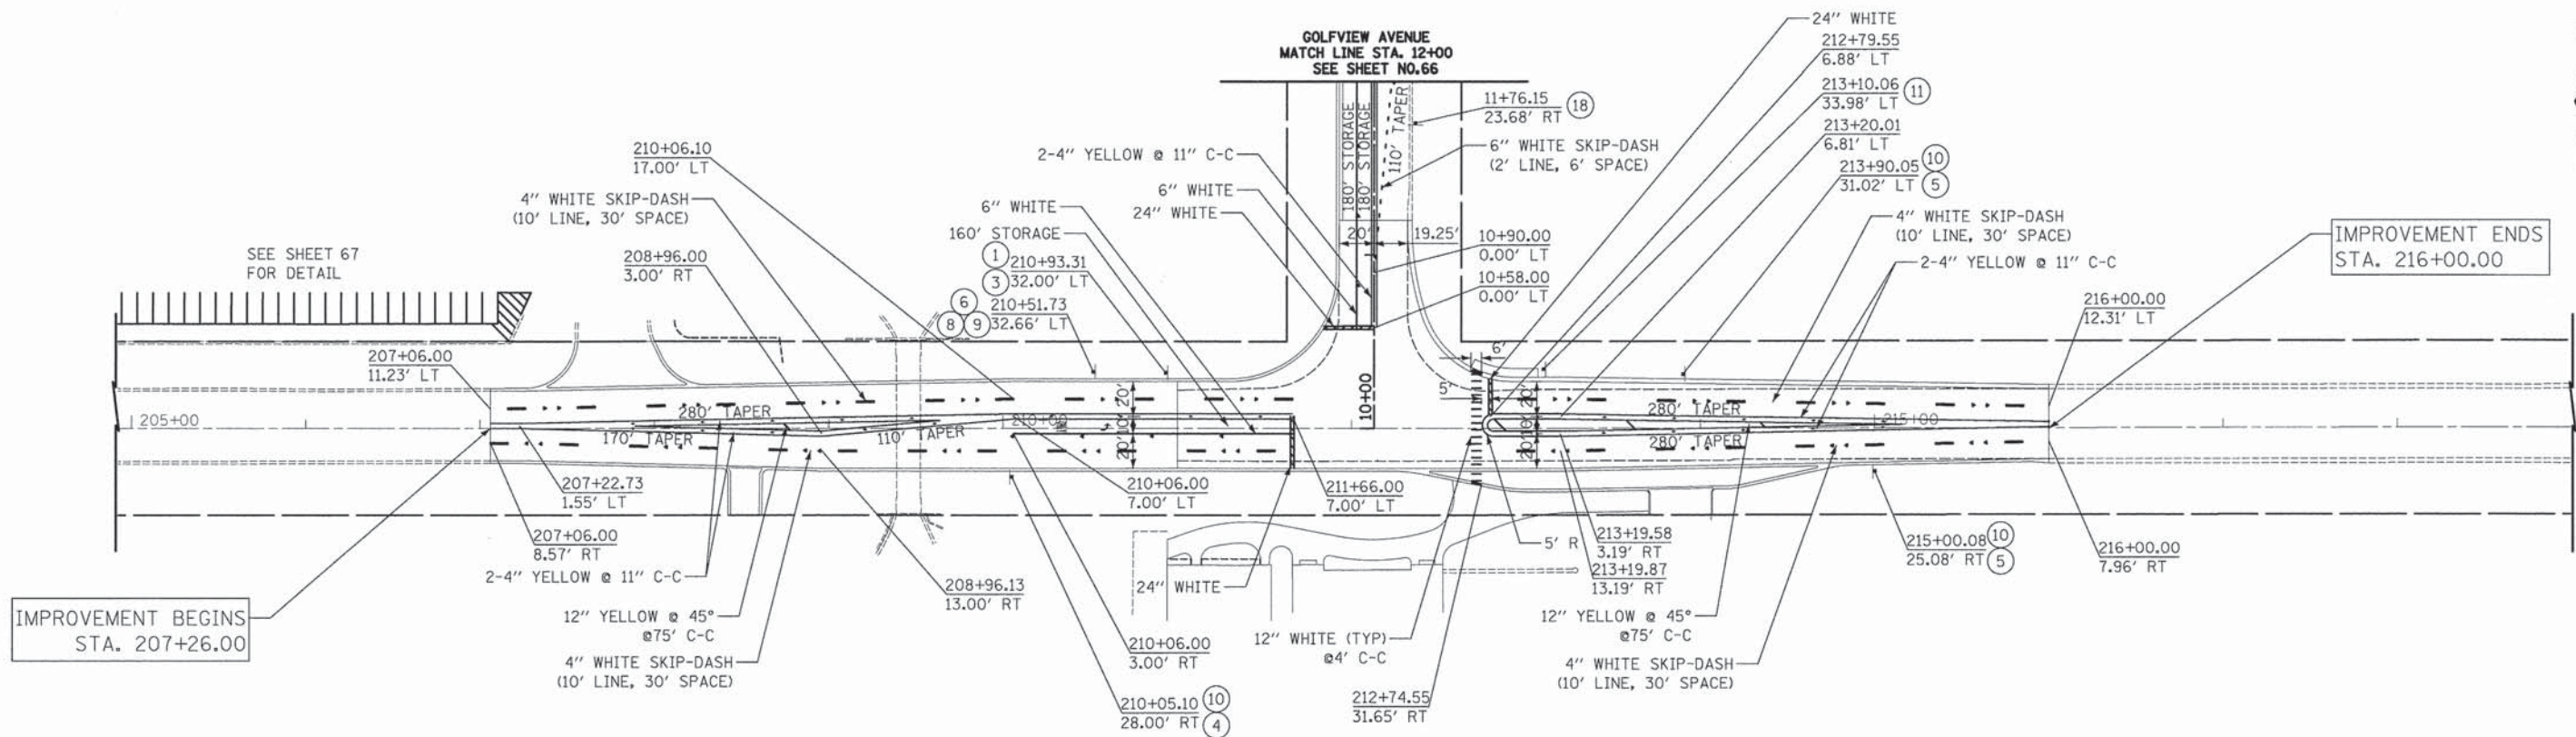


31ST STREET

FILE NAME = ... \2563_PMK_01.dgn	USER NAME = dte	DESIGNED - DTE	REVISED -	<b>STATE OF ILLINOIS DEPARTMENT OF TRANSPORTATION</b>	<b>PAVEMENT MARKING AND SIGNING PLAN</b>			F.A.U. RTE. 3784	SECTION 12-F3000-23-PK	COUNTY COOK	TOTAL SHEETS 131	SHEET NO. 65	
PLOT SCALE = 50.0000' / 1" = 50'		CHECKED - GAB	REVISED -		SCALE: 1" = 50'	SHEET NO. 1 OF 2 SHEETS	STA. 207+26.00 TO STA. 216+00.00	FED. ROAD DIST. NO. 1 ILLINOIS		CONTRACT NO. 63764			
PLOT DATE = 5/23/2013		DATE - 05/13/2013	REVISED -		FED. AID PROJECT								







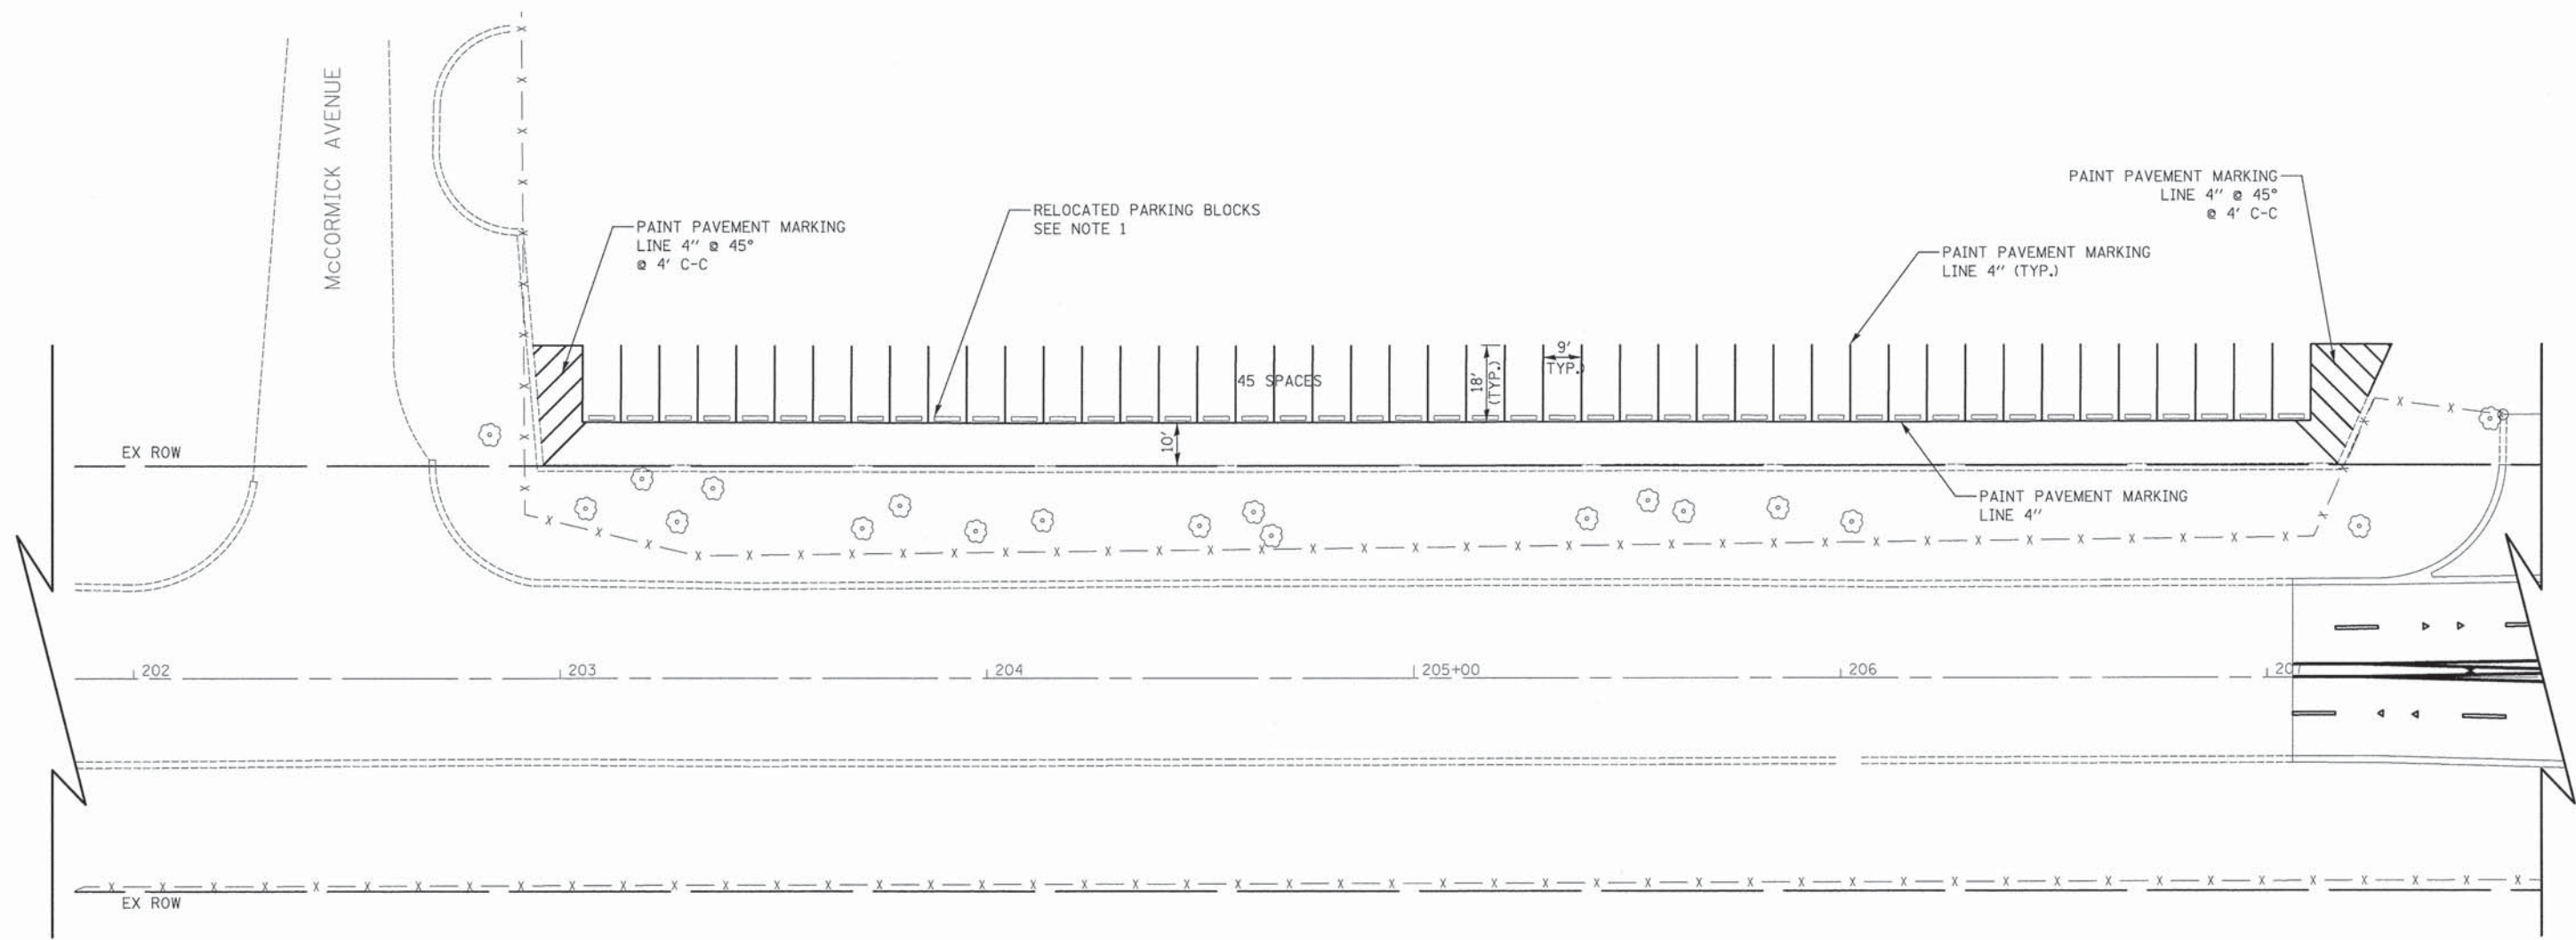

NOTES:



- EXISTING PARKING BLOCKS TO BE RELOCATED TO NEW PARKING STALLS SHALL BE PAID FOR AS "WHEEL STOP REMOVAL AND REPLACEMENT"

31ST STREET



FILE NAME = ...\\2563_PMK_03.dgn	USER NAME = dte	DESIGNED - DTE	REVISED -	<b>STATE OF ILLINOIS DEPARTMENT OF TRANSPORTATION</b>	<b>PAVEMENT MARKING PLAN</b>			F.A.U. RTE.	SECTION	COUNTY	TOTAL SHEETS	SHEET NO.
	PLOT SCALE = 28.0000' / in.	CHECKED - GAB	REVISED -					3784	12-F3000-23-PK	COOK	131	67
PLOT DATE = 5/6/2013	DATE - 05/13/2013	REVISED -	REVISED -	SCALE: 1" = 20'	SHEET NO. 1 OF 1 SHEETS	STA.	TO STA.	CONTRACT NO. 63764				
								FED. ROAD DIST. NO. - [ILLINOIS] FED. AID PROJECT				




-  SEEDING, CLASS 2A  
EXCAVATED TOPSOIL PLACEMENT, 4 INCH
-  SODDING, SALT TOLERANT


MATCH LINE STA. 12+00  
SEE SHEET NO. 69



IMPROVEMENT ENDS  
STA. 216+00.00

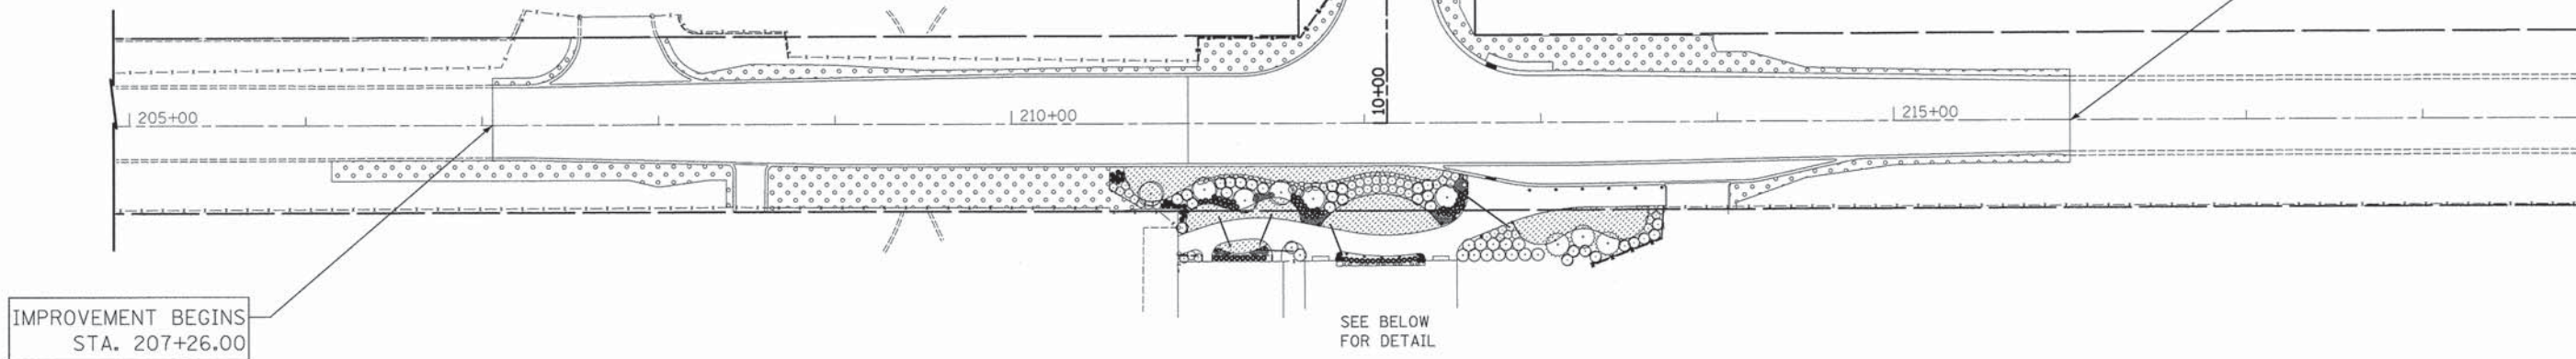

31ST STREET

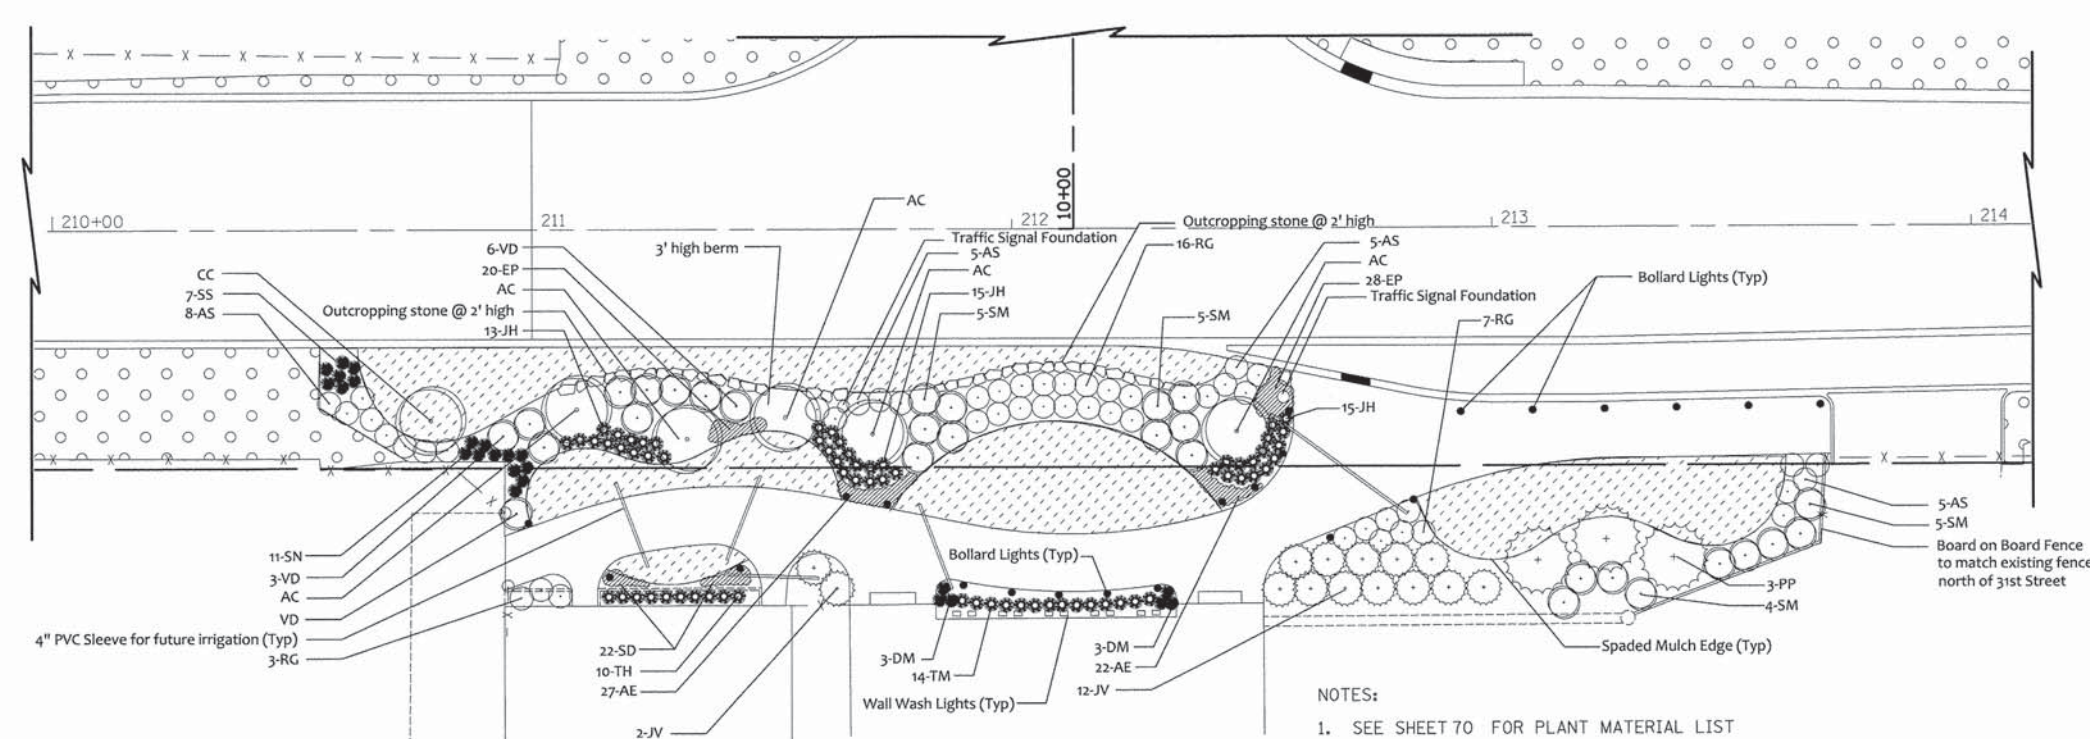

- NOTES:
- SEE SHEET 70 FOR PLANT MATERIAL LIST
  - 6 INCHES OF TOPSOIL SHALL BE PLACED UNDER NEW SOD AND PLANTINGS. THIS WORK SHALL BE INCLUDED IN THE COST OF "TOPSOIL EXCAVATION AND PLACEMENT."
  - TOPSOIL SHALL BE USED TO BUILD UP THE BERM. THIS WORK SHALL BE PAID FOR AS "TOPSOIL FURNISH AND PLACE, 24 INCH"




31ST STREET

FILE NAME = ...\\14-Landscaping\2563.LSC..01.dgn	USER NAME = dte	DESIGNED - KTK	REVISED -	<b>STATE OF ILLINOIS DEPARTMENT OF TRANSPORTATION</b>	<b>LANDSCAPING PLAN</b>			F.A.U. RTE. 3784	SECTION 12-F3000-23-PK	COUNTY COOK	TOTAL SHEETS 131	SHEET NO. 68
	PLLOT SCALE = 50,0000' / 11"	CHECKED - GAB	REVISED -		SCALE: 1" = 50'	SHEET NO. 1 OF 3 SHEETS	STA. 207+26.00 TO STA. 216+00.00	FED. ROAD DIST. NO. 1 ILLINOIS		CONTRACT NO. 63764		
	PLLOT DATE = 5/6/2013	DATE - 05/13/2013	REVISED -					FED. AID PROJECT				



SEEDING, CLASS 2A  
EXCAVATED TOPSOIL PLACEMENT, 4 INCH

MATCH LINE STA. 12+00  
SEE SHEET NO. 68

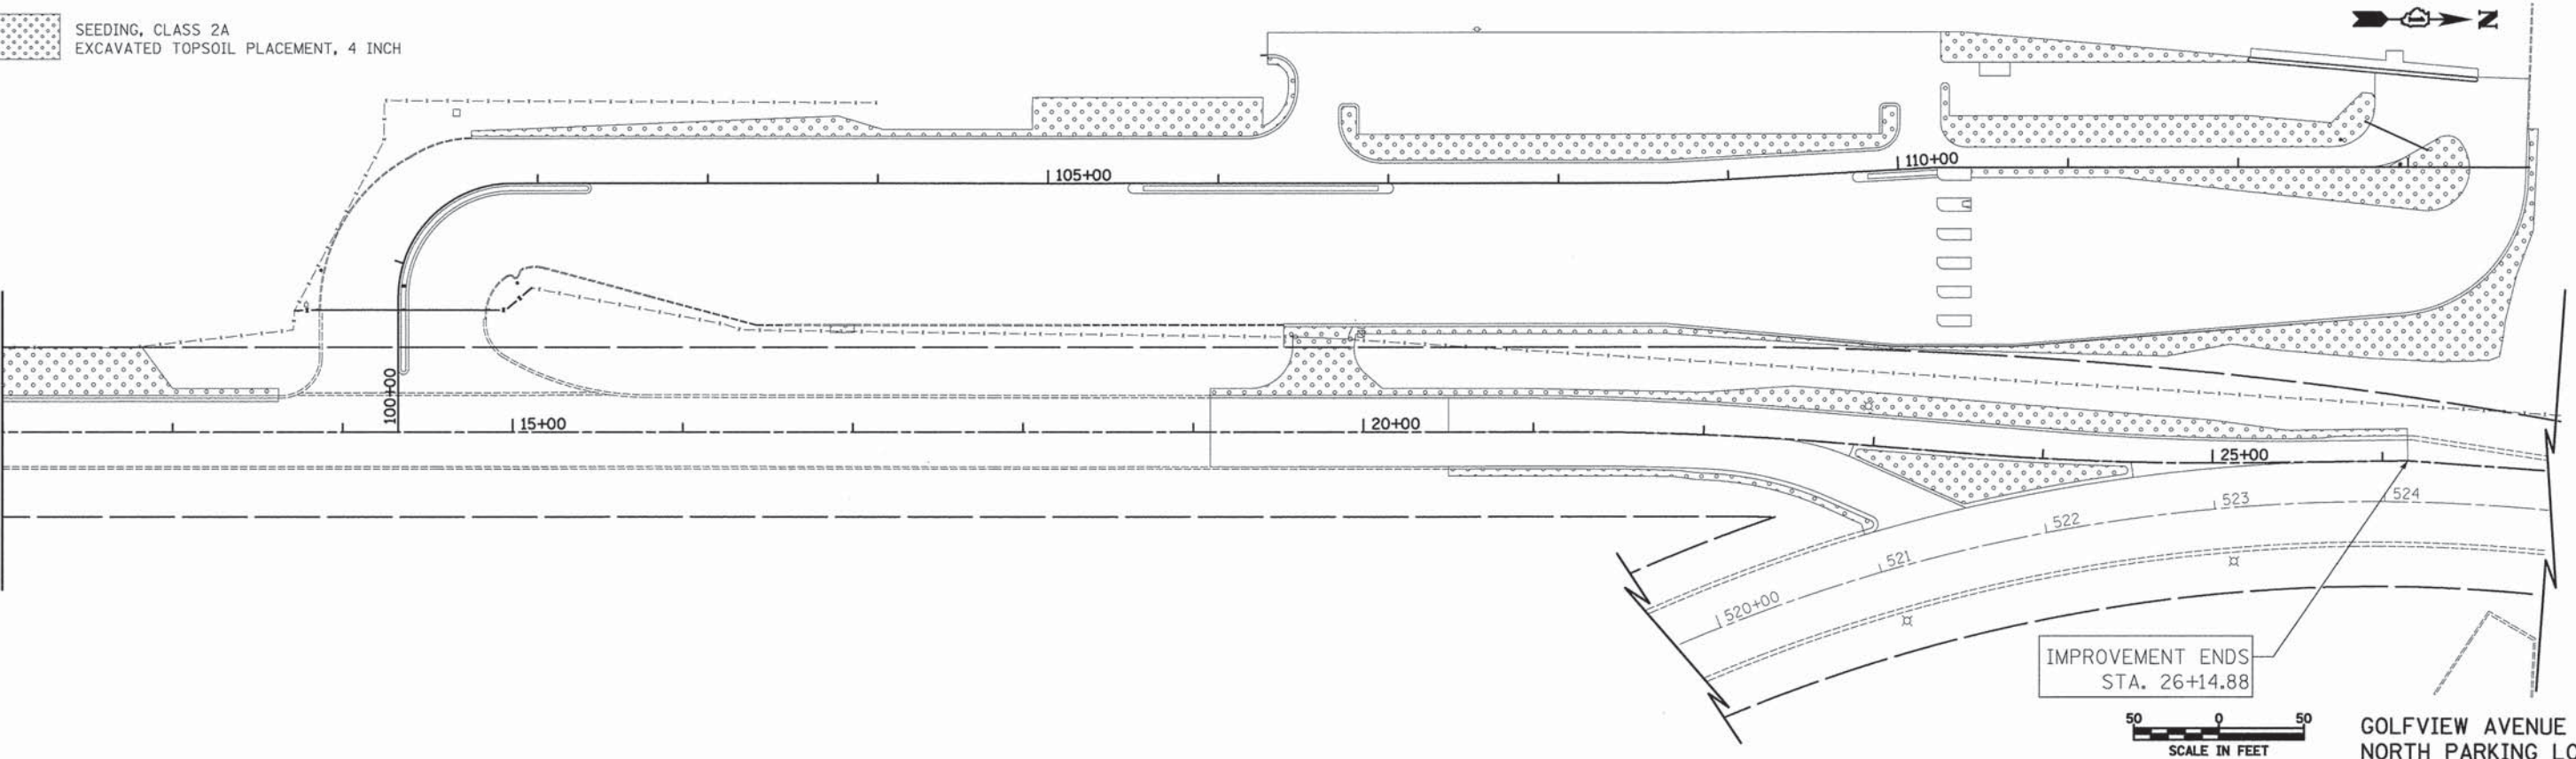

50 0 50  
SCALE IN FEET

GOLFVIEW AVENUE  
NORTH PARKING LOT



20 0 20  
SCALE IN FEET

GOLFVIEW AVENUE  
NORTH PARKING LOT

FILE NAME = ...\\14-Landscaping\2563_LSC_02.dgn	USER NAME = dte	DESIGNED - DTE	REVISED -
		DRAWN - DTE	REVISED -
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	PLOT DATE = 5/6/2013	DATE - 05/13/2013	REVISED -

**STATE OF ILLINOIS  
DEPARTMENT OF TRANSPORTATION**





**LANDSCAPING PLAN**

SCALE: 1" = 50' SHEET NO. 2 OF 3 SHEETS STA. 12+00.00 TO STA. 27+00.00


F.A.U. RTE.	SECTION	COUNTY	TOTAL SHEETS	SHEET NO.
3784	12-F3000-23-PK	COOK	131	69
FED. ROAD DIST. NO. 1 ILLINOIS				CONTRACT NO. 63764
FED. AID PROJECT				

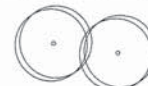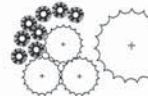

**31st STREET PLANT MATERIAL LIST**

	SYM	QTY	BOTANICAL NAME	IDOT ABBREVIATION
	AC	5	Amelanchier canadensis	T-AMELAN CAN SF 6'
	CC	1	Cercis canadensis	T-CERCIS CAN CL 6'
	JH	43	Juniperus horizontalis	E-JUNIP HOR WIL 18C
	JV	14	Juniperus virginiana	E-JUNIP VIRG 6'
	PP	3	Picea pungens	E-PICEA PUNGENS 6'
	TH	10	Taxus media 'Hicksii'	E-TAXUS X MD HKS 2'C
	TM	14	Taxus media 'Densiformis'	E-TAXUS X MD DN 2'C
	RG	26	Rhus aromatica 'Gro Low'	S-RHUS AROMA GRO 18C
	VD	10	Viburnum dentatum 'Blue Muffin'	S-VIBURN DENT BMA 3'
	SM	19	Syringa patula 'Miss Kim'	S-SYRINGA PAT MK 2'
	AE	0.49	Aster ericoides 'Heath Aster'	P PL ORNAMENT T GAL P
	AS	0.23	Aronia Arbutifolia 'Brilliantissima'	P PL ORNAMENT T GAL P
	DM	0.14	Dryopteris marginalis 'Leatherwood Fern'	P PL ORNAMENT T GAL P
	EP	0.48	Echinacea pallida 'Pale Coneflower'	P PL ORNAMENT T GAL P
	SD	0.22	Stylophorum diphyllum 'Celandine Poppy'	P PL ORNAMENT T GAL P
	SN	0.11	Sorghastrum nutans 'Indian Grass'	P PL ORNAMENT T 3G P
	SS	0.07	Schizachyrim scoparium 'Little Blue Stem'	P PL ORNAMENT T 3G P

NOTE: "PERENNIAL PLANTS, ORNAMENTAL TYPE, GALLON POT" AND "PERENNIAL PLANTS, ORNAMENTAL TYPE, 3-GALLON POT" ARE PAID FOR AS 100 POTS PER UNIT

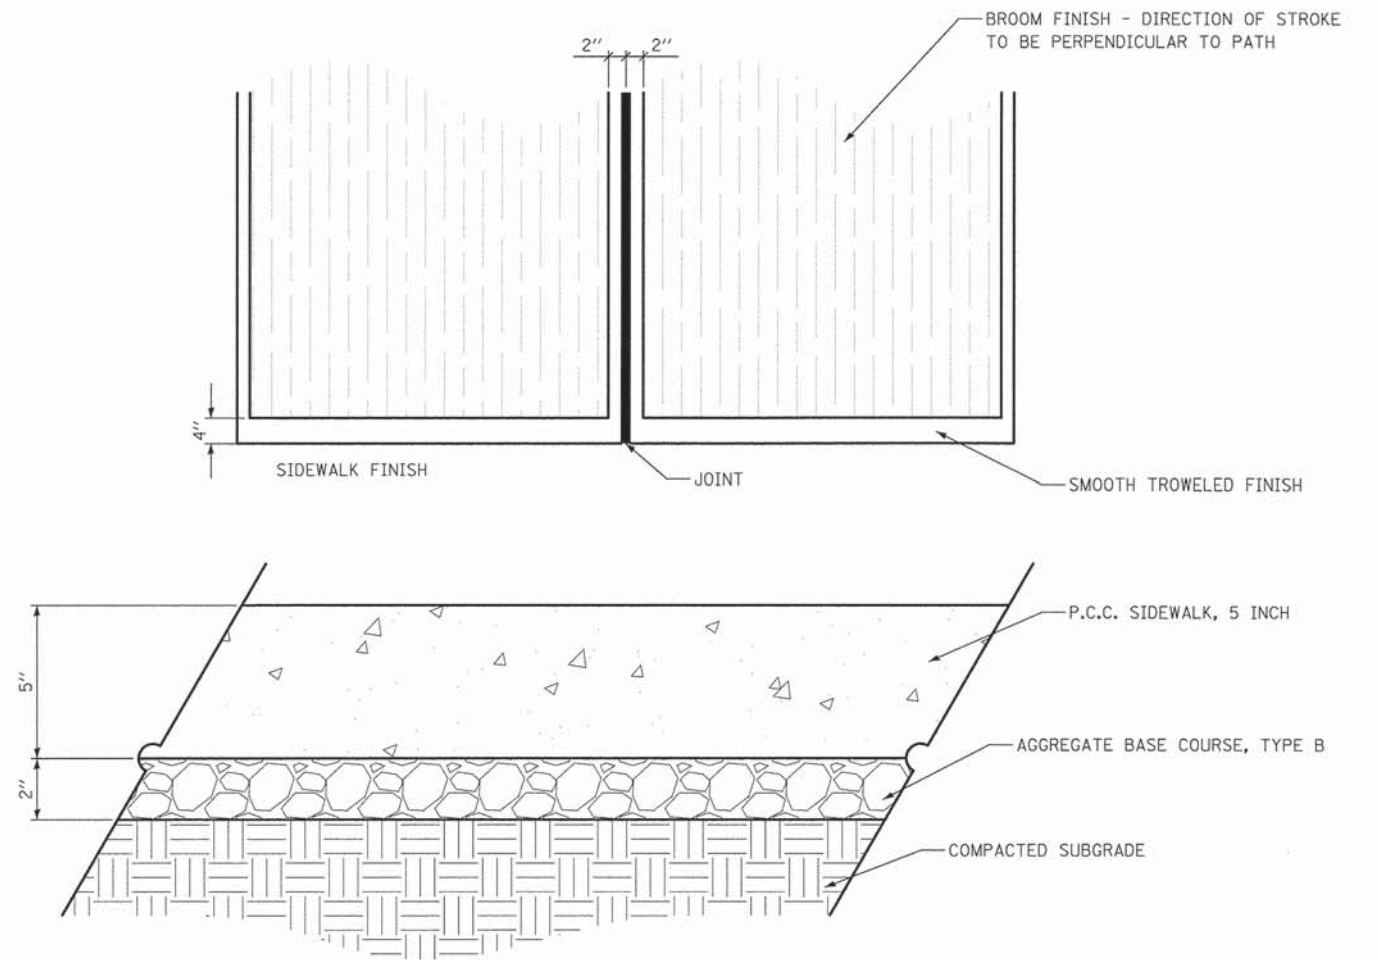

**SIDEWALK DETAIL**  
NOT TO SCALE



**NOTES FOR TEMPORARY TRAFFIC SIGNALS**



1. ALL CONTROL EQUIPMENT INCLUDING EMERGENCY PRE-EMPTION AND COMMUNICATION DEVICES FOR THE TEMPORARY TRAFFIC SIGNAL(S) SHALL BE FURNISHED BY THE CONTRACTOR.
2. ONLY CONTROLLERS SUPPLIED BY ONE OF THE DISTRICT APPROVED CLOSED LOOP EQUIPMENT MANUFACTURERS WILL BE APPROVED FOR USE AT TEMPORARY SIGNAL LOCATIONS. ALL CONTROLLERS USED FOR TEMPORARY TRAFFIC SIGNALS SHALL BE FULLY ACTUATED NEMA MICROPROCESSOR BASED WITH RS232 DATA ENTRY PORTS COMPATIBLE WITH EXISTING MONITORING SOFTWARE APPROVED BY IDOT DISTRICT 1, INSTALLED IN A NEMA TS2 CABINET. ONLY ONE BRAND OF CONTROLLER WILL BE ACCEPTED FOR ANY ONE CONTRACT.
3. ALL TRAFFIC SIGNAL SECTIONS AND PEDESTRIAN SIGNAL SECTIONS SHALL BE L.E.D. AND 12" (300 mm) DIAMETER. HEADS SHALL BE PLACED AS INDICATED ON THE TEMPORARY TRAFFIC SIGNAL PLAN OR AS DIRECTED BY THE ENGINEER. PEDESTRIAN SIGNALS SHALL INCLUDE SOLID INTERNATIONAL SYMBOLS. PEDESTRIAN SIGNALS WITH COUNTDOWN TIMERS SHALL BE USED WHEN THE EXISTING INSTALLATION UTILIZES COUNTDOWN TYPE OR AS DIRECTED BY THE ENGINEER. COUNTDOWN TYPE PEDESTRIAN SIGNALS ARE NOT TO BE INSTALLED AT A RAILROAD INTERSECTION. THE CONTRACTOR SHALL FURNISH ENOUGH CABLE SLACK TO RELOCATE HEADS TO ANY POSITION ON THE SPAN WIRE OR AT LOCATIONS ILLUSTRATED ON THE PLANS FOR CONSTRUCTION STAGING. THE TEMPORARY TRAFFIC SIGNAL SHALL REMAIN IN OPERATION DURING ALL SIGNAL HEAD RELOCATIONS. EACH TEMPORARY TRAFFIC SIGNAL HEAD SHALL HAVE ITS OWN CABLE FROM THE CONTROLLER CABINET TO THE SIGNAL HEAD.
4. ALL EXISTING STREET NAME AND INTERSECTION REGULATORY SIGNS SHALL BE REMOVED FROM EXISTING POLES, RELOCATED AND SECURELY FASTENED TO THE SPAN WIRE OR WOOD POLE AS DIRECTED BY THE ENGINEER.
5. ANY TEMPORARY SIGNAL WITHIN AN EXISTING CLOSED LOOP TRAFFIC SIGNAL SYSTEM SHALL BE INTERCONNECTED TO THAT SYSTEM USING SIMILAR BRAND CONTROL EQUIPMENT.
6. THE TEMPORARY TRAFFIC SIGNAL SHALL HAVE THE SIGNAL HEAD DISPLAYS, SIGNAL HEAD PLACEMENTS AND CONTROLLER PHASING MATCH THE EXISTING TRAFFIC SIGNAL AT THE TIME OF THE TURN ON, IF NO TRAFFIC STAGING IS IN PLACE OR WILL NOT BE STAGED ON THE DAY OF THE TURN ON.
7. UNINTERRUPTIBLE POWER SUPPLY (UPS) SYSTEMS SHALL BE INSTALLED AND MADE OPERATIONAL AT TEMPORARY TRAFFIC SIGNAL INSTALLATIONS WHERE UPS IS INSTALLED AT THE EXISTING TRAFFIC SIGNAL, TEMPORARY TRAFFIC SIGNALS AT RAILROAD INTERSECTIONS, AND TEMPORARY TRAFFIC SIGNALS AT INTERSECTIONS WITH FIRE STATION ACTUATED EMERGENCY VEHICLE PRE-EMPTION, OR WHEN INDICATED ON THE PLANS.
8. TRAFFIC SIGNAL MANAGEMENT SYSTEMS SHALL BE MAINTAINED IN OPERATION AS INDICATED ON THE PLANS OR AS DIRECTED BY THE ENGINEER. REQUIRED EQUIPMENT SHALL BE AS SHOWN ON THE PLANS AND THE CONTRACTOR SHALL PLACE THE EQUIPMENT IN OPERATION TO THE SATISFACTION OF THE ENGINEER AND THE AGENCY RESPONSIBLE FOR THE TRAFFIC SIGNAL MANAGEMENT SYSTEM.
9. DETECTION AT TEMPORARY TRAFFIC SIGNALS SHALL BE INCLUDED FOR ALL APPROACHES OF THE INTERSECTION UNLESS INDICATED OTHERWISE ON THE PLANS. THE DETECTION SYSTEM MUST MEET THE SPECIFICATIONS OF DISTRICT 1 AND THE CONTRACTOR SHALL PLACE THE DETECTORS INTO OPERATION TO THE SATISFACTION OF THE ENGINEER.
10. WHEN PAN, TILT, ZOOM CAMERAS ARE INSTALLED AT THE EXISTING INTERSECTION OR ARE CALLED FOR IN THE PLANS, THE CONTRACTOR SHALL BE RESPONSIBLE FOR INSTALLING AND MAINTAINING THE CAMERAS TO THE SATISFACTION OF THE ENGINEER AND THE AGENCY RESPONSIBLE FOR THE CAMERAS.
11. THE LEFT TURN ARROW INDICATIONS OF THESE SIGNAL HEADS SHALL BE BAGGED AND DISCONNECTED UNTIL THE BEGINNING OF M.O.T. STAGE IV.

THE FOLLOWING ITEMS SHALL BE REMOVED BY THE CONTRACTOR AND SHALL BE DISPOSED OF BY THEM OUTSIDE THE RIGHT-OF-WAY AT THEIR EXPENSE. THE SALVAGE VALUE OF THE REMOVED EQUIPMENT SHALL BE REFLECTED IN THE CONTRACT BID PRICE.

- 1 EACH CONTROLLER AND CABINET, COMPLETE
- 3 EACH SIGNAL POST
- 2 EACH STEEL MAST ARM ASSEMBLY AND POLE
- 3 EACH SIGNAL HEAD, 1-FACE, 3-SECTION
- 1 EACH SIGNAL HEAD, 1-FACE, 4-SECTION
- 1 EACH SIGNAL HEAD, 2-FACE, 3-SECTION
- 1 EACH SIGNAL HEAD, 3-FACE, 2-3 SECTION, 1-4 SECTION
- 2 EACH TRAFFIC SIGNAL BACKPLATE
- 1 EACH SERVICE INSTALLATION

THE FOLLOWING EXISTING TRAFFIC SIGNAL EQUIPMENT SHALL BE REMOVED BY THE CONTRACTOR AND SHALL REMAIN THE PROPERTY OF THE VILLAGE OF BROOKFIELD FIRE DEPARTMENT. THE CONTRACTOR SHALL SAFELY STORE AND ARRANGE FOR PICK UP OF ALL EQUIPMENT TO BE RETURNED TO THE FIRE DEPARTMENT AS PER THE TRAFFIC SIGNAL SPECIFICATIONS.

- 2 EACH LIGHT DETECTOR
- 1 EACH LIGHT DETECTOR AMPLIFIER

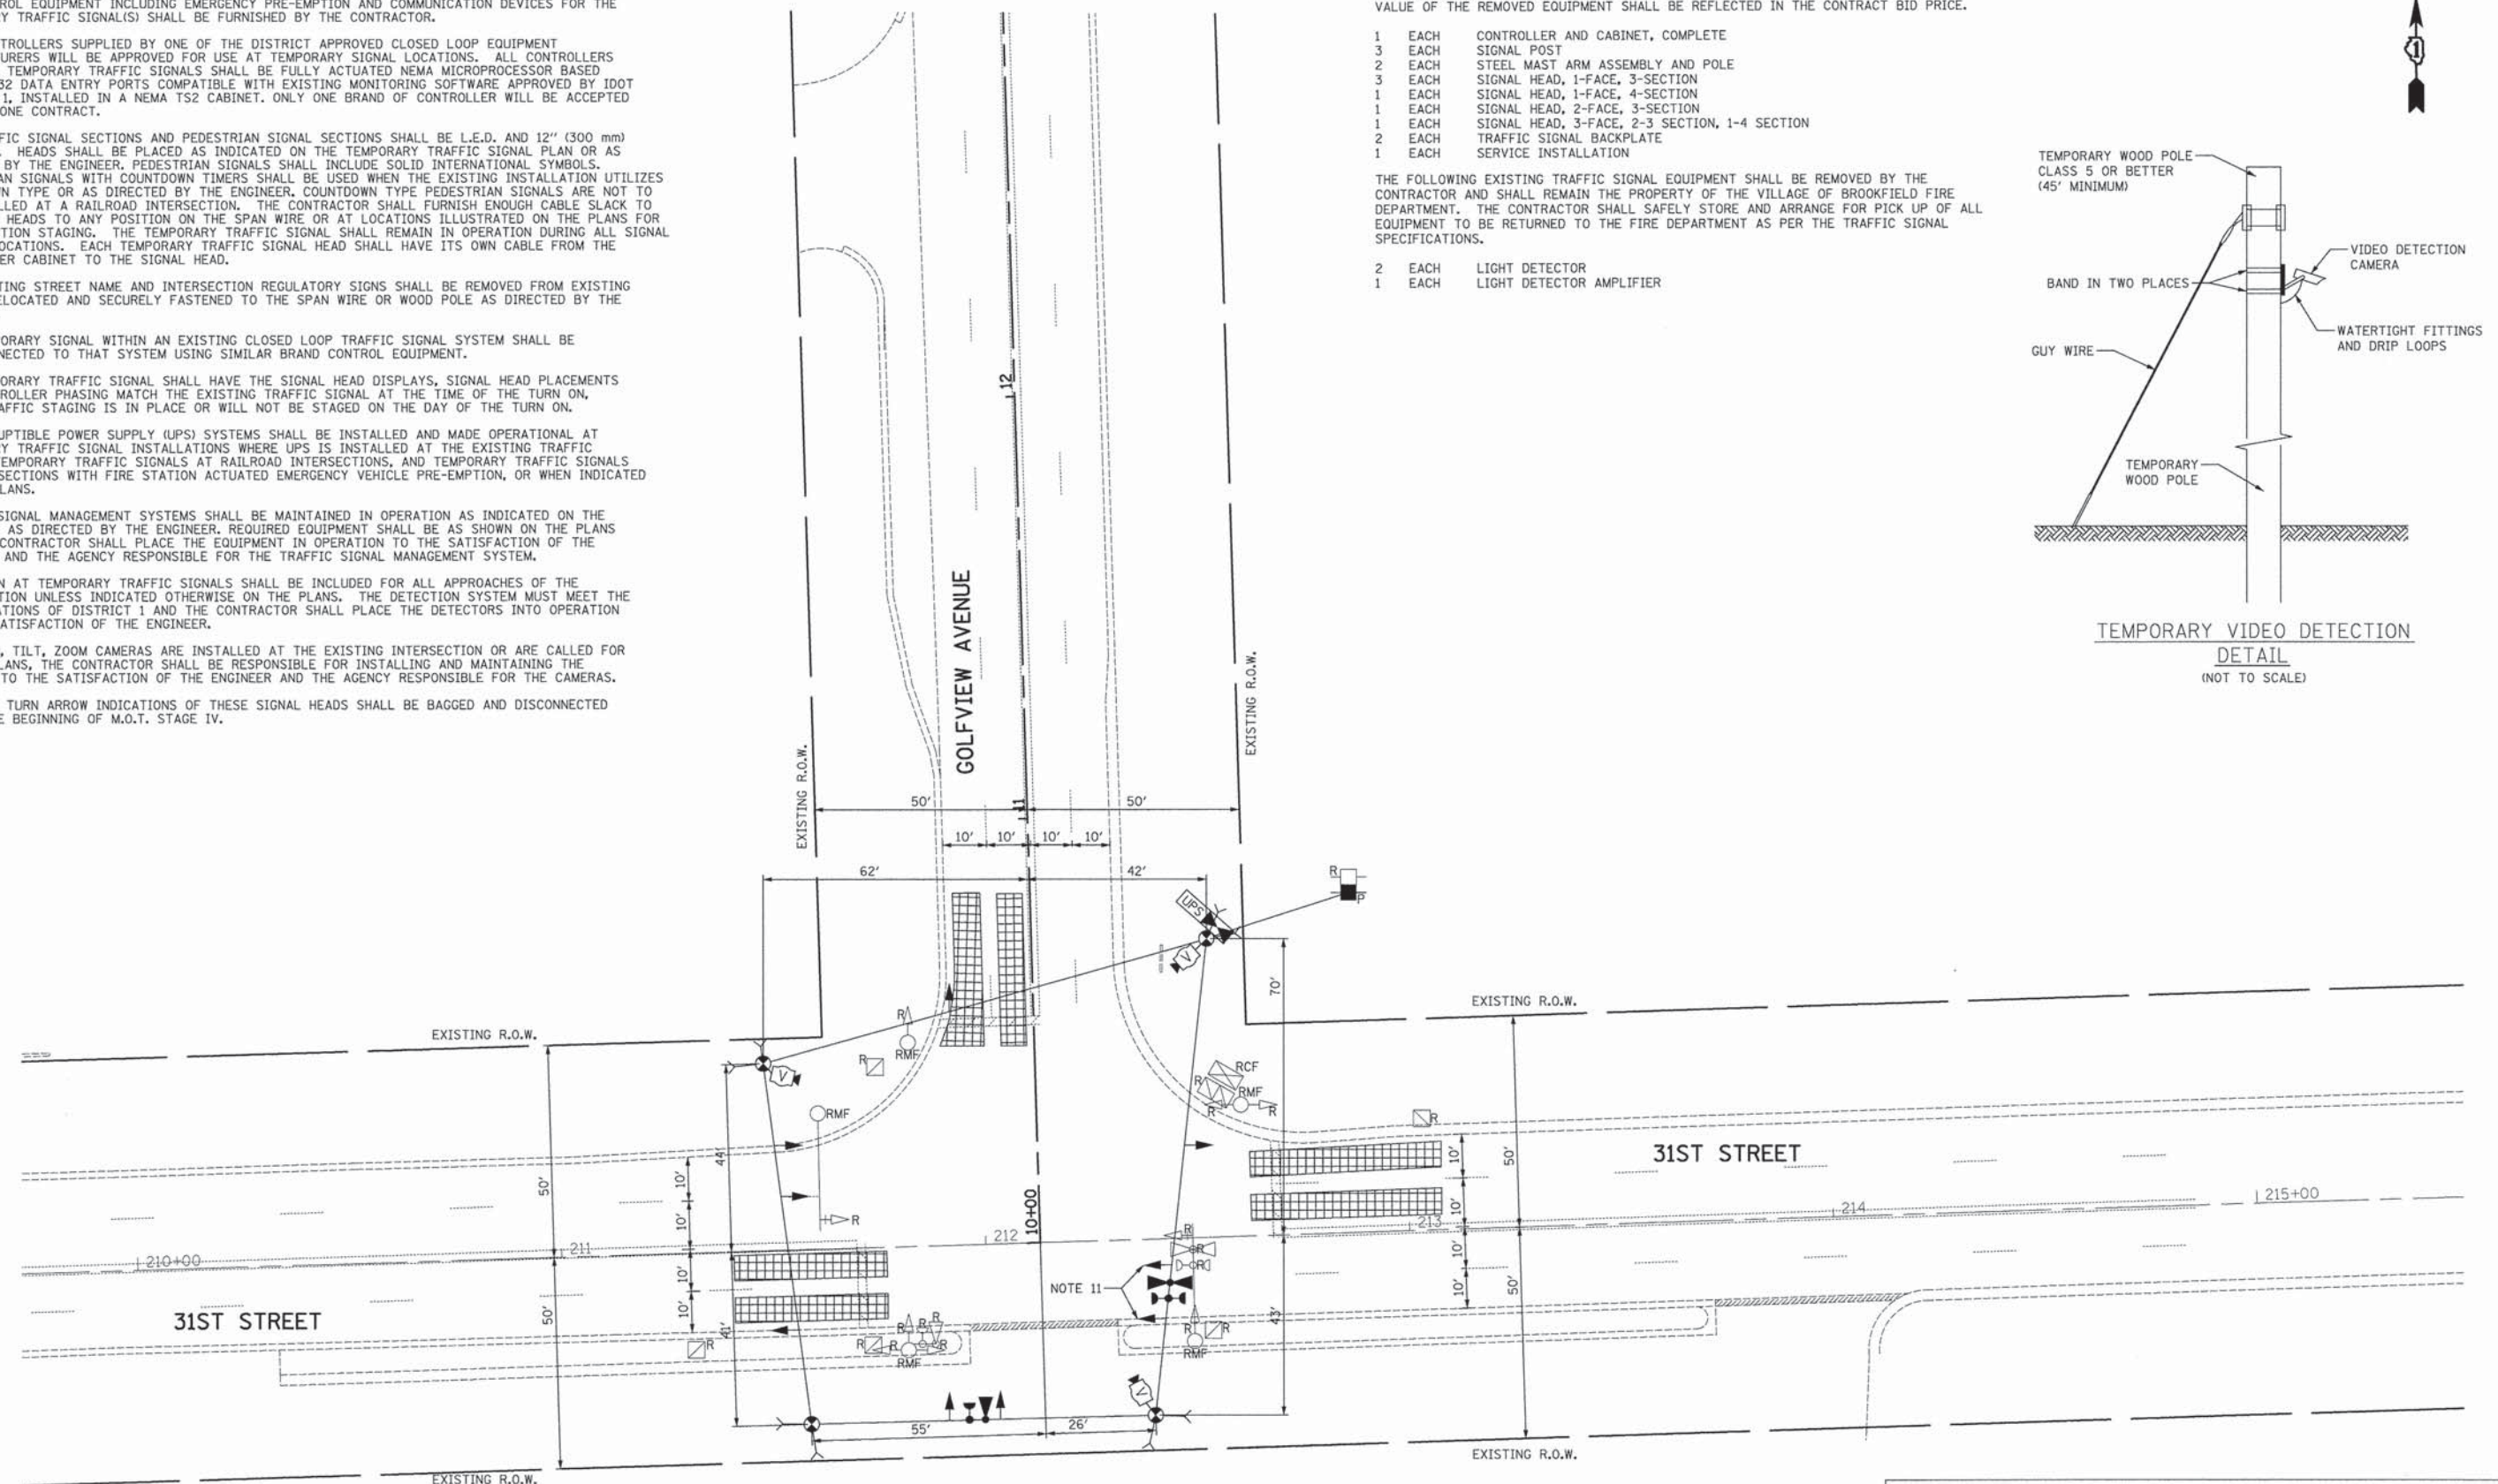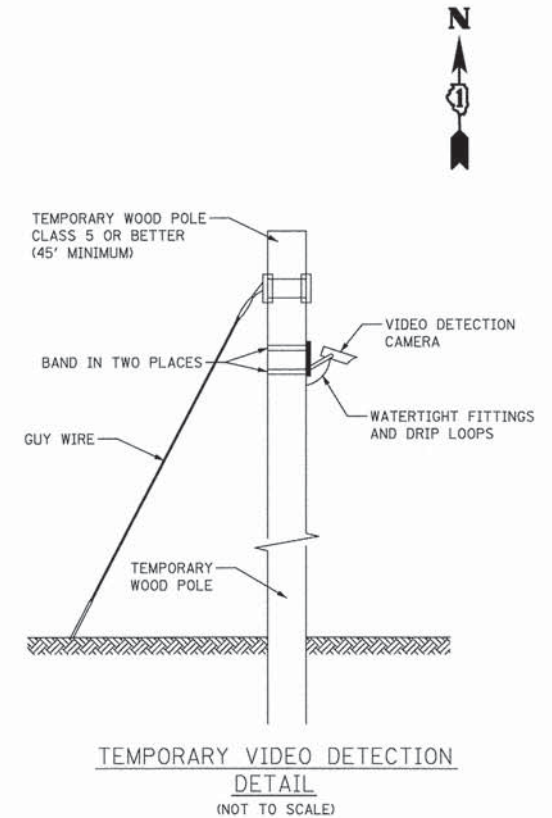

**RESTORATION OF WORK AREA.**  
 RESTORATION OF THE TRAFFIC SIGNAL WORK AREA SHALL BE INCIDENTAL TO THE RELATED PAY ITEM SUCH AS FOUNDATION, CONDUIT, HANDHOLE, TRENCH AND BACKFILL, ETC., AND NO EXTRA COMPENSATION SHALL BE ALLOWED. ALL ROADWAY SURFACES SUCH AS SHOULDER, MEDIAN, SIDEWALKS, PAVEMENT, ETC. SHALL BE REPLACED IN KIND. ALL DAMAGE TO MOWED LAWNS SHALL BE REPLACED WITH AN APPROVED SALT TOLERANT SOD, AND ALL DAMAGE TO UNMOWED FIELDS SHALL BE SEEDED IN ACCORDANCE WITH STANDARD SPECIFICATIONS 252 AND 250 RESPECTIVELY.



USER NAME = dte	DESIGNED - BRD	REVISED -
PLDT SCALE = 20,0000' / 1"	DRAWN - MFB	REVISED -
PLDT DATE = 5/6/2013	CHECKED - JJE	REVISED -
	DATE - 05/13/2013	REVISED -

**STATE OF ILLINOIS  
 DEPARTMENT OF TRANSPORTATION**

**TEMPORARY TRAFFIC SIGNAL INSTALLATION PLAN AND REMOVAL PLAN  
 GOLFVIEW AVENUE AT 31ST STREET - EXISTING CONDITIONS**


SCALE: 1" = 20' SHEET NO. 1 OF 1 SHEETS STA. TO STA.

F.A.U. RTE. 3784	SECTION 12-F3000-23-PK	COUNTY COOK	TOTAL SHEETS 131	SHEET NO. 71
CONTRACT NO. 63764				
FED. ROAD DIST. NO. 1 ILLINOIS FED. AID PROJECT				



NOTES FOR TEMPORARY TRAFFIC SIGNALS

1. THE LEFT TURN INDICATIONS OF THESE SIGNAL HEADS SHALL REMAIN BAGGED AND DISCONNECTED UNTIL THE BEGINNING OF M.O.T. STAGE IV.

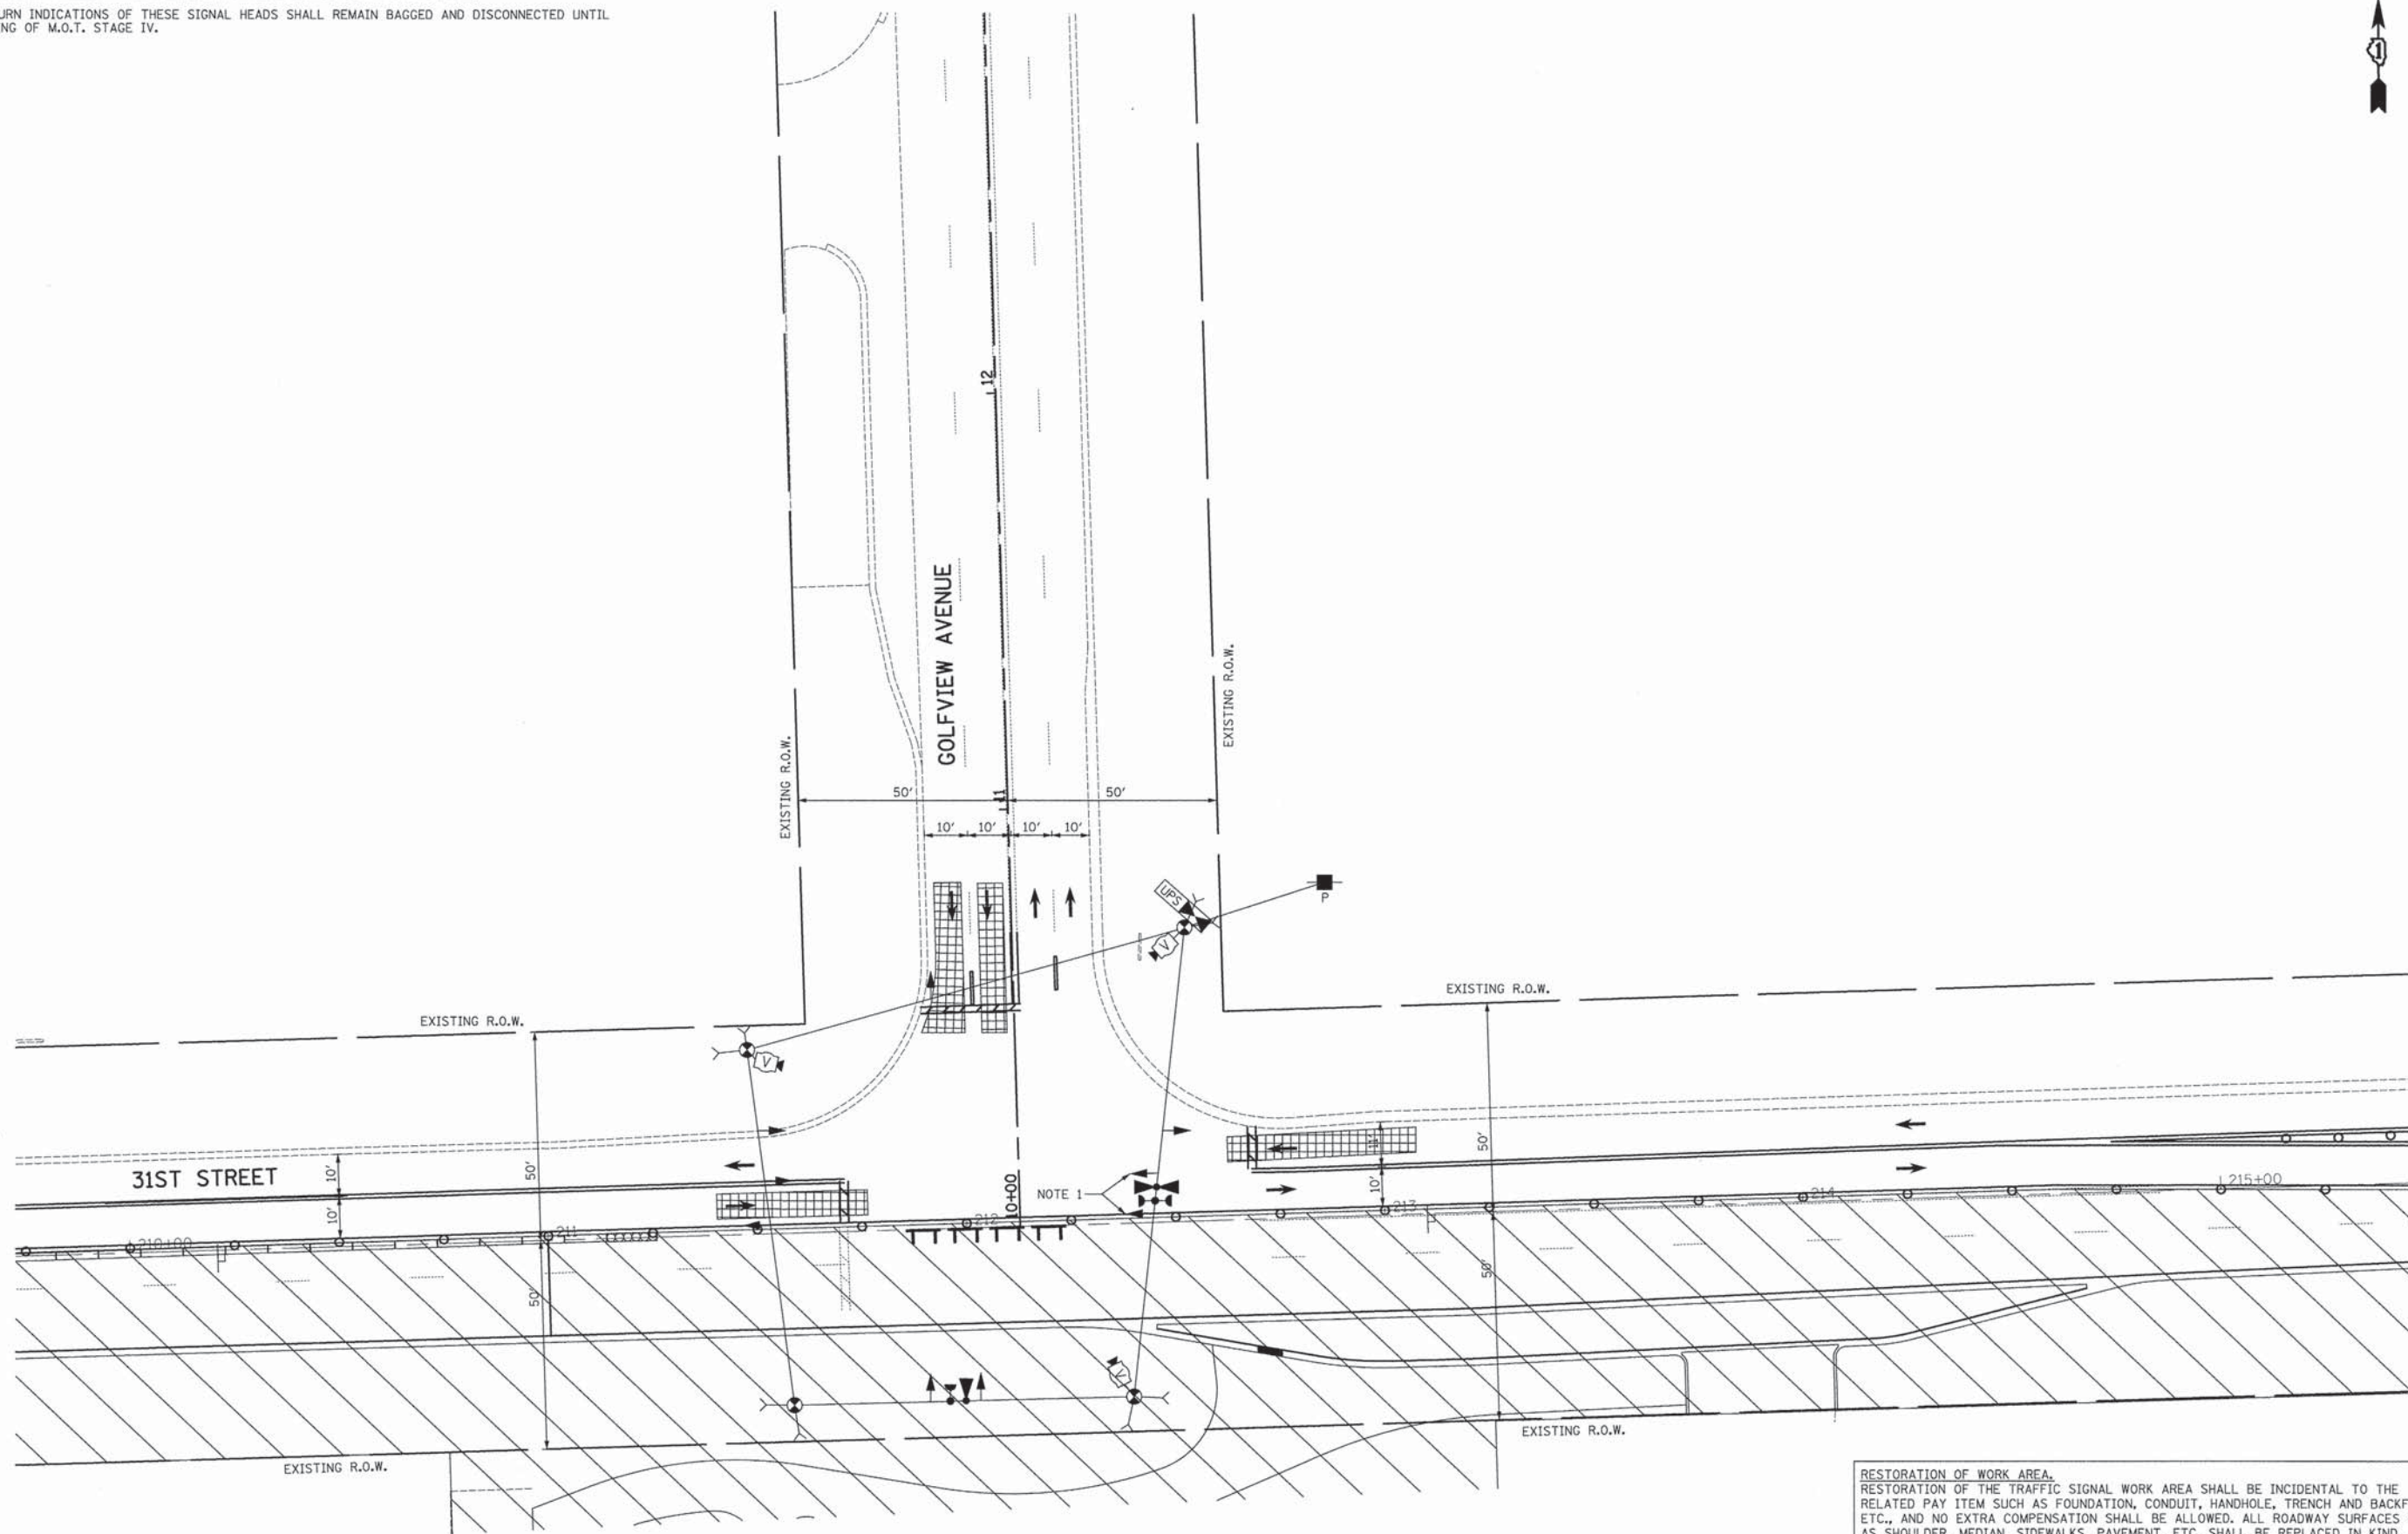

**RESTORATION OF WORK AREA.**  
 RESTORATION OF THE TRAFFIC SIGNAL WORK AREA SHALL BE INCIDENTAL TO THE RELATED PAY ITEM SUCH AS FOUNDATION, CONDUIT, HANDHOLE, TRENCH AND BACKFILL, ETC., AND NO EXTRA COMPENSATION SHALL BE ALLOWED. ALL ROADWAY SURFACES SUCH AS SHOULDER, MEDIAN, SIDEWALKS, PAVEMENT, ETC. SHALL BE REPLACED IN KIND. ALL DAMAGE TO MOWED LAWNS SHALL BE REPLACED WITH AN APPROVED SALT TOLERANT SOG, AND ALL DAMAGE TO UNMOWED FIELDS SHALL BE SEEDING IN ACCORDANCE WITH STANDARD SPECIFICATIONS 252 AND 250 RESPECTIVELY.



USER NAME = dte	DESIGNED - BRD	REVISED -
	DRAWN - MFB	REVISED -
PLOT SCALE = 20,0000' / in.	CHECKED - JJE	REVISED -
PLOT DATE = 5/6/2013	DATE - 05/13/2013	REVISED -

STATE OF ILLINOIS  
 DEPARTMENT OF TRANSPORTATION

TEMPORARY TRAFFIC SIGNAL STAGING PLAN  
 GOLFVIEW AVENUE AT 31ST STREET - M.O.T. STAGE I


SCALE: 1" = 20' SHEET NO. 1 OF 1 SHEETS STA. TO STA.

F.A.U. RTE.	SECTION	COUNTY	TOTAL SHEETS	SHEET NO.
3784	12-F3000-23-PK	COOK	131	72
CONTRACT NO. 63764				
FED. ROAD DIST. NO. 1   ILLINOIS   FED. AID PROJECT				



NOTES FOR TEMPORARY TRAFFIC SIGNALS

1. THE LEFT TURN INDICATIONS OF THESE SIGNAL HEADS SHALL REMAIN BAGGED AND DISCONNECTED UNTIL THE BEGINNING OF M.O.T. STAGE IV.

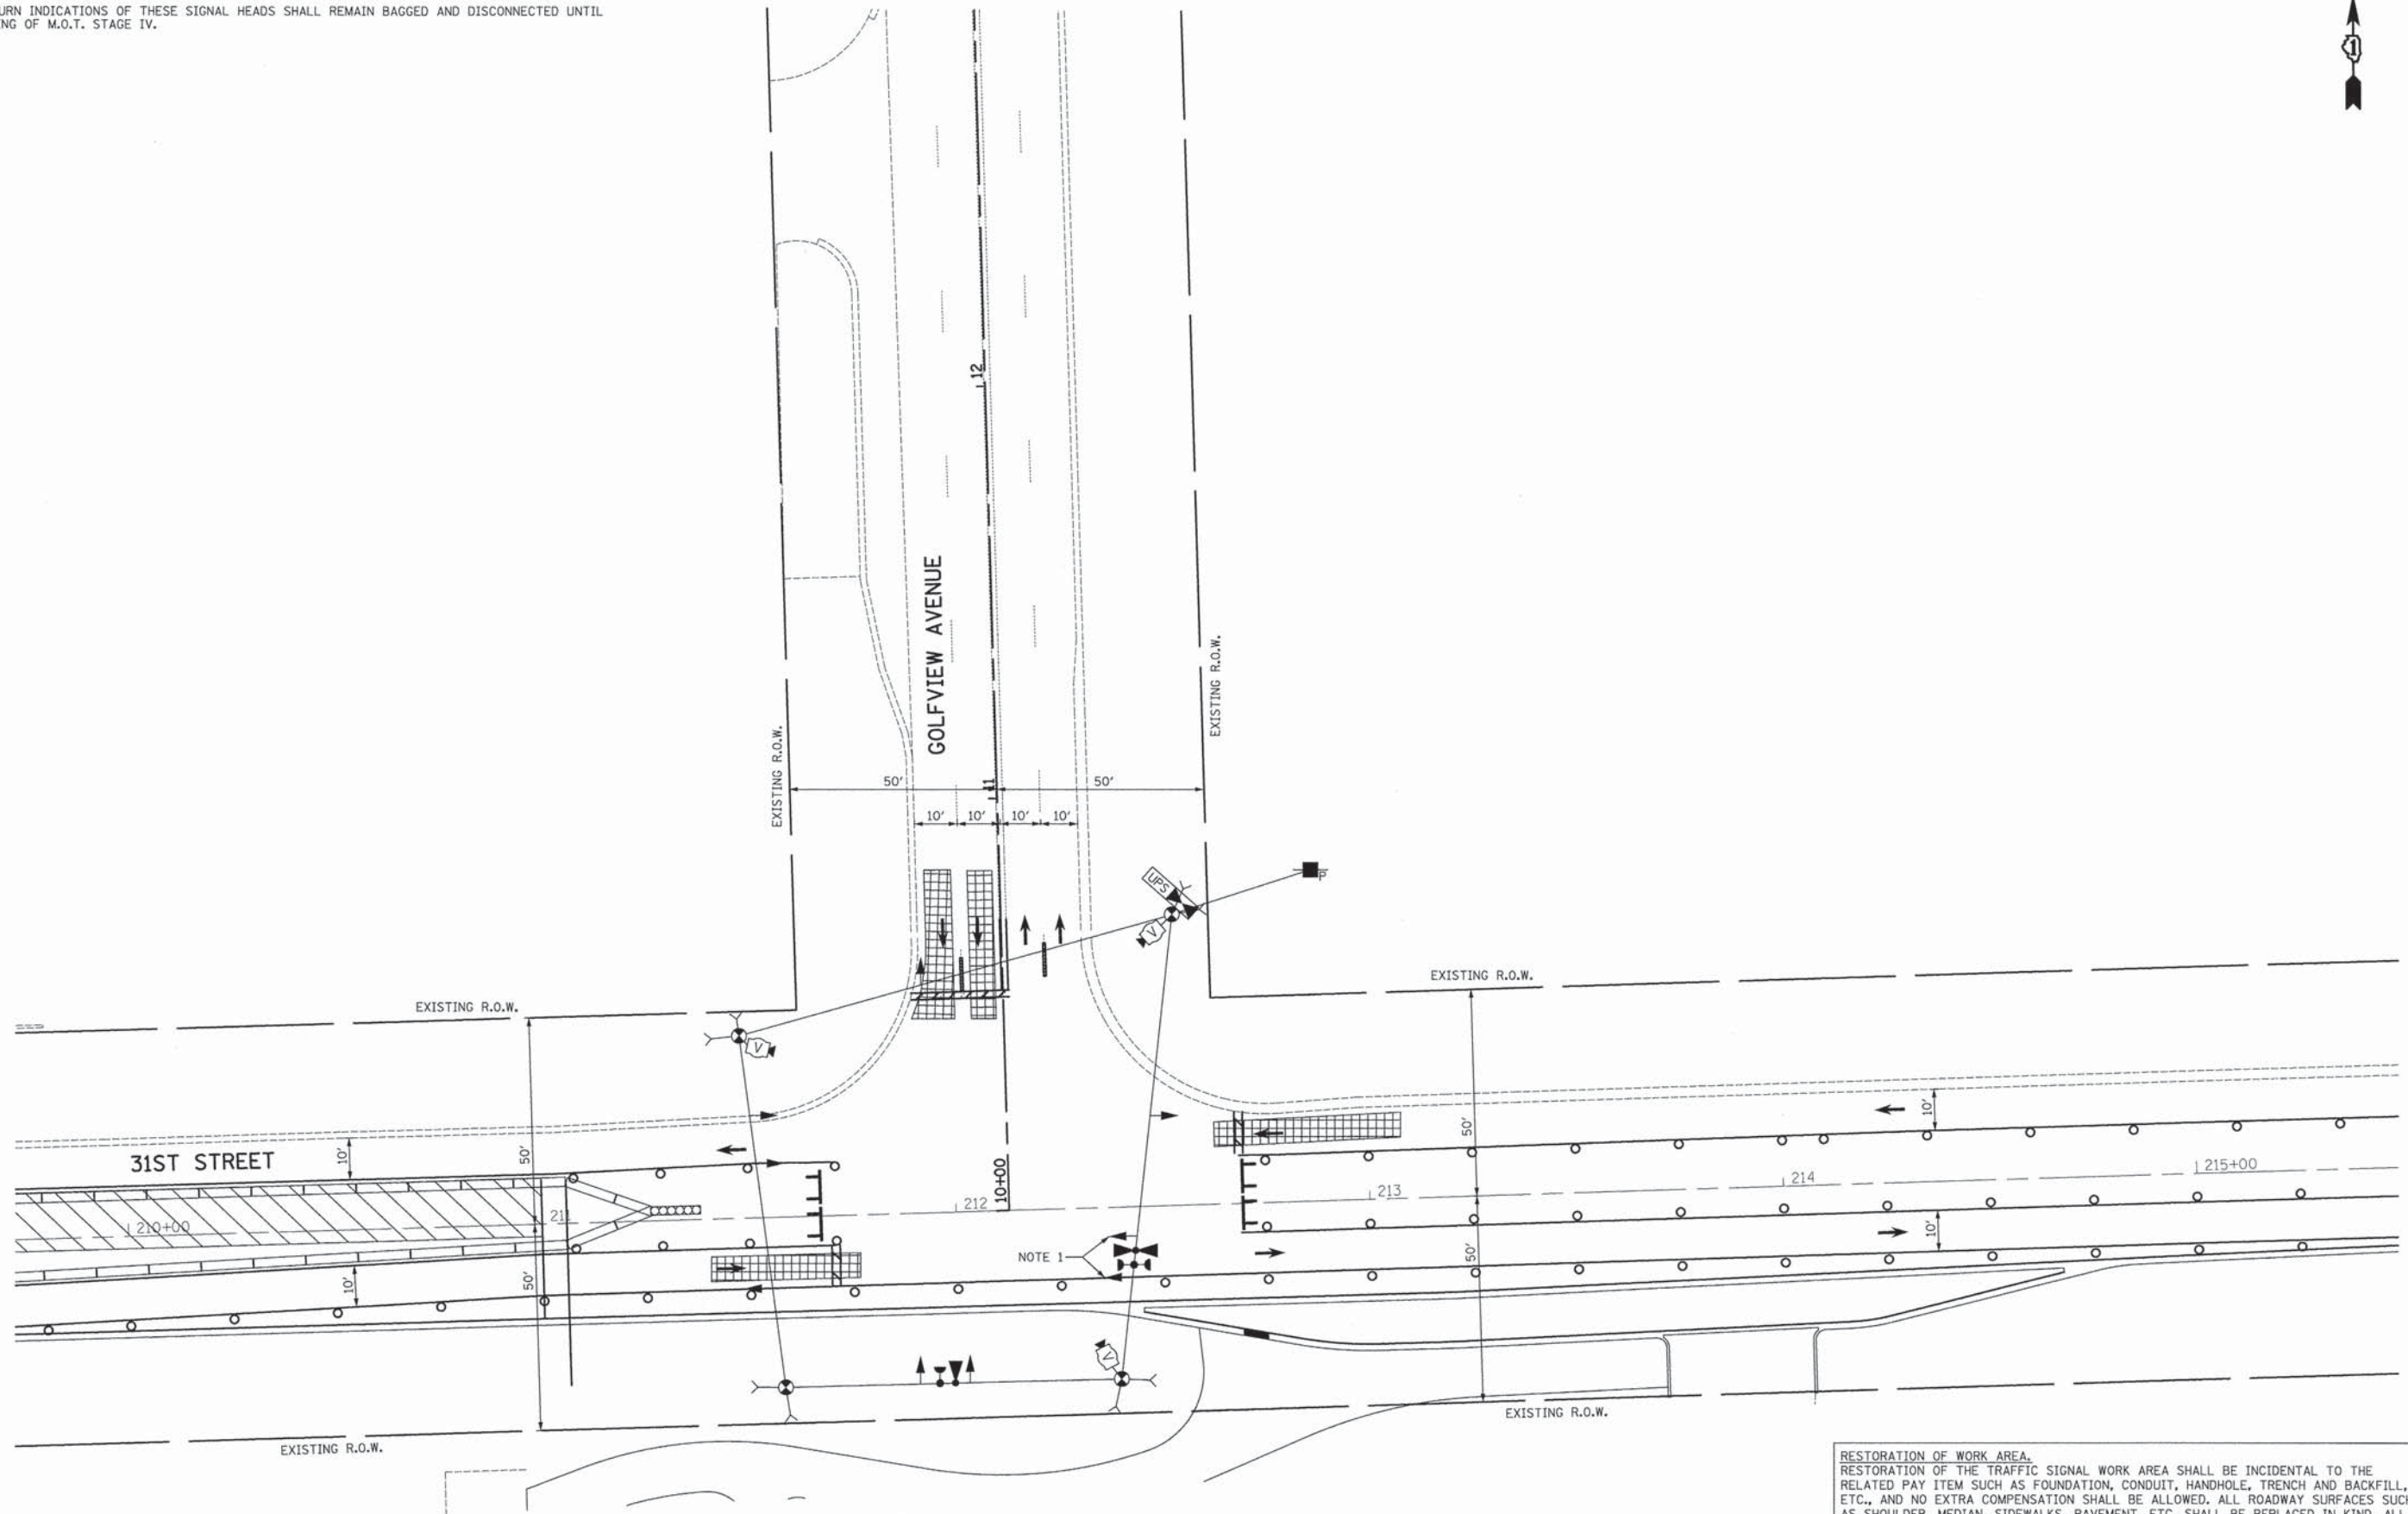

**RESTORATION OF WORK AREA.**  
 RESTORATION OF THE TRAFFIC SIGNAL WORK AREA SHALL BE INCIDENTAL TO THE RELATED PAY ITEM SUCH AS FOUNDATION, CONDUIT, HANDHOLE, TRENCH AND BACKFILL, ETC., AND NO EXTRA COMPENSATION SHALL BE ALLOWED. ALL ROADWAY SURFACES SUCH AS SHOULDER, MEDIAN, SIDEWALKS, PAVEMENT, ETC. SHALL BE REPLACED IN KIND. ALL DAMAGE TO MOWED LAWNS SHALL BE REPLACED WITH AN APPROVED SALT TOLERANT SOD, AND ALL DAMAGE TO UNMOWED FIELDS SHALL BE SEEDED IN ACCORDANCE WITH STANDARD SPECIFICATIONS 252 AND 250 RESPECTIVELY.



USER NAME = dte	DESIGNED - BRD	REVISED -
	DRAWN - MFB	REVISED -
PLOT SCALE = 20.0000' / 1" =	CHECKED - JJE	REVISED -
PLOT DATE = 5/6/2013	DATE - 05/13/2013	REVISED -

**STATE OF ILLINOIS  
 DEPARTMENT OF TRANSPORTATION**

**TEMPORARY TRAFFIC SIGNAL STAGING PLAN  
 GOLFVIEW AVENUE AT 31ST STREET - M.O.T. STAGE II**


SCALE: 1" = 20' SHEET NO. 1 OF 1 SHEETS STA. TO STA.

F.A.U. RTE.	SECTION	COUNTY	TOTAL SHEETS	SHEET NO.
3784	12-F3000-23-PK	COOK	131	73
<b>CONTRACT NO. 63764</b>				
<small>FED. ROAD DIST. NO. 1   ILLINOIS FED. AID PROJECT</small>				



NOTES FOR TEMPORARY TRAFFIC SIGNALS

1. THE LEFT TURN INDICATIONS OF THESE SIGNAL HEADS SHALL REMAIN BAGGED AND DISCONNECTED UNTIL THE BEGINNING OF M.O.T. STAGE IV.

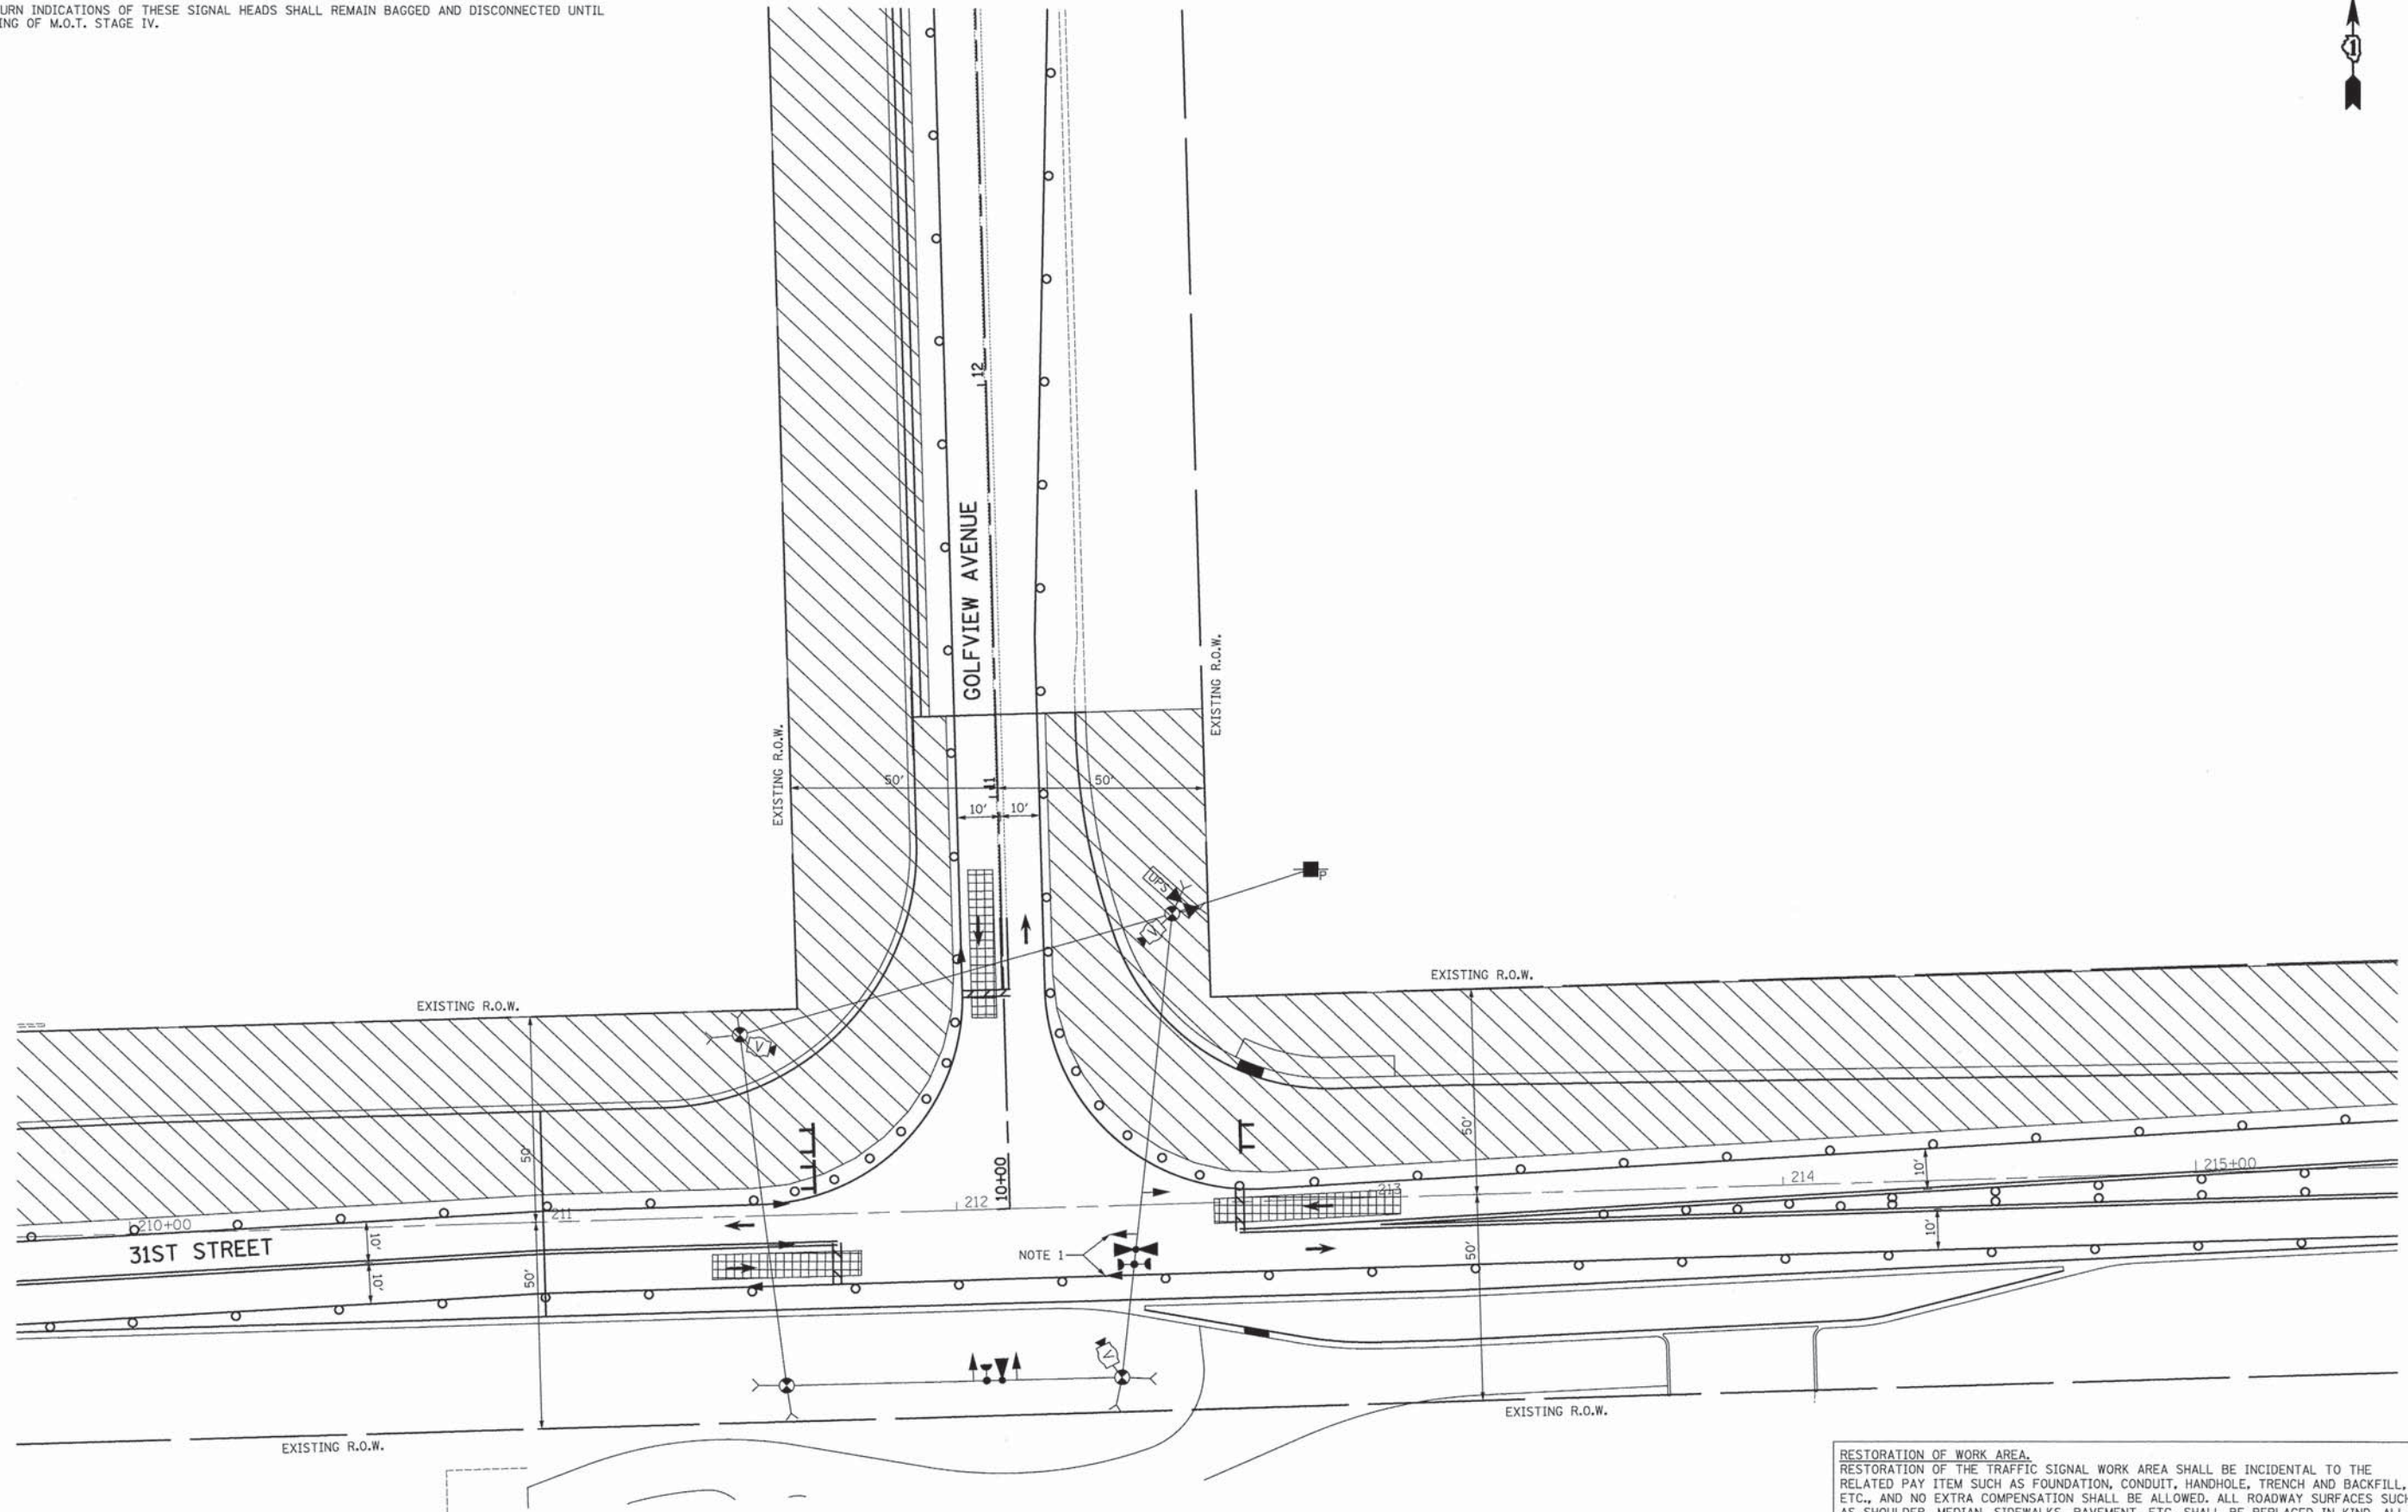

**RESTORATION OF WORK AREA.**  
 RESTORATION OF THE TRAFFIC SIGNAL WORK AREA SHALL BE INCIDENTAL TO THE RELATED PAY ITEM SUCH AS FOUNDATION, CONDUIT, HANDHOLE, TRENCH AND BACKFILL, ETC., AND NO EXTRA COMPENSATION SHALL BE ALLOWED. ALL ROADWAY SURFACES SUCH AS SHOULDER, MEDIAN, SIDEWALKS, PAVEMENT, ETC. SHALL BE REPLACED IN KIND. ALL DAMAGE TO MOWED LAWNS SHALL BE REPLACED WITH AN APPROVED SALT TOLERANT SOD, AND ALL DAMAGE TO UNMOWED FIELDS SHALL BE SEEDED IN ACCORDANCE WITH STANDARD SPECIFICATIONS 252 AND 250 RESPECTIVELY.



USER NAME = dte	DESIGNED - BRD	REVISED -
	DRAWN - MFB	REVISED -
PLDT SCALE = 20,0000' / 1" = 20'	CHECKED - JJE	REVISED -
PLDT DATE = 5/6/2013	DATE - 05/13/2013	REVISED -

**STATE OF ILLINOIS  
 DEPARTMENT OF TRANSPORTATION**

**TEMPORARY TRAFFIC SIGNAL STAGING PLAN  
 GOLFOVIEW AVENUE AT 31ST STREET - M.O.T. STAGE III**


SCALE: 1" = 20' SHEET NO. 1 OF 1 SHEETS STA. TO STA.

F.A.U. RTE.	SECTION	COUNTY	TOTAL SHEETS	SHEET NO.
3784	12-F3000-23-PK	COOK	131	74
				<b>CONTRACT NO. 63764</b>
FED. ROAD DIST. NO. 1 [ILLINOIS] FED. AID PROJECT				



NOTES FOR TEMPORARY TRAFFIC SIGNALS

1. THE LEFT TURN INDICATIONS OF THESE SIGNAL HEADS SHALL BE UNBAGGED AND ACTIVATED AT THE BEGINNING OF M.O.T. STAGE IV.

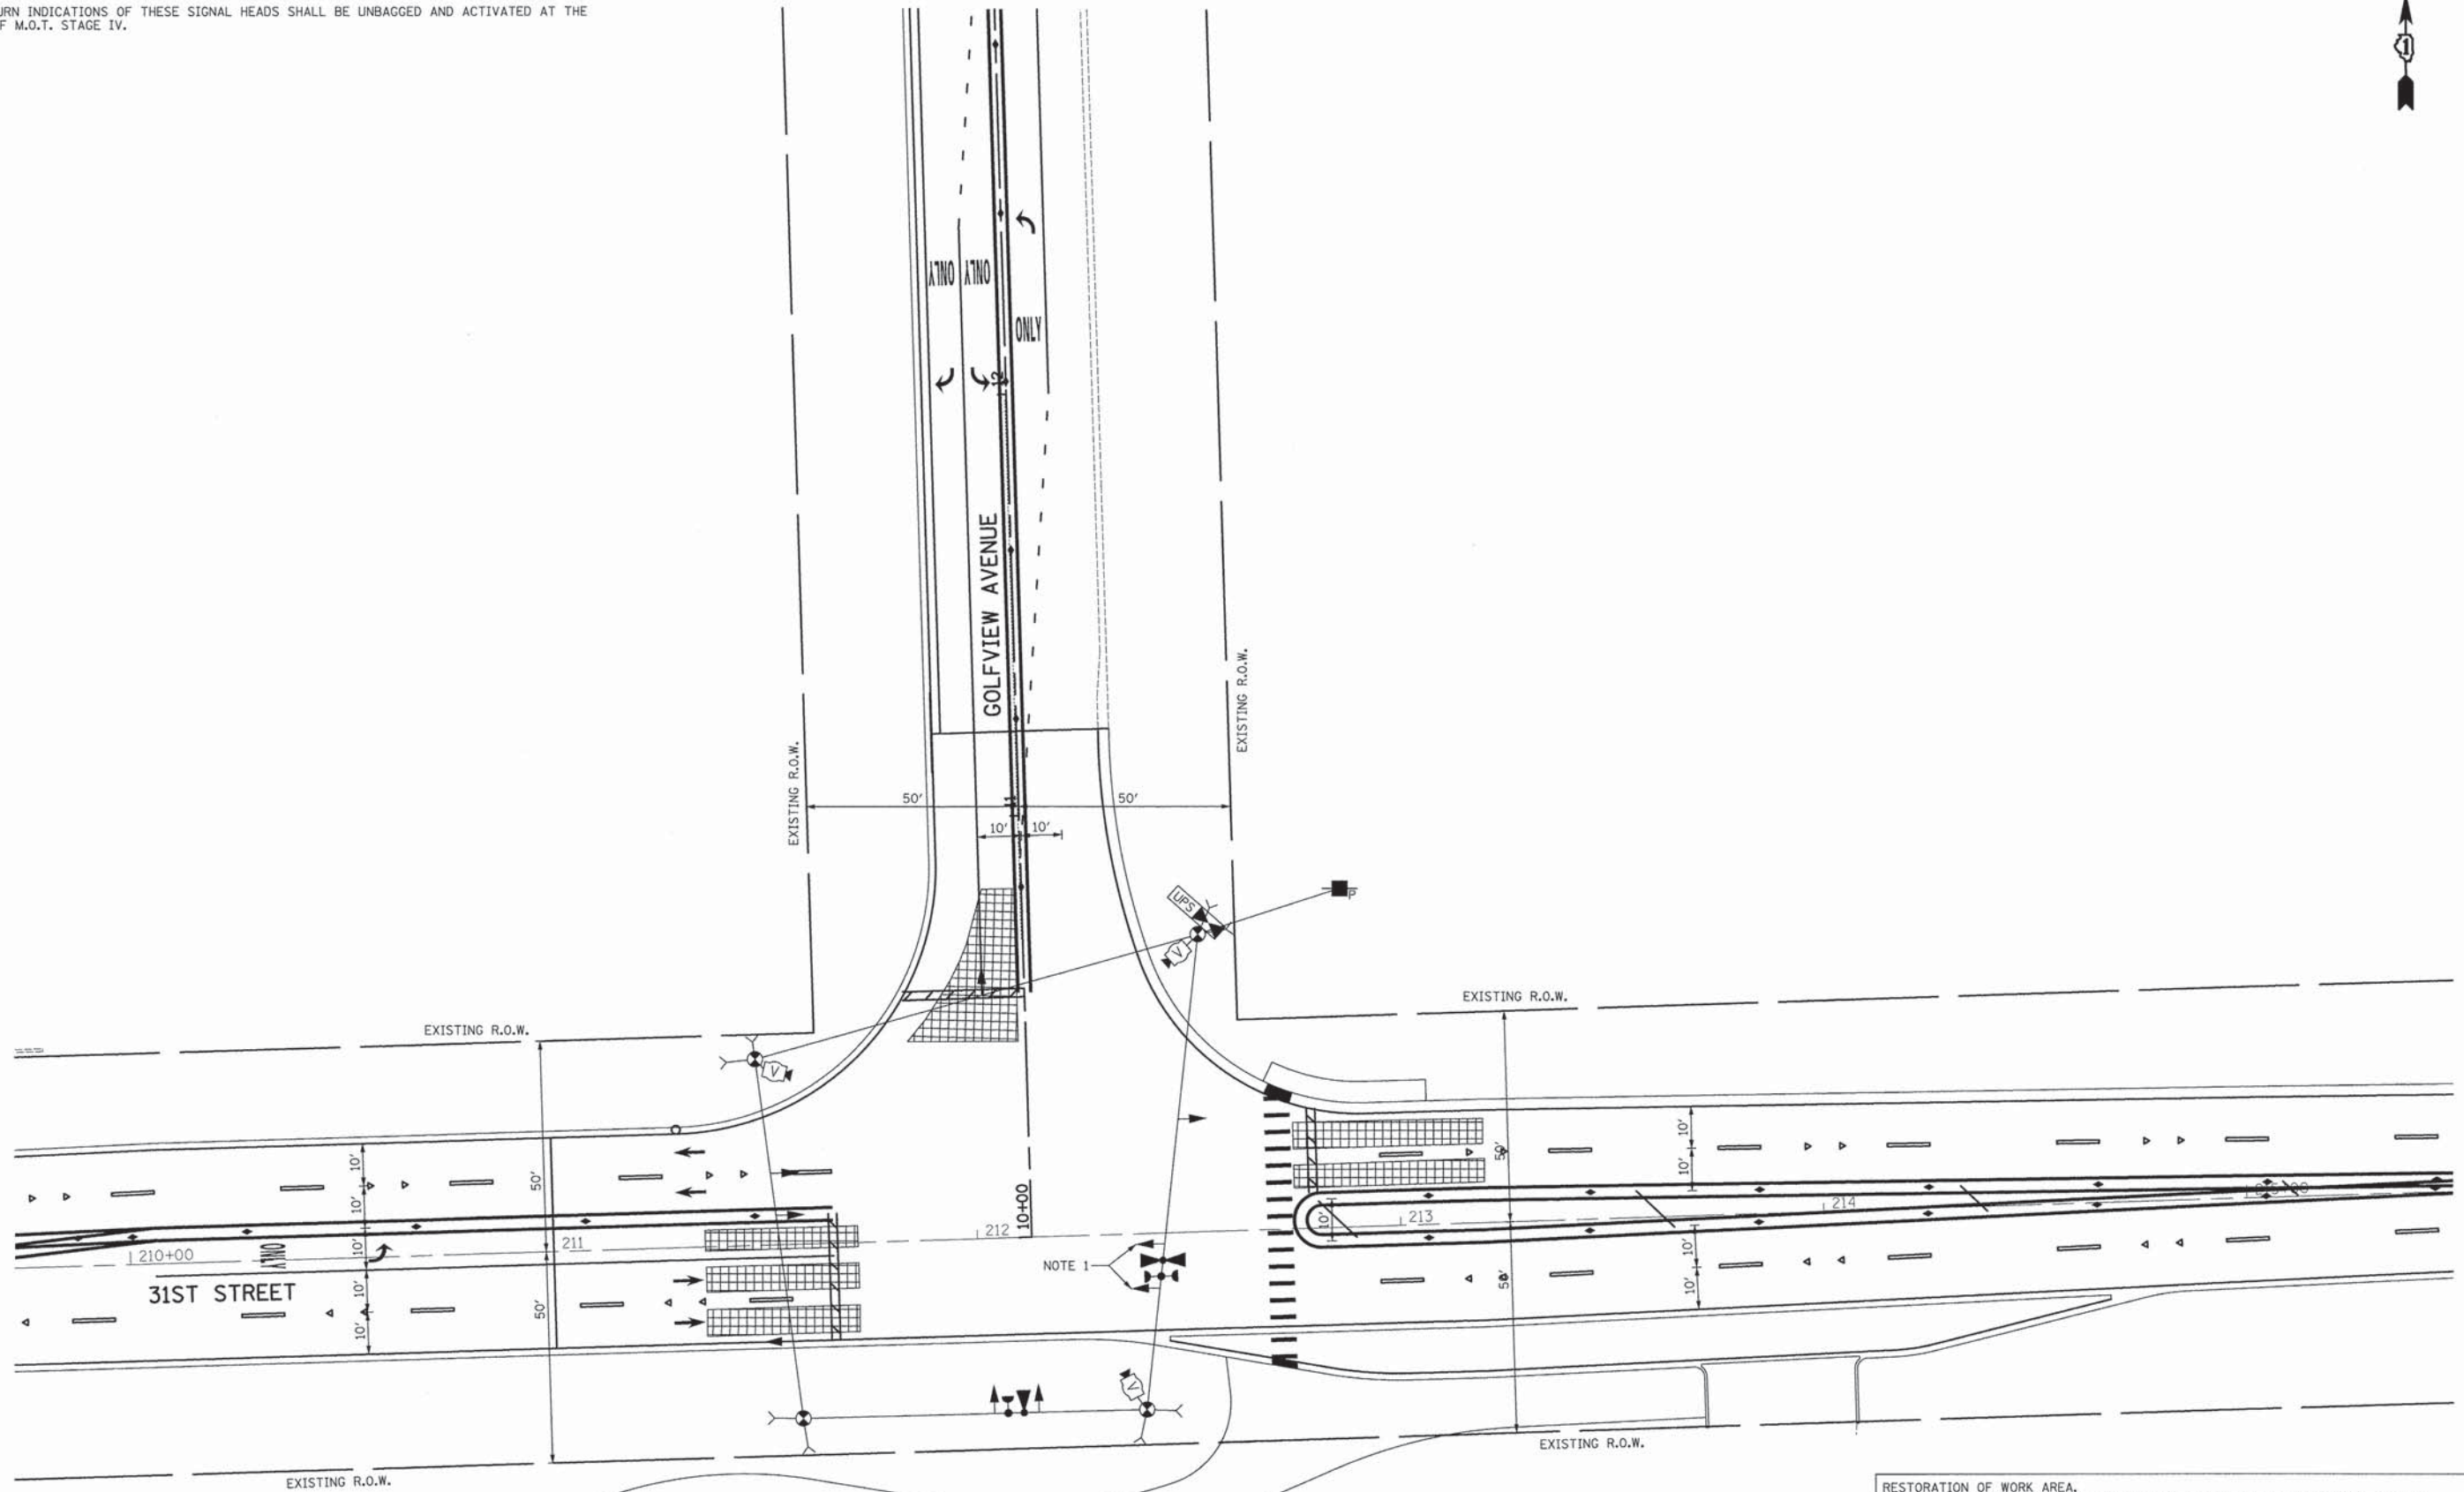

RESTORATION OF WORK AREA.  
 RESTORATION OF THE TRAFFIC SIGNAL WORK AREA SHALL BE INCIDENTAL TO THE RELATED PAY ITEM SUCH AS FOUNDATION, CONDUIT, HANDHOLE, TRENCH AND BACKFILL, ETC., AND NO EXTRA COMPENSATION SHALL BE ALLOWED. ALL ROADWAY SURFACES SUCH AS SHOULDER, MEDIAN, SIDEWALKS, PAVEMENT, ETC. SHALL BE REPLACED IN KIND. ALL DAMAGE TO MOWED LAWNS SHALL BE REPLACED WITH AN APPROVED SALT TOLERANT SOO, AND ALL DAMAGE TO UNMOWED FIELDS SHALL BE SEEDING IN ACCORDANCE WITH STANDARD SPECIFICATIONS 252 AND 250 RESPECTIVELY.




USER NAME = dte	DESIGNED - BRD	REVISED -
	DRAWN - MFB	REVISED -
PLDT SCALE = 20.0000' / 1" =	CHECKED - JJE	REVISED -
PLDT DATE = 5/6/2013	DATE - 05/13/2013	REVISED -

STATE OF ILLINOIS  
 DEPARTMENT OF TRANSPORTATION

TEMPORARY TRAFFIC SIGNAL STAGING PLAN  
 GOLFVIEW AVENUE AT 31ST STREET - M.O.T. STAGE IV  
 SCALE: 1" = 20' SHEET NO. 1 OF 1 SHEETS STA. TO STA.

F.A.U. RTE.	SECTION	COUNTY	TOTAL SHEETS	SHEET NO.
3784	12-F3000-23-PK	COOK	131	75
CONTRACT NO. 63764				
FED. ROAD DIST. NO. 1 (ILLINOIS) FED. AID PROJECT				



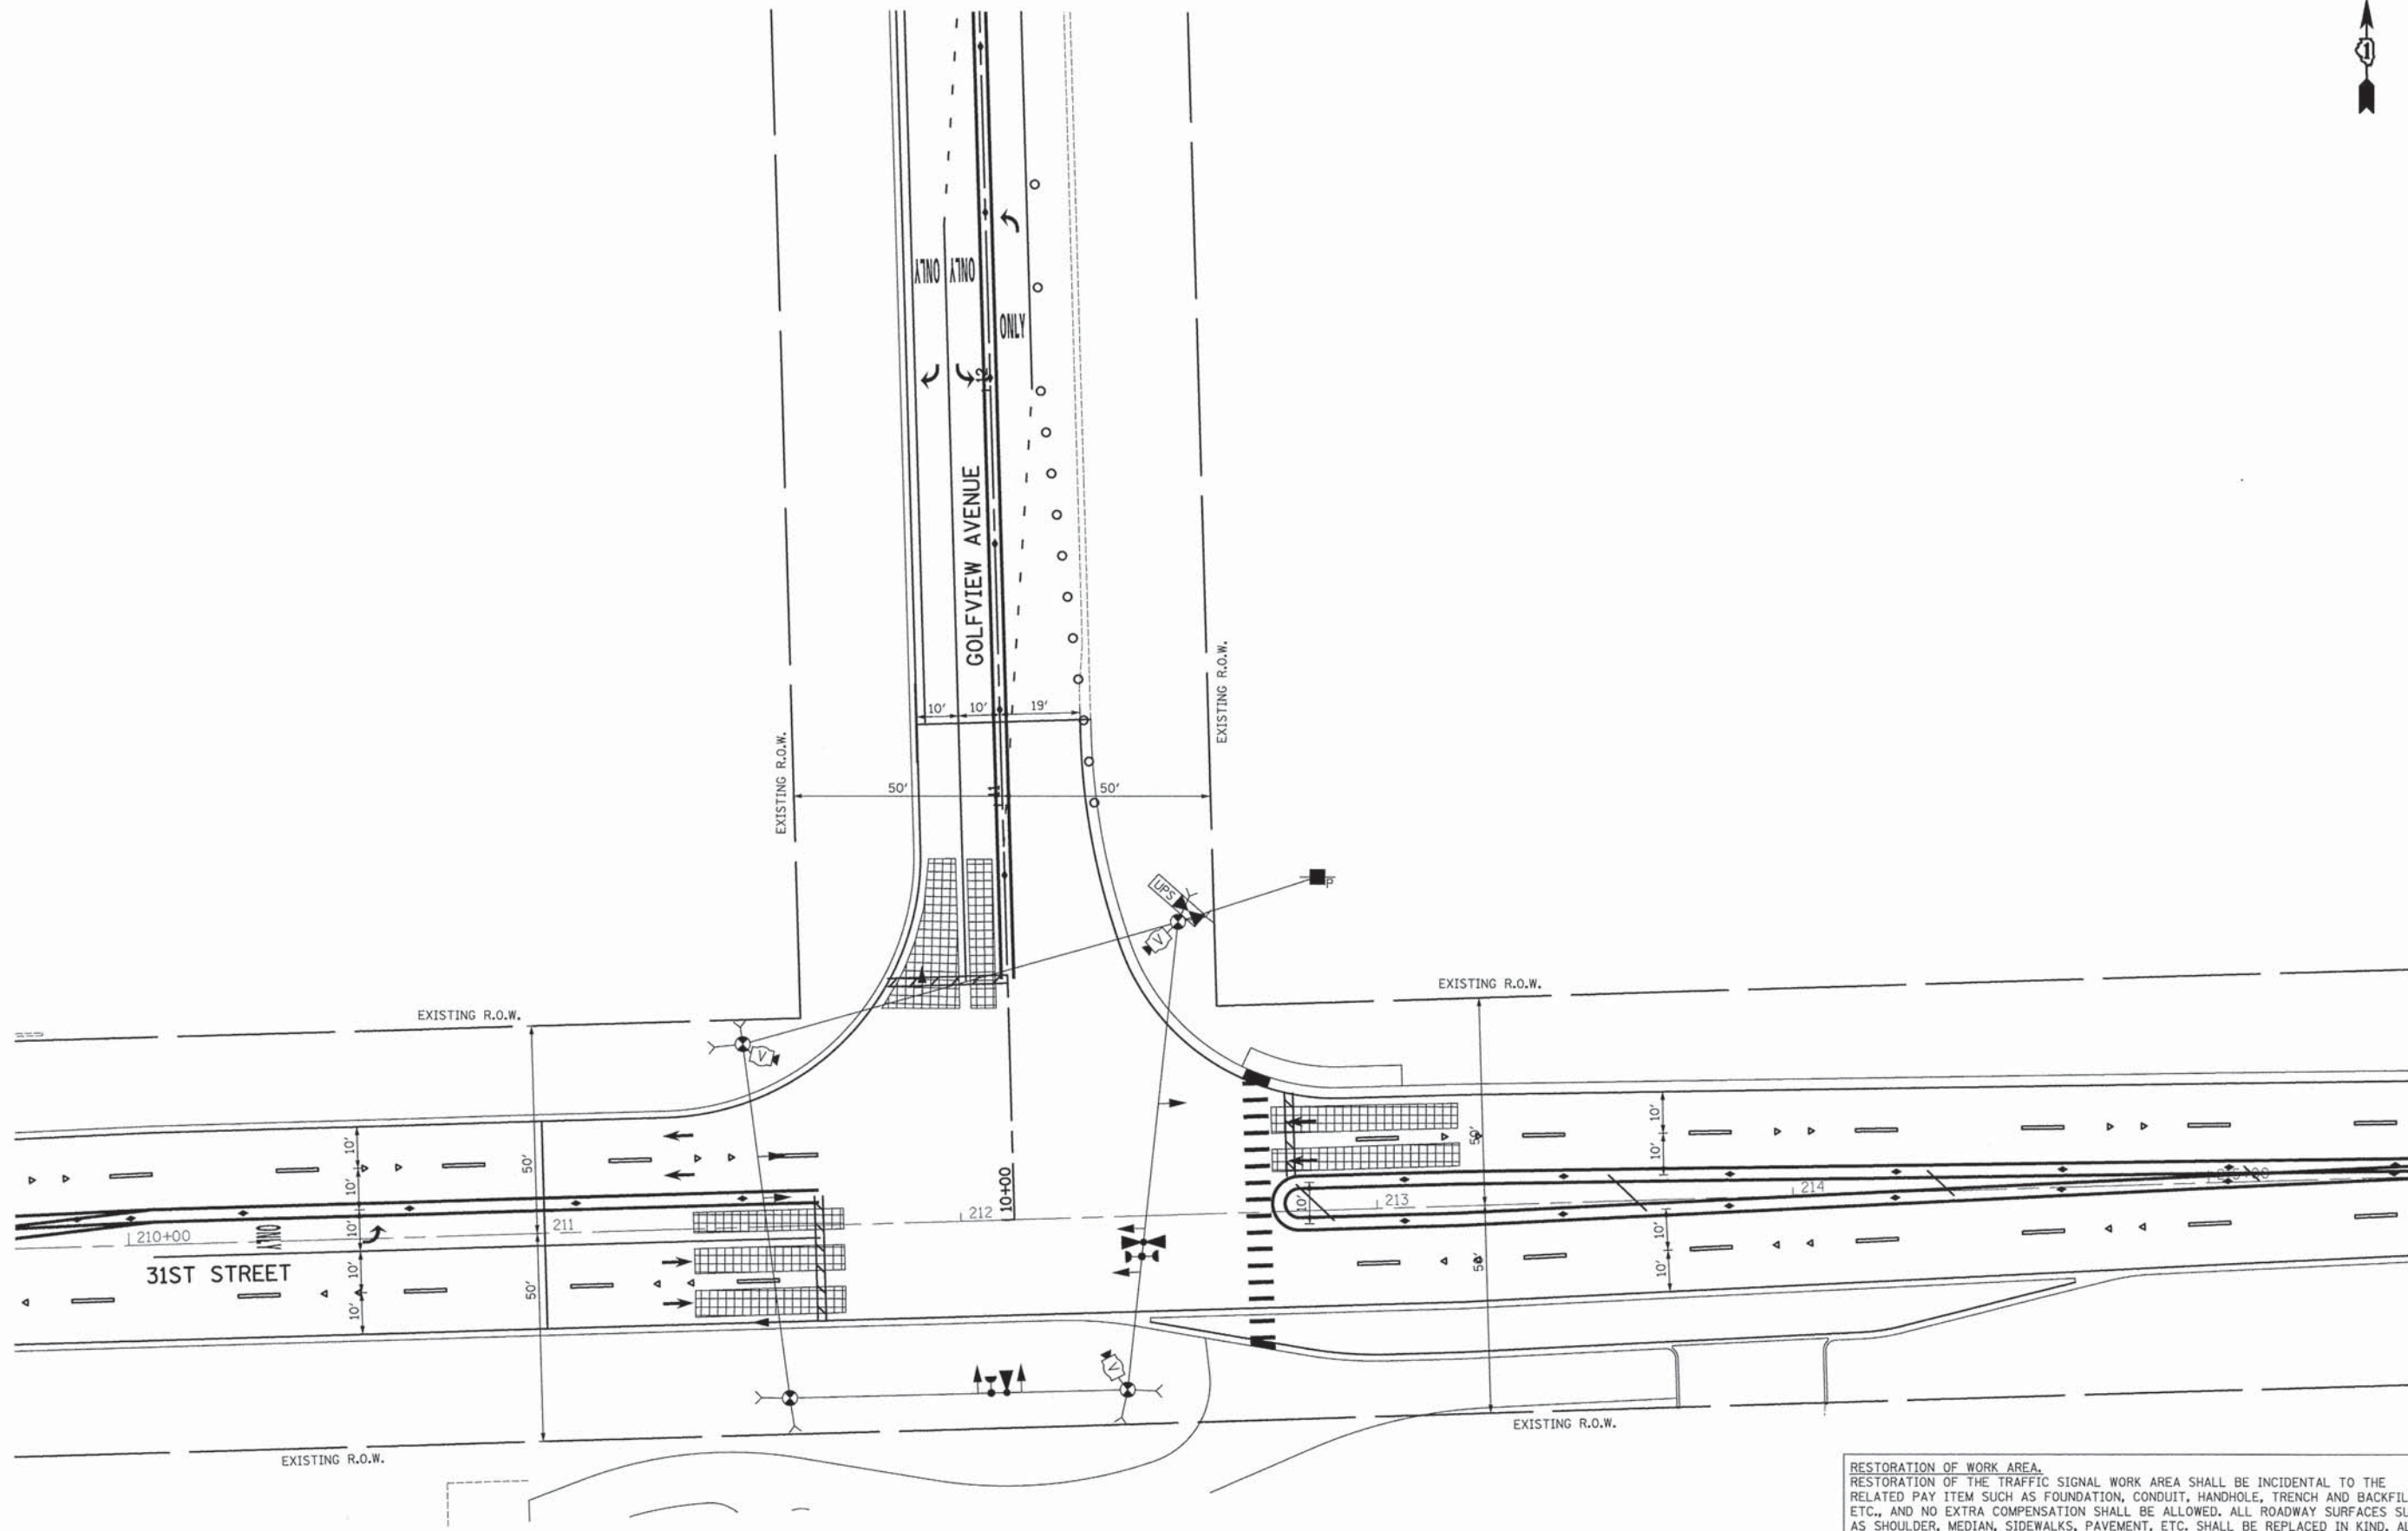

USER NAME = dte	DESIGNED - BRD	REVISED -
	DRAWN - MFB	REVISED -
PLOT SCALE = 20,0000' / 1" =	CHECKED - JJE	REVISED -
PLOT DATE = 5/6/2013	DATE - 05/13/2013	REVISED -

**STATE OF ILLINOIS  
 DEPARTMENT OF TRANSPORTATION**


**TEMPORARY TRAFFIC SIGNAL STAGING PLAN  
 GOLFVIEW AVENUE AT 31ST STREET - M.O.T. STAGE V**

SCALE: 1" = 20'    SHEET NO. 1 OF 1 SHEETS    STA.    TO STA.



F.A.U. RTE.	SECTION	COUNTY	TOTAL SHEETS	SHEET NO.
3784	12-F3000-23-PK	COOK	131	76
FED. ROAD DIST. NO. 1   ILLINOIS FED. AID PROJECT			<b>CONTRACT NO. 63764</b>	




TEMPORARY CONTROLLER SEQUENCE M.O.T. STAGES I-III

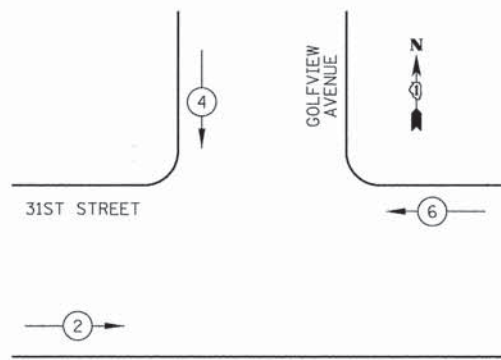


TEMPORARY CONTROLLER SEQUENCE M.O.T. STAGES IV-V

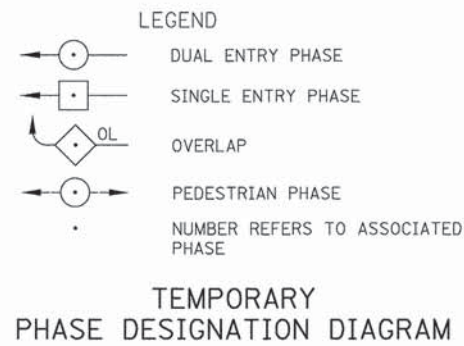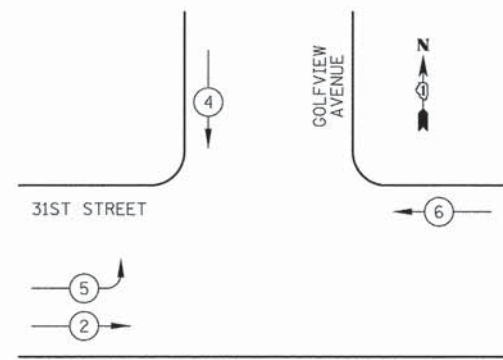

TEMPORARY EMERGENCY VEHICLE PREEMPTION SEQUENCE M.O.T. STAGES I-V

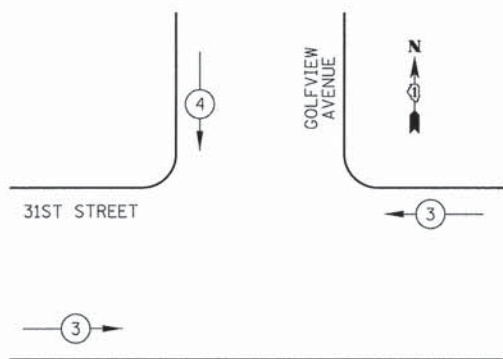

TEMPORARY EMERGENCY VEHICLE PREEMPTORS		
EMERGENCY VEHICLE PREEMPTOR	3	4
MOVEMENT	→	↓

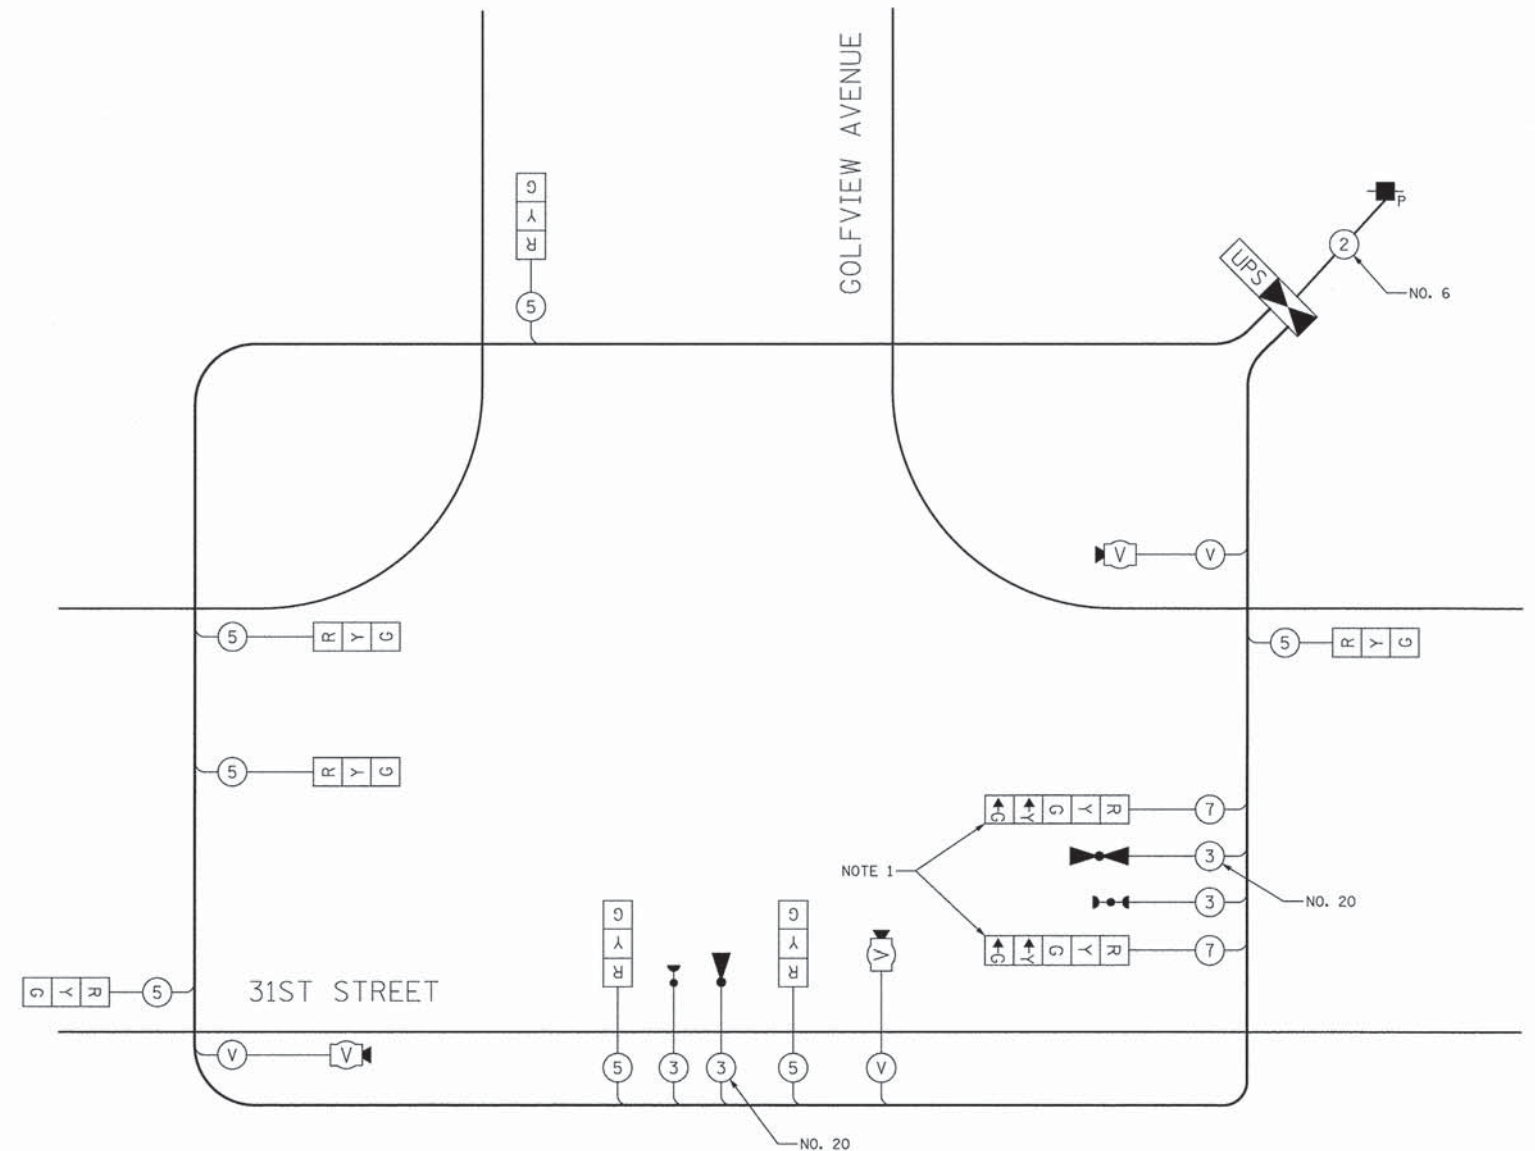

TEMPORARY CABLE PLAN  
NOT TO SCALE

TEMPORARY CABLE PLAN NOTES

1. THE LEFT TURN ARROW SECTIONS OF THESE SIGNAL HEADS SHALL REMAIN BAGGED AND DISCONNECTED UNTIL THE BEGINNING OF M.O.T. STAGE IV.

I.D.O.T. TRAFFIC SIGNAL INSTALLATION ELECTRICAL SERVICE REQUIREMENTS					TOTAL WATTAGE
TYPE	NO. LAMPS	WATTAGE		% OPERATION	
SIGNAL (RED)	9	INCAND.	LED	0.50	77
(YELLOW)	9		25	0.25	56
(GREEN)	9		15	0.25	34
ARROW	4		12	0.10	5
CONTROLLER	1		100	1.00	100
VIDEO SYSTEM	1		150	1.00	150
FLASHER				0.50	
TOTAL =					422

ENERGY COSTS TO: ILLINOIS DEPARTMENT OF TRANSPORTATION  
201 WEST CENTER COURT  
SCHAUMBURG, IL 60196-1096

ENERGY SUPPLY: CONTACT: JENNIFER BERTHOLD  
PHONE: (708) 410-5314  
COMPANY: COM ED

USER NAME = dta	DESIGNED - BRD	REVISED -
PLLOT SCALE = 28,00000 ' / in.	DRAWN - MFB	REVISED -
PLLOT DATE = 5/6/2013	CHECKED - JJE	REVISED -
	DATE - 05/13/2013	REVISED -

STATE OF ILLINOIS  
DEPARTMENT OF TRANSPORTATION

TEMPORARY CABLE PLAN, TEMPORARY PHASE DESIGNATION DIAGRAMS,  
& TEMPORARY EMERGENCY VEHICLE PREEMPTION SEQUENCES  
GOLFVIEW AVENUE AT 31ST STREET

NO SCALE SHEET NO. 1 OF 1 SHEETS STA. TO STA.

F.A.U. RTE.	SECTION	COUNTY	TOTAL SHEETS	SHEET NO.
3784	12-F3000-23-PK	COOK	131	77
CONTRACT NO. 63764				
FED. ROAD DIST. NO. 1 [ILLINOIS] FED. AID PROJECT				












PROPOSED CONTROLLER SEQUENCE

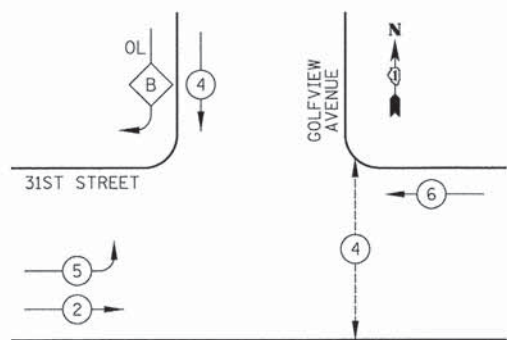

PROPOSED EMERGENCY VEHICLE PREEMPTION SEQUENCE

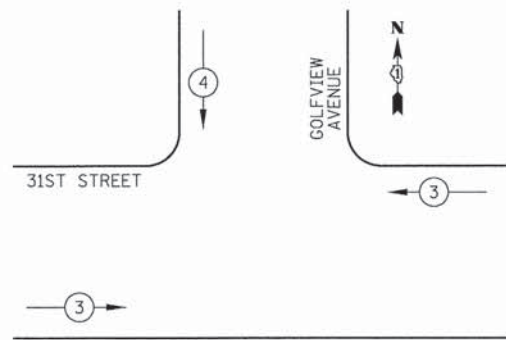

LEGEND

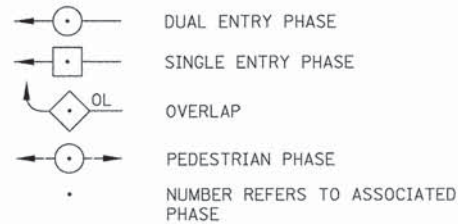

EMERGENCY VEHICLE PREEMPTORS		
EMERGENCY VEHICLE PREEMPTOR	3	4
MOVEMENT	←	↓

PHASE DESIGNATION DIAGRAM


RIGHT TURN OVERLAP PHASE DESIGNATION

OVERLAP LETTER	PERMISSIVE PHASE	PROTECTED PHASE
B	= 4	+ 5

SCHEDULE OF QUANTITIES

PAY ITEM	UNIT	QNTY.
SIGN PANEL - TYPE 1	SQ FT	23
ELECTRIC UTILITY SERVICE CONNECTION	L SUM	1
SERVICE INSTALLATION - GROUND MOUNTED	EACH	1
UNDERGROUND CONDUIT, GALVANIZED STEEL 2" DIA.	FOOT	770
UNDERGROUND CONDUIT, GALVANIZED STEEL 2 1/2" DIA.	FOOT	77
UNDERGROUND CONDUIT, GALVANIZED STEEL, 3" DIA.	FOOT	116
UNDERGROUND CONDUIT, GALVANIZED STEEL, 4" DIA.	FOOT	289
HANDHOLE	EACH	4
HEAVY-DUTY HANDHOLE	EACH	2
DOUBLE HANDHOLE	EACH	2
FULL-ACTUATED CONTROLLER AND TYPE IV CABINET	EACH	1
ELECTRIC CABLE IN CONDUIT, SIGNAL NO. 14 2C	FOOT	394
ELECTRIC CABLE IN CONDUIT, SIGNAL NO. 14 3C	FOOT	840
ELECTRIC CABLE IN CONDUIT, SIGNAL NO. 14 5C	FOOT	1424
ELECTRIC CABLE IN CONDUIT, SIGNAL NO. 14 7C	FOOT	682
ELECTRIC CABLE IN CONDUIT, LEAD-IN, NO. 14 1 PAIR	FOOT	1062
ELECTRIC CABLE IN CONDUIT, SERVICE, NO. 6 2C	FOOT	154
ELECTRIC CABLE IN CONDUIT, EQUIPMENT GROUNDING CONDUCTOR, NO. 6 1C	FOOT	730
TRAFFIC SIGNAL POST, GALVANIZED STEEL 16 FT.	EACH	2
STEEL MAST ARM ASSEMBLY AND POLE, 26 FT.	EACH	1
STEEL MAST ARM ASSEMBLY AND POLE, 34 FT.	EACH	1
STEEL MAST ARM ASSEMBLY AND POLE, 44 FT.	EACH	1
CONCRETE FOUNDATION, TYPE A	FOOT	12
CONCRETE FOUNDATION, TYPE C	FOOT	4
CONCRETE FOUNDATION, TYPE E 30-INCH DIAMETER	FOOT	24
CONCRETE FOUNDATION, TYPE E 36-INCH DIAMETER	FOOT	13
SIGNAL HEAD, LED, 1-FACE, 3-SECTION, MAST ARM MOUNTED	EACH	5
SIGNAL HEAD, LED, 1-FACE, 3-SECTION, BRACKET MOUNTED	EACH	1
SIGNAL HEAD, LED, 1-FACE, 5-SECTION, BRACKET MOUNTED	EACH	1
SIGNAL HEAD, LED, 1-FACE, 5-SECTION, MAST ARM MOUNTED	EACH	2
SIGNAL HEAD, LED, 2-FACE, 3-SECTION, BRACKET MOUNTED	EACH	1
SIGNAL HEAD, LED, 2-FACE, 1-3 SECTION, 1-5 SECTION, BRACKET MOUNTED	EACH	1
PEDESTRIAN SIGNAL HEAD, LED, 1-FACE, BRACKET MOUNTED WITH COUNTDOWN TIMER	EACH	2
TRAFFIC SIGNAL BACKPLATE, LOUVERED, ALUMINUM	EACH	7
INDUCTIVE LOOP DETECTOR	EACH	5
DETECTOR LOOP, TYPE I	FOOT	577
LIGHT DETECTOR	EACH	2
LIGHT DETECTOR AMPLIFIER	EACH	1
PEDESTRIAN PUSH-BUTTON	EACH	2
TEMPORARY TRAFFIC SIGNAL INSTALLATION	EACH	1
REMOVE EXISTING TRAFFIC SIGNAL EQUIPMENT	EACH	1
REMOVE EXISTING HANDHOLE	EACH	5
REMOVE EXISTING DOUBLE HANDHOLE	EACH	1
REMOVE EXISTING CONCRETE FOUNDATION	EACH	6
EMERGENCY VEHICLE PRIORITY SYSTEM LINE SENSOR CABLE, NO. 20 3/C	FOOT	432
UNINTERRUPTIBLE POWER SUPPLY, SPECIAL	EACH	1
TEMPORARY TRAFFIC SIGNAL TIMING	EACH	1

\* 100% COST TO VILLAGE OF BROOKFIELD FIRE DEPARTMENT

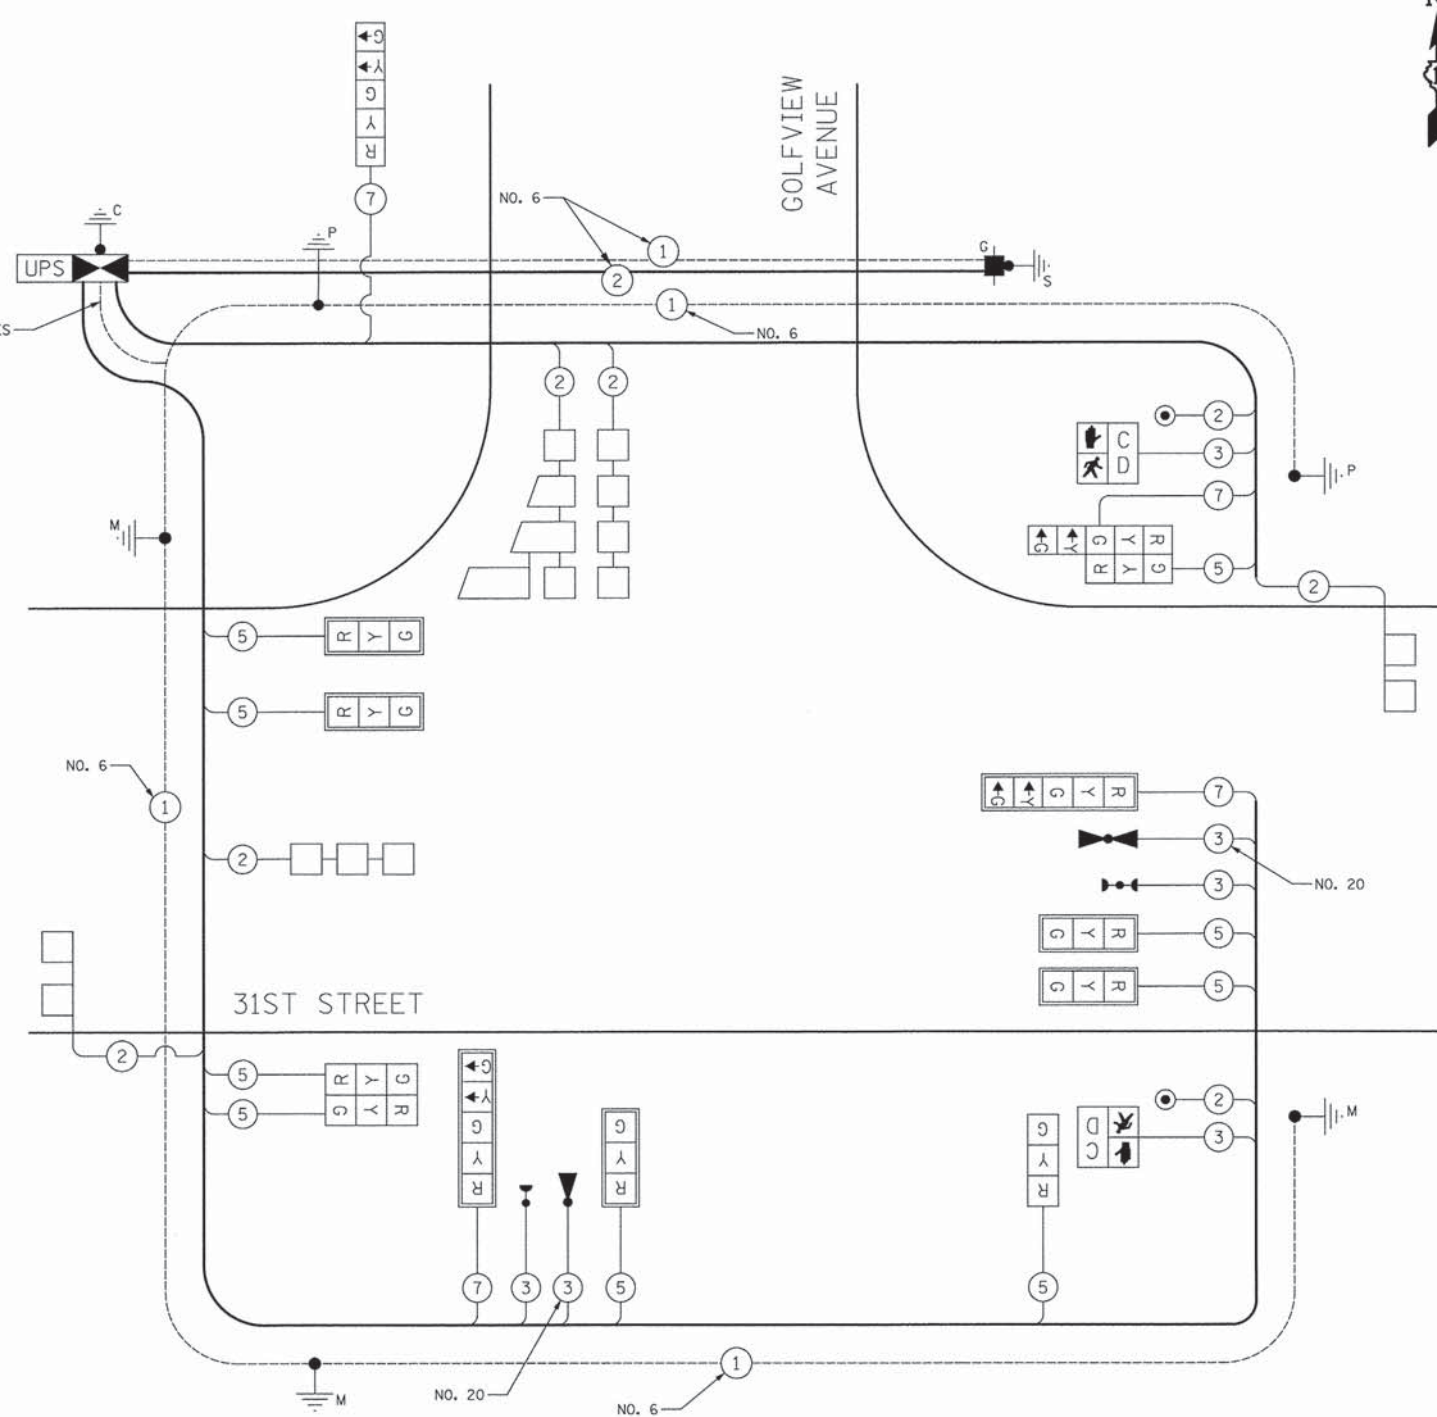

CABLE PLAN  
NOT TO SCALE

I.D.O.T. TRAFFIC SIGNAL INSTALLATION ELECTRICAL SERVICE REQUIREMENTS					TOTAL WATTAGE
TYPE	NO. LAMPS	WATTAGE		% OPERATION	
SIGNAL (RED)	13	INCAND.	LED	0.50	111
(YELLOW)	13			0.25	81
(GREEN)	13			0.25	49
ARROW	8			0.10	10
PED. SIGNAL	2			1.00	50
CONTROLLER	1			1.00	100
FLASHER					0.50
TOTAL =					401

ENERGY COSTS TO: ILLINOIS DEPARTMENT OF TRANSPORTATION  
201 WEST CENTER COURT  
SCHAUMBURG, IL 60196-1096

ENERGY SUPPLY: CONTACT: JENNIFER BERTHOLD  
PHONE: (708) 410-5314  
COMPANY: COM ED

USER NAME = dte	DESIGNED - BRD	REVISED -
PLDT SCALE = 20,0000' / 1" =	DRAWN - MFB	REVISED -
PLDT DATE = 5/6/2013	CHECKED - JJE	REVISED -
	DATE - 05/13/2013	REVISED -

STATE OF ILLINOIS  
DEPARTMENT OF TRANSPORTATION

CABLE PLAN, PHASE DESIGNATION DIAGRAM, EMERGENCY VEHICLE PREEMPTION SEQUENCE & SCHEDULE OF QUANTITIES  
GOLFVIEW AVENUE AT 31ST STREET

NO SCALE SHEET NO. 1 OF 1 SHEETS STA. TO STA.

F.A.U. RTE.	SECTION	COUNTY	TOTAL SHEETS	SHEET NO.
3784	12-F3000-23-PK	COOK	131	79
CONTRACT NO. 63764				
FED. ROAD DIST. NO. 1 ILLINOIS FED. AID PROJECT				





**NOTES FOR TEMPORARY TRAFFIC SIGNALS**



- ALL CONTROL EQUIPMENT INCLUDING EMERGENCY PRE-EMPTION AND COMMUNICATION DEVICES FOR THE TEMPORARY TRAFFIC SIGNAL(S) SHALL BE FURNISHED BY THE CONTRACTOR.
- ONLY CONTROLLERS SUPPLIED BY ONE OF THE DISTRICT APPROVED CLOSED LOOP EQUIPMENT MANUFACTURERS WILL BE APPROVED FOR USE AT TEMPORARY SIGNAL LOCATIONS. ALL CONTROLLERS USED FOR TEMPORARY TRAFFIC SIGNALS SHALL BE FULLY ACTUATED NEMA MICROPROCESSOR BASED WITH RS232 DATA ENTRY PORTS COMPATIBLE WITH EXISTING MONITORING SOFTWARE APPROVED BY IDOT DISTRICT 1, INSTALLED IN A NEMA TS2 CABINET. ONLY ONE BRAND OF CONTROLLER WILL BE ACCEPTED FOR ANY ONE CONTRACT.
- ALL TRAFFIC SIGNAL SECTIONS AND PEDESTRIAN SIGNAL SECTIONS SHALL BE L.E.D. AND 12" (300 mm) DIAMETER. HEADS SHALL BE PLACED AS INDICATED ON THE TEMPORARY TRAFFIC SIGNAL PLAN OR AS DIRECTED BY THE ENGINEER. PEDESTRIAN SIGNALS SHALL INCLUDE SOLID INTERNATIONAL SYMBOLS. PEDESTRIAN SIGNALS WITH COUNTDOWN TIMERS SHALL BE USED WHEN THE EXISTING INSTALLATION UTILIZES COUNTDOWN TYPE OR AS DIRECTED BY THE ENGINEER. COUNTDOWN TYPE PEDESTRIAN SIGNALS ARE NOT TO BE INSTALLED AT A RAILROAD INTERSECTION. THE CONTRACTOR SHALL FURNISH ENOUGH CABLE SLACK TO RELOCATE HEADS TO ANY POSITION ON THE SPAN WIRE OR AT LOCATIONS ILLUSTRATED ON THE PLANS FOR CONSTRUCTION STAGING. THE TEMPORARY TRAFFIC SIGNAL SHALL REMAIN IN OPERATION DURING ALL SIGNAL HEAD RELOCATIONS. EACH TEMPORARY TRAFFIC SIGNAL HEAD SHALL HAVE ITS OWN CABLE FROM THE CONTROLLER CABINET TO THE SIGNAL HEAD.
- ALL EXISTING STREET NAME AND INTERSECTION REGULATORY SIGNS SHALL BE REMOVED FROM EXISTING POLES, RELOCATED AND SECURELY FASTENED TO THE SPAN WIRE OR WOOD POLE AS DIRECTED BY THE ENGINEER.
- ANY TEMPORARY SIGNAL WITHIN AN EXISTING CLOSED LOOP TRAFFIC SIGNAL SYSTEM SHALL BE INTERCONNECTED TO THAT SYSTEM USING SIMILAR BRAND CONTROL EQUIPMENT.
- THE TEMPORARY TRAFFIC SIGNAL SHALL HAVE THE SIGNAL HEAD DISPLAYS, SIGNAL HEAD PLACEMENTS AND CONTROLLER PHASING MATCH THE EXISTING TRAFFIC SIGNAL AT THE TIME OF THE TURN ON, IF NO TRAFFIC STAGING IS IN PLACE OR WILL NOT BE STAGED ON THE DAY OF THE TURN ON.
- UNINTERRUPTIBLE POWER SUPPLY (UPS) SYSTEMS SHALL BE INSTALLED AND MADE OPERATIONAL AT TEMPORARY TRAFFIC SIGNAL INSTALLATIONS WHERE UPS IS INSTALLED AT THE EXISTING TRAFFIC SIGNAL, TEMPORARY TRAFFIC SIGNALS AT RAILROAD INTERSECTIONS, AND TEMPORARY TRAFFIC SIGNALS AT INTERSECTIONS WITH FIRE STATION ACTUATED EMERGENCY VEHICLE PRE-EMPTION, OR WHEN INDICATED ON THE PLANS.
- TRAFFIC SIGNAL MANAGEMENT SYSTEMS SHALL BE MAINTAINED IN OPERATION AS INDICATED ON THE PLANS OR AS DIRECTED BY THE ENGINEER. REQUIRED EQUIPMENT SHALL BE AS SHOWN ON THE PLANS AND THE CONTRACTOR SHALL PLACE THE EQUIPMENT IN OPERATION TO THE SATISFACTION OF THE ENGINEER AND THE AGENCY RESPONSIBLE FOR THE TRAFFIC SIGNAL MANAGEMENT SYSTEM.
- DETECTION AT TEMPORARY TRAFFIC SIGNALS SHALL BE INCLUDED FOR ALL APPROACHES OF THE INTERSECTION UNLESS INDICATED OTHERWISE ON THE PLANS. THE DETECTION SYSTEM MUST MEET THE SPECIFICATIONS OF DISTRICT 1 AND THE CONTRACTOR SHALL PLACE THE DETECTORS INTO OPERATION TO THE SATISFACTION OF THE ENGINEER.
- WHEN PAN, TILT, ZOOM CAMERAS ARE INSTALLED AT THE EXISTING INTERSECTION OR ARE CALLED FOR IN THE PLANS, THE CONTRACTOR SHALL BE RESPONSIBLE FOR INSTALLING AND MAINTAINING THE CAMERAS TO THE SATISFACTION OF THE ENGINEER AND THE AGENCY RESPONSIBLE FOR THE CAMERAS.
- THE GOLFVIEW AVENUE APPROACH WILL BE CLOSED DURING M.O.T. STAGE V. DURING THIS STAGE, THE SIGNAL HEADS FOR GOLFVIEW AVENUE TRAFFIC WILL BE BAGGED AND THE IL ROUTE 176 SIGNAL INDICATIONS WILL REST IN GREEN.

THE FOLLOWING ITEMS SHALL BE REMOVED BY THE CONTRACTOR AND SHALL BE DISPOSED OF BY THEM OUTSIDE THE RIGHT-OF-WAY AT THEIR EXPENSE. THE SALVAGE VALUE OF THE REMOVED EQUIPMENT SHALL BE REFLECTED IN THE CONTRACT BID PRICE.

- 1 EACH CONTROLLER AND CABINET, COMPLETE
- 3 EACH SIGNAL POST
- 2 EACH STEEL MAST ARM ASSEMBLY AND POLE
- 7 EACH SIGNAL HEAD, 1-FACE, 3-SECTION
- 1 EACH SIGNAL HEAD, 2-FACE, 1-3 SECTION, 1-5 SECTION
- 1 EACH SIGNAL HEAD, 3-FACE, 2-3 SECTION, 1-5 SECTION
- 4 EACH TRAFFIC SIGNAL BACKPLATE
- 1 EACH SERVICE INSTALLATION

THE FOLLOWING EXISTING TRAFFIC SIGNAL EQUIPMENT SHALL BE REMOVED BY THE CONTRACTOR AND SHALL REMAIN THE PROPERTY OF THE VILLAGE OF BROOKFIELD FIRE DEPARTMENT. THE CONTRACTOR SHALL SAFELY STORE AND ARRANGE FOR PICK UP OF ALL EQUIPMENT TO BE RETURNED TO THE FIRE DEPARTMENT AS PER THE TRAFFIC SIGNAL SPECIFICATIONS.

- 2 EACH LIGHT DETECTOR
- 1 EACH LIGHT DETECTOR AMPLIFIER

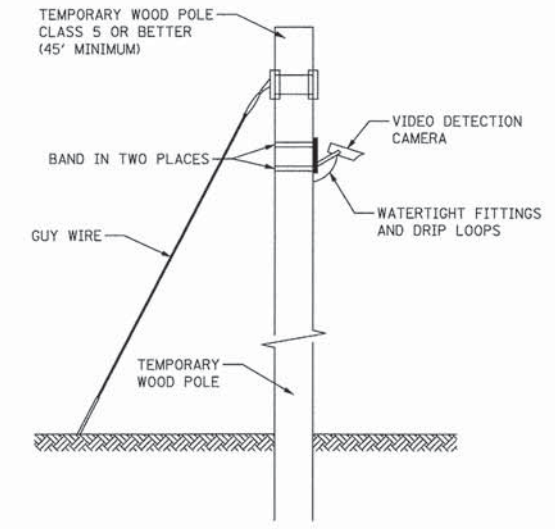
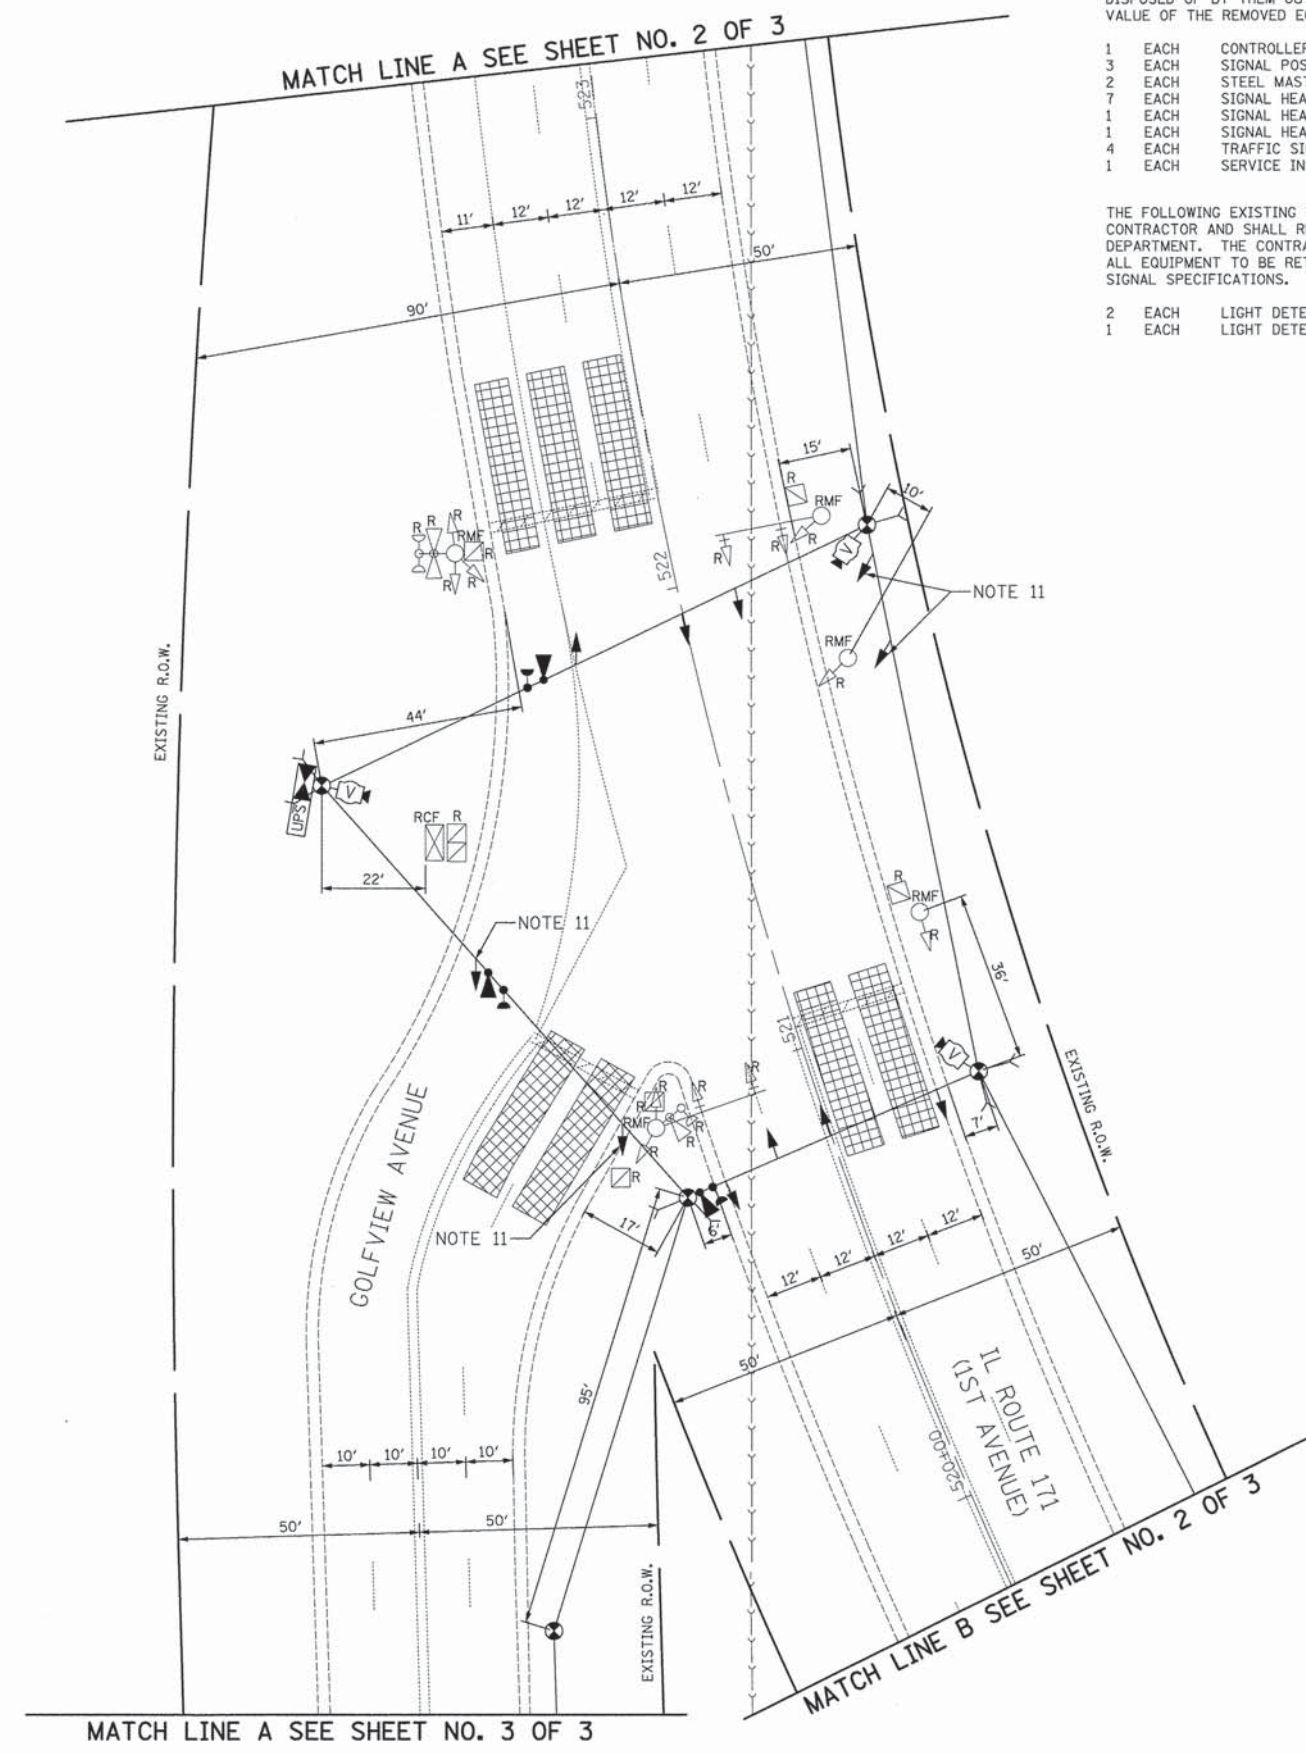


**RESTORATION OF WORK AREA.**  
 RESTORATION OF THE TRAFFIC SIGNAL WORK AREA SHALL BE INCIDENTAL TO THE RELATED PAY ITEM SUCH AS FOUNDATION, CONDUIT, HANDHOLE, TRENCH AND BACKFILL, ETC., AND NO EXTRA COMPENSATION SHALL BE ALLOWED. ALL ROADWAY SURFACES SUCH AS SHOULDER, MEDIAN, SIDEWALKS, PAVEMENT, ETC. SHALL BE REPLACED IN KIND. ALL DAMAGE TO MOWED LAWNS SHALL BE REPLACED WITH AN APPROVED SALT TOLERANT SOD, AND ALL DAMAGE TO UNMOWED FIELDS SHALL BE SEEDED IN ACCORDANCE WITH STANDARD SPECIFICATIONS 252 AND 250 RESPECTIVELY.

NOTE:  
 THE TRAFFIC SIGNAL CONTROLLER EQUIPMENT FOR THIS PROJECT SHALL BE "ECONOLITE" TO MATCH THE EXISTING ADJACENT SYSTEM.

	USER NAME = dte	DESIGNED - BRD	REVISED -	<b>STATE OF ILLINOIS</b> <b>DEPARTMENT OF TRANSPORTATION</b>	<b>TEMPORARY TRAFFIC SIGNAL INSTALLATION PLAN AND REMOVAL PLAN</b> <b>GOLFVIEW AVENUE AT IL ROUTE 171 (1ST AVENUE) - M.O.T. STAGES I-V</b>	F.A.U. RTE.	SECTION	COUNTY	TOTAL SHEETS	SHEET NO.
	PLOT SCALE = 20,0000' / 1" =	DRAWN - MFB	REVISED -			3784	12-F3000-23-PK	COOK	131	80
	PLOT DATE = 5/6/2013	CHECKED - JJE	REVISED -			CONTRACT NO. 63764				
					SCALE: 1" = 20'	SHEET NO. 1 OF 3 SHEETS	STA. TO STA.	FED. ROAD DIST. NO. 1   ILLINOIS FED. AID PROJECT		



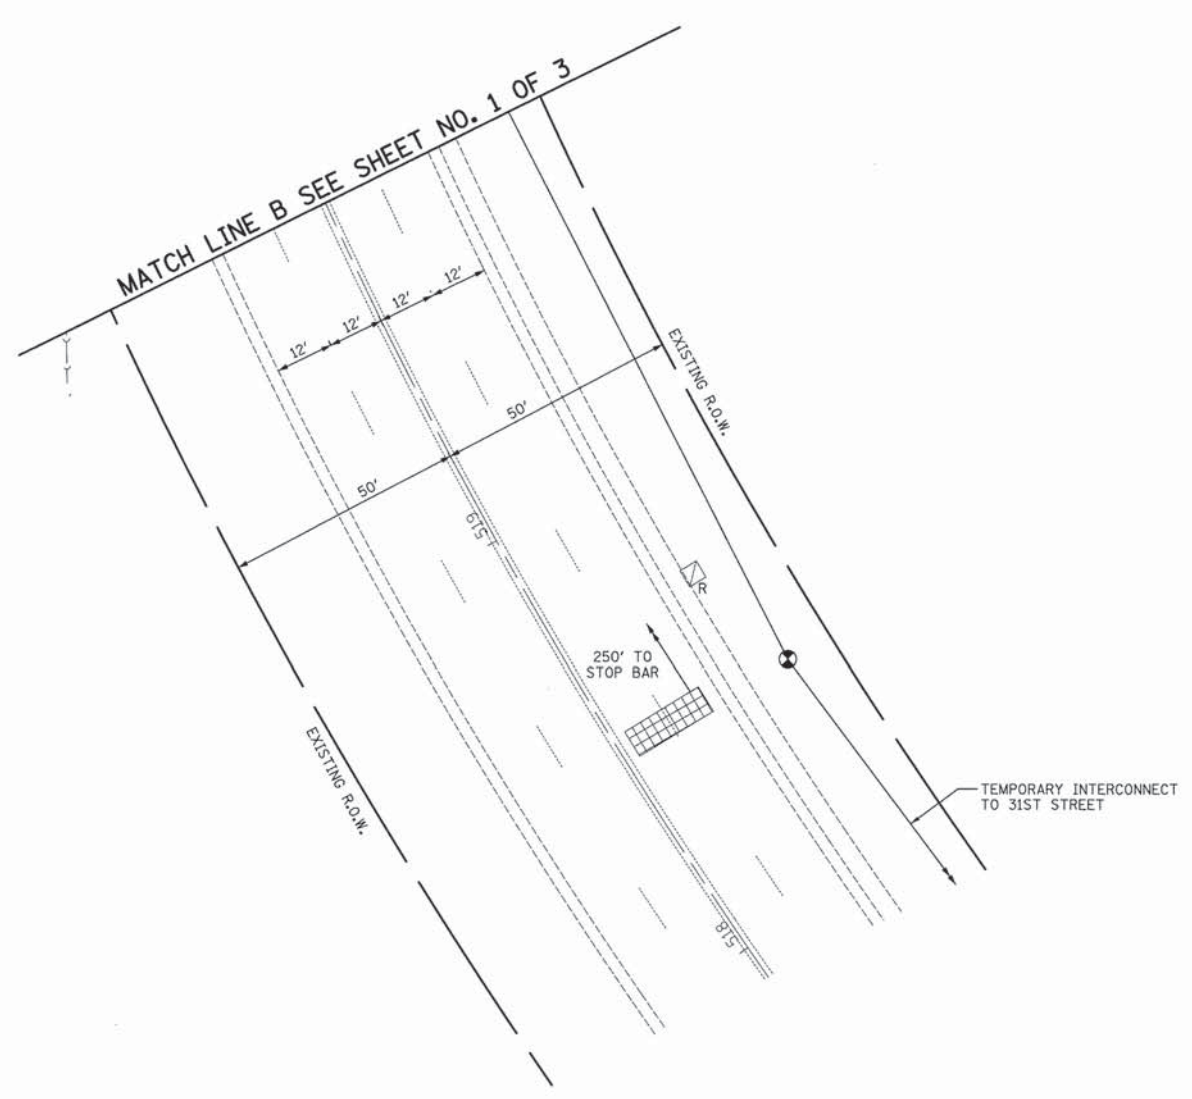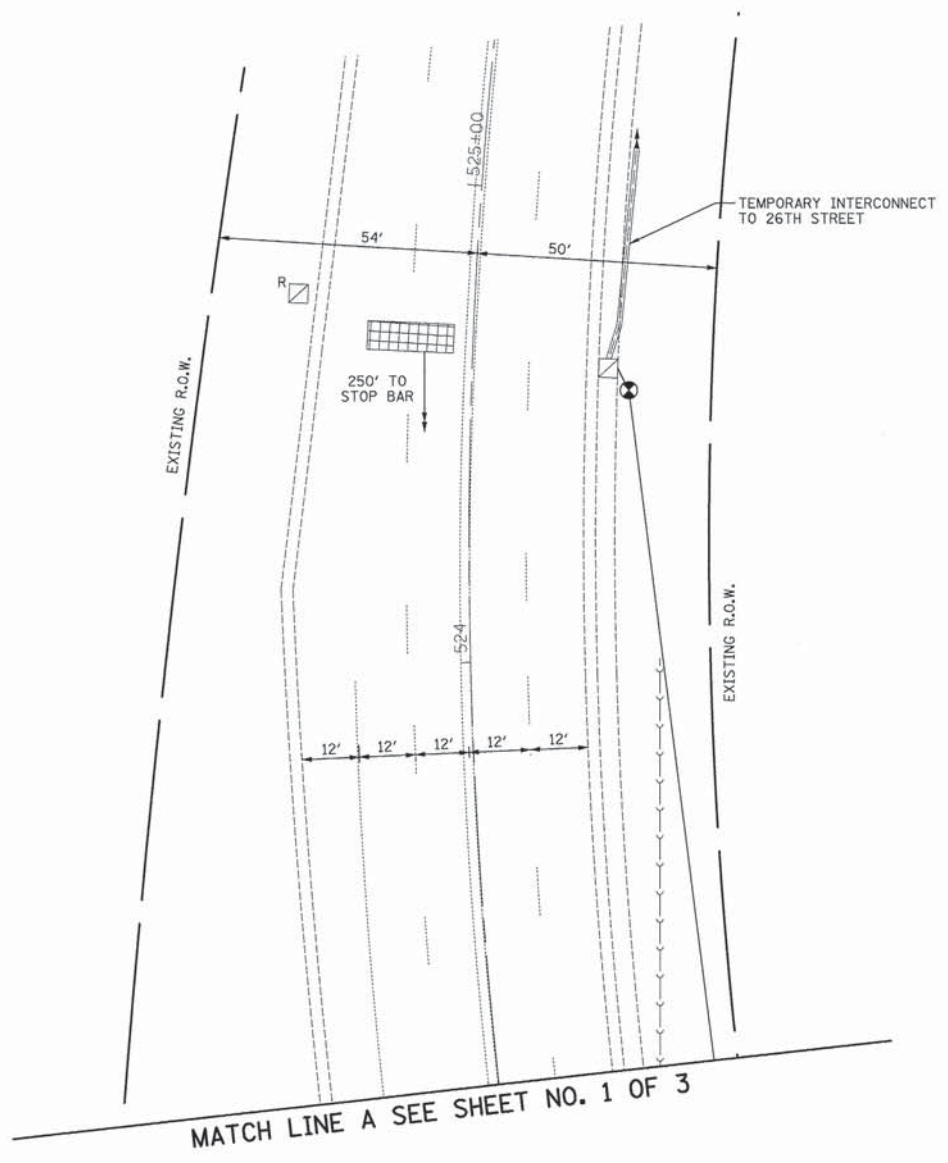

**RESTORATION OF WORK AREA.**  
 RESTORATION OF THE TRAFFIC SIGNAL WORK AREA SHALL BE INCIDENTAL TO THE RELATED PAY ITEM SUCH AS FOUNDATION, CONDUIT, HANDHOLE, TRENCH AND BACKFILL, ETC., AND NO EXTRA COMPENSATION SHALL BE ALLOWED. ALL ROADWAY SURFACES SUCH AS SHOULDER, MEDIAN, SIDEWALKS, PAVEMENT, ETC. SHALL BE REPLACED IN KIND. ALL DAMAGE TO MOWED LAWNS SHALL BE REPLACED WITH AN APPROVED SALT TOLERANT SOD, AND ALL DAMAGE TO UNMOWED FIELDS SHALL BE SEEDED IN ACCORDANCE WITH STANDARD SPECIFICATIONS 252 AND 250 RESPECTIVELY.

**NOTE:**  
 THE TRAFFIC SIGNAL CONTROLLER EQUIPMENT FOR THIS PROJECT SHALL BE "ECONOLITE" TO MATCH THE EXISTING ADJACENT SYSTEM.

	USER NAME = dte	DESIGNED - BRD	REVISED -
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**STATE OF ILLINOIS  
 DEPARTMENT OF TRANSPORTATION**

**TEMPORARY TRAFFIC SIGNAL INSTALLATION PLAN AND REMOVAL PLAN  
 GOLFVIEW AVENUE AT IL ROUTE 171 (1ST AVENUE) - M.O.T. STAGES I-V**

SCALE: 1" = 20'    SHEET NO. 2 OF 3 SHEETS    STA.    TO STA.

F.A.U. RTE.	SECTION	COUNTY	TOTAL SHEETS	SHEET NO.
3784	12-F3000-23-PK	COOK	131	81
CONTRACT NO. 63764				
FED. ROAD DIST. NO. 1   ILLINOIS   FED. AID PROJECT				



MATCH LINE A SEE SHEET NO. 1 OF 3


MATCH LINE B

MATCH LINE C



**RESTORATION OF WORK AREA.**  
 RESTORATION OF THE TRAFFIC SIGNAL WORK AREA SHALL BE INCIDENTAL TO THE RELATED PAY ITEM SUCH AS FOUNDATION, CONDUIT, HANDHOLE, TRENCH AND BACKFILL, ETC., AND NO EXTRA COMPENSATION SHALL BE ALLOWED. ALL ROADWAY SURFACES SUCH AS SHOULDER, MEDIAN, SIDEWALKS, PAVEMENT, ETC. SHALL BE REPLACED IN KIND. ALL DAMAGE TO MOWED LAWNS SHALL BE REPLACED WITH AN APPROVED SALT TOLERANT SOD, AND ALL DAMAGE TO UNMOWED FIELDS SHALL BE SEEDDED IN ACCORDANCE WITH STANDARD SPECIFICATIONS 252 AND 250 RESPECTIVELY.

**NOTE:**  
 THE TRAFFIC SIGNAL CONTROLLER EQUIPMENT FOR THIS PROJECT SHALL BE "ECONOLITE" TO MATCH THE EXISTING ADJACENT SYSTEM.


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	PLOT SCALE = 20.0000' / 1"	DRAWN - MFB	REVISED -
	PLOT DATE = 5/6/2013	CHECKED - JJE	REVISED -
		DATE - 05/13/2013	REVISED -

**STATE OF ILLINOIS  
 DEPARTMENT OF TRANSPORTATION**

**TEMPORARY TRAFFIC SIGNAL INSTALLATION PLAN AND REMOVAL PLAN  
 GOLFVIEW AVENUE AT IL ROUTE 171 (1ST AVENUE) - STAGES I-V**

SCALE: 1" = 20'    SHEET NO. 3 OF 3 SHEETS    STA.    TO STA.


F.A.U. RTE.	SECTION	COUNTY	TOTAL SHEETS	SHEET NO.
3784	12-F3000-23-PK	COOK	131	82
FED. ROAD DIST. NO. 1 [ILLINOIS] FED. AID PROJECT			CONTRACT NO. 63764	

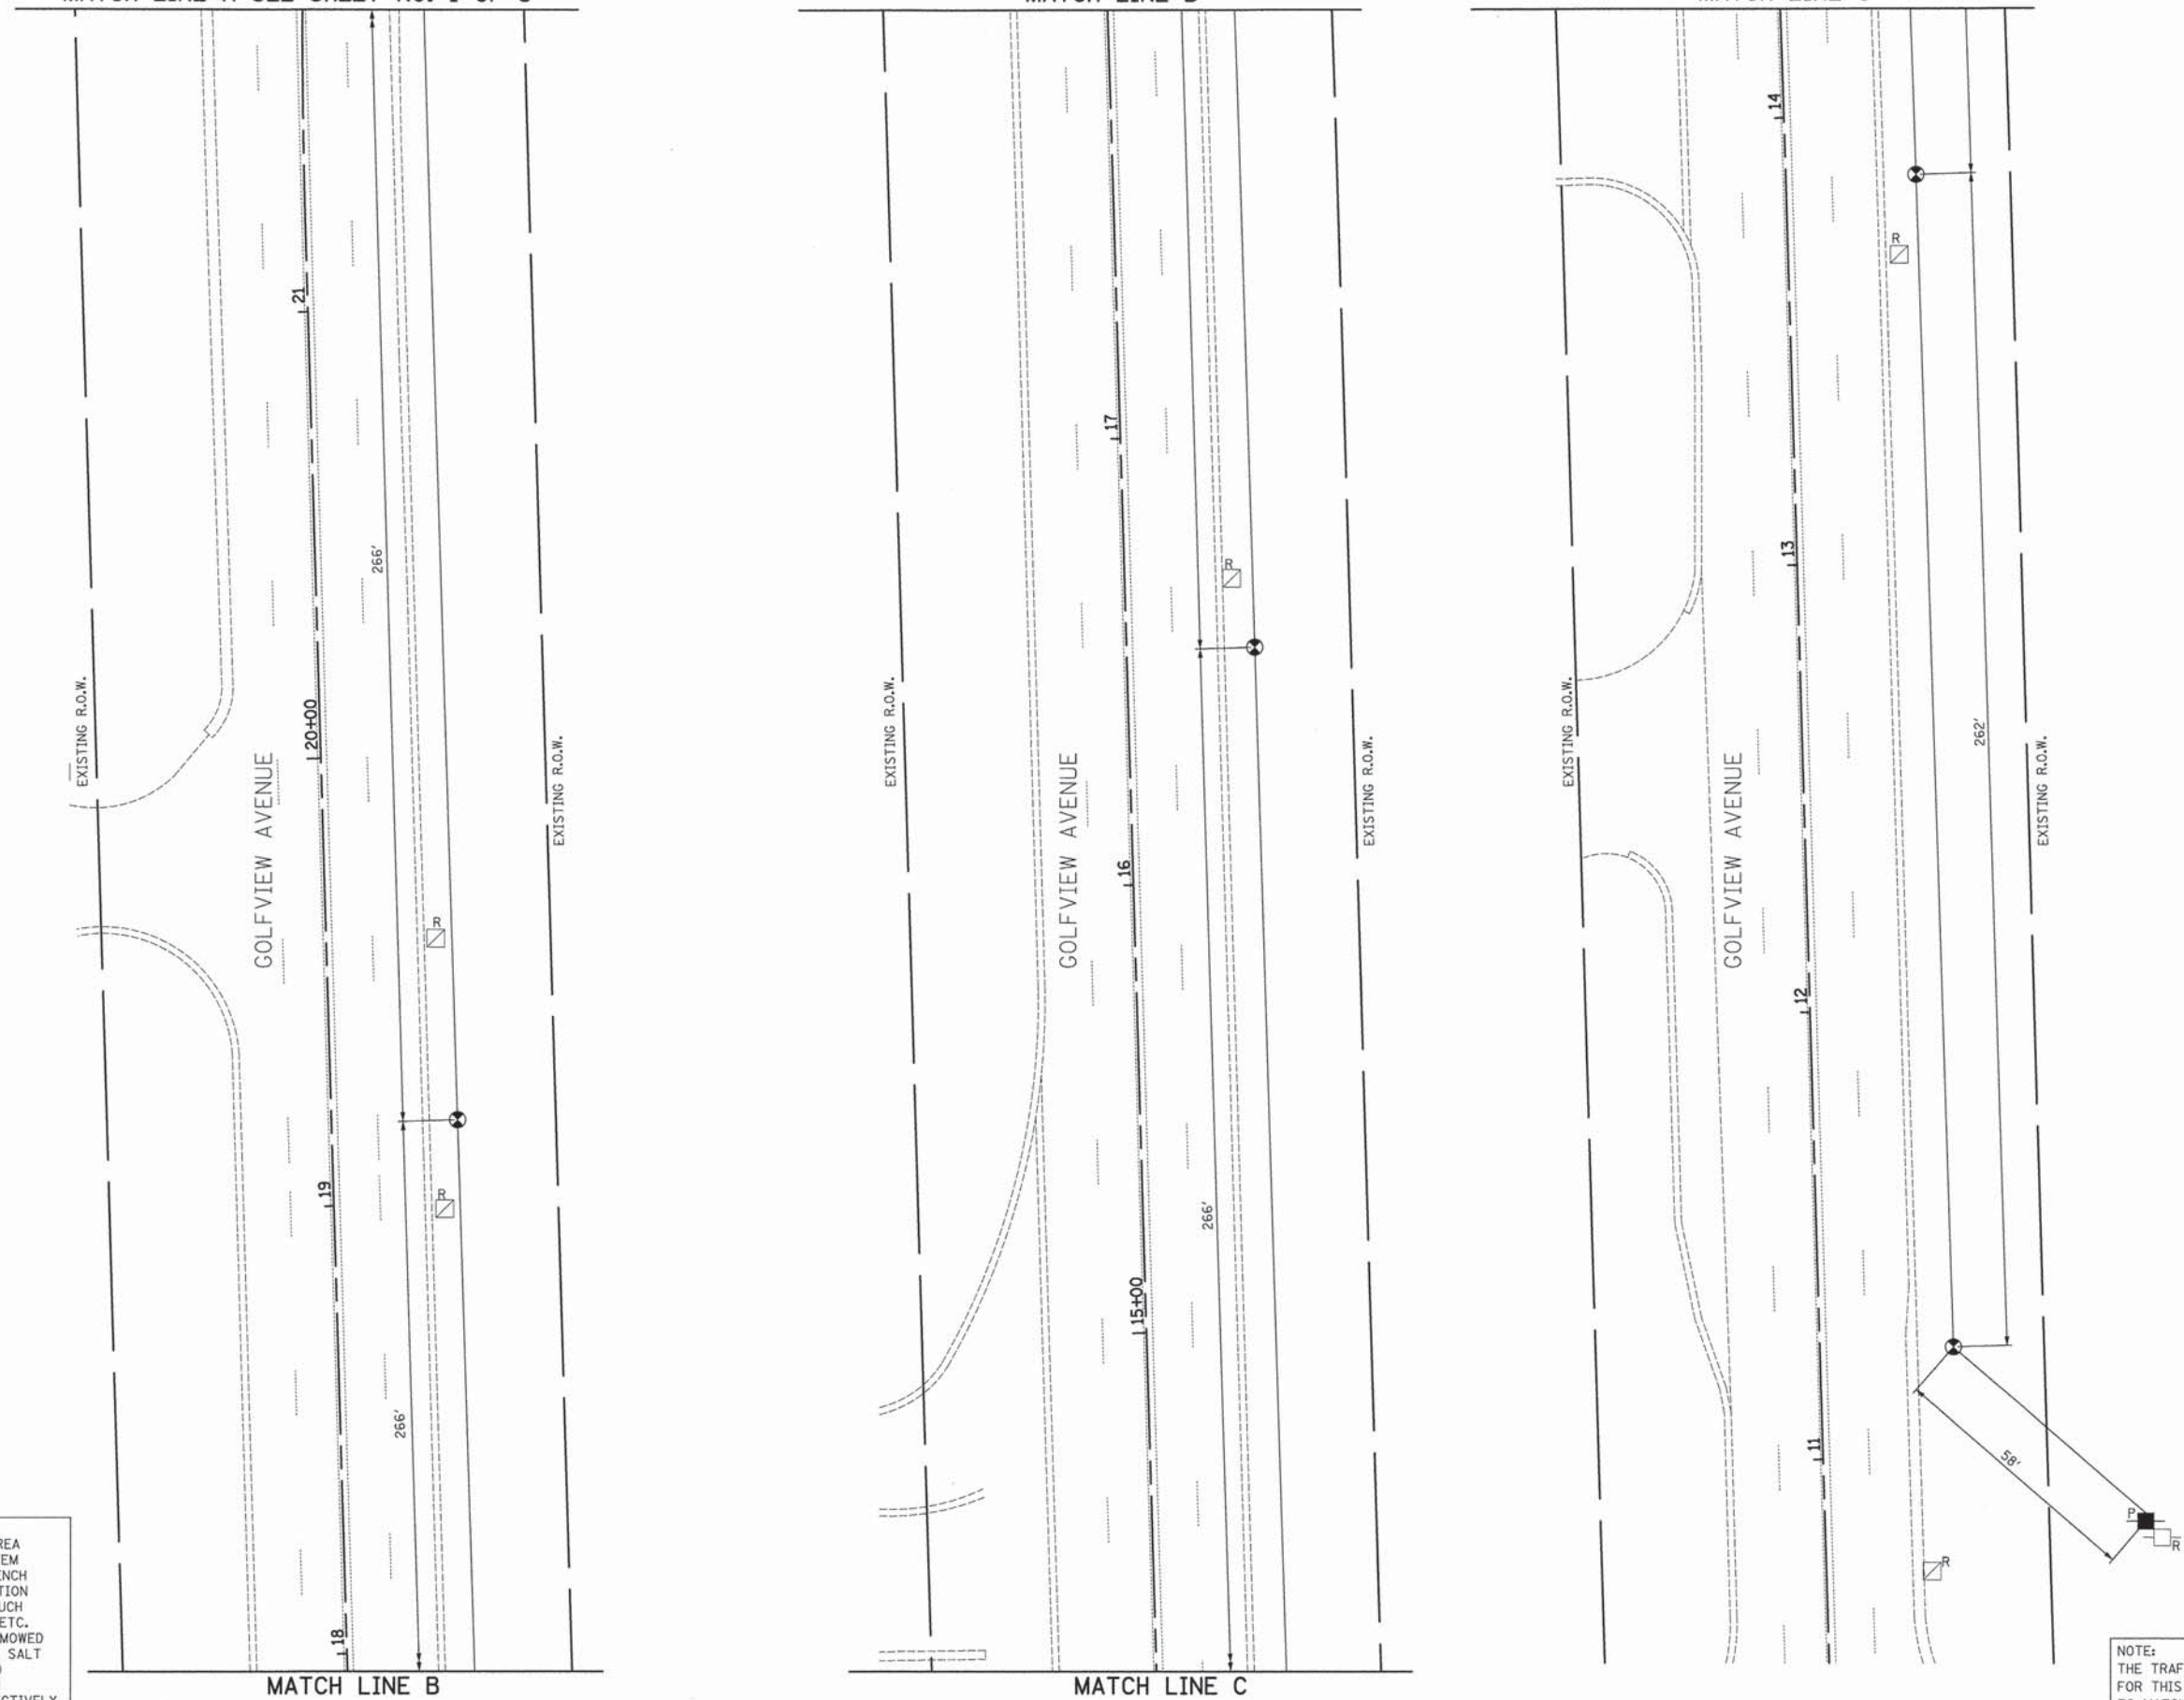







TEMPORARY CONTROLLER SEQUENCE

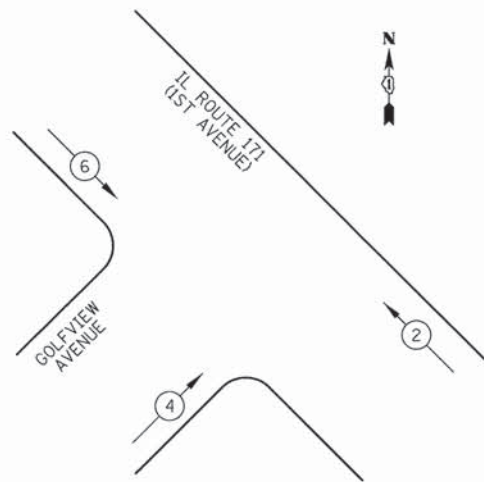

TEMPORARY EMERGENCY VEHICLE PREEMPTION SEQUENCE

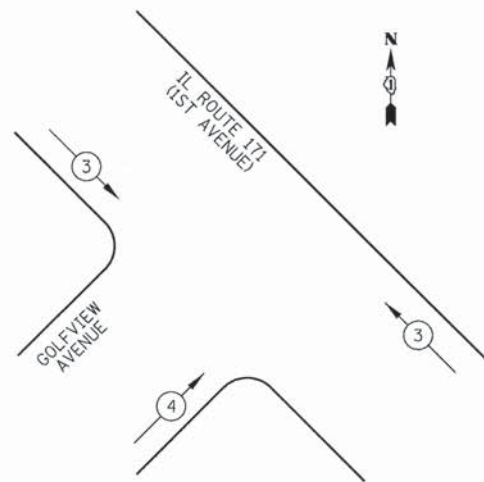

LEGEND

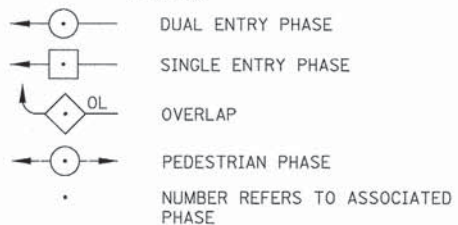


TEMPORARY EMERGENCY VEHICLE PREEMPTORS		
EMERGENCY VEHICLE PREEMPTOR	3	4
MOVEMENT		

NOTE: EMERGENCY VEHICLE PREEMPTION WILL BE DISABLED DURING M.O.T. STAGE V DUE TO GOLFVIEW AVENUE CLOSURE.

TEMPORARY PHASE DESIGNATION DIAGRAM

NOTE: SIGNAL WILL DWELL IN PHASE 2 & 6 GREEN DURING M.O.T. STAGE V DUE TO GOLFVIEW AVENUE CLOSURE.

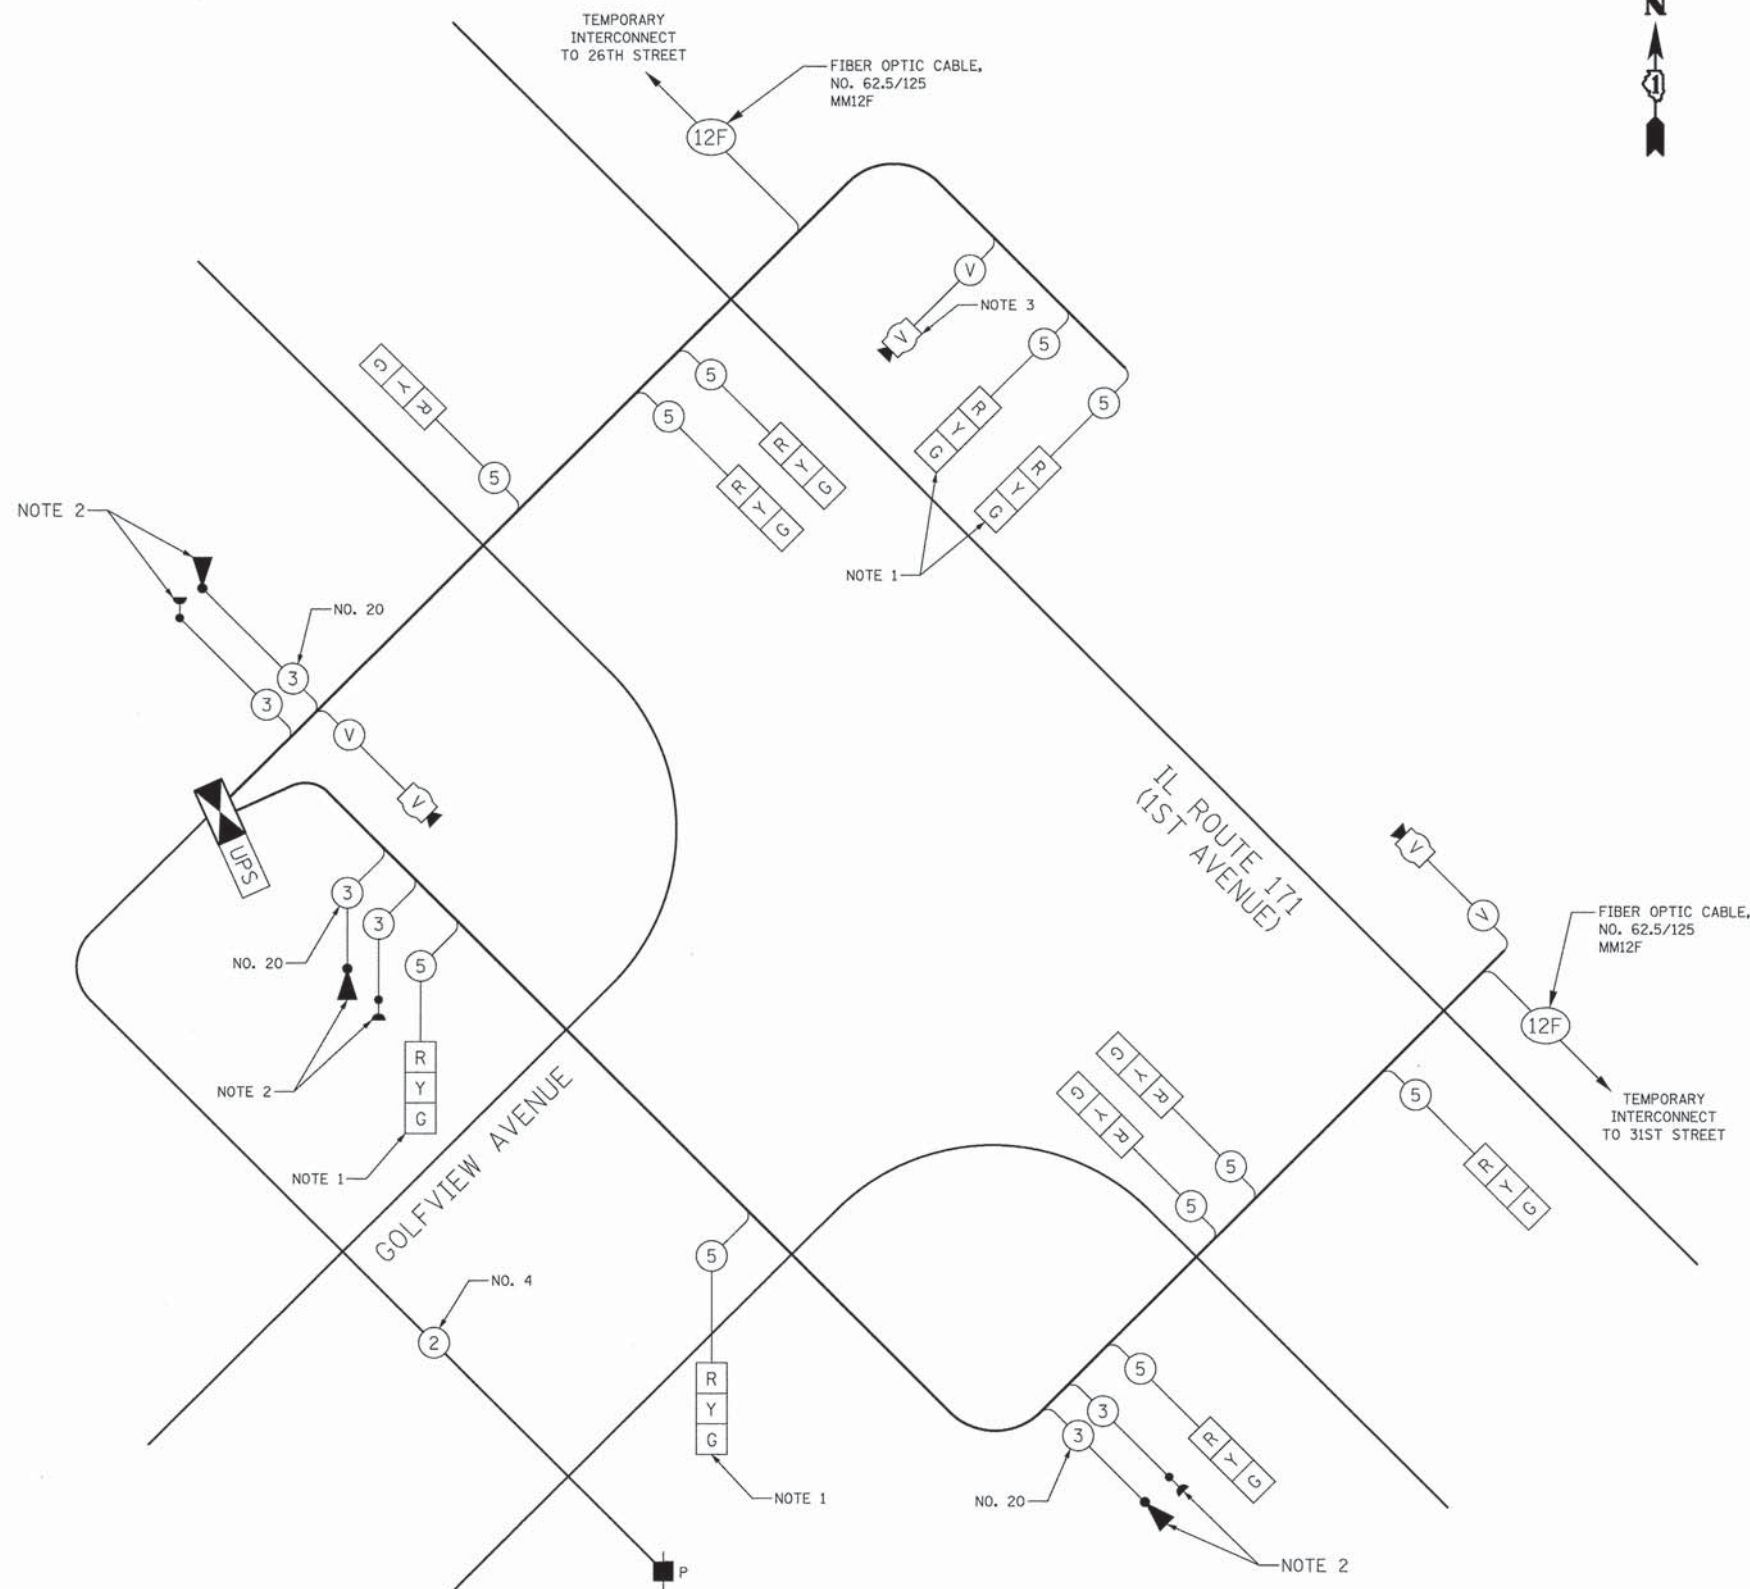

TEMPORARY CABLE PLAN  
NOT TO SCALE

CABLE PLAN NOTES

1. THESE SIGNAL HEADS SHALL BE DISCONNECTED DURING M.O.T. STAGE V.
2. THE EMERGENCY VEHICLE PREEMPTORS AND CONFIRMATION BEACONS SHALL BE DISCONNECTED DURING M.O.T. STAGE V.
3. THIS VIDEO DETECTOR SHALL BE DISCONNECTED DURING M.O.T. STAGE V. THE REMAINING VIDEO DETECTORS WILL REMAIN ACTIVE FOR PURPOSES OF SYSTEM DETECTION.

▲ REPLACE ENTIRE SHEET

NOTE: THE TRAFFIC SIGNAL CONTROLLER EQUIPMENT FOR THIS PROJECT SHALL BE "ECONOLITE" TO MATCH THE EXISTING ADJACENT SYSTEM.

I.D.O.T. TRAFFIC SIGNAL INSTALLATION ELECTRICAL SERVICE REQUIREMENTS					TOTAL WATTAGE
TYPE	NO. LAMPS	WATTAGE INCAND.	LED	% OPERATION	
SIGNAL (RED)	11		17	0.50	94
(YELLOW)	11		25	0.25	69
(GREEN)	11		15	0.25	42
CONTROLLER	1		100	1.00	100
VIDEO SYSTEM	1		150	1.00	150
FLASHER				0.50	
TOTAL =					455

ENERGY COSTS TO: ILLINOIS DEPARTMENT OF TRANSPORTATION  
201 WEST CENTER COURT  
SCHAUMBURG, IL 60196-1096  
ENERGY SUPPLY: CONTACT: JENNIFER BERTHOLD  
PHONE: (708) 410-5314  
COMPANY: COM ED



USER NAME = dte	DESIGNED - BRD	REVISED - 3-28-13 ▲
PLOT SCALE = 20,000' / 1" =	DRAWN - MFB	REVISED -
PLOT DATE = 5/6/2013	CHECKED - JJE	REVISED -
	DATE - 05/13/2013	REVISED -

STATE OF ILLINOIS  
DEPARTMENT OF TRANSPORTATION

TEMPORARY CABLE PLAN, TEMPORARY PHASE DESIGNATION DIAGRAM,  
& TEMPORARY EMERGENCY VEHICLE PREEMPTION SEQUENCE  
GOLFVIEW AVENUE AT IL ROUTE 171 (1ST AVENUE) - M.O.T. STAGES I-V  
NO SCALE SHEET NO. 1 OF 1 SHEETS STA. TO STA.

F.A.U. RTE.	SECTION	COUNTY	TOTAL SHEETS	SHEET NO.
3784	12-F3000-23-PK	COOK	131	83
CONTRACT NO. 63764				
FED. ROAD DIST. NO. 1 [ILLINOIS] FED. AID PROJECT				










MATCH LINE C SEE SHEET NO. 1 OF 2

MATCH LINE D

MATCH LINE E

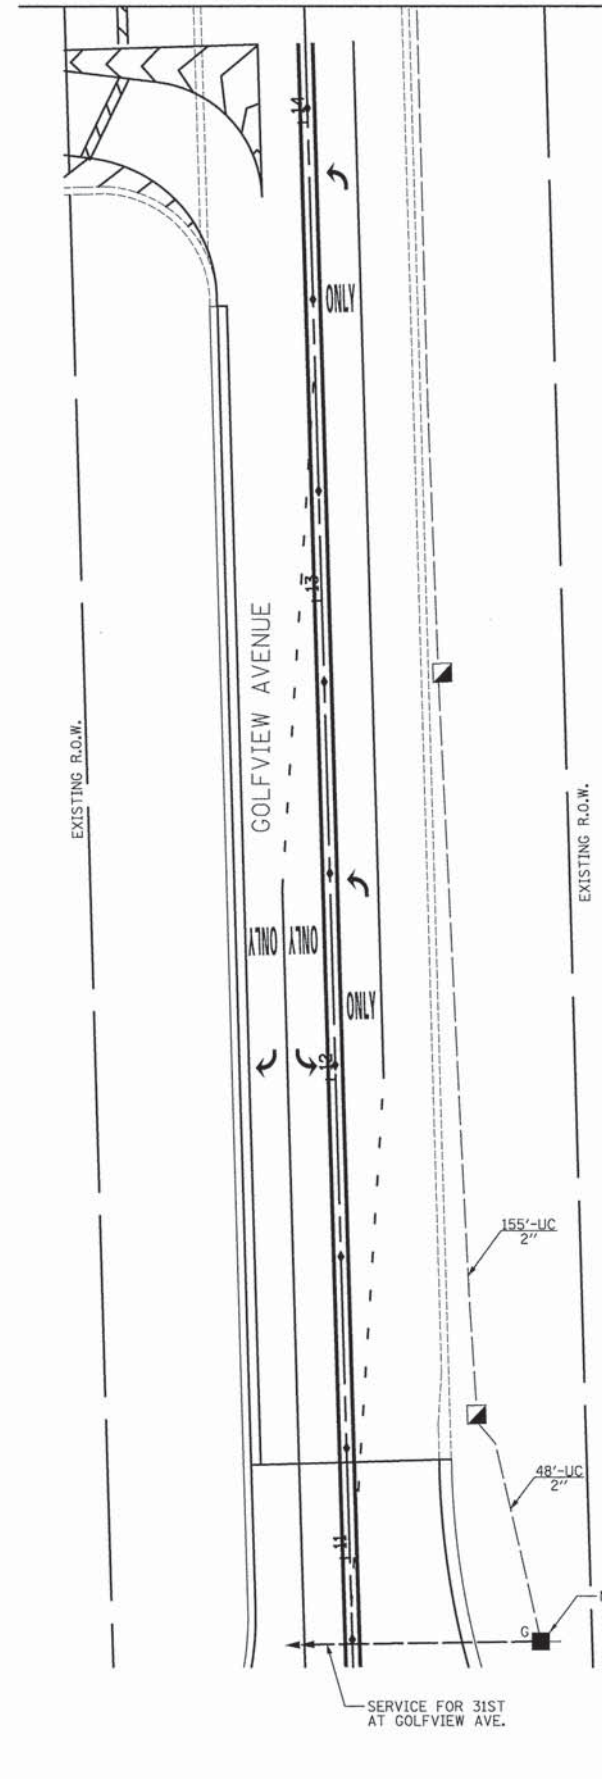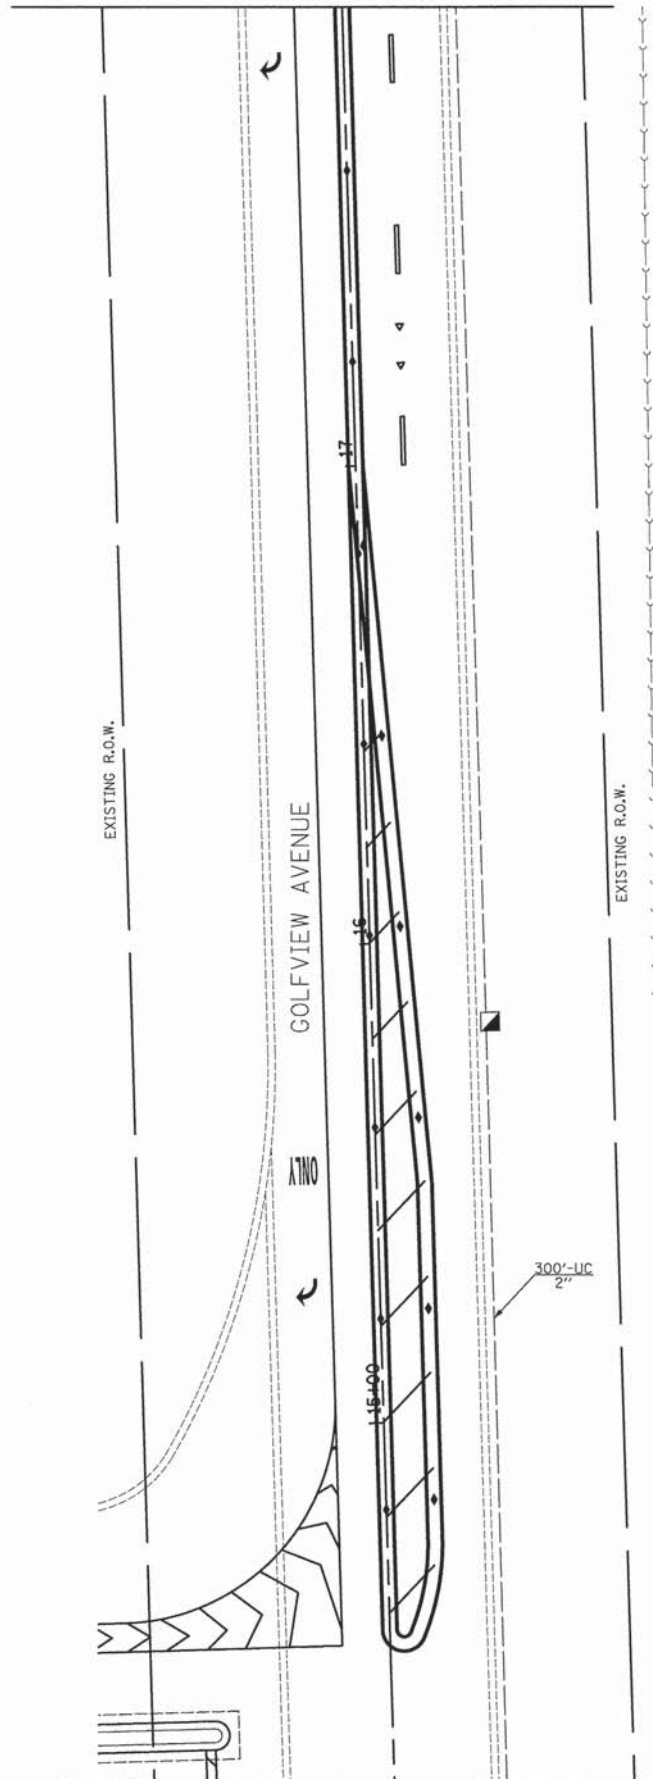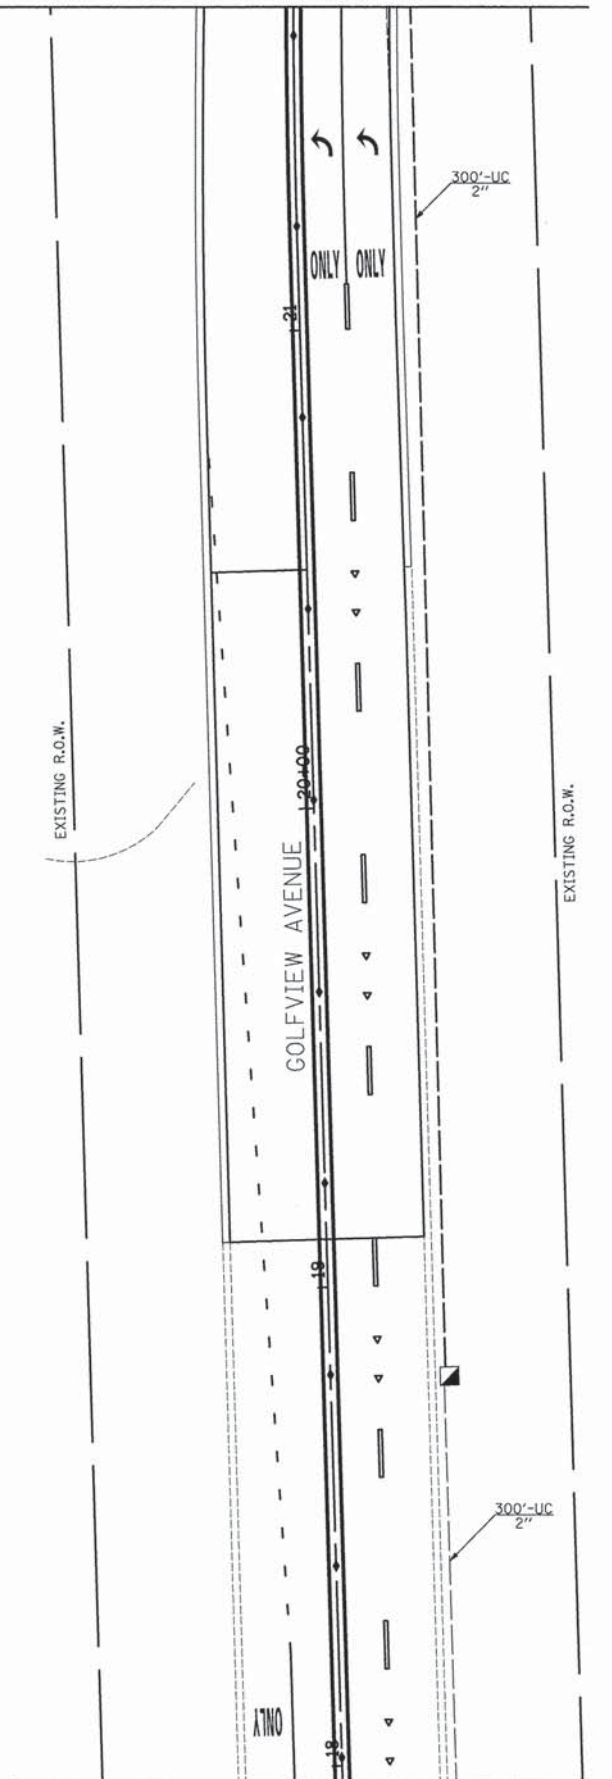

**RESTORATION OF WORK AREA.**  
 RESTORATION OF THE TRAFFIC SIGNAL WORK AREA SHALL BE INCIDENTAL TO THE RELATED PAY ITEM SUCH AS FOUNDATION, CONDUIT, HANDHOLE, TRENCH AND BACKFILL, ETC., AND NO EXTRA COMPENSATION SHALL BE ALLOWED. ALL ROADWAY SURFACES SUCH AS SHOULDER, MEDIAN, SIDEWALKS, PAVEMENT, ETC. SHALL BE REPLACED IN KIND. ALL DAMAGE TO MOWED LAWNS SHALL BE REPLACED WITH AN APPROVED SALT TOLERANT SOD, AND ALL DAMAGE TO UNMOWED FIELDS SHALL BE SEEDING IN ACCORDANCE WITH STANDARD SPECIFICATIONS 252 AND 250 RESPECTIVELY.

**NOTE:**  
 THE TRAFFIC SIGNAL CONTROLLER EQUIPMENT FOR THIS PROJECT SHALL BE "ECONOLITE" TO MATCH THE EXISTING ADJACENT SYSTEM.



USER NAME = dta	DESIGNED - BRD	REVISED -
PLOT SCALE = 20,0000' / 1"	DRAWN - MFB	REVISED -
PLOT DATE = 5/6/2013	CHECKED - JJE	REVISED -
	DATE - 05/13/2013	REVISED -




**STATE OF ILLINOIS  
 DEPARTMENT OF TRANSPORTATION**

**TRAFFIC SIGNAL MODERNIZATION PLAN  
 GOLFVIEW AVENUE AT IL ROUTE 171 (1ST AVENUE)**

SCALE: 1" = 20' SHEET NO. 2 OF 2 SHEETS STA. TO STA.

F.A.U. RTE.	SECTION	COUNTY	TOTAL SHEETS	SHEET NO.
3784	12-F3000-23-PK	COOK	131	85
CONTRACT NO. 63764				
FED. ROAD DIST. NO. 1 [ILLINOIS] FED. AID PROJECT				



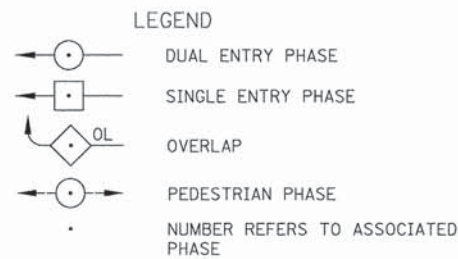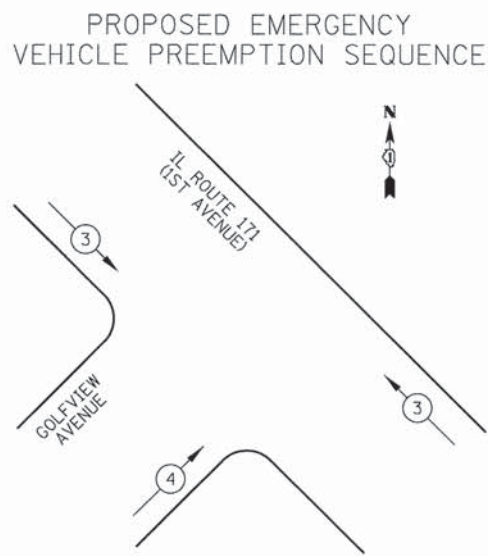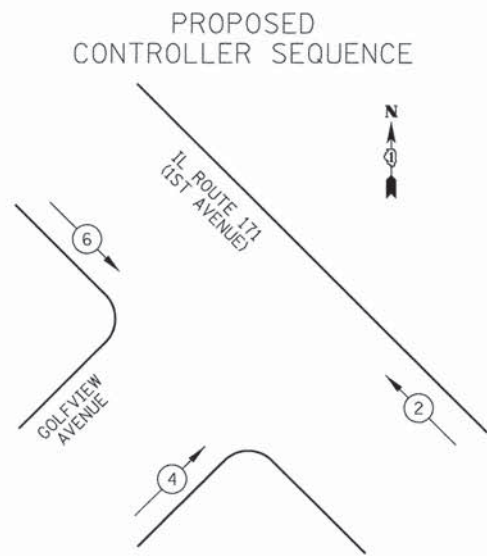

PHASE DESIGNATION DIAGRAM

PROPOSED EMERGENCY VEHICLE PREEMPTORS		
EMERGENCY VEHICLE PREEMPTOR	3	4
MOVEMENT		

THE END OF THE TRACER CABLE SHALL BE CONTINUOUS AND EXTEND INTO THE CONTROLLER CABINET.

NUMBER OF CABLES AS PER PLAN


SCHEDULE OF QUANTITIES

PAY ITEM	UNIT	QNTY.
SIGN PANEL - TYPE 1	SQ FT	17
SERVICE INSTALLATION - GROUND MOUNTED	EACH	1
UNDERGROUND CONDUIT, GALVANIZED STEEL 2" DIA.	FOOT	1856
UNDERGROUND CONDUIT, GALVANIZED STEEL 2 1/2" DIA.	FOOT	225
UNDERGROUND CONDUIT, GALVANIZED STEEL, 3" DIA.	FOOT	21
UNDERGROUND CONDUIT, GALVANIZED STEEL, 4" DIA.	FOOT	318
HANDHOLE	EACH	11
DOUBLE HANDHOLE	EACH	1
TRANSCIVER - FIBER OPTIC	EACH	1
ELECTRIC CABLE IN CONDUIT, SIGNAL NO. 14 3C	FOOT	367
ELECTRIC CABLE IN CONDUIT, SIGNAL NO. 14 5C	FOOT	2249
ELECTRIC CABLE IN CONDUIT, LEAD-IN, NO. 14 1 PAIR	FOOT	1768
ELECTRIC CABLE IN CONDUIT, SERVICE, NO. 4 2C	FOOT	1411
ELECTRIC CABLE IN CONDUIT, EQUIPMENT GROUNDING CONDUCTOR, NO. 6 1C	FOOT	2082
TRAFFIC SIGNAL POST, GALVANIZED STEEL 14 FT.	EACH	3
TRAFFIC SIGNAL POST, GALVANIZED STEEL 18 FT.	EACH	2
STEEL MAST ARM ASSEMBLY AND POLE, 22 FT.	EACH	1
STEEL MAST ARM ASSEMBLY AND POLE, 38 FT.	EACH	1
CONCRETE FOUNDATION, TYPE A	FOOT	20
CONCRETE FOUNDATION, TYPE C	FOOT	4
CONCRETE FOUNDATION, TYPE E 30-INCH DIAMETER	FOOT	20
SIGNAL HEAD, LED, 1-FACE, 3-SECTION, MAST ARM MOUNTED	EACH	3
SIGNAL HEAD, LED, 1-FACE, 3-SECTION, BRACKET MOUNTED	EACH	2
SIGNAL HEAD, LED, 2-FACE, 3-SECTION, BRACKET MOUNTED	EACH	1
OPTICALLY PROGRAMMED SIGNAL HEAD, LED, 1-FACE, 3-SECTION, BRACKET MOUNTED	EACH	2
OPTICALLY PROGRAMMED SIGNAL HEAD, LED, 1-FACE, 3-SECTION, MAST ARM MOUNTED	EACH	2
COMBINATION SIGNAL HEAD, LED, 2-FACE, 1-3 SECTION OPTICALLY PROGRAMMED, 1-3 SECTION, BRACKET MOUNTED	EACH	1
TRAFFIC SIGNAL BACKPLATE, LOUVERED, ALUMINUM	EACH	5
INDUCTIVE LOOP DETECTOR	EACH	6
DETECTOR LOOP, TYPE I	FOOT	378
* LIGHT DETECTOR	EACH	4
* LIGHT DETECTOR AMPLIFIER	EACH	1
TEMPORARY TRAFFIC SIGNAL INSTALLATION	EACH	1
REMOVE EXISTING TRAFFIC SIGNAL EQUIPMENT	EACH	1
REMOVE EXISTING HANDHOLE	EACH	12
REMOVE EXISTING DOUBLE HANDHOLE	EACH	1
REMOVE EXISTING CONCRETE FOUNDATION	EACH	6
* EMERGENCY VEHICLE PRIORITY SYSTEM LINE SENSOR CABLE, NO. 20 3/C	FOOT	702
FULL-ACTUATED CONTROLLER AND TYPE IV CABINET, SPECIAL	EACH	1
UNINTERRUPTABLE POWER SUPPLY, SPECIAL	EACH	1
TEMPORARY TRAFFIC SIGNAL TIMING	EACH	1
* 100% COST TO VILLAGE OF BROOKFIELD FIRE DEPARTMENT		

I.D.O.T. TRAFFIC SIGNAL INSTALLATION ELECTRICAL SERVICE REQUIREMENTS					TOTAL WATTAGE
TYPE	NO. LAMPS	INCAND.	LED	% OPERATION	
SIGNAL (RED)	14		17	0.50	119
(YELLOW)	14		25	0.25	88
(GREEN)	14		15	0.25	53
CONTROLLER	1		100	1.00	100
TOTAL =					359

ENERGY COSTS TO: ILLINOIS DEPARTMENT OF TRANSPORTATION  
201 WEST CENTER COURT  
SCHAUMBURG, IL 60196-1096

ENERGY SUPPLY: CONTACT: JENNIFER BERTHOLD  
PHONE: (708) 410-5314  
COMPANY: COM ED

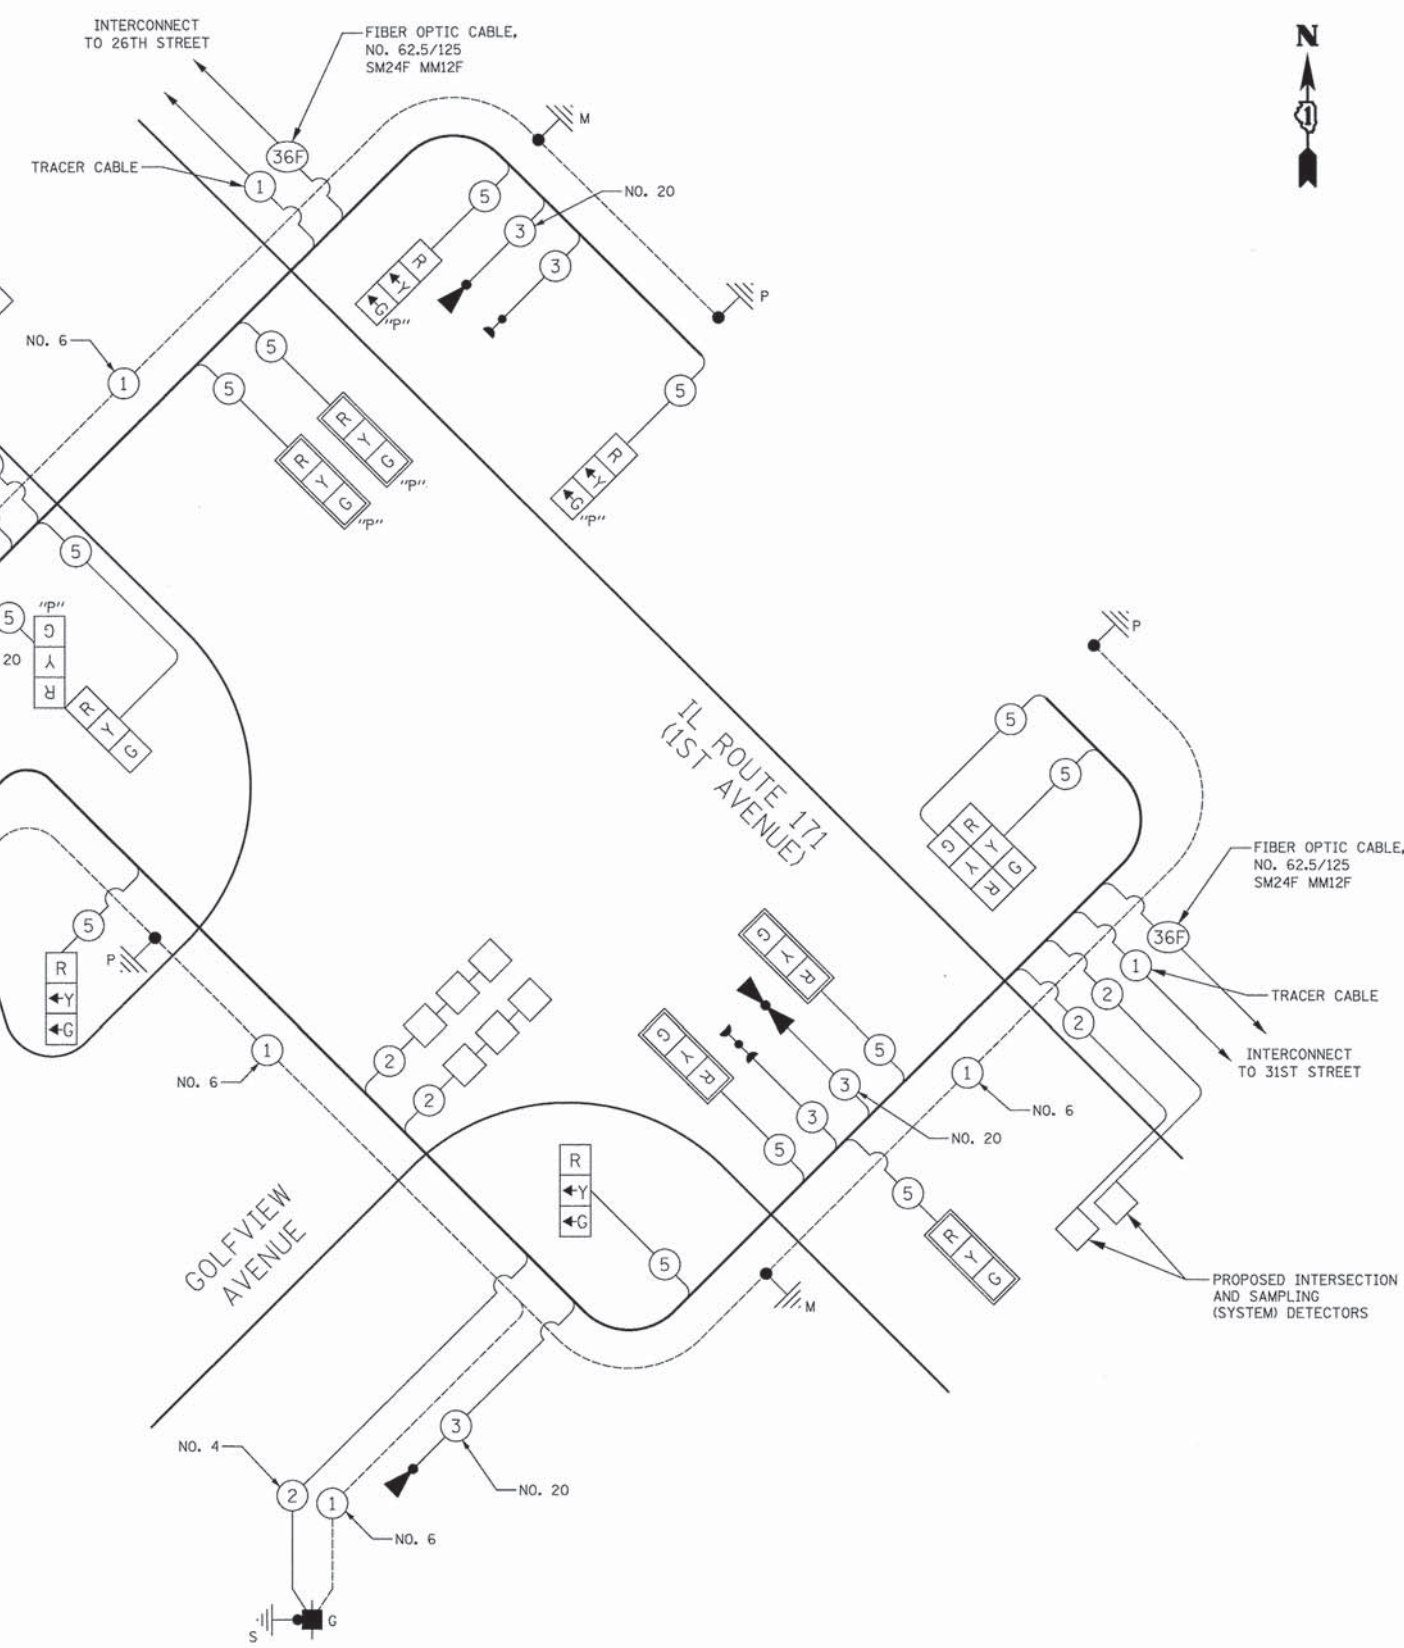

NOTE:  
THE TRAFFIC SIGNAL CONTROLLER EQUIPMENT FOR THIS PROJECT SHALL BE "ECONOLITE" TO MATCH THE EXISTING ADJACENT SYSTEM.



USER NAME = dte  
DESIGNED - BRD  
DRAWN - MFB  
CHECKED - JJE  
DATE - 05/13/2013  
PLLOT SCALE = 20,000' / 1" =  
PLLOT DATE = 5/6/2013



REVISED -  
REVISED -  
REVISED -  
REVISED -

STATE OF ILLINOIS  
DEPARTMENT OF TRANSPORTATION

CABLE PLAN, PHASE DESIGNATION DIAGRAM, EMERGENCY VEHICLE PREEMPTION SEQUENCE & SCHEDULE OF QUANTITIES  
GOLFVIEW AVENUE AT IL ROUTE 171 (1ST AVENUE)  
NO SCALE SHEET NO. 1 OF 1 SHEETS STA. TO STA.

F.A.U. RTE.	SECTION	COUNTY	TOTAL SHEETS	SHEET NO.
3784	12-F3000-23-PK	COOK	131	86
CONTRACT NO. 63764				
FED. ROAD DIST. NO. 1 (ILLINOIS) FED. AID PROJECT				



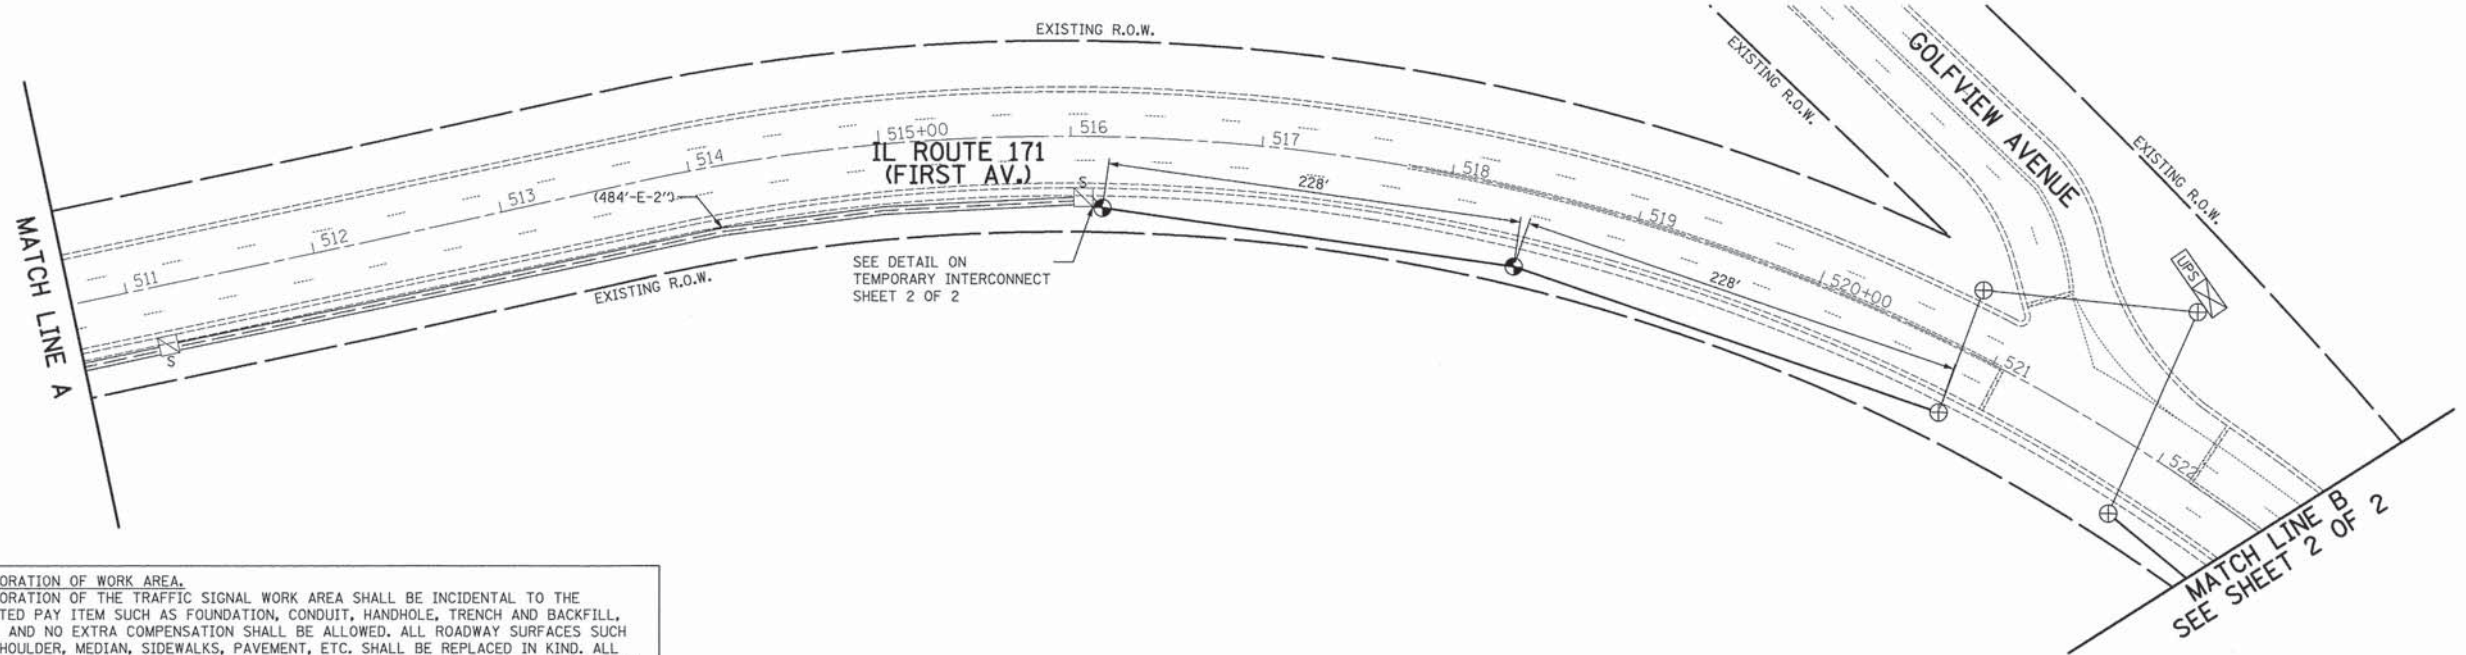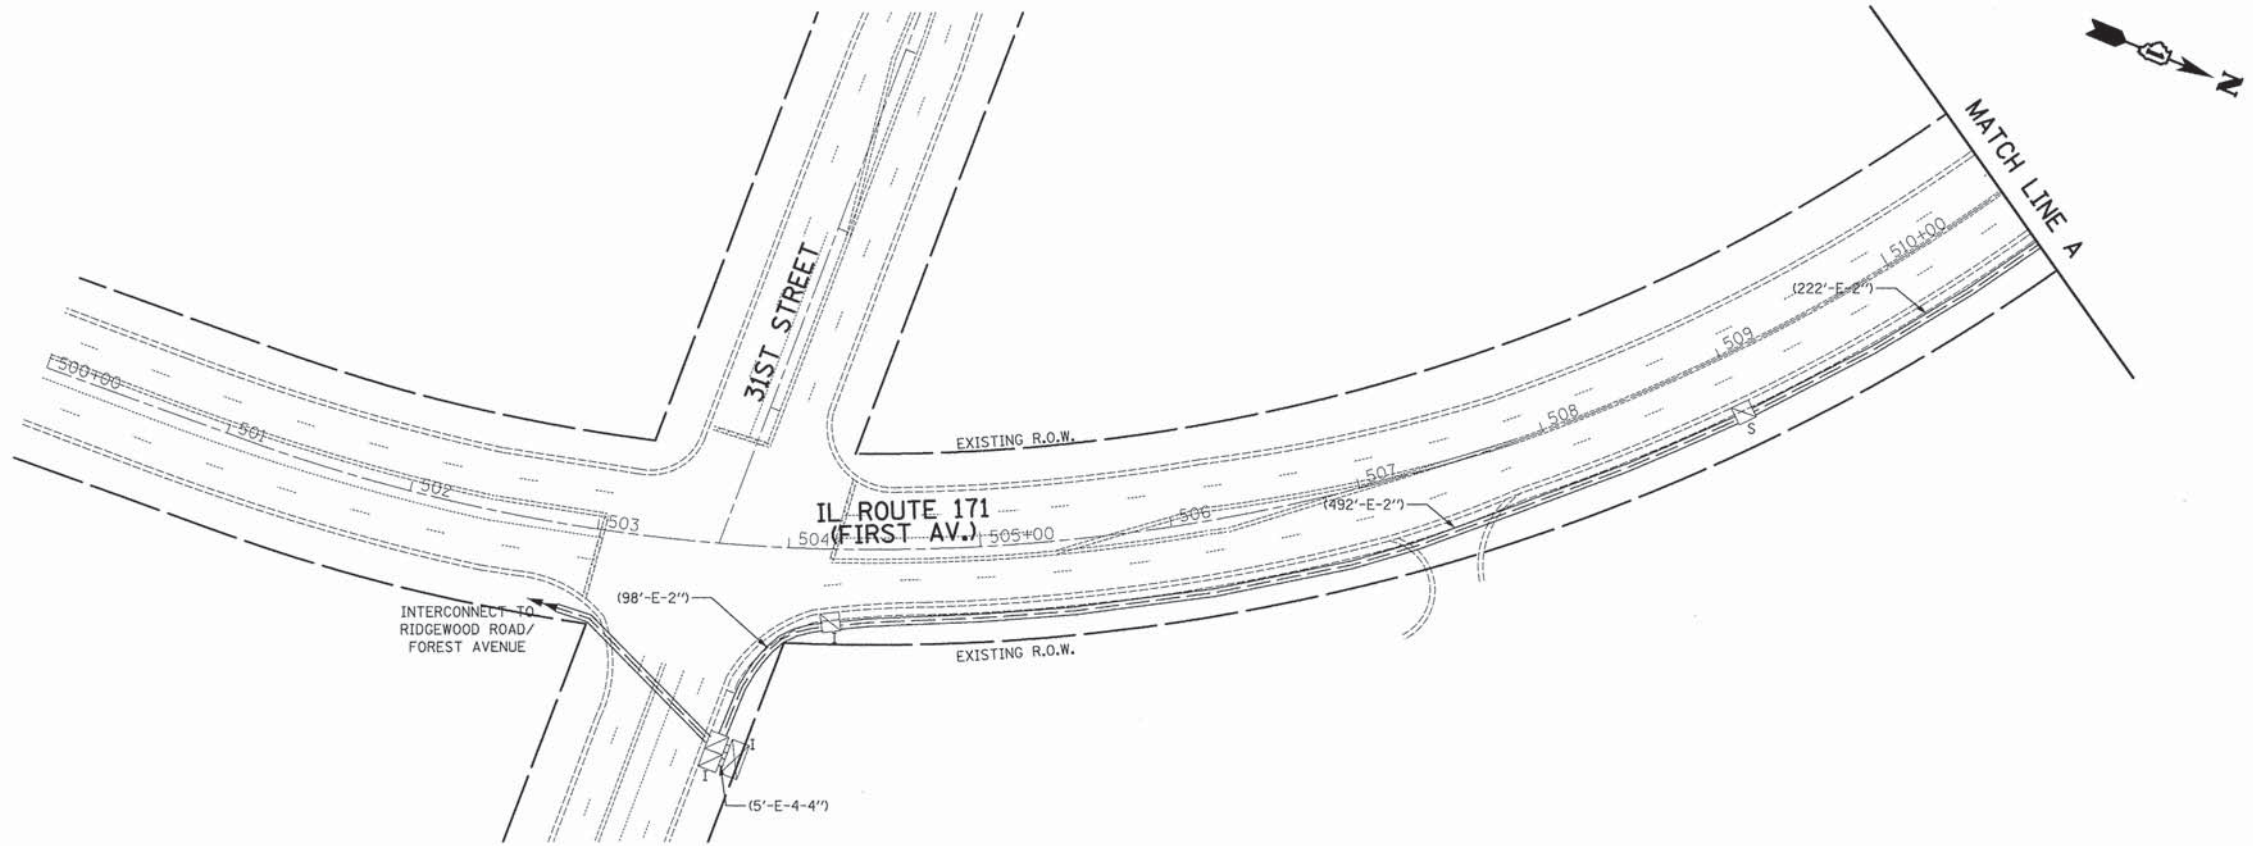


**RESTORATION OF WORK AREA.**  
 RESTORATION OF THE TRAFFIC SIGNAL WORK AREA SHALL BE INCIDENTAL TO THE RELATED PAY ITEM SUCH AS FOUNDATION, CONDUIT, HANDHOLE, TRENCH AND BACKFILL, ETC., AND NO EXTRA COMPENSATION SHALL BE ALLOWED. ALL ROADWAY SURFACES SUCH AS SHOULDER, MEDIAN, SIDEWALKS, PAVEMENT, ETC. SHALL BE REPLACED IN KIND. ALL DAMAGE TO MOWED LAWNS SHALL BE REPLACED WITH AN APPROVED SALT TOLERANT SOD, AND ALL DAMAGE TO UNMOWED FIELDS SHALL BE SEEDED IN ACCORDANCE WITH STANDARD SPECIFICATIONS 252 AND 250 RESPECTIVELY.


**NOTE:**  
 THE TRAFFIC SIGNAL CONTROLLER EQUIPMENT FOR THIS PROJECT SHALL BE "ECONOLITE" TO MATCH THE EXISTING ADJACENT SYSTEM.

	USER NAME = dte	DESIGNED - BRD	REVISED -	<b>STATE OF ILLINOIS</b> <b>DEPARTMENT OF TRANSPORTATION</b>	<b>TEMPORARY INTERCONNECT PLAN</b> <b>IL ROUTE 171 (1ST AVENUE)</b> <b>31ST STREET TO 26TH STREET</b>	F.A.U. RTE.	SECTION	COUNTY	TOTAL SHEETS	SHEET NO.
	PLDT SCALE = 50.0000' / 1" = 50'	DRAWN - MFB	REVISED -			3784	12-F3000-23-PK	COOK	131	87
	PLDT DATE = 5/6/2013	CHECKED - JJE	REVISED -			CONTRACT NO. 63764				
	DATE - 05/13/2013	REVISED -		SCALE: 1" = 50'	SHEET NO. 1 OF 2 SHEETS	STA.	TO STA.	FED. ROAD DIST. NO. 1   ILLINOIS FED. AID PROJECT		



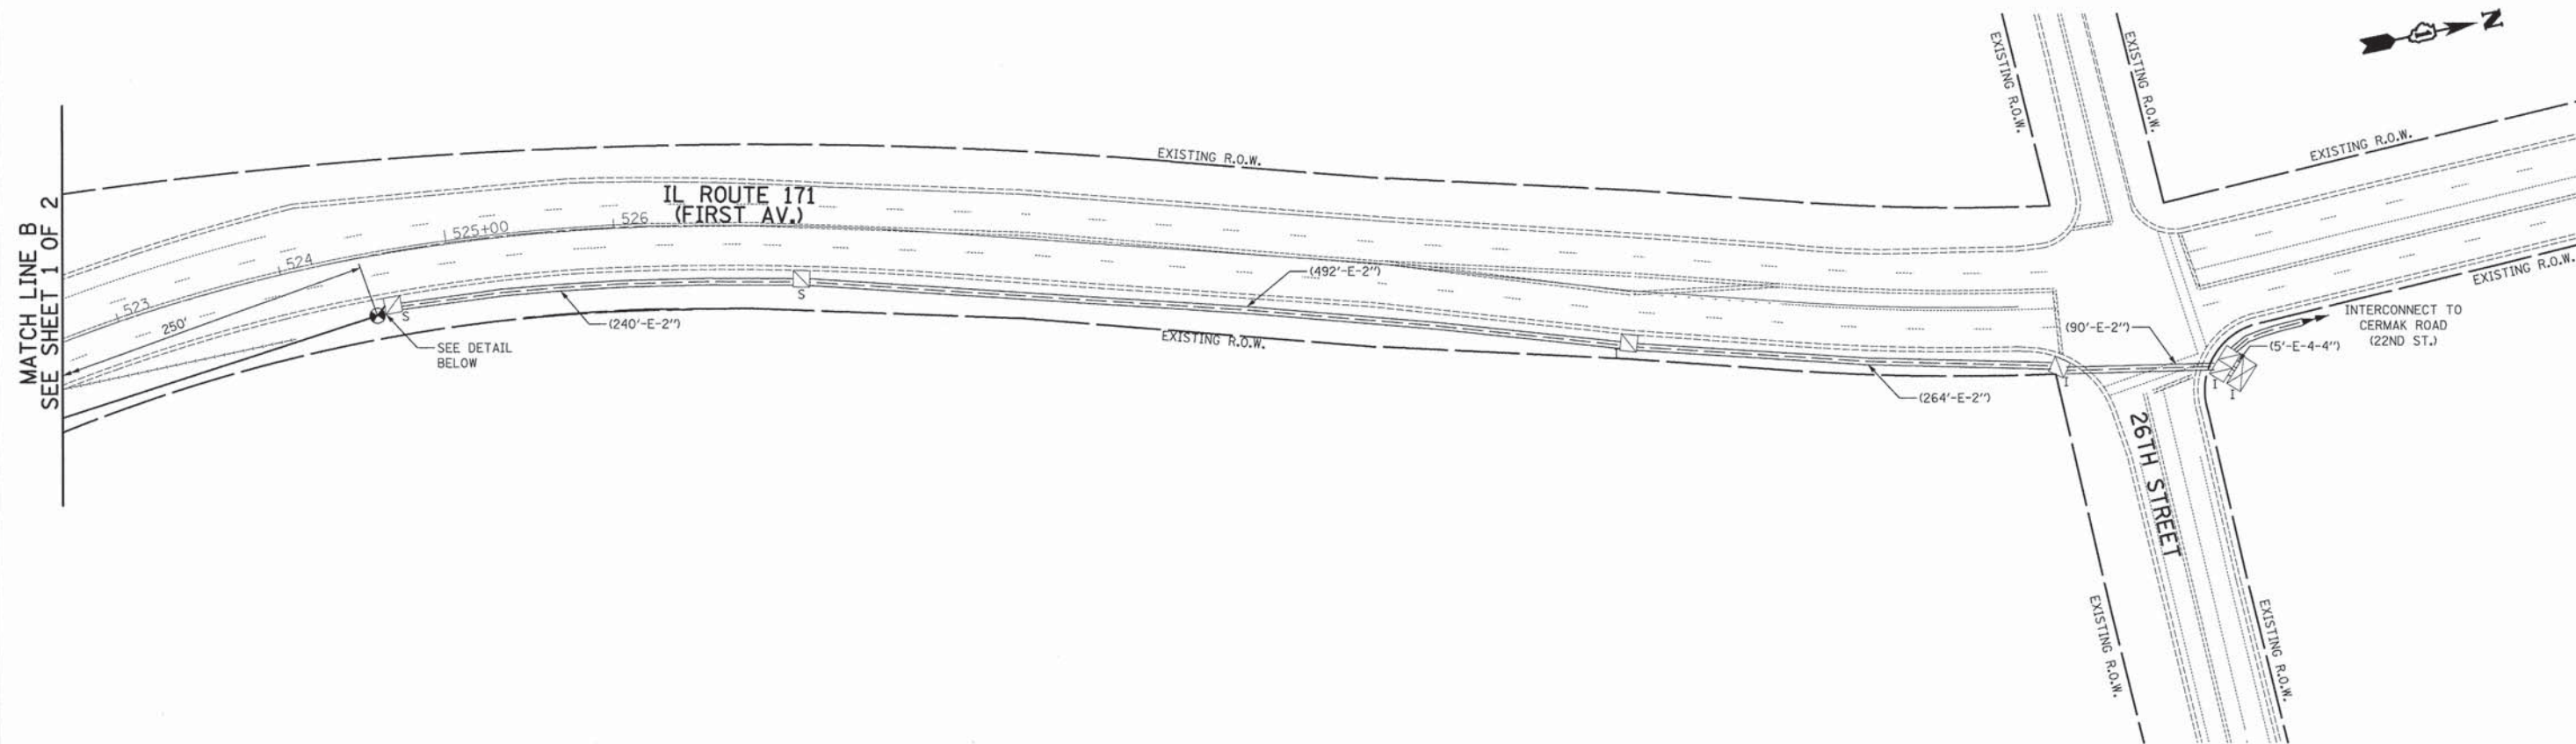

MATCH LINE B  
SEE SHEET 1 OF 2

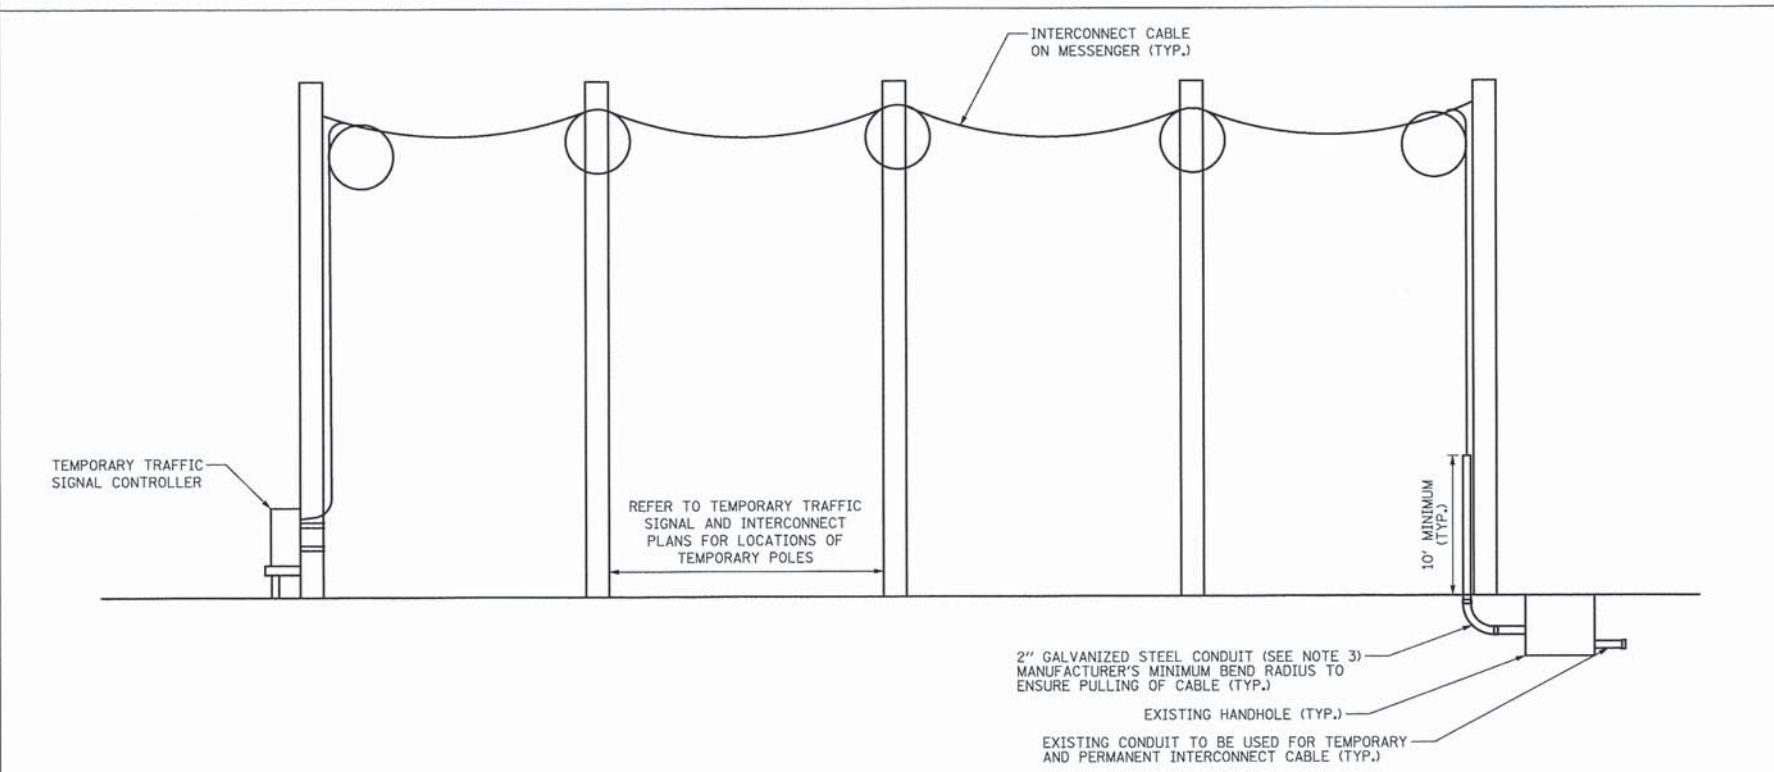

IL ROUTE 171 (FIRST AVENUE)  
AERIALLY SUPPORTED INTERCONNECT CABLE  
(NOT TO SCALE)

**TEMPORARY INTERCONNECT NOTES**



1. TRANSFER OF EXISTING TO TEMPORARY INTERCONNECT CABLE AND TEMPORARY INTERCONNECT CABLE TO PROPOSED MUST BE COMPLETED IN ONE WORKING DAY DURING NON-PEAK HOURS OR AS DIRECTED BY THE ENGINEER.
2. AFTER THE PROPOSED INTERCONNECT IS TURNED ON AND OPERATING TO THE SATISFACTION OF THE ENGINEER, THE TEMPORARY INTERCONNECT CABLE SHALL BE REMOVED.
3. THE 2" CONDUIT USED FOR THE TEMPORARY INTERCONNECT CABLE SHALL BE REMOVED TO BELOW GRADE AND CAPPED AT THE TIME THE TEMPORARY INTERCONNECT IS REMOVED.
4. THE CONTRACTOR MUST NOTIFY THE IDOT SIGNAL SYSTEM ENGINEER A MINIMUM OF SEVEN WORKING DAYS PRIOR TO THE START OF ANY WORK ON THE TRAFFIC SIGNAL INTERCONNECT.
5. ALL WORK AND MATERIALS INVOLVED IN THE INSTALLATION OF THE TEMPORARY INTERCONNECT AND ESTABLISHING SYSTEM OPERATION TO THE SATISFACTION OF THE ENGINEER AND THE IDOT SIGNAL SYSTEM ENGINEER SHALL BE INCLUDED IN THE PAY ITEM "TEMPORARY TRAFFIC SIGNAL INSTALLATION."

NOTE:  
THE TRAFFIC SIGNAL CONTROLLER EQUIPMENT FOR THIS PROJECT SHALL BE "ECONOLITE" TO MATCH THE EXISTING ADJACENT SYSTEM.

RESTORATION OF WORK AREA.  
RESTORATION OF THE TRAFFIC SIGNAL WORK AREA SHALL BE INCIDENTAL TO THE RELATED PAY ITEM SUCH AS FOUNDATION, CONDUIT, HANDHOLE, TRENCH AND BACKFILL, ETC., AND NO EXTRA COMPENSATION SHALL BE ALLOWED. ALL ROADWAY SURFACES SUCH AS SHOULDER, MEDIAN, SIDEWALKS, PAVEMENT, ETC. SHALL BE REPLACED IN KIND. ALL DAMAGE TO MOWED LAWNS SHALL BE REPLACED WITH AN APPROVED SALT TOLERANT SOD, AND ALL DAMAGE TO UNMOWED FIELDS SHALL BE SEEDED IN ACCORDANCE WITH STANDARD SPECIFICATIONS 252 AND 250 RESPECTIVELY.


	USER NAME = dta	DESIGNED - BRD	REVISED -	<b>STATE OF ILLINOIS</b> <b>DEPARTMENT OF TRANSPORTATION</b>	<b>TEMPORARY INTERCONNECT PLAN</b> <b>IL ROUTE 171 (1ST AVENUE)</b> <b>31ST STREET TO 26TH STREET</b>		F.A.U. RTE. 3784	SECTION 12-F3000-23-PK	COUNTY COOK	TOTAL SHEETS 131	SHEET NO. 88	
	PLOT SCALE = 50.0000' / 1" =	DRAWN - MFB	REVISED -		SCALE: 1" = 50'	SHEET NO. 2 OF 2 SHEETS	STA. TO STA.	FED. ROAD DIST. NO. 1 [ILLINOIS] FED. AID PROJECT				
	PLOT DATE = 5/6/2013	CHECKED - JJE	REVISED -				CONTRACT NO. 63764					
	DATE - 05/13/2013	REVISED -										



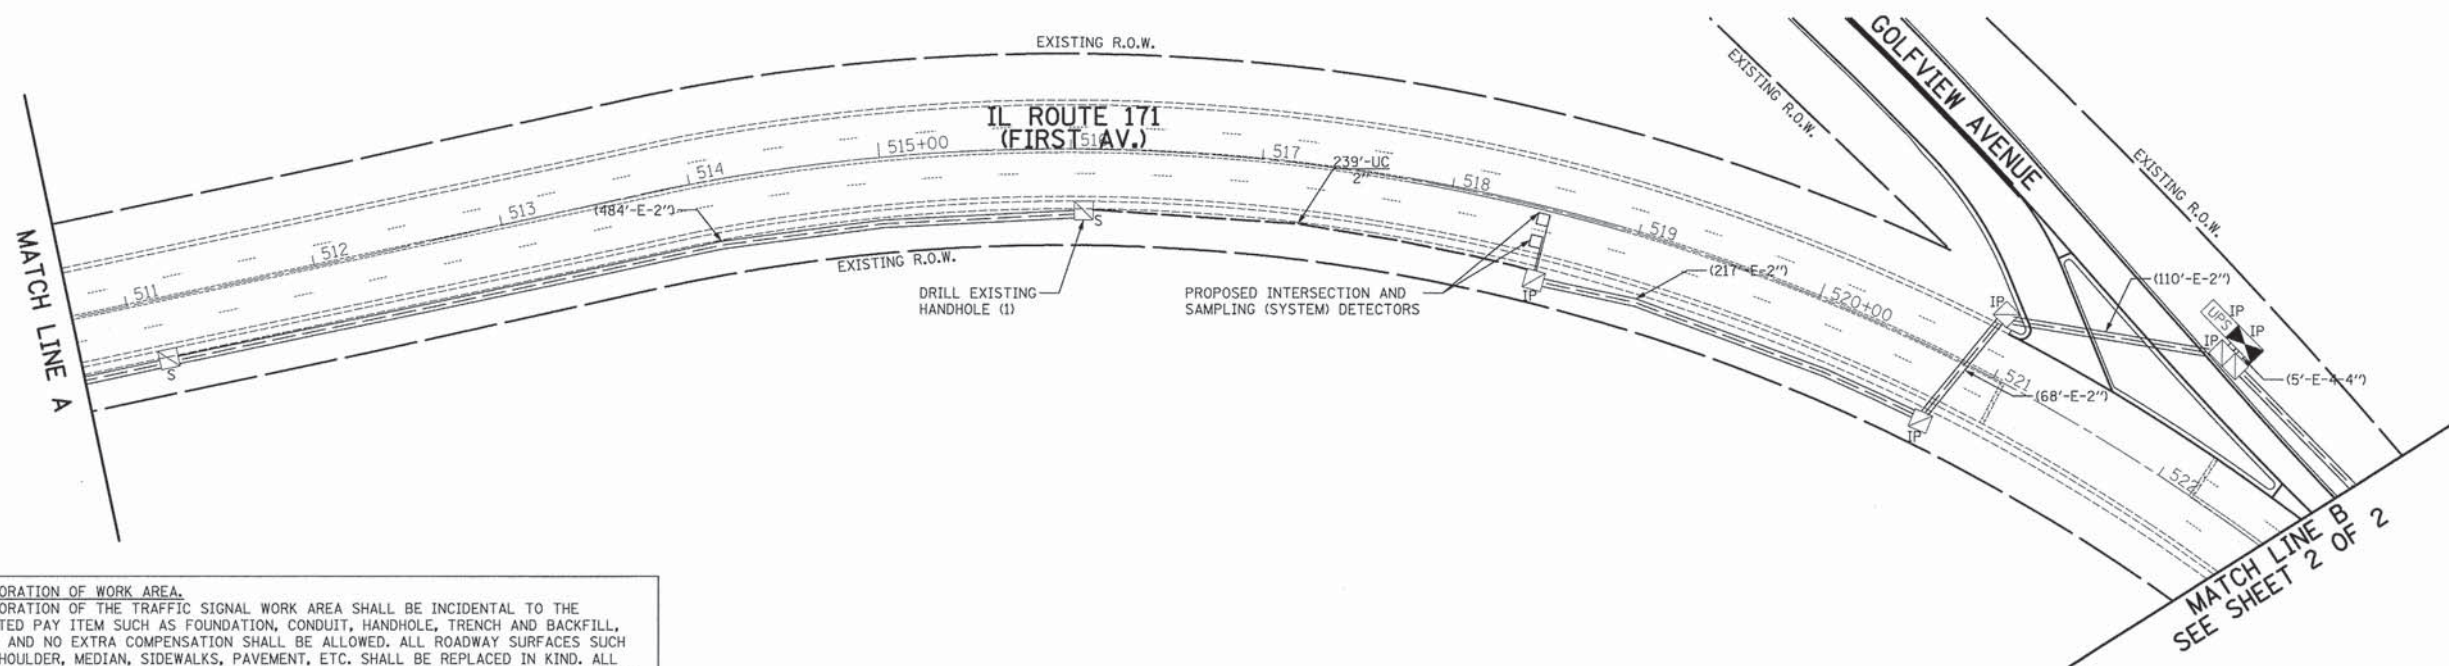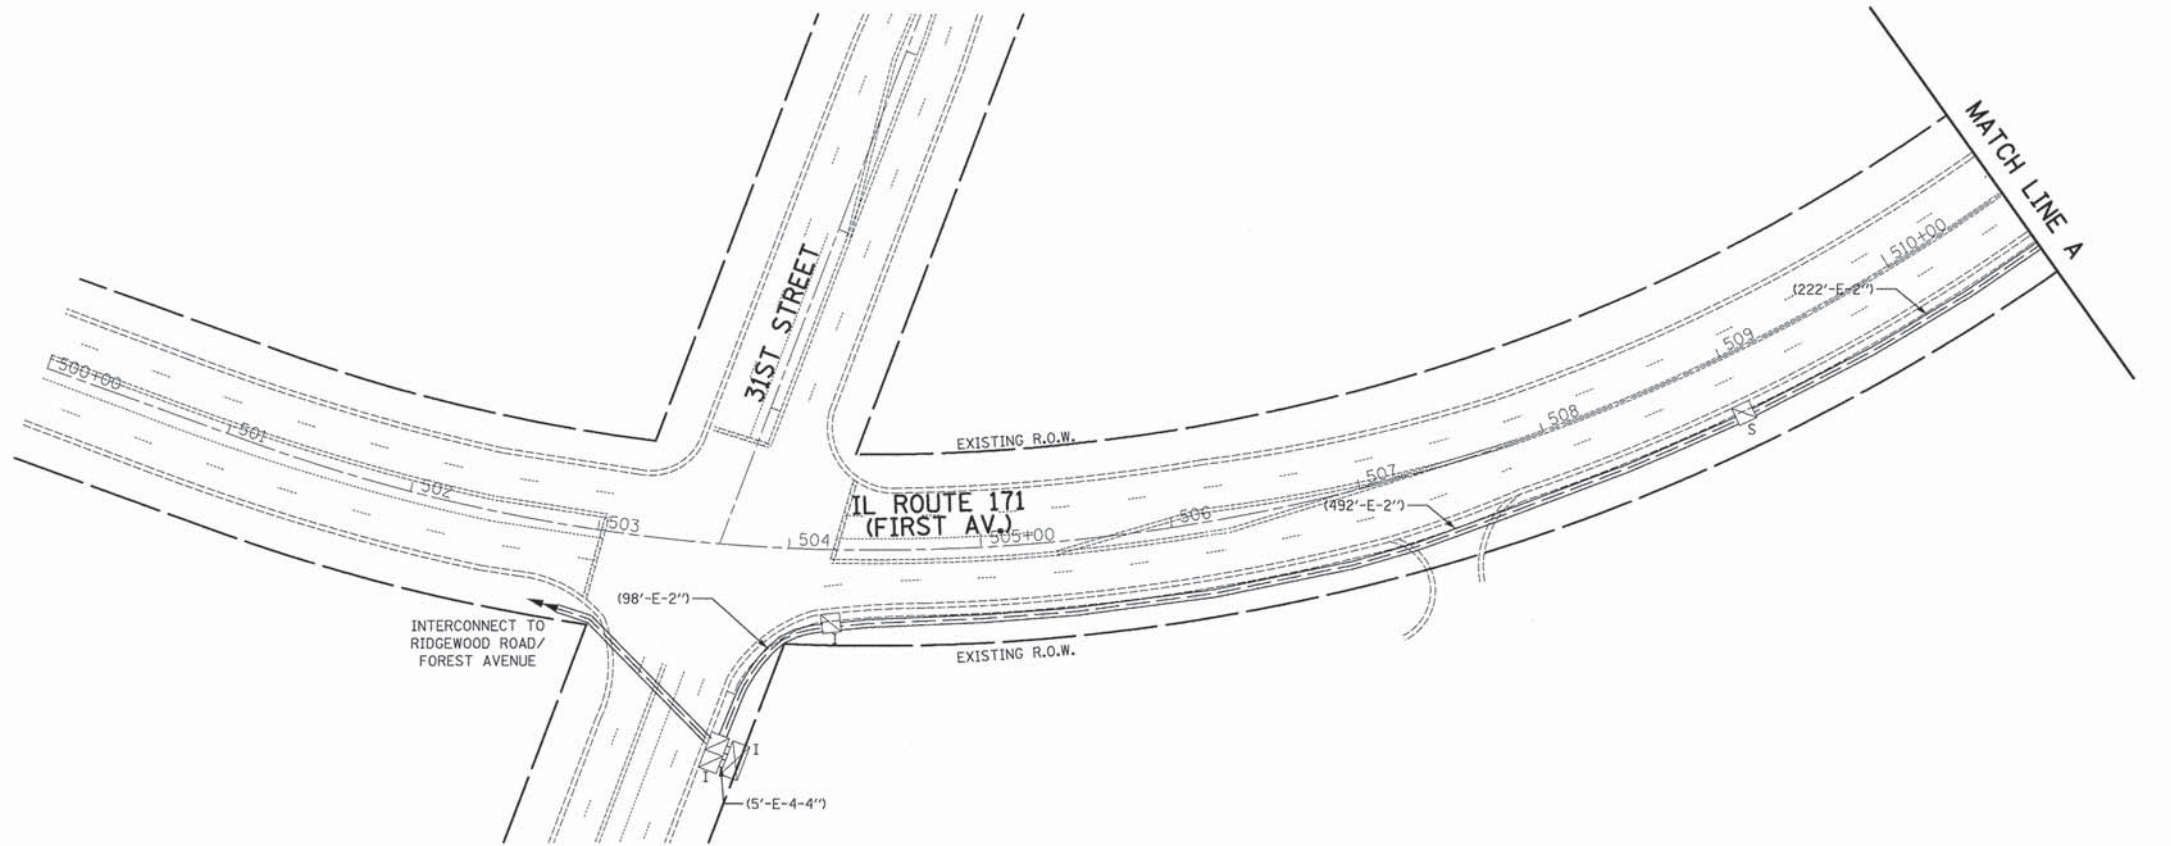


**RESTORATION OF WORK AREA.**  
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**NOTE:**  
 THE TRAFFIC SIGNAL CONTROLLER EQUIPMENT FOR THIS PROJECT SHALL BE "ECONOLITE" TO MATCH THE EXISTING ADJACENT SYSTEM.

	USER NAME = dte	DESIGNED - BRD	REVISED -	<b>STATE OF ILLINOIS</b> <b>DEPARTMENT OF TRANSPORTATION</b>	<b>INTERCONNECT PLAN</b> <b>IL ROUTE 171 (1ST AVENUE)</b> <b>31ST STREET TO 26TH STREET</b>		F.A.U. RTE. 3784	SECTION 12-F3000-23-PK	COUNTY COOK	TOTAL SHEETS 131	SHEET NO. 89
	PLOT SCALE = 58.0000' / 1" =	CHECKED - JJE	REVISED -				SCALE: 1" = 50'	SHEET NO. 1 OF 2 SHEETS	STA. TO STA.	<b>CONTRACT NO. 63764</b> <small>FED. ROAD DIST. NO. 1 [ILLINOIS] FED. AID PROJECT</small>	
	PLOT DATE = 5/6/2013	DATE - 05/13/2013	REVISED -								



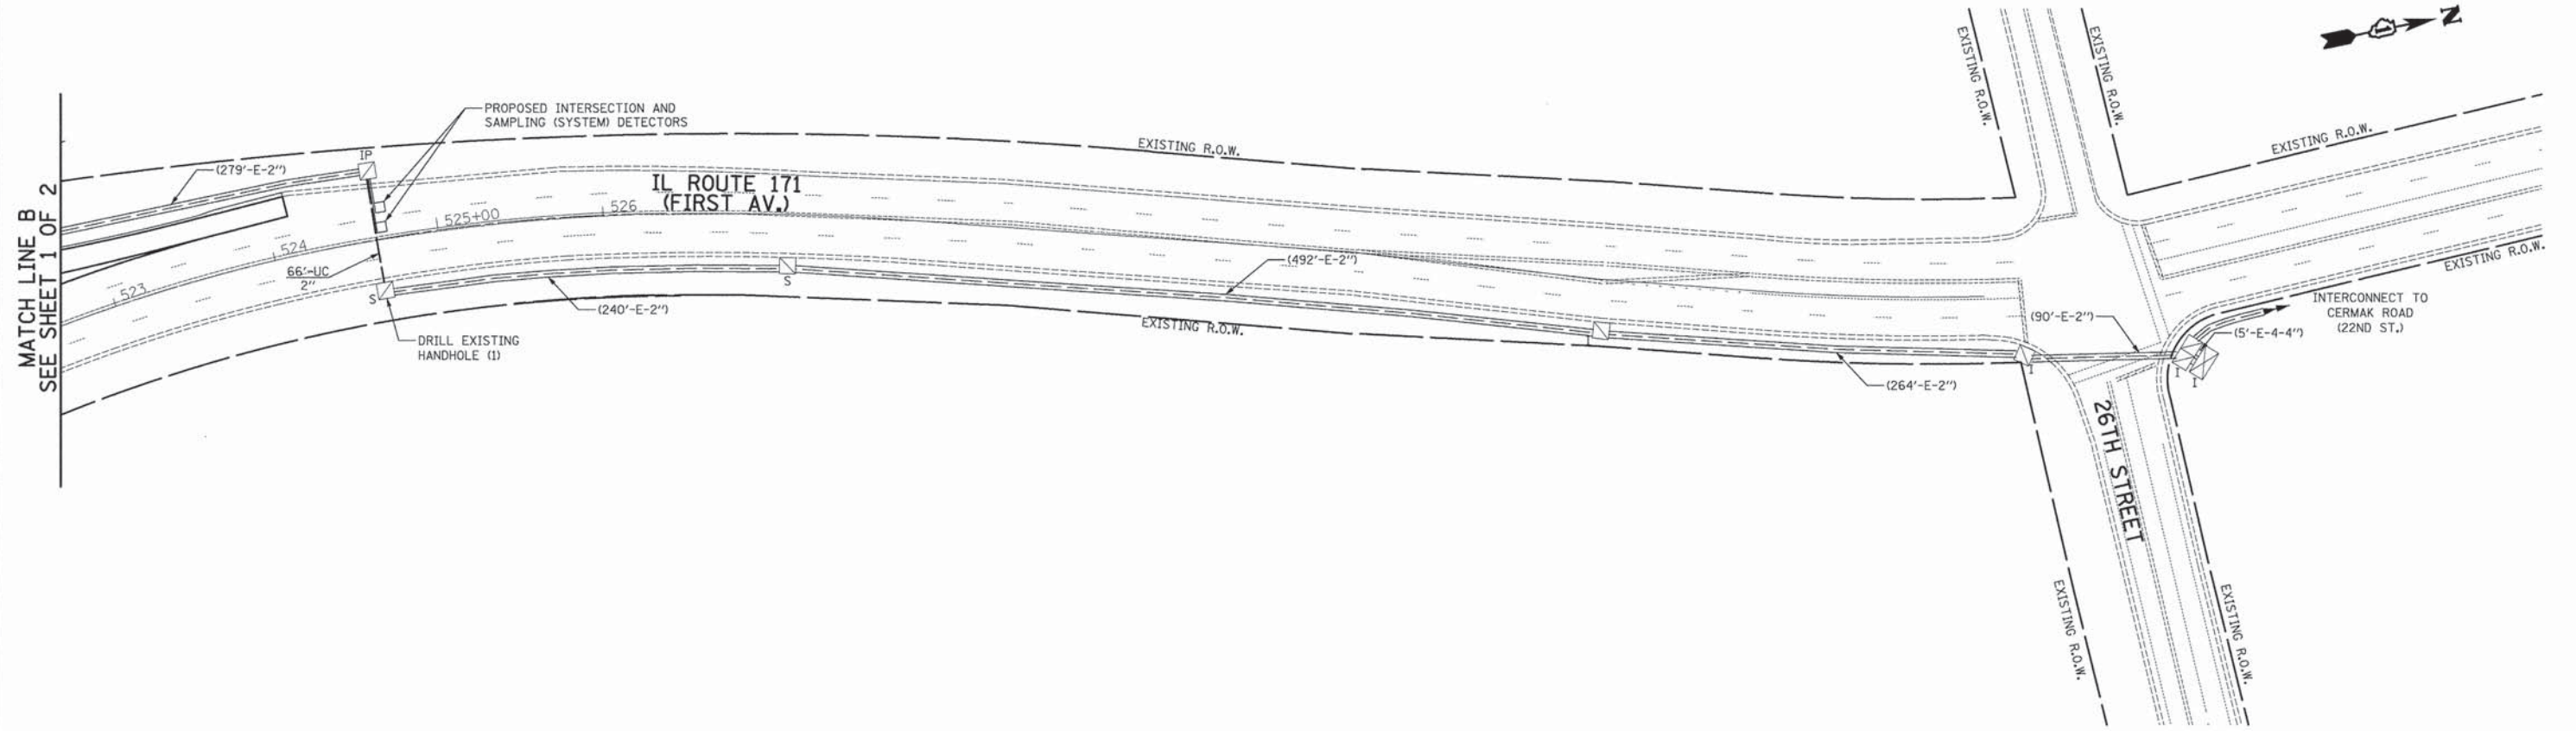

MATCH LINE B  
SEE SHEET 1 OF 2

RESTORATION OF WORK AREA.  
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NOTE:  
THE TRAFFIC SIGNAL CONTROLLER EQUIPMENT FOR THIS PROJECT SHALL BE "ECONOLITE" TO MATCH THE EXISTING ADJACENT SYSTEM.


	USER NAME = dte	DESIGNED - BRD	REVISED -	<b>STATE OF ILLINOIS DEPARTMENT OF TRANSPORTATION</b>	<b>INTERCONNECT PLAN IL ROUTE 171 (1ST AVENUE) 31ST STREET TO 26TH STREET</b>	F.A.U. RTE. 3784	SECTION 12-F3000-23-PK	COUNTY COOK	TOTAL SHEETS 131	SHEET NO. 90	
	PLOT SCALE = 50.0000' / 1" = 50'	CHECKED - JJE	REVISED -			SHEET NO. 2 OF 2 SHEETS	STA. TO STA.	CONTRACT NO. 63764			
	PLOT DATE = 5/6/2013	DATE - 05/13/2013	REVISED -			FED. ROAD DIST. NO. 1   ILLINOIS FED. AID PROJECT					





INTERCONNECT SCHEDULE OF QUANTITIES

PAY ITEM	UNIT	QNTY.
UNDERGROUND CONDUIT, GALVANIZED STEEL 2" DIA.	FOOT	305
MAINTENANCE OF EXISTING TRAFFIC SIGNAL INSTALLATION	EACH	2
ELECTRIC CABLE IN CONDUIT, TRACER, NO. 14 1C	FOOT	3529
DRILL EXISTING HANDHOLE	EACH	2
REMOVE ELECTRIC CABLE FROM CONDUIT	FOOT	2479
FIBER OPTIC CABLE IN CONDUIT, NO. 62.5/125, MM12F SM24F	FOOT	3575
RE-OPTIMIZE TRAFFIC SIGNAL SYSTEM LEVEL 2	EACH	1
REMOVE FIBER OPTIC CABLE FROM CONDUIT	FOOT	2502

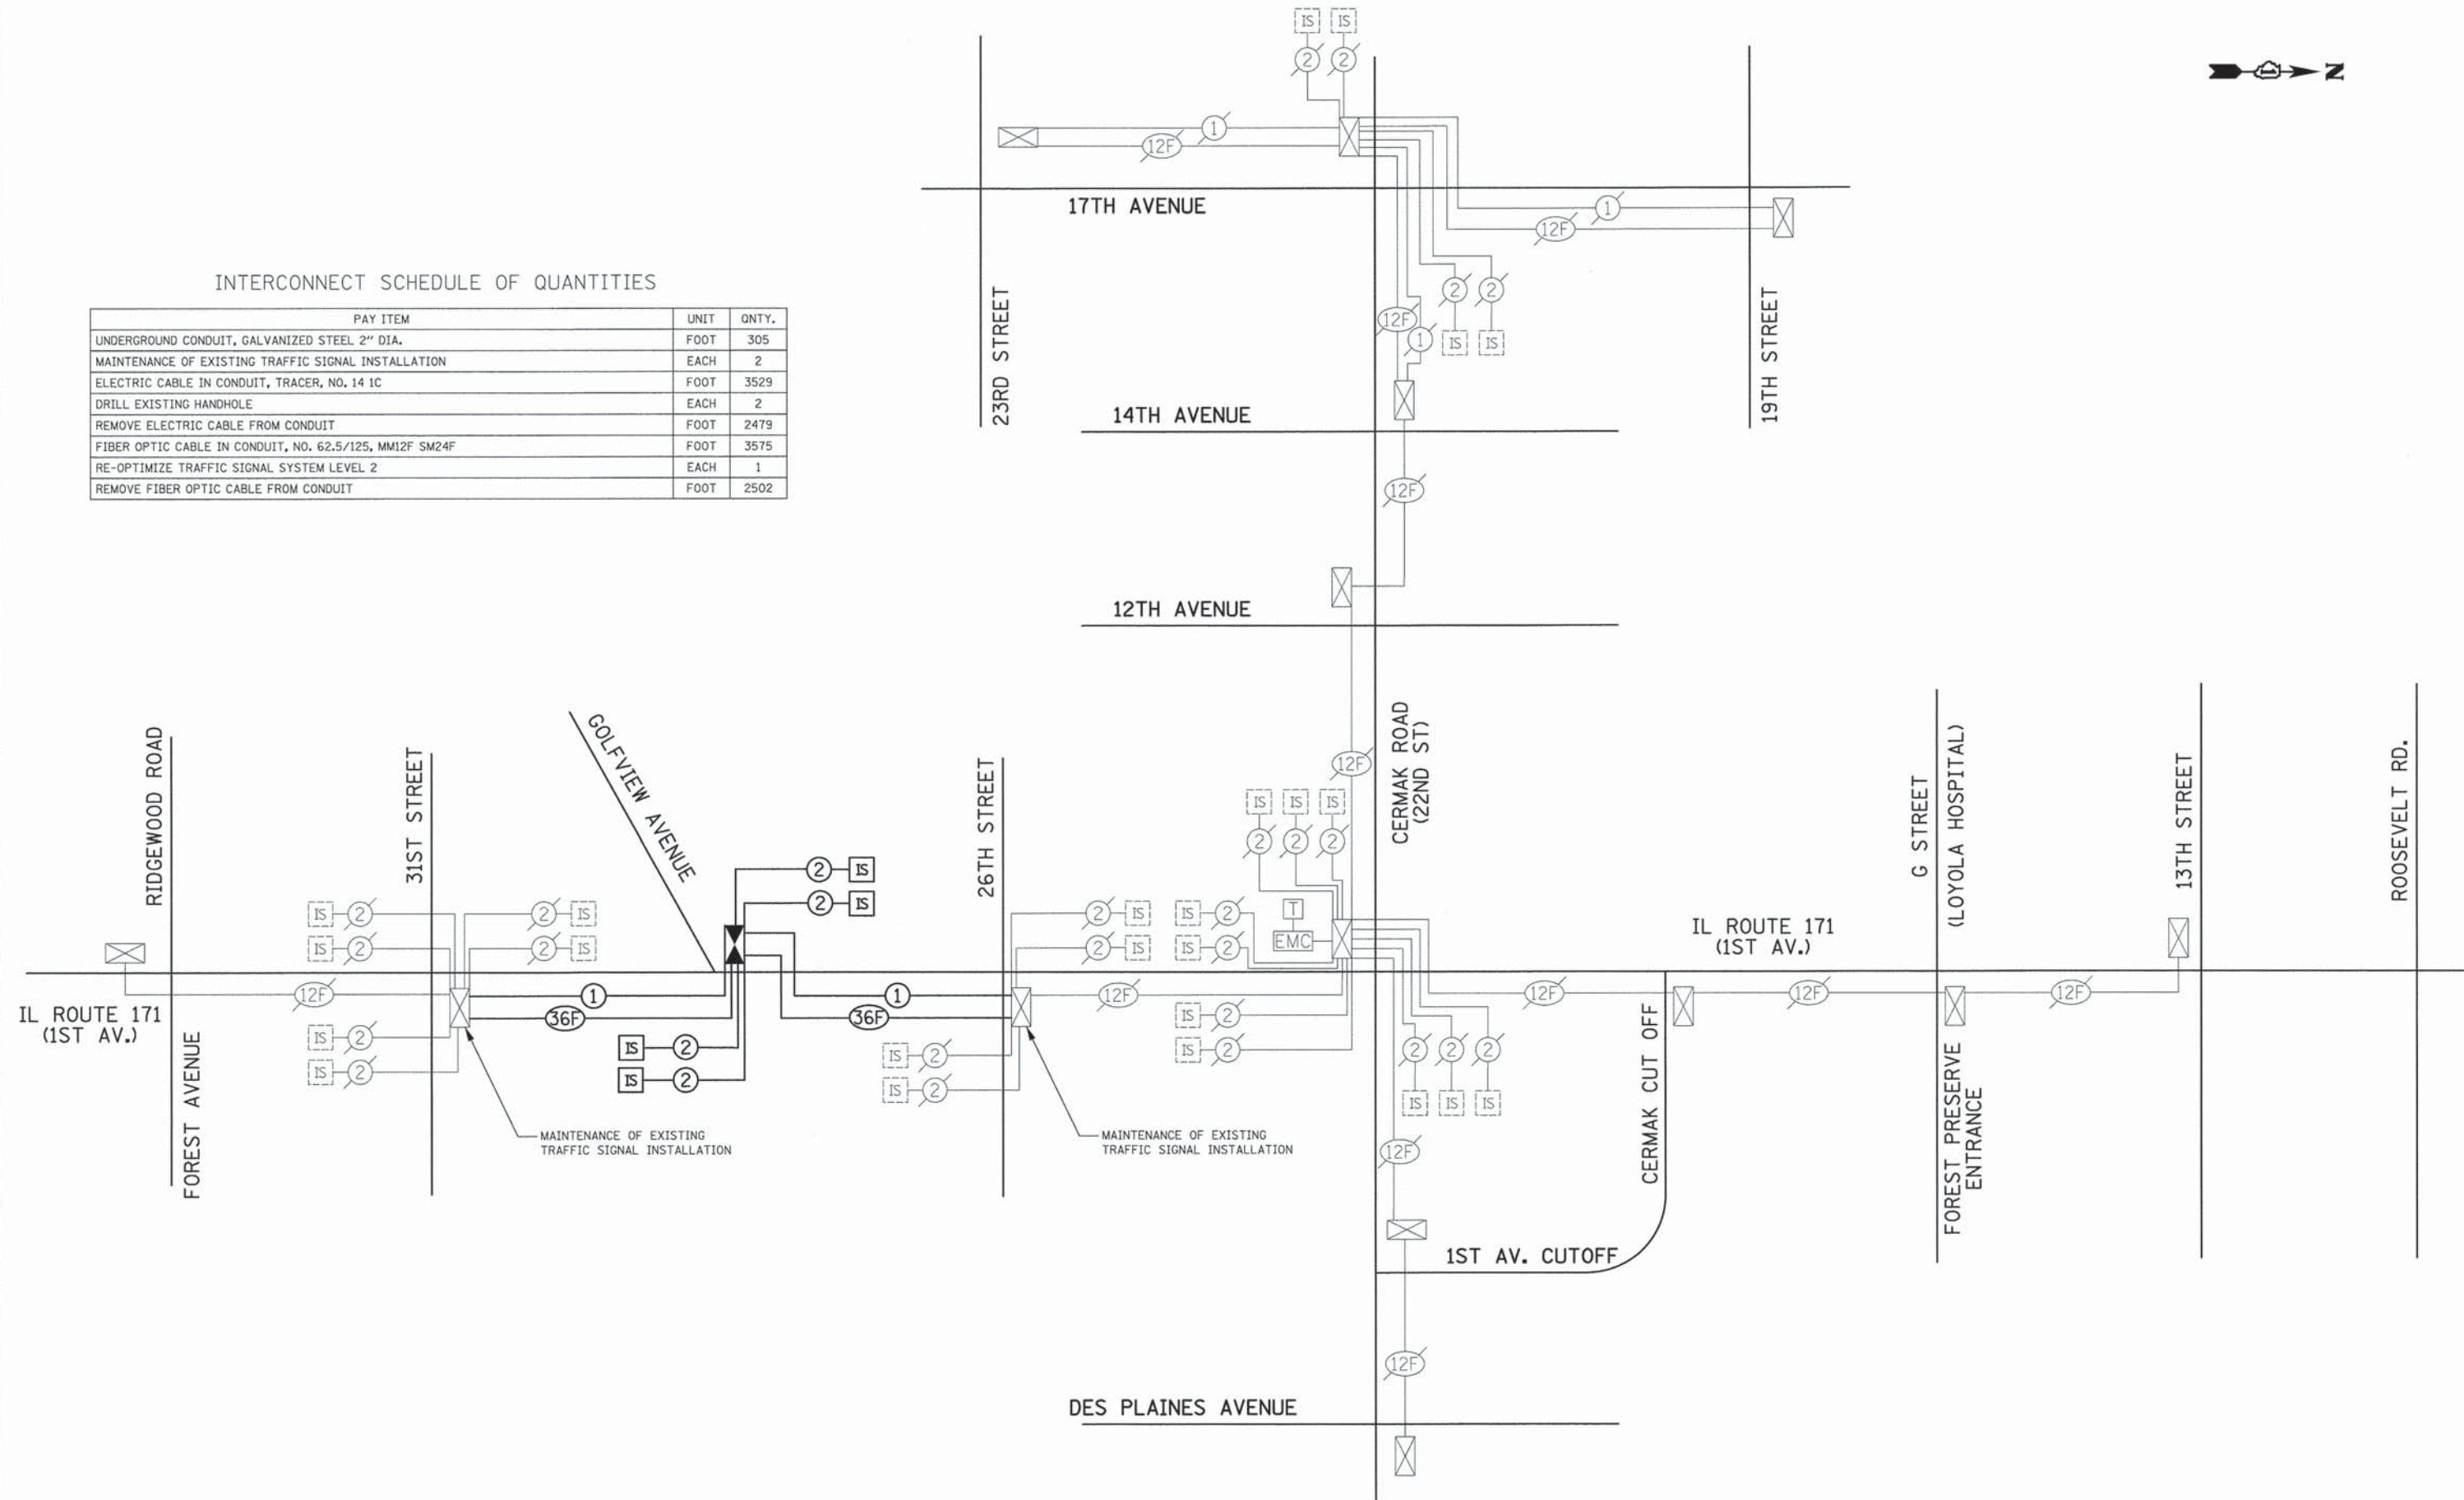

USER NAME = dte	DESIGNED - BRD	REVISED -
	DRAWN - MFB	REVISED -
PLOT SCALE = 50,0000' / 1"	CHECKED - JJE	REVISED -
PLOT DATE = 5/6/2013	DATE - 05/13/2013	REVISED -


STATE OF ILLINOIS  
DEPARTMENT OF TRANSPORTATION

INTERCONNECT SCHEMATIC  
IL ROUTE 171 (1ST AVENUE)  
CERMAK ROAD (22ND STREET)

NOT TO SCALE SHEET NO. 1 OF 1 SHEETS STA. TO STA.

F.A.U. RTE.	SECTION	COUNTY	TOTAL SHEETS	SHEET NO.
3784	12-F3000-23-PK	COOK	131	91
CONTRACT NO. 63764				
FED. ROAD DIST. NO. 1 (ILLINOIS) FED. AID PROJECT				



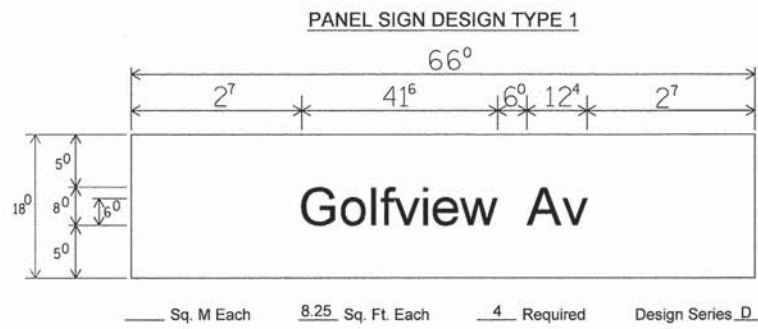


Sq. M Each 8.25 Sq. Ft. Each 4 Required Design Series D




Sq. M Each 6.00 Sq. Ft. Each 1 Required Design Series D

SUPPORTING CHANNELS

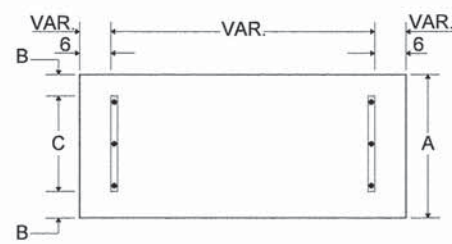


A	B	C
18"	2"	14"

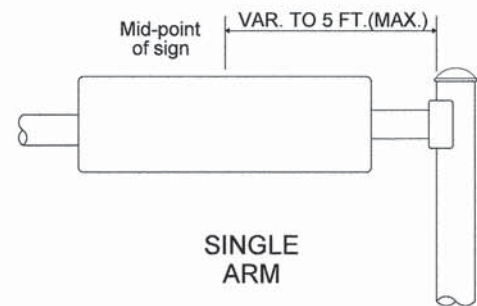


SIGNFIX ALUMINUM CHANNEL FRAMING SYSTEM shall be used. See Note #5.

SUPPORTING CHANNELS

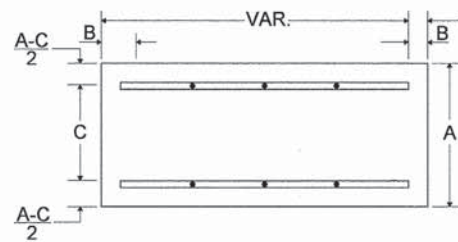

A	B	C
18"	2"	12"
30"	2"	22"

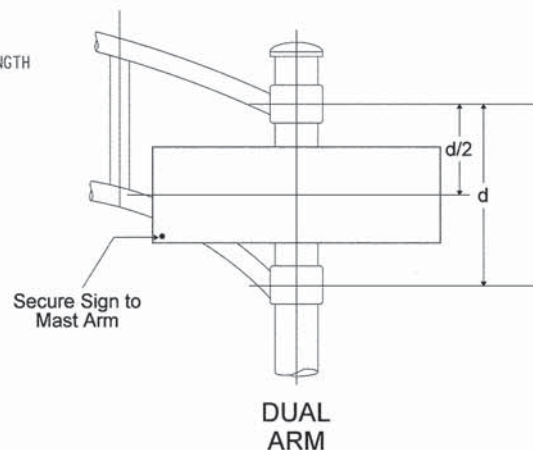

NOTE: SIGN DIMENSIONS ARE IN ENGLISH UNITS.

GENERAL NOTES

- WHERE MAST ARM MOUNTED STREET SIGNS ARE SPECIFIED, THE MAST ARM ASSEMBLY AND POLES SHALL BE DESIGNED TO SUPPORT THE LOADINGS CALLED FOR ON STANDARDS 8877001, 877002, 877006, 877011, 877012, AS APPLICABLE. PLUS TWO (2) SIGN PANELS 2'-6" X 8'-0" MOUNTED AS SHOWN. THE DESIGN SHALL BE IN ACCORDANCE WITH THE REQUIREMENTS OF THE CURRENT "STANDARD SPECIFICATIONS FOR THE STRUCTURAL SUPPORTS FOR HIGHWAY SIGNS, LUMINAIRES, AND TRAFFIC SIGNALS" AS PUBLISHED BY THE AMERICAN ASSOCIATION OF STATE HIGHWAY AND TRANSPORTATION OFFICIALS FOR 80 M.P.H. WIND VELOCITIES.
- ALL SIGNS SHALL HAVE A WHITE REFLECTORIZED LEGEND AND BORDER ON A GREEN REFLECTORIZED BACKGROUND, TYPE A SHEETING.
- THE SIGN LENGTH SHOULD BE INCREASED IN 6-INCH INCREMENTS, BUT THE OVER ALL LENGTH SHALL NOT EXCEED 8'-0".
- ALL BORDERS SHALL BE 3/4" WIDE AND CORNER RADIUS SHALL BE 2-1/4".
- SIGNFIX ALUMINUM CHANNEL FRAMING SYSTEM SHALL BE USED FOR ALL SIGNS ATTACHED TO SIGNAL POLES AND POSTS. LOCAL SUPPLIERS OF THE SIGNFIX ALUMINUM CHANNEL FRAMING SYSTEM ARE:

\* J.O. HERBERT CO. MIDLOTHIAN, VA  
\* WESTERN REMAC INC. WOODRIDGE, IL

PARTS LISTING:

SIGN CHANNEL PART #HPN053 (MED. CHANNEL)  
SIGN SCREWS 1/4" x 14 x 1" H.W.H #3  
SELF TAPPING WITH NEOPRENE WASHER  
BRACKETS PART #HPN034 (UNIVERSAL)  
CHANNEL CLAMPS WITH STAINLESS STEEL STRAPPING

OTHER BRANDS OF MOUNTING HARDWARE ARE ACCEPTABLE, BASED UPON THE DEPARTMENT'S APPROVAL AND COMPATIBILITY WITH THE CHANNEL/BACKET OF THE ABOVE PRODUCT.

UPPER TO LOWER CASE SPACING CHART 8-6 INCH SERIES "C" & "D"

EXAMPLE, 2<sup>3</sup> DENOTES 3/8"

SERIES	SECOND LETTER															
	a c d e		b h i k		f w		j		s t		v y		x		z	
	g o q	l m n p r u														
A W X	1 <sup>2</sup>	1 <sup>4</sup>	1 <sup>4</sup>	1 <sup>5</sup>	1 <sup>2</sup>	1 <sup>4</sup>	0 <sup>6</sup>	1 <sup>0</sup>	1 <sup>1</sup>	1 <sup>4</sup>	0 <sup>6</sup>	1 <sup>0</sup>	1 <sup>1</sup>	1 <sup>2</sup>	1 <sup>2</sup>	1 <sup>4</sup>
B	1 <sup>4</sup>	1 <sup>5</sup>	2 <sup>0</sup>	2 <sup>1</sup>	1 <sup>4</sup>	1 <sup>5</sup>	1 <sup>1</sup>	1 <sup>2</sup>	1 <sup>4</sup>	1 <sup>5</sup>	1 <sup>2</sup>	1 <sup>4</sup>	1 <sup>2</sup>	1 <sup>4</sup>	1 <sup>6</sup>	1 <sup>7</sup>
C E G	1 <sup>4</sup>	1 <sup>5</sup>	2 <sup>0</sup>	2 <sup>1</sup>	1 <sup>2</sup>	1 <sup>4</sup>	0 <sup>6</sup>	1 <sup>0</sup>	1 <sup>2</sup>	1 <sup>4</sup>	1 <sup>2</sup>	1 <sup>4</sup>	1 <sup>4</sup>	1 <sup>5</sup>	1 <sup>4</sup>	1 <sup>5</sup>
D O Q R	1 <sup>4</sup>	1 <sup>5</sup>	2 <sup>0</sup>	2 <sup>1</sup>	1 <sup>4</sup>	1 <sup>5</sup>	0 <sup>6</sup>	1 <sup>0</sup>	1 <sup>2</sup>	1 <sup>4</sup>	1 <sup>2</sup>	1 <sup>4</sup>	1 <sup>4</sup>	1 <sup>5</sup>	1 <sup>4</sup>	1 <sup>5</sup>
F	0 <sup>5</sup>	0 <sup>6</sup>	1 <sup>4</sup>	1 <sup>5</sup>	0 <sup>6</sup>	1 <sup>0</sup>	0 <sup>5</sup>	0 <sup>6</sup>	0 <sup>6</sup>	1 <sup>0</sup>	0 <sup>6</sup>	1 <sup>0</sup>	0 <sup>6</sup>	1 <sup>0</sup>	1 <sup>1</sup>	1 <sup>2</sup>
H I M N	2 <sup>0</sup>	2 <sup>1</sup>	2 <sup>2</sup>	2 <sup>4</sup>	2 <sup>0</sup>	2 <sup>1</sup>	1 <sup>4</sup>	1 <sup>5</sup>	1 <sup>6</sup>	1 <sup>7</sup>	1 <sup>6</sup>	1 <sup>7</sup>	2 <sup>0</sup>	2 <sup>1</sup>	2 <sup>0</sup>	2 <sup>1</sup>
J U	2 <sup>0</sup>	2 <sup>1</sup>	2 <sup>0</sup>	2 <sup>1</sup>	1 <sup>6</sup>	1 <sup>7</sup>	1 <sup>4</sup>	1 <sup>5</sup>	1 <sup>6</sup>	1 <sup>7</sup>	1 <sup>6</sup>	1 <sup>7</sup>	1 <sup>6</sup>	1 <sup>7</sup>	2 <sup>0</sup>	2 <sup>1</sup>
K L	1 <sup>1</sup>	1 <sup>2</sup>	1 <sup>6</sup>	1 <sup>7</sup>	1 <sup>1</sup>	1 <sup>2</sup>	0 <sup>5</sup>	0 <sup>6</sup>	1 <sup>1</sup>	1 <sup>2</sup>	1 <sup>1</sup>	1 <sup>2</sup>	1 <sup>1</sup>	1 <sup>2</sup>	1 <sup>2</sup>	1 <sup>4</sup>
P	1 <sup>2</sup>	1 <sup>4</sup>	1 <sup>4</sup>	1 <sup>5</sup>	1 <sup>2</sup>	1 <sup>4</sup>	0 <sup>5</sup>	0 <sup>6</sup>	1 <sup>1</sup>	1 <sup>2</sup>	1 <sup>1</sup>	1 <sup>2</sup>	1 <sup>2</sup>	1 <sup>4</sup>	1 <sup>2</sup>	1 <sup>4</sup>
S	1 <sup>2</sup>	1 <sup>4</sup>	1 <sup>6</sup>	1 <sup>7</sup>	1 <sup>2</sup>	1 <sup>4</sup>	0 <sup>6</sup>	1 <sup>0</sup>	1 <sup>2</sup>	1 <sup>4</sup>	1 <sup>2</sup>	1 <sup>4</sup>	1 <sup>2</sup>	1 <sup>4</sup>	1 <sup>2</sup>	1 <sup>4</sup>
T	1 <sup>1</sup>	1 <sup>2</sup>	1 <sup>6</sup>	1 <sup>7</sup>	0 <sup>6</sup>	1 <sup>0</sup>	0 <sup>6</sup>	1 <sup>0</sup>	1 <sup>1</sup>	1 <sup>2</sup>	1 <sup>1</sup>	1 <sup>2</sup>	1 <sup>1</sup>	1 <sup>2</sup>	1 <sup>2</sup>	1 <sup>4</sup>
V	0 <sup>6</sup>	1 <sup>0</sup>	1 <sup>4</sup>	1 <sup>5</sup>	1 <sup>1</sup>	1 <sup>2</sup>	0 <sup>6</sup>	1 <sup>0</sup>	1 <sup>2</sup>	1 <sup>4</sup>	1 <sup>2</sup>	1 <sup>4</sup>	1 <sup>2</sup>	1 <sup>4</sup>	1 <sup>2</sup>	1 <sup>4</sup>
Y	0 <sup>5</sup>	0 <sup>6</sup>	1 <sup>4</sup>	1 <sup>5</sup>	0 <sup>6</sup>	1 <sup>0</sup>	0 <sup>5</sup>	0 <sup>6</sup>	0 <sup>5</sup>	0 <sup>7</sup>	0 <sup>5</sup>	0 <sup>6</sup>	0 <sup>6</sup>	1 <sup>0</sup>	1 <sup>1</sup>	1 <sup>2</sup>
Z	1 <sup>6</sup>	1 <sup>7</sup>	2 <sup>2</sup>	2 <sup>4</sup>	1 <sup>6</sup>	1 <sup>7</sup>	1 <sup>2</sup>	1 <sup>4</sup>	1 <sup>6</sup>	1 <sup>7</sup>	1 <sup>6</sup>	1 <sup>7</sup>	1 <sup>6</sup>	1 <sup>7</sup>	2 <sup>0</sup>	2 <sup>1</sup>

LOWER CASE TO LOWER CASE SPACING CHART 6 INCH SERIES "C" & "D"

SERIES	SECOND LETTER															
	a c d e		b h i k		f w		j		s t		v y		x		z	
	g o q	l m n p r u														
F																
I																
R																
S																
T																
L																
E																
T																
T																
E																
R																

NUMBER TO NUMBER

SPACING CHART 8 INCH SERIES "C" & "D"

SERIES	SECOND NUMBER																			
	0		1		2		3		4		5		6		7		8		9	
	C	D	C	D	C	D	C	D	C	D	C	D	C	D	C	D	C	D	C	D
0 9	1 <sup>6</sup>	1 <sup>7</sup>	1 <sup>6</sup>	1 <sup>7</sup>	1 <sup>4</sup>	1 <sup>5</sup>	1 <sup>2</sup>	1 <sup>4</sup>	1 <sup>4</sup>	1 <sup>5</sup>	1 <sup>4</sup>	1 <sup>5</sup>	1 <sup>6</sup>	1 <sup>7</sup>	1 <sup>2</sup>	1 <sup>4</sup>	1 <sup>6</sup>	1 <sup>7</sup>	1 <sup>6</sup>	1 <sup>7</sup>
1	2 <sup>0</sup>	2 <sup>1</sup>	2 <sup>0</sup>	2 <sup>1</sup>	2 <sup>0</sup>	2 <sup>1</sup>	1 <sup>6</sup>	1 <sup>7</sup>	1 <sup>4</sup>	1 <sup>5</sup>	2 <sup>0</sup>	2 <sup>1</sup>	2 <sup>0</sup>	2 <sup>1</sup>	1 <sup>4</sup>	1 <sup>5</sup>	2 <sup>0</sup>	2 <sup>1</sup>	2 <sup>0</sup>	2 <sup>1</sup>
2 3 4	1 <sup>4</sup>	1 <sup>5</sup>	1 <sup>4</sup>	1 <sup>5</sup>	1 <sup>4</sup>	1 <sup>5</sup>	1 <sup>2</sup>	1 <sup>4</sup>	1 <sup>2</sup>	1 <sup>4</sup>	1 <sup>4</sup>	1 <sup>5</sup>	1 <sup>4</sup>	1 <sup>5</sup>	1 <sup>1</sup>	1 <sup>2</sup>	1 <sup>6</sup>	1 <sup>7</sup>	1 <sup>4</sup>	1 <sup>5</sup>
5	1 <sup>4</sup>	1 <sup>5</sup>	1 <sup>4</sup>	1 <sup>5</sup>	1 <sup>4</sup>	1 <sup>5</sup>	1 <sup>1</sup>	1 <sup>2</sup>	1 <sup>1</sup>	1 <sup>2</sup>	1 <sup>4</sup>	1 <sup>5</sup>	1 <sup>4</sup>	1 <sup>5</sup>	1 <sup>1</sup>	1 <sup>2</sup>	1 <sup>4</sup>	1 <sup>5</sup>	1 <sup>4</sup>	1 <sup>5</sup>
6	1 <sup>6</sup>	1 <sup>7</sup>	1 <sup>4</sup>	1 <sup>5</sup>	1 <sup>4</sup>	1 <sup>5</sup>	1 <sup>2</sup>	1 <sup>5</sup>	1 <sup>2</sup>	1 <sup>4</sup>	1 <sup>4</sup>	1 <sup>5</sup>	1 <sup>4</sup>	1 <sup>5</sup>	1 <sup>1</sup>	1 <sup>2</sup>	1 <sup>4</sup>	1 <sup>5</sup>	1 <sup>4</sup>	1 <sup>5</sup>
7	1 <sup>2</sup>	1 <sup>4</sup>	1 <sup>2</sup>	1 <sup>4</sup>	1 <sup>4</sup>	1 <sup>5</sup>	1 <sup>2</sup>	1 <sup>5</sup>	0 <sup>5</sup>	0 <sup>6</sup>	1 <sup>2</sup>	1 <sup>4</sup>	1 <sup>4</sup>	1 <sup>5</sup>	1 <sup>1</sup>	1 <sup>2</sup>	1 <sup>4</sup>	1 <sup>5</sup>	1 <sup>2</sup>	1 <sup>4</sup>
8	1 <sup>6</sup>	1 <sup>7</sup>	1 <sup>6</sup>	1 <sup>7</sup>	1 <sup>4</sup>	1 <sup>5</sup>	1 <sup>2</sup>	1 <sup>5</sup>	1 <sup>2</sup>	1 <sup>4</sup>	1 <sup>4</sup>	1 <sup>5</sup>	1 <sup>6</sup>	1 <sup>7</sup>	1 <sup>2</sup>	1 <sup>4</sup>	1 <sup>6</sup>	1 <sup>7</sup>	1 <sup>4</sup>	1 <sup>5</sup>

LETTERS	6 INCH UPPER CASE LETTERS				8 INCH UPPER CASE LETTERS				LETTERS	6 INCH LOWER CASE LETTERS			
	SERIES		SERIES		SERIES		SERIES			SERIES		SERIES	
	C	D	C	D	C	D	C	D		C	D	C	D
A	3 <sup>6</sup>	5 <sup>0</sup>	5 <sup>0</sup>	6 <sup>5</sup>	a	3 <sup>5</sup>	4 <sup>2</sup>						
B	3 <sup>2</sup>	4 <sup>0</sup>	4 <sup>3</sup>	5 <sup>3</sup>	b	3 <sup>5</sup>	4 <sup>2</sup>						
C	3 <sup>2</sup>	4 <sup>0</sup>	4 <sup>3</sup>	5 <sup>3</sup>	c	3 <sup>5</sup>	4 <sup>1</sup>						
D	3 <sup>2</sup>	4 <sup>0</sup>	4 <sup>3</sup>	5 <sup>3</sup>	d	3 <sup>5</sup>	4 <sup>2</sup>						
E	3 <sup>0</sup>	3 <sup>5</sup>	4 <sup>0</sup>	4 <sup>7</sup>	e	3 <sup>5</sup>	4 <sup>2</sup>						
F	3 <sup>0</sup>	3 <sup>5</sup>	4 <sup>0</sup>	4 <sup>7</sup>	f	2 <sup>3</sup>	2 <sup>6</sup>						
G	3 <sup>2</sup>	4 <sup>0</sup>	4 <sup>3</sup>	5 <sup>3</sup>	g	3 <sup>5</sup>	4 <sup>2</sup>						
H	3 <sup>2</sup>	4 <sup>0</sup>	4 <sup>3</sup>	5 <sup>3</sup>	h	3 <sup>5</sup>	4 <sup>2</sup>						
I	0 <sup>7</sup>	0 <sup>7</sup>	1 <sup>1</sup>	1 <sup>2</sup>	i	1 <sup>1</sup>	1 <sup>1</sup>						
J	3 <sup>0</sup>	3 <sup>6</sup>	4 <sup>0</sup>	5 <sup>0</sup>	j	2 <sup>0</sup>	2 <sup>2</sup>						
K	3 <sup>2</sup>	4 <sup>1</sup>	4 <sup>3</sup>	5 <sup>4</sup>	k	3 <sup>5</sup>	4 <sup>2</sup>						
L	3 <sup>0</sup>	3 <sup>5</sup>	4 <sup>0</sup>	4 <sup>7</sup>	l	1 <sup>1</sup>	1 <sup>1</sup>						
M	3 <sup>7</sup>	4 <sup>5</sup>	5 <sup>1</sup>	6 <sup>1</sup>	m	6 <sup>0</sup>	7 <sup>0</sup>						
N	3 <sup>2</sup>	4 <sup>0</sup>	4 <sup>3</sup>	5 <sup>3</sup>	n	3 <sup>5</sup>	4 <sup>2</sup>						
O	3 <sup>4</sup>	4 <sup>2</sup>	4 <sup>5</sup>	5 <sup>5</sup>	o	3 <sup>6</sup>	4 <sup>3</sup>						
P	3 <sup>2</sup>	4 <sup>0</sup>	4 <sup>3</sup>	5 <sup>3</sup>	p	3 <sup>5</sup>	4 <sup>2</sup>						
Q	3 <sup>4</sup>	4 <sup>2</sup>	4 <sup>5</sup>	5 <sup>5</sup>	q	3 <sup>5</sup>	4 <sup>2</sup>						
R	3 <sup>2</sup>	4 <sup>0</sup>	4 <sup>3</sup>	5 <sup>3</sup>	r	2 <sup>6</sup>	3 <sup>2</sup>						
S	3 <sup>2</sup>	4 <sup>0</sup>	4 <sup>3</sup>	5 <sup>3</sup>	s	3 <sup>6</sup>	4 <sup>2</sup>						
T	3 <sup>0</sup>	3 <sup>5</sup>	4 <sup>0</sup>	4 <sup>7</sup>	t	2 <sup>7</sup>	3 <sup>2</sup>						
U	3 <sup>2</sup>	4 <sup>0</sup>	4 <sup>3</sup>	5 <sup>3</sup>	u	3 <sup>5</sup>	4 <sup>2</sup>						
V	3 <sup>5</sup>	4 <sup>4</sup>	4 <sup>7</sup>	6 <sup>0</sup>	v	4 <sup>2</sup>	4 <sup>7</sup>						
W	4 <sup>4</sup>	5 <sup>2</sup>	6 <sup>0</sup>	7 <sup>0</sup>	w	5 <sup>5</sup>	6 <sup>4</sup>						
X	3 <sup>4</sup>	4 <sup>0</sup>	4 <sup>5</sup>	5 <sup>3</sup>	x	4 <sup>4</sup>	5 <sup>1</sup>						
Y	3 <sup>6</sup>	5 <sup>0</sup>	5 <sup>0</sup>	6 <sup>6</sup>	y	4 <sup>6</sup>	5 <sup>3</sup>						
Z	3 <sup>2</sup>	4 <sup>0</sup>	4 <sup>3</sup>	5 <sup>3</sup>	z	3 <sup>6</sup>	4 <sup>3</sup>						

NUMBER	6 INCH SERIES		8 INCH SERIES	
	C	D	C	D
1	2 <sup>2</sup>	1 <sup>4</sup>	1 <sup>5</sup>	2 <sup>0</sup>
2	3 <sup>2</sup>	4 <sup>0</sup>	4 <sup>3</sup>	5 <sup>3</sup>
3	3 <sup>2</sup>	4 <sup>0</sup>	4 <sup>3</sup>	5 <sup>3</sup>
4	3 <sup>5</sup>	4 <sup>0</sup>	4 <sup>7</sup>	5 <sup>7</sup>
5	3 <sup>2</sup>	4 <sup>0</sup>	4 <sup>3</sup>	5 <sup>3</sup>
6	3 <sup>2</sup>	4 <sup>0</sup>	4 <sup>3</sup>	5 <sup>3</sup>
7	3 <sup>2</sup>	4 <sup>0</sup>	4 <sup>3</sup>	5 <sup>3</sup>
8	3 <sup>2</sup>	4 <sup>0</sup>	4 <sup>3</sup>	5 <sup>3</sup>
9	3 <sup>2</sup>	4 <sup>0</sup>	4 <sup>3</sup>	5 <sup>3</sup>
0	3 <sup>4</sup>	4 <sup>2</sup>	4 <sup>5</sup>	5 <sup>5</sup>








**TRAFFIC SIGNAL MAST ARM AND SIGNAL POST**


MAST ARM MOUNTED SIGNALS IN EXISTING, PROPOSED OR FUTURE SIDEWALK/BICYCLE PATH AREA. INTERSECTION SHOWN WITH PEDESTRIAN SIGNALS AND PEDESTRIAN PUSHBUTTON DETECTORS.

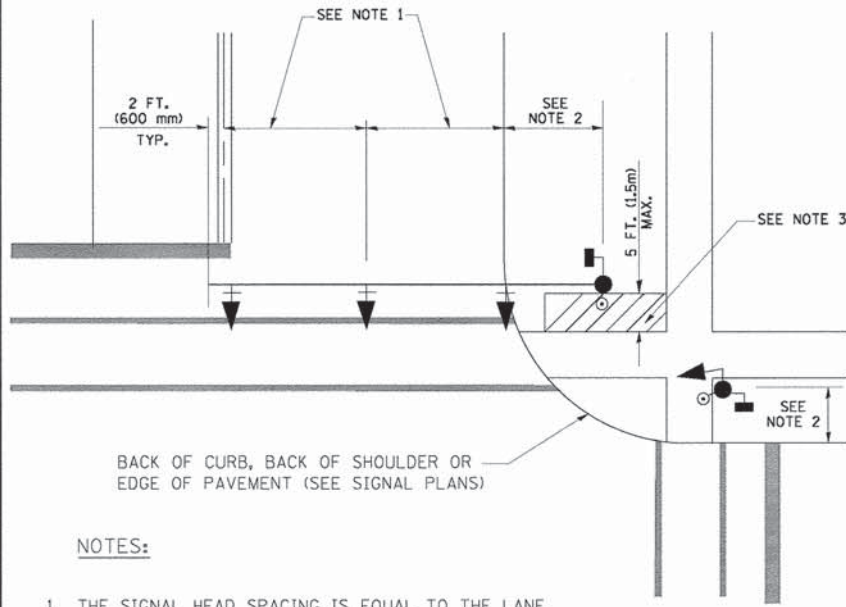

**NOTES:**

1. THE SIGNAL HEAD SPACING IS EQUAL TO THE LANE WIDTH OR AS SHOWN ON THE TRAFFIC SIGNAL PLAN.
2. REFER TO THE TRAFFIC SIGNAL EQUIPMENT OFFSET TABLE.
3. PROVIDE A LEVEL ALL-WEATHER SURFACE (CONCRETE SIDEWALK, ASPHALT BICYCLE PATH SURFACE OR MATCHING MATERIAL TO THE ADJACENT SURFACE) UP TO THE MAST ARM SHAFT OR THE SIGNAL POST.
4. THE FACE OF THE PEDESTRIAN PUSHBUTTON SHALL BE PARALLEL TO THE CROSSWALK TO BE USED.
5. THE LOCATIONS AND INSTALLATION OF PEDESTRIAN SIGNAL HEADS AND PEDESTRIAN PUSHBUTTONS SHALL MEET THE REQUIREMENTS OF THE MUTCD AND INFORMATION FOUND IN THE "AMERICANS WITH DISABILITIES ACT ACCESSIBILITY GUIDELINES FOR BUILDINGS AND FACILITIES."


**PEDESTRIAN SIGNAL POST AND PEDESTRIAN PUSH BUTTON POST**

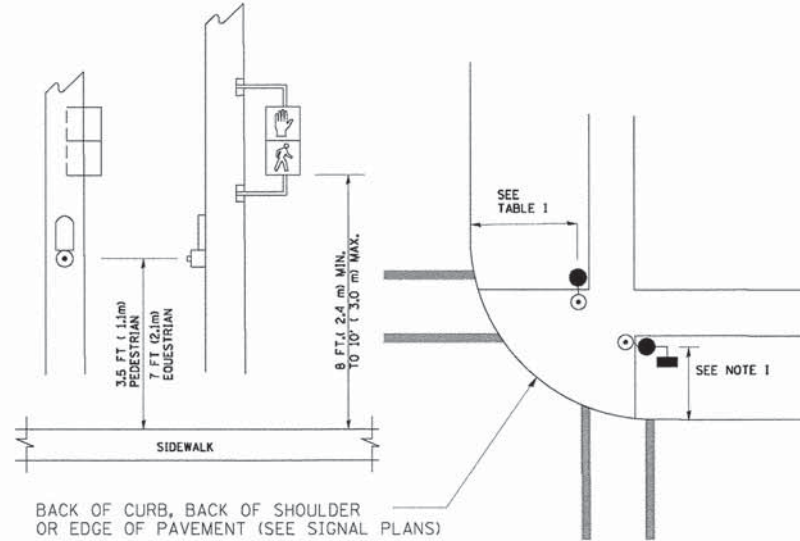

**NOTES:**

1. REFER TO THE TRAFFIC SIGNAL EQUIPMENT OFFSET TABLE.
2. PROVIDE A LEVEL ALL-WEATHER SURFACE (CONCRETE SIDEWALK, ASPHALT BICYCLE PATH SURFACE OR MATCHING MATERIAL TO THE ADJACENT SURFACE) UP TO THE PEDESTRIAN SIGNAL POST OR THE PEDESTRIAN PUSH BUTTON POST.
3. THE FACE OF THE PEDESTRIAN PUSHBUTTON SHALL BE PARALLEL TO THE CROSSWALK TO BE USED.
4. THE LOCATIONS AND INSTALLATION OF PEDESTRIAN SIGNAL HEADS AND PEDESTRIAN PUSHBUTTONS SHALL MEET THE REQUIREMENTS OF THE MUTCD AND INFORMATION FOUND IN THE "AMERICANS WITH DISABILITIES ACT ACCESSIBILITY GUIDELINES FOR BUILDINGS AND FACILITIES."

**RECOMMENDED PUSHBUTTON LOCATIONS**

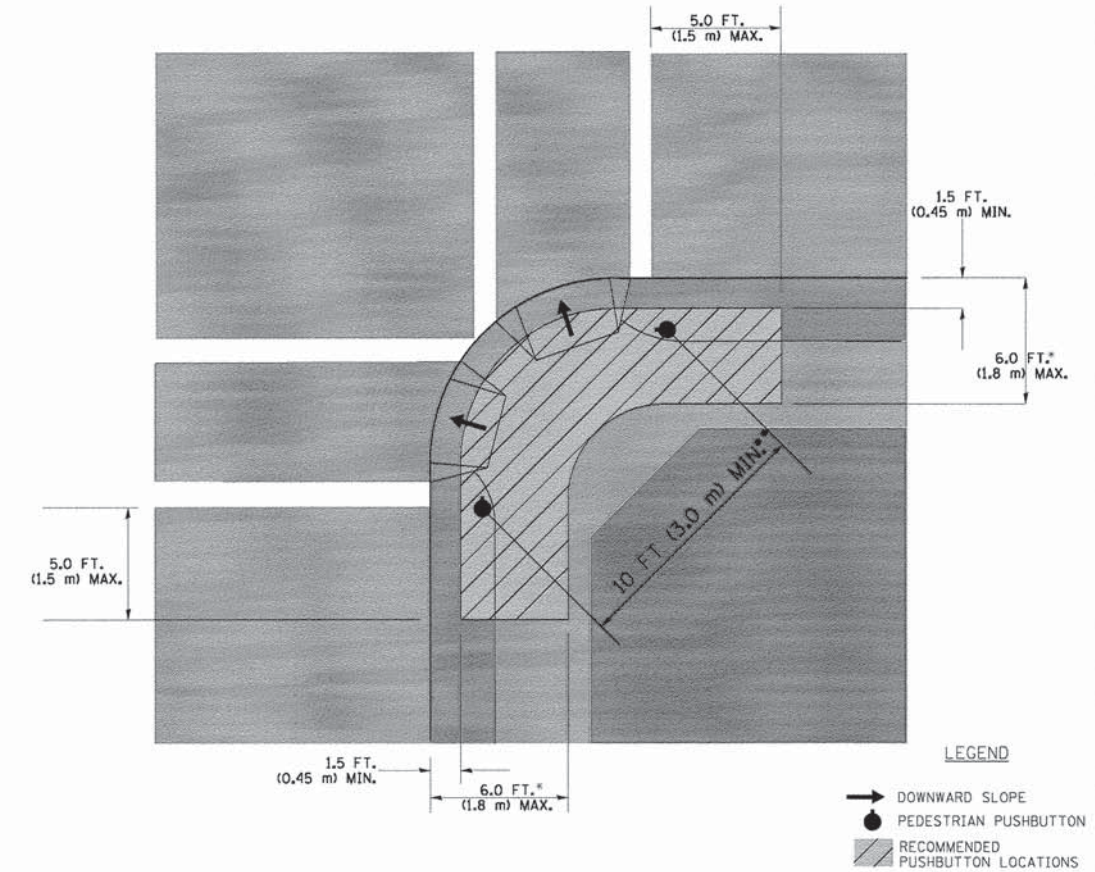

- WHERE THERE ARE CONSTRAINTS THAT MAKE IT IMPRACTICAL TO PLACE THE PEDESTRIAN PUSHBUTTON BETWEEN 1.5 FT (0.45 m) AND 6 FT ( 1.8 m) FROM THE EDGE OF THE CURB, SHOULDER, OR PAVEMENT, IT SHOULD NOT BE FURTHER THAN 10 FT (3 m) FROM THE EDGE OF CURB, SHOULDER, OR PAVEMENT.
- WHERE THERE ARE CONSTRAINTS ON A PARTICULAR CORNER THAT MAKE IT IMPRACTICAL TO PROVIDE THE 10 FT (3 m) SEPERATION BETWEEN THE TWO PEDESTRIAN PUSHBUTTONS, THE PUSHBUTTONS MAY BE PLACED CLOSER TOGETHER OR ON THE SAME POLE.

**NOTES:**

1. PEDESTRIAN SIGNAL HEADS SHALL BE MOUNTED WITH THE BOTTOM OF THE SIGNAL HOUSING INCLUDING BRACKETS NOT LESS THAN 8 FT (2.4 m) OR MORE THAN 10 FT (3 m) ABOVE SIDEWALK LEVEL, AND SHALL BE POSITIONED AND ADJUSTED TO PROVIDE MAXIMUM VISIBILITY AT THE BEGINNING OF THE CONTROLLED CROSSWALK.
2. THE BOTTOM OF THE SIGNAL HOUSING (INCLUDING BRACKETS) OF A VEHICULAR SIGNAL FACE THAT IS NOT LOCATED OVER A HIGHWAY SHALL BE AT LEAST 8 FT (2.4 m) BUT NOT MORE THAN 19 FT (5.8 m) ABOVE THE SIDEWALK OR, IF THERE IS NO SIDEWALK, ABOVE THE PAVEMENT GRADE AT THE CENTER OF THE ROADWAY.
3. THE BOTTOM OF THE SIGNAL HOUSING AND ANY RELATED ATTACHMENTS TO A SIGNAL FACE LOCATED OVER ANY PORTION OF A HIGHWAY SHALL BE ACCORDING TO CURRENT STATE STANDARDS 877001, 877002, 877006, 877011 AND 877012 WITH A MINIMUM OF 16 FT (5.0 m) AND A MAXIMUM OF 18 FT. (5.5 m) FROM THE HIGHEST POINT OF PAVEMENT.
4. THE BOTTOM OF THE TEMPORARY SPAN WIRE MOUNTED SIGNAL HOUSING AND ANY RELATED ATTACHMENTS TO A SIGNAL FACE LOCATED OVER ANY PORTION OF A HIGHWAY SHALL BE ACCORDING TO CURRENT STATE STANDARD 880001 WITH A MINIMUM OF 17 FT (5.18 m) FROM THE HIGHEST POINT OF PAVEMENT.
5. THE TOP OF THE SIGNAL HOUSING OF A SIGNAL FACE LOCATED OVER ANY PORTION OF A HIGHWAY SHALL NOT BE MORE THAN 25.6 FT (7.8 m) ABOVE THE PAVEMENT.


**TRAFFIC SIGNAL EQUIPMENT OFFSET**

TRAFFIC SIGNAL EQUIPMENT	COMBINATION CONCRETE CURB AND GUTTER (MINIMUM DISTANCE FROM BACK OF CURB TO CENTERLINE OF FOUNDATION)	SHOULDER/NON-CURBED AREA (MINIMUM DISTANCE FROM EDGE OF PAVEMENT TO CENTERLINE OF FOUNDATION)
TRAFFIC SIGNAL MAST ARM POLE	6 FT (1.8m)	SHOULDER WIDTH + 2 FT (0.6m), MINIMUM 10 FT (3.0m)
TRAFFIC SIGNAL POST	4 FT (1.2m)	SHOULDER WIDTH + 2 FT (0.6m), MINIMUM 10 FT (3.0m)
PEDESTRIAN SIGNAL POST	4 FT (1.2m)	SHOULDER WIDTH + 2 FT (0.6m), MINIMUM 10 FT (3.0m)
PEDESTRIAN PUSHBUTTON POST	4 FT (1.2m)	SHOULDER WIDTH + 2 FT (0.6m), MINIMUM 10 FT (3.0m)
TEMPORARY WOOD POLE	6 FT (1.8m)	SHOULDER WIDTH + 2 FT (0.6m), MINIMUM 10 FT (3.0m)
CONTROLLER CABINET	6 FT (1.8m) MINIMUM DISTANCE SEE NOTE 2	SHOULDER WIDTH + 6 FT (1.8m), MINIMUM 16 FT (4.9m) SEE NOTE 3.
SERVICE INSTALLATION, GROUND MOUNT	6 FT (1.8m) MINIMUM DISTANCE SEE NOTE 2	SHOULDER WIDTH + 6 FT (1.8m), MINIMUM 16 FT (4.9m) SEE NOTE 3.


**NOTES:**

1. CONTACT THE "AREA TRAFFIC SIGNAL MAINTENANCE AND OPERATIONS ENGINEER" FOR ASSISTANCE IN LOCATING THE TRAFFIC SIGNAL EQUIPMENT WHEN THERE ARE CONFLICTS WITH DITCHES OR THE MINIMUM OFFSET DISTANCES CANNOT BE MET.
2. MINIMUM DISTANCE FROM THE BACK OF CURB TO THE ROADWAY SIDE OF THE FOUNDATION.
3. MINIMUM DISTANCE FROM THE EDGE OF PAVEMENT TO THE ROADWAY SIDE OF THE FOUNDATION.
4. ANY CHANGES TO THE OFFSETS OF THE FOUNDATIONS, FROM THE MINIMUM DISTANCES LISTED IN THE "TRAFFIC SIGNAL EQUIPMENT OFFSET" CHART AND THE TRAFFIC SIGNAL INSTALLATION PLAN, COULD EFFECT THE PLACEMENT OF THE SIGNAL HEADS, PEDESTRIAN SIGNAL HEADS AND THE PEDESTRIAN PUSHBUTTONS. THE SIGNAL HEAD PLACEMENT ON THE MAST ARMS SHALL REMAIN AS PER THE TRAFFIC SIGNAL INSTALLATION PLAN AND THE "TRAFFIC SIGNAL MAST ARM AND SIGNAL POST" DETAIL ABOVE. THE PROPOSED MAST ARM LENGTHS MAY NEED TO BE REVISED TO MEET THE ABOVE REQUIREMENTS. THE PEDESTRIAN SIGNAL HEADS AND PEDESTRIAN PUSHBUTTONS MUST MEET THE REQUIREMENTS UNDER THE DETAILS ON THIS SHEET.



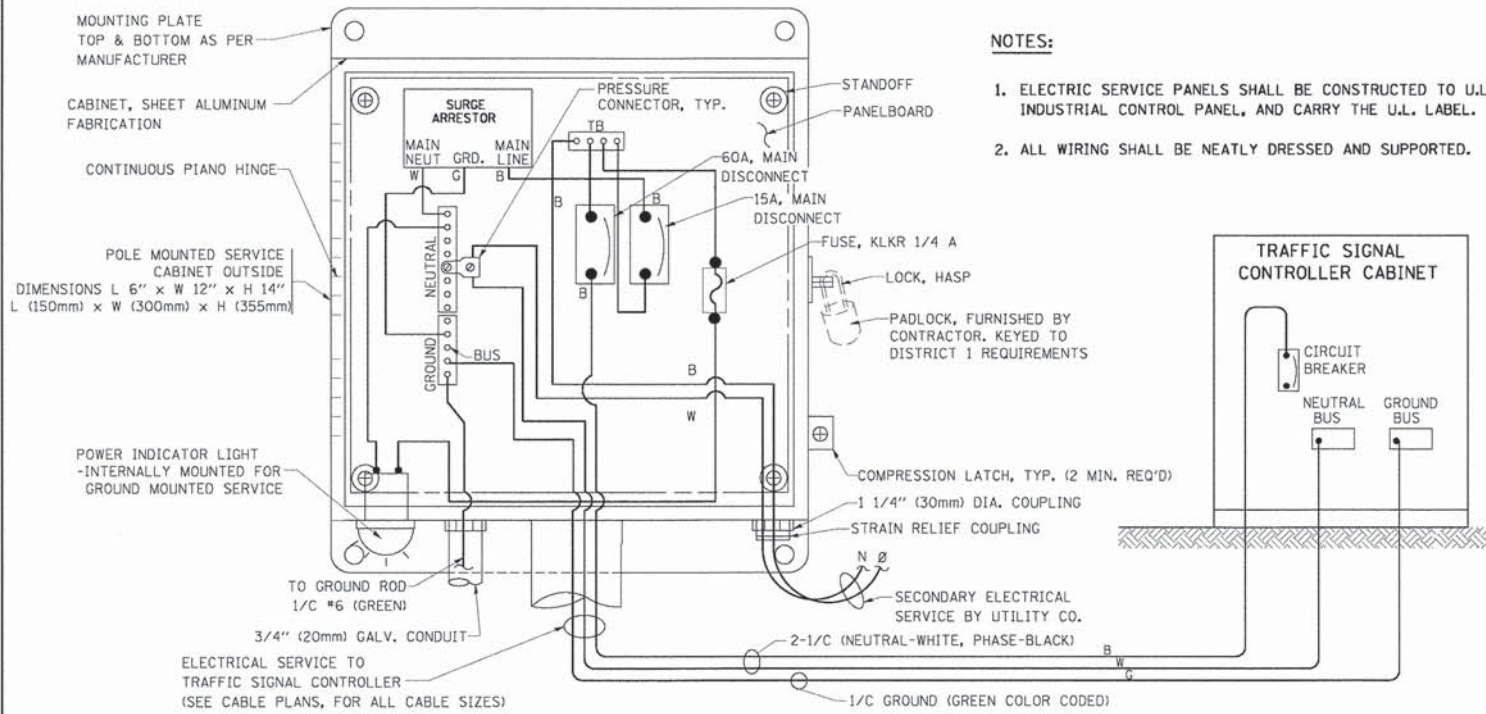


**ELECTRICAL SERVICE - PANEL DIAGRAM (TYPICAL FOR POLE AND GROUND MOUNTED SERVICE)**  
**SERVICE INSTALLATION POLE MOUNT (SHOWN)**  
 (NOT TO SCALE)


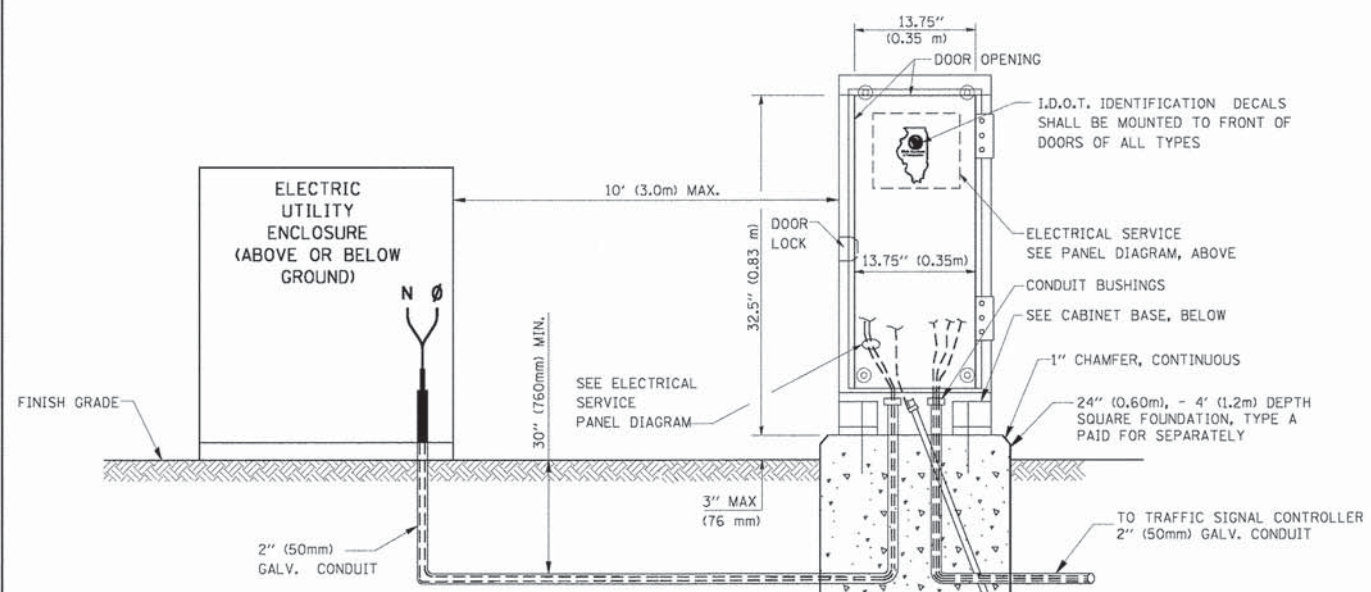


**SERVICE INSTALLATION GROUND MOUNT**  
 (NOT TO SCALE)


**CABINET - BASE BOLT PATTERN**  
 (NOT TO SCALE)

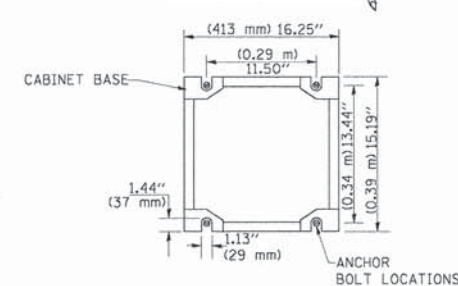


- NOTES:**
1. ELECTRIC SERVICE PANELS SHALL BE CONSTRUCTED TO U.L. STD 508, INDUSTRIAL CONTROL PANEL, AND CARRY THE U.L. LABEL.
  2. ALL WIRING SHALL BE NEATLY DRESSED AND SUPPORTED.

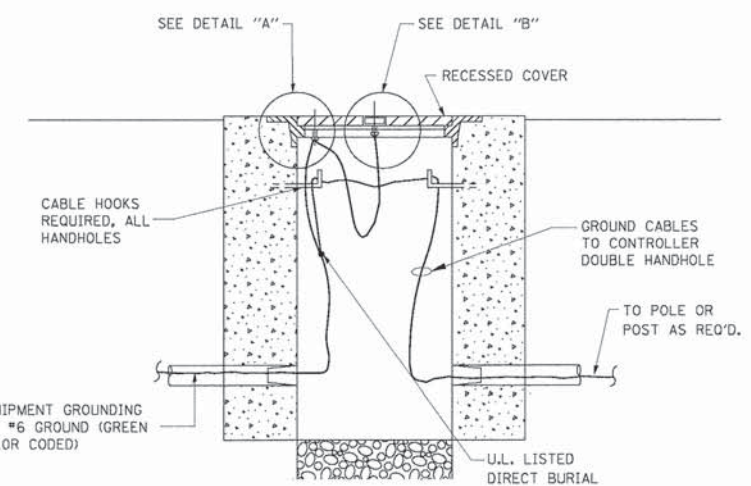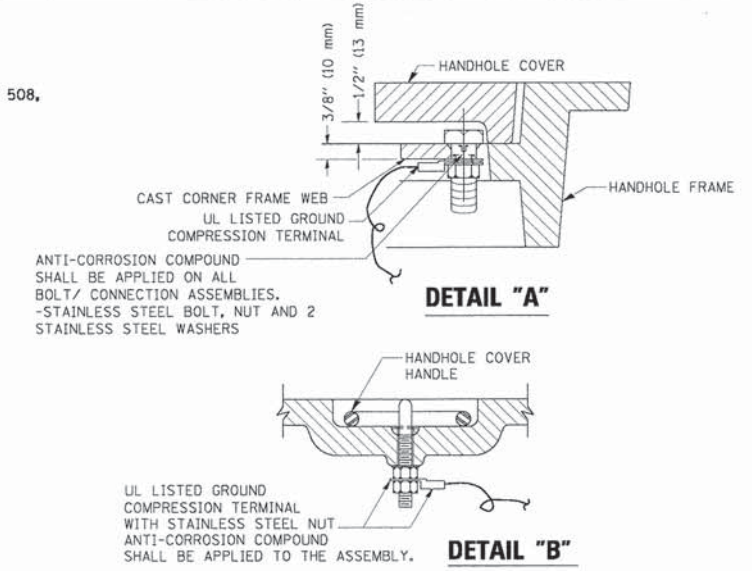


**HANDHOLE COVER & FRAME - GROUNDING DETAIL**  
 (NOT TO SCALE)

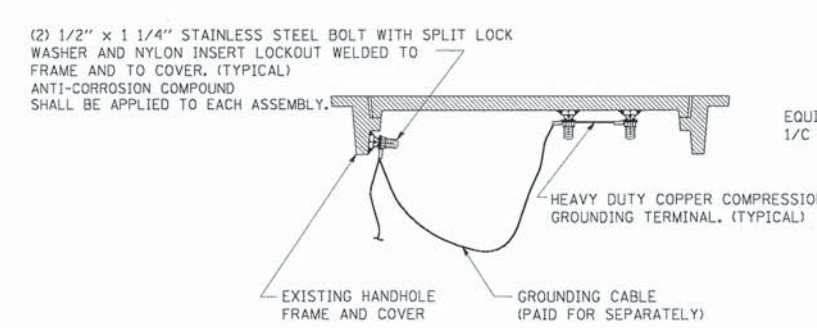

**EXISTING HANDHOLE COVER & FRAME - GROUNDING DETAIL**  
 (NOT TO SCALE)

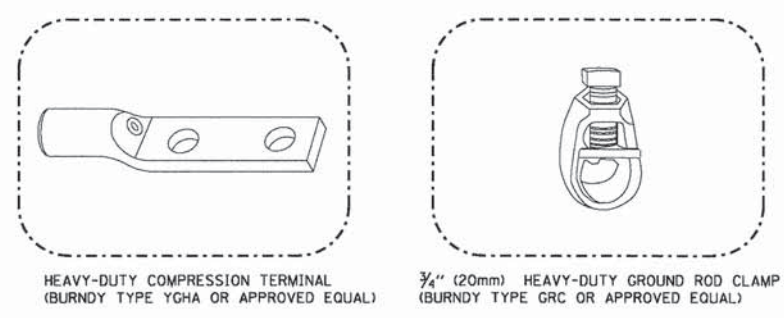

- NOTES:**
- ALL CLAMPS SHALL BE BRONZE OR COPPER, U.L. APPROVED.
  - GROUND CABLE SHALL BE LOOPED OVER HOOKS IN THE HANDHOLES. 6.5' (2.0m) SLACK SHALL BE PROVIDED IN SINGLE HANDHOLES. 13' (4.0m) OF SLACK SHALL BE PROVIDED IN DOUBLE HANDHOLES. 5' (1.4m) OF SLACK SHALL BE PROVIDED BETWEEN FRAME AND COVER.

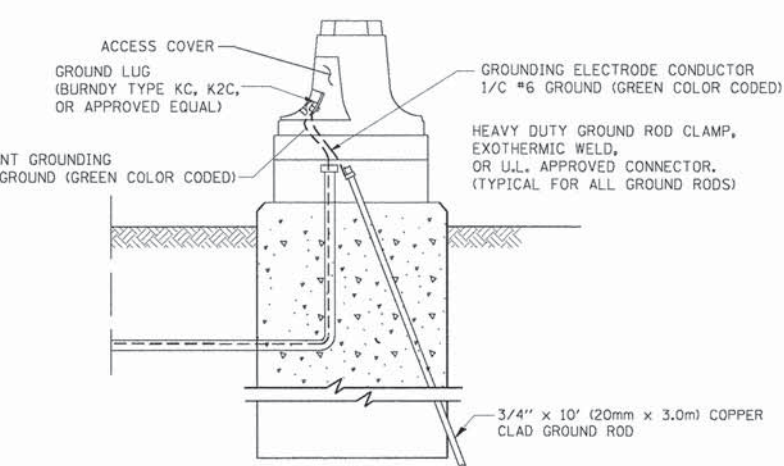

**MAST ARM POLE / POST-GROUNDING DETAIL**  
 (NOT TO SCALE)

**STATE OF ILLINOIS**  
**DEPARTMENT OF TRANSPORTATION**





**DISTRICT 1**  
**STANDARD TRAFFIC SIGNAL DESIGN DETAILS**

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	PLOT SCALE = 20,0000 / 1 IN.	CHECKED - DAD	REVISED -
	PLOT DATE = 10/6/2009	DATE - 10/28/09	REVISED -

SCALE:	SHEET NO. 3 OF 6 SHEETS	STA.	TO STA.
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F.A.U. RTE.	SECTION	COUNTY	TOTAL SHEETS	SHEET NO.
3784	12-F3000-23-PK	COOK	131	95
CONTRACT NO.				
FED. ROAD DIST. NO. 1   ILLINOIS FED. AID PROJECT				



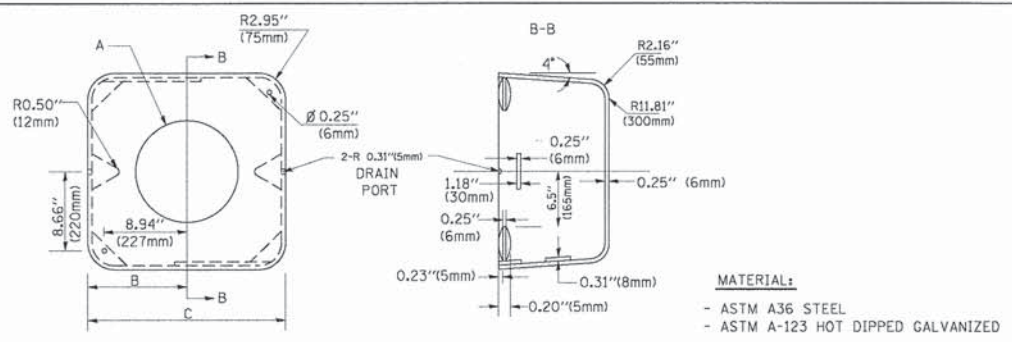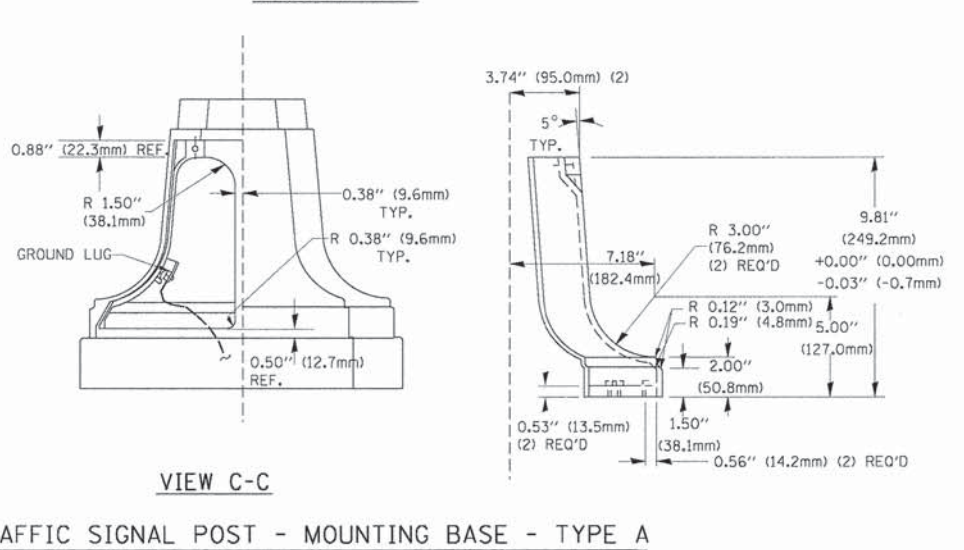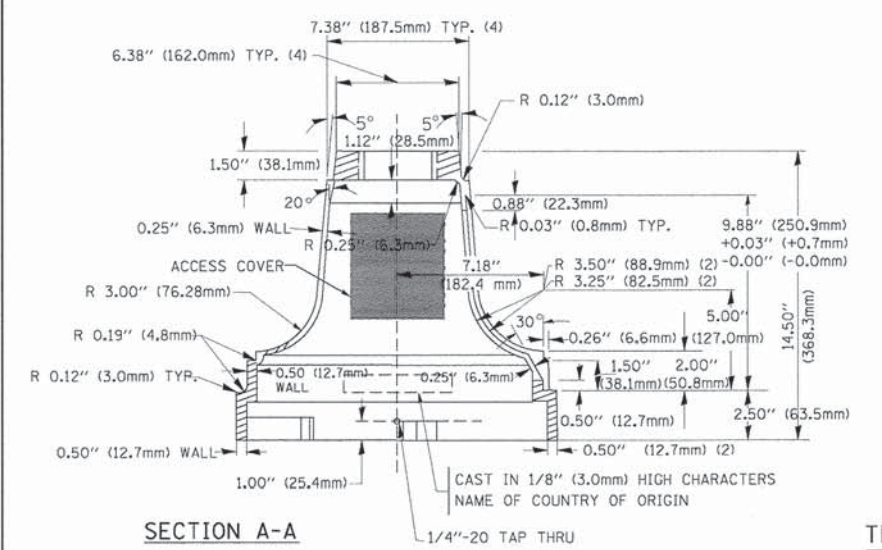
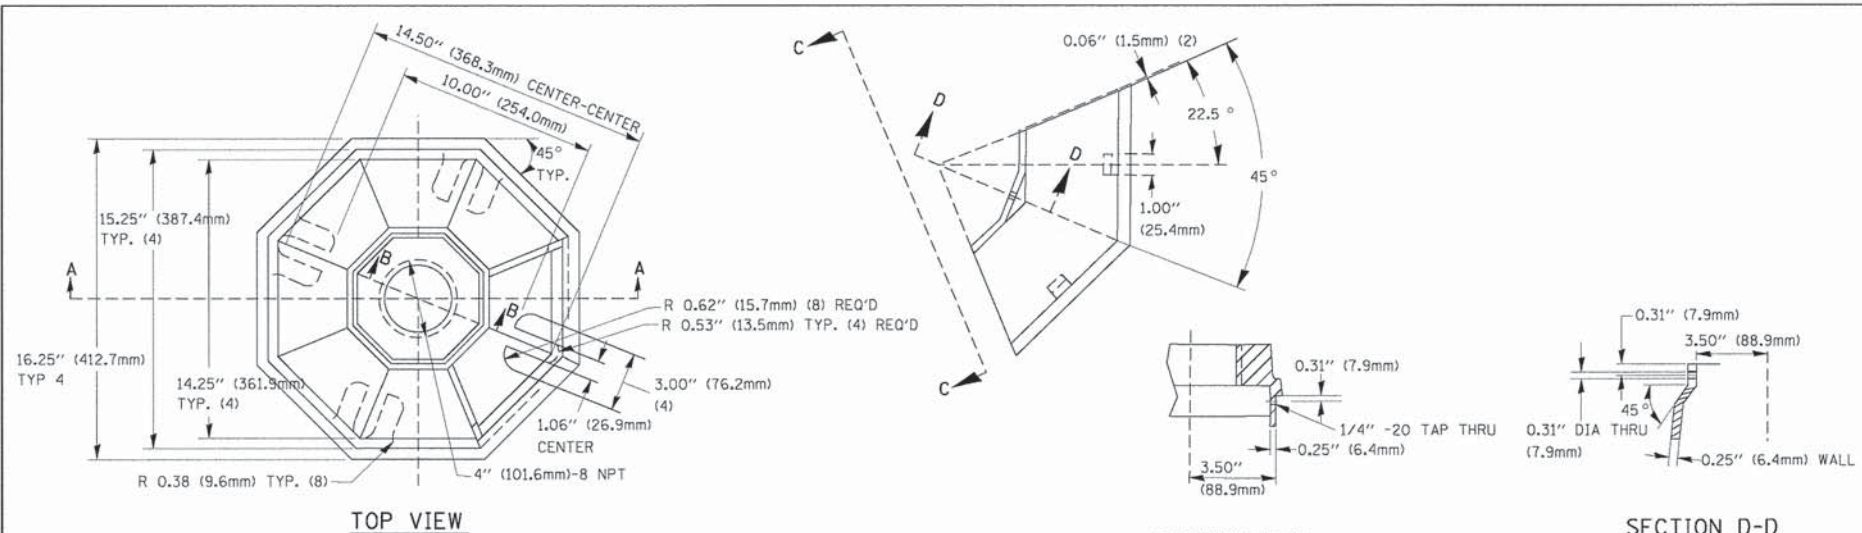


A	B	C	HEIGHT	WEIGHT
VARIES	9.5\"(241mm)	19\"(483mm)	7\" (178mm) - 12\" (300mm)	53 lbs (24kg)
VARIES	10.75\"(273mm)	21.5\"(546mm)	7\" (178mm) - 12\" (300mm)	68 lbs (31 kg)
VARIES	13.0\"(330mm)	26\"(660mm)	7\" (178mm) - 12\" (300mm)	81 lbs (37 kg)
VARIES	18.5\"(470mm)	37\"(940mm)	7\" (178mm) - 12\" (300mm)	126 lbs (57 kg)

**SHROUD**

NOTES:


- DIMENSION "A" IS EQUAL TO THE DIAMETER OF THE MAST ARM POLE AT THE TOP OF THE SHROUD. THE SHROUD SHALL BE TIGHT TO THE MAST ARM POLE.
- THE SUPPLIER SHALL VERIFY THE ABOVE DIMENSIONS BASED ON MAST ARM REQUIREMENTS.
- THE HEIGHT OF THE SHROUD SHALL COVER THE ANCHOR BOLTS, NUTS AND MAST ARM POLE BASE.

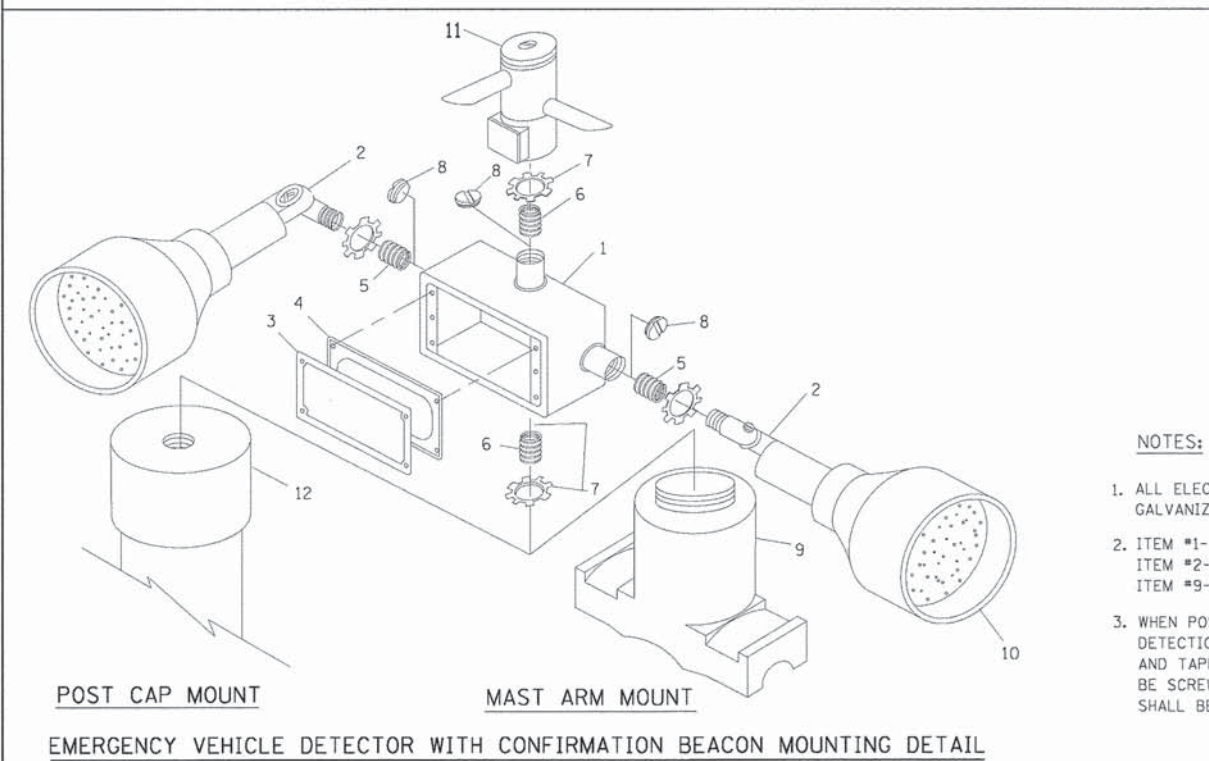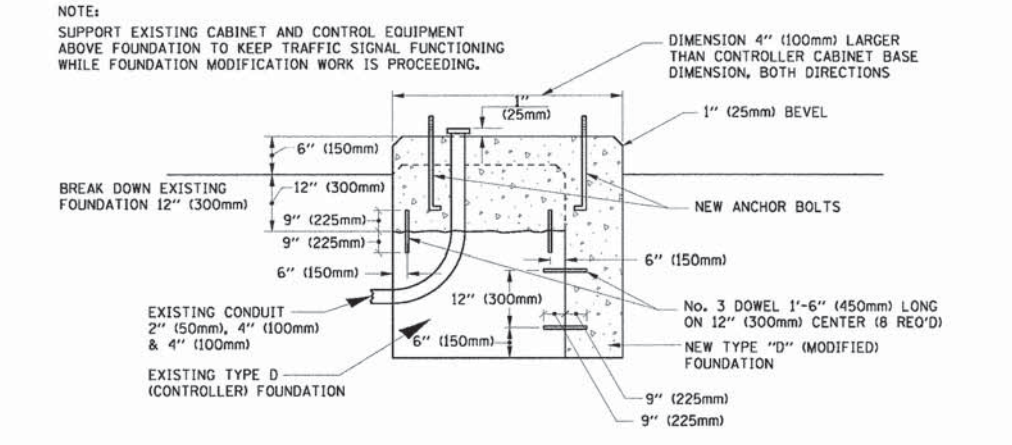

ITEM NO.	IDENTIFICATION
1	OUTLET BOX- GALV. 21 CU.IN. (0.000344 CU-M)
2	LAMP HOLDER AND COVER
3	OUTLET BOX COVER
4	RUBBER COVER GASKET
5	REDUCING BUSHING
6	3/4\"(19 mm) CLOSE NIPPLE
7	3/4\"(19 mm) LOCKNUT
8	3/4\"(19 mm) HOLE PLUG
9	SADDLE BRACKET - GALV.
10	6 WATT PAR 38 LED FLOOD LAMP
11	DETECTOR UNIT
12	POST CAP [18 FT. (5.4 m) POST MIN.]

NOTES:


- ALL ELECTRICAL ITEMS, EXCEPT ITEMS #2 AND #11 SHALL BE ALUMINUM OR GALVANIZED
- ITEM #1- OZ/GEDNEY FSX-1-50 OR EQUIVALENT  
ITEM #2- MULBERRY CON-O-SHADE LAMP SHIELD OR EQUIVALENT  
ITEM #9- "BAND-IT" SADDLE BRACKET OR EQUIVALENT
- WHEN POST MOUNTING IS SPECIFIED, ITEM #9 SHALL NOT BE REQUIRED. THE DETECTION UNIT SHALL BE MOUNTED DIRECTLY ON TOP OF THE CAP BY DRILLING AND TAPPING A 3/4\"(19 mm) HOLE WITH PIPE THREADS. THE POST CAP SHALL EITHER BE SCREWED TO THE TOP OF THE POST OR A MINIMUM OF 3 TIGHTENING SCREWS SHALL BE REQUIRED ON EACH CAP.

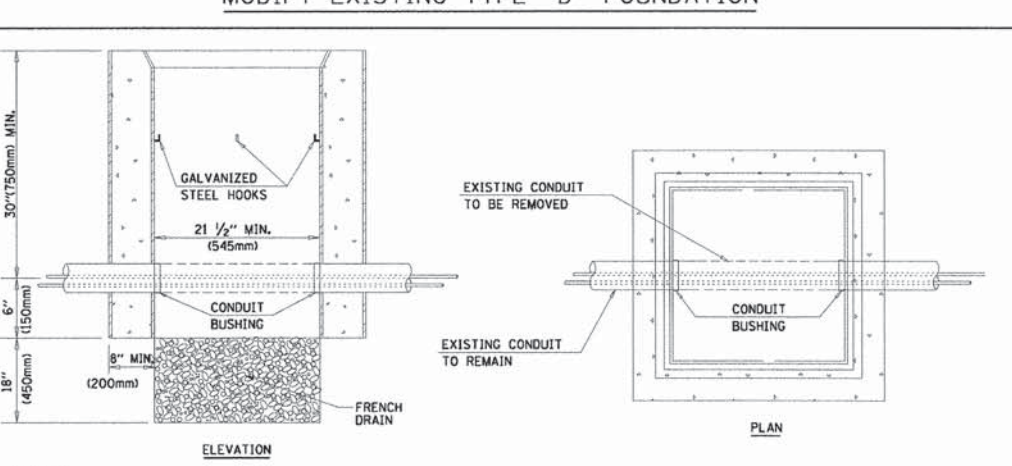


NOTES:

- HANDHOLE CONSTRUCTED PER STATE STANDARD 814001.
- REMOVAL OF THE EXISTING CONDUIT FROM THE HANDHOLE AND THE INSTALLATION OF THE CONDUIT BUSHINGS SHALL BE INCIDENTAL TO THE HANDHOLE.




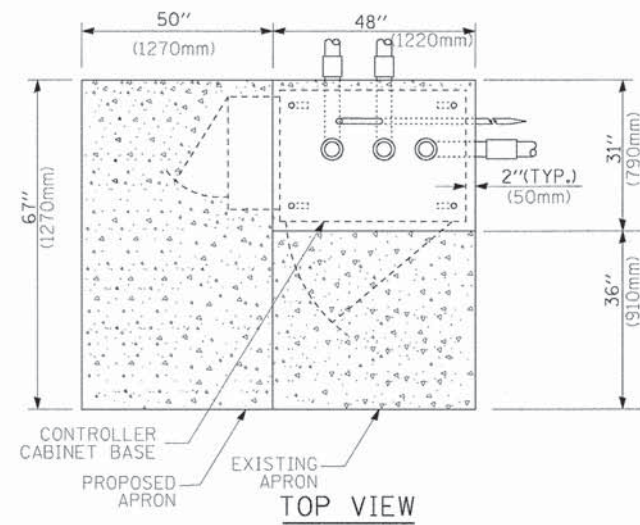

**TYPE D  
FOR GROUND MOUNTED  
CONTROLLER CABINET  
AND UPS BATTERY CABINET**

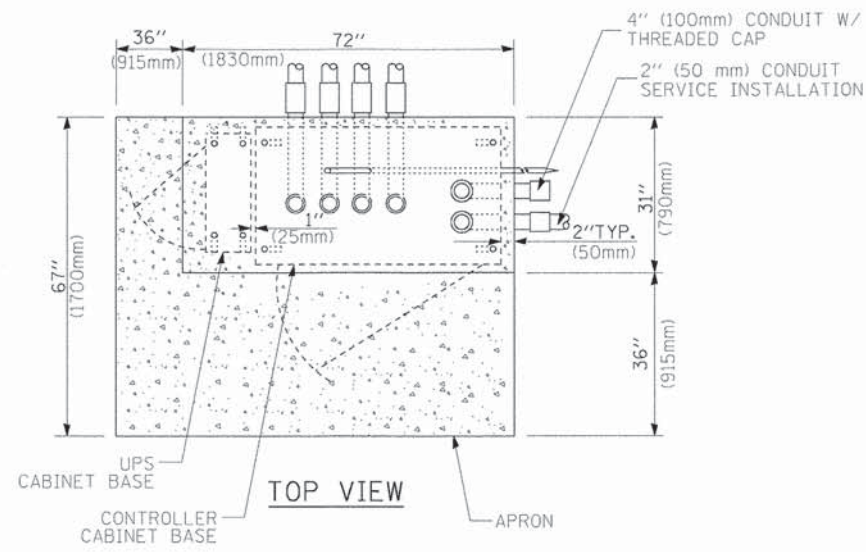



**TYPE C  
FOR GROUND MOUNTED  
CONTROLLER CABINET  
AND UPS BATTERY CABINET**

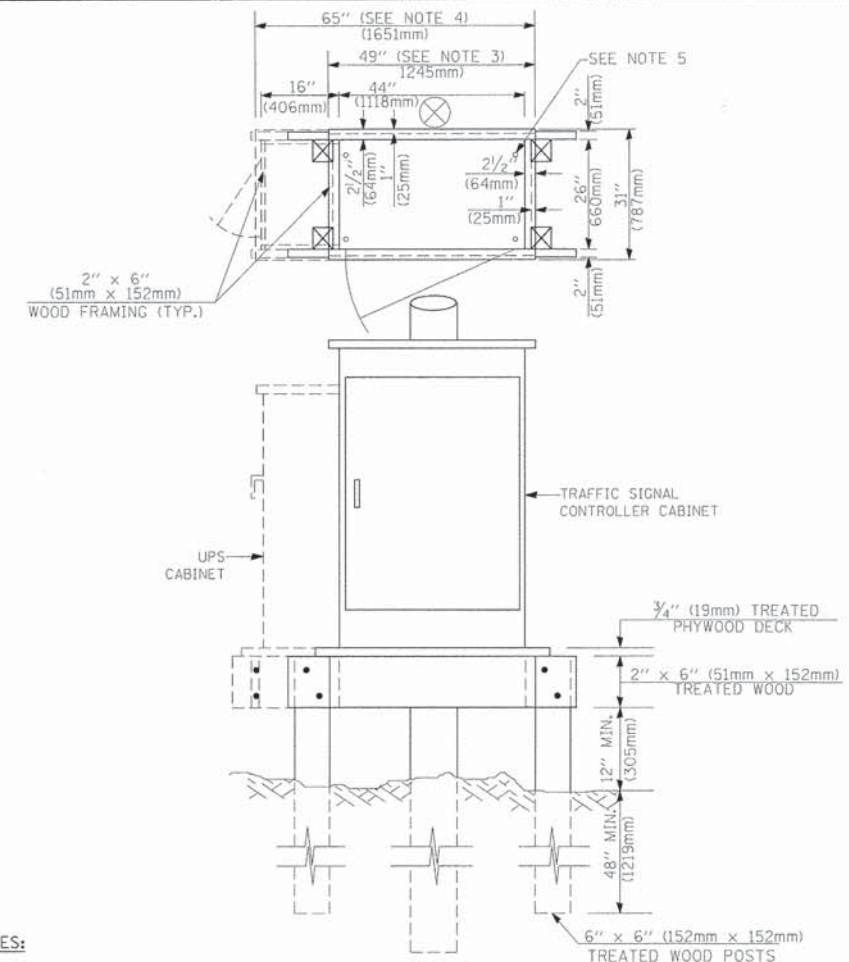

**NOTES:**

1. BASED ON CONTROLLER CABINET TYPE IV WITH BASE DIMENSIONS OF 26" x 44" (660mm x 1118mm). ADJUST PLATFORM SIZE TO FIT CABINET BASE DIMENSIONS BEING SUPPLIED.
2. BASED ON UNINTERRUPTIBLE POWER SUPPLY CABINET WITH BASE DIMENSIONS OF 16" x 25" (406mm x 635mm). ADJUST PLATFORM SIZE TO FIT CABINET BASE DIMENSIONS BEING SUPPLIED.
3. PLATFORM SIZE FOR CONTROLLER CABINET TYPE IV.
4. PLATFORM SIZE FOR CONTROLLER CABINET TYPE IV AND UNINTERRUPTIBLE POWER SUPPLY CABINET.
5. DRILLED HOLES THROUGH THE PLATFORM BASE TO MATCH THE CONTROLLER CABINET BOLT TEMPLATE. FASTEN THE CONTROLLER CABINET TO THE PLATFORM WITH CARRIAGE BOLTS, WASHERS AND NUTS.
6. FASTEN ALL SUPPORT WOOD FRAMING TO THE WOOD POSTS WITH 2 LAG SCREWS FOR EACH CONNECTION.

**TEMPORARY SIGNAL CONTROLLER  
WOOD SUPPORT PLATFORM**

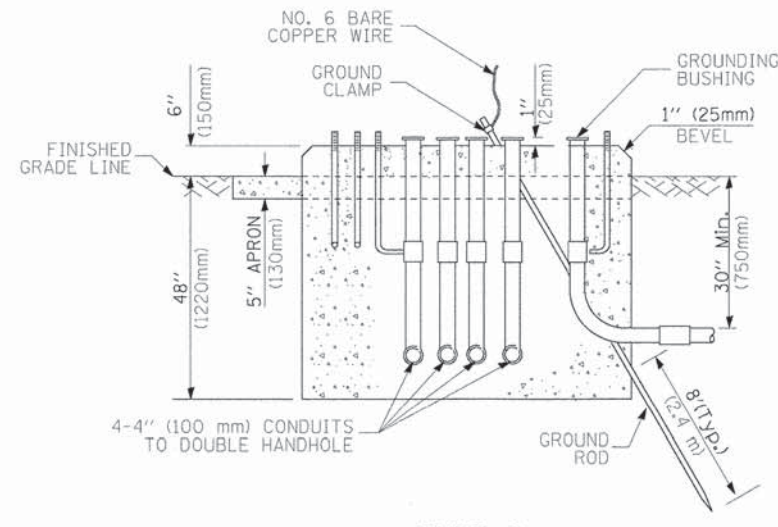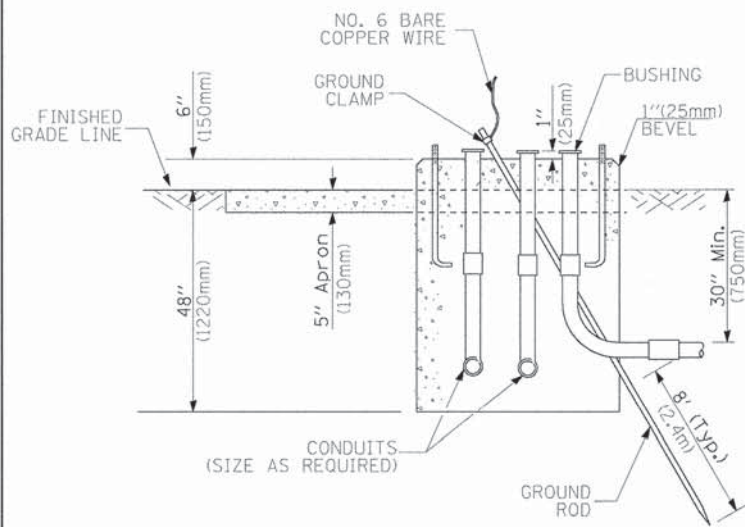

CABLE SLACK LENGTH	FEET	METER
HANDHOLE	6.5	2.0
DOUBLE HANDHOLE	13.0	4.0
SIGNAL POST	2.0	0.6
MAST ARM	2.0	0.6
CONTROLLER CABINET	1.5	0.5
FIBER OPTIC AT CABINET	13.0	4.0
ELECTRIC SERVICE AT (CABINET OR SERVICE LOCATION)	1.5	0.5
GROUND CABLE (SIGNAL POST, MAST ARM, CABINET)	1.5	0.5
GROUND CABLE (BETWEEN FRAME AND COVER)	5.0	1.6

**CABLE SLACK**

VERTICAL CABLE LENGTH	FEET	METER
MAST ARM POLE (MAST ARM MOUNTED SIGNAL HEAD) (L = MAST ARM LENGTH - DISTANCE TO SIGNAL HEAD FROM END OF ARM)	20.0+L	6.0+L
BRACKET MOUNTED (MAST ARM POLE OR SIGNAL POLE)	13.0	4.0
PEDESTRIAN PUSH BUTTON	6.0	2.0
SERVICE INSTALLATION POLE MOUNT TO SERVICE DROP	13.5	4.1
SERVICE INSTALLATION POLE MOUNT TO GROUND	13.5	4.1
SERVICE INSTALLATION GROUND MOUNT	6.0	2.0
FOUNDATION (SIGNAL POST, MAST ARM POLE, CONTROLLER CABINET, SERVICE-GROUND MOUNT)	3.0	1.0

**VERTICAL CABLE LENGTH**

FOUNDATION	DEPTH
TYPE A - Signal Post	4'-0" (1.2m)
TYPE C - CONTROLLER W/ UPS	4'-0" (1.2m)
TYPE D - CONTROLLER	4'-0" (1.2m)
SERVICE INSTALLATION, GROUND MOUNT, TYPE A - SQUARE	4'-0" (1.2m)

**DEPTH OF FOUNDATION**

MAST ARM LENGTH	FOUNDATION DEPTH	FOUNDATION DIAMETER	SPIRAL DIAMETER	QUANTITY OF REBARS	SIZE OF REBARS
Less than 30' (9.1 m)	10'-0" (3.0 m)	30" (750mm)	24" (600mm)	8	6(19)
Greater than or equal to 30' (9.1 m) and less than 40' (12.2 m)	13'-6" (4.1 m)	30" (750mm)	24" (600mm)	8	6(19)
Greater than or equal to 40' (12.2 m) and less than 50' (15.2 m)	11'-0" (3.4 m)	36" (900mm)	30" (750mm)	12	7(22)
Greater than or equal to 50' (15.2 m) and up to 55' (16.8 m)	13'-0" (4.0 m)	36" (900mm)	30" (750mm)	12	7(22)
Greater than or equal to 55' (16.8 m) and less than 65' (19.8 m)	15'-0" (4.6 m)	36" (900mm)	30" (750mm)	12	7(22)
Greater than or equal to 65' (19.8 m) and up to 75' (22.9 m)	21'-0" (6.4 m)	42" (1060mm)	36" (900mm)	16	8(25)
	25'-0" (7.6 m)	42" (1060mm)	36" (900mm)	16	8(25)

**NOTES:**

1. These foundation depths are for sites which have cohesive soils (clayey silt, sandy clay, etc.) along the length of the shaft, with an average Unconfined Compressive Strength (QU) > 1.0 tsf (100 kpa). This strength shall be verified by boring data prior to construction or with testing by the Engineer during foundation drilling. The Bureau of Bridges & Structures should be contacted for a revised design if other conditions are encountered.
2. Combination mast arm assemblies under 55 feet (16.8 m) shall use 36" (900 mm) diameter foundations.
3. Combination mast arm assemblies under 56 feet (16.8 m) through 75 feet (22.9 m) shall use 42" (1060 mm) diameter foundations.
4. For mast arm assemblies with dual arms refer to state standard 878001.

**DEPTH OF MAST ARM FOUNDATIONS, TYPE E**

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	PLOT SCALE = 20.0000 "/ IN.	CHECKED - DAD	REVISED -
	PLOT DATE = 10/6/2009	DATE - 10/28/09	REVISED -

**STATE OF ILLINOIS  
DEPARTMENT OF TRANSPORTATION**

**DISTRICT 1  
STANDARD TRAFFIC SIGNAL DESIGN DETAILS**

F.A.U. RTE.	SECTION	COUNTY	TOTAL SHEETS	SHEET NO.
3784	12-F3000-23-PK	COOK	131	97
CONTRACT NO.				
FED. ROAD DIST. NO. 1 ILLINOIS FED. AID PROJECT				

SCALE: SHEET NO. 5 OF 6 SHEETS STA. TO STA.



# TRAFFIC SIGNAL LEGEND

ITEM	REMOVAL	EXISTING	PROPOSED	ITEM	REMOVAL	EXISTING	PROPOSED	ITEM	REMOVAL	EXISTING	PROPOSED											
CONTROLLER CABINET				EMERGENCY VEHICLE LIGHT DETECTOR				ELECTRIC CABLE IN CONDUIT, TRACER, NO. 14 1/C, UNLESS NOTED OTHERWISE														
RAILROAD CONTROL CABINET				CONFIRMATION BEACON				COAXIAL CABLE														
COMMUNICATIONS CABINET				HANDHOLE				VENDOR CABLE FOR CAMERA														
MASTER CONTROLLER				HEAVY DUTY HANDHOLE				COPPER INTERCONNECT CABLE, NO. 18 3 PAIR TWISTED, SHIELDED														
MASTER MASTER CONTROLLER				DOUBLE HANDHOLE				FIBER OPTIC CABLE NO. 62.5/125, MM12F														
UNINTERRUPTIBLE POWER SUPPLY				JUNCTION BOX				FIBER OPTIC CABLE NO. 62.5/125, MM12F SM12F														
SERVICE INSTALLATION, (P) POLE OR (G) GROUND MOUNT				GALVANIZED STEEL CONDUIT IN TRENCH (T) OR PUSHED (P)				FIBER OPTIC CABLE NO. 62.5/125, MM12F 5M12F														
TELEPHONE CONNECTION (P) POLE OR (G) GROUND MOUNT				TEMPORARY SPAN WIRE, TETHER WIRE, AND CABLE				FIBER OPTIC CABLE NO. 62.5/125, (NUMBER OF FIBERS & TYPE TO BE NOTED ON PLANS)														
STEEL MAST ARM ASSEMBLY AND POLE				COMMON TRENCH				GROUND ROD AT (C) CONTROLLER, (H) HANDHOLE, (P) POST, (M) MAST ARM, OR (S) SERVICE														
ALUMINUM MAST ARM ASSEMBLY AND POLE				COILABLE NONMETALLIC CONDUIT (EMPTY)				CONTROLLER CABINET AND FOUNDATION TO BE REMOVED														
STEEL COMBINATION MAST ARM ASSEMBLY AND POLE WITH LUMINAIRE				SYSTEM ITEM				STEEL MAST ARM POLE AND FOUNDATION TO BE REMOVED														
STEEL COMBINATION MAST ARM ASSEMBLY AND POLE WITH PTZ CAMERA				INTERSECTION ITEM				ALUMINUM MAST ARM POLE AND FOUNDATION TO BE REMOVED														
SIGNAL POST				REMOVE ITEM				STEEL COMBINATION MAST ARM ASSEMBLY AND POLE WITH LUMINAIRE AND FOUNDATION TO BE REMOVED														
TEMPORARY WOOD POLE (CLASS 5 OR BETTER) 45 FOOT (13.7m) MINIMUM				RELOCATE ITEM				SIGNAL POST AND FOUNDATION TO BE REMOVED														
GUY WIRE				ABANDON ITEM				INTERSECTION & SAMPLING (SYSTEM) DETECTOR														
SIGNAL HEAD				12" (300mm) TRAFFIC SIGNAL SECTION				SAMPLING (SYSTEM) DETECTOR														
SIGNAL HEAD CONSTRUCTION STAGES (NUMBERS INDICATE THE CONSTRUCTION STAGE)				12" (300mm) RED WITH 8" (200mm) YELLOW AND GREEN TRAFFIC SIGNAL FACE				EXISTING INTERSECTION LOOP DETECTOR PROPOSED INTERSECTION AND SAMPLING (SYSTEM) DETECTOR														
SIGNAL HEAD WITH BACKPLATE				SIGNAL FACE				EXISTING PREFORMED INTERSECTION LOOP DETECTOR PROPOSED INTERSECTION AND SAMPLING (SYSTEM) DETECTOR														
SIGNAL HEAD OPTICALLY PROGRAMMED				SIGNAL FACE WITH BACKPLATE. "P" INDICATES PROGRAMMED HEAD				PREFORMED INTERSECTION AND SAMPLING (SYSTEM) DETECTOR														
FLASHER INSTALLATION (S DENOTES SOLAR POWER)				12" (300mm) PEDESTRIAN SIGNAL HEAD WALK/DON'T WALK SYMBOL				PREFORMED SAMPLING (SYSTEM) DETECTOR														
PEDESTRIAN SIGNAL HEAD				12" (300mm) PEDESTRIAN SIGNAL HEAD INTERNATIONAL SYMBOL, OUTLINED				<h2 style="margin: 0;">RAILROAD SYMBOLS</h2> <table border="1" style="width: 100%; border-collapse: collapse;"> <thead> <tr> <th style="width: 50%;">EXISTING</th> <th style="width: 50%;">PROPOSED</th> </tr> </thead> <tbody> <tr> <td></td> <td></td> </tr> <tr> <td></td> <td></td> </tr> <tr> <td></td> <td></td> </tr> <tr> <td></td> <td></td> </tr> <tr> <td></td> <td></td> </tr> </tbody> </table>			EXISTING	PROPOSED										
EXISTING	PROPOSED																					
PEDESTRIAN PUSHBUTTON DETECTOR				12" (300mm) PEDESTRIAN SIGNAL HEAD INTERNATIONAL SYMBOL, SOLID																		
ACCESSIBLE PEDESTRIAN PUSHBUTTON DETECTOR				PEDESTRIAN SIGNAL HEAD, INTERNATIONAL SYMBOL, WITH COUNTDOWN TIMER																		
ILLUMINATED SIGN "NO LEFT TURN"				RADIO INTERCONNECT																		
ILLUMINATED SIGN "NO RIGHT TURN"				RADIO REPEATER																		
DETECTOR LOOP, TYPE I				DENOTES NUMBER OF CONDUCTORS, ELECTRIC CABLE NO. 14, UNLESS NOTED OTHERWISE, ALL DETECTOR LOOP CABLE TO BE SHIELDED																		
PREFORMED DETECTOR LOOP				GROUND CABLE IN CONDUIT NO. 6 SOLID COPPER (GREEN)																		
MICROWAVE VEHICLE SENSOR																						
VIDEO DETECTION CAMERA																						
VIDEO DETECTION ZONE																						
PAN, TILT, ZOOM CAMERA																						
WIRELESS DETECTOR SENSOR																						
WIRELESS ACCESS POINT																						



DEVICES		LIGHTING		FIRE ALARM		ABBREVIATIONS		POWER	
\$	SINGLE POLE TOGGLE SWITCH MC = MOMENTARY CONTACT WP = WEATHERPROOF 3W = 3-WAY EX = EXPLOSION PROOF 4W = 4-WAY T = THERMAL OVERLOAD 2P = TWO POLE P = PILOT LIGHT 3P = THREE POLE D = DIMMING SWITCH LV = LOW VOLTAGE K = KEY OPERATED DIMMER SWITCH (wattage rating on plan)	☉	PHOTOCELL FOR CONTROL OF LIGHTING DUSK TO DAWN.	Ⓐ	GENERAL ALARM DEVICE	1P	SINGLE POLE	LC	LEAD COVERED
LC	LIGHTING CONTACT IN ENCLOSURE	☉	EXIT/DIRECTIONAL SIGN	ⒶV	GENERAL ALARM DEVICE WITH VISUAL ALARM DEVICE	2P	TWO POLE	LS	LOUD SPEAKER
LR	LIGHTING RELAY CABINET	☉	MANUAL/AUTOMATIC WALL MOUNTED MULTI TECHNOLOGY OCCUPANCY SENSOR. LEVITON-OSSMT-GDW VERIFY VOLTAGE MULTI TECHNOLOGY CEILING MOUNTED OCCUPANCY SENSOR LEVITON-OSC10-MDW	ⒶV	PRE-SIGNAL ALARM DEVICE	3P	THREE POLE	LTG	LIGHTING
DB	DOORBELL	☉	OCCUPANCY POWER PACK LEVITON-OSP20-RNH	ⒶV	PRE-SIGNAL DEVICE WITH VISUAL ALARM DEVICE	A	AMPERES (AMPS)	LV	LOW VOLTAGE
PC	PHOTOCELL	☉	MASTER CONTROL STATION W/5 BUTTONS LEVITON D8000	ⒶV	VOICE COMMUNICATION SPEAKER	AF	AMPERE FUSE	M	METER
TS	TIME SWITCH	☉	WALL MOUNTED OCCUPANCY SENSOR AIM FOR MAXIMUM COVERAGE. LEVITON ODWHB-10 WITH ODP13 POWER PACK 27TV	ⒶV	VOICE COMMUNICATION SPEAKER WITH VISUAL ALARM DEVICE	AS	AMPERE SWITCH	MC	(for switches) MOMENTARY CONTACT
⊖	THERMOSTAT	☉	RACEWAY AND WIRING	ⒶV	VOICE COMMUNICATION TELEPHONE	A/C	AIR CONDITIONER	MCB	MAIN CIRCUIT BREAKER
\$LO	LOCKOUT SWITCH	☉	CONDUIT RUN CONCEALED IN CEILING OR WALL. ARROW IMPLIES DIRECT PATH TO DESIGNATED PANEL	ⒶV	VISUAL ALARM DEVICE (PER FIRE PREVENTION)	AC	ALTERNATING CURRENT	MCC	MOTOR CONTROL CENTER
⊕	PUSHBUTTON STATION WITH ONE BUTTON	☉	CONDUIT RUN CONCEALED IN OR BELOW FLOOR	ⒶV	REMOTE ANNUNCIATOR LAMP FOR SELECTED DEVICE	ACL	ACROSS THE LINE	MCM	THOUSAND CIRCULAR MIL
⊕	PUSHBUTTON STATION WITH TWO BUTTONS	☉	GROUND WIRE CONCEALED IN CEILING OR WALL. ARROWHEAD DENOTES HOMERUN TO PANELBOARD. TICK MARK INDICATE QUANTITY OF WIRE. PHASE AND SWITCH LEGS DENOTED AS SHORT LINES. NEUTRAL DENOTED AS LONG LINE. GROUND WIRES DENOTED AS LONG LINES WITH DOT	ⒶV	HEAT DETECTOR (135° FIXED TEMPERATURE/RATE OF RISE)	AFF	ABOVE FLOOR FINISH	MERC	MERCURY VAPOR MANUFACTURER
⊕	PUSHBUTTON STATION WITH TWO BUTTONS AND PILOT LIGHT	☉	CONDUIT STUBBED UP	ⒶV	SYSTEM SMOKE DETECTOR	AIC	AMPERES INTERRUPTING CAPACITY	MFR	MANUFACTURER
⊕	PUSHBUTTON STATION WITH THREE BUTTONS	☉	CONDUIT STUBBED DOWN	ⒶV	SYSTEM SMOKE DETECTOR WITH INTEGRAL HORN	AL	ALUMINUM	MFS	MAIN FUSED SWITCH
⊕	KEY-RESET CONTROL STATION	☉	FLEXIBLE CONDUIT JUNCTION BOX (exposed or in ceiling)	ⒶV	SINGLE STATION SMOKE DETECTOR WITH BATTERY BACKUP	AMP	AMPERES	MH	MANHOLE
⊕	STOP-LOCK PUSHBUTTON STATION	☉	JUNCTION BOX (wall or ceiling mounted) "FB" INDICATES FLOOR BOX WITH BLANK COVER	ⒶV	HVAC DUCT SMOKE DETECTOR	ANN	ANNUNCIATOR	MH	MOUNTING HEIGHT
⊕	EMERGENCY POWER OFF MUSHROOM BUTTON	☉	EQUIPMENT TAG	ⒶV	BEAM SYSTEM SMOKE DETECTOR (UL-268) TRANSMITTER	ATS	AUTOMATIC TRANSFER SWITCH	MLO	MAIN LUGS ONLY
⊕	SINGLE RECEPTACLE (wall mounted)	☉	CONDUIT SEAL	ⒶV	BEAM SYSTEM SMOKE DETECTOR (UL-268) RECEIVER	AWG	AMERICAN WIRE GAUGE	MTD	MOUNTED
⊕	DUPLEX RECEPTACLE (wall mounted)	☉	MULTI-OUTLET ASSEMBLY	ⒶV	MANUAL PULL STATION	BAL	BALLAST	MTR	MOTOR
⊕	DOUBLE DUPLEX RECEPTACLE (wall mounted)	☉	WIREWAY	ⒶV	SPRINKLER WATERFLOW INDICATOR	BGB	BUILDING GROUND BOX	MV	MULTI-VAPOR
⊕	SINGLE RECEPTACLE (flush floor mounted)	☉	CABLE TRAY	ⒶV	SPRINKLER ALARM VALVE ATTACHMENT	BOC	BOTTOM OF CONDUIT	N	NEW
⊕	DUPLEX RECEPTACLE (flush floor mounted)	☉	BUSWAY (BUSDUCT)	ⒶV	SPRINKLER PRESSURE SWITCH	BR	BRANCH BREAKER	NC	NORMALLY CLOSED
⊕	DOUBLE DUPLEX RECEPTACLE (flush floor mounted)	☉	CABLE TAP BOX	ⒶV	HALON EXTINGUISHING SYSTEM	BRKR	BREAKER	NEC	NATIONAL ELECTRIC CODE
⊕	SINGLE RECEPTACLE (poke-thru)	☉	UNDERGROUND DUCTBANK	ⒶV	DRY CHEMICAL EXTINGUISHING SYSTEM	C	CONDUIT	NEUT	NEUTRAL
⊕	DUPLEX RECEPTACLE (poke-thru)	☉	UNDERGROUND DIRECT BURIAL CABLE	ⒶV	WET CHEMICAL EXTINGUISHING SYSTEM	C.U.	COEFFICIENT OF UTILIZATION	NF	NON-FUSED
⊕	DOUBLE DUPLEX RECEPTACLE (poke-thru)	☉	UNDERFLOOR DUCT SYSTEM: — INDICATES POWER DUCT — INDICATES TELEPHONE DUCT — INDICATES SYSTEM DUCT	ⒶV	GASEOUS EXTINGUISHING SYSTEM	CAB	CABINET	NO	NORMALLY OPENED
⊕	RECEPTACLE CONNECTED TO CELLULAR FLOOR SYSTEM	☉	VARIOUS SYMBOLS IDENTIFY LOCATION OF DIFFERENT TYPES OF OUTLETS OR CONNECTIONS TO UNDERFLOOR DUCT SYSTEM.	ⒶV	MAGNETIC/ELECTRONIC DOOR HOLD OPEN DEVICE	CATV	CABLE TELEVISION	NTS	NOT TO SCALE
⊕	SPLIT WIRED DUPLEX RECEPTACLE (two circuits)	☉	MANHOLE	ⒶV	ELECTRIC DOOR LOCK	CB	CIRCUIT BREAKER	OH	OVERHEAD
⊕	RECEPTACLE MOUNTED ABOVE COUNTERTOP	☉	HANDHOLE	ⒶV	SPRINKLER VALVE SUPERVISORY (TAMPER) SWITCH	CC	COMMUNICATIONS CONTRACTOR	P	(for switches) PILOT LIGHT
⊕	CLOCK OUTLET RECEPTACLE	☉	PULLBOX	ⒶV	CITY FIRE ALARM BOX TIE AND DISCONNECT PANEL	CCT	CIRCUIT	PA	PUBLIC ADDRESS
⊕	CLOCK OUTLET AND CLOCK FOR INTEGRATED CLOCK SYSTEM	☉	SIGNAL SYMBOLS	ⒶV	CITY FIRE ALARM BOX	CCTV	CLOSED CIRCUIT TELEVISION	PB	PULLBOX
⊕	ELEVATOR SELECTOR SWITCH FURNISHED BY ELEVATOR CONTRACTOR. INSTALLED BY E.C. CARBON MONOXIDE DETECTOR PER LOCAL CODE REQUIREMENTS	☉	BUZZER	ⒶV	CENTRAL STATION TIE AND DISCONNECT	CLO	CLOSET	PDU	POWER DISTRIBUTION UNIT
⊕		☉	CHIME	ⒶV	TROUBLE BELL WITH TEST AND SILENCE SWITCH WITH LAMP	Co.	COMPANY	PH	PHASE
⊕		☉	CLOSED CIRCUIT TELEVISION CAMERA	ⒶV	FIRE ALARM ANNUNCIATOR PANEL	CoAX	COAXIAL	PNL	PANEL
⊕		☉	INTERCOM (wall or ceiling mount)	ⒶV	FIRE ALARM CONTROL PANEL	ComEd	COMMONWEALTH EDISON COMPANY	PRI	PRIMARY
⊕		☉	TELEPHONE TERMINAL CABINET	ⒶV	VOICE COMMUNICATION CONTROL PANEL	COMP	COMPRESSOR	PROT	PROTECTION or PROTECTIVE
⊕		☉	AMPLIFIER	ⒶV	ELEVATOR STATUS/CONTROL PANEL	CONN	CONNECTED	PT	POTENTIAL TRANSFORMER
⊕		☉	TELEPHONE TERMINAL CABINET	ⒶV	HVAC DUCT FIRE DAMPER CONTROL	CONV	CONVENIENCE	PWR	POWER
⊕		☉	AMPLIFIER	ⒶV	DUCT SMOKE DETECTOR REMOTE TEST SWITCH WITH HORN AND LIGHT.	CP	CATHODIC PROTECTION	R	RESISTANCE
⊕		☉	TELEPHONE TERMINAL CABINET	ⒶV		CT	CURRENT TRANSFORMER	RC	REMOTE CONTROL
⊕		☉	AMPLIFIER	ⒶV		CU	COPPER	REC	RECTIFIER
⊕		☉	TELEPHONE TERMINAL CABINET	ⒶV		CUH	CABINET UNIT HEATER (for switches) DIMMER SWITCH	RECP	RECEPTACLE
⊕		☉	AMPLIFIER	ⒶV		D	DEDICATED	RF	RADIO FREQUENCY
⊕		☉	TELEPHONE TERMINAL CABINET	ⒶV		DC	DIRECT CURRENT	RH	RHEOSTAT
⊕		☉	AMPLIFIER	ⒶV		DISC.SW.	DISCONNECT SWITCH	RT	RAIN-TIGHT
⊕		☉	TELEPHONE TERMINAL CABINET	ⒶV		DP	DISTRIBUTION PANEL	RW	REWIRE
⊕		☉	AMPLIFIER	ⒶV		DPDT	DOUBLE POLE DOUBLE THROW	S	SWITCH
⊕		☉	TELEPHONE TERMINAL CABINET	ⒶV		DPST	DOUBLE POLE SINGLE THROW	S/T	SHUNT-TRIP
⊕		☉	AMPLIFIER	ⒶV		DWG	DRAWING	SEC	SECONDARY
⊕		☉	TELEPHONE TERMINAL CABINET	ⒶV		E/P	ELECTRIC/PNEUMATIC SWITCH	SC	SEPARATE CIRCUIT
⊕		☉	AMPLIFIER	ⒶV		E.C.	ELECTRICAL CONTRACTOR	SIG	SIGNAL
⊕		☉	TELEPHONE TERMINAL CABINET	ⒶV		EF	EXHAUST FAN	SPDT	SINGLE POLE DOUBLE THROW
⊕		☉	AMPLIFIER	ⒶV		EHD	ELECTRIC HAND DRYER	SPEC	SPECIFICATION
⊕		☉	TELEPHONE TERMINAL CABINET	ⒶV		EL	ELEVATION	SPKR	SPEAKER
⊕		☉	AMPLIFIER	ⒶV		ELEC	ELECTRIC (ITY)	SPST	SINGLE POLE SINGLE THROW
⊕		☉	TELEPHONE TERMINAL CABINET	ⒶV		EM	EMERGENCY	SS	STAINLESS STEEL
⊕		☉	AMPLIFIER	ⒶV		EMT	ELECTRICAL METALLIC CONDUIT	STA	STATION
⊕		☉	TELEPHONE TERMINAL CABINET	ⒶV		EP	EXPLOSION PROOF	SWBD	SWITCHBOARD
⊕		☉	AMPLIFIER	ⒶV		EQ	EQUIPMENT	SWGR	SWITCHGEAR
⊕		☉	TELEPHONE TERMINAL CABINET	ⒶV		ER	EXISTING TO REMAIN	SYM	SYMMETRICAL
⊕		☉	AMPLIFIER	ⒶV		EUH	ELECTRIC UNIT HEATER	SYS	SYSTEM
⊕		☉	TELEPHONE TERMINAL CABINET	ⒶV		EWC	ELECTRIC WATER COOLER	T	(for switches) THERMAL OVERLOAD
⊕		☉	AMPLIFIER	ⒶV		EW	ELECTRIC WATER HEATER	T/D	TELEPHONE/DATA
⊕		☉	TELEPHONE TERMINAL CABINET	ⒶV		EX	EXISTING TO REMAIN	TC	TERMINAL CABINET
⊕		☉	AMPLIFIER	ⒶV		F	FUSE or FUSED	TEL	TELEPHONE
⊕		☉	TELEPHONE TERMINAL CABINET	ⒶV		FA	FIRE ALARM	TEL.CL.	TELEPHONE CLOSET
⊕		☉	AMPLIFIER	ⒶV		FB	FLOOR BOX	TERM	TERMINAL
⊕		☉	TELEPHONE TERMINAL CABINET	ⒶV		FC	FAULT CURRENT	TGL	TOGGLE
⊕		☉	AMPLIFIER	ⒶV		FDC	FIRE DEPARTMENT CONNECTION	TL	TWIST-LOCK
⊕		☉	TELEPHONE TERMINAL CABINET	ⒶV		FLUOR	FLUORESCENT	TM	TRANSFER MANHOLE or VAULT
⊕		☉	AMPLIFIER	ⒶV		FLR	FLOOR	TOC	TOP OF CONDUIT
⊕		☉	TELEPHONE TERMINAL CABINET	ⒶV		FP	FAN POWERED BOX	TR	TRIP
⊕		☉	AMPLIFIER	ⒶV		FS	FUSED SWITCH	TRANS	TRANSFER
⊕		☉	TELEPHONE TERMINAL CABINET	ⒶV		GEN	GENERATOR	TTC	TELEPHONE TERMINAL CABINET
⊕		☉	AMPLIFIER	ⒶV		GFI	GROUND FAULT INTERRUPT	TV	TELEVISION
⊕		☉	TELEPHONE TERMINAL CABINET	ⒶV		GHW	GALVANIZED HEAVY WALL STEEL CONDUIT	TYP	TYPICAL
⊕		☉	AMPLIFIER	ⒶV		GP	GENERAL PURPOSE	UG	UNDERGROUND
⊕		☉	TELEPHONE TERMINAL CABINET	ⒶV		GRD	GROUND	UH	UNIT HEATER
⊕		☉	AMPLIFIER	ⒶV		GRS	GALVANIZED RIGID STEEL CONDUIT	UL	UNDERWRITERS LABORATORIES
⊕		☉	TELEPHONE TERMINAL CABINET	ⒶV		HID	HIGH INTENSITY DISCHARGE	UNG	UNGROUNDING
⊕		☉	AMPLIFIER	ⒶV		HP	HORSEPOWER	UNO	UNLESS NOTED OTHERWISE
⊕		☉	TELEPHONE TERMINAL CABINET	ⒶV		HPFF	HIGH POINT of FINISHED FLOOR	UPS	UNINTERRUPTABLE POWER SYSTEM
⊕		☉	AMPLIFIER	ⒶV		HPS	HIGH PRESSURE SODIUM	UV	UNDERVOLTAGE
⊕		☉	TELEPHONE TERMINAL CABINET	ⒶV		HV	HIGH VOLTAGE	V	VOLT
⊕		☉	AMPLIFIER	ⒶV		HZ	HERTZ (cycles per second)	VA	VOLT-AMPS
⊕		☉	TELEPHONE TERMINAL CABINET	ⒶV		I	CURRENT	VAV	VARIABLE AIR VOLUME
⊕		☉	AMPLIFIER	ⒶV		IC	INTERRUPTING CAPACITY	VC	VARNISHED CAMBRIC
⊕		☉	TELEPHONE TERMINAL CABINET	ⒶV		IG	ISOLATED GROUND	VP	VAPOR-PROOF
⊕		☉	AMPLIFIER	ⒶV		IMC	INTERMEDIATE METALLIC CONDUIT	VS	VARIABLE SPEED
⊕		☉	TELEPHONE TERMINAL CABINET	ⒶV		INC	INCANDESCENT	VT	VAPOR-TIGHT
⊕		☉	AMPLIFIER	ⒶV		JB	JUNCTION BOX	W	WATTS
⊕		☉	TELEPHONE TERMINAL CABINET	ⒶV		K	(for switches) KEY SWITCH	WH	WATT-HOUR
⊕		☉	AMPLIFIER	ⒶV		KO	KNOCK-OUT	WP	WATER-PROOF
⊕		☉	TELEPHONE TERMINAL CABINET	ⒶV		kVA	KILOVOLT-AMPERES	WT	WATER-TIGHT
⊕		☉	AMPLIFIER	ⒶV		kW	KILOWATT	X	EXISTING TO BE REMOVED
⊕		☉	TELEPHONE TERMINAL CABINET	ⒶV		kWH	KILOWATT-HOURS	XFMR	TRANSFORMER
⊕		☉	AMPLIFIER	ⒶV		LA	LIGHTNING ARRESTOR	XP	EXPLOSION PROOF
⊕		☉	TELEPHONE TERMINAL CABINET	ⒶV				XR	EXISTING TO BE RELOCATED




GENERAL NOTES

- ALL WORK SHALL CONFORM TO LOCAL BUILDING CODE AND ORDINANCES.
- ELECTRICAL CONTRACTOR SHALL BE RESPONSIBLE FOR COORDINATING HIS PORTION OF WORK WITH OTHER PORTIONS OF THE WORK.
- ELECTRICAL CONTRACTOR SHALL BE RESPONSIBLE FOR CONSTRUCTION MEANS, METHODS, TECHNIQUES, AND SAFETY TO THE PUBLIC AND TO THE PROPERTY BOTH PRIVATE AND PUBLIC.
- ELECTRICAL CONTRACTOR SHALL VISIT THE SITE AND BECOME FAMILIAR WITH HIS PORTION OF WORK.
- TEMPORARY LIGHT AND POWER FOR THE PROJECT (INSTALLATION, EQUIPMENT, MATERIALS AND MAINTENANCE) SHALL BE INCLUDED AS PART OF THE ELECTRICAL WORK, IN A MANNER CONSISTENT WITH NORMAL PRACTICE.
- ELECTRICAL CONTRACTOR SHALL BALANCE LOADS AT PANELS AND MAIN SERVICES SO THAT LOADS ARE BALANCED AND NO OVERLOADING SUBFEEDS, BRANCH CIRCUITS, ETC.
- BRANCH CIRCUITING IS DIAGRAMATIC IN NATURE AND INDICATES WHICH DEVICES ARE TO BE ON SAME CIRCUIT OR CONTROLLED FROM SAME SWITCH.
- ELECTRICAL CONTRACTOR SHALL BE RESPONSIBLE TO COORDINATE ELECTRICAL WORK WITH GENERAL CONTRACTOR, HVAC CONTRACTOR AND PLUMBING CONTRACTOR.
- ELECTRICAL CONTRACTOR SHALL REVIEW ARCHITECTURAL, MECHANICAL AND PLUMBING DRAWINGS TO ASCERTAIN EXACT LOCATION OF ELECTRICAL EQUIPMENT & PROVIDE ELECTRICAL SERVICE TO EQUIPMENT WHETHER OR NOT INDICATED ON ELECTRICAL DRAWINGS.
- ELECTRICAL CONTRACTOR SHALL OBTAIN AND ACQUAINT HIMSELF WITH MECHANICAL AND PLUMBING DRAWINGS FOR EXACT EQUIPMENT LOCATION, QUANTITY, HORSEPOWER RATING AND VOLTAGE PRIOR TO BIDDING. ADDITIONAL COST TO CONTRACT WILL NOT BE ACCEPTED FOR FAILURE TO PERUSE ALL CONTRACT DOCUMENTS.
- EXCAVATION AND BACKFILL FOR INSTALLATION OF ELECTRICAL WORK SHALL BE PART OF THE ELECTRICAL WORK.
- ELECTRICAL CONTRACTOR SHALL PROVIDE FLOOR AND WALL FIRE STOPPING FOR ALL PIPE AND CONDUIT PENETRATIONS THROUGH FLOOR CONSTRUCTION (3 HOUR) AND ANY OTHER RATED WALLS SUCH AS ELEVATOR SHAFTS (2 HOUR) OR STAIRWELLS (1 HOUR). FIRE STOP SHALL BE 'SPEC SEAL' AS MANUFACTURED BY SPECIFIED TECH. INC. OR APPROVED EQUAL.
- ANY CUTTING, CHANNELING, SLEEVES, OPENINGS FOR ELECTRICAL INSTALLATION SHALL BE PART OF THE ELECTRICAL WORK. BEFORE ANY WORK IS STARTED, WRITTEN APPROVAL MUST BE OBTAINED FROM ARCHITECT AND ANY DAMAGE SHALL BE REPAIRED AT ELECTRICAL CONTRACTOR'S EXPENSE.
- ELECTRICAL CONTRACTOR SHALL BE RESPONSIBLE TO PROVIDE AND INSTALL SUPPORTS FOR CABLE, BOXES, CONDUITS, ETC.  
ALL SUPPORTS SHALL ONLY BE ANCHORED TO BUILDING STRUCTURE. CEILING SUPPORTS SHALL NOT BE USED TO SUPPORT CABLE, BOXES, CONDUITS, ETC.
- ALL SUSPENDED CEILING GRIDS, MECHANICAL SYSTEMS, AUTOMATIC SPRINKLER SYSTEMS, ELECTRICAL SYSTEM COMPONENTS, AND PLUMBING SYSTEMS SHALL BE SUPPORTED ONLY FROM THE TOP OF BAR JOIST AND/OR STRUCTURE ABOVE. SUPPORT FROM BOTTOM CHORDS OF BAR JOIST IS NOT PERMITTED.
- ALL LAY-IN CEILING FIXTURES SHALL BE SECURED TO CEILING GRID PER ARTICLE #410 (c) 2005 N.E.C.
- EMERGENCY LIGHTING AND EXIT SIGNS SHALL BE BATTERY BACK-UP TYPE. SAID EQUIPMENT SHALL BE SPACED AND LOCATED THROUGHOUT ALL OCCUPIED SPACES TO MEET APPLICABLE CODES AND ARE SUBJECT TO THE APPROVAL OF THE LOCAL FIRE MARSHAL.
- ELECTRICAL CONTRACTOR SHALL ROUTE CONDUIT SERVING ROOFTOP EQUIPMENT WITH MECHANICAL PIPING.
- CONTROLS & OPERATING DEVICES WILL BE MOUNTED NO HIGHER THAN 54" FOR SIDE REACH AND 48" FOR FORWARD REACH. OUTLETS, ETC., WILL BE MOUNTED NO LESS THAN 15" ABOVE THE FLOOR [IAC 400.310(r)].
- PROVIDE ONE (1) NEMA 5-20R-WP-GFI RECEPTACLE NEXT TO EACH NEW RTU ON THE ROOF. REFER TO THE DRAWINGS FOR EXACT LOCATIONS.
- ELECTRICAL CONTRACTOR SHALL BE RESPONSIBLE FOR THE COMPLETE REMOVAL OF ALL EXISTING ELECTRICAL FIXTURES, PANELS, AND DEVICES, ALONG WITH RELATED WIRING AND CONDUIT. ELECTRICAL CONTRACTOR SHALL VISIT THE SITE TO DETERMINE THE EXACT SCOPE OF ELECTRICAL DEMOLITION. ALL WALLS INDICATED FOR REMOVAL SHALL INCLUDE ALL ELECTRICAL DEVICES AND RELATED WIRING AND CONDUIT. ALL SALVAGE VALUE SHALL BE RETURNED TO OWNER. ELECTRICAL CONTRACTOR SHALL CORRDINATE ALL ELECTRICAL SHUTDOWN AND DEMOLITION OF ALL ELECTRICAL EQUIPMENT AND FIXTURES WITH THE PROJECT MANAGER AND WITH ARECHITECTURAL PLANS. THE ELECTRICAL CONTRACTOR SHALL BE RESPONSIBLE FOR DISCONNECTING ALL EQUIPMENT TO BE REMOVED OR RELOCATED. COORDINATE DISCONNECTION WITH PROJECT MANAGER AND ARCHITECTURAL PLANS.
- VERIFY LOCATION AND REQUIREMENTS OF SIGNS PRIOR TO ROUGH-IN OF JUNCTION BOXES. SIGNS FURNISHED WITH DISCONNECT SWITCHES BY SIGN CONTRACTOR.
- IN ACCESSIBLE UNITS ALL ELECTRICAL DEVICES: SWITCHES, RECEPTACLES, PANELS, ETC.; MOUNTING HEIGHTS SHALL COMPLY WITH ADA AND VILLAGE OF BROOKFIELD REQUIREMENTS.
- IN GENERAL, CONDUIT SHALL BE CONCEALED, AND CONDUIT CAN BE EXPOSED IN UNFINISHED AREA OR WHERE OTHER MECHANICAL TRADES INSTALLED EXPOSED PIPING. EXPOSED CONDUIT SHALL BE RUN PARALLEL AND PERPENDICULAR TO BUILDING WALLS. VERIFY SURFACE RACEWAY AND EXPOSED CONDUIT INSTALLATIONS WITH ARCHITECT PRIOR TO INSTALLATION. CONDUIT INSTALLED IN FLOOR SLAB AND/OR IN GRADE SHALL BE GRH.
- TELEPHONE/DATA SYSTEM WORK SHALL BE PERFORMED BY ELECTRICAL CONTRACTOR.
- USE NO WIRE SMALLER THAN NO. 14 AWG COPPER, RATED AT 600 VOLTS, FOR POWER AND LIGHTING BRANCH CIRCUITS AND NO SMALLER THAN NO.14 AWG COPPER FOR CONTROL WIRING. BRANCH CIRCUIT CONDUCTORS FOR 20 AMPERE, 120 VOLT CIRCUITS SHALL BE NO. 12 AWG COPPER, WITH CONDUCTOR FROM PANELBOARD TO THE FIRST OUTLET AS FOLLOWS:  

0- 75 FEET	-----	#12 AWG (COPPER)
75-150 FEET	-----	#10 AWG (COPPER)
150-250 FEET	-----	#8 AWG (COPPER)
250-350 FEET	-----	#6 AWG (COPPER)


LIGHT FIXTURE SCHEDULE

TAG	MANUFACTURER DESCRIPTION	LAMP	VOLTS	WATTS	REMARKS
F1	HADCO #RX2120H5NAMNNAN OR EQUAL	LED	240	285	SINGLE FIXTURE MOUNTED TO ROUND POLE. SEE DRG E1.0
F2	HADCO RX2120H3NAMNNAN OR EQUAL	LED	240	285	SIMILAR TO F1
F3	HADCO RX2120H4NAMNNAN OR EQUAL	LED	240	285	NEW FIXTURE MOUNTED TO EXISTING POLE F&I MOUNTING HARDWARE
F4	HADCO RX2120H3NAMNNAN OR EQUAL	LED	240	285 EACH	SAME AS F1 EXCEPT 2 FIXTURE MOUNTED AT 180 DEG.
F5	NOT USED				
F6	ANP BLO201 OR EQUAL	LED	120V		42" BOLLARD LIGHT FIXTURE SEE DETAIL
F7	EMERGE WXGP OR EQUAL	LED	120V		GRADE MOUNTED WALL WASH FIXTURE
F8	HADCO RX2120H3NAMNNAN OR EQUAL	LED	240V	285	NEW FIXTURE MOUNTED TO EXISTING POLE. F&I MOUNTING HARDWARE
F9	NOT USED				
F10	NOT USED				
F11		LED	120V		EXTERIOR KIOSK MOUNTED LED FIXTURE FOR PRICING SIGN LIGHTING FURNISHED INSTALLED & WIRED BY EC

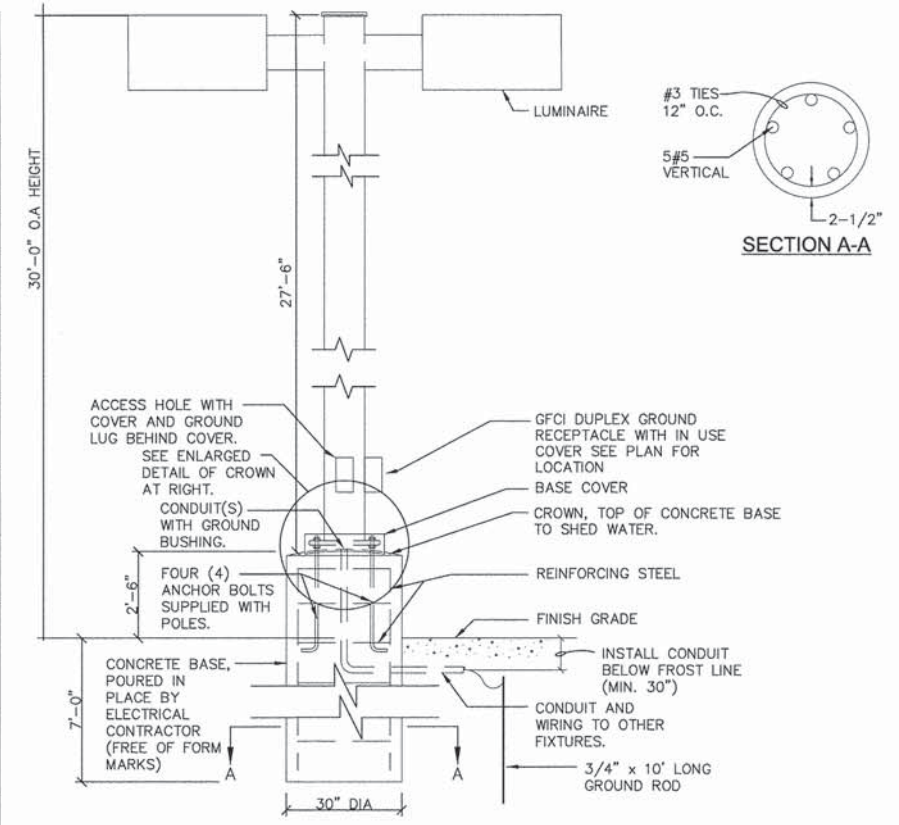

LIGHT POLE & CONCRETE BASE DETAIL

NOT TO SCALE  
TYPICAL FOR FIXTURES F1; CONCRETE BASE PAID FOR AS "CONCRETE FOUNDATION, SPECIAL"

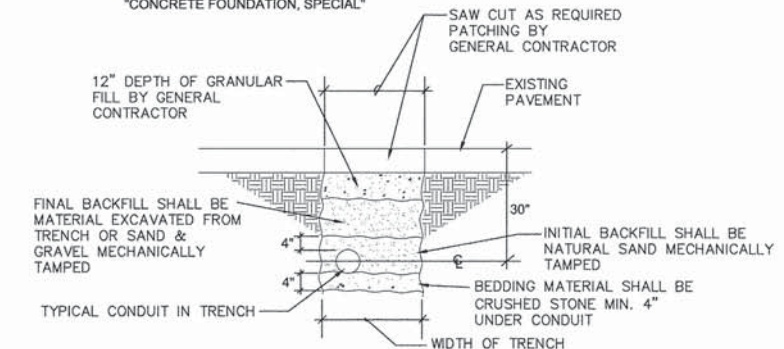


CONDUIT INSTALLATION DETAIL


CLOSED CIRCUIT CAMERA SYSTEM SCOPE

CLOSED CIRCUIT SECURITY CAMERA SYSTEM SCOPE EQUAL TO FOLLOWING & SHALL BE COMPATIBLE WITH THE MILESTONE ENTERPRISE VERSION 7.00 OR LATER.

- POLE MOUNTED CAMERAS SHALL BE WITH PAN TILE ZOOM DAY-NIGHT PTZ, DOME, NEMA 4X AT ENCLOSURE, 12X OPTICAL ZOOM POWER OVER ETHERNET CAPABILITY, MOUNTING BRACKET AXIS 5512-E PTZ DOME NETWORK CAMERA W/ POE 802, 3of CLASS 3 (CAMERAS POWERED FROM POLE MOUNTED CISCO 1552 WIRELESS ACCESS POINT)
- CEILING MOUNTED CAMERA IN KIOSK IS SIMILAR TO ITEM 1 EXCEPT NEMA 1 ENCLOSURE & 3X ZOOM & POWER OVER ETHERNET MIDSPAN, AXIS M5014 PTZ DOME NETWORK CAMERA.
- SYSTEM INSTALLED SHALL BE PERFORMED BY A QUALIFIED CLOSED CIRCUIT SECURITY CAMERA INSTALLER WITH MINIMUM 5 YEARS OF EXPERIENCE WITH POE. TECHNOLOGY. QUALIFIED INSTALLER SHALL BE RESPONSIBLE FOR A COMPLETE & OPERATING SYSTEM.

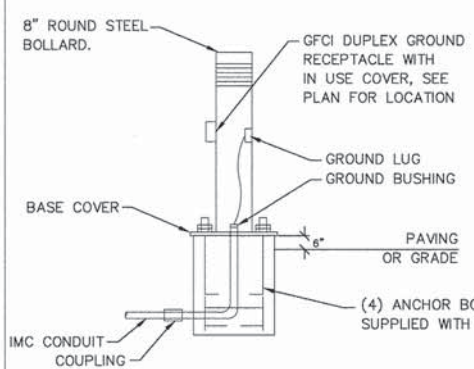

"F6" BOLLARD DETAIL

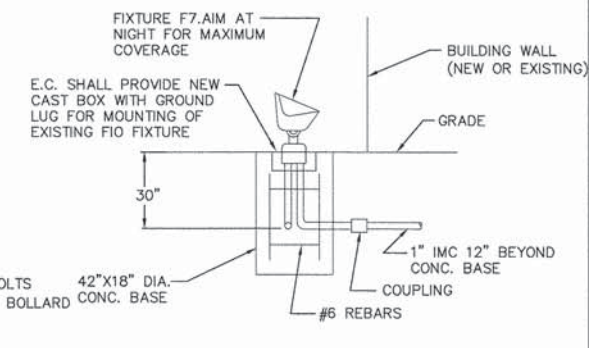

MOUNTING DETAIL OF F7 FIXTURE