

**INDEX OF SHEETS**

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**PROJECT LOCATED IN THE CITY OF CHICAGO**

DAN RYAN EXPRESSWAY:	ADT (2020)	DESIGN SPEED	POSTED SPEED
SB I-94 (DAN RYAN)	140,500	60 MPH	55 MPH
SB I-57	69,390	60 MPH	55 MPH
SB 95TH STREET EXIT RAMP	11,900	45 MPH	40 MPH
NB I-94 (DAN RYAN)	151,800	60 MPH	55 MPH
NB 95TH STREET ENTRANCE RAMP	10,500	45 MPH	40 MPH

**DESCRIPTION OF PROJECT**

LANDSCAPING AND IRRIGATION OF GATEWAYS AND CORNER GARDENS; CONSTRUCTION OF HMLT SERVICE PADS WITH MINI RETAINING WALLS LOCATED WITHIN THE PROJECT LIMITS.


**STATE OF ILLINOIS  
DEPARTMENT OF TRANSPORTATION  
DIVISION OF HIGHWAYS**

**PROPOSED HIGHWAY PLANS**


**F.A.I. ROUTE 94 (DAN RYAN EXPRESSWAY)  
SECTION 2005-068 LS  
GATEWAYS AND CORNER GARDENS  
NE, SE, NW & SW QUADRANTS AT 95TH STREET  
~~PROJECT.~~**

**COOK COUNTY  
C-91-104-06  
R. 14 E.**


F.A.I. RTE.	SECTION	COUNTY	TOTAL SHEETS	SHEET NO.
94	2005-068 LS	COOK	58	1
FED. ROAD DIST. NO.	ILLINOIS	FED. AID PROJECT		
D-91-104-06			<b>60A74</b>	

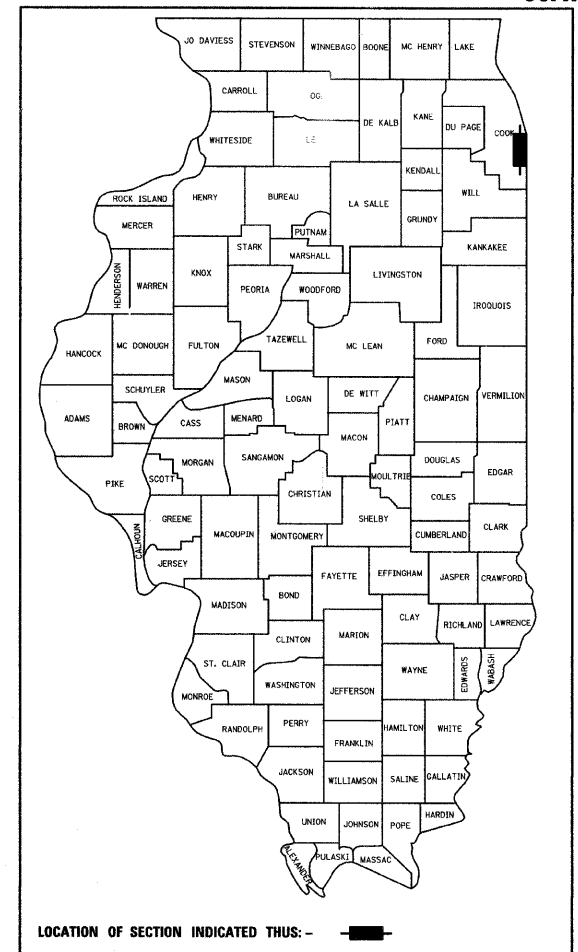

LOCATION OF SECTION INDICATED THUS: -

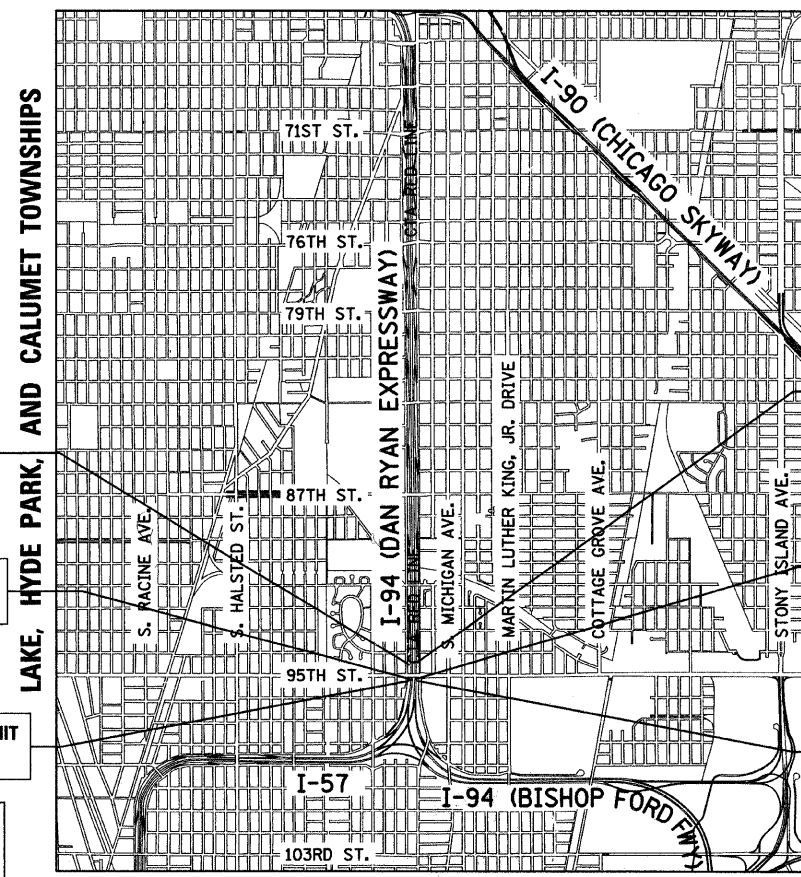

LAKE, HYDE PARK, AND CALUMET TOWNSHIPS

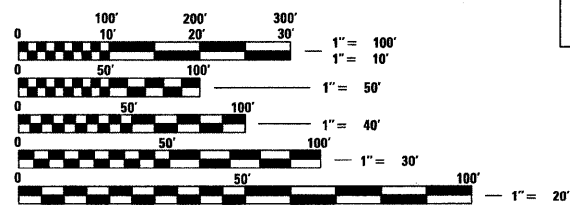

F.A.I. 94 (RYAN) PROJECT LIMIT  
STA. 1214 + 94.62 (SB I-94)

STA. 155 + 73.51 (SB I-57) =  
STA. 1205 + 00.00 (SB I-94)

F.A.I. 94 (RYAN) PROJECT LIMIT  
STA. 153 + 08.86 (SB I-57)

F.A.I. 94 (RYAN) PROJECT LIMIT  
STA. 2212 + 99.23 (NB I-94)

T. 38 N.  
T. 37 N.

STA. 258 + 32.25 (NB I-57) =  
STA. 2203 + 00.00 (NB I-94)

F.A.I. 94 (RYAN) PROJECT LIMIT  
STA. 257 + 75.55 (NB I-57)

FULL SIZE PLANS HAVE BEEN PREPARED USING STANDARD ENGINEERING SCALES; REDUCED SIZED PLANS WILL NOT CONFORM TO STANDARD SCALES. IN MAKING MEASUREMENTS ON REDUCED PLANS, THE ABOVE SCALES MAY BE USED

DIGGER:  
CHICAGO UTILITY ALERT NETWORK  
(312) 744-7000

CTA CONTACT:  
DAVID HEARD  
MANAGER, CONSTRUCTION MANAGEMENT OVERSIGHT  
(312) 681-3862

**LOCATION MAP**

0 1/2 MILE 1 MILE  
GROSS LENGTH OF PROJECT = 2,315.20 FT. = 0.44 MI.  
MAP SCALE: 1" = 1/2 MILE  
NET LENGTH OF PROJECT = 2,315.20 FT. = 0.44 MI.

STATE OF ILLINOIS  
DEPARTMENT OF TRANSPORTATION  
DIVISION OF HIGHWAYS

SUBMITTED JUNE 18, 2008

Diana M. O'Keefe  
DEPUTY DIRECTOR OF HIGHWAYS, REGION ENGINEER

August 15, 2008  
Eric E. Harrel  
SENIOR ENGINEER OF DESIGN AND ENVIRONMENT

August 15, 2008  
Christine M. Reed  
DIRECTOR OF HIGHWAYS, CHIEF ENGINEER

**CONTRACT 22C**



Signed Dean A. Kiesling  
Date JUNE 19, 2008



Signed Ernest C. Wong  
Date JUNE 13, 2008  
For Landscape Drawings 6, 7, 22-27, 34-36, 42

**TYLIN INTERNATIONAL**  
PRINTED BY THE AUTHORITY OF THE STATE OF ILLINOIS

DISTRICT ONE DESIGN / PROJECT MANAGER:  
BRIAN KUTTAB (847) 705 - 4431

**CONTRACT NO. 60A74**

F.A.I. RTE.	SECTION	COUNTY	TOTAL SHEETS	SHEET NO.
94	2005-068 LS	COOK	58	2
STA. 124+00 (SB 1-94) TO STA. 1214+95 (SB 1-94)				
STA. 287+76 (NB 1-94) TO STA. 2213+00 (NB 1-94)				
FED. ROAD DIST. NO.		ILLINOIS	FED. AID PROJECT	

60A74

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280001-04	TEMPORARY EROSION CONTROL SYSTEM
606001-03	CONCRETE CURB AND COMBINATION CONCRETE CURB AND GUTTER
701601-05	URBAN LANE CLOSURE, MULTILANE 1W OR 2W WITH NONTRAVERSABLE MEDIAN
701701-05	URBAN LANE CLOSURE MULTILANE INTERSECTION
701801-03	LANE CLOSURE MULTILANE 1W OR 2W CROSSWALK OR SIDEWALK CLOSURE
701901	TRAFFIC CONTROL DEVICES

GENERAL NOTES:

- THE CONTRACTOR SHALL NOT SET UP A YARD/FIELD OFFICE OR STOCKPILE MATERIALS ON IDOT OR CITY OF CHICAGO PROPERTY WITHOUT WRITTEN PERMISSION FROM IDOT OR CDOT.
- THE CONTRACTOR SHALL TAKE ALL NECESSARY SAFETY PRECAUTIONS TO PROTECT AND PROVIDE ACCESS TO ADJUTING PROPERTY, UTILITIES, PEDESTRIANS, AND VEHICULAR TRAFFIC.
- NIGHT OPERATIONS SHALL NOT BE ALLOWED.
- ALL ELEVATIONS SHOWN ARE BASED ON THE CHICAGO CITY DATUM OF 0.00, WHICH IS 579.19 FEET ABOVE MEAN TIDE NEW YORK. (NAVD 88)
- ANY DAMAGE DONE TO EXISTING ITEMS BY THE CONTRACTOR SHALL BE REPAIRED BY THE CONTRACTOR AT THE CONTRACTOR'S OWN EXPENSE AND TO THE SATISFACTION OF THE ENGINEER.
- THE CONTRACTOR SHALL PROVIDE ALL NECESSARY TRAFFIC CONTROL DEVICES NEEDED TO COMPLETE THE WORK. THIS WORK SHALL BE INCLUDED IN THE COST OF TRAFFIC CONTROL AND PROTECTION (SPECIAL).
- THE CONTRACTOR SHALL NOT MAINTAIN A PERMANENT PARTIAL RAMP OR SHOULDER CLOSURE ALONG THE MAINLINE I-94 (DAN RYAN) FOR THE DURATION OF THIS PROJECT. ONLY TEMPORARY PARTIAL RAMP OR SHOULDER CLOSURES SHALL BE PERMITTED.
- PLANS FOR THE WATER SERVICE CONNECTIONS FOR IRRIGATION SYSTEMS SHALL BE SUBMITTED FOR REVIEW AND APPROVAL TO:  
  
MR. JOHN FLYNN  
DEPARTMENT OF CONSTRUCTION AND PERMITS  
ROOM 906, CITY HALL  
121 NORTH LASALLE STREET  
CHICAGO, ILLINOIS 60602
- THE CONTRACTOR SHALL OBTAIN ALL NECESSARY PERMITS FROM THE CITY OF CHICAGO AND THE STATE OF ILLINOIS PRIOR TO COMMENCING CONSTRUCTION. THE COSTS SHALL BE INCLUDED IN THE CONTRACT. THE COST SHALL BE INCLUDED IN THE COST OF MOBILIZATION.
- PAYMENTS FOR ADJUSTMENTS TO WATER VALVE VAULTS SHALL NOT BE MADE TO THE CONTRACTOR UNTIL THIS WORK HAS BEEN INSPECTED AND APPROVED BY THE CITY OF CHICAGO DEPARTMENT OF WATER MANAGEMENT.
- PERMITS FROM THE DEPARTMENT OF WATER MANAGEMENT ARE REQUIRED FOR ALL WORK INVOLVING ADJUSTMENT OF STRUCTURES. THE DEPARTMENT OF WATER MANAGEMENT'S PERMIT SHALL BE OBTAINED BY A LICENSED SEWER DRAIN LAYER PRIOR TO START OF CONSTRUCTION. THE LICENSED SEWER CONTRACTOR/SUBCONTRACTOR SHALL SUBMIT TWO SETS OF PLANS APPROVED BY THE DEPARTMENT OF WATER MANAGEMENT FOR THE ISSUANCE OF THE SEWER PERMIT TO: BUREAU OF ENGINEERING SERVICES-SEWER SECTION, JARDINE PURIFICATION PLANT, EL+51, ROOM 313, 1000 E. OHIO ST., CHICAGO, IL 60611. INSPECTION WILL BE PROVIDED BY THE DEPARTMENT OF WATER MANAGEMENT.
- CITY OF CHICAGO WATER VALVE VAULTS AND SEWER STRUCTURES SHALL NOT BE CLOSED, COVERED, OR OTHERWISE OBSTRUCTED DURING CONSTRUCTION WITHOUT WRITTEN PERMISSION FROM THE CITY OF CHICAGO DEPARTMENT OF WATER MANAGEMENT.
- THE RESIDENT ENGINEER AND THE CONTRACTOR SHALL FIELD VERIFY THE CITY'S EXISTING SEWER FACILITIES IN THE LIMITS OF THE REFERENCED PROJECT FOR ANY CONFLICTS DUE TO THE PROPOSED IMPROVEMENT. ANY CONFLICT SHALL BE RESOLVED WITH THE DEPARTMENT OF WATER MANAGEMENT PRIOR TO START OF CONSTRUCTION.
- THE LOCATION OF THE ELECTRICAL EQUIPMENT AND CONDUIT, INSTALLED BY CONTRACT 62583, SHOWN IN THE PLANS IS APPROXIMATE. THE RESIDENT ENGINEER AND THE CONTRACTOR SHALL FIELD VERIFY THE EXACT LOCATION OF ALL ELECTRICAL ITEMS WITHIN THE PROJECT LIMITS WITH THE IDOT ELECTRICAL REPRESENTATIVE PRIOR TO THE START OF CONSTRUCTION. THE COST SHALL BE INCLUDED IN THE COST OF MOBILIZATION.
- IT IS CALLED TO THE CONTRACTOR'S ATTENTION THAT HE/SHE WILL BE REQUIRED TO PAY FOR ANY INSPECTION OR PERMIT FEES TO THE VARIOUS DEPARTMENTS OF THE CITY OF CHICAGO. THE COST FOR THESE FEES WILL NOT BE PAID FOR SEPARATELY BUT SHALL BE CONSIDERED INCLUDED IN THE COST OF MOBILIZATION. PERMIT FEES MUST BE PAID PRIOR TO COMMENCING CONSTRUCTION.
- A "BOXED" NOTE INDICATES AN ITEM OF WORK THAT IS NOT PAID FOR SEPARATELY, BUT IS PAID FOR AS PART OF ANOTHER ITEM LISTED IN THE SUMMARY OF QUANTITIES.
- THE CONTRACTOR SHALL SHOW PROOF OF PROCUREMENT, SOURCES, QUANTITIES AND VARIETIES FOR ALL SHRUBS, TREES, GROUND COVERS, PERENNIALS AND ORNAMENTAL GRASSES WITHIN 21 DAYS FOLLOWING THE AWARD OF CONTRACT. TIMELY PROCUREMENT OF ALL PLANT MATERIAL IS ESSENTIAL TO THE SUCCESSFUL COMPLETION AND SUBSTANTIAL COMPLETION ACCEPTANCE OF THE OVERALL PROJECT. THE COST SHALL BE INCLUDED IN THE COST OF THE INDIVIDUAL PLANT ITEMS.
- THE ENGINEER SHALL BE ALLOWED ACCESS TO THE FIELD OFFICE IN USE FOR CONTRACT 60A76 (22E).

SPECIAL COMMITMENTS:

- THE CONTRACTOR AND THE ENGINEER SHALL SUBMIT THE IRRIGATION SHOP DRAWINGS FOR REVIEW AND APPROVAL BY THE CITY OF CHICAGO - STREETSCAPE UNIT, 4 WEEKS IN ADVANCE, PRIOR TO THE START OF THE IRRIGATION WORK.
- THE CITY OF CHICAGO - STREETSCAPE UNIT REPRESENTATIVES SHALL BE INVITED TO PARTICIPATE IN THE CONSTRUCTION PROGRESS MEETINGS. THE MEETING'S SCHEDULE SHALL BE PROVIDED TO THE CITY OF CHICAGO IN ADVANCE.
- THE CITY OF CHICAGO - STREETSCAPE UNIT REPRESENTATIVES SHALL BE AFFORDED THE OPPORTUNITY TO OBSERVE ALL LANDSCAPING AND IRRIGATION WORK IN COORDINATION WITH AND CONCURRENCE OF THE ENGINEER.
- THE CONTRACTOR AND THE ENGINEER, IN COORDINATION WITH ILLINOIS DEPARTMENT OF TRANSPORTATION'S LANDSCAPING REPRESENTATIVE, SHALL PROVIDE A WRITTEN DESCRIPTION OF THE TURN OVER PROCEDURE OF THE IRRIGATION WORK AT THE END OF THE PROJECT TO THE CITY OF CHICAGO - STREETSCAPE UNIT.
- THE CITY OF CHICAGO - STREETSCAPE UNIT SHALL BE INVITED BY THE CONTRACTOR AND THE ENGINEER TO ATTEND AND PARTICIPATE IN THE FINAL PROJECT INSPECTION.

TYLIN INTERNATIONAL

REVISIONS	
NAME	DATE

ILLINOIS DEPARTMENT OF TRANSPORTATION  
F.A.I. 94 (DAN RYAN EXPRESSWAY)  
INDEX OF SHEETS, STATE STANDARDS,  
GENERAL NOTES, AND SPECIAL COMMITMENTS

SCALE: NONE  
DATE: JUNE 20, 2008  
DRAWN BY: JDF  
CHECKED BY: JPM

6/23/2008 12:00:05 PM

**CALENDAR OF CONSTRUCTION WORK**


PHASE	YEAR	WORK DATES		CONSTRUCTION WORK
		FROM	TO	
PHASE I	2009	MARCH 1	JUNE 1	CONSTRUCTION OF CORNER GARDENS AT THE NW AND SW QUADRANTS. EXCAVATION AND PLACEMENT OF POROUS GRANULAR MATERIAL, PLANTING MIX, GEOTECHNICAL FABRIC, AND MULCH (ALL CORNER GARDENS). INSTALLATION OF WATER SERVICE AND IRRIGATION SYSTEMS FOR ALL GATEWAYS AND CORNER GARDENS.
		MARCH 1	JUNE 1	INSTALLATION OF ALL WOODY PLANTS. WOODY PLANTS MUST BE CONTAINER OR DUG WHILE DORMANT AND MAINTAINED PROPERLY UNTIL PLANTED. ALL WOODY PLANTS MUST BE INSTALLED PRIOR TO PERENNIALS.
		MARCH 1	JUNE 1	INSTALL PERENNIAL PLANTS AFTER ALL WOODY PLANTS HAVE BEEN INSTALLED.
		JUNE 1		INTERIM COMPLETION DATE
PHASE I	2009	JUNE 1		CERTIFICATION TO THE BUREAU OF MAINTENANCE THAT ALL PLANTS HAVE BEEN INSTALLED AND ARE IN A LIVE HEALTHY CONDITION AND ELIGIBLE FOR A SEPTEMBER PERIOD OF ESTABLISHMENT INSPECTION.
PHASE	YEAR	WORK DATES		CONSTRUCTION WORK
		FROM	TO	
PHASE II	2009	JUNE 1, 2009	MAY 1, 2010	PROVIDE PLANT CARE REQUIRED FOR ALL PLANTS (WEEDING, WATERING, OR OTHER WORK WHICH IS NECESSARY TO MAINTAIN HEALTH AND SATISFACTORY APPEARANCE OF THE GATEWAY AND CORNER GARDENS) DURING THE PERIOD OF ESTABLISHMENT AND ACCORDING TO THE LANDSCAPE MAINTENANCE SPECIAL PROVISION.
		SEPT. 1	SEPT. 30	PERIOD OF ESTABLISHMENT INSPECTION.
		OCT. 1	OCT. 31	INSTALL BULBS.
		OCT. 1	OCT. 31	FALL SHUT DOWN.
		APRIL 1	MAY 1	SPRING START UP.
PHASE II	2010	MAY 1		COMPLETION DATE
	2010	MAY 17		FINAL INSPECTION DATE

**CONTRACTOR ACCESS ASSUMPTIONS**

FOR THE SE AND SW QUADRANTS ACCESS IS ASSUMED TO BE FROM THE FRONTAGE ROAD. ACCESS FROM THE EXPRESSWAY IS BLOCKED BY EXISTING BARRIER WALLS. THE EXISTING FENCE IS SHOWN TO BE REMOVED AND RE-ERECTED. THE CONTRACTOR SHALL MAINTAIN ACCESS CONTROL BY INSTALLING TEMPORARY CHAIN LINK FENCE (PORTABLE) WHILE EXISTING FENCE IS REMOVED. TEMPORARY FENCE (PORTABLE) IS INCLUDED IN THE COST OF TRAFFIC CONTROL AND PROTECTION (SPECIAL).

FOR THE NE AND NW QUADRANTS ACCESS IS ASSUMED TO BE FROM THE THE EXPRESSWAY. ACCESS FROM THE FRONTAGE ROAD IS BLOCKED BY EXISTING RETAINING WALLS. TEMPORARY EXPRESSWAY SHOULDER CLOSURES SHALL BE PERMITTED.

**QUADRANT NOMENCLATURE**

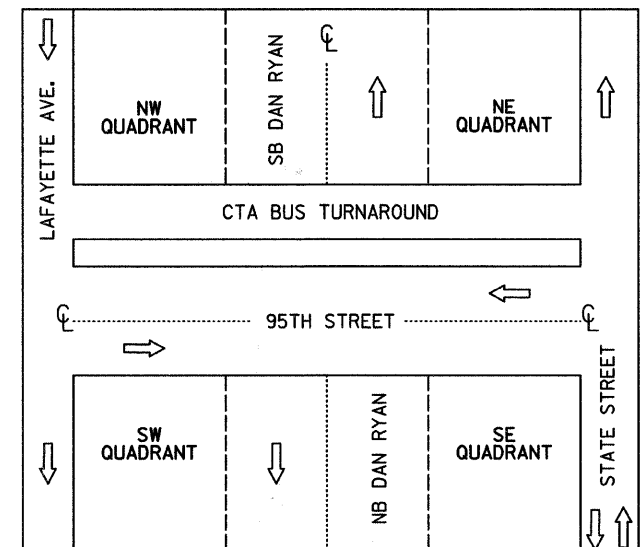

**IDOT HOT-MIX ASPHALT MIXTURE REQUIREMENTS**

ITEM	AC TYPE	AIR VOIDS
PAVEMENT REMOVAL AND REPLACEMENT		
HOT-MIX ASPHALT SURFACE COURSE, MIX "D", N70 1 1/2"	PG 64-22	4%@70Gyr
LEVELING BINDER (MACHINE METHOD), N70, 1 1/2"	PG 64-22/58-22	4%@70Gyr

THE UNIT WEIGHT USED TO CALCULATE ALL HMA SURFACE MIXTURE QUANTITIES IS 112/SQ YD/IN. USE 135 LB/SQ YD/IN. IF USING A SMA MIX.

WHEN RAP EXCEEDS 20%, THE NEW ASPHALT BINDER IN THE MIX SHALL BE PG 58-22.

REVISIONS	
NAME	DATE

ILLINOIS DEPARTMENT OF TRANSPORTATION  
 F.A.I. 94 (DAN RYAN EXPRESSWAY)  
 CALENDAR OF CONSTRUCTION, QUADRANT  
 NOMENCLATURE, HOT-MIX ASPHALT MIXTURE  
 REQUIREMENTS, AND ACCESS SUMMARY

SCALE: NONE DRAWN BY: JDF  
 DATE: JUNE 20, 2008 CHECKED BY: JPM

12/08/08 12:00:00 PM

PROJECT: GATEWAYS AND CORNER GARDENS AT 95TH STREET  
 COOK COUNTY / CITY OF CHICAGO

F.A.I. RTE.	SECTION	COUNTY	TOTAL SHEETS	SHEET NO.
94	2005-068 LS	COOK	58	4
STA. 153+09 (SB 1-57) TO STA. 221+95 (SB 1-94)				
STA. 257+76 (NB 1-57) TO STA. 2213+00 (NB 1-94)				
FED. ROAD DIST. NO.	ILLINOIS	FED. AID PROJECT		

60A74

SUMMARY OF QUANTITIES

CODE NUMBER	ITEM DESCRIPTION	UNIT	URBAN TOTAL	100% STATE		100% CITY OF CHICAGO
				DAN RYAN Y003	DAN RYAN Y007	DAN RYAN Y003
20200100	EARTH EXCAVATION	CU YD	295	295		
21101645	TOPSOIL FURNISH AND PLACE, 12"	SQ YD	472	472		
21101825	COMPOST FURNISH AND PLACE, 6"	SQ YD	472	472		
25000210	SEEDING, CLASS 2A	ACRE	0.75	0.75		
25000400	NITROGEN FERTILIZER NUTRIENT	POUND	112	112		
25000500	PHOSPHORUS FERTILIZER NUTRIENT	POUND	87	87		
25000600	POTASSIUM FERTILIZER NUTRIENT	POUND	74	74		
25100630	EROSION CONTROL BLANKET	SQ YD	2581	2581		
25200110	SODDING, SALT TOLERANT	SQ YD	12			12
28000250	TEMPORARY EROSION CONTROL SEEDING	POUND	54	54		
28000510	INLET FILTERS	EACH	30	30		
• 42001300	PROTECTIVE COAT	SQ YD	338			338
• 42400200	PORTLAND CEMENT CONCRETE SIDEWALK 5 INCH	SQ FT	90			90
• 44000500	COMBINATION CURB AND GUTTER REMOVAL	FOOT	20			20
• 44000600	SIDEWALK REMOVAL	SQ FT	49			49
• 44004250	PAVED SHOULDER REMOVAL	SQ YD	5			5
• 56104600	WATER VALVES 2"	EACH	3			3
• 60600605	CONCRETE CURB, TYPE B	FOOT	222.0	222.0		
• 66410400	CHAIN LINK FENCE TO BE REMOVED AND RE-ERECTED	FOOT	130	130		
67100100	MOBILIZATION	L SUM	1	1		
• 70101800	TRAFFIC CONTROL AND PROTECTION, (SPECIAL)	L SUM	1	1		
▲ 78000200	THERMOPLASTIC PAVEMENT MARKING - LINE 4"	FOOT	42			42
▲ 78000400	THERMOPLASTIC PAVEMENT MARKING - LINE 6"	FOOT	6			6
C2001061	SHRUB, CARYOPTERIS CLANDONENSIS 'LONGWOOD BLUE BLUEBEARD', 1-GALLON	EACH	630	630		
A2007254	TREE, ROBINIA PSEUDOACACIA CHICAGO BLUES (CHICAGO BLUES BLACK LOCUST), 4" CALIPER, BALLED AND BURLAPPED, MATCHING HEADS	EACH	25	25		
B2006385	TREE, SYRINGA VULGARIS PRESIDENT LINCOLN (PRESIDENT LINCOLN LILAC), 5' HEIGHT, BALLED AND BURLAPPED	EACH	21	21		
K0030470	PERENNIAL PLANT, ORNAMENTAL GRASS TYPE	UNIT	43	43		
K1003460	LANDSCAPE MAINTENANCE	CAL MO	11	11		
X0301407	PERENNIAL PLANTS, GALLON POT	UNIT	58	58		

▲ SPECIALTY ITEMS

\* - SPECIAL PROVISIONS

TYLIN INTERNATIONAL

REVISIONS	
NAME	DATE

ILLINOIS DEPARTMENT OF TRANSPORTATION  
 F.A.I. 94 (DAN RYAN EXPRESSWAY)  
 SUMMARY OF QUANTITIES  
 SHEET 1 OF 2

SCALE: NONE  
 DATE: JUNE 20, 2008  
 DRAWN BY: JDF  
 CHECKED BY: RTM

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PROJECT: GATEWAYS AND CORNER GARDENS AT 95TH STREET  
 COOK COUNTY / CITY OF CHICAGO

F.A.I. RTE.	SECTION	COUNTY	TOTAL SHEETS	SHEET NO.
94	2005-068 LS	COOK	58	5
STA. 153+09 (SB 1-57) TO STA. 1214+95 (SB 1-94)		2213+00 (NB 1-94)		
FED. ROAD DIST. NO.	ILLINOIS	FED. AID PROJECT		

60A74

SUMMARY OF QUANTITIES

CODE NUMBER	ITEM DESCRIPTION	UNIT	URBAN TOTAL	100% STATE		100% CITY OF CHICAGO
				DAN RYAN Y003	DAN RYAN Y007	DAN RYAN Y003
X0322256	TEMPORARY INFORMATION SIGNING	SQ FT	52	52		
X0322434	LIGHT TOWER SERVICE PAD, SPECIAL	EACH	2		2	
X0323973	SEDIMENT CONTROL, SILT FENCE	FOOT	892	892		
X0324525	PLANTING MIX FURNISH AND PLACE 36"	SQ YD	183	183		
X0325102	INSPECTION PIPE 4 INCH	EACH	2			2
X0325103	WATER METER IN VAULT, 2 INCH	EACH	3			3
X0325104	WATER TAP, 2 INCH	EACH	3			3
X0325105	IRRIGATION SYSTEM	SQ YD	1415			1415
X0325106	IRRIGATION SYSTEMS FALL SHUTDOWN	EACH	3			3
X0325107	IRRIGATION SYSTEMS SPRING STARTUP	EACH	3			3
X0325108	BACKFLOW PREVENTER (RPZ), 2 INCH	EACH	3			3
X0325109	POROUS GRANULAR MATERIAL	CU YD	62	62		
X0325132	SHAPING AND GRADING AT HIGH MAST LIGHT TOWER	SQ YD	45		45	
X0325604	WEED CONTROL, PRE-EMERGENT HERBICIDE	GALLON	1	1		
X0325970	SOIL CONDITIONER 3"	SQYD	3361	3361		
X0656300	PAVEMENT REMOVAL AND REPLACEMENT	SQ YD	39			39
X6065740	CONCRETE MEDIAN SURFACE, 5" (MODIFIED)	SQ FT	2647	2647		
XX104800	COMBINATION CONCRETE CURB AND GUTTER, TYPE B-V.12	FOOT	20.0			20.0
Z0013798	CONSTRUCTION LAYOUT	L SUM	1	1		
Z0027800	GEOTECHNICAL FABRIC	SQ YD	309	309		

TYLIN INTERNATIONAL

\* - SPECIAL PROVISIONS

REVISIONS	
NAME	DATE

ILLINOIS DEPARTMENT OF TRANSPORTATION  
 F.A.I. 94 (DAN RYAN EXPRESSWAY)  
 SUMMARY OF QUANTITIES  
 SHEET 2 OF 2  
 SCALE: NONE  
 DATE: JUNE 20, 2008  
 DRAWN BY: JDF  
 CHECKED BY: RTM

**SCHEDULE OF LANDSCAPE ITEMS - 95TH STREET GATEWAY - NORTHEAST**

Code	Item	Common Name	Size	Root	Remarks	Unit	Total	
<b>SHADE TREES</b>								
RO	Robinia pseudoacacia 'Chicago Blues'	Chicago Blues Black Locust	3" caliper	B&B	matching heads, 20' o.c.	each	3	
<b>INTERMEDIATE TREES</b>								
SV	Syringa vulgaris 'President Lincoln'	President Lincoln Lilac	5' height	B&B	12' o.c.	each	4	
<b>SHRUBS</b>								
CY	Caryopteris clandonensis 'Longwood Blue'	Longwood Blue Bluebeard	1 gallon	pot	18" o.c.	each	185	
<b>PERENNIAL PLANTS, GALLON POT</b>								
AC	Allium christophii	Christopher Ornamental Onion	1 gallon	pot	15" o.c.	UNIT	1.47	
AZ	Aster azureus	Sky Blue Aster	1 gallon	pot	18" o.c.	UNIT	1.06	
BS	Baptisia sphaerocarpa	Yellow Baptisia	1 gallon	pot	18" o.c.	UNIT	1.06	
NE	Nepeta x faassenii	Faassen's Catmint	1 gallon	pot	18" o.c.	UNIT	1.13	
NF	Nepeta x faassenii 'Walker's Low'	Walker's Low Faassen's Catmint	1 gallon	pot	18" o.c.	UNIT	1.13	
PE	Perovskia atriplicifolia	Russian Sage	1 gallon	pot	18" o.c.	UNIT	1.13	
RP	Ratibida pinnata	Prairie Coneflower	1 gallon	pot	18" o.c.	UNIT	1.13	
SB	Salvia nemorosa 'Blue Hill'	Blue Hill Salvia	1 gallon	pot	15" o.c.	UNIT	1.47	
							Total units:	9.58
<b>PERENNIAL PLANTS, ORNAMENTAL GRASS TYPE</b>								
BC	Bouteloua curtipendula	Side Oats Grama	1 gallon	pot	15" o.c.	UNIT	1.47	
MG	Miscanthus sinensis 'Graziella'	Maiden Eulalia Grass	1 gallon	pot	15" o.c.	UNIT	0	
MP	Miscanthus sinensis 'Purpurescens'	Purple Maiden Grass	1 gallon	pot	18" o.c.	UNIT	0	
PN	Panicum virgatum 'Northwind'	Northwind Switch Grass	1 gallon	pot	15" o.c.	UNIT	0	
PR	Panicum virgatum 'Rotstrahlbusch'	Rotstrahlbusch Switch Grass	1 gallon	pot	18" o.c.	UNIT	2.21	
PS	Panicum virgatum 'Shenandoah'	Shenandoah Switch Grass	1 gallon	pot	18" o.c.	UNIT	2.79	
SH	Sporobolus heterolepis	Prairie Dropseed	1 gallon	pot	18" o.c.	UNIT	0	
							Total units:	6.47

**SCHEDULE OF LANDSCAPE ITEMS - 95TH STREET GATEWAY - SUMMARY**

Code	Item	Common Name	Size	Root	Remarks	Unit	Total	
<b>SHADE TREES</b>								
RO	Robinia pseudoacacia 'Chicago Blues'	Chicago Blues Black Locust	3" caliper	B&B	matching heads, 20' o.c.	each	25	
<b>INTERMEDIATE TREES</b>								
SV	Syringa vulgaris 'President Lincoln'	President Lincoln Lilac	5' height	B&B	12' o.c.	each	21	
<b>SHRUBS</b>								
CY	Caryopteris clandonensis 'Longwood Blue'	Longwood Blue Bluebeard	1 gallon	pot	18" o.c.	each	630	
<b>PERENNIAL PLANTS, GALLON POT</b>								
AC	Allium christophii	Christopher Ornamental Onion	1 gallon	pot	15" o.c.	UNIT	7.23	
AZ	Aster azureus	Sky Blue Aster	1 gallon	pot	18" o.c.	UNIT	8.48	
BS	Baptisia sphaerocarpa	Yellow Baptisia	1 gallon	pot	18" o.c.	UNIT	6.13	
NE	Nepeta x faassenii	Faassen's Catmint	1 gallon	pot	18" o.c.	UNIT	6.2	
NF	Nepeta x faassenii 'Walker's Low'	Walker's Low Faassen's Catmint	1 gallon	pot	18" o.c.	UNIT	8.22	
PE	Perovskia atriplicifolia	Russian Sage	1 gallon	pot	18" o.c.	UNIT	8.15	
RP	Ratibida pinnata	Prairie Coneflower	1 gallon	pot	18" o.c.	UNIT	5.8	
SB	Salvia nemorosa 'Blue Hill'	Blue Hill Salvia	1 gallon	pot	15" o.c.	UNIT	7.23	
							Total units:	57.44
<b>PERENNIAL PLANTS, ORNAMENTAL GRASS TYPE</b>								
BC	Bouteloua curtipendula	Side Oats Grama	1 gallon	pot	15" o.c.	UNIT	7.23	
MG	Miscanthus sinensis 'Graziella'	Maiden Eulalia Grass	1 gallon	pot	15" o.c.	UNIT	4.68	
MP	Miscanthus sinensis 'Purpurescens'	Purple Maiden Grass	1 gallon	pot	18" o.c.	UNIT	1.49	
PN	Panicum virgatum 'Northwind'	Northwind Switch Grass	1 gallon	pot	15" o.c.	UNIT	7.68	
PR	Panicum virgatum 'Rotstrahlbusch'	Rotstrahlbusch Switch Grass	1 gallon	pot	18" o.c.	UNIT	8.46	
PS	Panicum virgatum 'Shenandoah'	Shenandoah Switch Grass	1 gallon	pot	18" o.c.	UNIT	5.32	
SH	Sporobolus heterolepis	Prairie Dropseed	1 gallon	pot	18" o.c.	UNIT	7.65	
							Total units:	42.51

**SCHEDULE OF LANDSCAPE ITEMS - 95TH STREET GATEWAY - SOUTHEAST**

Code	Item	Common Name	Size	Root	Remarks	Unit	Total	
<b>SHADE TREES</b>								
RO	Robinia pseudoacacia 'Chicago Blues'	Chicago Blues Black Locust	3" caliper	B&B	matching heads, 20' o.c.	each	7	
<b>INTERMEDIATE TREES</b>								
SV	Syringa vulgaris 'President Lincoln'	President Lincoln Lilac	5' height	B&B	12' o.c.	each	5	
<b>SHRUBS</b>								
CY	Caryopteris clandonensis 'Longwood Blue'	Longwood Blue Bluebeard	1 gallon	pot	18" o.c.	each	100	
<b>PERENNIAL PLANTS, GALLON POT</b>								
AC	Allium christophii	Christopher Ornamental Onion	1 gallon	pot	15" o.c.	UNIT	1.74	
AZ	Aster azureus	Sky Blue Aster	1 gallon	pot	18" o.c.	UNIT	2.26	
BS	Baptisia sphaerocarpa	Yellow Baptisia	1 gallon	pot	18" o.c.	UNIT	2.26	
NE	Nepeta x faassenii	Faassen's Catmint	1 gallon	pot	18" o.c.	UNIT	2.26	
NF	Nepeta x faassenii 'Walker's Low'	Walker's Low Faassen's Catmint	1 gallon	pot	18" o.c.	UNIT	1.54	
PE	Perovskia atriplicifolia	Russian Sage	1 gallon	pot	18" o.c.	UNIT	1.54	
RP	Ratibida pinnata	Prairie Coneflower	1 gallon	pot	18" o.c.	UNIT	1.54	
SB	Salvia nemorosa 'Blue Hill'	Blue Hill Salvia	1 gallon	pot	15" o.c.	UNIT	1.74	
							Total units:	14.88
<b>PERENNIAL PLANTS, ORNAMENTAL GRASS TYPE</b>								
BC	Bouteloua curtipendula	Side Oats Grama	1 gallon	pot	15" o.c.	UNIT	1.74	
MG	Miscanthus sinensis 'Graziella'	Maiden Eulalia Grass	1 gallon	pot	15" o.c.	UNIT	1.68	
MP	Miscanthus sinensis 'Purpurescens'	Purple Maiden Grass	1 gallon	pot	18" o.c.	UNIT	0	
PN	Panicum virgatum 'Northwind'	Northwind Switch Grass	1 gallon	pot	15" o.c.	UNIT	0	
PR	Panicum virgatum 'Rotstrahlbusch'	Rotstrahlbusch Switch Grass	1 gallon	pot	18" o.c.	UNIT	3.23	
PS	Panicum virgatum 'Shenandoah'	Shenandoah Switch Grass	1 gallon	pot	18" o.c.	UNIT	2.53	
SH	Sporobolus heterolepis	Prairie Dropseed	1 gallon	pot	18" o.c.	UNIT	0	
							Total units:	9.18

SITE DESIGN GROUP

TYLIN INTERNATIONAL

REVISIONS	
NAME	DATE

ILLINOIS DEPARTMENT OF TRANSPORTATION  
F.A.I. 94 (DAN RYAN EXPRESSWAY)

SUMMARY PLANT SCHEDULE  
SE + NE QUADRANTS AT 95TH ST. - NB I-94

SCALE: NTS  
DATE: June 20, 2008  
DRAWN BY: EM  
CHECKED BY: JO

\$DATE\$ \$TIME\$

SCHEDULE OF LANDSCAPE ITEMS - 95TH STREET GATEWAY - NORTHWEST							
Code	Item	Common Name	Size	Root	Remarks	Unit	Total
<b>SHADE TREES</b>							
RO	Robinia pseudoacacia 'Chicago Blues'	Chicago Blues Black Locust	3" caliper	B&B	matching heads, 20' o.c.	each	5
<b>INTERMEDIATE TREES</b>							
SV	Syringa vulgaris 'President Lincoln'	President Lincoln Lilac	5' height	B&B	12' o.c.	each	5
<b>SHRUBS</b>							
CY	Caryopteris clandonensis 'Longwood Blue'	Longwood Blue Bluebeard	1 gallon	pot	18" o.c.	each	198
<b>PERENNIAL PLANTS, GALLON POT</b>							
AC	Allium christophii	Christopher Ornamental Onion	1 gallon	pot	15" o.c.	UNIT	1.88
AZ	Aster azureus	Sky Blue Aster	1 gallon	pot	18" o.c.	UNIT	1.43
BS	Baptisia sphaerocarpa	Yellow Baptisia	1 gallon	pot	18" o.c.	UNIT	1.43
NE	Nepeta x faassenii	Faassen's Catmint	1 gallon	pot	18" o.c.	UNIT	1.43
NF	Nepeta x faassenii 'Walker's Low'	Walker's Low Faassen's Catmint	1 gallon	pot	18" o.c.	UNIT	1.43
PE	Perovskia atriplicifolia	Russian Sage	1 gallon	pot	18" o.c.	UNIT	1.36
RP	Ratibida pinnata	Prairie Coneflower	1 gallon	pot	18" o.c.	UNIT	1.36
SB	Salvia nemorosa 'Blue Hill'	Blue Hill Salvia	1 gallon	pot	15" o.c.	UNIT	1.88
							Total units: 12.2
<b>PERENNIAL PLANTS, ORNAMENTAL GRASS TYPE</b>							
BC	Bouteloua curtipendula	Side Oats Grama	1 gallon	pot	15" o.c.	UNIT	1.88
MG	Miscanthus sinensis 'Graziella'	Maiden Eulalia Grass	1 gallon	pot	15" o.c.	UNIT	0.62
MP	Miscanthus sinensis 'Purpurescens'	Purple Maiden Grass	1 gallon	pot	18" o.c.	UNIT	0
PN	Panicum virgatum 'Northwind'	Northwind Switch Grass	1 gallon	pot	15" o.c.	UNIT	1.08
PR	Panicum virgatum 'Rotstrahlbusch'	Rotstrahlbusch Switch Grass	1 gallon	pot	18" o.c.	UNIT	1.4
PS	Panicum virgatum 'Shenandoah'	Shenandoah Switch Grass	1 gallon	pot	18" o.c.	UNIT	0
SH	Sporobolus heterolepis	Prairie Dropseed	1 gallon	pot	18" o.c.	UNIT	2.71
							Total units: 7.69

SCHEDULE OF LANDSCAPE ITEMS - 95TH STREET GATEWAY - SOUTHWEST							
Code	Item	Common Name	Size	Root	Remarks	Unit	Total
<b>SHADE TREES</b>							
RO	Robinia pseudoacacia 'Chicago Blues'	Chicago Blues Black Locust	3" caliper	B&B	matching heads, 20' o.c.	each	7
<b>INTERMEDIATE TREES</b>							
SV	Syringa vulgaris 'President Lincoln'	President Lincoln Lilac	5' height	B&B	12' o.c.	each	4
<b>SHRUBS</b>							
CY	Caryopteris clandonensis 'Longwood Blue'	Longwood Blue Bluebeard	1 gallon	pot	18" o.c.	each	81
<b>PERENNIAL PLANTS, GALLON POT</b>							
AC	Allium christophii	Christopher Ornamental Onion	1 gallon	pot	15" o.c.	UNIT	2.14
AZ	Aster azureus	Sky Blue Aster	1 gallon	pot	18" o.c.	UNIT	1.38
BS	Baptisia sphaerocarpa	Yellow Baptisia	1 gallon	pot	18" o.c.	UNIT	1.38
NE	Nepeta x faassenii	Faassen's Catmint	1 gallon	pot	18" o.c.	UNIT	1.38
NF	Nepeta x faassenii 'Walker's Low'	Walker's Low Faassen's Catmint	1 gallon	pot	18" o.c.	UNIT	1.77
PE	Perovskia atriplicifolia	Russian Sage	1 gallon	pot	18" o.c.	UNIT	1.77
RP	Ratibida pinnata	Prairie Coneflower	1 gallon	pot	18" o.c.	UNIT	1.77
SB	Salvia nemorosa 'Blue Hill'	Blue Hill Salvia	1 gallon	pot	15" o.c.	UNIT	2.14
							Total units: 13.73
<b>PERENNIAL PLANTS, ORNAMENTAL GRASS TYPE</b>							
BC	Bouteloua curtipendula	Side Oats Grama	1 gallon	pot	15" o.c.	UNIT	2.14
MG	Miscanthus sinensis 'Graziella'	Maiden Eulalia Grass	1 gallon	pot	15" o.c.	UNIT	2.38
MP	Miscanthus sinensis 'Purpurescens'	Purple Maiden Grass	1 gallon	pot	18" o.c.	UNIT	1.49
PN	Panicum virgatum 'Northwind'	Northwind Switch Grass	1 gallon	pot	15" o.c.	UNIT	6.6
PR	Panicum virgatum 'Rotstrahlbusch'	Rotstrahlbusch Switch Grass	1 gallon	pot	18" o.c.	UNIT	1.62
PS	Panicum virgatum 'Shenandoah'	Shenandoah Switch Grass	1 gallon	pot	18" o.c.	UNIT	0
SH	Sporobolus heterolepis	Prairie Dropseed	1 gallon	pot	18" o.c.	UNIT	4.94
							Total units: 19.17

SCHEDULE OF LANDSCAPE ITEMS - 95TH STREET GATEWAY - SOUTHWEST CORNER GARDEN							
Code	Item	Common Name	Size	Root	Remarks	Unit	Total
<b>SHADE TREES</b>							
RO	Robinia pseudoacacia 'Chicago Blues'	Chicago Blues Black Locust	3" caliper	B&B	matching heads, 20' o.c.	each	3
<b>INTERMEDIATE TREES</b>							
SV	Syringa vulgaris 'President Lincoln'	President Lincoln Lilac	5' height	B&B	12' o.c.	each	0
<b>SHRUBS</b>							
CY	Caryopteris clandonensis 'Longwood Blue'	Longwood Blue Bluebeard	1 gallon	pot	18" o.c.	each	29
<b>PERENNIAL PLANTS, GALLON POT</b>							
AC	Allium christophii	Christopher Ornamental Onion	1 gallon	pot	15" o.c.	UNIT	0
AZ	Aster azureus	Sky Blue Aster	1 gallon	pot	18" o.c.	UNIT	1.13
BS	Baptisia sphaerocarpa	Yellow Baptisia	1 gallon	pot	18" o.c.	UNIT	0
NE	Nepeta x faassenii	Faassen's Catmint	1 gallon	pot	18" o.c.	UNIT	0
NF	Nepeta x faassenii 'Walker's Low'	Walker's Low Faassen's Catmint	1 gallon	pot	18" o.c.	UNIT	1.13
PE	Perovskia atriplicifolia	Russian Sage	1 gallon	pot	18" o.c.	UNIT	1.13
RP	Ratibida pinnata	Prairie Coneflower	1 gallon	pot	18" o.c.	UNIT	0
SB	Salvia nemorosa 'Blue Hill'	Blue Hill Salvia	1 gallon	pot	15" o.c.	UNIT	0
							Total units: 3.39

SCHEDULE OF LANDSCAPE ITEMS - 95TH STREET GATEWAY - NORTHWEST CORNER GARDEN							
Code	Item	Common Name	Size	Root	Remarks	Unit	Total
<b>SHADE TREES</b>							
RO	Robinia pseudoacacia 'Chicago Blues'	Chicago Blues Black Locust	3" caliper	B&B	matching heads, 20' o.c.	each	0
<b>INTERMEDIATE TREES</b>							
SV	Syringa vulgaris 'President Lincoln'	President Lincoln Lilac	5' height	B&B	12' o.c.	each	3
<b>SHRUBS</b>							
CY	Caryopteris clandonensis 'Longwood Blue'	Longwood Blue Bluebeard	1 gallon	pot	18" o.c.	each	37
<b>PERENNIAL PLANTS, GALLON POT</b>							
AC	Allium christophii	Christopher Ornamental Onion	1 gallon	pot	15" o.c.	UNIT	0
AZ	Aster azureus	Sky Blue Aster	1 gallon	pot	18" o.c.	UNIT	1.22
BS	Baptisia sphaerocarpa	Yellow Baptisia	1 gallon	pot	18" o.c.	UNIT	0
NE	Nepeta x faassenii	Faassen's Catmint	1 gallon	pot	18" o.c.	UNIT	0
NF	Nepeta x faassenii 'Walker's Low'	Walker's Low Faassen's Catmint	1 gallon	pot	18" o.c.	UNIT	1.22
PE	Perovskia atriplicifolia	Russian Sage	1 gallon	pot	18" o.c.	UNIT	1.22
RP	Ratibida pinnata	Prairie Coneflower	1 gallon	pot	18" o.c.	UNIT	0
SB	Salvia nemorosa 'Blue Hill'	Blue Hill Salvia	1 gallon	pot	15" o.c.	UNIT	0
							Total units: 3.66

SITE DESIGN GROUP


TYLIN INTERNATIONAL

REVISIONS		ILLINOIS DEPARTMENT OF TRANSPORTATION F.A.I. 94 (DAN RYAN EXPRESSWAY)
NAME	DATE	
		PLANT SCHEDULE SW + NW QUADRANTS AT 95TH ST. - SB 1-94 NW + SW CORNER GARDENS  SCALE: NTS DRAWN BY: EM DATE: June 20, 2008 CHECKED BY: JO

DATE \$ TIME \$

F.A.I. RTE.	SECTION	COUNTY	TOTAL SHEETS	SHEET NO.
94	2005-068 LS	COOK	58	8
STA. 153+09 (SB I-57) TO STA. 1214+95 (SB I-94)				
STA. 257+76 (NB I-57) TO STA. 2213+00 (NB I-94)				
FED. ROAD DIST. NO. ILLINOIS FED. AID PROJECT				

60A74

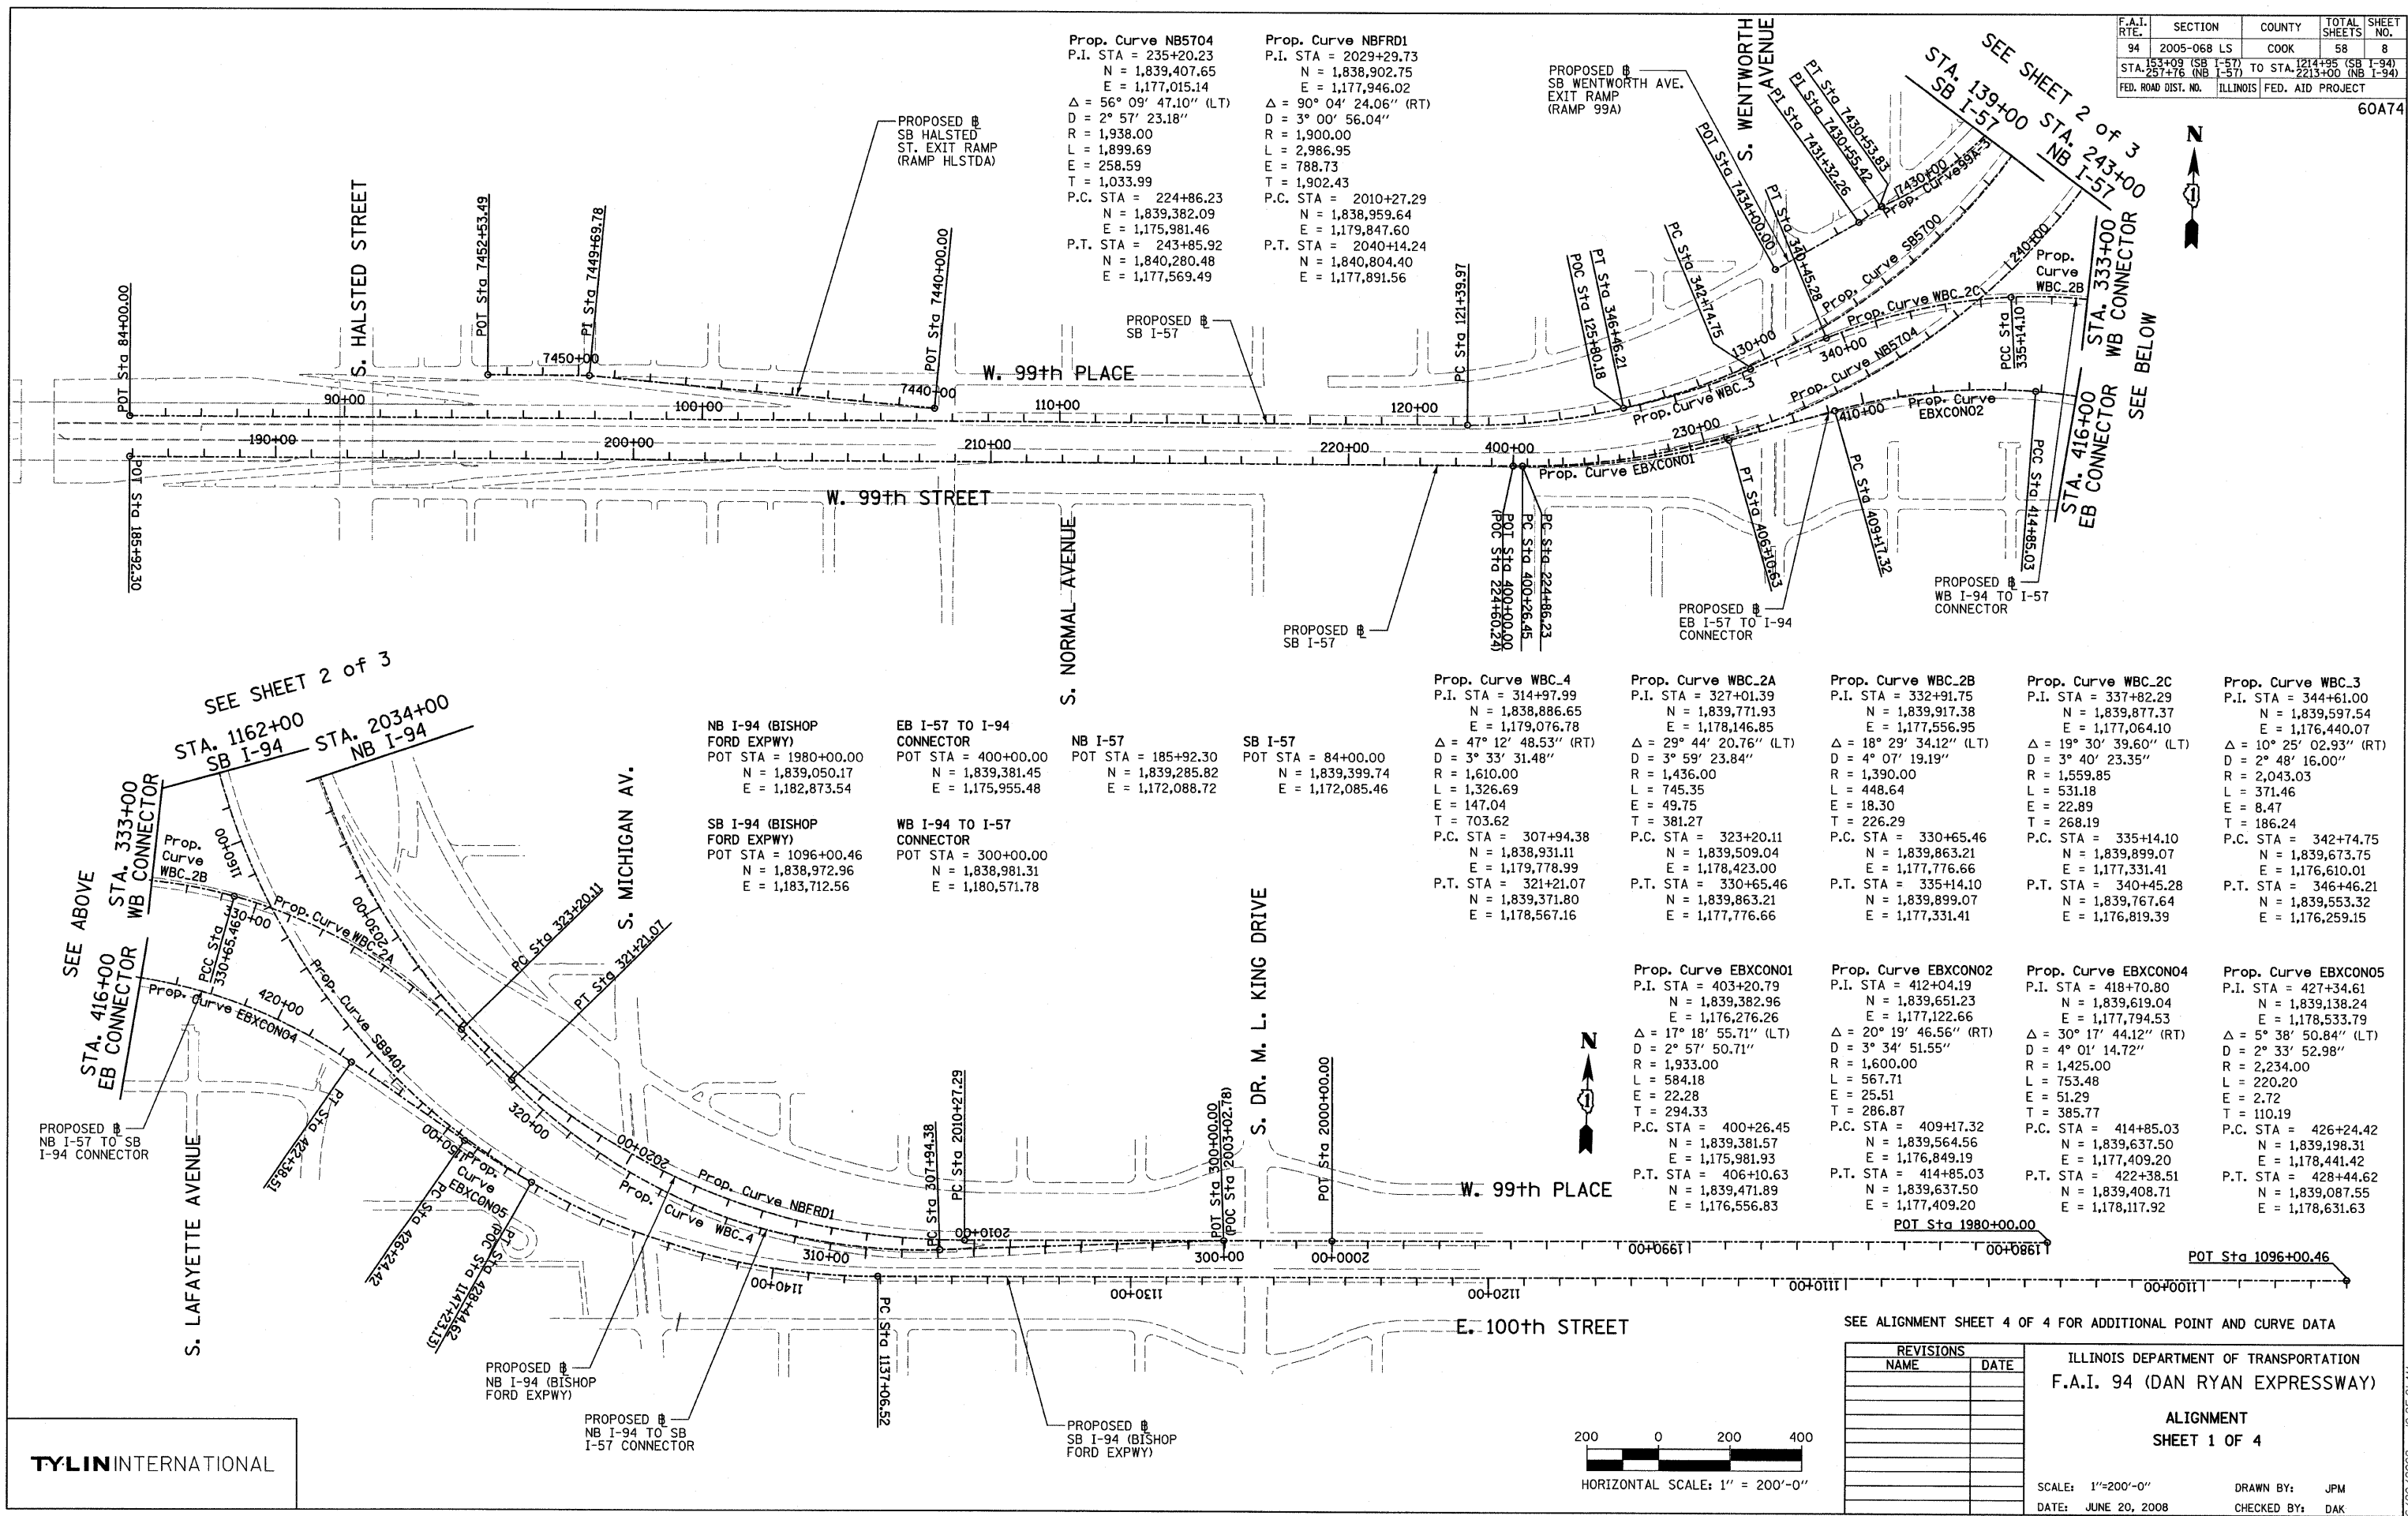

**Prop. Curve NB5704**  
 P.I. STA = 235+20.23  
 N = 1,839,407.65  
 E = 1,177,015.14  
 $\Delta = 56^\circ 09' 47.10''$  (LT)  
 D =  $2^\circ 57' 23.18''$   
 R = 1,938.00  
 L = 1,899.69  
 E = 258.59  
 T = 1,033.99  
 P.C. STA = 224+86.23  
 N = 1,839,382.09  
 E = 1,175,981.46  
 P.T. STA = 243+85.92  
 N = 1,840,280.48  
 E = 1,177,569.49

**Prop. Curve NBFRD1**  
 P.I. STA = 2029+29.73  
 N = 1,838,902.75  
 E = 1,177,946.02  
 $\Delta = 90^\circ 04' 24.06''$  (RT)  
 D =  $3^\circ 00' 56.04''$   
 R = 1,900.00  
 L = 2,986.95  
 E = 788.73  
 T = 1,902.43  
 P.C. STA = 2010+27.29  
 N = 1,838,959.64  
 E = 1,179,847.60  
 P.T. STA = 2040+14.24  
 N = 1,840,804.40  
 E = 1,177,891.56

**NB I-94 (BISHOP FORD EXPWY)**  
 POT STA = 1980+00.00  
 N = 1,839,050.17  
 E = 1,182,873.54

**EB I-57 TO I-94 CONNECTOR**  
 POT STA = 400+00.00  
 N = 1,839,381.45  
 E = 1,175,955.48

**NB I-57**  
 POT STA = 185+92.30  
 N = 1,839,285.82  
 E = 1,172,088.72

**SB I-57**  
 POT STA = 84+00.00  
 N = 1,839,399.74  
 E = 1,172,085.46

**SB I-94 (BISHOP FORD EXPWY)**  
 POT STA = 1096+00.46  
 N = 1,838,972.96  
 E = 1,183,712.56

**WB I-94 TO I-57 CONNECTOR**  
 POT STA = 300+00.00  
 N = 1,838,981.31  
 E = 1,180,571.78

**Prop. Curve WBC.4**  
 P.I. STA = 314+97.99  
 N = 1,838,886.65  
 E = 1,179,076.78  
 $\Delta = 47^\circ 12' 48.53''$  (RT)  
 D =  $3^\circ 33' 31.48''$   
 R = 1,610.00  
 L = 1,326.69  
 E = 147.04  
 T = 703.62  
 P.C. STA = 307+94.38  
 N = 1,838,931.11  
 E = 1,179,778.99  
 P.T. STA = 321+21.07  
 N = 1,839,371.80  
 E = 1,178,567.16

**Prop. Curve WBC.2A**  
 P.I. STA = 327+01.39  
 N = 1,839,771.93  
 E = 1,178,146.85  
 $\Delta = 29^\circ 44' 20.76''$  (LT)  
 D =  $3^\circ 59' 23.84''$   
 R = 1,436.00  
 L = 745.35  
 E = 49.75  
 T = 381.27  
 P.C. STA = 323+20.11  
 N = 1,839,509.04  
 E = 1,178,423.00  
 P.T. STA = 330+65.46  
 N = 1,839,863.21  
 E = 1,177,776.66

**Prop. Curve WBC.2B**  
 P.I. STA = 332+91.75  
 N = 1,839,917.38  
 E = 1,177,556.95  
 $\Delta = 18^\circ 29' 34.12''$  (LT)  
 D =  $4^\circ 07' 19.19''$   
 R = 1,390.00  
 L = 448.64  
 E = 18.30  
 T = 226.29  
 P.C. STA = 330+65.46  
 N = 1,839,863.21  
 E = 1,177,776.66  
 P.T. STA = 335+14.10  
 N = 1,839,899.07  
 E = 1,177,331.41

**Prop. Curve WBC.2C**  
 P.I. STA = 337+82.29  
 N = 1,839,973.37  
 E = 1,177,064.10  
 $\Delta = 19^\circ 30' 39.60''$  (LT)  
 D =  $3^\circ 40' 23.35''$   
 R = 1,559.85  
 L = 531.18  
 E = 268.19  
 T = 228.19  
 P.C. STA = 335+14.10  
 N = 1,839,899.07  
 E = 1,177,331.41  
 P.T. STA = 340+45.28  
 N = 1,839,767.64  
 E = 1,176,819.39

**Prop. Curve WBC.3**  
 P.I. STA = 344+61.00  
 N = 1,839,597.54  
 E = 1,176,440.07  
 $\Delta = 10^\circ 25' 02.93''$  (RT)  
 D =  $2^\circ 48' 16.00''$   
 R = 2,043.03  
 L = 371.46  
 E = 8.47  
 T = 186.24  
 P.C. STA = 342+74.75  
 N = 1,839,673.75  
 E = 1,176,610.01  
 P.T. STA = 346+46.21  
 N = 1,839,553.32  
 E = 1,176,259.15

**Prop. Curve EBXCNO1**  
 P.I. STA = 403+20.79  
 N = 1,839,382.96  
 E = 1,176,276.26  
 $\Delta = 17^\circ 18' 55.71''$  (LT)  
 D =  $2^\circ 57' 50.71''$   
 R = 1,933.00  
 L = 584.18  
 E = 22.28  
 T = 294.33  
 P.C. STA = 400+26.45  
 N = 1,839,381.57  
 E = 1,175,981.93  
 P.T. STA = 406+10.63  
 N = 1,839,471.89  
 E = 1,176,556.83

**Prop. Curve EBXCNO2**  
 P.I. STA = 412+04.19  
 N = 1,839,651.23  
 E = 1,177,122.66  
 $\Delta = 20^\circ 19' 46.56''$  (RT)  
 D =  $3^\circ 34' 51.55''$   
 R = 1,600.00  
 L = 567.71  
 E = 51.29  
 T = 286.87  
 P.C. STA = 409+17.32  
 N = 1,839,564.56  
 E = 1,176,849.19  
 P.T. STA = 414+85.03  
 N = 1,839,637.50  
 E = 1,177,409.20

**Prop. Curve EBXCNO4**  
 P.I. STA = 418+70.80  
 N = 1,839,619.04  
 E = 1,177,794.53  
 $\Delta = 30^\circ 17' 44.12''$  (RT)  
 D =  $4^\circ 01' 14.72''$   
 R = 1,425.00  
 L = 753.48  
 E = 51.29  
 T = 385.77  
 P.C. STA = 414+85.03  
 N = 1,839,637.50  
 E = 1,177,409.20  
 P.T. STA = 422+38.51  
 N = 1,839,408.71  
 E = 1,178,117.92

**Prop. Curve EBXCNO5**  
 P.I. STA = 427+34.61  
 N = 1,839,138.24  
 E = 1,178,533.79  
 $\Delta = 5^\circ 38' 50.84''$  (LT)  
 D =  $2^\circ 33' 52.98''$   
 R = 2,234.00  
 L = 220.20  
 E = 2.72  
 T = 110.19  
 P.C. STA = 426+24.42  
 N = 1,839,198.31  
 E = 1,178,441.42  
 P.T. STA = 428+44.62  
 N = 1,839,087.55  
 E = 1,178,631.63

SEE ALIGNMENT SHEET 4 OF 4 FOR ADDITIONAL POINT AND CURVE DATA


REVISIONS	
NAME	DATE

ILLINOIS DEPARTMENT OF TRANSPORTATION  
**F.A.I. 94 (DAN RYAN EXPRESSWAY)**

ALIGNMENT  
**SHEET 1 OF 4**

SCALE: 1"=200'-0"  
 DATE: JUNE 20, 2008

DRAWN BY: JPM  
 CHECKED BY: DAK

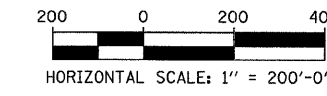


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F.A.I. RTE.	SECTION	COUNTY	TOTAL SHEETS	SHEET NO.
94	2005-068 LS	COOK	58	9
STA. 153+09 (SB I-57) TO STA. 1214+95 (SB I-94)				
STA. 257+76 (NB I-57) TO STA. 2213+00 (NB I-94)				
FED. ROAD DIST. NO. ILLINOIS FED. AID PROJECT				

60A74



Prop. Curve SB5700  
P.I. STA = 133+70.06  
N = 1,839,521.70  
E = 1,177,054.03  
 $\Delta = 66^\circ 11' 55.15''$  (LT)  
D =  $3^\circ 02' 10.83''$   
R = 1,887.00  
L = 2,180.21  
E = 365.53  
T = 1,230.09  
P.C. STA = 121+39.97  
N = 1,839,491.52  
E = 1,175,824.31  
P.T. STA = 143+20.18  
N = 1,840,659.02  
E = 1,177,522.68

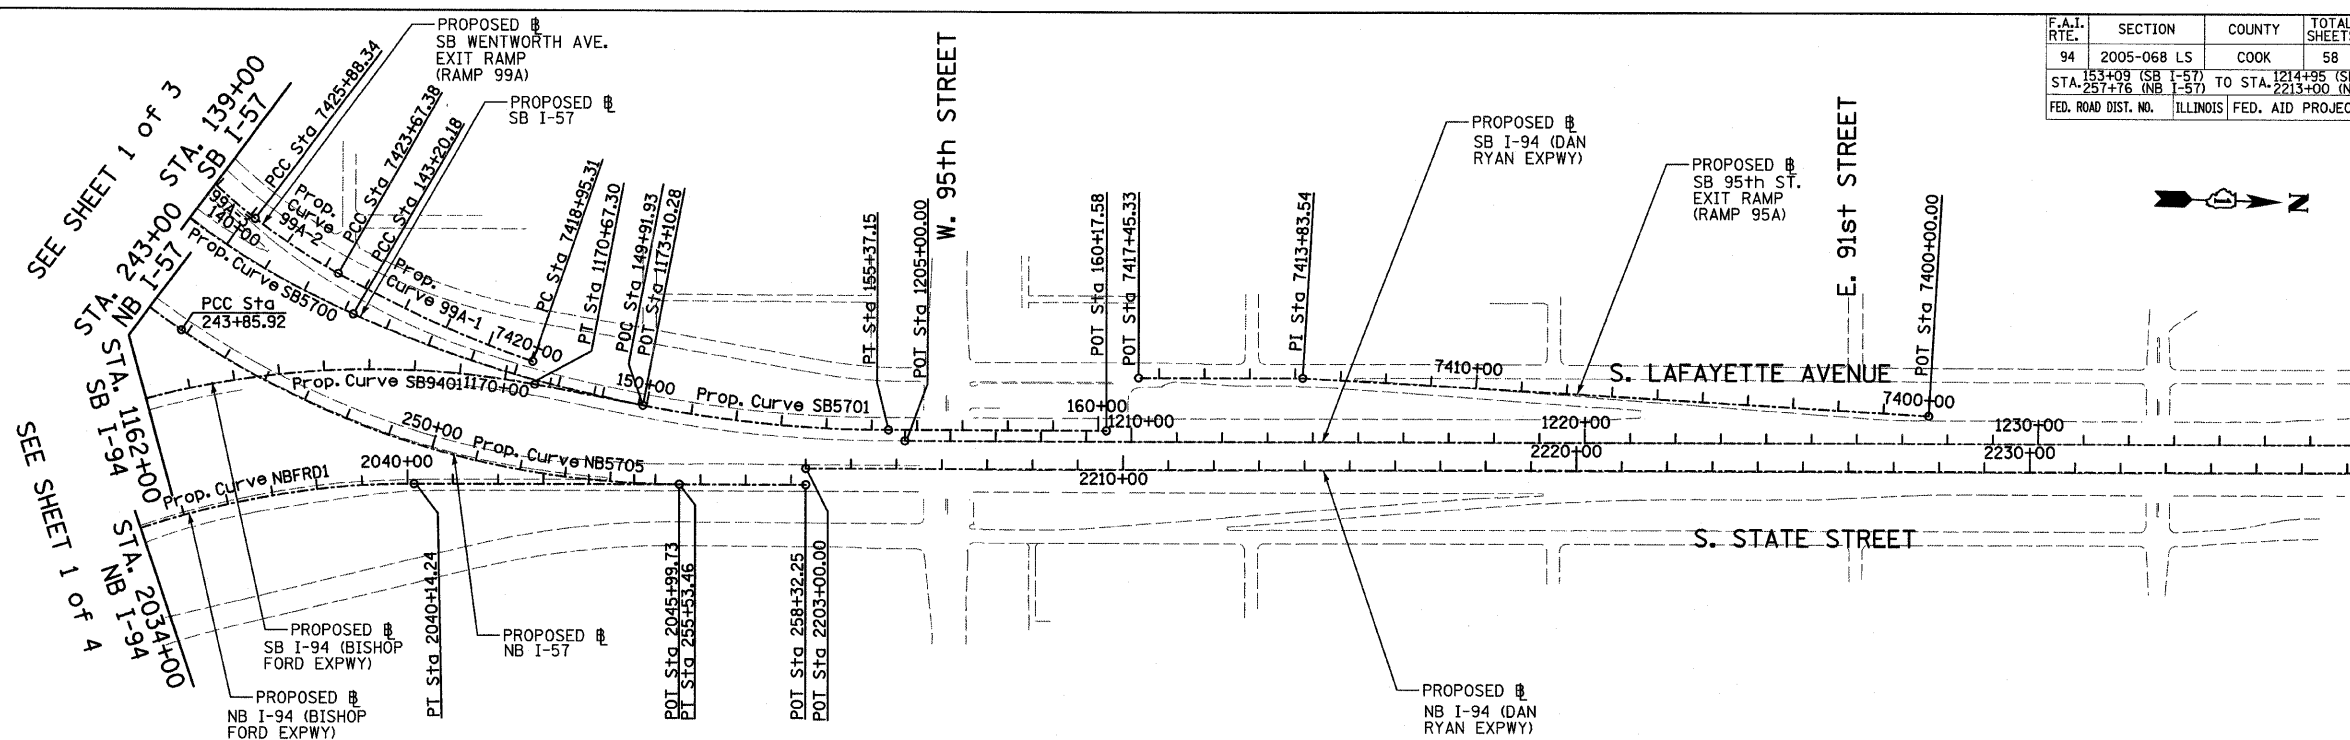Prop. Curve SB5701  
P.I. STA = 149+37.75  
N = 1,841,230.00  
E = 1,177,757.97  
 $\Delta = 24^\circ 02' 07.49''$  (LT)  
D =  $1^\circ 58' 30.13''$   
R = 2,901.00  
L = 1,216.96  
E = 65.01  
T = 617.56  
P.C. STA = 143+20.18  
N = 1,840,659.02  
E = 1,177,522.68  
P.T. STA = 155+37.15  
N = 1,841,847.31  
E = 1,177,740.29


Prop. Curve NB5705  
P.I. STA = 249+87.51  
N = 1,840,788.31  
E = 1,177,892.02  
 $\Delta = 34^\circ 03' 37.98''$  (LT)  
D =  $2^\circ 55' 02.28''$   
R = 1,964.00  
L = 1,167.54  
E = 90.07  
T = 601.59  
P.C. STA = 243+85.92  
N = 1,840,659.02  
E = 1,177,522.68  
P.T. STA = 255+53.46  
N = 1,841,389.65  
E = 1,177,874.80

Prop. Curve SB9401  
P.I. STA = 1160+15.97  
N = 1,838,783.95  
E = 1,177,299.83  
 $\Delta = 100^\circ 48' 58.07''$  (RT)  
D =  $2^\circ 59' 59.20''$   
R = 1,910.00  
L = 3,360.79  
E = 1,086.95  
T = 2,309.46  
P.C. STA = 1137+06.52  
N = 1,838,851.99  
E = 1,179,608.28  
P.T. STA = 1170+67.30  
N = 1,841,064.16  
E = 1,177,666.20


SB I-94 (DAN RYAN EXPWY)  
POT STA = 1205+00.00  
N = 1,841,884.04  
E = 1,177,763.25

SB I-57  
POT STA = 160+17.58  
N = 1,842,327.55  
E = 1,177,726.54  
NB I-57  
POT STA = 258+32.25  
N = 1,841,668.33  
E = 1,177,866.82  
NB I-94 (DAN RYAN EXPWY)  
POT STA = 2203+00.00  
N = 1,841,667.31  
E = 1,177,830.83

SB I-94 (BISHOP FORD EXPWY)  
POT STA = 1173+10.28  
N = 1,841,304.06  
E = 1,177,704.74  
NB I-94 (BISHOP FORD EXPWY)  
POT STA = 2045+99.73  
N = 1,841,389.65  
E = 1,177,874.80

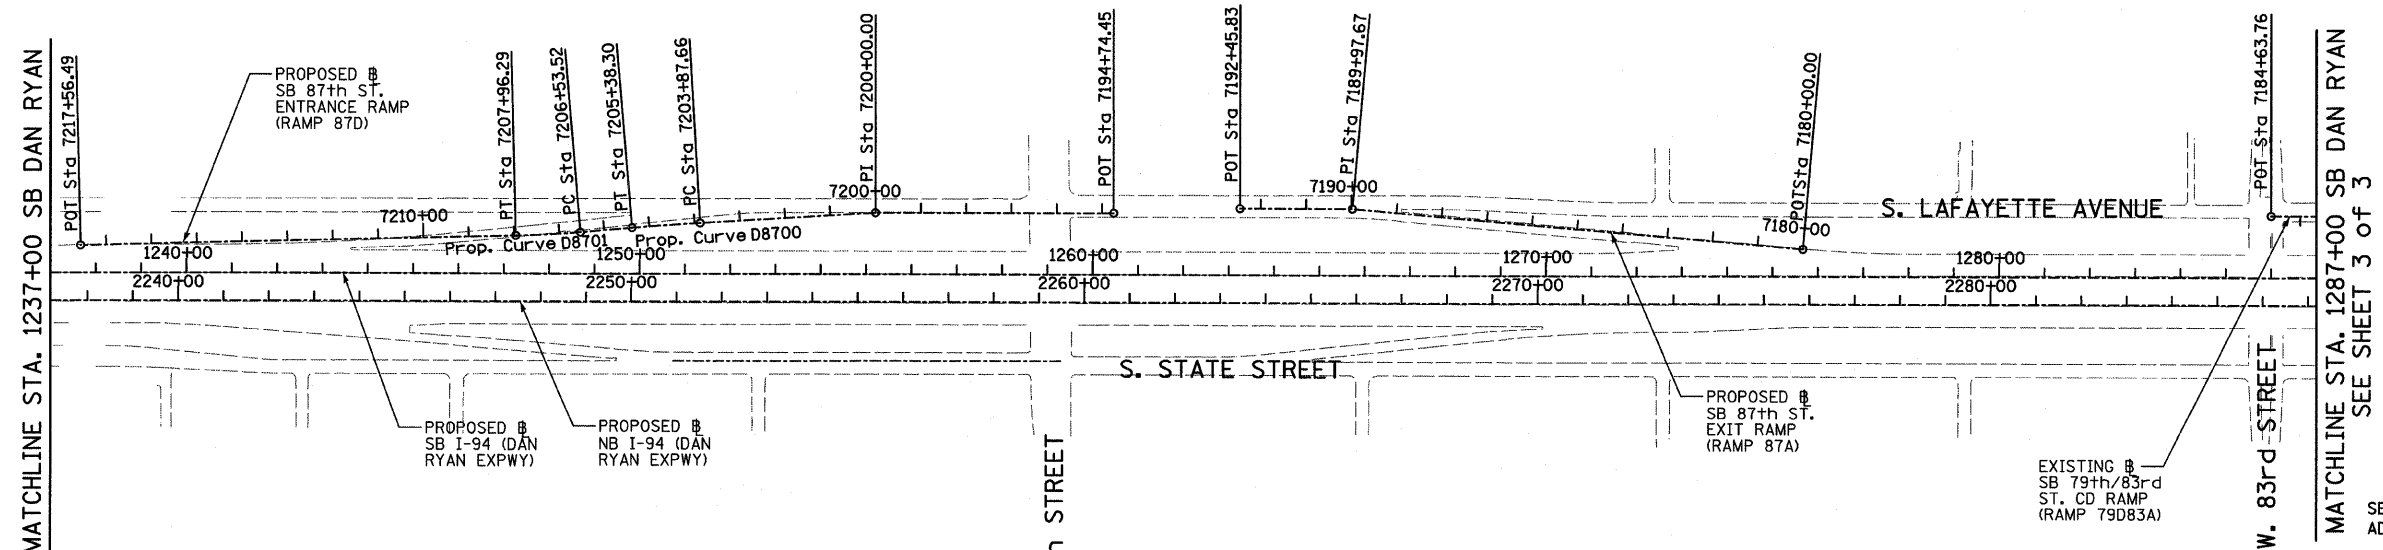

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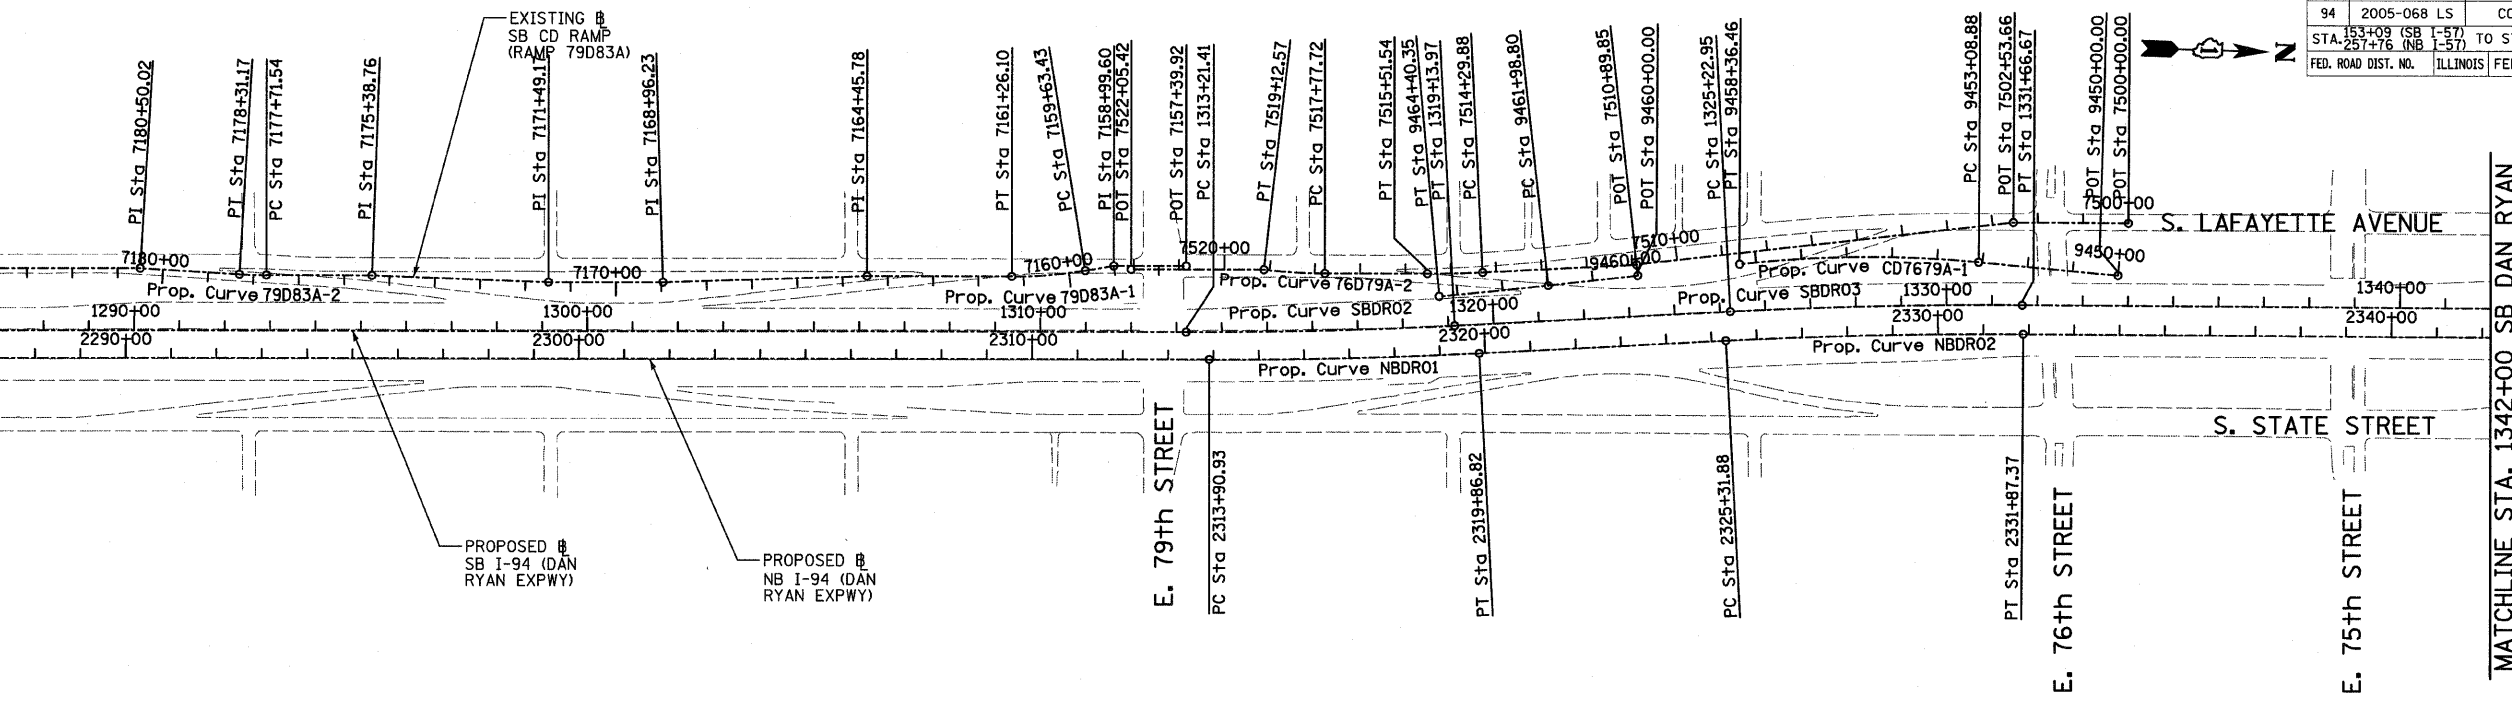


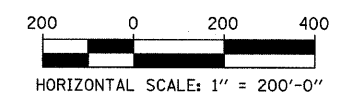REVISIONS	
NAME	DATE

ILLINOIS DEPARTMENT OF TRANSPORTATION  
F.A.I. 94 (DAN RYAN EXPRESSWAY)  
ALIGNMENT  
SHEET 2 OF 4  
SCALE: 1"=200'  
DATE: JUNE 20, 2008  
DRAWN BY: JPM  
CHECKED BY: DAK


6/20/2008 10:25:22 AM

SEE SHEET 2 of 3  
MATCHLINE STA. 1287+00 SB DAN RYAN




<b>Prop. Curve NBDRO1</b> P.I. STA = 2316+88.94 N = 1,853,051.58 E = 1,177,504.84 Δ = 2° 58' 38.60" (LT) D = 0° 29' 58.77" R = 11,467.00 L = 595.89 E = 3.87 T = 298.01 P.C. STA = 2313+90.93 N = 1,852,753.69 E = 1,177,513.37 P.T. STA = 2319+86.82 N = 1,853,348.62 E = 1,177,480.85	<b>Prop. Curve NBDRO2</b> P.I. STA = 2328+59.71 N = 1,854,218.69 E = 1,177,410.58 Δ = 3° 16' 48.34" (RT) D = 0° 30' 01.44" R = 11,450.00 L = 655.49 E = 4.69 T = 327.84 P.C. STA = 2325+31.88 N = 1,853,891.91 E = 1,177,436.97 P.T. STA = 2331+87.37 N = 1,854,546.43 E = 1,177,402.92	<b>Prop. Curve NBDRO3</b> P.I. STA = 2398+13.58 N = 1,861,170.38 E = 1,177,231.19 Δ = 44° 36' 17.12" (LT) D = 2° 44' 29.13" R = 2,090.00 L = 1,627.06 E = 168.99 T = 857.27 P.C. STA = 2389+56.30 N = 1,860,313.48 E = 1,177,256.19 P.T. STA = 2405+83.37 N = 1,861,762.92 E = 1,176,611.65	<b>Prop. Curve SBDR02</b> P.I. STA = 1316+17.76 N = 1,852,997.25 E = 1,177,445.02 Δ = 2° 58' 38.60" (LT) D = 0° 30' 08.86" R = 11,403.00 L = 592.56 E = 3.85 T = 296.35 P.C. STA = 1313+21.41 N = 1,852,701.02 E = 1,177,453.50 P.T. STA = 1319+13.97 N = 1,853,292.63 E = 1,177,421.16	<b>Prop. Curve SBDR03</b> P.I. STA = 1328+44.90 N = 1,854,220.54 E = 1,177,346.22 Δ = 3° 16' 11.04" (RT) D = 0° 30' 28.59" R = 11,280.00 L = 643.72 E = 4.59 T = 321.95 P.C. STA = 1325+22.95 N = 1,853,899.63 E = 1,177,372.14 P.T. STA = 1331+66.67 N = 1,854,542.40 E = 1,177,338.64	<b>Prop. Curve SBDR04</b> P.I. STA = 1397+75.78 N = 1,861,149.16 E = 1,177,163.97 Δ = 44° 32' 58.56" (LT) D = 2° 47' 41.70" R = 2,050.00 L = 1,593.95 E = 165.31 T = 839.71 P.C. STA = 1389+36.07 N = 1,860,309.83 E = 1,177,189.29 P.T. STA = 1405+30.02 N = 1,861,729.54 E = 1,176,557.11
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MATCHLINE STA. 1342+00 SB DAN RYAN

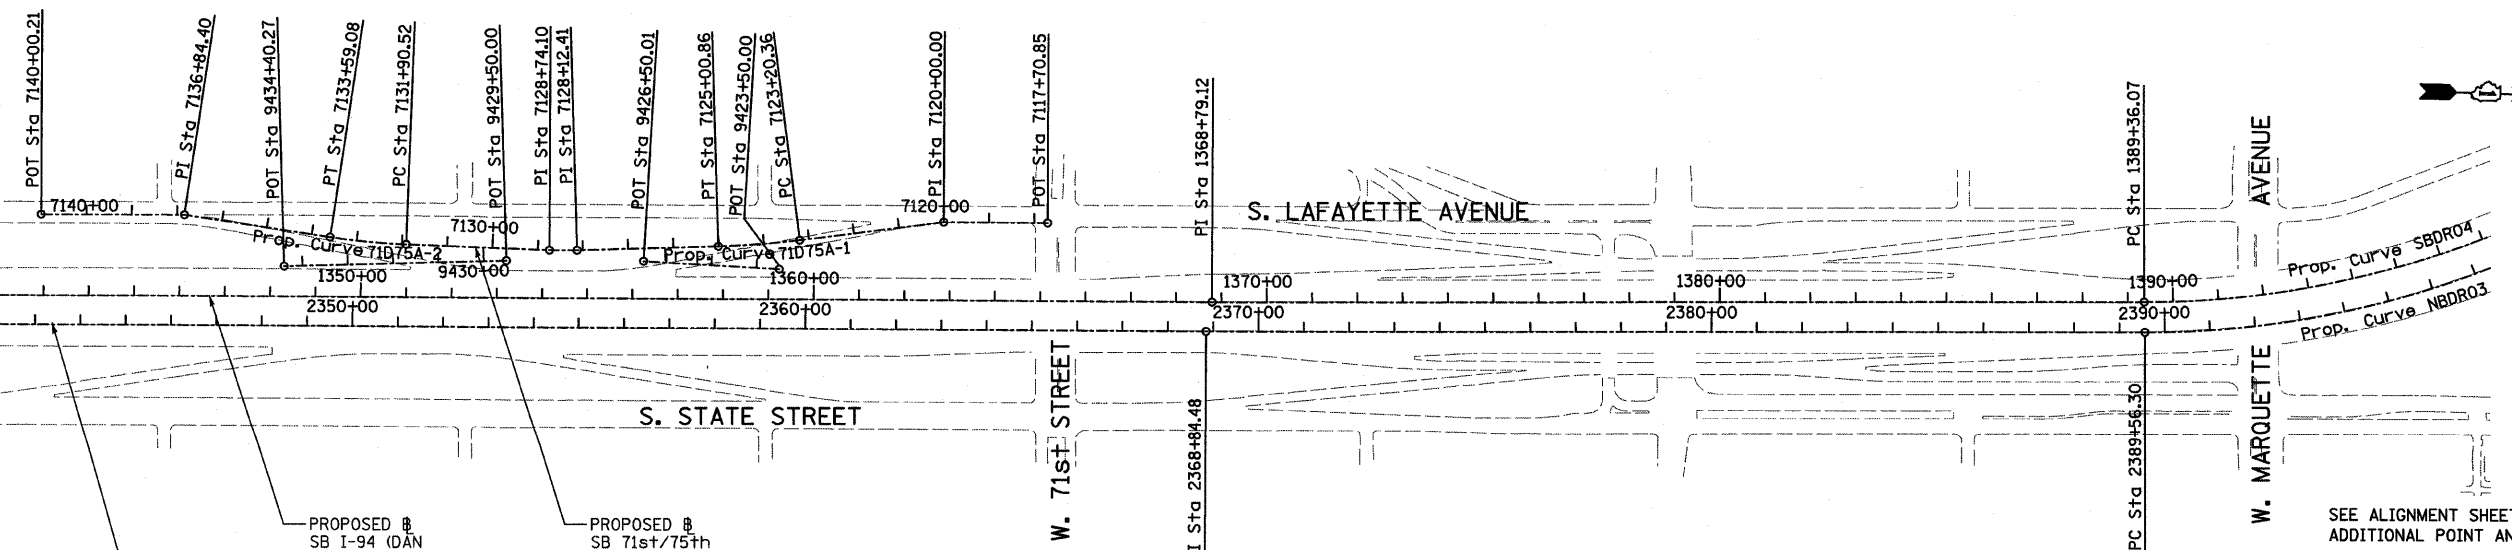

SEE ALIGNMENT SHEET 4 OF 4 FOR ADDITIONAL POINT AND CURVE DATA

TYLIN INTERNATIONAL

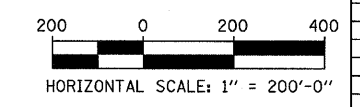

REVISIONS	
NAME	DATE

ILLINOIS DEPARTMENT OF TRANSPORTATION  
F.A.I. 94 (DAN RYAN EXPRESSWAY)

ALIGNMENT  
SHEET 3 OF 4

SCALE: 1"=200'  
DATE: JUNE 20, 2008

DRAWN BY: JPM  
CHECKED BY: DAK

6/20/2008 10:25:22 AM P:\02373\Road\2226\1222\0390\_33.dwg

F.A.I. RTE.	SECTION	COUNTY	TOTAL SHEETS	SHEET NO.
94	2005-068 LS	COOK	58	11
STA. 153+09 (SB I-57) TO STA. 257+76 (NB I-57)		1214+95 (SB I-94) TO STA. 2213+00 (NB I-94)		
FED. ROAD DIST. NO.		ILLINOIS FED. AID PROJECT		60A74

SB HALSTED ST.  
EXIT RAMP  
(RAMP HLSTDA)  
POT STA = 7440+00.00  
N = 1,839,490.94  
E = 1,174,333.70  
P.I. STA = 7449+69.78  
N = 1,839,551.73  
E = 1,173,365.83  
POT STA = 7452+53.49  
N = 1,839,544.76  
E = 1,173,082.20

SB WENTWORTH AVE.  
EXIT RAMP  
(RAMP 99A)  
POT STA = 7430+55.42  
N = 1,840,141.17  
E = 1,176,961.02  
POT STA = 7431+32.26  
N = 1,840,094.48  
E = 1,176,899.99  
POT STA = 7434+00.00  
N = 1,839,955.89  
E = 1,176,670.92

SB 95th ST. EXIT RAMP  
(RAMP 95A)  
POT STA = 7400+00.00  
N = 1,844,139.73  
E = 1,177,638.63  
P.I. STA = 7413+83.54  
N = 1,842,756.77  
E = 1,177,598.60  
POT STA = 7417+45.33  
N = 1,842,395.13  
E = 1,177,608.95

SB 87th ST. ENTRANCE RAMP  
(RAMP 87D)  
POT STA = 7194+74.45  
N = 1,847,424.06  
E = 1,177,468.58  
P.I. STA = 7200+00.00  
N = 1,846,898.74  
E = 1,177,484.09  
POT STA = 7217+56.49  
N = 1,845,147.17  
E = 1,177,609.78

SB 87th ST. EXIT RAMP  
(RAMP 87A)  
POT STA = 7180+00.00  
N = 1,848,946.30  
E = 1,177,501.00  
P.I. STA = 7189+97.67  
N = 1,847,950.35  
E = 1,177,442.53  
POT STA = 7192+45.83  
N = 1,847,702.29  
E = 1,177,449.63

Prop. Curve 99A-1  
P.I. STA = 7421+32.05  
N = 1,840,832.05  
E = 1,177,544.75  
 $\Delta = 10^\circ 49' 08.53''$  (RT)  
D = 2° 17' 30.59"  
R = 2,500.00  
L = 472.07  
E = 11.18  
T = 236.74  
P.C. STA = 7418+95.31  
N = 1,841,058.12  
E = 1,177,615.03  
P.T. STA = 7423+67.38  
N = 1,840,623.20  
E = 1,177,433.29

Prop. Curve 99A-2  
P.I. STA = 7424+78.02  
N = 1,840,525.59  
E = 1,177,381.20  
 $\Delta = 7^\circ 26' 49.68''$  (RT)  
D = 3° 22' 13.22"  
R = 1,700.00  
L = 220.96  
E = 3.60  
T = 110.64  
P.C. STA = 7423+67.38  
N = 1,840,623.20  
E = 1,177,433.29  
P.T. STA = 7425+88.34  
N = 1,840,435.56  
E = 1,177,316.90

Prop. Curve 99A-3  
P.I. STA = 7428+26.42  
N = 1,840,241.82  
E = 1,177,178.53  
 $\Delta = 29^\circ 38' 02.27''$  (RT)  
D = 6° 21' 58.31"  
R = 900.00  
L = 465.49  
E = 30.96  
T = 238.08  
P.C. STA = 7425+88.34  
N = 1,840,435.56  
E = 1,177,316.90  
P.T. STA = 7430+53.83  
N = 1,840,141.84  
E = 1,176,962.46

Prop. Curve D8700  
P.I. STA = 7204+62.99  
N = 1,846,437.54  
E = 1,177,524.69  
 $\Delta = 1^\circ 30' 03.72''$  (LT)  
D = 0° 59' 47.21"  
R = 5,750.00  
L = 150.64  
E = 0.49  
T = 75.32  
P.C. STA = 7203+87.66  
N = 1,846,512.58  
E = 1,177,518.09  
P.T. STA = 7205+38.30  
N = 1,846,362.71  
E = 1,177,533.26

Prop. Curve D8701  
P.I. STA = 7207+24.93  
N = 1,846,177.29  
E = 1,177,554.49  
 $\Delta = 3^\circ 27' 36.43''$  (RT)  
D = 2° 25' 25.25"  
R = 2,364.00  
L = 142.76  
E = 1.08  
T = 71.40  
P.C. STA = 7206+53.52  
N = 1,846,248.23  
E = 1,177,546.37  
P.T. STA = 7207+96.29  
N = 1,846,105.99  
E = 1,177,558.32

Prop. Curve 79D83A-1  
P.I. STA = 7160+44.94  
N = 1,852,394.55  
E = 1,177,340.32  
 $\Delta = 9^\circ 19' 12.90''$  (RT)  
D = 5° 43' 46.48"  
R = 1,000.00  
L = 162.67  
E = 3.32  
T = 81.51  
P.C. STA = 7159+63.43  
N = 1,852,474.58  
E = 1,177,324.82  
P.T. STA = 7161+26.10  
N = 1,852,313.07  
E = 1,177,342.65

Prop. Curve 79D83A-2  
P.I. STA = 7178+01.36  
N = 1,850,638.94  
E = 1,177,390.59  
 $\Delta = 3^\circ 24' 57.69''$  (RT)  
D = 5° 43' 46.48"  
R = 1,000.00  
L = 59.62  
E = 0.44  
T = 29.82  
P.C. STA = 7177+71.54  
N = 1,850,668.74  
E = 1,177,389.73  
P.T. STA = 7178+31.17  
N = 1,850,609.13  
E = 1,177,389.66

SB C-D RAMP  
(RAMP 79D83A)  
POT STA = 7157+39.92  
N = 1,852,696.86  
E = 1,177,308.11  
P.I. STA = 7158+99.60  
N = 1,852,537.24  
E = 1,177,312.68  
P.I. STA = 7164+45.78  
N = 1,851,993.52  
E = 1,177,351.80  
P.I. STA = 7168+96.23  
N = 1,851,543.85  
E = 1,177,378.34  
P.I. STA = 7171+49.17  
N = 1,851,291.02  
E = 1,177,385.58  
P.I. STA = 7175+38.76  
N = 1,850,901.43  
E = 1,177,383.07  
P.I. STA = 7180+50.02  
N = 1,850,390.38  
E = 1,177,382.88  
POT STA = 7184+63.76  
N = 1,849,976.81  
E = 1,177,394.72

SB 76th/79th ST.  
CD RAMP  
(RAMP 76D79A)  
POT STA = 7500+00.00  
N = 1,854,771.42  
E = 1,177,153.21  
P.I. STA = 7502+53.66  
N = 1,854,517.84  
E = 1,177,159.17  
P.I. STA = 7510+89.85  
N = 1,853,689.73  
E = 1,177,275.17  
POT STA = 7522+05.42  
N = 1,852,575.71  
E = 1,177,319.03

Prop. Curve 76D79A-1  
P.I. STA = 7514+90.72  
N = 1,853,290.06  
E = 1,177,306.25  
 $\Delta = 2^\circ 48' 22.72''$  (RT)  
D = 2° 18' 23.74"  
R = 2,484.00  
L = 121.66  
E = 0.75  
T = 60.84  
P.C. STA = 7514+29.88  
N = 1,853,350.72  
E = 1,177,301.54  
P.T. STA = 7515+51.54  
N = 1,853,229.24  
E = 1,177,307.99

Prop. Curve 76D79A-2  
P.I. STA = 7518+45.22  
N = 1,852,935.69  
E = 1,177,316.40  
 $\Delta = 6^\circ 31' 33.29''$  (RT)  
D = 4° 50' 21.01"  
R = 1,184.00  
L = 134.86  
E = 1.92  
T = 67.50  
P.C. STA = 7517+77.72  
N = 1,853,003.16  
E = 1,177,314.47  
P.T. STA = 7519+12.57  
N = 1,852,868.44  
E = 1,177,310.65

SB 76th/79th ST.  
CD EXIT CONNECTOR  
(CD7679A)  
POT STA = 9450+00.00  
N = 1,854,751.70  
E = 1,177,298.94  
Prop. Curve CD7679A-1  
P.I. STA = 9455+73.58  
N = 1,854,179.28  
E = 1,177,230.83  
 $\Delta = 11^\circ 37' 34.33''$  (LT)  
D = 2° 12' 13.26"  
R = 2,600.00  
L = 527.58  
E = 13.44  
T = 264.70  
P.C. STA = 9453+08.88  
N = 1,854,443.44  
E = 1,177,247.69  
P.T. STA = 9458+36.46  
N = 1,853,917.14  
E = 1,177,267.55

SB 76th/79th ST.  
CD ENTRANCE CONNECTOR  
(CD7679B)  
POT STA = 9460+00.00  
N = 1,853,693.06  
E = 1,177,298.94  
Prop. Curve CD7679B-1  
P.I. STA = 9463+19.58  
N = 1,853,376.57  
E = 1,177,343.27  
 $\Delta = 1^\circ 13' 13.54''$  (RT)  
D = 0° 30' 18.91"  
R = 11,340.00  
L = 241.55  
E = 0.64  
T = 120.78  
P.C. STA = 9461+98.80  
N = 1,853,496.18  
E = 1,177,326.52  
P.T. STA = 9464+40.35  
N = 1,853,256.63  
E = 1,177,357.48

SB 71st/75th ST.  
CD RAMP  
(RAMP 71D75A)  
POT STA = 7117+70.85  
N = 1,857,886.40  
E = 1,177,086.26  
P.I. STA = 7120+00.00  
N = 1,857,657.31  
E = 1,177,091.65  
P.I. STA = 7128+12.41  
N = 1,856,850.29  
E = 1,177,177.64  
P.I. STA = 7128+74.10  
N = 1,856,788.62  
E = 1,177,179.10  
P.I. STA = 7136+84.40  
N = 1,855,981.27  
E = 1,177,124.75  
POT STA = 7140+00.21  
N = 1,855,665.56  
E = 1,177,132.18

Prop. Curve 71D75A-1  
P.I. STA = 7124+10.68  
N = 1,857,251.52  
E = 1,177,154.81  
 $\Delta = 5^\circ 35' 23.99''$  (RT)  
D = 3° 05' 49.45"  
R = 1,850.00  
L = 180.49  
E = 2.20  
T = 90.32  
P.C. STA = 7123+20.36  
N = 1,857,340.76  
E = 1,177,140.92  
P.T. STA = 7125+00.86  
N = 1,857,161.34  
E = 1,177,159.94

Prop. Curve 71D75A-2  
P.I. STA = 7132+74.89  
N = 1,856,387.85  
E = 1,177,175.17  
 $\Delta = 6^\circ 30' 28.18''$  (RT)  
D = 3° 51' 39.25"  
R = 1,484.00  
L = 168.56  
E = 2.40  
T = 84.37  
P.C. STA = 7131+90.52  
N = 1,856,472.22  
E = 1,177,176.00  
P.T. STA = 7133+59.08  
N = 1,856,304.13  
E = 1,177,164.79

SB 71st/75th ST.  
CD EXIT CONNECTOR  
(RAMP CD7175A)  
POT STA = 9423+50.00  
N = 1,857,297.2866  
E = 1,177,207.4713  
POT STA = 9426+50.01  
N = 1,856,997.4225  
E = 1,177,198.1891  
CD ENTRANCE CONNECTOR  
(RAMP CD7175B)  
POT STA = 9429+50.00  
N = 1,856,694.2083  
E = 1,177,205.3235  
POT STA = 9434+40.27  
N = 1,856,204.7281  
E = 1,177,233.1786

REVISIONS	
NAME	DATE

ILLINOIS DEPARTMENT OF TRANSPORTATION  
F.A.I. 94 (DAN RYAN EXPRESSWAY)

ALIGNMENT  
SHEET 4 OF 4

SCALE: NO SCALE DRAWN BY: JPA  
DATE: JUNE 20, 2008 CHECKED BY: JPM


TYLIN INTERNATIONAL

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F.A.I. RTE.	SECTION	COUNTY	TOTAL SHEETS	SHEET NO.
94	2005-068 LS	COOK	58	12
STA. 1234+00 (SB I-57) TO STA. 1214+95 (SB I-94)				
STA. 257+76 (NB I-57) TO STA. 2213+00 (NB I-94)				
FED. ROAD DIST. NO. ILLINOIS FED. AID PROJECT				

60A74

SEE SHEET 2 OF 7  
MATCH LINE "B"

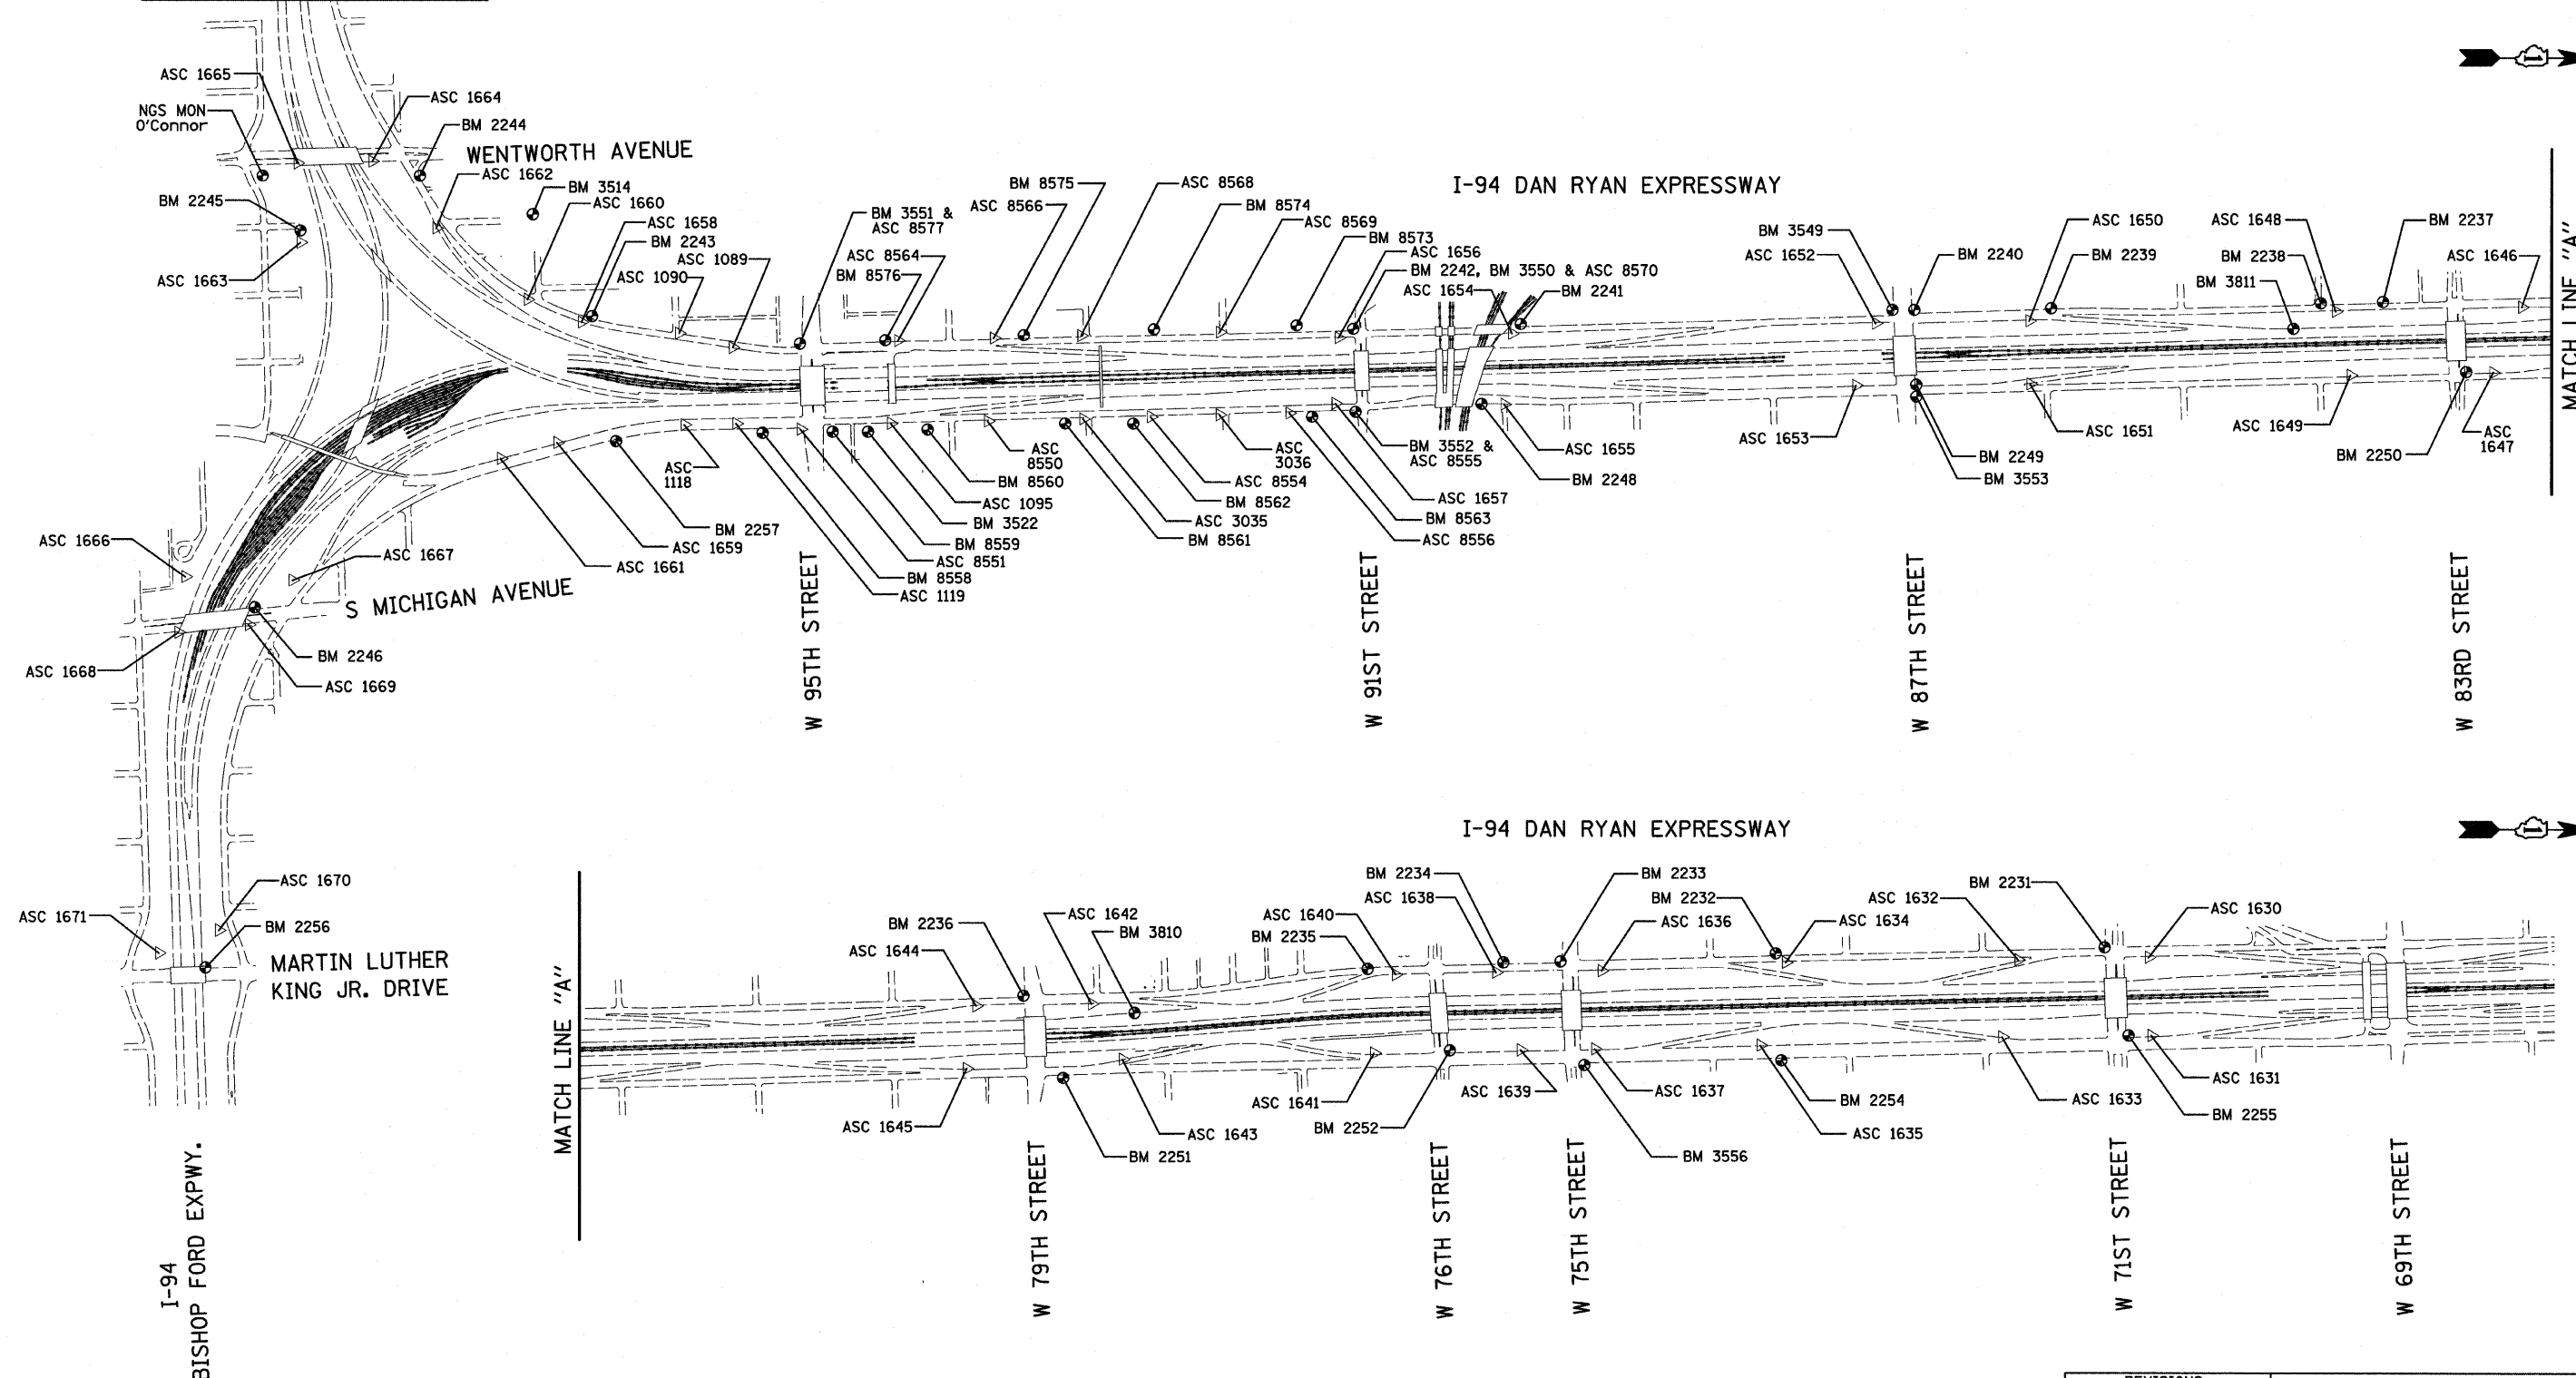

American Surveying Consultants, P.C.  
SURVEYING-ENGINEERING-GEODETIC-SUPPORTING SCIENTISTS  
1837 Pine Bluff, Chicago, IL 60611 6030 N. Northbrook, Skokie, IL 60077


REVISIONS	
NAME	DATE

ILLINOIS DEPARTMENT OF TRANSPORTATION  
F.A.I. 94 (DAN RYAN EXPRESSWAY)  
SURVEY TIES FOR CONTROL POINTS  
SHEET 1 OF 7  
SCALE: 1"=400'  
DATE: JUNE 20, 2008  
DRAWN BY: GSP  
CHECKED BY: MMW

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F.A.I. RTE.	SECTION	COUNTY	TOTAL SHEETS	SHEET NO.
94	2005-068 LS	COOK	58	13
STA. 153+09 (SB 1-57) TO STA. 2214+95 (SB 1-94)				
STA. 257+76 (NB 1-57)		TO STA. 2213+00 (NB 1-94)		
FED. ROAD DIST. NO.	ILLINOIS	FED. AID PROJECT		

60A74

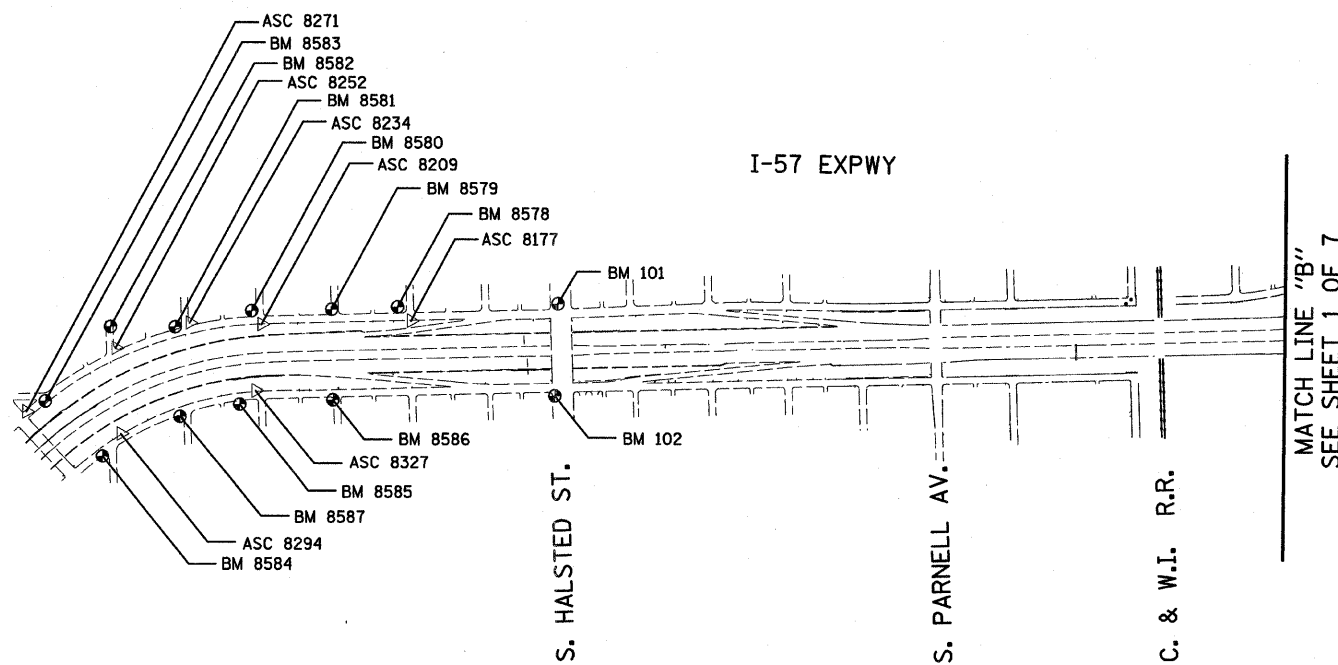

American Surveying Consultants, P.C.  
 SURVEYORS-ENGINEERS-GEODETISTS-AND-SCIENTISTS  
 1137 Flock St., Chicago, IL 60601 609 N. Northwest Hwy., Chicago, IL 60631  
 312-461-4211



















REVISIONS	
NAME	DATE

ILLINOIS DEPARTMENT OF TRANSPORTATION  
 F.A.I. 94 (DAN RYAN EXPRESSWAY)  
 SURVEY TIES FOR CONTROL POINTS  
 SHEET 2 OF 7  
 SCALE: 1"=400'  
 DATE: JUNE 20, 2008  
 DRAWN BY: GSP  
 CHECKED BY: MMW

6/20/2008 10:25:25 AM

F.A.I. RTE.	SECTION	COUNTY	TOTAL SHEETS	SHEET NO.
94	2005-068 LS	COOK	58	14
STA. 153+09 (SB I-57) TO STA. 1214+95 (SB I-94)		STA. 257+76 (NB I-57) TO STA. 2213+00 (NB I-94)		
FED. ROAD DIST. NO.		ILLINOIS FED. AID PROJECT		

60A74

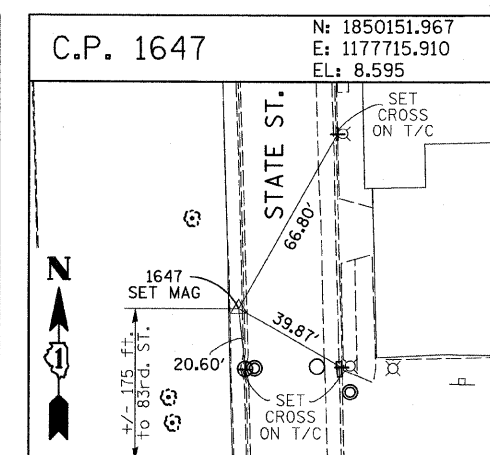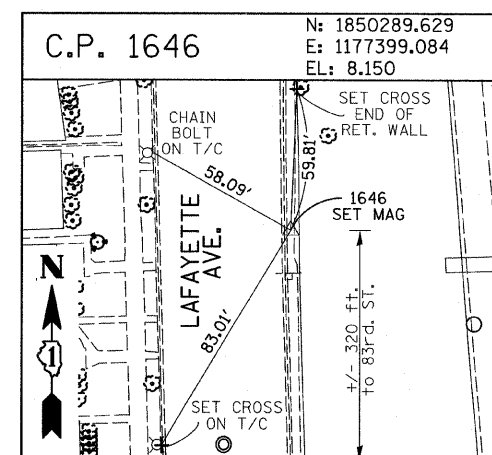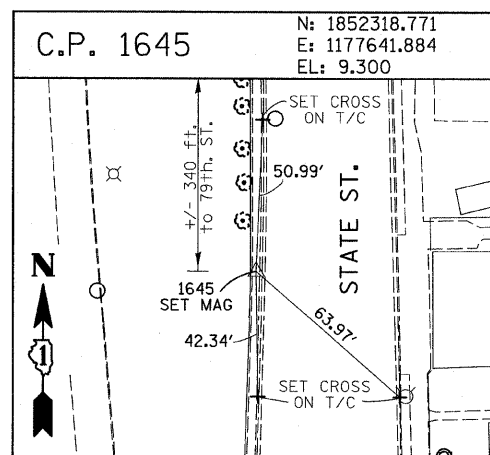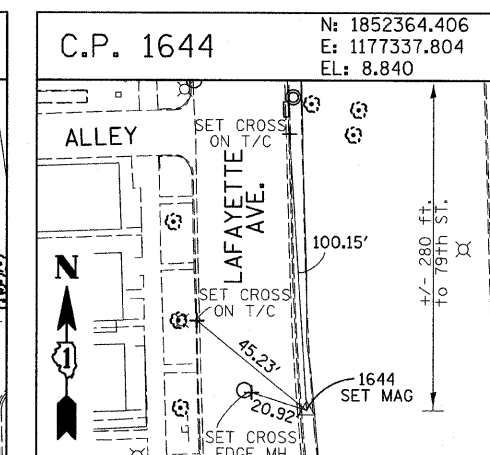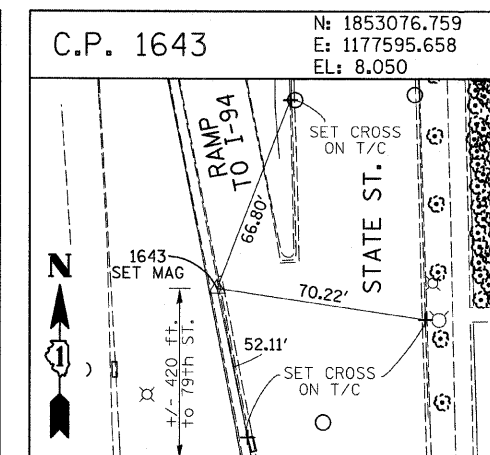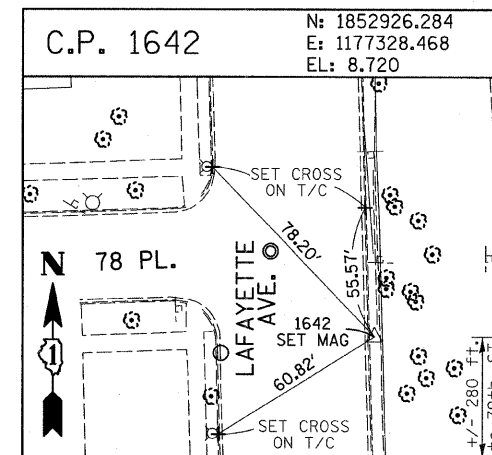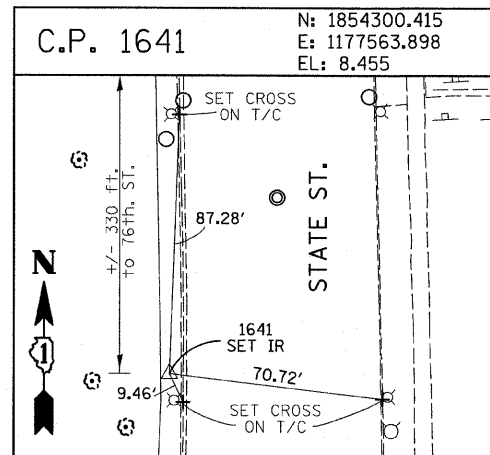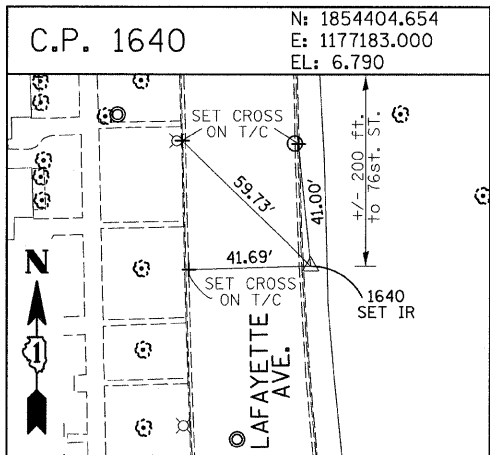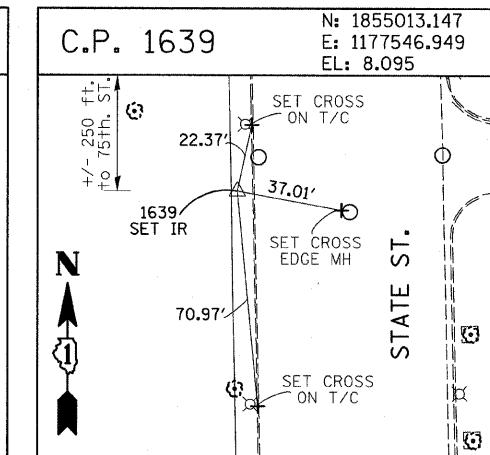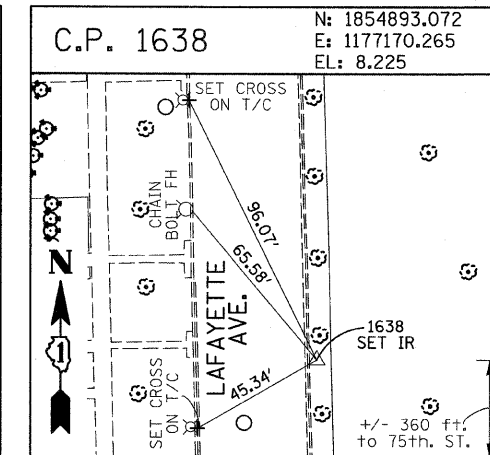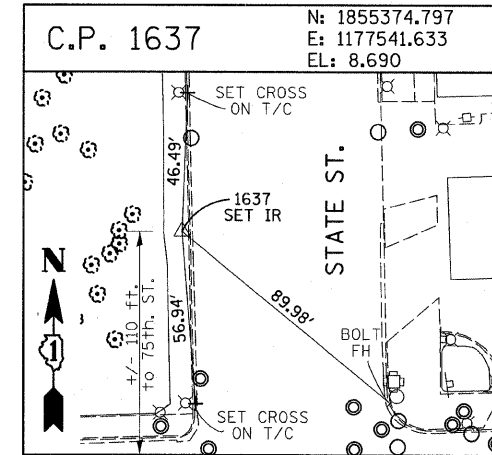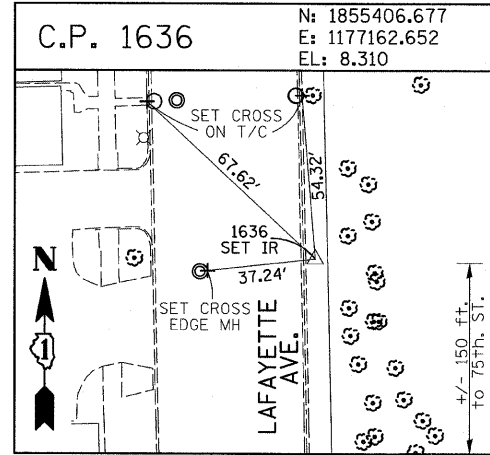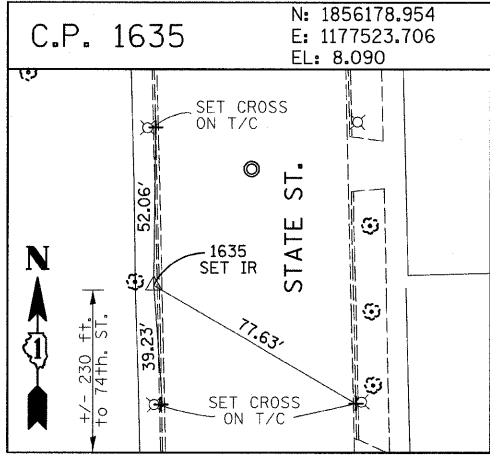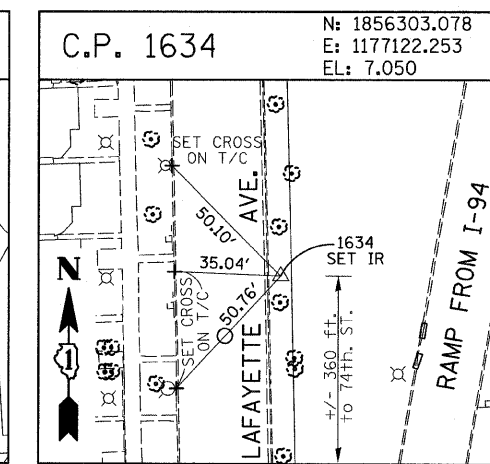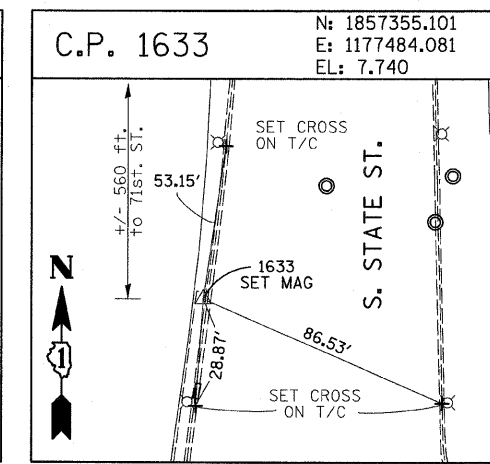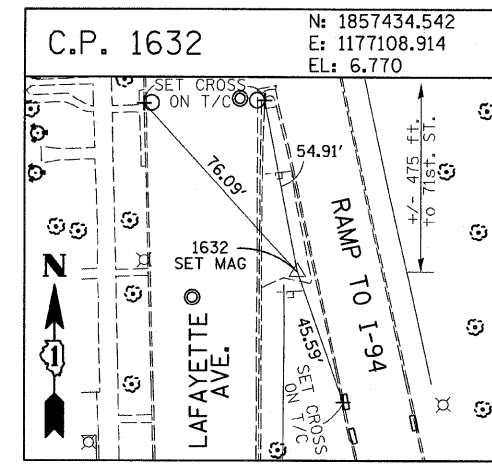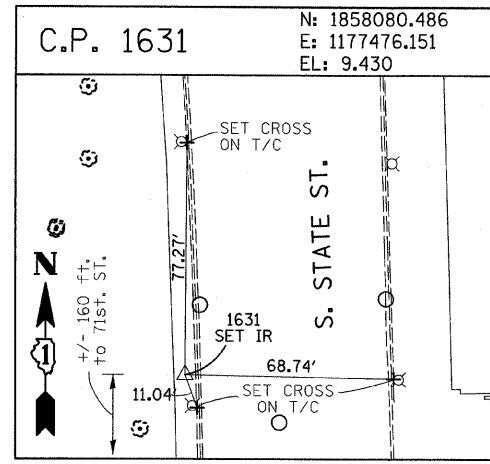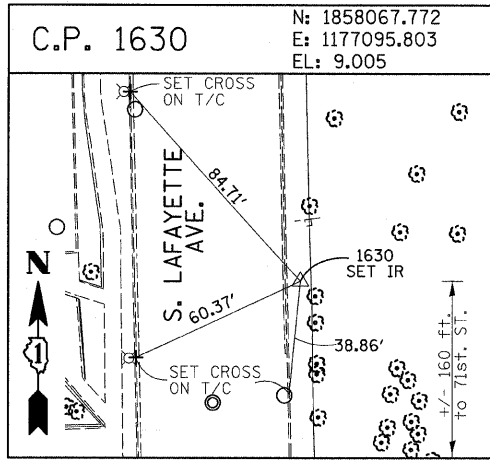

American Surveying Consultants, P.C.  
 1837 Flood Rd., Suite 111, Elmhurst, IL 60121  
 630-584-4221



















REVISIONS	
NAME	DATE

ILLINOIS DEPARTMENT OF TRANSPORTATION  
 F.A.I. 94 (DAN RYAN EXPRESSWAY)  
 SURVEY TIES FOR CONTROL POINTS  
 SHEET 3 OF 7  
 SCALE: 1"=30'  
 DATE: JUNE 20, 2008  
 DRAWN BY: GSP  
 CHECKED BY: MMW

6/20/2008 10:25:27 AM

F.A.I. RTE.	SECTION	COUNTY	TOTAL SHEETS	SHEET NO.
94	2005-068 LS	COOK	58	15
STA. 153+09 (SB I-57)		TO STA. 121+95 (SB I-94)		
STA. 251+76 (NB I-57)		TO STA. 2213+00 (NB I-94)		
FED. ROAD DIST. NO.		ILLINOIS FED. AID PROJECT		

60A74

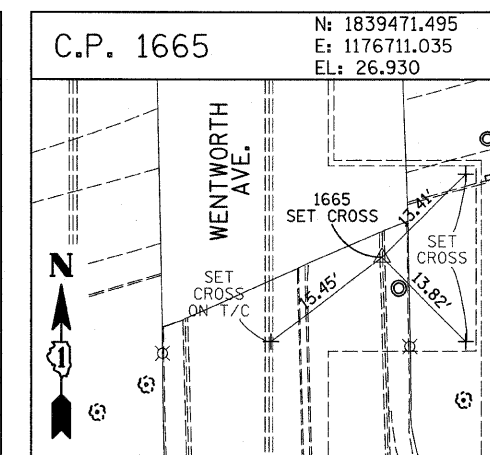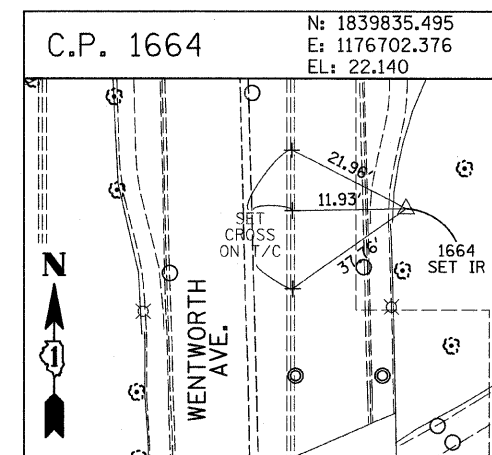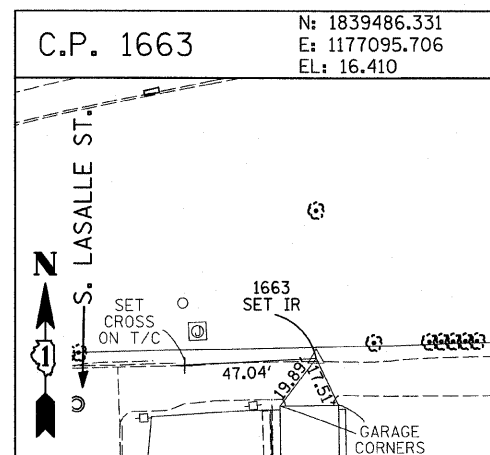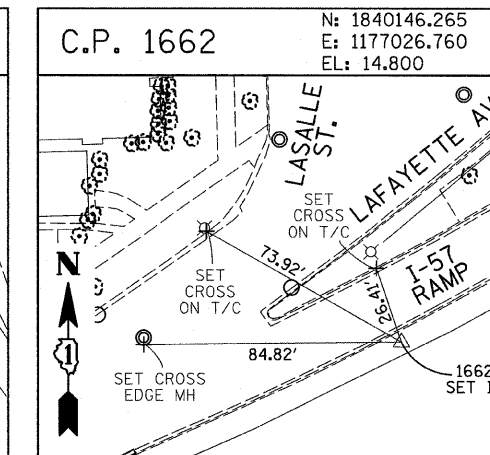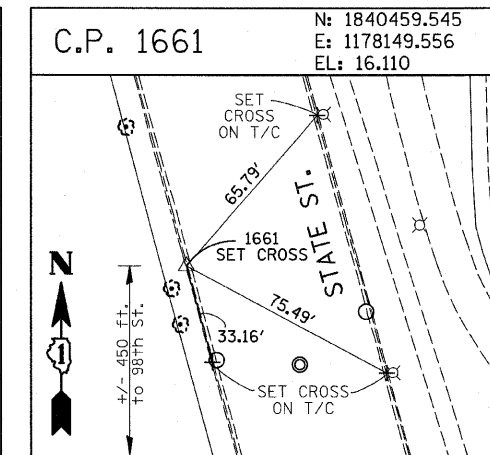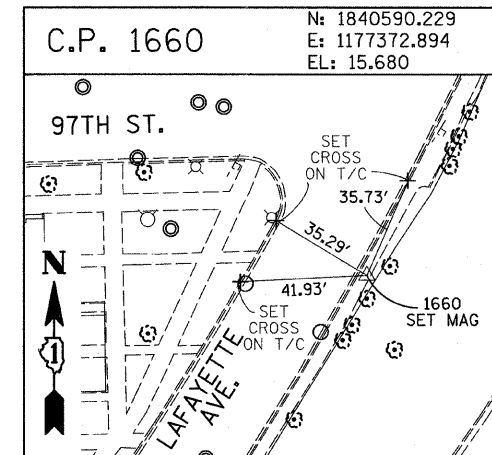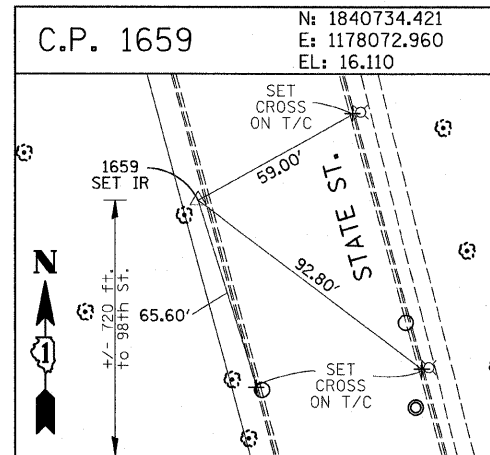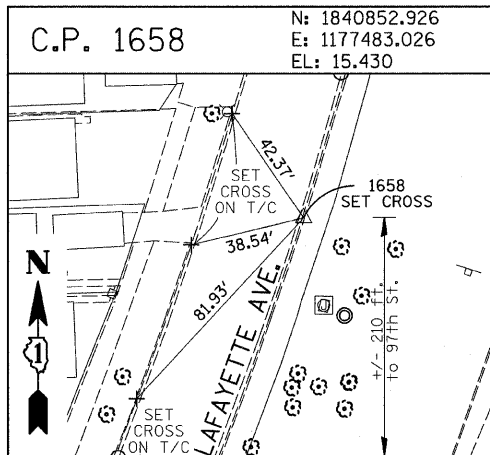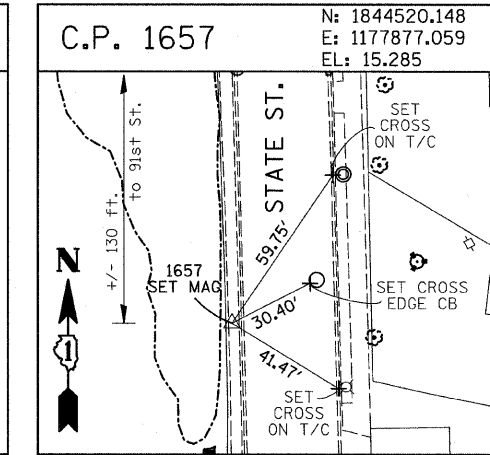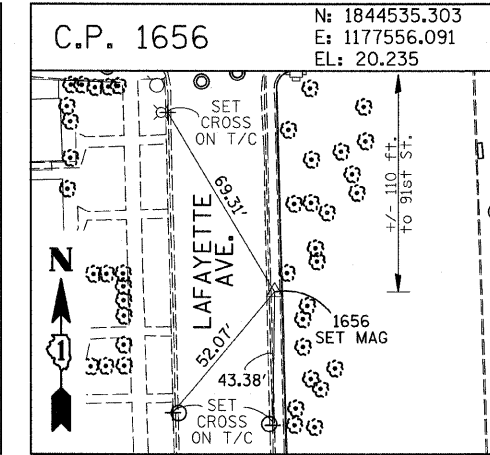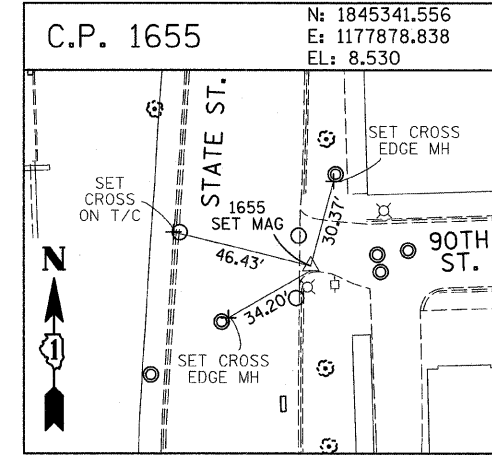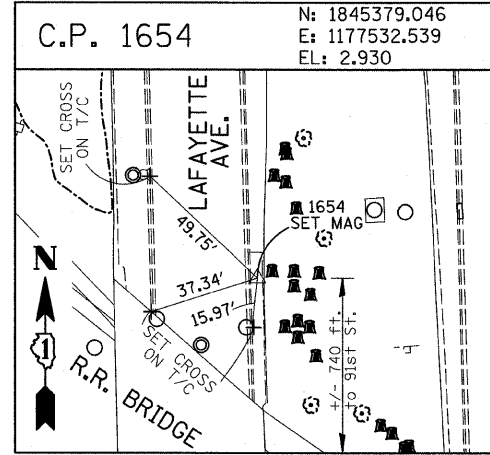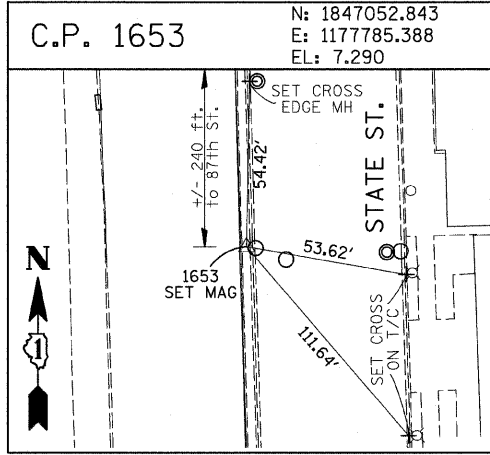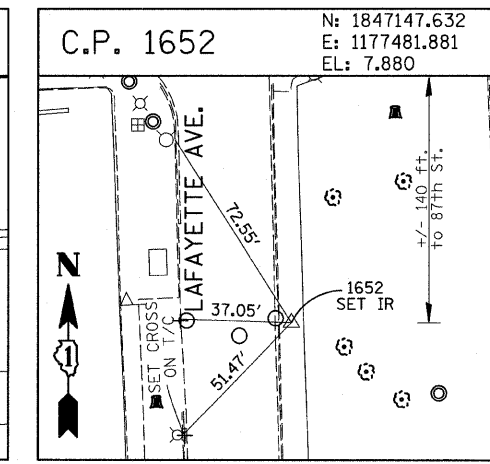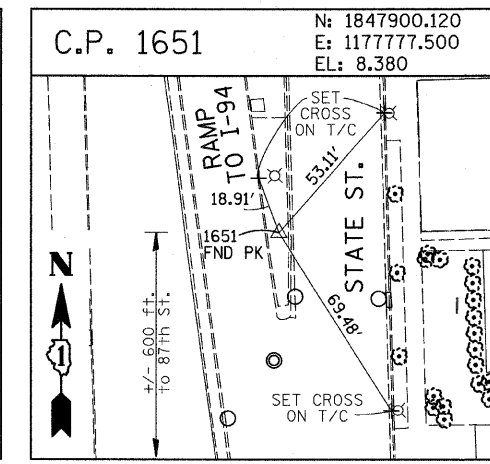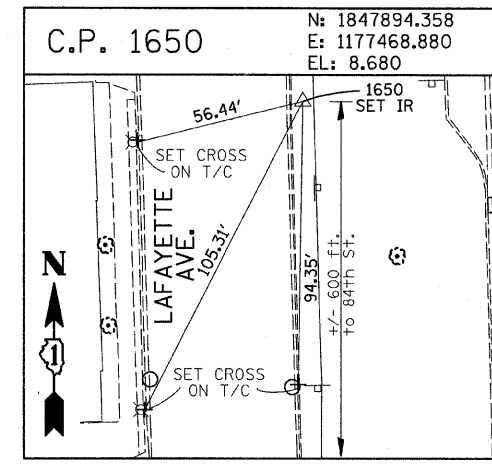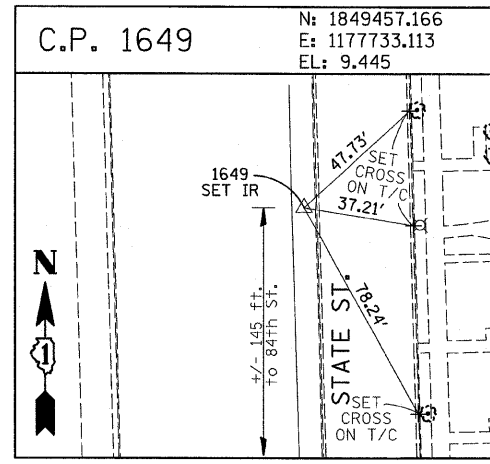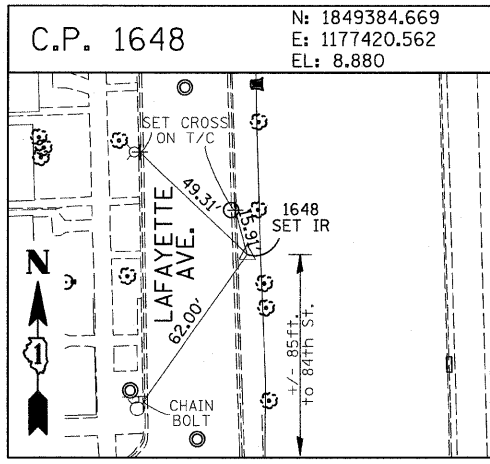

American Surveying Consultants, P.C.  
 SURVEYORS-ENGINEERS-ARCHITECTS-MAPPING SCIENTISTS  
 1637 Flossmoor Rd., Suite 111, Chicago, IL 60643







REVISIONS	
NAME	DATE

ILLINOIS DEPARTMENT OF TRANSPORTATION  
 F.A.I. 94 (DAN RYAN EXPRESSWAY)  
 SURVEY TIES FOR CONTROL POINTS  
 SHEET 4 OF 7  
 SCALE: 1"=30'  
 DATE: JUNE 20, 2008  
 DRAWN BY: GSP  
 CHECKED BY: MMW

6/20/2008 10:25:28 AM

F.A.I. RTE.	SECTION	COUNTY	TOTAL SHEETS	SHEET NO.
94	2005-068 LS	COOK	58	16
STA. 153+09 (SB 1-57) TO STA. 1214+95 (SB 1-94)				
STA. 251+76 (NB 1-57) TO STA. 2213+00 (NB 1-94)				
FED. ROAD DIST. NO.		ILLINOIS FED. AID PROJECT		

60A74

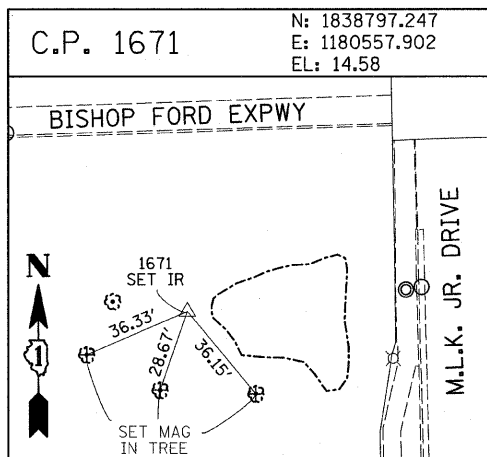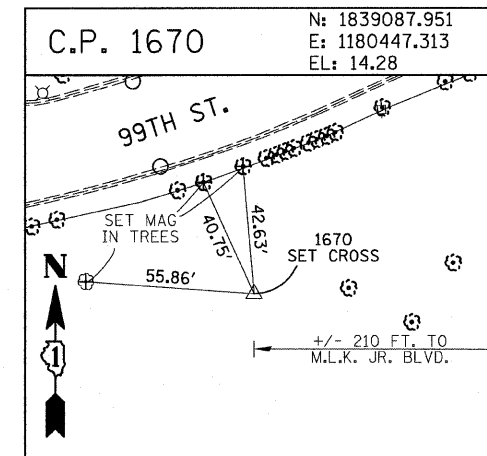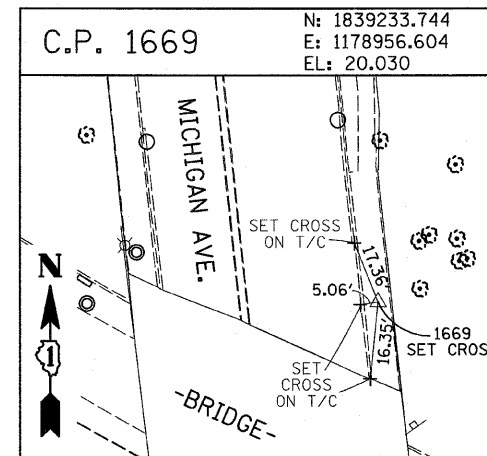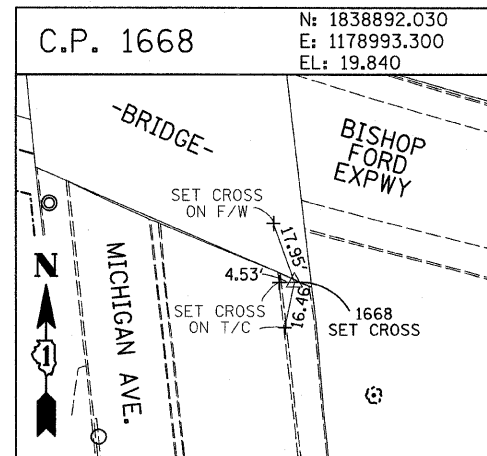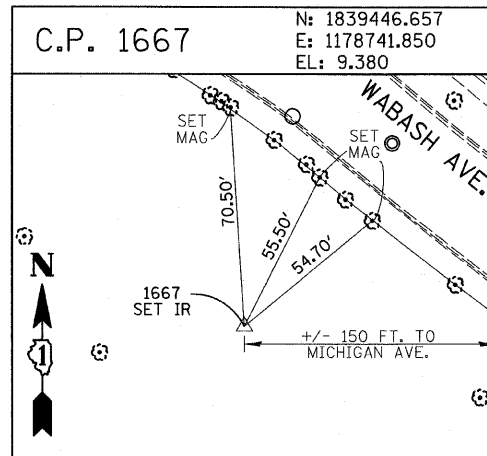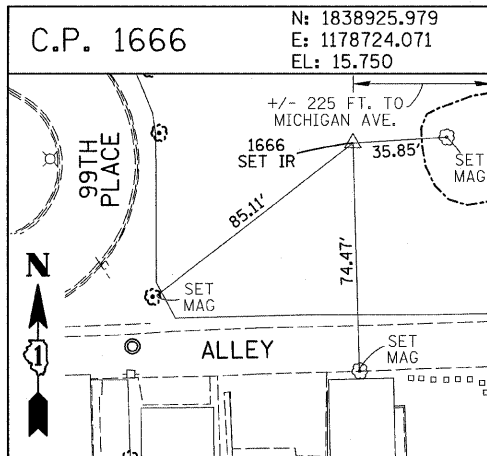

**PROJECT BENCHMARKS**

- BM 2231 ELEVATION= 10.24 FEET  
SET CROSS ON CHAIN BOLT OF FIRE HYDRANT ON THE SOUTHWEST CORNER OF 71ST STREET AND LAFAYETTE AVENUE.
- BM 2232 ELEVATION= 8.46 FEET  
SET CROSS ON CHAIN BOLT OF FIRST FIRE HYDRANT SOUTH OF 73RD STREET ON THE WEST SIDE OF LAFAYETTE AVENUE. APPROXIMATELY 330 FEET SOUTH OF 73RD STREET.
- BM 2233 ELEVATION= 9.90 FEET  
SET CROSS ON NORTHWEST BOLT OF FIRE HYDRANT ON THE NORTHWEST CORNER OF 75TH STREET AND LAFAYETTE AVENUE.
- BM 2234 ELEVATION= 9.56 FEET  
SET CROSS ON CHAIN BOLT OF FIRST FIRE HYDRANT SOUTH OF 75TH STREET ON THE WEST SIDE OF LAFAYETTE AVENUE. APPROXIMATELY 320 FEET SOUTH OF 75TH STREET.
- BM 2235 ELEVATION= 7.50 FEET  
SET CROSS ON CHAIN BOLT OF FIRST FIRE HYDRANT SOUTH OF 76TH STREET ON THE WEST SIDE OF LAFAYETTE. APPROXIMATELY 330 FEET SOUTH OF 76TH STREET.
- BM 2236 ELEVATION= 10.41 FEET  
SET CROSS ON WEST BOLT OF FIRE HYDRANT ON THE SOUTHWEST CORNER OF 79TH STREET AND LAFAYETTE AVENUE.
- BM 2237 ELEVATION= 9.20 FEET  
SET CROSS ON CHAIN BOLT OF FIRST FIRE HYDRANT NORTH OF 83RD STREET ON THE WEST SIDE OF LAFAYETTE AVENUE. APPROXIMATELY 350 FEET NORTH OF 83RD STREET.
- BM 2238 ELEVATION= 10.04 FEET  
SET CROSS ON CHAIN BOLT OF FIRE HYDRANT OF THE NORTHWEST CORNER OF 4TH STREET AND LAFAYETTE AVENUE.
- BM 2239 ELEVATION= 9.59 FEET  
SET CROSS ON CHAIN BOLT OF SECOND FIRE HYDRANT NORTH OF 87TH STREET ON THE WEST SIDE OF LAFAYETTE AVENUE. APPROXIMATELY 720 FEET NORTH OF 87TH STREET.
- BM 2240 ELEVATION= 9.49 FEET  
SET CROSS ON THE NORTHWEST BOLT OF FIRE HYDRANT ON THE SOUTHWEST CORNER OF 78TH STREET AND LAFAYETTE AVENUE.
- BM 2241 ELEVATION= 3.63 FEET  
SET SQUARE CUT ON TOP OF CURB NEXT TO LIGHT POLE ON THE NORTHWEST CORNER OF LAFAYETTE AVENUE AND RAILROAD BRIDGE. APPROXIMATELY 770 FEET NORTH OF 91ST STREET.
- BM 2242 ELEVATION= 22.82 FEET  
SET CROSS ON CHAIN BOLT OF FIRE HYDRANT ON THE SOUTHWEST CORNER OF 91ST STREET AND LAFAYETTE AVENUE.
- BM 2243 ELEVATION= 15.68 FEET  
SET SQUARE CUT ON THE TOP OF CURB NEXT TO THIRD LIGHT POLE NORTH OF 97TH STREET ON THE WEST SIDE OF LAFAYETTE AVENUE. APPROXIMATELY 260 FEET NORTH OF 97TH STREET.
- BM 2244 ELEVATION= 15.94 FEET  
SET SQUARE CUT ON TOP OF CURB NEXT TO LIGHT POLE ON THE NORTH SIDE OF 98TH STREET. APPROXIMATELY 120 FEET EAST OF WENTWORTH AVENUE.

- BM 2245 ELEVATION= 16.35 FEET  
SET SQUARE CUT ON THE EAST END OF CURB AT THE NORTHEAST CORNER OF FIRST ALLEY NORTH OF 99TH STREET. APPROXIMATELY 35 FEET EAST OF LASALLE STREET.
- BM 2246 ELEVATION= 20.00 FEET  
SET SQUARE CUT WITH CROSS ON TOP OF ABUTMENT WALL ON THE NORTHWEST CORNER OF STATE STREET BRIDGE OVER THE BISHOP FORD EXPRESSWAY. APPROXIMATELY 20 FEET NORTH OF THE NORTH EDGE OF THE BRIDGE.
- BM 2248 ELEVATION= 9.77 FEET  
SET CROSS ON CHAIN BOLT OF FIRST FIRE HYDRANT NORTH OF RAILROAD BRIDGE ON THE EAST SIDE OF STATE STREET. APPROXIMATELY 110 FEET SOUTH OF 90TH STREET.
- BM 2249 ELEVATION= 9.67 FEET  
SET CROSS ON CHAIN BOLT OF FIRE HYDRANT ON THE NORTHWEST CORNER OF 87TH AND STATE STREET.
- BM 2250 ELEVATION= 10.03 FEET  
SET CROSS ON CHAIN BOLT OF FIRE HYDRANT ON THE NORTHWEST CORNER OF 83RD ST. AND STATE STREET.
- BM 2251 ELEVATION= 10.95 FEET  
FOUND CROSS ON EAST BOLT OF FIRE HYDRANT ON THE EAST SIDE OF STATE STREET. APPROXIMATELY 135 FEET NORTH OF 79TH STREET.
- BM 2252 ELEVATION= 10.02 FEET  
SET CROSS ON WEST BOLT OF FIRE HYDRANT ON THE NORTHWEST CORNER OF STATE STREET AND 76TH STREET.
- BM 2254 ELEVATION= 9.17 FEET  
SET CROSS ON CHAIN BOLT OF FIRST FIRE HYDRANT SOUTH OF 73RD STREET ON THE EAST SIDE OF STATE STREET. APPROXIMATELY 330 FEET SOUTH OF 73RD STREET.
- BM 2255 ELEVATION= 11.25 FEET  
SET CROSS ON CHAIN BOLT OF FIRE HYDRANT ON THE NORTHWEST CORNER OF 71ST STREET AND STATE STREET.
- BM 2256 ELEVATION= 16.36 FEET  
SET SQUARE CUT ON TOP OF ABUTMENT WALL ON THE NORTHWEST CORNER OF MARTIN LUTHER KING DRIVE BRIDGE OVER THE BISHOP FORD EXPRESSWAY. APPROXIMATELY 1 FOOT NORTH OF THE NORTH END OF THE BRIDGE.
- BM 2257 ELEVATION= 18.25 FEET  
SET CROSS ON NORTHEAST BOLT OF LIGHT POLE BASE ON THE EAST SIDE OF STATE STREET. APPROXIMATELY 970 FEET SOUTH OF 95TH STREET.
- BM 2258 ELEVATION= 10.53 FEET  
SET CROSS ON NORTHWEST BOLT OF LIGHT BASE ON NORTHWEST CORNER OF 71ST STREET AND LAFAYETTE AVENUE.

REVISIONS	
NAME	DATE

ILLINOIS DEPARTMENT OF TRANSPORTATION  
F.A.I. 94 (DAN RYAN EXPRESSWAY)

SURVEY TIES FOR CONTROL POINTS  
SHEET 5 OF 7

















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DATE: JUNE 20, 2008  
DRAWN BY: GSP  
CHECKED BY: MMW

6/20/2008 10:25:29 AM



F.A.I. RTE.	SECTION	COUNTY	TOTAL SHEETS	SHEET NO.
94	2005-068 LS	COOK	58	17
153+08 (SB 1-37)		214+98 (SB 1-94)		
STA. 237+76 (NB 1-37)		223+00 (NB 1-94)		
FED. ROAD DIST. NO.		ILLINOIS FED. AID PROJECT		

60A74

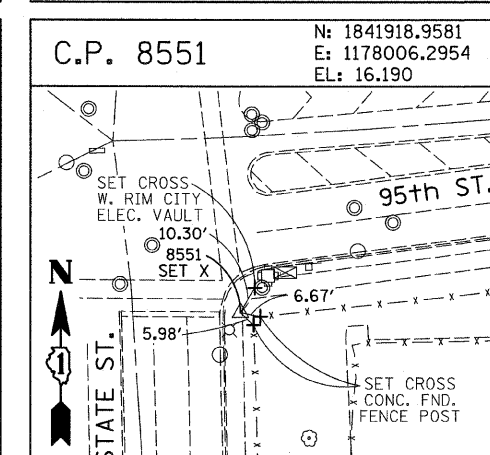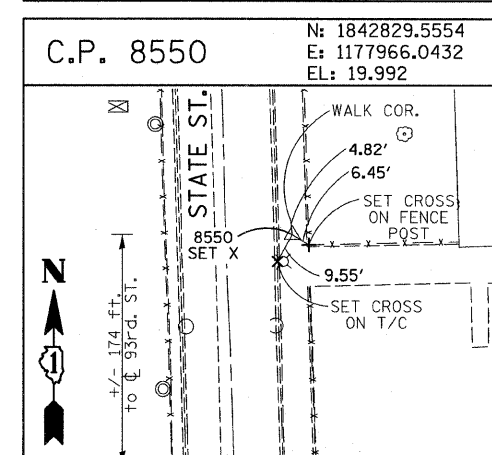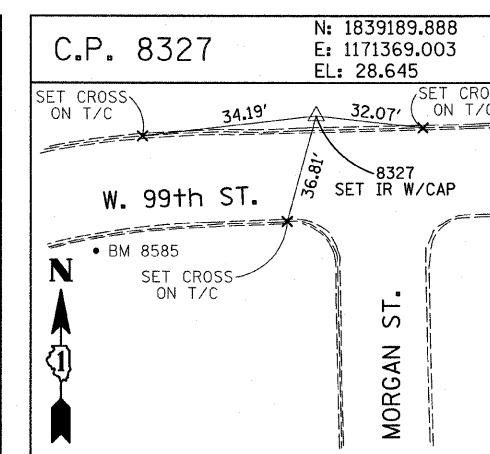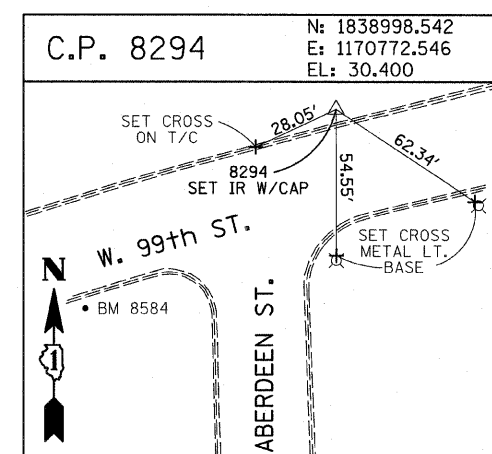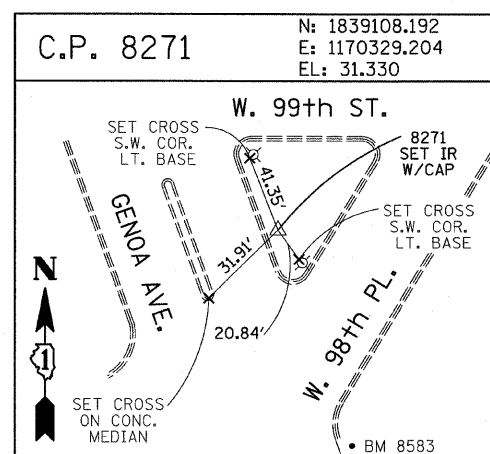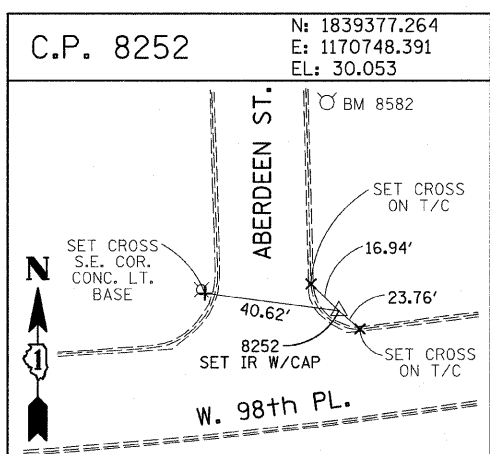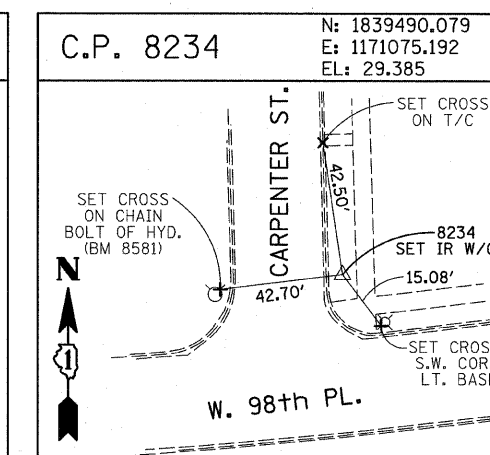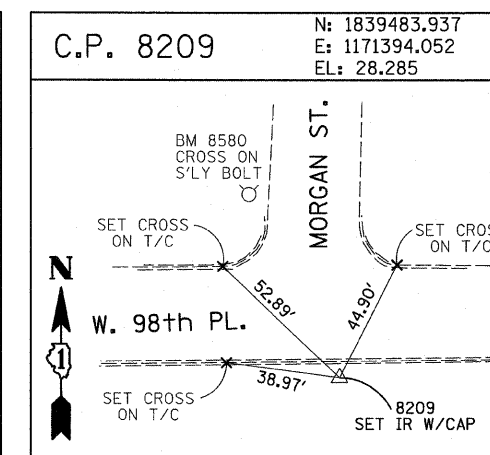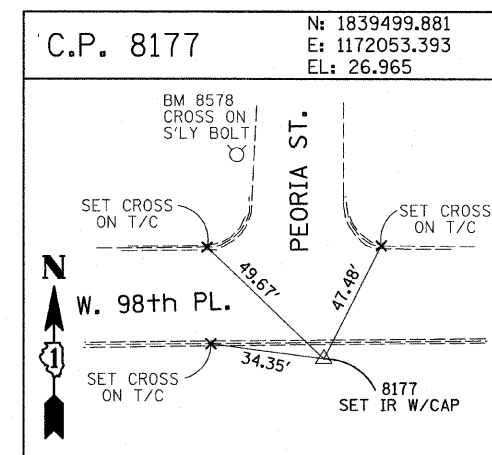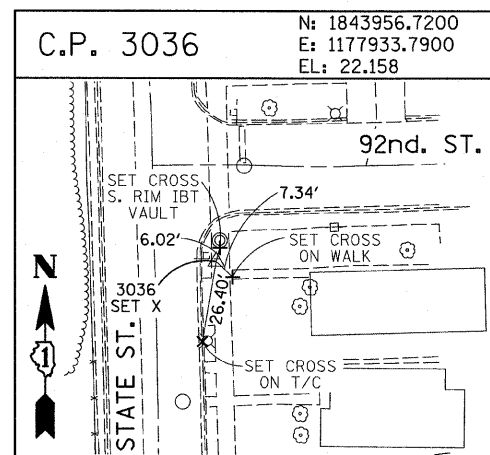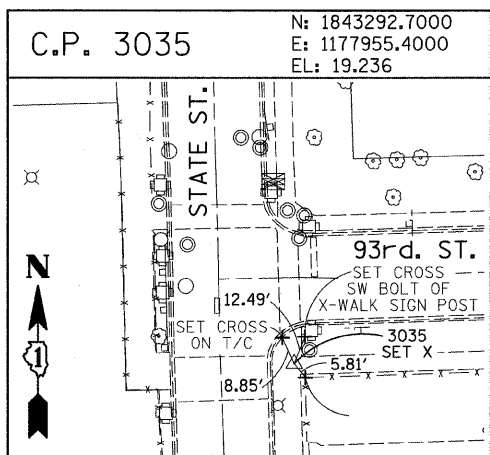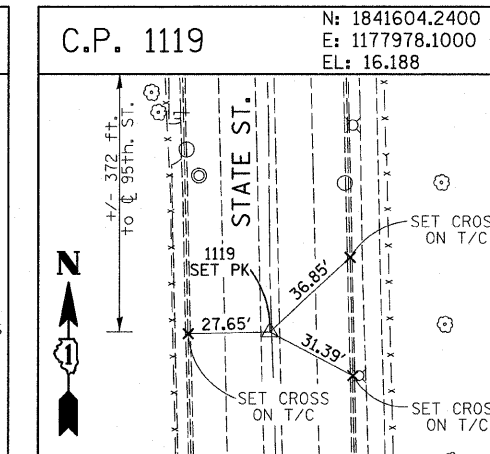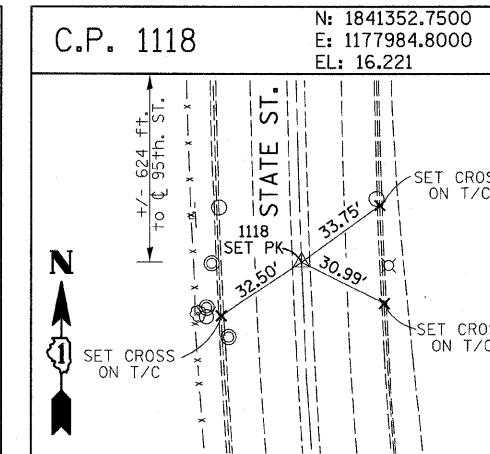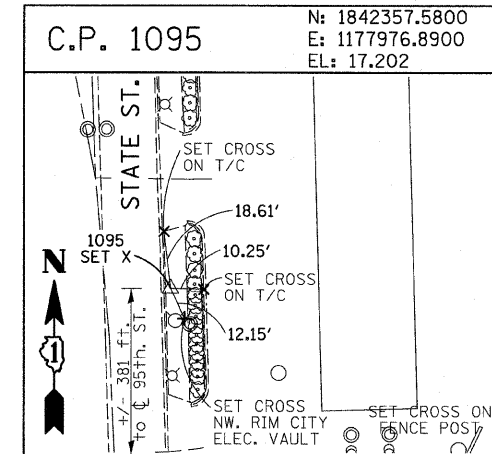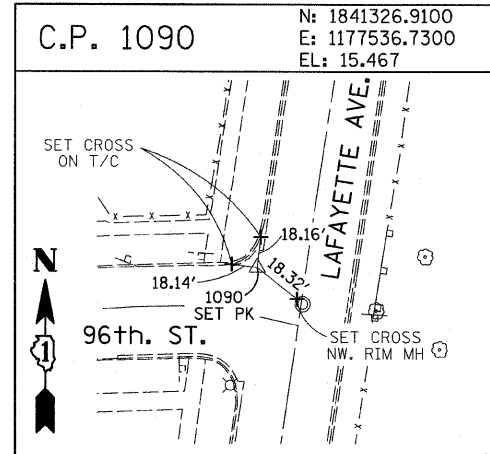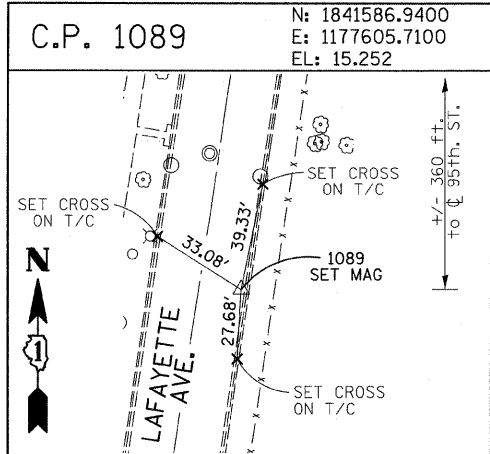

American Surveying Consultants, P.C.  
 1877 Piquette Ave., Chicago, IL 60611 6032 N. Northbrook Rd., Chicago, IL 60062

REVISIONS	
NAME	DATE










ILLINOIS DEPARTMENT OF TRANSPORTATION  
 F.A.I. 94 (DAN RYAN EXPRESSWAY)  
 SURVEY TIES FOR CONTROL POINTS  
 SHEET 6 OF 7

SCALE: 1"=30'  
 DATE: JUNE 20, 2008  
 DRAWN BY: GSP  
 CHECKED BY: MMW

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F.A.I. RTE.	SECTION	COUNTY	TOTAL SHEETS	SHEET NO.
94	2005-068 LS	COOK	58	18
STA. 153+09 (SB 1-57) TO STA. 2214+95 (SB 1-94)				
STA. 257+76 (NB 1-57) TO STA. 2213+00 (NB 1-94)				
FED. ROAD DIST. NO.		ILLINOIS	FED. AID PROJECT	

60A74

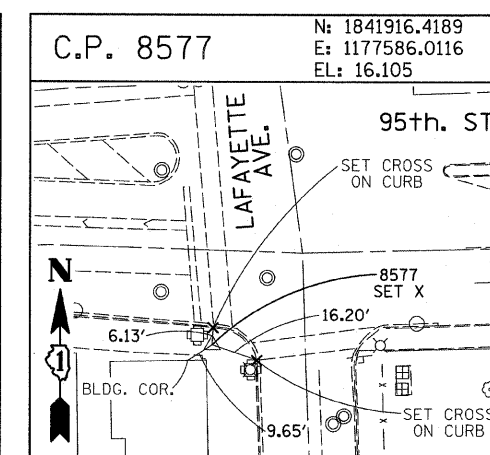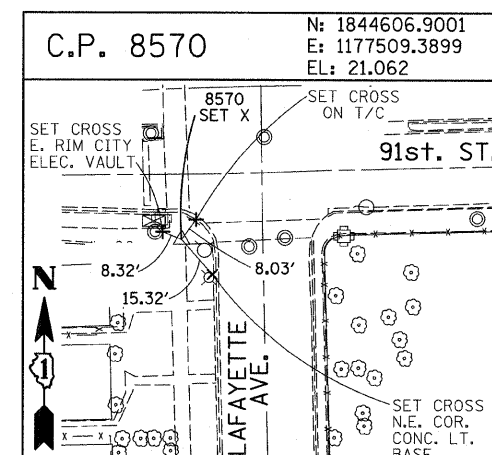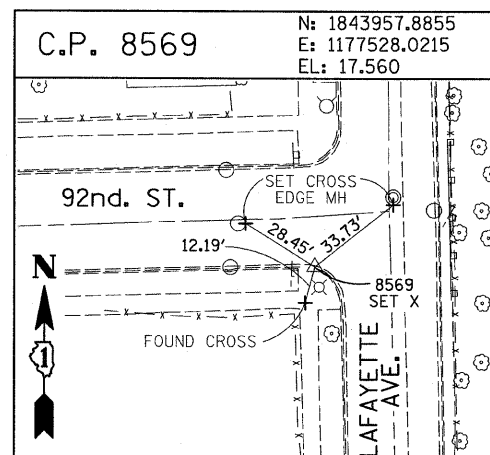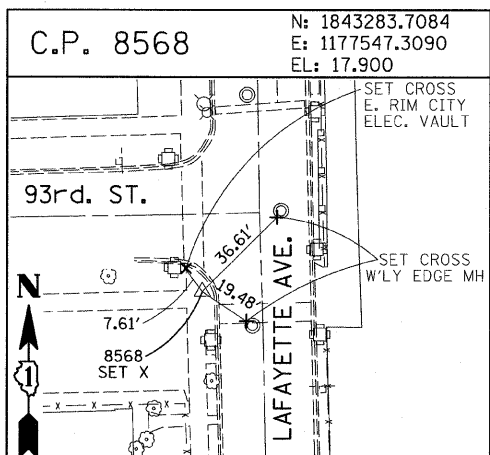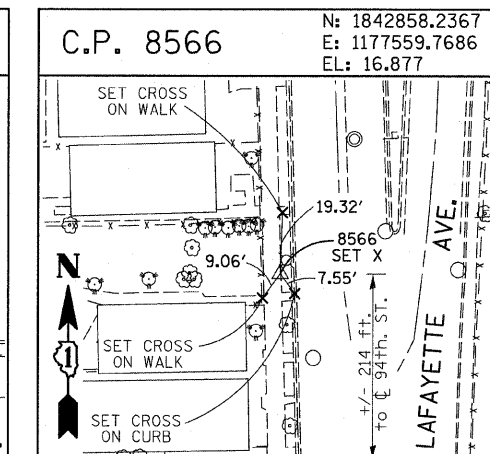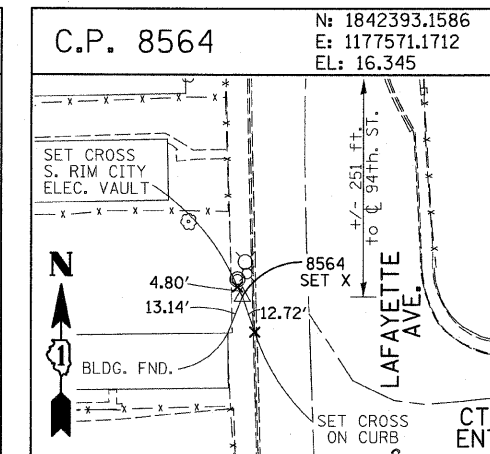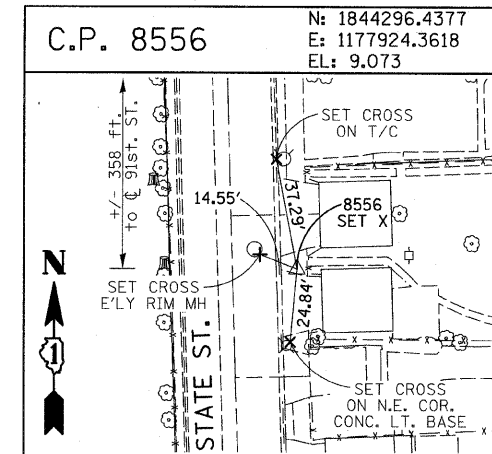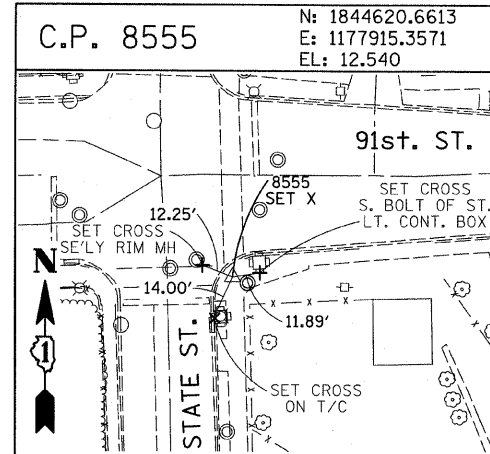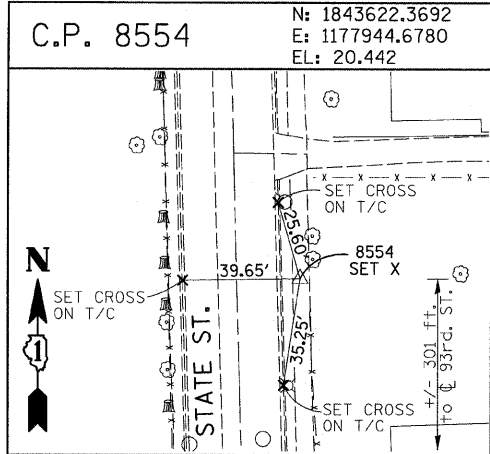

**PROJECT BENCHMARKS**

BM 101 ELEVATION= 24.89 FEET  
SET SQUARE CUT ON SOUTHERLY CURB OF WEST 98TH PLACE. APPROXIMATELY 70 FEET EAST OF THE CENTERLINE OF GREEN STREET.

BM 102 ELEVATION= 27.36 FEET  
SET CROSS ON SOUTHERLY FLANGE BOLT OF FIRE HYDRANT AT THE SOUTHWEST CORNER OF WEST 99TH STREET AND GREEN STREET.

BM 8558 ELEVATION= 17.73 FEET  
SET SQUARE CUT ON SOUTHEAST CORNER OF FOURTH LIGHT BASE SOUTH OF 95TH STREET, ON THE EAST SIDE OF STATE STREET.

BM 8559 ELEVATION= 17.10 FEET  
SET SQUARE CUT ON SOUTHWEST CORNER OF CONCRETE SIGN BASE AT THE NORTHWEST CORNER OF THE MOBIL GAS STATION PROPERTY AT THE NORTHEAST CORNER OF 95TH STREET AND STATE STREET.

BM 8560 ELEVATION= 17.50 FEET  
SET SQUARE CUT ON SOUTHEAST CORNER OF CONCRETE BUS SLAB ON THE EAST SIDE OF STATE STREET. APPROXIMATELY 50 FEET SOUTH OF THE CENTERLINE OF 94TH STREET.

BM 8561 ELEVATION= 19.77 FEET  
SET CROSS ON SOUTHEASTERLY FLANGE BOLT OF FIRST FIRE HYDRANT SOUTH OF 93RD STREET, ON THE EAST SIDE OF STATE STREET.

BM 8562 ELEVATION= 22.29 FEET  
SET CROSS ON SOUTHEASTERLY FLANGE BOLT OF FIRST FIRE HYDRANT NORTH OF 93RD STREET, ON THE EAST SIDE OF STATE STREET.

BM 8563 ELEVATION= 20.47 FEET  
SET CROSS ON SOUTHEASTERLY FLANGE BOLT OF FIRST FIRE HYDRANT SOUTH OF 91ST STREET, ON THE EAST SIDE OF STATE STREET.

BM 8573 ELEVATION= 19.89 FEET  
SET SQUARE CUT ON EAST SIDE OF SIDEWALK OPPOSITE TO THE SECOND FIRE HYDRANT SOUTH OF 91ST STREET, ON THE WEST SIDE OF LAFAYETTE AVENUE.

BM 8574 ELEVATION= 18.90 FEET  
SET CROSS ON THE WESTERLY FLANGE BOLT OF FIRE HYDRANT APPROXIMATELY AT 9224 S. LAFAYETTE AVENUE, ON THE WEST SIDE OF LAFAYETTE AVENUE.

BM 8575 ELEVATION= 17.77 FEET  
SET CROSS ON THE WESTERLY FLANGE BOLT OF FIRE HYDRANT APPROXIMATELY AT 9326 S. LAFAYETTE AVENUE, ON THE WEST SIDE OF LAFAYETTE AVENUE.

BM 8576 ELEVATION= 17.43 FEET  
SET CROSS ON THE WESTERLY FLANGE BOLT OF FIRE HYDRANT AT THE VACANT LOT BETWEEN 9416 AND 9422 S. LAFAYETTE AVENUE, ON THE WEST SIDE OF LAFAYETTE AVENUE.

BM 8578 ELEVATION= 27.92 FEET  
SET CROSS ON SOUTHERLY FLANGE BOLT OF FIRE HYDRANT AT THE NORTHWEST CORNER OF WEST 98TH PLACE AND PEORIA STREET.

BM 8579 ELEVATION= 28.59 FEET  
SET CROSS ON SOUTHERLY FLANGE BOLT OF FIRE HYDRANT AT THE NORTHWEST CORNER OF WEST 98TH PLACE AND SANGAMON STREET.

BM 8580 ELEVATION= 29.24 FEET  
SET CROSS ON SOUTHERLY FLANGE BOLT OF FIRE HYDRANT AT THE NORTHWEST CORNER OF WEST 98TH PLACE AND MORGAN STREET.

BM 8581 ELEVATION= 30.82 FEET  
SET CROSS ON CHAIN BOLT OF FIRE HYDRANT ON THE NORTHWEST CORNER OF CARPENTER STREET AND WEST 98TH PLACE.

BM 8582 ELEVATION= 30.69 FEET  
SET CROSS ON CHAIN BOLT OF FIRST FIRE HYDRANT NORTH OF WEST 98TH PLACE, ON THE EAST SIDE OF ABERDEEN STREET.

BM 8583 ELEVATION= 33.14 FEET  
SET SQUARE CUT ON CONCRETE BRIDGE WALL AT THE SOUTHEASTERLY CORNER OF GENOA AVENUE AND 99TH STREET.

BM 8584 ELEVATION= 32.36 FEET  
SET CROSS ON CHAIN BOLT OF FIRST FIRE HYDRANT WEST OF ABERDEEN STREET, ON THE SOUTHERLY SIDE OF 99TH STREET.

BM 8585 ELEVATION= 30.28 FEET  
SET CROSS ON SOUTHERLY FLANGE BOLT OF FIRST FIRE HYDRANT WEST OF MORGAN STREET, ON THE SOUTH SIDE OF 99TH STREET.

BM 8586 ELEVATION= 28.75 FEET  
SET CROSS ON NORTHERLY FLANGE BOLT OF FIRE HYDRANT AT THE SOUTHWEST CORNER OF 99TH STREET AND SANGAMON STREET.

BM 8587 ELEVATION= 31.19 FEET  
SET CROSS ON SOUTHERLY FLANGE BOLT OF FIRE HYDRANT AT THE SOUTHWEST CORNER OF 99TH STREET AND CARPENTER STREET.

BM 3514 ELEVATION= 17.56 FEET  
SET CROSS ON CHAIN BOLT OF HYDRANT AT SOUTHWEST INTERSECTION OF LASALLE ST. AND 97TH ST.

BM 3522 ELEVATION= 18.06 FEET  
SET CROSS ON SOUTH SOUTHEAST FLANGE BOLT OF HYDRANT ± HALFWAY BETWEEN NORTH AND SOUTH ENTRANCE TO CITGO, EAST SIDE OF STATE ST. AND NORTH OF 95TH ST.

BM 3549 ELEVATION= 9.49 FEET  
SET CROSS WESTERLY FLANGE BOLT OF HYDRANT AT SOUTHWEST INTERSECTION OF 87TH ST. AND LAFAYETTE AVE.

BM 3550 ELEVATION= 22.88 FEET  
SET CROSS WESTERLY FLANGE BOLT OF HYDRANT AT SOUTHWEST INTERSECTION OF 91ST ST. AND LAFAYETTE AVE.

BM 3551 ELEVATION= 17.50 FEET  
SET CROSS NORTHERLY FLANGE BOLT OF HYDRANT AT SOUTHWEST INTERSECTION OF 95TH ST. AND LAFAYETTE AVE.

BM 3552 ELEVATION= 14.81 FEET  
SET CROSS NORTHEAST BOLT OF TRAFFIC SIGNAL/LIGHT BASE AT SOUTHEAST INTERSECTION OF 91ST ST. AND STATE ST.

BM 3553 ELEVATION= 8.47 FEET  
SET CROSS NORTHWEST BOLT OF TRAFFIC SIGNAL/LIGHT BASE AT NORTHEAST INTERSECTION OF 87TH ST. AND STATE ST.

BM 3556 ELEVATION= 9.06 FEET  
SET CROSS EASTERLY FLANGE BOLT OF HYDRANT AT NORTHEAST CORNER OF 75TH ST. AND STATE ST.

BM 3558 ELEVATION= 18.15 FEET  
SET CROSS SOUTHWESTERLY FLANGE BOLT OF HYDRANT AT NORTHWEST INTERSECTION OF NORMAL ST. AND 98TH PLACE.

BM 3810 ELEVATION= 0.29 FEET  
CUT SQUARE ON SOUTHERLY CORNER OF METAL BASE FOR OVERHEAD SIGN, ON THE WESTERLY SIDE OF SOUTHBOUND DAN RYAN, OPPOSITE OF WEST 17TH PLACE, APPROXIMATELY 1000 FEET NORTH OF 79TH STREET BRIDGE.

BM 3811 ELEVATION= 1.95 FEET  
CUT SQUARE ON SOUTHEASTERLY CORNER OF METAL BASE FOR OVERHEAD SIGN, ON THE WESTERLY SIDE OF SOUTHBOUND DAN RYAN APPROXIMATELY 840 FEET SOUTHERLY OF 83RD STREET.

REVISIONS	
NAME	DATE

ILLINOIS DEPARTMENT OF TRANSPORTATION  
F.A.I. 94 (DAN RYAN EXPRESSWAY)

SURVEY TIES FOR CONTROL POINTS  
SHEET 7 OF 7


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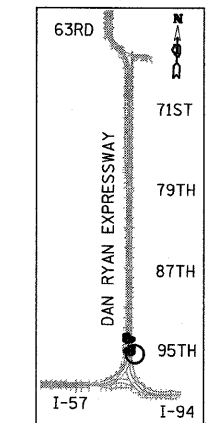
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F.A.I. RTE.	SECTION	COUNTY	TOTAL SHEETS	SHEET NO.
94	2005-068 LS	COOK	58	19
STA. 257+76 (NB I-57)		TO STA. 2214+95 (SB I-94)		
FED. ROAD DIST. NO.		ILLINOIS	FED. AID PROJECT	


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MATCHLINE NB I-94 (RYAN) STA. 2204+50.00



LOCATION MAP

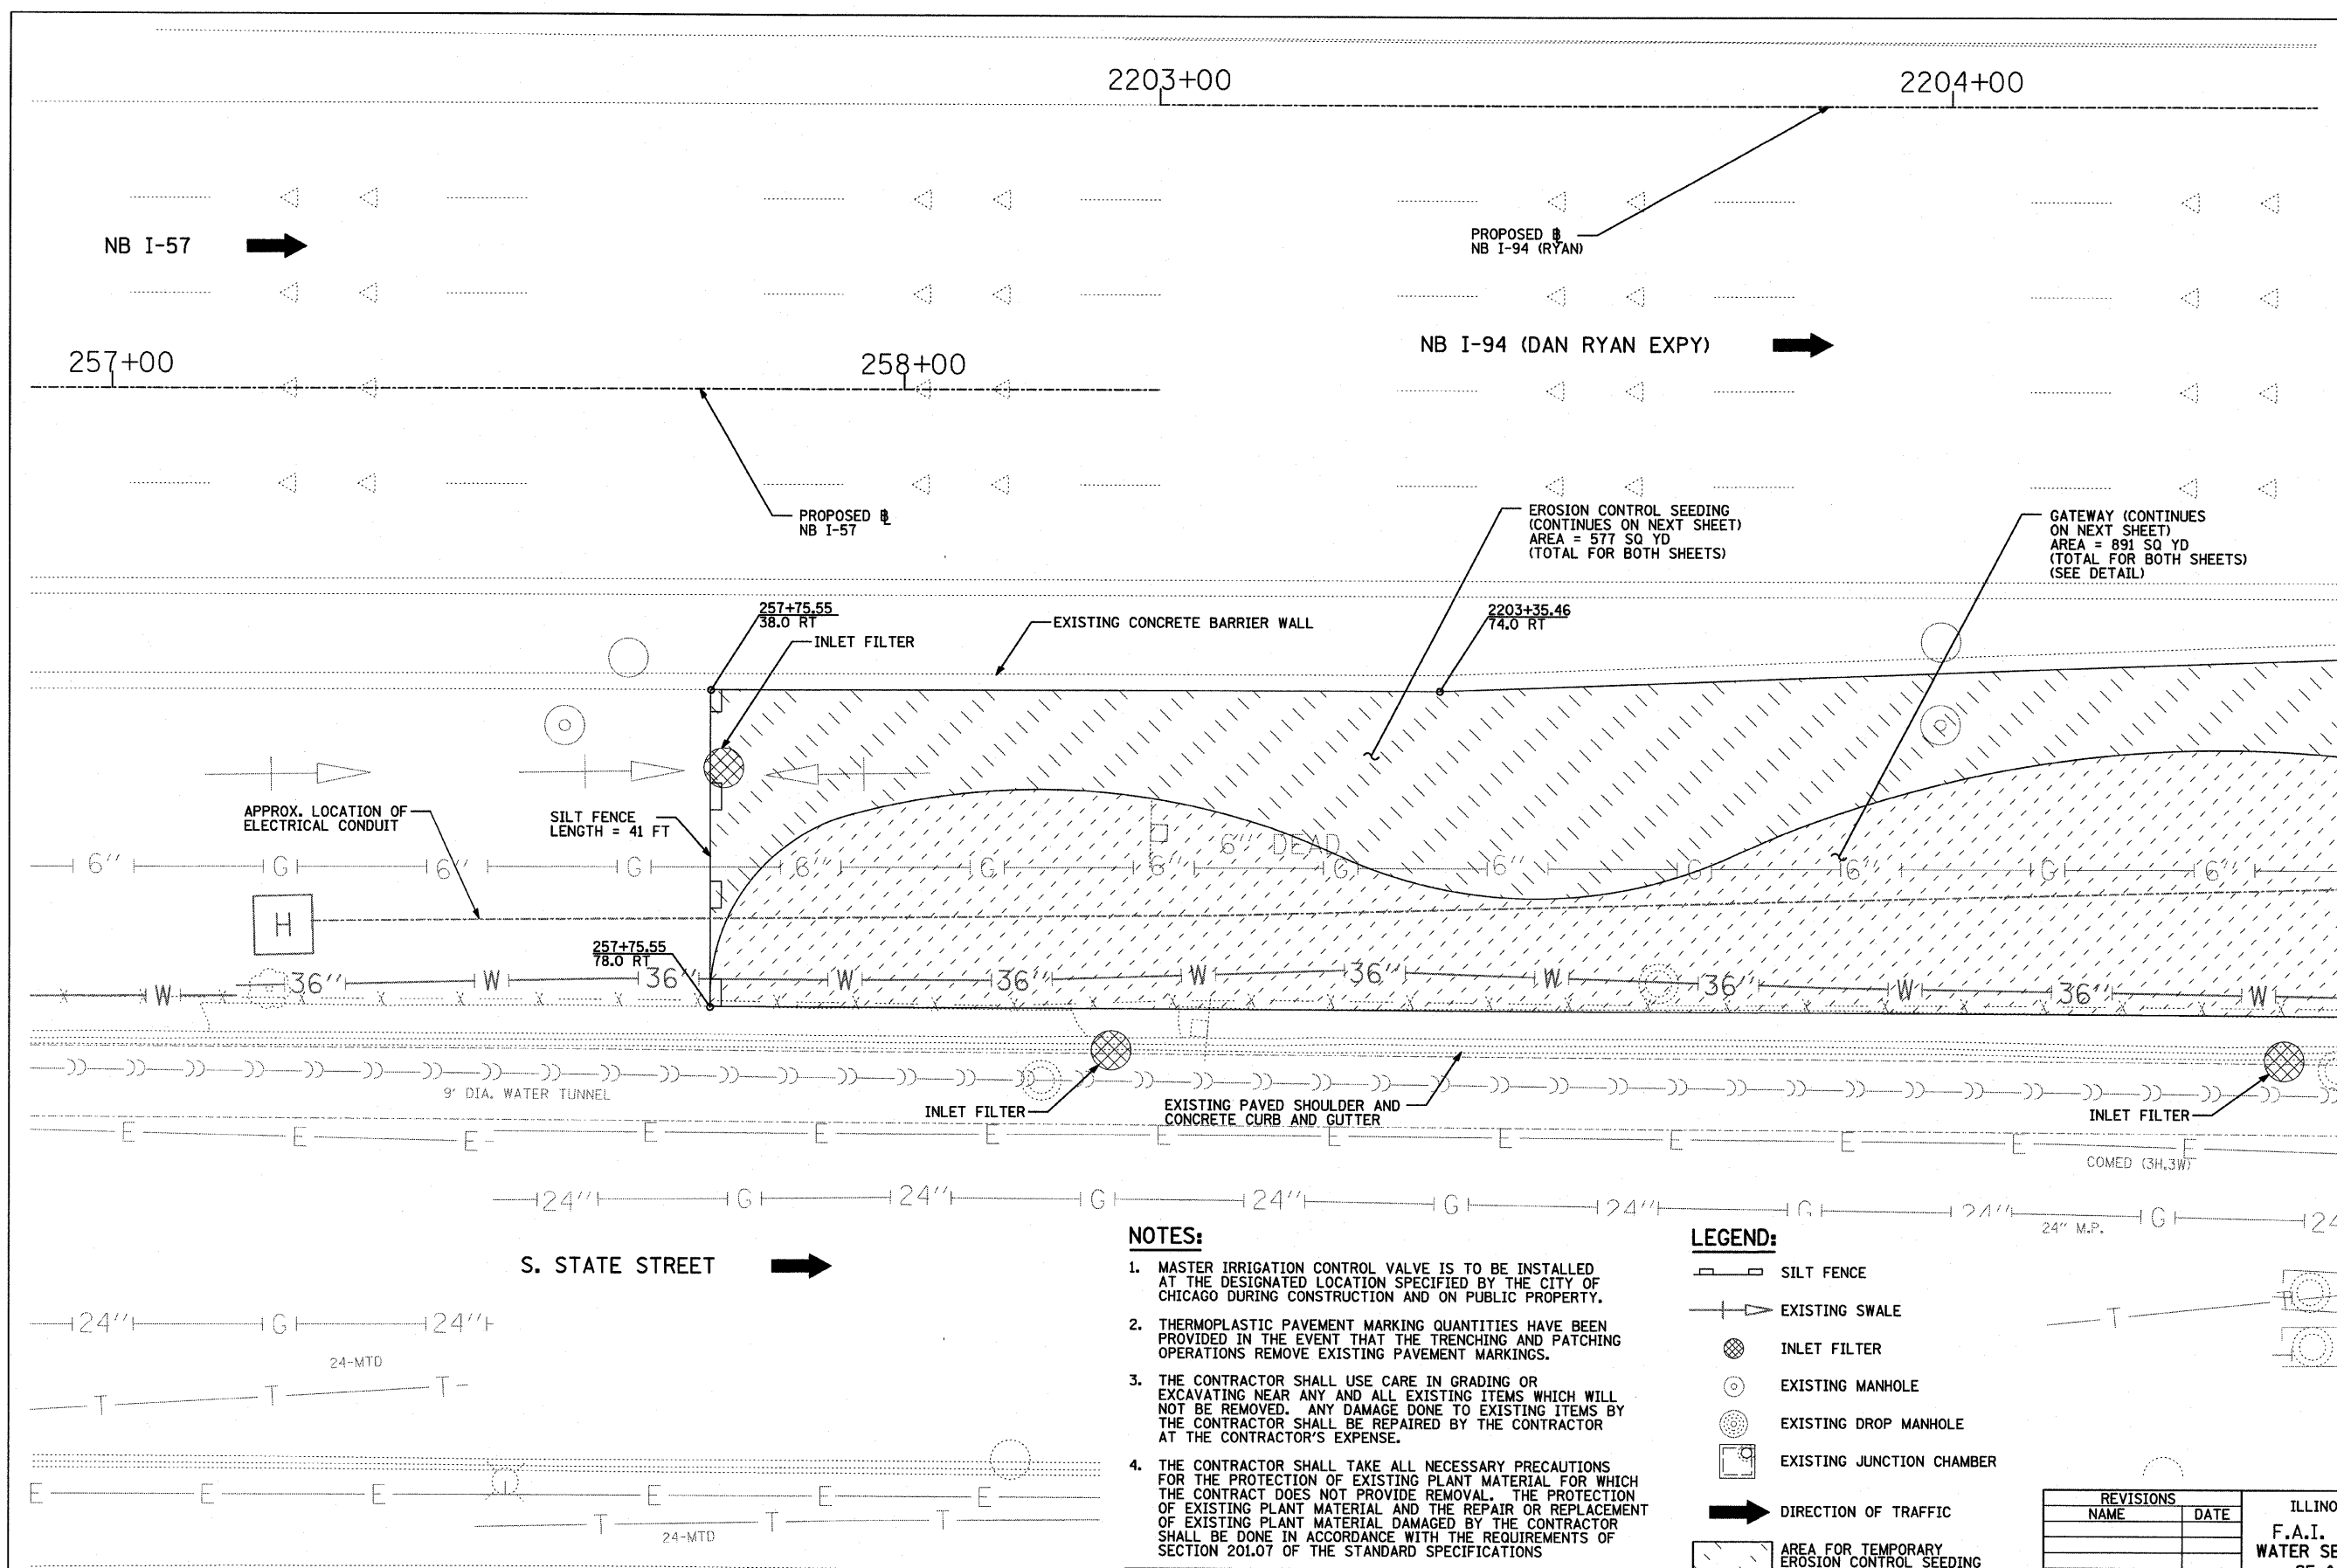

**NOTES:**

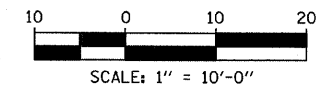1. MASTER IRRIGATION CONTROL VALVE IS TO BE INSTALLED AT THE DESIGNATED LOCATION SPECIFIED BY THE CITY OF CHICAGO DURING CONSTRUCTION AND ON PUBLIC PROPERTY.
2. THERMOPLASTIC PAVEMENT MARKING QUANTITIES HAVE BEEN PROVIDED IN THE EVENT THAT THE TRENCHING AND PATCHING OPERATIONS REMOVE EXISTING PAVEMENT MARKINGS.
3. THE CONTRACTOR SHALL USE CARE IN GRADING OR EXCAVATING NEAR ANY AND ALL EXISTING ITEMS WHICH WILL NOT BE REMOVED. ANY DAMAGE DONE TO EXISTING ITEMS BY THE CONTRACTOR SHALL BE REPAIRED BY THE CONTRACTOR AT THE CONTRACTOR'S EXPENSE.
4. THE CONTRACTOR SHALL TAKE ALL NECESSARY PRECAUTIONS FOR THE PROTECTION OF EXISTING PLANT MATERIAL FOR WHICH THE CONTRACT DOES NOT PROVIDE REMOVAL. THE PROTECTION OF EXISTING PLANT MATERIAL AND THE REPAIR OR REPLACEMENT OF EXISTING PLANT MATERIAL DAMAGED BY THE CONTRACTOR SHALL BE DONE IN ACCORDANCE WITH THE REQUIREMENTS OF SECTION 201.07 OF THE STANDARD SPECIFICATIONS
5. ANY EXISTING SUB-BASE MATERIAL SHALL BE REPLACED IN KIND WITH SUB-BASE GRANULAR MATERIAL, TYPE B 6". THE COST SHALL BE INCLUDED IN THE PROPOSED RESTORATION PAY ITEM.

**LEGEND:**

- SILT FENCE
- EXISTING SWALE
- INLET FILTER
- EXISTING MANHOLE
- EXISTING DROP MANHOLE
- EXISTING JUNCTION CHAMBER
- DIRECTION OF TRAFFIC
- AREA FOR TEMPORARY EROSION CONTROL SEEDING
- GATEWAY AREA (SEE LANDSCAPE PLANS)
- IRRIGATION WATER SERVICE (SEE PLANS FOR TYPE)

REVISIONS	
NAME	DATE

ILLINOIS DEPARTMENT OF TRANSPORTATION  
 F.A.I. 94 (DAN RYAN EXPRESSWAY)  
 WATER SERVICE AND EROSION CONTROL PLAN  
 SE & NE QUADRANTS AT 95TH ST -  
 NB I-57 STA. 257+75.55 TO  
 NB I-94 STA. 2204+50.00  
 SHEET 1 OF 3  
 SCALE: 1"=10'-0"  
 DATE: JUNE 20, 2008  
 DRAWN BY: JDF  
 CHECKED BY: JPM


**TYLIN** INTERNATIONAL

**NOTES:**



1. MASTER IRRIGATION CONTROL VALVE IS TO BE INSTALLED AT THE DESIGNATED LOCATION SPECIFIED BY THE CITY OF CHICAGO DURING CONSTRUCTION AND ON PUBLIC PROPERTY.
2. THERMOPLASTIC PAVEMENT MARKING QUANTITIES HAVE BEEN PROVIDED IN THE EVENT THAT THE TRENCHING AND PATCHING OPERATIONS REMOVE EXISTING PAVEMENT MARKINGS.
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5. ANY EXISTING SUB-BASE MATERIAL SHALL BE REPLACED IN KIND WITH SUB-BASE GRANULAR MATERIAL, TYPE B 6", THE COST SHALL BE INCLUDED IN THE PROPOSED RESTORATION PAY ITEM.

**LEGEND:**

- SILT FENCE
- EXISTING SWALE
- INLET FILTER
- EXISTING MANHOLE
- EXISTING DROP MANHOLE
- EXISTING JUNCTION CHAMBER
- DIRECTION OF TRAFFIC
- AREA FOR TEMPORARY EROSION CONTROL SEEDING
- GATEWAY AREA (SEE LANDSCAPE PLANS)
- IRRIGATION WATER SERVICE (SEE PLANS FOR TYPE)

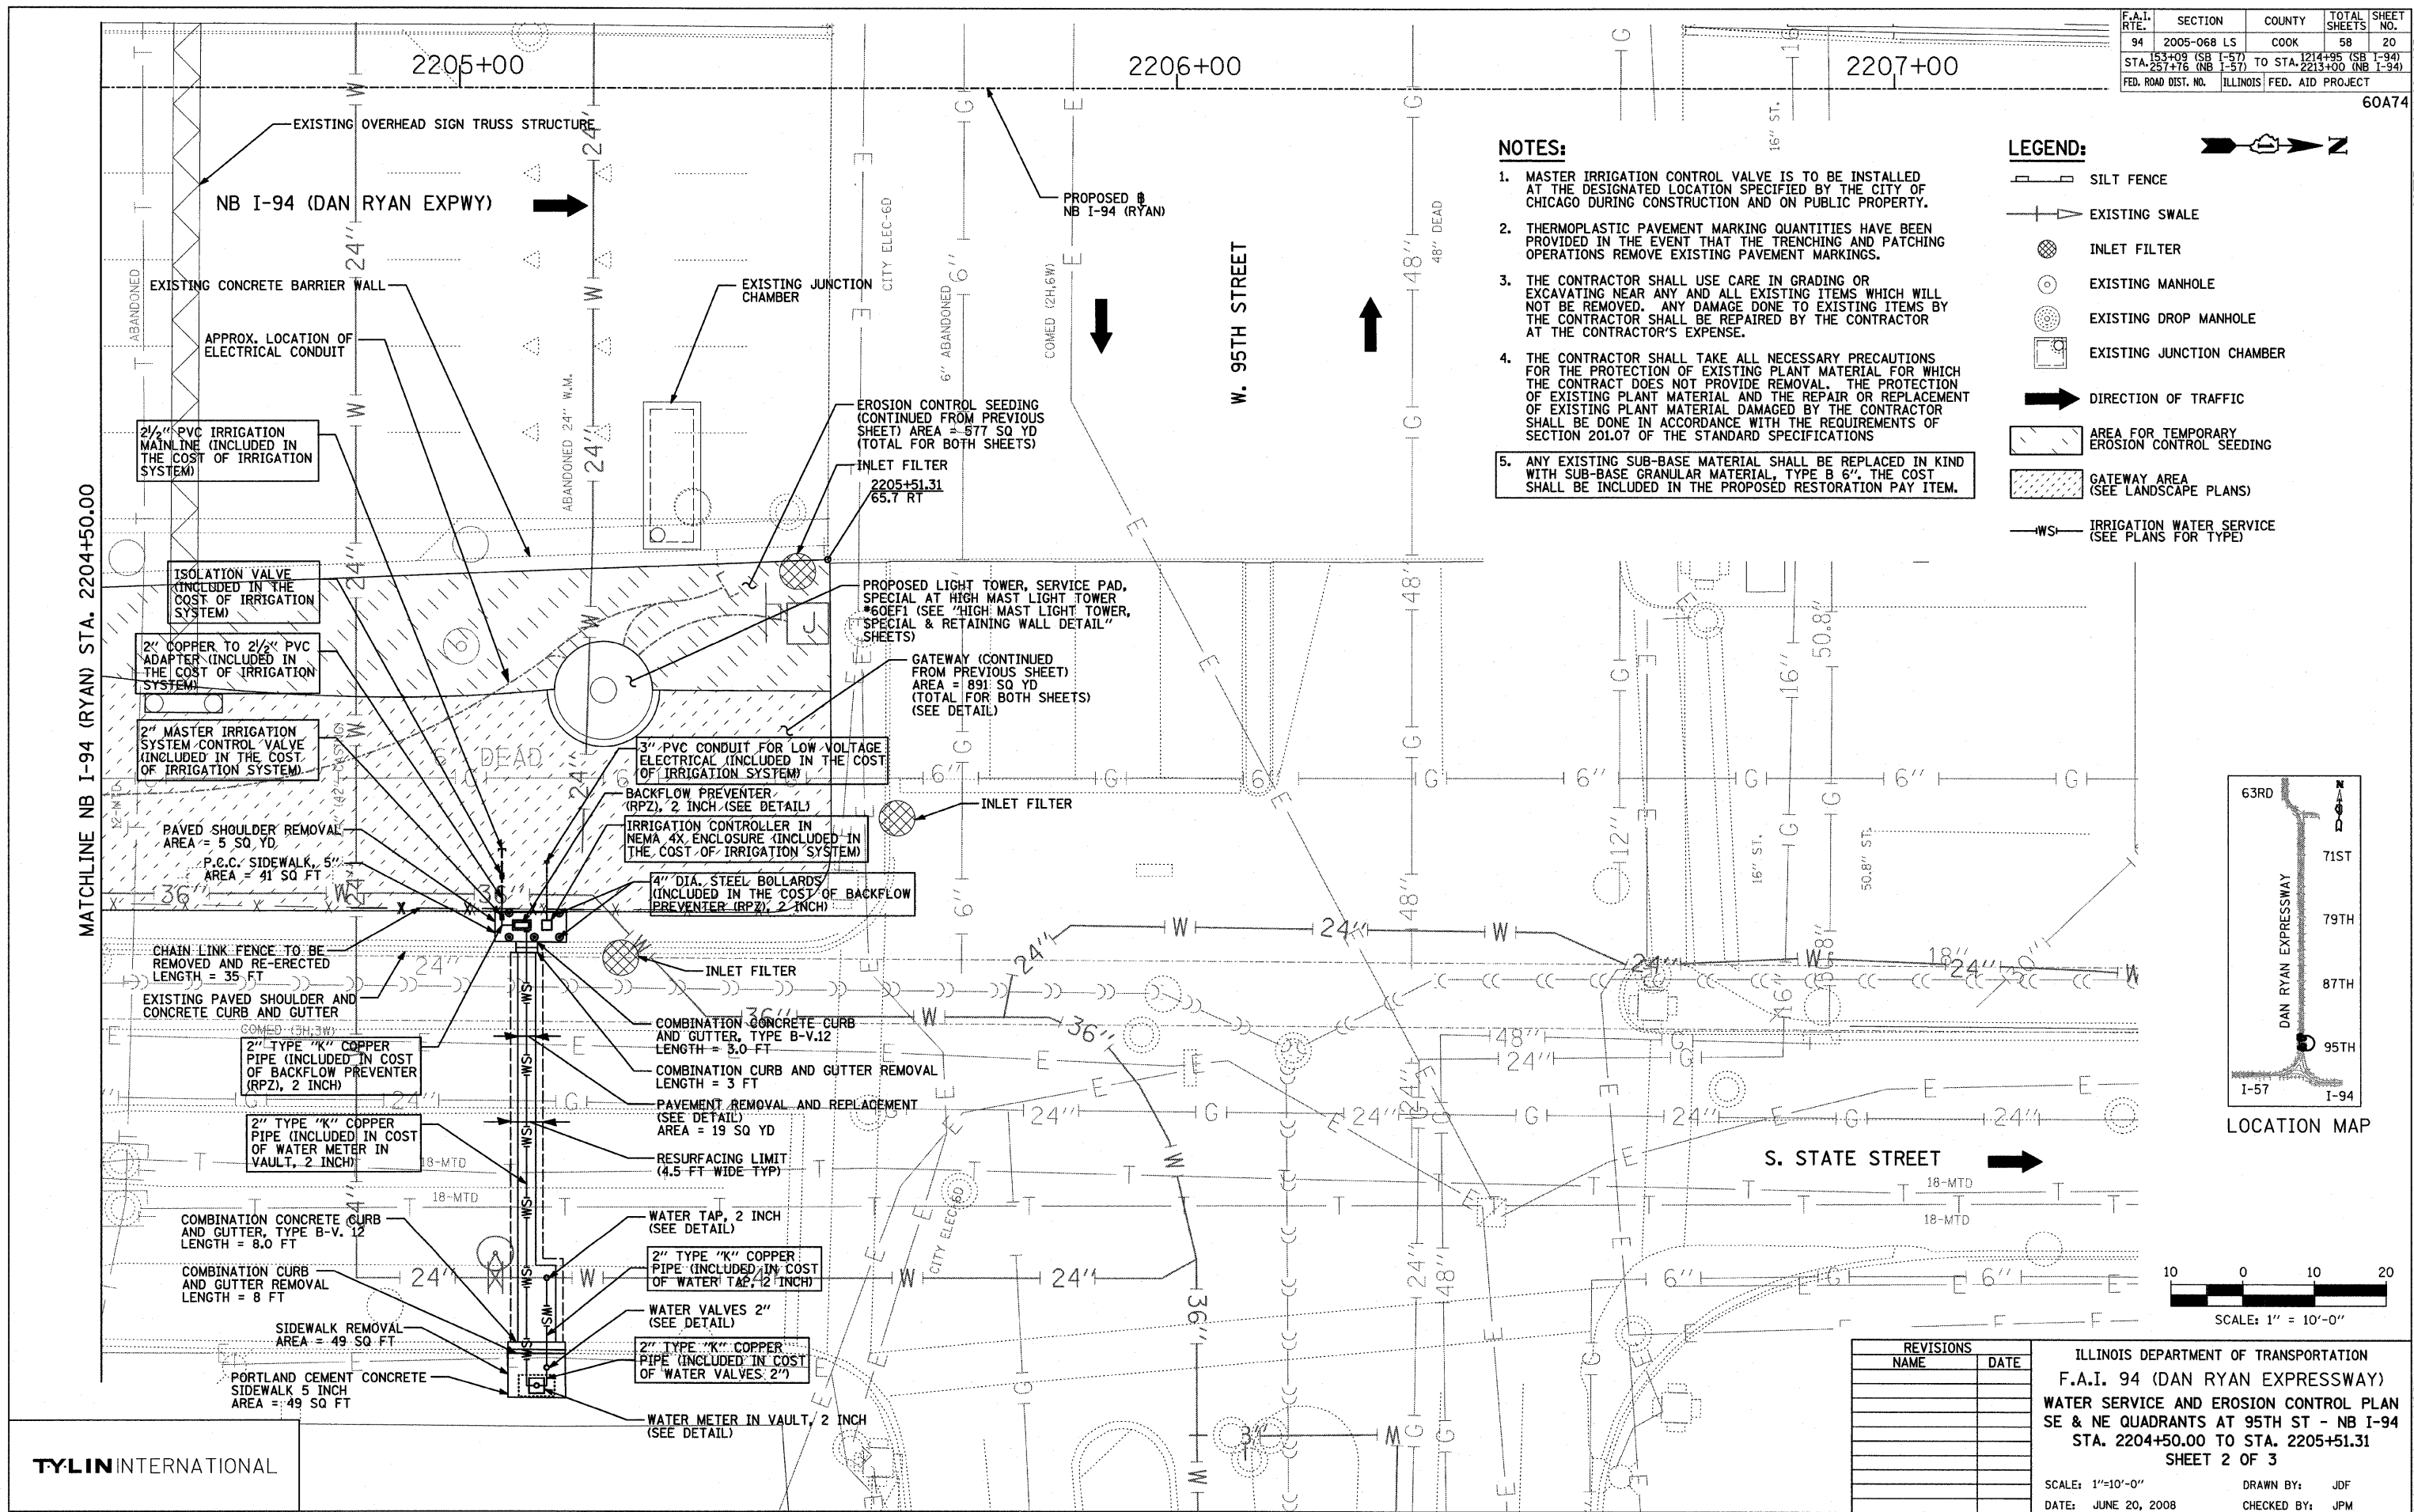

MATCHLINE NB I-94 (RYAN) STA. 2204+50.00

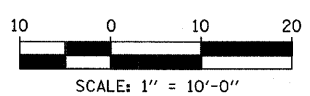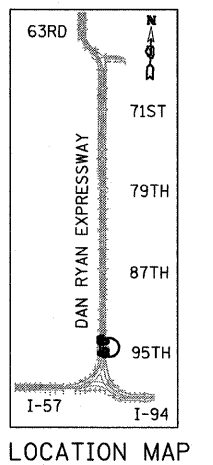


REVISIONS	
NAME	DATE

ILLINOIS DEPARTMENT OF TRANSPORTATION  
 F.A.I. 94 (DAN RYAN EXPRESSWAY)  
 WATER SERVICE AND EROSION CONTROL PLAN  
 SE & NE QUADRANTS AT 95TH ST - NB I-94  
 STA. 2204+50.00 TO STA. 2205+51.31  
 SHEET 2 OF 3

SCALE: 1"=10'-0"  
 DATE: JUNE 20, 2008


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F.A.I. RTE.	SECTION	COUNTY	TOTAL SHEETS	SHEET NO.
94	2005-068 LS	COOK	58	21
STA. 153+08 (SB I-57) TO STA. 2214+95 (SB I-94)		ILLINOIS FED. AID PROJECT		
STA. 257+76 (NB I-57) TO STA. 2213+00 (NB I-94)		60A74		

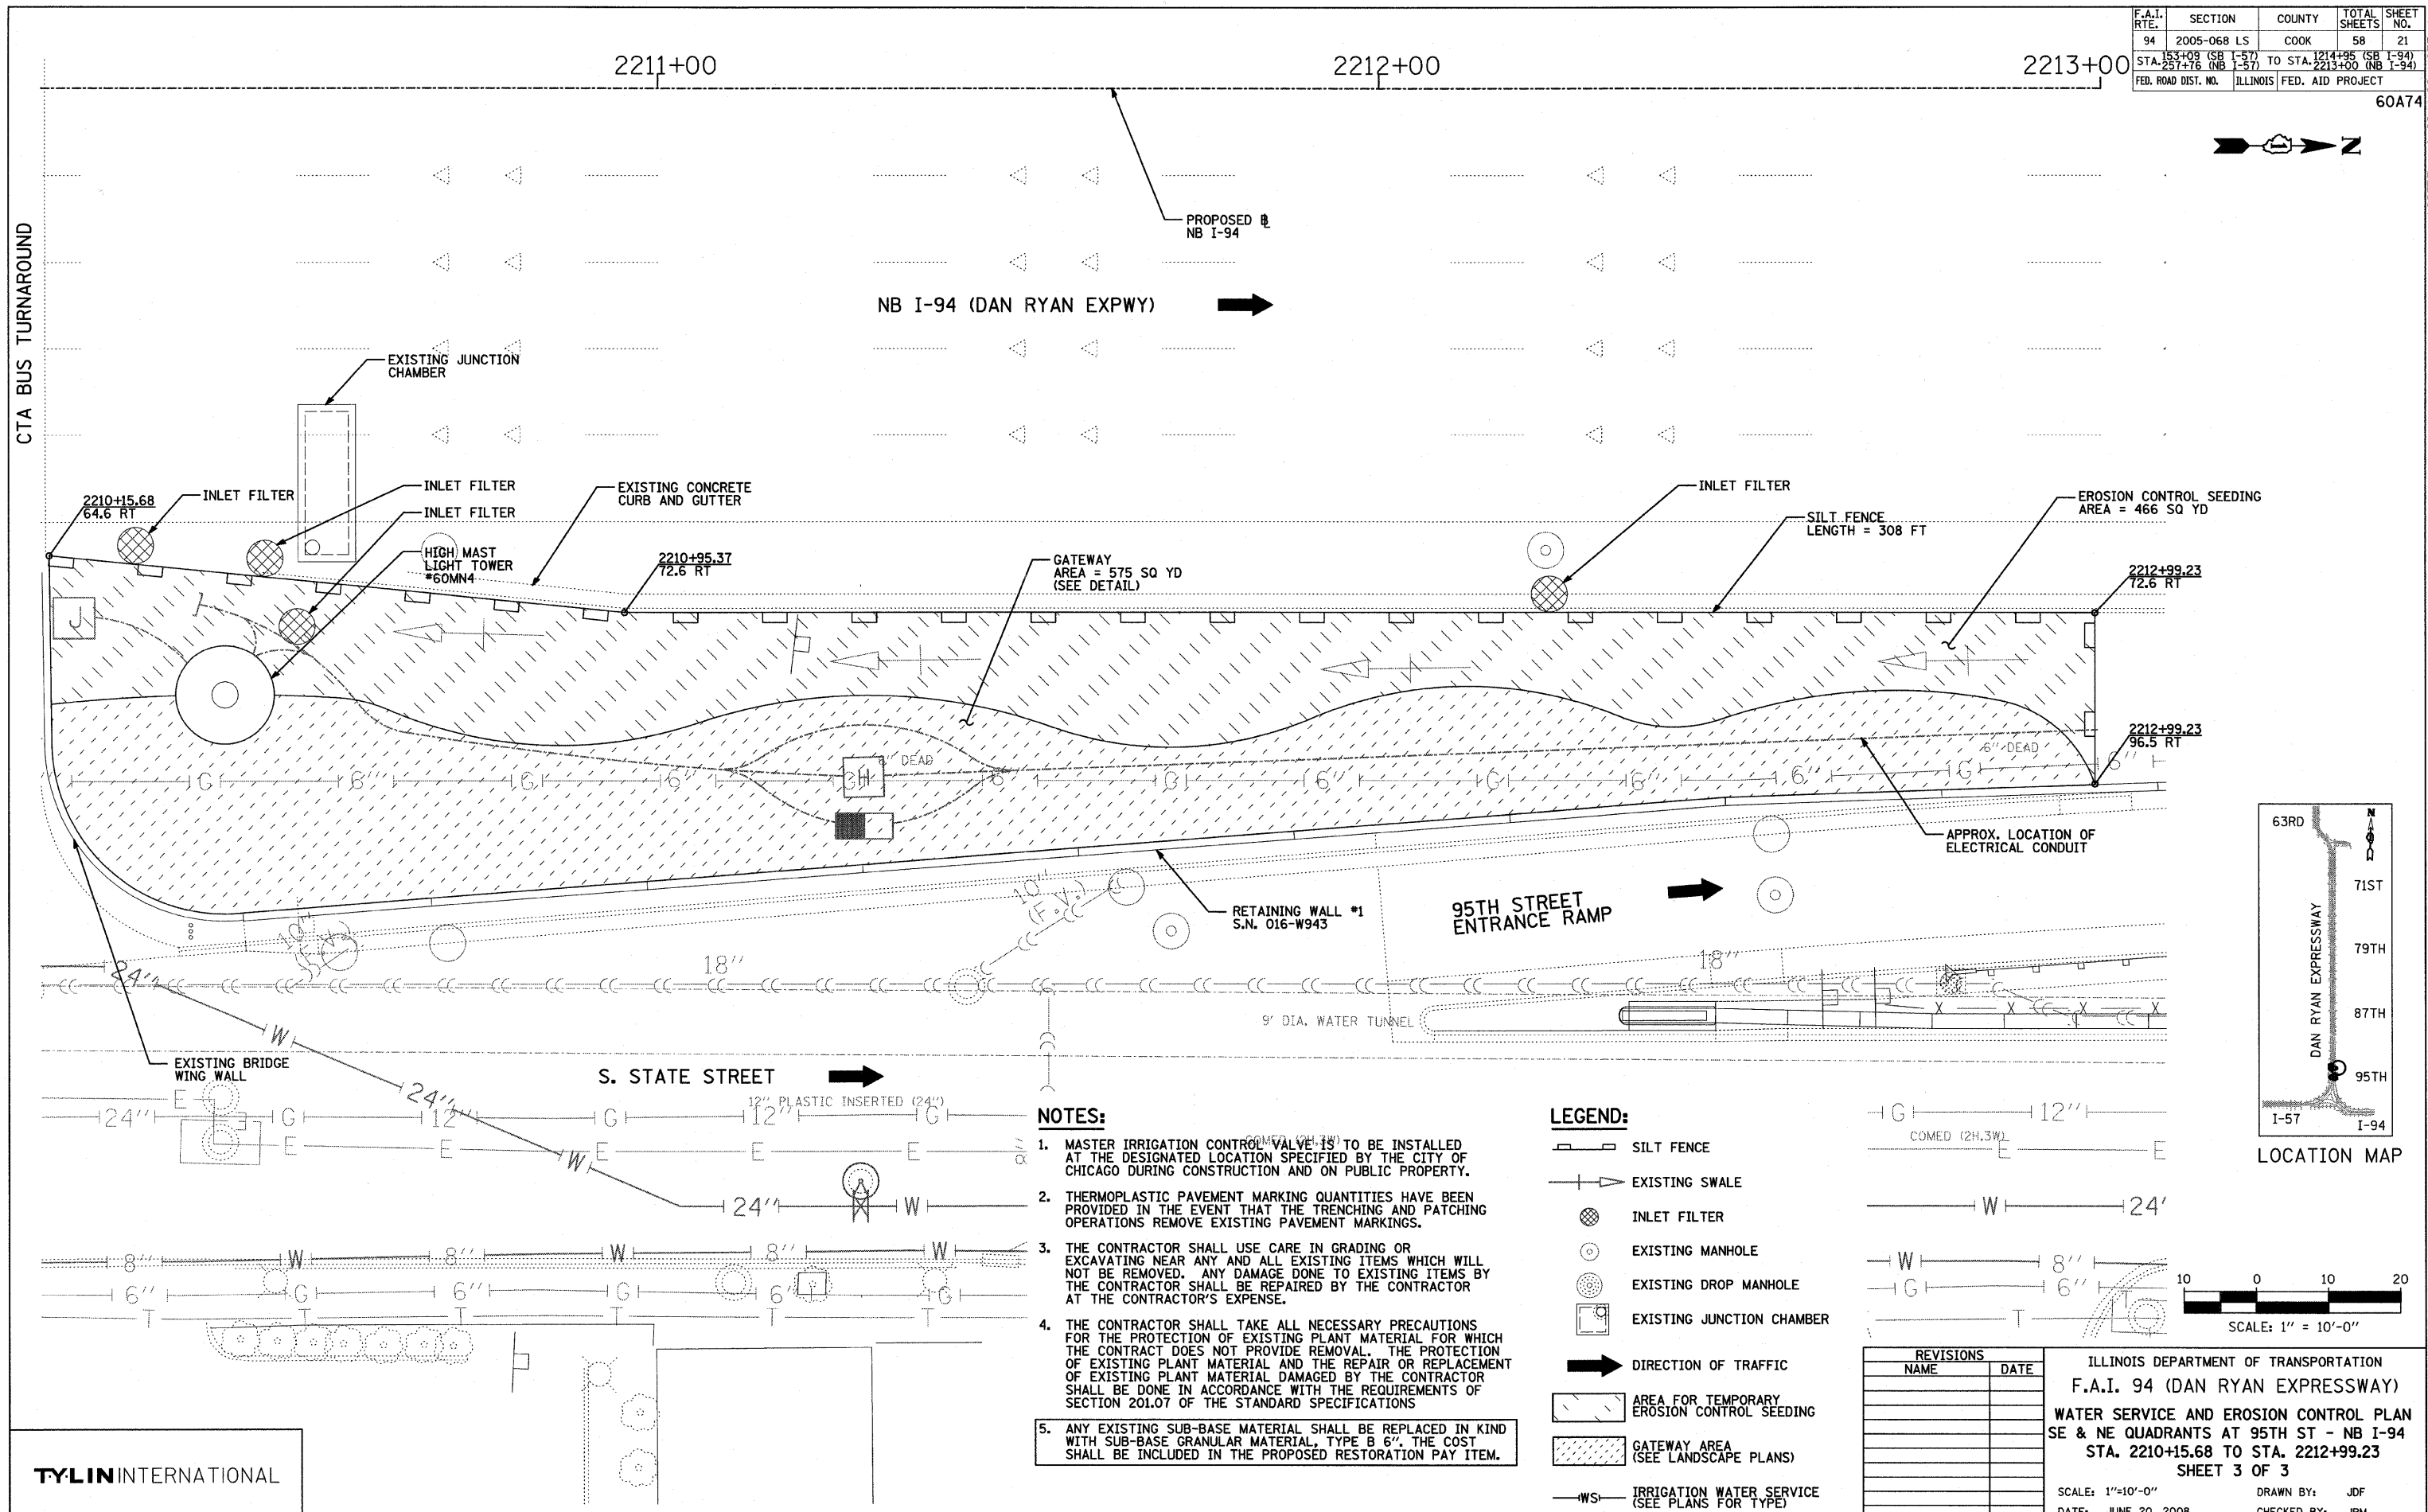

- NOTES:**
1. MASTER IRRIGATION CONTROL VALVE IS TO BE INSTALLED AT THE DESIGNATED LOCATION SPECIFIED BY THE CITY OF CHICAGO DURING CONSTRUCTION AND ON PUBLIC PROPERTY.
  2. THERMOPLASTIC PAVEMENT MARKING QUANTITIES HAVE BEEN PROVIDED IN THE EVENT THAT THE TRENCHING AND PATCHING OPERATIONS REMOVE EXISTING PAVEMENT MARKINGS.
  3. THE CONTRACTOR SHALL USE CARE IN GRADING OR EXCAVATING NEAR ANY AND ALL EXISTING ITEMS WHICH WILL NOT BE REMOVED. ANY DAMAGE DONE TO EXISTING ITEMS BY THE CONTRACTOR SHALL BE REPAIRED BY THE CONTRACTOR AT THE CONTRACTOR'S EXPENSE.
  4. THE CONTRACTOR SHALL TAKE ALL NECESSARY PRECAUTIONS FOR THE PROTECTION OF EXISTING PLANT MATERIAL FOR WHICH THE CONTRACT DOES NOT PROVIDE REMOVAL. THE PROTECTION OF EXISTING PLANT MATERIAL AND THE REPAIR OR REPLACEMENT OF EXISTING PLANT MATERIAL DAMAGED BY THE CONTRACTOR SHALL BE DONE IN ACCORDANCE WITH THE REQUIREMENTS OF SECTION 201.07 OF THE STANDARD SPECIFICATIONS.
  5. ANY EXISTING SUB-BASE MATERIAL SHALL BE REPLACED IN KIND WITH SUB-BASE GRANULAR MATERIAL, TYPE B 6". THE COST SHALL BE INCLUDED IN THE PROPOSED RESTORATION PAY ITEM.

- LEGEND:**
- [Symbol] SILT FENCE
  - [Symbol] EXISTING SWALE
  - [Symbol] INLET FILTER
  - [Symbol] EXISTING MANHOLE
  - [Symbol] EXISTING DROP MANHOLE
  - [Symbol] EXISTING JUNCTION CHAMBER
  - [Symbol] DIRECTION OF TRAFFIC
  - [Symbol] AREA FOR TEMPORARY EROSION CONTROL SEEDING
  - [Symbol] GATEWAY AREA (SEE LANDSCAPE PLANS)
  - [Symbol] IRRIGATION WATER SERVICE (SEE PLANS FOR TYPE)

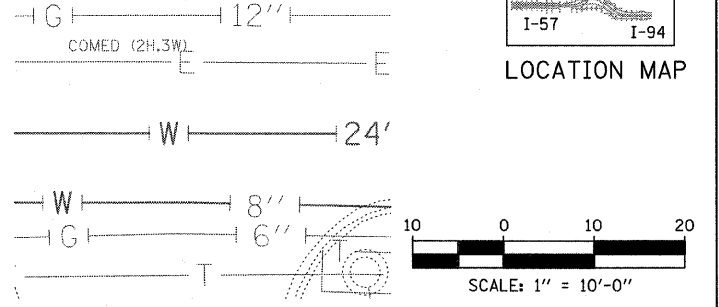




REVISIONS		ILLINOIS DEPARTMENT OF TRANSPORTATION	
NAME	DATE	F.A.I. 94 (DAN RYAN EXPRESSWAY)	
		WATER SERVICE AND EROSION CONTROL PLAN	
		SE & NE QUADRANTS AT 95TH ST - NB I-94	
		STA. 2210+15.68 TO STA. 2212+99.23	
		SHEET 3 OF 3	
		SCALE: 1"=10'-0"	DRAWN BY: JDF
		DATE: JUNE 20, 2008	CHECKED BY: JPM

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F.A.I. RTE.	SECTION	COUNTY	TOTAL SHEETS	SHEET NO.
94	2005-068 LS	COOK	58	22
STA. 256+32.33	TO STA. 2207+00			
FED. ROAD DIST. NO.	ILLINOIS	FED. AID PROJECT		

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**SITE DESIGN GROUP**  
**TYLIN INTERNATIONAL**


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REVISIONS	
NAME	DATE

ILLINOIS DEPARTMENT OF TRANSPORTATION  
F.A.I. 94 (DAN RYAN EXPRESSWAY)  
95TH STREET GATEWAY LANDSCAPING AND IRRIGATION  
PLANTING BED LAYOUT PLANS  
SE QUADRANTS AT 95TH ST. - NB I-94  
SCALE: 1"=20'  
DATE: JUNE 20, 2008  
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CHECKED BY: JO

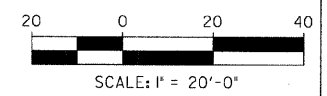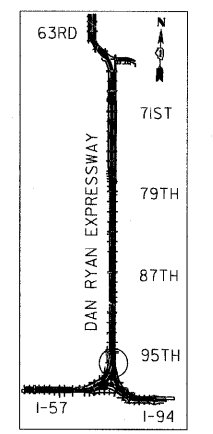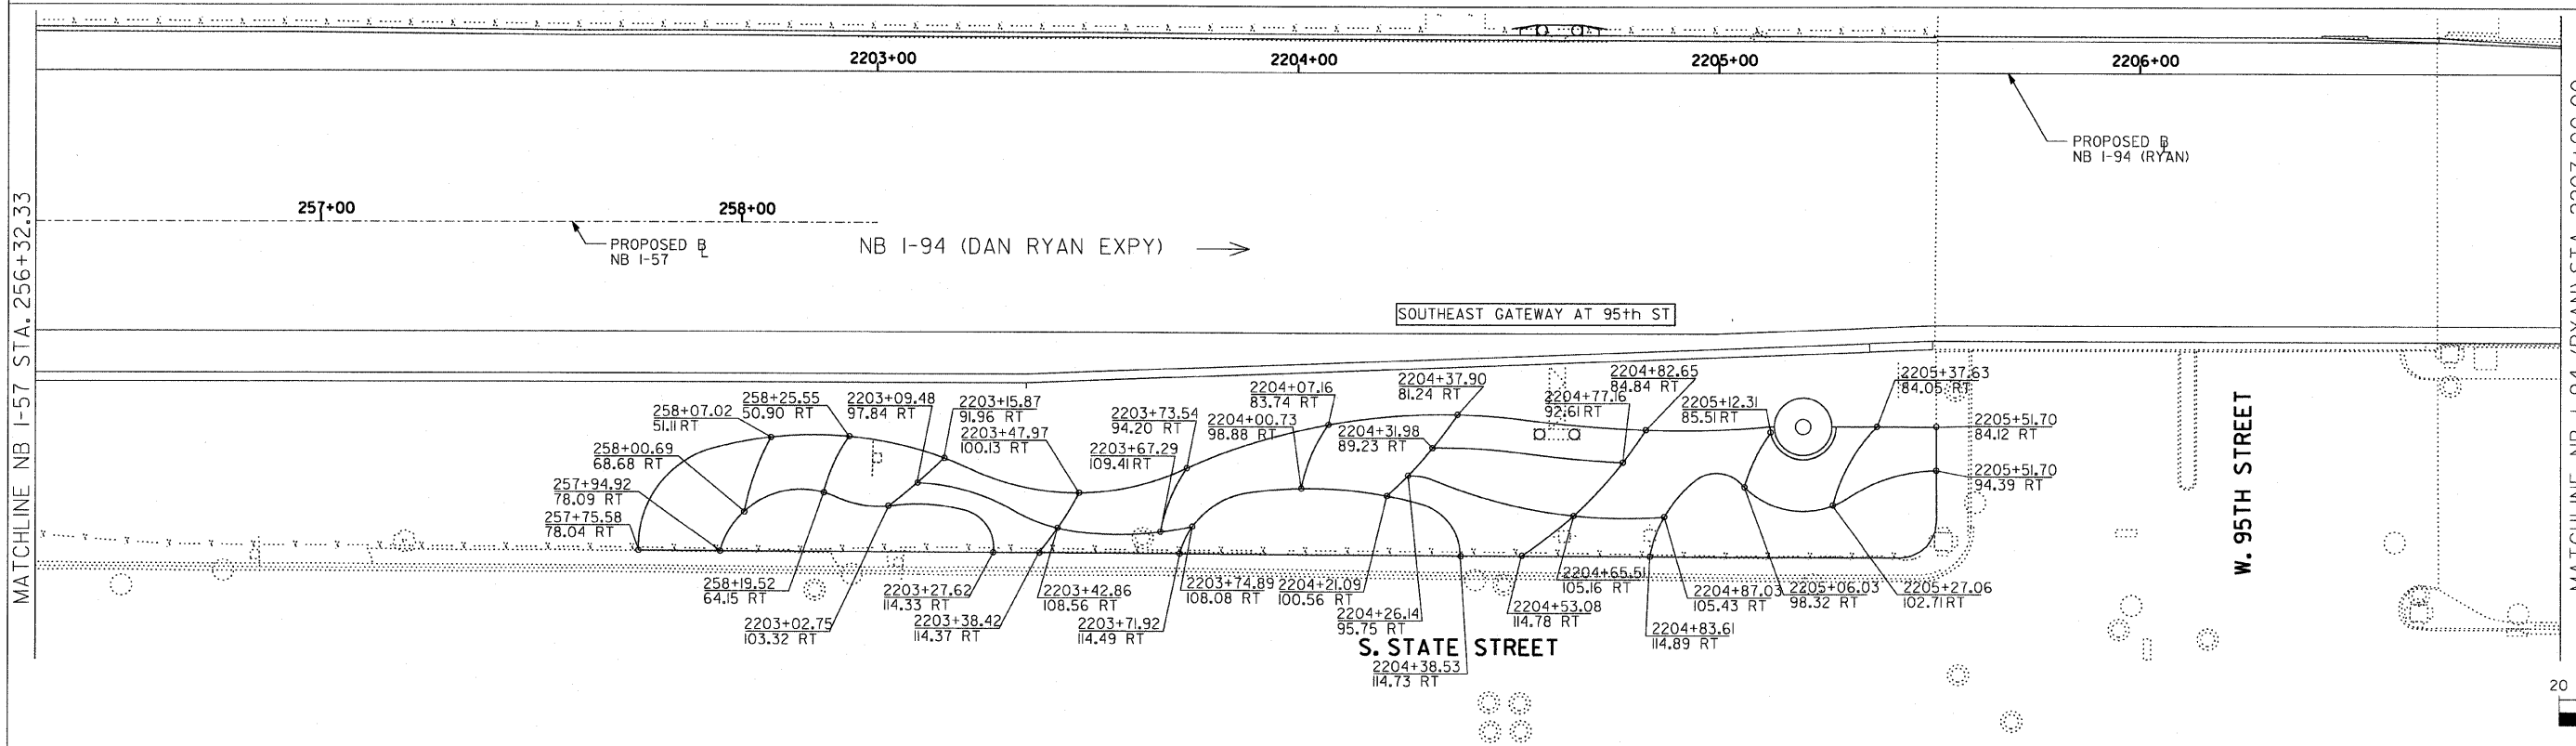
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F.A.I. RTE.	SECTION	COUNTY	TOTAL SHEETS	SHEET NO.
94	2005-068 LS	COOK	58	23
STA. 2207+00	TO STA. 2213+00			
FED. ROAD DIST. NO.	ILLINOIS	FED. AID PROJECT		
		60A74		




MATCHLINE NB STA. 2207+00.00

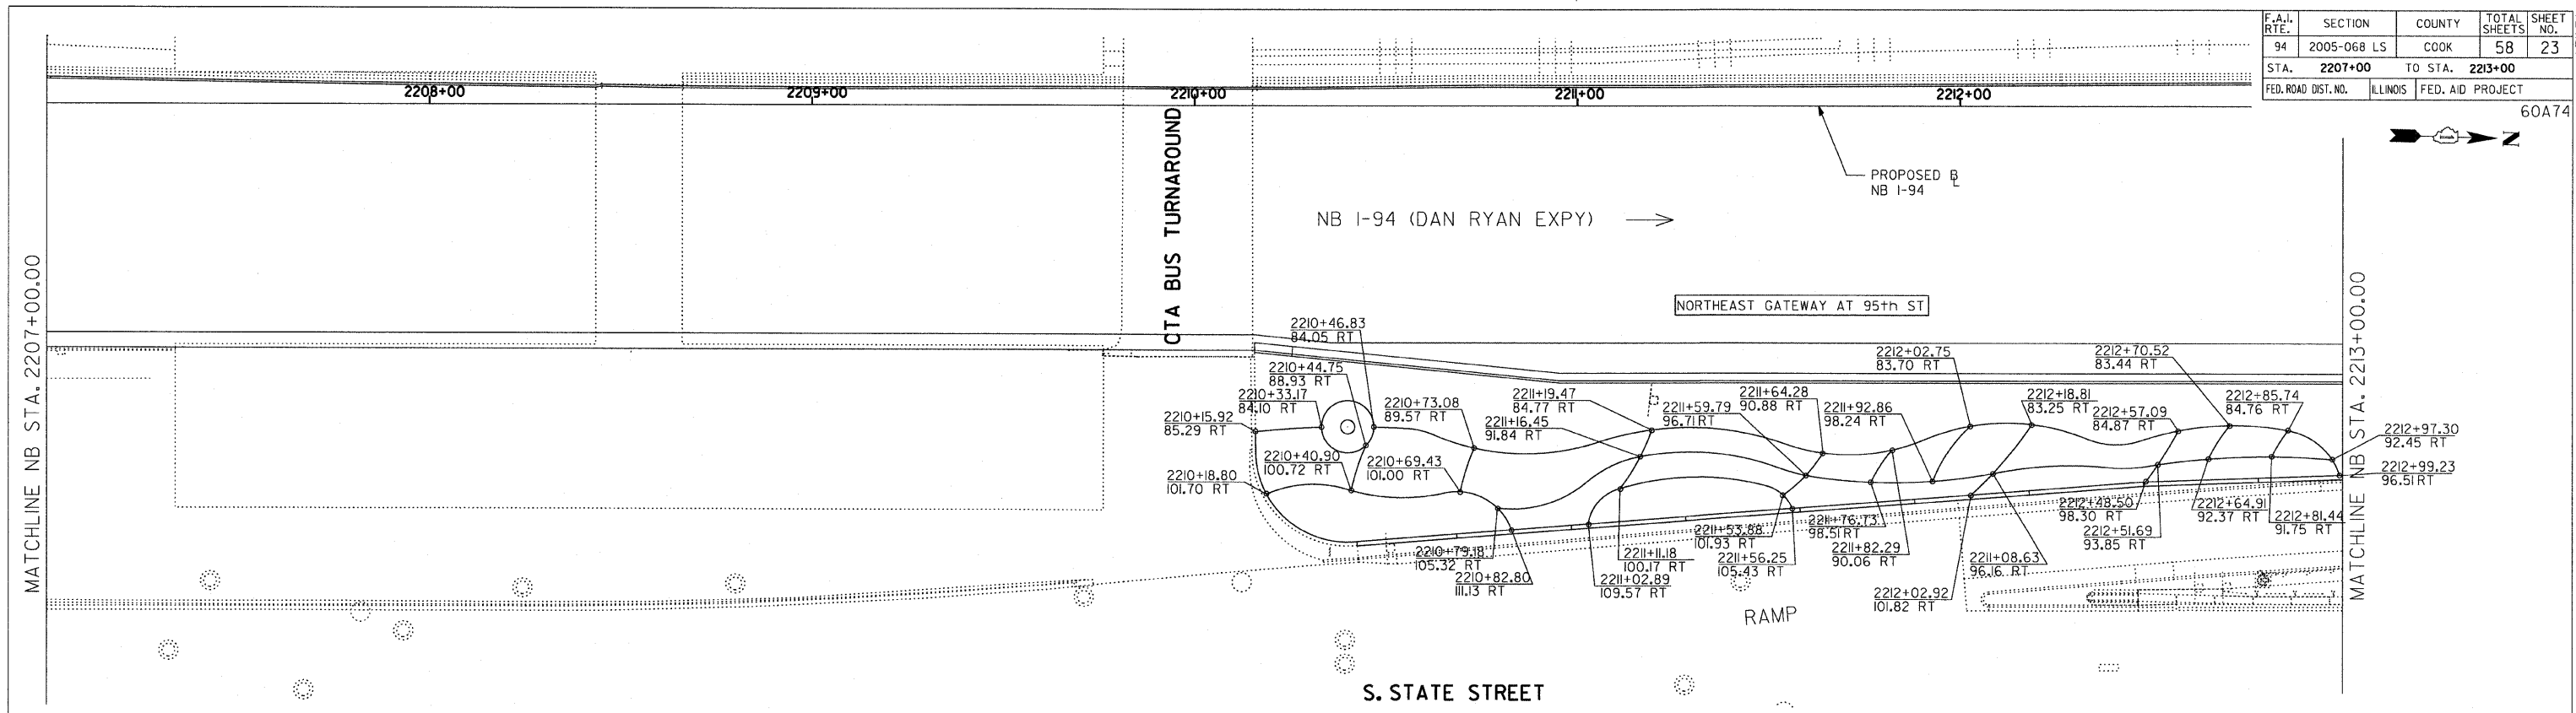MATCHLINE NB STA. 2213+00.00

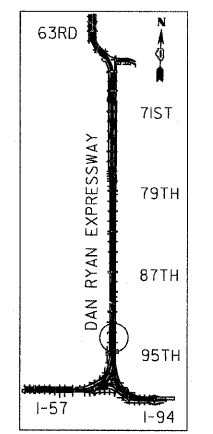

LOCATION MAP

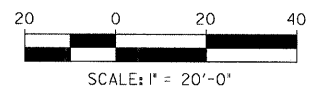

**SITE DESIGN GROUP**

**TYLIN INTERNATIONAL**

NOTE: THE LOCATION OF ALL PLANT MATERIAL SHALL BE STAKED BY THE CONTRACTOR FOR APPROVAL BY THE ENGINEER IN FIELD, PRIOR TO INSTALLATION. INDIVIDUAL TREES SHALL BE STAKED WITH IDENTITIES WRITTEN ON STAKES. SHRUB AND PERENNIAL BEDS SHALL BE OUTLINED WITH STAKES AND PAINTED LINES.

REVISIONS	
NAME	DATE

ILLINOIS DEPARTMENT OF TRANSPORTATION  
 F.A.I. 94 (DAN RYAN EXPRESSWAY)  
 95TH STREET GATEWAY LANDSCAPING AND IRRIGATION  
 PLANTING BED LAYOUT PLANS  
 NE QUADRANTS AT 95TH ST. - NB I-94

SCALE: 1"=20'  
 DATE: JUNE 20, 2008





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
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F.A.I. RTE.	SECTION	COUNTY	TOTAL SHEETS	SHEET NO.
94	2005-068 LS	COOK	58	24
STA. 256+32.33		TO STA. 2207+00		
FED. ROAD DIST. NO.	ILLINOIS	FED. AID PROJECT		

60A74



**SITE DESIGN GROUP**  
**TYLIN INTERNATIONAL**

**LEGEND:**  
 AREA TO BE DRIP IRRIGATED  
**NOTE:**  
 ALL CORNER GARDENS AND PERENNIAL AND SHRUB BEDS SHALL BE IRRIGATED.

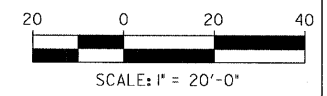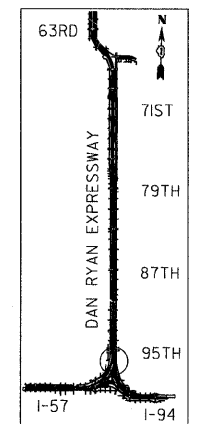
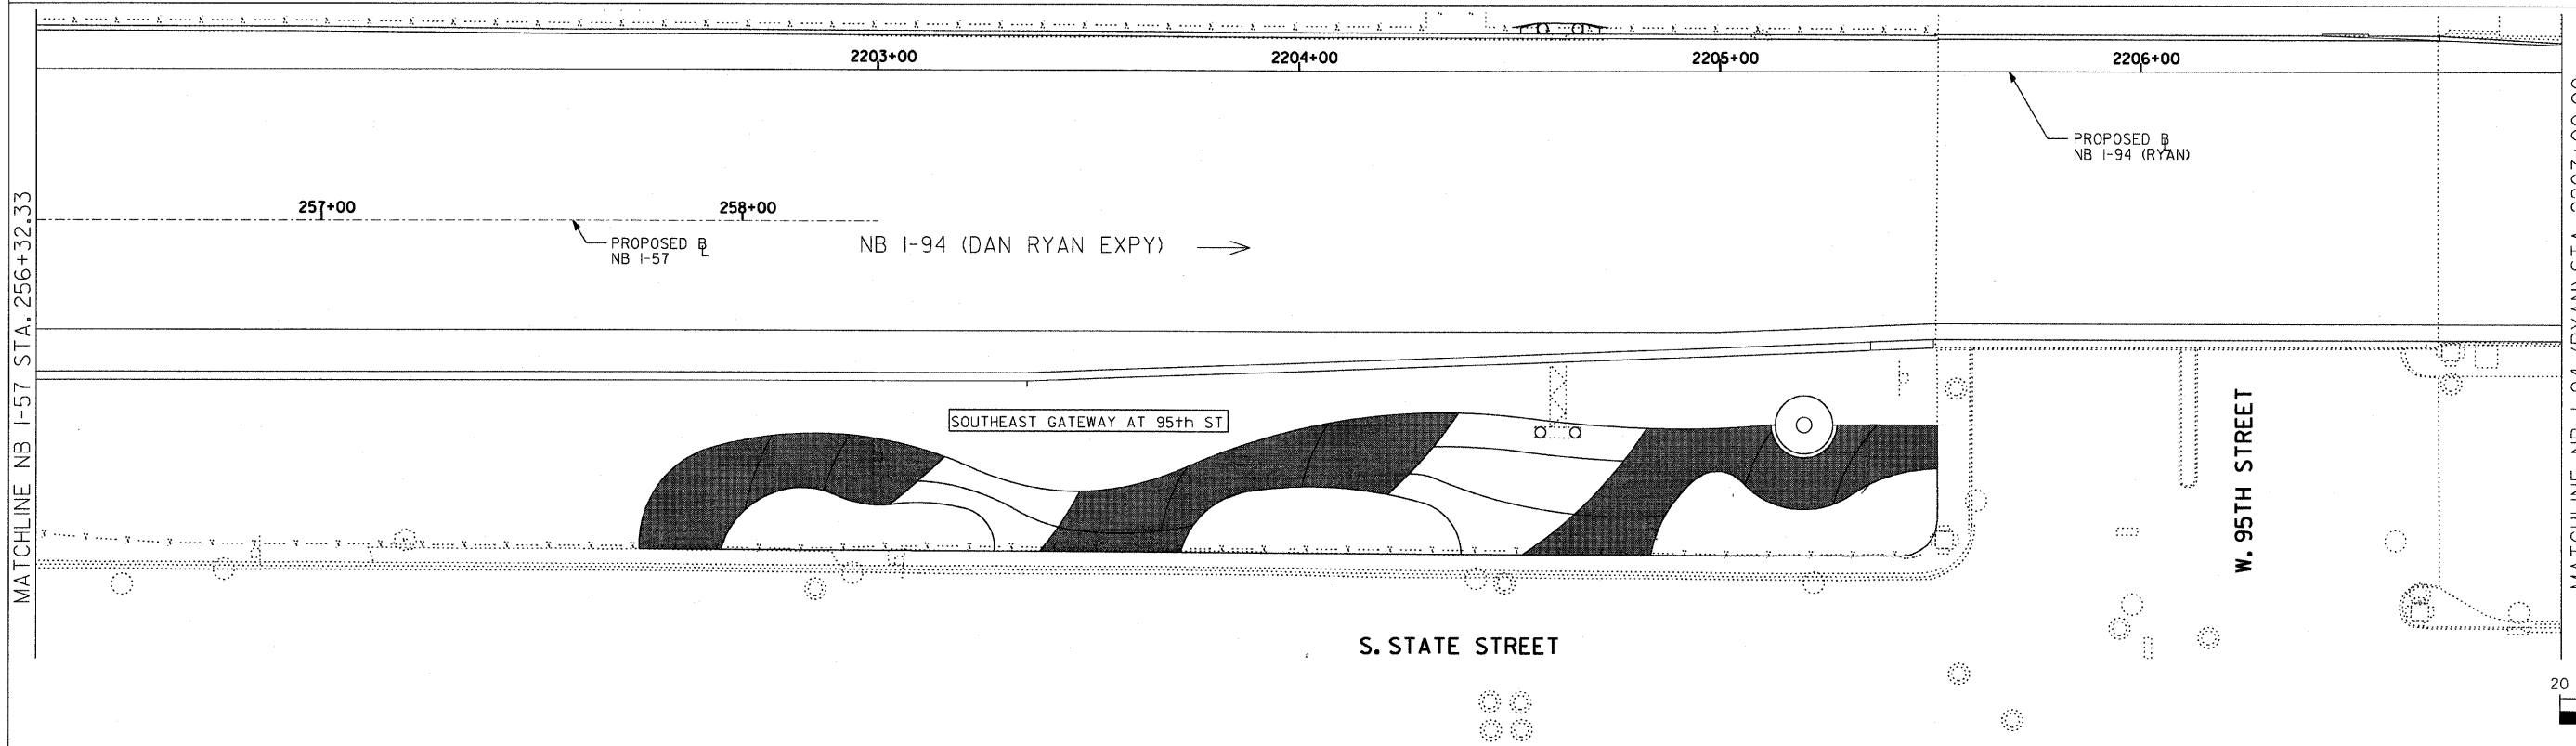
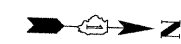
REVISIONS	
NAME	DATE

ILLINOIS DEPARTMENT OF TRANSPORTATION  
 F.A.I. 94 (DAN RYAN EXPRESSWAY)  
 95TH STREET GATEWAY LANDSCAPING AND IRRIGATION  
 IRRIGATION PLANS  
 SE QUADRANTS AT 95TH ST. - NB I-94  
 SCALE: 1"=20'  
 DATE: JUNE 20, 2008  
 DRAWN BY: EM  
 CHECKED BY: JO




F.A.I. RTE.	SECTION	COUNTY	TOTAL SHEETS	SHEET NO.
94	2005-068 LS	COOK	58	25
STA. 2207+00		TO STA. 2213+00		
FED. ROAD DIST. NO.	ILLINOIS	FED. AID PROJECT		

60A74

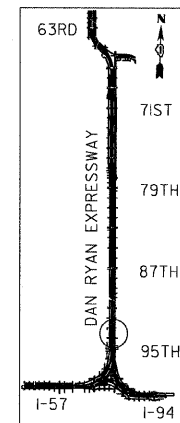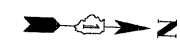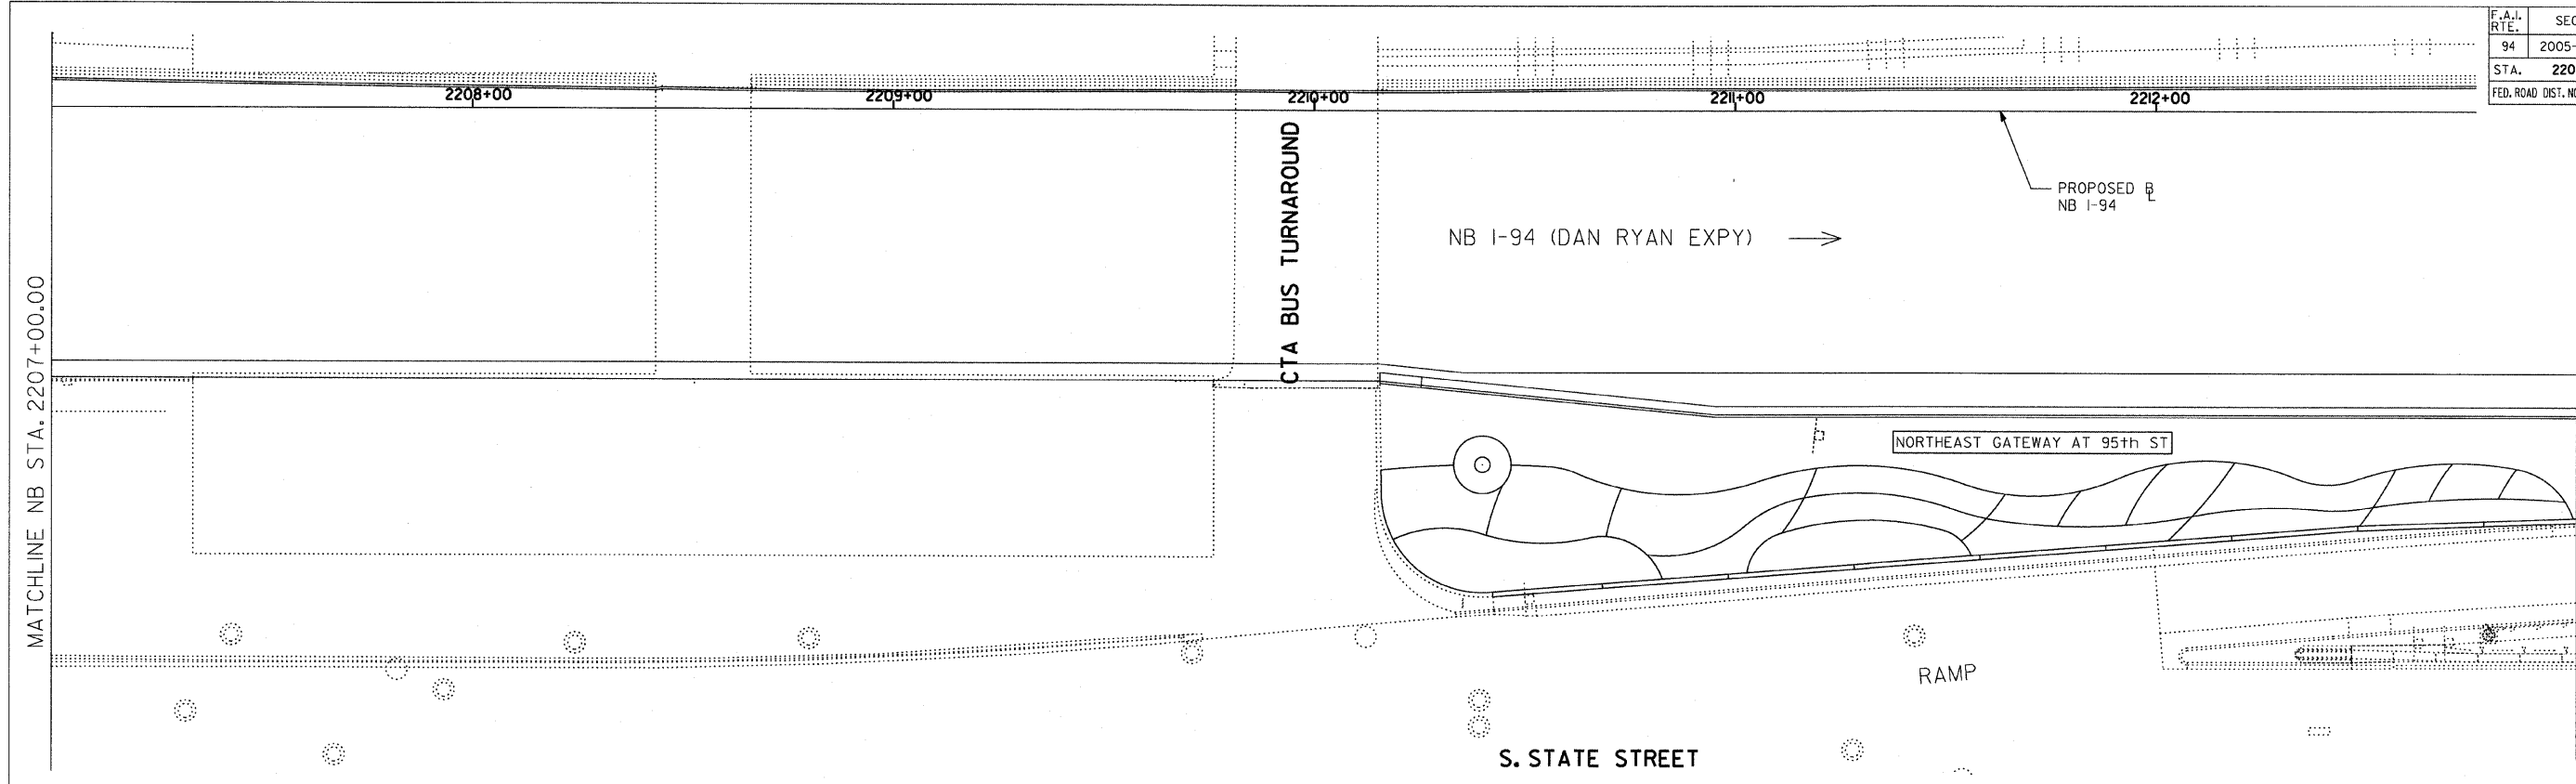

LOCATION MAP

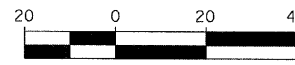

**SITE DESIGN GROUP**

**TYLIN INTERNATIONAL**

**LEGEND:**

AREA TO BE DRIP IRRIGATED

**NOTE:**

1. THE NORTHEAST GATEWAY SHALL NOT BE IRRIGATED.

REVISIONS	
NAME	DATE

ILLINOIS DEPARTMENT OF TRANSPORTATION  
**F.A.I. 94 (DAN RYAN EXPRESSWAY)**  
 95TH STREET GATEWAY LANDSCAPING AND IRRIGATION

IRRIGATION PLANS  
 NE QUADRANTS AT 95TH ST. - NB I-94

SCALE: 1"=20'  
 DATE: JUNE 20, 2008  
 DRAWN BY: EM  
 CHECKED BY: JO


DATE\$

F.A.I. RTE.	SECTION	COUNTY	TOTAL SHEETS	SHEET NO.
94	2005-068 LS	COOK	58	26
STA. 256+32.33		TO STA. 2207+00		
FED. ROAD DIST. NO.	ILLINOIS	FED. AID PROJECT		

60A74



- LEGEND:**
- SHADE TREE
  - ORNAMENTAL TREE
  - SHRUB
  - PERENNIALS / ORNAMENTAL GRASSES

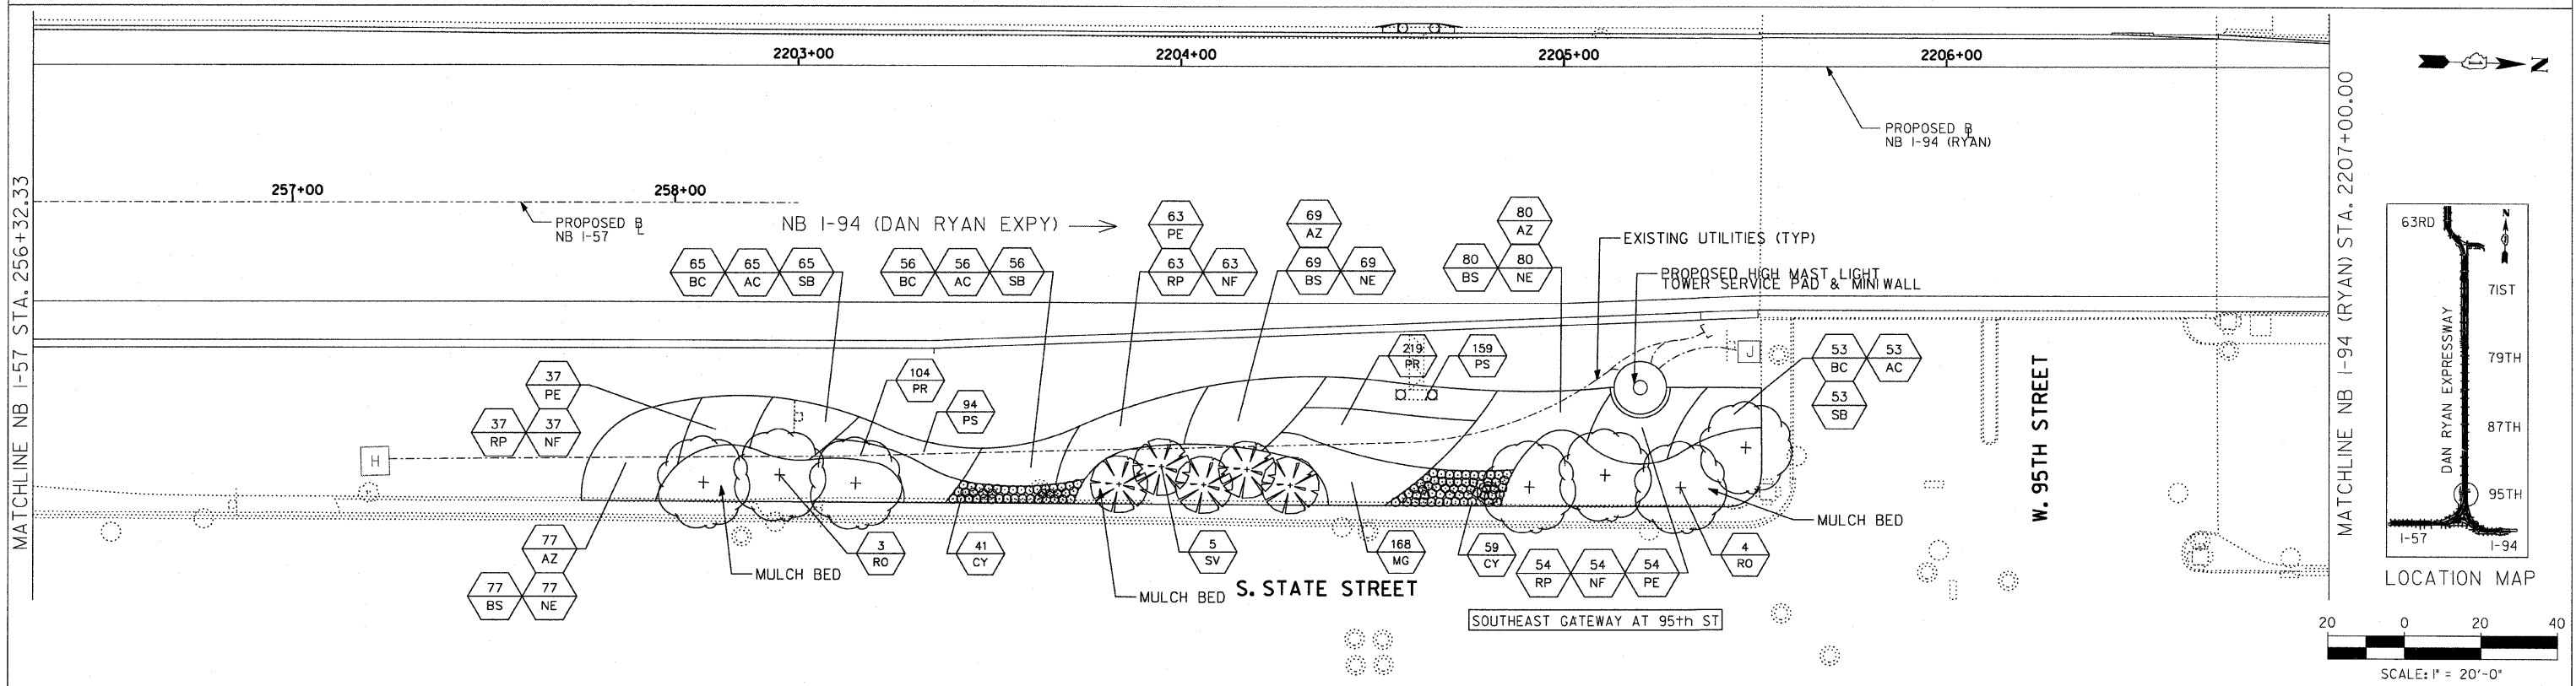


**SITE DESIGN GROUP**


**TYLIN INTERNATIONAL**

REVISIONS	
NAME	DATE

ILLINOIS DEPARTMENT OF TRANSPORTATION  
**F.A.I. 94 (DAN RYAN EXPRESSWAY)**  
 95TH STREET GATEWAY LANDSCAPING AND IRRIGATION  
 LANDSCAPE PLANS  
 SE QUADRANTS AT 95TH ST. - NB I-94  
 SCALE: 1"=20'  
 DATE: JUNE 20, 2008  
 DRAWN BY: EM  
 CHECKED BY: JO

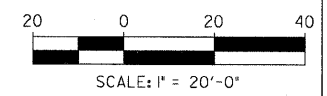





F.A.I. RTE.	SECTION	COUNTY	TOTAL SHEETS	SHEET NO.
94	2005-068 LS	COOK	58	27
STA. 2207+00		TO STA. 2213+00		
FED. ROAD DIST. NO.	ILLINOIS	FED. AID PROJECT		
		60A74		

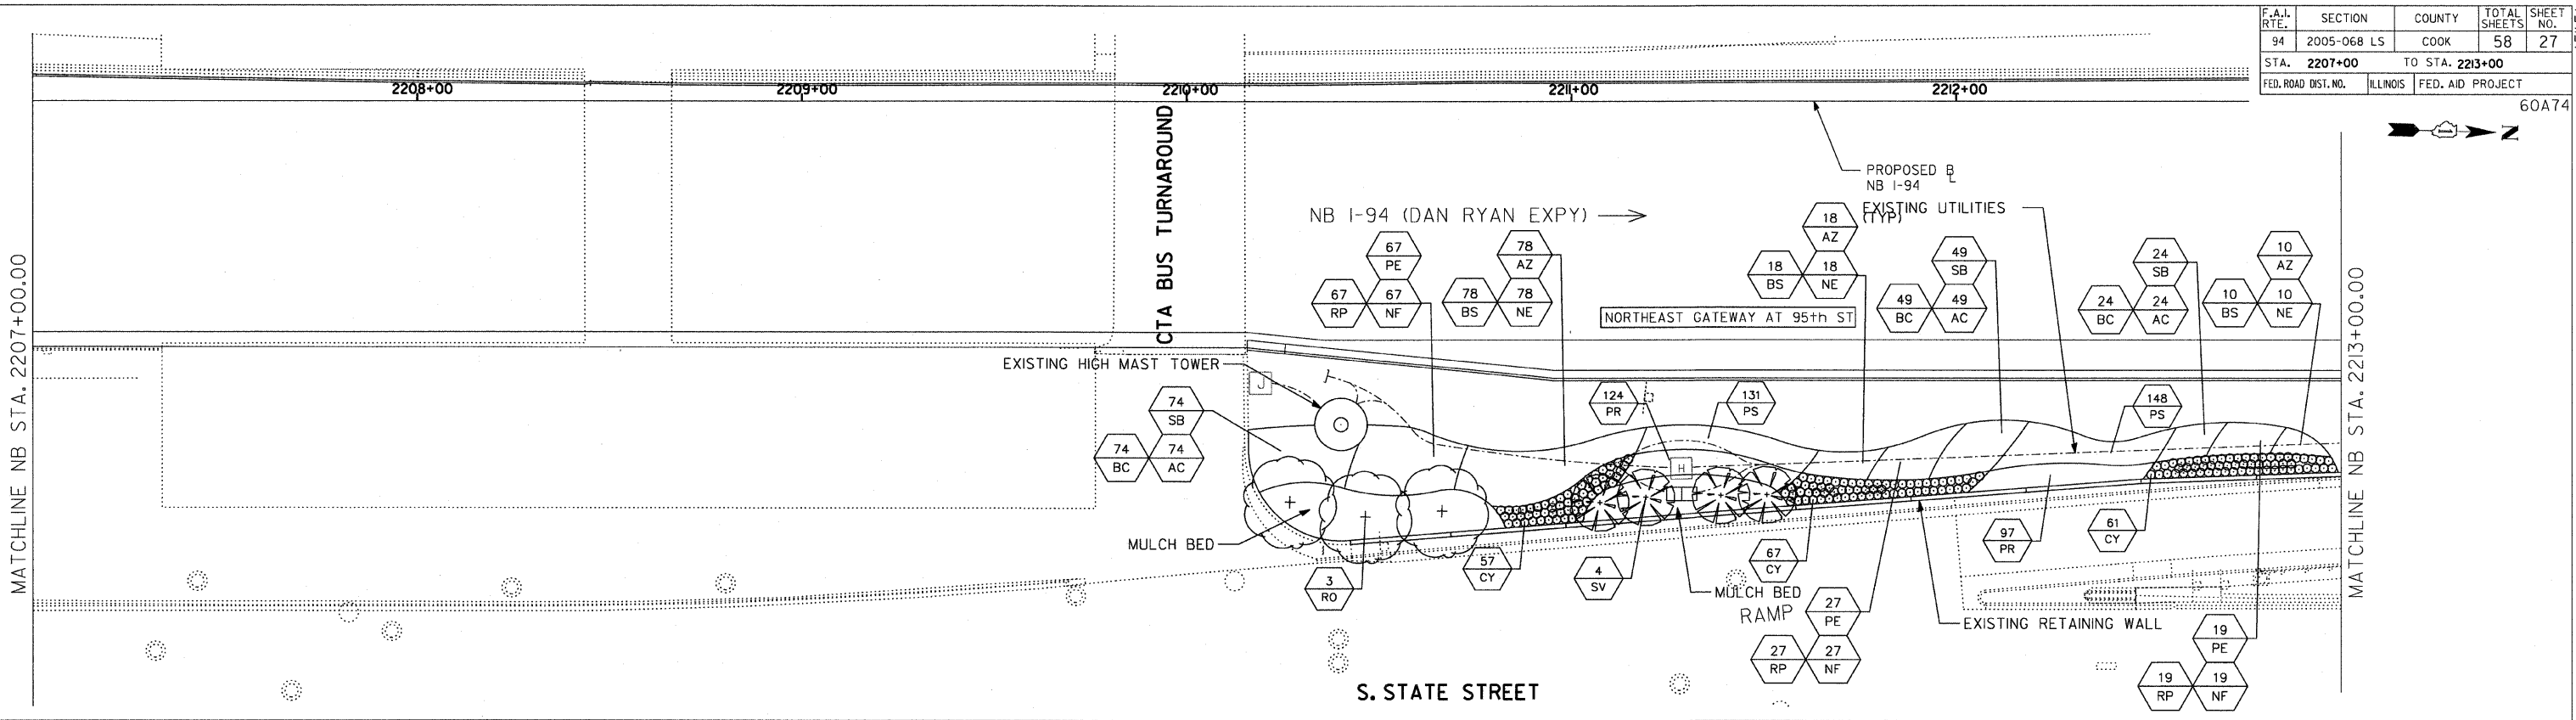


MATCHLINE NB STA. 2207+00.00

MATCHLINE NB STA. 2213+00.00


LEGEND:

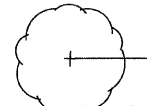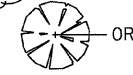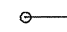-  SHADE TREE
-  ORNAMENTAL TREE
-  SHRUB
-  PERENNIALS/GRASSES

**SITE DESIGN GROUP**  
**TYLIN INTERNATIONAL**

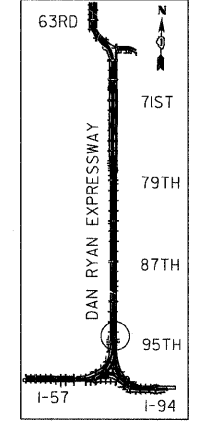

LOCATION MAP

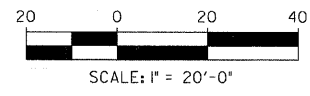


REVISIONS		ILLINOIS DEPARTMENT OF TRANSPORTATION F.A.I. 94 (DAN RYAN EXPRESSWAY) 95TH STREET GATEWAY LANDSCAPING AND IRRIGATION LANDSCAPE PLANS NE QUADRANTS AT 95TH ST. - NB I-94
NAME	DATE	



SCALE: 1"=20'  
DATE: JUNE 20, 2008  
DRAWN BY: EM  
CHECKED BY: JO

F.A.I. RTE.	SECTION	COUNTY	TOTAL SHEETS	SHEET NO.
94	2005-068 LS	COOK	58	28
STA. 153+09 (SB I-57) TO STA. 2214+95 (SB I-94)				
STA. 257+76 (NB I-57) TO STA. 2213+00 (NB I-94)				
FED. ROAD DIST. NO.		ILLINOIS	FED. AID PROJECT	


60A74

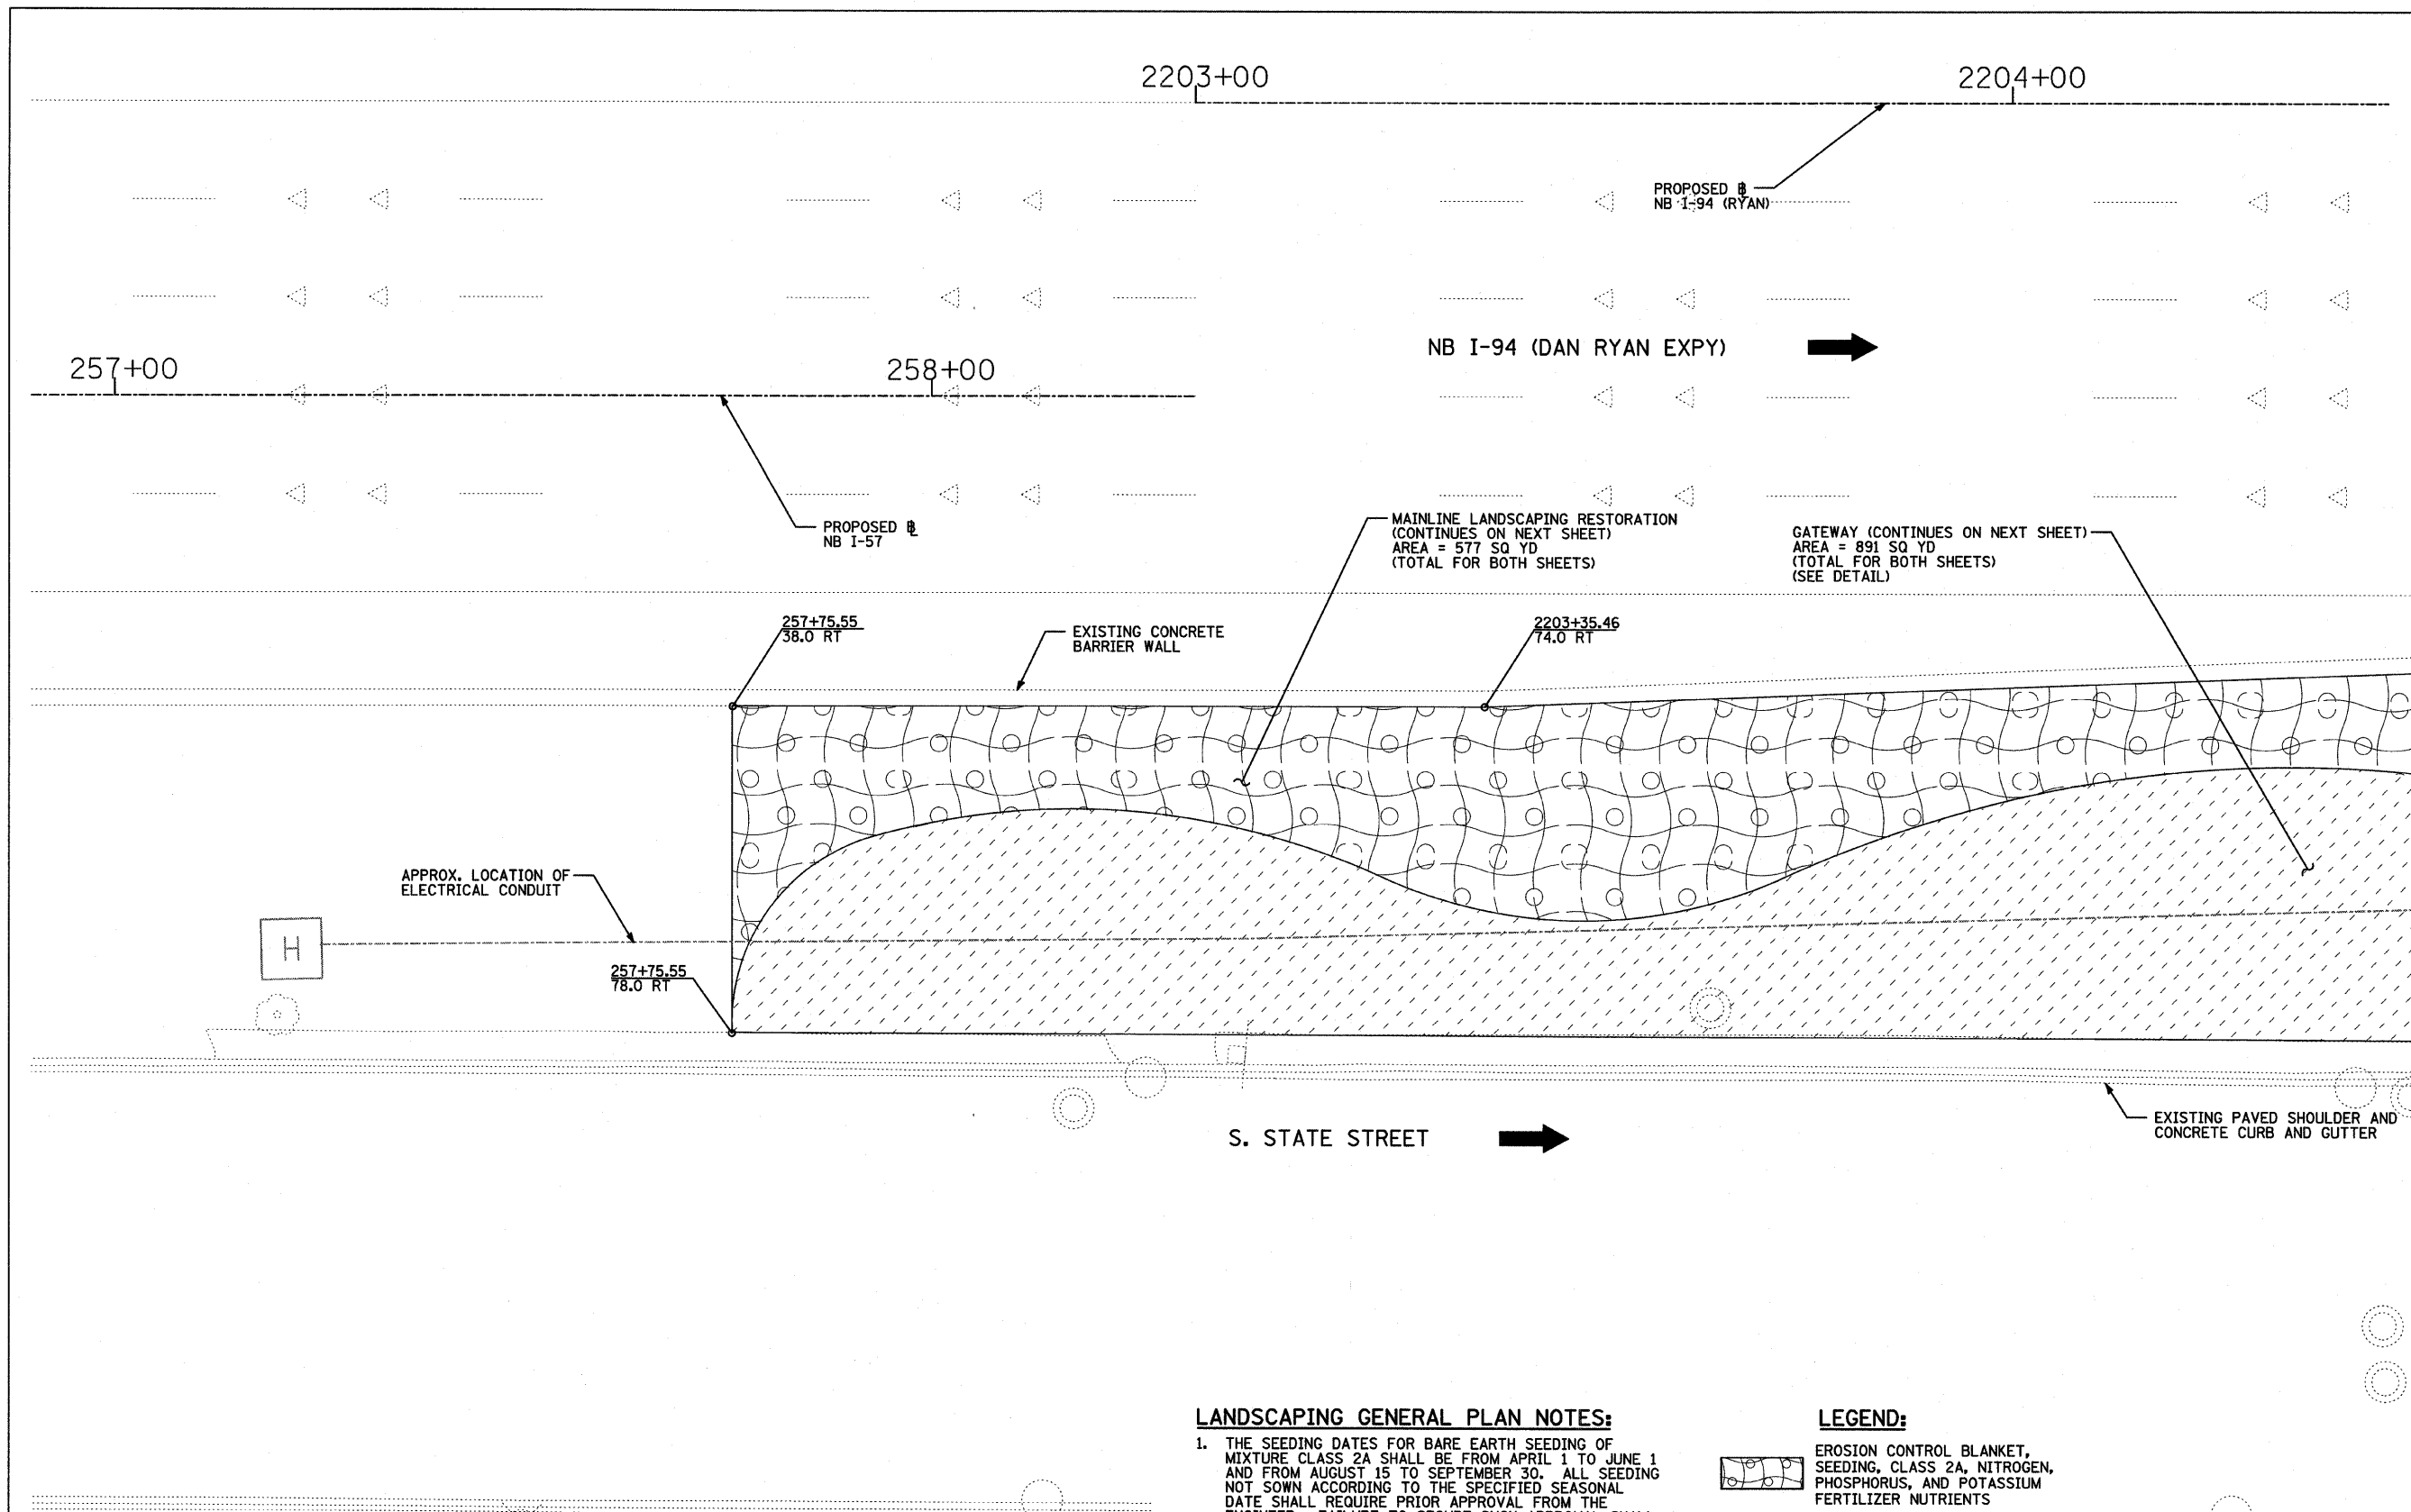

MATCHLINE NB I-94 (RYAN) STA. 2204+50.00

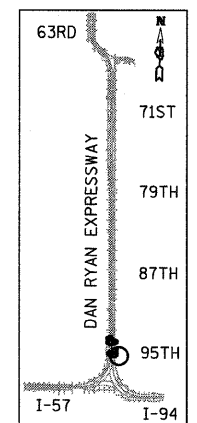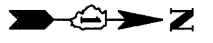




LOCATION MAP

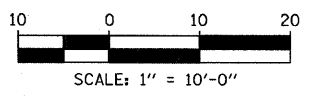

**LANDSCAPING GENERAL PLAN NOTES:**

1. THE SEEDING DATES FOR BARE EARTH SEEDING OF MIXTURE CLASS 2A SHALL BE FROM APRIL 1 TO JUNE 1 AND FROM AUGUST 15 TO SEPTEMBER 30. ALL SEEDING NOT SOWN ACCORDING TO THE SPECIFIED SEASONAL DATE SHALL REQUIRE PRIOR APPROVAL FROM THE ENGINEER. FAILURE TO SECURE SUCH APPROVAL SHALL RESULT IN THE REJECTION OF THE SEEDING AND REPLACEMENT BY THE CONTRACTOR AS HIS/HER EXPENSE.
2. AREAS TO BE SEEDING BETWEEN NOVEMBER 1 AND APRIL 1 SHALL REQUIRE DORMANT SEEDING, WHICH SHALL BE INCLUDED IN THE COST OF SEEDING CLASS 2A.
3. LAYOUT OF LANDSCAPED AREAS WILL REQUIRE APPROVAL OF THE ENGINEER PRIOR TO SEEDING AND PLANTING.

**LEGEND:**

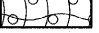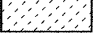-  EROSION CONTROL BLANKET, SEEDING, CLASS 2A, NITROGEN, PHOSPHORUS, AND POTASSIUM FERTILIZER NUTRIENTS
-  GATEWAY AREA (SEE LANDSCAPE PLANS)
-  DIRECTION OF TRAFFIC



REVISIONS	
NAME	DATE

ILLINOIS DEPARTMENT OF TRANSPORTATION  
 F.A.I. 94 (DAN RYAN EXPRESSWAY)  
 MAINLINE LANDSCAPING RESTORATION  
 SE & NE QUADRANTS AT 95TH ST -  
 NB I-57 STA. 257+75.55 TO  
 NB I-94 STA. 2204+50.00  
 SHEET 1 OF 3  
 SCALE: 1"=10'-0" DRAWN BY: JDF  
 DATE: JUNE 20, 2008 CHECKED BY: JPM

**TYLIN** INTERNATIONAL

6/20/2008 10:26:05 AM




F.A.I. RTE.	SECTION	COUNTY	TOTAL SHEETS	SHEET NO.
94	2005-068 LS	COOK	58	29
STA. 153+08 (SB I-57) TO STA. 227+78 (NB I-94)		STA. 1214+85 (SB I-94) TO STA. 2213+00 (NB I-94)		
FED. ROAD DIST. NO.	ILLINOIS FED. AID PROJECT		60A74	

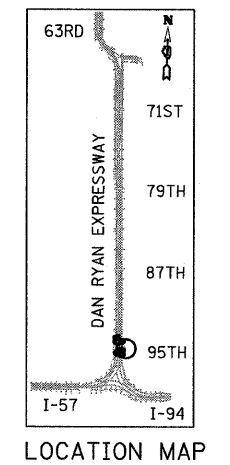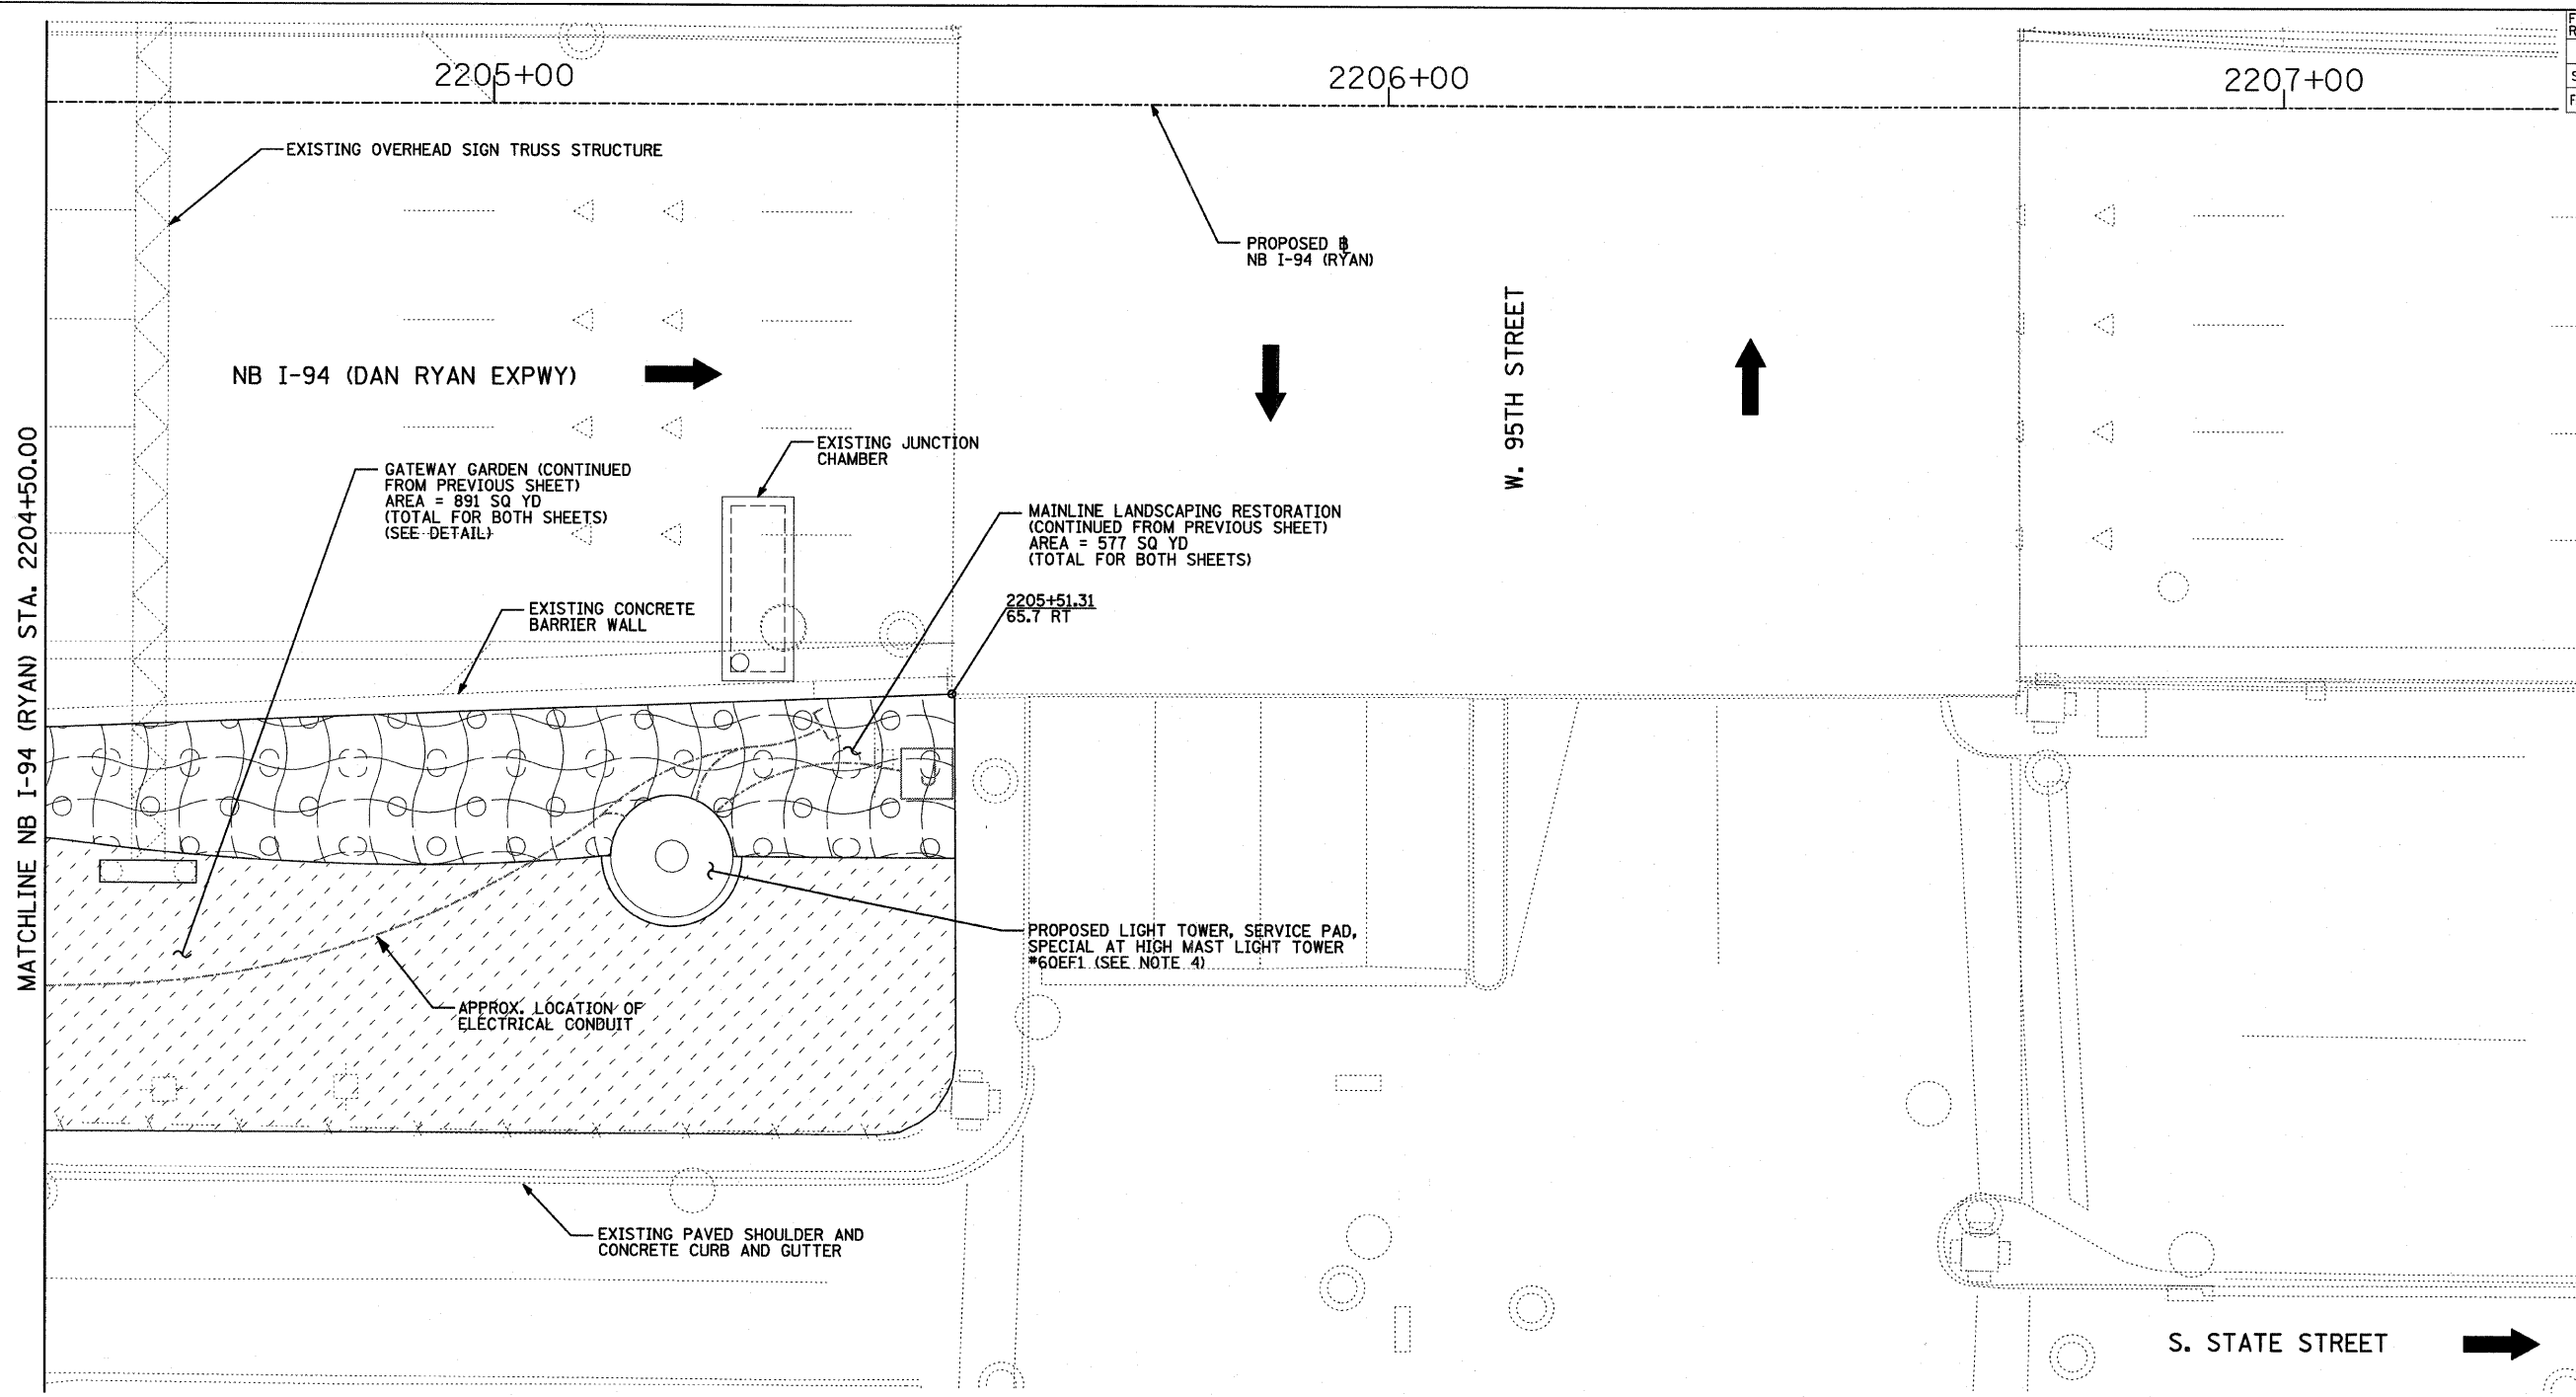


**LANDSCAPING GENERAL PLAN NOTES:**

1. THE SEEDING DATES FOR BARE EARTH SEEDING OF MIXTURE CLASS 2A SHALL BE FROM APRIL 1 TO JUNE 1 AND FROM AUGUST 15 TO SEPTEMBER 30. ALL SEEDING NOT SOWN ACCORDING TO THE SPECIFIED SEASONAL DATE SHALL REQUIRE PRIOR APPROVAL FROM THE ENGINEER. FAILURE TO SECURE SUCH APPROVAL SHALL RESULT IN THE REJECTION OF THE SEEDING AND REPLACEMENT BY THE CONTRACTOR AS HIS/HER EXPENSE.
2. AREAS TO BE SEEDD BETWEEN NOVEMBER 1 AND APRIL 1 SHALL REQUIRE DORMANT SEEDING, WHICH SHALL BE INCLUDED IN THE COST OF SEEDING CLASS 2A.
3. LAYOUT OF LANDSCAPED AREAS WILL REQUIRE APPROVAL OF THE ENGINEER PRIOR TO SEEDING AND PLANTING.
4. QUANTITIES FOR TOPSOIL FURNISH AND PLACE, 12" AND COMPOST FURNISH AND PLACE, 6" HAVE BEEN PROVIDED FOR THE AREA AROUND THE HMLT SERVICE PAD. A RADIUS OF 20 FT FROM THE EDGE OF THE SERVICE PAD WAS USED TO CALCULATE THIS QUANTITY.

**LEGEND:**

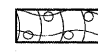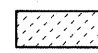-  EROSION CONTROL BLANKET, SEEDING, CLASS 2A, NITROGEN, PHOSPHORUS, AND POTASSIUM FERTILIZER NUTRIENTS
-  GATEWAY AREA (SEE LANDSCAPE PLANS)
-  DIRECTION OF TRAFFIC

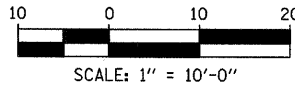

REVISIONS	
NAME	DATE



ILLINOIS DEPARTMENT OF TRANSPORTATION  
 F.A.I. 94 (DAN RYAN EXPRESSWAY)  
 MAINLINE LANDSCAPING RESTORATION  
 SE & NE QUADRANTS AT 95TH ST - NB I-94  
 STA. 2204+50.00 TO STA. 2205+51.31  
 SHEET 2 OF 3  
 SCALE: 1"=10'-0" DRAWN BY: JDF  
 DATE: JUNE 20, 2008 CHECKED BY: JPM

**TYLIN** INTERNATIONAL

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F.A.I. RTE.	SECTION	COUNTY	TOTAL SHEETS	SHEET NO.
94	2005-068 LS	COOK	58	30
STA. 257+76 (NB I-57)		TO STA. 1214+95 (SB I-94)		
FED. ROAD DIST. NO.		ILLINOIS	FED. AID PROJECT	

60A74

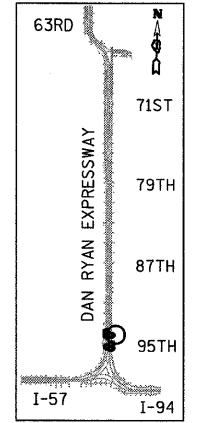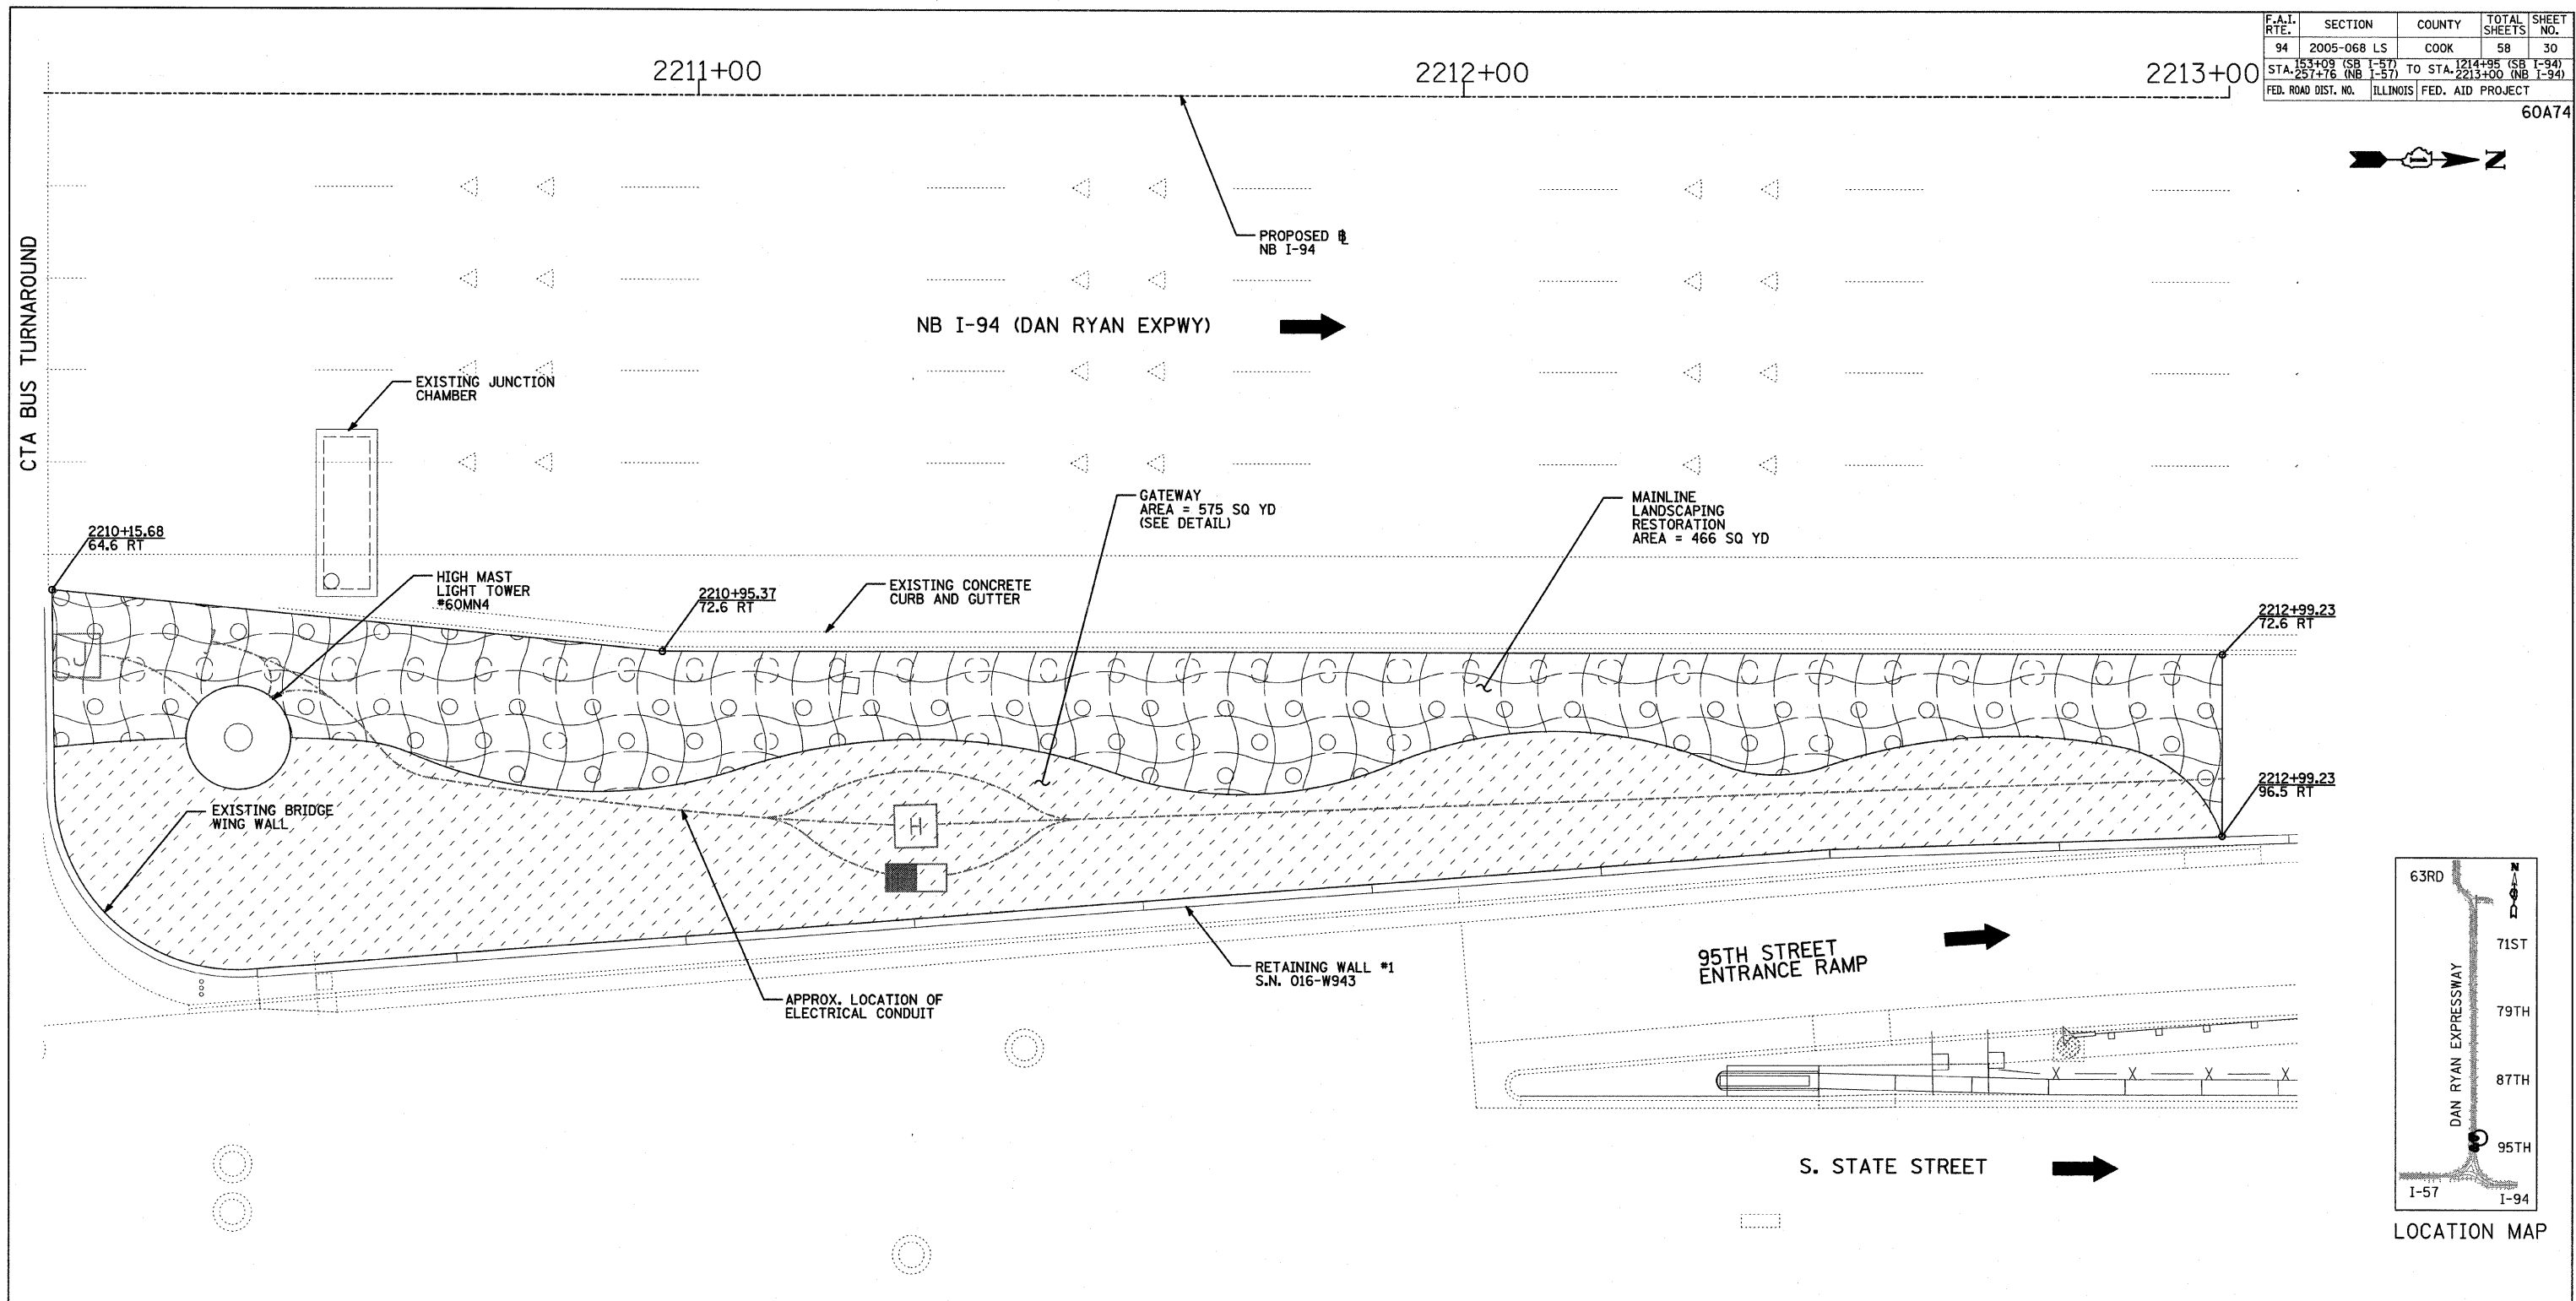


LOCATION MAP

**LANDSCAPING GENERAL PLAN NOTES:**

1. THE SEEDING DATES FOR BARE EARTH SEEDING OF MIXTURE CLASS 2A SHALL BE FROM APRIL 1 TO JUNE 1 AND FROM AUGUST 15 TO SEPTEMBER 30. ALL SEEDING NOT SOWN ACCORDING TO THE SPECIFIED SEASONAL DATE SHALL REQUIRE PRIOR APPROVAL FROM THE ENGINEER. FAILURE TO SECURE SUCH APPROVAL SHALL RESULT IN THE REJECTION OF THE SEEDING AND REPLACEMENT BY THE CONTRACTOR AS HIS/HER EXPENSE.
2. AREAS TO BE SEEDDED BETWEEN NOVEMBER 1 AND APRIL 1 SHALL REQUIRE DORMANT SEEDING, WHICH SHALL BE INCLUDED IN THE COST OF SEEDING CLASS 2A.
3. LAYOUT OF LANDSCAPED AREAS WILL REQUIRE APPROVAL OF THE ENGINEER PRIOR TO SEEDING AND PLANTING.

**LEGEND:**

- EROSION CONTROL BLANKET, SEEDING, CLASS 2A, NITROGEN, PHOSPHORUS, AND POTASSIUM FERTILIZER NUTRIENTS
- GATEWAY AREA (SEE LANDSCAPE PLANS)
- DIRECTION OF TRAFFIC

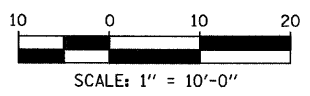

REVISIONS	
NAME	DATE

ILLINOIS DEPARTMENT OF TRANSPORTATION  
**F.A.I. 94 (DAN RYAN EXPRESSWAY)**  
**MAINLINE LANDSCAPING RESTORATION**  
**SE & NE QUADRANTS AT 95TH ST - NB I-94**  
**STA. 2210+15.68 TO STA. 2212+99.23**  
**SHEET 3 OF 3**


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DATE: JUNE 20, 2008

DRAWN BY: JDF  
CHECKED BY: JPM

**TYLIN**INTERNATIONAL

6/20/2008 10:26:17 AM

F.A.I. RTE.	SECTION	COUNTY	TOTAL SHEETS	SHEET NO.
94	2005-068 LS	COOK	58	31
STA. 153+09 (SB I-57) TO STA. 154+00 (SB I-57)		1214+95 (SB I-94) TO STA. 2213+00 (NB I-94)		
FED. ROAD DIST. NO.		ILLINOIS FED. AID PROJECT		60A74

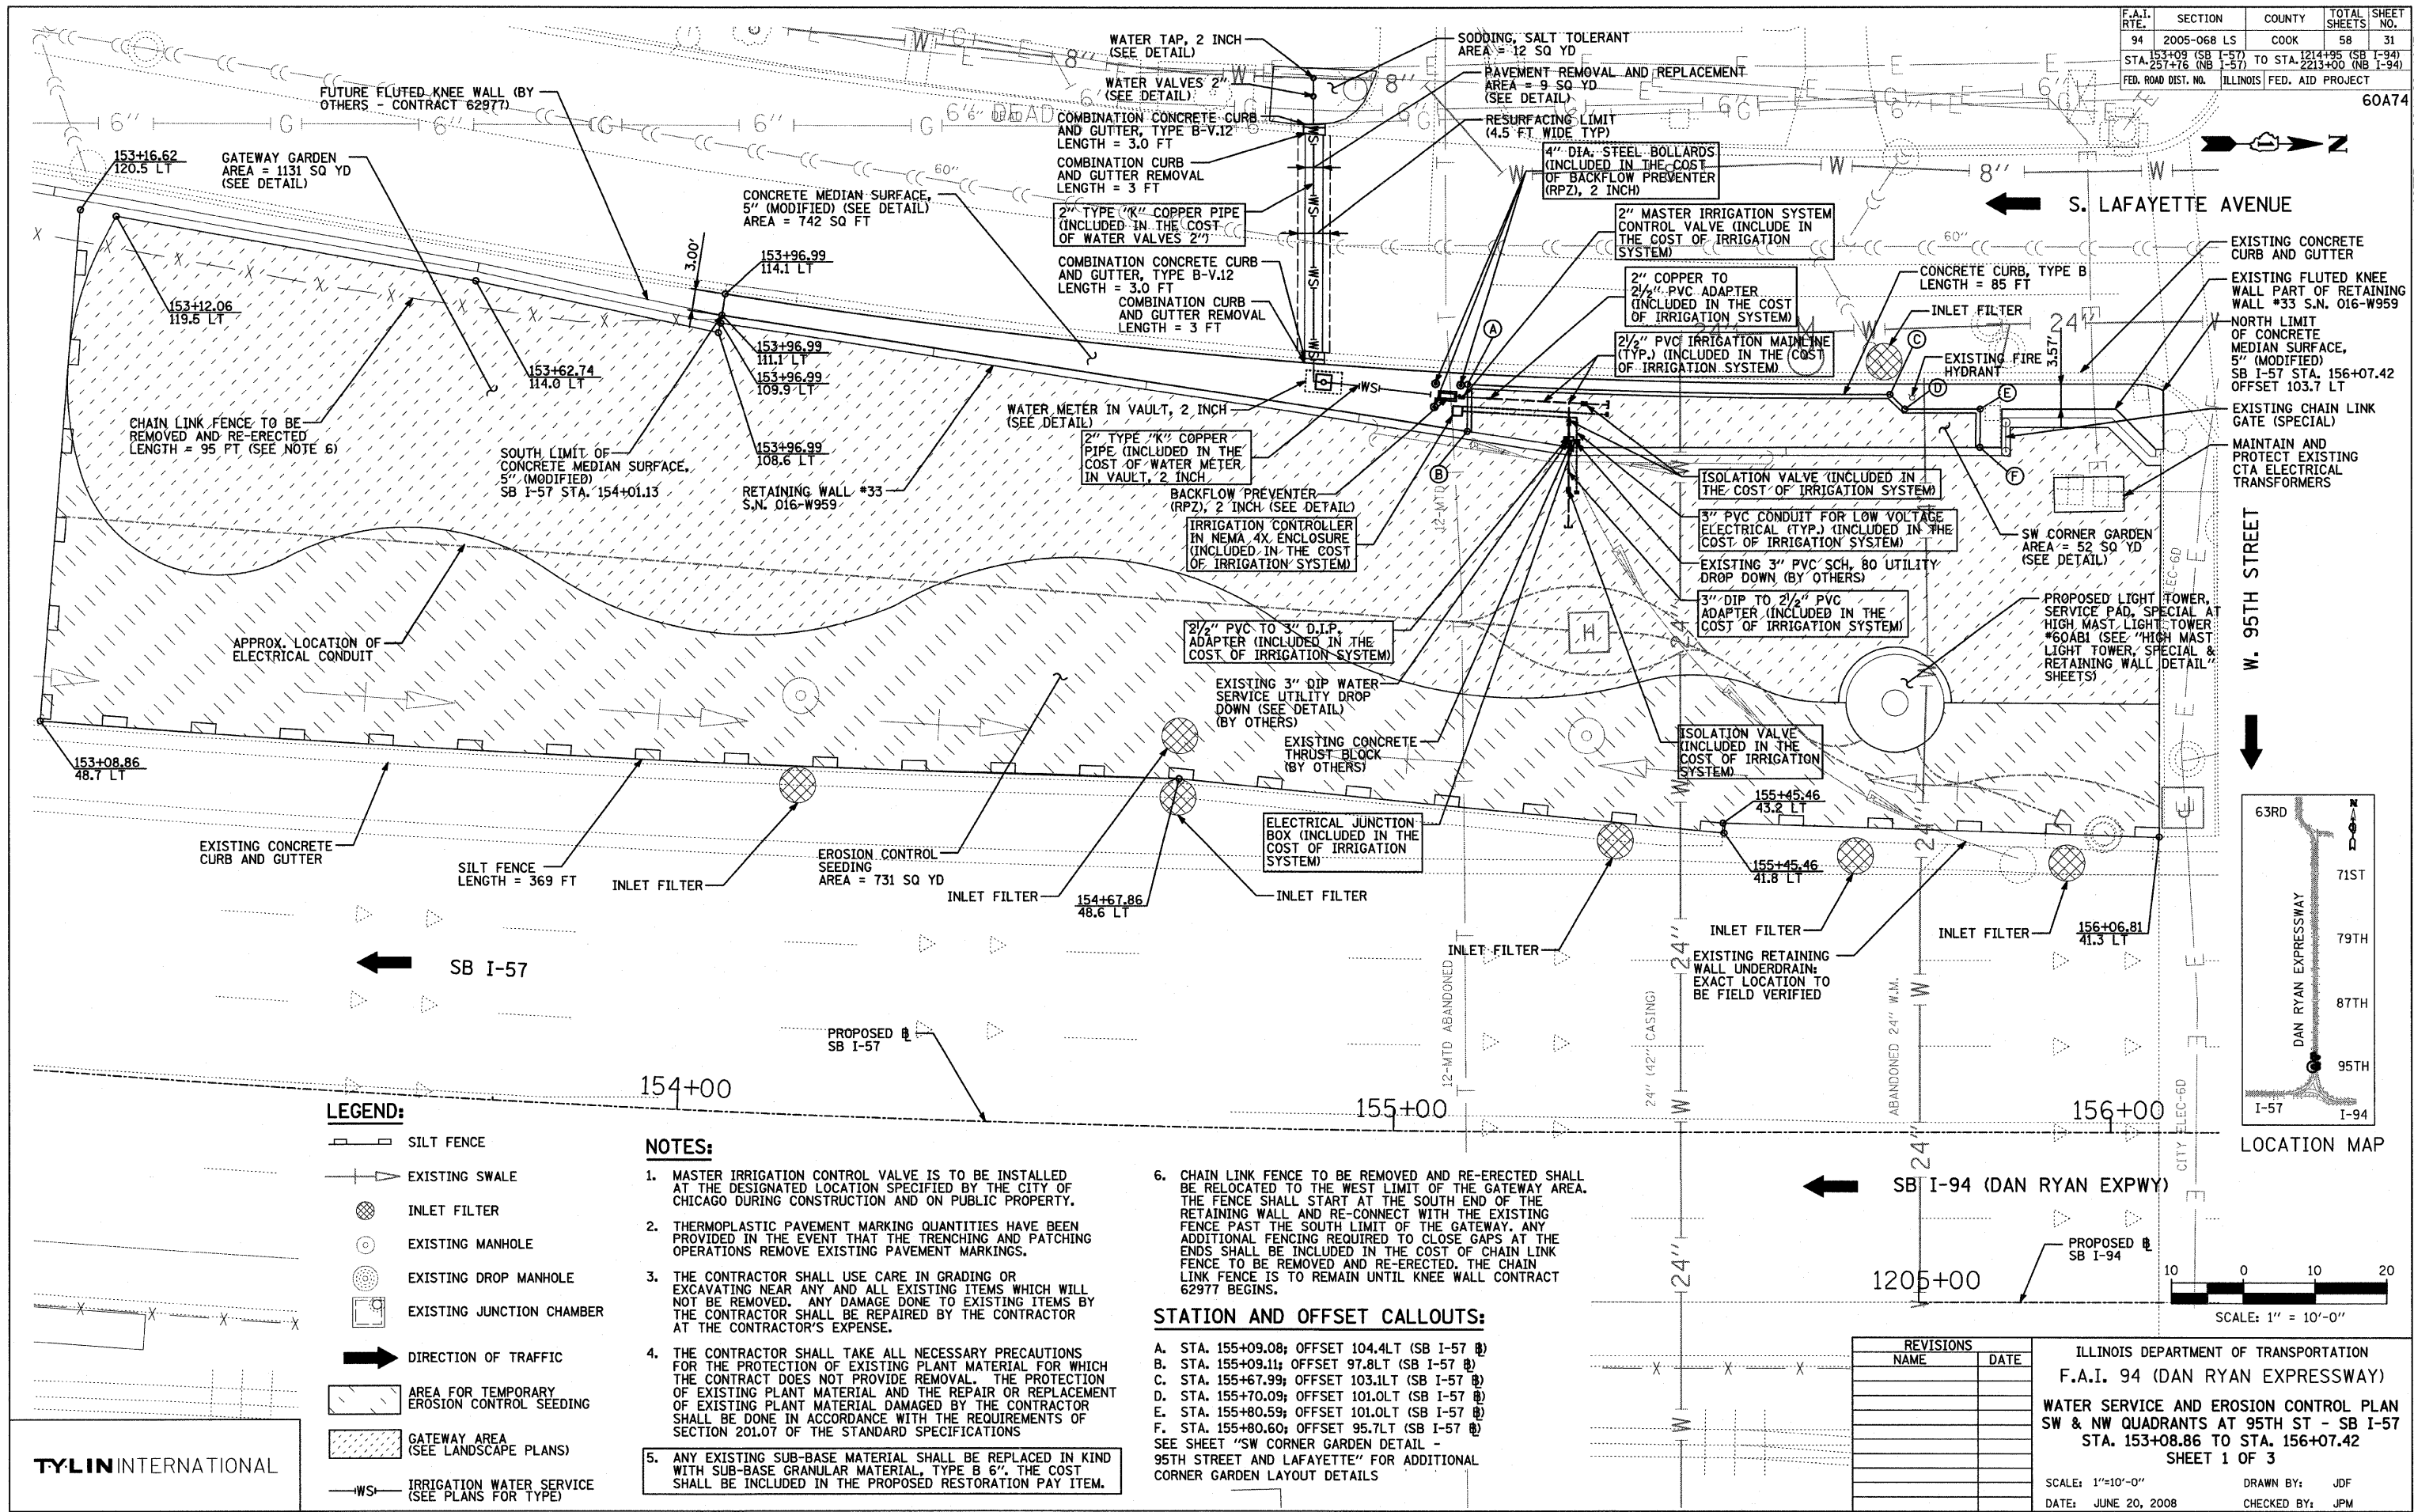

**LEGEND:**

- SILT FENCE
- EXISTING SWALE
- INLET FILTER
- EXISTING MANHOLE
- EXISTING DROP MANHOLE
- EXISTING JUNCTION CHAMBER
- DIRECTION OF TRAFFIC
- AREA FOR TEMPORARY EROSION CONTROL SEEDING
- GATEWAY AREA (SEE LANDSCAPE PLANS)
- IRRIGATION WATER SERVICE (SEE PLANS FOR TYPE)

**NOTES:**

1. MASTER IRRIGATION CONTROL VALVE IS TO BE INSTALLED AT THE DESIGNATED LOCATION SPECIFIED BY THE CITY OF CHICAGO DURING CONSTRUCTION AND ON PUBLIC PROPERTY.
2. THERMOPLASTIC PAVEMENT MARKING QUANTITIES HAVE BEEN PROVIDED IN THE EVENT THAT THE TRENCHING AND PATCHING OPERATIONS REMOVE EXISTING PAVEMENT MARKINGS.
3. THE CONTRACTOR SHALL USE CARE IN GRADING OR EXCAVATING NEAR ANY AND ALL EXISTING ITEMS WHICH WILL NOT BE REMOVED. ANY DAMAGE DONE TO EXISTING ITEMS BY THE CONTRACTOR SHALL BE REPAIRED BY THE CONTRACTOR AT THE CONTRACTOR'S EXPENSE.
4. THE CONTRACTOR SHALL TAKE ALL NECESSARY PRECAUTIONS FOR THE PROTECTION OF EXISTING PLANT MATERIAL FOR WHICH THE CONTRACT DOES NOT PROVIDE REMOVAL. THE PROTECTION OF EXISTING PLANT MATERIAL AND THE REPAIR OR REPLACEMENT OF EXISTING PLANT MATERIAL DAMAGED BY THE CONTRACTOR SHALL BE DONE IN ACCORDANCE WITH THE REQUIREMENTS OF SECTION 201.07 OF THE STANDARD SPECIFICATIONS
5. ANY EXISTING SUB-BASE MATERIAL SHALL BE REPLACED IN KIND WITH SUB-BASE GRANULAR MATERIAL, TYPE B 6". THE COST SHALL BE INCLUDED IN THE PROPOSED RESTORATION PAY ITEM.

6. CHAIN LINK FENCE TO BE REMOVED AND RE-ERECTED SHALL BE RELOCATED TO THE WEST LIMIT OF THE GATEWAY AREA. THE FENCE SHALL START AT THE SOUTH END OF THE RETAINING WALL AND RE-CONNECT WITH THE EXISTING FENCE PAST THE SOUTH LIMIT OF THE GATEWAY. ANY ADDITIONAL FENCING REQUIRED TO CLOSE GAPS AT THE ENDS SHALL BE INCLUDED IN THE COST OF CHAIN LINK FENCE TO BE REMOVED AND RE-ERECTED. THE CHAIN LINK FENCE IS TO REMAIN UNTIL KNEE WALL CONTRACT 62977 BEGINS.

**STATION AND OFFSET CALLOUTS:**



- A. STA. 155+09.08; OFFSET 104.4LT (SB I-57 @)
  - B. STA. 155+09.11; OFFSET 97.8LT (SB I-57 @)
  - C. STA. 155+67.99; OFFSET 103.1LT (SB I-57 @)
  - D. STA. 155+70.09; OFFSET 101.0LT (SB I-57 @)
  - E. STA. 155+80.59; OFFSET 101.0LT (SB I-57 @)
  - F. STA. 155+80.60; OFFSET 95.7LT (SB I-57 @)
- SEE SHEET "SW CORNER GARDEN DETAIL - 95TH STREET AND LAFAYETTE" FOR ADDITIONAL CORNER GARDEN LAYOUT DETAILS

REVISIONS	
NAME	DATE

ILLINOIS DEPARTMENT OF TRANSPORTATION  
**F.A.I. 94 (DAN RYAN EXPRESSWAY)**  
**WATER SERVICE AND EROSION CONTROL PLAN**  
**SW & NW QUADRANTS AT 95TH ST - SB I-57**  
**STA. 153+08.86 TO STA. 156+07.42**  
**SHEET 1 OF 3**


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 DATE: JUNE 20, 2008  
 DRAWN BY: JDF  
 CHECKED BY: JPM

**TYLIN INTERNATIONAL**

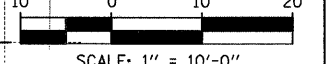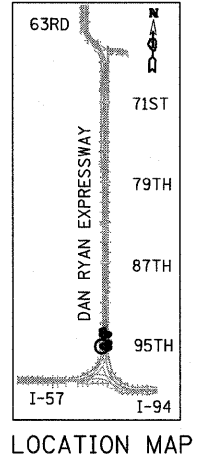


F.A.I. RTE.	SECTION	COUNTY	TOTAL SHEETS	SHEET NO.
94	2005-068 LS	COOK	58	32
STA. 1213+00 (SB I-94) TO STA. 1214+95 (SB I-94)		STA. 2213+00 (NB I-94)		
FED. ROAD DIST. NO.		ILLINOIS FED. AID PROJECT		


60A74

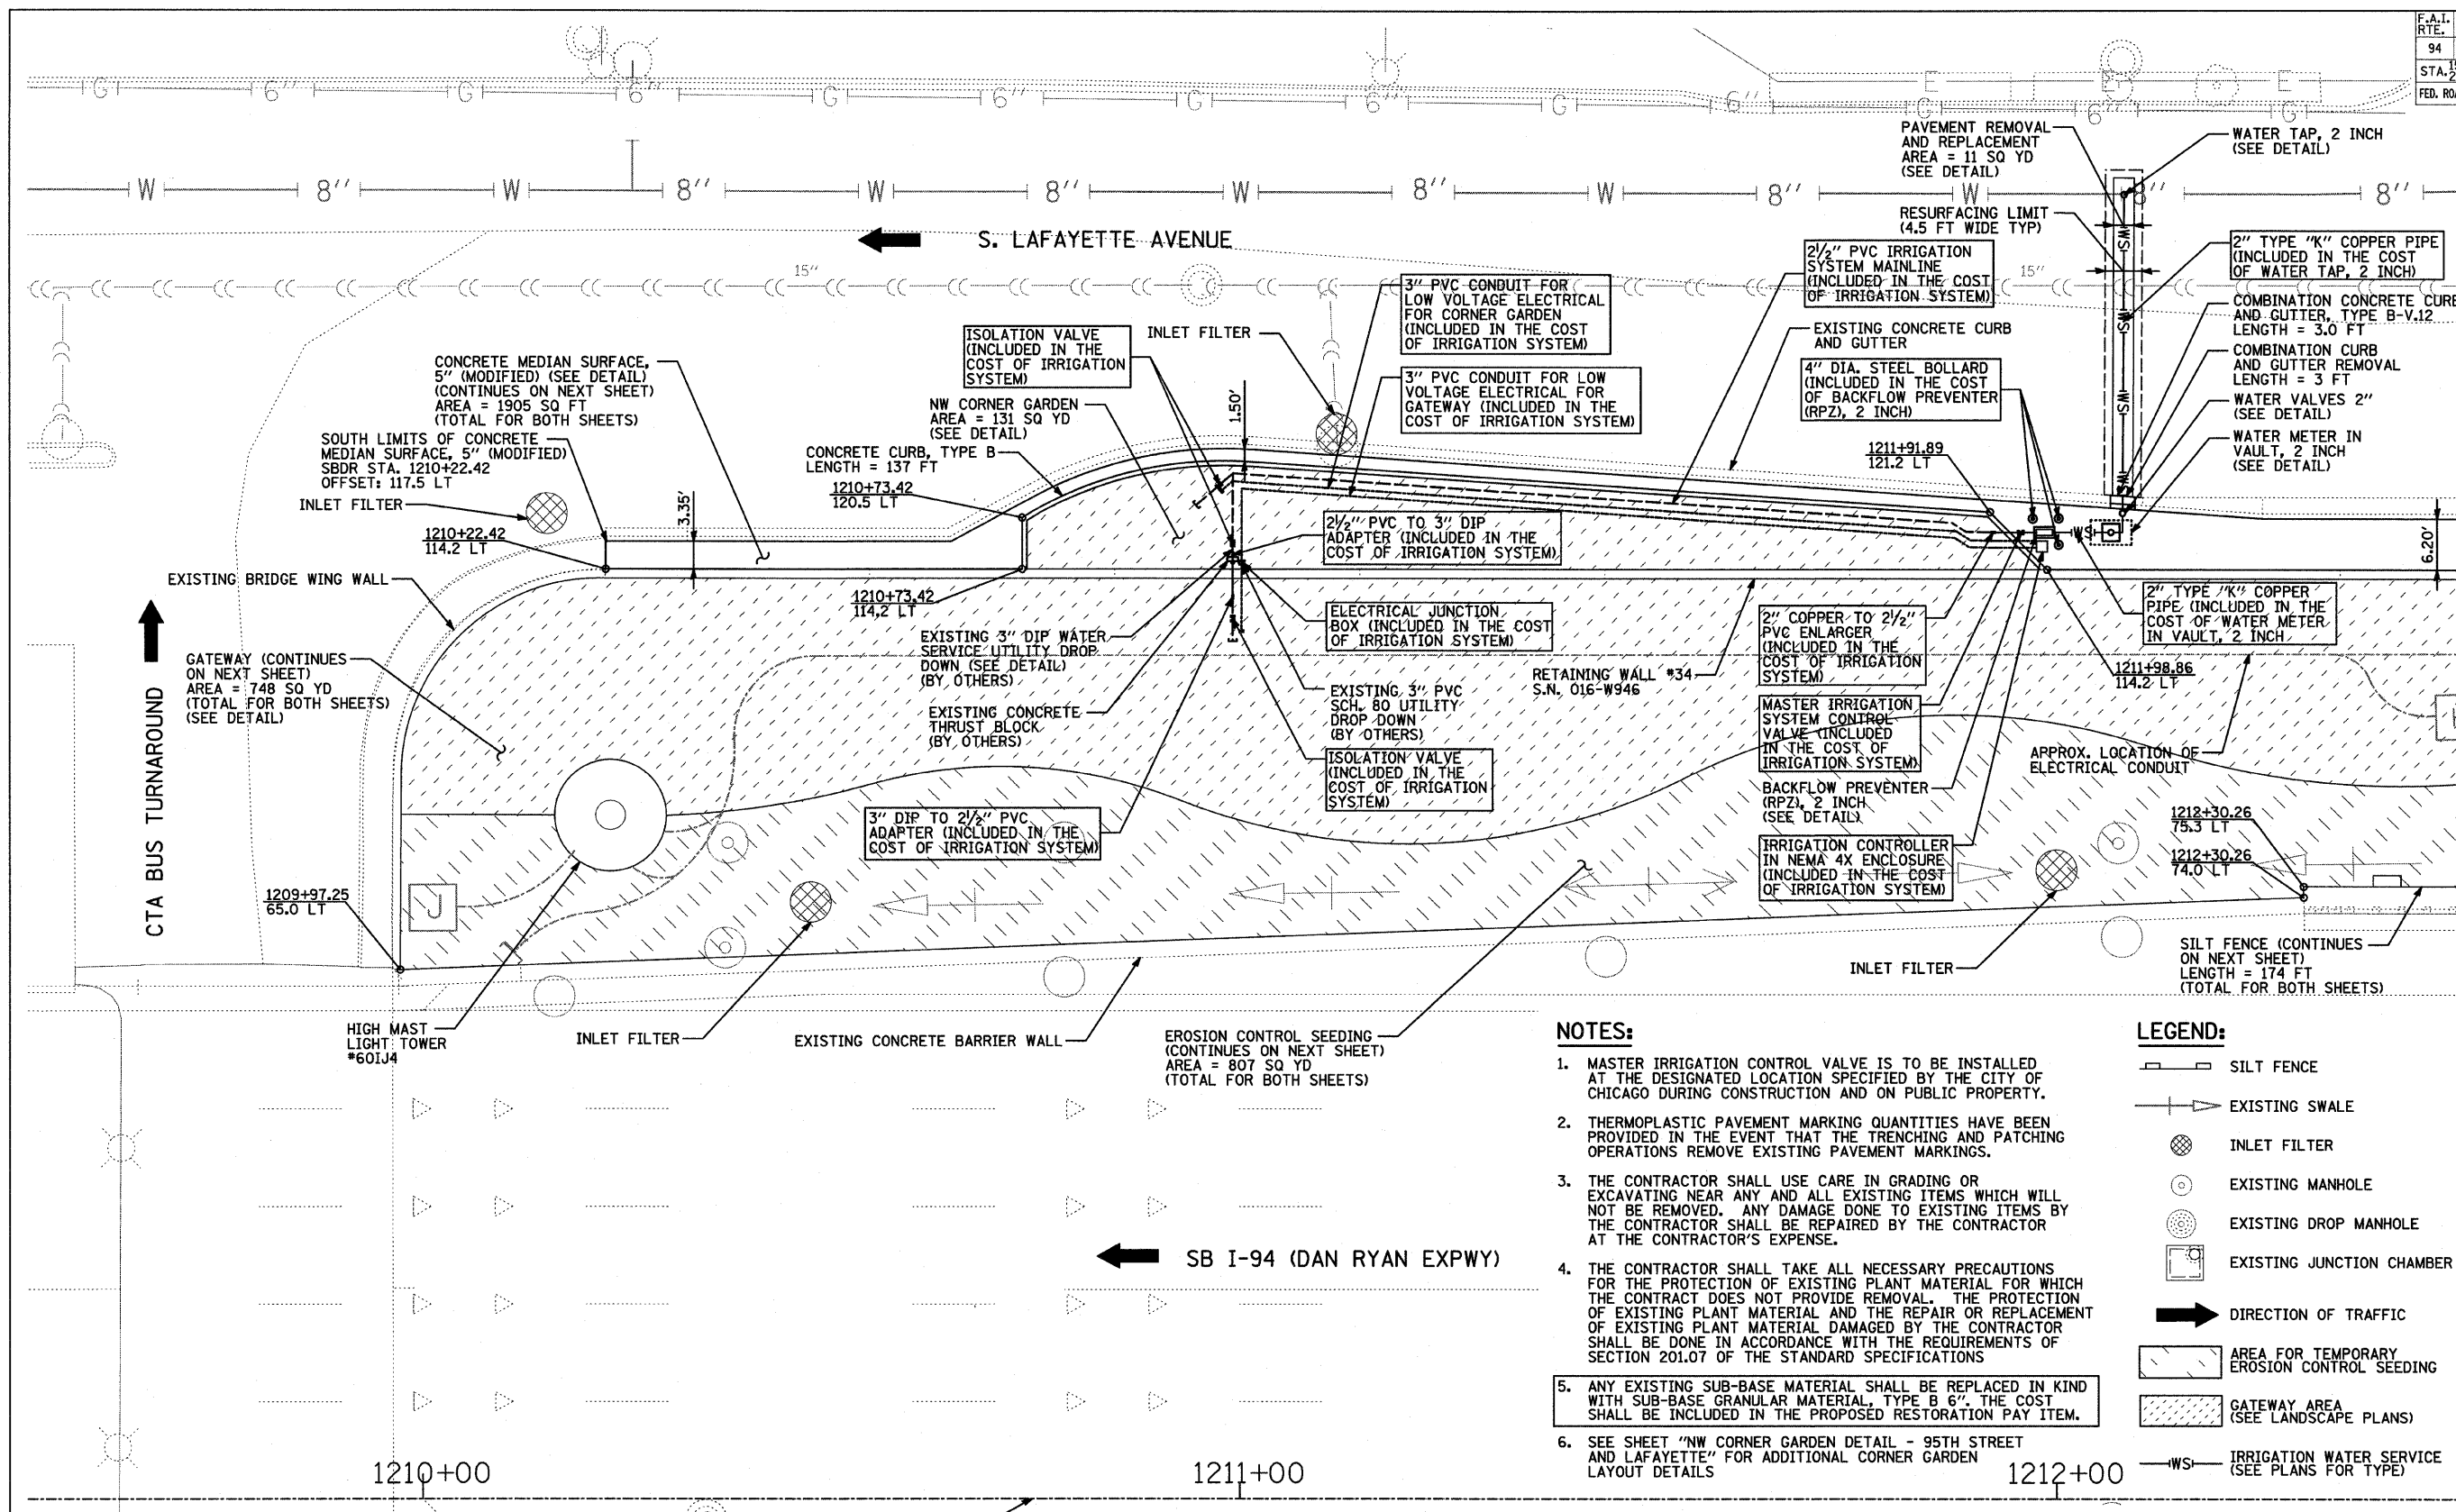

MATCHLINE SB I-94 (RYAN) STA. 1212+50.00

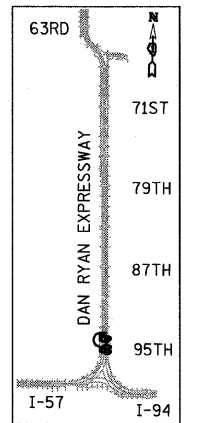

LOCATION MAP

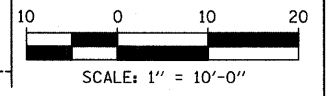

**NOTES:**

1. MASTER IRRIGATION CONTROL VALVE IS TO BE INSTALLED AT THE DESIGNATED LOCATION SPECIFIED BY THE CITY OF CHICAGO DURING CONSTRUCTION AND ON PUBLIC PROPERTY.
2. THERMOPLASTIC PAVEMENT MARKING QUANTITIES HAVE BEEN PROVIDED IN THE EVENT THAT THE TRENCHING AND PATCHING OPERATIONS REMOVE EXISTING PAVEMENT MARKINGS.
3. THE CONTRACTOR SHALL USE CARE IN GRADING OR EXCAVATING NEAR ANY AND ALL EXISTING ITEMS WHICH WILL NOT BE REMOVED. ANY DAMAGE DONE TO EXISTING ITEMS BY THE CONTRACTOR SHALL BE REPAIRED BY THE CONTRACTOR AT THE CONTRACTOR'S EXPENSE.
4. THE CONTRACTOR SHALL TAKE ALL NECESSARY PRECAUTIONS FOR THE PROTECTION OF EXISTING PLANT MATERIAL FOR WHICH THE CONTRACT DOES NOT PROVIDE REMOVAL. THE PROTECTION OF EXISTING PLANT MATERIAL AND THE REPAIR OR REPLACEMENT OF EXISTING PLANT MATERIAL DAMAGED BY THE CONTRACTOR SHALL BE DONE IN ACCORDANCE WITH THE REQUIREMENTS OF SECTION 201.07 OF THE STANDARD SPECIFICATIONS
5. ANY EXISTING SUB-BASE MATERIAL SHALL BE REPLACED IN KIND WITH SUB-BASE GRANULAR MATERIAL, TYPE B 6". THE COST SHALL BE INCLUDED IN THE PROPOSED RESTORATION PAY ITEM.
6. SEE SHEET "NW CORNER GARDEN DETAIL - 95TH STREET AND LAFAYETTE" FOR ADDITIONAL CORNER GARDEN LAYOUT DETAILS

**LEGEND:**

- SILT FENCE
- EXISTING SWALE
- INLET FILTER
- EXISTING MANHOLE
- EXISTING DROP MANHOLE
- EXISTING JUNCTION CHAMBER
- DIRECTION OF TRAFFIC
- AREA FOR TEMPORARY EROSION CONTROL SEEDING
- GATEWAY AREA (SEE LANDSCAPE PLANS)
- IRRIGATION WATER SERVICE (SEE PLANS FOR TYPE)

REVISIONS	
NAME	DATE

ILLINOIS DEPARTMENT OF TRANSPORTATION  
**F.A.I. 94 (DAN RYAN EXPRESSWAY)**  
 WATER SERVICE AND EROSION CONTROL PLAN  
 SW & NW QUADRANTS AT 95TH ST - SB I-94  
 STA. 1209+97.25 TO STA. 1212+50.00  
**SHEET 2 OF 3**

SCALE: 1"=10'-0"  
 DATE: JUNE 20, 2008  
 DRAWN BY: JDF  
 CHECKED BY: JPM


**TYLIN**INTERNATIONAL

6/20/2008 10:26:41 AM



F.A.I. RTE.	SECTION	COUNTY	TOTAL SHEETS	SHEET NO.
94	2005-068 LS	COOK	58	33
153+09 (SB I-57)			1214+95 (SB I-94)	
STA. 257+76 (NB I-57)			TO STA. 2213+00 (NB I-94)	
FED. ROAD DIST. NO.	ILLINOIS	FED. AID PROJECT		

60A74

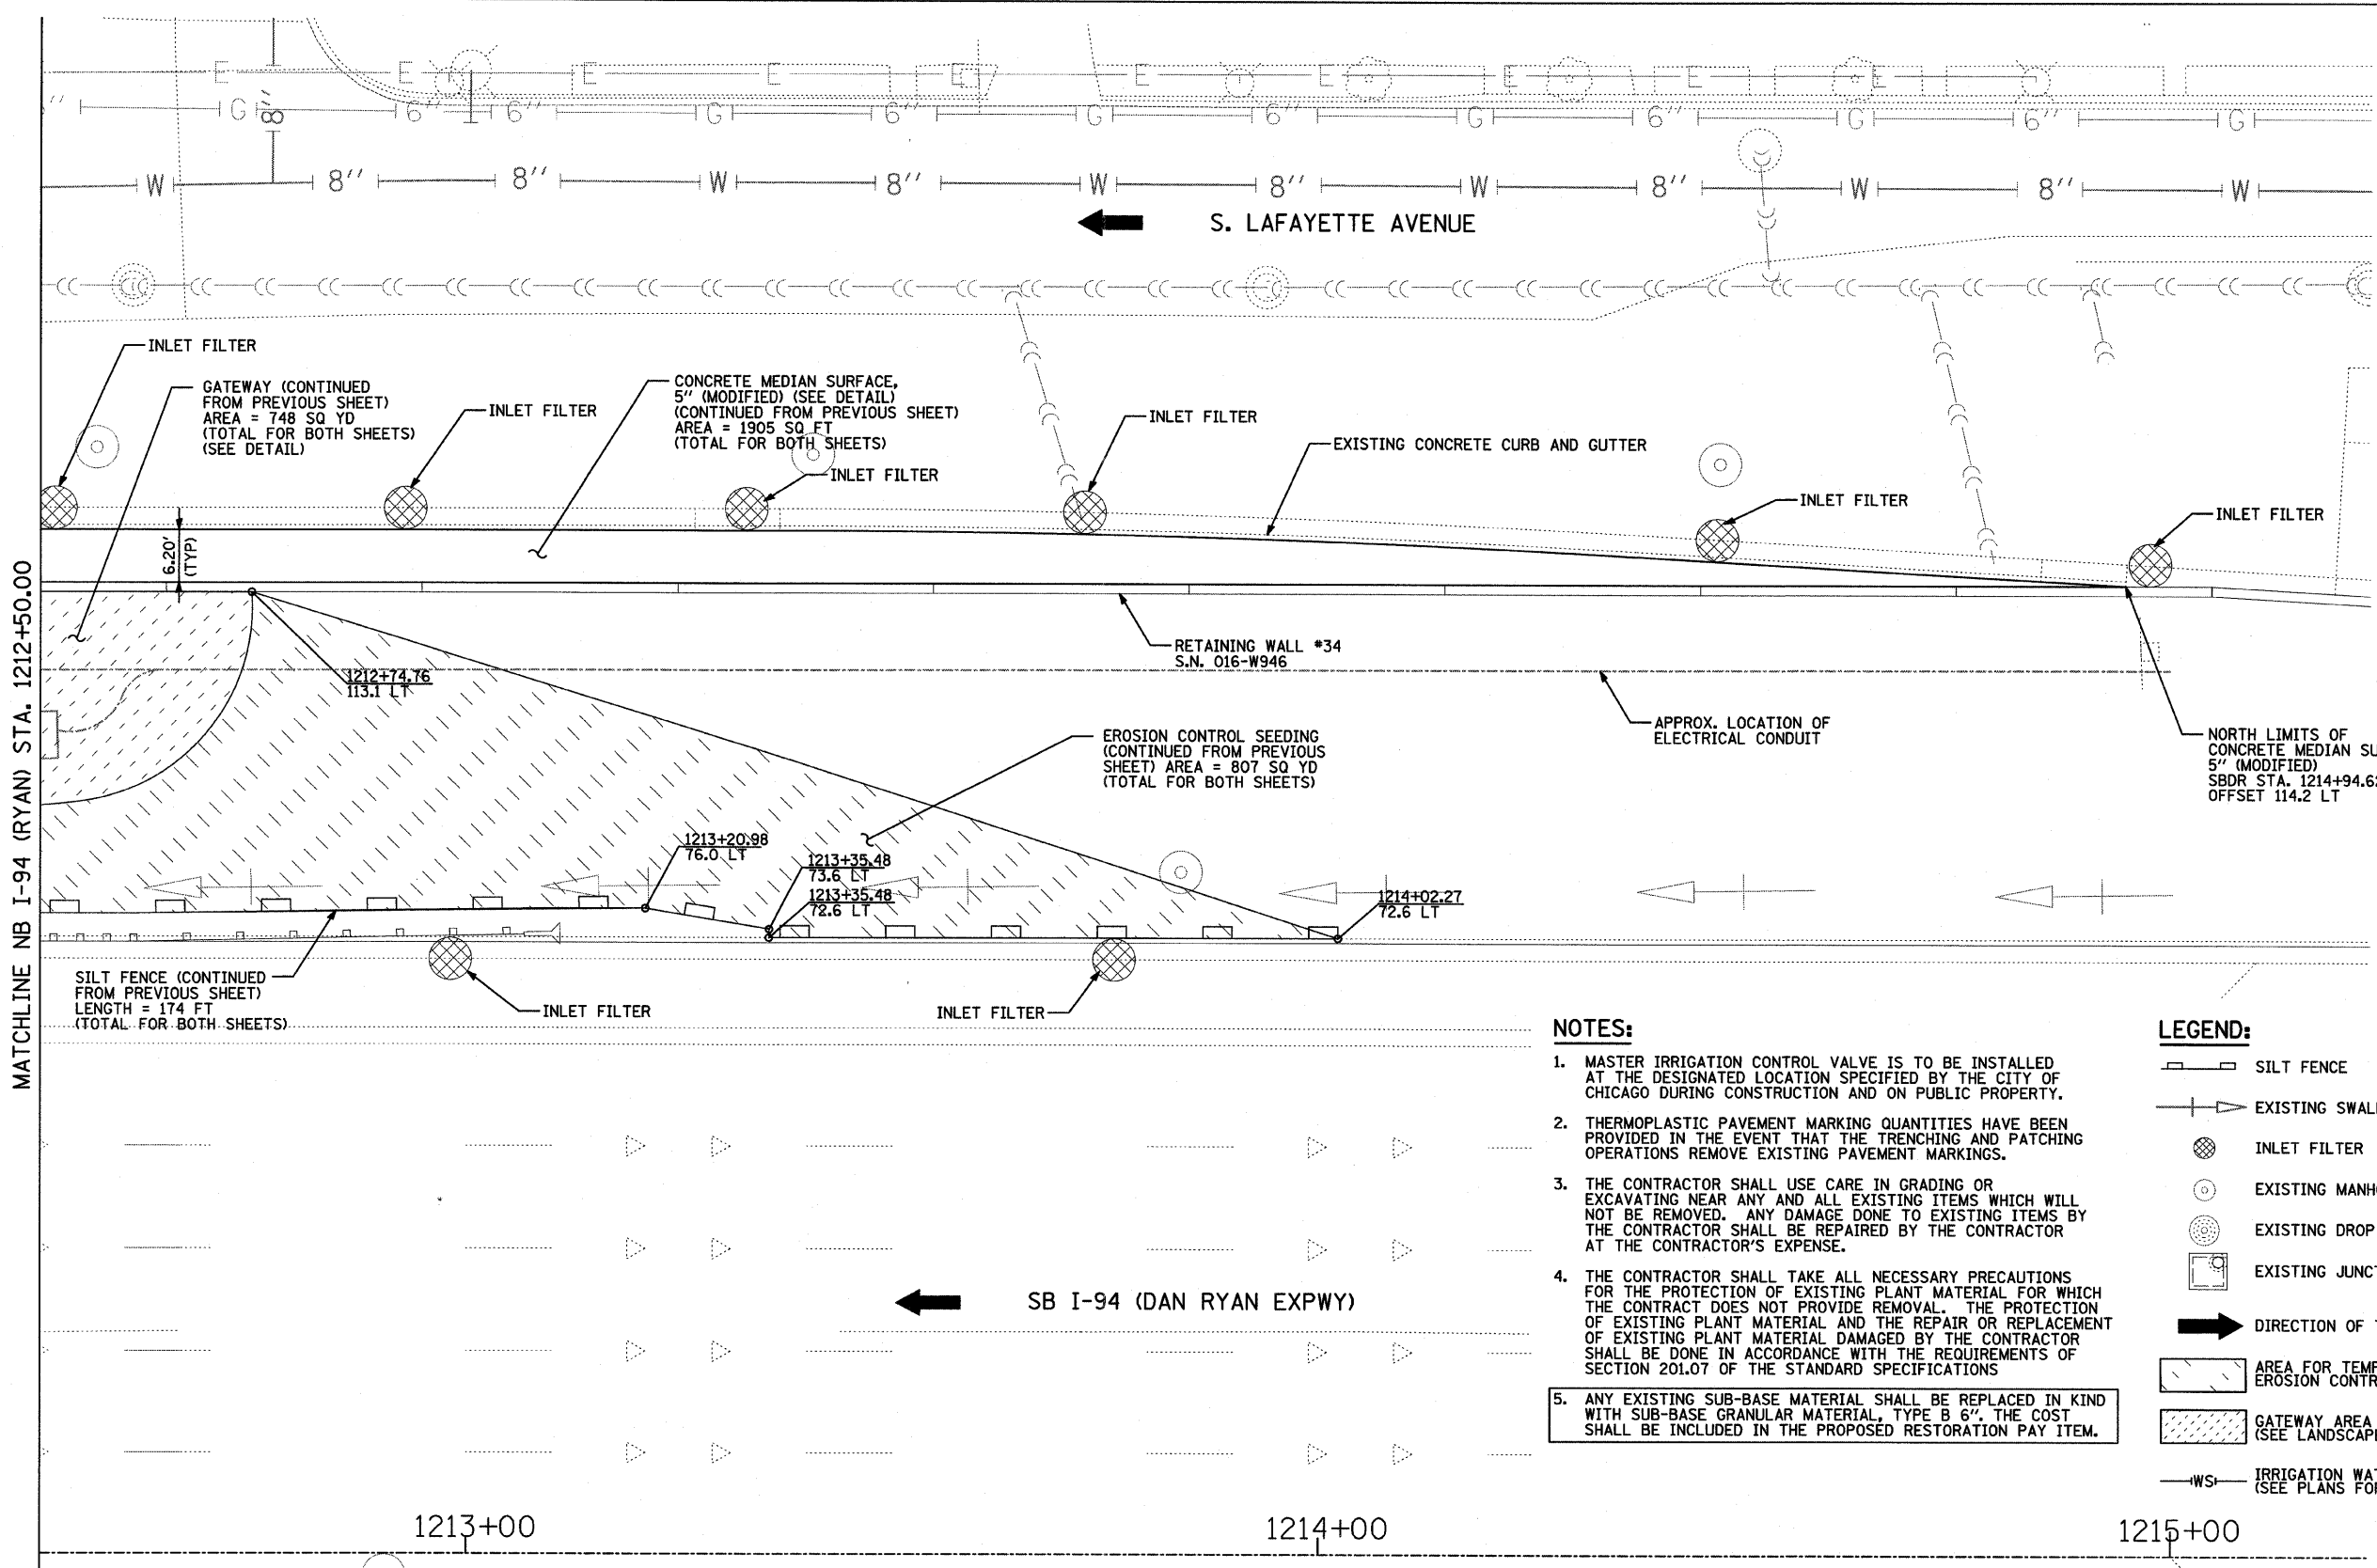

MATCHLINE NB I-94 (RYAN) STA. 1212+50.00

S. LAFAYETTE AVENUE


SB I-94 (DAN RYAN EXPWY)

**NOTES:**


1. MASTER IRRIGATION CONTROL VALVE IS TO BE INSTALLED AT THE DESIGNATED LOCATION SPECIFIED BY THE CITY OF CHICAGO DURING CONSTRUCTION AND ON PUBLIC PROPERTY.
2. THERMOPLASTIC PAVEMENT MARKING QUANTITIES HAVE BEEN PROVIDED IN THE EVENT THAT THE TRENCHING AND PATCHING OPERATIONS REMOVE EXISTING PAVEMENT MARKINGS.
3. THE CONTRACTOR SHALL USE CARE IN GRADING OR EXCAVATING NEAR ANY AND ALL EXISTING ITEMS WHICH WILL NOT BE REMOVED. ANY DAMAGE DONE TO EXISTING ITEMS BY THE CONTRACTOR SHALL BE REPAIRED BY THE CONTRACTOR AT THE CONTRACTOR'S EXPENSE.
4. THE CONTRACTOR SHALL TAKE ALL NECESSARY PRECAUTIONS FOR THE PROTECTION OF EXISTING PLANT MATERIAL FOR WHICH THE CONTRACT DOES NOT PROVIDE REMOVAL. THE PROTECTION OF EXISTING PLANT MATERIAL AND THE REPAIR OR REPLACEMENT OF EXISTING PLANT MATERIAL DAMAGED BY THE CONTRACTOR SHALL BE DONE IN ACCORDANCE WITH THE REQUIREMENTS OF SECTION 201.07 OF THE STANDARD SPECIFICATIONS
5. ANY EXISTING SUB-BASE MATERIAL SHALL BE REPLACED IN KIND WITH SUB-BASE GRANULAR MATERIAL, TYPE B 6". THE COST SHALL BE INCLUDED IN THE PROPOSED RESTORATION PAY ITEM.

**LEGEND:**

- SILT FENCE
- EXISTING SWALE
- INLET FILTER
- EXISTING MANHOLE
- EXISTING DROP MANHOLE
- EXISTING JUNCTION CHAMBER
- DIRECTION OF TRAFFIC
- AREA FOR TEMPORARY EROSION CONTROL SEEDING
- GATEWAY AREA (SEE LANDSCAPE PLANS)
- IRRIGATION WATER SERVICE (SEE PLANS FOR TYPE)

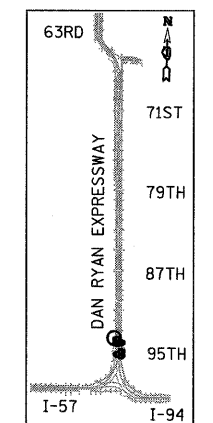

LOCATION MAP

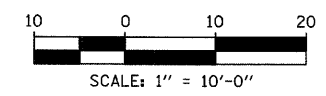

REVISIONS	
NAME	DATE

ILLINOIS DEPARTMENT OF TRANSPORTATION  
**F.A.I. 94 (DAN RYAN EXPRESSWAY)**  
**WATER SERVICE AND EROSION CONTROL PLAN**  
**SW & NW QUADRANTS AT 95TH ST - SB I-94**  
**STA. 1212+50.00 TO STA. 1214+94.62**  
**SHEET 3 OF 3**

SCALE: 1"=10'-0"  
 DATE: JUNE 20, 2008


DRAWN BY: JDF  
 CHECKED BY: JPM

**TYLIN** INTERNATIONAL

6/20/2008 10:26:47 AM


F.A.I. RTE.	SECTION	COUNTY	TOTAL SHEETS	SHEET NO.
94	2005-068 LS	COOK	58	34
STA. 153+00		TO STA. 1213+00		
FED. ROAD DIST. NO.		ILLINOIS	FED. AID PROJECT	

60A74

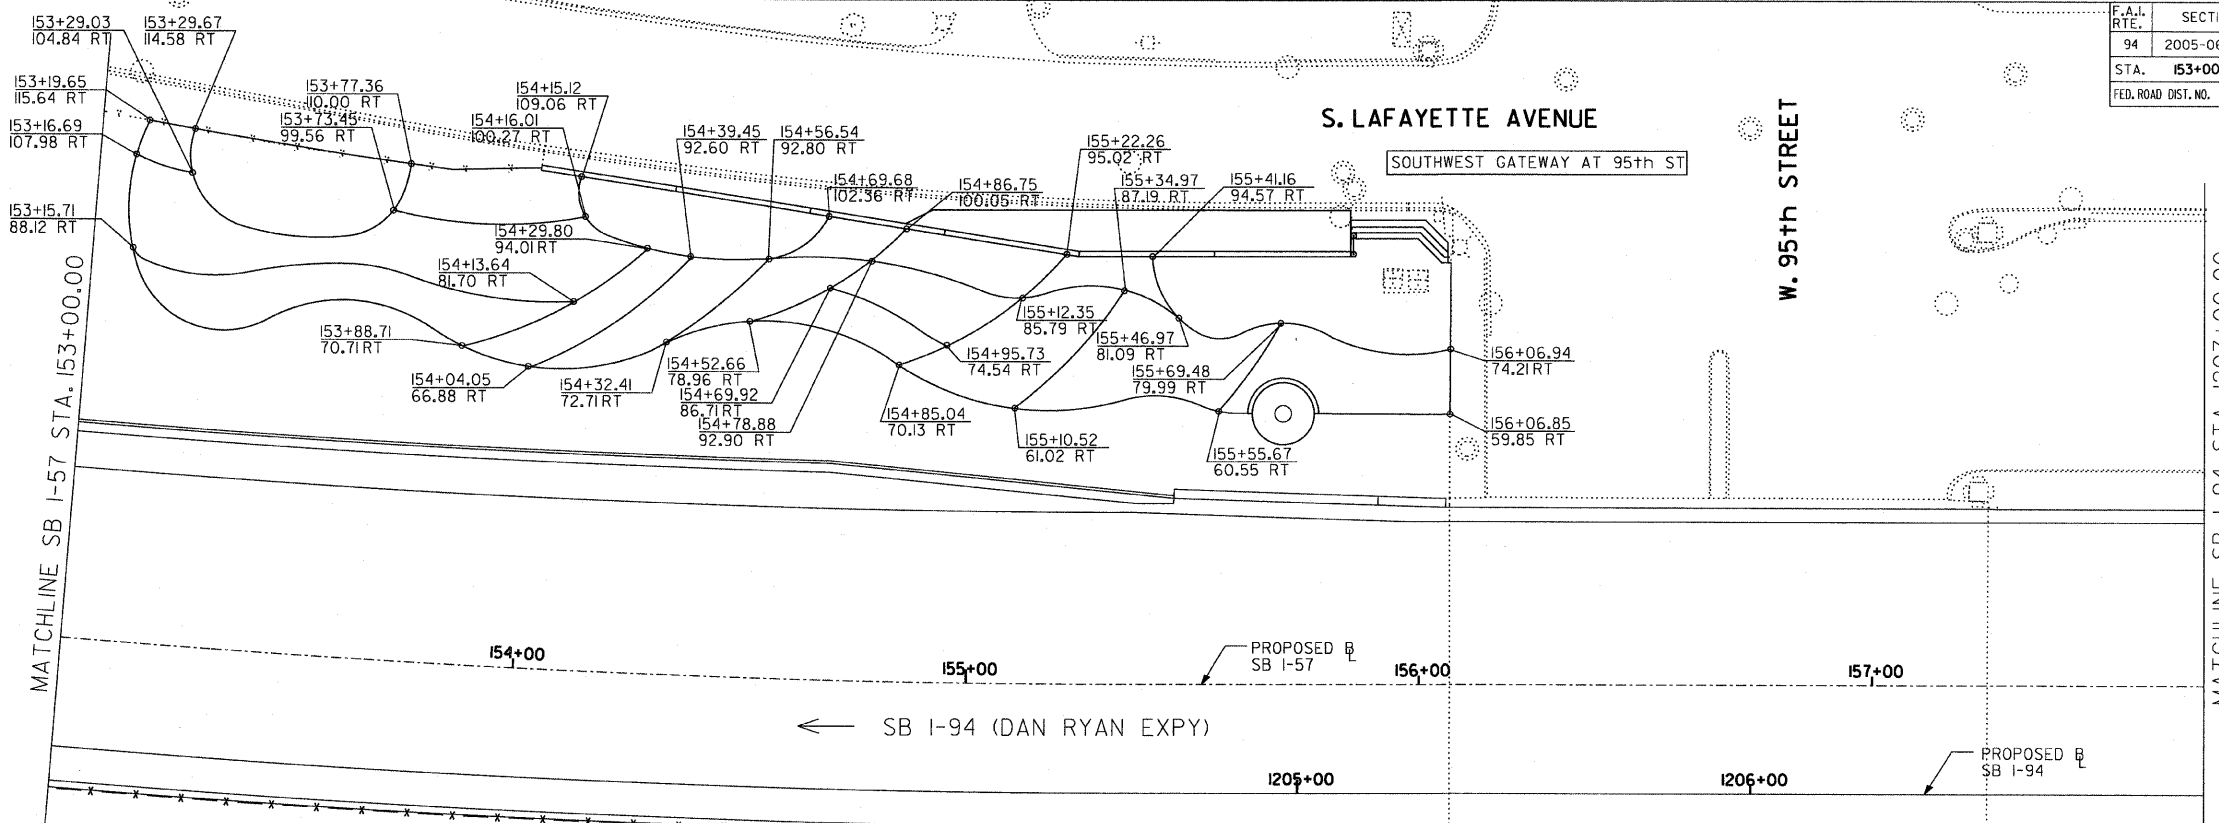


S. LAFAYETTE AVENUE

NORTHWEST GATEWAY AT 95th ST

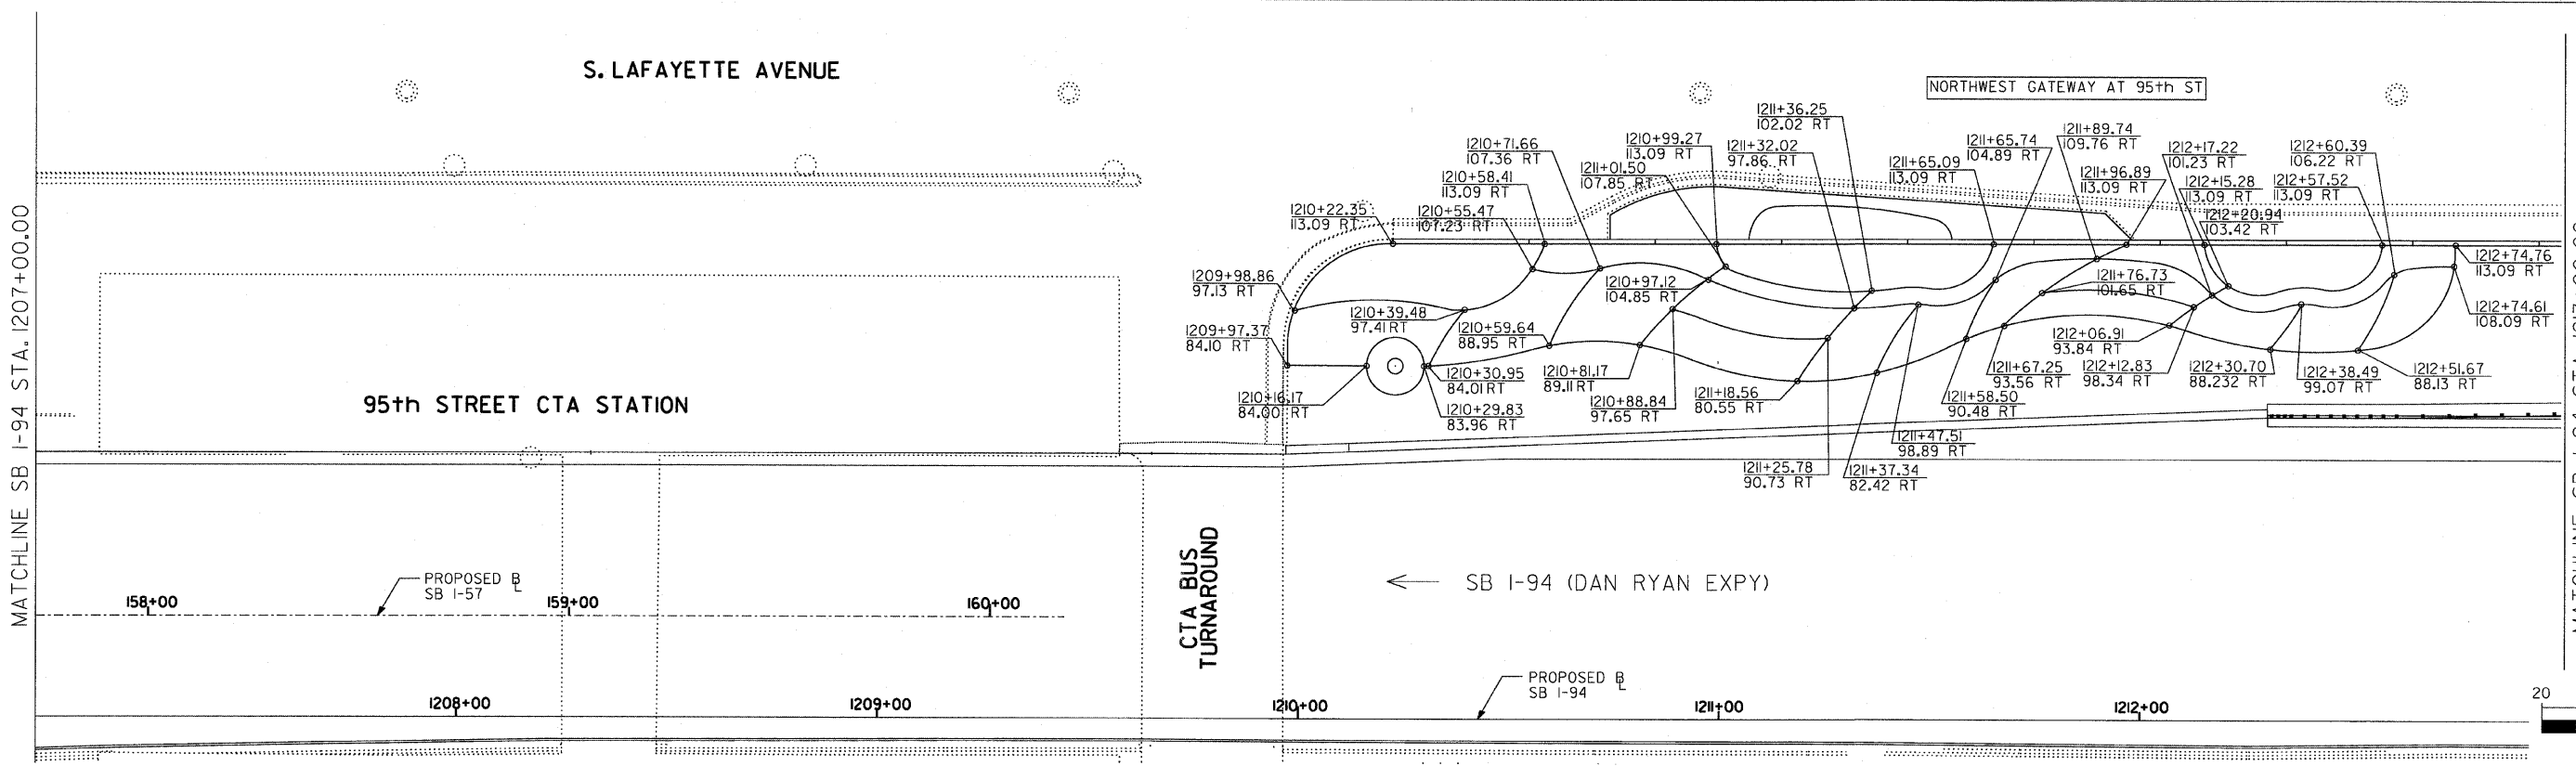


95th STREET CTA STATION

CTA BUS TURNAROUND

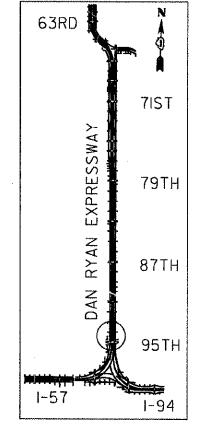

LOCATION MAP

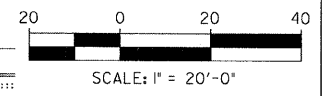

SITE DESIGN GROUP

TYLIN INTERNATIONAL




NOTE: THE LOCATION OF ALL PLANT MATERIAL SHALL BE STAKED BY THE CONTRACTOR FOR APPROVAL BY THE ENGINEER IN FIELD, PRIOR TO INSTALLATION. INDIVIDUAL TREES SHALL BE STAKED WITH IDENTITIES WRITTEN ON STAKES. SHRUB AND PERENNIAL BEDS SHALL BE OUTLINED WITH STAKES AND PAINTED LINES.

REVISIONS	
NAME	DATE


ILLINOIS DEPARTMENT OF TRANSPORTATION  
 F.A.I. 94 (DAN RYAN EXPRESSWAY)  
 95TH STREET GATEWAY LANDSCAPING AND IRRIGATION  
 PLANTING BED LAYOUT PLANS  
 SW + NW QUADRANTS AT 95TH ST. - SB I-94  
 SCALE: 1"=20'  
 DATE: June 20, 2008  
 DRAWN BY: EM  
 CHECKED BY: JO

F.A.J. RTE.	SECTION	COUNTY	TOTAL SHEETS	SHEET NO.
94	2005-068 LS	COOK	58	35
STA. 153+00	TO STA. 1213+00			
FED. ROAD DIST. NO.	ILLINOIS	FED. AID PROJECT		

60A74

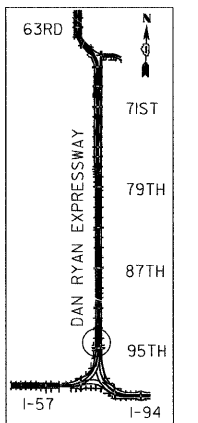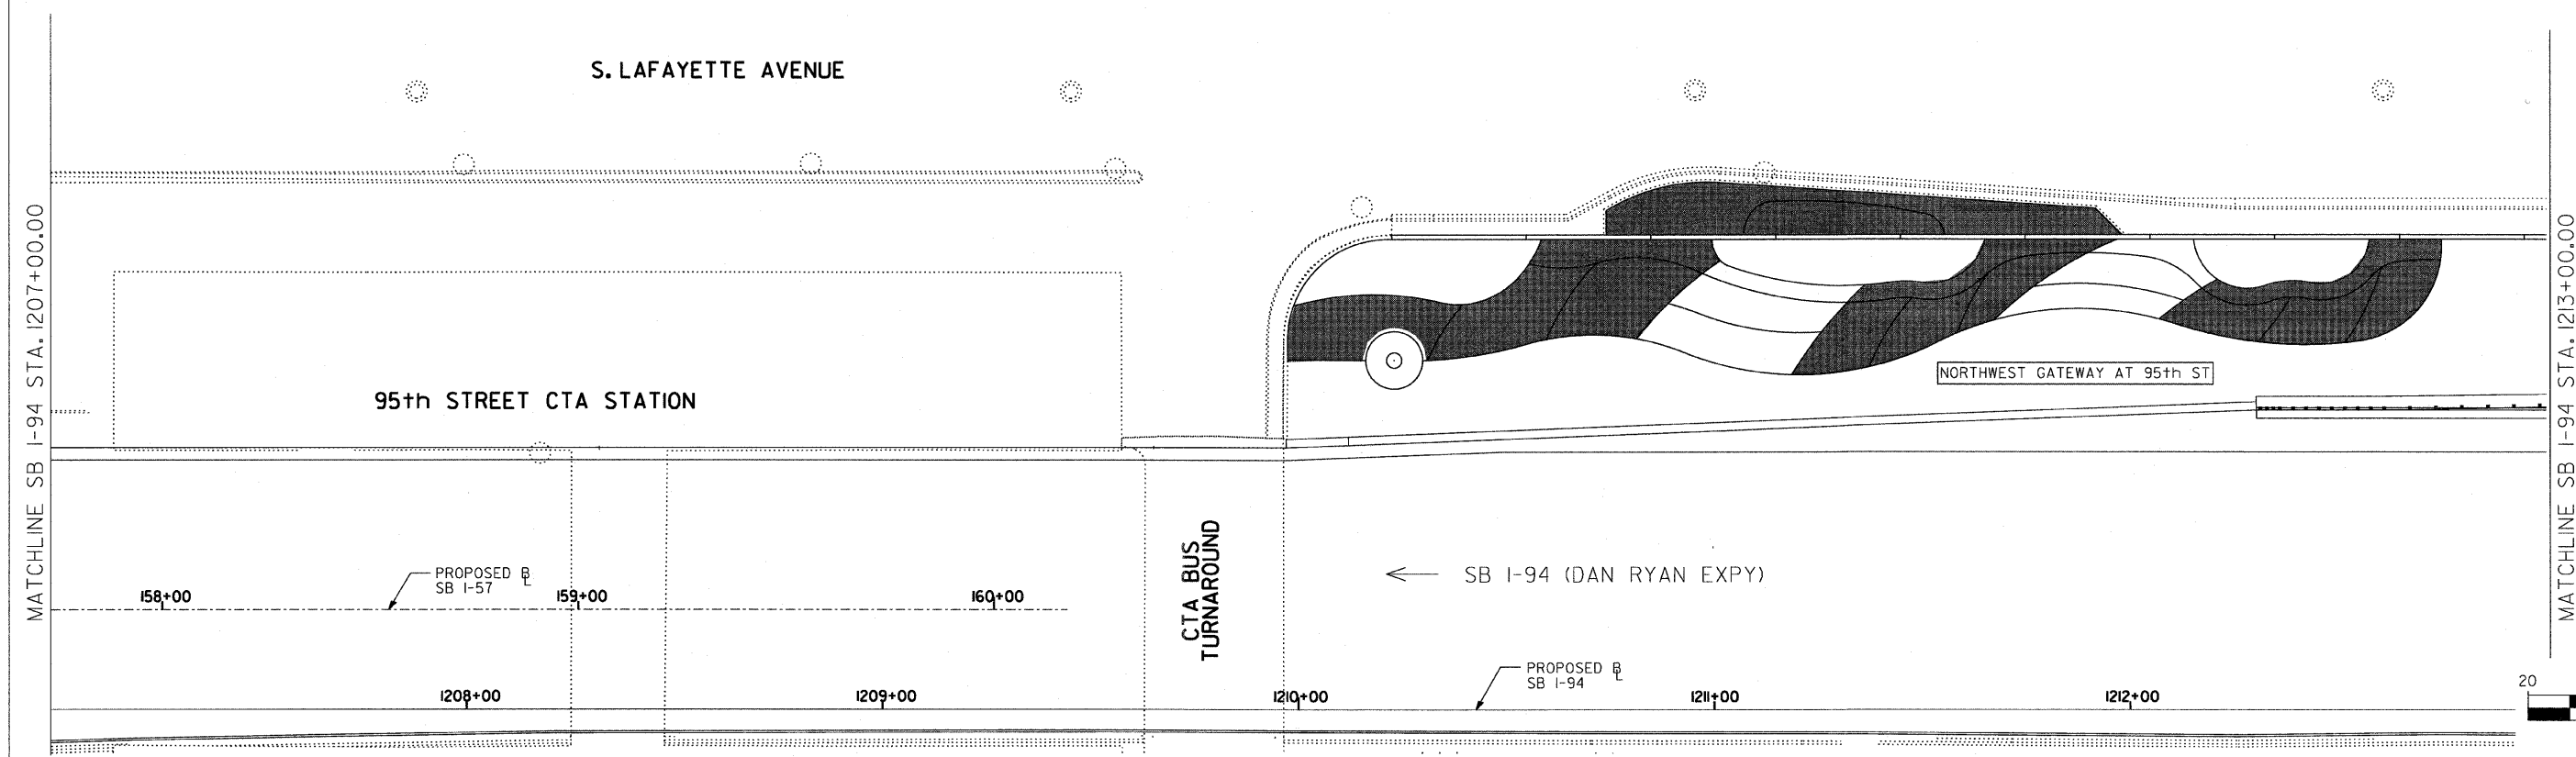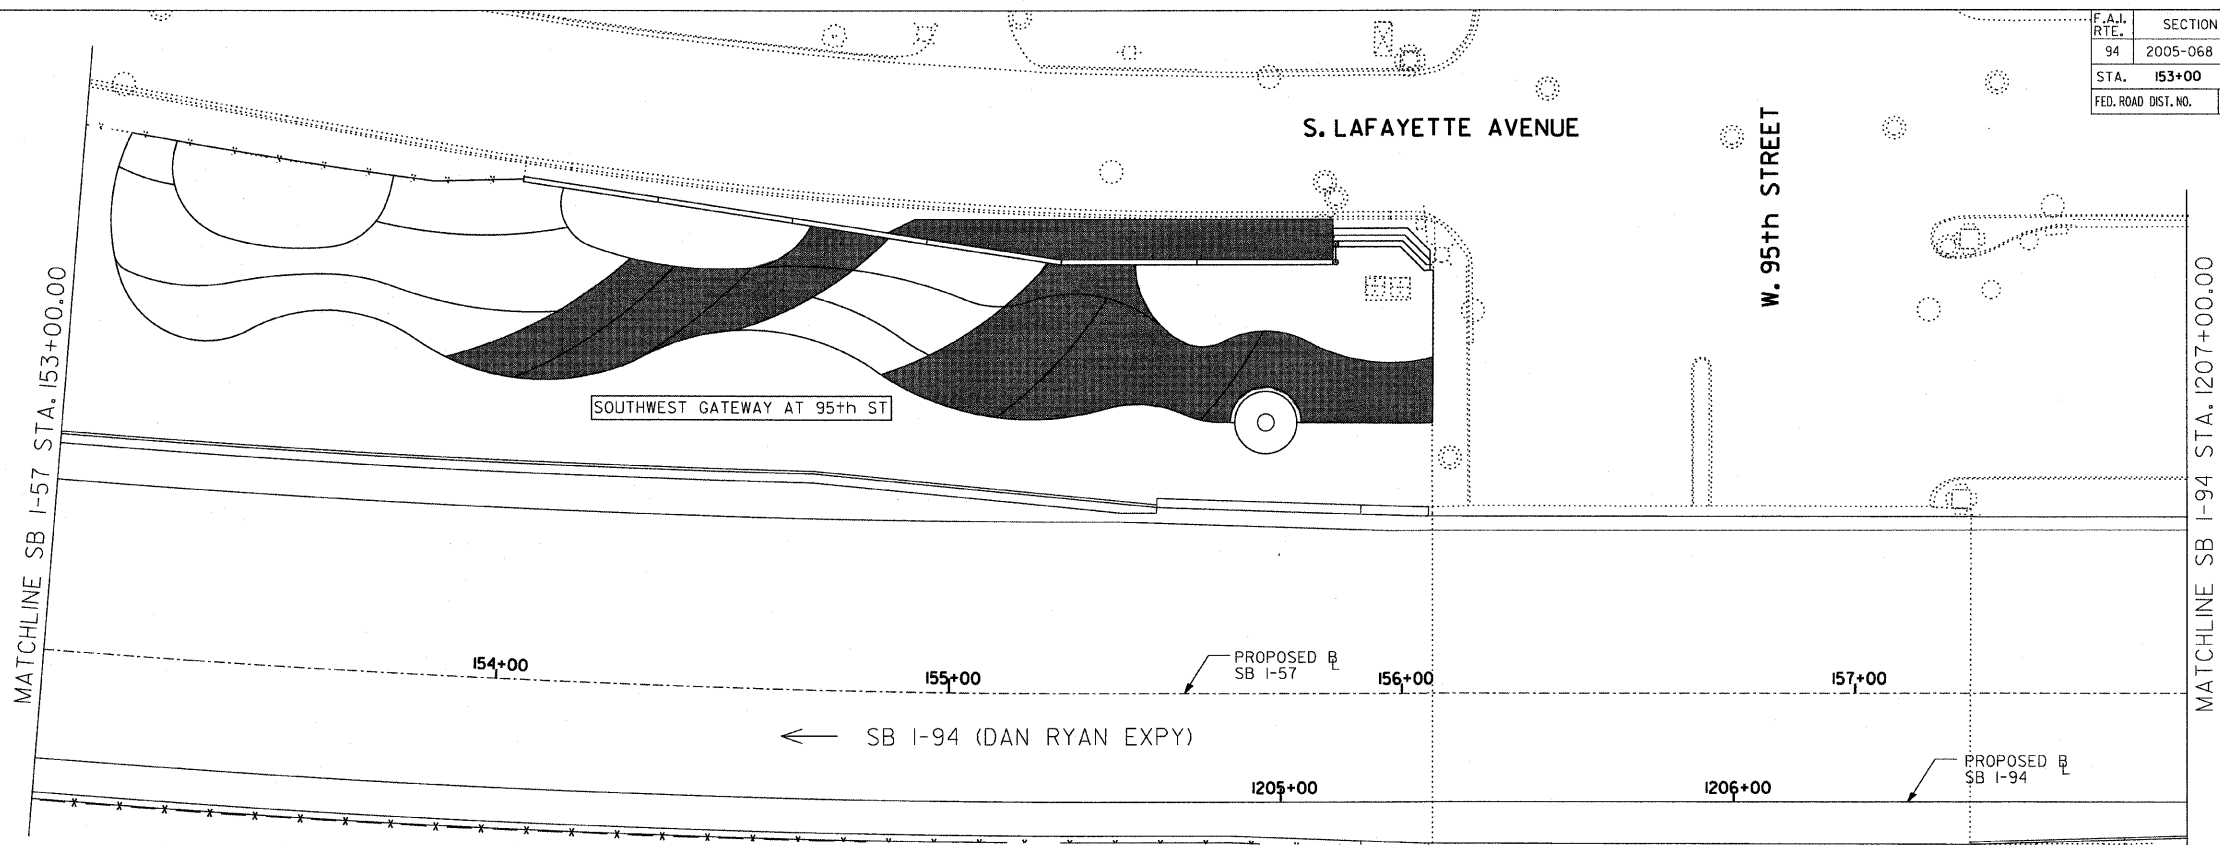

LOCATION MAP

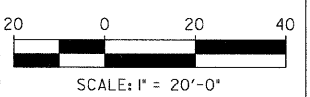

**SITE DESIGN GROUP**

**TYLIN INTERNATIONAL**

**LEGEND:**

AREA TO BE DRIP IRRIGATED

**NOTE:**  
ALL CORNER GARDENS AND PERENNIAL AND SHRUB BEDS SHALL BE IRRIGATED.

REVISIONS	
NAME	DATE

ILLINOIS DEPARTMENT OF TRANSPORTATION  
F.A.J. 94 (DAN RYAN EXPRESSWAY)

**95TH STREET GATEWAY LANDSCAPING AND IRRIGATION**

IRRIGATION PLANS  
SW + NW QUADRANTS AT 95TH ST. - SB I-94



SCALE: 1"=20'  
DATE: **June 20, 2008**

DRAWN BY: EM  
CHECKED BY: JO

DATE \$ TIME \$

F.A.I. RTE.	SECTION	COUNTY	TOTAL SHEETS	SHEET NO.
94	2005-068 LS	COOK	58	36
STA. 153+00		TO STA. 1213+00		
FED. ROAD DIST. NO.		ILLINOIS	FED. AID PROJECT	

60A74


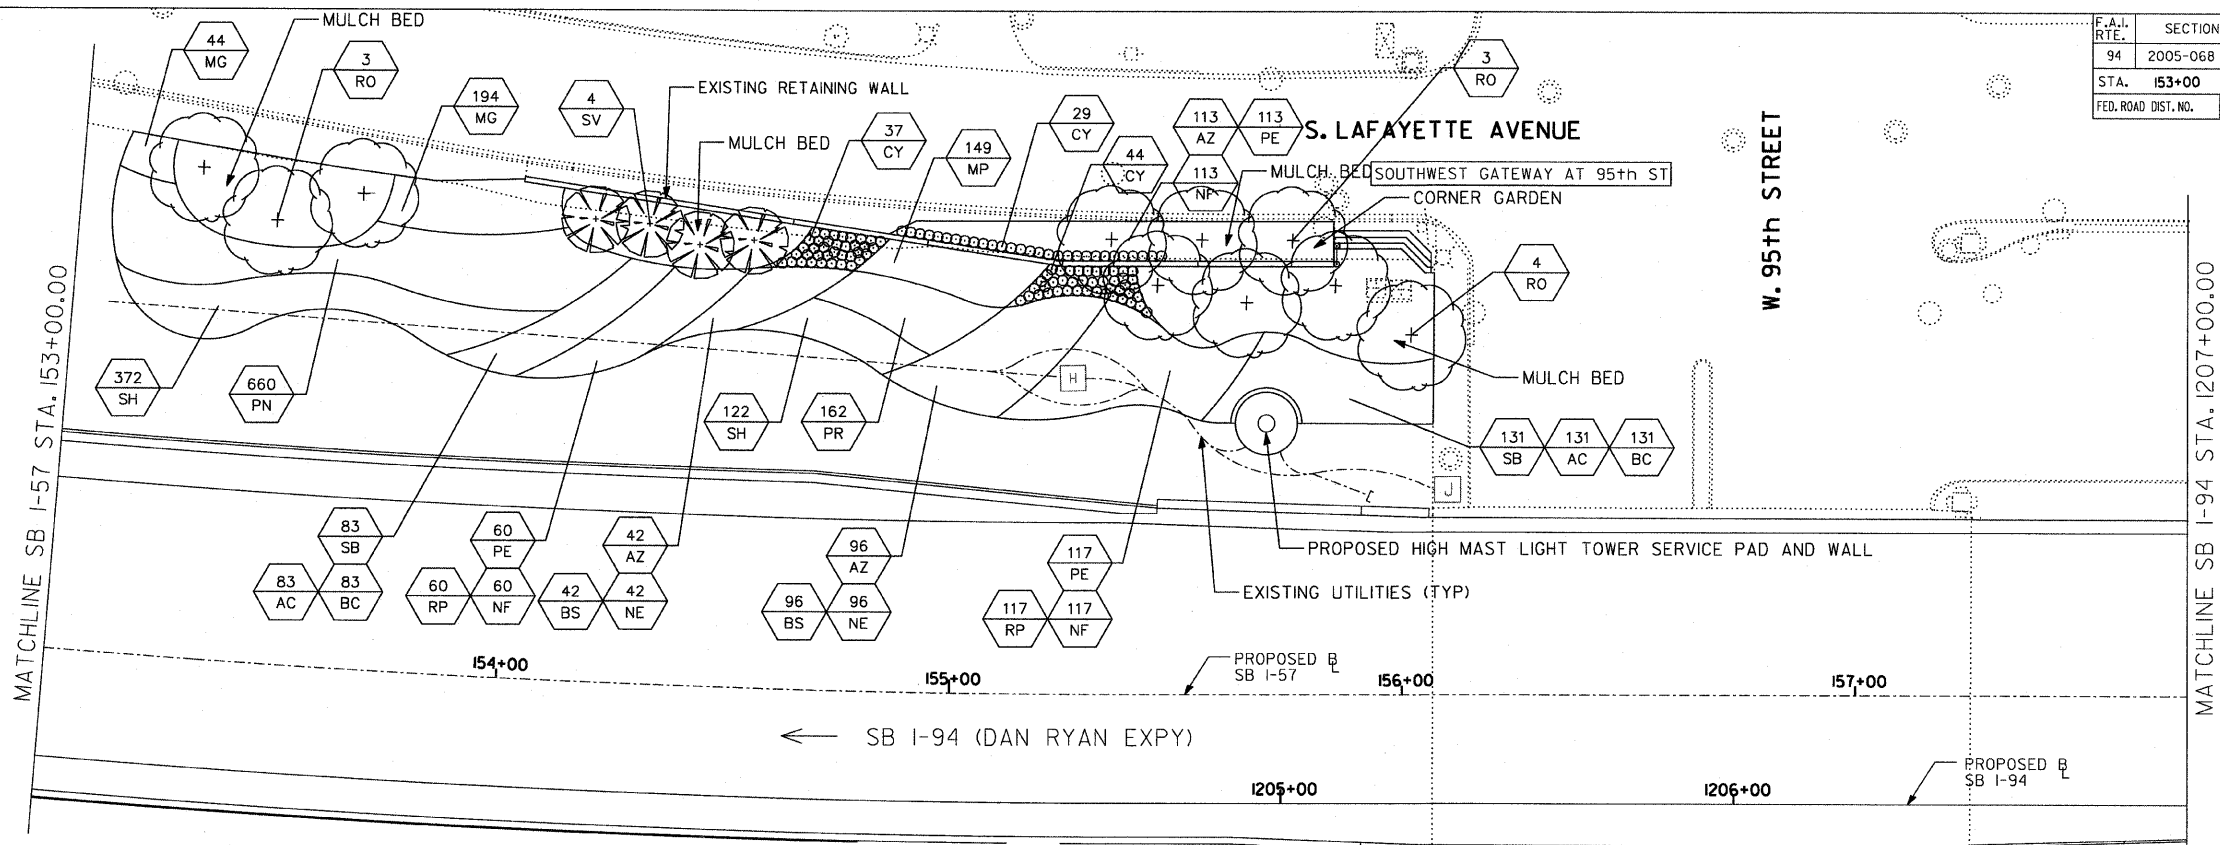
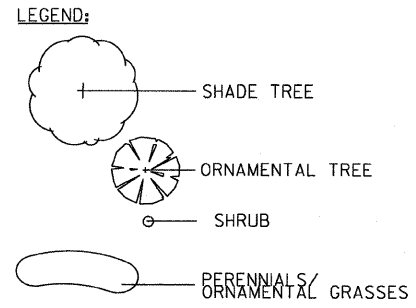


S. LAFAYETTE AVENUE


MATCHLINE SB I-94 STA. 1207+00.00

95th STREET CTA STATION

CTA BUS TURNAROUND

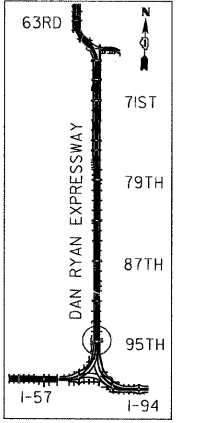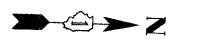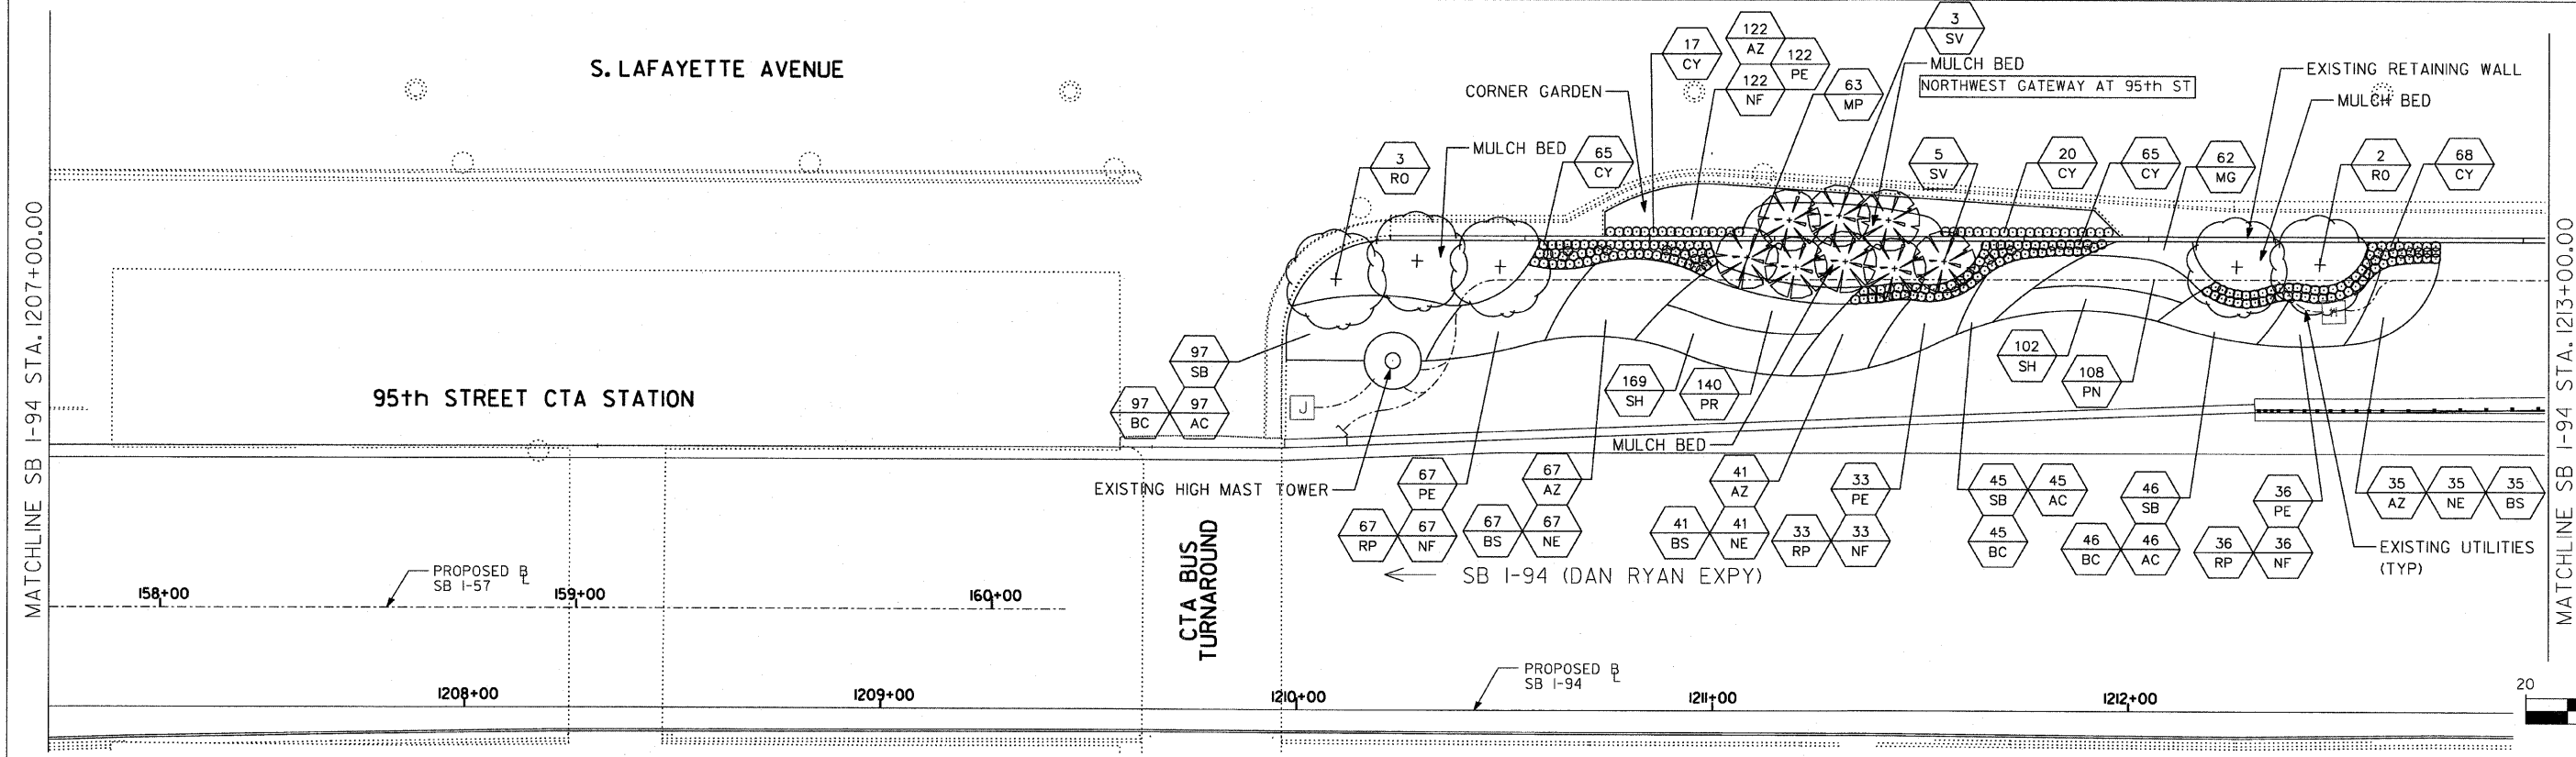

LOCATION MAP

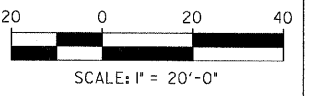


SITE DESIGN GROUP  
**TYLIN** INTERNATIONAL


REVISIONS	
NAME	DATE

ILLINOIS DEPARTMENT OF TRANSPORTATION  
 F.A.I. 94 (DAN RYAN EXPRESSWAY)  
 95TH STREET GATEWAY LANDSCAPING AND IRRIGATION  
 LANDSCAPE PLANS  
 SW + NW QUADRANTS AT 95TH ST. - SB I-94  
 SCALE: 1"=20'  
 DATE: June 20, 2008  
 DRAWN BY: EM  
 CHECKED BY: JO

DATE: \$ TIME: \$

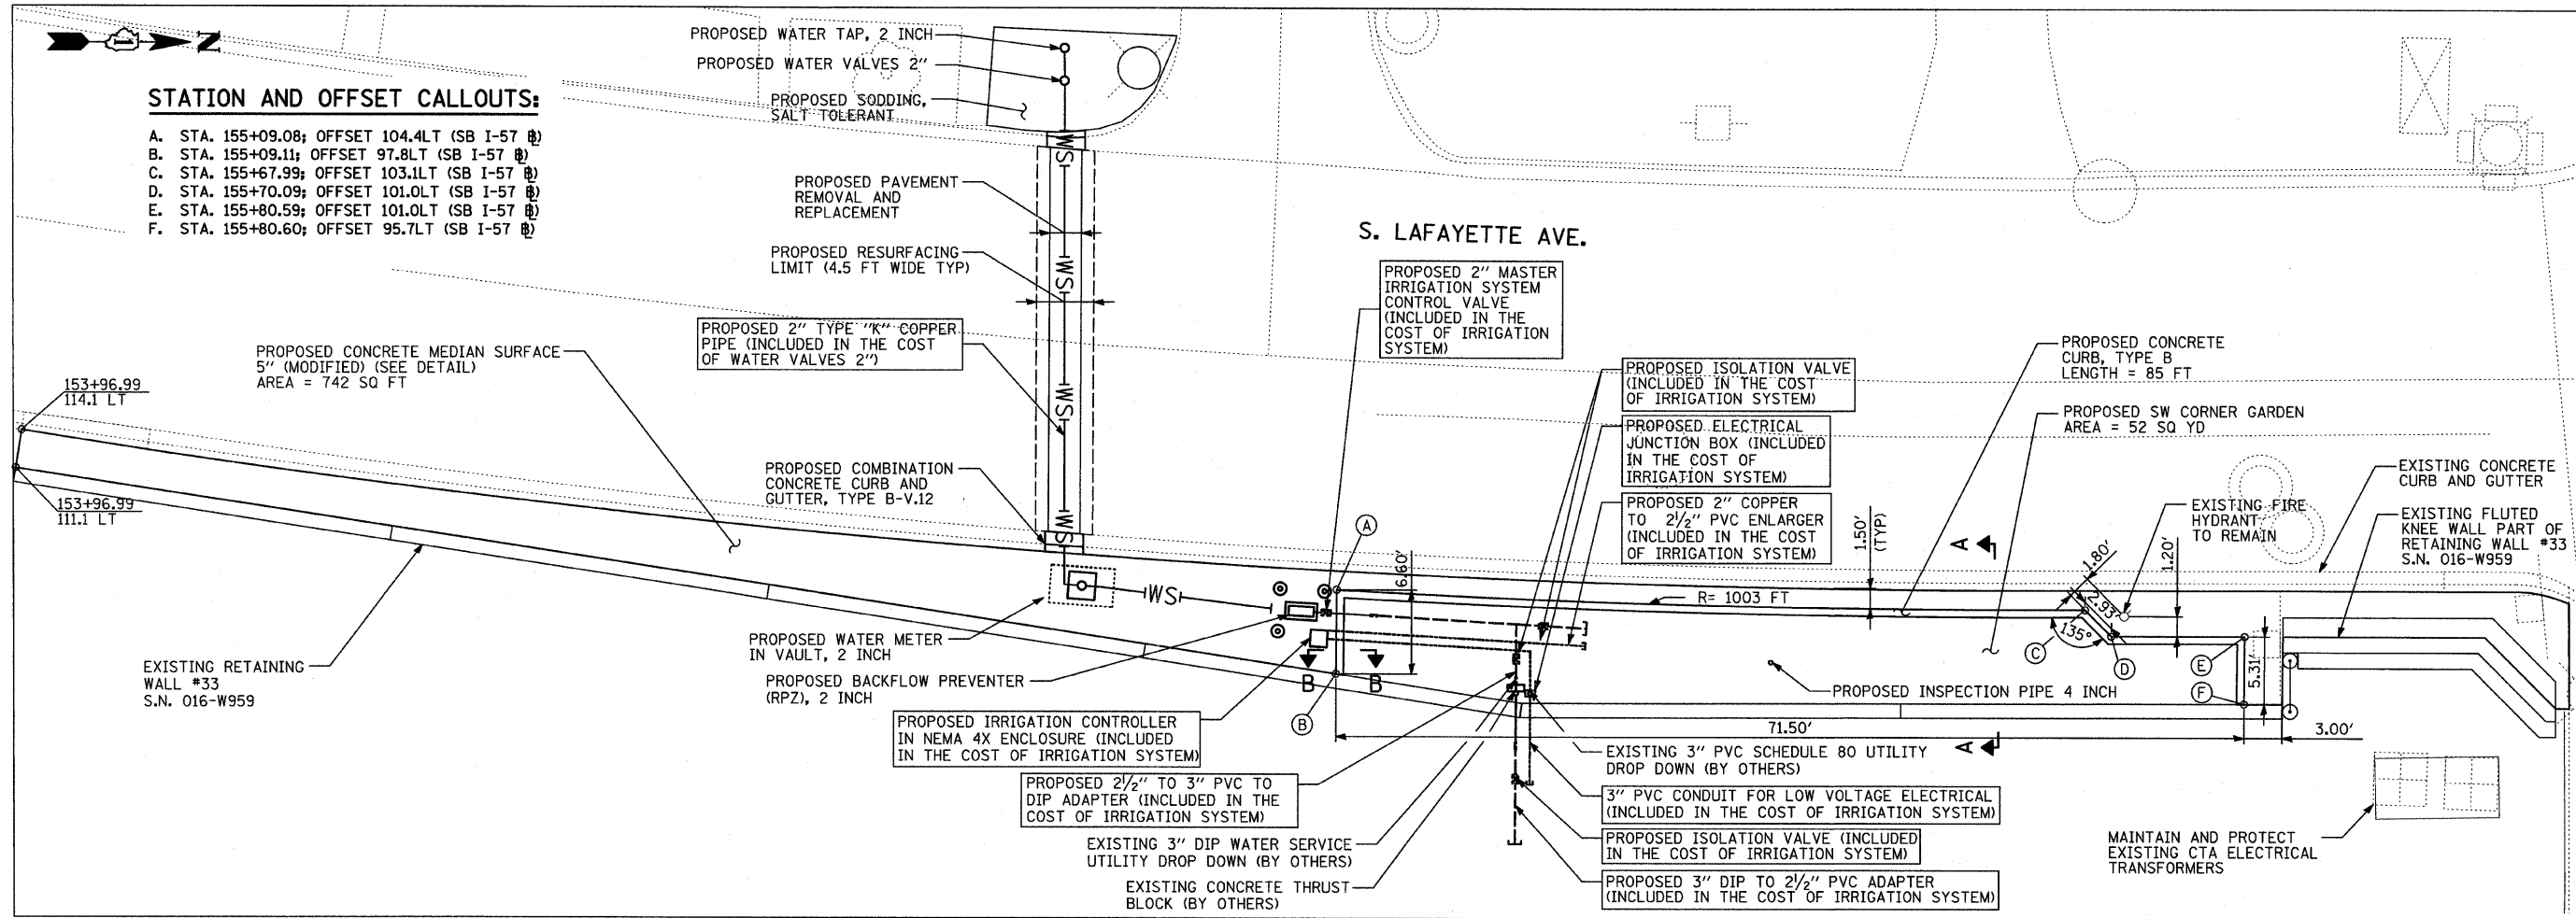

**SW CORNER GARDEN AT 95TH STREET**

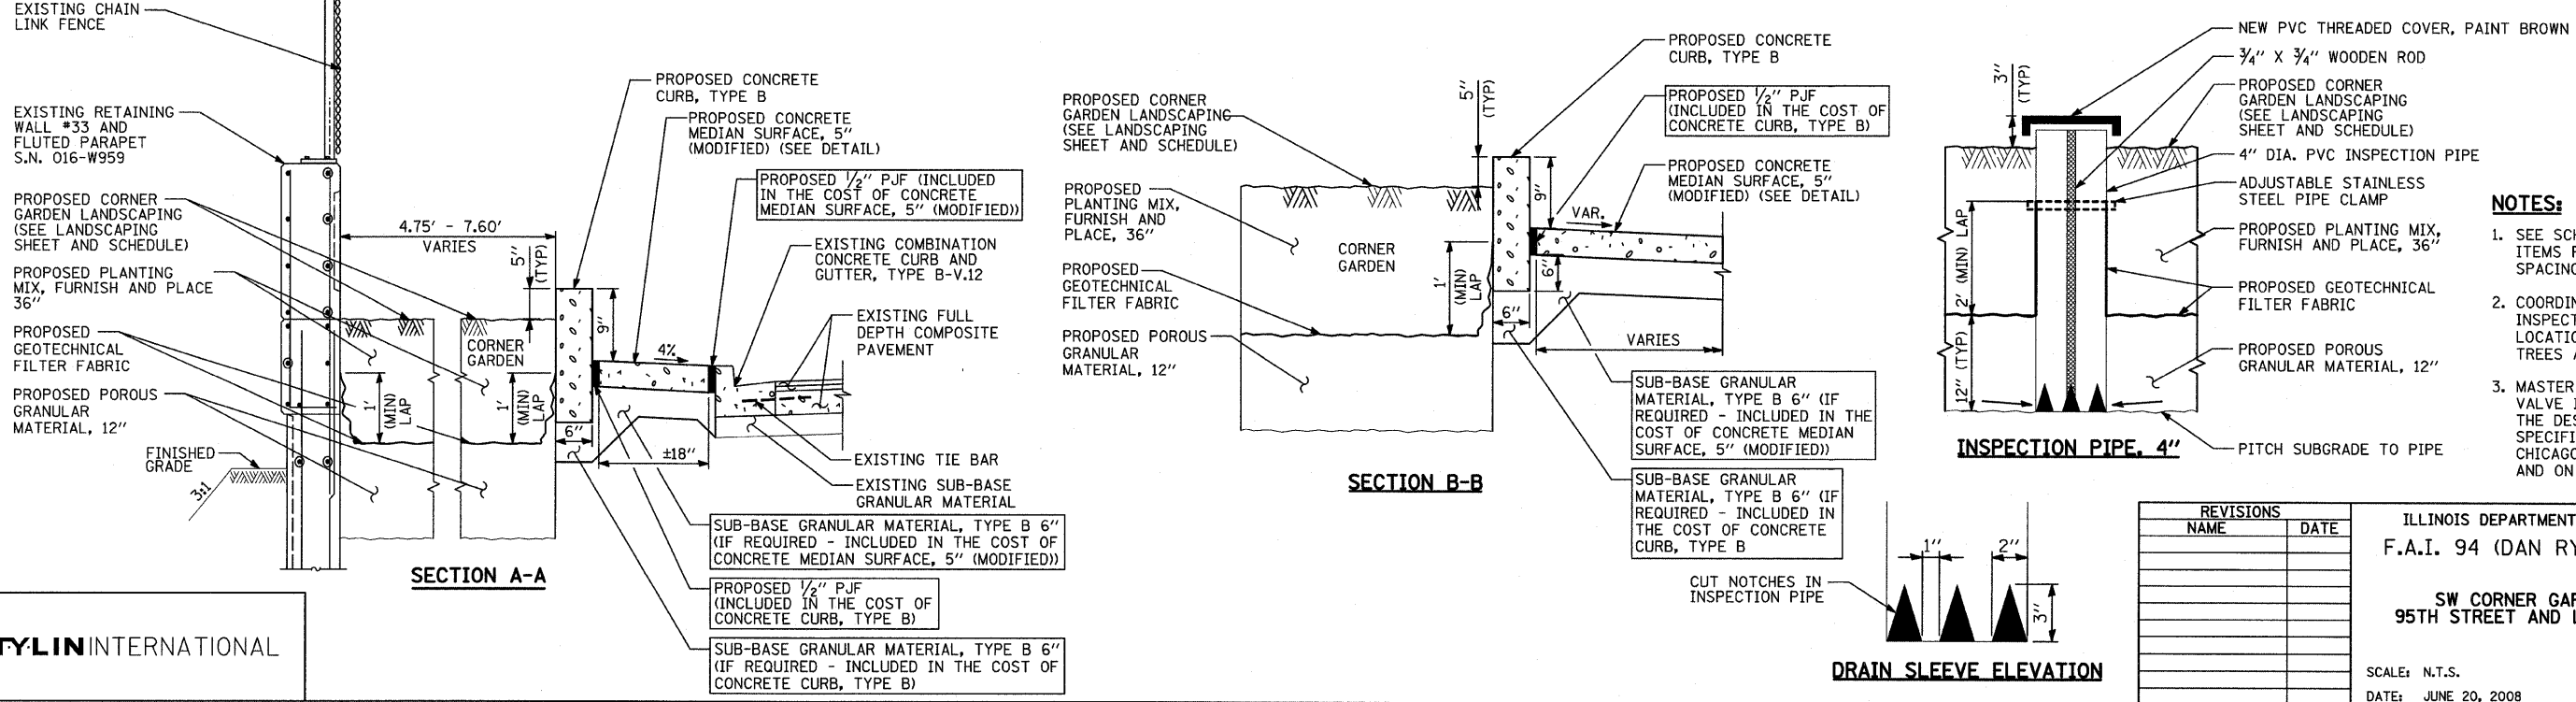

TYLIN INTERNATIONAL

REVISIONS	
NAME	DATE



ILLINOIS DEPARTMENT OF TRANSPORTATION  
**F.A.I. 94 (DAN RYAN EXPRESSWAY)**

**SW CORNER GARDEN DETAIL - 95TH STREET AND LAFAYETTE AVENUE**

SCALE: N.T.S.      DRAWN BY: JDF  
 DATE: JUNE 20, 2008      CHECKED BY: JPM



F.A.I. RTE.	SECTION	COUNTY	TOTAL SHEETS	SHEET NO.
94	2005-068 LS	COOK	58	39
STA. 153+08 (SB I-57) TO STA. 154+00 (SB I-57)		TO STA. 156+07.42 (SB I-94)		
STA. 257+76 (NB I-57)		TO STA. 2213+00 (NB I-94)		
FED. ROAD DIST. NO.	ILLINOIS FED. AID PROJECT		60A74	

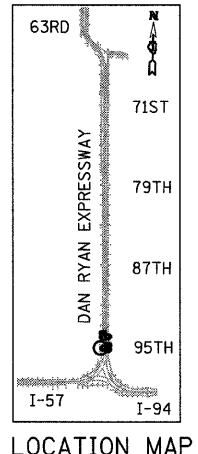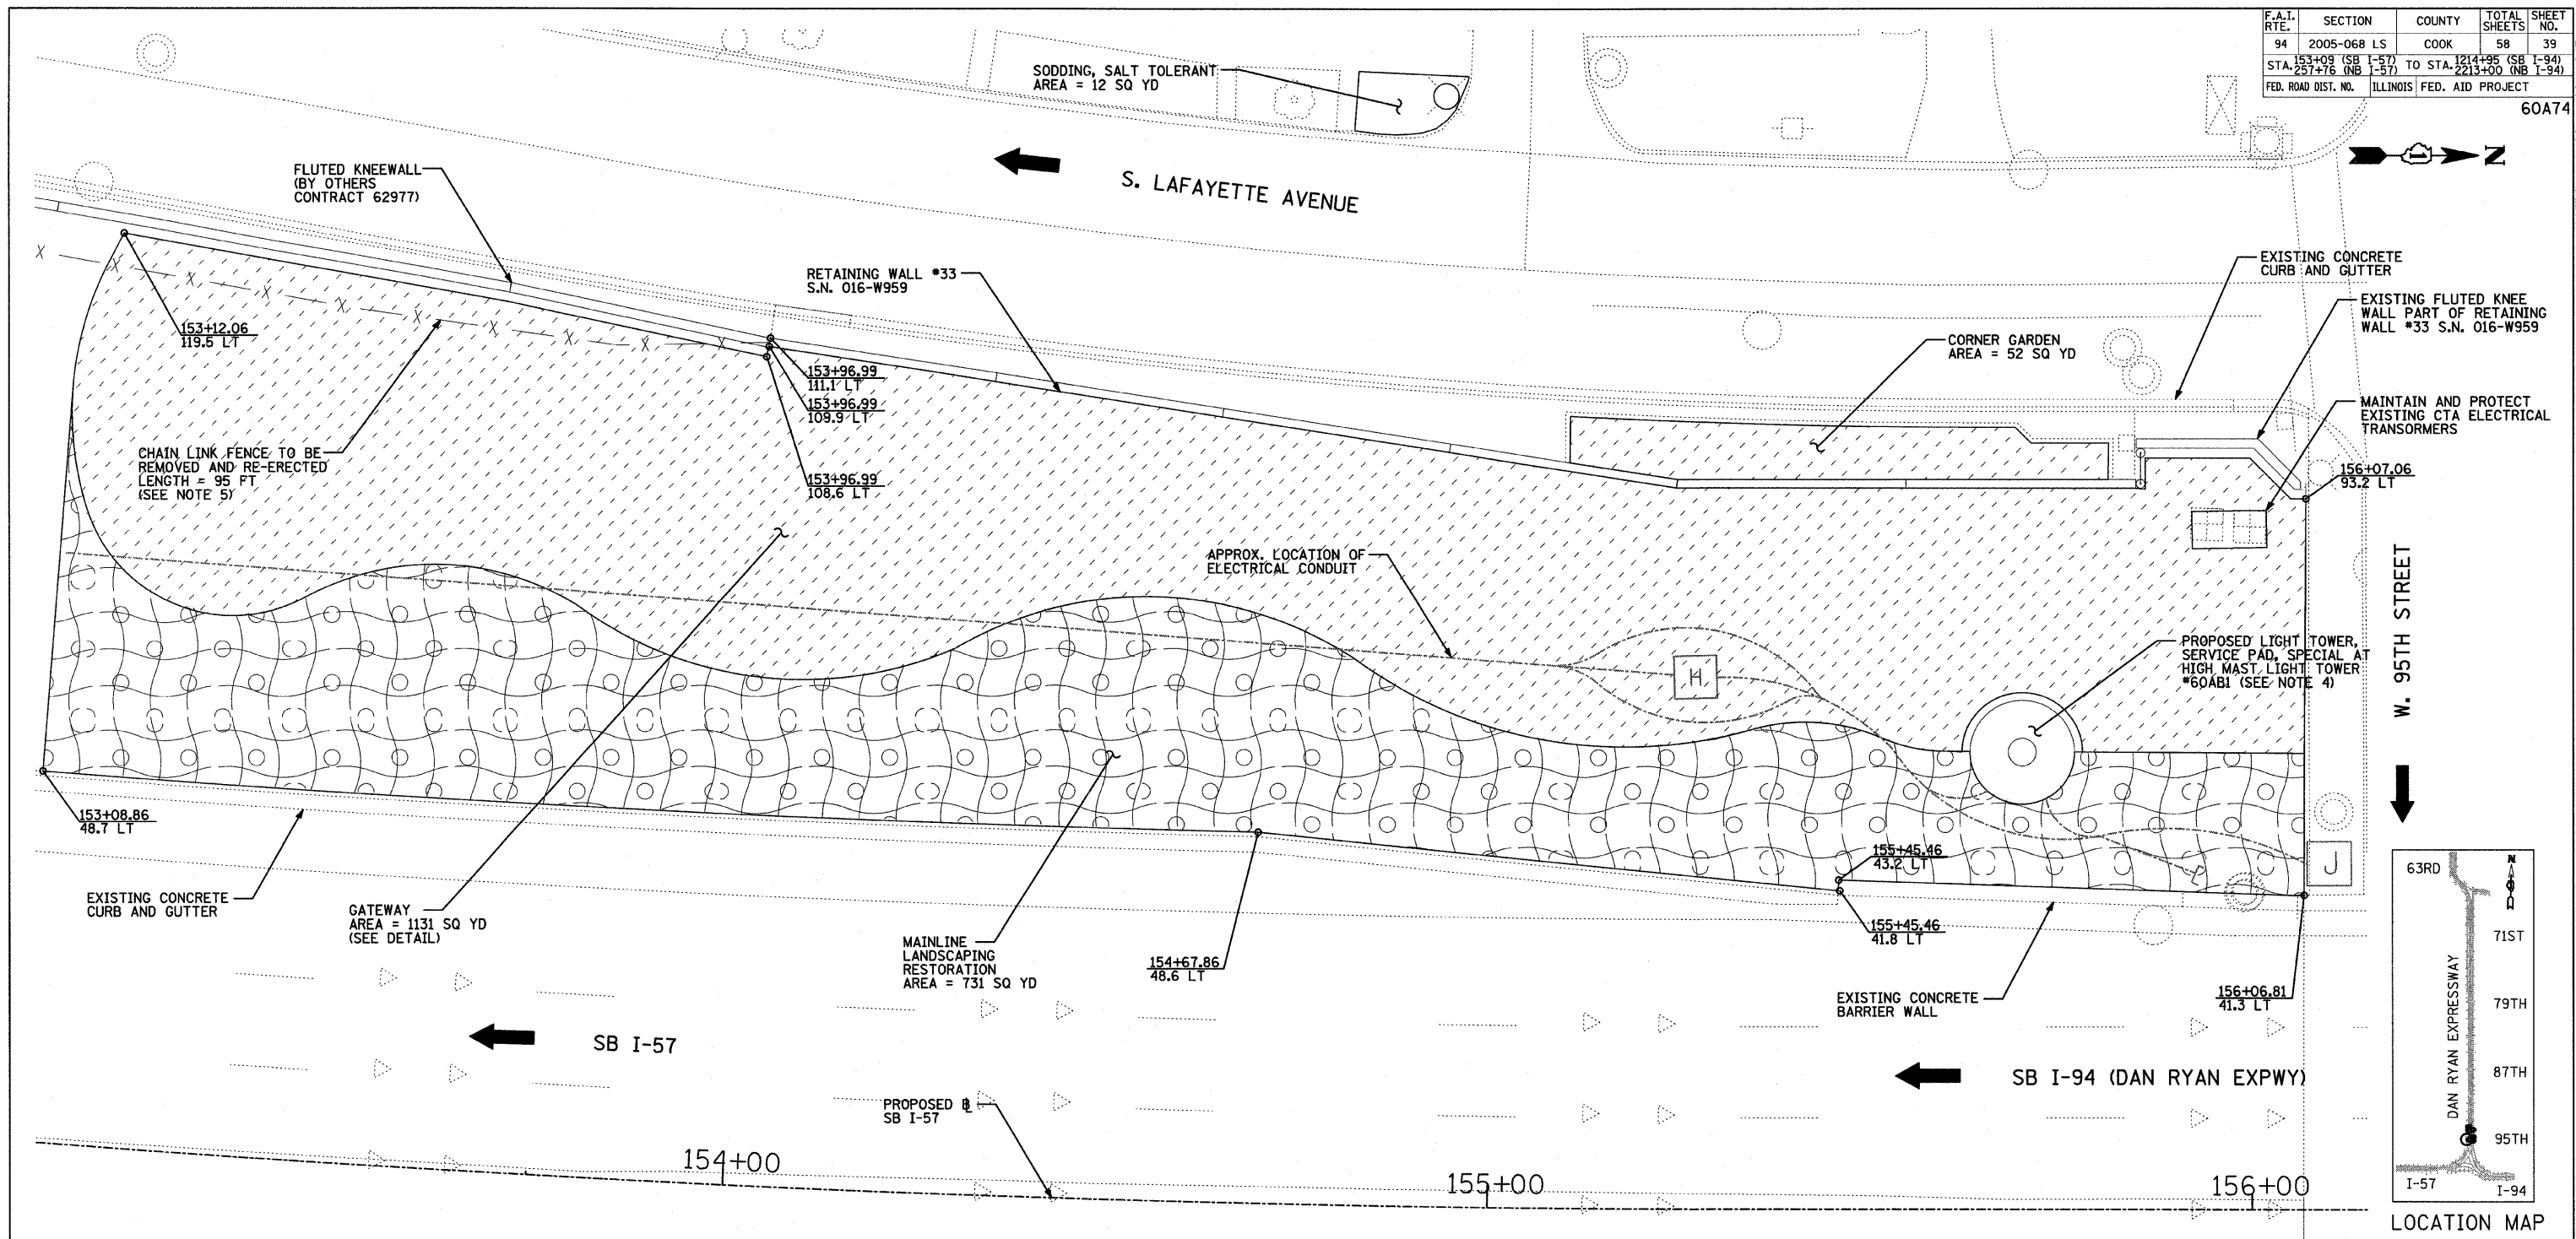

**LANDSCAPING GENERAL PLAN NOTES:**

1. THE SEEDING DATES FOR BARE EARTH SEEDING OF MIXTURE CLASS 2A SHALL BE FROM APRIL 1 TO JUNE 1 AND FROM AUGUST 15 TO SEPTEMBER 30. ALL SEEDING NOT SOWN ACCORDING TO THE SPECIFIED SEASONAL DATE SHALL REQUIRE PRIOR APPROVAL FROM THE ENGINEER. FAILURE TO SECURE SUCH APPROVAL SHALL RESULT IN THE REJECTION OF THE SEEDING AND REPLACEMENT BY THE CONTRACTOR AS HIS/HER EXPENSE.
2. AREAS TO BE SEEDD BETWEEN NOVEMBER 1 AND APRIL 1 SHALL REQUIRE DORMANT SEEDING, WHICH SHALL BE INCLUDED IN THE COST OF SEEDING CLASS 2A.
3. LAYOUT OF LANDSCAPED AREAS WILL REQUIRE APPROVAL OF THE ENGINEER PRIOR TO SEEDING AND PLANTING.
4. QUANTITIES FOR TOPSOIL FURNISH AND PLACE, 12" AND COMPOST FURNISH AND PLACE, 6" HAVE BEEN PROVIDED FOR THE AREA AROUND THE HMLT SERVICE PAD. A RADIUS OF 20 FT FROM THE EDGE OF THE SERVICE PAD WAS USED TO CALCULATE THIS QUANTITY.
5. CHAIN LINK FENCE TO BE REMOVED AND RE-ERECTED SHALL BE RELOCATED TO THE WEST LIMIT OF THE GATEWAY AREA. THE FENCE SHALL START AT THE SOUTH END OF THE RETAINING WALL AND RE-CONNECT WITH THE EXISTING FENCE PAST THE SOUTH LIMIT OF THE GATEWAY. ANY ADDITIONAL FENCING REQUIRED TO CLOSE GAPS AT THE ENDS SHALL BE INCLUDED IN THE COST OF CHAIN LINK FENCE TO BE REMOVED AND RE-ERECTED. THE CHAIN LINK FENCE IS TO REMAIN UNTIL KNEE WALL CONTRACT 62977 BEGINS.

**LEGEND:**

- EROSION CONTROL BLANKET, SEEDING, CLASS 2A, NITROGEN, PHOSPHORUS, AND POTASSIUM FERTILIZER NUTRIENTS
- GATEWAY AREA (SEE LANDSCAPE PLANS)
- DIRECTION OF TRAFFIC

REVISIONS	
NAME	DATE

ILLINOIS DEPARTMENT OF TRANSPORTATION  
F.A.I. 94 (DAN RYAN EXPRESSWAY)  
**MAINLINE LANDSCAPING RESTORATION**  
SW & NW QUADRANTS AT 95TH ST - SB I-57  
STA. 153+08.86 TO STA. 156+07.42  
SHEET 1 OF 3


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DATE: JUNE 20, 2008  
DRAWN BY: JDF  
CHECKED BY: JPM

**TYLIN INTERNATIONAL**

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F.A.I. RTE.	SECTION	COUNTY	TOTAL SHEETS	SHEET NO.
94	2005-068 LS	COOK	58	40
STA. 153+09 (SB I-57) TO STA. 257+76 (NB I-57)			TO STA. 1214+95 (SB I-94)	
FED. ROAD DIST. NO.	ILLINOIS	FED. AID PROJECT		

60A74

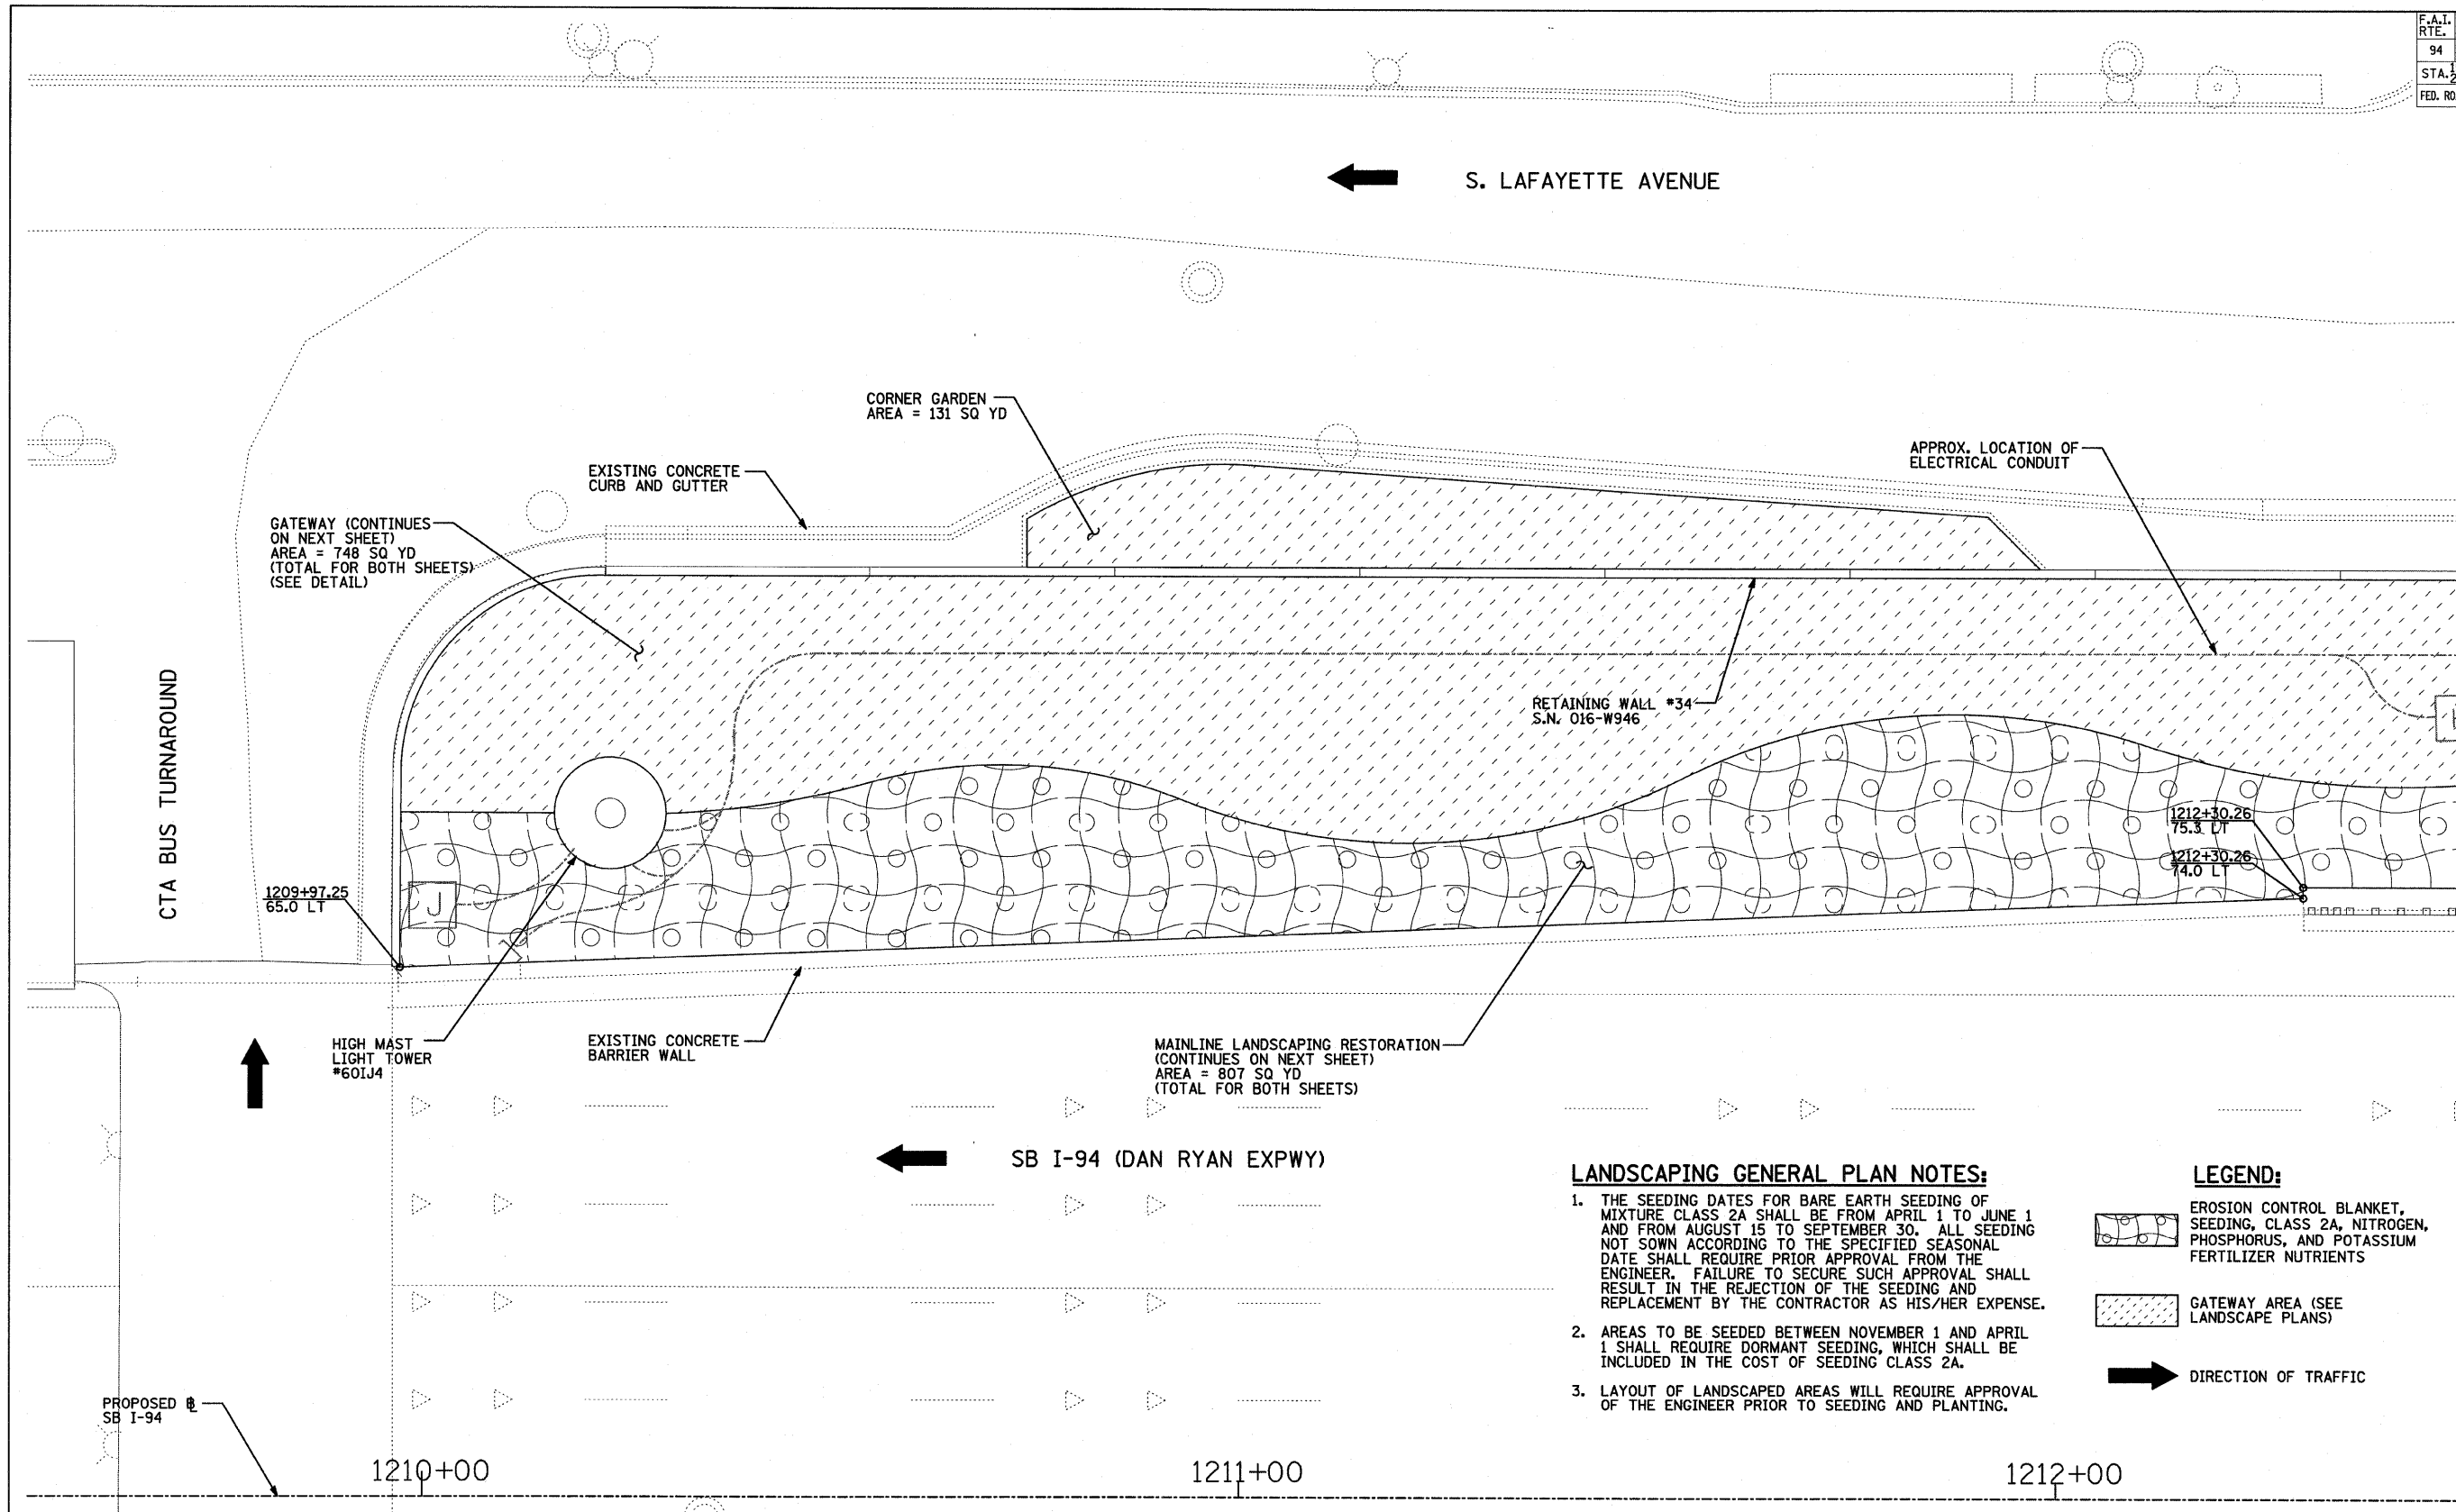

GATEWAY (CONTINUES ON NEXT SHEET)  
AREA = 748 SQ YD  
(TOTAL FOR BOTH SHEETS)  
(SEE DETAIL)

CORNER GARDEN  
AREA = 131 SQ YD

EXISTING CONCRETE CURB AND GUTTER

APPROX. LOCATION OF ELECTRICAL CONDUIT

RETAINING WALL #34  
S.N. 016-W946

1209+97.25  
65.0 LT

1212+30.26  
75.3 LT

1212+30.26  
74.0 LT

HIGH MAST LIGHT TOWER  
#601J4

EXISTING CONCRETE BARRIER WALL

MAINLINE LANDSCAPING RESTORATION  
(CONTINUES ON NEXT SHEET)  
AREA = 807 SQ YD  
(TOTAL FOR BOTH SHEETS)

SB I-94 (DAN RYAN EXPWY)

**LANDSCAPING GENERAL PLAN NOTES:**



1. THE SEEDING DATES FOR BARE EARTH SEEDING OF MIXTURE CLASS 2A SHALL BE FROM APRIL 1 TO JUNE 1 AND FROM AUGUST 15 TO SEPTEMBER 30. ALL SEEDING NOT SOWN ACCORDING TO THE SPECIFIED SEASONAL DATE SHALL REQUIRE PRIOR APPROVAL FROM THE ENGINEER. FAILURE TO SECURE SUCH APPROVAL SHALL RESULT IN THE REJECTION OF THE SEEDING AND REPLACEMENT BY THE CONTRACTOR AS HIS/HER EXPENSE.
2. AREAS TO BE SEEDED BETWEEN NOVEMBER 1 AND APRIL 1 SHALL REQUIRE DORMANT SEEDING, WHICH SHALL BE INCLUDED IN THE COST OF SEEDING CLASS 2A.
3. LAYOUT OF LANDSCAPED AREAS WILL REQUIRE APPROVAL OF THE ENGINEER PRIOR TO SEEDING AND PLANTING.

**LEGEND:**

EROSION CONTROL BLANKET, SEEDING, CLASS 2A, NITROGEN, PHOSPHORUS, AND POTASSIUM FERTILIZER NUTRIENTS

GATEWAY AREA (SEE LANDSCAPE PLANS)

DIRECTION OF TRAFFIC

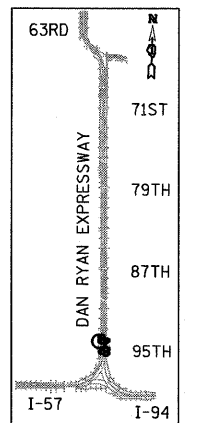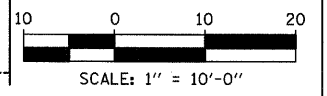

LOCATION MAP

**TYLIN** INTERNATIONAL

REVISIONS	
NAME	DATE

ILLINOIS DEPARTMENT OF TRANSPORTATION  
F.A.I. 94 (DAN RYAN EXPRESSWAY)  
MAINLINE LANDSCAPING RESTORATION  
SW & NW QUADRANTS AT 95TH ST - SB I-94  
STA. 1209+97.25 TO STA. 1212+50.00  
SHEET 2 OF 3

SCALE: 1"=10'-0"  
DATE: JUNE 20, 2008

DRAWN BY: JDF  
CHECKED BY: JPM

6/20/2008 10:27:42 AM



F.A.I. RTE.	SECTION	COUNTY	TOTAL SHEETS	SHEET NO.
94	2005-068 LS	COOK	58	41
STA. 153+09 (SB I-57)	TO STA. 1214+95 (SB I-94)			
STA. 257+76 (NB I-57)	TO STA. 2213+00 (NB I-94)			
FED. ROAD DIST. NO.	ILLINOIS	FED. AID PROJECT		

60A74



← S. LAFAYETTE AVENUE

GATEWAY (CONTINUED FROM PREVIOUS SHEET)  
AREA = 748 SQ YD  
(TOTAL FOR BOTH SHEETS)  
(SEE DETAIL)

EXISTING CONCRETE  
CURB AND GUTTER

MAINLINE LANDSCAPING RESTORATION  
(CONTINUED FROM PREVIOUS SHEET)  
AREA = 807 SQ YD  
(TOTAL FOR BOTH SHEETS)

APPROX. LOCATION OF  
ELECTRICAL CONDUIT

MATCHLINE NB I-94 (RYAN) STA. 1212+50.00

1212+74.76  
113.1 L

1213+20.98  
76.0 L

1213+35.48  
73.8 LT  
1213+35.48  
72.6 LT




1214+02.27  
72.6 LT


← SB I-94 (DAN RYAN EXPWY)

**LANDSCAPING GENERAL PLAN NOTES:**

1. THE SEEDING DATES FOR BARE EARTH SEEDING OF MIXTURE CLASS 2A SHALL BE FROM APRIL 1 TO JUNE 1 AND FROM AUGUST 15 TO SEPTEMBER 30. ALL SEEDING NOT SOWN ACCORDING TO THE SPECIFIED SEASONAL DATE SHALL REQUIRE PRIOR APPROVAL FROM THE ENGINEER. FAILURE TO SECURE SUCH APPROVAL SHALL RESULT IN THE REJECTION OF THE SEEDING AND REPLACEMENT BY THE CONTRACTOR AS HIS/HER EXPENSE.
2. AREAS TO BE SEEDIED BETWEEN NOVEMBER 1 AND APRIL 1 SHALL REQUIRE DORMANT SEEDING, WHICH SHALL BE INCLUDED IN THE COST OF SEEDING CLASS 2A.
3. LAYOUT OF LANDSCAPED AREAS WILL REQUIRE APPROVAL OF THE ENGINEER PRIOR TO SEEDING AND PLANTING.

**LEGEND:**

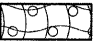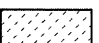-  EROSION CONTROL BLANKET, SEEDING, CLASS 2A, NITROGEN, PHOSPHORUS, AND POTASSIUM FERTILIZER NUTRIENTS
-  GATEWAY AREA (SEE LANDSCAPE PLANS)
-  DIRECTION OF TRAFFIC

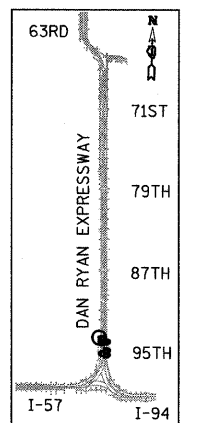


LOCATION MAP

PROPOSED SB I-94

1213+00

1214+00

1215+00

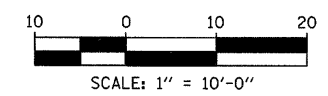

TYLIN INTERNATIONAL


REVISIONS	
NAME	DATE

ILLINOIS DEPARTMENT OF TRANSPORTATION  
F.A.I. 94 (DAN RYAN EXPRESSWAY)  
MAINLINE LANDSCAPING RESTORATION  
SW & NW QUADRANTS AT 95TH ST - SB I-94  
STA. 1212+50.00 TO STA. 1214+94.62  
SHEET 3 OF 3


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DRAWN BY: JDF  
CHECKED BY: JPM

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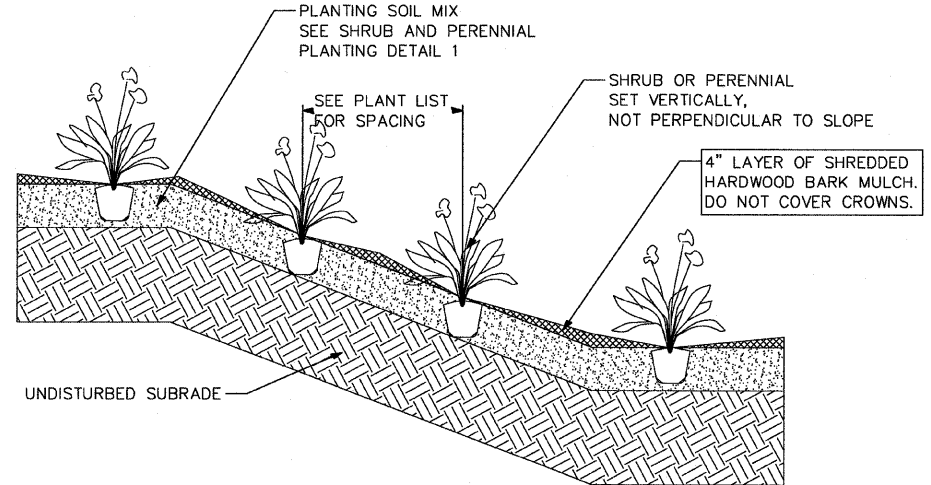


**1 SHRUB AND PERENNIAL PLANTING DETAIL**  
NOT TO SCALE

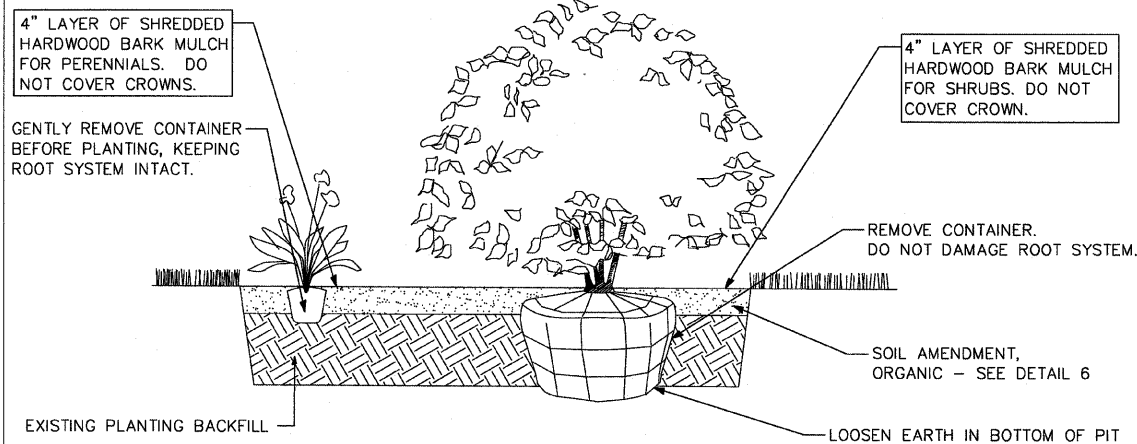


NOTE: PERENNIAL SPACING AND SPECIES VARIES - SEE PLANT SCHEDULES/REMARKS.

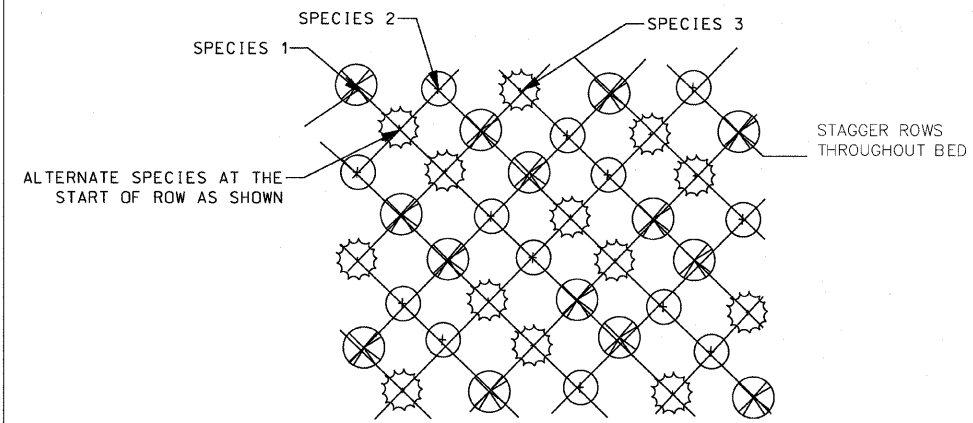
**2 PERENNIAL PLANTING DETAIL (3 VARIETIES)**  
NOT TO SCALE




**5 SHRUB/PERENNIAL PLANTING ON SLOPE DETAIL**  
NOT TO SCALE

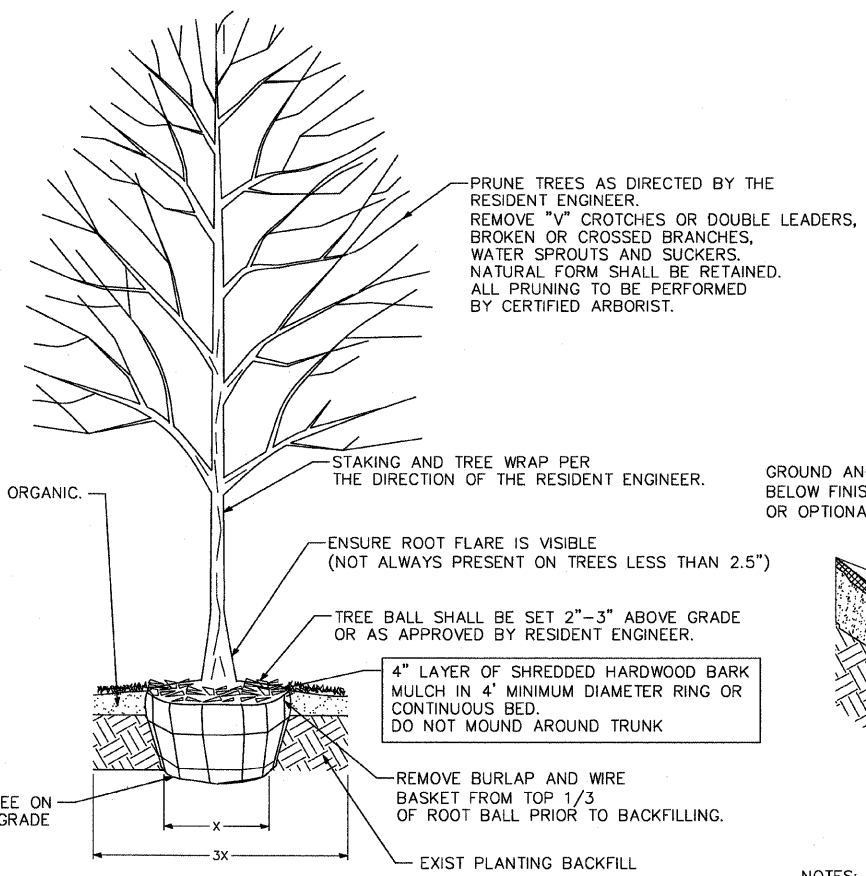

**3 TREE PLANTING DETAIL**  
NOT TO SCALE

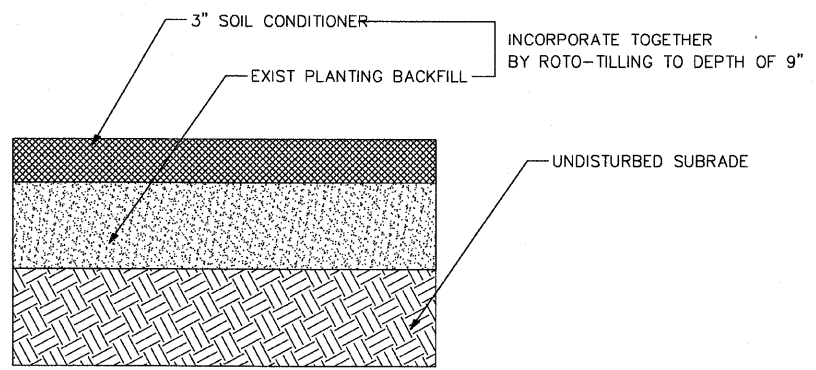

**6 SOIL AMENDMENT, ORGANIC DETAIL**  
NOT TO SCALE

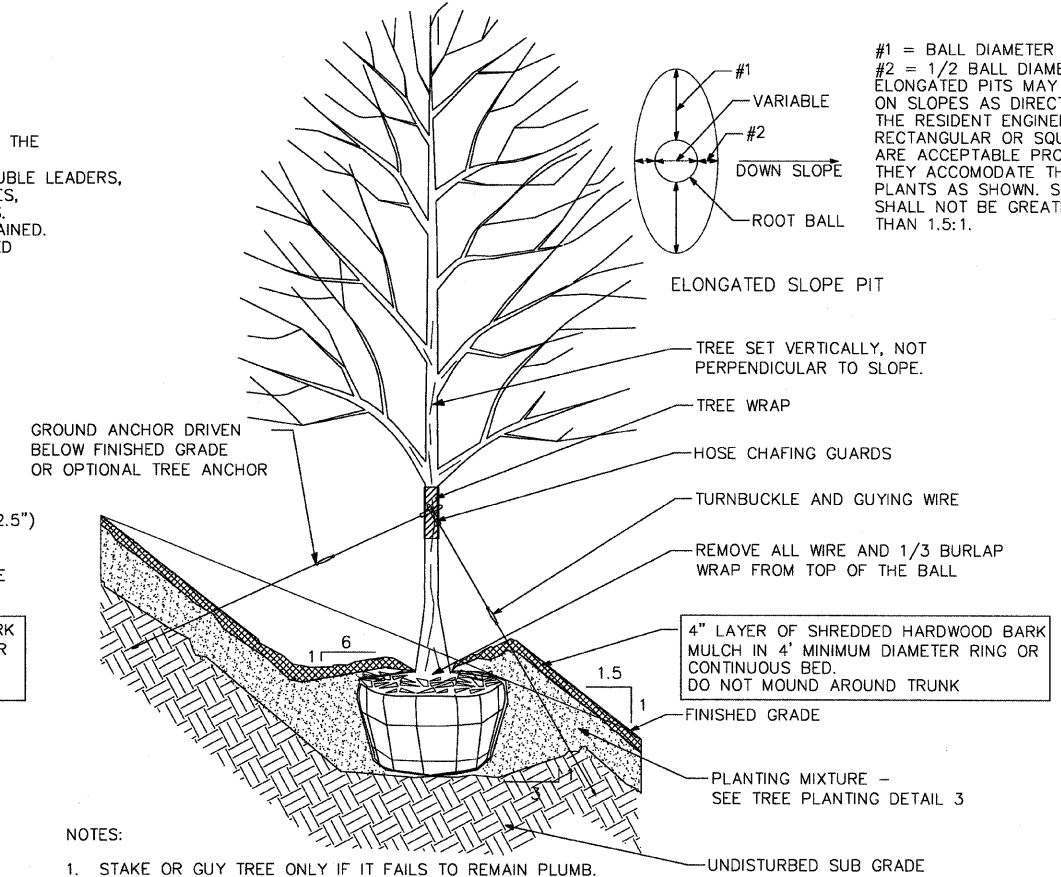

NOTES:

1. STAKE OR GUY TREE ONLY IF IT FAILS TO REMAIN PLUMB.
2. METHOD TO BE APPROVED BY THE RESIDENT ENGINEER.

**4 TREE PLANTING ON SLOPE DETAIL**  
NOT TO SCALE

NOTES:

1. PLANT QUANTITIES SHOWN ON DRAWINGS ARE FOR CONTRACTOR'S CONVENIENCE IN ESTIMATING ONLY. CONTRACTOR IS RESPONSIBLE FOR PROVIDING PLANT MATERIALS SUFFICIENT TO COVER AREAS SHOWN ON PLANS AT THE SPACINGS INDICATED.
2. PLANTINGS SHALL CONFORM TO CITY OF CHICAGO CODES AND SPECIFICATIONS.
3. CONTRACTOR SHALL PERFORM DUE DILIGENCE IN LOCATING SPECIFIED PLANT MATERIAL.
4. NO SUBSTITUTIONS OF PLANT MATERIAL, QUANTITIES OR SIZES UNLESS APPROVED BY RESIDENT ENGINEER.
5. LAYOUT TO BE APPROVED BY RESIDENT ENGINEER PRIOR TO PLANTING.
6. MULCH TO BE APPLIED EVENLY TO PLANTING BED, DO NOT COVER CROWNS OF PLANTS OR MOUND AT TRUNK.
7. TREE PLANTING METHOD SHALL BE APPROVED BY RESIDENT ENGINEER PRIOR TO FULL SCALE INSTALLATION.
8. CONTRACTOR MAY BACKFILL TREE PITS WITH EXIST EXCAVATED EARTH FROM PIT EXCEPT WHERE UNSUITABLE SOILS AND/OR CLAY IS ENCOUNTERED. CONTRACTOR SHALL HAUL OFF AND PROPERLY DISPOSE OF ANY UNSUITABLE SOILS AND/OR CLAY ENCOUNTERED.

**SITE DESIGN GROUP**  
**TYLIN INTERNATIONAL**


ITEM IS PAID FOR AS PART OF INDIVIDUAL PLANT ITEMS

REVISIONS	
NAME	DATE

ILLINOIS DEPARTMENT OF TRANSPORTATION  
F.A.I. 94 (DAN RYAN EXPRESSWAY)  
95TH STREET GATEWAY LANDSCAPING AND IRRIGATION  
LANDSCAPE DETAILS

SCALE: NTS  
DATE: June 20, 2008  
DRAWN BY: EM  
CHECKED BY: JO


SCALE: \$

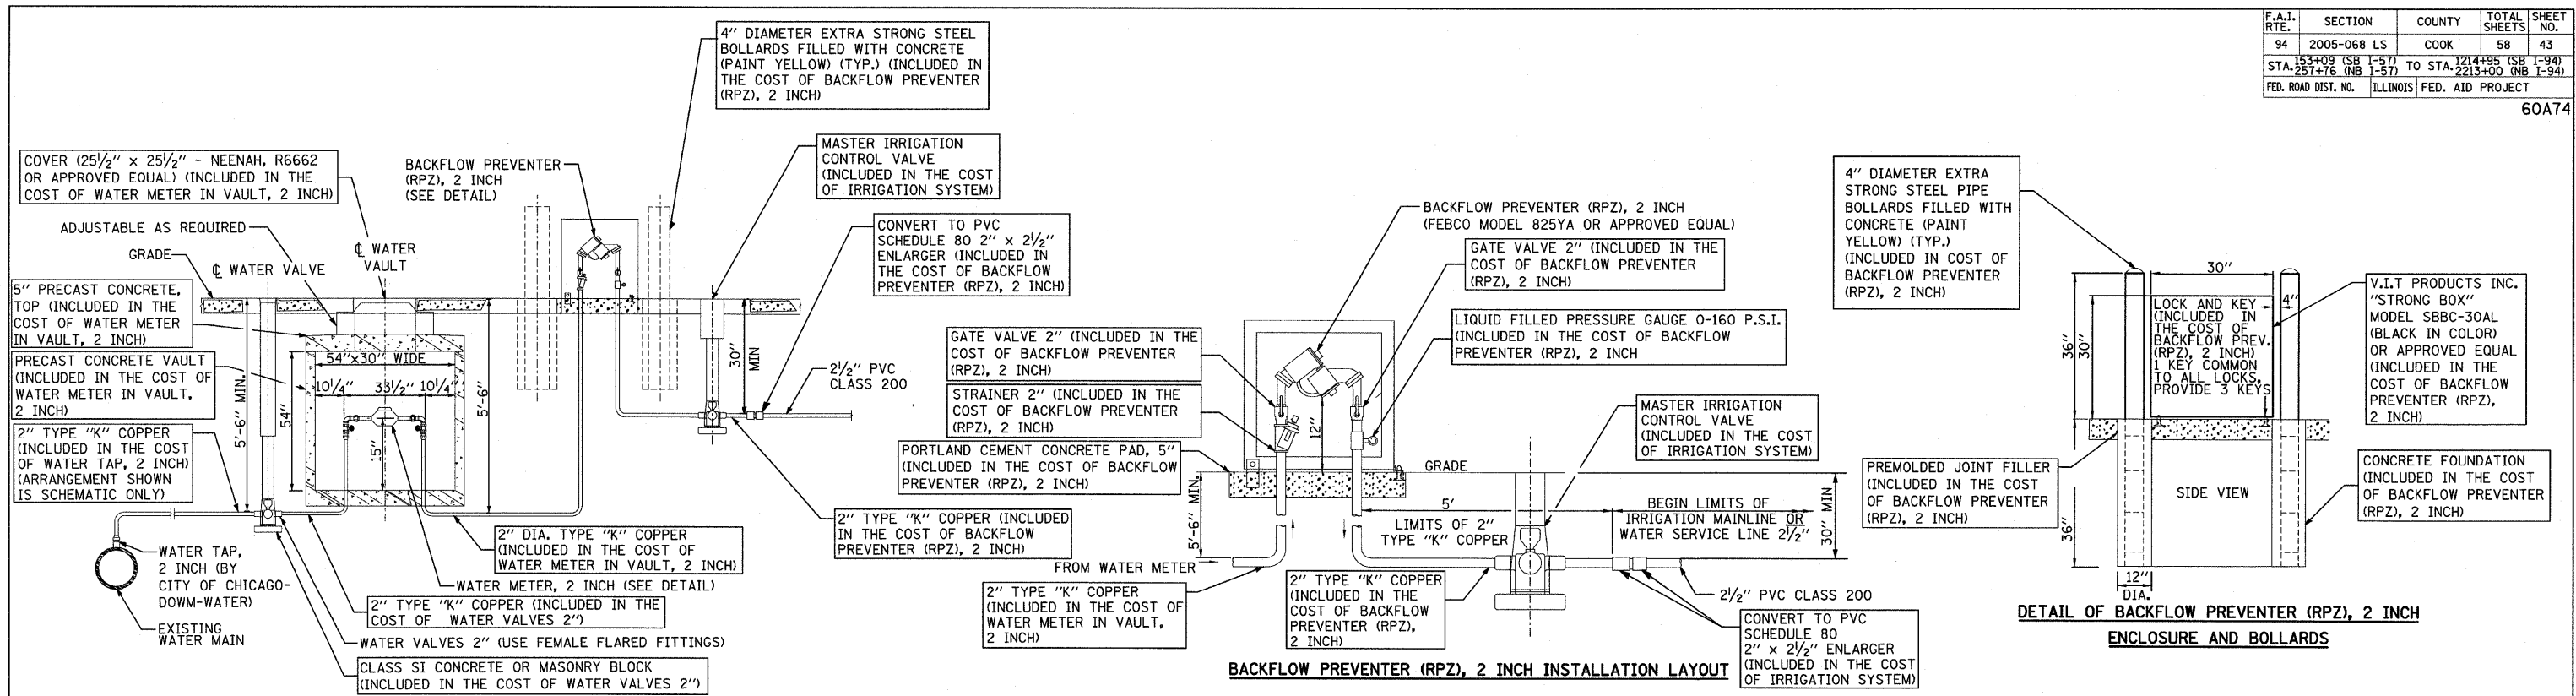


**TYPICAL METER INSTALLATION FOR 2" WATER SERVICE WITH BACK FLOW PREVENTER (RPZ), 2 INCH**

**BACKFLOW PREVENTER (RPZ), 2 INCH INSTALLATION LAYOUT**

**DETAIL OF BACKFLOW PREVENTER (RPZ), 2 INCH ENCLOSURE AND BOLLARDS**

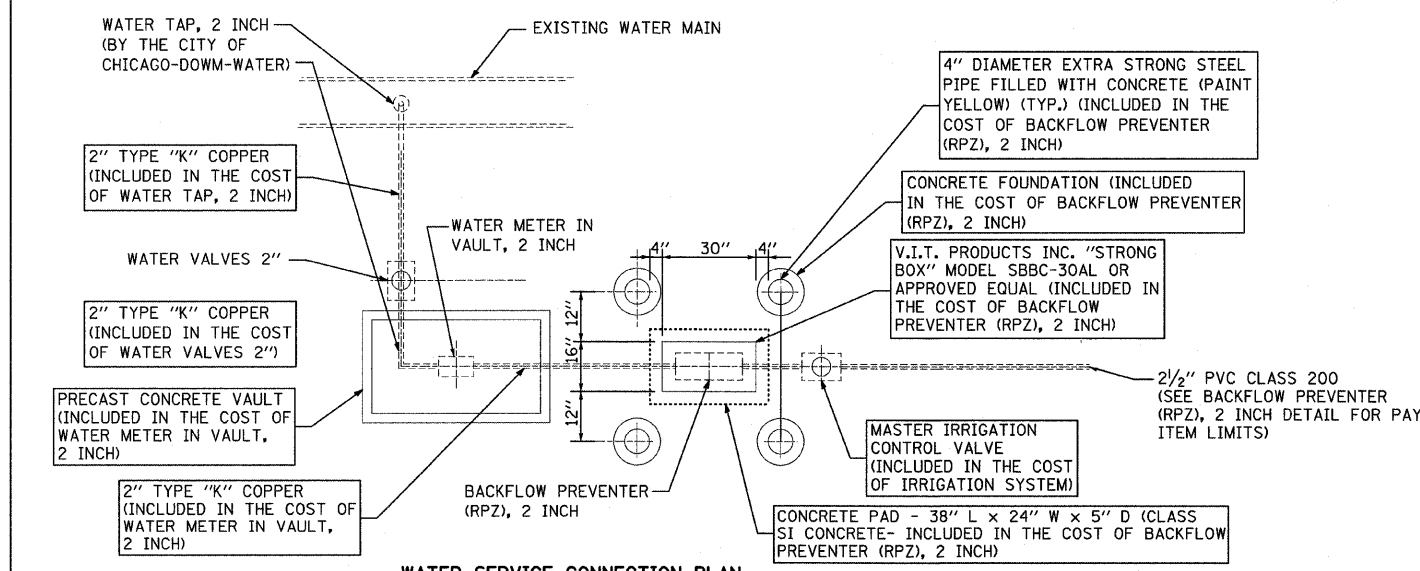


**WATER SERVICE CONNECTION PLAN (TYPICAL EQUIPMENT LAYOUT PLAN)**

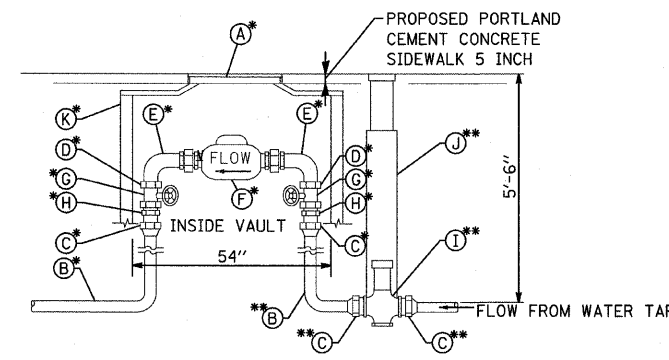

- A FRAME AND LID (NEENAH R6662)
- B 2" TYPE "K" COPPER PIPE
- C FEMALE FLARED FITTING
- D BRASS BUSHING
- E BENT METER COUPLING
- F METER
- G FULL PORT CONTROL VALVE
- H MALE I.P.S. TO FLARED ADAPTER
- I ROUNDWAY
- J WATER VALVE ASSEMBLY
- K PRECAST CONCRETE VAULT

\*- ITEMS ARE INCLUDED IN THE COST OF WATER METER IN VAULT, 2 INCH  
 \*\*-ITEMS ARE INCLUDED IN THE COST OF WATER VALVES 2"


**NEW COPPER 2" WATER SERVICE STANDARD METER VAULT**

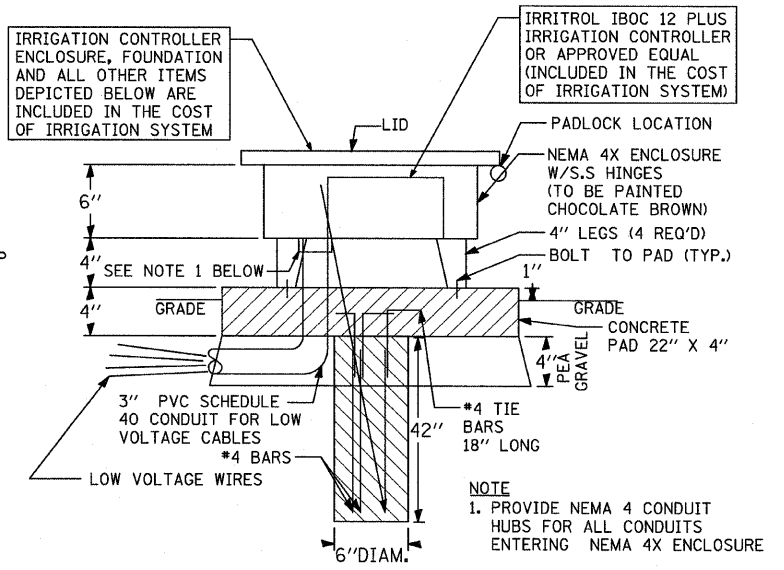


**IRRIGATION CONTROLLER NEMA 4X ENCLOSURE - DETAIL N.T.S.**

REVISIONS	
NAME	DATE


6/20/2008 10:27:42 AM P:\02373\road\220\wrc\220a74.dgn

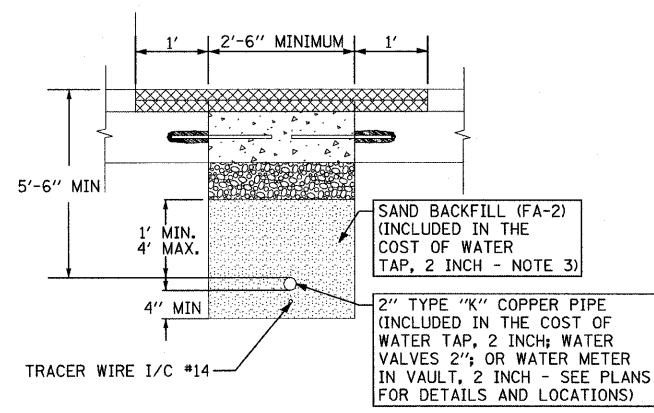


**2" TYPE "K" COPPER PIPE - PAVEMENT SECTION**  
N.T.S.

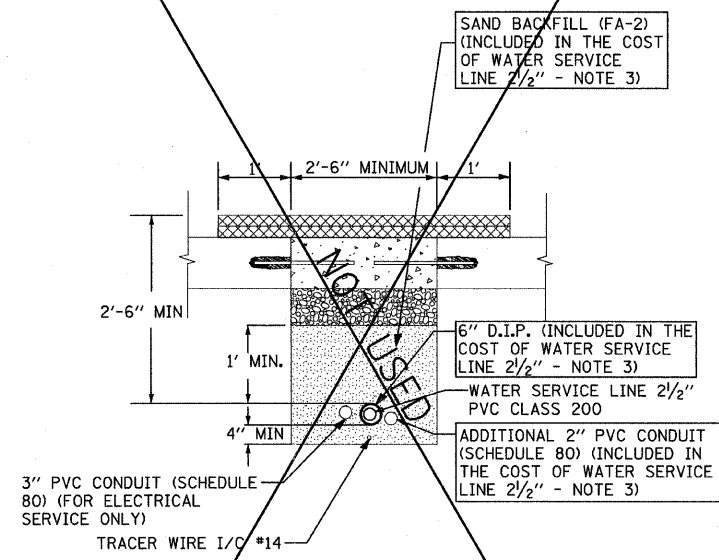


**2 1/2" PVC CLASS 200 - PAVEMENT SECTION**  
N.T.S.

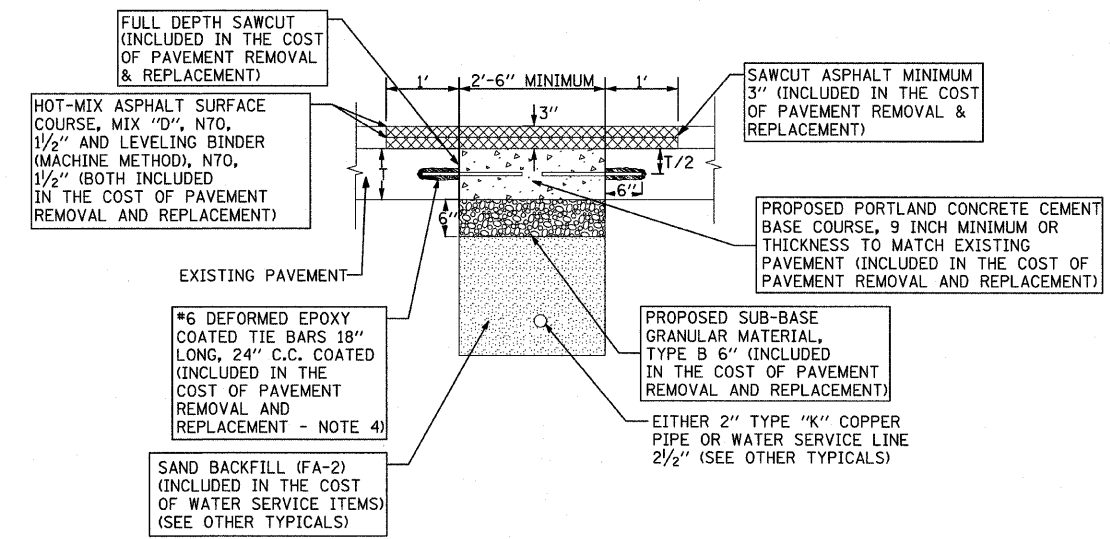

**PAVEMENT REMOVAL & REPLACEMENT - TYPICAL**  
N.T.S.

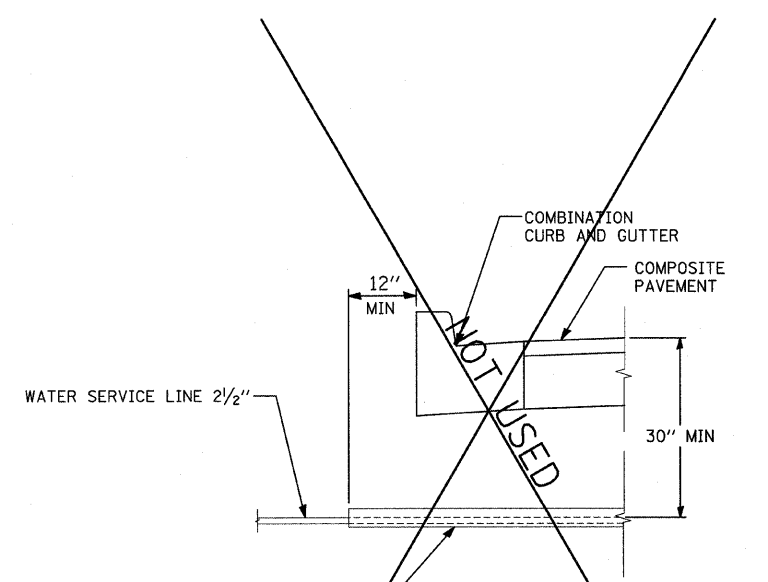

**SLEEVING INSTALLATION REQUIREMENTS WITH CURB**  
N.T.S.

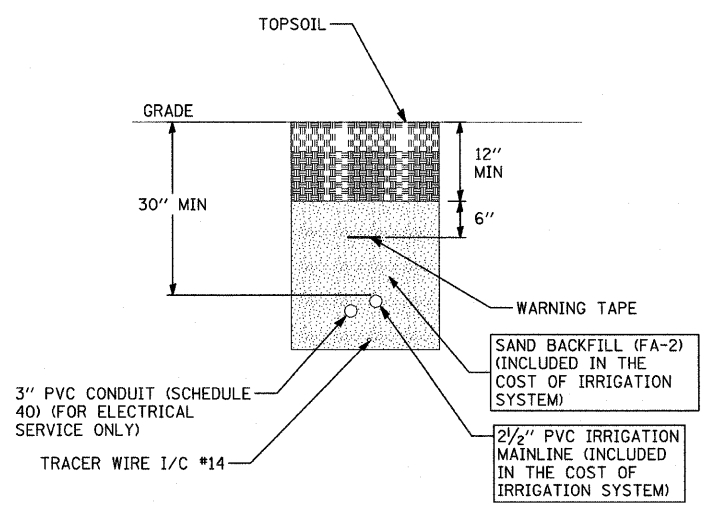


**TYPICAL SECTION OF 2 1/2" IRRIGATION MAINLINE IN GATEWAY**


- NOTES:**
1. ALL TIE BARS TO BE EPOXY COATED (INCLUDED IN THE COST OF PAVEMENT REMOVAL AND REPLACEMENT).
  2. ADDITIONAL ONE FOOT (1') OF HOT-MIX ASPHALT SURFACE REMOVAL ON EITHER SIDE OF CONCRETE PATCH SHALL BE REMOVED PRIOR TO PLACING HOT-MIX ASPHALT SURFACE COURSE.
  3. PIPE BEDDING, TAMPED IN PLACE 4" MINIMUM UNDER PIPE AND 1'-0" ABOVE TOP OF PIPE. SHALL BE WELL SPADED ON BOTH SIDES OF PIPE.
  4. TIE BARS MAY BE DELETED SUBJECT TO APPROVAL BY THE ENGINEER.
  5. ALL CONTROL WIRING MUST BE PLACED INSIDE 3" SCHEDULE 80 PVC PIPE FOR ALL PAVED AREA CROSSINGS. THIS WORK AND MATERIALS SHALL CONFORM TO THE NATIONAL ELECTRICAL CODE REQUIREMENTS. THE COST OF THIS WORK WILL BE INCLUDED IN COST OF IRRIGATION SYSTEM.

REVISIONS	
NAME	DATE


6/20/2008 10:27:24 AM

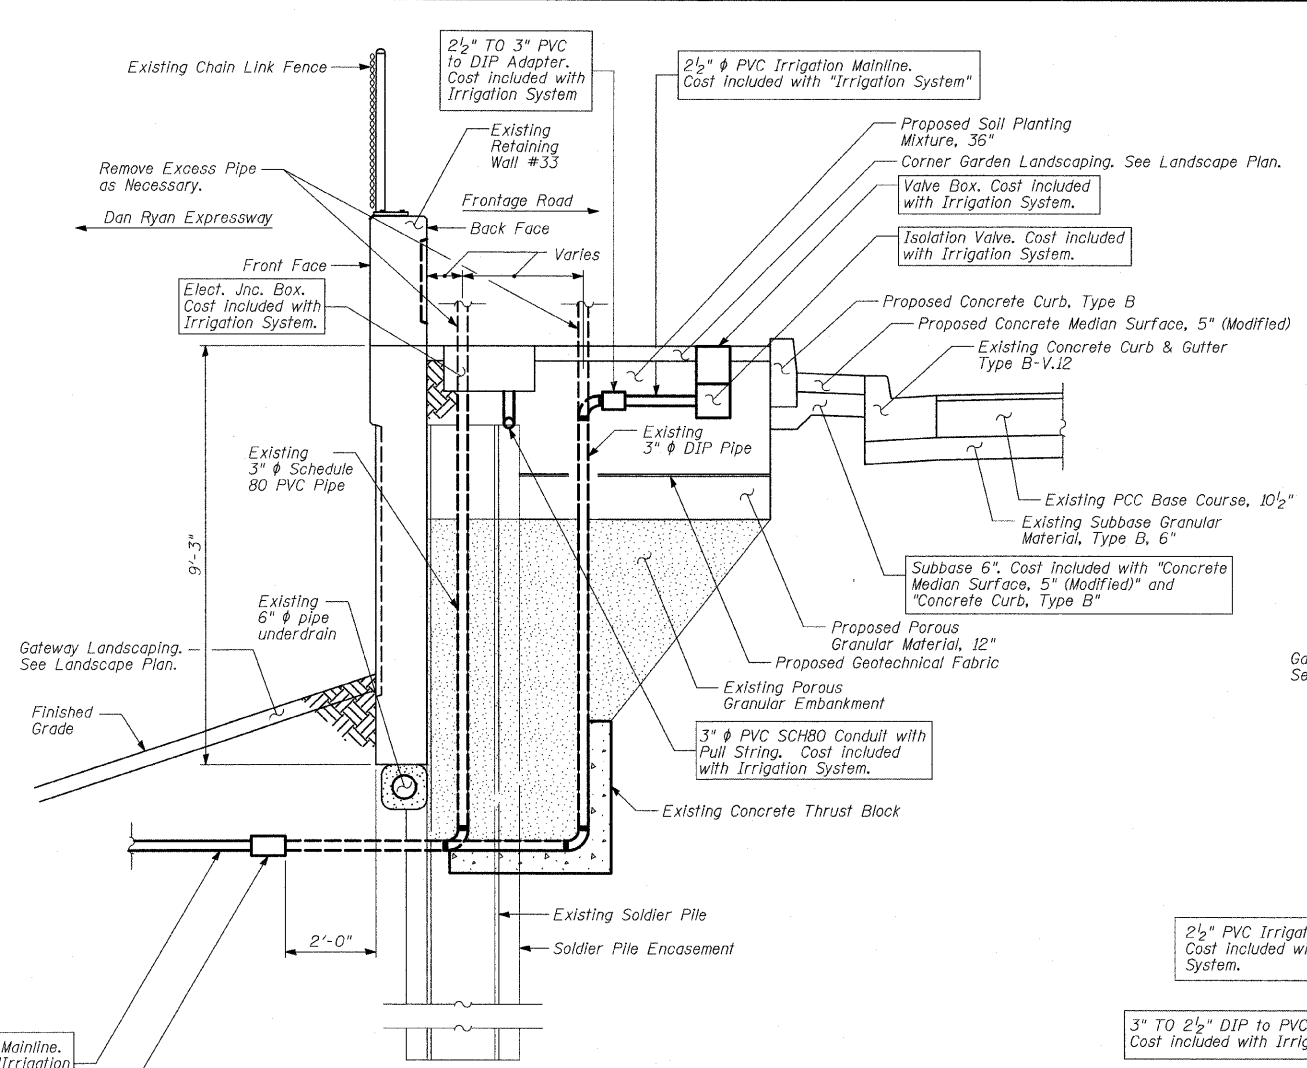

**ELEVATION - WATER SERVICE & ELECTRICAL LINES AT SOLDIER PILE RETAINING WALL #33**  
(SW Corner Garden)

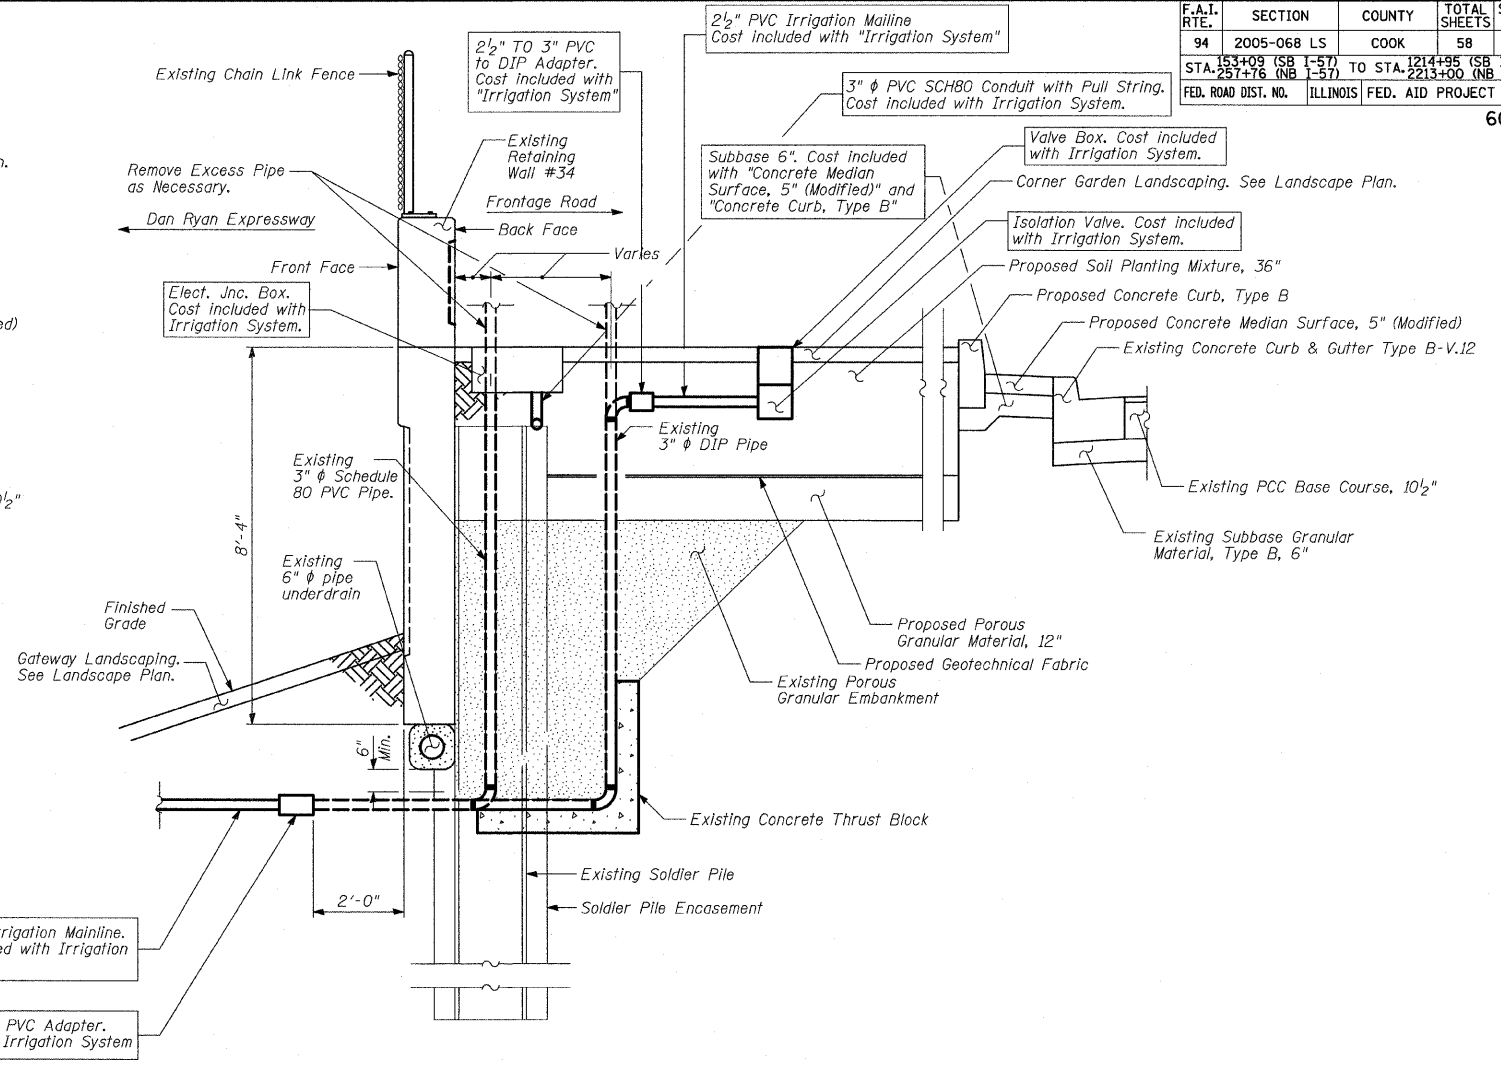

**ELEVATION - WATER SERVICE & ELECTRICAL LINES AT SOLDIER PILE RETAINING WALL #34**  
(NW Corner Garden)

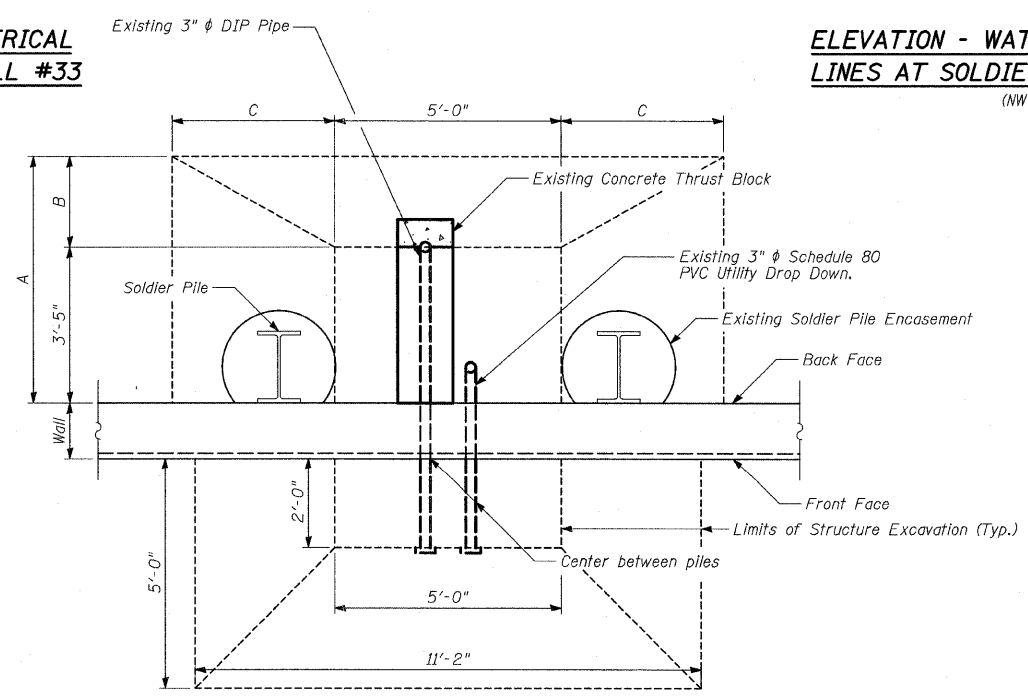

**EXISTING PLAN - WATER SERVICE & ELECTRICAL LINES AT SOLDIER PILE RETAINING WALL**  
For Information Only

**LEGEND**

- Porous Granular Embankment
- Portland Cement Concrete

Wall	A	B	C
33	7'-10"	4'-5"	7'-8"
34	7'-9"	4'-3"	6'-9"

REVISIONS	
NAME	DATE

ILLINOIS DEPARTMENT OF TRANSPORTATION  
F.A.I. 94 (DAN RYAN EXPRESSWAY)


GATEWAY AND CORNER GARDEN  
UTILITY DROP DOWN DETAILS

SCALE: N.T.S. DRAWN BY: MAF  
DATE: JUNE 20, 2008 CHECKED BY: DAK, TGB

F.A.I. RTE.	SECTION	COUNTY	TOTAL SHEETS	SHEET NO.
94	2005-068 LS	COOK	58	46
STA. 153+09 (SB 1-57) TO STA. 257+76 (NB 1-57)	TO STA. 1214+95 (SB 1-94) TO STA. 2213+00 (NB 1-94)			
FED. ROAD DIST. NO.	ILLINOIS FED. AID PROJECT			


60A74

**NOTE:**  
THIS OPTION WILL BE USED WHEN THE CARRIAGE WALK MEASURES LESS THAN 12" IN WIDTH

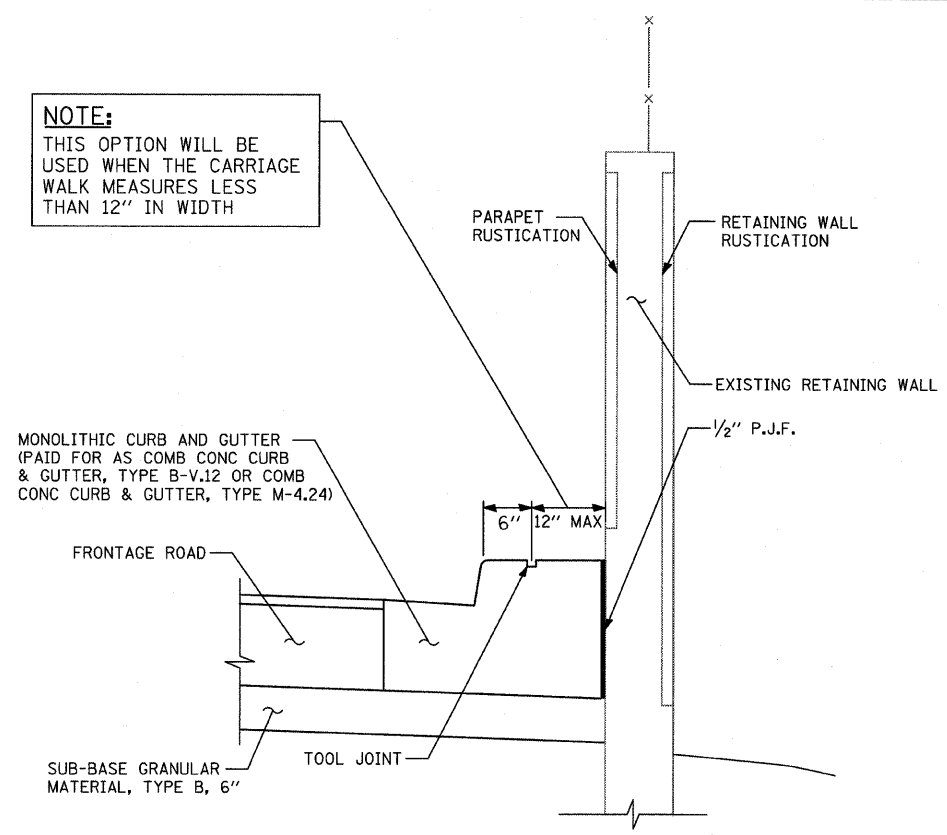


**SECTION - CARRIAGE WALK "A"**  
WIDTH < 12"

**NOTE:**  
THIS OPTION WILL BE USED WHEN THE CARRIAGE WALK MEASURES 12" TO 18" IN WIDTH

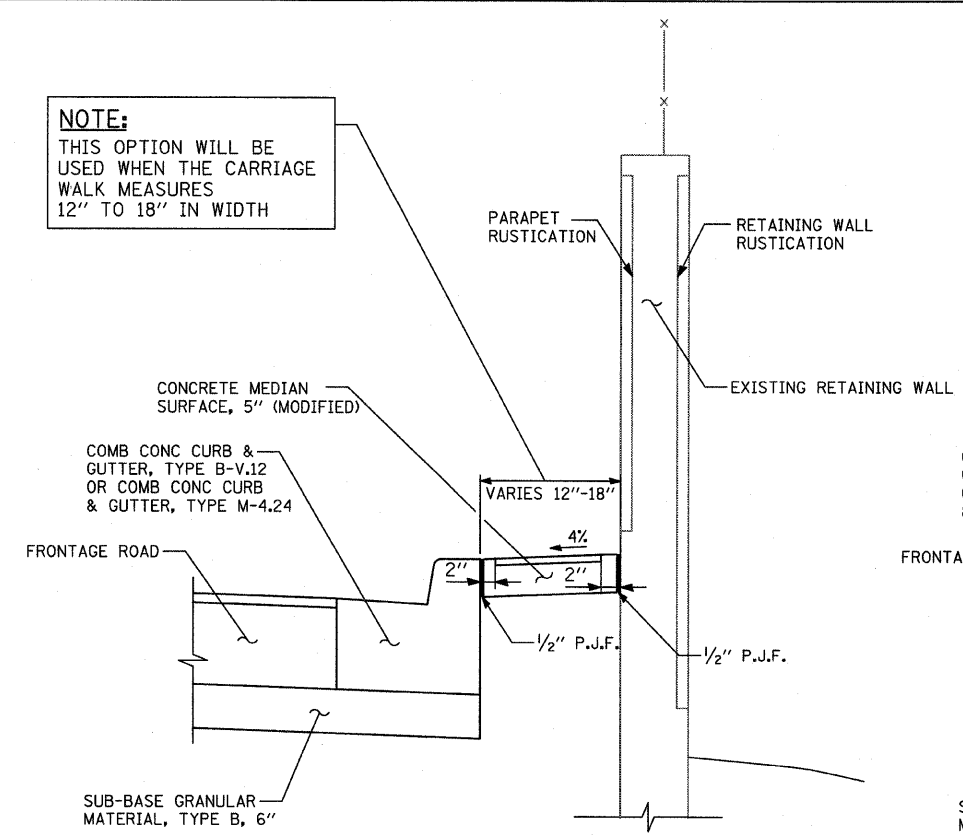


**SECTION - CARRIAGE WALK "B"**  
WIDTH = 12" TO 18"

**NOTE:**  
THIS OPTION WILL BE USED WHEN THE CARRIAGE WALK MEASURES GREATER THAN 18" IN WIDTH

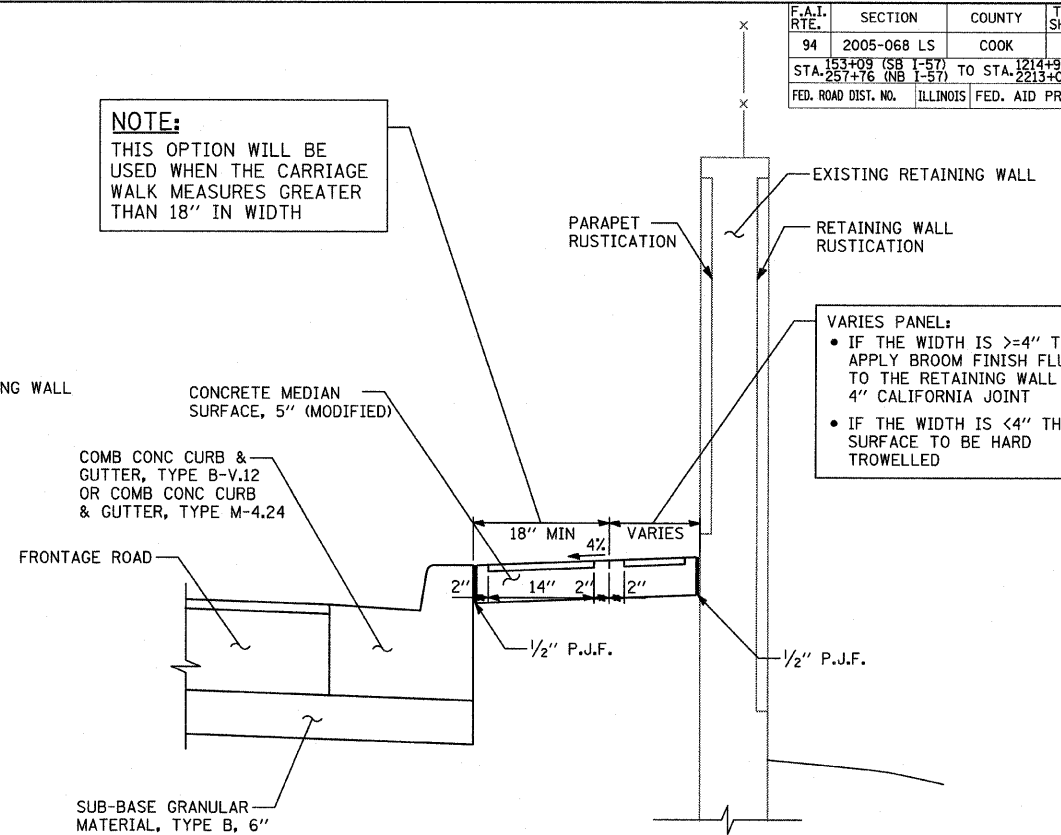


**SECTION - CARRIAGE WALK "C"**  
WIDTH > 18"

**VARIES PANEL:**  
• IF THE WIDTH IS >=4" THEN APPLY BROOM FINISH FLUSH TO THE RETAINING WALL WITH 4" CALIFORNIA JOINT  
• IF THE WIDTH IS <4" THEN SURFACE TO BE HARD TROWELLED

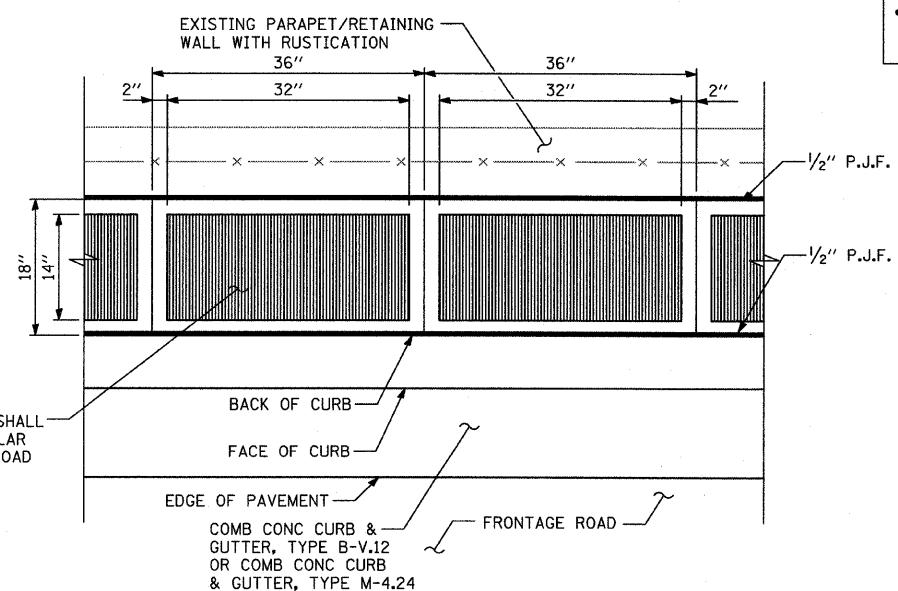

**PLAN DETAIL "A": COORDINATE WITH CARRIAGE WALK "B"**  
CALIFORNIA FINISH

**VARIES PANEL:**  
• IF THE WIDTH IS >=4" THEN APPLY BROOM FINISH FLUSH TO THE RETAINING WALL WITH 4" CALIFORNIA JOINT  
• IF THE WIDTH IS <4" THEN SURFACE TO BE HARD TROWELLED

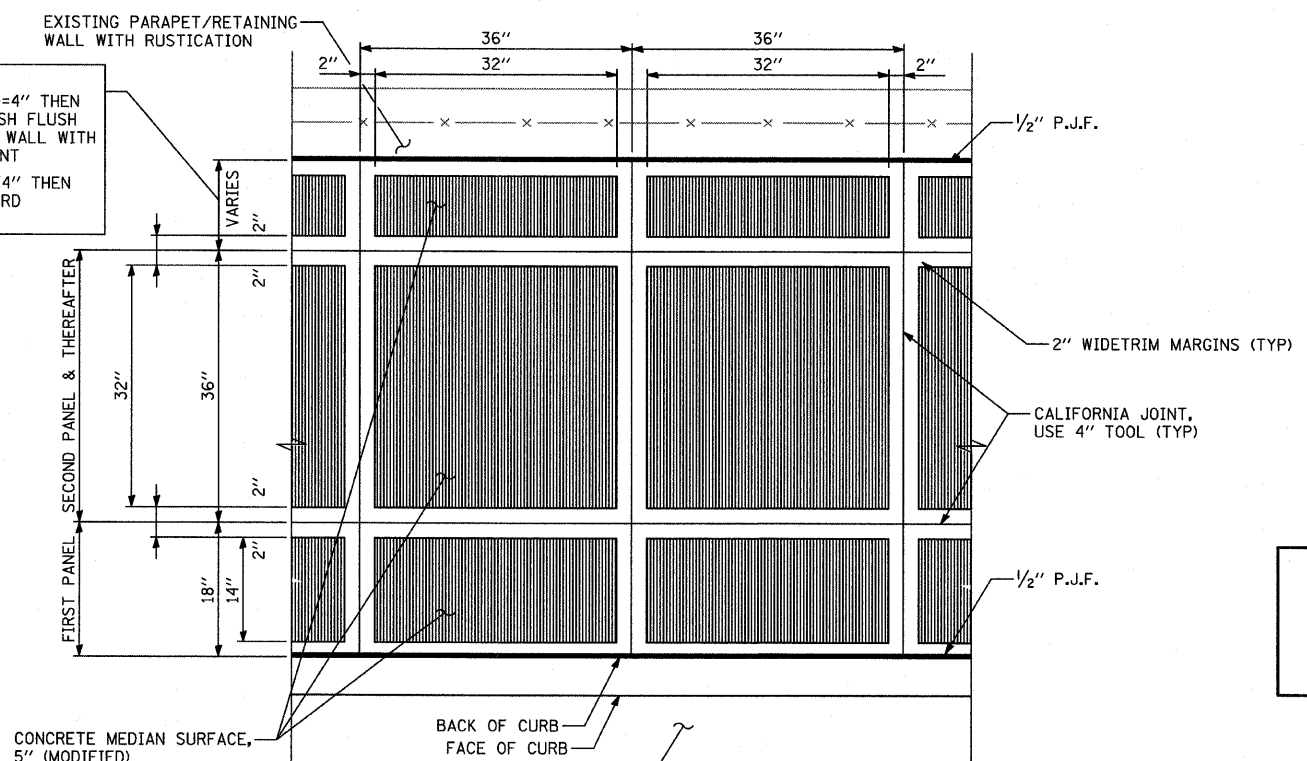

**PLAN DETAIL "B": COORDINATE WITH CARRIAGE WALK "C"**  
CALIFORNIA FINISH

**NOTE:**  
NOT ALL ITEMS SHOWN IN THIS DETAIL ARE PROPOSED. SEE PLANS FOR PROPOSED ITEMS.

REVISIONS	
NAME	DATE


ILLINOIS DEPARTMENT OF TRANSPORTATION  
F.A.I. 94 (DAN RYAN EXPRESSWAY)  
**CONCRETE MEDIAN SURFACE, 5" (MODIFIED) WITH CALIFORNIA FINISH DETAIL**  
SCALE: NONE  
DATE: JUNE 20, 2008  
DRAWN BY: MGP  
CHECKED BY: JPM

**TYLIN** INTERNATIONAL

6/20/2008 10:27:46 AM P:\02373\road\2005\2005-068\2005-068-033.dgn


F.A.I. RTE.	SECTION	COUNTY	TOTAL SHEETS	SHEET NO.
94	2005-068 LS	COOK	58	47
153+08 (SB I-57) TO STA. 221+00 (NB I-94)		1214+95 (SB I-94) TO STA. 221+00 (NB I-94)		
FED. ROAD DIST. NO.		ILLINOIS FED. AID PROJECT		

60A74

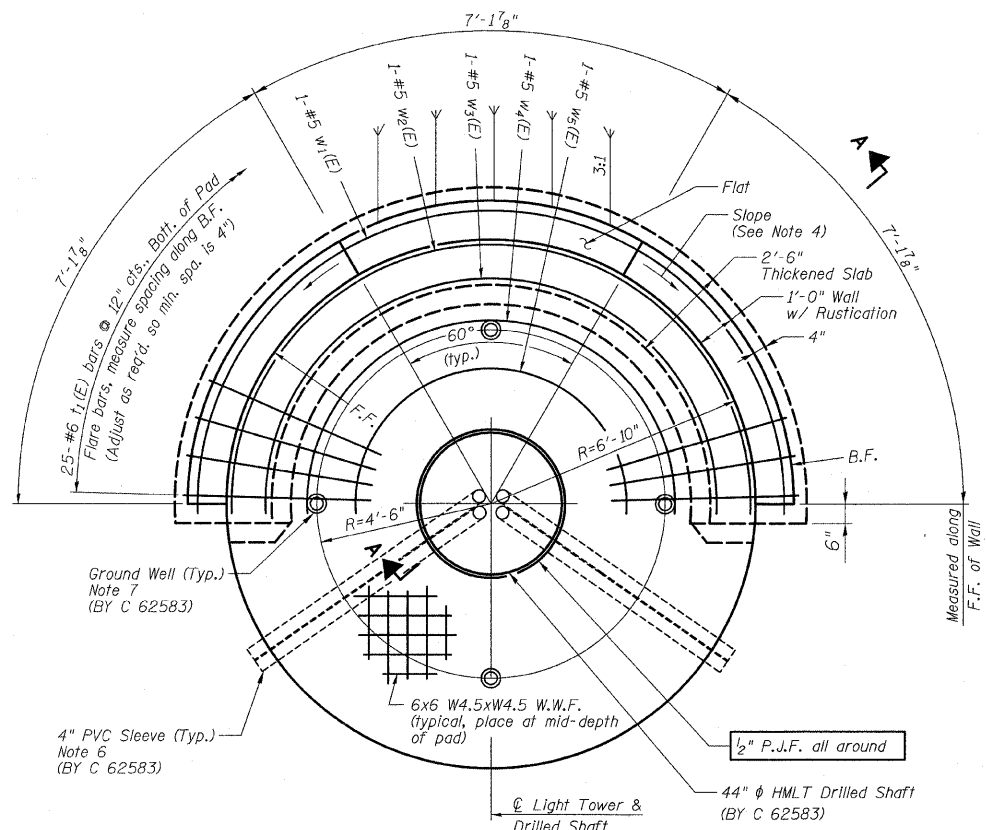


**PLAN VIEW**

Place Bars  $w_1(E)$  thru  $w_5(E)$  @ 12" cts., Bott. of Pad (HMLT 60EF1 at Sta. 2205+20.00 NB I-94 @) (HMLT 60AB4 at Sta. 155+70.00 SB I-57 @)

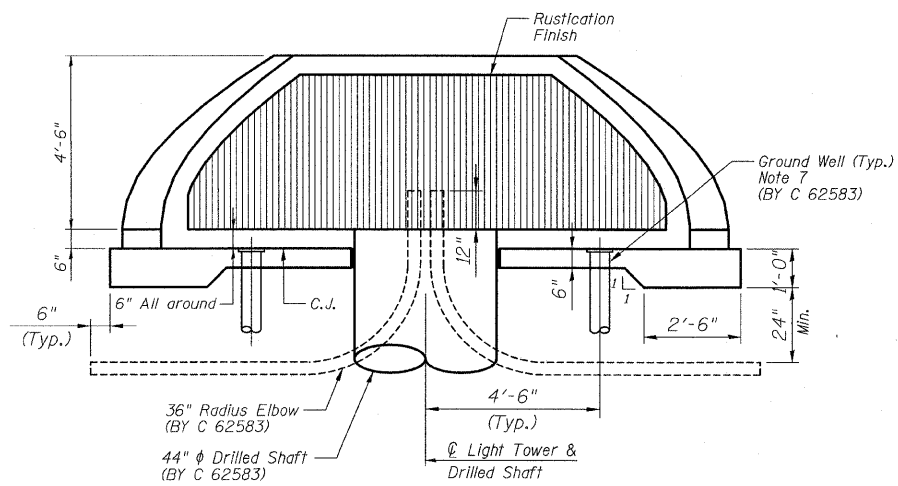

**ELEVATION VIEW**

(HMLT not shown for clarity) (HMLT 60EF1 at Sta. 2205+20.00 NB I-94 @) (HMLT 60AB1 at Sta. 155+70.00 SB I-57 @)

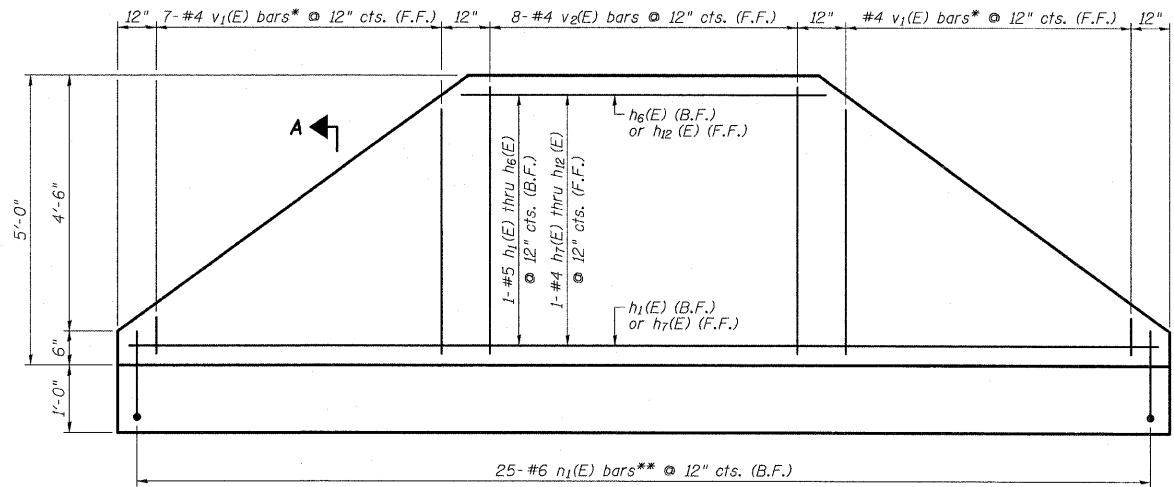

\* Cut to fit, use remainder of bars at opposite end of wall. See Cutting Diagram, Sheet 26 of 49.  
\*\* Cut to fit where necessary, discard excess.

**5'-0" RETAINING WALL ELEVATION (PROJECTED)**

(Looking at F.F.) (HMLT 60EF1 at Sta. 2205+20.00 NB I-94 @) (HMLT 60AB1 at Sta. 155+70.00 SB I-57 @)


**NOTES**

1. F.F. and B.F. denote Front Face and Back Face, respectively.
2. HMLT denotes High Mast Light Tower.
3. Refer to HMLT Service Pad, Special & Retaining Wall Details 2 for Bar Bending Diagrams, Bill of Material, Bar Sections and Details.
4. T/Wall slope is constant along the arc of any given radius.
5. Place horizontal tails of  $n_1(E)$  bars radially.
6. PVC sleeves must be extended 6 inches by Contract 62583 beyond the edge of the concrete pad.
7. Ground wells 4'-6" as measured from centerline of the HMLT to centerline of the well to be installed by Contract 62583. Adjust service pad reinforcement to miss wells. Any necessary vertical adjustments will be performed by the contractor who installed the ground wells at the specific location.


REVISIONS	
NAME	DATE

ILLINOIS DEPARTMENT OF TRANSPORTATION  
F.A.I. 94 (DAN RYAN EXPRESSWAY)  
HIGH MAST LIGHT TOWER SERVICE PAD,  
SPECIAL & RETAINING WALL DETAILS  
SHEET 1 OF 2


S.N. DESIGNED BY: MAF  
SCALE: N.T.S. DRAWN BY: MAF  
DATE: JUNE 20, 2008 CHECKED BY: PF

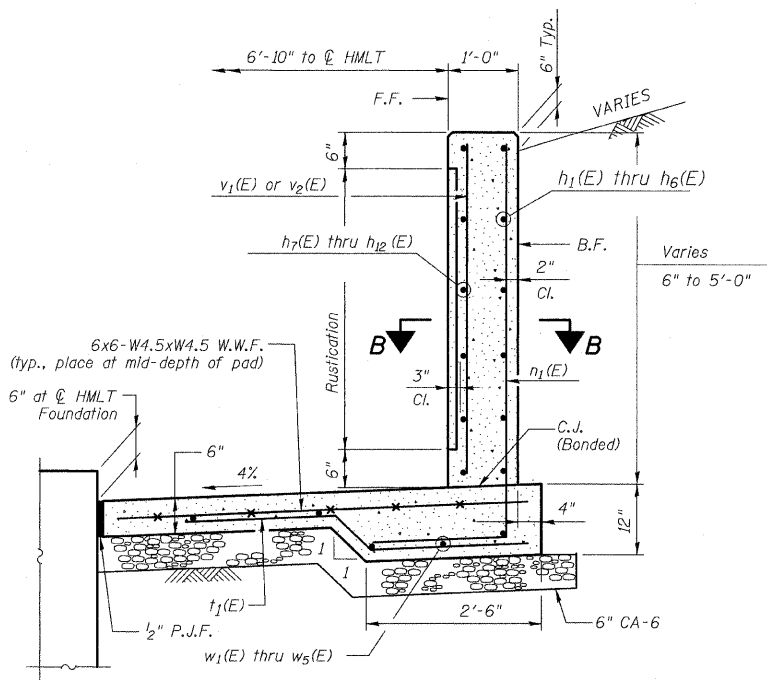


**SECTION A-A**

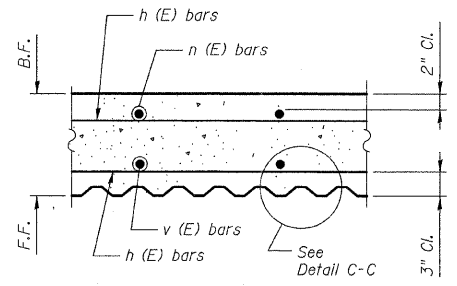

**SECTION B-B**

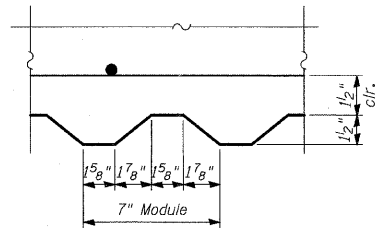

**DETAIL C-C**

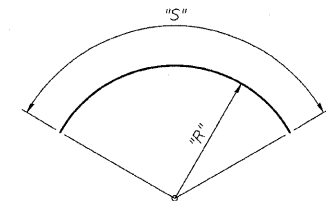

Bar	"R"	"S"
h1(E)	7'-7"	23'-6"
h2(E)	7'-7"	20'-10"
h3(E)	7'-7"	17'-8"
h4(E)	7'-7"	14'-6"
h5(E)	7'-7"	11'-4"
h6(E)	7'-7"	8'-2"
h7(E)	7'-1 1/2"	22'-1"
h8(E)	7'-1 1/2"	19'-7"
h9(E)	7'-1 1/2"	16'-7"
h10(E)	7'-1 1/2"	13'-7"
h11(E)	7'-1 1/2"	10'-8"
h12(E)	7'-1 1/2"	7'-8"
w1(E)	7'-7"	24'-4"
w2(E)	6'-8"	21'-7"
w3(E)	5'-10"	18'-10"
w4(E)	4'-9"	15'-5"
w5(E)	3'-6"	11'-6"

Note: "R" and "S" measured along bar  $\bar{c}$

**BARS w1(E) thru w5(E) & h1(E) thru h12(E)**

**BILL OF MATERIAL**  
Light Tower Service Pad, Special with 5'-0" Wall (Note 4)


Bar	No.	Size	Length	Shape
h1(E)	1	#5	23'-6"	Curve
h2(E)	1	#5	20'-10"	Curve
h3(E)	1	#5	17'-8"	Curve
h4(E)	1	#5	14'-6"	Curve
h5(E)	1	#5	11'-4"	Curve
h6(E)	1	#5	8'-2"	Curve
h7(E)	1	#4	22'-1"	Curve
h8(E)	1	#4	19'-7"	Curve
h9(E)	1	#4	16'-7"	Curve
h10(E)	1	#4	13'-7"	Curve
h11(E)	1	#4	10'-8"	Curve
h12(E)	1	#4	7'-8"	Curve
n1(E)	25	#6	7'-4"	Rect
t1(E)	25	#6	5'-1"	Rect
v1(E)	7	#4	5'-0"	Rect
v2(E)	8	#4	4'-8"	Rect
w1(E)	1	#5	24'-4"	Curve
w2(E)	1	#5	21'-7"	Curve
w3(E)	1	#5	18'-10"	Curve
w4(E)	1	#5	15'-5"	Curve
w5(E)	1	#5	11'-6"	Curve

**NOTES**

1. F.F. and B.F. denote Front Face and Back Face, respectively.
2. HMLT denotes High Mast Light Tower.
3. See IDOT Standard Drawing BE501 for additional High Mast Light Tower foundation and ground well details.
4. Reinforcement Bars designated (E) shall be epoxy coated.
5. Refer to High Mast Light Tower Service Pad, Special & Retaining Wall Details 1 for location and orientation of conduit sleeves and grounding wells.
6. Contractor shall maintain integrity of Frontage Roads as may be required in excavating for HMLT service pad walls.
7. Provide Protective Coat to top, front face, exposed portion of back face, and ends of walls, and top and edges of pad.


**TOTAL BILL OF MATERIAL**

Item	Unit	Total
Light Tower, Service Pad, Special	Each	2

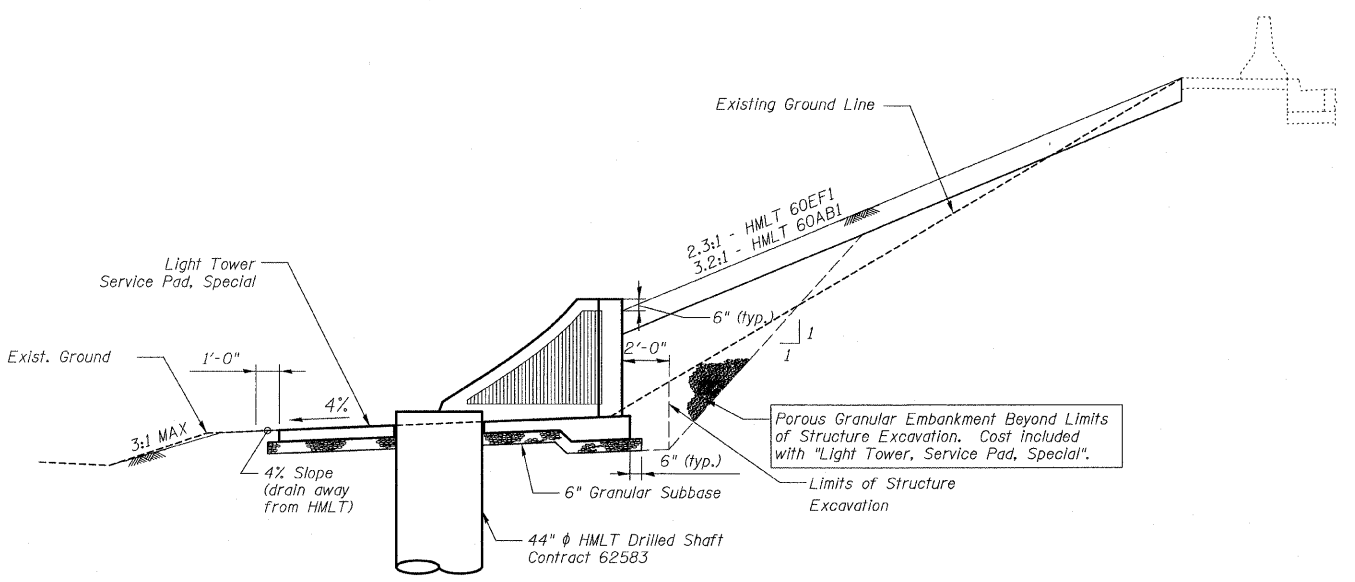


**SECTION THRU EMBANKMENT**


(At Typ. Tower Location)  
HMLT not shown for clarity

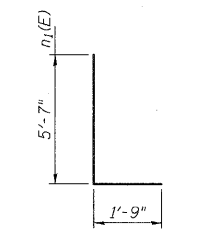

**BAR n1(E)**

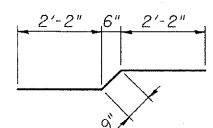

**BAR t1(E)**

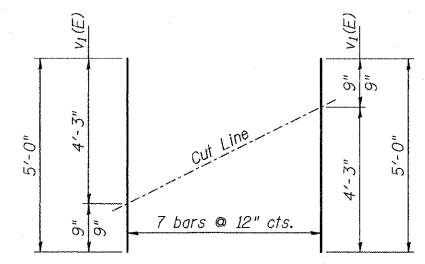


**\* CUTTING DIAGRAM**

Bars v1(E)

**BILL OF MATERIAL**  
(Per HMLT)

Item	Unit	Total
Welded Wire Fabric	Sq. Yd.	18
Structure Excavation	Cu. Yd.	11
Concrete Structures	Cu. Yd.	7.2
Reinforcement Bars, Epoxy Coated	Pound	775
Rustication Finish	Sq. Ft.	55
Protective Coat	Sq. Yd.	29
Sub-Base Granular Material, Type B 6"	Sq. Yd.	22
Porous Granular Embankment	Cu. Yd.	48

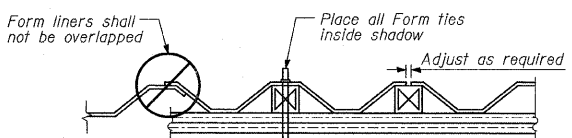

**SUGGESTED FORMWORK DETAIL**


REVISIONS	
NAME	DATE

ILLINOIS DEPARTMENT OF TRANSPORTATION  
F.A.I. 94 (DAN RYAN EXPRESSWAY)  
HIGH MAST LIGHT TOWER SERVICE PAD,  
SPECIAL & RETAINING WALL DETAILS  
SHEET 2 OF 2

SCALE: N.T.S.  
DATE: JUNE 20, 2008  
DESIGNED BY: MAF  
DRAWN BY: MAF, TB  
CHECKED BY: PF



PROFILE SURVEYED BY DATE  
 POINTS CHECKED  
 NOTE BOOK NO. NOTED  
 NO. STRUCTURE INDICATING CHRD

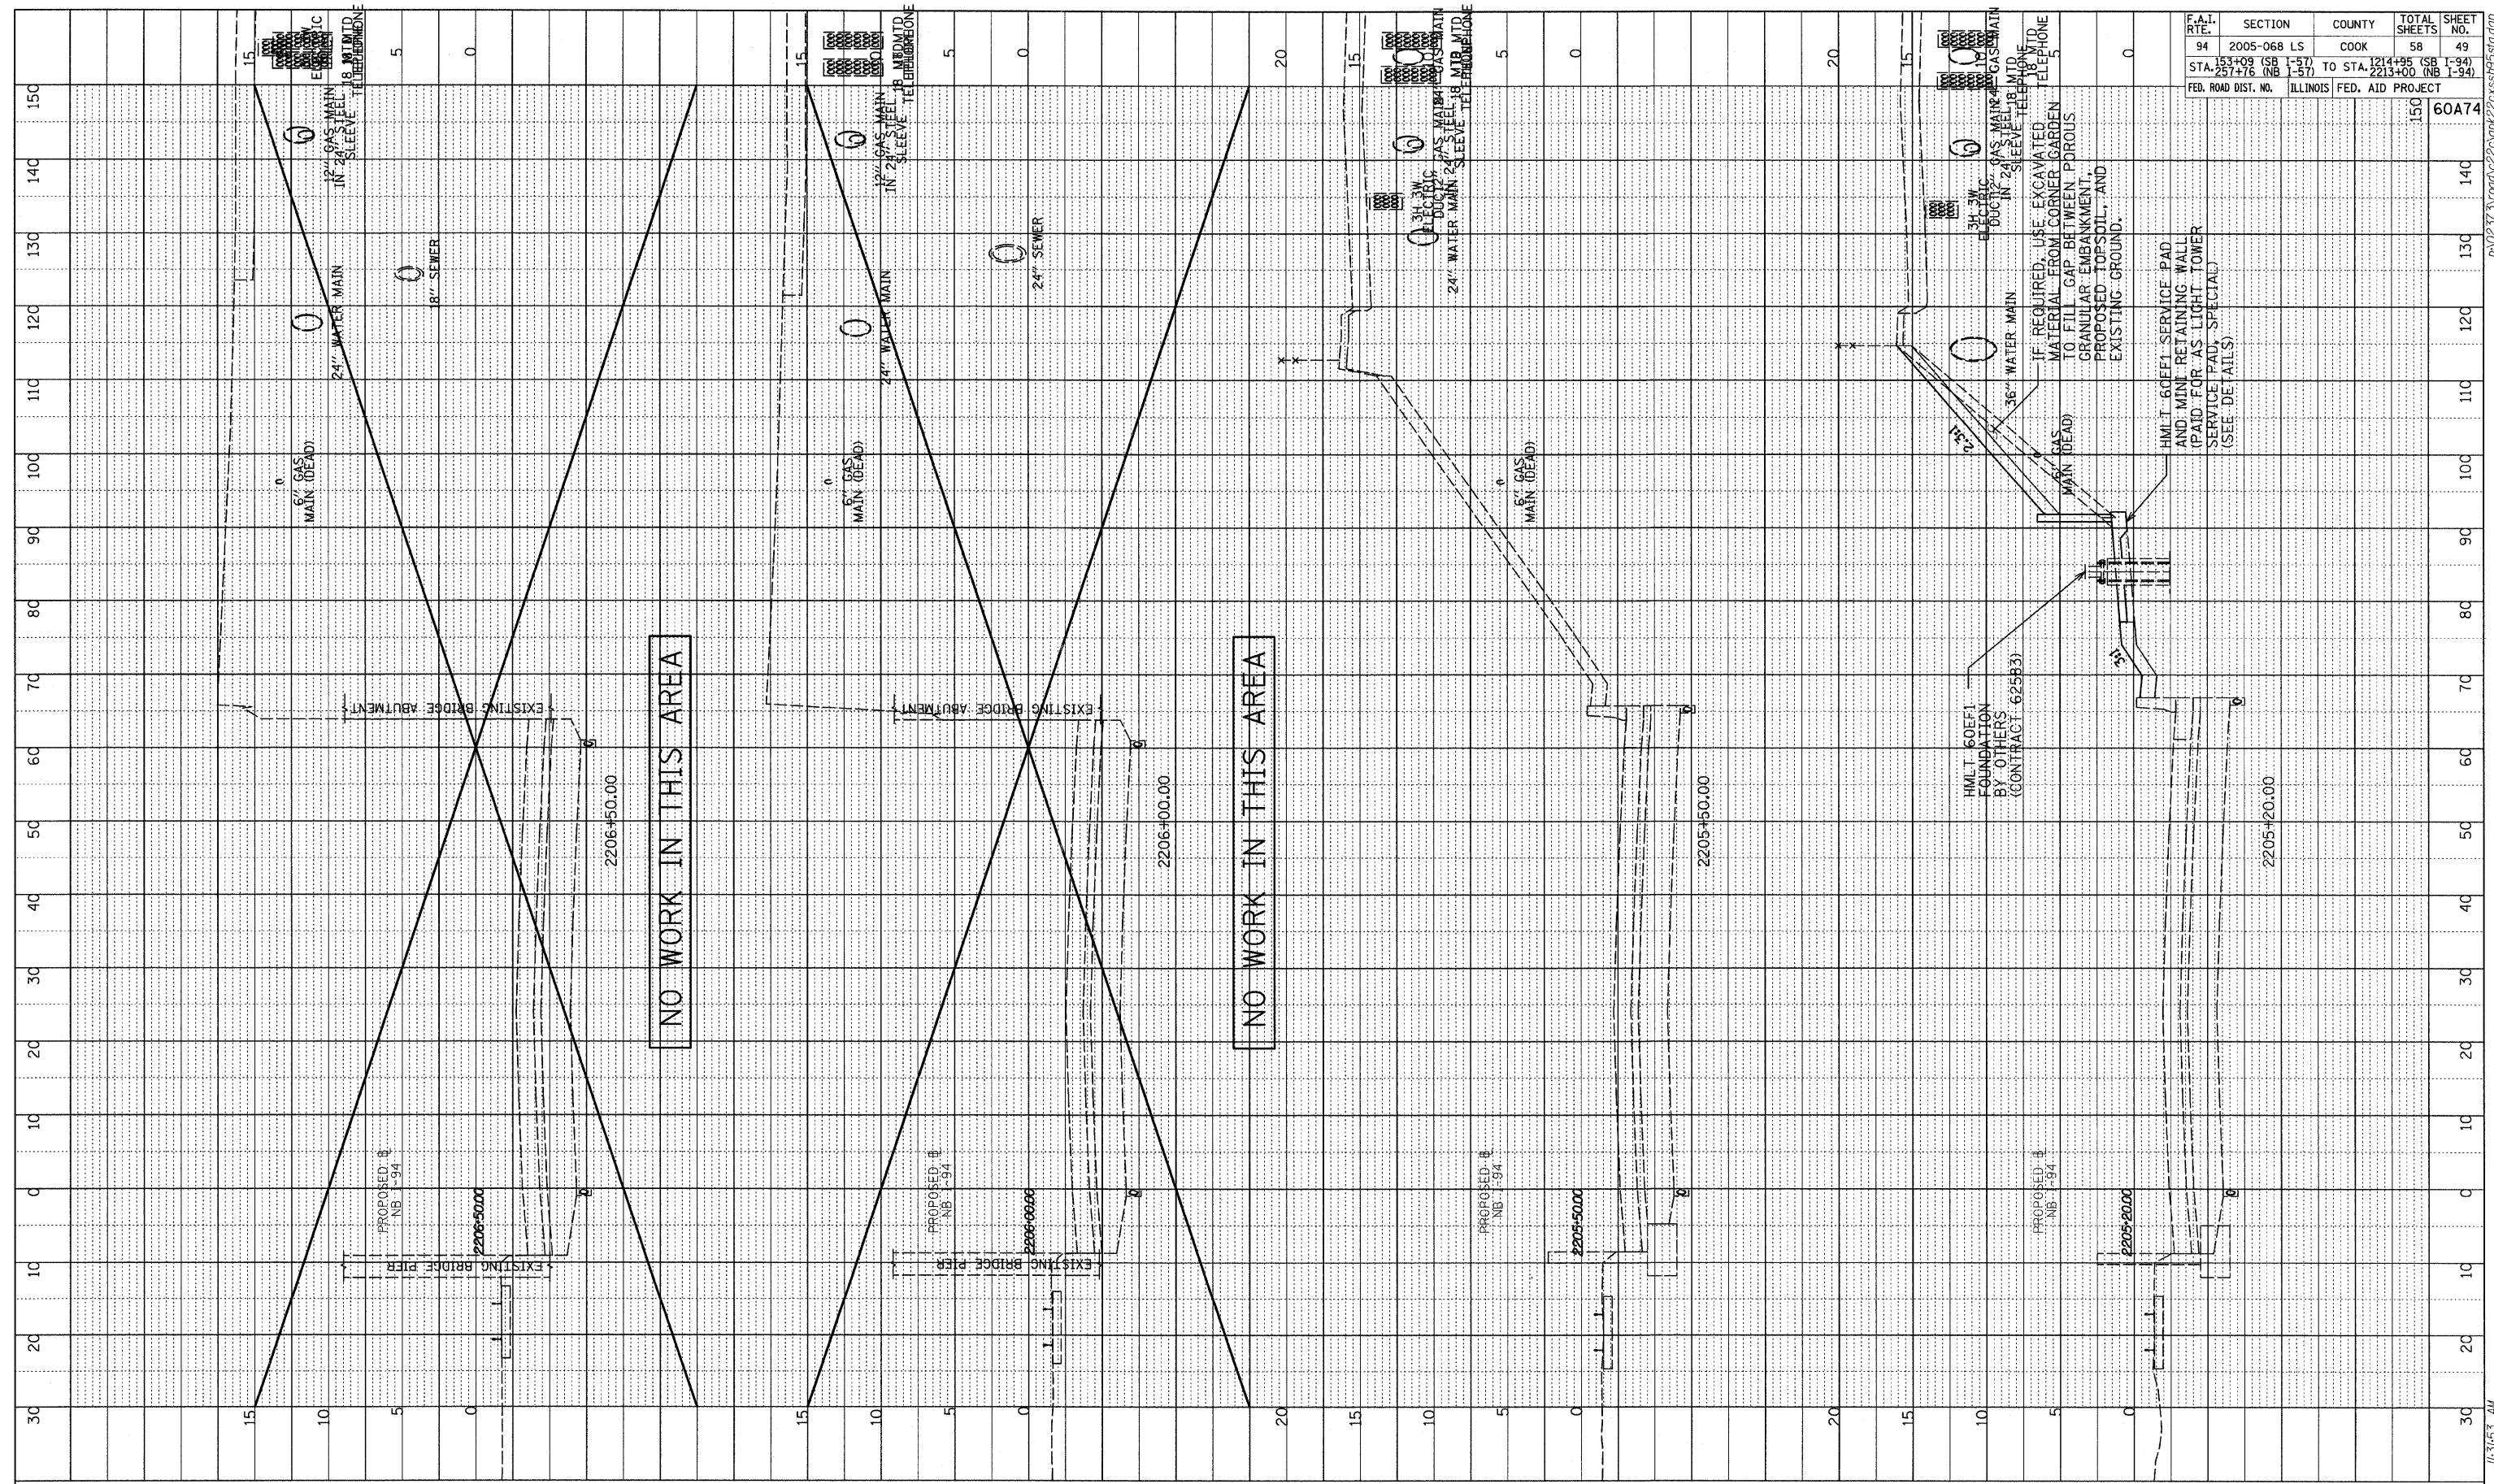

F.A.I. RTE.	SECTION	COUNTY	TOTAL SHEETS	SHEET NO.
94	2005-068 LS	COOK	58	49
STA. 153+09 (SB I-57) TO STA. 1214+95 (SB I-94)				
STA. 257+76 (NB I-57) TO STA. 2213+00 (NB I-94)				
FED. ROAD DIST. NO. ILLINOIS FED. AID PROJECT				
				150
				60A74

TYLIN INTERNATIONAL




NB I-94 (DAN RYAN EXPRESSWAY)  
 STA. 2205+20 TO STA. 2206+50

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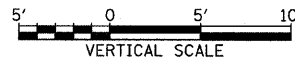
PROFILE	SURVEYED	BY	DATE
NOTE BOOK	PLANS CHECKED		
NO.	BLANK NOTED		
	STRUCTURE NOTATIONS CHRD		

F.A.I. RTE.	SECTION	COUNTY	TOTAL SHEETS	SHEET NO.
94	2005-068 LS	COOK	58	50
STA. 153+09 (SB I-57)	TO STA. 1214+95 (SB I-94)			
257+76 (NB I-57)				
FED. ROAD DIST. NO.	ILLINOIS FED. AID PROJECT			

60A74

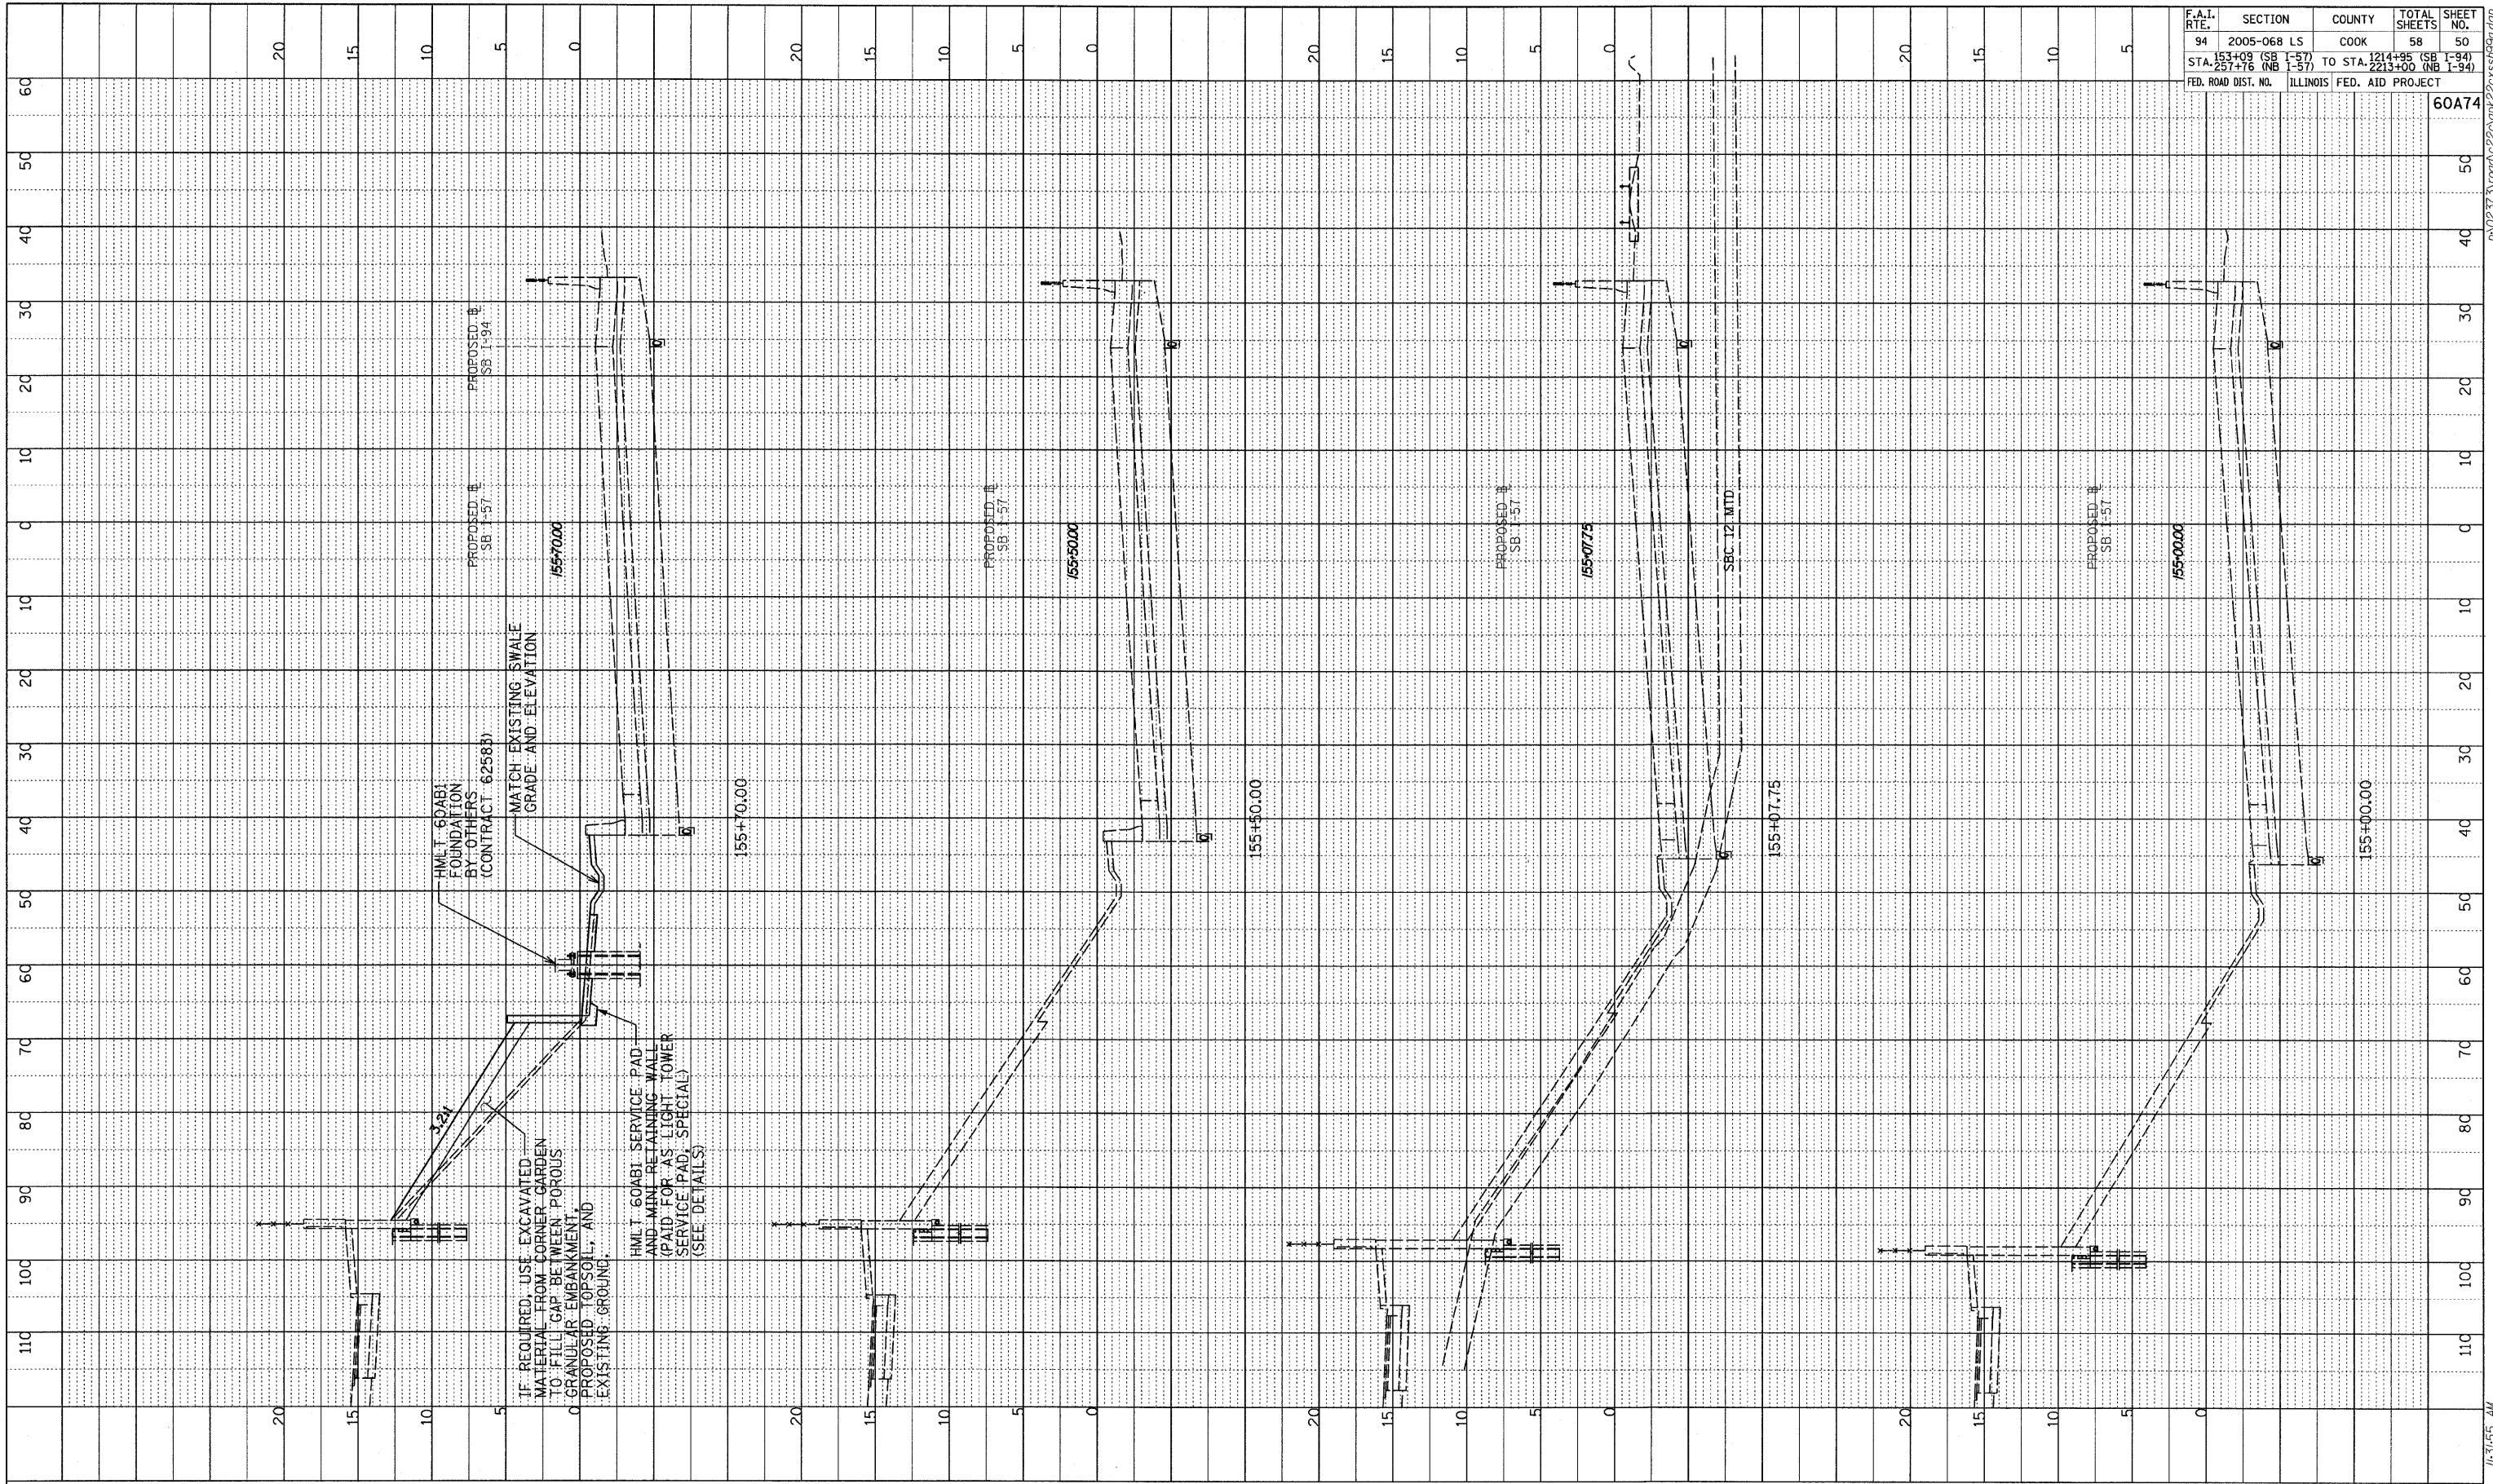

TYLIN INTERNATIONAL




I-57 SOUTHBOUND  
STA. 155+00 TO STA. 155+70


6/20/2008 10:51:55 AM

**LIGHT TOWER FOUNDATION DEPTH "D"**


MOUNTING HEIGHT	SOIL CONDITIONS					
	SOFT CLAY Qu = 0.375 TON/SQ. FT	MEDIUM CLAY Qu = 0.75 TON/SQ. FT	STIFF CLAY Qu = 1.50 TON/SQ. FT	LOOSE SAND φ = 34°	MEDIUM SAND φ = 37.5°	DENSE SAND φ = 40°
90 FT (27 m)	29 FT (8.779 m)	20 FT (6.035 m)	15 FT (4.389 m)	15 FT (4.389 m)	13 FT (3.840 m)	12 FT (3.429 m)
100 FT (30 m)	32 FT (9.754 m)	22 FT (6.706 m)	16 FT (4.877 m)	16 FT (4.877 m)	14 FT (4.267 m)	13 FT (3.81 m)
110 FT (33 m)	35 FT (10.719 m)	24 FT (7.377 m)	18 FT (5.365 m)	18 FT (5.365 m)	15 FT (4.694 m)	14 FT (4.191 m)
120 FT (36 m)	38 FT (11.705 m)	26 FT (8.046 m)	19 FT (5.652 m)	19 FT (5.652 m)	17 FT (5.120 m)	16 FT (4.572 m)

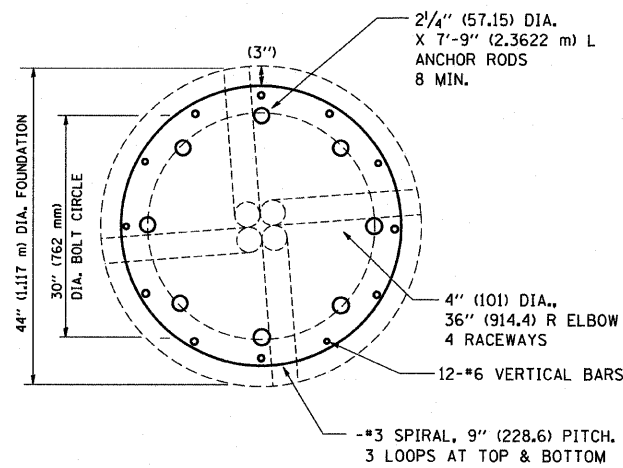


**SECTION-B-B**

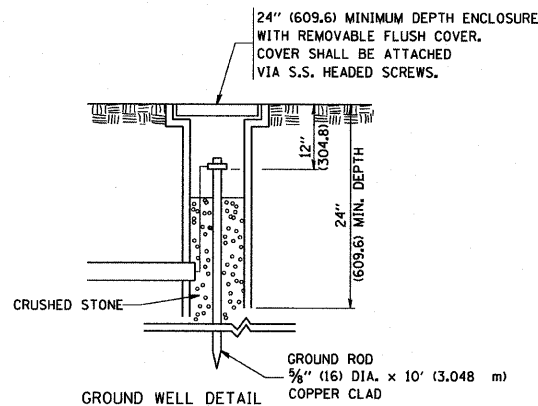

**GROUND WELL DETAIL**

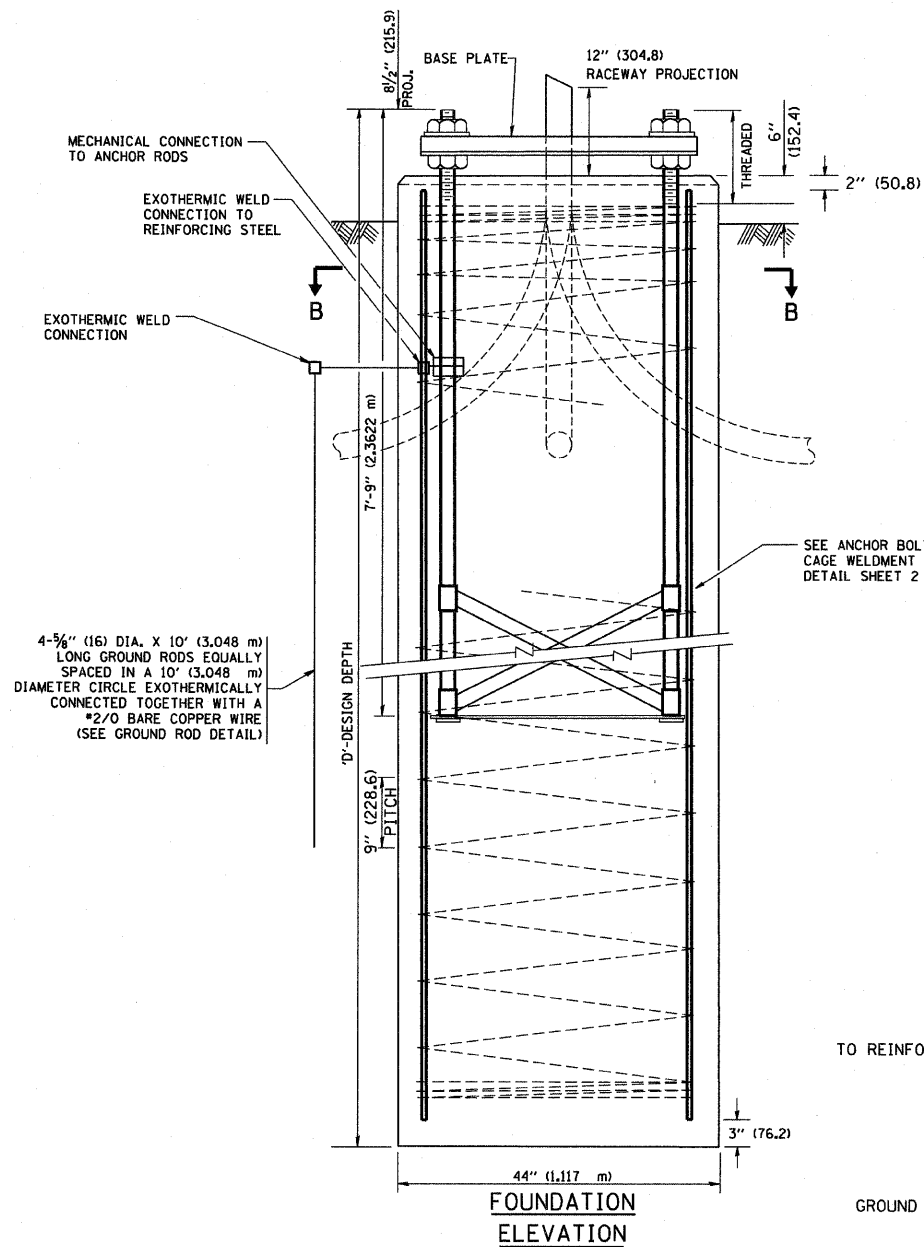

4-5/8" (16) DIA. X 10' (3.048 m) LONG GROUND RODS EQUALLY SPACED IN A 10' (3.048 m) DIAMETER CIRCLE EXOTHERMICALLY CONNECTED TOGETHER WITH A #2/O BARE COPPER WIRE (SEE GROUND ROD DETAIL)

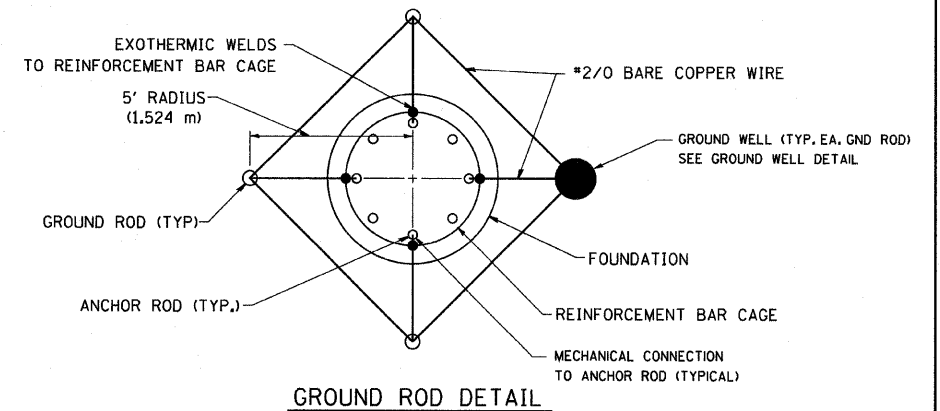


**GROUND ROD DETAIL**

**DESIGN NOTES**


- ALL DIMENSIONS IN INCHES (MILLIMETERS) UNLESS OTHERWISE SHOWN
- THE ANCHOR RODS SHALL BE VERTICAL NO ADJUSTMENT SHALL BE ALLOWED AFTER THE FOUNDATION IS PLACED.
- THE GAP BETWEEN THE FOUNDATION AND THE BASE PLATE SHALL BE ENCLOSED WITH A STAINLESS STEEL SCREEN FASTENED WITH A STAINLESS STEEL BAND.
- THE TOP OF THE FOUNDATION TO 18" (450) BELOW GRADE SHALL BE FORMED.
- SURFACE WATER WILL NOT BE PERMITTED TO ENTER THE HOLE AND ALL WATER WHICH MAY HAVE INFILTRATED INTO THE HOLE SHALL BE REMOVED BEFORE PLACING CONCRETE.
- THE LIGHT TOWER SHALL NOT BE ERECTED UNTIL AFTER THE CONCRETE HAS BEEN CURED ACCORDING TO ARTICLE 1020.13.
- ANCHOR RODS SHALL BE STRAIGHT AND SHALL BE ACCORDING TO AASHTO M 314 OR ASTM F1554, GRADE 725(GRADE 105) AND GALVANIZED ACCORDING TO ARTICLE 1006.9.
- ANCHOR ROD INFORMATION SHALL BE SUBMITTED FOR APPROVAL AND SHALL BE FULLY COORDINATED FOR APPROVAL WITH TOWER MANUFACTURER REQUIREMENTS.
- REINFORCEMENT BARS SHALL BE ACCORDING TO ARTICLE 1006.10
- TWO ANCHOR RODS OPPOSITE EACH OTHER SHALL HAVE THE ANCHOR ROD THREADS PEENED AFTER NUTS ARE INSTALLED.

**FOR INFORMATION ONLY**


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PLOT SCALE = 50.000' / IN.		CHECKED -	DATE -	SCALE: NONE		SHEET NO. 1 OF 2 SHEETS		STA. TO STA.		CONTRACT NO. 60A74		FED. ROAD DIST. NO. 1 ILLINOIS FED. AID PROJECT				

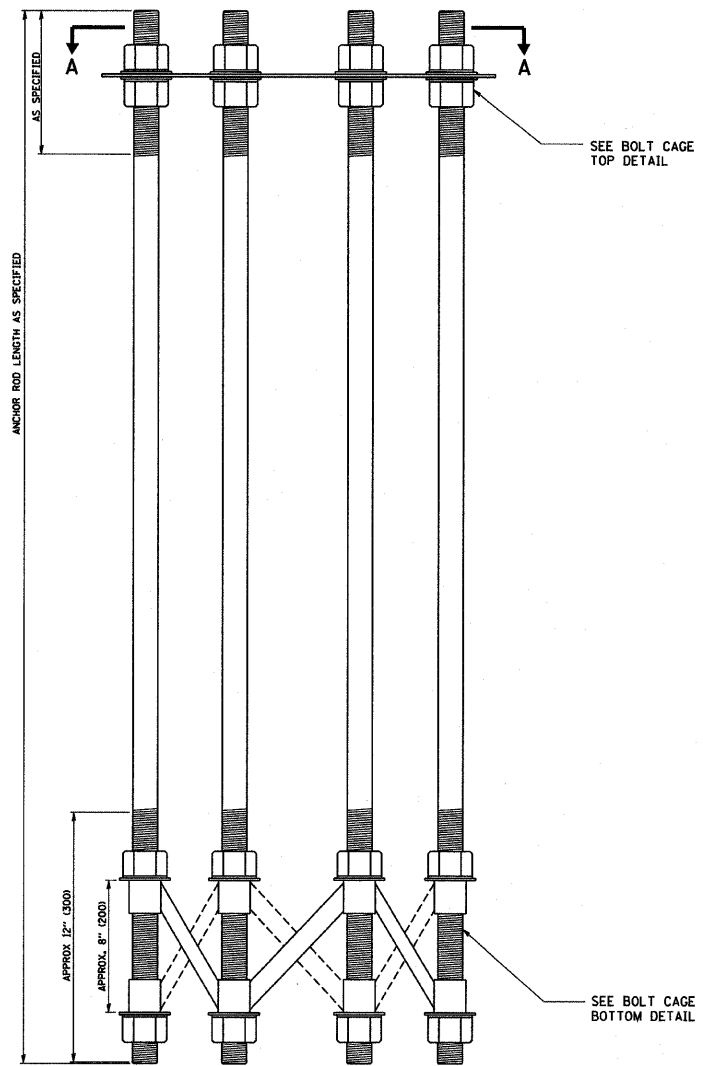


ANCHOR BOLT CAGE

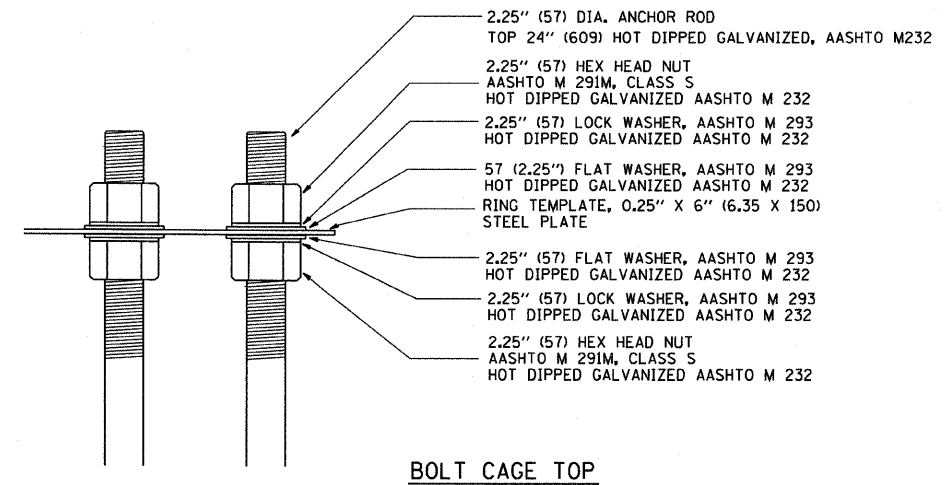

BOLT CAGE TOP

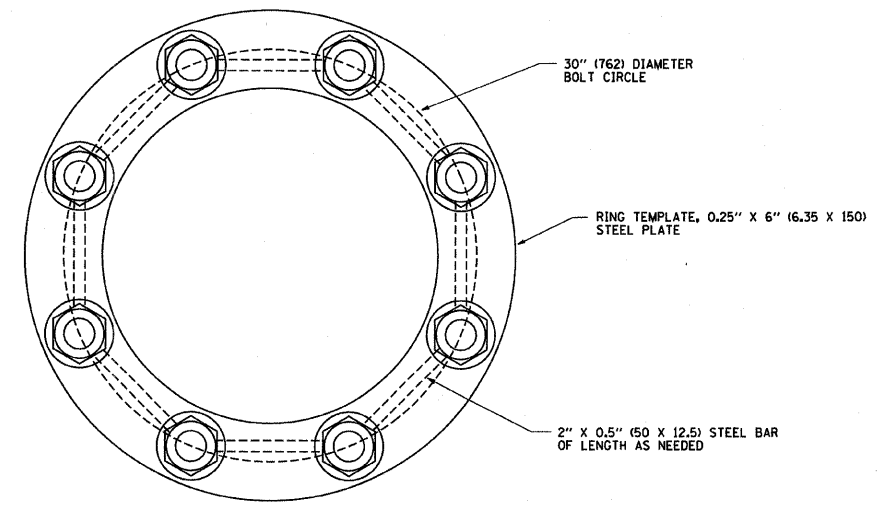

SECTION A-A

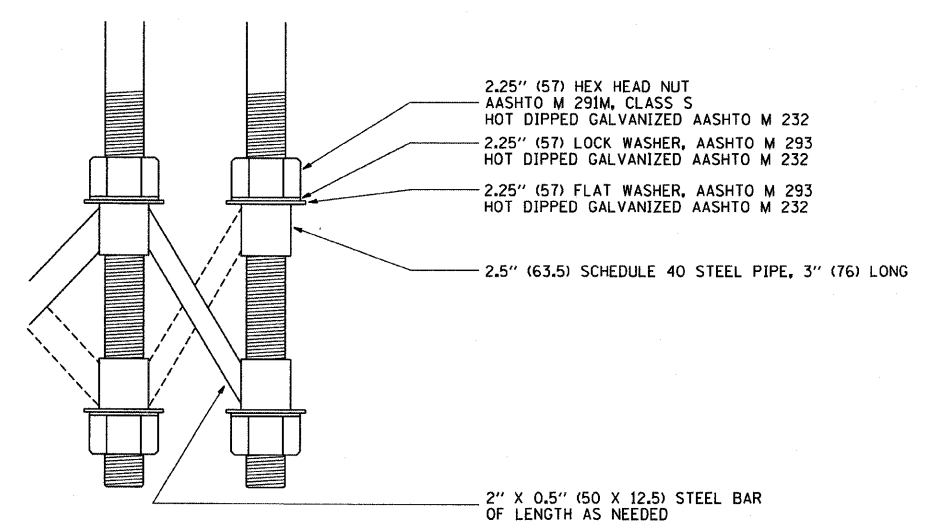


BOLT CAGE BOTTOM

**NOTES**

1. ALL DIMENSIONS IN INCHES (MILLIMETERS) UNLESS OTHERWISE SHOWN
2. ANCHOR RODS SHALL BE STRAIGHT AND SHALL BE ACCORDING TO AASHTO M 314 OR ASTM F1554, GRADE 725 (GRADE 105) AND GALVANIZED ACCORDING TO ARTICLE 1006.09.
3. ANCHOR ROD INFORMATION SHALL BE SUBMITTED FOR APPROVAL AND SHALL BE FULLY COORDINATED WITH TOWER MANUFACTURERS REQUIREMENTS.

**FOR INFORMATION ONLY**

FILE NAME = W:\distsd\22x34\be581.dgn	USER NAME = geglenobt	DESIGNED - DRAWN -	REVISED - REVISED -	R. TOMSONS 04-22-02	<b>STATE OF ILLINOIS DEPARTMENT OF TRANSPORTATION</b>	<b>HIGH MAST LIGHT TOWER</b>		F.A. RTE.	SECTION	COUNTY	TOTAL SHEETS	SHEET NO.		
	PLOT SCALE = 50.000' / IN.	CHECKED -	REVISED -			94	2005-DWGLS	COOK	58	52				
	PLOT DATE = 1/4/2008	DATE -	REVISED -			SCALE: NONE		SHEET NO. 2 OF 2 SHEETS	STA.	TO STA.	CONTRACT NO. 60A74			
90 FT TO 120 FT (27 m TO 36 m) FOUNDATION DETAIL											BE-501		FED. ROAD DIST. NO. 1 ILLINOIS FED. AID PROJECT	

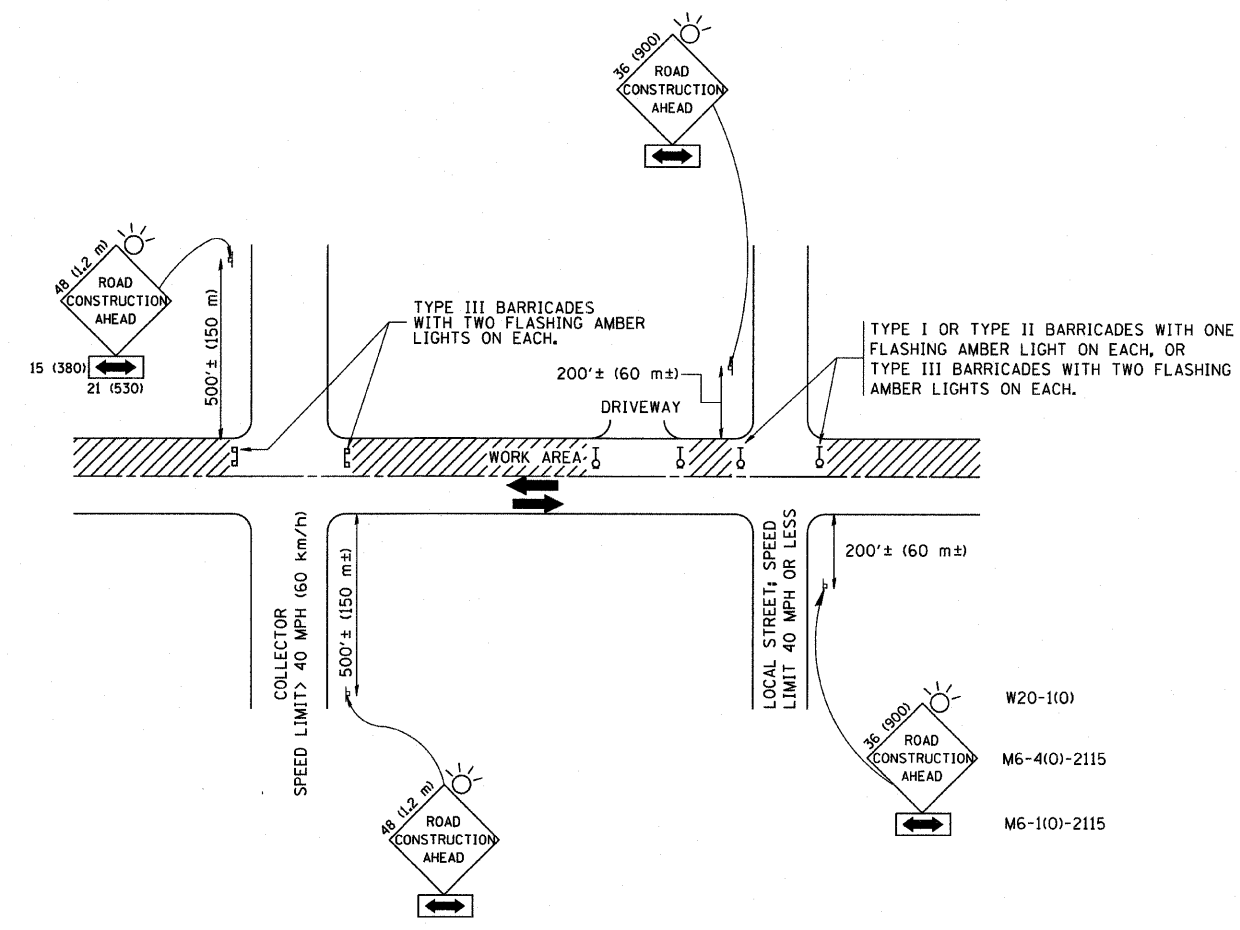

TRAFFIC CONTROL AND PROTECTION FOR SIDE ROADS, INTERSECTIONS, AND DRIVEWAYS

NOTES:

- A. FOR NO LANE RESTRICTION ON THE SIDE ROAD OR DRIVEWAYS
  1. SIDE ROAD WITH A SPEED LIMIT OF 40 MPH (60 km/h) OR LESS AS SHOWN ON THE DRAWING AND AS DIRECTED BY THE ENGINEER:
    - a) ONE ROAD CONSTRUCTION AHEAD SIGN 36 x 36 (900x900) WITH A FLASHER AND FLAG MOUNTED ON IT APPROXIMATELY 200' (60 m) IN ADVANCE OF THE MAIN ROUTE.
    - b) THE CLOSED PORTION OF THE MAIN ROUTE SHALL BE PROTECTED BY BLOCKING WITH TYPE I, TYPE II OR TYPE III BARRICADES, 1/3 OF THE CROSS SECTION OF THE CLOSED PORTION.
  2. SIDE ROAD WITH A SPEED LIMIT GREATER THAN 40 MPH (60 km/h) AS SHOWN ON THE DRAWING AND AS DIRECTED BY THE ENGINEER:
    - a) ONE ROAD CONSTRUCTION AHEAD SIGN 48 x 48 (1.2 m x 1.2 m) WITH A FLASHER MOUNTED ON IT APPROXIMATELY 500' (150 m) IN ADVANCE OF THE MAIN ROUTE.
    - b) THE CLOSED PORTION OF THE MAIN ROUTE SHALL BE PROTECTED BY BLOCKING WITH TYPE III BARRICADES, 1/2 OF THE CROSS SECTION OF THE CLOSED PORTION.
- B. FOR A LANE CLOSURE ON A SIDE ROAD OR DRIVEWAY:
 

USE APPLICABLE PORTIONS OF THE TYPICAL APPLICATION OF TRAFFIC CONTROL DEVICES (STD. 701501, STD. 701606 OR THE APPROPRIATE STANDARD). THE SPACING OF SIGNS AND BARRICADES SHALL BE ADJUSTED FOR FIELD CONDITIONS AS DIRECTED BY THE ENGINEER. THE DIRECTIONAL ARROW SHALL BE COVERED OR REMOVED WHEN NO LONGER CONSISTENT WITH THE SIDE ROAD LANE CLOSURE.
- C. ADVANCE WARNING SIGNS ARE TO BE OMITTED ON DRIVEWAY UNLESS OTHERWISE NOTED.
- D. THE TRAFFIC CONTROL AND PROTECTION FOR SIDE ROADS, INTERSECTIONS, AND DRIVEWAYS SHALL BE INCIDENTAL TO THE COST OF SPECIFIED TRAFFIC CONTROL STANDARDS OR ITEMS.

All dimensions are in millimeters (inches) unless otherwise shown.



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		DRAWN -	REVISED - A. HOUSEH 03-06-96
		CHECKED -	REVISED - A. HOUSEH 10-15-96
		DATE - 06-89	REVISED - T. RAMMACHER 01-06-00

STATE OF ILLINOIS  
DEPARTMENT OF TRANSPORTATION

TRAFFIC CONTROL AND PROTECTION FOR  
SIDE ROADS, INTERSECTIONS, AND DRIVEWAYS

SCALE: NONE SHEET NO. 1 OF 1 SHEETS STA. TO STA.

F.A. RTE.	SECTION	COUNTY	TOTAL SHEETS	SHEET NO.
94	2005-DWLS	COOK	58	53
TC-10			CONTRACT NO. 60A74	
FED. ROAD DIST. NO. 1   ILLINOIS FED. AID PROJECT				

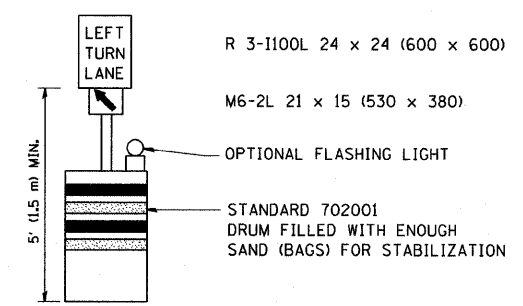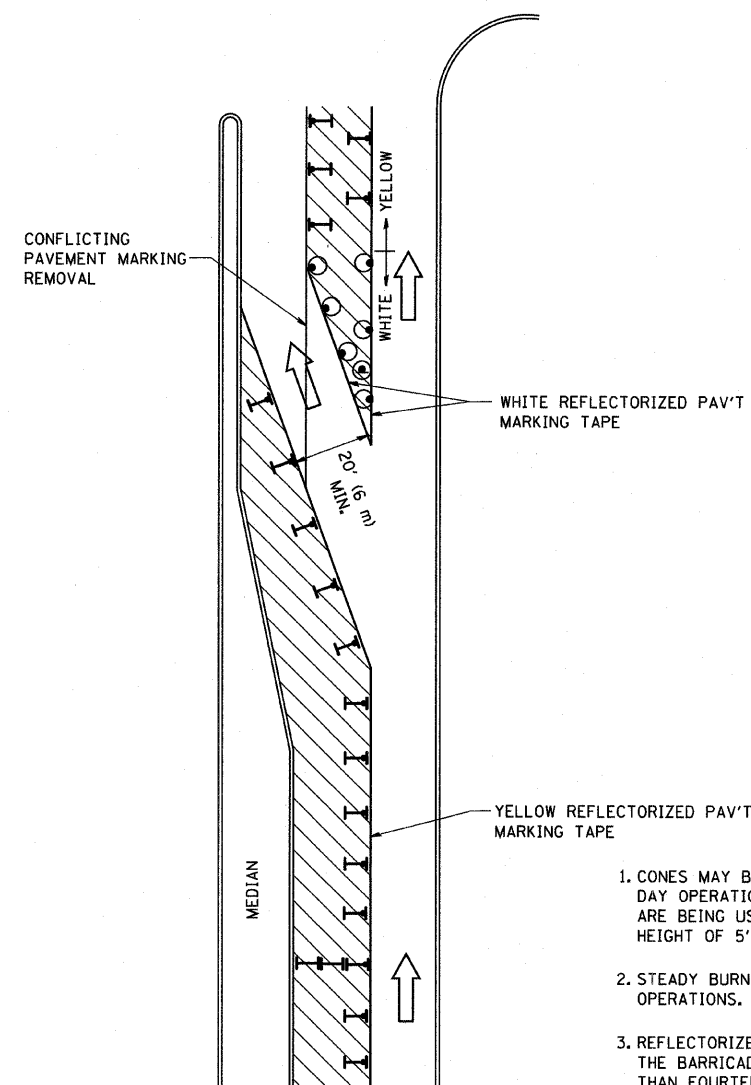

**GENERAL NOTES**

1. CONES MAY BE SUBSTITUTED FOR BARRICADES OR DRUMS AT HALF THE SPACING DURING DAY OPERATIONS. CONES SHALL BE A MINIMUM OF 28 (710) IN HEIGHT. WHEN CONES ARE BEING USED, THE "LEFT TURN LANE" SIGN MAY BE SKID MOUNTED AT A MINIMUM HEIGHT OF 5' (1.5 m).
2. STEADY BURNING LIGHTS WILL NOT BE REQUIRED ON BARRICADES OR DRUMS FOR DAY OPERATIONS. ALL LIGHTS SHALL BE MONODIRECTIONAL.
3. REFLECTORIZED TEMPORARY PAVEMENT MARKING TAPE SHALL BE PLACED THROUGHOUT THE BARRICADED AREA OF EACH TURN BAY WHERE THE CLOSURE TIME IS GREATER THAN FOURTEEN DAYS.
4. THIS APPLICATION ALSO APPLIES WHEN WORK IS BEING PERFORMED IN THE RIGHT LANE(S) AND THE RIGHT TURN BAY IS TO REMAIN OPEN. UNDER THIS CONDITION, "RIGHT TURN LANE" R3-100 24 x 24 (600 x 600) AND M6-2R 21 x 15 (530 x 380) SHALL BE USED.
5. THESE CONTROLS SHALL SUPPLEMENT MAINLINE TRAFFIC CONTROL FOR LANE CLOSURES.
6. LONGITUDINAL DIMENSIONS MAY BE ADJUSTED TO FIT FIELD CONDITIONS.
7. FORM BT 725 IS REQUIRED.
8. TRAFFIC CONTROL AND PROTECTION AT TURN BAYS (TO REMAIN OPEN TO TRAFFIC) SHALL BE INCLUDED IN THE COST SPECIFIED TRAFFIC CONTROL STANDARDS OR ITEMS.

**LEGEND**

- WORK AREA
- LANE OPEN TO TRAFFIC
- TYPE I OR II BARRICADE WITH STEADY BURN LIGHT
- DRUM WITH STEADY BURN LIGHT
- DRUM WITH SIGN (WITH OPTIONAL FLASHING LIGHT) SEE DETAIL
- TYPE I OR II CHECK BARRICADE WITH FLASHING LIGHT

All dimensions are in Inches (millimeters) unless otherwise shown.

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		DATE -	REVISED -T. RAMMACHER 01-06-00


**STATE OF ILLINOIS  
DEPARTMENT OF TRANSPORTATION**

**TRAFFIC CONTROL AND PROTECTION AT TURN BAYS  
(TO REMAIN OPEN TO TRAFFIC)**


SCALE: NONE SHEET NO. 1 OF 1 SHEETS STA. TO STA.

F.A. RTE. 94	SECTION 2005-DW&LS	COUNTY Cook	TOTAL SHEETS 58	SHEET NO. 54
TC-14		CONTRACT NO. 60A74		
FED. ROAD DIST. NO. 1 ILLINOIS FED. AID PROJECT				


PARTIAL RAMP CLOSURE DETAILS

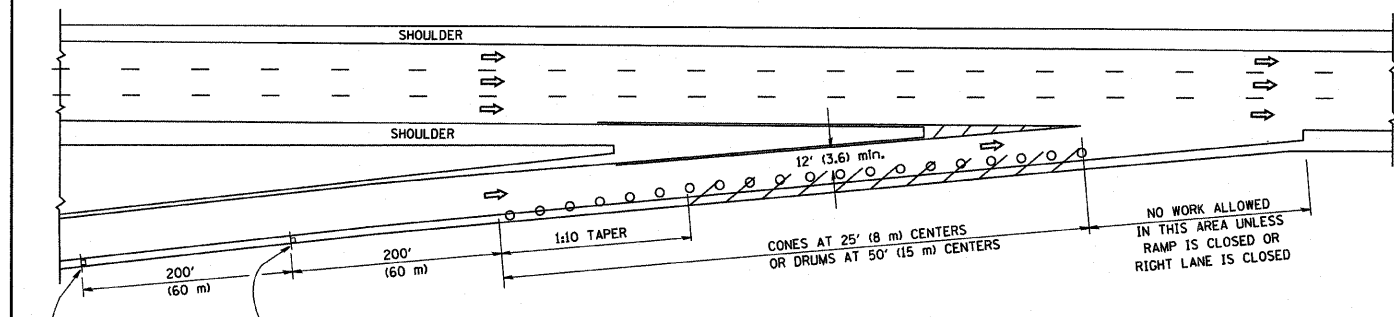

TYPICAL ENTRANCE RAMP

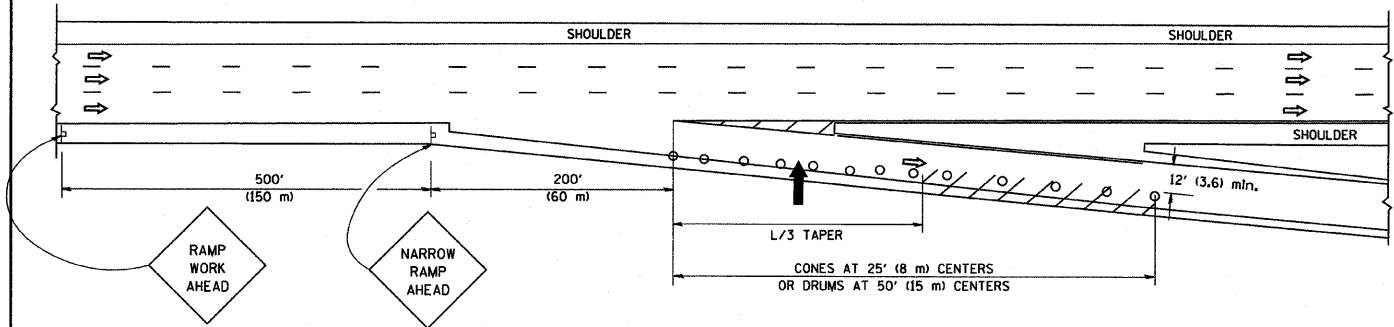

TYPICAL EXIT RAMP

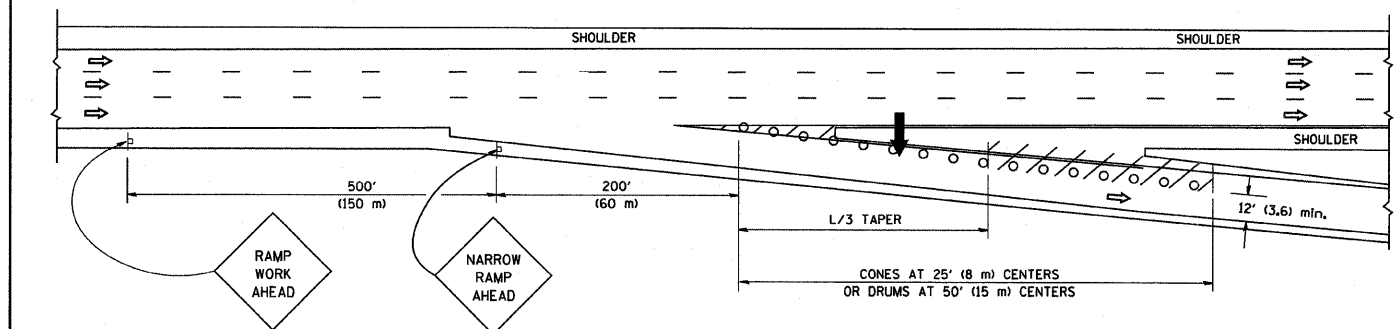

TYPICAL EXIT RAMP

SYMBOLS


- ARROWBOARD
- WORK AREA
- SIGN ON PORTABLE OR PERMANENT SUPPORT
- FLAGGER WITH CONTROL SIGN
- TYPE II BARRICADE, DRUM OR VERTICAL BARRICADE WITH STEADY BURN MONO-DIRECTIONAL LIGHT
- CONE, DRUM OR BARRICADE

GENERAL NOTES


1. THE "L" DISTANCE EQUALS:  

SPEED LIMIT	FORMULAS
45 mph (80 km/h) OR GREATER:	METRIC ENGLISH L=0.65(W)(S) L=(W)(S)
W = WIDTH OF OFFSET IN FEET (METERS)	S = NORMAL POSTED SPEED MPH (KM/H)
2. PLASTIC DRUMS WITH HIGH PERFORMANCE REFLECTIVE SHEETING AND STEADY BURNING LIGHTS ARE REQUIRED FOR ALL NIGHTTIME CLOSURES.
3. ALL SIGNS SHALL BE POST MOUNTED IF THE CLOSURE TIME EXCEEDS FOUR DAYS.
4. FLASHING LIGHTS SHALL BE USED DURING THE HOURS OF DARKNESS AND SHALL BE INSTALLED ABOVE THE FIRST TWO SETS OF SIGNS.

SHOULDER CLOSURE DETAILS

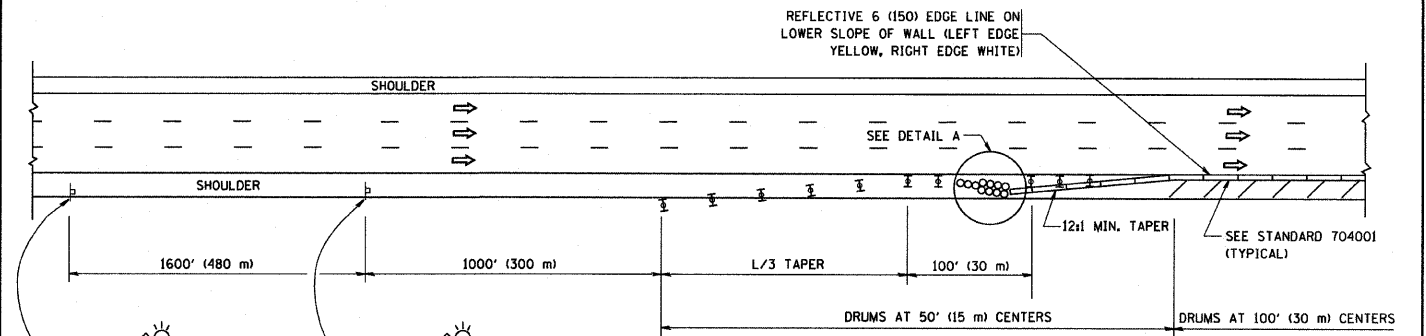

PERMANENT SHOULDER CLOSURE

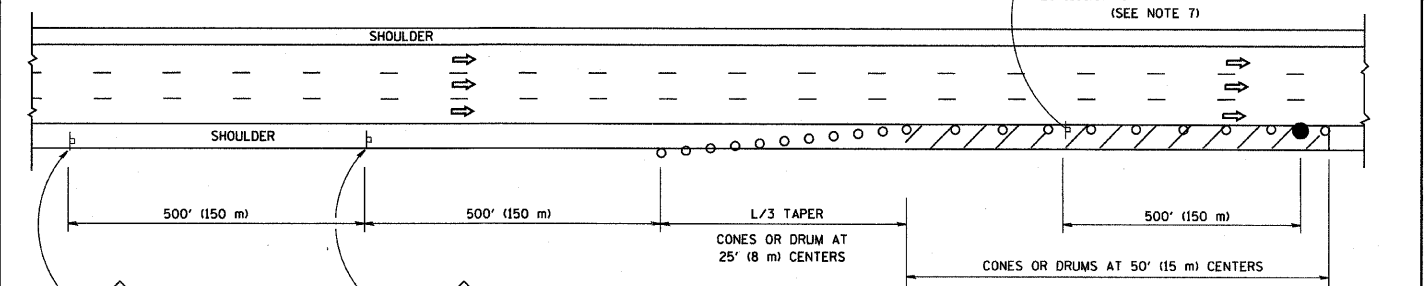

DAYTIME SHOULDER CLOSURE

OR WHEN SPECIFIED INSTALL TEMPORARY CONCRETE BARRIER WALL WITH BARRIER WALL REFLECTORS PER TRAFFIC CONTROL AND PROTECTION (EXPRESSWAYS)


THIS DETAIL IS USED WHERE:  
 1. VEHICLES, EQUIPMENT, WORKERS OR THEIR ACTIVITIES ENCRUCH IN AN AREA CLOSER THAN 15' (4.5 m) TO THE EDGE OF PAVEMENT FOR A PERIOD IN EXCESS OF 15 MINUTES.

ARRAY DESIGN PER MANUFACTURER TO BE NCHRP 350 COMPLIANT FOR POSTED SPEED.

DETAIL "A"  
 IMPACT ATTENUATOR, TEMPORARY  
 (SEE NOTE 5)

ALL DIMENSIONS ARE IN INCHES (MILLIMETERS) UNLESS OTHERWISE SHOWN.

FILE NAME = W:\diststd\22x34\td17.dgn	USER NAME = gaglianobt	DESIGNED - DRAWN - D.W.S.	REVISED - J.A.F. 12-02 REVISED - 04-03 REVISED - J.A.F. 12-06 REVISED - S.P.B. 01-07	<b>STATE OF ILLINOIS DEPARTMENT OF TRANSPORTATION</b>	<b>TRAFFIC CONTROL DETAILS FOR FREEWAY SHOULDER CLOSURES AND PARTIAL RAMP CLOSURES</b>			F.A. RTE. 94	SECTION 2005-068 LS	COUNTY Cook	TOTAL SHEETS 58	SHEET NO. 55
PLOT SCALE = 50.0000 "/ IN.	PLOT DATE = 1/4/2008	CHECKED - DATE - 11-96	SCALE: NONE		SHEET NO. 1 OF 1 SHEETS	STA.	TO STA.	FED. ROAD DIST. NO. 1 ILLINOIS FED. AID PROJECT				

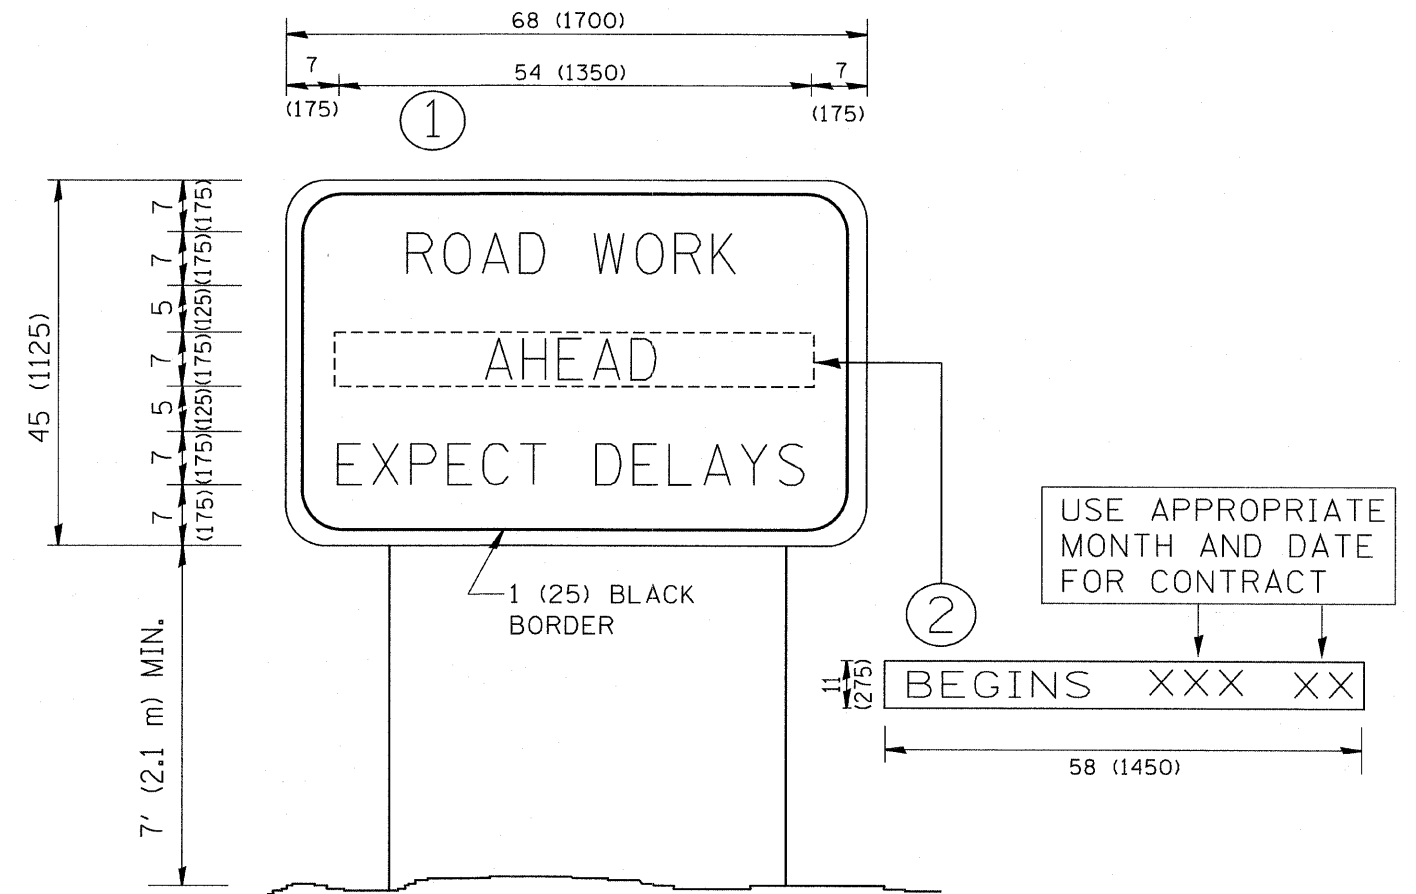

**NOTES:**

1. USE BLACK LETTERING ON ORANGE BACKGROUND.
2. ERECT SIGNS IN ADVANCE OF THE LOCATION FOR THE "ROAD CONSTRUCTION AHEAD" SIGN AT LOCATIONS AS DIRECTED BY THE ENGINEER.
3. ERECT SIGN ① WITH INSTALLED PANEL ② ONE WEEK PRIOR TO THE START OF CONSTRUCTION.
4. REMOVE PANEL ② SOON AFTER THE START OF CONSTRUCTION.
5. SEE SPECIAL PROVISION FOR "TEMPORARY INFORMATION SIGNING" FOR ADDITIONAL INFORMATION.
6. ONE SIGN ASSEMBLY EQUALS 25.70 SQ. FT. (2.3 SQ. M.)
7. SHALL BE PAID FOR AS TEMPORARY INFORMATION SIGNING.

ALL DIMENSIONS ARE IN INCHES (MILLIMETERS) UNLESS OTHERWISE SHOWN.



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	PLOT DATE = 1/4/2008	DATE -	REVISED - C. JUCIUS 01-31-07

**STATE OF ILLINOIS  
DEPARTMENT OF TRANSPORTATION**

<b>ARTERIAL ROAD INFORMATION SIGN</b>	
SCALE: NONE	SHEET NO. 1 OF 1 SHEETS
STA.	TO STA.


F.A. RTE.	SECTION	COUNTY	TOTAL SHEETS	SHEET NO.
94	2005-D68LS	Cook	58	56
TC-22			CONTRACT NO. 60A74	
FED. ROAD DIST. NO. 1 ILLINOIS FED. AID PROJECT				



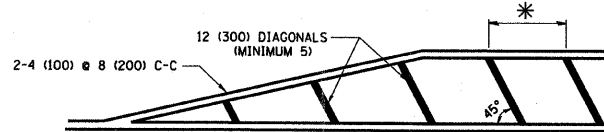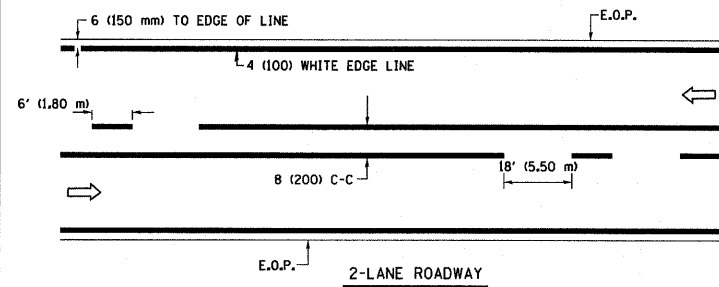


\* FOR MEDIAN LENGTHS WHERE DIAGONAL SPACING CANNOT BE ATTAINED, USE 5 (FIVE) EQUALLY SPACED DIAGONAL LINES.  
 \* DIAGONAL LINE SPACING: 20' (6.1 m) C-C

**PAINTED MEDIANS**


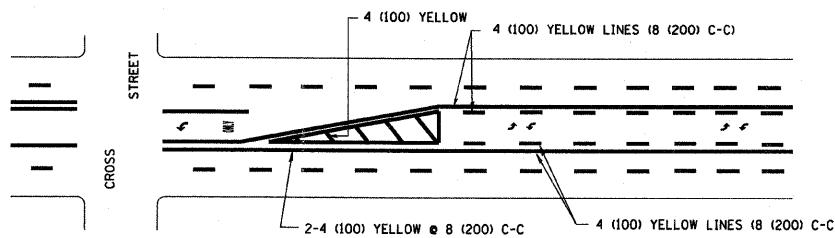


A MINIMUM OF TWO PAIRS OF TURN ARROWS SHALL BE USED, WHITE IN COLOR. ADDITIONAL PAIRS SHALL BE PLACED AT 200' (60 m) TO 300' (90 m) INTERVALS.

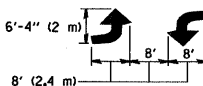

**MEDIAN WITH TWO-WAY LEFT TURN LANE**



**TYPICAL PAINTED MEDIAN MARKING**

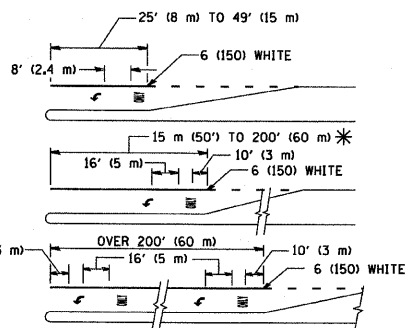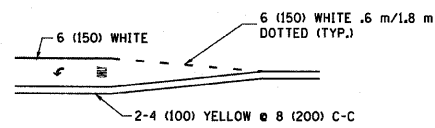


FULL SIZE LETTERS 8' (2.4 m) AND ARROWS SHALL BE USED.  
 AREA = 15.8 SQ. FT. (1.47 m<sup>2</sup>) ONLY AREA = 22.9 SQ. FT. (2.13 m<sup>2</sup>)  
 \* TURN LANES IN EXCESS OF 400' (120 m) IN LENGTH MAY HAVE AN ADDITIONAL SET OF ARROW - "ONLY" INSTALLED MIDWAY BETWEEN THE OTHER TWO SETS OF ARROW - "ONLY".

**TYPICAL LEFT (OR RIGHT) TURN LANE**


**TYPICAL TURN LANE MARKING**

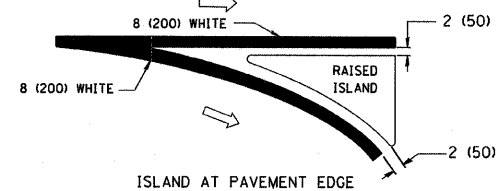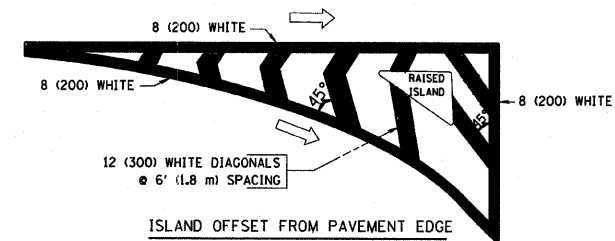

**TYPICAL ISLAND MARKING**

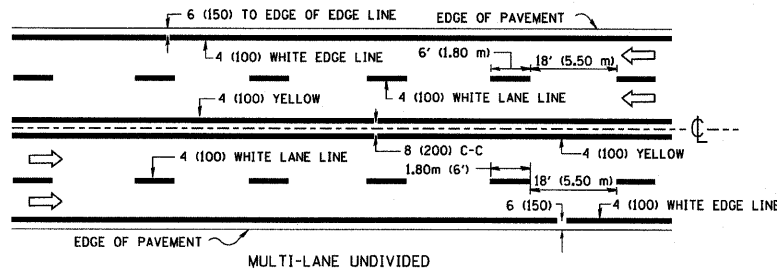


**MULTI-LANE UNDIVIDED**

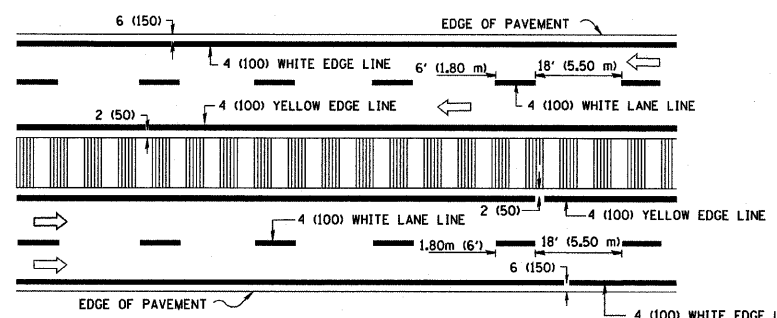

**MULTI-LANE DIVIDED WITH MOUNTABLE MEDIAN**

NOTE: MEDIANS WITH BARRIER CURB DO NOT REQUIRE AN EDGE LINE


**TYPICAL LANE AND EDGE LINE MARKING**

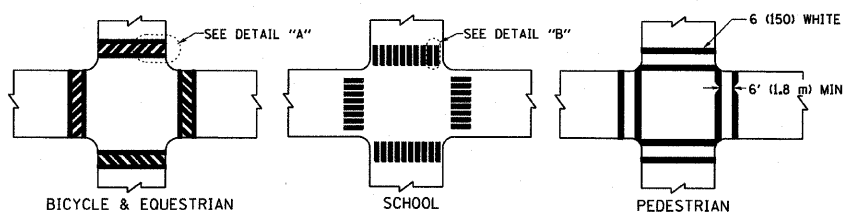


**BICYCLE & EQUESTRIAN**

**SCHOOL**

**PEDESTRIAN**

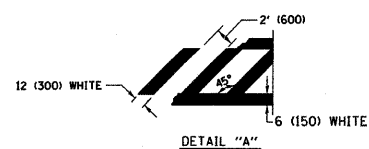

**DETAIL "A"**

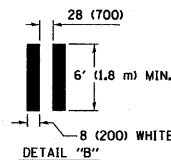

**DETAIL "B"**

**TYPICAL CROSSWALK MARKING**

TYPE OF MARKING	WIDTH OF LINE	PATTERN	COLOR	SPACING / REMARKS
CENTERLINE ON 2 LANE PAVEMENT	4 (100)	SKIP-DASH	YELLOW	6' (1.80 m) LINE WITH 18' (5.50 m) SPACE
CENTERLINE ON MULTI-LANE UNDIVIDED PAVEMENT	2 @ 4 (100)	SOLID	YELLOW	8 (200) C-C
NO PASSING ZONE LINES: FOR ONE DIRECTION FOR BOTH DIRECTIONS	4 (100) 2 @ 4 (100)	SOLID SOLID	YELLOW YELLOW	8 (200) C-C
LANE LINES	4 (100) 5 (125) ON FREEWAYS	SKIP-DASH SKIP-DASH	WHITE WHITE	6' (1.80 m) LINE WITH 18' (5.50 m) SPACE
DOTTED LINES (EXTENSIONS OF CENTER, LANE OR TURN LANE MARKINGS)	SAME AS LINE BEING EXTENDED	SKIP-DASH	SAME AS LINE BEING EXTENDED	2' (600) LINE WITH 6' (1.8) SPACE
EDGE LINES	4 (100)	SOLID	YELLOW-LEFT WHITE-RIGHT	OUTLINE MOUNTABLE MEDIANS IN YELLOW; EDGE LINES ARE NOT USED NEXT TO BARRIER CURB
TURN LANE MARKINGS	6 (150) LINE; FULL SIZE LETTERS & SYMBOLS (8' (2.4 m))	SOLID	WHITE	SEE TYPICAL TURN LANE MARKING DETAIL
TWO WAY LEFT TURN MARKING	2 @ 4 (100) EACH DIRECTION 8' (2.4 m) LEFT ARROW	SKIP-DASH AND SOLID IN PAIRS	YELLOW WHITE	6' (1.8 m) LINE WITH 18' (5.50 m) SPACE FOR SKIP-DASH; 8 (200) C-C BETWEEN SOLID LINE AND SKIP-DASH LINE SEE TYPICAL TWO-WAY LEFT TURN MARKING DETAIL
CROSSWALK LINES (PEDESTRIAN) A. DIAGONALS (BIKE & EQUESTRIAN) B. LONGITUDINAL BARS (SCHOOL)	2 @ 6 (150) 12 (300) @ 45° 8 (200) @ 90°	SOLID SOLID SOLID	WHITE WHITE WHITE	NOT LESS THAN 6' (1.8 m) APART 2' (600) APART 2'-4" (700) APART SEE TYPICAL CROSSWALK MARKING DETAILS.
STOP LINES	24 (600)	SOLID	WHITE	PLACE 4' (1.2 m) IN ADVANCE OF AND PARALLEL TO CROSSWALK, IF PRESENT. OTHERWISE, PLACE AT DESIRED STOPPING POINT, PARALLEL TO CROSSROAD CENTERLINE, WHERE POSSIBLE
PAINTED MEDIANS	2 @ 4 (100) WITH 12 (300) DIAGONALS @ 45°	SOLID	YELLOW; TWO WAY TRAFFIC WHITE; ONE WAY TRAFFIC	8 (200) C-C FOR THE DOUBLE LINE SEE TYPICAL PAINTED MEDIAN MARKING.
GORE MARKING AND CHANNELIZING LINES	8 (200) WITH 12 (300) DIAGONALS @ 45°	SOLID	WHITE	DIAGONALS; 20' (6.1 m) (LESS THAN 30 MPH (50 km/h))
RAILROAD CROSSING	24 (600) TRANSVERSE LINES; "RR" IS 6' (1.8 m) LETTERS; 16 (400) LINE FOR "X"	SOLID	WHITE	SEE STATE STANDARD 780001 AREA OF: "R"=3.6 SQ. FT. (0.33m <sup>2</sup> ) EACH "X"=54.0 SQ. FT. (5.0 m <sup>2</sup> )

FOR FURTHER DETAILS ON PAVEMENT MARKING REFER TO STREET MARKING STANDARDS, PRINTED BY CITY OF CHICAGO, DEPARTMENT OF TRANSPORTATION, BUREAU OF TRAFFIC.

ALL DIMENSIONS ARE IN INCHES (MILLIMETERS) UNLESS OTHERWISE SHOWN.



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	PLOT SCALE = 50,000' / IN.	CHECKED -	REVISED -
	PLOT DATE = 1/4/2008	DATE -	REVISED -

**STATE OF ILLINOIS  
DEPARTMENT OF TRANSPORTATION**

**CITY OF CHICAGO  
TYPICAL PAVEMENT MARKINGS**








SCALE: NONE SHEET NO. 1 OF 2 SHEETS STA. TO STA.

F.A. RTE. #	SECTION	COUNTY	TOTAL SHEETS	SHEET NO.
94	2005-068 LS	Cook	58	57
TC-24		CONTRACT NO. 60A74		
FED. ROAD DIST. NO. 1 [ILLINOIS] FED. AID PROJECT				

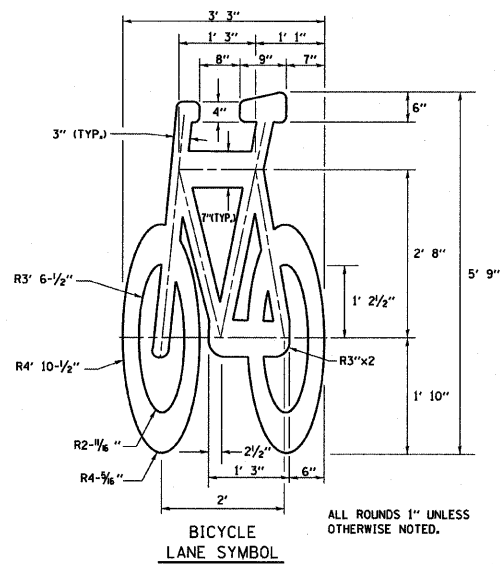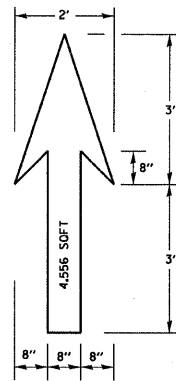

**NOTE:**  
 1.) FOR BIKE LANE SYMBOLS ONLY, USE PRE-FORMED THERMOPLASTIC WITH A MINIMUM THICKNESS OF 90 MILS, MINIMUM SKID RESISTANCE VALUE OF 60 BPN, & A MINIMUM INDEX OF REFRACTION OF 1.50.  
 2.) THE RESIDENT ENGINEER SHALL CONTACT MR. BEN COMBERG AT 312-744-8093 AT LEAST ONE CALENDAR WEEK PRIOR TO INSTALLING BIKE LANE SYMBOLS.

**TYPICAL BIKE LANE SYMBOLS**  
 DRAWING #28

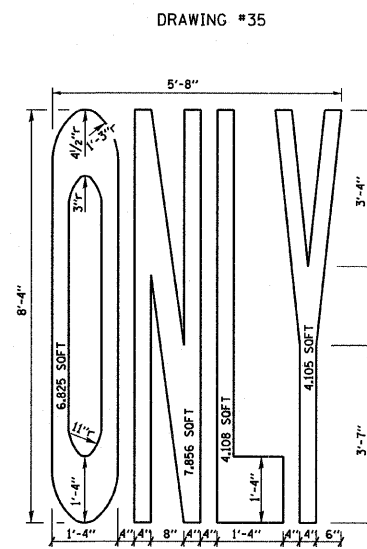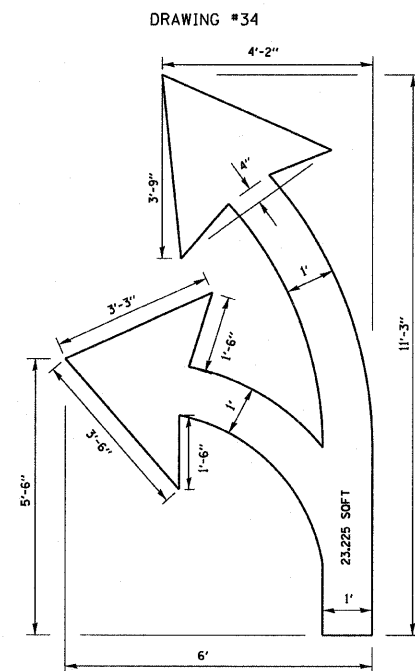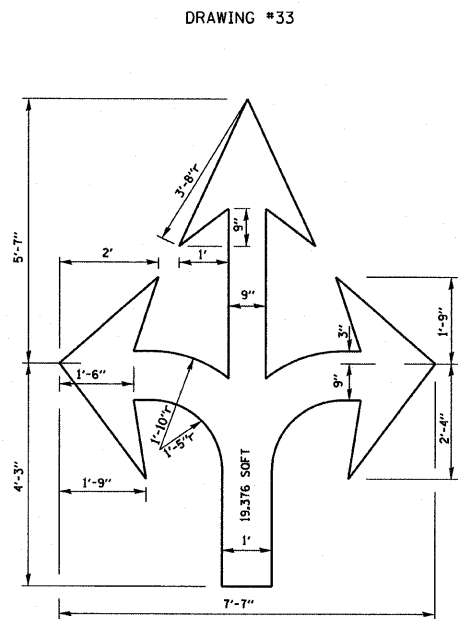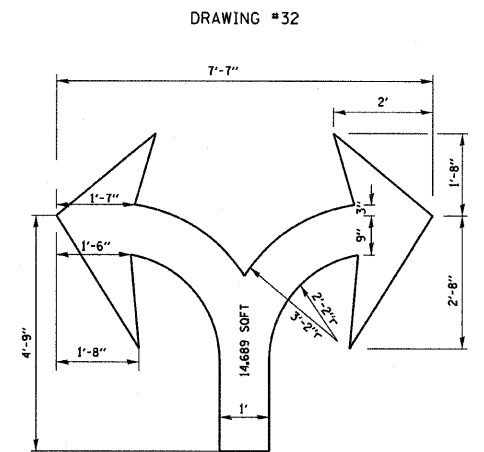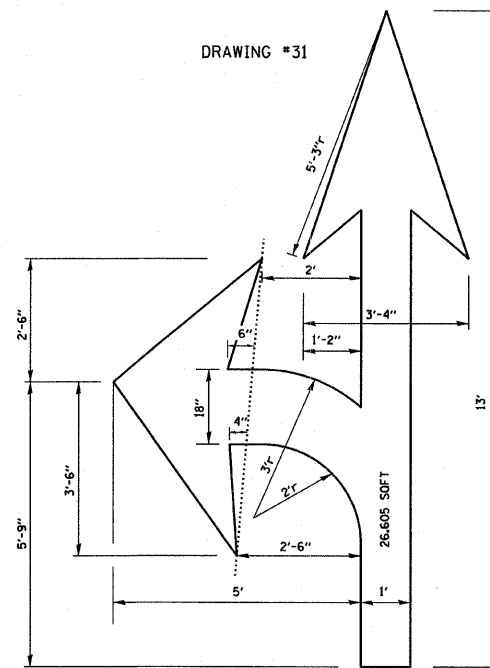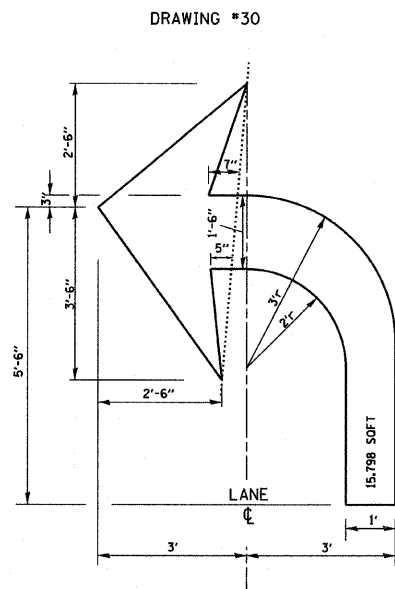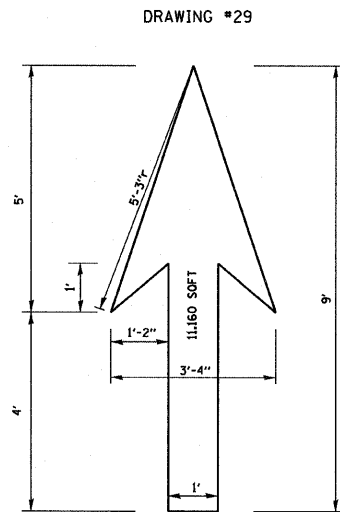

**NOTE:**  
 ALL MARKINGS SHALL BE SOLID WHITE UNLESS OTHERWISE NOTED IN THE PLANS

FILE NAME = W:\diststd\22x34\to24.dgn

USER NAME = gogliano

DESIGNED -

REVISED - T. RAMMACHER 12-07-00

DRAWN -

REVISED -

PLOT SCALE = 50.000' / IN.

CHECKED -

PLOT DATE = 1/4/2008

DATE -

**STATE OF ILLINOIS**  
**DEPARTMENT OF TRANSPORTATION**

**CITY OF CHICAGO**  
**TYPICAL PAVEMENT MARKINGS**

SCALE: NONE SHEET NO. 2 OF 2 SHEETS STA. TO STA.

F.A. RTE.	SECTION	COUNTY	TOTAL SHEETS	SHEET NO.
94	2005-0168 LS	COOK	58	58
TC-24			CONTRACT NO. 60A74	
FED. ROAD DIST. NO. 1 ILLINOIS FED. AID PROJECT				