

PROJECT ENDS
STA 8+70

PROJECT BEGINS
STA 8+42

LIMITS OF 10YR
FLOOD = 626.0

LIMITS OF 10YR FLOOD = 626.0

NON-ERODABLE
COFFERDAM

NON-ERODABLE
COFFERDAM



RIP RAP, 600 SY
26" LONG, INSTALL UP TO ELEVATION 624
6" BEDDING (CLASS A1)
22" BLANKET THICKNESS

BFE = 627.0

COMPENSATORY STORAGE AREA

MIDDLE FORK
SCHOOL

WAGNER ROAD

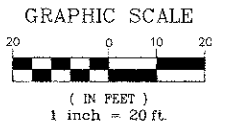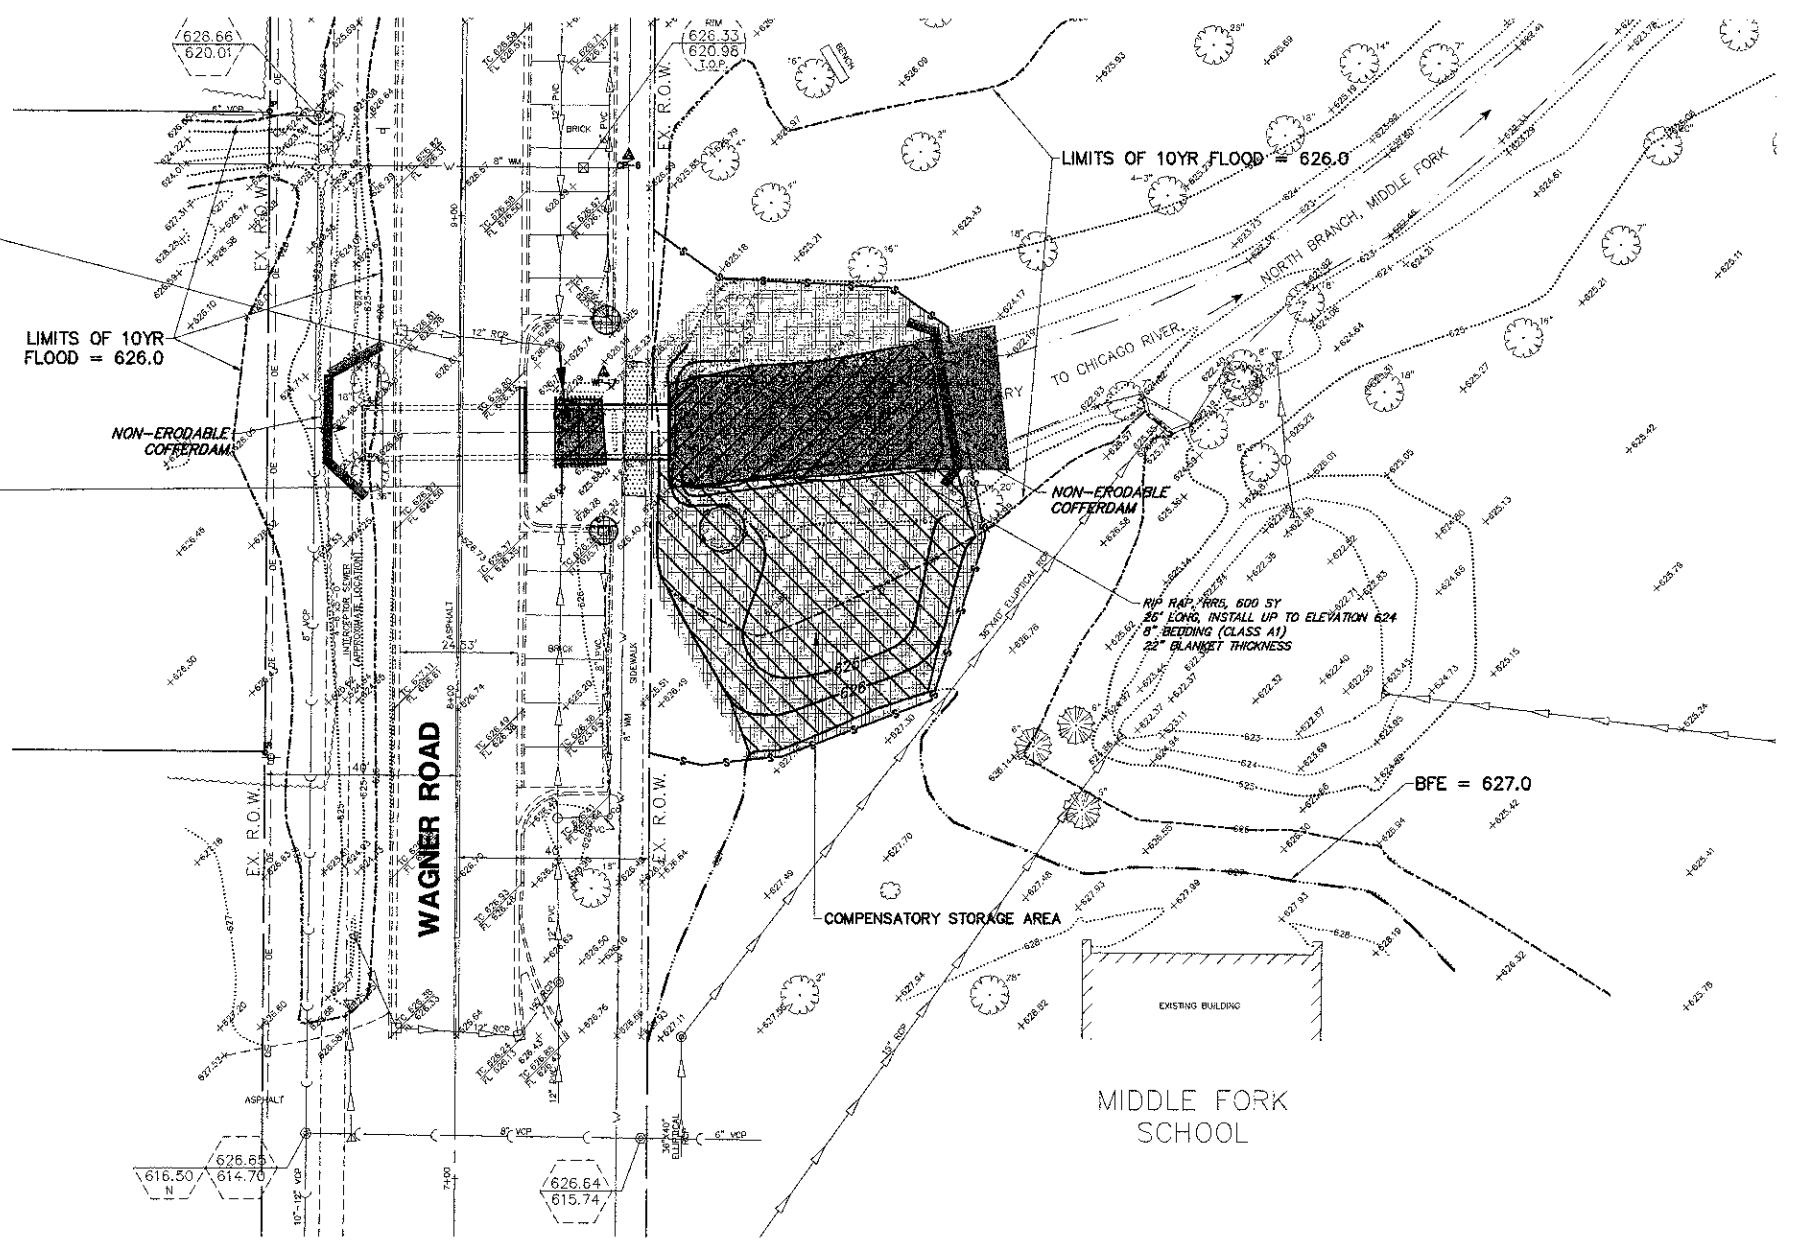

EROSION CONTROL LEGEND

- PERIMETER EROSION CONTROL
- INLET FILTER BASKET
- EROSION CONTROL BLANKET
9" TOPSOIL, SALT TOLERANT SEED
IDOT CLASS 4B EROSION CONTROL
BLANKET NAG S150 (3:1 SLOPES)
- STONE RIP-RAP
- WATERS OF THE U.S.
- WATERS OF THE U.S.
IMPACTED BY IMPROVEMENTS
- TOTAL AREA: 1470 SF.

NOTES:

1. ALL WORK SHALL BE COMPLETED IN DRY CONDITIONS.
2. ALL DISTURBED AREAS WILL BE STABILIZED WITH I.D.O.T. CLASS 4B SEED MIX AND NAG-S150 EROSION CONTROL BLANKET.

FILE NAME = 3509.213-Wagner-PR1.dwg	USER NAME = BRIAN WESOLOWSKI	DESIGNED - BVS	REVISED - 6/29/12	SUNSET RIDGE ROAD & WAGNER ROAD SECTION 10-0050-00-SW VILLAGE OF NORTFIELD, ILLINOIS	EROSION AND SEDIMENT CONTROL PLAN			FAU RTE	SECTION	COUNTY	TOTAL SHEETS	SHEET NO.			
	PLOT SCALE = 1" = .0833'	DRAWN - BVS	REVISED -		SCALE 1"=20'	SHEET NO.	OF	SHEETS	STA.	TO STA.	2777	10-0050-00-SW	COOK	15	7
	PLOT DATE = 4/30/2012	CHECKED - LJD	REVISED -												
		DATE - 4/30/12	REVISED -												
											CONTRACT # 63729		ILLINOIS FED. AID PROJECT		