


	SEEDING, CLASS 1 (MOD)		SEEDING, CLASS 2A (MOD)
	SEEDING CLASS 4		SEEDING CLASS 4A
	SEEDING, CLASS 4A (MOD)		SODDING, SALT TOLERANT

FERTILIZER NUTRIENTS	APPLICATION RATE (SEEDED AREAS)	APPLICATION RATE (SODDED AREAS)
NITROGEN	90 LB/ACRE	60 LB/ACRE
PHOSPHORUS	90 LB/ACRE	60 LB/ACRE
POTASSIUM	90 LB/ACRE	60 LB/ACRE

- NOTES:
- SEEDING CLASS 4A SHALL BE USED AT DITCH/SWALE BOTTOMS FROM STA. 86+42.45 TO STA. 141+00.
  - SEEDING CLASS 4A (MOD) SHALL BE USED AT DITCH/SWALE BOTTOMS FROM STA. 141+00 TO STA. 248+17.62.
  - SEEDING CLASS 4 SHALL BE USED AT THE FIRST 10 FEET OF DITCH BOTTOM UPSTREAM OF DITCH CHECK RESTRICTORS.
  - A 10 FOOT MOW-STRIP OF SEEDING CLASS 2A (MOD) SHALL BE PLACED BEHIND CURB/SHOULDER ADJACENT TO AREAS OF SEEDING CLASS 4A AND SEEDING CLASS 4A (MOD).
  - HEAVY DUTY EROSION CONTROL BLANKET SHALL BE PLACED ON ALL SEEDED AREAS.
  - ALL PAVEMENT MARKINGS SHALL BE WET REFLECTIVE PREFORMED PLASTIC UNLESS OTHERWISE NOTED.

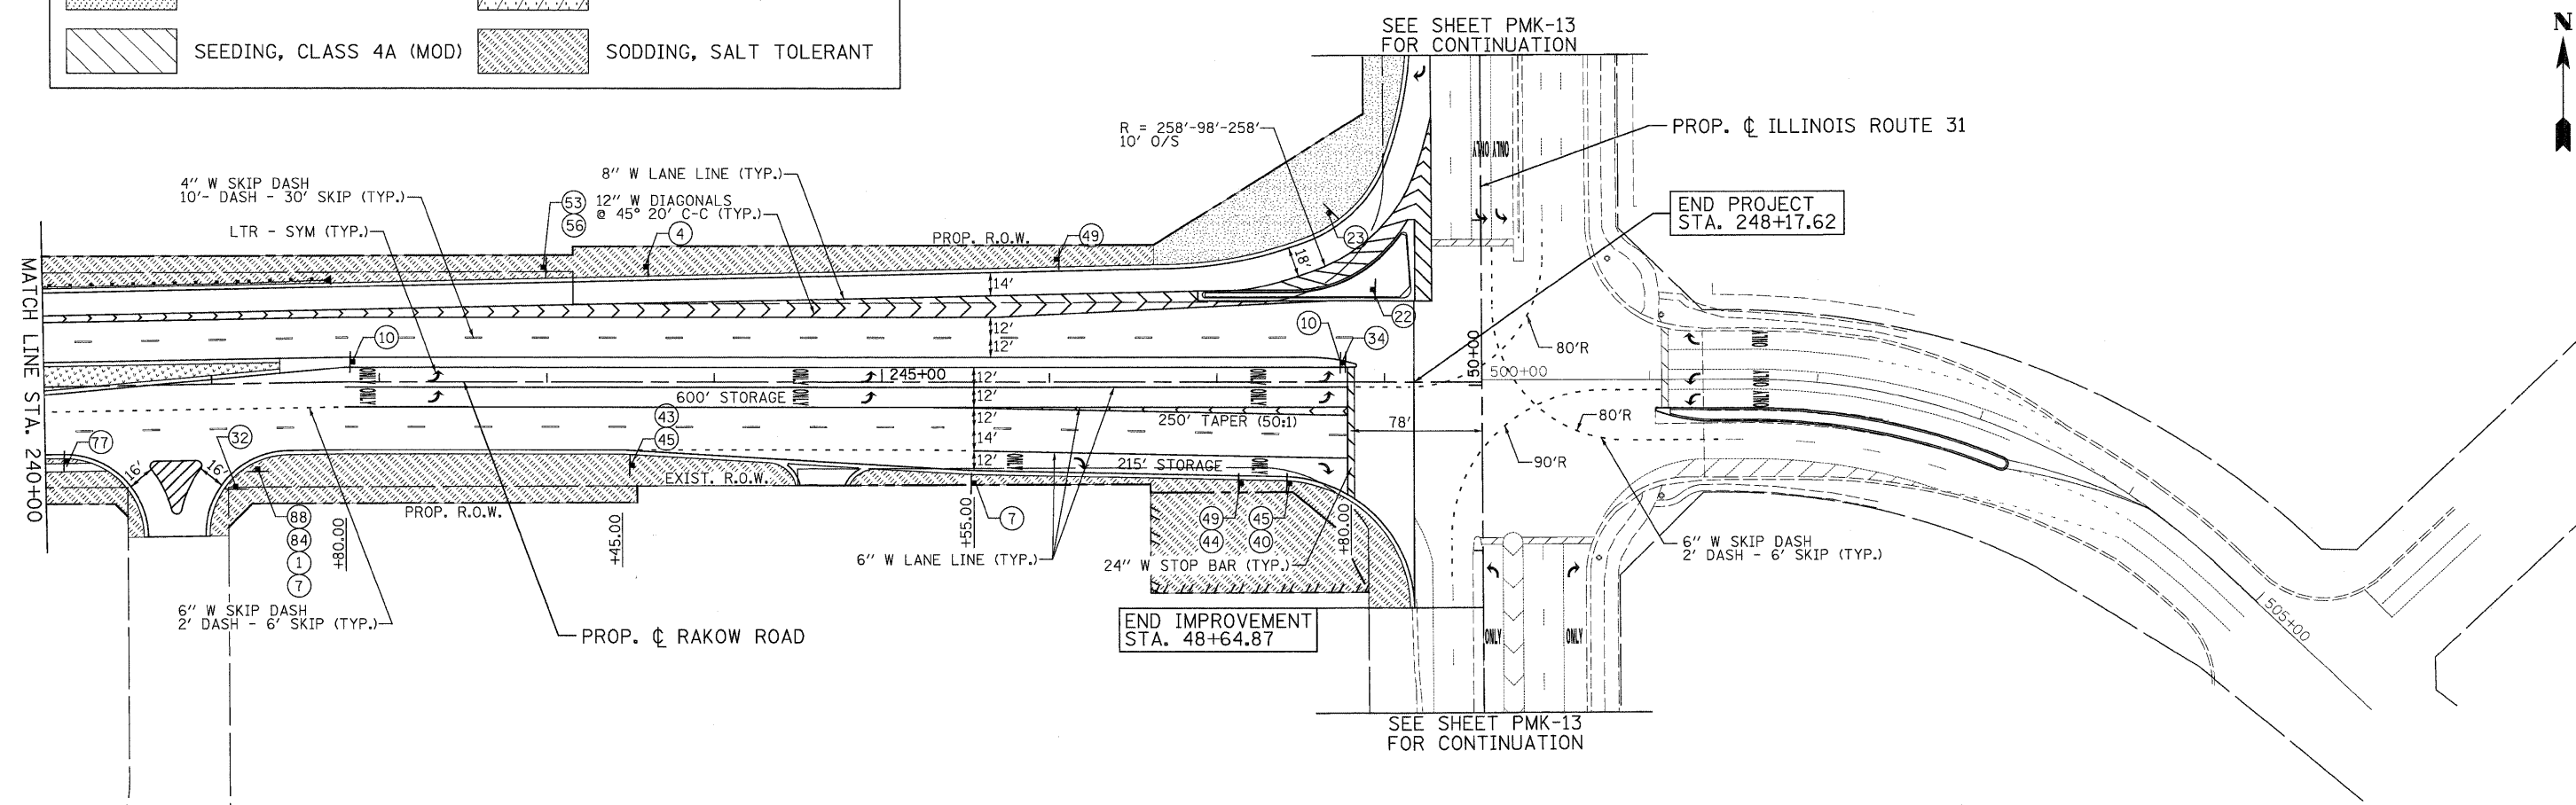

	USER NAME = Rdky_Lisle	DESIGNED - MJP	REVISED -		<b>RAKOW ROAD FROM ACKMAN ROAD TO ILLINOIS ROUTE 31 PROPOSED PAVEMENT MARKING/LANDSCAPING PLAN</b>	F.A.P. RTE. 0336	SECTION 05-00308-00-WR	COUNTY MCHENRY	TOTAL SHEETS 606	SHEET NO. 274
	PLOT CONFIG = PDF(Grey, Large).plt	DRAWN - TCK	REVISED -			SCALE: 1"=50'	SHEET NO. PMK 7 OF 21	STA. 225+00 TO STA. PROJ. END	FED. ROAD DIST. NO. ILLINOIS	FED. AID PROJECT
	PLOT SCALE = 1:50	CHECKED - JAH	REVISED -							
	PLOT DATE = 7/29/2010	DATE - 8/2/2010	REVISED -							

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