

BEGIN STRIPING
STA. 37+04.52

BEGIN IMPROVEMENT
STA. 39+99.75


END IMPROVEMENT
STA. 58+03.97

END STRIPING
STA. 61+35.81

	SEEDING, CLASS 1 (MOD)		SEEDING, CLASS 2A (MOD)
	SEEDING CLASS 4		SEEDING CLASS 4A
	SEEDING, CLASS 4A (MOD)		SODDING, SALT TOLERANT

- NOTES:**
- SEEDING CLASS 4A SHALL BE USED AT DITCH/SWALE BOTTOMS FROM STA. 86+42.45 TO STA. 141+00.
 - SEEDING CLASS 4A (MOD) SHALL BE USED AT DITCH/SWALE BOTTOMS FROM STA. 141+00 TO STA. 248+17.62.
 - SEEDING CLASS 4 SHALL BE USED AT THE FIRST 10 FEET OF DITCH BOTTOM UPSTREAM OF DITCH CHECK RESTRICTORS.
 - A 10 FOOT MOW-STRIP OF SEEDING CLASS 2A (MOD) SHALL BE PLACED BEHIND CURB/SHOULDER ADJACENT TO AREAS OF SEEDING CLASS 4A AND SEEDING CLASS 4A (MOD).
 - HEAVY DUTY EROSION CONTROL BLANKET SHALL BE PLACED ON ALL SEEDED AREAS.
 - ALL PAVEMENT MARKINGS SHALL BE WET REFLECTIVE PREFORMED PLASTIC UNLESS OTHERWISE NOTED.

FERTILIZER NUTRIENTS	APPLICATION RATE (SEEDED AREAS)	APPLICATION RATE (SODDED AREAS)
NITROGEN	90 LB/ACRE	60 LB/ACRE
PHOSPHORUS	90 LB/ACRE	60 LB/ACRE
POTASSIUM	90 LB/ACRE	60 LB/ACRE

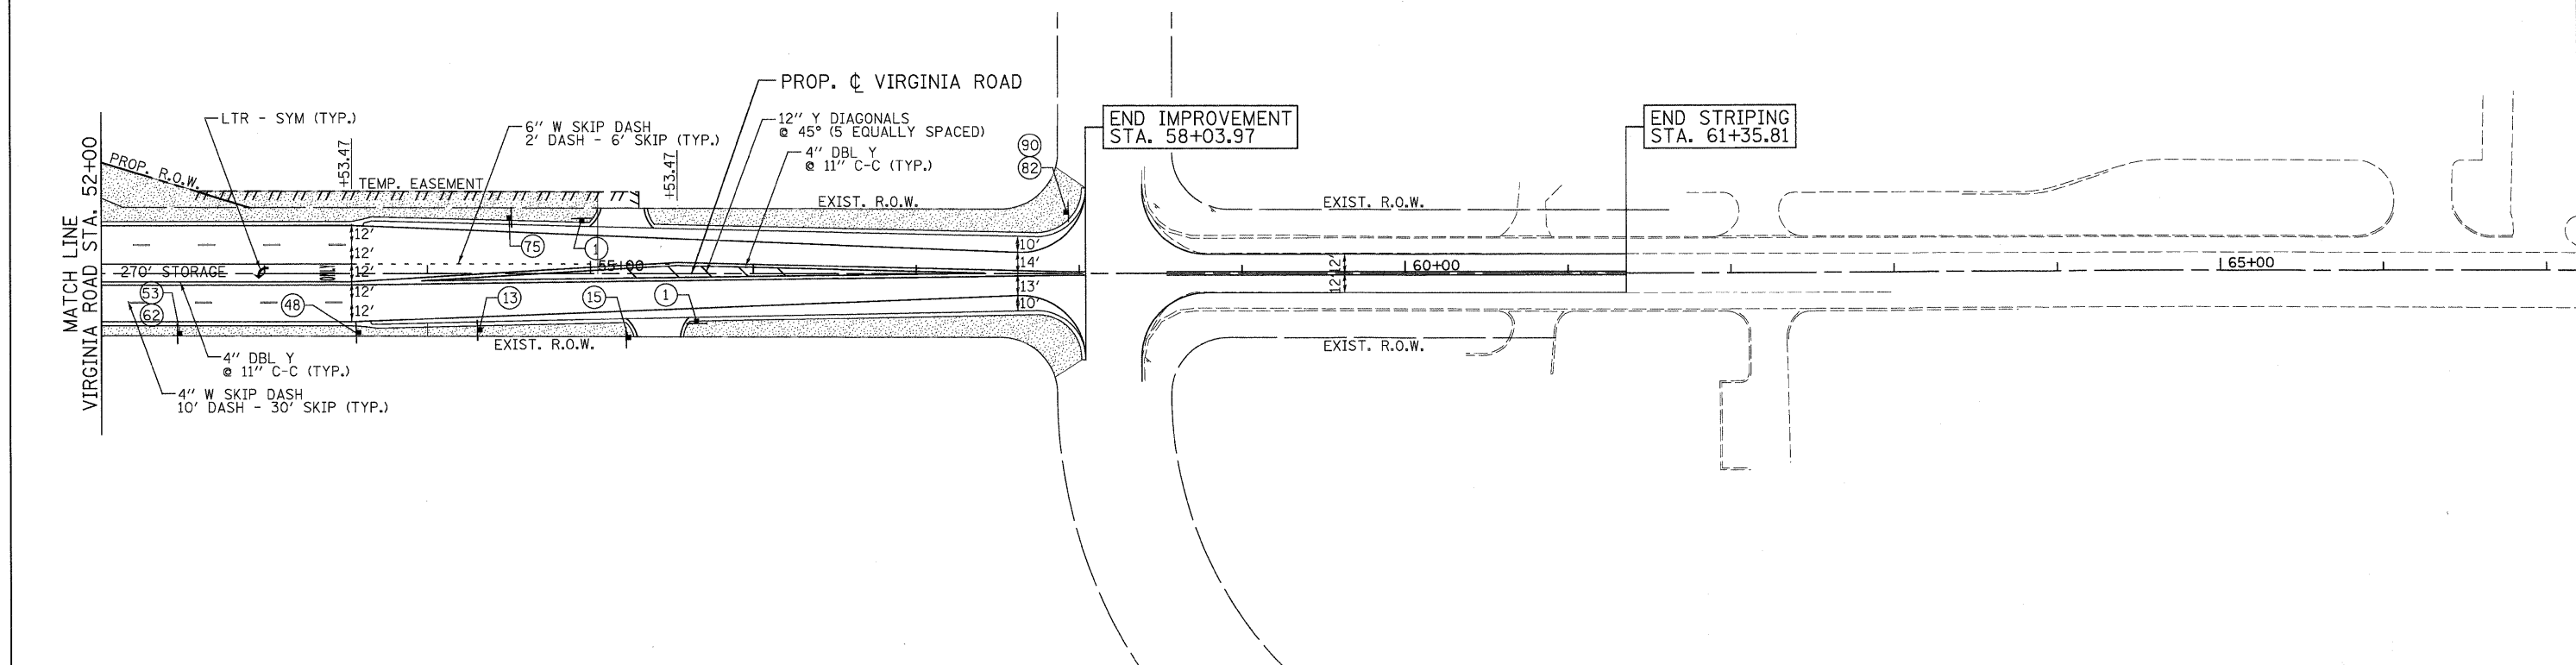

USER NAME = Rdwj.Lisle	DESIGNED - MJP	REVISED -
PLOT CONFIG = PDF(Grey, Large).plt	DRAWN - TCK	REVISED -
PLOT SCALE = 1:50	CHECKED - JAH	REVISED -
PLOT DATE = 7/29/2010	DATE - 8/2/2010	REVISED -



**MCHENRY COUNTY
DIVISION OF TRANSPORTATION**

**RAKOW ROAD FROM ACKMAN ROAD TO ILLINOIS ROUTE 31
VIRGINIA ROAD PROPOSED PAVEMENT MARKING/LANDSCAPING PLAN**

SCALE: 1"=50' SHEET NO. PMK 11 OF 21 STA. TO STA.

F.A.P. RTE. 0336	SECTION 05-00308-00-WR	COUNTY MCHENRY	TOTAL SHEETS 606	SHEET NO. 278
FED. ROAD DIST. NO. ILLINOIS FED. AID PROJECT		CONTRACT NO. 63398		

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