


- NOTES:**
- SEEDING CLASS 4A SHALL BE USED AT DITCH/SWALE BOTTOMS FROM STA. 86+42.45 TO STA. 141+00.
 - SEEDING CLASS 4A (MOD) SHALL BE USED AT DITCH/SWALE BOTTOMS FROM STA. 141+00 TO STA. 248+17.62.
 - SEEDING CLASS 4 SHALL BE USED AT THE FIRST 10 FEET OF DITCH BOTTOM UPSTREAM OF DITCH CHECK RESTRICTORS.
 - A 10 FOOT MOW-STRIP OF SEEDING CLASS 2A (MOD) SHALL BE PLACED BEHIND CURB/SHOULDER ADJACENT TO AREAS OF SEEDING CLASS 4A AND SEEDING CLASS 4A (MOD).
 - HEAVY DUTY EROSION CONTROL BLANKET SHALL BE PLACED ON ALL SEEDED AREAS.
 - ALL PAVEMENT MARKINGS SHALL BE WET REFLECTIVE PREFORMED PLASTIC UNLESS OTHERWISE NOTED.

FERTILIZER NUTRIENTS	APPLICATION RATE (SEEDED AREAS)	APPLICATION RATE (SODDED AREAS)
NITROGEN	90 LB/ACRE	60 LB/ACRE
PHOSPHORUS	90 LB/ACRE	60 LB/ACRE
POTASSIUM	90 LB/ACRE	60 LB/ACRE

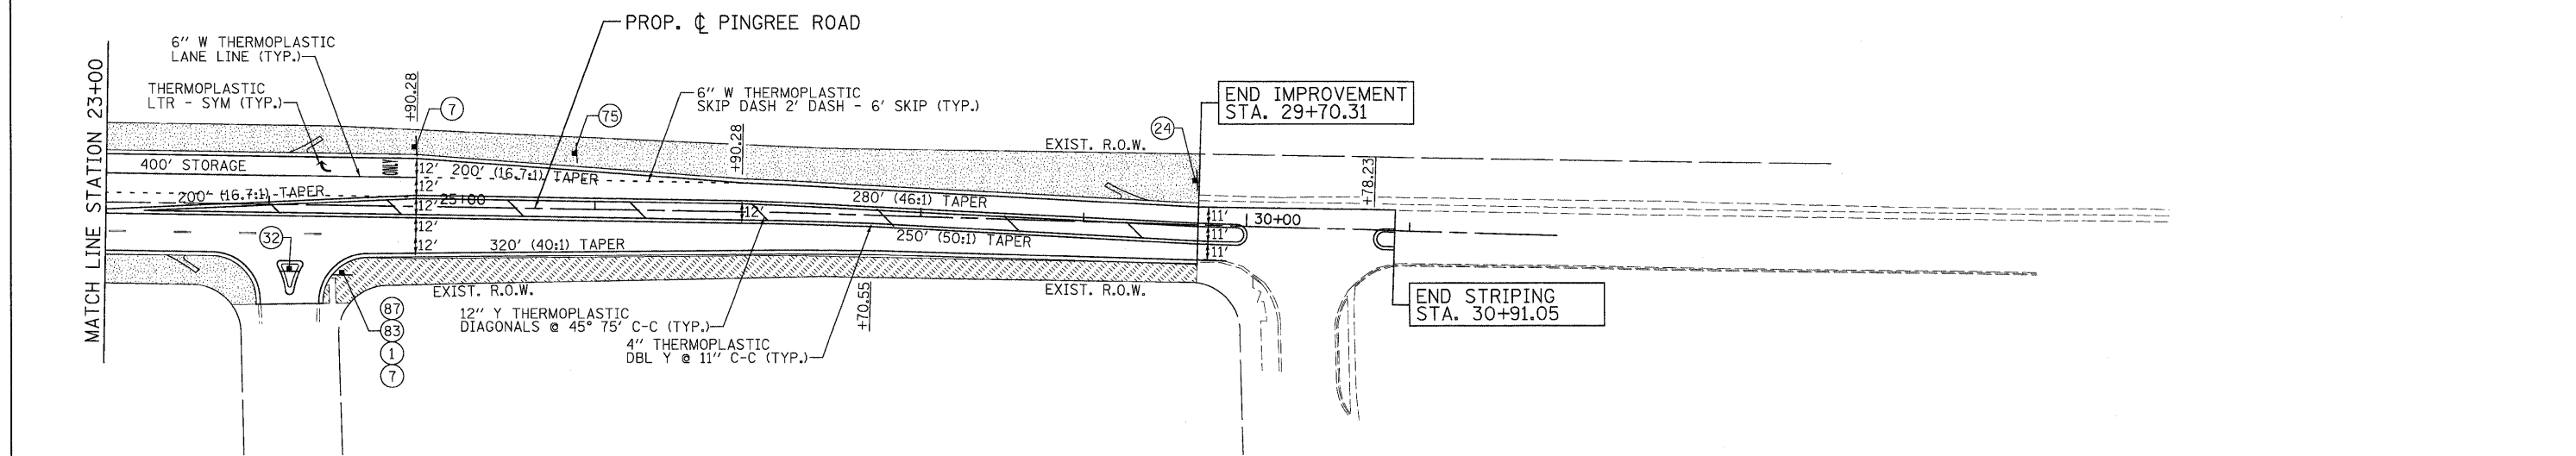

PATRICK ENGINEERING INC. LISLE, ILLINOIS	USER NAME = Rdwy_Lisle PLOT CONFIG = PDF(Grey_Large).plt PLOT SCALE = 1:50 PLOT DATE = 7/29/2010	DESIGNED - MJP DRAWN - TCK CHECKED - JAH DATE - 8/2/2010	REVISED - REVISED - REVISED - REVISED -	MCHENRY COUNTY DIVISION OF TRANSPORTATION	RAKOW ROAD FROM ACKMAN ROAD TO ILLINOIS ROUTE 31 PINGREE ROAD PROPOSED PAVEMENT MARKING/LANDSCAPING PLAN	F.A.P. RTE. 0336 SECTION 05-00308-00-WR COUNTY MCHENRY FED. ROAD DIST. NO. ILLINOIS FED. AID PROJECT	TOTAL SHEETS 606 SHEET NO. 279 CONTRACT NO. 63398
	SCALE: 1"=50' SHEET NO. PMK 12 OF 21 STA. TO STA.						

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