

Utility Quality Level "A": Visually Verified Test Hole
Utility Quality Level "B": Designating/non Visually Verified Test Hole Utility Quality Level "C": Research with Survey Utility Quality Level "D": Records Research

UTILITY OWNERS

AT&T = TELEPHONE BP = PIPELINE COM-ED = ELECTRIC

COM-ED = ELECTRIC
IDOT = ELECTRIC
KINDER MORGAN = PIPELINE
MWRD = WATER
NICOR = GAS
UNITE = FIBER OPTIC
VILLAGE OF MCCOOK = WATER
WEST SHORE = PIPELINE

DESIGNED IP

DRAWN KI

CHECKED KFS

DATE 9/20/13

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Utilities shown on these plans as depicted in the legend have been investigated by Cardno TBE in accordance with SUE Industry Standards. All other information shown has been provided to Cardno TBE by others. Cardno TBE's OL'B'' SUE field investigation was performed 7/13/13 through 9/13/13. Changes to utilities after 9/13/13 may have been made and therefore may result in variances from this plan. Consideration should be given to updating this plan if deemed advisable prior to final design and construction.

ALL UTILITIES SHOWN QUALITY LEVEL "B" UNLESS NOTED OTHERWISE.










TBE Job No. IL09510524 SUE Plan Page: 5 of 12

F.A.P RTE.		SECT	TION		COUNT	Υ Υ	TOTAL	SHEET NO.	
372/373		2013-	037B-R		Cook		787	101	
	Contract No. 60W75								
EED DO	AD DICT	NO	TI I TMOTE	IDOT	Drotoot No				

STATE OF ILLINOIS **DEPARTMENT OF TRANSPORTATION** 

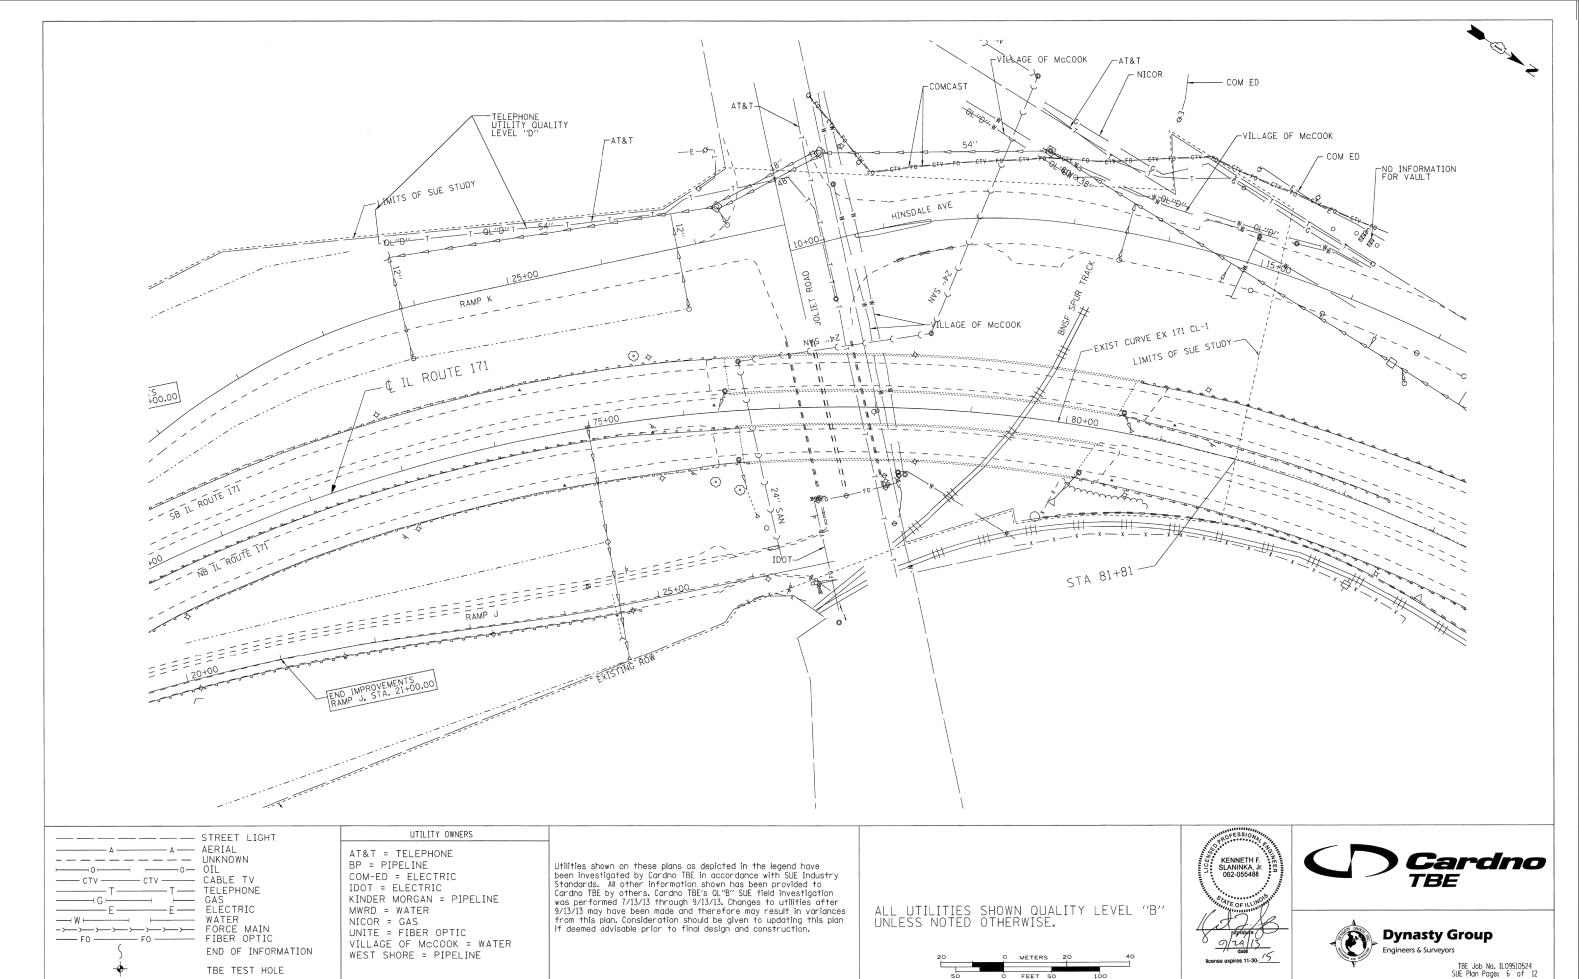

STATE OF ILLINOIS
DEPARTMENT OF TRANSPORTATION

Utility Quality Level "A": Visually Verified Test Hole

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Utility Quality Level "D": Records Research

Utility Quality Level "B": Designating/non Visually Verified Test Hole

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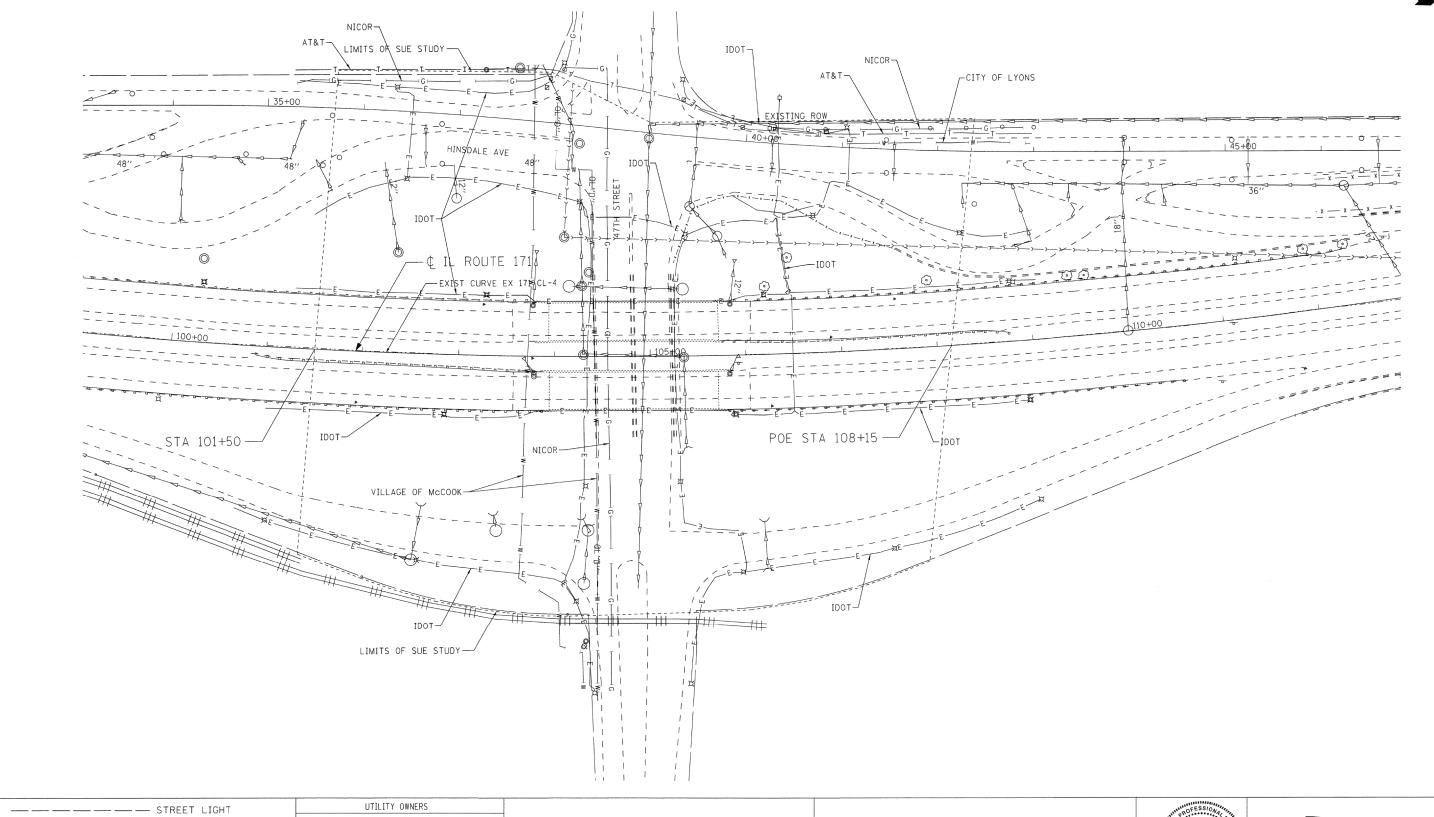
DATE 9/20/13


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AT&T = TELEPHONE

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DATE 9/20/13

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STATE OF ILLINOIS

**DEPARTMENT OF TRANSPORTATION** 

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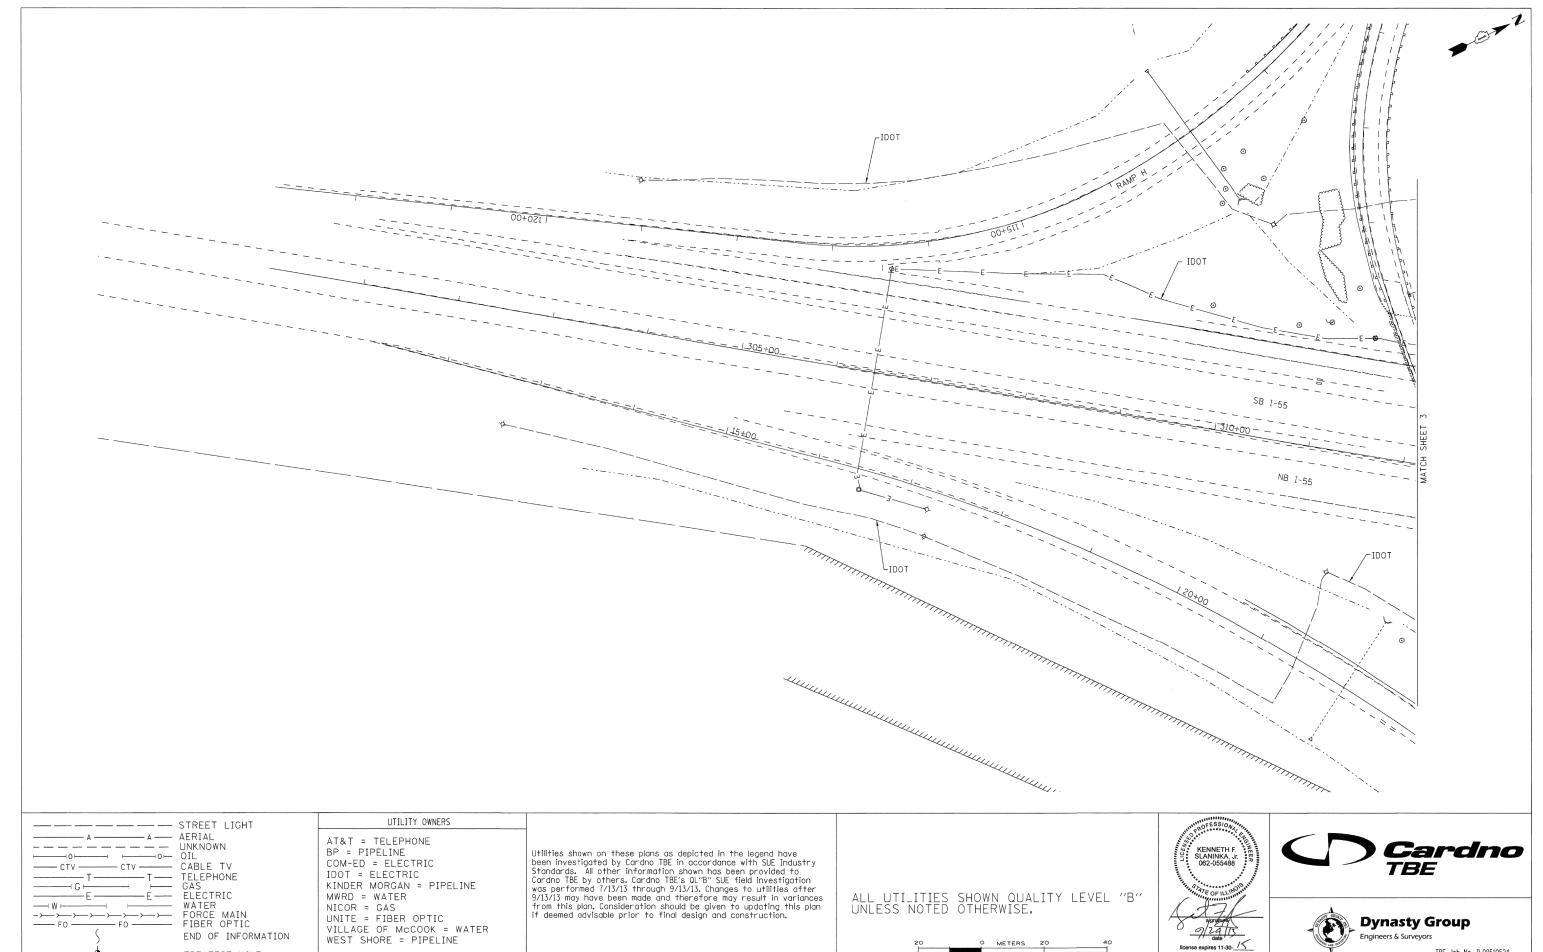
IL 171 (1st Ave.) 47th Street to 55th Street Summit, Illinois

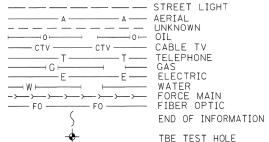



TBE Job No. IL09510524 SUE Plan Page: 7 of 12

F.A.P RTE.	SE	COUNTY	TOTAL SHEETS	SHEET NO.			
372/373	2013-037B-R			Cook	787	103	
				Contract N	o.60W7	5	
FED. RO	FED. ROAD DIST. NO   ILLINOIS   IDOT Project No.						



Utility Quality Level "A": Visually Verified Test Hole
Utility Quality Level "B": Designating/non Visually Verified Test Hole DESIGNED IP REVISED DRAWN KLC REVISED CHECKED KFS REVISED DATE 9/20/13 REVISED

TBE TEST HOLE

Utility Quality Level "C": Research with Survey


Utility Quality Level "D": Records Research


STATE OF ILLINOIS DEPARTMENT OF TRANSPORTATION IL 171 (1st Ave.) 47th Street to 55th Street Summit, Illinois



TBE Job No. IL09510524 SUE Plan Page: 8 of 12

F.A.P RTE.	SECTION		COUNTY	TOTAL	SHEET NO.			
72/373	2013-0	37B-R		Cook	787	104		
			Contract N	lo. 60W7	5			

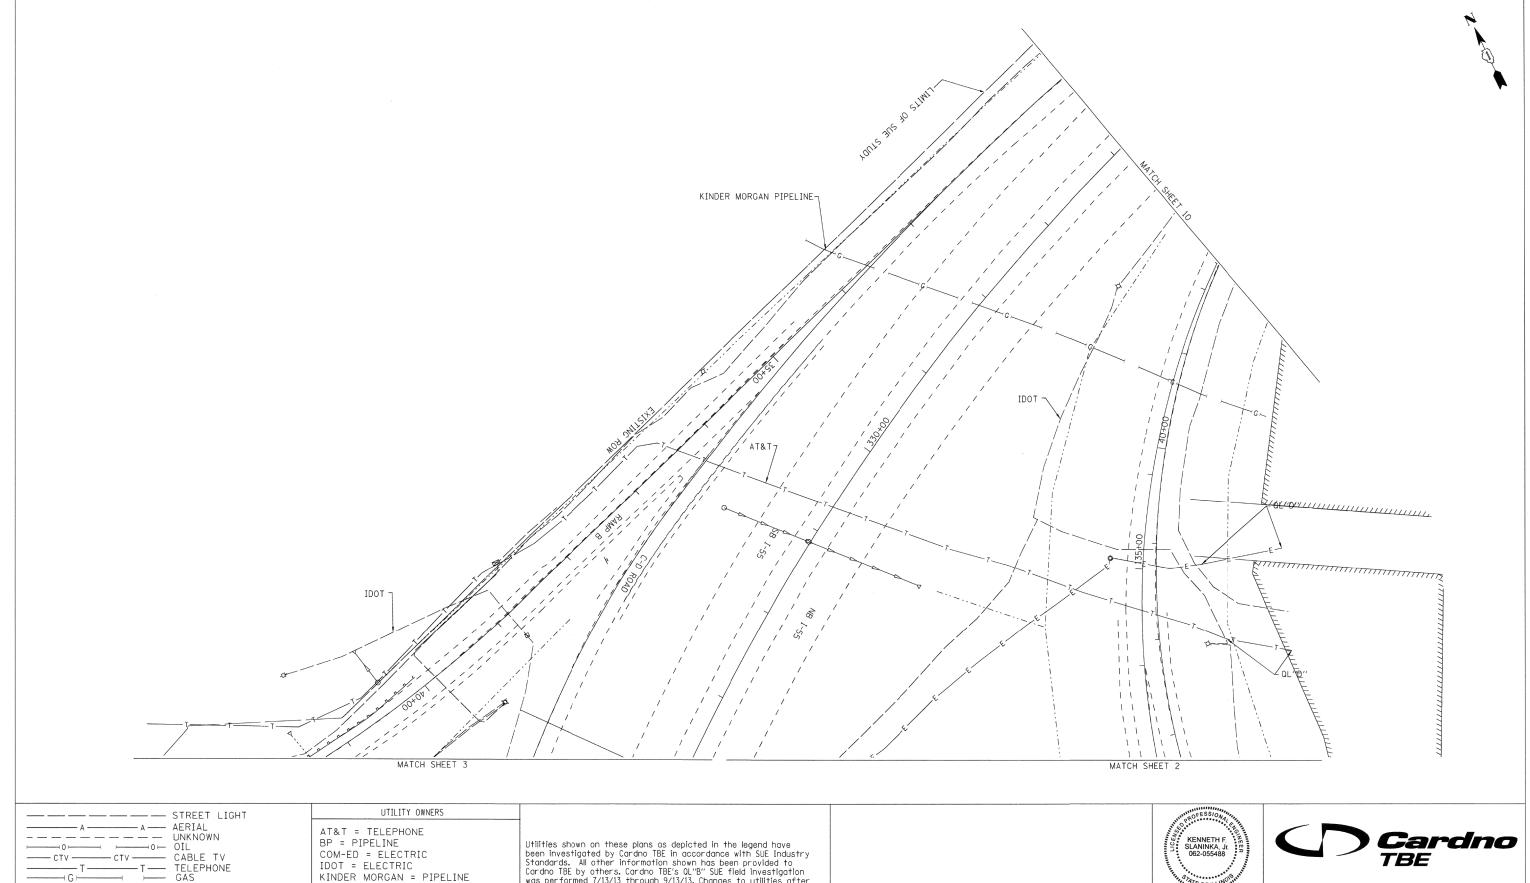

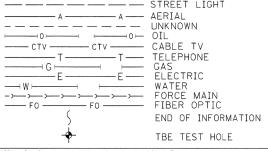

Utility Quality Level "A": Visually Verified Test Hole
Utility Quality Level "B": Designating/non Visually Verified Test Hole Utility Quality Level "C": Research with Survey

Utility Quality Level "D": Records Research

MWRD = WATER

DESIGNED IP

DRAWN KLC

CHECKED KFS

DATE 9/20/13

NICOR = GAS UNITE = FIBER OPTIC VILLAGE OF McCOOK = WATER WEST SHORE = PIPELINE

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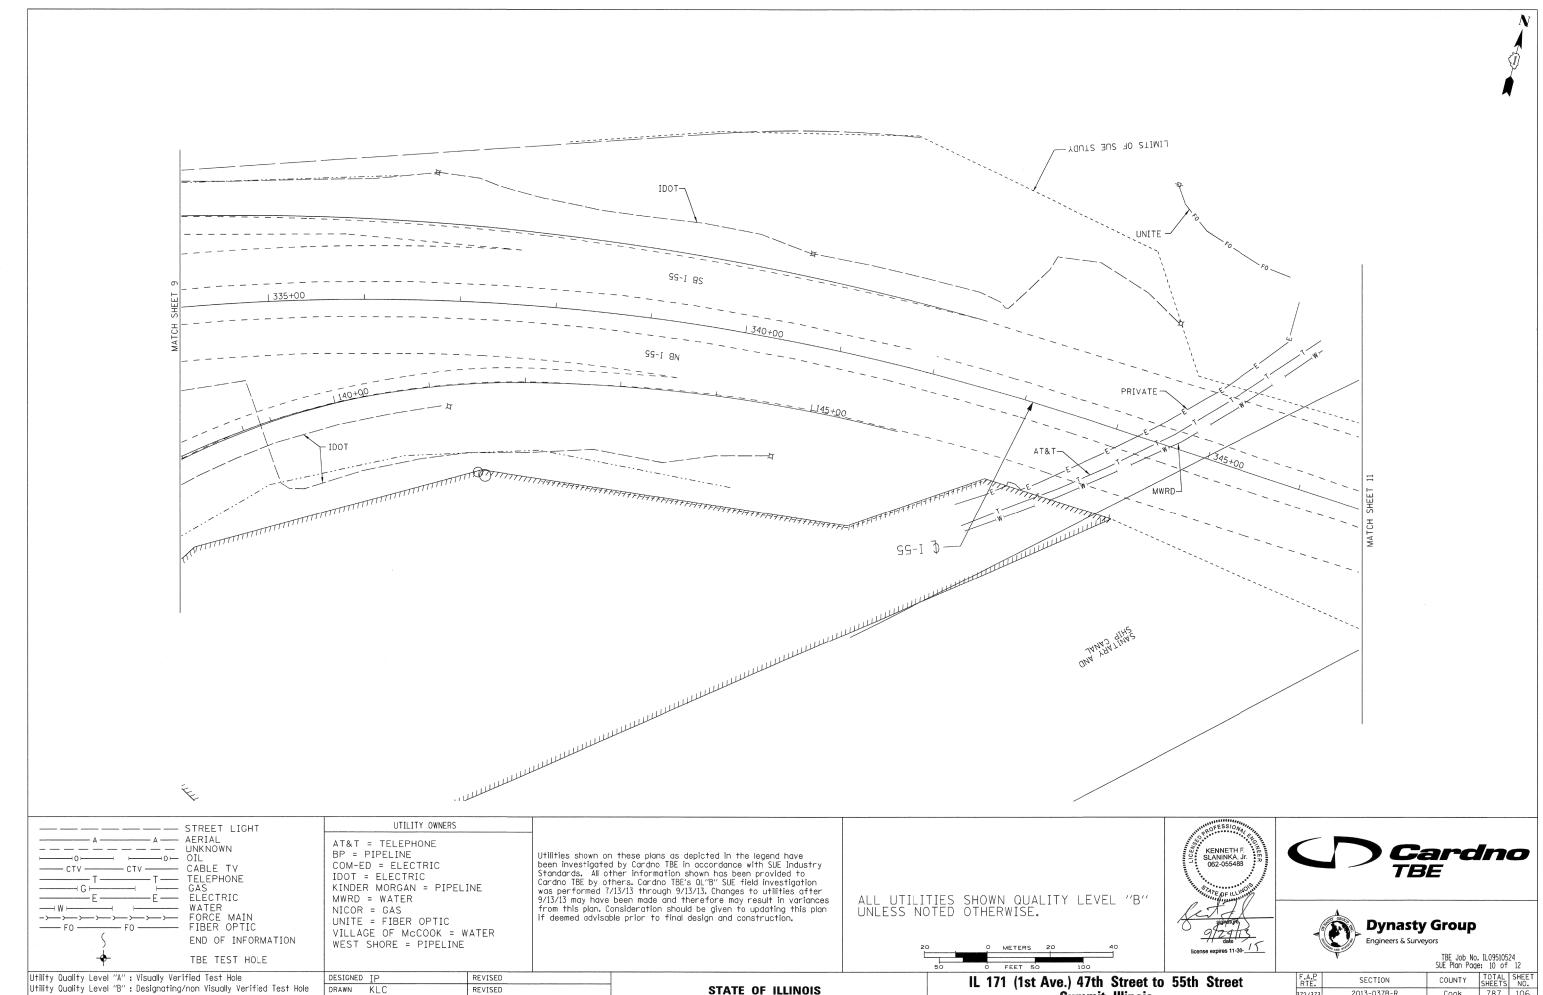




TBE Job No. IL09510524 SUE Plan Page: 9 of 12

1	F.A.P RTE.	SECTION			COUNTY	TOTAL SHEETS	SHEET NO.	
	372/373	2013-037B-R			Cook	787	105	
1					Contract No	60W7	5	
ı	FED. RO	AD DIST.	NO.	ILL INOIS	IDOT	Project No.		

STATE OF ILLINOIS **DEPARTMENT OF TRANSPORTATION** 



STATE OF ILLINOIS

**DEPARTMENT OF TRANSPORTATION** 

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Utility Quality Level "C": Research with Survey


Utility Quality Level "D": Records Research


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DATE 9/20/13

COUNTY TOTAL SHEET NO. Cook 787 106 SECTION 2013-037B-R 372/373 Contract No. 60W75 FED. ROAD DIST. NO. \_ ILLINOIS IDOT Project No.



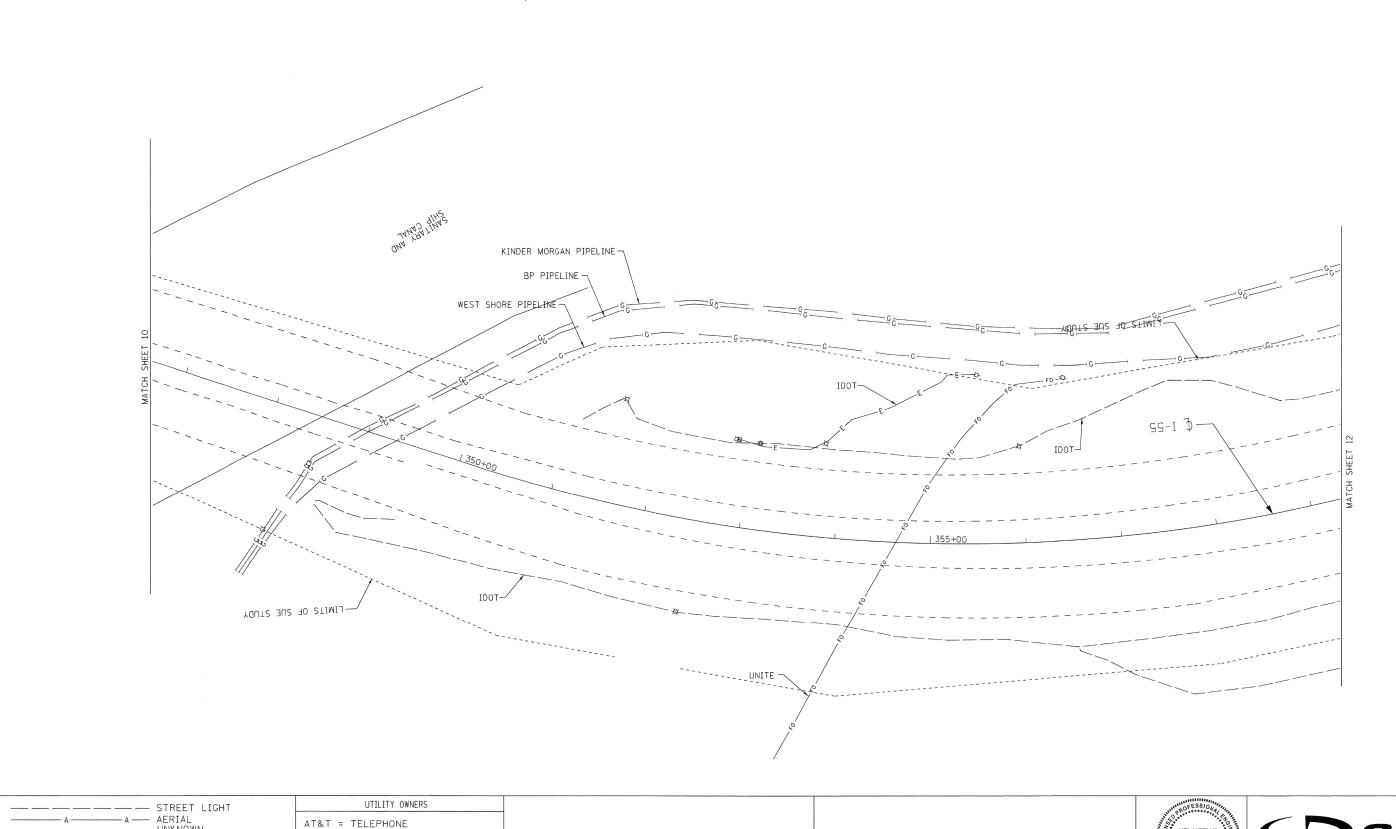

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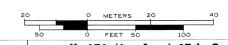
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DATE 9/20/13
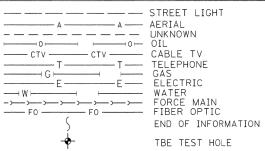
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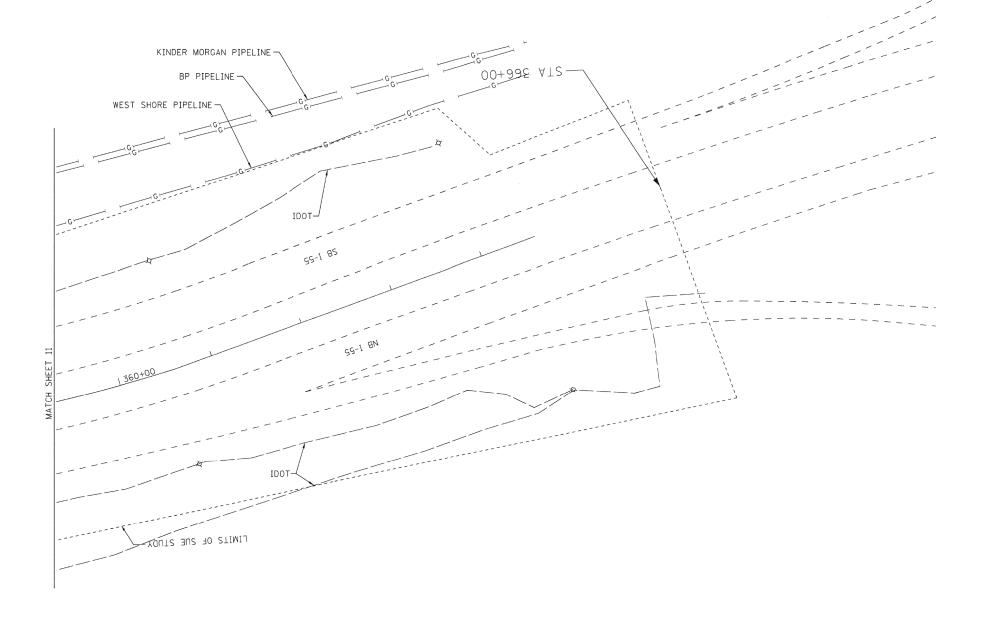



TBE Job No. IL09510524 SUE Plan Page: 11 of 12

F.A.P RTE. SECTION				COUNTY	TOTAL SHEETS	SHEET NO.			
372/373		2013-037B-R		Cook	787	107			
					Contract No. 60W75				
BEG 84				THE THIOTIC					

STATE OF ILLINOIS **DEPARTMENT OF TRANSPORTATION** 





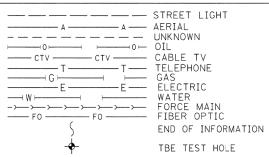

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MWRD = WATER
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VILLAGE OF McCOOK = WATER
WEST SHORE = PIPELINE

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DESIGNED IP

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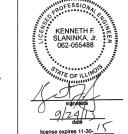
CHECKED KFS

DATE 9/20/13

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TBE Job No. IL09510524 SUE Plan Page: 12 of 12

F.A.P RTE.		SECTION				INTY	TOTAL SHEETS	SHEET NO.
372/373	2013-037B-R			Co	ok	787	108	
				Contr	act No	60W7	5	
FFD. RO	AD DIST.	NO.	TLLINOIS	IDOT	Project	No.		

STATE OF ILLINOIS DEPARTMENT OF TRANSPORTATION

# STATE OF ILLINOIS DEPARTMENT OF TRANSPORTATION DIVISION OF HIGHWAYS

# **PLAT OF HIGHWAYS**

**ROUTE: IL-171 (FIRST AVENUE)** 

**SECTION:** 

**COUNTY: COOK** 

LIMITS: FROM 47TH STREET

TO 55TH STREET


JOB NO.: R-90-011-11

PARCEL NUMBER	OWNER	SHEET NUMBER	PROPERTY ACQUIRED BY
0JL0001A	THE METROPOLITAN WATER RECLAMATION DISTRICT OF GREATER CHICAGO	2	
OJL0001B	THE METROPOLITAN WATER RECLAMATION DISTRICT OF GREATER CHICAGO	2	

0

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MC HENRY LAKE

\*\* SCHAUMBURG

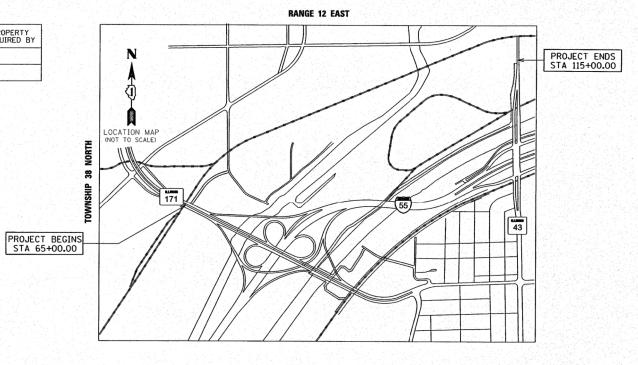KANE

DU PAGE

WILL

DISTRICT HEADQUARTERS: - \*\*

LOCATION OF SECTION INDICATED THUS: - ---
PRINTED BY THE AUTHORITY

OF THE STATE OF ILLINOIS



LOCATION MAP

STATION 65+00.00 (IL-171) TO

STATION 115+00.00 (IL-43)


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FILE NAME =	DESIGNED -	REVISED -	_
\ROW\D160W75-sht-plat-01.dgn	DRAWN -	REVISED -	Sà ha
JSER NAME = jmajewski	CHECKED -	REVISED -	enginee
PLOT DATE = 6/17/2015	DATE - 6/12/2015	REVISED -	



STATE OF ILLINOIS	
DEPARTMENT OF TRANSPORTATION	

PLAT OF HIGHWAY	F.A.P RTE.	SECTION	COUNTY	TOTAL	SHEET NO.
PLAT OF HIGHWAY	372/373	3 2013-037B-R	COOK	787	109
			CONTRACT	NO. 6	50W75
SCALE: SHEET 1 OF 2 SHEETS STA. TO STA.		ILLINOIS FED. A	ID PROJECT		

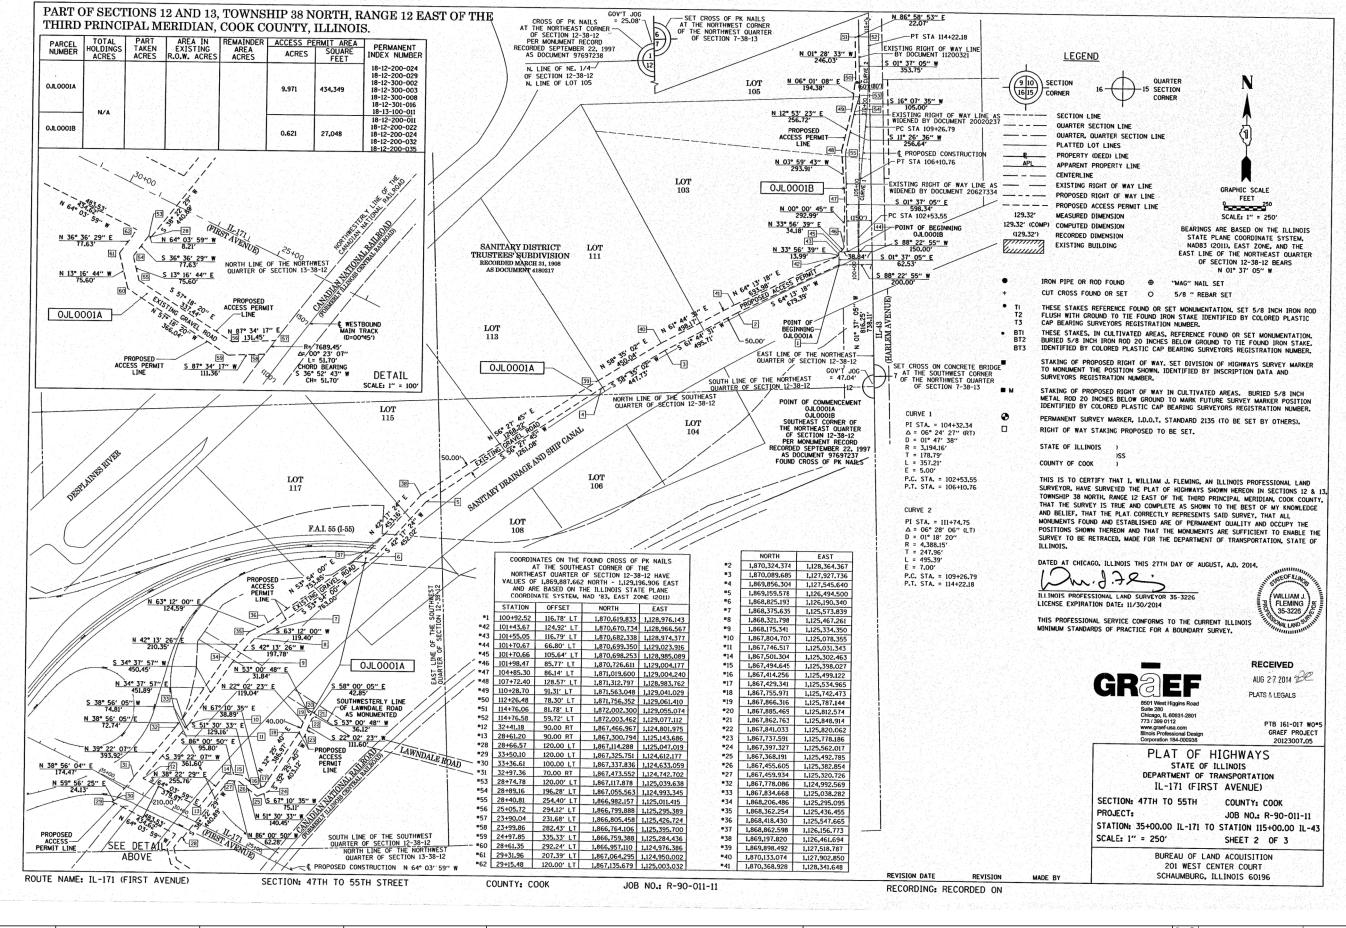

FILE NAME =	DESIGNED -	REVISED -
\ROW\D160W75-sht-plat-02.dgn	DRAWN -	REVISED -
USER NAME = jmajewski	CHECKED -	REVISED -
PLOT DATE = 6/17/2015	DATE - 6/12/2015	REVISED -




SCALE:

SHEET

2 OF

PLAT (	PLAT OF HIGHWAY				SECTION		COUNTY	TOTAL SHEETS	SHEET NO.
				372/373	2013-037B-R		COOK	787	110
							CONTRACT	NO. 6	OW75
2 NF 2	SHEETS	STA	TO STA		TI I INDIC E	ED AT	D DDO IECT		

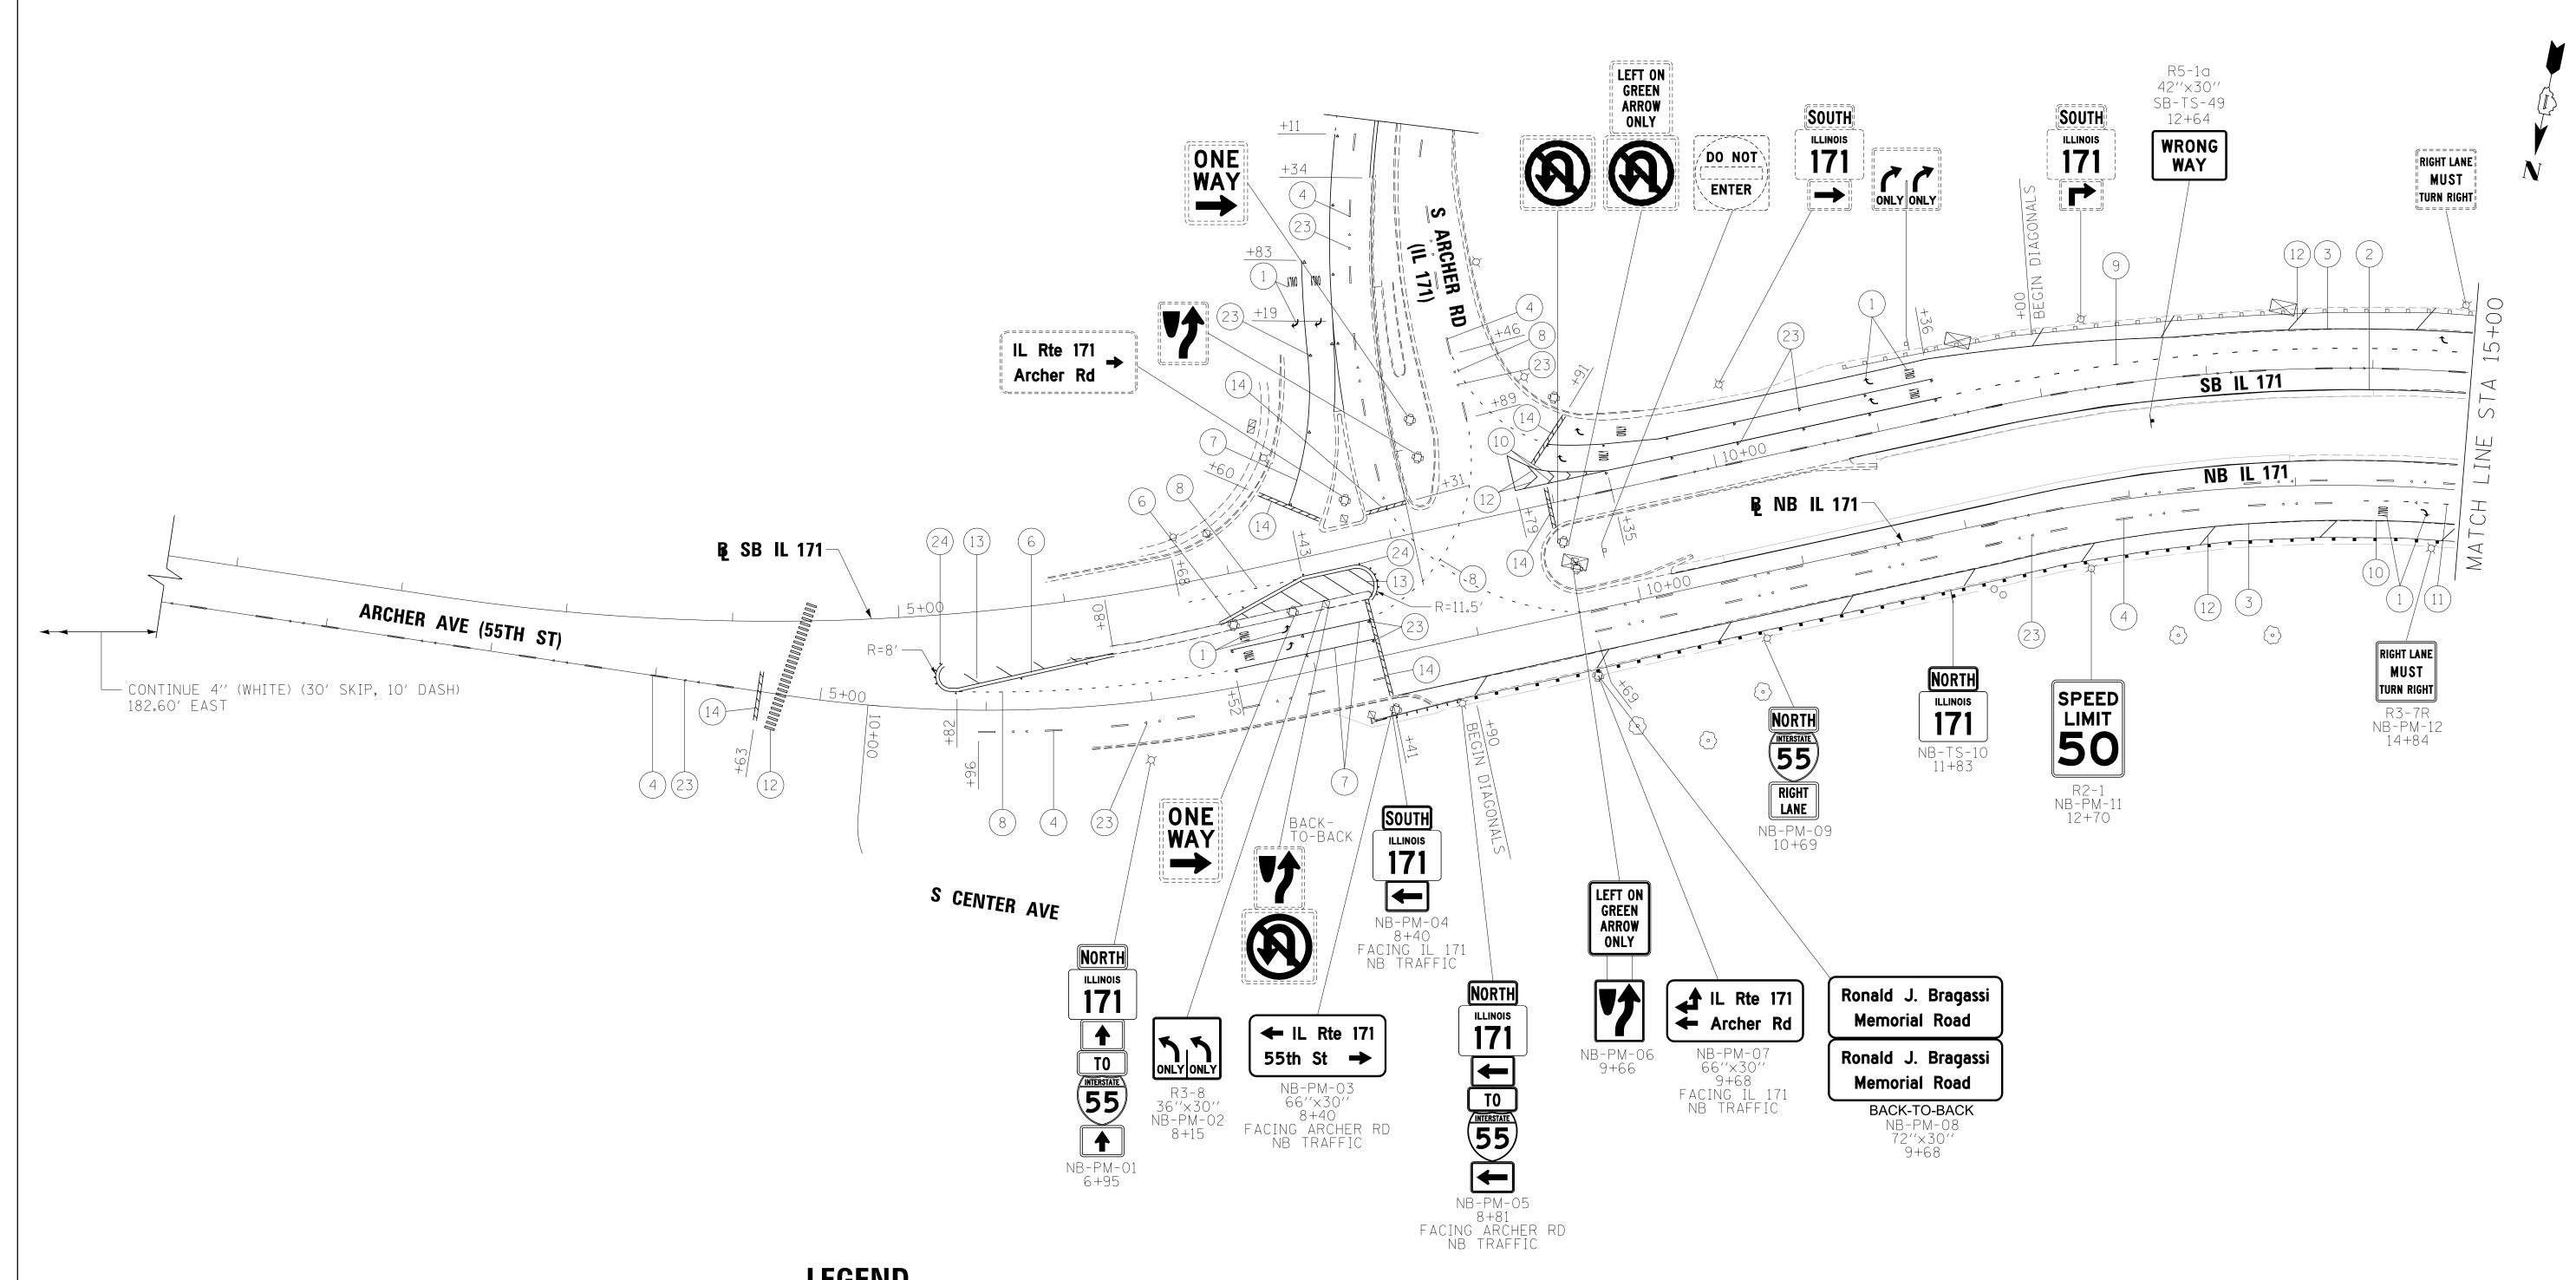

- THERMOPLASTIC PAVEMENT MARKING LETTERS AND SYMBOLS
- THERMOPLASTIC PAVEMENT MARKING LINE 4" (YELLOW)
- THERMOPLASTIC PAVEMENT MARKING LINE 4" (WHITE)
- THERMOPLASTIC PAVEMENT MARKING LINE 4" (WHITE) (30" SKIP, 10" DASH)
- THERMOPLASTIC PAVEMENT MARKING LINE 4" (WHITE) (6" SKIP, 2" DASH)
- 6 THERMOPLASTIC PAVEMENT MARKING LINE 4" (YELLOW) (DOUBLE CENTERLINE)

- 7 THERMOPLASTIC PAVEMENT MARKING LINE 6" (WHITE)
- THERMOPLASTIC PAVEMENT MARKING -LINE 6" (WHITE) (6" SKIP - 2" DASH)
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- THERMOPLASTIC PAVEMENT MARKING LINE 12" (WHITE)

- THERMOPLASTIC PAVEMENT MARKING LINE 12" (YELLOW)
- THERMOPLASTIC PAVEMENT MARKING LINE 24" (WHITE)
- POLYUREA PAVEMENT MARKING TYPE I -LETTERS AND SYMBOLS
- POLYUREA PAVEMENT MARKING TYPE I -LINE 4" (YELLOW)
- POLYUREA PAVEMENT MARKING TYPE I -LINE 4" (WHITE)
- POLYUREA PAVEMENT MARKING TYPE I -LINE 4" (WHITE) (30" SKIP - 10" DASH)

SCALE: 1''=50' SHEET 1 OF 9 SHEETS STA.

- POLYUREA PAVEMENT MARKING TYPE I -LINE 4" (WHITE) (6' SKIP - 2' DASH)
- POLYUREA PAVEMENT MARKING TYPE I LINE 8" (WHITE)
- POLYUREA PAVEMENT MARKING TYPE I -LINE 6" (WHITE) (9" SKIP - 3" DASH)
- POLYUREA PAVEMENT MARKING TYPE I LINE 12" (WHITE)
- RAISED REFLECTIVE PAVEMENT MARKER (ONE-WAY CRYSTAL)
- RAISED REFLECTIVE PAVEMENT MARKER (ONE-WAY AMBER)

TO STA. 15+00.00



WAY EXISTING SIGN



WAY PROPOSED SIGN

FILE NAME =	DESIGNED - AG	REVISED -
\D160W75-sht-IL171-pmk-NB-01.dgn	DRAWN - TMB	REVISED -
USER NAME = tblank	CHECKED - JMM	REVISED -
PLOT DATE = 8/31/2015	DATE - 6/12/2015	REVISED -

1. POLYUREA PAVEMENT MARKING SHALL BE USED

ON ALL PORTLAND CEMENT CONCRETE PAVEMENT.

THIS INCLUDES BRIDGE DECKS, APPROACH SLABS,

AT 75' CENTERS. ALL OTHER SPACING PER DISTRICT

ONE STANDARD TC-13 UNLESS NOTED ON PLANS.

AND BRIDGE APPROACH CONNECTOR PAVEMENT.

2. SHOULDER DIAGONAL SPACING SHALL BE PLACED


**NOTES:** 



STATE OF ILLINOIS
<b>DEPARTMENT OF TRANSPORTATION</b>

PAVEMENT MARKING AND	F.A.P RTE.	
SIGNING PLANS	372/373	

A.P TE.	SECTION	COUNTY	TOTAL SHEETS	SHE
2/373	2013-037B-R	COOK	787	11
		CONTRACT	NO. 6	OW7
	ILLINOIS FED. A	ID PROJECT		

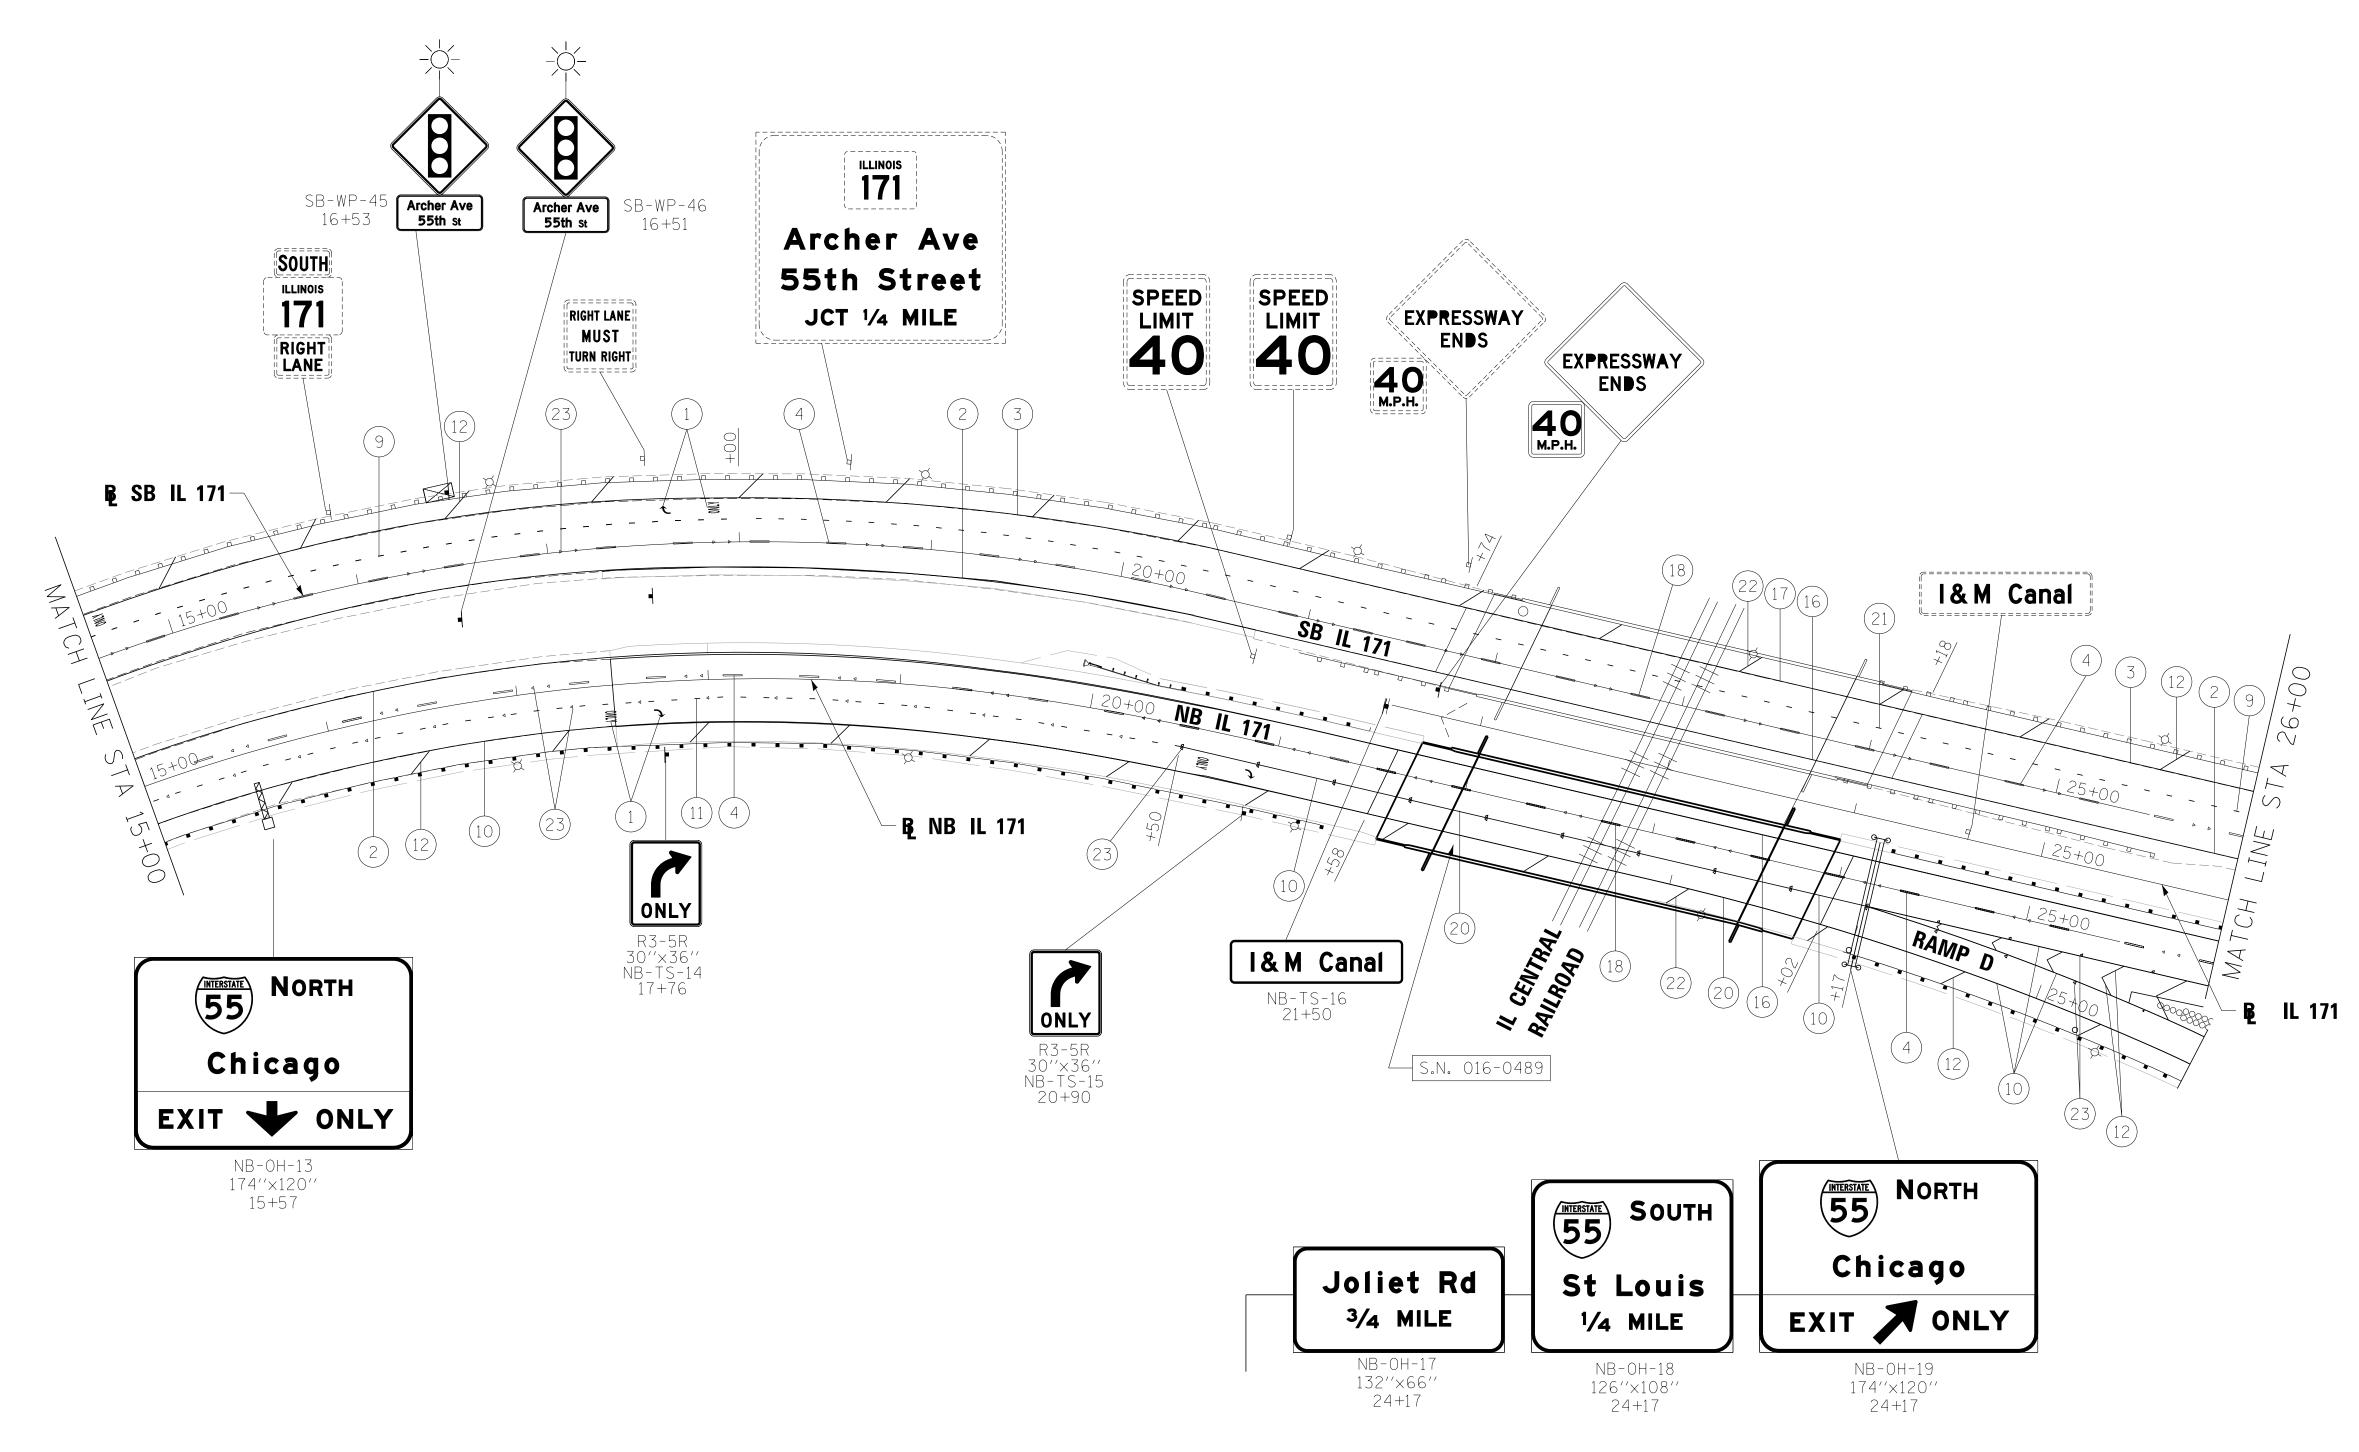

- THERMOPLASTIC PAVEMENT MARKING LETTERS AND SYMBOLS
- THERMOPLASTIC PAVEMENT MARKING LINE 4" (YELLOW)
- THERMOPLASTIC PAVEMENT MARKING LINE 4" (WHITE)
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- THERMOPLASTIC PAVEMENT MARKING LINE 24" (WHITE)
- POLYUREA PAVEMENT MARKING TYPE I LETTERS AND SYMBOLS
- POLYUREA PAVEMENT MARKING TYPE I LINE 4" (YELLOW)
- POLYUREA PAVEMENT MARKING TYPE I -LINE 4" (WHITE)
- POLYUREA PAVEMENT MARKING TYPE I RAISED REFLECTIVE PAVEMENT MARKER LINE 4" (WHITE) (30" SKIP 10" DASH) (ONE-WAY AMBER)

SCALE: 1''=50' SHEET

- POLYUREA PAVEMENT MARKING TYPE I LINE 4" (WHITE) (6' SKIP 2' DASH)
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- POLYUREA PAVEMENT MARKING TYPE I -LINE 12" (WHITE)
- RAISED REFLECTIVE PAVEMENT MARKER (ONE-WAY CRYSTAL)





WAY PROPOSED SIGN

FILE NAME =	DESIGNED - AG	REVISED -
\D160W75-sht-IL171-pmk-NB-02.dgn	DRAWN - TMB	REVISED -
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PLOT DATE = 8/31/2015	DATE - 6/12/2015	REVISED -




STATE OF ILLINOIS
<b>DEPARTMENT OF TRANSPORTATION</b>


PAVEMENT MARKING	ΔΝΩ
SIGNING PLANS	

2 OF 9 SHEETS STA. 15+00.00 TO STA. 26+00.00

ĮĖ.	SECT	ION			COUNTY	TOTA SHEET	N	SHI N
/373	/373 2013-037B-R				COOK	787		1
					CONTRACT	NO.	6	OW
		ILLINOIS	FED.	AII	) PROJECT			

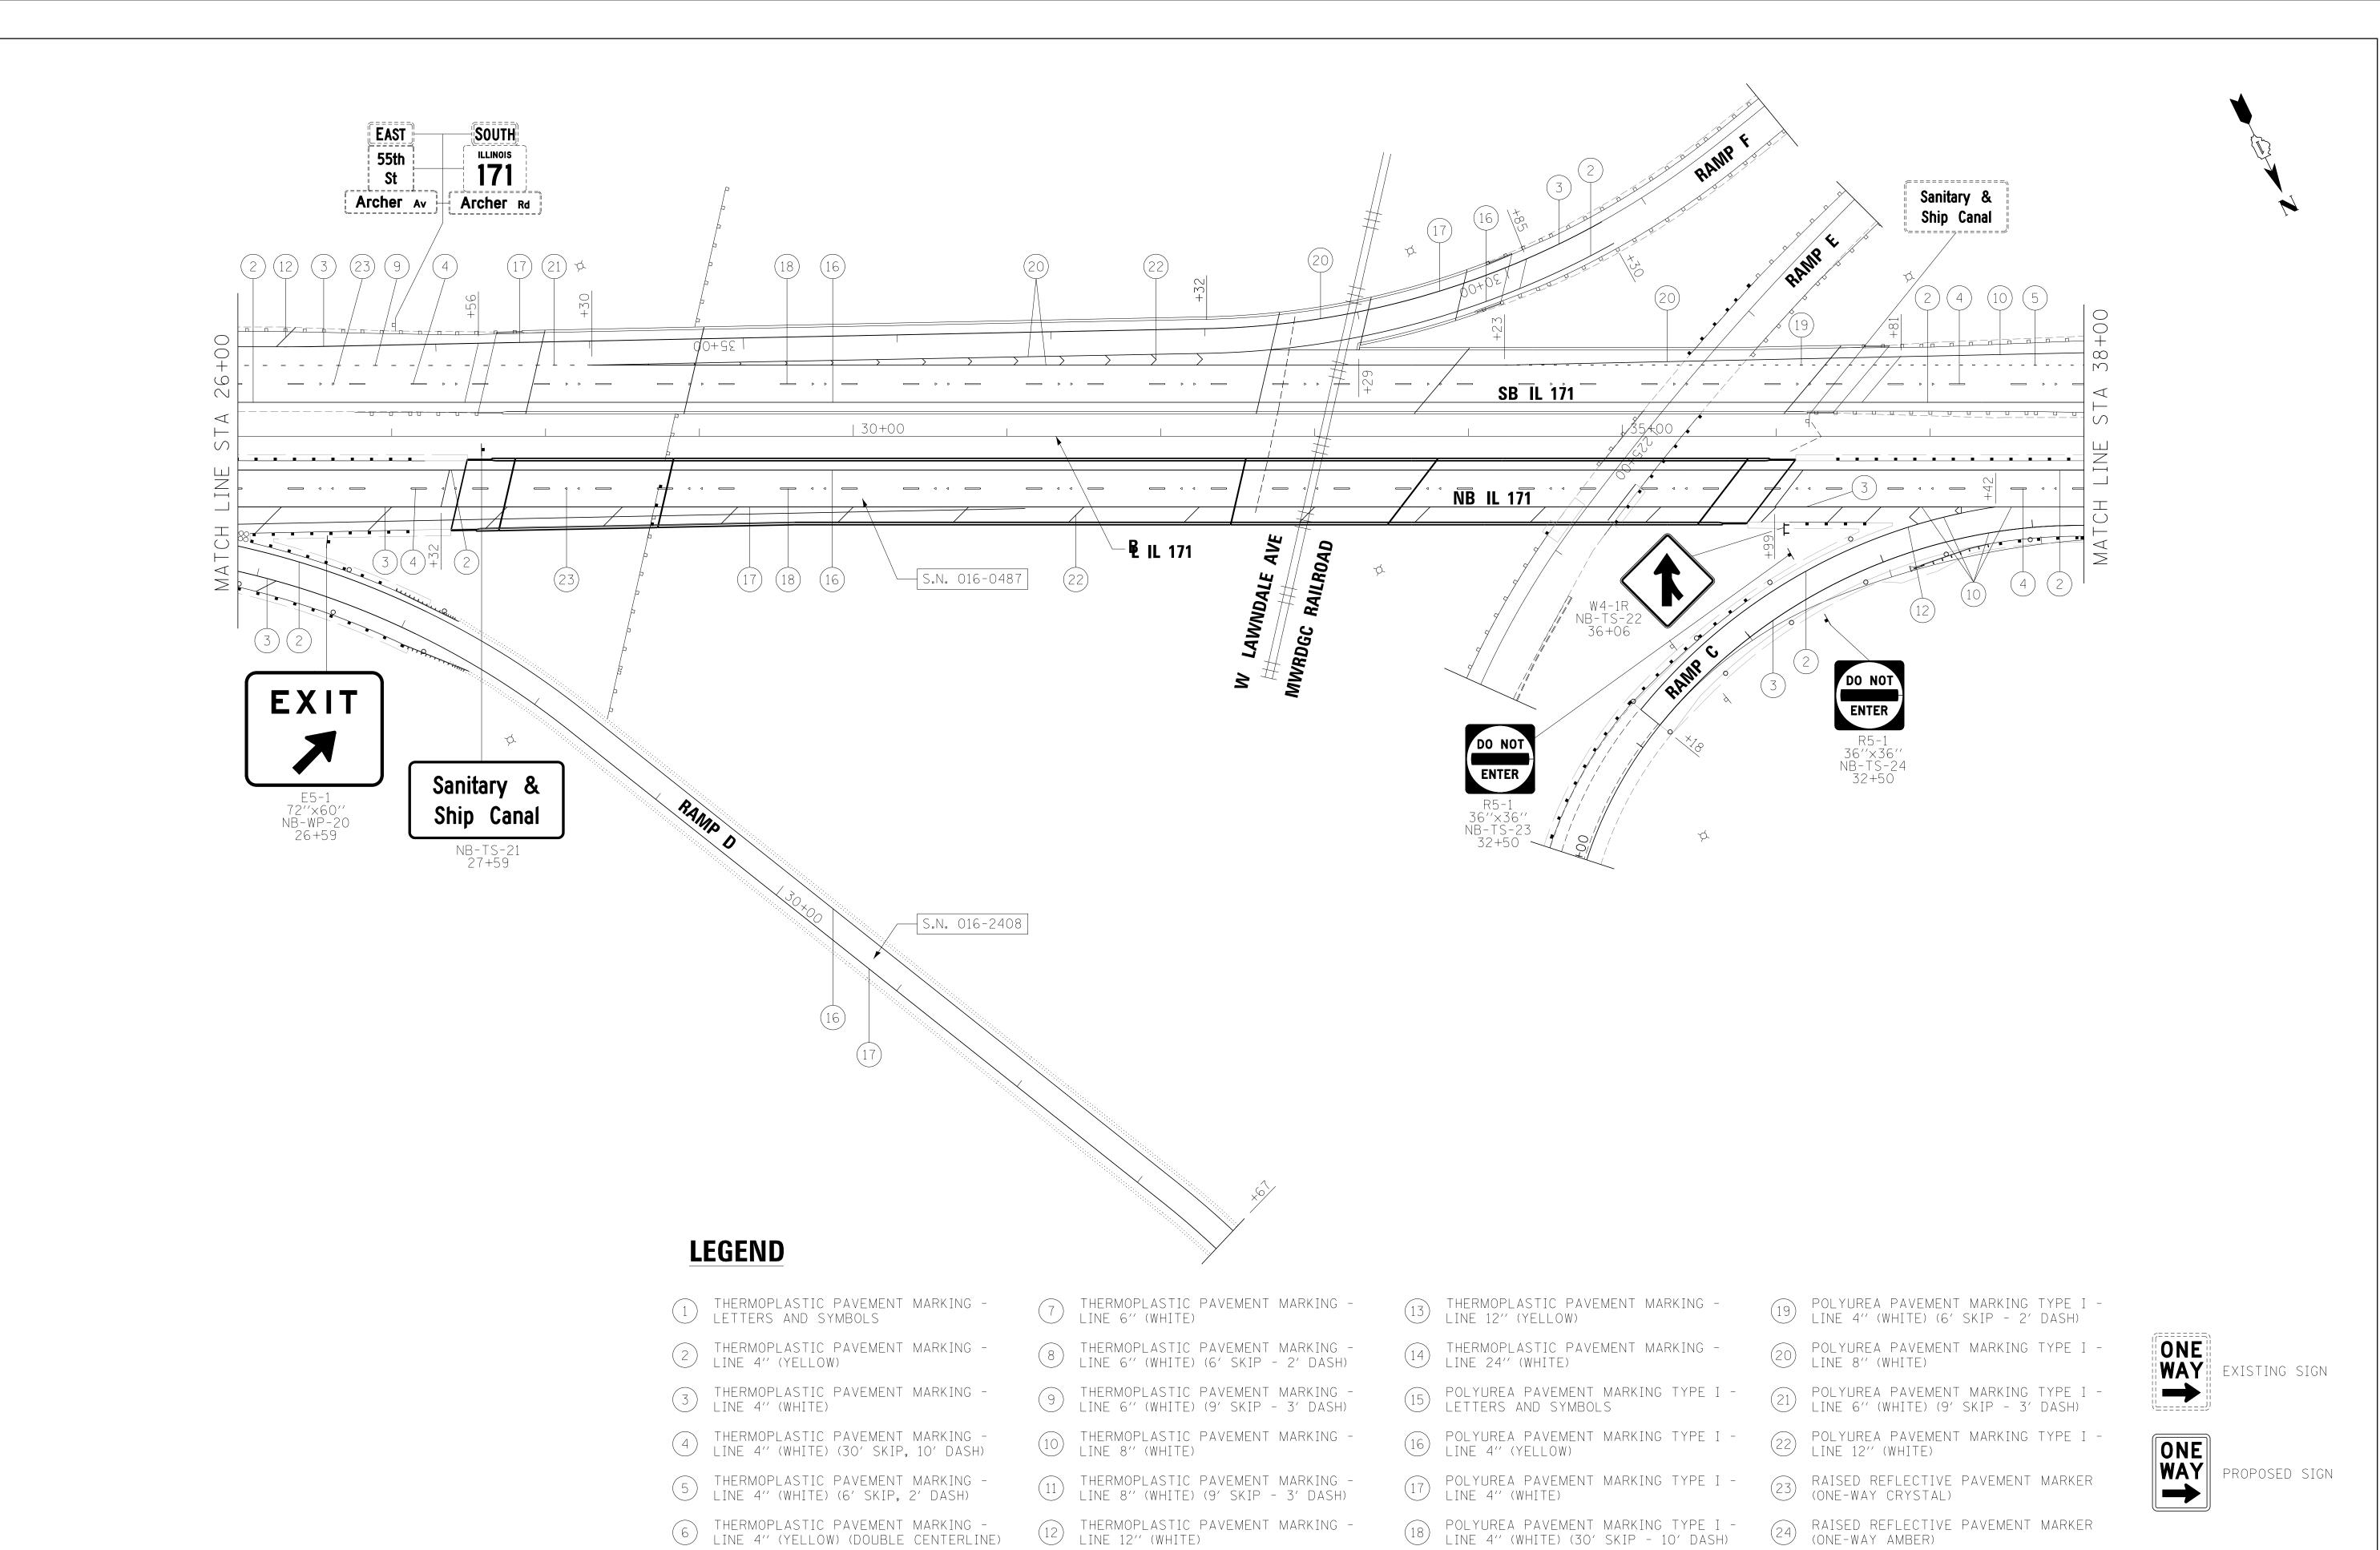

TOTAL SHEET NO. FILE NAME = DESIGNED - AG REVISED SECTION COUNTY **PAVEMENT MARKING AND** benesch engineers - scientists - planners **STATE OF ILLINOIS** - TMB REVISED DRAWN ..\D160W75-sht-IL171-pmk-NB-03.dgn 787 | 113 372/373 2013-037B-R COOK SIGNING PLANS DEPARTMENT OF TRANSPORTATION - JMM REVISED CHECKED JSER NAME = tblank CONTRACT NO. 60W75 DATE REVISED SCALE: 1''=50' SHEET 3 OF 9 SHEETS STA. 26+00.00 TO STA. 38+00.00 PLOT DATE = 8/31/2015 - 6/12/2015 ILLINOIS FED. AID PROJECT

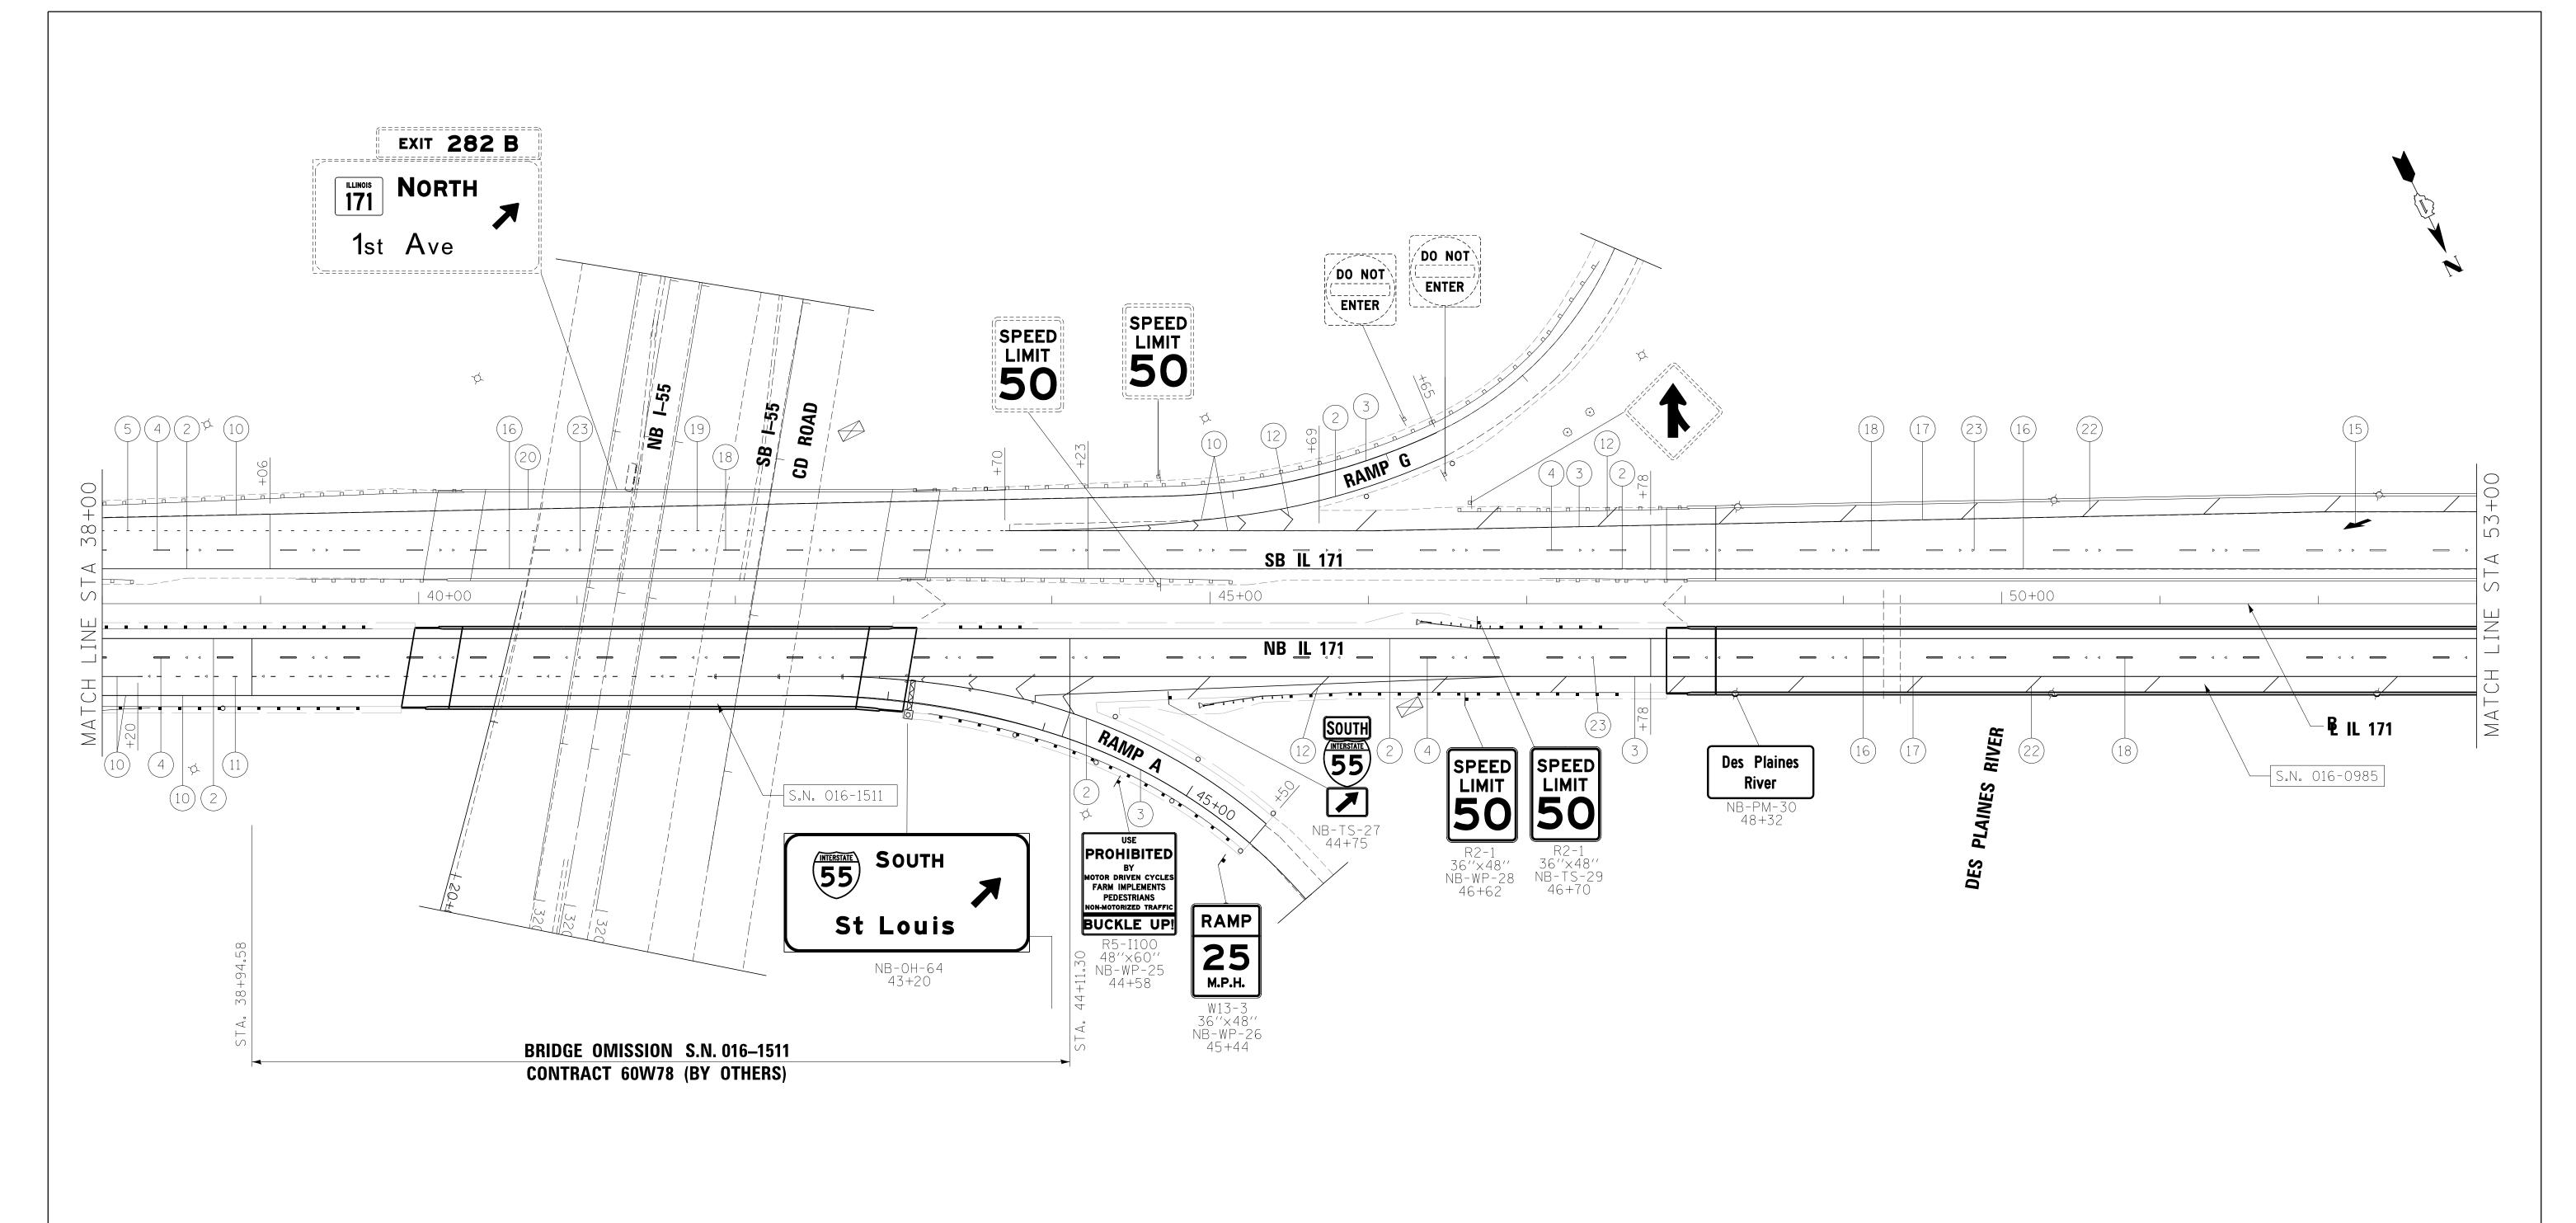

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**WAY** EXISTING SIGN




FILE NAME =	DESIGNED -	AG	REVISED -
\D160W75-sht-IL171-pmk-NB-04.dgn	DRAWN -	TMB	REVISED -
USER NAME = tblank	CHECKED -	JMM	REVISED -
PLOT DATE = 8/31/2015	DATE -	6/12/2015	REVISED -



STATE OF ILLINOIS
DEPARTMENT OF TRANSPORTATION

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	SIGNING PLANS										
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.P	SECTION	COUNTY	TOTAL SHEETS	SHEET NO.
373	2013-037B-R	COOK	787	114
		CONTRACT	NO. 6	OW75
	THE THOTOLETED AT	D DDO IECT		

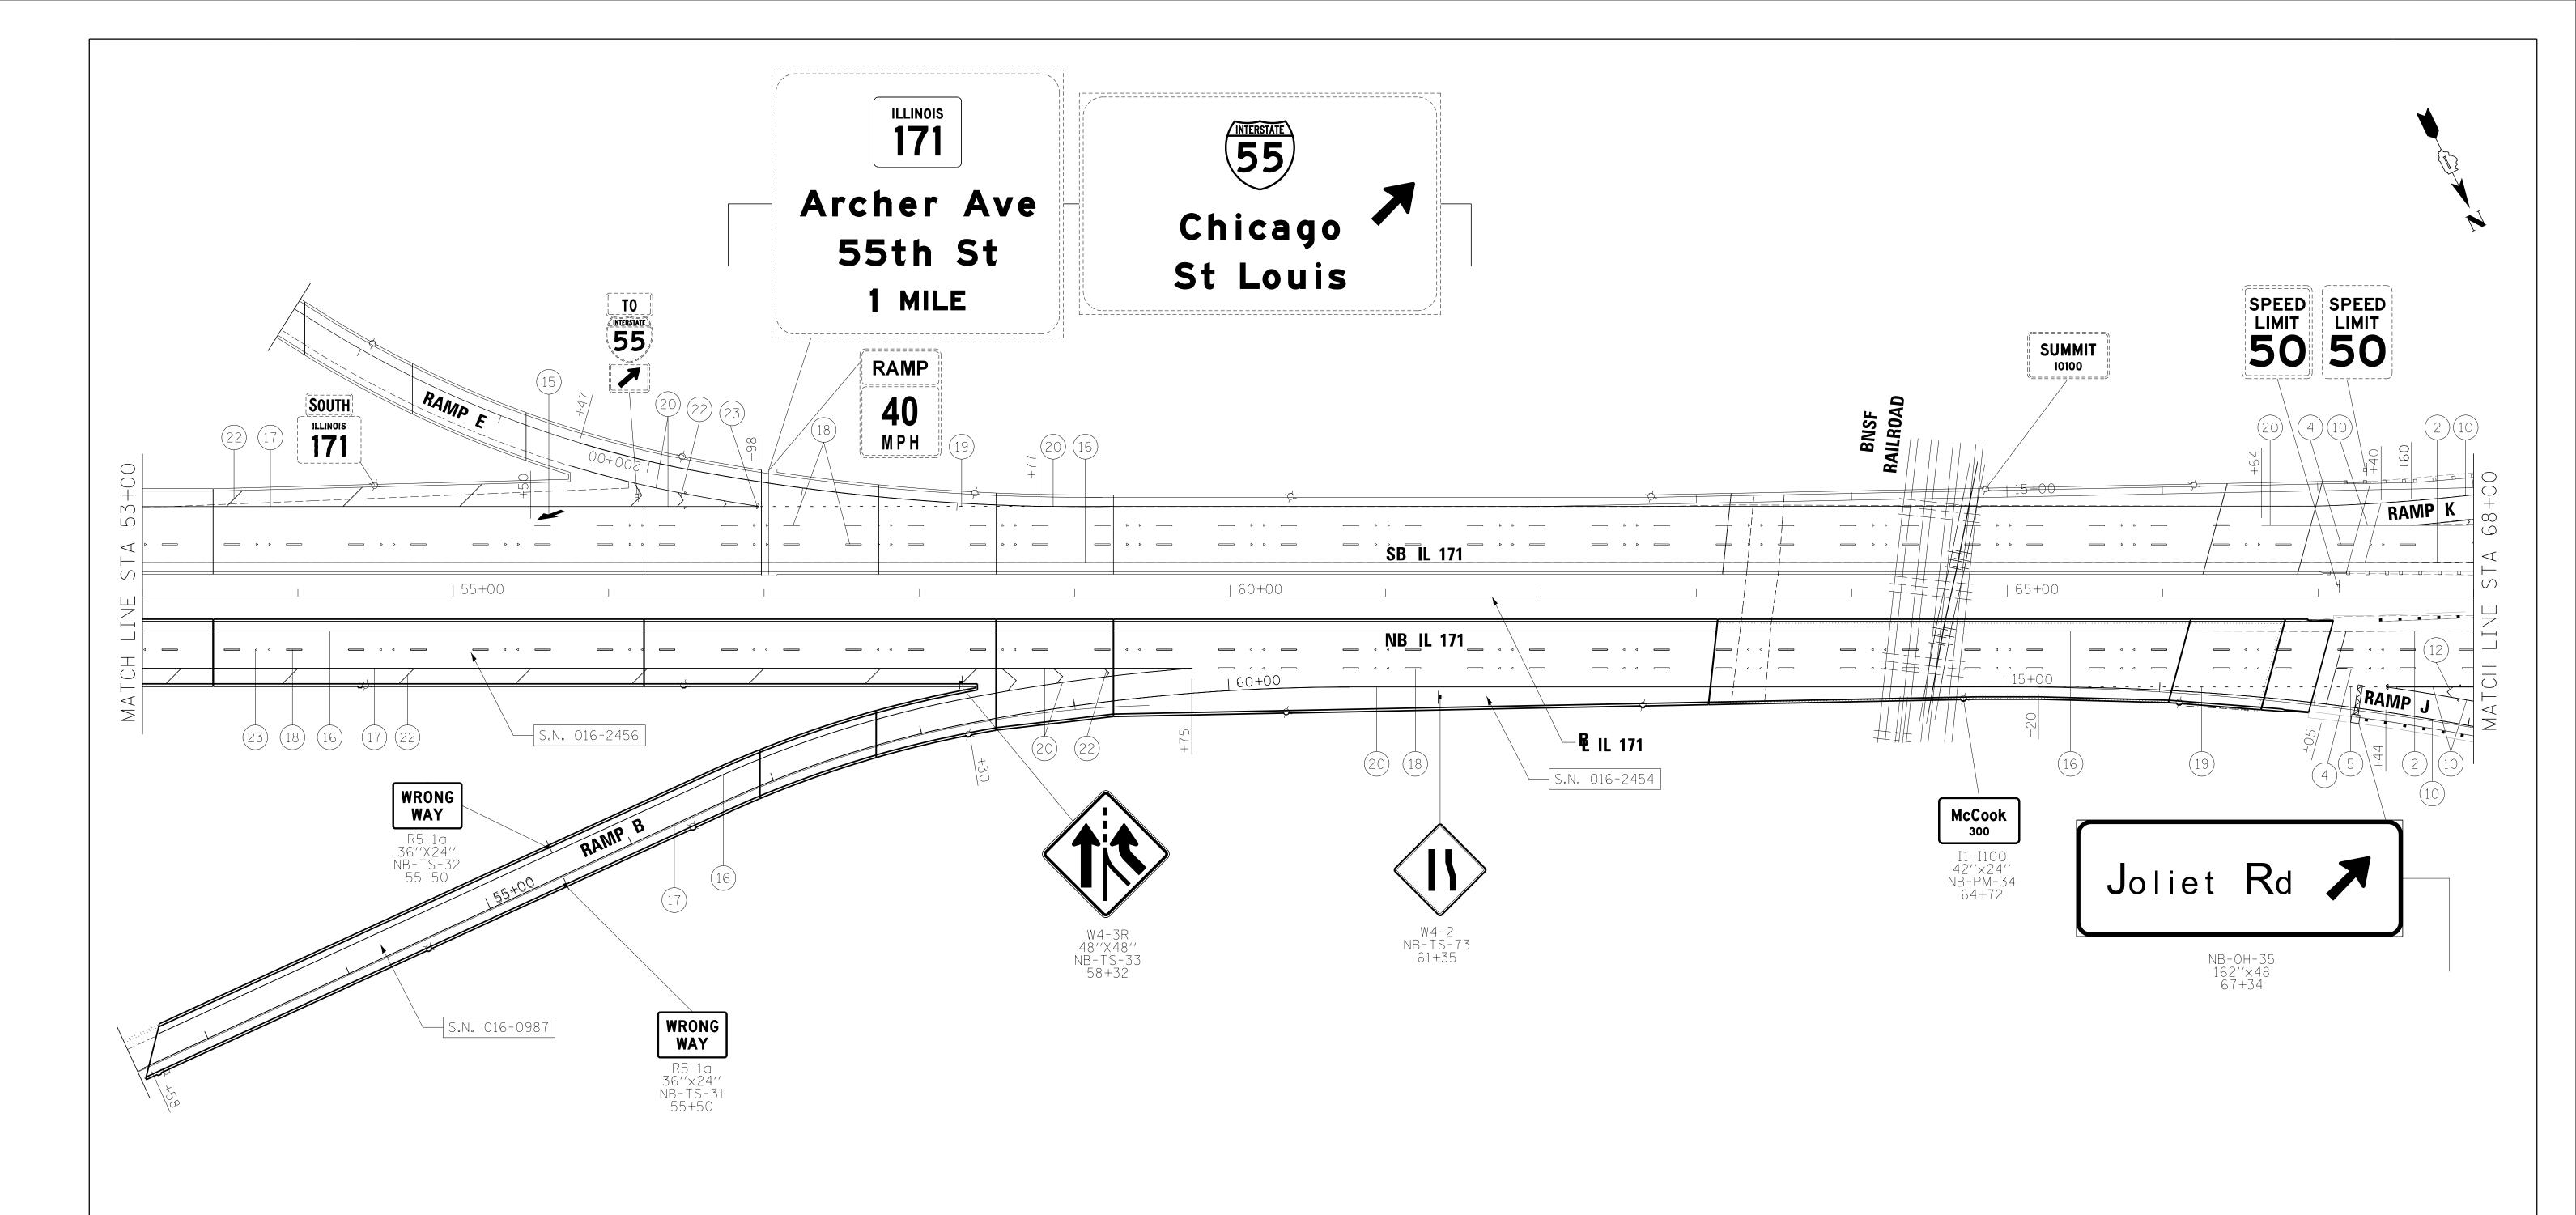

- THERMOPLASTIC PAVEMENT MARKING LETTERS AND SYMBOLS
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- THERMOPLASTIC PAVEMENT MARKING LINE 12" (WHITE)

- THERMOPLASTIC PAVEMENT MARKING LINE 12" (YELLOW)
- THERMOPLASTIC PAVEMENT MARKING LINE 24" (WHITE)
- POLYUREA PAVEMENT MARKING TYPE I LETTERS AND SYMBOLS
- POLYUREA PAVEMENT MARKING TYPE I LINE 4" (YELLOW)
- POLYUREA PAVEMENT MARKING TYPE I LINE 4" (WHITE)
- POLYUREA PAVEMENT MARKING TYPE I LINE 4" (WHITE) (30" SKIP 10" DASH)

- POLYUREA PAVEMENT MARKING TYPE I LINE 4" (WHITE) (6' SKIP 2' DASH)
- POLYUREA PAVEMENT MARKING TYPE I LINE 8" (WHITE)
- POLYUREA PAVEMENT MARKING TYPE I LINE 6" (WHITE) (9" SKIP 3" DASH)
- POLYUREA PAVEMENT MARKING TYPE I -LINE 12" (WHITE)
- RAISED REFLECTIVE PAVEMENT MARKER (ONE-WAY CRYSTAL)
- RAISED REFLECTIVE PAVEMENT MARKER (ONE-WAY AMBER)



WAY EXISTING SIGN




FILE NAME =	DESIGNED - AG	REVISED -		
\D160W75-sht-IL171-pmk-NB-05.dgn	DRAWN - TMB	REVISED -	benesch	
USER NAME = tblank	CHECKED - JMM	REVISED -	engineers · scientists · planners	DEPART
PLOT DATE = 8/31/2015	DATE - 6/12/2015	REVISED -	·	

STATE OF ILLINOIS
<b>DEPARTMENT OF TRANSPORTATION</b>

PAVEMENT MARKING AND	F.A.P RTE.	
SIGNING PLANS	372/373	
	_	
SCALE: 1"=50"   SHEET   5 OF 9   SHEETS   STA. 53+00.00   TO STA. 68+00.00		

SECTION	COUNTY	TOTAL SHEETS	SHEET NO.
2013-037B-R	COOK	787	115
	CONTRACT	NO. 6	OW75
THE THOTOLETED AT			

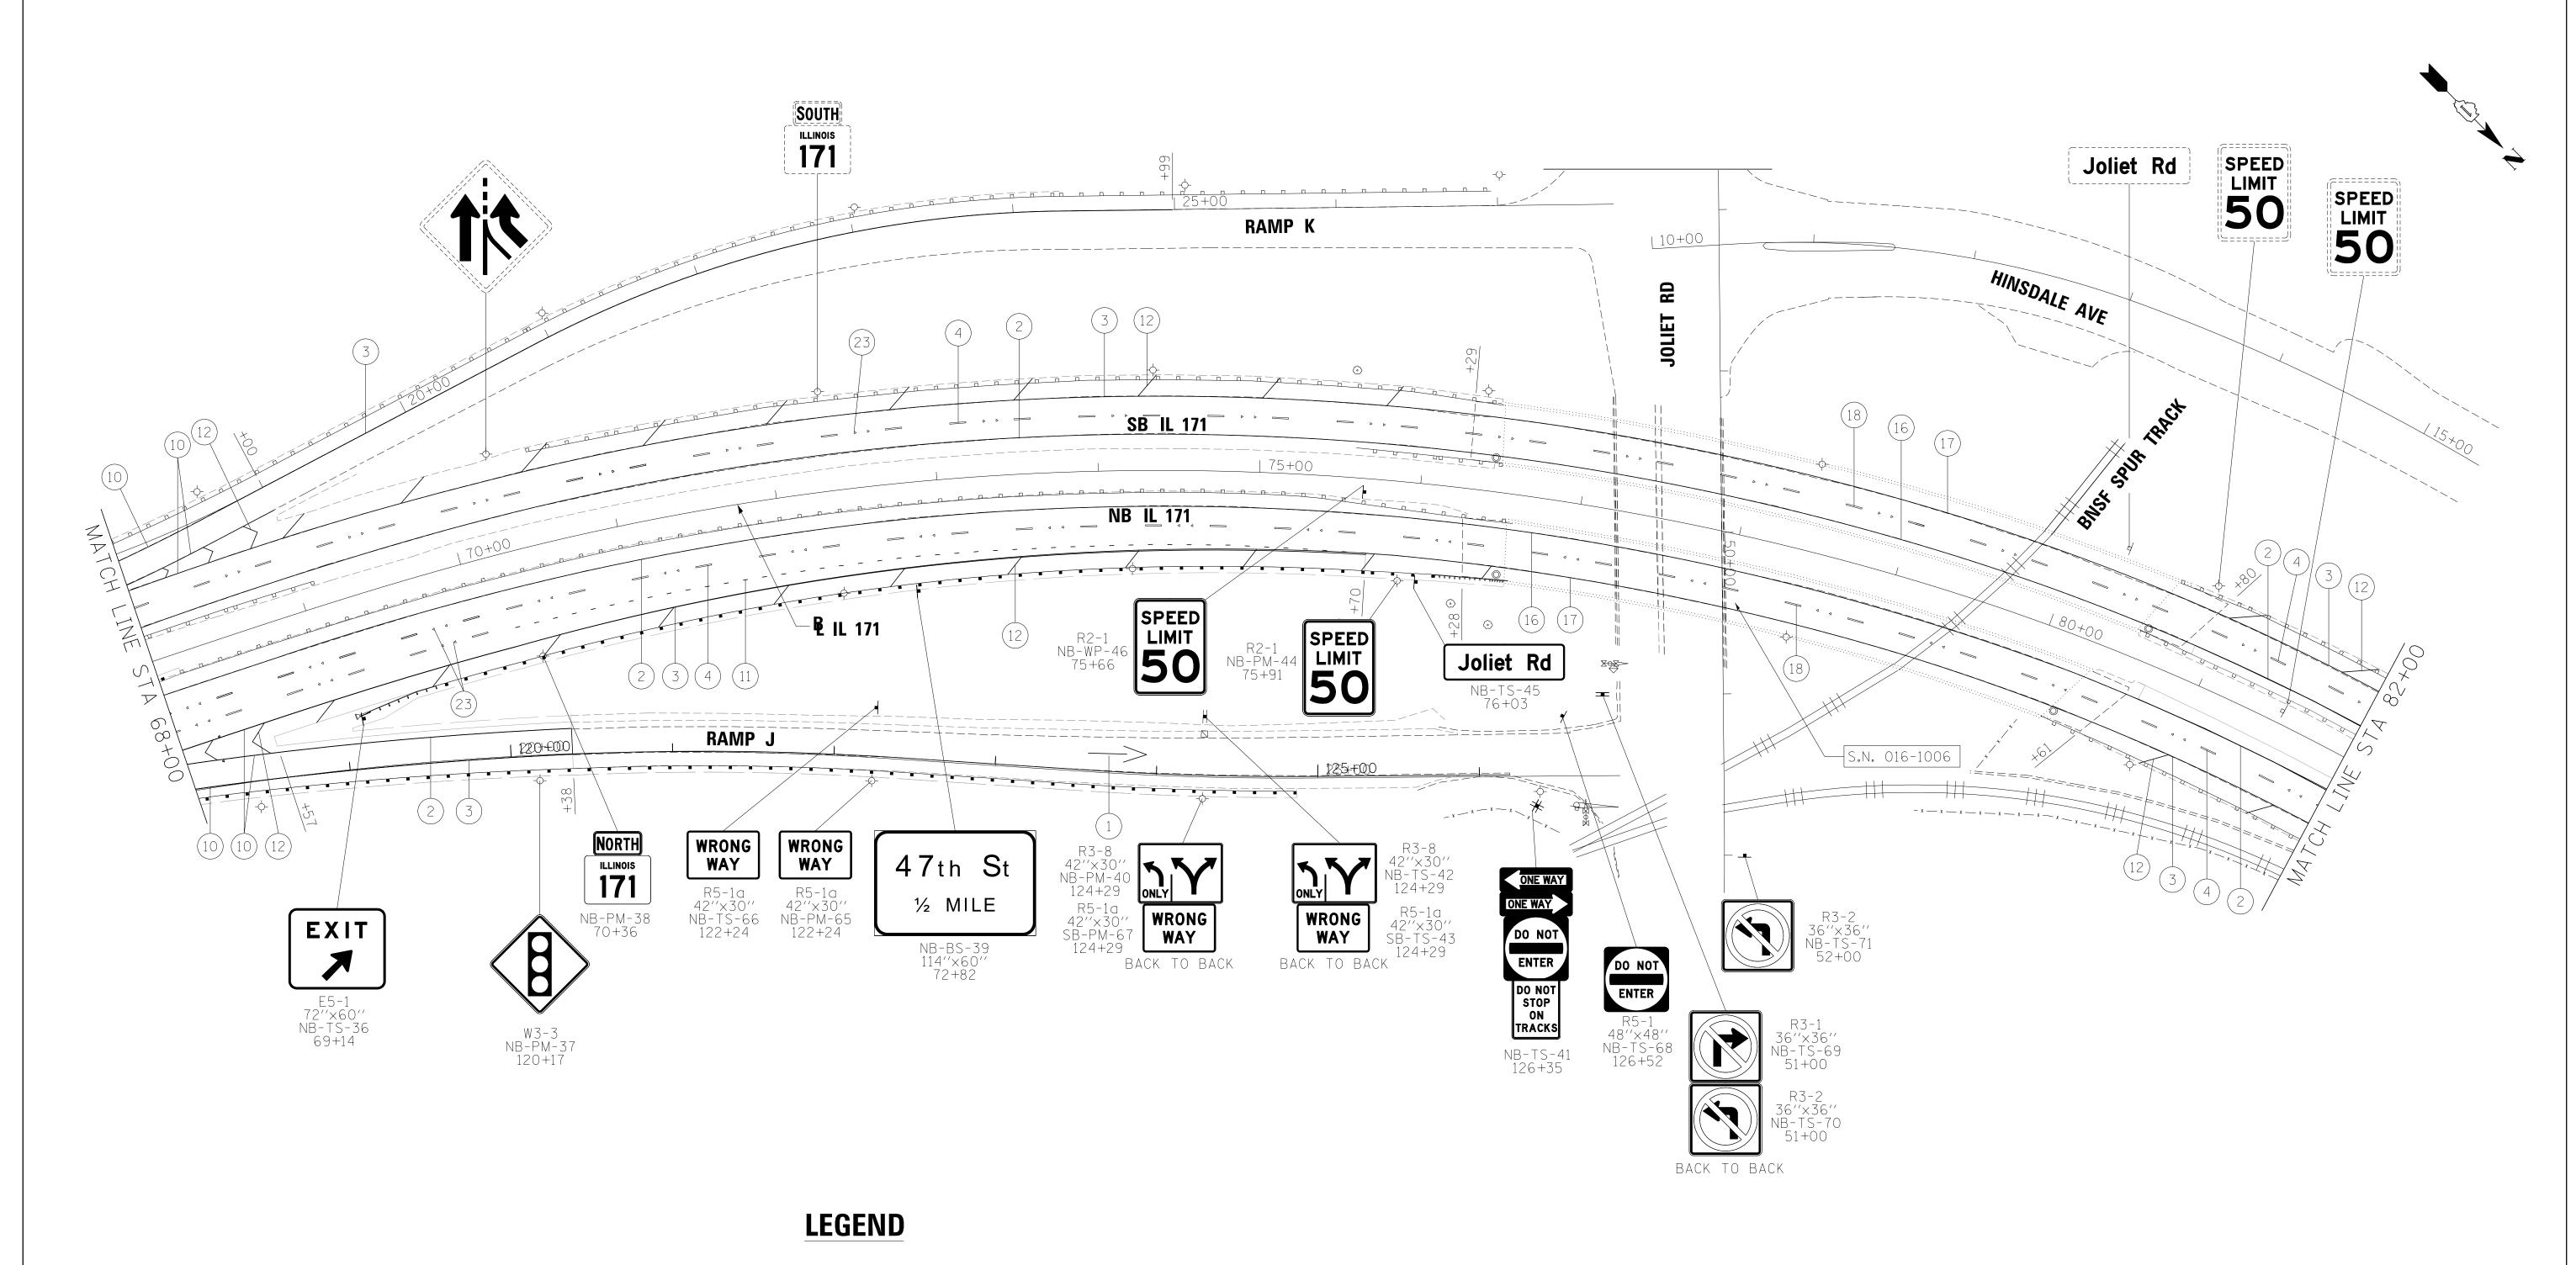

- THERMOPLASTIC PAVEMENT MARKING LETTERS AND SYMBOLS
- THERMOPLASTIC PAVEMENT MARKING LINE 4" (YELLOW)
- THERMOPLASTIC PAVEMENT MARKING LINE 4" (WHITE)
- THERMOPLASTIC PAVEMENT MARKING LINE 4" (WHITE) (30' SKIP, 10' DASH)
- THERMOPLASTIC PAVEMENT MARKING LINE 4" (WHITE) (6" SKIP, 2" DASH)
- THERMOPLASTIC PAVEMENT MARKING LINE 4" (YELLOW) (DOUBLE CENTERLINE)

- 7 THERMOPLASTIC PAVEMENT MARKING LINE 6" (WHITE)
- THERMOPLASTIC PAVEMENT MARKING LINE 6" (WHITE) (6" SKIP 2" DASH)
- 9 THERMOPLASTIC PAVEMENT MARKING LINE 6" (WHITE) (9" SKIP 3" DASH)
- THERMOPLASTIC PAVEMENT MARKING LINE 8" (WHITE)
- THERMOPLASTIC PAVEMENT MARKING LINE 8" (WHITE) (9" SKIP 3" DASH)
- THERMOPLASTIC PAVEMENT MARKING -LINE 12" (WHITE)

- THERMOPLASTIC PAVEMENT MARKING LINE 12" (YELLOW)
- THERMOPLASTIC PAVEMENT MARKING LINE 24" (WHITE)
- POLYUREA PAVEMENT MARKING TYPE I LETTERS AND SYMBOLS
- POLYUREA PAVEMENT MARKING TYPE I LINE 4" (YELLOW)
- POLYUREA PAVEMENT MARKING TYPE I -LINE 4" (WHITE)

- POLYUREA PAVEMENT MARKING TYPE I LINE 4" (WHITE) (6' SKIP 2' DASH)
- POLYUREA PAVEMENT MARKING TYPE I LINE 8" (WHITE)
- POLYUREA PAVEMENT MARKING TYPE I -LINE 6" (WHITE) (9" SKIP 3" DASH)
- POLYUREA PAVEMENT MARKING TYPE I -LINE 12" (WHITE)
- RAISED REFLECTIVE PAVEMENT MARKER (ONE-WAY CRYSTAL)
- POLYUREA PAVEMENT MARKING TYPE I RAISED REFLECTIVE PAVEMENT MARKER LINE 4" (WHITE) (30" SKIP 10" DASH) (ONE-WAY AMBER)



WAY EXISTING SIGN



WAY PROPOSED SIGN

FILE NAME =	DESIGNED -	AG	REVISED -
\D160W75-sht-IL171-pmk-NB-06.dgn	DRAWN -	TMB	REVISED -
USER NAME = tblank	CHECKED -	JMM	REVISED -
PLOT DATE = 8/31/2015	DATE -	6/12/2015	REVISED -




STATE OF ILLINOIS
<b>DEPARTMENT OF TRANSPORTATION</b>

PAVEMENT MARKING AND	F.A.P RTE.	
SIGNING PLANS	372/373	

SCALE: 1''=50' | SHEET | 6 OF 9 | SHEETS | STA. 68+00.00 | TO STA. 82+00.00 |

. P	SECTION	COUNTY	TOTAL SHEETS	SHEET NO.
373	2013-037B-R	COOK	787	116
		CONTRACT	NO. 6	OW75
	THE TWO IS EED AT	D PROJECT		

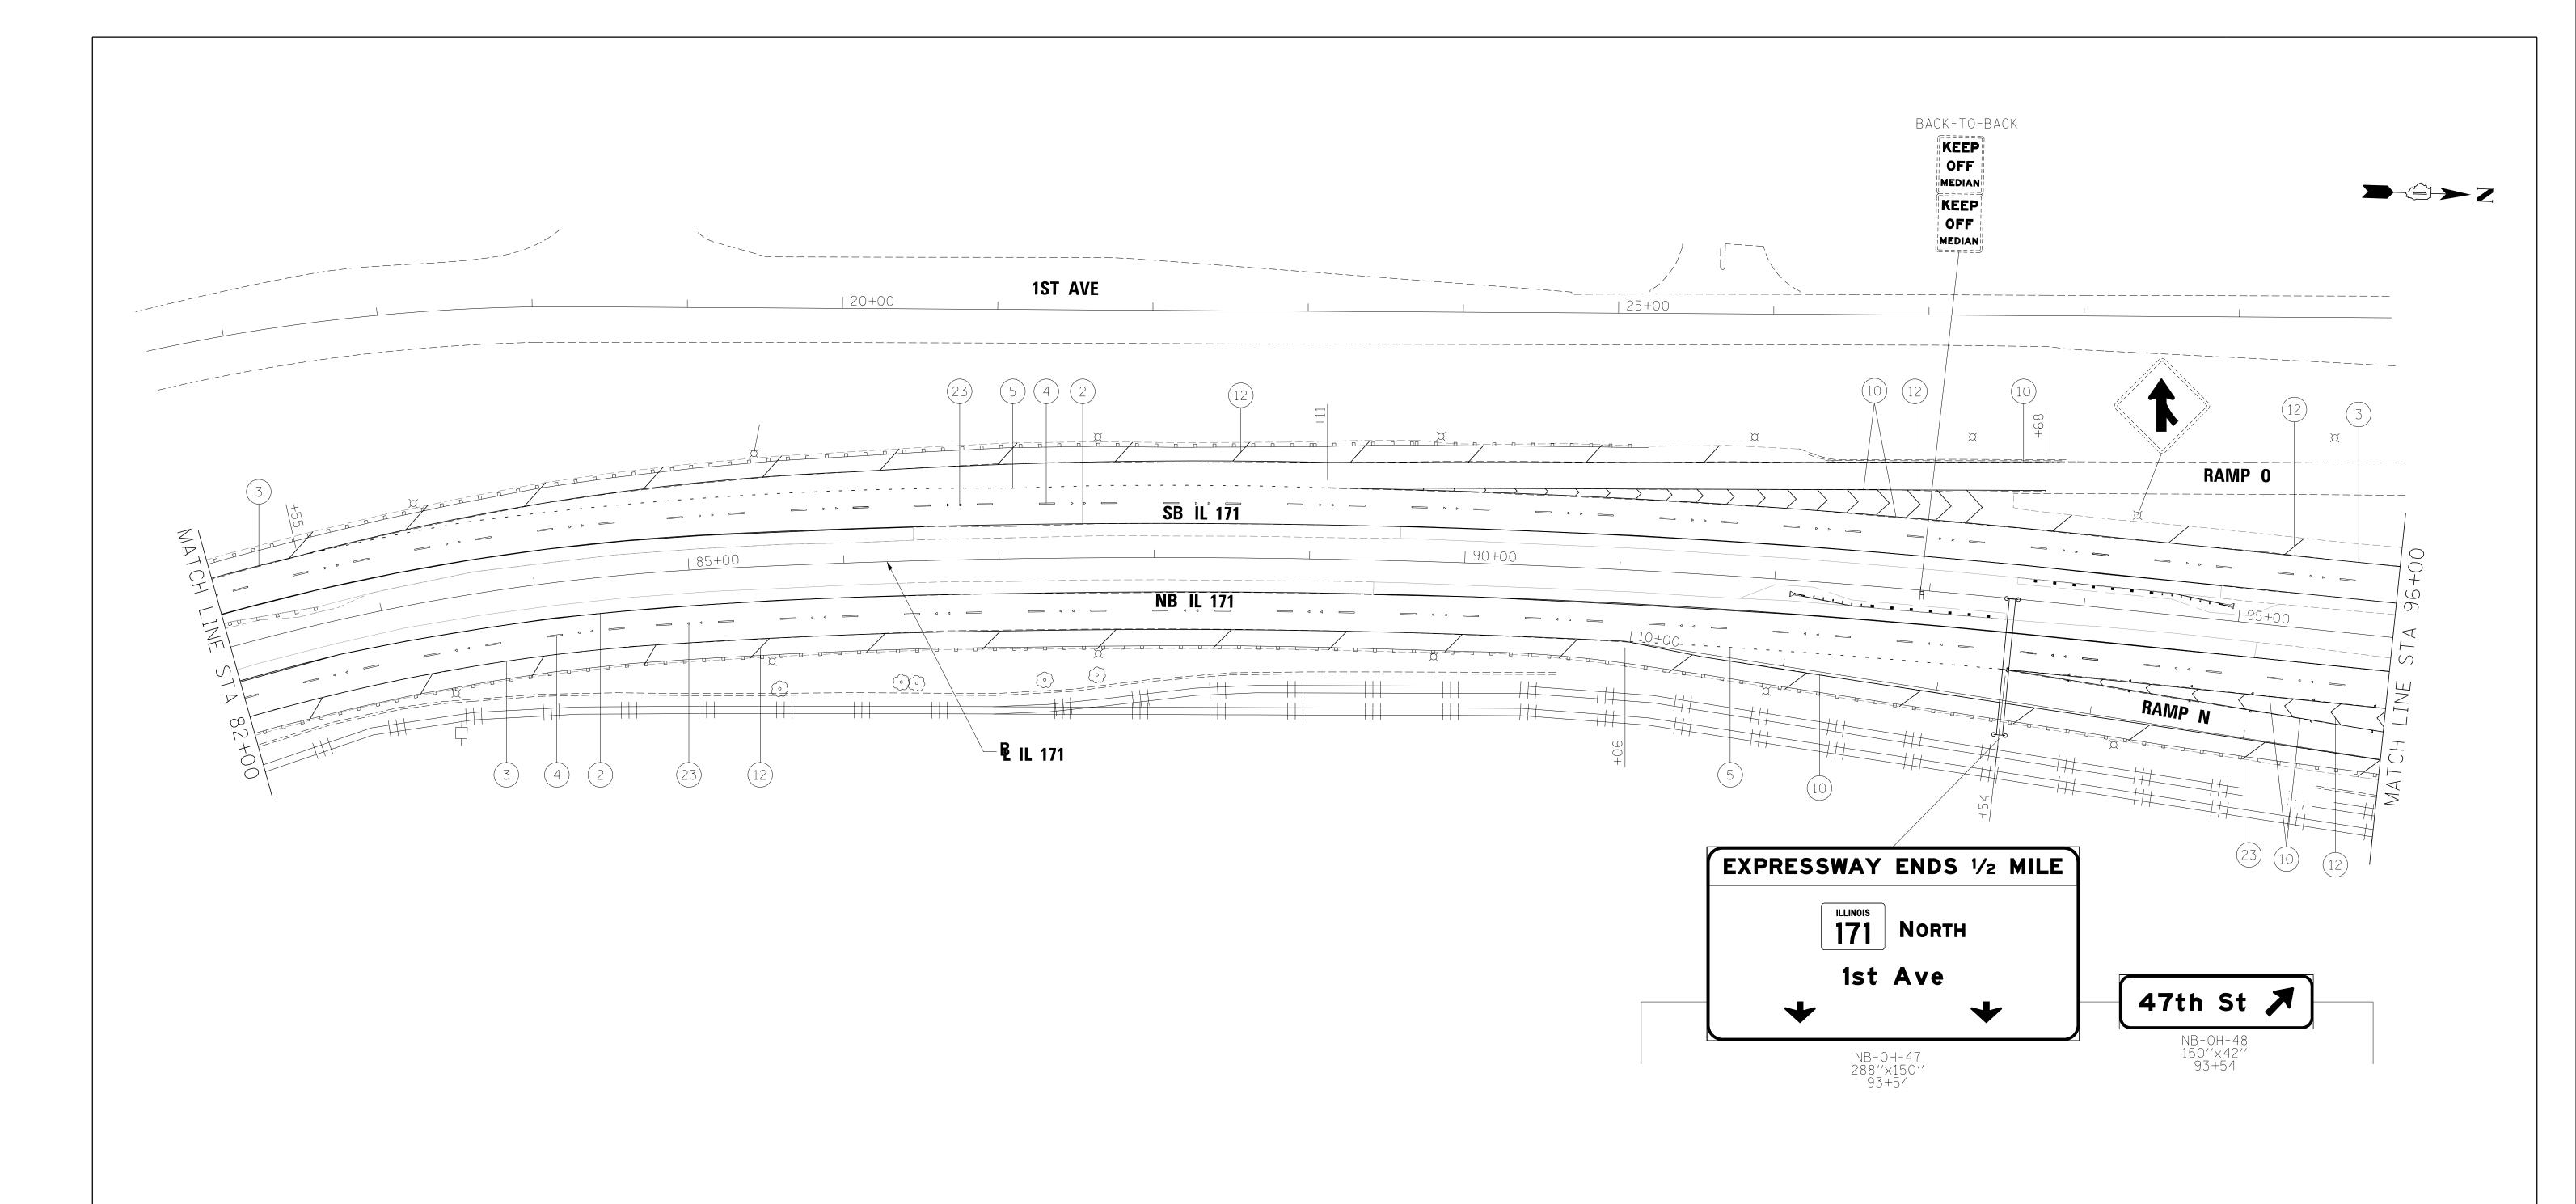

- THERMOPLASTIC PAVEMENT MARKING -LETTERS AND SYMBOLS
- THERMOPLASTIC PAVEMENT MARKING LINE 4" (YELLOW)
- THERMOPLASTIC PAVEMENT MARKING LINE 4" (WHITE)
- THERMOPLASTIC PAVEMENT MARKING LINE 4" (WHITE) (30' SKIP, 10' DASH)
- THERMOPLASTIC PAVEMENT MARKING LINE 4" (WHITE) (6" SKIP, 2" DASH)
- 6 THERMOPLASTIC PAVEMENT MARKING -LINE 4" (YELLOW) (DOUBLE CENTERLINE)

- 7 THERMOPLASTIC PAVEMENT MARKING LINE 6" (WHITE)
- THERMOPLASTIC PAVEMENT MARKING LINE 6" (WHITE) (6" SKIP 2" DASH)
- THERMOPLASTIC PAVEMENT MARKING LINE 6" (WHITE) (9" SKIP 3" DASH)
- THERMOPLASTIC PAVEMENT MARKING LINE 8" (WHITE)
- THERMOPLASTIC PAVEMENT MARKING LINE 8" (WHITE) (9" SKIP 3" DASH)
- THERMOPLASTIC PAVEMENT MARKING -LINE 12" (WHITE)

- THERMOPLASTIC PAVEMENT MARKING LINE 12" (YELLOW)
- THERMOPLASTIC PAVEMENT MARKING -LINE 24" (WHITE)
- POLYUREA PAVEMENT MARKING TYPE I -LETTERS AND SYMBOLS
- POLYUREA PAVEMENT MARKING TYPE I LINE 4" (YELLOW)
- POLYUREA PAVEMENT MARKING TYPE I -LINE 4" (WHITE)
- POLYUREA PAVEMENT MARKING TYPE I RAISED REFLECTIVE PAVEMENT MARKER LINE 4" (WHITE) (30" SKIP 10" DASH) (ONE-WAY AMBER)

- POLYUREA PAVEMENT MARKING TYPE I -LINE 4" (WHITE) (6' SKIP 2' DASH)
- POLYUREA PAVEMENT MARKING TYPE I LINE 8" (WHITE)
- POLYUREA PAVEMENT MARKING TYPE I LINE 6" (WHITE) (9" SKIP 3" DASH)
- POLYUREA PAVEMENT MARKING TYPE I -LINE 12" (WHITE)
- RAISED REFLECTIVE PAVEMENT MARKER (ONE-WAY CRYSTAL)



**WAY** EXISTING SIGN



FILE NAME =	DESIGNED -	AG	REVISED -
\D160W75-sht-IL171-pmk-NB-07.dgn	DRAWN -	TMB	REVISED -
USER NAME = tblank	CHECKED -	JMM	REVISED -
PLOT DATE = 8/31/2015	DATE -	6/12/2015	REVISED -




STATE OF ILLINOIS
<b>DEPARTMENT OF TRANSPORTATION</b>

PAVEMENT MARKING AND SIGNING PLANS									
	SCALE:	1''=50'	SHEET	7 OF	9	SHEETS	STA.	82+00.00	TO STA. 96+00.00

SECTION		COUNTY	TOTAL SHEETS	SHEET NO.
2013-037B-R	COOK	787	117	
	CONTRACT	NO. 6	OW75	
ILLINOIS FE	D. AI	D PROJECT		



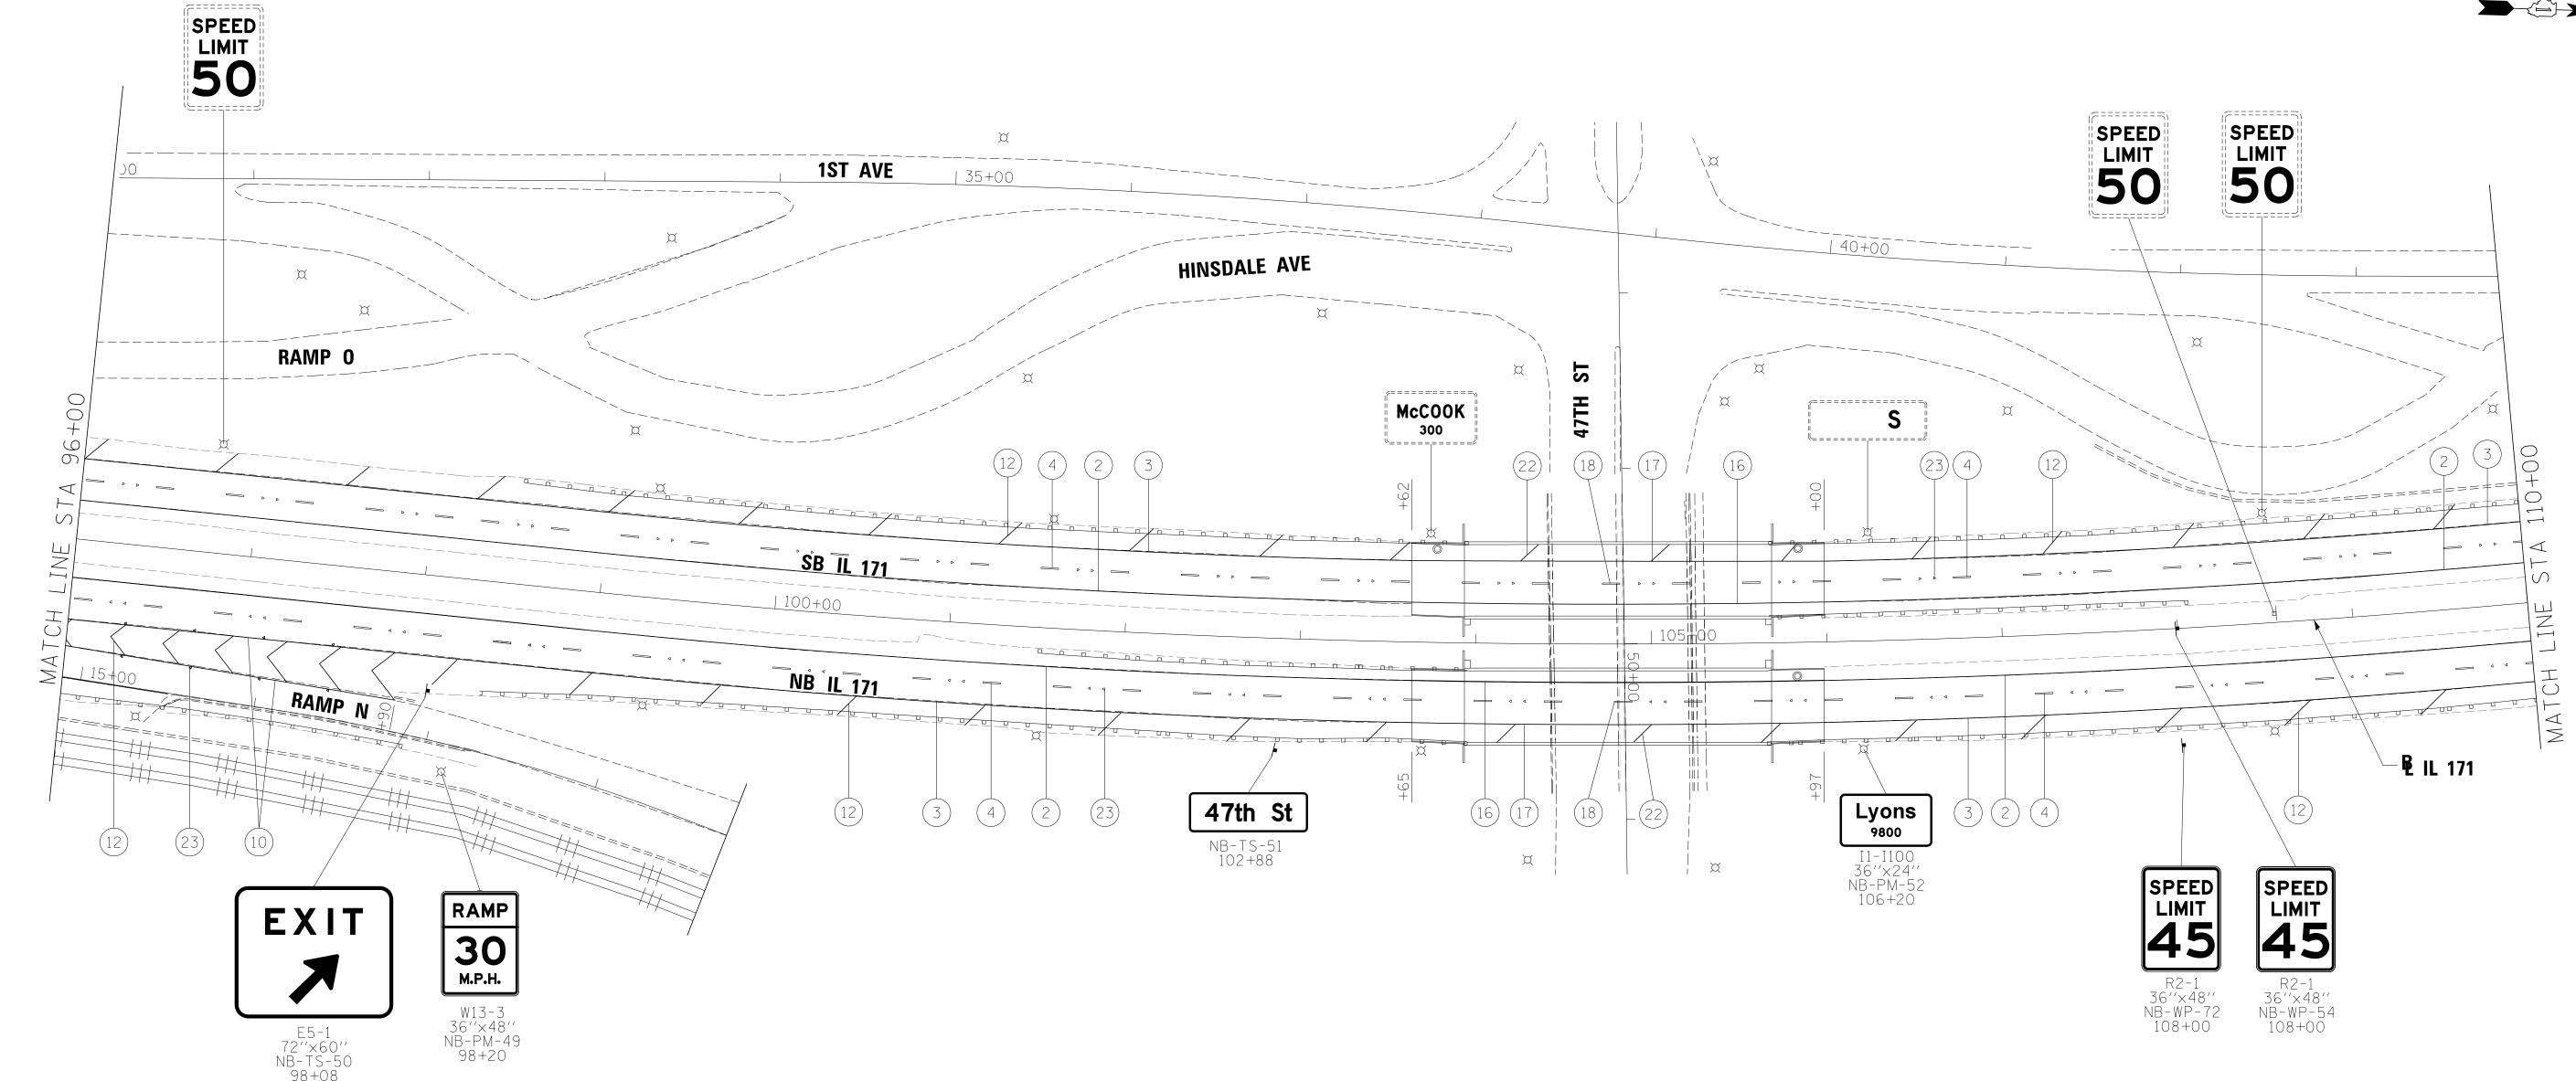

- THERMOPLASTIC PAVEMENT MARKING -LETTERS AND SYMBOLS
- THERMOPLASTIC PAVEMENT MARKING LINE 4" (YELLOW)
- THERMOPLASTIC PAVEMENT MARKING LINE 4" (WHITE)
- THERMOPLASTIC PAVEMENT MARKING LINE 4" (WHITE) (30' SKIP, 10' DASH)
- THERMOPLASTIC PAVEMENT MARKING LINE 4" (WHITE) (6" SKIP, 2" DASH)
- THERMOPLASTIC PAVEMENT MARKING LINE 4" (YELLOW) (DOUBLE CENTERLINE)

- 7 THERMOPLASTIC PAVEMENT MARKING LINE 6" (WHITE)
- THERMOPLASTIC PAVEMENT MARKING LINE 6" (WHITE) (6" SKIP 2" DASH)
- 9 THERMOPLASTIC PAVEMENT MARKING LINE 6" (WHITE) (9" SKIP 3" DASH)
- THERMOPLASTIC PAVEMENT MARKING LINE 8" (WHITE)
- THERMOPLASTIC PAVEMENT MARKING LINE 8" (WHITE) (9" SKIP 3" DASH)
- THERMOPLASTIC PAVEMENT MARKING -LINE 12" (WHITE)

- THERMOPLASTIC PAVEMENT MARKING LINE 12" (YELLOW)
- THERMOPLASTIC PAVEMENT MARKING -LINE 24" (WHITE)
- POLYUREA PAVEMENT MARKING TYPE I -LETTERS AND SYMBOLS
- POLYUREA PAVEMENT MARKING TYPE I -LINE 4" (WHITE)
- POLYUREA PAVEMENT MARKING TYPE I RAISED REFLECTIVE PAVEMENT MARKER LINE 4" (WHITE) (30" SKIP 10" DASH) (ONE-WAY AMBER)

- POLYUREA PAVEMENT MARKING TYPE I -LINE 4" (WHITE) (6' SKIP 2' DASH)
- POLYUREA PAVEMENT MARKING TYPE I LINE 8" (WHITE)
- POLYUREA PAVEMENT MARKING TYPE I -LINE 6" (WHITE) (9" SKIP 3" DASH)
- POLYUREA PAVEMENT MARKING TYPE I LINE 4" (YELLOW)


  POLYUREA PAVEMENT MARKING TYPE I LINE 12" (WHITE)
  - RAISED REFLECTIVE PAVEMENT MARKER (ONE-WAY CRYSTAL)



**WAY** EXISTING SIGN



FILE NAME =	DESIGNED - AG	REVISED -			PAVEMENT MARKING AND	F.A.P RTF.	SECTION	COUNTY TOTAL SHEET SHEET NO.
\D160W75-sht-IL171-pmk-NB-08.dgn	DRAWN - TMB	REVISED -	benesch	STATE OF ILLINOIS	SIGNING PLANS	372/373	2013-037B-R	СООК 787 118
USER NAME = tblank	CHECKED - JMM	REVISED -	engineers · scientists · planners	DEPARTMENT OF TRANSPORTATION	SIGIVING 1 LANS			CONTRACT NO. 60W75
PLOT DATE = 8/31/2015	DATE - 6/12/2015	REVISED -			SCALE: 1''=50'   SHEET	0	ILLINOIS FED. A	ID PROJECT

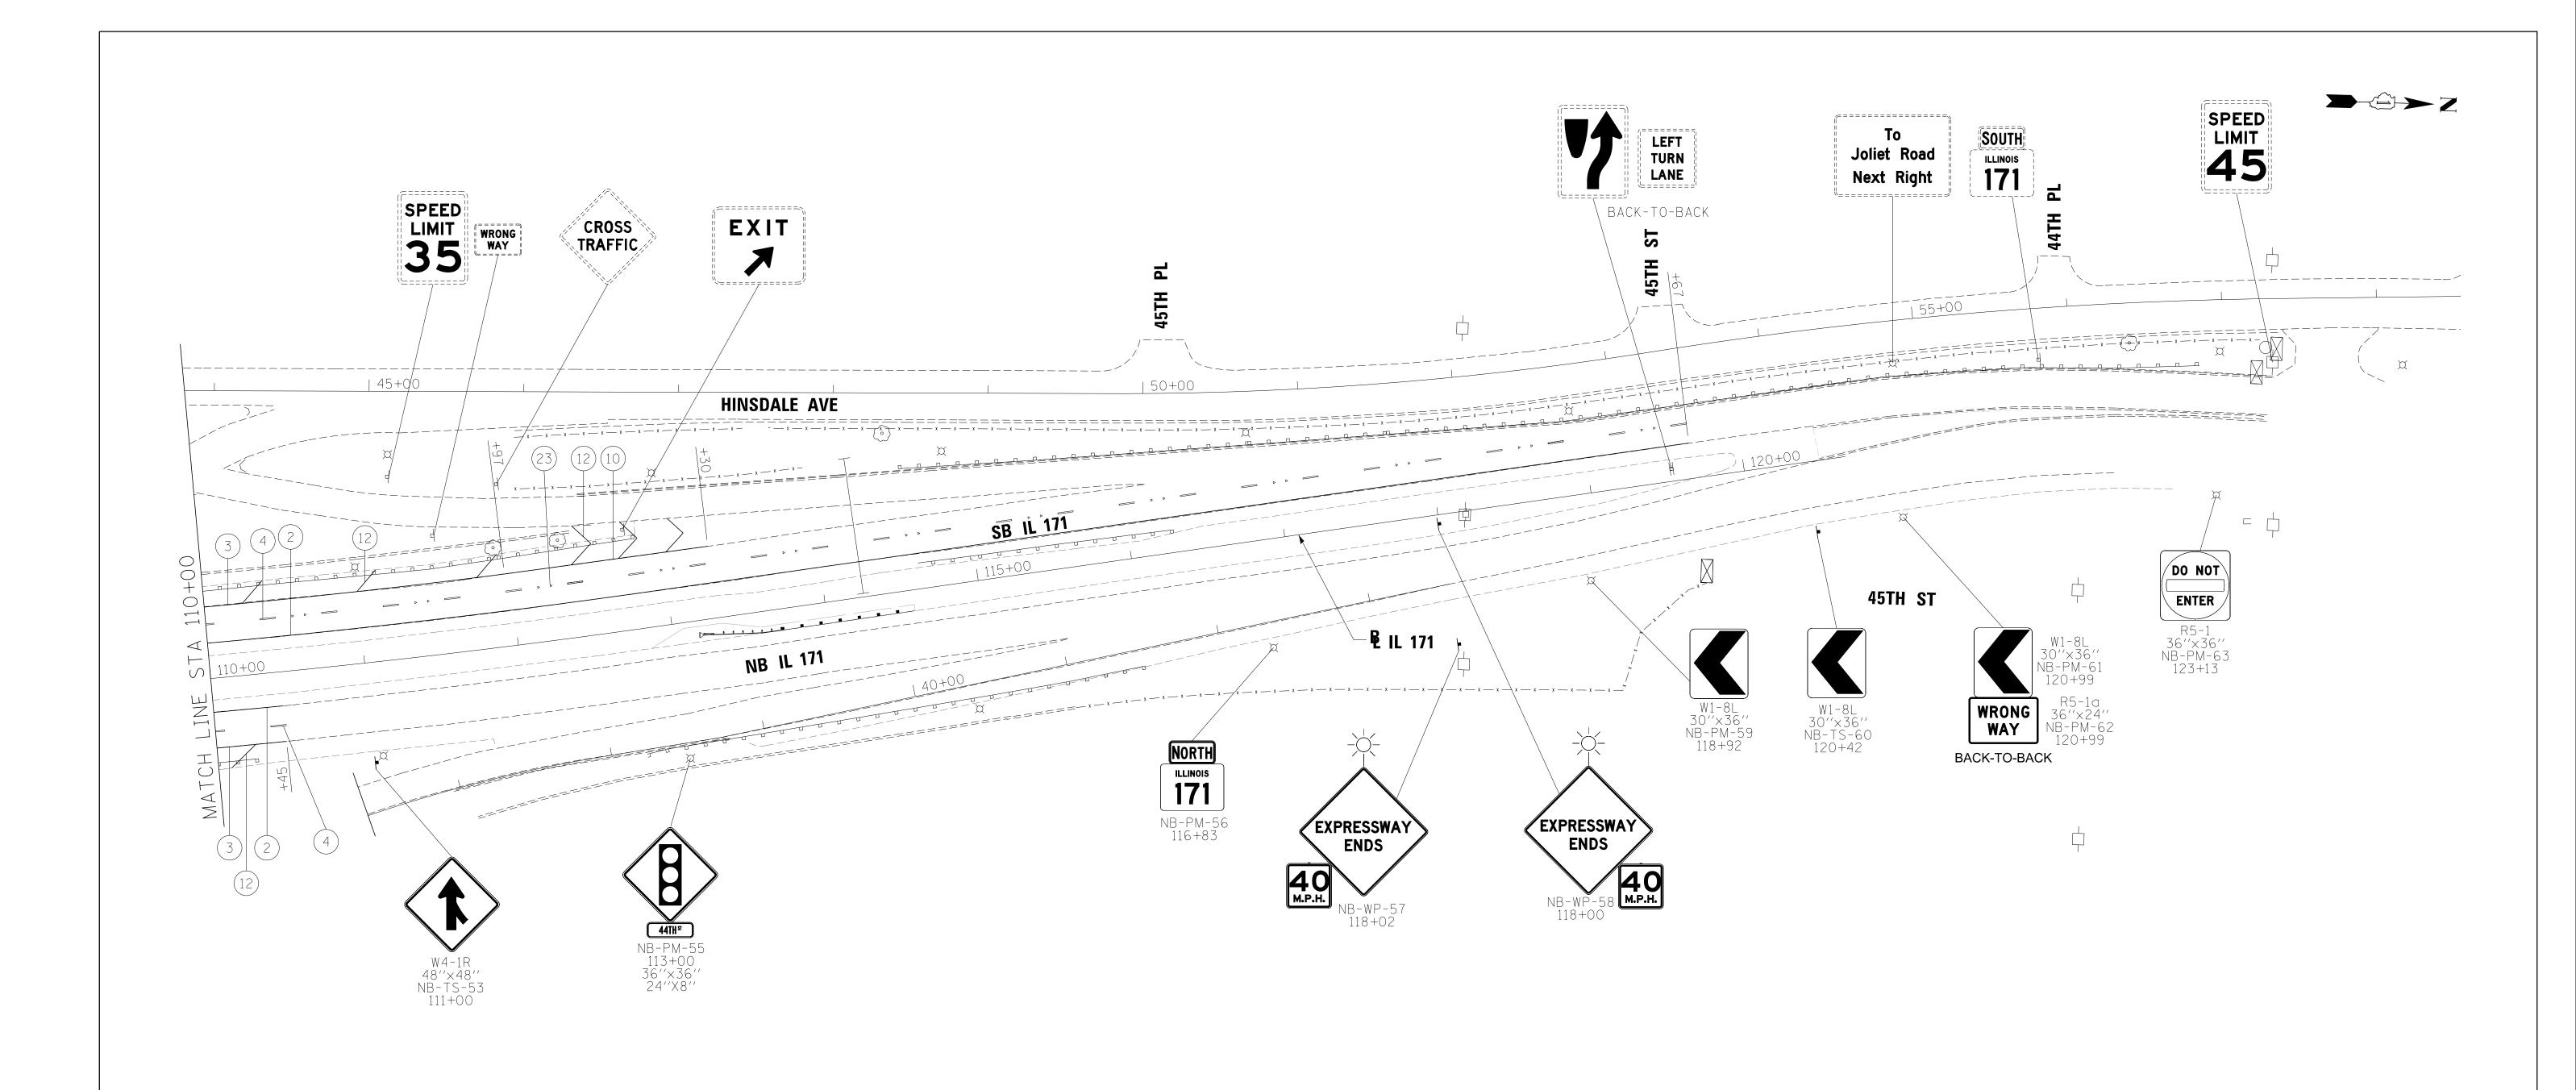

- THERMOPLASTIC PAVEMENT MARKING LETTERS AND SYMBOLS
- THERMOPLASTIC PAVEMENT MARKING LINE 4" (YELLOW)
- THERMOPLASTIC PAVEMENT MARKING LINE 4" (WHITE)
- THERMOPLASTIC PAVEMENT MARKING LINE 4" (WHITE) (30' SKIP, 10' DASH)
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- THERMOPLASTIC PAVEMENT MARKING LINE 8" (WHITE)
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- THERMOPLASTIC PAVEMENT MARKING LINE 12" (YELLOW)
- THERMOPLASTIC PAVEMENT MARKING LINE 24" (WHITE)
- POLYUREA PAVEMENT MARKING TYPE I -LETTERS AND SYMBOLS
- POLYUREA PAVEMENT MARKING TYPE I LINE 4" (YELLOW)
- POLYUREA PAVEMENT MARKING TYPE I -LINE 4" (WHITE)
- POLYUREA PAVEMENT MARKING TYPE I RAISED REFLECTIVE PAVEMENT MARKER LINE 4" (WHITE) (30" SKIP 10" DASH) (ONE-WAY AMBER)

- POLYUREA PAVEMENT MARKING TYPE I -LINE 4" (WHITE) (6' SKIP 2' DASH)
- POLYUREA PAVEMENT MARKING TYPE I LINE 8" (WHITE)
- POLYUREA PAVEMENT MARKING TYPE I LINE 6" (WHITE) (9" SKIP 3" DASH)
- POLYUREA PAVEMENT MARKING TYPE I -LINE 12" (WHITE)
- RAISED REFLECTIVE PAVEMENT MARKER (ONE-WAY CRYSTAL)



**WAY** EXISTING SIGN




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\D160W75-sht-IL171-pmk-NB-09.dgn	DRAWN	-	TMB	REVISED	-
USER NAME = tblank	CHECKED	_	JMM	REVISED	-
PLOT DATE = 8/31/2015	DATE	_	6/12/2015	REVISED	-



STATE OF ILLINOIS	
DEPARTMENT OF TRANSPORTATION	


		-								
SCALE:	1′′=50′	SHEET	9 OF	9	SHEETS	STA.	110+00.00	TO STA.120+65	.86	_

. P	SECTION	COUNTY	TOTAL SHEETS	SHEET NO.
373	2013-037B-R	COOK	787	119
		CONTRACT	NO. 6	OW75
	TILINOIS FED AT	D PROJECT		

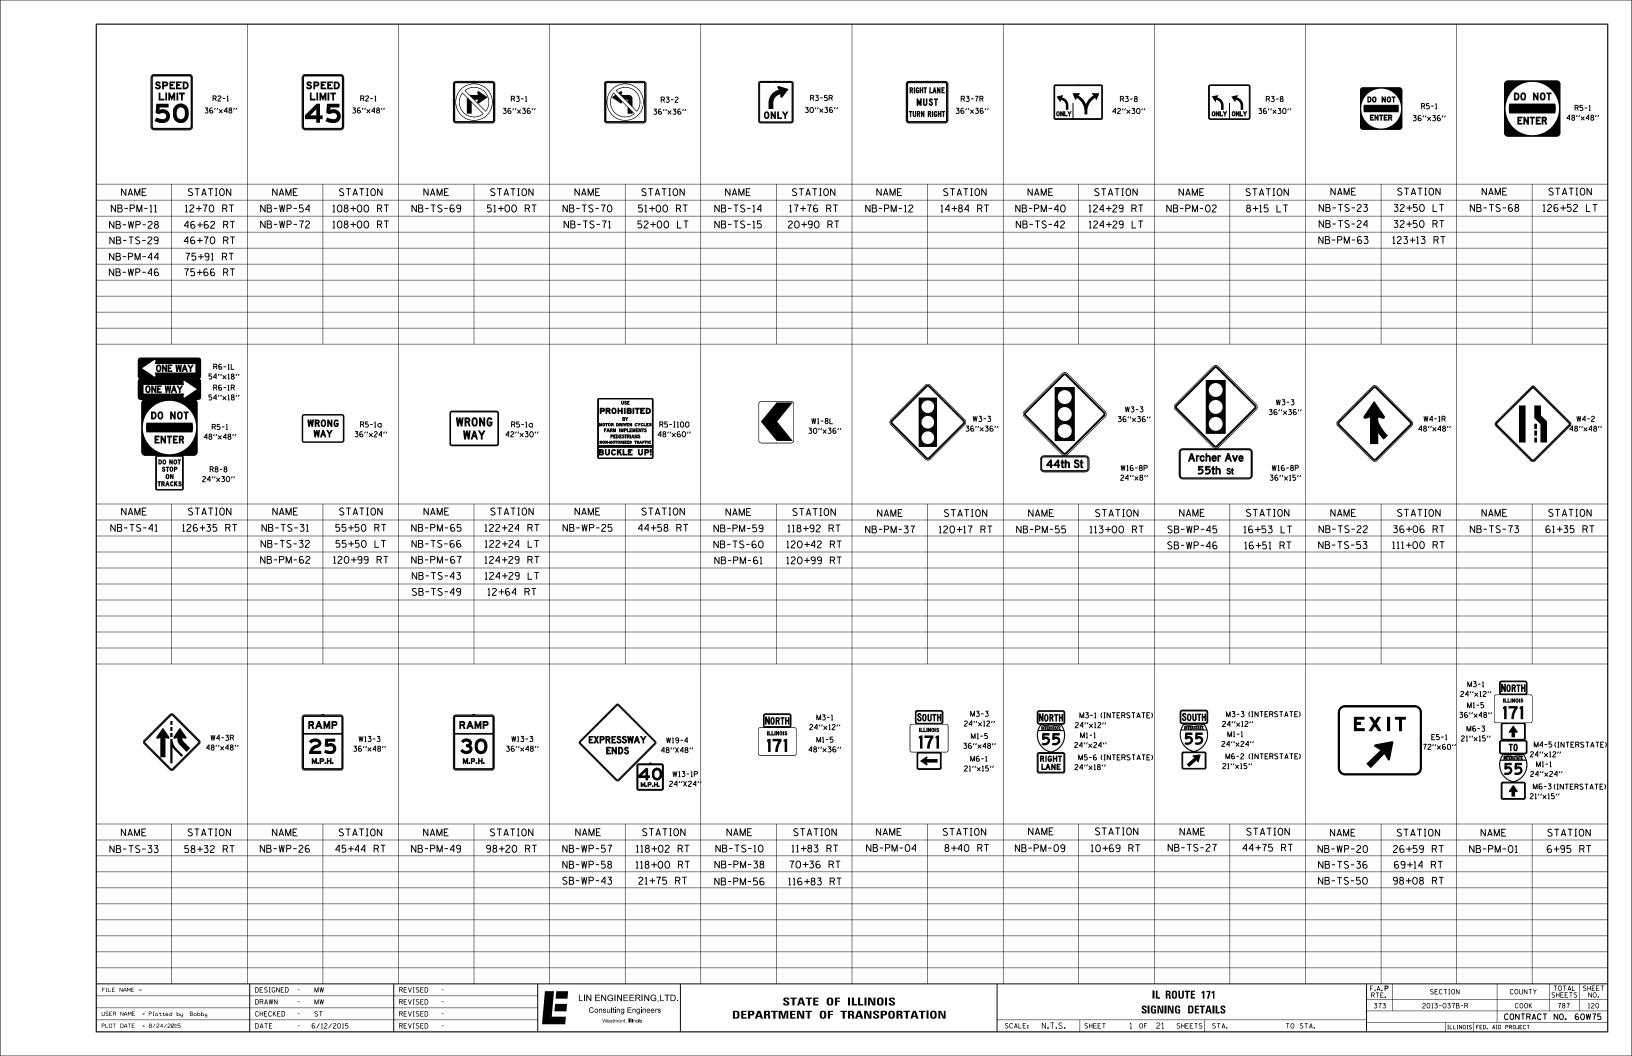

M3-1 24"×12"  M1-5 36"×48"  M6-1 21"×15"  T0  M555 24  M6-1 21"×15"	M4-5(INTERSTATE) M'×12" M1-14" M'-24" M-3 (INTERSTATE) M'-3(INTERSTATE)	12" GAP BETWEEN THE SIGNS	R10-5 10W 30"×36" R4-7 24"×30"	McC 30 I1-I 42''x	100	Lyc 98/ I1-1: 36''x	100										
NAME	STATION	NAME	STATION	NAME	STATION	NAME	STATION										
NB-PM-05	8+81 RT	NB-PM-06	9+66 LT	NB-PM-34	64+72 RT	NB-PM-52	106+20 RT										
										1							
USER NAME = Plotted PLOT DATE = 8/24/201		DESIGNED - MV DRAWN - MV CHECKED - ST DATE - 6/1	V -	REVISED         -           REVISED         -           REVISED         -           REVISED         -		LIN ENGINE  Consulting  Westmont	EERING,LTD. Engineers Blinds  DEPART	STATE OF I	LLINOIS RANSPORTAT	ION	SCALE: N.T.S.	SIG	L ROUTE 171 GNING DETAILS 21 SHEETS STA.	T0 S	F.A. 73	73   2013-037B-R   COOF	787 121 ACT NO. 60W75

1:5

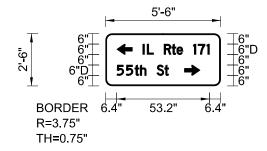

Panel Style: Guide\_Sign.ssi M.U.T.C.D.: 2009 Edition

Panel Style: Guide Sign.ssi

Dimensions are in inches.tenths

WIDTH x HGHT. 5'-6" x 2'-6" BORDER WIDTH 0.75" CORNER RADIUS 3.75" MOUNTING Overhead BACKGROUND TYPE: ZZ Sheeting COLOR: Green LEGEND/BORDER TYPE: ZZ Sheeting COLOR: White/White

NB-PM-03, STA 8+40 RT

SIGN NUMBER

SYMBOL	ROT	Х	Υ	WID	НТ
ARUP	90	6.4	18	6	9
ARUP	270	45.2	6	6	9

Letter locations are panel edge to lower left corner

LETTER POSITIONS (X)												LENGTH SERIES/SIZE									
ı	L	R	t	е	1	7	1														D 2000
21.4	23.8	33.5	38	40.8	50.3	53	58.1													38.2	6,6⁄4.5
5	5	t	h	S	t																D 2000
6.4	11.7	16.8	19.8	29.4	33.8															29.8	6,6/4.5
																					_
																					1
																					1
																				+	1


FILE NAME =	DESIGNED	-	MW	REVISED	-	Г
	DRAWN	-	MW	REVISED	-	L
USER NAME = Plotted by Bobby	CHECKED	-	ST	REVISED	-	
PLOT DATE = 8/24/2015	DATE	-	6/12/2015	REVISED	-	•

LIN ENGINEERING,LTD.
Consulting Engineers
Westmont, Illinois

STATE OF ILLINOIS
DEPARTMENT OF TRANSPORTATION

IL ROUTE 171	F.A.P RTE.	SECTION	COUNTY	TOTAL	SHEET NO.
SIGNING DETAILS	373	2013-037B-R	соок	787	122
			CONTRACT	NO.	50W75
SCALE: N.T.S.   SHEET 3 OF 21 SHEETS   STA. TO STA.		ILLINOIS FED. A	ID PROJECT		

1:50

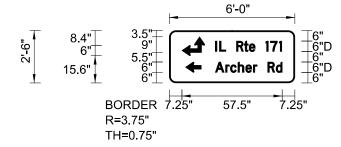

Panel Style: Guide\_Sign.ssi M.U.T.C.D.: 2009 Edition

Panel Style: Guide\_Sign.ssi

Dimensions are in inches.tenths

Letter locations are panel edge to lower left corner

SIGN NUMBER	NB-PM-07, STA 9+68 RT						
WIDTH x HGHT.	6'-0" x 2'-6"						
BORDER WIDTH	0.75"						
CORNER RADIUS	3.75"						
MOUNTING	Ground						
BACKGROUND	TYPE: ZZ Sheeting						
	COLOR: Green						
LEGEND/BORDER	TYPE: ZZ Sheeting						
	COLOR: White/White						

SYMBOL	ROT	Х	Υ	WID	HT
ARUP	180	14.4	17.4	6	9
ARUP	270	7.2	15.6	6	9
ARUP	270	9.3	6	6	9

												LETTER	R POSIT	IONS	(X)				L	.ENGTH	SERIES
İ	L	R	t	е	1	7	1														D 2000
26.4	28.8	38.5	42.9	45.7	55.3	57.9	63													38.2	6,6/4.5
Α	r	С	h		r		d														D 2000
26.4	32.2	35	39.3	43.8	48.1	56.4	61.2													38.4	6⁄4.5

FILE NAME =	DESIGNED - MW	REVISED -
	DRAWN - MW	REVISED -
USER NAME = Plotted by Bobby	CHECKED - ST	REVISED -
PLOT DATE = 8/24/2015	DATE - 6/12/2015	REVISED -


LIN ENGINEERING,LT
 Consulting Engineers
Westmont, Illinois

STATI	E OI	F ILLINOIS
DEPARTMENT	0F	TRANSPORTATION

SCALE:

			IL R	OUTE 1	71		F.A.P RTE.	SECTION	COUNTY	TOTAL SHEETS	
		SII	CMIN	IG DET	AII C		373	2013-037B-R	COOK	787	123
		31	UIVIII	NO DEI	AILU				CONTRACT	NO. 6	50W75
N.T.S.	SHEET	4 OF	21	SHEETS	STA.	TO STA.		ILLINOIS FED. A	D PROJECT		

1:50

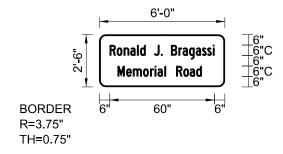

Panel Style: Guide\_Sign.ssi M.U.T.C.D.: 2009 Edition

Panel Style: Guide\_Sign.ssi

Dimensions are in inches.tenths

WIDTH x HGHT. 6'-0" x 2'-6" BORDER WIDTH 0.75" CORNER RADIUS 3.75" MOUNTING Overhead ZZ Sheeting BACKGROUND TYPE: COLOR: Green LEGEND/BORDER TYPE: ZZ Sheeting COLOR: White/White

NB-PM-08, STA 9+68 RT

SIGN NUMBER

SYMBOL	ROT	Х	Υ	WID	HT

Letter locations are panel edge to lower left corner

																LETTER	POSIT	IONS	(X)			LE	ENGTH	SERIES/SIZ
R	0	n	а	ı	d	J		В	r	а	g	а	s	s	i									C 2000
6	10.1	14	17.8	21.7	23.5	31.4	35.4	41.2	45.5	47.8	51.5	55.4	59	61.9	65.2								60	6/4.5
М	е	m	0	r	i				0	а	d													C 2000
10.5	15.5	19.3	25.2	29.2	31.8	33.4	37.3	44.2	48.3	51.9	55.6											4	48.2	6/4.5
										-														
	<u> </u>									<del>                                     </del>														

FILE NAME =	DESIGNED	-	MW	REVISED	-
	DRAWN	-	MW	REVISED	-
USER NAME = Plotted by Bobby	CHECKED	-	ST	REVISED	-
PLOT DATE = 8/27/2015	DATE	-	6/12/2015	REVISED	-

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Consulting Engineers
Westmont, Illinois

STATE OF ILLINOIS
DEPARTMENT OF TRANSPORTATION

IL ROUTE	171	F.A.P RTE.	SECTION	COUNTY	TOTAL SHEETS	SHEET NO.
SIGNING DE	373	2013-037B-R	COOK	787	124	
Jidivilla DL	IAILU			CONTRACT	NO. 6	50W75
SCALE: N.T.S. SHEET 5 OF 21 SHEETS	S STA. TO STA.		ILLINOIS FED. AI	D PROJECT		

1:75



M.U.T.C.D.: 2003 Edition

Letter locations are panel edge to lower left corner

SIGN NUMBER NB-OH-13, STA 15+57 RT WIDTH x HGHT. 14'-6" x 10'-0" BORDER WIDTH CORNER RADIUS 12" MOUNTING Overhead BACKGROUND ZZ Sheeting COLOR: Green TYPE: ZZ Sheeting LEGEND/BORDER COLOR: Black, White/White

SYMBOL	ROT	Х	Υ	WID	HT
M1_1	0	38	72	36	36
DOWN_ARROW	0	70	8	32	22

Panel Style: guide\_exp\_overhead.ssi
Dimensions are in inches.tenths

										LE	ETTER POS	TIONS	(X)					LENGTH SERIES/SIZ
N	0	R	Т	Н														EM 2000
86.1	98.8	109.6	118.8	128														50 12,10
С	h	i	С	а	g	0												EM 2000
46	60.5	74.6	81.4	93.1	106	118.9												81.9 13.3⁄9.7
Е	Х	ı	Т															EM 2000
15.5	26.7	40.7	46.1															39.5 12
0	N	L	Y															EM 2000
114	127	140.1	149.7															47.8 12
									+									


FILE NAME =	DESIGNED - MW	KENIZED -	
	DRAWN - MW	REVISED -	
USER NAME = Plotted by Lin42	CHECKED - ST	REVISED -	
PLOT DATE = 6/5/2015	DATE - 6/12/2015	REVISED -	



STATE C	F ILLINOIS
DEPARTMENT OF	TRANSPORTATION

IL ROUTE 171	F.A.P RTE.	SECTION	COUNTY	TOTAL SHEETS	SHEET NO.
SIGNING DETAILS	373	2013-037B-R	соок	787	125
			CONTRACT	NO. 6	OW75
SCALE: N.T.S.   SHEET 6 OF 21 SHEETS   STA. TO STA.		ILLINOIS FED. A	ID PROJECT		

1:50

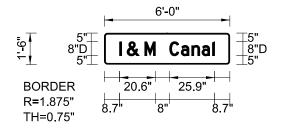

Panel Style: GuideSign\_D3-1.ssi M.U.T.C.D.: 2009 Edition

Panel Style: GuideSign\_D3-1.ssi
Dimensions are in inches.tenths

Letter locations are panel edge to lower left corner

SIGN NUMBER	NB-TS-16, STA 21+50 LT							
WIDTH x HGHT.	6'-0" x 1'-6"							
BORDER WIDTH	0.75"							
CORNER RADIUS	1.875"							
MOUNTING	Ground							
BACKGROUND	TYPE: AP Sheeting							
	COLOR: Green							
LEGEND/BORDER	TYPE: AP Sheeting							
	COLOR: White/White							

SYMBOL	ROT	Х	Υ	WID	HT

									LETTE	R P	OSITIONS	(X)						LENG	GTH SERIES/SIZE
I &	_		a n		I														D 2000
8.7 13	23.1	37.4	44 50.1	55.9	62													54	6 8,8/6
															<u> </u>				
										+									
				1															


FILE NAME =	DESIGNED - MW	REVISED -	
	DRAWN - MW	REVISED -	
USER NAME = Plotted by Lin42	CHECKED - ST	REVISED -	Ľ
PLOT DATE = 6/5/2015	DATE - 6/12/2015	REVISED -	

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 Consulting Engineers
Westmont, Illinois

STATI	E OF	ILLINOIS
DEPARTMENT	0F	TRANSPORTATION

IL ROUTE	171	F.A.F RTE.	P SECT	ION	COUNTY	TOTAL SHEETS	SHEET NO.
SIGNING DE	TAIL S	373	3 2013-0	37B-R	соок	787	126
	AILU				CONTRACT	NO. 6	60W75
SCALE: N.T.S. SHEET 7 OF 21 SHEETS	STA. T	O STA.		ILLINOIS FED. A	D PROJECT		

1:75

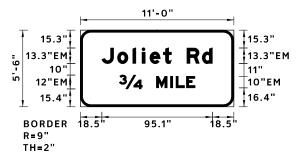

Panel Style: guide\_con\_distance\_edited.ssi M.U.T.C.D.: 2003 Edition

M.U.I.C.D.: 2003 Edition

Letter locations are panel edge to lower left corner

SIGN NUMBER

WIDTH x HGHT.

BORDER WIDTH

CORNER RADIUS

MOUNTING

BACKGROUND

LEGEND/BORDER

SYMBOL

NB-OH-17, STA 24+17 RT

TYPE: ZZ Sheeting

COLOR: White/White

ROT X Y WID HT

ZZ Sheeting

COLOR: Green

11'-0" x 5'-6"

Overhead

TYPE:

Panel Style: guide\_con\_distance\_edited.ssi

Dimensions are in inches.tenths

LETTER POSITIONS (X) LENGTH SERIES/SIZE R EM 2000 0 I t d 18.5 31.9 45.1 53 | 59.8 | 71.4 | 91.6 | 104.8 95.1 | 13.3/9.7 3/4 м | т Ε EM 2000 L 33.4 65.4 77.5 82.3 91.3 65.3 12,10


FILE NAME =	DESIGNED - MW	REVISED -
	DRAWN - MW	REVISED -
USER NAME = Plotted by Lin42	CHECKED - ST	REVISED -
PLOT DATE = 6/8/2015	DATE - 6/12/2015	REVISED -

LIN ENGINEERING,LTD.
Consulting Engineers
Westmont, Illinois

STATE OF ILLINOIS	
DEPARTMENT OF TRANSPORTATION	

		IL ROU	TE 171		F.A.P RTE.	SECTION	COUNTY	TOTAL SHEETS	
		SIGNING	DETAILS		373	2013-037B-R	соок	787	127
							CONTRACT	NO.	60W75
SCALE: N.T.	. SHEET	8 OF 21 SH	EETS STA.	TO STA.		ILLINOIS FED. AI	ID PROJECT		

1:75

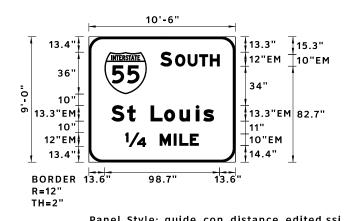

Panel Style: guide\_con\_distance\_edited.ssi M.U.T.C.D.: 2003 Edition

SIGN NUMBER NB-OH-18, STA 24+17 RT WIDTH x HGHT. 10'-6" x 9'-0" BORDER WIDTH CORNER RADIUS 12" MOUNTING Overhead BACKGROUND TYPE: ZZ Sheeting COLOR: Green TYPE: ZZ Sheeting LEGEND/BORDER COLOR: White/White

SYMBOL	ROT	Х	Υ	WID	HT
M1_1	0	13.6	58.6	36	36

Panel Style: guide\_con\_distance\_edited.ssi
Dimensions are in inches.tenths

Letter locations are panel edge to lower left corner

												LETTER	POSIT	IONS	(X)					l	LENGTH	SERIES/SIZE
S	0		Т	Н																		EM 2000
61.7	74.4	85.2	95.1	104.3																	50.7	
S	t		0		i	S																EM 2000
19.5		53.3	64.9	<del> </del>	92.2	98.7																13.3/9.7
1/4	М		L	Е																		EM 2000
31.5	61.1	73.2	78	87																	62.9	12,10
		1		1																		
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FILE NAME =	DESIGNED - MW	REVISED -
	DRAWN - MW	REVISED -
USER NAME = Plotted by Lin42	CHECKED - ST	REVISED -
PLOT DATE = 6/5/2015	DATE - 6/12/2015	REVISED -

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Westmont, Illinois

STATE OF ILLINOIS
DEPARTMENT OF TRANSPORTATION

SCALE:

		II.	L ROL	UTE 1	71		F.A.P RTE.	SECT	ΓΙΟΝ		COUNTY	TOTAL SHEETS	SHEET NO.
		cic	MING	DET/	AII C		373	2013-0	37B-R		СООК	787	128
		Jiu	IVIIIVU	DLI	TILO						CONTRACT	NO.	60W75
N.T.S.	SHEET	9 OF	21 s	SHEETS	STA.	TO STA.			ILLINOIS	FED. AI	D PROJECT		

1:75



Panel Style: guide\_exp\_overhead.ssi M.U.T.C.D.: 2003 Edition 
 SYMBOL
 ROT
 X
 Y
 WID
 HT

 M1\_1
 0
 38
 72
 36
 36

 ARMED
 45
 71
 5
 22.3
 35.6

NB-OH-19, STA 24+17 RT

ZZ Sheeting

ZZ Sheeting

COLOR: Black,White/White

14'-6" x 10'-0"

Overhead

COLOR: Green

TYPE:

TYPE:

12"

SIGN NUMBER

WIDTH x HGHT.

BORDER WIDTH

CORNER RADIUS

MOUNTING

BACKGROUND

LEGEND/BORDER

Letter locations are panel edge to lower left corner

Panel Style: guide\_exp\_overhead.ssi
Dimensions are in inches.tenths

															LETT	rer po	SITIC	NS	(X)						L	ENGTH	SERIES/SIZE
N 86	O 98.	.8 109			H 127.9																					49.9	EM 2000,E 2000 12,10
C	h	_			a	g	0																				EM 2000
46 O	60. N	.5 74 I L	_	Y Y	93.1	106	118.9		1	+																	13.3⁄9.7 EM 2000
		.2 134																								47.8	
Е	X	_		Т																							EM 2000
19.3	30.	.6 44	.6	50					<u> </u>	+																39.5	12
			-						-	+																	
									+	+																	
										+																	
									<u> </u>	+																	
	-		+						+	+				-						+							

FILE NAME =	DESIGNED - MW	REVISED -
	DRAWN - MW	REVISED -
USER NAME = Plotted by Lin42	CHECKED - ST	REVISED -
PLOT DATE = 6/5/2015	DATE - 6/12/2015	REVISED -



STATE	OF ILLINOIS	
DEPARTMENT	OF TRANSPORTATI	ON

IL ROUTE 171	F.A.P RTE.	SECTION	COUNTY	TOTAL	SHEET NO.
SIGNING DETAILS	373	2013-037B-R	соок	787	129
			CONTRACT	NO. (	60W75
SCALE: N.T.S.   SHEET 10 OF 21 SHEETS   STA. TO STA.		ILLINOIS FED. A	D PROJECT		

1:50

3'-0" 3.5" 9 3" 3.5" 3.5" 3.5" Sanitary & Ship Canal 8.9" 11" BORDER R=1.5" TH=0.5" 6.05" 4" 6.05"

Panel Style: GuideSign\_D3-1.ssi M.U.T.C.D.: 2009 Edition

NB-TS-21, STA 27+59 RT

AP Sheeting

AP Sheeting

3'-0" x 1'-6"

0.5"

1.5"

Ground

TYPE:

COLOR: Green TYPE:

COLOR: White/White

ROT X Y WID HT

SIGN NUMBER

WIDTH x HGHT.

BORDER WIDTH

CORNER RADIUS

MOUNTING

SYMBOL

BACKGROUND

LEGEND/BORDER

Letter locations are panel edge to lower left corner

Panel Style: GuideSign\_D3-1.ssi Dimensions are in inches.tenths

												LETTE	R POSI	TIONS	(X)					LENGT	H SERIES/SIZE
S 5.7	a 8.3	n 10.9	i 13.7	t 14.6	a 16.3	r 18.9	y 20.3	& 26.8												24.6	C 2000 4/3
S 6	h 8.9	i 11.6	p 12.9	C 18.9	a 21.7	n 24.3	a 26.8	I 29.4												23.9	C 2000
	0.0		12.0	10.0		21.0	20.0	20.1												20.0	
																					1
																					1
																					-
																					-

FILE NAME =	DESIGNED - MW	REVISED -
	DRAWN - MW	REVISED -
USER NAME = Plotted by Lin42	CHECKED - ST	REVISED -
PLOT DATE = 6/5/2015	DATE - 6/12/2015	REVISED -




STATE OF ILLINOIS
DEPARTMENT OF TRANSPORTATION

IL ROUT	171		F.A.P RTE.	SECTION	COUNTY	TOTAL SHEETS	SHEET NO.
SIGNING D	FTAILS		373	2013-037B-R	соок	787	130
JIGIVING L	LIAILS				CONTRACT	NO. 6	50W75
SCALE: N.T.S. SHEET 11 OF 21 SHEE	TS STA.	TO STA.		ILLINOIS FED. A	ID PROJECT		

Panel Style: GuideSign\_D3-1.ssi
Dimensions are in inches.tenths

1:50

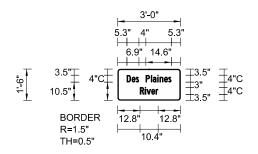

Panel Style: GuideSign\_D3-1.ssi M.U.T.C.D.: 2009 Edition

Letter locations are panelledge to lower left corner

SCALE:

SIGN NUMBER	NB-PM-30, STA 48+32 RT							
WIDTH x HGHT.	3'-0" x 1'-6"							
BORDER WIDTH	0.5"							
CORNER RADIUS	1.5"							
MOUNTING	Ground							
BACKGROUND	TYPE: AP Sheeting							
	COLOR: Green							
LEGEND/BORDER	TYPE: AP Sheeting							
	COLOR: White/White							

SYMBOL	ROT	Х	Υ	WID	HT

											LETTER	R POSI	TIONS	(X)						LENGTH	SERIES/SIZE
D 5.3	e 8.1	s 10.5	P 16.2	I 19.1	a 20.2	 n 24.1	 													25.4	C 2000 4⁄3
R	i	V	е	r																	C 2000
12.8	15.6	16.6	19.3	21.9																10.4	4/3


FILE NAME =	DESIGNED - MW	REVISED -
	DRAWN - MW	REVISED -
USER NAME = Plotted by Lin42	CHECKED - ST	REVISED -
PLOT DATE = 6/5/2015	DATE - 6/12/2015	REVISED -



STATI	E OF	ILLINOIS
DEPARTMENT	0F	TRANSPORTATION

		IL R	OUTE 1	71		F.A.P RTE.	SECTION		COUNTY	TOTAL SHEETS	SHEET NO.
		SIGNII	NG DET	AII C		373	2013-037B-R		соок	787	131
		Sidivii	NO DEI	AILU					CONTRACT	NO. (	60W75
N.T.S.	SHEET	12 OF 21	SHEETS	STA.	TO STA.		ILLINOIS	FED. AI	D PROJECT		

1:75

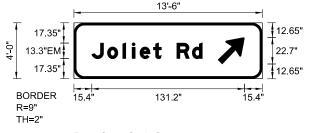

Panel Style: Guide Sign.ssi M.U.T.C.D.: 2009 Edition

Panel Style: Guide Sign.ssi

Dimensions are in inches.tenths

Letter locations are panel edge to lower left corner

SIGN NUMBER	NB-OH-35, STA 67+34 RT							
WIDTH x HGHT.	13'-6" x 4'-0"							
BORDER WIDTH	2"							
CORNER RADIUS	9"							
MOUNTING	Overhead							
BACKGROUND	TYPE: ZZ Sheeting							
	COLOR: Green							
LEGEND/BORDER	TYPE: ZZ Sheeting							
	COLOR: White/White							

SYMBOL	ROT	Х	Υ	WID	HT
ARMED	45	123.9	12.6	18.3	29.3

LETTER POSITIONS (X)  LENGTH SERIESSIZE																							
J						t	R	d															EM 2000
15.4	28.8	8 42	2 5	0 5	6.7	68.3	88.5	101.7														95.1	13.3/10
	<u> </u>										<u> </u>												
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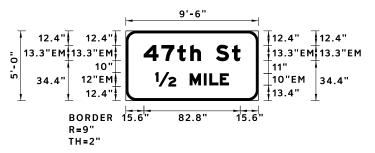
FILE NAME =	DESIGNED - MW	REVISED -
	DRAWN - MW	REVISED -
USER NAME = Plotted by Lin42	CHECKED - ST	REVISED -
PLOT DATE = 6/5/2015	DATE - 6/12/2015	REVISED -



STATE OF ILLINOIS	
DEPARTMENT OF TRANSPORTATION	N

IL ROUTE 171	F.	A.P TE.	SECTION	COUNTY	TOTAL	SHEET NO.
SIGNING DETAILS	3	373	2013-037B-R	соок	787	132
				CONTRACT	NO.	60W75
SCALE: N.T.S.   SHEET 13 OF 21 SHEETS   STA. TO STA.			ILLINOIS FED. A	ID PROJECT		

1:75



Panel Style: guide\_con\_distance\_edited.ssi M.U.T.C.D.: 2003 Edition

Panel Style: guide\_con\_distance\_edited.ssi

Dimensions are in inches.tenths

Letter locations are panel edge to lower left corner

SIGN NUMBER	NB-BS-39, STA 72+82 RT							
WIDTH x HGHT.	9'6" x 5'0"							
BORDER WIDTH	2"							
CORNER RADIUS	9"							
MOUNTING	Overhead							
BACKGROUND	TYPE: ZZ Sheeting							
	COLOR: Green							
LEGEND/BORDER	TYPE: ZZ Sheeting							
	COLOR: White/White							

SYMBOL	ROT	Х	Υ	WID	HT

																LETTER	POSI	ΓΙΟNS	(X)										LENGTH	SERIES/SI
7	t	h	S	t																										EM 2000
30.7	44.4	55.6	77.7	91.5																									82.8	13.3,13.3⁄9.7
М	ı	L	Е																											EM 2000
55.2	67.3	72.1	81.1																										62.9	12,10
																											+			
																													$\Box$	
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					-				-																		+	_	$\vdash$	
		1	1	<u> </u>	1	1	<u> </u>		1								1										+ +	+		
		-		-	+																								$\vdash$	
	30.7 M	30.7 44.4 M I	30.7 44.4 55.6 M I L	30.7 44.4 55.6 77.7	30.7 44.4 55.6 77.7 91.5 M I L E	30.7 44.4 55.6 77.7 91.5 M I L E	30.7 44.4 55.6 77.7 91.5 M I L E	30.7 44.4 55.6 77.7 91.5 M I L E	30.7 44.4 55.6 77.7 91.5 M I L E	30.7 44.4 55.6 77.7 91.5 M I L E	30.7 44.4 55.6 77.7 91.5 M I L E	30.7 44.4 55.6 77.7 91.5	30.7 44.4 55.6 77.7 91.5	30.7 44.4 55.6 77.7 91.5	30.7 44.4 55.6 77.7 91.5	7 t h S t	7         t         h         S         t           30.7         44.4         55.6         77.7         91.5           M         I         L         E	7         t         h         S         t           30.7         44.4         55.6         77.7         91.5           M         I         L         E	7         t         h         S         t	7         t         h         S         t	7         t         h         S         t	7         t         h         S         t	7         t         h         S         t	7         t         h         S         t         l	7         t         h         S         t         l	7         t         h         S         t         l	7         t         h         S         t         l	7         t         h         S         t         l	7         t         h         S         t         l	7         t         h         S         t         l

FILE NAME =	DESIGNED - MW	REVISED -	
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USER NAME = Plotted by Lin42	CHECKED - ST	REVISED -	
PLOT DATE = 6/5/2015	DATE - 6/12/2015	REVISED -	_

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Consulting Engineers
Westmont, Illinois

STATE	OF ILLINOIS	
DEPARTMENT	OF TRANSPORTATI	ON


SCALE:

IL ROUTE 171							SECTION	COUNTY	TOTAL SHEETS	SHEET NO.
		SIGNI	NG DET	AII C		373	2013-037B-R	соок	787	133
		Sidivi	NO DEI	AILU				CONTRACT	NO. 6	50W75
N.T.S.	SHEET	14 OF 21	SHEETS	STA.	TO STA.		ILLINOIS FE	D. AID PROJECT		

Panel Style: street name 12–9in\_edited.ssi

Dimensions are in inches.tenths

1:50

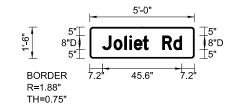

Panel Style: street name 12-9in\_edited.ssi M.U.T.C.D.: 2009 Edition

Letter locations are panel edge to lower left corner

SIGN NUMBER	NB-TS-45, STA 76+03 RT
WIDTH x HGHT.	5'-0" x 1'-6"
BORDER WIDTH	0.75"
CORNER RADIUS	1.88"
MOUNTING	Ground
BACKGROUND	TYPE: AP Sheeting
	COLOR: Green
LEGEND/BORDER	TYPE: AP Sheeting
	COLOR: White White

SYMBOL	ROT	Х	Υ	WID	HT


LETTER POSITIONS (X)												LENGT	H SERIES/SIZE									
J	0	I	i	е	t	R	d															D 2000
7.2	13.8	19.9	22.8	25.4	30.5	41.7	48														45.6	8/6
																						1

FILE NAME =	DESIGNED - MW	REVISED -
	DRAWN - MW	REVISED -
USER NAME = Plotted by Lin42	CHECKED - ST	REVISED -
PLOT DATE = 6/5/2015	DATE - 6/12/2015	REVISED -

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Consulting Engineers
Westmont, Illinois

STATE	OF ILLINOIS	
DEPARTMENT	OF TRANSPORTATI	ON

		IL R	OUTE 1	71		F.A.P RTE.	SECTION	COUNTY	TOTAL SHEETS	SHEET NO.
		SIGNII	NC DET	AII C		373	2013-037B-R	соок	787	134
SIGNING DETAILS								CONTRACT	NO. 6	50W75
SCALE: N.T.S.	SHEET	15 OF 21	SHEETS	STA.	TO STA.	ILLINOIS FED. AID PROJECT				

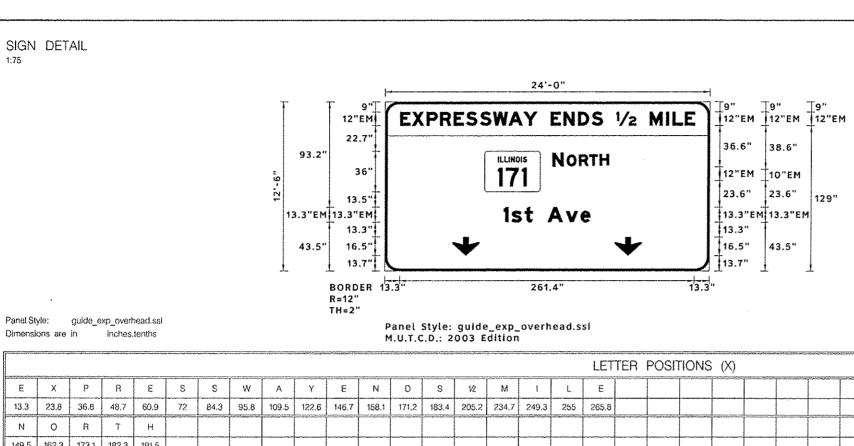

SIGN NUMBER	NB-OH-47, STA 93+54 RT
WIDTH x HGHT.	24'-0" x 12'-6"
BORDER WIDTH	2"
CORNER RADIUS	12"
MOUNTING	Overhead
BACKGROUND	TYPE: ZZ Sheeling
	COLOR: Green
LEGEND/BORDER	TYPE: ZZ Sheeting
	COLOR: White,BlackWhite

			yaran ka	i de la companya de la companya de la companya de la companya de la companya de la companya de la companya de	
SYMBOL	ROT	Χ	Υ	WID	HT
M1-I100A	O	88.4	70.3	49.1	36
ARDOWN	0	60	13.7	24	16.5
ARDOWN	0	204	13.7	24	16.5

Letter	locations	are	panel edge	to	lower	left	COIDE
POSTO:	10Cation is	aic	har in onde	10	MARCH	522-15	CONTRO

																		LET	TER	POSIT	TIONS	(X)							_			Ł.F	ENGTH	SERIES/SI
E	X	р	R	E	S	S	W	A	Υ	Ε	N	D	S	1/2	М	1	Ł	Ε												l .		T		EM 2000
3.3	23.8	36.8	48.7	60.9	72	84.3	95.8	109.5	122.6	146.7	158.1	171.2	183.4	205.2	234.7	249.3	255	265.8															261.4	12
N	0	R	T	Н																		-					-							EM 2000
9.5	162.3	173.1	182.3	191,5			ļ	ļ																									50	12,10
1	s	t		V	e																											Francisco		EM 2000
.6	112.5	124.1	144.3	160,8	173.7		ļ			ļ			ļ		-30-00-00-00-00-00-00-00-00-00-00-00-00-										77 - Carlo 1975 - 1	2000-0000-0000000000000000000000000000	8)000,000,000,000			ļ			76.9	13.3,13.3⁄9.7
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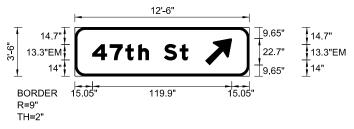
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	DRAWN -	MA	REVISED .	LIN ENGINEERING,LTD.	ł
USER NAME : Plotted by Lin42	CHECKED -	ST	REVISED -	Consulting Engineers	
PLOT DATE = 6/5/2015	DATE -	6/12/2015	REVISED -	Westvorn, Sirials	

STATE OF ILLINOIS
DEPARTMENT OF TRANSPORTATION

IL ROUTE 171
SIGNING DETAILS
SCALE: N.T.S. SHEET 16 OF 21 SHEETS STA.

TO STA.

1:75



Panel Style: Guide\_sign.ssi M.U.T.C.D.: 2009 Edition

Panel Style: Guide\_sign.ssi

Dimensions are in inches.tenths

Letter locations are panel edge to lower left corner

SIGN NUMBER	NB-OH-48, STA 93+54 RT
WIDTH x HGHT.	12'-6" x 3'-6"
BORDER WIDTH	2"
CORNER RADIUS	9"
MOUNTING	Overhead
BACKGROUND	TYPE: ZZ Sheeting
	COLOR: Green
LEGEND/BORDER	TYPE: ZZ Sheeting
	COLOR: White/White

SYMBOL	ROT	Х	Υ	WID	HT
ARMED	45	112.3	9.6	18.3	29.3

												LE	TTER PO	MOITIE	IS (X)					LENGTH	SERIES/SI
4	7	t	h	S	t																EM 2000
15.1	30.1	43.6	54.7	76.8	90.4															82.2	13.3/10
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FILE NAME =	DESIGNED - MW	REVISED -	
	DRAWN - MW	REVISED -	
USER NAME = Plotted by Lin42	CHECKED - ST	REVISED -	
PLOT DATE = 6/5/2015	DATE - 6/12/2015	REVISED -	-


LIN ENGINEERING,LT
Consulting Engineers
Westmont, Illinois

STATE C	F ILLINOIS
DEPARTMENT OF	TRANSPORTATION

IL ROUTE 171	F.A.P RTE.	SECTION	COUNTY	TOTAL SHEETS	SHEE NO.
SIGNING DETAILS	373	2013-037B-R	соок	787	136
			CONTRACT	NO. 6	50W75
SCALE: N.T.S.   SHEET 17 OF 21 SHEETS   STA. TO STA.		ILLINOIS FED. A	ID PROJECT		

SIGN DETAIL

1:50

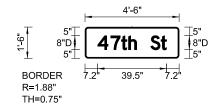

Panel Style: street name 12-9in\_edited.ssi M.U.T.C.D.: 2009 Edition

Panel Style: street name 12–9in\_edited.ssi

Dimensions are in inches.tenths

Letter locations are panel edge to lower left corner

SIGN NUMBER	NB-TS-51, STA 102+88 RT
WIDTH x HGHT.	4'-6" x 1'-6"
BORDER WIDTH	0.75"
CORNER RADIUS	1.88"
MOUNTING	Ground
BACKGROUND	TYPE: AP Sheeting
	COLOR: Green
LEGEND/BORDER	TYPE: AP Sheeting
	COLOR: White/White

SYMBOL	ROT	Х	Υ	WID	HT

											LE	TTER P	DSITIC	ONS	(X)					LENGT	H SERIES/SI.
4	7	t	h	S	t																D 2000
7.2	14.8	20.8	24.9	37.6	43.6															39.5	8/6
																					7
																					1
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FILE NAME =	DESIGNED - MW	REVISED -
	DRAWN - MW	REVISED -
USER NAME = Plotted by Lin42	CHECKED - ST	REVISED -
PLOT DATE = 6/5/2015	DATE - 6/12/2015	REVISED -

LIN ENGINEERING,LTD
 Consulting Engineers
Westmont, Illinois

STATI	E OF	ILLINOIS
DEPARTMENT	0F	TRANSPORTATION

IL ROUTE 171	F.A.P RTE.	SECTION	COUNTY	TOTAL SHEETS	SHEET NO.
SIGNING DETAILS	373	2013-037B-R	соок	787	137
			CONTRACT	NO.	60W75
SCALE: N.T.S.   SHEET 18 OF 21 SHEETS  STA. TO STA.		ILLINOIS FED. A	D PROJECT		

SIGN DETAIL

1:7



NB-OH-64, STA 43+20 RT SIGN NUMBER WIDTH x HGHT. 15'–6" x 7'–6" BORDER WIDTH CORNER RADIUS 12" MOUNTING Overhead BACKGROUND TYPE: ZZ Sheeting COLOR: Green TYPE: LEGEND/BORDER ZZ Sheeting COLOR: White/White

SYMBOL	ROT	Х	Υ	WID	HT
M1_1	0	21.7	40.3	36	36
ARMED	45	141.6	33.6	18.3	29.3

Panel Style: guide\_con\_distance\_edited.ssi

Dimensions are in inches.tenths

Letter locations are panel edge to lower left corner

											LETTE	R POSIT	IONS	(X)				LE	ENGTH	SERIES/SIZE
S 69.7	O 82.4	U 93.2	T 103.1	H 112.3															50.7	EM 2000 12,10
S 39.1	t 52.6	L 72.9	0	u 99.2	i 113 3															EM 2000 13.3/10
33.1	32.0	72.9	00	33.2	110.0	113.0													03.3	10.010
																-				
																+				

FILE NAME =	=	DESIGNED	-	MW	REVISED	-	
		DRAWN	-	MW	REVISED	-	
USER NAME	= Plotted by Lin42	CHECKED	-	ST	REVISED	-	
PLOT DATE	= 6/5/2015	DATE	-	6/12/2015	REVISED	-	

 LIN ENGINEERING,LTD
 Consulting Engineers
Westmont, Illinois

STATE OF ILLINOIS
DEPARTMENT OF TRANSPORTATION

			IL I	ROUTE 1	71		F.A.P RTE.	SECTION	COUNTY	TOTAL SHEETS	SHEET NO.
			SIGNI	NG DET	AII C		373	2013-037B-R	COOK	787	138
			Jidivi	NO DEI	AILO				CONTRACT	NO. 6	OW75
SCALE:	N.T.S.	SHEET	19 OF 21	SHEETS	STA.	TO STA.		ILLINOIS FED. AI	D PROJECT		

1						72000100	72000200	72000300	72400100	72400200	7240310	7240320	7240330	72700100	72800100	73000100	73100100	73400100	73600100	73600200	73700100	73700200	73700300	X0326865	X7310110
		SIGN SCHE	DULE			SIGN PANEL -		SIGN PANEL -	REMOVE SIGN PANEL	PANEL	REMOVESIGN		REMOVE SIGN	STRUCTURAL STEEL SIGN	TELESCOPING STEEL SIGN	WOOD SIGN	BASE FOR TELESCOPING	CONCRETE	REMOVE OVERHEAD SIGN	REMOVE OVERHEAD SIGN	REMOVE GROUND	REMOVE CONCRETE FOUNDATION -	REMOVE CONCRETE	POST MOUNTED FLASHING	BASE FOR TELESCOPING SIGN
ĺ						TYPE 1	TYPE 2	TYPE 3	ASSEMBLY - TYPE A	ASSEMBLY - TYPE B	PANEL - TYPE 1	PANEL - TYPE 2	PANEL - TYPE 3	SUPPORT - BREAKAWAY	SUPPORT	SUPPORT	SIGN SUPPORT	FOUNDATIONS	STRUCTURE -	STRUCTURE -	MOUNTED SIGN SUPPORT	GROUND	FOUNDATION - OVERHEAD	BEACON INSTALLATION	SUPPORT,
<del></del>					GN AREA						-								SPAN	CANTILEVER		MOUNT			SPECIAL
SIGN NAME	STATION	OFFSET	ALIGNMENT	,	T) HEIGHT (FT	-	SQ FT	SQ FT	EACH	EACH	SQ FT	SQ FT	SQ FT	POUND	FOOT	FOOT	EACH	CU YD	EACH	EACH	EACH	EACH	EACH	EACH	EACH
1				M3-1 2.00 M1-5 3.00	1.00 4.00	2.00	12.00				2.00	12.00													
1				M6-3 1.75	1.25	2.19	12.00				2.19	12.00													
NB-PM-01	6+95	RT	IL 171 NB	M4-5 2.00	1.00	2.00					2.00														
1				M1-1 2.00	2.00	4.00					4.00														
				M6-3 1.75	1.25	2.19					2.19														
NB-PM-02	8+15	LT	IL 171 NB	R3-8 3.00	2.50	7.50					7.50														
NB-PM-03	8+40	RT	IL 171 NB	Guide Sign 5.50	2.50	2.00	13.75				2.00	15.00													
NB-PM-04	8+40	RT	IL 171 NB	M3-3 2.00 M1-5 3.00	1.00 4.00	2.00	12.00				2.00	12.00					1								
NB-FIVEO4	8140	l Ki	IL I/I NB	M6-1 1.75	1.25	2.19	12.00				2.19	12.00													
				M3-1 2.00	1.00	2.00					2.00														
1				M1-5 3.00	4.00		12.00					12.00													
NB-PM-05	8+81	RT	IL 171 NB	M6-1 1.75	1.25	2.19					2.19														
1.0.100	3.01	'''	127,1140	M4-5 2.00	1.00	2.00					2.00						1								
1				M1-1 2.00	2.00	4.00					4.00														
				M6-3 1.75 R10-5 2.50	1.25 3.00	2.19				-	7.50						-								
NB-PM-06	9+66	LT	IL 171 NB	R10-5 2.50 R4-7 2.00	2.50	7.50 5.00				+	5.00						1								
NB-PM-07	9+68	RT	IL 171 NB	Guide Sign 6.00	2.50	3.00	15.00				3.00	15.00													
NB-PM-08	9+68	RT	IL 171 NB	Guide Sign 6.00	2.50		15.00					21.25													
NB-PM-08	9+68	RT	IL 171 NB	Guide Sign 6.00	2.50		15.00					21.25													
1			IL 171 NB	M3-1 2.00	1.00	2.00					2.00														
NB-PM-09	10+69	RT	IL 171 NB	M1-1 2.00	2.00	4.00					4.00														
1			IL 171 NB	M5-6 2.00	1.50	3.00					3.00														
NB-TS-10	11+83	RT -	IL 171 NB	M3-1 2.00	1.00	2.00	12.00				2.00	12.00			13.0										
SB-TS-49	12+64	RT	IL 171 NB IL171 SB	M1-5 4.00 R5-1a 3.50	3.00 2.50	8.75	12.00				-	12.00			16.5										
NB-PM-11	12+70	RT	IL 171 NB	R2-1 3.00	4.00	0.75	12.00					12.00			10.5										
NB-PM-12	14-84	RT	IL 171 NB	R3-7R 3.00	3.00	9.00					9.00														
NB-OH-13	15+57	RT	IL 171 NB	Guide Sign 14.50	10.00			145.00					145.00								2	2			
SB-WP-45	16+53	LT	IL 171 SB	W3-3 3.00	3.00	9.00				1						17.5								1	
				W16-8P 3.00	1.25	3.75				_															
SB-WP-46	16+51	RT	IL 171 SB	W3-3 3.00	3.00	9.00										16.1								1	
NB-TS-14	17+76	RT	IL 171 NB	W16-8P 3.00 R3-5R 2.50	1.25 3.00	3.75 7.50					7.50				16.0										
NB-TS-14 NB-TS-15	20+90	RT	IL 171 NB	R3-5R 2.50	3.00	7.50					7.50				16.0										
NB-TS-16	21+50	LT	IL 171 NB	Guide Sign 6.00	1.50	9.00			1		1.22				28.0										
SB-WP-43	21+75	RT	IL 171 SB	W13-1P 2.00	2.00	4.00										32.0									
				W19-4 4.00	4.00		16.00									32.0									
NB-OH-17	24+17	RT	IL 171 NB	Guide Sign 11.00	5.50			60.50			1		60.50										_		
NB-OH-18	24+17	RT	IL 171 NB	Guide Sign 10.50	9.00			94.50			-		94.50				1		1				2		
NB-OH-19 NB-WP-20	24+17 26+59	RT RT	IL 171 NB IL 171 NB	Guide Sign 14.50 E5-1 6.00	10.00 5.00			145.00 30.00		1	+		145.00			34.3	1								
NB-TS-21			IL 171 NB	Guide Sign 3.00	1.50	4.50		30.00	1	1	+				12.3	34.3									
NB-TS-22		RT	IL 171 NB	W4-1R 4.00	4.00		16.00		1	1	1				36.7										
NB-TS-23		LT	RAMP C	R5-1 3.00	3.00	9.00			1						16.9										
NB-TS-24		RT	RAMP C	R5-1 3.00	3.00	9.00			1						12.4										
NB-OH-64		RT	IL 171 NB	Guide Sign 15.50	7.50			116.25			1		116.25			_				1			1		
NB-WP-25		RT	RAMP A	R5-I100 4.00	5.00		20.00			1	+					33.8	1								
NB-WP-26	45+44	RT	RAMP A	W13-3 3.00 M3-3 2.00	4.00 1.00	2.00	12.00			1	-					17.3									
NB-TS-27	44+75	RT	IL 171 NB	M3-3 2.00 M1-1 2.00		4.00			1		+				14.9										
1	,5	'''		M6-2 1.75	1.25	2.19			1 -		<del> </del>				1 - " 1										
NB-WP-28	46+62	RT	IL 171 NB	R2-1 3.00	4.00		12.00			1	1					16.7									
NB-TS-29		RT	IL 171 NB	R2-1 3.00	4.00		12.00			1					16.0										
NB-PM-30	48+32	RT	IL 171 NB	Guide Sign 3.00	1.50	4.50	1		1	1	4.50	1				1			1						

FILE NAME =	DESIGNED - MW	REVISED -
	DRAWN - MW	REVISED -
USER NAME = Plotted by Bobby	CHECKED - ST	REVISED -
PLOT DATE = 8/24/2015	DATE - 6/12/2015	REVISED -



STATI	E OF	ILLINOIS
DEPARTMENT	OF	TRANSPORTATIO

			IL R	OUTE 1	F.A.P RTE.	SECTION	COUNTY	TOTAL SHEETS	SHEET NO.		
			SIGNII	IG DET	AII C		373	2013-037B-R	COOK	787	139
			JIGIVII	IU DLI	AILU				CONTRACT	NO.	50W75
SCALE:	N.T.S.	SHEET	20 OF 21	SHEETS	STA.	TO STA.		ILLINOIS FED. AI	D PROJECT		


		SIGN SCH	EDULE				72000100 SIGN PANEL - TYPE 1	72000200 SIGN PANEL - TYPE 2	72000300 SIGN PANEL - TYPE 3	72400100  REMOVE SIGN PANEL ASSEMBLY -	PANEL ASSEMBLY -			7240330 REMOVE SIGN PANEL - TYPE 3	72700100 STRUCTURAL STEEL SIGN SUPPORT -	72800100  TELESCOPING STEEL SIGN SUPPORT	73000100 WOOD SIGN SUPPORT	73100100  BASE FOR TELESCOPING SIGN SUPPORT	73400100  CONCRETE FOUNDATIONS	73600100  REMOVE  OVERHEAD  SIGN  STRUCTURE -	73600200 REMOVE OVERHEAD SIGN STRUCTURE -	73700100  REMOVE GROUND MOUNTED	73700200  REMOVE  CONCRETE  FOUNDATION -  GROUND	73700300 REMOVE CONCRETE FOUNDATION -	X0326865  POST MOUNTED FLASHING BEACON	X7310110  BASE FOR  TELESCOPING  SIGN  SUPPORT,
				_	SIGN	AREA				TYPE A	TYPE B				BREAKAWAY					SPAN	CANTILEVER	SIGN SUPPORT	MOUNT	OVERHEAD	INSTALLATION	SPECIAL
SIGN NAME	STATION	OFFSET	ALIGNMENT	DESCRIPTION	WIDTH (FT)	HEIGHT (FT)	) SQ FT	SQ FT	SQ FT	EACH	EACH	SQ FT	SQ FT	SQ FT	POUND	FOOT	FOOT	EACH	CU YD	EACH	EACH	EACH	EACH	EACH	EACH	EACH
NB-TS-31	55+50	RT	RAMP B	R5-1a	3.00	2.00	6.00			1						9.0										1
NB-TS-32	55+50	LT	RAMP B	R5-1a	3.00	2.00	6.00	15.00		1	-					9.0		1								1
NB-TS-33 NB-TS-73	58+32 61+30	RT RT	RAMP B IL 171 NB	W4-3R W4-2	4.00	4.00 4.00		16.00 16.00			1					13.0 11.0		1								1
NB-PM-34	64+72	RT	IL 171 NB	11-1100	3.50	2.00	7.00	16.00	+			7.00				11.0										
NB-OH-35	67+34	RT	IL 171 NB	Guide Sign	13.50	4.00	7.00	<del>                                     </del>	54.00			7.00		54.00							1			1		
NB-TS-36	69+14	RT	IL 171 NB	E5-1	6.00	5.00			30.00		1					36.3										
NB-PM-37	120+17	RT	RAMP J	W3-3	3.00	3.00	9.00						16.00													
NB-PM-38	70+36	RT	IL 171 NB	M3-1	2.00	1.00	2.00					2.00														
				M1-5	4.00	3.00	1	12.00	<del></del>				12.00													
NB-BS-39 NB-PM-40	72+82 124+29	RT RT	IL 171 NB RAMP J	Guide Sign R3-8	9.50 3.50	5.00 2.50	8.75	+	47.50				10.00	47.50	594.3				1.4			2	2			$\vdash$
IND-FIVI-40	124729	NI	NAIVIFJ	R5-8	4.00	4.00	0.73	16.00				9.00	10.00													
ND 75 65	425.25		24421	R6-1L	4.50	1.50	6.75	15.55				3.00		1		45.4										
NB-TS-41	126+35	RT	RAMP J	R6-1R	4.50	1.50	6.75									15.1										
				R8-8	2.00	2.50	5.00					5.00														
NB-TS-42	124+29	LT	RAMP J	R3-8	3.50	2.50	8.75				1					14.3										
NB-TS-43	75 - 01	DT	U 474 ND	R5-1a	3.50	2.50	8.75	12.00					12.00													$\vdash$
NB-PM-44 NB-WP-46	75+91 75+66	RT RT	IL 171 NB IL 171 NB	R2-1 R2-1	3.00	4.00 4.00	+	12.00 12.00			1		12.00				16.3									$\vdash$
NB-TS-45	76+03	RT	IL 171 NB	Guide Sign	5.00	1.50	7.50	12.00		1						34.5	10.3									
NB-OH-47	93+54	RT	IL 171 NB	Guide Sign	24.00	12.50	7.50	+	300.00	1				300.00		34.3								_		
NB-OH-48	93+54	RT	IL 171 NB	Guide Sign	12.50	3.50			43.75					43.75						1 1				2		
NB-TS-50	98+08	RT	IL 171 NB	E5-1	6.00	5.00			30.00		1					37.8										
NB-PM-49	98+20	RT	IL 171 NB	W13-3	3.00	4.00		12.00					12.00													
NB-TS-51	102+88	RT	IL 171 NB	Guide Sign	4.50	1.50	6.75					6.75				14.5										$\vdash$
NB-PM-52 NB-WP-54	106+20 108+00	RT RT	IL 171 NB IL 171 NB	I1-I100 R2-1	3.00	2.00 4.00	6.00	12.00			1	6.00	12.00				16.5									
NB-WP-72	108+00	RT	IL 171 NB	R2-1	3.00	4.00		12.00			-		12.00				16.5									
NB-TS-53	111+00	RT	IL 171 NB	W4-1R	4.00	4.00		16.00			1						33.0									
NB-PM-55	113+00	RT	IL 171 NB	W3-3	3.00	3.00	9.00					6.25														
146 1 141 55	113100	101	12 17 110	W16-8P	2.00	0.67	1.33					1.33														
NB-PM-56	116+83	RT	IL 171 NB	M3-1	2.00	1.00	2.00					2.00														
				M1-5 W19-4	4.00 4.00	3.00 4.00	+	12.00 16.00	+				12.00													
NB-WP-58	118+00	RT	IL 171 NB	W13-1P	2.00	2.00	4.00	10.00			1						32.3								1	
NR MR E7	119103	RT	II 171 NB	W19-4	4.00	4.00		16.00			1						34.6								1	
NB-WP-57	118+02	N I	IL 171 NB	W13-1P	2.00	2.00	4.00				1						34.0								1	
NB-PM-59	118+92	RT	IL 171 NB	W1-8L	2.50	3.00	7.50					7.50														
NB-TS-60	120+42	RT	IL 171 NB	W1-8L	2.50	3.00	7.50			1						13.7										
NB-PM-61 NB-PM-62	120+99 120+99	RT RT	IL 171 NB IL 171 NB	W1-8L R5-1a	2.50 3.00	3.00 2.00	7.50 6.00	+				7.50 6.00														
NB-PM-63	123+13	RT	IL 171 NB	R5-1a	3.00	3.00	9.00	+				9.00														
NB-PM-65	122+24	RT	RAMP J	R5-1a	3.50	2.50	8.75																			
NB-TS-66	122+24	LT	RAMP J	R5-1a	3.50	2.50	8.75									14.3										
NB-PM-67	124+29	RT	RAMP J	R5-1a	3.50	2.50	8.75																			
NB-TS-68	126+52	LT	RAMP J	R5-1	4.00	4.00		16.00								15.8										
NB-TS-69		RT	JOLIET RD	R3-1	3.00	3.00	9.00			1						14.8										
NB-TS-70 NB-TS-71		1	JOLIET RD JOLIET RD	R3-2 R3-2	3.00	3.00	9.00	+	+					<del>                                     </del>		14.8						-	-			$\vdash$
IND-13-/1	32±00	1 11	1 JOLIET KD	N3-2	3.00	3.00	3.00									14.0										
			TO	TAL			372.46	402.75	1096.50	10.00	16.00	163.77	230.50	1006.50	594.30	466.70	317.02	1.00	1.40	2.00	2.00	4.00	4.00	6.00	4.00	3.00
				D TOTAL		1	373	403	1097	10	16	164	231	1007	595	467	318	1	2	2	2	4	4	6	4	3

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FILE NAME =	DESIGNED - MW	REVISED -
	DRAWN - MW	REVISED -
USER NAME = Plotted by Bobby	CHECKED - ST	REVISED -
PLOT DATE = 8/24/2015	DATE - 6/12/2015	REVISED -



STATE	: 01	F ILLINOIS
DEPARTMENT	0F	TRANSPORTATION

	IL ROUTE 171							SECTION	COUNTY	TOTAL SHEETS	SHEET NO.
			SIGNII	NG DET	AII C		373	2013-037B-R	соок	787	140
			Sidivii	NO DEI	MILO				CONTRACT	NO. 6	50W75
SCALE:	N.T.S.	SHEET	21 OF 21	SHEETS	STA.	TO STA.		ILLINOIS FED. A	ID PROJECT		

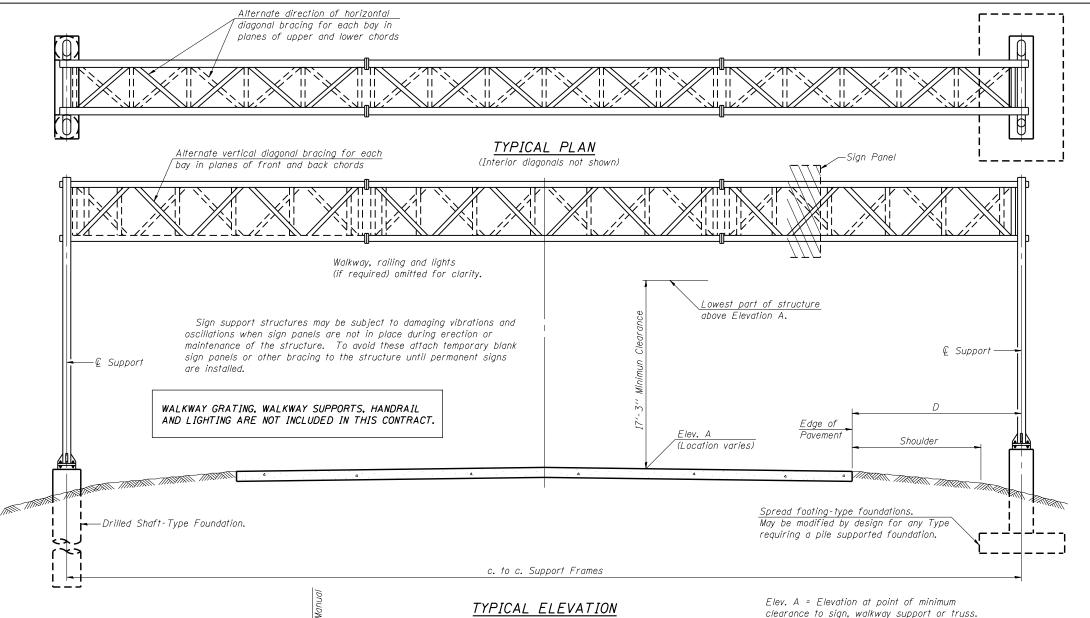

## (Looking at Face of Signs\*\*)

End Support

34'-0'', max Type III-A

REVISED

REVISED

REVISED

REVISED

Structure Number	Station	Design Truss Type	c. to c. Supports	Elev. A	Dim. D	Height of Tallest Sign	Total Sign Area
1S016S171R000.0-005	93+53.70	I-A	88.00′	620.80	22.31′	12.50′	343.75 S.F.
1S016S171R000 <b>.</b> 0-001	24+16.60	I - A	68.00′	626.60	16.00′	11.50′	338.50 S.F.

<sup>\*\*</sup>Looking upstation for structures with signs both sides.

\* If M270 Gr. 50W (M222) steel is proposed, chemistry for plate to be used shall first be approved by the Engineer as suitable for galvanizing and welding.

#### GENERAL NOTES

DESIGN: AASHTO Standard Specifications for Structural Supports for Highway Signs, Luminaires and Traffic Signals. ("AASHTO Specifications")

CONSTRUCTION: Current (at time of letting) Illinois Department of Transportation Standard Specifications for Road and Bridge Construction, Supplemental Specifications and Special Provisions. ("Standard Specifications")

LOADING: 90 M.P.H. WIND VELOCITY

WALKWAY LOADING: Dead load plus 500 lbs, concentrated live load.

DESIGN STRESSES:

Field Units

f'c = 3,500 p.s.i.

fy = 60,000 p.s.i. (reinforcement)

WELDING: All welds to be continuous unless otherwise shown. All welding to be done in accordance with current AWS D1.1 and D1.2 Structural Welding Codes (Steel and Aluminum) and the Standard Specificiations.

MATERIALS: Aluminum Alloys as shown throughout plans. All Structural Steel Pipe shall be ASTM A53 Grade B or A500 Grade B or C. If A500 pipe is substituted for A53, then the outside diameter shall be as detailed and wall thickness greater than or equal to A53. All Structural Steel Plates and Shapes shall conform to AASHTO M270 Gr. 36, Gr. 50 or Gr. 50W\*. Stainless steel for shims, sleeves and handhole covers shall be ASTM A240, Type 302 or 304, or another alloy suitable for exterior exposure and acceptable to the Engineer.

The steel pipe and stiffening ribs at the base plate for the column shall have a minimum longitudinal Charpy V-Notch (CVN) energy of 15 lb.-ft. at 40° F. (Zone 2) before galvanizing.

FASTENERS FOR ALUMINUM TRUSSES: All bolts noted as "high strength" must satisfy the requirements of AASHTO M164 (ASTM A325), or approved alternate, and must have matching lock nuts. Threaded studs for splices (if Members interfere) must satisfy the requirements of ASTM A449, ASTM A193, Grade B7, or approved alternate, and must have matching lock nuts. Bolts and lock nuts not required to be high strength must satisfy the requirements of ASTM A307. All bolts and lock nuts must be hot dip galvanized per AASHTO M232. The lock nuts must have nylon or steel inserts. A stainless steel flat washer conforming to ASTM A240 Type 302 or 304, is required under both head and nut or under both nuts where threaded studs are used. High strength bolt installation shall conform to Article 505.04 (f) (2)d of the IDOT Standard Specifications for Road and Bridge Construction. Rotational capacity ("ROCAP") testing of bolts will not be required.

U-BOLTS AND EYEBOLTS: U-Bolts and Eyebolts must be produced from ASTM A276 Type 304, 304L, 316 or 316L, Condition A, cold finished stainless steel, or an equivalent material acceptable to the Engineer. All nuts for U-Bolts and Eyebolts must be lock nuts equivalent to ASTM A307 with nylon or steel inserts and hot dip galvanized per AASHTO M232. A stainless steel flat washer conforming to ASTM A240, Type 302 or 304, is required under each U-Bolt and Eyebolt lock nut.

GALVANIZING: All Steel Grating, Plates, Shapes and Pipe shall be Hot Dip Galvanized after fabrication in accordance with AASHTO M111. Painting is not

ANCHOR RODS: Shall conform to ASTM F1554 Gr. 105.

CONCRETE SURFACES: All concrete surfaces above an elevation 6" below the lowest final ground line at each foundation shall be cleaned and coated with Concrete Sealer in accordance with the Standard Specifications.

REINFORCEMENT BARS: Reinforcement Bars designated (E) shall be epoxy coated in accordance with the Standard Specifications.

FOUNDATIONS: The contract unit price for Concrete Foundations and Drilled Shaft Concrete Foundations shall include reinforcement bars complete in place.

#### TOTAL BILL OF MATERIAL

ITEM	UNIT	TOTAL
OVERHEAD SIGN STRUCTURE SPAN TYPE I-A	Foot	156
OVERHEAD SIGN STRUCTURE SPAN TYPE II-A	Foot	
OVERHEAD SIGN STRUCTURE SPAN TYPE III-A	Foot	
OVERHEAD SIGN STRUCTURE WALKWAY TYPE A	Foot	
CONCRETE FOUNDATIONS	Cu. Yds.	
DRILLED SHAFT CONCRETE FOUNDATIONS	Cu. Yds.	<i>25.6</i>

0S-A-1

10 p.s.1

analysis for all components.

8-21-13

30 p.s.f. (See Sign Structures

Manual for max. sign areas)

Maximum Lenath

c. to c. Support Frames (See Sign Structures Manual)

DESIGN WIND LOADING DIAGRAM

Parameters shown are basis for I.D.O.T. Standards and Sign Manual Tables. Installations not within dimensional limits shown require special


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=	Consulting Engineers Springfield, Illinois	PLOT SCALE =	_	DRAWN	-	HP
•	Springheia, illinois	PLOT DATE =	07/30/2015	CHECKED	-	JJA

10 p.s.f.

STATE OF ILLINOIS **DEPARTMENT OF TRANSPORTATION** 

OVERHEAD SIGN STRUCTURES - GENERAL PLAN & **ELEVATION - ALUMINUM TRUSS & STEEL SUPPORTS** SHEET NO. 1 OF 19 SHEETS

SECTION COUNTY 372/373 2013-037B-R COOK 787 141 CONTRACT NO. 60W75

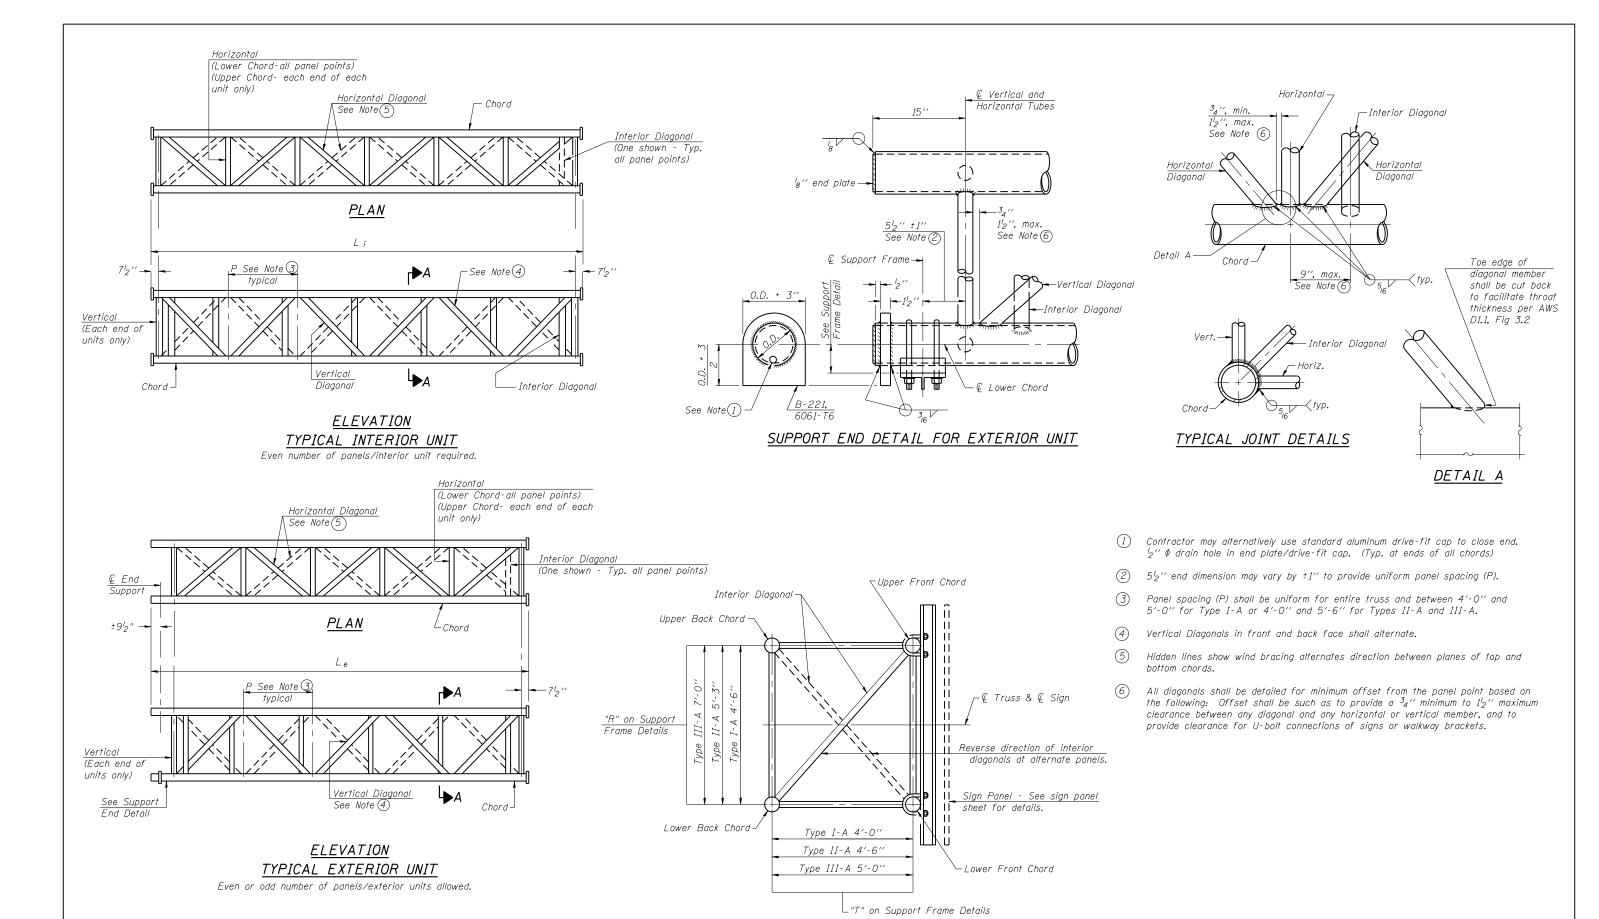

SECTION A-A

*OS-A-2* 6-1-12

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STATE OF ILLINOIS
DEPARTMENT OF TRANSPORTATION

OVERHEAD	SIGN STRUCTURES - ALUMINUM TRUSS	
DETAILS	FOR TRUSS TYPES I-A, II-A AND III-A	
	SHEET NO. 2 OF 19 SHEETS	

F.A.P. SECTION COUNTY TOTAL SHEETS NO.


372/373 2013-037B-R COOK 787 142

CONTRACT NO. 60W75

| ILLINOIS | FED. AID | PROJECT


#### TRUSS UNIT TABLE


Structure		Trues   Chard   Harianatal and 1		zontals; Vertical,	Camber	Splicing Flange														
Number	Station	Type	No. Panels		Panel	No.	No. Panels		Panel				-	at Midspan	Bolt.		Weld	Sizes	A	В
			per Unit	Lgth.(L <sub>e</sub> )	Lgin.(P)	Reg a.	per Unit	Lgth.(L; )	Lgin.(P)	0.D.	Wall	0.D.	Wall		No./Splice	Dia.	W	W <sub>1</sub>		
1S016S171R000.0-005	93+53.70	<i>I-A</i>	6	30'-1 <sub>2</sub> "	4'-812"	1	6	29′-6"	4'-812"	5"	<sup>5</sup> 16 "	21/2"	<sup>5</sup> 16 "	234"	6	<sup>7</sup> 8"	<sup>5</sup> 16 "	4"	8 <sup>3</sup> 4"	11 <sup>3</sup> 4"
																			.	1
1S016S171R000.0-001	24+16.60	<i>I-A</i>	7	34′-10"	4'-812"	0	-	-	-	5"	<sup>5</sup> 16 "	21/2"	<sup>5</sup> 16 "	1 <sup>5</sup> 8"	6	78"	5 <sub>16</sub> "	4"	8 <sup>3</sup> 4"	11 <sup>3</sup> 4 "

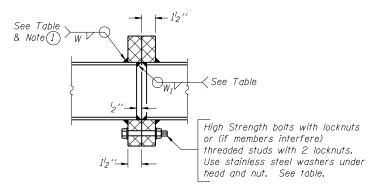

#### SECTION B-B

1 Splicing Flanges shall be attached to each truss unit with the truss shop assembled to camber shown. Truss units shall be in proper alignment and flange surfaces shall be shop bolted into full contact before welding. Sufficient external welds or tacks shall be made to secure flanges until remaining welds are made after disassembly. Adjacent flanges shall be "match marked" to insure proper field assembly.

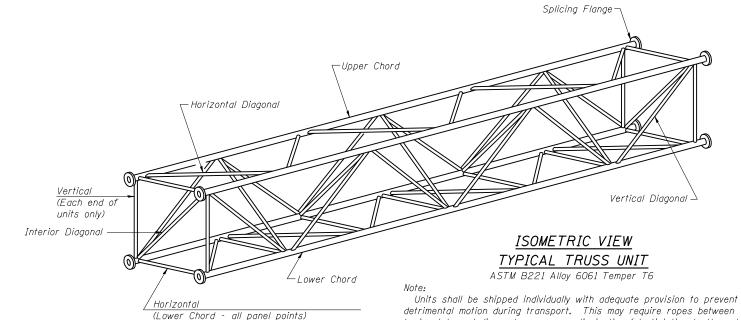


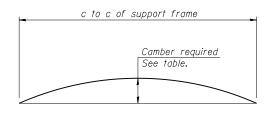

(Upper Chord - each end of each unit only)

CAMBER DIAGRAM Camber curve shown is theoretical. Actual camber attained by slope changes at splices between units.

#### CAMBER ATTAINMENT EXAMPLES:

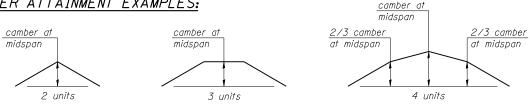

Camber shown is for fabrication only, measured with truss fully supported. (No-load condition)

#### 0S4-A-2

6 - 1 - 12

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Consulting Engineers  Springfield, Illinois	PLOT SCALE =	
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#### STATE OF ILLINOIS **DEPARTMENT OF TRANSPORTATION**

OVERHEAD SIGN STRUCTURES – ALUMINUM TRUSS DETAILS	F.A.P. RTE.	SECTION	COUNTY	TOTAL SHEETS	SHEET NO.
FOR TRUSS TYPES I-A, II-A AND III-A		2013-037B-R	COOK	787	143
TON THOSE THE I-A, II-A AND III-A			CONTRACT	NO. 6	OW75
SHEET NO. 3 OF 19 SHEETS		TILINOIS EED AT	n ppn iect		


horizontals and diagonals or energy dissipating (elastic) ties to the vehicle.

The Contractor is responsible for maintaining the configuration and

protection of the units.

# Drill 6 holes 16'' larger than bolt diameter. \*Flange I.D.


#### TRUSS TYPES I-A, II-A, & III-A

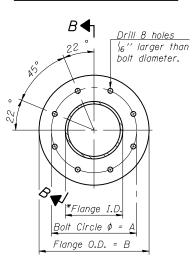


## TRUSS TYPES II-A & III-A SPLICING FLANGES

ASTM B221, Alloy 6061-T6 or ASTM B209, Alloy 6061-T651

\*To fit O.D. of Chord with maximum gap of  $\frac{1}{6}$ ".

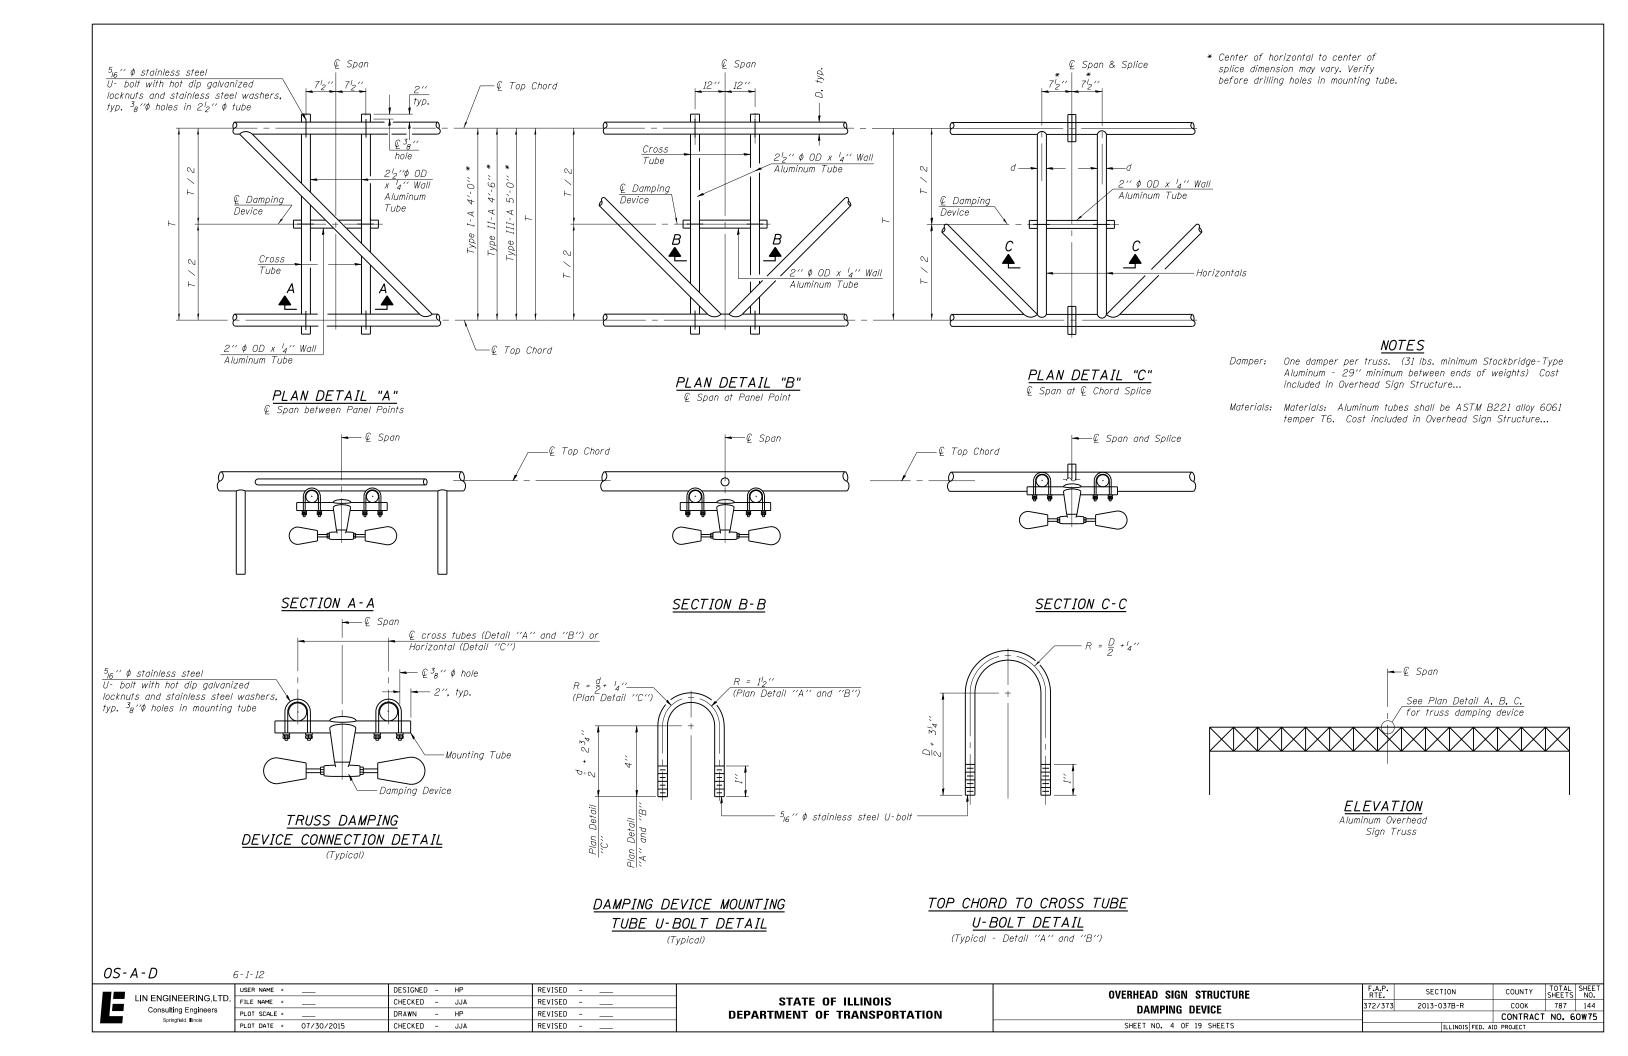

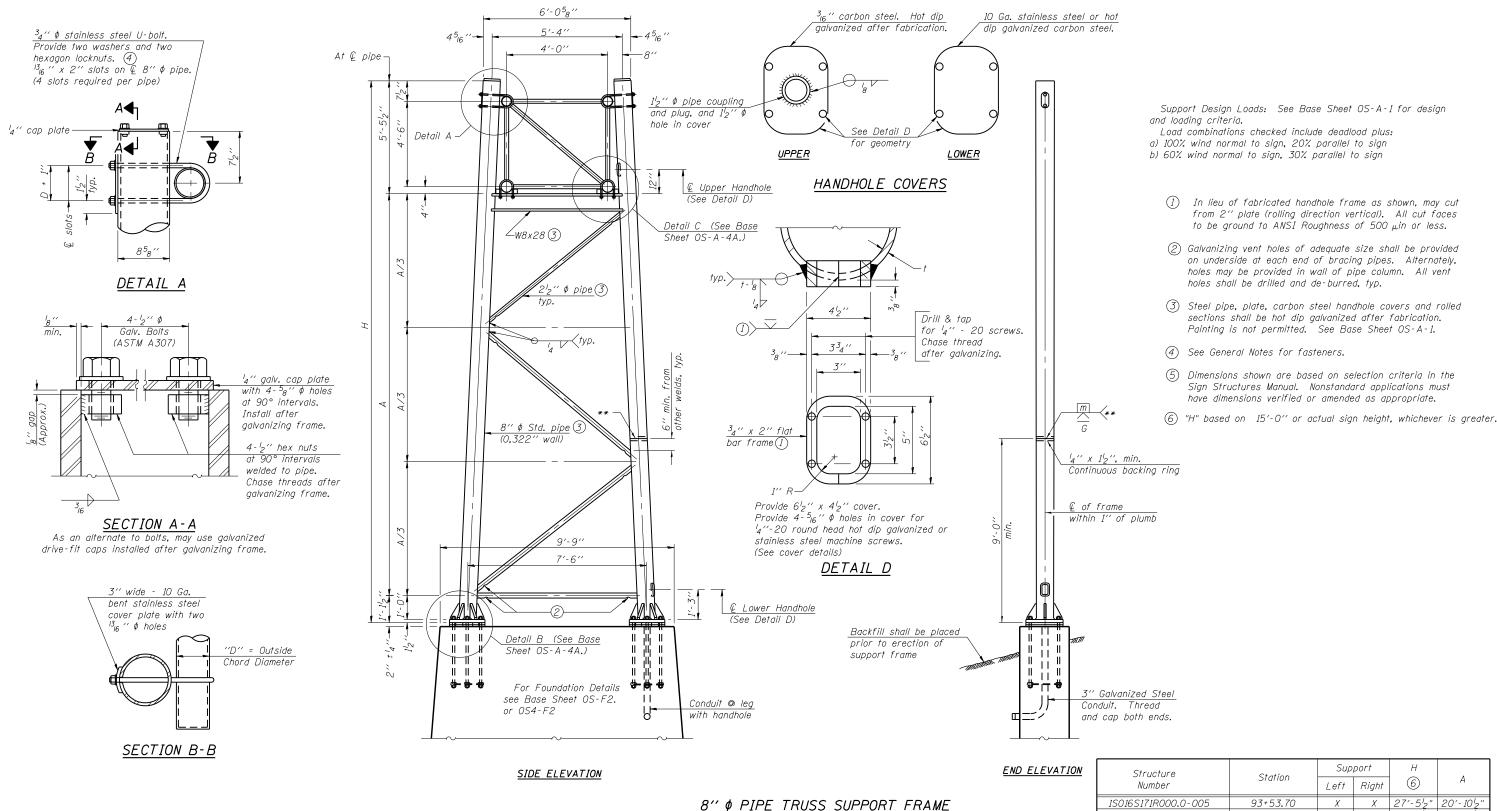

\*\* One butt welded joint is allowed only on one post per support frame. If used, weld procedure must be preapproved by Engineer and joint shall receive 100% RT or UT (tension criteria) at Contractor's expense.

Structure	Ctation	Sup	port	Н		
Number	Station	Left	Right	6	A	
1S016S171R000.0-005	93+53.70	Χ	Χ	27'-5 <sup>1</sup> 2"	20'-10 <sup>1</sup> 2"	
1S016S171R000.0-001	24+16.60	Χ	Χ	27'-5 <sup>1</sup> 2"	20'-10 <sup>1</sup> 2"	

0S-A-4

6-1-12 LIN ENGINEERING,LTD


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STATE OF ILLINOIS **DEPARTMENT OF TRANSPORTATION** 

	OVERHEAD	SIGN	ST	RUCTURES	
SUPPORT	FRAME FOR	TYPE	I–A	ALUMINUM	TRUSS
	SHEET N	10. 5 C	F 19	SHEETS	

F.A.P. RTE.	SECTION	COUNTY	TOTAL SHEETS	SHEE NO.
372/373	2013-037B-R	COOK	787	145
		CONTRACT	NO. 6	OW75
	ILLINOIS FED. A	D PROJECT		



LIN ENGINEERING,LTD.
Consulting Engineers
Springfield, Illinois

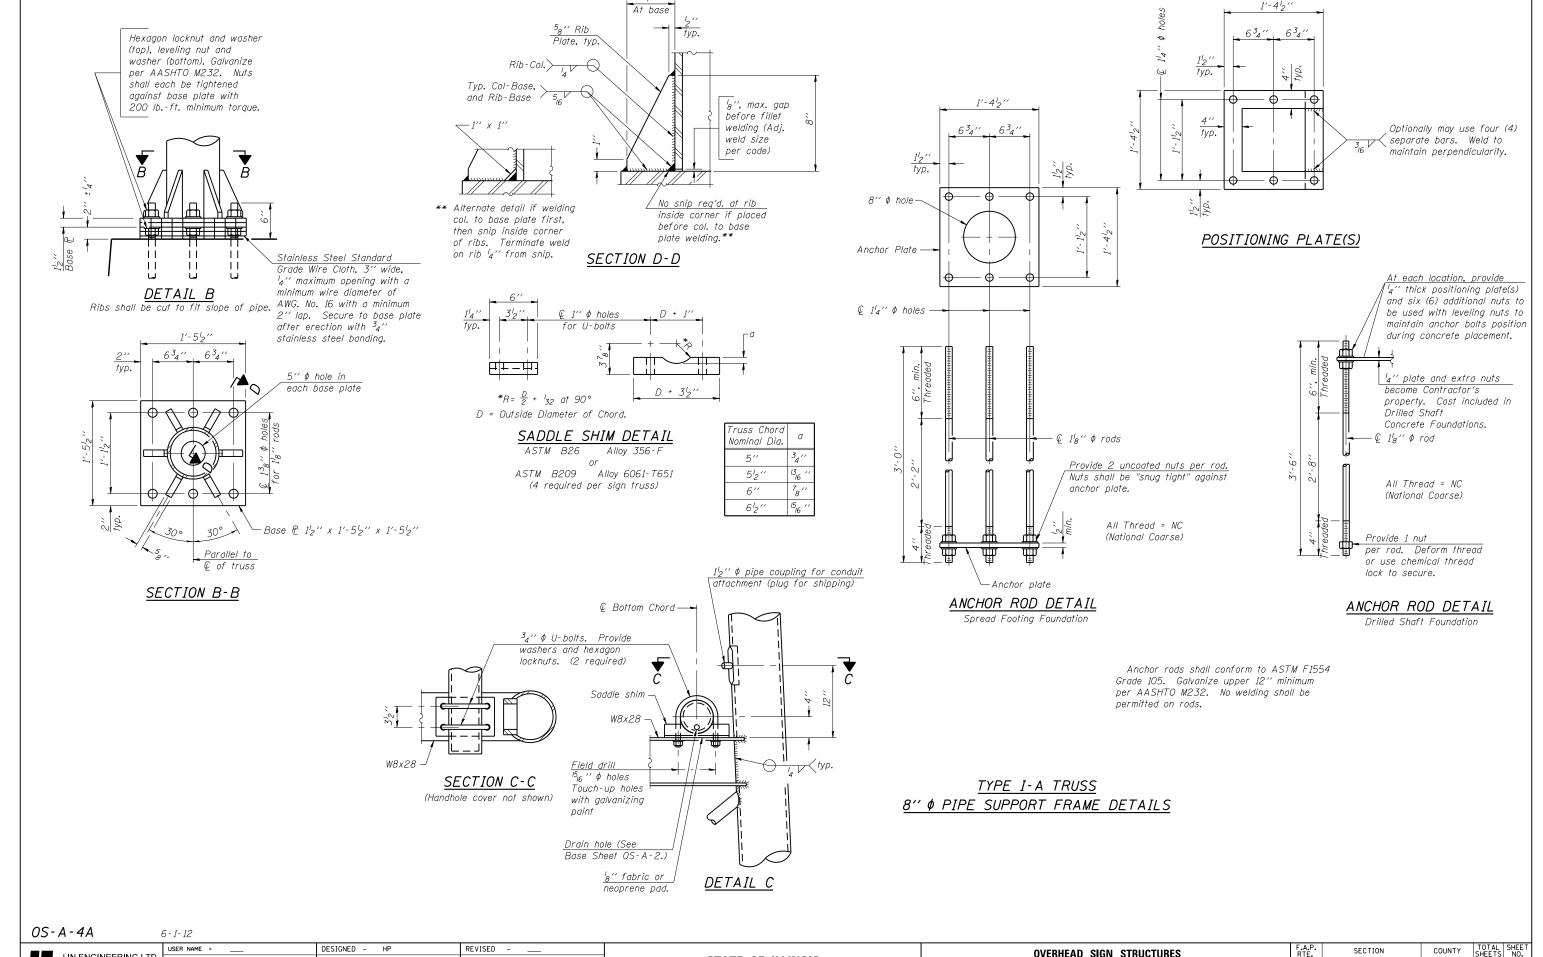STATE OF ILLINOIS
DEPARTMENT OF TRANSPORTATION

OVERHEAD SIGN STRUCTURES

SUPPORT FRAME DETAILS - ALUMINUM TRUSS

SHEET NO. 6 OF 19 SHEETS

F.A.P. RTE. SECTION COUNTY SHEET NO. 6 OF 19 SHEETS

F.A.P. RTE. SECTION COUNTY SHEET NO. 6 OF 19 SHEETS


F.A.P. RTE. SECTION COUNTY SHEET NO. 6 OF 19 SHEETS

F.A.P. RTE. SECTION COUNTY SHEET NO. 6 OF 19 SHEETS

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F.A.P. RTE. SECTION COUNTY SHEET NO. 6 OF 19 SHEETS

F.A.P. RTE. SECTION COUNTY SHEET NO. 6 OF 19 SHEETS

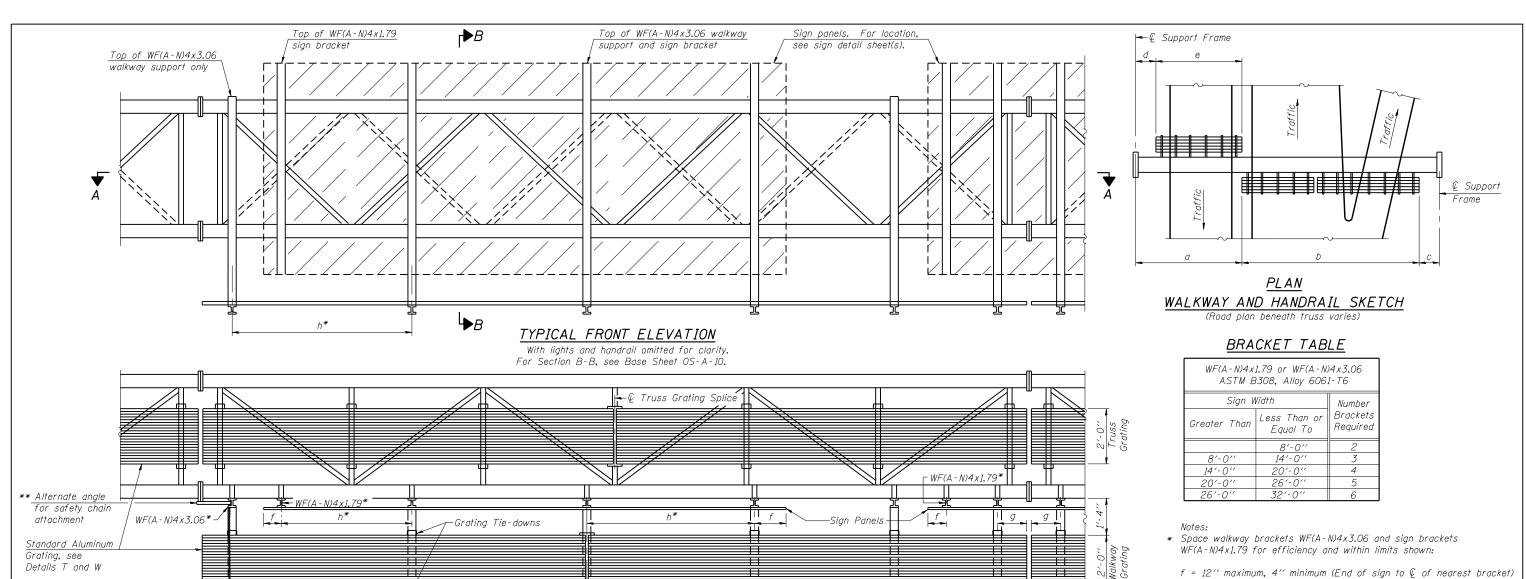

- g = 12" maximum, 4" minimum (End of walkway grating to € of nearest support bracket)
- h = 6'-0'' maximum ( $\mathbb Q$  to  $\mathbb Q$  sign and/or walkway support brackets, WF(A-N)4x1.79 or WF(A-N)4x3.06)
- k = 2" maximum gap between adjacent walkway grating sections and handrail ends
- \*\* If walkway bracket at safety chain location is behind sign, add angle to bracket, see Alternate Safety Chain Attachment on Base Sheet OS-A-11.

For Details T and W, Section B-B and Grating Splice Details see Base Sheet OS-A-10.

For Handrail Details see Base Sheet OS-A-11.

#### SECTION A-A

- Handrail, see OS-A-11

**∏**— € Walkway Grating Splice

Details F and G

see OS-A-11

Handrail and walkway shall span a minimum of three brackets between splices and/or gap joints. Place all sign and walkway brackets as close to panel points as practical. Handrail joints, grating, and light support splices placed as needed.

WALKWAY GRATING, WALKWAY SUPPORTS, HANDRAIL AND LIGHTING ARE NOT INCLUDED IN THIS CONTRACT. INFORMATION SHOWN ON THIS SHEET SHALL BE USED FOR TRUSS GRATING AND SIGN BRACKETS ONLY.

Safety Chain

Each end

Structure Number	Station	а	Ь	С	d	е	Walkway Grating and Handrail Lengths

← € Handrail Joint

Truss grating to facilitate inspection shall run full length (center to center of support frames) ±12" on overhead trusses. Cost of truss grating is included in "Overhead Sign Structure".

> Walkway and Truss Grating width dimensions are nominal and may vary ± 1/2" based on available standard widths.

0S-A-9

6 - 1 - 12 LIN ENGINEERING,LTD. Consulting Engineers

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STATE OF ILLINOIS **DEPARTMENT OF TRANSPORTATION** 


**OVERHEAD SIGN STRUCTURES ALUMINUM WALKWAY DETAILS** SHEET NO. 7 OF 19 SHEETS

H K---| F--- H

Light fixture supports.


Length as required for lighting fixtures. (If required)

> SECTION COUNTY 372/373 2013-037B-R COOK 787 147 CONTRACT NO. 60W75

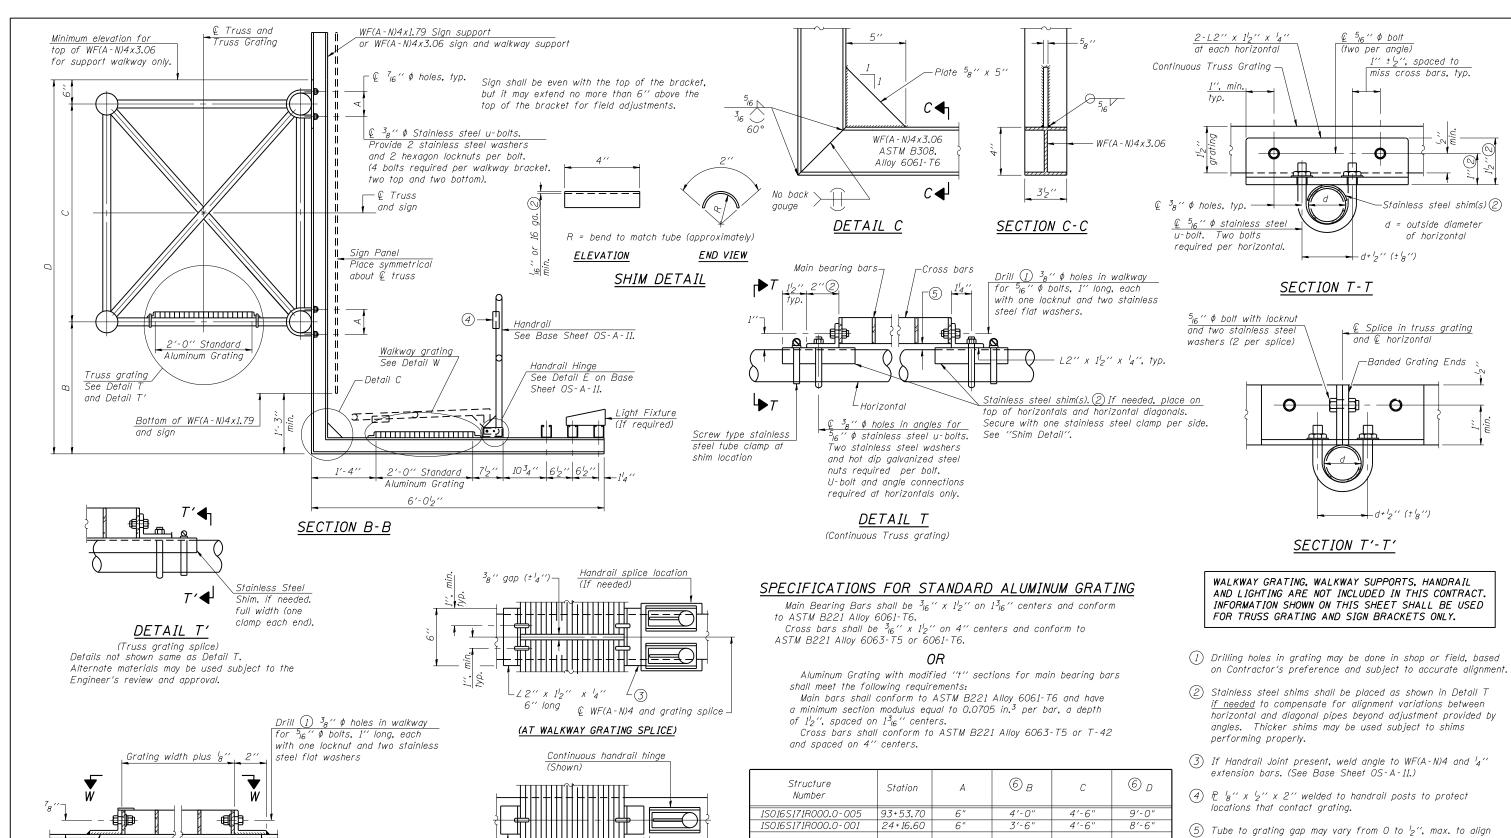

long at grating splices. DETAIL W (Walkway grating)

6-1-12

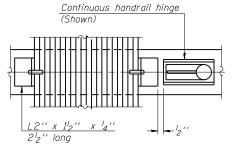

(CONTINUOUS WALKWAY GRATING)

SECTION W-W

Structure Number	Station	А	⑥ <sub>B</sub>	С	6 D
1S016S171R000 <b>.</b> 0-005	93+53.70	6"	4'-0"	4'-6"	9'-0"
1S016S171R000 <b>.</b> 0-001	24+16.60	6"	3′-6"	4′-6"	8′-6"

- walkway, allow for camber, etc.
- (6) Based on actual height of tallest sign given on OS-A-1.

0S - A - 10

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2½" long at continuous grating,

STATE OF ILLINOIS **DEPARTMENT OF TRANSPORTATION** 

OVERH ALUMIN						
SHE	ET N	0. 8	OF	19	SHEETS	

SECTION COUNTY 372/373 2013-037B-R COOK 787 148 CONTRACT NO. 60W75

#### BAR LIST - EACH FOUNDATION

Bar	Number	Size	Length	Shape
v4 (E)	16	#9	F less 5"	
#4 b	ar spiral (	E) - see	Side Elevatio	on

#### NOTES

The foundation dimensions shown are based on the presence of mostly cohesive soils with an average Unconfined Compressive Strength (Qu) of at least 1.25 tsf, which must be determined by previous soil investigations at the jobsite. When other conditions are indicated, the boring data will be included in the plans and the foundation dimensions shown will be the result of site specific designs.


If the conditions encountered are different than those indicated, the Contractor shall notify the Engineer to determine if the foundation dimensions need to be modified. If dimensions "B" or "F" are revised by more than 12" by the Contractor, "as-built" plans shall be prepared and submitted to the District Bureau of Operations for future reference.

No sonotubes or decomposable forms shall be used below the lower conduit entrance. Permanent metal forms or other shielding may not be left in place below that elevation without the Engineer's written permission.

Concrete shall be placed monolithically, without construction joints.


Backfill shall be placed per Article 502 of Standard Specification and prior to erection of support column.


A normal surface finish followed by a Concrete Sealer application will be required on concrete surfaces above the lowest elevation 6" below finished ground line. Cost included in Drilled Shaft Concrete Foundation.

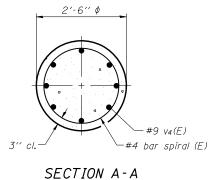

DETAILS FOR 8" \$ SUPPORT FRAME

TYPE I-A TRUSS

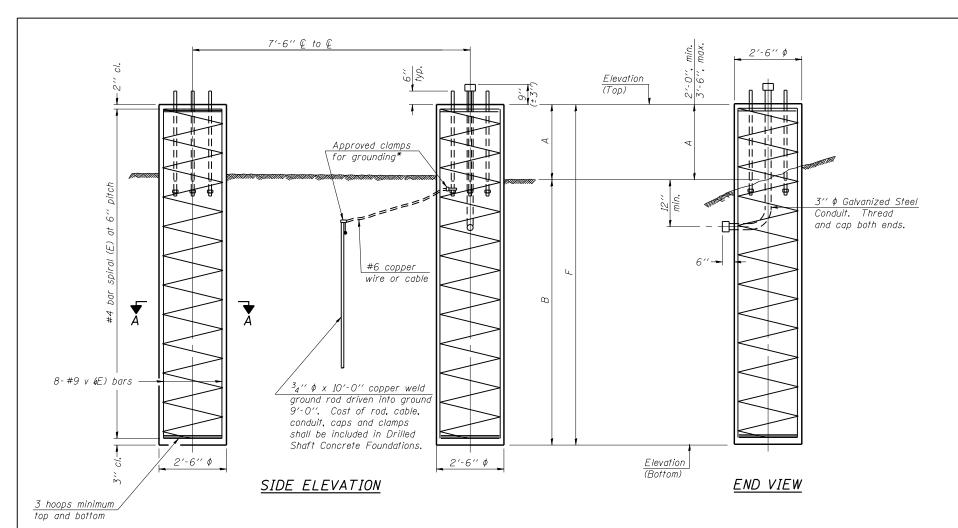

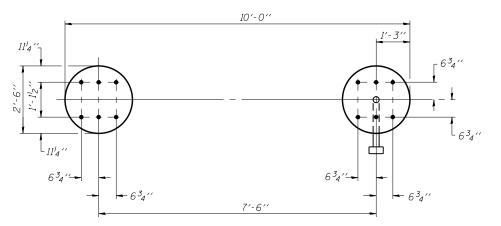

For anchor rod size and placement, see Support Frame Detail Sheet.

\* Anchor rod shall be ground or filed to bright metal at clamp and cable connection location.

PLAN

			Left Foundation			Right Foundation				Class DS		
Structure Number	Station	Elevation Top	Elevation Bottom	А	В	F	Elevation Top	Elevation Bottom	А	В	F	Concrete (Cu. Yds.)
1S016S171R000.0-005	93+53.70	620,80	603.30	3.00′	14.50′	17.50′	620.80	603.30	3.00′	14.50′	17.50′	12.8
1S016S171R000.0-001	24+16.60	626.60	609.10	3.00′	14.50′	17.50′	626.60	609.10	3.00′	14.50′	17.50′	12.8
	·											

#### 0S4-F2


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Consulting Engineers	Р
Springfield, Illinois	Р

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STATE OF ILLINOIS
DEPARTMENT OF TRANSPORTATION

OVERHEAD	SIGN	STRUCTURE	S				
DRILLED SHAFT DETAILS							
SHEET NO	. 9 01	F 19 SHEETS					




#### TYPICAL ELEVATION Looking in Direction of Traffic

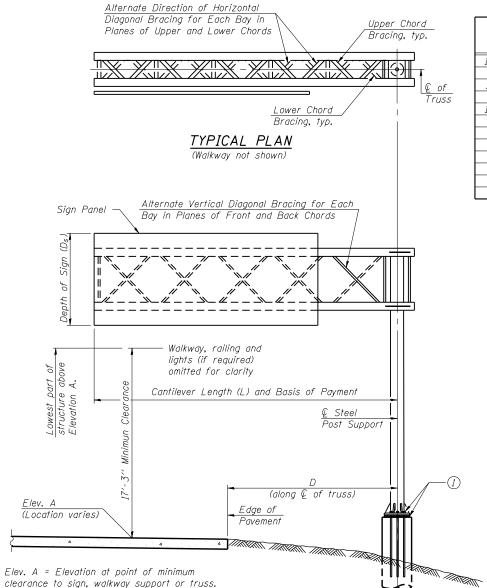Sign support structures may be subject to damaging vibrations and oscillations when sign panels are not in place during erection or maintenance of the structure. To avoid these vibrations and oscillations, consideration should be given to attaching temporary blank sign panels to the structure.

> WALKWAY GRATING, WALKWAY SUPPORTS, HANDRAIL AND LIGHTING ARE NOT INCLUDED IN THIS CONTRACT.

Structure Number	Station	Design Truss Type	Cantilever Length (L)	Elev. A	Dim. D	Ds	Total Sign Area
1C016S171R000.0-002	67+34.00	III-C-A	30.00′	620.60	18.27′	4.00′	56.00 S.F.
1C016S171R000.0-001	43+20.00	III-C-A	30.00′	620.60	12.40′	7.50′	116.25 S.F.
1C016S171R000.0-000	15+57.00	III-C-A	30.00′	619.80	15.44′	10.00′	145.00 S.F.

Truss Type	Maximum Sign Area	Maximum Length
I-C-A	170 Sq. Ft.	25 Ft.
II-C-A	340 Sq. Ft.	30 Ft.
III-C-A	400 Sq. Ft.	40 Ft.

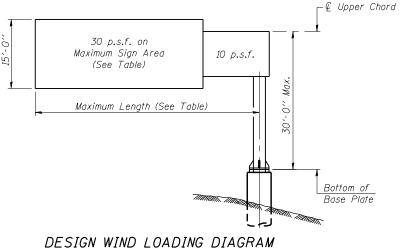

Parameters shown are basis for I.D.O.T. Standards Installations not within dimensional limits shown require special analysis for all components.

Trusses shall be shipped individually with adequate provision to prevent detrimental motion during transport. This may require ropes between horizontals and diagonals or energy dissipating (elastic) ties to the vehicle. The contractor is responsible for maintaining the configuration and protection of the trusses.

- (1) After adjustments to level truss and insure adequate vertical clearance, all top and leveling nuts shall be tightened against the base plate with a minimum torque of 200 lb.-ft. Stainless steel mesh shall then be placed around the perimeter of the base plate. Secure to base plate with stainless steel banding.
- \* If M270 Gr. 50W (M222) steel is proposed, chemistry for plate to be used shall first be approved by the Engineer as suitable for galvanizing and welding.

#### GENERAL NOTES

DESIGN: AASHTO Standard Specifications for Structural Supports for Highway Signs, Luminaires and Traffic Signals. ("AASHTO Specifications")

CONSTRUCTION: Current (at time of letting) Illinois Department of Transportation Standard Specifications for Road and Bridge Construction, Supplemental Specifications and Special Provisions. ("Standard Specifications")

LOADING: 90 M.P.H. WIND VELOCITY

WALKWAY LOADING: Dead load plus 500 lbs. concentrated live load.

DESIGN STRESSES: Field Units  $f'_{c} = 3.500 \text{ p.s.i.}$ 

fy = 60,000 p.s.i. (reinforcement)

WELDING: All welds to be continuous unless otherwise shown. All welding to be done in accordance with current AWS D1.1 and D1.2 Structural Welding Codes (Steel and Aluminum) and the Standard Specificiations.

MATERIALS: Aluminum Alloys as shown throughout plans. All Structural Steel Pipe shall be ASTM A53 Grade B or A500 Grade B or C. If A500 pipe is substituted for A53, then the outside diameter shall be as detailed and wall thickness greater than or equal to A53. All Structural Steel Plates and Shapes shall conform to AASHTO M270 Gr. 36, Gr. 50 or Gr. 50W\*. Stainless steel for shims, sleeves and handhole covers shall be ASTM A240, Type 302 or 304, or another alloy suitable for exterior exposure and acceptable to the Engineer. The steel pipe and stiffening ribs at the base plate for the column shall have a minimum longitudinal Charpy V-Notch (CVN) energy of 15 lb.-ft. at 40° F. (Zone 2) before galvanizing.

FASTENERS FOR ALUMINUM TRUSSES: All bolts noted as "high strength" must satisfy the requirements of AASHTO MI64 (ASTM A325), or approved alternate, and must have matching lock nuts. Threaded studs for splices (if Members interfere) must satisfy the requirements of ASTM A449, ASTM A193, Grade B7, or approved alternate, and must have matching lock nuts. Bolts and lock nuts not required to be high strength must satisfy the requirements of ASTM A307. All bolts and lock nuts must be hot dip galvanized per AASHTO M232. The lock nuts must have nylon or steel inserts. A stainless steel flat washer conforming to ASTM A240 Type 302 or 304, is required under both head and nut or under both nuts where threaded studs are used. High strength bolt installation shall conform to Article 505.04 (f) (2)d of the IDOT Standard Specifications for Road and Bridge Construction. Rotational capacity ("ROCAP") testing of bolts will not be required.

U-BOLTS AND EYEBOLTS: U-Bolts and Eyebolts must be produced from ASTM A276 Type 304, 304L, 316 or 316L, Condition A, cold finished stainless steel, or an equivalent material acceptable to the Engineer. All nuts for U-Bolts and Eyebolts must be lock nuts equivalent to ASTM A307 with nylon or steel inserts and hot dip galvanized per AASHTO M232. A stainless steel flat washer conforming to ASTM A240, Type 302 or 304, is required under each U-Bolt and Eyebolt lock nut.

GALVANIZING: All Steel Grating, Plates, Shapes and Pipe shall be Hot Dip Galvanized after fabrication in accordance with AASHTO M111. Painting is not permitted.

ANCHOR RODS: Shall conform to ASTM F1554 Gr. 105.

CONCRETE SURFACES: All concrete surfaces above an elevation 6" below the lowest final around line at each foundation shall be cleaned and coated with Concrete Sealer in accordance with the Standard Specifications.

REINFORCEMENT BARS: Reinforcement Bars designated (E) shall be epoxy coated in accordance with the Standard Specifications.

FOUNDATIONS: The contract unit price for Drilled Shaft Concrete Foundations shall include reinforcement bars complete in place.

#### TOTAL BILL OF MATERIAL

ITEM	UNIT	TOTAL
OVERHEAD SIGN STRUCTURE CANTILEVER TYPE I-C-A	Foot	
OVERHEAD SIGN STRUCTURE CANTILEVER TYPE II-C-A	Foot	
OVERHEAD SIGN STRUCTURE CANTILEVER TYPE III-C-A	Foot	90
OVERHEAD SIGN STRUCTURE WALKWAY, TYPE A	Foot	
DRILLED SHAFT CONCRETE FOUNDATIONS	Cu. Yds.	30.6


#### OSC-A-1


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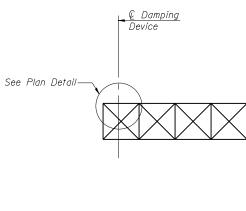
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#### STATE OF ILLINOIS **DEPARTMENT OF TRANSPORTATION**

A.P. TE.	SECTION	COUNTY	TOTAL SHEETS	SHEET NO.
/373	2013-037B-R	COOK	787	150
		CONTRACT	NO. 6	OW75
	TILINOIS EED AT	ID PROJECT		





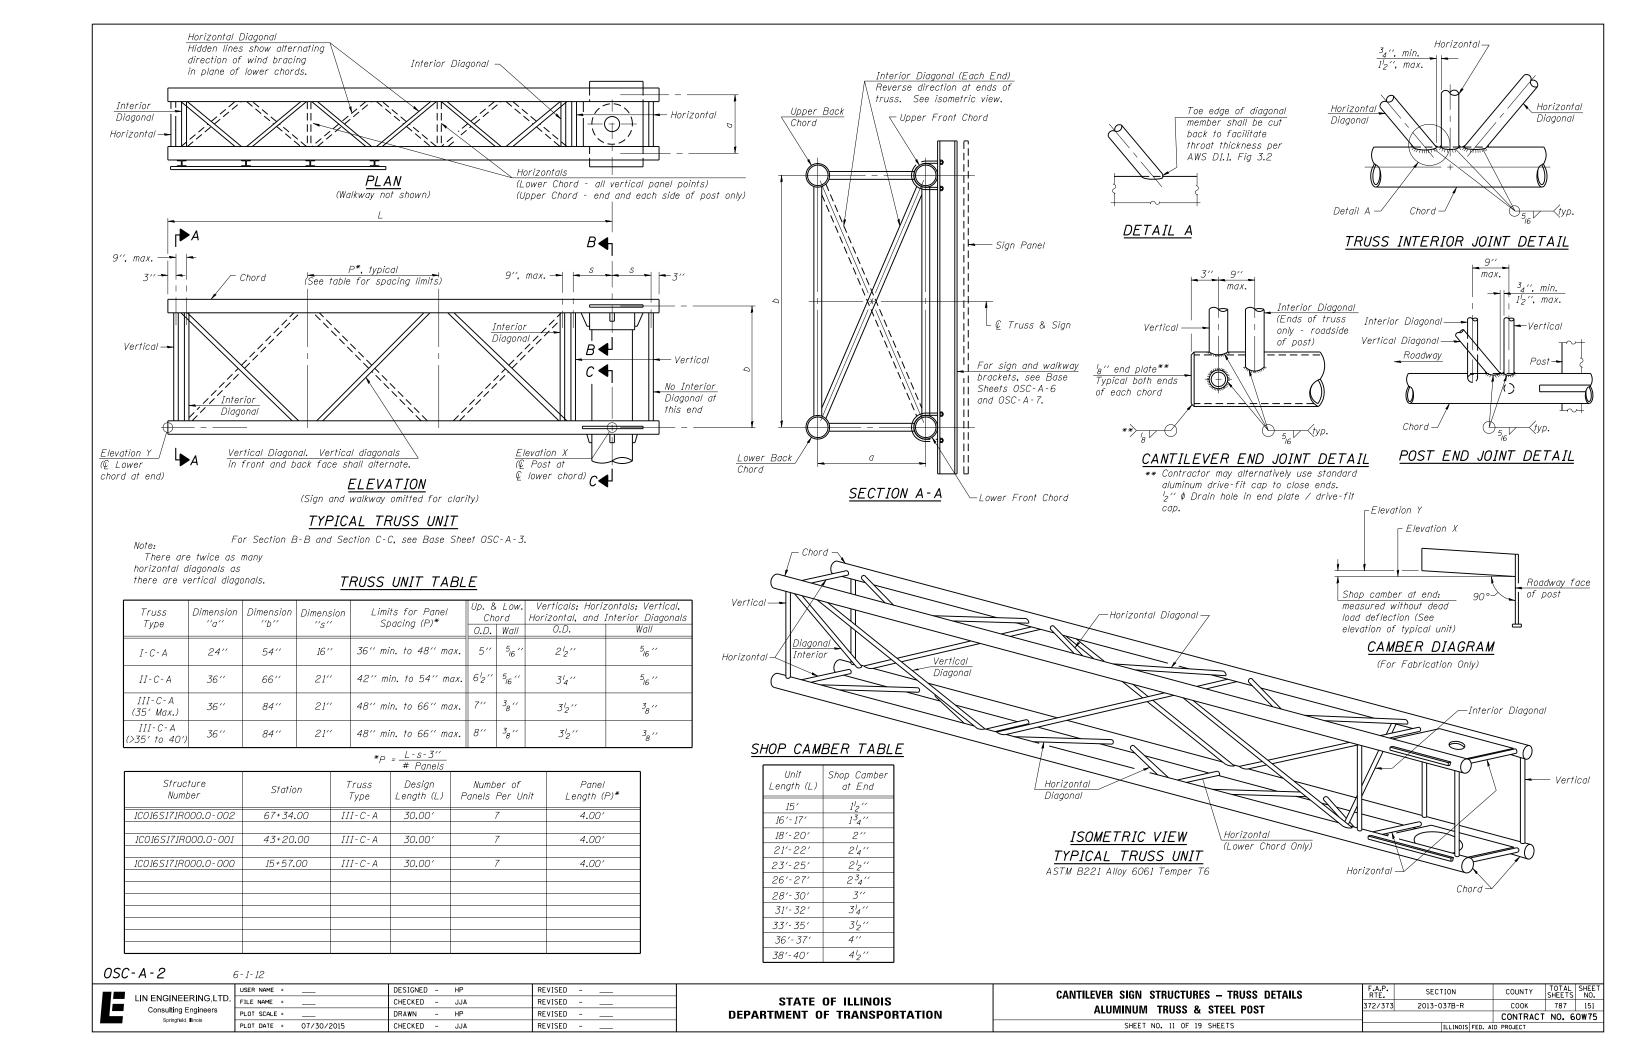

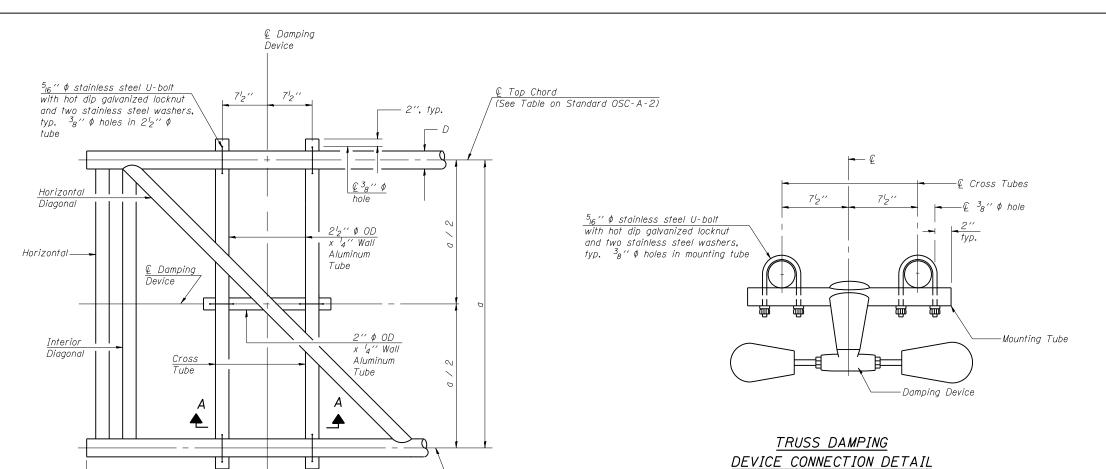GENERAL NOTES One damper per truss. (31 lbs. Stockbridge-Type Aluminum-29" minimum between ends of weights) Damper:

ELEVATION Aluminum Cantilever

Sign Structure

Materials: Aluminum tubes shall be ASTM B221 alloy 6061

temper T6

Device € Top Chord <sup>5</sup><sub>16</sub> " φ stainless steel U-bolt SECTION A-A

€ Top Chord

DAMPING DEVICE MOUNTING TUBE U-BOLT DETAIL

(Typical)

TOP CHORD TO CROSS TUBE U-BOLT DETAIL (Typical)

OSC-A-D

LIN ENGINEERING,LTD. Consulting Engineers

6-1-12


2'-0" (±6")

PLAN DETAIL

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STATE OF ILLINOIS **DEPARTMENT OF TRANSPORTATION** 

SECTION COUNTY **CANTILEVER SIGN STRUCTURE** 2013-037B-R COOK 787 152 372/373 DAMPING DEVICE CONTRACT NO. 60W75 SHEET NO. 12 OF 19 SHEETS

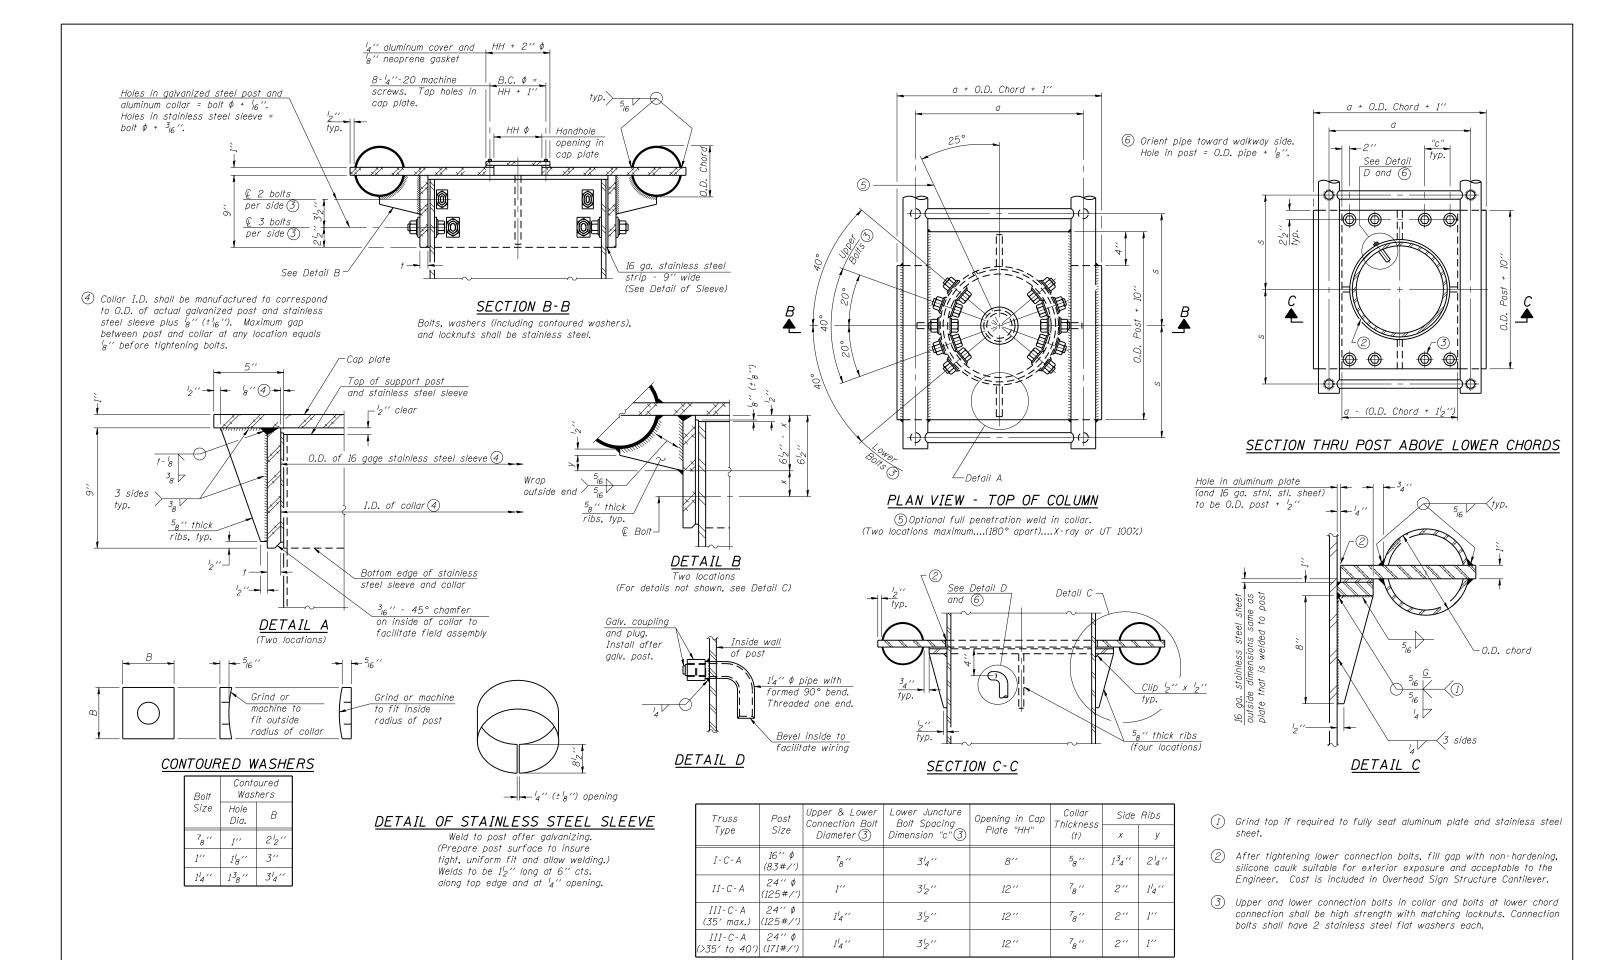

OSC-A-3

LIN ENGINEERING,LTD.

Consulting Engineers
Springfald Illinois

6-1-12

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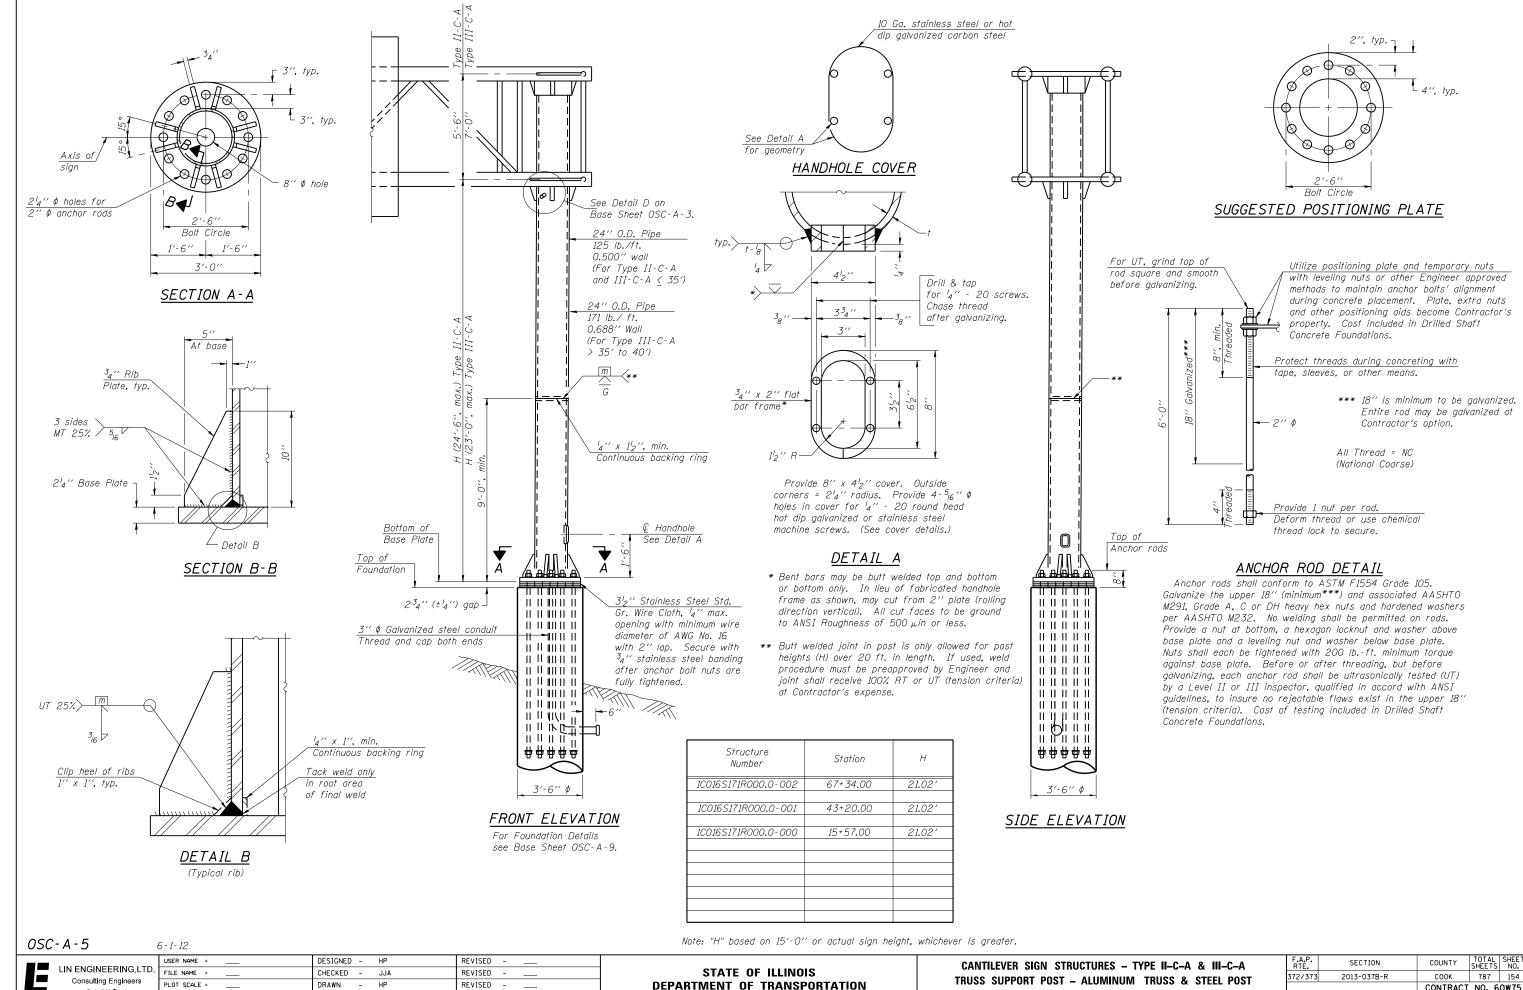
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STATE OF ILLINOIS
DEPARTMENT OF TRANSPORTATION

CANTILEVER SIGN STRUCTURES - JUNCTURE DETAILS
ALUMINUM TRUSS & STEEL POST

SHEET NO. 13 OF 19 SHEETS



**DEPARTMENT OF TRANSPORTATION** 


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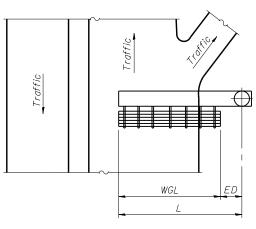
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REVISED -

TRUSS SUPPORT POST - ALUMINUM TRUSS & STEEL POST SHEET NO. 14 OF 19 SHEETS


2013-037B-R CONTRACT NO. 60W75



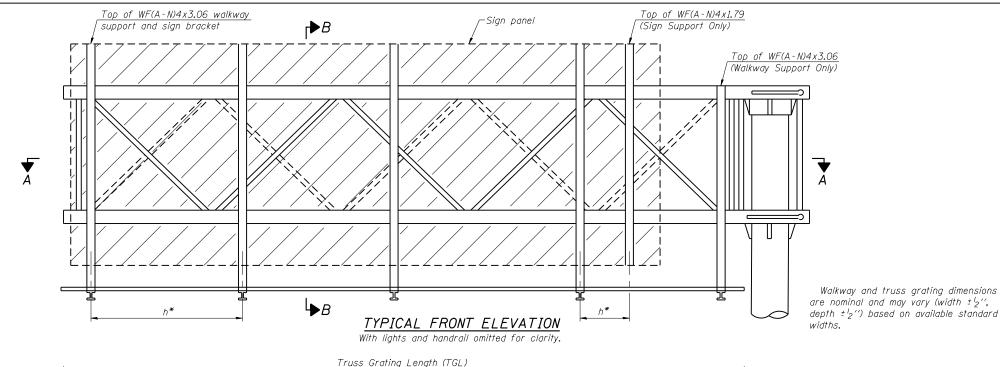

<u>PLAN</u> <u>WALKWAY AND HANDRAIL SKETCH</u>

(Road plan beneath truss varies)

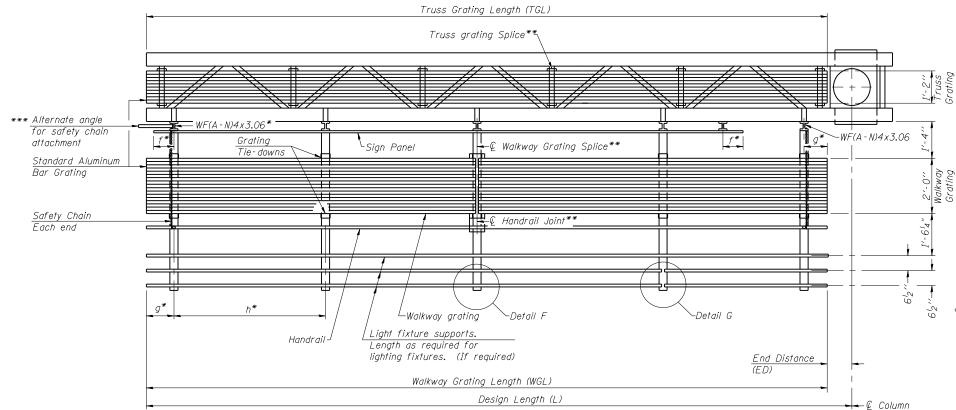

Structure Number	Station	WGL	ED	TGL
1C016S171R000.0-002	67+34.00			28.50′
1C016S171R000 <b>.</b> 0-001	43+20.00			28.50′
1C016S171R000.0-000	15+57.00			28.50′

#### Notes:

- Space walkway brackets WF(A-N)4x3.06 and sign brackets WF(A-N)4x1.79 for efficiency and within limits shown:
- f = 12" maximum, 4" minimum (End of sign to € of nearest bracket)
- g = 12" maximum, 4" minimum (End of walkway to © of nearest bracket)
- h = 6'-0'' maximum (C to C sign and/or walkway support brackets, WF(A-N)4x1.79 or WF(A-N)4x3.06)
- \*\*\* If walkway bracket at safety chain location is behind sign, add angle to bracket. See alternate safety chain attachment on base sheet OSC-A-8

For details of sign placement, sign/walkway brackets, truss and walkway gratings, grating splices and Section B-B, see Base Sheet OSC-A-7.

For details of handrail, handrail joint, safety chain and Details F and G, see Base Sheet OSC-A-8.

Truss grating to facilitate inspection shall run full length of cantilevers. Cost of truss grating is included in Overhead Sign Structure Cantilever.

#### SECTION A-A

Handrail and walkway grating shall span a minimum of three brackets between splices.

\*\* Use and location of handrail joints or grating splices are optional, based on lengths needed and material availability.

$$TGL = L - (\frac{Post \ O.D.}{2} + 6")$$

#### BRACKET TABLE

WF(A-N)4x1.79 or WF(A-N)4x3.06 ASTM B308, Alloy 6061-T6							
Sign W	Number						
Greater Than	Less Than or Equal To	Brackets Required					
	8'-0''	2					
8'-0''	14'-0''	3					
14'-0''	20'-0''	4					
20'-0''	26'-0''	5					
26'-0''	32'-0''	6					

WALKWAY GRATING, WALKWAY SUPPORTS, HANDRAIL AND LIGHTING ARE NOT INCLUDED IN THIS CONTRACT. INFORMATION SHOWN ON THIS SHEET SHALL BE USED FOR TRUSS GRATING AND SIGN BRACKETS ONLY.

0SC-A-6

6 - 1 - 12


LIN ENGINEERING,LTD.
Consulting Engineers
Springfield, Illinois


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STATE OF ILLINOIS
DEPARTMENT OF TRANSPORTATION

CANTILEVER SIGN STRUCTURES – ALUMINUM WALKWAY DETAILS – ALUMINUM TRUSS & STEEL POST
SHEET NO. 15 OF 19 SHEETS


F.A.P. RTE.	SECTION	COUNTY	TOTAL SHEETS	SHEET NO.
372/373	2013-037B-R	соок	787	155
		CONTRACT	NO. 6	OW75
	ILLINOIS FED. A	D PROJECT		



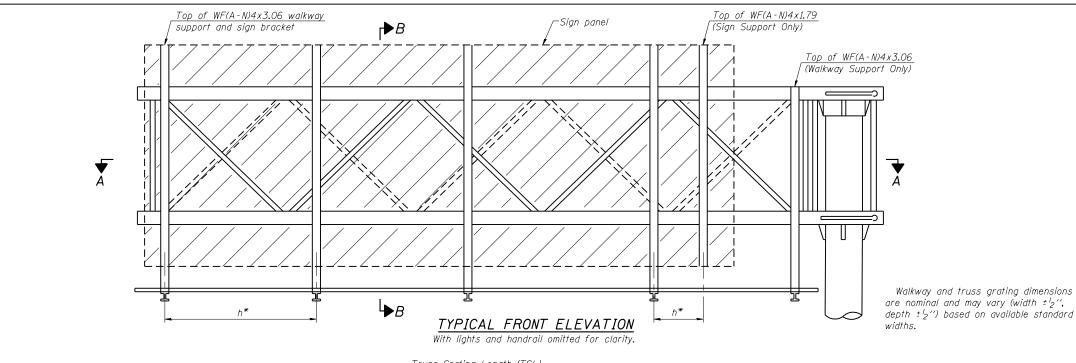
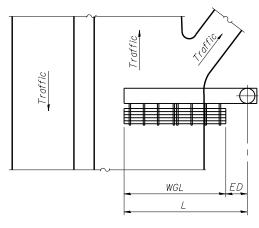
<u>PLAN</u> WALKWAY AND HANDRAIL SKETCH

(Road plan beneath truss varies)

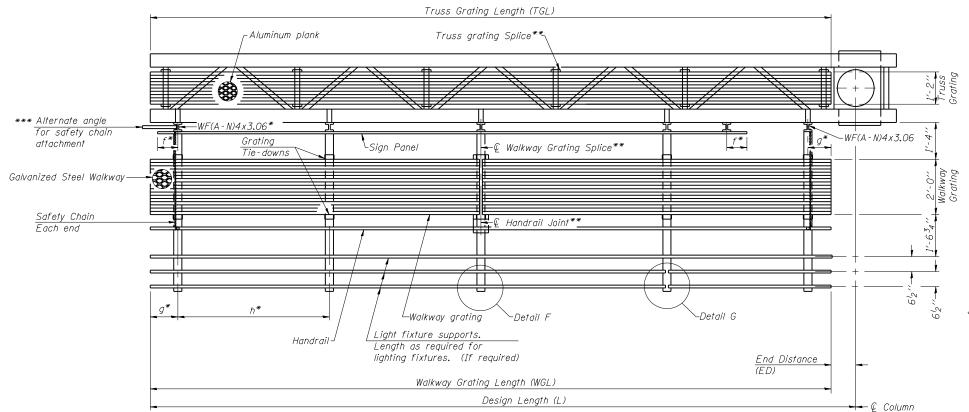

Structure Number	Station	WGL	ED	TGL
1C016S171R000.0-002	67+34.00			28.50′
1C016S171R000.0-001	43+20.00			28.50′
1C016S171R000.0-000	15+57.00			28.50′

#### Notes:

- Space walkway brackets WF(A-N)4x3.06 and sign brackets WF(A-N)4x1.79 for efficiency and within limits shown:
- f = 12'' maximum, 4'' minimum (End of sign to € of nearest bracket)
- g = 12'' maximum, 4'' minimum (End of walkway to € of nearest bracket)
- h = 6' 0'' maximum ( $\ell$  to  $\ell$  sign and/or walkway support brackets, WF(A-N)4x1.79 or WF(A-N)4x3.06)
- \*\*\* If walkway bracket at safety chain location is behind sign, add angle to bracket. See alternate safety chain attachment on base sheet OSC-A-8.

For details of sign placement, sign/walkway brackets, truss and walkway gratings, grating splices and Section B-B, see Base Sheet OSC-A-7S.

For details of handrail, handrail joint, safety chain and Details F and G, see Base Sheet OSC-A-8.

## <u>SECTION</u> A-A

Truss grating to facilitate inspection shall run full length of cantilevers. Cost of truss grating is included in Overhead Sign Structure Cantilever.

Handrail and walkway grating shall span a minimum of three brackets between splices.

\*\* Use and location of handrail joints or grating splices are optional, based on lengths needed and material availability.

$$TGL = L - (\frac{Post \ O.D.}{2} + 6")$$

#### BRACKET TABLE

WF(A-N)4x1.79 or WF(A-N)4x3.06 ASTM B308, Alloy 6061-T6								
Sign W	Number							
Greater Than	Less Than or Equal To	Brackets Required						
	8'-0''	2						
8'-0''	14'-0''	3						
14'-0''	20'-0''	4						
20'-0''	26'-0''	5						
26′-0′′	32'-0''	6						

WALKWAY GRATING, WALKWAY SUPPORTS, HANDRAIL AND LIGHTING ARE NOT INCLUDED IN THIS CONTRACT. INFORMATION SHOWN ON THIS SHEET SHALL BE USED FOR TRUSS GRATING AND SIGN BRACKETS ONLY.

OSC-A-6S

6-1-12 USER NAM


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Springfield, Illinois	PLO


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STATE OF ILLINOIS
DEPARTMENT OF TRANSPORTATION

CANTILEVER SIGN			S	STRUCTURES			- ALTERNATE STEEL				
WALKWAY	DET	AILS	- 1	ALU	JM	INL	IM	TRUSS	&	STEEL	POST
		SHEE	ΞT	NO.	16	OF	19	SHEETS			

		 D PROJECT	NO. 6	OW75		
372/373	2013-037B-R	соок	787	156		
F.A.P. RTE.	SECTION	COUNTY	TOTAL SHEETS	SHEET NO.		



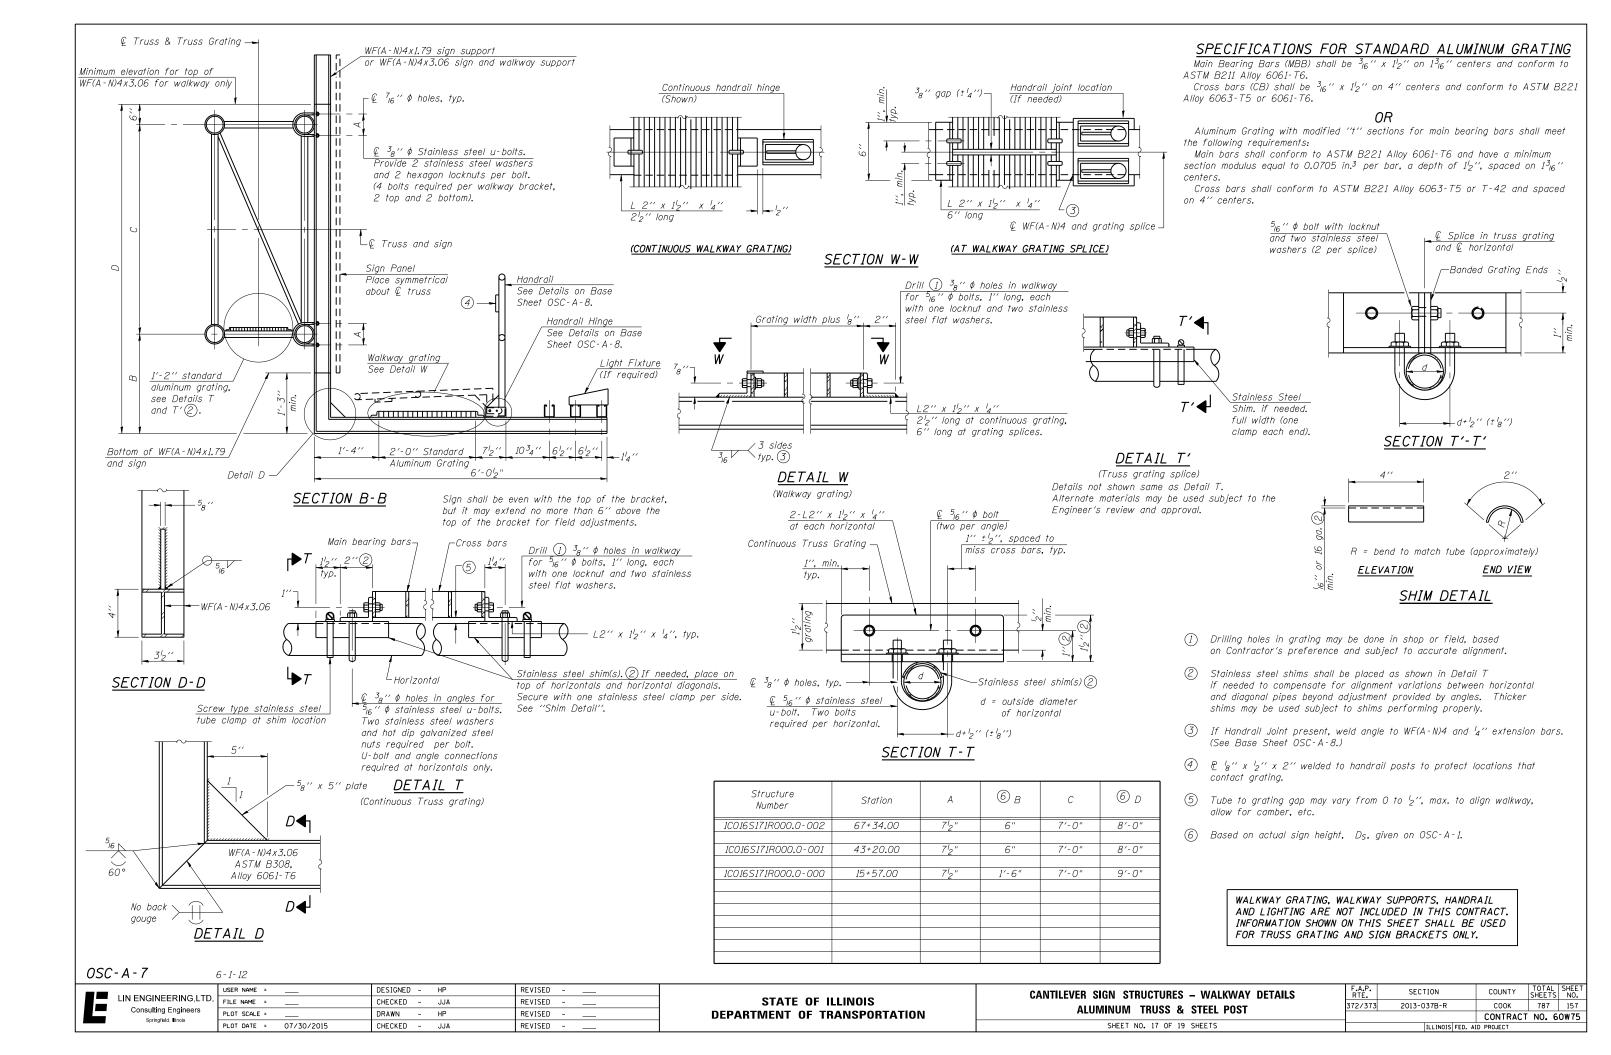
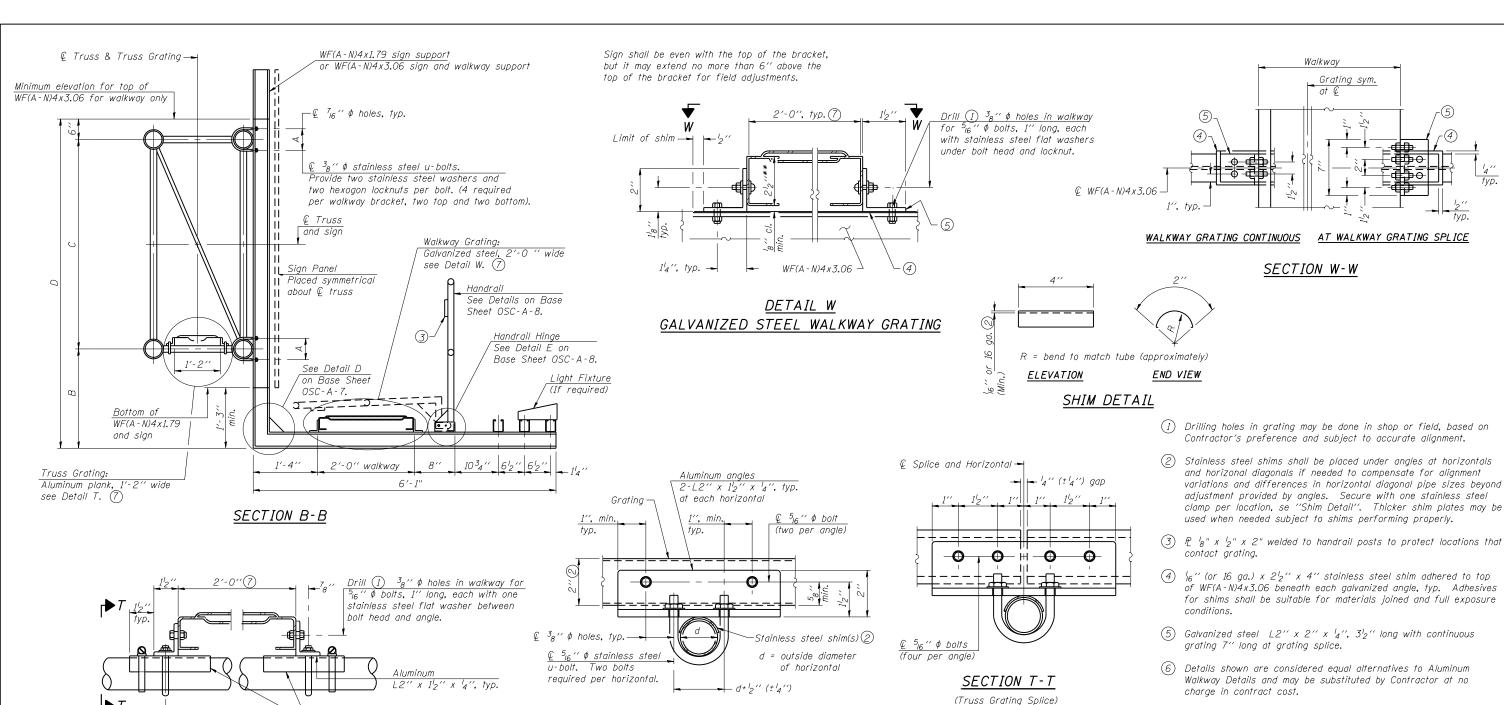
#### ALUMINUM TRUSS GRATING

Structure Number	Station	Α	8 <sub>B</sub>	С	8 D
1C016S171R000.0-002	67+34.00	712"	6"	7′-0"	8'-0"
1C016S171R000.0-001	43+20.00	7 <sup>1</sup> 2"	6"	7′-0"	8'-0"
1C016S171R000.0-000	15+57 <b>.</b> 00	7 <sup>1</sup> 2"	1′-6"	7′-0"	9′-0"

- of WF(A-N)4x3.06 beneath each galvanized angle, typ. Adhesives for shims shall be suitable for materials joined and full exposure
- (7) Perforated or expanded metal grating providing a skid resistant (non-serrated) surface and capable of supporting a 500 pound concentrated load with a 6'-0" clear span. Walkway and truss grating dimensions are nominal and may vary (width  $\pm {}^{l}_{2}$ ", depth 12") based on available standard sizes. Cut ends of grating shall be free of burrs or hazardous projections and coated with zinc-rich primer or equivalent.
- (8) Based on actual sign height, Ds, given on OSC-A-1.

WALKWAY GRATING, WALKWAY SUPPORTS, HANDRAIL AND LIGHTING ARE NOT INCLUDED IN THIS CONTRACT. INFORMATION SHOWN ON THIS SHEET SHALL BE USED FOR TRUSS GRATING AND SIGN BRACKETS ONLY.

OSC-A-7S

LIN ENGINEERING,LTD. Consulting Engineers

6-1-12

 $\frac{(c)}{5}$   $\frac{3}{8}$  "  $\phi$  holes in angles for  $\frac{5}{16}$  "  $\phi$  stainless steel u-bolts.

Two stainless steel washers

and hot dip galvanized steel

U-bolt and angle connections required at horizontals only.

nuts required per bolt.

USER NAME = DESIGNED - HP REVISED FILE NAME = CHECKED - JJA REVISED PLOT SCALE = DRAWN REVISED -PLOT DATE = 07/30/2015 CHECKED - JJA REVISED -

Stainless steel shim(s),

DETAIL T

(Truss grating at horizontal)

if needed for alignment, (2)

SECTION T-T


**CANTILEVER SIGN STRUCTURES ALTERNATE WALKWAY DETAILS** SHEET NO. 18 OF 19 SHEETS

Alternate splice details and locations may be used

subject to the Engineer's review and approval.

SECTION COUNTY 372/373 2013-037B-R COOK 787 158 CONTRACT NO. 60W75

STATE OF ILLINOIS	
DEPARTMENT OF TRANSPORTATION	

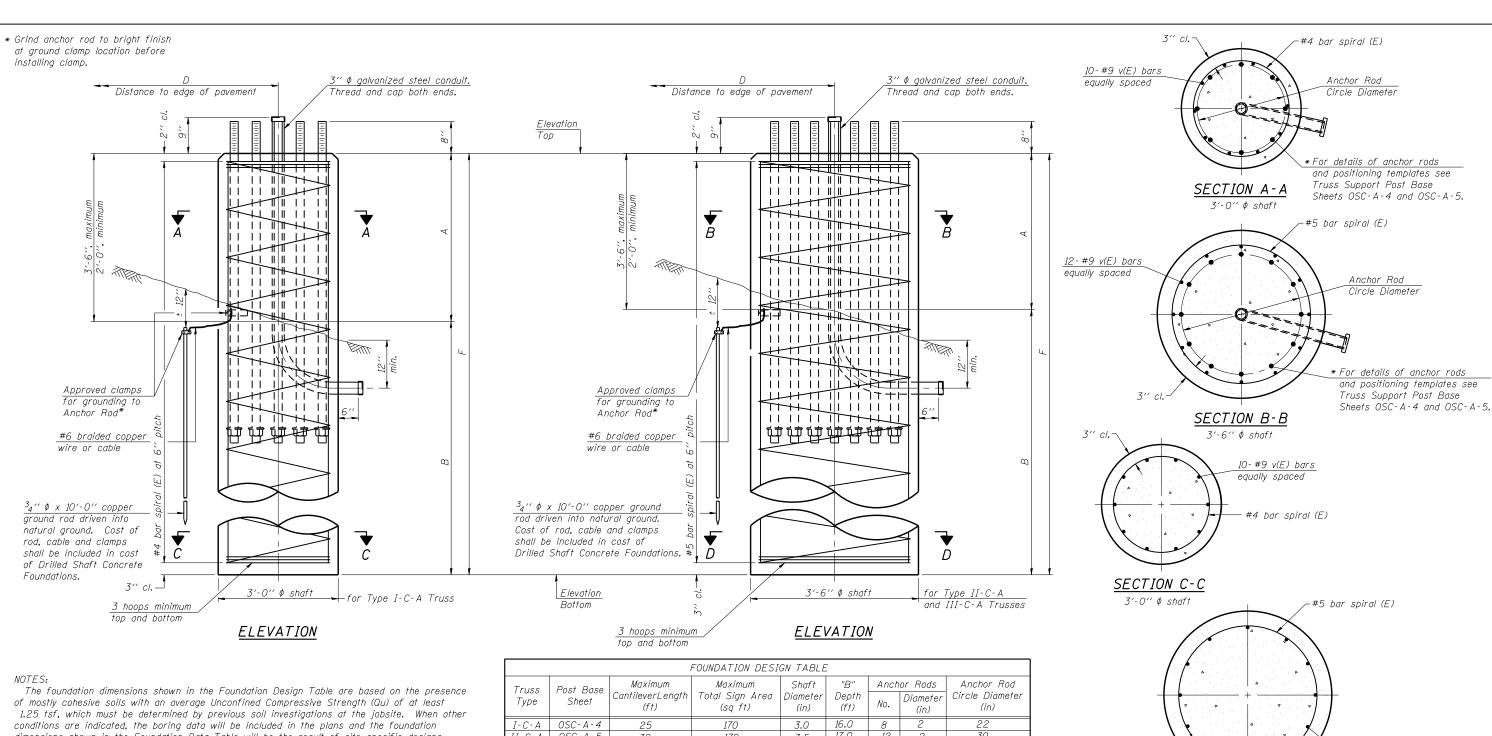

dimensions shown in the Foundation Data Table will be the result of site specific designs.

If the conditions encountered are different than those indicated, the Contractor shall notify the Engineer to determine if the foundation dimensions need to be modified. If dimensions "B" or "F" are revised by more than 12" by the Contractor, "as-built" plans shall be prepared and submitted to the District Bureau of Operations for future reference.

No sonotubes or decomposable forms shall be used below the lower conduit entrance. Permanent metal forms or other shielding may not be left in place below that elevation without the Engineer's written permission.

Concrete shall be placed monolithically, without construction joints.

Backfill shall be placed per Article 502 of Standard Specification and prior to erection of

A normal surface finish followed by a Concrete Sealer application will be required on concrete surfaces above the lowest elevation 6" below finished ground line. Cost included in "Drilled Shaft Concrete Foundation".

	FOUNDATION DESIGN TABLE												
Truss Type	Post Base Sheet	Maximum CantileverLength (ft)	Maximum Total Sign Area (sq ft)	Shaft Diameter (in)	"B" Depth (ft)	Anch No.	or Rods Diameter (in)	Anchor Rod Circle Diameter (in)					
I-C-A	OSC-A-4	25	170	3.0	16.0	8	2	22					
II-C-A	0SC-A-5	30	170	3.5	17.0	12	2	30					
II-C-A	0SC-A-5	30	340	<b>3.</b> 5	21.5	12	2	30					
III-C-A	0SC-A-5	<i>3</i> 5	170	<b>3.</b> 5	19.0	12	2	30					
III-C-A	0SC-A-5	35	250	3.5	22.5	12	2	30					
III-C-A	0SC-A-5	<i>3</i> 5	400	3.5	26.5	12	2	30					
III-C-A	OSC-A-5	40	400	3.5	32.0	12	2	30					
	-												

FOUNDATION

Shaft

Diameter

3.50′

Truss

Туре

III-C-A

III-C-A 3.50'

III-C-A 3.50'

12	2 3	0 0 0 0		3'' (	<u>SE</u> (	CTION D-D
N DATA T	ABLE	I	I	I	I	
Elevation Top	Elevation Bottom	Qu	А	В	F	Class DS Concrete Cubic Yards
620.60	592.10	1.25 tsf	2.00′	26.50′	28.50′	10.2
620.60	592.10	1.25 tsf	2.00′	26.50′	28.50′	10.2
619.80	591.30	1.25 tsf	2.00′	26.50′	28.50′	10.2

OSC-A-9

8-21-13

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Consulting Engineers  Springfield, Illinois	PLOT SCALE =	
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	PLOT DATE =	07/30/2015	CHECKED	-	JJA	REVISED	-	_

STATE OF ILLINOIS **DEPARTMENT OF TRANSPORTATION** 

Station

67+34.00

43+20.00

15+57.00

Structure

Number

1C016S171R000.0-002

1C016S171R000.0-001

1C016S171R000.0-000

CANTILEVER SIGN STRUCTURES - DRILLED SHAFT **ALUMINUM TRUSS & STEEL POST** SHEET NO. 19 OF 19 SHEETS

F.A.P. RTE.	SECTION	COUNTY	TOTAL SHEETS	SHEET NO.
372/373	2013-037B-R	соок	787	159
		CONTRACT	NO. 6	OW75
	ILLINOIS FED. A	ID PROJECT		

12-#9 v(E) bars


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Geo Services, Inc. Geolechical Environmental & Cayl Engineering Book Manual Court Supplier Geolechical Environmental & Cayl Engineering Book Services Book Services Book S				N	IL R			OGGE	Date D BY		6/13
COUNTY Cook DRIL											tic
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12.0" ASPHALT	.π	(11)	(,,,	(131)	(70)	CLAY LOAM-dark brown & gray	_π	(11)	(,,,	(131)	(70)
	6.80					spotted black-stiff to very stiff (Fill) (continued)		┚			
12.0" CRUSHED STONE		_	3			(continuea)		$\neg$	3		
CLAY LOAM-dark brown & gray	5.80		5		4			-	4	1.5 P	14
spotted black-stiff to very stiff (Fill)		-	١Ů					+			
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The Unconfined Compressive Strength (UCS) Failure Mode is indicated by (B-Bulge, S-Shear, P-Penetrometer)
The SPT (N value) is the sum of the last two blow values in each sampling zone (AASHTO T206)
BBS, from 137 (Rev. 8-99)

			SC	IL BORING LOG		Page	1	of
						Date	9/1	7
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The Unconfined Compressive Strength (UCS) Failure Mode is indicated by (B-Bulge, S-Shear, P-Penetrometer)
The SPT (N value) is the sum of the last two blow values in each sampling zone (AASHTO T206)
BBS, from 137 (Rev. 8-99)



The Unconfined Compressive Strength (UCS) Failure Mode is indicated by (B-Bulge, S-Shear, P-Penetrometer)
The SPT (N value) is the sum of the last two blow values in each sampling zone (AASHTO T206)
BBS, from 137 (Rev. 8-99)

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PLOT DATE = 6/17/2015	DATE - 6/12/2015	REVISED -

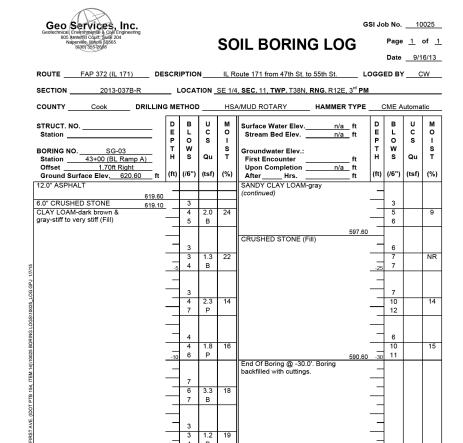

STATE OF ILLINOIS DEPARTMENT OF TRANSPORTATION		OV	ERHEAD :	SIGN ST	RUCTURE		F.A.P RTE.	SECTION	COUNTY	TOTAL SHEETS	SHEET NO.
		SOIL BORING LOGS							соок	787	160
									CONTRACT N		NO. 60W75
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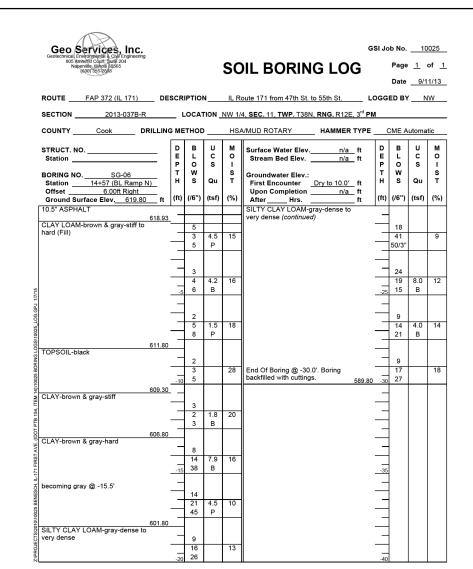
SANDY CLAY LOAM-gray

Geo Services, Inc. Geolechical Environmental & Culf Engineer Bernstell Culf Supplemental Supplemental Supplem		RIPTIO		SOIL BORING		Date	1 of 9/11/	13
SECTION	R	LOCAT	TION SE	1/4, <b>SEC</b> . 11, <b>TWP</b> . T38N,	RNG. R12E, 3 <sup>rd</sup> PM	l		
COUNTY Cook	DRILLING MI	ETHOD		GEO PROBE	HAMMER TYPE		I/A	
STRUCT. NO.   Station   SG-04	E P T H	L 0 W	C S Qu	M Surface Water Elev. Stream Bed Elev. I S Groundwater Elev.: First Encounter Upon Completion After Hrs. CLAY LOAM-brown-ve	n/a ft  Dry ft  Dry ft  ft  ft	D B L P O T W H S (ft) (/6")	C S Qu	M O I S T
12.0" CRUSHED STONE  CLAY LOAM-brown & gray-very stiff (Fill)	637.10		2.5 B	hard (continued)		-25	4.1 1 B	18
			2.8 B	14			3.5 B	17
CRUSHED STONE	628.60	0		End Of Boring @ -30.0 backfilled with cuttings		-30		
CLAY LOAM-brown-very stiff to hard			2.5 P	18				
		5	5.0 B	19		35		

The Unconfined Compressive Strength (UCS) Failure Mode is indicated by (B-Bulge, S-Shear, P-Penetrometer)
The SPT (N value) is the sum of the last two blow values in each sampling zone (AASHTO T206)
BBS, from 137 (Rev. 8-99)

Geo Services, Inc. Geotechnical, Environmental & Civil Engineering 805 Jumherst Court, Suite 204	)						GSI J			
Naperville, Illinois 50565 (630) 355-2818					SC	IL BORING LOG		Page	1_	of _
								Date	8/2	1/13
ROUTE FAP 372 (IL 171)	DE	SCR	IPTIO	N	IL R	oute 171 from 47th St. to 55th St.	LOGG	ED BY	′ĸ	(D
SECTION	2	_ ι	OCA	TION_	NW 1/	4, SEC. 11, TWP. T38N, RNG. R12E, 3"	РМ			
COUNTY Cook D	RILLING	З МЕ	тног		HS	A/MUD ROTARY HAMMER TY	PE	CME A	utoma	tic
STRUCT. NO.		D	В	U	М	Surface Water Elevn/a ft	В	В	U	м
Station	_	E	L	С	0	Stream Bed Elevft	=	L	С	0
		P	o w	s	l s		P	o w	s	S
BORING NO.         SG-05           Station         95+70 (BL IL171           Offset         1.30ft Right	1	н		Qu	Ť	Groundwater Elev.: First EncounterDry to 10.0'ft	1	s	Qu	Ť
Offset 1.30ft Right						Upon Completionn/a ft				
Ground Surface Elev. 621.90	ft ft	(ft)	(/6")	(tsf)	(%)	After Hrs ft	(ft)	(/6")	(tsf)	(%)
5.0" TOPSOIL-black	621.48					SILTY CLAY LOAM with				
CLAY to CLAY LOAM-brown & gray-very stiff to hard (Apparent					14	FRACTURED ROCK-gray-very dense (continued)				
Fill)		_	3	3.7	21	dense (communa)	_	50/3"	4.5	10
		_	3	3.7 B	21		_	1	P.5	10
		_	۱Ť	Ť		598	3.90		i i	
			l			SILTY LOAM-gray-dense		1		
		_	2				_	12		
		_	1	4.0	19		_	17		14
		-5	3	Р			25	23		
		_				SANDY LOAM-gray-dense to very	3.40	1		
			5			dense	_	23		
		_	6	5.0	16		_	30		20
			6	В			_	34		
CANDY OLAY	613.90						_	1		
SANDY CLAY LOAM-brown-medium dense		_	2				_	23		
(Apparent Fill)			4		13	End Of Boring @ -30.0'. Boring	_	27		22
		-10	4		"	backfilled with cuttings.	.90 -30			
	611.40									
CLAY LOAM-brown-hard							_	1		
		_	2	5.7	18		_	1		
		_	8	5.7 B	l '°			1		
	608.90	_	۲	۲			_	1		
SILTY CLAY LOAM-gray-dense	000.00		1		1		_	1		
			20					]		
			23		12			1		
		15	24				-35	1		
SILTY LOAM-gray-dense	606.40						_	1		
o.e Lorum gray acrisc			20				_	1		
			34	1	10			1		
		_	23							
OIL TV OLAV LOAM	603.90									
SILTY CLAY LOAM with FRACTURED ROCK-gray-very		_	22				_	1		
dense				5.5	10	1		1		

The Unconfined Compressive Strength (UCS) Failure Mode is indicated by (B-Bulge, S-Shear, P-Penetrometer)
The SPT (N value) is the sum of the last two blow values in each sampling zone (AASHTO T206)
BBS, from 137 (Rev. 8-99)



The Unconfined Compressive Strength (UCS) Failure Mode is indicated by (B-Bulge, S-Shear, P-Penetrometer)
The SPT (N value) is the sum of the last two blow values in each sampling zone (AASHTO T206)
BBS, from 137 (Rev. 8-99)

FILE NAME =	DESIGNED -	REVISED -
\D160W75-sht-lin-NB-02.dgn	DRAWN -	REVISED -
USER NAME = jmajewski	CHECKED -	REVISED -
PLOT DATE = 6/17/2015	DATE - 6/12/2015	REVISED -




OTATE OF ULUNION		OVERHEA	D SIGN S	TRUCTURE		F.A.P RTE.	SECTION	COUNTY	TOTAL SHEETS	SHEET NO.
STATE OF ILLINOIS		SO.		LOGS		372/373	2013-037B-R	COOK	787	161
DEPARTMENT OF TRANSPORTATION			L DOMING	LUGU				CONTRACT	NO. 60	OW75
	SCALE:	SHEET 2 OF	3 SHEETS	STA.	TO STA.		ILLINOIS FED. AI	D PROJECT		

Geo Services, Inc. Geotechnical Environmental & Cuid Engineering 805 Asserted Schutz Sudi 2014 Naperville, jillihoffs 50565 (egg) 55-3866				SC	IL BORIN	G LOG	Page <u>1</u> 0
ROUTE FAP 373 (IL 171) DE	SCRI	PTIOI	N	IL R	oute 171 from 47th St.	to 55th St.	LOGGED BY N
<b>SECTION</b> 2013-037B-R	_ L	OCAT	LION _	NW 1/	4, SEC. 13, TWP. T38N	I, RNG. R12E, 3 <sup>rd</sup>	PM
COUNTY Cook DRILLING	S ME	THOD			GEO PROBE	_ HAMMER TYP	PEN/A
STRUCT. NO.	D E	B L	U C	M	Surface Water Elev.	n/a ft	
Station	P	o W	s	S	Stream Bed Elev.		
BORING NO.         SG-09           Station         15+81 (NB IL171)           Offset         45.50ft Right	н	s	Qu	Ť	Groundwater Elev.: First Encounter	Dry_ft	
Offset 45.50ft Right Ground Surface Elev. 612.00 ft	(ft)	(/6")	(tsf)	(%)	First Encounter Upon Completion After Hrs.	ft ft	
TOPSOIL-black				30			
	_			-			
CLAY LOAM with Gravel &	$\exists$						
Stone-brown & gray (Fill)	_			12			
	4						
	-5			9			
	_						
	$\exists$			12			
602.50	$\equiv$						
603.50	$\exists$						
Auger Refual @ -8.5'. End Of Boring @ -8.5'. Boring backfilled with cuttings.	=						
backfilled with cuttings.	-10						
	_						
	_						
	_						
	$\equiv$						
	45						
	 15 						
	=						
	_						
	=						
	_						
	_						

Geo Services, Inc. Geotechnical Environmental & Chilf Engineering 805 Amhert Cdurff Suife 204 Naiperville, Jillydis 20565 (egg) 955-2988						33130	b No.	1	
Naperville, Illinois 50565 (630) 355-2818				SC	OIL BORING LOG				
POUTE FAD 272 (II 474) PE	000	IDTIO				000			
					oute 171 from 47th St. to 55th St. L		ום טם		IVV
COUNTY Cook DRILLING					14, SEC. 13, TWP. T38N, RNG. R12E, 3 <sup>rd</sup> Pl		CME A	utoma	tic
STRUCT. NO.	D E	B L	U	М	Surface Water Elev. <u>n/a</u> ft	D	B L	U	M
Station	Р	0	s	1	Stream Bed Elevn/a_ ft	P	0	s	1
BORING NO.         SG-09A           Station         15+81 (NB IL-171)	T H	w s	Qu	S	Groundwater Elev.: First Encounter 26.0' ft	H	W S	Qu	S
Offset 29.90ft Right Ground Surface Elev. 613.90 ft	(ft)	(/6")	(tsf)	(%)	Upon Completion n/a ft After Hrs. ft	(ft)	(/6")	(tsf)	(%
11.0" ASPHALT			. ,	` '	CLAY LOAM-brown & gray-very	<u> </u>		<u> </u>	
CLAY LOAM-brown & gray-very	_	5			stiff (Possible Fill) (continued)	_	3		
stiff to hard (Fill)	_	4 6	4.3 B	16		_	6 8	3.5 B	16
	_	Ť				_		Ť	
	-	3				-	5		
	_	8	4.5 P	15		-25	12 20	3.8 P	15
	5	Ť				_		Ė	
	_	10			SANDY SILT-gray-very dense	)	50/1"		
	_	8 10	3.0 P	8		_			
	_					_			
	_	7				_	50/1"		
	10	14 16	3.0 P	14	583.90	-30			33
	-10				End Of Boring @ -30.0'. Boring backfilled with cuttings.	-50			
	_	8				_			
	_	50/4"		13		_			
	_					_			
	_	3	0.0			_			
	-15	4 8	3.3 B	20		-35			
598.40 CLAY LOAM-brown & gray-very									
stiff (Possible Fill)	_	4	2.7	19		_			
	_	7	2.7 B	19		_			
	_					_			
	_	2	27	21		_			
	-20	4 5	2.7 B	21		-40			

FILE NAME =	DESIGNED -	REVISED -				OVERHEAD SIGN ST	DIICTIIDE	F.A.P	SECTION	COUNTY	TOTAL SHEET
\D160W75-sht-lin-NB-03.dgn	DRAWN -	REVISED -	<b>benesch</b>	STATE OF ILLINOIS		SOIL BORING I		372/373	2013-037B-R	соок	787 162
USER NAME = jmajewski	CHECKED -	REVISED -	engineers - scientists - planners	DEPARTMENT OF TRANSPORTATION		SUIL BURING I	.069			CONTRACT	NO. 60W75
PLOT DATE = 6/17/2015	DATE - 6/12/2015	REVISED -	,		SCALE:	SHEET 3 OF 3 SHEETS	STA. TO STA.		ILLINOIS FED.	AID PROJECT	



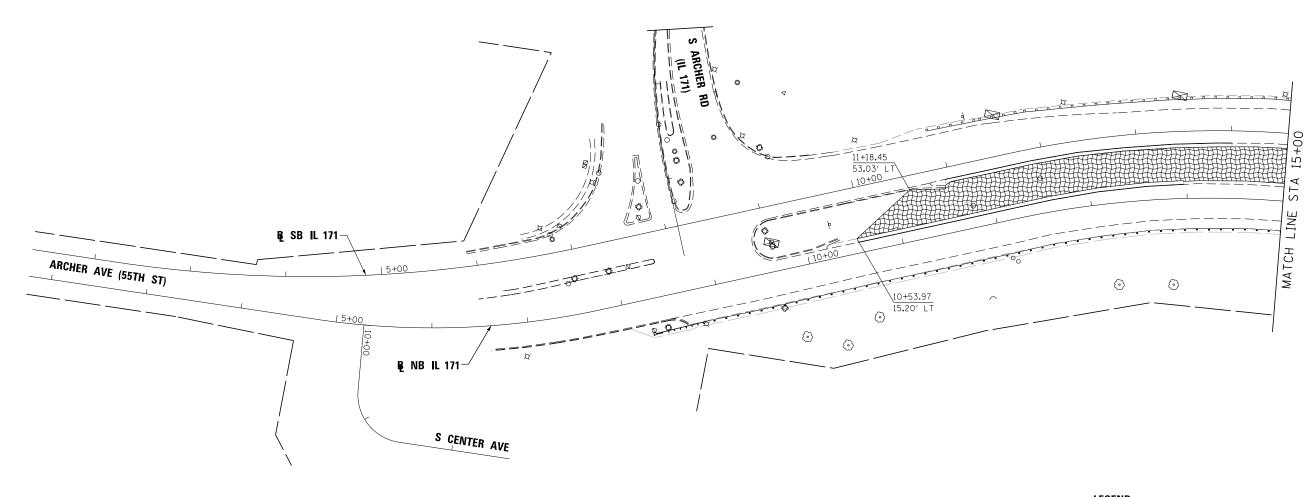

- 1. THE SEEDING DATES FOR BARE EARTH SEEDING OF MIXTURE CLASS 4 (MODIFIED) AND 4B SHALL BE FROM NOVEMBER 15 TO MARCH 15. ALL SEEDING NOT SHOWN ACCORDING TO THE SPECIFIED SEASONAL DATE SHALL REQUIRE PRIOR WRITTEN APPROVAL FROM THE ENGINEER. FAILURE TO SECURE SUCH APPROVAL SHALL RESULT IN THE REJECTION OF THE SEEDING AND REPLACEMENT BY THE CONTRACTOR AT HIS/HER EXPENSE.
- 2. TOPSOIL FURNISH AND PLACE, 6" SHOULD BE PLACED IN LOCATIONS OF THE MEDIAN CROSS OVERS.

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WETLAND



4" TOPSOIL, SEEDING, CLASS 2A



6" TOPSOIL, SEEDING, CLASS 4, (MODIFIED) EROSION CONTROL BLANKET




FILE NAME =	DESIGNED -	SEW	REVISED -
\D160W75-sht-IL171-ls-NB-01.dgn	DRAWN -	ТМВ	REVISED -
USER NAME = jmajewskı	CHECKED -	WLS	REVISED -
PLOT DATE = 6/17/2015	DATE -	6/12/2015	REVISED -



STATE	E OF	ILLINOIS
DEPARTMENT	0F	TRANSPORTATION

			LAND	)SC/	APING	PLAN		F.A.P RTE.	SECTION		COUNTY	TOTAL SHEETS	SHEET NO.
١				1	L 171			372/373	2013-037B-R		COOK	787	163
ŀ											CONTRACT	NO.	60W75
١	SCALE: 1''=50'	SHEET	1 OF	8	SHEETS	STA.	TO STA. 15+00.00		ILLINOIS	FED. AI	D PROJECT		



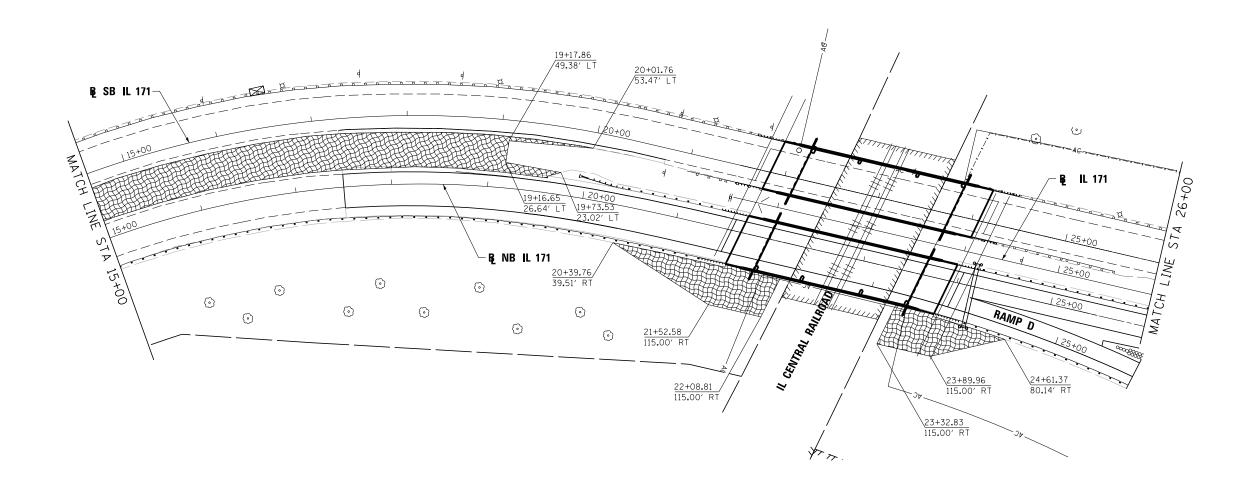

- 1. THE SEEDING DATES FOR BARE EARTH SEEDING OF MIXTURE CLASS 4 (MODIFIED) AND 4B SHALL BE FROM NOVEMBER 15 TO MARCH 15. ALL SEEDING NOT SHOWN ACCORDING TO THE SPECIFIED SEASONAL DATE SHALL REQUIRE PRIOR WRITTEN APPROVAL FROM THE ENGINEER. FAILURE TO SECURE SUCH APPROVAL SHALL RESULT IN THE REJECTION OF THE SEEDING AND REPLACEMENT BY THE CONTRACTOR AT HIS/HER EXPENSE.
- 2. TOPSOIL FURNISH AND PLACE, 6" SHOULD BE PLACED IN LOCATIONS OF THE MEDIAN CROSS OVERS.

#### LEGEND:

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WETLAND

4" TOPSOIL, SEEDING, CLASS 2A

6" TOPSOIL, SEEDING, CLASS 4, (MODIFIED) EROSION CONTROL BLANKET



6" TOPSOIL, SEEDING, CLASS 4B, EROSION CONTROL BLANKET






STATE OF	ILLINOIS
DEPARTMENT OF T	<b>TRANSPORTATION</b>

SCALE: 1"=50"

LANDSCAPING PLAN		F.A.P RTE.	SECTION	COUNTY	TOTAL SHEETS	SHEE NO.
		372/373	2013-037B-R	соок	787	164
				CONTRACT	NO.	60W75
	SHEFT 2 OF 8 SHEFTS STA. 15+00.00 TO STA. 26+00.00		TILITNOIS EED A	ID PROJECT		



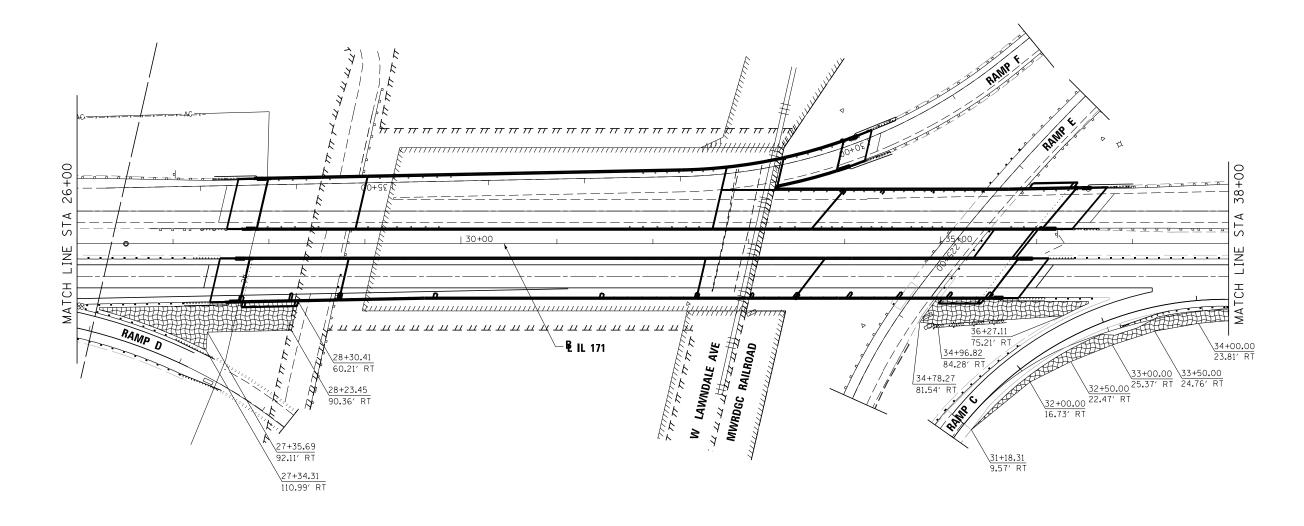

- 1. THE SEEDING DATES FOR BARE EARTH SEEDING OF MIXTURE CLASS 4 (MODIFIED) AND 4B SHALL BE FROM NOVEMBER 15 TO MARCH 15. ALL SEEDING NOT SHOWN ACCORDING TO THE SPECIFIED SEASONAL DATE SHALL REQUIRE PRIOR WRITTEN APPROVAL FROM THE ENGINEER, FAILURE TO SECURE SUCH APPROVAL SHALL RESULT IN THE REJECTION OF THE SEEDING AND REPLACEMENT BY THE CONTRACTOR AT HIS/HER EXPENSE.
- 2. TOPSOIL FURNISH AND PLACE, 6" SHOULD BE PLACED IN LOCATIONS OF THE MEDIAN CROSS OVERS.

#### LEGEND:

WETLAND



4" TOPSOIL, SEEDING, CLASS 2A



6" TOPSOIL, SEEDING, CLASS 4, (MODIFIED) EROSION CONTROL BLANKET




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\DIODW/3-SHC-1E1/1-15-ND-03.0gH	N - TMB REVISED -
USER NAME = jmajewsk1 CHECI	ED - WLS REVISED -
PLOT DATE = 6/17/2015 DATE	- 6/12/2015 REVISED -



STATE OF	ILLINOIS
DEPARTMENT OF	TRANSPORTATION

LANDSCAPING PLAN						F.A.P RTE.	SEC.	TION	COUNTY	TOTAL	SHEET NO.			
					L 171				372/373	2013-0	)37B-R	соок	787	165
IL 1/1										CONTRACT	NO.	60W75		
SCALE:	1′′=50′	SHEET	3 OF	8	SHEETS	STA.	26+00.00	TO STA. 38+00.00			ILLINOIS FED.	AID PROJECT		

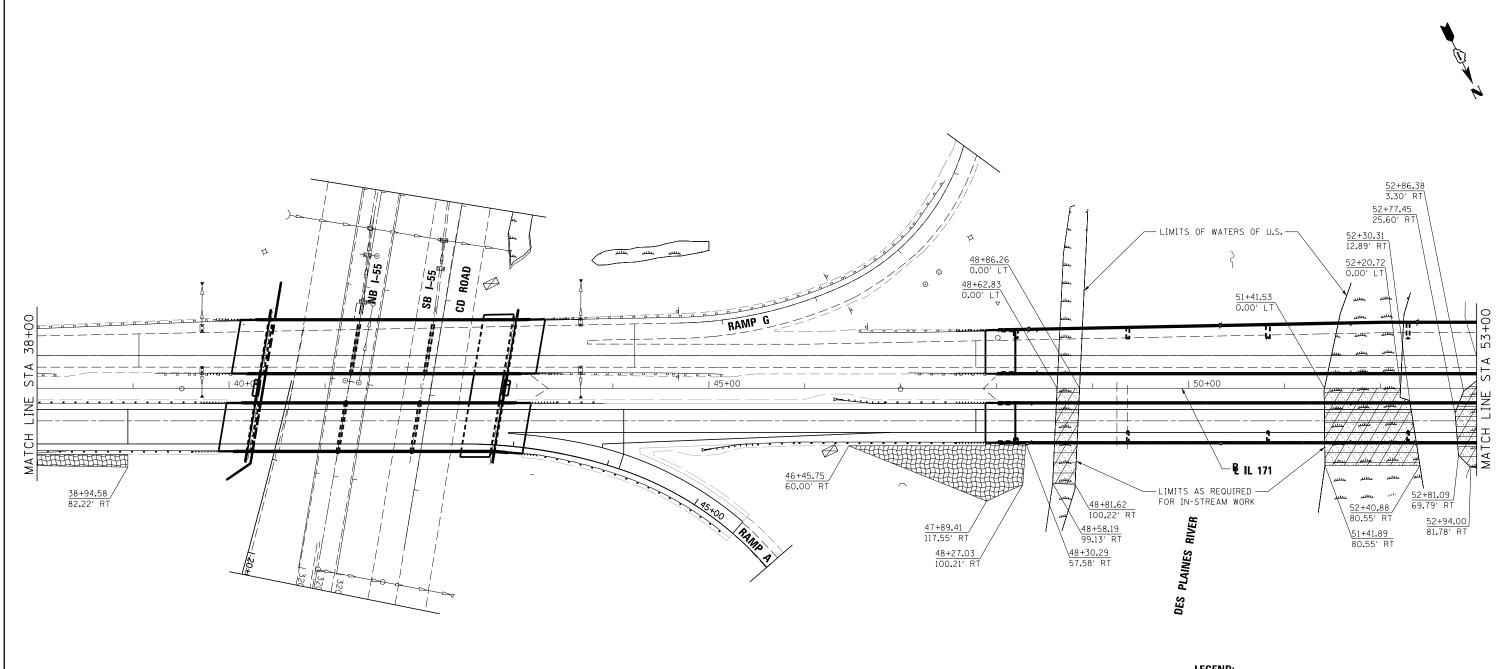

- 1. THE SEEDING DATES FOR BARE EARTH SEEDING OF MIXTURE CLASS 4 (MODIFIED) AND 4B SHALL BE FROM NOVEMBER 15 TO MARCH 15. ALL SEEDING NOT SHOWN ACCORDING TO THE SPECIFIED SEASONAL DATE SHALL REQUIRE PRIOR WRITTEN APPROVAL FROM THE ENGINEER. FAILURE TO SECURE SUCH APPROVAL SHALL RESULT IN THE REJECTION OF THE SEEDING AND REPLACEMENT BY THE CONTRACTOR AT HIS/HER EXPENSE.
- 2. TOPSOIL FURNISH AND PLACE, 6" SHOULD BE PLACED IN LOCATIONS OF THE MEDIAN CROSS OVERS.

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					_	

WETLAND

4" TOPSOIL, SEEDING, CLASS 2A


6" TOPSOIL, SEEDING, CLASS 4, (MODIFIED) EROSION CONTROL BLANKET

FILE NAME =	DESIGNED	-	SEW	REVISED	-
\D160w75-sht-IL171-ls-NB-04.dgn	DRAWN	-	ТМВ	REVISED	-
USER NAME = jmajewski	CHECKED	-	WLS	REVISED	-
PLOT DATE = 6/17/2015	DATE	-	6/12/2015	REVISED	-



STATE OF	ILLINOIS
DEPARTMENT OF	TRANSPORTATION

LANDSCAPING PLAN							F.A.P RTE.	SEC.	LION	COUNTY	TOTAL SHEETS	SHEET NO.				
						IL 171					372/373	2013-0	37B-R	соок	787	166
									CONTRACT	NO.	60W75					
	SCALE:	1′′=50′	SHEET	4 OF	8	SHEETS	STA.	38+00.00	TO STA.	53+00.00			ILLINOIS FED. A	ID PROJECT		

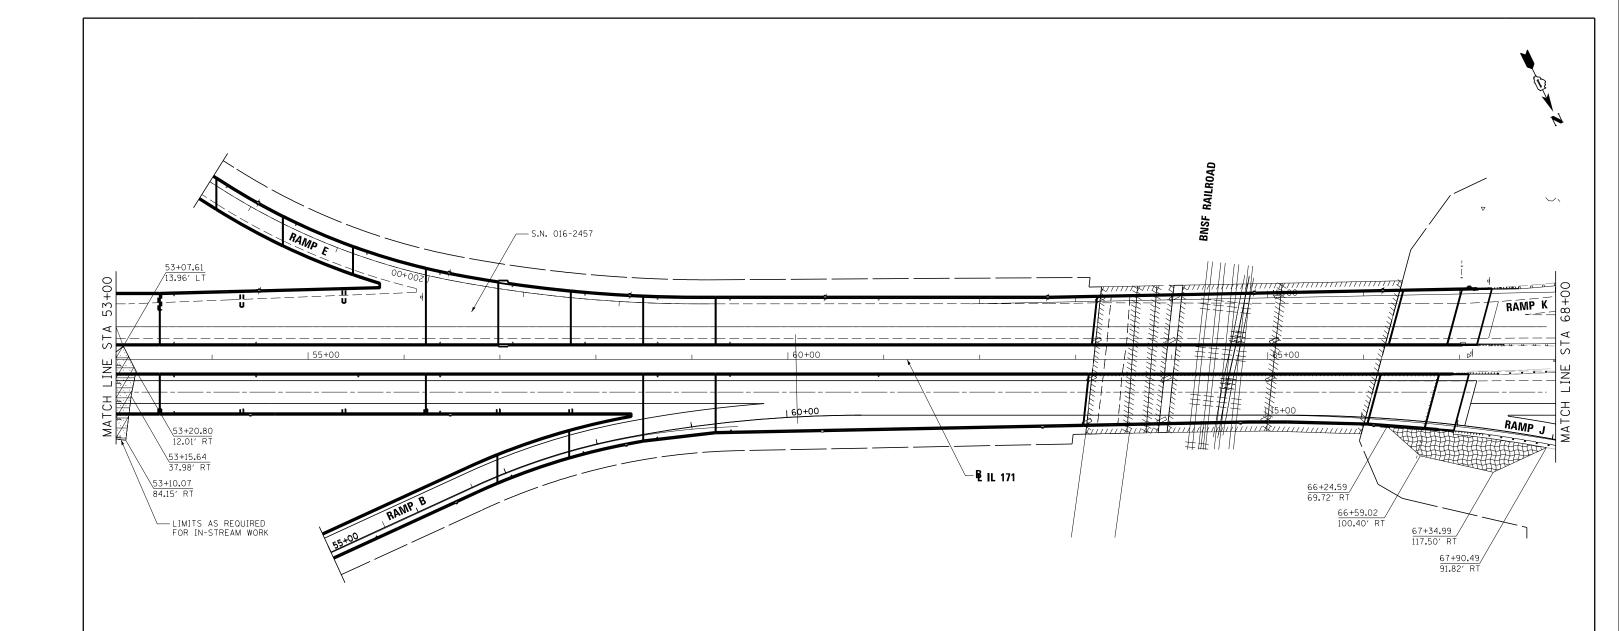

- 1. THE SEEDING DATES FOR BARE EARTH SEEDING OF MIXTURE CLASS 4 (MODIFIED) AND 4B SHALL BE FROM NOVEMBER 15 TO MARCH 15. ALL SEEDING NOT SHOWN ACCORDING TO THE SPECIFIED SEASONAL DATE SHALL REQUIRE PRIOR WRITTEN APPROVAL FROM THE ENGINEER. FAILURE TO SECURE SUCH APPROVAL SHALL RESULT IN THE REJECTION OF THE SEEDING AND REPLACEMENT BY THE CONTRACTOR AT HIS/HER EXPENSE.
- 2. TOPSOIL FURNISH AND PLACE, 6" SHOULD BE PLACED IN LOCATIONS OF THE MEDIAN CROSS OVERS.


WETLAND



4" TOPSOIL, SEEDING, CLASS 2A



6" TOPSOIL, SEEDING, CLASS 4, (MODIFIED) EROSION CONTROL BLANKET

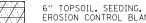


FILE NAME =	DESIGNED - SEW	REVISED -
\D160W75-sht-IL171-ls-NB-05.dgn	DRAWN - TMB	REVISED -
USER NAME = jmajewski	CHECKED - WLS	REVISED -
PLOT DATE = 6/17/2015	DATE - 6/12/2015	REVISED -



STATE OF	ILLINOIS
DEPARTMENT OF T	RANSPORTATION

LANDSCAPING PLAN	F.A.P RTE.	SECTION	COUNTY	TOTAL SHEETS	SHEET NO.
IL 171	372/373	2013-037B-R	соок	787	167
			CONTRACT	NO. 6	50W75
SCALE: 1''=50'   SHEET		ILLINOIS FED. A	ID PROJECT		

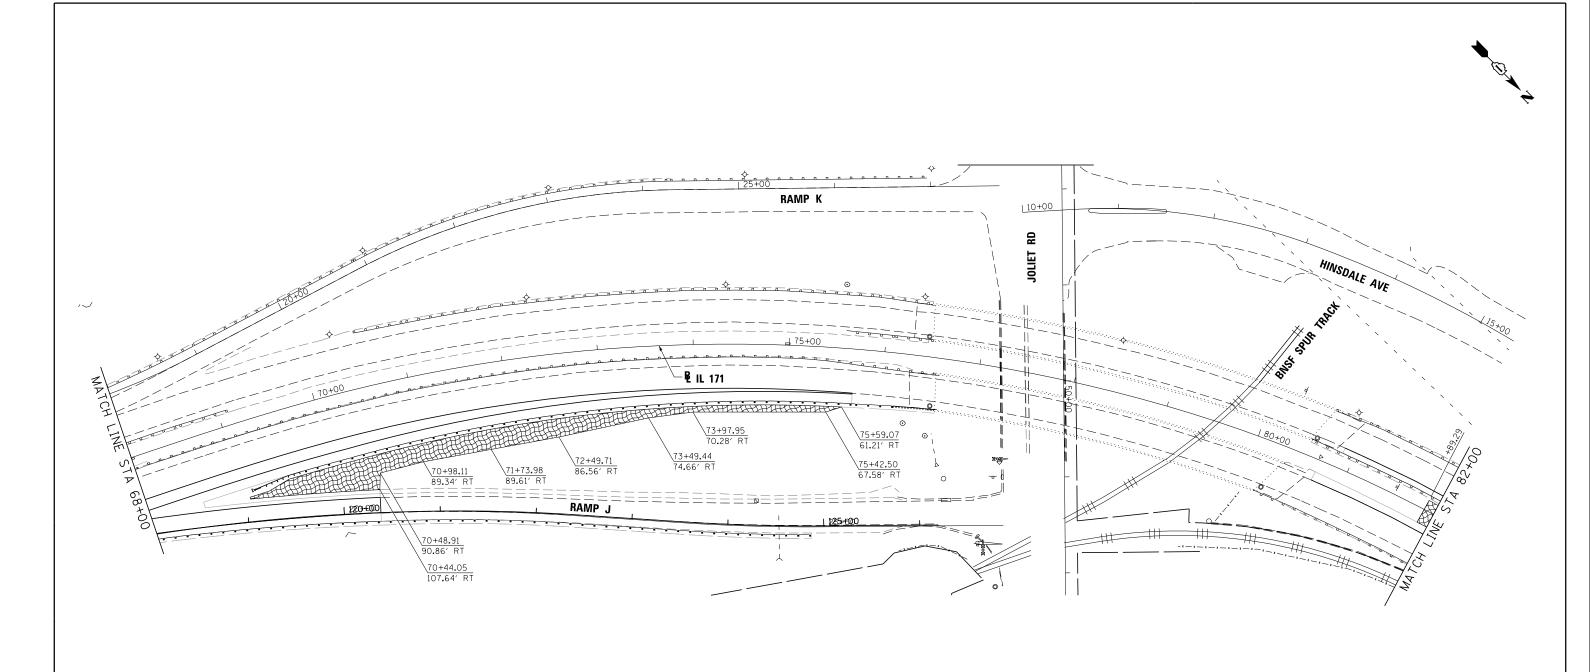

- 1. THE SEEDING DATES FOR BARE EARTH SEEDING OF MIXTURE CLASS 4 (MODIFIED) AND 4B SHALL BE FROM NOVEMBER 15 TO MARCH 15. ALL SEEDING NOT SHOWN ACCORDING TO THE SPECIFIED SEASONAL DATE SHALL REQUIRE PRIOR WRITTEN APPROVAL FROM THE ENGINEER. FAILURE TO SECURE SUCH APPROVAL SHALL RESULT IN THE REJECTION OF THE SEEDING AND REPLACEMENT BY THE CONTRACTOR AT HIS/HER EXPENSE.
- 2. TOPSOIL FURNISH AND PLACE, 6" SHOULD BE PLACED IN LOCATIONS OF THE MEDIAN CROSS OVERS.

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WETLAND



4" TOPSOIL, SEEDING, CLASS 2A



6" TOPSOIL, SEEDING, CLASS 4, (MODIFIED) EROSION CONTROL BLANKET




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\D160W75-sht-IL171-ls-NB-06.dgn	DRAWN - TMB	REVISED -
USER NAME = jmajewski	CHECKED - WLS	REVISED -
PLOT DATE = 6/17/2015	DATE - 6/12/2015	REVISED -



STATE OF	ILLINOIS
DEPARTMENT OF	TRANSPORTATION

LANDSCAPING PLAN	F.A.P RTE.	SECTION	COUNTY	TOTAL SHEETS	
IL 171	372/373	2013-037B-R	соок	787	168
			CONTRACT	NO. 6	60W75
SCALE: 1"=50"   SHEET   6 OF 8   SHEETS   STA. 68+00.00   TO STA. 82+00.00		ILLINOIS FED. A	ID PROJECT		



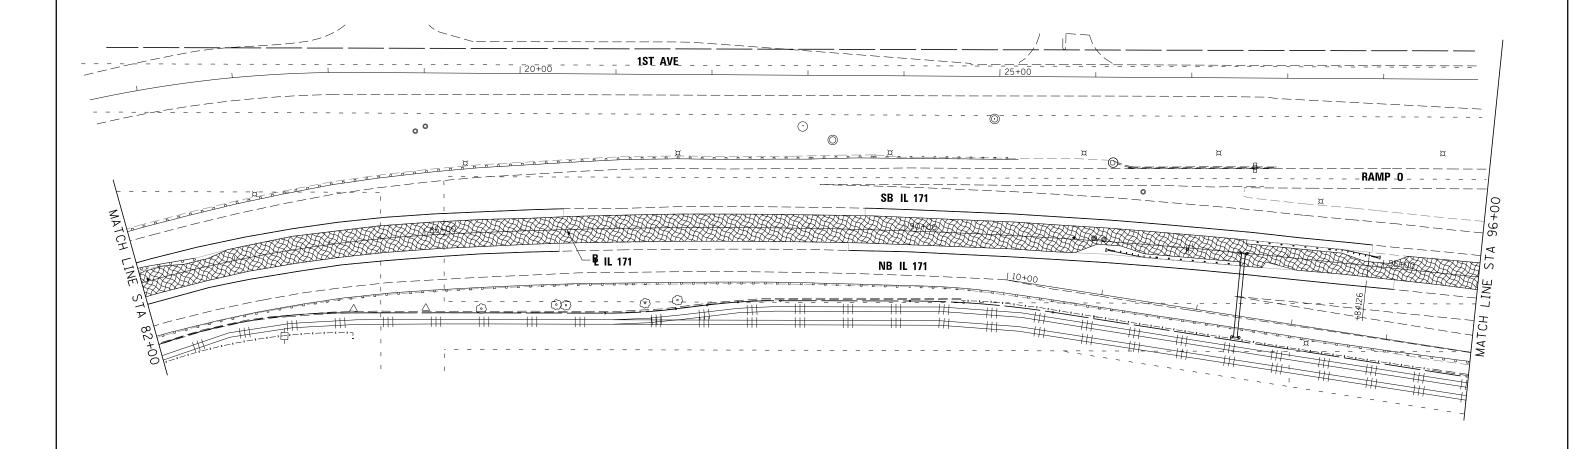

- 1. THE SEEDING DATES FOR BARE EARTH SEEDING OF MIXTURE CLASS 4 (MODIFIED) AND 4B SHALL BE FROM NOVEMBER 15 TO MARCH 15. ALL SEEDING NOT SHOWN ACCORDING TO THE SPECIFIED SEASONAL DATE SHALL REQUIRE PRIOR WRITTEN APPROVAL FROM THE ENGINEER. FAILURE TO SECURE SUCH APPROVAL SHALL RESULT IN THE REJECTION OF THE SEEDING AND REPLACEMENT BY THE CONTRACTOR AT HIS/HER EXPENSE.
- 2. TOPSOIL FURNISH AND PLACE, 6" SHOULD BE PLACED IN LOCATIONS OF THE MEDIAN CROSS OVERS.

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WETLAND



4" TOPSOIL, SEEDING, CLASS 2A



6" TOPSOIL, SEEDING, CLASS 4, (MODIFIED) EROSION CONTROL BLANKET



6" TOPSOIL, SEEDING, CLASS 4B, EROSION CONTROL BLANKET

FILE NAME =	DESIGNED - SEW	REVISED -
\D160W75-sht-IL171-ls-NB-07.dgn	DRAWN - TMB	REVISED -
USER NAME = jmajewski	CHECKED - WLS	REVISED -
PLOT DATE = 6/17/2015	DATE - 6/12/2015	REVISED -




STATE OI	F ILLINOIS
DEPARTMENT OF	TRANSPORTATION

SCALE: 1"=50' SHEET

LANDSCAPING PLAN	F.A.P RTE.	SECTION	COUNTY	TOTAL SHEETS	SHEET NO.	
IL 171		372/373	2013-037B-R	COOK	787	169
IE 1/1				CONTRACT	NO. 6	OW75
7 OF 8 SHEFTS STA. 82+00.00	TO STA. 96+00.00		TILINOIS FED A	D PROJECT		



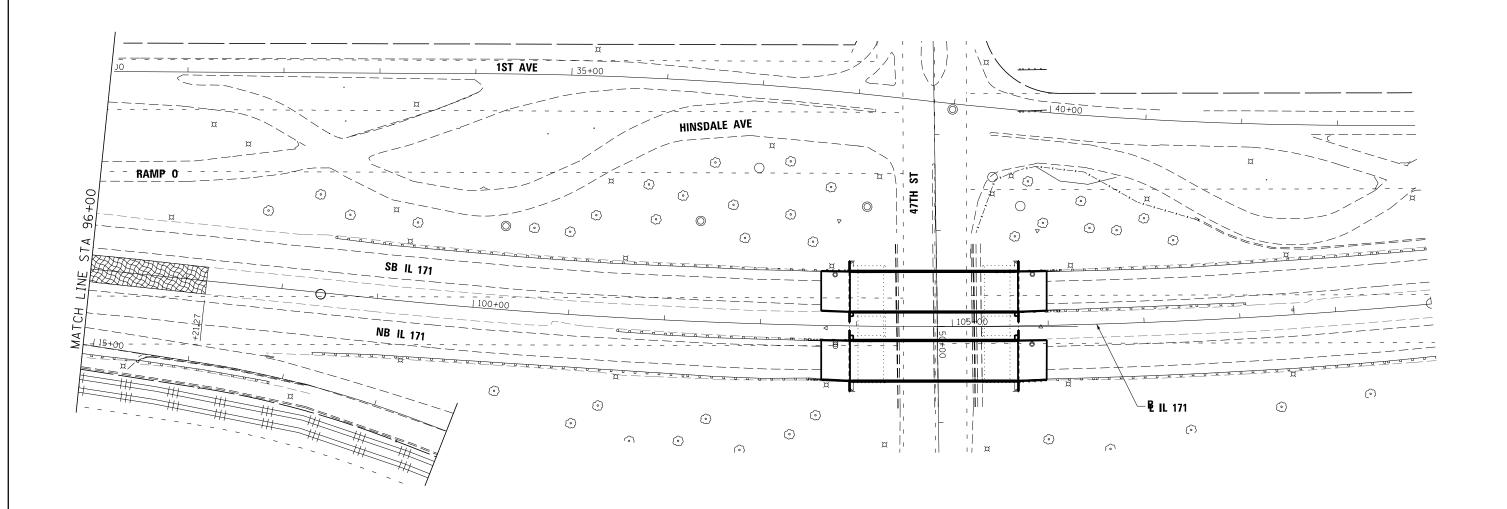

- 1. THE SEEDING DATES FOR BARE EARTH SEEDING OF MIXTURE CLASS 4 (MODIFIED) AND 4B SHALL BE FROM NOVEMBER 15 TO MARCH 15. ALL SEEDING NOT SHOWN ACCORDING TO THE SPECIFIED SEASONAL DATE SHALL REQUIRE PRIOR WRITTEN APPROVAL FROM THE ENGINEER. FAILURE TO SECURE SUCH APPROVAL SHALL RESULT IN THE REJECTION OF THE SEEDING AND REPLACEMENT BY THE CONTRACTOR AT HIS/HER EXPENSE.
- 2. TOPSOIL FURNISH AND PLACE, 6" SHOULD BE PLACED IN LOCATIONS OF THE MEDIAN CROSS OVERS.

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WETLAND



4" TOPSOIL, SEEDING, CLASS 2A



6" TOPSOIL, SEEDING, CLASS 4, (MODIFIED) EROSION CONTROL BLANKET



FILE NAME =	DESIGNED -	SEW	REVISED	-
\D160W75-sht-IL171-ls-NB-08.dgn	DRAWN -	ТМВ	REVISED	-
USER NAME = jmajewskı	CHECKED -	WLS	REVISED	-
PLOT DATE = 6/17/2015	DATE -	6/12/2015	REVISED	-





STATE OF	ILLINOIS
DEPARTMENT OF	TRANSPORTATION

2.11200711 1110 1 27111						F.A.P RTE.	SECTION	COUNTY	TOT A			
						372/373	2013-037B-R	соок	787			
											CONTRACT	NO.
in'	SHEET	A OF	8	SHEETS	STA	96+00 00	TO STA	110+00 00		THE INOTE SED. A	ID DDO IECT	

	LIGHTING AND ELECTRICAL LEGEND
SYMBOL	DESCRIPTION
R	EXISTING HIGH MAST LIGHTING TOWER UNIT TO BE REMOVED, 120 FT. 750W HPS LUMINAIRES, ARROWS INDICATE QUANTITY AND ORIENTATION OF LUMINAIRES
O E	EXISTING UNDERPASS LUMINAIRE
O R	EXISTING UNDERPASS LUMINAIRE TO BE REMOVED
$\bowtie$	EXISTING BASE MOUNTED LIGHTING CONTROLLER
$\bigotimes_{R}$	EXISTING BASE MOUNTED LIGHTING CONTROLLER, TO BE REMOVED
<del></del>	EXISTING ELECTRIC SERVICE INSTALLATION
J <sub>E</sub>	EXISTING JUNCTION BOX
R	EXISTING CONDUIT TO BE REMOVED
	EXISTING UNDERGROUND UNIT DUCT TO BE ABANDONED
R R R R	EXISTING SIGN LIGHTING TO BE REMOVED
o—Œ	EXISTING LIGHT POLE
0—R	EXISTING LIGHT POLE, TO BE REMOVED
Ω <sub>ε</sub>	EXISTING NAVIGATION LIGHT
$\square_{R}$	EXISTING NAVIGATION LIGHT, TO BE REMOVED
12	PROPOSED HIGH MAST LIGHTING TOWER UNIT, 120 FT, 400W HPS LUMINAIRES, ARROWS INDICATE QUANTITY AND ORIENTATION OF LUMINAIRES, SHADED BOX INDICATES TOWER HANDHOLE ORIENTATION
<b>⊶</b> ∑	PROPOSED TEMPORARY LIGHTING UNIT, SIZE AND TYPE AS NOTED
•-¤	PROPOSED LIGHTING UNIT MOUNTED ON BREAKAWAY TRANSFORMER BASE, 47.5FT. M.H., 400W HPS TYPE M-C-III COBRAHEAD LUMINAIRE MOUNTED ON 15FT DAVIT ARM U.N.O.
•-₩	PROPOSED STRUCTURE MOUNTED LIGHTING UNIT, 47.5 FT. M.H., 400W HPS TYPE M-C-III COBRAHEAD LUMINAIRE MOUNTED ON 6FT DAVIT ARM U.N.O.
leq	PROPOSED NAVIGATION LIGHT, RED 180 DEGREE
	PROPOSED NAVIGATION LIGHT, GREEN 360 DEGREE
Image: Control of the control of the control of the	PROPOSED UNDERPASS LUMINAIRE, PIER MOUNT, 100W HPS TYPE M-C-IV
	PROPOSED LIGHTING CONTROLLER, SIZE AND TYPE AS NOTED
-	PROPOSED ELECTRIC SERVICE INSTALLATION
J	PROPOSED JUNCTION BOX, SIZE AND TYPE AS NOTED
——— I	PROPOSED UNIT DUCT, SIZE AND TYPE AS NOTED
	PROPOSED CABLE OR UNIT DUCT IN EXPOSED OR EMBEDDED CONDUIT, SIZE AND TYPE AS NOTED
Marine Carlo Communica	PROPOSED CABLE OR UNIT DUCT IN UNDERGROUND CONDUIT, SIZE AND TYPE AS NOTED
<b>⊣</b> .	ELECTRIC GROUND ROD

#### **INDEX OF SHEETS**

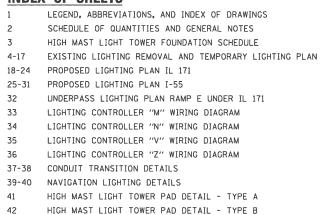


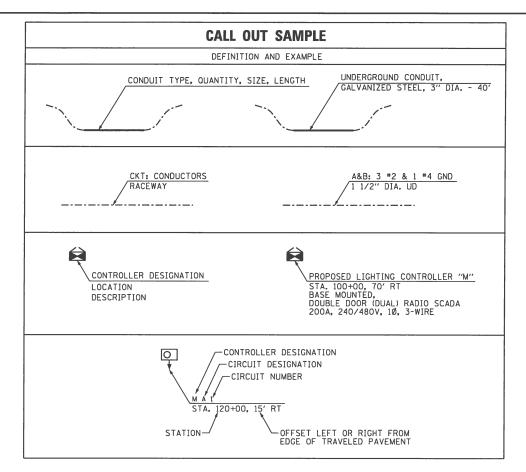

#### **IDOT-D1 STANDARDS:**

DRAWING NO. 43	STANDARD NO. BE-205A	TITLE LIGHTING CONTROLLER, BASE MOUNTED, 480 VOLT, 200 AMP (DUAL) RADIO SCADA
44	BE-205B	LIGHTING CONTROLLER, BASE MOUNTED, 480 VOLT, 200 AMP (DUAL) RADIO SCADA
45	BE-205C	LIGHTING CONTROLLER, BASE MOUNTED, 480 VOLT, 200 AMP (DUAL) RADIO SCADA
46	BE-205D	LIGHTING CONTROLLER, BASE MOUNTED, 480 VOLT, 200 AMP (DUAL) RADIO SCADA
47	BE-220	ELECTRIC SERVICE INSTALLATION, AERIAL, REMOTE DISCONNECT
48	BE-305	LIGHT POLE FOUNDATION, METAL
49	BE-330	LIGHT POLE MOUNTED ON CONCRETE PARAPET WALL, 15" (381 MM) BOLT CIRCLE
50	BE-410	DAVIT LIGHT POLE, 47'-6" (14.478 M) MOUNTING HEIGHT
51	BE-505A	HIGH MAST LIGHT TOWER 120 FT TO 140 FT
52	BE-505B	HIGH MAST LIGHT TOWER 120 FT TO 140 FT
53	BE-505C	HIGH MAST LIGHT TOWER 120 FT TO 140 FT
54	BE-506A	HIGH MAST LIGHT TOWER 120 FT TO 140 FT FOUNDATION DETAIL
55	BE-506B	HIGH MAST LIGHT TOWER 120 FT TO 140 FT FOUNDATION DETAIL
56	BE-701	LUMINAIRE SAFETY CABLE ASSEMBLY
57	BE-702	MISC. ELECTRICAL DETAILS, SHEET A
58	BE-703	MISC. ELECTRICAL DETAILS, SHEET B
59	BE-800	TEMPORARY LIGHT POLE DETAILS
60	BE-801	TEMPORARY AERIAL CABLE INSTALLATION
61	BE-902	PIER/ABUTMENT MOUNTED UNDERPASS LUMINAIRE INSTALLATION DETAILS

	ABBREVIATIONS
ABBREVIATION	DESCRIPTION
AC	ALTERNATING CURRENT
A/C	AERIAL CABLE
CB	CIRCUIT BREAKER
CKT	CIRCUIT
CM	CENTIMETER
CP	CONTROL PANEL
CT	CURRENT TRANSFORMER
DA	DAVIT ARM
DC	DIRECT CURRENT
DIA	DIAMETER
DP	DISTRIBUTION PANEL
E	EXISTING TO REMAIN
ECA	ELECTRIC CABLE ASSEMBLY
FT	FEET OR FOOT
FU	FUSE
GND	GROUND
HID	HIGH INTENSITY DISCHARGE
JB	JUNCTION BOX
KVA	KILOVOLT-AMPERE
KW	KILOWATTS
М	METER
MA	MAST ARM
MC	MULTI-CONDUCTOR
MM	MILLIMETER
M.H.	MOUNTING HEIGHT
MW NO. #	MESSENGER WIRE
N.T.S.	NUMBER NOT TO SCALE
P.1.3.	PROPOSED
PB	PUSH BUTTON
PNL	PANEL
PVC	POLYVINYL CHLORIDE
PVCC RGC	PVC COATED RIGID GALVANIZED CONDUIT
PT I	POTENTIAL TRANSFORMER
R	EXISTING UNIT TO BE REMOVED
RR	EXISTING UNIT TO BE REMOVED AND REINSTALLED
RECP	RECEPTACLE
RGC	RIGID GALVANIZED CONDUIT
SEL SW	SELECTOR SWITCH
ss	STAINLESS STEEL
STA.	STATION
UD OU	UNIT DUCT
U.N.O.	UNLESS NOTED OTHERWISE
UGC, GS	UNDERGROUND CONDUIT, GALVANIZED STEEL
WP	WOOD POLE
XFMR	TRANSFORMER
HPS	HIGH PRESSURE SODIUM
LPS	LOW PRESSURE SODIUM
LTFN	LIQUID TIGHT FLEXIBLE NON-METALLIC

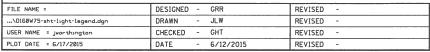



LEGEND, ABBREVIATIONS, AND INDEX OF DRAWINGS							
SCALE: NO	SCALE	SHEET	1	OF	61	SHEETS	STA.

TO STA.

F.A.P RTE.	SECTI	ON		COUNTY	TOTAL SHEETS	SHEET NO.
372/373	2013-037B-R			COOK	787	171
				CONTRACT	NO. 6	OW75
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STATE OF ILLINOIS
DEPARTMENT OF TRANSPORTATION

#### LIGHTING BILL OF MATERIALS

S.P.	DESCRIPTION	UNIT	TOTAL QUANTITY
	LOCATING UNDERGROUND CABLE	FOOT	25000
*	ELECTRIC SERVICE INSTALLATION	EACH	2
*	ELECTRIC UTILITY SERVICE CONNECTION	L SUM	1
*	UNDERGROUND CONDUIT, GALVANIZED STEEL, 3" DIA.	FOOT	1807
*	CONDUIT ATTACHED TO STRUCTURE, 1" DIA., PVC COATED GALVANIZED STEEL	FOOT	145
*	CONDUIT ATTACHED TO STRUCTURE, 2" DIA., PVC COATED GALVANIZED STEEL	FOOT	1296
*	CONDUIT ATTACHED TO STRUCTURE, 2 1/2" DIA., PVC COATED GALVANIZED STEEL	FOOT	170
	CONDUIT EMBEDDED IN STRUCTURE, 2" DIA., PVC	FOOT	3331
	JUNCTION BOX, STAINLESS STEEL, ATTACHED TO STRUCTURE, 6" X 6" X 4"	EACH	2
	JUNCTION BOX, STAINLESS STEEL, ATTACHED TO STRUCTURE, 12" X 12" X 6"	EACH	17
	JUNCTION BOX, STAINLESS STEEL, ATTACHED TO STRUCTURE, 18" X 12" X 6"	EACH	17
*	UNIT DUCT, 600V, 3-1C NO.2, 1/C NO.4 GROUND, (XLP-TYPE USE), 1 1/2" DIA. POLYETHYLENE	FOOT	30082
*	UNIT DUCT, 600V, 3-1C NO.4, 1/C NO.6 GROUND, (XLP-TYPE USE), 1 1/4" DIA. POLYETHYLENE	FOOT	1493
*	ELECTRIC CABLE IN CONDUIT, 600V (XLP-TYPE USE) 1/C NO. 10	FOOT	507
*	ELECTRIC CABLE IN CONDUIT, 600V (XLP-TYPE USE) 1/C NO. 6	FOOT	200
*	ELECTRIC CABLE IN CONDUIT, 600V (XLP-TYPE USE) 1/C NO. 4	FOOT	7620
*	ELECTRIC CABLE IN CONDUIT, 600V (XLP-TYPE USE) 1/C NO. 2	FOOT	21060
*	ELECTRIC CABLE IN COUNDUIT, 600V (XLP-TYPE USE) 1/C 350MCM	FOOT	903
*	LUMINAIRE, SODIUM VAPOR, HORIZONTAL MOUNT, 400 WATT	EACH	39
*	LUMINAIRE, SODIUM VAPOR, HIGH MAST, HORIZONTAL MOUNT, 400 WATT	EACH	206
*	UNDERPASS LUMINAIRE, 100 WATT, HIGH PRESSURE SODIUM VAPOR	EACH	2
	LIGHT POLE, ALUMINUM, 47.5 FT. M.H., 6 FT. DAVIT ARM	EACH	18
	LIGHT POLE, ALUMINUM, 47.5 FT. M.H., 15 FT. DAVIT ARM	EACH	21
*	LIGHT TOWER, 120 FT. MOUNTING HEIGHT, LUMINAIRE MT 12	EACH	39
	LIGHT POLE FOUNDATION, METAL, 15" BOLT CIRCLE, 10" X 8"	EACH	21
	LIGHT TOWER FOUNDATION, 54" DIAMETER	FOOT	641.5
	BREAKAWAY DEVICE, TRANSFORMER BASE, 15 INCH BOLT CIRCLE	EACH	21
	REMOVAL OF TEMPORARY LIGHTING UNIT	EACH	6
	REMOVAL OF LIGHTING UNIT, NO SALVAGE	EACH	49
	REMOVAL OF POLE FOUNDATION	EACH	22
	REMOVAL OF NAVIGATION OBSTRUCTION WARNING LIGHTING SYSTEM	L SUM	1
	REMOVAL OF LIGHTING CONTROLLER	EACH	2
	REMOVAL OF ELECTRIC SERVICE INSTALLATION	EACH	2
	REMOVAL OF LIGHTING CONTROLLER FOUNDATION	EACH	2
	REMOVE ELECTRIC CABLE FROM CONDUIT	FOOT	10,556
*	LUMINAIRE SAFETY CABLE ASSEMBLY	EACH	39
*	MAINTENANCE OF LIGHTING SYSTEM	CAL MO	13
*	LIGHT TOWER, SERVICE PAD	EACH	16
*	LIGHT TOWER, SERVICE PAD, SPECIAL	EACH	23
*	LIGHTING CONTROLLER, BASE MOUNTED, 480VOLT, 200AMP (DUAL), RADIO SCADA	EACH	2
*	NAVIGATION LIGHTING SYSTEM	L SUM	1
*	REMOVAL OF LIGHT TOWER, NO SALVAGE	EACH	41
*	REMOVAL OF TOWER FOUNDATION	EACH	45

#### **UNIT DUCT DESIGNATIONS**

THE CONTRACTOR SHALL INSTALL UNIT DUCT ACCORDING TO THE FOLLOWING TABLE:

LOCATION #	CONTROLLER	UNIT DUCT
L0173	М	UNIT DUCT, 600V, 3-1/C NO. 2, 1/C NO. 4 GROUND, (XLP-TYPE USE), $1^{1}\!\!/_{2}$ " DIA. POLYETHYLENE
L0175	N	UNIT DUCT, 600V, 3-1/C NO. 2, 1/C NO. 4 GROUND, (XLP-TYPE USE), 1/2" DIA. POLYETHYLENE
L0171	V	UNIT DUCT, 600V, 3-1/C NO. 4, 1/C NO. 6 GROUND, (XLP-TYPE USE), 11/4" DIA. POLYETHYLENE
L0177	Z	UNIT DUCT, 600V, 3-1/C NO. 2, 1/C NO. 4 GROUND, (XLP-TYPE USE), 1/2" DIA. POLYETHYLENE

#### DESIGNED - GRR FILE NAME = REVISED ...\D160W75-sht-liaht-S0Q-GenNotes.dan DRAWN - JLW REVISED JSER NAME = jworthington HECKED GHT REVISED PLOT DATE = 8/31/2015 - 6/12/2015 REVISED DATE



#### STATE OF ILLINOIS **DEPARTMENT OF TRANSPORTATION**

SCALE: NO SCALE SHEET

#### **GENERAL NOTES**

- 1. ELECTRICAL WORK SHALL BE PREFORMED IN ACCORDANCE WITH THE LATEST CODES, STANDARDS, AND THE IDOT STANDARD SPECIFICATIONS FOR ROAD AND BRIDGE CONSTRUCTION (LATEST VERSION), AND SUPPLEMENTAL SPECIFICATIONS
- 2. CONTRACTOR SHALL INSTALL CONDUIT EXPANSION/DEFLECTION COUPLING AT STRUCTURE JOINTS AS NEEDED PER IDOT-D1 STANDARD DRAWING NO. BE-703 AT NO ADDITIONAL COST.
- 3. CONTRACTOR SHALL INSTALL LIGHT POLES AND HIGH MAST LIGHT TOWERS AT THE LOCATIONS INDICATED ON THE PLANS, MAINTAINING ADEQUATE CLEARANCE FROM OVERHEAD UTILITY LINES. CONTRACTOR SHALL BE RESPONSIBLE TO VERIFY CLEARANCES PER THE NATIONAL ELECTRICAL SAFETY CODE AND/OR THE REQUIREMENTS OF THE UTILITY COMPANIES. THE LOCATION OF BURIED AND ABOVE GROUND UTILITIES SHOWN ARE APPROXIMATE AND ARE SHOWN FOR INFORMATION ONLY. REROUTING, DISCONNECTION, RELOCATION, PROTECTION ETC., OF ANY UTILITIES MUST BE COORDINATED BETWEEN THE CONTRACTOR, UTILITY COMPANY, AND OWNER. THE CONTRACTOR SHALL VERIFY THE EXACT LOCATION OF ALL UNDERGROUND UTILITIES PRIOR TO CONSTRUCTION.
- 4. THE CONTRACTOR IS RESPONSIBLE FOR UNCOVERING OR HAND DIGGING AROUND UTILITIES AS NECESSARY. THE COST OF THIS WORK IS TO BE INCLUDED WITH THE APPLICABLE PAY ITEM REQUIRING THIS WORK.
- 5. THE CONTRACTOR SHALL CALL NASER GHOLEH AT (708) 524-2145 TO REQUEST A FORMAL MAINTENANCE TRANSFER BEFORE ANY WORK, LIGHTING OR OTHER
- 6. NO LIGHTING CIRCUIT OR PORTION THEREOF SHALL BE REMOVED FROM NIGHTIME OPERATION WITHOUT APPROVAL OF THE ENGINEER. ALL EXISTING LIGHT POLES AND HIGH MAST LIGHT TOWERS SHALL OPERATE FROM DUSK TO DAWN DAILY FOR THE DURATION OF THIS PROJECT TO MAINTAIN ILLUMINATION OF TRAVELED ROADWAYS. SPECIFIC LIGHT POLES AND HIGH MAST LIGHT TOWERS SHALL BE REMOVED AND REPLACED PER THE PLANS BY THE CONTRACTOR DURING CONSTRUCTION AS DIRECTED BY THE ENGINEER.
- 7. THE SUGGESTED CONSTRUCTION STAGING FOR LIGHTING WORK IS AS FOLLOWS:
  - LOCATE EXISTING UNDERGROUND LIGHTING CABLES AT THE I-55 INTERCHANGE INSTALL NEW LIGHTING CONTROLLER "M", CONTROLLER "N", AND ELECTRIC
  - REMOVE AND REPLACE NORTHBOUND LIGHTING
    REMOVE AND REPLACE NAVIGATION LIGHTING

  - INSTALL CONDUIT SYSTEMS AND UNDERPASS LIGHTING FOR THE IL-171 BRIDGES OVER RAMP E
  - INSTALL PROPOSED HIGH MAST TOWER FOUNDATIONS, WORK PADS, AND TOWERS
     CUTOVER LIGHTING CIRCUITS DURING DAY TO AVOID OUTAGES AT NIGHT
     REMOVE EXISTING HIGH MAST LIGHTING AS PROPOSED HIGH MAST LIGHTING

  - BECOMES OPERATIONAL
  - REMOVE EXISTING LIGHTING CONTROLLER "M", CONTROLLER "N", AND ELECTRIC
- 8. CONTRACTOR SHALL COORDINATE ELECTRIC SERVICE REPLACEMENTS FOR CONTROLLERS "M" AND "N" WITH COMED. CONTACT DARRYL BELL AT 630,985,0410. CONTROLLER "M" ACCOUNT NUMBER IS 0534411008. CONTROLLER "N" ACCOUNT NUMBER IS 0885081050.

SCHEDULE OF QUANTITIES		F.A.P RTE.	SECTION	COUNTY	TOTAL SHEETS	SHEET NO.
AND GENERAL NOTES		372/373	2013-037B-R	соок	787	172
AND GENERAL NOTES				CONTRACT	NO. 6	OW75
2 OF 61 SHEFTS STA.	TO STA.		TILL INDIS FED. A	ID PROJECT		

				HIGH MAST	LIGHT TOWER	FOUNDATION SCHEDULE		
HIGH MAST LIGHT TOWER	HIGH MAST LIGHT TOWER FOUNDATION LOCATION		TOWER FOUNDATION DES	IGN DÉÞÞGH MF4ST	LUMINATER AIMING	SERVICE PAD TYPE	LUMINAIRE AIMING	
IDENTIFCATION	STATION	OFFSET (NOTE 4)	BASELINE		SIGN D性時時 MAST TOWER HEIGHT (FT) LUMINAIRE AIMING	(SEE NOTE 7)	EUWINAINE AIWING	
6 MAB3	351+34	38′ LT	I-55	17.5	В	PERPENDICULAR TO I-55	В	
4 MAB4	357+70	43′ LT	I-55	17.5	В	PERPENDICULAR TO I-55	В	
4 MAB5	363+87	42′ LT	I-55	17.5	В	PERPENDICULAR TO I-55	В	
8 MEF1	35+77	35′ RT	RAMP B	15.0	А	PERPENDICULAR TO I-55	А	AVOID EXISTING UNDERGROUND LIGHTING CABLE NEARBY
8 MEF2	336+69	40' RT	I-55	17.5	А	PERPENDICULAR TO I-55	А	
6 MEF3	343+89	31′ LT	I-55	17.5	В	PERPENDICULAR TO I-55	В	
6 MIJ1	41+83	51′ LT	RAMP B	16.5	А	PERPENDICULAR TO RAMP B	А	AVOID EXISTING UNDERGROUND LIGHTING CABLE NEARBY
8 MIJ2	53+47	44' LT	RAMP A	16.5	А	PERPENDICULAR TO I-55	А	
6 MIJ3	48+75	70' RT	RAMP A	15.0	А	PERPENDICULAR TO RAMP A	А	
4 MIJ4	44+46	40' RT	RAMP A	15.0	В	PERPENDICULAR TO IL-171	В	
4 MKL1	24+13	48′ RT	RAMP G	16.5	В	PERPENDICULAR TO IL-171	В	
6 MKL2	315+08	49' LT	RAMP G	25.0	А	PERPENDICULAR TO I-55	А	
4 MKL3	20+20	65′ RT	RAMP G	17.5	А	PERPENDICULAR TO RAMP G	Α	
6 MKL4	212+06	32′ RT	RAMP E	17.5	В	7 DEGREES LEFT OF PERP. TO RAMP E	В	
6 MMN1	114+61	50' LT	RAMP H	16.5	В	PERPENDICULAR TO I-55	В	
6 MMN2	119+35	46′ RT	RAMP H	15.0	А	PERPENDICULAR TO I-55	А	
6 NAB3	348+71	50' RT	I-55	17.5	В	PERPENDICULAR TO I-55	В	
4 NAB4	353+79	47′ RT	I-55	17.5	В	PERPENDICULAR TO I-55	В	
4 NAB5	358+74	50' RT	I-55	15.0	В	PERPENDICULAR TO I-55	В	
4 NAB6	363+89	49′ RT	I-55	17.5	В	PERPENDICULAR TO I-55	В	AVOID EXISTING UNDERGROUND LIGHTING CABLE NEARBY
6 NCD1	38+66	76′ RT	RAMP D	16.5	А	PERPENDICULAR TO RAMP E	Α	
6 NCD2	329+62	46′ RT	I-55	16.5	А	PERPENDICULAR TO I-55	A	
4 NCD3	240+75	49' RT	RAMP E	16.5	А	PERPENDICULAR TO I-55	Α	
6 NCD4	341+99	50' RT	I-55	17.5	В	PERPENDICULAR TO I-55	В	
6 NEF1	26+62	50' RT	RAMP C	16.5	Α	13 DEGREES LEFT OF PERP. TO RAMP C	A	
6 NEF2	30+69	66' RT	RAMP C	17.5	В	9 DEGREES LEFT OF PERP. TO RAMP C	В	
6 NEF3	22+74	50' RT	RAMP C	17.5	A	PERPENDICULAR TO I-55	A	
4 NEF4	38+58	41' RT	IL-171	15.0	В	PERPENDICULAR TO IL-171	В	
4 NGH1	38+66	57' LT	IL-171	17.5	В	PERPENDICULAR TO IL-171	В	
4 NGH4	315+27	51' RT	I-55	16.5	В	PERPENDICULAR TO I-55	В	
6 NGH5	217+22	61' RT	RAMP E	17.5	В	PERPENDICULAR TO RAMP E	В	AVOID EXISTING UNDERGROUND LIGHTING CABLE NEARBY
6 NIJ1	18+70	50' RT	RAMP F	15.0	A	PERPENDICULAR TO I-55	B	AVOID EXISTING UNDERGROUND LIGHTING CABLE NEARBY
4 NIJ2	13+49	44' RT	RAMP F	15.5	A	PERPENDICULAR TO I-55	Α Α	AVOID EXISTING UNDERGROUND LIGHTING CABLE NEARBY
6 NKL1	33+46	65' LT	RAMP D	17.5	В	PERPENDICULAR TO RAMP D	В	ATOLD ENTOTING GRAPENONGOIND FIGHTING CADLE NEARDI
4 NKL2	33+42	30' RT	IL-171	17.5	A	PERPENDICULAR TO IL-171	В	
6 NKL6	28+01	29' RT	RAMP D	17.5	В	31 DEGREES LEFT OF PERP. TO RAMP D	В	
4 NMN1	30+51	30' RT	RAMP F	20.5	В	PERPENDICULAR TO IL-171	В	AVOID EXISTING UNDERGROUND TELEPHONE CABLE NEARBY
6 NMN2	26+43	45' RT	RAMP F	15.0	В	PERPENDICULAR TO RAMP F	В	AVOID EXISTING UNDERGROUND TELEFRONE CABLE NEARBY
4 NMN5	36+05	45 KT	RAMP F	17.5	В	PERPENDICULAR TO IL-171	в	


- 1. SEE LEGEND AND ABBREVIATIONS DRAWING FOR SYMBOLS AND CALLOUTS.
- 2. SEE HIGH MAST DETAIL DRAWINGS FOR LIGHT TOWER AND FOUNDATION DETAILS.
- 3. THE SCHEDULE ON THIS DRAWING REPLACES THE "SHAFT LENGTH TABLE" ON LIGHT TOWER FOUNDATION DETAIL.
- 4. OFFSET SHOWN IS TO CENTERLINE OF DRILLED SHAFT.
- 5. COORDINATE ALL WORK WITH CIVIL WORK, STRUCTURAL WORK, AND SUGGESTED STAGES OF CONSTRUCTION AND TRAFFIC CONTROL PLANS.
- 6. THE CONTRACTOR SHALL VERIFY THE EXISTING AND PROPOSED GROUND ELEVATIONS AND SLOPES PRIOR TO BEGINNING ANY FOUNDATION DRILLING WORK. THE CONTRACTOR SHALL IMMEDIATELY NOTIFY THE ENGINEER IF THERE ARE ANY CONFLICTS WITH THE PROPOSED FOUNDATION AND WORK PAD LOCATIONS OR TYPES. THE FOUNDATIONS MUST BE DRILLED TO THE DESIGN DEPTH. MODIFICATIONS TO THE WORK PAD TYPES SHALL BE APPROVED BY THE ENGINEER.
- 7. SERVICE PAD TYPE A IS FLAT. SERVICE PAD TYPE B INCLUDES LOW RETAINING WALL DUE TO SLOPE.


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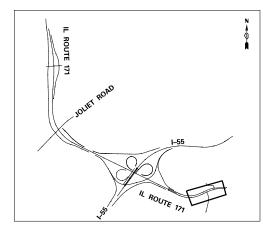


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			2013-037B-R	соок	787	173
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3 OF 61 SHEFTS STA.	TO STA.		TILL INDIS FED. AT	ID PROJECT		





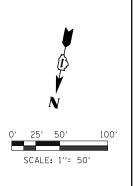


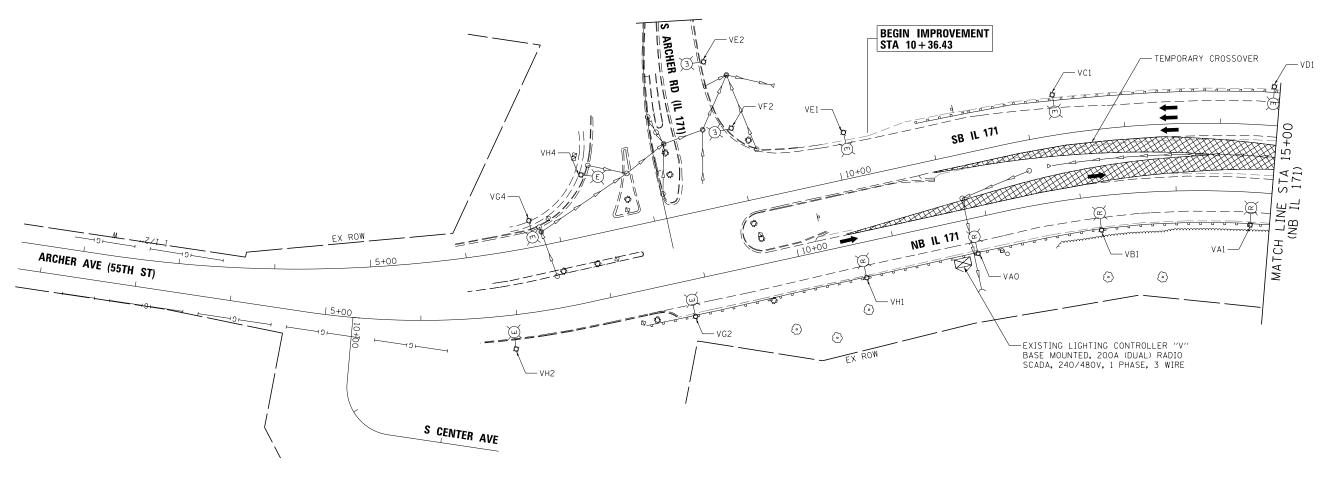
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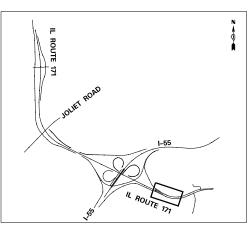
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	SCALE:	1''=50'	SHEET	4 OF	61	SHEETS	STA.	TO STA.

F.A.P RTE.	SECTION		COUNTY	TOTAL SHEETS	SHEET NO.
372/373	2013-037B-R		COOK	787	174
			CONTRACT	NO. 6	OW75
	ILLINOIS	FED. A	D PROJECT		



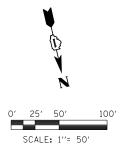


1. REMOVAL OF SIGN LIGHTING SHALL BE PAID FOR AS "REMOVAL OF LIGHTING UNIT, NO SALVAGE" REGARDLESS OF THE NUMBER OF INDIVIDUAL SIGN LUMINAIRES.

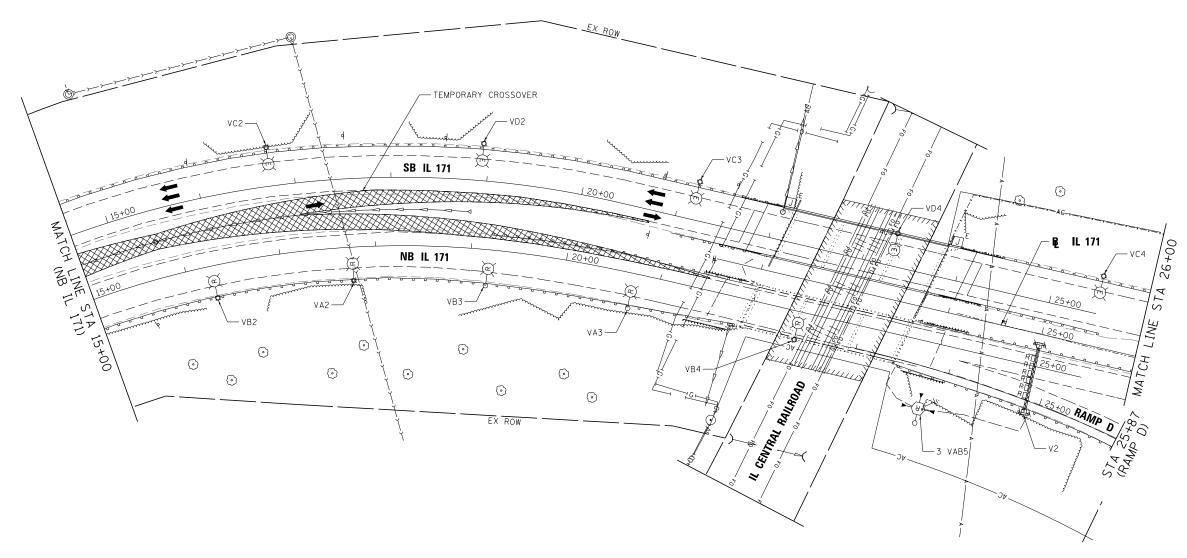



FILE NAME =	DESIGNED - GRR	REVISED -	_
\D160W75-sht-IL171-exlight-NB-02.dgn	DRAWN - JLW	REVISED -	🎏 benesch
USER NAME = jworthington	CHECKED - GHT	REVISED -	engineers - scientists - planners
PLOT DATE = 8/31/2015	DATE - 6/12/2015	REVISED -	


STATI	E OF	ILLINOIS
DEPARTMENT	0F	TRANSPORTATION


						F.A.P SECTION			TOTAL SHE SHEETS NO	
	TEMPORARY LIGHTING PLAN			372/373	2013-037B-R	cod	)K	787	175	
							CONT	RACT N	10. 6	OW75
	SCALE: 1''=50'	SHEET 5 OF 61 SHEETS	STA.	TO STA.		ILLINOIS	FED. AID PROJEC	Т		

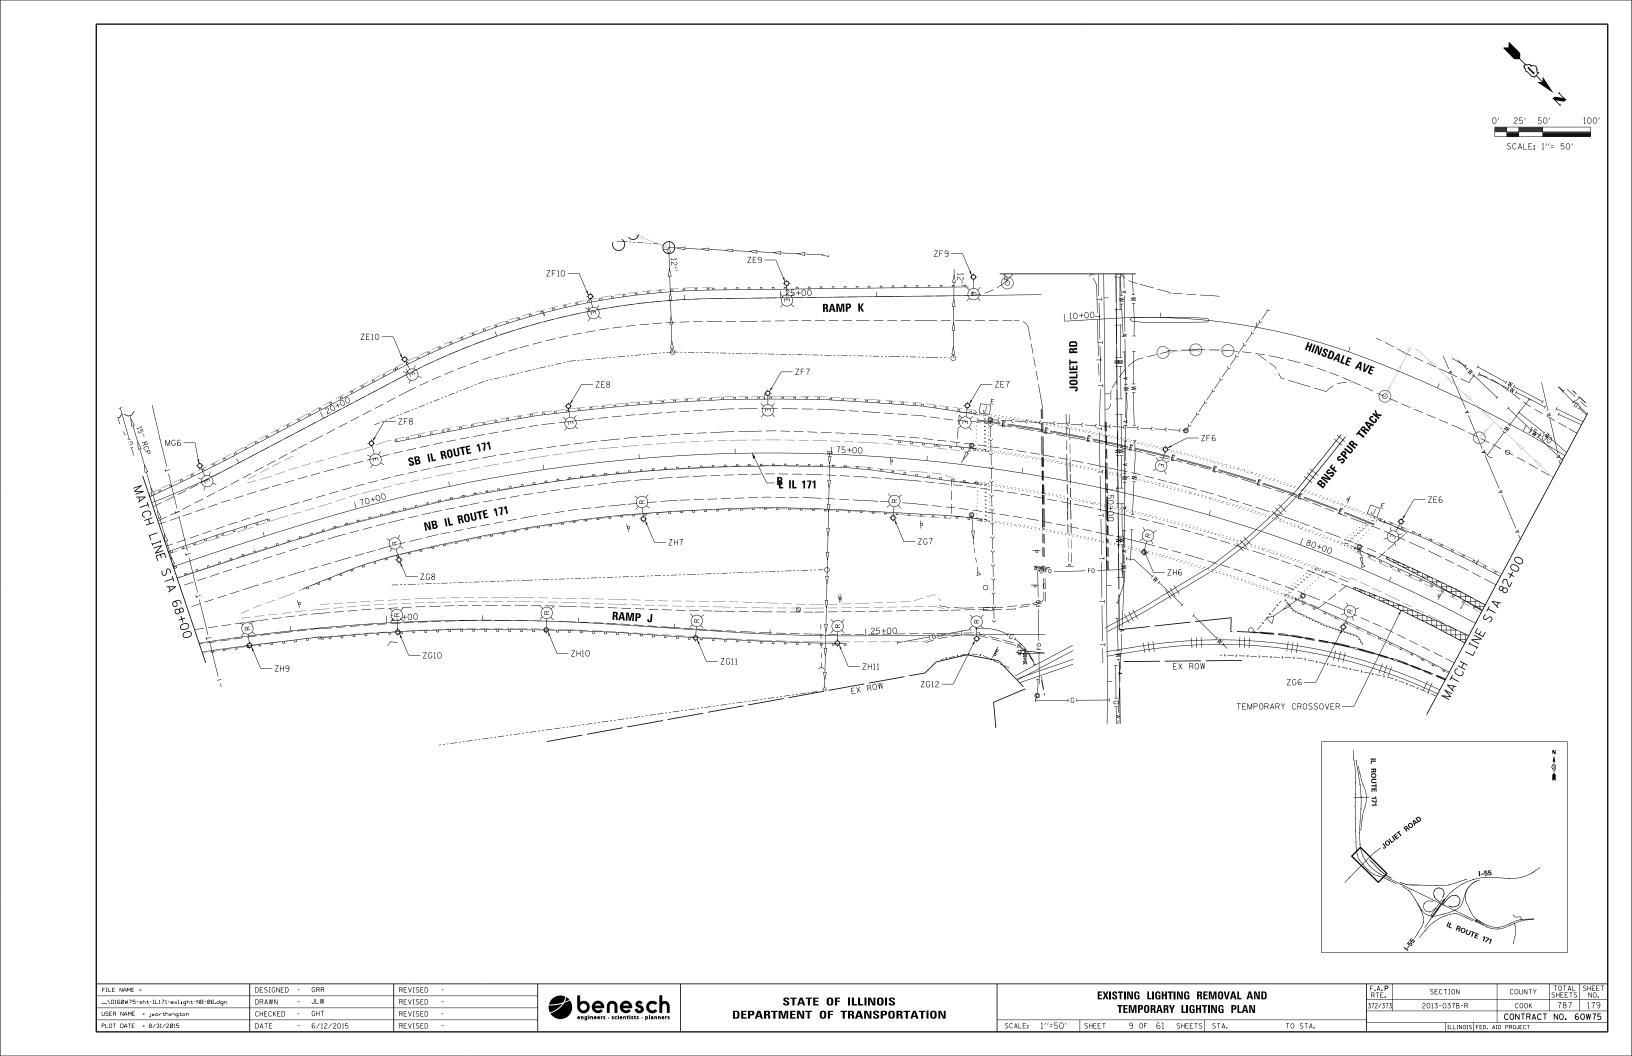

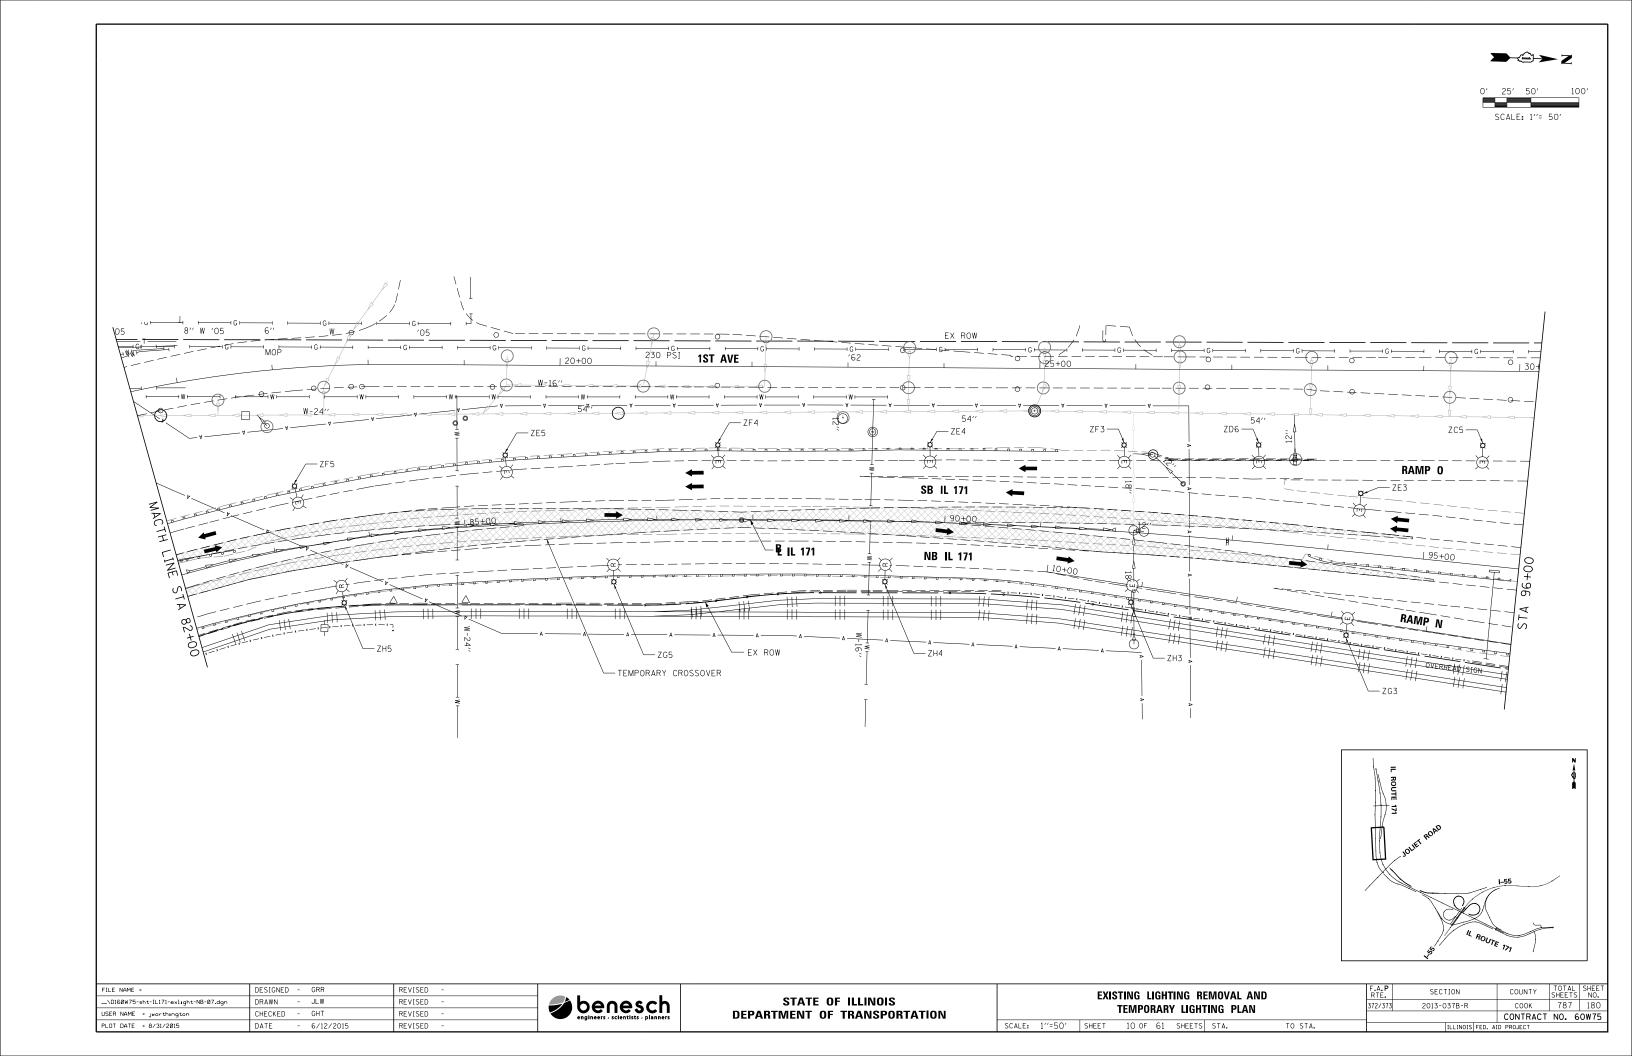

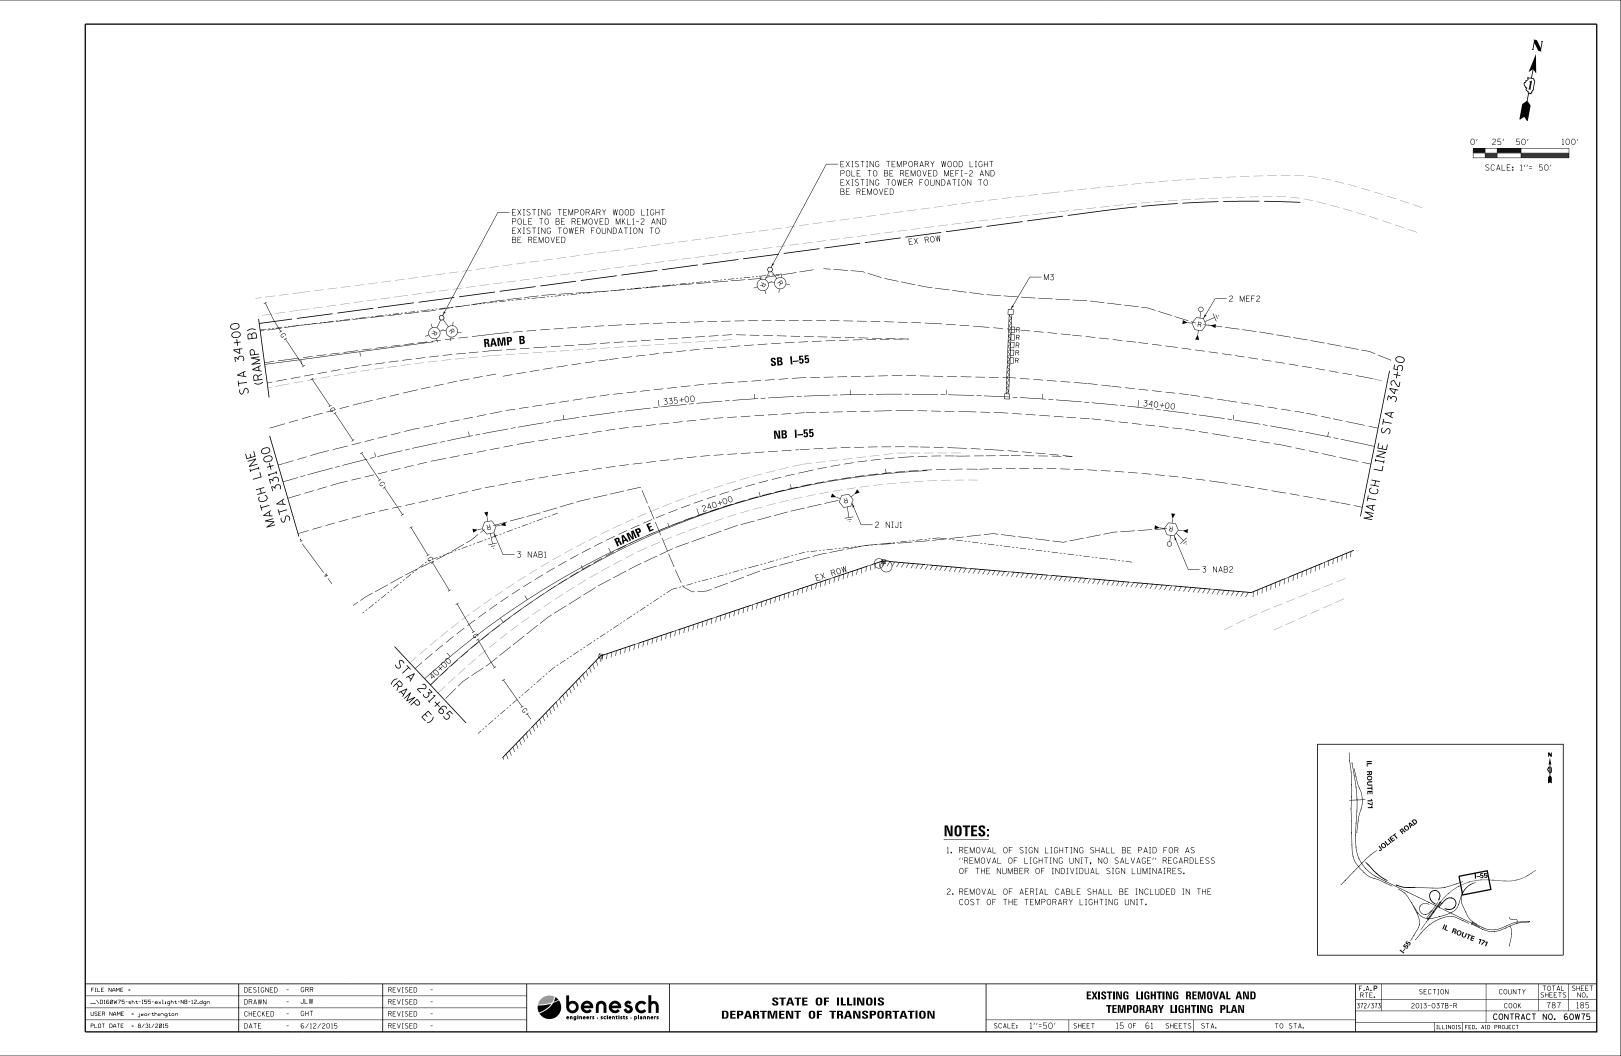

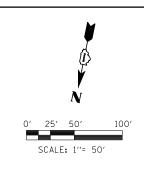

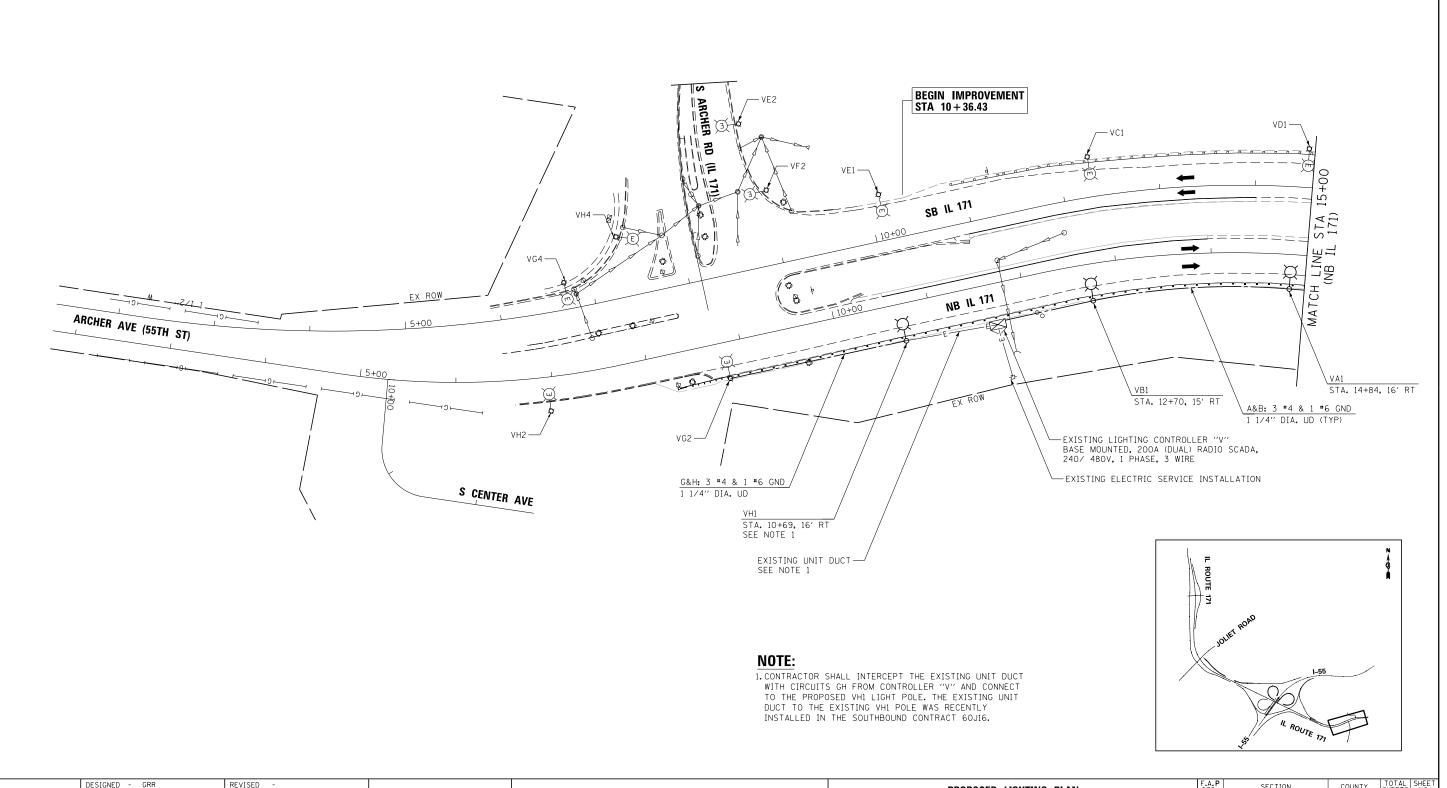



FILE NAME =	DESIGNED - GRR	REVISED -	_			
\D160W75-sht-IL171-prlight-NB-01.dgn	DRAWN - JLW	REVISED -	benesch			
USER NAME = jworthington	CHECKED - GHT	REVISED -	engineers - scientists - planners			
PLOT DATE = 8/31/2015	DATE - 6/12/2015	REVISED -	,			

STATI	E OF	ILLINOIS
DEPARTMENT	OF 7	<b>TRANSPORTATION</b>


SCALE: 1"=50"

PROPOSED LIGHTING PLAN IL 171		F.A.P RTE.	SECTION	COUNTY	TOTAL SHEETS	SHEE NO.				
			372/373	2013-037B-R	соок	787	188			
IE 1/1						CONTRACT	NO. 6	50W75		
SHEET	18 OF	61	SHEETS	STA.	TO STA.		ILLINOIS FED. A	ID PROJECT		

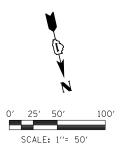

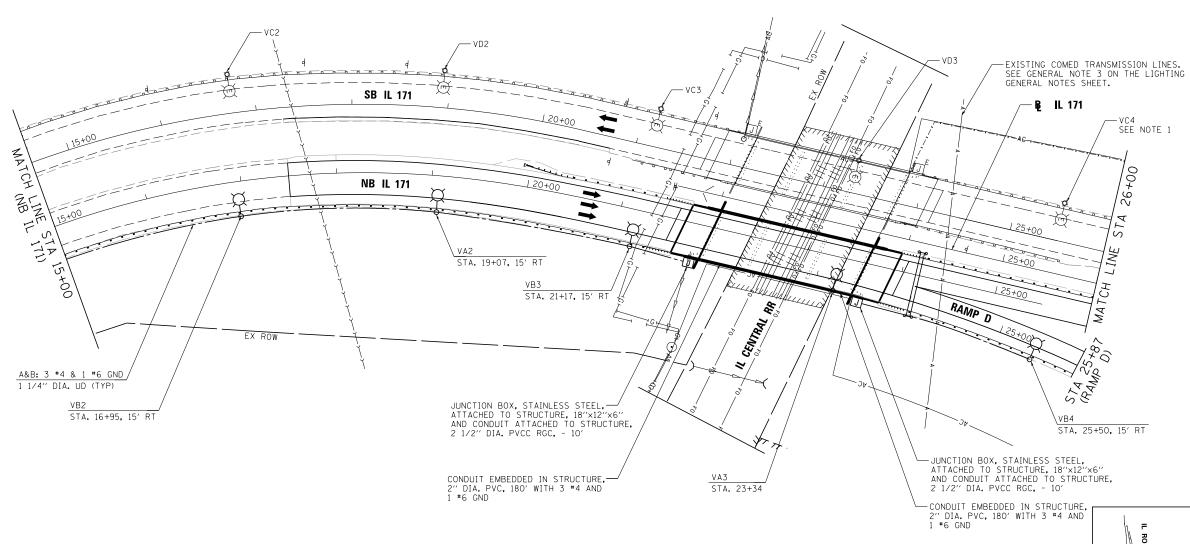

1. AFTER PROPOSED CIRCUITS MN FROM CONTROLLER "N" TO THE PROPOSED HIGH MAST TOWER 4 NMN5 AND EXISTING NAVIGATION LIGHTING WEST OF THIS POLE ARE INSTALLED, CONTRACTOR SHALL DISCONNECT EXISTING CONTROLLER "V" CIRCUITS CD FEED TO THE EXISTING HIGH MAST TOWER 3 VCD5 AND NAVIGATION LIGHTS AT THIS POLE. DISCONNECTION SHALL BE PERFORMED PRIOR TO CONNECTING THE EXISTING NAVIGATION LIGHTING TO CONTROLLER "N" CIRCUITS MN.

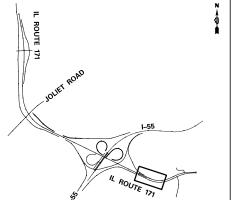


FILE NAME =	DESIGNED - GRR RE	EVISED -
\D160W75-sht-IL171-prlight-NB-02.dgn	DRAWN - JLW RE	EVISED -
USER NAME = Jworthington	CHECKED - GHT RE	EVISED -
PLOT DATE = 8/31/2015	DATE - 6/12/2015 RE	EVISED -


	_		
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_		benesch	
		engineers · scientists · planners	
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STATE OF ILLINOIS						
DEPARTMENT OF	TRANSPORTATION					

	PROPOSED LIGHTING PLAN					F.A.P RTE.	SECTION	COUNTY	TOTAL	SHEET NO.	
							372/373	2013-037B-R	соок	787	189
	IL 1/1							CONTRACT	NO. 6	OW75	
SCALE:	1''=50'	SHEET	19 OF 6	1 SHEETS	STA.	TO STA.		ILLINOIS FED. AID PROJECT			

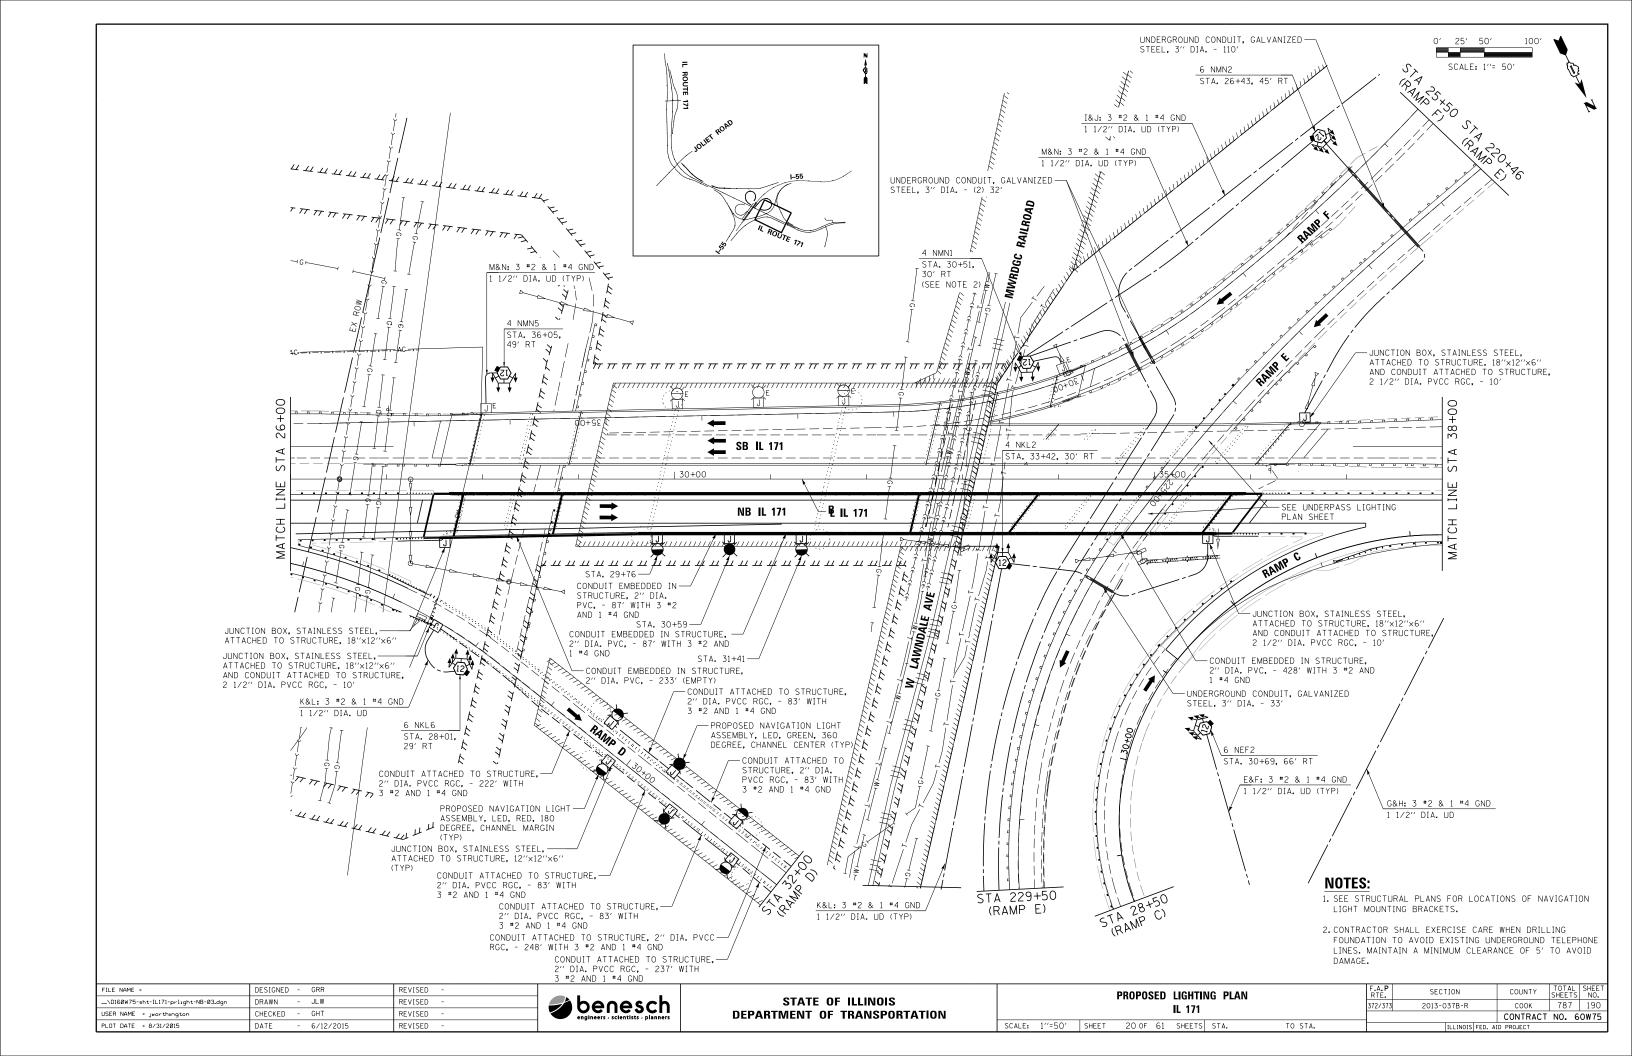

- 1. CONTRACTOR SHALL REMOVE THE EXISTING "LB" FITTING, CONDUIT NIPPLE, AND CONDUIT RUNNING DOWN TO THE GROUND. THE COSTS FOR THIS REMOVAL WORK SHALL BE INCLUDED IN THE COST OF THE PROPOSED JUNCTION BOX. CONTRACTOR SHALL THEN INSTALL THE PROPOSED STAINLESS STEEL JUNCTION BOX WITH NEW 2" DIA, PVCC RGC NIPPLE BETWEEN THE EXISTING EMBEDDED JUNCTION BOX AND THE PROPOSED ATTACHED JUNCTION BOX AND 2 1/2" DIA, PVCC RGC DOWN TO THE GROUND.
- 0′ 25′ 50′ 100′ SCALE: 1′′= 50′
- 2. CONTRACTOR SHALL REMOVE THE EXISTING CABLES FROM THE CONDUIT PRIOR TO INSTALLATION OF THE PROPOSED CABLES. REMOVAL OF THE EXISTING CABLES SHALL BE PAID FOR UNDER PAY ITEM "REMOVE ELECTRIC CABLE FROM CONDUIT" FOR EACH CABLE REMOVED.

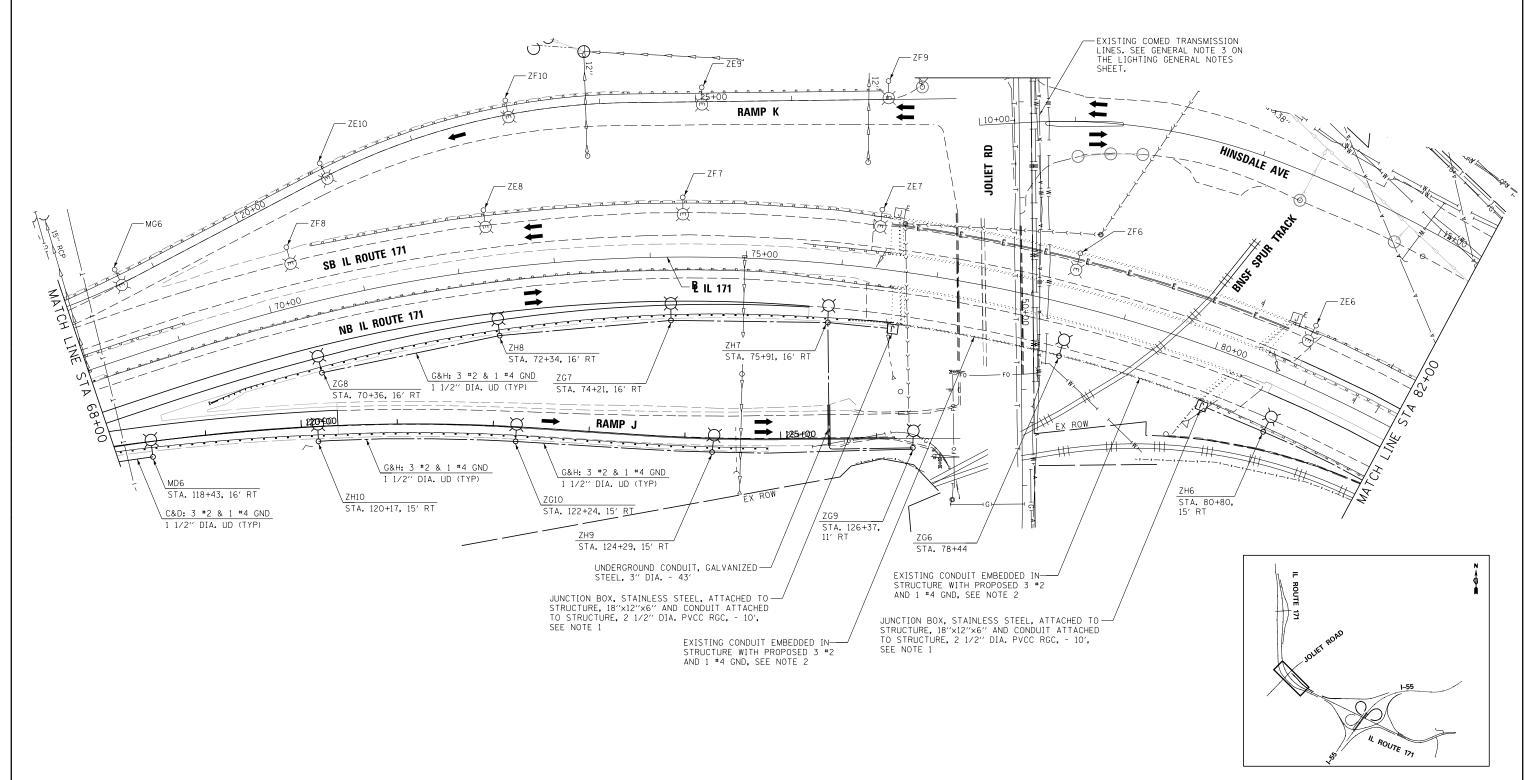



ILE NAME =	DESIGNED - GRR	REVISED -	_
\D160W75-sht-IL171-prlight-NB-06.dgn	DRAWN - JLW	REVISED -	benesch
SER NAME = jworthington	CHECKED - GHT	REVISED -	engineers - scientists - planners
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STATE OF ILLINOIS	
DEPARTMENT OF TRANSPORTATION	


SCALE: 1"=50' SHEET

PROPOSED LIGHTING PLAN			SECTION	COUNTY	TOTAL SHEETS	SHEET NO.
IL 171		372/373	2013-037B-R	COOK	787	193
IL 1/1				CONTRACT	NO. 6	OW75
23 OF 61 SHEETS STA.	TO STA.	ILLINOIS FED. AID PROJECT				



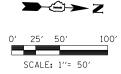

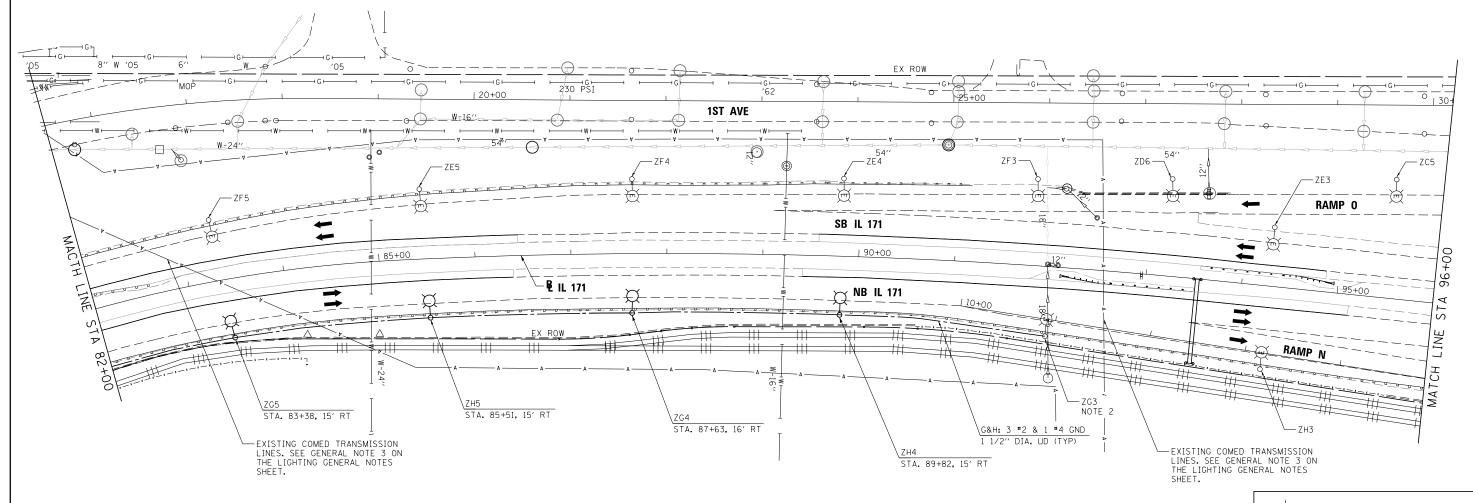- 1. CONTROLLER "Z" IS LOCATED IN NORTHWEST QUADRANT OF 47TH STREET INTERCHANGE.
- 2. CONTRACTOR SHALL INSTALL UNIT DUCT TO THIS EXISTING LIGHT POLE THAT WAS INSTALLED UNDER CONTRACT 60J16. DISCONNECT EXISTING UNIT DUCT RUNNING SOUTH PRIOR TO CONNECTING PROPOSED UNIT DUCT. ANY CABLE SPLICES AND FUSES REQUIRED SHALL BE INCLUDED IN THE COST OF THE PROPOSED UNIT DUCT.

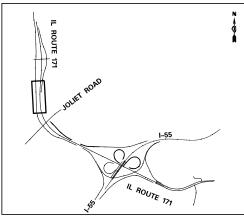



FILE NAME =	DESIGNED	-	GRR	REVISED	-
\D160W75-sht-IL171-prlight-NB-07.dgn	DRAWN	-	JLW	REVISED	-
USER NAME = jworthington	CHECKED	-	GHT	REVISED	-
PLOT DATE = 8/31/2015	DATE	-	6/12/2015	REVISED	-





STATE OF ILLINOIS		
DEPARTMENT OF TRANSPORTATION		
	 111 501	


PROPOSED	LIGHTING PLAN			F.A.P RTE. SECTION			COUNTY	TOTAL SHEETS	SHEE NO.
	IL 171		372/373	2013-037B-R		COOK	787	194	
							CONTRACT	NO.	50W75
24 OF 61	SHEETS	STA.	TO STA.		ILLINOIS	FED. AI	D PROJECT		

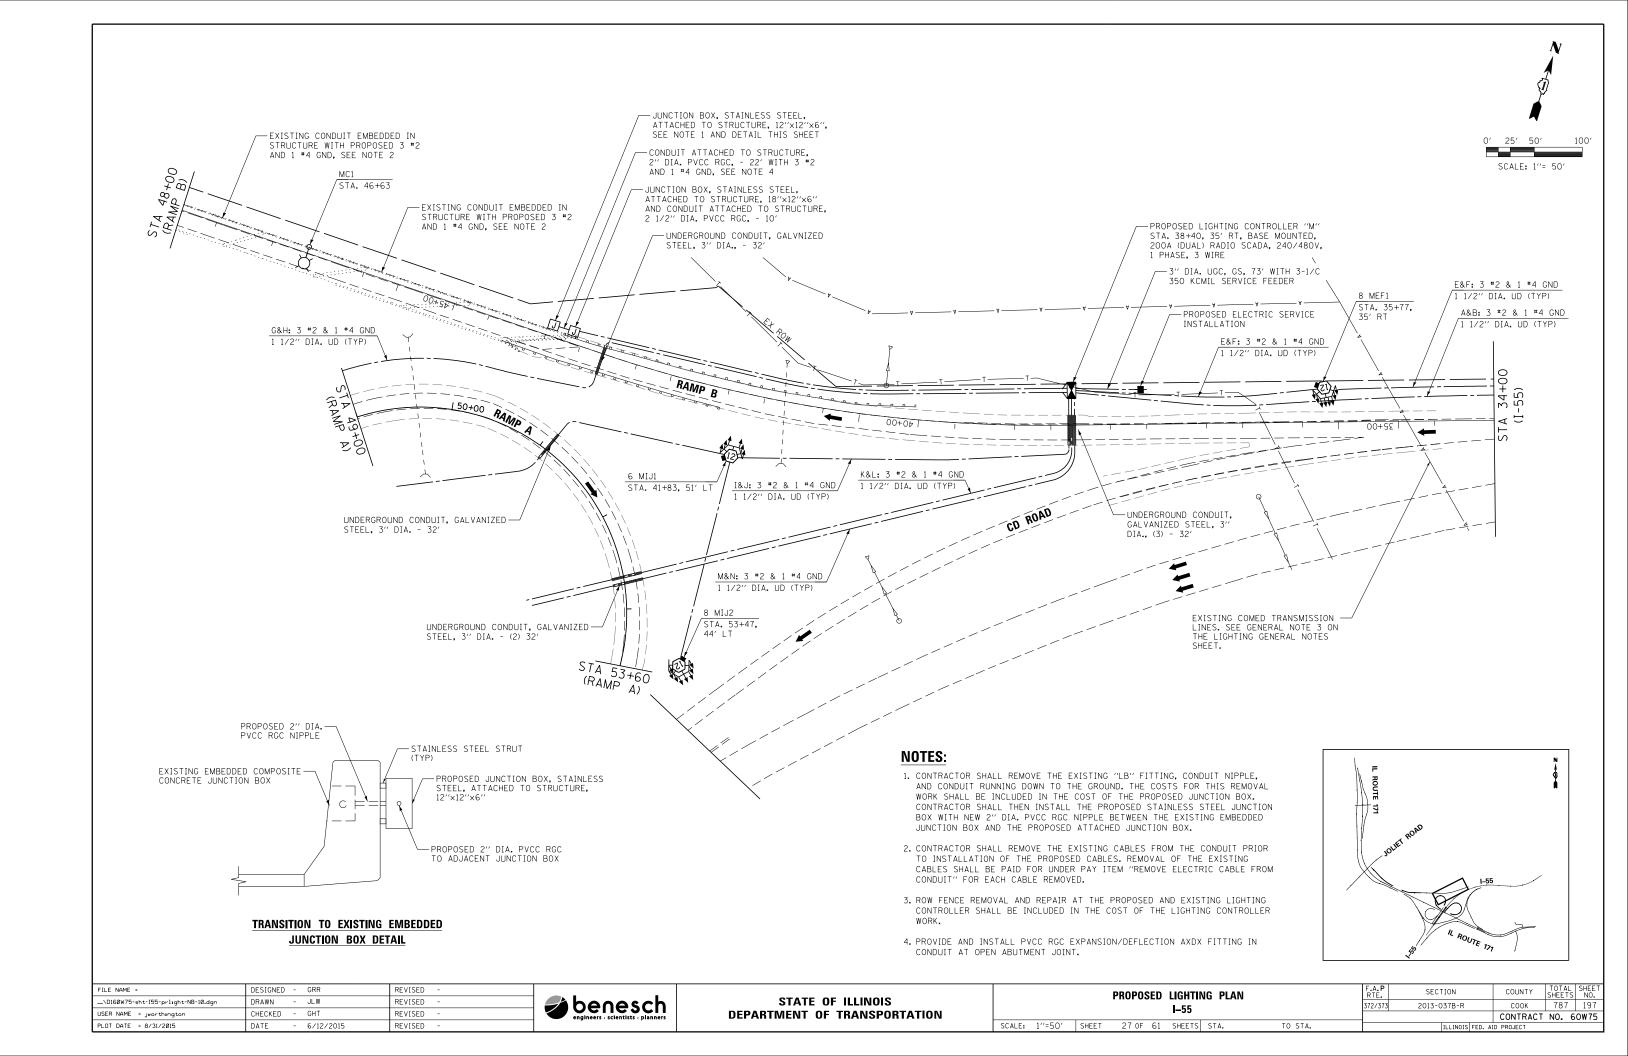


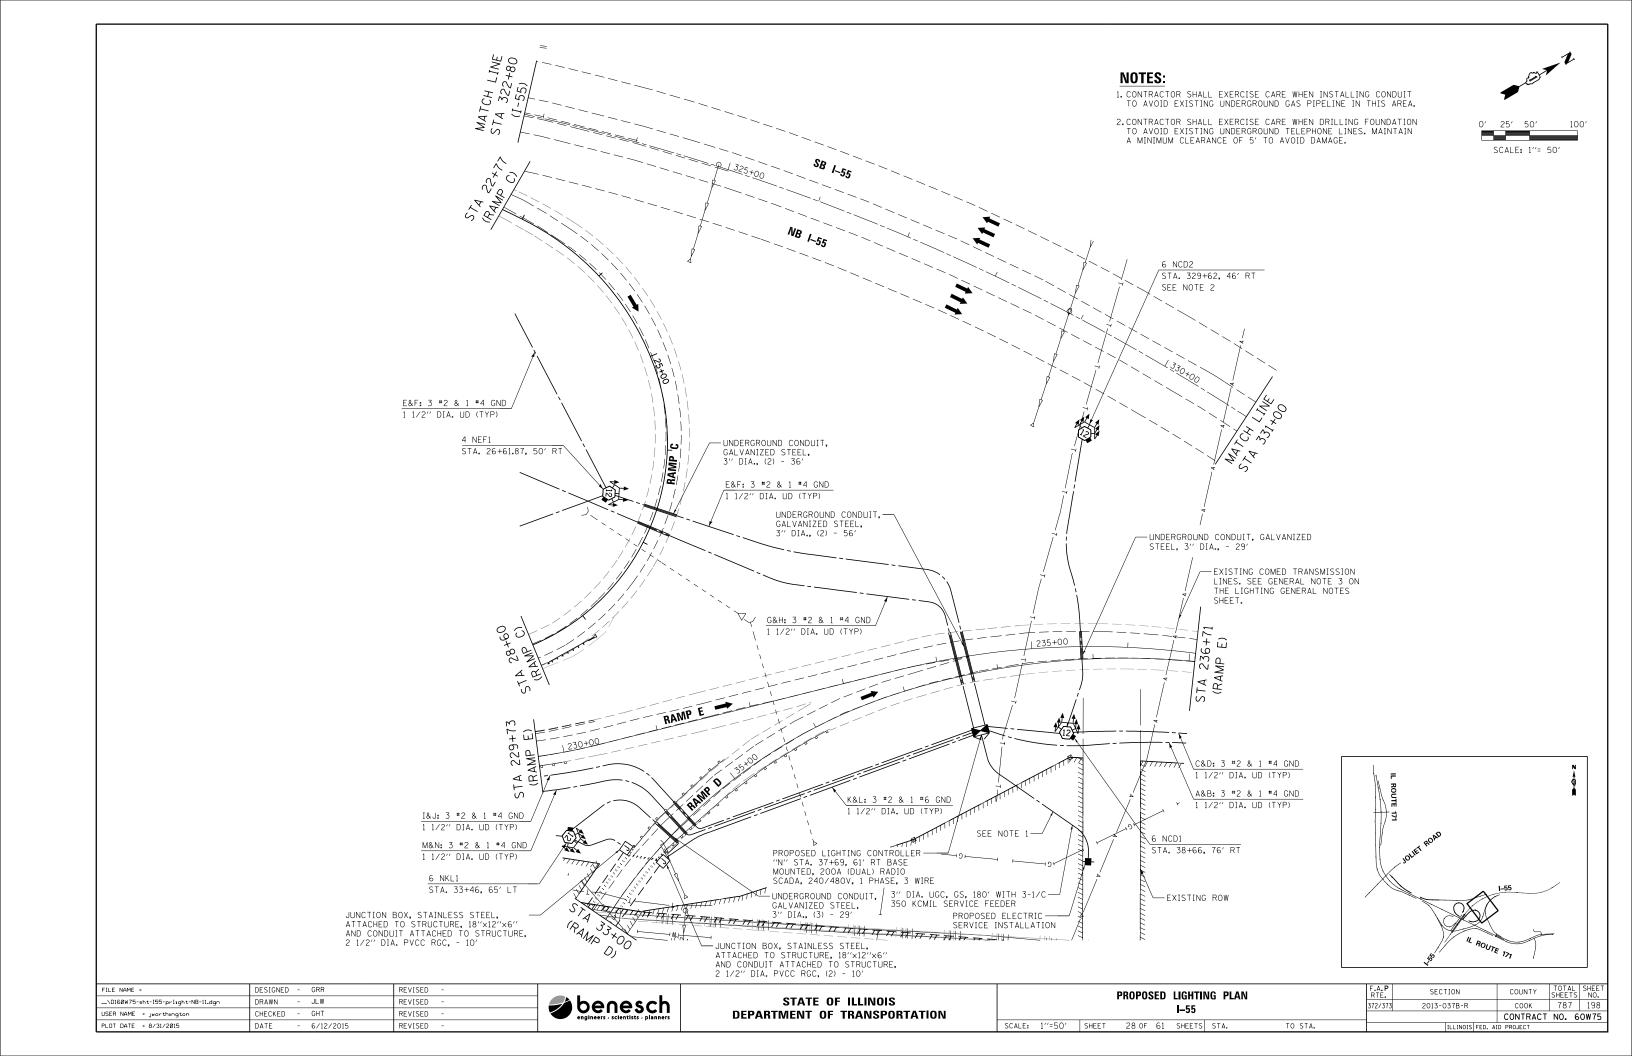


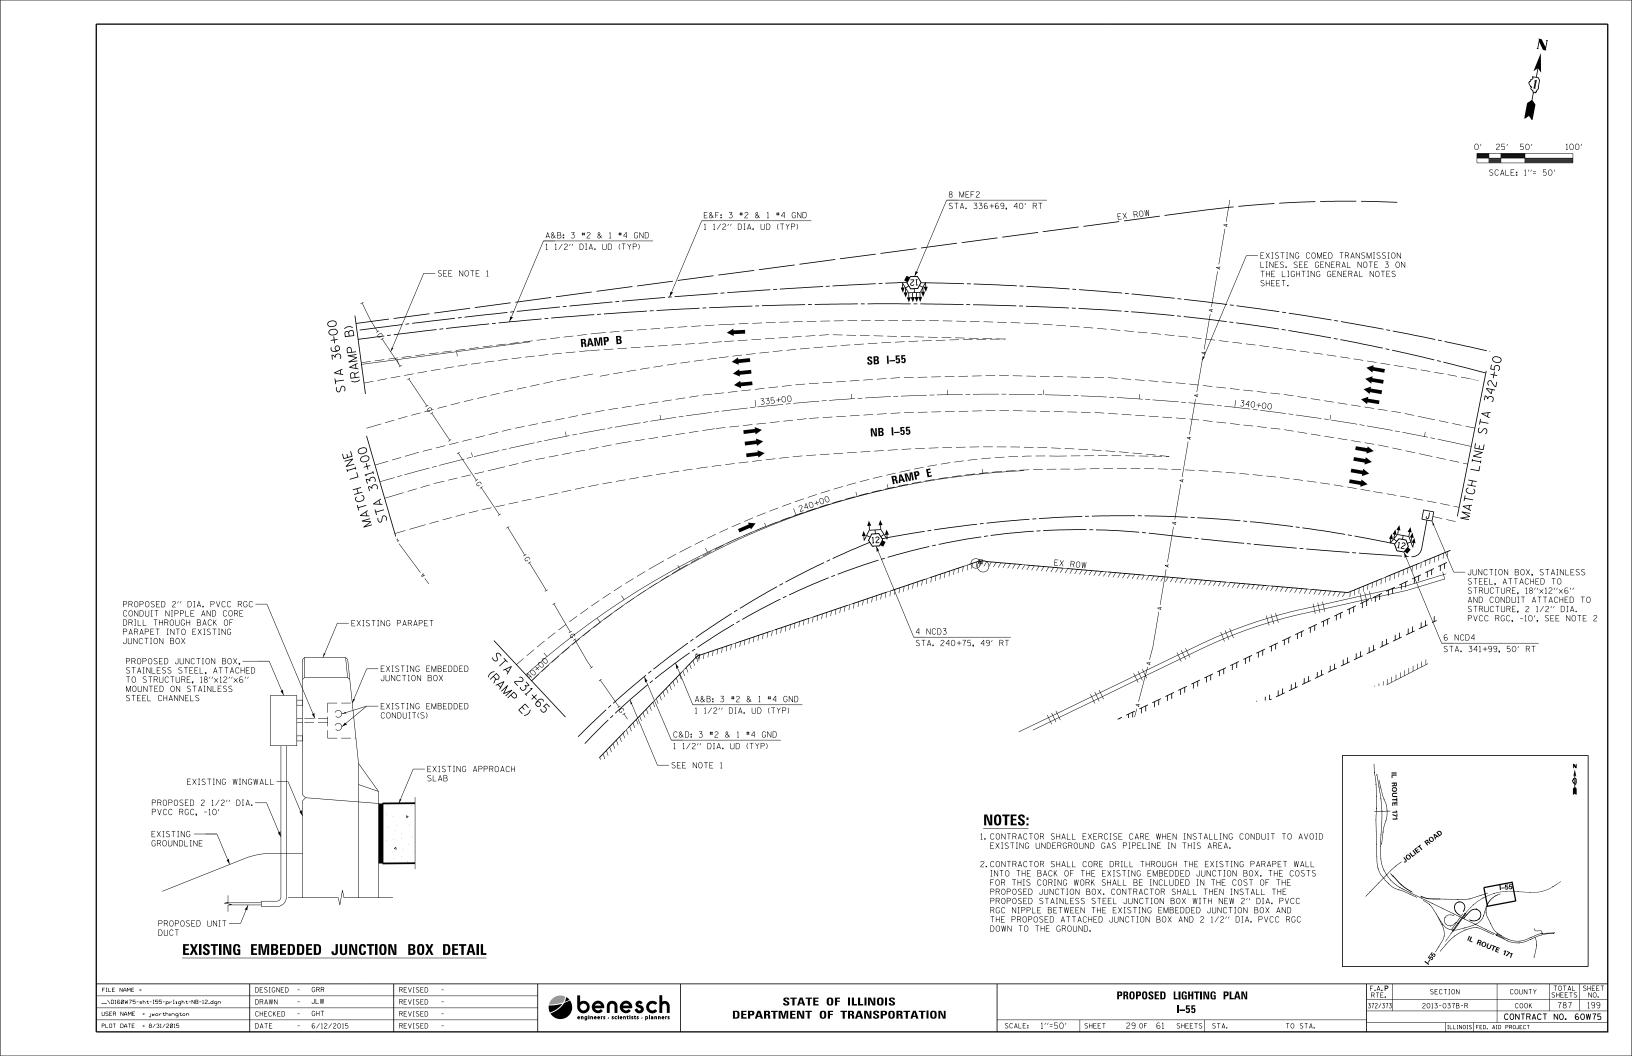


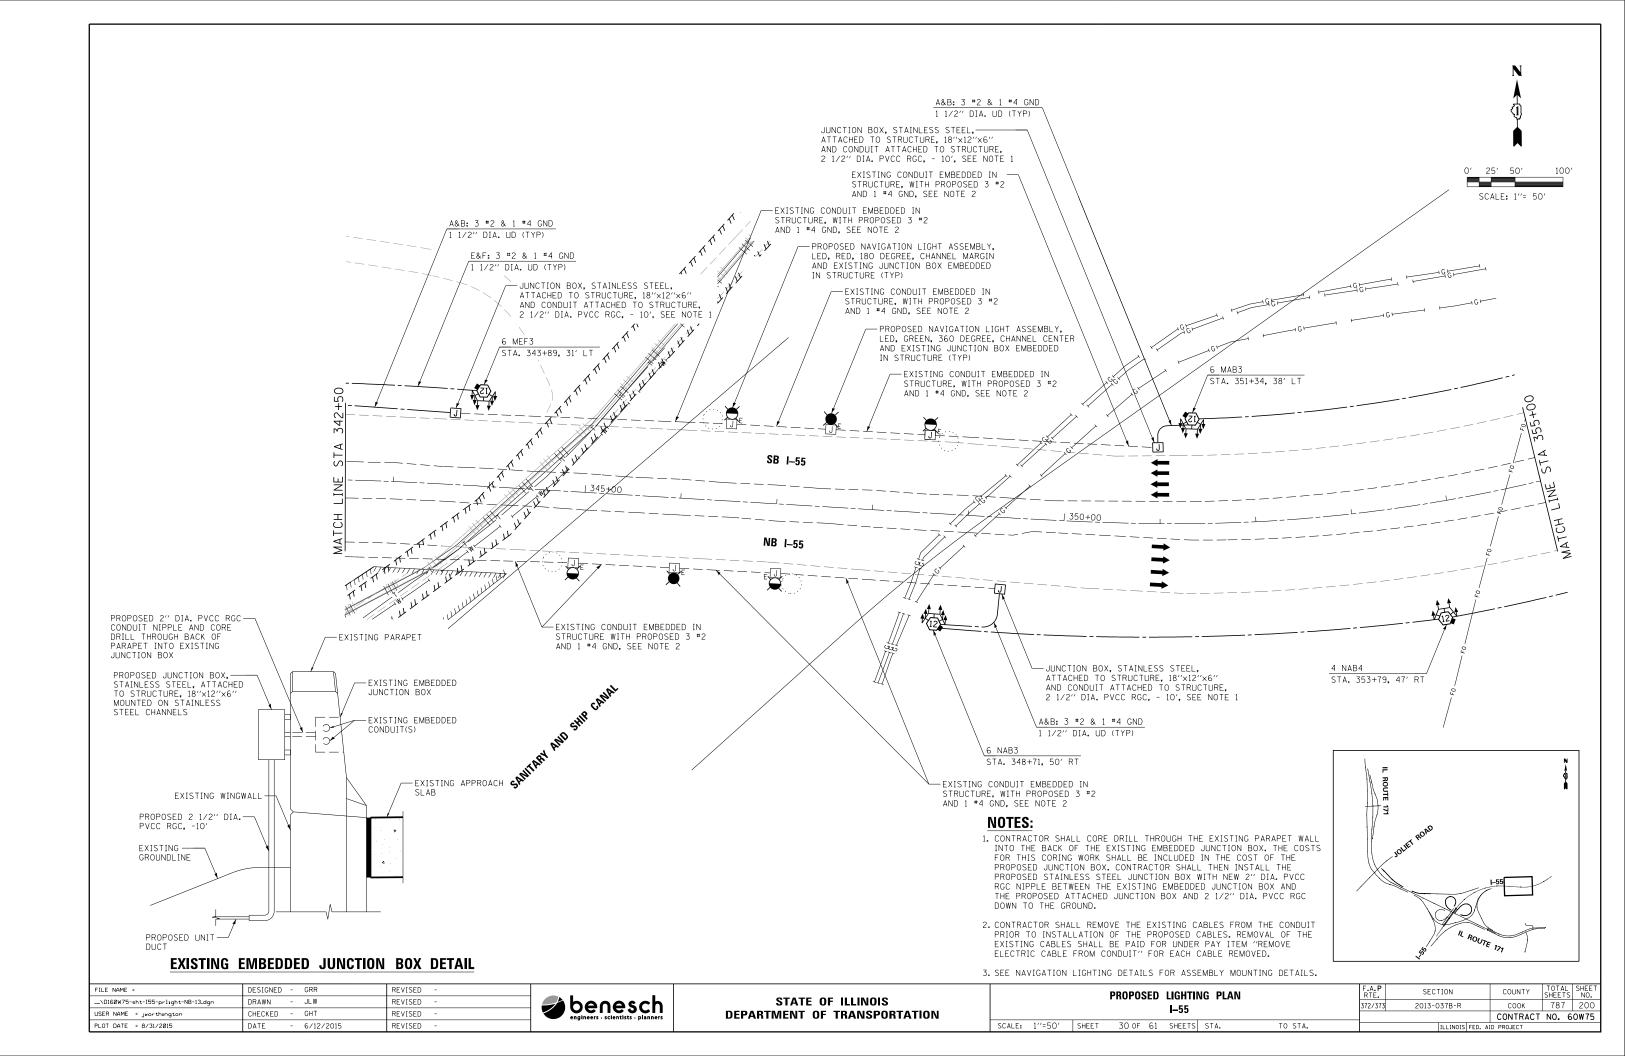

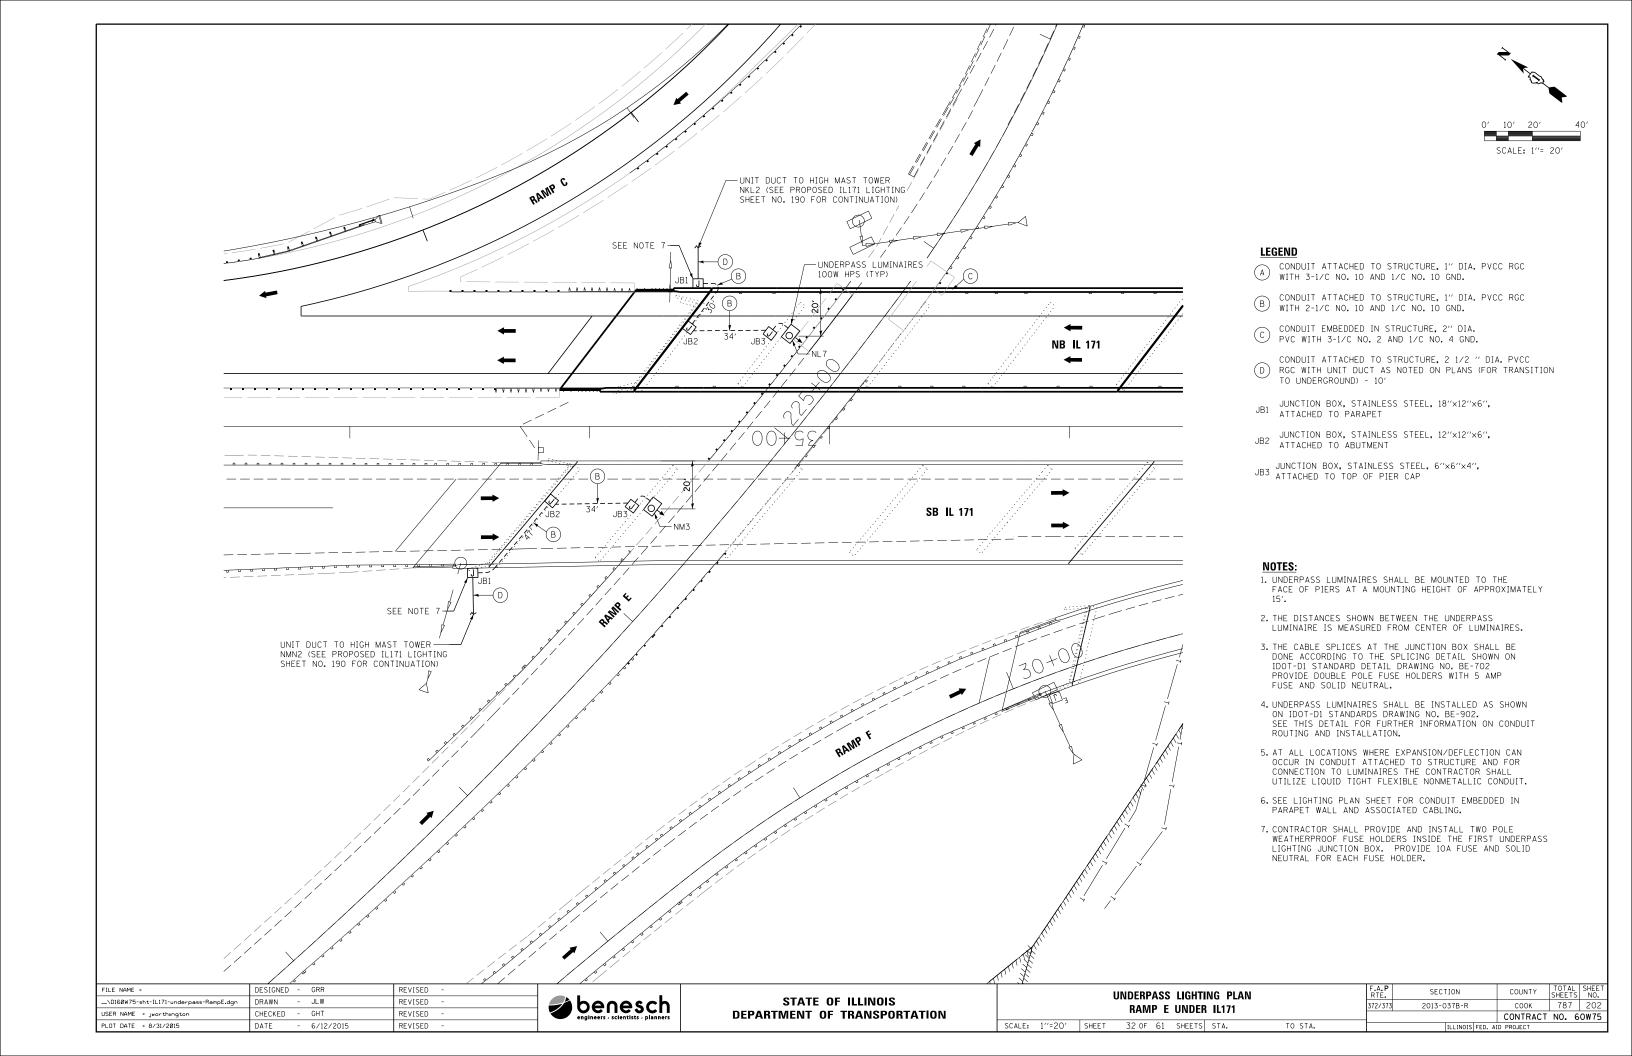

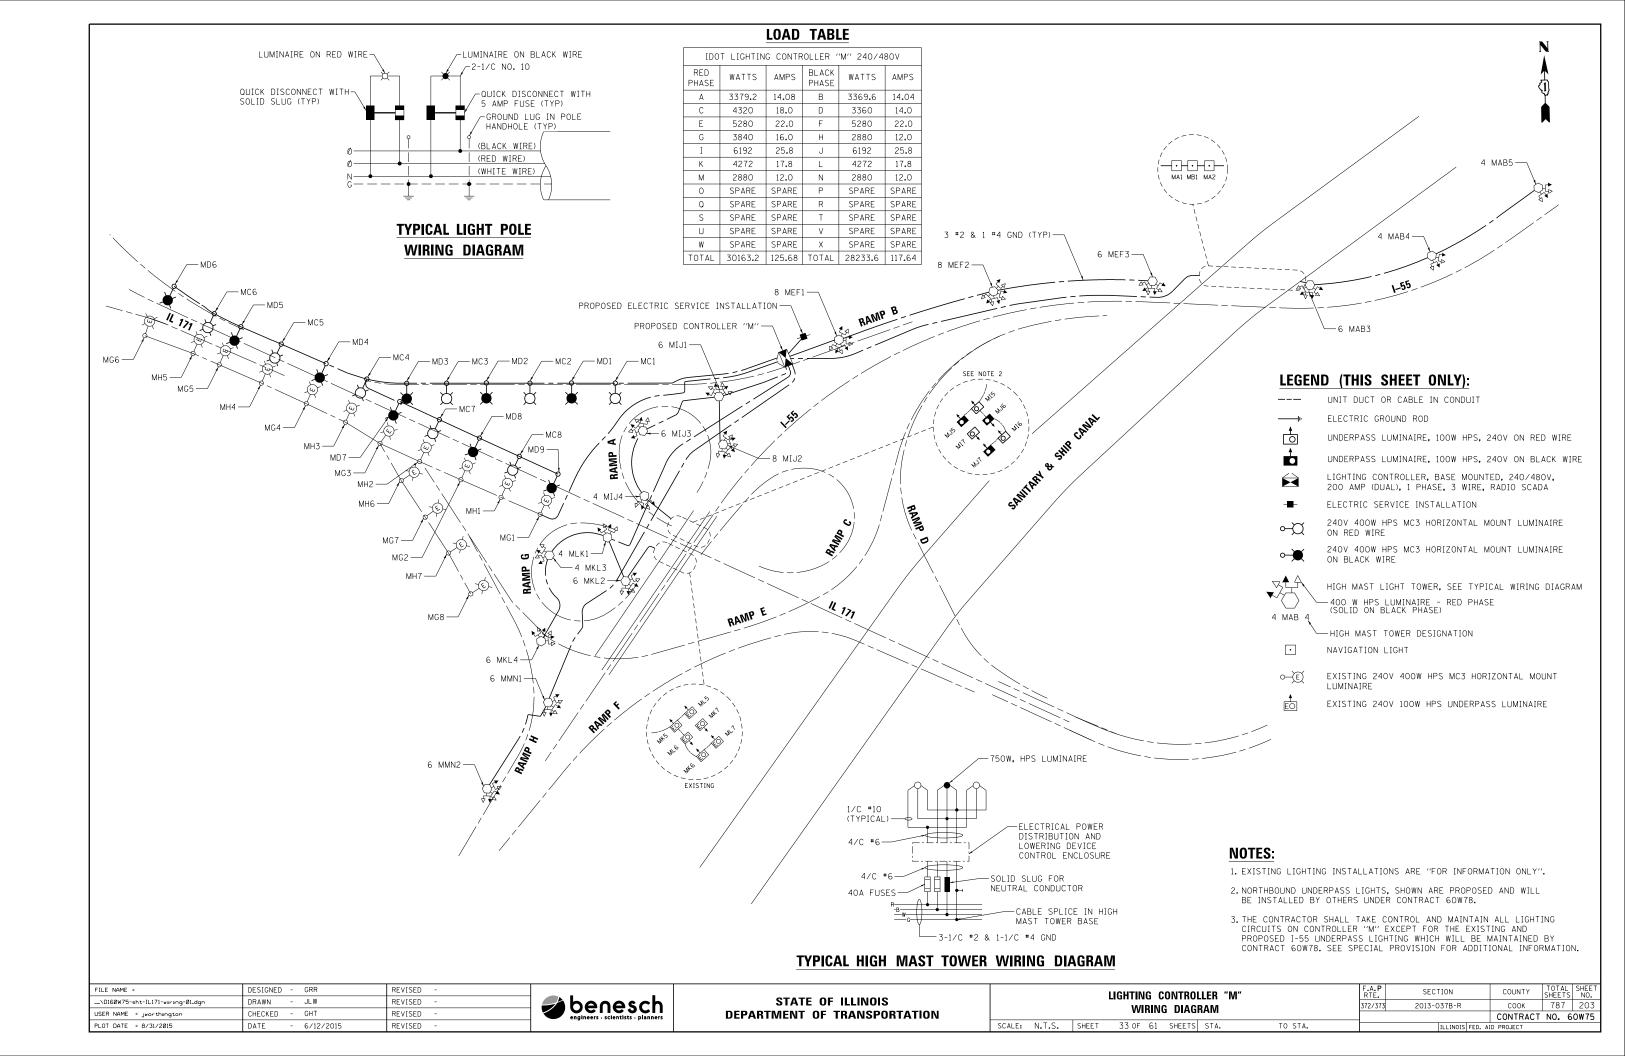

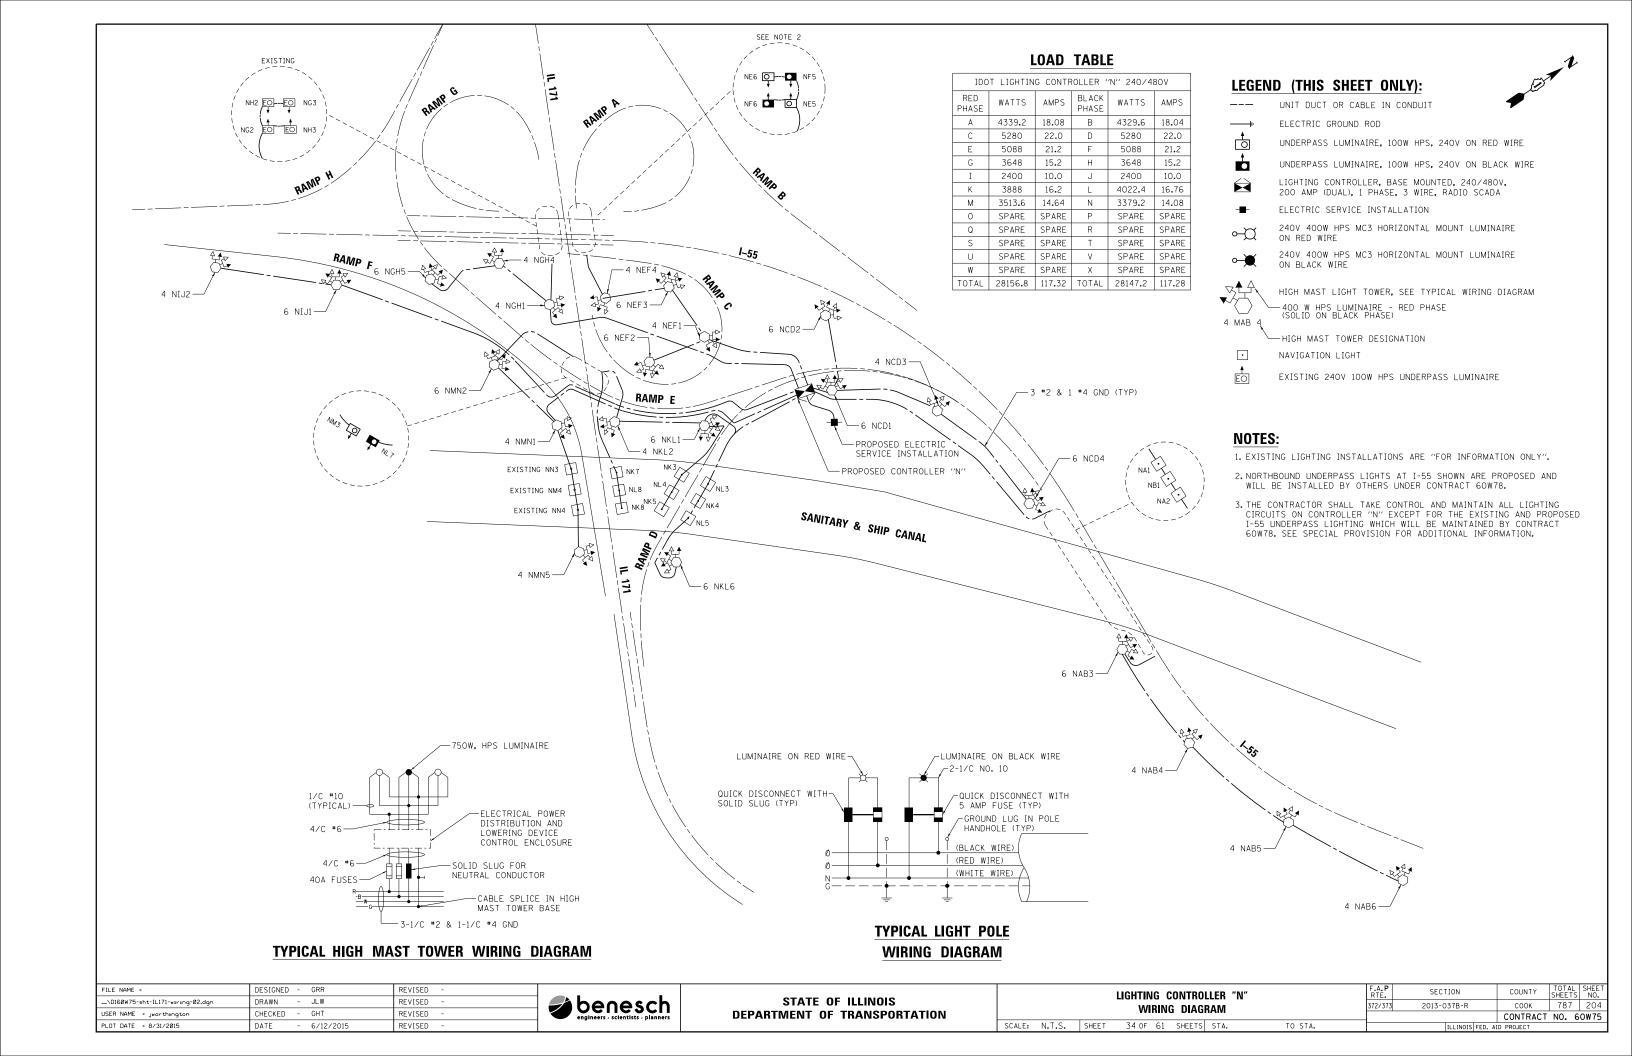

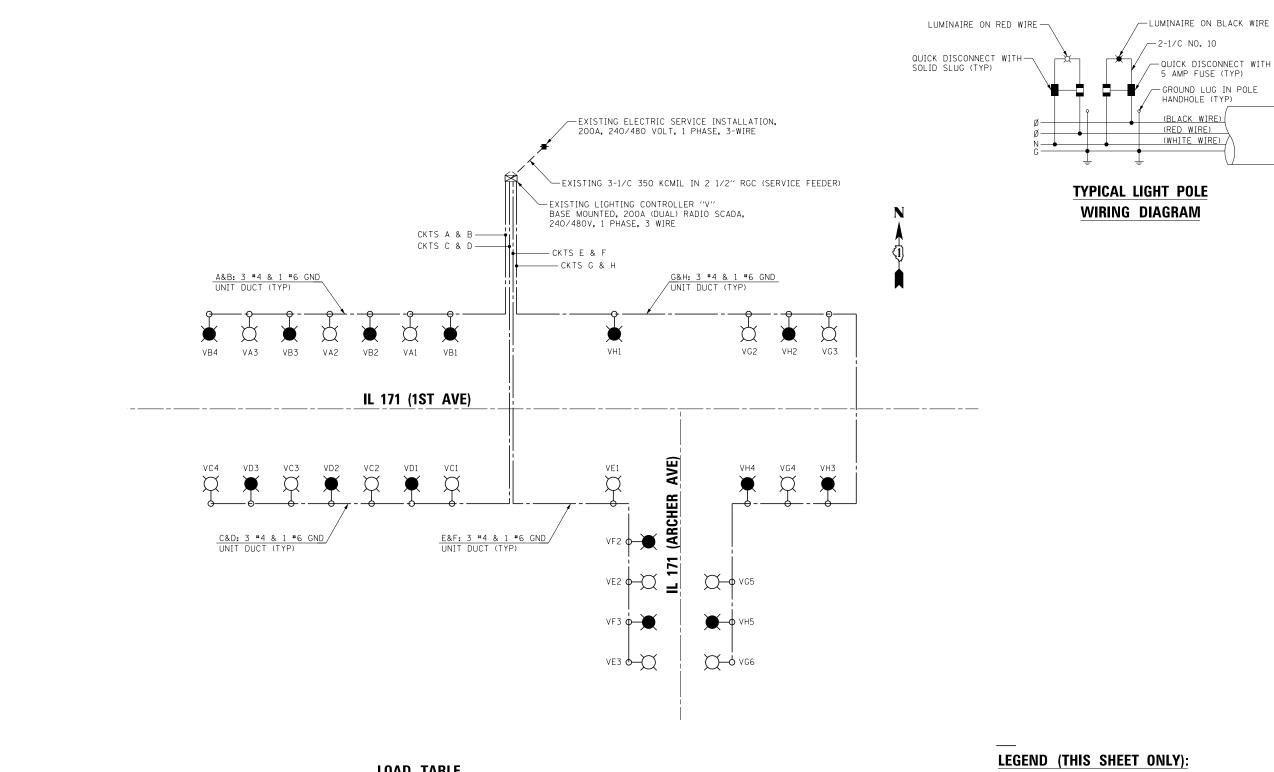


### LOAD TABLE


IDOT	IDOT LIGHTING CONTROLLER "V" 240/480V									
RED PHASE	WATTS	AMPS	BLACK PHASE	WATTS	AMPS					
Α	1434	6.0	В	1912	8.0					
С	1912	8.0	D	1434	6.0					
E	1434	6.0	F	956	4.0					
G	2390	10.0	Н	2390	10.0					
I	SPARE	SPARE	J	SPARE	SPARE					
TOTAL	7170	30.0	TOTAL	6692	28.0					

- 1. EXISTING LIGHTING INSTALLATIONS ARE "FOR INFORMATION ONLY".
- 2. SOUTHBOUND LIGHTS AND LIGHTS AT/EAST OF ARCHER AVE ARE EXISTING TO REMAIN.

- --- UNIT DUCT OR CABLE IN CONDUIT
  - ELECTRIC GROUND ROD
- EXISTING LIGHTING CONTROLLER, BASE MOUNTED, 240/480V, 200 AMP (DUAL) RADIO SCADA, 1 PHASE, 3 WIRE
- ELECTRIC SERVICE INSTALLATION
- 240V 400W HPS MC3 HORIZONTAL MOUNT LUMINAIRE ON BLACK WIRE

FILE NAME =	DESIGNED - GRR	REVISED -		07475 05 HILIDOO	LIGHTING CONTROLLER "V"		RTE.	SECTION	COUNTY SHEETS NO.
\D160W75-sht-[L171-wiring-03.dgn	DRAWN - JLW	REVISED -	🛘 🚄 benesch 📗	STATE OF ILLINOIS	WIRING DIAGRAM		372/373	2013-037B-R	соок 787 205
USER NAME = jworthington	CHECKED - GHT	REVISED -	engineers - scientists - planners	DEPARTMENT OF TRANSPORTATION	Wining Diagnam		·		CONTRACT NO. 60W75
PLOT DATE = 8/31/2015	DATE - 6/12/2015	REVISED -			scale: N.T.S. SHEET 35 OF 61 SHEETS STA.	TO STA.		ILLINOIS FED. A	ID PROJECT

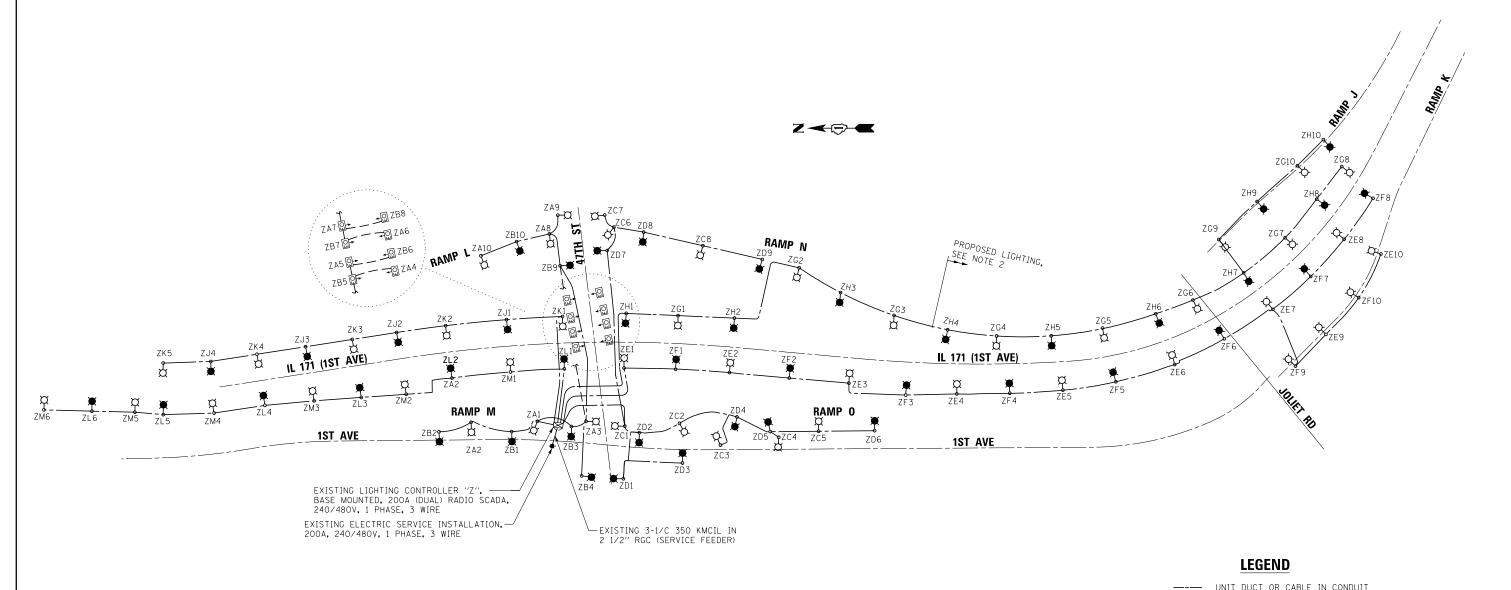

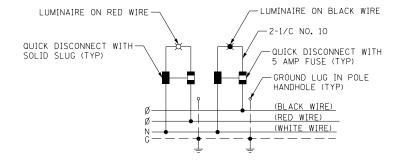

# TYPICAL LIGHT POLE **WIRING DIAGRAM**

#### FILE NAME = DESIGNED - GRR REVISED ...\D160W75-sht-IL171-wiring-04.dgn DRAWN - JLW REVISED USER NAME = jworthington HECKED REVISED PLOT DATE = 8/31/2015 - 6/12/2015 REVISED

# benesch engineers - scientists - planners

# LOAD TABLE


				_	
IDOT	LIGHTIN	G CONTF	ROLLER '	′Z'′ 240	/480V
RED PHASE	WATTS	AMPS	BLACK PHASE	WATTS	AMPS
А	3348	14.0	В	3348	14.0
С	3824	15.9	D	4302	17.9
E	4780	19.9	F	4780	19.9
G	4780	19.9	Н	4780	19.9
I	SPARE	SPARE	J	1912	8.0
K	2390	10.0	L	2868	12.0
М	2868	12.0	N	SPARE	SPARE
0	SPARE	SPARE	Р	SPARE	SPARE
TOTAL	21990	91.7	TOTAL	21990	91.7
	RED PHASE A C E G I K M O	RED PHASE WATTS A 3348 C 3824 E 4780 G 4780 I SPARE K 2390 M 2868 O SPARE	RED PHASE WATTS AMPS  A 3348 14.0 C 3824 15.9 E 4780 19.9 G 4780 19.9 I SPARE SPARE K 2390 10.0 M 2868 12.0 O SPARE SPARE	RED PHASE         WATTS         AMPS PHASE         BLACK PHASE           A         3348         14.0         B           C         3824         15.9         D           E         4780         19.9         F           G         4780         19.9         H           I         SPARE         SPARE         J           K         2390         10.0         L           M         2868         12.0         N           O         SPARE         SPARE         P	RED PHASE         WATTS         AMPS PHASE         BLACK PHASE         WATTS           A         3348         14.0         B         3348           C         3824         15.9         D         4302           E         4780         19.9         F         4780           G         4780         19.9         H         4780           I         SPARE         SPARE         J         1912           K         2390         10.0         L         2868           M         2868         12.0         N         SPARE           O         SPARE         P         SPARE

- --- UNIT DUCT OR CABLE IN CONDUIT
- ELECTRIC GROUND ROD
- EXISTING LIGHTING CONTROLLER, BASE MOUNTED, 240/480V, 200 AMP (DUAL) RADIO SCADA, 1 PHASE, 3 WIRE
- ELECTRIC SERVICE INSTALLATION
- 240V 400W HPS MC3 HORIZONTAL MOUNT LUMINAIRE ON RED WIRE
- 240V 400W HPS MC3 HORIZONTAL MOUNT LUMINAIRE ON BLACK WIRE
- UNDERPASS LUMINAIRE, 100W HPS, 240V ON RED WIRE
- UNDERPASS LUMINAIRE, 100W HPS, 240V ON BLACK WIRE
- EXISTING 240V 100W HPS UNDERPASS LUMINAIRE

### NOTES:


- 2. SOUTHBOUND LIGHTS AND ALL LIGHTS AT THE 47TH STREET INTERCHANGE ARE EXISTING AND WILL REMAIN.

SECTION LIGHTING CONTROLLER "Z" STATE OF ILLINOIS 2013-037B-R WIRING DIAGRAM **DEPARTMENT OF TRANSPORTATION** CONTRACT NO. 60W75 SCALE: N.T.S. SHEET 36 OF 61 SHEETS STA. TO STA.

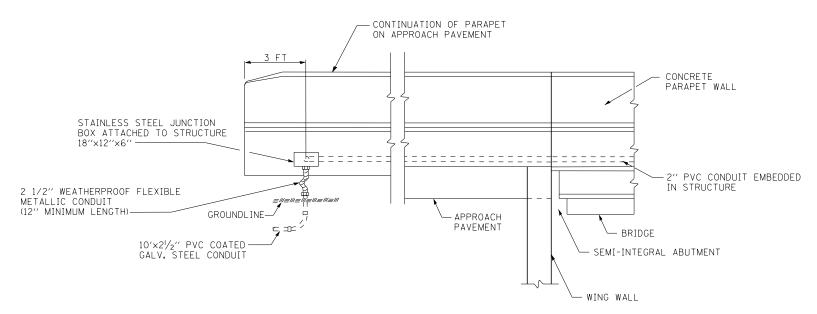

### **CONDUIT DETAIL**


(SEMI-INTEGRAL ABUTMENT-SN 016-0489)

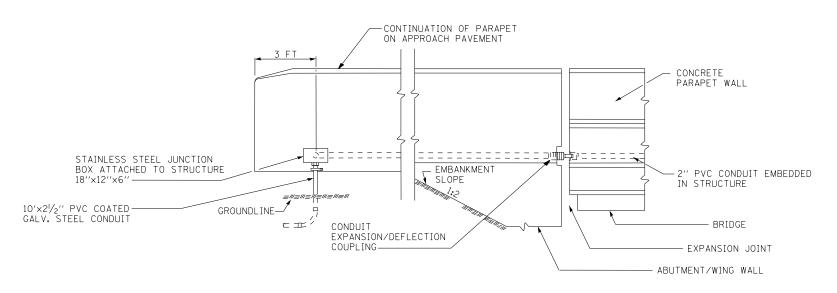


### **CONDUIT DETAIL**

(OPEN ABUTMENT)

FILE NAME =	DESIGNED - GRR	REVISED -			CONDUIT TRANSITION DETAILS	F.A.P SECTION	COUNTY TOTAL SHEET
\D160W75-sht-IL171-conduit-detail-NB-01.de	gr DRAWN - JLW	REVISED -	<b>benesch</b>	STATE OF ILLINOIS	CONDOIT TRANSITION DETAILS	372/373 2013-037B-R	соок 787 207
USER NAME = jworthington	CHECKED - GHT	REVISED -	engineers - scientists - planners	DEPARTMENT OF TRANSPORTATION			CONTRACT NO. 60W75
PLOT DATE = 8/31/2015	DATE - 6/12/2015	REVISED -	]		SCALE: N.T.S. SHEET 37 OF 61 SHEETS STA. TO STA.	ILLINOIS	FED. AID PROJECT

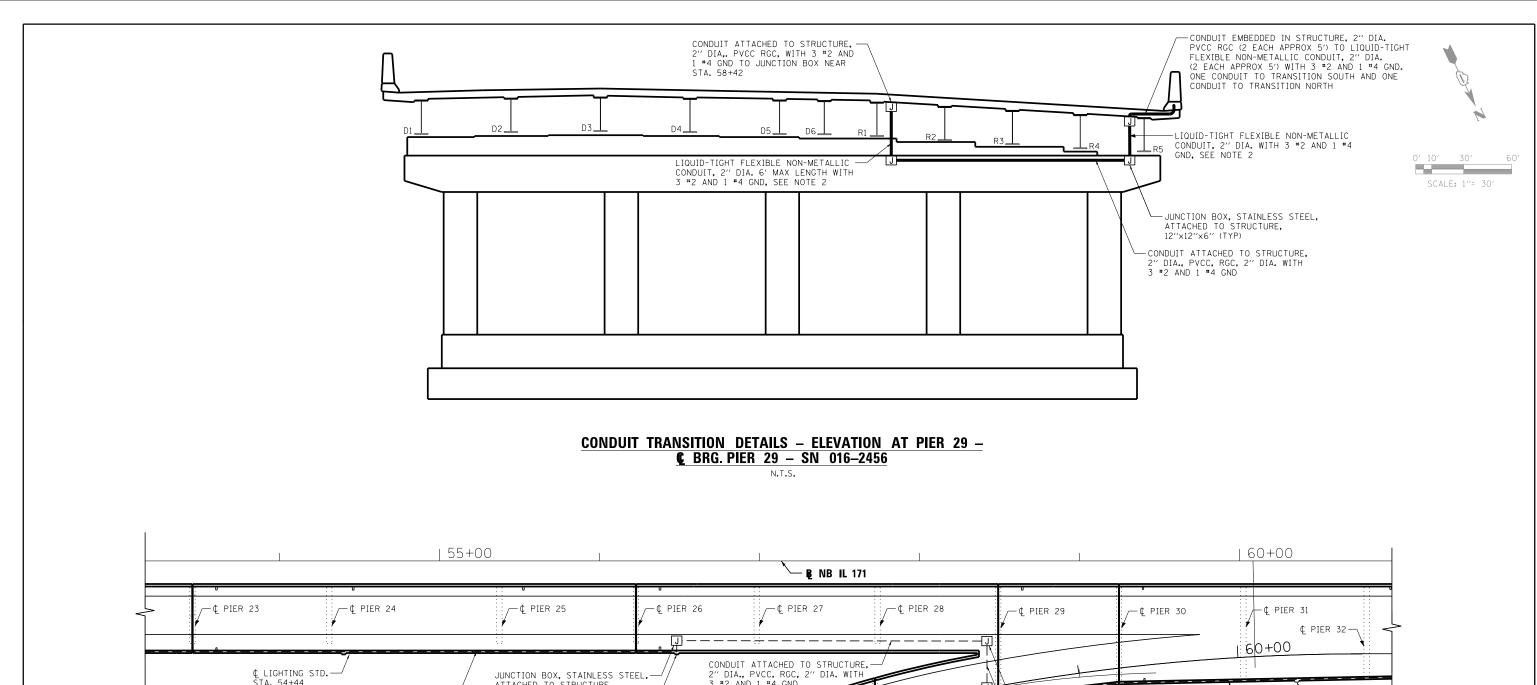

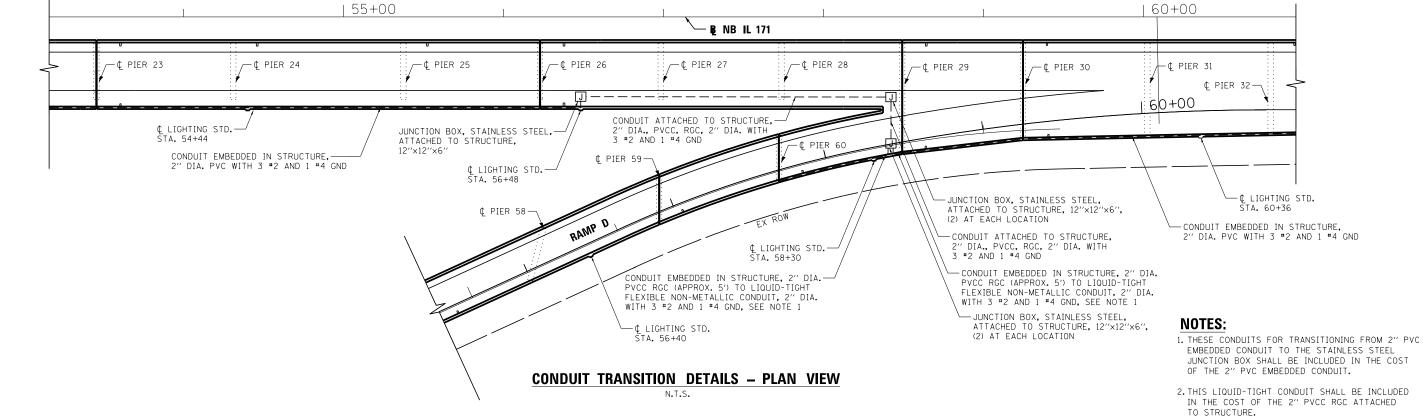



FILE NAME =	DESIGNED -	GRR	REVISED -				(	сомры	TRANSIT	ION DETAILS	2	F.A.P RTE.	SECTION	COUNTY	SHEET	L SHEET
\D160W75-sht-[L171-conduit-detail-NB-02.dgr	DRAWN -	JLW	REVISED -	🛘 🚄 benesch 📗	STATE OF ILLINOIS		`			1011 5217112	•	372/373	2013-037B-R	соок	787	/ 208
USER NAME = jworthington	CHECKED -	GHT	REVISED -	engineers - scientists - planners	DEPARTMENT OF TRANSPORTATION									CONTRAC	T NO.	60W75
PLOT DATE = 8/31/2015	DATE -	6/12/2015	REVISED -			SCALE: N.T.S.	SHEET	38 0	F 61 SHEE	TS STA.	TO STA.		ILLINOIS FED.	AID PROJECT		


	HIGH MAST LIGHT TOWER FOUNDATION SCHEDULE									
HIGH MAST LIGHT TOWER					HIGH MAST LIGHT TOWER FOUNDATION	HIGH MAST	LUMINAIRE AIMING	SERVICE PAD TYPE	LUMINAIRE AIMING	
IDENTIFCATION	STATION	OFFSET (NOTE 4)	BASELINE	DESIGN DEPTH (FT)	TOWER HEIGHT (FT)	LOWINAINE AIMINO	(SEE NOTE 7)	LOWINAINE AIMINO		
6 MAB3	351+34	38′ LT	I-55	17.5	В	PERPENDICULAR TO I-55	В			
4 MAB4	357+70	43′ LT	I-55	17.5	В	PERPENDICULAR TO I-55	В			
4 MAB5	363+87	42′ LT	I-55	17.5	В	PERPENDICULAR TO I-55	В			
8 MEF1	35+77	35′ RT	RAMP B	15.0	А	PERPENDICULAR TO I-55	А	AVOID EXISTING UNDERGROUND LIGHTING CABLE NEARBY		
8 MEF2	336+69	40′ RT	I-55	17.5	А	PERPENDICULAR TO I-55	А			
6 MEF3	343+89	31′ LT	I-55	17.5	В	PERPENDICULAR TO I-55	В			
6 MIJ1	41+83	51' LT	RAMP B	16.5	А	PERPENDICULAR TO RAMP B	А	AVOID EXISTING UNDERGROUND LIGHTING CABLE NEARBY		
8 MIJ2	53+47	44′ LT	RAMP A	16.5	А	PERPENDICULAR TO I-55	А			
6 MIJ3	48+75	70′ RT	RAMP A	15.0	А	PERPENDICULAR TO RAMP A	А			
4 MIJ4	44+46	40′ RT	RAMP A	15.0	В	PERPENDICULAR TO IL-171	В			
4 MKL1	24+13	48′ RT	RAMP G	16.5	В	PERPENDICULAR TO IL-171	В			
6 MKL2	315+08	49' LT	RAMP G	25.0	А	PERPENDICULAR TO I-55	А			
4 MKL3	20+20	65′ RT	RAMP G	17.5	А	PERPENDICULAR TO RAMP G	A			
6 MKL4	212+06	32′ RT	RAMP E	17.5	В	7 DEGREES LEFT OF PERP. TO RAMP E	В			
6 MMN1	114+61	50' LT	RAMP H	16.5	В	PERPENDICULAR TO I-55	 B			
6 MMN2	119+35	46′ RT	RAMP H	15.0	A	PERPENDICULAR TO I-55	Δ			
6 NAB3	348+71	50′ RT	I-55	17.5	В	PERPENDICULAR TO I-55	В			
4 NAB4	353+79	47′ RT	I-55	17.5	В	PERPENDICULAR TO I-55	B			
4 NAB5	358+74	50′ RT	I-55	15.0	B	PERPENDICULAR TO I-55	В			
4 NAB6	363+89	49' RT	I-55	17.5	В	PERPENDICULAR TO I-55	В	AVOID EXISTING UNDERGROUND LIGHTING CABLE NEARBY		
6 NCD1	38+66	76′ RT	RAMP D	16.5	Δ	PERPENDICULAR TO RAMP E	Δ	AVOID EXISTING GIADENGINGGIAD ETGITTING CABLE INEMARK		
6 NCD2	329+62	46′ RT	I-55	16.5	Δ	PERPENDICULAR TO I-55	Λ			
4 NCD3	240+75	49' RT	RAMP E	16.5	Δ	PERPENDICULAR TO I-55	Λ			
6 NCD4	341+99	50′ RT	I-55	17.5	B R	PERPENDICULAR TO I-55				
6 NEF1	26+62	50' RT	RAMP C	16.5	Λ	13 DEGREES LEFT OF PERP. TO RAMP C	Λ			
6 NEF2	30+69	66′ RT	RAMP C	17.5	R	9 DEGREES LEFT OF PERP. TO RAMP C	В			
6 NEF3	22+74	50' RT	RAMP C	17.5	Λ	PERPENDICULAR TO I-55	Λ			
4 NEF4	38+58	41′ RT	IL-171	15.0	В	PERPENDICULAR TO IL-171	A 			
4 NGH1	38+66	57' LT	IL-171	17.5	D D	PERPENDICULAR TO IL-171	В			
4 NGH4	315+27		I-55		D	PERPENDICULAR TO I-55	В			
6 NGH5		51′ RT		16.5	D	PERPENDICULAR TO RAMP E	<del>_</del>	AVOID EVICTING UNDERCROUND LIGHTING CARLE NEADRY		
	217+22	61′ RT	RAMP E	17.5	Δ		B .	AVOID EXISTING UNDERGROUND LIGHTING CABLE NEARBY		
6 NIJ1	18+70	50′ RT	RAMP F	15.0	Α	PERPENDICULAR TO 1-55	<u>A</u>	AVOID EXISTING UNDERGROUND LIGHTING CABLE NEARBY		
4 NIJ2	13+49	44′ RT	RAMP F	15.5	A	PERPENDICULAR TO I-55	A	AVOID EXISTING UNDERGROUND LIGHTING CABLE NEARBY		
6 NKL1	33+46	65′ LT	RAMP D	17.5	Р В	PERPENDICULAR TO RAMP D	<u>B</u> .			
4 NKL2	33+42	30′ RT	IL-171	17.5	A	PERPENDICULAR TO IL-171	A			
6 NKL6	28+01	29′ RT	RAMP D	17.5	R	31 DEGREES LEFT OF PERP. TO RAMP D	В	AVOID EVICTIVE CONTRACTOR TO THE TOTAL TO THE TOTAL TOTAL TO THE TOTAL TO THE TOTAL TOTAL TO THE TOTAL TOTAL TO THE TOTAL TOTAL TOTAL TO THE TOTAL T		
4 NMN1	30+51	30′ RT	RAMP F	20.5	В	PERPENDICULAR TO IL-171	<u>B</u>	AVOID EXISTING UNDERGROUND TELEPHONE CABLE NEARBY		
6 NMN2	26+43	45′ RT	RAMP F	15.0	В	PERPENDICULAR TO RAMP F	В			
4 NMN5	36+05	49′ RT	RAMP F	17.5	В	PERPENDICULAR TO IL-171	В			

- 1. SEE LEGEND AND ABBREVIATIONS DRAWING FOR SYMBOLS AND CALLOUTS.
- 2. SEE HIGH MAST DETAIL DRAWINGS FOR LIGHT TOWER AND FOUNDATION DETAILS.
- 3. THE SCHEDULE ON THIS DRAWING REPLACES THE "SHAFT LENGTH TABLE" ON LIGHT TOWER FOUNDATION DETAIL.
- 4. OFFSET SHOWN IS TO CENTERLINE OF DRILLED SHAFT.
- 5. COORDINATE ALL WORK WITH CIVIL WORK, STRUCTURAL WORK, AND SUGGESTED STAGES OF CONSTRUCTION AND TRAFFIC CONTROL PLANS.
- 6. THE CONTRACTOR SHALL VERIFY THE EXISTING AND PROPOSED GROUND ELEVATIONS AND SLOPES PRIOR TO BEGINNING ANY FOUNDATION DRILLING WORK. THE CONTRACTOR SHALL IMMEDIATELY NOTIFY THE ENGINEER IF THERE ARE ANY CONFLICTS WITH THE PROPOSED FOUNDATION AND WORK PAD LOCATIONS OR TYPES. THE FOUNDATIONS MUST BE DRILLED TO THE DESIGN DEPTH. MODIFICATIONS TO THE WORK PAD TYPES SHALL BE APPROVED BY THE ENGINEER.
- 7. SERVICE PAD TYPE A IS FLAT. SERVICE PAD TYPE B INCLUDES LOW RETAINING WALL DUE TO SLOPE.

FILE NAME =	DESIGNED -	GRR	REVISED -			HIGH MAST LIGHT TOWER	F.A	4. P	SECTION	COUNTY TOTAL SHEET
\D160W75-sht-IL171-highmast-schedule.dgn	DRAWN -	JLW	REVISED -	benesch	STATE OF ILLINOIS	FOUNDATION SCHEDULE	372	2/373	2013-037B-R	COOK 787 173
USER NAME = jworthington	CHECKED -	GHT	REVISED -	engineers · scientists · planners	DEPARTMENT OF TRANSPORTATION	TOUNDATION SCIEDOLE				CONTRACT NO. 60W75
PLOT DATE = 8/31/2015	DATE -	6/12/2015	REVISED -			SCALE: N.T.S.   SHEET 3 OF 61 SHEETS STA.	TO STA.		ILLINOIS FED. AI'	PROJECT

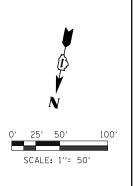

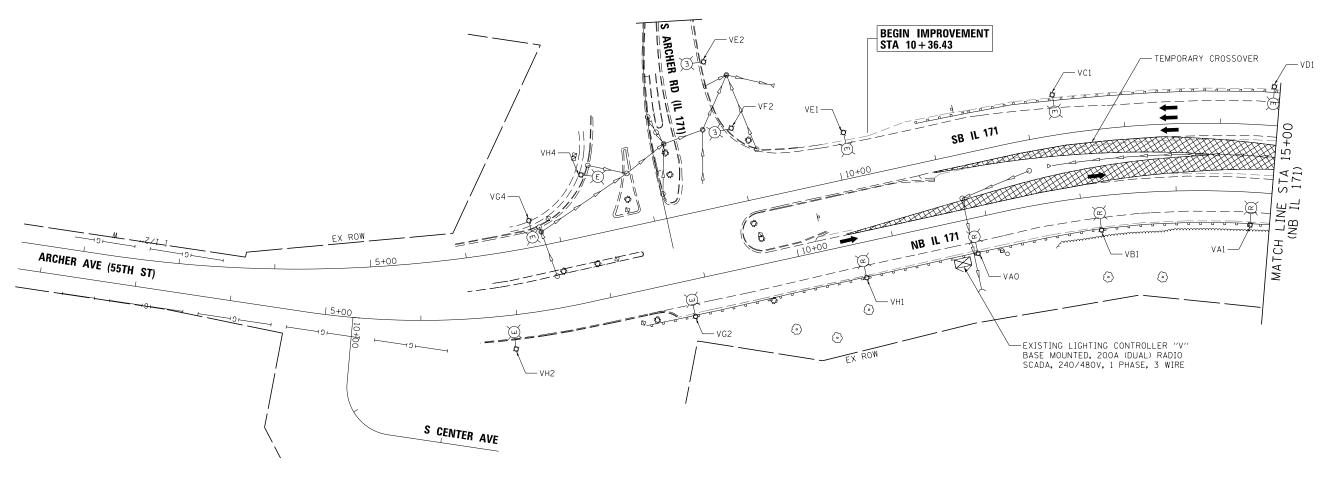

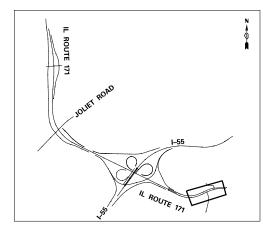



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\D160W75-sht-IL171-exl:ght-NB-01.dgn	DRAWN - JLW	REVISED -	🥔 benes
USER NAME = jworthington	CHECKED - GHT	REVISED -	engineers - scientists
PLOT DATE = 8/31/2015	DATE - 6/12/2015	REVISED -	,

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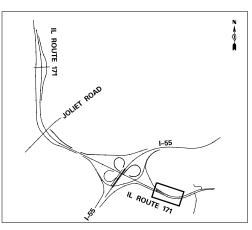
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	SCALE:	1''=50'	SHEET	4 OF	61	SHEETS	STA.	TO STA.

F.A.P RTE.	SECTION		COUNTY	TOTAL SHEETS	SHEET NO.
372/373	2013-037B-R	COOK	787	174	
			CONTRACT	NO. 6	OW75
	ILLINOIS	FED. A	D PROJECT		



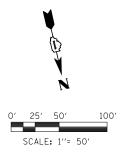

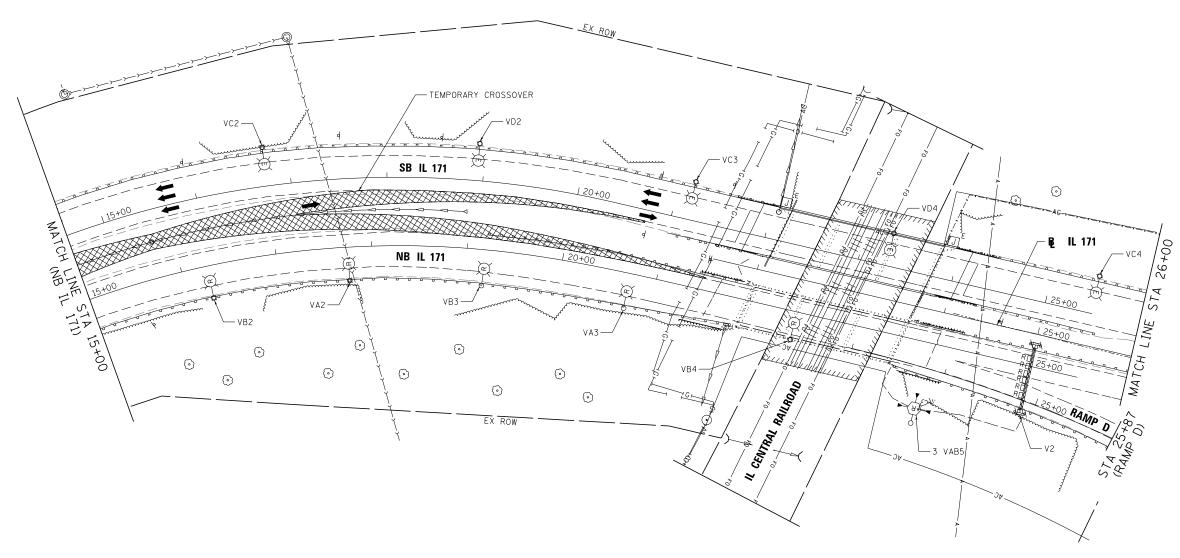
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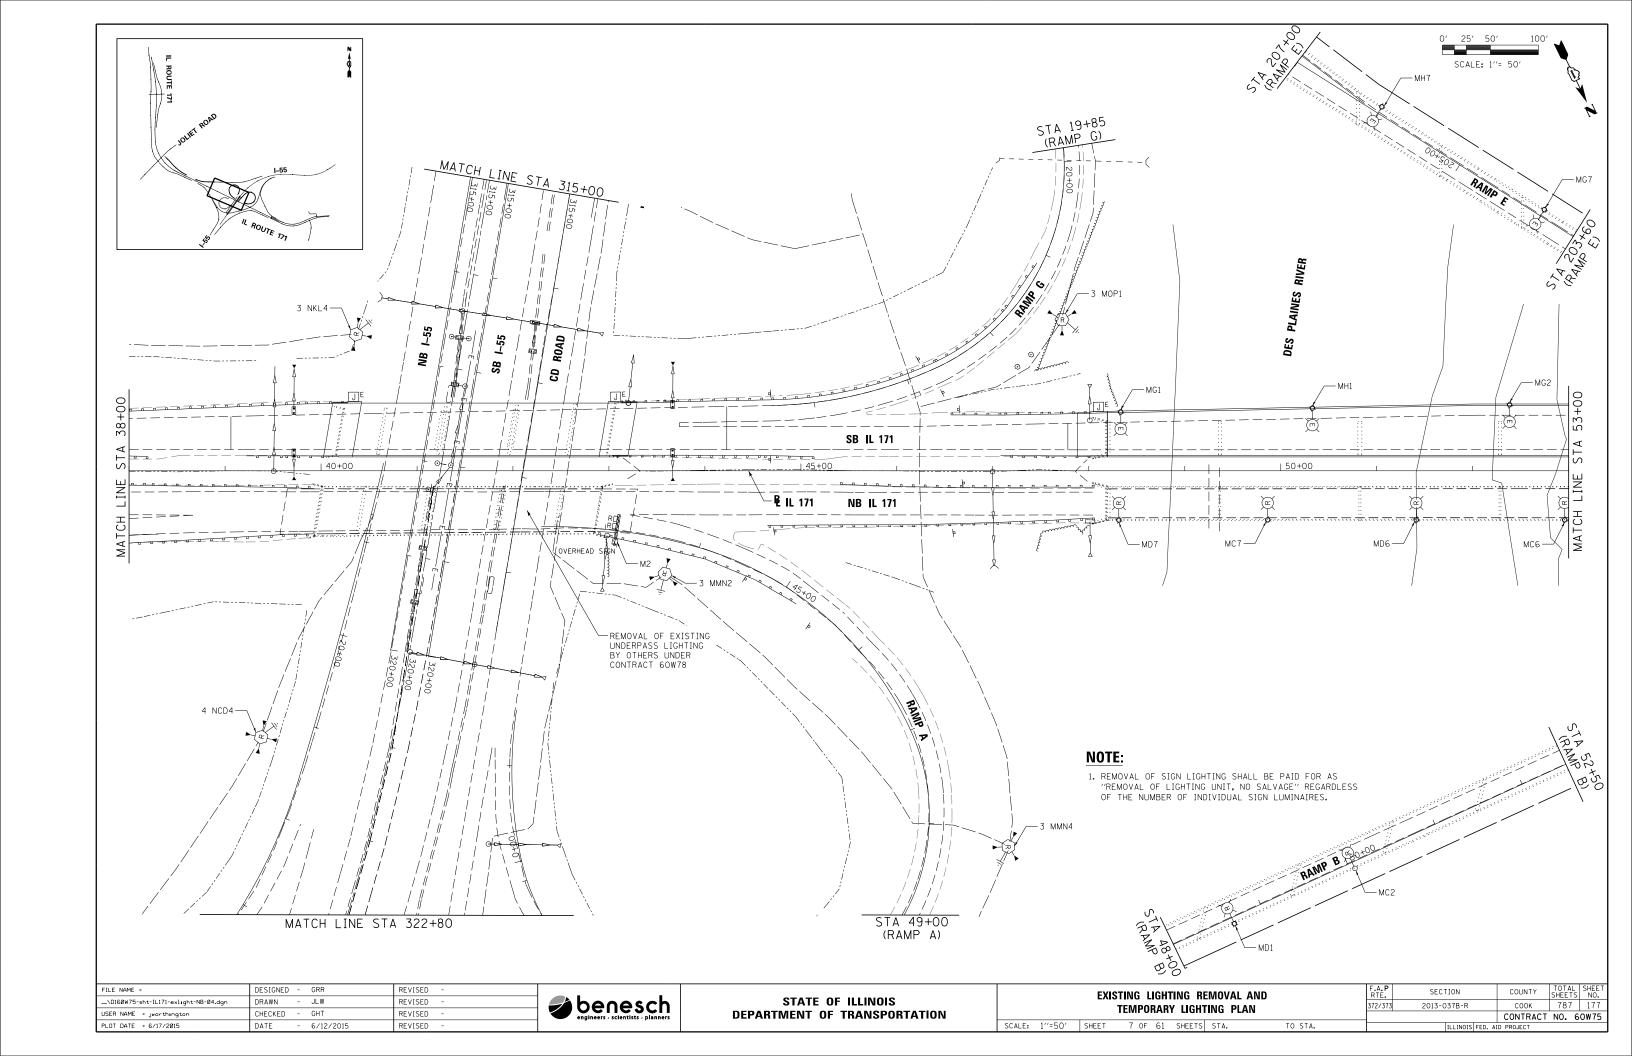



ILE NAME =	DESIGNED - GRR	REVISED -	_
ND160W75-sht-IL171-exlight-NB-02.dgn	DRAWN - JLW	REVISED -	🎏 benesch
SER NAME = jworthington	CHECKED - GHT	REVISED -	engineers - scientists - planners
OT DATE = 8/31/2015	DATE - 6/12/2015	REVISED -	•


STATE OF ILLINOIS	
DEPARTMENT OF TRANSPORTATION	


EXISTING LIGHTING REMOVAL AND						SECTION	COUNTY	TOTAL	SHEET NO.
TEMPORARY LIGHTING PLAN				372/373	2013-037B-R	соок	787	175	
							CONTRACT	NO. 6	50W75
	SCALE: 1''=50'	SHEET 5 OF 61 SHEETS	STA.	TO STA.		ILLINOIS F	FED. AID PROJECT		




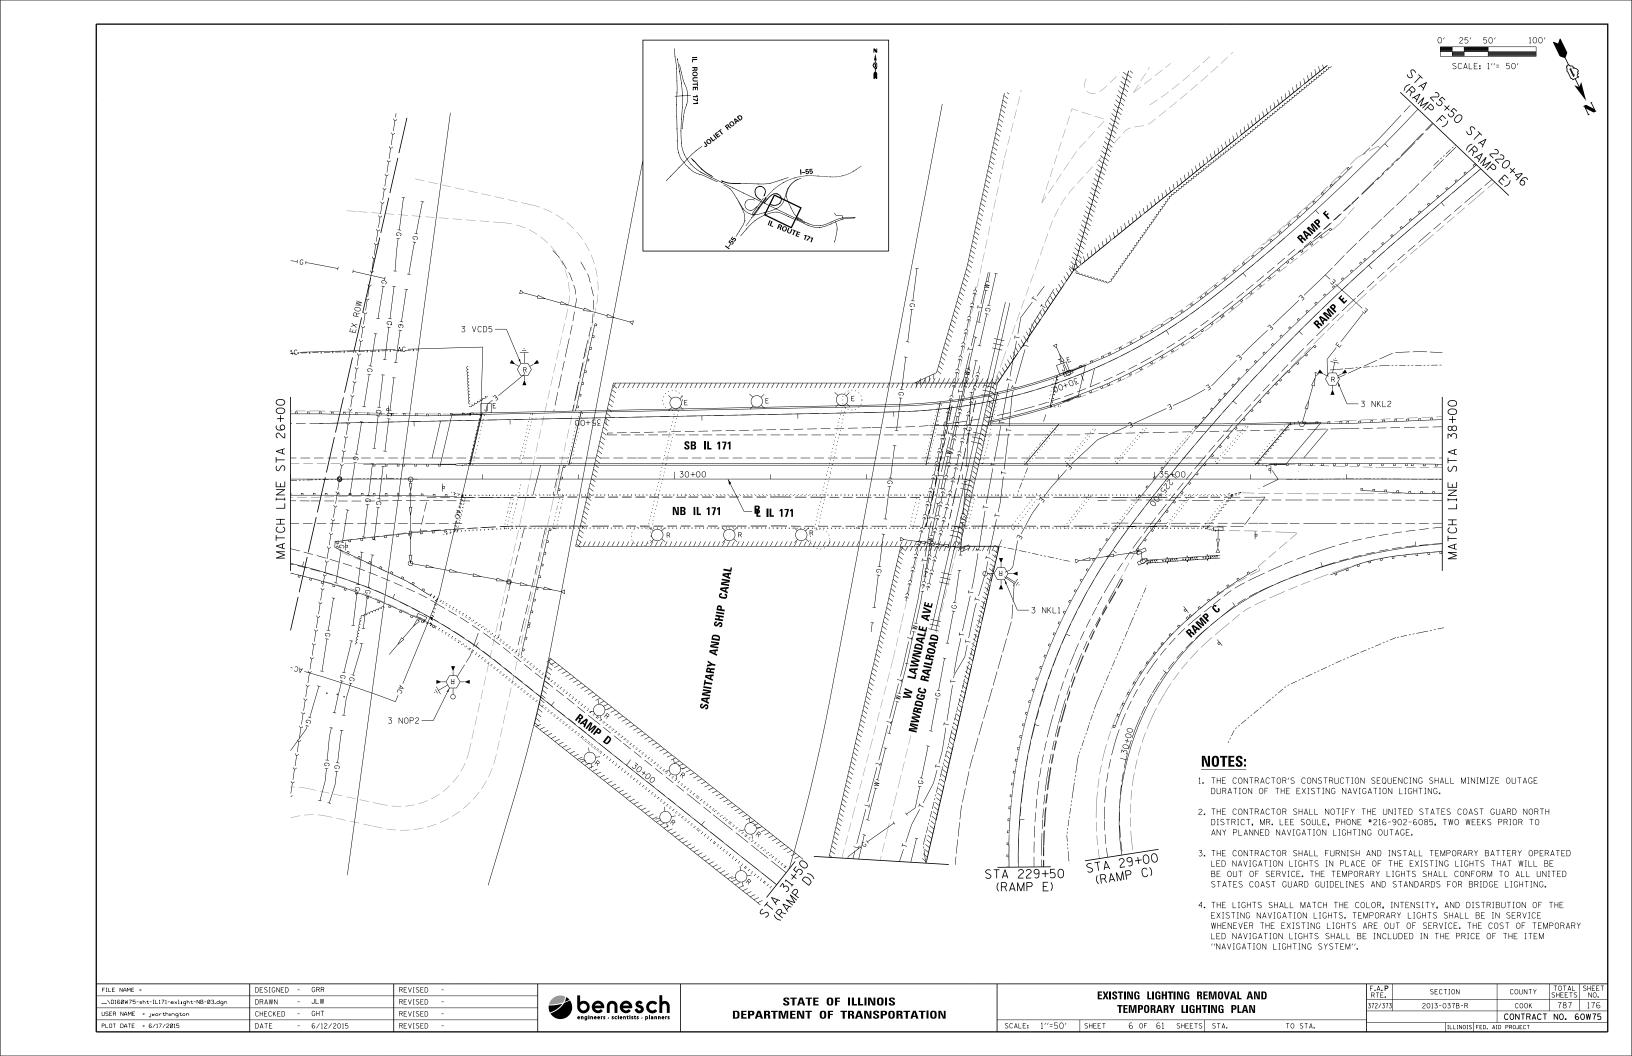


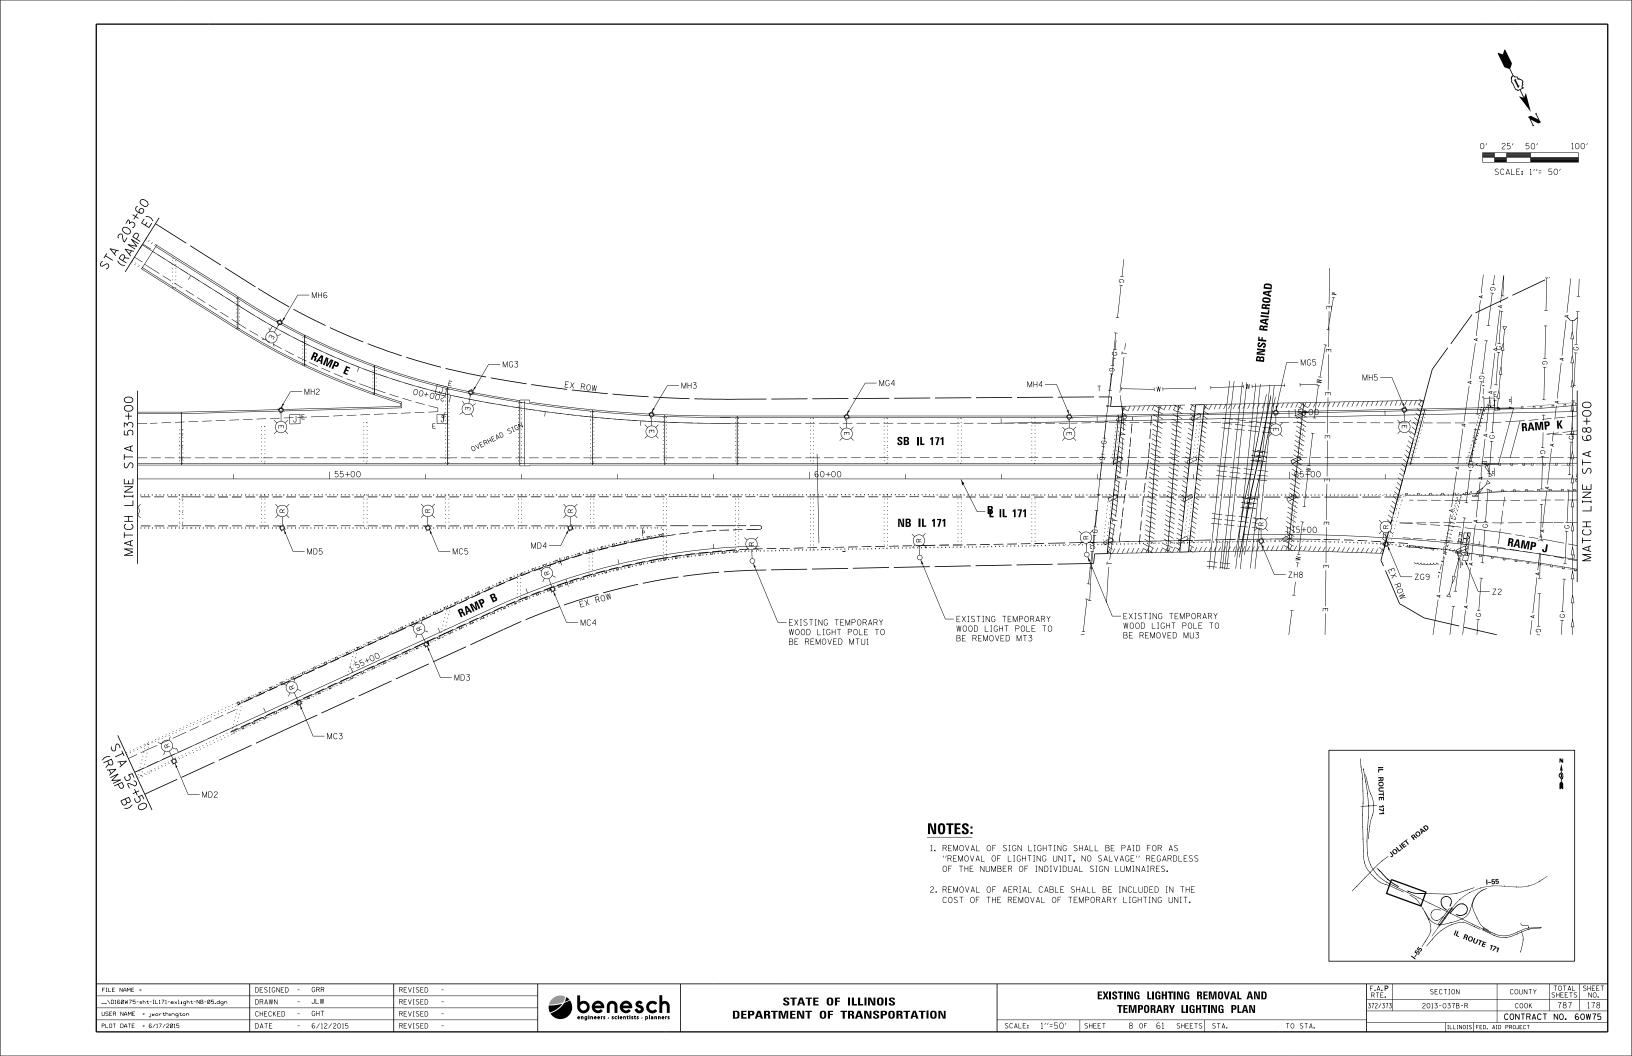


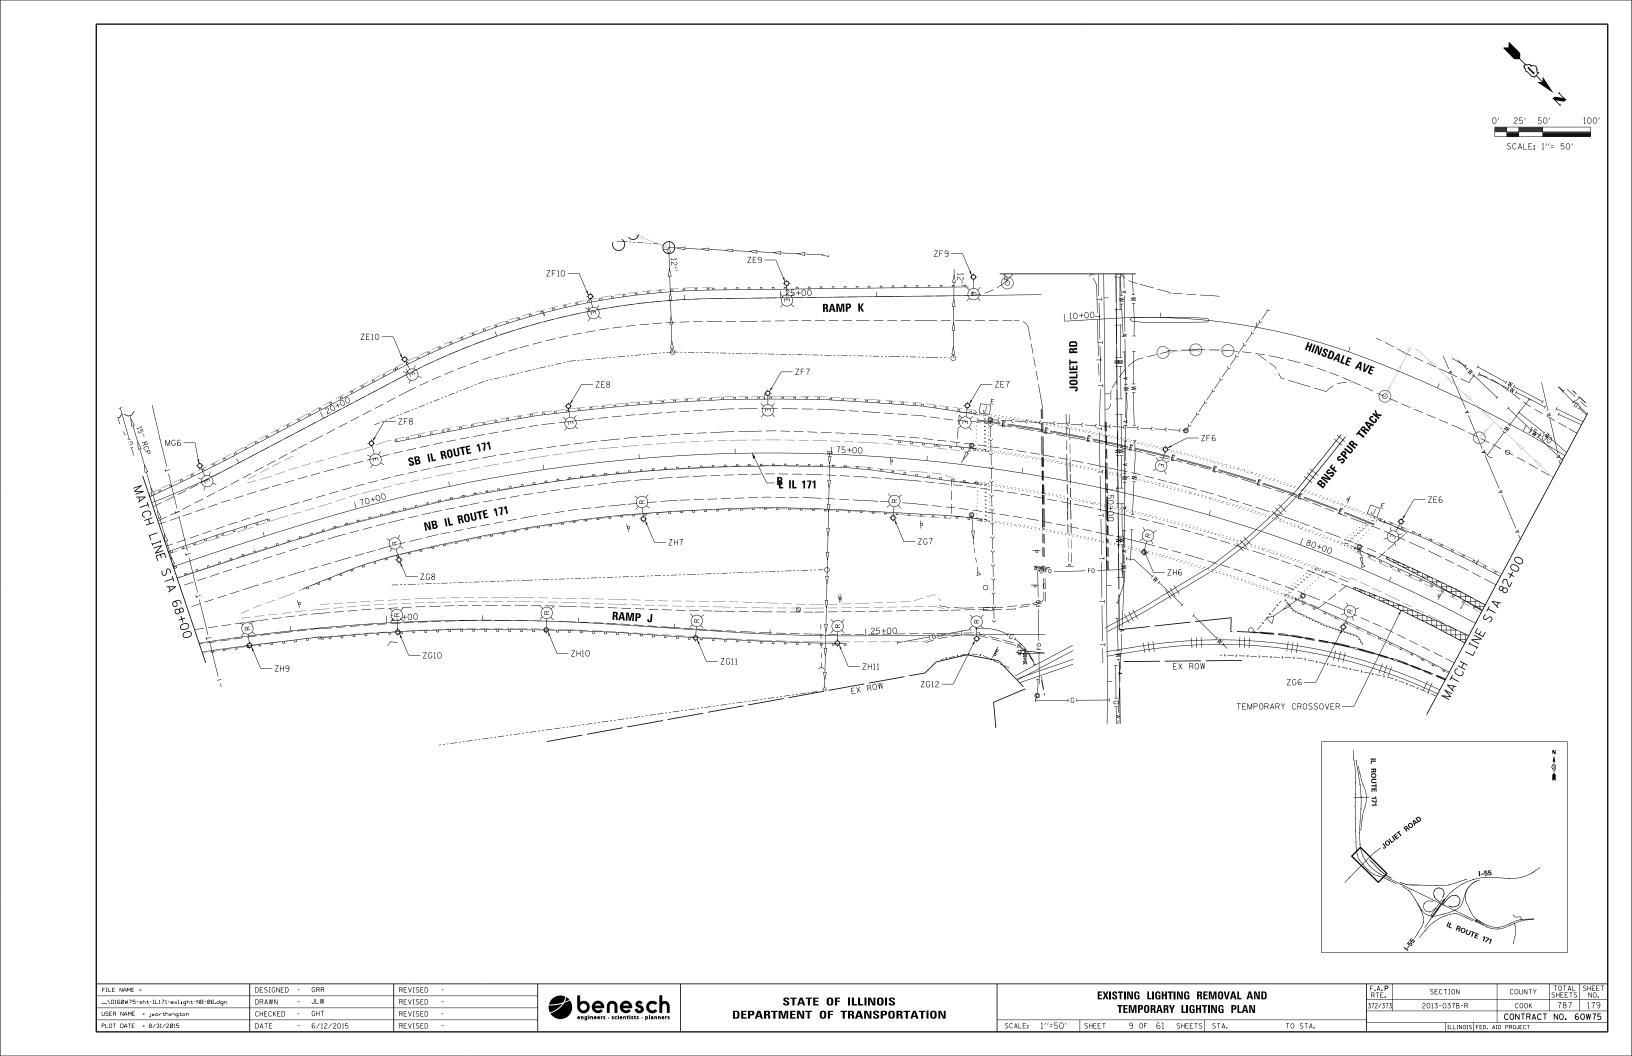


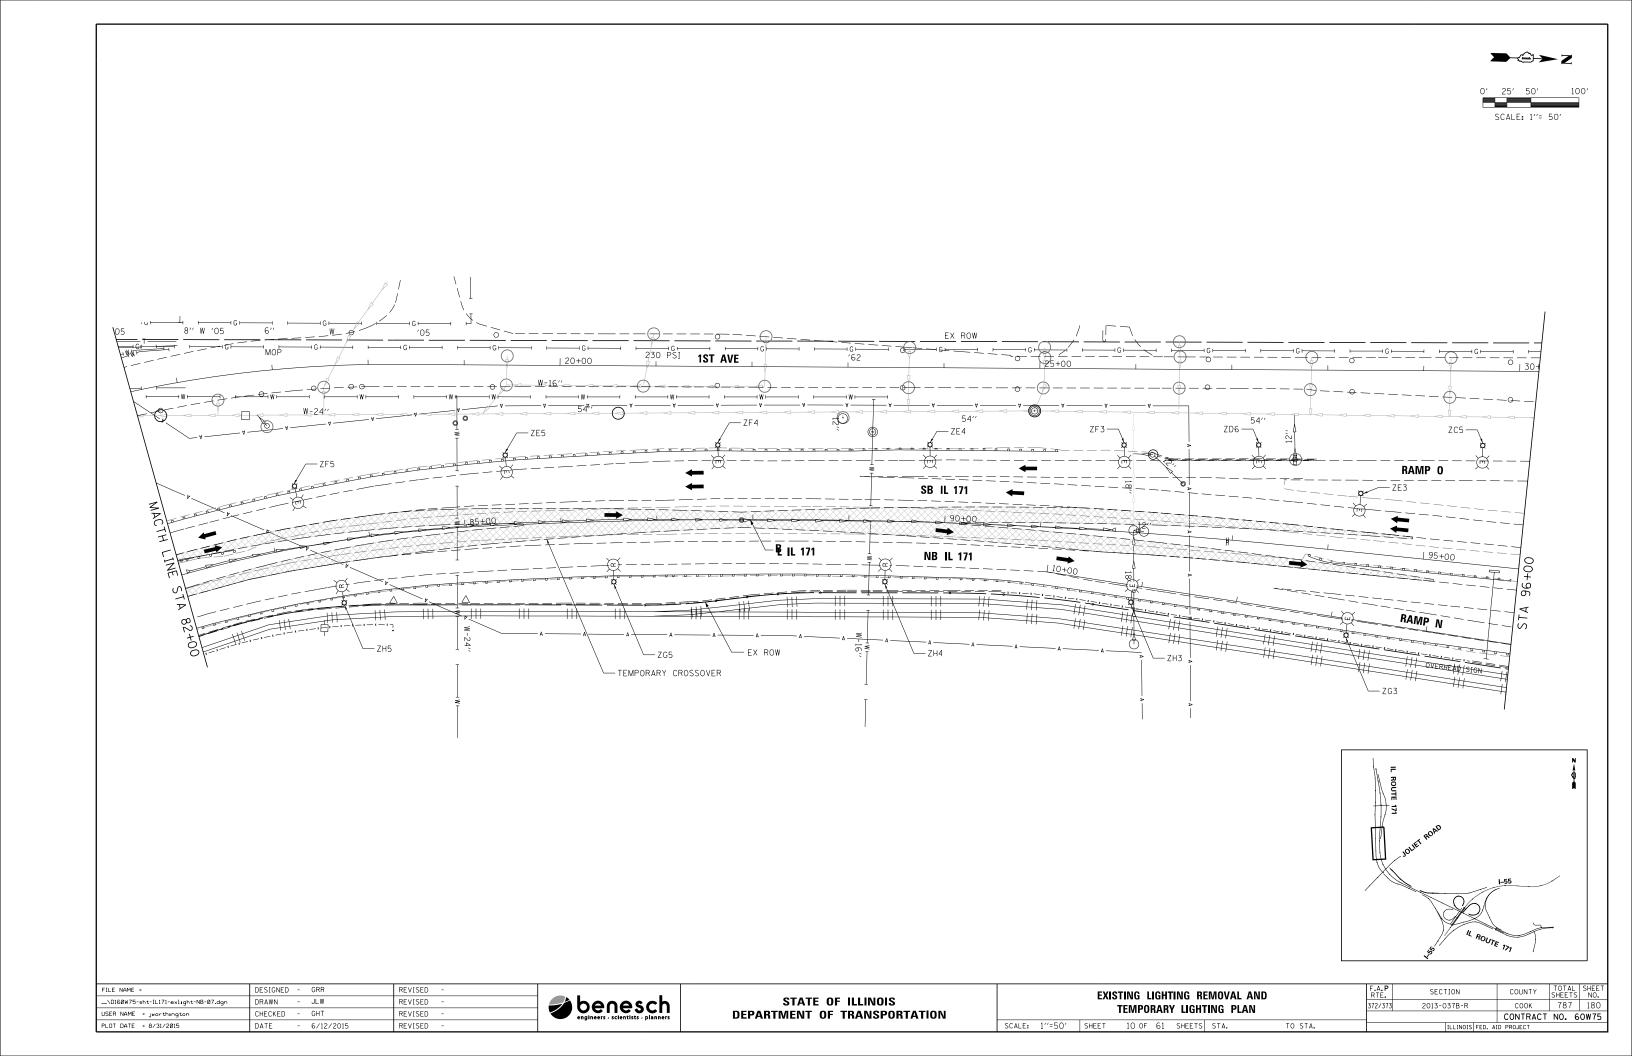


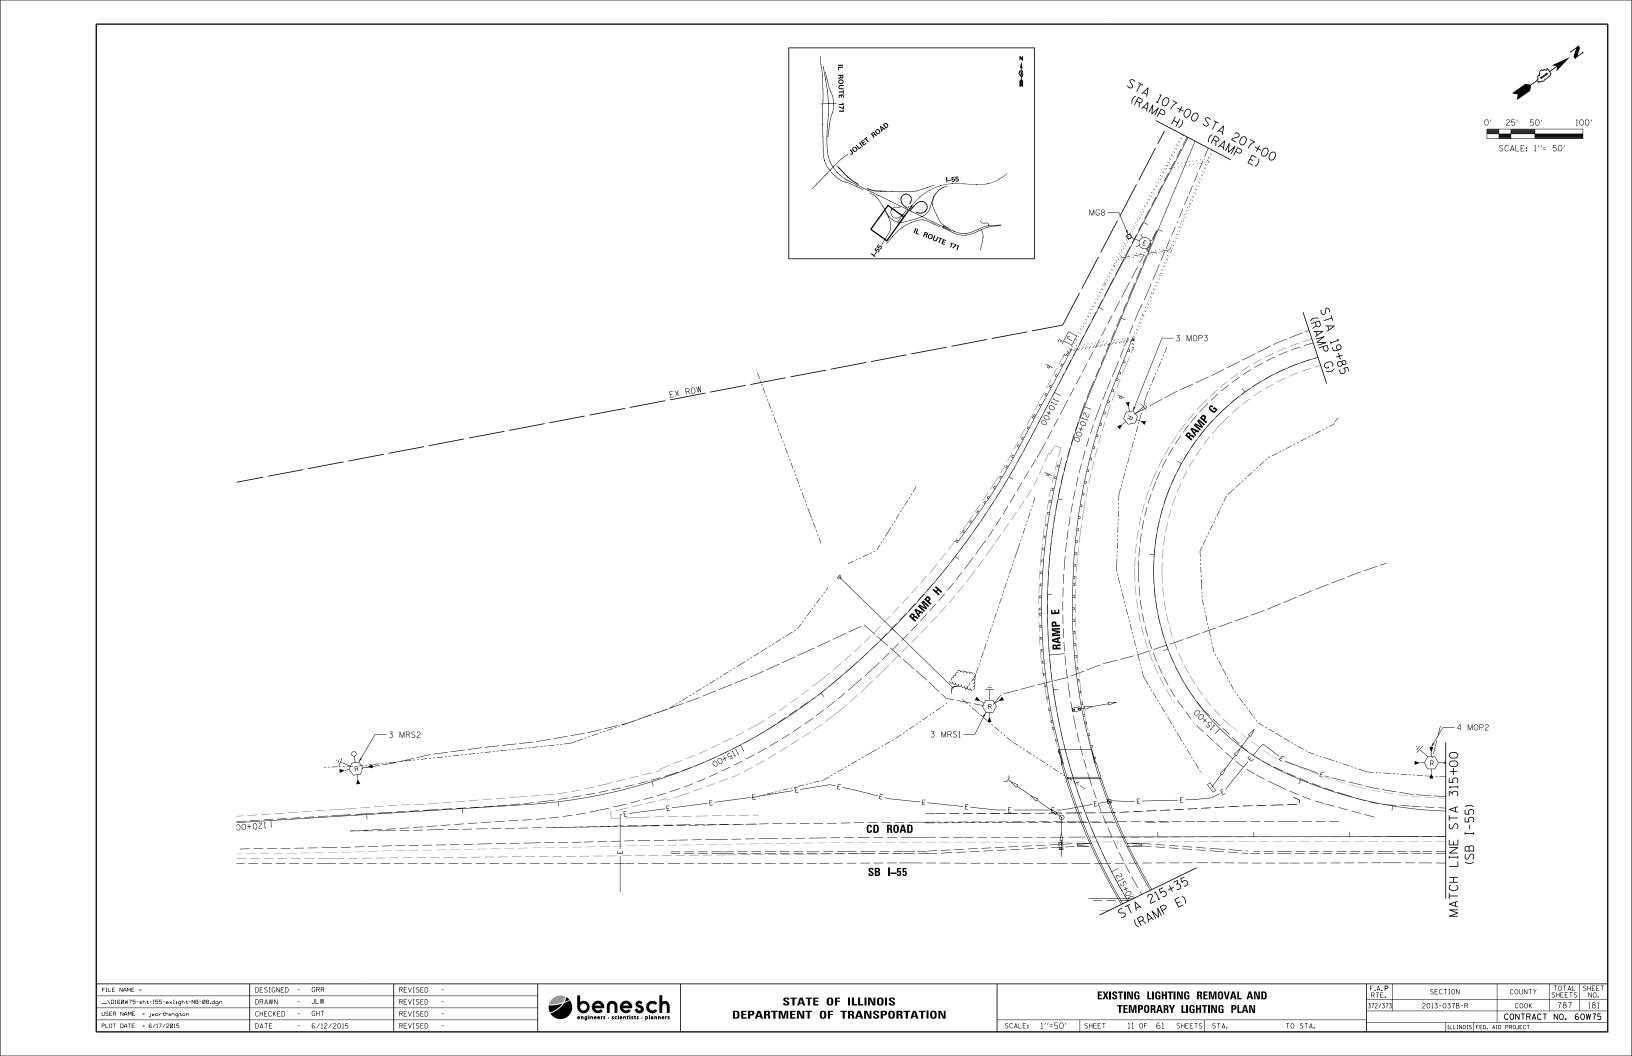


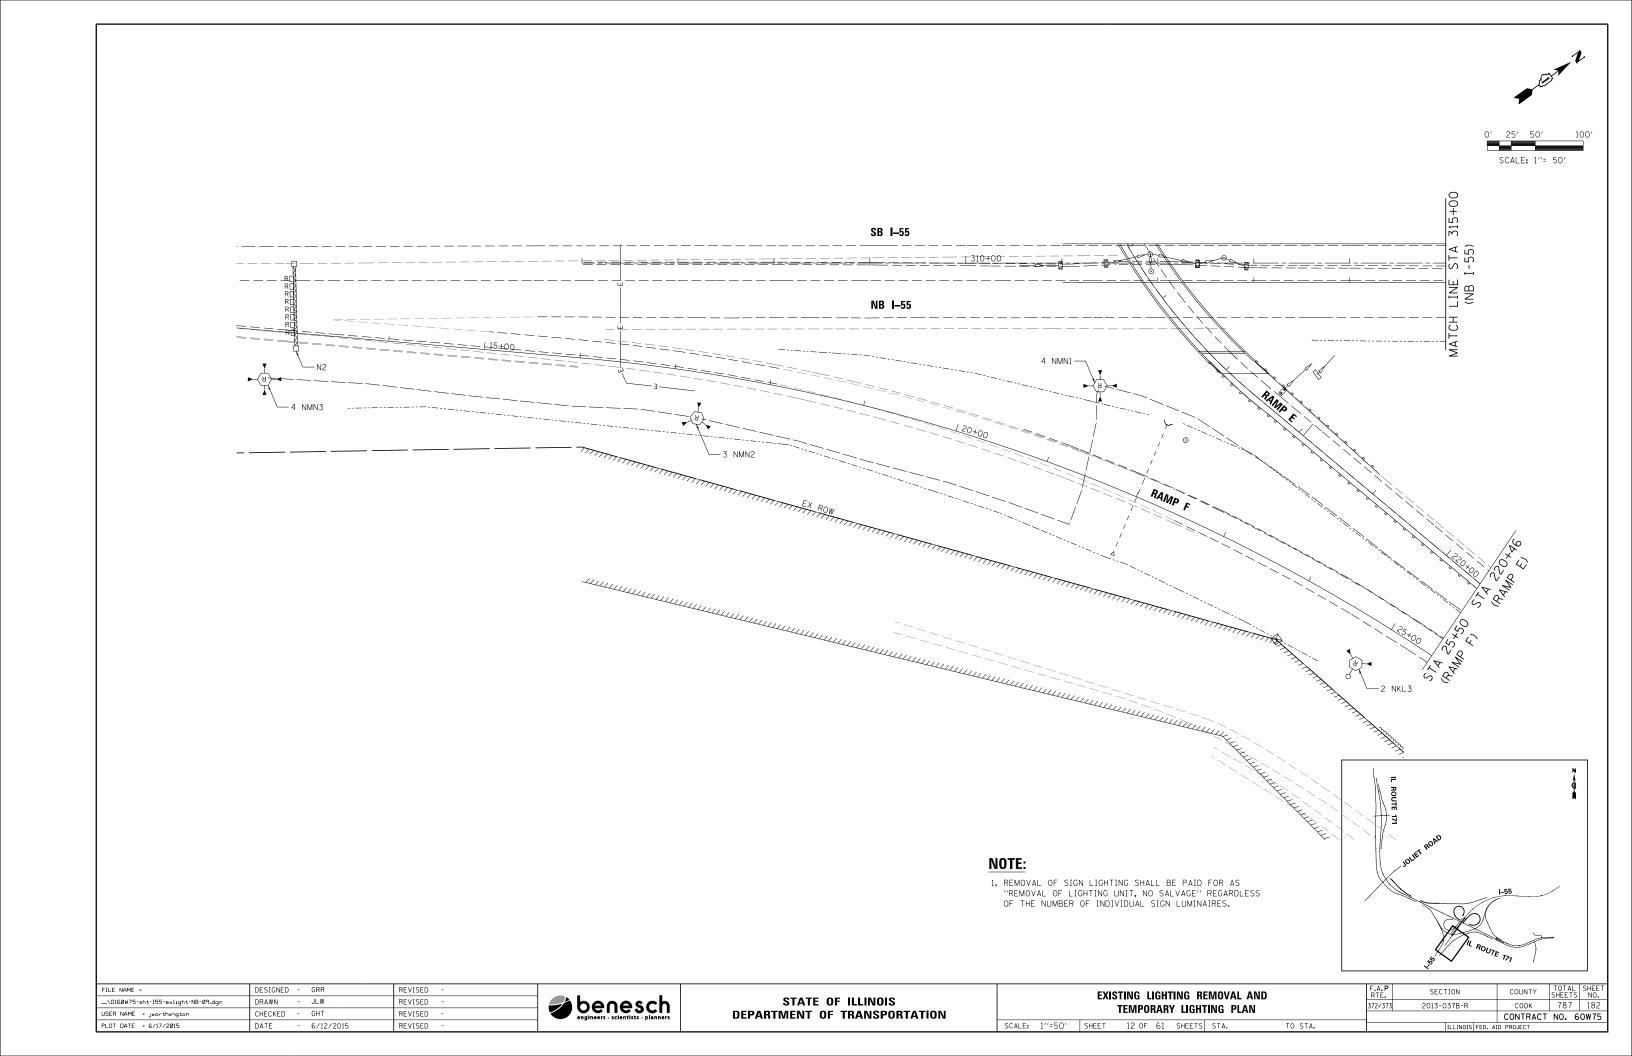

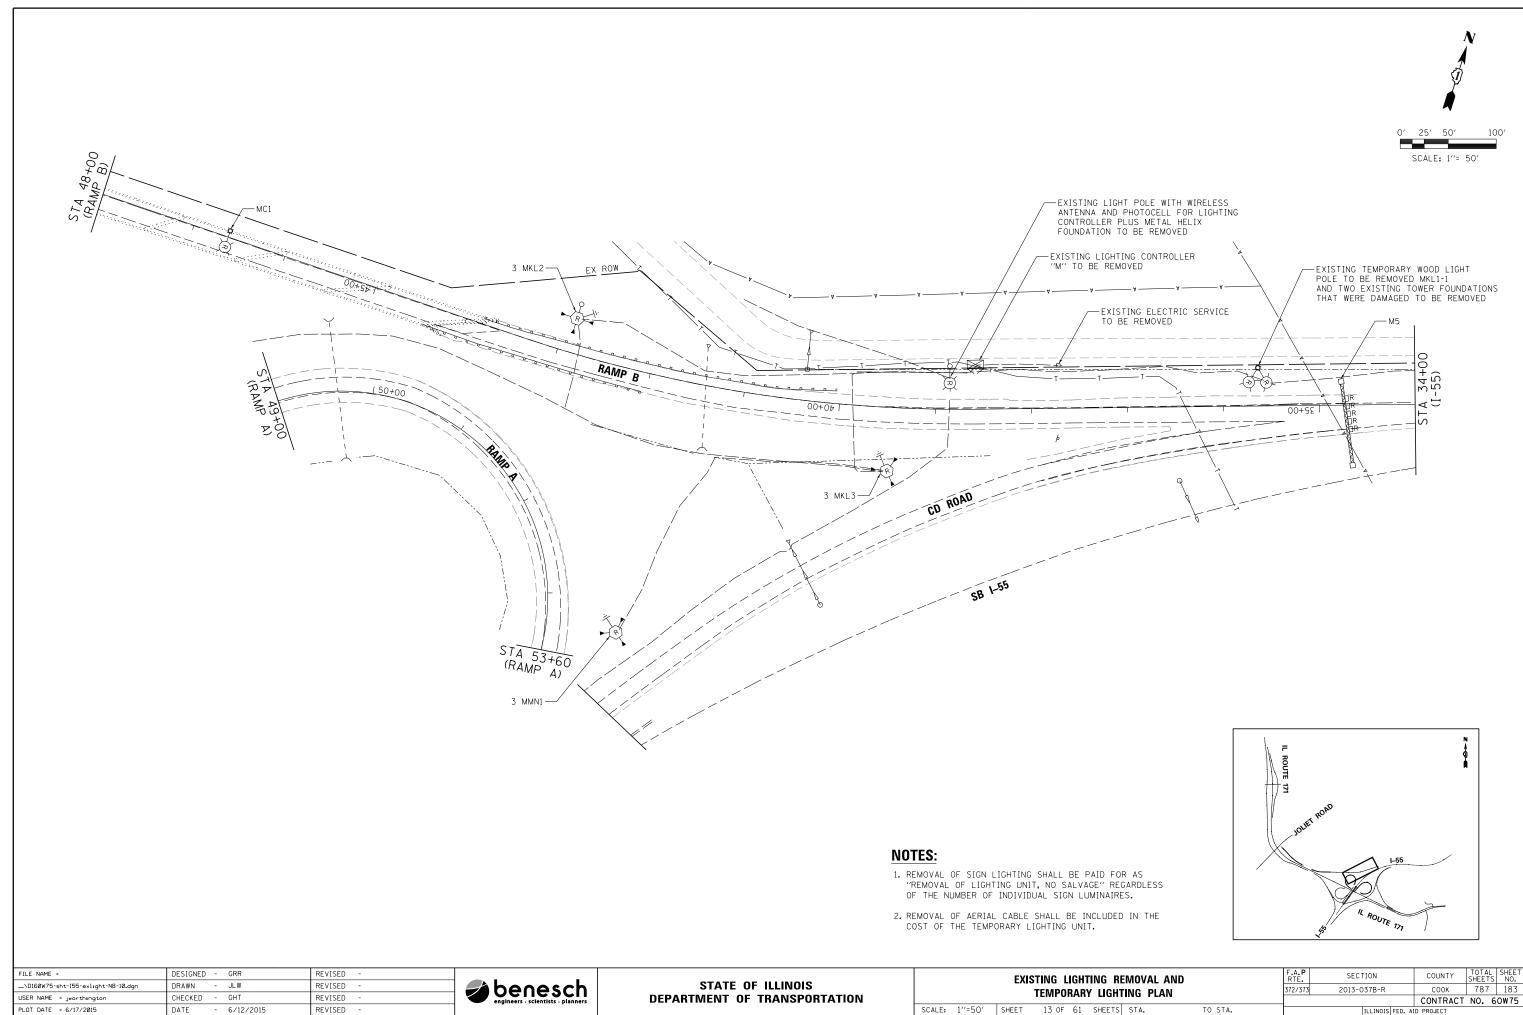

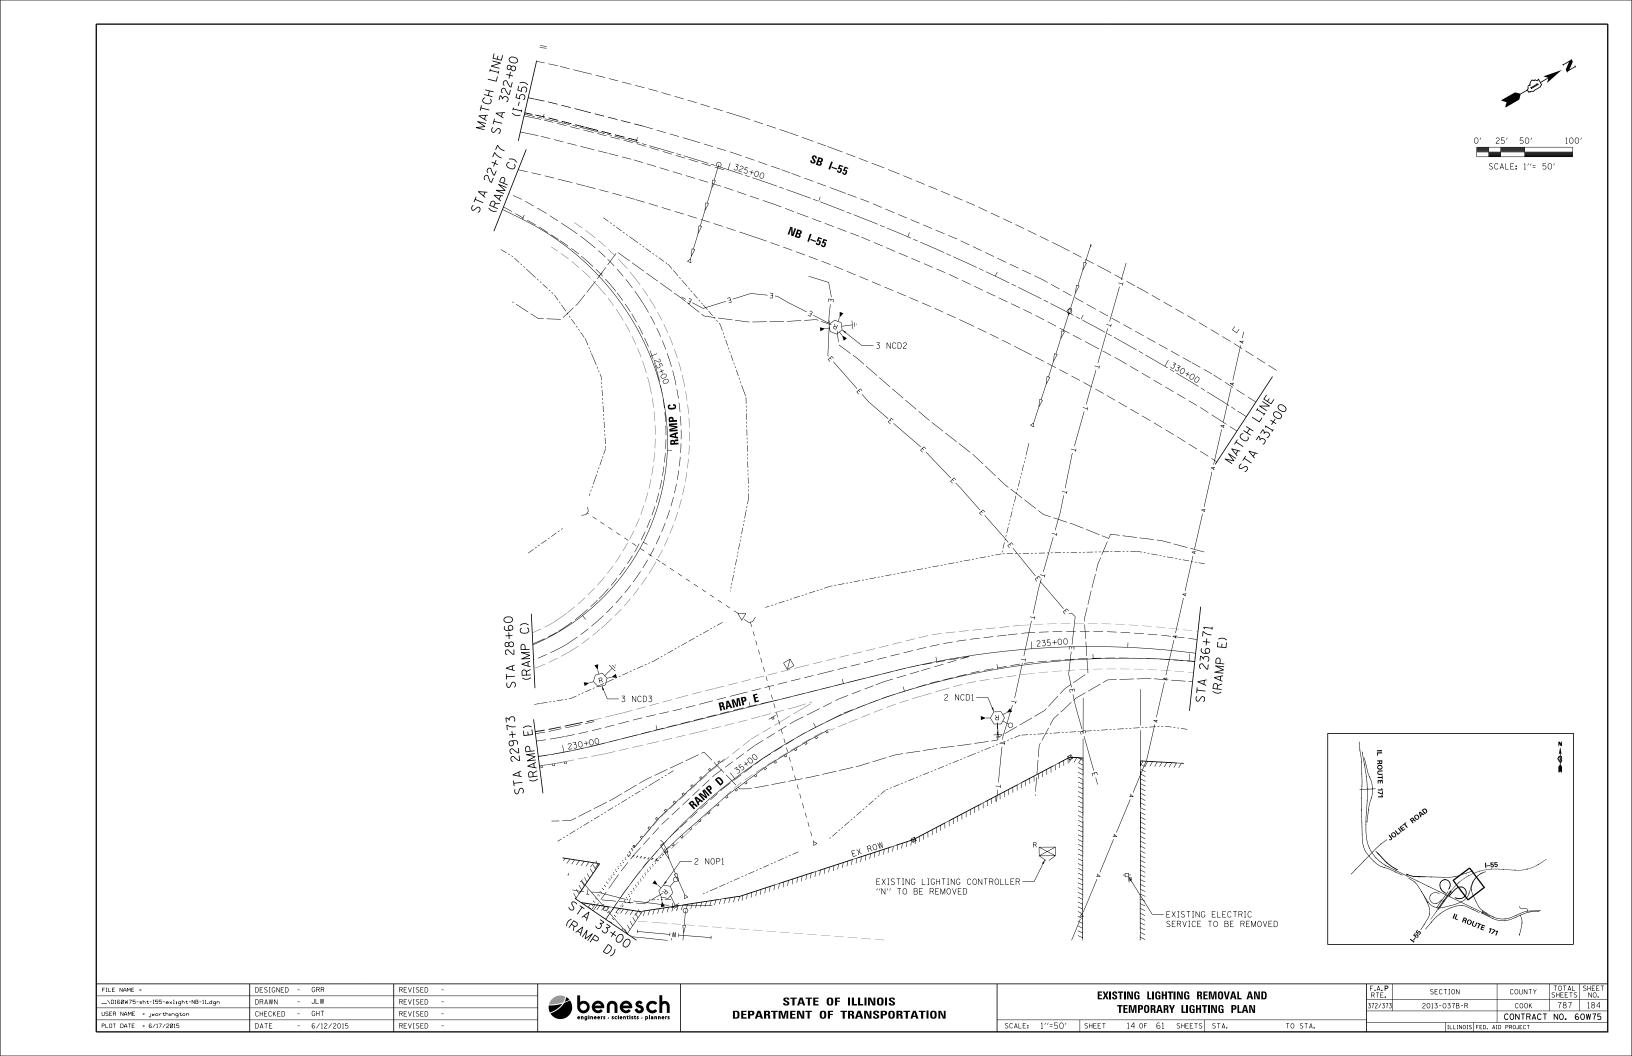


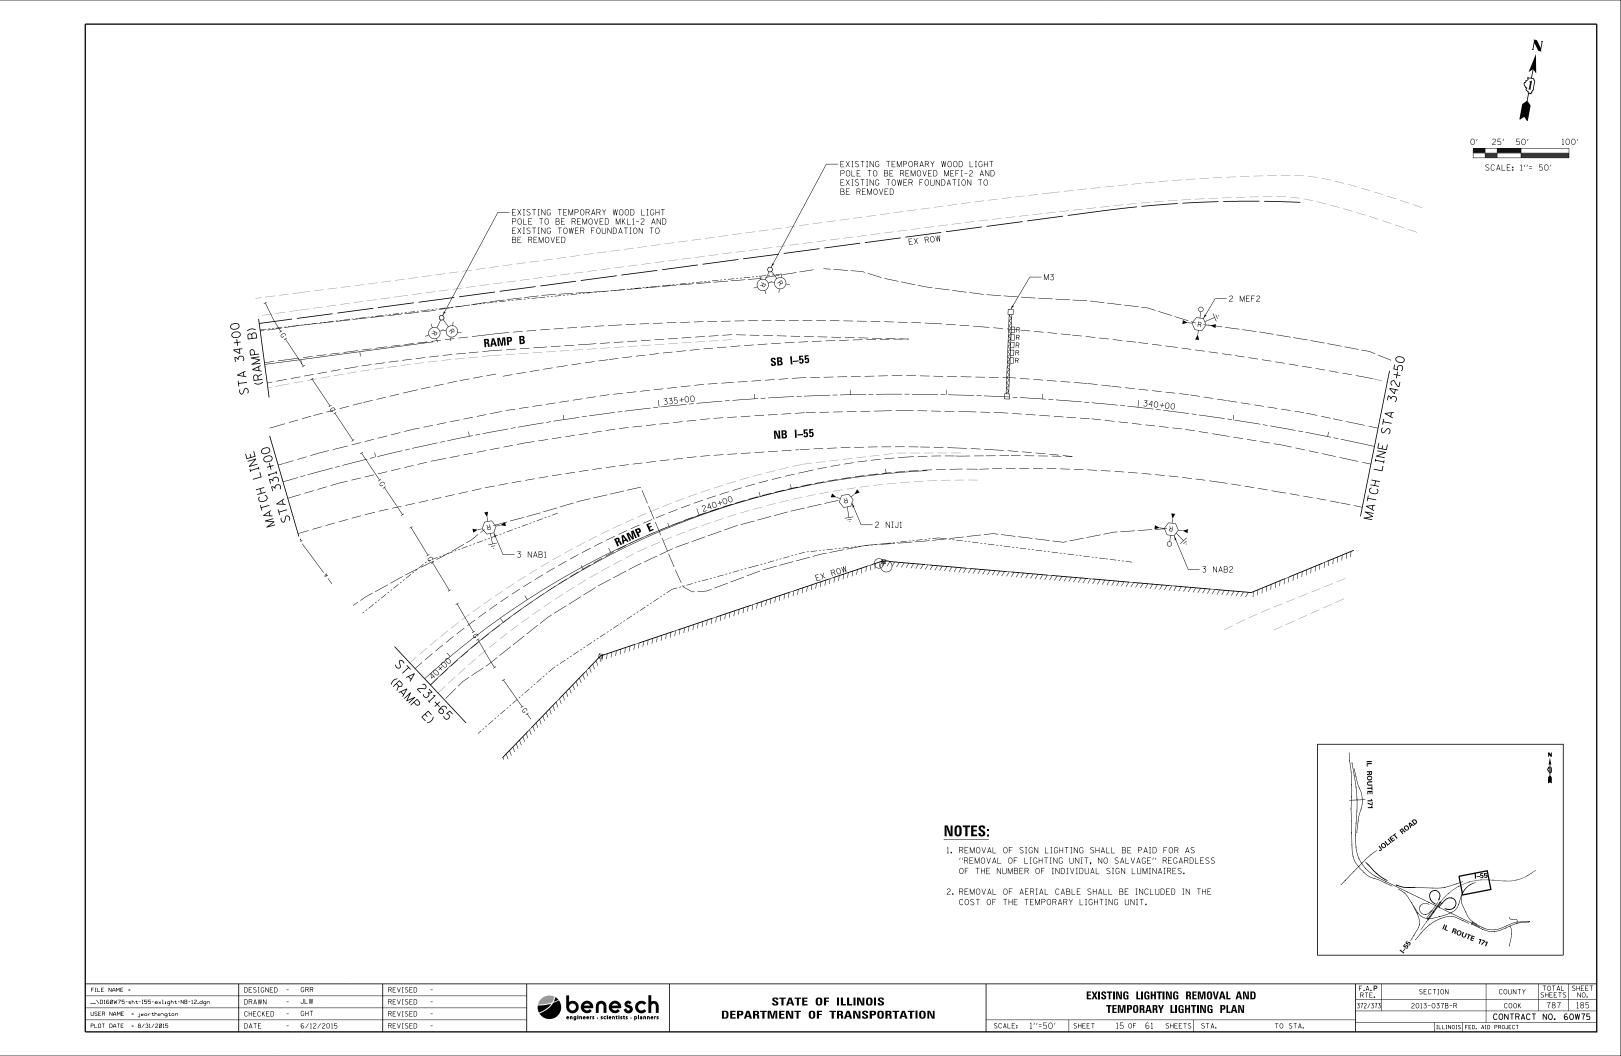


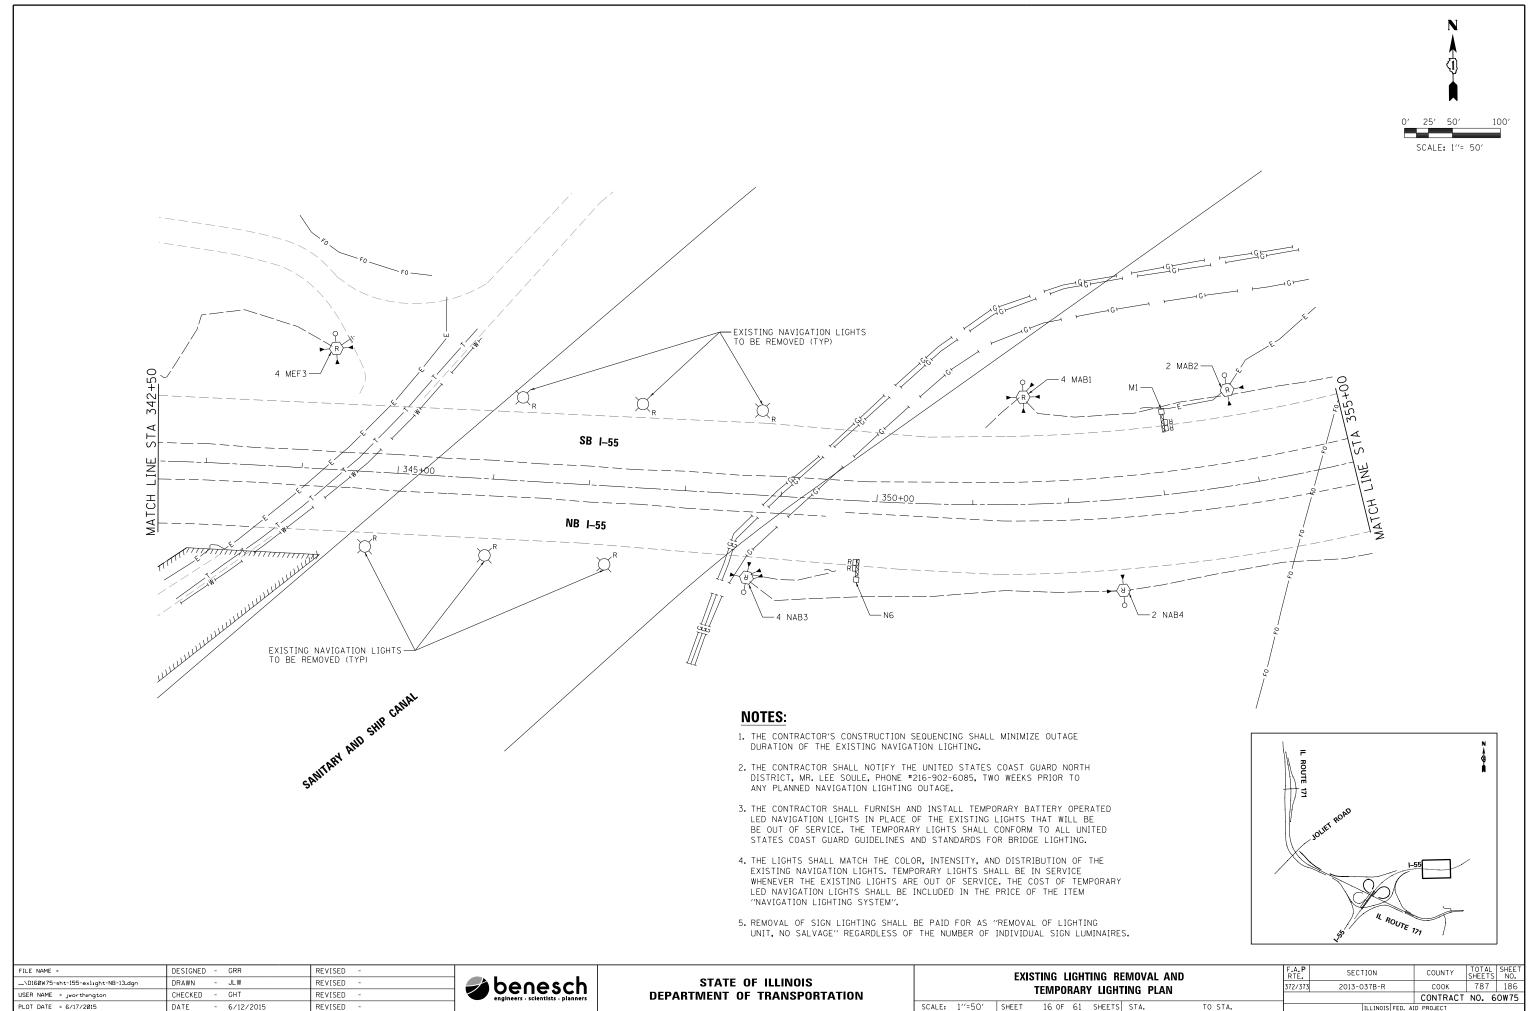

EXISTING LIGHTING REMOVAL AND				F.A.P RTE.			
TEMPORARY LIGHTING PLAN					372/373		
					••		
FFT	16.0F	61	SHEETS	STA.	TO STA.		_


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		CONTRACT	NO. 6	OW75
372/373	2013-037B-R	соок	787	186
F.A.P RTE.	SECTION	COUNTY	TOTAL SHEETS	SHEE'

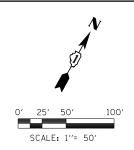

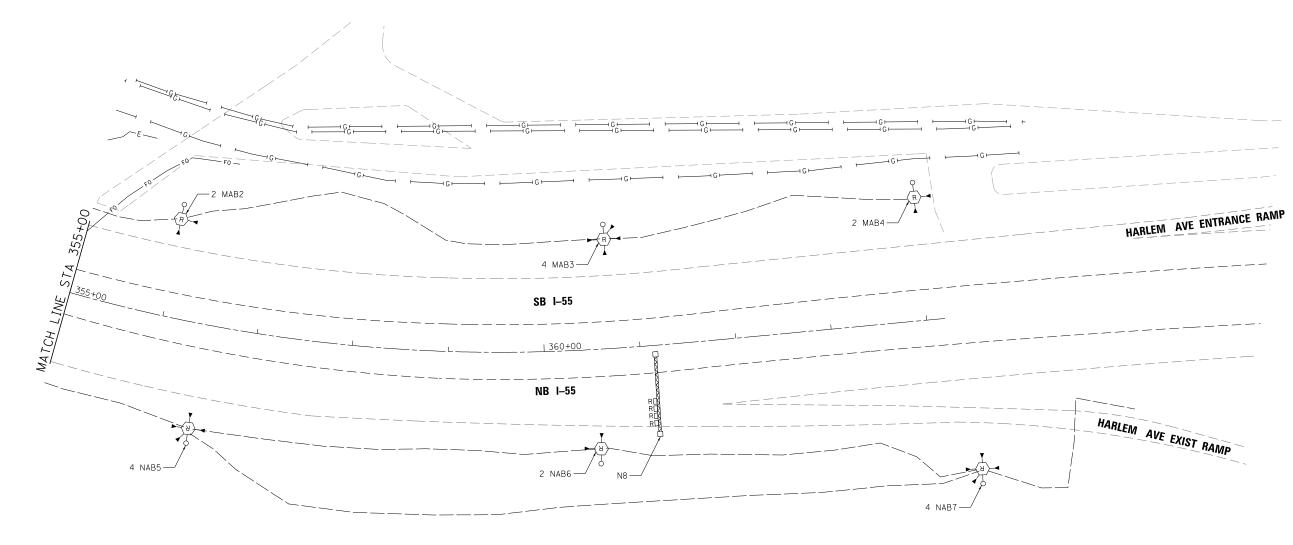

## NOTE:


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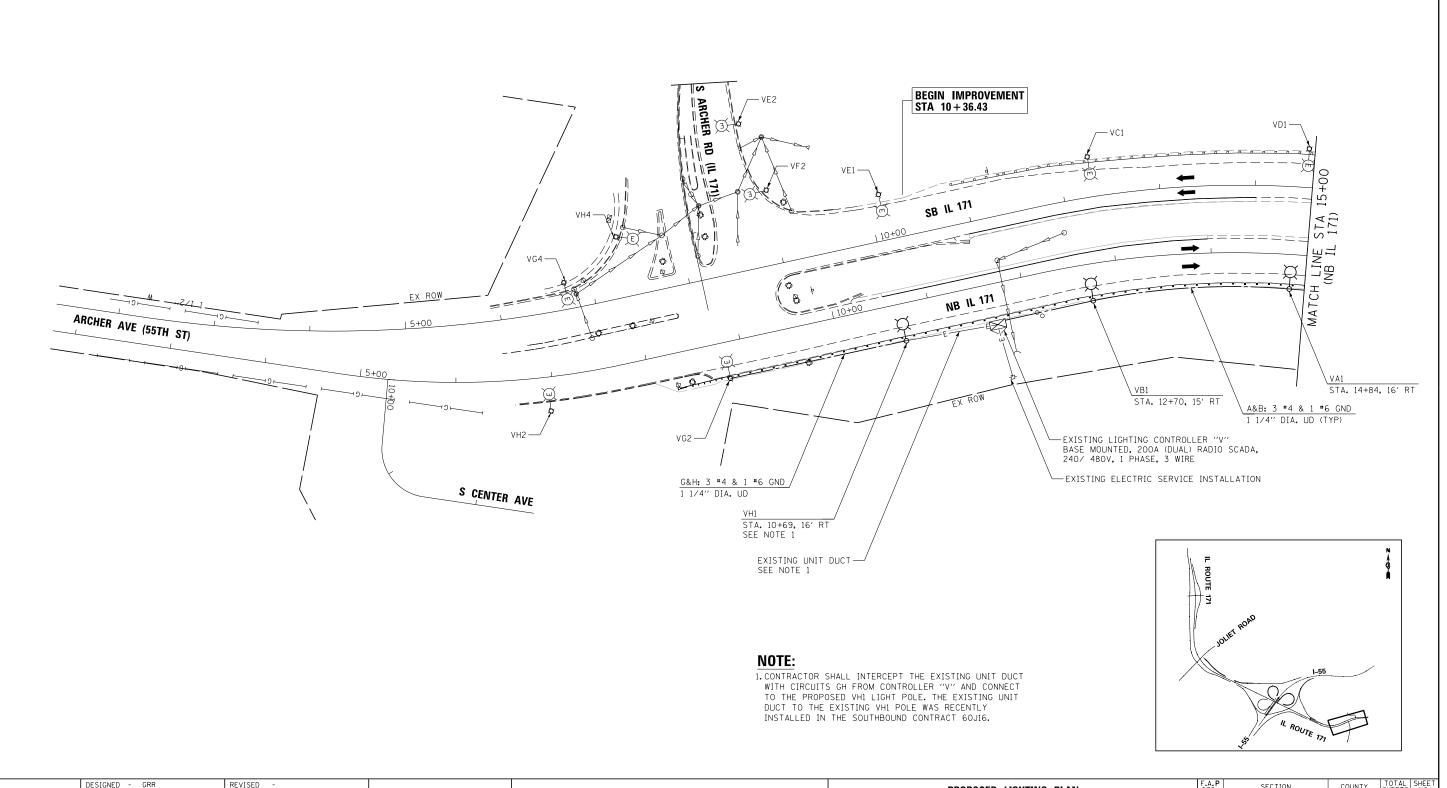

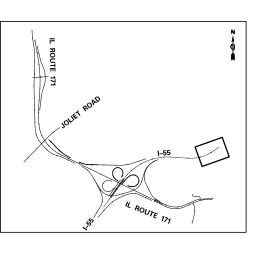
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\D160W75-sht-I55-exlight-NB-14.dgn	DRAWN - JLW	REVISED -	benesch
USER NAME = jworthington	CHECKED - GHT	REVISED -	engineers - scientists - planners
PLOT DATE = 6/17/2015	DATE - 6/12/2015	REVISED -	·

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	EXISTING LIGHTING REMOVAL AND TEMPORARY LIGHTING PLAN					F.A.P RTE.	SECTIO	N	COUNTY	TOTAL SHEETS	SHEE NO.			
						372/373	2013-037	B-R	COOK	787	187			
									CONTRACT	NO. 6	OW 75			
	SCALE:	1′′=50′	SHEET	17 OF	61	SHEETS	STA.	TO STA.		ILI	INOIS FED. AI	D PROJECT		



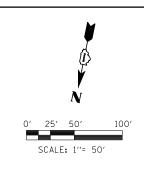



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\D160W75-sht-IL171-prlight-NB-01.dgn	DRAWN - JLW	REVISED -	benesch
USER NAME = jworthington	CHECKED - GHT	REVISED -	engineers - scientists - planners
PLOT DATE = 8/31/2015	DATE - 6/12/2015	REVISED -	,

STATI	E OF	ILLINOIS
DEPARTMENT	OF 1	<b>TRANSPORTATION</b>

SCALE: 1"=50"


PROPOSED LIGHTING PLAN			F.A.P RTE.	SECTION	COUNTY	TOTAL SHEETS	SHEE NO.			
IL 171				372/373	2013-037B-R	соок	787	188		
IE 1/1						CONTRACT	NO. 6	50W75		
SHEET	18 OF	61	SHEETS	STA.	TO STA.		ILLINOIS FED. A	ID PROJECT		

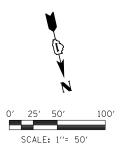

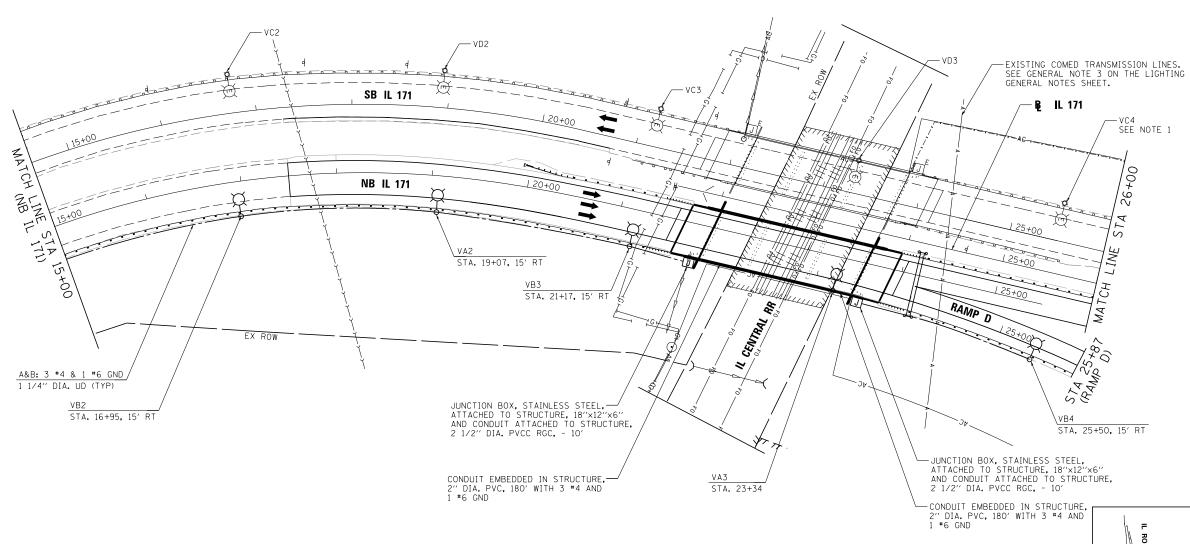

## NOTE:

1. AFTER PROPOSED CIRCUITS MN FROM CONTROLLER "N" TO THE PROPOSED HIGH MAST TOWER 4 NMN5 AND EXISTING NAVIGATION LIGHTING WEST OF THIS POLE ARE INSTALLED, CONTRACTOR SHALL DISCONNECT EXISTING CONTROLLER "V" CIRCUITS CD FEED TO THE EXISTING HIGH MAST TOWER 3 VCD5 AND NAVIGATION LIGHTS AT THIS POLE. DISCONNECTION SHALL BE PERFORMED PRIOR TO CONNECTING THE EXISTING NAVIGATION LIGHTING TO CONTROLLER "N" CIRCUITS MN.

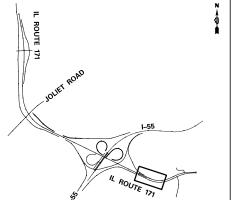



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\D160W75-sht-IL171-prlight-NB-02.dgn	DRAWN - JLW RE	EVISED -
USER NAME = Jworthington	CHECKED - GHT RE	EVISED -
PLOT DATE = 8/31/2015	DATE - 6/12/2015 RE	EVISED -


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	PROPOSED LIGHTING PLAN IL 171				F.A.P RTE.	SECTION	COUNTY	TOTAL	SHEET NO.		
					372/373	2013-037B-R	соок	787	189		
	IE 1/1							CONTRACT	NO. 6	OW75	
SCALE:	1''=50'	SHEET	19 OF 6	1 SHEETS	STA.	TO STA.		ILLINOIS FED. A	ID PROJECT		






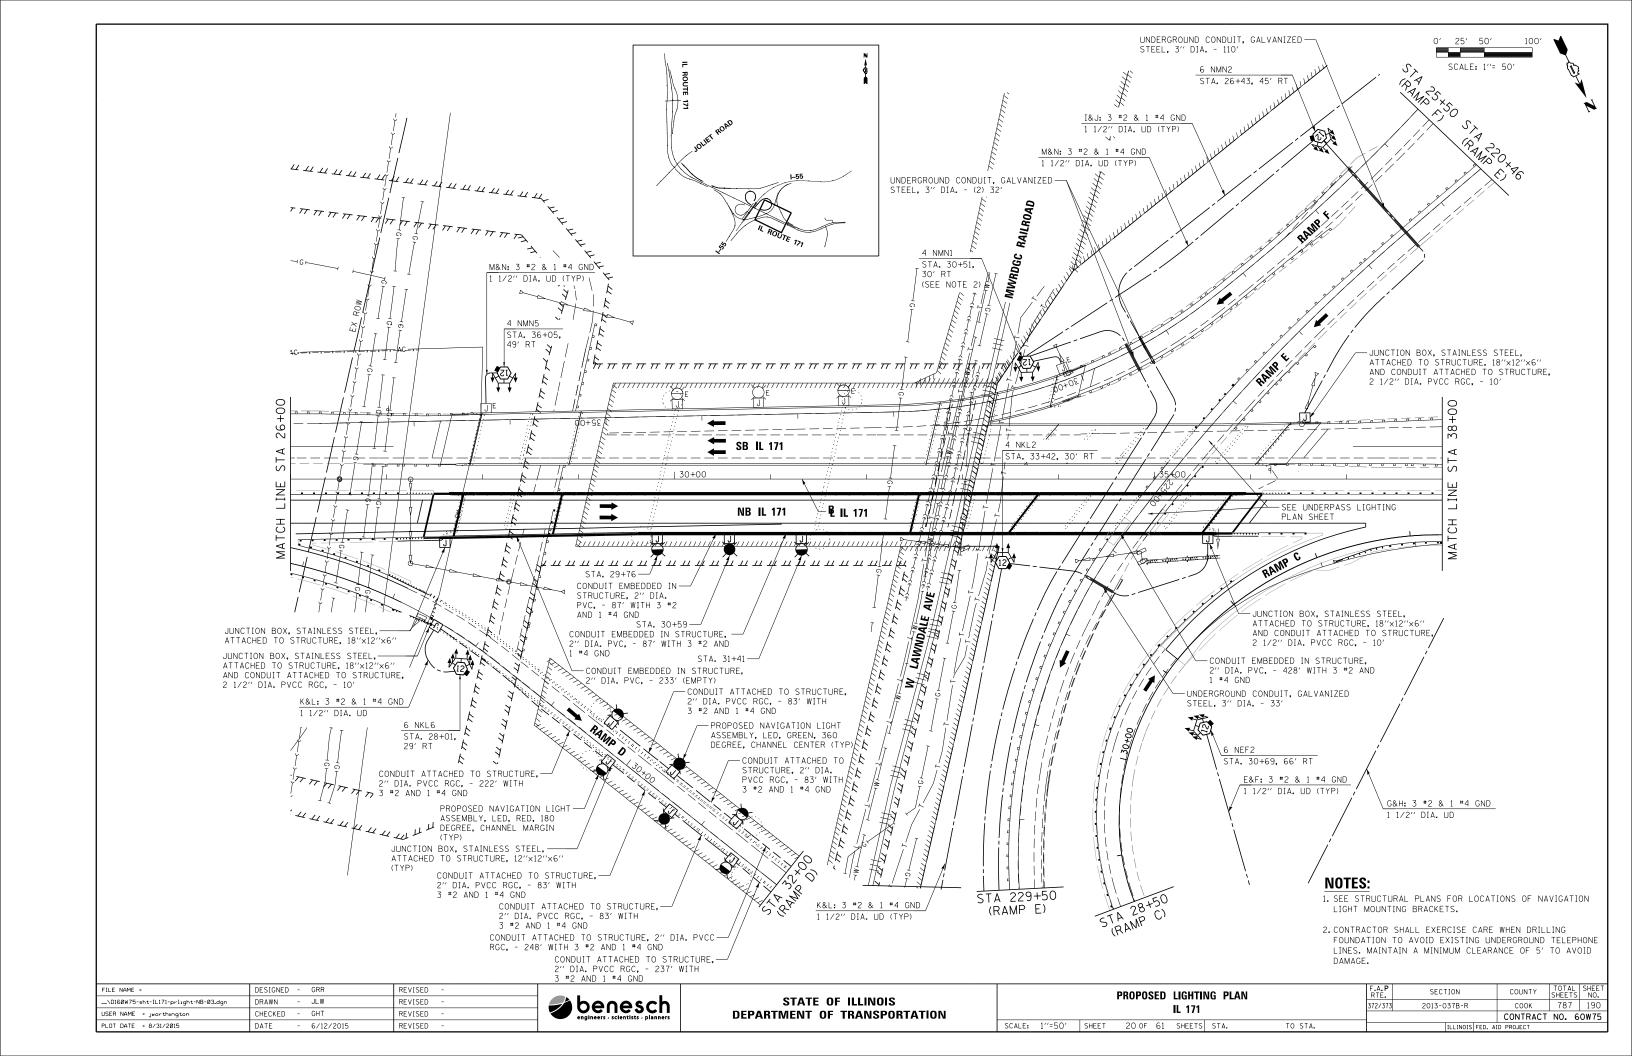
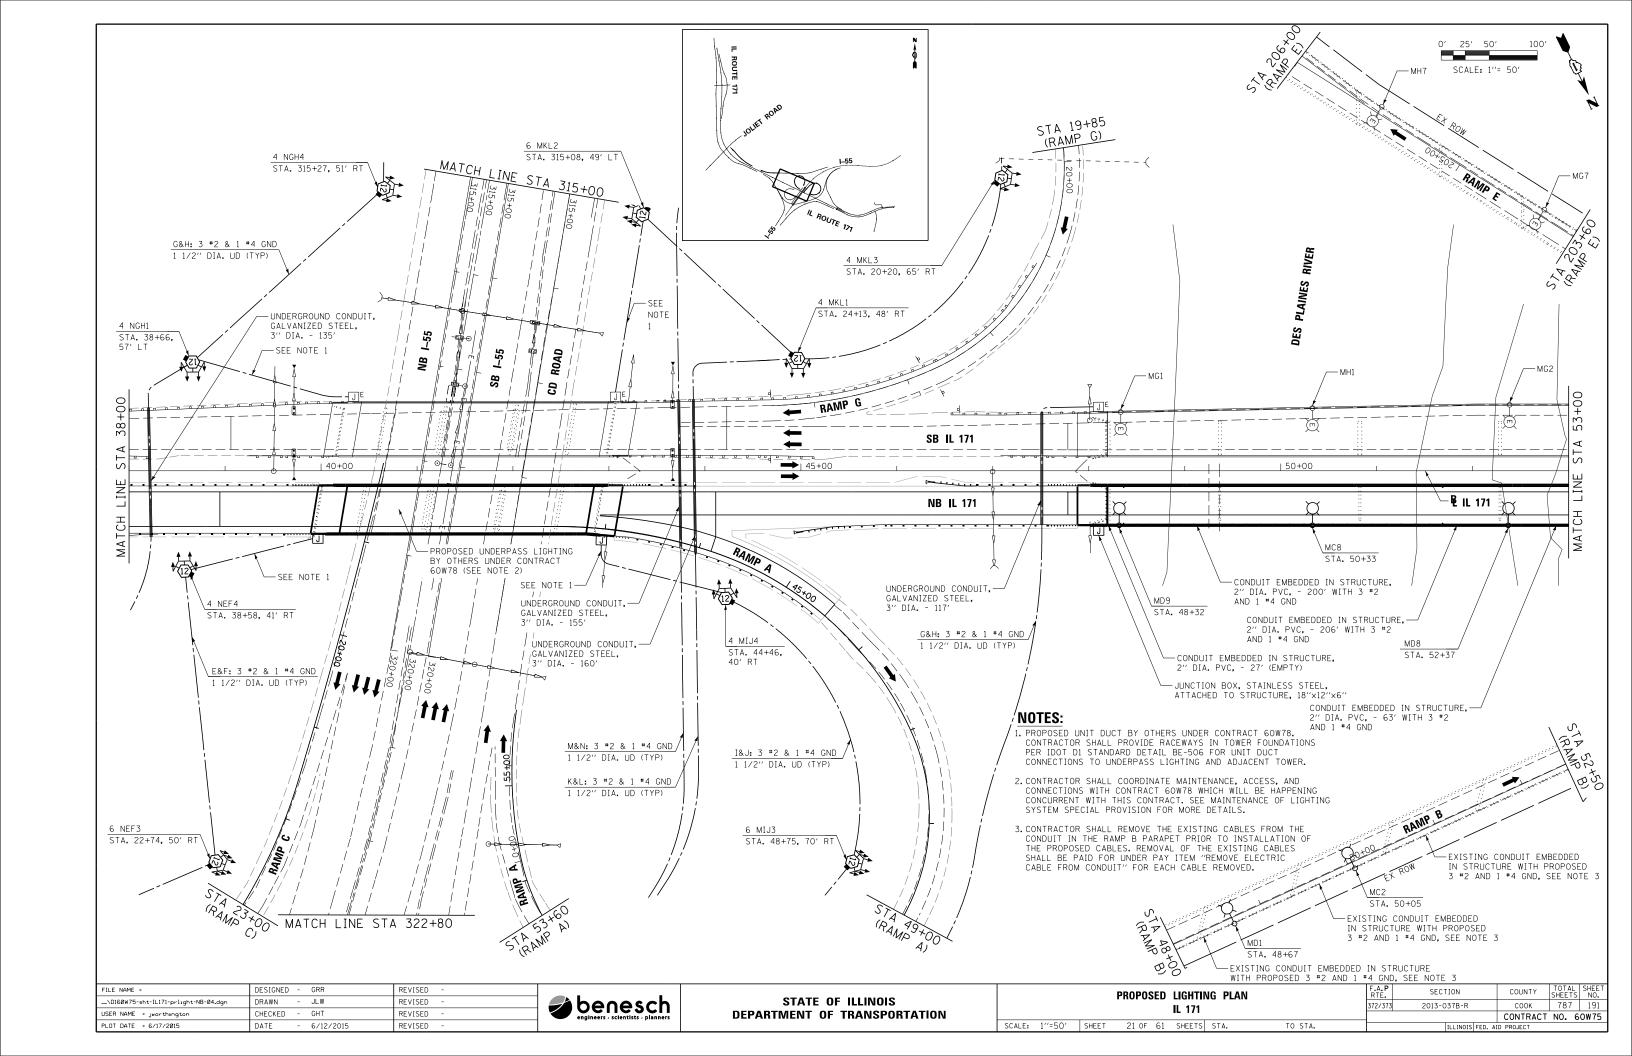
## NOTES:

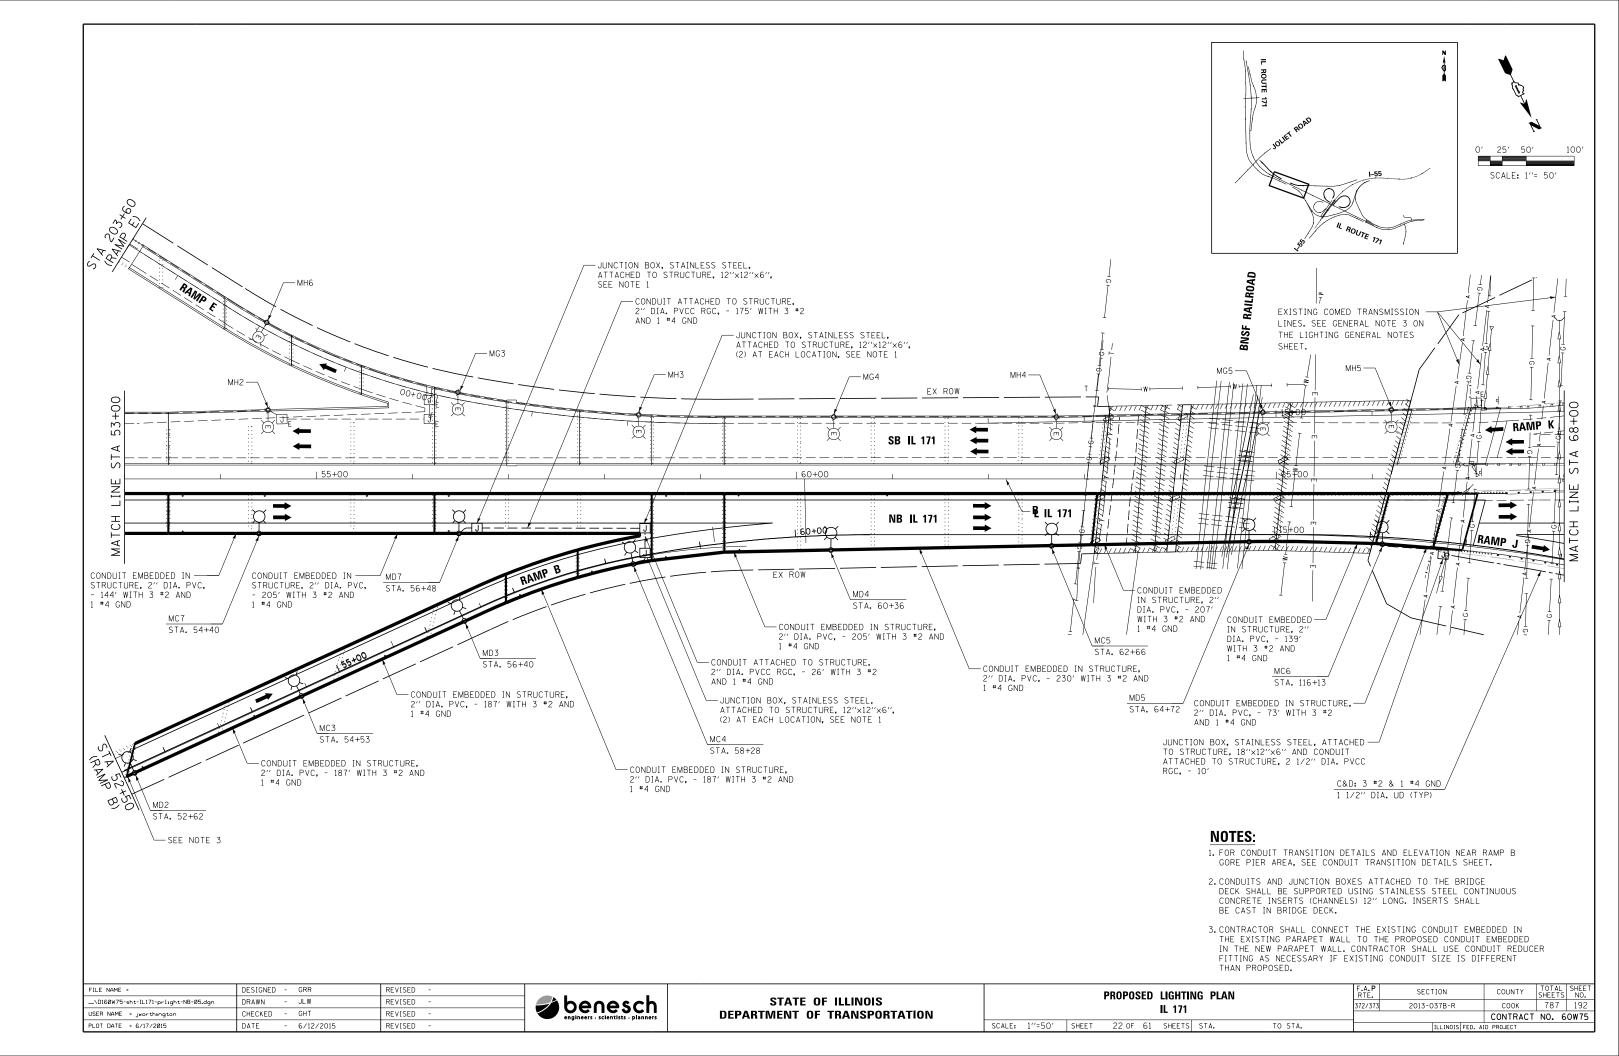- 1. CONTRACTOR SHALL REMOVE THE EXISTING "LB" FITTING, CONDUIT NIPPLE, AND CONDUIT RUNNING DOWN TO THE GROUND. THE COSTS FOR THIS REMOVAL WORK SHALL BE INCLUDED IN THE COST OF THE PROPOSED JUNCTION BOX. CONTRACTOR SHALL THEN INSTALL THE PROPOSED STAINLESS STEEL JUNCTION BOX WITH NEW 2" DIA, PVCC RGC NIPPLE BETWEEN THE EXISTING EMBEDDED JUNCTION BOX AND THE PROPOSED ATTACHED JUNCTION BOX AND 2 1/2" DIA, PVCC RGC DOWN TO THE GROUND.
- 0′ 25′ 50′ 100′ SCALE: 1′′= 50′
- 2. CONTRACTOR SHALL REMOVE THE EXISTING CABLES FROM THE CONDUIT PRIOR TO INSTALLATION OF THE PROPOSED CABLES. REMOVAL OF THE EXISTING CABLES SHALL BE PAID FOR UNDER PAY ITEM "REMOVE ELECTRIC CABLE FROM CONDUIT" FOR EACH CABLE REMOVED.

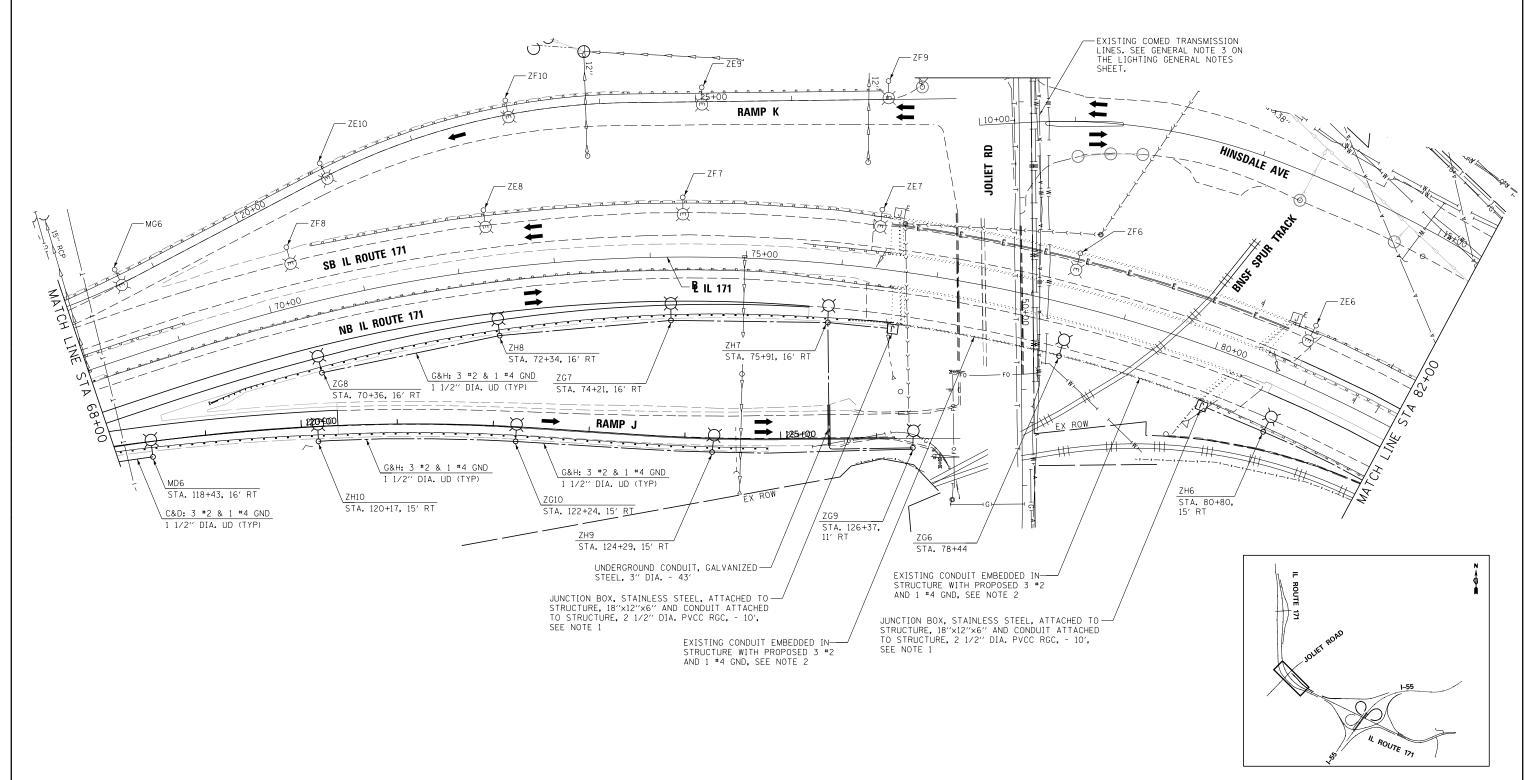



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\D160W75-sht-IL171-prlight-NB-06.dgn	DRAWN - JLW	REVISED -	benesch
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STATE OF ILLINOIS	
DEPARTMENT OF TRANSPORTATION	

SCALE: 1"=50' SHEET


PROPOSED LIGHTING PLAN		F.A.P RTE.	SECTION	COUNTY	TOTAL SHEETS	SHEET NO.
		372/373	2013-037B-R	COOK	787	193
IE 171				CONTRACT	NO. 6	OW75
23 OF 61 SHEETS STA.	TO STA.	ILLINOIS FED. AID PROJECT				



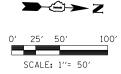
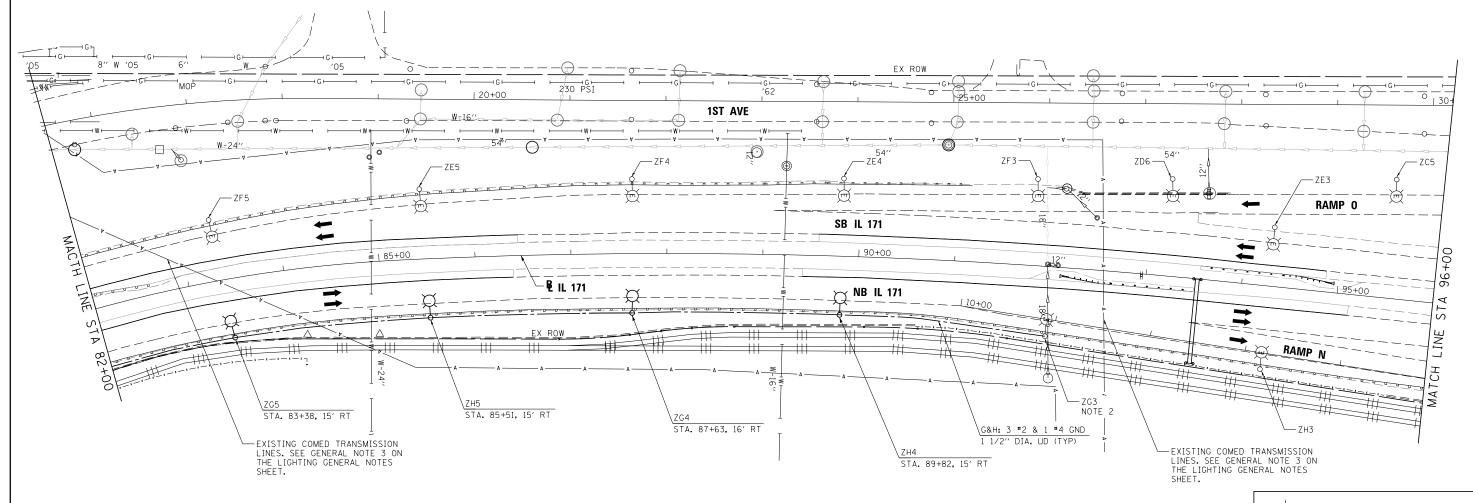
## NOTES:

- 1. CONTROLLER "Z" IS LOCATED IN NORTHWEST QUADRANT OF 47TH STREET INTERCHANGE.
- 2. CONTRACTOR SHALL INSTALL UNIT DUCT TO THIS EXISTING LIGHT POLE THAT WAS INSTALLED UNDER CONTRACT 60J16. DISCONNECT EXISTING UNIT DUCT RUNNING SOUTH PRIOR TO CONNECTING PROPOSED UNIT DUCT. ANY CABLE SPLICES AND FUSES REQUIRED SHALL BE INCLUDED IN THE COST OF THE PROPOSED UNIT DUCT.

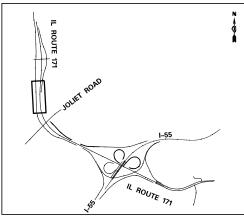

FILE NAME =	DESIGNED	-	GRR	REVISED	-
\D160W75-sht-IL171-prlight-NB-07.dgn	DRAWN	-	JLW	REVISED	-
USER NAME = jworthington	CHECKED	-	GHT	REVISED	-
PLOT DATE = 8/31/2015	DATE	-	6/12/2015	REVISED	-



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DEPARTMENT OF TRANSPORTATION		
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PROPOSED LIGHTING PLAN		F.A.P RTE.	SECTION		COUNTY	TOTAL SHEETS	SHEE NO.		
	IL 171			372/373	2013-037B-R		COOK	787	194
							CONTRACT	NO.	50W75
24 OF 61	SHEETS	STA.	TO STA.		ILLINOIS	FED. AI	D PROJECT		

