
## STATE OF ILLINOIS DEPARTMENT OF TRANSPORTATION

# PLANS FOR PROPOSED FEDERAL AID HIGHWAY

MUN ROUTE 4756 THOMPSON BOULEVARD BUFFALO GROVE RD TO WEILAND ROAD

MUN ROUTE 4801 BRANDYWYN LANE APTAKISIC RD TO PRAIRIE RD

SECTION 16-00106-02-RS
PROJECT NO. PR6D(061)
RECONSTRUCTION AND RESURFACING PROJECT
VILLAGE OF BUFFALO GROVE
LAKE COUNTY

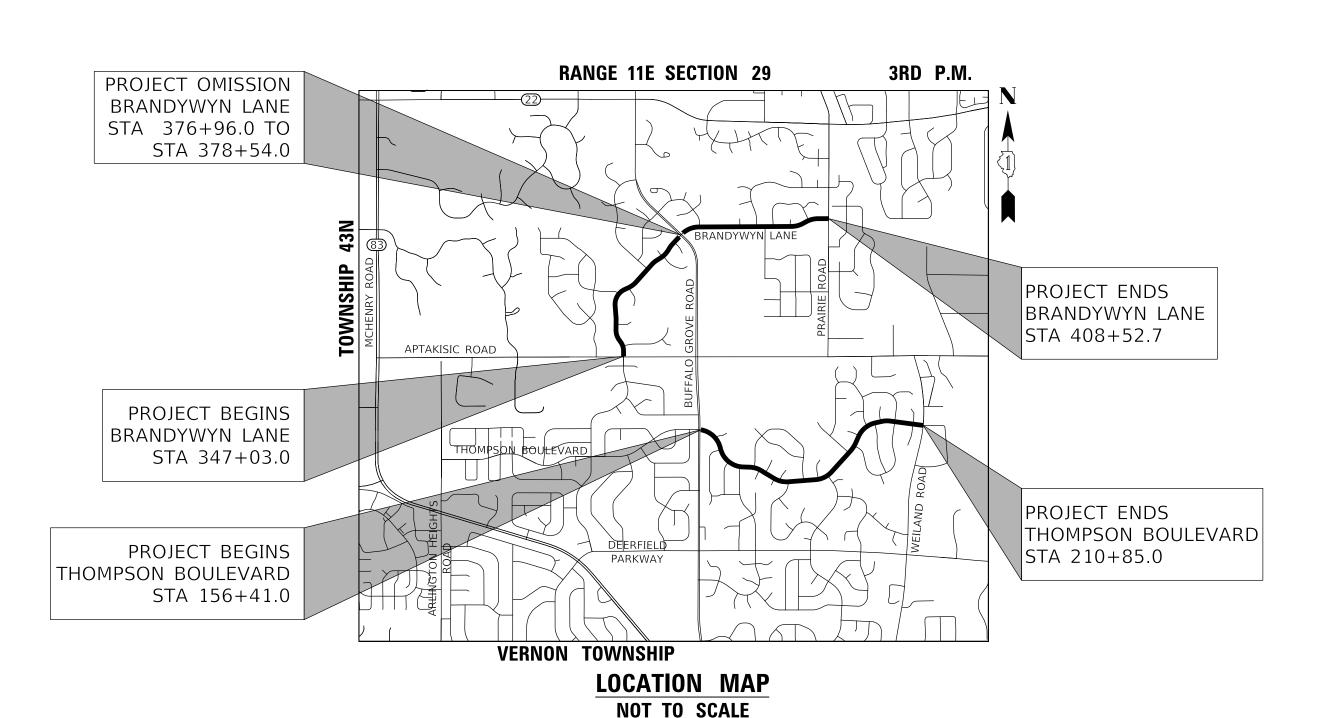

### **PROJECT LENGTH:**

THOMPSON BOULEVARD RECONSTRUCTION BRANDYWYN LANE RECONSTRUCTION BRANDYWYN LANE RESURFACE

(STA 156+41.0 TO STA 210+85.0) — 5,444.0 FT (1.031 MI) (STA 347+03.0 TO STA 369+30.0) — 2,227.0 FT (0.422 MI) (STA 369+30.0 TO STA 376+96.0) (STA 378+54.0 TO STA 408+52.7) — 3,764.7 FT (0.713 MI) (NET)

PROJECT TOTAL — 11,593.7 FT (2.196 MI) (GROSS)
PROJECT TOTAL — 11,435.7 FT (2.166 MI) (NET)

### FOR INDEX OF SHEETS AND LIST OF STATE STANDARDS, SEE SHEET NO. 2

THOMPSON BOULEVARD
DESIGN DESIGNATION = MINOR COLLECTOR
DESIGN SPEED = 30 MPH
POSTED SPEED = 25 MPH
DESIGN YEAR = 2040
ADT = 1,500 - 5,100 (2040)

BRANDYWYN LANE
DESIGN DESIGNATION = MINOR COLLECTOR
DESIGN SPEED = 25 MPH
POSTED SPEED = 25 MPH
DESIGN YEAR = 2040
ADT = 1,500 - 3,500 (2040)


100' 200' 300' — 1" = 100'
0 10' 20' 30' — 1" = 10'
0 50' 100'
0 50' 100'
0 50' 100'
0 50' 100'
0 50' 100'
0 100' — 1" = 30'
0 50' 100' — 1" = 30'

FULL SIZE PLANS HAVE BEEN PREPARED USING STANDARD ENGINEERING SCALES. REDUCED SIZED PLANS WILL NOT CONFORM TO STANDARD SCALES. IN MAKING MEASUREMENTS ON REDUCED PLANS, THE ABOVE SCALES MAY BE USED.

J.U.L.I.E.
JOINT UTILITY LOCATION INFORMATION FOR EXCAVATION
1-800-892-0123
OR 811

'EDERAL AID PROGRAM ENGINEER: CARMEN E. RAMOS, P.E. SCHAUMBUF


CONTRACT NO. 61G70

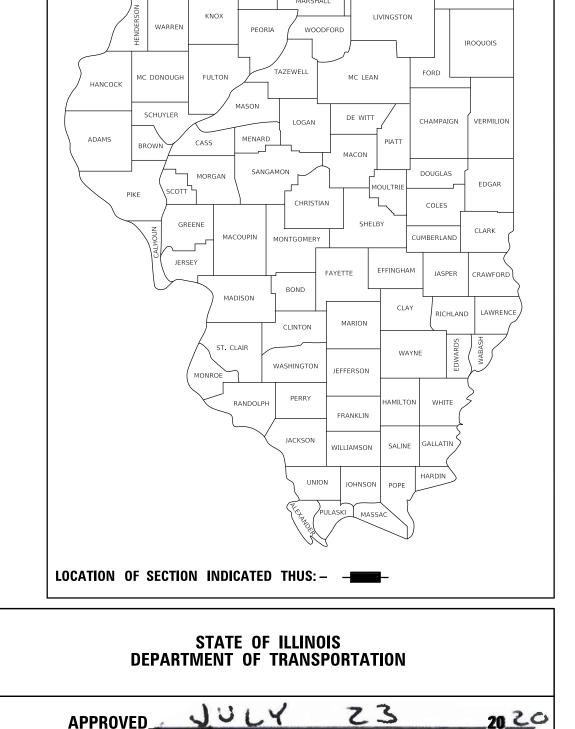

16-00106-02-RS

222 1

CONTRACT NO 61G70

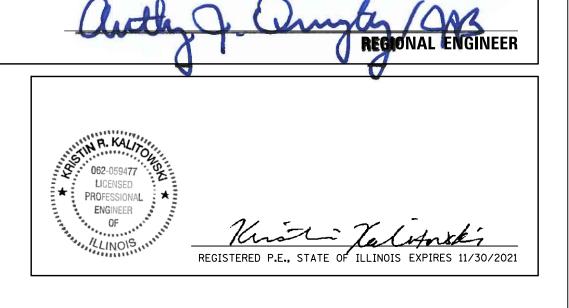

VILLAGE OF BUFFALO GROVE

OF LOCAL ROADS AND STREETS

Au/2 18

PASSED\_

RELEASING FOR BID BASED ON LIMITED

200

PLANS PREPARED BY:

Two Pierce Place, Suite 1400 - Itasca, Illinois 60143
Tel: 630.773.3900 - Fax: 630.773.3975
www.civiltechinc.com

### **GENERAL NOTES**

- ALL CONSTRUCTION SHALL BE PERFORMED ACCORDING TO THE ILLINOIS DEPARTMENT OF TRANSPORTATION "STANDARD SPECIFICATIONS FOR ROAD AND BRIDGE CONSTRUCTION" APRIL 1, 2016, THE "SUPPLEMENTAL SPECIFICATIONS AND RECURRING SPECIAL PROVISIONS" JANUARY 1, 2020, THE "STANDARD SPECIFICATIONS FOR WATER AND SEWER MAIN CONSTRUCTION IN ILLINOIS" LATEST EDITION, THE DETAILS IN THESE PLANS, THE CONTRACT DOCUMENTS, ALL APPLICABLE REQUIREMENTS OF THE ILLINOIS DEPARTMENT OF TRANSPORTATION. THE IEPA, THE VILLAGE OF BUFFALO GROVE AND ORDINANCES OF AUTHORITIES HAVING JURISDICTION AND ALL ADDENDA THERETO.
- EASEMENTS FOR THE EXISTING UTILITIES, BOTH PUBLIC AND PRIVATE AND UTILITIES WITHIN PUBLIC RIGHTS- OF WAY ARE SHOWN ON THE PLANS ACCORDING TO AVAILABLE RECORDS. THE CONTRACTOR SHALL BE RESPONSIBLE FOR DETERMINING THE EXACT LOCATION IN THE FIELD OF THESE UTILITY LINES AND THEIR PROTECTION FROM DAMAGE DUE TO CONSTRUCTION OPERATIONS. IF EXISTING UTILITY LINES OF ANY NATURE ARE ENCOUNTERED WHICH CONFLICT WITH NEW CONSTRUCTION, THE CONTRACTOR SHALL NOTIFY THE ENGINEER IMMEDIATELY SO THAT THE CONFLICT MAY BE RESOLVED.
- WHENEVER, DURING CONSTRUCTION OPERATIONS, ANY LOOSE MATERIAL IS DEPOSITED IN THE FLOW LINE OF GUTTERS, DRAINAGE STRUCTURES, DITCHES, ETC. SUCH THAT THE NATURAL FLOW LINE OF WATER IS OBSTRUCTED, THE LOOSE MATERIAL WILL BE REMOVED AT THE CLOSE OF EACH WORKING DAY. AT THE CONCLUSION OF CONSTRUCTION OPERATIONS, ALL DRAINAGE STRUCTURES AND FLOW LINES SHALL BE FREE FROM DIRT AND DEBRIS.
- THE CONTRACTOR SHALL VERIFY ALL DIMENSIONS AND EXISTING CONDITIONS AFFECTING THEIR WORK WITH THE ACTUAL CONDITIONS AT THE IOB SITE PRIOR TO ORDERING MATERIALS IN ADDITION. THE CONTRACTOR MUST VERIFY THE LINE AND GRADES, IF THERE ARE ANY DISCREPANCIES FROM WHAT IS SHOWN ON THE CONSTRUCTION PLANS, STANDARD SPECIFICATION AND/OR SPECIAL DETAILS. THE CONTRACTOR SHALL SECURE WRITTEN INSTRUCTION FROM THE ENGINEER PRIOR TO PROCEEDING WITH ANY PART OF THE WORK AFFECTED BY OMISSION OR DISCREPANCIES. FAILING TO SECURE SUCH INSTRUCTION, THE CONTRACTOR WILL BE CONSIDERED TO HAVE PROCEEDED AT HIS/HER OWN RISK.
- 5. ALL PAVEMENT DIMENSIONS ARE SHOWN TO EDGE OF PAVEMENT UNLESS OTHERWISE NOTED.
- WHERE SECTION OR SUBSECTION MONUMENTS ARE ENCOUNTERED, THE ENGINEER SHALL BE NOTIFIED BEFORE THE MONUMENTS ARE REMOVED. THE CONTRACTOR SHALL CAREFULLY PRESERVE ALL PROPERTY MARKS AND MONUMENTS UNTIL THE OWNER, AUTHORIZED SURVEYOR OR AGENT HAS WITNESSED OR OTHERWISE REFERENCED THEIR LOCATION.
- THE CONTRACTOR SHALL NOTIFY THE ENGINEER AT LEAST 72 HOURS PRIOR TO BEGINNING WORK.
- 8. IF DURING CONSTRUCTION THE CONTRACTOR ENCOUNTERS OR OTHERWISE BECOMES AWARE OF ANY SEWERS OR UNDERDRAINS OTHER THAN THOSE SHOWN ON THE PLANS. HE/SHE SHALL INFORM THE ENGINEER. WHO SHALL DIRECT THE WORK NECESSARY TO MAINTAIN OR REPLACE THE FACILITIES IN SERVICE AND TO PROTECT THEM FROM DAMAGE DURING CONSTRUCTION IF MAINTAINED, EXISTING FACILITIES TO BE MAINTAINED THAT ARE DAMAGED BECAUSE OF NON -COMPLIANCE WITH THIS PROVISION SHALL BE REPLACED.
- THE CONTRACTOR SHALL PROVIDE TEMPORARY TOILET FACILITIES AND HAND SANITIZING STATIONS FOR THE USE OF ALL CONTRACTORS PERSONNEL EMPLOYED ON THE WORK SITE. THE FACILITIES SHALL BE MAINTAINED IN PROPER SANITARY CONDITION THROUGHOUT THE PROJECT. THE LOCATION OF THE TEMPORARY FACILITIES SHALL BE APPROVED BY THE ENGINEER.
- 10. THE CONTRACTOR IS RESPONSIBLE FOR COMPLYING WITH THE NPDES PERMIT AND SWPPP MANUAL. IF NO NPDES PERMIT OR SWPPP MANUAL IS NEEDED FOR THE PROJECT THE CONTRACTOR SHALL PERFORM SOIL EROSION SEDIMENT CONTROL BEST PRACTICES OR AS DIRECTED BY THE OWNER TO PREVENT ILLICIT DISCHARGES FROM THE SITE.

### **UTILITY NOTES**

- UNDERGROUND WORK SHALL INCLUDE TRENCHING, DISPOSAL OF EXCESS MATERIAL, DEWATERING, INSTALLATION OF PIPE, CASTINGS, STRUCTURES, BACKFILLING OF TRENCHES AND COMPACTION, AND TESTING AS SHOWN ON THE CONSTRUCTION PLANS. FITTINGS AND ACCESSORIES NECESSARY TO COMPLETE THE WORK MAY NOT BE SPECIFIED. ALL SEWER SHALL BE INSTALLED USING A LASER AND BEGIN AT THE DOWNSTREAM END.
- MACHINE CORE ALL CONNECTIONS TO EXISTING STRUCTURES USING A CORE DRILL. HAMMERING OR SAWING OF STRUCTURES WILL NOT BE ALLOWED
- ALL CONNECTIONS TO EXISTING SANITARY MANHOLES SHALL BE INSTALLED WITH A NEOPRENE BOOT SECURED WITH DOUBLE STAINLESS STEEL STRAPS MEETING THE REQUIREMENTS OF ASTM C-923.
- ALL CONNECTIONS TO EXISTING OR DISSIMILAR STORM/SANITARY LINES SHALL BE DONE WITH STAINLESS STEEL NON-SHEAR COUPLINGS.
- STONE BEDDING AND BACKELL SHALL BE OMITTED FOR A DISTANCE OF 15 FEET UP AND DOWNSTREAM OF SEWERS DRAINING TO OR FROM PONDS OR STREAMS. THE REPLACED BEDDING SHALL BE SILTY CLAY SOIL MECHANICALLY COMPACTED TO 90% MODIFIED PROCTOR DENSITY. THE USE OF PERMEABLE SOILS WILL NOT BE PERMITTED.
- ALL WATER MAIN SHALL HAVE MECHANICAL RESTRAINED TYPE JOINTS AT ALL CONNECTIONS AND FITTINGS IN ADDITION. ALL HARDWARE SHALL BE STAINLESS STEEL.
- THRUST BLOCKING SHALL BE PROVIDED ON WATER MAIN AT ALL BENDS, TEES, ELBOWS, ETC. INDIVIDUAL INSPECTION FOR ALL THRUST BLOCKING IS REQUIRED. THRUST BLOCKING SHALL BE POURED IN PLACE CONCRETE, PRECAST BLOCKS MAY BE USED AS APPROVED BY THE ENGINEER.
- CONTRACTOR SHALL ROTATE PROPOSED CURBLINE STRUCTURES AS NEEDED TO AVOID UTILITY CONFLICTS.

### PROJECT SPECIFIC NOTES

- THE CONTRACTOR SHALL INDEMNIFY THE OWNER, ENGINEER, THE MUNICIPALITY AND THEIR AGENTS, FROM ALL LIABILITY INVOLVED IN CONSTRUCTION. INSTALLATION AND TESTING OF THE WORK ON THIS
- ALL ELEVATIONS ARE ON NAVD 88 VERTICAL DATUM.
- THE CONTRACTOR SHALL BE RESPONSIBLE FOR THE INSTALLATION AND MAINTENANCE OF ALL TRAFFIC CONTROL TO ADEQUATELY INFORM AND PROTECT THE PUBLIC OF ALL CONSTRUCTION OPERATIONS.
- PRIOR TO PLACEMENT OF FABRIC AND STONE, THE SUBGRADE SHALL BE PROOF-ROLLED IN THE PRESENCE OF THE ENGINEER. PROOF-ROLLING SHALL BE DONE USING A THREE AXLE DUMP TRUCK TOGETHER WITH LOAD WEIGHING AT LEAST TWENTY -FIVE (25) TONS. THE LOAD SHALL BE UNIFORMLY PLACED IN THE DUMP BODY. ALL DEFICIENCIES SHALL BE REPAIRED AND RE-PROOF-ROLLED UNTIL FOUND ACCEPTABLE TO THE ENGINEER.
- AGGREGATE SURGRADE IMPROVEMENT (CU YD) HAS BEEN PROVIDED FOR USE AT THE LOCATIONS INDICATED FOR SOILS THAT TEND TO BE UNSTABLE AND/OR UNSUITABLE. THE ACTUAL NEED FOR REMOVAL AND REPLACEMENT WITH ASI WILL BE DETERMINED IN THE FIELD AT THE TIME OF CONSTRUCTION BY THE GEOTECHNICAL ENGINEER. ALL POTENTIALLY UNSTABLE SOILS SHOULD BE TESTED WITH A STATIC OR DYNAMIC CONE PENETROMETER AND TREATED IN ACCORDANCE WITH ARTICLE 301.04 OF THE SSRBC AND IDOT SUBGRADE STABILITY MANUAL. IF UNSTABLE AND/OR UNSUITABLE SOILS ARE NOT ENCOUNTERED, THEN THE QUANTITY SHALL BE DEDUCTED AND NO ADDITIONAL COMPENSATION WILL BE DUE TO THE CONTRACTOR.

ANY AGGREGATE SUBGRADE IMPROVEMENT CONTAMINATED AND/OR DAMAGED BY THE CONTRACTOR'S VEHICLES AND/OR EQUIPMENTS IS TO BE REMOVED AND REPLACED AS DIRECTED BY THE ENGINEER AT THE CONTRACTOR'S EXPENSE

- 6. ALL CONCRETE SHALL HAVE A LIGHT BROOM FINISH APPLIED WITHIN 1 HOUR OF FINAL STRIKING.
- 7. ALL CONCRETE SHALL HAVE A WHITE, IDOT TYPE 3 CURING COMPOUND APPLIED TO THE SURFACE WITHIN FINAL STRIKING AT THE MANUFACTURER RECOMMENDED APPLICATION RATE
- 8. 3/4" THICK PRE-MOLDED FIBER EXPANSION JOINS WITH 2, 3/4"x18" PLAIN ROUND, STEEL DOWEL BARS SHALL BE INSTALLED IN ALL CURBS AT FORTY-FIVE FOOT (45') INTERVALS AND AT ALL P.C.'S. P.T.'S AND CURB RETURNS, ALTERNATE ENDS OF THE DOWEL BARS SHALL BE GREASED AND FITTED WITH METAL EXPANSION TUBES, ALL EXPANSION JOINTS MUST BE FREE OF CONCRETE FOR FULL DEPTH. CONTRACTION JOINTS SHALL BE TOOLED AT 15' INTERVALS
- 9. ALL DOWEL BARS AND TIE BARS SHALL BE EPOXY COATED UNLESS NOTED OTHERWISE.
- 10. ALL PAVEMENT SUBGRADE SHALL BE COMPACTED TO 95% MODIFIED PROCTOR DENSITY. ALL SUBGRADE IN LAWN AREAS SHALL BE COMPACTED TO 90% MODIFIED PROCTOR DENSITY.
- 11. SPREAD SCREENED TOPSOIL ON ALL DISTURBED AREAS AND PROPOSED GREEN AREAS. TOPSOIL SHALL COMPLY WITH REQUIREMENTS OF ARTICLE 1081.05.
- 12. IN TYPE B-4.12 CURB, ALL TYPE 11 FRAMES SHALL BE 6 INCHES HIGH WITH 5' TAPERS TO MATCH CURB HEIGHT.
- 13. THE SIDEWALK ON ONE SIDE OF THE EACH STREET AND SIDESTREET MUST REMAIN OPEN AND ACCESSIBLE AT ALL TIMES, CONSTRUCTION STAGING SHALL BE COORDINATED WITH THE ENGINEER TOE ENSURE ONE SIDEWALK REMAINS OPEN

### INDEX OF DRAWINGS

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86 - 93 94 - 130 131 - 167	EROSION CONTROL AND LANDSCAPING INTERSECTION GRADING PLANS SIDEWALK ADA RAMP DETAILS PAVEMENT MARKING AND SIGNING PLAN
86 - 93 94 - 130 131 - 167 168 - 171	EROSION CONTROL AND LANDSCAPING INTERSECTION GRADING PLANS SIDEWALK ADA RAMP DETAILS PAVEMENT MARKING AND SIGNING PLAN

DESCRIPTION

### **IDOT HIGHWAY STANDARDS**

STANDARD NO. DESCRIPTION

000001-07	STANDARD SYMBOLS, ABBREVIATIONS AND PATTERNS
280001-07	TEMPORARY EROSION CONTROL SYSTEMS
424001-11	PERPENDICULAR CURB RAMPS FOR SIDEWALKS
424011-04	CORNER PARALLEL CURB RAMPS FOR SIDEWALK
442201-03	CLASS C AND D PATCHES
602001-02	CATCH BASIN TYPE A
602011-02	CATCH BASIN TYPE C
602301-04	INLET - TYPE A
602401-06	PRECAST MANHOLE TYPE A 4' DIAMETER
602601-06	PRECAST REINFORCED CONCRETE FLAT SLAB TOP
602701-02	MANHOLE STEPS
604001-05	FRAME AND LIDS TYPE 1
604051-04	FRAME AND GRATE TYPE 11
606001-07	CONCRETE CURB TYPE B & COMBINATION CONCRETE CURB & GUTTER
701006-05	OFF-ROAD OPERATIONS, 2L, 2W, 15' TO 24" FROM PAVEMENT EDGE
701011-04	OFF-ROAD MOVING OPERATIONS, 2L, 2W, DAY ONLY
701101-05	OFF-ROAD OPERATIONS, MULTILANE, 15' TO 24" FROM PAVEMENT EDGE
701301-04	LANE CLOSURE 2L, 2W SHORT TIME OPERATIONS
701311-03	LANE CLOSURE 2L, 2W MOVING OPERATIONS - DAY ONLY
701501-06	URBAN LANE CLOSURE, 2L, 2W, UNDIVIDED
701701-10	URBAN LANE CLOSURE, MULTILANE INTERSECTION
701801-06	SIDEWALK, CORNER OR CROSSWALK CLOSURE
701901-08	TRAFFIC CONTROL DEVICES
780001-05	TYPICAL PAVEMENT MARKINGS

### IDOT DISTRICT ONE STANDARDS

STANDARD NO.	DESCRIPTION
BD-08	DETAILS FOR FRAMES AND LIDS ADJUSTMENT WITH MILLING
TC-10	TRAFFIC CONTROL AND PROTECTION FOR SIDE ROADS, INTERSECTIONS, AND DRIVEWAYS
TC-13	DISTRICT ONE TYPICAL PAVEMENT MARKINGS
TC-14	TRAFFIC CONTROL AND PROTECTION AT TURN BAYS (TO REMAIN OPEN TO TRAFFIC)
TC-16	PAVEMENT MARKING LETTERS AND SYMBOLS FOR TRAFFIC STAGING
TC-21	DETOUR SIGNING FOR CLOSING STATE HIGHWAYS
TC-22	ARTERIAL ROAD INFORMATION SIGN



Two Pierce Place, Suite 1400 Itasca, Illinois 60143 Tel: 630,773,3900 Fax: 630,773,3975

DESIGNED	-	TGB	REVISED -
DRAWN	-	JRR	REVISED -
CHECKED	-	KRK	REVISED -
DATE	-	7/27/2020	REVISED -

STATE OF ILLINOIS **DEPARTMENT OF TRANSPORTATION** 

COUNTY HEETS **GENERAL NOTES** 16-00106-02-RS LAKE 222 CONTRACT NO 61G70 SHEET 1 OF 2 SHEETS

### **EROSION CONTROL NOTES**

- 1. AT A MINIMUM, THE CONTRACTOR SHALL INSTALL AND MAINTAIN SOIL EROSION AND SEDIMENT CONTROL BEST MANAGEMENT PRACTICES IN ACCORDANCE WITH THE REQUIREMENTS SET FORTH IN THE LATEST EDITION OF THE ILLINOIS ENVIRONMENTAL PROTECTION AGENCY'S URBAN MANUAL.
- 2. DISTURBED AREAS AND AREAS USED FOR STORAGE OF MATERIALS THAT ARE EXPOSED TO PRECIPITATION SHALL BE INSPECTED FOR EVIDENCE OF, OR THE POTENTIAL FOR, POLLUTANTS ENTERING THE DRAINAGE SYSTEM WHERE DISCHARGE LOCATIONS OR POINTS ARE ACCESSIBLE. THEY SHALL BE INSPECTED TO ASCERTAIN WHETHER EROSION CONTROL MEASURES ARE EFFECTIVE IN PREVENTING SIGNIFICANT IMPACTS TO RECEIVING WATERS.
- LOCATIONS WHERE VEHICLES ENTER OR EXIT THE SITE SHALL BE INSPECTED FOR EVIDENCE OF OFF SITE SEDIMENT TRACKING. THE CONTRACTOR SHALL BE RESPONSIBLE FOR CLEANING THE ROAD OF ANY MATERIAL THAT IS FROM THE PROJECT. THIS WILL BE DONE AT THE CLOSE OF EACH DAY OF WORK OR MORE FREQUENTLY AS FIELD CONDITIONS WARRANT.
- ALL STORM WATER STRUCTURES WITH OPEN LIDS SHALL BE PROTECTED WITH INLET FILTER BASKETS DURING CONSTRUCTION. SEDIMENT SHALL BE REMOVED AS NEEDED AND BASKETS SHALL BE REPAIRED OR REPLACED AS NEEDED
- AFTER ACHIEVING PERMANENT VEGETATION, ALL EROSION AND SEDIMENT CONTROL DEVICES SHALL BE REMOVED, AND THE DRAINAGE STRUCTURES SHALL BE CLEANED.
- THE CONTRACTOR SHALL KEEP A WATER SOURCE AT THEIR DISPOSAL FOR THE PURPOSE OF WATERING DOWN SOIL ON SITE AND ADJACENT ROADWAYS WHICH OTHERWISE MAY BECOME AIRBORNE.
- THE CONTRACTOR SHALL STABILIZE ALL IDLE. DISTURBED AREAS WITHIN SEVEN DAYS OF CESSATION OF THE CONSTRUCTION ACTIVITIES IN THAT AREA.
- THE CONTRACTOR IS EXPRESSLY ADVISED NOT TO DISTURB AREAS WHICH ARE OUTSIDE THOSE NECESSARY TO PROVIDE THE IMPROVEMENTS AS CALLED FOR IN THE PLANS.
- 9. ALL EROSION CONTROL MEASURES SHALL BE REPLACED IF DAMAGED OR MAINTAINED THROUGHOUT
- 10. ALL BYPASS CHANNELS, MUST BE CONSTRUCTED SO THAT CHANNEL FLOWS WILL NOT CAUSE EROSION OF EXCAVATED MATERIAL IN EACH CASE A SEDIMENTATION BASIN MUST BE CONSTRUCTED SO AS TO ALLOW THE SEDIMENT TO SETTLE PRIOR TO THE DOWNSTREAM OUTLET OF THE PROJECT AREA.
- 11. PUMPS MAY BE USED AS BYPASS DEVICES, BUT IN NO CASE WILL THE WATER BE DIVERTED OUTSIDE THE PROJECT LIMIT, ALL PUMPED WATER SHALL BE FREE OF SILT, PUMPING MAY REOUIRE THE USE OF A SEDIMENT CONTAINMENT FILTER BAG AND OTHER SUPPLEMENTAL SEDIMENT CONTROL MEASURES.
- 12. CONCRETE WASHOUT FACILITIES SHALL BE MADE AVAILABLE IF NEEDED, AND PROPERLY MAINTAINED THROUGHOUT THE PROJECT.
- 13. PROPERLY MANAGE ALL MATERIAL STORAGE AREAS, PORTABLE TOILETS, AND EQUIPMENT FUELING, CLEANING, AND MAINTENANCE AREAS TO ENSURE THESE AREAS ARE FREE OF SPILLS, LEAKS, OR OTHER POTENTIAL POLLUTANTS.
- 14. WASTE, CONSTRUCTION DEBRIS, AND BUILDING MATERIALS SHALL BE COLLECTED AND PLACED IN

### **VILLAGE OF BUFFALO GROVE NOTES**

- 1. FRAMES, LIDS, GRATES, VALVES, FIRE HYDRANTS, ETC. WHICH ARE ABANDONED OR REPLACED IN THIS PROJECT SHALL BE SALVAGED AND REMAIN PROPERTY OF THE VILLAGE OF BUFFALO GROVE. THE CONTRACTOR SHALL COORDINATE DELIVERY TO THE VILLAGE'S SELECTED SITE. ANY DAMAGE TO THE SALVAGED ITEMS DUE TO THE CONTRACTORS NEGLIGENCE SHALL BE REPLACED.
- 2. THE CONTRACTOR SHALL GIVE NOTICES AND COMPLY WITH APPLICABLE LAWS, ORDINANCES, RULES, REGULATIONS AND LAWFUL ORDERS OF ALL PUBLIC AUTHORITIES BEARING ON SAFETY OF PERSONS OR PROPERTY OR THEIR PROTECTION FROM DAMAGE, INJURY OR LOSS.
- NO SIGNAGE IS TO BE REMOVED. IF SIGNS ARE TAKEN DOWN FOR CONSTRUCTION PURPOSES, THEY MUST BE RE-ERECTED ON THE SAME DAY TO THE SATISFACTION OF THE ENGINEER.
- 4. ANY BRANCHES THAT REQUIRE TRIMMING FOR EQUIPMENT CLEARANCE/CONSTRUCTION OPERATIONS MUST BE APPROVED BY THE ENGINEER.

### **COMMITMENTS**

1. THE VILLAGE SHALL PREPARE AND SEND LETTERS TO ANY RESIDENTS WITH ADA NEEDS PRIOR TO CONSTRUCTION.

### **POINTS OF CONTACT**

VILLAGE OF BUFFALO GROVE MR. KYLE E. JOHNSON, P.E. 51 RAUPP BOULEVARD BUFFALO GROVE, IL 60089 PH: 847.459.2523

MR. PHILIP DIRK LAKE COUNTY DIVISION OF TRANSPORTATION 600 W WINCHESTER ROAD LIBERTYVILLE, IL 60048 PH: 847.377.7000 dphilipp@lakecountyil.gov www.lakecountypassage.com

LAKE COUNTY PASSAGE

ADLAI E. STEVENSON HIGH SCHOOL DISTRICT 125 1 STEVENSON DRIVE LINCOLNSHIRE, IL 60069 PH: 847.415.4000

KILDEER COUNTRYSIDE SCHOOL DISTRICT 96 1050 IVY HALL LANE BUFFALO GROVE, IL 60089 PH: 847.459.4260

MERIDIAN MIDDLE SCHOOL DISTRICT 102 2195 BRANDYWYN LANE BUFFALO GROVE, IL 60089 PH: 847.955.3500

AT&T DISTRIBUTION (UTILITY COMPANY) MR. TIM GERDES 1000 COMMERCE DRIVE OAK BROOK, IL 60523 PH: 630.573.6414 tg7394@att.com

COMCAST (UTILITY COMPANY) MR ROBERT STOLL 688 IINDUSTRIAL DRIVE FLMHURST, IL 60126 PH: 224.229.5849 Robert Stoll@comcast.com

COM ED (UTILITY COMPANY) MS. TERRI BLECK 1500 FRANKLIN BOULEVARD LIBERTYVILLE, IL 60048 PH: 847.816.5239 terri.bleck@comEd.com

NICOR GAS (UTILITY COMPANY) MR. CHARLES PARROTT 1844 FERRY ROAD NAPERVILLE, IL 60563 PH: 630.388.3319 cparrot@southernco.com

NORTH SHORE GAS (UTILITY COMPANY) MR. JAY HAMMER 3001 GRAND AVENUE WAUKEGAN, IL 60085 PH: 224.338.9093 iav.hammer@northshoregasdeliverv.com

CIVILTECH www.civiltechinc.com

Two Pierce Place, Suite 1400 Itasca, Illinois 60143 Tel: 630,773,3900 Fax: 630,773,3975

TGB DESIGNED -REVISED DRAWN JRR REVISED CHECKED DATE REVISED 7/27/2020

STATE OF ILLINOIS **DEPARTMENT OF TRANSPORTATION** 

FALL RTE COUNTY SHEETS **GENERAL NOTES** 16-00106-02-RS LAKE 222 CONTRACT NO 61G70 SHEET 2 OF 2 SHEETS

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SPECIALLY ILEM SPECIAL PROVISION					THOMPSON BOULEVARD	BRANDYWYN LANE	THOMPSON BOULEVARD	BRANDYWYN LANE
×	20101100	TREE TRUNK PROTECTION	EACH	461	173	221	60	7
x	20101200	TREE ROOT PRUNING	EACH	461	173	221	60	7
	20200100	EARTH EXCAVATION	CU YD	8,189	5,812	1,892	359	126
		·			,	*		
	20201200	REMOVAL AND DISPOSAL OF UNSUITABLE MATERIAL	CU YD	2,574	1,386	1,188		
Х	20800150	TRENCH BACKFILL	CU YD	664	509	155		
	21001000	GEOTECHNICAL FABRIC FOR GROUND STABILIZATION	SQ YD	5,636	5,636			
	21101505	TOPSOIL EXCAVATION AND PLACEMENT	CU YD	3,814	1,728	2,086		
	21101615	TOPSOIL FURNISH AND PLACE, 4"	SQ YD	950	450	450	50	
(	25000110	SEEDING, CLASS 1A	ACRE	5.50	2.25	2.75	0.25	0.25
×	25000400	NITROGEN FERTILIZER NUTRIENT	POUND	497	203	248	23	23
κ.	25000600	POTASSIUM FERTILIZER NUTRIENT	POUND	497	203	248	23	23
(	25100115	MULCH, METHOD 2	ACRE	11.00	4.50	5.50	0.50	0.50
(	25200200	SUPPLEMENTAL WATERING	UNIT	81	33	40	4	4
	28000250	TEMPORARY EROSION CONTROL SEEDING	POUND	550	225	275	25	25
	28000305	TEMPORARY DITCH CHECKS	FOOT	32	32			
	28000400	PERIMETER EROSION BARRIER	FOOT	1,801	333	1,468		

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DATE	-	7/27/2020	REVISED -
CHECKED	-	KRK	REVISED -
DRAWN	-	JRR	REVISED -
DESIGNED	-	TGB	REVISED -

STATI	E OF	ILLINOIS
DEPARTMENT	OF	TRANSPORTATION

	MUN RTE	SECTION	COUNTY	TOTAL SHEETS	SHEET NO
SUMMARY OF QUANTITIES	4756 4801	16-00106-02-RS	LAKE	222	4
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HEET 1 OF 8 SHEETS		ILLINOIS FED A	D PROJECT		

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SPECIAL I TEM					THOMPSON BOULEVARD	BRANDYWYN LANE	THOMPSON BOULEVARD	BRANDYWYN LANE
	28000510	INLET FILTERS	EACH	147	71	51	11	14
								-
	28001100	TEMPORARY EROSION CONTROL BLANKET	SQ YD	2	2			
X	30300001	AGGREGATE SUBGRADE IMPROVEMENT	CU YD	1,720	1,105	615		
X	30300112	AGGREGATE SUBGRADE IMPROVEMENT 12"	SQ YD	5,363	5,363		•	
X	31102100	SUBBASE GRANULAR MATERIAL, TYPE C 4"	SQ YD	6,870	2,511	3,831	304	224
	35101400	AGGREGATE BASE COURSE, TYPE B	TON	248	136	112		
	35101598	AGGREGATE BASE COURSE, TYPE B 3"	SQ YD	4,717	4,717			
	35101700	AGGREGATE BASE COURSE, TYPE B 5"	SQ YD	5,610	2,243	2,260	670	437
	35800100	PREPARATION OF BASE	SQ YD	38,489	17,377	9,217	9,570	2,325
	35800200	AGGREGATE BASE REPAIR	TON	961	434	230	239	58
	40600290	BITUMINOUS MATERIALS (TACK COAT)	POUND	22,978	4,971	12,715	2,153	3,139
	40600400	MIXTURE FOR CRACKS, JOINTS, AND FLANGEWAYS	TON	30		24		6
	40600982	HOT-MIX ASPHALT SURFACE REMOVAL - BUTT JOINT	SQ YD	158		158		
	40600990	TEMPORARY RAMP	SQ YD	440	368	72		
X	40602978	HOT-MIX ASPHALT BINDER COURSE, IL- 9.5, N50	TON	1,826		1,500		326
X	40603080	HOT-MIX ASPHALT BINDER COURSE, IL-19.0, N50	TON	6,529	3,488	1,361	1,354	326

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STATE OF ILLINOIS
DEPARTMENT OF TRANSPORTATION

COUNTY TOTAL SHEET SHEETS NO LAKE 222 5 MUN RTE SECTION SUMMARY OF QUANTITIES CONTRACT NO 61G70 SHEET 2 OF 8 SHEETS

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LTY I	L PRO	CODE NO.	ITEM	UNIT	TOTAL QUANTITY		DWAY 004	CUL D	E SACS
SPECIALTY ITEM	SPECIAL PROVISION					THOMPSON BOULEVARD	BRANDYWYN LANE	THOMPSON BOULEVARD	BRANDYWYN LANE
		40604060	HOT-MIX ASPHALT SURFACE COURSE, IL-9.5, MIX "D", N50	TON	7,075	2,473	2,824	1,083	695
		42001300	PROTECTIVE COAT	SQ YD	13,555	5,788	6,363	889	515
		42300200	PORTLAND CEMENT CONCRETE DRIVEWAY PAVEMENT, 6 INCH	SQ YD	1,992	1,021	971		
		4240000					0.400	4.000	2005
		42400200	PORTLAND CEMENT CONCRETE SIDEWALK 5 INCH	SQ FT	52,001	20,399	21,638	6,028	3,936
		44000100	PAVEMENT REMOVAL	SQ YD	45,086	23,166	9,723	9,619	2,578
					13,000	23,100	3,7,23	3,023	2,370
		44000161	HOT-MIX ASPHALT SURFACE REMOVAL, 3"	SQ YD	2,880		2,880		
								***************************************	
		44000163	HOT-MIX ASPHALT SURFACE REMOVAL, 3 1/2"	SQ YD	4,512				4,512
	Х	44000200	DRIVEWAY PAVEMENT REMOVAL	SQ YD	2,114	1,018	1,096		
		44000500	COMBINATION CURB AND GUTTER REMOVAL	FOOT	26,010	10,970	13,334	1,062	644
		44000600	SIDEWALK REMOVAL	SQ FT	56,948	24,563	22,421	6,028	3,936
		X4405030	LONGITUDINAL PARTIAL DEPTH REMOVAL 3"	FOOT	666		570		96
		44201692	CLASS D PATCHES, TYPE II, 4 INCH	SQ YD	217	165	52		
		++201032	CLASS & FATCHES, THE II, 4 INCH	30 10	217	103	JE		***************************************
		44201694	CLASS D PATCHES, TYPE III, 4 INCH	SQ YD	134	100	34		
		44201713	CLASS D PATCHES, TYPE I, 6 INCH	SQ YD	296		237		59
		44201717	CLASS D PATCHES, TYPE II, 6 INCH	SQ YD	688		552		136
		44201721	CLASS D PATCHES, TYPE III, 6 INCH	SQ YD	688		552		136
		-							

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	MUN RTE	SECTION	COUNTY	TOTAL	SHEET
SUMMARY OF QUANTITIES	4756 4801	16-00106-02-RS	LAKE	222	6
			CONTRACT	NO 61	G70
SHEET 3 OF 8 SHEETS		ILLINOIS FED A	ID PROJECT		~

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L PRC	CODE NO.	ITEM	UNIT	TOTAL QUANTITY		DWAY 004	CUL D	E SACS
SPECIAL PROVISION					THOMPSON BOULEVARD	BRANDYWYN LANE	THOMPSON BOULEVARD	BRANDYWY LANE
	44201723	CLASS D PATCHES, TYPE IV, 6 INCH	SQ YD	296		237		59
	44209000	LONGITUDINAL PARTIAL DEPTH PATCHING	TON	26		22		4
	550A0050	STORM SEWERS, CLASS A, TYPE 1 12"	FOOT	125	69	56		
•	550A0340	STORM SEWERS, CLASS A, TYPE 2 12"	FOOT	217	154	63		
	55100500	STORM SEWER REMOVAL 12"	FOOT	1,196	880	316		
	55100700	STORM SEWER REMOVAL 15"	FOOT	6		6		
	60200105	CATCH BASINS, TYPE A, 4'-DIAMETER, TYPE 1 FRAME, OPEN LID	EACH	1	1			
	60201105	CATCH BASINS, TYPE A, 4'-DIAMETER, TYPE 11 FRAME AND GRATE	EACH	10	8	2		
	60206905	CATCH BASINS, TYPE C, TYPE 1 FRAME, OPEN LID	EACH	1	1			
	60218400	MANHOLES, TYPE A, 4'-DIAMETER, TYPE 1 FRAME, CLOSED LID	EACH	3	3			
	60221100	MANHOLES, TYPE A, 5'-DIAMETER, TYPE 1 FRAME, CLOSED LID	EACH	1		1		
	60236800	INLETS, TYPE A, TYPE 11 FRAME AND GRATE	EACH	17	9	8		
	60404800	FRAMES AND GRATES, TYPE 11	EACH	82	46	36		
	60406000	FRAMES AND LIDS, TYPE 1, OPEN LID	EACH	1		1		
	60406100	FRAMES AND LIDS, TYPE 1, CLOSED LID	EACH	35	23	11	1	
	60500050	REMOVING CATCH BASINS	EACH	3	3			

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	MUN RTE	SECTION	COUNTY	TOTAL SHEETS	SHEET NO
SUMMARY OF QUANTITIES	4756 4801	16-00106-02-R5	LAKE	222	7
			CONTRACT	NO 61	G70
SHEET 4 OF 8 SHEETS		ILLINOIS FED A	ID PROJECT		

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X X 669  X X 669  X X 669	ODE NO.  00500060  00603900  06900200  6900530  6901001	REMOVING INLETS  COMBINATION CONCRETE CURB AND GUTTER, TYPE B-6.12 (ABUTTING EXISTING PAVEMENT)  NON-SPECIAL WASTE DISPOSAL  SOIL DISPOSAL ANALYSIS  REGULATED SUBSTANCES PRE-CONSTRUCTION PLAN  REGULATED SUBSTANCES FINAL CONSTRUCTION REPORT	EACH FOOT CU YD EACH LSUM	TOTAL QUANTITY  11  8,632  82  1	20% \ ROA 00 THOMPSON BOULEVARD  8  82  1	BRANDYWYN LANE  3  8,203		E SACS  BRANDYWYN LANE  429
X X 669  X X 669  X X 669	60500060 60603900 66900200 6900530	REMOVING INLETS  COMBINATION CONCRETE CURB AND GUTTER, TYPE B-6.12 (ABUTTING EXISTING PAVEMENT)  NON-SPECIAL WASTE DISPOSAL  SOIL DISPOSAL ANALYSIS  REGULATED SUBSTANCES PRE-CONSTRUCTION PLAN	EACH  FOOT  CU YD  EACH  LSUM	9UANTITY  11  8,632  . 82  . 1	THOMPSON BOULEVARD  8  82  1	BRANDYWYN LANE	THOMPSON	BRANDYWYN LANE
X 606  X 669  X X 669	6900200 6900530 6901001	COMBINATION CONCRETE CURB AND GUTTER, TYPE B-6.12 (ABUTTING EXISTING PAVEMENT)  NON-SPECIAL WASTE DISPOSAL  SOIL DISPOSAL ANALYSIS  REGULATED SUBSTANCES PRE-CONSTRUCTION PLAN	FOOT  CU YD  EACH  LSUM	8,632	8 82 1	LANE 3		LANE
X 606  X 669  X X 669	6900200 6900530 6901001	COMBINATION CONCRETE CURB AND GUTTER, TYPE B-6.12 (ABUTTING EXISTING PAVEMENT)  NON-SPECIAL WASTE DISPOSAL  SOIL DISPOSAL ANALYSIS  REGULATED SUBSTANCES PRE-CONSTRUCTION PLAN	FOOT  CU YD  EACH  LSUM	8,632	1			429
X X 669  X X 669	6900200 	NON-SPECIAL WASTE DISPOSAL  SOIL DISPOSAL ANALYSIS  REGULATED SUBSTANCES PRE-CONSTRUCTION PLAN	CU YD  EACH  LSUM	1	1	8,203		429
X X 669  X X 669	6900200 	NON-SPECIAL WASTE DISPOSAL  SOIL DISPOSAL ANALYSIS  REGULATED SUBSTANCES PRE-CONSTRUCTION PLAN	CU YD  EACH  LSUM	1	1	8,203		429
χ x 669 χ x 669	6900530	SOIL DISPOSAL ANALYSIS  REGULATED SUBSTANCES PRE-CONSTRUCTION PLAN	EACH LSUM	1	1			
χ x 669 χ x 669	6900530	SOIL DISPOSAL ANALYSIS  REGULATED SUBSTANCES PRE-CONSTRUCTION PLAN	EACH LSUM	1	1			
χ x 669	6901001	REGULATED SUBSTANCES PRE-CONSTRUCTION PLAN	LSUM	1	1			
χ x 669	6901001	REGULATED SUBSTANCES PRE-CONSTRUCTION PLAN	LSUM	1	1			
Х X 669	6901003	REGULATED SUBSTANCES FINAL CONSTRUCTION REPORT	LSUM	1	_			
X X 669	6901003	REGULATED SUBSTANCES FINAL CONSTRUCTION REPORT	LSUM	1	1 _			
					1			
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χ X 669	6901006	REGULATED SUBSTANCES MONITORING	CAL DA	50	25	25		
671	7100100	MOBILIZATION	L SUM	1	0.5	0.5		
701	0107025	CHANGEABLE MESSAGE SIGN	CAL DA	392	140	252		
703	0300100	SHORT TERM PAVEMENT MARKING	FOOT	1,923	557	1,366		
703	0300150	SHORT TERM PAVEMENT MARKING REMOVAL	SQ FT	483	140	343		
703	0300210	TEMPORARY PAVEMENT MARKING LETTERS AND SYMBOLS	SQ FT	99	36	63		
703	0300220	TEMPORARY PAVEMENT MARKING - LINE 4"	FOOT	8,643	4,240	4,403		
703	0300240	TEMPORARY PAVEMENT MARKING - LINE 6"	FOOT	404	317	87		
703	0300260	TEMPORARY PAVEMENT MARKING - LINE 12"	FOOT	793	302	491		
703	0300280	TEMPORARY PAVEMENT MARKING - LINE 24"	FOOT	190	155	35		

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	MUN RTE	SECTION	COUNTY	TOTAL	SHEET NO	
SUMMARY OF QUANTITIES	4756 4801	16-00106-02-RS	LAKE	222	8	
	CONTRACT NO 61G70					
SHEET 5 OF 8 SHEETS	ILLINOIS FED AID PROJECT					

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LTY I	CODE NO.	ITEM	UNIT	TOTAL QUANTITY		ROADWAY 0004		CUL DE SACS	
SPECIALTY ITEM SPECIAL PROVISION					THOMPSON BOULEVARD	BRANDYWYN LANE	THOMPSON BOULEVARD	BRANDYWYN LANE	
	70300900	PAVEMENT MARKING TAPE, TYPE IV - LETTERS AND SYMBOLS	SQ FT	210	61	149			
	70300904	PAVEMENT MARKING TAPE, TYPE IV 4"	FOOT	2,476	717	1,759			
	70300906	PAVEMENT MARKING TAPE, TYPE IV 6"	FOOT	539	156	383			
	70300924	PAVEMENT MARKING TAPE, TYPE IV 24"	FOOT	144	42	102			
Х	78000100	THERMOPLASTIC PAVEMENT MARKING - LETTERS AND SYMBOLS	SQ FT	99	36	63			
Х	78000200	THERMOPLASTIC PAVEMENT MARKING - LINE 4"	FOOT	8,643	4,240	4,403			
X	78000400	THERMOPLASTIC PAVEMENT MARKING - LINE 6"	FOOT	404	317	87			
X	78000600	THERMOPLASTIC PAVEMENT MARKING - LINE 12"	FOOT	793	302	491			
X	78000650	THERMOPLASTIC PAVEMENT MARKING - LINE 24"	FOOT	190	155	35			
X	78009004	MODIFIED URETHANE PAVEMENT MARKING - LINE 4"	FOOT	18,450	13,065	5,385			
X	78009024	MODIFIED URETHANE PAVEMENT MARKING - LINE 24"	FOOT	137	97	40			
× ×	K0036120	MULCH PLACEMENT 4"	SQ YD	922	346	442	120	14	
	X0327980	PAVEMENT MARKING REMOVAL - WATER BLASTING	SQ FT	1,322	383	939			
X	X2080250	TRENCH BACKFILL, SPECIAL	CU YD	1,309	555	673	49	32	
X	X2130010	EXPLORATION TRENCH, SPECIAL	FOOT	500	250	250			
	X4021000	TEMPORARY ACCESS (PRIVATE ENTRANCE)	EACH	71	34	37			

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	MUN RTE	SECTION	COUNTY	TOTAL	SHEET
SUMMARY OF QUANTITIES	4756 4801	16-00106-02-RS	LAKE	222	9
			CONTRACT	NO 61	G70
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LTY I	CODE NO.	ITEM	UNIT	TOTAL QUANTITY	ROADWAY 0004		CUL DE SACS	
SPECIALTY ITEM SPECIAL PROVIS					THOMPSON BOULEVARD	BRANDYWYN LANE	THOMPSON BOULEVARD	BRANDYWYN LANE
X	X4022000	TEMPORARY ACCESS (COMMERCIAL ENTRANCE)	EACH	1		1		
X	X4023000	TEMPORARY ACCESS (ROAD)	EACH	49	25	24		
X	X4240800	DETECTABLE WARNINGS (SPECIAL)	SQ FT	1,602	819	783		
X	X4401198	HOT-MIX ASPHALT SURFACE REMOVAL (VARIABLE DEPTH)	SQ YD	12,131		12,131		
X	X6013600	PIPE UNDERDRAINS 4" (MODIFIED)	FOOT	11,796	6,552	5,244		
X	X6026050	SANITARY MANHOLES TO BE ADJUSTED	EACH	17	12	5		
Х	X6026051	SANITARY MANHOLES TO BE RECONSTRUCTED	EACH	7	4	3		
X	X6030310	FRAMES AND LIDS TO BE ADJUSTED (SPECIAL)	EACH	1		1		
X	X6040205	FRAMES AND LIDS, SPECIAL	EACH	2	1	1		
X	X6064200	COMBINATION CONCRETE CURB AND GUTTER, TYPE B-6.12 (SPECIAL)	FOOT	17,245	11,010	4,959	1,061	215
X	X6065750	CONCRETE MEDIAN SURFACE, 6 INCH (SPECIAL)	SQ FT	71				71
· X	X7010216	TRAFFIC CONTROL AND PROTECTION, (SPECIAL)	L SUM	1	0.5	0.5		
X	X7030005	TEMPORARY PAVEMENT MARKING REMOVAL	SQ FT	1,592	461	1,131		
X	XX001342	DOMESTIC WATER SERVICE BOX TO BE REPLACED	EACH	12	5	7		
Х	XX006821	CONCRETE TRUCK WASHOUT	L SUM	1	0.5	0.5		
X	Z0013798	CONSTRUCTION LAYOUT	L SUM	1	0.5	0.5		

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	MUN RTE	SECTION	COUNTY TOTAL SHEETS		SHEET NO	
SUMMARY OF QUANTITIES	4756 4801	16-00106-02-R5	LAKE	222	10	
	CONTRACT NO 61G70					
SHEET 7 OF 8 SHEETS		ILLINOIS FED AI	PROJECT	****		

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	Y ITEM PROVISION			UNIT	TOTAL QUANTITY		FED ILLAGE	100% VILLAGE		
	IL PR(	CODE NO.	ITEM			ROADWAY 0004		CUL DE SACS		
	SPECIALTY SPECIAL PR					THOMPSON BOULEVARD	BRANDYWYN LANE	THOMPSON BOULEVARD	BRANDYWYN LANE	
	X Z0017400		DRAINAGE & UTILITY STRUCTURES TO BE ADJUSTED	EACH	89	49	39	1		
-		X Z0017700 DRAINAGE & UTILITY STRUCTURES TO BE RECONSTRUCTED  X Z0030850 TEMPORARY INFORMATION SIGNING								
	X			EACH	5	4	1			
	х			SQ FT	1,106	643	463			
	X	Z0033700	LONGITUDINAL JOINT SEALANT	FOOT	15,297	5,458	6,029	2,370	1,440	
	X	Z0056608	STORM SEWER (WATER MAIN REQUIREMENTS) 12 INCH	FOOT	1,208	892	316			
	X	Z0073510	TEMPORARY TRAFFIC SIGNAL TIMING	EACH	5	3	2			
#	X	Z0076600	TRAINEES	HOUR	500	250	250			
<b>井</b>	X	Z0076604	TRAINEES TRAINING PROGRAM GRADUATE	HOUR	500	250	250			
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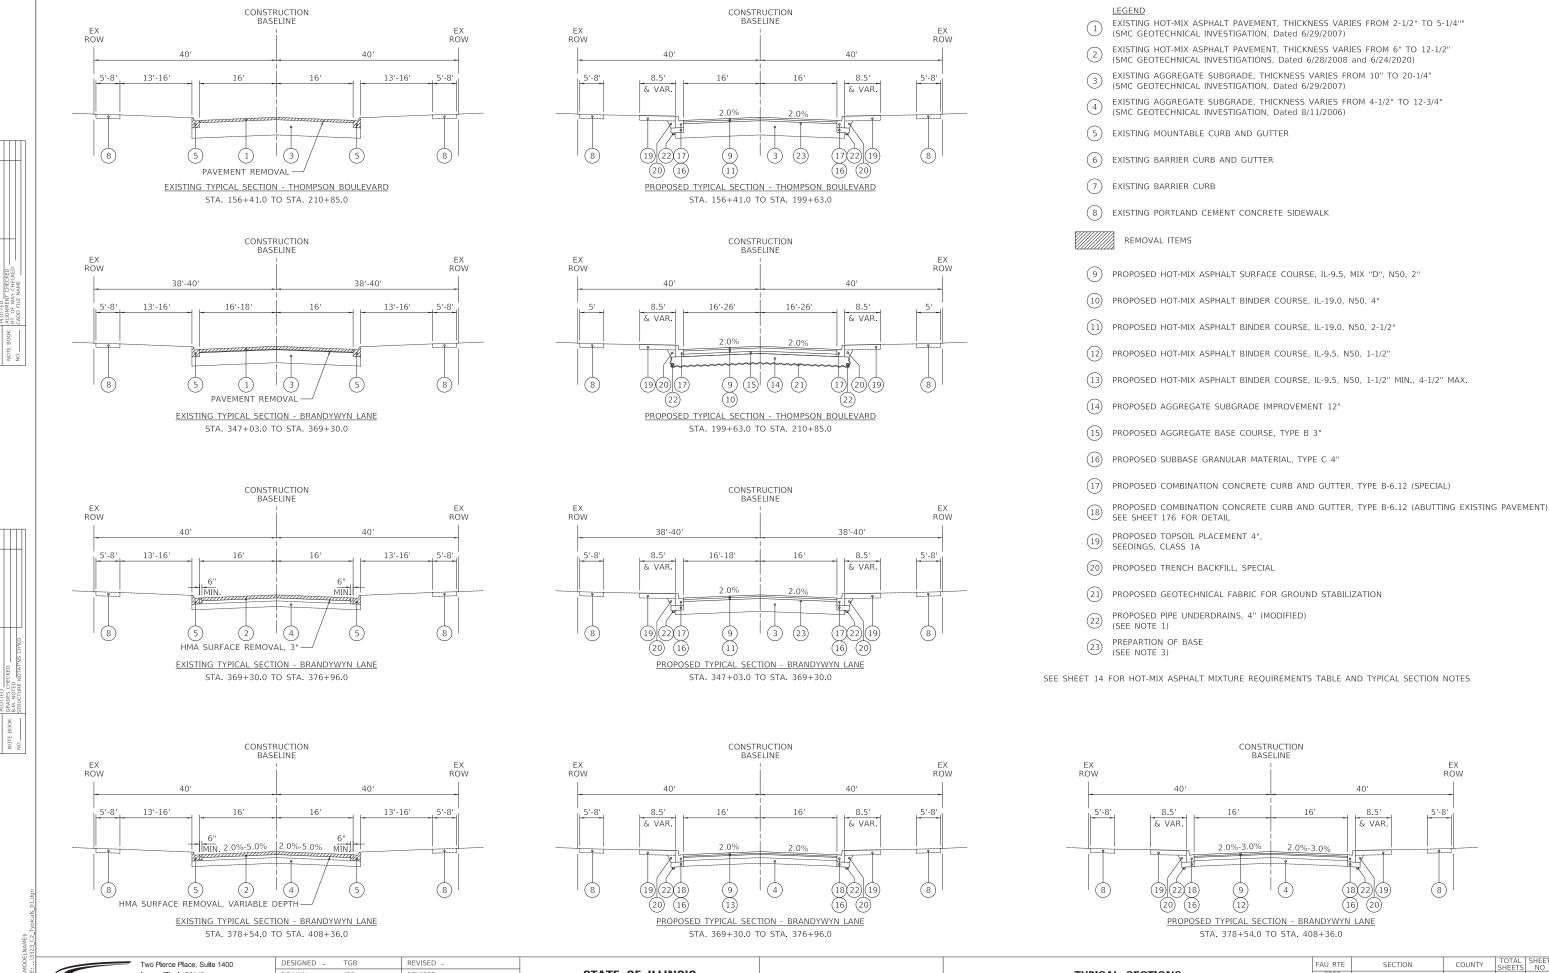
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STATE OF ILLINOIS DEPARTMENT OF TRANSPORTATION

SECTION SUMMARY OF QUANTITIES 16-00106-02-RS SHEET 8 OF 8 SHEETS ILLINOIS FED AID PROJECT



TYPICAL SECTIONS

SHEET 1 OF 3 SHEETS

16-00106-02-RS

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CONTRACT NO 61G70

**STATE OF ILLINOIS** 

**DEPARTMENT OF TRANSPORTATION** 

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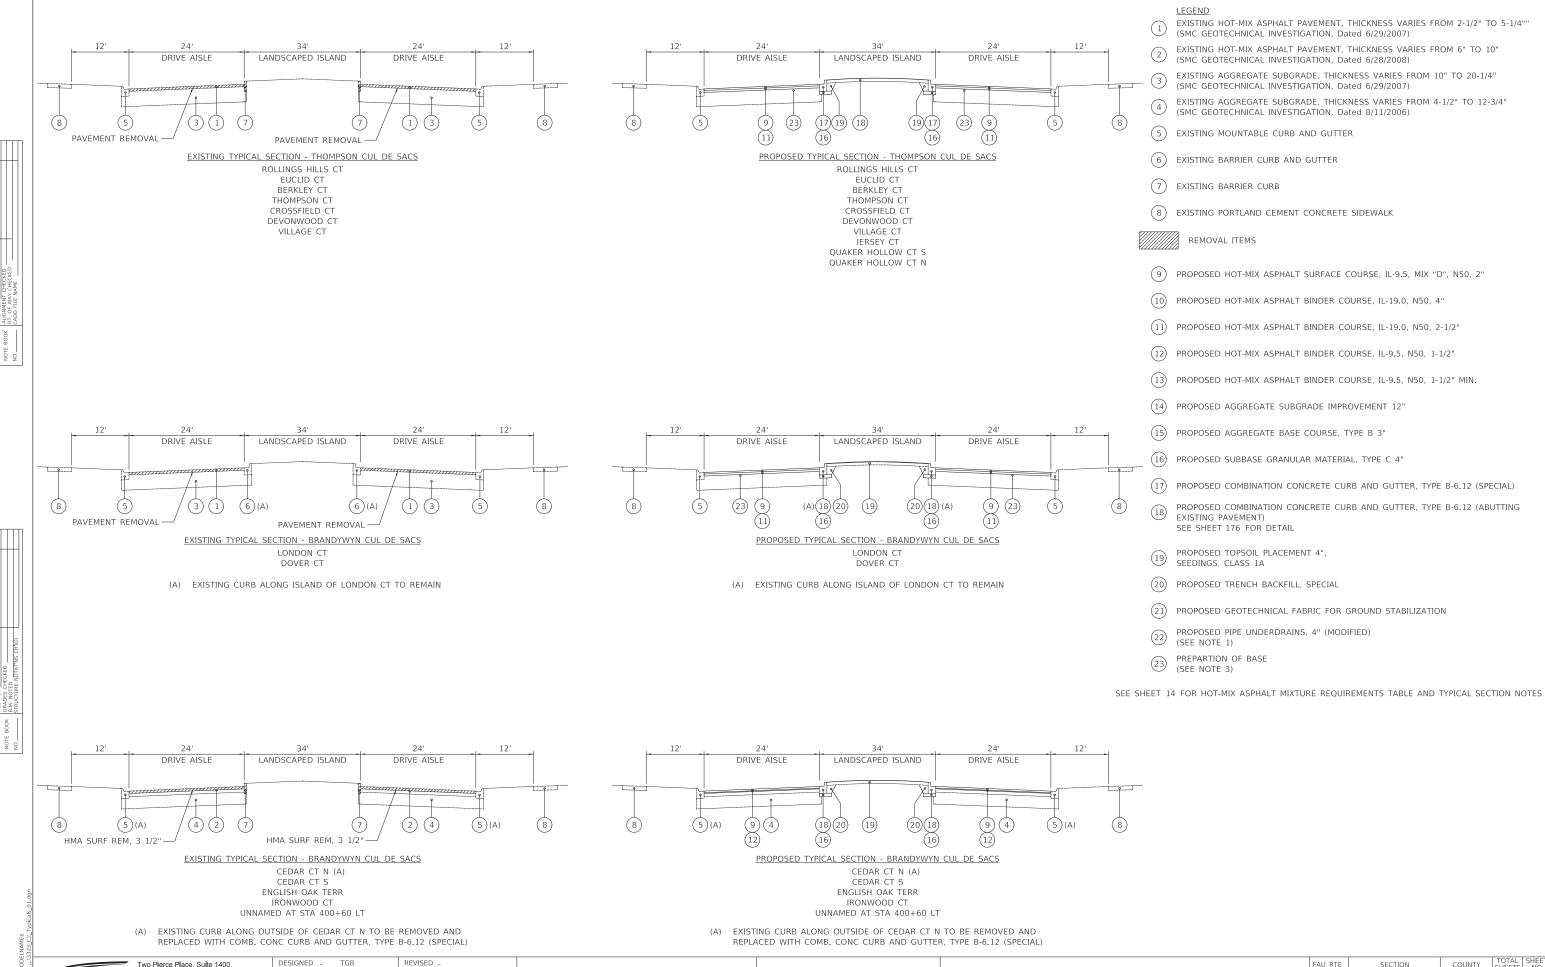
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**DEPARTMENT OF TRANSPORTATION** 

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CONTRACT NO 61G70

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TYPICAL SECTIONS

SHEET 2 OF 3 SHEETS

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### **HOT-MIX ASPHALT MIXTURE REQUIREMENTS**

PAY ITEM	PERCENT AIR VOIDS @ Ndes.
PAVEMENT RECONSTRUCTION, 6"	
HOT-MIX ASPHALT SURFACE COURSE, MIX "D", N50 (IL 9.5mm); 2"	3.5% @ 50 GYR.
HOT-MIX ASPHALT BINDER COURSE, IL-19.0, N50; 4"	3.5% @ 50 GYR.
PAVEMENT RECONSTRUCTION, 4-1/2"	
HOT-MIX ASPHALT SURFACE COURSE, MIX "D", N50 (IL 9.5mm); 2"	3.5% @ 50 GYR.
HOT-MIX ASPHALT BINDER COURSE, IL-19.0, N50; 2-1/2"	3.5% @ 50 GYR.
PAVEMENT RESURFACING W/ PROFILE ADJUSTMENT	
HOT-MIX ASPHALT SURFACE COURSE, MIX "D", N50 (IL 9.5mm); 2"	3.5% @ 50 GYR.
HOT-MIX ASPHALT BINDER COURSE, IL-9.5, N50; 1-1/2" MIN., 4-1/2" MAX.	3.5% @ 50 GYR.
PAVEMENT RESURFACING	
HOT-MIX ASPHALT SURFACE COURSE, MIX "D", N50 (IL 9.5mm); 2"	3.5% @ 50 GYR.
HOT-MIX ASPHALT BINDER COURSE, IL-9.5, N50; 1-1/2"	3.5% @ 50 GYR.
CLASS D PATCHES, 6"	
CLASS D PATCH (HMA BINDER IL-19 MM); 6"	4% @ 70 GYR.
CLASS D PATCHES, 4"	
CLASS D PATCH (HMA BINDER IL-19 MM); 4"	4% @ 70 GYR.
LONGITUDINAL PARTIAL DEPTH PATCHING; 3"	
HOT-MIX ASPHALT SURFACE COURSE, MIX "D", N50 (IL 9.5mm); 3"	4% @ 50 GYR.

- THE UNIT WEIGHT USED TO CALCULATE ALL HOT-MIX ASPHALT SURFACE MIXTURES IS 112 LB/SY-IN.
- THE "AC TYPE" FOR POLYMERIZED HMA MIXES SHALL BE "SBS/SBR PG 76-22" AND FOR NON-POLYMERIZED HMA THE "AC TYPE" SHALL BE "PG 64-22" UNLESS MODIFIED BY DISTRICT ONE SPECIAL PROVISIONS.
- 3. FOR USE OF RECYCLED MATERIALS SEE SPECIAL PROVISIONS.
- LONGITUDINAL JOINT SEALANT SHALL BE PLACED AT PAVEMENT JOINT LINES, OVER BINDER IL-9.5 AND


- 1. UNDERDRAINS AT THE OUTSIDE EDGE OF PAVEMENT TO BE INSTALLED FOR 50' ON EACH SIDE OF CURB LINE DRAINAGE STRUCTURES TO DRAIN THE AGGREGATE SUBGRADE. TRANSVERSE UNDERDRAINS WILL BE INSTALLED AT THE LOW POINTS OF THE PROFILE AND AT ANY UNDERCUTS DETERMINED IN
- 2. GEOTECHNICAL REPORTS ARE AVAILABLE FROM THE VILLAGE OF BUFFALO GROVE REPRESENTATIVE.
- ANY ADDITIONAL SUBBASE REMOVAL REQUIRED TO ACCOMMODATE PROPOSED HMA PAVEMENT THICKNESS SHALL BE PAID FOR AS "EARTH EXCAVATION". ANY ADDITIONAL SUBBASE REQUIRED TO RAISE EXISTING SUBBASE ELEVATION TO THE ELEVATION OF THE BOTTOM OF THE PROPOSED HMA PAVEMENT SHALL BE PAID FOR AS "AGGREGATE BASE REPAIR".


Two Pierce Place, Suite 1400 Itasca, Illinois 60143 Tel: 630.773.3900 Fax: 630.773.3975


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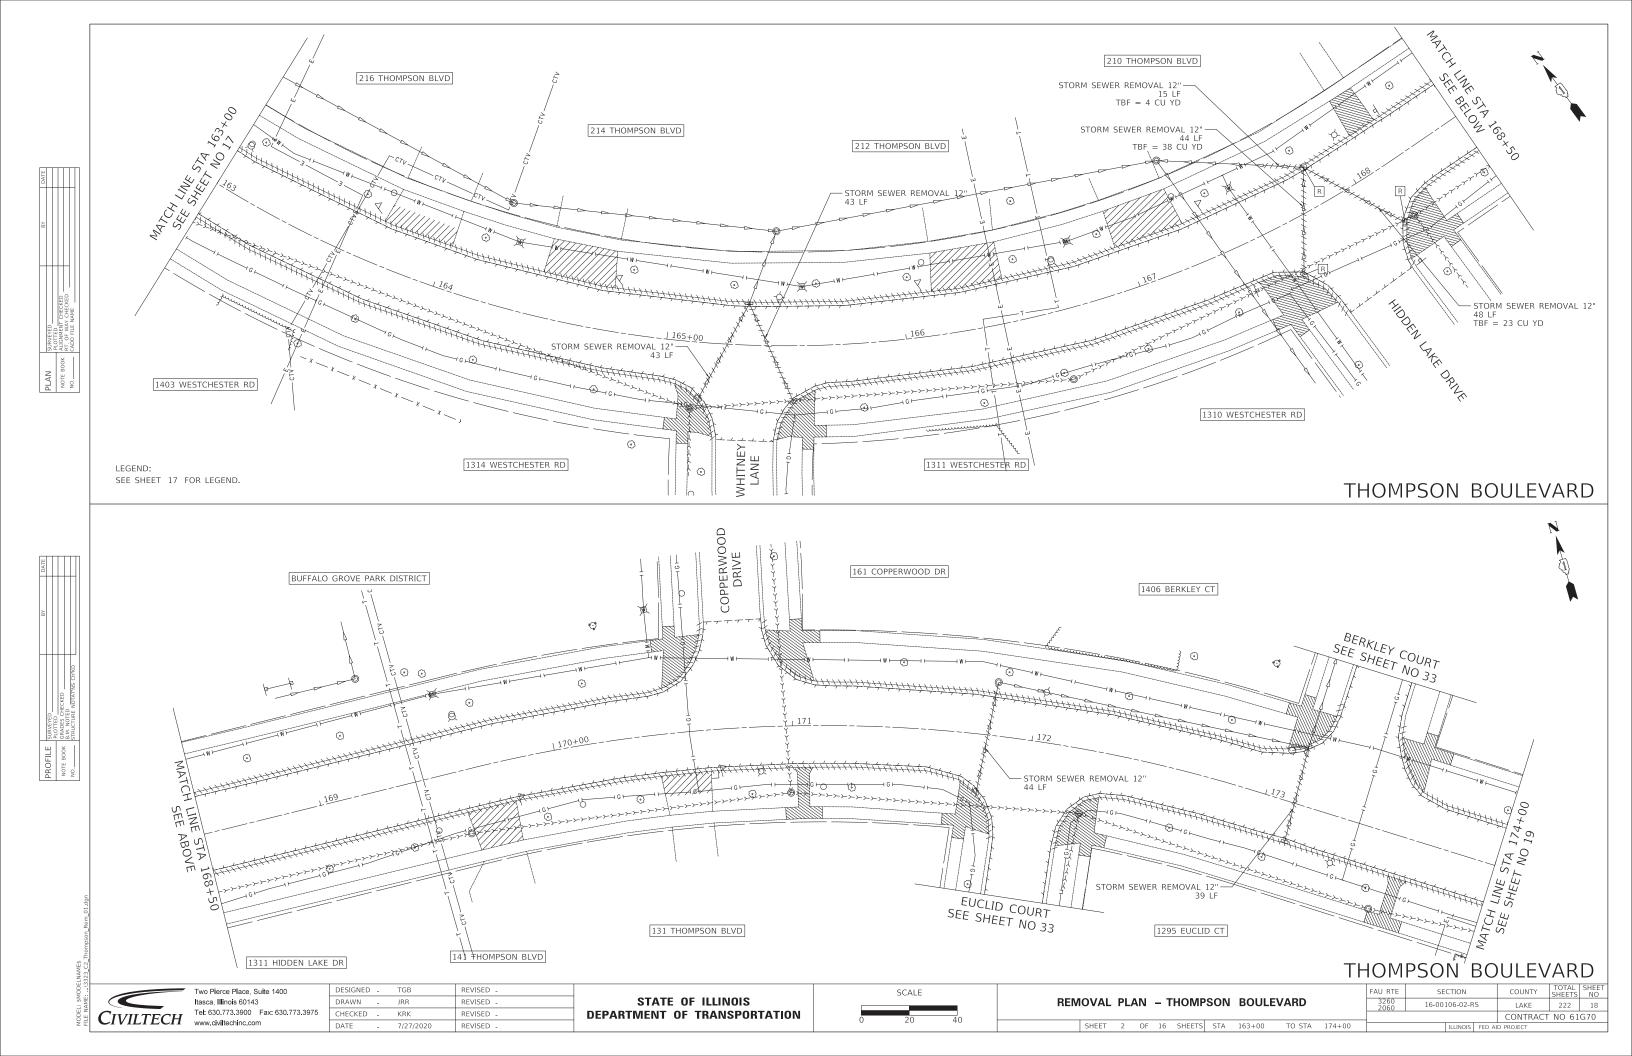
STATE OF ILLINOIS **DEPARTMENT OF TRANSPORTATION** 

TOTAL SHEET NO 222 14 COUNTY TYPICAL SECTIONS 16-00106-02-RS LAKE CONTRACT NO 61G70 SHEET 3 OF 3 SHEETS



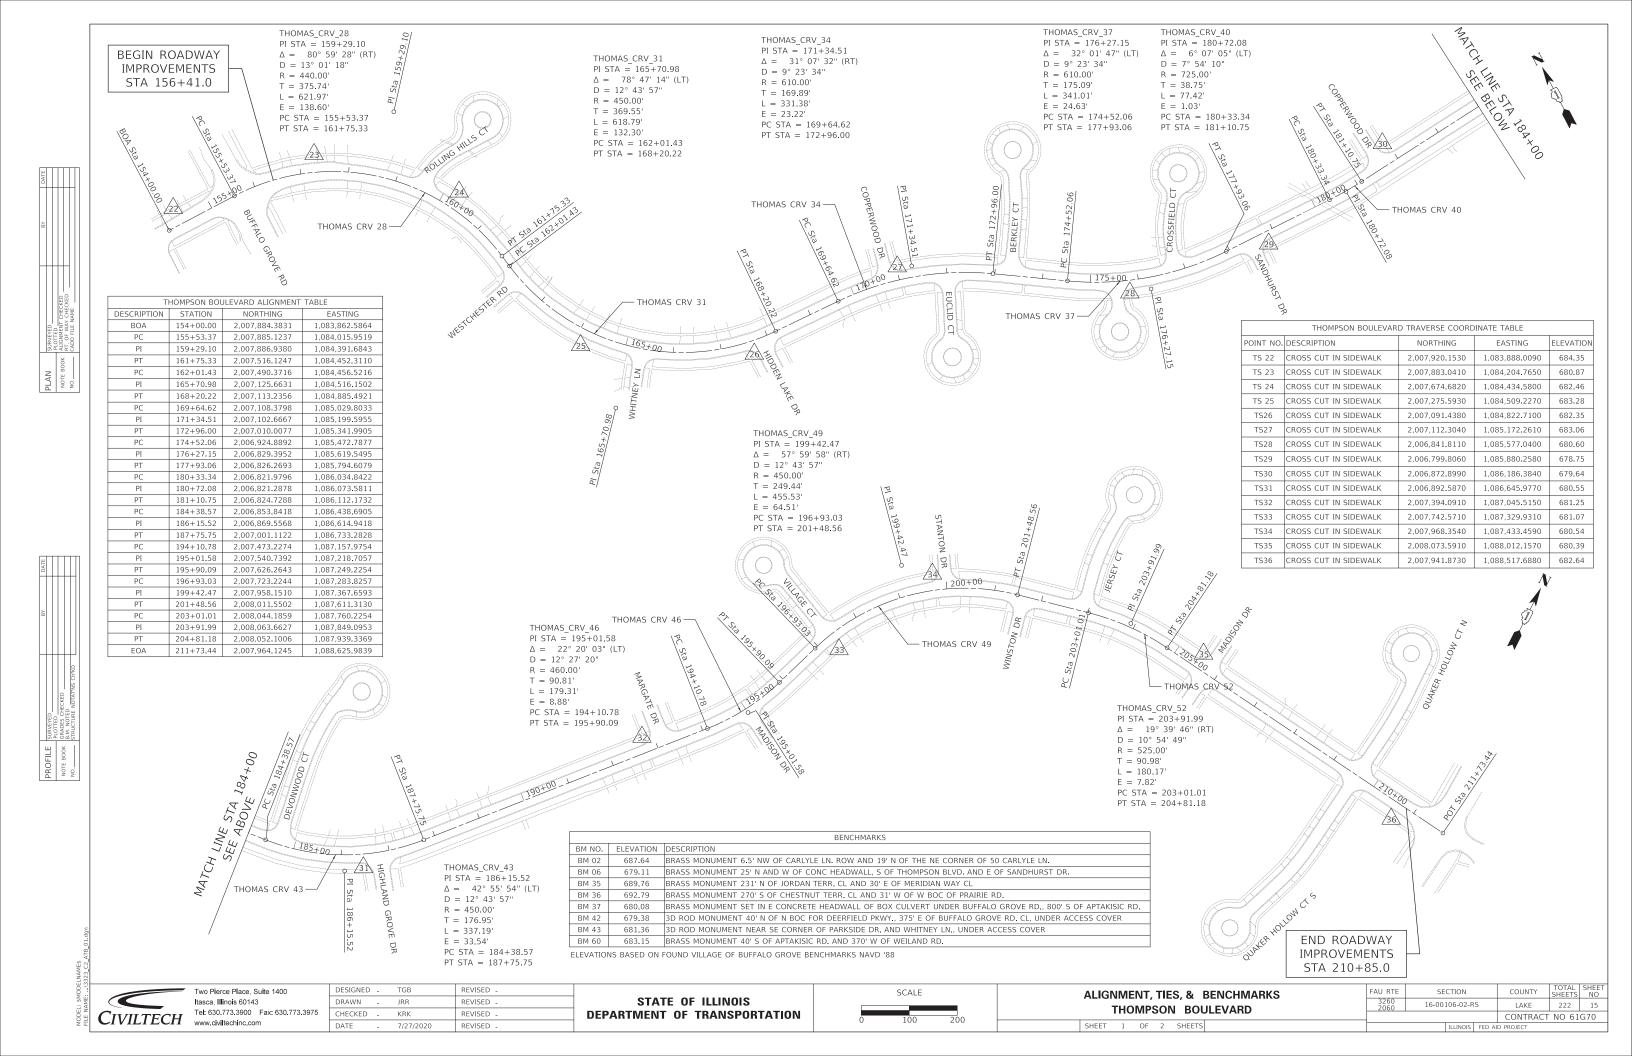

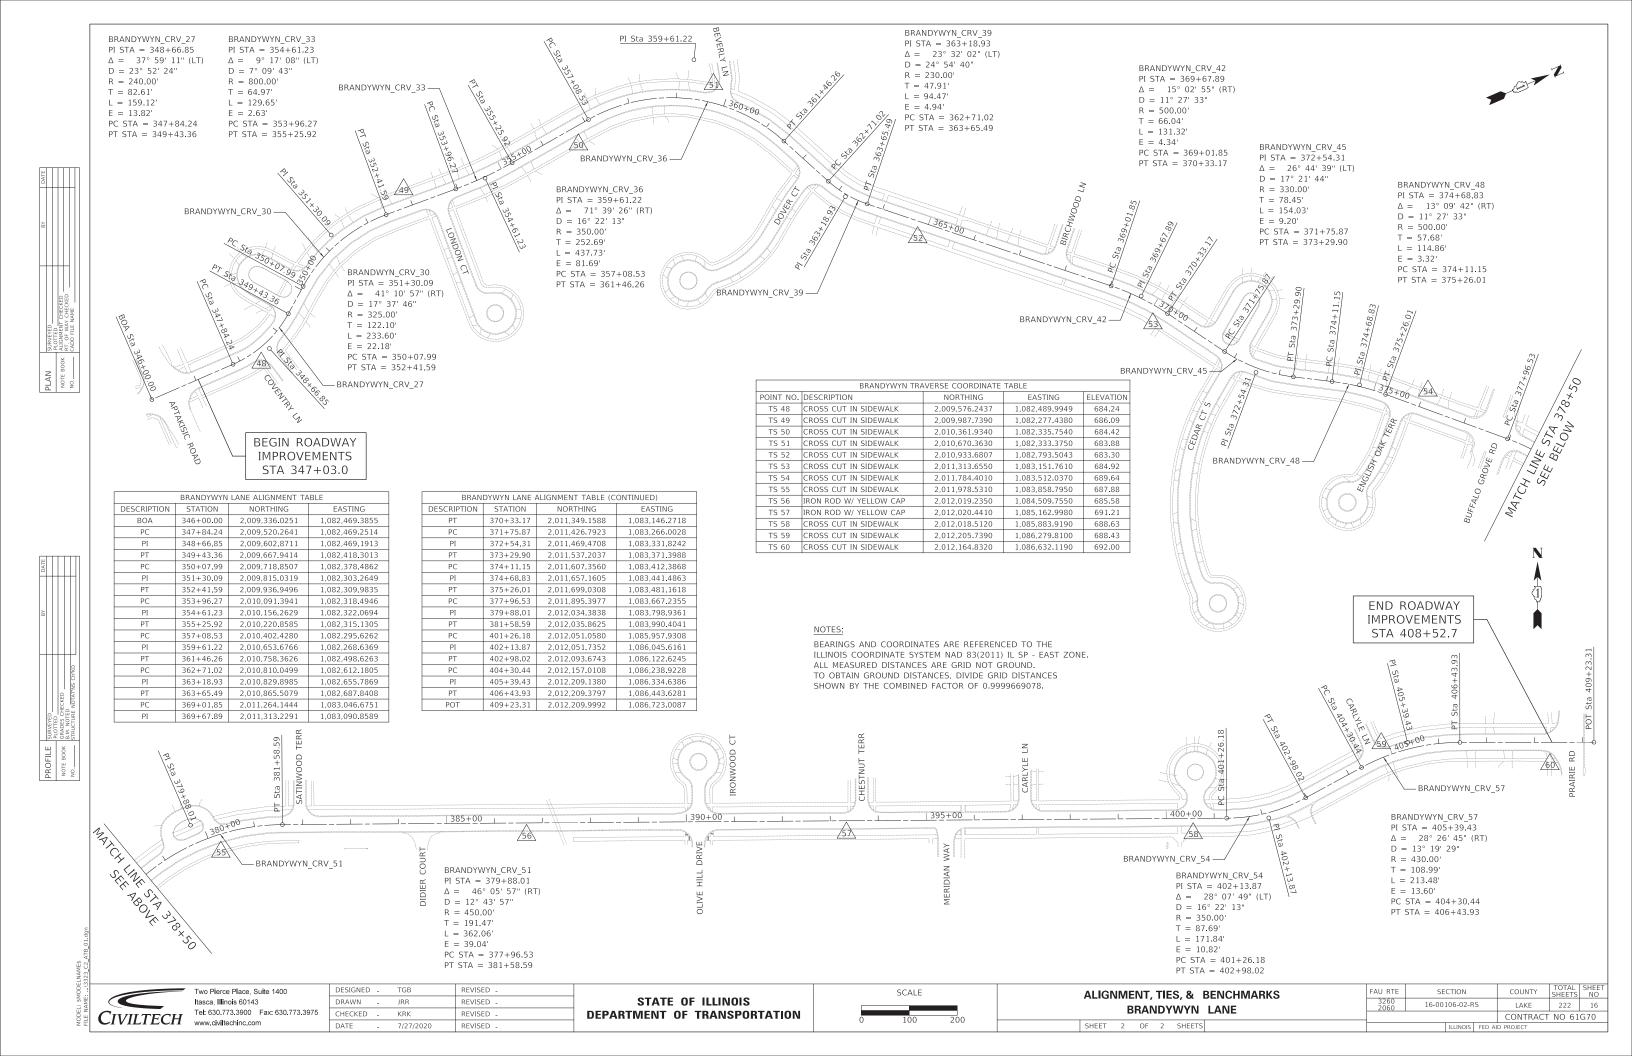

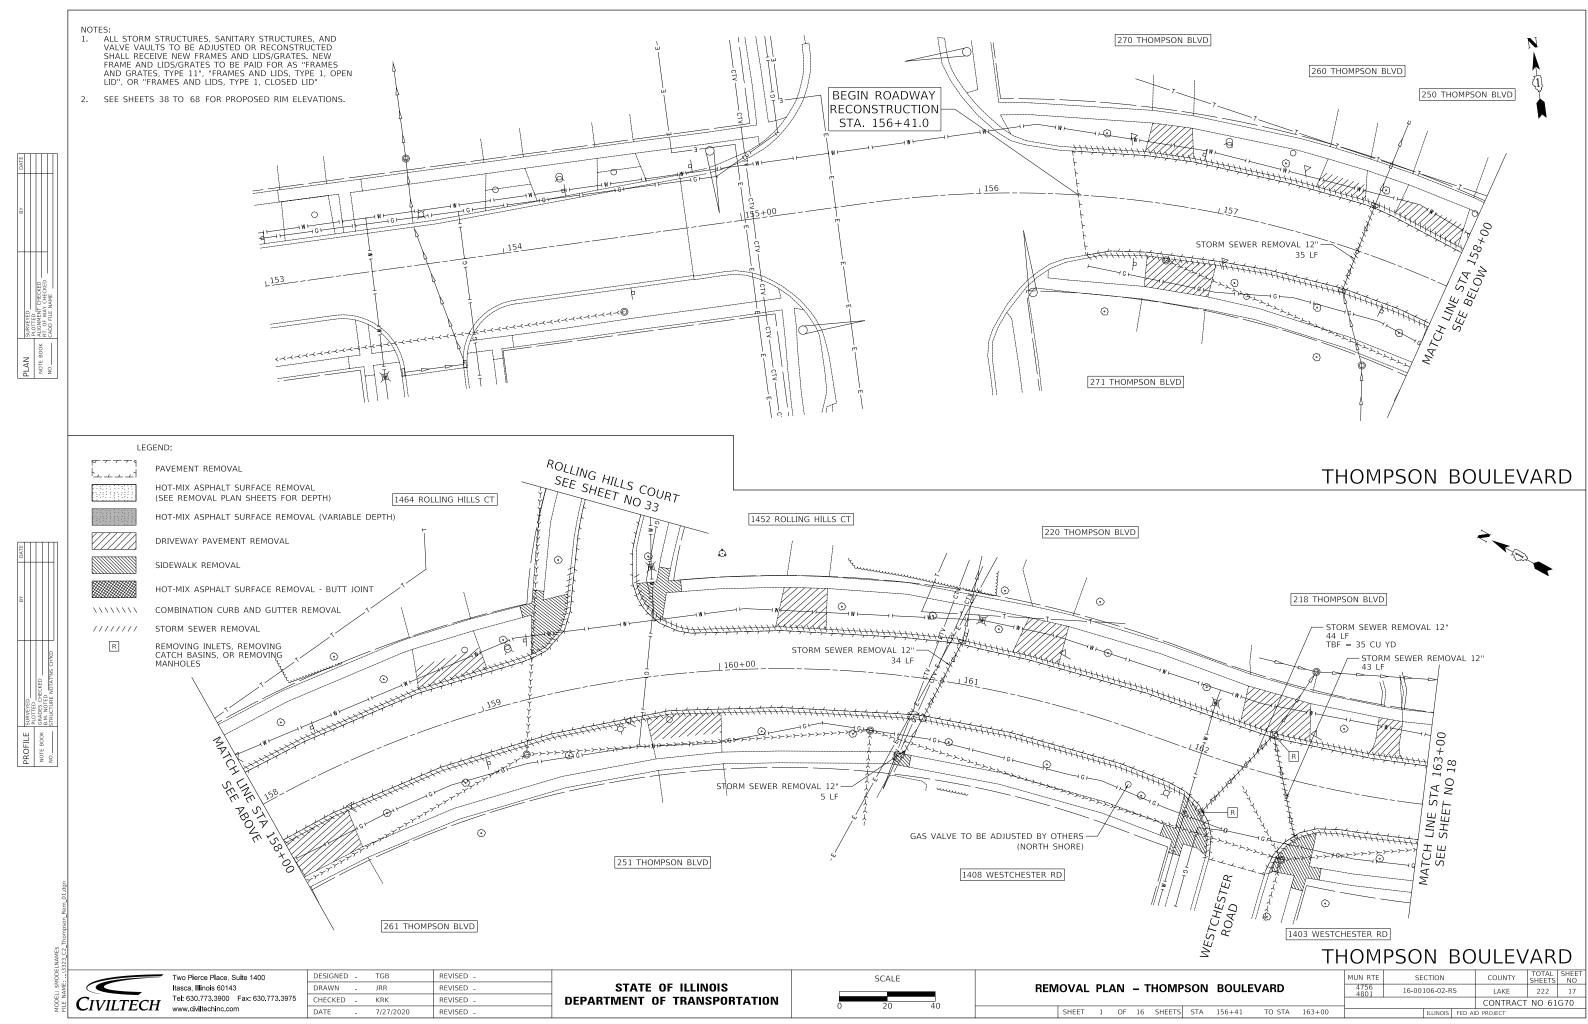

1316 BERKLEY CT CROSSFIELD COURT SEE SHEET NO 33 1382 BERKLEY CT STORM SEWER REMOVAL 12" 48 LF The state of the s - STORM SEWER REMOVAL 12" 48 LF SANDHURST DRIVE 65 THOMPSON CT 1298 SANDHURST DR THOMPSON COURT 15 THOMPSON CT 55 THOMPSON CT

25 THOMPSON CT

THOMPSON BOULEVARD



LEGEND:

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Tel: 630.773.3900 Fax: 630.773.3975
www.civiltechinc.com

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45 THOMPSON CT


STATE OF ILLINOIS **DEPARTMENT OF TRANSPORTATION** 


35 THOMPSON CT


REMOVAL PLAN - THOMPSON BOULEVARD SHEET 3 OF 16 SHEETS STA 174+00 TO STA 179+00

COUNTY TOTAL SHEET NO LAKE 222 19 16-00106-02-RS CONTRACT NO 61G70

SEE SHEET 17 FOR LEGEND.

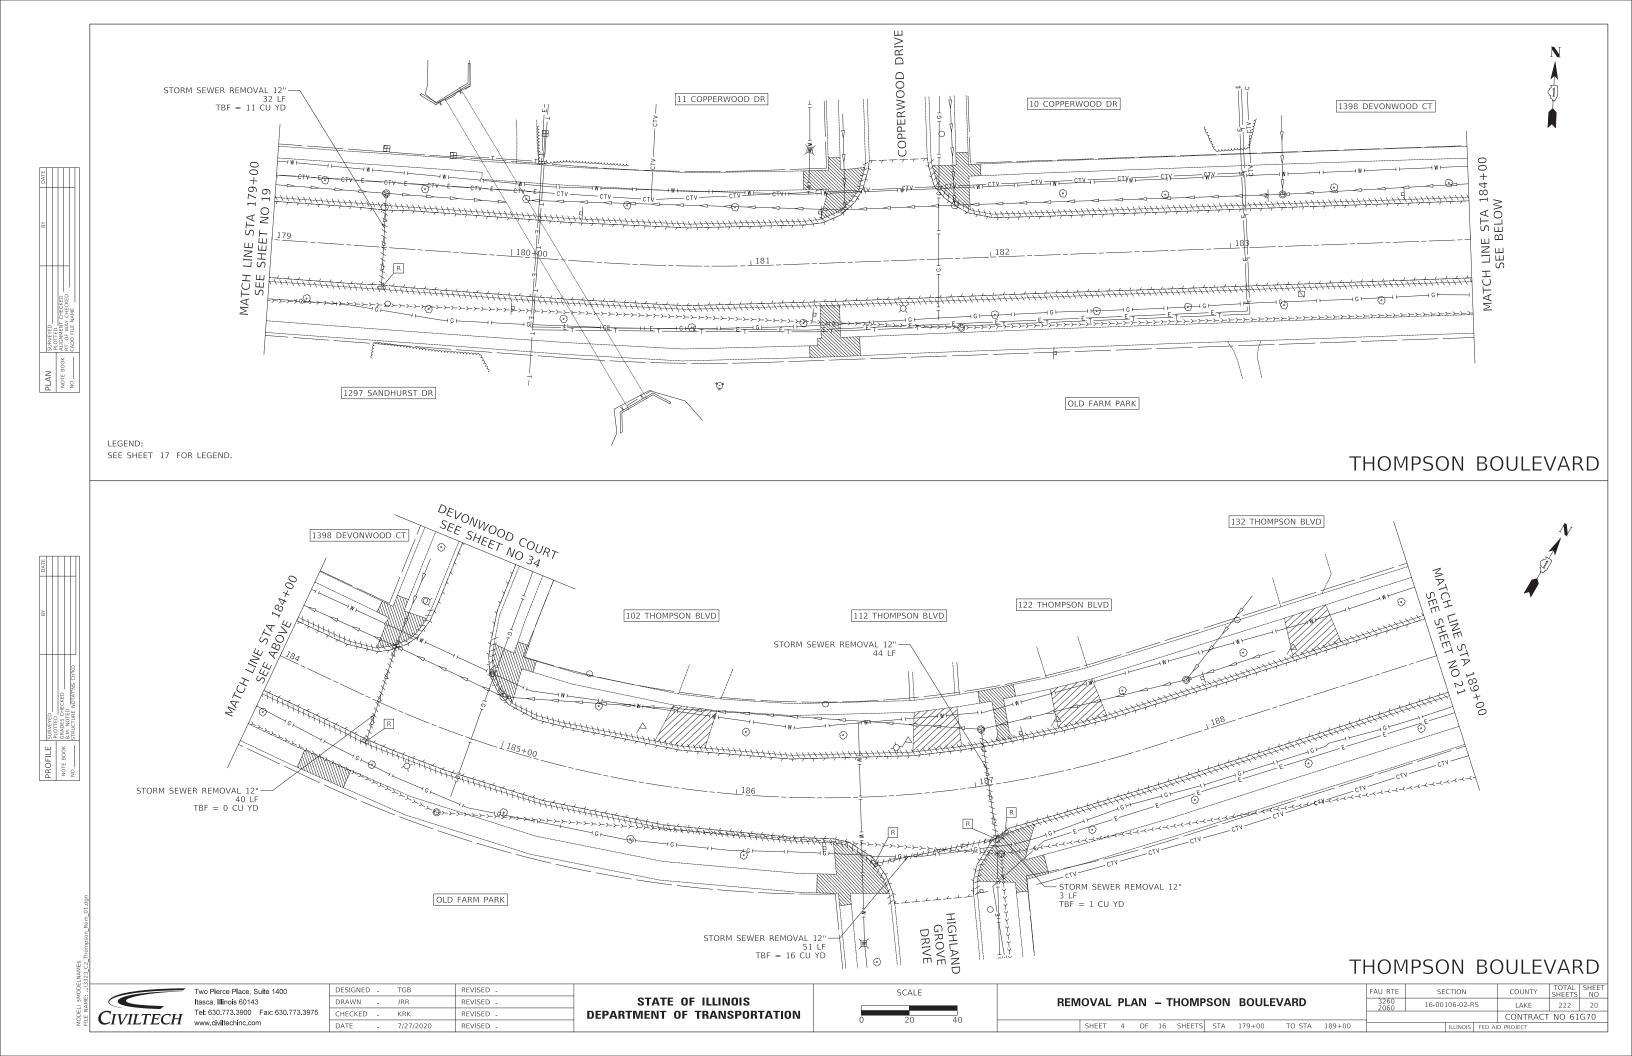


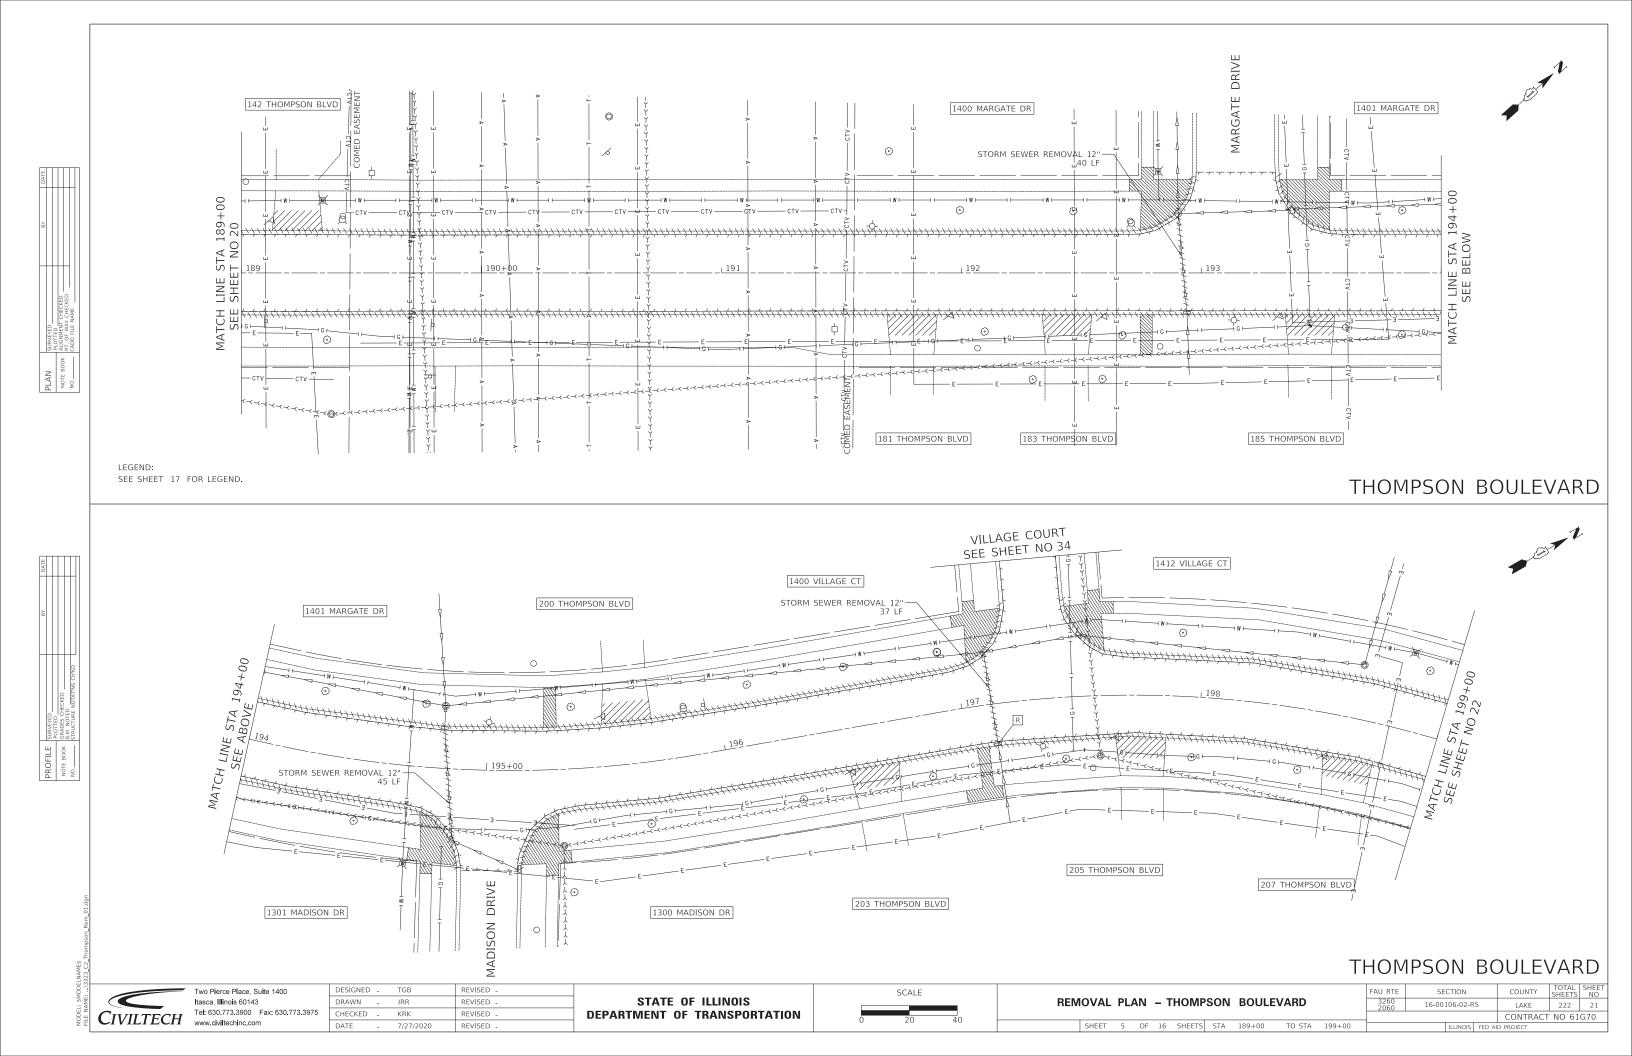

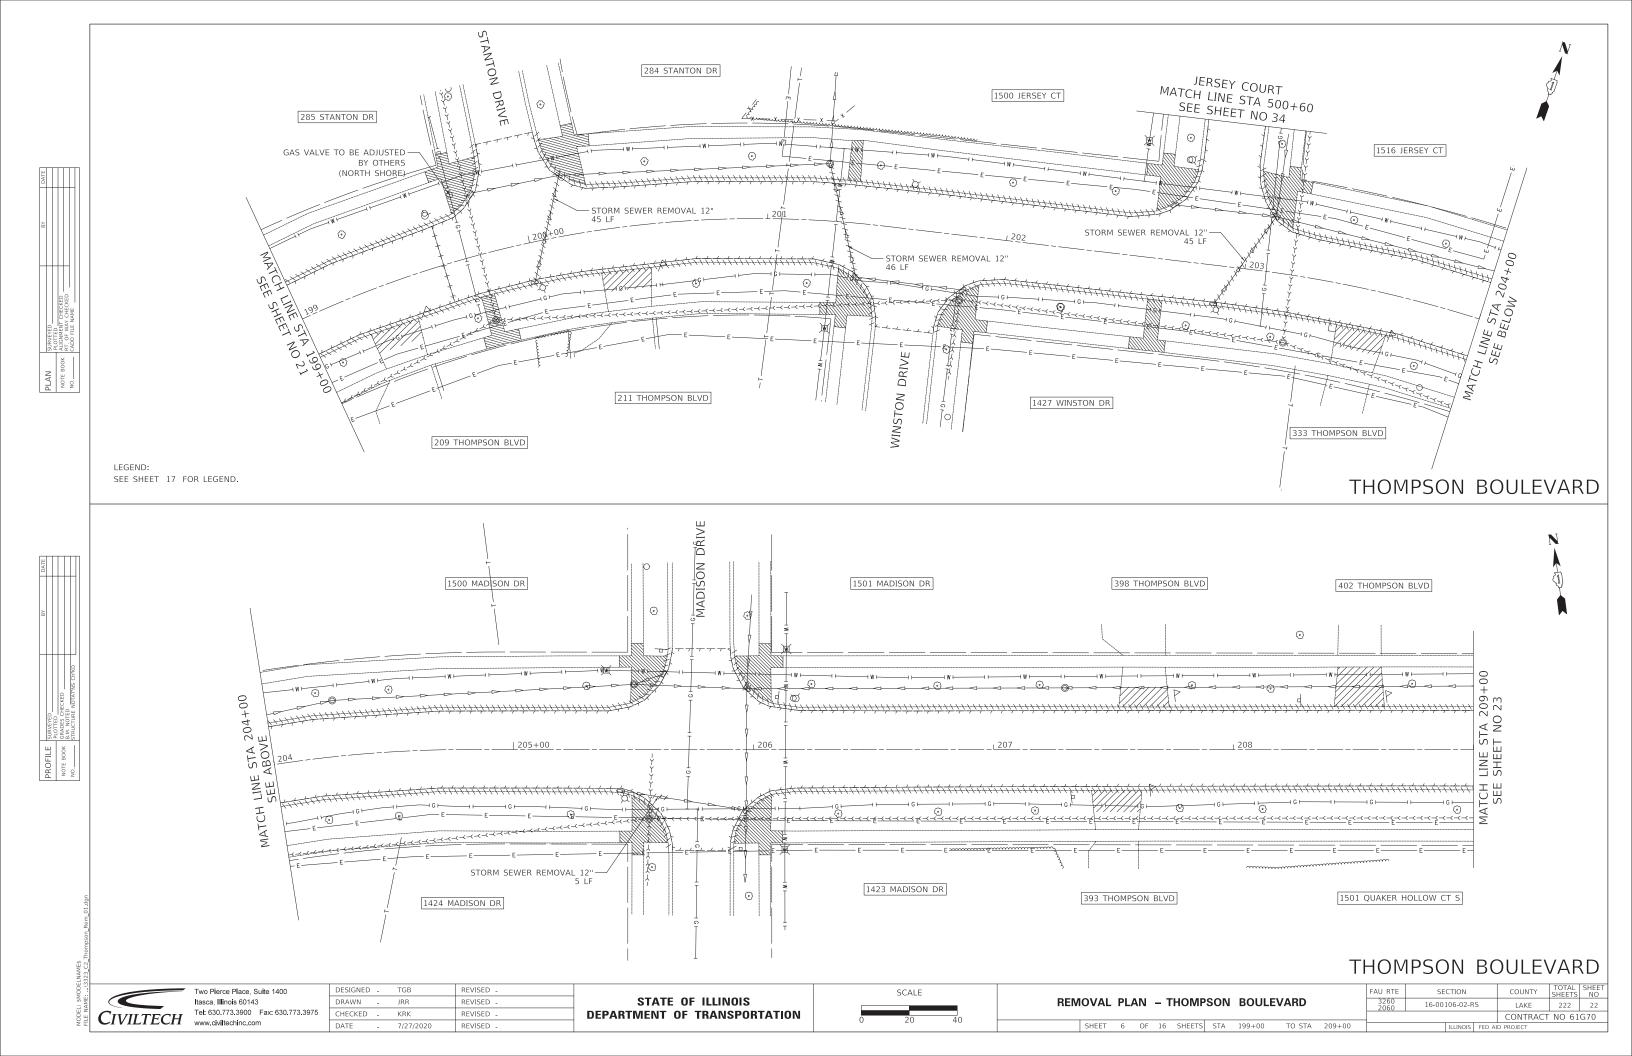





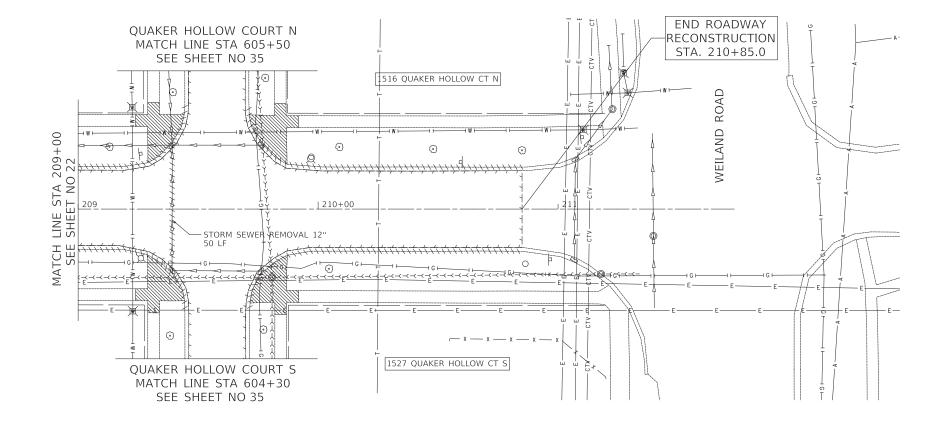

LEGEND: SEE SHEET 17 FOR LEGEND.

### THOMPSON BOULEVARD



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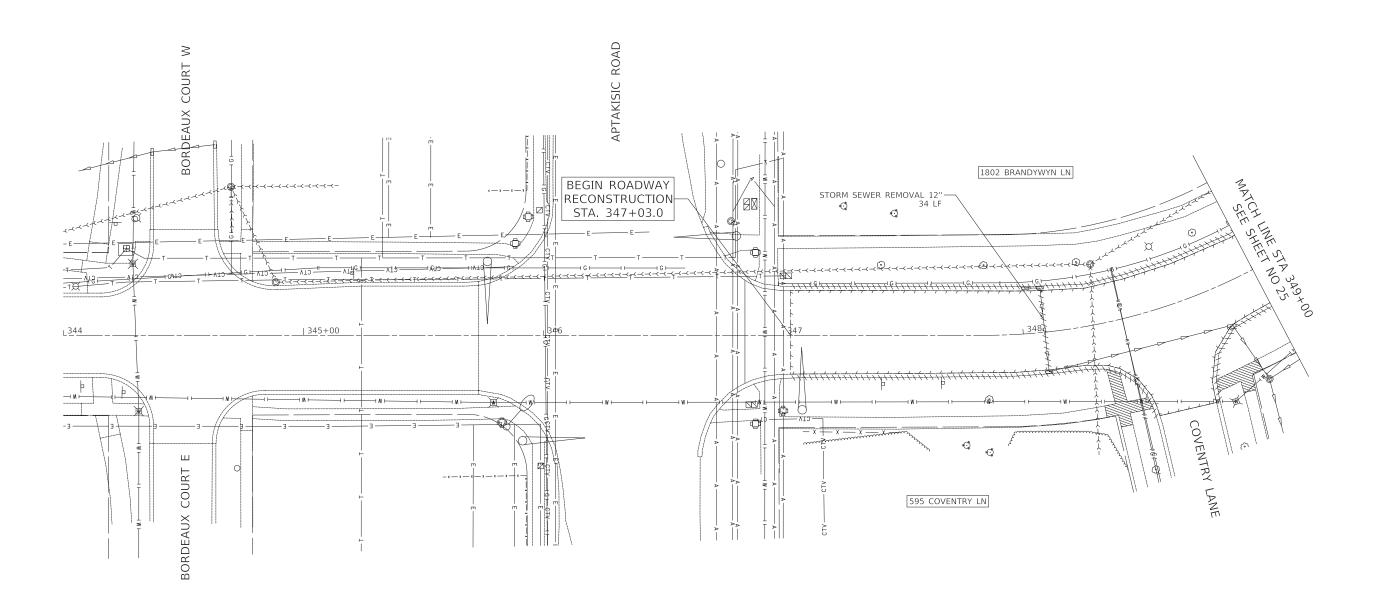
JRR

REVISED -STATE OF ILLINOIS REVISED -**DEPARTMENT OF TRANSPORTATION** REVISED -

REMOVAL PLAN - THOMPSON BOULEVARD SHEET 7 OF 16 SHEETS STA 209+00 TO STA 210+85

COUNTY TOTAL SHEET NO LAKE 222 23 16-00106-02-RS CONTRACT NO 61G70





LEGEND:

SEE SHEET 17 FOR LEGEND.

### BRANDYWYN LANE



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Tel: 630.773.3900 Fax: 630.773.3975
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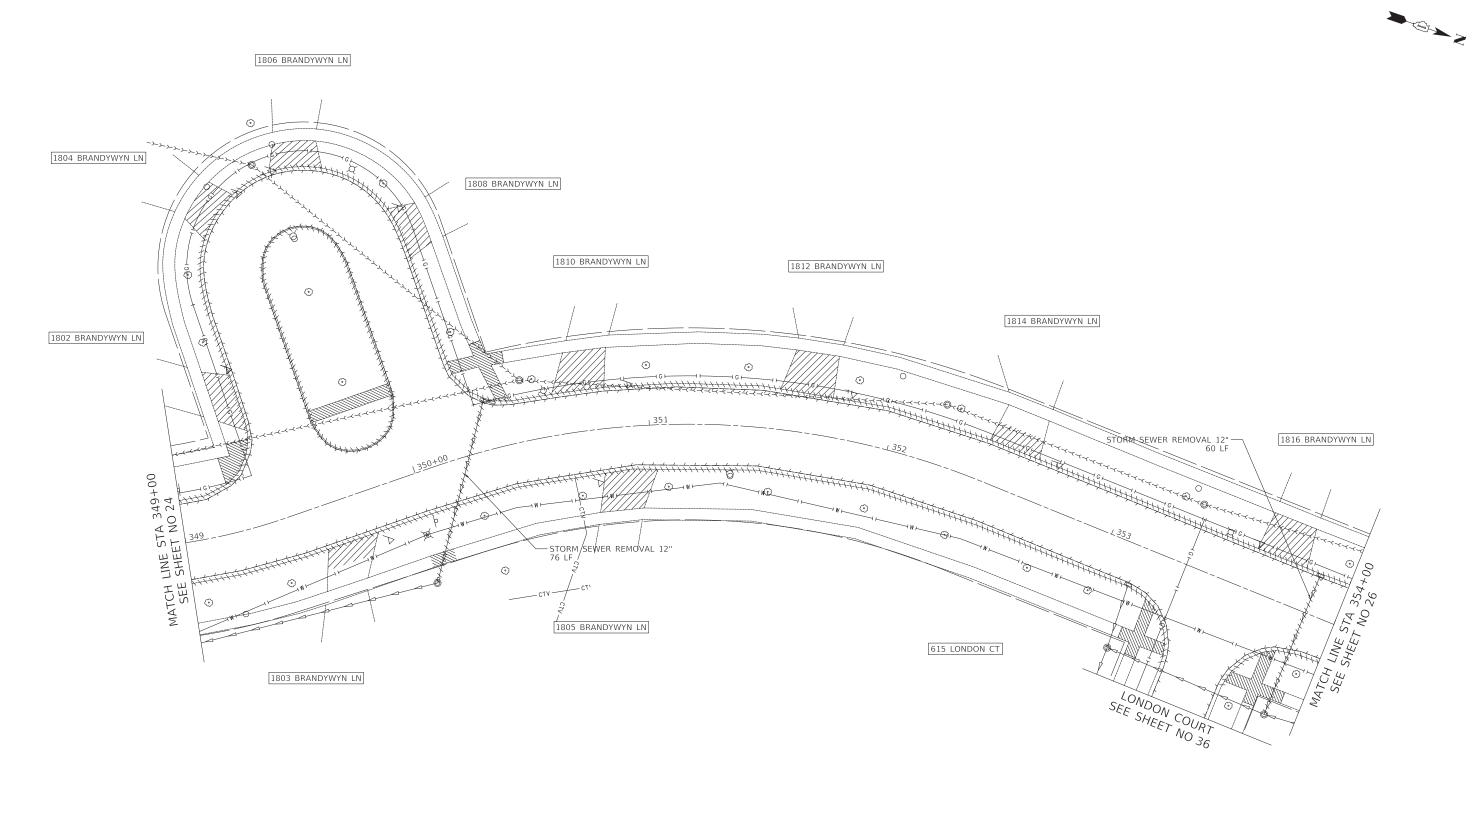
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EVISED -	DEPARTMENT OF TRANSPORTATION
EVISED -	

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REMOVAL PLAN - BRANDYWYN LANE SHEET 8 OF 16 SHEETS STA 347+03 TO STA 349+00

COUNTY TOTAL SHEET NO
LAKE 222 24 16-00106-02-RS CONTRACT NO 61G70





LEGEND:

SEE SHEET 17 FOR LEGEND.


### BRANDYWYN LANE



Two Pierce Place, Suite 1400 tlasca, Illinois 60143
Tel: 630.773.3900 Fax: 630.773.3975
www.civiltechinc.com


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STATE OF ILLINOIS **DEPARTMENT OF TRANSPORTATION** 

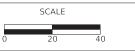


REMOVAL PLAN - BRANDYWYN LANE SHEET 9 OF 16 SHEETS STA 349+00 TO STA 354+00

COUNTY TOTAL SHEET NO LAKE 222 25 16-00106-02-RS CONTRACT NO 61G70



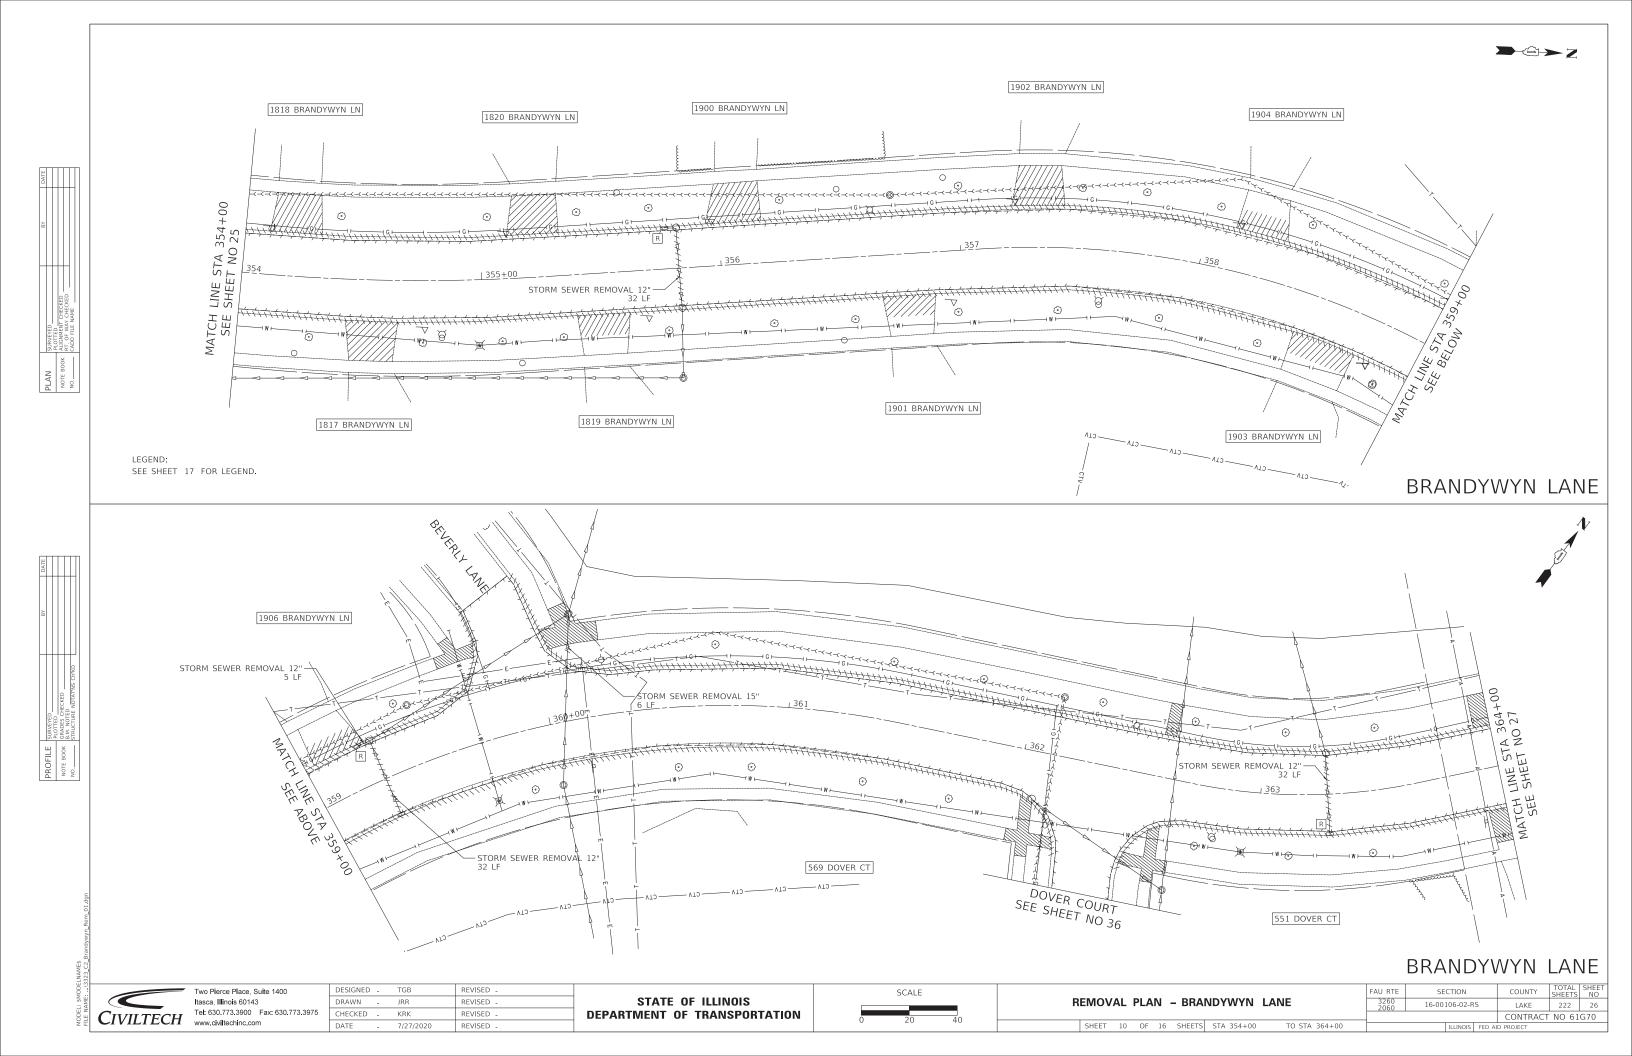

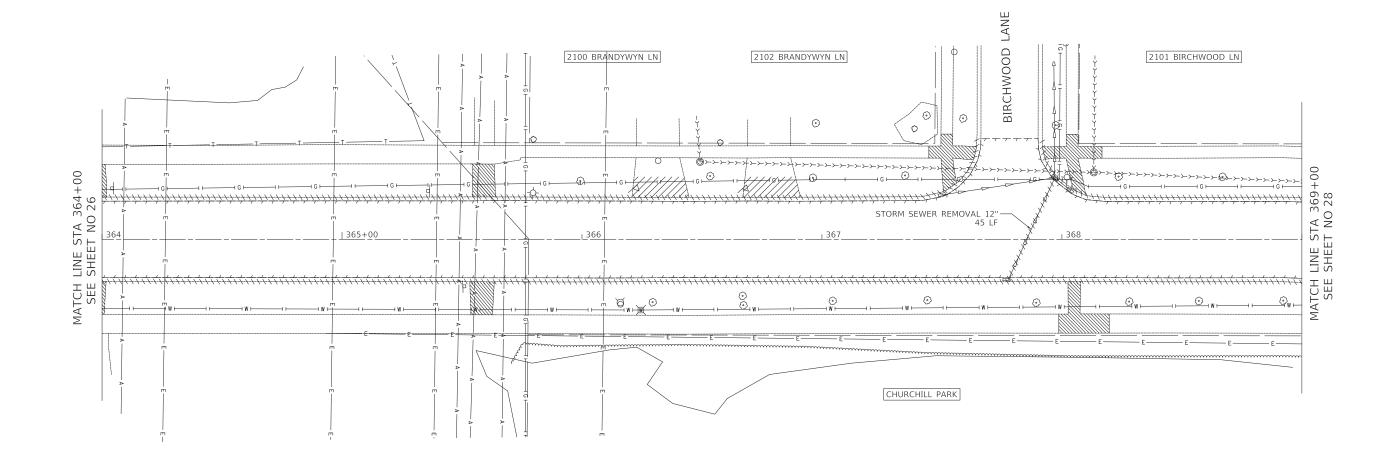

SEE SHEET 17 FOR LEGEND.

### BRANDYWYN LANE



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REVISED -STATE OF ILLINOIS REVISED . **DEPARTMENT OF TRANSPORTATION** REVISED .

REMOVAL PLAN - BRANDYWYN LANE SHEET 11 OF 16 SHEETS STA 364+00 TO STA 369+00

COUNTY TOTAL SHEET NO LAKE 222 27 16-00106-02-RS

CONTRACT NO 61G70



424 CEDAR CT N 426 CEDAR CT N 422 CEDAR CT N 2106 BRANDYWYN LN END RECONSTRUCTION, HOT-MIX ASPHALT SURFACE REMOVAL, 3 1/2" BEGIN RESURFACING 2108 BRANDYWYN LN STA. 369+30.0 MATCH LINE STA 369+00 SEE SHEET NO 27 2110 BRANDYWYN LN - HOT-MIX ASPHALT SURFACE REMOVAL (VARIABLE DEPTH) (SEE NOTE 1) HOT-MIX ASPHALT SURFACE REMOVAL, 3" HOT-MIX ASPHALT SURFACE REMOVAL, 3 1/2"-453 CEDAR CT S CEDAR COURT S SEE SHEET NO 37 HOT-MIX ASPHALT SURFACE REMOVAL (VARIABLE DEPTH) (SEE NOTE 1) 419 CEDAR CT S

CONTRACTOR SHALL PERFORM VARIABLE DEPTH MILLING ALONG RADIUS RETURN TO REGRADE CURBLINE AND PROVIDE ADA COMPLIANT SLOPES


LEGEND:

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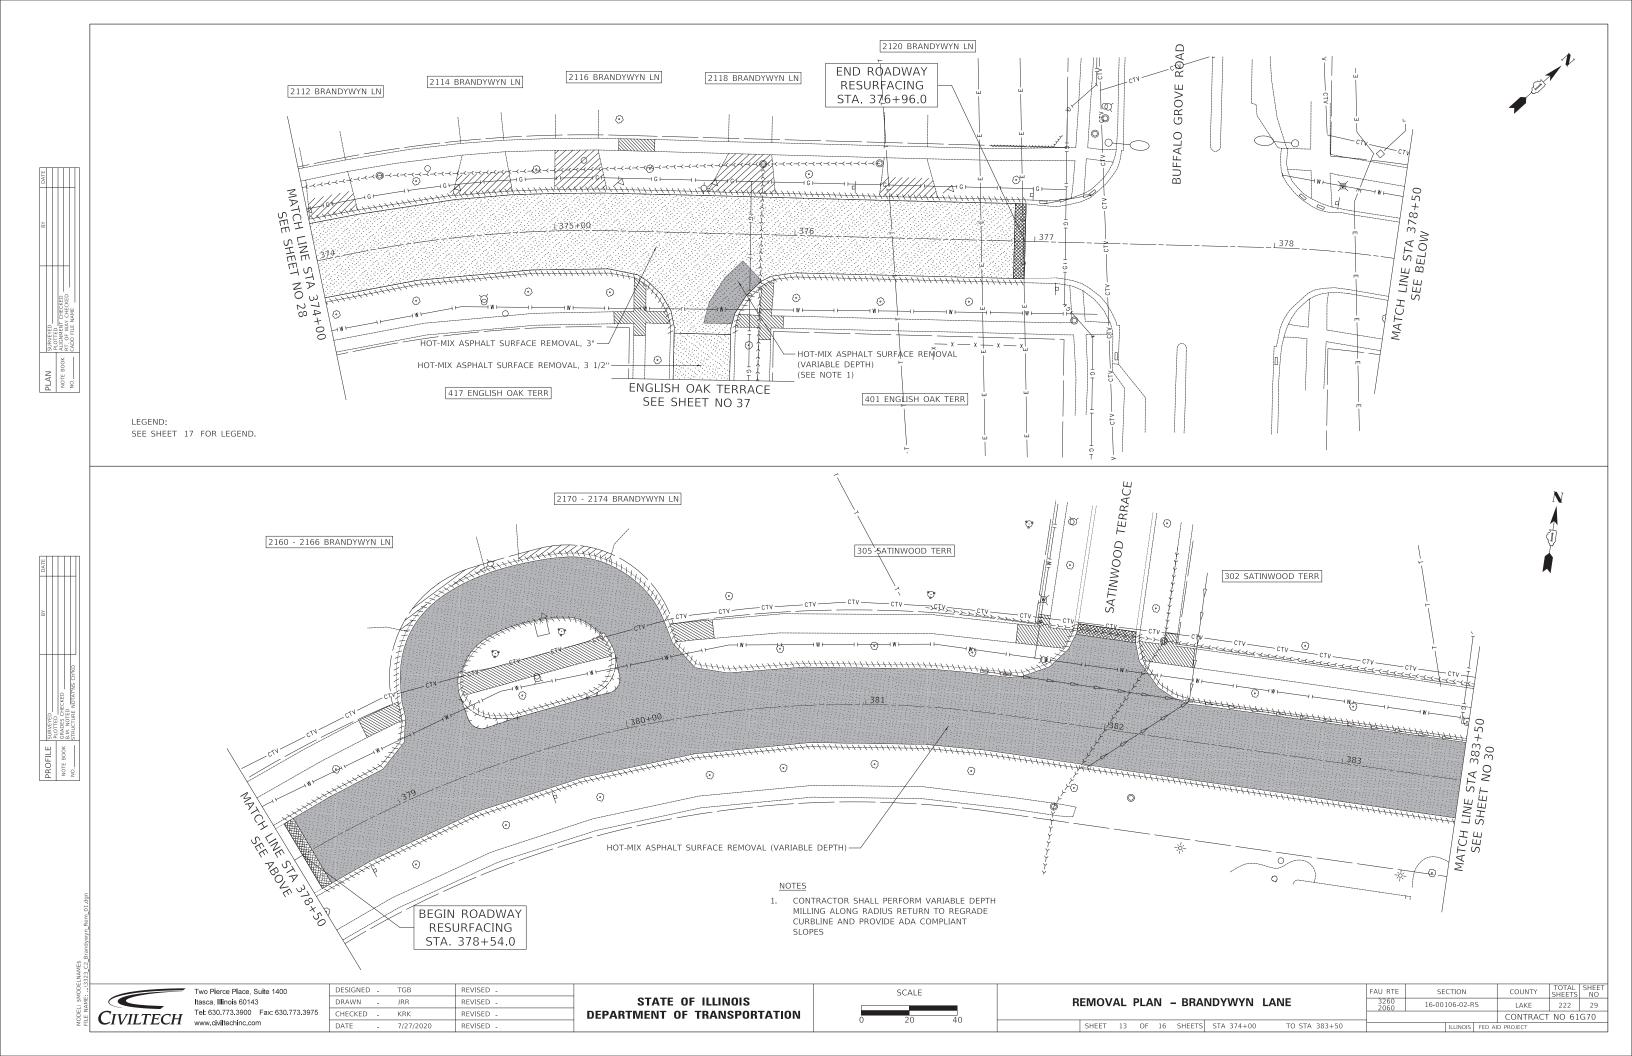
STATE OF ILLINOIS **DEPARTMENT OF TRANSPORTATION** 





REMOVAL PLAN - BRANDYWYN LANE SHEET 12 OF 16 SHEETS STA 369+00 TO STA 374+00


SHEETS NO 16-00106-02-RS LAKE CONTRACT NO 61G70

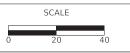
BRANDYWYN LANE



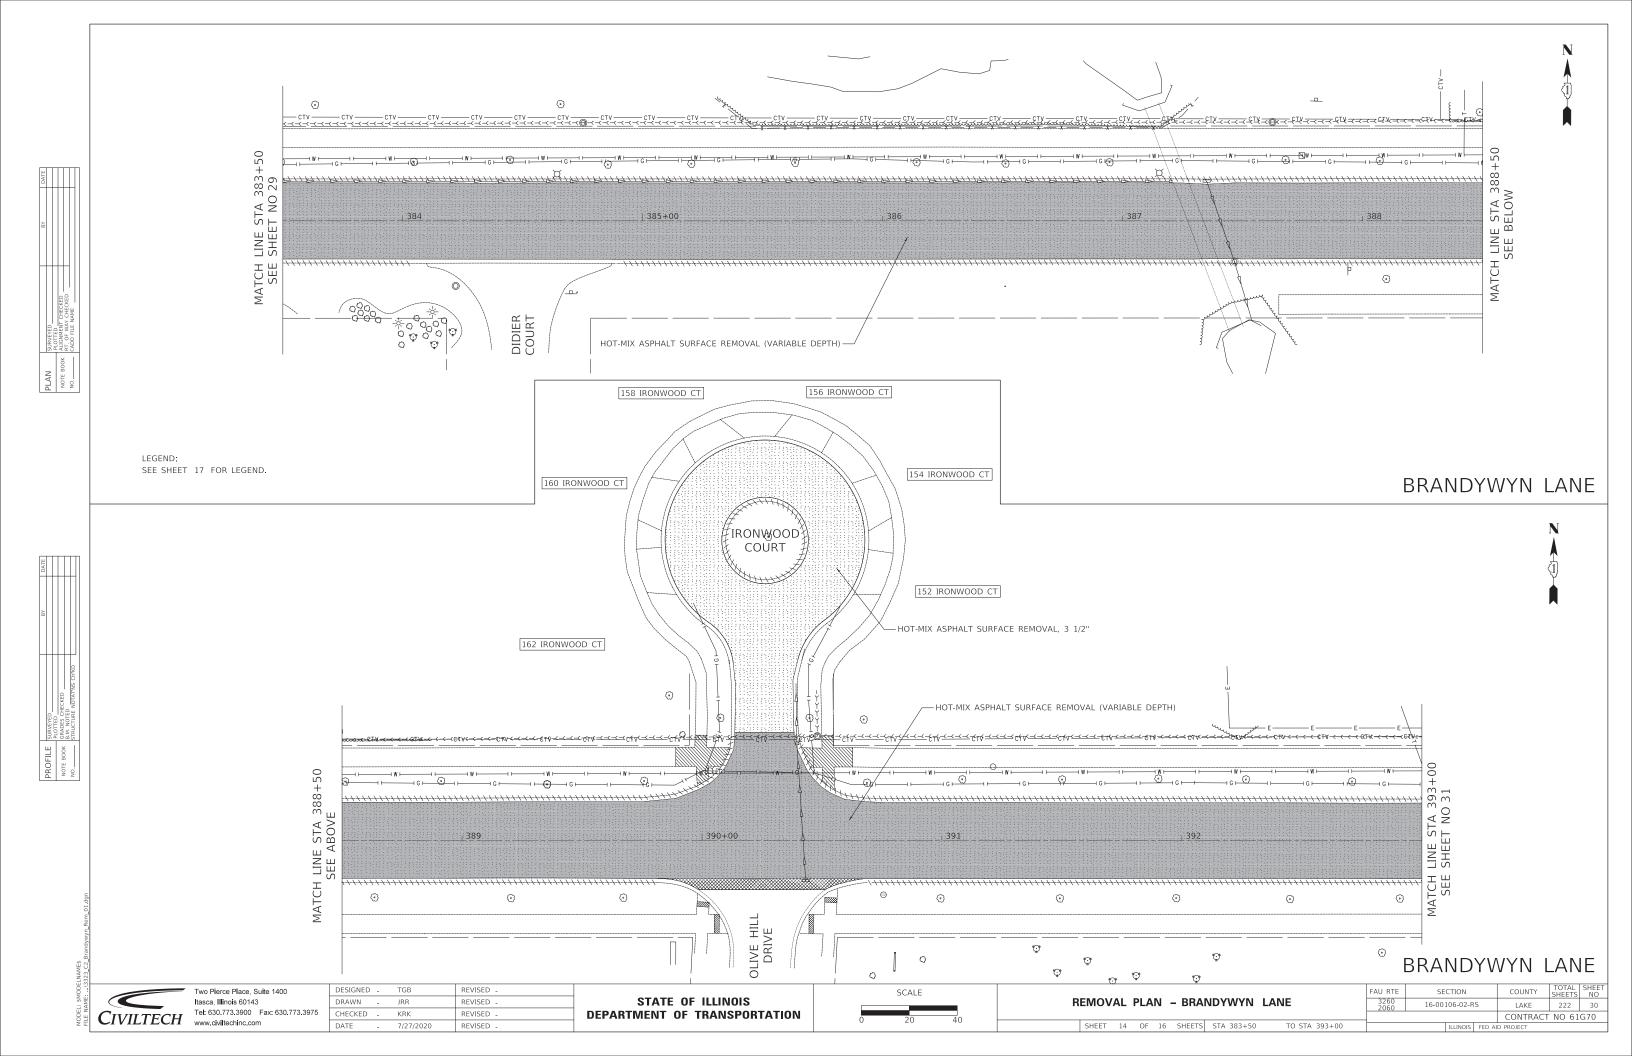

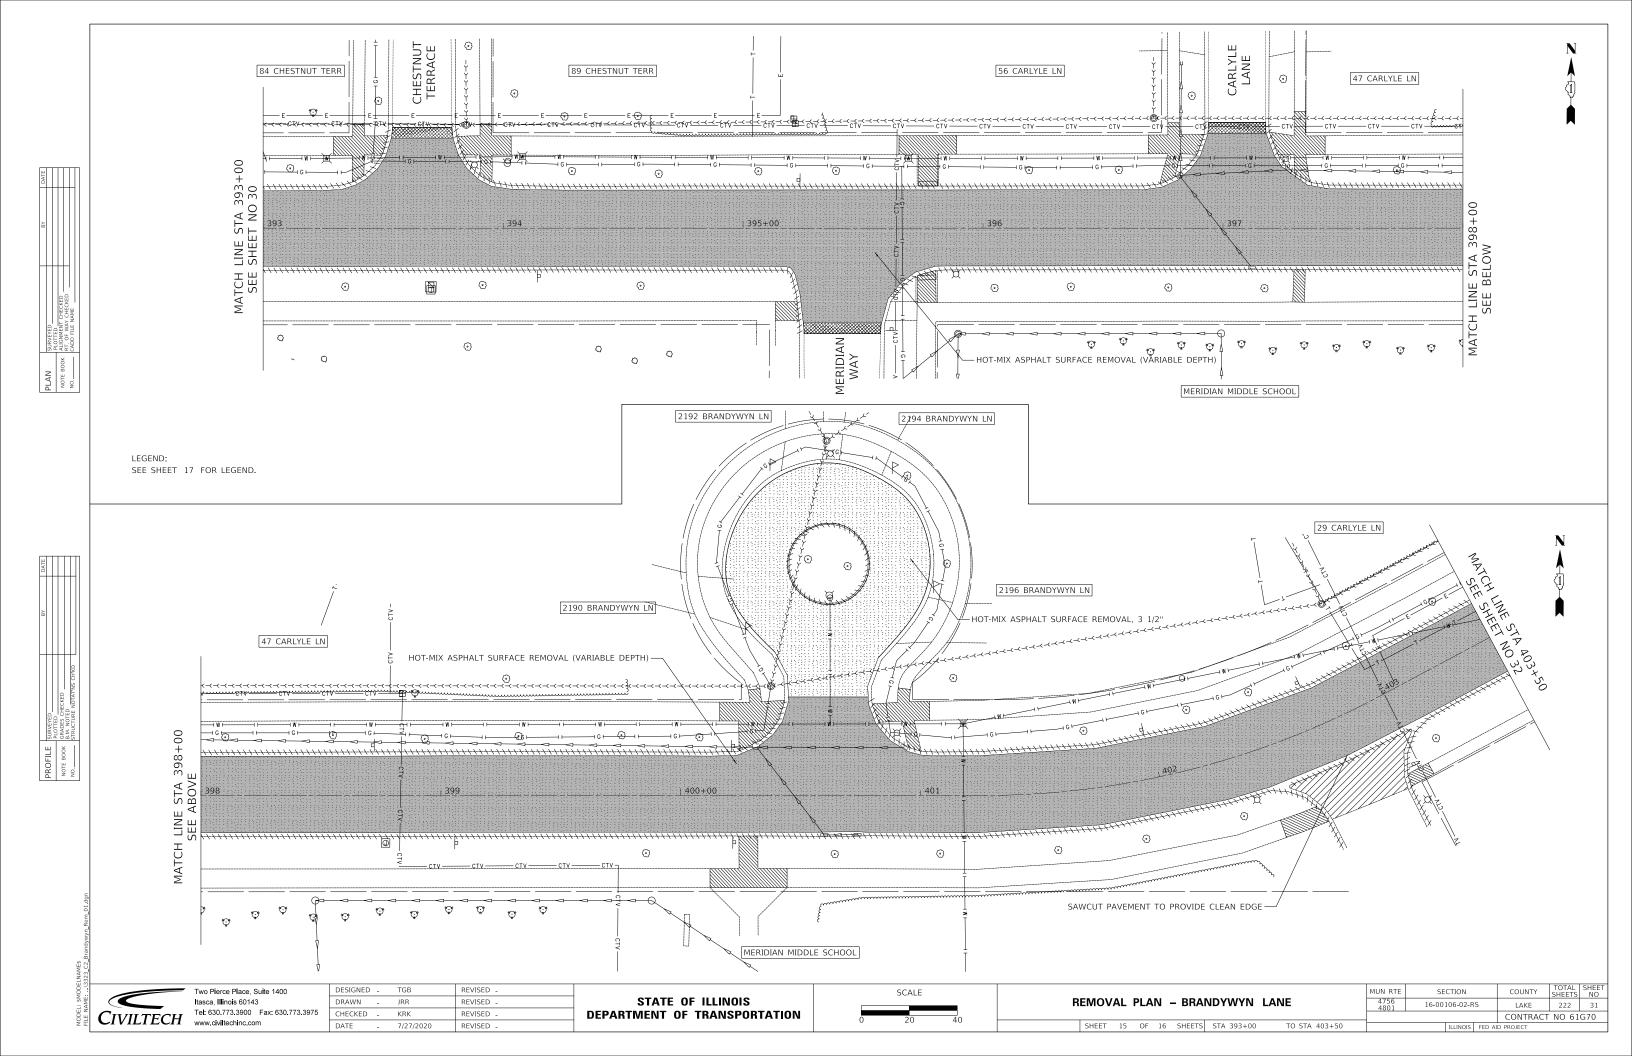

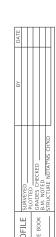

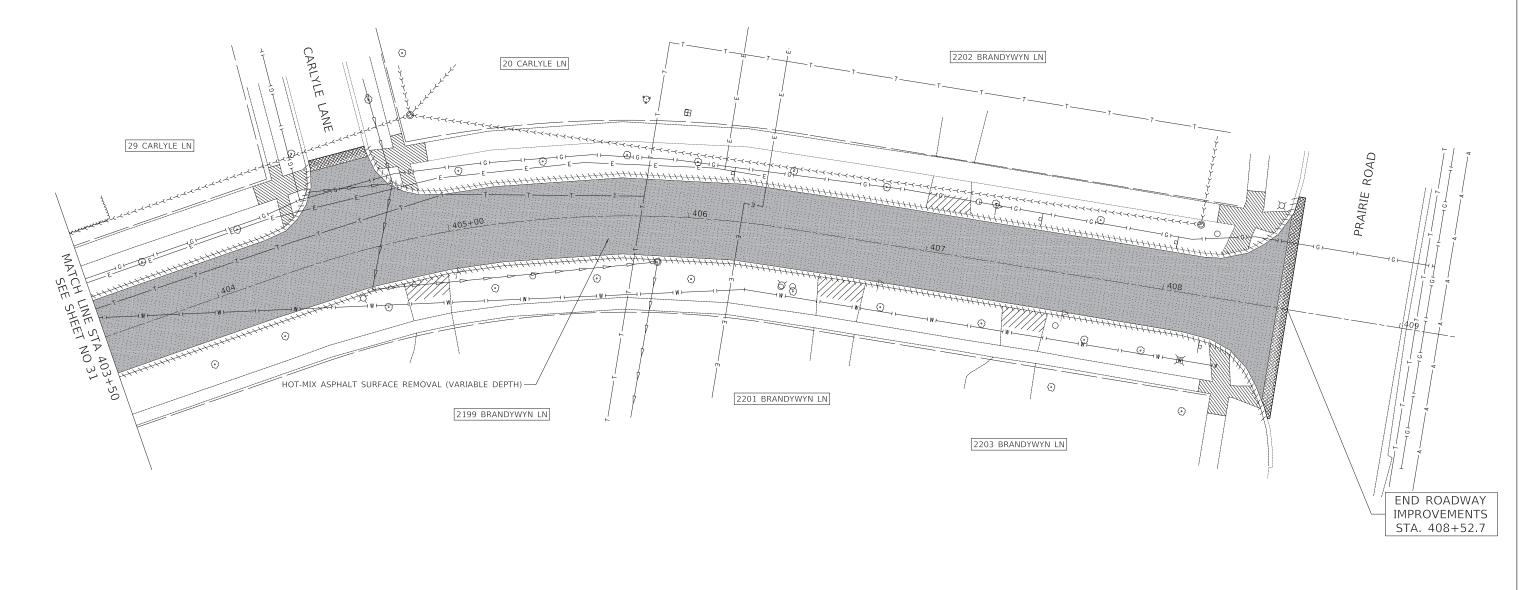

LEGEND: SEE SHEET 17 FOR LEGEND.


Two Pierce Place, Suite 1400 Itasca, Illinois 60143
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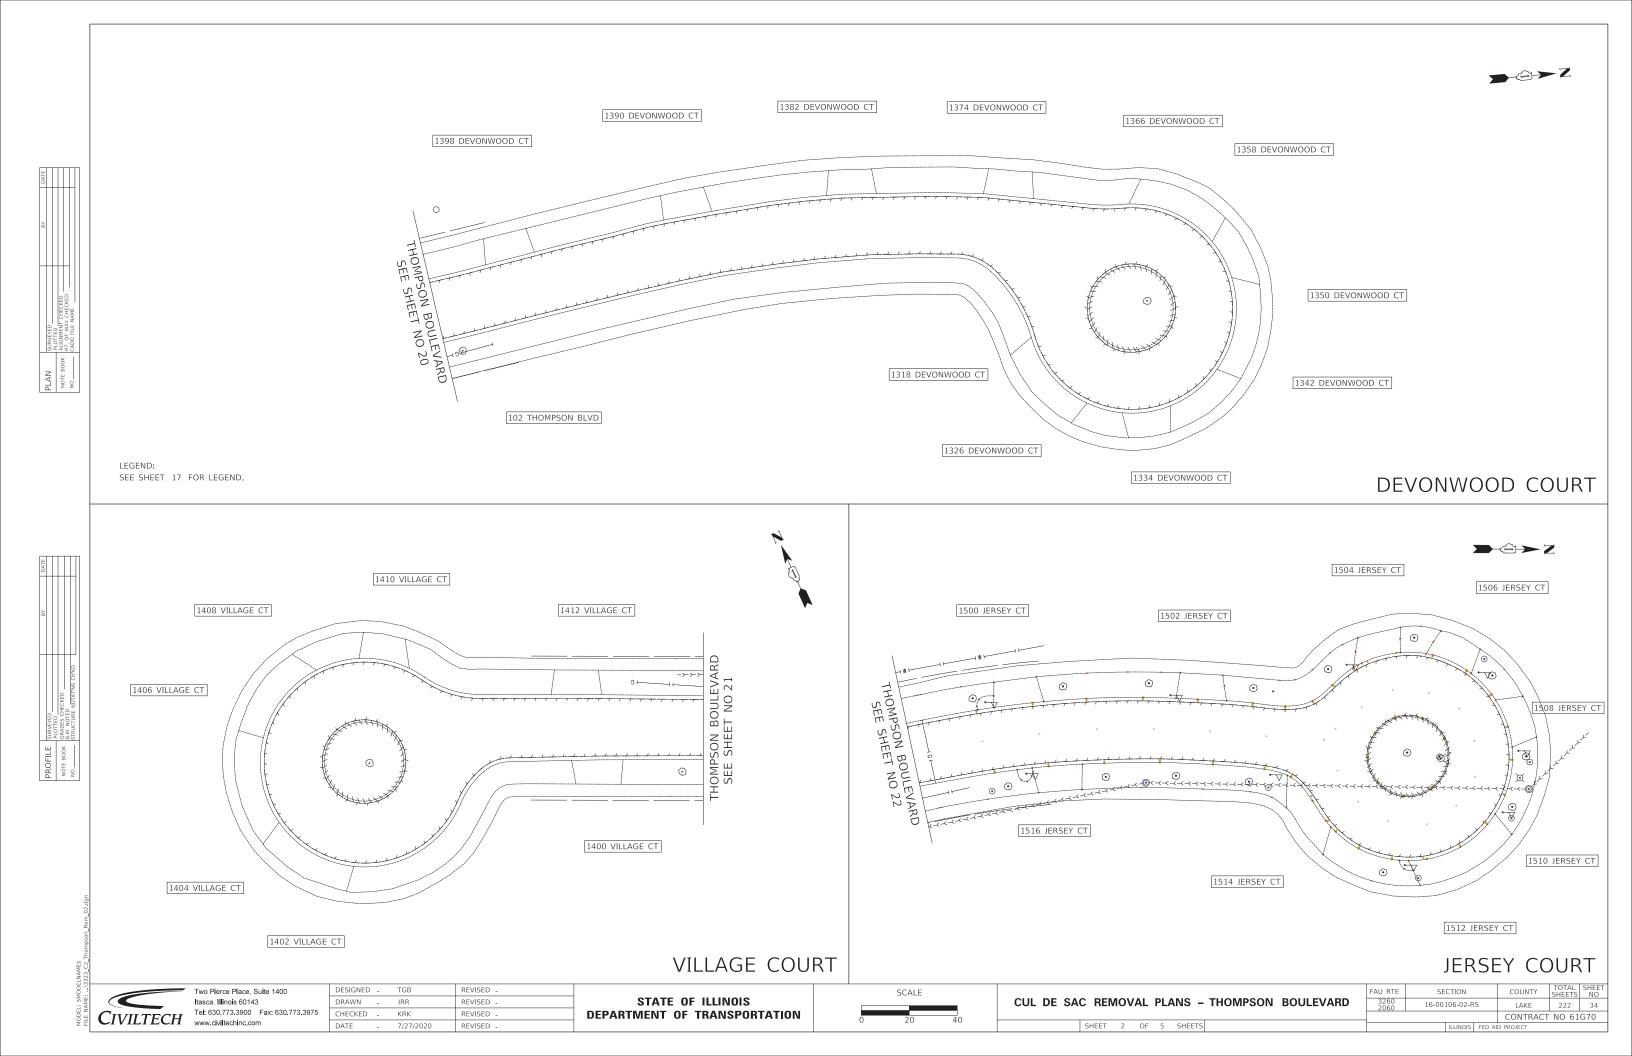
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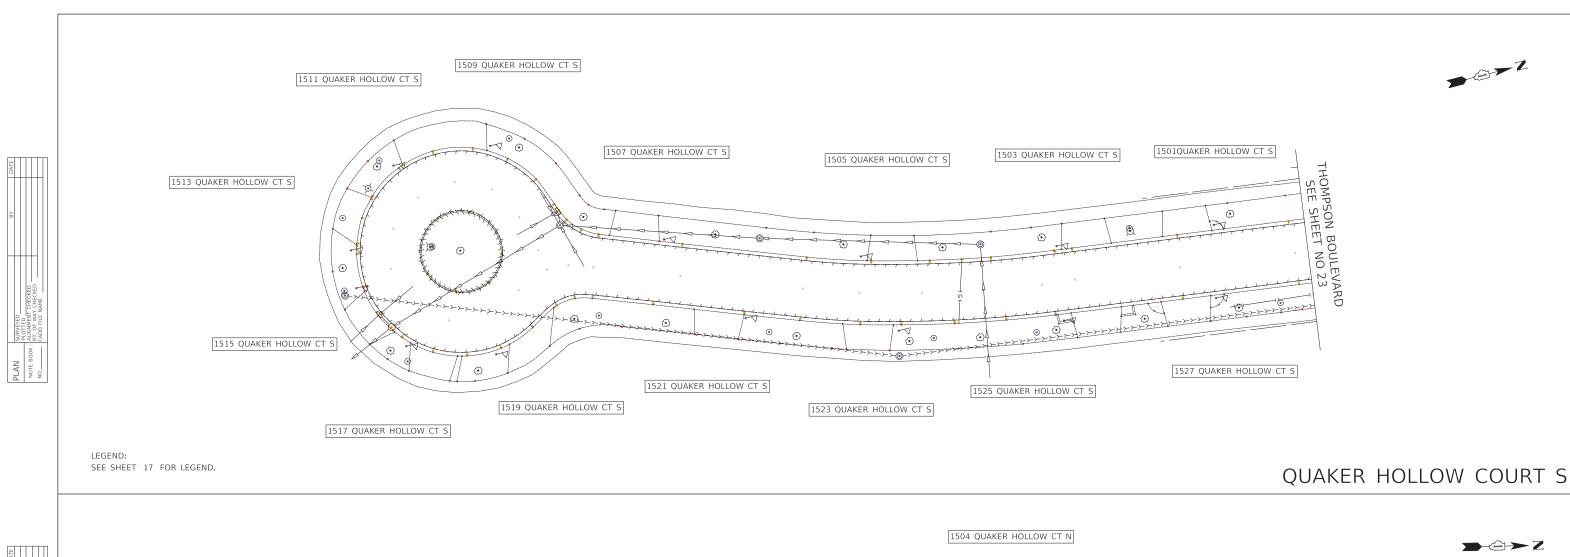
STATE OF ILLINOIS DEPARTMENT OF TRANSPORTATION


REMOVAL PLAN - BRANDYWYN LANE SHEET 16 OF 16 SHEETS STA 403+50 TO STA 408+52.7

COUNTY TOTAL SHEET NO
LAKE 222 32 16-00106-02-RS CONTRACT NO 61G70





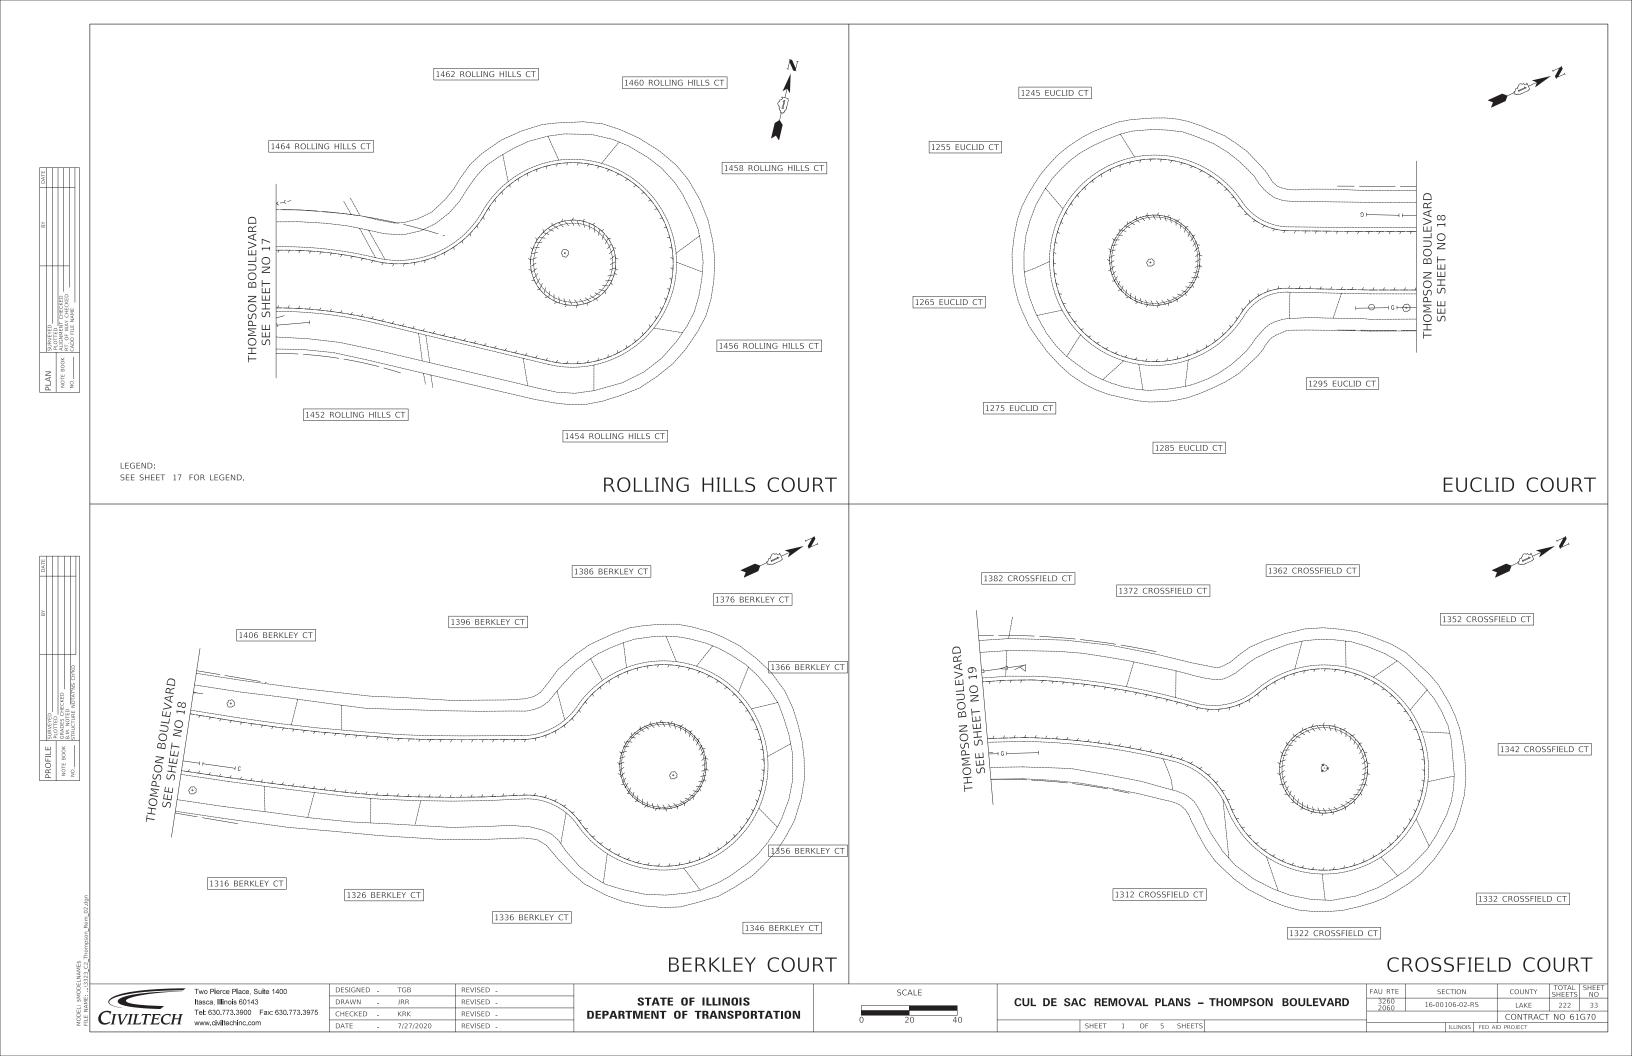

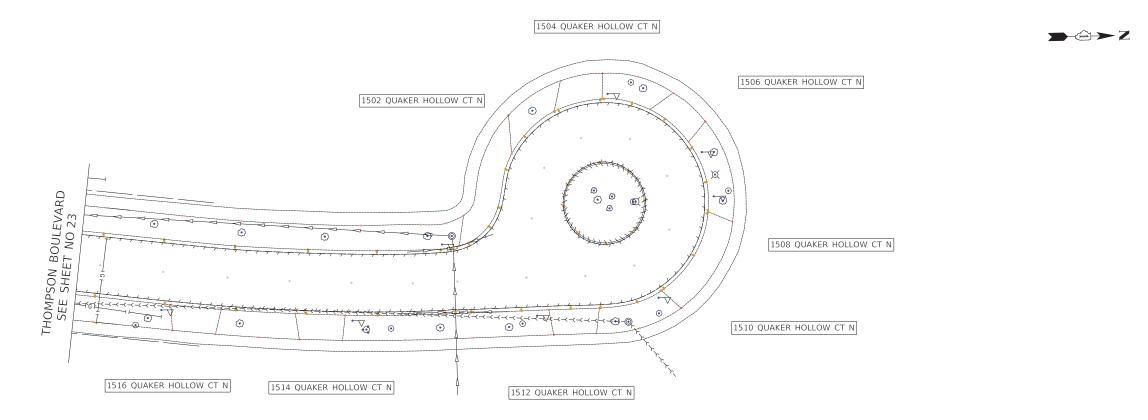


Itasca, Illinois 60143 CIVILTECH Tel: 630.773.3900 Fax: 630.773.3975 www.civiltechinc.com


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STATE OF ILLINOIS **DEPARTMENT OF TRANSPORTATION** 

CUL DE SAC REMOVAL PLANS - THOMPSON BOULEVARD SHEET 3 OF 5 SHEETS

QUAKER HOLLOW COURT N 16-00106-02-RS CONTRACT NO 61G70



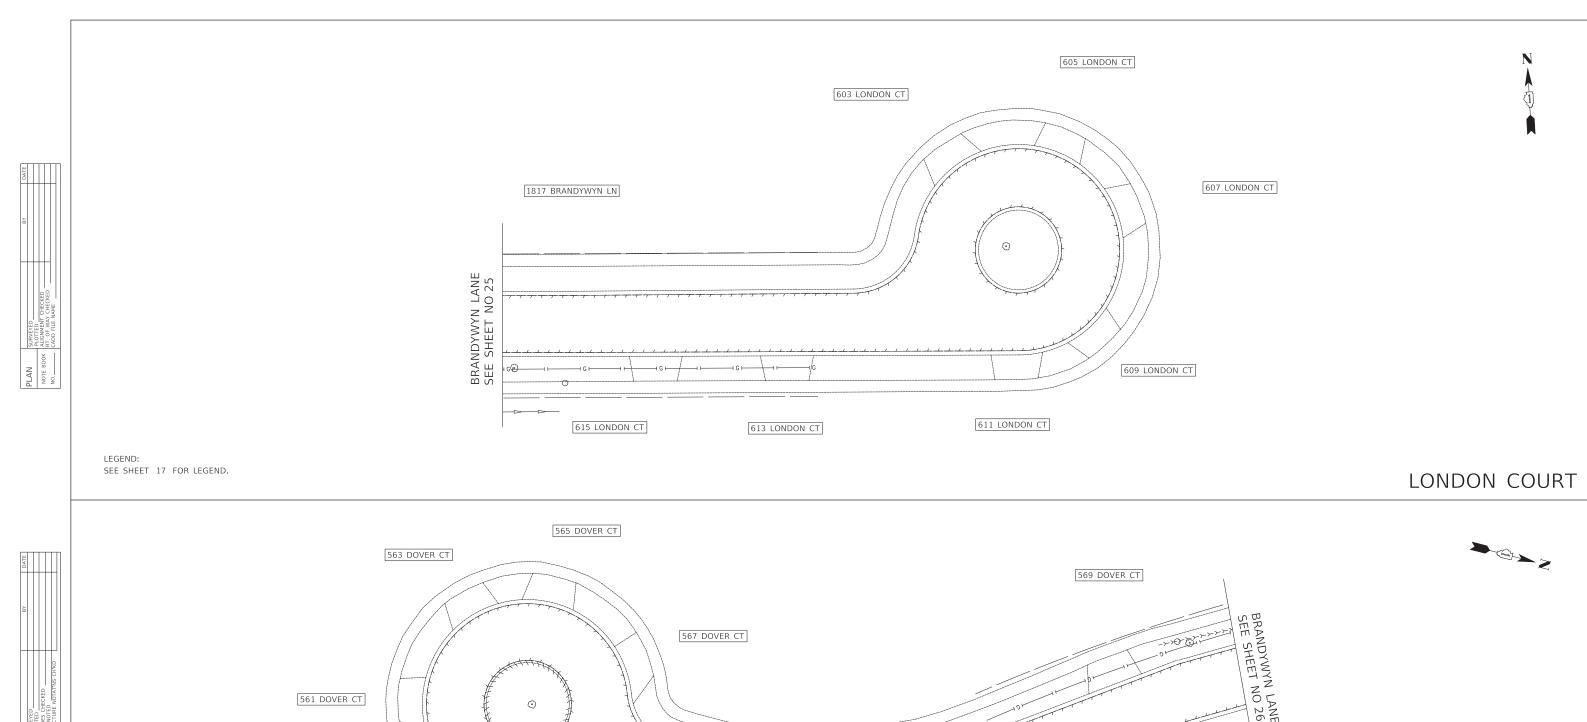
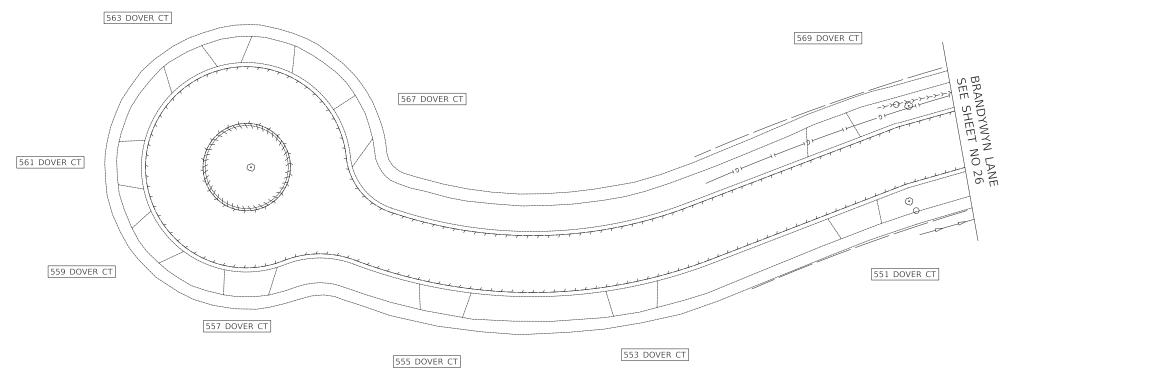
### DOVER COURT



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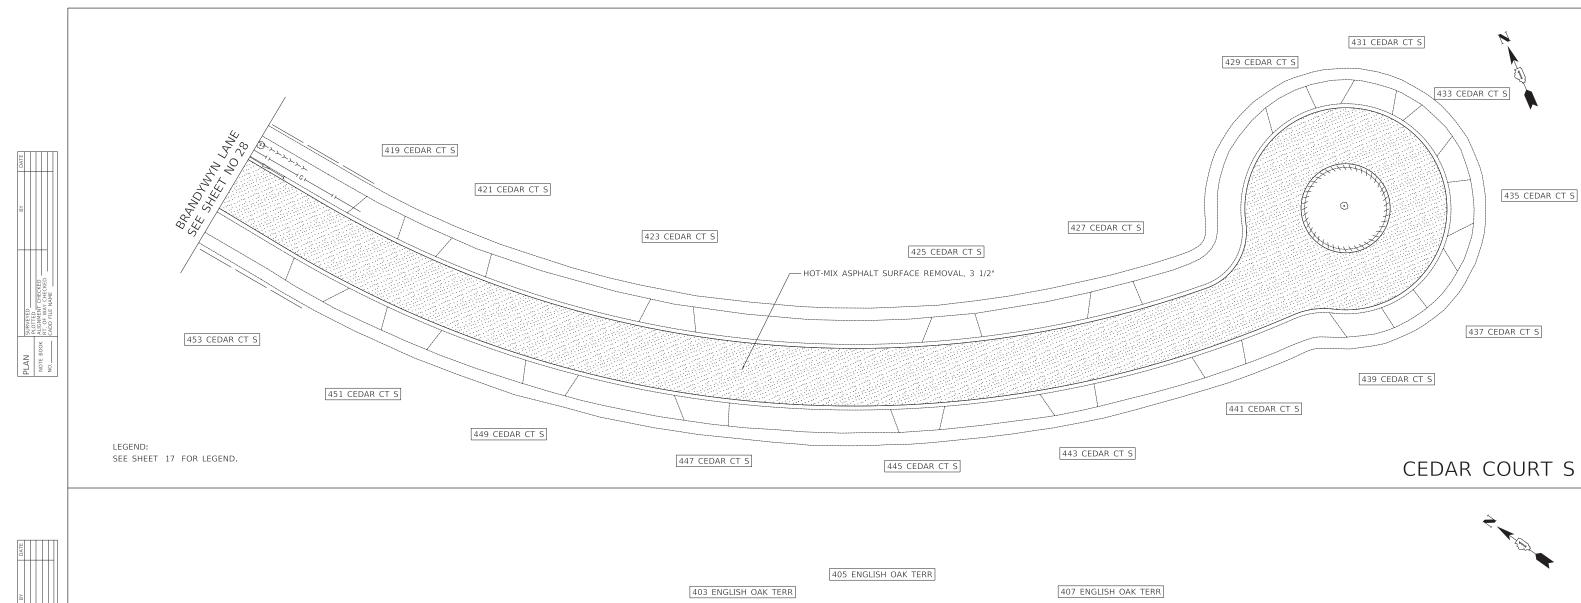
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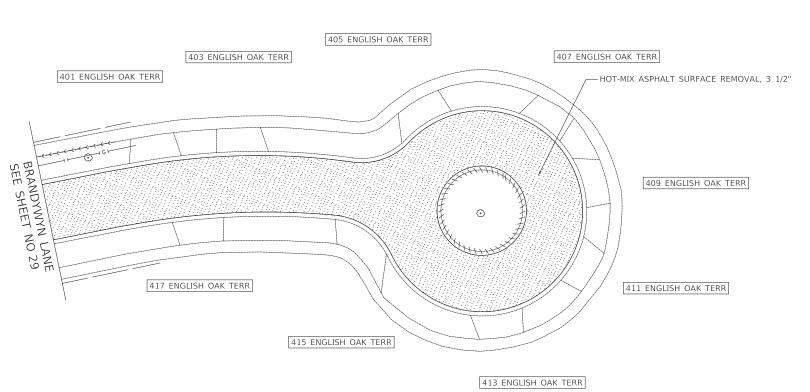
STATE OF ILLINOIS	
RTMENT OF TRANSPORTATION	

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L	 					- BRANDYWYN	LANE	
	SHEET	4	OF	5	SHEETS			

FAU RTE	SECTION		COUNTY	TOTAL SHEETS	SHEE					
3260 2060	16-00106-02-R	RS.	LAKE	222	36					
		CONTRACT	NO 61	G70						
	ILLINOIS	D PROJECT								





## ENGLISH OAK TERRACE

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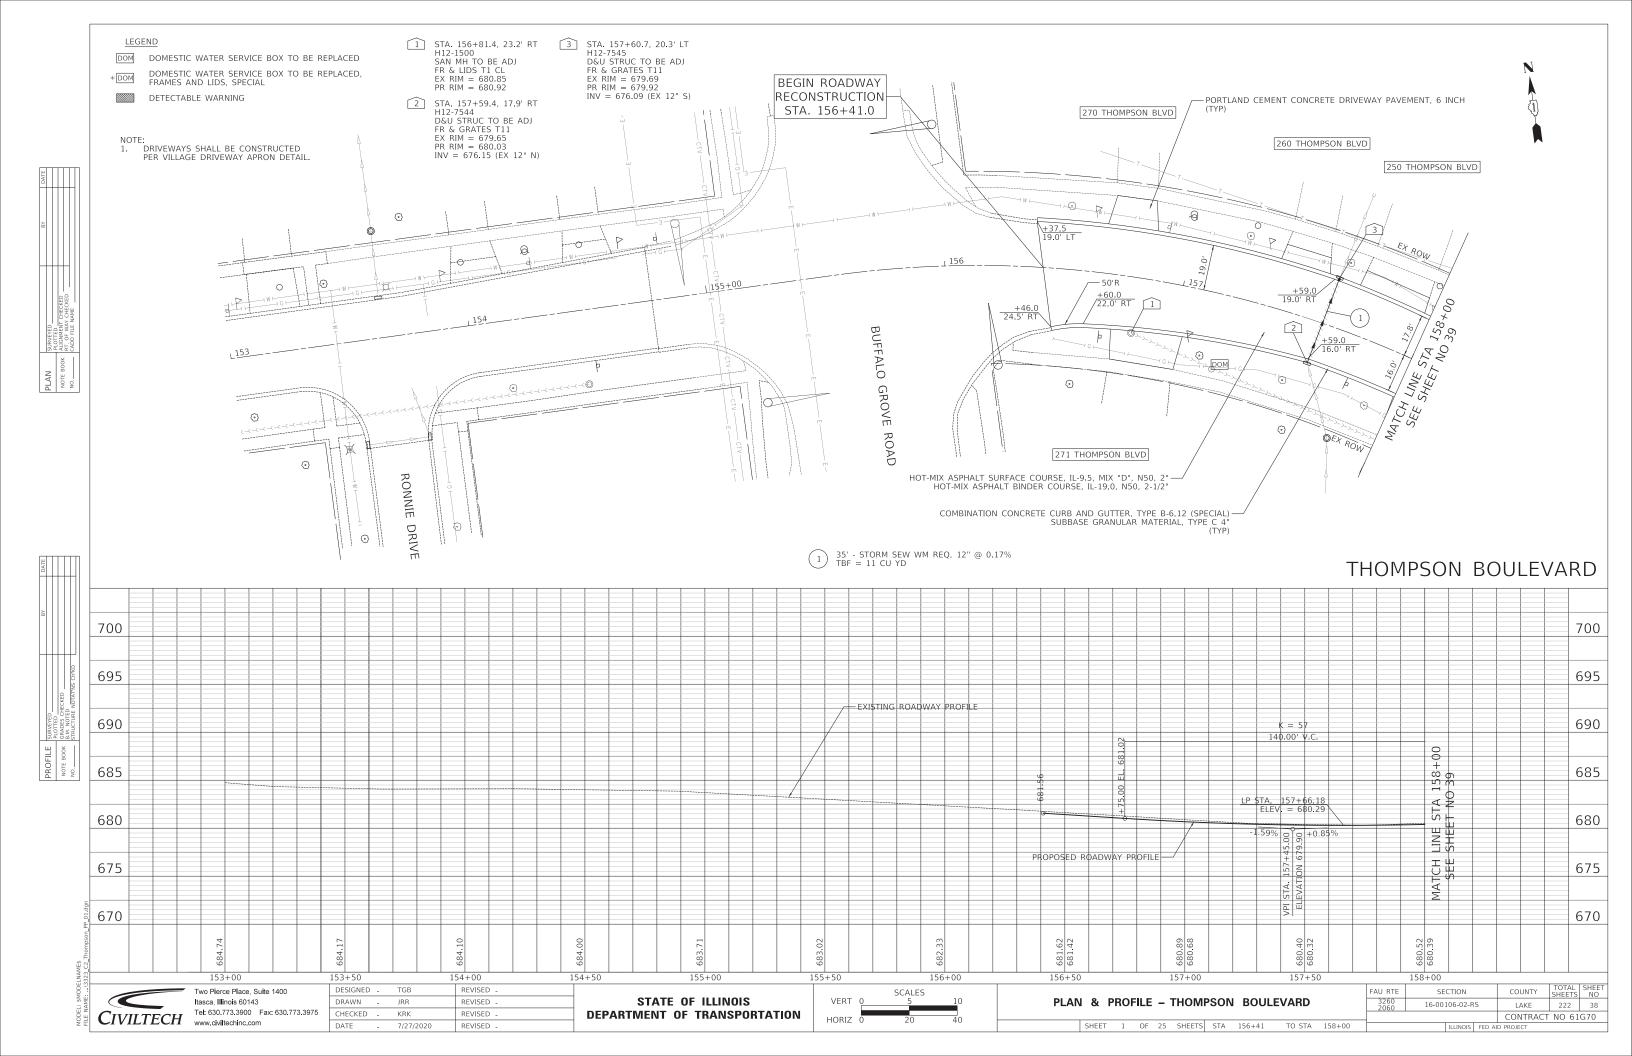
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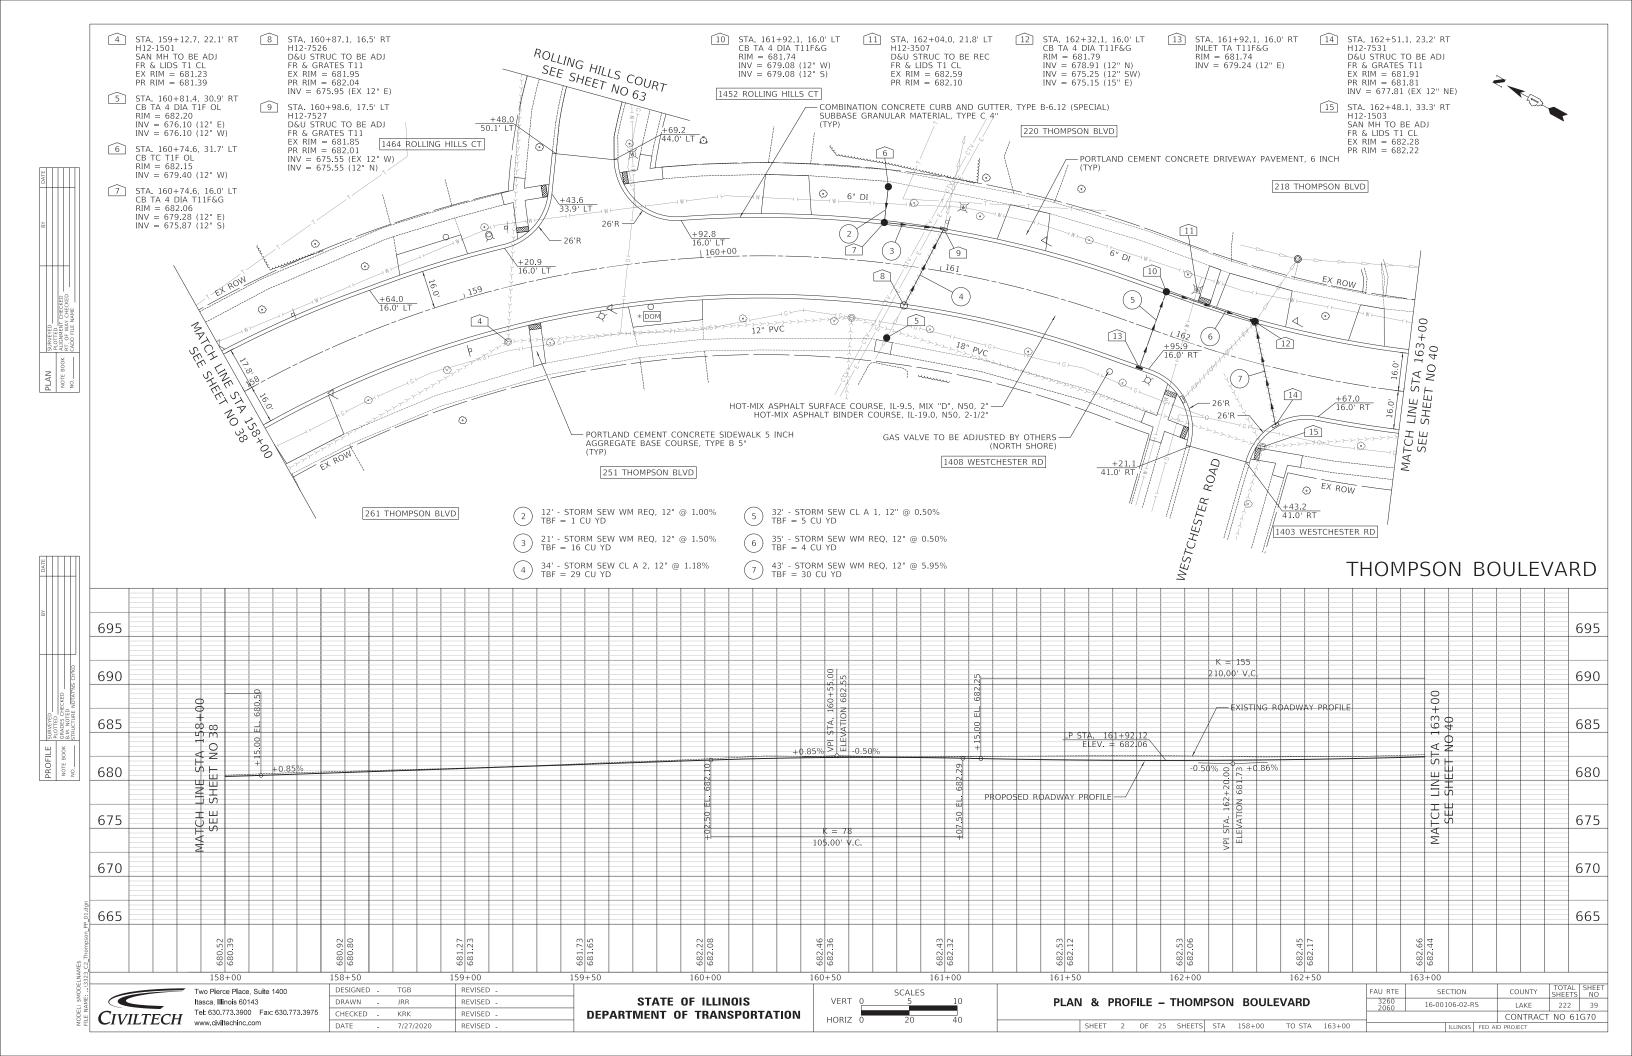
STATE OF ILLINOIS **DEPARTMENT OF TRANSPORTATION** 


CUL DE SAC REMOVAL PLAN - BRANDYWYN LANE SHEET 5 OF 5 SHEETS


COUNTY TOTAL SHEET NO


LAKE 222 37 16-00106-02-RS CONTRACT NO 61G70







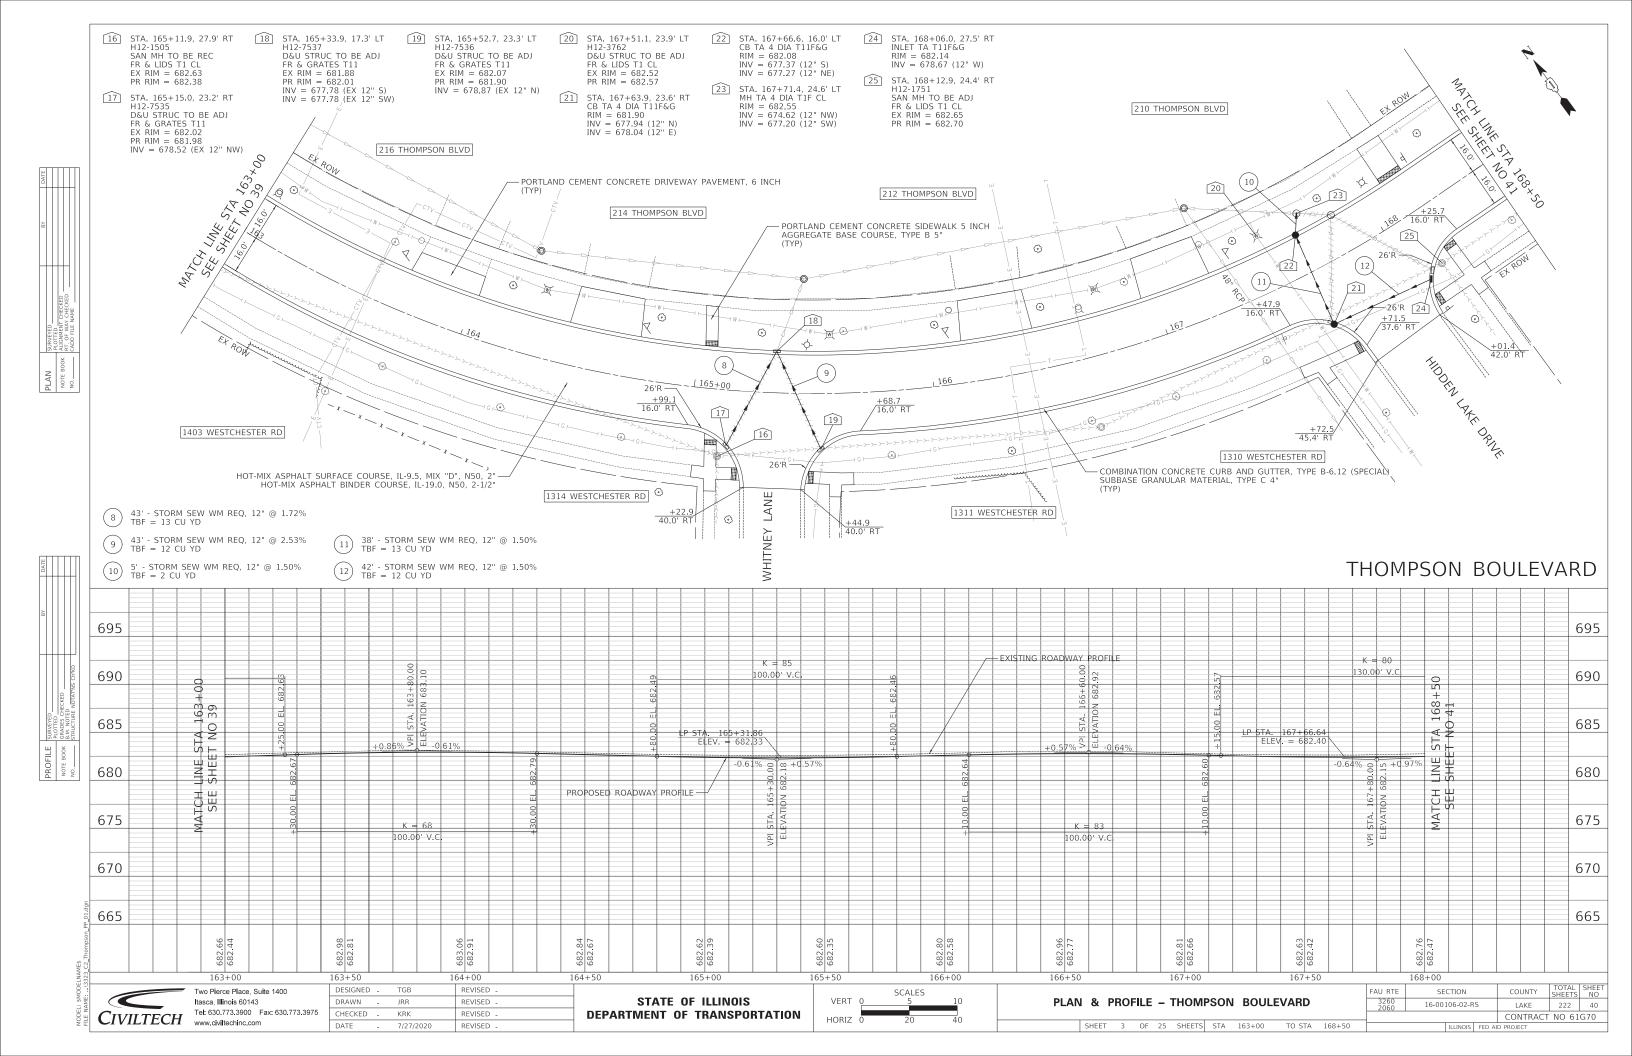


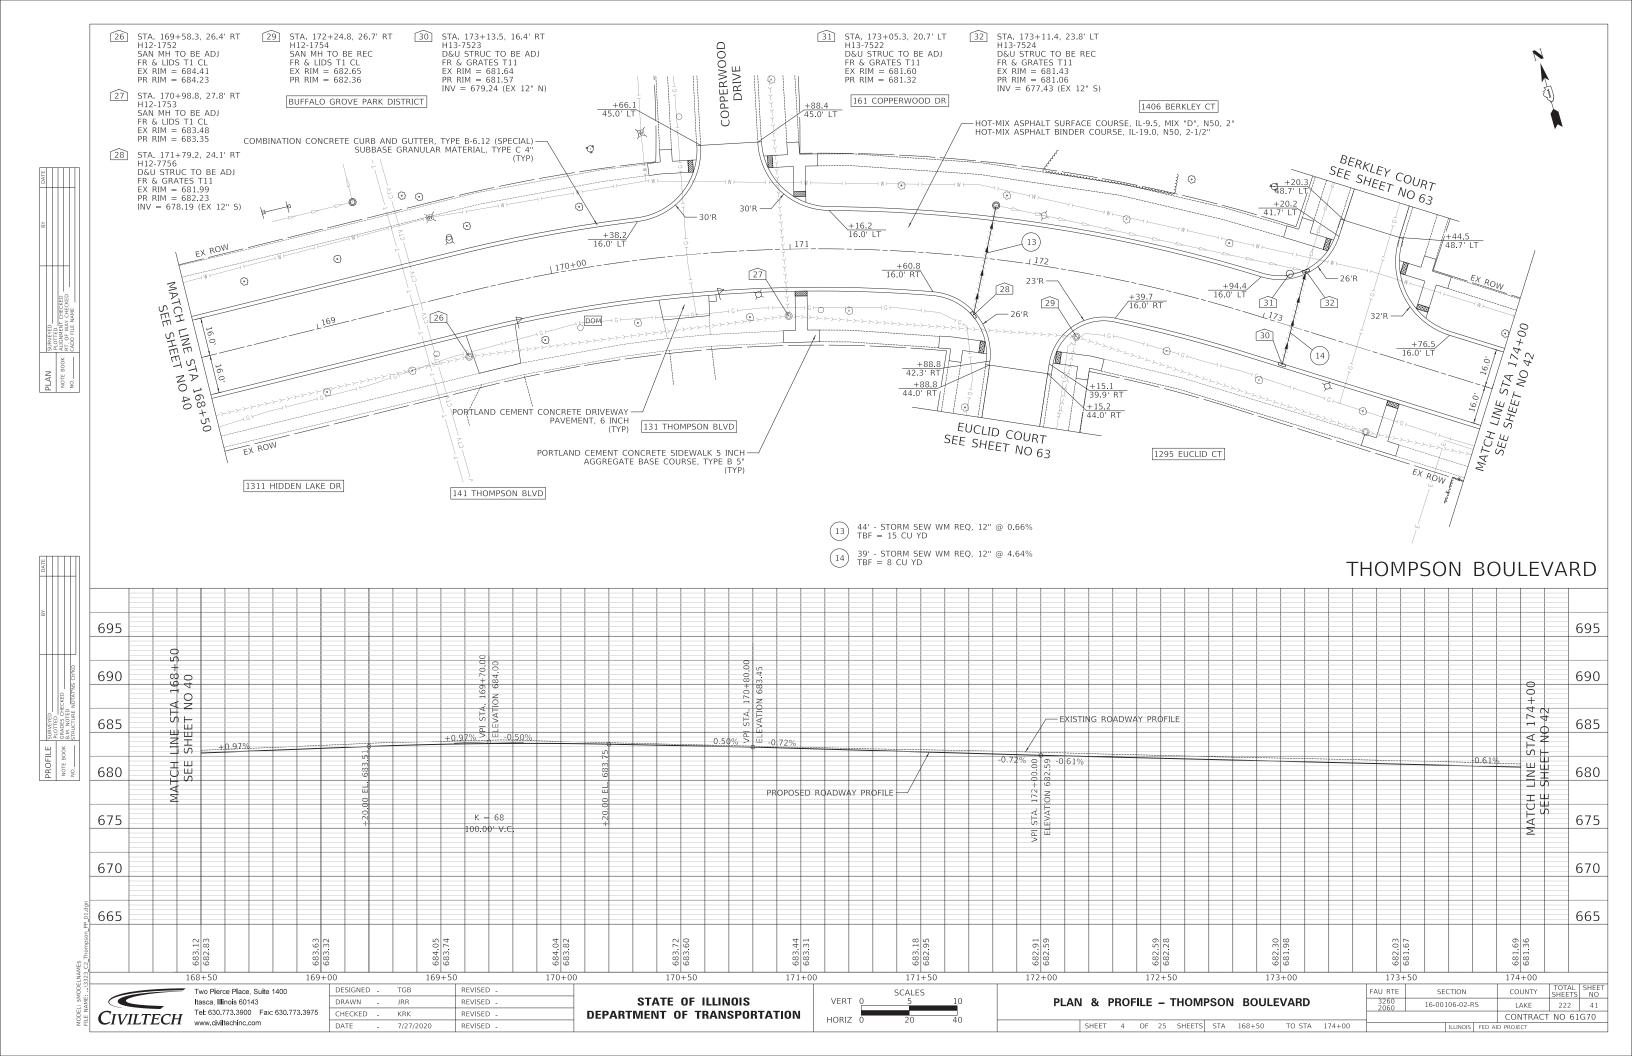


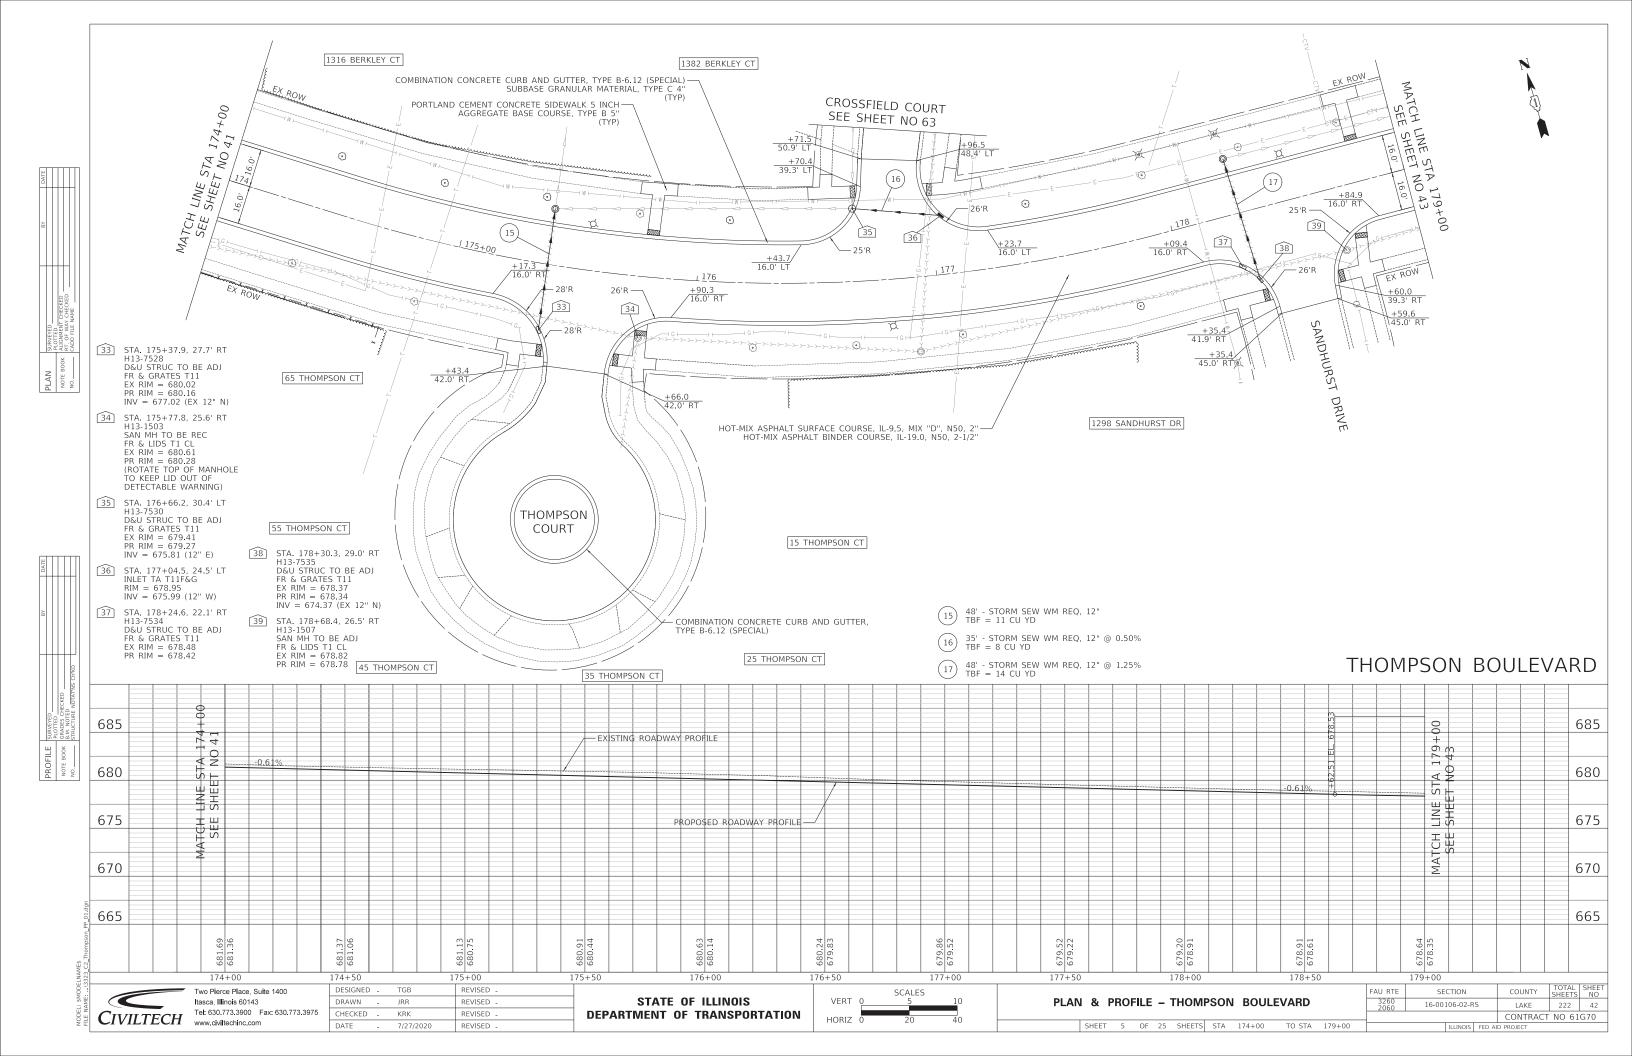


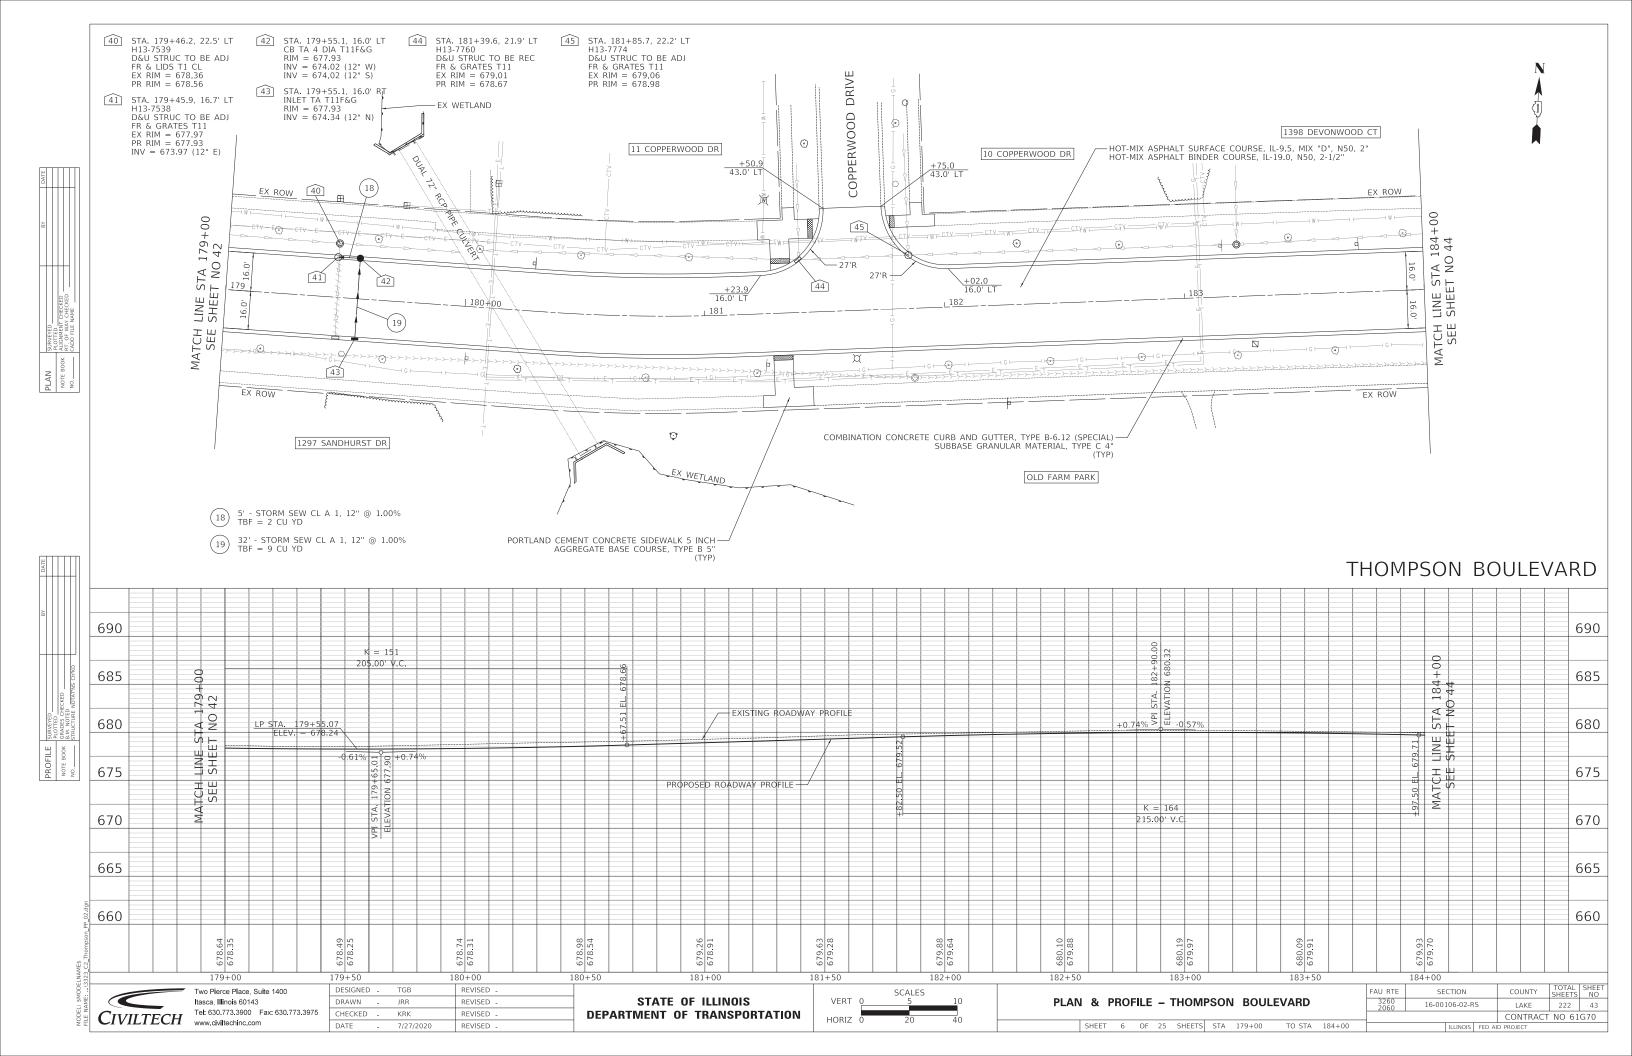


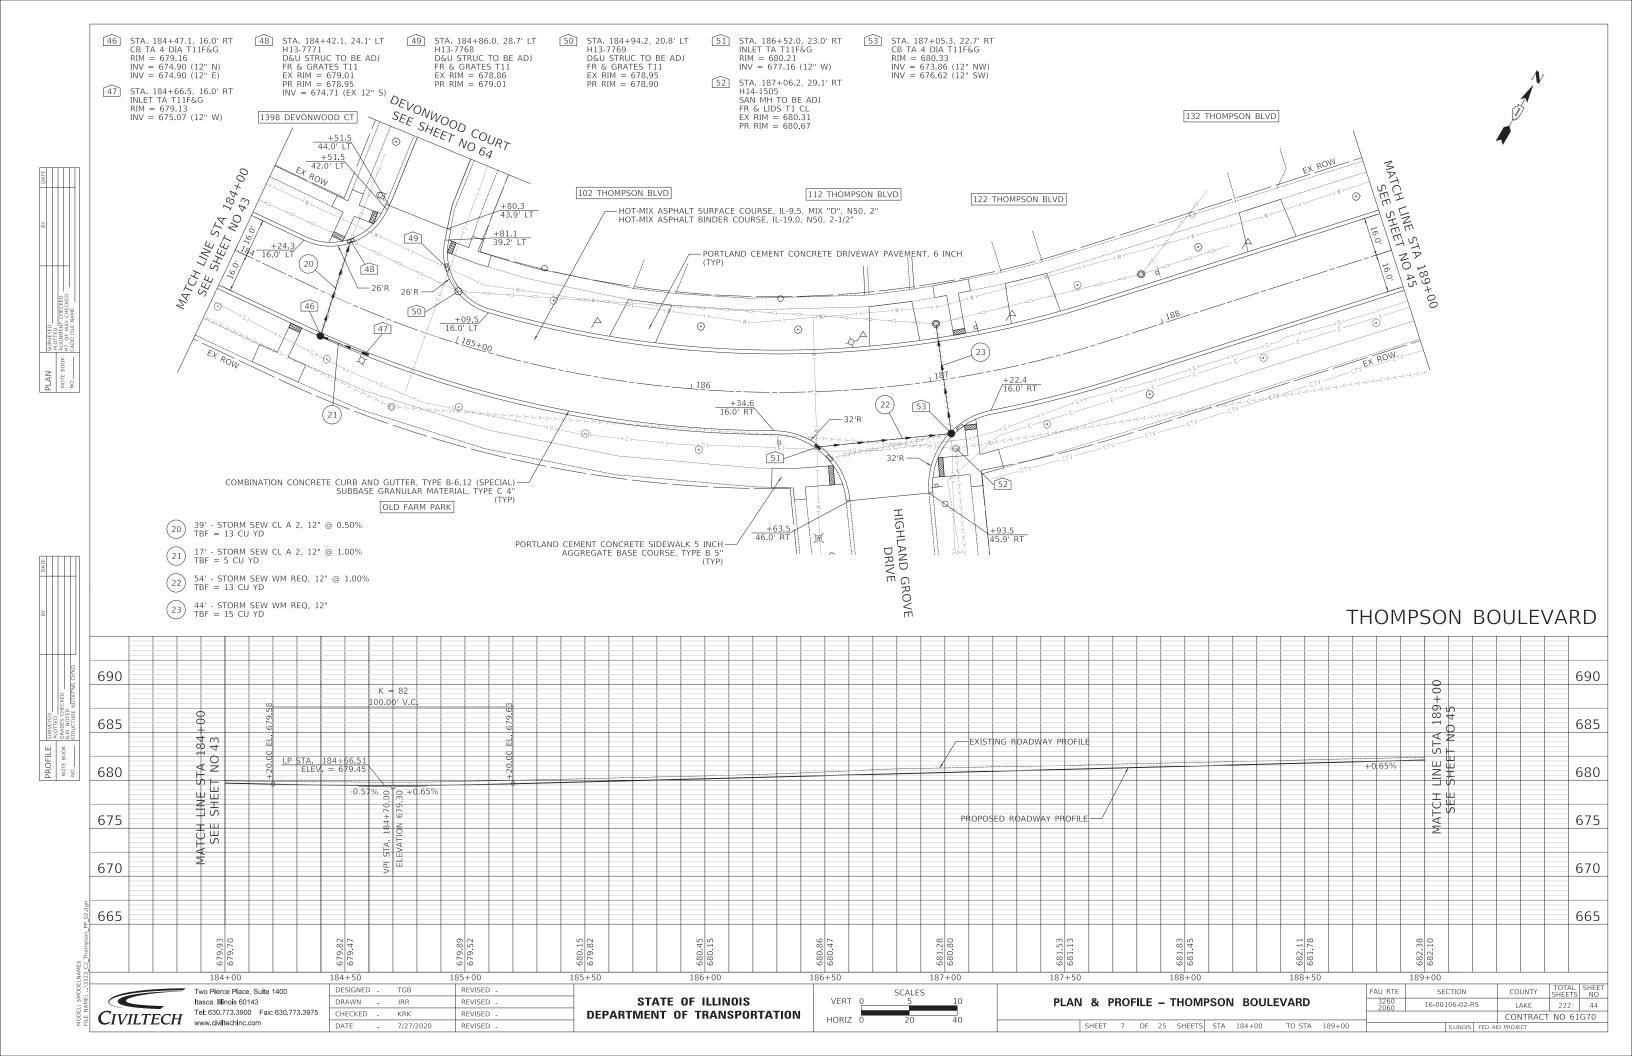


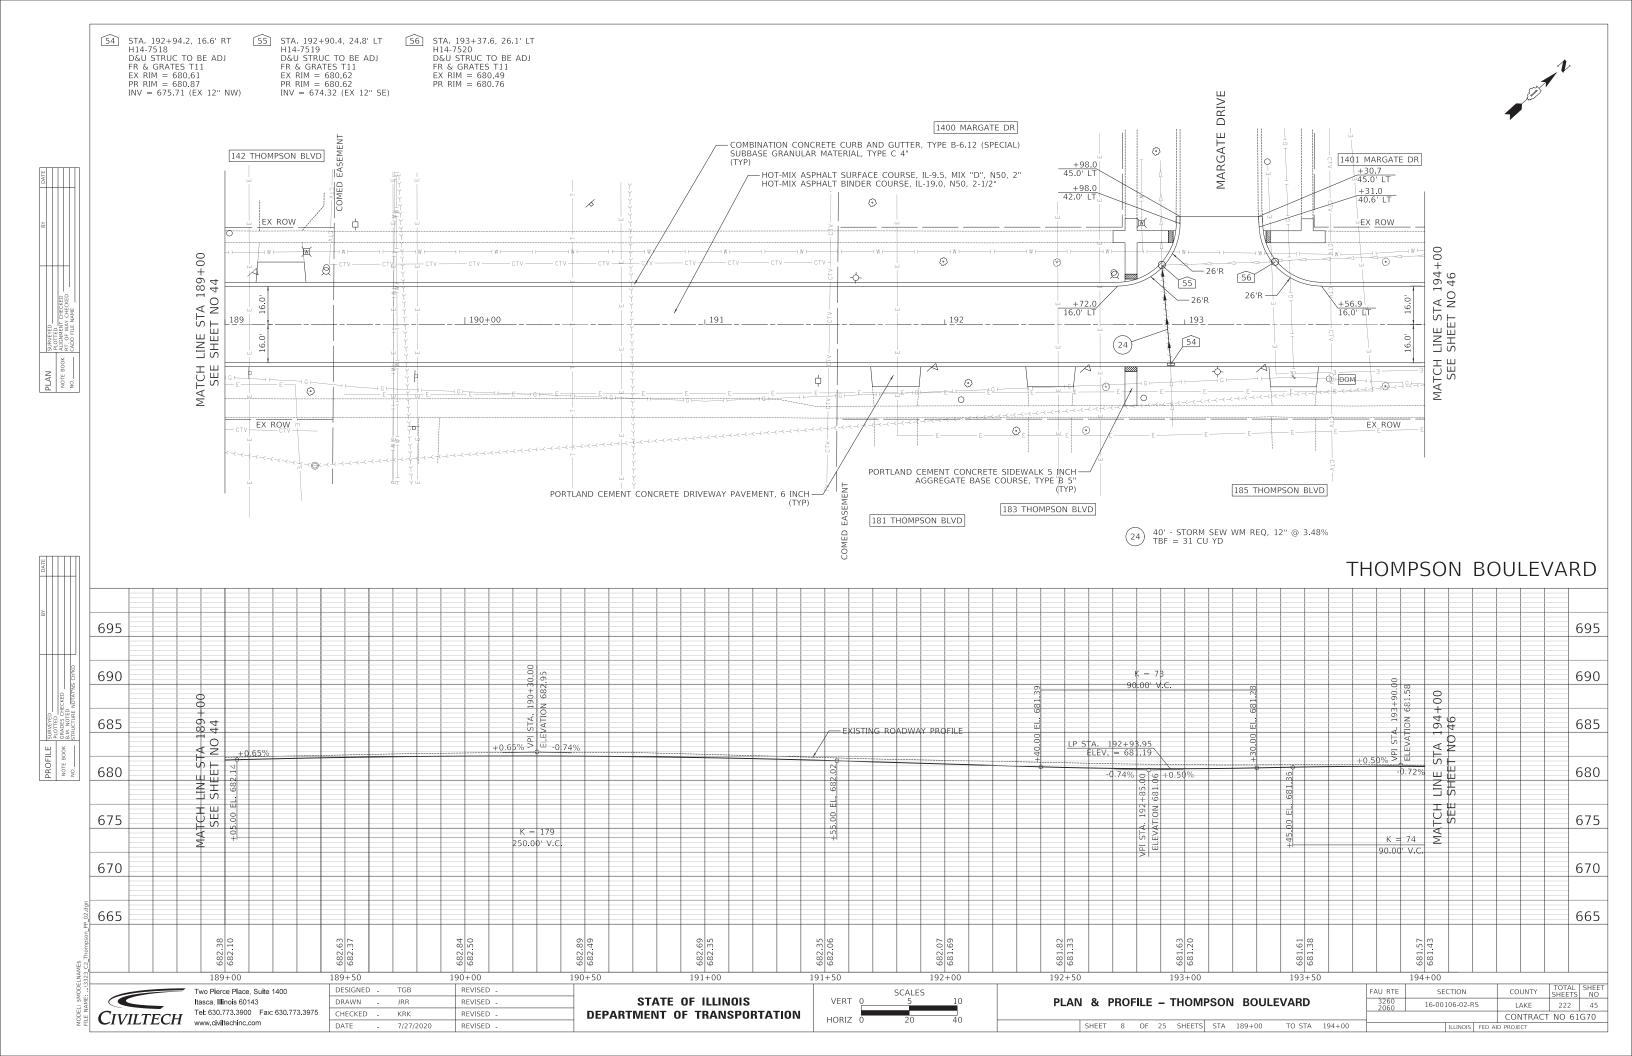


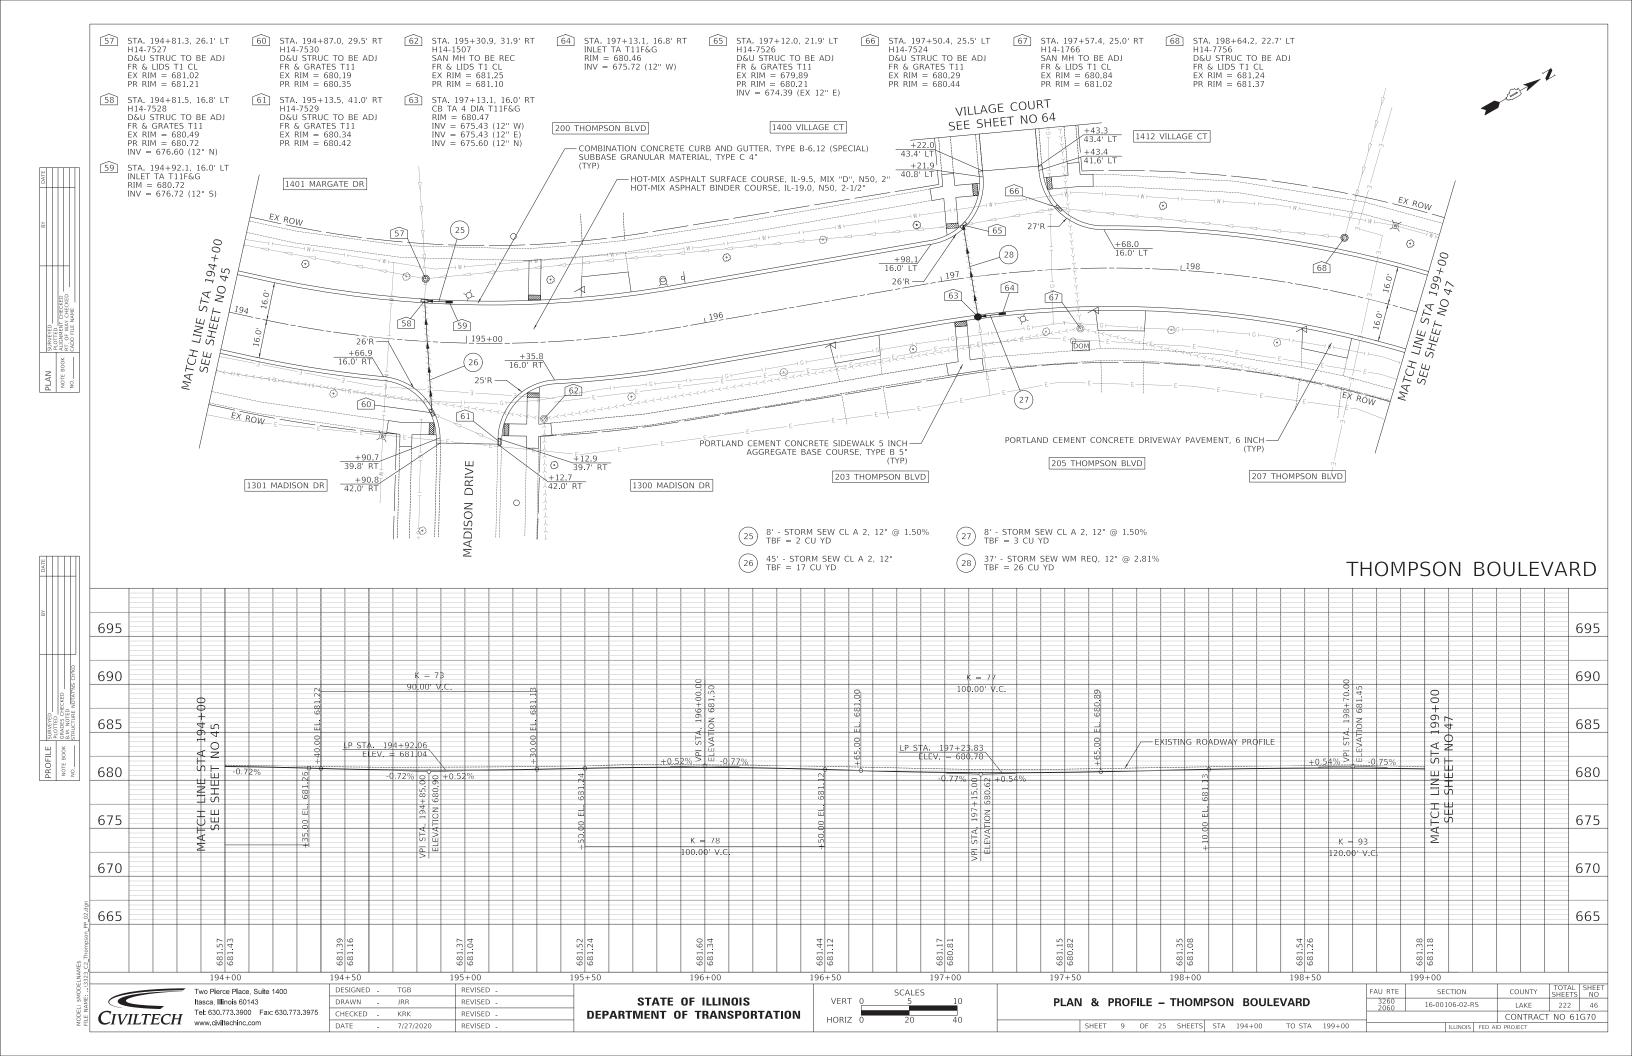


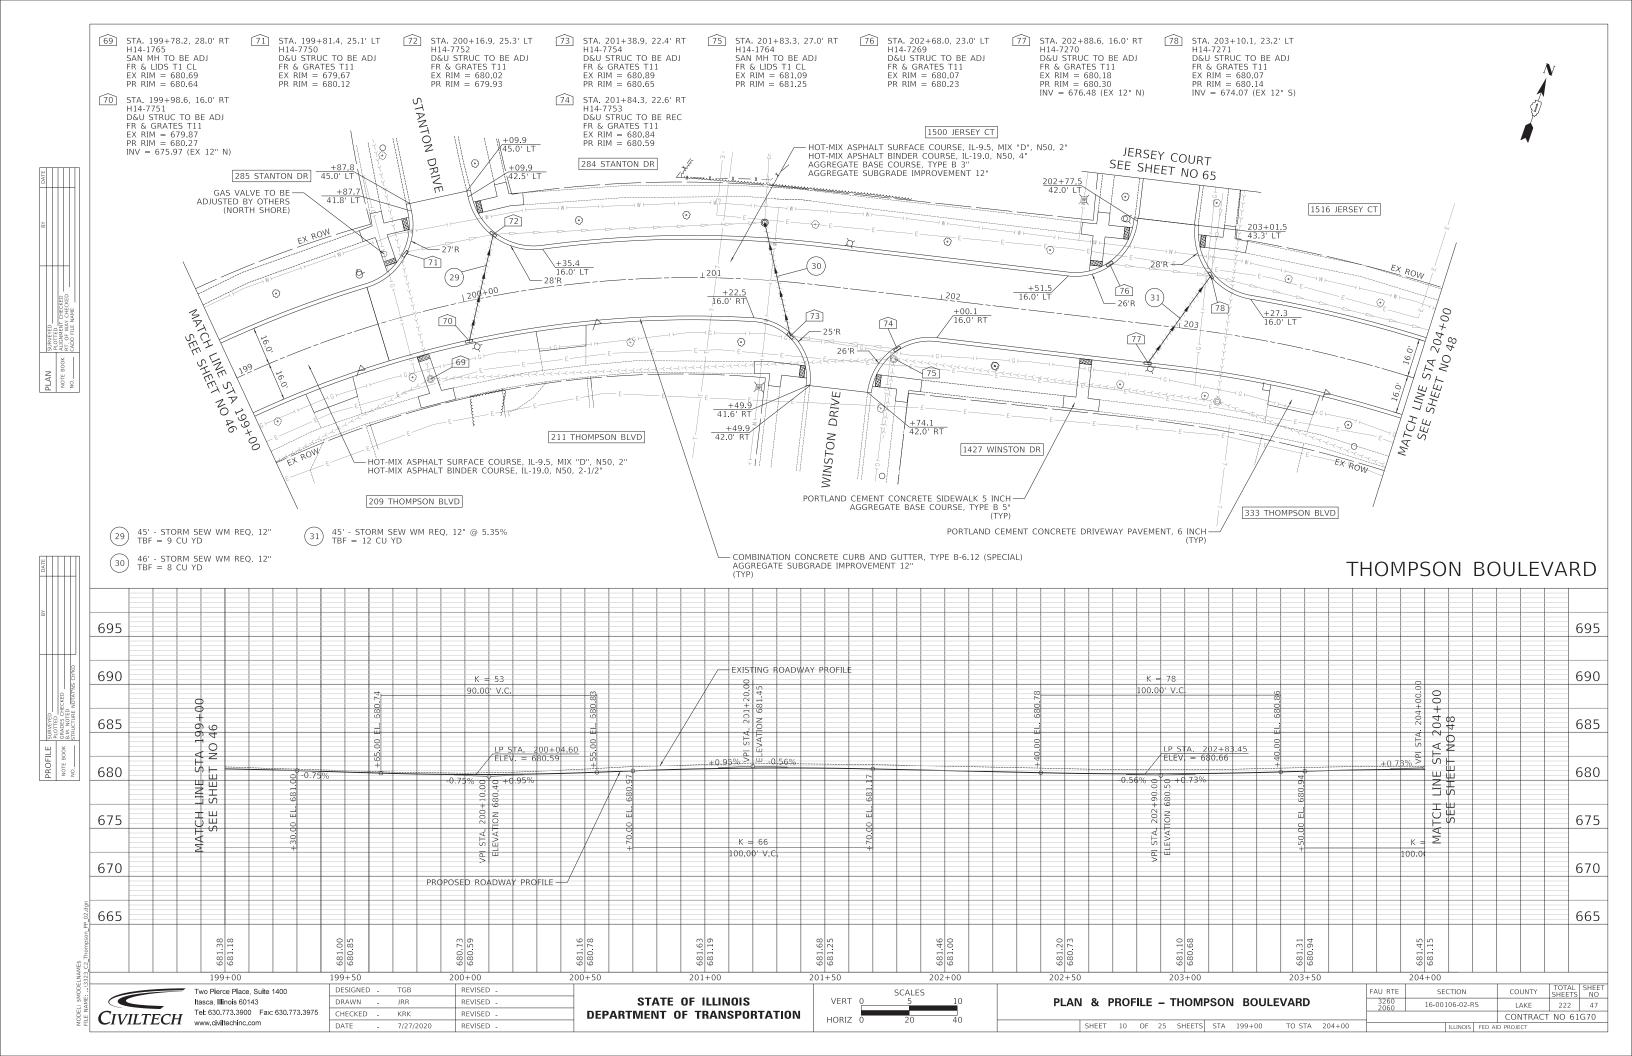


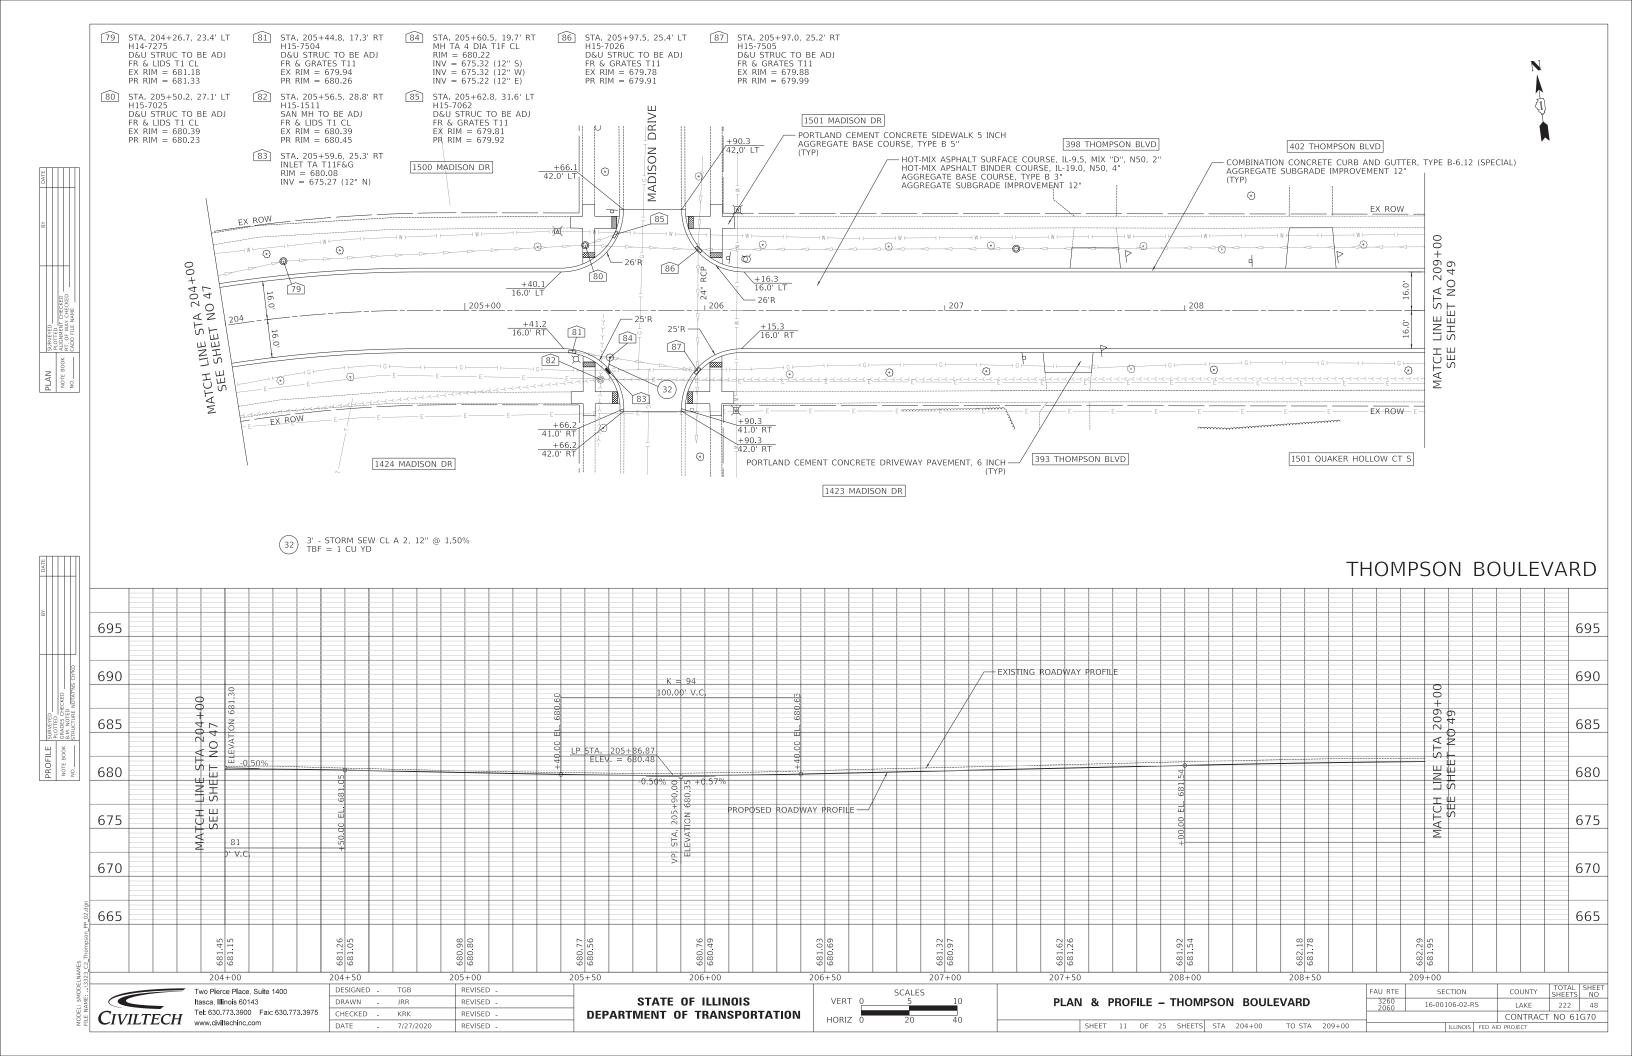


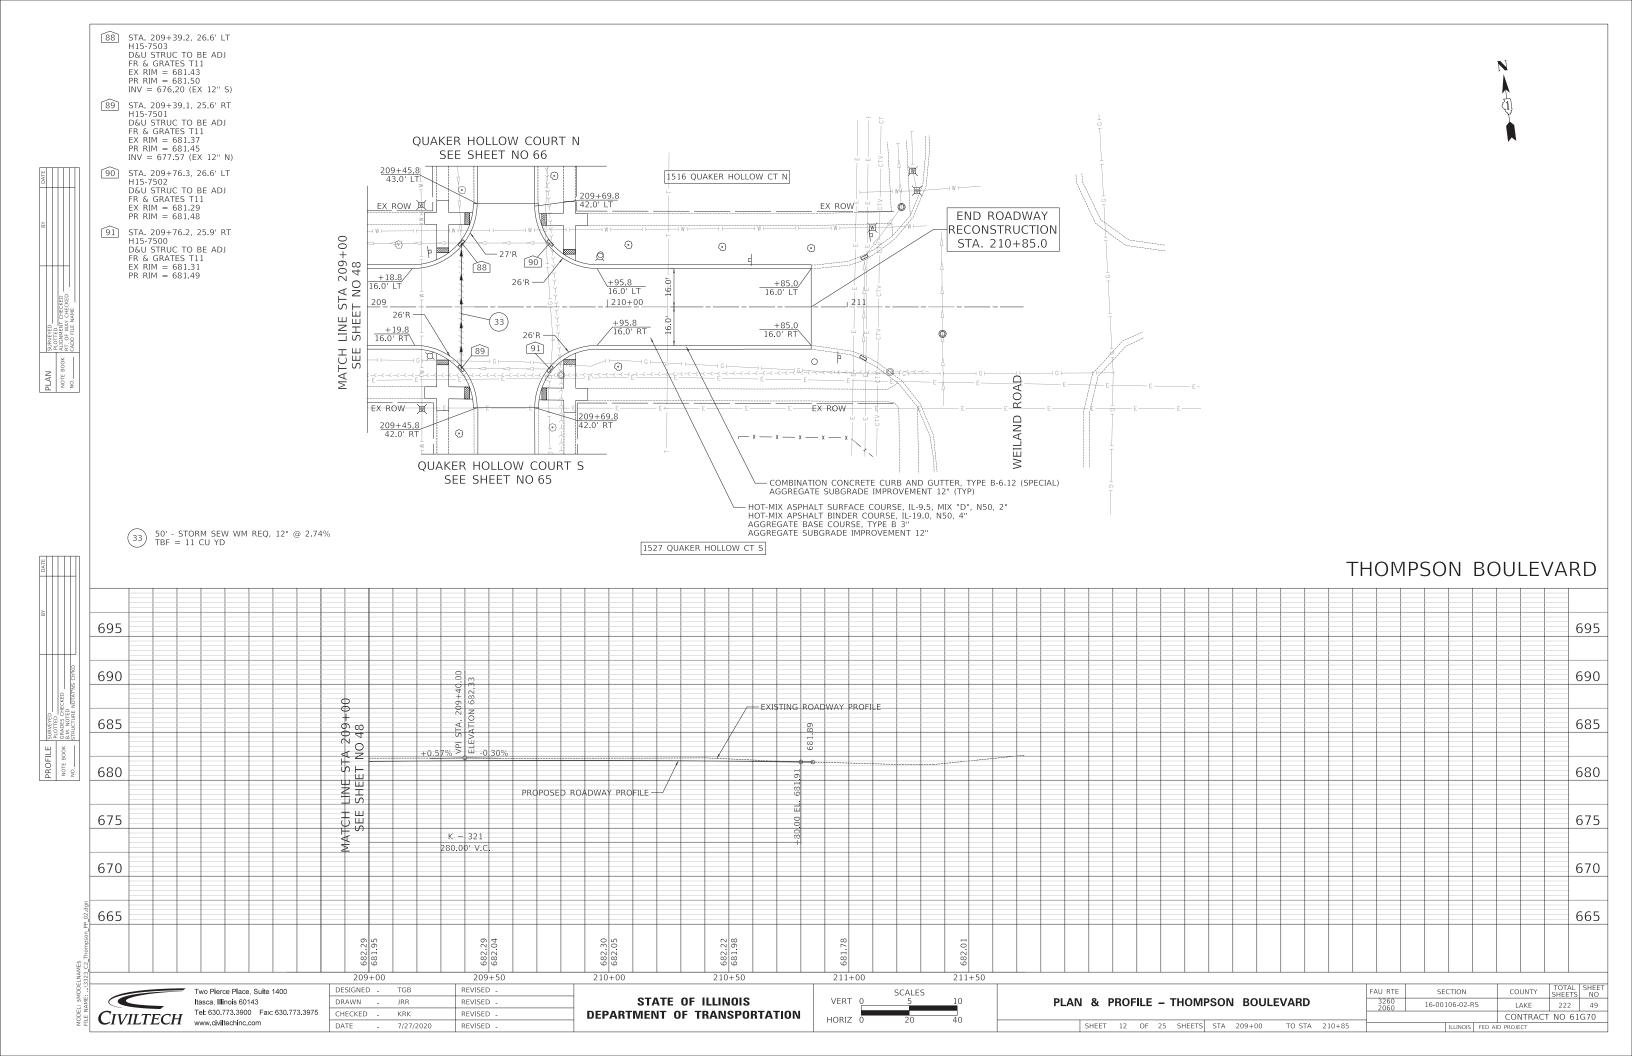


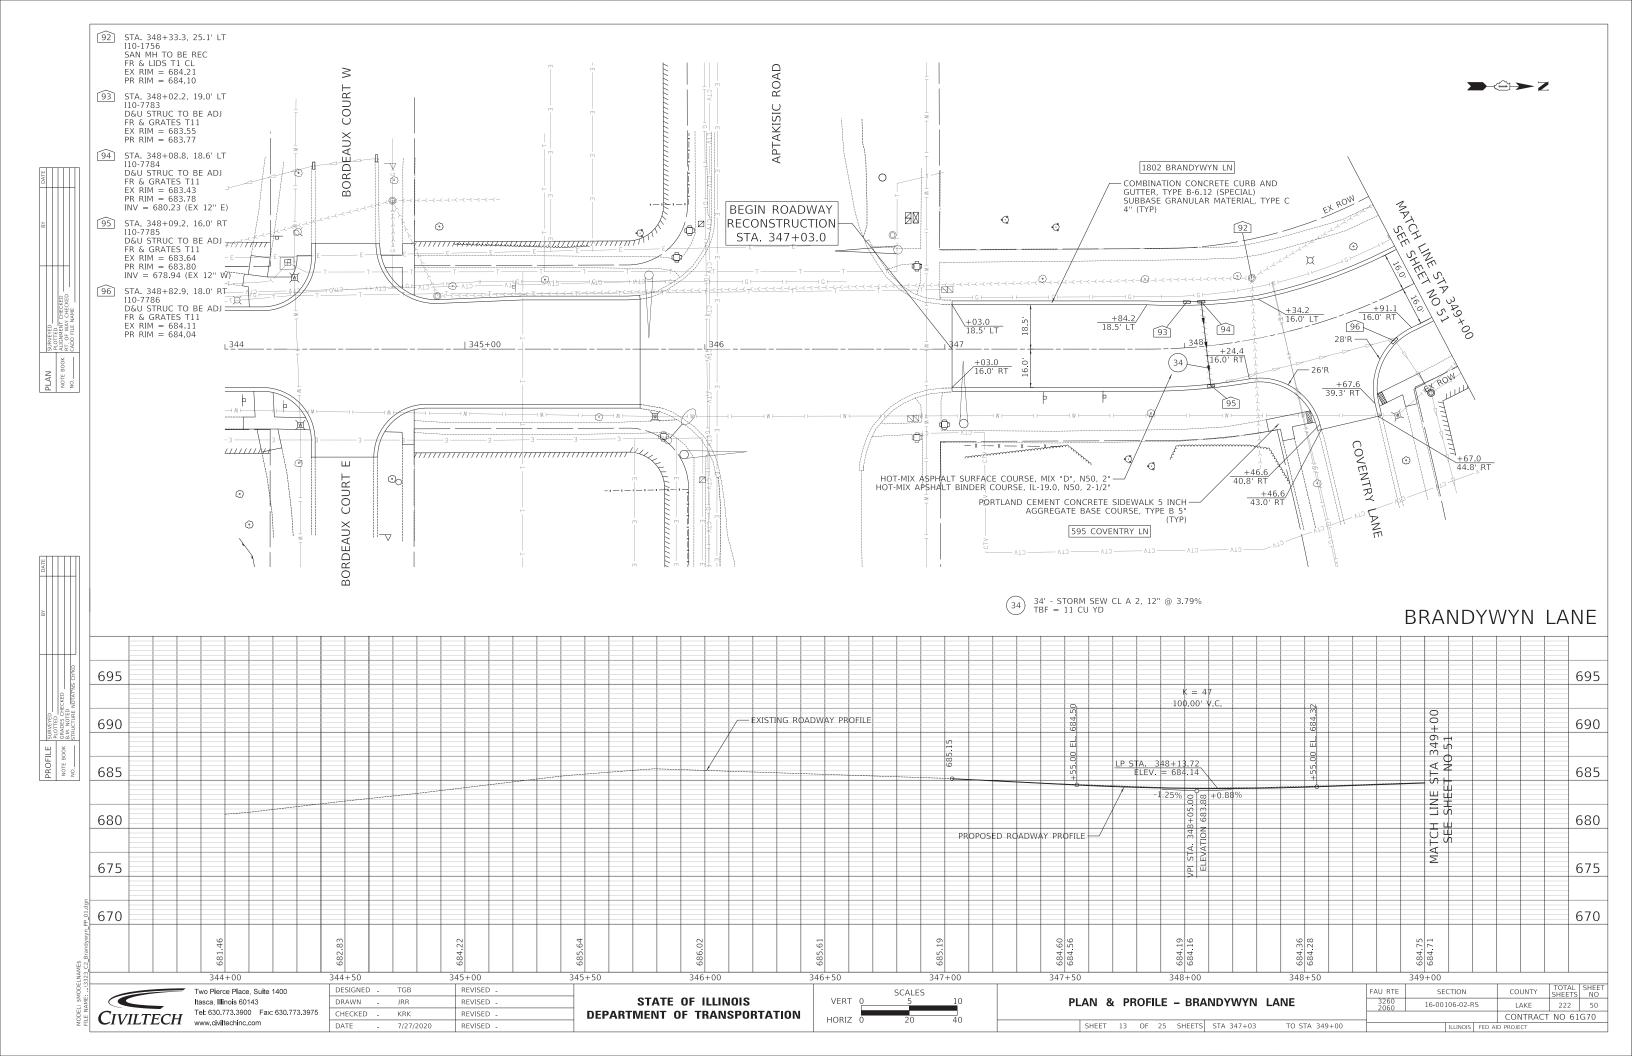


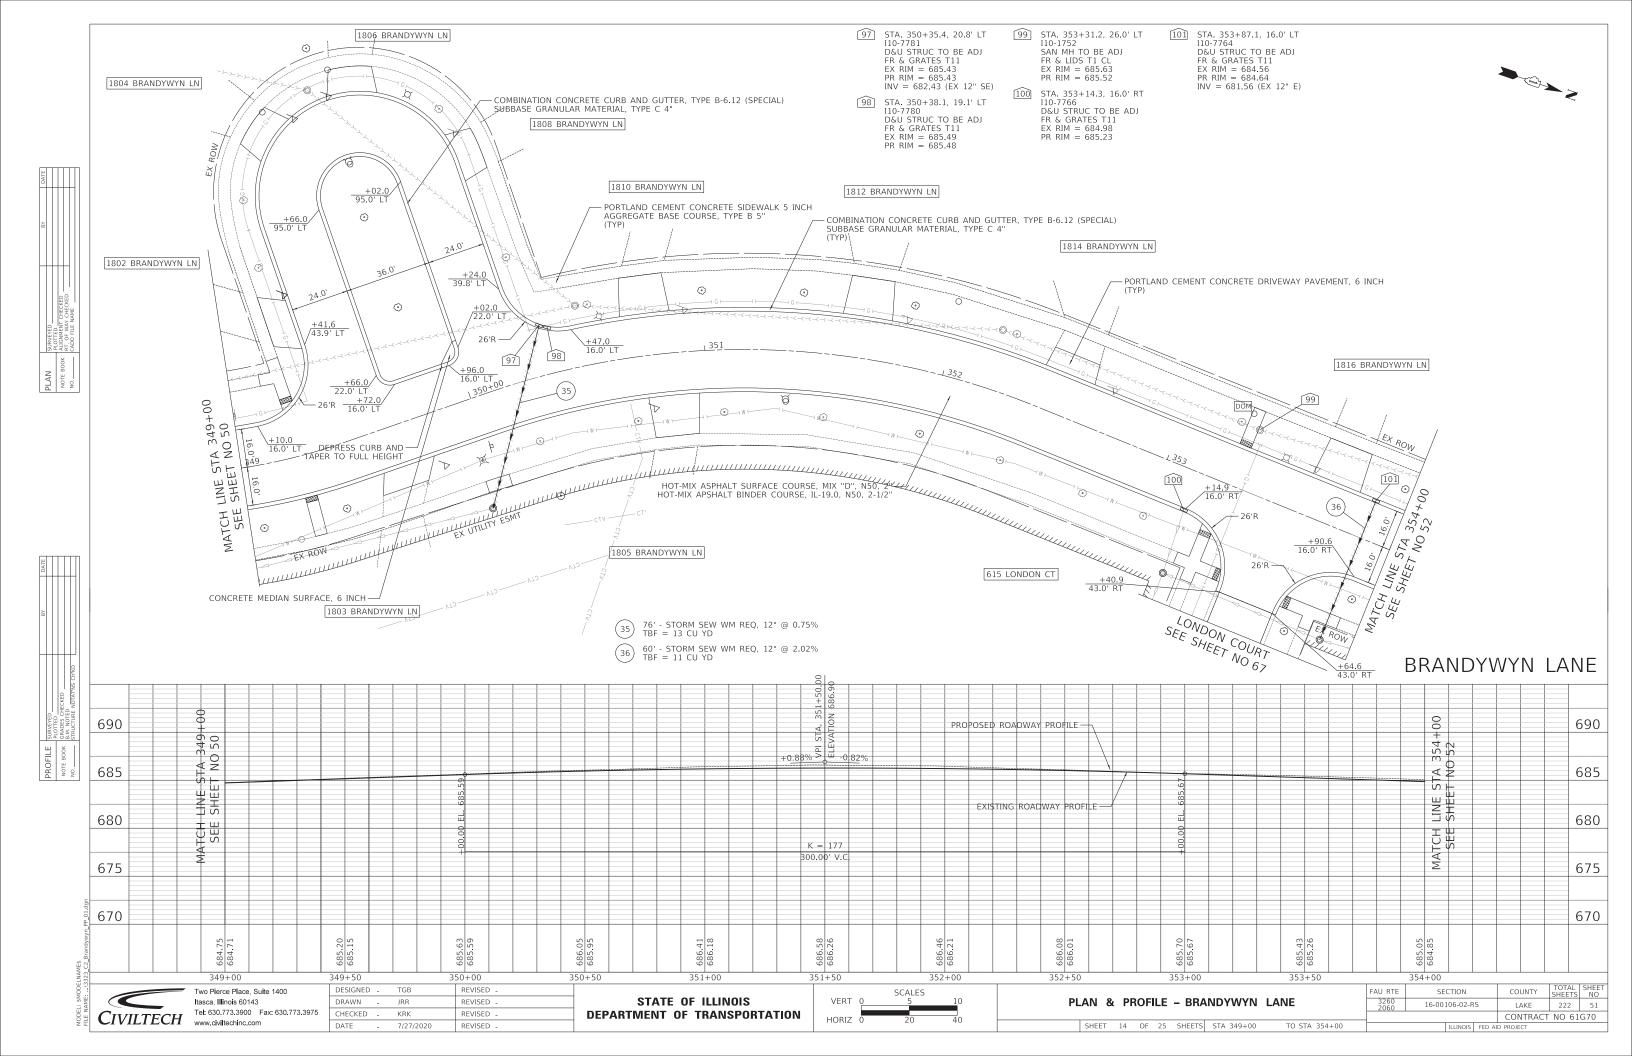


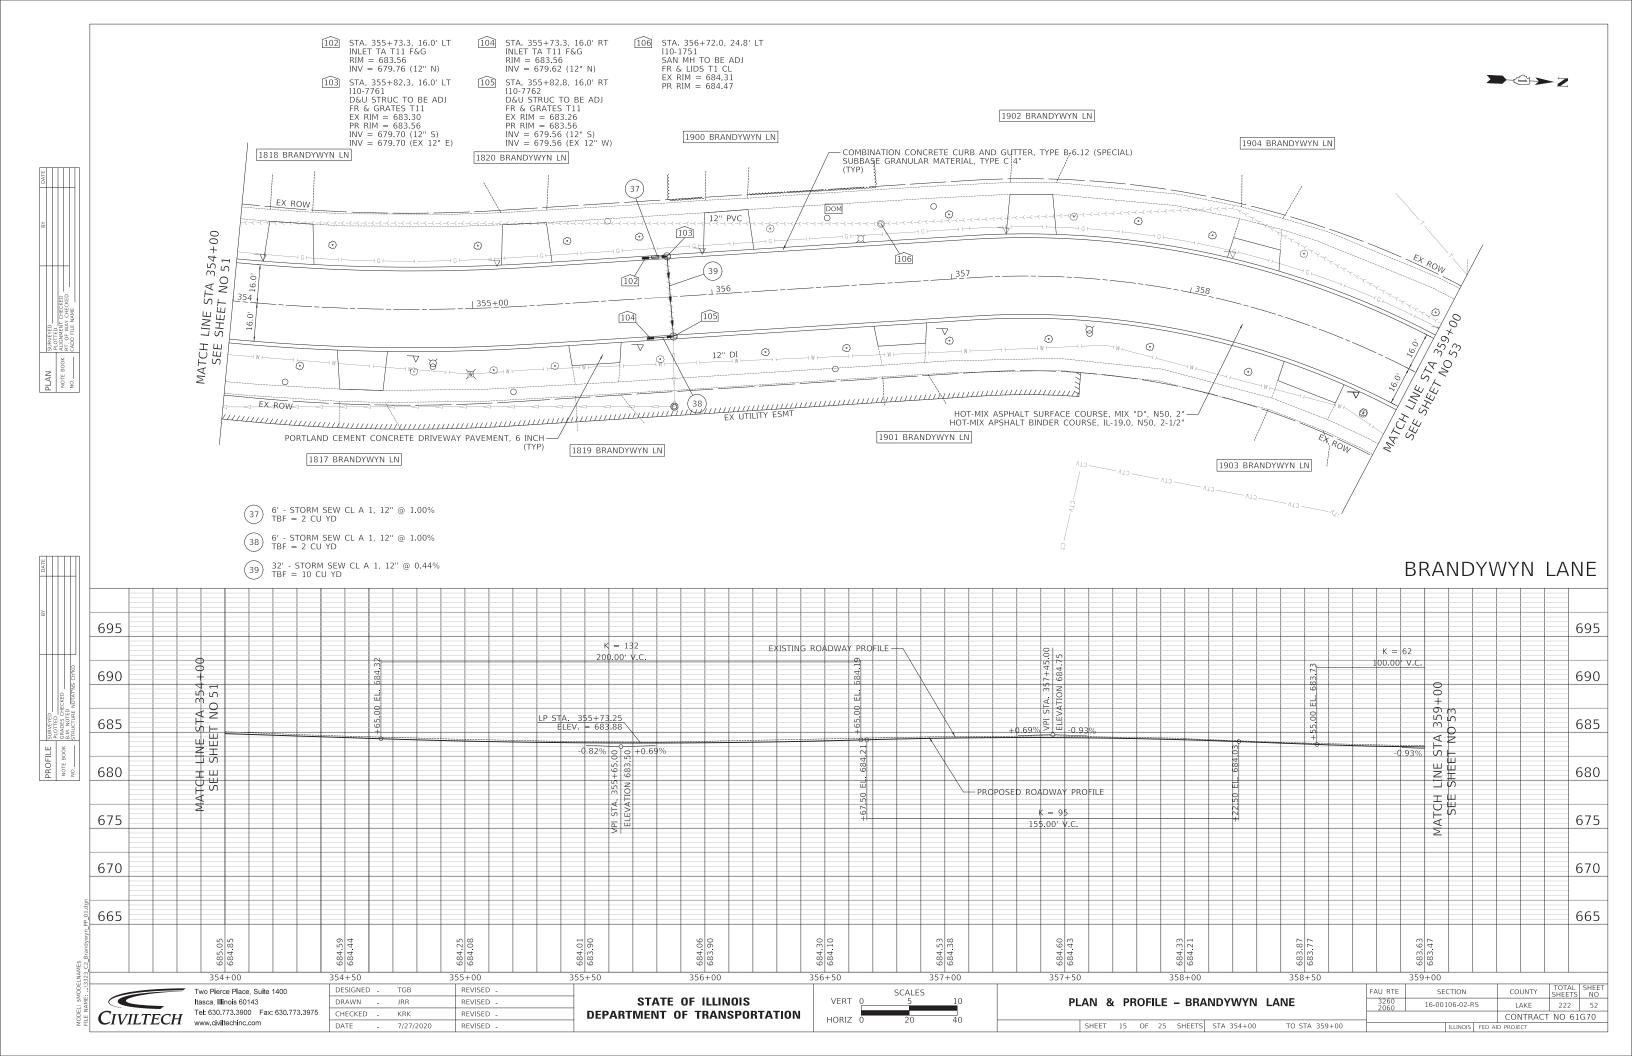


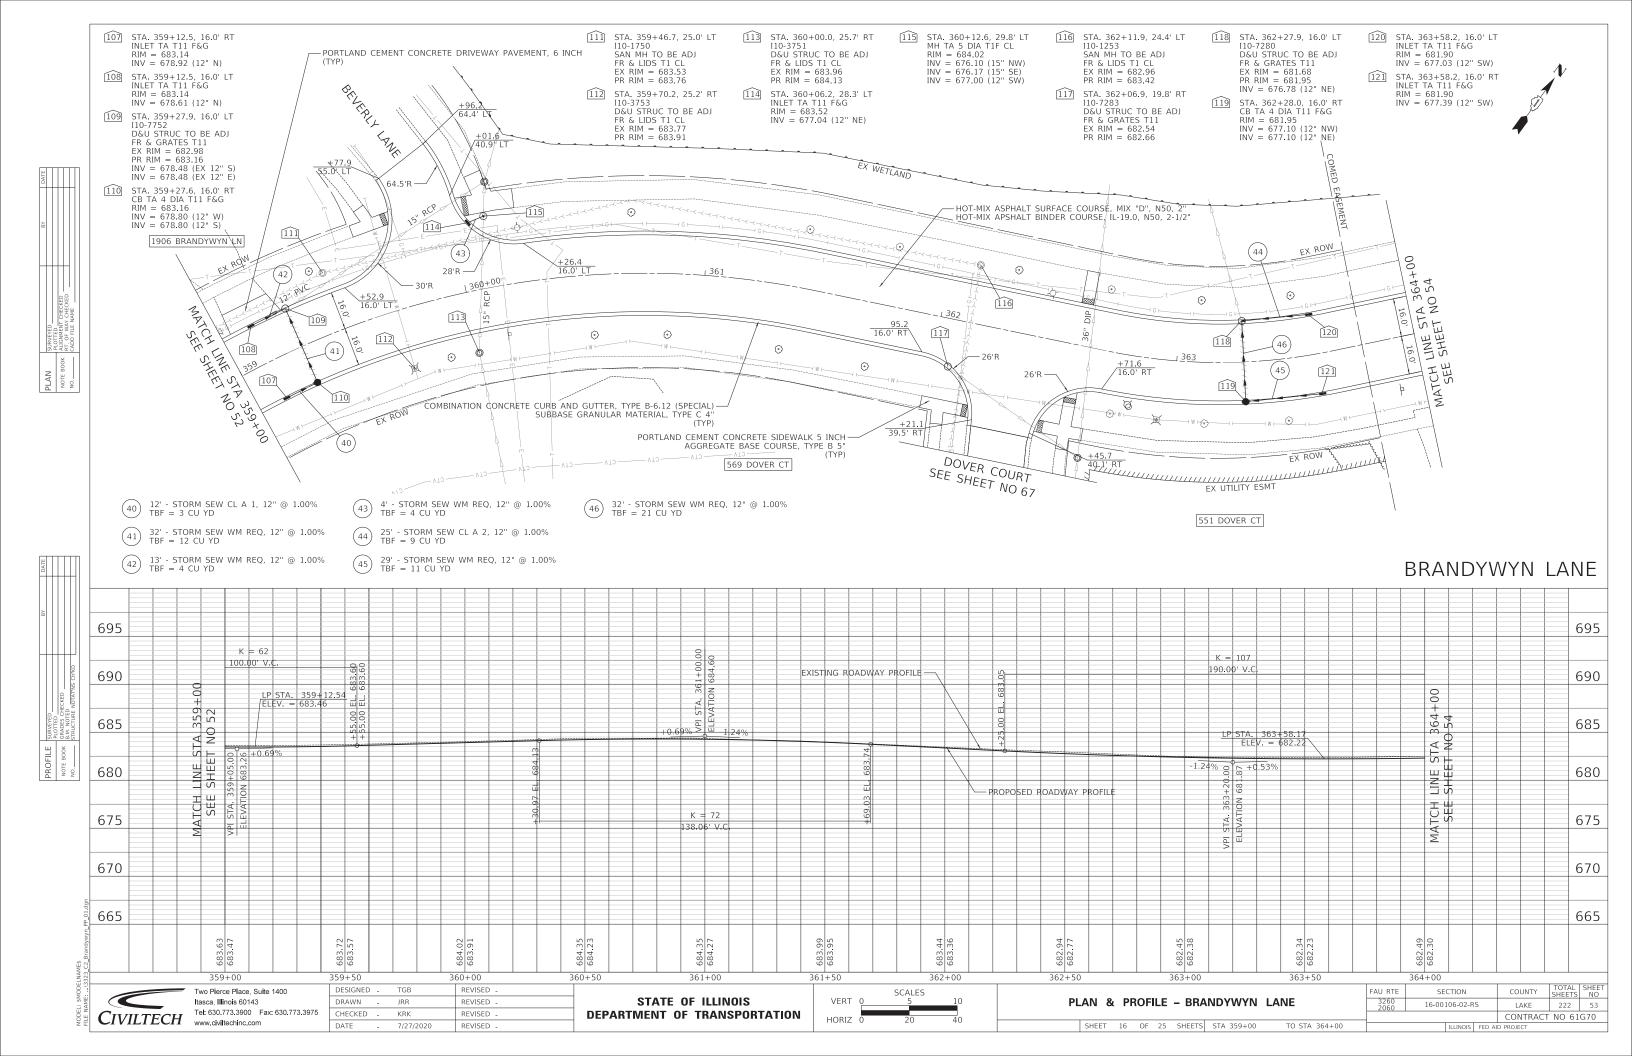


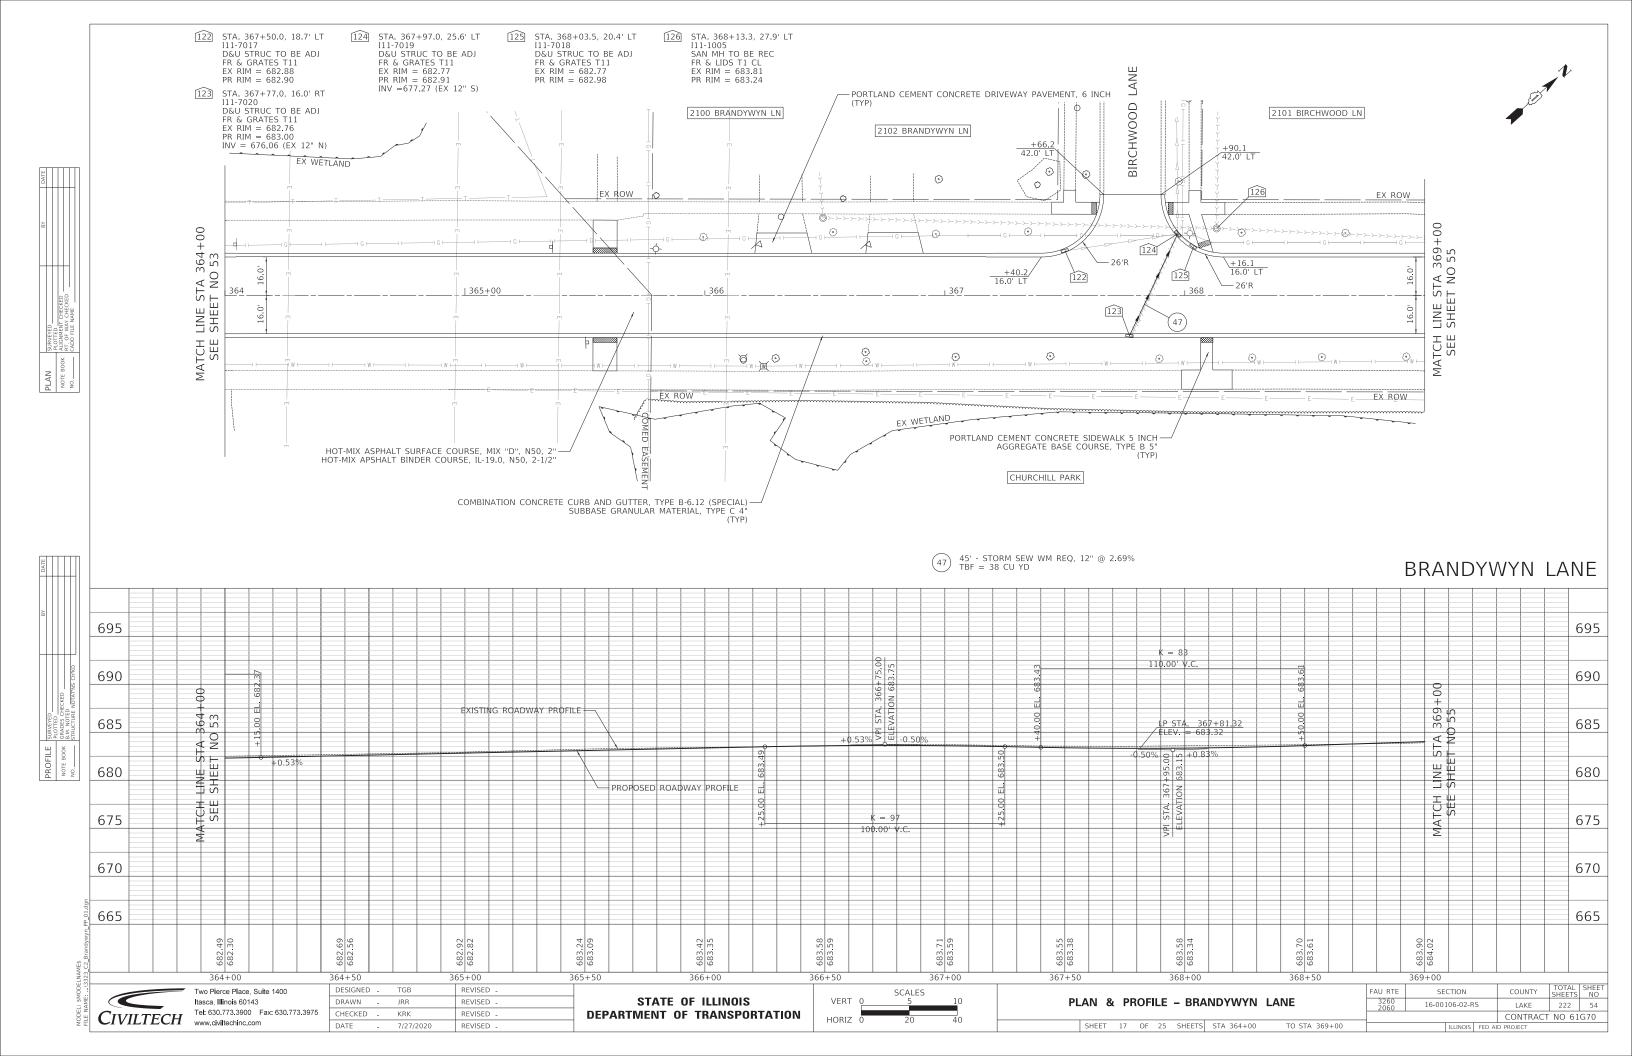


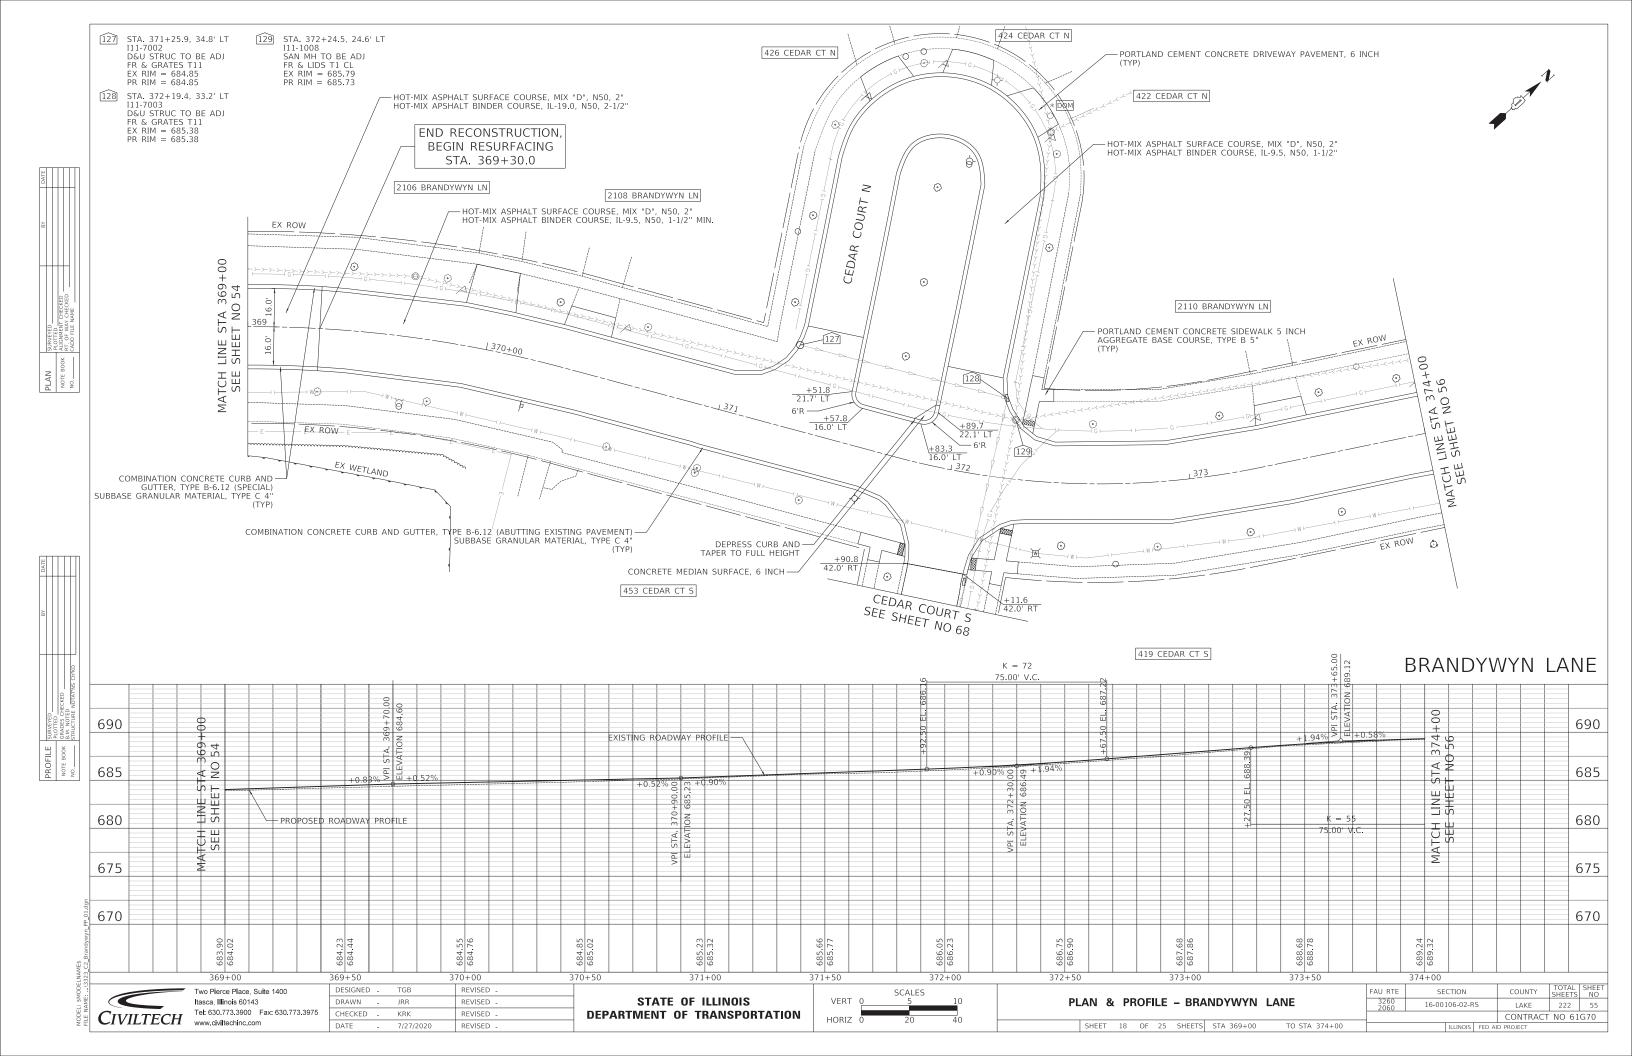


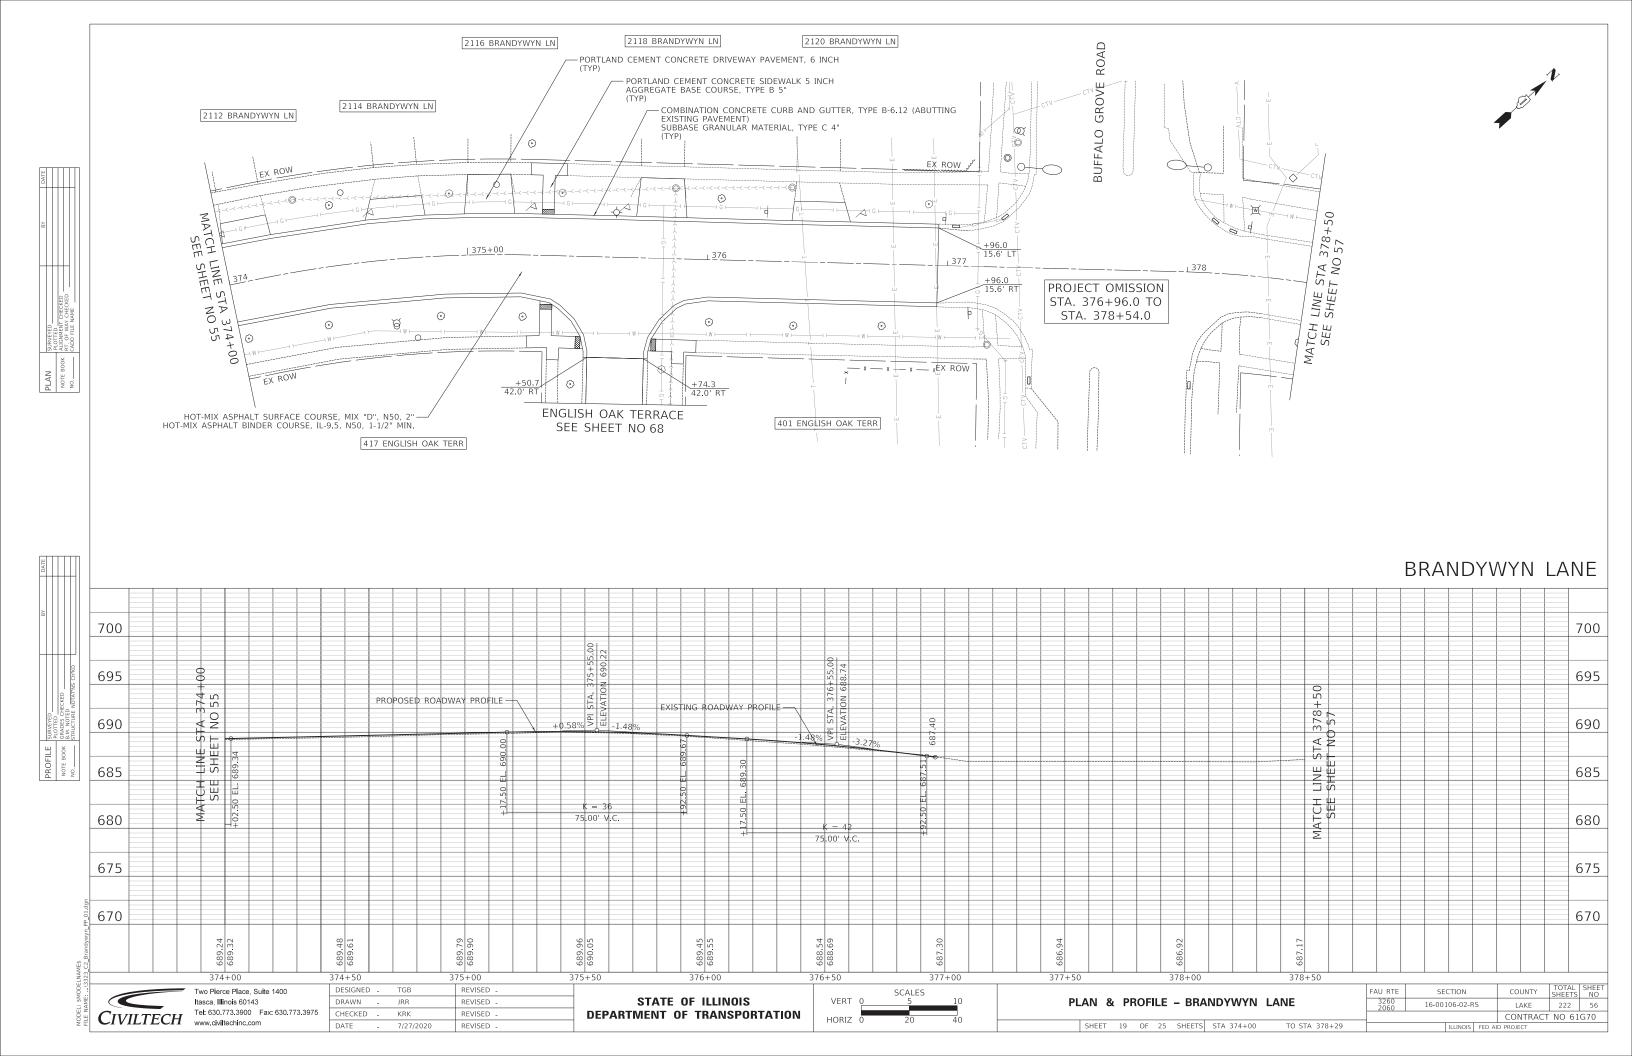


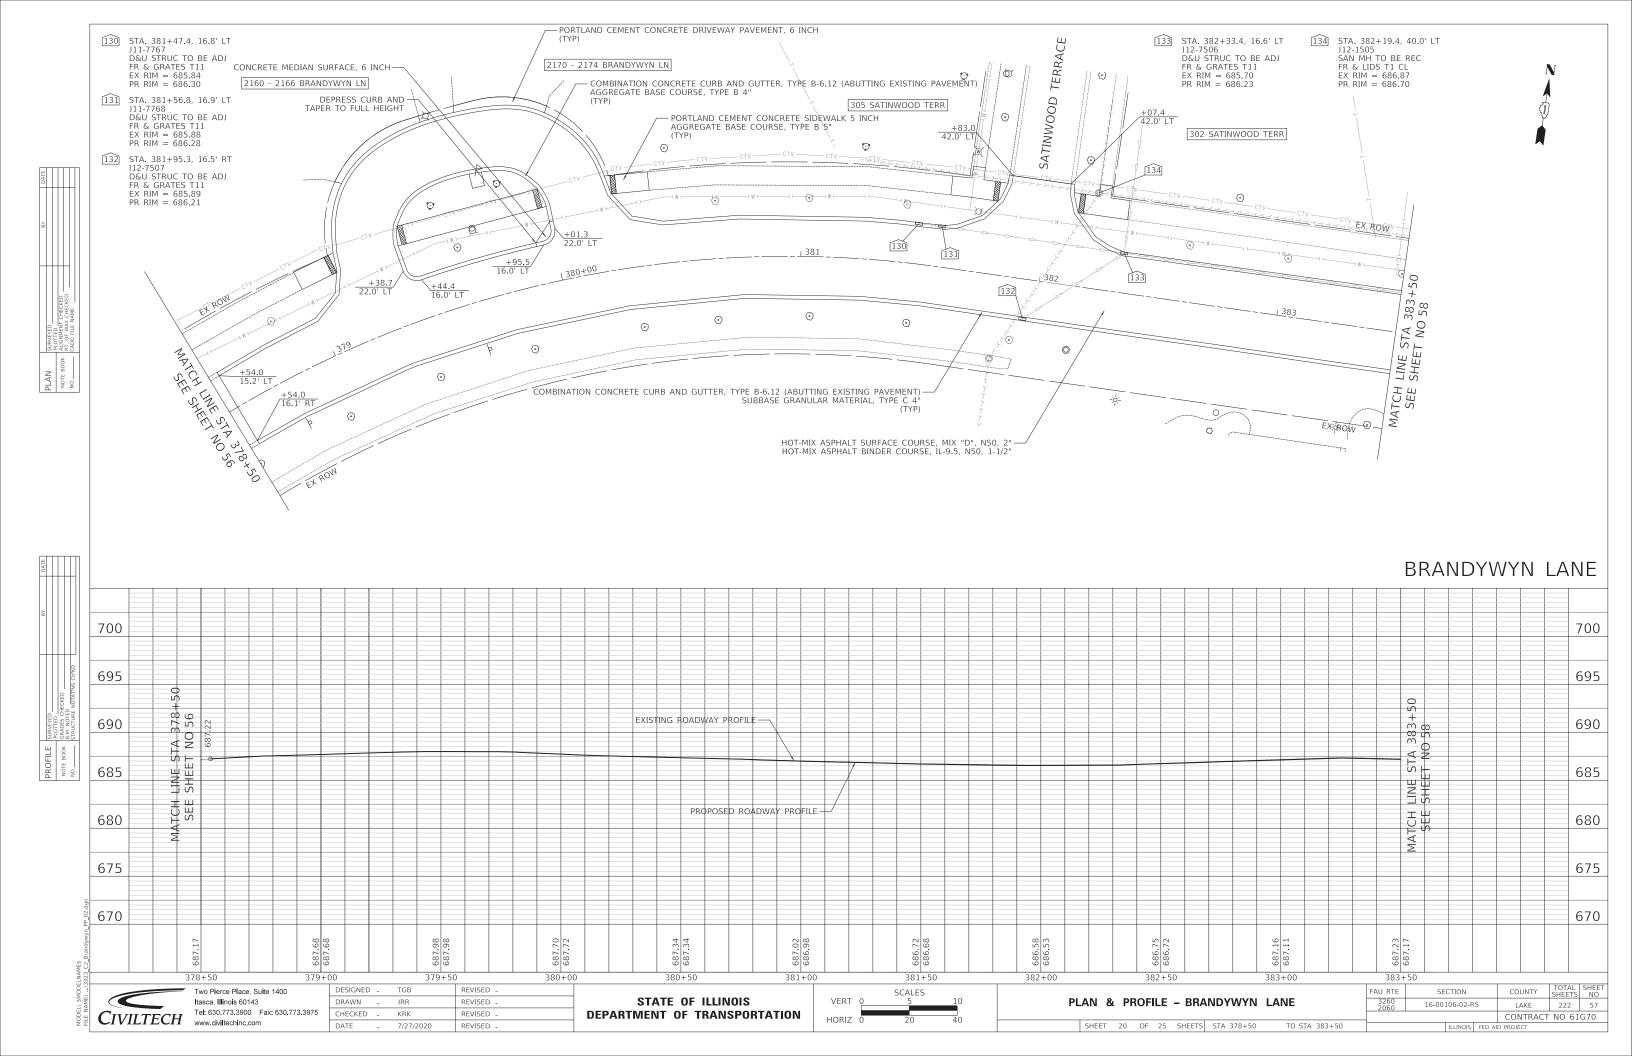


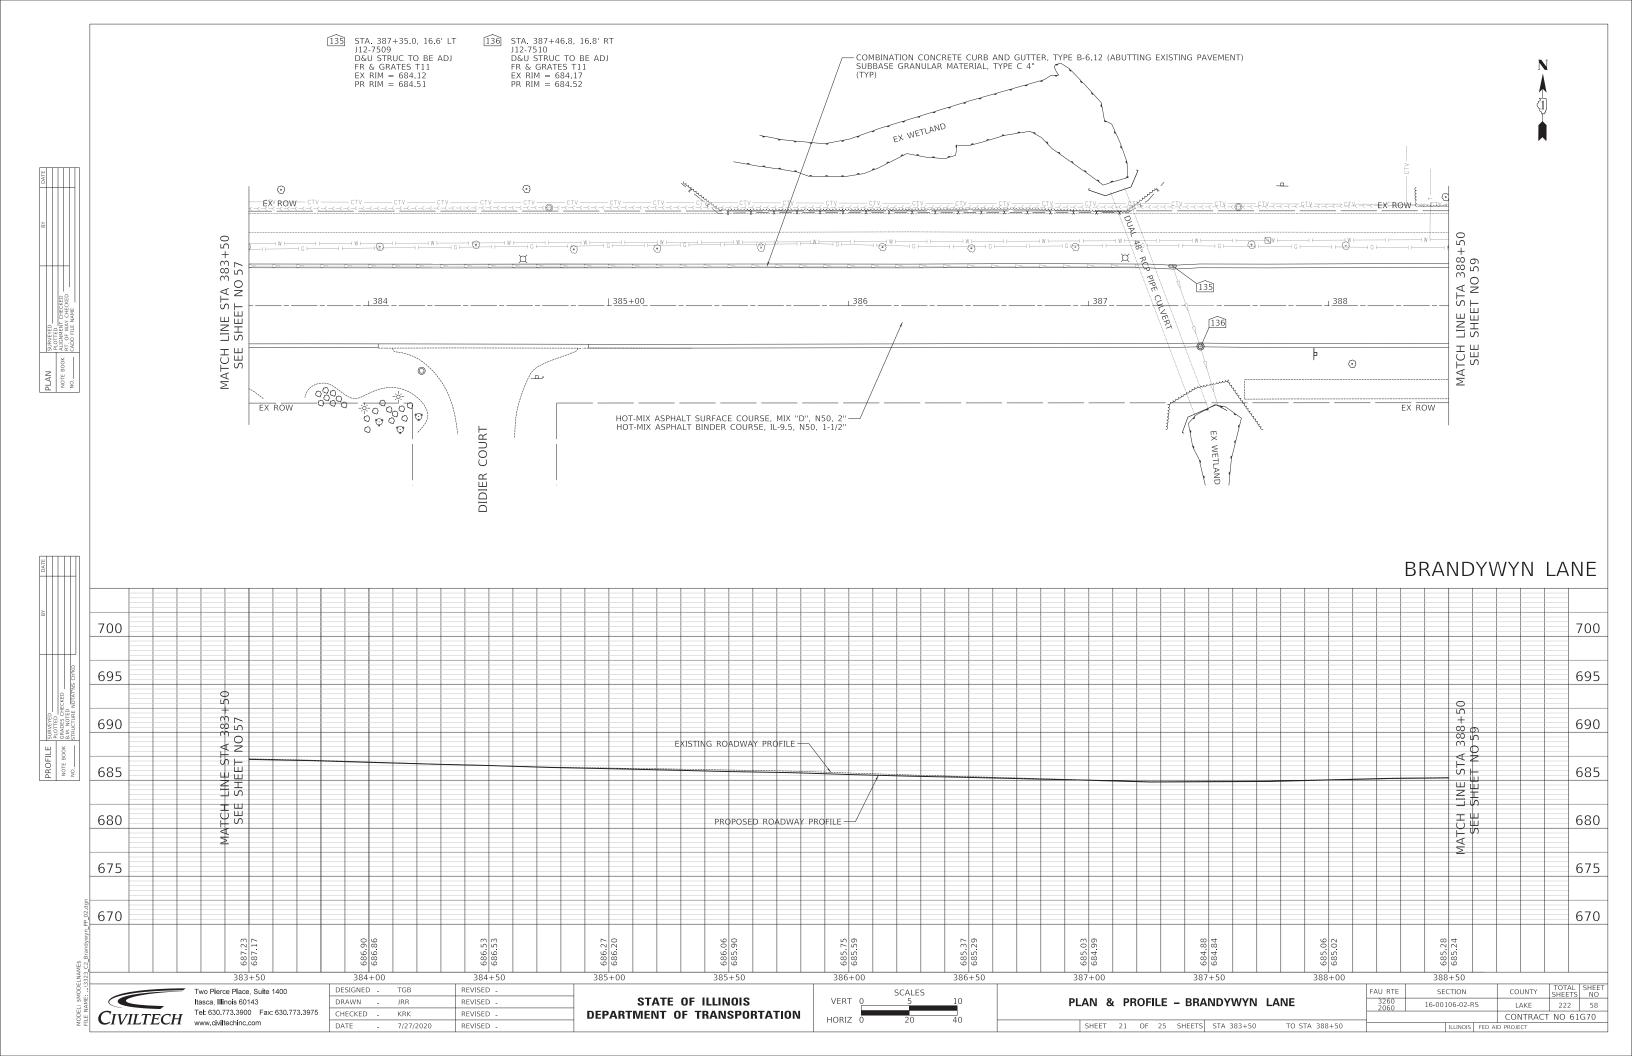


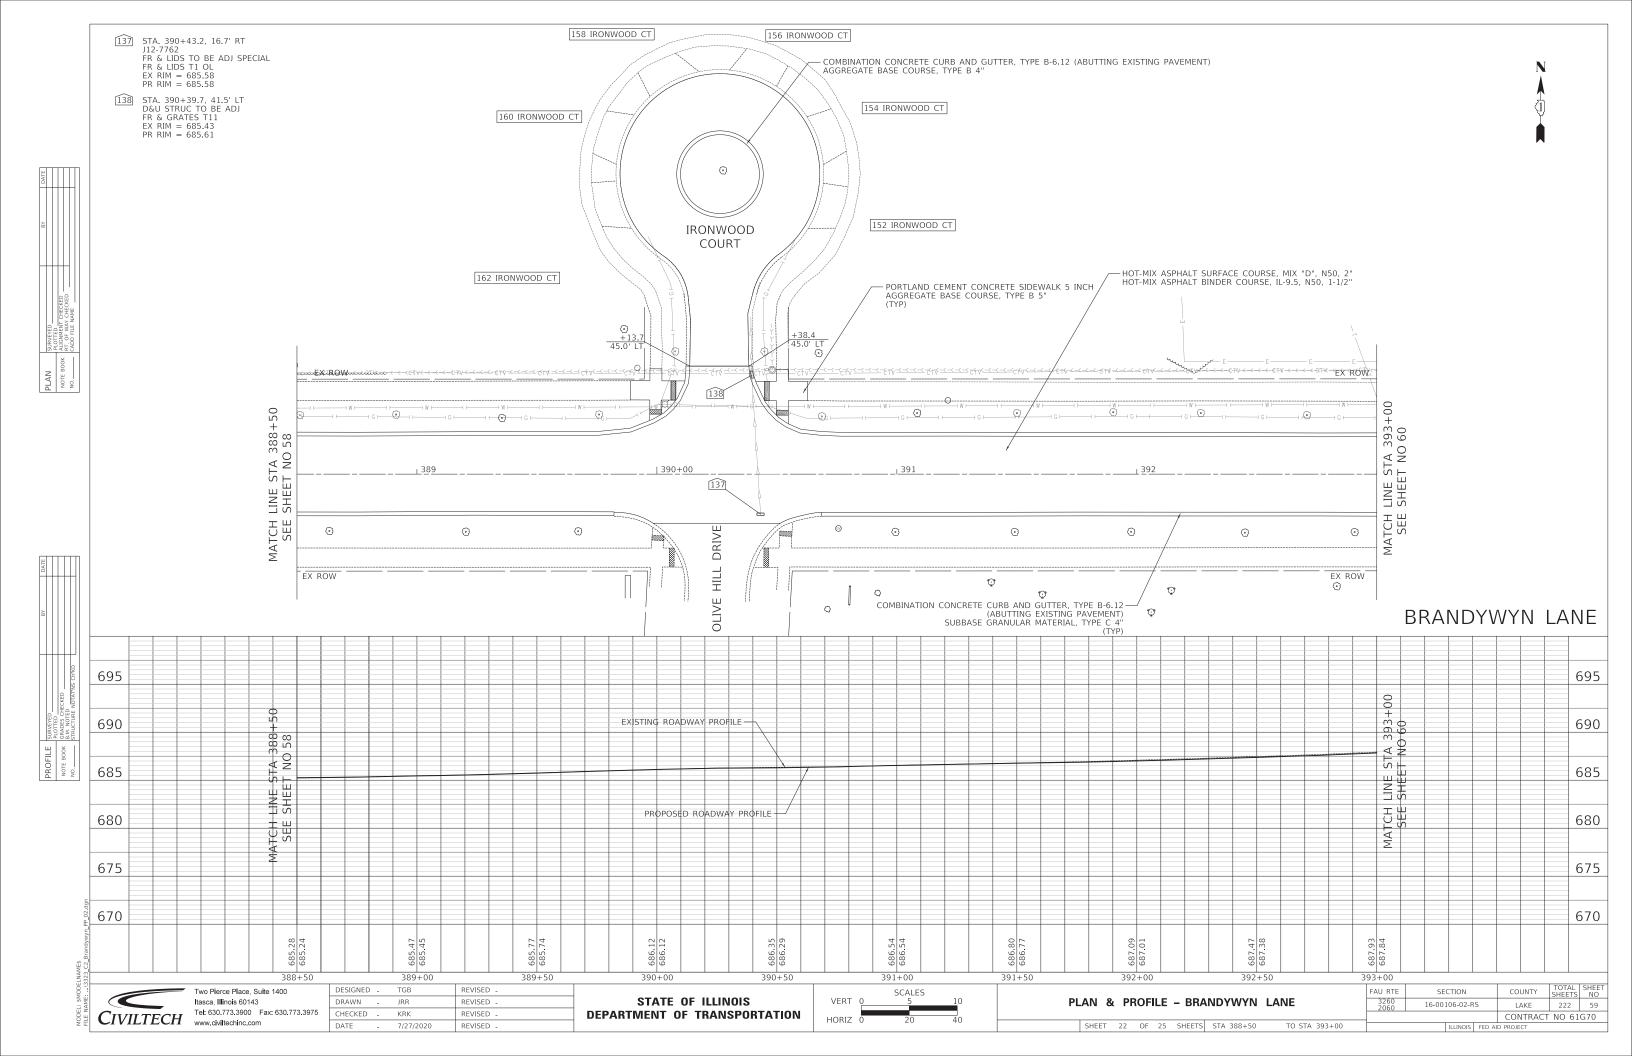


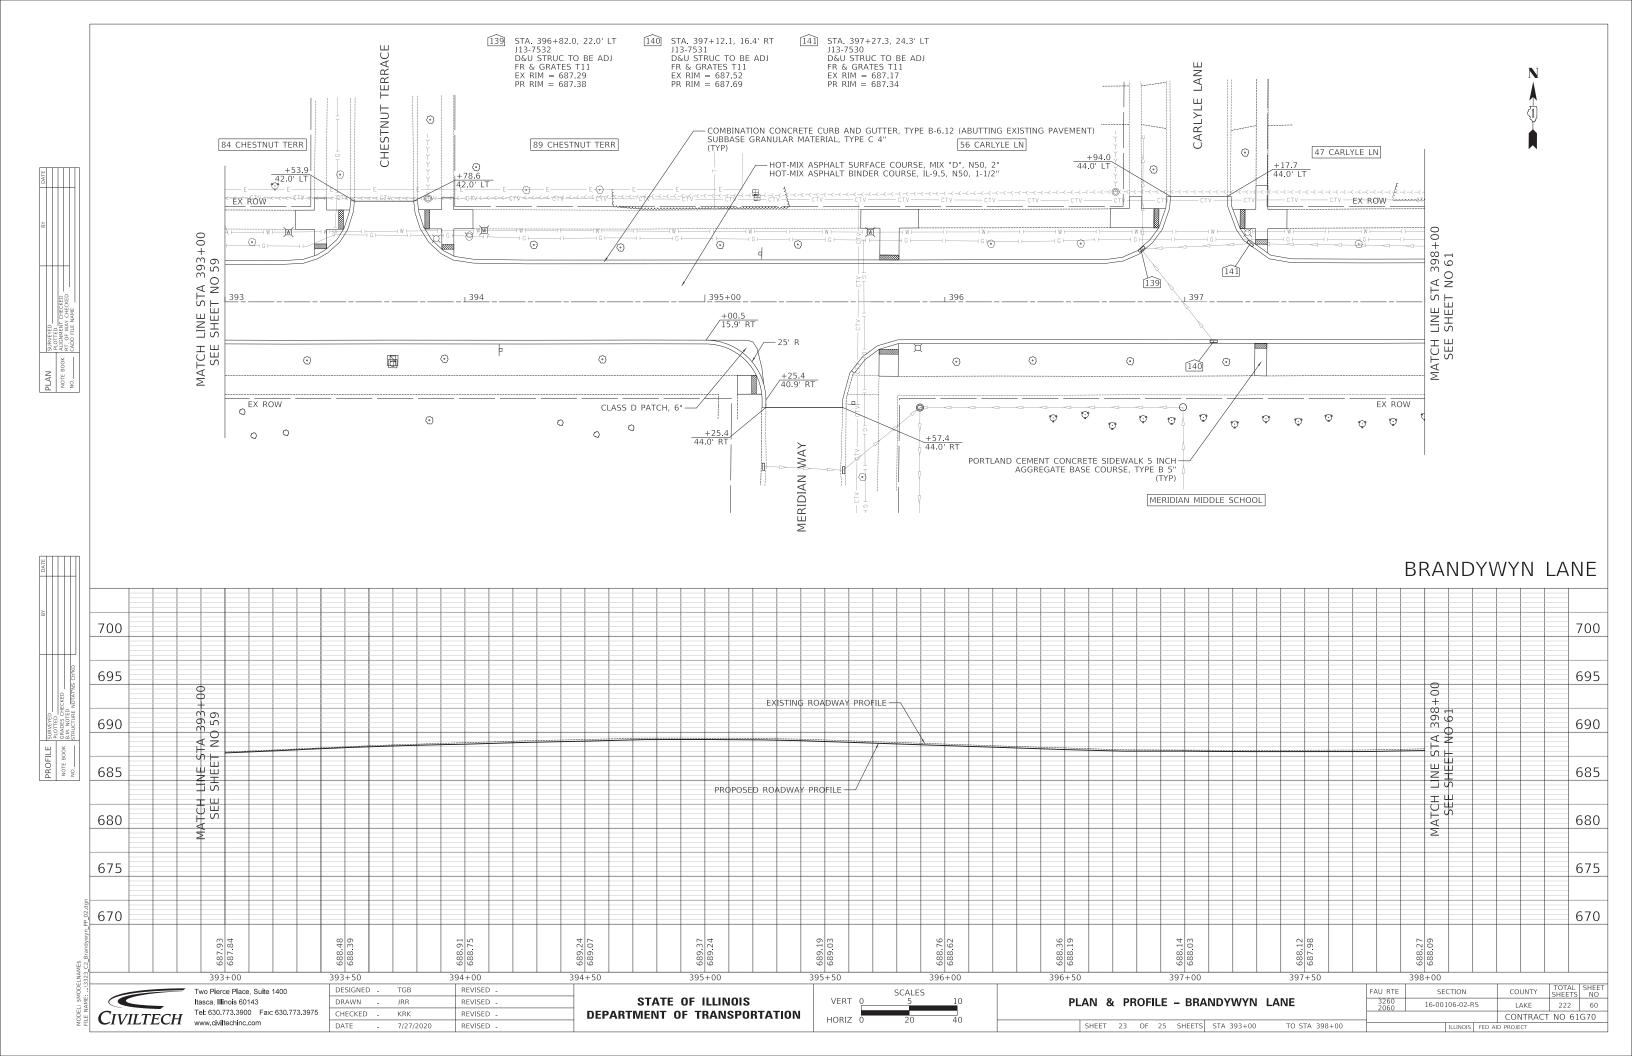


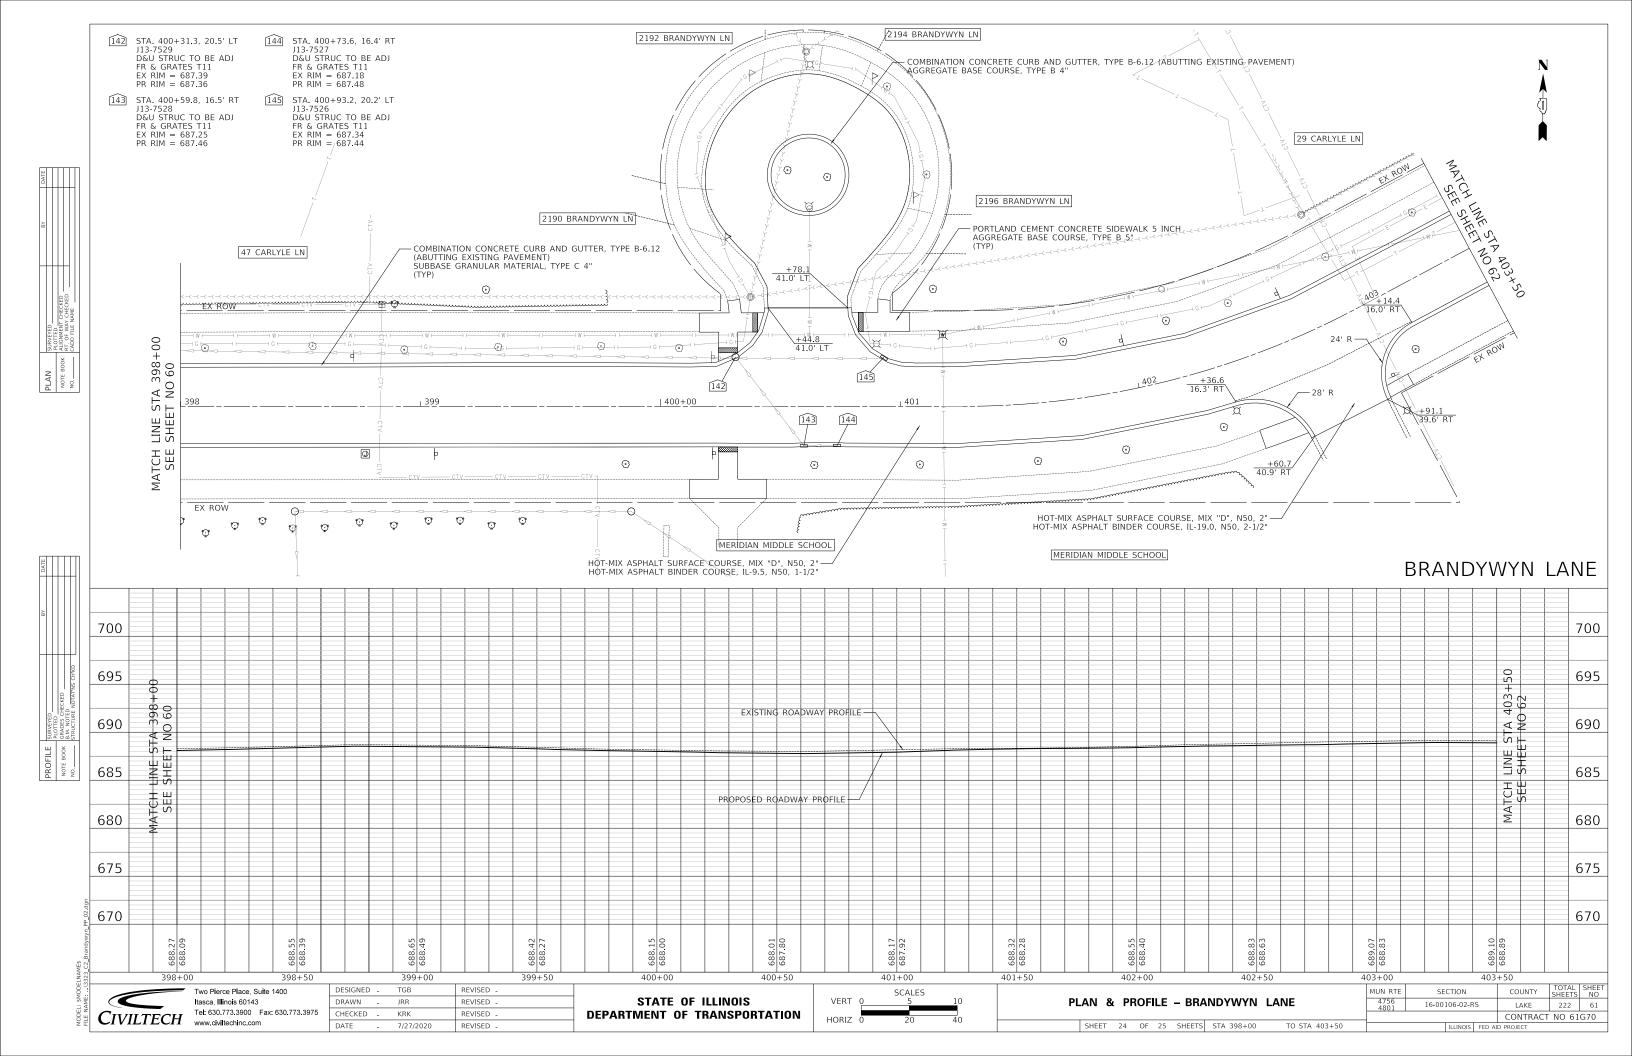


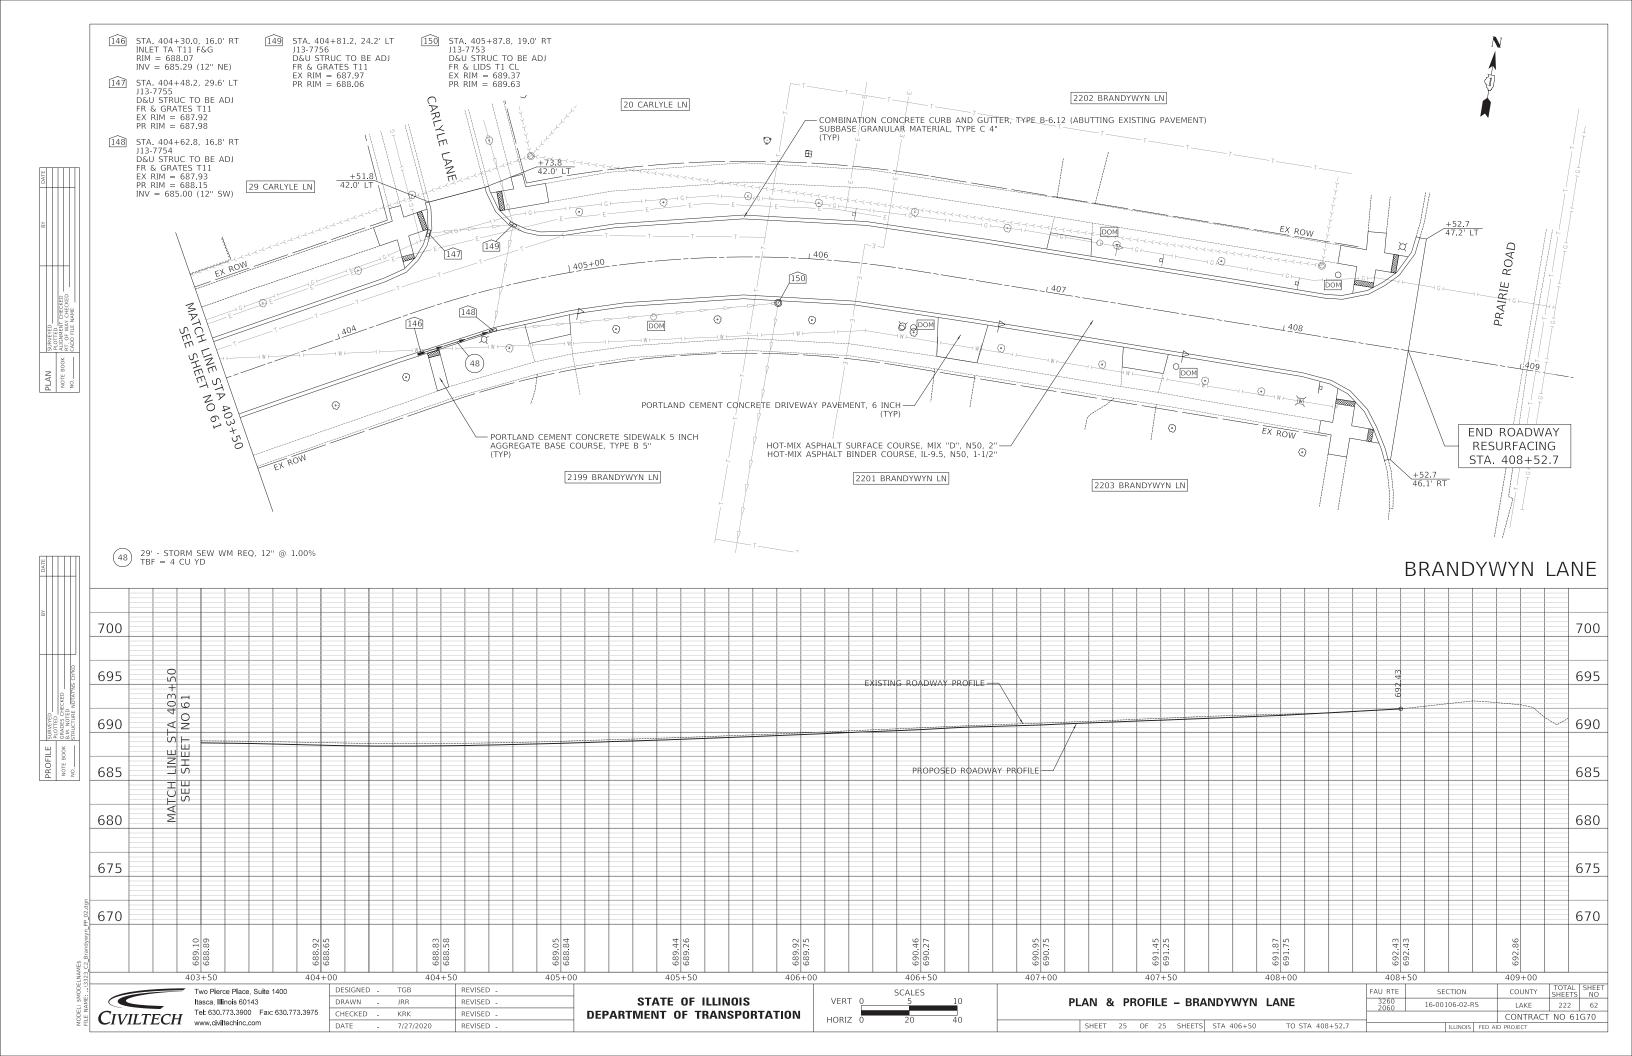

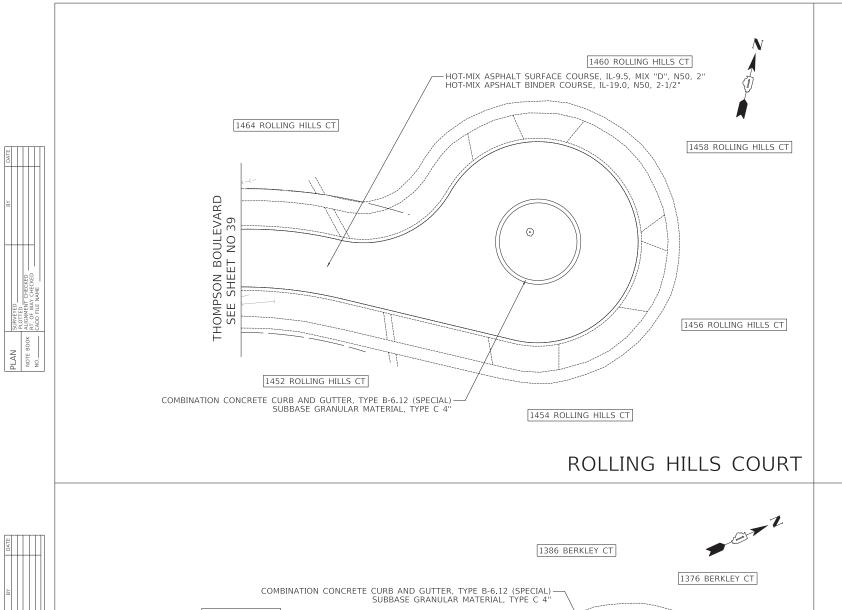

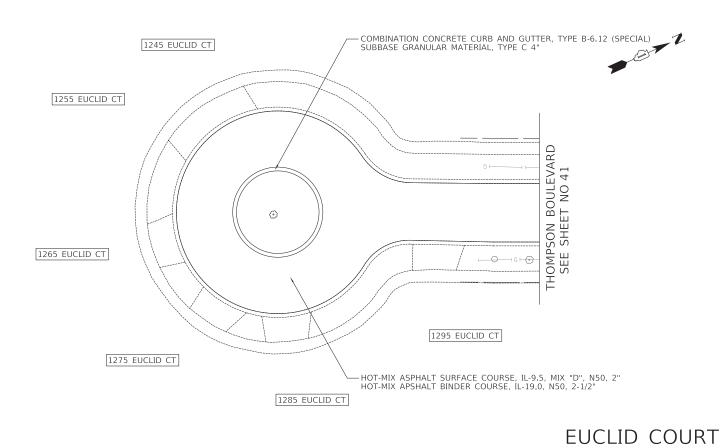

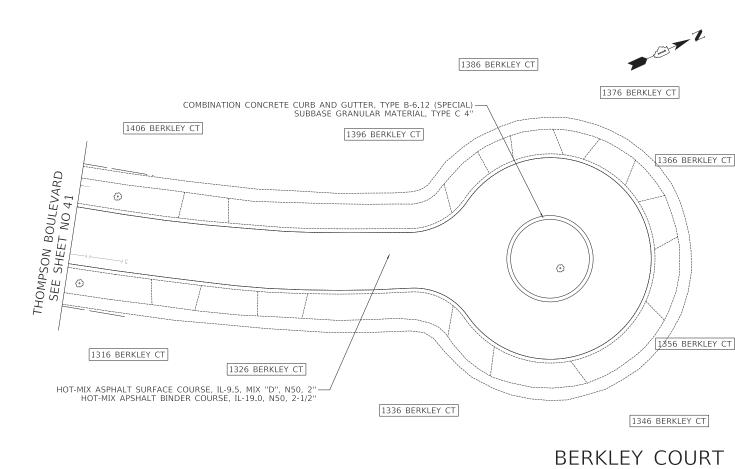

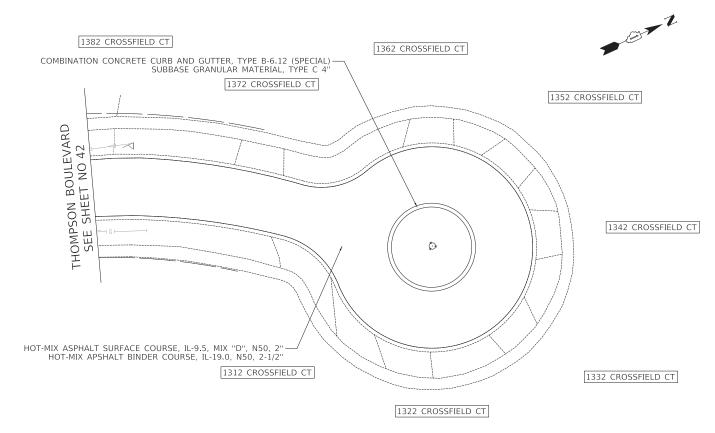

### CROSSFIELD COURT

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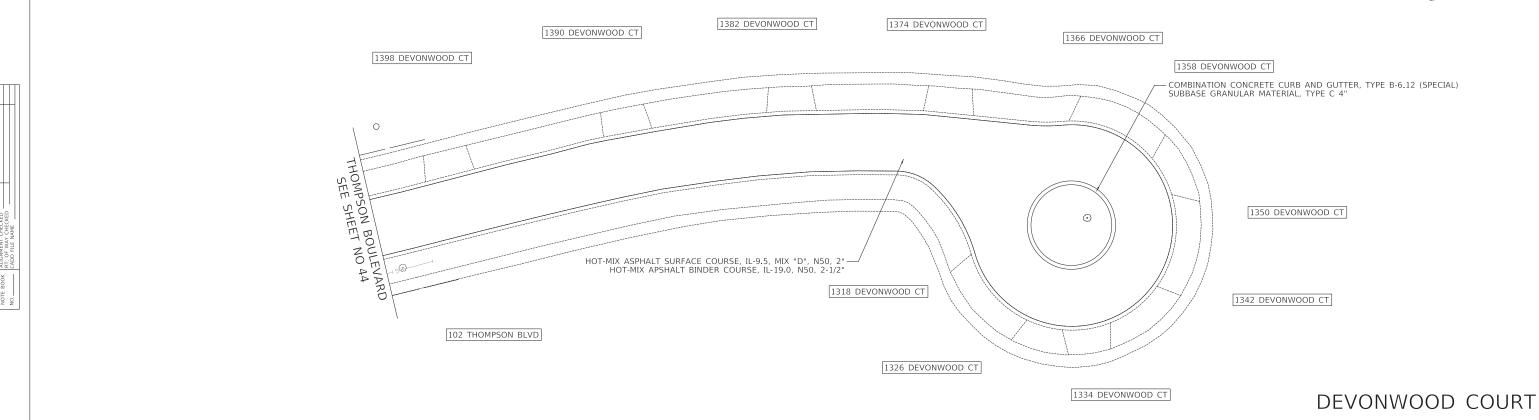
STATE OF ILLINOIS **DEPARTMENT OF TRANSPORTATION** 


CUL DE SAC PLANS - THOMPSON BOULEVARD SHEET 1 OF 6 SHEETS

COUNTY SHEETS NO

222 63 16-00106-02-RS LAKE CONTRACT NO 61G70





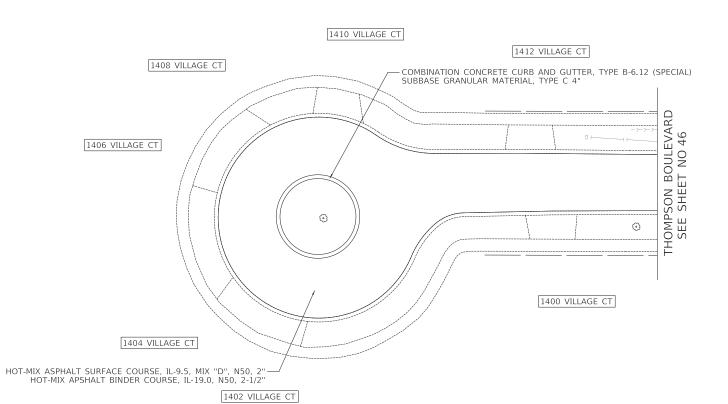




VILLAGE COURT



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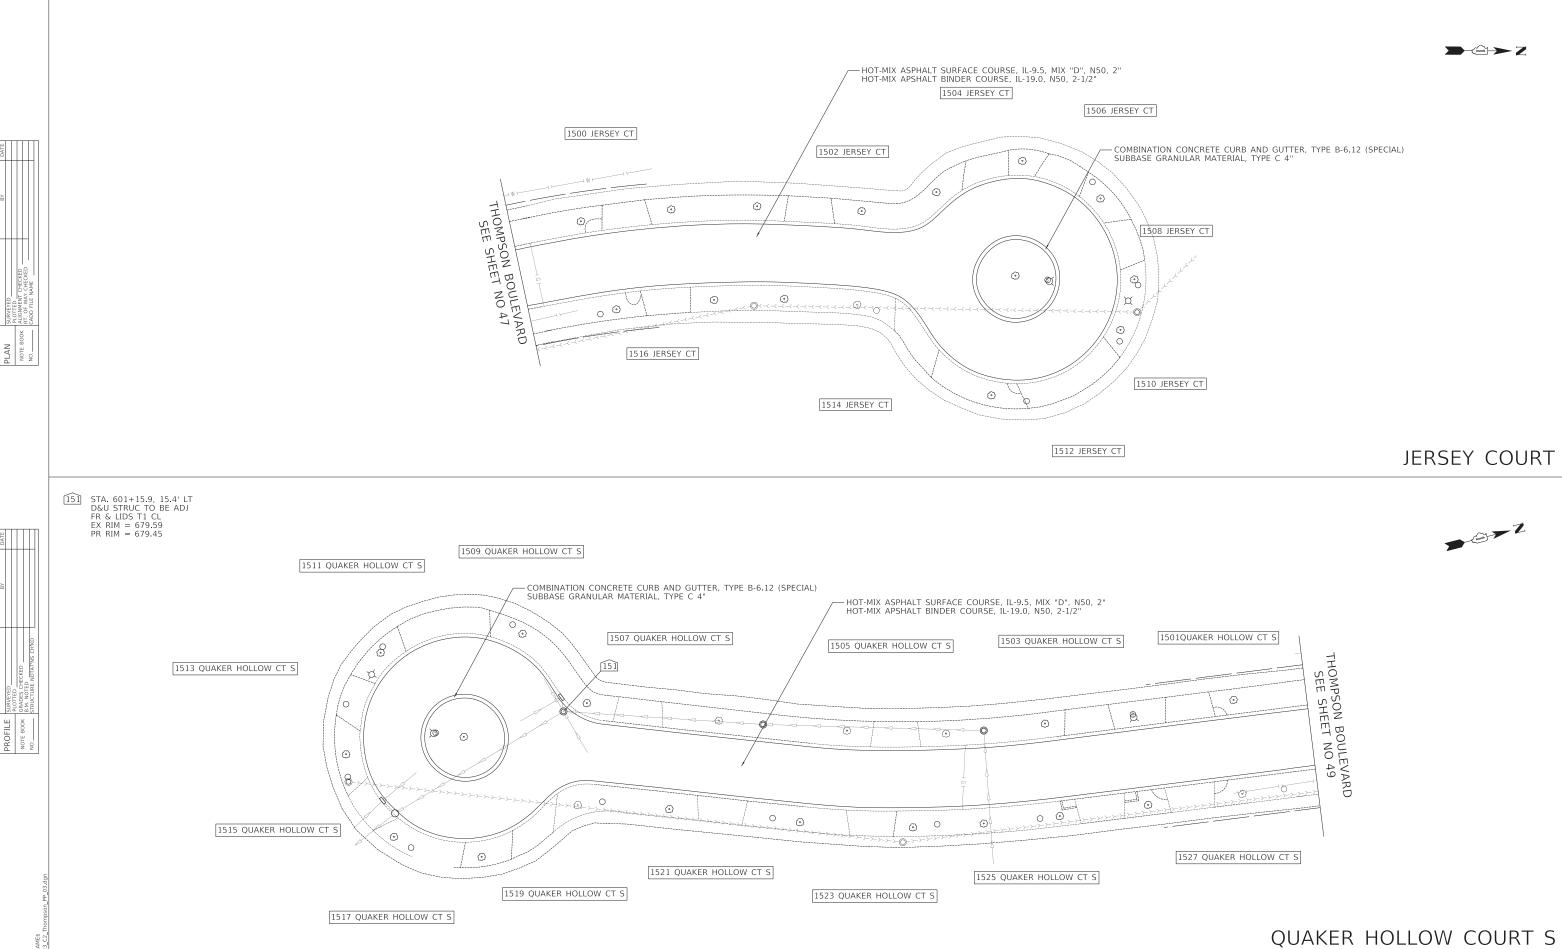
DESIGNED -TGB REVISED -DRAWN JRR REVISED REVISED 7/27/2020

STATE OF ILLINOIS **DEPARTMENT OF TRANSPORTATION** 

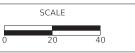

CUL DE SAC PLANS - THOMPSON BOULEVARD SHEET 2 OF 6 SHEETS

AU RTE	SECTION		COUNTY	TOTAL SHEETS	SHEE
3260 2060	16-00106-02-RS		LAKE	222	64
			CONTRACT NO 61G70		
THIMOIS FED AID PROJECT					



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TOTAL SHEET NO 222 65

CONTRACT NO 61G70

COUNTY

LAKE

16-00106-02-RS

CUL DE SAC PLANS - THOMPSON BOULEVARD

SHEET 3 OF 6 SHEETS

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Itasca, Illinois 60143

REVISED -


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STATE OF ILLINOIS

**DEPARTMENT OF TRANSPORTATION** 



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DESIGNED -TGB REVISED -DRAWN JRR REVISED -REVISED -REVISED -DATE 7/27/2020


STATE OF ILLINOIS **DEPARTMENT OF TRANSPORTATION** 

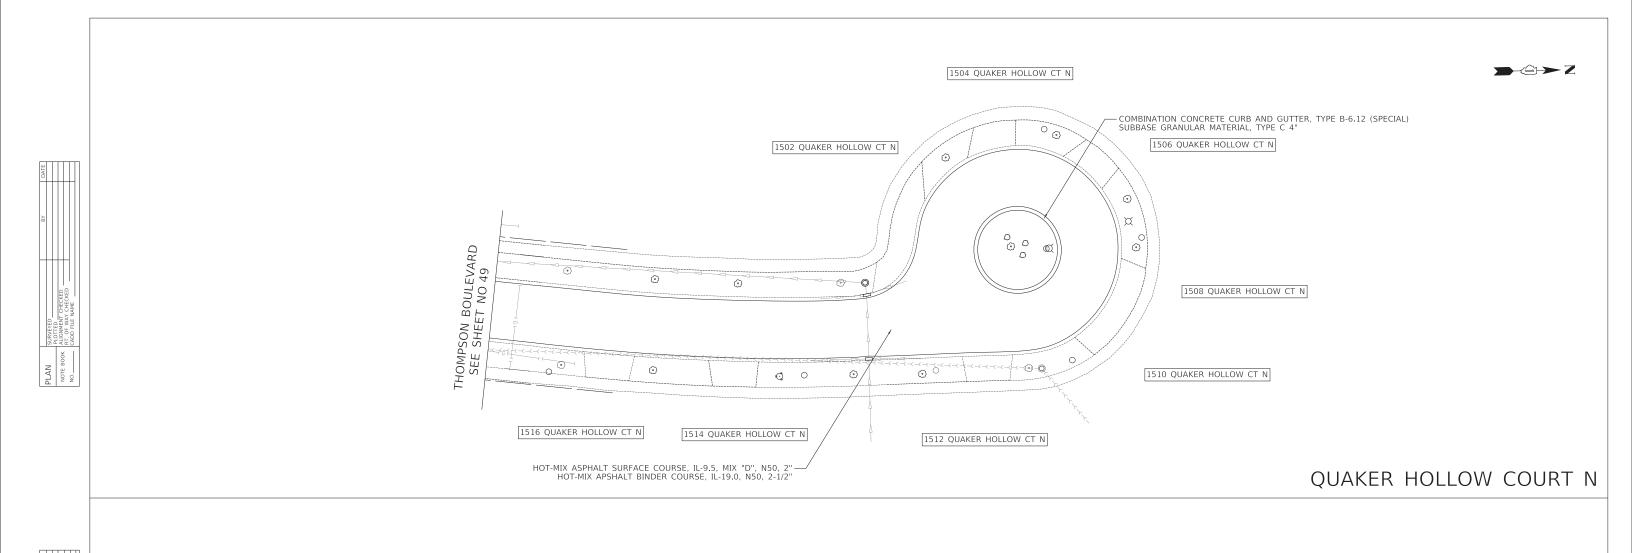


CUL DE SAC PLANS - THOMPSON BOULEVARD SHEET 4 OF 6 SHEETS

COUNTY TOTAL SHEET NO

LAKE 222 66 SECTION 16-00106-02-RS CONTRACT NO 61G70

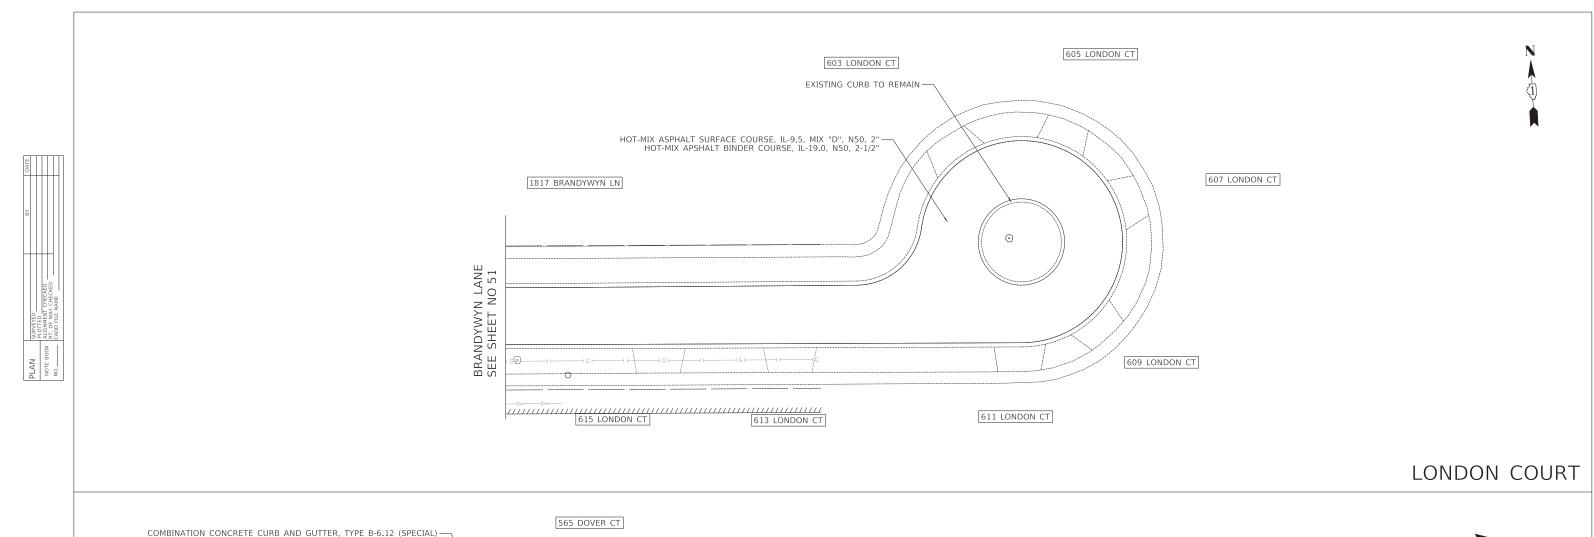

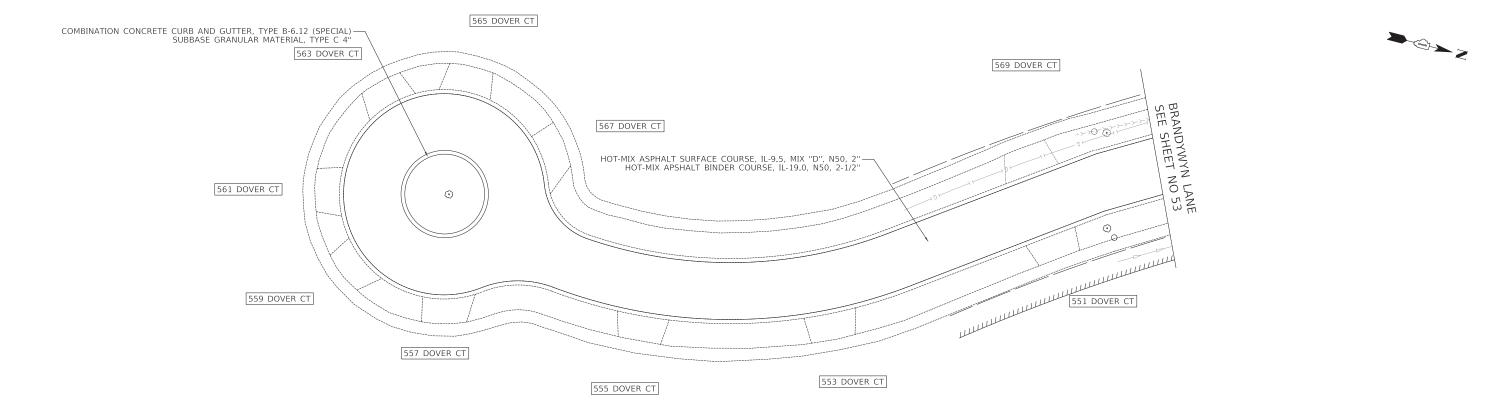

## DOVER COURT



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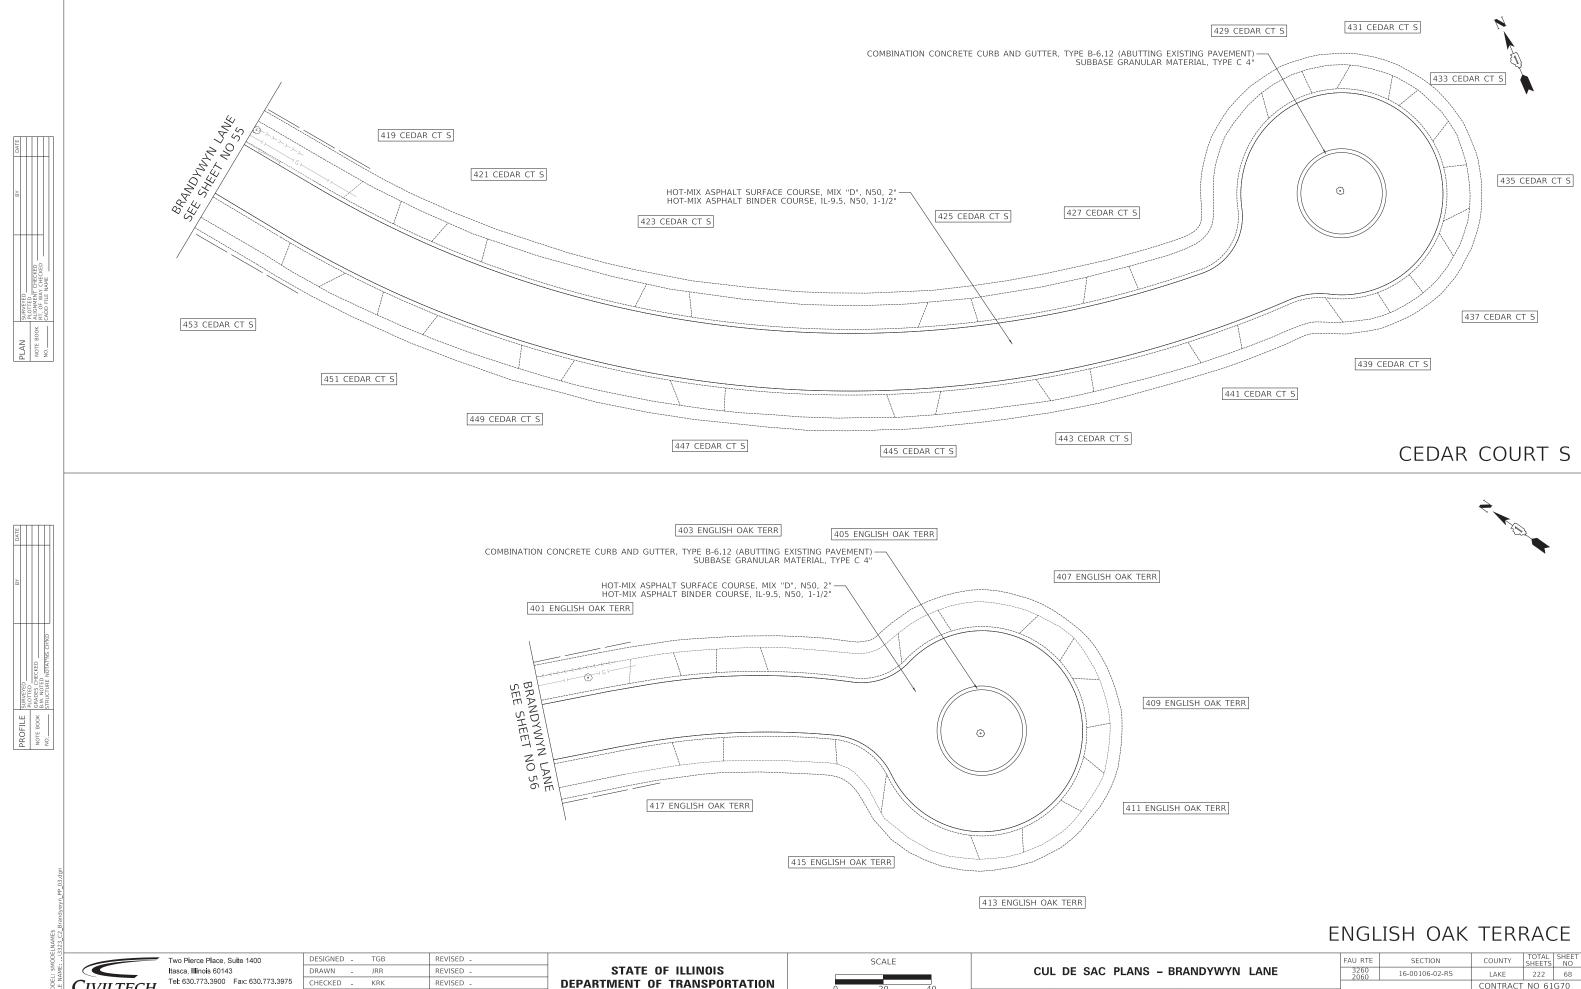
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STATE OF ILLINOIS **DEPARTMENT OF TRANSPORTATION** 

CUL DE SAC PLANS - BRANDYWYN LANE SHEET 5 OF 6 SHEETS

COUNTY TOTAL SHEET NO
LAKE 222 67 SECTION COUNTY 3260 2060 16-00106-02-RS CONTRACT NO 61G70

Itasca, Illinois 60143



CONTRACT NO 61G70

SHEET 6 OF 6 SHEETS

CIVILTECH Tel: 630.773.3900 F

REVISED

7/27/2020

#### MAINTENANCE OF TRAFFIC GENERAL NOTES

- NO WORK SHALL BEGIN UNTIL THE TRAFFIC CONTROL MEASURES ARE IN PLACE. THE CONTRACTOR SHALL AT ALL TIMES PROVIDE TRAFFIC PROTECTION BY THE APPLICATION OF TRAFFIC CONTROL DEVICES ACCORDING TO THE "STANDARD SPECIFICATIONS" AND AS SHOWN ON THE PLANS
- THE PERMANENT TRAFFIC CONTROL SHOWN ON THE PLANS IS THE MINIMUM REQUIREMENT, ADDITIONAL TRAFFIC CONTROL DEVICES AS SPECIFIED BY THE ABOVE HIGHWAY STANDARDS AND THE SPECIAL PROVISIONS SHALL BE PLACED BY THE CONTRACTOR TO THE SATISFACTION OF THE ENGINEER. ALL TRAFFIC CONTROL DEVICES SHALL BE CONSIDERED INCLUDED IN THE LUMP SUM PAY ITEM "TRAFFIC CONTROL AND PROTECTION, (SPECIAL)" UNLESS OTHERWISE SHOWN ON THE PLANS OR IN THE SPECIAL
- ALL TRAFFIC CONTROL WARNING SIGNS AND ASSOCIATED SIGNING MOUNTED WITH THE WARNING SIGNS SHALL HAVE BLACK LEGENDS AND BORDERS ON FLUORESCENT ORANGE REFLECTIVE SHEETING.
- 4. ALL CONSTRUCTION SIGNS, BARRICADES AND OTHER DEVICES REQUIRED TO CONTROL TRAFFIC SHALL BE FURNISHED. INSTALLED AND MAINTAINED BY THE CONTRACTOR
- ALL TRAFFIC CONTROL DEVICES SHALL BE REMOVED, COVERED OR TURNED AWAY FROM TRAFFIC IMMEDIATELY WHEN THEY ARE NO LONGER NECESSARY. WHEN A SIGN IS COVERED, ITS POST SHALL HAVE A REFLECTIVE 3 INCH X 6 INCH DELINEATOR INSTALLED.
- THE FIRST TWO WARNING SIGNS IN EACH DIRECTION OF TRAVEL SHALL BE EQUIPPED WITH MONO-DIRECTIONAL AMBER FLASHING LIGHTS DURING HOURS OF DARKNESS. FLAGS ARE OPTIONAL
- TRAFFIC CONTROL DEPICTED IN THESE PLANS AND THE APPLICABLE IDOT DETAILS AND STANDARDS ARE THE MINIMUM REQUIREMENTS. OTHER WORK OR SIGNING MAY BE REQUIRED BY THE ENGINEER. TRAFFIC CONTROL AND PROTECTION SHALL BE PERFORMED IN ACCORDANCE WITH THE STANDARD SPECIFICATIONS, DIVISION 700; APPLICABLE GUIDELINES IN THE ILLINOIS MANUAL ON UNIFORM TRAFFIC CONTROL DEVICES FOR STREETS AND HIGHWAYS; AND APPLICABLE HIGHWAY STANDARDS FOR TRAFFIC CONTROL, UNLESS HEREIN REVISED.
- THE EXACT NUMBER, LOCATION, AND SPACING OF ALL SIGNS AND TRAFFIC CONTROL DEVICES SHALL FIT FIELD CONDITIONS AS DIRECTED BY THE ENGINEER.
- 9. ALL SIGNS SHALL BE MOUNTED ON METAL POSTS, 7 FEET ABOVE THE EXISTING GROUND. ALL SIGNS THAT REMAIN IN THE SAME LOCATION FOR MORE THAN TWO DAYS SHALL BE DRIVEN A MINIMUM OF 3 FEET INTO THE GROUND. A J.U.L.I.E. LOCATE SHALL BE PERFORMED PRIOR TO THE INSTALLATION OF THE POSTS.
- 10. BARRICADES SHALL BE PLACED ADJACENT TO PAVEMENT EDGES WHERE WIDENING. CURB AND GUTTER OR OVERLAYING WORK IS BEING DONE. AS SPECIFIED IN SECTION 701 OF THE STANDARD SPECIFICATIONS BARRICADES SHALL ALSO BE PLACED AT ALL OPEN TRENCHES. EXCAVATIONS, OPEN OR EXPOSED SEWER STRUCTURES, AND AT ANY OTHER LOCATIONS DESIGNATED BY THE ENGINEER. BARRICADES SHALL BE PLACED AT 50' CENTERS ALONG TANGENTS, 25' ALONG TAPERS AND 10' AROUND RADII UNLESS OTHERWISE DIRECTED BY THE ENGINEER. BARRICADES THAT MUST BE PLACED IN EXCAVATED AREAS SHALL HAVE LEG EXTENSIONS INSTALLED SUCH THAT THE TOPS OF THE BARRICADES ARE IN COMPLIANCE WITH THE HEIGHT REQUIREMENTS OF STANDARD 701901. LIGHTS SHALL BE ATTACHED TO BARRICADES IN COMPLIANCE WITH ARTICLE 701.16 OF THE 2020 SUPPLEMENTAL SPECIFICATIONS AND RECURRING SPECIAL PROVISIONS.
- 11. TYPE III BARRICADES ARE TO BE PLACED IN ACCORDANCE WITH STANDARD 701901 UNLESS AUTHORIZED BY THE ENGINEER TO USE AN ALTERNATE ARRANGEMENT.
- 12. THE CONTRACTOR SHALL INFORM THE ENGINEER OF ANY STAGE CHANGE AT LEAST TWO WEEKS IN ADVANCE OF THE CHANGE.
- 13. EXISTING TRAFFIC CONTROL SIGNS AND DEVICES SHALL BE REMOVED OR RELOCATED BY THE CONTRACTOR AFTER THE TRAFFIC CONTROL REQUIREMENTS ARE MET OR AS AUTHORIZED BY THE ENGINEER: ANY SIGNS OR DEVICES LEFT IN PLACE ARE TO BE PROTECTED FROM DAMAGE AND MAINTAINED. ANY DAMAGE CAUSED BY HIS WORK SHALL BE REPAIRED TO THE SATISFACTION OF THE ENGINEER AT THE EXPENSE OF THE CONTRACTOR
- 14. EXCEPT FOR APPROVED CLOSURES AS DEPICTED ON THE MAINTENANCE OF TRAFFIC PLANS, ALL ROADS SHALL BE KEPT OPEN TO TRAFFIC DURING THE ENTIRE CONSTRUCTION PERIOD. THE CONTRACTOR MAY CLOSE ONE LANE OF TRAFFIC (BECAUSE OF CONSTRUCTION) ONLY BETWEEN THE HOURS OF 9:00 AM AND
- 15. WHEN NECESSARY TO CLOSE ONE LANE OF THE ROADWAY ON TWO-LANE ROADS, THE CONTRACTOR SHALL MAINTAIN TWO-WAY TRAFFIC DURING THE RESTRICTED HOURS WITH THE USE OF SIGNS AND FLAGGERS AS SHOWN ON THE TRAFFIC CONTROL STANDARDS. WHEN NECESSARY TO CLOSE ONE LANE OF THE ROADWAY ON FOUR-LANE ROADS, THE CONTRACTOR SHALL MAINTAIN TWO-WAY TRAFFIC DURING THE RESTRICTED HOURS WITH THE USE OF SIGNS AND BARRICADES AS SHOWN ON THE TRAFFIC CONTROL STANDARDS. ALL EXISTING LANES OF TRAFFIC IN EACH DIRECTION SHALL BE MAINTAINED BETWEEN 3:00 PM AND 9:00 AM WHEN NO CONSTRUCTION ACTIVITIES ARE BEING CARRIED ON. THE ENGINEER MAY WAIVE THE LANE CLOSURE TIME RESTRICTION AT HIS/HER DISCRETION
- 16. "WORKERS" SIGNS SHALL ONLY BE ERECTED WHEN WORKERS ARE PRESENT. SIGN MUST BE COVERED OR REMOVED WHEN NO WORKERS ARE PRESENT. THIS WORK SHALL BE INCLUDED IN THE COST OF "TRAFFIC CONTROL AND PROTECTION. (SPECIAL)".
- 17. THE CONTRACTOR SHALL ERECT TEMPORARY STREET NAME SIGNS ON METAL POSTS THROUGHOUT CONSTRUCTION TO THE SATISFACTION OF THE ENGINEER. THE COST OF THESE SIGNS SHALL BE INCLUDED IN THE PAY ITEM "TRAFFIC CONTROL AND PROTECTION, (SPECIAL)".

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- 18 QUANTITIES FOR SHORT-TERM PAVEMENT MARKINGS, SHORT-TERM PAVEMENT MARKING REMOVAL TEMPORARY PAVEMENT MARKINGS, AND TEMPORARY PAVEMENT MARKING REMOVAL ARE NOT INCLUDED IN THE ITEM "TRAFFIC CONTROL AND PROTECTION, (SPECIAL)" AND SHALL BE MEASURED SEPARATELY FOR
- 19. THE "ROAD CLOSED" (R11-2) SIGNS SHALL BE MOUNTED ON THE TYPE III BARRICADES. ALL TYPE III BARRICADES SHALL HAVE 2 AMBER TYPE A-LOW INTENSITY FLASHING LIGHTS SPACED NEAR THE
- 20. WHEN WORKING ADJACENT TO THE ROAD AND UTILIZING DAILY LANE CLOSURES, DROP-OFFS ADJACENT TO THE TRAVEL LANES SHALL BE KEPT TO A MINIMUM. DROP-OFFS GREATER THAN 18" WILL NOT BE ALLOWED WHEN TRAFFIC IS PRESENT IN THE ADJACENT LANE. THE CONTRACTOR WILL BE REQUIRED TO PERFORM THE EXCAVATION REQUIRED FOR THE CONSTRUCTION DURING THE TIME THAT THE ADJACENT LANE IS CLOSED. AS NOTED ABOVE, PRIOR TO REOPENING THE LANE TO TRAFFIC THE CONTRACTOR SHALL PLACE SUFFICIENT MATERIAL TO REDUCE THE DROP-OFF TO LESS THAN 18". ALL AREAS UNDERCUT FOR AGGREGATE SUBGRADE IMPROVEMENT SHALL NOT BE LEFT UNFILLED OVERNIGHT. DROP-OFFS GREATER THAN 24 INCHES SHALL NOT BE LEFT UNFILLED OVERNIGHT. THE CONTRACTOR SHALL BE RESPONSIBLE TO DETERMINE THE AMOUNT OF WORK THAT CAN BE COMPLETED WITHIN THE TIME OF THE DAILY LANE CLOSURE, NO ADDITIONAL COMPENSATION SHALL BE ALLOWED TO COMPLY WITH THIS REQUIREMENT.
- 21. UTILITY TRENCHES SHALL BE COVERED OR FILLED AT THE END OF EACH DAY. THIS WORK SHALL BE INCLUDED IN THE COST OF "TRAFFIC CONTROL AND PROTECTION, (SPECIAL)".
- 22. SEE HIGHWAY STANDARDS AND DISTRICT ONE DETAILS FOR ADDITIONAL REQUIREMENTS AND
- 23. DRIVEWAY ACCESS AND ACCESS TO SIDE ROADS SHALL BE MAINTAINED AT ALL TIMES THROUGH THE USE OF "TEMPORARY ACCESS (PRIVATE ENTRANCE)" AND "TEMPORARY ACCESS (ROAD)". PEDESTRIAN ACCESS ACROSS ROADWAYS SHALL BE MAINTAINED AT ALL TIMES THROUGH THE USE OF "TEMPORARY ACCESS (ROAD)." AT THE DIRECTION OF THE ENGINEER, DRIVEWAYS MAY BE CLOSED FOR A MAXIMUM OF 7 DAYS TO FACILITATE DRIVEWAY, SIDEWALK, AND CURB AND GUTTER CONSTRUCTION. THE CONTRACTOR SHALL WORK COOPERATIVELY WITH THE RESIDENTS AND ENGINEER TO ACCOMMODATE ACCESS THROUGHOUT THE PROJECT.
- 24 THE SIDEWALK ON ONE SIDE OF THE STREET MUST REMAIN OPEN AND ACCESSIBLE AT ALL TIMES. CONSTRUCTION STAGING SHALL BE COORDINATED WITH THE ENGINEER AND CONTRACTOR TO ENSURE ONE SIDEWALK REMAINS OPEN. SIGNING DIRECTING PEDESTRIANS TO THE OPEN SIDEWALK SHALL IN ACCORDANCE WITH IDOT HIGHWAY STANDARD 701801. THE WORK REQUIRED TO COMPLY WITH THESE REQUIREMENTS SHALL BE INCLUDED IN THE COST OF "TRAFFIC CONTROL AND PROTECTION, (SPECIAL)"
- 25. A QUANTITY FOR "TEMPORARY RAMP"HAS BEEN INCLUDED TO PROVIDE TEMPORARY RAMPS AT SIDE STREETS AND DRIVEWAYS TO ACCOMMODATE THE DIFFERENCES IN ELEVATION BETWEEN THE EXISTING PAVEMENT AND THE NEWLY CONSTRUCTED PAVEMENT DURING STAGED CONSTRUCTION. REMOVAL OF THIS MATERIAL SHALL BE INCLUDED IN THE COST OF "TEMPORARY RAMP". SECTIONS OF EXISTING PAVEMENT SHOWN FOR REMOVAL DURING STAGE 2 MAY NEED TO BE REMOVED DURING STAGE 1 IN ORDER TO ACCOMMODATE THE RAMPS NEEDED FOR DRIVEWAY AND SIDE STREET ACCESS.

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COUNTY HEETS MAINTENANCE OF TRAFFIC - GENERAL NOTES 16-00106-02-RS LAKE 222 69 CONTRACT NO 61G70 SHEET 1 OF 2 SHEETS

### **SEQUENCE OF CONSTRUCTION**

ANY CHANGES TO THE STAGING OF THE PROJECT MUST BE PRESENTED BY THE CONTRACTOR TO THE ENGINEER FOR APPROVAL

#### RECONSTRUCTION

WORK ON THOMPSON BOULEVARD AND BRANDYWYN LANE MAY OCCUR AT THE SAME TIME.

- 1. INSTALL TEMPORARY INFORMATION SIGNS SEVEN (7) DAYS IN ADVANCE OF CONSTRUCTION
- 2. PLACE ALL ADVANCE CONSTRUCTION SIGNS PER IDOT HIGHWAY STANDARD 701501. FURNISH AND INSTALL ADDITIONAL TRAFFIC CONTROL AND PROTECTION MEASURES.
- 3. INSTALL EROSION CONTROL MEASURES AND TREE PROTECTION. PERFORM TREE ROOT PRUNING.
- REMOVE CONFLICTING PAVEMENT MARKINGS AND PLACE TEMPORARY MARKINGS AS SHOWN IN MOT PLAN - STAGE 1. IMPLEMENT TEMPORARY TRAFFIC SIGNAL TIMINGS. IMPLEMENT EASTBOUND THOMPSON BOULEVARD DETOUR. IMPLEMENT NORTHBOUND BRANDYWYN LANE DETOUR. BEGIN ONE-WAY TRAFFIC ALONG BOTH ROADS.
- REMOVE THE EXISTING COMBINATION CURB AND GUTTER, DRIVEWAY PAVEMENT, ROADWAY PAVEMENT, AND SIDEWALKS ON THE SOUTH SIDE OF THOMPSON BOULEVARD AND THE EAST SIDE OF BRANDYWYN LANE. SOUTH OF BUFFALO GROVE ROAD.
- CONSTRUCT STORM SEWERS AND DRAINAGE STRUCTURES. TRAFFIC SHALL BE MAINTAINED THROUGH THE USE OF FLAGGERS IN ACCORDANCE WITH IDOT HIGHWAY STANDARD 701501. A QUANTITY FOR "CLASS D PATCH, 4 INCH" HAS BEEN INCLUDED FOR PATCHING THE EXISTING PAVEMENT AT EACH LATERAL TO BE CONSTRUCTED.
- PROOF ROLL THE EXISTING SUBGRADE AND PERFORM UNDER OPERATIONS AT LOCATIONS DIRECTED BY THE ENGINEER.
- INSTALL GEOTECHNICAL FABRIC AND AGGREGATE SUBGRADE ALONG THOMPSON BOULEVARD, EAST OF STA. 199+63. CONSTRUCT ROADWAY PAVEMENT THROUGH THE BINDER COURSE.
- CONSTRUCT NEW COMBINATION CURB AND GUTTER, DRIVEWAY PAVEMENT, ROADWAY PAVEMENT AND SIDEWALK ON THE SOUTH SIDE OF THOMPSON BOULEVARD AND THE FAST SIDE OF BRANDYWYN LANE, GAP THE EXISTING STRUCTURES THAT REQUIRE ADJUSTMENT.
- 10. ADJUST THE EXISTING STRUCTURES WITHIN THE CURBLINE, INSTALL UNDERDRAIN SYSTEM, AND PLACE NEW CURBLINE CONCRETE CURB AND GUTTER GAPS.
- 11. REMOVE CONFLICTING PAVEMENT MARKINGS AND PLACE TEMPORARY MARKINGS AS SHOWN IN MOT PLAN - STAGE 2. SHIFT ONE-WAY TRAFFIC TO THE SOUTH SIDE OF THOMPSON BOULEVARD AND THE EAST SIDE OF BRANDYWYN LANE
- 12. REMOVE THE EXISTING COMBINATION CURB AND GUTTER, DRIVEWAY PAVEMENT, ROADWAY PAVEMENT, AND SIDEWALKS ON THE NORTH SIDE OF THOMPSON BOULEVARD AND THE EAST
- 13. PROOF ROLL THE EXISTING SUBGRADE AND PERFORM UNDER OPERATIONS AT LOCATIONS DIRECTED BY THE ENGINEER.
- 14. INSTALL GEOTECHNICAL FABRIC AND AGGREGATE SUBGRADE ALONG THOMPSON BOULEVARD. EAST OF STA. 199+63. CONSTRUCT ROADWAY PAVEMENT THROUGH THE BINDER COURSE.
- 15. CONSTRUCT NEW AGGREGATE BASE COURSE, COMBINATION CURB AND GUTTER, DRIVEWAY PAVEMENT, ROADWAY PAVEMENT, AND SIDEWALK ON THE NORTH SIDE OF THOMPSON BOULEVARD AND THE EAST SIDE OF BRANDYWYN LANE. GAP THE EXISTING STRUCTURES THAT REQUIRE ADJUSTMENT.
- 16. ADJUST THE EXISTING STRUCTURES WITHIN THE CURBLINE, INSTALL UNDERDRAIN SYSTEM, AND PLACE NEW CURBLINE CONCRETE CURB AND GUTTER GAPS.
- 17. PLACE TEMPORARY PAVEMENT MARKINGS TO MATCH THE FINAL PAVEMENT MARKINGS AS SHOWN ON THE STRIPING PLAN.
- 18. END TEMPORARY TRAFFIC SIGNAL TIMINGS. OPEN THOMPSON BOULEVARD AND BRANDYWYN LANE TO TWO-WAY TRAFFIC.
- 19. COMPLETE LANDSCAPING RESTORATION
- 20. PLACE SURFACE COURSE ALONG BOTH ROADS, TWO-WAY TRAFFIC SHALL BE MAINTAINED THROUGH THE USE OF FLAGGERS IN ACCORDANCE WITH IDOT HIGHWAY STANDARD 701501.
- 21. INSTALL PERMANENT STRIPING.
- 22. REMOVE CONSTRUCTION SIGNS

### RESURFACING

THIS WORK MAY BE COMPLETED IN CONJUNCTION WITH WORK ITEMS FOR THE RECONSTRUCTION

WORK NORTH OF BUFFALO GROVE ROAD MAY NOT BEGIN UNTIL SCHOOL DISTRICT 102 (MERIDIAN MIDDLE SCHOOL) HAS ENDED ITS 2020-21 SESSION, THE TENTATIVE DATE OF WHICH IS JUNE 9, 2021. WORK NORTH OF BUFFLO GROVE ROAD MUST BE CONSTRUCTED THROUGH BINDER COURSE AND LANDSCAPE RESTORATION COMPLETE PRIOR TO DISTRICT 102 BEGINNING ITS 2021-22 SESSION, THE TENTATIVE DATE OF WHICH IS AUGUST 16, 2021. FINAL SURFACE MAY BE PLACED ON A SATURDAY WHILE SCHOOL IS IN SESSION. THE CONTRACTOR MUST COORDINATE DATES WITH:

MERIDIAN MIDDLE SCHOOL DISTRICT 102 2195 BRANDYWYN LANE BUFFALO GROVE, IL 60089 PH: 847.955.3500

- PLACE ALL ADVANCE CONSTRUCTION SIGNS ALONG BRANDYWYN LANE PER IDOT HIGHWAY STANDARD 701501. FURNISH AND INSTALL ADDITIONAL TRAFFIC CONTROL AND PROTECTION
- 2. INSTALL EROSION CONTROL MEASURES AND TREE PROTECTION. PERFORM TREE ROOT PRUNING.
- REMOVE THE EXISTING COMBINATION CURB AND GUTTER, DRIVEWAY PAVEMENT, AND
- CONSTRUCT NEW COMBINATION CURB AND GUTTER, DRIVEWAY PAVEMENT, AND SIDEWALK. GAP THE EXISTING STRUCTURES THAT REQUIRE ADJUSTMENT.
- ADJUST THE EXISTING STRUCTURES WITHIN THE CURBLINE, INSTALL UNDERDRAIN SYSTEM, AND PLACE NEW CURBLINE CONCRETE CURB AND GUTTER GAPS
- COMPLETE LANDSCAPING RESTORATION
- MILL EXISTING PAVEMENT.
- CONSTRUCT PAVEMENT PATCHING AS DETERMINED BY THE ENGINEER.
- PLACE BINDER AND SURFACE COURSE. TWO-WAY TRAFFIC SHALL BE MAINTAINED THROUGH THE USE OF FLAGGERS IN ACCORDANCE WITH IDOT HIGHWAY STANDARD 701501.
- 11. INSTALL PERMANENT STRIPING
- 12. REMOVE CONSTRUCTION SIGNS.

### **LEGEND**


- (1) EXISTING PAVEMENT
- EXISTING AGGREGATE
- PROPOSED HMA BINDER
- PROPOSED AGGREGATE BASE COURSE
- PROPOSED CURB AND GUTTER
- PROPOSED TRENCH BACKFILL, SPECIAL
- LINE 4" (WHITE EDGE LINE)
- LINE 4" (YELLOW EDGE LINE)
- CONSTRUCTION ZONE





TRAFFIC FLOW




DRUMS WITH MONO-DIRECTIONAL STEADY-BURN LIGHT

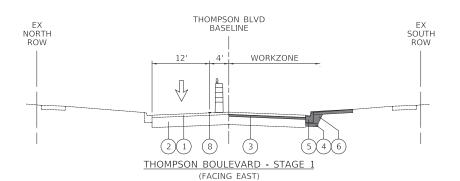

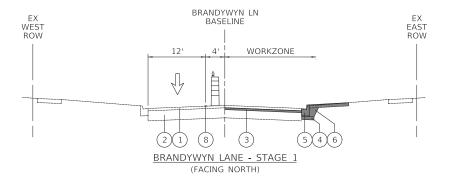

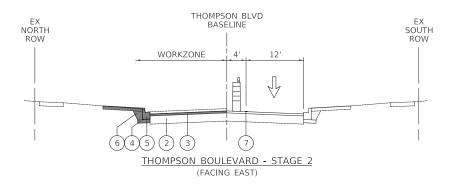

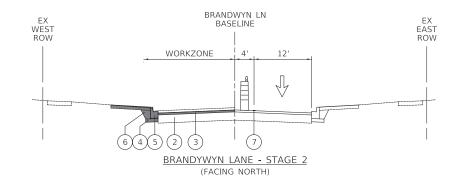





Two Pierce Place, Suite 1400 Itasca, Illinois 60143 Tel: 630,773,3900 Fax: 630,773,3975 DESIGNED TGB REVISED DRAWN JRR REVISED DATE 7/27/2020 REVISED

STATE OF ILLINOIS **DEPARTMENT OF TRANSPORTATION** 

COUNTY HEETS MAINTENANCE OF TRAFFIC - GENERAL NOTES 16-00106-02-RS LAKE 222 CONTRACT NO 61G70 SHEET 2 OF 2 SHEETS

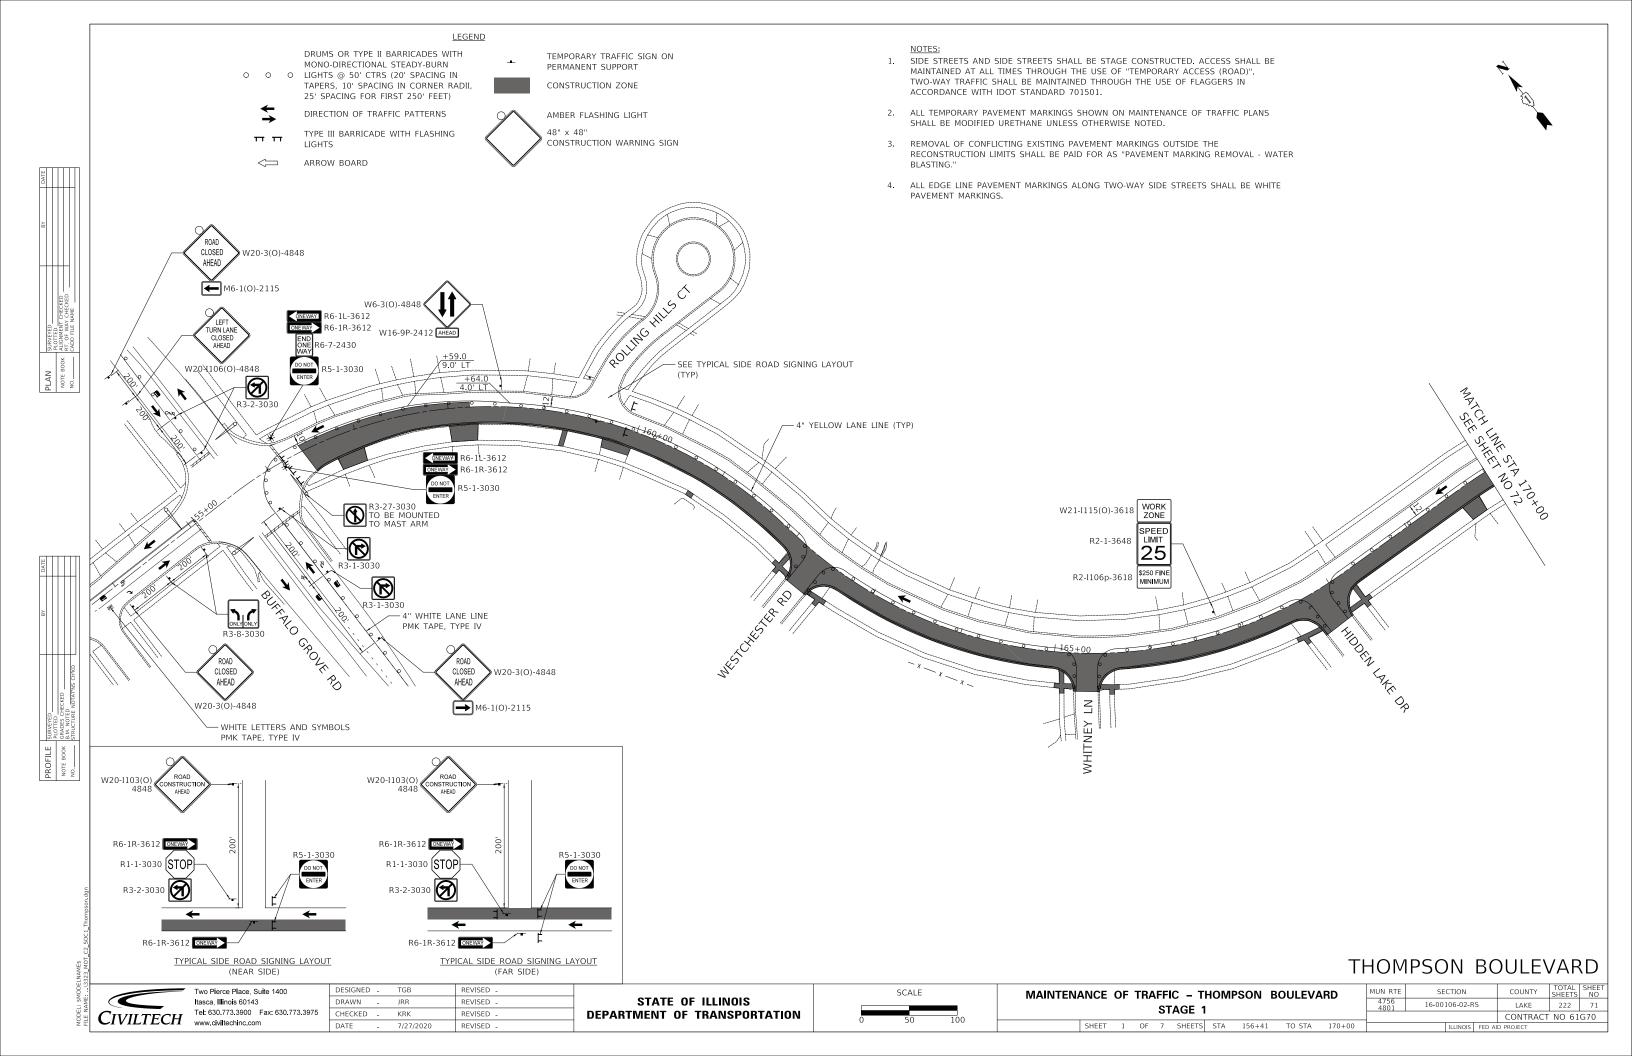



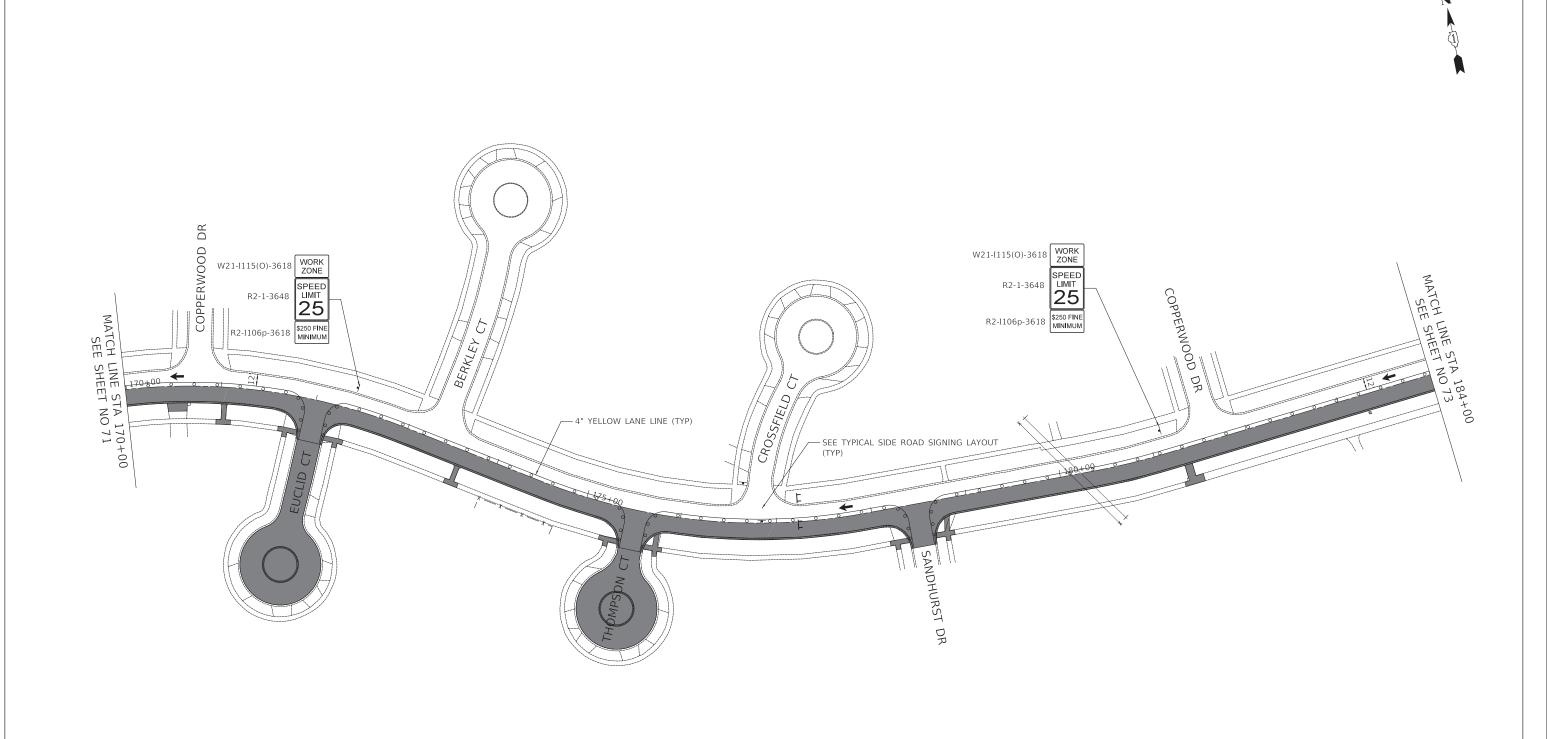

# THOMPSON BOULEVARD




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STATE OF ILLINOIS **DEPARTMENT OF TRANSPORTATION**  SCALE

MAINTENANCE OF TRAFFIC - THOMPSON BOULEVARD STAGE 1 SHEET 2 OF 7 SHEETS STA 170+00 TO STA 184+00

COUNTY TOTAL SHEET NO
LAKE 222 72
CONTRACT NO 61G70 16-00106-02-RS



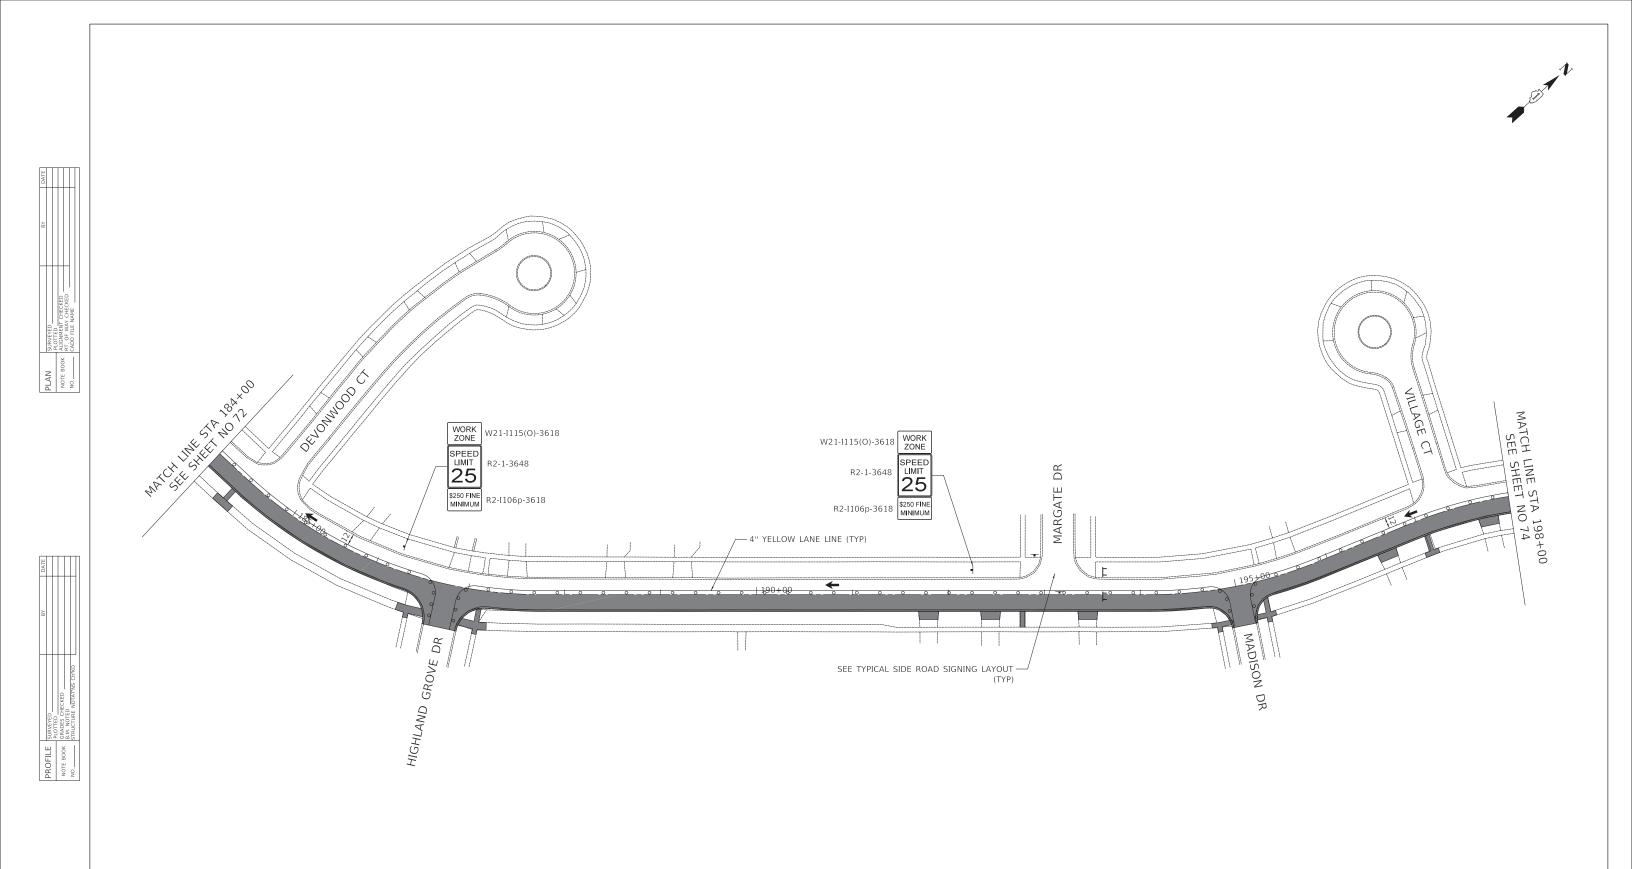


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STATE OF ILLINOIS **DEPARTMENT OF TRANSPORTATION**  SCALE

MAINTENANCE OF TRAFFIC - THOMPSON BOULEVARD STAGE 1 SHEET 3 OF 7 SHEETS STA 184+00 TO STA 198+00

COUNTY TOTAL SHEET NO LAKE 222 73 16-00106-02-RS CONTRACT NO 61G70



16-00106-02-RS

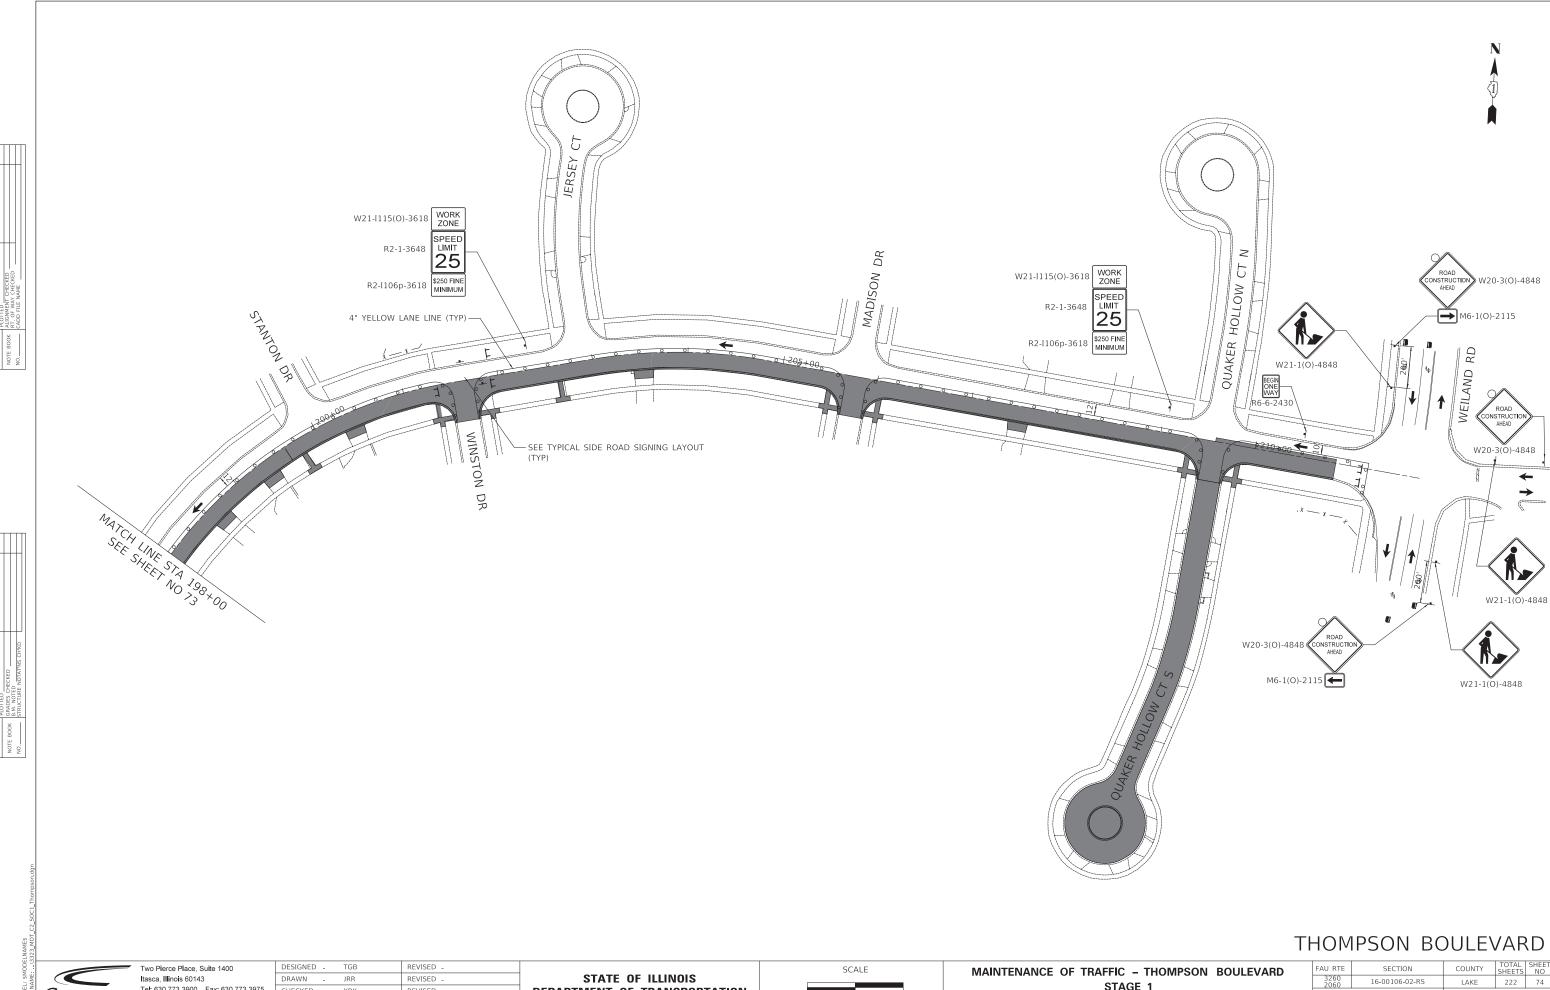CONTRACT NO 61G70

STAGE 1

SHEET 4 OF 7 SHEETS STA 198+00 TO STA 210+85

STATE OF ILLINOIS

**DEPARTMENT OF TRANSPORTATION** 


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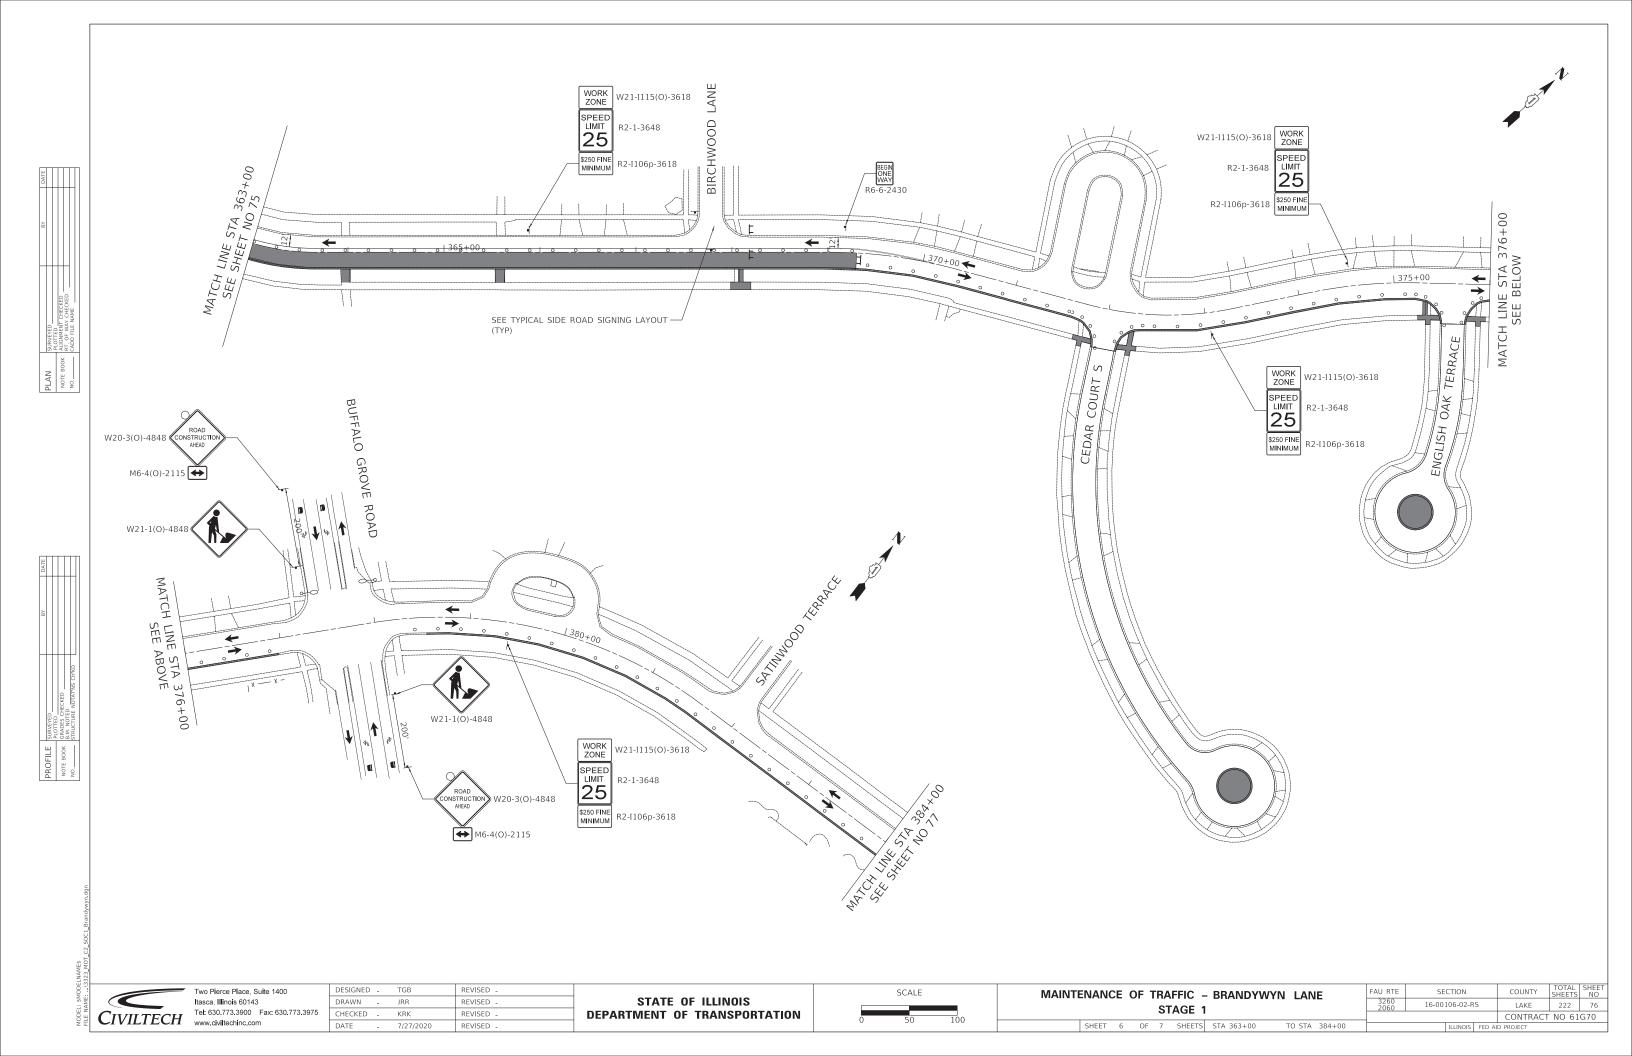
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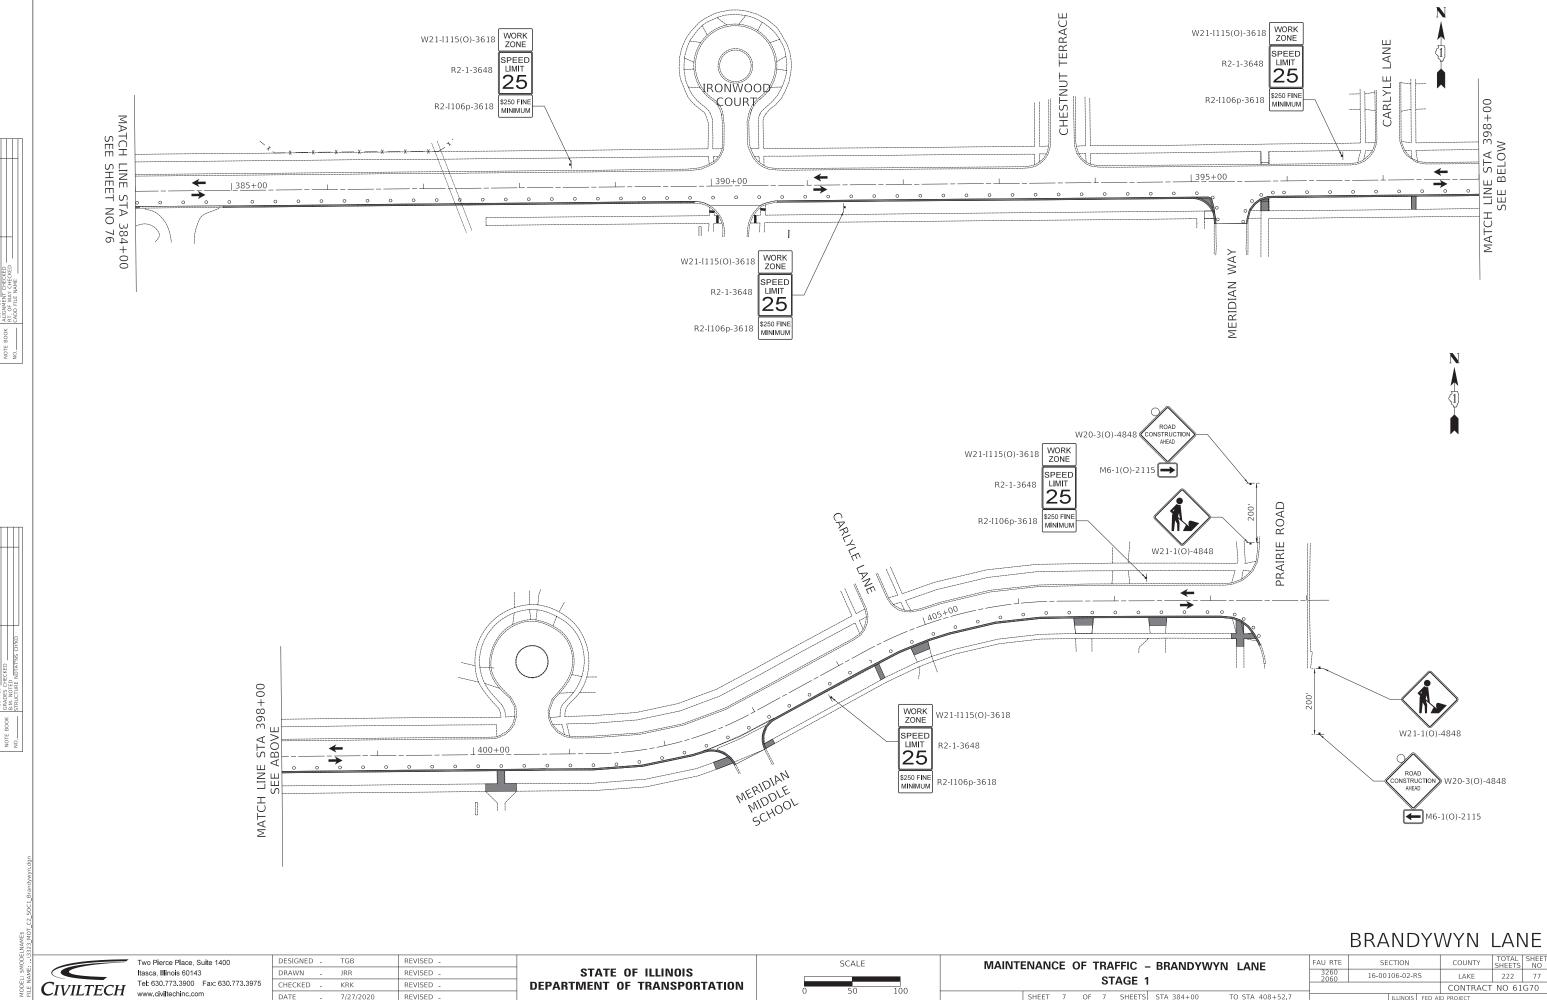
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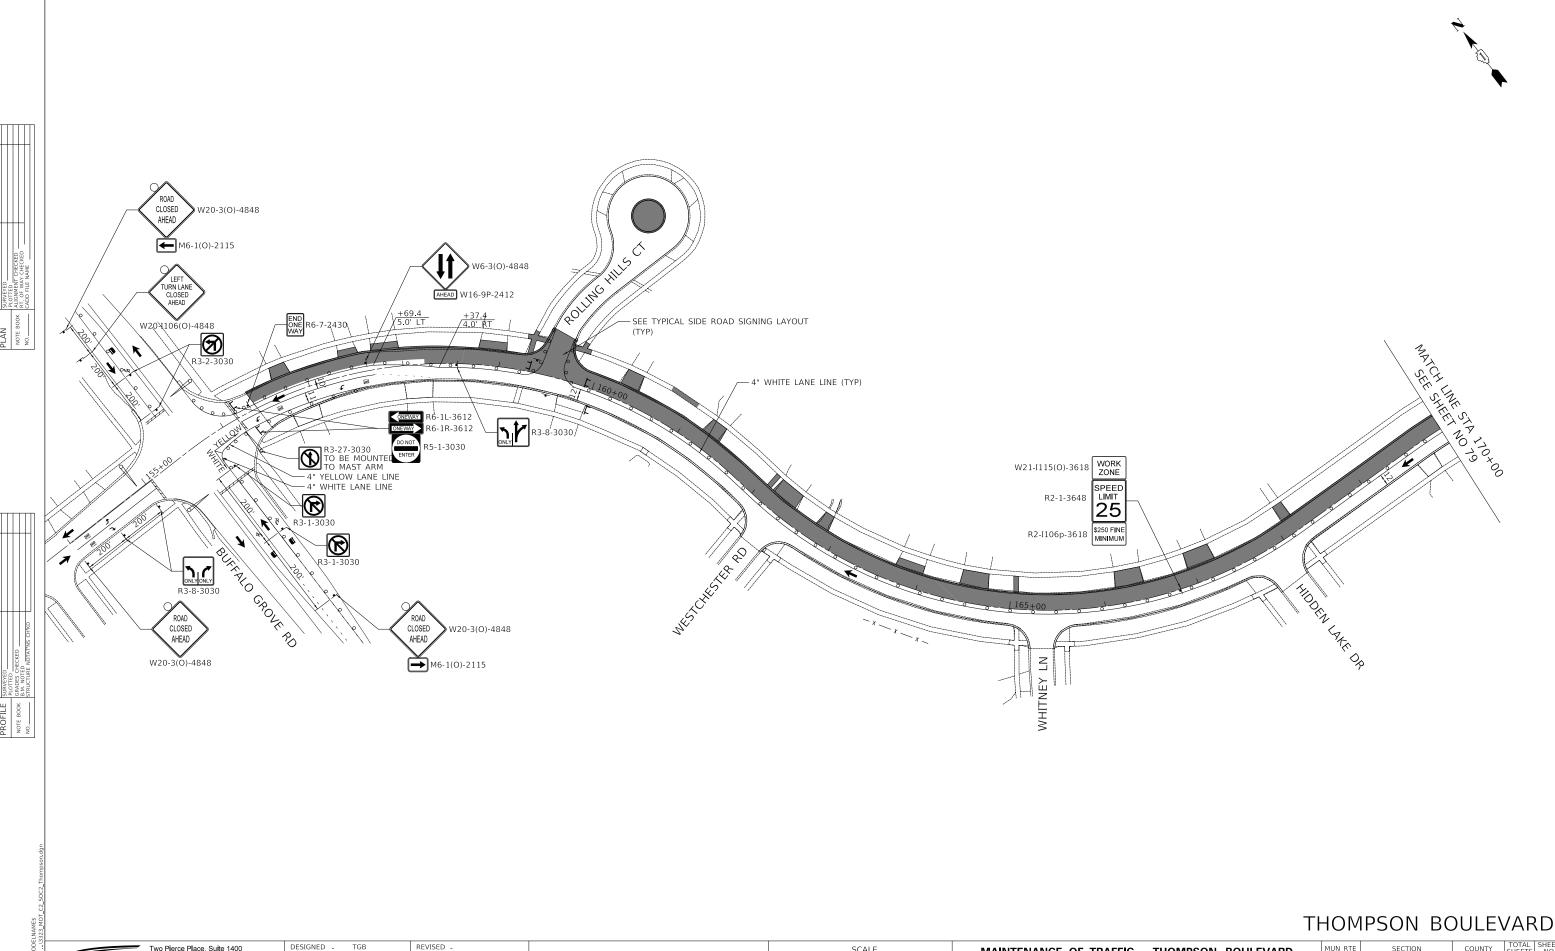




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**DEPARTMENT OF TRANSPORTATION** 

SHEET 7 OF 7 SHEETS STA 384+00 TO STA 408+52.7 CONTRACT NO 61G70

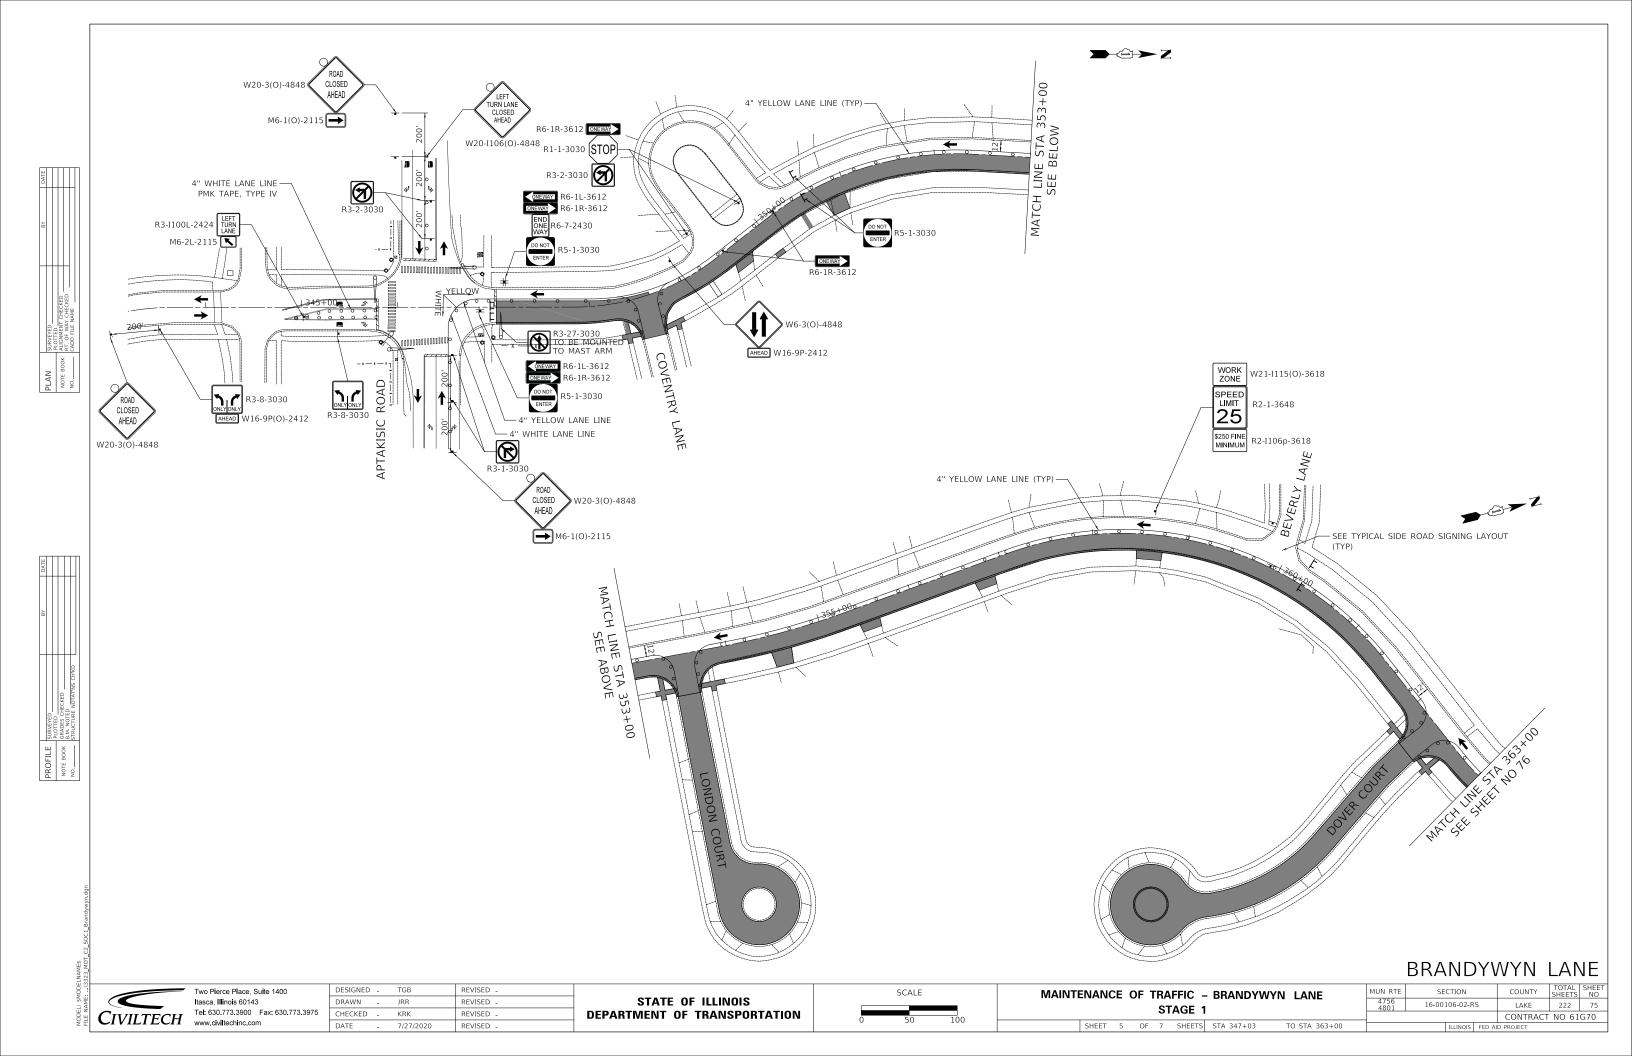

STATE OF ILLINOIS

**DEPARTMENT OF TRANSPORTATION** 

MAINTENANCE OF TRAFFIC - THOMPSON BOULEVARD

STAGE 2

SHEET 1 OF 7 SHEETS STA 156+41 TO STA 170+00

COUNTY SHEETS NO

LAKE 222 78

CONTRACT NO 61G70

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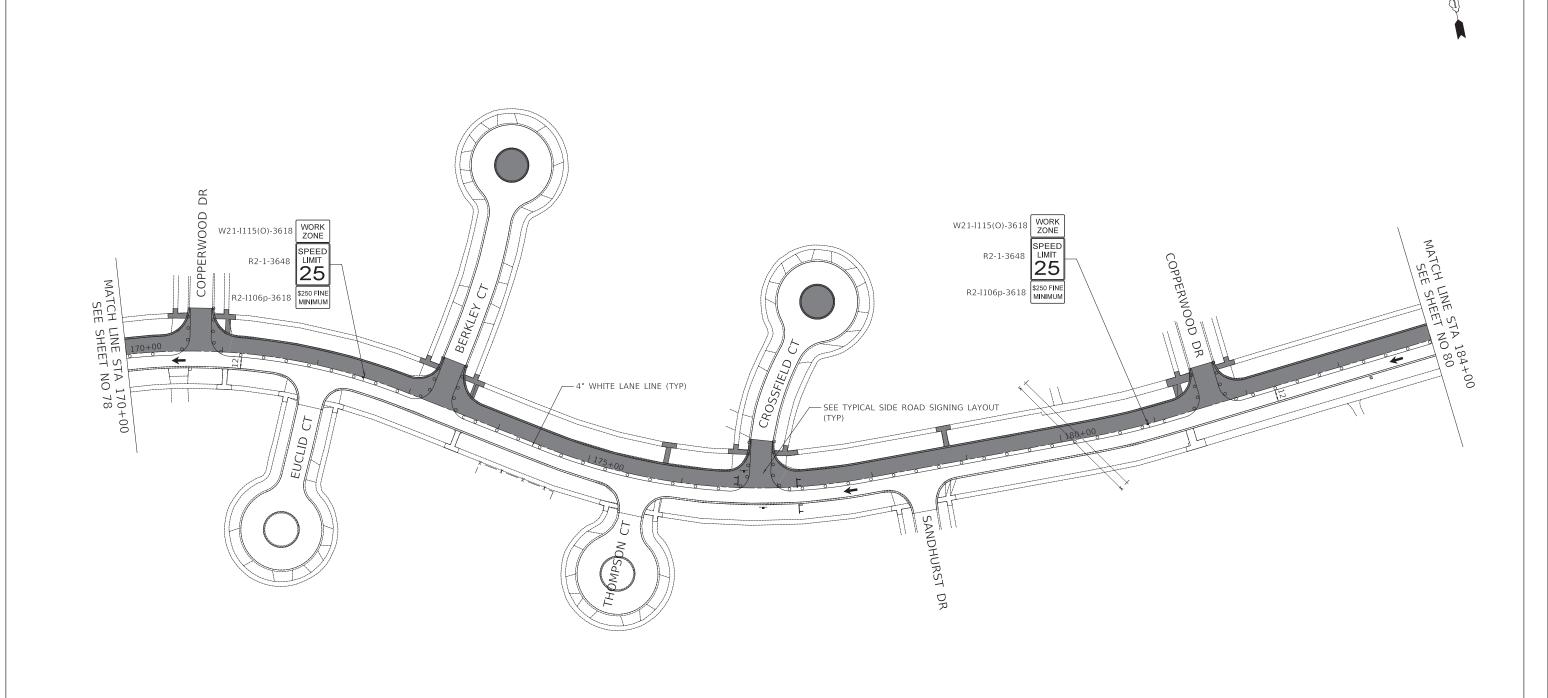
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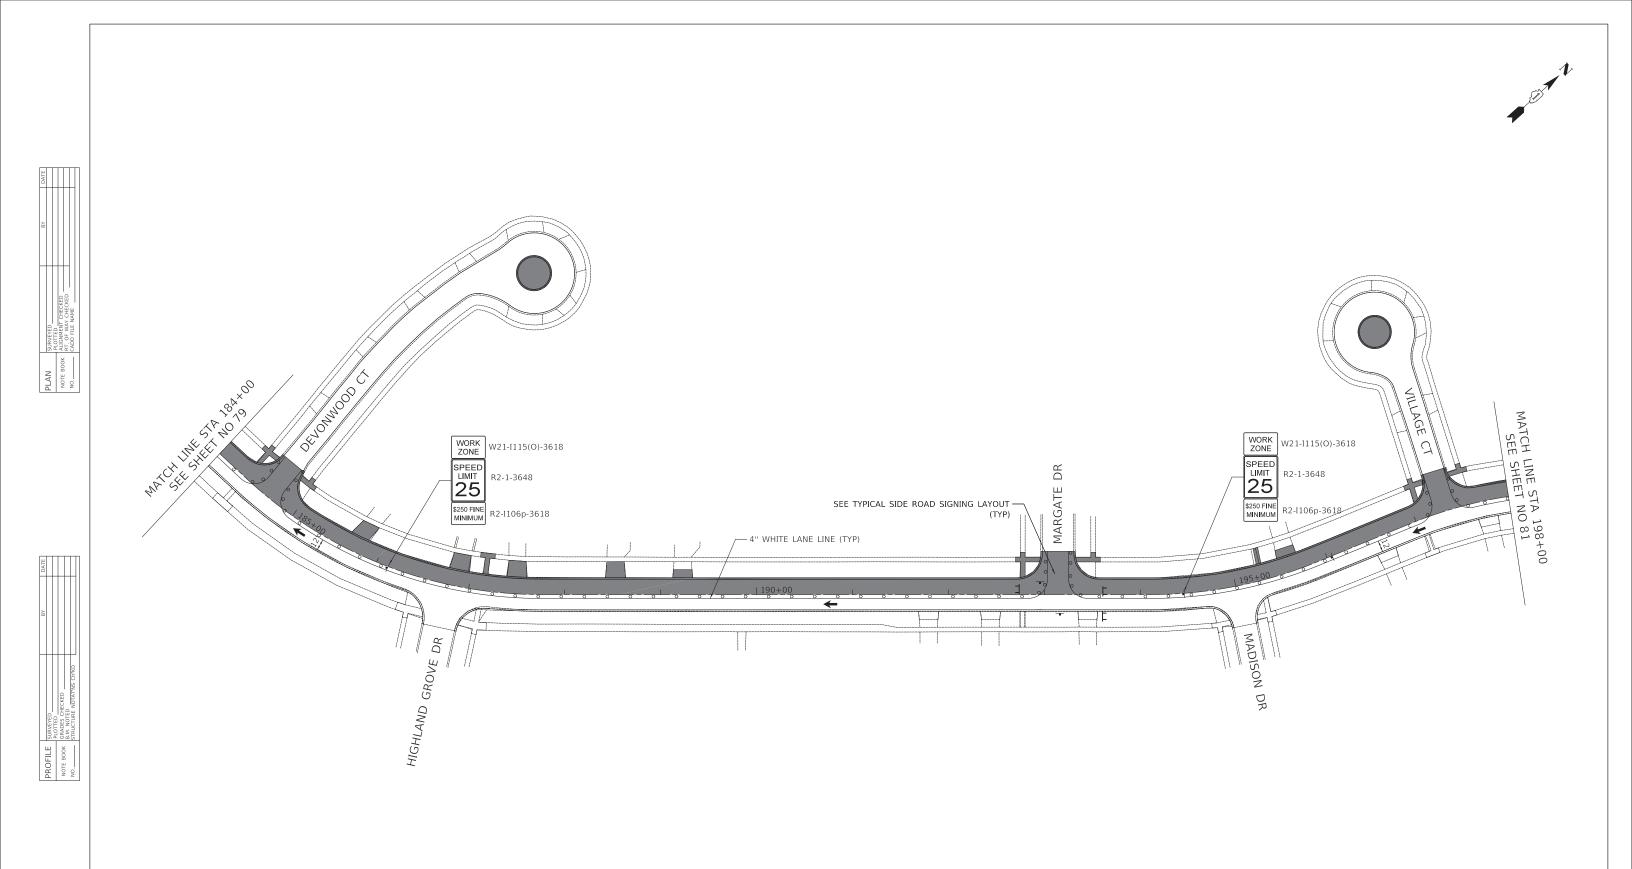
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STATE OF ILLINOIS **DEPARTMENT OF TRANSPORTATION** 

MAINTENANCE OF TRAFFIC - THOMPSON BOULEVARD STAGE 2 SHEET 2 OF 7 SHEETS STA 170+00 TO STA 184+00

COUNTY TOTAL SHEET NO LAKE 222 79

CONTRACT NO 61G70 16-00106-02-RS





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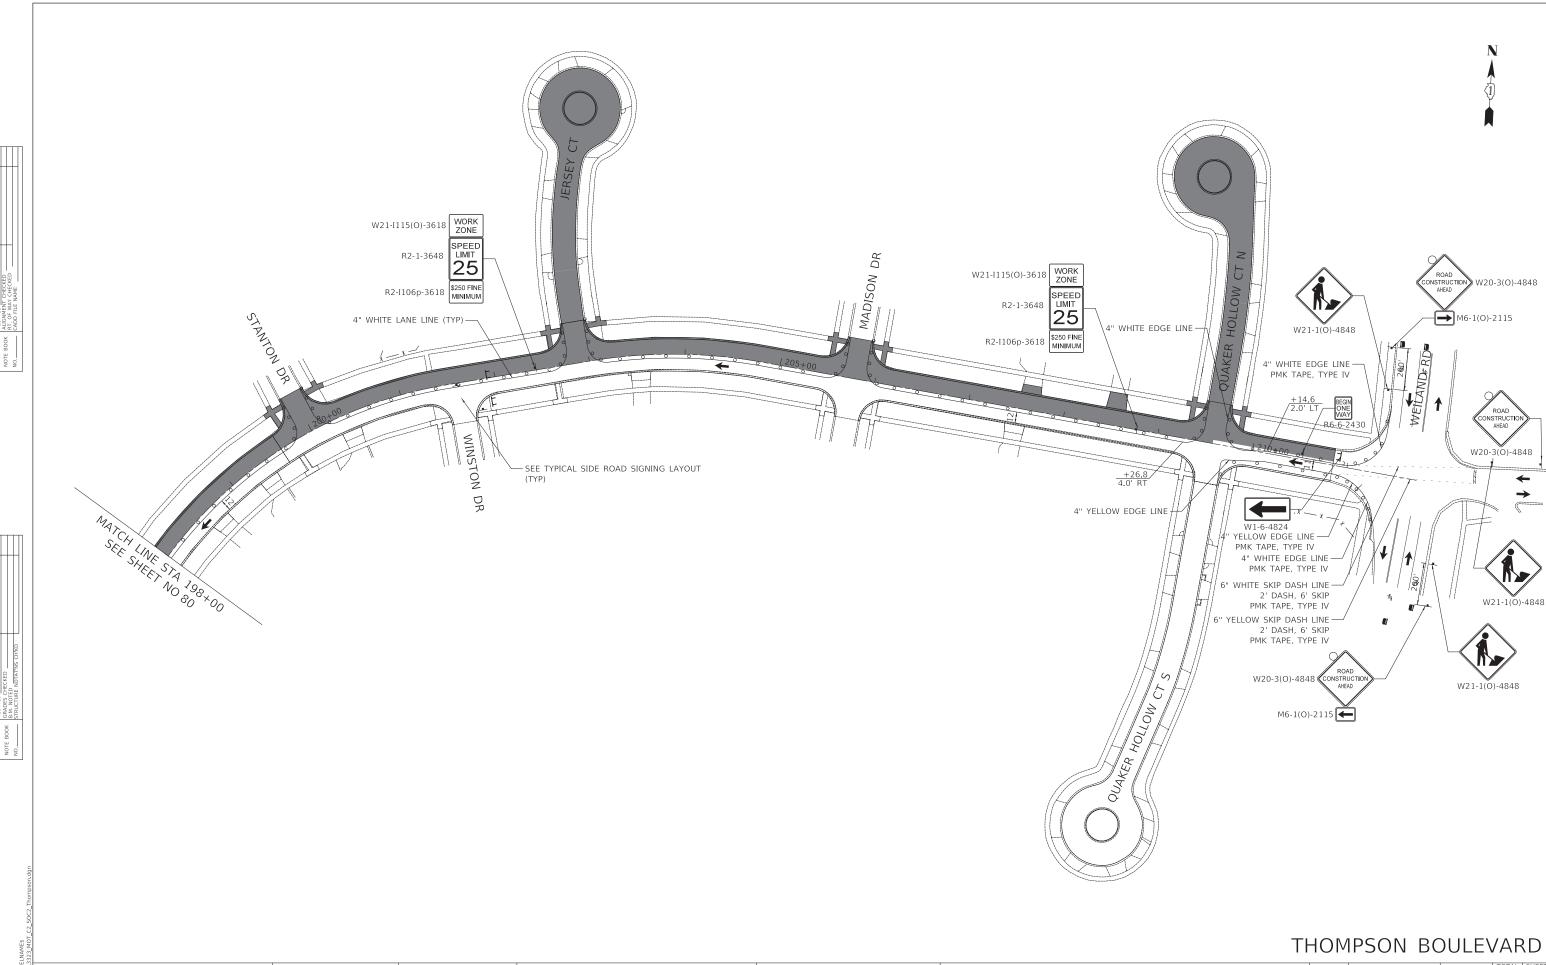
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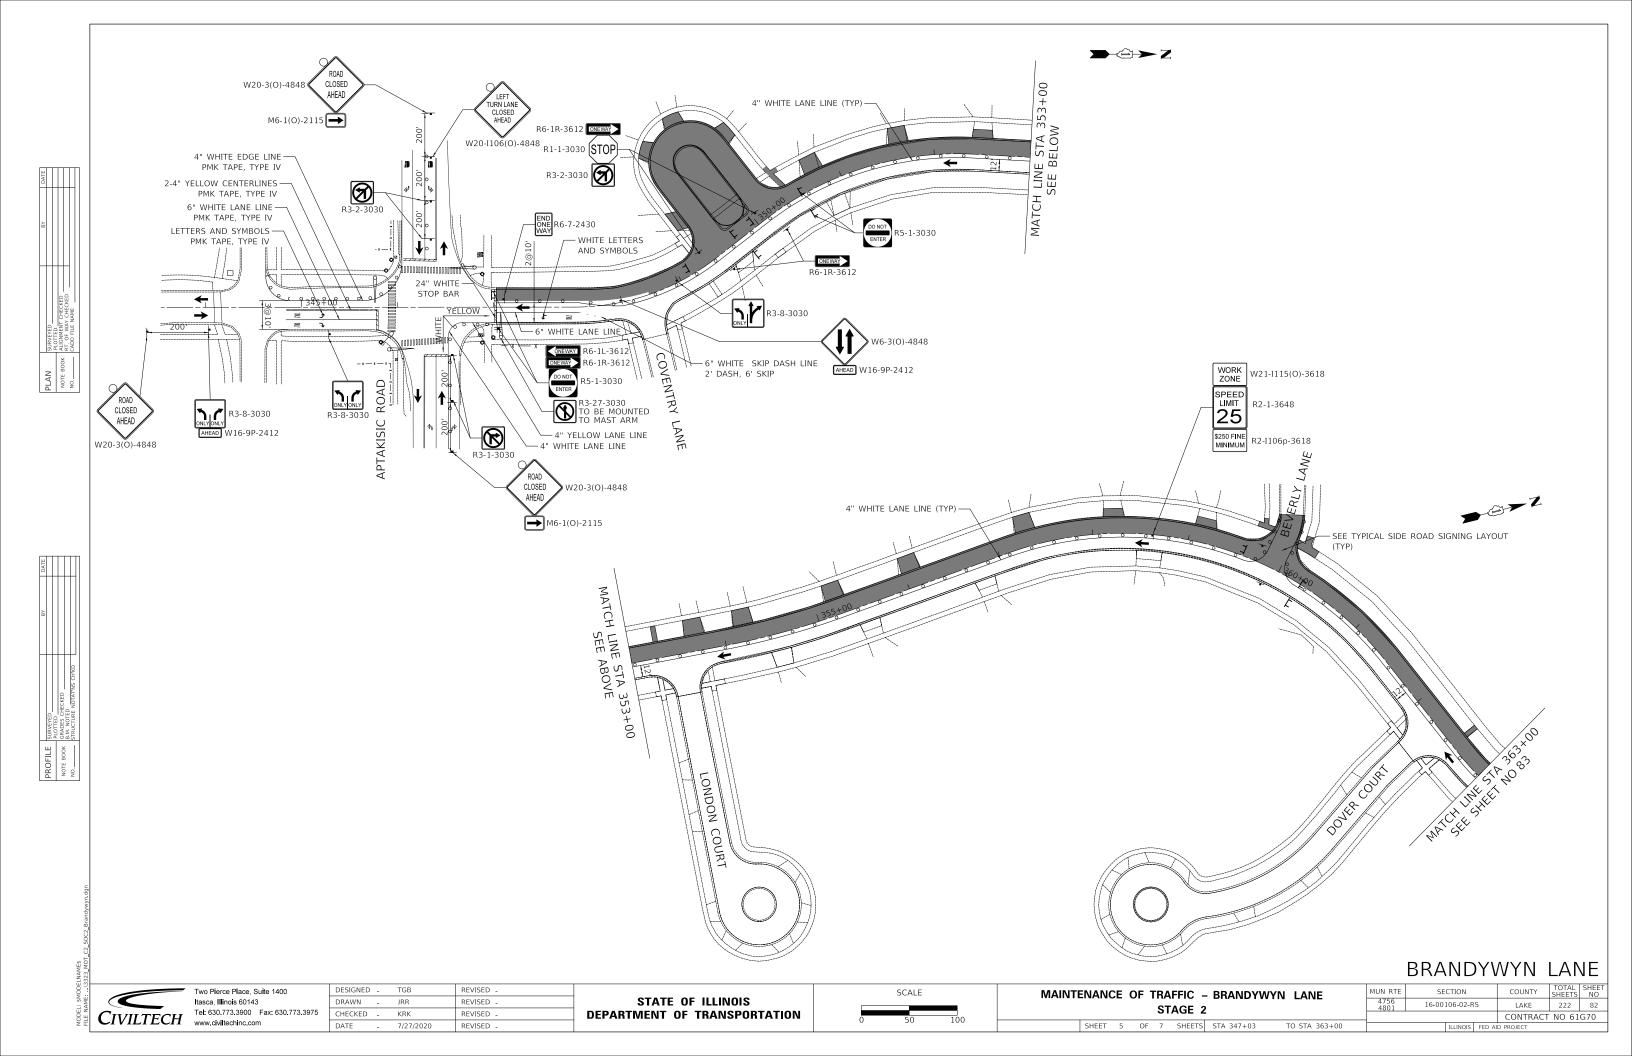
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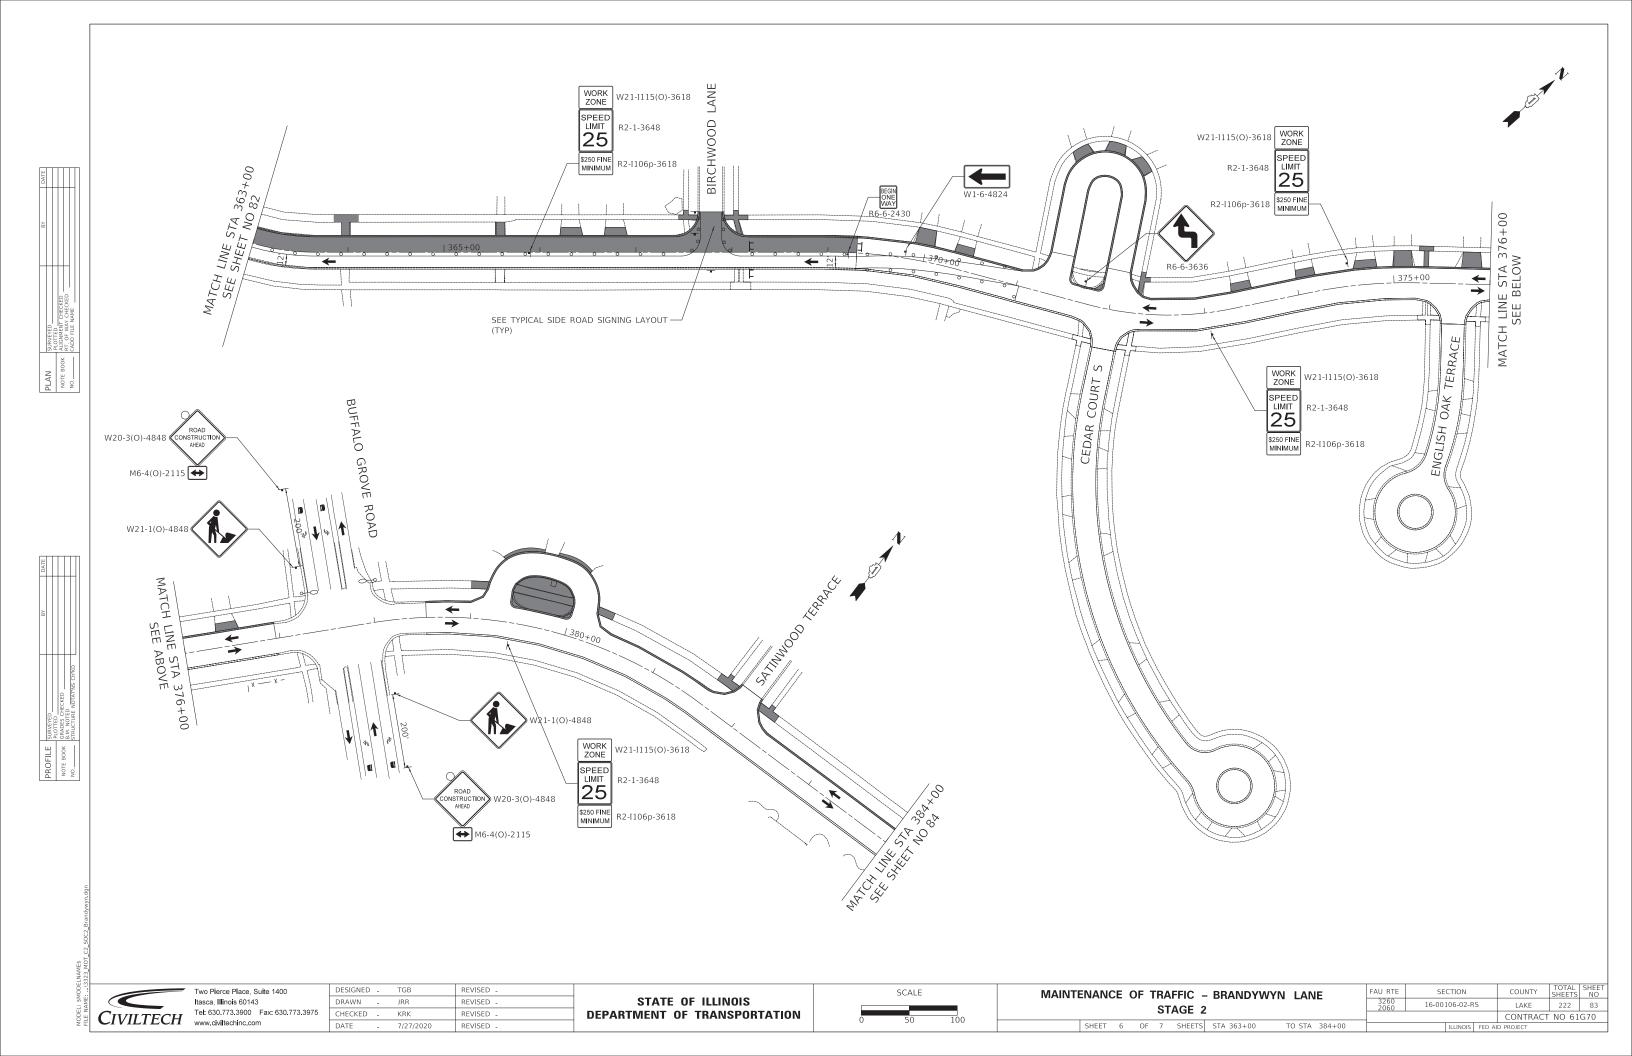
STATE OF ILLINOIS **DEPARTMENT OF TRANSPORTATION**  SCALE


MAINTENANCE OF TRAFFIC - THOMPSON BOULEVARD STAGE 2 SHEET 4 OF 7 SHEETS STA 198+00 TO STA 210+85


COUNTY SHEETS NO

LAKE 222 81 16-00106-02-RS CONTRACT NO 61G70





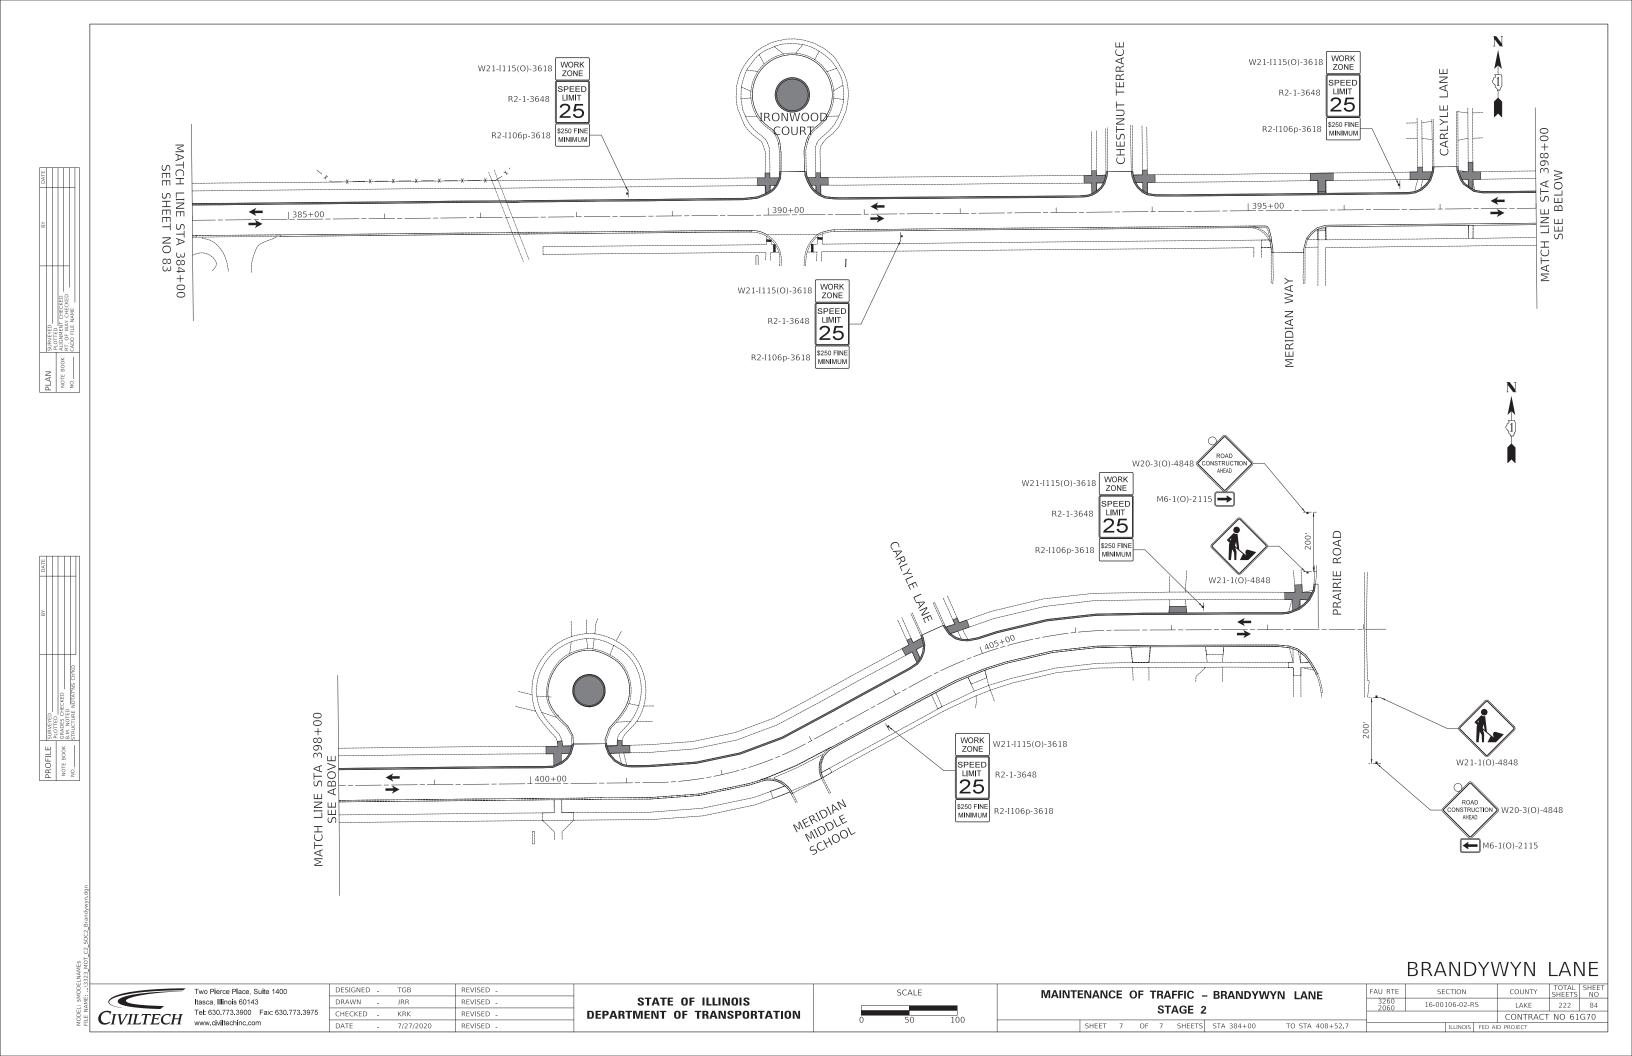

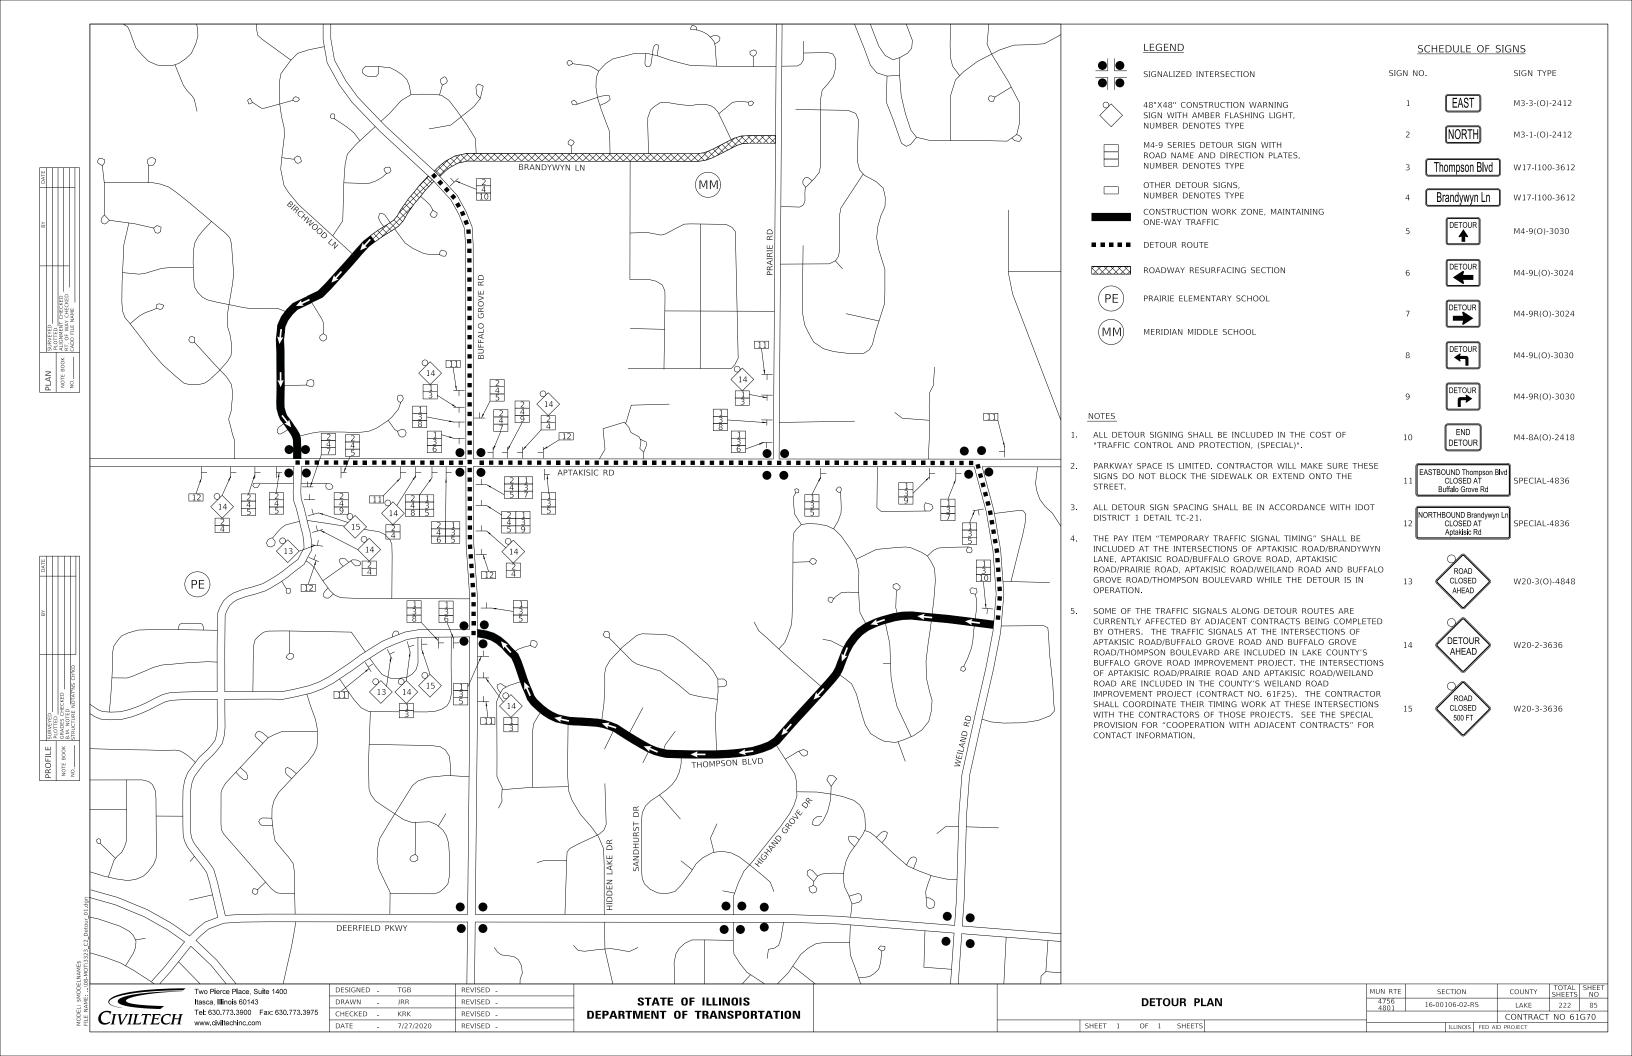

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### SEDIMENTATION AND EROSION CONTROL NOTES

- SEDIMENT CONTROL MEASURES SHALL BE INSTALLED PRIOR TO THE COMMENCEMENT OF HYDROLOGIC DISTURBANCE OF UPLAND AREAS
- FOR THOSE DEVELOPMENTS THAT REQUIRE A DESIGNATED PROSION CONTROL INSPECTOR (DECI), INSPECTIONS AND DOCUMENTATION SHALL BE PREFORMED, AT A MINIMUM:

- UPON COMPLETION OF SEDIMENT AND RUNOFF CONTROL MEASURES (INCLUDING PERIMETER CONTROLS AND DIVERSIONS), PRIOR TO PROCEEDING WITH ANY OTHER EARTH DISTURBANCE OR GRADING.
- AFTER EVERY SEVEN (7) CALENDAR DAYS OR STORM EVENT WITH GREATER THAN 0.5 INCH OF RAINFALL OR LIQUID EQUIVALENT PRECIPITATION

- SOIL DISTURBANCE SHALL BE CONDUCTED IN A MANNER AS TO MINIMIZE EROSION. IF STRIPPING, CLEARING, GRADING, OR LANDSCAPING ARE TO BE DONE IN PHASES, THE PERMITEE SHALL PLAN FOR APPROPRIATE SOIL EROSION AND SEDIMENT CONTROL MEASURES.
- A STABILIZED MAT OF CRUSHED STONE MEETING IDOT GRADATION CA-1 UNDERLAIN WITH FILTER FABRIC AND IN ACCORDANCE WITH THE ILLINOIS URBAN MANUAL, OR OTHER FABRIC AND IN ACCORDANCE WITH THE ILLINOIS URBAN MANUAL, OR OTHER APPROPRIATE MEASURE(S) AS APPROVED BY THE ENFORCEMENT OFFICER, SHALL BE INSTALLED AT ANY POINT WHERE TRAFFIC WILL BE ENTERING OR LEAVING A CONSTRUCTION SITE. SEDIMENT OR SOIL REACHING AN IMPROVED PUBLIC RIGHT-OF-WAY, STREET, ALLEY OR PARKING AREA SHALL BE REMOVED BY SCRAPING OR STREET CLEANING AS ACCUMULATIONS WARRANT AND TRANSPORTED TO A CONTROLLED SEDIMENT
- TEMPORARY DIVERSIONS SHALL BE CONSTRUCTED AS NECESSARY TO DIRECT LL RUNOFF FROM HYDROLOGICALLY DISTURBED AREAS TO AN APPROPRIATE SEDIMENT TRAP OR BASIN.
- DISTURBED AREAS SHALL BE STABILIZED WITH TEMPORARY OR PERMANENT MEASURES WITHIN SEVEN (7) CALENDAR DAYS FOLLOWING THE END OF ACTIVE HYDROLOGIC DISTRUBANCE OR REDISTURBANCE.
- ALL STOCKPILES SHALL HAVE APPROPRIATE MEASURES TO PREVENT EROSION. STOCKPILES SHALL NOT BE PLACED IN FLOOD PRONE AREAS OR WETLANDS AND DESIGNATED BUFFERS.
- SLOPES STEEPER THAN 3H:1V SHALL BE STABILIZED WITH APPROPRIATE MEASURES AS APPROVED BY THE ENFORCEMENT OFFICER.
- APPROPRIATE EROSION CONTROL BLANKET SHALL BE INSTALLED ON ALL INTERIOR DETENTION BASIN SIDE SLOPES BETWEEN THE NORMAL WATER LEVEL AND HIGH WATER LEVEL.
- STORM SEWERS THAT ARE OR WILL BE FUNCTIONING DURING CONSTRUCTION SHALL BE PROTECTED BY AN APPROPRIATE SEDIMENT CONTROL MEASURE.
- IF DEWATERING SERVICES ARE USED, ADJOINING PROPERTIES AND DISCHARGE LOCATIONS SHALL BE PROTECTED FROM EROSION AND SEDIMENTATION.
  DISCHARGES SHALL BE ROUTED THROUGH AN APPROVED ANIONIC POLYMER DEWATERING SYSTEM OR A SIMILAR MEASURE AS APPROVED BY THE ENFORCEMENT OFFICER. DEWATERING SYSTEMS SHOULD BE INSPECTED DAILY DURING OPERATIONAL PERIODS. THE ENFORCEMENT OFFICER, OR APPROVED REPRESENTATIVE, MUST BE PRESENT AT THE COMMENCEMENT OF DEWATERING ACTIVITIES
- IF INSTALLED EROSION AND SEDIMENT CONTROL MEASURES DO NOT MINIMIZE SEDIMENT LEAVING THE DEVELOPMENT SITE, ADDITIONAL MEASURES SUCH AS ANIONIC POLYMERS OR FILTRATION SYSTEMS MAY BE REQUIRED BY THE ENFORCEMENT OFFICER.
- M. ALL TEMPORARY AND PERMANENT EROSION CONTROL MEASURES MUST BE MAINTAINED AND REPAIRED AS NEEDED. THE PROPERTY OWNER SHALL BE ULTIMATELY RESPONSIBLE FOR MAINTENANCE AND REPAIR.
- M. ALL TEMPORARY SEDIMENT CONTROL MEASURES SHALL BE REMOVED WITHIN 30 DAYS AFTER FINAL STABILIZATION IS ACHIEVED OR AFTER THE TEMPORARY MEASURES ARE NO LONGER NEEDED.
- THE EROSION CONTROL MEASURES INDICATED ON THE PLANS ARE THE MINIMUM REQUIREMENTS. ADDITIONAL MEASURES MAY BE REQUIRED, AS DIRECTED BY THE ENGINEER, ENFORCEMENT OFFICER, OR OTHER GOVERNING
- ESTIMATED QUANTITIES HAVE BEEN PROVIDED FOR EROSION CONTROL MEASURES TO BE USED AT THE DIRECTION OF THE RESIDENT ENGINEER.
- PERIMETER EROSION BARRIER SHALL BE INSTALLED ONE (1) FOOT FROM RIGHT-OF-WAY OR EASEMENT UNLESS OTHERWISE NOTED ON THE PLANS. REFERENCE THE PLAT OF HIGHWAY SHEETS FOR STATIONS AND OFFSETS.
- SEE DRAINAGE AND UTILITY SHEETS FOR RIPRAP CLASSES AND QUANTITIES.
- QUANTITIES OF EROSION CONTROL MAT, FLOATING SILT CURTAIN, FLOCCULATION LOGS, AND FLOCCULATION POWDER HAVE BEEN PROVIDED AND ARE TO BE MADE AVAILABLE FOR USE AT THE DIRECTION OF THE
- PERMANENT DITCH CHECKS AND TEMPORARY SEDIMENT TRAPS SHALL BE PAID FOR AS EARTH EXCAVATION, STONE RIPRAP CLASS A2, STONE RIPRAP CLASS A4, AND FILTER FABRIC.
- TEMPORARY FENCE SHALL BE PLACED THROUGHOUT THE LIMITS OF THE PROJECT WHERE PERIMETER EROSION BARRIER IS NOT ALREADY UTILIZED AND AROUND ALL TREES THAT ARE TO BE PROTECTED AT THE DIRECTION OF THE ENGINEER, WHICH SHALL BE PAID FOR AS "TEMPORARY FENCE".

## **EROSION CONTROL PLAN**

THIS PROJECT DISTURBS 20.62 ACRES OF TOTAL LAND AREA. COMPLIANCE WITH THE NATIONAL POLLUTION DISCHARGE ELIMINATION SYSTEM (NPDES) STORMWATER PERMIT IS ONLY NECESSARY IF A PROJECT DISTURBS 1.0 OR MORE ACRES OF TOTAL LAND AREA; AN NPDES PERMIT IS REQUIRED FOR THIS PROJECT.

### DRAINAGE BASINS OF LAKE COUNTY

- I. FOX RIVER WATERSHED
  - Upper Fox River
  - Sequoit Creek Fish Lake Drain
  - Squaw Creek
  - Lower Fox River
  - 6. Mutton Creek
  - Slocum Lake Drain
- Tower Lake Drain Flint Creek
- II. DES PLAINES RIVER WATERSHED
- 10. North Mill Creek
- 11. Mill Creek
- 12. Newport Drainage Ditch 13. Upper Des Plaines River
- 15. Indian Creek
- 16. Lower Des Plaines River Buffalo Creek
- III. LAKE MICHIGAN WATERSHED
- Kellogg Creek
- 20. Dead River
- 21. Waukegan River
- 22. Pettibone Creek
- 23. Bluff/Ravine
- IV. CHICAGO RIVER WATERSHED 24. Skokie River

147

11

FACH

ACRE

- 25. Middle Fork
- 26. West Fork

# ound Lak Round Lake Vernor 8 Tower Long

### ESTIMATED QUANTITIES

461	EACH	TREE TRUNK PROTECTION
461	EACH	TREE ROOT PRUNING
550	POUND	TEMPORARY EROSION CONTROL SEEDING
32	FOOT	TEMPORARY DITCH CHECKS

INLET FILTERS

MULCH, METHOD 2

### SMC TYPICAL CONSTRUCTION SEQUENCE (PER STAGE)

- INSTALLATION OF SOIL EROSION AND SEDIMENT CONTROL SE/SC MEASURES A. SELECTIVE VEGETATION REMOVAL FOR SILT FENCE INSTALLATION

  - B. SILT FENCE INSTALLATION
    C. CONSTRUCTION FENCING AROUND AREAS NOT TO BE DISTURBED
  - D. STABILIZED CONSTRUCTION ENTRANCE
- TREE REMOVAL WHERE NECESSARY (CLEAR & GRUB)
- CONSTRUCT SEDIMENT TRAPPING DEVICES (SEDIMENT TRAPS, BASINS, ETC.)
- CONSTRUCT DETENTION FACILITIES AND OUTLET CONTROL STRUCTURE WITH RESTRICTOR & TEMPORARY PERFORATED RISER
- STRIP TOPSOIL, STOCKPILE TOPSOIL AND GRADE SITE
- TEMPORARILY STABILIZE TOPSOIL STOCKPILES (SEED AND SILT FENCE AROUND TOE
- INSTALL STORM SEWER, SANITARY SEWER, WATER AND ASSOCIATED INLET & OUTLET PROTECTION
- PERMANENTLY STABILIZE DETENTION BASIN WITH SEED AND EROSION CONTRLOL
- TEMPORARILY STABILIZE ALL AREAS INCLUDING LOTS THAT HAVE REACHED TEMPORARY GRADE
- INSTALL ROADWAYS 10.
- PERMANENTLY STABILIZE ALL OUTLOT AREAS 11.
- 12. INSTALL STRUCTURES AND GRADE INDIVIDUAL LOTS
- PERMANENTLY STABILIZE LOTS
- REMOVE ALL TEMPORARY SE/SC MEASURES AFTER THE SITE IS STABILIZED WITH

SOIL EROSION AND SEDIMENT CONTROL MAINTENANCE MUST OCCUR EVERY TWO WEEKS AND AFTER EVERY 1/2" OR GREATER RAINFALL EVENT.

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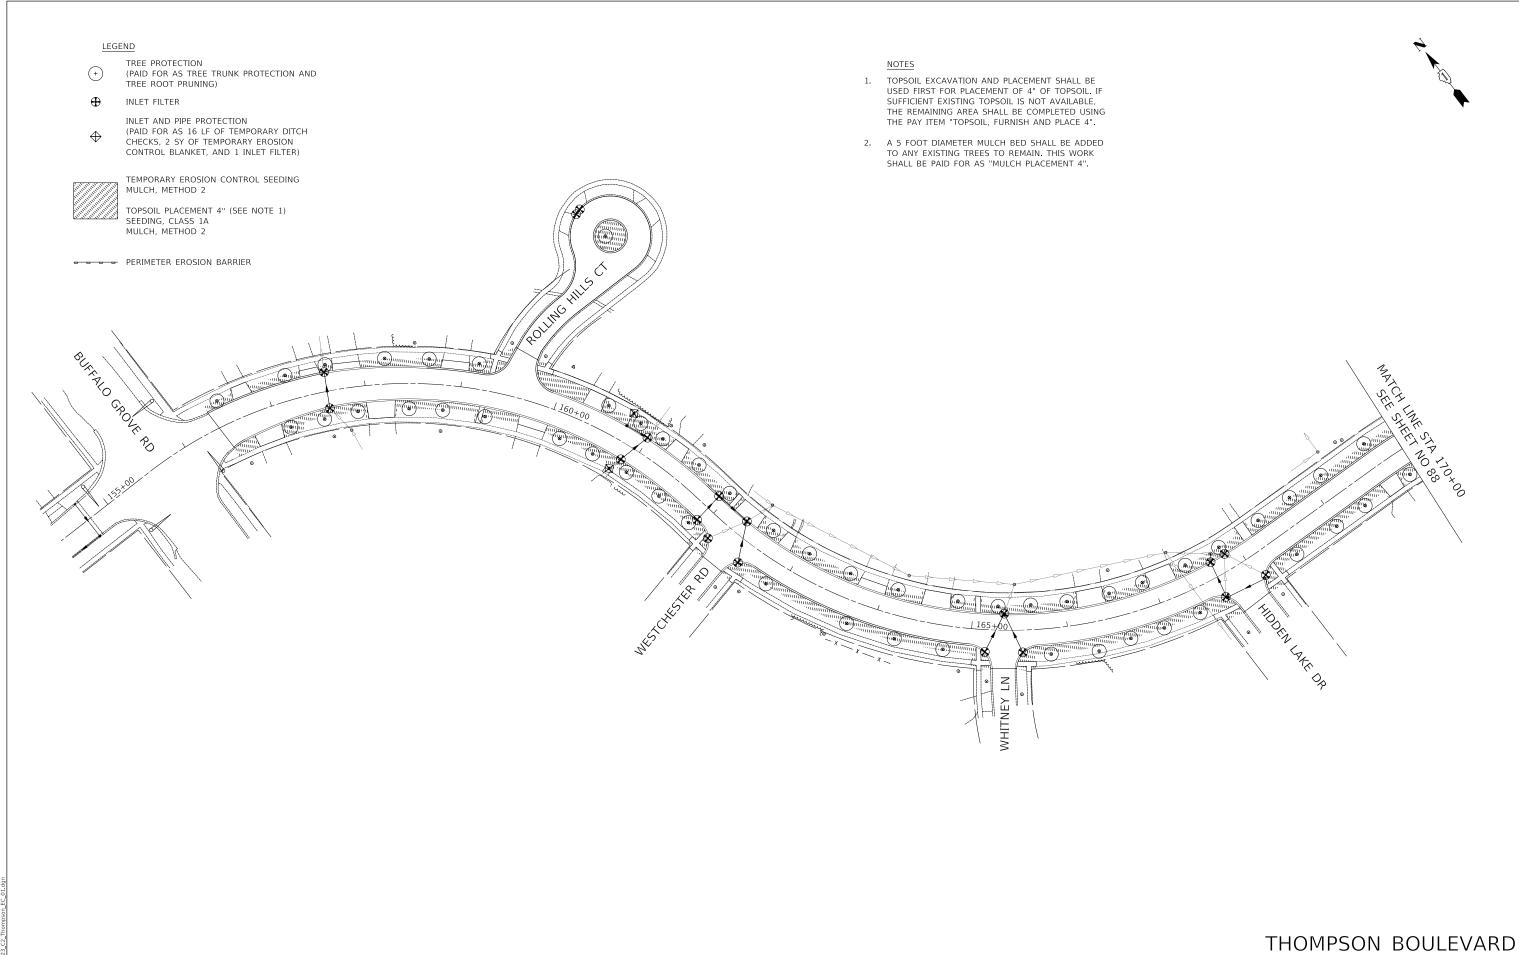
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TGB DESIGNED -REVISED DRAWN JRR REVISED REVISED DATE 7/27/2020 REVISED

STATE OF ILLINOIS **DEPARTMENT OF TRANSPORTATION** 

**EROSION CONTROL PLAN** SHEET 1 OF 8 SHEETS STA TO STA

FAU RTE	SECTION			COUNTY	TOTAL SHEETS	SHEE NO
3260 2060	16-001	106-02-R	tS.	LAKE	222	86
				CONTRACT	NO 61	G70



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STATE OF ILLINOIS	
DEPARTMENT OF TRANSPORTATION	

SCALE	
50	100

**EROSION CONTROL AND LANDSCAPING** SHEET 2 OF 8 SHEETS STA 156+25 TO STA 170+00

MUN RTE	SECTION			COUNTY	TOTAL SHEETS	SHE
4756 4801	16-00106-02-RS			LAKE	222	87
			CONTRACT	NO 61	G70	
	ILLINOIS FED AII					



MATCH LINE STA 170+00 SEE SHEET NO 87 SANDHURST DR EX WETLAND

## THOMPSON BOULEVARD



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LEGEND


SEE SHEET 87 FOR LEGEND.

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SCALE

EROSION CONTROL AND LANDSCAPING SHEET 3 OF 8 SHEETS STA 170+00 TO STA 184+00

COUNTY TOTAL SHEET NO
LAKE 222 88 16-00106-02-RS CONTRACT NO 61G70



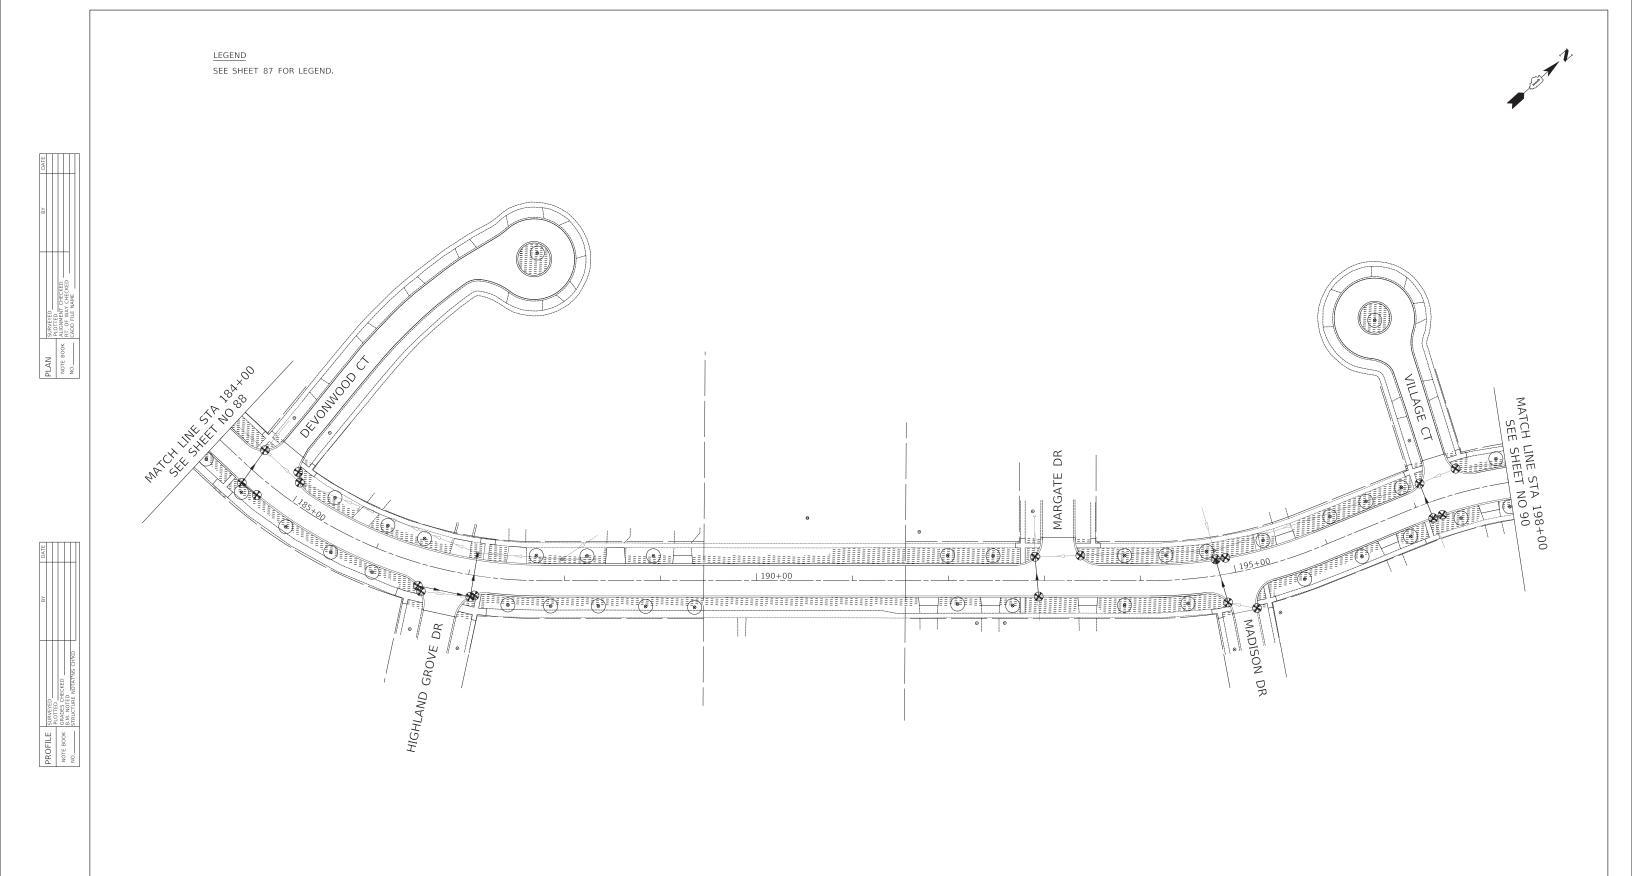

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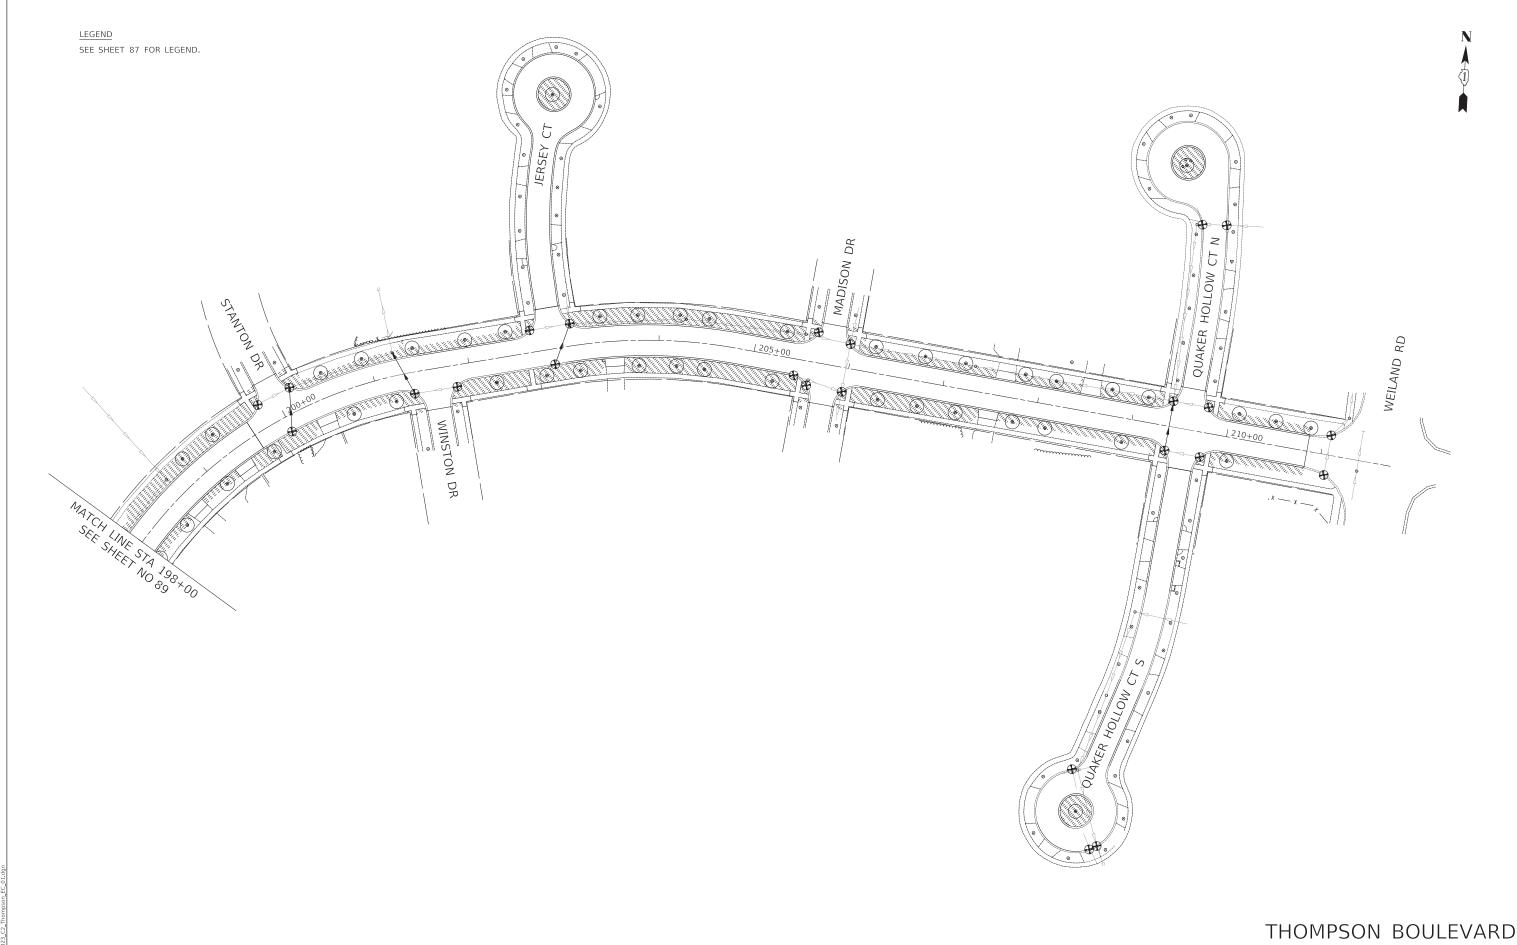
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STATE OF ILLINOIS **DEPARTMENT OF TRANSPORTATION** 

	SCALE	
)	50	100

EROSION CONTROL AND LANDSCAPING SHEET 4 OF 8 SHEETS STA 184+00 TO STA 198+00

AU RTE	SECTION		COUNTY	TOTAL SHEETS	SHEE
3260 2060	16-00106-02-RS		LAKE	222	89
			CONTRACT NO 61G70		
ILLINOIS FED AI		D PROJECT			



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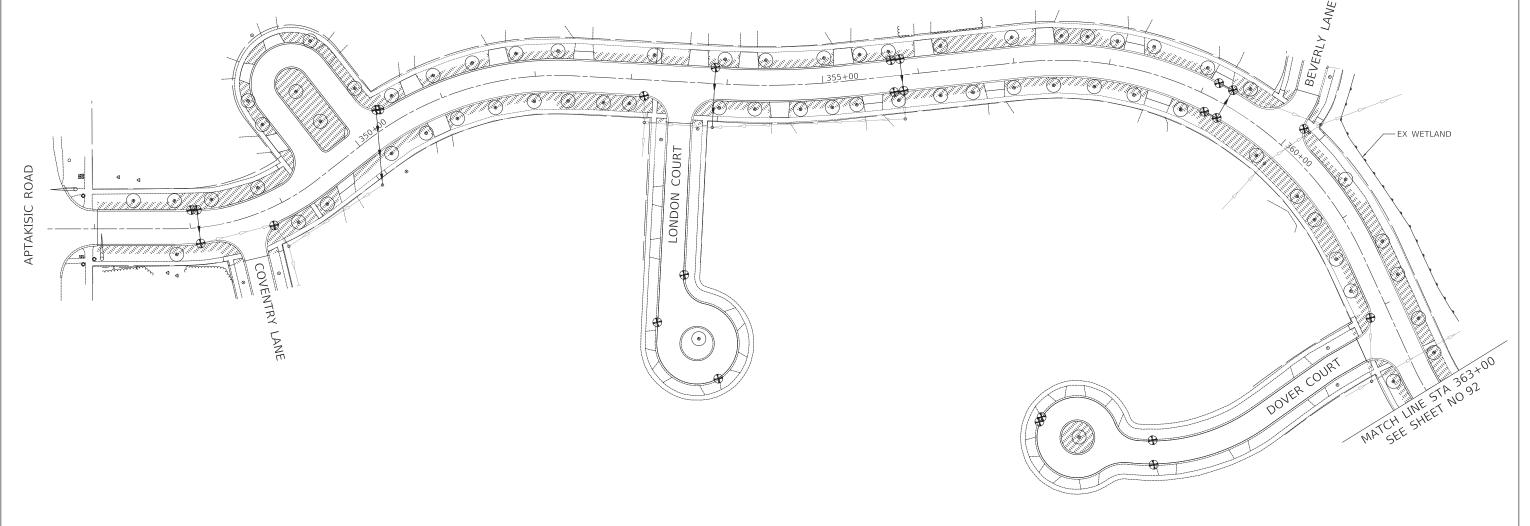
STATE OF ILLINOIS **DEPARTMENT OF TRANSPORTATION**  SCALE

**EROSION CONTROL AND LANDSCAPING** SHEET 5 OF 8 SHEETS STA 198+00 TO STA 210+85

COUNTY TOTAL SHEET NO LAKE 222 90 16-00106-02-RS CONTRACT NO 61G70

SEE SHEET 87 FOR LEGEND.





## BRANDYWYN LANE


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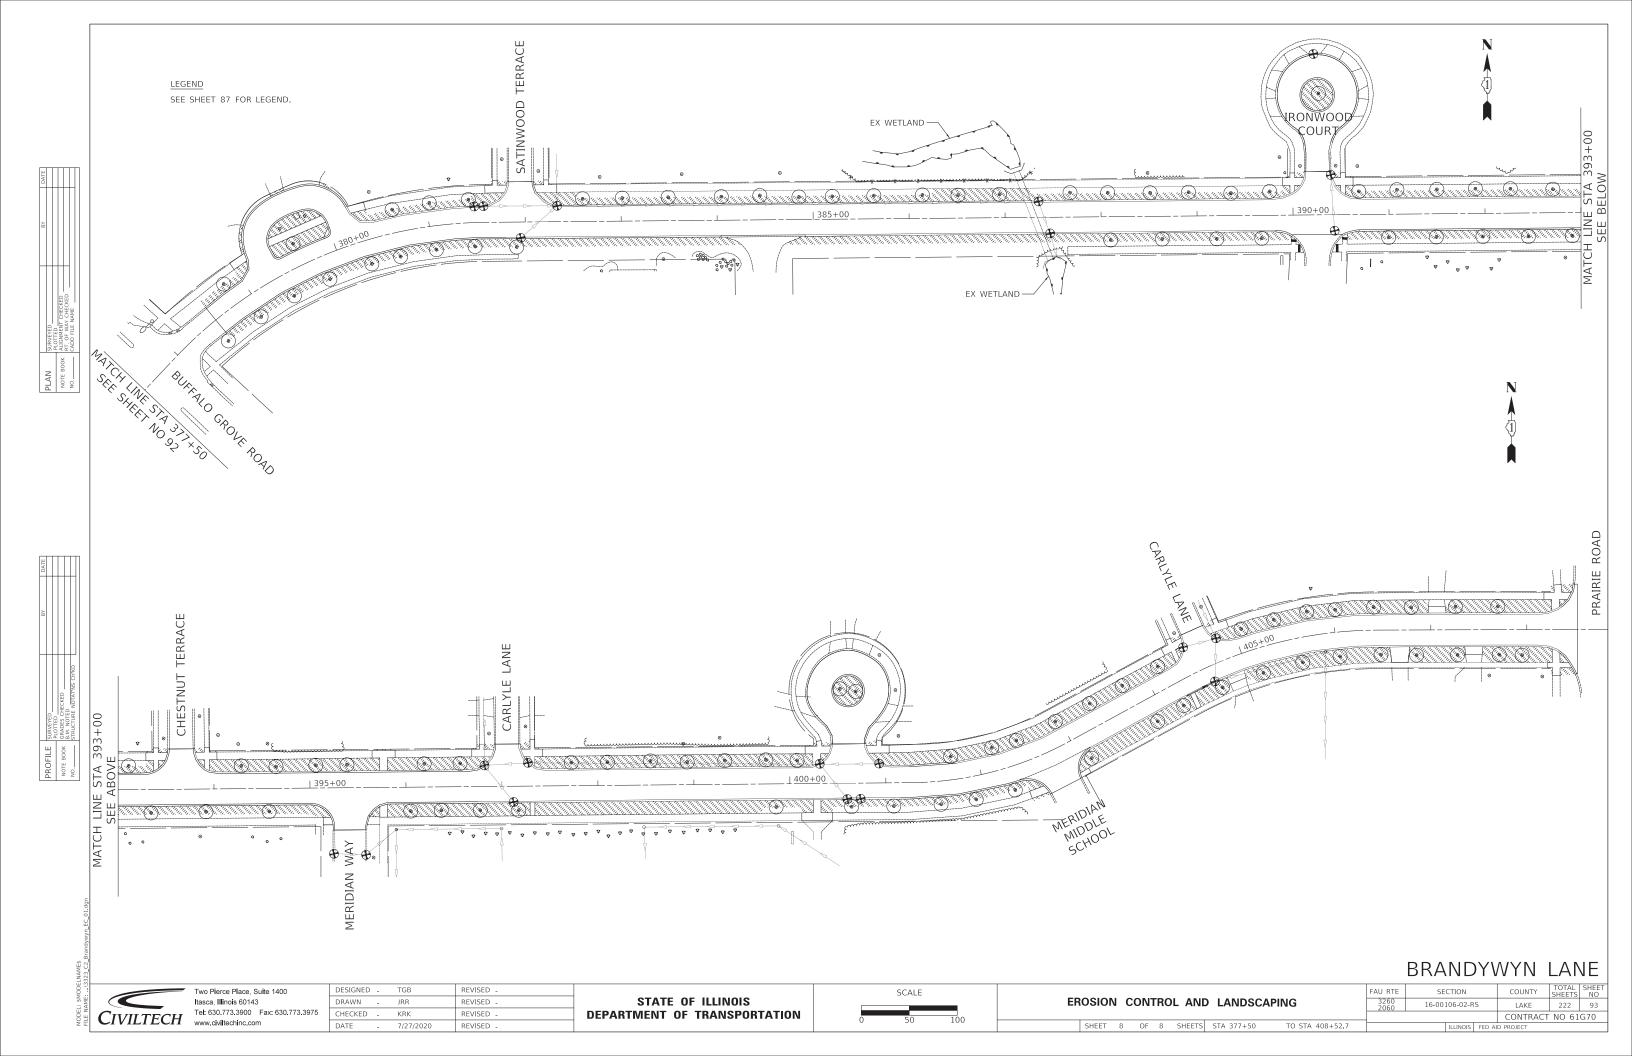
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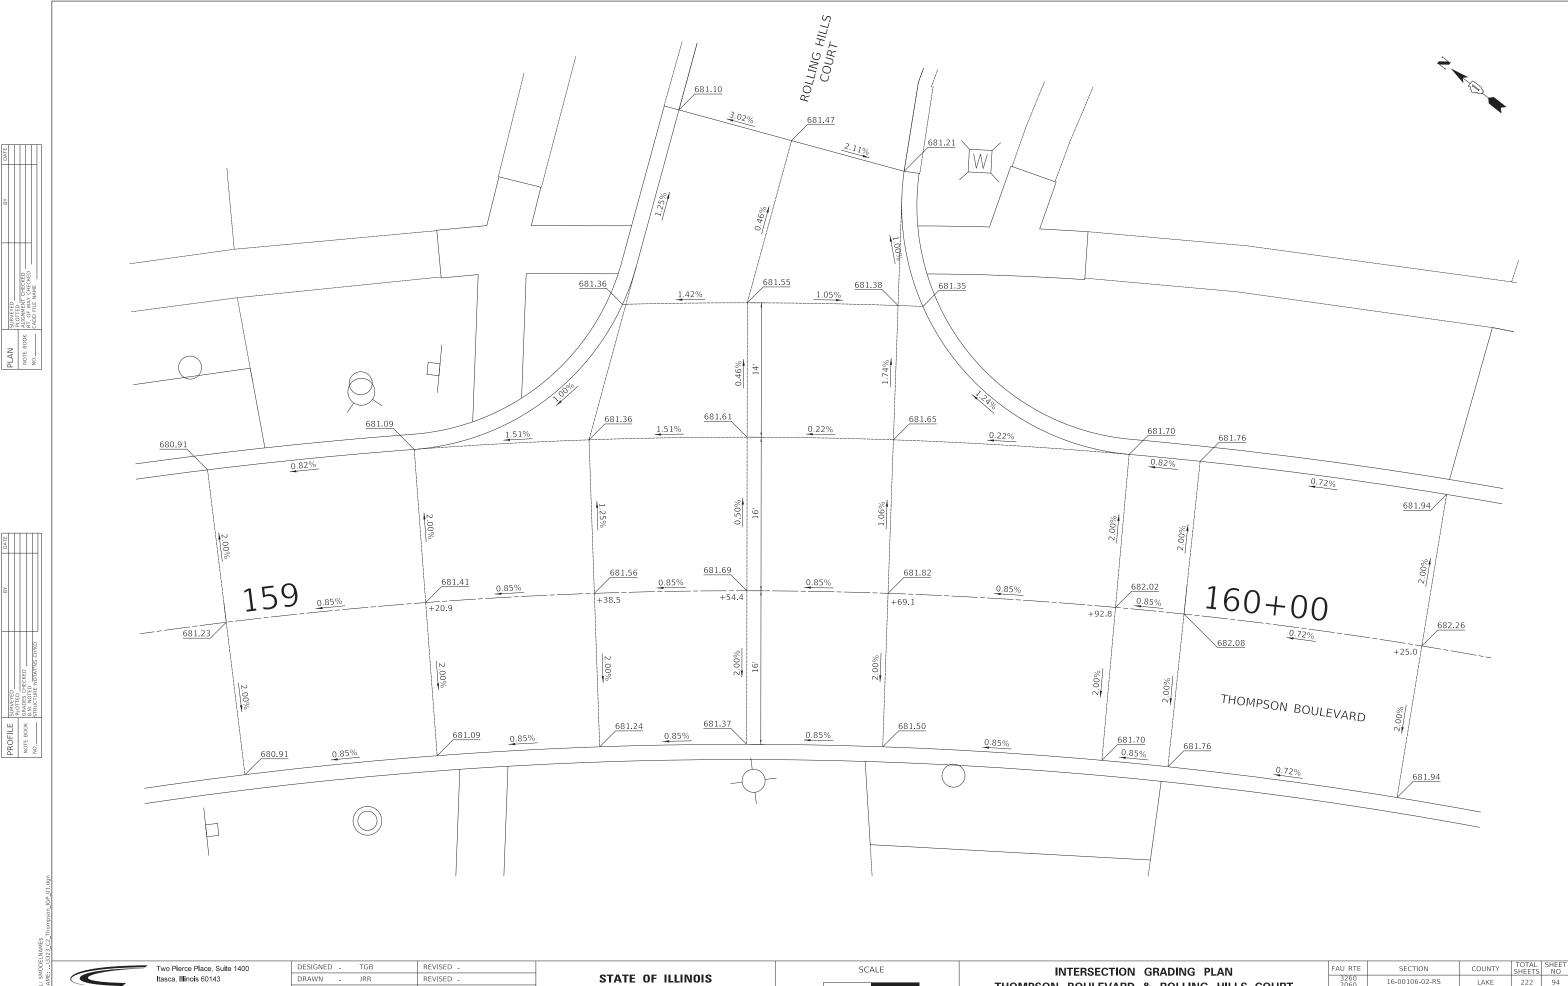
STATE OF ILLINOIS **DEPARTMENT OF TRANSPORTATION**  SCALE

EROSION CONTROL AND LANDSCAPING SHEET 6 OF 8 SHEETS STA 347+03 TO STA 363+00

COUNTY TOTAL SHEETS NO LAKE 222 91 16-00106-02-RS CONTRACT NO 61G70





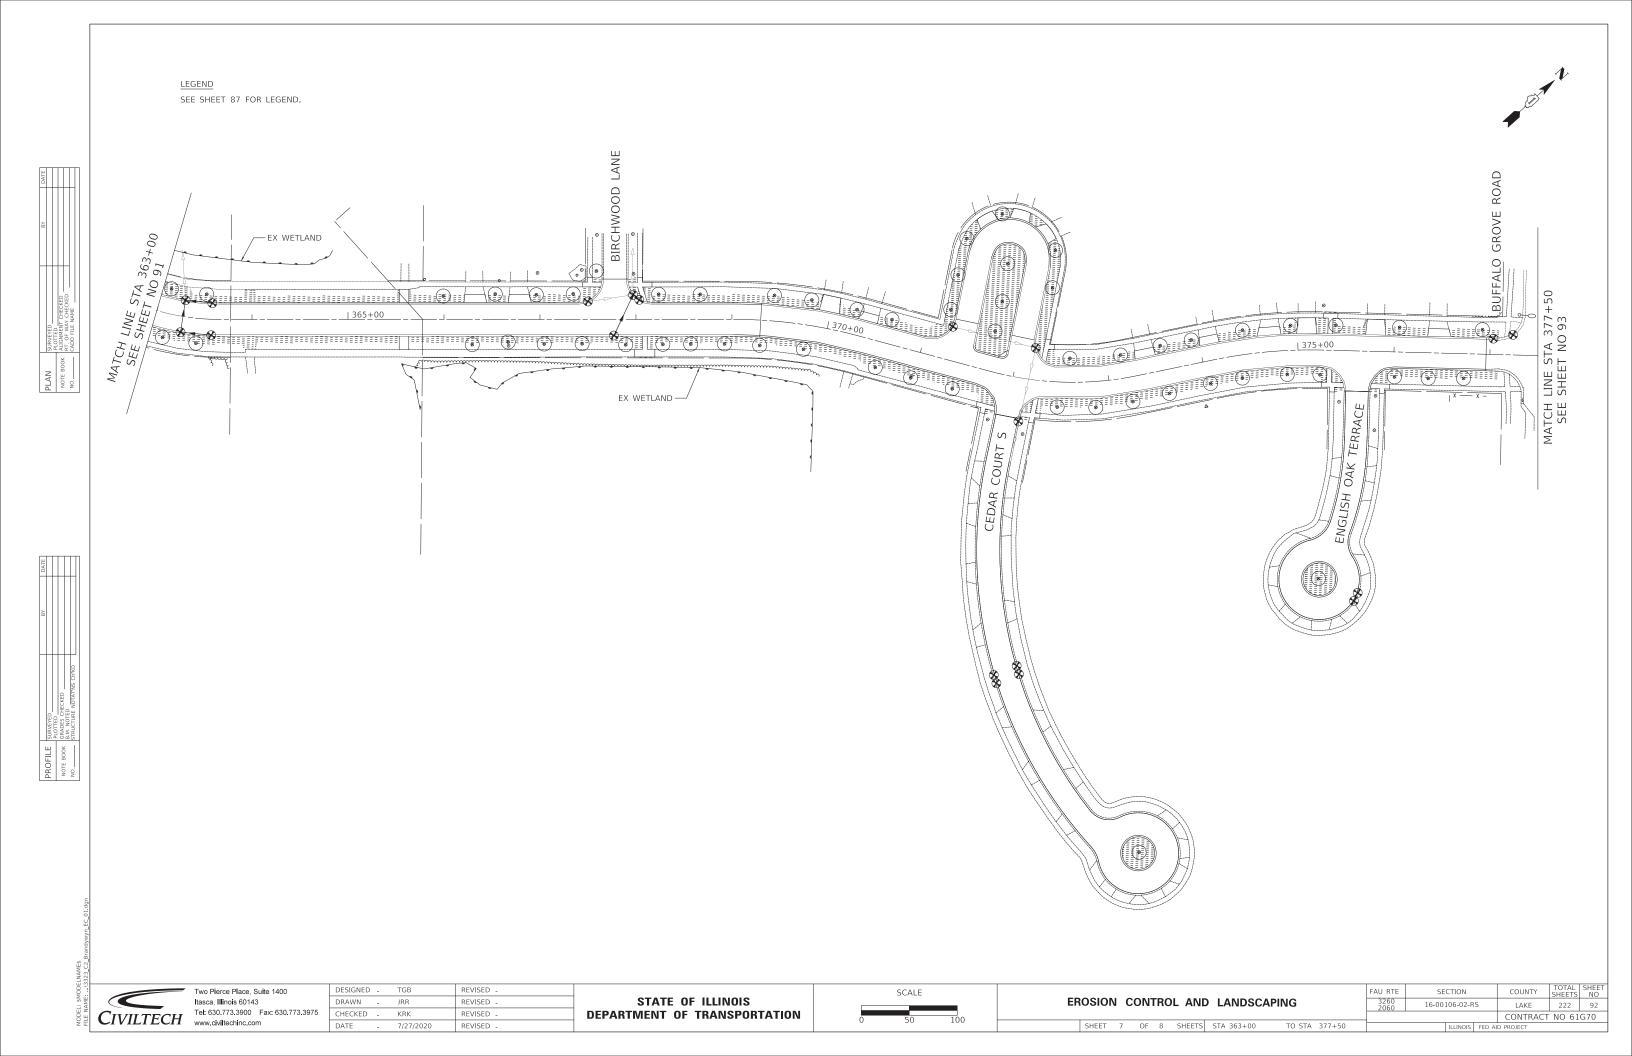



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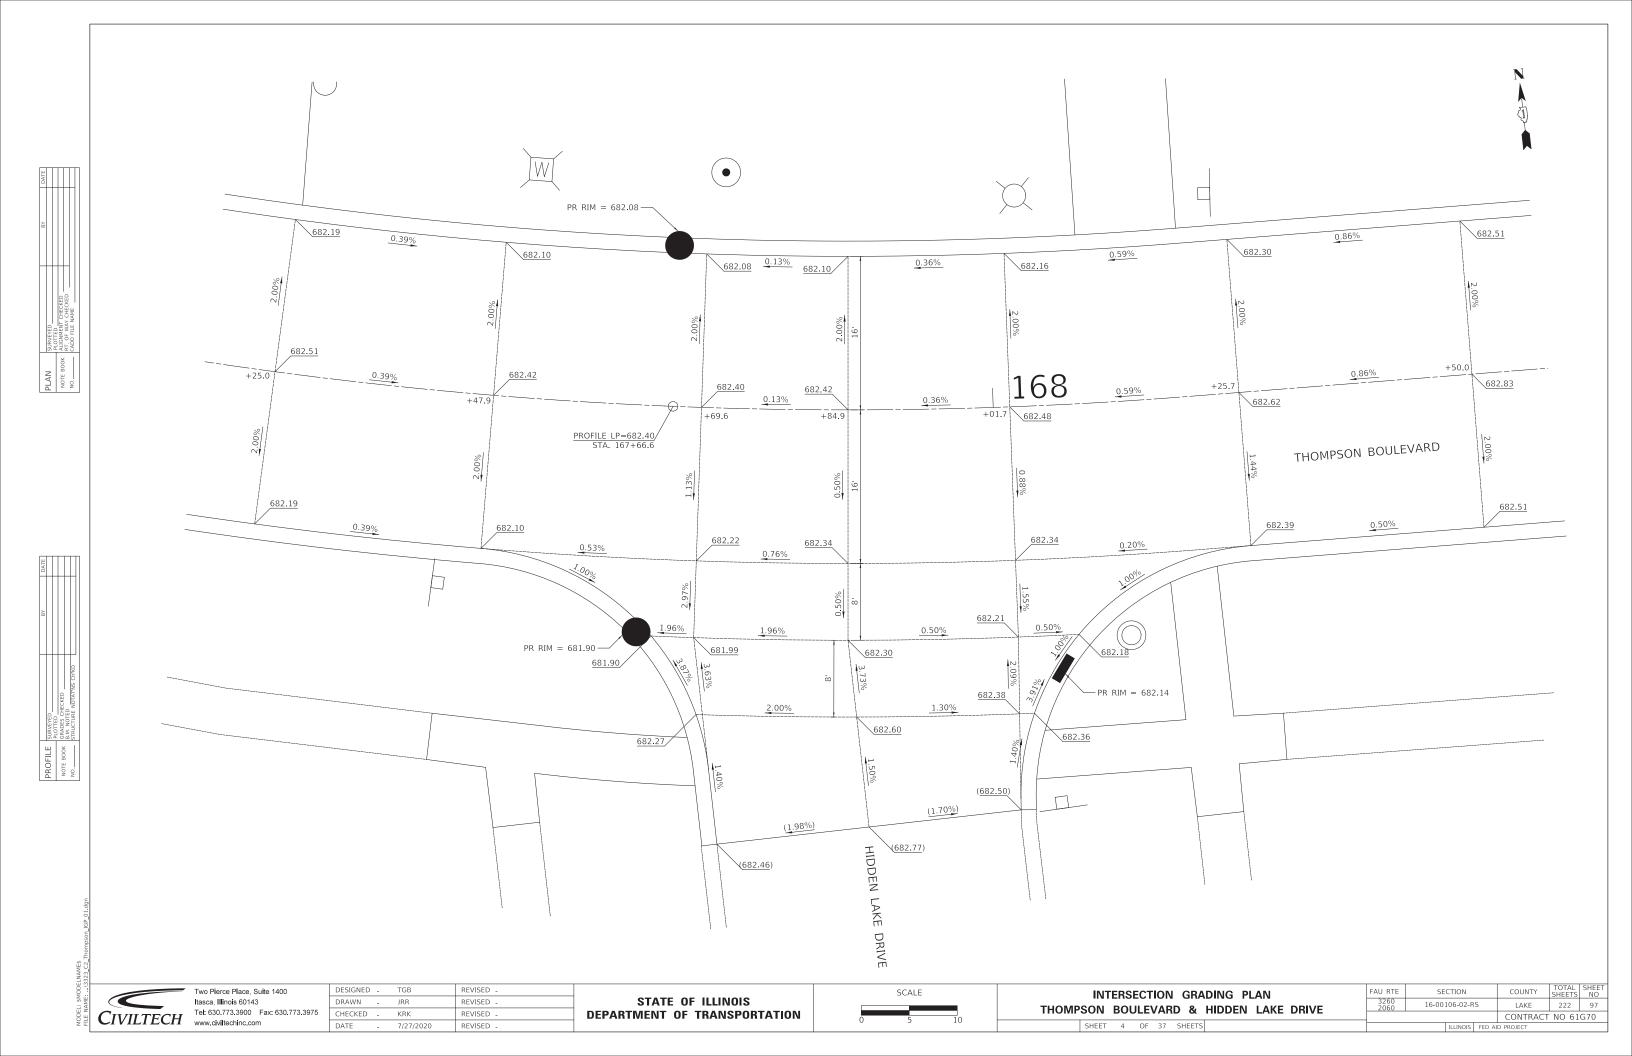
KRK 7/27/2020 REVISED - **DEPARTMENT OF TRANSPORTATION** 


THOMPSON BOULEVARD & ROLLING HILLS COURT SHEET 1 OF 37 SHEETS


COUNTY TOTAL SHEET NO
LAKE 222 94 16-00106-02-RS CONTRACT NO 61G70




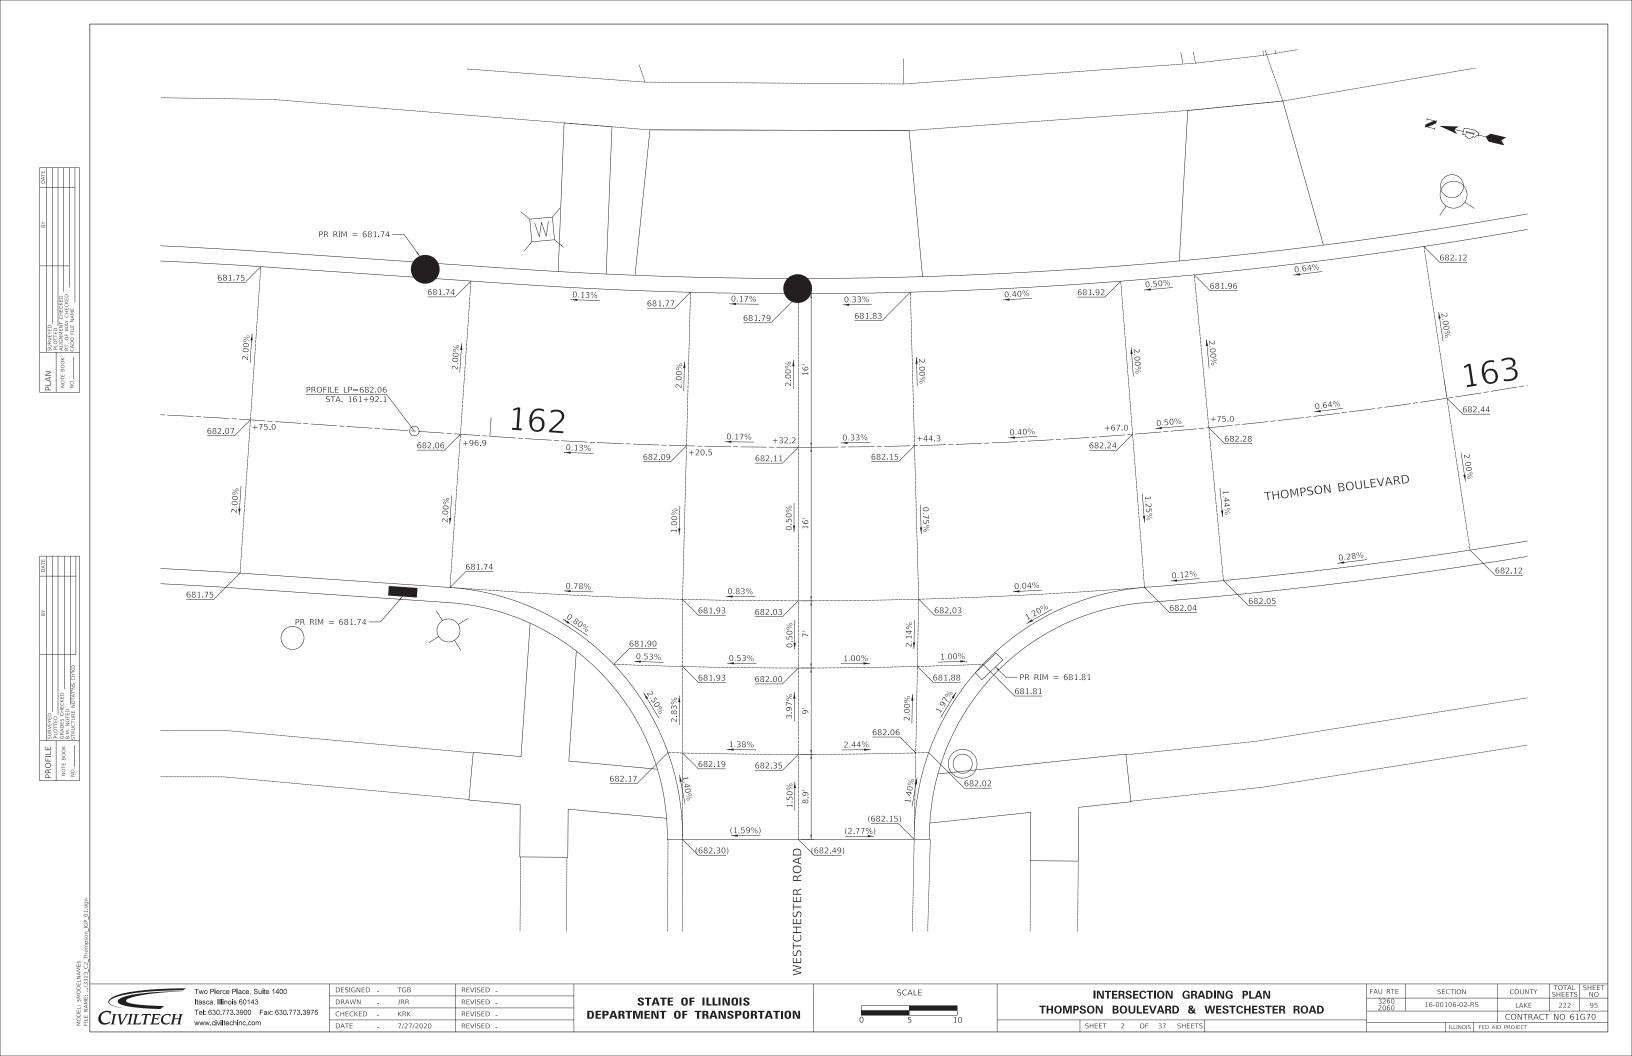

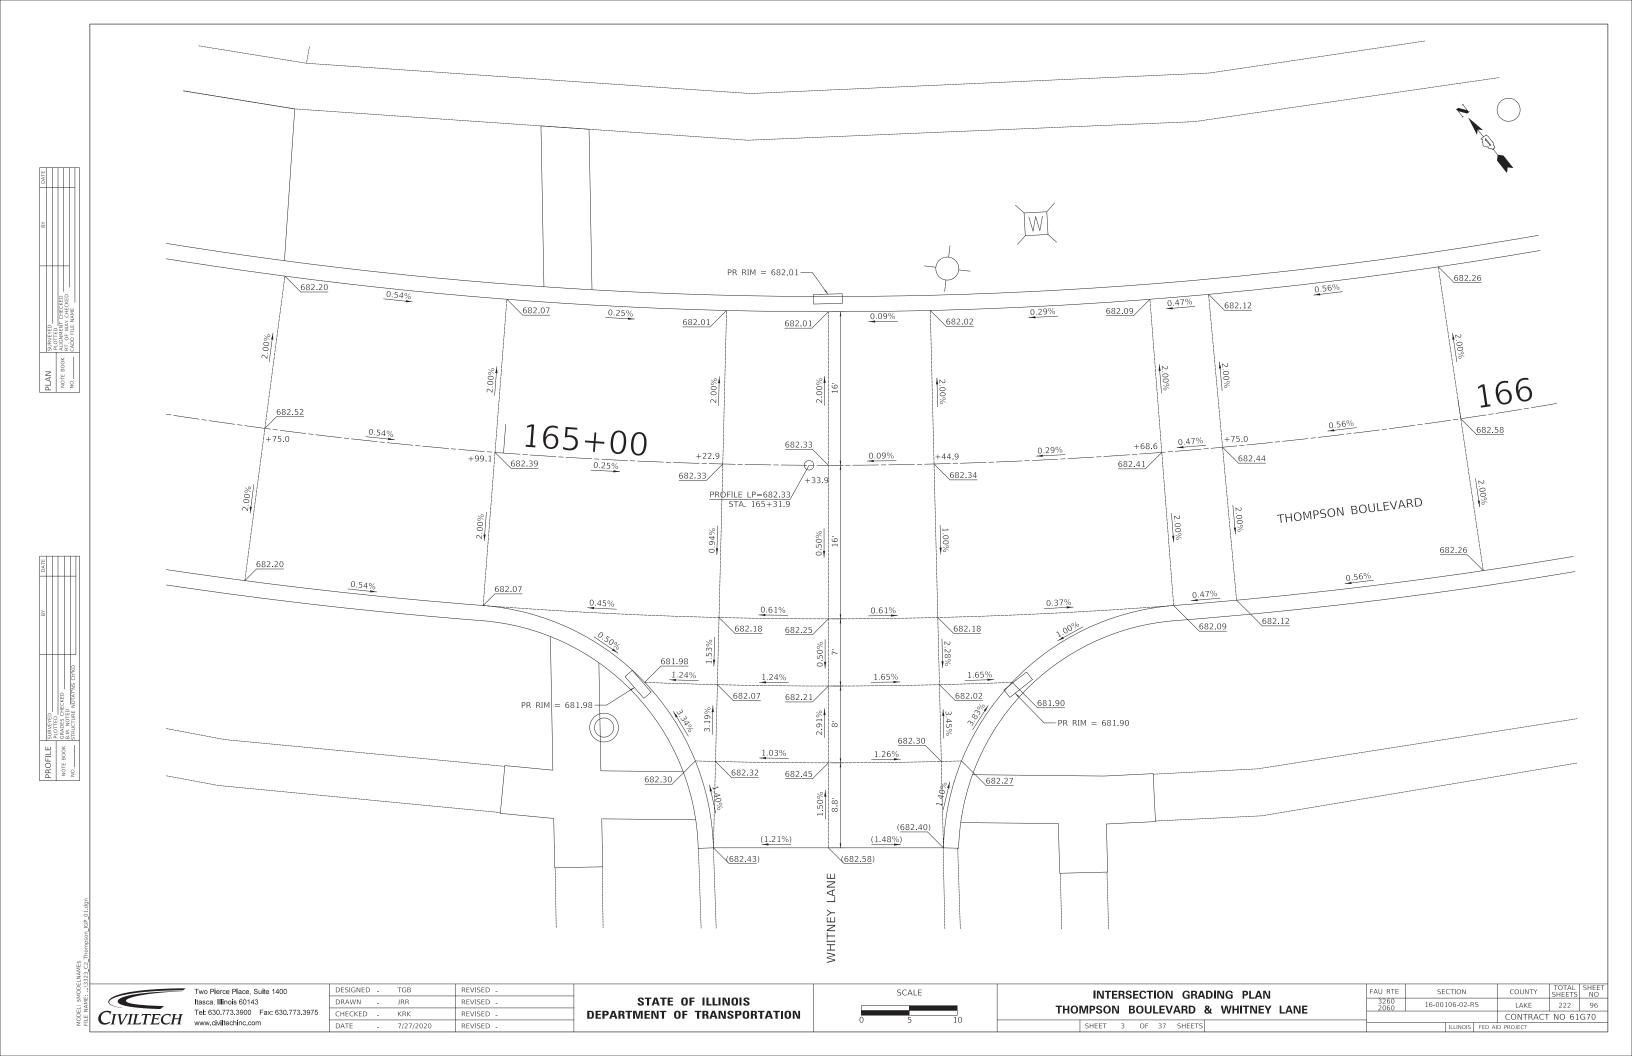

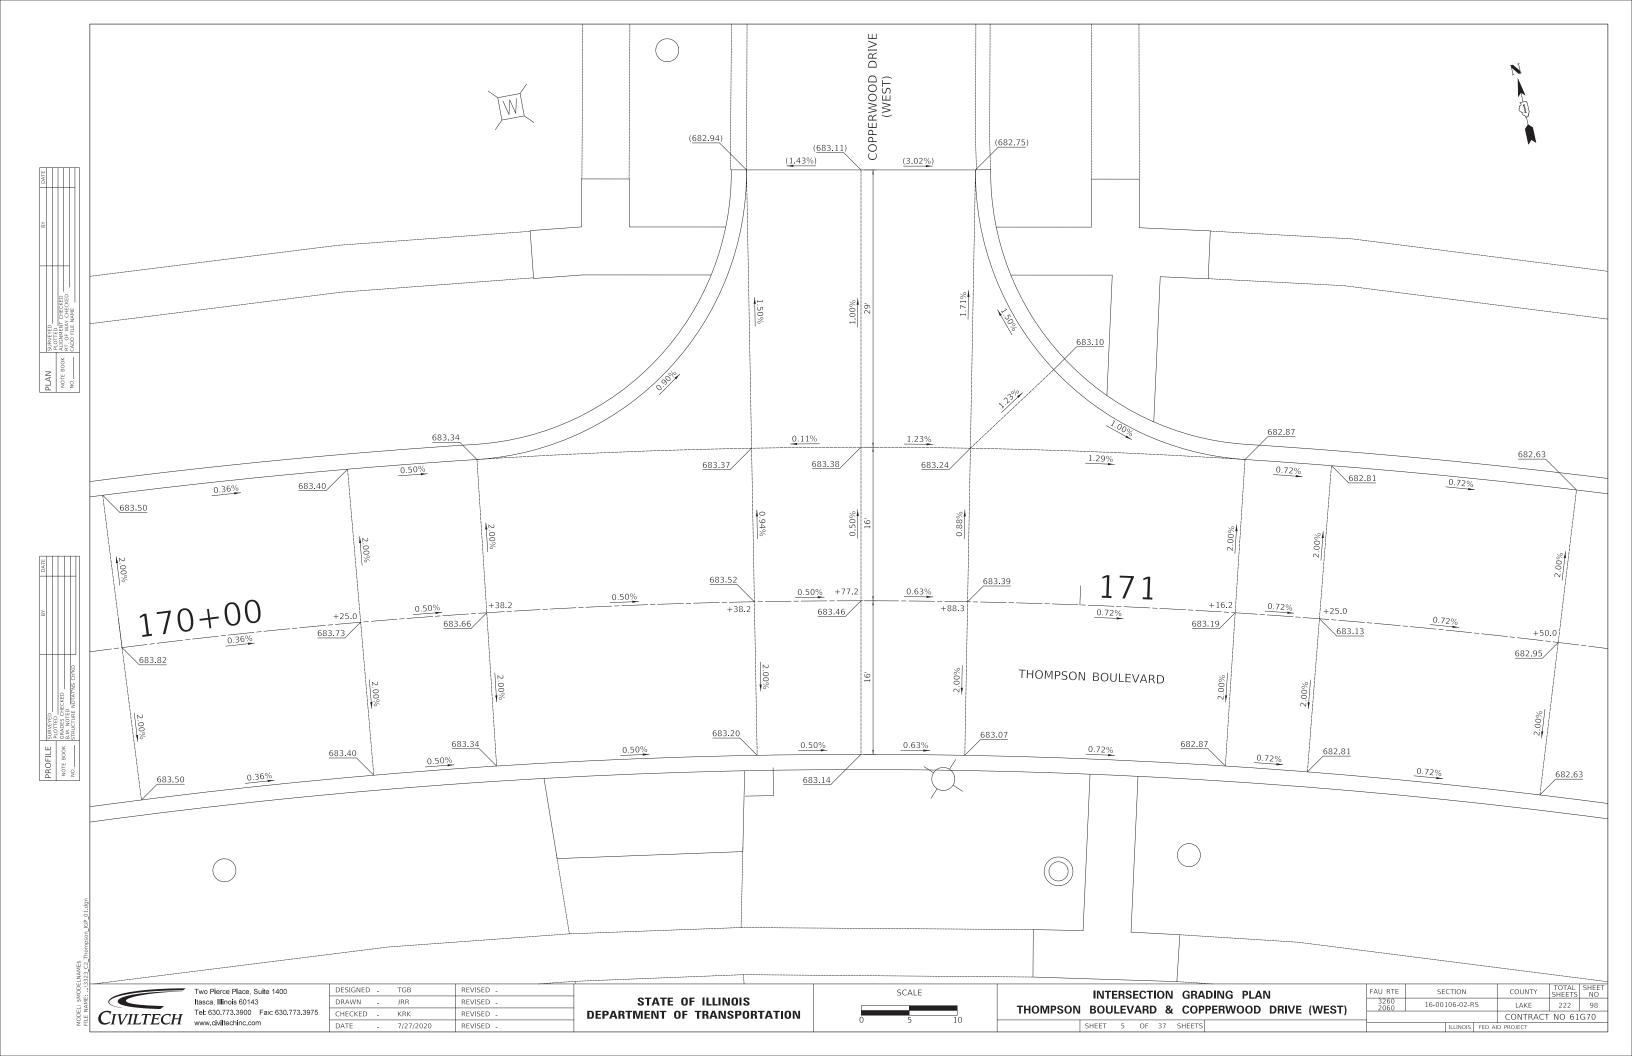

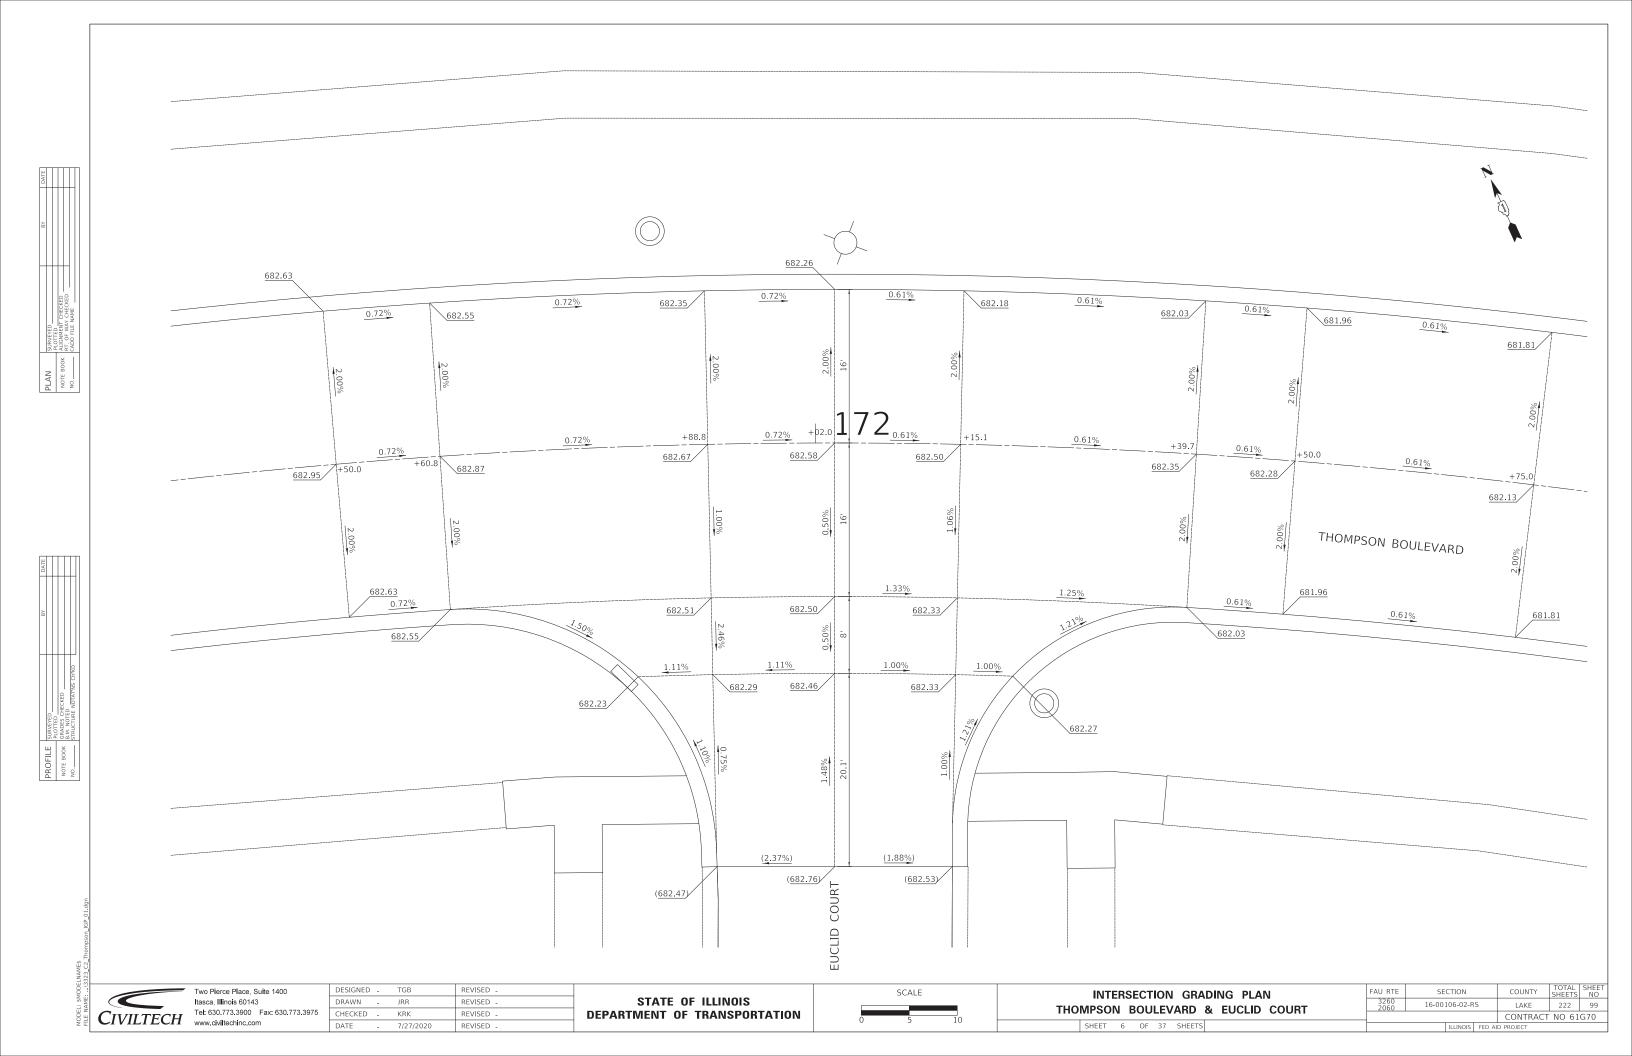

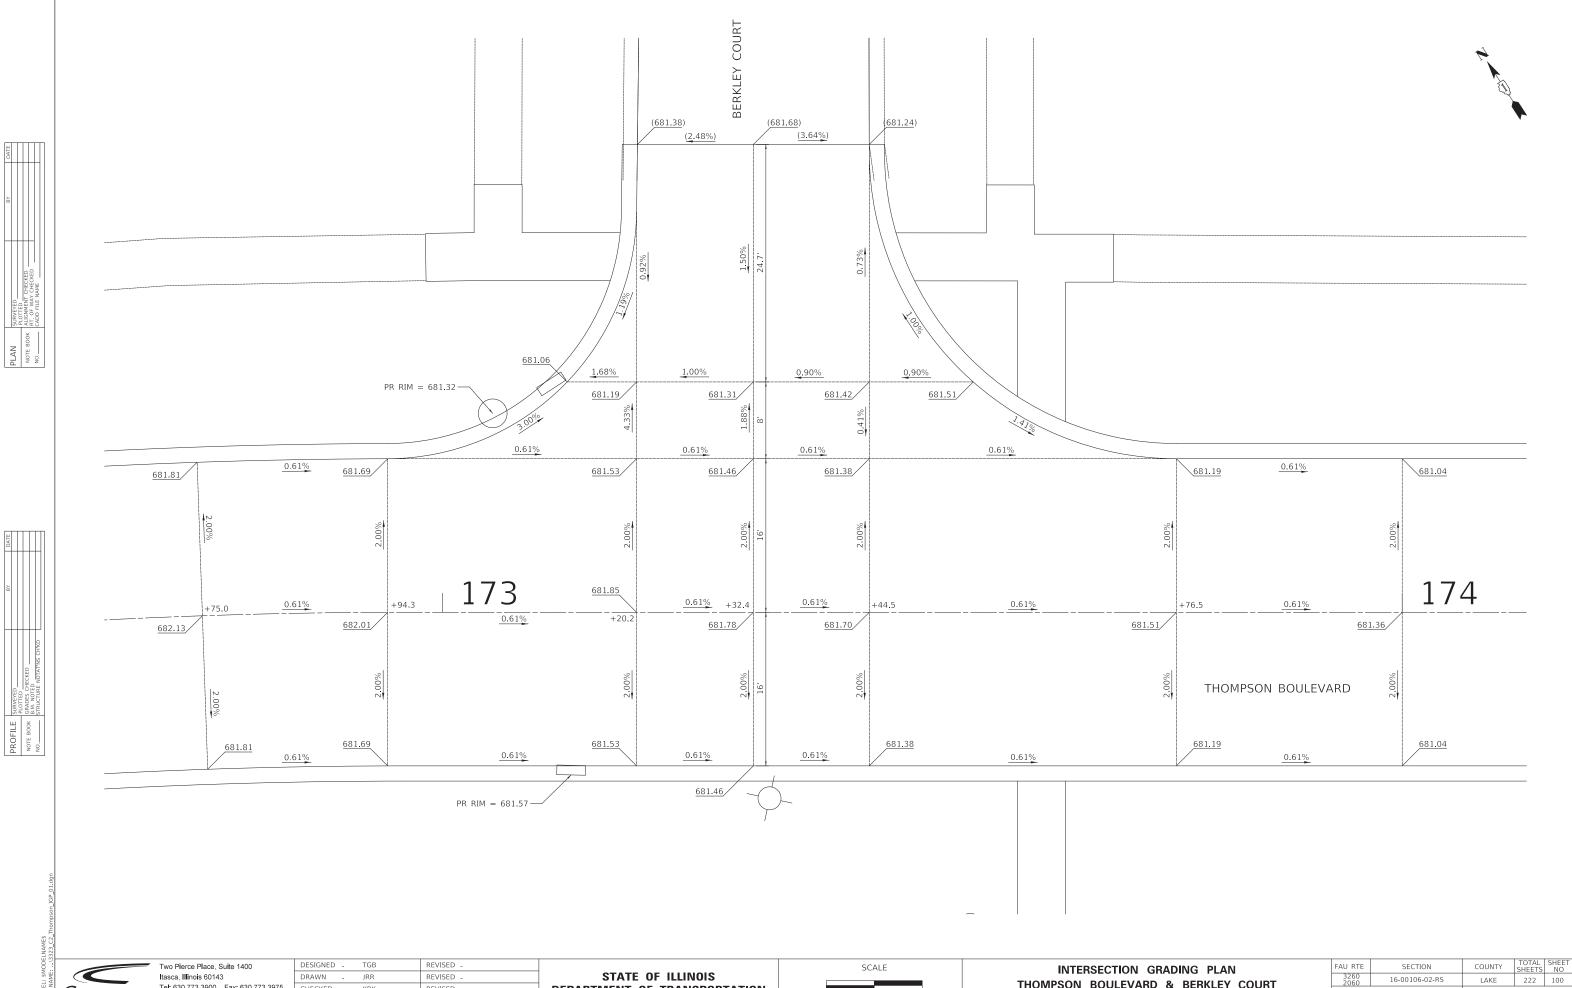

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**DEPARTMENT OF TRANSPORTATION** 

16-00106-02-RS THOMPSON BOULEVARD & BERKLEY COURT CONTRACT NO 61G70 SHEET 7 OF 37 SHEETS