11-08-2019 LETTING ITEM 073

FOR INDEX OF SHEETS, SEE SHEET NO. 2 FOR INDEX OF HIGHWAY STANDARDS, SEE SHEET NO. 2

#### STATE OF ILLINOIS **DEPARTMENT OF TRANSPORTATION**

## PLANS FOR PROPOSED **FEDERAL AID HIGHWAY**

**BROOKFIELD AND CONGRESS PARK METRA STATION COVERED BICYCLE SHELTERS SECTION NO.: 17-00130-00-MS** PROJECT NO.: DFKO(929) VILLAGE OF BROOKFIELD **COOK COUNTY** 

C-91-294-18

TRAFFIC DATA ADT (2014) = POSTED SPEED LIMIT = 25 MPH DESIGN SPEED LIMIT = 25 MPH

**DESIGN DESIGNATION** MINOR COLLECTOR

> PROJECT LOCATED IN THE **VILLAGE OF BROOKFIELD**

**CONGRESS PARK METRA STATION** STA 1+00 TO STA 2+88 SCALE: 1" = 20'

**FULL SIZE PLANS HAVE BEEN PREPARED USING STANDARD** ENGINEERING SCALES, REDUCED SIZED PLANS WILL NOT CONFORM TO STANDARD SCALES. IN MAKING MEASUREMENTS ON REDUCED PLANS, THE ABOVE SCALES MAY BE USED.

CONTRACT NO. 61G07

Know what's below. Call before you dig.

- AREA OF IMPROVEMENT GROSS LENGTH OF IMPROVEMENT = 226 FT = .04 MI NET LENGTH OF IMPROVEMENT = 226 FT = .04 MI

SECTION 17-00130-00-M8 COOK RUNOIS PROJECT DFKO(929) CONTRACT NO. 61G07



LOCATION OF SECTION **INDICATED THUS:** 

3RD PM

(NOT TO SCALE)

BROOKFIELD **METRA STATION** STA 1+27 TO STA 1+65



PRINTED BY THE AUTHORITY OF THE STATE OF ILLINOIS





- ◆ Civil Engineers
- Municipal Consultants
- Westchester, IL, 60154-2780 Phone: 708-865-0300

FEDERAL AID PROGRAM ENGINEER: CARMEN E. RAMOS, SCHAUMBURG, IL

◆ Established 1911 www.ehancock.com

EHE PROJECT NO 125-19-08280

## **INDEX OF SHEETS**

## **IDOT HIGHWAY STANDARDS**

SHEET NO.	DESCRIPTION
1	COVER SHEET, LOCATION MAP
2	INDEX OF SHEETS, AND IDOT HIGHWAY STANDARDS
3	GENERAL NOTES
4	SUMMARY OF QUANTITIES
5-6	TYPICAL SECTIONS
7-8	REMOVAL PLANS
9-10	PROPOSED PLANS
11-12	JOB SPECIFIC DETAILS
13	TRAFFIC CONTROL AND PROTECTION FOR SIDE ROADS, INTERSECTIONS, AND DRIVEWAYS (TC-10)

STANDARD NO.	DESCRIPTION
000001-07	STANDARD SYMBOLS, ABBREVIATIONS AND PATTERNS
280001-07	TEMPORARY EROSION CONTROL SYSTEMS
424001-11	PERPENDICULAR CURB RAMPS FOR SIDEWALKS
701501-06	URBAN LANE CLOSURE, 2-LANE, 2-WAY, UNDIVIDED
701701-10	URBAN LANE CLOSURE, MULTILANE INTERSECTION
701801-06	SIDEWALK, CORNER, OR CROSSWALK CLOSURE
701901-08	TRAFFIC CONTROL DEVICES

### UNDERGROUND UTILITIES

BEFORE STARTING ANY EXCAVATION, THE CONTRACTOR SHALL CALL "JULIE" AT 811 FOR FIELD LOCATIONS OF BURIED ELECTRICAL, TELEPHONE AND GAS FACILITIES. (48 HOURS NOTIFICATION IS REQUIRED).

THE LOCATIONS OF THE UNDERGROUND UTILITIES IF SHOWN ON THE PLANS HAVE BEEN OBTAINED BY FIELD SURVEYS AND SEARCHES OF AVAILABLE RECORDS. IT IS BELIEVED THAT DATA IS ESSENTIALLY CORRECT, BUT THE VILLAGE OF BROOKFIELD, THE ILLINOIS DEPARTMENT OF TRANSPORTATION AND/OR OTHER OFFICES AND AGENCIES ASSOCIATED WITH THE DEVELOPMENT OF THESE PLANS DO NOT GUARANTEE THEIR ACCURACY OR COMPLETENESS. THE CONTRACTOR WILL BE REQUIRED TO VERIFY THE EXACT LOCATION OF EACH FACILITY WITH THE UTILITY COMPANY, AND SHALL TAKE DUE CARE IN ALL PHASES OF THE CONSTRUCTION TO PROTECT ANY SUCH FACILITIES WHICH MAY BE AFFECTED BY THE WORK. ANY DAMAGE TO EXISTING UTILITIES SHALL BE REPAIRED.

THE CONTRACTOR SHALL COORDINATE CONSTRUCTION ACTIVITIES WITH UTILITY COMPANIES AND THE VILLAGE OF BROOKFIELD.

### TREE PROTECTION

EXISTING TREES AT PARKWAYS OUTSIDE OF CONSTRUCTION LIMITS SHALL REMAIN DURING THE CONSTRUCTION. ANY DAMAGE TO EXISTING TREES BY THE CONTRACTOR SHALL BE REPLACED IN KIND BY THE CONTRACTOR.

### **OPEN EXCAVATIONS**

THE CONTRACTOR SHALL NOT LEAVE ANY EXCAVATION NECESSARY FOR PAVEMENT PATCHES OR STRUCTURE ADJUSTMENTS OPEN OVERNIGHT. THE CONTRACTOR SHALL BE RESPONSIBLE FOR COMPLETELY BACKFILLING OR INSTALLING A PLATE OVER ALL EXCAVATIONS AT THE END OF EACH DAY.

#### **CONCRETE BREAKERS**

WHEN REMOVING PAVEMENT AND/OR OTHER STRUCTURES, THE CONTRACTOR SHALL NOT USE ANY TYPE OF CONCRETE BREAKERS SUCH AS DROP HAMMERS, THAT MIGHT DAMAGE UNDERGROUND PUBLIC OR PRIVATE UTILITIES.

### **SAW CUTTING**

THE CONTRACTOR SHALL SAW CUT ASPHALT PAVEMENT AS INDICATED ON THE PLANS TO SEPARATE THE EXISTING PAVEMENT TO BE REMOVED BY APPROVED MEANS OR AN APPROVED CONCRETE SAW TO A DEPTH AS DIRECTED BY THE ENGINEER. SUITABLE GUIDELINES OR DEVICES SHALL BE USED TO ASSURE CUTTING A NEAT, STRAIGHT LINE AS SHOWN ON THE PLANS. CARE SHALL BE TAKEN BY THE CONTRACTOR AS NOT TO DAMAGE THE REMAINING PAVEMENT DIRECTLY ADJACENT TO THE PAVEMENT TO BE REMOVED. ANY DAMAGE TO THE EXISTING PAVEMENT RESULTING FROM PAVEMENT REMOVAL OPERATIONS SHALL BE REPAIRED.

### FIELD OFFICE

THE CONTRACTOR WILL NOT BE ALLOWED TO SET UP A YARD OR FIELD OFFICE ON STATE OR VILLAGE PROPERTY WITHOUT WRITTEN PERMISSION FROM THE ENGINEER.

		0==0		F.A.U. RTE.	SECTION	COUNTY	TOTAL SHEETS	SHEET NO.
GENERAL NOTES				-	17-00130-00-MS	соок	13	3
	,					CONTRACT	NO. 6	1G07
SCALE: NONE	SHEET NO. 1 OF 1 SHEETS	STA	TO STA	FED. I	ROAD DIST. NO. 1 ILLINOI	S FED. AID PRO	DJECT	

Aug 20, 2019 - 18:47am
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S.P.	S.I.	Code No.	ltem	Unit	Total Quantity	Const. Type Code 0028 80%Federal 20%Local
		20200100	EARTH EXCAVATION	CU YD	50	50
		704004	TODGOU EURANGU AND DEACE A"	SQ YD	60	60
		21101615	TOPSOIL FURNISH AND PLACE, 4"	30,10	60	00
		25200100	SODDING	SQ YD	60	60
		0500000	CURRENT WATERWE	UNIT	5	5
		25200200	SUPPLEMENTAL WATERING	UNII	3	3
		35101600	AGGREGATE BASE COURSE, TYPE B 4"	SQ YD	200	200
		42400200	PORTLAND CEMENT CONCRETE SIDEWALK 5 INCH	SQFT	960	960
		42400300	PORTLAND CEMENT CONCRETE SIDEWALK & INCH	SQPT	708	768
				SQ FT	10	10
_		42400800	DETECTABLE WARNINGS	30(1)	10	10
		44000500	COMBINATION CURB AND GUTTER REMOVAL	FOOT	10	10
•		44000600	SIDEWALK REMOVAL	SQ FT	660	660
		60604100	COMBINATION CONCRETE CURB AND GUTTER, TYPE B-6.12 [MODIFIED]	FOOT	10	10
•	•	66900200	NON-SPECIAL WASTE DISPOSAL	CU YD	30	30
-		66901001	REGULATED SUBSTANCES PRE-CONSTRUCTION PLAN	LSUM	1	1
	*	66901002	ON-SITE MONITORING OF REGULATED SUBSTANCES	CAL DA	1	3
	*	66901003	REGULATED SUBSTANCES FINAL CONSTRUCTION REPORT	LSUM	1	1
		66900530	SOIL DISPOSAL ANALYSIS	EACH	2	2
		67100100	MOBILIZATION	LSUM	1	1
	<del> </del>	67100100	WORLEZATION			-
		70102620	TRAFFIC CONTROL AND PROTECTION, STANDARD 701501	LSUM	1	1
		70102635	TRAFFIC CONTROL AND PROTECTION, STANDARD 701701	LSUM	1	1
	-	70102640	TRAFFIC CONTROL AND PROTECTION, STANDARD 701801	LSUM	1	1
		.0102040			_	-
	*	78008230	POLYUREA PAVEMENT MARKING LINE TYPE I - LINE 6"	FOOT	160	160
		78008250	POLYUREA PAVEMENT MARKING LINE TYPE I - LINE 12"	FOOT	250	250
	-	XX008686	BIKE SHELTER	EACH	4	4
•	-	Z0003855	BICYCLE RACKS	EACH	10	10
`		20048665	RAILROAD PROTECTIVE LIABILITY INSURANCE	LSUM	1	1
	-	XX00933	g Bicycle repair Station	EACH	2	2
ļ	+			_		


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	ANNOUNCE POR AN	Civil Engineers     Municipal Consultants     Established 1911

1	DATE -	6-28-19	REVISED	**
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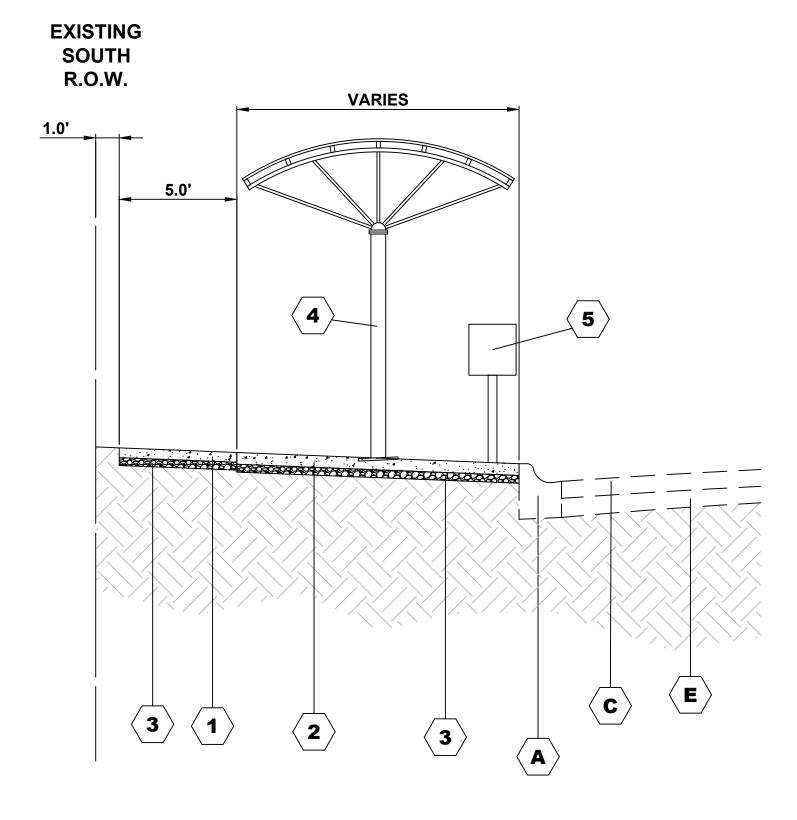
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DEPARTMENT	OF TRANSPORTATION	Į

SCALE: NONE

		RTE.	SECTION		
	SUMMARY OF QUANTITIES				17-00130-00-MS
_	SHEET NO. 1 OF 1 SHE	ETS STA	TO STA	FEO.	ROAD DIST. NO. 1 ILLINOIS

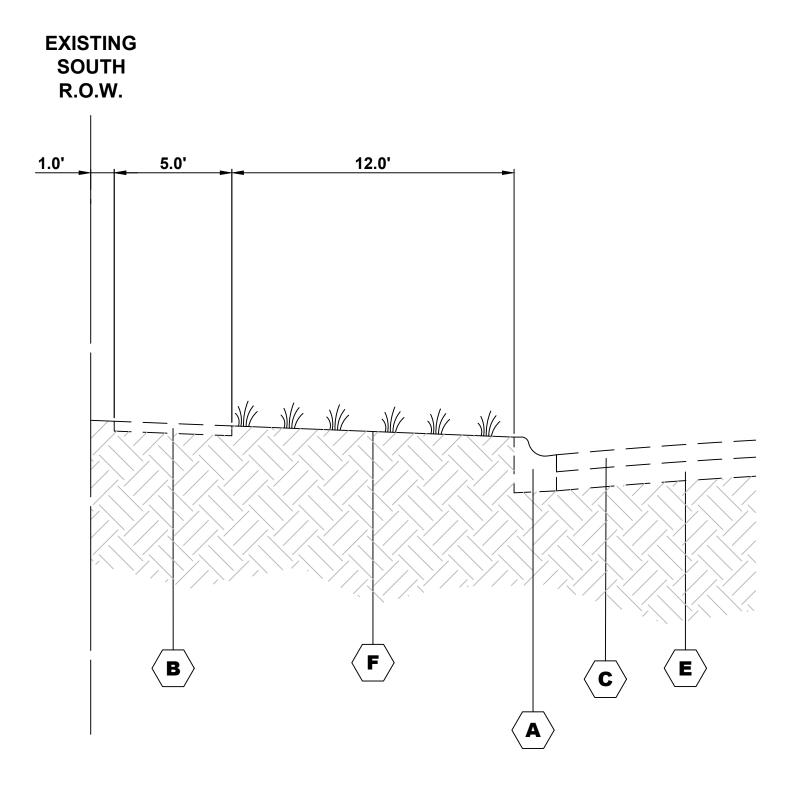

# EXISTING TYPICAL SECTION CONGRESS PARK METRA STATION STA 1+00 TO STA 2+88



## PROPOSED TYPICAL SECTION CONGRESS PARK METRA STATION STA 1+00 TO STA 2+88

		LEGEND OF SYMBOLS
	SYMBOL	DESCRIPTION
	<b>(A</b> )	EXISTING COMBINATION CONCRETE CURB AND GUTTER, TYPE B-6.12
5	<b>B</b>	EXISTING PORTLAND CEMENT CONCRETE SIDEWALK
EXISTII	<b>(c</b> )	EXISTING PORTLAND CEMENT CONCRETE PAVEMENT
EX	D	EXISTING HOT-MIX ASPHALT BINDER AND SURFACE COURSES
	E	EXISTING AGGREGATE BASE COURSE
	<b>(F</b> )	EXISTING LANDSCAPED PARKWAY
	1	PROPOSED PORTLAND CEMENT CONCRETE SIDEWALK, 5"
SED	<b>2</b>	PROPOSED PORTLAND CEMENT CONCRETE SIDEWALK, 6"
0	3	AGGREGATE BASE COURSE, TYPE B, 4"
PROP	4	PROPOSED BICYCLE SHELTER (SEE JOB SPECIFIC DETAILS SHEET FOR INFO)
	5	BICYCLE REPAIR STATION

HANCOCK	Years of
ENGINEERING	100+ 100+ 100+

◆ Civil Engineers

◆ Municipal Consultants

◆ Established 1911

9933 Roosevelt Road Westchester, IL, 60154-2780 Phone: 708-865-0300 www.ehancock.com

 DESIGNED - REVISED 

 DRAWN - TG, SFB, DMM
 REVISED 

 CHECKED - REVISED 

 DATE - 6-28-19
 REVISED

STATE OF ILLINOIS
DEPARTMENT OF TRANSPORTATION

TYPICAL SECTIONS

SHEET NO. 1 OF 2 SHEETS STA. TO STA.

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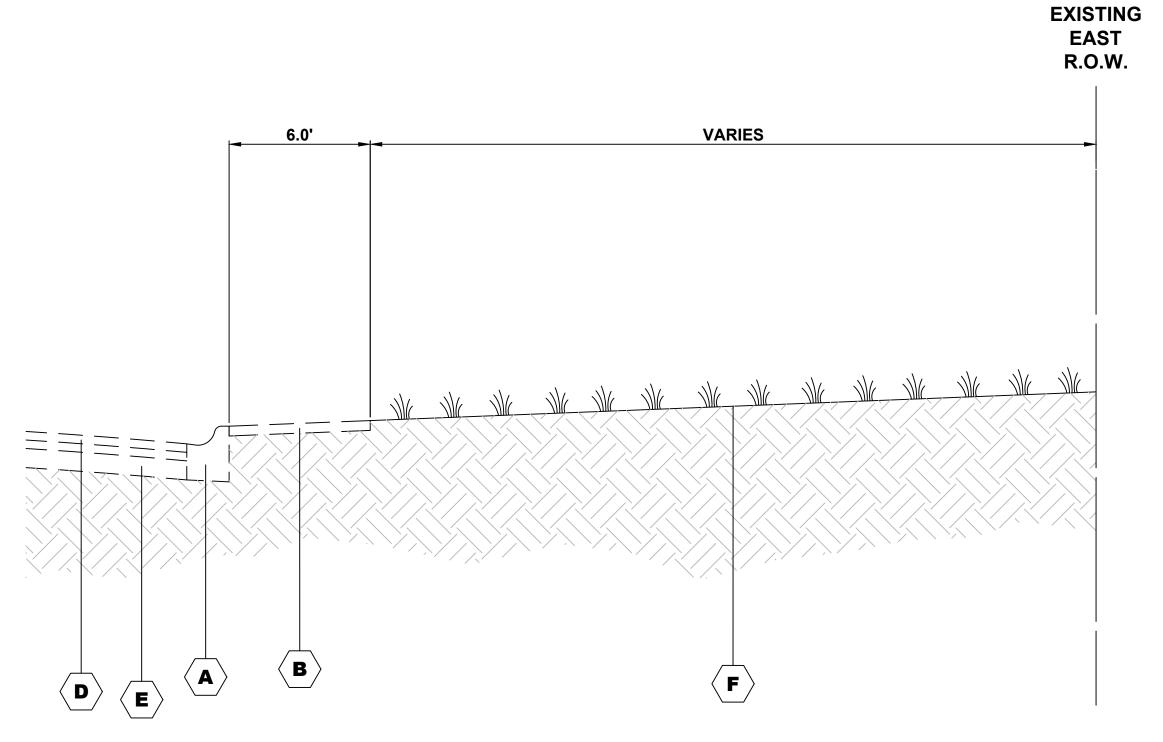
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- 17-00130-00-MS COOK 13 5


CONTRACT NO. 61G07

FED. ROAD DIST. NO. 1 ILLINOIS FED. AID PROJECT

E.H.E. PROJECT NO. 125-19-08280



## **EXISTING TYPICAL SECTION BROOKFIELD METRA STATION STA 1+27 TO STA 1+65**

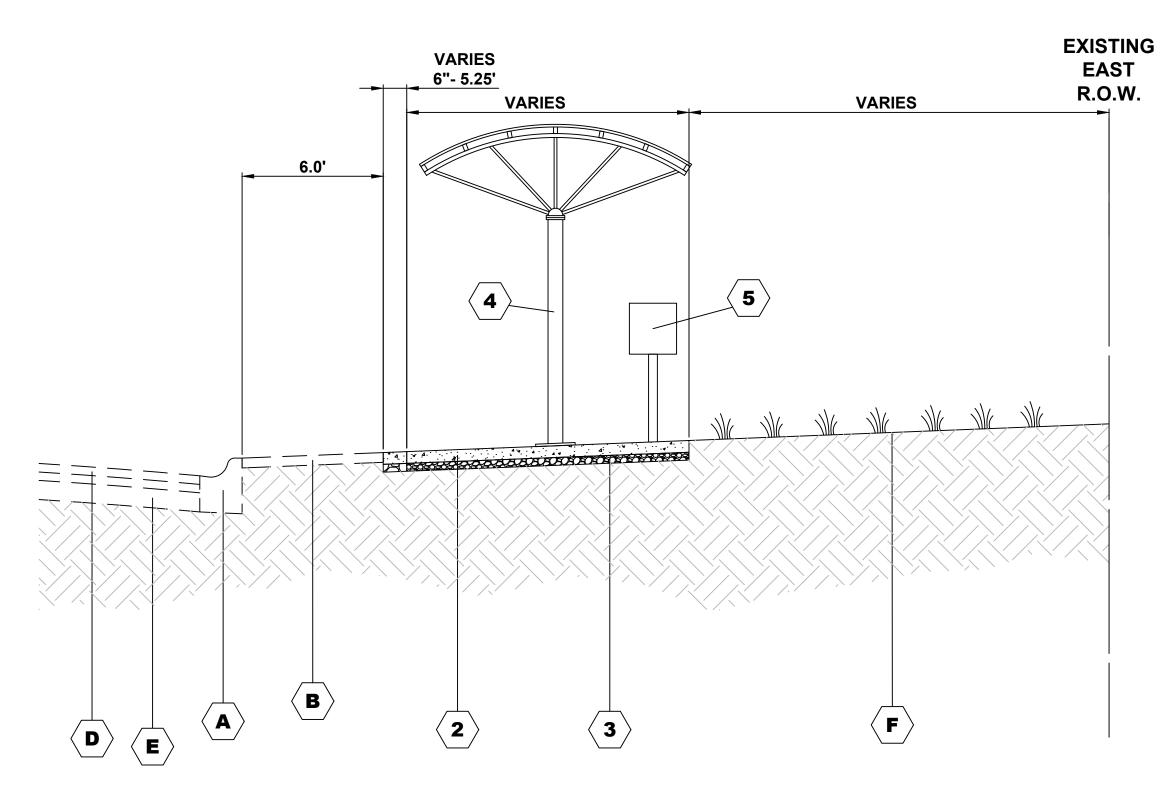

### PROPOSED TYPICAL SECTION

**BROOKFIELD METRA STATION STA 1+27 TO STA 1+65** 

Â	HANCOCK ENGINEERING	lence
	ENGINEERING	100+ Y Expel

Civil Engineers Municipal Consultants Established 1911

REVISED -DESIGNED - -REVISED -DRAWN - TG, SFB, DMM REVISED -CHECKED - -REVISED -6-28-19

**STATE OF ILLINOIS DEPARTMENT OF TRANSPORTATION** 


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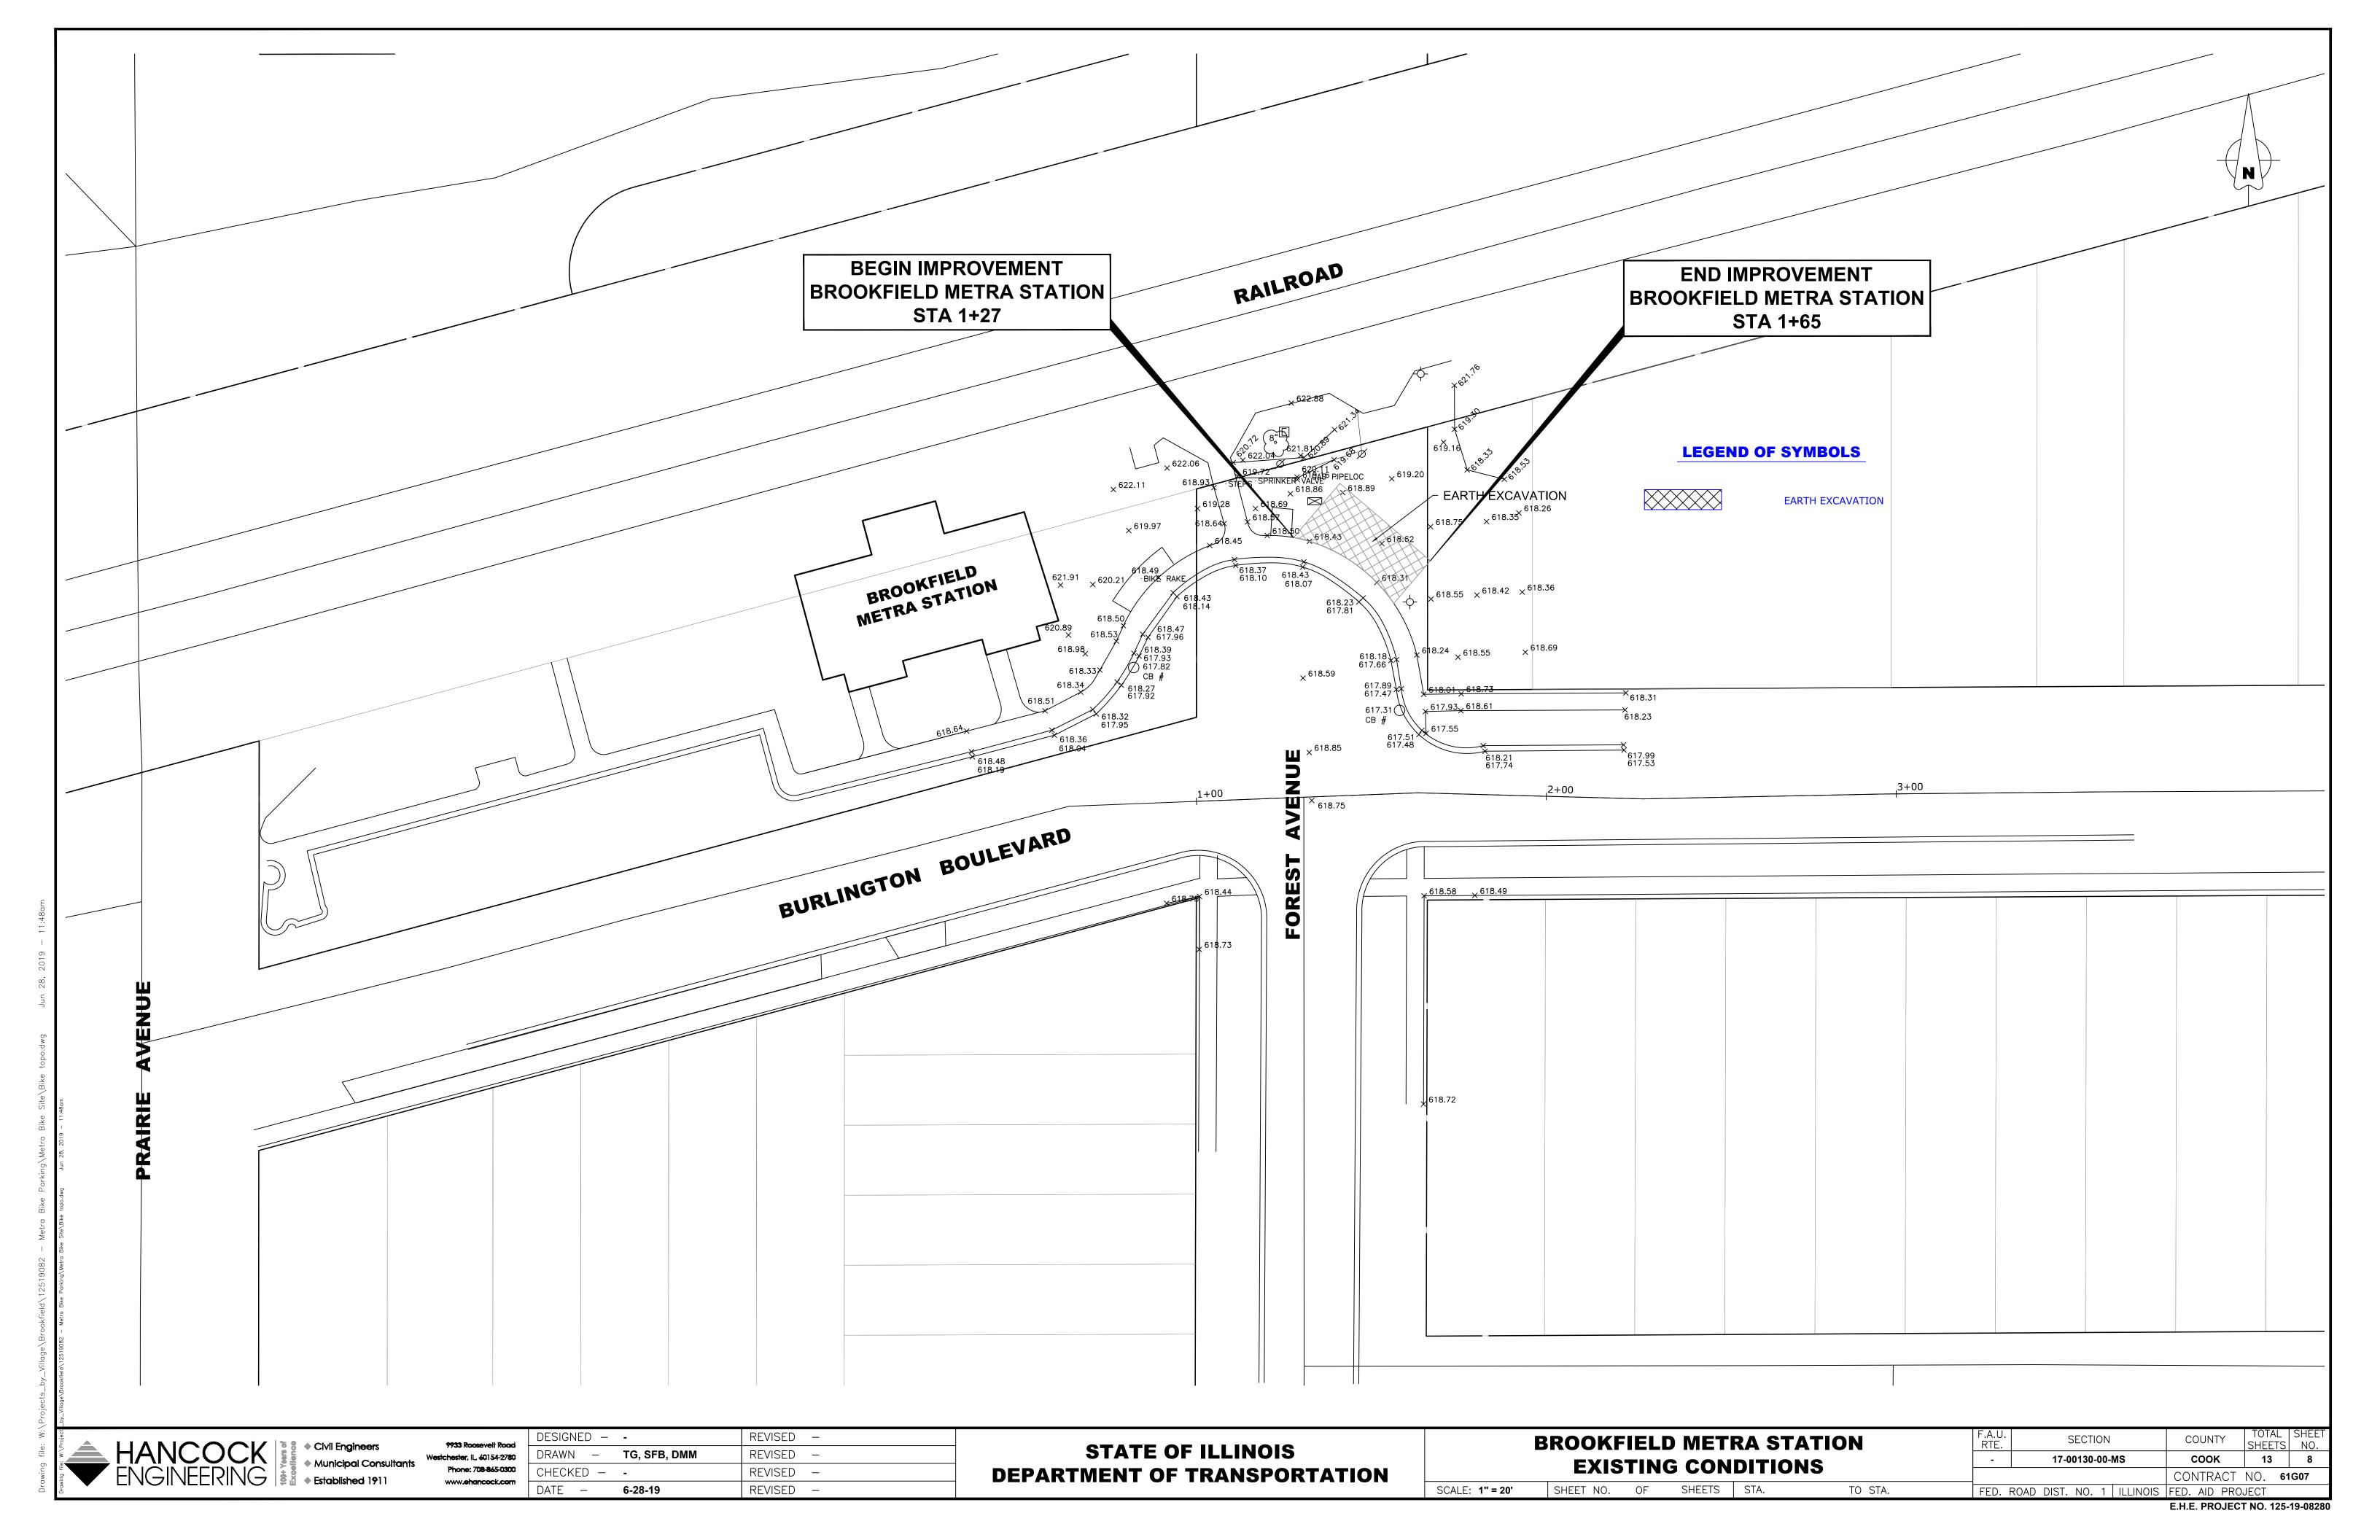
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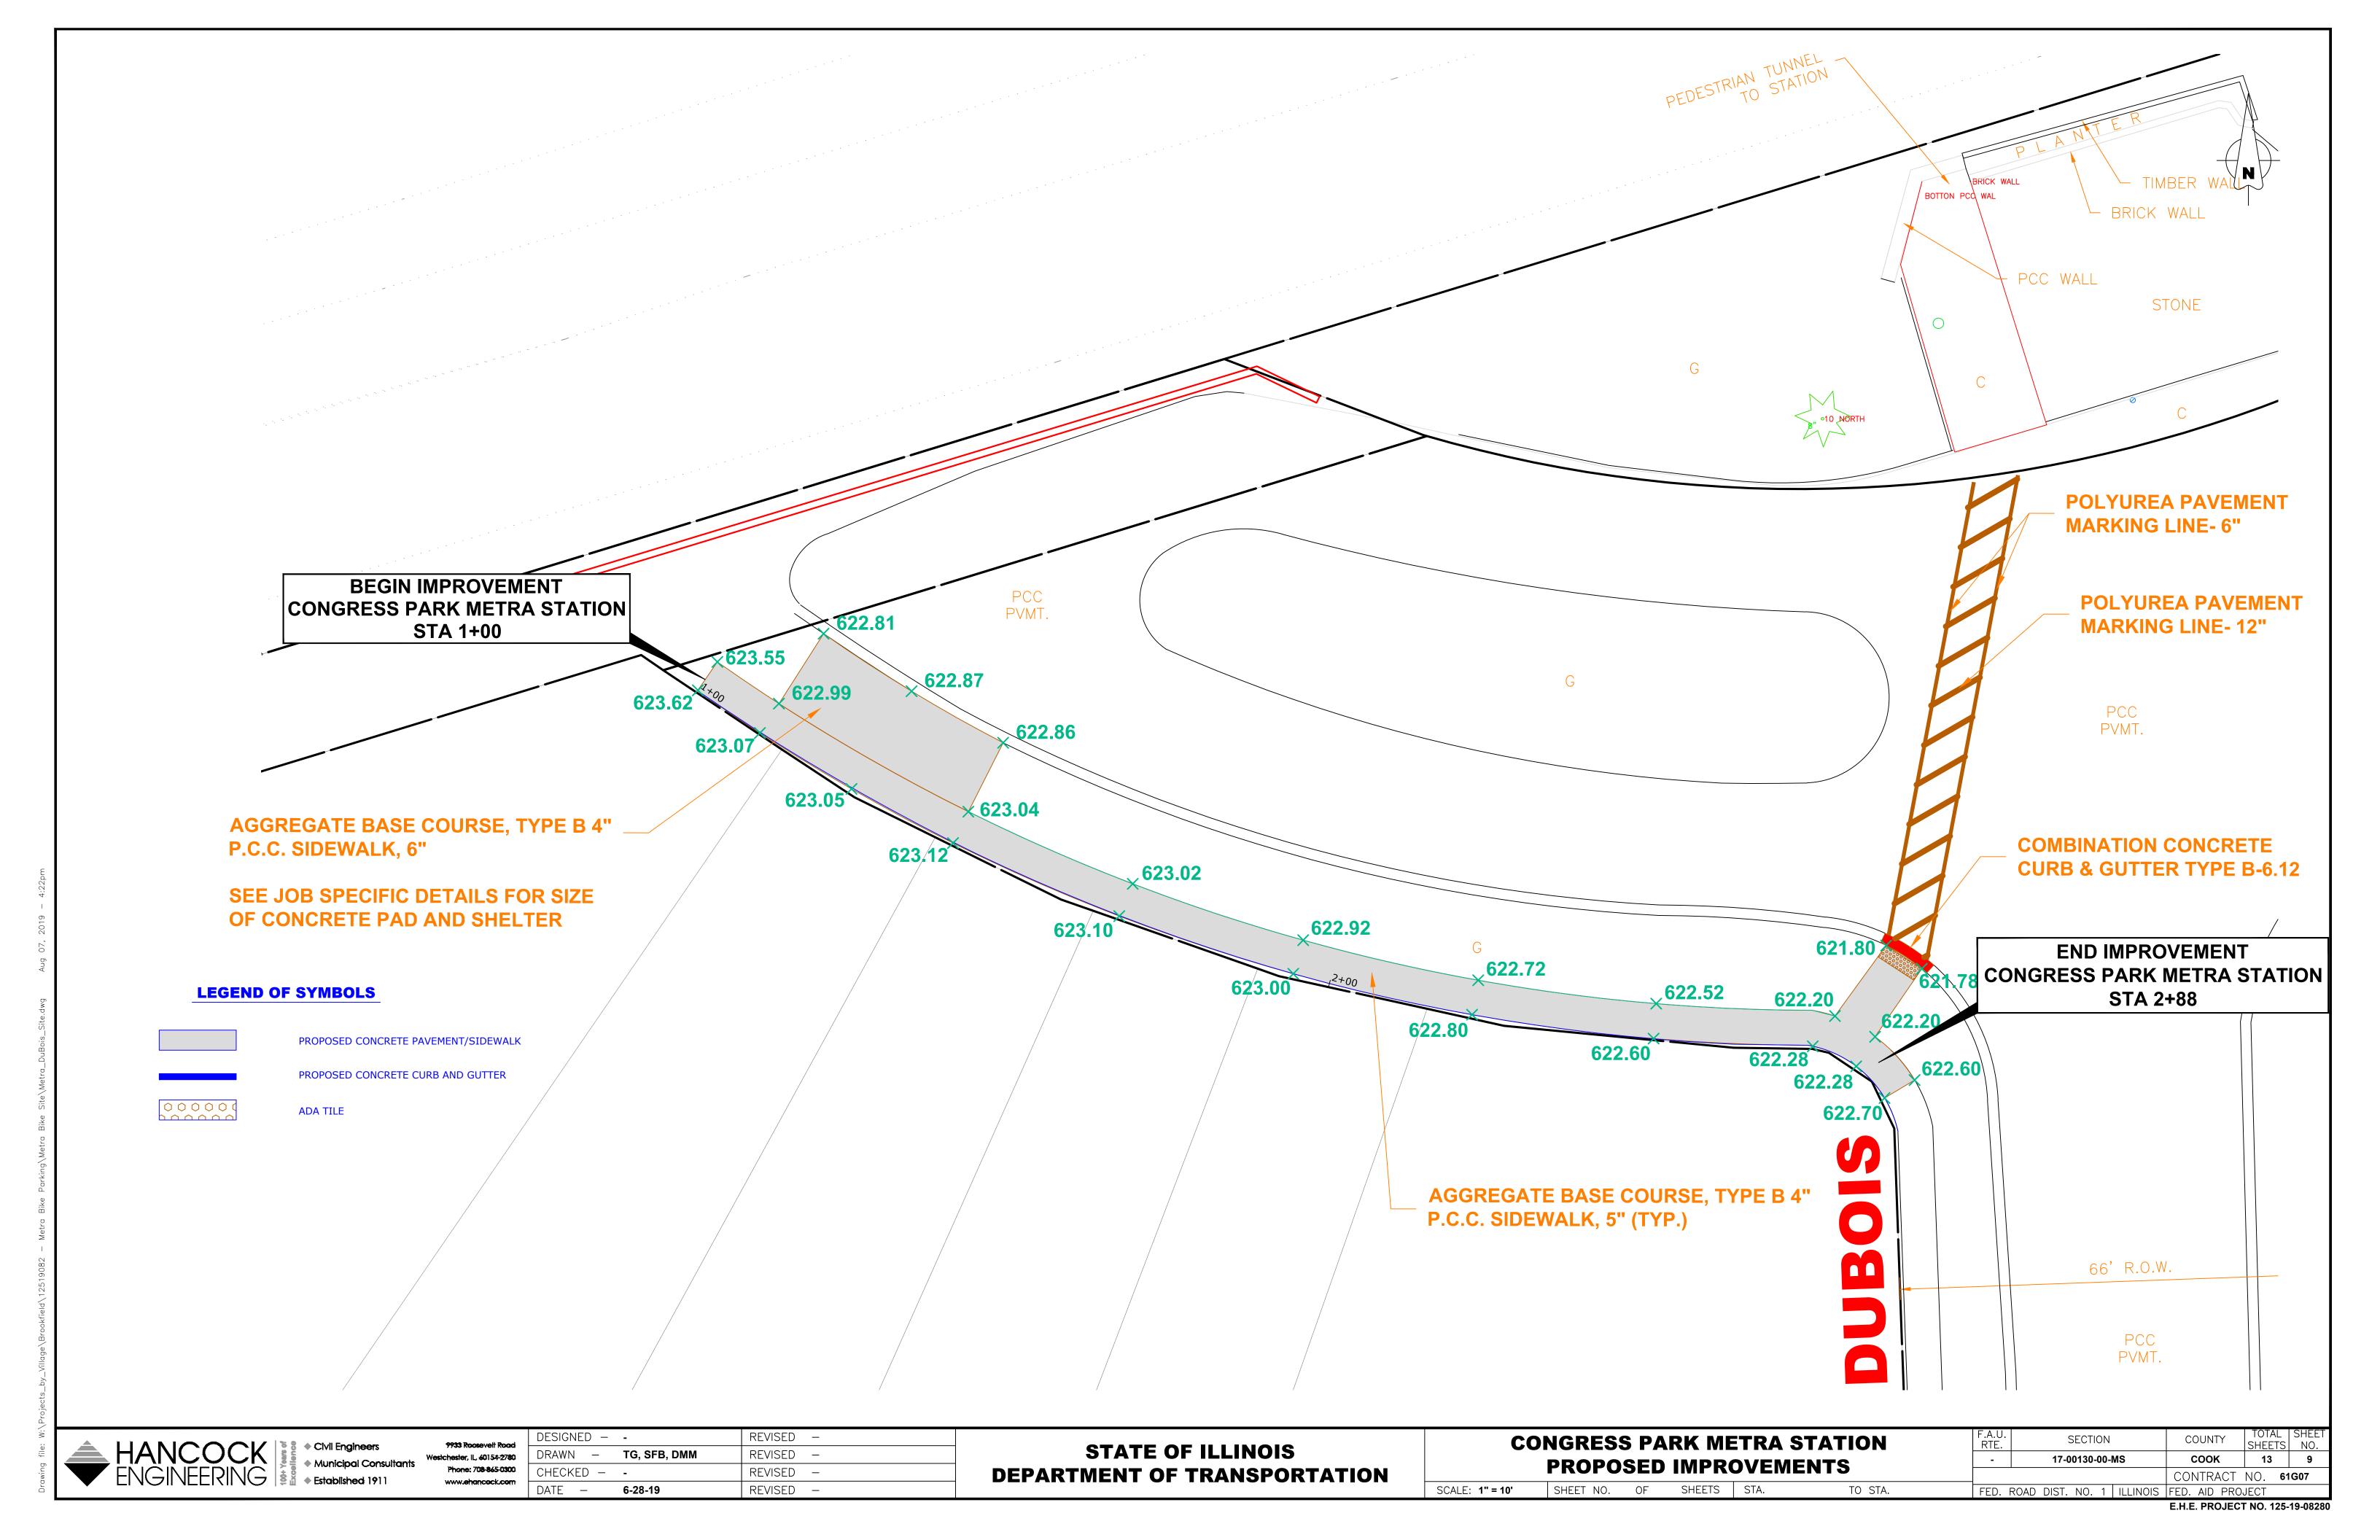
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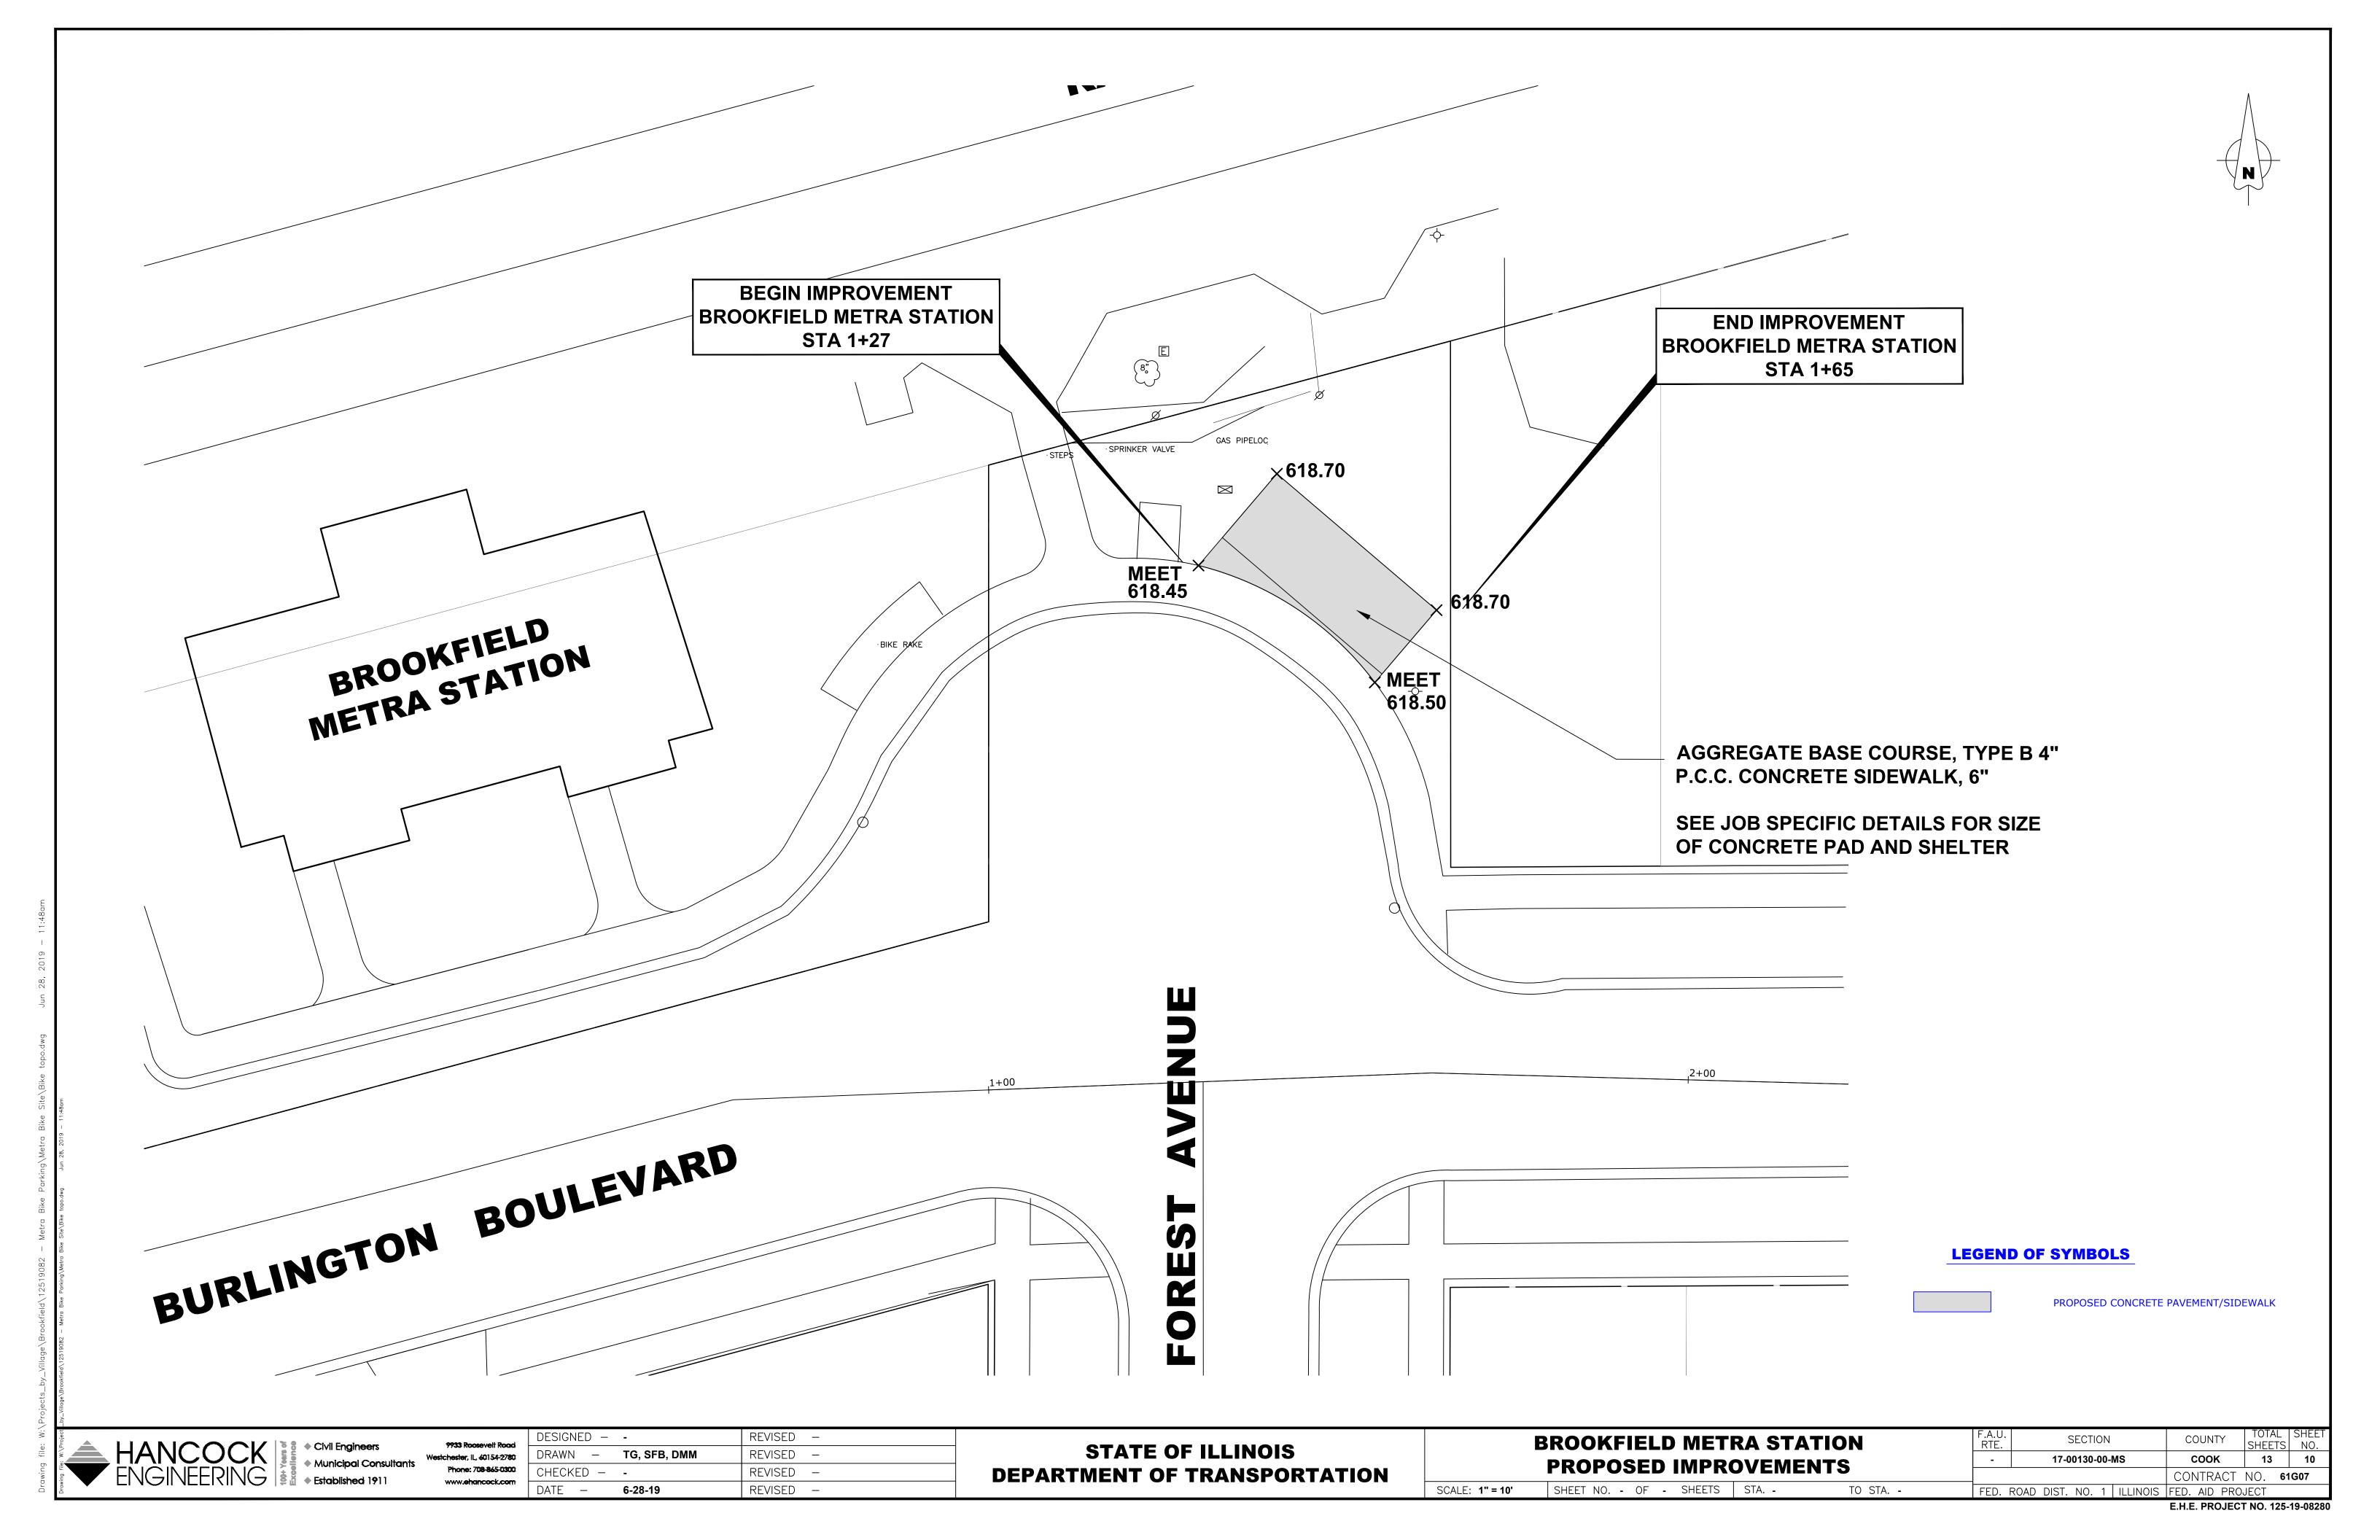
E.H.E. PROJECT NO. 125-19-08280


	LEGEND OF SYMBOLS								
	SYMBOL	DESCRIPTION							
EXISTING	<b>(A</b> )	EXISTING COMBINATION CONCRETE CURB AND GUTTER, TYPE B-6.12							
	<b>B</b>	EXISTING PORTLAND CEMENT CONCRETE SIDEWALK							
	<b>(c</b> )	EXISTING PORTLAND CEMENT CONCRETE PAVEMENT							
		EXISTING HOT-MIX ASPHALT BINDER AND SURFACE COURSES							
	E	EXISTING AGGREGATE BASE COURSE							
	<b>(F</b> )	EXISTING LANDSCAPED PARKWAY							
PROPOSED	1	PROPOSED PORTLAND CEMENT CONCRETE SIDEWALK, 5"							
	<b>2</b>	PROPOSED PORTLAND CEMENT CONCRETE SIDEWALK, 6"							
	3	AGGREGATE BASE COURSE, TYPE B, 4"							
	4	PROPOSED BICYCLE SHELTER (SEE JOB SPECIFIC DETAILS SHEET FOR INFO)							
	<b>(5</b> )	BICYCLE REPAIR STATION							







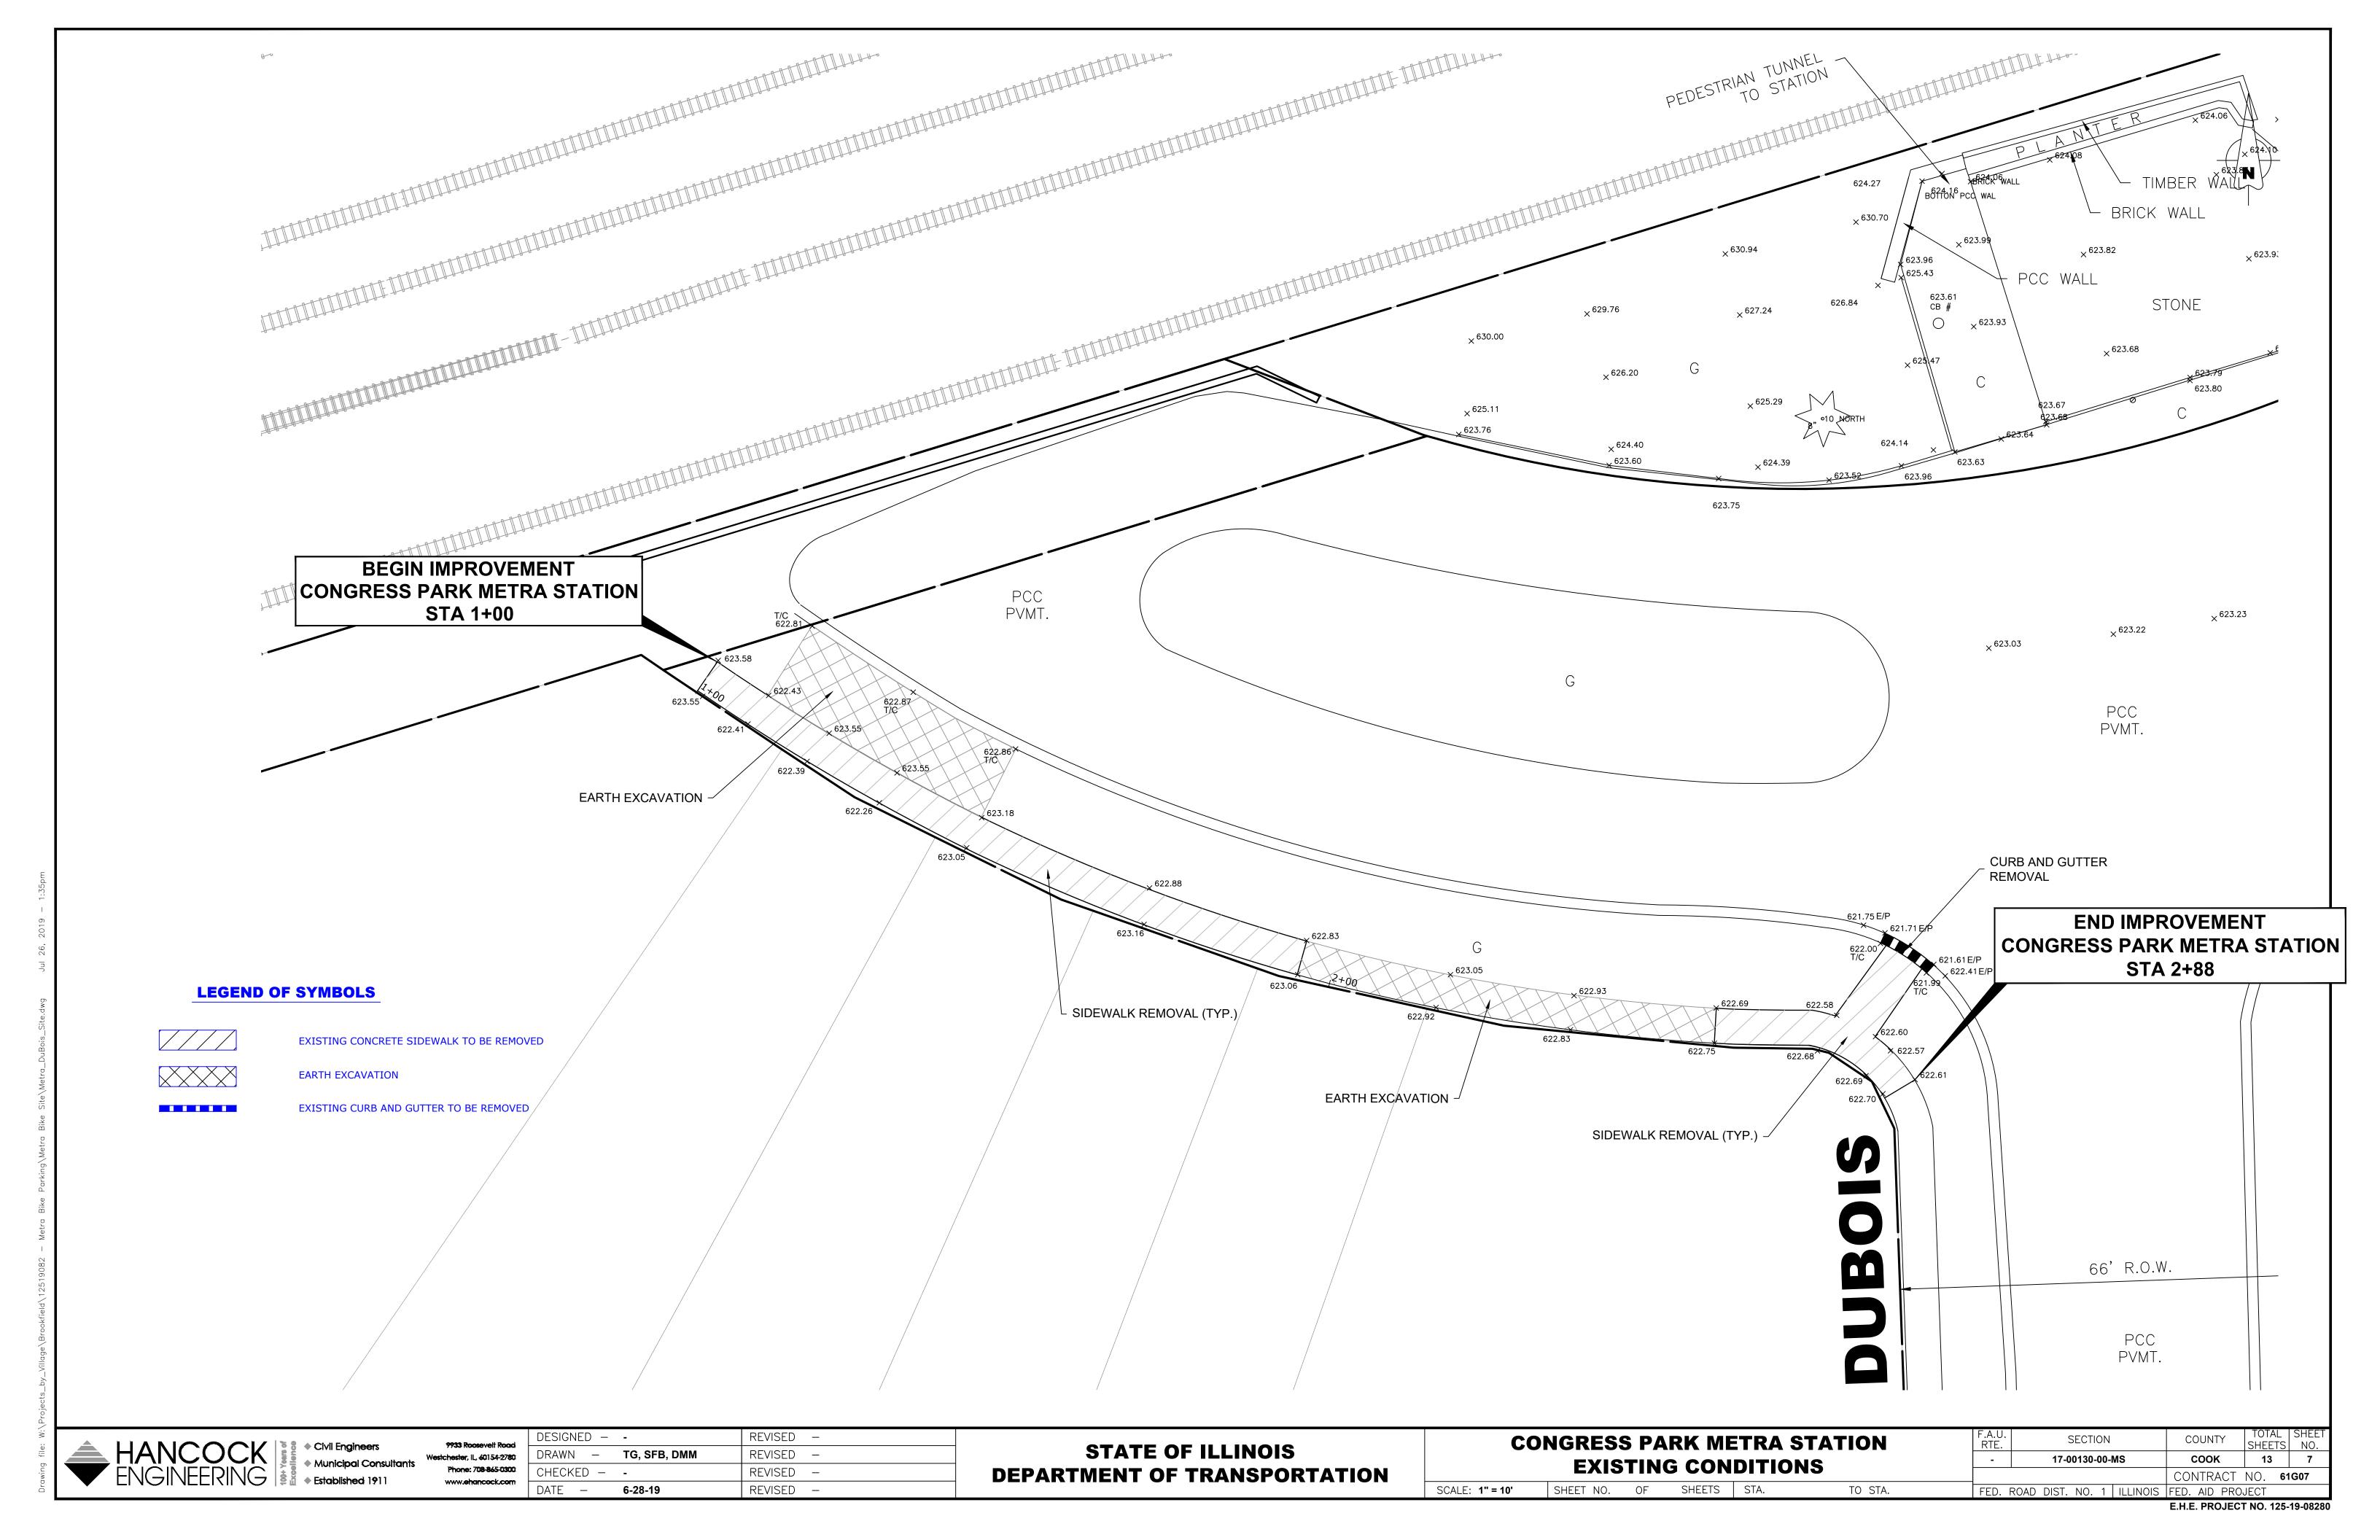

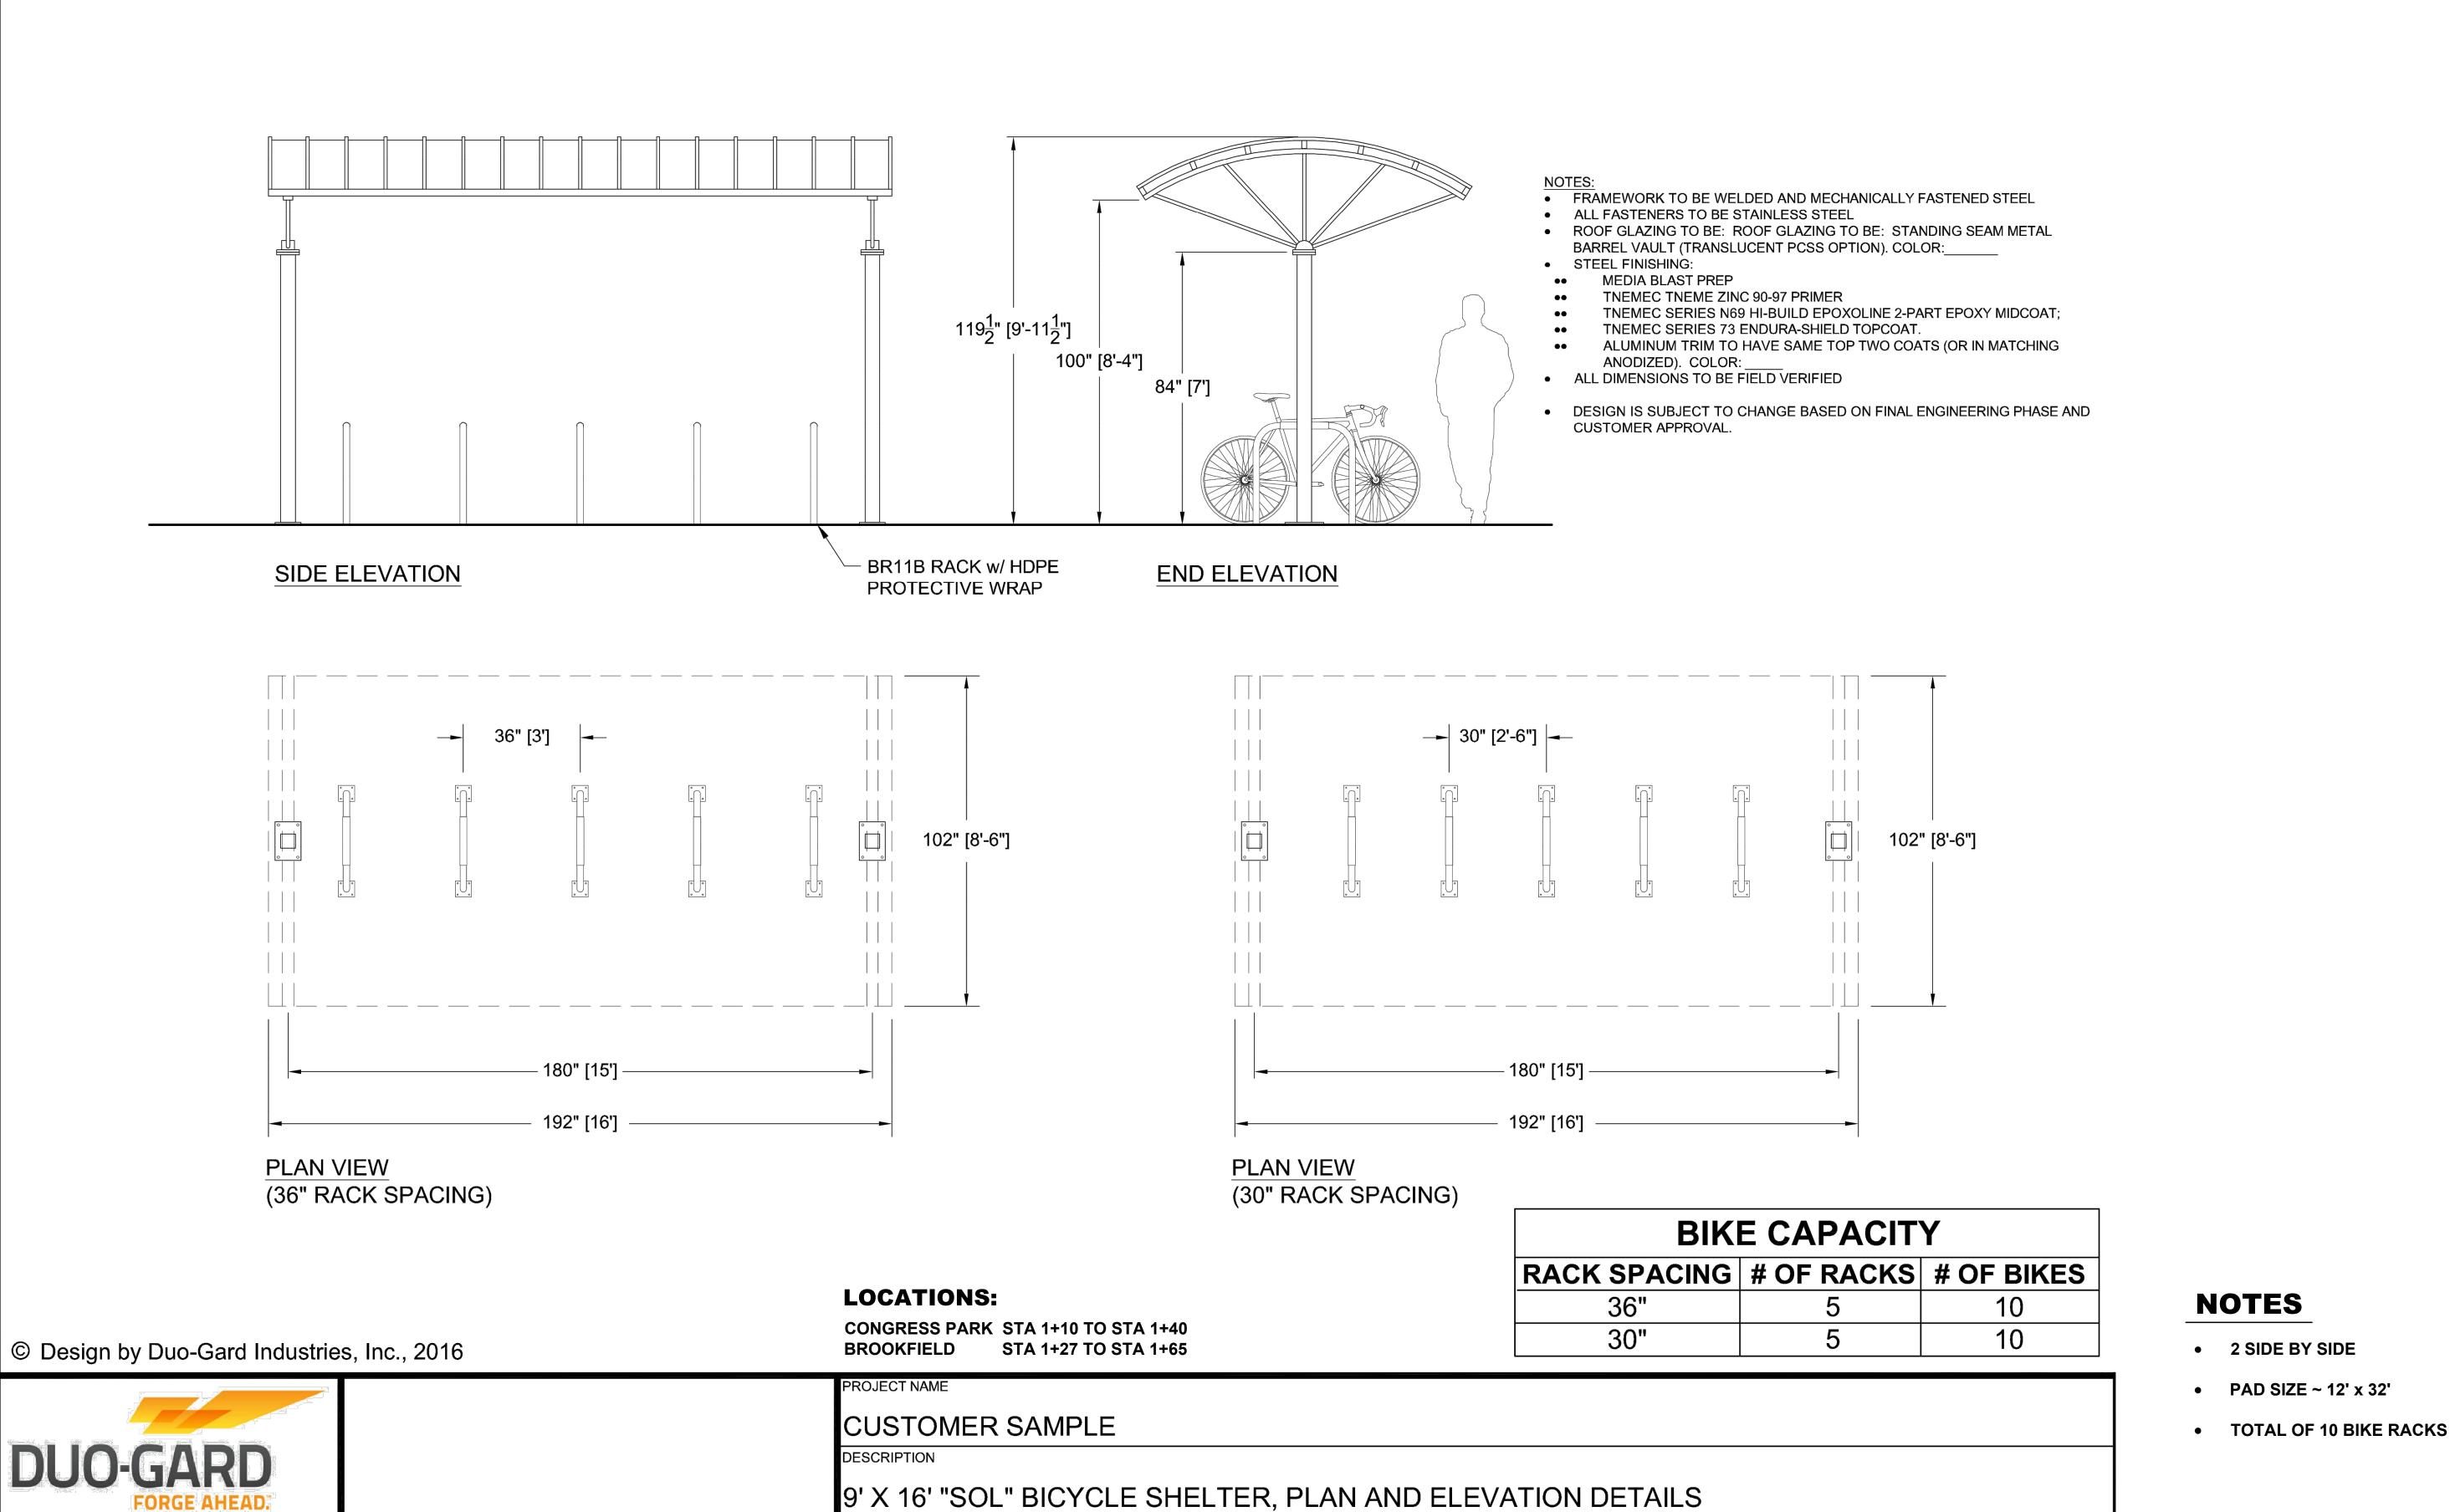

HANCOCK CIVIL Engineers

- Civil Engineers
- Municipal Consultants
- Municipal Consultants
- Established 1911

- Municipal Consultants
- Minicipal Consultants
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DRW'G DATE

9.1.2016

PAGE

3/16" = 1'-0"

DRWNG#

0916SOL

Duo-Gard Industries, Inc.

Tel (734) 207-9700 Fax (734) 207-7995

www.duo-gard.com

E.H.E. PROJECT NO. 125-19-08280

CONTRACT NO. 61G07

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COUNTY


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SECTION

17-00130-00-MS

FED. ROAD DIST. NO. 1 | ILLINOIS | FED. AID PROJECT

**VELODOME SHELTERS** 32 ANN ST CLIFTON, NJ 07013 TOLL FREE: 1-888-995-8090 PHONE: (973) 264-9100 www.velodomeshelters.com

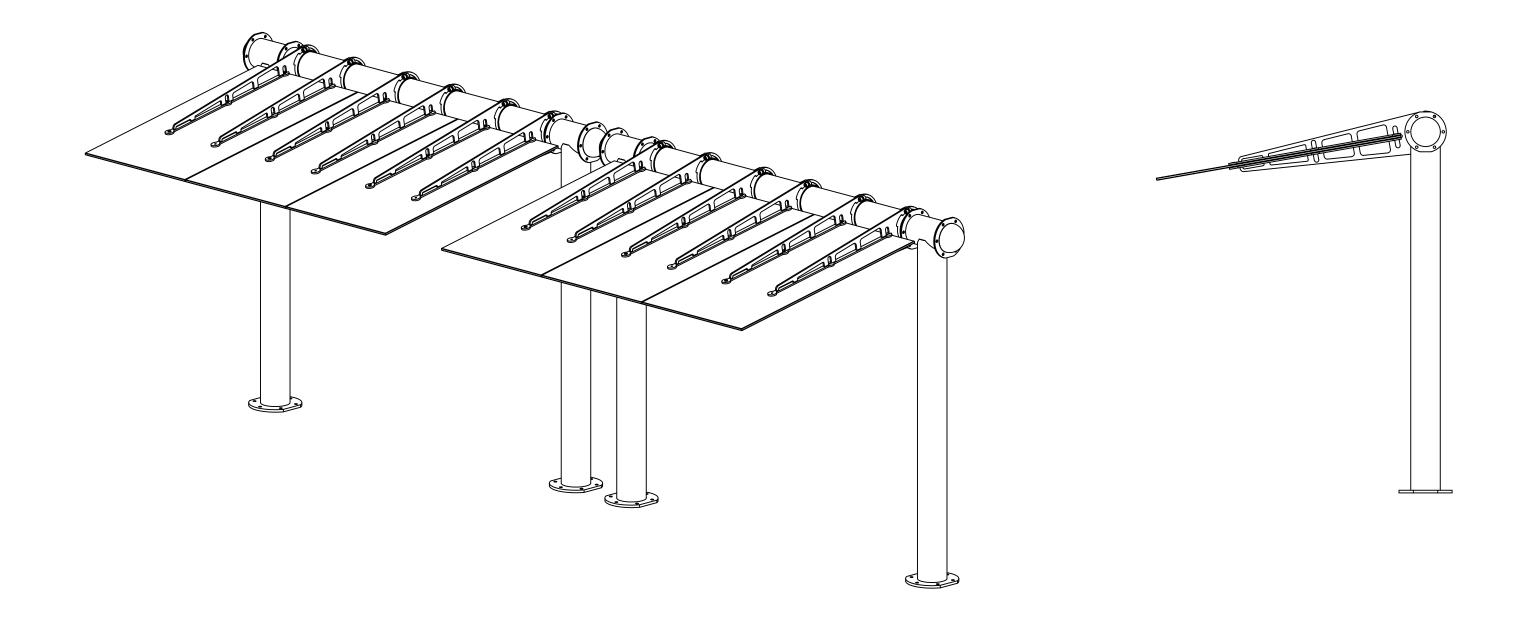


## STRATUS SHELTER BY DERO

### **NOTES**

- 2 SIDE BY SIDE
- PAD SIZE ~ 11' X 30'
- TOTAL OF 8 BIKE RACKS

### **LOCATIONS:**

CONGRESS PARK STA 1+10 TO STA 1+40 BROOKFIELD STA 1+27 TO STA 1+65

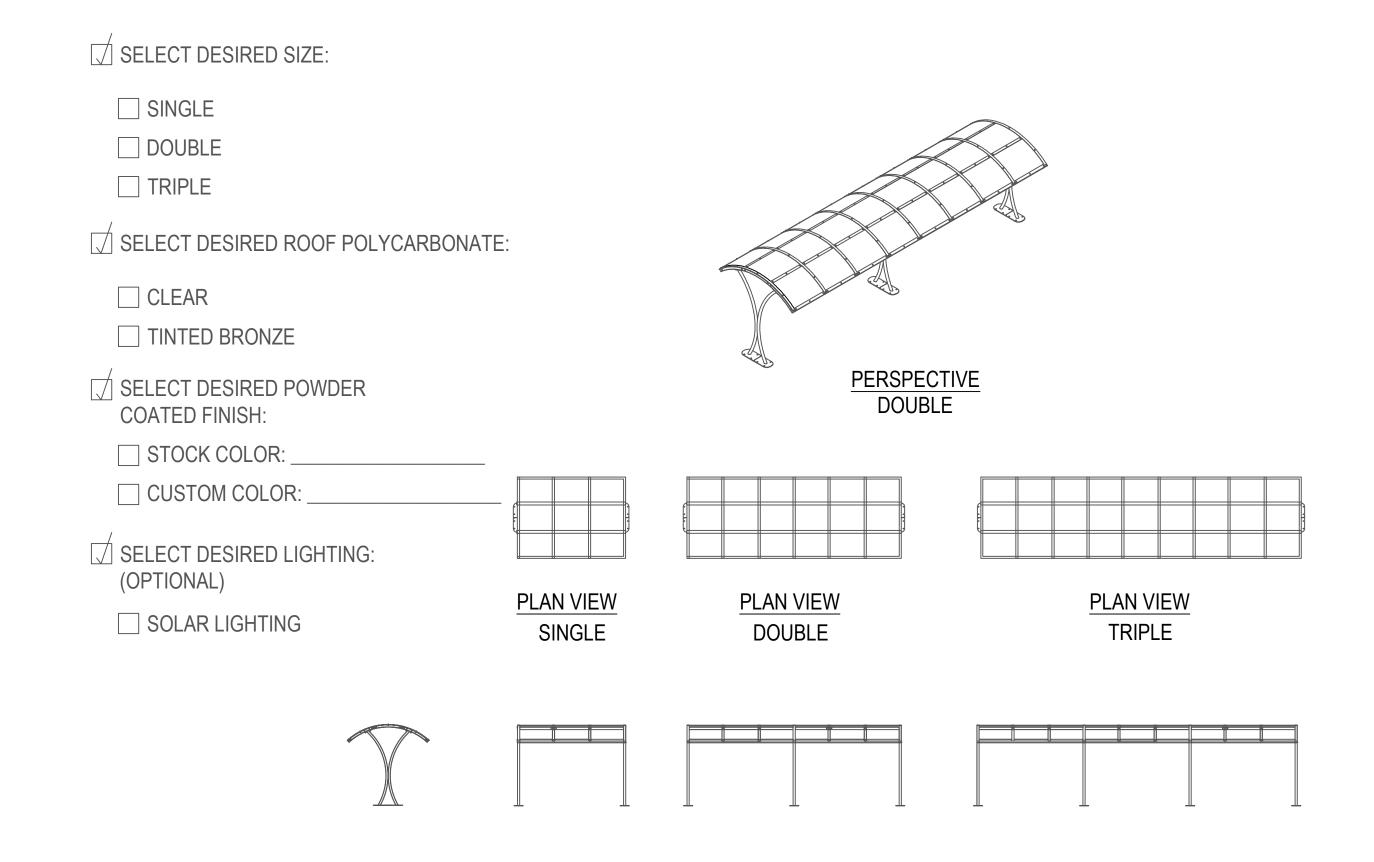

FRONT ELEVATION

DOUBLE

**PROFESSIONAL** 

ACCEPTED

DECLINED

**ENGINEERING REPORT:** 

**SPECIFICATIONS** 

FRAME: STEEL **ROOF:** TWIN WALL, 6MM POLYCARBONATE; UV PROTECTION

**ELEVATION** 

**DIMENSIONS:** 

SINGLE: 12'-10" L X 9'-0" W X 8'-10"H DOUBLE: 24'-7" L X 9'-0" W X 8'-10"H TRIPLE: 36 -4" L X 9'-0" W X 8'-10" H

NOTES:

- 1. SEE MANUFACTURER FOR COLOR OPTIONS. (CUSTOM COLORS AVAILABLE)
- 2. INSTALLATION TO BE COMPLETED IN ACCORDANCE WITH MANUFACTURER'S SPECIFICATIONS.

FRONT ELEVATION

SINGLE

- 3. DO NOT SCALE DRAWING.
- 4. THIS DRAWING IS INTENDED FOR USE BY ARCHITECTS, ENGINEERS, CONTRACTORS, CONSULTANTS AND DESIGN PROFESSIONALS FOR PLANNING PURPOSES ONLY. THIS DRAWING MAY NOT BE USED FOR CONSTRUCTION.
- 5. ALL INFORMATION CONTAINED HEREIN WAS CURRENT AT THE TIME OF DEVELOPMENT BUT MUST BE REVIEWED AND APPROVED BY THE PRODUCT MANUFACTURER TO BE CONSIDERED ACCURATE.
- 6. CONTRACTOR'S NOTE: FOR PRODUCT AND COMPANY INFORMATION VISIT www.CADdetails.com/info AND ENTER REFERENCE NUMBER 5001-005.

### Details

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SCALE: NONE

### **NOTES**

FRONT ELEVATION

**TRIPLE** 

- 2 SIDE BY SIDE
- PAD SIZE ~ 9' X 29'
- TOTAL OF 8 BIKE RACKS

REVISION DATE 07/26/2019




DESIGNED - -REVISED -REVISED -TG, SFB, DMM CHECKED - -REVISED DATE -REVISED 6-28-19

**STATE OF ILLINOIS DEPARTMENT OF TRANSPORTATION** 

CADdetails.com COUNTY SECTION **JOB SPECIFIC DETAILS** 17-00130-00-MS COOK CONTRACT NO. 61G07 SHEET NO. 2 OF 2 SHEETS STA. -TO STA. -

13 12

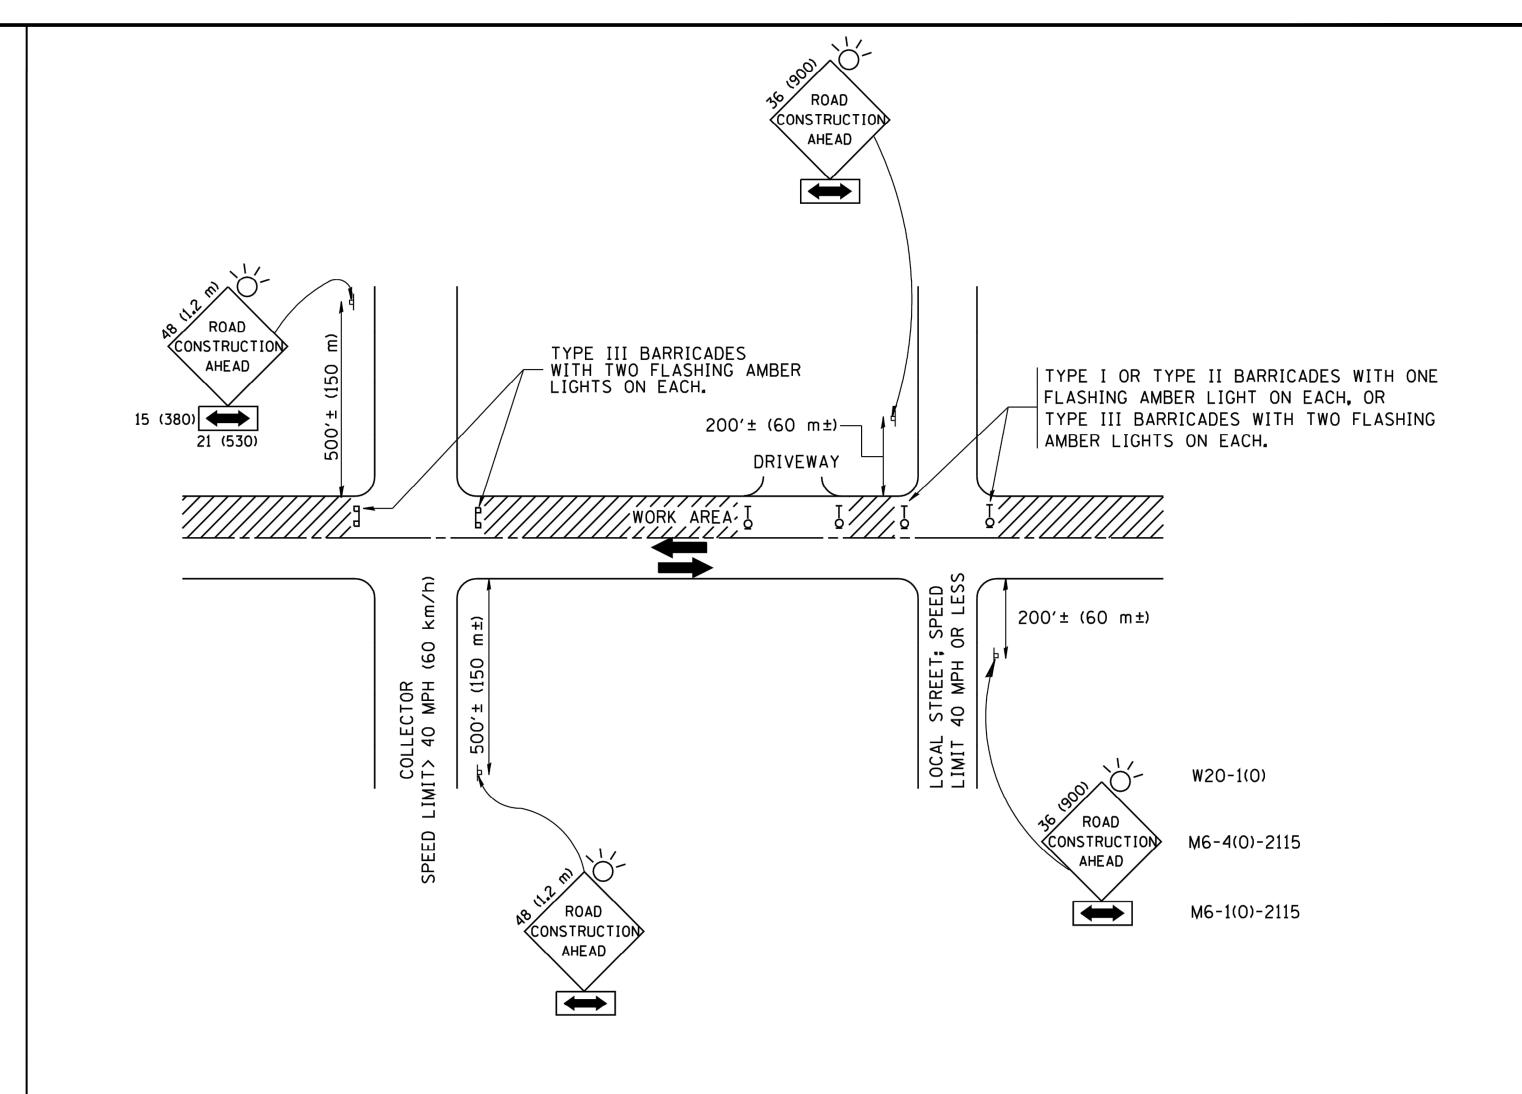

TRAFFIC CONTROL AND PROTECTION FOR SIDE ROADS, INTERSECTIONS, AND DRIVEWAYS

### NOTES:

- A. FOR NO LANE RESTRICTION ON THE SIDE ROAD OR DRIVEWAYS
- 1. SIDE ROAD WITH A SPEED LIMIT OF 40 MPH (60 km/h) OR LESS AS SHOWN ON THE DRAWING AND AS DIRECTED BY THE ENGINEER:
- O) ONE ROAD CONSTRUCTION AHEAD SIGN 36 × 36 (900×900) WITH A FLASHER AND FLAG MOUNTED ON IT APPROXIMATELY 200' (60 m) IN ADVANCE OF THE MAIN ROUTE.
- b) THE CLOSED PORTION OF THE MAIN ROUTE SHALL BE PROTECTED BY BLOCKING WITH TYPE I, TYPE II OR TYPE III BARRICADES, 1/3 OF THE CROSS SECTION OF THE CLOSED PORTION.
- 2. SIDE ROAD WITH A SPEED LIMIT GREATER THAN 40 MPH (60 km/h) AS SHOWN ON THE DRAWING AND AS DIRECTED BY THE ENGINEER:
- O) ONE **ROAD CONSTRUCTION AHEAD** SIGN 48 × 48 (1.2 m × 1.2 m) WITH A FLASHER MOUNTED ON IT APPROXIMATELY 500' (150 m) IN ADVANCE OF THE MAIN ROUTE.
- b) THE CLOSED PORTION OF THE MAIN ROUTE SHALL BE PROTECTED BY BLOCKING WITH TYPE III BARRICADES, 1/2 OF THE CROSS SECTION OF THE CLOSED PORTION.
- 3. WHEN THE SIDE ROAD LIES BETWEEN THE BEGINNING OF THE MAINLINE SIGNING AND THE WORK ZONE, A SINGLE HEADED ARROW (M6-1) SHALL BE USED IN LIEU OF THE DOUBLE HEADED ARROW (M6-4).

- B. FOR A LANE CLOSURE ON A SIDE ROAD OR DRIVEWAY:
- USE APPLICABLE PORTIONS OF THE TYPICAL APPLICATION OF TRAFFIC CONTROL DEVICES (STD. 701501, STD. 701606 OR THE APPROPRIATE STANDARD). THE SPACING OF SIGNS AND BARRICADES SHALL BE ADJUSTED FOR FIELD CONDITIONS AS DIRECTED BY THE ENGINEER. THE DIRECTIONAL ARROW SHALL BE COVERED OR REMOVED WHEN NO LONGER CONSISTENT WITH THE SIDE ROAD LANE CLOSURE.
- C. ADVANCE WARNING SIGNS ARE TO BE OMITTED ON DRIVEWAY UNLESS OTHERWISE NOTED.
- D. THE TRAFFIC CONTROL AND PROTECTION FOR SIDE ROADS, INTERSECTIONS, AND DRIVEWAYS SHALL BE INCIDENTAL TO THE COST OF SPECIFIED TRAFFIC CONTROL STANDARDS OR ITEMS.

All dimensions are in millimeters (inches) unless otherwise shown.

FILE NAME =	USER NAME = gaglianobt	DESIGNED - LHA	REVISED - J. OBERLE 10-18-95		TRAFFIC CONTROL AND PROTECTION FOR	F.A.U. RTE.	SECTION	COUNTY	TOTAL SHEET SHEETS NO.
W:\diststd\22x34\tc10.dgn		DRAWN -	REVISED - A. HOUSEH 03-06-96	STATE OF ILLINOIS		-	17-00130-00-MS	соок	13 13
	PLOT SCALE = 50.000 '/ IN.	CHECKED -	REVISED - A. HOUSEH 10-15-96	DEPARTMENT OF TRANSPORTATION	SIDE ROADS, INTERSECTIONS, AND DRIVEWAYS		TC-10	CONTRACT	T NO. 61G07
	PLOT DATE = 1/4/2008	DATE - 06-89	REVISED -T. RAMMACHER 01-06-00		SCALE: NONE SHEET NO. 1 OF 1 SHEETS STA. TO STA.	FED. ROAD '	DIST. NO. 1 ILLIN	IOIS FED. AID PRO	₹OJECT