


MAINTENANCE OF TRAFFIC GENERAL NOTES


1. TRAFFIC CONTROL FOR STAGES I & II WILL BE PAID FOR AS A LUMP SUM, "TRAFFIC CONTROL AND PROTECTION, (SPECIAL)".
2. TRAFFIC CONDITIONS, ACCIDENTS, AND OTHER UNFORESEEN EMERGENCY CONDITIONS MAY REQUIRE THE ENGINEER TO RESTRICT, MODIFY OR REMOVE LANE CLOSURES OR CHANNELIZATION SHOWN IN THE PLANS. THE CONTRACTOR SHALL RESPOND PROMPTLY TO THE TIME OF NOTIFICATION BY THE ENGINEER FOR THE MAINTENANCE OF TRAFFIC CONTROL DEVICES.
3. SIDE STREETS SHALL REMAIN OPEN ALL TIMES. SPECIAL CONSIDERATION MAY BE GIVEN TO A SHORT TERM CLOSURE ON AS-NEEDED BASIS. THESE CLOSURES WILL BE COORDINATED WITH THE RESIDENT ENGINEER.
4. ALL COUNTY OWNED UTILITY STRUCTURES SHALL BE KEPT ACCESSIBLE AT ALL TIMES DURING CONSTRUCTION. STRUCTURES SHALL BE ADJUSTED TO MATCH THE TEMPORARY PAVEMENT AND GRADING ELEVATION. ALL TEMPORARY ADJUSTMENTS TO STRUCTURES REQUIRED AS A RESULT OF THE STAGED MAINTENANCE OF TRAFFIC WILL NOT BE PAID FOR, BUT SHALL BE CONSIDERED INCLUDED IN THE COST OF THE FINAL ADJUSTMENT ITEM.
5. EXCAVATION REQUIRED TO CONSTRUCT THE TEMPORARY PAVEMENT PRIOR TO STAGE I SHALL BE MEASURED FOR PAYMENT AND SHALL BE PAID FOR AS "EARTH EXCAVATION". QUANTITIES FOR THIS WORK HAVE BEEN INCLUDED IN THE EARTHWORK ITEM FOR THE STAGE.
6. ALL OBSTRUCTIONS SHALL BE REMOVED PRIOR TO CONSTRUCTING THE TEMPORARY PAVEMENT AND SHIFTING TRAFFIC ONTO IT. REMOVAL ITEMS ARE SHOWN ON THE REMOVAL SHEET.
7. THE WORK ZONE SPEED LIMIT SHALL BE 35 MPH.
8. THE REMOVAL OF THE BRIDGE MEDIAN AND TEMPORARY HMA SURFACE COURSE 1 1/2" ON THE BRIDGE DECK SHALL BE PAID FOR AS CONCRETE REMOVAL.
9. TEMPORARY PAVEMENT SHALL CONSIST OF HMA BINDER IL-19MM, 8" AND HMA SURFACE COURSE "D", N50, 2".

SEQUENCE OF CONSTRUCTION

- STAGE I**
1. INSTALL EROSION CONTROL DEVICES PER SHEET 8. MAINTAIN TRAFFIC USING IDOT STANDARD 701101.
 2. INSTALL TRAFFIC CONTROL DEVICES ALONG THE WEST SIDE OF THE ROADWAY. COVERUP ALL CONFLICTING EXISTING PAVEMENT MARKINGS AND SIGN USING COUNTY STANDARD LC7002.
 3. REMOVE CURB AND GUTTER AND BRIDGE MEDIAN USING COUNTY STANDARD LC7002.
 4. CONSTRUCT TEMPORARY PAVEMENT FROM STA 38+45.31 TO STA. 43+46.38 USING COUNTY STANDARD LC7002.
 5. INSTALL BIKEWAY DETOUR PLAN AS SHOWN ON SHEET 11.
 6. INSTALL STAGE I TRAFFIC CONTROL.
 7. SHIFT TRAFFIC TO EAST SIDE OF ROADWAY TO UTILIZE THE EXISTING AND TEMPORARY PAVEMENT.
 8. REMOVE THE EXISTING CURB AND GUTTER ON THE WEST SIDE.
 9. CONSTRUCT THE APPROACH SLAB, BRIDGE DECK BEAMS, PARAPET, AND THE TRENCH DRAIN ALONG THE BIKEWAY UNDERNEATH THE BRIDGE.
- STAGE II**
1. MAINTAIN BIKEWAY DETOUR FOR TRAIL UNDERNEATH BRIDGE AS SHOWN ON SHEET 11. REMOVE ALL CONFLICTING EXISTING PAVEMENT MARKINGS AND SIGNS. INSTALL STAGE II TRAFFIC CONTROL PLAN.
 2. REMOVE TEMPORARY PAVEMENT ON THE EAST SIDE OF THE ROAD CONSTRUCTED IN STAGE I.
 3. SHIFT TRAFFIC TO THE WEST SIDE TO UTILIZE THE EXISTING PAVEMENT AND BRIDGE DECK BEAMS CONSTRUCTED IN STAGE I.
 4. PRIOR TO REMOVAL OF THE EXISTING BRIDGE DECK BEAMS ON THE EAST SIDE CONSTRUCT TEMPORARY PAVEMENT FROM STA. 39+86.90 TO STA. 40+10.65 ALONG THE NORTHBOUND LANES. INSTALL TEMPORARY CONCRETE BARRIER ON THE TEMPORARY PAVEMENT AND THE EXISTING NORTHBOUND BRIDGE DECK.
 5. CONSTRUCT THE APPROACH SLAB, BRIDGE DECK BEAMS, AND CURB AND GUTTER AND RESTORE THE MEDIAN ON THE EAST SIDE.
 6. REMOVE BIKEWAY DETOUR PLAN.
 7. PLACE PERMANENT PAVEMENT MARKINGS.
 8. REMOVE TEMPORARY EROSION CONTROL DEVICES.

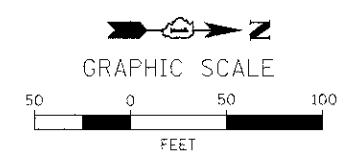

- LEGEND**
- CONSTRUCTION ZONE
 - TEMPORARY HMA PAVEMENT
 - TEMPORARY CONCRETE BARRIER
 - TEMPORARY IMPACT ATTENUATOR
 - VERTICAL SIGN PANELS (GROUND MOUNTED)
 - BARRICADE TYPE II WITH MONO DIRECTIONAL STEADY BURNING LIGHT
 - FLASHING ARROW BOARD
 - TRAFFIC DIRECTION

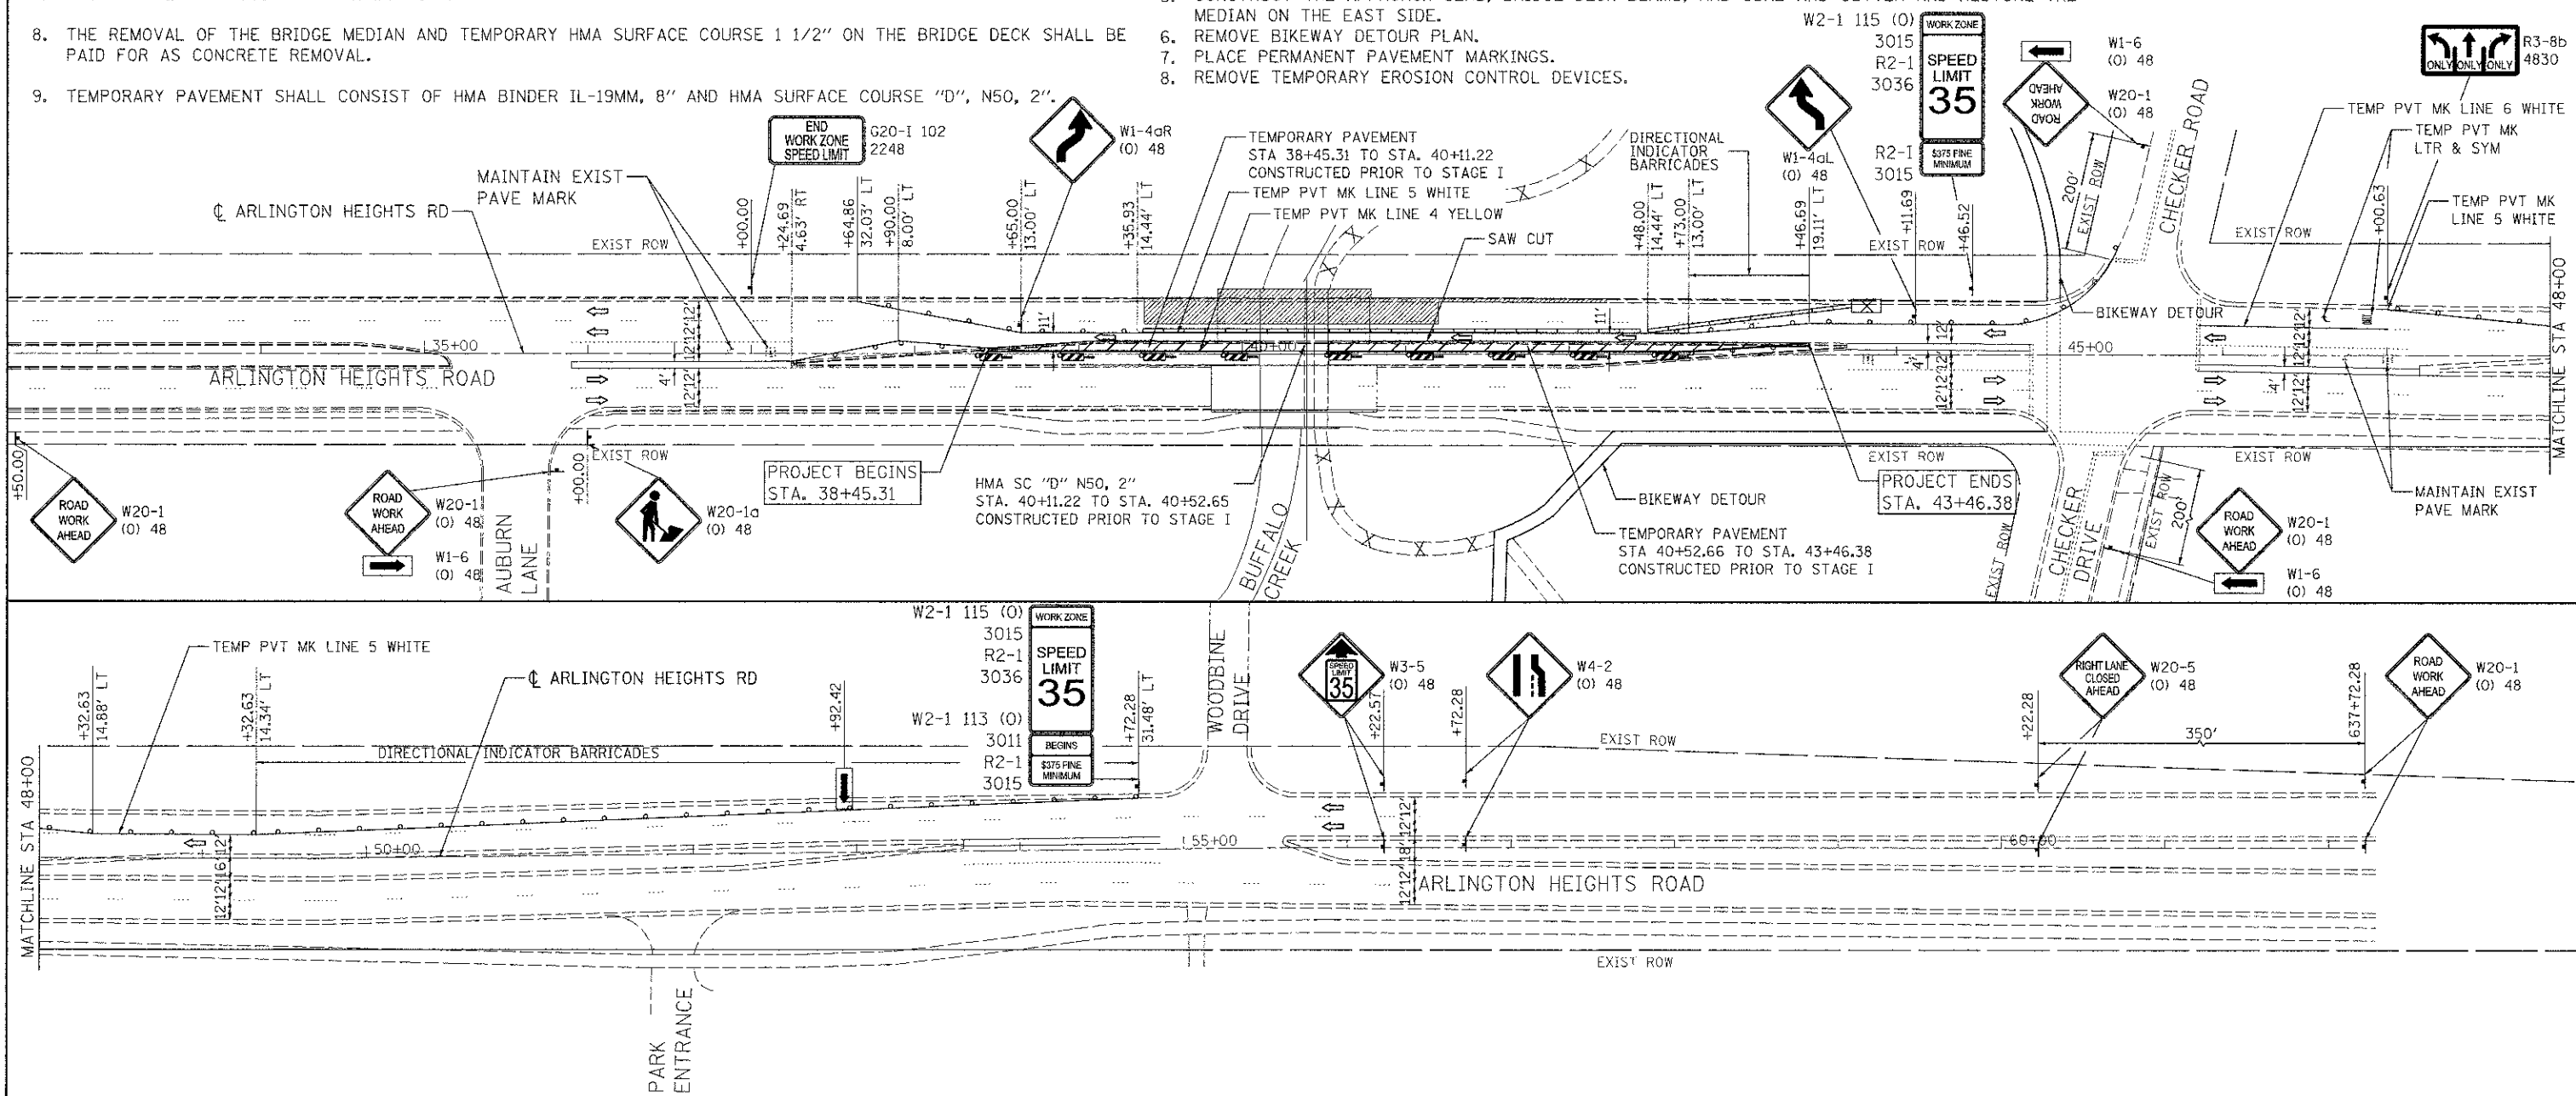

FILE NAME = LC1143-sh1-staging1.dgn	USER NAME = 3282111743	DESIGNED - TC	REVISED -	STATE OF ILLINOIS DEPARTMENT OF TRANSPORTATION	MAINTENANCE OF TRAFFIC PLAN STAGE I	F.A.U. RTE. = 2626	SECTION = 10-00193-07-BR	COUNTY = LAKE	TOTAL SHEETS = 37	SHEET NO. = 10	
	PLOT SCALE = 50.0000' / 1" =	DRAWN - LOM	REVISED -			SCALE: 1" = 50'	SHEET 1 OF 1 SHEETS	STA. 37+24.69 TO STA. 54+72.28	CONTRACT NO. 63713		ILLINOIS FED. AID PROJECT
	PLOT DATE = 8/28/2012	CHECKED - PK	REVISED -								
		DATE = 4/2012	REVISED -								