
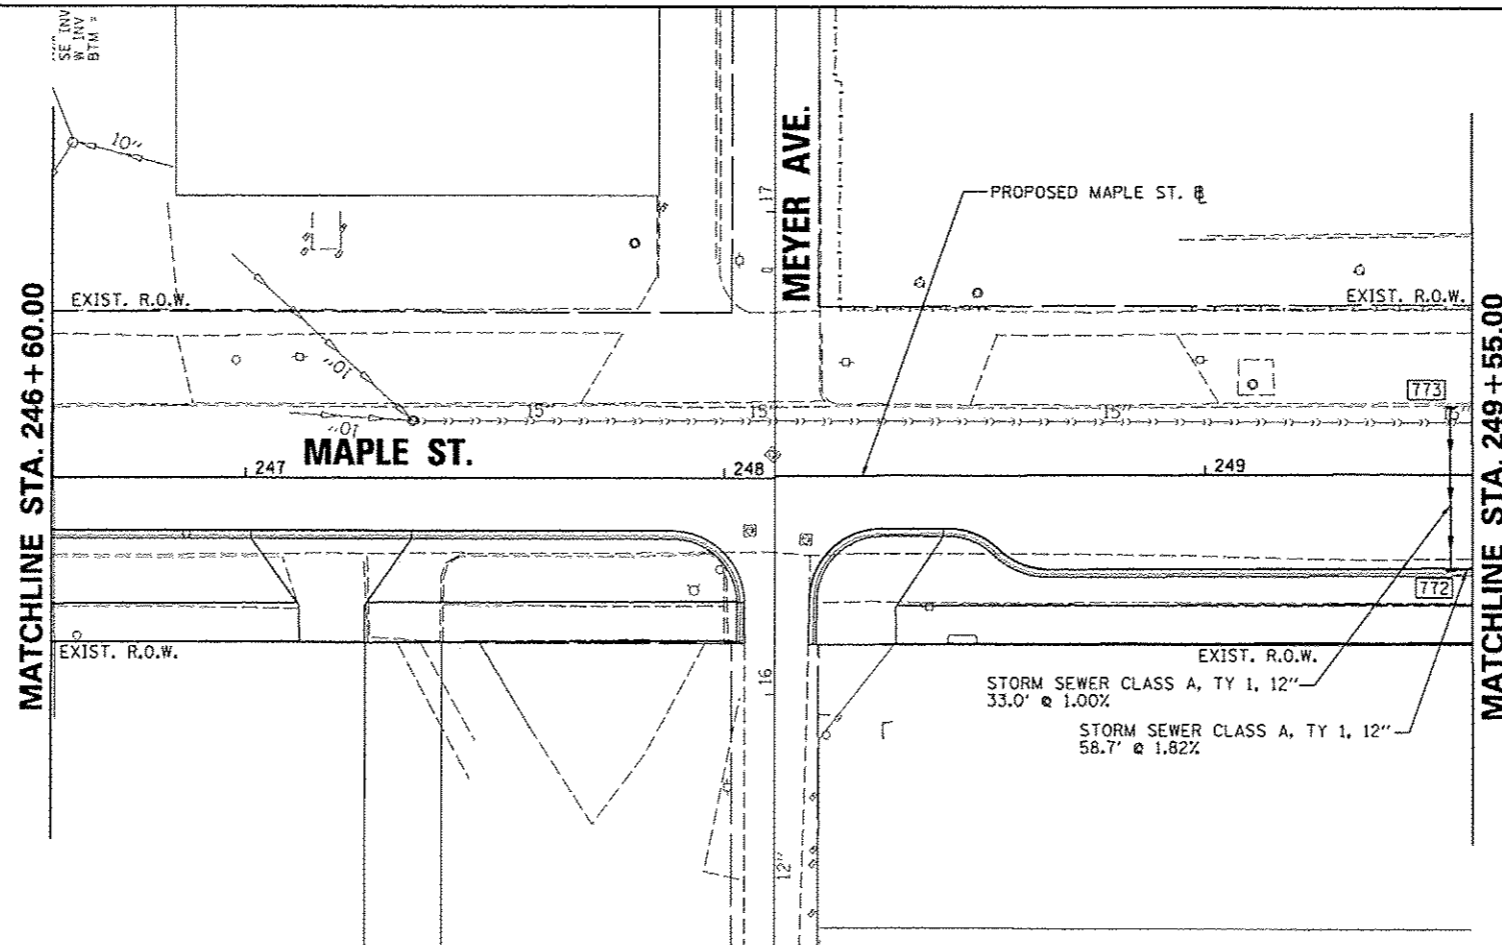


772 STA. 249+50.94, 19.5' RT
 INLET TY G-1
 RIM = 500.63
 INV (NE) = 497.52
 INV (SE) = 497.42


773 STA. 249+50.94, 13.5' LT
 INLET TY G-1
 RIM = 500.48
 INV (SW) = 497.85

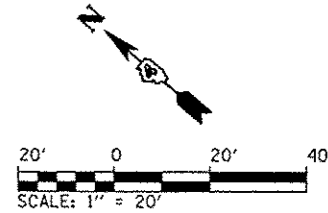

CMT
 CRAWFORD, MURPHY & TILLY, INC.
 CONSULTING ENGINEERS
 License No. 194-000613

PLAN	DATE
REVISION	BY
NOTED	
ALIGNMENT	
PROPOSED	
ROAD FILE NAME	
NO.	

PROFILE	DATE
REVISION	BY
NOTED	
GRADES CHECKED	
STRUCTURE NOTATION	
NO.	

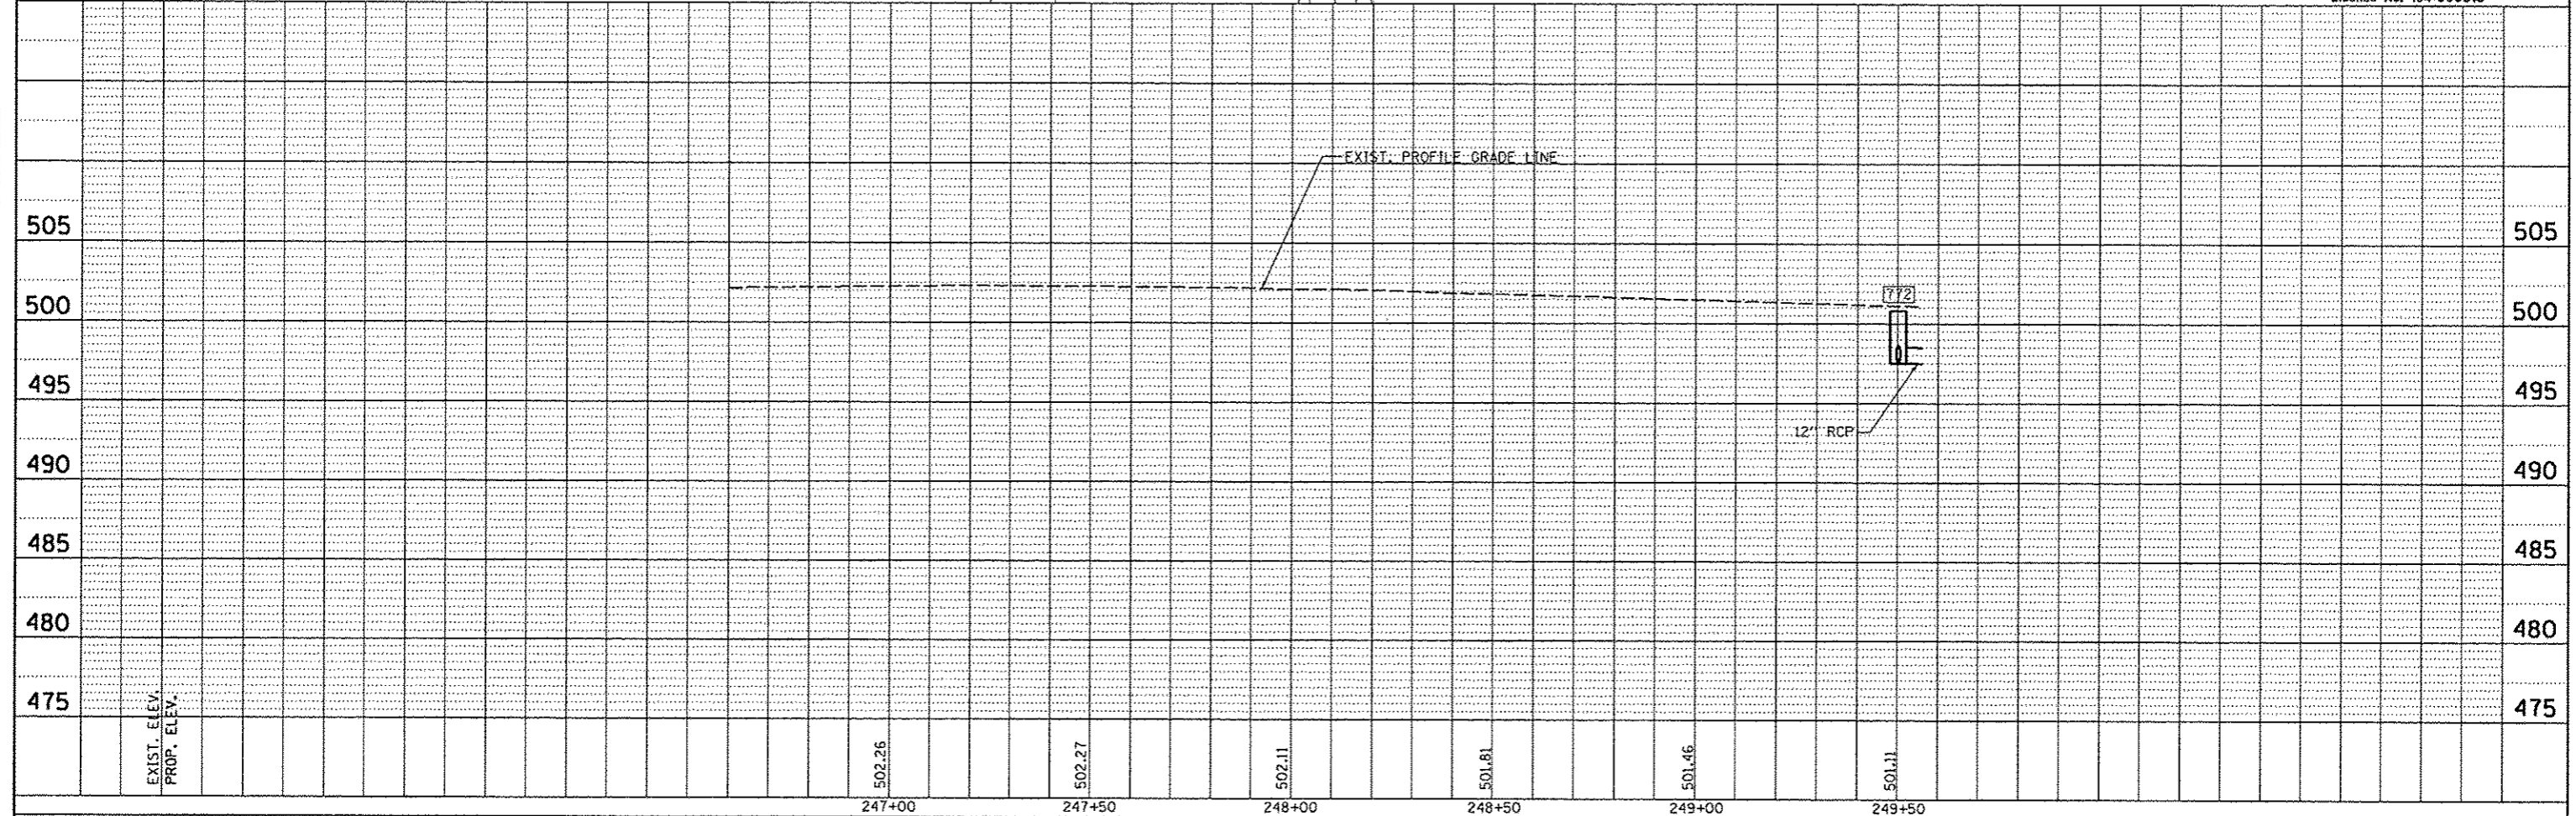

FILE NAME *	USER NAME = kovan01511	DESIGNED - RMM	REVISED -	STATE OF ILLINOIS DEPARTMENT OF TRANSPORTATION	MAPLE STREET DRAINAGE PLAN AND PROFILE	F.A.U. RTE.	SECTION	COUNTY	TOTAL SHEETS	SHEET NO.
or\pwise_work\do_not_delete\dm73472\04180155-shr-drain-pip184.dgn	DRAWN - RJE	REVISED -	12-00356-01-PV			PEORIA	519	229		
PLOT SCALE = 3/8" = 1' / in.	CHECKED - E.J.H.	REVISED -	CONTRACT NO. 89626							
PLOT DATE = 07/23/2012	DATE - 7/18/12	REVISED -	ILLINOIS FED. AID PROJECT TIG-8093(150)							
				SCALE: 1" = 20'		SHEET NO. OF SHEETS		STA. 246+60.00 TO STA. 249+55.00		