

PLAN	DATE
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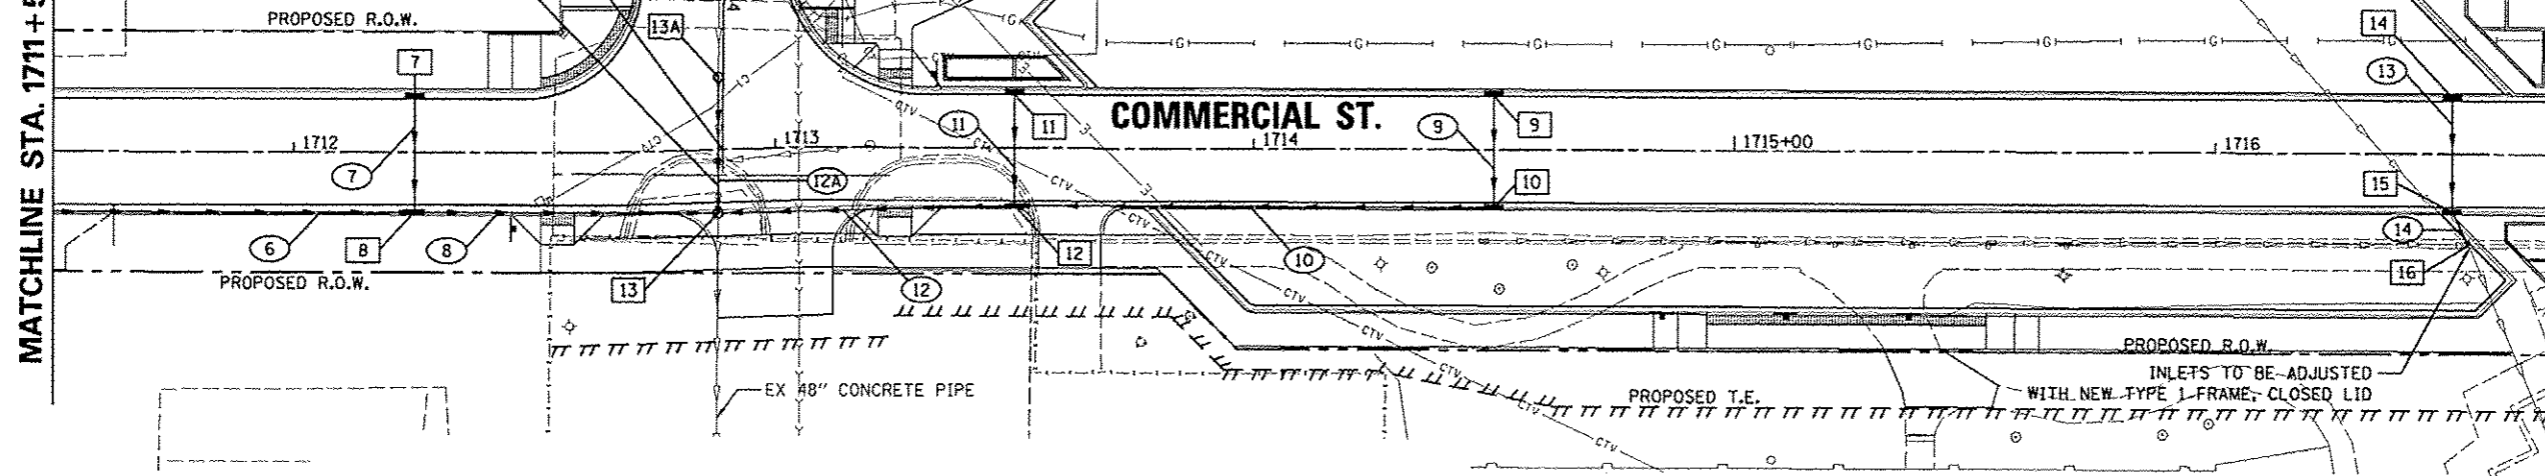
PROFILE	DATE
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NOTE: ABOVE GROUND UTILITY ELEVATION SHALL BE ADJUSTED TO MEET PROWAG AND ADA STANDARDS

STA. 1712+88.99 COMMERCIAL ST. = STA. 804+36.97 OAK ST.
SEE PREVIOUS COMMERCIAL STREET DRAINAGE PLAN FOR BRICK PIPE REPLACEMENT DETAIL.

MATCHLINE STA. 1711+50.00



MATCHLINE STA. 1716+70.23



SEE STATE STREET DRAINAGE SHEET

PIPE NUMBER	FROM STRUCTURE	U/S INVERT	TO STRUCTURE	O/S INVERT	CLASS TYPE	DIAM.	LENGTH	SLOPE	CLSM
6	6	460.50	8	459.75	STORM SEWERS, CLASS A, TYPE 2	12	109.0	0.69	79
7	7	460.50	8	460.25	STORM SEWERS, CLASS A, TYPE 2	12	21.0	1.19	14
8	8	459.75	13	459.25	STORM SEWERS, CLASS A, TYPE 2	12	59.1	0.85	47
9	9	460.00	10	459.75	STORM SEWERS, CLASS A, TYPE 2	12	21.0	1.19	14
10	10	459.75	12	459.25	STORM SEWERS, CLASS A, TYPE 2	12	99.0	0.51	67
11	11	459.75	12	459.50	STORM SEWERS, CLASS A, TYPE 2	12	21.0	1.19	13
12	12	459.25	13	459.00	STORM SEWERS, CLASS A, TYPE 2	12	57.9	0.43	45
12A	13A	459.10	13	458.90	STORM SEWER SPEC 48	48	21.2	0.94	18
13	14	460.25	15	460.00	STORM SEWERS, CLASS A, TYPE 2	12	21.0	1.19	13
14	15	460.00	16	459.90	STORM SEWERS, CLASS A, TYPE 2	12	5.1	1.96	3

STRUCTURE NUMBER	STA	OFFSET	TYPE	RIM	INVERTS								
					N	NE	E	SE	S	SW	W	NW	
7	1712+25.00	11.33	LT	INLETS TYPE G-1	465.05				460.50				
8	1712+25.00	11.33	RT	INLET-MANHOLE, TYPE G-1, 4' DIA.	465.05			459.75			459.75		460.25
9	1714+50.00	11.33	LT	INLETS TG-1 SPL	464.56				460.00				
10	1714+50.00	11.33	RT	INLETS TG-1 SPL	464.56						459.75		459.75
11	1713+50.00	11.33	RT	INLETS TYPE G-1	464.25				459.75				
12	1713+50.00	11.33	RT	INLET-MANHOLE, TG-1, 4' DIA, SPL	464.25		459.25				459.25		459.50
13	1712+87.67	13.21	RT	MAN TA 7 DIA TIF CL	465.08		459.00		458.9 EX		459.25		458.90
13A	1712+88.66	15.00	LT	MAN TA 7 DIA TIF CL	465.10				459.10				459.1 EX
14	1716+49.30	11.33	LT	INLETS TG-1 SPL	464.65				460.25				
15	1716+49.30	11.33	RT	INLETS TG-1 SPL	464.65					460.00			460.00
16	1716+52.80	18.90	RT	EXISTING INLET W/ NEW TIF CL	464.85	459.90			458.3 EX				458.4 EX

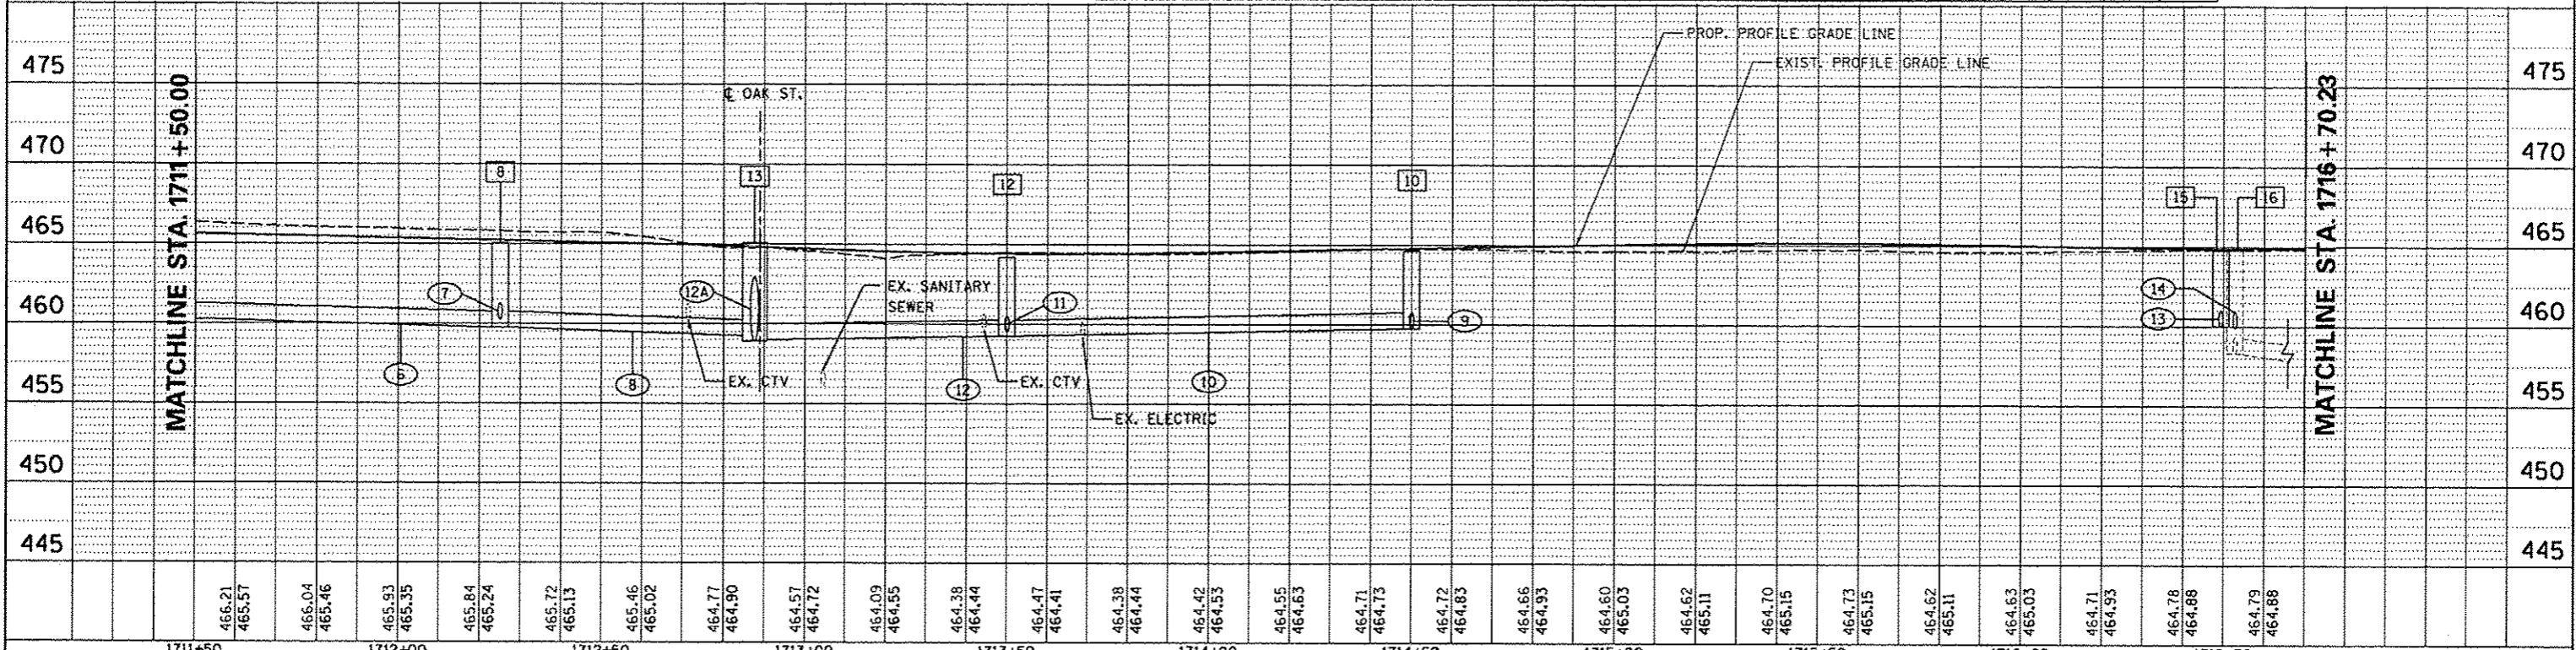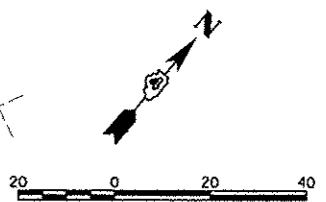

FILE NAME	USER NAME	DESIGNED	REVISED	STATE OF ILLINOIS DEPARTMENT OF TRANSPORTATION		COMMERCIAL STREET DRAINAGE PLAN		F.A.U. RTE.	SECTION	COUNTY	TOTAL SHEETS	SHEET NO.
al\pwise\work\do_not_delete\dms75322\0410	kovan@1511	KJC	-	CONTRACT NO. 89626		SCALE: 1"=20'		12-00356-01-PV	PEORIA	519	236	
		KJC	-	DATE: 7/18/12		SHEET NO. OF SHEETS						
		MCH	-			STA. 1711+50 TO STA. 1716+70.23						
			-			ILLINOIS FED. AID PROJECT						