
STATE OF ILLINOIS

DEPARTMENT OF TRANSPORTATION

DIVISION OF HIGHWAYS

PLANS FOR PROPOSED FEDERAL AID HIGHWAY


SOUTHERN DU PAGE COUNTY REGIONAL TRAIL 101st STREET CONNECTOR - WATERFALL GLEN SPUR **WOODWARD AVENUE TO LEMONT ROAD SECTION 03-00001-06-BT** PROJECT NO: M-8003 (440) **DUPAGE COUNTY** C-91-309-04

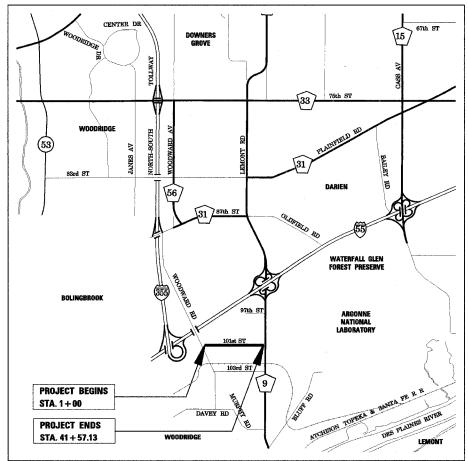

DOWNERS GROVE TOWNSHIP T37N R11E GROSS LENGTH OF PROJECT = 4,057.13 FT = 0.768 MILE NET LENGTH OF PROJECT = 4,057.13 FT = 0.768 MILE

SECTION 03-00001-06-BT DUPAGE

CONTRACT NO.: 83805

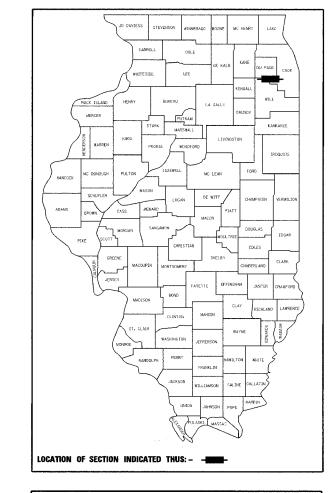

STATE OF ILLINOIS DEPARTMENT OF TRANSPORTATION Charles F. Fokarski APPROVED June 10 LOCAL ROADS ENGINEER APPROVED June 13, Diane O'Keele/AP DEPUTY DIRECTOR OF HIGHWAYS - REGION ENGINEER

PLANS PREPARED BY: RJN GROUP, INC. **CONSULTING ENGINEERS** WHEATON, ILLINOIS

ILLINOIS PROFESSIONAL DESIGN FIRM LICENSE No. 184-000813


PRINTED BY THE AUTHORITY OF THE STATE OF ILLINOIS

INDEX OF SHEETS

- 1. COVER SHEET
- 2. GENERAL NOTES
- 3. SUMMARY OF QUANTITIES AND TYPICAL SECTIONS
- 4. SCHEDULES
- 5-11, PLAN & PROFILE
- 12-15. LANDSCAPING AND EROSION CONTROL PLAN
- 16-26. CROSS SECTIONS 27. CULVERT EXTENSION
- 28. CULVERT EXTENSION DETAILS
- 29. HANDRAIL DETAILS
- 30. DETAIL PRUNING FOR SAFETY AND EQUIPMENT CLEARANCE

HIGHWAY STANDARDS

STANDARD SYMBOLS, ABBREVIATIONS AND PATTERNS
TEMPORARY EROSION CONTROL SYSTEMS
SIDEWALK RAMPS ACCESSIBLE TO THE DISABLED
PRECAST REINFORCED CONCRETE FLARED END SECTION
MANHOLE, TYPE A
FRAME AND LIDS. TYPE 1
CONCRETE CURB TYPE B AND COMBINATION CONCRETE
CURB AND GUTTER
CHAIN LINK FENCE
OFF ROAD OPERATIONS, MULTILANE, 4.5m (15') TO 600mm (24")
FROM PAVEMENT EDGE
OFF-ROAD OPERATIONS, MULTILANE, MORE THAN 4.5 m (15') AWA'
LANE CLOSURE, 2L. 2W. SHORT TIME OPERATIONS
URBAN LANE CLOSURE. MULTILANE. 2W WITH MOUNTABLE MEDIAN
URBAN LANE CLOSURE. MULTILANE INTERSECTION
TRAFFIC CONTROL DEVICES

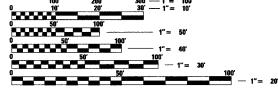

ENGINEERING SCALES. REDUCED SIZED PLANS WILL NOT CONFORM TO STANDARD SCALES. IN MAKING MEASUREMENTS ON REDUCED PLANS, THE ABOVE SCALES MAY BE USED.

JOINT UTILITY LOCATION INFORMATION FOR EXCAVATION 1-800-892-0123

PLANS PREPARED FOR **DUPAGE COUNTY DIVISION OF TRANSPORTATION CHARLES F. TOKARSKI, P.E. COUNTY ENGINEER**

CONTRACT NO. 83805

NOT TO SCALE

DESIGN SPEED OF MULTI-USE

PATH = 20 MPH

William Very OF ILLINOIS (SHEETS 27-29)

WILLIAM . VEGRZYN 4983

REGISTERED P.E. STATE OF ILLINOIS

GENERAL NOTES

- 1. NO WORK SHALL COMMENCE UNTIL TRAFFIC CONTROL REQUIREMENTS ARE MET.
- ALL UTILITIES, SCHOOL DISTRICTS, LOCAL POLICE, AND FIRE DEPARTMENTS SHALL BE NOTIFIED BY THE CONTRACTOR PRIOR TO THE START OF CONSTRUCTION.
- 3. DURING THE CONSTRUCTION, THE CONTRACTOR WILL BE REQUIRED, AT HIS EXPENSE, TO HAVE AVAILABLE A WATER TRUCK OR SIMILAR EQUIPMENT TO CONTROL DUST. IF NECESSARY, THE CONTRACTOR SHALL BE REQUIRED TO CONTROL DUST DURING NON-WORKING HOURS.
- 4. ALL EXCESS MATERIAL (BROKEN CONCRETE, CULVERT PIPE, WASTE ROADWAY EXCAVATION, SURPLUS MATERIAL FROM SEWER TRENCHES, ETC.) SHALL BE LEGALLY DISPOSED OF OUTSIDE THE LIMITS OF THE RICHT-OF-WAY. IT SHALL BE THE CONTRACTOR'S RESPONSIBILITY TO SELECT DUMP SITE. PAYMENT FOR THIS WORK SHALL BE INCLUDED IN THE CONTRACT UNIT PRICE FOR EARTH EXCAVATION.
- 5. TEMPORARY FENCE SHOULD BE ERECTED ALONG THE DRIPLINE OF EXISTING TREES TO REMAIN WITHIN THE LIMITS OF CONSTRUCTION, AFTER TREES ARE SAFELY FENCED NOTHING IS TO BE STORED, DRIVEN, OR DISTURBED INSIDE THE FENCE. REMOVE PROTECTIVE TEMPORARY FENCE ONLY AFTER ALL CONSTRUCTION WORK HAS BEEN COMPLETED.
- 6. EROSION CONTROL WORK ITEMS ARE CONSIDERED TO BE HIGH PRIORITY ITEMS ON THIS CONTRACT. THE ENGINEER WILL IMPLEMENT ALL PROVISIONS OF THE SPECIFICATION NECESSARY TO ASSURE THAT EROSION CONTROL ITEMS ARE CONSTRUCTED AND MAINTAINED IN A TIMELY WAY. ALL EROSION CONTROL MEASURES SHALL BE INSTALLED PRIOR TO BEGINNING ANY CONSTRUCTION ACTIVITIES WHICH WILL POTENTIALLY CREATE ERODABLE CONDITIONS.
- 7. THE LANDSCAPING AND EROSION CONTROL MEASURES SHOWN ARE BUT A GRAPHICAL REPRESENTATION OF SUGGESTED MEASURES. DEVIATIONS FROM THIS PLAN ARE TO BE EXPECTED PENDING A JOBSITE INSPECTION BETWEEN THE CONTRACTOR AND THE DEPARTMENT.

TREE REMOVAL CLEARING HEDGE REMOVAL

- TREES NOT MARKED FOR REMOVAL SHALL BE CONSIDERED AS DESIGNATED TO BE SAVED AND SHALL BE PROTECTED UNDER THE PROVISIONS OF ARTICLE 201.05 OF THE STANDARD SPECIFICATIONS.
- 2. ALL LIMBS, BRANCHES, AND OTHER DEBRIS RESULTING FROM THIS WORK MUST BE REMOVED FROM THE RIGHT-OF-WAY AND DISPOSED OF AT THE END OF EACH DAY IN ACCORDANCE WITH ARTICLE 202.03. THE COST OF THIS WORK WILL NOT BE PAID FOR SEPARATELY BUT SHALL BE INCLUDED IN THE CONTRACT UNIT PRICE FOR TREE REMOVAL.
- ALL CLEARING, REMOVAL OF BUSHES, HEDGES AND TREES UNDER SIX (6) INCHES IN DIAMETER WILL BE INCLUDED IN THE CONTRACT UNIT PRICE FOR EARTH EXCAVATION.

OVERHANGING LIMBS

- ALL CUTS OVER ONE (1) INCH IN DIAMETER SHALL BE MADE FLUSH WITH THE NEXT LARGE BRANCH.
- 2. ALL LIMBS, BRANCHES, AND OTHER DEBRIS RESULTING FROM THIS WORK MUST BE REMOVED FROM THE RIGHT-OF-WAY AND DISPOSED OF AT THE END OF EACH DAY IN ACCORDANCE WITH ARTICLE 202.03. THE COST OF THIS WORK WILL NOT BE PAID FOR SEPARATELY BUT SHALL BE INCLUDED IN THE CONTRACT UNIT PRICE FOR AS PRUNING FOR SAFETY AND EQUIPMENT CLEARANCE.
- 3. ALL BRANCHES THAT ARE LESS THAN 8 FEET ABOVE THE FINISHED SURFACE OF THE TRAIL SHALL BE REMOVED BY A CERTIFIED ARBORIST. THIS WORK SHALL BE UNDERTAKEN IN A TIMELY FASHION SO AS NOT TO INTERFERE WITH CONSTRUCTION. THIS WORK WILL BE PAID FOR AS "PRUNING FOR SAFETY AND EQUIPMENT CLEARANCE".

TOPSOIL

- TOPSOIL SHALL BE PLACED TO A DEPTH OF SIX (6) INCHES AND BE MEASURED IN SOLIARE YARDS.
- 2. THE CROSS SECTIONS INDICATE THE FINISHED GRADE OF TOPSOIL.
- 3. TOPSOIL SHALL NOT BE STOCKPILED WITHIN THE LIMITS OF CONSTRUCTION; THE LOCATIONS OF TOPSOIL STOCKPILES WITHIN THE RIGHT-OF-WAY MUST BE APPROVED BY THE FUNCINEFE

ROADWAY EXCAVATION

- 1. ALL EXISTING CULVERTS, STORM SEWERS, OR DRAINAGE STRUCTURES MARKED FOR REMOVAL ON THE PLANS OR DESIGNATED IN THE FIELD BY THE ENGINEER TO BE REMOVED SHALL BE REMOVED AND ANY EXCAVATION SHALL BE BACKFILLED WITH A GRANULAR MATERIAL MEETING THE SPECIFICATIONS FOR FA-1 OR FA-2. THE COST OF ALL LABOR AND MATERIALS REQUIRED TO COMPLETE THIS WORK SHALL BE INCLUDED IN THE CONTRACT UNIT PRICES FOR STORM SEWER OR PIPE CULVERT UNLESS PAID FOR AS A SPECIFIC ITEM.
- 2. ALL EXISTING GRANULAR AND BITUMINOUS MATERIALS TO BE REMOVED AND NOT PAID AS A SPECIFIC ITEM SHALL BE CONSIDERED EARTH EXCAVATION AND WILL BE PAID FOR AT THE UNIT PRICE FOR EARTH EXCAVATION. THE CONTRACTOR WILL HAVE THE OPTION OF REMOVING THE EXISTING BITUMINOUS MATERIAL BY GRINDING OR EXCAVATION THE MATERIAL. IF THE BITUMINOUS MATERIAL IS REMOVED BY EXCAVATION, IT MAY NOT BE USED IN EMBANKMENT AREAS UNLESS SPECIFICALLY AUTHORIZED BY THE ENGINEER. BITUMINOUS MATERIAL REMOVED BY GRINDING MAY BE USED AS EMBANKMENT MATERIAL. NO BITUMINOUS MATERIAL SHALL BE REMOVED IN AREAS TO BE USED FOR TEMPORARY ROADWAY.
- THE CONTRACTOR SHALL NOT CROSS COMPLETED BASE COURSE OR EXISTING PAYEMENT NOT SCHEDULED TO BE REMOVED WITH LOADED SCRAPERS OR TRACK FOILIPMENT.
- 4. ALL EMBANKMENTS AND SUB-GRADE SHALL BE COMPACTED TO THE SATISFACTION OF THE ENGINEER PRIOR TO PLACING AGGREGATE SUBGRADE OR SUB-BASE GRANULAR MATERIAL.

STORM SEWERS STRUCTURES UTILITIES

- THE STATION / OFFSET / ELEVATIONS NOTED FOR ALL DRAINAGE STRUCTURES LOCATED IN THE CURB LINE REFER TO THE POSITION OF THE ADJACENT PROPOSED EDGE OF PAVEMENT. THE CONTRACTOR SHALL BE RESPONSIBLE FOR DETERMINING THE OFFSET NECESSARY FOR THE STRUCTURES TO SET THE FRAME AND GRATES IN THE PROPER LOCATION. ALL OTHER STRUCTURES ARE DIMENSIONED TO THE CENTER OF THE STRUCTURE; ELEVATION INDICATES RIM GRADES.
- 2. THE CONTRACTOR SHALL BE RESPONSIBLE FOR CONTACTING LOCAL AGENCIES MAINTAINING SANITARY SEWERS, WATERMAINS, AND STREET LIGHTS TO VERIFY THE MATERIALS AND METHODS ALLOWED FOR THE ADJUSTMENT, RELOCATION, OR EXTENSION OF THE UTILITY INVOLVED.
- 3. THE LOCATION AND ELEVATION OF EXISTING UTILITIES ARE APPROXIMATE AND ARE PROVIDED BY THE OWNERS. THE EXACT LOCATIONS AND ELEVATIONS ARE TO BE VERIFIED BY THE CONTRACTOR THROUGH THE OWNER OF THE UTILITY.
- EMBANKMENTS SHALL BE COMPLETED TO THE SATISFACTION OF THE ENGINEER PRIOR TO EXCAVATION FOR STORM SEWER.
- . THE COST OF MAKING STORM SEWER CONNECTIONS TO EXISTING OR PROPOSED SEWER SHALL BE INCLUDED IN THE CONTRACT UNIT PRICE FOR THE STORM SEWER BEING CONNECTED.
- MANHOLES AND CATCH BASINS TYPE A WHERE THE DIFFERENCE BETWEEN THE RIM ELEVATION AND INVERT ELEVATION IS LESS THAN SIX (6) FEET, SHALL BE CONSTRUCTED WITH FLAT TOPS.
- ALL ADJUSTMENTS OR RECONSTRUCTIONS SHALL INCLUDE THE REMOVAL AND REPLACEMENT, AT THE CONTRACTOR'S EXPENSE, OF ALL UNSUITABLE TWO (2) FOOT INSIDE DIAMETER ADJUSTING RINGS.
- 8. ADJUSTMENT OF STRUCTURES MAINTAINED BY OTHER AGENCIES SHALL BE MADE TO THE SATISFACTION OF THE ENGINEER AND THE AGENCY MAINTAINING THE SYSTEM OF THE STRUCTURE INFOLING
-). ALL MANHOLES AND INLETS SHALL HAVE POURED INVERTS. THE COST OF INVERTS SHALL BE INCLUDED IN THE COST OF THE STRUCTURE.
- IO. ALL FIELD TILES ENCOUNTERED SHALL BE CAREFULLY PRESERVED AND CONNECTED TO PROPOSED DRAINAGE STRUCTURES, SEWERS, OR DITCHES, AS DIRECTED BY THE ENGINEER; THIS WORK WILL BE PAID FOR AT THE APPLICABLE CONTRACT UNIT PRICE OR IN ACCORDANCE WITH ARTICLE 109.04 OF THE STANDARD SPECIFICATIONS.

COUNTY HIGHWAY	FISCAL YEAR	TOTAL SHEETS	SHEET NO.
	2005	30	2
C 03-000	01-06-BT	DUP	AGE COUNTY

CONTRACT NO.: 83805

BITUMINOUS CONCRETE SURFACE COURSE AND BITUMINOUS BASE COURSE

- BITUMINOUS CONCRETE SURFACE COURSE, SUPERPAVE SHALL NOT BE PLACED UNTIL ALL EARTH EXCAVATION, TOPSOIL PLACEMENT, AGGREGATE BASE COURSE, AND BITUMINOUS CONCRETE BINDER COURSE, SUPERPAVE HAVE BEEN COMPLETED TO THE SATISFACTION OF THE ENGINEER.
- 3. THE MAXIMUM COMPACTED THICKNESS OF ANY LIFT OF BINDER OR SURFACE COURSE, SUPERPAVE SHALL BE 2.5 INCHES.
- 4. THE MAXIMUM COMPACTED THICKNESS OF A LIFT OF BASE COURSE WILL BE FOUR (4) INCHES UNLESS OTHERWISE AUTHORIZED BY THE ENGINEER.
- BASE COURSE SHALL NOT BE PLACED ADJACENT TO CURB AND GUTTER UNTIL THE CURB AND GUTTER HAS BEEN BACKFILLED TO THE SATISFACTION OF THE ENGINEER.

TRENCH BACKFILL

. WHERE TRENCH BACKFILL IS REQUIRED, THE MATERIAL USED SHALL BE COMPACTED AS SPECIFIED IN ARTICLE 550.07 OF THE STANDARD SPECIFICATIONS USING METHOD ONE

TRAFFIC CONTROL AND PROTECTION

- TRAFFIC CONTROL AND PROTECTION SHALL BE PERFORMED IN ACCORDANCE WITH THE TRAFFIC CONTROL PLAN AND SECTION 701 OF THE STANDARD SPECIFICATIONS AS AMENDED BY THE SPECIAL PROVISION FOR CONSTRUCTION ZONE TRAFFIC CONTROL (CHECK SHEET LRS 9).
- THE TYPE III BARRICADES ARE TO BE PLACED IN ACCORDANCE WITH STANDARD 702001 UNLESS AUTHORIZED BY THE ENGINEER TO USE AN ALTERNATE ARRANGEMENT.
- 3. ANY DROP OFF GREATER THAN THREE (3) INCHES BUT LESS THAN SIX (6) INCHES, WITHIN EIGHT (8) FEET OF THE PAVEMENT EDGE, SHALL BE PROTECTED BY TYPE I OR TYPE II BARRICADES, DRUMS OR VERTICAL PANELS WITH MONODIRECTIONAL STEADY-BURN LIGHTS AT 100 FOOT CENTER TO CENTER SPACING. IF THE DROP OFF WITHIN EIGHT (8) FEET OF THE PAVEMENT EDGE EXCEEDS SIX (6) INCHES, THE BARRICADES, DRUMS OR VERTICAL PANELS MENTIONED ABOVE SHALL BE PLACED AT FIFTY (50) FOOT CENTER TO CENTER SPACING. BARRICADES THAT MUST BE PLACED IN EXCAVATED AREAS SHALL HAVE LEG EXTENSIONS INSTALLED SUCH THAT THE TOP OF THE BARRICADE IS IN COMPLIANCE WITH THE HEIGHT REQUIREMENTS OF STANDARD TOZOOOI.
- 4. TYPE I OR TYPE II BARRICADES WITH TWO-WAY FLASHING LIGHTS SHALL BE REQUIRED AT ALL OPEN TRENCHES, EXCAVATIONS, OPEN OR EXPOSED SEWER STRUCTURES, TRANSVERSE PAVEMENT JOINTS, MATERIALS OR EQUIPMENT WITHIN THE RIGHT-OF-WAY (NUMBER AND SPACING DEPENDS ON THE CONDITIONS); AND AT LOCATIONS DESIGNATED BY THE ENGINEER OR LOCAL LAW ENFORCEMENT AGENCIES.
- 5. TYPE I, II AND / OR III BARRICADES WITH TWO-WAY FLASHING LIGHTS WILL BE REQUIRED TO GUIDE TRAFFIC AWAY FROM PAVEMENT AREAS CLOSED FOR CONSTRUCTION.
- THE COST OF SUPPLYING, ERECTING, AND MAINTAINING BARRICADES, WARNING LIGHTS, AND SIGNS WILL BE INCLUDED IN THE CONTRACT LUMP SUM PRICE FOR TRAFFIC CONTROL AND PROTECTION.
- WHERE REQUIRED, TRAFFIC SIGNS SHALL BE RELOCATED FOR EACH STAGE OF CONSTRUCTION.
- 8. ARROW BOARDS WILL BE REQUIRED WHEN IMPLEMENTING ALL LANE CLOSURES.
- THE FOLLOWING TRAFFIC CONTROL STANDARDS ARE THE MINIMUM REQUIREMENTS FOR THE TRAFFIC CONTROL FOR THIS PROJECT: 701101, 701106, 701301, 701606, 701701 & 702001.

DATE	REVISION	DATE	REVISION	SCALE		
				DRAWN BY	DATE	K
				CHECKED BY	DATE	-2
				APPROVED BY DWB	DATE	GRO

RJN GROUP, INC.

Southern DuPage County Regional Trail 101st Street Connector — Waterfall Glen Spur

GENERAL NOTES

DATE: JUNE 9, 2005
PROJECT No.: 11-1900-01

TEM	CODE	SUMMARY OF QUANTITIES	Y047 BIKE/ PEDESTRIAN	Y007	YO47 BIKE/PEDESTRIAN		
NO.	NUMBER	PAY ITEM	UNIT	TOTAL QUANTITY	PATH	MINOR STRUCTURE	PATH (LOO%, CNTY)
1	20100110	TREE REMOVAL (6 TO 15 UNITS DIAMETER)	UNIT	314	314		
2	20101000	TEMPORARY FENCE	FOOT	1,000	1,000		
3	20200100	EARTH EXCAVATION	CU YD	2,668	2,668		
4	20201200	REMOVAL AND DISPOSAL OF UNSUITABLE MATERIAL	CU YD	1,679	1,679		
5	20700420	POROUS GRANULAR EMBANKMENT, SUBGRADE	CU YD	300	300		
6	20800150	TRENCH BACKFILL	CU YD	68	68		
7	21101625	TOPSOIL FURNISH AND PLACE, 6"	SQ YD	7,351	7,351		
8	25000200	SEEDING, CLASS 2	ACRE	0.05	0.05		
9	25000400	NITROGEN FERTILIZER NUTRIENT	POUND	5	5		
10	25000500	PHOSPHORUS FERTILIZER NUTRIENT	POUND	5	5		
11	25000600	POTASSIUM FERTILIZER NUTRIENT	POUND	5	5		
12	25000322	SEEDING, CLASS 5A	ACRE	1.47	1.47		
13	25000775	SELECTIVE MOWING STAKES	EACH	4	4		
14	25002014	SEEDING, CLASS 4A (MODIFIED)	ACRE	1.47	1.47		
15	25100630	EROSION CONTROL BLANKET	SQ YD	7,351	7,351		
16	28000250	TEMPORARY EROSION CONTROL SEEDING	POUND	166	166		
17		TEMPORARY DITCH CHECKS	EACH	20	20		
18	28000400	PERIMETER EROSION BARRIER	FOOT	6,980	6,980		
19		INLET AND PIPE PROTECTION	EACH	13	13		
20		AGGREGATE BASE COURSE, TYPE B	CU YD	826	826		
21		PORTLAND CEMENT CONCRETE SIDEWALK, 6 INCH	SQ FT	60	60		
22		DETECTABLE WARNINGS	SQ FT	20	20		
23		COMBINATION CURB AND GUTTER REMOVAL	FOOT	32	32		
24	50102400	CONCRETE REMOVAL	CU YD	1.4		1.4	
25	50800105	REINFORCEMENT BARS	POUND	3,830		3,830	
26	51000105	PIPE HANDRAIL	FOOT	33		33	
27	54002020	EXPANSION BOLTS 3/4 INCH	EACH	40		40	
28	54003000	CONCRETE BOX CULVERTS	CU YD	19.2		19.2	
29	54213657	PRECAST REINFORCED CONCRETE FLARED END SECTIONS 12"	EACH	5	5		
30	550A0050	STORM SEWERS, CLASS A, TYPE 1 12"	FOOT	70	70		
31	550A0070	STORM SEWERS, CLASS A, TYPE 1 15"	FOOT	7	7		

CONTRACT NO.: 83805	COUNTY	FISCAL	TOTAL	SHEET
	HIGHWAY	YEAR	SHEETS	NO.
		2005	30	3

							30 3
				·	SEC 03-0000		DUPAGE COUNT
		SUMMARY OF QUANTITIES			Y047 BIKE/	Y007	Y047 BIKE/PEDESTRIAN
ITEM			LIMITT	TOTAL	PEDESTRIAN	MINOR	PATH
NO _e	NUMBER 550A0340	PAY ITEM STORM SEWERS, CLASS A, TYPE 2 12"	FOOT	QUANTITY 57	PATH 57	STRUCTURE	(100% CNTY)
33	55040450	STORM SEWERS, CLASS A, TYPE 2 36"	FOOT	10	10		
34	55100500	STORM SEWER REMOVAL 12"	FOOT	15	15		
35	55100700	STORM SEWER REMOVAL 15"	F00T	6	6		
36	60221100	MANHOLES, TYPE A, 5'-DIAMETER, TYPE 1 FRAME, CLOSED LID	EACH	1	1		
37	60223800	MANHOLES, TYPE A, 6'-DIAMETER, TYPE 1 FRAME, CLOSED LID	EACH	1	1		
38	60250200	CATCH BASINS TO BE ADJUSTED	EACH	3	3		
39	60252800	CATCH BASINS TO BE RECONSTRUCTED	EACH	2	2		
40	60255410	CATCH BASINS TO BE CLEANED	EACH	5			5
41	60605000	COMBINATION CONCRETE CURB AND GUTTER, TYPE B-6.24	FOOT	17	17		
42	63200310	GUARDRAIL REMOVAL	FOOT	71	71		
43	66400305	CHAIN LINK FENCE, 6'	FOOT	40	40		
44	66410300	CHAIN LINK FENCE REMOVAL	FOOT	80	80		
45	67100100	MOBILIZATION	L SUM	1	1		
46	70102625	TRAFFIC CONTROL AND PROTECTION, STANDARD 701606	L SUM	1	1		
47	70102635	TRAFFIC CONTROL AND PROTECTION, STANDARD 701701	L SUM	1	1		
48	Z0013798	CONSTRUCTION LAYOUT	L SUM	1	1		
49	Z0041700	PLUG EXISTING STORM SEWERS	EACH	2	2		
50	A2001720	TREE, ACER SACCHARUM (SUGAR MAPLE), 2-1/2" CALIPER, BALLED AND BURLAPPED	EACH	12	12		
51	A2004820	TREE, SKYLINE THORNLESS COMMON HONEYLOCUST, 2-1/2" CALIPER, BALLED AND BURLAPPED	EACH	12	12		
52	A2007820	TREE, AMERICAN LINDEN/BASSWOOD, 2-1/2" CALIPER, BALLED AND BURLAPPED	EACH	12	12		
53	C2009636	SHRUB, SAMBUCUS CANADENSIS (AMERICAN ELDER) 3' HEIGHT, BALLED AND BURLAPPED	EACH	6	6		
54	C2012448	SHRUB, VIBURNUM LENTAGO (NANNYBERRY), 4' HEIGHT, BALLED AND BURLAPPED	EACH	3	3		
55	K0026505	WETLAND EMERGENT PLANTINGS	UNIT	200	200		
56	K1003679	MULCH	CU YD	4	4		
57	K1004595	PRUNING FOR SAFETY AND EQUIPMENT CLEARANCE	L SUM	1	1	, , , , , , , , , , , , , , , , , , , ,	
58	XX003437	REMOVE AND REINSTALL EXISTING PRECAST REINFORCED CONCRETE FLARED END SECTIONS	EACH	1	1		
59	XX005676	RED-OSIER DOGWOOD	EACH	6	6		
60	X4066414	BITUMINOUS CONCRETE SURFACE COURSE, SUPERPAVE, MIX "C", N50	TON	504	504		

1 May 1 May 2 May 2

VARIES 2' 10' 2' VARIES 101st STREET ROW

(6' MIN.)

1' TYP.

PGL
27

6:1

9:00

2: VARIES


101st STREET ROW

PGL
27

5: 5

PROPOSED TYPICAL SECTION

(NOT TO SCALE)
TWO-WAY SHARED USE TRAIL FROM WOODWARD AVENUE TO LEMONT ROAD
STATION 1+00 TO 2+12.26
STATION 2+26.16 TO 41+53

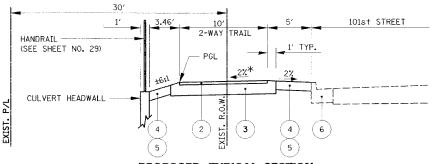

PROPOSED TYPICAL SECTION

(NOT TO SCALE)
TWO-WAY SHARED USE TRAIL AT CULVERT HEADWALL
STATION 2+12.26 TO 2+26.16

BITUMINOUS MIX	TURE REQUIR	EMENTS	
PAY ITEM	AC TYPE	VOIDS	MAX RAP %
BITUMINOUS CONCRETE SURFACE COURSE, SUPERPAVE, MIX "C", N50	PG 64-22	4% @ 50 Gyr.	15

THE UNIT WEIGHT USED TO CALCULATE ALL BITUMINOUS SURFACE MIXTURE QUANTITIES IS $\underline{112}$ LBS/SQ YD/INCH.

- 1 EXISTING GRADE
- (2) BITUMINOUS CONCRETE SURFACE COURSE, SUPERPAVE, MIX "C", N50 2"
- 3 AGGREGATE BASE COURSE, TYPE B ~ 6"
- (4) TOPSOIL EXCAVATION AND PLACEMENT 6"
- 5 SEEDING
- 6 EXISTING COMBINATION CURB & GUTTER, TYPE B-6.24
- * CROSS-SLOPE PATH 2% DOWN TO THE NORTH FROM STA. 1+81 TO STA. 3+67.

NO.	DATE	BY	REVISION	DATE	REVISION	SCALE			
						DRAWN BY	JMC	DATE	IK
						CHECKED BY	MRH	DATE	-6
						APPROVED BY	DWB	DATE	GRO

RJN GROUP, INC. consulting engineers

Southern DuPage County Regional Trail 101st Street Connector — Waterfall Glen Spur SUMMARY OF QUANTITIES AND TYPICAL SECTIONS

DATE: JUNE 9, 2005
PROJECT No.: 11-1900-01
SHEET:

STATION	OFFSET	6 - 15 UNITS	STATION	OFFSET	6 - 15 UNITS
5+27	11' RT	7′′	14+55	15' RT	7''
5+36	2' LT	11"	15+13	13' RT	6′′
8+12	15′ RT	11"	15+89	1' RT	6′′
8+28	5' LT	7''	16+15	13' RT	8′′
8+33	7' LT	9"	17+99	13' RT	11''
8+52	9' LT	9"	19+08	15' RT	8′′
9+03	14′ RT	12"	19+68	15' RT	8"
9+16	5' LT	6"	20+17	3' LT	6"
9+56	15′ RT	9′′	20+41	7′ RT	8"
9+79	3′ RT	9"	23+19	8' LT	6"
10+17	5′ RT	13''	23+26	17' RT	9"
10+49	21' RT	13''	23+54	7' LT	9"
11+38	15′ RT	8′′	26+54	15' RT	6′′
12+11	7′ RT	7"	27+45	14' RT	8"
13+07	5′ RT	6"	27+67	1' RT	11''
13+32	15′ RT	13''	28+35	5' LT	11"
13+88	11' RT	6′′	31+06	18' RT	9"
14+43	2' RT	6′′	39+95	7' LT	15''
				TOTAL	314 UNI

EROSION	CONTRO	L					
		TEMPORARY	INLET & PIPE			TEMPORARY	INLET & PIP
STATION	OFFSET	DITCH CHECKS	PROTECTION	STATION	OFFSET	DITCH CHECKS	PROTECTION
		28000300	28000500			28000300	28000500
5+01	23′ RT	1		35+99	29' RT	1	
5+77	21' RT	1		37+55	30' RT	1	
6+53	20' RT	1		39+00	30' RT	1	
7+23	23′ RT	1		2+31	16' RT		1
7+99	25' RT	1		4+62	22' RT		1
8+77	27′ RT	1		4+39	19′ RT		1
9+55	29' RT	1		8+51	7′ LT		1
10+24	32′ RT	1		10+04	6′ LT		1
13+00	28′ RT	1		10+75	34′ RT		1
14+59	27′ RT	1		23+19	8′ LT		1
16+77	26′ RT	1		24+18	27' RT		1
26+99	27′ RT	1		25+71	27′ RT		1
28+38	18' RT	1		36+72	10' LT		1
29+99	21' RT	1		40+17	6′ LT		1
31+56	27′ RT	1		41+08	22' RT		1
33+00	27′ RT	1		41+45	6′ LT		1
34+54	28′ RT	1					
	***************************************				TOTALS	20	13

COUNTY HIGHWAY	FISCAL YEAR	TOTAL SHEETS	SHEET NO.
	2005	30	4
SEC 03-000	01-06-BT	DUP	AGE COUNTY

CONTRACT NO.: 83805


FENCE										
		CHAIN LINK	CHAIN LINK							
STATION	OFFSET	FENCE, 6'	FENCE REMOVAL							
		66400305	66410300							
14+25	11' LT	20′	40′							
33+07	15′ LT	20′	40′							
	TOTALS	40′	80′							


DRAIN	AGE															
STATION	OFFSET	TRENCH BACKFILL	PRECAST REINFORCED CONCRETE FLARED END SECTIONS, 12"	STORM SEWERS, CLASS A, TYPE 1 12" (FT)	STORM SEWERS, CLASS A, TYPE 1 15" (FT)	STORM SEWERS, CLASS A, TYPE 2 12" (FT)	STORM SEWERS, CLASS A, TYPE 2 36" (FT)	STORM SEWER REMOVAL 12" (FT)	STORM SEWER REMOVAL 15" (FT)	MANHOLES, TYPE A 5'-DIAMETER, TYPE 1 FRAME, CLOSED LID	MANHOLES, TYPE A 6'-DIAMETER, TYPE 1 FRAME, CLOSED LID	CATCH BASINS TO BE ADJUSTED	TO BE RECONSTRUCTED	CATCH BASINS TO BE CLEANED	PLUG EXISTING	REMOVE AND REINSTALL EXISTING PRECAST REINFORCED CONCRETE FLARED END SECTION
		20800150	54213657	550A0050	550A0070	550A0340	550A0450	55100500	55100700	60221100	60223800	60250200	60252800	60255410	Z0041700	XX003437
2+38	5′ RT	18.20				25										
8+51	10′ RT	5.04		26												
10+04	12.5′ RT	5.63		29												
23+20	11' RT	10.91				32									354-	
40+11	2' RT	10.92		15				15								,
28+50	12' RT	2.14			7				6							
2+36	8.5′ LT	15.08		"			10									
8+51	7' LT		1													
8+51	26' RT		1													
10+04	6′ LT		1													
10+04	30.5′ RT		1													
23+20	8' LT		1													
2+44	8' LT									1						
23+21	30.5′ RT										1					
28+50	6' RT											1		1		
33+41	10' RT											1		1		
36+91	15' RT											1		1		
29+89	10' RT												1	1		
40+05	9' RT												1	1		
2+29	10' RT														2	
28+50	19' RT															1
	TOTALS	68	5	70	7	57	10	15	6	1	1	3	2	5	2	1


	REM & DISP OF UNSUITABLE MATERIAL (PGES) (CU YD)	REM & DISP OF UNSUITABLE MATERIAL (TOPSOIL) (CU YD)	EARTH EXCAVATION (CU YD)	STORM SEWER EXCAVATION (CU YD)	TOTAL SUITABLE EXCAVATION (CU YD)	EXCAVATION TO BE USED IN EMBANKMENT (ADJ FOR 15% SHRINKAGE (CU YD)	EMBANKMENT (CU YD)	EARTHWORK BALANCE WASTE (+) OR SHORTAGE -) (CU YD)
1+00 TO 10+00	0	353	432	38	470	400	220	+180
10+00 T0 20+00	0	388	617	6	623	530	48	+482
20+00 TO 30+00	0	435	734	13	747	635	91	+544
30+00 TO 41+57.13	0	503	885	11	896	762	188	+574
TOTALS	0	1,679	2,668	68	2,736	2,327	547	+1,780


	DATE	BY	REVISION	NO.	DATE	BY	REVISION	SCALE		·
Ī								DRAWN BY	JMC	DATE
I								CHECKED BY	MRH	DATE
Ī								APPROVED BY	D₩B	DATE


N	RJN GROUP, INC.
4	CONSULTING ENGINEERS

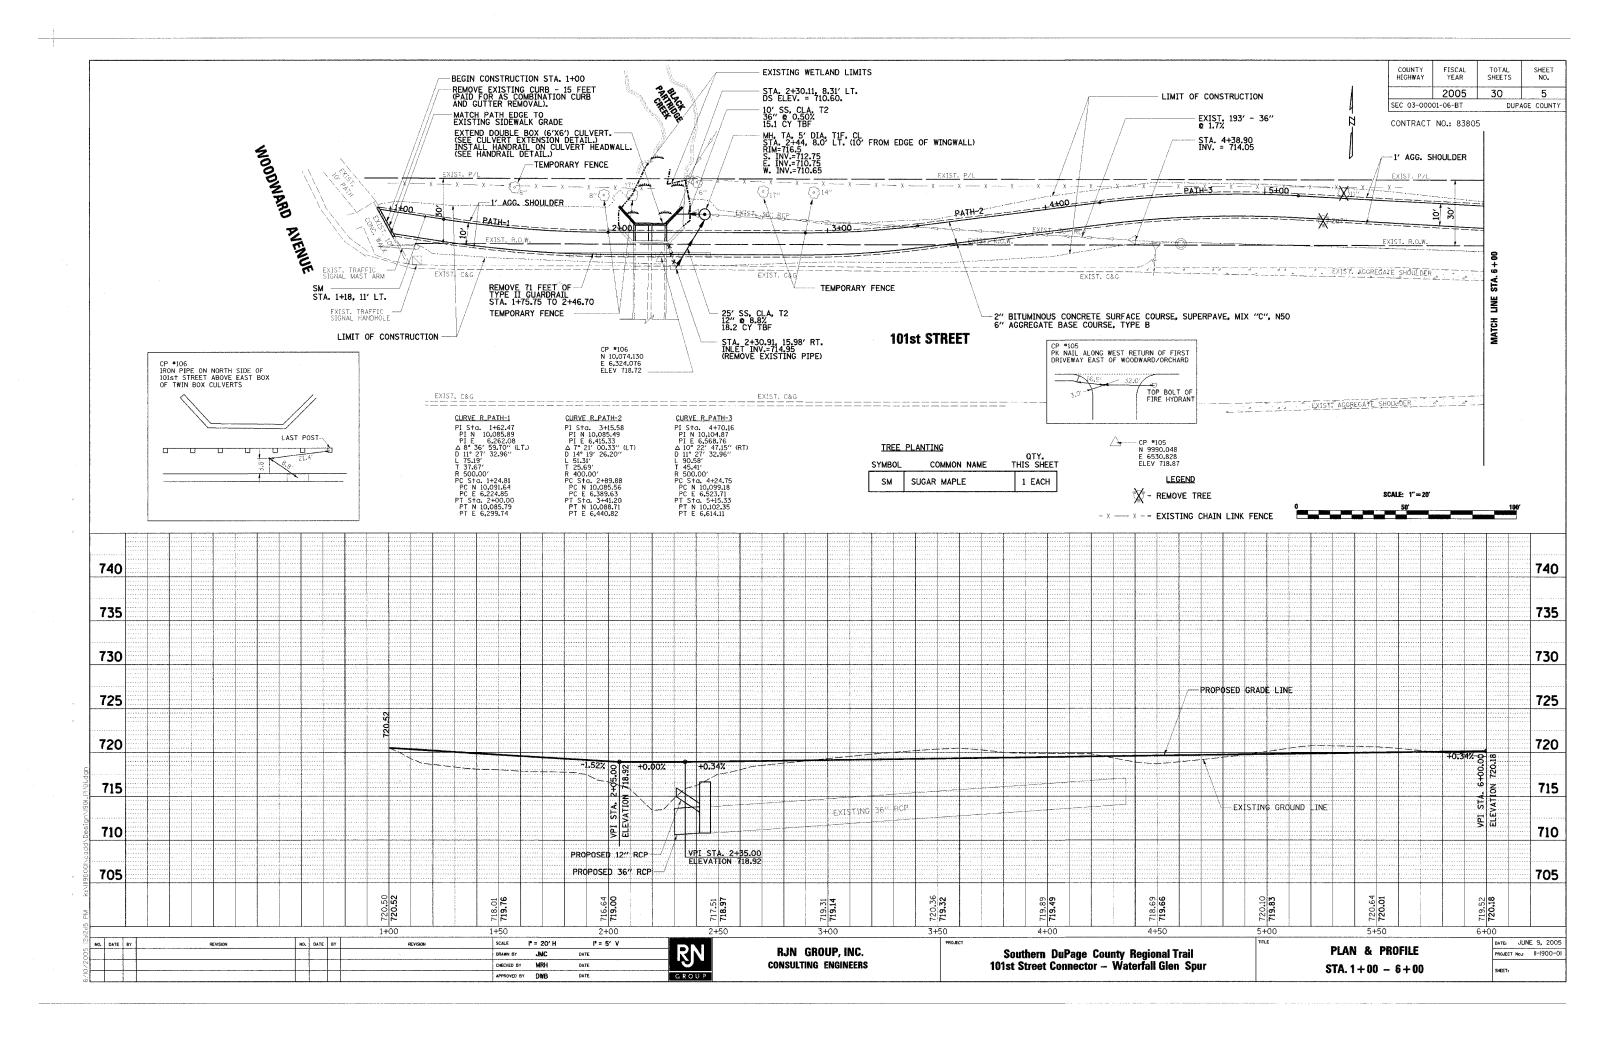


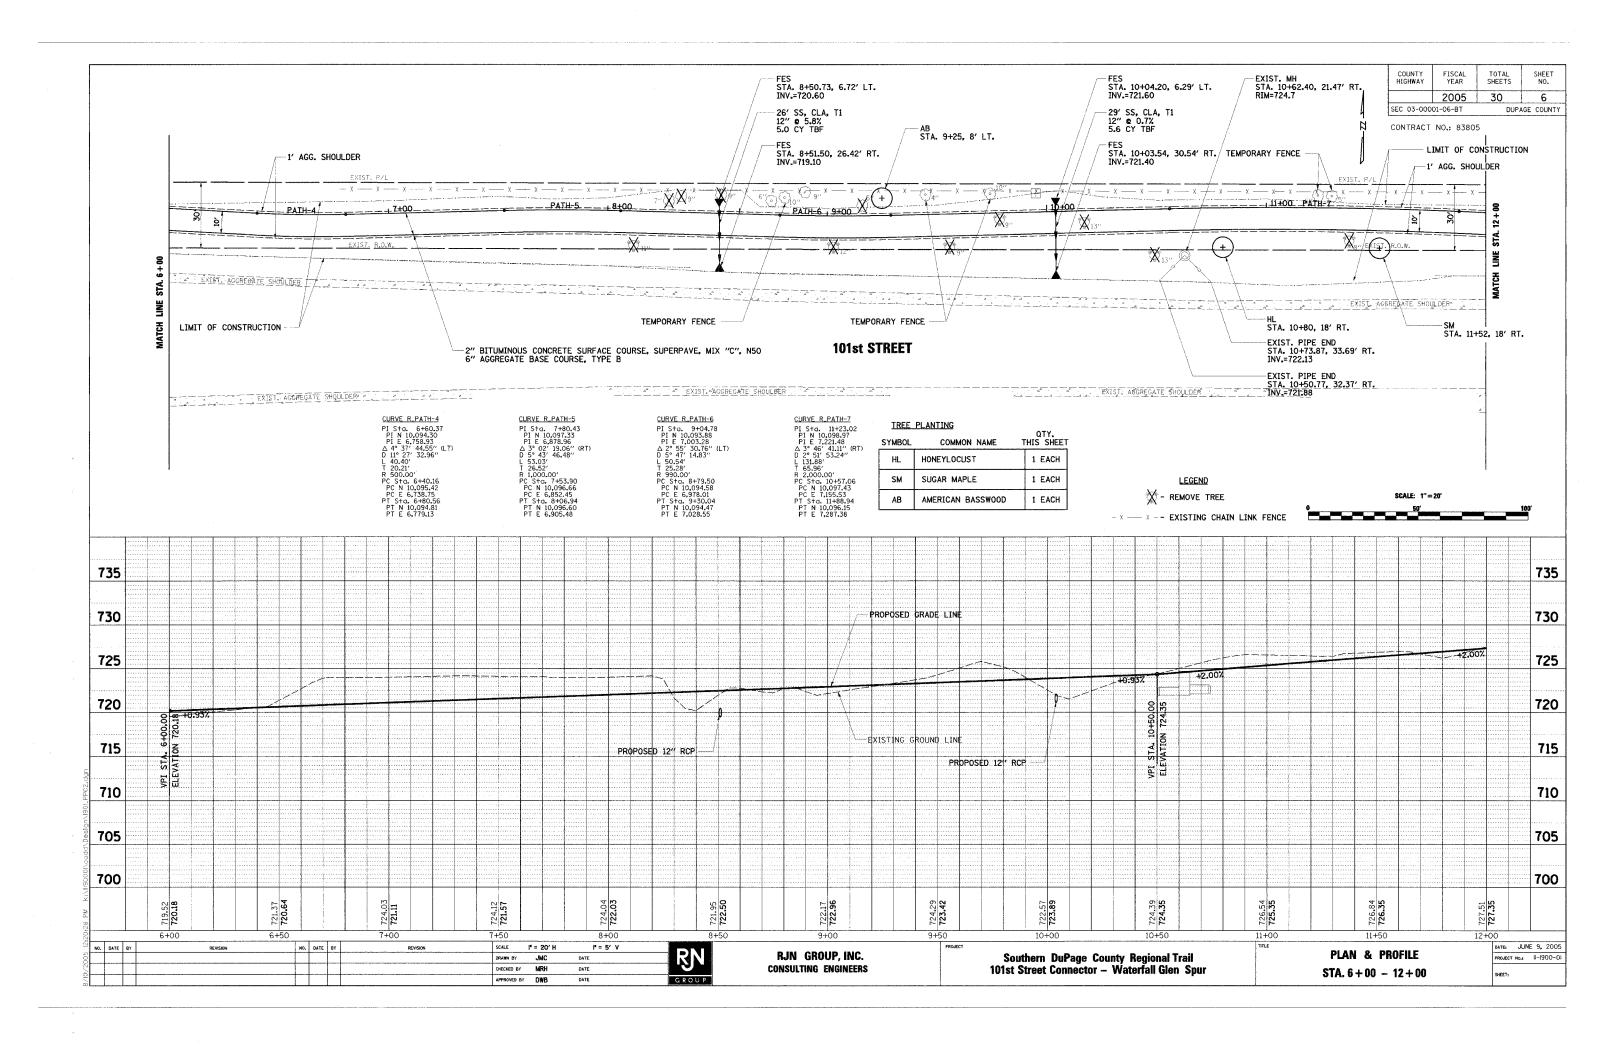


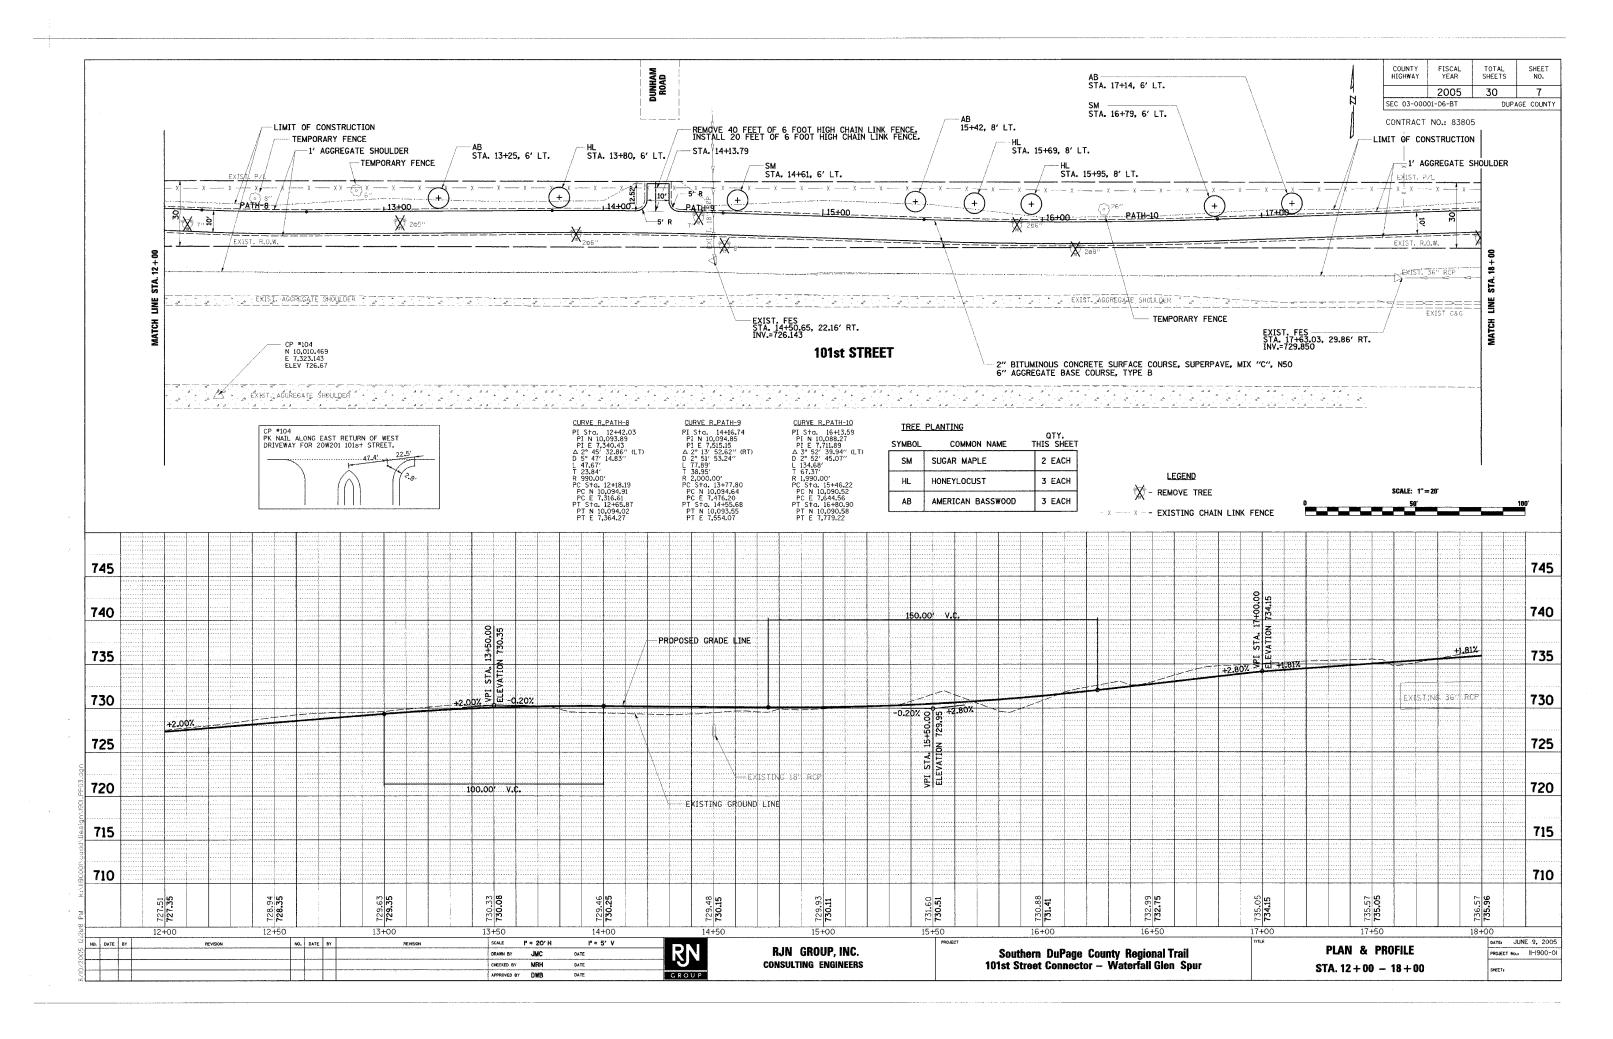


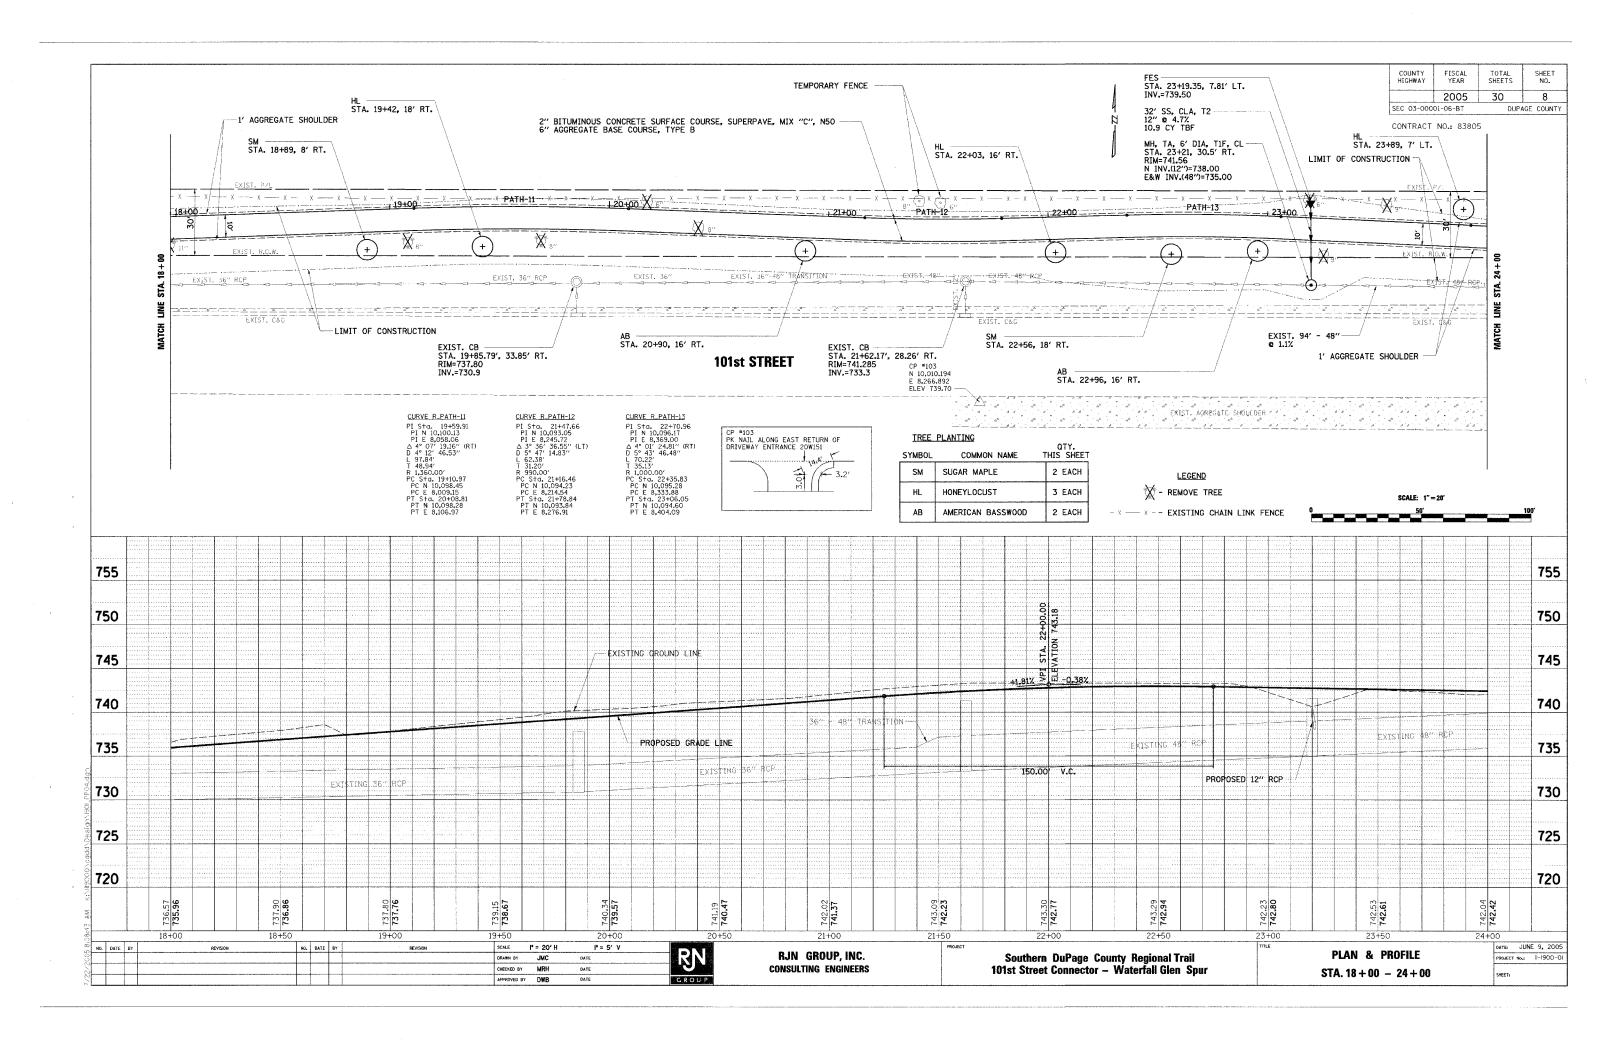


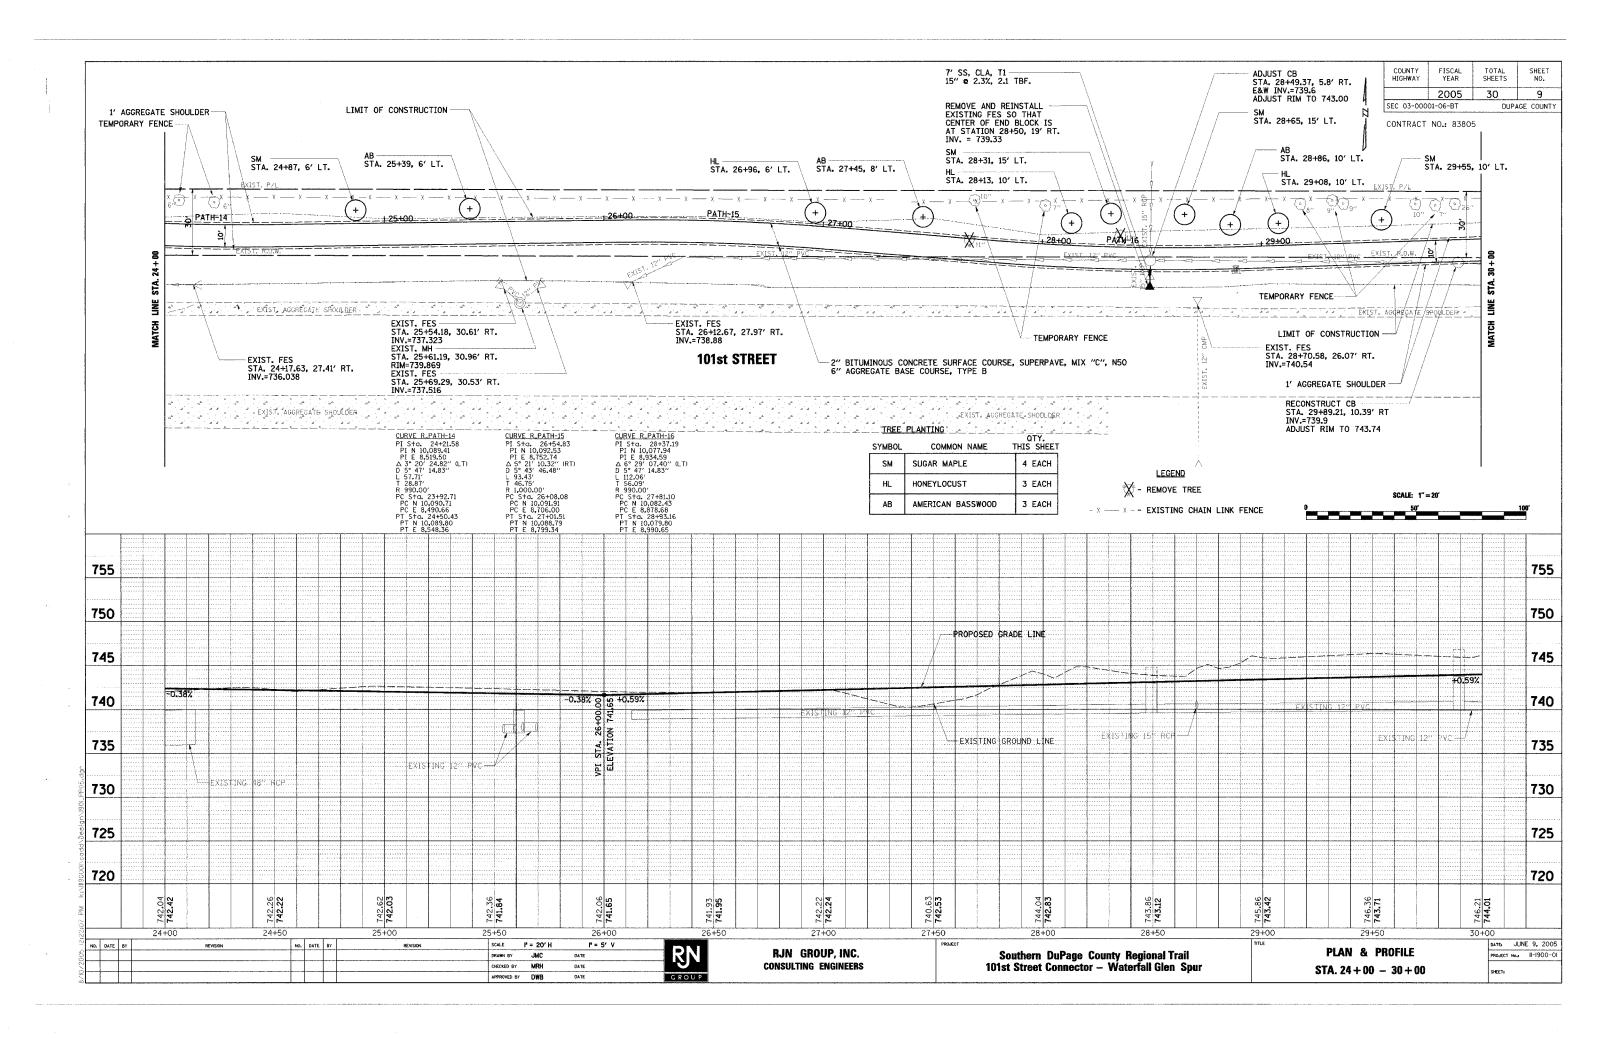


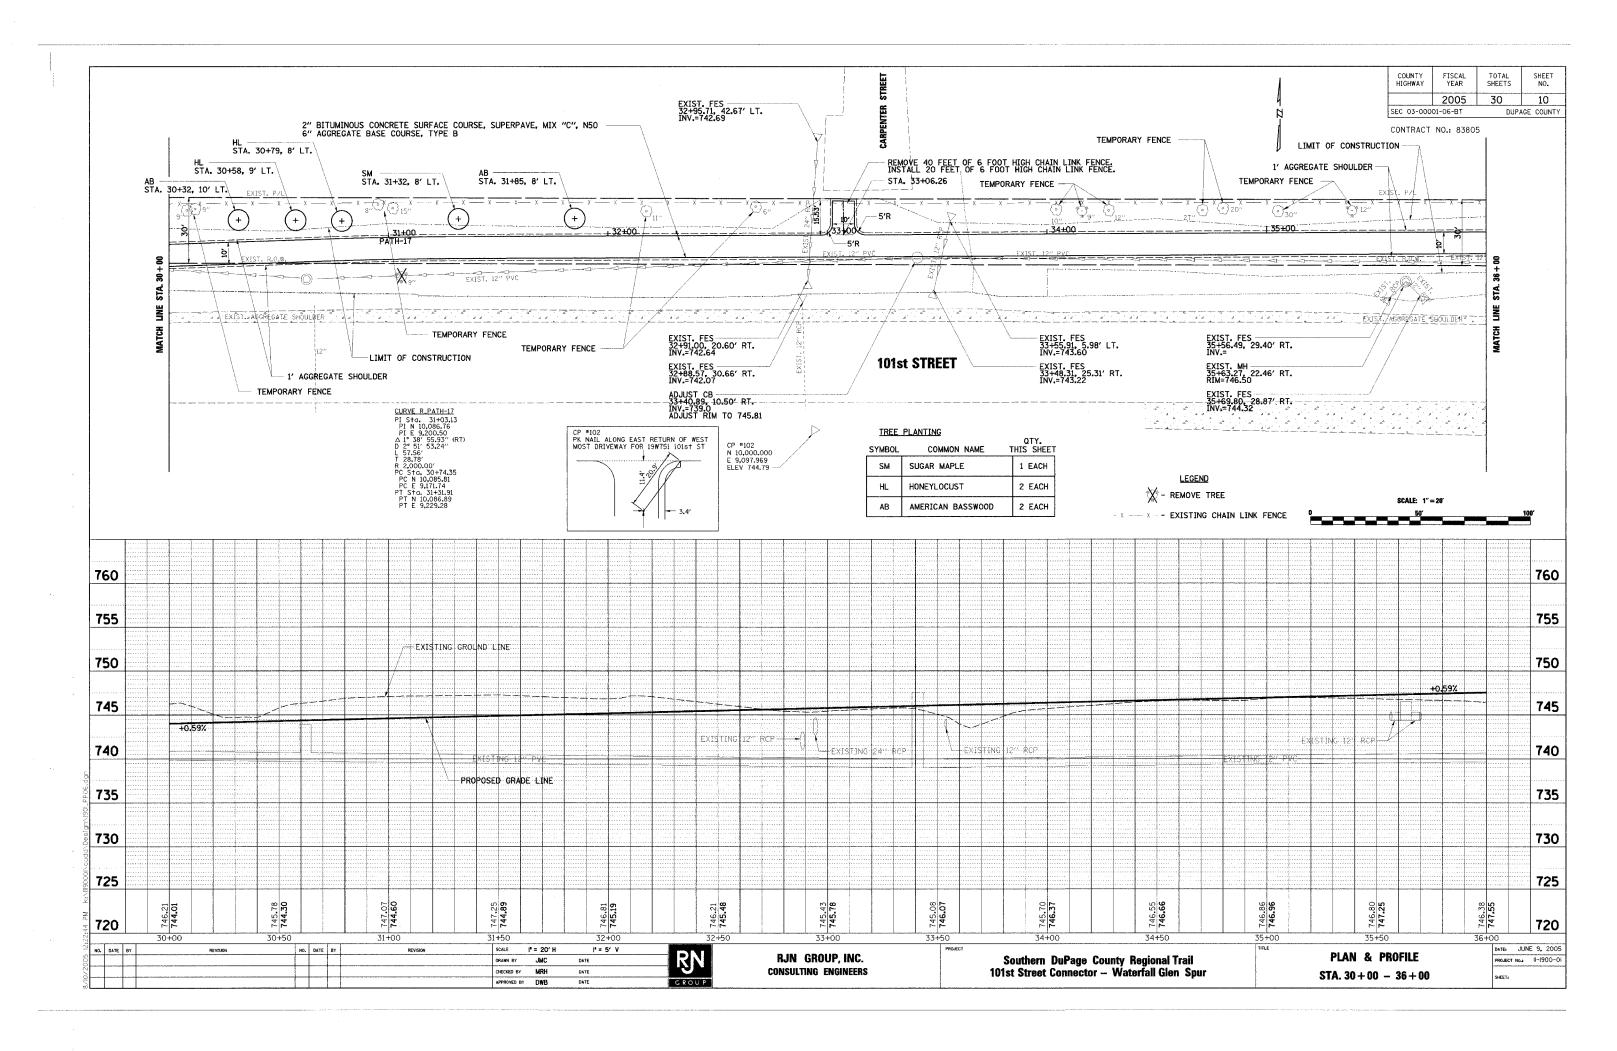

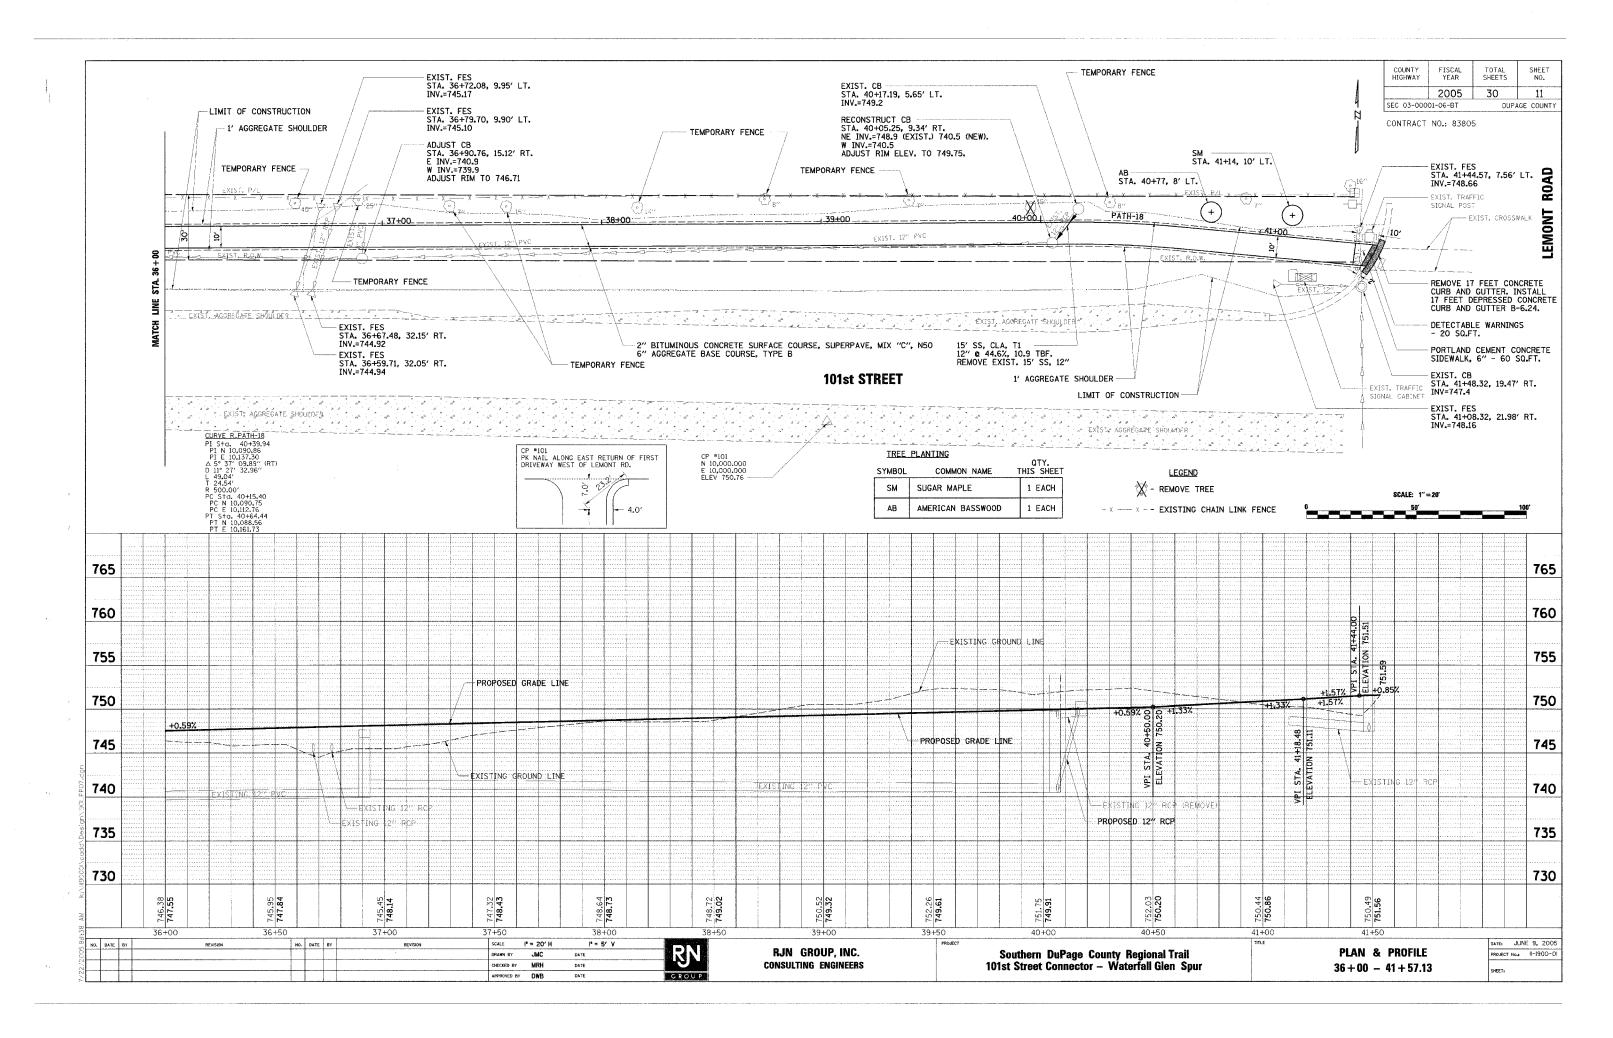


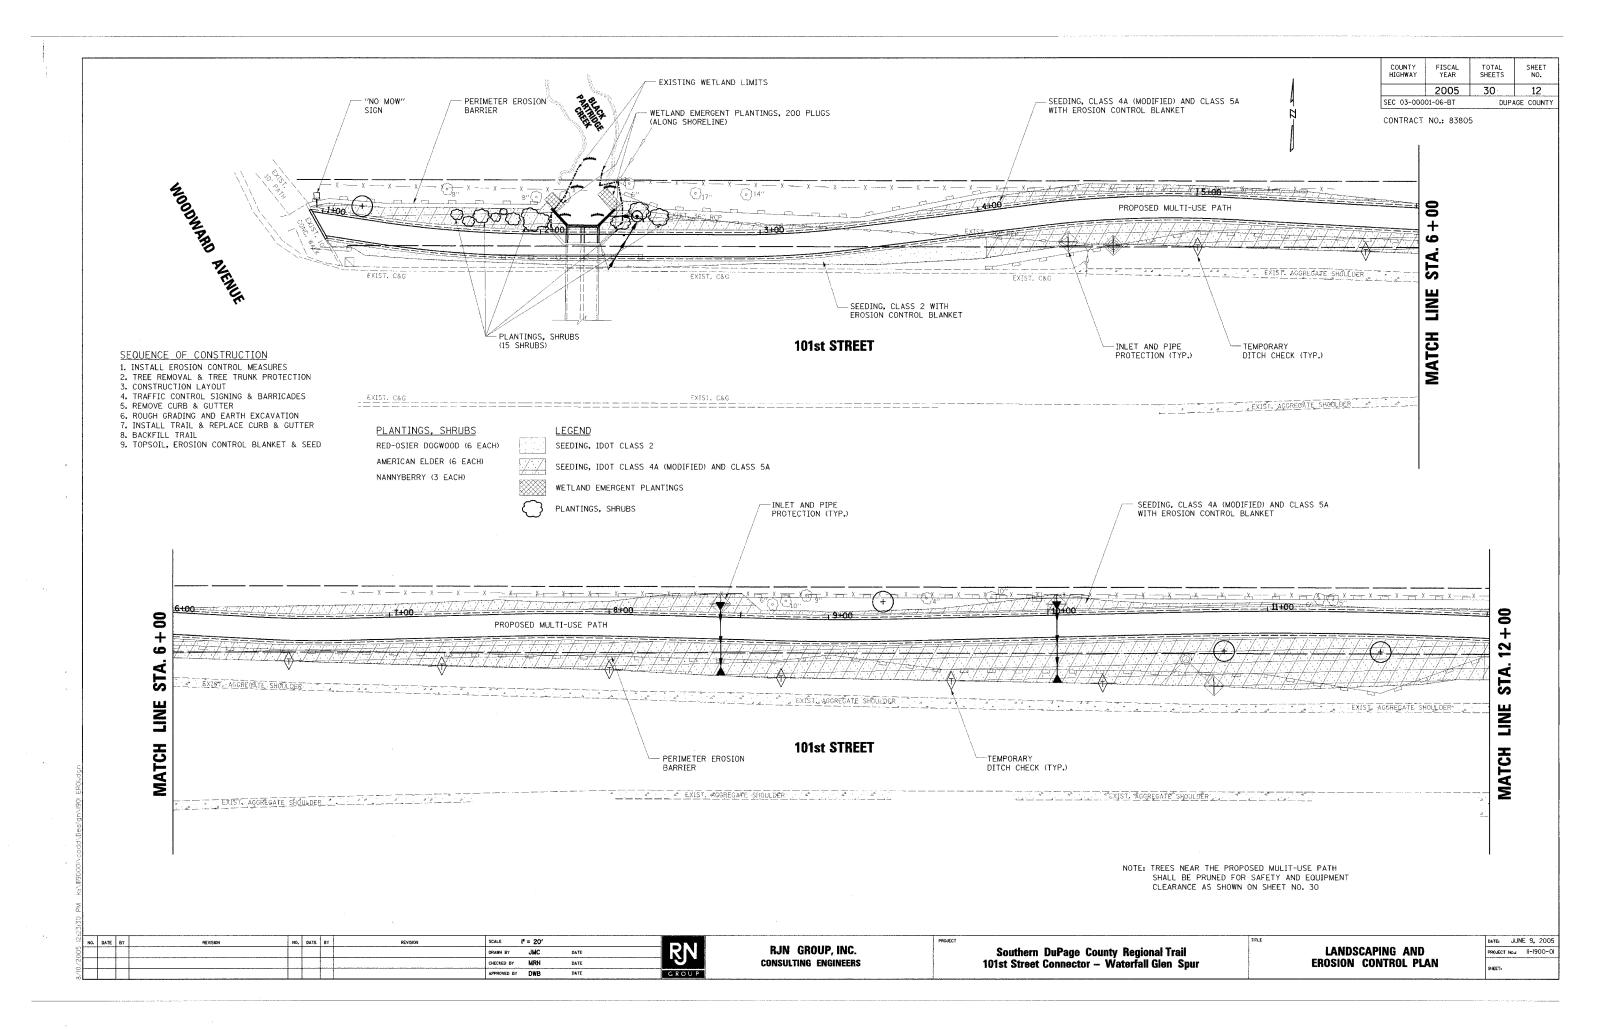

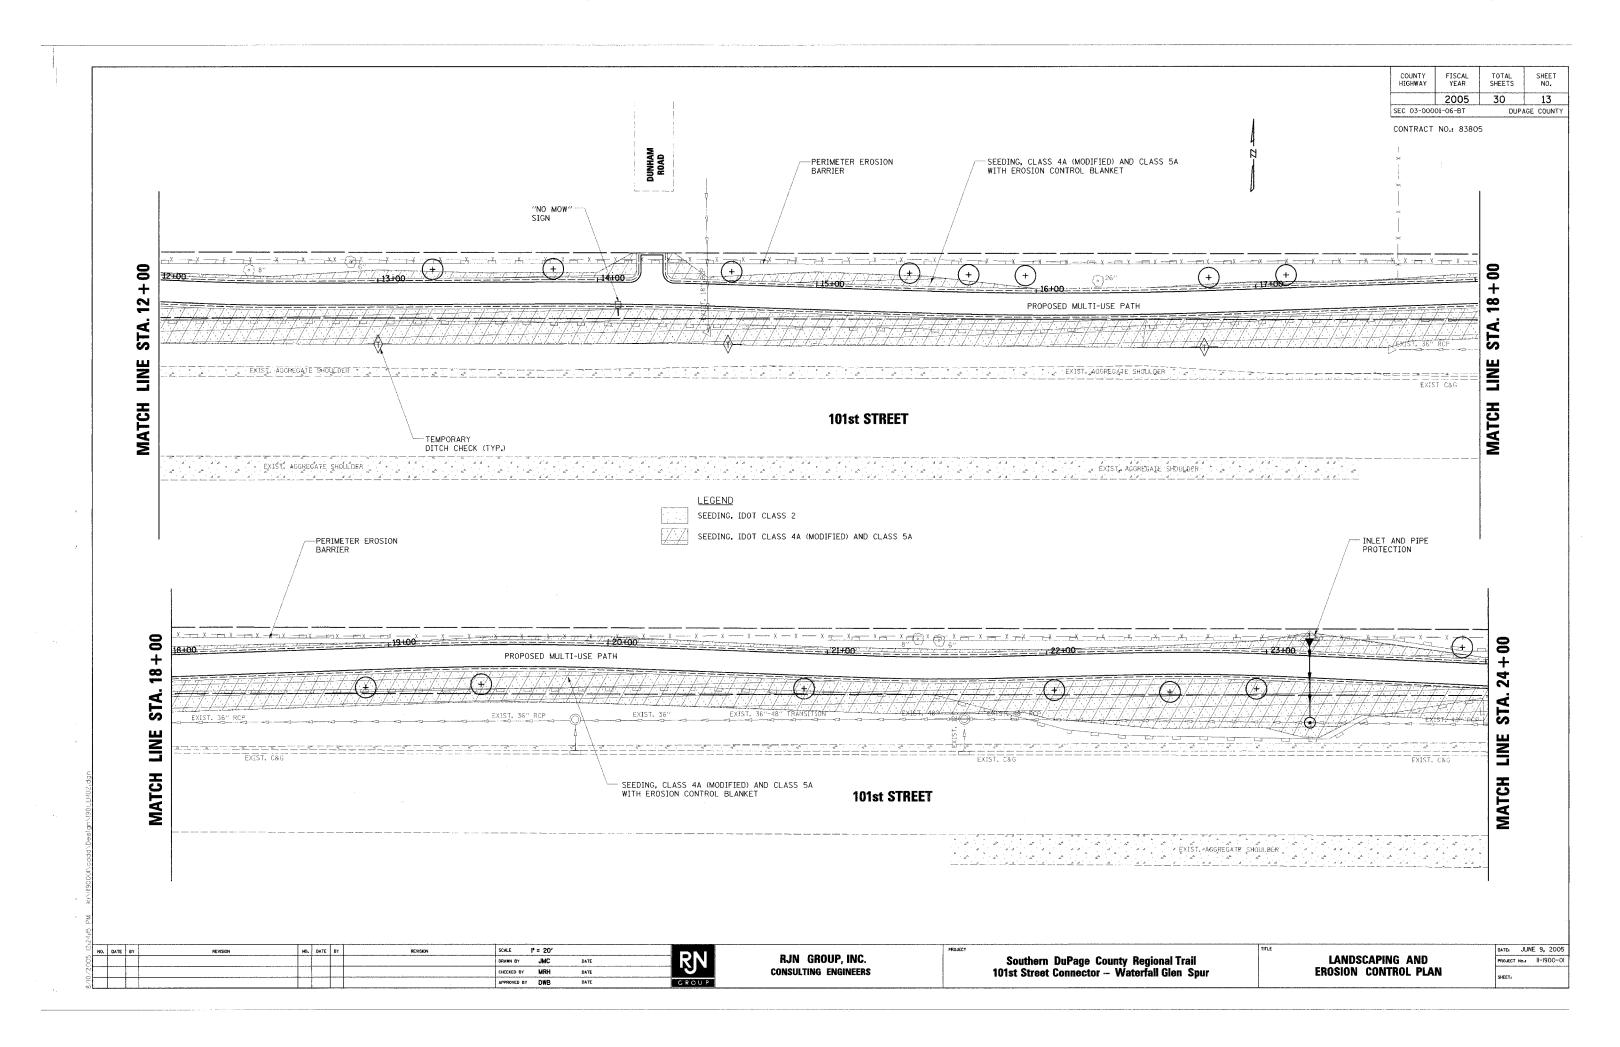

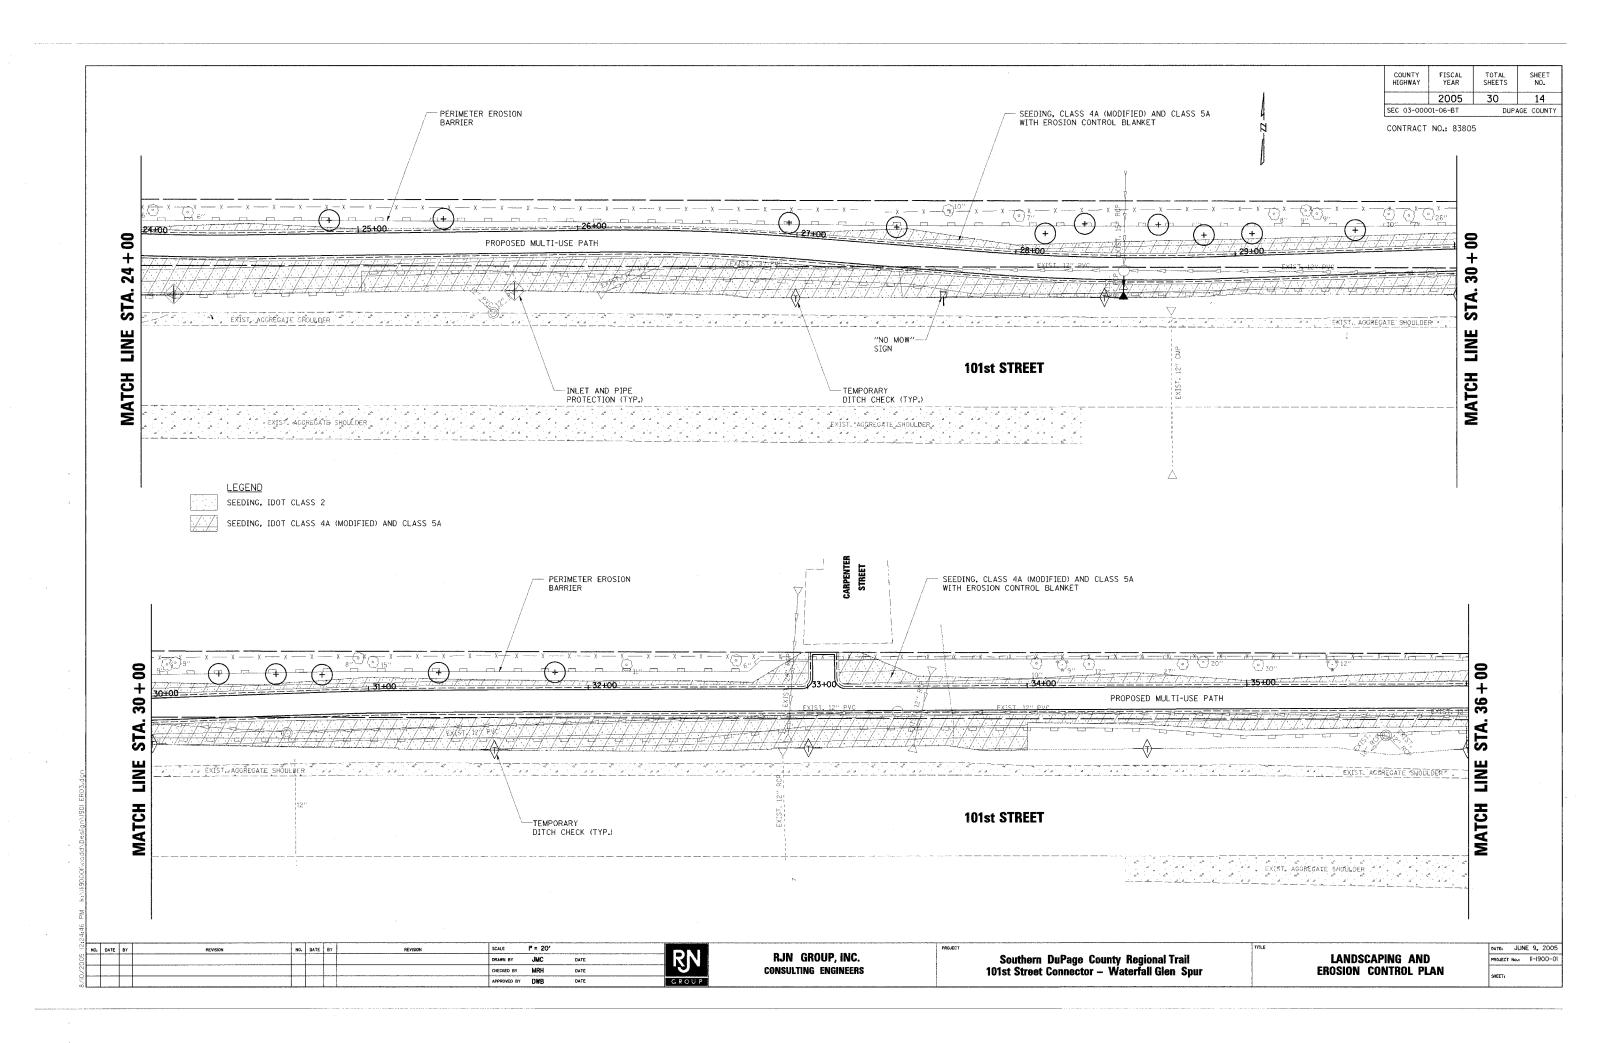

CONTRACT NO.: 83805

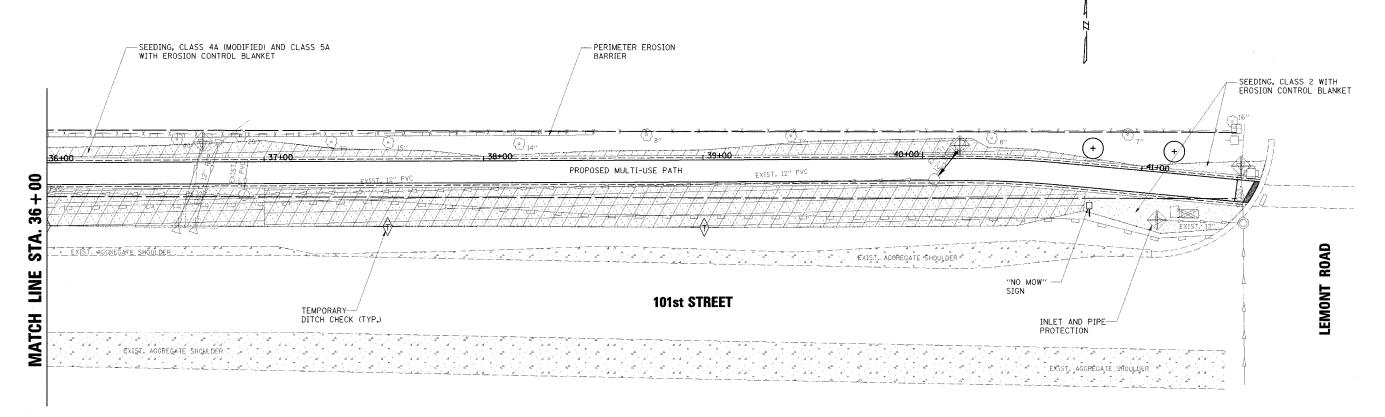

EROSION CONTROL NOTES

- 1. ALL WORK SHALL BE DONE IN ACCORDANCE WITH SECTION 15-116 OF THE DU PAGE COUNTY COUNTYWIDE STORM WATER AND FLOOD PLAIN ORDINANCE, EFFECTIVE SEPTEMBER 24, 1991 AND ALL SUBSEQUENT REVISIONS. ALL SEDIMENT AND EROSION CONTROL MEASURES WILL BE INSTALLED PER IDOT STANDARD 280001 OR AS SPECIFIED HEREIN AND PAID FOR IN ACCORDANCE WITH SECTION 280 OF THE STANDARD SPECIFICATIONS. ALL CONSTRUCTION ACTIVITIES WILL BE IN ACCORDANCE WITH THE NATIONAL POLLUTANT DISCHARGE ELIMINATION SYSTEM STORM WATER PERMIT ILR40.
- EROSION CONTROL SHALL BE PROVIDED IN ACCORDANCE WITH THE SEQUENCE OF STAGE CONSTRUCTION. THE CONTRACTOR SHALL SUBMIT A DETAILED SCHEDULE FOR APPROVAL.
- SEDIMENT AND EROSION CONTROL DEVICES SHALL BE FUNCTIONAL BEFORE THE PROJECT SITE IS OTHERWISE DISTURBED.
- 4. ALL DISTURBED AREAS SHALL BE SEEDED OR SODDED AS SOON AS PRACTICAL AFTER CONSTRUCTION ACTIVITIES IN THAT AREA HAVE CONCLUDED. ALL ERODABLE/BARE AREAS SHALL BE SEEDED EVERY 7 DAYS WITH TEMPORARY EROSION CONTROL SEEDING. ERODABLE AREAS OUTSIDE AND DOWN SLOPE FROM THE CONSTRUCTION LIMITS SHALL BE SIMILARLY SEEDED.
- 5. THE CONTRACTOR SHALL TAKE ALL PRECAUTIONS TO PROTECT WETLANDS TO REMAIN FROM DAMAGE BY SEDIMENT, CONSTRUCTION EQUIPMENT OR BY HIS WORK CREWS. THE CONTRACTOR SHALL ASSURE THAT DEBRIS OR ANY CONSTRUCTION MATERIAL IS NOT DISPOSED OF IN WETLANDS.
- 6. WATER PUMPED OR OTHERWISE DISCHARGED FROM THE SITE DURING CONSTRUCTION DEWATERING 14. SHALL BE FILTERED.
- WHEN TEMPORARY DRAINAGE IS ESTABLISHED, EROSION CONTROL MEASURES MAY BE REQUIRED BY THE ENGINEER.
- 8. GRAVEL ROADS, ACCESS DRIVES, PARKING AREAS OF SUFFICIENT WIDTH AND LENGTH, AND VEHICLE WASH DOWN FACILITIES IF NECESSARY, SHALL BE PROVIDED TO PREVENT SOIL FROM BEING TRACKED ONTO PUBLIC OR PRIVATE ROADWAYS. ANY SOIL REACHING A PUBLIC OR PRIVATE ROADWAY SHALL BE REMOVED BEFORE THE END OF EACH WORKDAY AND AS NEEDED.

- CLEANING OF VEHICLES AND EQUIPMENT, INCLUDING CONCRETE MIXERS, SHALL BE PERFORMED IN A MANNER TO REDUCE THE AMOUNT OF POLLUTANTS TRIBUTARY TO STORM SEWERS AND OPEN WATERS TO THE MAXIMUM EXTENT PRACTICAL.
- 10. ALL NECESSARY MEASURES SHALL BE TAKEN TO CONTAIN ANY FUEL OR POLLUTION RUNOFF. LEAKING EQUIPMENT OR SUPPLIES SHALL BE IMMEDIATELY REPAIRED OR REMOVED FROM THE SITE.
- SEDIMENT COLLECTED DURING CONSTRUCTION BY THE VARIOUS TEMPORARY EROSION CONTROL SYSTEMS SHALL BE DISPOSED OF ON THE SITE ON A REGULAR BASIS. SEDIMENT SHALL BE REMOVED FROM EROSION CONTROL SYSTEMS WHEN THE HEIGHT OF THE SEDIMENT EXCEEDS ONE-HALF OF THE HEIGHT OF THE FILTER DEVICE.
- 2. THE ENGINEER SHALL INSPECT EROSION CONTROL MEASURES PERIODICALLY AND WITHIN 24 HOURS OF ANY STORM EXCEEDING ¹/₂ INCH PRECIPITATION. DAMAGED AND INEFFECTIVE EROSION CONTROL MEASURES SHALL BE REPAIRED OR REPLACED WITHIN 72 HOURS. EROSION CONTROL SYSTEMS REPLACED DUE TO SEDIMENT LOADING WILL BE PAID FOR AT THE CONTRACT UNIT PRICE FOR THE APPLICABLE EROSION CONTROL ITEM.
- THE COST OF REPAIRING OR REMOVING SEDIMENT FROM EROSION CONTROL SYSTEMS SHALL BE INCLUDED IN THE CONTRACT UNIT PRICE FOR THE APPLICABLE EROSION CONTROL ITEM.
- 14. ALL EROSION CONTROL MEASURES SHALL BE KEPT OPERATIONAL AND MAINTAINED CONTINUOUSLY THROUGHOUT THE PERIOD OF LAND DISTURBANCE UNTIL PERMANENT SEDIMENT AND EROSION CONTROL MEASURES ARE OPERATIONAL.
- ALL DISTURBED AREAS SHALL BE DRESSED WITH 6" OF TOPSOIL, SEEDED AND COVERED WITH AN EROSION CONTROL BLANKET STAPLED DOWN PER THE MANUFACTURER'S RECOMMENDATION.
- 16. OMIT FERTILIZER FOR CLASS 4A (MODIFIED) AND CLASS 5A SEEDING.

LEGEND

SEEDING, IDOT CLASS 2

SEEDING, IDOT CLASS 4A (MODIFIED) AND CLASS 5A

NO. DATE BY REVISION NO. DATE BY REVISION SCALE |* = 20'

ORANN BY JMC DATE


CHECKED BY MRH DATE


APPROVED BY DWB DATE


RJN GROUP, INC.


Southern DuPage County Regional Trail 101st Street Connector — Waterfall Glen Spur LANDSCAPING AND EROSION CONTROL PLAN


DATE: JUNE 9, 2005
PROJECT No.: II-1900-01
SHEET:

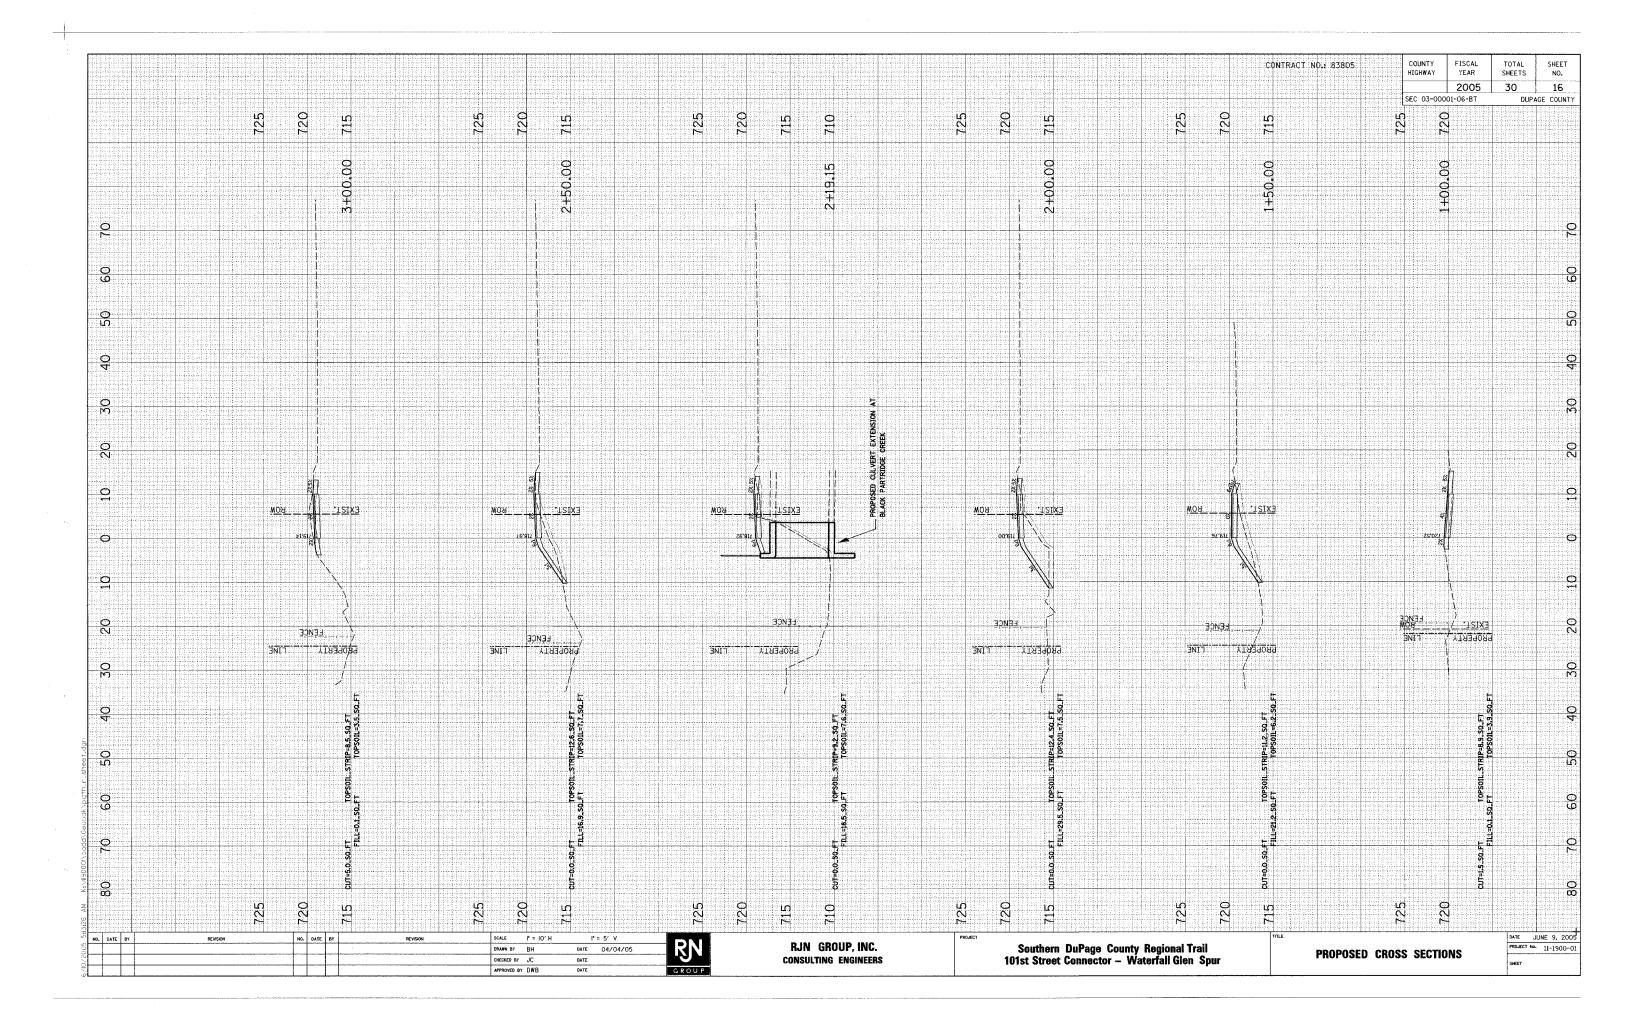


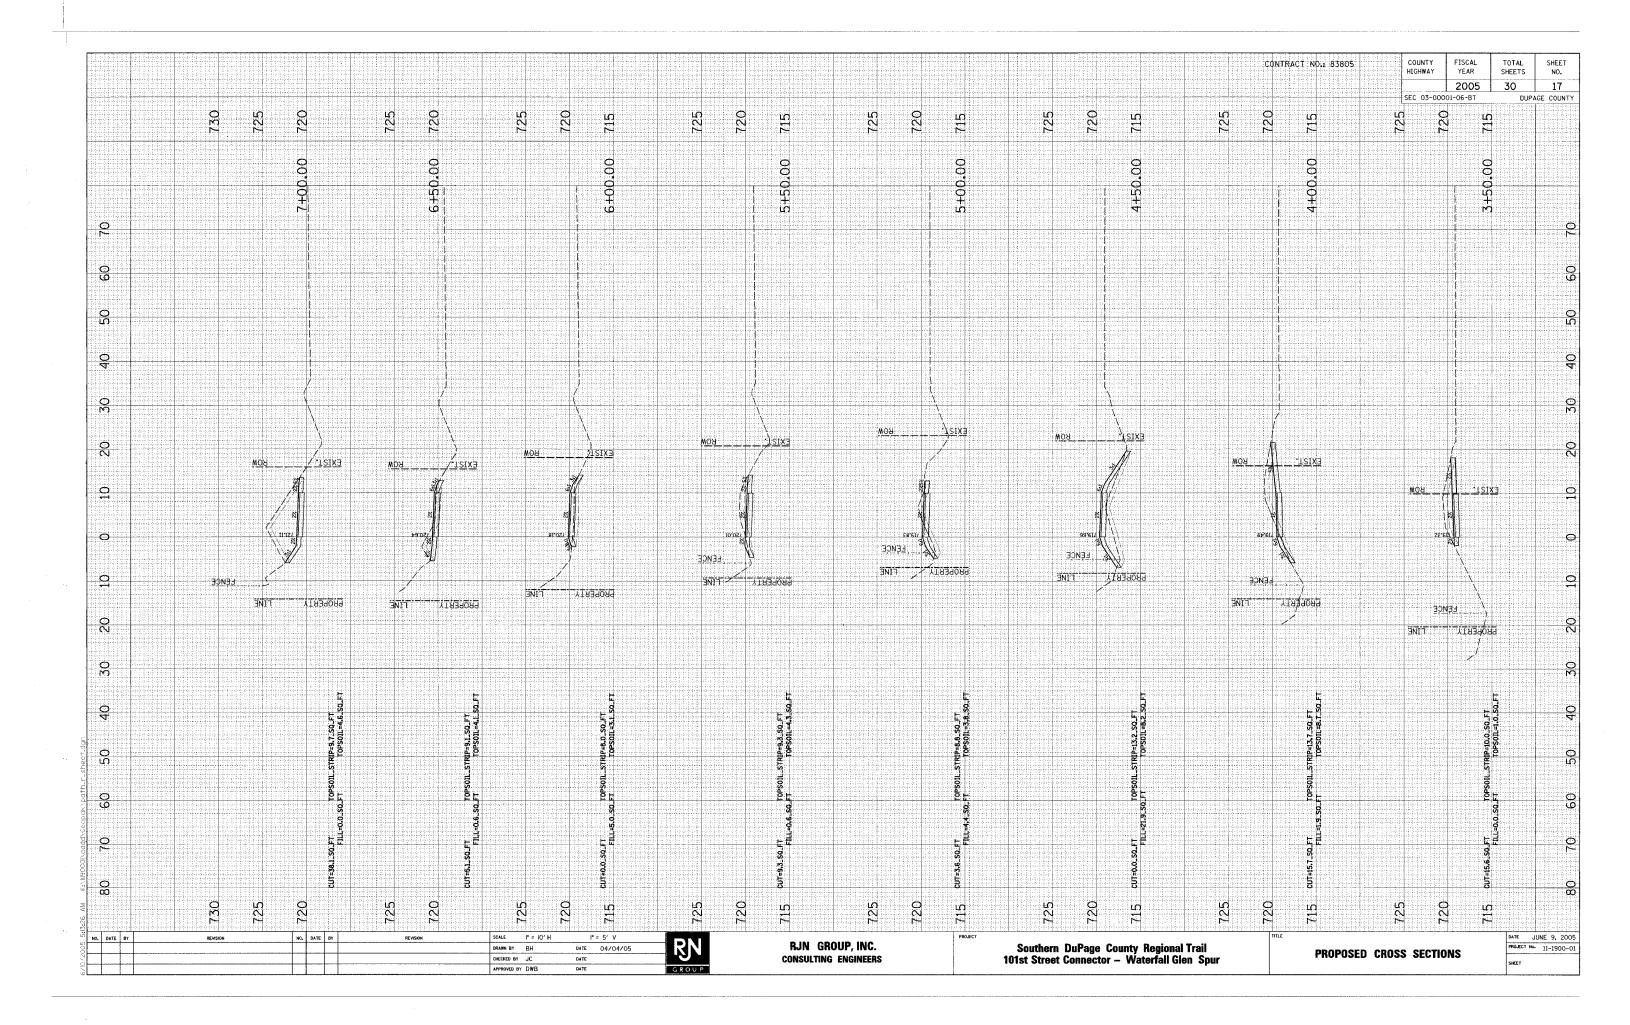


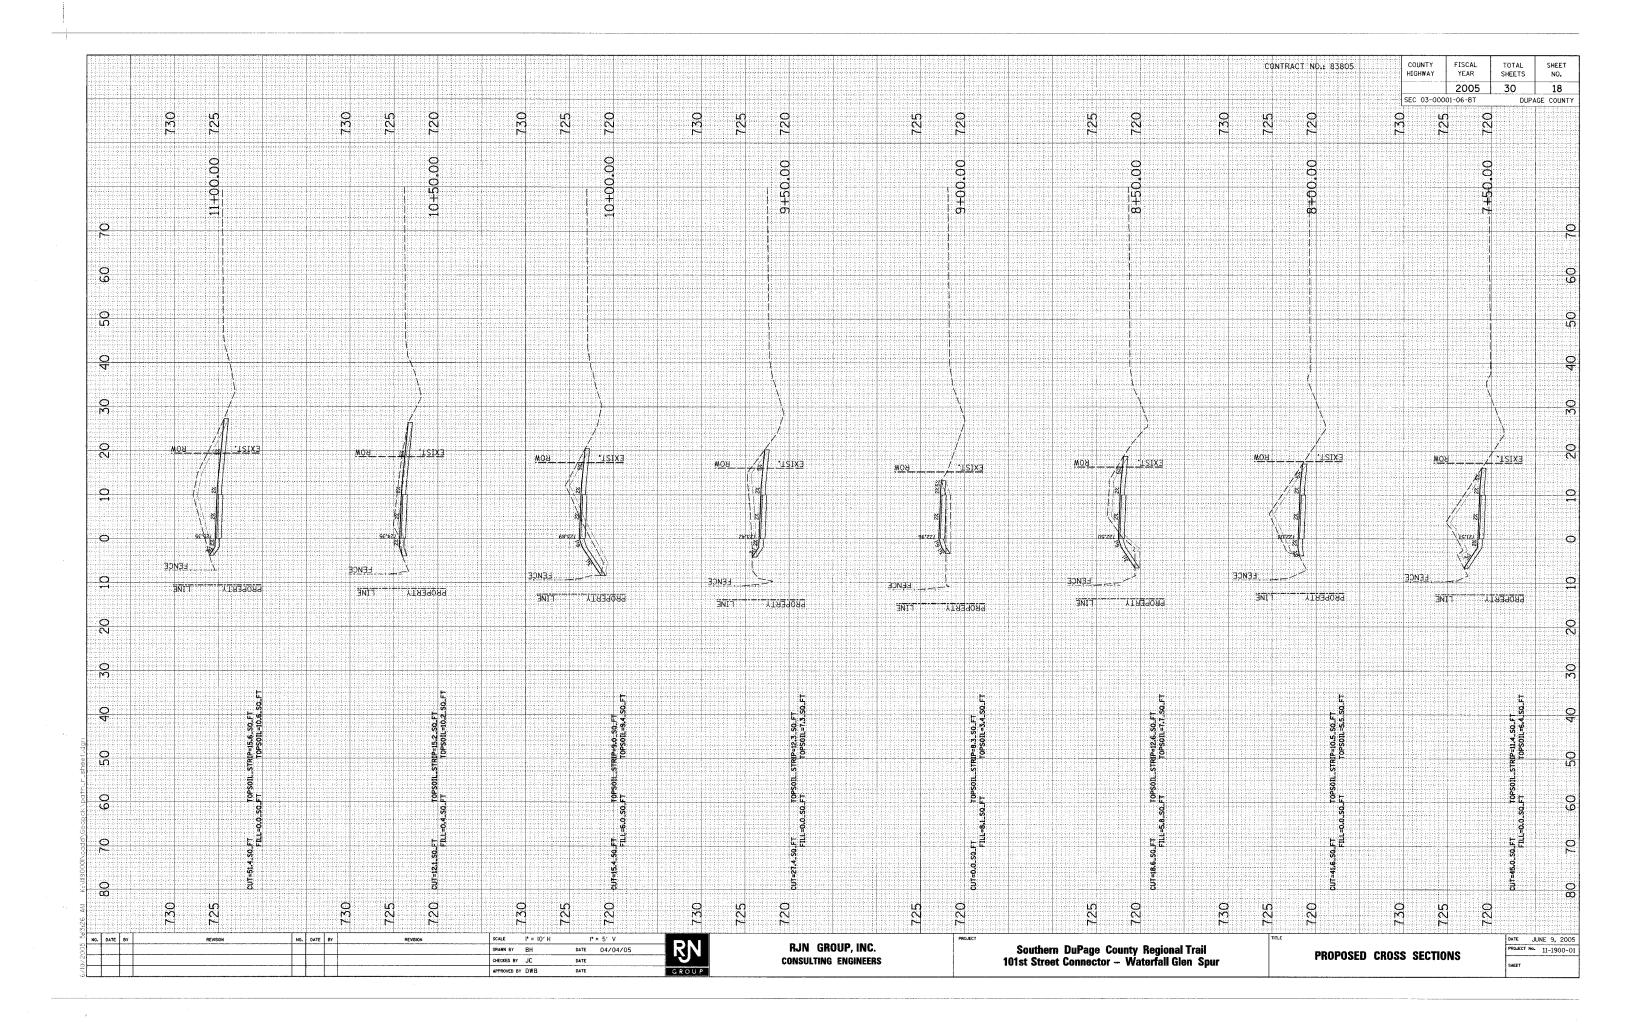


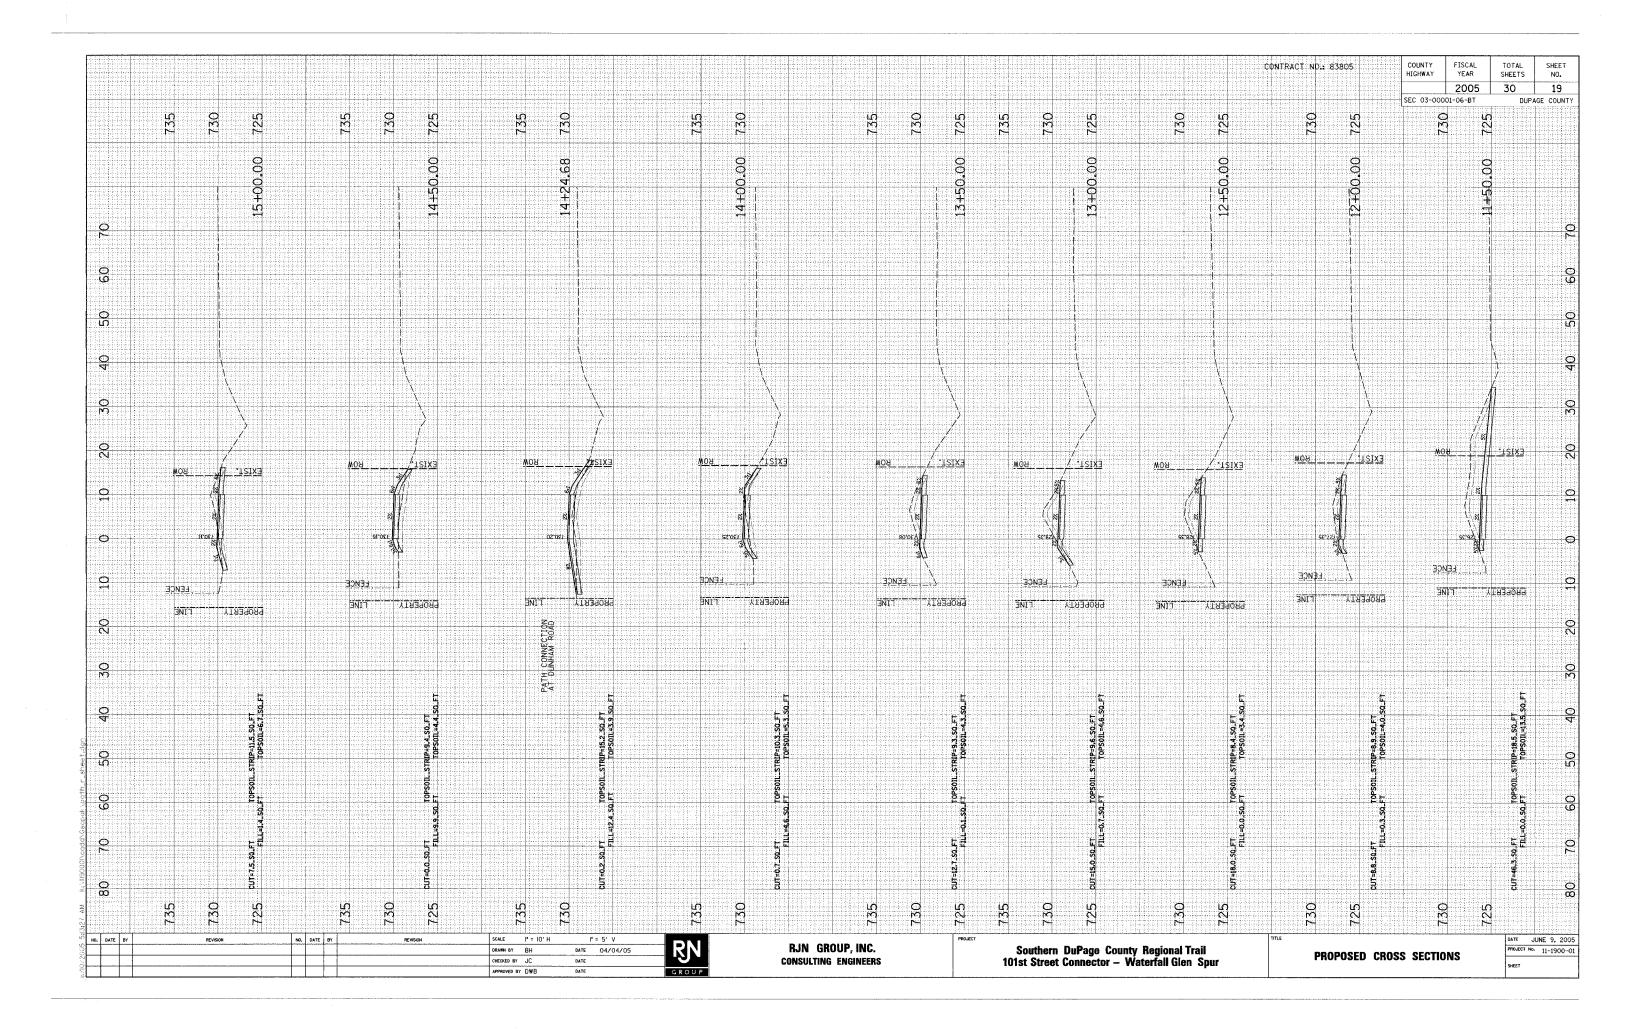


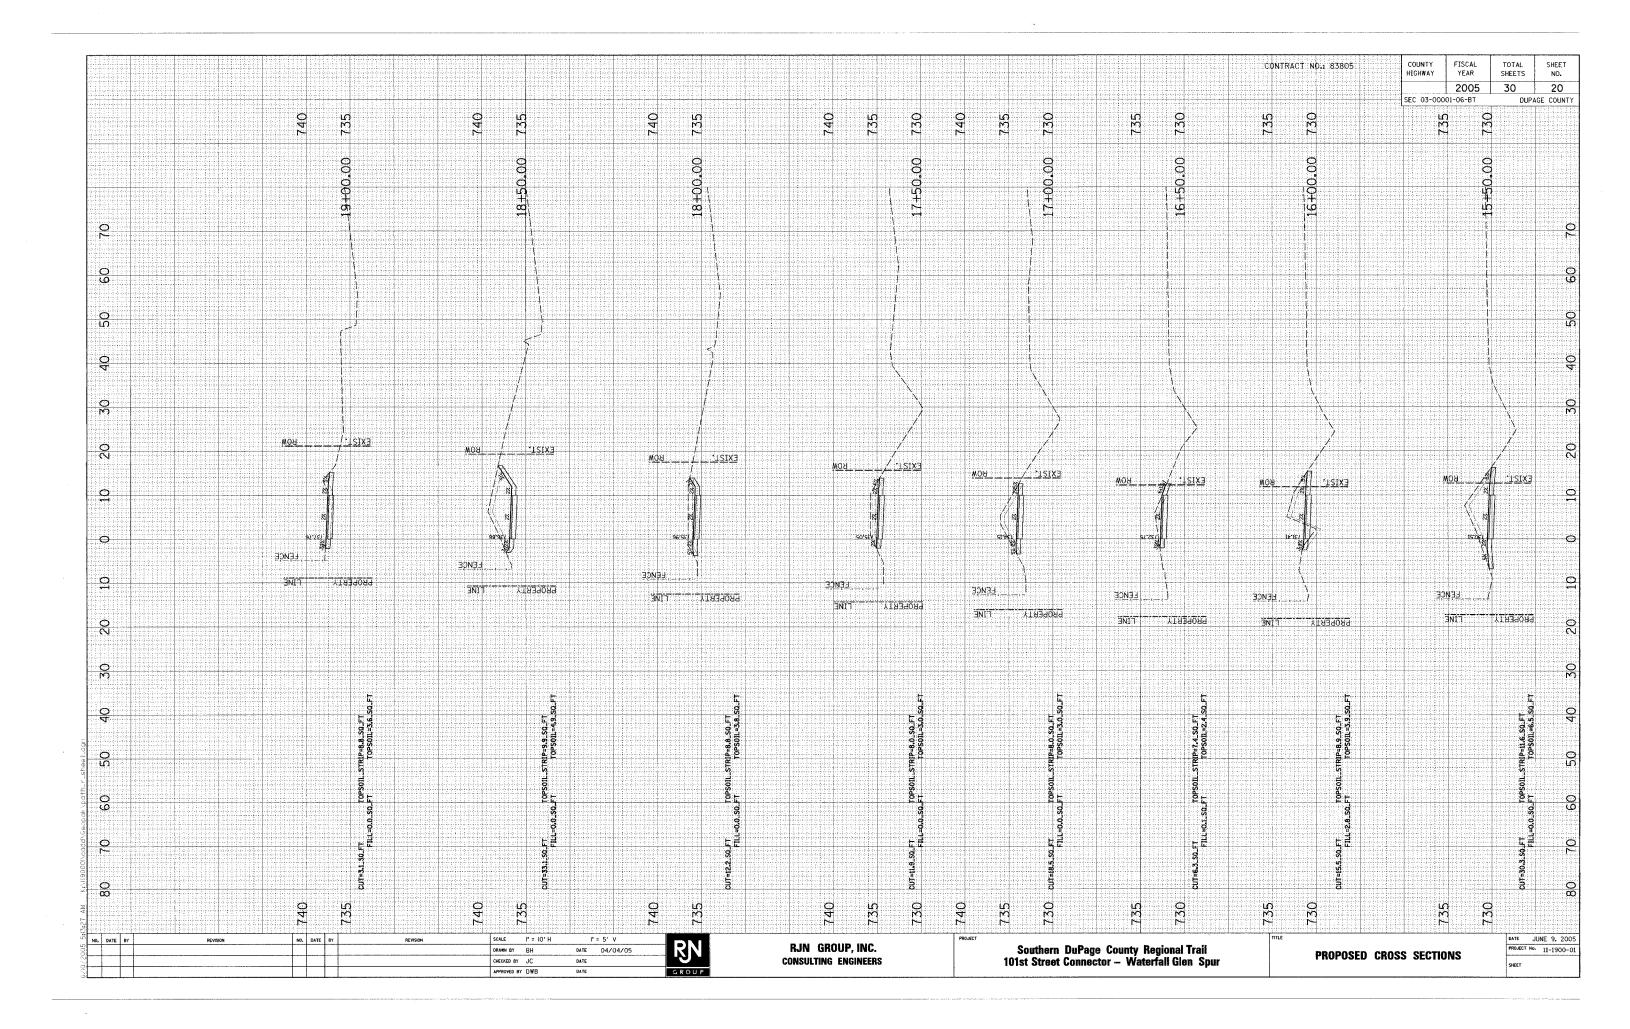


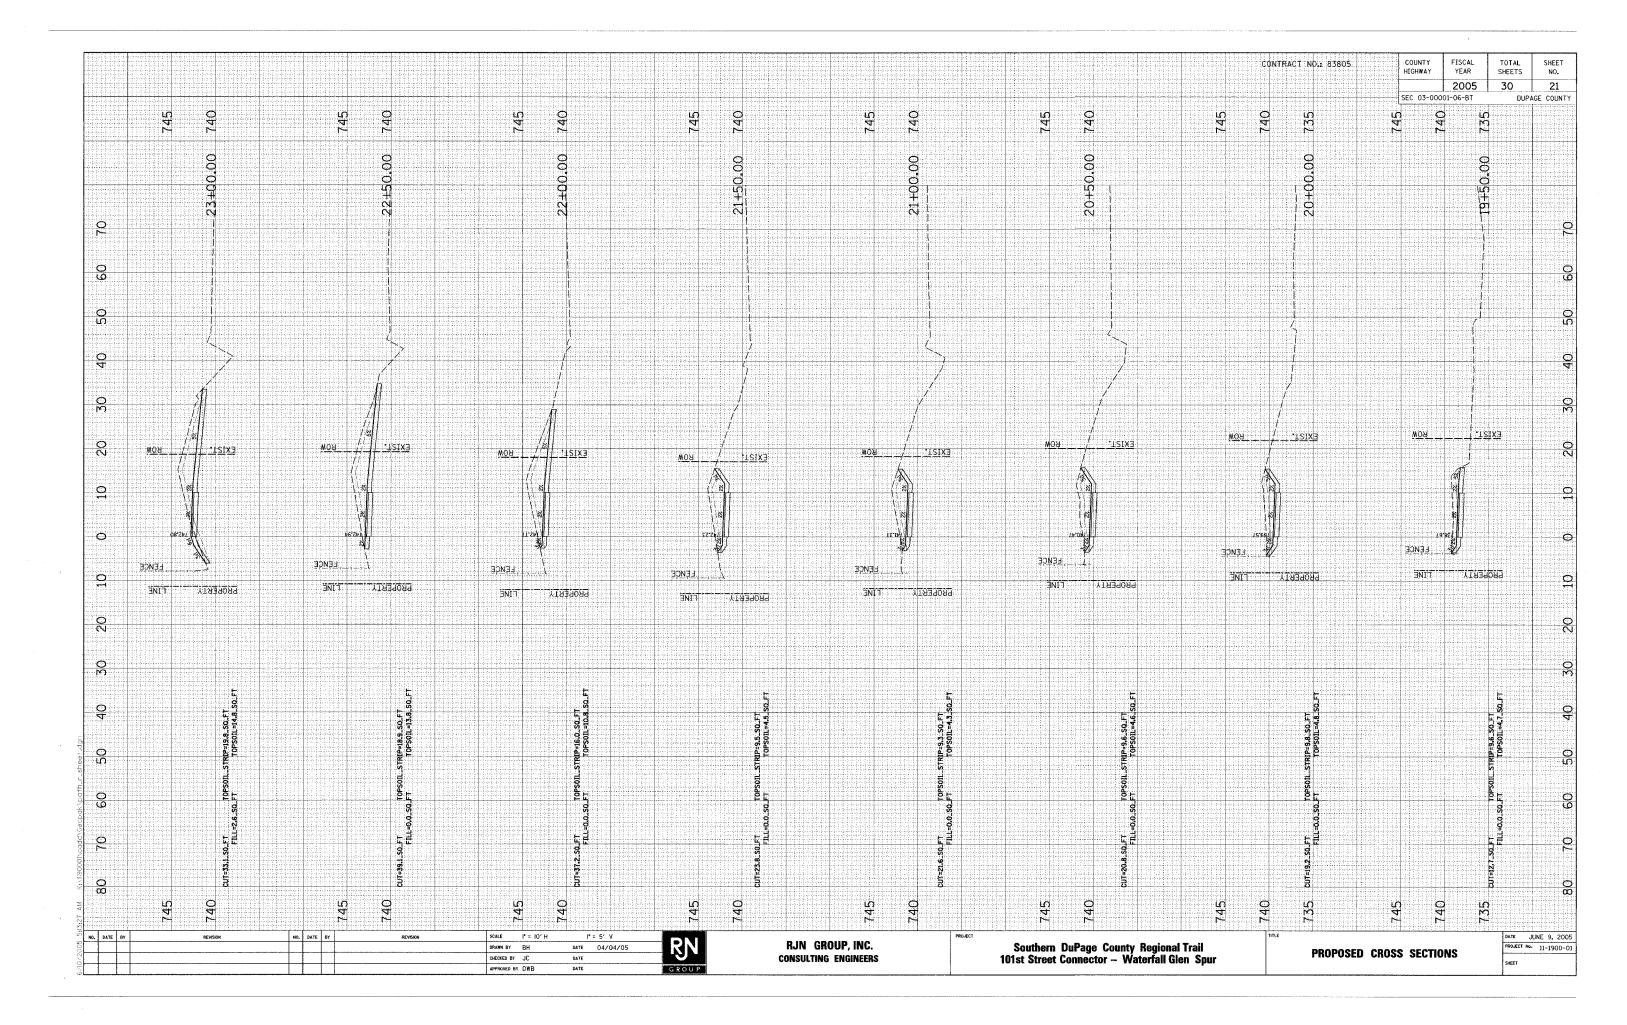

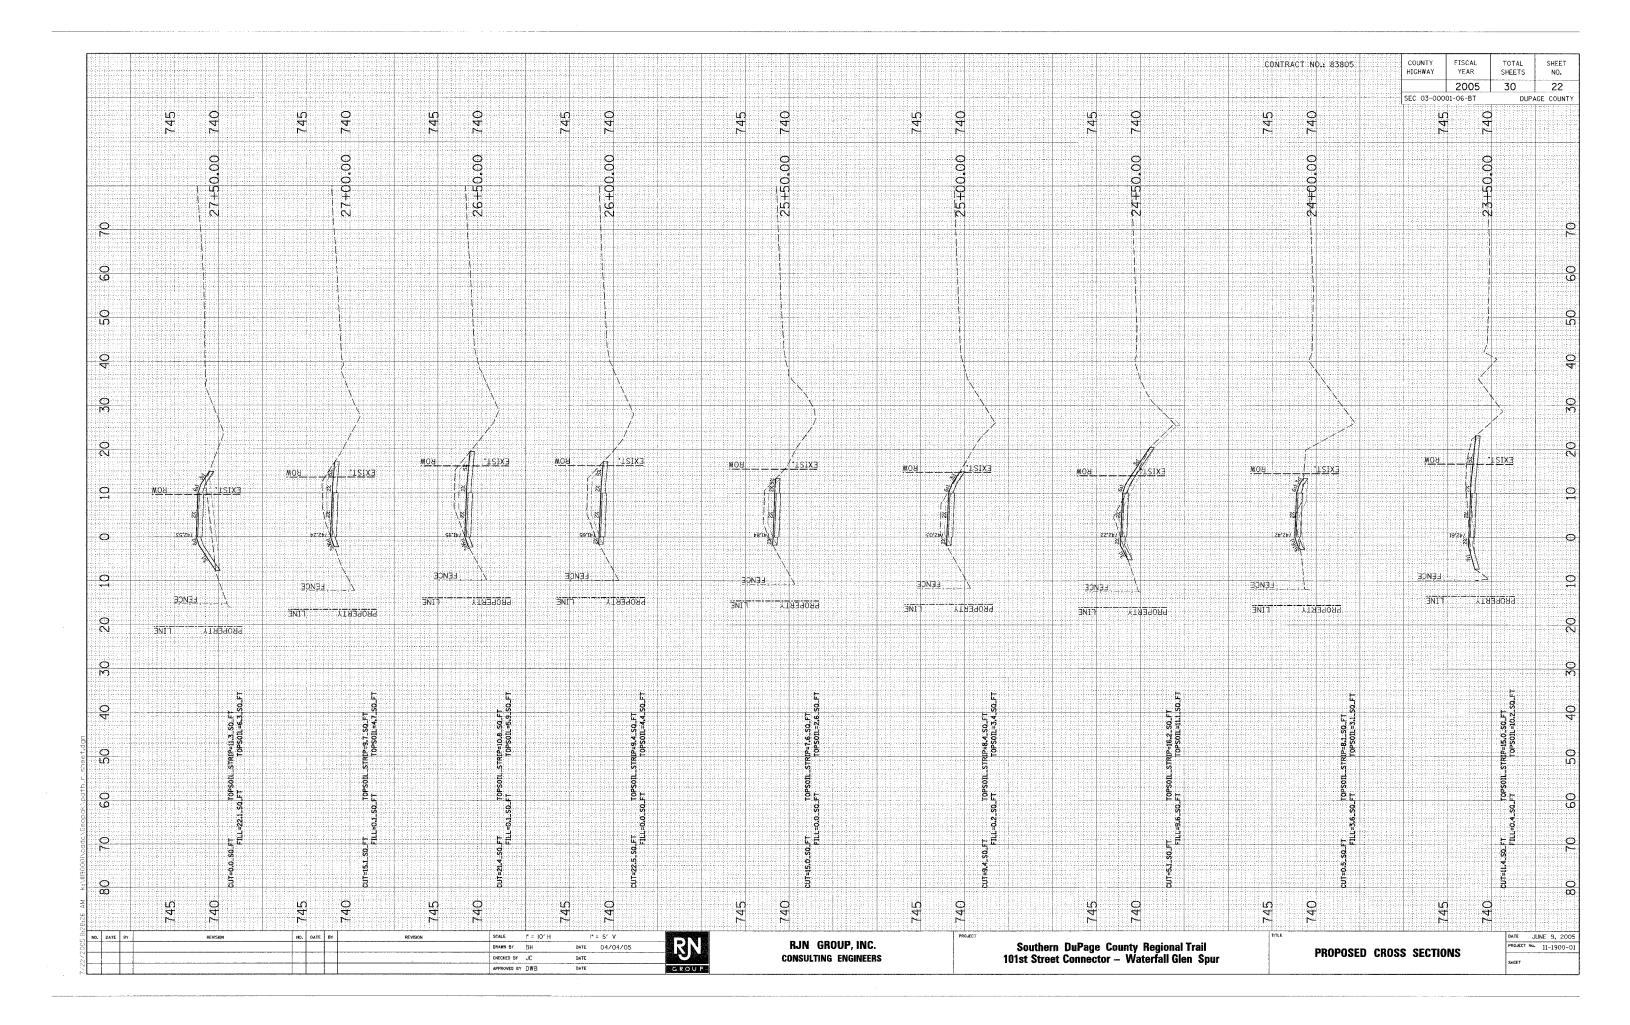

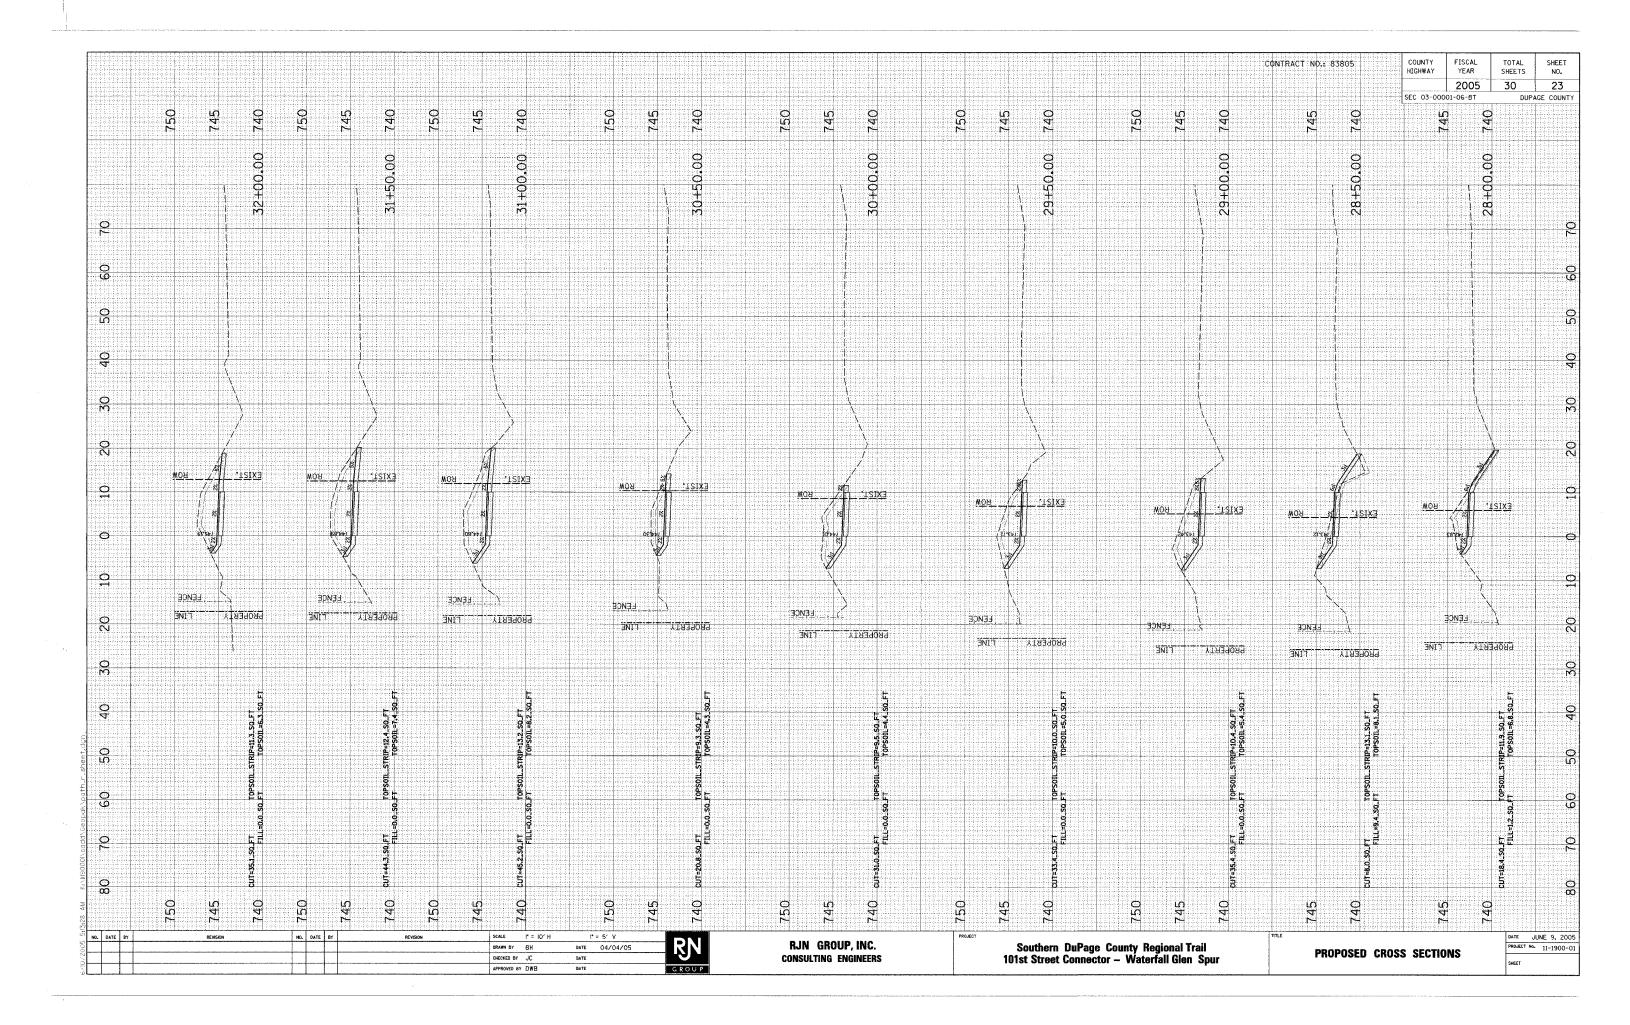

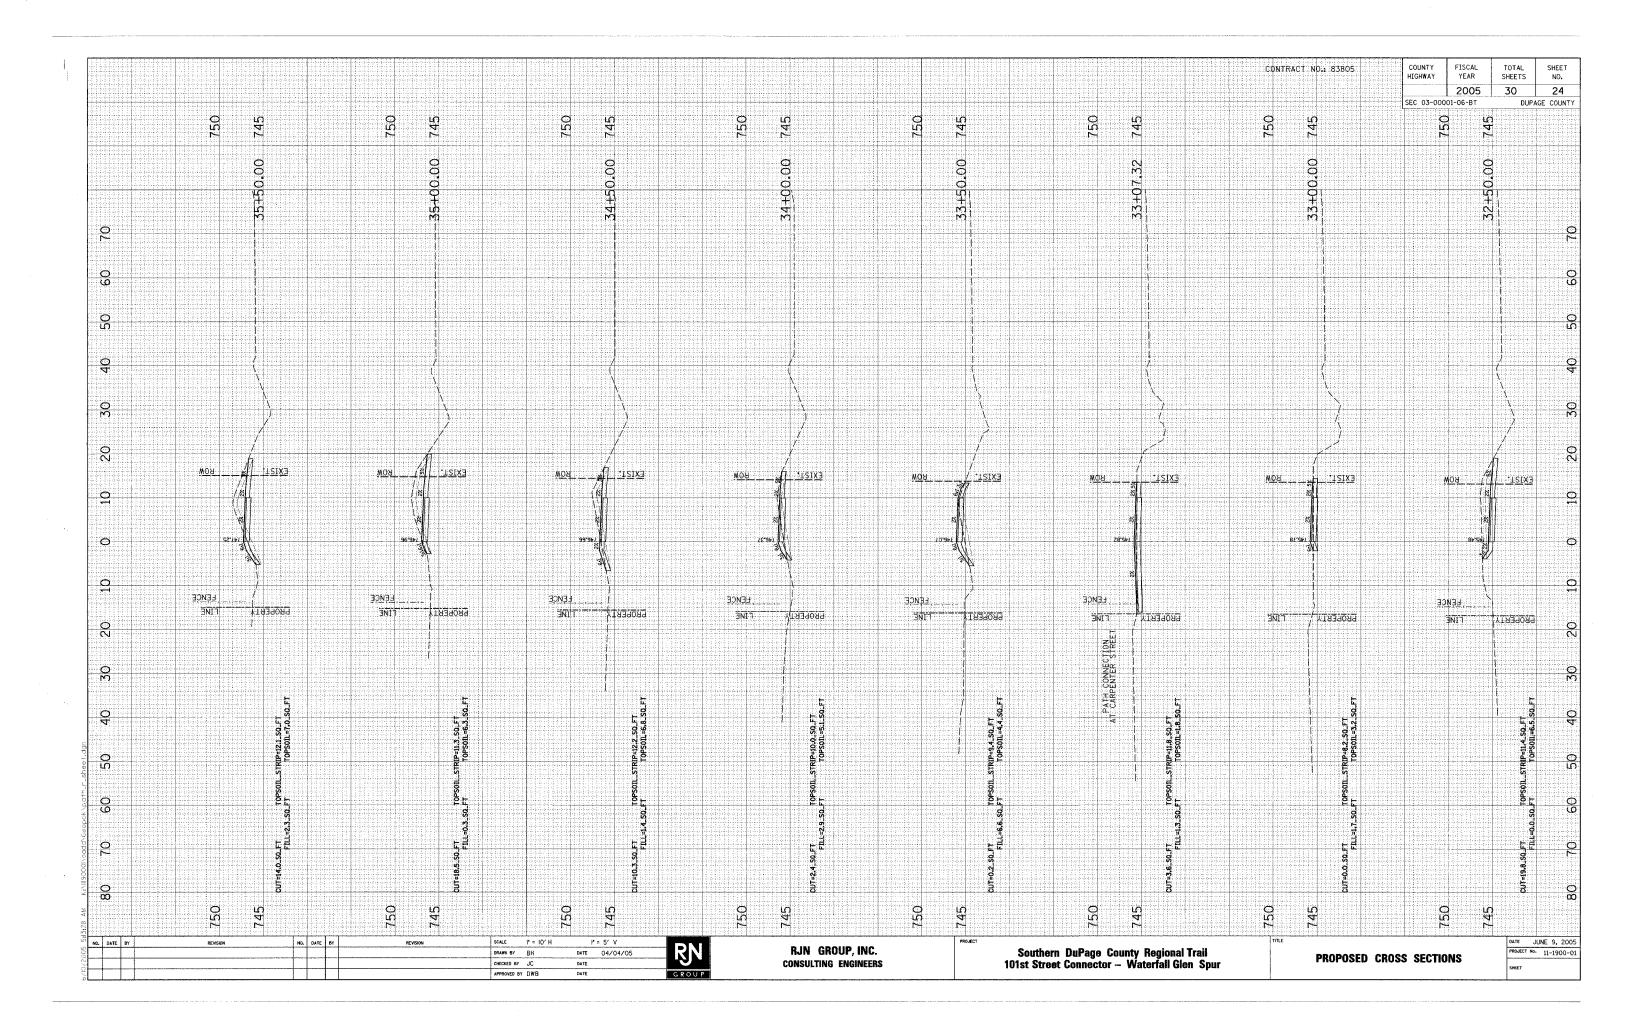

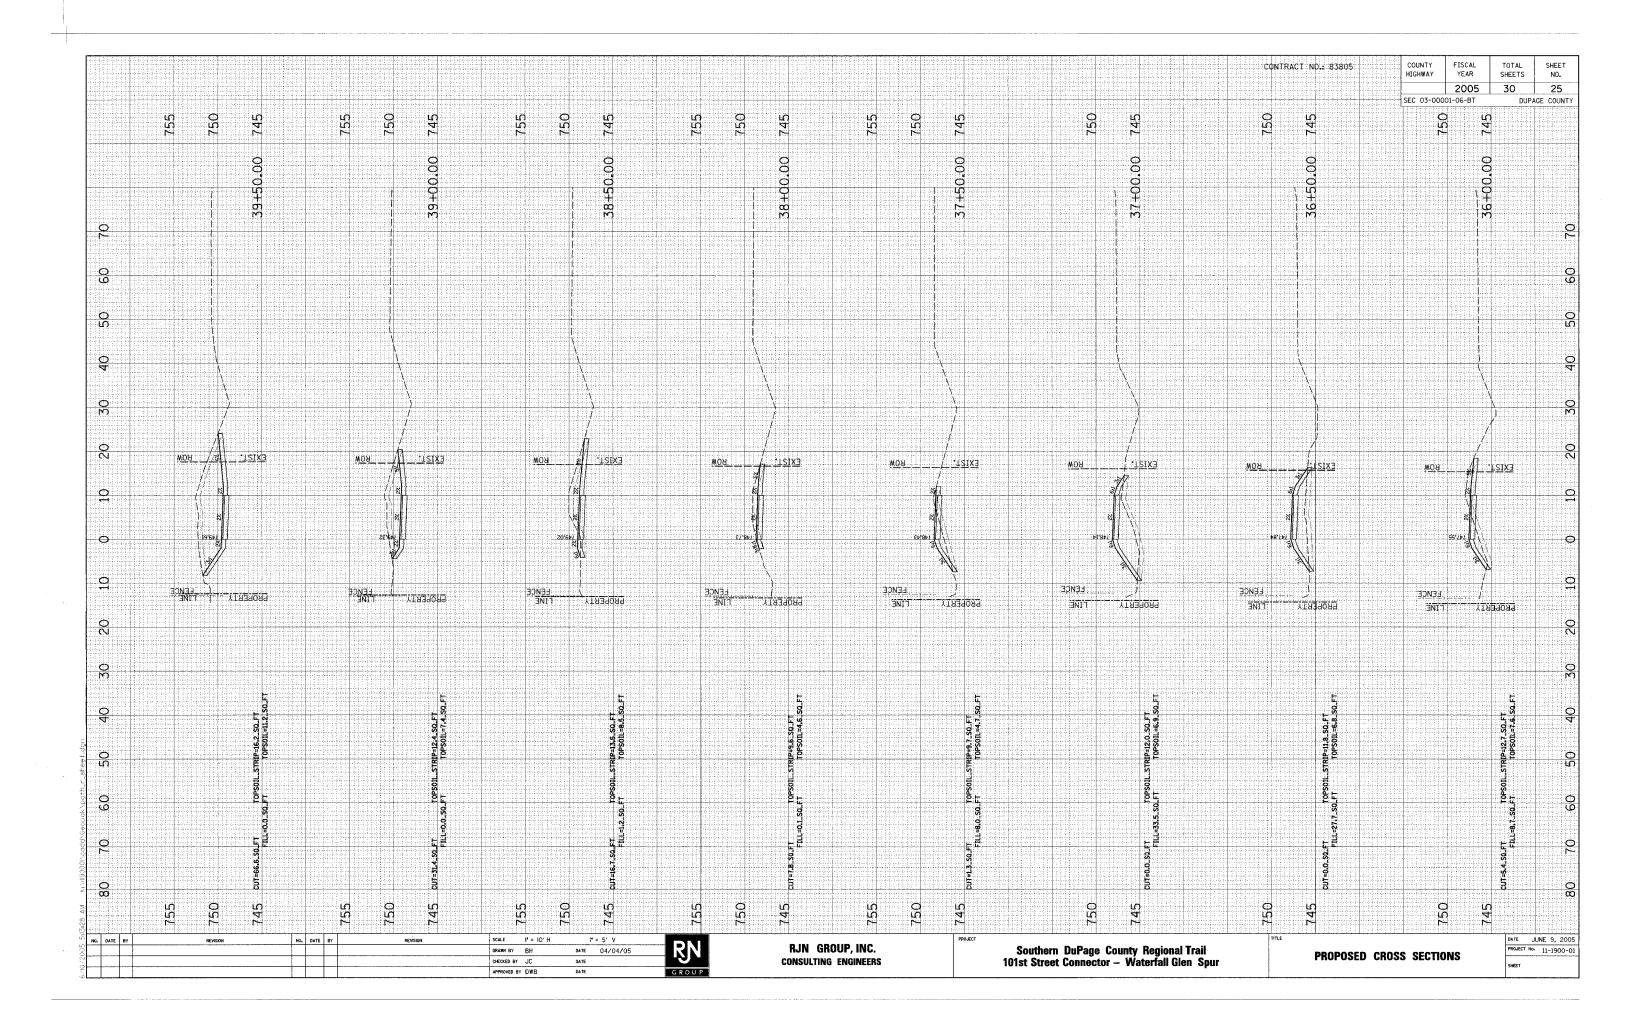



Benchmark: Chiseled "x" on east end of existing headwall. Elev. 718.76

* Match invert and slope of existing culvert

Existing Structure: Double 6'x6' Precast Concrete Box Culvert, extended in 1998.

Steel Handrail See Sheet 3 of 3 for

location and details

Flow

© Culvert—— Path Sta. 2+19.15

No Salvage.

CONTRACT NO.: 83805


GENERAL NOTES

Plan dimensions and details relative to existing structure have been taken from existing plans and are subject to nominal construction variations. It shall be the Contractor's responsibility to verify such dimensions and details in the field and make necessary approved adjustments prior to construction or ordering of materials. Such variations shall not be cause for additional compensation for a change in the scope of the work, however, the Contractor will be paid for the quantity actually furnished at the unit price for the work.

Reinforcement bars shall conform to the requirements of AASHTO M 31 or M 322 Grade 60.

All Construction joints shall be bonded.

Coordinate construction of the east wingwall with storm sewer reconstruction plans.

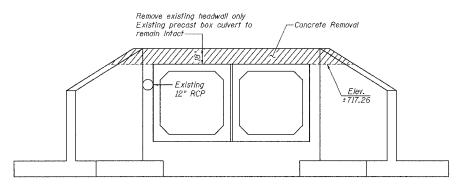

REMOVAL NOTES:

Cut existing reinforcement flush with removal surface.

Existing 12" storm sewer shall be removed.

REMOVAL DETAILS

Looking South



I certify to the best of my knowledge, information and belief, this bridge, box culvert design is structurally adequate for the design loading shown on the plans. The design is an economical one for the style of structure and complies with requirements of the current "AASHTO Standard Specification for Highway Bridges".

LOADING HS20-44

DESIGN SPECIFICATIONS

AASHTO 17th Ed. - 2002

DESIGN STRESSES

FIELD UNITS

 $f'_0 = 3,500 \text{ psi}$ $f_y = 60,000 \text{ psi (reinforcement)}$

TOTAL BILL OF MATERIAL

ITEM	UNIT	TOTAL
Concrete Removal	Cu. Yd.	1.4
Concrete Box Culverts	Cu. Yd.	19.2
Reinforcement Bars	Pound	3830
Expansion Bolts 3/4 Inch	Each	40
Pipe Handrail	Foot	33

<u>PLAN</u>

10'-0" Multi-Use Path

---- P.G.L.

10'-0" Multi-Use Path

Invert Elev. 710.59*

LONGITUDINAL SECTION

Existing 12" RCP 1

— Profile Grade Elev. = 718.92 -Back of Existing C&G


DATE	BY	REVISION	NO.	DATE	 REVISION	SCALE	N/A		
						DRAWN BY	BLB	DATE	RN
						CHECKED BY	₩JV	DATE	.9.
						APPROVED BY		DATE	GROUP


RJN GROUP, INC. CONSULTING ENGINEERS

Southern DuPage County Regional Trail 101st Street Connector — Waterfall Glen Spur

CULVERT EXTENSION


DATE: JUNE 9, 2005
PROJECT No.: II-1900-01
SHEET: 1 of 3

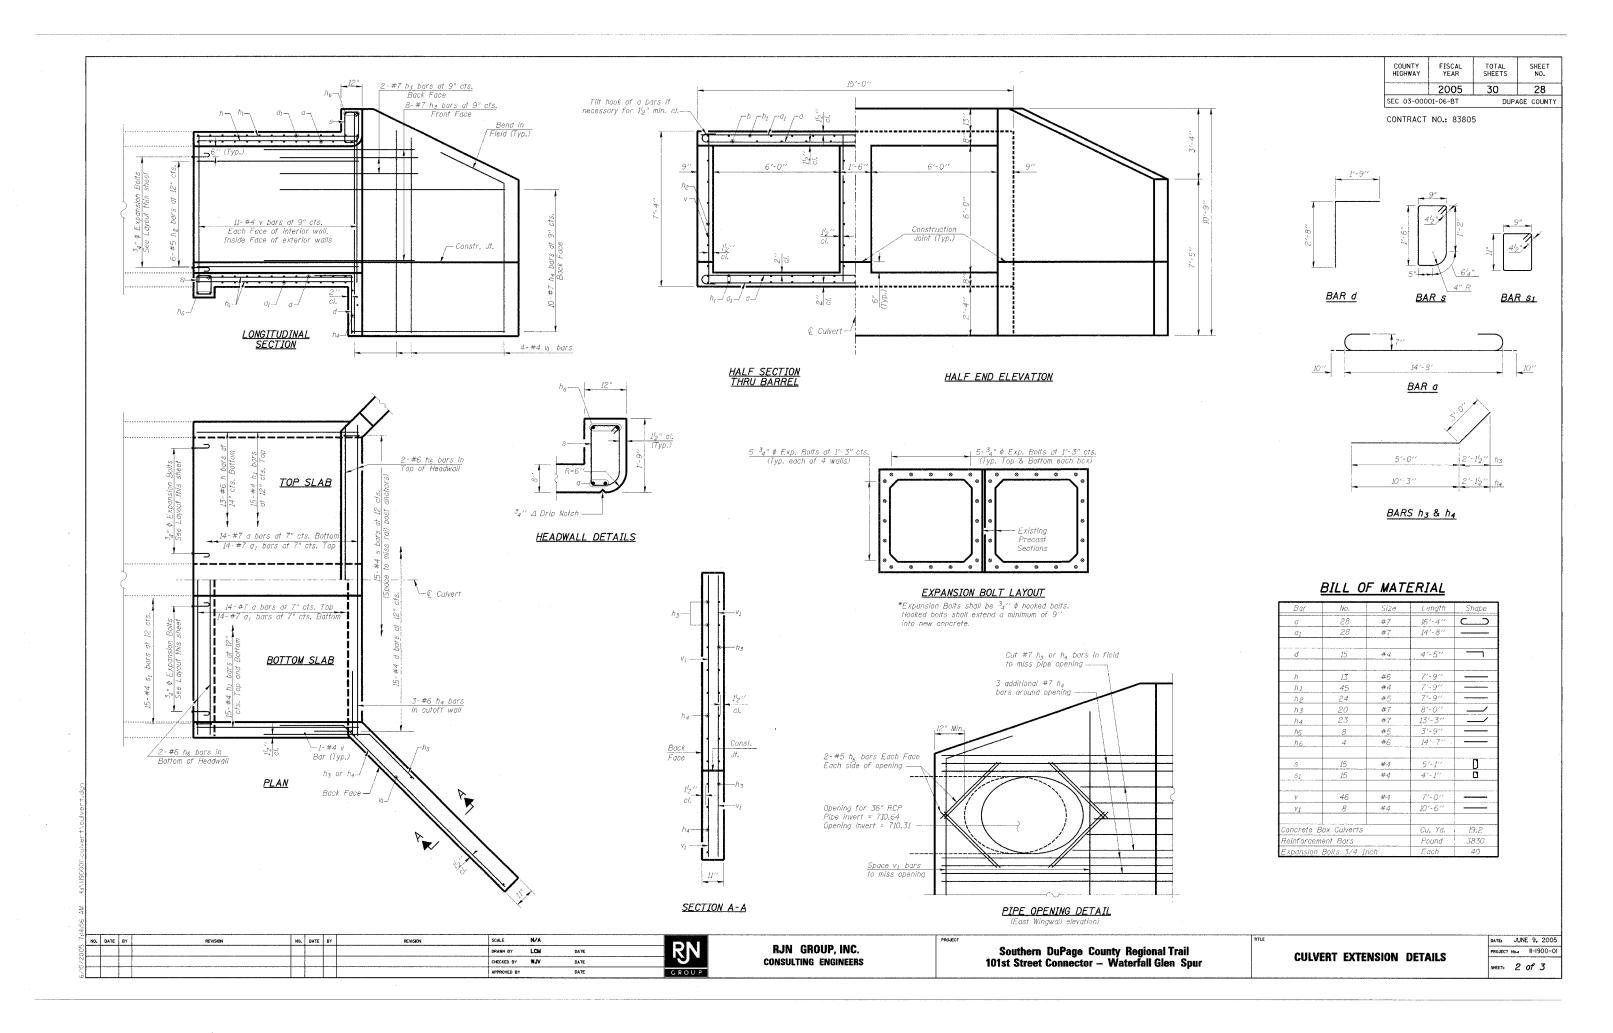

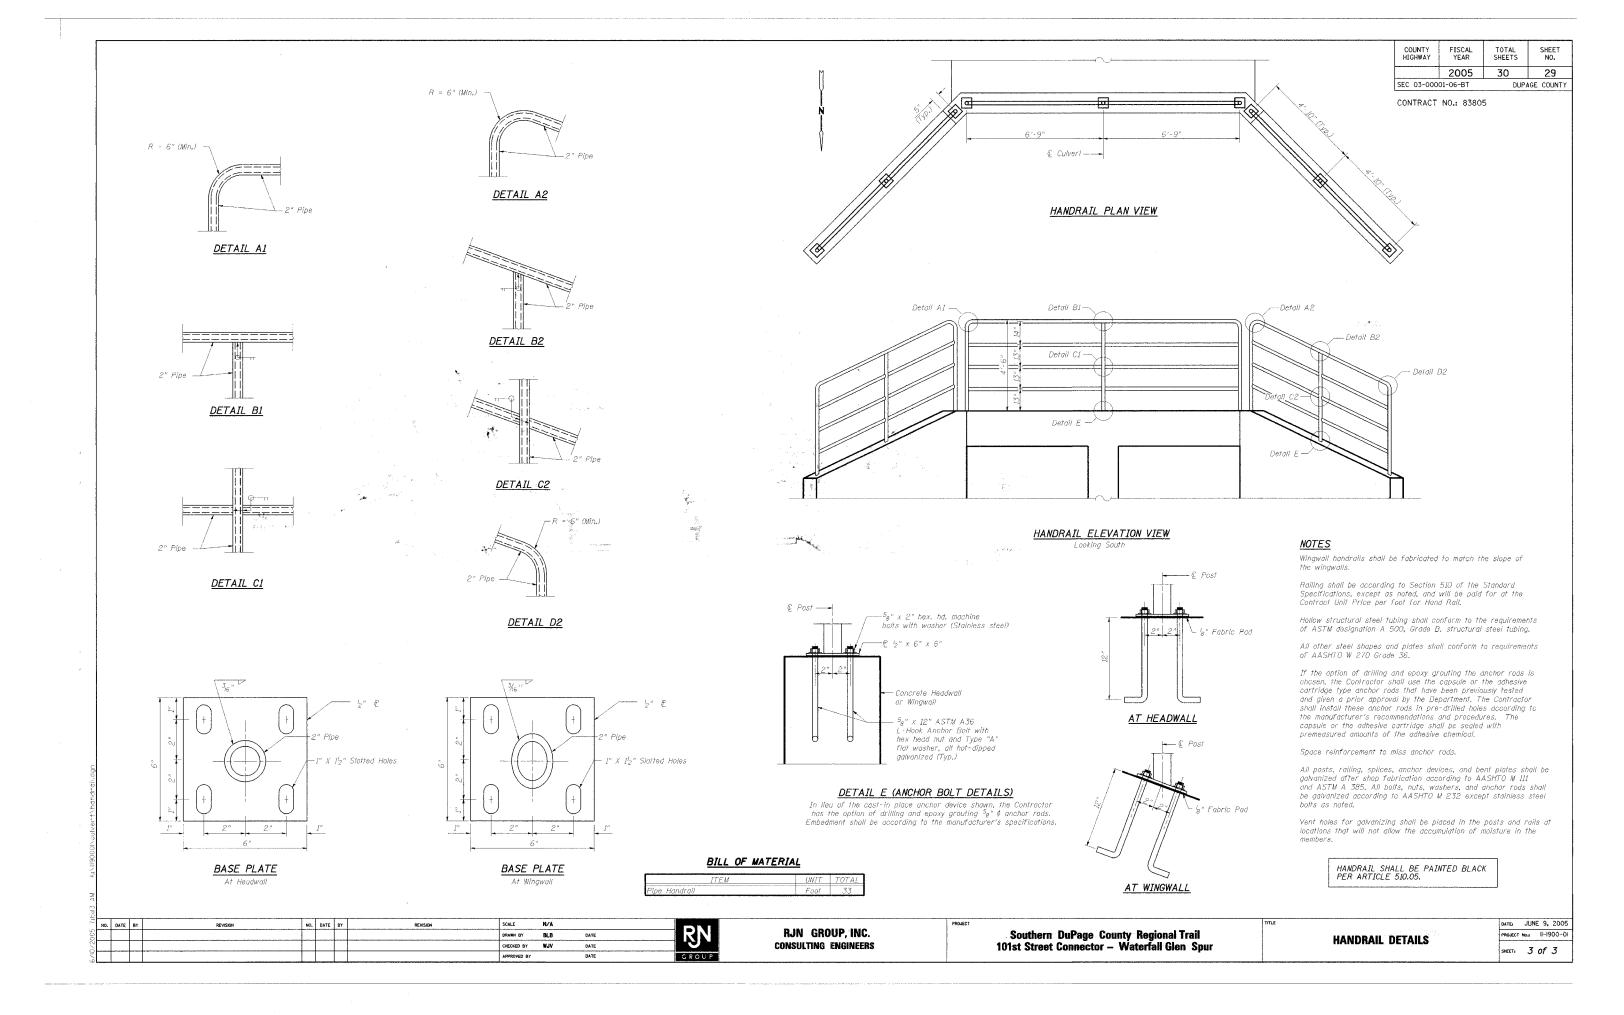

COUNTY HIGHWAY	FISCAL YEAR	TOTAL SHEETS	SHEET NO.
	2005	30	30
SEC 03-000	01-06-BT	DUPA	GE COUNTY

CONTRACT NO.: 83805

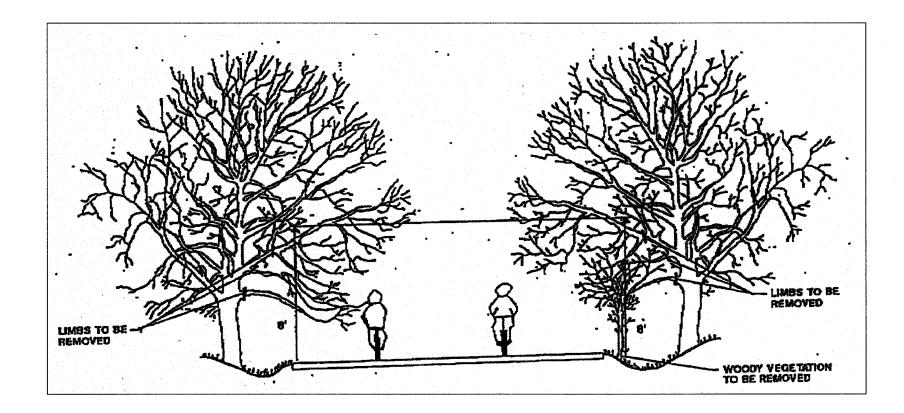

GENERAL NOTES

1. THE NATIONAL ARBORIST ASSOCIATIONS PRUNING STANDARDS FOR SHADE TREES CLASS II - STANDARD PRUNING SPECIFICATIONS SHALL BE FOLLOWED.

REVISION NO. DATE BY REVISION SCALE NOT TO SCALE

DRAWN BY JMC DATE

CHECKED BY MRH DATE

APPROVED BY DWB DATE

RN

RJN GROUP, INC. CONSULTING ENGINEERS

Southern DuPage County Regional Trail 101st Street Connector — Waterfall Glen Spur PRUNING FOR SAFETY AND EQUIPMENT CLEARANCE

DATE: JUNE 9, 2005
PROJECT No.: II-1900-01
SHEET: II-1900-01