
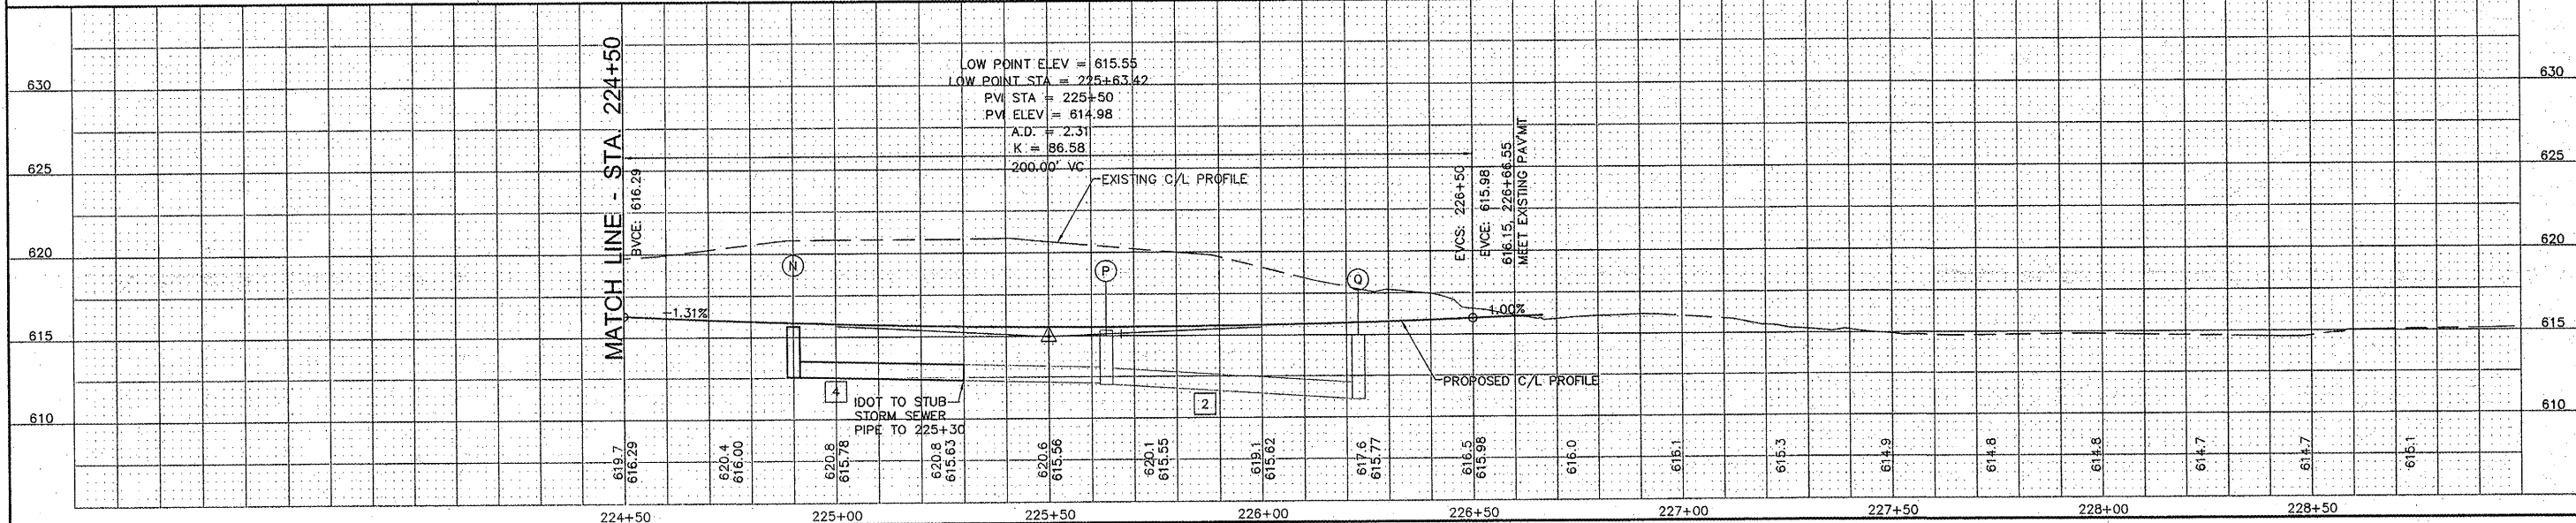
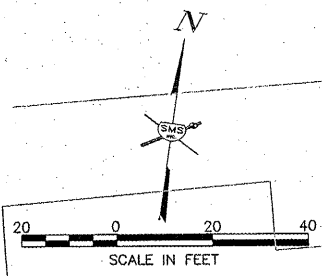


STORM SEWERS

- 1 Q TO R 37 FT. 12" SSI @ 1.43% BY OTHERS
- 2 P TO Q 65 FT. 12" SSI @ 1.25% BY OTHERS
- 3 O TO P 60 FT. 12" SSI @ 1.03% BY OTHERS
- 4 N TO P 35 FT. 12" SSI @ 0.58% BY OTHERS
- 4 N TO P 41 FT. 12" SSI @ 0.58% TRENCH BACKFILL 3.1 CU. YDS.
- 5 M TO N 51.5 FT. 12" SSI @ 0.93% TRENCH BACKFILL 6.8 CU. YDS.

DRAINAGE STRUCTURES

- M INLET, TY. A-3V
STA. 224+90, 19.60' LT.
T.C. = 616.12
12" S. F.L. = 613.12
- N INLET, TY. B-3V
STA. 224+90, 31.54' RT.
T.C. = 615.64
12" N. F.L. = 612.64
12" E. F.L. = 612.54
- O INLET, TY. A-15
STA. 225+63.42, 26.20' LT.
T.C. = 615.72
12" S. F.L. = 612.72
(BY OTHERS)
- P INLET, TY. B-15
STA. 225+63.42, 33.68' RT.
T.C. = 615.32
12" N. F.L. = 612.10
12" E. F.L. = 612.00
12" W. F.L. = 612.10
(BY OTHERS)
- Q INLET, TY. B-15
STA. 226+22.78, 52.99' RT.
T.C. = 614.97
12" W. F.L. = 611.19
12" E. F.L. = 611.09
(BY OTHERS)
- R MANHOLE
4' DIA. TY. 1 CLOSED LID
STA. 226+58.48, 53.05' RT.
STA. 171+83.44, 30.57' LT.
TOP. = 615.31
12" W. F.L. = 610.56
18" N. F.L. = 610.06±
18" S. F.L. = 610.06±
(BY OTHERS)

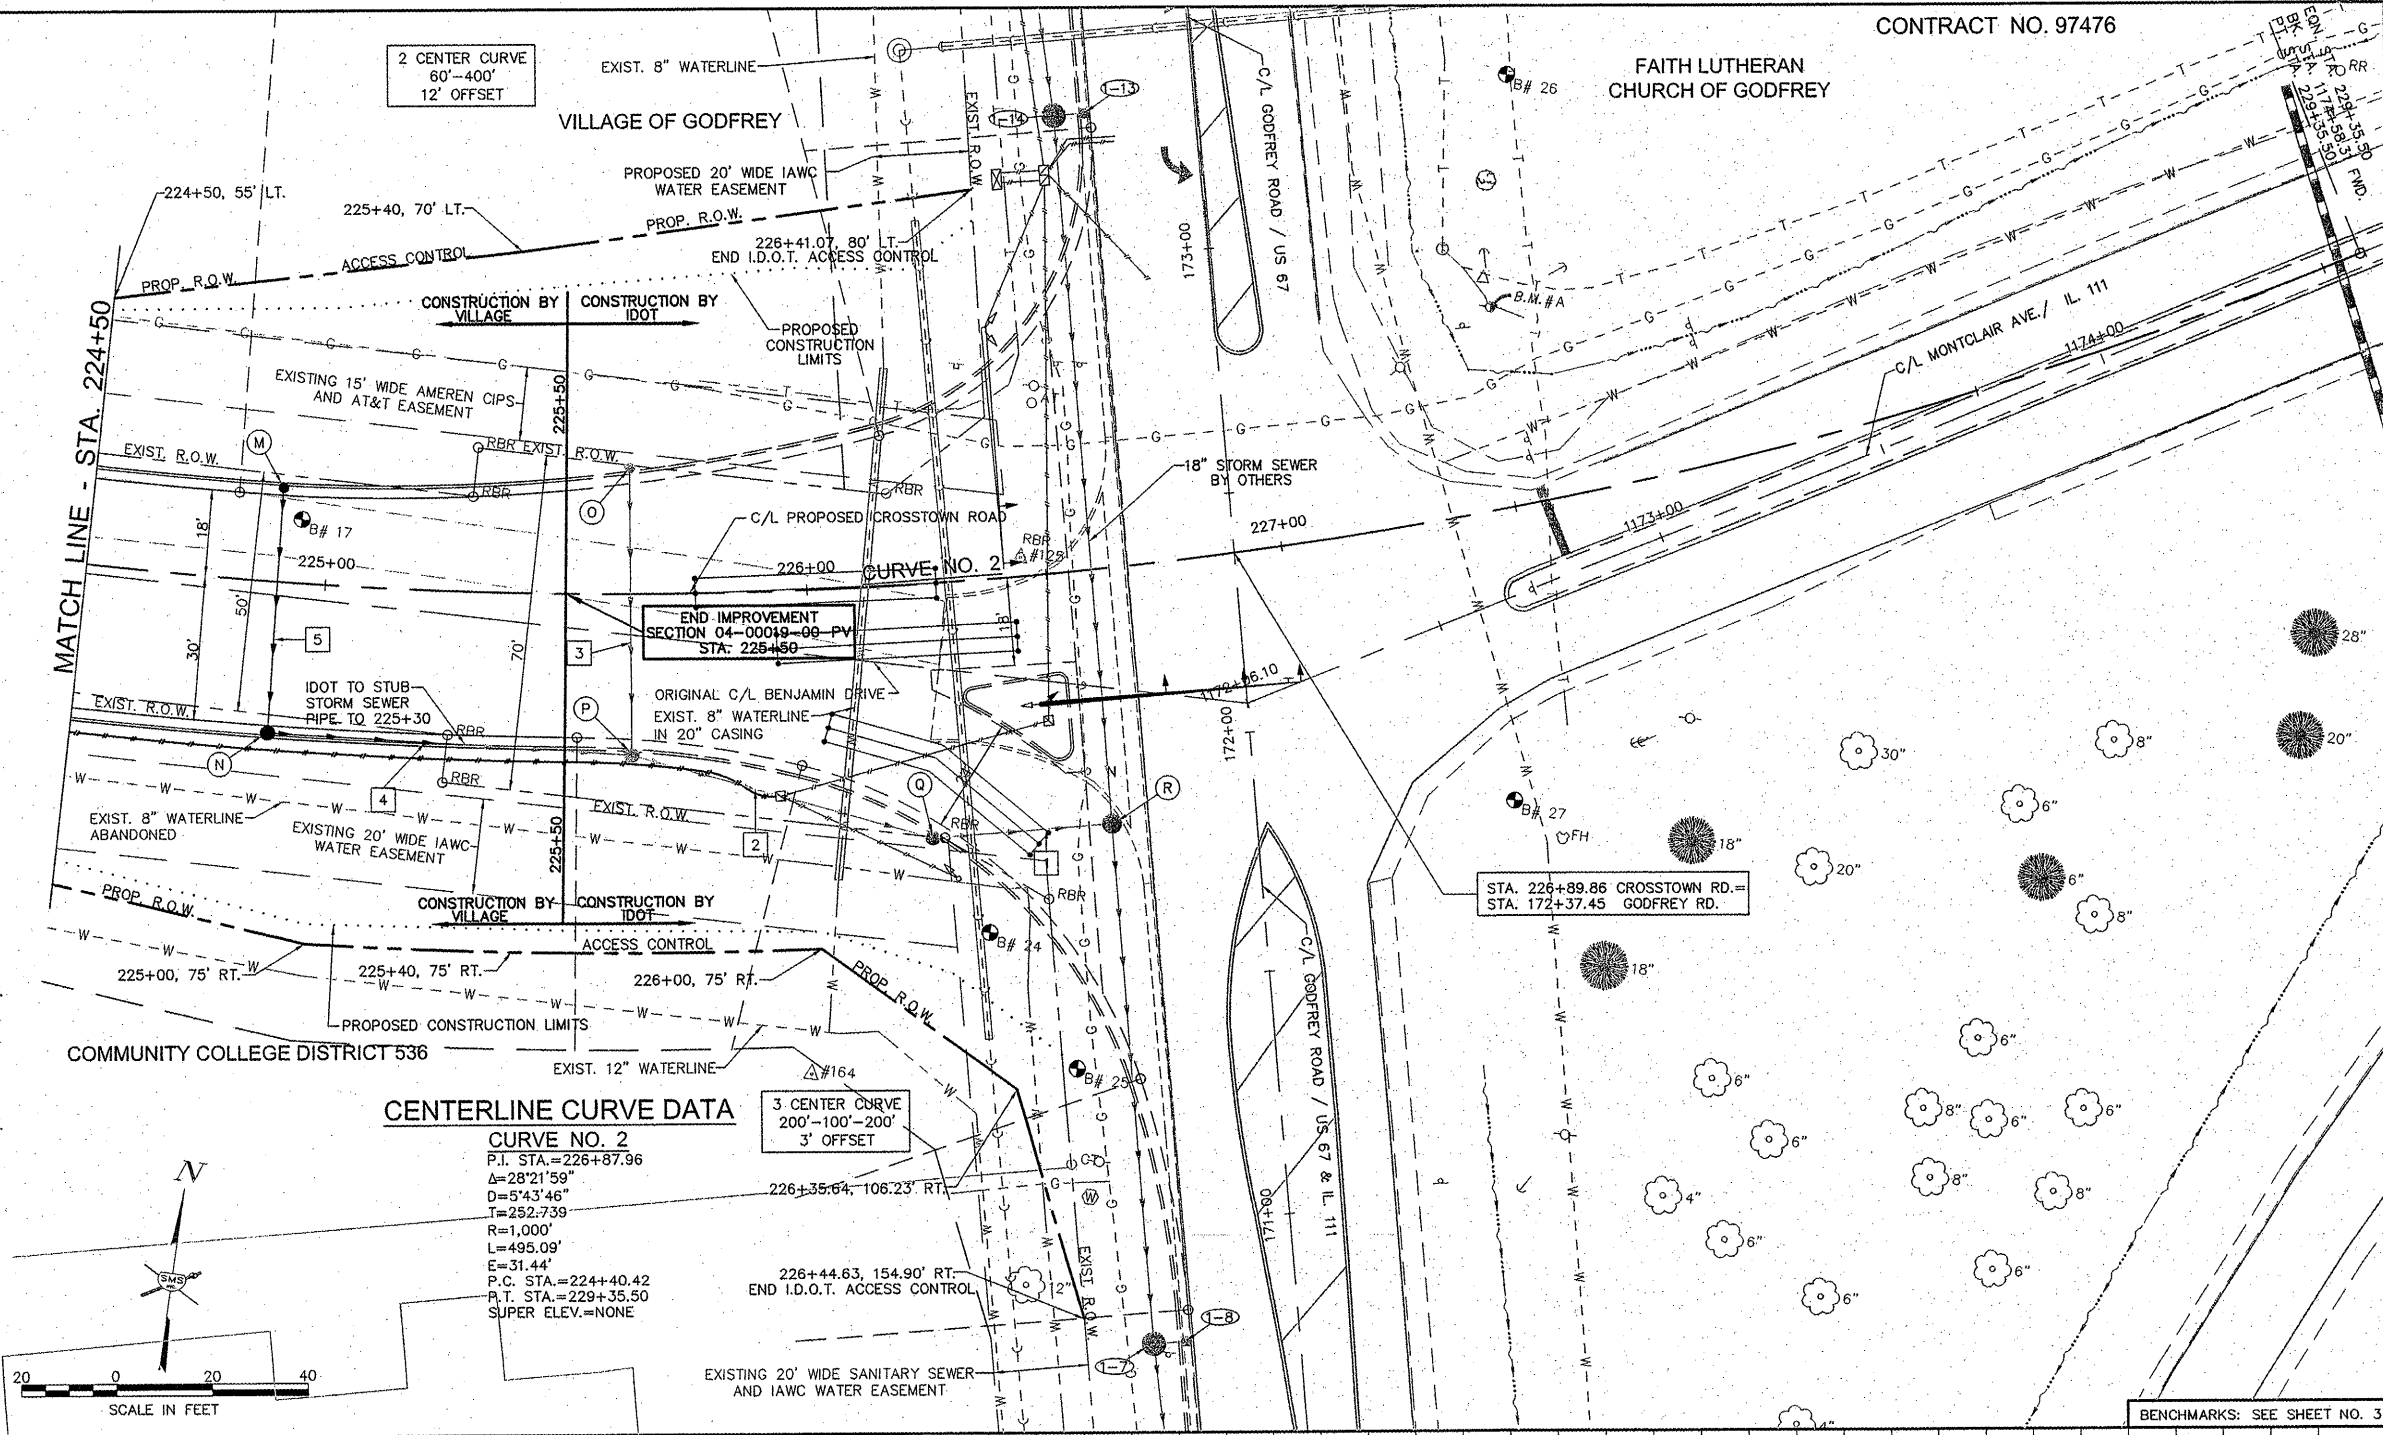

SMS ENGINEERS
 Sheppard, Morgan & Schwaab, Inc.
 CONSULTING ENGINEERS AND LAND SURVEYORS
 215 Market Street, P.O. Box E, Alton, IL 62002 618462-9755 E-mail: mail@smsengineers.com
 10 Central Industrial Drive, Granite City, IL 62040 618877-5700 E-mail: mail@smsengineers.com
 DESIGN FIRM # 184-000992

VILLAGE OF GODFREY, ILLINOIS
 SECTION 04-00019-00-PV
 CROSSTOWN ROAD - PHASE 1 A
 PLAN AND PROFILE

DWG. NO.	GCTR ROADWAY PP 18.DWG
REF. BK.	PG.
JOB NO.	237334
DSN. BY:	DEG
DWN. BY:	CAD
CHK. BY:	DEG
DATE:	APRIL 2011
SCALE:	1" = 20' H. 1" = 5' V.
SHEET	12 OF 38