

| CODE NO. | ITEM | UNIT | TOTAL QUANTITY | CONSTRUCTION CODE | |
|-----------------|---|-------|----------------|-------------------|-------------|
| | | | | LANDSCAPING | LANDSCAPING |
| | | | | 90% FED | 0% FED |
| | | | | 10% STATE | 100% STATE |
| | | | | 0031 | 0031 |
| URBAN | URBAN | | | | |
| 73400200 | DRILLED SHAFT CONCRETE FOUNDATIONS | CU YD | 21.3 | 21.3 | |
| A2000224 | TREE, ACER X FREEMANII MARMO (MARMO FREEMAN MAPLE), 3" CALIPER, BALLED AND BURLAPPED | EACH | 4 | 4 | |
| A2002368 | TREE, BETULA NIGRA (RIVER BIRCH), 7' HEIGHT, BALLED AND BURLAPPED | EACH | 5 | 5 | |
| A2003220 | TREE, CORYLUS COLURNA (TURKISH FILBERT), 2-1/2" CALIPER, BALLED AND BURLAPPED | EACH | 4 | 4 | |
| A2006432 | TREE, QUERCUS ALBA (WHITE OAK), 4" CALIPER, BALLED AND BURLAPPED | EACH | 1 | 1 | |
| A2007632 | TREE, TAXODIUM DISTICHUM (COMMON BALD CYPRESS), 4" CALIPER, BALLED AND BURLAPPED | EACH | 5 | 5 | |
| A2018724 | TREE, ULMUS CARPINIFOLIA MORTON, (ACCOLADE ELM), 4" CALIPER, BALLED AND BURLAPPED | EACH | 4 | 4 | |
| A2018620 | TREE, ULMUS CARPINIFOLIA MORTON, (ACCOLADE ELM HYBRID), 3" CALIPER, BALLED AND BURLAPPED | EACH | 3 | 3 | |
| B2000767 | TREE, AMERLANCHIER X GRANDIFLORA AUTUMN BRILLIANCE (AUTUMN BRILLIANCE APPLE SERVICEBERRY, 8' HEIGHT, CLUMP FORM, BALLED AND BURLAPPED | EACH | 3 | 3 | ⚠ |
| B2001772 | TREE, CRATAEGUS CRUSGALLI VAR. INERMIS (THORNLESS COCKSPUR HAWTHORN), 8' HEIGHT, CLUMP FORM, BALLED AND BURLAPPED | EACH | 13 | 13 | |
| C2000138 | SHRUB, AESCULUS PARVIFLORA (BOTTLEBRUSH BUCKEYE), 3-1/2' HEIGHT, BALLED AND BURLAPPED | EACH | 6 | 6 | |
| C2011938 | SHRUB, VIBURNUM DENTATUM RALPH SENIOR (AUTUMN JAZZ ARROWWOOD VIBURNUM), 3-1/2' HEIGHT, BALLED AND BURLAPPED | EACH | 37 | 37 | |
| C2001063 | SHRUB, BUDDLEIA DAVIDII PEAKEEP (ENGLISH PEACOCK BUTTERFLY BUSH), 18" HEIGHT, CONTAINER GROWN, 3-GALLON | EACH | 3 | 3 | ⚠ |
| C2001846 | SHRUB, CORNUS SERICEA ISANTI (ISANTI REDTWIG DOGWOOD), 3' HEIGHT, BALLED AND BURLAPPED | EACH | 75 | 75 | ⚠ |
| C2003725 | SHRUB, HYPERICUM KALMIANUM AMES (AMES ST. JOHNSWORT), 24" HEIGHT, CONTAINER GROWN, 5-GALLON | EACH | 40 | 40 | ⚠ |
| C2003933 | SHRUB, ILEX VERTICILLATA RED SPRITE (RED SPRITE WINTERBERRY), 24" HEIGHT, CONTAINER GROWN, 5-GALLON | EACH | 100 | 100 | ⚠ |
| C2003936 | SHRUB, ILEX VERTICILLATA WINTER RED (WINTER RED WINTERBERRY), 3' HEIGHT, BALLED AND BURLAPPED | EACH | 61 | 61 | ⚠ |

* DENOTES SPECIALTY ITEM

** DENOTES NON-PARTICIPATING ITEM

⚠ Rev. 11-7-14



| | | |
|------------------------------|------------------|-----------|
| 0160X62-shr-500.dgn | DESIGNED - JLV | REVISED - |
| USER NAME = BAW:rbort | DRAWN - BAW | REVISED - |
| PLOT SCALE = 24.8283 / 1 in. | CHECKED - JMG | REVISED - |
| PLOT DATE = 8/19/2014 | DATE - 8/20/2014 | REVISED - |

STATE OF ILLINOIS
DEPARTMENT OF TRANSPORTATION

| | | | |
|-----------------------|---------|-------------|--------------|
| SUMMARY OF QUANTITIES | | | |
| SCALE: NONE | SHEET 3 | OF 6 SHEETS | STA. TO STA. |

| | | | | |
|---------------------------|-----------|--------|--------------|-----------|
| F.A.I. RTE. | SECTION | COUNTY | TOTAL SHEETS | SHEET NO. |
| 90/94/290 | 2013-0741 | COOK | 58 | 6 |
| CONTRACT NO. 60X62 | | | | |
| ILLINOIS FED. AID PROJECT | | | | |

FILE PATH: P:\388039\purchasing\materials\local\2014\60X62\0160X62-shr-500.dgn

| CODE NO. | ITEM | UNIT | TOTAL QUANTITY | CONSTRUCTION CODE | |
|---------------------|---|-------|----------------|-------------------|-------------|
| | | | | LANDSCAPING | LANDSCAPING |
| | | | | 90% FED | 0% FED |
| | | | | 10% STATE | 100% STATE |
| | | | | 0031 | 0031 |
| URBAN | URBAN | | | | |
| K0029634 | WEED CONTROL, PRE-EMERGENT GRANULAR HERBICIDE | POUND | 208 | 208 | |
| K0036118 | MULCH PLACEMENT, 3" | SO YD | 27 | 27 | ▲ |
| ** K1003660 | MOWING CYCLES | EACH | 36 | | 36 |
| X0370080 | COMBINATION CURB AND GUTTER TYPE V.12 (COOT) | FOOT | 20 | 20 | |
| X6640200 | TEMPORARY CHAIN LINK FENCE | FOOT | 1,424 | 1,424 | |
| X7010216 | TRAFFIC CONTROL AND PROTECTION, (SPECIAL) | L SUM | 1 | 1 | |
| XX003885 | IRRIGATION SYSTEM | L SUM | 1 | 1 | |
| 21101800 | COMPOST FURNISH AND PLACE, 1" | SO YD | 2511 | 2511 | ▲ |
| X0327802 | PLANTING SOIL MIX FURNISH AND PLACE, 12" | SO YD | 2,328 | 2,328 | |
| X0327808 | PLANTING SOIL MIX FURNISH AND PLACE, 18" | SO YD | 1006 | 1006 | ▲ |
| X0327814 | PLANTING SOIL MIX FURNISH AND PLACE, 24" | SO YD | 696 | 696 | ▲ |
| X0327820 | PLANTING SOIL MIX FURNISH AND PLACE, 30" | SO YD | 809 | 809 | |
| XX007408 | PRECAST WALL TYPE A | FOOT | 91 | 91 | |
| XX007409 | PRECAST WALL TYPE B | FOOT | 41 | 41 | |
| XX007410 | PRECAST WALL TYPE C | FOOT | 110 | 110 | |
| * X0327880 | WAYFINDING SIGN, SPECIAL | L SUM | 1 | 1 | |
| Z0013797 | STABILIZED CONSTRUCTION ENTRANCE | SO YD | 54 | 54 | |

* DENOTES SPECIALTY ITEM

** DENOTES NON-PARTICIPATING ITEM

▲ Rev. 11-7-14

FILE PATH: c:\p\388823\p\11\accesson\local\m\c\0308\Documents\311\americas\Transportation\62029108_Civil\Share_11\908_CDD\908_Roadway\Sheets\6062_Contract\0181862-sh1-506.dgn



D:\62\sh1-506.dgn
 USER NAME = BAW\bart
 PLOT SCALE = 20.0292 1/1 in.
 PLOT DATE = 8/19/2014

DESIGNED - JLV
 DRAWN - BAW
 CHECKED - JMG
 DATE - 8/20/2014

REVISED -
 REVISED -
 REVISED -
 REVISED -

STATE OF ILLINOIS
 DEPARTMENT OF TRANSPORTATION

SUMMARY OF QUANTITIES

SCALE: NONE SHEET 5 OF 6 SHEETS STA. TO STA.

| | | | | |
|--------------------|-----------|--------|---------------------------|-----------|
| F.A.I. RTE. | SECTION | COUNTY | TOTAL SHEETS | SHEET NO. |
| 90/94/290 | 2013-0741 | COOK | 58 | 8 |
| CONTRACT NO. 60X62 | | | ILLINOIS FED. AID PROJECT | |

EROSION CONTROL GENERAL NOTES

1. THE CONSTRUCTION LIMITS WILL BE STAKED AND APPROVED BY THE ENGINEER PRIOR TO COMMENCING CONSTRUCTION. THE CONSTRUCTION LIMITS MAY BE ADJUSTED BY THE ENGINEER AND NO ADDITIONAL COMPENSATION WILL BE PAID TO THE CONTRACTOR FOR CHANGES IN CONSTRUCTION LIMITS.
2. EROSION CONTROL ITEMS ARE CONSIDERED HIGH PRIORITY ITEMS IN THIS CONTRACT. THE ENGINEER WILL IMPLEMENT ALL PROVISIONS OF SPECIFICATION NECESSARY TO ASSURE THAT EROSION CONTROL ITEMS ARE CONSTRUCTED AND MAINTAINED IN A TIMELY MANNER. THE CONTRACTOR SHALL INSTALL TEMPORARY EROSION CONTROL MEASURES PRIOR TO THE START OF CONSTRUCTION OPERATIONS WHICH WILL POTENTIALLY CREATE ERODIBLE CONDITIONS. PLACEMENT AND MAINTENANCE OF TEMPORARY EROSION CONTROL SYSTEMS WILL BE UTILIZED THROUGHOUT THE CONSTRUCTION LIMITS.
3. TEMPORARY EROSION CONTROL MEASURES SHALL BE CONSTRUCTED AS SHOWN ON THE PLANS AND AS DIRECTED BY THE ENGINEER. THE WORK SHALL BE COMPLETED IN ACCORDANCE WITH SECTION 280 OF THE STANDARD SPECIFICATIONS, CONTRACT SPECIAL PROVISIONS AND THE STORM WATER POLLUTION PREVENTION PLAN (SWPPP).
4. THE CONTRACTOR SHALL UTILIZE THE GENERAL MAINTENANCE GUIDELINES AS OUTLINED IN THE SWPPP TO ENSURE GOOD AND EFFECTIVE OPERATING CONDITION OF THE VEGETATION AND EROSION AND SEDIMENT CONTROL MEASURES.
5. A COPY OF THE APPROVED EROSION AND SEDIMENT CONTROL PLAN SHALL BE MAINTAINED ON SITE. ALL CHANGES TO THE SOIL EROSION AND SEDIMENT CONTROL PLAN SHALL BE NOTED ON THE SITE.
6. THE CONTRACTOR SHALL PERFORM ALL WORK AS DIRECTED BY THE ENGINEER AND AS SHOWN IN HIGHWAY STANDARD 280001-07. STRAW BALES AND SILT FENCE SHALL NOT BE USED FOR INLET AND PIPE PROTECTION BUT SHALL INSTEAD CONSIST OF TEMPORARY DITCH CHECKS, TEMPORARY SEEDING AND TEMPORARY EROSION CONTROL BLANKET.
7. THE EROSION CONTROL MEASURES SHOWN ARE BUT A GRAPHICAL REPRESENTATION OF SUGGESTED MEASURES. DEVIATIONS FROM THIS PLAN ARE TO BE EXPECTED PENDING A JOBSITE INSPECTION BETWEEN THE CONTRACTOR AND THE DEPARTMENT.
8. THE CONTRACTOR WILL BE REQUIRED TO IMPLEMENT AND MAINTAIN SEDIMENT CONTROL MEASURES PRIOR TO STRIPPING EXISTING VEGETATION.
9. THE CONTRACTOR SHALL INSPECT ALL EROSION AND SEDIMENT CONTROL MEASURES WEEKLY AND AFTER EACH RAINFALL, 0.5 INCHES OR GREATER IN A 24 HOUR PERIOD, OR EQUIVALENT SNOWFALL. ADDITIONALLY DURING WINTER MONTHS, ALL MEASURES SHOULD BE CHECKED AFTER EACH SIGNIFICANT SNOWMELT. ANY NECESSARY REPAIRS OR CLEANUP TO MAINTAIN THE EFFECTIVENESS OF SAID MEASURES SHALL BE MADE IMMEDIATELY.
10. TEMPORARY EROSION CONTROL SEEDING SHALL BE APPROVED PER SUB-STAGE AS SOON AS ROUGH GRADING IS COMPLETED IN A SECTION. STABILIZATION OF DISTURBED AREAS MUST BE INITIATED WITHIN 1 WORKING DAY OF TEMPORARY OR PERMANENT CESSATION OF EARTH DISTURBING ACTIVITIES AND SHALL BE COMPLETED AS SOON AS POSSIBLE BUT NO LATER THAN 14 DAYS FROM THE INITIATION OF STABILIZATION OF WORK IN AN AREA.
11. ANY AREA WHERE THERE IS NO PROPOSED GRADING, THE EXISTING GROUND COVER SHALL REMAIN.
12. TEMPORARY STOCKPILE LOCATIONS SHALL BE APPROVED BY THE ENGINEER AND WILL REQUIRE SILT FENCE AND TEMPORARY SEEDING.
13. THE CONTRACTOR SHALL INSTALL, MAINTAIN AND ROUTINELY CLEAN INLET FILTERS AT ALL EXISTING OPEN LID DRAINAGE STRUCTURES AS SHOWN ON THE PLANS PRIOR TO THE START OF PRE-STAGE WORK. THE INLET FILTERS SHALL BE MAINTAINED AND CLEANED UNTIL NO LONGER REQUIRED OR AS DIRECTED BY THE ENGINEER. THE INSTALLATION, MAINTENANCE AND ROUTINE CLEANING OF INLET FILTERS ARE INCLUDED IN THE COST OF INLET FILTERS.
14. DURING CONSTRUCTION OPERATIONS, WHEN ANY LOOSE MATERIAL IS DEPOSITED IN THE FLOW LINE OF DITCHES, GUTTERS OR DRAINAGE STRUCTURES SO THAT THE NATURAL FLOW OF WATER IS OBSTRUCTED, THE MATERIAL SHALL BE REMOVED AT THE CLOSE OF EACH WORKING DAY. THIS WORK WILL NOT BE PAID FOR SEPARATELY BUT SHALL BE CONSIDERED INCLUDED IN THE COST OF THE PROJECT.
15. AT THE CONCLUSION OF CONSTRUCTION OPERATIONS, ALL DRAINAGE STRUCTURES SHALL BE FREE FROM DIRT AND DEBRIS. THIS WORK WILL NOT BE PAID FOR SEPARATELY BUT SHALL BE CONSIDERED INCLUDED IN THE COST OF THE PROJECT.
16. ALL EROSION CONTROL MEASURES PLACED DURING CONSTRUCTION SHALL REMAIN IN PLACE AND BE MAINTAINED UNTIL NO LONGER REQUIRED.
17. PERIMETER EROSION BARRIER SHALL BE PLACED AS SHOWN ON THE PLANS OR AS DIRECTED BY THE ENGINEER.

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18. ENSURE THAT EXISTING TREES TO REMAIN ARE PRESERVED AND MAINTAINED HEALTHY. PRESERVATION MEASURES MAY INCLUDE BUT ARE NOT LIMITED TO, TREE PROTECTION, TREE ROOT PRUNING, TREE PRUNING, & SUPPLEMENTAL WATERING TO ASSURE AND MAINTAIN THE HEALTH OF THE TREES.


TEMPORARY EROSION CONTROL SCHEDULE

| MULCH, METHOD 2 | TEMPORARY EROSION CONTROL SEEDING | PERIMETER EROSION BARRIER | INLET FILTERS | TEMPORARY CHAIN LINK FENCE | STABILIZED CONSTRUCTION ENTRANCE |
|-----------------|-----------------------------------|---------------------------|---------------|----------------------------|----------------------------------|
| ACRE | POUND | FOOT | EACH | FOOT | 50 YD |
| 1.00 | 98 | 471 | 10 | 1,424 | 54 |

INLET FILTER SCHEDULE

| LOCATION | | ALIGNMENT | AMOUNT (EACH) |
|------------|------------|-----------|---------------|
| STATION | OFFSET | | |
| 3701+21.40 | 108.48' LT | PEORIA | 1 |
| 3701+45.19 | 108.54' LT | PEORIA | 1 |
| 3702+48.08 | 56.16' RT | PEORIA | 1 |
| 3702+48.17 | 63.23' LT | PEORIA | 1 |
| 3706+12.90 | 12.11' LT | PEORIA | 1 |
| 3706+32.90 | 12.00' LT | PEORIA | 1 |
| 3706+45.93 | 1.97' RT | PEORIA | 1 |
| 3706+49.03 | 21.40' RT | PEORIA | 1 |
| 7798+79.78 | 28.04' LT | HARRISON | 1 |
| 7800+71.00 | 28.09' LT | HARRISON | 1 |
| TOTAL | | | 10 |

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 User: amk
 Date: 10/15/2014
 State of Illinois Department of Transportation
 Contract No. 2013-0741
 Section: COOK
 Sheet No. 58 of 21
 Contract No. 60X62

| | | | | | | | | | | | | |
|---|-----------------|----------------------|---|--|-------------|---------|---------------------------|---------|--------------------|--------------|-----------|------|
|  | DESIGNED - JULY | REVISED - 10/15/2014 | STATE OF ILLINOIS DEPARTMENT OF TRANSPORTATION | EROSION AND SEDIMENTATION CONTROL PLAN GENERAL NOTES AND SCHEDULE | | | F.A.I. R/E | SECTION | COUNTY | TOTAL SHEETS | SHEET NO. | |
| | USER NAME: amk | DRAWN: AMK | | REVISED: - | SCALE: NONE | SHEET 1 | OF 1 SHEETS | STA. | TO STA. | 90/94/230 | 2013-0741 | COOK |
| | CHECKED: JMG | REVISED: - | | | | | | | CONTRACT NO. 60X62 | | | |
| | DATE: 8/20/2014 | REVISED: - | | | | | ILLINOIS FED. AID PROJECT | | | | | |

EARTHWORK SCHEDULE

| LOCATION | EARTH EXCAVATION CU YD | REMOVAL AND DISPOSAL OF UNSUITABLE MATERIAL | | (1) (2) EXCAVATION TO BE USED IN EMBANKMENT (15% SHRINKAGE) [EARTH EXCAVATION * 0.85] CU YD | (1) EMBANKMENT CU YD | (1) EARTHWORK BALANCE WASTE (+) OR SHORTAGE (-) CU YD | (2) FURNISHED EXCAVATION CU YD | (3) (4) NON-SPECIAL WASTE DISPOSAL CU YD |
|--|---------------------------|---|--------------------------|--|-------------------------|--|-----------------------------------|---|
| | | EXISTING TOPSOIL CU YD | (5) PR UNDERCUT CU YD | | | | | |
| PEORIA STREET (SOUTH OF I-290) (3) (4) | 824 | 540 | 50 | 0 | 1,508 | -1,508 | 1,508 | 1,200 |
| PEORIA STREET (NORTH OF I-290) (3) (4) | 201 | 42 | | 0 | 0 | 0 | 1,508 | 1,200 |
| TOTAL | 1,025 | 632 | | 0 | 1,508 | | 1,508 | 1,200 |
| NON-SPECIAL WASTE ADJUSTMENT | | | | | | | | |
| ADJUSTED TOTAL | 1,025 | 632 | | 0 | 1,508 | | 1,508 | 1,200 |

NOTES:

- (1) NOT A PAY ITEM
- (2) FURNISHED EXCAVATION IS ASSUMED TO EQUAL THE EMBANKMENT NEEDED DUE TO THE UNCERTAINTY IN THE PERCENTAGE OF EARTH EXCAVATION THAT IS CLASSIFIED AS NON-SPECIAL WASTE. AS SUCH, THE QUANTITY FOR EARTH EXCAVATION AVAILABLE FOR EMBANKMENT IS ASSUMED TO BE ZERO.
- (3) ACTUAL VOLUMES OF NON-SPECIAL WASTE SHALL BE DETERMINED IN THE FIELD AT THE TIME OF CONSTRUCTION.
- (4) A QUANTITY HAS BEEN ASSUMED FOR NON-SPECIAL WASTE DISPOSAL BASED ON THE PRELIMINARY SOIL INVESTIGATION LOCATIONS. SEE SPECIAL PROVISIONS REGARDING LOCATIONS AND REQUIREMENTS FOR PROPER HANDLING AND DISPOSAL.
- (5) A QUANTITY OF 50 CUBIC YARDS HAS BEEN ASSUMED FOR PROPOSED UNDERCUT.

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LANDSCAPING SCHEDULE

| ABBREV. CODE | BOTANICAL NAME | COMMON NAME | TYPE | SIZE | ROOT | REMARKS | QUANTITY | UNIT | | |
|---|--|--------------------------------------|------------------------|----------------|------|--|----------|-------|-------|-------|
| SHADE TREES | | | | | | | | | | |
| AF | ACER X FREEMANII 'MARMO' | MARMO FREEMAN MAPLE | | 3" CAL | B&B | SPECIMEN QUALITY | 4 | EACH | | |
| CCL | CORYLUS COLURNA | TURKISH FILBERT | | 2.5" CAL | B&B | SPECIMEN QUALITY | 4 | EACH | | |
| OA | QUERCUS ALBA | WHITE OAK | | 4" CAL | B&B | SPECIMEN QUALITY | 1 | EACH | | |
| UDL | ULMUS 'MORTON' | ACCOLADE ELM | | 4" CAL | B&B | SPECIMEN QUALITY | 4 | EACH | | |
| UDS | ULMUS 'MORTON' | ACCOLADE ELM HYBRID | | 3" CAL | B&B | SPECIMEN QUALITY | 3 | EACH | | |
| TD | TAXODIUM DISTICHUM | COMMON BALD CYPRESS | | 4" CAL | B&B | MATCHING HEADS | 5 | EACH | | |
| ORNAMENTAL TREES | | | | | | | | | | |
| AGA | AMERLANCHIER X GRANDIFLORA 'AUTUMN BRILLIANCE' | AUTUMN BRILLIANCE APPLE SERVICEBERRY | | 8' HT | B&B | CLUMP FORM, MATCHING HEADS | 3 | EACH | | |
| BN | BETULA NIGRA | RIVER BIRCH | | 7' HT | B&B | SPECIMEN QUALITY | 5 | EACH | | |
| CC | CRATAEGUS CRUGALLI VAR. INERMIS | THORNLESS COCKSPUR HAWTHORN | | 8' HT | B&B | CLUMP FORM, MATCHING HEADS | 13 | EACH | | |
| SHRUBS | | | | | | | | | | |
| AP | AESCLUSUS PARVIFLORA | BOTTLEBRUSH BUCKEYE | | 42" HT | B&B | SPACED AS SHOWN | 6 | EACH | | |
| BD | BUDDLEIA DAVIDII 'PEAKEEP' | ENGLISH PEACOCK BUTTERFLY BUSH | | 18" HT / 3 GAL | POT | SPACED AS SHOWN | 3 | EACH | | |
| CA | CORNUS SERICEA 'ISANTI' | ISANTI REDTWIG DOGWOOD | | 36" HT | B&B | SPACED AS SHOWN | 75 | EACH | | |
| HYP | HYPERICUM KALMIANUM 'AMES' | AMES ST. JOHNSWORT | | 24" HT / 5 GAL | POT | SPACED AS SHOWN | 40 | EACH | | |
| IVN | ILEX VERTICILLATA 'RED SPRITE' | RED SPRITE WINTERBERRY | | 24" HT / 5 GAL | POT | SPACED AS SHOWN, FEMALE AND MALE BOTH NEEDED | 100 | EACH | | |
| IVS | ITEA VIRGINICA 'SPRICH' | LITTLE HENRY VIRGINIA SWEETSPIRE | | 18" HT / 3 GAL | POT | SPACED AS SHOWN | 34 | EACH | | |
| IVR | ILEX VERTICILLATA 'WINTER RED' | WINTER RED WINTERBERRY | | 36" HT | B&B | SPACED AS SHOWN, FEMALE AND MALE BOTH NEEDED | 61 | EACH | | |
| JCK | JUNIPERUS CHINENSIS 'KALLAY'S COMPACT' | KALLAY'S COMPACT PFITZER JUNIOR | | 18" WD / 3 GAL | POT | SPACED 30" OC | 900 | EACH | | |
| RAG | RHUS AROMATICA 'GRO LOW' | GROW LOW FRAGRANT SUMAC | | 15" HT / 3 GAL | POT | SPACED AS SHOWN | 283 | EACH | | |
| SM | SYRINGA MEYERI 'PALIBIN' | DWARF KOREAN LILAC | | 30" HT | B&B | SPACED AS SHOWN | 48 | EACH | | |
| VD | VIBURNUM DENTATUM 'RALPH SENIOR' | AUTUMN JAZZ ARROWOOD VIBURNUM | | 42" HT | B&B | SPACED AS SHOWN | 37 | EACH | | |
| PERENNIALS, GRASSES, GROUNDCOVER AND BULBS | | | | | | | | | | |
| AC | ASARUM CANADENSE | WILD GINGER | ORNAMENTAL | 3" POT | POT | SPACED 12" OC | 17.0 | UNIT | | |
| AGL | ALLIUM 'GLOBEMASTER' | GLOBEMASTER ALLIUM | BULB | TOP SIZE | BULB | SPACED 12" OC MIN, DISTRIBUTE IN CLUSTERS THROUGHOUT BED | 4.6 | UNIT | | |
| BAI | BAPTISIA AUSTRALIS | BLUE WILD INDIGO | PRAIRIE | 1 GAL | POT | SPACED 30" OC MIN, DISTRIBUTE EVENLY WITHIN BED | 0.2 | UNIT | | |
| CEA | CAREX ELATA 'AUREA' | BOWLES GOLDEN SEDGE | SEDGE MEADOW | 1 GAL | POT | SPACED 18" OC MIN, DISTRIBUTE EVENLY WITHIN BED | 5.6 | UNIT | | |
| CLO | CHASMANTHIUM LATIFOLIUM | NORTHERN SEA OATS | PRAIRIE | 1 GAL | POT | SPACED 24" OC | 2.1 | UNIT | | |
| CMI | CAREX MORROWII 'ICE DANCE' | ICE DANCE SEDGE | SEDGE MEADOW | 1 GAL | POT | SPACED 18" OC | 1.5 | UNIT | | |
| CMO | CAREX MUSKINGUMENSIS 'OEHME' | OEHME PALM SEDGE | SEDGE MEADOW | 1 GAL | POT | SPACED 24" OC | 2.2 | UNIT | | |
| CRO | CROCUS VERNUS 'FLOWER RECORD' | FLOWER RECORD VENUS | BULB | TOP SIZE | BULB | SPACED 4" OC MAX, DISTRIBUTE IN CLUSTERS THROUGHOUT BED | 61.2 | UNIT | | |
| EPG | ECHINACEA 'TANGERINE DREAM' | TANGERINE DREAM CONEFLOWER | ORNAMENTAL | 1 GAL | POT | SPACED 18" OC MIN, DISTRIBUTE EVENLY WITHIN BED | 2.4 | UNIT | | |
| EPM | ECHINACEA 'MAGNUS' | MAGNUS CONEFLOWER | ORNAMENTAL | 1 GAL | POT | SPACED 24" OC MIN, DISTRIBUTE EVENLY WITHIN BED | 0.6 | UNIT | | |
| HC | HEUCHERA 'PALACE PURPLE' | PALACE PURPLE CORALBELLS | ORNAMENTAL | 1 GAL | POT | SPACED 24" OC MIN, DISTRIBUTE EVENLY WITHIN BED | 0.5 | UNIT | | |
| LSK | LIATRIS SPICATA 'KOBOLD' | KOBOLD GAYFEATHER | ORNAMENTAL | 1 GAL | POT | SPACED 18" OC MIN, DISTRIBUTE EVENLY WITHIN BED | 0.5 | UNIT | | |
| LSR | LIRIOPE SPICATA | CREEPING LILYTURF | ORNAMENTAL | 3" POT | POT | SPACED 12" OC MIN, DISTRIBUTE EVENLY WITHIN BED | 13.0 | UNIT | | |
| NDL | NARCISSUS 'DUTCHMASTER' | DUTCHMASTER DAFFODIL | BULB | TOP SIZE | BULB | SPACED 6" OC MIN, DISTRIBUTE IN CLUSTERS THROUGHOUT BED | 16.4 | UNIT | | |
| NMH | NARCISSUS 'MOUNT HOOD' | MOUNT HOOD DAFFODIL | BULB | TOP SIZE | BULB | SPACED 6" OC MIN, DISTRIBUTE IN CLUSTERS THROUGHOUT BED | 16.0 | UNIT | | |
| PAH | PENNISETUM ALOPRECOIDES 'HAMELIN' | DWARF FOUNTAIN GRASS | ORNAMENTAL | 1 GAL | POT | SPACED 24" OC MIN, DISTRIBUTE EVENLY WITHIN BED | 3.0 | UNIT | | |
| PAR | PEROVSKIA ATRIPILICIFOLIA | RUSSIAN SAGE | ORNAMENTAL | 1 GAL | POT | SPACED 24" OC | 1.0 | UNIT | | |
| PDF | PENSTEMON DIGITALIS | FOXGLOVE BEARDTONGUE | ORNAMENTAL | 1 GAL | POT | SPACED 24" OC MIN, DISTRIBUTE EVENLY WITHIN BED | 1.2 | UNIT | | |
| SAJ | SEDUM SPECTABILE 'AUTUMN JOY' | AUTUMN JOY SEDUM | ORNAMENTAL | 1 GAL | POT | SPACED 18" OC MIN, DISTRIBUTE EVENLY WITHIN BED | 0.7 | UNIT | | |
| SH | SPOROBOLUS HETEROLEPIS | PRAIRIE DROPSEED | PRAIRIE | 1 GAL | POT | SPACED 24" OC | 4.3 | UNIT | | |
| SLB | SYMPHYOTRICHUM LAEVE | SMOOTH BLUE ASTER | PRAIRIE | 1 GAL | POT | SPACED 24" OC MIN, DISTRIBUTE EVENLY WITHIN BED | 0.8 | UNIT | | |
| SNI | SORGHASTRUM NUTANS 'INDIAN STEEL' | BLUE INDIAN GRASS | PRAIRIE | 1 GAL | POT | SPACED 24" OC MIN, DISTRIBUTE EVENLY WITHIN BED | 1.8 | UNIT | | |
| TRH | TULIPA 'RED RIDING HOOD' | RED RIDING HOOD TULIP | BULB | TOP SIZE | BULB | SPACED 6" OC MIN, DISTRIBUTE IN CLUSTERS THROUGHOUT BED | 21.4 | UNIT | | |
| THP | TULIPA 'RED IMPRESSION' | DARWIN HYBRID RED IMPRESSION TULIP | BULB | TOP SIZE | BULB | SPACED 6" OC MAX, DISTRIBUTE IN CLUSTERS THROUGHOUT BED | 21.4 | UNIT | | |
| TURF GRASS | | | | | | | | | | |
| SODDING, SALT TOLERANT | | | SODDING, SALT TOLERANT | | | | SY | ROLLS | 2,328 | SO YD |

EXISTING TREE SCHEDULE

| STATION | OFFSET | LT/RT | NO. STEMS | SIZE | TREE | TREE | TREE | TREE PROTECTION | TREE | MULCH |
|---------|---------|-------|-----------|-----------|---------|---------|---------|------------------|---------|------------|
| | | | | DIAMETER | REMOVAL | PRUNING | PRUNING | (PAID FOR AS | ROOT | PLACEMENT, |
| | | | | INCH | 6-15 | 1 - 10 | OVER 10 | TEMPORARY FENCE) | PRUNING | 3" |
| | | | | | UNIT | EACH | EACH | FOOT | EACH | SO YD |
| 3700+17 | 150.21' | LT | 1 | 13 | 13 | | | | | 3 |
| 3700+15 | 25.25' | LT | 1 | 18 | | | 1 | 180 | 1 | 3 |
| 3700+15 | 53.09' | LT | 1 | 10 | | 1 | | 100 | 1 | 3 |
| 3700+16 | 25.45' | RT | 1 | 20 | | | 1 | 200 | 1 | 3 |
| 3700+67 | 140.54' | LT | 1 | 14 | | | 1 | 140 | 1 | 3 |
| 3702+32 | 66.92' | RT | 4 | 5,6,6,7 | | 4 | | 70 | 1 | 3 |
| 3702+40 | 66.63' | RT | 6 | 2,3,3,4,4 | | 1 | | 40 | 1 | 3 |
| 3702+43 | 61.34' | LT | 5 | 3,3,3,4,6 | | 5 | | 60 | 1 | 3 |
| 3702+49 | 72.96' | LT | 3 | 5,6,7 | | 3 | | 70 | 1 | 3 |
| 3705+44 | 57.86' | LT | 1 | 3 | | 1 | | 30 | 1 | 3 |
| TOTAL | | | | | 13 | 15 | 3 | 890 | 9 | 27 |

PLANTING SOIL MIX SCHEDULE

| TYPE | PLANTING SOIL MIX FURNISH AND PLACE, 12" | PLANTING SOIL MIX FURNISH AND PLACE, 18" | PLANTING SOIL MIX FURNISH AND PLACE, 24" | PLANTING SOIL MIX FURNISH AND PLACE, 30" | COMPOST FURNISH AND PLACE, 1" |
|------------|--|--|--|--|-------------------------------|
| | SO YD | SO YD | SO YD | SO YD | SO YD |
| SODDING | 2,328 | | | | |
| TREES | | | | 809 | 809 |
| SHRUBS | | | 696 | | 696 |
| PERENNIALS | | 1,006 | | | 1,006 |
| TOTAL | 2,328 | 1,006 | 696 | 809 | 2,511 |

A A



DESIGNED - JLV
 DRAWN - BAW
 CHECKED - JMG
 DATE - 8/29/2014

REVISED - 10/15/2014
 REVISED -
 REVISED -
 REVISED -

STATE OF ILLINOIS
 DEPARTMENT OF TRANSPORTATION

LANDSCAPING PLAN
 SCHEDULE

SCALE: NONE SHEET 1 OF 1 SHEETS STA. TO STA.

F.A.I. R.T.E. 90/94/290
 SECTION 2013-0741
 COUNTY COOK
 TOTAL SHEETS 58 SHEET NO. 29
 CONTRACT NO. 60X62
 ILLINOIS FED. AID PROJECT


HARRISON STREET

I-290 EXPRESSWAY



LANDSCAPING LEGEND


- EXISTING TREE TO REMAIN
- TREE REMOVAL
- TREE PRUNING
- TREE ROOT PRUNING
- TREE PROTECTION (PAID FOR AS TEMPORARY FENCE)
- PROPOSED SHADE TREE
- PROPOSED ORNAMENTAL TREE
- PROPOSED EVERGREEN TREE
- SHRUBS
- SODDING, SALT TOLERANT TOPSOIL FURNISH AND PLACE, 12" NITROGEN FERTILIZER NUTRIENT POTASSIUM FERTILIZER NUTRIENT SUPPLEMENTAL WATERING

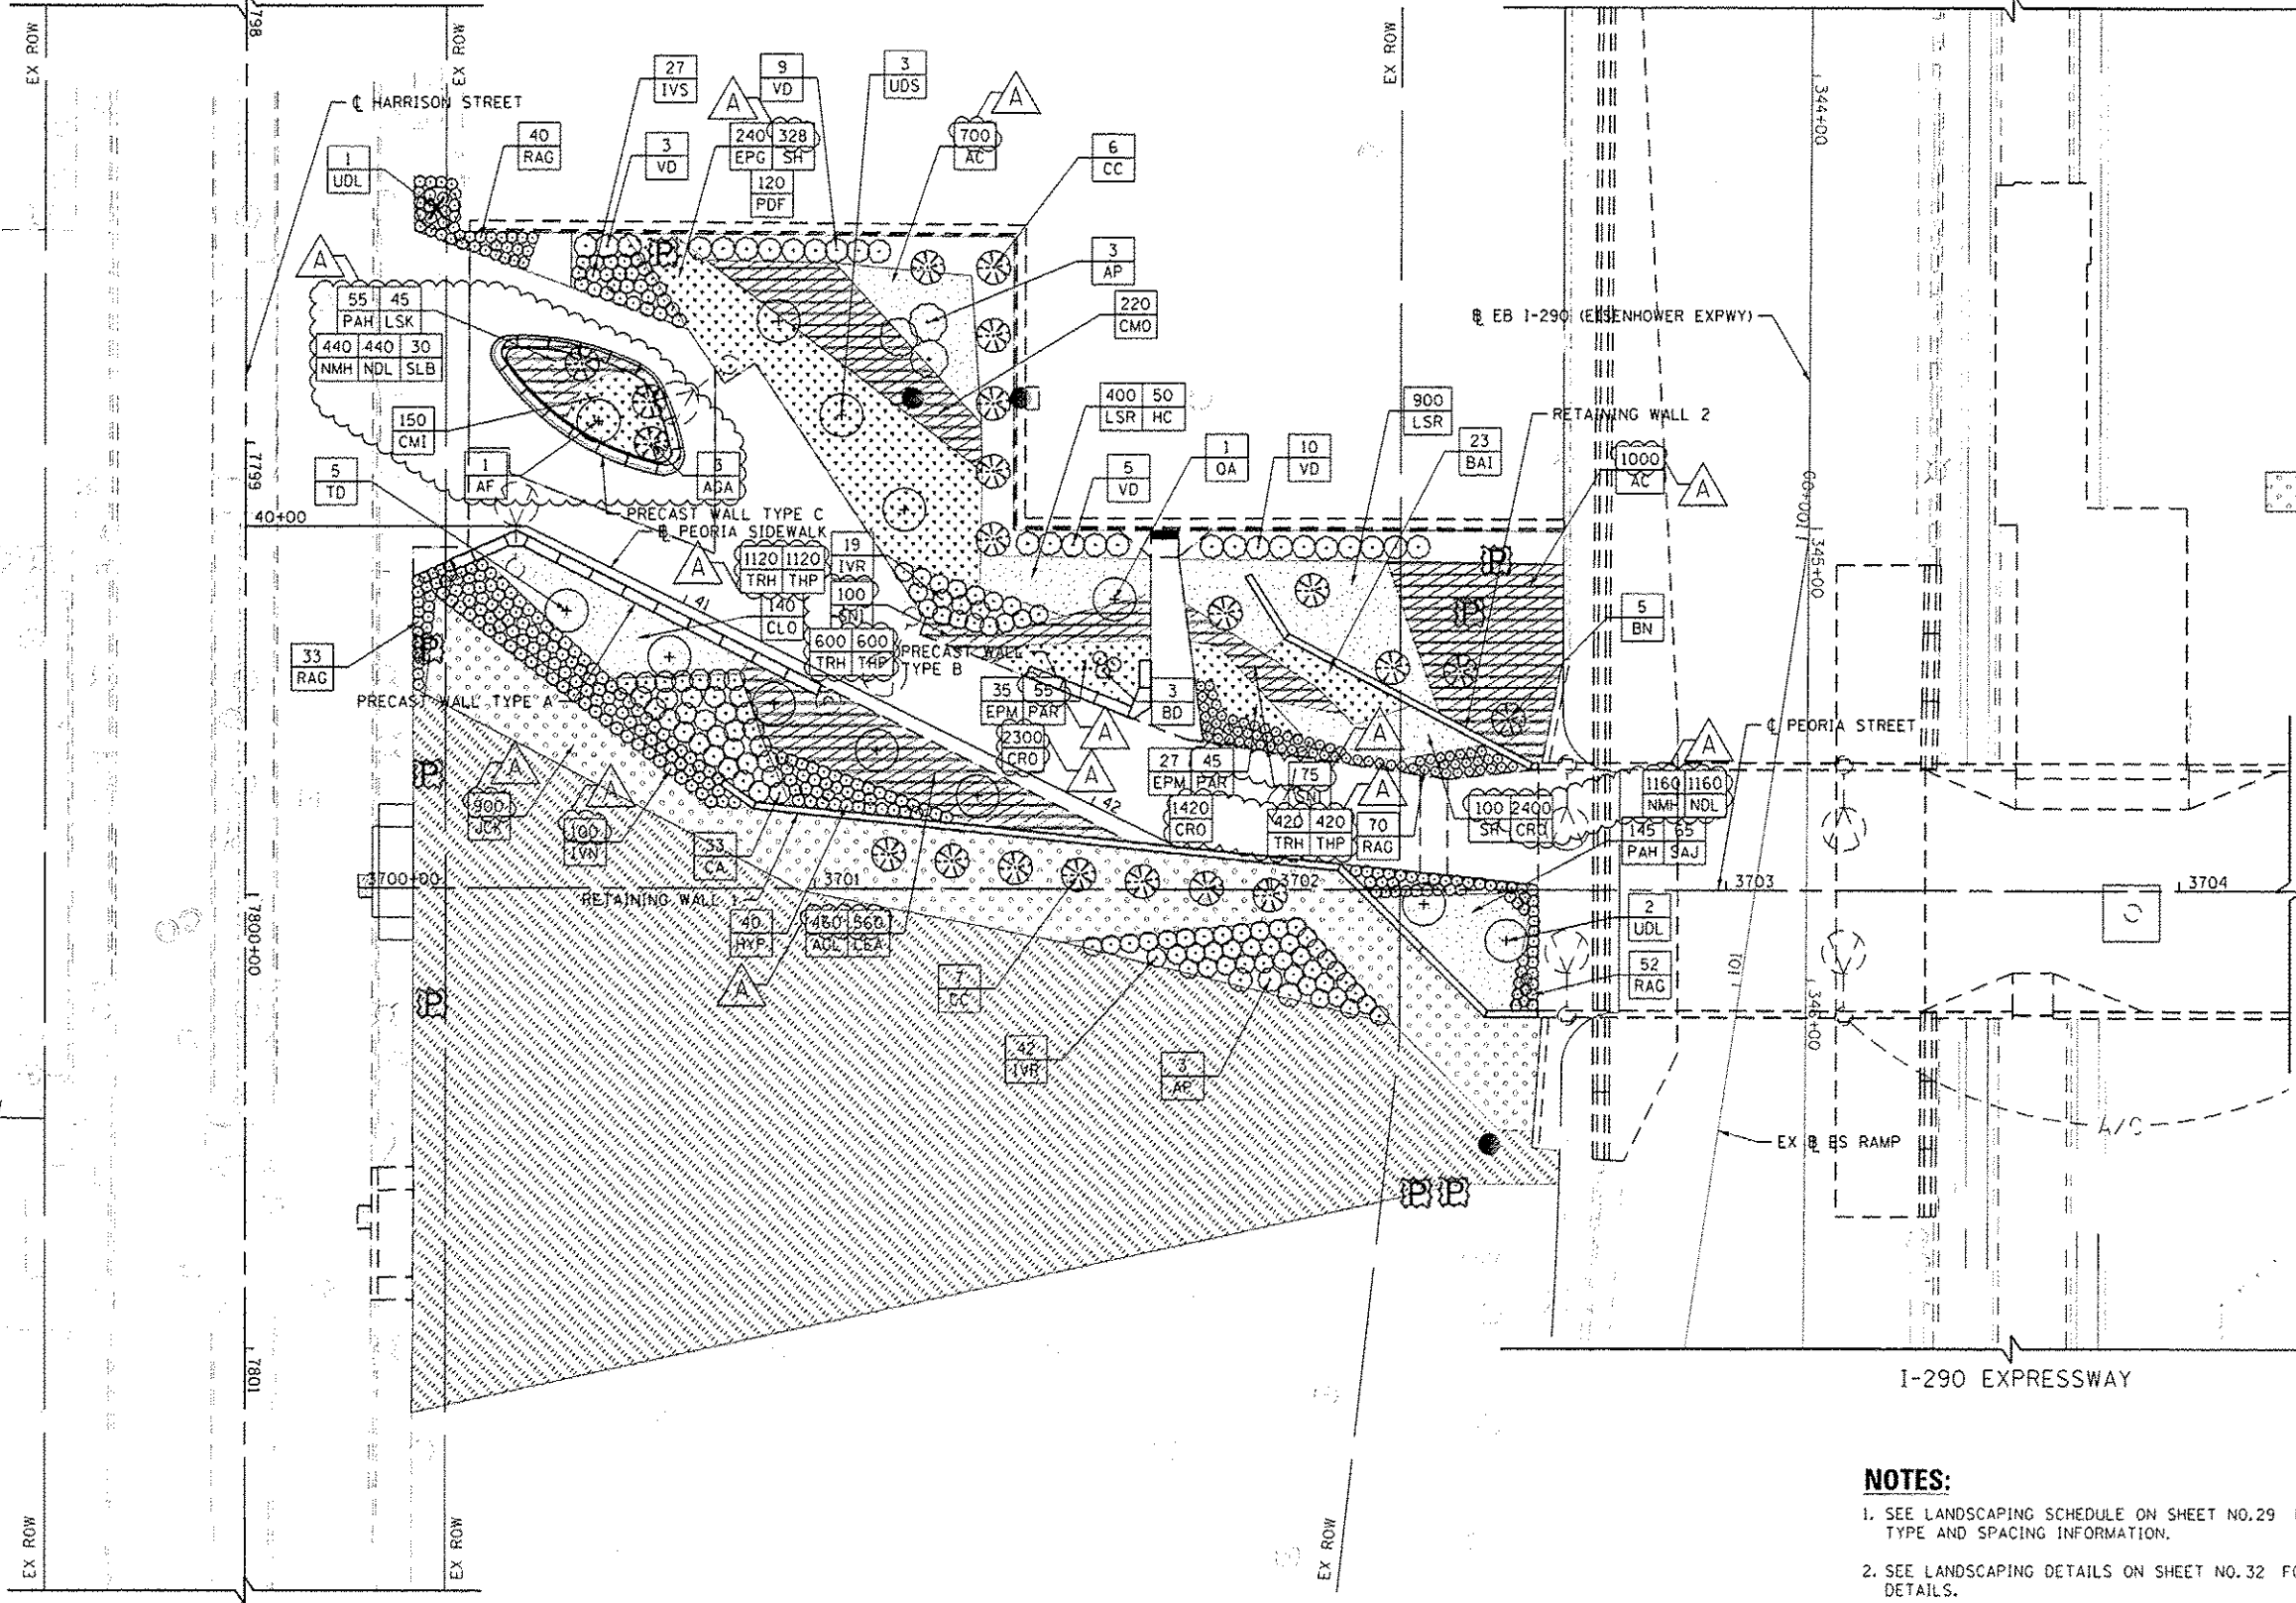

PEORIA STREET
 SEE SHEET NO. 31
 MATCH LINE STA 3704+25

NOTES:

1. SEE LANDSCAPING SCHEDULE ON SHEET NO.29 FOR PLANT TYPE AND SPACING INFORMATION.
2. SEE LANDSCAPING DETAILS ON SHEET NO.32 FOR PLANTING DETAILS.

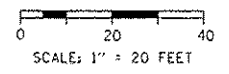

FILE PATH: P:\11389329\project\11389329\11389329.dwg
 USER: baw
 PLOT SCALE: 40.0000 1/16"
 PLOT DATE: 10/15/2014



DIG: 602-Sht-Landsc-01.dwg
 USER NAME: BAW
 PLOT SCALE: 40.0000 1/16"
 PLOT DATE: 10/15/2014

DESIGNED - JLV
 DRAWN - BAW
 CHECKED - JMG
 DATE - 8/20/2014

REVISED - 10/15/2014
 REVISED -
 REVISED -
 REVISED -

**STATE OF ILLINOIS
 DEPARTMENT OF TRANSPORTATION**

**LANDSCAPING PLAN
 PEORIA STREET**

SCALE: 1"=20' SHEET 1 OF 2 SHEETS STA. 3700+00 TO STA. 3704+25

| F.A.I. R.T.E. | SECTION | COUNTY | TOTAL SHEETS | SHEET NO. |
|--------------------|-----------|--------|---------------------------|-----------|
| 90/94/290 | 2013-0741 | COOK | 58 | 30 |
| CONTRACT NO. 60X62 | | | ILLINOIS FED. AID PROJECT | |

60X62 - CALENDAR OF LANDSCAPE CONSTRUCTION AND ESTABLISHMENT WORK

| ITEM | 2016 | | | | | | | | | | | | | | |
|---|--|----------|-------|--|-----|------|-------------------------|--------|-----------|---|----------|----------|---|---|--|
| | JANUARY | FEBRUARY | MARCH | APRIL | MAY | JUNE | JULY | AUGUST | SEPTEMBER | OCTOBER | NOVEMBER | DECEMBER | | | |
| | PHASE II | | | PHASE III | | | PHASE IV | | | PHASE V | | PHASE VI | | | |
| PLANT MATERIAL INSPECTION | | | | | | | | | | | | | | | |
| SUBMIT COMPLETED PLANT INSPECTION FORMS TO IDOT | IDOT INSPECTS SPRING PLANT MATERIAL AT VARIOUS NURSERIES | | | | | | | | | SUBMIT COMPLETED PLANT INSPECTION SHEETS TO IDOT FOR SPRING 2017 REPLACEMENTS | | | | | |
| IRRIGATION | | | | | | | | | | | | | | | |
| PLACE THE IRRIGATION SYSTEMS INTO OPERATION (START-UP) AND PREPARING THE IRRIGATION SYSTEMS FOR WINTER (SHUT-DOWN) IN ACCORDANCE WITH THE DETAILED SPECIFICATIONS | | | | SPRING START-UP | | | | | | FALL SHUT-DOWN | | | | | |
| MONITOR SOIL MOISTURE CONDITIONS IN ALL PLANTING BEDS. ADJUST IRRIGATION CONTROLLERS AND HEADS AS REQUIRED TO MAINTAIN PROPER COVERAGE. (SEE SPECIAL PROVISION) | | | | 2 | | 4 | | 8 | | 8 | | 4 | | 2 | |
| WOODY PLANTINGS & WOODY PLANT CARE | | | | | | | | | | | | | | | |
| SPRING PLANTING OF TREES AND SHRUBS: | | | | | | | | | | | | | | | |
| MARCH 15 - APRIL 30 (EVERGREEN) | | | | SPRING PLANTING - INITIAL INSTALLATION OF EVERGREENS | | | | | | PERIOD OF ESTABLISHMENT INSPECTION BY IDOT AND UIC | | | | | |
| MARCH 15 - MAY 30 (DECIDUOUS) | | | | SPRING PLANTING - INITIAL INSTALLATION OF DECIDUOUS TREES AND SHRUBS | | | | | | | | | | | |
| PERIOD OF ESTABLISHMENT OF TREES AND SHRUBS: WATER: ALL TREES AND SHRUBS EVERY TWO WEEKS (INCLUDED IN COST OF TREE AND SHRUB INSTALLATION) WEED: ALL TREES AND SHRUBS EVERY TWO WEEKS (INCLUDED IN COST OF TREE AND SHRUB INSTALLATION) | | | | 2 | | 2 | | 2 | | 2 | | 2 | | 2 | |
| SUPPLEMENTAL WATERING (NON-IRRIGATED AREA) EVERY TWO WEEKS | | | | 2 | | 2 | | 2 | | 2 | | | | | |
| WOODY PLANT CARE OF TREES & SHRUBS (SEE SPECIAL PROVISION) | | | | | | | | | | | | | | | |
| PERENNIAL PLANTING AND PERENNIAL PLANT CARE | | | | | | | | | | | | | | | |
| INSTALL PERENNIALS (ORNAMENTAL, SEDGE, AND PRAIRIE TYPE) | | | | PLANT PERENNIALS | | | | | | REPLANT PERENNIALS - IF NECESSARY | | | | | |
| PERIOD OF ESTABLISHMENT WORK WATER PERENNIALS TWICE A WEEK FOR FOUR WEEKS AFTER INSTALLATION WEED PERENNIAL BEDS EVERY TWO WEEKS | | | | | | | PERIOD OF ESTABLISHMENT | | | | | | | | |
| PERENNIAL PLANT CARE AFTER COMPLETION OF PERIOD OF ESTABLISHMENT (EVERY 30 DAYS) | | | | | | | 1 | | 1 | | 1 | | | | |
| SUPPLEMENTAL WATERING (NON-IRRIGATED AREA) AFTER COMPLETION OF PERIOD OF ESTABLISHMENT (ONCE A WEEK) | | | | | | | 4 | | 4 | | 4 | | 2 | | |
| INSTALL BULBS | | | | | | | | | | PLANT BULBS | | | | | |
| TURF RESTORATION AND ESTABLISHMENT WORK | | | | | | | | | | | | | | | |
| SODDING, SALT TOLERANCE | | | | | | | | | | | | | | | |
| SPRING: MARCH 15 TO JUNE 30 | | | | SPRING INSTALLATION | | | | | | | | | | | |
| FALL: SEPTEMBER 1 TO NOVEMBER 30 | | | | | | | | | | | | | | | |
| MOWING: TWICE A MONTH WHEN GRASS IS ACTIVELY GROWING | 1 | | 2 | | 2 | | 2 | | 2 | | 2 | | 2 | | |
| BROADLEAF WEED CONTROL IN TURF | | | | IF NECESSARY | | | | | | IF NECESSARY | | | | | |

FILE PATH: I:\Projects\60X62\part\landscape\60X62.dwg
 USER: JLV
 DATE: 10/15/2014
 DRAWN: BAW
 CHECKED: JMG
 DATE: 8/20/2014
 DESIGNED: JLV
 REVISED: 10/15/2014
 USER: JLV
 DATE: 10/15/2014
 DRAWN: BAW
 CHECKED: JMG
 DATE: 8/20/2014



| | | |
|--------------------------------|------------------|----------------------|
| D:\60X62-Site-Landscape-03.dwg | DESIGNED - JLV | REVISED - 10/15/2014 |
| USER NAME: BAW | DRAWN - BAW | REVISED - |
| PLOT SCALE: 48,0000 / 1" | CHECKED - JMG | REVISED - |
| PLOT DATE: 10/15/2014 | DATE - 8/20/2014 | REVISED - |

STATE OF ILLINOIS
DEPARTMENT OF TRANSPORTATION

LANDSCAPING DETAILS
CALENDAR OF CONSTRUCTION AND ESTABLISHMENT OF WORK
SCALE: NONE SHEET 3 OF 4 SHEETS STA. TO STA.

| | | | | |
|---------------------------|-----------|--------|--------------------|-----------|
| F.A.I. R.I.E. | SECTION | COUNTY | TOTAL SHEETS | SHEET NO. |
| 90/94/290 | 2013-0741 | COOK | 68 | 34 |
| ILLINOIS FED. AID PROJECT | | | CONTRACT NO. 60X62 | |





LEGEND

- RAINBIRD 1804 SAM SPRAY HEAD MP ROTATOR NOZZLE PART, HUNTER PROS-04-PRS40-CV SPRAY HEAD MP ROTATOR NOZZLE PART OR APPROVED EQUAL
 - ⊙ RAINBIRD 1804 SAM SPRAY HEAD MP ROTATOR NOZZLE FULL, HUNTER PROS-04-PRS40-CV SPRAY HEAD MP ROTATOR NOZZLE FULL OR APPROVED EQUAL
 - RAINBIRD 1812 SAM SPRAY HEAD MPR/VAN NOZZLES PART, HUNTER PROS-12-PRS30-CV SPRAY HEAD PRO SPRAY NOZZLES PART OR APPROVED EQUAL
 - RAINBIRD 1812 SAM SPRAY HEAD MPR/VAN NOZZLES FULL, HUNTER PROS-12-PRS30-CV SPRAY HEAD PRO SPRAY NOZZLES FULL OR APPROVED EQUAL
 - ⊙ RAINBIRD 1812 SAM SPRAY HEAD MP ROTATOR NOZZLE PART, HUNTER PROS-12-PRS40-CV SPRAY HEAD MP ROTATOR NOZZLE PART OR APPROVED EQUAL
 - ⊙ RAINBIRD 1812 SAM SPRAY HEAD MP ROTATOR NOZZLE FULL, HUNTER PROS-12-PRS40-CV SPRAY HEAD MP ROTATOR NOZZLE FULL OR APPROVED EQUAL
 - 1" & 1.5" HUNTER PGV, RAINBIRD PGA ELECTRIC VALVES OR APPROVED EQUAL; SIZE PER PLAN
 - ▼ HUNTER 1" HQ-44RC SERIES, RAINBIRD 1" 44-RC QUICK COUPLER OR APPROVED EQUAL
 - W— EXISTING IRRIGATION LINE
 - W— CL 200 PVC PIPE - 2" MAINLINE
 - - - PE HD100 PIPE- LATERAL LINE; SIZES VARY
 - ⊘ 2" ISOLATION GATE VALVE
 - ⊙ EXTRA WIRE DROP
 - 2" PIPE SIZE
 - PVC CLASS 200 SLEEVE- SIZE PER PLAN
- 4"/2" SL
 L WIRE SLEEVE SIZE
 L PIPE SLEEVE
- CONTROLLER NUMBER
 STATION NUMBER
 1-13
 1.5" 53
 ZONE GPM
 VALVE SIZE
- PULSE WIRE COLOR CODE #14 GA.:
- | VALVE # |
|---------------|
| RED 131721 |
| BLUE 141822 |
| YELLOW 151923 |
| ORANGE 162024 |
- WHITE - COMMON #14 GA.
 MULTI-STRAND WIRE NOT ALLOWED

NOTES

1. REMOVE EXISTING IRRIGATION SYSTEM WHEN IN CONFLICT WITH PROPOSED IMPROVEMENTS. THIS WORK WILL NOT BE PAID FOR SEPARATELY BUT SHALL BE INCLUDED IN THE COST OF IRRIGATION SYSTEM.
2. CONNECT TO EXISTING 2" LINE. WIRING OF NEW SYSTEM WILL CONFORM TO WORK WITH EXISTING CONTROL BOX. IF 6 SIGNAL WIRES ARE AVAILABLE, DOUBLERS ARE NOT NEEDED. IF DOUBLERS ARE USED, VERIFY THAT 2 SPARE TERMINALS ARE AVAILABLE IN THE EXISTING CONTROLLER. IF NOT, NOTIFY THE ENGINEER AND UNIVERSITY OF ILLINOIS AT CHICAGO.
3. MAINLINE COMPONENTS SHOWN OUTSIDE PLANTING BEDS FOR GRAPHICAL PURPOSES ONLY. PLACE ALL COMPONENTS IN BEDS/TURF, TYP.
4. USE TSM DOUBLER ON ZONES 13 AND 14 IF 6 SIGNAL WIRES ARE NOT AVAILABLE.
5. USE TSM DOUBLER ON ZONES 17 AND 18 IF 6 SIGNAL WIRES ARE NOT AVAILABLE.
6. ALL PROPOSED IRRIGATION ITEMS SHOWN ON THE PLANS WILL NOT BE PAID FOR SEPARATELY BUT SHALL BE INCLUDED IN THE COST OF IRRIGATION SYSTEM.

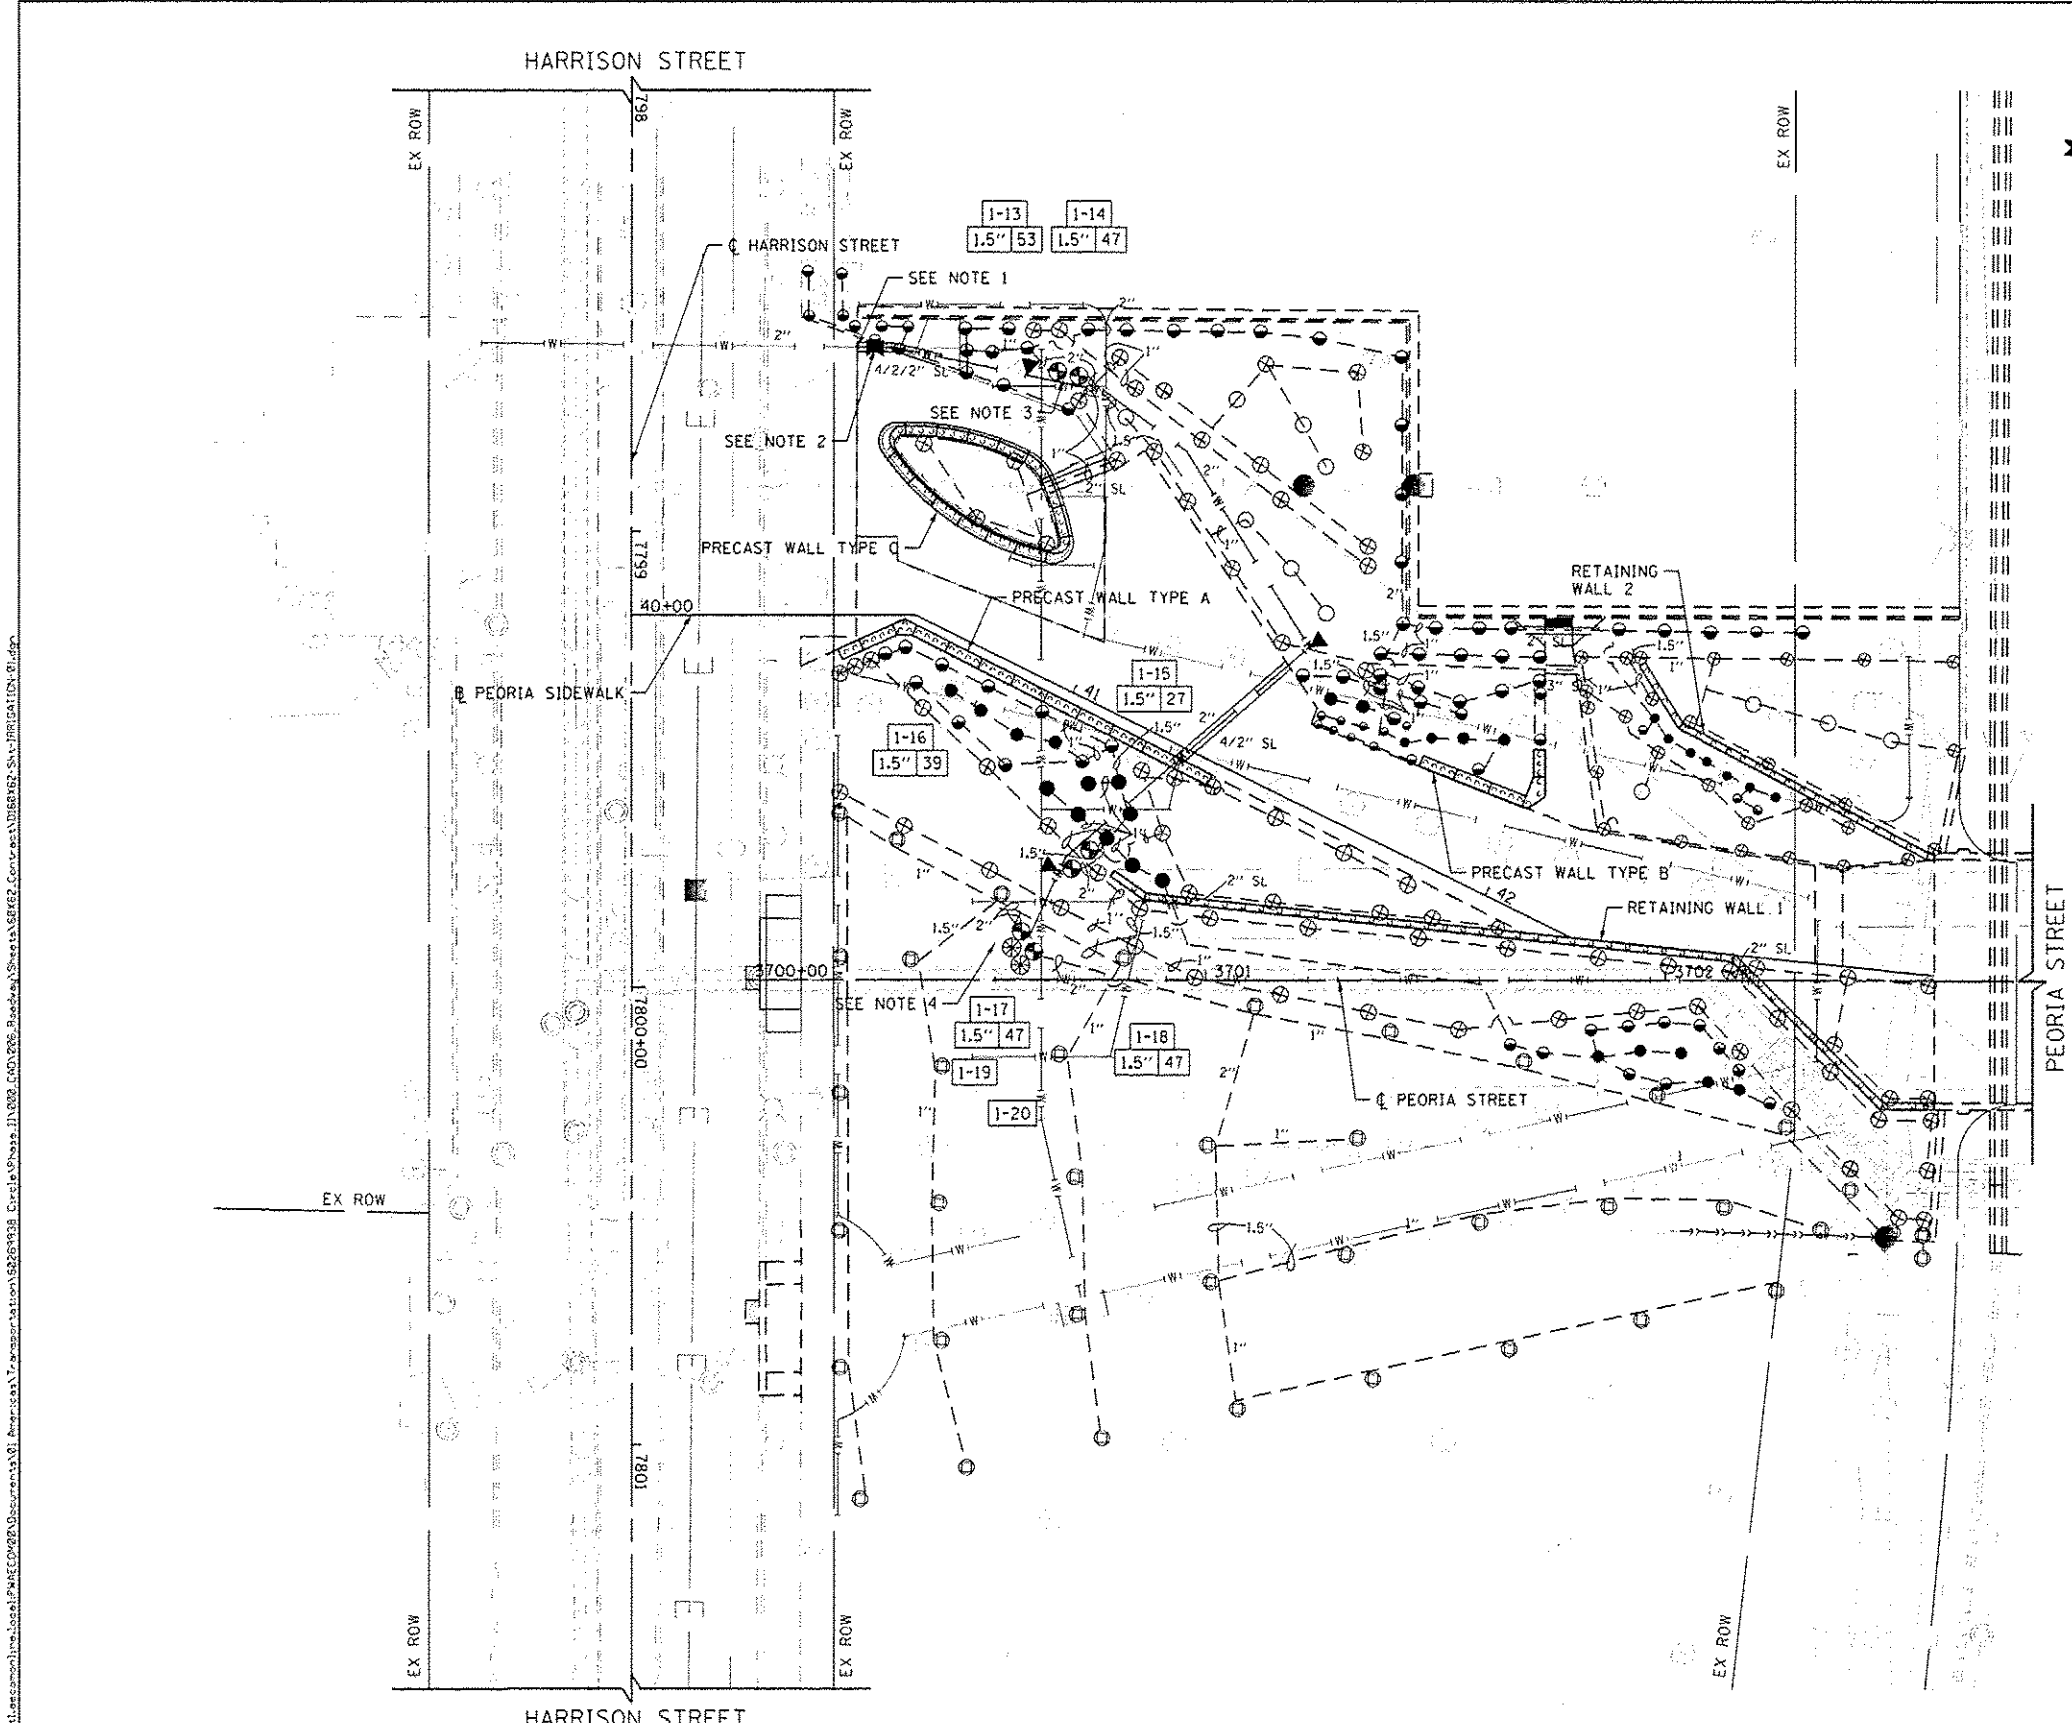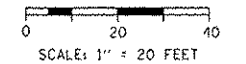

C:\Users\jba\Documents\Projects\606X62\606X62-01\606X62-01.dgn
 10/15/2014 10:15:28 AM
 TRAN SYSTEMS, INC.



| | | |
|-------------------------------------|------------------|----------------------|
| DWG NO: 606X62-01-IRRIGATION-01.dgn | DESIGNED - JLV | REVISED - 10/15/2014 |
| USER NAME: BAW1001 | DRAWN - BAW | REVISED - |
| PLOT SCALE: 40.0000 / 1" | CHECKED - JMG | REVISED - |
| PLOT DATE: 10/15/2014 | DATE - 8/20/2014 | REVISED - |

**STATE OF ILLINOIS
 DEPARTMENT OF TRANSPORTATION**

**IRRIGATION PLAN
 PEORIA STREET**

SCALE: 1"=20' SHEET 1 OF 1 SHEETS STA. 3700+00 TO STA. 3702+80

| | | | | |
|---------------------------|-----------|--------|--------------|-----------|
| F.A.I. R.T.E. | SECTION | COUNTY | TOTAL SHEETS | SHEET NO. |
| 90/94/290 | 2013-0741 | COOK | 58 | 37 |
| CONTRACT NO. 60X62 | | | | |
| ILLINOIS FED. AID PROJECT | | | | |

