


FILE NAME = G:\115\110223\Work_Drwn_3 MO Ave PH2\AC000 Streets\Grade Beam_Plan.dgn

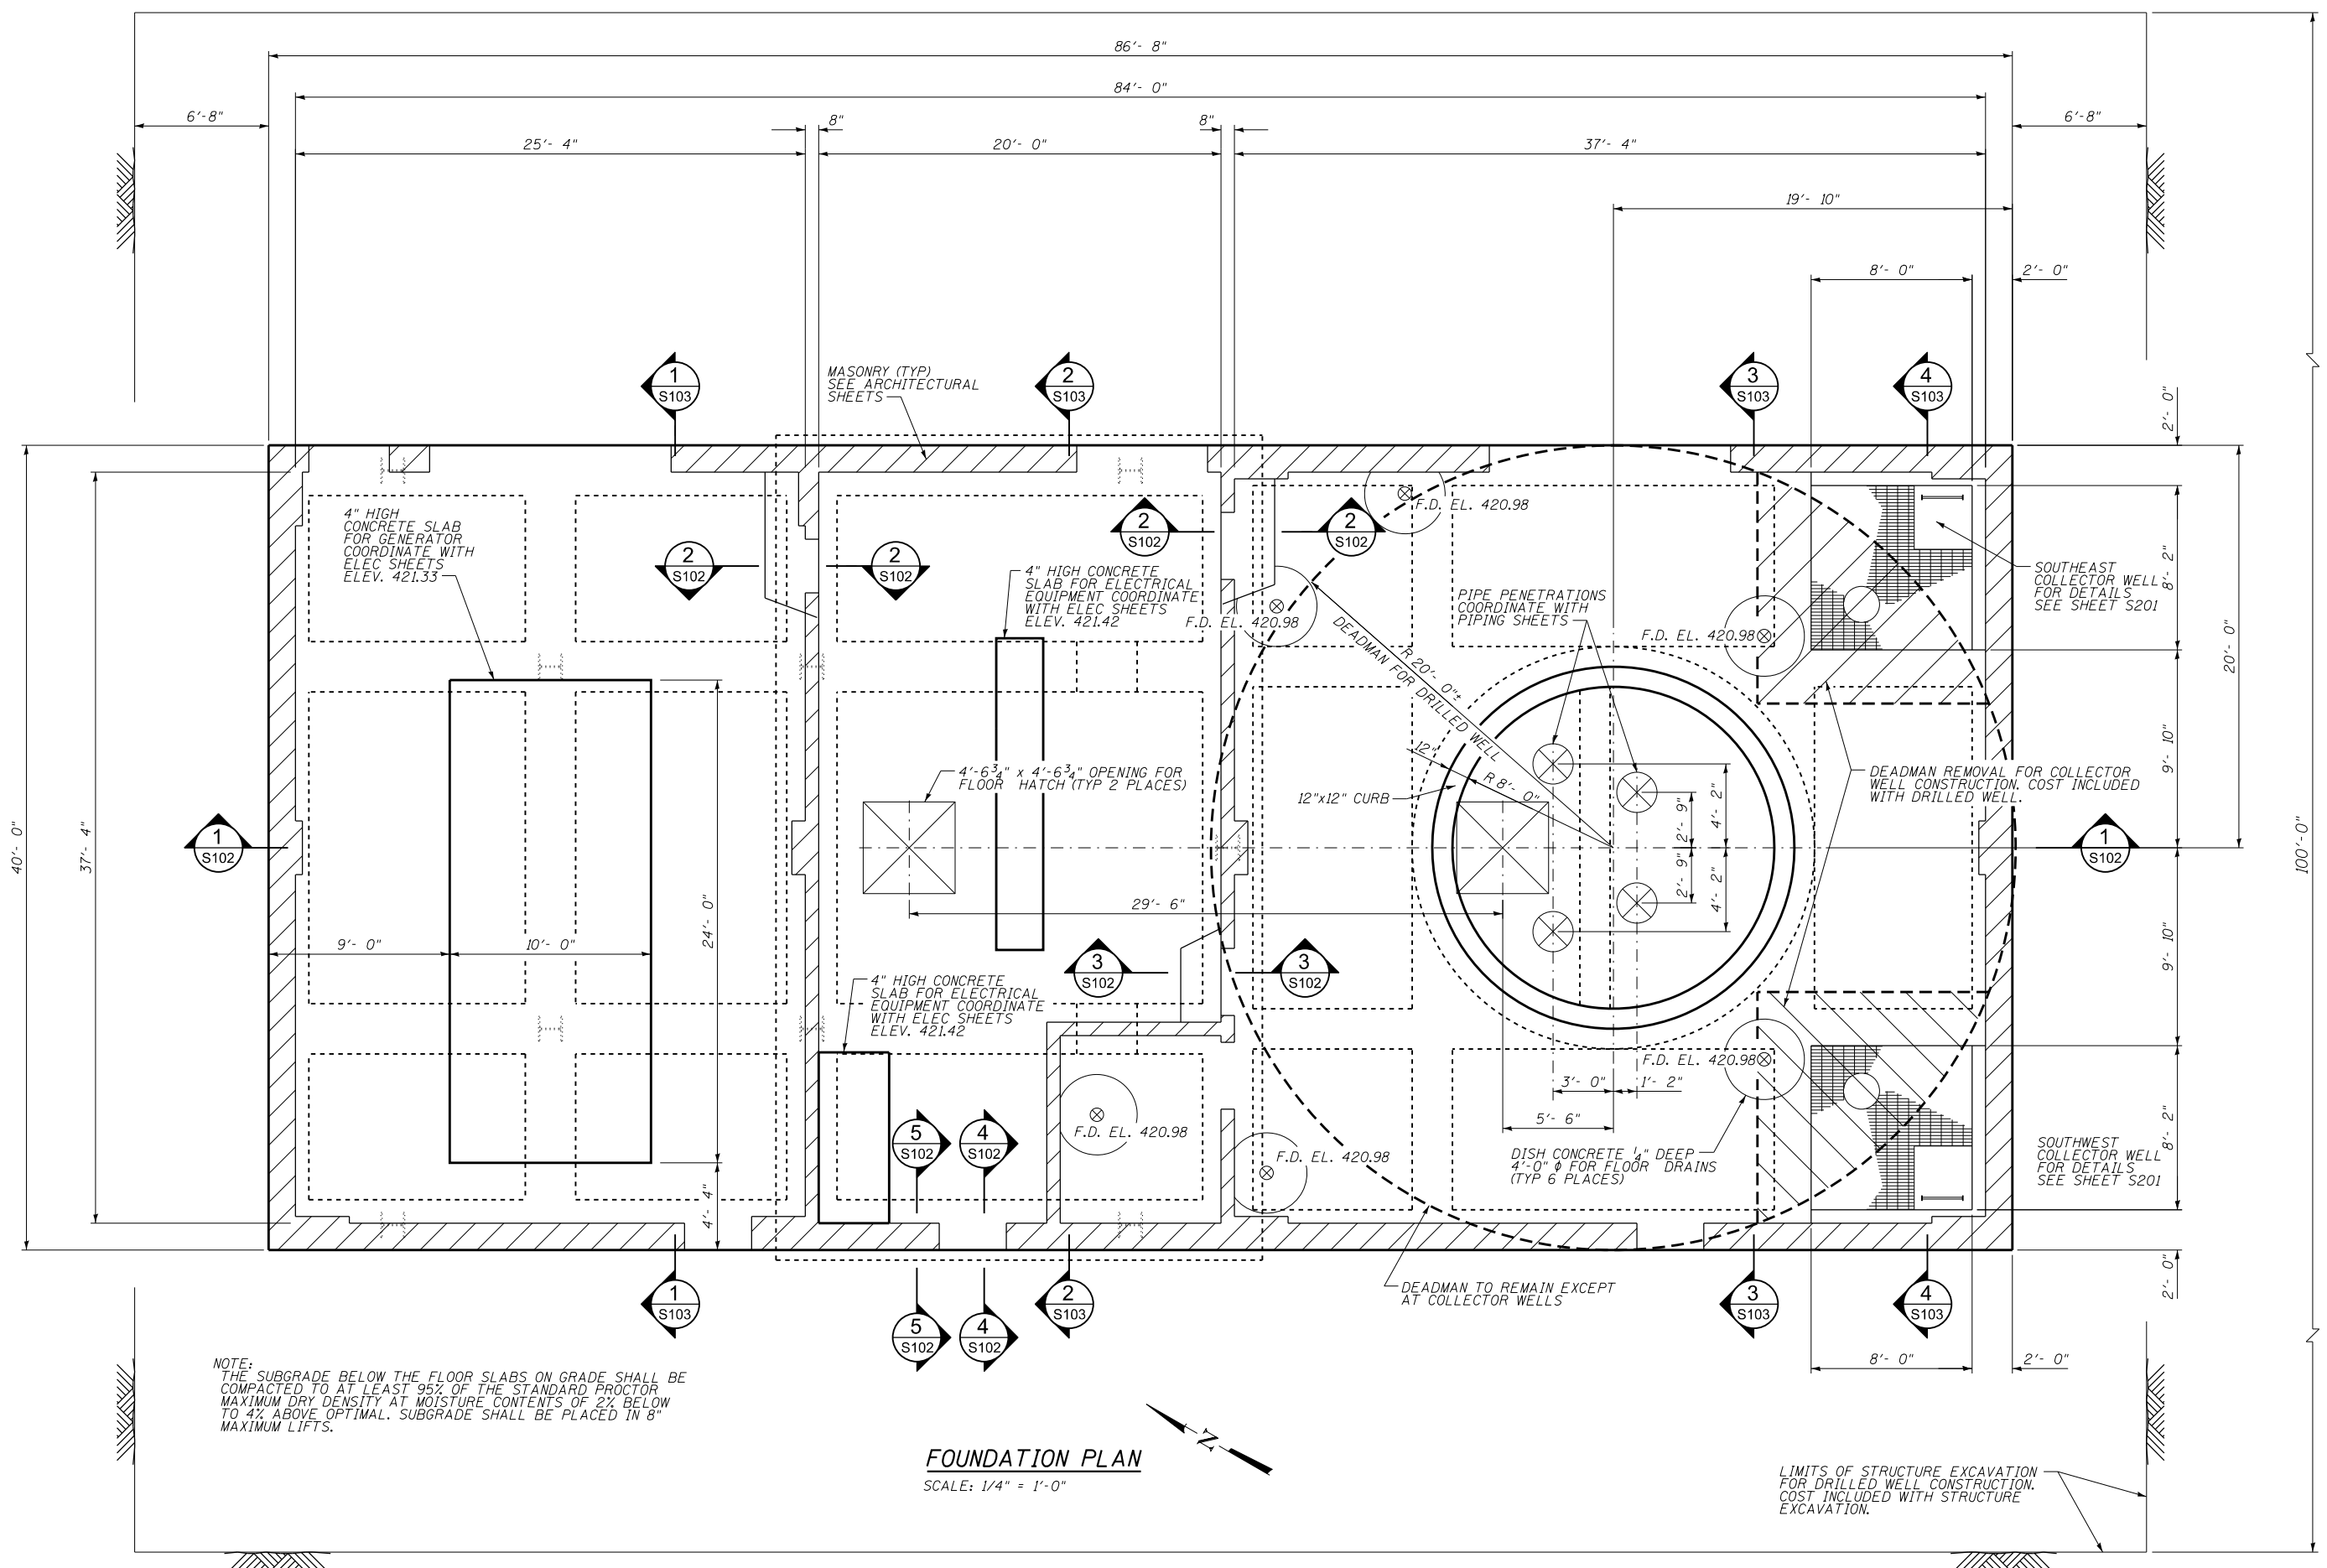

NOTE:
THE SUBGRADE BELOW THE FLOOR SLABS ON GRADE SHALL BE COMPACTED TO AT LEAST 95% OF THE STANDARD PROCTOR MAXIMUM DRY DENSITY AT MOISTURE CONTENTS OF 2% BELOW TO 4% ABOVE OPTIMAL. SUBGRADE SHALL BE PLACED IN 8" MAXIMUM LIFTS.

FOUNDATION PLAN
SCALE: 1/4" = 1'-0"

LIMITS OF STRUCTURE EXCAVATION FOR DRILLED WELL CONSTRUCTION. COST INCLUDED WITH STRUCTURE EXCAVATION.

USER NAME = seb	DESIGNED - RJP	REVISED -
PLOT SCALE = 25.0007' / in.	DRAWN - BGJ	REVISED -
PLOT DATE = 8/23/2014	CHECKED - ADL	REVISED -
	DATE - 8/22/2014	REVISED -

WELL HOUSE BUILDING - FOUNDATION PLAN			
MISSOURI AVENUE DEEP WELL FACILITY			
SCALE:	SHEET	OF SHEETS	STA. TO STA.

S101			
F.A.I. RTE. = 64	SECTION = 82-4T-1	COUNTY = ST. CLAIR	TOTAL SHEETS = 185
		SHEET NO. = 79	
CONTRACT NO. 76C99			
ILLINOIS FED. AID PROJECT			