
NNE /PI AN PREPARATION ENGINEER: KEN ENG /JENPAI CHANG (847) 705-4432

FOR INDEX OF SHEETS, SEE SHEET NO. 2 FOR LOCATION MAPS, SEE SHEET NO. 4

IMPROVEMENTS LOCATED IN THE VILLAGES OF GLENVIEW, NILES AND LAKE BLUFF.

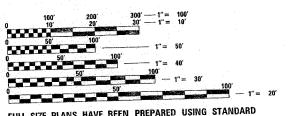

FULL SIZE PLANS HAVE BEEN PREPARED USING STANDARD ENGINEERING SCALES. REDUCED SIZED PLANS WILL NOT CONFORM TO STANDARD SCALES. IN MAKING MEASUREMENTS ON REDUCED PLANS, THE ABOVE SCALES MAY BE USED.

J.U.L.I.E.
JOINT UTILITY LOCATION INFORMATION FOR EXCAVATION
1-800-892-0123

CONTRACT NO. 62635

STATE OF ILLINOIS
DEPARTMENT OF TRANSPORTATION
DIVISION OF HIGHWAYS

PROPOSED HIGHWAY PLANS

VARIOUS ROUTES
SECTION 2003–067I
SCOUR COUNTERMEASURES
COOK & LAKE COUNTIES
C-91–171–03

LOCATION 1: SN 016-0307, IL 43, WAUKEGAN RD OVER THE WEST FORK OF THE NORTH BRANCH OF THE CHICAGO RIVER

LOCATION 2: SN 016-0928, U.S. 14, CALDWELL AVE. OVER THE NORTH BRANCH OF THE CHICAGO RIVER

LOCATION 3: SN 049-0013, IL 176 OVER THE EAST SKOKIE DITCH

RTE. SECTION COUNTY TOTAL SHEET NO. VARIOUS 2003-0671 COOK & LAKE 2.3 1

D-91-171-03



STATE OF ILLINOIS
DEPARTMENT OF TRANSPORTATION
DIVISION OF HIGHWAYS

SUBMITTED OCTABER 25 20 06

Deputy DIRECTOR OF HIGHWAYS, REGION ENGINEE

INTERIM ENGINEER OF DESIGN

Meton R. See P. D. OHER ENGINEER

PRINTED BY THE AUTHORITY OF THE STATE OF ILLINOIS

INDEX OF SHEETS

- TITLE SHEET
- INDEX OF SHEETS STATE STANDARDS GENERAL NOTES
- SUMMARY OF QUANTITIES
- LOCATION MAPS
- 5-6 RIPRAP PLACEMENT DETAILS
- LOCATION 1: SN 016-0307, IL 43, WAUKEGAN ROAD OVER THE WEST FORK OF THE NORTH BRANCH OF THE CHICAGO RIVER
- 9-10 LOCATION 2: SN 016-0928, U.S. 14, CALDWELL AVENUE OVER THE NORTH BRANCH OF THE
- 11-12 LOCATION 3: SN 049-0013, IL 176 OVER THE EAST SKOKIE DITCH
- 13-15 PLAT OF HIGHWAYS
- 16-18 CROSS SECTIONS
- TEMPORARY INFORMATION SIGNING
- TRAFFIC CONTROL AND PROTECTION FOR SIDE ROADS, INTERSECTIONS AND DRIVEWAYS
- 21-23 DEWATERING

STATE STANDARDS

STANDARD	DESCRIPTION
701201 -02	LANE CLOSURE, 2L, 2W, DAY ONLY ON-ROAD TO 24" OFF-ROAD FOR SPEEDS 2 45 M
701501 -03	URBAN LANE CLOSURE 2L, 2W UNDIVIDED
701601 -04	URBAN LANE CLOSURE MULTILANE 1W OR 2W WITH NONTRAVERSABLE MEDIAN
701606 -04	URBAN LANE CLOSURE, MULTILANE 2W WITH MOUNTABLE MEDIAN
702001 -06	TRAFFIC CONTROL DEVICES

GENERAL NOTES

			CONTRA	AC I	NO. 62	635
F.A RTE.	SECTIO	V	COUNT	Υ	SHEETS	SHEET NO.
VAR.	2003-0671		VARIO	OUS	23	2
STA.		1	O STA.			
FED. RO.	AD DIST. NO.	ILLIN	DIS FED.	AID	PROJECT	

BEFORE STARTING ANY EXCAVATION, THE CONTRACTOR SHALL CALL "J.U.L.I.E."
(JOINT UTILITY LOCATION INFORMATION FOR EXCAVATION) AT 800-892-0123 FOR FIELD LOCATIONS OF BURIED ELECTRIC, TELEPHONE & GAS FACILITIES. (48 HOURS NOTIFICATION IS REQUIRED.)

THE CONTRACTOR WILL NOT BE ALLOWED TO SET UP A YARD OR FIELD OFFICE ON STATE PROPERTY WITHOUT WRITTEN PERMISSION FROM THE DEPARTMENT.

EXCAVATION INTO THE STREAM BED FOR STONE RIPRAP INSTALLATION SHALL NOT BE DEEPER THAN THE BOTTOM OF THE FOOTING OF THE PIER OR ABUTMENT TO BE PROTECTED.

DEBRIS REMOVAL, IF ENCOUNTERED, SHALL BE DONE IN ACCORDANCE WITH ARTICLE 109.04 OF THE STANDARD SPECIFICATIONS FOR ROAD AND BRIDGE CONSTRUCTION.

IT SHALL BE THE CONTRACTOR'S RESPONSIBILITY TO VERIFY ALL DIMENSIONS & CONDITIONS EXISTING IN THE FIELD PRIOR TO CONSTRUCTION & ORDERING OF MATERIALS.

THE CONTRACTOR SHALL CONTACT THE DISTRICT ONE TRAFFIC CONTROL SUPERVISOR AT $(847)\ 705-4470$ A MINIMUM OF 72 HOURS IN ADVANCE OF BEGINNING WORK.

ALL AREAS (INCLUDING WETLAND AREAS) OUTSIDE THE LIMITS OF RIPRAP PLACEMENT AND/OR CHANNEL EXCAVATION WHICH ARE DISTURBED (WHERE EXISTING SOIL CONTOURS HAVE BEEN ALTERED AND/OR EXISTING VEGETATION HAS BEEN DESTROYED BY THE CONTRACTOR'S OPERATIONS) SHALL BE RESTORED BY REGRADING TO THE ORIGINAL CONTOURS AND/OR SEEDING WITH SEEDING, CLASSES 4 AND 5, AND MULCHING WITH EROSION CONTROL BLANKET. PLACE TEMPORARY SEEDING AND TEMPORARY EROSION CONRITOL BLANKET AS NEEDED. THIS WORK WILL NOT BE PAID FOR SEPARATELY, BUT THE COSTS SHALL BE CONSIDERED INCLUDED IN THE CONTRACT UNIT PRICES FOR THE CONSTRUCTION ITEMS INVOLVED, AND NO ADDITIONAL COMPENSATION WILL BE ALLOWED.

THE CONTRACTOR IS ADVISED TO AVOID OR MINIMIZE ANY DISTURBANCE TO EXISTING VEGETATION OUTSIDE THE LIMITS OF RIPRAP PLACEMENT AND CHANNEL EXCAVATION WORK DUE TO THE SUBSTANTIAL DIFFICULTY AND COST OF RESTORING THE DISTURBED AREAS.

THE CONTRACTOR IS ADVISED TO AVOID OR MINIMIZE ANY DISTURBANCE TO EXISTING STORM SEWER OUTLETS WITHIN THE LIMITS OF RIPRAP PLACEMENT AND CHANNEL EXCAVATION.

THE CONTRACTOR MUST PROTECT PAVEMENT WHEN DUMPING RIP RAP ONTO PAVEMENT AND WILL BE RESPONSIBLE FOR RESTORING PAVEMENT MARKINGS.

ANY GUARDRAIL OR SIGNS DAMAGED BY THE CONTRACTOR'S OPERATIONS SHALL BE REPLACED IN KIND AT THE CONTRACTOR'S EXPENSE.

THE CONTRACTOR SHALL BE REQUIRED TO PROVIDE ACCESS TO ABUTTING PROPERTY AT ALL TIMES DURING THE CONSTRUCTION OF THIS PROJECT.

DO NOT SCALE PLANS FOR CONSTRUCTION DIMENSIONS.

THE CONTRACTOR SHALL SUBMIT DEWATERING AND SEDIMENT CONTROL PLANS FOR EACH SITE.

THE CONTRACTOR SHALL CONTACT THE DESIGNER AFTER DEWATERING FOR FINAL RIPRAP OR SLOPE MATTRESS PLACEMENT.

COMMITMENTS

LANE CLOSURES WILL NOT BE PERMITTED ON ILLINOIS ROUTE 176 FROM JULY 1ST TO JULY 8TH.

THE CONTRACTOR IS RESPONSIBLE FOR ALL DAMAGES TO THE EXISTING GUARDRAIL AT PARCEL IFOOLIOPE. THE EXISTING GUARDRAIL WILL BE REMOVED AND REINSTALLED AT THE CONTRACTOR'S EXPENSE SHOULD THE CONTRACTOR CHOOSE TO ACCESS THE NORTH BRANCH OF THE CHICAGO RIVER AT THAT LOCATION.

ILLINOIS DEPARTMENT OF TRANSPORTATION INDEX OF SHEETS STATE STANDARDS **GENERAL NOTES** SCALE: VERT. DRAWN BY CHECKED BY

DATE NAME SCALE NAME

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RTE. SECTION COUNTY TOTAL SHEET NO.
VAR. 2003-0671 VARIOUS 23 3
FED. ROAD DIST. NO. 1 ILLINOIS HIGHWAY PROJECT
CONTRACT NO. 62635

				1	SFTY-ZA		l									-	ROAD DIST, NO. RACT NO. 62	l ILLINOIS	HIGHWAY PROJE
			URBAN		JF17-6M							 	-			CONT	MACT INU. DZI	000	
	SUMMARY OF QUANTITIES		100%.STATE		COUNTY	LAKE CO.													
CODE NO	ITEM .	UNIT	TOTAL QUANTITIES	1	LOC. 2 016-0928	LOC. 3													
20300100	CHANNEL EXCAVATION	CU YD	14	14				<u> </u>											
28100107	STONE RIPRAP, CLASS A4	SQ YD	2230	915	1015	300													
	FILTER FABRIC	SQ YD	2230	915	1015	300													
67000400	ENGINEER'S FIELD OFFICE. TYPE A	CAL MO	3	1	i	1					-								
67100100	MOBILIZATION	L SUM	1	0.33	0.33	0.34													
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X0301853	DEWATERING STRUCTURE NO. 2	EACH	1		1	}								der state for the same					
X0301854	DEWATERING STRUCTURE NO. 3	EACH	1			1													
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REVISIONS					
NAME	DATE				


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ILLINOIS DEPARTMENT OF TRANSPORTATION SUMMARY OF QUANTITIES

PLOT DATE: 10/25/2006




R 12 E

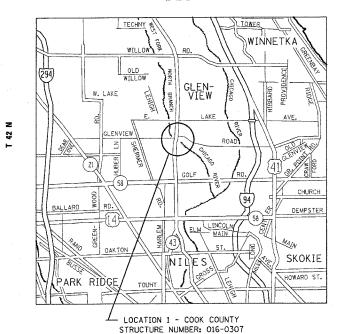

IL 43, WAUKEGAN ROAD
OVER
THE WEST FORK OF THE NORTH BRANCH OF THE CHICAGO RIVER
LOCATED IN NORTHFIELD TOWNSHIP

TRAFFIC DATA
SPEED LIMIT = 40 MPH
2005 ADT = 29,700

R 13 E

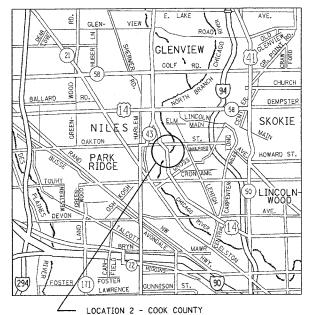


T 41 N

U.S. 14, CALDWELL AVENUE OVER THE NORTH BRANCH OF THE CHICAGO RIVER LOCATED IN NILES TOWNSHIP

STRUCTURE NUMBER: 016-0928

TRAFFIC DATA
SPEED LIMIT = 40 MPH
2005 ADT = 19,200

R 12 E

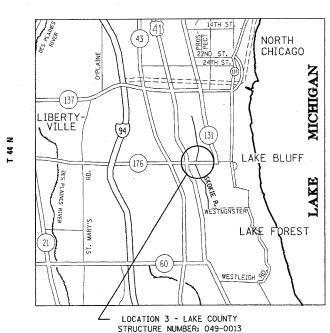

IL 176 OVER THE EAST SKOKIE DITCH LOCATED IN SHIELDS TOWNSHIP.

> TRAFFIC DATA SPEED LIMIT = 40 MPH 2005 ADT = 12,300


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> > DATE
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> > ILLINOIS DEPARTMENT OF TRANSPORTATION
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> > LOCATION MAPS
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> > HORIZ.
> > DATE
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> > CHECKED BY

PLOT DATE = 18/25/2886
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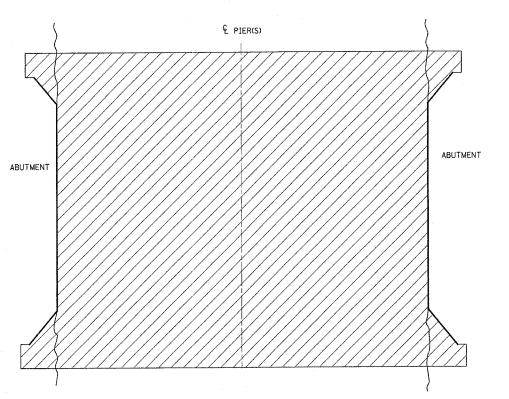
CONTRACT NO. 62635

	Ų		401	110. 02	000
SECTION	1	COUNT	Y	TOTAL SHEETS	SHEET NO.
2003-0	67I	VARIO	OUS	23	5
	то	STA.			
AD DIST. NO.	ILLINOIS	FED.	AID	PROJECT	ī
	2003-00	SECTION 2003-0671 To	SECTION COUNT 2003-067I VARIO TO STA.	SECTION COUNTY 2003-067I VARIOUS TO STA.	2003-067I VARIOUS 23

RIPRAP PLACEMENT DETAIL, LOCATIONS 1, 2 AND 3

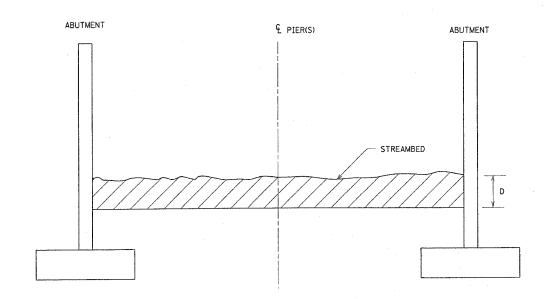

TYPICAL SECTION ACROSS CHANNEL



PLAN VIEW

NOTES


D = DEPTH OF THE RIPRAP


LOCATION	D	RIPRAP SIZE
1	2.3	A4
2	2.3	A4
3	2.3	A4

ILLINOIS DEPARTMENT OF TRANSPORTATION		REVISIONS
TELINOIS DEL ANTIMENT OF THANSFORTATION	DATE	NAME
	├	
RIPRAP PLACEMENT DETAIL		
ALE: VERT. DRAWN BY		
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FED. ROAD DIST. NO. ILLINOIS FED. AID PROJECT

RIPRAP PLACEMENT DETAIL, LOCATION 1, 2 AND 3



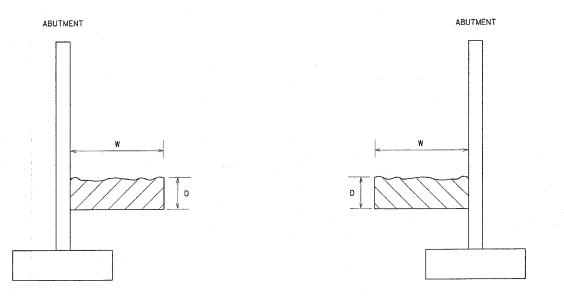


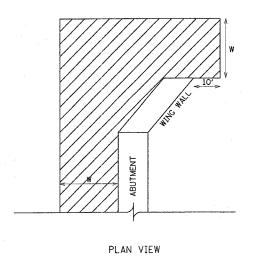
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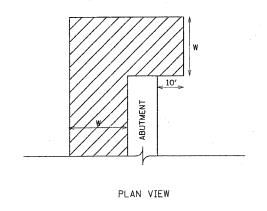
D = DEPTH OF THE RIPRAP

LOCATION	RIPRAP SIZE	D	W		
1	A 4	2.3	25		
3	A4	2.3	14		

TYPICAL SECTION AT ABUTMENT



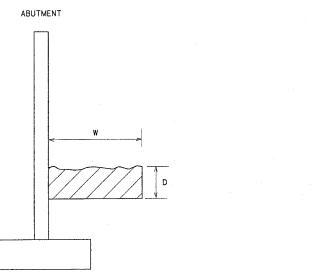

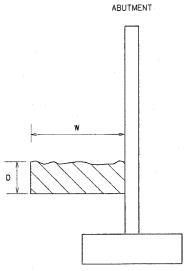


NOTES

D = DEPTH OF THE RIPRAP

LOCATION	RIPRAP SIZE	D	W
2	A4	2.3	25

TYPICAL SECTION AT ABUTMENT

REVISIONS NAME DATE	ILLINOIS DEPARTMENT OF TRANSPORTATION
	RIPRAP PLACEMENT DETAIL
	SCALE: YERT. DRAWN BY DATE CHECKED BY

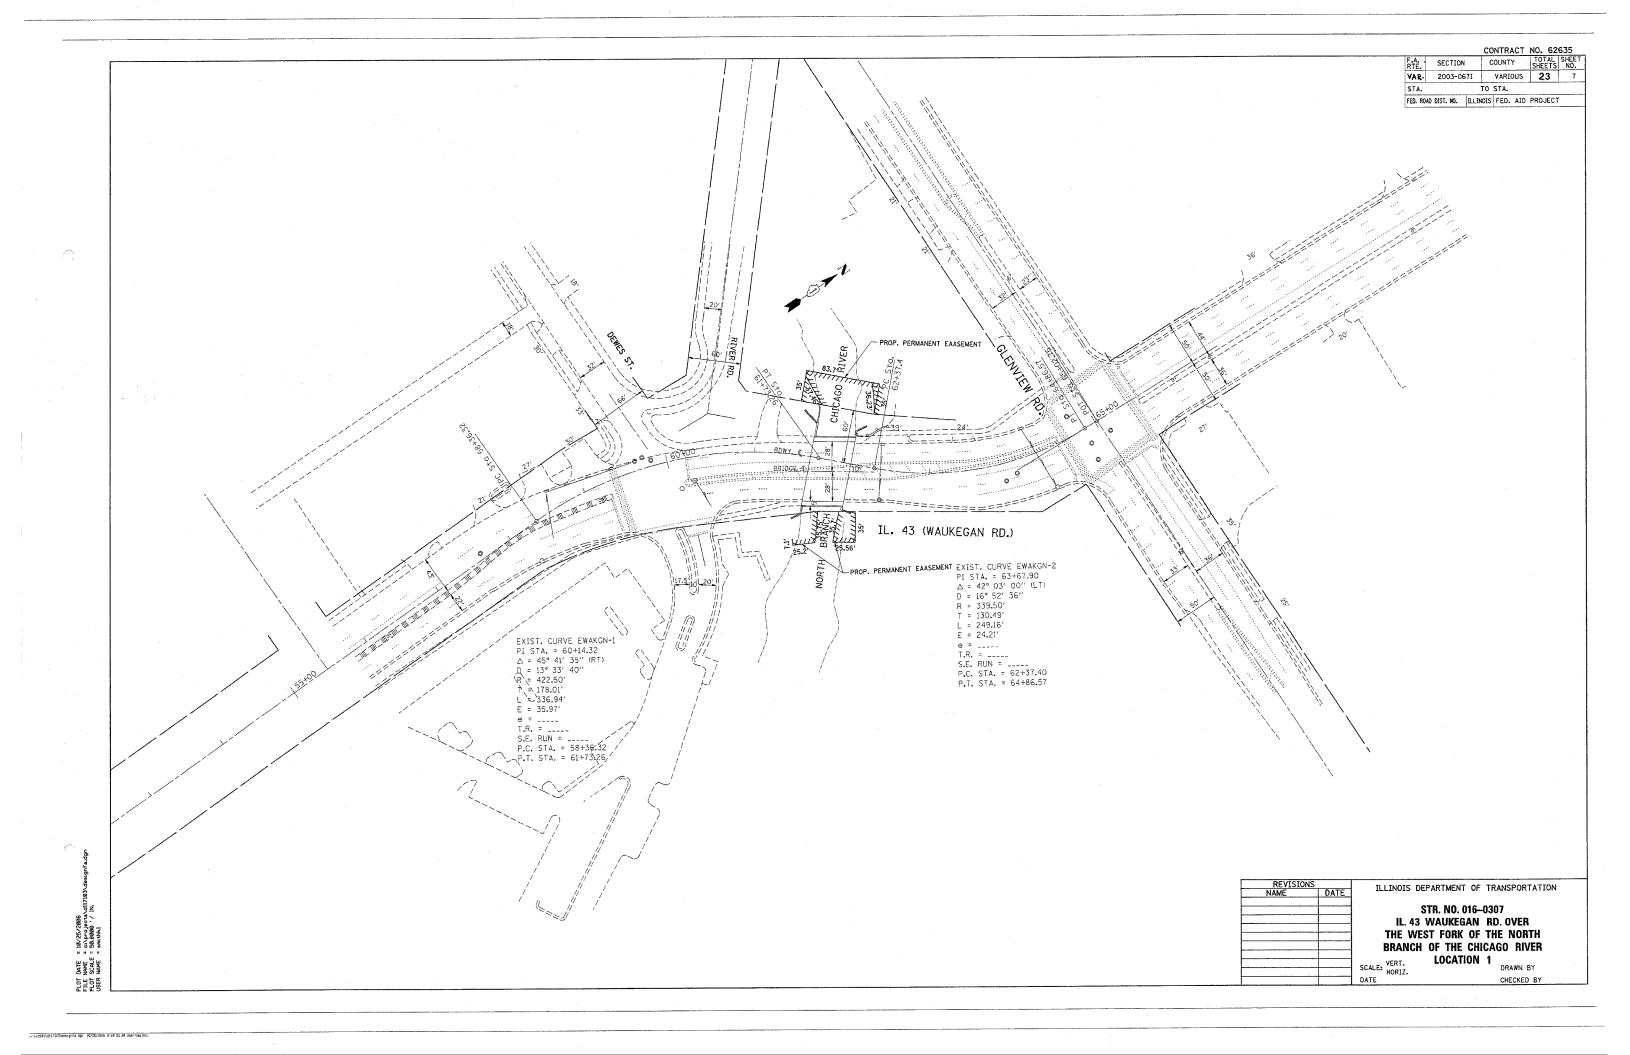


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62635

WEST FORK OF
THE NORTH BRANCH OF
THE CHICAGO RIVER
FLOW



PLAN

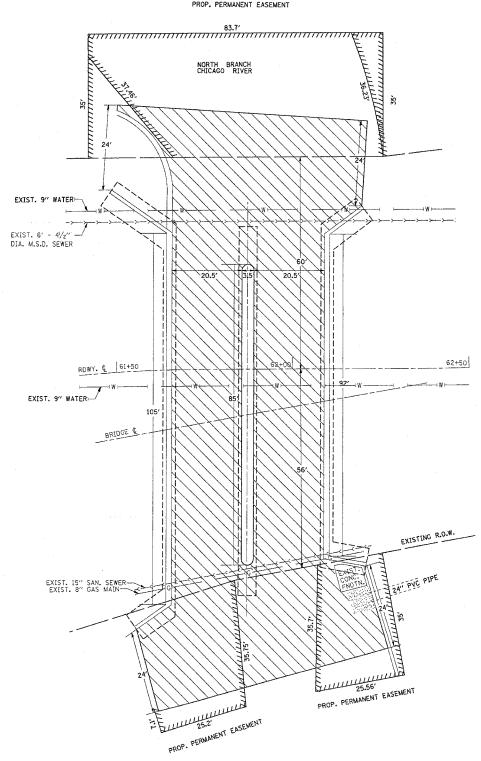ELEVATION EXISTING GROUND

ACCESS TO THIS SITE IS LIMITED. THE CONTRACTOR SHALL ONLY ACCESS THIS SITE BY RAISING AND/OR LOWERING ALL EQUIPMENT AND MATERIAL OVER THE SIDES OF THE BRIDGE. THE CONTRACTOR WILL NOT BE ALLOWED OTHER ACCESS WITHOUT WRITTEN PERMISSION FROM THE ENGINEER. THIS WORK WILL NOT BE PAID FOR SEPARATELY, BUT SHALL BE CONSIDERED AS INCLUDED IN THE CONTRACT UNIT PRICES FOR THE CONSTRUCTION ITEMS INVOLVED AND NO ADDITIONAL COMPENSATION WILL BE ALLOWED

BM 1: BRASS MARKER SET IN CONCRETE, LOCATED 38" W. OF E. FACE AND 41' S. OF THE FACE OF A TWO STORY BRICK BUILDING AT 1930 PRAIRIE STREET.

EL. = 633.58 (VILLAGE ELEVATION).

BM 2: CUT IN E. HEADWALL OF BRIDGE ON S. SIDE OF GLENVIEW ROAD OVER WEST FORK NORTH BRANCH OF CHICAGO RIVER. EL. = 631.36 (VILLAGE ELEVATION)

	REVISIONS		ILLINOIS DEPARTMENT OF	TRANSPORTATION
	NAME	DATE		THATE ON TATION
ļ			STR. NO. 010	50307
-			IL. 43 WAUKEGA	N RD. OVER
			THE WEST FORK O	F THE NORTH
-			BRANCH OF THE C	HICAGO RIVER
			LOCATIO	
			SCALE: NONE	DRAWN BY
			DATE	CHECKED BY

SECTION COUNTY TOTAL SHEETS NO.
2003-0671 VARIOUS 23 9 STA. TO STA.
FED. ROAD DIST. NO. | ILLINOIS | FED. AID | PROJECT ILLINOIS DEPARTMENT OF TRANSPORTATION STR. NO. 016-0928 U.S. 14 (CALDWELL AVE.) OVER N. BRANCH CHICAGO RIVER LOCATION 2 SCALE: VERT. HORIZ. DRAWN BY CHECKED BY

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SECTION COUNTY TOTAL SHEETS NO.


2003-0671 VARIOUS 23 10 F.A. RTE. VAR. STA. TO STA. FED. ROAD DIST. NO. ILLINOIS FED. AID PROJECT

62635

	71.5' BACK TO BACK OF ABUTMENTS	EXISTING GROUND LINE

ELEVATION

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<u>PLAN</u>

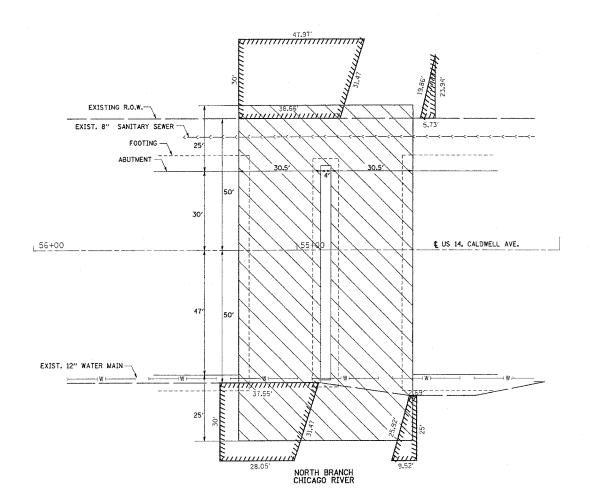ACCESS TO THIS SITE IS LIMITED. THE CONTRACTOR SHALL ONLY ACCESS THIS SITE BY RAISING AND/OR LOWERING ALL EQUIPMENT AND MATERIAL OVER THE SIDES OF THE BRIDGE. THE CONTRACTOR WILL NOT BE ALLOWED OTHER ACCESS WITHOUT WRITTEN PERMISSION FROM THE ENGINEER. THIS WORK WILL NOT BE PAID FOR SEPARATELY, BUT SHALL BE CONSIDERED AS INCLUDED IN THE CONTRACT UNIT PRICES FOR THE CONSTRUCTION ITEMS INVOLVED AND NO ADDITIONAL COMPENSATION WILL BE ALLOWED

U.S.G.S. BM 49: NW CORNER OF SIDEWALK ON BRIDGE.
EL. = 623.185
OAKTON STREET OVER THE NORTH BRANCH OF THE CHICAGO RIVER

U.S.G.S. BM 50: OAKTON ST. AND CALDWELL AVE.

CUT ON CORNER OF BASE LIGHT STANDARD ON N.W. CORNER OF INTERSECTION EL. = 623.64

REVISIONS		ILLINOIS DEPARTMENT	OF TRANSPORTATION
NAME	DATE	ICEINOIS DEI ANTWENT	OF THAIRST OFFICE
		STR. NO. U.S. 14 (CALDW N. Branch Ch Locat	ELL AVE.) OVER HICAGO RIVER
		SCALE: NONE	DRAWN BY
		DATE 10/25/2006	CHECKED BY

IO/25/2006 c:\projects\dil7lO3\designia.dgn smittkl RTE. SECTION COUNTY TOTAL SHEETS NO.
2003-0671 VARIOUS 23 11 STA. TO STA.
FED. ROAD DIST. NO. | ILLINOIS | FED. AID | PROJECT TO STA. PROP. PERMANENT EASEMENT ILL. ROUTE 176 ABANDONED NORTH SHORE RAILROAD CRADE (NO TRACKS) ILLINOIS DEPARTMENT OF TRANSPORTATION STR. NO. 049-0013 IL. 176 OVER THE EAST SKOKIE DITCH LOCATION 3 SCALE: VERT. HORIZ. DRAWN BY DATE CHECKED BY

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30" CONC. CULVERT

1159+00

EXIST. 10" WATER MAIN -

EXIST. 12" FLARED END SECTION

PROP. PERMANENT EASEMENT

-ABUTMENT

EXIST. 12" FLARED END SECTION


E. SKOKIE DITCH

EXISTING R.O.W.

PLAN

F.A. SECTION COUNTY 2003-067I VARIOUS **23** 12 STA. TO STA. FED. ROAD DIST. NO. ILLINOIS FED. AID PROJECT

62635

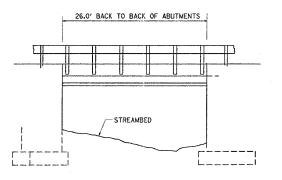

ELEVATION

ACCESS TO THIS SITE IS LIMITED. THE CONTRACTOR SHALL ONLY ACCESS THIS SITE BY RAISING AND/OR LOWERING ALL EQUIPMENT AND MATERIAL OVER THE SIDES OF THE BRIDGE OR ON SOUTH SIDE OF BRIDGE FROM SWALE UNDER COM ED AND TELEPHONE LINES. THE CONTRACTOR WILL NOT BE ALLOWED OTHER ACCESS WITHOUT WRITTEN PERMISSION FROM THE ENGINEER. THIS WORK WILL NOT BE PAID FOR SEPARATELY, BUT SHALL BE CONSIDERED AS INCLUDED IN THE CONTRACT UNIT PRICES FOR THE CONSTRUCTION ITEMS INVOLVED AND NO ADDITIONAL COMPENSATION WILL BE ALLOWED

NOTE: LOW CLEARANCE UNDER BRIDGE

TBM 7: CUT ON WINGWALL (NW CORNER OF BRIDGE)
16.2 FT. LEFT OF STA. 1159+28
EL. = 672.18

BM 7: CHISELED ON TOP OF SOUTH END OF WEST ABUTMENT OF ABANDONED C. & N.S. R.R., 70 FT. RT. STA. 1159+10 EL. = 673.70

ŀ	REVISIONS NAME	DATE	ILLINOIS DEPARTMENT OF TRANSPORTATION		
			STR. NO. 049–0013 IL. 176 OVER The East Skokie Ditch		
}				LOCATION 3	
ŀ			SCALE: NONE	DRAWN BY	
ı			DATE 10/25/2006	CHECKED BY	

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CONTRACT NO. 62635 PART OF SEC. 35, T42N, R12E OF THE 3RD P.M., COOK COUNTY, ILLINOIS F.A.U. RTE. SECTION. COUNTY TOTAL SHEET NO. VAR. 2003-0671 VARIOUS 23 13 ACQUIRED BY PERMANENT INDEX PART TAKEN PREVIOUSLY DEDICATED (ACRES) EASEMENT AREA STA. PERMANENT FEB. RUAD DIST. NO. ILLINGIS FED. AID PROJECT 0.090 0.003 (132 SQ. FT.) 04-35-400-014 RENEE D. CARDELLA TRUST LINDA J. ENRIGHT TRUS 0.000 0.090 1FQ0103PE PERMANENT LEGEND 0.056 04-35-400-016 0.000 STA: 62+25.75 OFFSET: 95.00 L 0.641 0.000 VILLAGE OF GLENVIEW 1F00104PE 0.008 (346 SQ. FT.) PERMANENT 04-35-400-004 0.000 0.139 0.000 CHRIS E. KRUGER 0.139 1F00105PE PERMANENT 0.000 18.705 0.015 (654 SQ. FT.) 04-35-402-012 N 44'38'46' 9.04' 18.705 0.000 KRAFT FOODS HOLDINGS INC. 1FQ0106PE 04-35-401-011-1001 THRU 1072 PERMANENT 2.470 0,018 (772 SQ. FT.) 0.000 0.000 1F00107PE SECTION LINE STA: 62+16.71 OFFSET: 95.00 L QUARTER SECTION LINE QUARTER, QUARTER SECTION LINE -FOUND IRON ROD 3,16" NORTH & 10.75" EAST PLATTED LOT LINE -FOUND IRON ROD ON RIGHT-OF-WAY LINE RIVER LOT PROPERTY (DEED) LINE HUTCHING'S ADDITION HATTENDORF'S APPARENT PROPERTY LINE hutching's TO OAK GLENN Subdivision CENTERLINE SUBDIVISION ____ EXISTING RIGHT OF WAY LINE 1FQ0104PE PROPOSED RIGHT OF WAY LINE -EXISTING RIGHT-OF-WAY LINE - EXISTING RIGHT-OF-WAY LINE PROPOSED EASEMENT 129.32 MEASURED DIMENSION COMPUTED DIMENSION 129.32'(COMP.) RECORD DATA (' GLENVIEW ROAD EXISTING BUILDING FOUND NOTCH IN CURB ON EAST PROPERTY LINE 64+86.57 PK NAIL SET IRON ROD SET - FXISTING RIGHT-OF-WAY LINE REPLACED AFTER CONSTRUCTION IRON PIPE OR ROD FOUND EXISTING RIGHT-OF-WAY LINE Part of S 89'32'15" E 156.14' (156.14')

S 89'32'15" F 158 33' (158 41'

J.D. LOVETT'S SUBDIVISION RECORDED SEPTEMBER 6, 1949 AS DOC. 14625980 (CONDOMINIUM ASSOCIATION AT THE CLOISTERS)

LOT 8 IN

ASSESSORS

DIVISION OF

35-42-12

REC. APRIL 11, 1874 AS DOC. NO. 156006

∕o ˈ

FOUND CUT CROSS. 1.67' NORTHWESTERLY

1FQ0107PE

SEE DETAIL B

LOT 1 IN

TECHNOLOGY CENTER

FOUND IRON PIPE 8.36' NORTHWESTERLY

Kraft INC.

ALLEY

S 89'40'10" E

MacLean's Subdivision

1FQ0104PE

SEE DETAIL A

ST.

PART OF LOT 8 M ASSESSORS DIVISION OF 36-62-12

d

0

50.00

FOUND IRON PIPE --0.35' EAST FOUND IRON PIPE--0.29' EAST

N 00"9'50" E ---39.62' (39.52')

R=150.00' L=53.34'-(R=150.00' L=52.05')

WAU K

[= 173.08. de Ting E

R=488.70° L=89.80° (R=488.70° L=89.80°)


R=488.70 L=83.30

GLENVIEW GUARANTY

SAVINGS & LOAN ASSOCIATION

DEWES ADDITION TO OAK GLEN

DEWES

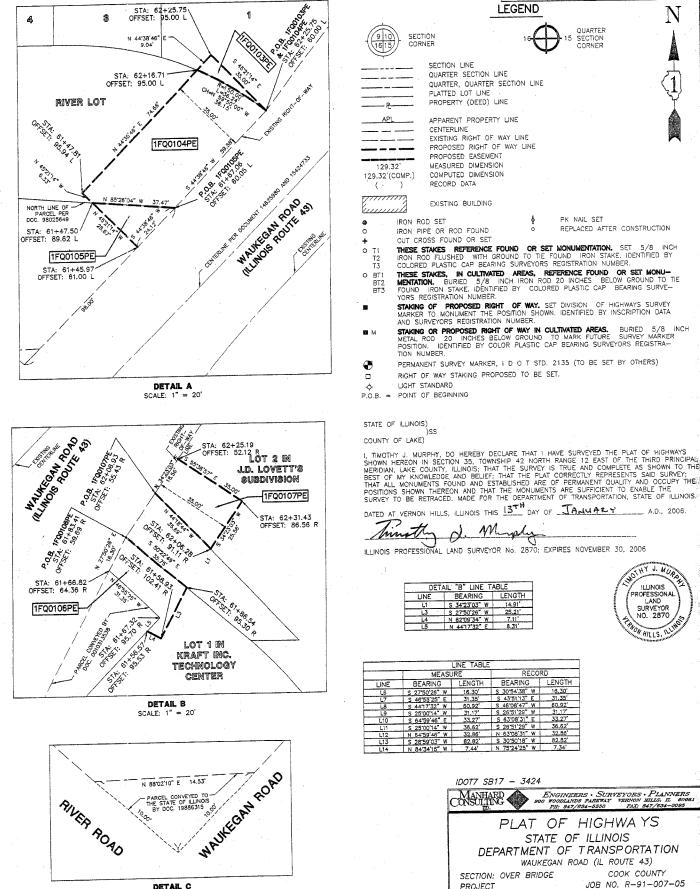

SCALE: 1" = 4'

01/13/06

12/19/05

05/24/05

REVISED PARCEL LIMITS AND OWNERS

REVISED PER IDOT REVIEW - TEMPORARY TO PERMANENT EASEMENTS

REVISED PER IDOT REVIEW

RECORDING: RECORDED ON

DESCRIPTION

CUT CROSS FOUND OR SET

LIGHT STANDARD

S 64*59'46" E \$ 25'00'14" W 36.62' N 64'59'46" W 32.86' \$ 28'59'03" W 82.82'

RYP

RYP

BY

THESE STAKES REFERENCE FOUND OR SET MONUMENTATION. SET 5/8 INCH IRON ROD FLUSHED WITH GROUND TO TIE FOUND IRON STAKE. IDENTIFIED BY COLORED PLASTIC CAP BEARING SURVEYORS REGISTRATION NUMBER.

THESE STAKES, IN CULTIVATED AREAS, REFERENCE FOUND OR SET MONU-

MENTATION. BURIED 5/8 INCH IRON ROD 20 INCHES BELOW GROUND TO TI FOUND IRON STAKE. IDENTIFIED BY COLORED PLASTIC CAP BEARING SURVE— YORS REGISTRATION NUMBER.

STAKING OF PROPOSED RIGHT OF WAY. SET DIVISION OF HIGHWAYS SURVEY MARKER TO MONUMENT THE POSITION SHOWN. IDENTIFIED BY INSCRIPTION DATA AND SURVEYORS REGISTRATION NUMBER.

PERMANENT SURVEY MARKER, I D O T STD. 2135 (TO BE SET BY OTHERS)

Muphy

S 34"23"03" W 14.91" S 27"50"26" W 25.21"

IDOT7 SB17 - 3424

SECTION: OVER BRIDGE

STATION 61+56.57 SCALE: 1" = 50'

CONSULTING (**)

PROJECT

ENGINEERS · SURVEYORS · PLANNERS

000 MODDLANDS PAREWAY VERNON HILLS, IL 60061

COOK COUNTY JOB NO. R-91-007-05

TO STATION 62+25.75

SHEET 6 OF 9

PLAT OF HIGHWAYS STATE OF ILLINOIS DEPARTMENT OF TRANSPORTATION WAUKEGAN ROAD (IL ROUTE 43)

BUREAU OF LAND ACQUISITION

201 WEST CENTER COURT


SCHAUMBURG, ILLINOIS 60196

AS DOCUMENT NO.


RIGHT OF WAY STAKING PROPOSED TO BE SET.

STACING OR PROPOSED RIGHT OF WAY IN CULTIVATED AREAS.

BURIED 5/8 INCH
METAL ROD 20 INCHES BELOW GROUND TO MARK FUTURE SURVEY MARKER
POSITION. IDENTIFIED BY COLOR PLASTIC CAP BEARING SURVEYORS REGISTRATION NUMBER.

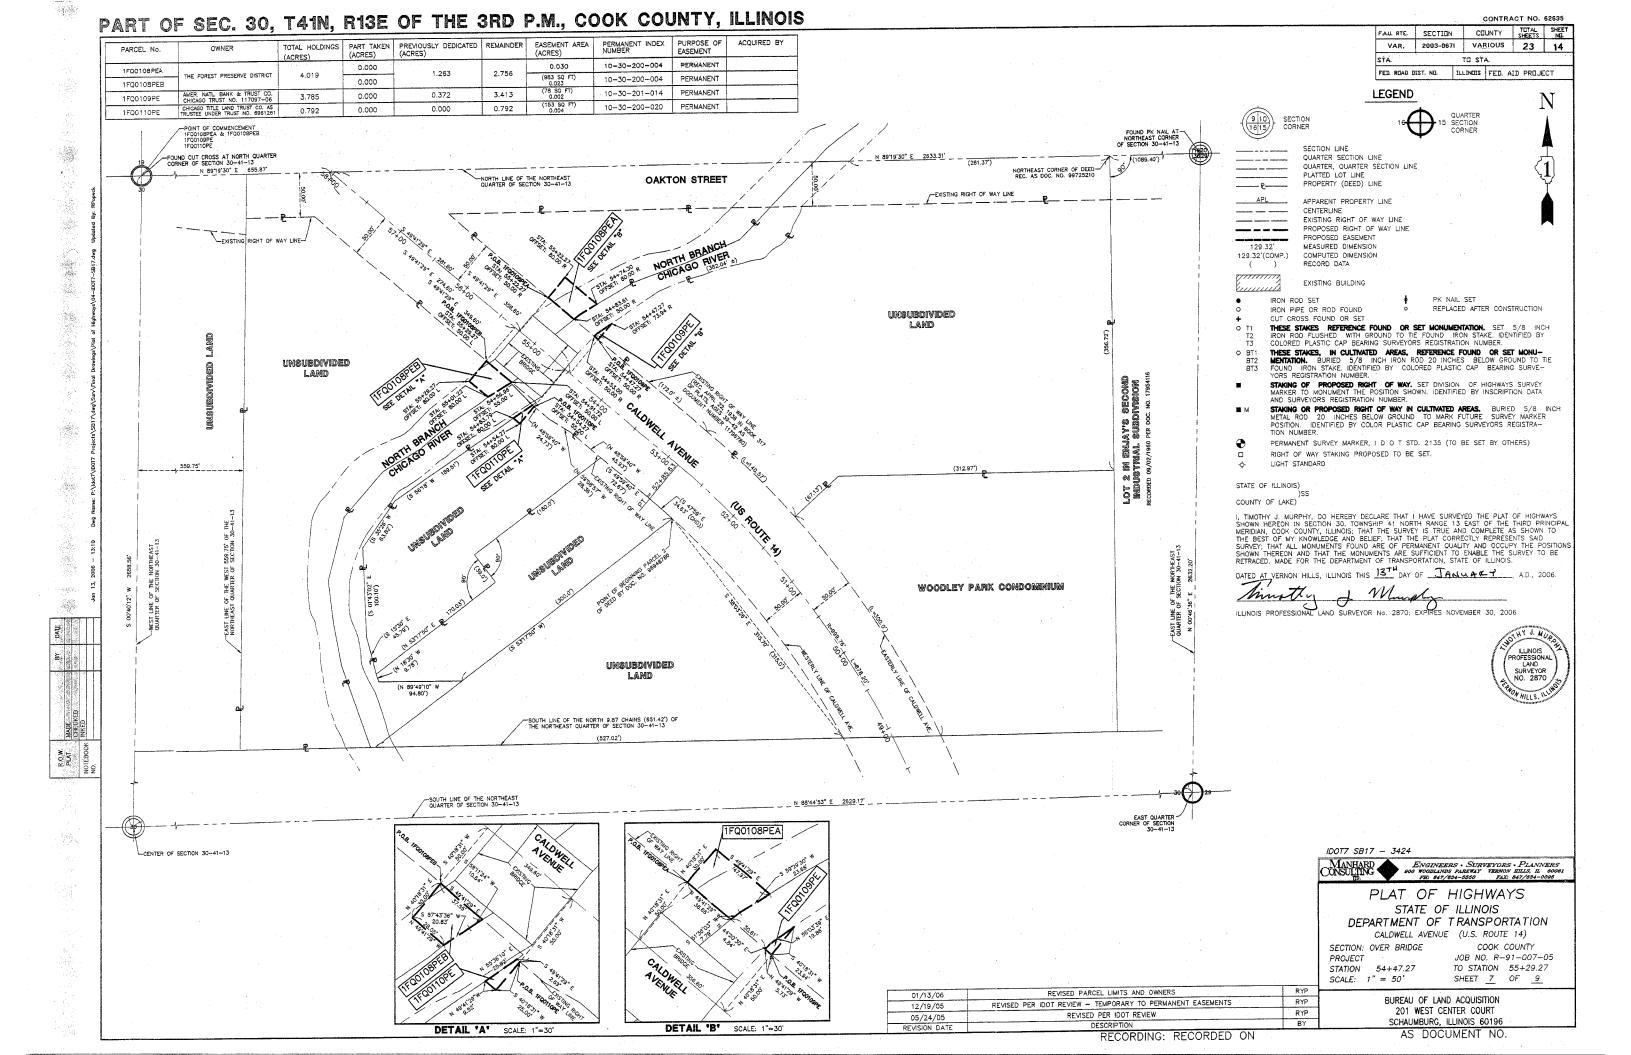

PART OF SEC. 20, T44, R12E OF THE 3RD P.M., LAKE COUNTY, ILLINOIS CONTRACT NO. 62635 CHUNTY TOTAL SHEET SHEETS NO. F.A.U. RTE. SECTION PART TAKEN PREVIOUSLY DEDICATED
(ACRES) (ACRES) EASEMENT AREA VAR. 2003-0671 VARIOUS 23 15 (ACRES) TO STA. 0.004 (158 SQ. FT.) 0.039 12-20-101-044 PERMANENT 0.039 0.000 1FQ0115PEA FED. ROAD DIST. NO. ILLINGIS FED. AID PROJECT VILLAGE OF LAKE BLUFF 0.007 (289 SQ. FT.) 12-20-101-099 PERMANENT 0.000 0.275 0.000 0.275 1FQ0115PEB LEGEND SECTION LINE QUARTER SECTION LINE 379 410 400 431 QUARTER, QUARTER SECTION LINE PLATTED LOT LINE PROPERTY (DEED) LINE 378 225 432 APPARENT PROPERTY LINE **GOLDMAN'S SUBDIVISION OF LOTS 81 AND 82 IN** 377 CENTERLINE EXISTING RIGHT OF WAY LINE GOLDMAN'S OREEN BAY ROAD IN HIGHLANDS N 88"59"45" E 90.00" (90") 376 PROPOSED RIGHT OF WAY LINE PROPOSED EASEMENT 50.00 EAST 406 404 4 4 0 0 80 % 375 129.32'(COMP.) COMPUTED DIMENSION N 88'59'45" E 374 436 EXISTING BUILDING ALLEY EAST UNE OF NORTHE NORTHEAST QUARTER ALLEY 224 PK NAIL SET FOUNTAIN COURT 365 IRON ROD SET 366 REPLACED AFTER CONSTRUCTION IRON PIPE OR ROD FOUND 369 THESE STAKES REFERENCE FOUND OR SET MONUMENTATION. SET 5/8 INCH IRON ROD FLUSHED WITH GROUND TO TIE FOUND IRON STAKE. IDENTIFIED BY COLORED PLASTIC CAP BEARING SURVEYORS REGISTRATION NUMBER. & 88 THESE STAKES, IN CULTIVATED AREAS, REFERENCE FOUND OR SET MONU-MENTATION. BURIED 5/8 INCH IRON ROD 20 INCHES BELOW GROUND TO TIE FOUND IRON STAKE. IDENTIFIED BY COLORED PLASTIC CAP BEARING SURVE— MARGARET PARK YORS REGISTRATION NUMBER. EXISTING RIGHT-OF-WAY LINE AS SHOWN ON DOC. 263517 (N 87'38'25" E) STAKING OF PROPOSED RIGHT OF WAY, SET DIVISION OF HIGHWAYS SURVEY MARKER TO MONUMENT THE POSITION SHOWN. IDENTIFIED BY INSCRIPTION DATA AND SURVEYORS REGISTRATION NUMBER. NORTH LINE OF THE SOUTH HALF OF THE NORTHWEST QUARTER OF SECTION 20-44-12 1161+00 1159+00 -1153+57.93 1158+00 STAKING OR PROPOSED RIGHT OF WAY IN CULTIVATED AREAS. BURIED 5/8 INCH METAL ROD 20 INCHES BELOW GROUND TO MARK FUTURE SURVEY MARKER POSITION. IDENTIFIED BY COLOR PLASTIC CAP BEARING SURVEYORS REGISTRA— (ILLINOIS ROUTE 176) ROCKLAND ROAD TION NUMBER. FORMER SOUTH RIGHT OF WAY LINE AS SHOWN ON DOC. 26351 PERMANENT SURVEY MARKER, I D O T STD. 2135 (TO BE SET BY OTHERS) RIGHT OF WAY STAKING PROPOSED TO BE SET. LIGHT STANDARD - EXISTING RIGHT-OF-WAY CONVEYED TO STATE OF ILLINOIS PUBLIC WORKS PER DOC. 134058 P.O.B .= POINT OF BEGINNING FOUND IRON PIPE ON LINE FOUND IRON SPIKE 40.36 S FOUND IRON ROD STATE OF ILLINOIS) COUNTY OF LAKE) I, TIMOTHY J. MURPHY, DO HEREBY DECLARE THAT I HAVE SURVEYED THE PLAT OF HIGHWAYS SHOWN HEREON IN SECTION 20, TOWNSHIP 44 NORTH RANGE 12 EAST OF THE THIRD PRINCIPAL MERIDIAN, LAKE COUNTY, ILLINOIS; THAT THE SURVEY IS TRUE AND COMPLETE AS SHOWN TO THE BEST OF MY KNOWLEDGE AND BELIEF; THAT THE PLAT CORRECTLY REPRESENTS AND SURVEY, THAT ALL MONUMENTS FOUND AND ESTABLISHED ARE OF PERMANENT QUALITY AND OCCUPY THE POSITIONS SHOWN THEREON AND THAT THE MONUMENTS ARE SUFFICIENT TO ENABLE THE SURVEY TO BE RETRACED. MADE FOR THE DEPARTMENT OF TRANSPORTATION, STATE OF ILLINOIS. DATED AT VERNON HILLS, ILLINOIS THIS 20 DAY OF DECE ABER____, A.D., 2005. UNSUBDIVIDED LAND unsubdivided Land ILLINOIS PROFESSIONAL LAND SURVEYOR No. 2870; EXPIRES NOVEMBER 30, 2006 366 STA: 1159+60.82 OFFSET: 49.00 L /-S 02°21'35" E N 87"38"25" FQ00115PEB IDOT7 SB17 - 3424 87'38'25' 26.58' ENGINEERS · SURVEYORS · PLANNERS 900 WOODLANDS PAREWAY VERNON HILLS, IL 60061 STA: 1159+60.82 OFFSET: 33.00 L P.O.B. ___ 1FQ0115PEA P.O.B. OFFSET: 33.0 1FQ0115PEB S 87'38'25" W STA: 1159+15.82 / OFFSET: 43.00 L PLAT OF HIGHWAYS LN 09 38 23" W 16.13 FQ00115PEA STATE OF ILLINOIS DEPARTMENT OF TRANSPORTATION ROCKLAND ROAD (IL ROUTE 176) 1160+00 SECTION: OVER BRIDGE LAKE COUNTY EXISTING CENTERLINE JOB NO. R-91-007-05 PROJECT ROCKLAND ROAD TO STATION 1159+60.82 STATION 1159+15.82 (IL ROUTE 176) SCALE: 1" = 50' SHEET 9 OF 9 BUREAU OF LAND ACQUISITION 201 WEST CENTER COURT REVISED PER IDOT REVIEW - TEMPORARY TO PERMANENT EASEMENTS RYP DETAIL 12/19/05 SCHAUMBURG, ILLINOIS 60196 AS DOCUMENT NO. RECORDING: RECORDED ON

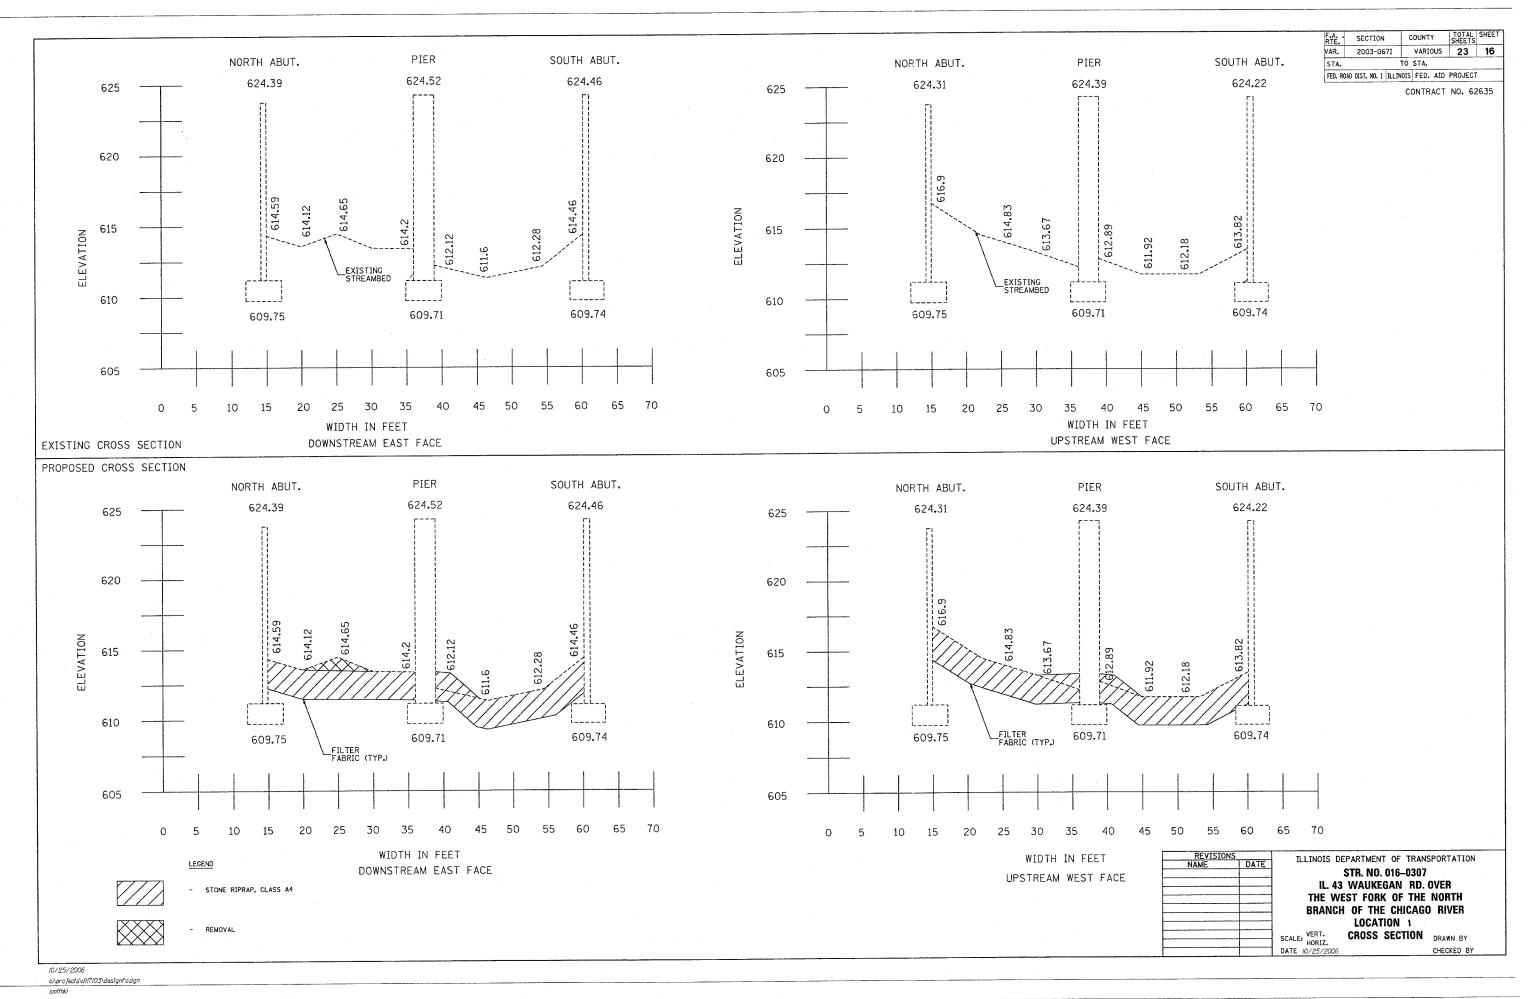


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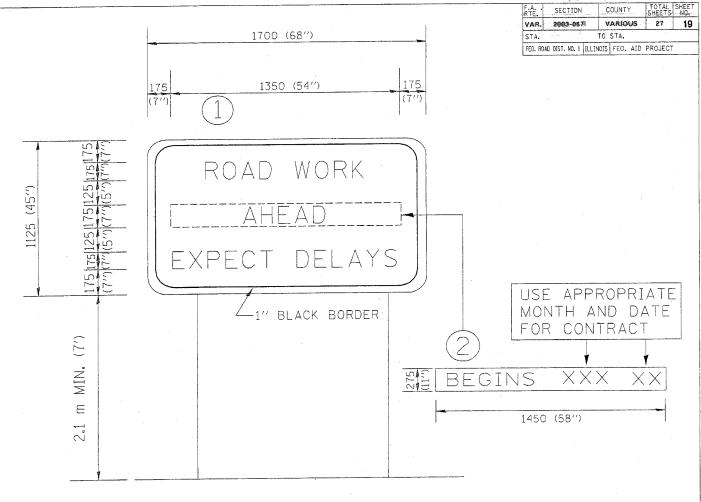
CONTRACT NO. 62635 RTE. SECTION COUNTY TOTAL SHEETS NO.
VAR. 2003-0671 VARIOUS 23 17 STA. TO STA. FED. ROAD DIST. NO. ILLINOIS FED. AID PROJECT NORTH ABUT. SOUTH ABUT SOUTH ABUT NORTH ABUT. 605 600.82 600.76 600.76 600.76 - 600.76 600.82 600 598.10 60 100 110 120 130 140 150 160 170 180 190 20 30 40 50 70 WIDTH IN FEET UPSTREAM EAST FACE WIDTH IN FEET DOWNSTREAM WEST FACE NORTH ABUT. SOUTH ABUT 620 SOUTH ABUT NORTH ABUT. 600.76 600.76 600.82 __ 600.76 600 _FILTER FABRIC (TYP.) 598.10 598.10 100 110 120 130 140 150 150 160 170 WIDTH IN FEET LEGEND REVISIONS NAME ILLINOIS DEPARTMENT OF TRANSPORTATION UPSTREAM EAST FACE WIDTH IN FEET STR. NO. 056-0028 U.S. 14 (CALDWELL AVENUE) | DATE = 18/25/2886 | NAME = c:\projects\dlf? | SCALE = 58.8889 '/ IN. | NAME = smithkl DOWNSTREAM WEST FACE - STONE RIPRAP, CLASS A4 OVER THE NORTH BRANCH OF THE CHICAGO RIVER LOCATION 2
SCALE: VERT. HORIZ.

ONTE CHECKED BY

jec.cs/0117103/designgs.dgs 10/25/2005 3:15:40 AM Jose - mmilitak (



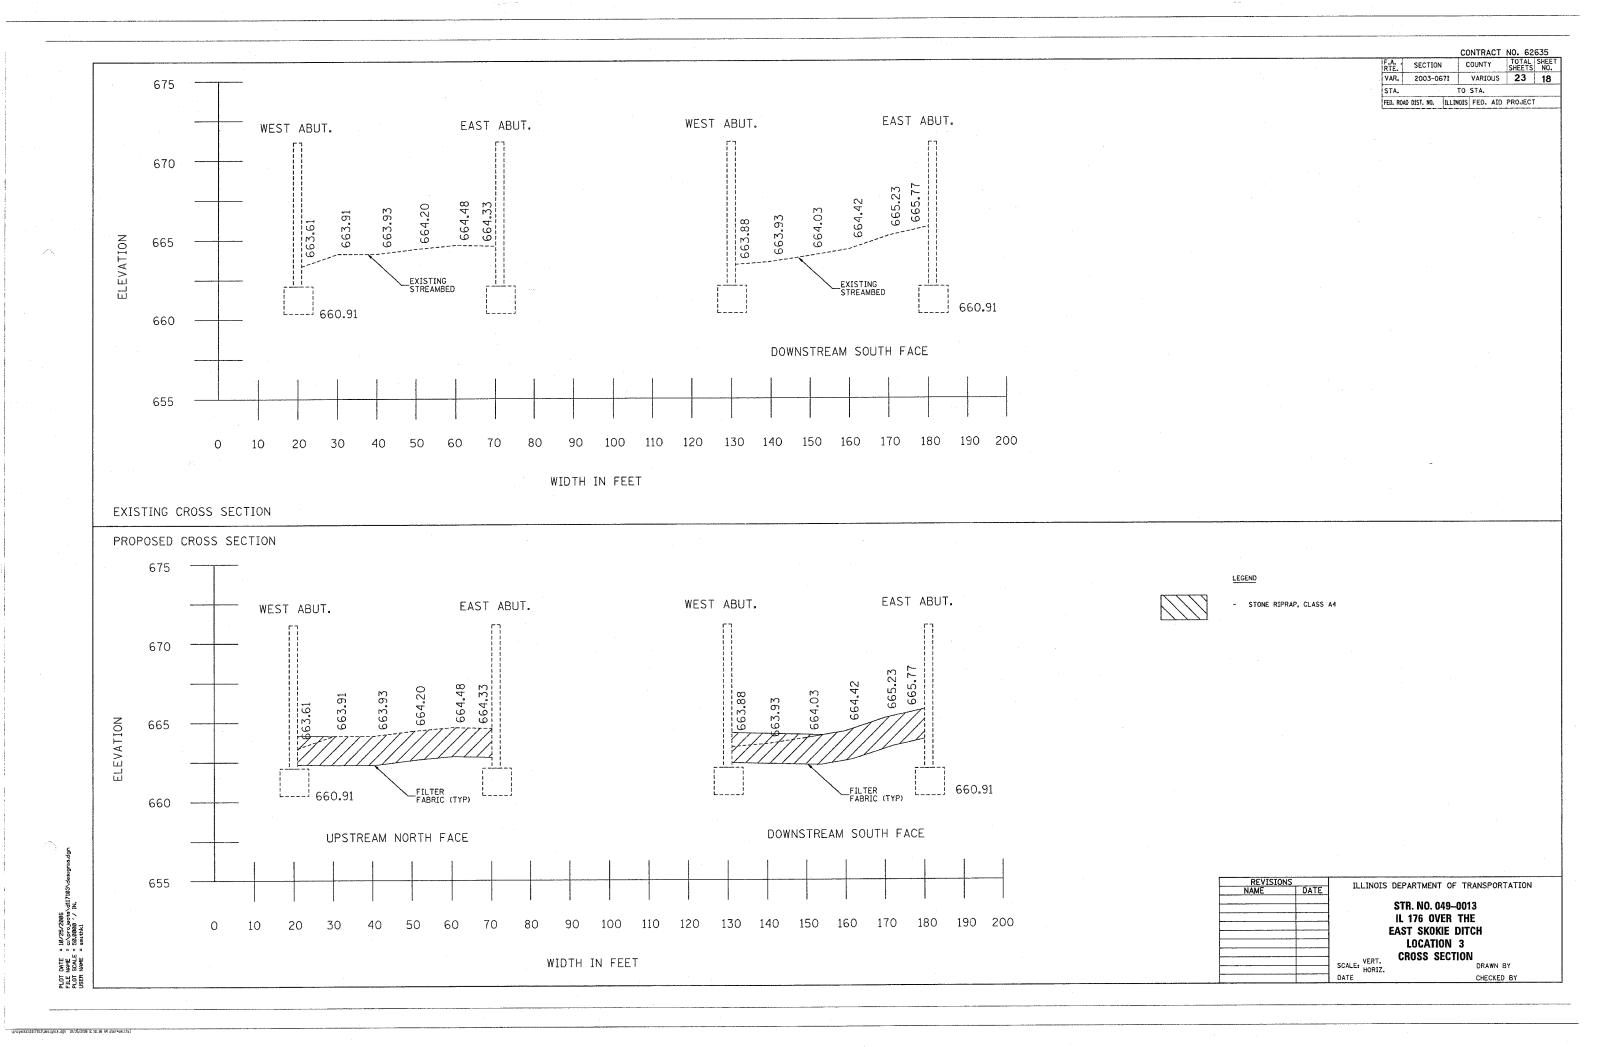



NOTES:


- 1. USE BLACK LETTERING ON ORANGE BACKGROUND.
- 2. ERECT SIGNS IN ADVANCE OF THE LOCATION FOR THE "ROAD CONSTRUCTION AHEAD" SIGN AT LOCATIONS AS DIRECTED BY THE ENGINEER.
- 3. ERECT SIGN (1) WITH INSTALLED PANEL (2) ONE WEEK PRIOR TO THE START OF CONSTRUCTION.
- 4. REMOVE PANEL 2 SOON AFTER THE START OF CONSTRUCTION.
- 5. SEE SPECIAL PROVISION FOR "TEMPORARY INFORMATION SIGNING" FOR ADDITIONAL INFORMATION.
- 6. ONE SIGN ASSEMBLY EQUALS 2.3 SQ. M. (25.70 SQ. FT.)

ALL DIMENSIONS ARE IN MILLIMETERS (INCHES) Unless otherwise shown.

ILLINOIS DEPARTMENT OF TRANSPORTATION TEMPORARY INFORMATION SIGNING DRAWN BY: BUR, OF DESIGN DATE 10/18/2002 CHECKED BY

REVISION DATE: 02/02/99

CONTRACT NO. 62635

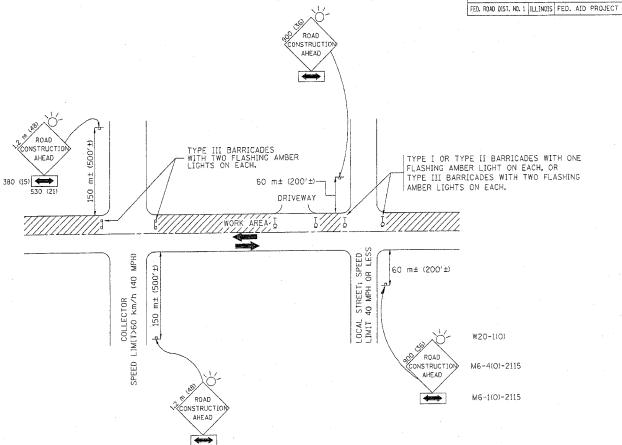

TRAFFIC CONTROL AND PROTECTION FOR SIDE ROADS, INTERSECTIONS, AND DRIVEWAYS

NOTES:

- A. FOR NO LANE RESTRICTION ON THE SIDE ROAD OR DRIVEWAYS
- SIDE ROAD WITH A SPEED LIMIT OF 60 km/h (40 MPH) OR LESS AS SHOWN ON THE DRAWING AND AS DIRECTED BY THE ENGINEER;
- O) ONE **ROAD CONSTRUCTION AHEAD** SIGN 900x900 (36x36) WITH A FLASHER AND FLAG MOUNTED ON IT APPROXIMATELY 60 m (200") IN ADVANCE OF THE MAIN ROUTE.
- b) THE CLOSED PORTION OF THE MAIN ROUTE SHALL BE PROTECTED BY BLOCKING WITH TYPE I, TYPE II OR TYPE III BARRICADES, 1/3 OF THE CROSS SECTION OF THE CLOSED PORTION.
- 2. SIDE ROAD WITH A SPEED LIMIT GREATER THAN 60 km/h (40 MPH) AS SHOWN ON THE DRAWING AND AS DIRECTED BY THE ENGINEER:
- O) ONE ROAD CONSTRUCTION AHEAD SIGN 1.2 m x 1.2 m (48×48) WITH A FLASHER MOUNTED ON 1T APPROXIMATELY 150 m (500') IN ADVANCE OF THE MAIN ROUTE.
- b) THE CLOSED PORTION OF THE MAIN ROUTE SHALL BE PROTECTED BY BLOCKING WITH TYPE III BARRICADES, 1/2 OF THE CROSS SECTION OF THE CLOSED PORTION.
- 3, WHEN THE SIDE ROAD LIES BETWEEN THE BEGINNING OF THE MAINLINE SIGNING AND THE WORK ZONE, A SINGLE HEADED ARROW (MG-1) SHALL BE USED IN LIEU OF THE DOUBLE HEADED ARROW (MG-4).

- B. FOR A LANE CLOSURE ON A SIDE ROAD OR DRIVEWAY:
- USE APPLICABLE PORTIONS OF THE TYPICAL APPLICATION OF TRAFFIC CONTROL DEVICES (STD. 701501, STD. 701606 OR THE APPROPRIATE STANDARD). THE SPACING OF SIGNS AND BARRICADES SHALL BE ADJUSTED FOR FIELD CONDITIONS AS DIRECTED BY THE ENGINEER. THE DIRECTIONAL ARROW SHALL BE COVERED OR REMOVED WHEN NO LONGER CONSISTENT WITH THE SIDE ROAD LANE CLOSURE.
- C. ADVANCE WARNING SIGNS ARE TO BE OMITTED ON DRIVEWAY UNLESS OTHERWISE NOTED.
- D. THE TRAFFIC CONTROL AND PROTECTION FOR SIDE ROADS, INTERSECTIONS, AND DRIVEWAYS SHALL BE INCIDENTAL TO THE COST OF SPECIFIED TRAFFIC CONTROL STANDARDS OR ITEMS.

		REVISIO
	DATE	NAME
TI	6/89	LHA
	09/08/94	T. RAMMACHER
	10/18/95	J, OBERLE
	03/06/96	A. HOUSEH
	10/15/96	A. HOUSEH
	01/06/00	T. RAMMACHER
SC/		

ILLINOIS DEPARTMENT OF TRANSPORTATION
TRAFFIC CONTROL AND PROTECTION
FOR

SIDE ROADS, INTERSECTIONS, AND DRIVEWAYS

SCALE: VERT. HORIZ. DATE 10/18/2002

DRAWN BY CHECKED BY

REVISION DATE: 01/06/00

riday October 18,2002 @ 10:20:23 AM

| CONTRACT NO. 6263 | F.A. | SECTION | COUNTY | TOTAL | SHEET | SHEET

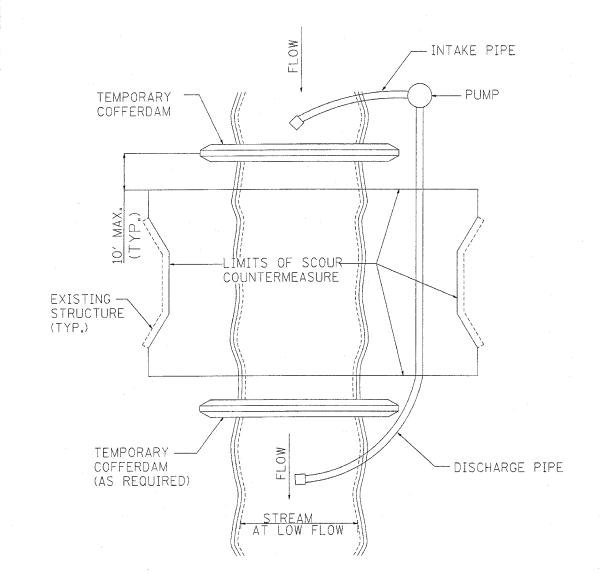


FIGURE D1. TEMPORARY COFFERDAM WITH PUMP BYPASS

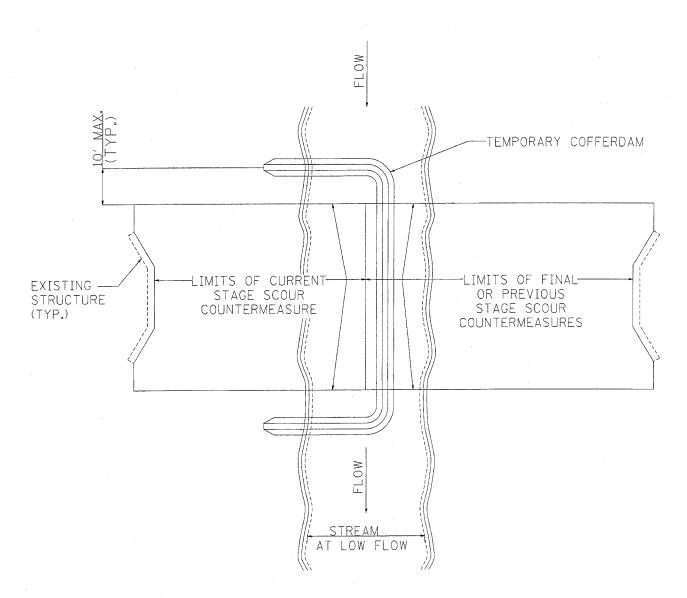


FIGURE D2. STAGED IN-STREAM COFFERDAM DIVISION


NOTE: DEWATERING SYSTEM DETAILS SHALL BE USED IN CONJUNCTION WITH THE PROJECT SPECIAL PROVISIONS.

REVISIONS NAME			ILLINOIS DEPARTMENT OF TRANSPORTATION	
		DEWATERING SYSTEM DETAILS VARIOUS ROUTES VARIOUS COUNTIES		
		SCALE: VERT. HORIZ. DATE 5/12/2006	DRAWN BY CHECKED BY	


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| CONTRACT NO. 6263 | F.A. | SECTION | COUNTY | TOTAL | SHEET | NO. | VAR. | 2003-0671 | VARIOUS | 23 | 23 | STA. | TO STA. | FED. ROAD DIST. NO. | ILLINOIS | FED. AID | PROJECT |



ELEVATION

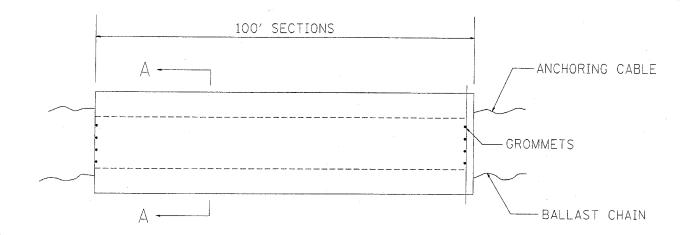

SECTION A-A

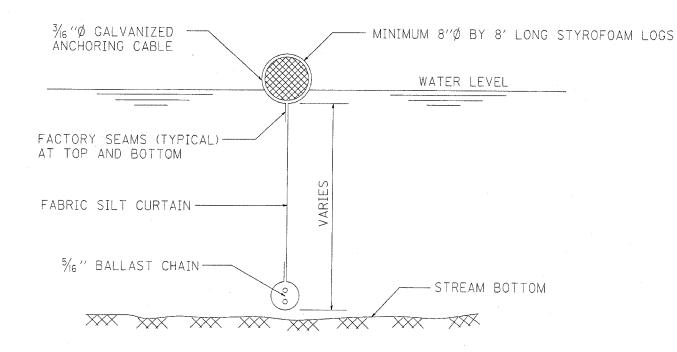FLOTATION BOOM

NOTES:

- 1. FLOTATION BOOM SHALL BE ANCHORED TO PREVENT DRIFT SHOREWARD OR DOWNSTREAM. ANCHORAGES SHALL BE INSTALLED ON BOTH SHORE AND STREAM SIDE.
- 2. SHORE ANCHORS SHALL CONSIST OF A POST WITH DEADMAN OR APPROVED EQUAL. STREAM ANCHORS SHALL BE OF SUFFICIENT SIZE TO STABILIZE THE BARRIER WITH NUMBER AND SPACING DEPENDENT ON WATERWAY VELOCITIES.
- 3. FABRIC SECTIONS SHALL BE CONNECTED END TO END WITH MINIMUM 5%" DIAMETER POLYPROPYLENE ROPE.
- 4. DESIGN OF BOOM AND ANCHORAGE SHALL BE IN ACCORDANCE WITH MANUFACTURER'S RECOMENDATIONS. BOTTOM OF BOOM SHALL REACH BOTTOM OF WATERWAY USING ONE OR TWO VERTICAL SECTIONS AS REQUIRED.
- 5. MAINTENANCE SHALL BE PERFORMED AS NEEDED. CONTRACTOR SHALL REMOVE THE BOOM AT COMPLETION OF WORK IN A MANNER THAT WILL PREVENT SILTATION OF THE WATERWAY.

APPLICATION: FLOTATION BOOMS TO BE USED TO CONTROL EROSION, TURBIDITY AND DEBRIS WHEN WORKING IN WATERWAYS.

REVISIONS
NAME
DATE

ILLINOIS DEPARTMENT OF TRANSPORTATION

DEWATERING SYSTEM DETAIL

FLOTATION BOOM DETAIL

SCALE: VERT.
HORIZ.
DATE 5/12/2006

CHECKED BY

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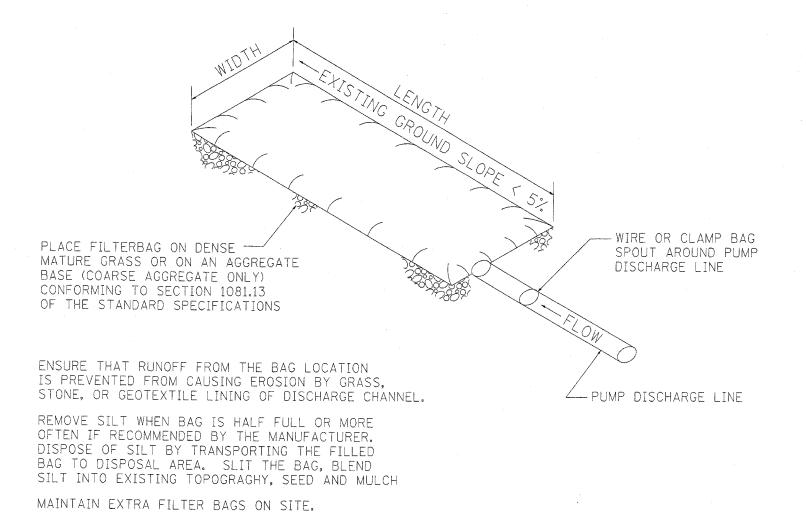


FIGURE S1. SEDIMENT FILTER BAG

REPLACE DAMAGED BAGS PROMPTLY

TYPICAL FLOW RATE: 10 GPM x W x L

NOTE: DEWATERING SYSTEM DETAILS SHALL BE USED IN CONJUNCTION WITH THE PROJECT SPECIAL PROVISIONS.

> ILLINOIS DEPARTMENT OF TRANSPORTATION DEWATERING SYSTEM DETAILS VARIOUS ROUTES VARIOUS COUNTIES SCALE: VERT. HORIZ. DATE 5/12/200 DRAWN BY

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