01-20-2023 LETTING ITEM 054

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STATE OF ILLINOIS
DEPARTMENT OF TRANSPORTATION
DIVISION OF HIGHWAYS

# PROPOSED HIGHWAY PLANS


CENTRAL TRAFFIC MANAGEMENT SYSTEM
PHASE 2
NORTHWEST COOK COUNTY AREA
PROJECT NO: CMAQ-MSXC(263)
SECTION: 2023 TRAFFIC 02
ROUTES: VARIOUS
COOK COUNTY
C-91-246-22

FOR LOCATION MAP SEE SHEETS NO. 3 & NO. 4

**VARIOUS TOWNSHIPS** 

#### D-91-196-22



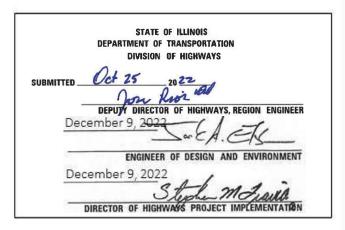

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FOR INDEX OF SHEETS, SEE SHEET NO. 2

FULL SIZE PLANS HAVE BEEN PREPARED USING STANDARD ENGINEERING SCALES. REDUCED SIZED PLANS WILL NOT CONFORM TO STANDARD SCALES. IN MAKING MEASUREMENTS ON REDUCED PLANS, THE ABOVE SCALES MAY BE USED.

J.U.L.I.E. JOINT UTILITY LOCATION INFORMATION FOR EXCAVATION 1-800-892-0123 OR 811

PROJECT ENGINEER: KAMIL A. KOBYLKA, (847) 705–4734 PROJECT MANAGER: DARYLE DREW, (847) 705–4424

CONTRACT NO. 62T54

SHT NO.	DESCRIPTION		
1	COVER SHEET		
2 <b>-</b> 3 4 <b>-</b> 5	INDEX OF SH LOCATION MA		/AY STANDARDS, AND GENERAL NOTES
6 <b>-</b> 9	SUMMARY OF		
10-16			TRAFFIC SIGNAL DESIGN DETAILS (TS-05)
17	DISTRICT ONI	E MAST ARM	MOUNTED STREET NAME SIGNS (TS-02)
SHT NO.	LOCATION NO.	TS NO.	INTERSECTION NAME
18-20	1	10560	ROSELLE RD AT I-90 WB RAMP
21-24 25 <b>-</b> 26	2 3	10293 2990	ROSELLE RD AT CENTRAL RD ROSELLE RD AT IL RTE 62 (ALGONQUIN RD)
27-29	4	3230	MEACHAM RD AT IL RTE 72 (HIGGINS RD)
30-31	5	22	MEACHAM RD AT WOODFIELD RD
32-33	6 7	10 2810	MEACHAM RD AT AMERICAN LN MEACHAM RD AT IL RTE 58 (GOLF RD)
34-36 37-38	8	14	MEACHAM RD AT REMINGTON RD
39 <b>-</b> 40	9	12	MEACHAM RD AT TOWER RD / MCCONNOR PKWY
41-43	10	11	MEACHAM RD AT JUDICH WAY / THOREALL DD
44-45 46-47	11 12	15 13	MEACHAM RD AT ZURICH WAY / THOREAU DR MEACHAM RD AT DRUMMER DR
48-51	13	14780	MEACHAM RD AT IL RTE 62 (ALGONQUIN RD)
52-53	83	3	SPRINGINSGUTH RD AT WESTBOUND FRONTAGE RD
54-55 56 <b>-</b> 57	84 85	6 2	SPRINGINSGUTH RD AT EASTBOUND FRONTAGE RD RODENBURG RD AT WESTBOUND FRONTAGE RD
58 <b>-</b> 57	86	5	RODENBURG RD AT EASTBOUND FRONTAGE RD
60-61	87	4	WRIGHT BLVD AT WESTBOUND FRONTAGE RD
62 <b>-</b> 63 64-67	88 15	7 13765	WRIGHT BLVD AT EASTBOUND FRONTAGE RD
64-67 68 <b>-</b> 70	15 16	13765 13775	BARRINGTON RD AT US RTE 20 (LAKE ST) BARRINGTON RD AT WALNUT AVE
71-73	17	13745	BARRINGTON RD AT IL RTE 19 (IRVING PARK RD)
74 <b>-</b> 75	18	7860	BARRINGTON RD AT TOWER DR
76-77 78 <b>-</b> 79	19 20	21285 21280	BARRINGTON RD AT RAMBLEWOOD DR BARRINGTON RD AT BUTTITTA DR / LAURIE LN
80-81	21	4165	BARRINGTON RD AT BOURBON PKWY / WEATHERSFIELD WAY
82-84	22	4180	BARRINGTON RD AT SCHAUMBURG RD
85 <b>-</b> 86 87-88	23 24	4182 21130	BARRINGTON RD AT HOLMES WAY BARRINGTON RD AT OLD CHURCH RD
89-91	25	4170	BARRINGTON RD AT OLD CHORCH RD
92-93	26	2725	BARRINGTON RD AT IL RTE 58 (GOLF RD)
94-95	27	20400	BARRINGTON RD AT IL RTE 73 (HIGGING RD)
96 <b>-</b> 97 98-99	28 29	3290 20402	BARRINGTON RD AT IL RTE 72 (HIGGINS RD) IL RTE 58 (GOLF RD) AT HOFFMAN EST SC
100-101	30	21370	IL RTE 58 (GOLF RD) AT KNOLLWOOD DR
102-103	30.5	2870	IL RTE 58 (GOLF RD) AT MOON LAKE BLVD/WALNUT LN
104-105 106-107	31 32	11270 1325	US RTE 20 (LAKE ST) AT BARTLETT RD US RTE 20 (LAKE ST) AT OAK AVE
108-109	33	1330	US RTE 20 (LAKE ST) AT PARK AVE
110-112	34	6077	US RTE 20 (LAKE ST) AT NORTH AVE
113-114 115-116	35 36	20575 13762	US RTE 20 (LAKE ST) AT WALNUT AVE US RTE 20 (LAKE ST) AT CENTER AVE
117-118	37	13760	US RTE 20 (LAKE ST) AT CHURCH ST
119-121	38	7695	US RTE 20 (LAKE ST) AT ONTARIOVILLE RD / BEAR FLAG DR
122-123 124-126	39 40	21910 13770	US RTE 20 (LAKE ST) AT IL 390 RAMP US RTE 20 (LAKE ST) AT GREENBROOK BLVD
127-128	41	7870	US RTE 20 (LAKE ST) AT BARTELS RD / ARLINGTON DR
129-131	42	6030	US RTE 20 (LAKE ST) AT GARY AVE
132-133 134-135	43 44	7875 22025	US RTE 20 (LAKE ST) AT BRYN MAWR AVE US RTE 20 (LAKE ST) AT RODENBURG RD
134-133	45	6065	US RTE 20 (LAKE ST) AT RODENBORG RD US RTE 20 (LAKE ST) AT SPRINGFIELD DR
138-139	46	22240	IL RTE 62 (ALGONQUIN RD) AT PENNY RD
140-142 143-144	47 48	2940 22230	IL RTE 62 (ALGONQUIN RD) AT BARRINGTON RD IL RTE 62 (ALGONQUIN RD) AT WILLOWMERE DR
145-146	48	2960	IL RTE 62 (ALGONQUIN RD) AT WILLOWMERE DR IL RTE 62 (ALGONQUIN RD) AT HUNTINGTON BLVD
147-148	50	7655	IL RTE 62 (ALGONQUIN RD) AT LEXINGTON DR
149-150 151-152	51 52	2957 2955	IL RTE 62 (ALGONQUIN RD) AT WINSTON DR IL RTE 62 (ALGONQUIN RD) AT ELA RD
151-152 153-154	53	2955 2970	IL RTE 62 (ALGONQUIN RD) AT ELA RD IL RTE 62 (ALGONQUIN RD) AT HARPER COLLEGE DR
155-156	54	7885	IL RTE 62 (ALGONQUIN RD) AT QUENTIN RD
157	55 56	14750 14760	IL RTE 62 (ALGONQUIN RD) AT HAMMOND DR
158-159 160-161	56 57	14760 14755	IL RTE 62 (ALGONQUIN RD) AT PLUM GROVE RD / PROGRESS PKWY IL RTE 62 (ALGONQUIN RD) AT PARKSIDE DR
162-164	58	14765	IL RTE 62 (ALGONQUIN RD) AT THOREAU DR / THORNTREE DR
165-166	59	2930	IL RTE 62 (ALGONQUIN RD) AT ARBOR DR / FRONTAGE RD
167-168 169-170	60 61	2670 2665	IL RTE 62 (ALGONQUIN RD) AT IL RTE 53 (ROHLWING RD) WEST RAMF IL RTE 62 (ALGONQUIN RD) AT IL RTE 53 (ROHLWING RD) EAST RAMP
171-172	62	2980	IL RTE 62 (ALGONQUIN RD) AT MAGNOLIA DR
173-174	63	21595	IL RTE 62 (ALGONQUIN RD) AT NEWPORT DR
175-176	64	14741	IL RTE 62 (ALGONQUIN RD) AT WEBER DR / OLD WILKE RD
177-178 179-180	65 66	14744 2985	IL RTE 62 (ALGONQUIN RD) AT WEBER DR / OLD WILKE RD IL RTE 62 (ALGONQUIN RD) AT NEW WILKE RD
181-182	67	2708	IL RTE 62 (ALGONQUIN RD) AT MARKET PL / WALMART ENT
183-184	68	1935	IL RTE 19 (IRVING PARK RD) AT BARTLETT RD
185-186 187-188	69 70	8940 1980	IL RTE 19 (IRVING PARK RD) AT PARK BLVD / PARK AVE IL RTE 19 (IRVING PARK RD) AT LINCOLN AVE / SUNNYDALE BLVD
189-190	71	1985	IL RTE 19 (IRVING PARK RD) AT EINCOEN AVE 7 SONNTBALE BEVB
191-192	72	13756	IL RTE 19 (IRVING PARK RD) AT WESTVIEW PLAZA
193-194	73	13750	IL RTE 19 (IRVING PARK RD) AT MENARDS ENTRANCE

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197-198	75	21450	IL RTE 19 (IRVING PARK RD) AT OLDE SALEM RD
199-200	76	1975	IL RTE 19 (IRVING PARK RD) AT WISE RD / GEORGETOWN AVE
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203-204	78	1965	IL RTE 19 (IRVING PARK RD) AT SPRING RD
205-206	79	21710	IL RTE 19 (IRVING PARK RD) AT IL 390 FRONTAGE RD WEST
207-208	80	21709	IL RTE 19 (IRVING PARK RD) AT IL 390 FRONTAGE RD EAST
209-210	81	7635	IL RTE 19 (IRVING PARK RD) AT RODENBURG RD
211-212	82	7637	IL RTE 19 (IRVING PARK RD) AT WRIGHT BLVD
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216-228			INTERCONNECT PLAN FOR BARRINGTON RD SOUTH TO NORTH
229-239			INTERCONNECT PLAN FOR US-20 WEST TO EAST
240-253			INTERCONNECT PLAN FOR IL-19 WEST TO EAST
254-258			INTERCONNECT PLAN FOR ROSELLE RD SOUTH TO NORTH
259 <b>-</b> 276			INTERCONNECT PLAN FOR IL-62 WEST TO EAST
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289-300			CABINET DETAIL
301			COMMUNICATIONS VAULT, COMPOSITE CONCRETE DETAIL
302			IDOT DISTRICT 1 HQ BUILDING DETAIL
303			D1HQ FIBER OPTIC
304			CAMERA MOUNTING DETAIL
305			TRAFFIC CONTROL AND PROTECTION FOR SIDE ROADS, INTERSECTIONS
			AND DRIVEWAYS (TC-10)
306			TRAFFIC CONTROL AND PROTECTION AT TURN BAYS (TO REMAIN OPEN
			TRAFFIC) & ARTERIAL ROAD INFORMATION SIGN (TC-14 & TC-22)

#### **IDOT HIGHWAY STANDARDS**

STD. NO.	TITLE
000001-08	STANDARD SYMBOLS, ABBREVIATIONS, AND PATTERNS
001001-02	AREAS OF REINFORCEMENT BARS
001006	DECIMAL OF AN INCH AND OF A FOOT
280001-07	TEMPORARY EROSION CONTROL SYSTEMS
701001-02	OFF-RD OPERATIONS, 2L, 2W MORE THAN 15' (4.5m) AWAY
701006-05	OFF-RD OPERATIONS, 2L, 2W, 15' (4.5m) TO 24" (600mm) FROM PAVEMENT EDGE
701101-05	OFF-RD OPERATIONS, MULTILANE, 15' (4.5 m) TO 24" (600 mm) FROM PAVEMENT EDGE
701106-02	OFF-RD OPERATIONS, MULTILANE, MORE THAN 15' (4.5m) AWAY
701301-04	LANE CLOSURE, 2L, 2W, SHORT TIME OPERATIONS
701426-09	LANE CLOSURE, MULTILANE, INTERMITTENT OR MOVING OPER., FOR SPEEDS≥45 MPH
701427-05	LANE CLOSURE, MULTILANE, INTERMITTENT OR MOVING OPER., FOR SPEEDS≤40 MPH
701601-09	URBAN LANE CLOSURE, MULTILANE, 1W OR 2W WITH NONTRAVERSABLE MEDIAN
701606-10	URBAN SINGLE LANE CLOSURE, MULTILANE, 2W WITH MOUNTABLE MEDIAN
701701-10	URBAN LANE CLOSURE, MULTILANE INTERSECTION
701801-06	SIDEWALK, CORNER OR CROSSWALK CLOSURE
701901-08	TRAFFIC CONTROL DEVICES
814001-03	HANDHOLES
814006-03	DOUBLE HANDHOLES
857001-01	STANDARD PHASE DESIGNATION DIAGRAMS AND PHASE SEQUENCES
862001-01	UNINTERRUPTABLE POWER SUPPLY (UPS)
873001-02	TRAFFIC SIGNAL GROUNDING & BONDING

#### **RLR NOTES**

DUE TO THE PRESENCE OF A RED LIGHT RUNNING (RLR) CAMERA FOR THE BELOW LISTED LOCATIONS, CONTRACTOR SHALL NOTIFY THE VILLAGE AND RLR CAMERA COMPANY PRIOR TO THE START OF CONSTRUCTION. THE VILLAGE OR THE RLR CAMERA COMPANY SHALL MAKE THE CAMERA INOPERATIVE FOR THE TIME OF CONSTRUCTION. ANY RLR CAMERA EQUIPMENT THAT IS IN CONFLICT WITH THE PROPOSED CONSTRUCTION SHALL BE REMOVED BY ITS RESPECTIVE OWNERS PRIOR TO THE START OF CONSTRUCTION.

RLR CAMERA LOCATION:

TS 3290 IL RTE 72 (HIGGINS RD) AT BARRINGTON ROAD TS 2725 IL RTE 58 (GOLF RD) AT BARRINGTON ROAD

VILLAGE OF HOFFMAN ESTATES AMERICAN TRAFFIC SOLUTIONS 1900 HASSELL ROAD 7681 FAST GRAY ROAD HOFFMAN ESTATES, IL 60195 SCOTTSDALE, AZ 85260 (847) 882-9100

TS 6030 US RTE 20 (LAKE ST) AT GARY AVENUE

VILLAGE OF ROSELLE RED SPEED, LLC 31 S PROSPECT ST 400 EISENHOWER, LANE ROSELLE, IL 60172 LOMBARD, IL 60148 (630) 980-2000

TS 2665 IL RTE 62 (ALGONQUIN RD) AT IL RTE 53 (ROHLWING RD) EAST RAMP TS 2985 IL RTE 62 (ALGONQUIN RD) AT NEW WILKE RD

CITY OF ROLLING MEADOWS RED SPEED, LLC 3600 KIRCHOFF ROAD 400 EISENHOWER, LANE ROLLING MEADOWS, IL 6008 LOMBARD, IL 60148 (847) 394-8500

#### **RLR NOTES CONTINUED**

TS 13765 US RTE 20 (LAKE ST) AT BARRINGTON RD

VILLAGE OF HANOVER PARK RED SPEED, LLC 2121 W LAKE STREET 400 EISENHOWER, LANE HANOVER PARK, IL 60133 LOMBARD, IL 60148 (630) 823-5600

#### **GENERAL NOTES**

THE CONTRACTOR SHALL CONTACT THE TRAFFIC CONTROL SUPERVISOR AT KALPANA.KANNAN-HOSADURGA@ILLINOIS.GOV, 72 HOURS IN ADVANCE OF BEGINNING WORK.

IT SHALL BE THE CONTRACTOR'S RESPONSIBILITY TO VERIEY ALL DIMENSIONS AND CONDITIONS EXISTING IN THE FIELD PRIOR TO ORDERING MATERIALS AND BEGINNING CONSTRUCTION

ALL EXISTING R.O.W. SHOWN IS APPROXIMATE AND MAY NEED TO BE VERIFIED IN THE FIELD. ALL PROPOSED WORK SHALL TAKE PLACE WITHIN EXISTING ROW WITHIN EXISTING FACILITIES INCLUDING HANDHOLES, CONDUITS, OR TRAFFIC SIGNAL CABINETS.

THE EXACT LOCATION OF ALL UTILITIES SHALL BE FIELD VERIFIED BY THE CONTRACTOR BEFORE ORDERING ANY MATERIALS AND STARTING ANY WORK. FOR LOCATIONS OF UTILITIES. LOCALLY OWNED EQUIPMENT, LEASED ENFORCEMENT CAMERA SYSTEM FACILITIES AND IDOT UNDERGROUND FACILITIES. CONTACT THE LOCAL COUNTIES, MUNICIPALITIES AND IDOT FOR LOCATES. THE CONTRACTOR SHALL CALL "JULIE" AT (800) 892-0123 OR 811, IN THE CITY OF CHICAGO CONTACT DIGGER AT (312) 744-7000 FOR FIELD LOCATIONS OF BURIED UTILITIES (48 HOURS NOTIFICATION REQUIRED).

IF THIS CONTRACT REQUIRES THE SERVICES OF AN ELECTRICAL CONTRACTOR. THE CONTRACTOR SHALL BE RESPONSIBLE AT HIS/HER OWN EXPENSE FOR LOCATING EXISTING IDOT ELECTRICAL FACILITIES PRIOR TO PERFORMING ANY WORK, IF THIS CONTRACT DOES NOT REQUIRE THE SERVICES OF AN ELECTRICAL CONTRACTOR, THE CONTRACTOR MAY REQUEST ONE FREE LOCATE FOR EXISTING IDOT ELECTRICAL FACILITIES FROM THE DISTRICT ONE ELECTRICAL MAINTENANCE CONTRACTOR PRIOR TO THE START OF ANY WORK, ADDITIONAL REQUESTS MAY BE AT THE EXPENSE OF THE CONTRACTOR. THE LOCATION OF UNDERGROUND TRAFFIC FACILITIES DOES NOT RELIEVE THE CONTRACTOR OF THEIR RESPONSIBILITY TO REPAIR ANY FACILITIES DAMAGED DURING CONSTRUCTION AT THEIR EXPENSE.

THE CONTRACTOR SHALL CHECK THE PROPOSED TRAFFIC SIGNAL EQUIPMENT LOCATIONS FOR UNDERGROUND AND OVERHEAD UTILITY CONFLICTS. THE CONTRACTOR SHALL NOTIFY THE AREA ENGINEER, THE RESIDENT ENGINEER, AND ANY IMPACTED UTILITY COMPANY OF THE CONFLICT, AND SHALL COORDINATE AND RESOLVE THE ISSUE PRIOR TO ORDERING MATERIALS, AND PRIOR TO POURING FOUNDATIONS.

THE CONTRACTOR SHALL COORDINATE CONSTRUCTION ACTIVITIES WITH UTILITY COMPANIES, LOCAL GOVERNMENT AGENCIES AND IDOT.

RESTORATION OF THE TRAFFIC SIGNAL WORK AREA SHALL BE INCLUDED IN THE RELATED PAY ITEM SUCH AS FOUNDATION, CONDUIT, HANDHOLE, ETC., AND NO EXTRA COMPENSATION SHALL BE ALLOWED. ALL ROADWAY SURFACES SUCH AS SHOULDERS, MEDIAN, SIDEWALKS, PAVEMENT, ETC. SHALL BE REPLACED IN KIND, ALL DAMAGE TO MOWED LAWNS SHALL BE REPLACED WITH AN APPROVED SOD, AND ALL DAMAGED TO UNMOWED FIELDS SHALL BE SEEDED IN ACCORDANCE WITH STANDARD SPECIFICATIONS 252 AND 250 RESPECTIVELY. THE CONTRACTOR IS RESPONSIBLE FOR RETURNING ALL AREAS AFFECTED BY EQUIPMENT OR LABORERS TO EXISTING CONDITIONS.

PARTIAL PAYMENT AS DESCRIBED IN ARTICLE 109.07(b) OF THE STANDARD SPECIFICATIONS WILL NOT BE ALLOWED FOR ITEMS INCLUDED IN THIS CONTRACT.

THE CONTRACTOR SHALL SOLELY BE RESPONSIBLE FOR THE INSTALLATION AND MAINTENANCE OF ADEQUATE SIGNS, TRAFFIC CONTROL DEVICES, AND WARNING DEVICES TO INFORM THE PROTECT THE PUBLIC DURING ALL CONSTRUCTION ACTIVITIES.

THE CONTRACTOR SHALL COORDINATE WITH IDOT, CCDOT, AND EQUIPMENT VENDORS FOR THE BEST LOCATION AND ORIENTATION OF EACH PROPOSED PTZ CAMERA PRIOR TO CAMERA INSTALLATION.

THE CONTRACTOR SHALL MARK THE RECORD DRAWINGS TO REFLECT ANY CHANGES TO THE PLANS. THE RECORD DRAWINGS REQUIREMENTS ARE IDENTIFIED IN SECTION 801.16 OF THE STANDARD SPECIFICATIONS AND SPECIAL PROVISIONS.

THE QUANTITY FOR THE ROD AND CLEAN EXISTING CONDUIT IS FOR USE WITH EXISTING CONDUITS WHICH HAVE ALL EXISTING CABLES REMOVED. THE QUANTITY PROVIDED IS A NOMINAL QUANTITY AND SHALL BE USED AS NEEDED OR AS DETERMINED BY THE ENGINEER BASED ON FIELD CONDITIONS

THE QUANTITY FOR TEMPORARY INFORMATION SIGNING IS FOR USE WITH DISTRICT DETAIL ARTERIAL ROAD INFORMATION SIGN (TC 22). ONE SIGN IS TO BE USED FOR EACH END OF EACH INTERCONNECT CORRIDOR, MAIN ROUTE, OR ZONE.

		USER NAME = \$USER\$	DESIGNED -	EA	REVISED - 12-2-2022
<u> 10</u>	GANDHI AND ASSOCIATES, INC. ENGINEERS AND PLANNERS 6035 N. NORTHIBEST HIGHWAY SUITE 306 CHICAGO, ILLINOIS 60631 TEL.(1773)774-590		DRAWN -	EA, AV	REVISED -
		PLOT SCALE = 40.0000 '/ in.	CHECKED -	MS	REVISED -
		PLOT DATE = \$DATE\$	DATE -	10/31/2022	REVISED -

IL RTE 19 (IRVING PARK RD) AT MENARDS ENTRANCE

STATE OF ILLINOIS **DEPARTMENT OF TRANSPORTATION** 

INDEV OF					05115041 110550	F.A RTE.	SECTION	COUNTY	TOTAL SHEETS	S
INDEX OF	SHEETS, HI	GHWAY	STAND	ARDS &	GENERAL NOTES	VAR	2023 TRAFFIC 02	VARIOUS	306	
								CONTRACT	NO. 6	2
SCALE: N.T.S.	SHEET NO.	OF	SHEETS	STA.	TO STA.	FED. RO	DAD DIST. NO ILLINOIS FED. A	ID PROJECT		Т

193-194

13750

THE WORK IN THIS CONTRACT IS LIMITED TO THE INSTALLATION OF THE HANDHOLES, CONDUITS, TRACER CABLE, PTZ CAMERAS, SWITCHES, CONTROLLERS, AND FIBER OPTIC CABLE AS WELL AS ANY OTHER COMPONENTS AS SPECIFIED IN THE SCHEDULE OF QUANTITIES. THERE ARE NO PHASE CHANGES. PLANS USE EXISTING RECORD DRAWINGS WHICH SHOW PROPOSED EQUIPMENT FROM PREVIOUS CONTRACTS. WORK SHALL ONLY INCLUDE WHAT IS SPECIFIED IN THE SCHEDULE OF QUANTITIES. PHASING FOR THE NEW CONTROLLERS SHALL BE REPLICATED FROM EXISTING CONTROLLERS.

FOR WORK AT THE VILLAGE OF SCHAUMBURG TRAFFIC SIGNALS CONTRACTOR TO COORDINATE WORK AND ARRANGE FOR ANY MAINTENANCE TRANSFERS WITH VILLAGE MAINTAINER - H&H ELECTRIC AT (708) 453-0202. THE CONTRACTOR WILL NEED TO OBTAIN A ROW ENTRY PERMIT AS WELL AS TRANSFER MAINTENANCE OF THE SIGNALS THAT ARE SHOWN BELOW:

WOODFIELD RD AT MEACHAM RD
AMERICAN LN AT MEACHAM RD
1-90 RAMP AT MEACHAM RD
REMINGTON RD AT MEACHAM RD
TOWER RD/MCCONNOR PKWY AT MEACHAM RD
ZURICH WAY/THOREAU DR AT MEACHAM RD
PROGRESS PKWY/DRUMMER DR AT MEACHAM RD
SPRINGINSGUTH RD AT WESTBOUND FRONTAGE RD
SPRINGINSGUTH RD AT WESTBOUND FRONTAGE RD
RODENBURG RD AT WESTBOUND FRONTAGE RD
WRIGHT BLVD AT WESTBOUND FRONTAGE RD
WRIGHT BLVD AT WESTBOUND FRONTAGE RD
WRIGHT BLVD AT WESTBOUND FRONTAGE RD

#### **CONFLICTS AMONG OTHER PROJECTS**

BELOW NOTES ARE INTENDED TO IDENTIFY PROJECTS WITHIN SAME LOCATION AS THIS CONTRACT. COORDIANTION WILL BE REQUIRED AMONG THE DESIGNERS, RE, AND CONTRACTORS AND SHALL BE REFLECTED IN THE UNIT PRICES. WORK SHALL BE PLANNED ACCORDINGLY.

#### LOCATION #4

CONTRACTOR SHOULD COORDINATE WORK WITH WORK UNDER CONTRACT 62R81. CONTRACT 62R81. CONTRACT 62R81. CONTRACT 62TS4 ONLY THEN CAN THE WORK ON THIS CONTRACT BE INITIATED. CONTRACT OR TO PLAN WORK ACCORDINGLY.

#### LOCATION #7

CONTRACTOR SHOULD COORDINATE WORK WITH WORK UNDER CONTRACT 62R81. CONTRACT 62R81 CONSISTS OF SYSTEM EXPANSION 1 AND SHOULD BE COMPLETED FIRST PRIOR TO CONTRACT 62T54 ONLY THEN CAN THE WORK ON THIS CONTRACT BE INITIATED. CONTRACTOR TO PLAN WORK ACCORDINGLY.

#### LOCATION #13

CONTRACTOR MIGHT NEED TO COORDINATE WORK WITH WORK UNDER CONTRACT 61G20. CONTRACT 61G20 IS NEAR COMPLETION AND SHOULD BE COMPLETED FIRST PRIOR TO CONTRACT 62T54 ONLY THEN CAN THE WORK ON THIS CONTRACT BE INITIATED. CONTRACTOR TO PLAN WORK ACCORDINGLY.

#### LOCATION #17

CONTRACTOR MIGHT NEED TO COORDINATE WORK WITH WORK UNDER CONTRACT 62K02. CONTRACT 62K02 IS NEAR COMPLETION AND SHOULD BE COMPLETED FIRST PRIOR TO CONTRACT 62T54 ONLY THEN CAN THE WORK ON THIS CONTRACT BE INITIATED. CONTRACTOR TO PLAN WORK ACCORDINGLY. CONTRACT 62K02 WILL INSTALL BLACK PAINTED EXTENSION ASSEMBLY POLE FOR PTZ CAMERA.

#### LOCATION #26

CONTRACTOR WILL NEED TO COORDINATE WORK WITH WORK UNDER CONTRACT 62N97. CONTRACT 62N97 IS SCHEDULED CONCURRENTLY WITH CONTRACT 62T54 AND WILL RECONSTRUCT ENTIRE INTERSECTION. CONTRACT 62T54 CAN START WORK BEFORE 62N97 IF MATERIALS AVAILABLE. ADDITIONAL SLACK IN FIBER SHALL BE PROVIDED TO ACCOUNT FOR THAT, WORK SHALL NOT BE DUPICATED SOME EQUIPMENT RELOCATION MIGHT BE NECESSARY, PTZ INSTALL PRIMARILY AS SHOWN ON PLANS UNLESS COMBINATION MAST ARM IS IN PLACE UNDER 62N97. CONTRACTOR TO PLAN WORK ACCORDINGLY. COORDIANTION WILL BE REQUIRED AMONG THE DESIGNERS, RE, AND CONTRACTORS.

#### LOCATION #2

CONTRACTOR SHOULD COORDINATE WORK WITH WORK UNDER CONTRACT 62R81. CONTRACT 62R81 CONSISTS OF SYSTEM EXPANSION 1 AND SHOULD BE COMPLETED FIRST PRIOR TO CONTRACT 62T54 ONLY THEN CAN THE WORK ON THIS CONTRACT BE INITIATED. CONTRACTOR TO PLAN WORK ACCORDINGLY.

#### CONFLICTS AMONG OTHER PROJECTS CONTINUED

#### OCATION #29

CONTRACTOR WILL NEED TO COORDINATE WORK WITH WORK UNDER CONTRACT 62N97. CONTRACT 62N97 IS SCHEDULED CONCURRENTLY WITH CONTRACT 62T54 AND WILL RECONSTRUCT ENTIRE INTERSECTION. CONTRACT 62T54 CAN START WORK BEFORE 62N97 IF MATERIALS AVAILABLE, ADDITIONAL SLACK IN FIBER SHALL BE PROVIDED TO ACCOUNT FOR THAT, WORK SHALL NOT BE DUPLICATED SOME EQUIPMENT RELOCATION MIGHT BE NECESSARY, PTZ INSTALL PRIMARILY AS SHOWN ON PLANS UNLESS COMBINATION MAST ARM IS IN PLACE UNDER 62N97. CONTRACTOR TO PLAN WORK ACCORDINGLY. COORDIANTION WILL BE REQUIRED AMONG THE DESIGNERS, RE, AND CONTRACTORS.

#### LOCATION #30.5

CONTRACTOR SHOULD COORDINATE WORK WITH WORK UNDER CONTRACT 62R81. CONTRACT 62R81. CONTRACT 62R81. CONTRACT 62TS4 ONLY THEN CAN THE WORK ON THIS CONTRACT BE INITIATED. CONTRACT OR TO PLAN WORK ACCORDINGLY.

#### LOCATION #3

CONTRACTOR WILL NEED TO COORDINATE WORK WITH WORK UNDER CONTRACT 62P51. CONTRACT 62P51 IS SCHEDULED CONCURRENTLY WITH CONTRACT 62T54 AND WILL RECONSTRUCT ENTIRE INTERSECTION. CONTRACT 62T54 CAN START WORK BEFORE 62P51 IF MATERIALS AVAILABLE. ADDITIONAL SLACK IN FIBER SHALL BE PROVIDED TO ACCOUNT FOR THAT, WORK SHALL NOT BE DUPLICATED SOME EQUIPMENT RELOCATION MIGHT BE NECESSARY, PTZ INSTALL PRIMARILY AS SHOWN ON PLANS UNLESS COMBINATION MAST ARM IS IN PLACE UNDER 62P51. CONTRACTOR TO PLAN WORK ACCORDINGLY. COORDIANTION WILL BE REQUIRED AMONG THE DESIGNERS. RE, AND CONTRACTORS.

#### LOCATION #32

CONTRACTOR WILL NEED TO COORDINATE WORK WITH WORK UNDER CONTRACT 62P51. CONTRACT 62P51 IS SCHEDULED CONCURRENTLY WITH CONTRACT 62T54 AND WILL RECONSTRUCT ENTIRE INTERSECTION. CONTRACT 62T54 CAN START WORK BEFORE 62P51 IF MATERIALS AVAILABLE. ADDITIONAL SLACK IN FIBER SHALL BE PROVIDED TO ACCOUNT FOR THAT, WORK SHALL NOT BE DUPILCATED SOME EQUIPMENT RELOCATION MIGHT BE NECESSARY, PTZ INSTALL PRIMARILY AS SHOWN ON PLANS UNLESS COMBINATION MAST ARM IS IN PLACE UNDER 62P51. CONTRACTOR TO PLAN WORK ACCORDINGLY. COORDIANTION WILL BE REQUIRED AMONG THE DESIGNERS, RE, AND CONTRACTORS.

#### LOCATION #47

CONTRACTOR WILL NEED TO COORDINATE WORK WITH WORK UNDER CONTRACT 62K04. CONTRACT 62K04 IS SCHEDULED CONCURRENTLY WITH CONTRACT 62T54 AND WILL RECONSTRUCT ENTIRE INTERSECTION. CONTRACT 62K04 SHOULD BE COMPLETED FIRST PRIOR TO CONTRACT 62T54 ONLY THEN CAN THE WORK ON THIS CONTRACT BE INITIATED. ADDITIONAL SLACK IN FIBER SHALL BE PROVIDED TO ACCOUNT FOR THAT, WORK SHALL NOT BE DUPLICATED SOME EQUIPMENT RELOCATION MIGHT BE NECESSARY, PTZ INSTALL PRIMARILY AS SHOWN ON PLANS ONCE 62K04 INSTALL COMBINATION MAST ARM. CONTRACTOR TO PLAN WORK ACCORDINGLY. COORDIANTION WILL BE REQUIRED AMONG THE DESIGNERS, RE, AND CONTRACTORS.

#### LOCATION #55

CONTRACTOR WILL NEED TO COORDINATE WORK WITH WORK UNDER CONTRACT XXXXX. CONTRACT XXXXX IS SCHEDULED AFTER CONTRACT 62T54 AND WILL RECONSTRUCT ENTIRE INTERSECTION. CONTRACT 62T54 CAN START WORK BEFORE XXXXX IF MATERIALS AVAILABLE. ADDITIONAL SLACK IN FIBER SHALL BE PROVIDED TO ACCOUNT FOR THAT, WORK SHALL NOT BE DUPLICATED SOME EQUIPMENT RELOCATION MIGHT BE NECESSARY, PTZ INSTALL PRIMARILY AS SHOWN ON PLANS UNLESS COMBINATION MAST ARM IS IN PLACE UNDER XXXXX. CONTRACTOR TO PLAN WORK ACCORDINGLY. COORDIANTION WILL BE REQUIRED AMONG THE DESIGNERS, RE, AND CONTRACTORS.

#### LOCATION #58

CONTRACTOR MIGHT NEED TO COORDINATE WORK WITH WORK UNDER CONTRACT 61G20. CONTRACT 61G20 IS NEAR COMPLETION AND SHOULD BE COMPLETED FIRST PRIOR TO CONTRACT 62T54 ONLY THEN CAN THE WORK ON THIS CONTRACT BE INITIATED. CONTRACTOR TO PLAN WORK ACCORDINGLY.

#### LOCATION #64

CONTRACTOR WILL NEED TO COORDINATE WORK WITH WORK UNDER CONTRACT 62P72. CONTRACT 62P72 IS SCHEDULED CONCURENTLY WITH CONTRACT 62T54 AND WILL RECONSTRUCT ENTIRE INTERSECTION. CONTRACT 62T54 CAN START WORK BEFORE 62P72 IF MATERIALS AVAILABLE. ADDITIONAL SLACK IN FIBER SHALL BE PROVIDED TO ACCOUNT FOR THAT, WORK SHALL NOT BE DUPLICATED SOME EQUIPMENT RELOCATION MIGHT BE NECESSARY, PTZ INSTALL PRIMARILY AS SHOWN ON PLANS UNLESS COMBINATION MAST ARM IS IN PLACE UNDER 62P72. CONTRACTOR TO PLAN WORK ACCORDINGLY. COORDIANTION WILL BE REQUIRED AMONG THE DESIGNERS, RE, AND CONTRACTORS.

#### OCATION #68

CONTRACTOR MIGHT NEED TO COORDINATE WORK WITH WORK UNDER CONTRACT 61H15. CONTRACT 61H15 IS APPROACHING COMPLETION AND SHOULD BE COMPLETED FIRST PRIOR TO CONTRACT 62T54 ONLY THEN CAN THE WORK ON THIS CONTRACT BE INITIATED. CONTRACTOR TO PLAN WORK ACCORDINGLY.

#### CONFLICTS AMONG OTHER PROJECTS CONTINUED

#### LOCATION #7

CONTRACTOR WILL NEED TO COORDINATE WORK WITH WORK UNDER CONTRACT 62J30. CONTRACT 62J30 IS SCHEDULED CONCURENTLY WITH CONTRACT 62T54 AND WILL RECONSTRUCT ENTIRE INTERSECTION. CONTRACT 62T54 CAN START WORK BEFORE 62P72 IF MATERIALS AVAILABLE. ADDITIONAL SLACK IN FIBER SHALL BE PROVIDED TO ACCOUNT FOR THAT, WORK SHALL NOT BE DUPLICATED SOME EQUIPMENT RELOCATION MIGHT BE NECESSARY, PTZ INSTALL PRIMARILY AS SHOWN ON PLANS. SIGNAL CONTROLLER QUANTITY IS PROVIDED AT THIS LOCATION BUT INSTALLATION WILL DEPEND ON CONTRACT 62J30 OTHERWISE THIS CONTROLLER SHALL BE DELIVERED TO IDOT SPARE PARTS IF NOT USED. CONTRACTOR TO PLAN WORK ACCORDINGLY. COORDIANTION WILL BE REQUIRED AMONG THE DESIGNERS, RE, AND CONTRACTORS.

LOCATION NO.	TS NO.	INTERSECTION NAME
1	10560	ROSELLE RD AT I-90 WB RAMP
2	10293	ROSELLE RD AT CENTRAL RD
3	2990	ROSELLE RD AT IL RTE 62 (ALGONQUIN RD)
4	3230	MEACHAM RD AT IL RTE 72 (HIGGINS RD)
5	22	MEACHAM RD AT WOODFIELD RD
6	10	MEACHAM RD AT AMERICAN LN
7	2810	MEACHAM RD AT IL RTE 58 (GOLF RD)
8	14	MEACHAM RD AT REMINGTON RD
9	12	MEACHAM RD AT TOWER RD / MCCONNOR PKWY
10	11	MEACHAM RD AT I-90 WB EXIT RAMP
11	15	MEACHAM RD AT ZURICH WAY / THOREAU DR
12	13	MEACHAM RD AT DRUMMER DR
13	14780	MEACHAM RD AT IL RTE 62 (ALGONQUIN RD)
46	22240	IL RTE 62 (ALGONQUIN RD) AT PENNY RD
47	2940	IL RTE 62 (ALGONQUIN RD) AT BARRINGTON RD
48	22230	IL RTE 62 (ALGONQUIN RD) AT WILLOWMERE DR
49	2960	IL RTE 62 (ALGONQUIN RD) AT HUNTINGTON BLVD
50	7655	IL RTE 62 (ALGONQUIN RD) AT LEXINGTON DR
51	2957	IL RTE 62 (ALGONQUIN RD) AT WINSTON DR
52	2955	IL RTE 62 (ALGONQUIN RD) AT ELA RD
53	2970	IL RTE 62 (ALGONQUIN RD) AT HARPER COLLEGE DR
54	7885	IL RTE 62 (ALGONQUIN RD) AT QUENTIN RD
55	14750	IL RTE 62 (ALGONQUIN RD) AT HAMMOND DR
56	14760	IL RTE 62 (ALGONQUIN RD) AT PLUM GROVE RD / PROGRESS PKWY
57	14755	IL RTE 62 (ALGONQUIN RD) AT PARKSIDE DR
58	14765	IL RTE 62 (ALGONQUIN RD) AT THOREAU DR / THORNTREE DR
59	2930	IL RTE 62 (ALGONQUIN RD) AT ARBOR DR / FRONTAGE RD
60	2670	IL RTE 62 (ALGONQUIN RD) AT IL RTE 53 (ROHLWING RD) WEST RAMP
61	2665	IL RTE 62 (ALGONQUIN RD) AT IL RTE 53 (ROHLWING RD) EAST RAMP
62	2980	IL RTE 62 (ALGONQUIN RD) AT MAGNOLIA DR
63	21595	IL RTE 62 (ALGONQUIN RD) AT NEWPORT DR
64	14741	IL RTE 62 (ALGONQUIN RD) AT ESSEX WAY / CARRIAGE WAY DR
65	14744	IL RTE 62 (ALGONQUIN RD) AT WEBER DR / OLD WILKE RD
66	2985	IL RTE 62 (ALGONQUIN RD) AT NEW WILKE RD
67	2708	IL RTE 62 (ALGONQUIN RD) AT MARKET PL / WALMART ENT

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GANDHI AND ASSOCIATES, INC. ENGINEERS AND PLANNERS		
6035 N. NORTHWEST HIGHWAY SUITE 306 CHICAGO, ILLINOIS 60631 TEL.(773)774-5910	PLC	
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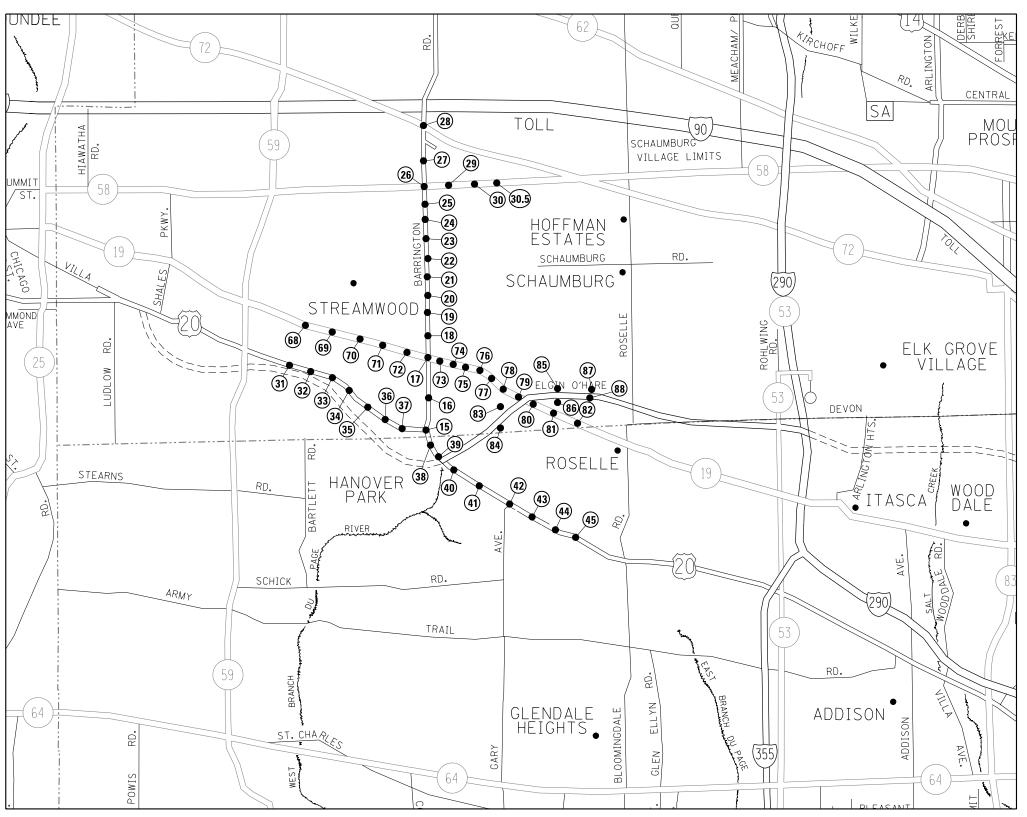
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HIGGINS

• ELK GROVE • VILLAGE

LOCATION MAP						F.A RTE.	SECTION	COUNTY	TOTAL SHEETS	SHEET NO.
(SHEET 1 OF 2)						VAR	2023 TRAFFIC 02	VARIOUS	306	4
(OILLI I UI Z)								CONTRACT	NO. 6	2T54
SCALE: N.T.S.	SHEET NO.	OF	SHEETS	STA.	TO STA.	FED. R	DAD DIST. NO ILLINOIS FED. AI	D PROJECT		



LOCATION	TC NO	INTERCECTION NAME
NO.	TS NO.	INTERSECTION NAME
15	13765	BARRINGTON RD AT US RTE 20 (LAKE ST)
16	13775	BARRINGTON RD AT WALNUT AVE
17	13745	BARRINGTON RD AT IL RTE 19 (IRVING PARK RD)
18	7860	BARRINGTON RD AT TOWER DR
19	21285	BARRINGTON RD AT RAMBLEWOOD DR
20	21280	BARRINGTON RD AT BUTTITTA DR / LAURIE LN
21	4165	BARRINGTON RD AT BOURBON PKWY / WEATHERSFIELD WAY
22	4180	BARRINGTON RD AT SCHAUMBURG RD
23	4182	BARRINGTON RD AT HOLMES WAY
24	21130	BARRINGTON RD AT OLD CHURCH RD
25	4170	BARRINGTON RD AT BODE RD
26	2725	BARRINGTON RD AT IL RTE 58 (GOLF RD)
27	20400	BARRINGTON RD AT ST ALEXIUS MEDICAL CTR
28	3290	BARRINGTON RD AT IL RTE 72 (HIGGINS RD)
29	20402	IL RTE 58 (GOLF RD) AT HOFFMAN EST SC
30	21370	IL RTE 58 (GOLF RD) AT KNOLLWOOD DR
30.5	2870	IL RTE 58 (GOLF RD) AT MOON LAKE BLVD/WALNUT LN
31	11270	US RTE 20 (LAKE ST) AT BARTLETT RD
32	1325	US RTE 20 (LAKE ST) AT OAK AVE
33	1330	US RTE 20 (LAKE ST) AT PARK AVE
34	6077	US RTE 20 (LAKE ST) AT NORTH AVE
35	20575	US RTE 20 (LAKE ST) AT WALNUT AVE
36	13762	US RTE 20 (LAKE ST) AT CENTER AVE
37	13760	US RTE 20 (LAKE ST) AT CHURCH ST
38	7695	US RTE 20 (LAKE ST) AT ONTARIOVILLE RD / BEAR FLAG DR
39	21910	US RTE 20 (LAKE ST) AT IL 390 RAMP
40	13770	US RTE 20 (LAKE ST) AT GREENBROOK BLVD
41	7870	US RTE 20 (LAKE ST) AT BARTELS RD / ARLINGTON DR
42	6030	US RTE 20 (LAKE ST) AT GARY AVE
43	7875	US RTE 20 (LAKE ST) AT BRYN MAWR AVE
44	22025	US RTE 20 (LAKE ST) AT RODENBURG RD
45	6065	US RTE 20 (LAKE ST) AT SPRINGFIELD DR
68	1935	IL RTE 19 (IRVING PARK RD) AT BARTLETT RD
69	8940	IL RTE 19 (IRVING PARK RD) AT PARK BLVD / PARK AVE
70	1980	IL RTE 19 (IRVING PARK RD) AT LINCOLN AVE / SUNNYDALE BLVD
71	1985	IL RTE 19 (IRVING PARK RD) AT EAST AVE
72	13756	IL RTE 19 (IRVING PARK RD) AT WESTVIEW PLAZA
73	13750	IL RTE 19 (IRVING PARK RD) AT MENARDS ENTRANCE
74	13755	IL RTE 19 (IRVING PARK RD) AT KINGSBURY DR
75	21450	IL RTE 19 (IRVING PARK RD) AT OLDE SALEM RD
76	1975	IL RTE 19 (IRVING PARK RD) AT WISE RD / GEORGETOWN AVE
77	1976	IL RTE 19 (IRVING PARK RD) AT MERCURY DR
78	1965	IL RTE 19 (IRVING PARK RD) AT SPRING RD
79	21710	IL RTE 19 (IRVING PARK RD) AT IL 390 FRONTAGE RD WEST
80	21709	IL RTE 19 (IRVING PARK RD) AT IL 390 FRONTAGE RD EAST
81	7635	IL RTE 19 (IRVING PARK RD) AT RODENBURG RD
82	7637	IL RTE 19 (IRVING PARK RD) AT WRIGHT BLVD
83	3	SPRINGINSGUTH RD AT WESTBOUND FRONTAGE RD
84	6	SPRINGINSGUTH RD AT EASTBOUND FRONTAGE RD
85	2	RODENBURG RD AT WESTBOUND FRONTAGE RD
86	5	RODENBURG RD AT EASTBOUND FRONTAGE RD
87	4	WRIGHT BLVD AT WESTBOUND FRONTAGE RD
88	7	WRIGHT BLVD AT EASTBOUND FRONTAGE RD

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GANDHI AND ASSOCIATES, INC. ENGINEERS AND PLANNERS	
6035 N. NORTHBEST HIGHBAY SUITE 306 CHICAGO, ILLINOIS 60631 TEL.(773)774-5910	PL
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LOCATION MAP							SECTION	COUNTY	SHEETS	NO.
(SHEET 2 OF 2)						VAR	2023 TRAFFIC 02	VARIOUS	306	5
(SILLI Z OI Z)								CONTRACT	NO. 6	2T54
SCALE: N.T.S.	SHEET NO.	OF	SHEETS	STA.	TO STA.	FED. R	OAD DIST. NO ILLINOIS FED. A	ID PROJECT		

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				80% FED 20% STATE COOK COUNTY	80% FED 20% STATE DUPAGE COUNTY	100% VILLAGE OF SCHAUMBURG
CODE			TOTAL	INTERCONNECT	INTERCONNECT	INTERCONNECT
NO.	ITEM	UNIT	QUANTITY	0021	0021	0021
NO.			QUANTITI	URBAN	URBAN	URBAN
28000400	PER IMETER EROS ION BARR I ER	FOOT	400	400		
66900200	NON-SPECIAL WASTE DISPOSAL	CU YD	35	35		
66900530	SOIL DISPOSAL ANALYSIS	EACH	5	5		
			٠			
66901001	REGULATED SUBSTANCES PRE-CONSTRUCTION PLAN	L SUM	1	1		
66901003	REGULATED SUBSTANCES FINAL CONSTRUCTION REPORT	L SUM	1	1		
66901006	REGULATED SUBSTANCES MONITORING	CAL DA	5	E		
60901006	REGULATED SUBSTANCES MUNITURING	CALDA	5	5		
67100100	MOBILIZATION	L SUM	1	0.75	0.25	
		1			,	
70102625	TRAFFIC CONTROL AND PROTECTION, STANDARD 701606	L SUM	1	0.75	0.25	
70102630	TRAFFIC CONTROL AND PROTECTION, STANDARD 701601	L SUM	1	0.75	0.25	
		3				
70102635	TRAFFIC CONTROL AND PROTECTION, STANDARD 701701	L SUM	1	0.75	0.25	
70102640	TRAFFIC CONTROL AND PROTECTION, STANDARD 701801	L SUM	1	0.75	0.25	
81028200	UNDERGROUND CONDUIT, GALVANIZED STEEL, 2" DIA.	FOOT	5,183	5,183		
01020200	STABLICATION OF CONTROL OF CLUB, 2 DIVIN	1001	0,100	6,165		
81028240	UNDERGROUND CONDUIT, GALVANIZED STEEL, 4" DIA.	FOOT	546	546		
81400100	HANDHOLE	EACH	12	12		
85000200	MAINTENANCE OF EXISTING TRAFFIC SIGNAL INSTALLATION	EACH	88	67	8	13

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DEPARTMENT OF TRANSPORTATION

	SUMMARY OF QUANTITIES (SHEET 1 OF 4)							SECTION	COUNTY	TOTAL SHEETS	SHEET NO.
								2023 TRAFFIC 02	VARIOUS	306	6
			(31	LLI I OI	וד		1		CONTRAC	T NO. 6	2T54
	SCALE: N.T.S.	SHEET NO.	OF	SHEETS	STA.	TO STA.	FED. ROA	D DIST. NO ILLINOIS FED.	AID PROJECT		

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					CONSTRUCTION CODE	
				80% FED 20% STATE COOK COUNTY	80% FED 20% STATE DUPAGE COUNTY	100% VILLAGE OF SCHAUMBURG
CODE			TOTAL	INTERCONNECT	INTERCONNECT	INTERCONNECT
NO.	ITEM	UNIT	QUANTITY	0021	0021	0021
			90/111111	URBAN	URBAN	URBAN
87300925	ELECTRIC CABLE IN CONDUIT, TRACER, NO. 14 1C	FOOT	181,903	175,758		6,145
				,		-,
87900200	DRILL EXISTING HANDHOLE	EACH	12	12		
88500100	INDUCTIVE LOOP DETECTOR	EACH	159	133	26	
			_	_	_	
89501250	RELOCATE EXISTING TRAFFIC SIGNAL EQUIPMENT	EACH	9	7	2	
89501410	RELOCATE EXISTING EMERGENCY VEHICLE PRIORITY SYSTEM, PHASING UNIT	EACH	12	11	1	
69501410	RELOCATE EXISTING EMERGENCT VEHICLE PRIORITY STSTEM, PRASING UNIT	EACH	12	11	'	
89502300	REMOVE ELECTRIC CABLE FROM CONDUIT	FOOT	300,163	288,363		11,800
				,		,
89502350	REMOVE AND REINSTALL ELECTRIC CABLE FROM CONDUIT	FOOT	1,064	1,064		
9						
89502375	REMOVE EXISTING TRAFFIC SIGNAL EQUIPMENT	EACH	76	62	8	6
3			8			
X0324599	ROD AND CLEAN EXISTING CONDUIT	FOOT	107,866	103,566		4,300
X0327616	MAINTAINING ITS DURING CONSTRUCTION	CAL MO	2	2		
X1400102	OUTDOOR RATED NETWORK CABLE	FOOT	6,016	4,765	1,038	213
X1400215	REMOTE CONTROLLED VIDEO SYSTEM	EACH	33	27	5	1
			_			
X1400216	LAYER II (DATALINK) SWITCH	EACH	77	56	7	14
X1400217	TERMINATE FIBER IN CABINET	EACH	1,308	996	108	204
A1400211		LAGIT	1,000	330	100	204
X1400219	SPLICE FIBER IN CABINET	EACH	384	294	36	54
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	(SHEET 2 OF 4)							2023 TRAFFIC 02	VARIOUS	306	7
١.		(SHELL 2 01 4)							CONTRAC	T NO. 6	2T54
	SCALE: N.T.S. SHEET NO. OF SHEETS STA. TO STA.				FED. ROAD D	DIST. NO [ILLINOIS FED. A	ID PROJECT				

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				80% FED 20% STATE COOK COUNTY	80% FED 20% STATE DUPAGE COUNTY	100% VILLAGE OF SCHAUMBURG
CODE			TOTAL	INTERCONNECT	INTERCONNECT	INTERCONNECT
NO.	ITEM	UNIT	QUANTITY	0021	0021	0021
NO.			QUANTITI	URBAN	URBAN	URBAN
,		4 20 19				
X1400221	UPGRADE EXISTING CONTROLLER TO NTCIP SPECIAL	EACH	31	24		7
X1400305	FIBER OPTIC PATCH PANEL, 144 PORT, RACK MOUNT	EACH	1	1		
X1400460	LAYER III (NETWORK) SWITCH	EACH	8	6	1	1
X6700407	ENGINEER'S FIELD OFFICE, TYPE A (D1)	CAL MO	12	12		
X8101100	UNDERGROUND CONDUIT, MULTI-DUCT, 7-16MM MICRODUCTS	FOOT	9,459	9,459		
X8570215	FULL-ACTUATED CONTROLLER IN EXISTING CABINET	EACH	27	17	4	6
					_	
X8570226	FULL-ACTUATED CONTROLLER AND TYPE IV CABINET, SPECIAL	EACH	19	16	3	
X8570231	FULL-ACTUATED CONTROLLER AND TYPE V CABINET, SPECIAL	EACH	1	1		
X8620200	UNINTERRUPTABLE POWER SUPPLY, SPECIAL	EACH	16	13	3	
X8710029	FIBER OPTIC CABLE 24 FIBERS, SINGLE MODE	FOOT	48,039	41,894		6,145
X8710030	FIBER OPTIC CABLE 48 FIBERS, SINGLE MODE	FOOT	131,607	115,896	15,711	
X8710039	FIBER OPTIC CABLE 144 FIBERS, SINGLE MODE	FOOT	12,202			12,202
Z0010688	CAMERA MOUNTING ASSEMBLY	EACH	20	16	4	
Z0030850	TEMPORARY INFORMATION SIGNING	SQ FT	464	412	52	
Z0033052				_		
	COMMUNICATIONS VAULT	EACH	5	5		

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STATE OF ILLINOIS
DEPARTMENT OF TRANSPORTATION

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		SU	MMAI	RY OF QU	ANTITIES	3	F.A RTE.	SECTION	COUNTY	TOTAL SHEETS	SHEET NO.
		(SHEET 3 OF 4)							VARIOUS	306	8
Į	(31111 3 01 4)								CONTRACT	T NO. 6	32T54
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					80% FED 20% STATE	80% FED 20% STATE	100% VILLAGE OF SCHAUMBURG
Г					COOK COUNTY	DUPAGE COUNTY	INTERCONNECT
	CODE	ITCM		TOTAL	INTERCONNECT	INTERCONNECT	INTERCONNECT
	NO.	ITEM	UNIT	QUANTITY	0021	0021	0021
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ł	Z0033056	OPTIMIZE TRAFFIC SIGNAL SYSTEM	EACH	3	3		
ł				į.			
	X8101092	UNDERGROUND CONDUIT, MULTI-DUCT, 3-16MM MICRODUCTS	FOOT	313	313		
Ì							
	<b>X</b> 8 <b>7</b> 10049	POWER OVER ETHERNET EXTENDER	EACH	5	4	1	
-							
	X8620310	REMOVE AND REPLACE BATTERIES FOR UNINTERRUPTABLE POWER SUPPLY	EACH	27	25	2	
+	V0228020	CENTRACS LICENSE EXPANSION	FACIL	66	F2		12
	AU328020	CENTRACS LICENSE EXPANSION	EACH	66	53		13
	X1400514	TACTICS LICENSE EXPANSION	EACH	16	8	8	
ŀ							
t	X1400512	FIBER OPTIC INTERCONNECT CENTER, 24 PORT	EACH	21	15		6
-	X1400513	FIBER OPTIC INTERCONNECT CENTER, 48 PORT	EACH	61	47	7	7
ا ہے	.9						
Ø		TRAINEES TRAINING PROGRAM CRADUATE	HOURS		500		
Ø	<b>Z0076</b> 604	TRAINEES -TRAINING PROGRAM GRADUATE	HOURS	500	500		
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STATE OF ILLINOIS **DEPARTMENT OF TRANSPORTATION** 

SUMMARY OF QUANTITIES (SHEET 4 OF 4) SCALE: N.T.S. | SHEET NO. OF SHEETS | STA. TO STA.

CONSTRUCTION CODE

| Ø 0042 | COUNTY | TOTAL | SHEET | SHEETS | NO. | VARIOUS | 306 | 9 | CONTRACT | NO. 62754 F.A. SECTION
VAR | 2023 TRAFFIC 02 FED. ROAD DIST. NO. \_ ILLINOIS FED. AID PROJECT

# TRAFFIC SIGNAL LEGEND

(NOT TO SCALE)

				(NOT TO SCALE)				
<u>LTEM</u>	EXISTING	PROPOSED	ITEM	EXISTING	PROPOSED	<u>ITEM</u>	EXISTING	PROPOSED
CONTROLLER CABINET	$\boxtimes$		HANDHOLE -SOUARE			SIGNAL HEAD -(P) PROGRAMMABLE SIGNAL HEAD	R Y	R R Y
COMMUNICATION CABINET	ECC	СС	-ROUND HEAVY DUTY HANDHOLE					GG
MASTER CONTROLLER	EMC	MC	-SOUARE -ROUND	H ®	⊞ ⊕			<b>4</b> 7 <b>4</b> 7 <b>4</b> 6 <b>9 9</b>
MASTER MASTER CONTROLLER	EMMC	ммс	DOUBLE HANDHOLE			SIGNAL HEAD WITH BACKPLATE		
UNINTERRUPTABLE POWER SUPPLY	<b>3</b>	<b>3</b>	JUNCTION BOX		0	-(P) PROGRAMMABLE SIGNAL HEAD -(RB) RETROREFLECTIVE BACKPLATE		$\begin{bmatrix} R \\ Y \\ G \end{bmatrix}$ $\begin{bmatrix} R \\ Y \\ G \end{bmatrix}$ $\begin{bmatrix} R \\ Y \\ G \end{bmatrix}$
SERVICE INSTALLATION -(P) POLE MOUNTED	-D- <sup>P</sup>	- <b>■</b> -P	RAILROAD CANTILEVER MAST ARM	$X \longrightarrow X \longrightarrow X$	I <del>ci I</del>			<b>4 4 4 4 4 4 4 4 4 4</b>
SERVICE INSTALLATION			RAILROAD FLASHING SIGNAL	<del>∑O</del> ∑	X+X		P RB	P RB
-(G) GROUND MOUNTED -(GM) GROUND MOUNTED METERED	$\boxtimes^G \boxtimes^{GM}$	<b>⊠</b> <sup>G</sup> <b>⊠</b> <sup>GM</sup>	RAILROAD CROSSING GATE	<del>≥0≥</del>	X+X-	PEDESTRIAN SIGNAL HEAD		
TELEPHONE CONNECTION	ET	T	RAILROAD CROSSBUCK	否	*	AT RAILROAD INTERSECTIONS	透	Ā
STEEL MAST ARM ASSEMBLY AND POLE	0	•—	RAILROAD CONTROLLER CABINET		P∢	PEDESTRIAN SIGNAL HEAD WITH COUNTDOWN TIMER	© C	<b>₽</b> C <b>★</b> D
ALUMINUM MAST ARM ASSEMBLY AND POLE	0		UNDERGROUND CONDUIT (UC), GALVANIZED STEEL			W 8 500 158		3.500.00
STEEL COMBINATION MAST ARM ASSEMBLY AND POLE WITH LUMINAIRE	o; <u>x</u> —	•*	TEMPORARY SPAN WIRE, TETHER WIRE, AND CABLE	-		ILLUMINATED SIGN "NO LEFT TURN"/"NO RIGHT TURN"		<b>9</b>
SIGNAL POST -(BM) BARREL MOUNTED - TEMPORARY	0	● BM	SYSTEM ITEM INTERSECTION ITEM	S	SP IP	NUMBER OF CONDUCTORS, ELECTRIC CABLE NO. 14, UNLESS NOTED OTHERWISE, ALL DETECTOR LOOP CABLE TO BE SHIELDED	<u> </u>	
WOOD POLE	$\otimes$	Θ	REMOVE ITEM	1	r R	GROUND CABLE IN CONDUIT.	- (1*6)	(1 <del>*</del> 6)
GUY WIRE	>-	>-	RELOCATE ITEM		RL	NO. 6 SOLID COPPER (GREEN)		
SIGNAL HEAD	>	-	ABANDON ITEM		Α	ELECTRIC CABLE IN CONDUIT, TRACER NO. 14 1/C	<u>—</u>	-1-
SIGNAL HEAD WITH BACKPLATE	+I> P P	+ <b>►</b> P P	CONTROLLER CABINET AND FOUNDATION TO BE REMOVED		RCF	COAXIAL CABLE	<u>—</u> ©́—	—©—
SIGNAL HEAD OPTICALLY PROGRAMMED FLASHER INSTALLATION	-D' +D'	F FS	MAST ARM POLE AND FOUNDATION TO BE REMOVED		RMF	VENDOR CABLE	<del>_</del>	
-(FS) SOLAR POWERED	or or s	F FS	SIGNAL POST AND FOUNDATION TO BE REMOVED		RPF	COPPER INTERCONNECT CABLE, NO. 18, 3 PAIR TWISTED, SHIELDED	<u>6#13</u>	——————————————————————————————————————
PEDESTRIAN SIGNAL HEAD	-0	-1	DETECTOR LOOP, TYPE I	ПО		FIBER OPTIC CABLE -NO. 62.5/125, MM12F		
PEDESTRIAN PUSH BUTTON -(APS) ACCESSIBLE PEDESTRIAN PUSH BUTTON			PREFORMED DETECTOR LOOP	$\begin{bmatrix} \hat{P} \end{bmatrix}$ $\begin{pmatrix} \hat{P} \end{pmatrix}$	P P	-NO. 62.5/125, MM12F SM12F -NO. 62.5/125, MM12F SM24F		
RADAR DETECTION SENSOR	R	R	SAMPLING (SYSTEM) DETECTOR	$[\underline{s}]$ $(\underline{s})$	s s			
VIDEO DETECTION CAMERA	<b>₽</b>	<b>▽</b>	INTERSECTION AND SAMPLING (SYSTEM) DETECTOR	$[\underline{i}\underline{s}]$ $(\underline{i}\underline{s})$	IS (S)	CDOLLAD DOD		6 W B 6
RADAR/VIDEO DETECTION ZONE			QUEUE AND SAMPLING (SYSTEM) DETECTOR	(05) (05)	os (os	GROUND ROD -(C) CONTROLLER -(M) MAST ARM	* * * * *	$\stackrel{\stackrel{\scriptscriptstyle \perp}{}^{\scriptscriptstyle C}}{\bar{\uparrow}}^{\scriptscriptstyle C} \stackrel{\stackrel{\scriptscriptstyle \perp}{}^{\scriptscriptstyle M}}{\bar{\uparrow}}^{\scriptscriptstyle P} \stackrel{\stackrel{\scriptscriptstyle \perp}{}^{\scriptscriptstyle S}}{\bar{\uparrow}}^{\scriptscriptstyle S}$
PAN, TILT, ZOOM (PTZ) CAMERA	PTZ	PTZ	WIRELESS DETECTOR SENSOR	0	<b>®</b>	-(P) POST -(S) SERVICE		
EMERGENCY VEHICLE LIGHT DETECTOR	8	₩	WIRELESS ACCESS POINT					
CONFIMATION BEACON	o-0	н						
WIRELESS INTERCONNECT	o <del>-11  </del>	• <del>••   </del>						
WIRELESS INTERCONNECT RADIO REPEATER	ERR	RR						

<b>9</b>	GANDHI AND ASSOCIATES, INC. ENGREES AND PLANERS GOUS IN CONTINUES I NORTHWEST INCHIAY SUITE DOS CHICAGO, ILLINOIS 60631 TEL.(773)774-5910	


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STATE OF ILLINOIS	
DEPARTMENT OF TRANSPORTATION	


			DIS	TRICT O	VE		F.A RTE.	SECTION	COUNTY	TOTAL SHEETS	SHEET NO.
						DETAILS	VAR	2023 TRAFFIC 02	VARIOUS	306	10
	OTANDAND MATTIC CIGINAL DECIGIO DETAILO							TS-05	CONTRACT	NO. 6	2T54
	SHEET	NO.	OF	SHEETS	STA.	TO STA.		ILLINOIS FED. A	D PROJECT		

- 2. THE NUMBER OF LOOP TURNS SHALL BE AS RECOMMENDED BY THE AMPLIFIER MANUFACTURER. ALL ADJACENT SIDES OF THE LOCPS SHALL BE INSTALLED IN SUCH A WAY THAT THE CURRENT FLOW IS IN THE SAME DIRECTION TO REINFORCE ITS MAGNETIC FIELDS FOR SMALL VEHICLE DETECTION.
- 3. EACH LOOP LEAD-IN SHALL BE IDENTIFIED AND PERMANENTLY TAGGED IN THE HANDHOLE. EACH LEAD-IN CABLE TAG SHALL INDICATE THE LOCATION OF THE LOOP, LOOP ROTATION (CLOCKWISE/COUNTERCLOCKWISE), LOOP LEAD-IN DIRECTION (IN OR OUT), LOOP CABLE NUMBER AND LOCATION IN CABINET, AND NUMBER OF TURNS IN THE DETECTOR LOOPS IN WATER PROOF INK AS INDICATED ON THE DISTRICT 1 STANDARD TRAFFIC SIGNAL DESIGN DETAIL. THE CONTRACTOR SHALL MARK LOOP LOCATIONS ON RECORD DRAWINGS AND PRESENT TO THE ENGINEER AFTER FINAL INSPECTION. LOOPS SHALL BE MARKED BY LANE AND LOOP NUMBER. SEE DETAIL BELOW.
- 4. ALL LOOP CABLE SHALL BE FASTENED WITH PLASTIC TIE WRAP TO THE HANDHOLE HOOKS.
- 5. IN ASPHALT PAVEMENT, LOOPS SHOULD BE PLACED IN THE BINDER AND DIVEHOLES MARKED AT THE CURB WITH A SAW-CUT. THE SAW-CUT SHALL BE CUT IN ACCORDANCE WITH LOCAL AND E.P.A. DUST CONTROL REQUIREMENTS. DETECTOR LOOP(S) SHALL NOT BE INSTALLED IN WET CONDITIONS AND THE SAW-CUTS MUST BE FREE OF DEBRIS AND RESIDUE SUCH AS DUST AND WATER WHICH IS TO BE ACHIEVED BY THE USE OF COMPRESSED AIR, WIRE BRUSHING AND HEAT DRYING ACCORDING TO SEALANT MANUFACTURER REQUIREMENTS. THE DETECTOR WIRE SHALL BE HELD IN PLACE BY THE USE OF FORM WEDGES. WEDGES SHALL BE SPACED NO MORE THAN 18" (450 mm) APART.
- 6. LOOP SPLICES SHALL BE SOLDERED USING A SOLDERING IRON. BLOW TORCHES OR OTHER DEVICES WHICH OXIDIZE COPPER CABLE SHALL NOT BE ALLOWED FOR SOLDERING OPERATIONS. SEE DETAIL BELOW RIGHT.
- 7. PREFORMED DETECTOR LOOPS SHALL BE USED, AS SHOWN ON THE PLANS, WHERE NEW CONCRETE PAVEMENT IS PROPOSED. THE INSTALLATION OF PREFORMED LOOPS SHALL BE IN ACCORDANCE WITH THE DISTRICT 1 SPECIFICATIONS OR AS DIRECTED BY THE ENGINEER.

### LOOP LEAD-IN CABLE TAG

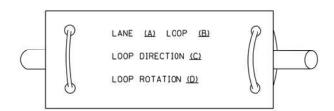



- A. LANE 1 IS THE LANE CLOSEST TO THE CENTERLINE OF THE ROADWAY
- B. LOOP "1 IS THE LOOP IN THE LANE CLOSEST TO THE INTERSECTION.
- C. LABEL LOOP CABLE "IN" OR LOOP CABLE "OUT".
- D. LABEL LOOP CABLE CLOCKWISE OR LOOP CABLE COUNTERCLOCKWISE.

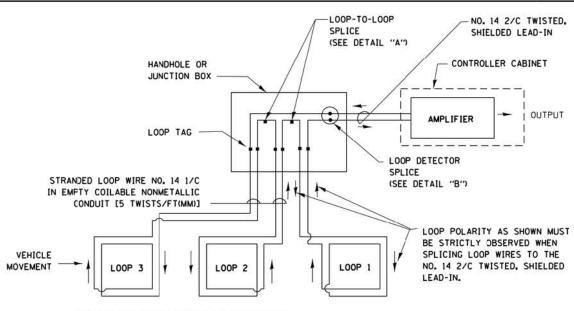

#### **DETECTOR LOOP WIRING SCHEMATIC**

- . LOOPS SHALL BE SPLICED IN SERIES.
- SAW-CUTS SHALL BE A MINIMUM WIDTH OF 5/16" (8 mm).
- SAW-CUT DEPTHS SHALL BE 3" (75 mm). IF IN CONCRETE,
   THE SAW-CUT DEPTH SHALL BE TO THE TOP OF THE REINFORCEMENT.
- LOOP CORNERS SHALL BE DRILLED WITH A 2" (50 mm) DIAMETER CORE.

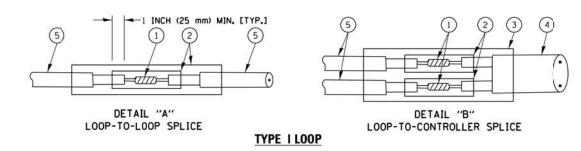

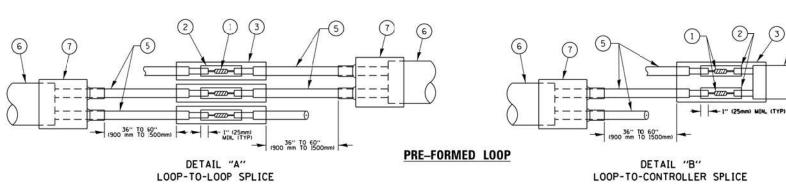

#### LOOP DETECTOR SPLICE

- 1 WESTERN UNION SPLICE SOLDERED WITH ROSIN CORE FLUX. ALL EXPOSED SURFACES OF THE SOLDER SHALL BE SMOOTH. THE WESTERN UNION SPLICES SHALL BE STAGGERED.
- (2) WCSMW 30/100 HEAT SHRINK TUBE, MINIMUM LENGTH 3" (75 mm), UNDERWATER GRADE.
- (3) WCS 200/750 HEAT SHRINK TUBE, MINIMUM LENGHT 6" (150 mm), UNDERWATER GRADE.


SCALE:

4 NO. 14 2/C TWISTED, SHIELDED CABLE.

- 5 LOOP CONDUCTOR WITH FLEXIBLE PLASTIC TUBE.
- 6 PRE-FORMED LOOP
- TXL POLYOLEFIN 2 CONDUCTOR
  BREAKOUT SEALS. TYCO CBR-2 OR APPROVED EQUAL


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# TRAFFIC SIGNAL MAST ARM AND SIGNAL POST MAST ARM MOUNTED SIGNALS IN EXISTING, PROPOSED OR FUTURE SIDEWALKBICYCLE PATH AREA. INTERSECTION SHOWN WITH PEDESTRIAN SIGNALS AND PEDESTRIAN PUSHBUTTON DETECTORS.

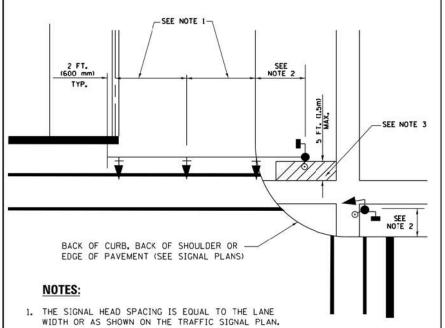


- 2. REFER TO THE TRAFFIC SIGNAL EQUIPMENT OFFSET TABLE.
- PROVIDE A LEVEL ALL-WEATHER SURFACE (CONCRETE SIDEWALK, ASPHALT BICYCLE PATH SURFACE OR MATCHING MATERIAL TO THE ADJACENT SURFACE) UP TO THE MAST ARM SHAFT OR THE SIGNAL POST
- THE FACE OF THE PEDESTRIAN PUSHBUTTON SHALL BE PARALLEL TO THE CROSSWALK TO BE USED.
- 5. THE LOCATIONS AND INSTALLATION OF PEDESTRIAN SIGNAL HEADS AND PEDESTRIAN PUSHBUTTONS SHALL MEET THE REQUIREMENTS OF THE MUTCD AND INFORMATION FOUND IN THE "AMERICANS WITH DISABILITIES ACT ACCESSIBILITY GUIDELINES FOR BUILDINGS AND FACILITIES."

# PEDESTRIAN SIGNAL POST AND PEDESTRIAN PUSH BUTTON POST

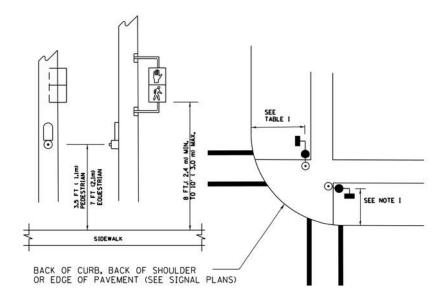

#### NOTES:

- 1. REFER TO THE TRAFFIC SIGNAL EQUIPMENT OFFSET TABLE.
- 2. PROVIDE A LEVEL ALL-WEATHER SURFACE (CONCRETE SIDEWALK, ASPHALT BICYCLE PATH SURFACE OR MATCHING MATERIAL TO THE ADJACENT SURFACE) UP TO THE PEDESTRIAN SIGNAL POST OR THE PEDESTRIAN PUSH BUTTON POST.
- THE FACE OF THE PEDESTRIAN PUSHBUTTON SHALL BE PARALLEL TO THE CROSSWALK TO BE USED.
- 4. THE LOCATIONS AND INSTALLATION OF PEDESTRIAN SIGNAL HEADS AND PEDESTRIAN PUSHBUTTONS SHALL MEET THE REQUIREMENTS OF THE MUTCD AND INFORMATION FOUND IN THE "AMERICANS WITH DISABILITIES ACT ACCESSIBILITY GUIDELINES FOR BUILDINGS AND FACILITIES."

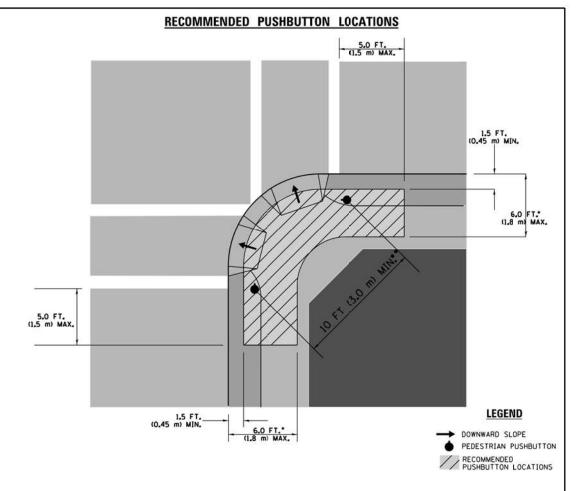

- WHERE THERE ARE CONSTRAINTS THAT MAKE IT IMPRACTICAL TO PLACE THE PEDESTRIAN PUSHBUTTON BETWEEN 1.5 FT (0.45 m) AND 6 FT ( 1.8 m) FROM THE EDGE OF THE CURB, SHOULDER, CR PAVEMENT, IT SHOULD NOT BE FURTHER THAN 10 FT (3 m) FROM THE EDGE OF CURB, SHOULDER, OR PAVEMENT.
- •• WHERE THERE ARE CONSTRAINTS ON A PARTICULAR CORNER THAT MAKE IT IMPRACTICAL TO PROVIDE THE 10 FT (3 m) SEPERATION BETWEEN THE TWO PEDESTRIAN PUSHBUTTONS. THE PUSHBUTTONS MAY BE PLACED CLOSER TOGETHER OR ON THE SAME POLE.

#### NOTES:

- 1. PEDESTRIAN SIGNAL HEADS SHALL BE MOUNTED WITH THE BOTTOM OF THE SIGNAL HOUSING INCLUDING BRACKETS NOT LESS THAN 8 FT (2.4 m) OR MORE THAN 10 FT (3 m) ABOVE SIDEWALK LEVEL, AND SHALL BE FOSITIONED AND ADJUSTED TO PROVIDE MAXIMUM VISIBILITY AT THE BEGINNING OF THE CONTROLLED CROSSWALK.
- 2. THE BOTTOM OF THE SIGNAL HOUSING (INCLUDING BRACKETS) OF A VEHICULAR SIGNAL FACE THAT IS NOT LOCATED OVER A HIGHWAY SHALL BE AT LEAST 8 FT (2.4 m) BUT NOT MORE THAN 19 FT (5.8 m) ABOVE THE SIDEWALK OR, IF THERE IS NO SIDEWALK, ABOVE THE PAVEMENT GRADE AT THE CENTER OF THE ROADWAY.
- 3. THE BOTTOM OF THE SIGNAL HOUSING AND ANY RELATED ATTACHMENTS TO A SIGNAL FACE LOCATED OVER ANY PORTION OF A HIGHWAY SHALL BE ACCORDING TO CURRENT STATE STANDARDS 877001, 877002, 877006, 877011 AND 877012 WITH A MINIMUM OF 16 FT (5.0 m) AND A MAXIMUM OF 18 FT. (5.5 m) FROM THE HIGHEST POINT OF PAVEMENT.
- 4. THE BOTTOM OF THE TEMPORARY SPAN WIRE MOUNTED SIGNAL HOUSING AND ANY RELATED ATTACHMENTS TO A SIGNAL FACE LOCATED OVER ANY PORTION OF A HIGHWAY SHALL BE ACCORDING TO CURRENT STATE STANDARD 880001 WITH A MINIMUM OF 17 FT (5.18 m) FROM THE HIGHEST POINT OF PAVEMENT.
- THE TOP OF THE SIGNAL HOUSING OF A SIGNAL FACE LOCATED OVER ANY PORTION OF A HIGHWAY SHALL NOT BE MORE THAN 25.6 FT (7.8 m) ABOVE THE PAVEMENT.

#### TRAFFIC SIGNAL EQUIPMENT OFFSET

THAT TO STORAGE ENGINEERY OF SET								
TRAFFIC SIGNAL EQUIPMENT	COMBINATION CONCRETE CURB AND GUTTER (MINIMUM DISTANCE FROM BACK OF CURB TO CENTERLINE OF FOUNDATION)	SHOULDER/NON-CURBED AREA (MINIMUM DISTANCE FROM EDGE OF PAVEMENT TO CENTERLINE OF FOUNDATION)						
TRAFFIC SIGNAL MAST ARM POLE	6 FT (1.8m)	SHOULDER WIDTH + 2 FT (0.6m), MINIMUM 10 FT (3.0m)						
TRAFFIC SIGNAL POST	4 FT (1.2m)	SHOULDER WIDTH + 2 FT (0.6m), MINIMUM 10 FT (3.0m)						
PEDESTRIAN SIGNAL POST	4 FT (1.2m)	SHOULDER WIDTH + 2 FT (0,6m), MINIMUM 10 FT (3,0m)						
PEDESTRIAN PUSHBUTTON POST	4 FT (1.2m)	SHOULDER WIDTH + 2 FT (0.6m), MINIMUM 10 FT (3.0m)						
TEMPORARY WOOD POLE	6 FT (1.8m)	SHOULDER WIDTH + 2 FT (0.6m), MINIMUM 10 FT (3.0m)						
CONTROLLER CABINET	6 FT (1.8m) MINIMUM DISTANCE SEE NOTE 2	SHOULDER WIDTH + 6 FT (1.8m), MINIMUM 16 FT (4.9m) SEE NOTE 3.						
SERVICE INSTALLATION, GROUND MOUNT	6 FT (1.8m) MINIMUM DISTANCE SEE NOTE 2	SHOULDER WIDTH + 6 FT (1.8m), MINIMUM 16 FT (4.9m) SEE NOTE 3.						

#### NOTES:


- CONTACT THE "AREA TRAFFIC SIGNAL MAINTENANCE AND OPERATIONS ENGINEER" FOR ASSISTANCE IN LOCATING THE TRAFFIC SIGNAL EQUIPMENT WHEN THERE ARE CONFLICTS WITH DITCHES OR THE MINIMUM OFFSET DISTANCES CANNOT BE MET.
- 2. MINIMUM DISTANCE FROM THE BACK OF CURB TO THE ROADWAY SIDE OF THE FOUNDATION.
- 3. MINIMUM DISTANCE FROM THE EDGE OF PAVEMENT TOTHE ROADWAY SIDE OF THE FOUNDATION.
- 4. ANY CHANGES TO THE OFFSETS OF THE FOUNDATIONS, FROM THE MINIMUM DISTANCES LISTED IN THE "TRAFFIC SIGNAL EQUIPMENT OFFSET" CHART AND THE TRAFFIC SIGNAL INSTALLATION PLAN, COULD EFFECT THE PLACEMENT OF THE SIGNAL HEADS, PEDESTRIAN SIGNAL HEADS AND THE PEDESTRIAN PUSHBUTTONS. THE SIGNAL HEAD PLACEMENT ON THE MAST ARMS SHALL REMAIN AS PER THE TRAFFIC SIGNAL INSTALLATION PLAN AND THE "TRAFFIC SIGNAL MAST ARM AND SIGNAL POST" DETAIL ABOVE. THE PROFOSED MAST ARM LENGTHS MAY NEED TO BE REVISED TO MEET THE ABOVE REQUIREMENTS. THE PEDESTRIAN SIGNAL HEADS AND PEDESTRIAN PUSHBUTTONS MUST MEET THE REQUIREMENTS UNDER THE DETAILS ON THIS SHEET.

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# STATE OF ILLINOIS DEPARTMENT OF TRANSPORTATION

DISTRICT ONE				F.A RTE.	SECTION	COUNTY	TOTAL SHEETS	SHEET NO.		
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	OTANDAND MATTIC CIGNAL DESIGN DETAILS						TS-05	CONTRACT	NO. 6	2T54
	SHEET NO.	OF	SHEETS	STA.	TO STA.	ILLINOIS FED. AID PROJECT				



**DEPARTMENT OF TRANSPORTATION** 
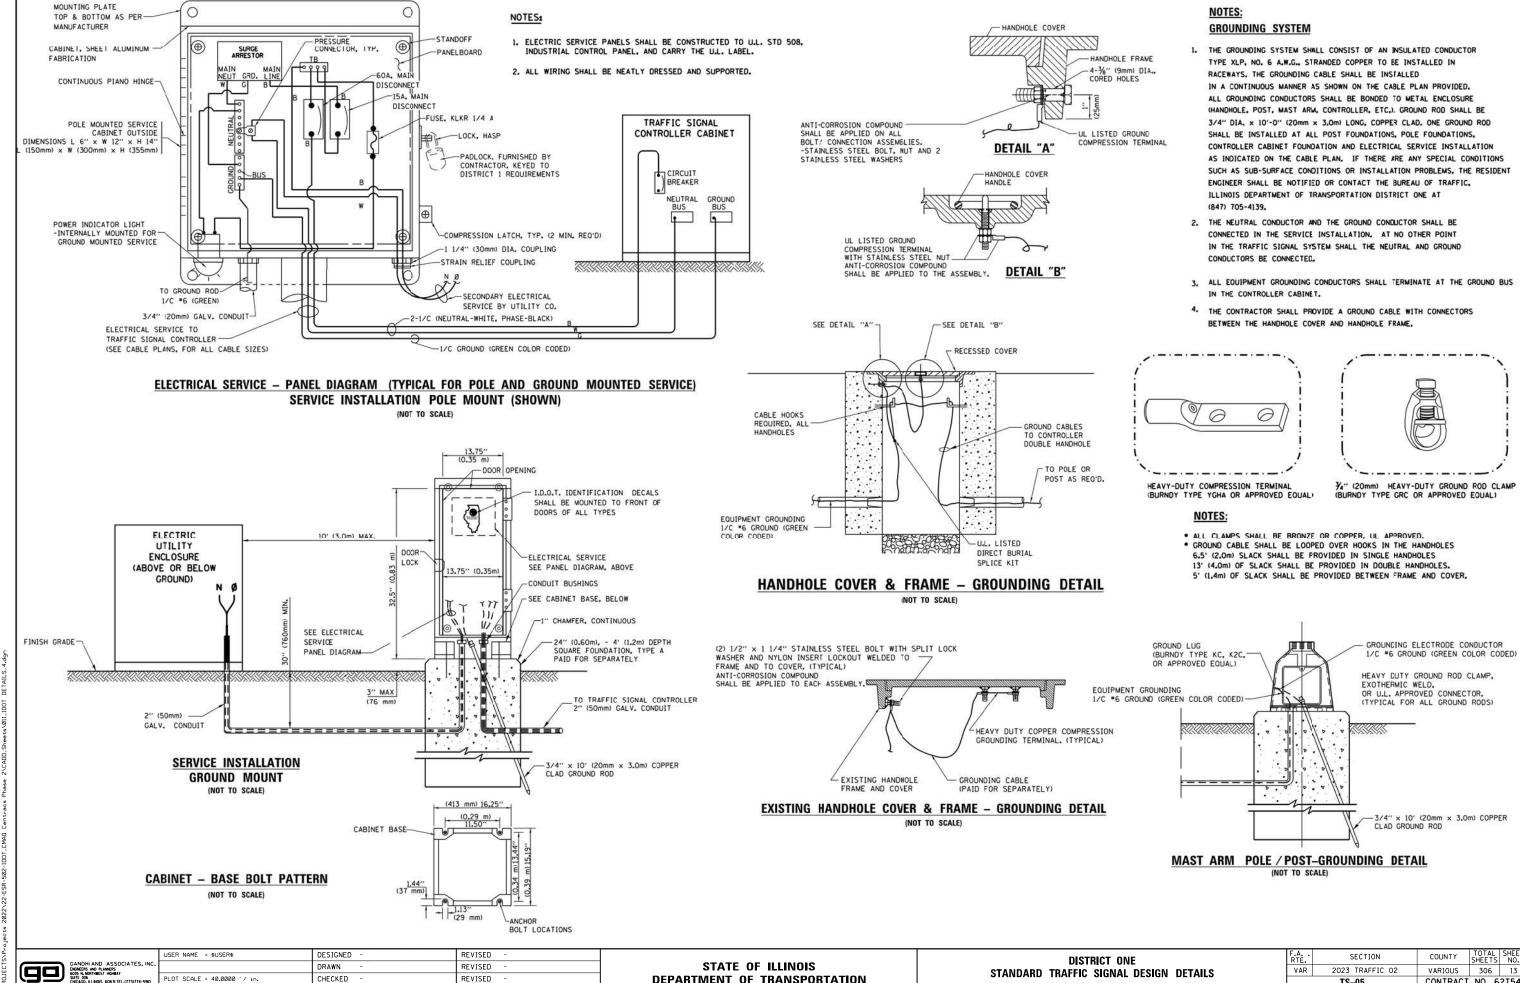
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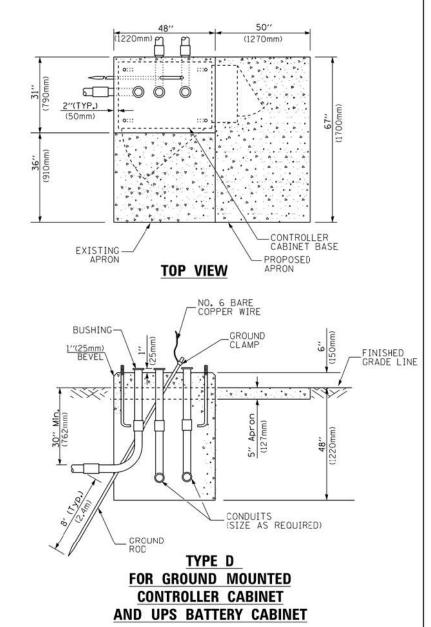
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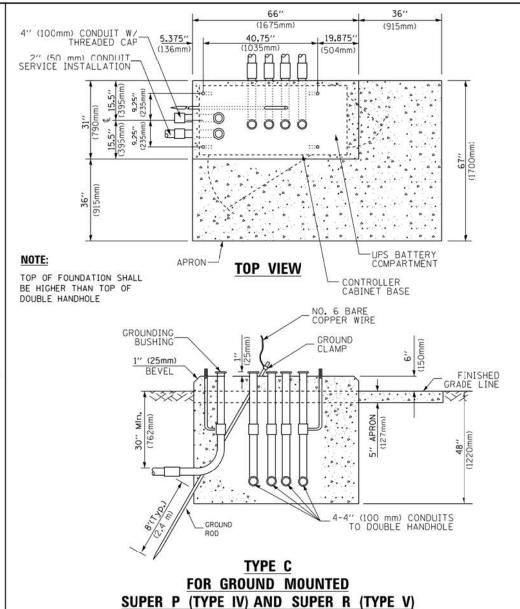
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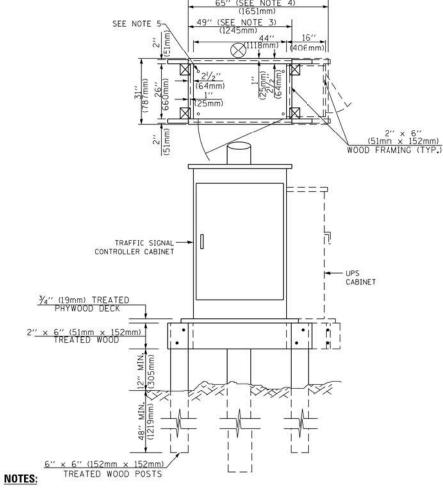
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**CONTROLLER CABINETS** 



- BASED ON CONTROLLER CABINET TYPE IV WITH BASE DIMENSIONS OF 26" x 44" (660mm x 1118mm).
   ADJUST PLATFORM SIZE TO FIT CABINET BASE DIMENSIONS BEING SUPPLIED
- BASED ON UNINTERRUPTIBLE POWER SUPPLY CABINET WITH BASE DIMENSIONS OF 16" x 25" (406mm x 635mm).
   ADJUST PLATFORM SIZE TO FIT CABINET BASE DIMENSIONS BEING SUPPLIED.
- 3. PLATFORM SIZE FOR CONTROLLER CABINET TYPE IV.
- 4. PLATFORM SIZE FOR CONTROLLER CABINET TYPE IV AND UNINTERRUPTIBLE POWER SUPPLY CABINET.
- 5. DRILLED HOLES THROUGH THE PLATFORM BASE TO MATCH THE CONTROLLER CABINET BOLT TEMPLATE. FASTEN THE CONTROLLER CABINET TO THE PLATFORM WITH CARRIAGE BOLTS, WASHERS AND NUTS.
- 6. FASTEN ALL SUPPORT WOOD FRAMING TO THE WOOD POSTS WITH 2 LAG SCREWS FOR EACH CONNECTION.

## TEMPORARY SIGNAL CONTROLLER WOOD SUPPORT PLATFORM

CABLE SLACK LENGTH	FEET	METER
HANDHOLE	6.5	2.0
DOUBLE HANDHOLE	13.0	4.0
SIGNAL POST	2.0	0.6
MAST ARM	2.0	0.6
CONTROLLER CABINET	1.5	0.5
FIBER OPTIC AT CABINET	13.0	4.0
ELECTRIC SERVICE AT (CABINET OR SERVICE LOCATION)	1.5	0.5
GROUND CABLE (SIGNAL POST, MAST ARM, CABINET)	1.5	0.5
GROUND CABLE (BETWEEN FRAME AND COVER)	5.0	1.6

VERTICAL CABLE LENGTH	FEET	METER
MAST ARM POLE ( MAST ARM MOUNTED SIGNAL HEAD) (L = MAST ARM LENGTH - DISTANCE TO SIGNAL HEAD FROM END OF ARM)	20.0+L	6.0+L
BRACKET MOUNTED (MAST ARM POLE OR SIGNAL POLE)	13.0	4.0
PEDESTRIAN PUSH BUTTON	6.0	2.0
SERVICE INSTALLATION POLE MOUNT TO SERVICE DROP	13.5	4.1
SERVICE INSTALLATION POLE MOUNT TO GROUND	13.5	4.1
SERVICE INSTALLATION GROUND MOUNT	6.0	2.0
FOUNDATION (SIGNAL POST, MAST ARM POLE, CONTROLLER CABINET, SERVICE-GROUND MOUNT)	3.0	1.0

#### VERTICAL CABLE LENGTH

		6.
CABLE SLACK		

FOUNDATION	DEPTH
TYPE A - Signal Post	4'-0" (1.2m)
TYPE C - CONTROLLER W/ UPS	4'-0" (1.2m)
TYPE D - CONTROLLER	4'-0" (1.2m)
SERVICE INSTALLATION, GROUND MOUNT, TYPE A - SOUARE	4'-0'' (1.2m)

#### **DEPTH OF FOUNDATION**

Mast Arm Length	① Foundation Depth	Foundation Diameter	Spiral Diameter	Quantity of Rebars	Size of Rebars
Less than 30' (9.1 m)	10'-0" (3.0 m)	30" (750mm)	24" (600mm)	8	6(19)
Greater than or equal to	13'-6" (4.1 m)	30" (750mm)	24" (600mm)	8	6(19)
30' (9.1 m) and less than 40' (12.2 m)	11'-0" (3.4 m)	36" (900mm)	30" (750mm)	12	7(22)
Greater than or equal to 40' (12.2 m) and less than 50' (15.2 m)	13'-0" (4.0 m)	36" (900mm)	30" (750mm)	12	7(22)
Greater than or equal to 50' (15.2 m) and up to 55' (16.8 m)	15'-0" (4.6 m)	36" (900mm)	30" (750mm)	12	7(22)
Greater than or equal to 56' (16.8 m) and less than 65' (19.8 m)	21'-0" (6.4 m)	42" (1060mm)	36" (900mm)	16	8(25)
Greater than or equal to 65' (19.8 m) and up to 75' (22.9 m)	25'-0" (7.6 m)	42" (1060mm)	36" (900mm)	16	8(25)

- These foundation depths are for sites which have cohesive soils (clayer silt, sandy clay, etc.) along
  the length of the shaft, with an average Unconfined Compressive Strength (Ou) > 1.0 tsf (100 kpa).
  This strength shall be verified by boring data prior to construction or with testing by the Engineer
  during foundation drilling. The Bureau of Bridges & structures should be contacted for a revised
  design if other conditions are encountered.
- 2. Combination mast arm assemblies under 55 feet (16.8 m) shall use 36" (900 mm) diameter foundations.
- 3. Combination most arm assemblies under 56 feet (16.8 m) through 75 feet (22.9 m) shall use 42" (1060 mm) diameter foundations
- 4. For most arm assemblies with dual arms refer to state standard 878001...


### DEPTH OF MAST ARM FOUNDATIONS, TYPE E

	USER
GANDHI AND ASSOCIATES, INC. ENGINEERS AND PLANNERS	
6035 N. NORTHWEST HIGHWAY Suite 306 Chicago, Illinois 60631 Tel.(773)774-5910	PLOT
	PLOT

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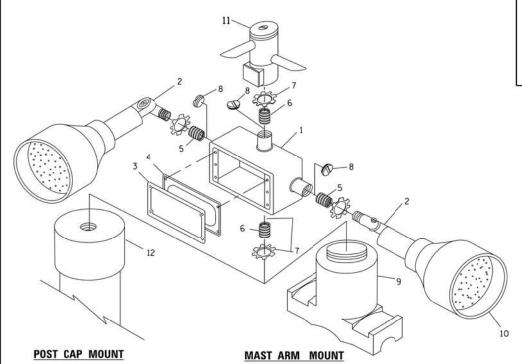
STATE OF ILLINOIS **DEPARTMENT OF TRANSPORTATION** 


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STANDARD TRAFFIC SIGNAL DESIGN		DETAILS	VAR	2023 TRAFFIC 02	VARIOUS	306	14				
OTANDAND MARTIO ONNIAL DEGICAL DETAILS						TS-05	CONTRACT	NO. 6	2T54		
	SHEET	NO.	OF	SHEETS	STA.	TO S	TA.	ILLINOIS FED. AID PROJECT			

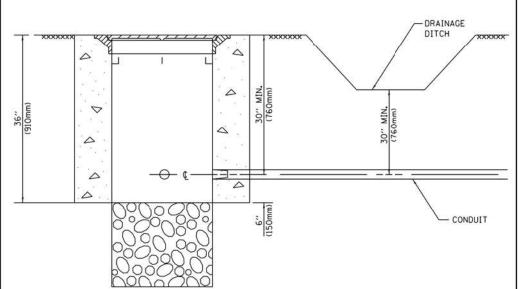


- 1. CONDUIT DEPTH SHALL BE A MINIMUM OF 30" (760mm) BELOW THE BOTTOM OF THE DRAINAGE DITCH OR ANY SLOPING GROUND
- 2. THE MINIMUM CONDUIT DEPTH APPLIES TO ALL CONDUIT PLACED UNDER ROADWAY PAVEMENT, MULTI-USE PATHS, SIDEWALKS AND SOIL SURFACES.
- 3. THE MINIMUM CONDUIT DEPTH APPLIES TO ALL HANDHOLES, HEAVY DUTY HANDHOLES AND DOUBLE HANDHOLES.

## HANDHOLE WITH MINIMUM CONDUIT DEPTH



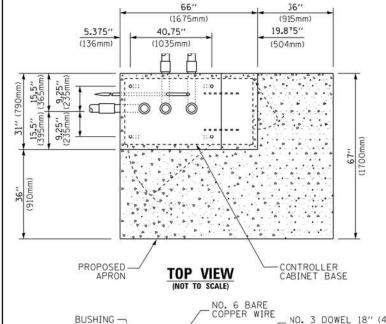

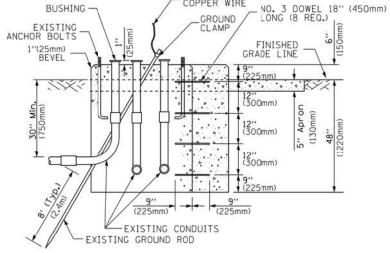


# MODIFY EXISTING TYPE "D" FOUNDATION

## TO TYPE "C" FOUNDATION IDENTIFICATION 1 OUTLET BOX- GALV. 21 CU,IN. (0.000344 CU-M) 2 LAMP HOLDER AND COVER 3 OUTLET BOX COVER RUBBER COVER GASKET REDUCING BUSHING Y4"(19 mm) CLOSE NIPPLE 3/4"(19 mm) LOCKNUT 13 mm) HOLE PLUG SADDLE BRACKET - GALV. 6 WATT PAR 38 LED FLOOD LAMP DETECTOR UNIT POST CAP [18 FT. (5.4 m) POST MIN.]

#### NOTES:


- 1. ALL ELECTRICAL ITEMS, EXCEPT ITEMS #2 AND #11 SHALL BE ALUMINUM OR
- 2. ITEM \*1- OZ/GEDNEY FSX-1-50 OR EQUIVALENT ITEM #2- MULBERRY CON-O-SHADE LAMP SHIELD OR EQUIVALENT ITEM #9- "BAND-IT" SADDLE BRACKET OR EQUIVALENT
- 3. WHEN POST MOUNTING IS SPECIFIED, ITEM \*9 SHALL NOT BE REQUIRED. THE DETECTION UNIT SHALL BE MOUNTED DIRECTLY ON TOP OF THE CAP BY DRILLING AND TAPPING A 3/4 "(19 mm) HOLE WITH PIPE THREADS. THE POST CAP SHALL EITHER BE SCREWED TO THE TOP OF THE POST OR A MINIMUM OF 3 TIGHTENING SCREWS SHALL BE REQUIRED ON EACH CAP. **EMERGENCY VEHICLE DETECTOR WITH CONFIRMATION BEACON MOUNTING DETAIL**

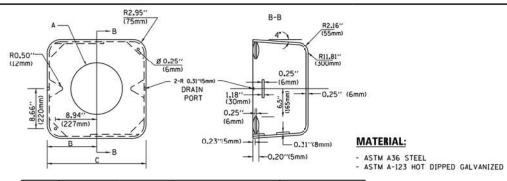

Α	В	С	HEIGHT	WEIGHT
VARIES	9.5"(241mm)	19"(483mm)	7" (178mm) - 12" (300mm)	53 lbs (24kg)
VARIES	10.75"(273mm)	21.5"(546mm)	7" (178mm) - 12" (300mm)	68 lbs (31 kg)
VARIES	13.0"(330mm)	26"(660mm)	7" (178mm) - 12" (300mm)	81 lbs (37 kg)
VARIES	18.5"(470mm)	37"(940mm)	7" (178mm) - 12" (300mm)	126 lbs (57 kg)

#### SHROUD

- DIMENSION "A" IS EQUAL TO THE DIAMETER OF THE MAST ARM POLE AT THE TOP OF THE SHROUD.
  THE SHROUD SHALL BE TIGHT TO THE MAST ARM POLE.
- 2. THE SUPPLIER SHALL VERIFIED THE ABOVE DIMENSIONS BASED ON MAST ARM REQUIREMENTS.
- 3. THE HEIGHT OF THE SHROUD SHALL COVER THE ANCHOR BOLTS, NUTS AND MAST ARM FOLE BASE.

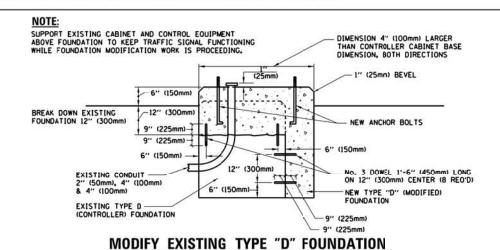

# STEEL HOOKS TO BE REMOVED EXISTING CONDUIT TO REMAIN

1. HANDHOLE CONSTRUCTED PER STATE STANDARD 814001.

ELEVATION

2. REMOVAL OF THE EXISTING CONDUIT FROM THE HANDHOLE AND THE INSTALLATION OF THE CONDUIT BUSHINGS SHALL BE INCLUDED WITH THE COST OF THE HANDHOLE.

#### HANDHOLE TO INTERCEPT EXISTING CONDUIT

GANDHI AND ASSOCIATES, INC. ENGRETS AND FLANGES GOSS A MORTHEST HORPAY SUITE JOS CHICAGO, LLINDIS 6063 TELA7731774-590	
	ı


	USER NAME = \$USER\$	DESIGNED -	REVISED -	
CIATES. INC.		DRAWN -	REVISED -	
L.(773)774-5910	PLOT SCALE = 40.0000 '/ in.	CHECKED -	REVISED -	
	PLOT DATE = \$DATE\$	DATE -	REVISED -	
				-

STATE OF ILLINOIS **DEPARTMENT OF TRANSPORTATION** 


DISTRICT ONE STANDARD TRAFFIC SIGNAL DESIGN DETAILS SHEET NO. OF SHEETS STA.


COUNTY 2023 TRAFFIC 02 VARIOUS 306 15 TS-05 CONTRACT NO. 62T54

PLAN

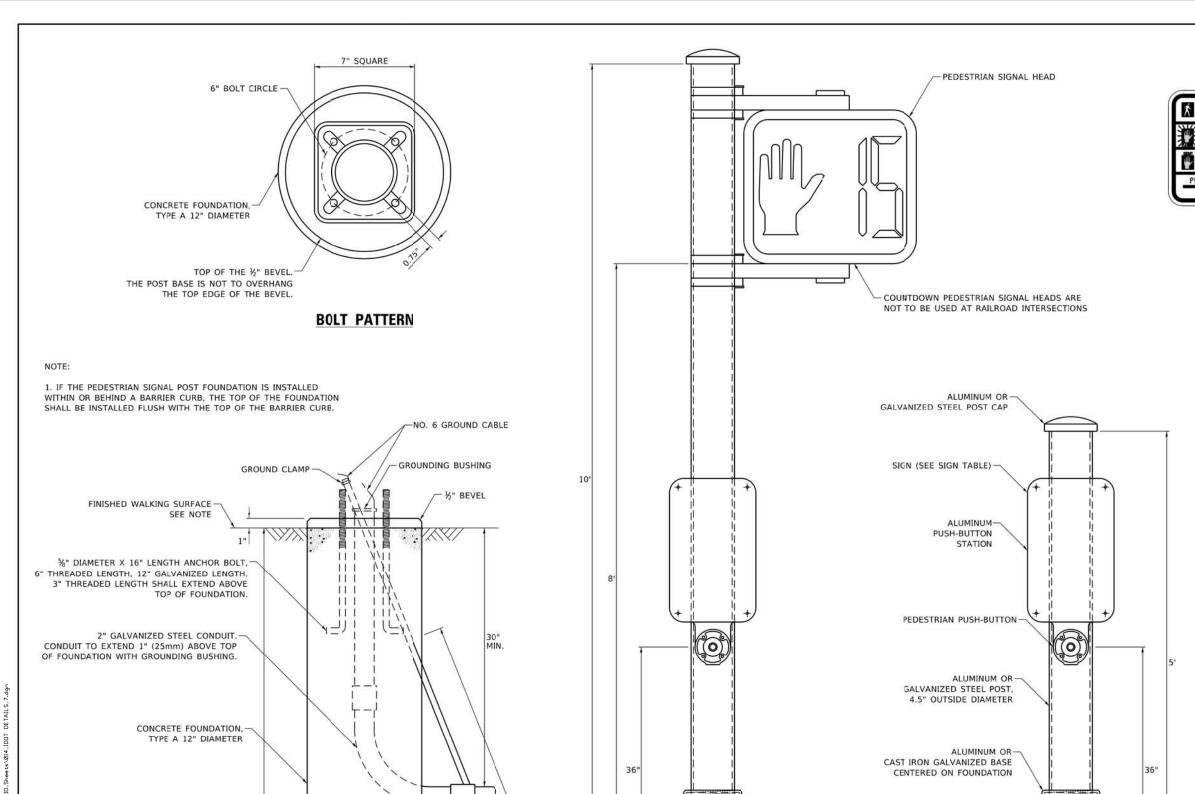

DON'T CROSS TO CROSS

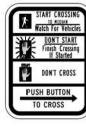

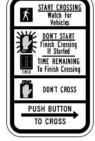

R10-3e

R10-3b

#### SIGN TABLE

R10-3d

SIGN	DIMENSIONS
R10-3b (RAILROAD ONLY)	9" X 12"
R10-3d (RAILROAD ONLY)	9" X 12"
R10-3e	9" X 15"

#### NOTES:

- 1. THE SIGN PANELS SHALL BE TYPE AP SHEETING.
- 2. THE ARROW ON SIGNS FOR PUSH-BUTTONS SERVING TWO DIRECTIONS ON THE SAME PHASE SHALL BE BI-DIRECTIONAL.
- 3. THE SIGN FOR DUAL-CALL PUSH-BUTTONS SHALL HAVE NO ARROW.

## CONCRETE FOUNDATION, TYPE A 12-INCH DIAMETER

%" DIAMETER X 10' LENGTH-

GROUND ROD

## PEDESTRIAN SIGNAL POST, 10 FT.

## PEDESTRIAN SIGNAL POST, 5 FT.

DRILLED AND TAPPED -GROUNDING HOLE

FINISHED WALKING SURFACE

		USE
	GANDHI AND ASSOCIATES, INC. ENGINEERS AND PLANNERS	
ردو	6035 N. NORTHWEST HIGHWAY SUITE 306 CHICAGO, ILLINOIS 60631 TEL.(773)774-5910	PLO
		PLO

	USER NAME = \$USER\$	DESIGNED	-	IP	REVISED	-	10/15/2020
INC.		DRAWN	-	IP	REVISED	-	
910	PLOT SCALE = 40.0000 '/ in.	CHECKED	-	LP	REVISED	-	
_	PLOT DATE = \$DATE\$	DATE	-	10/15/2018	REVISED	-	


STATE OF ILLINOIS **DEPARTMENT OF TRANSPORTATION** 


SECTION DISTRICT ONE VAR STANDARD TRAFFIC SIGNAL DESIGN DETAILS TS-05 SHEET NO. OF SHEETS STA.

2023 TRAFFIC 02 VARIOUS 306 16 CONTRACT NO. 62T54

#### SIGN PANEL - TYPE 1 OR TYPE 2

## 3.75 11.125 3.875 Sample Rd

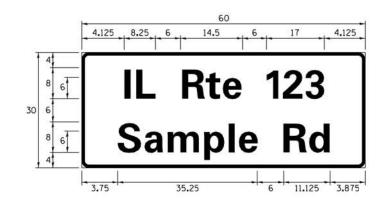

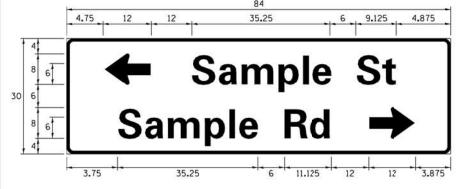

DESIGN	AREA	SIGN PANEL	SHEET ING	OTY.
SERIES	(SQ FT)	TYPE	TYPE	REQUIRED
D OR C	-	1 OR 2	7.7	23 <del>0</del> 0

ALL DIMENSIONS ARE IN INCHES EXCEPT NOTED OTHERWISE

## COMMON STREET NAME ABBREVIATIONS AND WIDTHS

NAME	ADDDEWATION	WIDTH (INCH)			
NAME	ABBREVATION	SERIES "C"	SERIES "D"		
AVENUE	Ave	15.000	18.250		
BOULEVARD	Blvd	17.125	20.000		
CIRCLE	Cir	11.125	13.000		
COURT	C+	8. 250	9.625		
DRIVE	Dr	8. 625	10.125		
HIGHWAY	Hwy	18.375	22.000		
ILLINOIS	IL	7.000	8. 250		
LANE	Ln	9. 125	10.750		
PARKWAY	Pkwy	23.375	27. 375		
PLACE	PI	7. 125	7. 750		
ROAD	Rd	9. 625	11.125		
ROUTE	Rte	12.625	14.500		
STREET	S†	8.000	9.125		
TERRACE	Ter	12.625	14.625		
TRAIL	Tr	7. 750	9.125		
UNITED STATES	US	10.375	12.250		

### **GENERAL NOTES**

- 1. WHERE MAST ARM MOUNTED STREET NAME SIGNS ARE SPECIFIED, THE MAST ARM ASSEMBLY AND POLES SHALL BE DESIGNED TO SUPPORT THE LOADINGS CALLED FOR ON STANDARDS 877001, 877002, 877006, 877011 AND 877012, AS APPLICABLE, PLUS TWO (2) SIGN PANELS 2'-6" x 8'-0" MOUNTED AS SHOWN. THE DESIGN SHALL BE IN ACCORDANCE WITH THE REQUIREMENTS OF THE CURRENT "STANDARD SPECIFICATIONS FOR STRUCTURAL SUPPORTS FOR HIGHWAY SIGNS, LUMINAIRES, AND TRAFFIC SIGNALS" AS PUBLISHED BY THE AMERICAN ASSOCIATION OF STATE HIGHWAY AND TRANSPORTATION OFFICIALS FOR 80 M.P.H. WIND VELOCITY.
- 2. ALL SIGNS SHALL CONSIST OF A WHITE LEGEND AND BORDER (TYPE ZZ SHEETING) ON A GREEN BACKGROUND (TYPE ZZ
- 3. THE SIGN LENGTH SHALL BE IN 6-INCH INCREMENTS, BUT THE OVERALL LENGTH SHALL NOT EXCEED 8'-O". ALL BORDERS SHALL BE 34" WIDE. CORNER RADIUS SHALL BE 1-7/8". THE SPACING BETWEEN THE WORDS SHOULD BE 6". IF POSSIBLE, BUT MAY BE REDUCED TO 5" WHEN SPACING IS CRITICAL. A MINIMUM OF 2-1/2" SHALL BE INCLUDED BETWEEN THE WORD AND THE RIGHT AND LEFT EDGES OF THE SIGN.
- 4. A PREFERRED METHOD FOR THE SIGN DESIGN IS TO USE SERIES "D" LETTER ON A ONE-LINE SIGN 18" IN HEIGHT AND A MAXIMUM OF 8'-0" IN WIDTH. IF SERIES "D" DOES NOT FIT ON A 8"-0" SIGN, THEN SERIES "C" SHOULD BE TRIED. IF SERIES "C" DOES NOT FIT ON A 8'-0" SIGN, A 30" HIGH TWO-LINE SIGN CAN BE USED. THE CROSSROAD DESIGNATION AS TO STREET, AVENUE, ETC. SHOULD BE SPELLED OUT ON THE SECOND LINE, IF THE ABBREVIATION CANNOT FIT ON THE FIRST LINE.
- 5. LED ILLUMINATED STREET NAME SIGNS CAN BE USED IN PLACE OF REGULAR SIGN PANELS BUT ANY SPECIAL WORDING AND SYMBOLOGY MUST BE APPROVED BY THE DEPARTMENT. GENERAL DESIGN REQUIREMENT AS LISTED ABOVE (COLOR, FONT, SIZE, ETC.) MUST BE FOLLOWED.
- 6. SIGNFIX ALUMINUM CHANNEL FRAMING SYSTEM SHALL BE USED FOR ALL SIGNS ATTACHED TO SIGNAL POLES AND

LOCAL SUPPLIERS: PARTS LISTING:

- J.O. HERBERT COMPANY, INC SIGN CHANNEL MIDLOTHIAN, VA SIGN SCREWS

WOODRIDGE, IL

PART #HPN053 (MED. CHANNEL) 1/4" × 14 × 1" H.W.H. #3 SELF TAPPING WITH NEOPRENE WASHER PART #HPN034 (UNIVERSAL)

- WESTERN REMAC, INC. BRACKETS


CHANNEL CLAMPS WITH STAINLESS STEEL STRAPPING

SCALE:


OTHER BRANDS OF MOUNTING HARDWARE ARE ACCEPTABLE, BASED UPON THE DEPARTMENT'S APPROVAL AND COMPATIBILITY WITH THE CHANNEL/BRACKET OF THE ABOVE PRODUCT.

## MOUNTING LOCATION

ARM OR POLE MOUNTED

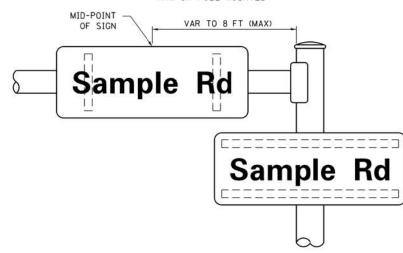

## SUPPORTING CHANNELS

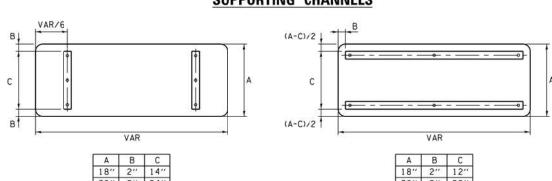

#### STANDARD ALPHABETS SPACING CHART


(8") UPPER CASE AND (6") LOWER CASE

	FHWA SEF	RIES "C"			FHWA SER	IES "D"	
CHARACTER	LEFT SPACING (INCH)	WIDTH (INCH)	RIGHT SPACING (INCH)	CHARACTER	LEFT SPACING (INCH)	WIDTH (INCH)	RIGHT SPACING (INCH)
А	0.240	5.122	0.240	А	0.240	6.804	0.240
В	0.880	4.482	0.480	В	0.960	5.446	0.400
С	0.720	4.482	0.720	С	0.800	5.446	0.800
D	0.880	4.482	0.720	D	0.960	5.446	0.800
E	0.880	4.082	0.480	E	0.960	4.962	0.400
E	0.880	4.082	0.240	F	0.960	4.962	0.240
G	0.720	4.482	0.720	G	0.800	5.446	0.800
Н	0.880	4.482	0.880	Н	0.960	5.446	0.960
I	0.880	1.120	0.880	I	0.960	1.280	0.960
J	0.240	4.082	0.880	J	0.240	5.122	0.960
K	0.880	4.482	0.480	K	0.960	5.604	0,400
L	0.880	4.082	0.240	L	0.960	4.962	0.240
М	0.880	5. 284	0.880	M	0.960	6. 244	0.960
N	0.880	4.482	0.880	N	0.960	5.446	0.960
0	0.720	4. 722	0.720	0	0.800	5.684	0.800
P	0.880	4.482	0.720	Р	0.960	5.446	0.240
0	0.720	4. 722	0.720	0	0.800	5. 684	0.800
R	0.880	4.482	0.480	R	0.960	5.446	0.400
S	0.480	4.482	0.480	S	0.400	5.446	0.400
Ţ	0.240	4.082	0.240	T	0. 240	4. 962	0. 240
U	0.880	4. 482	0.880	U	0.960	5.446	0.960
V	0.240	4.962	0.240	V	0.240	6.084	0. 240
W	0.240	6.084	0.240	W	0.240	7. 124	0. 240
X	0.240	4. 722	0.240	X	0.400	5.446	0.400
Y	0.240	5. 122	0.240	Y	0.240	6. 884	0.240
Z	0.480	4.482	0.480	Z	0.400	5.446	0.400
a	0.320	3. 842	0.640	0	0.400	4.562	0. 720
ь	0.720	4.082	0.480	ь	0.800	4.802	0.480
С	0.480	4.002	0.240	С	0.480	4. 722	0.240
d	0.480	4.082	0.720	d	0.480	4.802	0.800
е	0.480	4.082	0.320	e	0.480	4. 722	0. 320
f	0.320	2.480	0.160	f	0.320	2.882	0.160
g n	0.480	4.082	0.720	g h	0.480	4. 802	0.800
ī	0.720	1.120	0. 720	i	0.800	1.280	0. 800
j	0.000	2. 320	0.720	j	0.000	2.642	0.800
k	0.720	4. 322	0.160	k	0.800	5. 122	0.160
1	0.720	1.120	0.720	1	0.800	1.280	0.800
m	0.720	6. 724	0.640	m	0.800	7. 926	0.720
n	0.720	4. 082	0.640	n	0.800	4. 722	0. 720
0	0.480	4.082	0.480	0	0.480	4. 882	0. 480
P	0.720	4. 082	0.480	P	0.800	4. 802	0.480
q	0.480	4.082	0.720	q	0.480	4. 802	0.800
r	0.720	2.642	0.160	r	0.800	3.042	0.160
s	0. 320	3. 362	0.240	s	0.320	3. 762	0. 240
t	0.080	2.882	0.080	†	0.080	3. 202	0.080
u	0.640	4.082	0.720	u	0.720	4. 722	0.800
~	0.160	4. 722	0.160	v	0.160	5.684	0.160
w	0.160	7. 524	0.160	w	0.160	9.046	0.160
×	0.000	5. 202	0.000	×	0.000	6. 244	0.000
ý	0.160	4. 962	0.160	ý	0.160	6.004	0.160
z	0.240	3. 362	0. 240	Z	0. 240	4.002	0. 240
1	0.720	1.680	0.880	1	0.800	2.000	0. 960
2	0.480	4. 482	0.480	2	0.800	5.446	0.800
3	0.480	4. 482	0.480	3	1.440	5. 446	0.800
4	0. 240	4. 962	0.720	4	0.160	6.004	0.960
5	0.480	4. 482	0.480	5	0.800	5.446	0.800
6	0.720	4. 482	0.720	6	0.800	5.446	0.800
7	0.240	4. 482	0.720	7	0.560	5.446	0.560
8	0.480	4. 482	0.480	8	0.800	5.446	0.800
9	0.480	4. 482	0.480	9	0.800	5.446	0.800
ō	0.720	4. 722	0. 720	0	0.800	5. 684	0.800
-	0.240	2.802	0. 240	-	0. 240	2.802	0. 240
			-	_		-	-

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c.		DRAWN	-	LP	REVISED	-	
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STATE OF ILLINOIS **DEPARTMENT OF TRANSPORTATION** 

			F.A RTE.	SECTION	COUNTY	TOTAL SHEETS	SHEE NO.		
AAST ARM MOUNTED STREET NAME SIGNS		VAR	2023 TRAFFIC 02	VARIOUS	306	17			
_	, , , , , , , , , , , , , , , , , , ,			0.0.10		TS-02	CONTRACT	NO. 6	2T54
	SHFFT NO. (	OF SHEETS	STA.	TO STA.		TILINOIS EED AT	D PROJECT		

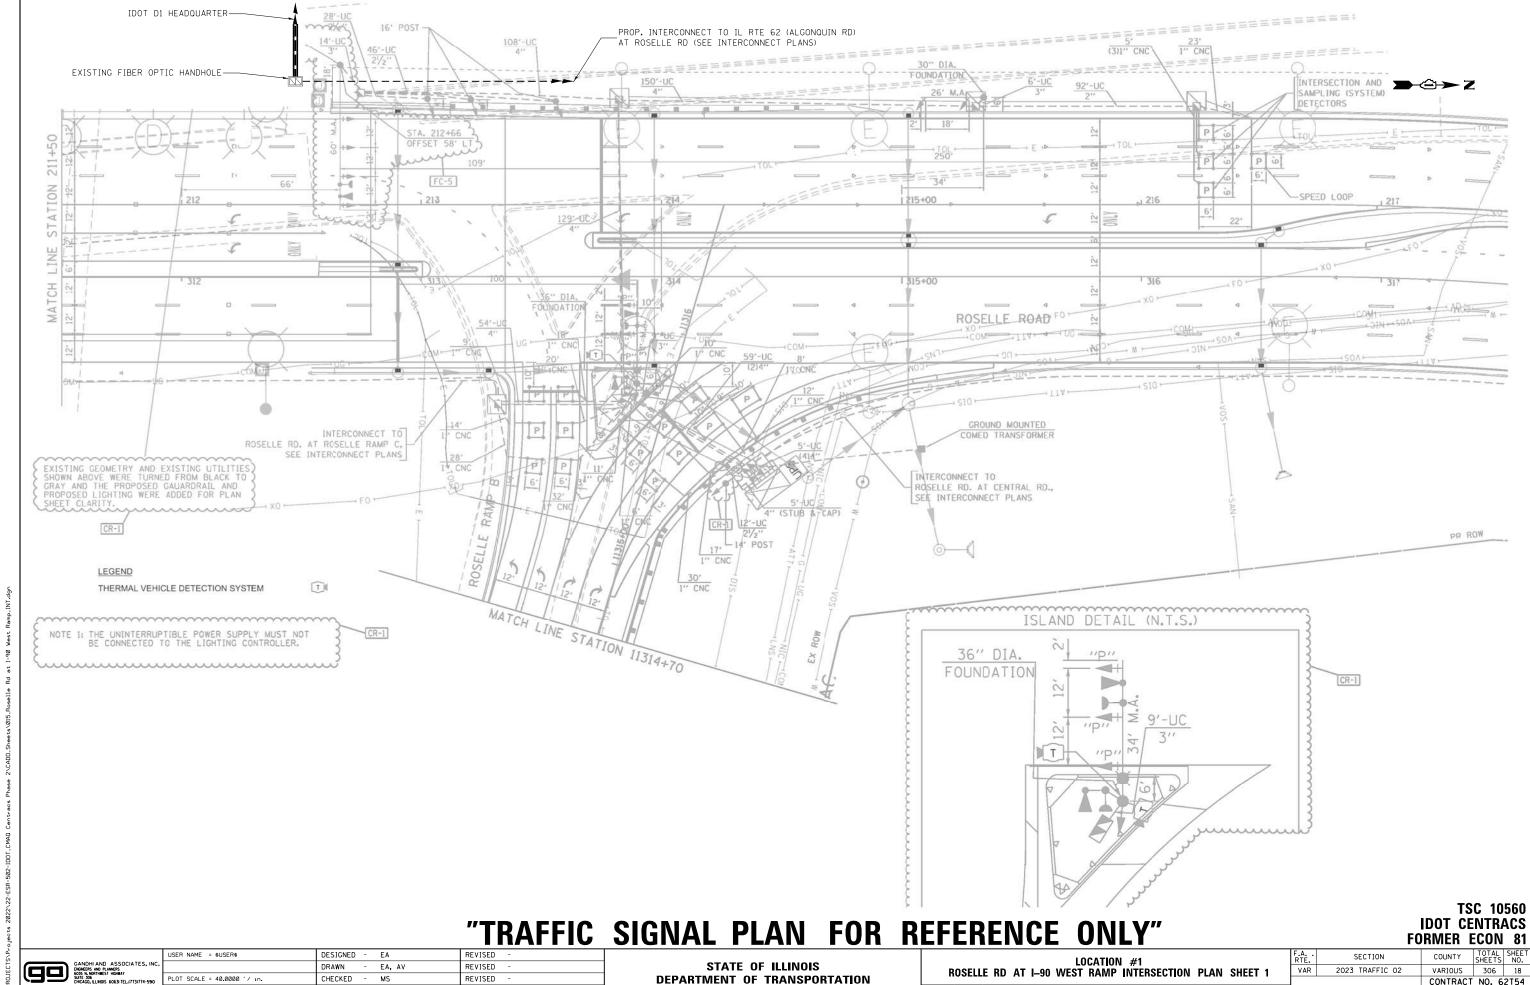


**DEPARTMENT OF TRANSPORTATION** 


SCALE: N.T.S. SHEET NO. OF SHEETS STA.

CONTRACT NO. 62T54

CHECKED

- 10/31/2022

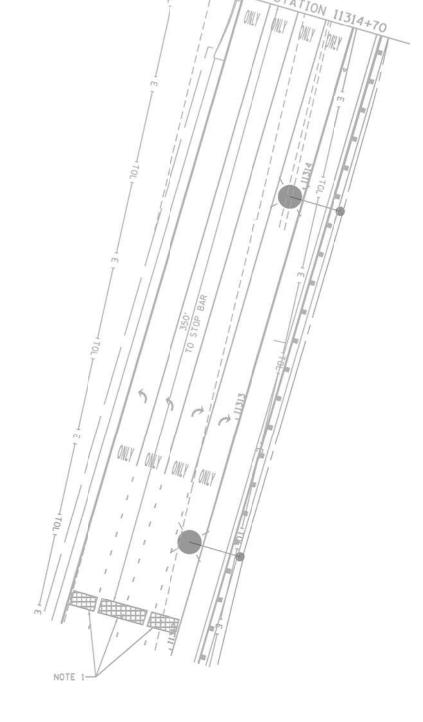

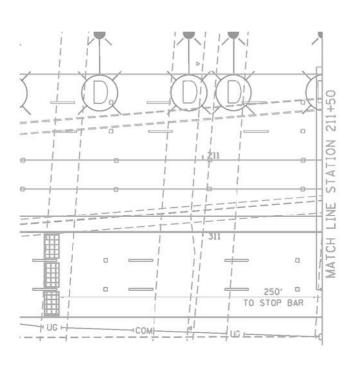

EXISTING GEOMETRY AND EXISTING UTILITIES
SHOWN ABOVE WERE TURNED FROM BLACK TO
GRAY AND THE PROPOSED GAUARDRAIL AND
PROPOSED LIGHTING WERE ADDED FOR PLAN
SHEET CLARITY.

CR-1


# "TRAFFIC SIGNAL PLAN FOR REFERENCE ONLY"

TSC 10560 IDOT CENTRACS FORMER ECON 81

GANDHI AND ASSOCIATES, INC. EXAMERS AND PLANGERS
GOSS NAOPHNESTS HORDINAY
SUITE 306
CMCAGO, LLINOIS 6063 TEL.17731774-590

STATE OF ILLINOIS
DEPARTMENT OF TRANSPORTATION

LOCATION #1								
ROSELLE RE	AT I-90	WEST	RAMP II	NTERSECTION	PLAN SHEET 2			
SCALE: N.T.S.	SHEET NO.	OF	SHEETS	STA.	TO STA.			

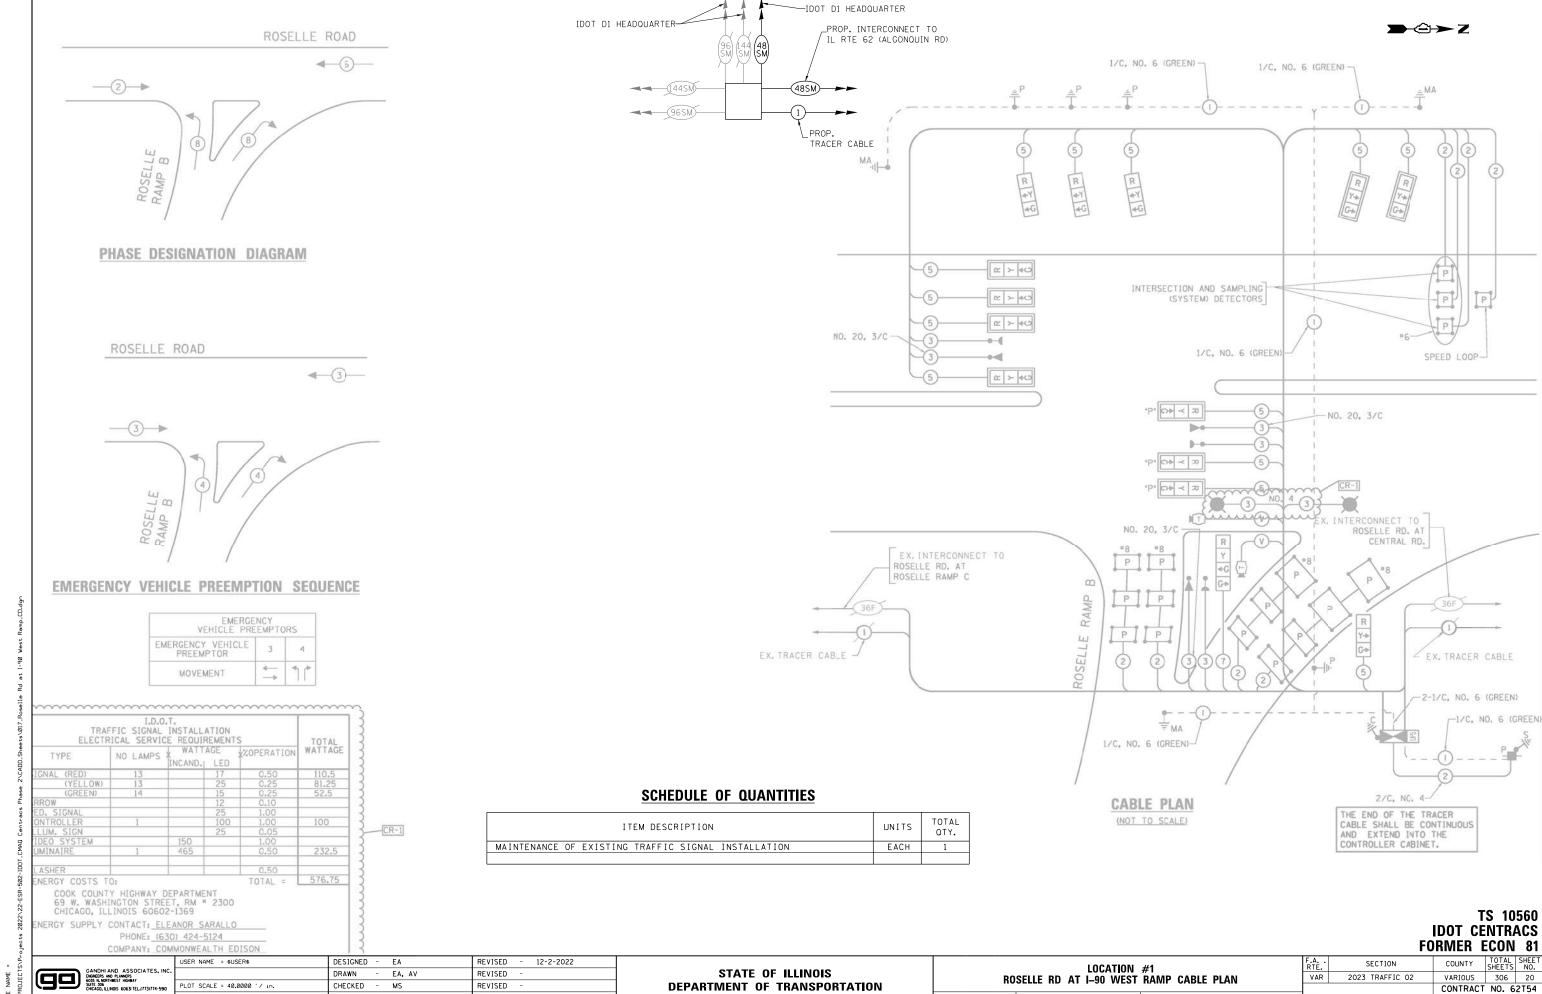

SCALE: N.T.S.


SHEET NO. OF SHEETS STA.

FED. ROAD DIST. NO. \_ ILLINOIS FED. AID PROJECT

PLOT DATE = \$DATE\$

DATE

- 10/31/2022

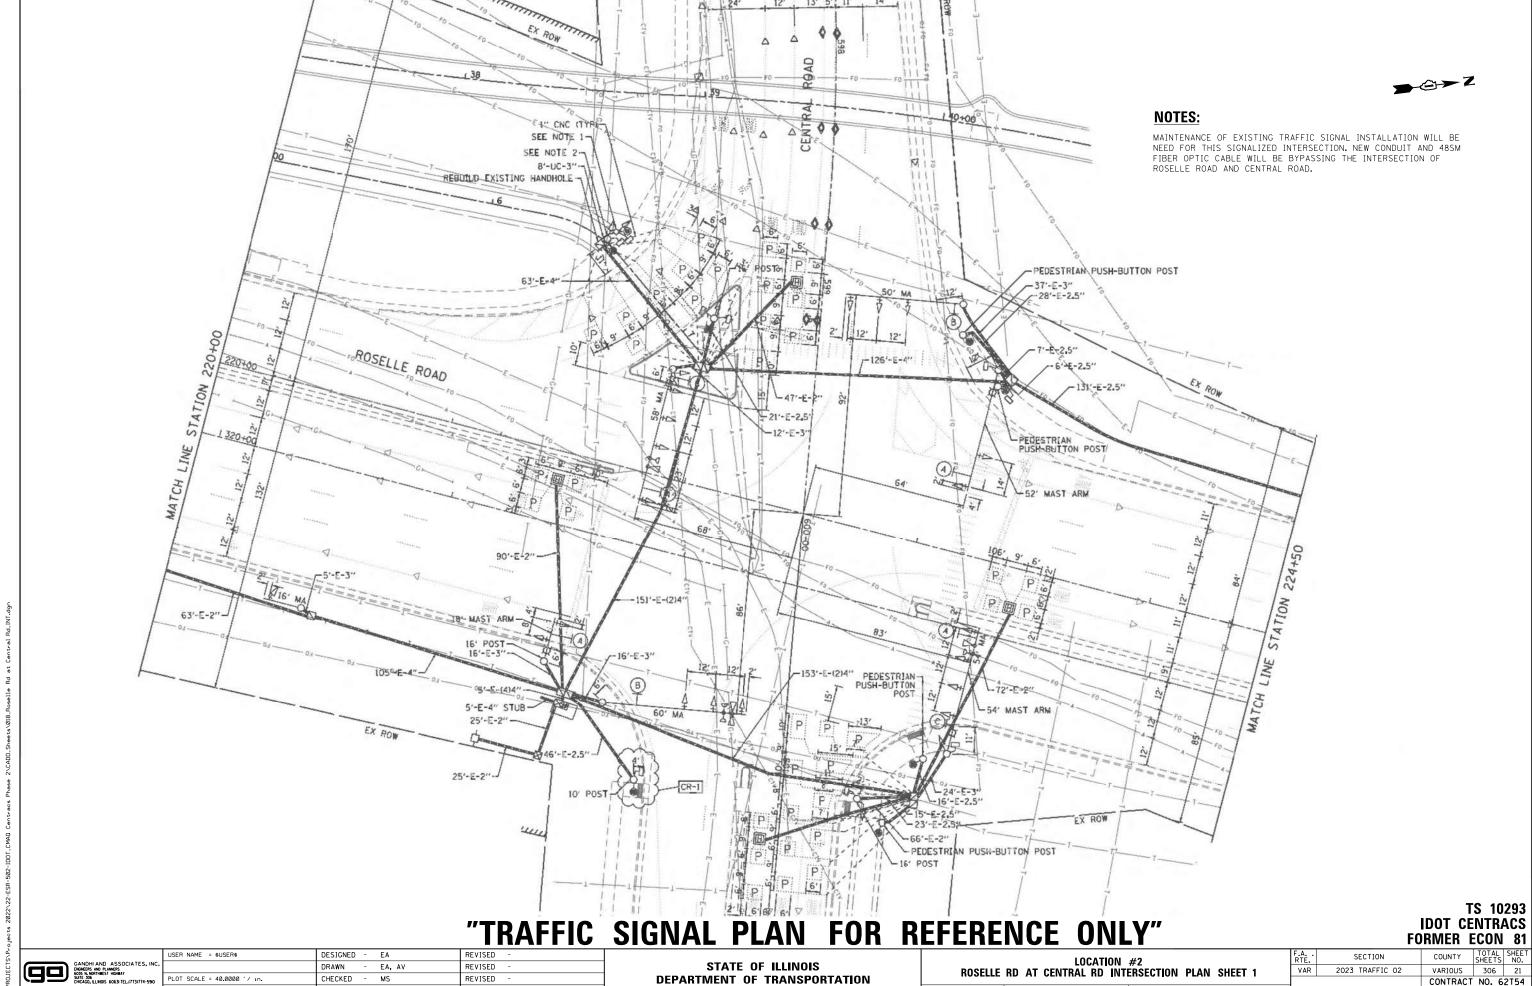


SCALE: N.T.S. SHEET NO. OF SHEETS STA.

CONTRACT NO. 62T54

DATE

- 10/31/2022

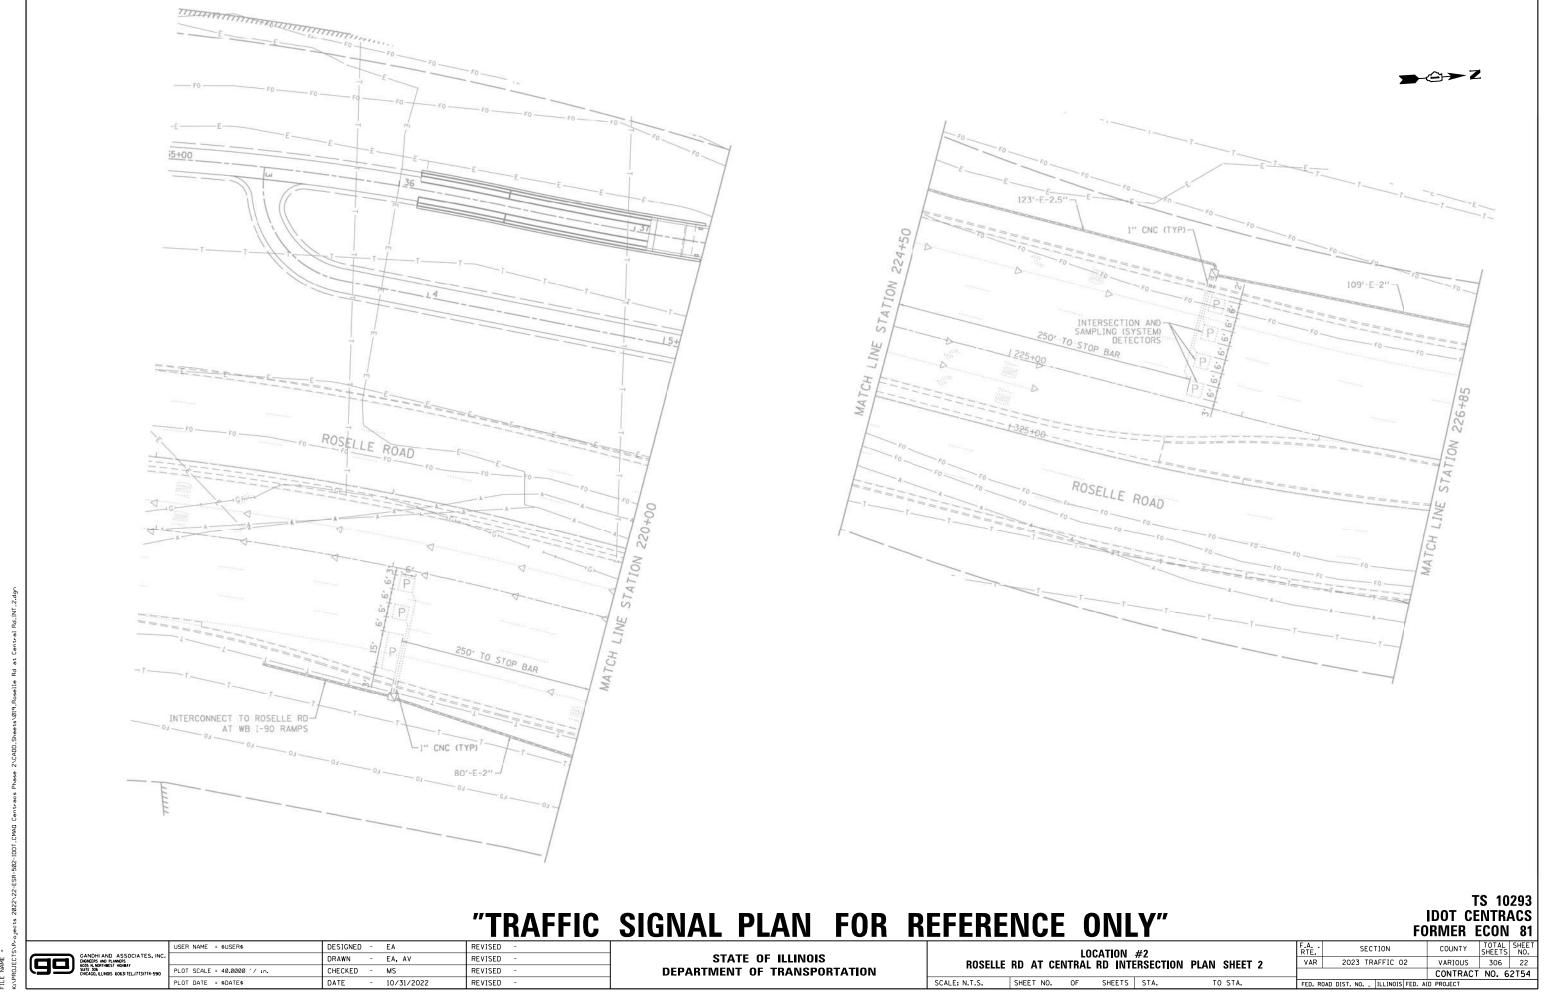


STATE OF ILLINOIS DEPARTMENT OF TRANSPORTATION

LOCATION #2
ROSELLE RD AT CENTRAL RD INTERSECTION PLAN SHEET 2

SCALE: N.T.S. SHEET NO. OF SHEETS STA.

DRAWN - EA, AV

- 10/31/2022

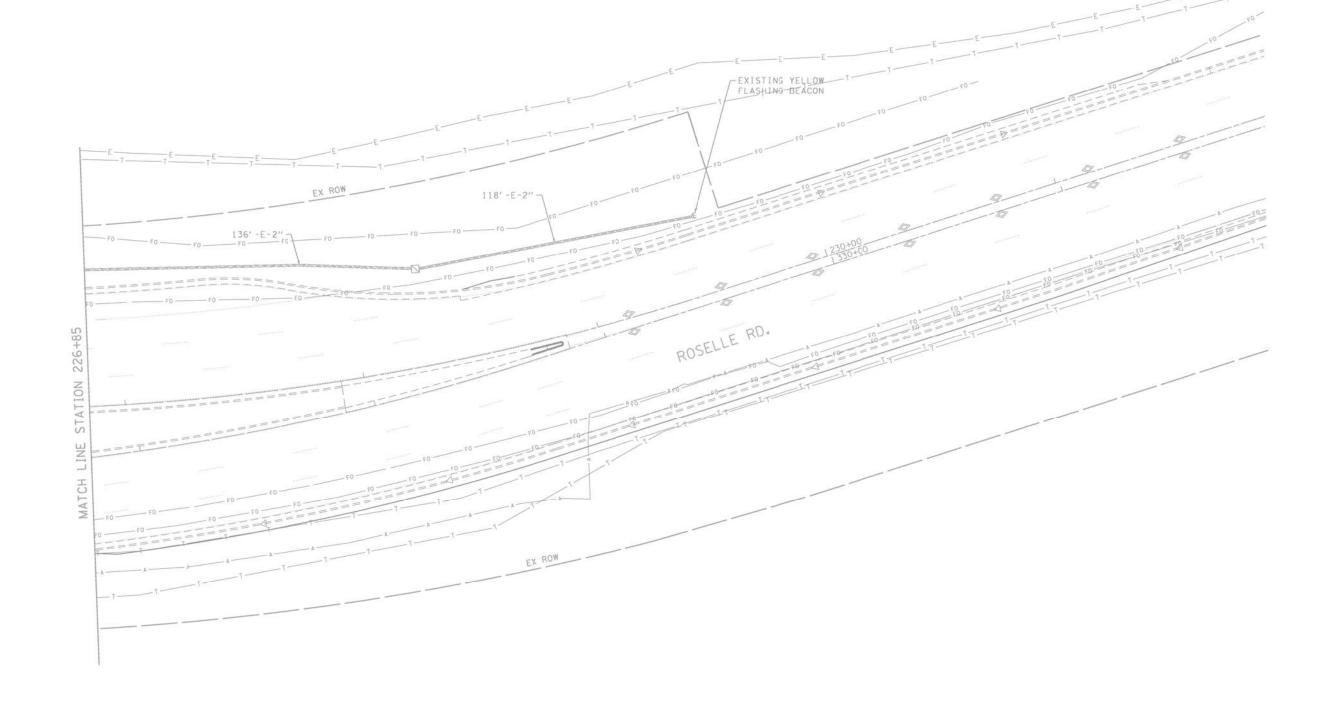

# "TRAFFIC SIGNAL PLAN FOR REFERENCE ONLY"


TS 10293 IDOT CENTRACS FORMER ECON 81

GANDHI AND ASSOCIATES, INC.
EMPARES AND PLANERS
6031 % NORTHEST INDIMAY
SOLUTION OF SECULATION OF SEC

STATE OF ILLINOIS DEPARTMENT OF TRANSPORTATION

ROSELLE RD AT CENTRAL RD INTERSECTION PLAN SHEET 3

SCALE: N.T.S. SHEET NO. OF SHEETS STA. TO STA.

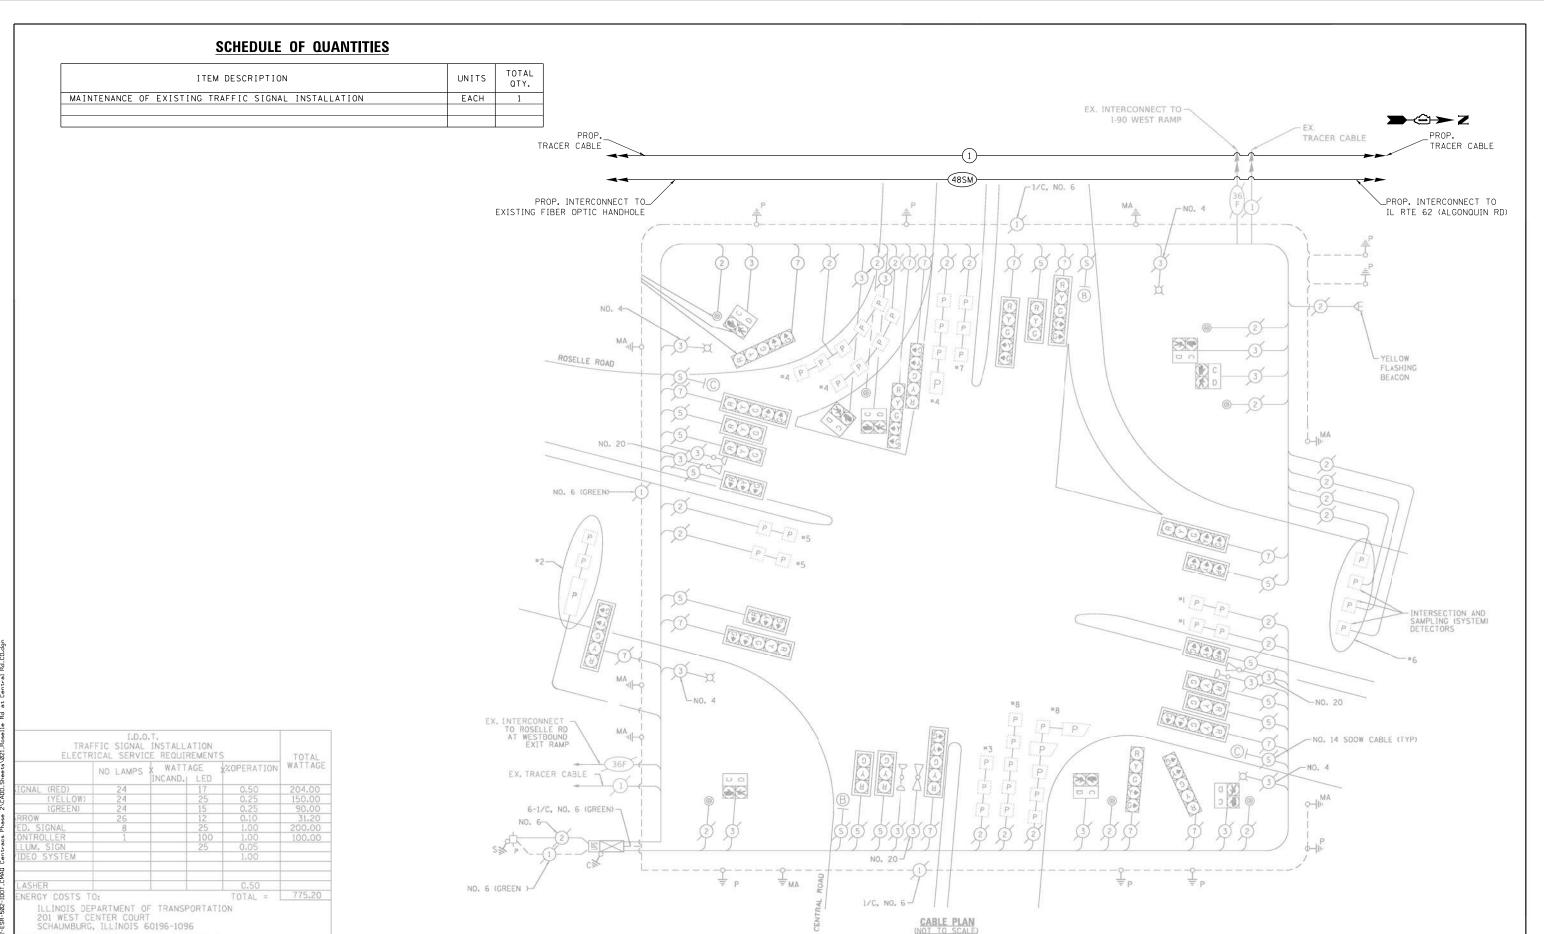

TS 10293 IDOT CENTRACS FORMER ECON 81

COUNTY TOTAL SHEET NO.
VARIOUS 306 24
CONTRACT NO. 62154

NERGY SUPPLY CONTACT: ELEANOR SARALLO

PHONE: (630) 424-5124
COMPANY: COMMONWEALTH EDISON


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٠.		DRAWN	-	EA, AV	REVISED -
	PLOT SCALE = 40.0000 '/ in.	CHECKED	-	MS	REVISED -
	PLOT DATE = \$DATE\$	DATE	-	10/31/2022	REVISED -

STATE OF ILLINOIS
DEPARTMENT OF TRANSPORTATION


SCALE: N.T.S.

LOCATION	RTE.	SECTION	
ROSELLE RD AT CENTRAI		VAR	2023 TRAFFIC 02
SHEET NO. OF SHEETS	STA. TO	STA. FED. R	OAD DIST. NO ILLINOIS FED. AI

FILE NAME = K\*VPBO IECTS/Pro isc+s

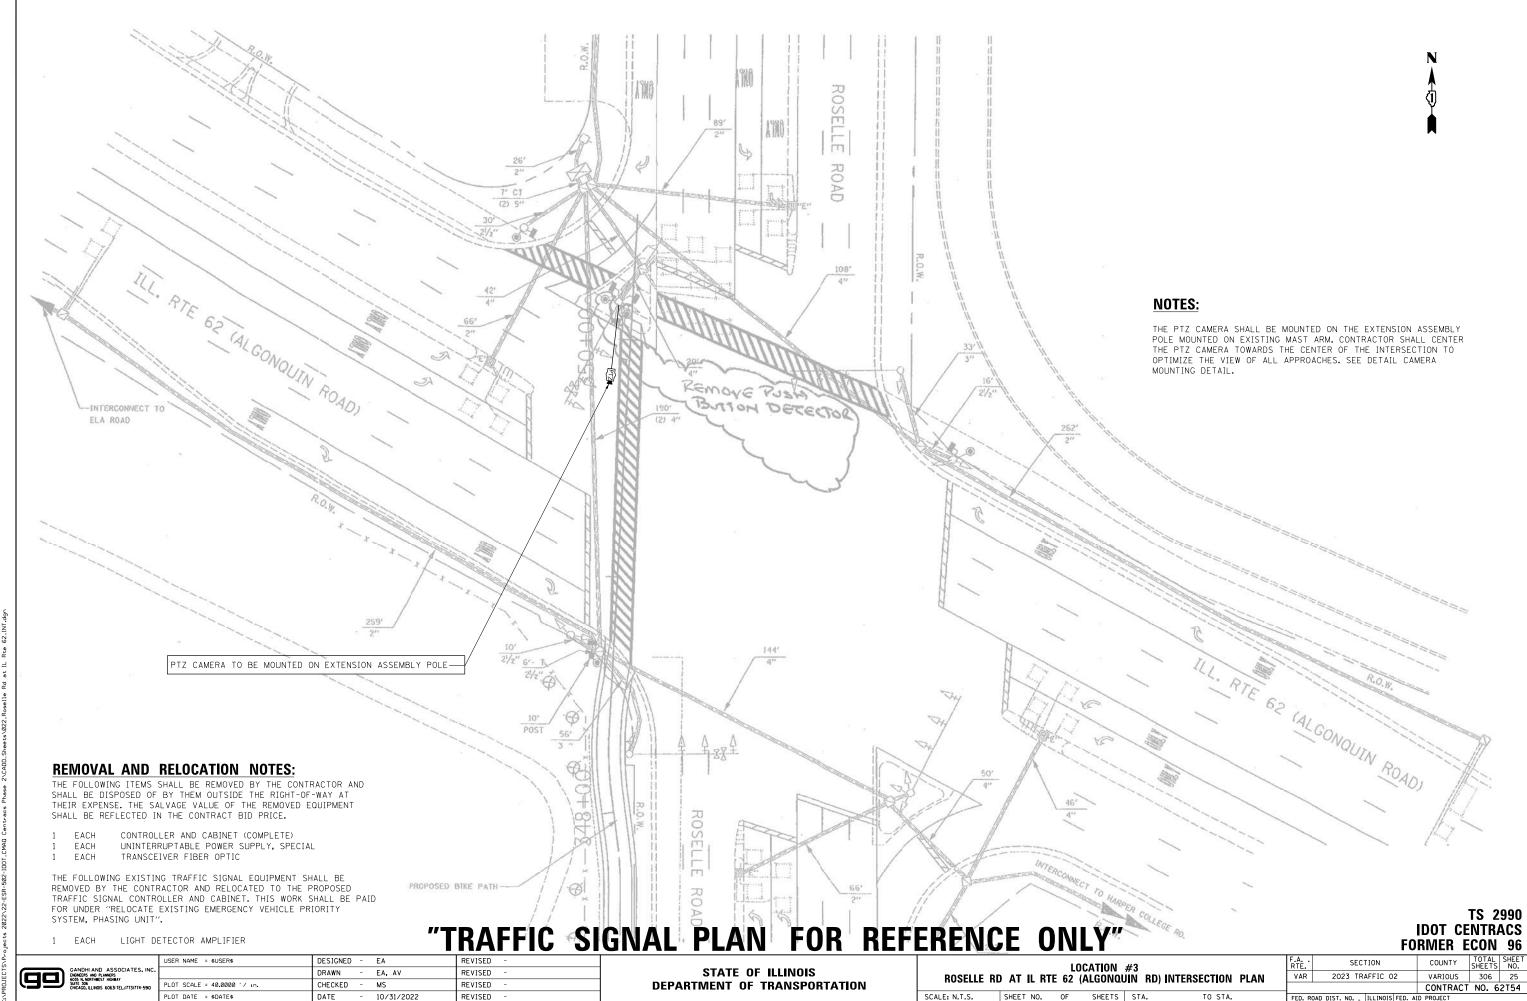

K-VPRO IFCTS/Projects

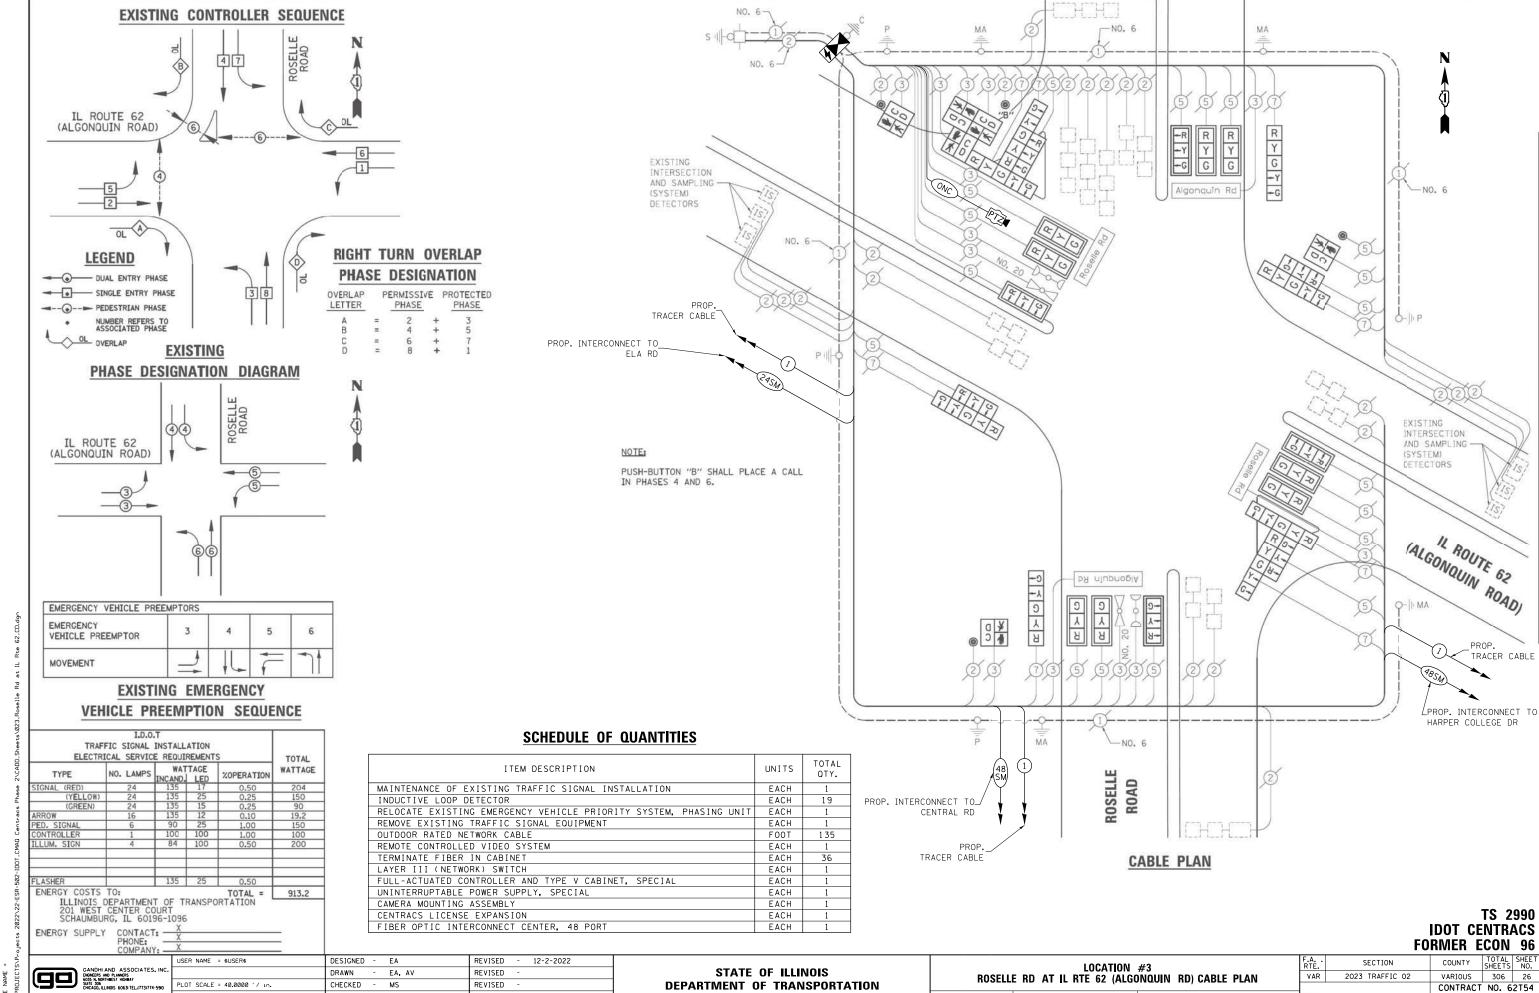


SHEET NO. OF SHEETS STA.

PLOT DATE = \$DATE\$

DATE

- 10/31/2022

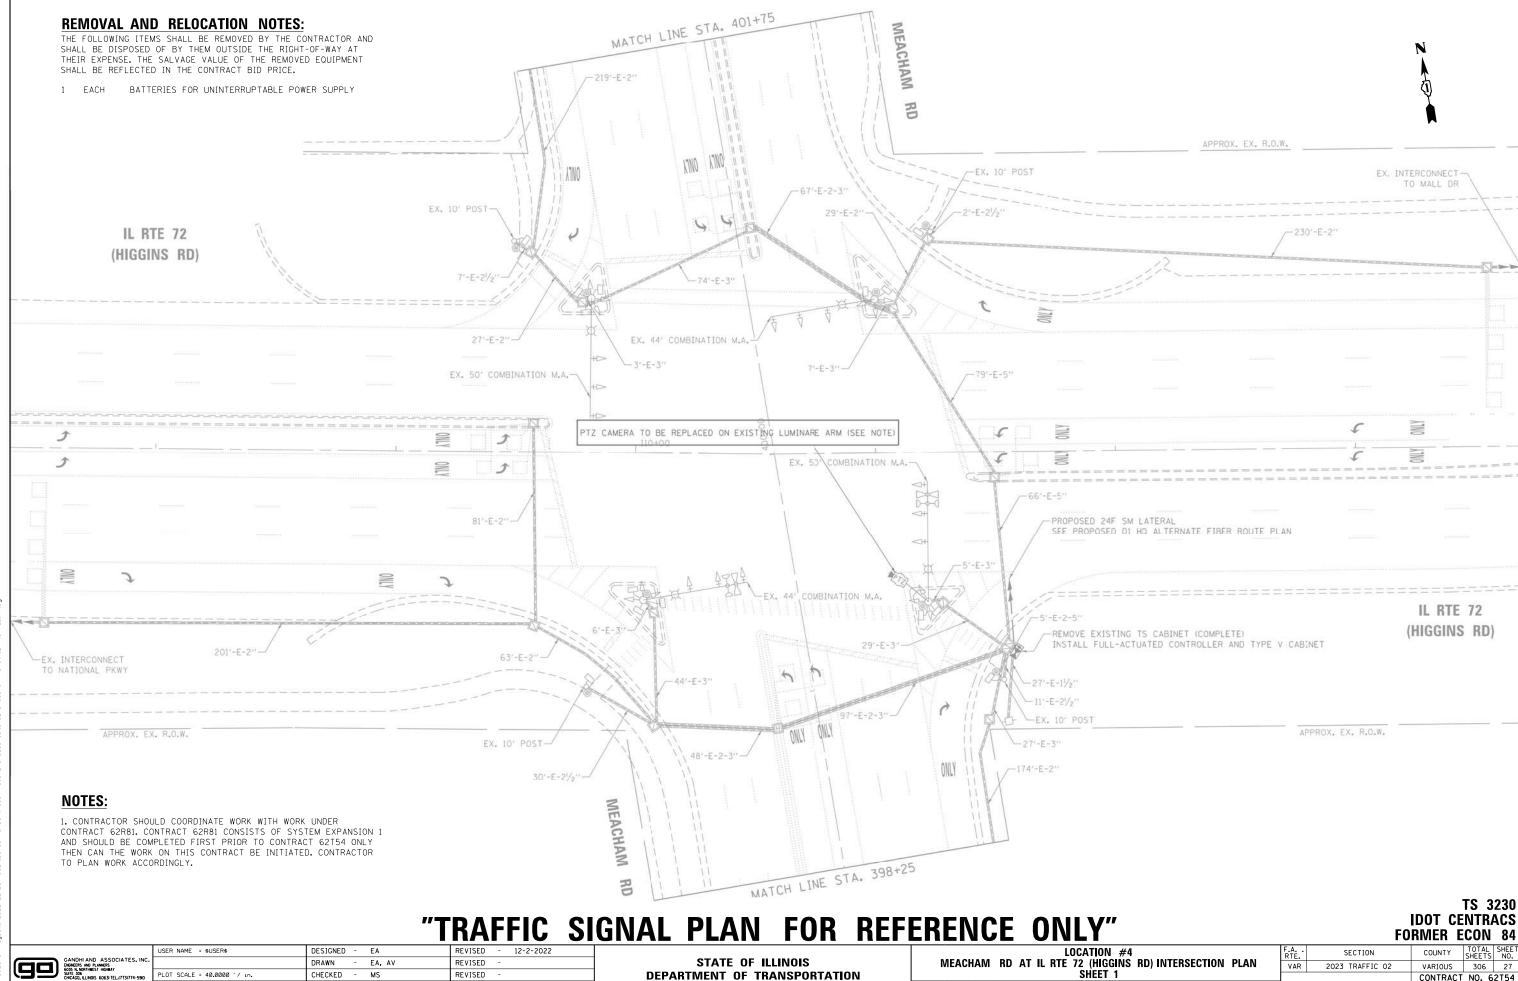

**DEPARTMENT OF TRANSPORTATION** 

SHEET 1

SHEET NO. OF SHEETS STA.

SCALE: N.T.S.

CONTRACT NO. 62T54


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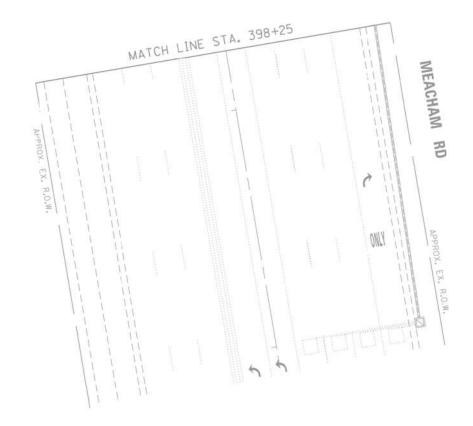
DATE

MS

- 10/31/2022


REVISED



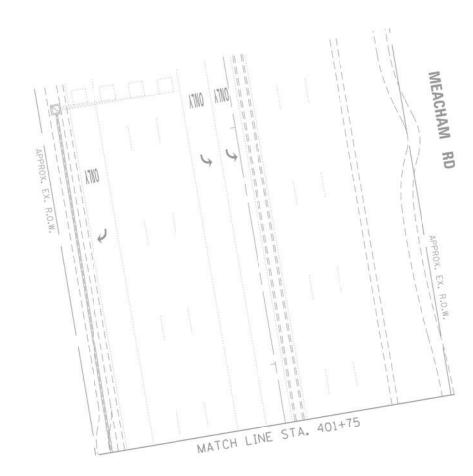

# "TRAFFIC SIGNAL PLAN FOR REFERENCE ONLY"


TS 3230 IDOT CENTRACS FORMER ECON 84 

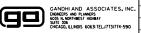

USER NAME = \$USER\$	DESIGNED	-	EA	REVISED -
	DRAWN	-	EA, AV	REVISED -
PLOT SCALE = 40.0000 '/ in.	CHECKED	-	MS	REVISED -
PLOT DATE = \$DATE\$	DATE	-	10/31/2022	REVISED -

STATE OF ILLINOIS DEPARTMENT OF TRANSPORTATION

			CATION			F.A RTE.	SECTION
MEACHAM	KD AI IL	. KIE		NS KD	) INTERSECTION PLAN	VAR	2023 TRAFFIC 02
			SHEET 2				
SCALE: N.T.S.	SHEET NO.	OF	SHEETS	STA.	TO STA.	FED. RO	OAD DIST. NO ILLINOIS FED.

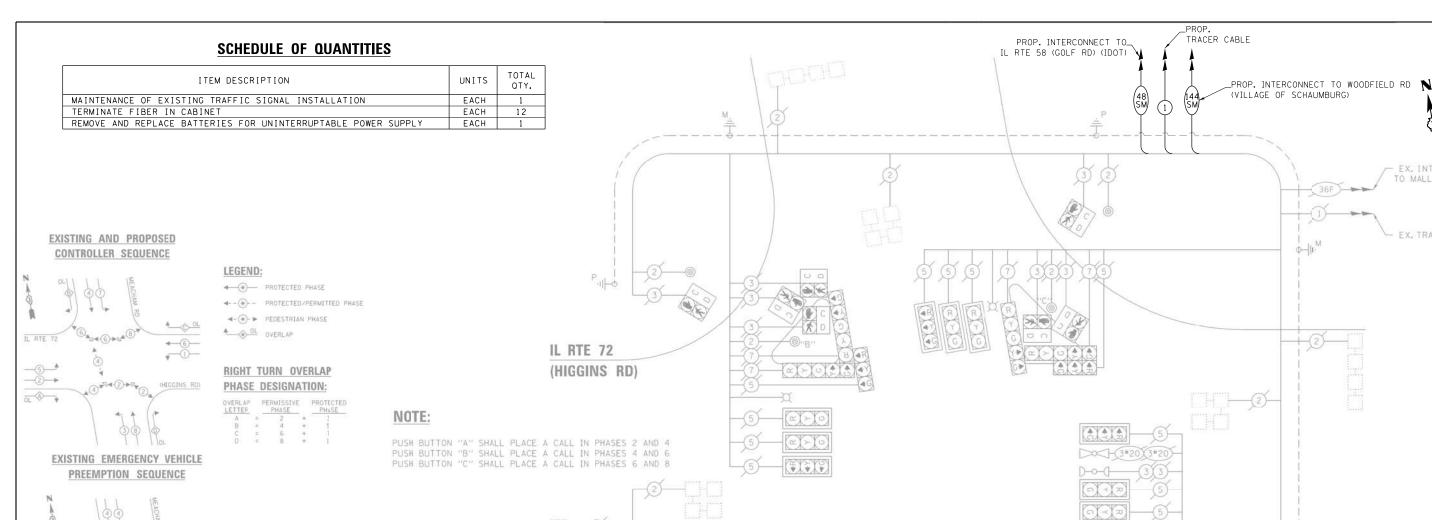

\_3\_**^**\_3→

# TRAFFIC SIGNAL

TYPE	NO. OF LAMPS	LED WATTAGE	OPERATION	TOTAL WATTAGE
SIGNAL (RED)	24	11	50	132.0
(YELLOW)	24	20	5	24.0
(GREEN)	24	12	45	129.6
PERMISSIVE ARROW	16	10	10	16.0
PED. SIGNAL	14	20	100	280.0
CONTROLLER	1	100	100	100.0
UPS	1	25	100	25.0
VIDEO SYSTEM	2	150	100	-
BLANK-OUT SIGN		25	5	-
FLASHER	1.5		50	200
STREET NAME SIGN	- 19	120	50	(+)
LUMINAIRE	-	2	-	
			TOTAL =	438.9


ILLINOIS DEPARTMENT OF TRANSPORTATION

201 W CENTER CT SCHAUMBURG, IL 60196

ENERGY SUPPLY: CONTACT: DAVE SCHACHT

TYPE	NO. OF LAMPS	LED WATTAGE	0PERATION	TOTAL
SIGNAL (RED)	24	11	50	132.0
(YELLOW)	24	20	5	24.0
(GREEN)	24	12	45	129.6
PERMISSIVE ARROW	16	10	10	16.0
PED. SIGNAL	14	20	100	280.0
CONTROLLER	1	100	100	100.0
UPS	1	25	100	25.0
VIDEO SYSTEM	24	150	100	-
BLANK-OUT SIGN	-	25	5	-
FLASHER	1.00		50	170
STREET NAME SIGN	19	120	50	(+)
LUMINAIRE	12	_	-	-
			TOTAL =	438.9

PHONE: (630) 437-2129 COMPANY: COMMONWEALTH EDISON JSER NAME = \$USER\$

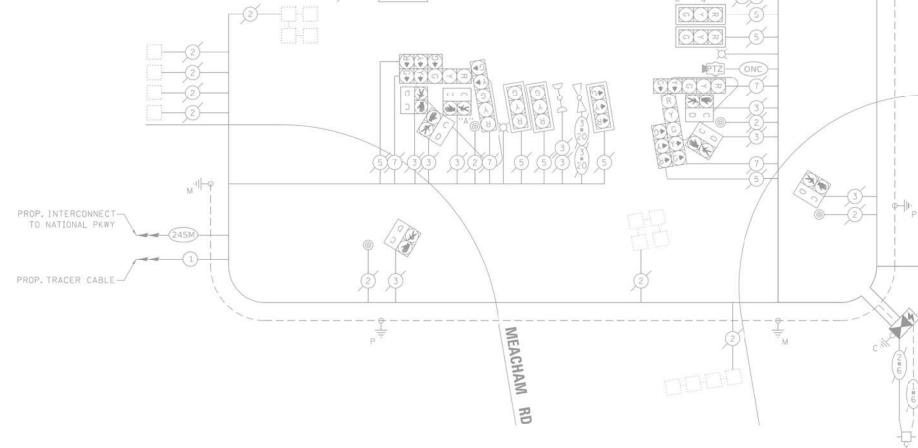

DESIGNED - EA REVISED -12-2-2022 DRAWN - EA, AV REVISED LOT SCALE = 40.0000 '/ in. CHECKED - MS REVISED PLOT DATE = \$DATE\$ DATE - 10/31/2022 REVISED

STATE OF ILLINOIS **DEPARTMENT OF TRANSPORTATION** 

LOCATION #4 MEACHAM RD AT IL RTE 72 (HIGGINS RD) CABLE PLAN SHEET NO. OF SHEETS STA.


**FORMER ECON 84** SECTION COUNTY 2023 TRAFFIC 02 VAR VARIOUS 306 29 CONTRACT NO. 62T54 FED. ROAD DIST. NO. \_ ILLINOIS FED. AID PROJECT

TS 3230 IDOT CENTRACS

- EX. INTERCONNECT TO MALL DR

EX. TRACER CABLE

-PROPOSED 24F SM LATERAL SEE PROPOSED D1 HO ALTERNATE FIBER ROUTE PLAN

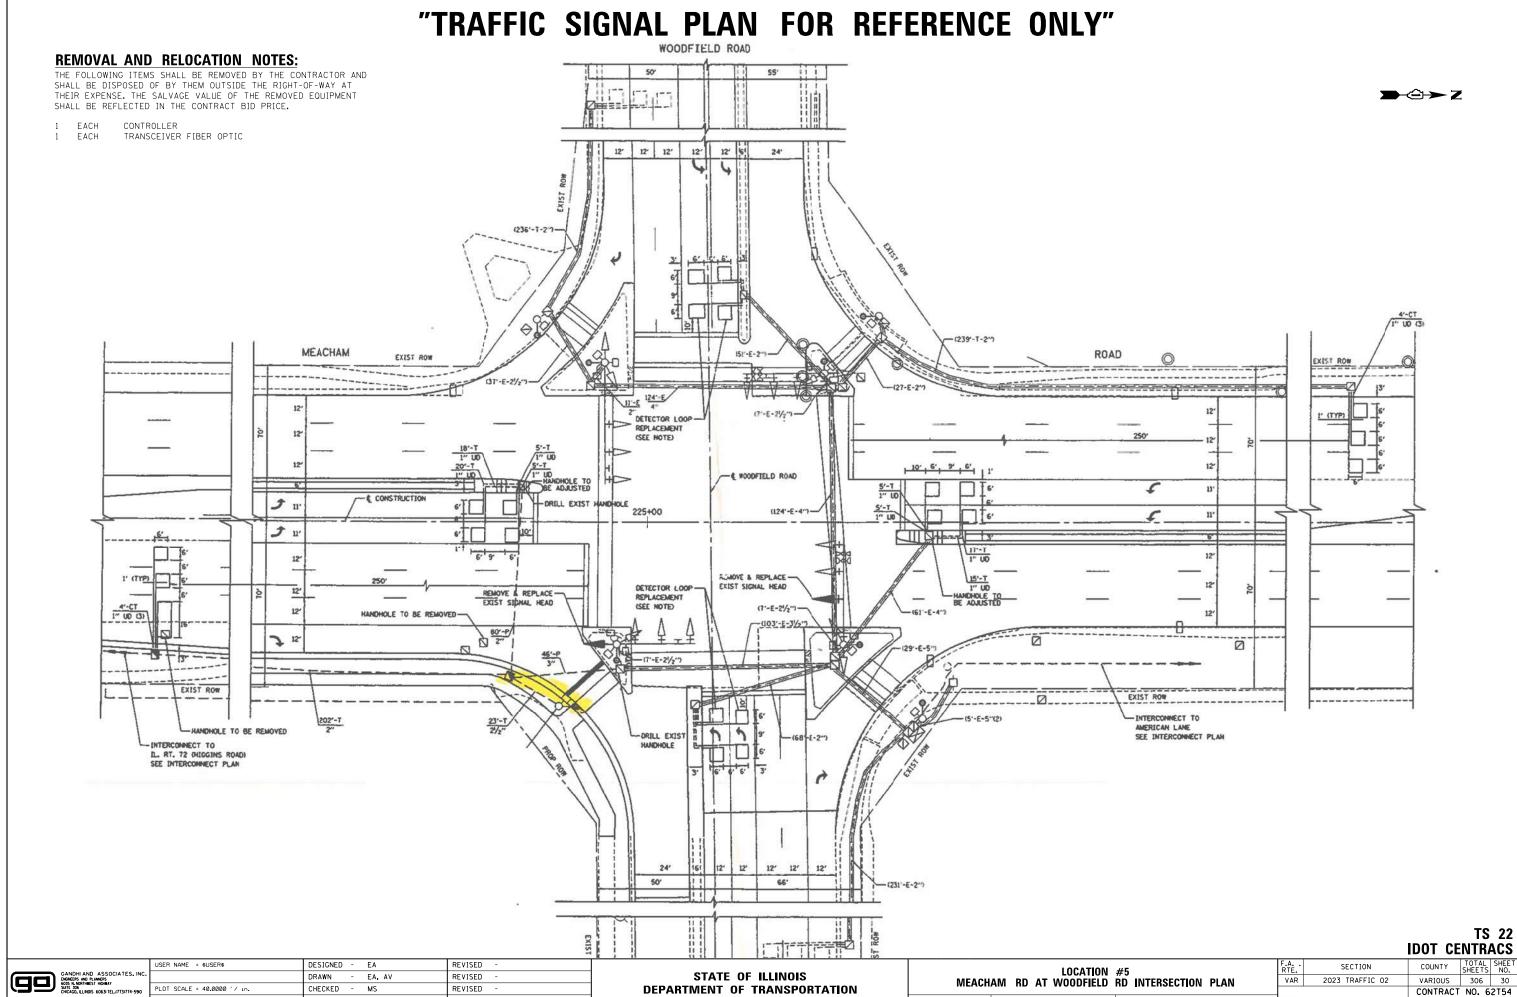


SHEET NO. OF SHEETS STA.

PLOT DATE = \$DATE\$

DATE

- 10/31/2022

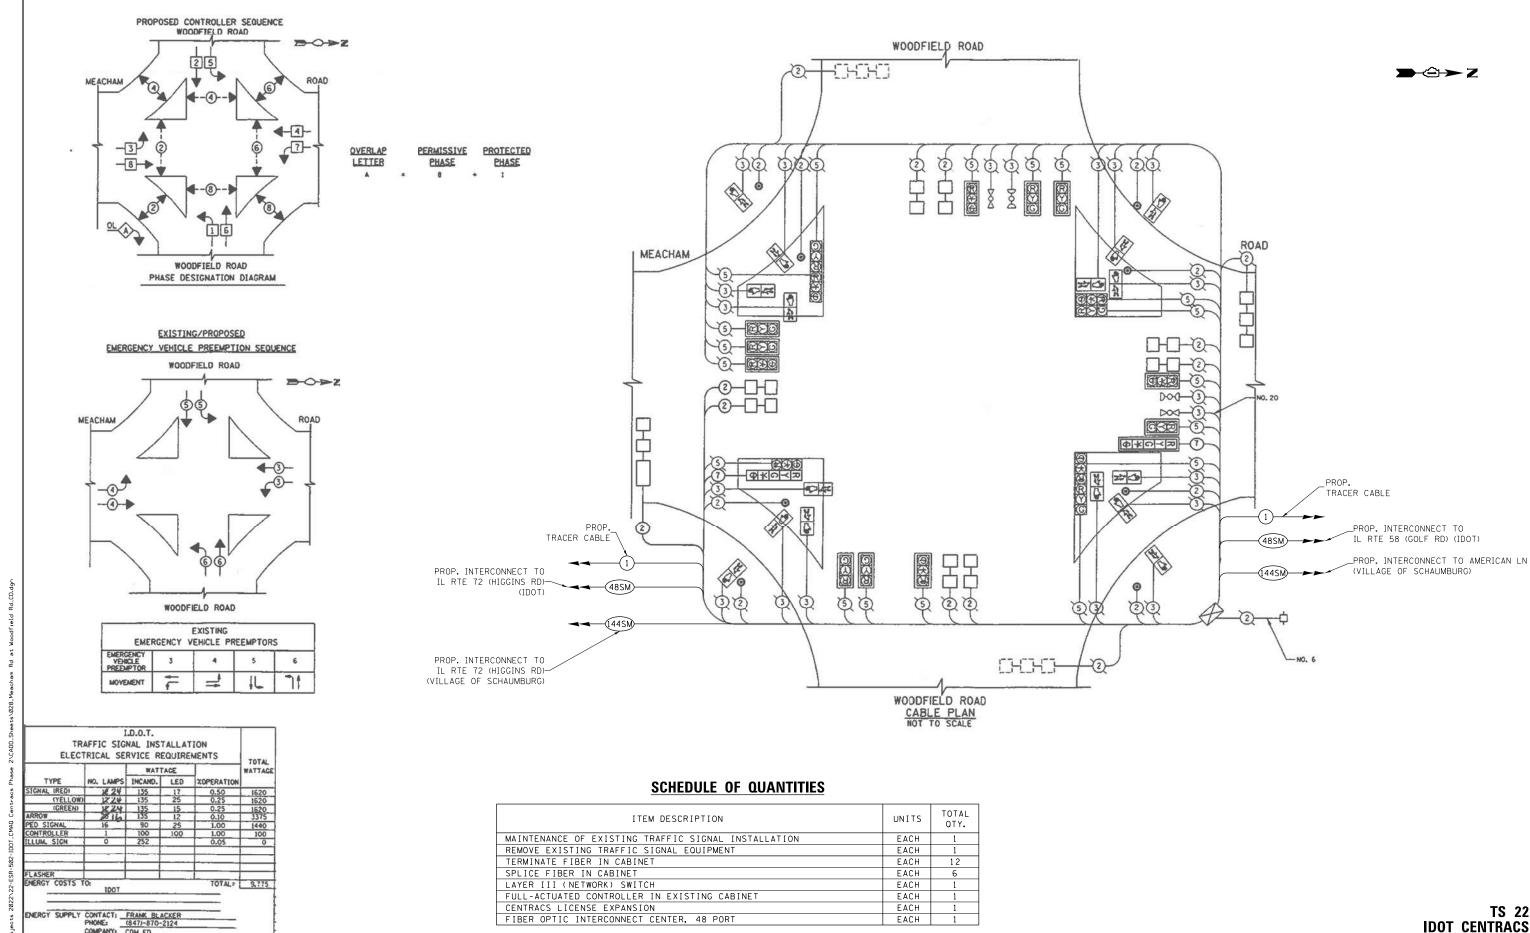

STATE OF ILLINOIS

**DEPARTMENT OF TRANSPORTATION** 

SECTION

2023 TRAFFIC 02

FED. ROAD DIST. NO. \_ ILLINOIS FED. AID PROJECT

VAR

LOCATION #5

MEACHAM RD AT WOODFIELD RD CABLE PLAN

SHEET NO. OF SHEETS STA.

COUNTY

VARIOUS 306 31

CONTRACT NO. 62T54

K:\PROJECTS\Projects 2022\22-

CHICAGO, LLINOIS 60631 TEL.(773)774-5

SER NAME = \$USER\$

PLOT DATE = \$DATE\$

DESIGNED - EA

- EA, AV

- 10/31/2022

DRAWN


DATE

CHECKED

REVISED - 12-2-2022

REVISED

REVISED

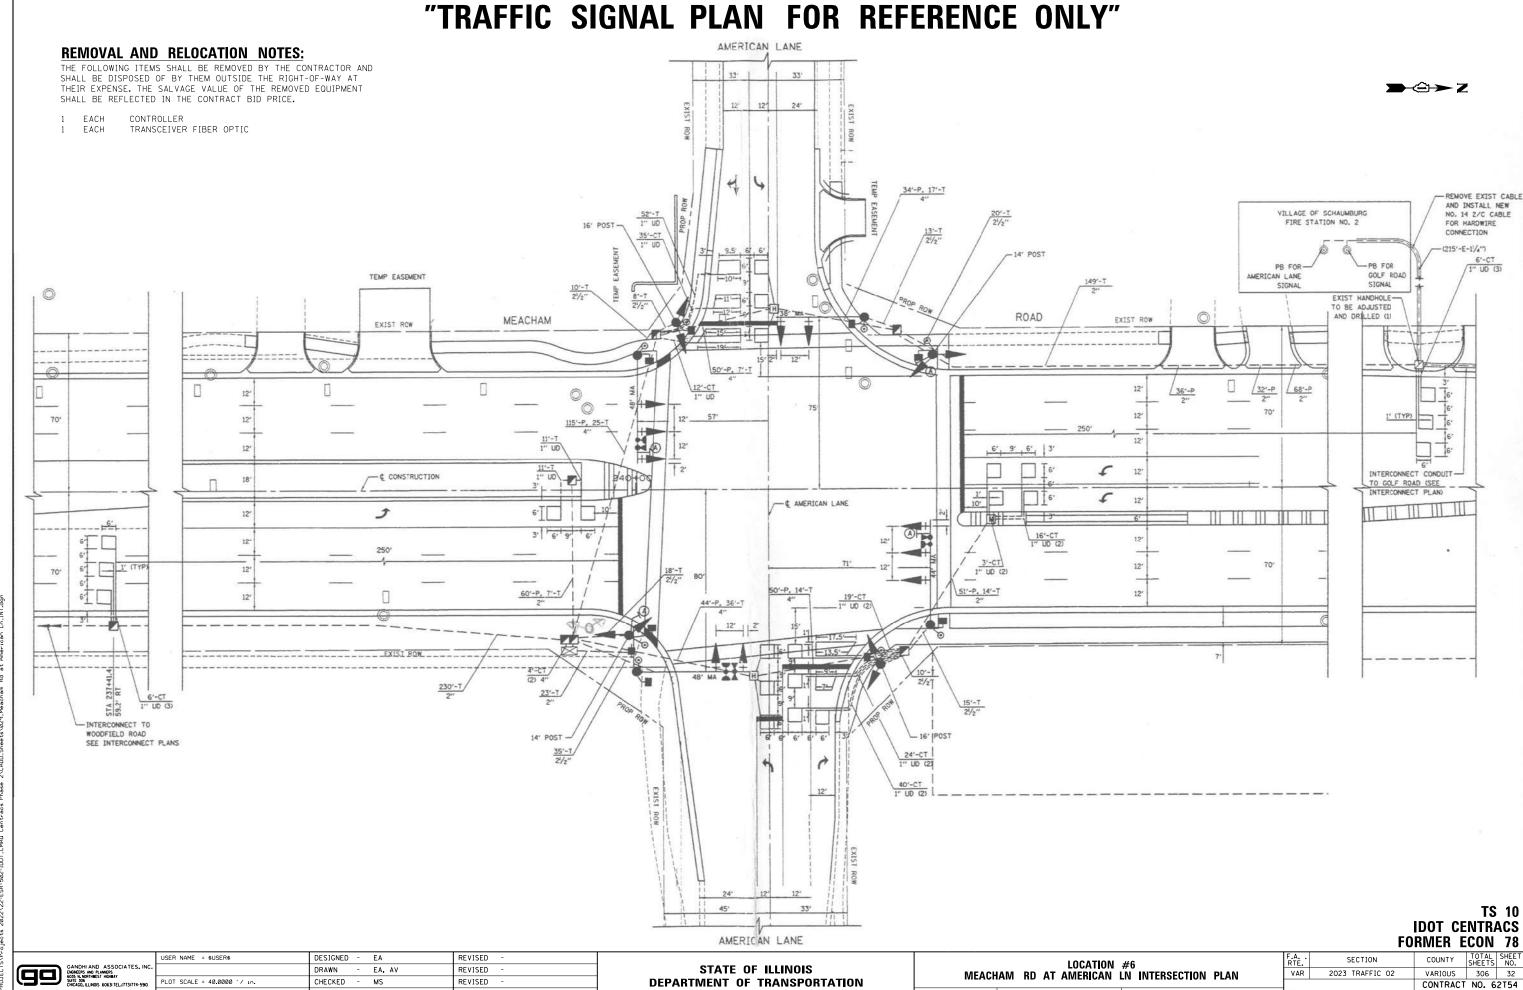


SHEET NO. OF SHEETS STA.

PLOT DATE = \$DATE\$

DATE

- 10/31/2022

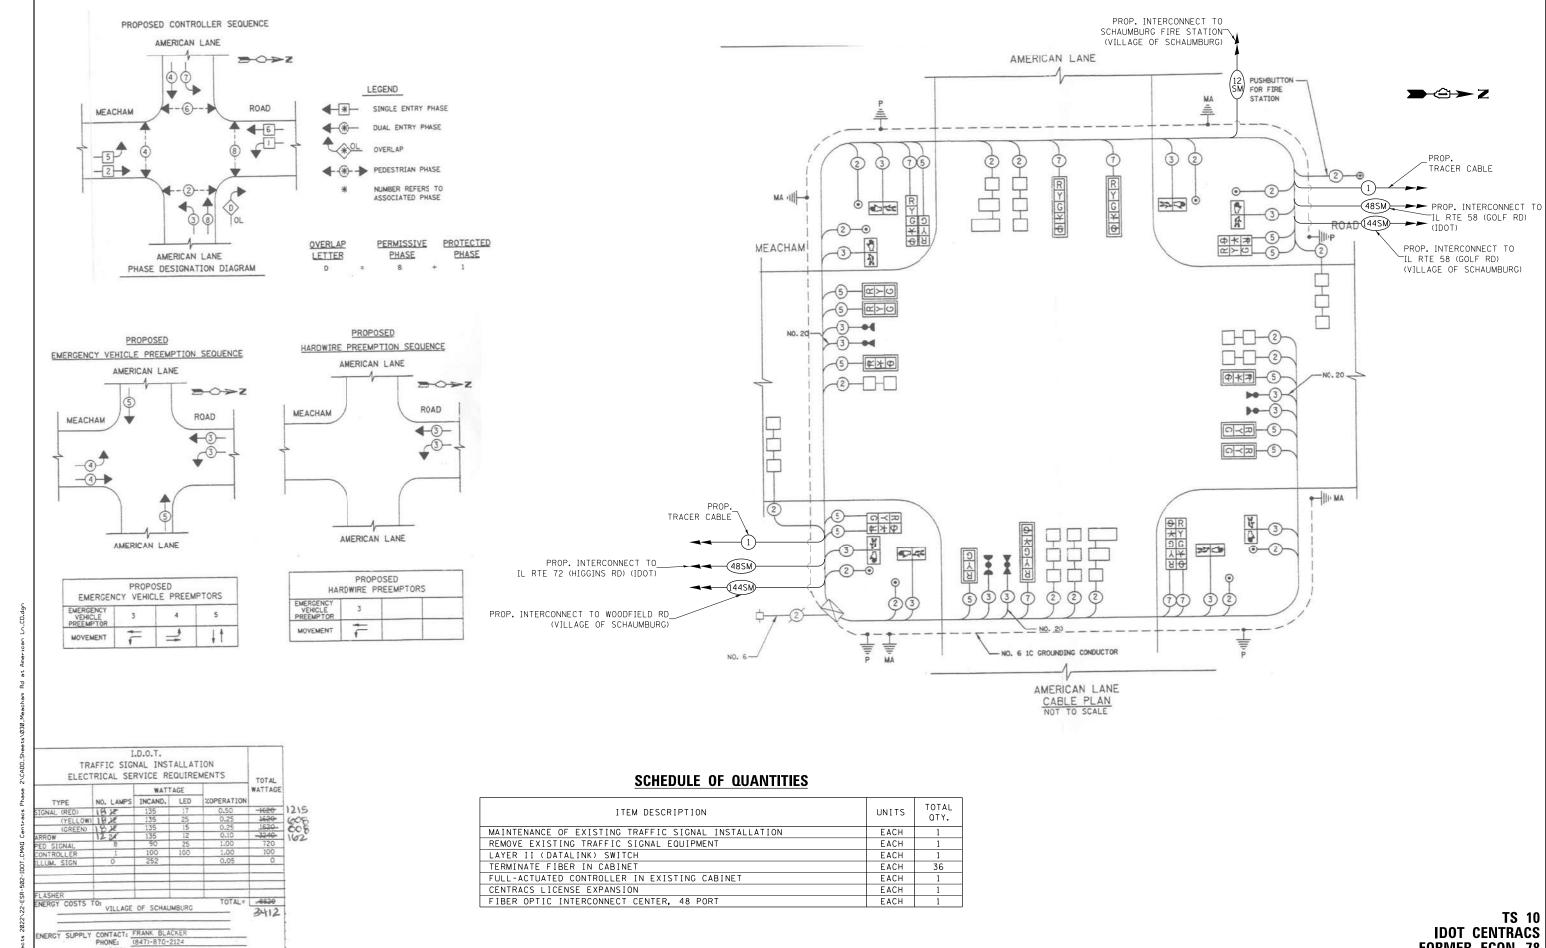

CHICAGO, LLINOIS 60631 TEL.(773)774-5

COMPANY:

DRAWN - EA, AV CHECKED PLOT DATE = \$DATE\$ DATE

DESIGNED - EA

MS

USER NAME = \$USER\$


REVISED - 12-2-2022 REVISED REVISED - 10/31/2022 REVISED

STATE OF ILLINOIS **DEPARTMENT OF TRANSPORTATION** 

LOCATION #6 MEACHAM RD AT AMERICAN LN CABLE PLAN SHEET NO. OF SHEETS STA.

SECTION COUNTY 2023 TRAFFIC 02 VARIOUS 306 33 VAR CONTRACT NO. 62T54 FED. ROAD DIST. NO. \_ ILLINOIS FED. AID PROJECT

**FORMER ECON 78** 

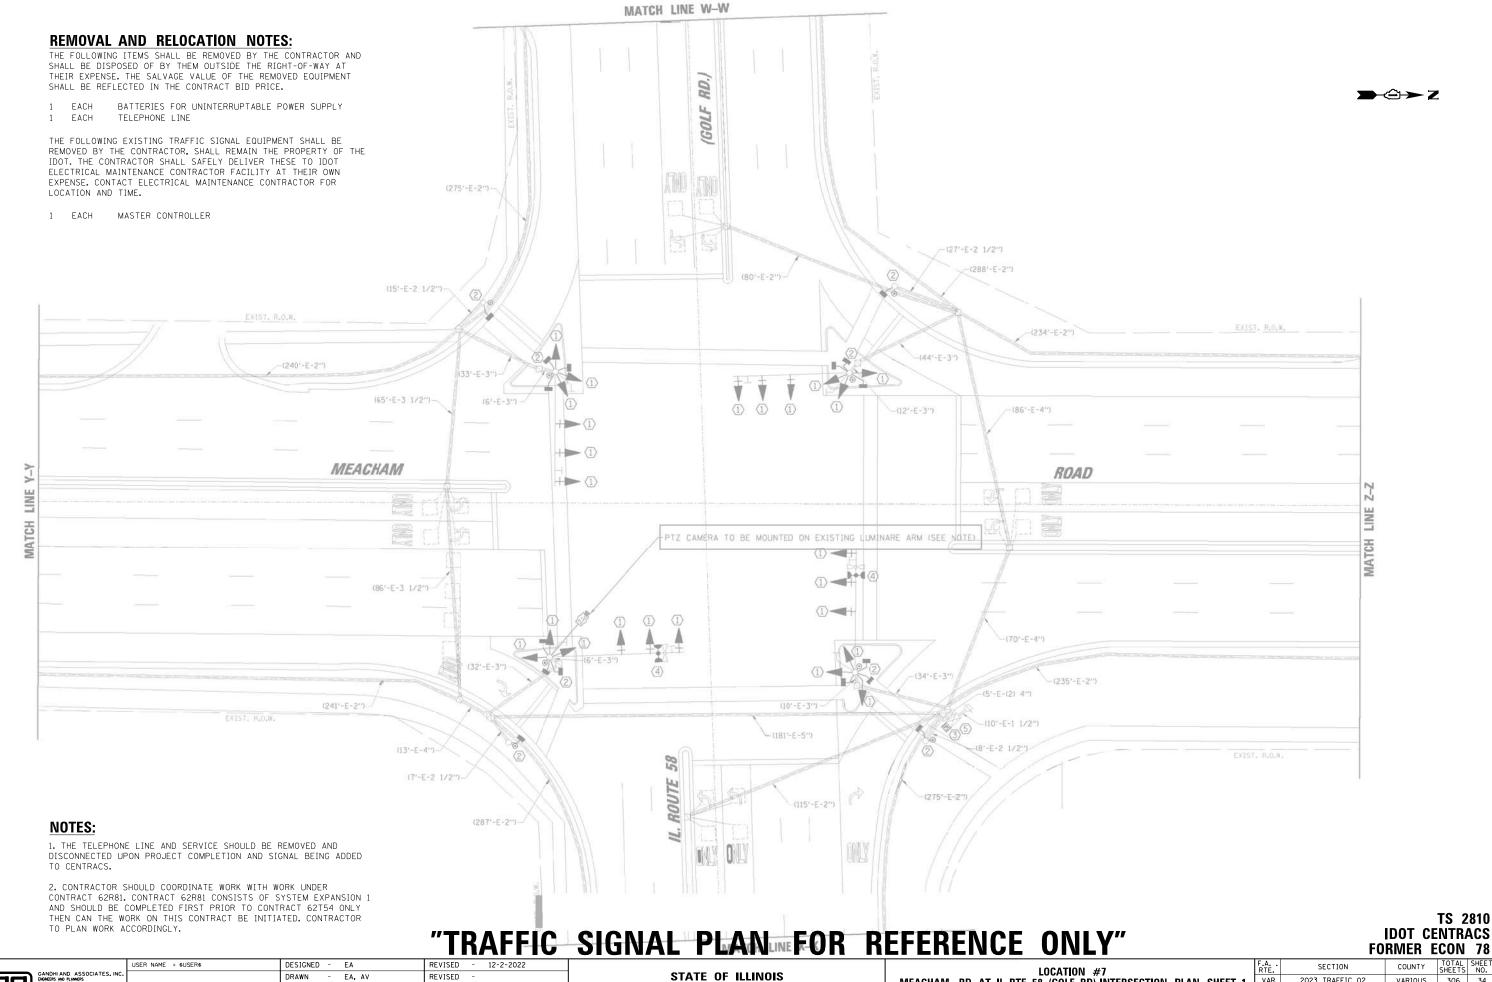

ENGINEERS AND PLANNERS
6035 N. MORTHWEST HIGHWAY
SUITE 306
CHICAGO, LLINOIS 60631 TEL.171


- EA, AV CHECKED - 10/31/2022 REVISED DATE

**DEPARTMENT OF TRANSPORTATION** 

MEACHAM RD AT IL RTE 58 (GOLF RD) INTERSECTION PLAN SHEET 1 SCALE: N.T.S. SHEET NO. OF SHEETS STA.


COUNTY TOTAL SHEET NO.

VARIOUS 306 34 2023 TRAFFIC 02 VAR CONTRACT NO. 62T54

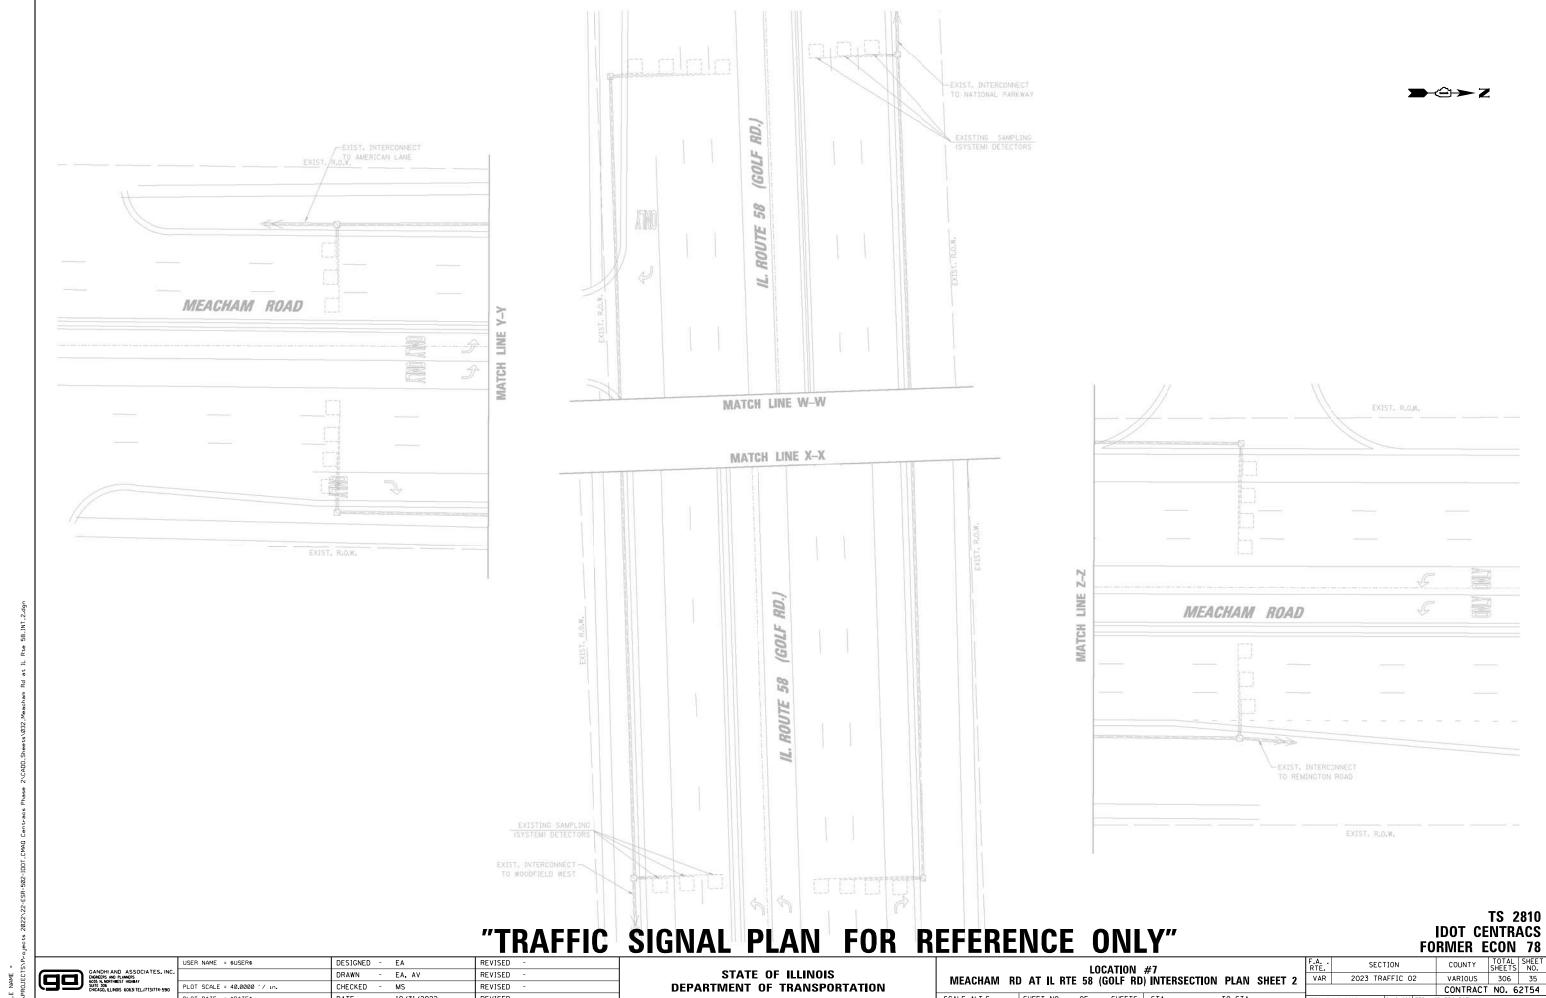

SCALE: N.T.S. SHEET NO. OF SHEETS STA.

DATE - 10/31/2022

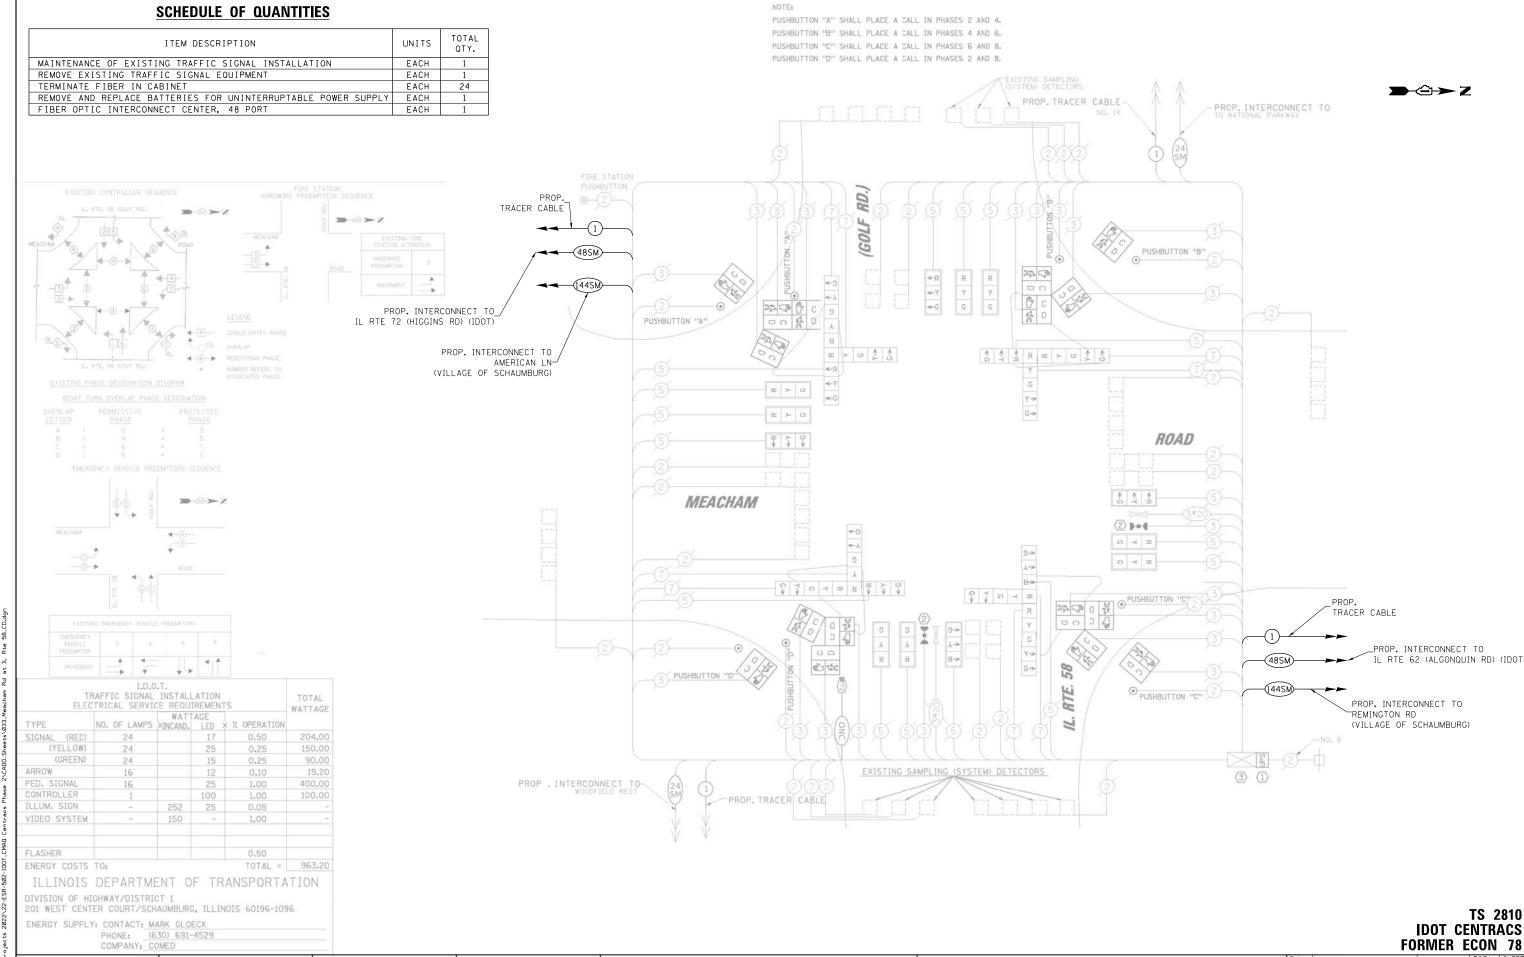

K:\PROJECTS\Projects 2022\2

GANDHI AND ASSOCIATES
EXPRESS AND PLAMBES
GOSS IN NORTHEEST HOWHAY
SUITE 306
CHICAGO, ILLINOIS GOG3I TEL.17731774

STATE OF ILLINOIS
DEPARTMENT OF TRANSPORTATION

MEACHAM RD AT IL RTE 58 (GOLF RD) CABLE PLAN

SHEET NO. OF SHEETS STA. TO STA.

### "TRAFFIC SIGNAL PLAN FOR REFERENCE ONLY"

#### **REMOVAL AND RELOCATION NOTES:**

THE FOLLOWING ITEMS SHALL BE REMOVED BY THE CONTRACTOR AND SHALL BE DISPOSED OF BY THEM OUTSIDE THE RIGHT-OF-WAY AT THEIR EXPENSE. THE SALVAGE VALUE OF THE REMOVED EQUIPMENT SHALL BE REFLECTED IN THE CONTRACT BID PRICE.

USER NAME = \$USER\$

PLOT DATE = \$DATE\$

DESIGNED - EA

- EA, AV

- 10/31/2022

DRAWN

DATE

CHECKED

REVISED

REVISED

REVISED

REVISED



COUNTY

VARIOUS 306 37

CONTRACT NO. 62T54

SECTION


2023 TRAFFIC 02

VAR

LOCATION #8

MEACHAM RD AT REMINGTON RD INTERSECTION PLAN

SHEET NO. OF SHEETS STA.

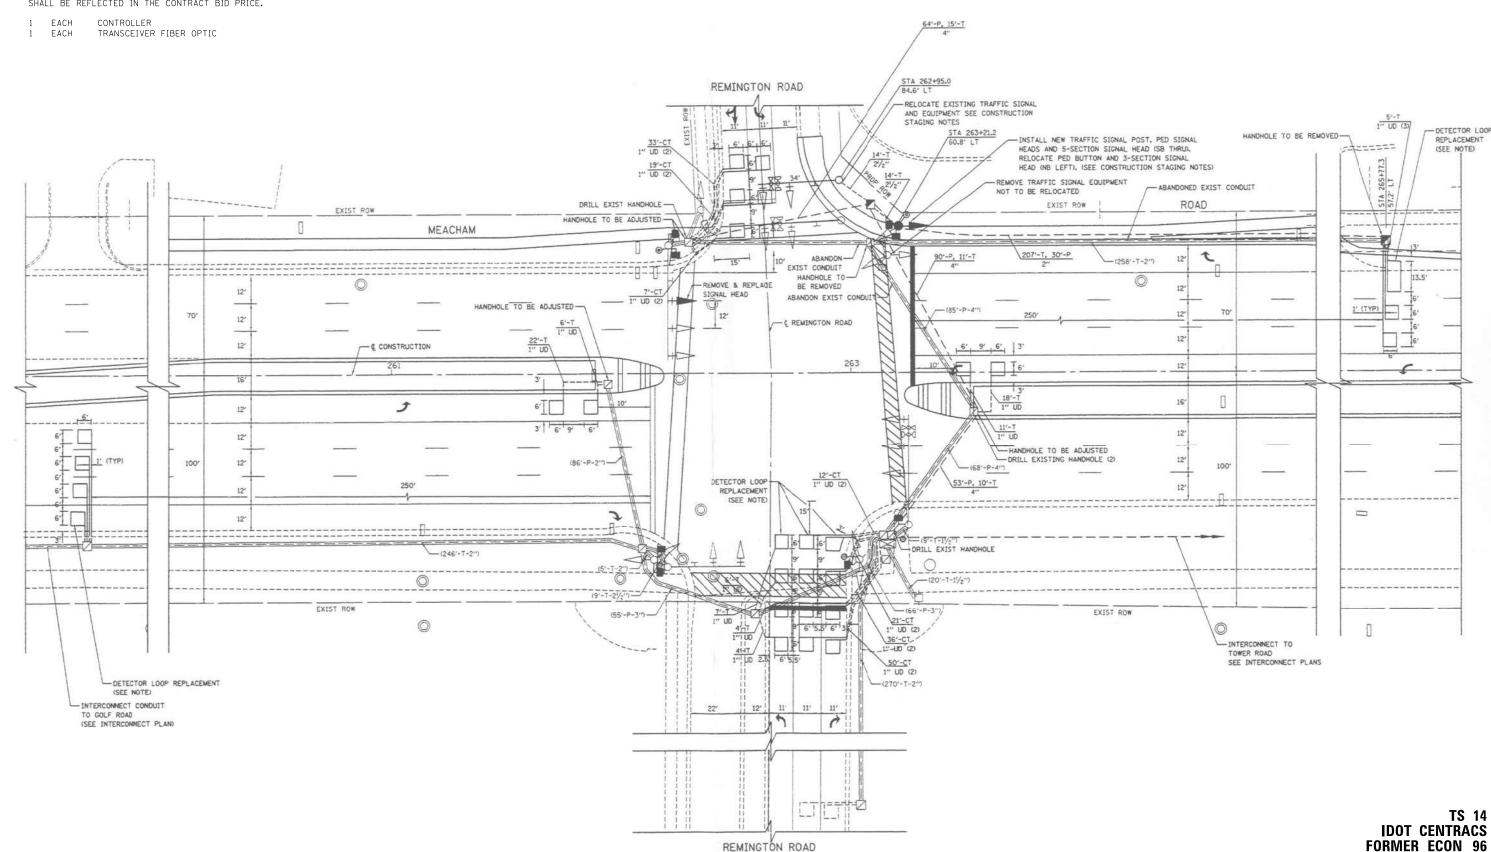


STATE OF ILLINOIS

**DEPARTMENT OF TRANSPORTATION** 

K:\PROJECTS\Projects 2022\22-

ENGINEERS AND PLANNERS
6035 N. NORTHBEST HIGHBAY
SUITE 306
CHICAGO, ILLINOIS 60631 TEL.177

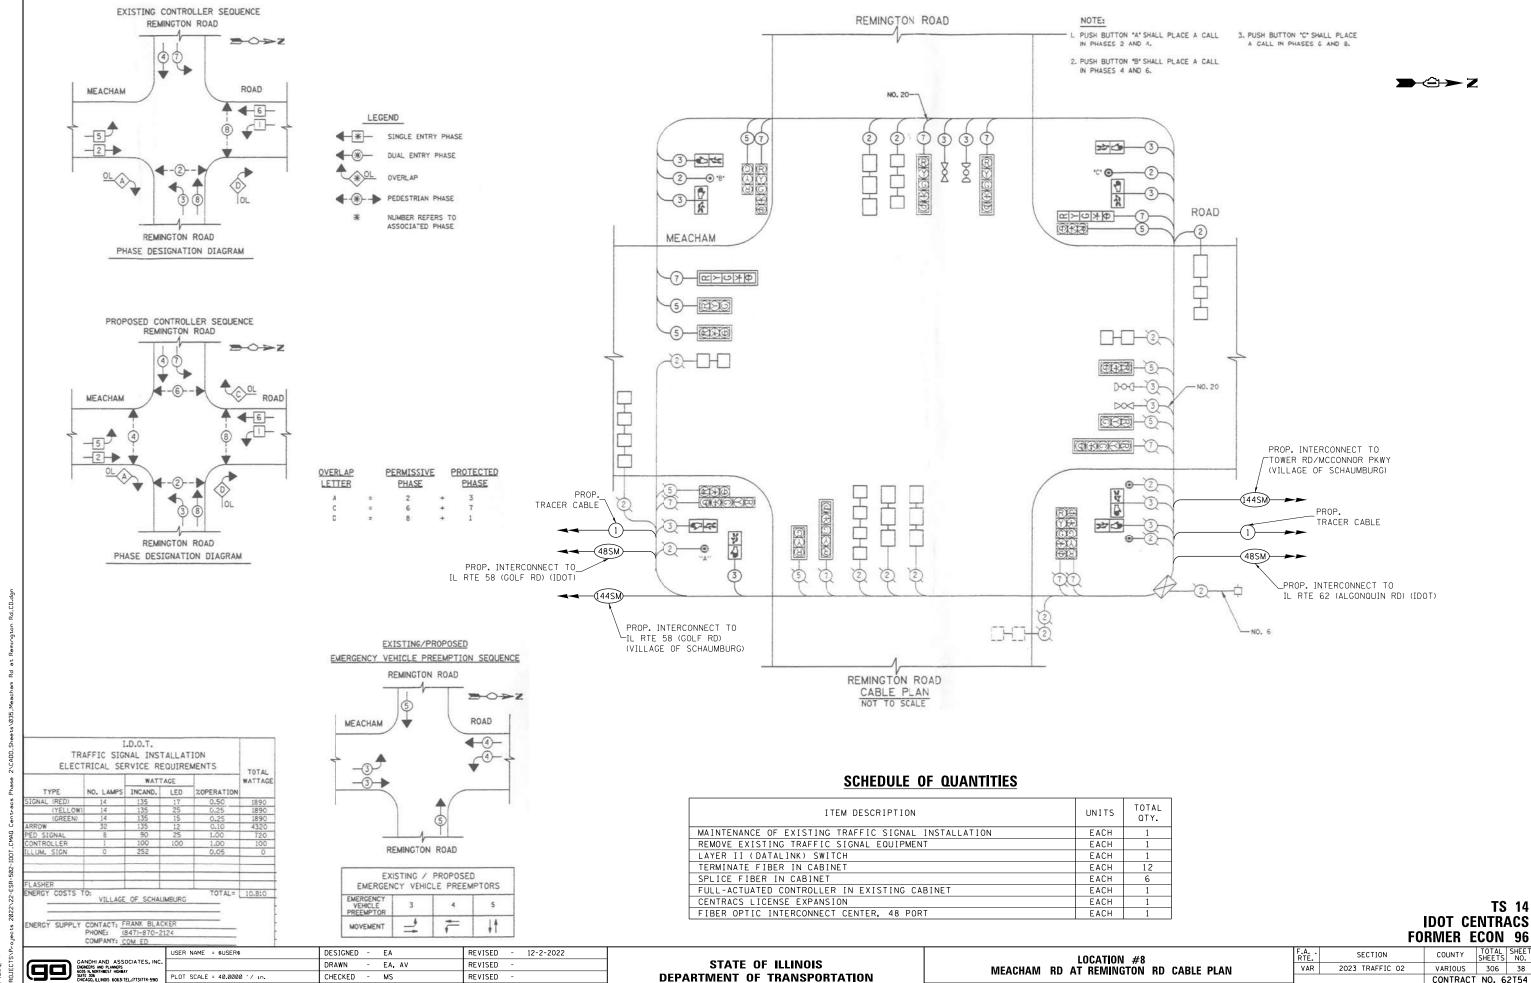

**DEPARTMENT OF TRANSPORTATION** 

SHEET NO. OF SHEETS STA.

CONTRACT NO. 62T54


FED. ROAD DIST. NO. \_ ILLINOIS FED. AID PROJECT

CHECKED

- 10/31/2022

DATE

REVISED

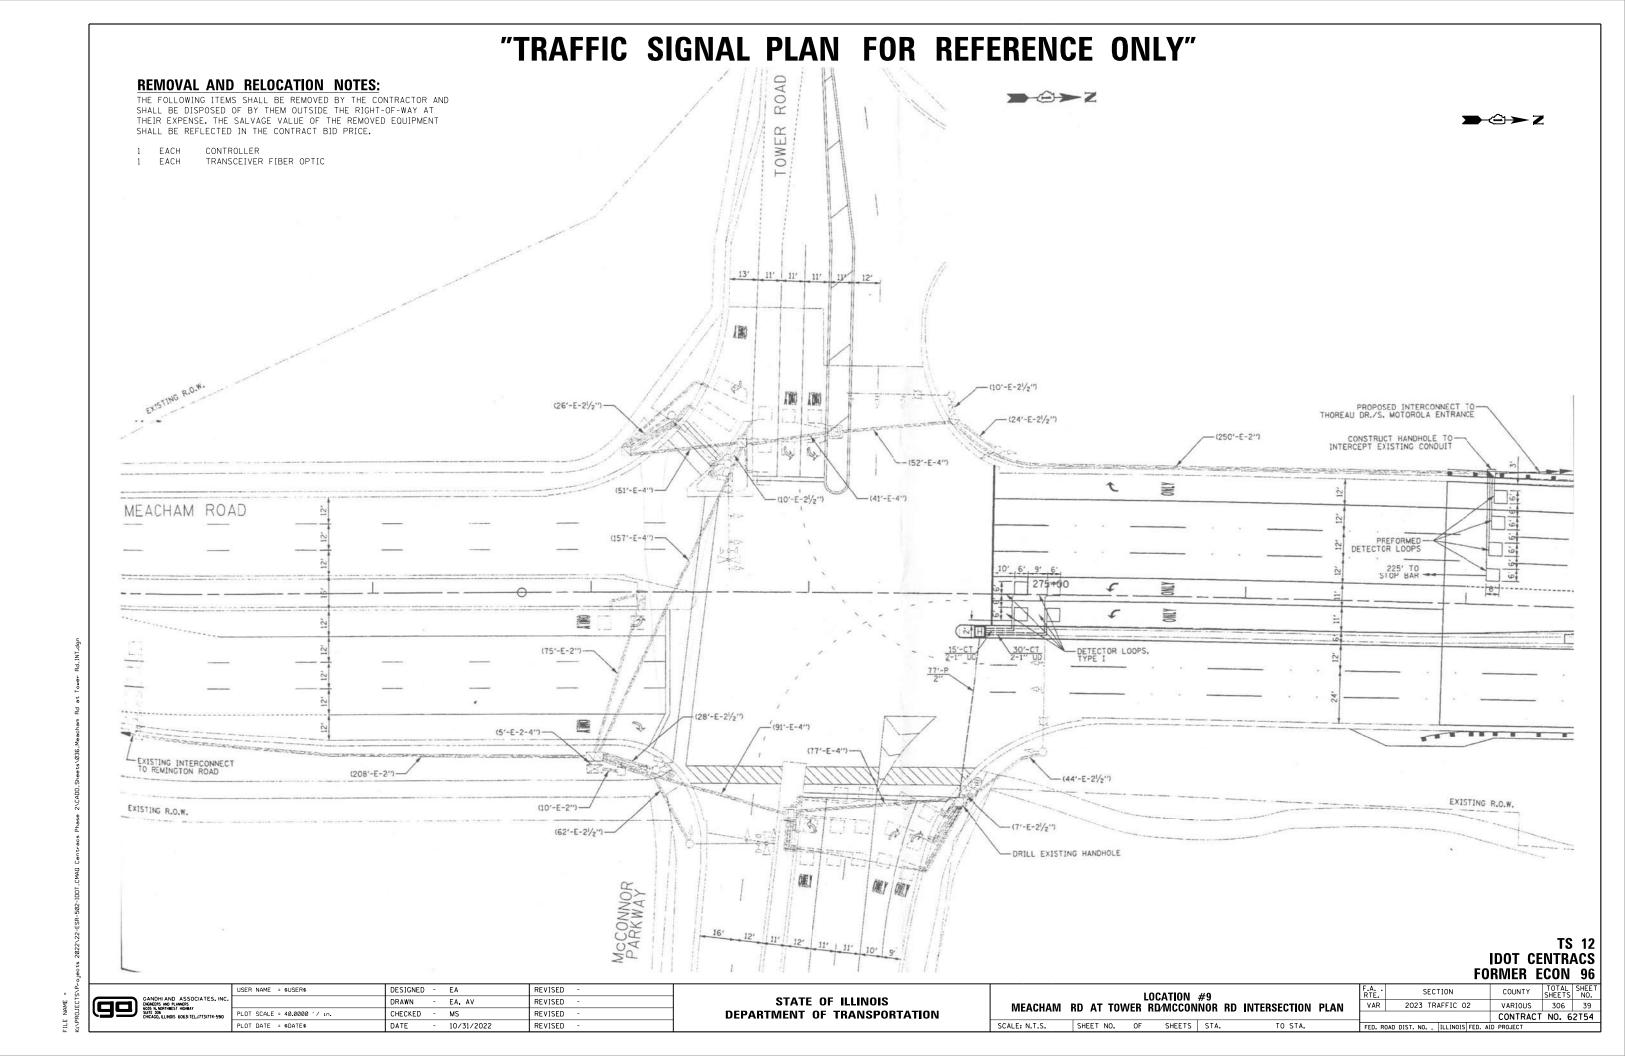


#### PHASE DESIGNATION DIAGRAM


DICUT	TUDN	AVEDI AD	DUACE	DESTRUCTION
H10H1	IUMN	UVERLAP	LUASE	DESIGNATION

OVERLAP		PERMISSIVE	3	PROTECTED
LETTER		PHASE		PHASE
Α	=	2	+	3
В	2	4	+	5
С	2	6	+	7
D	=	8	+	1

#### EXISTING AND PROPOSED EMERGENCY VEHICLE PREEMPTION SEQUENCE

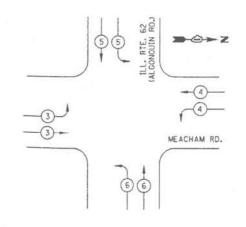

EXISTING EMERGEN	CY VEHICL	E PREE	MPTORS	
EMERGENCY VEHICLE PREEMPTOR	3	4	5	6
MOVEMENT		-	1-	-

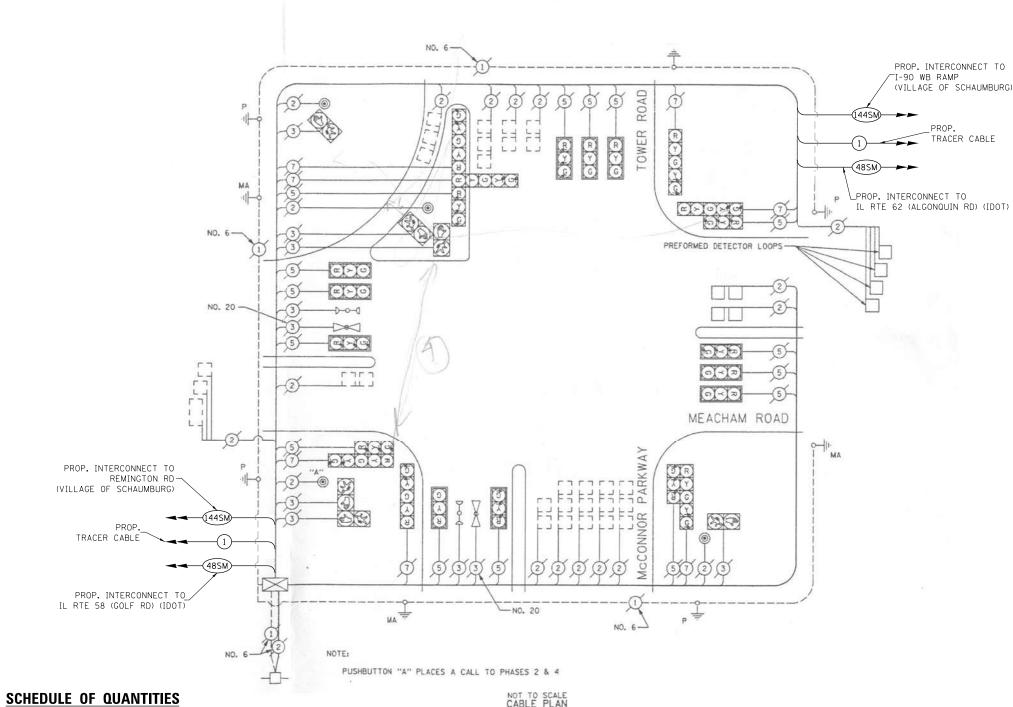

ITEM DESCRIPTION	UNITS	TOTAL QTY.
MAINTENANCE OF EXISTING TRAFFIC SIGNAL INSTALLATION	EACH	1
REMOVE EXISTING TRAFFIC SIGNAL EQUIPMENT	EACH	1
LAYER II (DATALINK) SWITCH	EACH	1
TERMINATE FIBER IN CABINET	EACH	12
SPLICE FIBER IN CABINET	EACH	6
FULL-ACTUATED CONTROLLER IN EXISTING CABINET	EACH	1
CENTRACS LICENSE EXPANSION	EACH	1
FIBER OPTIC INTERCONNECT CENTER, 48 PORT	EACH	1

TS 12 IDOT CENTRACS **FORMER ECON 96** 

 $\Rightarrow \Leftrightarrow z$ 


REVISED - 12-2-2022 USER NAME = \$USER\$ DESIGNED - EA DRAWN - EA, AV REVISED CHECKED - 10/31/2022 REVISED

STATE OF ILLINOIS **DEPARTMENT OF TRANSPORTATION**  LOCATION #9
MEACHAM RD AT TOWER RD/MCCONNOR PKWY CABLE PLAN VAR SHEET NO. OF SHEETS STA.

COUNTY TOTAL SHEET NO.

VARIOUS 306 40

CONTRACT NO. 62T54 SECTION 2023 TRAFFIC 02

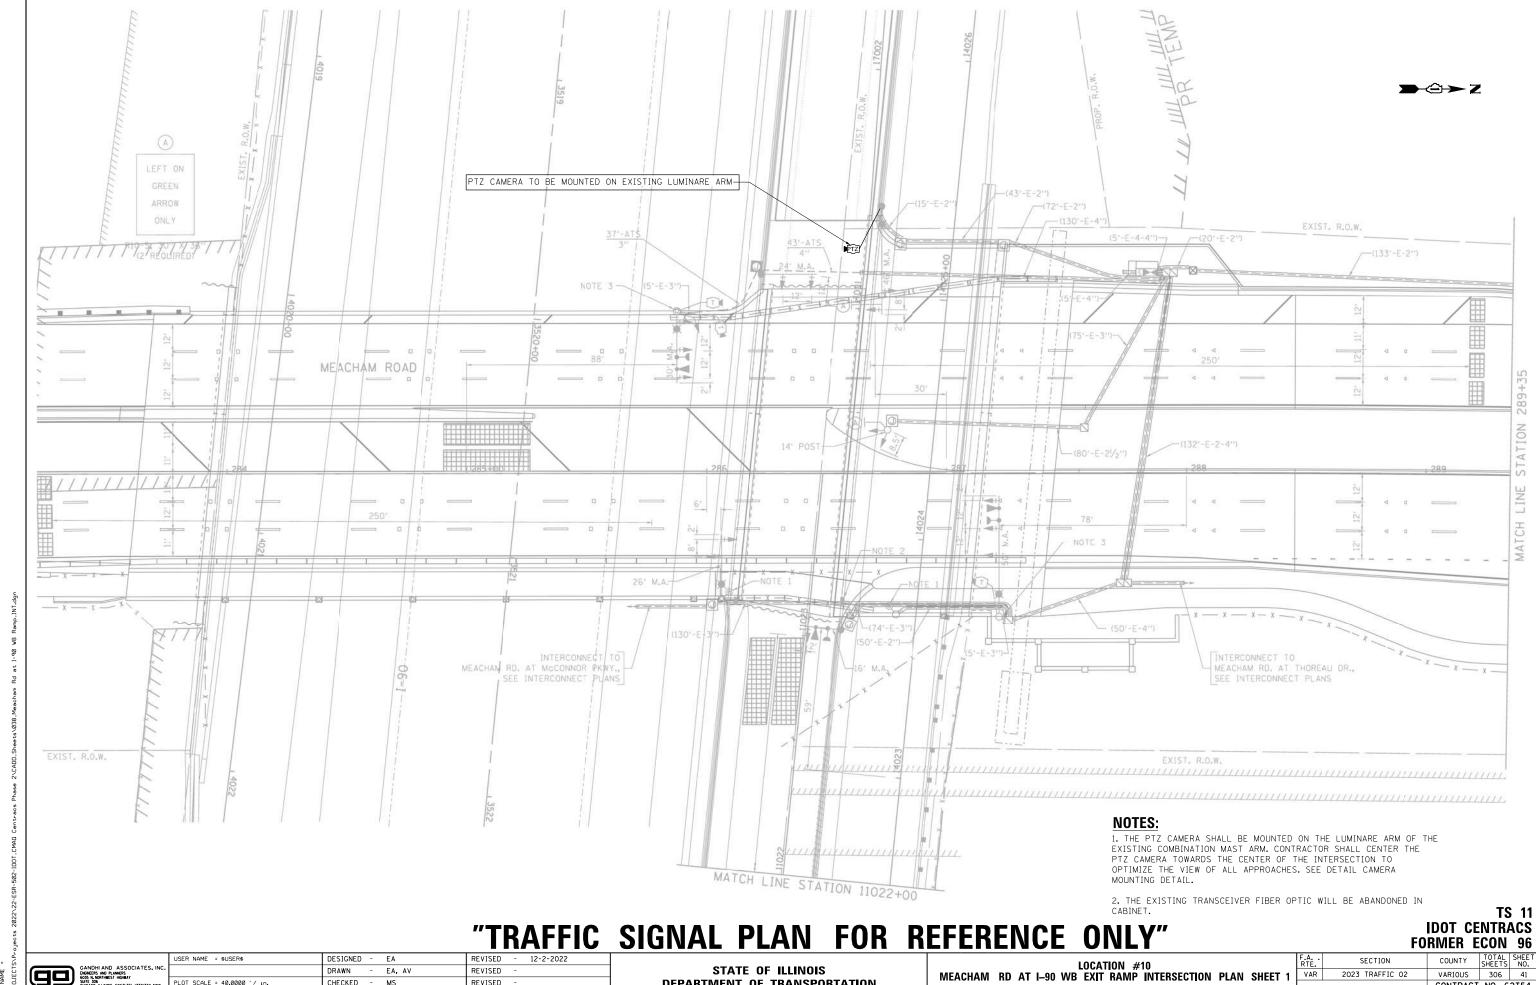

**DEPARTMENT OF TRANSPORTATION** 

SHEET NO. OF SHEETS STA.


CONTRACT NO. 62T54


CHECKED

MS

- 10/31/2022

REVISED

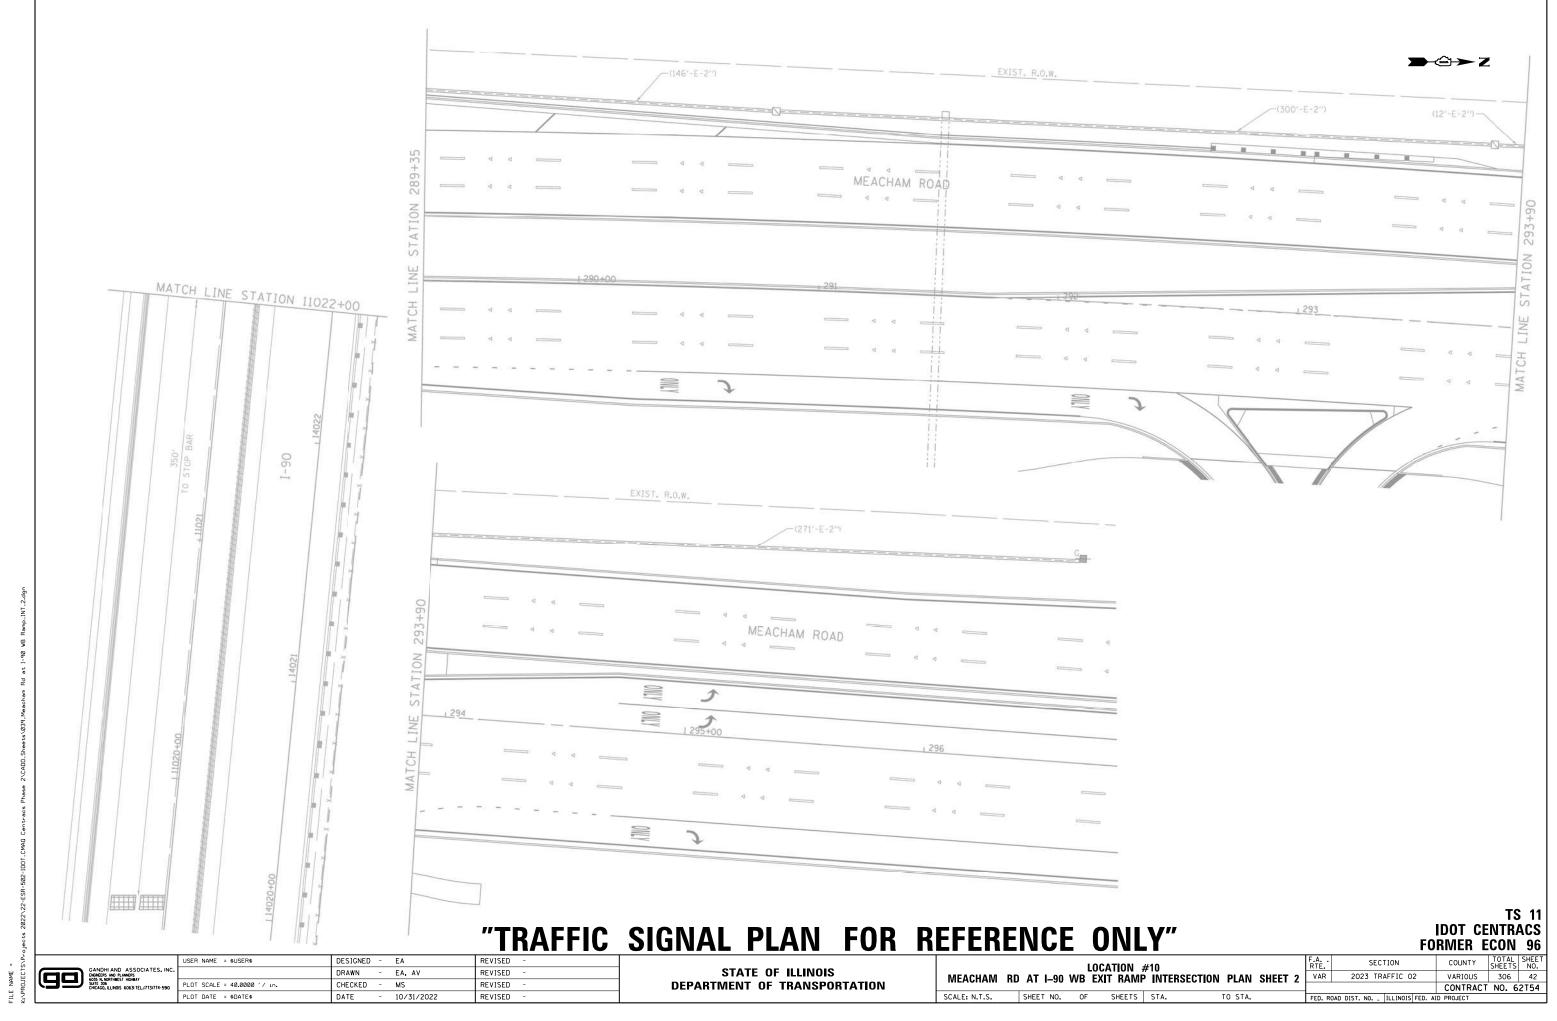

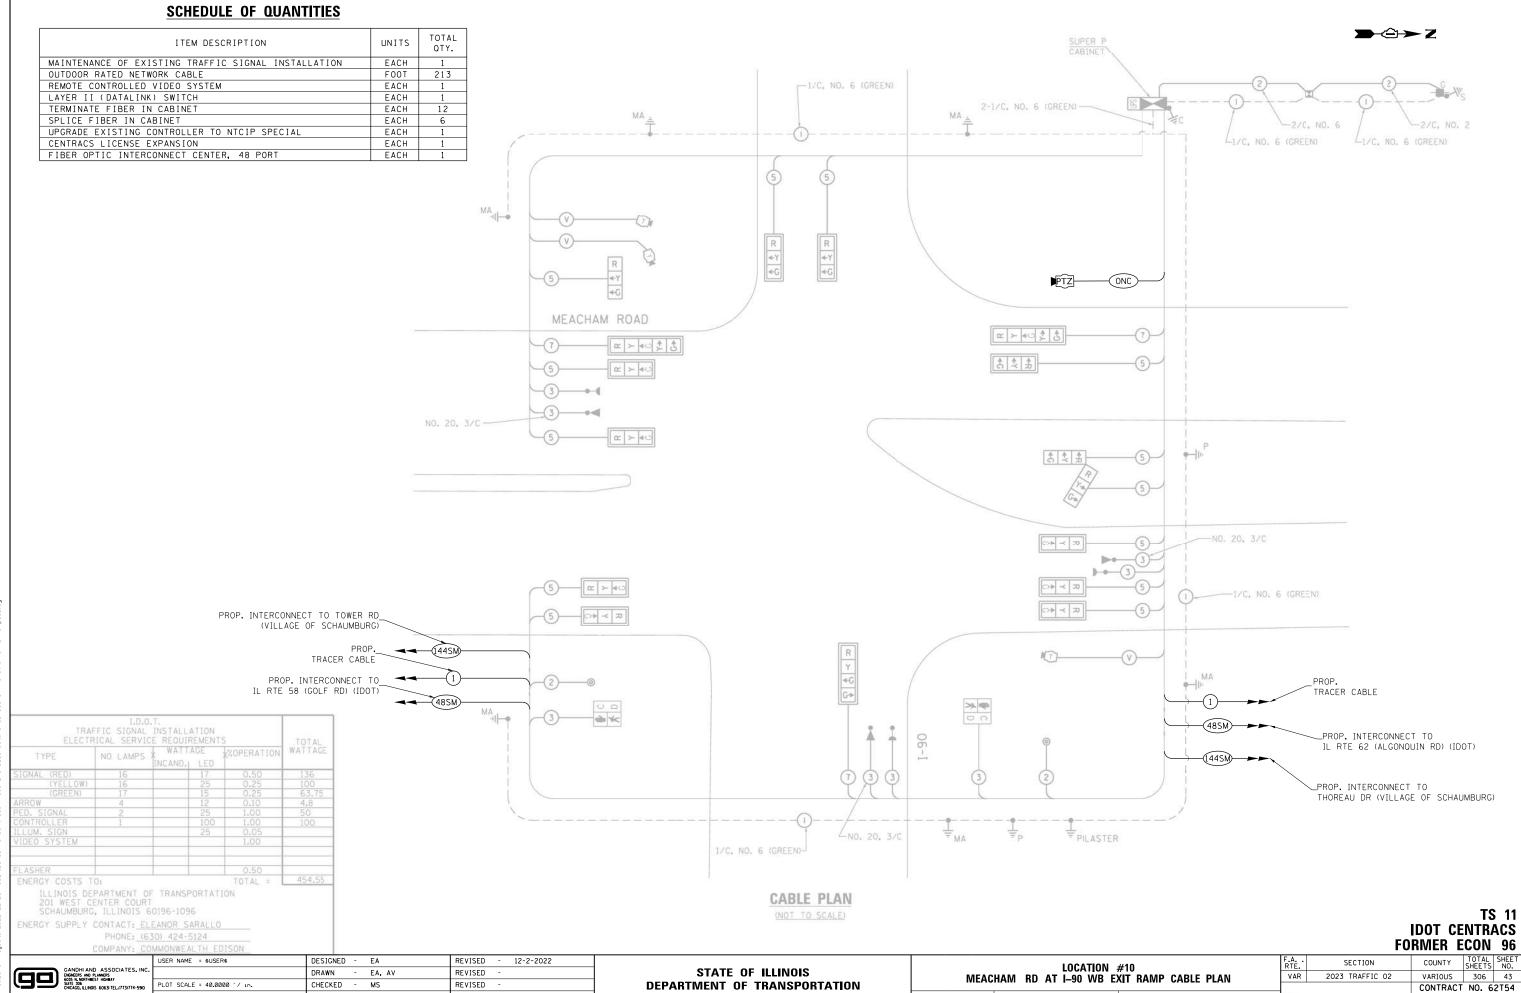

SCALE: N.T.S.


SHEET NO. OF SHEETS STA.

FED. ROAD DIST. NO. \_ ILLINOIS FED. AID PROJECT

PLOT DATE = \$DATE\$

DATE

- 10/31/2022

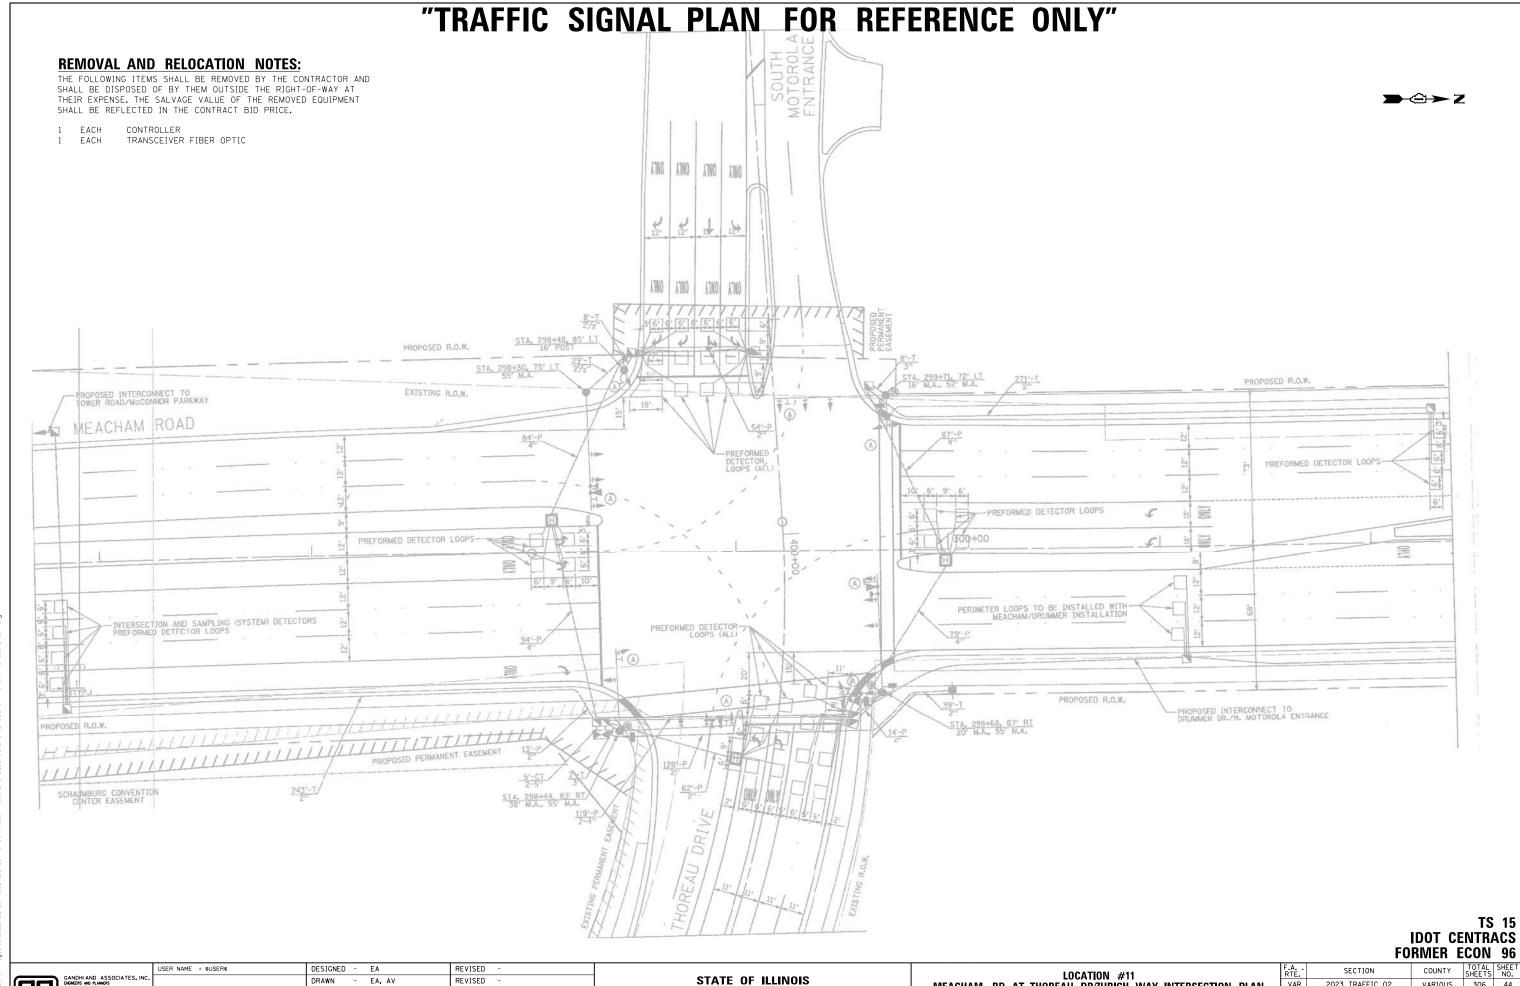


K:\PROJECTS\Projects 2022\;

CANDHI AND ASSOCIATES, INI
EGABERS AND FLANGES
6035 N. MORTHWEST INDIMAY
SOLUTION OF CHICAGO, ELENDIS 60631 TEL./7731774-5910

DEPARTMENT OF TRANSPORTATION


MEACHAM RD AT THOREAU DRZURICH WAY INTERSECTION PLAN

ALE: N.T.S. | SHEET NO. OF SHEETS | STA. TO STA.

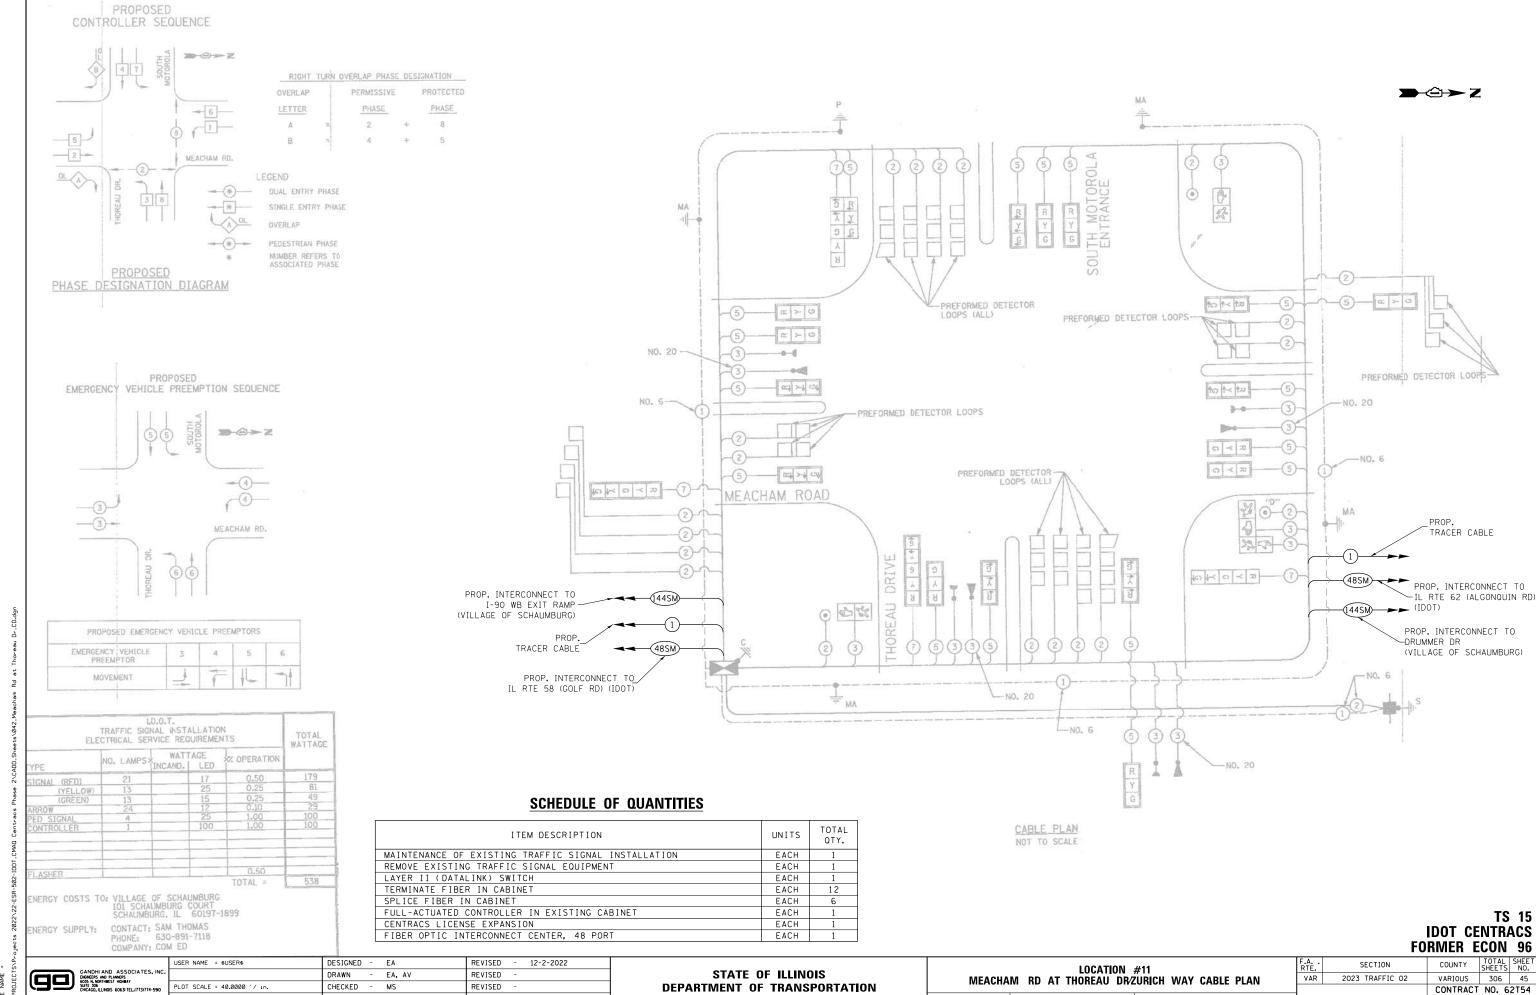

DATE


- 10/31/2022

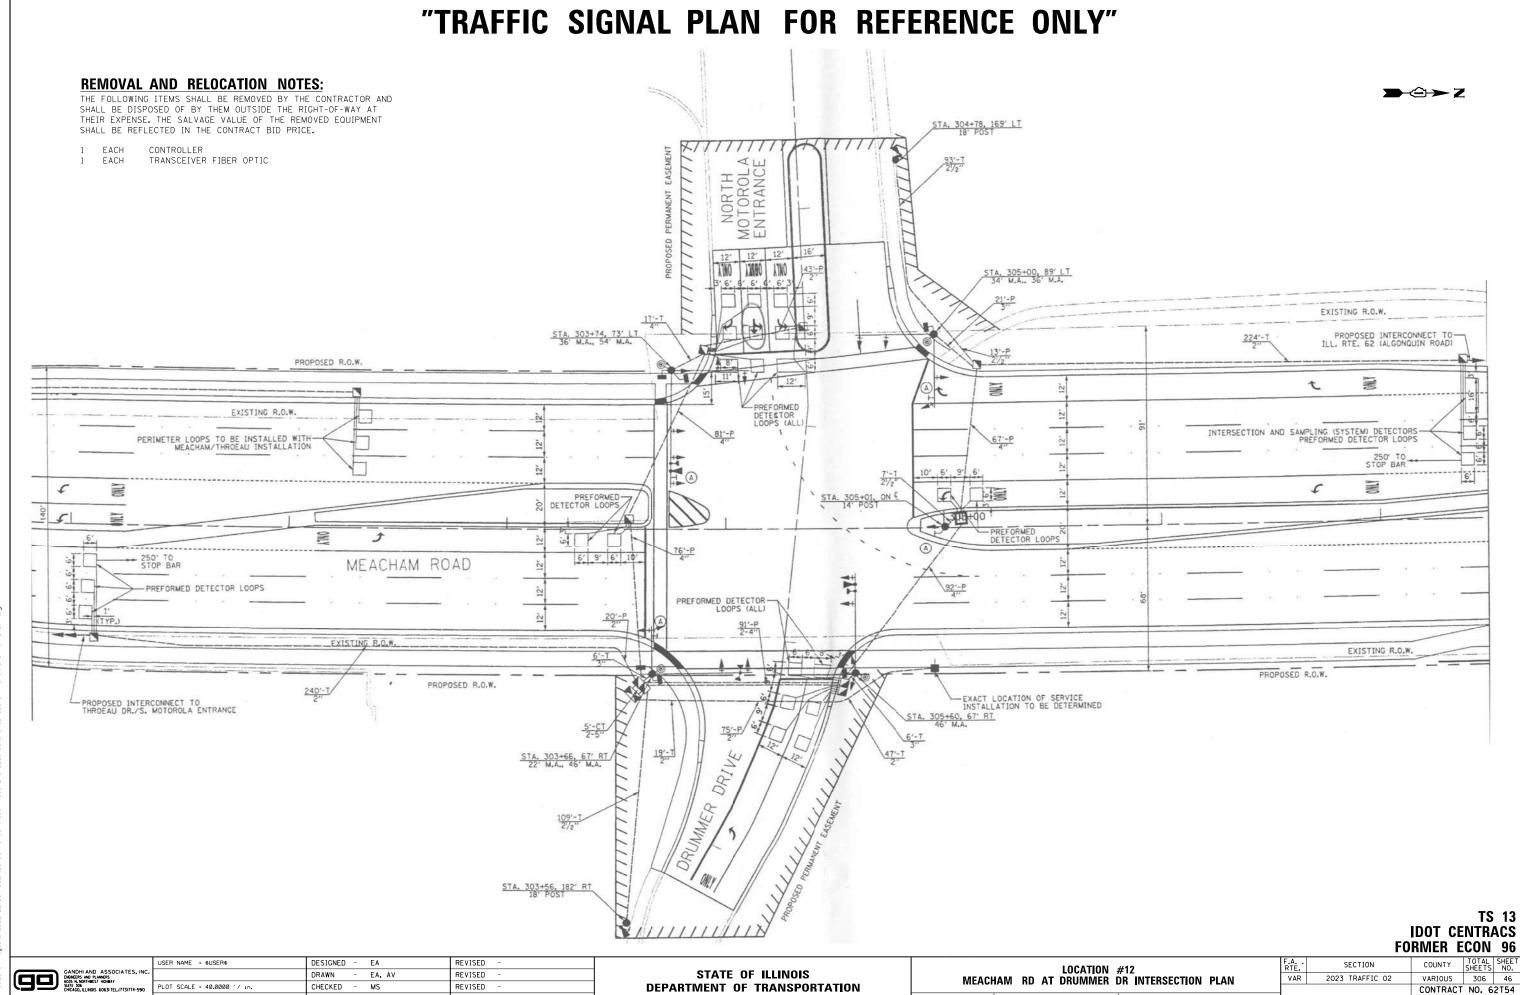

PLOT DATE = \$DATE\$

DATE

- 10/31/2022

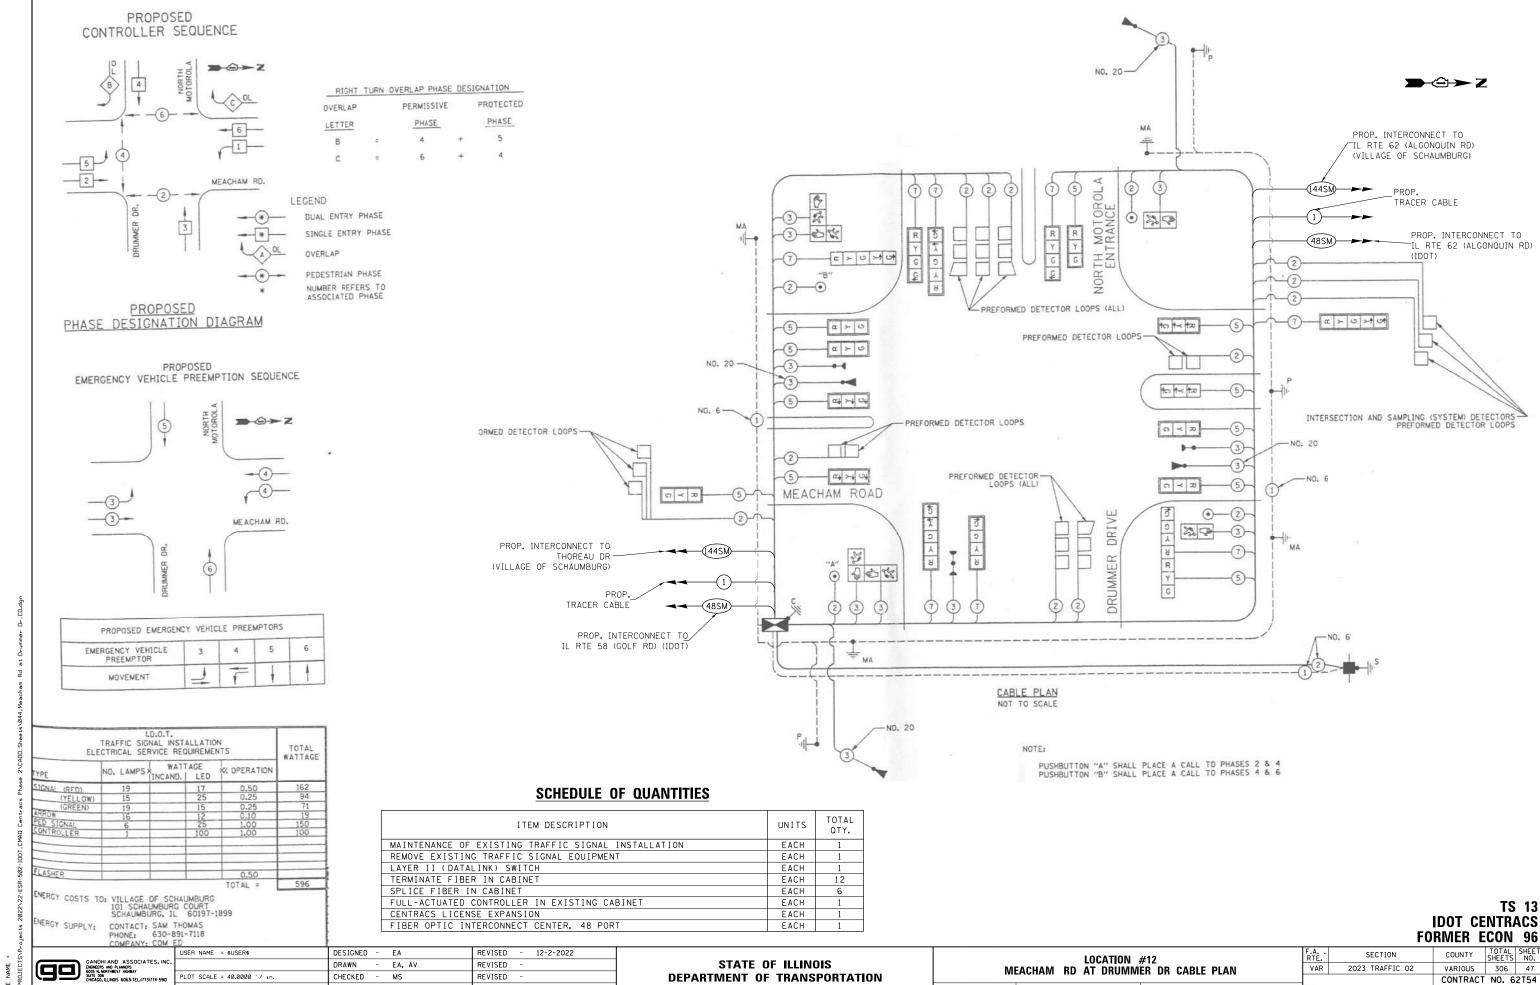

PLOT DATE = \$DATE\$

DATE

- 10/31/2022

THE FOLLOWING EXISTING TRAFFIC SIGNAL EQUIPMENT SHALL BE REMOVED BY THE CONTRACTOR, SHALL REMAIN THE PROPERTY OF THE IDOT. THE CONTRACTOR SHALL SAFELY DELIVER THESE TO IDOT ELECTRICAL MAINTENANCE CONTRACTOR FACILITY AT THEIR OWN EXPENSE. CONTACT ELECTRICAL MAINTENANCE CONTRACTOR FOR LOCATION AND TIME.

TRANSCEIVER FIBER OPTIC

MASTER CONTROLLER

EACH TELEPHONE LINE

LEFT ON GREEN **ARROW** ONLY

R10-5 30"X36" SIGN PANEL TYPE I (8 REQUIRED) (A)

#### **NOTES:**

1. THE PTZ CAMERA SHALL BE MOUNTED ON THE LUMINARE ARM OF THE EXISTING COMBINATION MAST ARM. CONTRACTOR SHALL CENTER THE PTZ CAMERA TOWARDS THE CENTER OF THE INTERSECTION TO OPTIMIZE THE VIEW OF ALL APPROACHES. SEE DETAIL CAMERA MOUNTING DETAIL.

2. THE TELEPHONE LINE AND SERVICE SHOULD BE REMOVED AND DISCONNECTED UPON PROJECT COMPLETION AND SIGNAL BEING ADDED

3. CONTRACTOR MIGHT NEED TO COORDINATE WORK WITH WORK UNDER CONTRACT 61G20. CONTRACT 61G20 IS NEAR COMPLETION AND SHOULD BE COMPLETED FIRST PRIOR TO CONTRACT 62T54 ONLY THEN CAN THE WORK ON THIS CONTRACT BE INITIATED. CONTRACTOR TO PLAN WORK ACCORDINGLY.

### 1" CNC (TYP.) (SEE NOTE 1 26' M.A. - 30" DIA. FDN. (10' DEPTH) APPROX. STA. 125+18.9, 75.6' LT APPROX. STA. 122+15.0, 90.0' LT 42' COMB M.A. - 36" DIA. FDN. (13' DEPTH) APPROX. STA. 123+41.1, 87.3' LT 1" CNC (TYP.) (SEE NOTE 1) 19'-UC-3" 48' COMB M.A. - 36" DIA, FDN. (18' DEPTH) — APPROX. STA. 122+05.1, 73.4' LT PR ROW 145'-UC-4" EX ROW -79'-UC-2" 7'-UC-4"-2 ROAD) 181'-UC-2-4"-GONDUIN I PTZ CAMERA TO BE MOUNTED ON EXISTING LUMINARE ARM-79'-UC-2" RTE. 62 SEE RTE. 45' COMB M.A. - '36" DIA. TON. (13' DEPTH) APPROX. STA. 123+99.8, 42.8' RT -116'-UC-2" APPROX. STA. 123+94.3, 540 I" CNC (TYP.) (SEE , NOT -PROPOSED INTERCONNECT TO THORNTREE LN -14'-UC-3" 26' M.A. - 30" DIA FDN (11' DEPTH) APPROX. STA. 122+37.94, 68.6' RT APPROX. STA. 124+50.2, 691 RT 30'-UC-3" 32'-UC-4" PR ROW (TELEPHONE SERVICE) TEMP EASEMENT 58' COMB M.A. - 42" DIA. FDN. (27' DEPTH) APPROX. STA. 122+90.8, 92.5' RT 49'-UC-2' TS 14780

### "TRAFFIC SIGNAL PLAN FOR REFERENCE ONLY"


**IDOT CENTRACS FORMER ECON 96** COUNTY


CANDHI AND ASSOCI ENGINEERS AND PLANNERS 6035 N. NORTHIEST HIGHBAY SUITE 306 CHICAGO, ILLINOIS 60631 TEL.(

JSER NAME = \$USER\$ DESIGNED - EA DRAWN - EA, AV REVISED CHECKED MS REVISED REVISED DATE 10/31/2022

STATE OF ILLINOIS **DEPARTMENT OF TRANSPORTATION** 

LOCATION #13 SECTION MEACHAM RD AT IL RTE 62 (ALGONQUIN RD) INTERSECTION PLAN 2023 TRAFFIC 02 VAR VARIOUS 306 48 SHEET 1 CONTRACT NO. 62T54 SHEET NO. OF SHEETS STA.

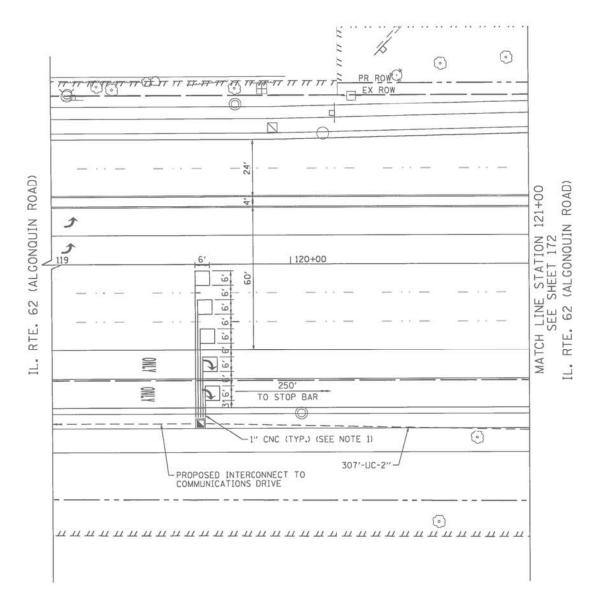

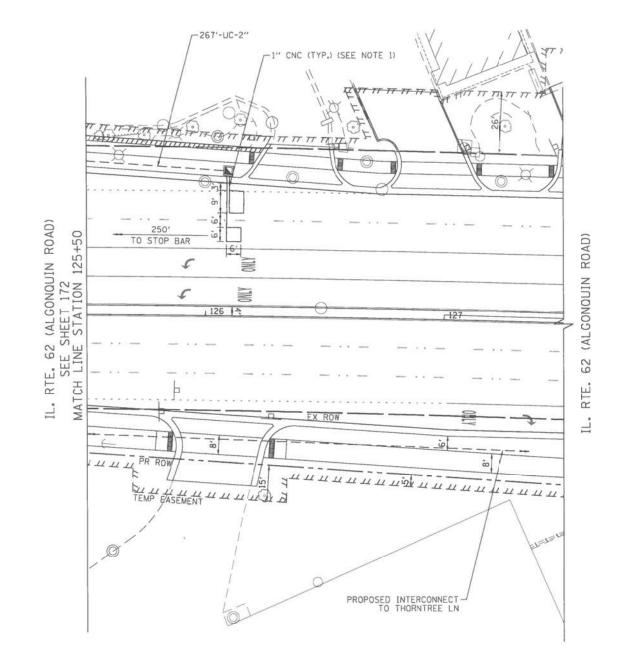


## "TRAFFIC SIGNAL PLAN FOR REFERENCE ONLY"

TS 14780 IDOT CENTRACS FORMER ECON 96



STATE OF ILLINOIS DEPARTMENT OF TRANSPORTATION

MEACHAM	RD AT		LOCATION 62 (ALGONO SHEET 2	QUIN	RD) INTERSECTION	PLAN	VAI
SCALE: N.T.S.	SHEET	NO. OF	SHEETS	STA.	TO STA.		FED.

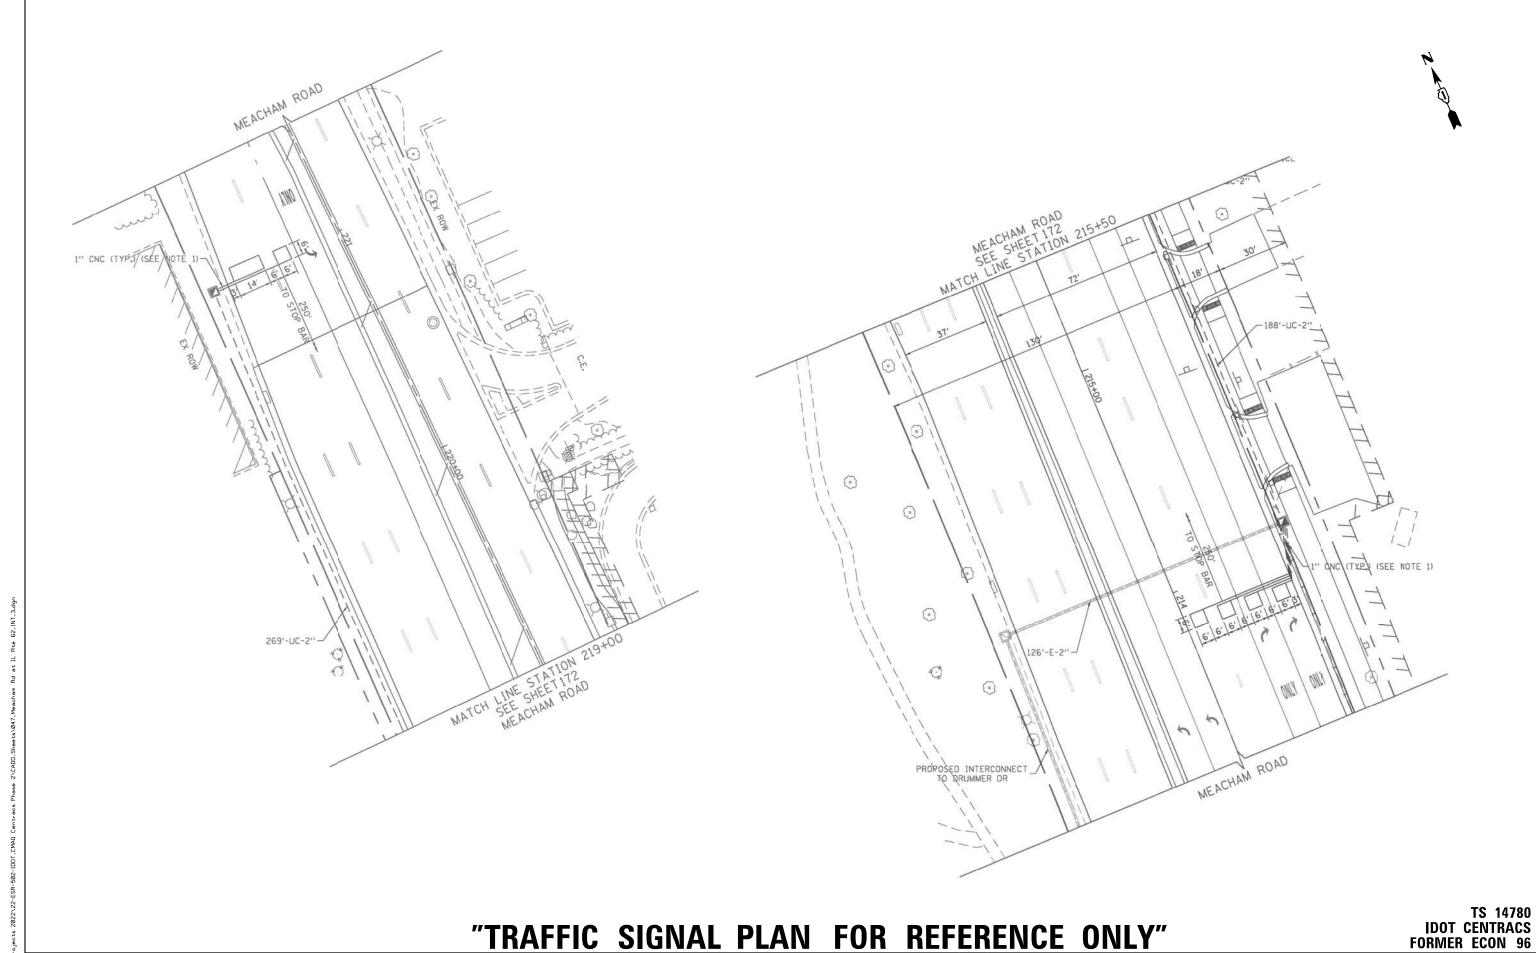

DESIGNED - EA REVISED DRAWN - EA, AV CHECKED - MS REVISED DATE - 10/31/2022 REVISED

STATE OF ILLINOIS DEPARTMENT OF TRANSPORTATION

LOCATION #13
MEACHAM RD AT IL RTE 62 (ALGONQUIN RD) INTERSECTION PLAN
SHEET 3 SHEET NO. OF SHEETS STA.


NIE. SECTION COUNTY TOTAL SHEETS NO.

VAR 2023 TRAFFIC 02 VARIOUS 306 50

CONTRACT NO. 62754

FED. ROAD DIST. NO. | ILLINOIS FED. AID PROJECT

FORMER ECON 96

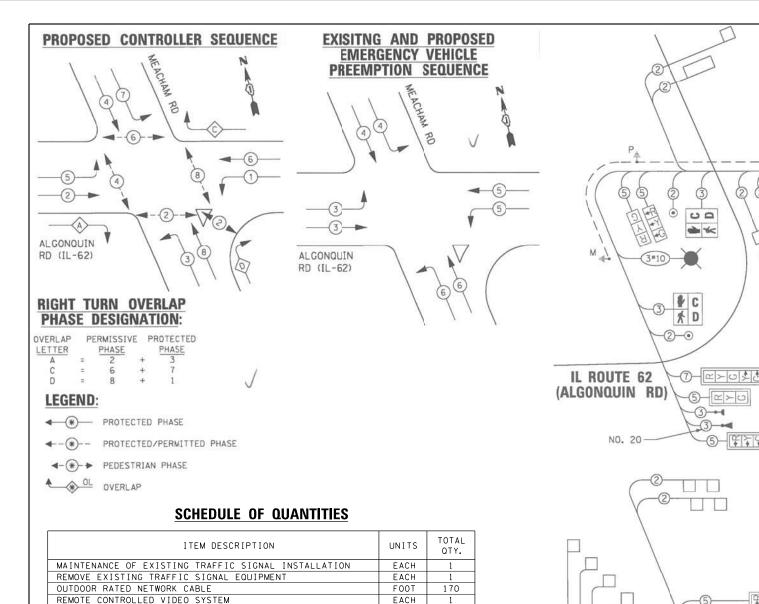

ITEM DESCRIPTION	UNITS	TOTAL OTY.
MAINTENANCE OF EXISTING TRAFFIC SIGNAL INSTALLATION	EACH	1
REMOVE EXISTING TRAFFIC SIGNAL EQUIPMENT	EACH	1
OUTDOOR RATED NETWORK CABLE	FOOT	170
REMOTE CONTROLLED VIDEO SYSTEM	EACH	1
TERMINATE FIBER IN CABINET	EACH	48
LAYER III (NETWORK) SWITCH	EACH	1
CENTRACS LICENSE EXPANSION	EACH	1
FIRER OPTIC INTERCONNECT CENTER 48 PORT	EVCH	1

### TRAFFIC SIGNAL **ELECTRICAL SERVICE REQUIREMENTS**

NO. OF LED % TOTAL

TYPE	LAMPS	WATTAGE	OPERATION	WATTAGE
SIGNAL (RED)	26 /	-11	50	143.0
(YELLOW)	26 /	20	5	26.0
(GREEN)	26 J	12	45	140.4 4
PERMISSIVE ARROW	20 J	10	10	20.0
PED. SIGNAL	10 √	20	100	200.0
CONTROLLER	1 1	100	100	100.0 4
UPS	1 🗸	25	100	25.0
VIDEO SYSTEM	-	150	100	
BLANK-OUT SIGN	*	25	5	
FLASHER	7,	-	50	
STREET NAME SIGN	-	120	50	
LUMINAIRE	4 J	285	50	570.0
			TOTAL =	1224.4 d

ENERGY COSTS TO:

VILLAGE OF SCHAUMBURG 101 SCHAUMBURG COURT

SCHAUMBURG, ILLINOIS 60193-1899

ENERGY SUPPLY: CONTACT: PHONE:\_ COMPANY: COMMONWEALTH EDISON

ACCOUNT NUMBER:

DESIGNED - EA REVISED - 12-2-2022 DRAWN - EA, AV REVISED CHECKED - MS REVISED DATE - 10/31/2022 REVISED

STATE OF ILLINOIS **DEPARTMENT OF TRANSPORTATION**  LOCATION #13
MEACHAM RD AT IL RTE 62 (ALGONQUIN RD) CABLE PLAN SHEET 1 SHEET NO. OF SHEETS STA.

CABLE PLAN

(NOT TO SCALE)

**FORMER ECON 96** SECTION COUNTY 2023 TRAFFIC 02 VAR VARIOUS 306 51 CONTRACT NO. 62T54

DISCONNECTED (SPARE)

TRACER CABLE

LPROP. INTERCONNECT TO THOREAU DR/THORNTREE LI

PROP. INTERCONNECT TO IL RTE 58 (GOLF RD) (IDOT


TS 14780 IDOT CENTRACS

TRACER CABLE

a \* \_3\_a¥ 3 4 PROP. INTERCONNECT TO\_ PARKSIDE DR DISCONNECTED (SPARE)-PROP. INTERCONNECT TO DRUMMER DR (VILLAGE OF SCHAUMBURG)

-(1#6)

>2 00 1. THE EXISTING TRANSCEIVER FIBER OPTIC WILL BE ABANDONED IN CABINET.

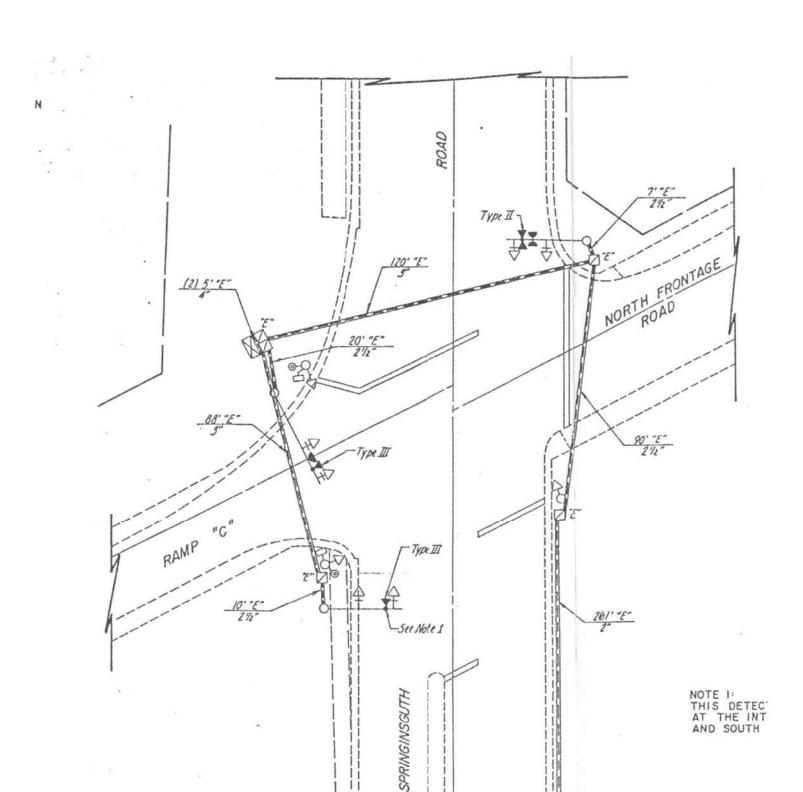


### "TRAFFIC SIGNAL PLAN FOR REFERENCE ONLY"

TS 3 IDOT CENTRACS FORMER ECON 89


GANDHI AND. ASSOCIATES, INC.
EGARETS AND PLANERS
6035 N. NORTHESS! HOWHAY
SOTO. NO. CONTROL OF THE CONTROL OF T

STATE OF ILLINOIS DEPARTMENT OF TRANSPORTATION SCALE: N.T.S. SHEET NO. OF SHEETS STA. TO STA. FED. ROAD DIST.

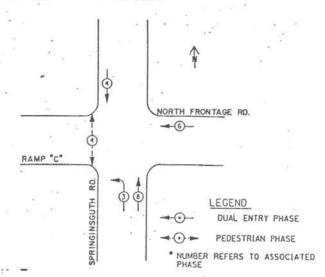


### PHASE DESIGNATION DIAGRAM

DUAL ENTRY - ALL LEGS
PROTECTED/PERMITTED LEFT TURN PHASING

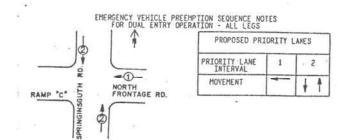

### **SCHEDULE OF QUANTITIES**

ITEM DESCRIPTION	UNITS	TOTAL OTY.
MAINTENANCE OF EXISTING TRAFFIC SIGNAL INSTALLATION	EACH	1
LAYER II (DATALINK) SWITCH	EACH	1
TERMINATE FIBER IN CABINET	EACH	12
SPLICE FIBER IN CABINET	EACH	6
UPGRADE EXISTING CONTROLLER TO NTCIP SPECIAL	EACH	1
CENTRACS LICENSE EXPANSION	EACH	1
FIBER OPTIC INTERCONNECT CENTER, 24 PORT	EACH	1

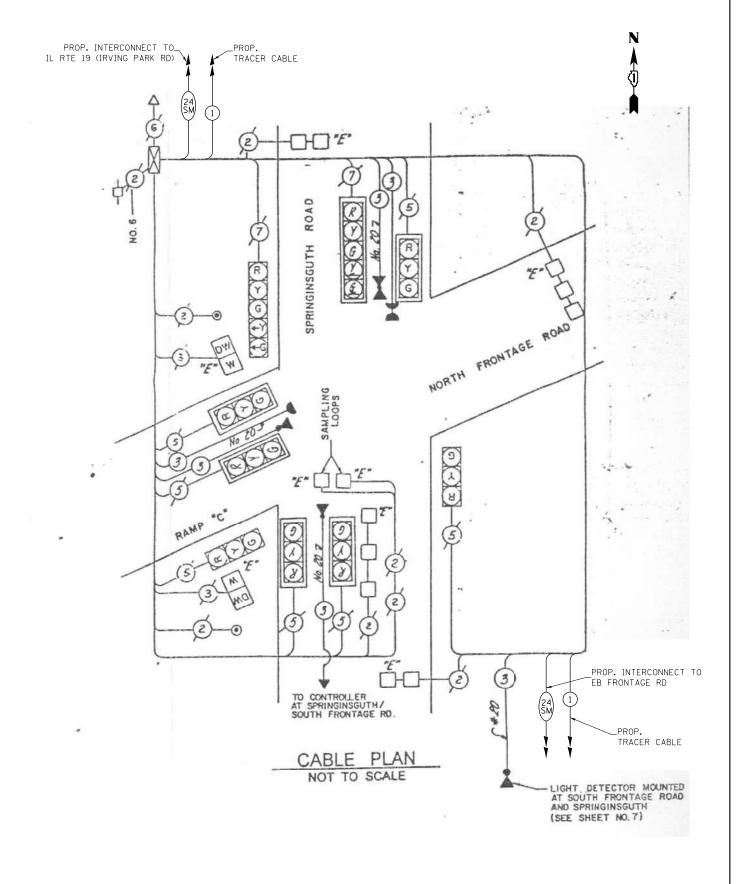

TS 3 IDOT CENTRACS FORMER ECON 89




USER NAME = \$USER\$	DESIGNED	-	EA	REVISED	-	12-2-2
	DRAWN	-	EA, AV	REVISED	-	
PLOT SCALE = 40.0000 '/ in.	CHECKED	-	MS	REVISED	-	
PLOT DATE = \$DATE\$	DATE	-	10/31/2022	REVISED	-	

STATE OF ILLINOIS
DEPARTMENT OF TRANSPORTATION

		LO	CATION #	#83		F.A RTE.	
SPRI	NGINSGUTH F				RD CABLE PLAN	VAR	20
SCALE: N.T.S.	SHEET NO.	OF	SHEETS	STA.	TO STA.	FED. RO	DAD DIST.

1. THE EXISTING TRANSCEIVER FIBER OPTIC WILL BE ABANDONED IN CABINET.



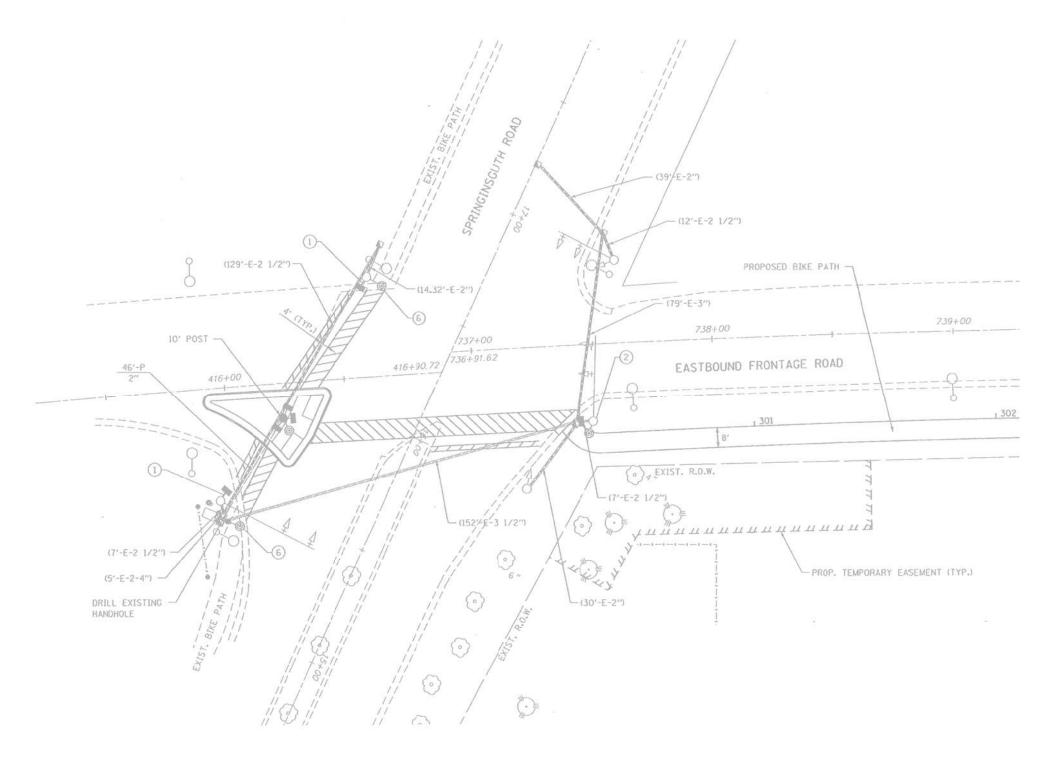

# "TRAFFIC SIGNAL PLAN FOR REFERENCE ONLY"

TS 6 IDOT CENTRACS FORMER ECON 89

GANDHI AND ASSOCIATES, INC.
BURKERS MO PLAMERS
SOST NO PLAMERS
ONICAGO, ELINOIS 6063 TEL/1773/774-590

 USER NAME
 = \$USER\$
 DESIGNED
 EA
 REVISED
 12-2-2022

 DRAWN
 EA, AV
 REVISED

 PLOT SCALE = 40.0000 '/ in.
 CHECKED
 MS
 REVISED

 PLOT DATE = \$DATE\$
 DATE
 10/31/2022
 REVISED


STATE OF ILLINOIS
DEPARTMENT OF TRANSPORTATION

SPRINGINSGUTH RD AT EB FRONTAGE RD INTERSECTION PLAN

E: N.T.S. SHEET NO. OF SHEETS STA. TO STA. FED. RO.



ITEM DESCRIPTION	UNITS	TOTAL QTY.
MAINTENANCE OF EXISTING TRAFFIC SIGNAL INSTALLATION	EACH	1
LAYER II (DATALINK) SWITCH	EACH	1
TERMINATE FIBER IN CABINET	EACH	12
UPGRADE EXISTING CONTROLLER TO NTCIP SPECIAL	EACH	1
CENTRACS LICENSE EXPANSION	EACH	1
FIBER OPTIC INTERCONNECT CENTER, 24 PORT	EACH	1
		1

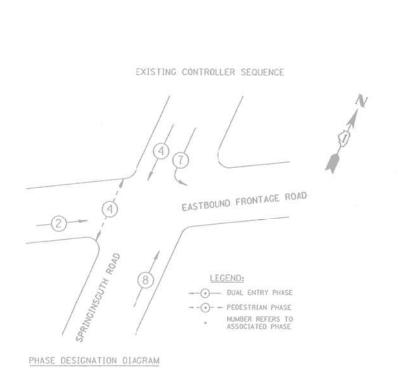

PROPOSED CONTROLLER SEQUENCE

EASTBOUND FRONTAGE ROAD

LEGEND:

DUAL ENTRY PHASE

NUMBER REFERS TO
ASSOCIATED PHASE

PHASE DESIGNATION DIAGRAM

TS 6 IDOT CENTRACS FORMER ECON 89

GANDHI AND ASSOCIATES, INC.

DEMORPRS MO PLANGES
GOSS ANGENEST MOMBAY
SURE 308
DECAGO, LL NOIS 6063 TEL./173174-590

PLOT

PLOT

CABLE PLAN NOT TO SCALE

> STATE OF ILLINOIS DEPARTMENT OF TRANSPORTATION

TRACER CABLE

PROP. INTERCONNECT TO\_ WB FRONTAGE RD

039-5


EASTBOUND FRONTAGE ROAD

SPRINGINSGUTH RD AT EB FRONTAGE RD CABLE PLAN

T.S. SHEET NO. OF SHEETS STA. TO STA.

1. THE EXISTING TRANSCEIVER FIBER OPTIC WILL BE ABANDONED IN CABINET.



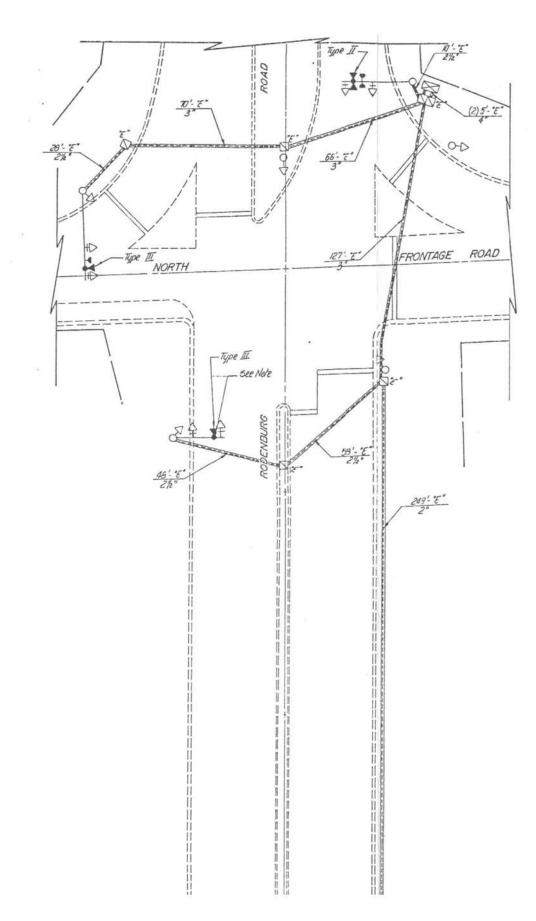

### "TRAFFIC SIGNAL PLAN FOR REFERENCE ONLY"

TS 2 IDOT CENTRACS FORMER ECON 89


GANDHI AND ASSOCIATES, INC.

BOARERS AND PLANERS
GOST AND PLANERS
SIZE SEE
SIZE SEE
CHACOL, LLNOS 60631 TEL, 1773/174-590

STATE OF ILLINOIS
DEPARTMENT OF TRANSPORTATION


RODENBURG RD AT WB FRONTAGE RD INTERSECTION PLAN


N.T.S. SHEET NO. OF SHEETS STA. TO STA.

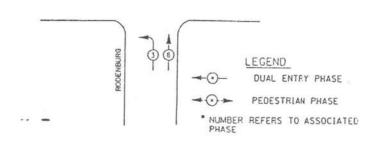

#### PHASE DESIGNATION DIAGRAM

DUAL ENTRY - ALL LEGS
PROTECTED/PERMITTED LEFT TURN PHASING

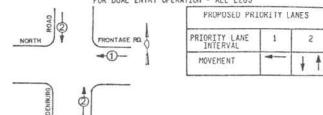

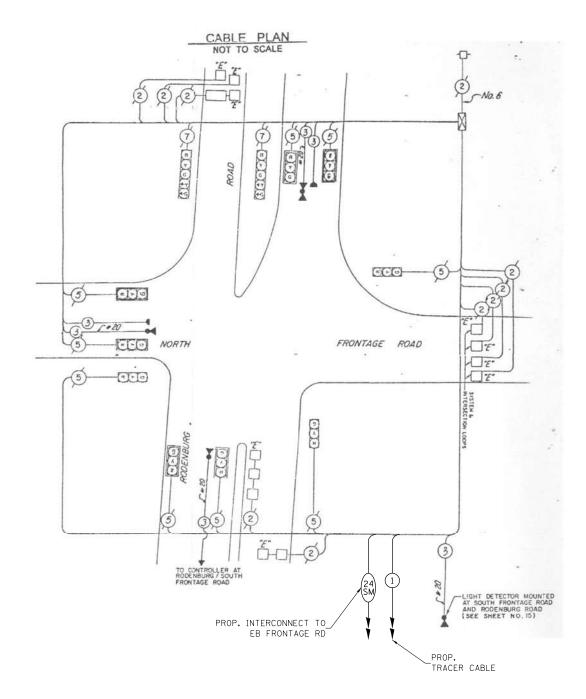


#### **SCHEDULE OF QUANTITIES**

ITEM DESCRIPTION	UNITS	TOTAL OTY.
MAINTENANCE OF EXISTING TRAFFIC SIGNAL INSTALLATION	EACH	1
LAYER II (DATALINK) SWITCH	EACH	1
TERMINATE FIBER IN CABINET	EACH	12
UPGRADE EXISTING CONTROLLER TO NTCIP SPECIAL	EACH	1
CENTRACS LICENSE EXPANSION	EACH	1
FIBER OPTIC INTERCONNECT CENTER, 24 PORT	EACH	1

TS 2
IDOT CENTRACS FORMER ECON 89

COUNTY TOTAL SHEET NO.
VARIOUS 306 57


CONTRACT NO. 62T54

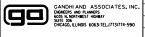

	USER NAME
CIATES. INC.	
L.(773)774-59IO	PLOT SCALE
	PLOT DATE


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	DRAWN	-	EA, AV	REVISED	-	
PLOT SCALE = 40.0000 '/ in.	CHECKED	-	MS	REVISED	-	
PLOT DATE = \$DATE\$	DATE	-	10/31/2022	REVISED	-	

1. THE EXISTING TRANSCEIVER FIBER OPTIC WILL BE ABANDONED IN CABINET.

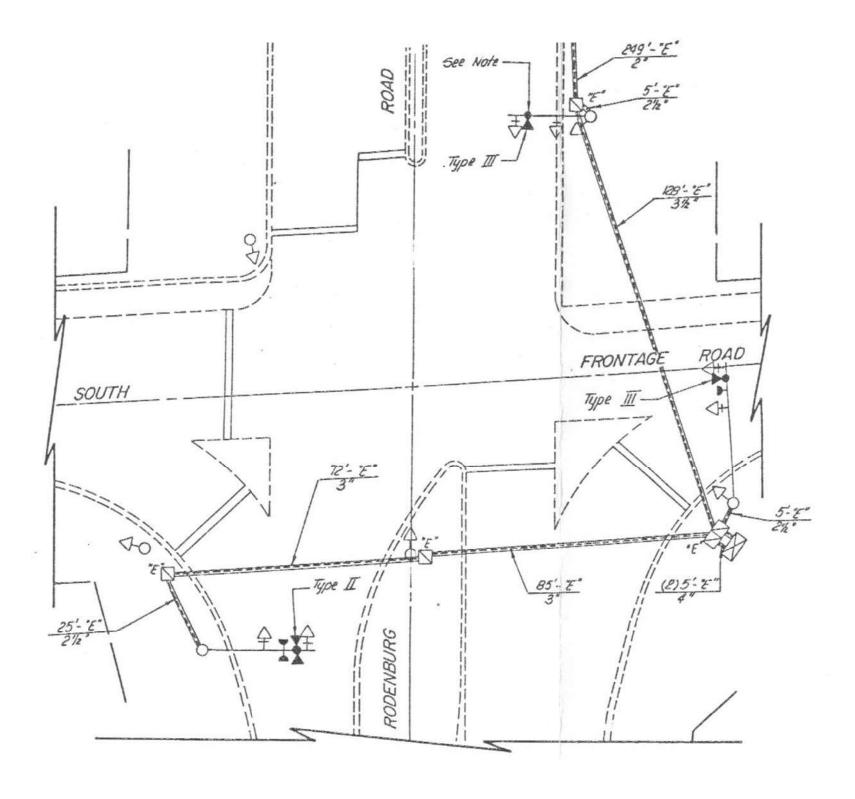

# "TRAFFIC SIGNAL PLAN FOR REFERENCE ONLY"

TS 5 IDOT CENTRACS FORMER ECON 89

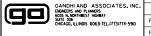



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	DRAWN	-	EA, AV	REVISED
PLOT SCALE = 40.0000 '/ in.	CHECKED	-	MS	REVISED
PLOT DATE = \$DATE\$	DATE	-	10/31/2022	REVISED

STATE OF ILLINOIS
DEPARTMENT OF TRANSPORTATION

DODEND	UDO DD AT		OCATION 4		INTEROCOTION DIAM
KODENR	UKG KD AI	FR	FRUNTAGE	: KD	INTERSECTION PLAN
SCALE: N.T.S.	SHEET NO.	OF	SHEETS	STA.	TO STA.


REFERRING TO STANDARD 2393. THE VEHICULAR AND PEDESTRIAN PHASES USED ARE DESIGNATED BELOW.

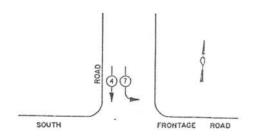


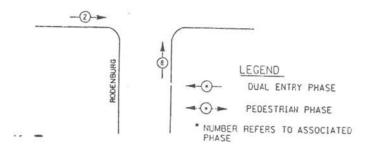

### PHASE DESIGNATION DIAGRAM

DUAL ENTRY - ALL LEGS
PROTECTED/PERMITTED LEFT TURN PHASING

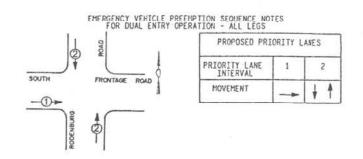

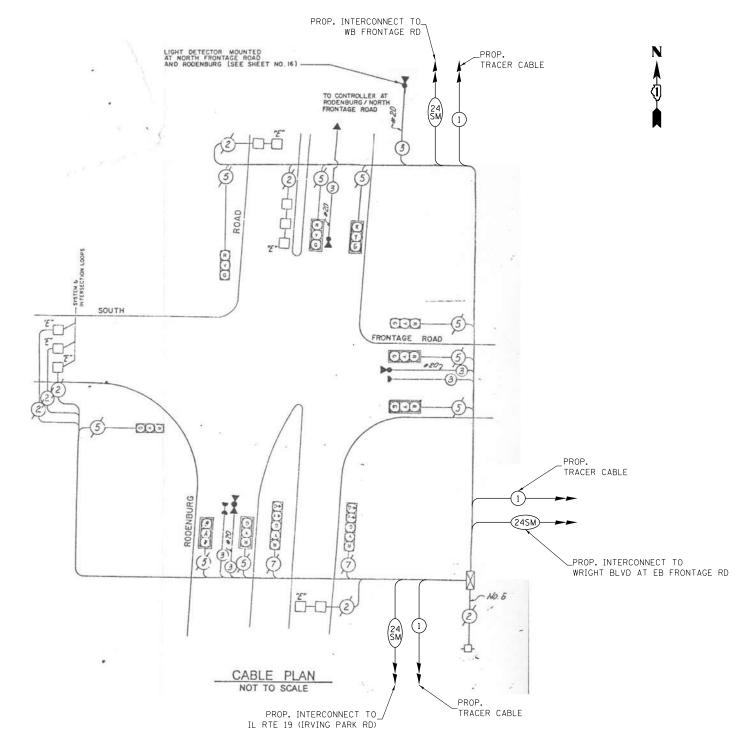

#### SCHEDULE OF QUANTITIES


ITEM DESCRIPTION	UNITS	TOTAL OTY.
MAINTENANCE OF EXISTING TRAFFIC SIGNAL INSTALLATION	EACH	1
LAYER II (DATALINK) SWITCH	EACH	1
TERMINATE FIBER IN CABINET	EACH	36
UPGRADE EXISTING CONTROLLER TO NTCIP SPECIAL	EACH	1
CENTRACS LICENSE EXPANSION	EACH	1
FIBER OPTIC INTERCONNECT CENTER, 24 PORT	EACH	1

TS 5 IDOT CENTRACS FORMER ECON 89



	USER	NAM
SOCIATES, INC.		
N TEL.(773)774-5910	PLOT	SCAL
	PLOT	DAT

SER NAME = \$USER\$	DESIGNED	-	EA	REVISED	-	12-2-2022
	DRAWN	-	EA, AV	REVISED	-	
LOT SCALE = 40.0000 '/ in.	CHECKED	-	MS	REVISED	-	
LOT DATE = \$DATE\$	DATE	-	10/31/2022	REVISED	-	

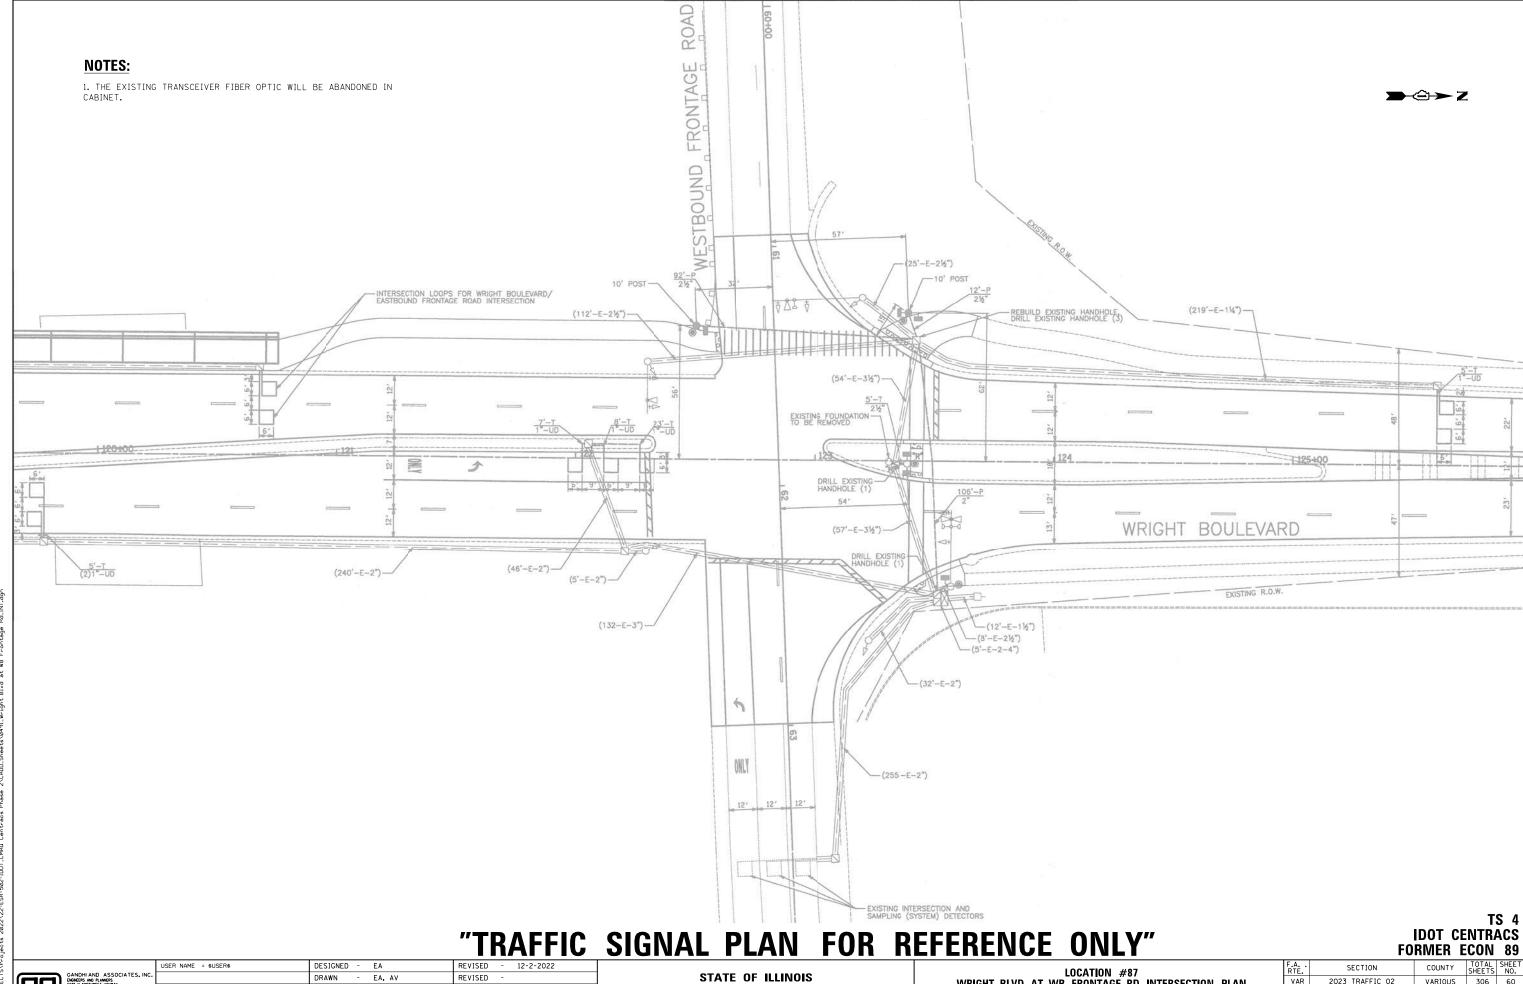

GANDHI AND ASSOCIATES.
ENGINEERS AND PLANERS
GOSTA NORTHEST HIGHAY
SUITE 306
GOSTAGO, LUNOIS 60631 TEL.(773)774-5

DRAWN - EA, AV CHECKED - MS REVISED DATE - 10/31/2022 REVISED


DEPARTMENT OF TRANSPORTATION

LOCATION #87
WRIGHT BLVD AT WB FRONTAGE RD INTERSECTION PLAN SCALE: N.T.S. SHEET NO. OF SHEETS STA.


COUNTY TOTAL SHEET NO.

VARIOUS 306 60

CONTRACT NO. 62154 2023 TRAFFIC 02 VAR

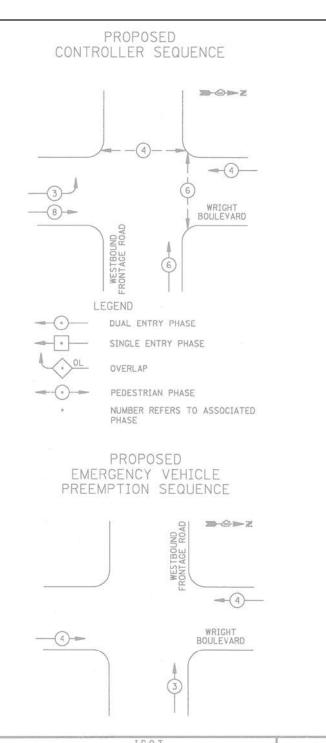


I.D.O.T. TRAFFIC SIGNAL INSTALLATION ELECTRICAL SERVICE REQUIREMENTS							
TYPE	NO. LAMPS	WATT	AGE LED	X OPERATION			
SIGNAL (RED)	11		17	0.50	94		
(YELLOW)	11		25	0.25	69		
(GREEN)	11		15	0.25	41		
ARROW	4		12	0.10	5		
PED. SIGNAL	6		25	1.00	150		
CONTROLLER	1		100	1,00	100		
FLASHER				0,50			
				TOTAL =	459		
ENERGY COSTS T ENERGY SUPPLY:	201 WEST SCHAUMBI CONTACT:	CENTER JRG, IL 6 MARK GL (630) 69	COURT 0196-10 0ECKLE	96	ION		

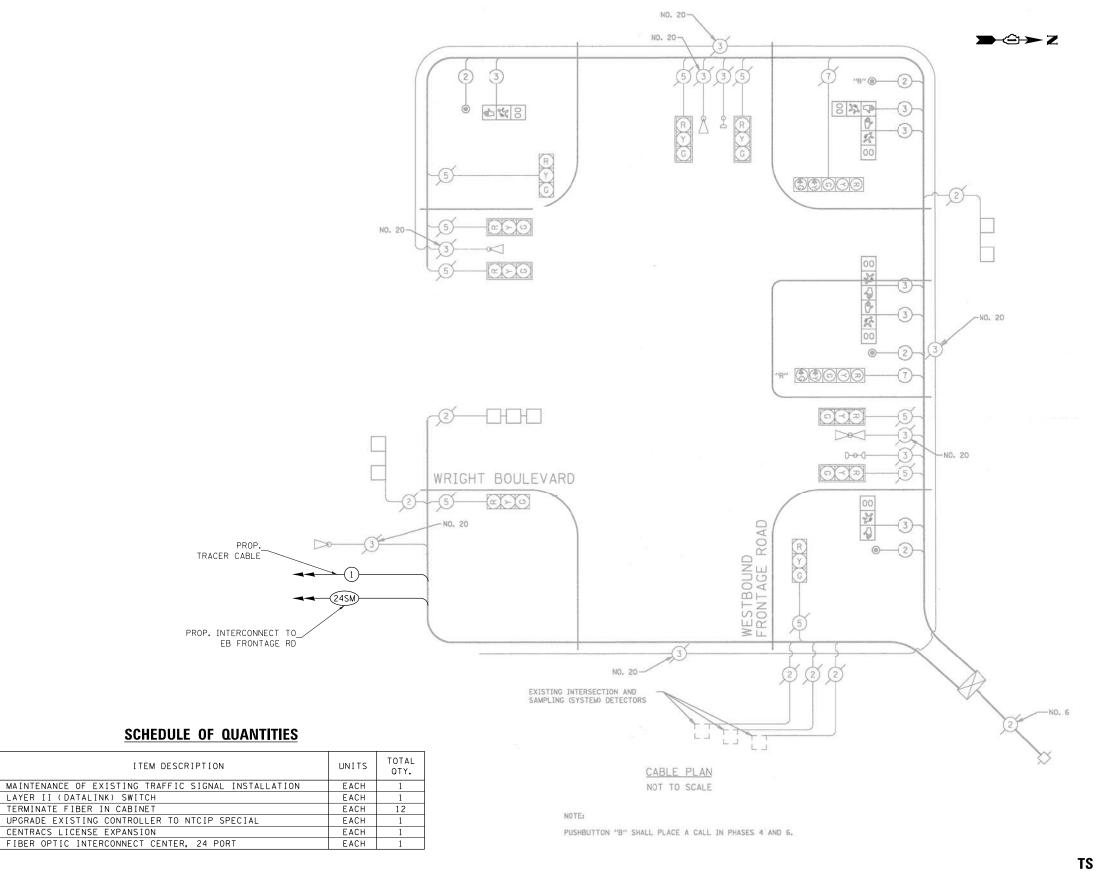

TS 4 IDOT CENTRACS FORMER ECON 89

USER NAME = \$USER\$ DESIGNED - EA REVISED - 12-2-2022 SECTION COUNTY LOCATION #87 STATE OF ILLINOIS DRAWN - EA, AV REVISED 2023 TRAFFIC 02 VAR VARIOUS 306 61 WRIGHT BLVD AT WB FRONTAGE RD CABLE PLAN CHECKED - MS REVISED **DEPARTMENT OF TRANSPORTATION** CONTRACT NO. 62T54 DATE - 10/31/2022 SHEET NO. OF SHEETS STA. PLOT DATE = \$DATE\$ REVISED FED. ROAD DIST. NO. \_ ILLINOIS FED. AID PROJECT

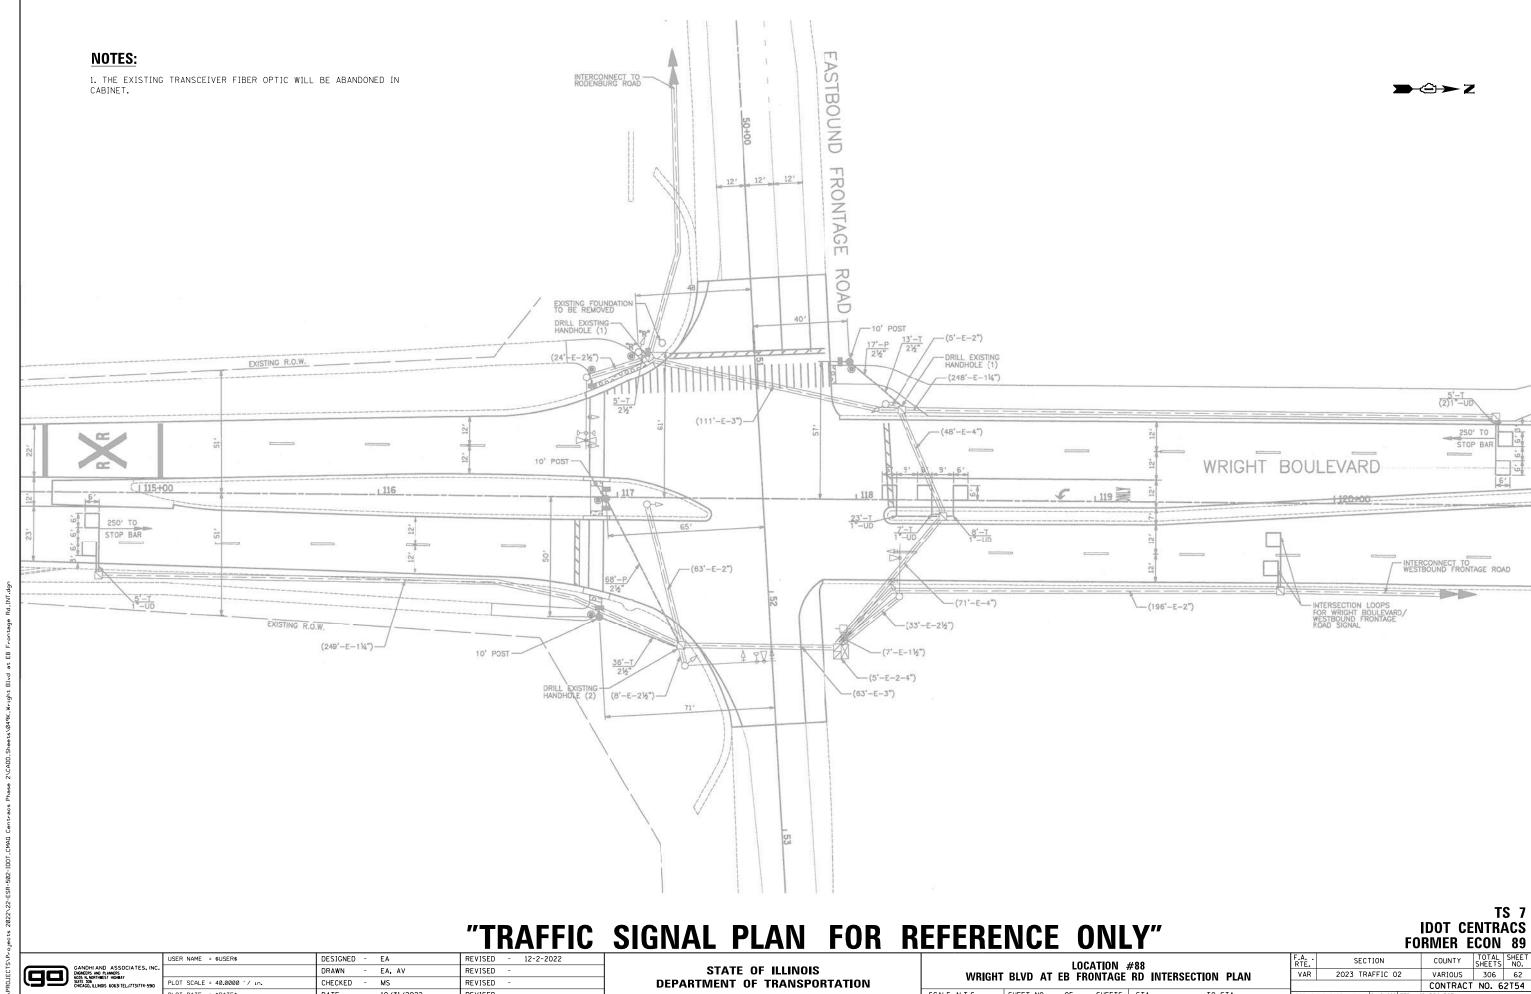

STATE OF ILLINOIS

**DEPARTMENT OF TRANSPORTATION** 

2023 TRAFFIC 02

VAR

SCALE: N.T.S. SHEET NO. OF SHEETS STA.

REVISED

REVISED


REVISED

DRAWN - EA, AV

- 10/31/2022

CHECKED - MS

DATE

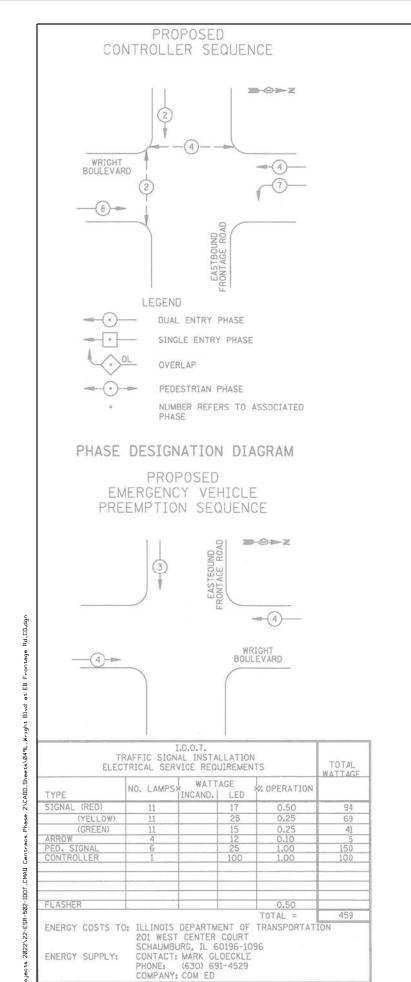

USER NAME = \$USER\$

PLOT DATE = \$DATE\$

LAYER II (DATALINK) SWITCH

TERMINATE FIBER IN CABINET

CENTRACS LICENSE EXPANSION

REVISED - 12-2-2022

SPLICE FIBER IN CABINET

REVISED

REVISED

REVISED

DESIGNED - EA

- EA, AV


MS

- 10/31/2022

DRAWN

DATE

CHECKED

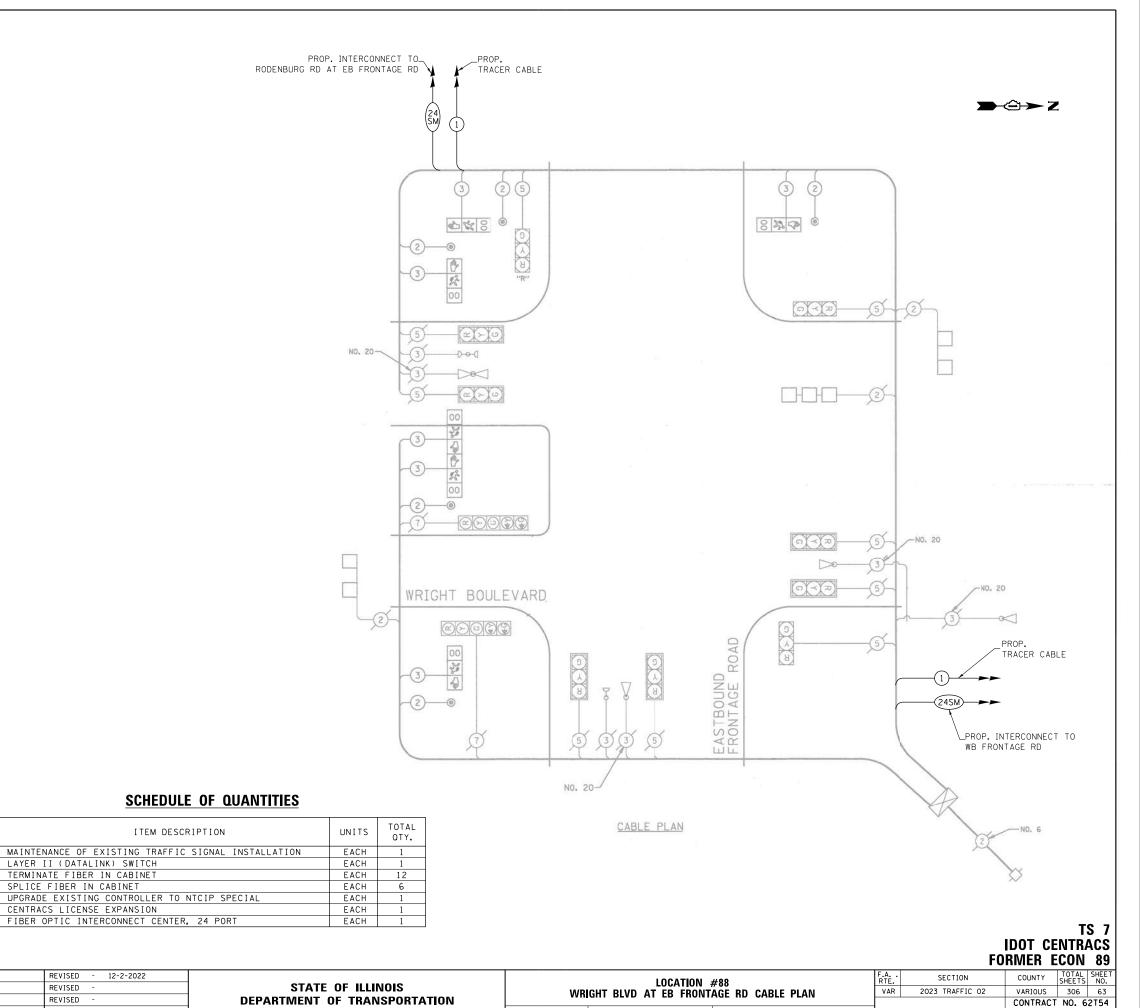


SHEET NO. OF SHEETS STA.

FED. ROAD DIST. NO. \_ ILLINOIS FED. AID PROJECT

SCALE: N.T.S.


GANDHI AND ASSOCIATES, IN
ENGRETS AND PLANERS
GOS N. MORTHREST HIGHBAY
SUIT 306
CHICAGO, LLINDS 6063 TEL. (773)774-599

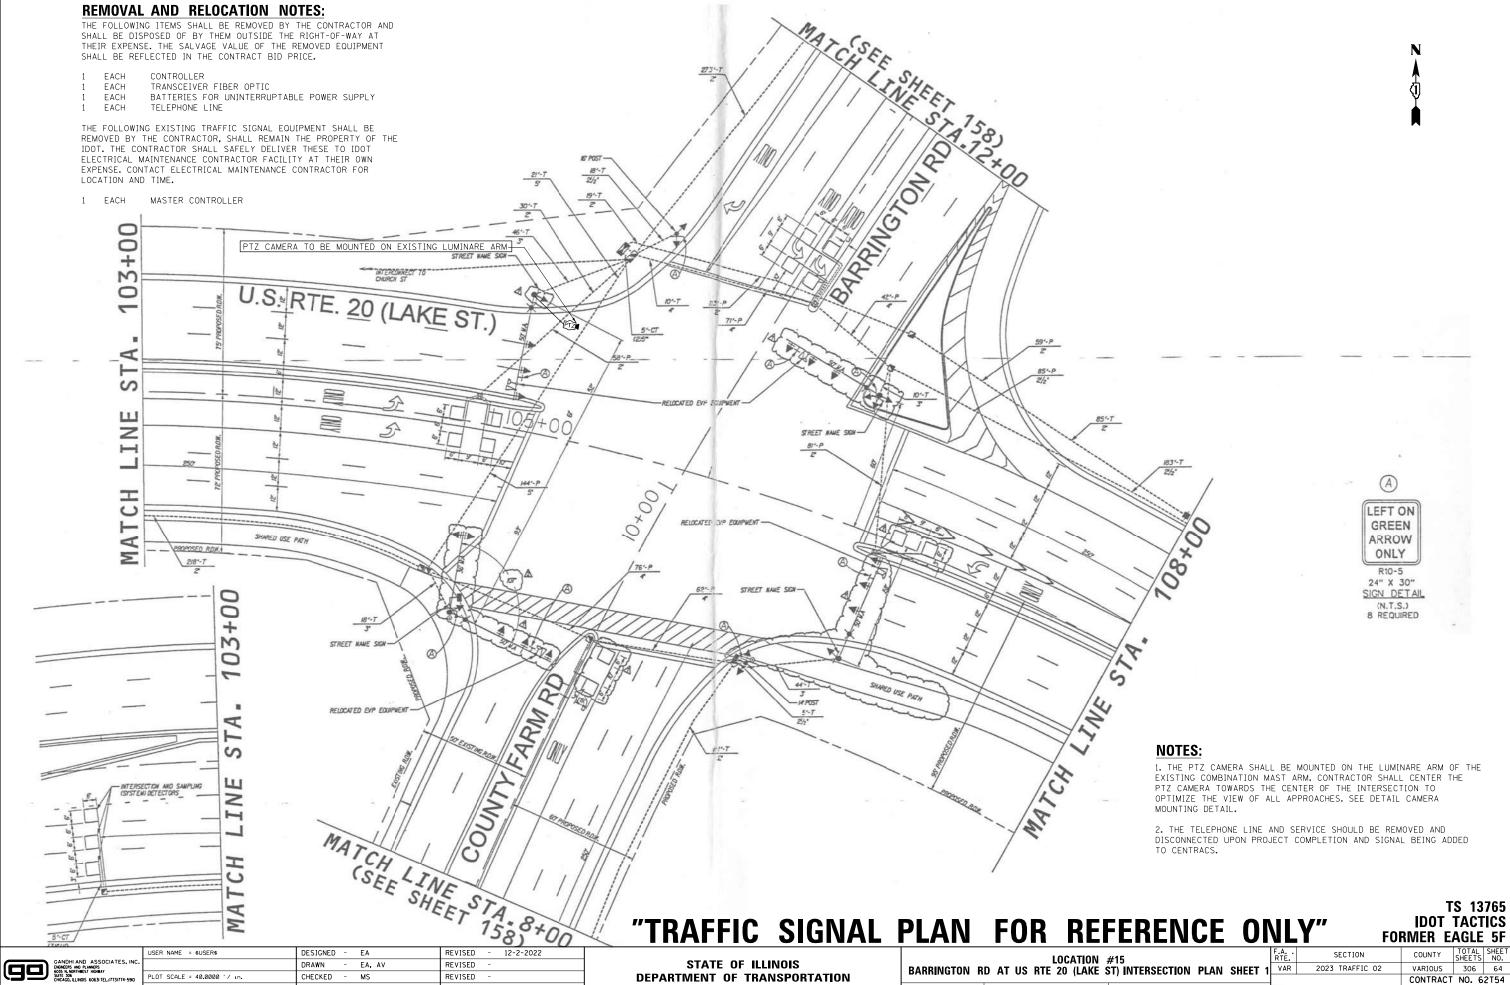


K:\PROJECTS\Projects 202

DATE

10/31/2022

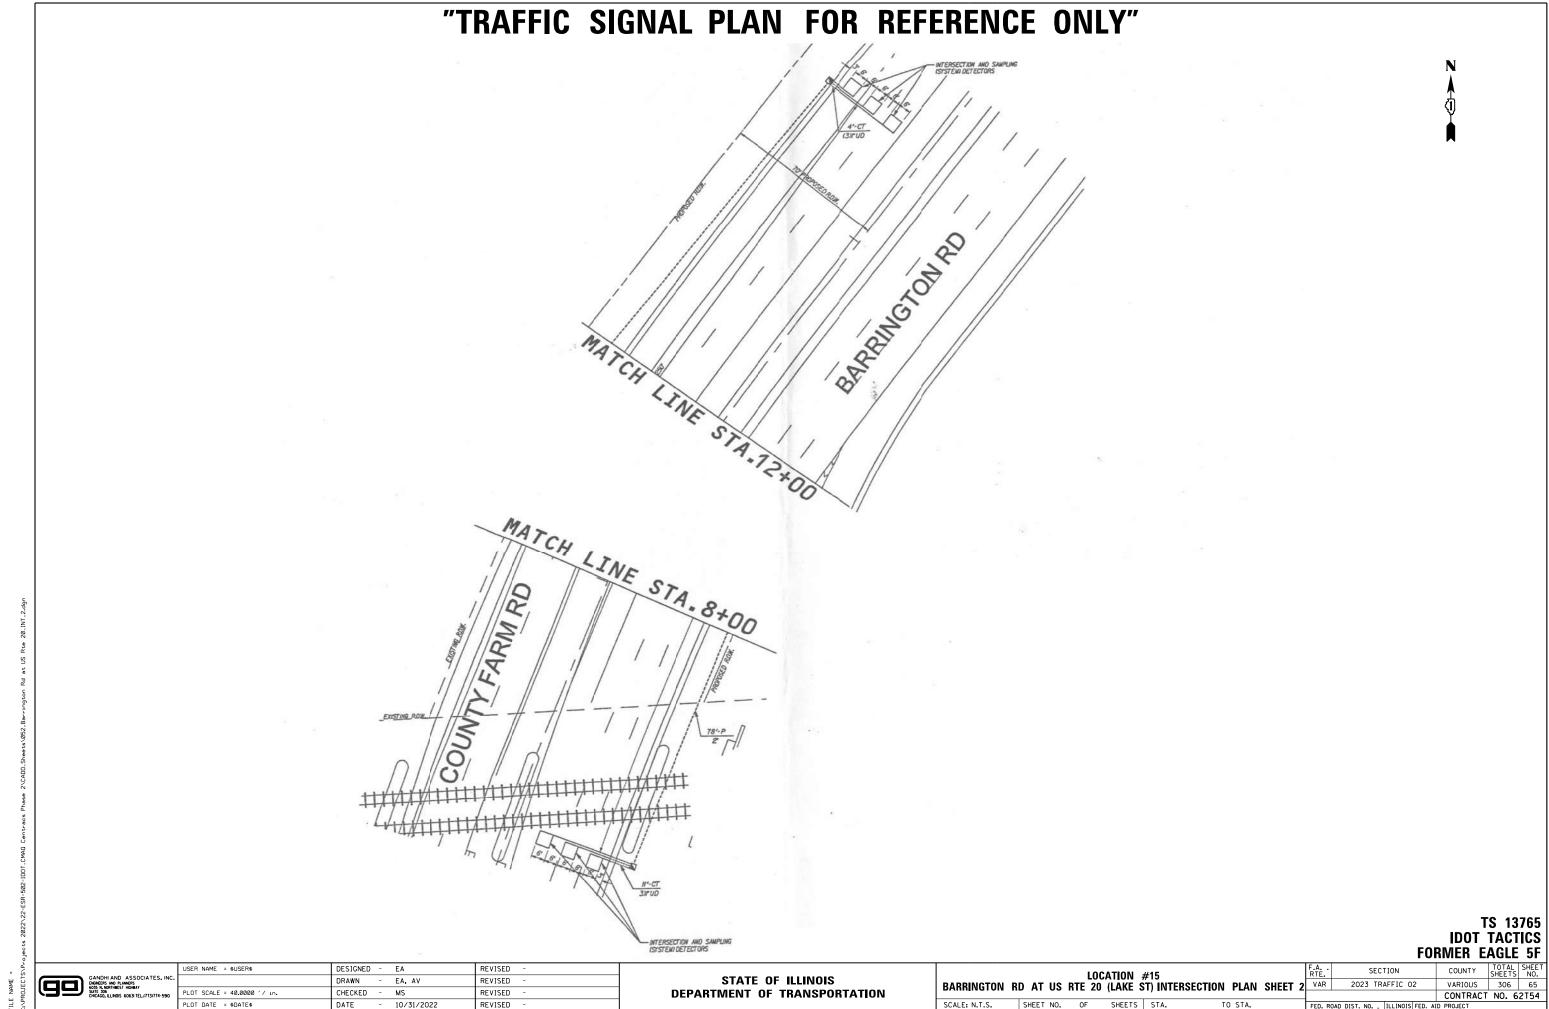

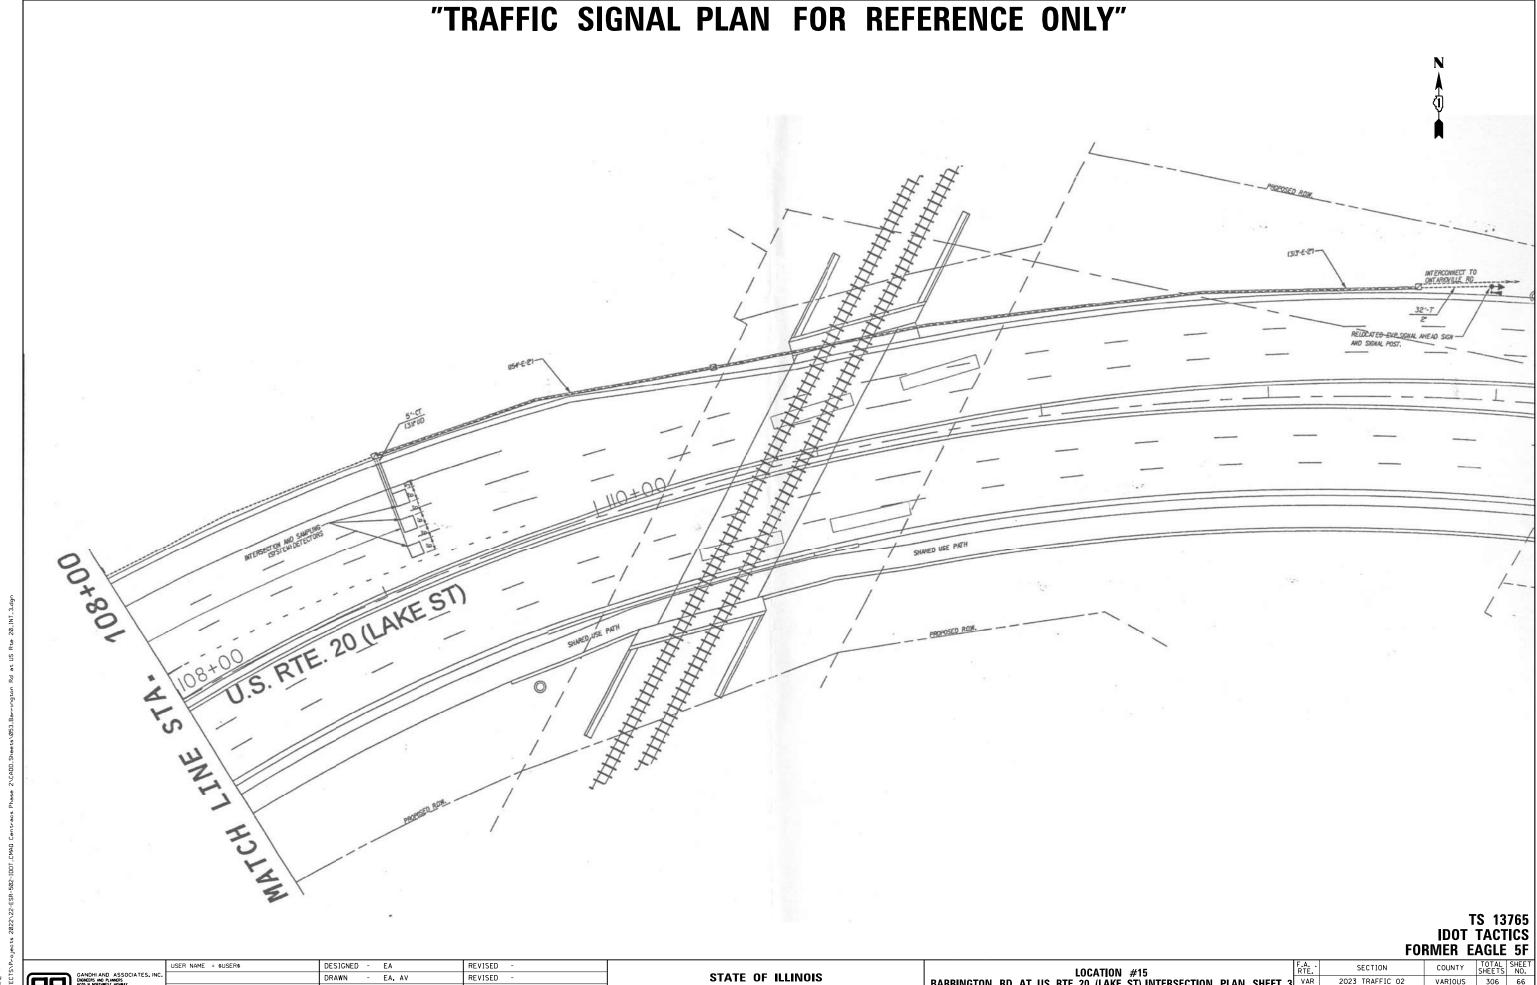

CHECKED - MS REVISED - 10/31/2022

STATE OF ILLINOIS
DEPARTMENT OF TRANSPORTATION

LOCATION #15
BARRINGTON RD AT US RTE 20 (LAKE ST) INTERSECTION PLAN SHEET 3 SHEET NO. OF SHEETS STA.

COUNTY TOTAL SHEET NO.
VARIOUS 306 66
CONTRACT NO. 62T54 2023 TRAFFIC 02

#### SCHEDULE OF QUANTITIES

ITEM DESCRIPTION	UNITS	TOTAL QTY.
MAINTENANCE OF EXISTING TRAFFIC SIGNAL INSTALLATION	EACH	1
REMOVE AND REINSTALL ELECTRIC CABLE FROM CONDUIT	FOOT	1064
REMOVE EXISTING TRAFFIC SIGNAL EQUIPMENT	EACH	1
OUTDOOR RATED NETWORK CABLE	FOOT	116
REMOTE CONTROLLED VIDEO SYSTEM	EACH	1
TERMINATE FIBER IN CABINET	EACH	48
LAYER III (NETWORK) SWITCH	EACH	1
FULL-ACTUATED CONTROLLER IN EXISTING CABINET	EACH	1
REMOVE AND REPLACE BATTERIES FOR UNINTERRUPTABLE POWER SUPPLY	EACH	1
TACTICS LICENSE EXPANSION	EACH	1
FIBER OPTIC INTERCONNECT CENTER, 48 PORT	EACH	1

PUSH BUTTON "A" SHALL PLACE A CALL IN PHASES 2 AND 4

RIGHT TURN OVERLAP PHASE DESIGNATION

	OVERLAP		PROTECTED	
_	LETTER		PHASE	_
	В	-	5	3.30
	C	-	CONTINUOUS (HOT)	

I.D.O.T. TRAFFIC SIGNAL INSTALLATION ELECTRICAL SERVICE REQUIREMENTS TOTAL WATTAGE NO. OF LAMPSXINCAND LED XX OPERATIONS TOTAL = 513.5 VILLAGE OF HANOVER PARK (630) 691-4608

PROPOSED CABLE PLAN PROP, INTERCONNECT TO\_ WALNUT AVE TRACER CABLE INTERSECTION AND SAMPLING BARRINGTON RD (SYSTEM) DETECTORS NO.6 PROP. INTERCONNECT TO\_ MUMBER OF GROUND-CABLES AS PER PLANS BEAR FLAG DR \_1020 MA= PROP. 9 PTZ TRACER CABLE ගරුරිග් ග් (48SM) TRACER CABLE PROP. INTERCONNECT TO\_ CHURCH ST ONC EFOS A U.S. 20 RTE INTERSECTION AND SAMPLING (LAKE ST) (SYSTEM) DETECTORS ITERSECTION AND SAMPLING (SYSTEM) DETECTORS **□**-③ OLE (MA) ALLATION (3) (3) (3) (4) (4) (4) (5) (6) COPPER (GREEN) PTIC CABLE 9 9 9 9 9 9 9 9 \_EXIST. TRACER CABLE NOTE: ALL LOOP DETECTORS AT THIS INTERSECTION SHALL BE PREFORMED. INTERSECTION AND SAMPLING-(SYSTEM) DETECTORS \_EXIST. INTERCONNECT TO ONTARIOVILLE RD CONTROLLER SEQUENCE COUNTY FARM RD BARRINGTON RD EMERGENCY VEHICLE PREEMPTION SEQUENCE BARRINGTON RD CONT (HOT) 44 U.S. RTE 20 (LAKE ST). U.S. RTE 20 (LAKE ST) 2 **EMERGENCY** VEHICLE PREEMPTORS LEGEND EMERGENCY VEHICLE PREEMPTOR → ₩ SINGLE ENTRY PHASE - DUAL ENTRY PHASE OVERLAP MOVEMENT - PEDESTRIAN PHASE COUNTY FARM RD COUNTY FARM RD NUMBER REFERS TO ASSOCIATED PHASE

PHASE DESIGNATION DIAGRAM

TS 13765 **IDOT TACTICS FORMER EAGLE 5F** 

ENGAGERS AND PLANGERS
6035 N. NORTHWEST HIGHWAY
SUITE 306
CHCAGO, LLINOIS 6063I TEL.477

COMPANY:

2121 W. LAKE ST HANOVER PARK, ILLINOIS 60133

ENERGY SUPPLY - CONTACT: .

SIGNAL (RED)

ENERGY COSTS TO:

USER NAME = \$USER\$ DESIGNED - EA REVISED 12-2-2022 DRAWN - EA, AV REVISED CHECKED REVISED DATE - 10/31/2022 REVISED PLOT DATE = \$DATE\$

STATE OF ILLINOIS **DEPARTMENT OF TRANSPORTATION** 


LOCATION #15 BARRINGTON RD AT US RTE 20 (LAKE ST) CABLE PLAN SHEET NO. OF SHEETS STA.

SECTION COUNTY 2023 TRAFFIC 02 VARIOUS 306 67 VAR CONTRACT NO. 62T54

THE FOLLOWING ITEMS SHALL BE REMOVED BY THE CONTRACTOR AND SHALL BE DISPOSED OF BY THEM OUTSIDE THE RIGHT-OF-WAY AT THEIR EXPENSE. THE SALVAGE VALUE OF THE REMOVED EQUIPMENT SHALL BE REFLECTED IN THE CONTRACT BID PRICE.

EACH TRANSCEIVER FIBER OPTIC

1 EACH BATTERIES FOR UNINTERRUPTABLE POWER SUPPLY

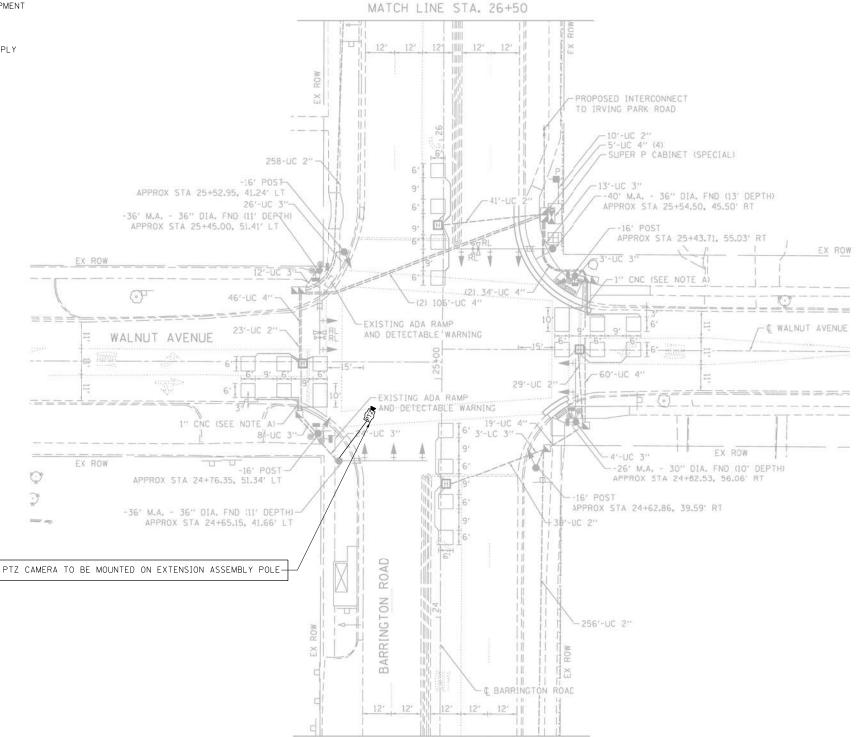

### NOTES:

THE PTZ CAMERA SHALL BE MOUNTED ON THE EXTENSION ASSEMBLY POLE MOUNTED ON EXISTING MAST ARM, CONTRACTOR SHALL CENTER THE PTZ CAMERA TOWARDS THE CENTER OF THE INTERSECTION TO OPTIMIZE THE VIEW OF ALL APPROACHES. SEE DETAIL CAMERA MOUNTING DETAIL.

### "TRAFFIC SIGNAL PLAN FOR REFERENCE ONLY"

MATCH LINE STA. 23+50

TS 13775 **IDOT CENTRACS FORMER ECON 158** 




ENGAGERS AND PLANGERS
6035 N. NORTHWEST HIGHWAY
SUITE 306
CHCAGO, LLINOIS 6063I TEL.477


USER NAME = \$USER\$ DESIGNED - EA REVISED - 12-2-2022 DRAWN - EA, AV REVISED CHECKED REVISED - 10/31/2022 REVISED DATE

STATE OF ILLINOIS **DEPARTMENT OF TRANSPORTATION** 

BARRINGTON RD AT WALNUT AVE INTERSECTION PLAN SHEET 1 SCALE: N.T.S. SHEET NO. OF SHEETS STA.

SECTION COUNTY 2023 TRAFFIC 02 VARIOUS 306 68 VAR CONTRACT NO. 62T54

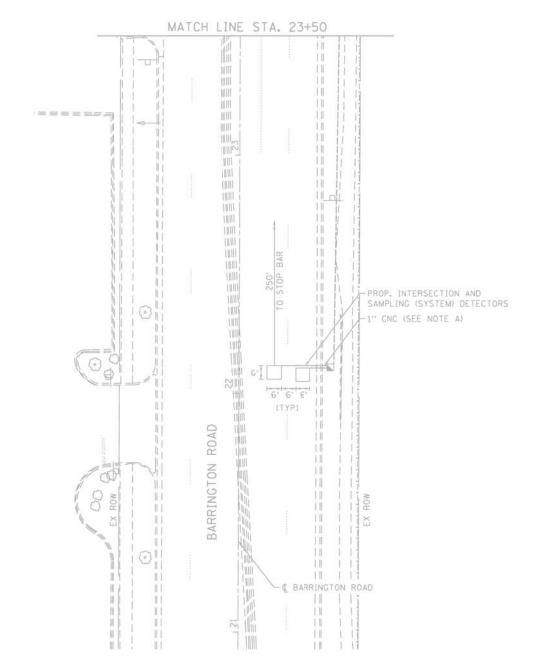

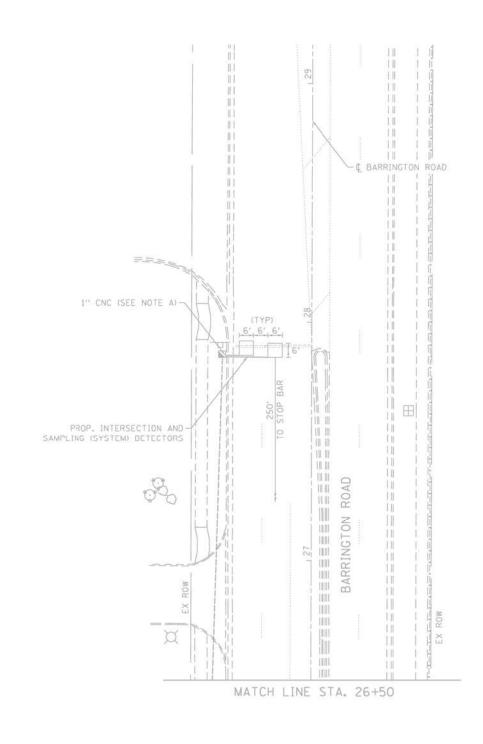

### "TRAFFIC SIGNAL PLAN FOR REFERENCE ONLY"

TS 13775 IDOT CENTRACS FORMER ECON 158




| DESIGNED - EA REVISED - | DRAWN - EA, AV REVISED - | | DRAWN - EA, AV REVISED - | | DREVISED - | | DREVISED - | | DREVISED - | | DREVISED - | DATE - | DAT

STATE OF ILLINOIS
DEPARTMENT OF TRANSPORTATION


BARRINGTON RD AT WALNUT AVE INTERSECTION PLAN SHEET 2

SCALE: N.T.S. SHEET NO. OF SHEETS STA. TO STA.



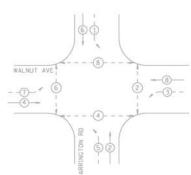

#### PROPOSED EMERGENCY VEHICLE PREEMPTION SEQUENCE

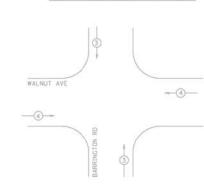

TE	RAFFIC	SIGNAL
ELECTRICAL	SERVIC	CE REQUIREMENTS

TYPE	NO. LAMPS	LED WATTAGE	% OPERATION	TOTAL WATTAGE
SIGNAL (RED)	14	11	50	77.0
(YELLOW)	14	20	5	14.0
(GREEN)	14	12	45	75.6
PERMISSIVE ARROW	14	10	10	14.0
PED. SIGNAL	8	20	100	160.0
CONTROLLER	1	100	100	100.0
UPS	1	25	100	5.0
VIDEO SYSTEM	-	150	100	-
BLANK-OUT SIGN	-	25	5	-
FLASHER	-	-	50	_
STREET NAME SIGN	4	120	50	240.0
LUMINAIRE	-	-	-	-
ENERCY COST TO			TOTAL =	685.6

NERGY COST TO:

VILLAGE OF HANOVER PARK 2121 WEST LAKE STREET HANOVER PARK, ILLINOIS 60133

ENERGY SUPPLY: CONTACT: MR. JOE STACHO PHONE: (630) 424-5704

COMPANY: COMMONWEALTH EDISON

ACCOUNT NUMBER: - - -

	USER NAME = \$USER\$	DESIGNED	-	EA	REVISED - 12-2-2022					
. INC.		DRAWN	-	EA, AV	REVISED -					
-5910	PLOT SCALE = 40.0000 '/ in.	CHECKED	-	MS	REVISED -					
	PLOT DATE = \$DATE\$	DATE	-	10/31/2022	REVISED -					

STATE OF ILLINOIS **DEPARTMENT OF TRANSPORTATION** 

P

PROPOSED INTERSECTION AND SAMPLING (SYSTEM) DETECTORS

WALNUT AVENUE

evA tunioW

LOCATION #16
BARRINGTON RD AT WALNUT AVE CABLE PLAN SHEET NO. OF SHEETS STA.

CABLE PLAN (NOT TO SCALE)

PROP. INTERCONNECT TO IL RTE 19 (IRVING PARK RD)

R Walnut Ave

BARRINGTON ROAD

**FORMER ECON 158** COUNTY TOTAL SHEET NO.

VARIOUS 306 70 SECTION 2023 TRAFFIC 02 VAR CONTRACT NO. 62T54 FED. ROAD DIST. NO. \_ ILLINOIS FED. AID PROJECT

PROPOSED INTERSECTION AND SAMPLING (SYSTEM) DETECTORS

TRACER CABLE

TS 13775 IDOT CENTRACS

\_PROP. INTERCONNECT TO US RTE 20 (LAKE ST)

PROP. TRACER CABLE

0-2-

to 1 < 0 < 2 - 7-


to 1 x 0 x 2 - 1)-

0 < 2 -5

LEGEND -O- PEDESTRIAN PHASE OL OVERLAP

SCHEDULE OF QUANTITIES

ITEM DESCRIPTION	UNITS	TOTAL QTY.
MAINTENANCE OF EXISTING TRAFFIC SIGNAL INSTALLATION	EACH	1
REMOVE EXISTING TRAFFIC SIGNAL EQUIPMENT	EACH	1
OUTDOOR RATED NETWORK CABLE	FOOT	266
REMOTE CONTROLLED VIDEO SYSTEM	EACH	1
LAYER II (DATALINK) SWITCH	EACH	1
TERMINATE FIBER IN CABINET	EACH	12
SPLICE FIBER IN CABINET	EACH	6
UPGRADE EXISTING CONTROLLER TO NTCIP SPECIAL	EACH	1
CAMERA MOUNTING ASSEMBLY	EACH	1
REMOVE AND REPLACE BATTERIES FOR UNINTERRUPTABLE POWER SUPPLY	EACH	1
CENTRACS LICENSE EXPANSION	EACH	1
FIBER OPTIC INTERCONNECT CENTER, 48 PORT	EACH	1

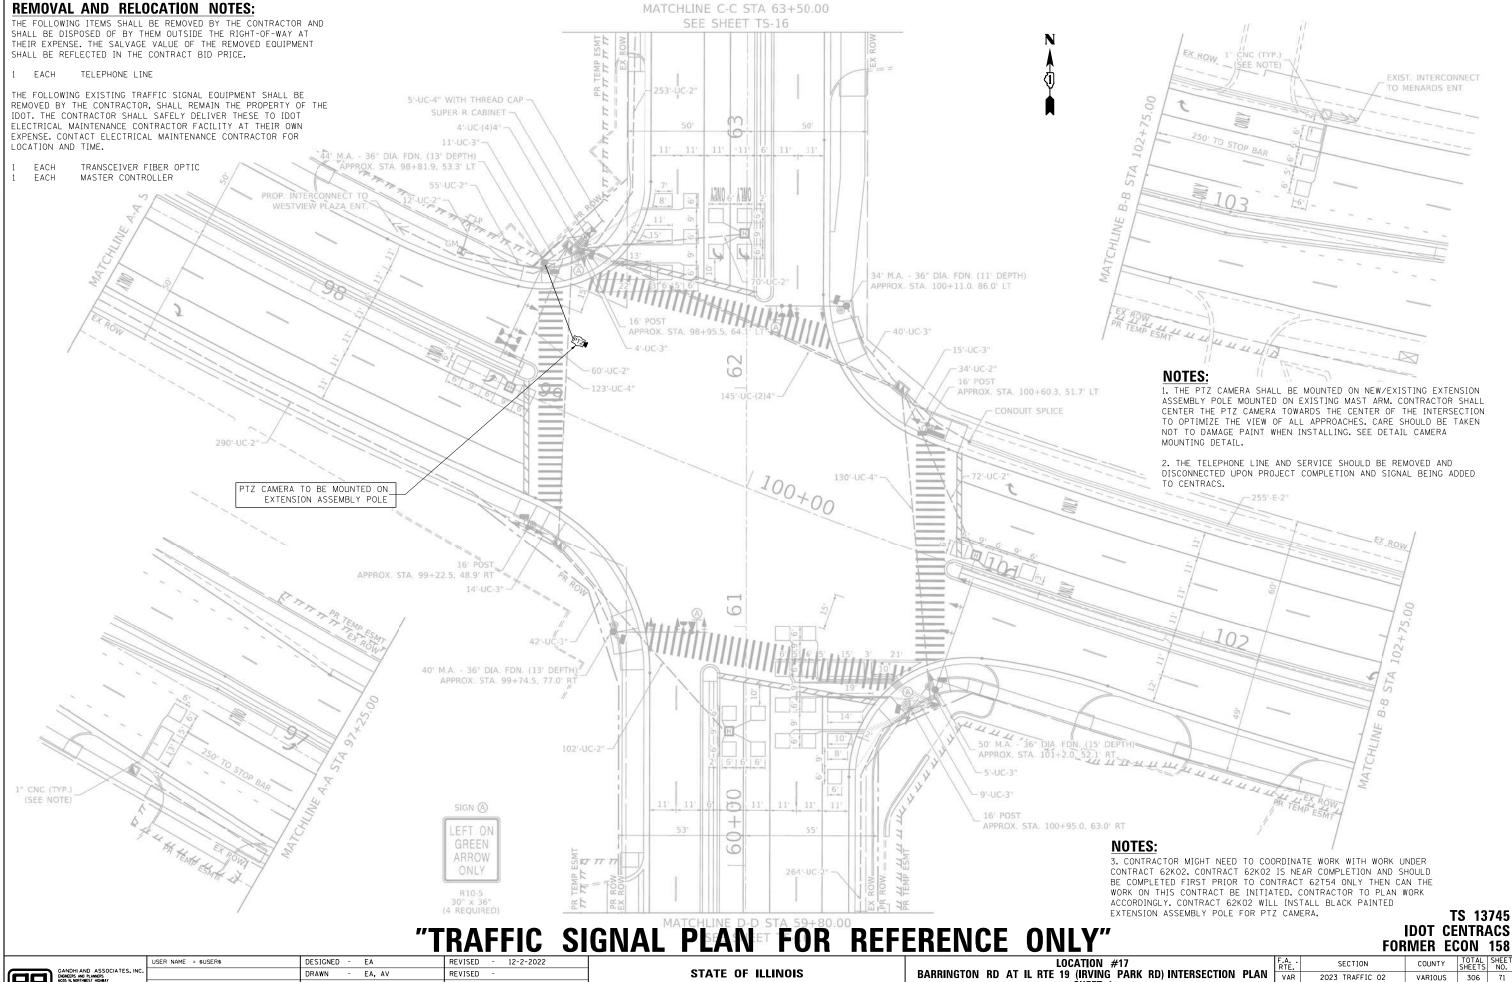

**DEPARTMENT OF TRANSPORTATION** 

SHEET 1

SHEET NO. OF SHEETS STA.

SCALE: N.T.S.

CONTRACT NO. 62T54


CHECKED


DATE

MS

10/31/2022

REVISED

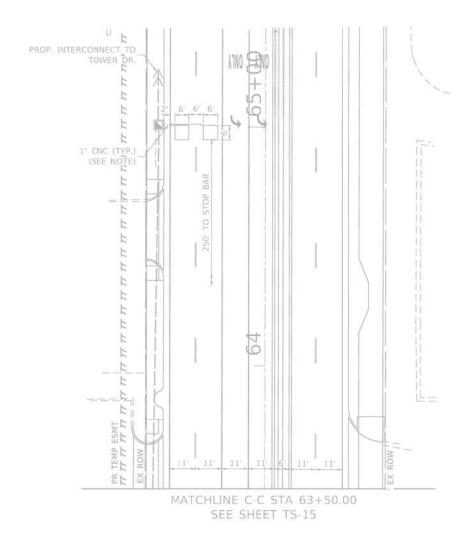

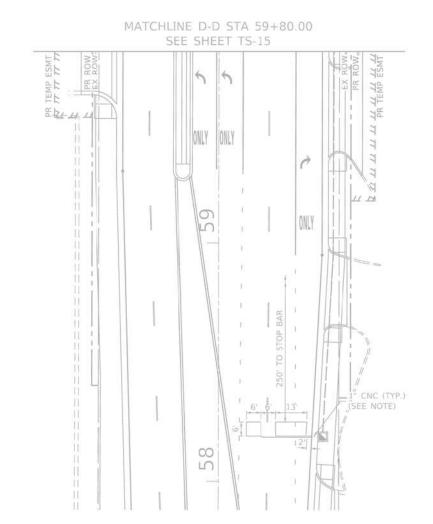

### "TRAFFIC SIGNAL PLAN FOR REFERENCE ONLY"

TS 13745
IDOT CENTRACS
FORMER ECON 158


COUNTY TOTAL SHEET NO.
02 VARIOUS 306 72
CONTRACT NO. 62754
IS FED. AID PROJECT




USER NAME = \$USER\$	DESIGNED	-	EA	REVISED -
	DRAWN	-	EA, AV	REVISED -
PLOT SCALE = 40.0000 '/ in.	CHECKED	-	MS	REVISED -
PLOT DATE = \$DATE\$	DATE	-	10/31/2022	REVISED -

STATE OF ILLINOIS
DEPARTMENT OF TRANSPORTATION

LUCATION #17							F.A SECTION			COUNT	
BARRINGTON RD AT IL RTE 19 (IRVING PARK RD) INTERSECTION PLAN   SHEET 2						VAR	R 2023 TRAFFIC 02			VARIO	
					CONTI						
SCALE: N.T.S.	SHEET NO.	OF	SHEETS	STA.	TO STA.		FED. R	OAD DIST. NO	ILLINOIS	FED. AI	D PROJECT

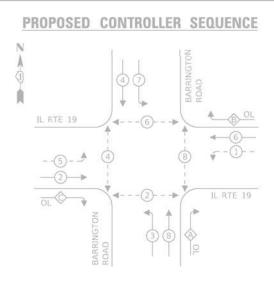

#### PROPOSED EMERGENCY VEHICLE PREEMPTION SEQUENCE

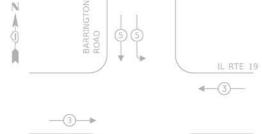

TF	RAFFIC	SIGN	AL
ELECTRICAL	SERVIC	E REC	QUIREMENTS

TYPE	LAMPS	WATTAGE	OPERATION	WATTAGE
SIGNAL (RED)	20	11	50	110.0
(YELLOW)	20	20	5	20.0
(GREEN)	20	12	45	108.0
PERMISSIVE ARROW	20	10	10	20.0
PED, SIGNAL	8	20	100	160.0
CONTROLLER	1	100	100	100.0
UPS	1	25	100	25.0
VIDEO SYSTEM	- 12	150	100	
BLANK-OUT SIGN		25	5	
FLASHER	-	-	50	-
STREET NAME SIGN	4	120	50	240
LUMINAIRE	9	165	50	
			TOTAL =	783.0

ENERGY COSTS TO:

ILLINOIS DEPARTMENT OF TRANSPORTATION

201 WEST CENTRAL COURT SCHAUMBURG, IL 60196-1096

IL RTE 19

ENERGY SUPPLY: CONTACT: JOE STACHO

PHONE: 630-424-5704 COMPANY: IDOT USER NAME = \$USER\$



	DISCONNECTED (SPARE)	SCHEDULE OF QUAN	<u> </u>
EGEND:	TRACER CABLE  ROP. INTERCONNECT TO TOWER DR	ITEM DESCRIPTION  MAINTENANCE OF EXISTING TRAFFIC SIGNAL INSTALLATI REMOVE EXISTING TRAFFIC SIGNAL EQUIPMENT OUTDOOR RATED NETWORK CABLE REMOTE CONTROLLED VIDEO SYSTEM TERMINATE FIBER IN CABINET	UNITS TOTAL OTY.  ON EACH 1 EACH 1 FOOT 80 EACH 1 EACH 1 EACH 48
PROTECTED/PERMITTED PHASE  PEDESTRIAN PHASE  OUR OVERLAP  OUR DESCRIPTION OF THE PROTECTED PHASE SUPERIOR OF THE PROTECTED PHA	2#6 c 1 36 F 2 2 2	LAYER III (NETWORK) SWITCH CENTRACS LICENSE EXPANSION FIBER OPTIC INTERCONNECT CENTER, 48 PORT	EACH 1 EACH 1 EACH 1
VERLAP PHASE DESIGNATION:  DISCONNECTED (SPARE)		1#0	DISCONNECTED (SPARE)
RETIAP PERMISSIVE PROTECTED PHASE  A = 8 + 1 B = 6 + 7 C = 2 + 3  TRACER CABLE  1  48SM	3	R R R R Inving Park	PROP. TRACER CABLE  48SM  PROP. INTERCONNECT TO  MENARDS ENT
PROP. INTERCONNECT TO	BARRINGTON STATE ONC STATE	Y→ G→ M D (S) → C Z	2 2 7 2 2 3
IL HOUTE 13	7		
	(7)—(2)—(2)—(3)—(4)—(4)—(4)—(4)—(4)—(4)—(4)—(4)—(4)—(4		IRVING PARK ROAD
2 2	2	BARRINGTON ROAD  S S S S S S S S S S S S S S S S S S S	3 5 3
NOTE: THE EXISTING 36 FIBER OPTIC CABLES AT THE INTERSECTION OF IL RTE 19 (IRVING PARK ROAD) AND BARRINGTON ROAD SHALL BE DISCONNECTED AND REMAIN AS SPARE. THE EXISTING 36F CABLES SHALL BE LABELED IN THE FIELD WITH TAG AS IDOT FIBER SPARE.	48 1 SM	②②⑦ ⑦ P P	
PROP. INTERCO WA	NNECT TO	CABLE PLAN (NOT TO SCALE)  G  Y→ G→	
			TS 13745 IDOT CENTRACS FORMER FCON 158

DESIGNED - EA REVISED - 12-2-2022 DRAWN - EA, AV REVISED PLOT SCALE = 40.0000 '/ in. CHECKED - MS REVISED PLOT DATE = \$DATE\$ DATE - 10/31/2022 REVISED


STATE OF ILLINOIS **DEPARTMENT OF TRANSPORTATION** 

LOCATION #17 BARRINGTON RD AT IL RTE 19 (IRVING PARK RD) CABLE PLAN VAR SHEET 1 SCALE: N.T.S. SHEET NO. OF SHEETS STA. TO STA.

COUNTY TOTAL SHEETS NO.

VARIOUS 306 73 SECTION 2023 TRAFFIC 02 CONTRACT NO. 62T54 FED. ROAD DIST. NO. \_ ILLINOIS FED. AID PROJECT

FORMER ECON 158

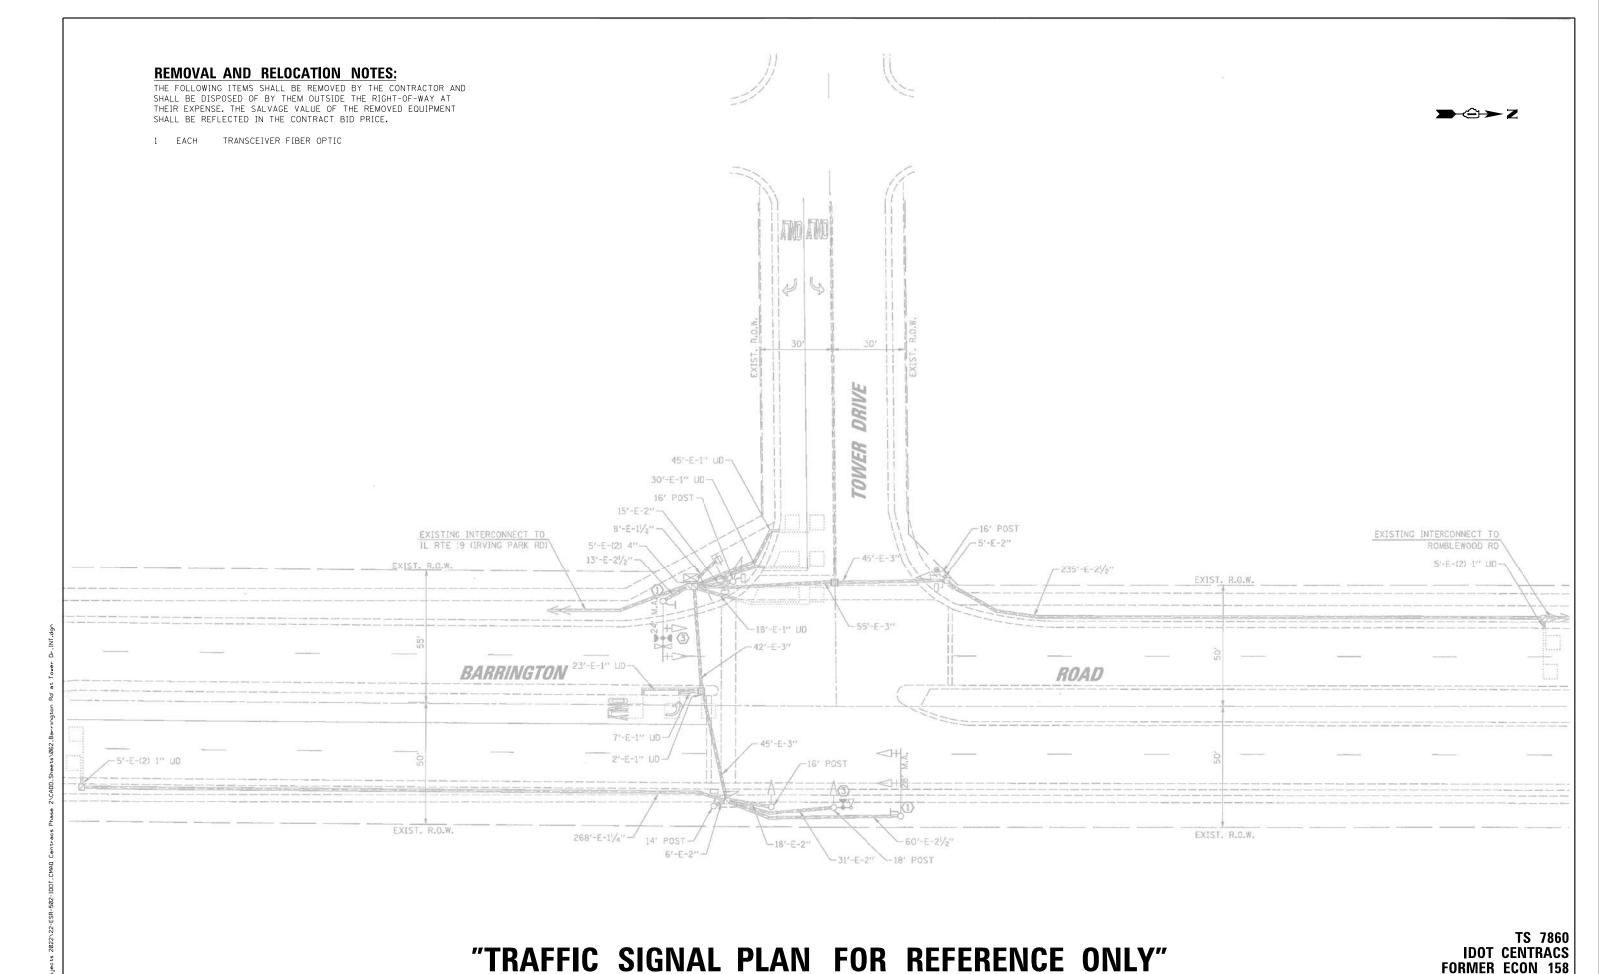

GANDHI AND. ASSOCIATES, INC.

DIAMERS AND PLANERS
605 N. INCRITINEST HORIAY
605 N. INCRIT

STATE OF ILLINOIS
DEPARTMENT OF TRANSPORTATION

BARRINGTON RD AT TOWER DR INTERSECTION PLAN

SCALE: N.T.S. SHEET NO. OF SHEETS STA. TO STA.

 FORMER ECON 158


 SECTION
 COUNTY SHEETS NO.

 2023 TRAFFIC 02
 VARIOUS 306 74

 CONTRACT NO. 62T54

VAR



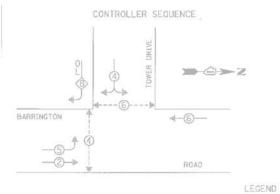

DUAL ENTRY PHASE

PEDESTRIAN PHASE NUMBER REFERS TO ASSOCIATED PHASE

#### PHASE DESIGNATION DIAGRAM

OVERLAP LETTER		PERMISSIVE PHASE	E		PROTECTED PHASE
В	2	4		+	5
			-B		
		4	TOWER DRIVE		<b>&gt;</b> ⊕>z
		+	TOW		
BARRINGT	ON			4-(	3
	③→			0	OAD

EXISTING EMERGEN	CY VEHICLE PR	EEMP LORS
EMERGENCY VEHICLE PREEMPTOR	3	4
MOVEMENT	4	

TDAT

TRAFFIC SIGNAL INSTALLATION ELECTRICAL SERVICE REQUIREMENTS						
TYPE	NO. OF LAMPS	WAT XINCAND,	LED	× % OPERATION	WATTAGE	
SIGNAL (RED)	9		17	0,50	76.50	
(YELLOW)	9		25	0.25	56.25	
(GREEN)	9		15	0.25	33.75	
ARROW	8		12	0.10	9.50	
PED. SIGNAL	4		25	1.00	100.00	
CONTROLLER	1		100	1.00	100.00	
ILLUM. SIGN	2		25	0.05	2.50	
VIDEO SYSTEM	н.		150	1.00	-	
BATTERY BACKUP SYSTEM			-	1.00		
FLASHER				0,50		
ENERGY COSTS T	Oz			TOTAL =	378,50	

#### ILLINOIS DEPARTMENT OF TRANSPORTATION

DIVISION OF HIGHWAY/DISTRICT 1


201 WEST CENTER COURT/SCHAUMBURG, ILLINOIS 60196-1096

ENERGY SUPPLY: CONTACT: MARTY RUBIN

PHONE:	(847) 608-2400	
COMPANY:	COMED	
	USER NAME = \$USER\$	Τ

USER NAME = \$USER\$	DESIGNED	-	EA	REVISED -
	DRAWN	-	EA, AV	REVISED -
PLOT SCALE = 40.0000 '/ in.	CHECKED	-	MS	REVISED -
PLOT DATE = \$DATE\$	DATE	-	10/31/2022	REVISED -

#### STATE OF ILLINOIS **DEPARTMENT OF TRANSPORTATION**

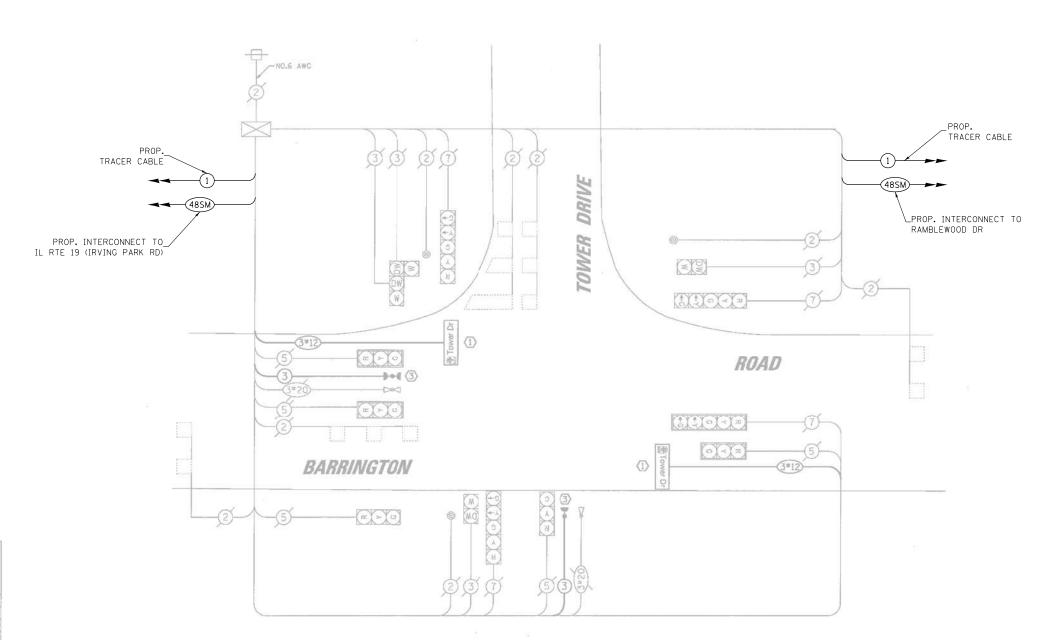

#### SCHEDULE OF QUANTITIES

ITEM DESCRIPTION

MAINTENANCE OF EXISTING TRAFFIC SIGNAL INSTALLATION

REMOVE EXISTING TRAFFIC SIGNAL EQUIPMENT

FIBER OPTIC INTERCONNECT CENTER, 48 PORT

UPGRADE EXISTING CONTROLLER TO NTCIP SPECIAL

LAYER II (DATALINK) SWITCH

TERMINATE FIBER IN CABINET SPLICE FIBER IN CABINET

CENTRACS LICENSE EXPANSION

#### **CABLE PLAN**

UNITS	TOTAL QTY.	
EACH	1	
EACH	1	
EACH	1	
EACH	12	
EACH	6	
EACH	1	
EACH	1	
EACH	1	

TS 7860 IDOT CENTRACS **FORMER ECON 158** 


COUNTY TOTAL SHEET NO.

VARIOUS 306 75 SECTION LOCATION #18 BARRINGTON RD AT TOWER DR CABLE PLAN 2023 TRAFFIC 02 VAR CONTRACT NO. 62T54 SCALE: N.T.S. SHEET NO. OF SHEETS STA. FED. ROAD DIST. NO. \_ ILLINOIS FED. AID PROJECT

THE FOLLOWING ITEMS SHALL BE REMOVED BY THE CONTRACTOR AND SHALL BE DISPOSED OF BY THEM OUTSIDE THE RIGHT-OF-WAY AT THEIR EXPENSE. THE SALVAGE VALUE OF THE REMOVED EQUIPMENT SHALL BE REFLECTED IN THE CONTRACT BID PRICE.

TRANSCEIVER FIBER OPTIC BATTERIES FOR UNINTERRUPTABLE POWER SUPPLY EACH



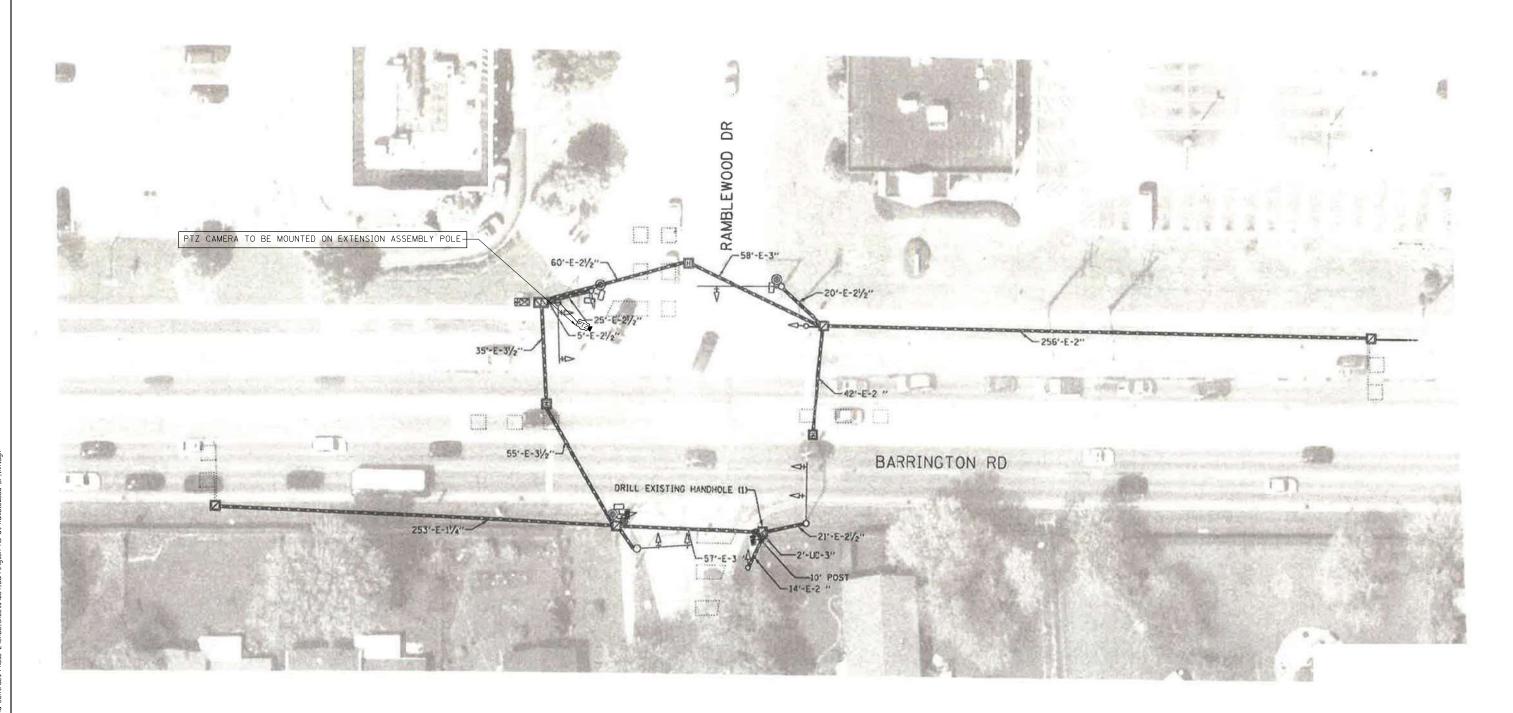

#### NOTES:

THE PTZ CAMERA SHALL BE MOUNTED ON THE EXTENSION ASSEMBLY POLE MOUNTED ON EXISTING MAST ARM. CONTRACTOR SHALL CENTER THE PTZ CAMERA TOWARDS THE CENTER OF THE INTERSECTION TO OPTIMIZE THE VIEW OF ALL APPROACHES. SEE DETAIL CAMERA MOUNTING DETAIL.

## "TRAFFIC SIGNAL PLAN FOR REFERENCE ONLY"

TS 21285 IDOT CENTRACS **FORMER ECON 158** 

90	GANDHI AND ASSOCIATES. ENGREERS AND PLANNERS 6035 N. NORTHWEST HICHWAY SUITE 306 CHICAGO, ILLINOIS 60631 TEL.(773)774-

PLOT DATE = \$DATE\$


DESIGNED - EA DRAWN - EA, AV REVISED CHECKED REVISED DATE - 10/31/2022 REVISED

STATE OF ILLINOIS **DEPARTMENT OF TRANSPORTATION** 

LOCATION #19
BARRINGTON RD AT RAMBLEWOOD DR INTERSECTION PLAN SCALE: N.T.S. SHEET NO. OF SHEETS STA.

COUNTY TOTAL SHEETS NO.

VARIOUS 306 76 SECTION 2023 TRAFFIC 02 VAR CONTRACT NO. 62T54

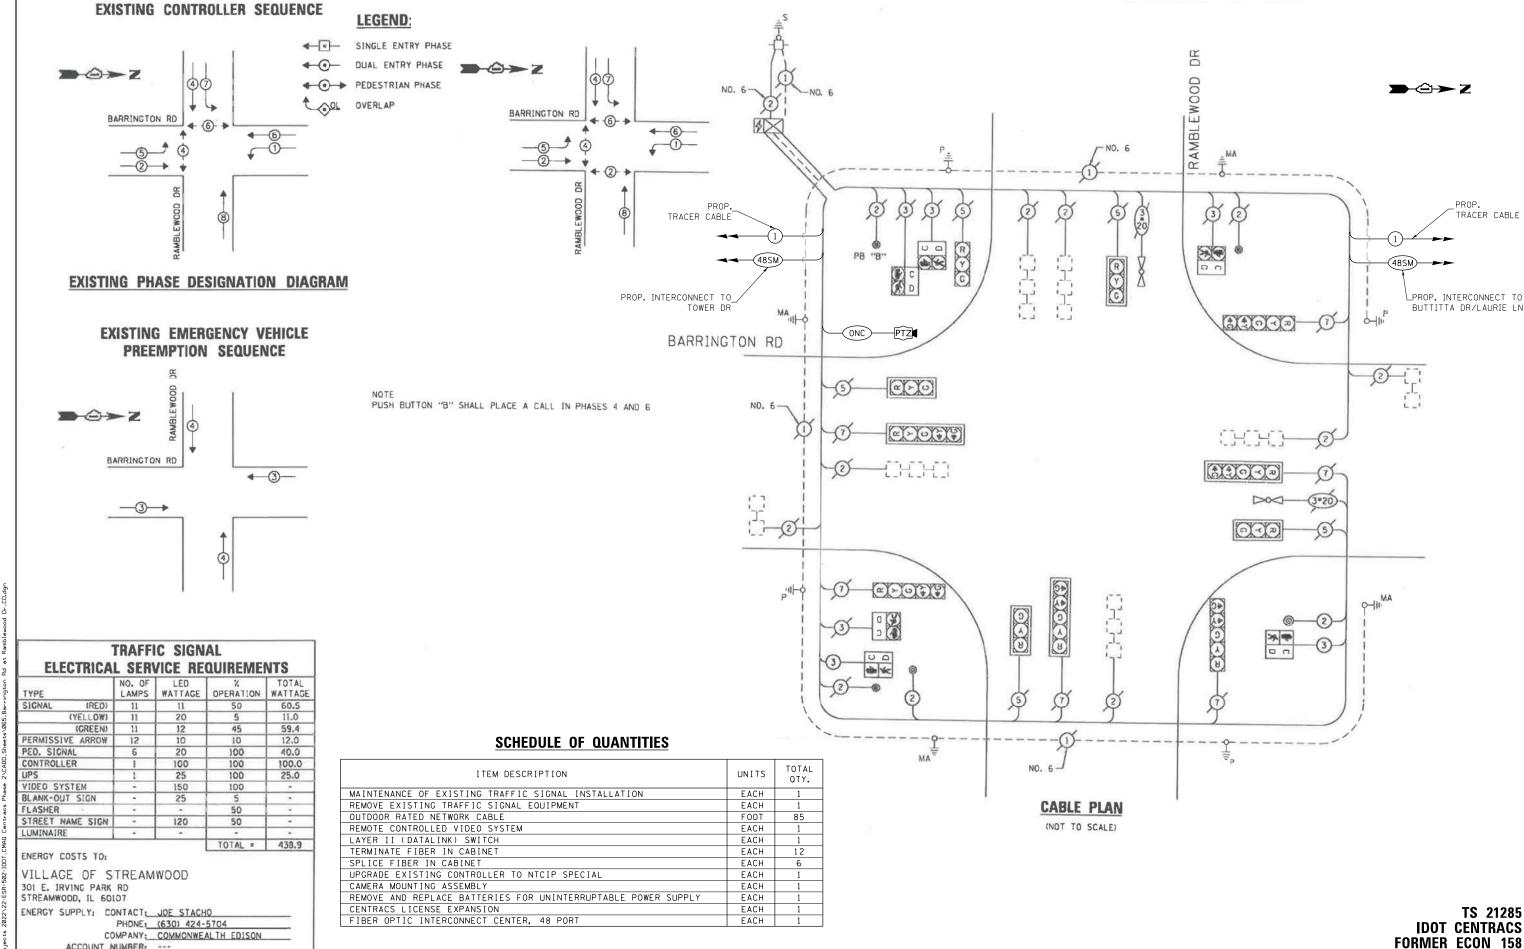

STATE OF ILLINOIS

**DEPARTMENT OF TRANSPORTATION** 

COUNTY

VARIOUS 306 77

CONTRACT NO. 62T54

SECTION

2023 TRAFFIC 02

VAR

LOCATION #19

BARRINGTON RD AT RAMBLEWOOD DR CABLE PLAN

SHEET NO. OF SHEETS STA.

ACCOUNT NUMBERS

PLOT DATE = \$DATE\$

DESIGNED - EA

CHECKED

DATE

DRAWN - EA, AV


- 10/31/2022

REVISED

REVISED

REVISED

REVISED

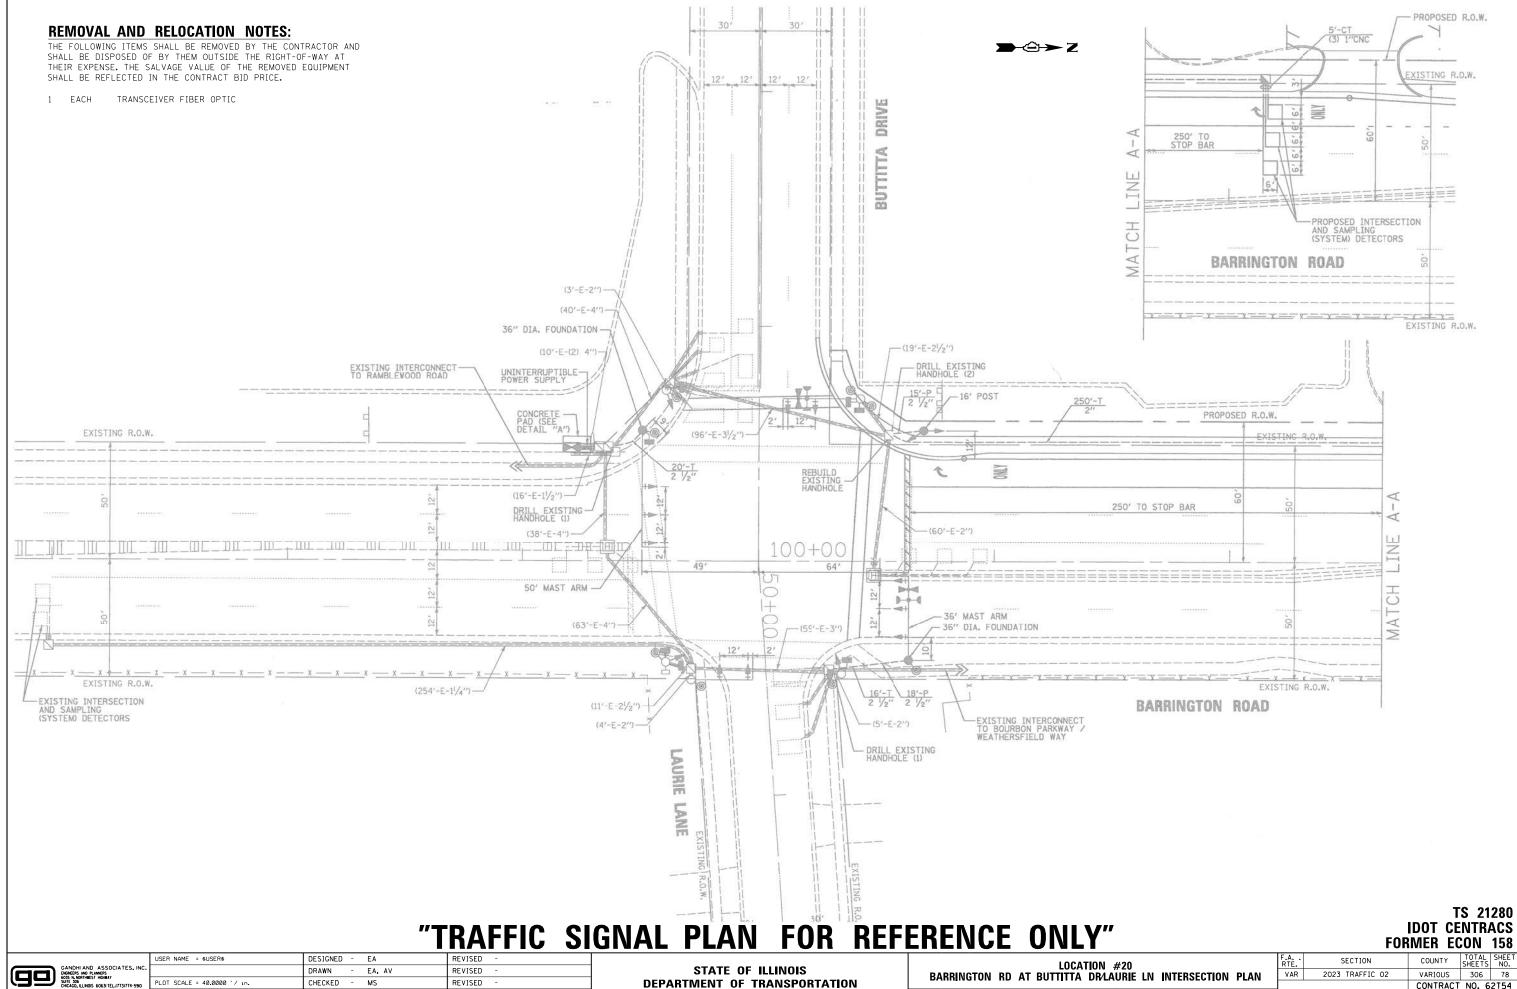


CHECKED MS REVISED PLOT DATE = \$DATE\$ DATE - 10/31/2022 REVISED

**DEPARTMENT OF TRANSPORTATION** 

SCALE: N.T.S. SHEET NO. OF SHEETS STA.

CONTRACT NO. 62T54

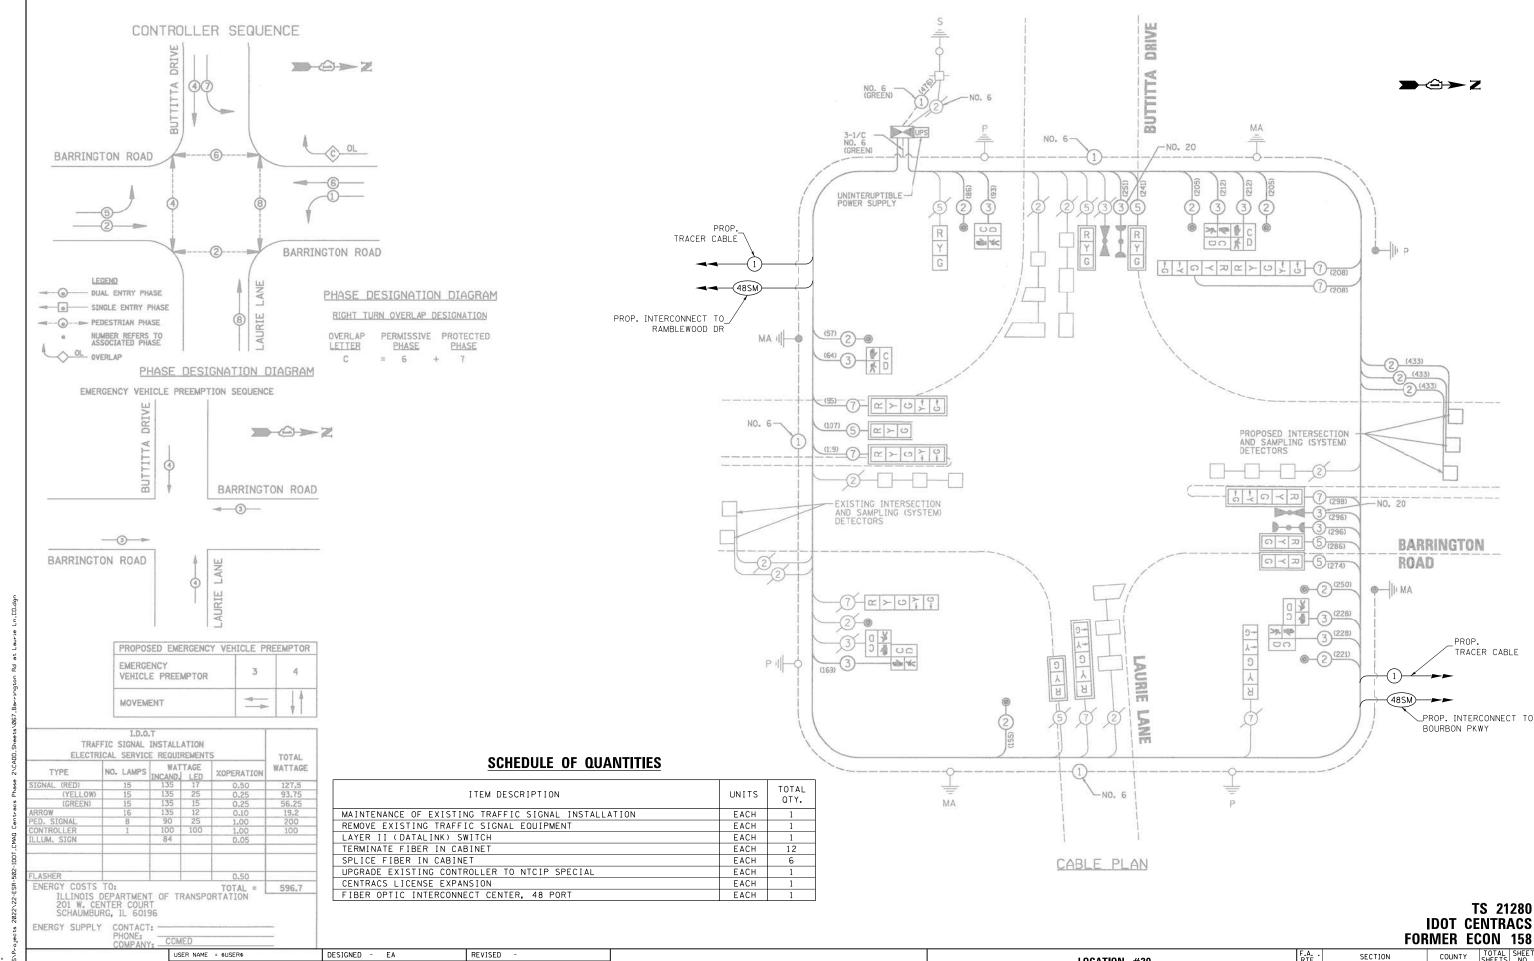


GANDHI AND ASSOCIATES, IN
ENGRETS AND PLANERS
GOS N. MORTHREST HIGHBAY
SUIT 306
CHICAGO, LLINDS 6063 TEL. (773)774-599

DRAWN - EA, AV REVISED CHECKED MS REVISED PLOT DATE = \$DATE\$ DATE - 10/31/2022 REVISED

STATE OF ILLINOIS **DEPARTMENT OF TRANSPORTATION** 

LOCATION #20 BARRINGTON RD AT BUTTITTA DRAAURIE LN CABLE PLAN SHEET NO. OF SHEETS STA.

COUNTY 2023 TRAFFIC 02 VARIOUS 306 79 VAR CONTRACT NO. 62T54 FED. ROAD DIST. NO. \_ ILLINOIS FED. AID PROJECT

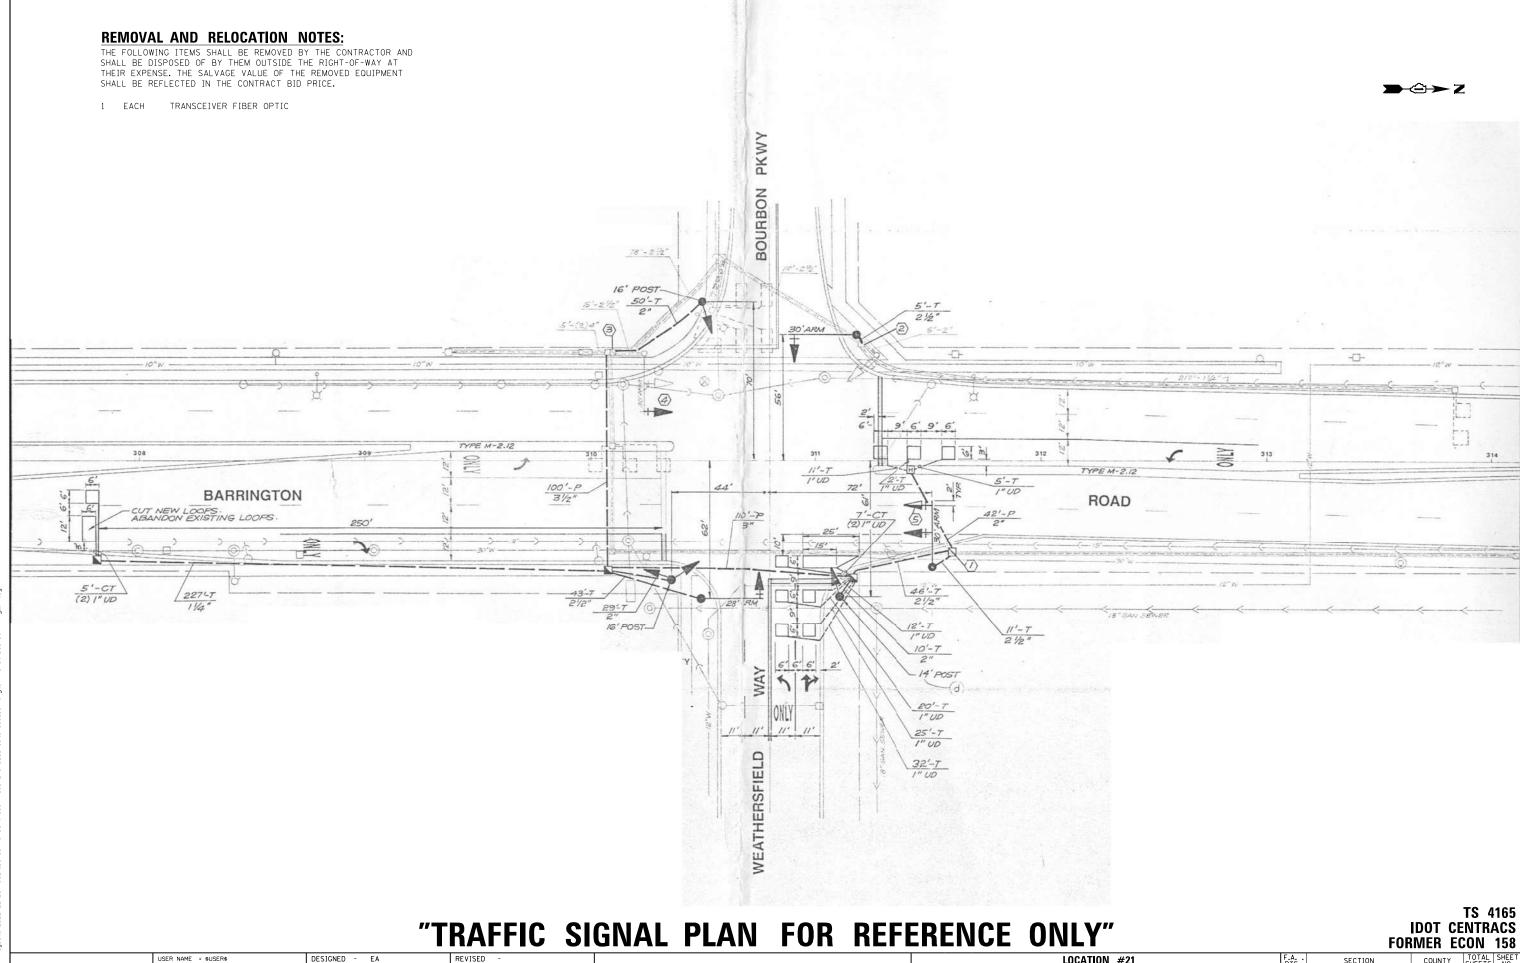

K:\PROJECTS\Projects 2022

GANDHI AND ASSOCIATES, INC.
EXCRESS AND PREMERS
6053 N. ROFFREST HOPMARY
SUIT 306
CHCACO, LL NOIS 6063 TEL.17731774-590

REVISED

REVISED


REVISED

STATE OF ILLINOIS
DEPARTMENT OF TRANSPORTATION

LOCATION #21
BARRINGTON RD AT BOURBON PKWY/WEATHERSFIELD WAY INTERSECTION PLAN

N.T.S. SHEET NO. OF SHEETS STA. TO STA.



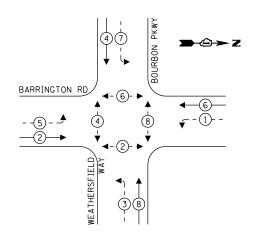

#### **LEGEND:**


**★** PROTECTED PHASE


PROTECTED/PERMITTED PHASE

◆- (\*)- ► PEDESTRIAN PHASE

◆ OL OVERLAP

#### **EXISTING EMERGENCY VEHICLE** PREEMPTION SEQUENCE

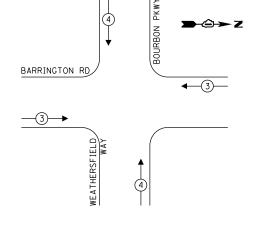

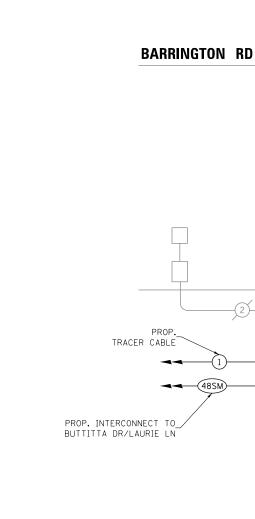

PROP.

#### SCHEDULE OF QUANTITIES

ITEM DESCRIPTION	UNITS	TOTAL QTY.
MAINTENANCE OF EXISTING TRAFFIC SIGNAL INSTALLATION	EACH	1
REMOVE EXISTING TRAFFIC SIGNAL EQUIPMENT	EACH	1
LAYER II (DATALINK) SWITCH	EACH	1
TERMINATE FIBER IN CABINET	EACH	12
SPLICE FIBER IN CABINET	EACH	6
UPGRADE EXISTING CONTROLLER TO NTCIP SPECIAL	EACH	1
CENTRACS LICENSE EXPANSION	EACH	1
FIBER OPTIC INTERCONNECT CENTER, 48 PORT	EACH	1

**CABLE PLAN** 


**BOURBON PKWY** 

WEATHERSFIELD WAY

TS 4165 IDOT CENTRACS **FORMER ECON 158** 

\_PROP. TRACER CABLE

LPROP. INTERCONNECT TO SCHAUMBURG RD

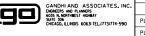


	USER NAME = \$USER\$	DESIGNED -	EA	REVISED -
٠		DRAWN -	EA, AV	REVISED -
	PLOT SCALE = 40.0000 '/ in.	CHECKED -	MS	REVISED -
	PLOT DATE = \$DATE\$	DATE -	10/31/2022	REVISED -

STATE OF ILLINOIS **DEPARTMENT OF TRANSPORTATION** 

SECTION LOCATION #21
BARRINGTON RD AT BOURBON PKWY/WEATHERSFIELD WAY CABLE PLAN 2023 TRAFFIC 02 SHEET NO. OF SHEETS STA. TO STA.

COUNTY TOTAL SHEET NO.
VARIOUS 306 81
CONTRACT NO. 62154

**→**②→ Z

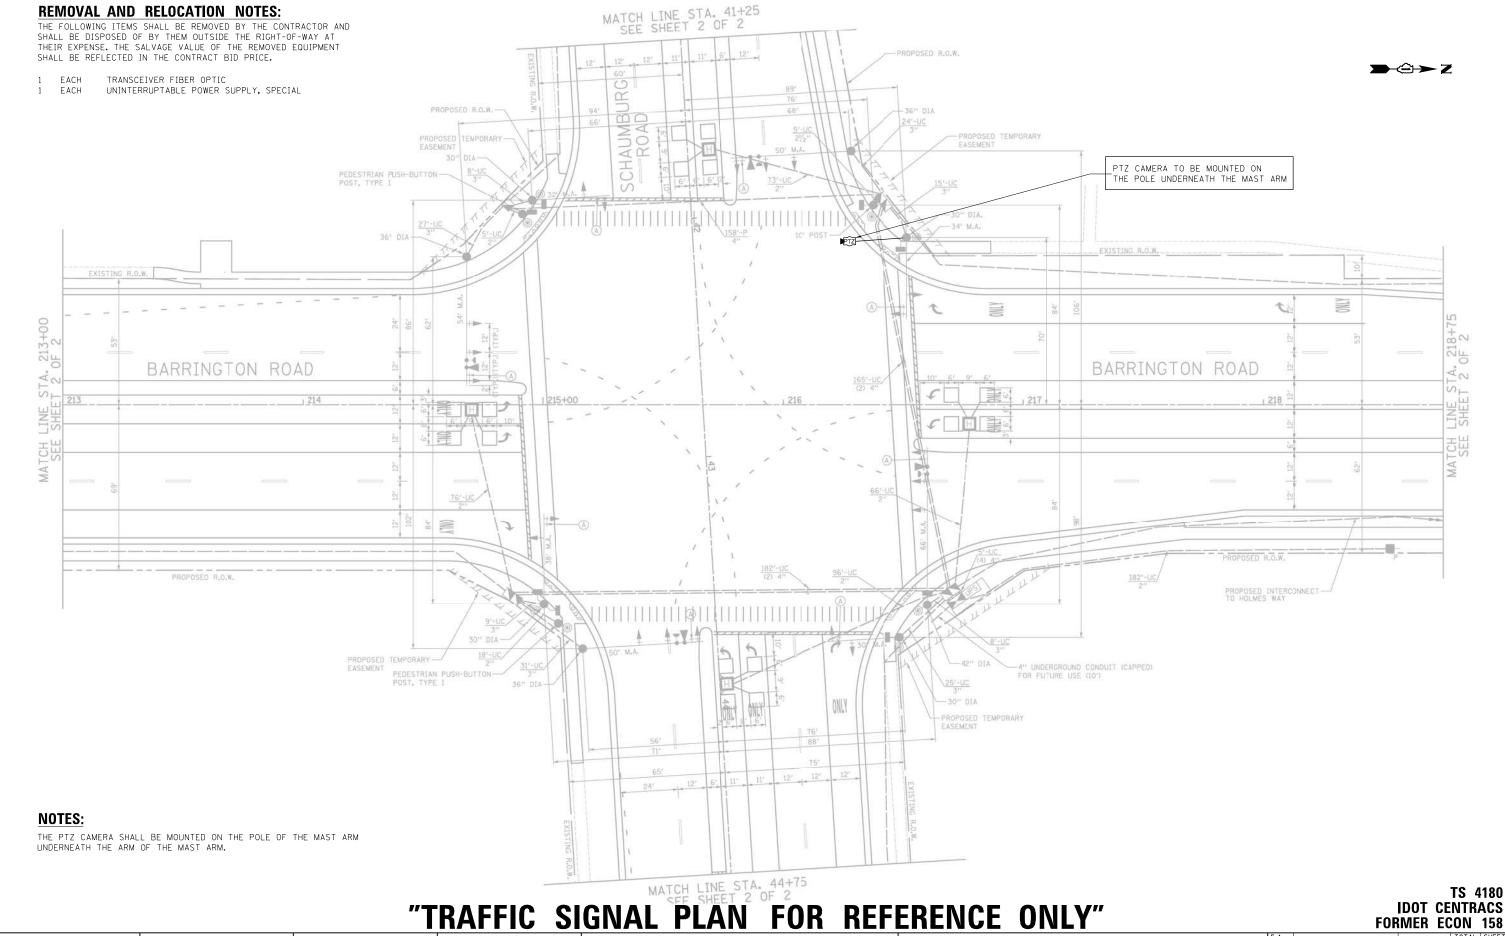

K:\PROJECTS\Projects 2022\22-ES

GANDHI AND ASSOCIAT ENCRETS NOP LAMERS SUBSTANCE HIGHBAY SUITE 306 CHICAGO, LLINOIS 60631 TEL.(1731)

STATE OF ILLINOIS
DEPARTMENT OF TRANSPORTATION


BARRINGTON RD AT SCHAUMBURG RD INTERSECTION PLAN SHEET 1

SCALE: N.T.S. | SHEET NO. | OF | SHEETS | STA. | TO STA.







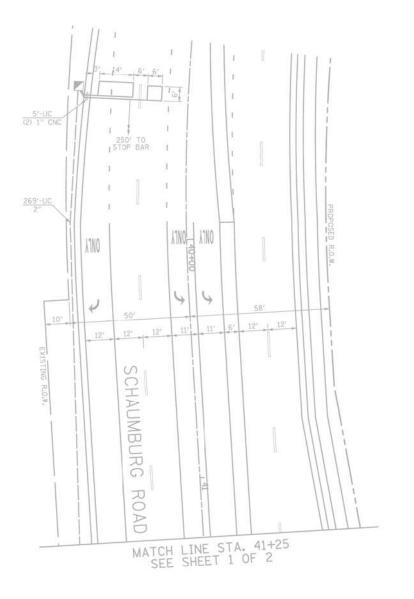



## "TRAFFIC SIGNAL PLAN FOR REFERENCE ONLY"

TS 4180 IDOT CENTRACS FORMER ECON 158



USER NAME = \$USER\$ DESIGNED - EA DRAWN - EA, AV CHECKED - MS PLOT DATE = \$DATE\$ DATE - 10/31/2022

REVISED REVISED REVISED


STATE OF ILLINOIS **DEPARTMENT OF TRANSPORTATION** 

LOCATION #22
BARRINGTON RD AT SCHAUMBURG RD INTERSECTION PLAN SHEET 2 SCALE: N.T.S. SHEET NO. OF SHEETS STA.

COUNTY TOTAL SHEET NO.

VARIOUS 306 83

CONTRACT NO. 62154 SECTION 2023 TRAFFIC 02 VAR

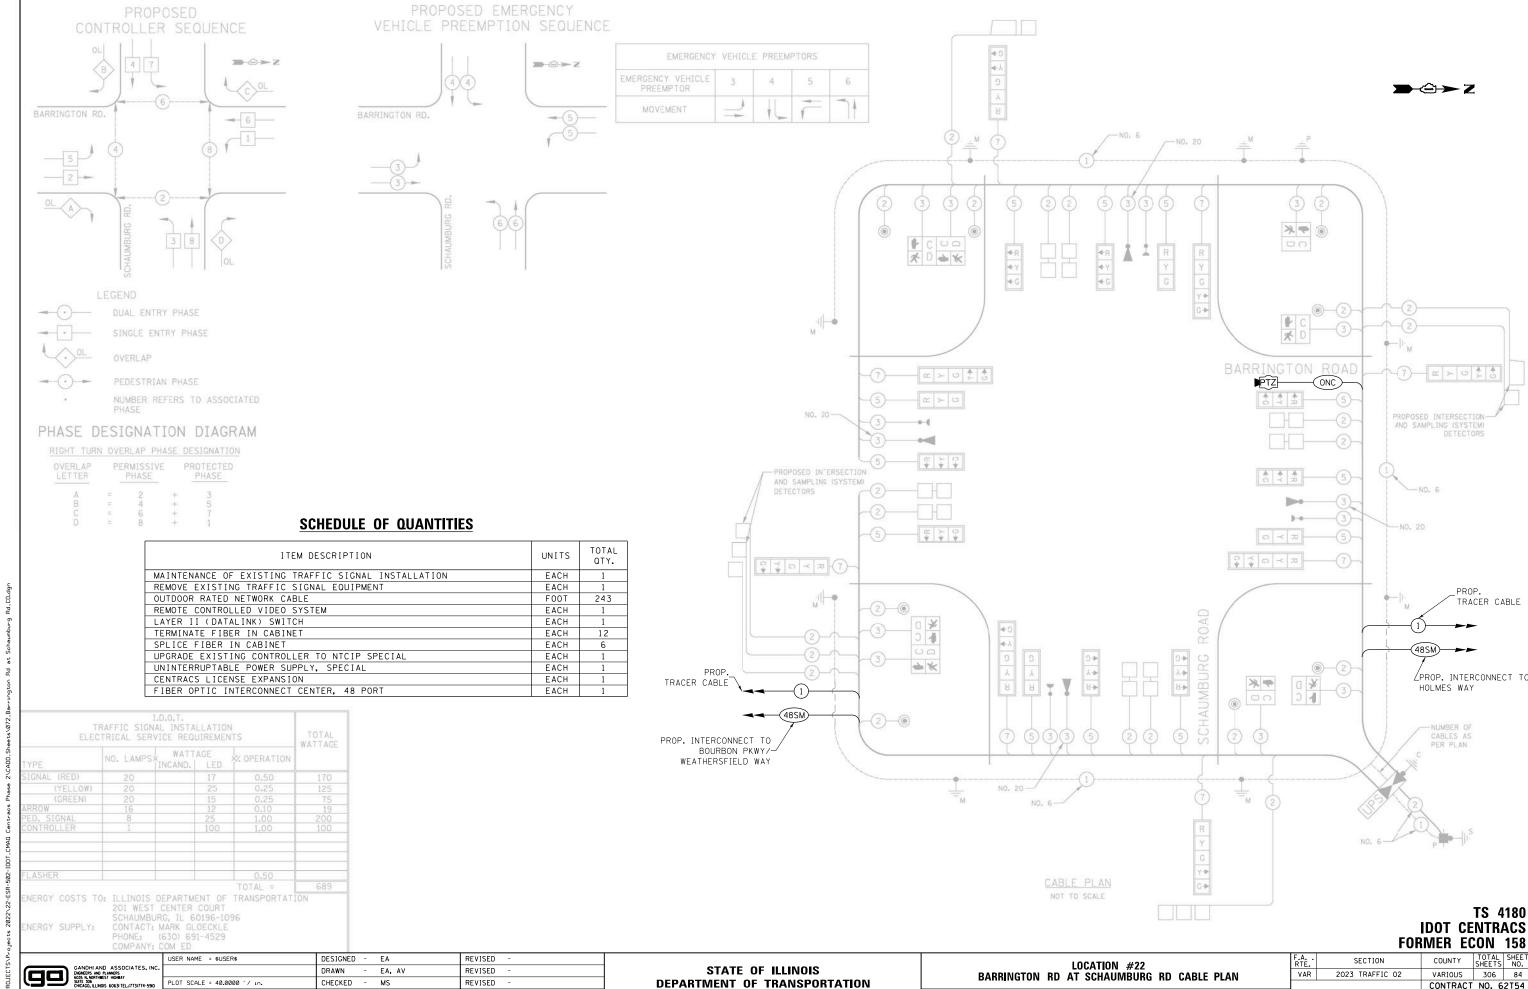

**DEPARTMENT OF TRANSPORTATION** 

SHEET NO. OF SHEETS STA.

CONTRACT NO. 62T54

FED. ROAD DIST. NO. \_ ILLINOIS FED. AID PROJECT

CHECKED

DATE


PLOT DATE = \$DATE\$

MS

- 10/31/2022

REVISED

REVISED

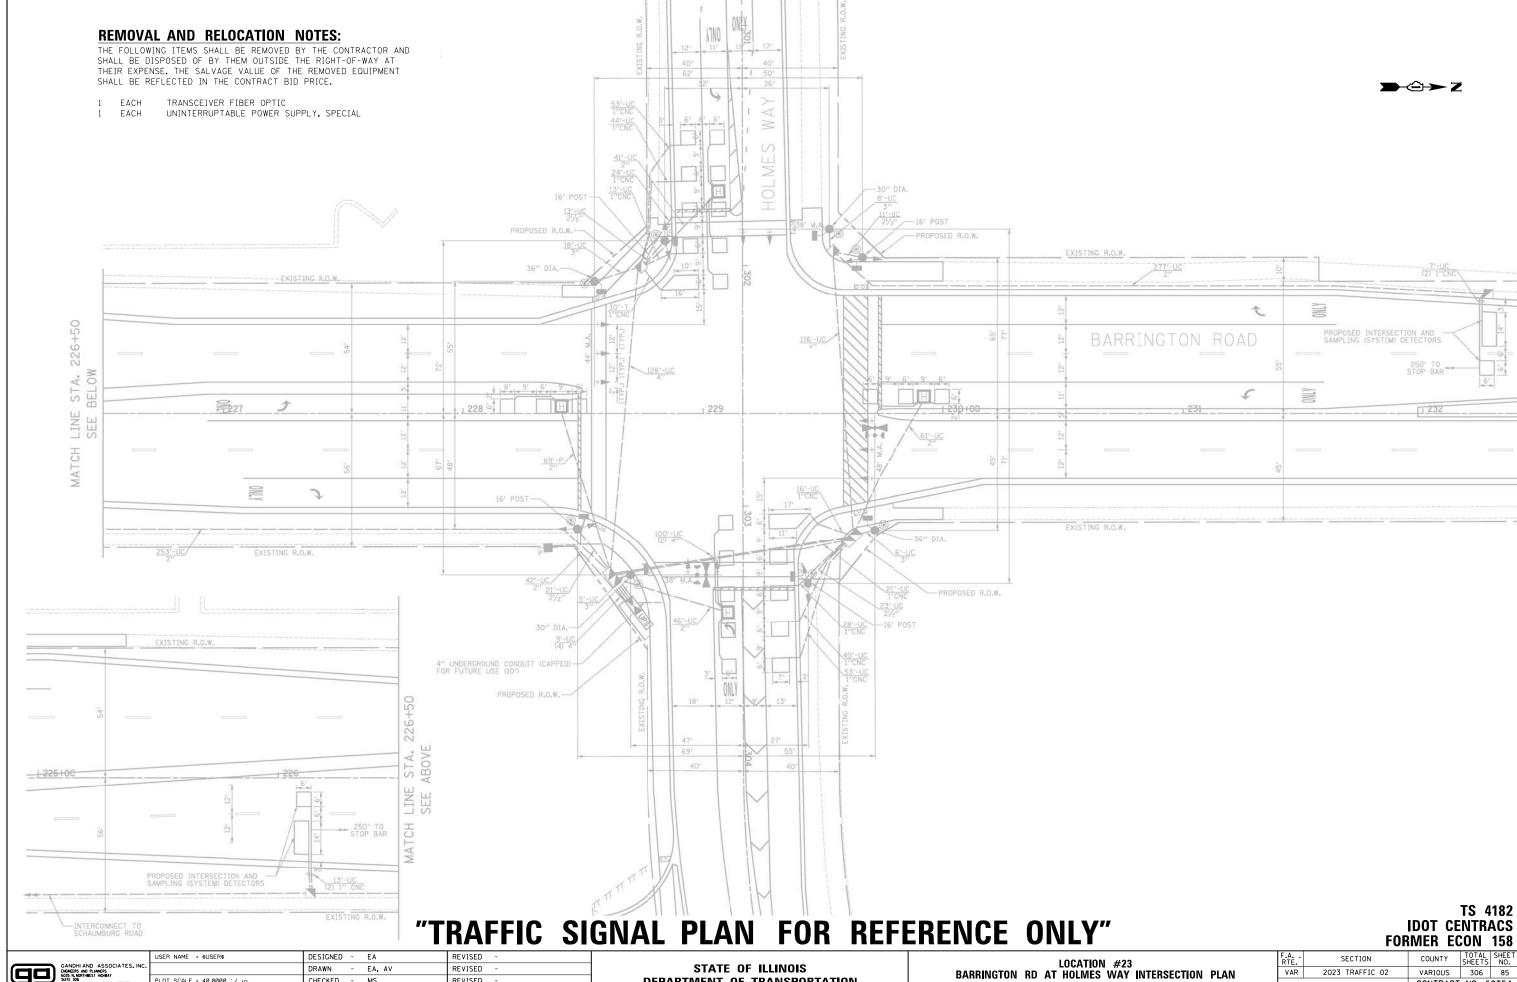


CHECKED REVISED DATE - 10/31/2022 PLOT DATE = \$DATE\$ REVISED

**DEPARTMENT OF TRANSPORTATION** 

SCALE: N.T.S. SHEET NO. OF SHEETS STA.

CONTRACT NO. 62T54

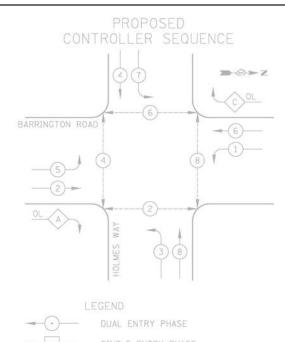

OVERLAP

PEDESTRIAN PHASE

NUMBER REFERS TO ASSOCIATED


#### PHASE DESIGNATION DIAGRAM

RIGHT TURN OVERLAP PHASE DESIGNATION

I.D.O.T.
TRAFFIC SIGNAL INSTALLATION
ELECTRICAL SERVICE REQUIREMENTS

ERGY COSTS TO: ILLINOIS DEPARTMENT OF TRANSPORTATION 201 WEST CENTER COURT SCHAUMBURG, IL 60196-1096 CONTACT: MARK GLOECKLE

(630) 691-4529

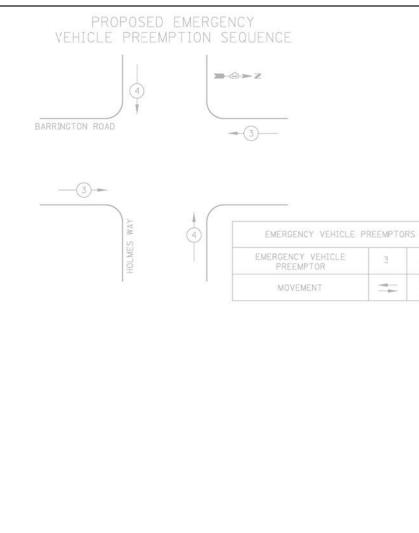

SCHEDI	JLE OF	OUANTITIES	

ITEM DESCRIPTION	UNITS	TOTAL QTY.
MAINTENANCE OF EXISTING TRAFFIC SIGNAL INSTALLATION	EACH	1
REMOVE EXISTING TRAFFIC SIGNAL EQUIPMENT	EACH	1
LAYER II (DATALINK) SWITCH	EACH	1
TERMINATE FIBER IN CABINET	EACH	12
SPLICE FIBER IN CABINET	EACH	6
UPGRADE EXISTING CONTROLLER TO NTCIP SPECIAL	EACH	1
UNINTERRUPTABLE POWER SUPPLY, SPECIAL	EACH	1
CENTRACS LICENSE EXPANSION	EACH	1
FIBER OPTIC INTERCONNECT CENTER, 48 PORT	EACH	1

### SCHEDOLE OF GOVINILIES

ITEM DESCRIPTION	UNITS	TOTAL QTY.
MAINTENANCE OF EXISTING TRAFFIC SIGNAL INSTALLATION	EACH	1
REMOVE EXISTING TRAFFIC SIGNAL EQUIPMENT	EACH	1
LAYER II (DATALINK) SWITCH	EACH	1
TERMINATE FIBER IN CABINET	EACH	12
SPLICE FIBER IN CABINET	EACH	6
UPGRADE EXISTING CONTROLLER TO NTCIP SPECIAL	EACH	1
UNINTERRUPTABLE POWER SUPPLY, SPECIAL	EACH	1
CENTRACS LICENSE EXPANSION	EACH	1
FIBER OPTIC INTERCONNECT CENTER, 48 PORT	EACH	1

### TS 4182 IDOT CENTRACS **FORMER ECON 158**

**→**②→ Z

\* = 0

BARRINGTON ROAD

PROPOSED INTERSECTION AND-SAMPLING (SYSTEM) DETECTORS

0-0-0

o ≺ z

\$ \$ 0 ≺ R

PROP

TRACER CABLE

(48SM)—**►** 

LINTERCONNECT TO OLD CHURCH

PROP.



GANDHI AND ASSOCIATES, IN
ENGINEERS AND PLANNERS
GOSTA, NORTHEEST HIGHBAY
SUTE 306
CHICAGO, LLINDIS 60631 TEL.(773)774-598

USER NAME = \$USER\$ DESIGNED - EA REVISED DRAWN - EA, AV REVISED PLOT SCALE = 40.0000 '/ in. CHECKED - MS REVISED PLOT DATE = \$DATE\$ DATE - 10/31/2022 REVISED

TOTAL WATTAGE

X OPERATION

TOTAL =

STATE OF ILLINOIS **DEPARTMENT OF TRANSPORTATION** 

TRACER CABLE

PROP. INTERCONNECT TO\_ SCHAUMBURG RD

LOCATION #23							F.A RTE.	SECTION	COUNTY	TOTAL SHEETS	SHEET NO.
BARRINGTON RD AT HOLMES WAY CABLE PLAN					VAR	2023 TRAFFIC 02	VARIOUS	306	86		
							CONTRACT	NO. 6	2T54		
	SHEET NO.	OF	SHEETS	STA.		TO STA.	FED. R	OAD DIST. NO ILLINOIS FED. A	ID PROJECT		

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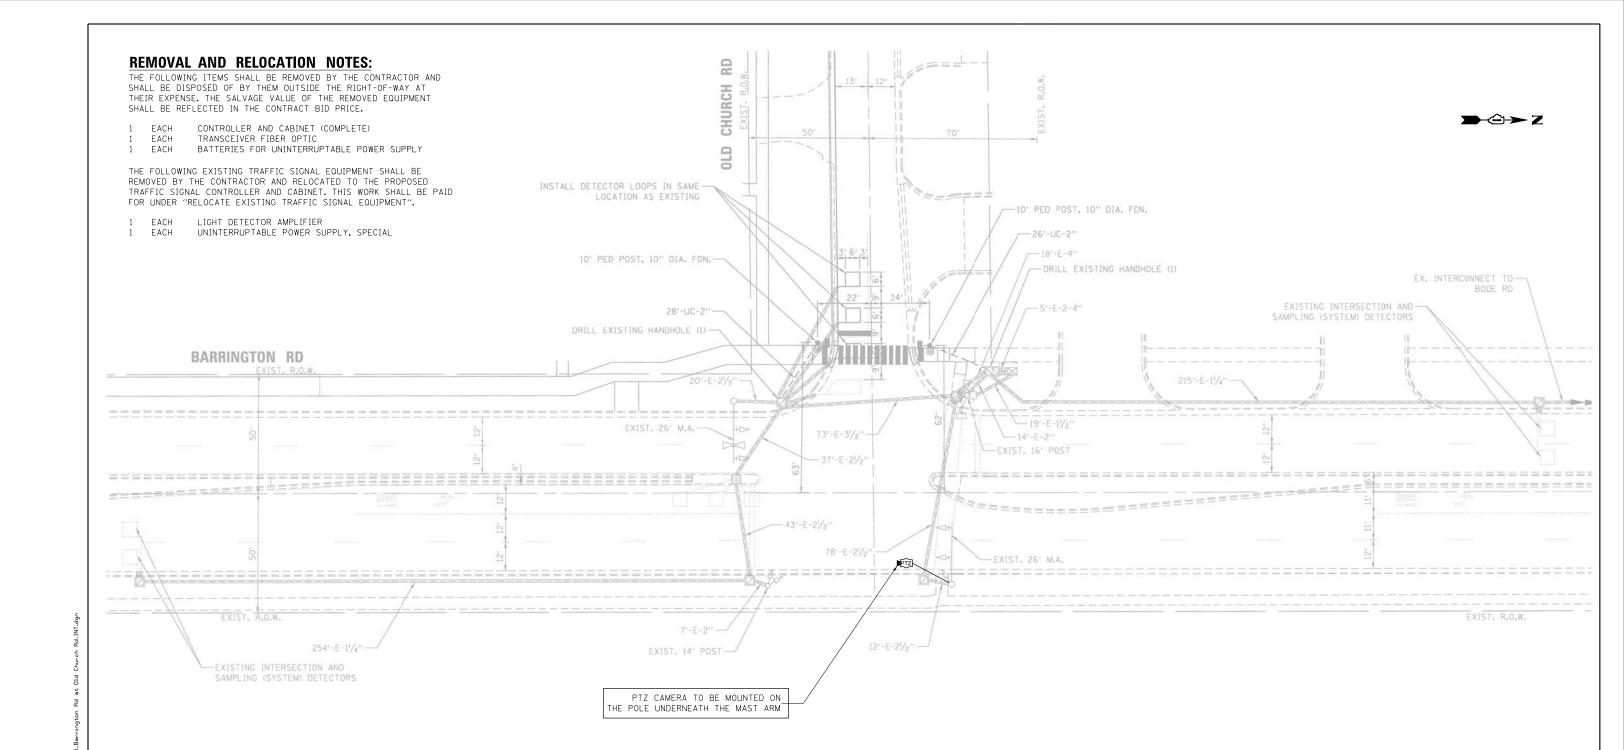
NO. 20-

m > □

-PROPOSED INTERSECTION AND SAMPLING (SYSTEM) DETECTORS

SCALE: N.T.S.

\*



#### NOTES:

THE PTZ CAMERA SHALL BE MOUNTED ON THE POLE OF THE MAST ARM UNDERNEATH THE ARM OF THE MAST ARM.

### "TRAFFIC SIGNAL PLAN FOR REFERENCE ONLY"

TS 21130 **IDOT CENTRACS FORMER ECON 150** 




USER NAME = \$USER\$ DESIGNED - EA DRAWN - EA, AV REVISED CHECKED REVISED - 10/31/2022 REVISED DATE

STATE OF ILLINOIS **DEPARTMENT OF TRANSPORTATION** 


LOCATION #24 BARRINGTON RD AT OLD CHURCH RD INTERSECTION PLAN SCALE: N.T.S. SHEET NO. OF SHEETS STA.

SECTION COUNTY 2023 TRAFFIC 02 VARIOUS 306 87 VAR CONTRACT NO. 62T54



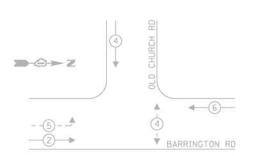

#### PROPOSED CONTROLLER SEQUENCE

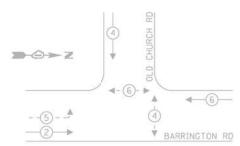




LEGEND:

TRACER CABLE

EX. INTERSECTION AND SAMPLING (SYSTEM) DETECTORS

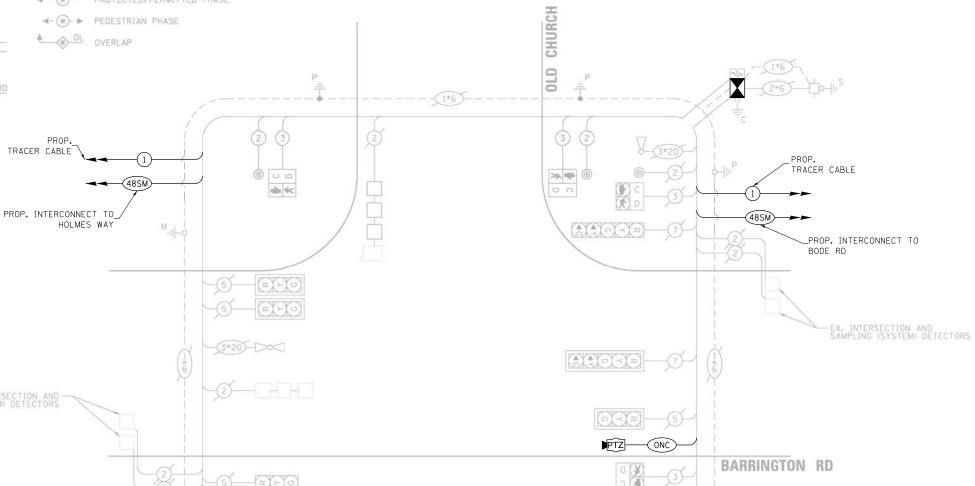


CABLE PLAN

(NOT TO SCALE)

SCALE: N.T.S.

RD

#### EXISTING AND PROPOSED **EMERGENCY VEHICLE** PREEMPTION SEQUENCE

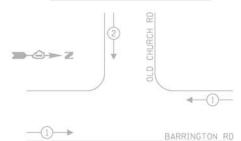

#### TRAFFIC SIGNAL ELECTRICAL SERVICE REQUIREMENTS NO. OF LED % TOTAL

TYPE	LAMPS	WATTAGE	OPERATION	WATTAGE
SIGNAL (RED)	8	11	50	44.0
(YELLOW)	8	20	5	8.0
(GREEN)	8	12	45	43.2
PERMISSIVE ARROW	4	10	10	4.0
PED. SIGNAL	4	20	100	80.0
CONTROLLER	1	100	100	100.0
UPS	1	25	100	25.0
VIDEO SYSTEM	- 1	150	100	1 27
BLANK-OUT SIGN		25	5	120
FLASHER	- 1	-	50	120
STREET NAME SIGN	- 14	120	50	-
LUMINAIRE	12	-	-	197
			TOTAL -	2010

ENERGY COSTS TO:

VILLAGE OF SCHAUMBURG

101 SCHAUMBURG CT SCHAUMBURG, IL 60193 ENERGY SUPPLY: CONTACT: -

PHONE: -COMPANY: COMMONWEALTH EDISON
ACCOUNT NUMBER: 19241-25012

#### SCHEDULE OF QUANTITIES

ITEM DESCRIPTION	UNITS	TOTAL QTY.
MAINTENANCE OF EXISTING TRAFFIC SIGNAL INSTALLATION	EACH	1
INDUCTIVE LOOP DETECTOR	EACH	6
RELOCATE EXISTING TRAFFIC SIGNAL EQUIPMENT	EACH	1
RELOCATE EXISTING EMERGENCY VEHICLE PRIORITY SYSTEM, PHASING UNIT	EACH	1
REMOVE EXISTING TRAFFIC SIGNAL EQUIPMENT	EACH	1
OUTDOOR RATED NETWORK CABLE	FOOT	191
REMOTE CONTROLLED VIDEO SYSTEM	EACH	1
LAYER II (DATALINK) SWITCH	EACH	1
TERMINATE FIBER IN CABINET	EACH	12
SPLICE FIBER IN CABINET	EACH	6
FULL-ACTUATED CONTROLLER AND TYPE IV CABINET, SPECIAL	EACH	1
REMOVE AND REPLACE BATTERIES FOR UNINTERRUPTABLE POWER SUPPY	EACH	1
CENTRACS LICENSE EXPANSION	EACH	1
FIBER OPTIC INTERCONNECT CENTER, 48 PORT	EACH	1


TS 21130 IDOT CENTRACS FORMER ECON 150 COUNTY SHEETS NO.
VARIOUS 306 88
CONTRACT NO. 62154

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	USER NAME = \$USER\$	DESIGNED	-	EA	REVISED	-	12-2-2022
٠		DRAWN	-	EA, AV	REVISED	-	
	PLOT SCALE = 40.0000 '/ in.	CHECKED	-	MS	REVISED	-	
	PLOT DATE = \$DATE\$	DATE	-	10/31/2022	REVISED	-	


STATE OF ILLINOIS **DEPARTMENT OF TRANSPORTATION** 

		LOCATION :	#24		F.A RTE.	SECTION	
BARRINGTON RD AT OLD CHURCH				RD CABLE PLAN	VAR	2023 TRAFFIC 02	
							(
.S.	SHEET NO.	OF SHEETS	STA.	TO STA.	FED. R	DAD DIST. NO ILLINOIS FED.	AID P

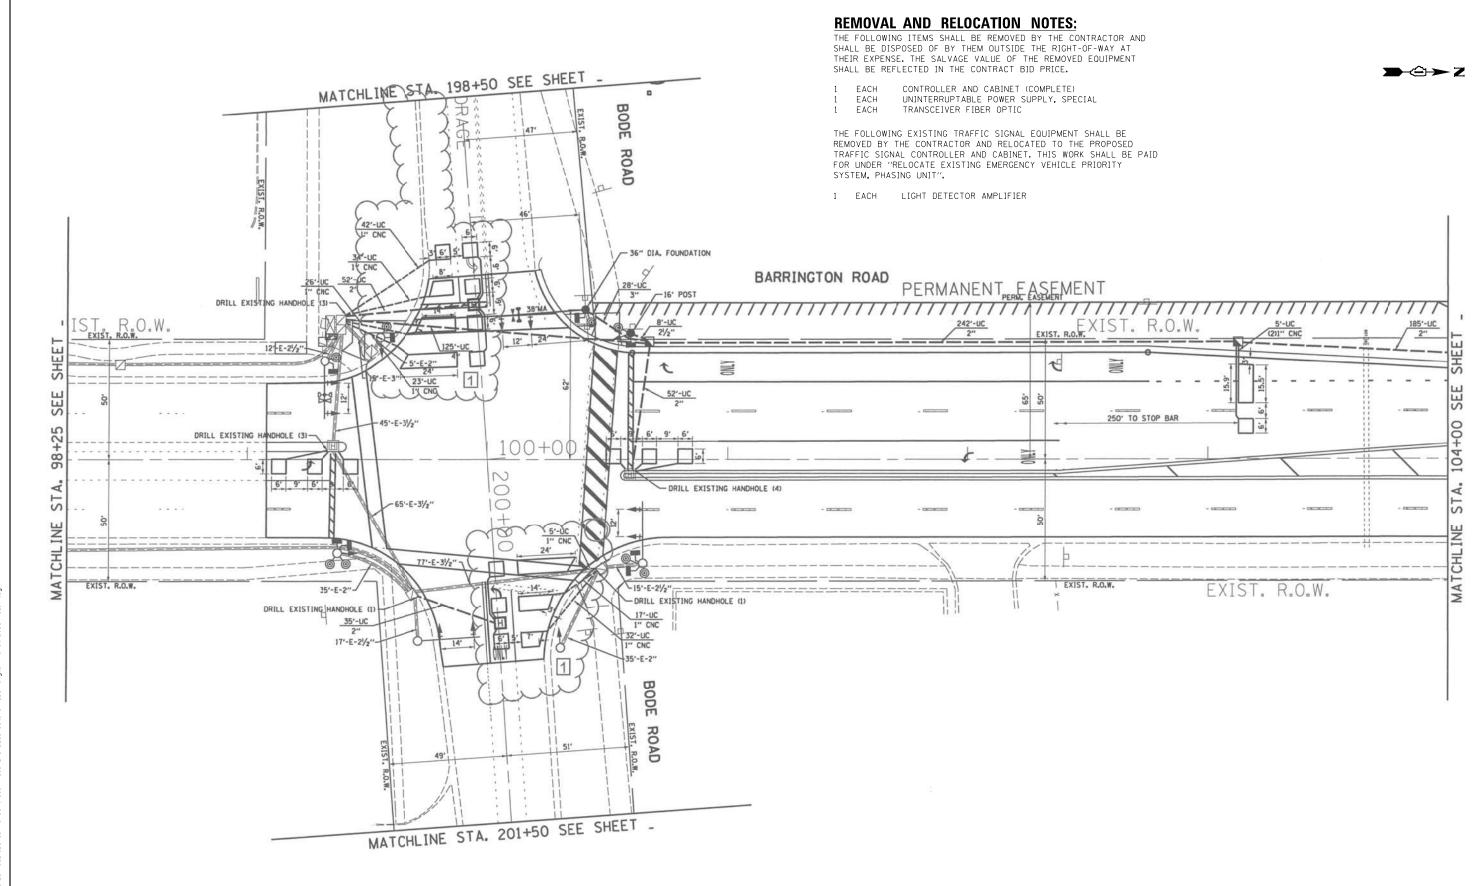

### "TRAFFIC SIGNAL PLAN FOR REFERENCE ONLY"

TS 4170 IDOT CENTRACS FORMER ECON 150

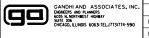


	USER NAME = \$USER\$	DESIGNED	-	EA	REVISED -	
ıc.		DRAWN	-	EA, AV	REVISED -	
。[	PLOT SCALE = 40.0000 '/ in.	CHECKED	-	MS	REVISED -	
	PLOT DATE = \$DATE\$	DATE	-	10/31/2022	REVISED -	
						1

STATE OF ILLINOIS
DEPARTMENT OF TRANSPORTATION

LOCATION #25										
ARRINGT	ON RI	D AT	BODE	RD I	NT	ERSECTION	PLAN	SHEET	1	
.T.S.	SHEET	NO.	OF	SHEET	·s	STA.	TO	STA.		

| NO. | NO.

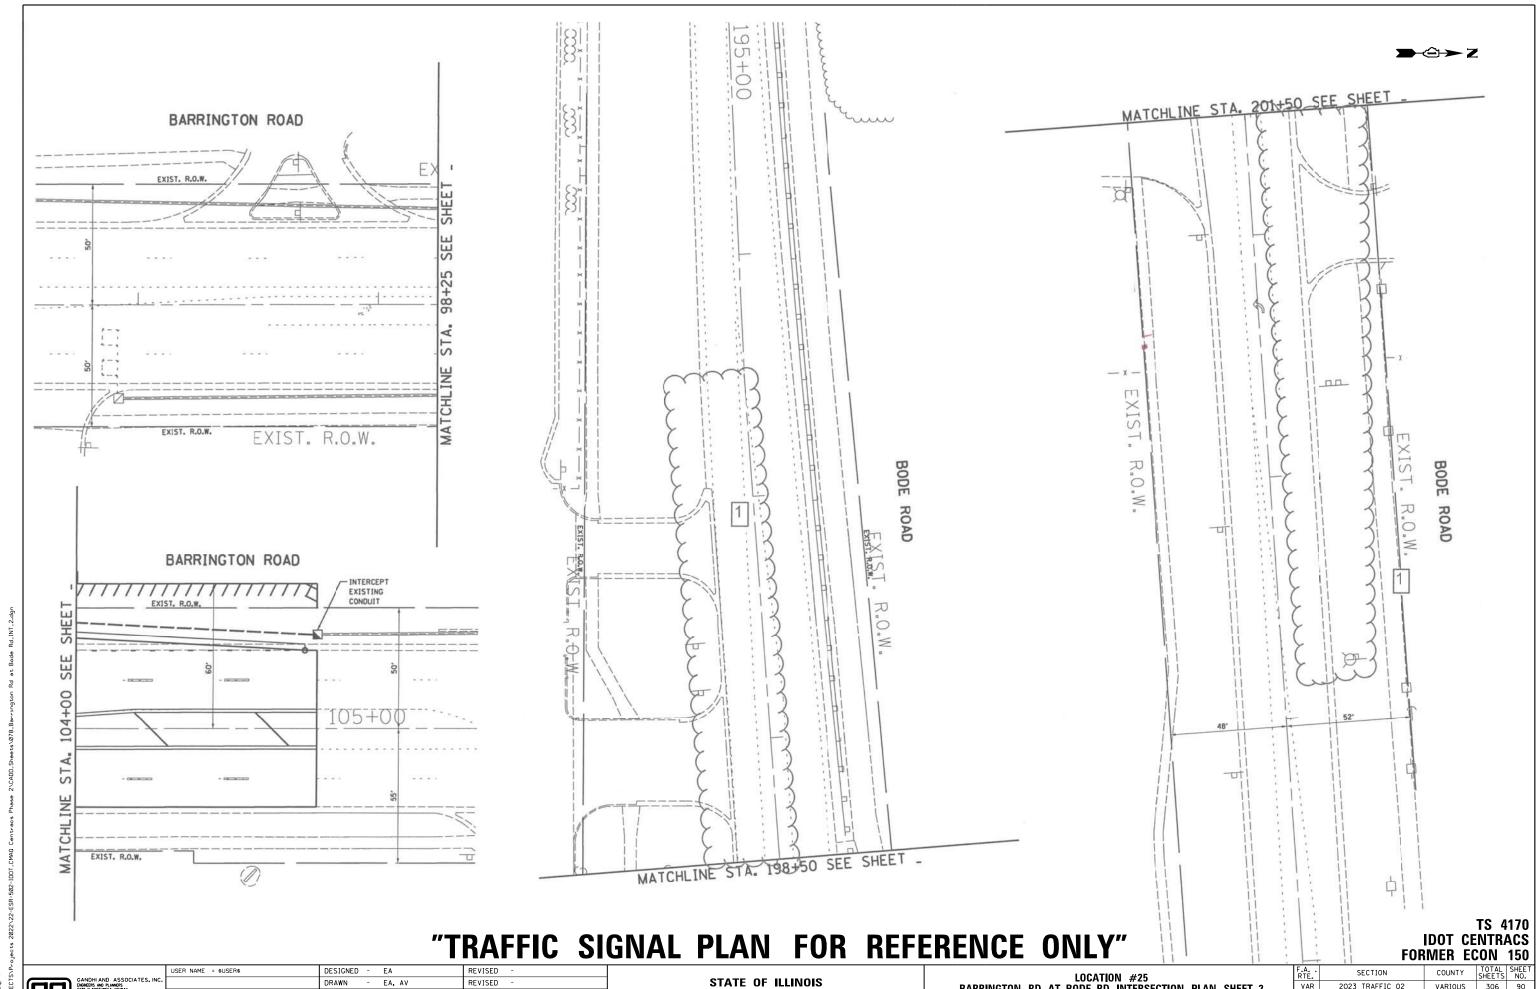


DRAWN - EA, AV CHECKED - MS - 10/31/2022

**DEPARTMENT OF TRANSPORTATION** 

LOCATION #25
BARRINGTON RD AT BODE RD INTERSECTION PLAN SHEET 2 SHEET NO. OF SHEETS STA.

2023 TRAFFIC 02

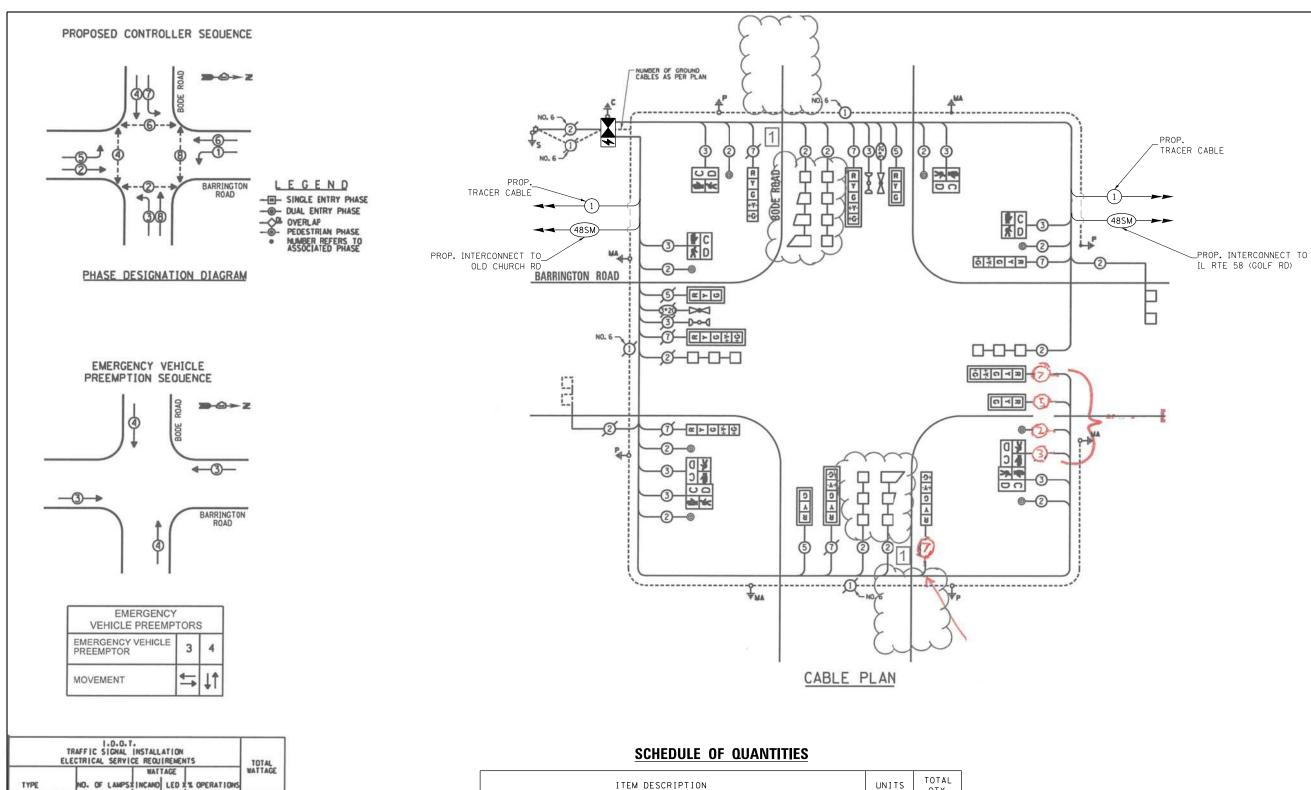

ITEM DESCRIPTION	UNITS	TOTAL OTY.
MAINTENANCE OF EXISTING TRAFFIC SIGNAL INSTALLATION	EACH	1
INDUCTIVE LOOP DETECTOR	EACH	8
RELOCATE EXISTING EMERGENCY VEHICLE PRIORITY SYSTEM, PHASING UNIT	EACH	1
REMOVE EXISTING TRAFFIC SIGNAL EQUIPMENT	EACH	1
LAYER II (DATALINK) SWITCH	EACH	1
TERMINATE FIBER IN CABINET	EACH	12
SPLICE FIBER IN CABINET	EACH	6
FULL-ACTUATED CONTROLLER AND TYPE IV CABINET, SPECIAL	EACH	1
UNINTERRUPTABLE POWER SUPPLY, SPECIAL	EACH	1
CENTRACS LICENSE EXPANSION	EACH	1
FIBER OPTIC INTERCONNECT CENTER, 48 PORT	EACH	1

TS 4170 IDOT CENTRACS FORMER ECON 150

 $\Rightarrow \Rightarrow z$ 

GANDHI AND ASSOCIATES, INC.
EMAKERS AND PLANERS
OSIS IN MORTHWEST INCIDIAN
SOLIT JOS
CHICAGO, ILLINOS 6063 IEL./173174-590

ENERGY SUPPLY - CONTACT: \_ PHONE: \_ COMPANY: \_

VILLAGE OF HOFFMAN ESTATES 1900 HASSEL ROAD HOFFMAN ESTATES+ ILLINOIS 60169

JOE STACHO

16301 424-5704

SIGNAL (RED)

ARROW
PEO. SIGNAL
CONTROLLER
ILLUM, SIGN
LUMINAIRE
VIDEO SYSTEM

ENERGY COSTS TO:


0.50

TOTAL = 541.20

STATE OF ILLINOIS
DEPARTMENT OF TRANSPORTATION

SCALE: N.T.S.

K:NPROJECTSNP-ojects 2022\22-ESR-502-IDOT\_

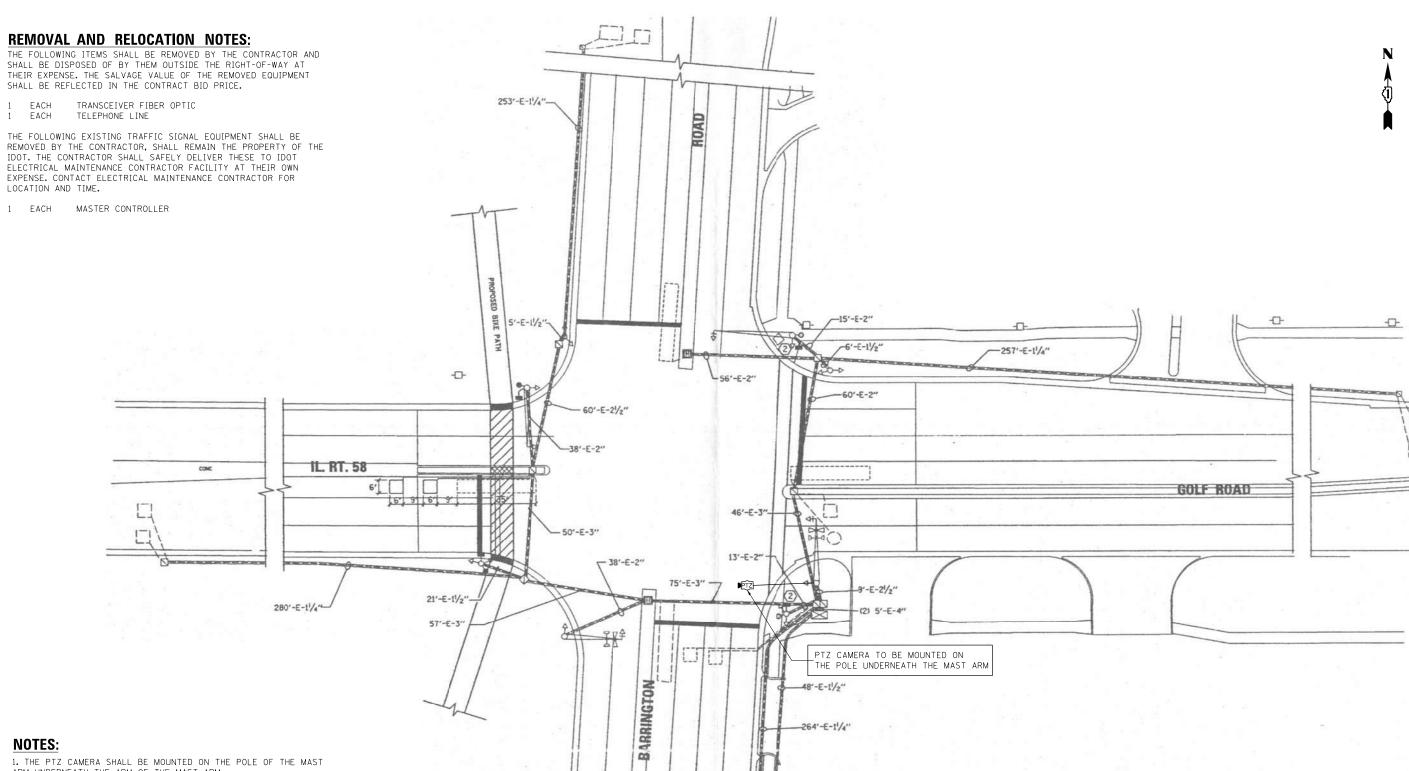


ARM UNDERNEATH THE ARM OF THE MAST ARM.

2. THE TELEPHONE LINE AND SERVICE SHOULD BE REMOVED AND DISCONNECTED UPON PROJECT COMPLETION AND SIGNAL BEING ADDED TO CENTRACS.

3, CONTRACTOR WILL NEED TO COORDINATE WORK WITH WORK UNDER CONTRACT 62N97. CONTRACT 62N97 IS SCHEDULED CONCURRENTLY WITH CONTRACT 62T54 AND WILL RECONSTRUCT ENTIRE INTERSECTION. CONTRACT 62T54 CAN START WORK BEFORE 62N97 IF MATERIALS AVAILABLE. ADDITIONAL SLACK IN FIBER SHALL BE PROVIDED TO ACCOUNT FOR THAT, WORK SHALL NOT BE DUPLICATED SOME EQUIPMENT RELOCATION MIGHT BE NECESSARY, PTZ INSTALL PRIMARILY AS SHOWN ON PLANS UNLESS COMBINATION MAST ARM IS IN PLACE UNDER 62N97. CONTRACTOR TO PLAN WORK ACCORDINGLY. COORDIANTION WILL BE REQUIRED AMONG THE DESIGNERS, RE, AND CONTRACTORS.

### "TRAFFIC SIGNAL PLAN FOR REFERENCE ONLY"

TS 2725 **IDOT CENTRACS FORMER ECON 150** 

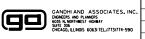

	USER NAME = \$USER\$	DESIGNED	-	EA	REVISED	-	12-2-2022
NC.		DRAWN	-	EA, AV	REVISED	-	
10	PLOT SCALE = 40.0000 '/ in.	CHECKED	-	MS	REVISED	-	
	PLOT DATE = \$DATE\$	DATE	-	10/31/2022	REVISED	-	

STATE OF ILLINOIS **DEPARTMENT OF TRANSPORTATION** 

LOCATION #26								
BARRINGT	ON RD AT	IL RTI	E 58 (GO	LF RD)	INTERSECTION PLAN			
SCALE: N.T.S.	SHEET NO.	OF	SHEETS	STA.	TO STA.			

SECTION COUNTY 2023 TRAFFIC 02 VARIOUS 306 92 VAR CONTRACT NO. 62T54

#### TRACER CABLE TRACER CABLE R Y G +Y +G \_PROP. INTERCONNECT TO ST ALEXIUS MEDICAL CTR PROP. INTERCONNECT TO\_ \$ + 0 × B & > 0 + 0 BARRINGTON \* \* O < D EXISTING INTERSECTION **SCHEDULE OF QUANTITIES** AND SAMPLING (SYSTEM) DETECTORS TOTAL UNITS ROAD QTY. \$ \$ 0 × R EACH EACH FOOT 78 EACH EACH 36 EACH EACH EACH EACH 58 =<sub>MA</sub> NO. 6-NUMBER OF GROUND CABLES AS PER PLAN **CABLE PLAN EXISTING** TRACER CABLE CONTROLLER SEQUENCE PROP. INTERCONNECT TO THOFFMAN ESTATE SHOPPING CENTER EXISTING EMERGENCY VEHICLE PREEMPTION SEQUENCE BARRINGTON LEGEND: SINGLE ENTRY PHASE BARRINGTON PERMISSIVE PROTECTED **4**-3)-PHASE DUAL ENTRY PHASE EMERGENCY VEHICLE PREEMPTOR NUMBER REFERS TO ASSOCIATED PHASE MOVEMENT TS 2725 **IDOT CENTRACS EXISTING PHASE DESIGNATION DIAGRAM FORMER ECON 150** DESIGNED - EA REVISED

# ITEM DESCRIPTION

MAINTENANCE OF EXISTING TRAFFIC SIGNAL INSTALLATION REMOVE EXISTING TRAFFIC SIGNAL EQUIPMENT OUTDOOR RATED NETWORK CABLE REMOTE CONTROLLED VIDEO SYSTEM TERMINATE FIBER IN CABINET UPGRADE EXISTING CONTROLLER TO NTCIP SPECIAL LAYER III (NETWORK) SWITCH CENTRACS LICENSE EXPANSION FIBER OPTIC INTERCONNECT CENTER, 48 PORT

I.D.O.T.
TRAFFIC SIGNAL INSTALLATION
ELECTRICAL SERVICE REQUIREMENTS NO. LAMPS INCAND. L.E.D.

ENERGY COSTS - BILLED TO: IL DEPT. OF TRANSPORTATION
(ADDRESS) 201 W. CENTER COURT
(ADDRESS) SCHAUMBURG, IL 60196-1096

ENERGY SUPPLY - CONTACT: DAYE SCHACHT
PHONE: 630-437-2129
COMPANY: COMED - OAKBROOK TERRACE

USER NAME = \$USER\$

DRAWN - EA, AV REVISED CHECKED REVISED DATE - 10/31/2022 REVISED

STATE OF ILLINOIS **DEPARTMENT OF TRANSPORTATION** 

LOCATION #26 BARRINGTON RD AT IL RTE 58 (GOLF RD) CABLE PLAN SHEET NO. OF SHEETS STA.

COUNTY SECTION 2023 TRAFFIC 02 VARIOUS 306 93 VAR CONTRACT NO. 62T54

#### **REMOVAL AND RELOCATION NOTES:**

THE FOLLOWING ITEMS SHALL BE REMOVED BY THE CONTRACTOR AND SHALL BE DISPOSED OF BY THEM OUTSIDE THE RIGHT-OF-WAY AT THEIR EXPENSE. THE SALVAGE VALUE OF THE REMOVED EQUIPMENT SHALL BE REFLECTED IN THE CONTRACT BID PRICE.

CHECKED

- 10/31/2022


REVISED

1 EACH TRANSCEIVER FIBER OPTIC

### "TRAFFIC SIGNAL PLAN FOR REFERENCE ONLY"




CONTRACT NO. 62T54

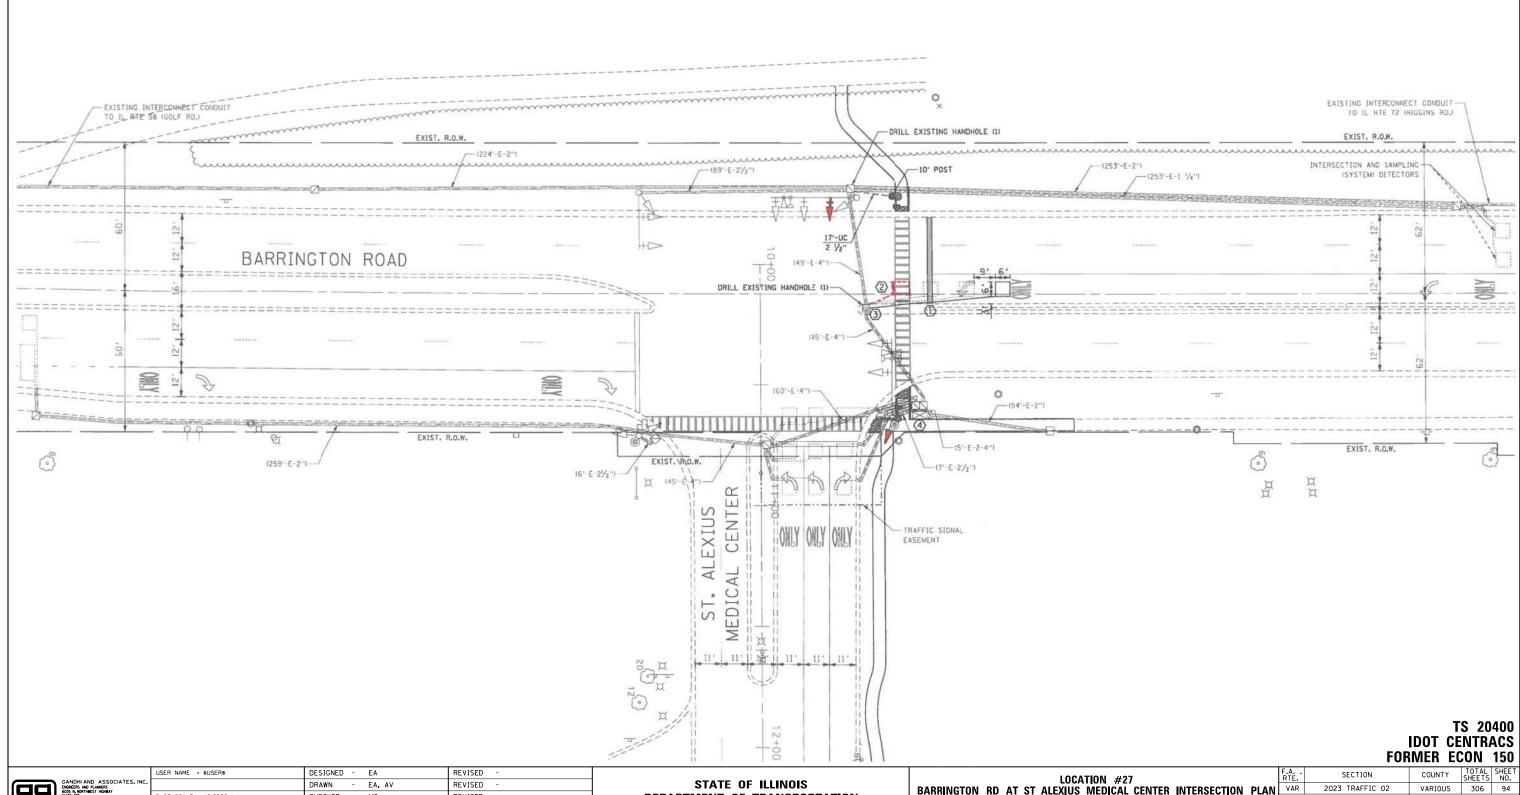

**DEPARTMENT OF TRANSPORTATION** 

SHEET NO. OF SHEETS STA.

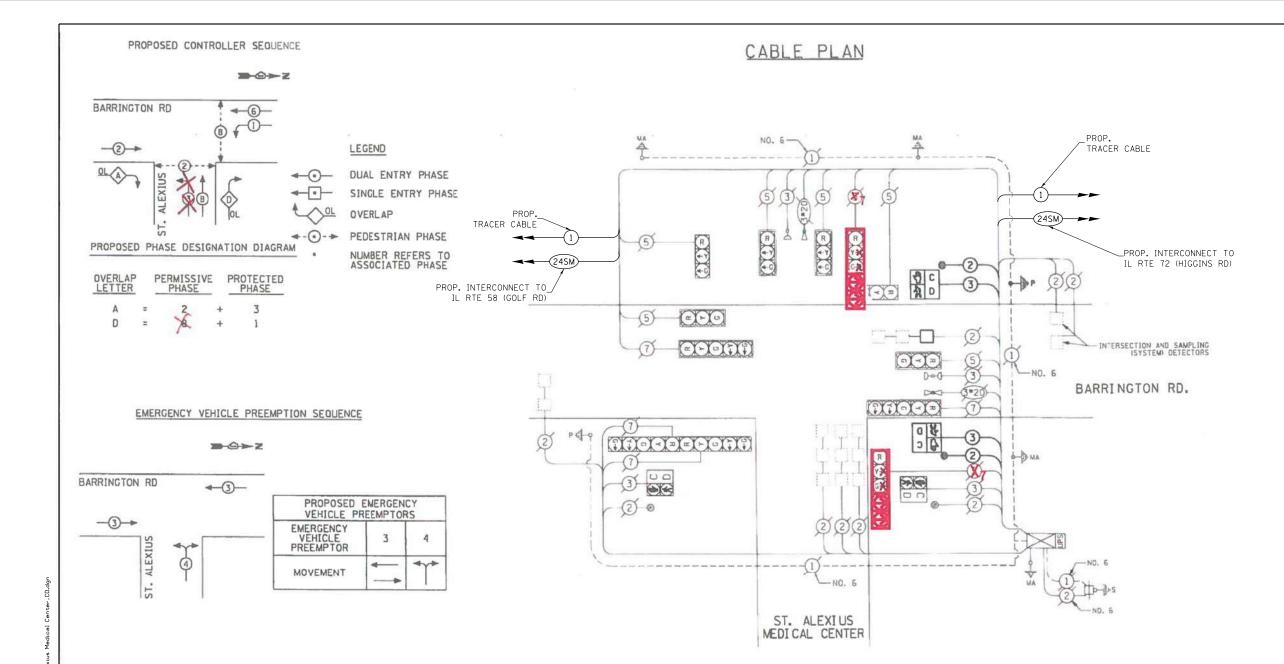

ELEC	TOTAL					
TYPE	NO. OF LAMPS	WATT XINCAND.		x % OPERATION	WAT 1 AUL	
SIGNAL (RED)	12		17	0.50	102.00	
(YELLOW)	12		25	0.25	75,00 45,00 9,60	
(GREEN)	15		15 12	0.25		
ARROW	8					
PED. SIGNAL	4		25	1.00	100.00	
CONTROLLER	LER 1 10	100	1.00	100.00		
ILLUM. SIGN	-	-				
U.P.S.	1		25	1.00	25,00	
ENERGY COSTS	TO:			TOTAL =	456.60	
VII	LAGE OF	HOFF	MAN I	ESTATES		

#### **SCHEDULE OF QUANTITIES**

ITEM DESCRIPTION	UNITS	TOTAL QTY.
MAINTENANCE OF EXISTING TRAFFIC SIGNAL INSTALLATION	EACH	1
REMOVE EXISTING TRAFFIC SIGNAL EQUIPMENT	EACH	1
LAYER II (DATALINK) SWITCH	EACH	1
TERMINATE FIBER IN CABINET	EACH	12
SPLICE FIBER IN CABINET	EACH	6
UPGRADE EXISTING CONTROLLER TO NTCIP SPECIAL	EACH	1
CENTRACS LICENSE EXPANSION	EACH	1
FIBER OPTIC INTERCONNECT CENTER, 24 PORT	EACH	1

TS 20400 IDOT CENTRACS **FORMER ECON 150** 

**→**②→ Z

	UJL
GANDHI AND ASSOCIATES, INC. ENGINEERS AND PLANNERS 6035 N. NORTHHEST HIGHWAY	
SUST E 306 CHICAGO, ILLINOIS 60631 TEL.(773)774-5910	PLO
	PLO

HOFFMAN ESTATES, ILLINOIS 60195

ENERGY SUPPLY: CONTACT: LEN STADLER
PHONE: (847) 691-4376
COMPANY: COMED


1900 HASSELL ROAD

	USER NAME = \$USER\$	DESIGNED	-	EA	REVISED -
۱C.		DRAWN	-	EA, AV	REVISED -
0	PLOT SCALE = 40.0000 '/ in.	CHECKED	-	MS	REVISED -
	PLOT DATE = \$DATE\$	DATE	-	10/31/2022	REVISED -

STATE OF ILLINOIS **DEPARTMENT OF TRANSPORTATION** 

	LOCATION #27					F.A RTE.	SECTION		
ı	BARRINGTO	N RD AT				CENTER CABLE PLAN	VAR	2023 TRAFFIC 02	
ı									Γ
ı	SCALE: N.T.S.	SHEET NO.	OF	SHEETS	STA.	TO STA.	FED. RO	DAD DIST. NO ILLINOIS FED. A	ID

COUNTY TOTAL SHEET NO.
VARIOUS 306 95
CONTRACT NO. 62154

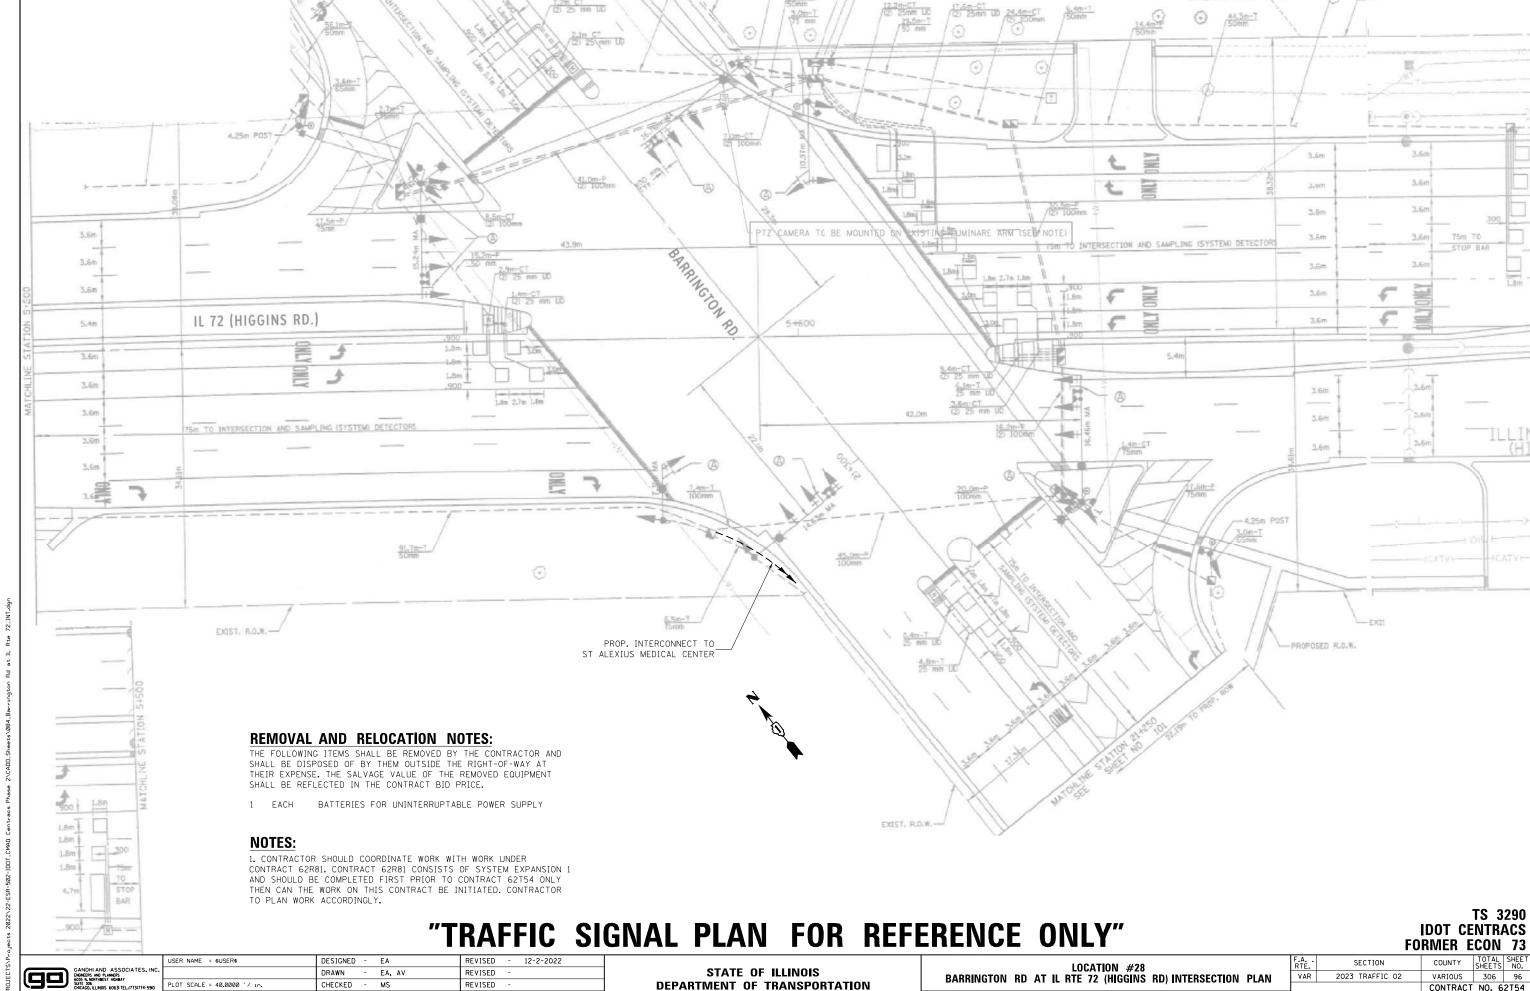

**DEPARTMENT OF TRANSPORTATION** 

SCALE: N.T.S. SHEET NO. OF SHEETS STA.


CONTRACT NO. 62T54

CHECKED

- 10/31/2022

DATE

REVISED

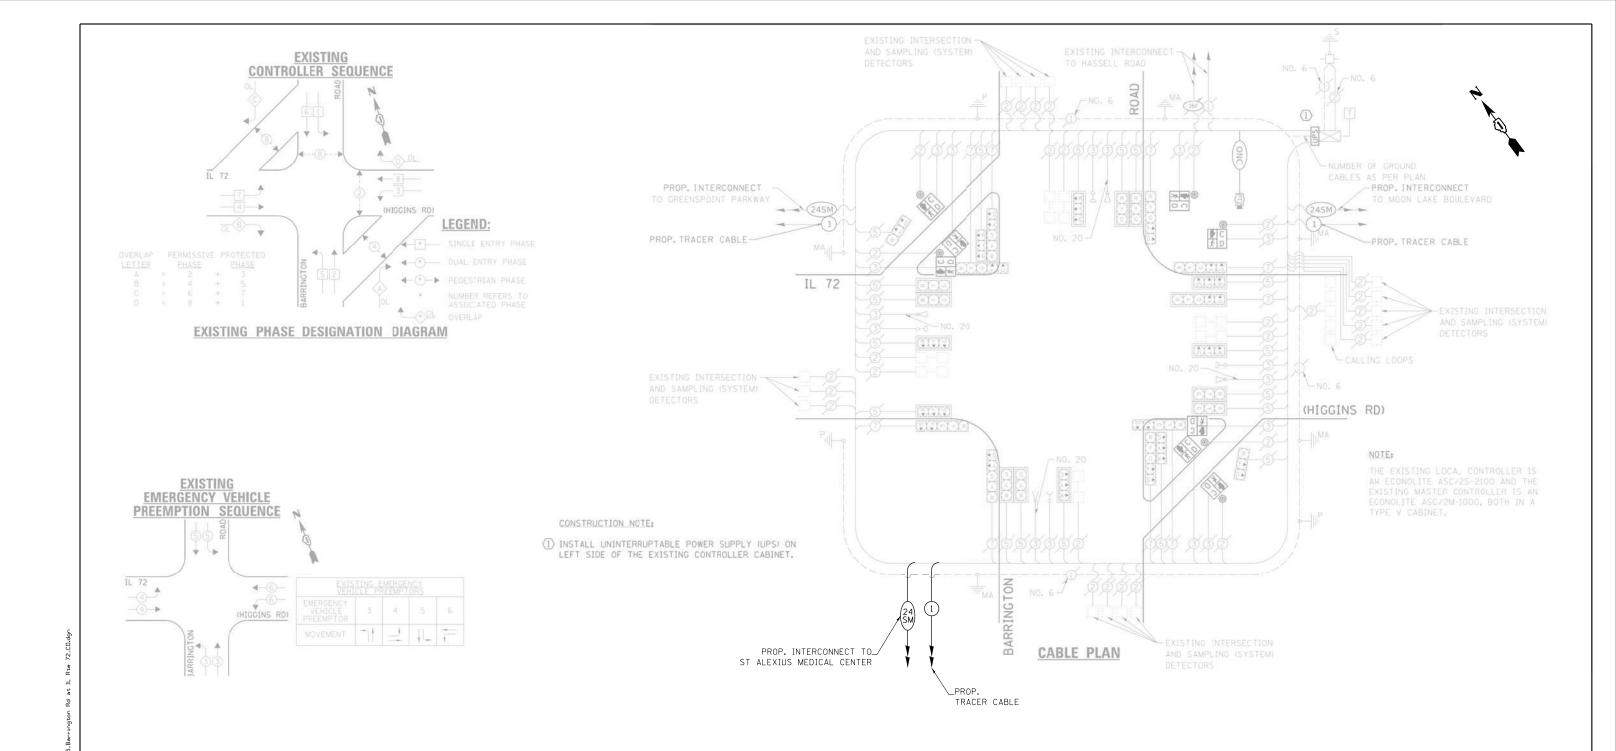

		WATT	AGE		
TYPE	NO. LAMPS	INCAND.	L.E.D.	OPERATION	
SIGNAL (YELLOW)					
ARROW			12:		21.6
	- 8				
			6.4		
VIDEO SYSTEM					
BATTERY BACKUP					
					846.1

#### **SCHEDULE OF QUANTITIES**

ITEM DESCRIPTION	UNITS	TOTAL QTY.
MAINTENANCE OF EXISTING TRAFFIC SIGNAL INSTALLATION	EACH	1
TERMINATE FIBER IN CABINET	EACH	12
REMOVE AND REPLACE BATTERIES FOR UNINTERRUPTABLE POWER SUPPLY	EACH	1

#### TS 3290 **IDOT CENTRACS** FORMER ECON 73

VARIOUS 306 97

CONTRACT NO. 62T54

COUNTY

DESIGNED - EA REVISED DRAWN - EA, AV REVISED CHECKED - MS REVISED PLOT DATE = \$DATE\$ DATE - 10/31/2022 REVISED

STATE OF ILLINOIS **DEPARTMENT OF TRANSPORTATION** 


SECTION LOCATION #28 2023 TRAFFIC 02 BARRINGTON RD AT IL RTE 72 (HIGGINS RD) CABLE PLAN VAR SHEET NO. OF SHEETS STA. FED. ROAD DIST. NO. \_ ILLINOIS FED. AID PROJECT



THE FOLLOWING ITEMS SHALL BE REMOVED BY THE CONTRACTOR AND SHALL BE DISPOSED OF BY THEM OUTSIDE THE RIGHT-OF-WAY AT THEIR EXPENSE. THE SALVAGE VALUE OF THE REMOVED EQUIPMENT SHALL BE REFLECTED IN THE CONTRACT BID PRICE.

ILL. RTE. 58 (GOLF ROAD)

1 EACH CONTROLLER 1 EACH TRANSCEIVER FIBER OPTIC

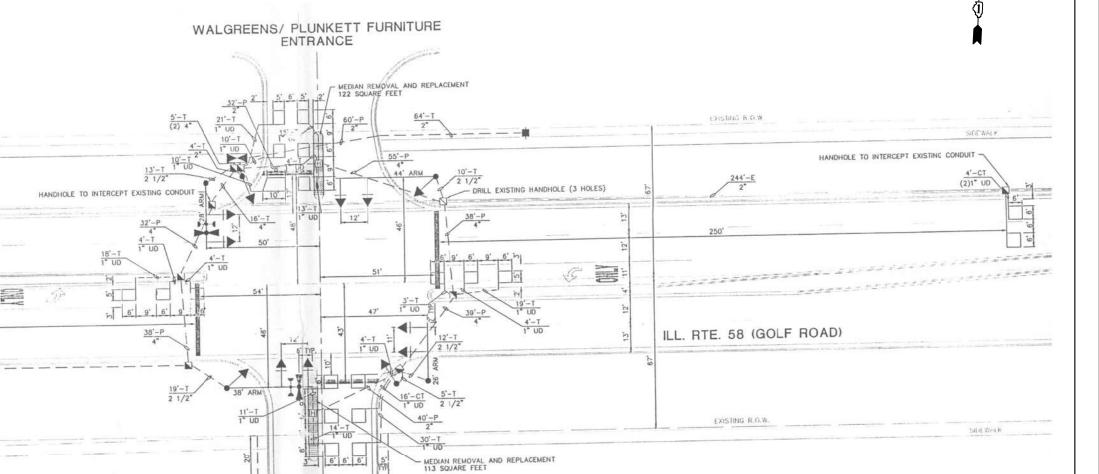

PROPOSED PERMANENT MAINTENANCE EASEMENT

#### NOTES:

1. CONTRACTOR WILL NEED TO COORDINATE WORK WITH WORK UNDER CONTRACT 62N97. CONTRACT 62N97 IS SCHEDULED CONCURRENTLY WITH CONTRACT 62T54 AND WILL RECONSTRUCT ENTIRE INTERSECTION. CONTRACT 62T54 CAN START WORK BEFORE 62N97 IF MATERIALS AVAILABLE. ADDITIONAL SLACK IN FIBER SHALL BE PROVIDED TO ACCOUNT FOR THAT, WORK SHALL NOT BE DUPLICATED SOME EOUIPMENT RELOCATION MIGHT BE NECESSARY, PTZ INSTALL PRIMARILY AS SHOWN ON PLANS UNLESS COMBINATION MAST ARM IS IN PLACE UNDER 62N97. CONTRACTOR TO PLAN WORK ACCORDINGLY. COORDIANTION WILL BE REQUIRED AMONG THE DESIGNERS, RE, AND CONTRACTORS.

### "TRAFFIC SIGNAL PLAN FOR REFERENCE ONLY"

HOFFMAN VILLAGE

SHOPPING CENTER

ENTRANCE

TS 20402 IDOT CENTRACS FORMER ECON 150

GANDHI AND ASSOCIATES, INC.

ENGACERS AND PLANSES
6035 N. NORTHREST HIGHBAY
SUIT 336
CHICAGO, LLINOIS 60631 TEL.17731774-590

USER NAME = \$USER\$

DESIGNED - EA

DRAWN - EA, AV

PLOT SCALE = 40.0000 '/ in.

CHECKED - MS

PLOT DATE = \$DATE\$

DATE - 10/31/2022

REVISED


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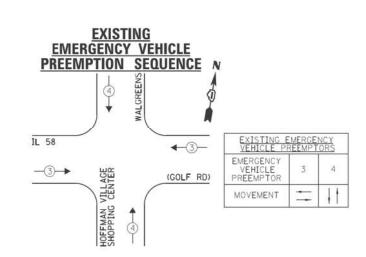
REVISED

STATE OF ILLINOIS
DEPARTMENT OF TRANSPORTATION


LOCATION #29
IL RTE 58 (GOLF RD) AT HOFFMAN ESTATES SHOPPING CENTER INTERSECTION PLAN

E: N.T.S. | SHEET NO. | OF | SHEETS | STA. | TO STA.



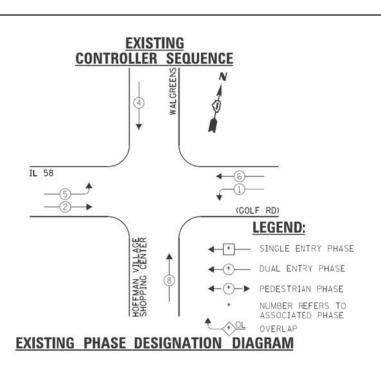

		WATT	AGE		
TYPE	NO. LAMPS	INCAND.	L.E.D.	OPERATION	
SIGNAL (RED)	12	135	17	0.50	102.0
SIGNAL (YELLOW)	12	135	25	0.25	75.0
SIGNAL (GREEN)	12	135	15	0,25	45.0
ARROW	8	135	12	0.10	9.6
PED. SIGNAL	-	90	25	1.00	-
CONTROLLER	1	-	100	1.00	100.0
LUMINAIRE		17.	250	0.50	-
L.E.D. ST. NAME SIGN	-		64	0.50	-
VIDEO SYSTEM		19	150	1.00	
BATTERY BACKUP	1		25	1.00	25.0
ILLUMINATED SIGN	-	-	25	0.05	-
				TOTAL =	356.6
ENERGY COSTS - E	(ADDRESS)	201 W.	CENTE		
ENERGY SUPPLY -	CONTACT:	DAVE S	CHACH	T	50
	PHONE:				
	COMPANY.	COMED	<ul> <li>— OAK</li> </ul>	BROOK TERRA	CF

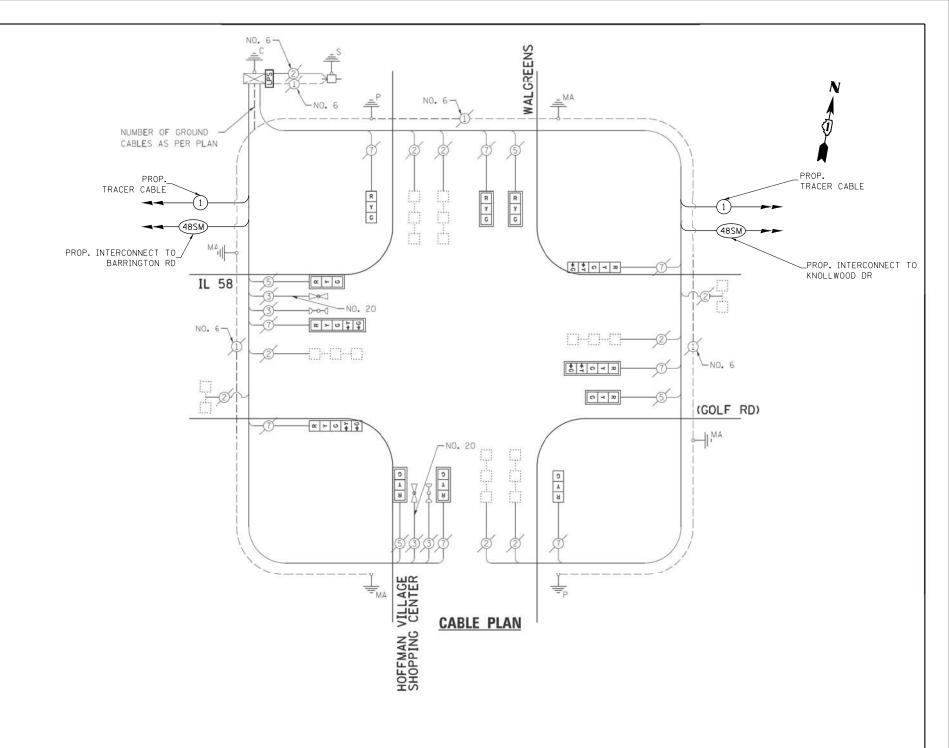

#### SCHEDULE OF QUANTITIES

ITEM DESCRIPTION	UNITS	TOTAL QTY.
MAINTENANCE OF EXISTING TRAFFIC SIGNAL INSTALLATION	EACH	1
REMOVE EXISTING TRAFFIC SIGNAL EQUIPMENT	EACH	1
LAYER II (DATALINK) SWITCH	EACH	1
TERMINATE FIBER IN CABINET	EACH	12
SPLICE FIBER IN CABINET	EACH	6
FULL-ACTUATED CONTROLLER IN EXISTING CABINET	EACH	1
CENTRACS LICENSE EXPANSION	EACH	1
FIBER OPTIC INTERCONNECT CENTER, 48 PORT	EACH	1

TS 20402 IDOT CENTRACS FORMER ECON 150

GANDHI AND ASSOCIATES, INC.

DEXECTS AND PLANETS

SOSS N. NORWEST HOWAY

SUIT 308

PHICAGO, LLINOIS 6063/ IELJ/173/174-590

STATE OF ILLINOIS
DEPARTMENT OF TRANSPORTATION

LOCATION #29
IL RTE 58 (GOLF RD) AT HOFFMAN ESTATES SHOPPING CENTER
CABLE PLAN

SCALE: N.T.S. SHEET NO. OF SHEETS STA. TO STA.

THE FOLLOWING ITEMS SHALL BE REMOVED BY THE CONTRACTOR AND SHALL BE DISPOSED OF BY THEM OUTSIDE THE RIGHT-OF-WAY AT THEIR EXPENSE. THE SALVAGE VALUE OF THE REMOVED EQUIPMENT SHALL BE REFLECTED IN THE CONTRACT BID PRICE.


CONTROLLER

EACH TRANSCEIVER FIBER OPTIC

BATTERIES FOR UNINTERRUPTABLE POWER SUPPLY

#### **NOTES:**

1. THE PTZ CAMERA SHALL BE MOUNTED ON THE POLE OF THE MAST ARM UNDERNEATH THE ARM OF THE MAST ARM.

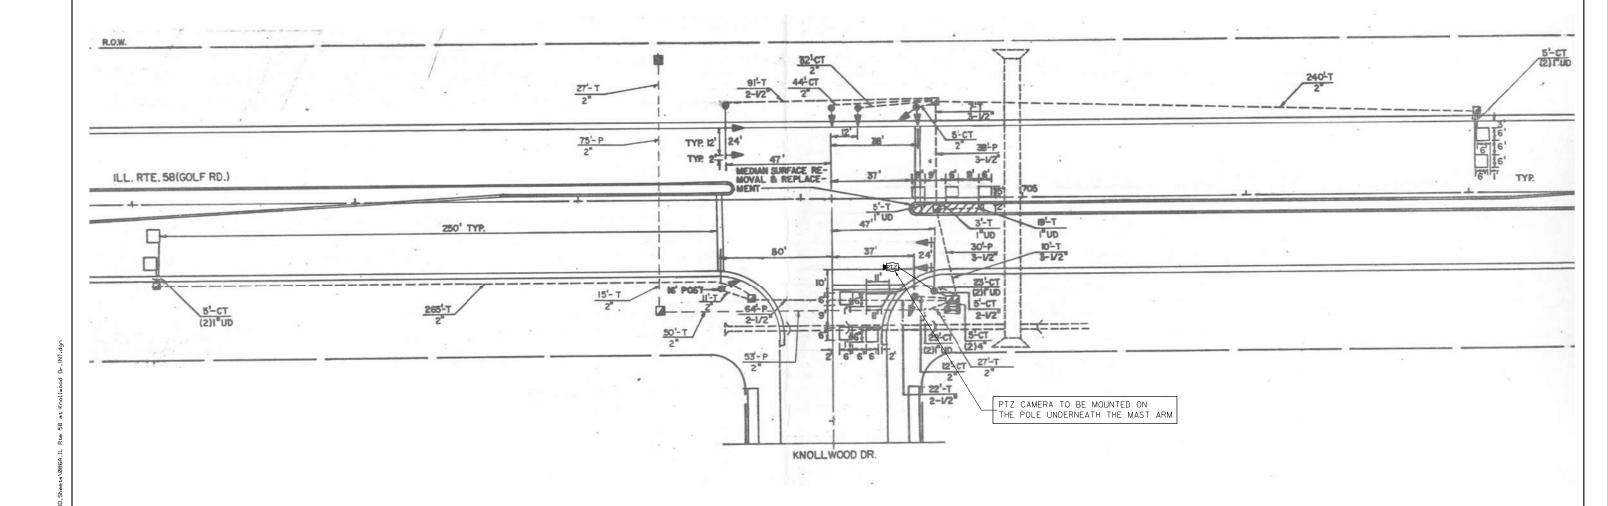

### "TRAFFIC SIGNAL PLAN FOR REFERENCE ONLY"

TS 21370 IDOT CENTRACS FORMER ECON 150



		MHILIE	-	angrita	
CIATES, INC.					
.(773)774-5910	PLOT	SCALE	=	40.0000 ′/	
	PLOT	DATE	=	\$DATE\$	

DESIGNED - EA DRAWN - EA, AV REVISED CHECKED - MS REVISED DATE - 10/31/2022 REVISED

STATE OF ILLINOIS **DEPARTMENT OF TRANSPORTATION** 

LOCATION #30 IL RTE 72 (GOLF RD) AT KNOLLWOOD DR INTERSECTION PLAN							
SCALE: N.T.S.	SHEET NO.	OF	SHEETS	STA.	TO STA.		

COUNTY TOTAL SHEET NO. 2023 TRAFFIC 02 VARIOUS 306 100 VAR CONTRACT NO. 62T54