



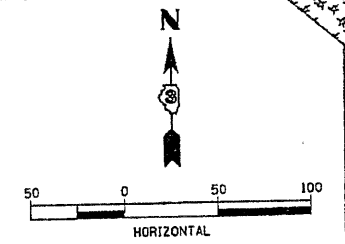

LAYOUT 08/05/09
 DRAWN 10/01/10
 REVIEWED DPA 10/01/10
 C:\185-ERD-EW.dgn

LEGEND:

- EROSION CONTROL BLANKET
- HEAVY DUTY EROSION CONTROL BLANKET
- MULCH METHOD 2 PROCEDURE 3
- STABILIZED CONSTRUCTION ENTRANCE
- RIPRAP GRADATION 4
- INLET PROTECTION
- CONCRETE TRUCK WASHOUT
- PERIMETER EROSION CONTROL BARRIER TYPE 1
- PERIMETER EROSION CONTROL BARRIER TYPE 2
- JAY HOOKS IN EROSION CONTROL BARRIER
- DITCH CHECKS

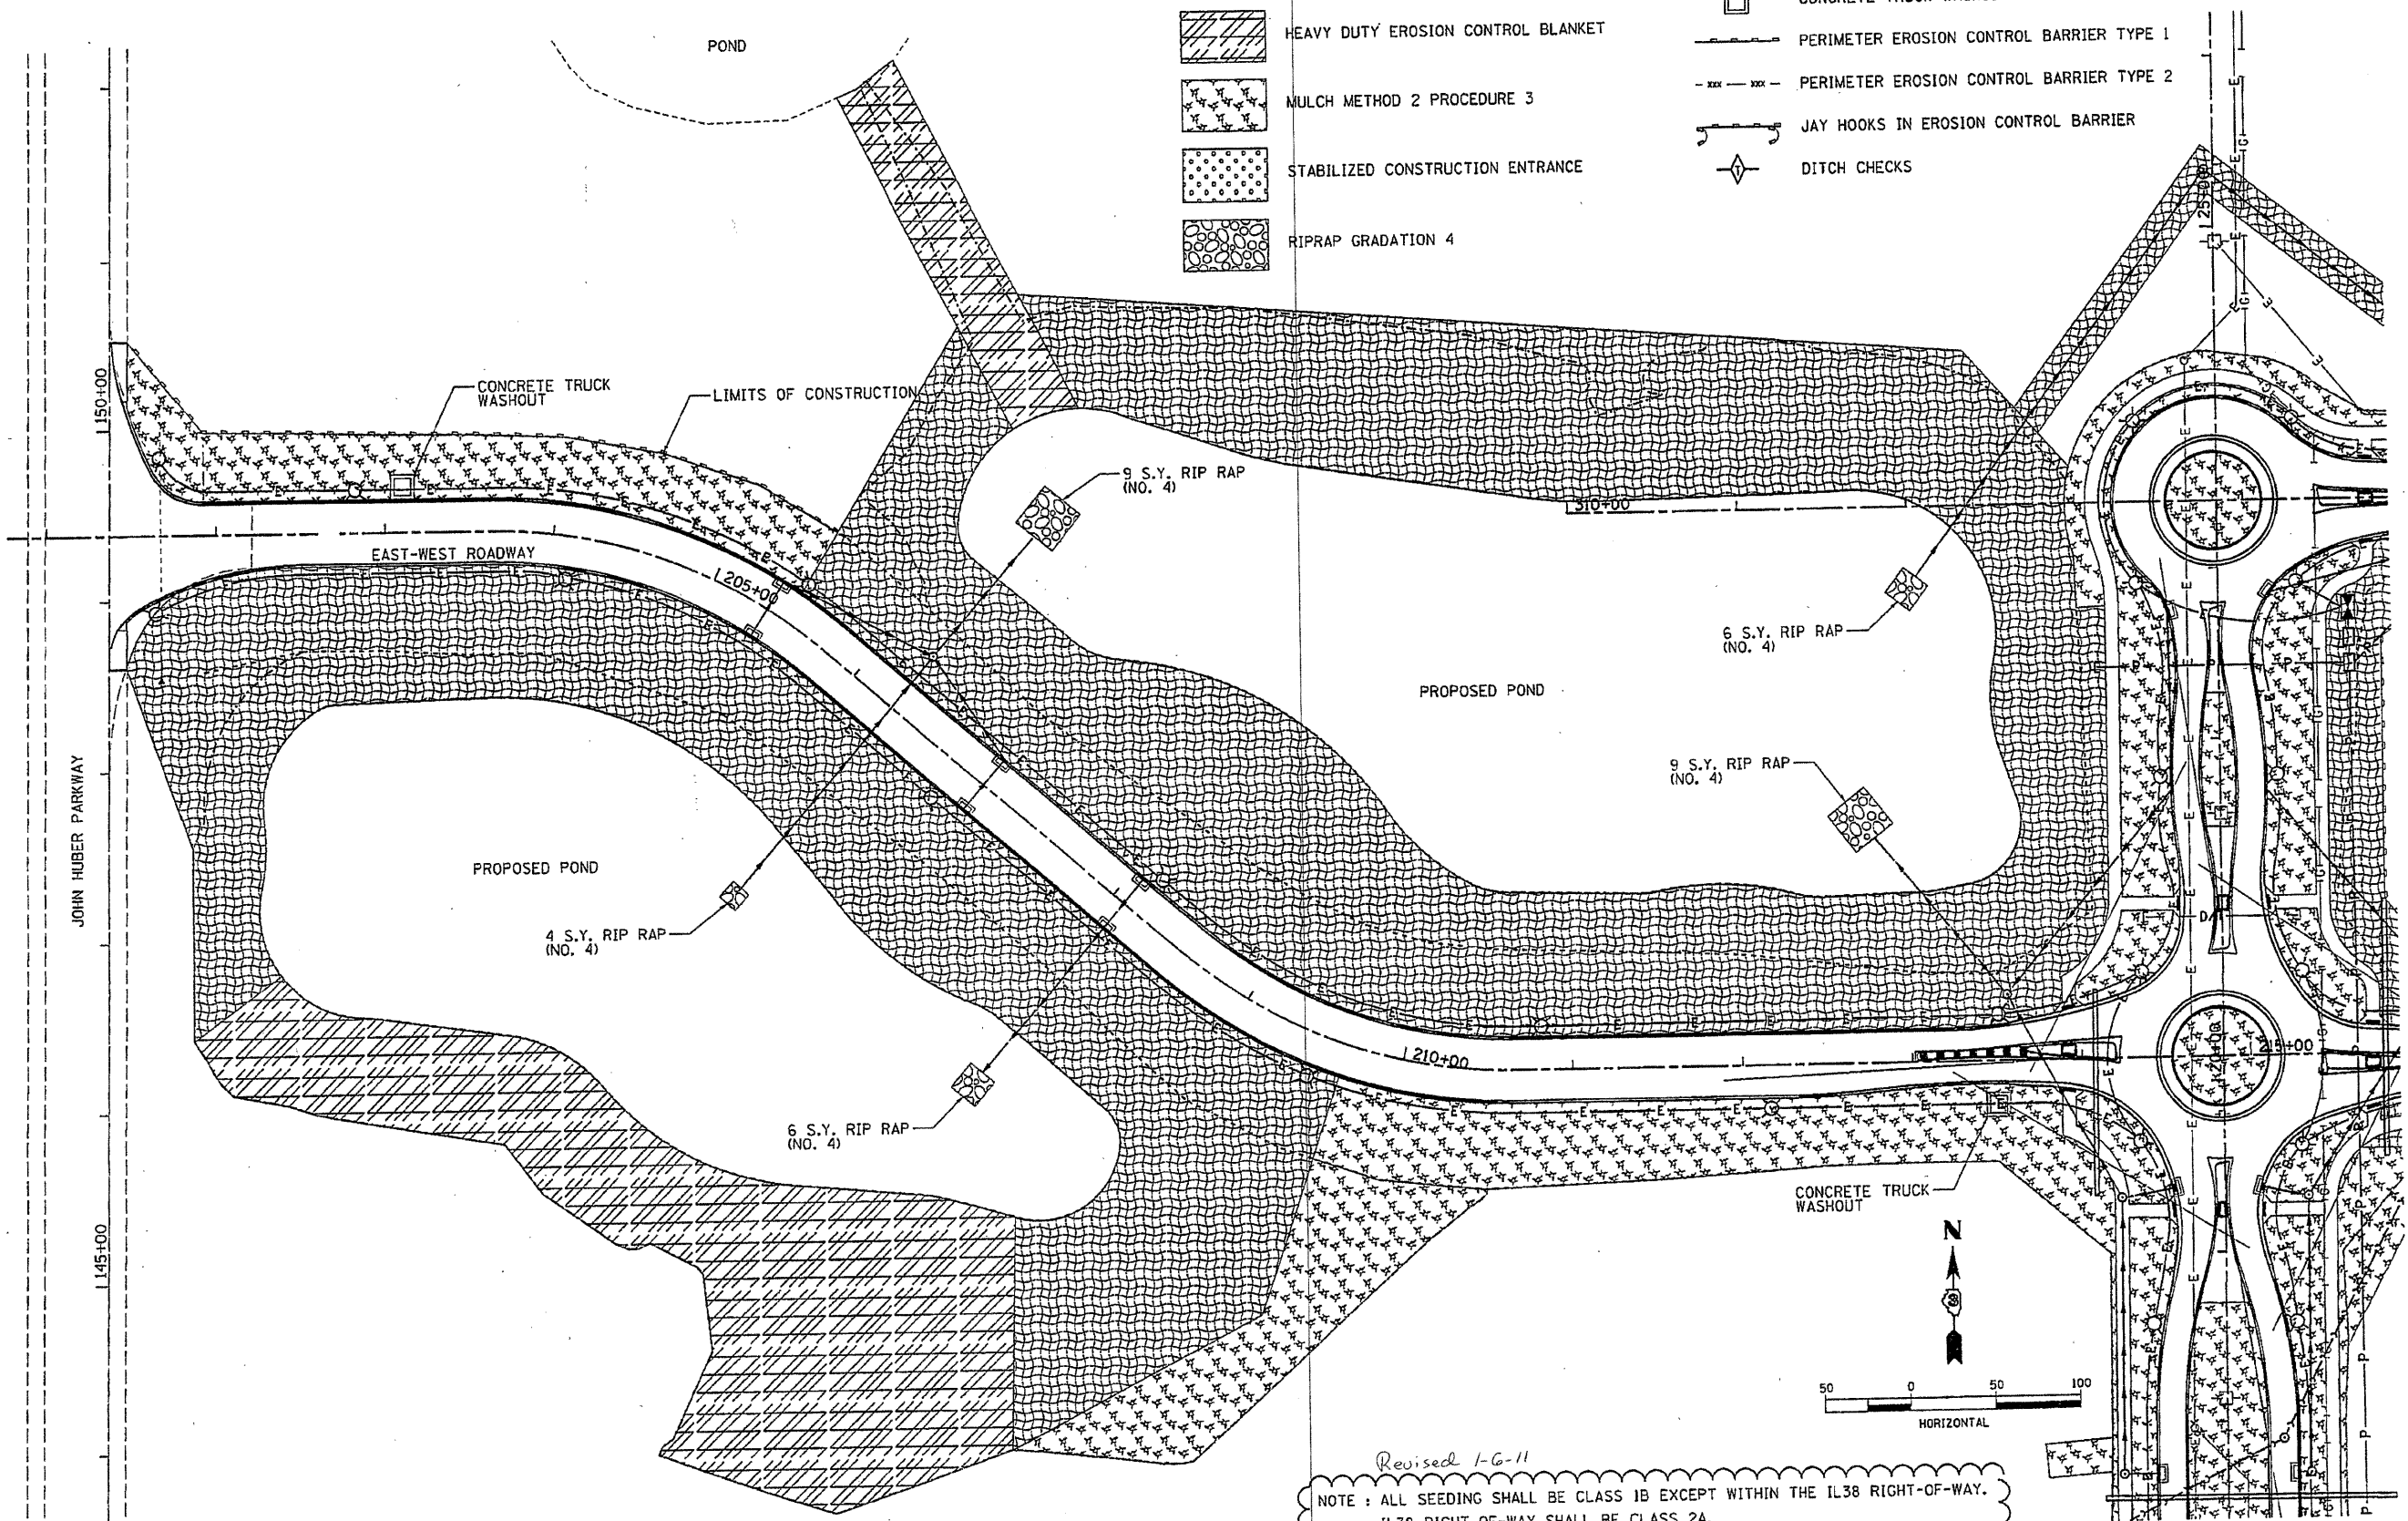

Revised 1-6-11
 NOTE : ALL SEEDING SHALL BE CLASS 1B EXCEPT WITHIN THE IL38 RIGHT-OF-WAY.
 IL38 RIGHT-OF-WAY SHALL BE CLASS 2A.

FILE NAME =	USER NAME =	DESIGNED - DPA	REVISED -
C-185-ERD-EW.dgn		DRAWN - MWH	REVISED -
	PLOT SCALE = 100.000' / in.	CHECKED - DPA	REVISED -
	PLOT DATE = 01/04/2011	DATE - 11/04/10	REVISED -

**STATE OF ILLINOIS
 DEPARTMENT OF TRANSPORTATION**

NORTHERN ILLINOIS UNIVERSITY
 FAR WEST CAMPUS EXPANSION
 EAST-WEST ROADWAY EROSION CONTROL PLAN
 SCALE: 1" = 50' SHEET NO. OF SHEETS STA. 200+00 TO STA. 207+00

F.A.P. RTE.	SECTION	COUNTY	TOTAL SHEETS	SHEET NO.
567	05-00002-00-PV	DEKALB	148	72
CONTRACT NO. 87476				
ILLINOIS FED. AID PROJECT				