



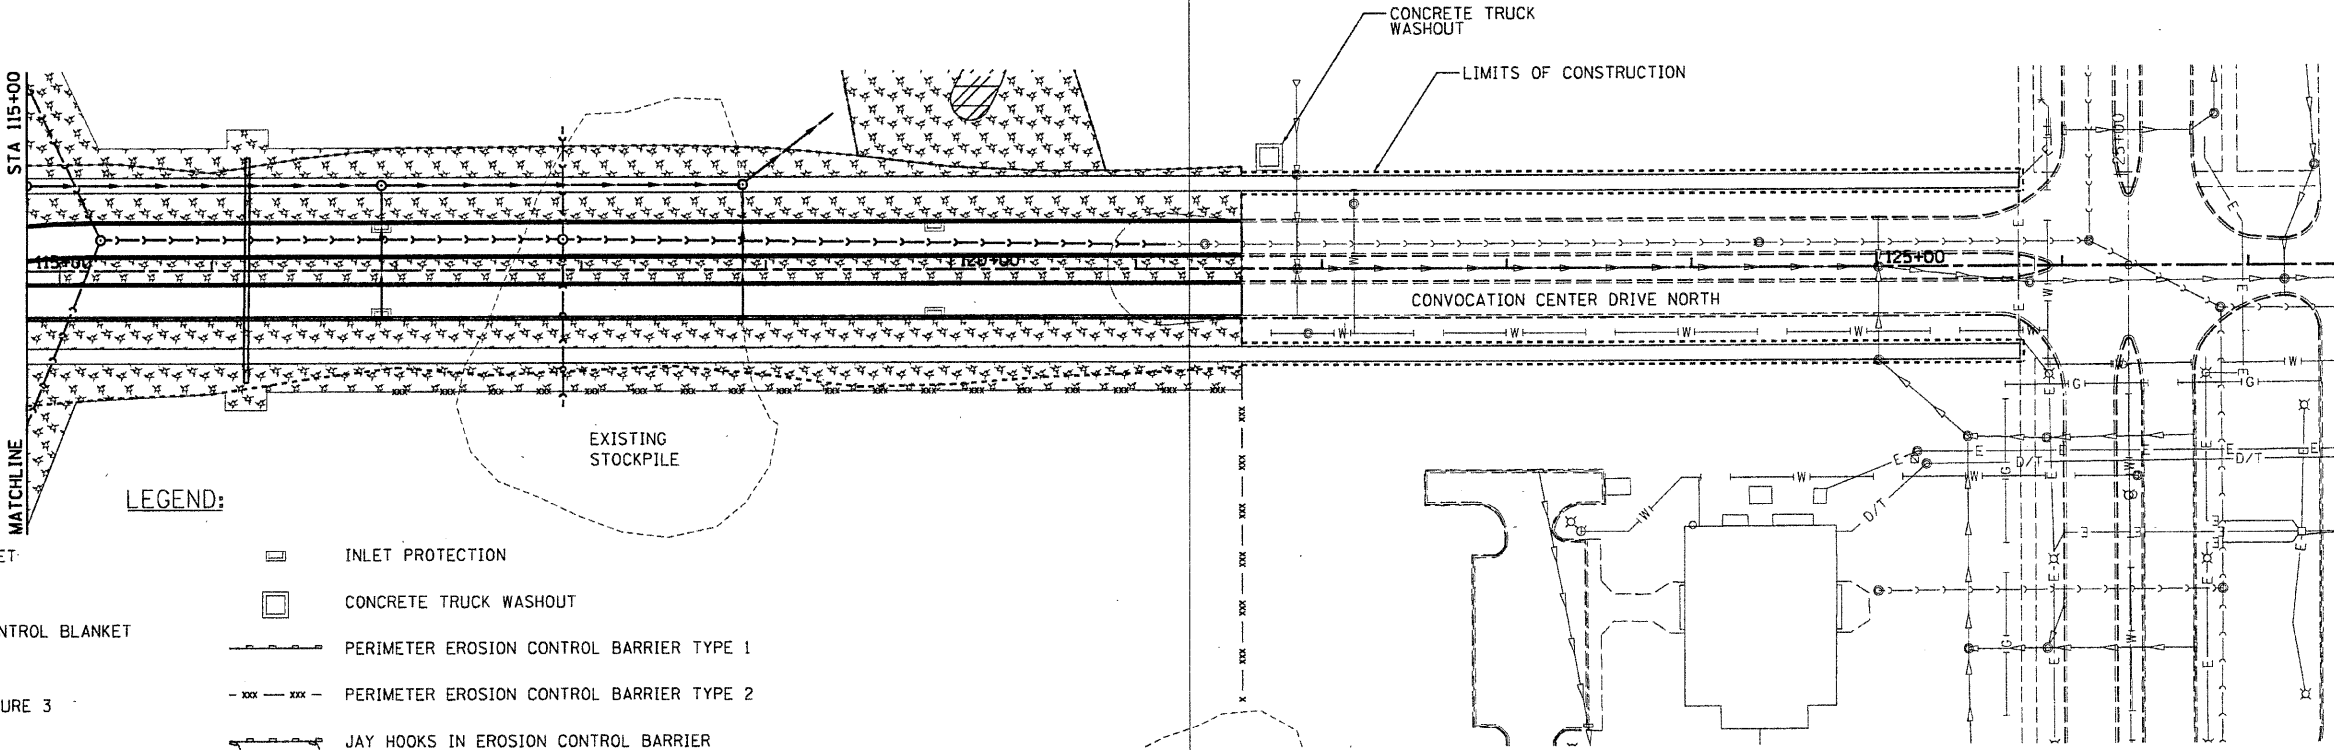

Hanson Professional Services Inc.

09/01/10 MWH
10/01/10 MWH
10/01/10 DPA
01/04/2011
C:\ADD\Road\Sheet\AC-187-ERO-CCDN.dgn

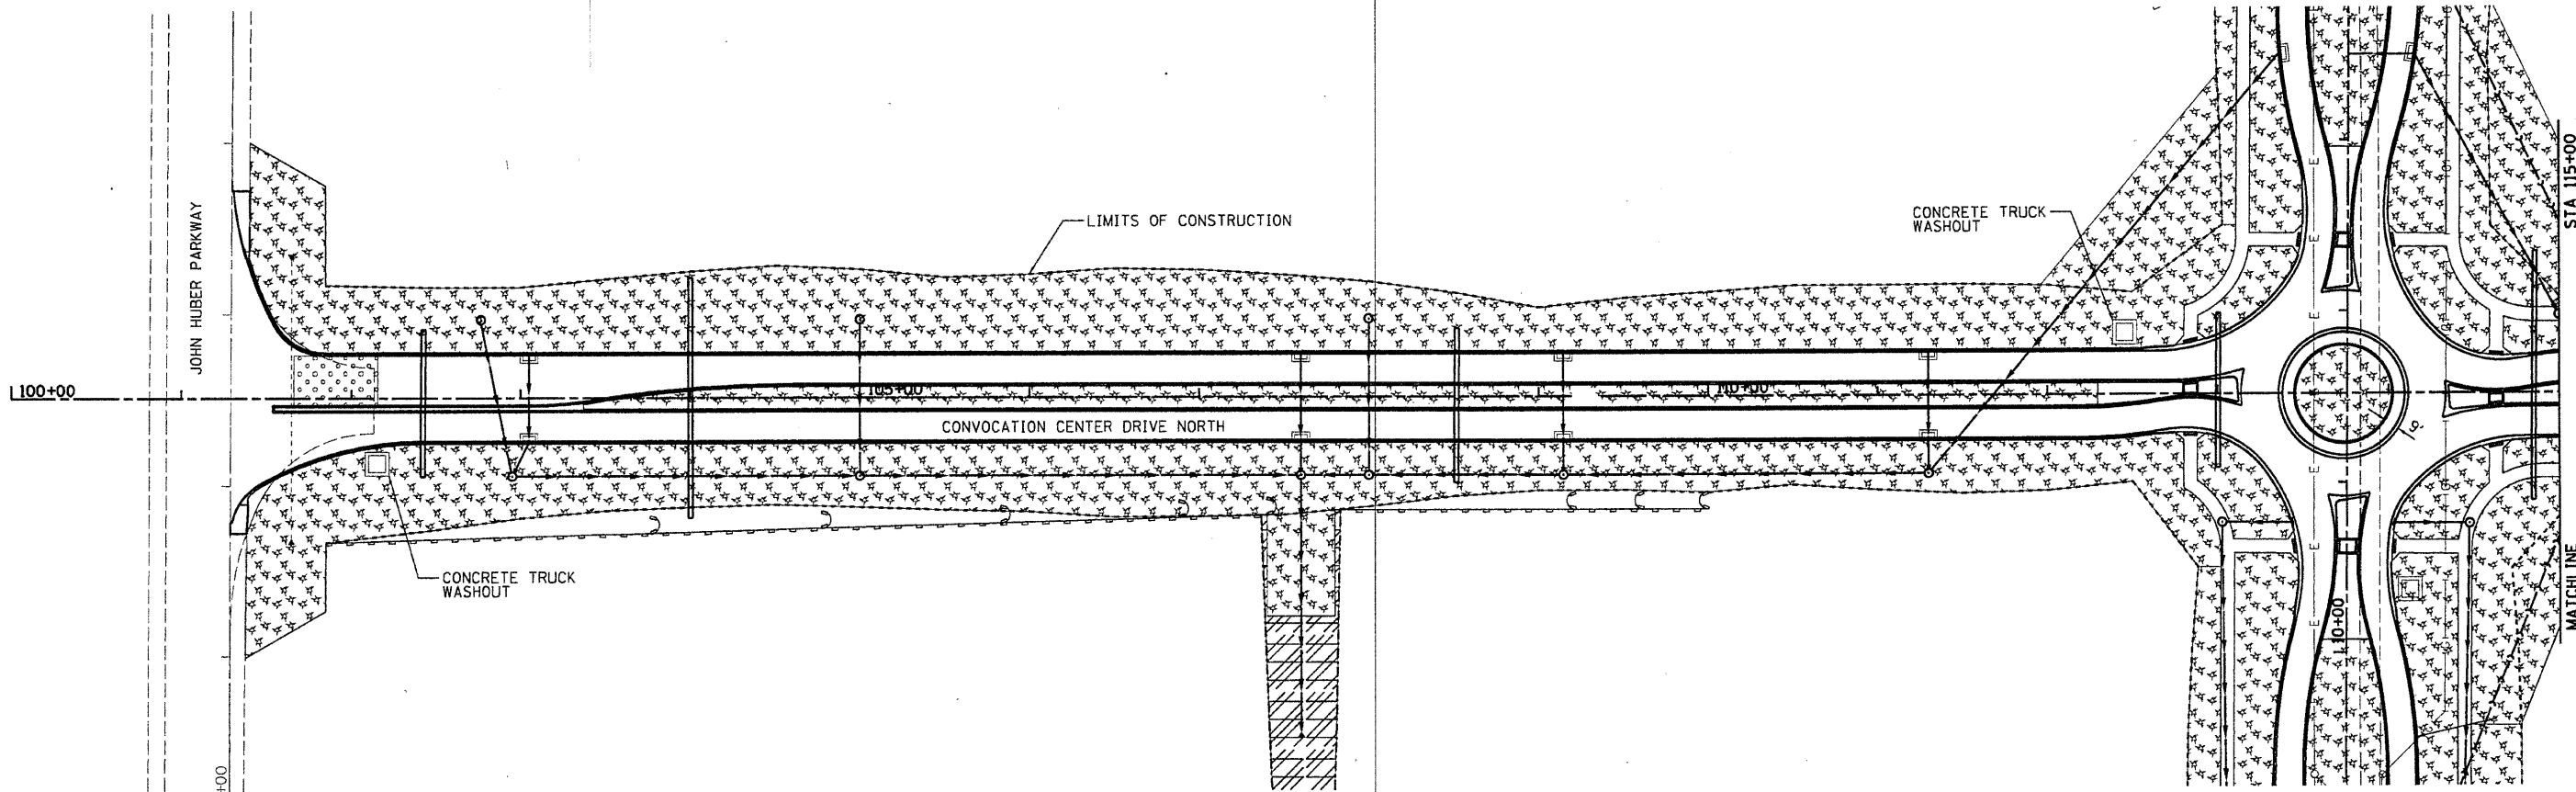


LEGEND:

- EROSION CONTROL BLANKET
- HEAVY DUTY EROSION CONTROL BLANKET
- MULCH METHOD 2 PROCEDURE 3
- STABILIZED CONSTRUCTION ENTRANCE
- RIPRAP GRADATION 4
- INLET PROTECTION
- CONCRETE TRUCK WASHOUT
- PERIMETER EROSION CONTROL BARRIER TYPE 1
- PERIMETER EROSION CONTROL BARRIER TYPE 2
- JAY HOOKS IN EROSION CONTROL BARRIER
- DITCH CHECKS

NOTE : ALL SEEDING SHALL BE CLASS 1B EXCEPT WITHIN THE IL38 RIGHT-OF-WAY.
IL38 RIGHT-OF-WAY SHALL BE CLASS 2A.

Revised 1-6-11

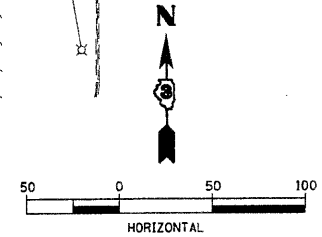

FILE NAME = C-187-ERO-CCDN.dgn	USER NAME =	DESIGNED - DPA	REVISED -	STATE OF ILLINOIS DEPARTMENT OF TRANSPORTATION	NORTHERN ILLINOIS UNIVERSITY FAR WEST CAMPUS EXPANSION CONVOCATION CENTER DRIVE NORTH EROSION CONTROL PLAN	F.A.P. RTE. =	SECTION	COUNTY	TOTAL SHEETS	SHEET NO.	
PLOT SCALE = 1/8" = 1'-0"	CHECKED - DPA	REVISED -	567			06-00002-00-PV	DEKALB	148	73		
PLOT DATE = 01/04/2011	DATE - 11/04/10	REVISED -	SCALE: 1" = 50'			SHEET NO. OF SHEETS STA. 100+00 TO STA. 123+00		ILLINOIS FED. AID PROJECT		CONTRACT NO. 87476	