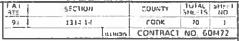


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STATE STANDARDS

		NC
000001-07	STANDARD SYMBOLS, ABBREVIATIONS AND PATTERNS	NC
001001-02	AREAS OF REINFORCEMENT BARS	G
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606001-07	CONCRETE CURB TYPE B AND COMBINATION CONCRETE CURB AND GUTTER	1.
701101 - 05	OFF-RD OPERATIONS, MULTILANE, 15' (4.5M) TO 24" (600 MM) FROM PAVEMENT EDGE	
701106-02	OFF-ROAD OPERATIONS, MULTI-LANE, MORE THAN 15' AWAY	2.
701400-09	APPROACH TO LANE CLOSURE, FREEWAY/EXPRESSWAY	
701401 - 12	LANE CLOSURE, FREEWAY/EXPRESSWAY	
701411-09	LANE CLOSURE, MULTI-LANE, AT ENTRANCE OR EXIT RAMP, FOR SPEEDS \geq 45 MPH	
701427-05	LANE CLOSURE, MULTILANE, INTERMITTENT OR MOVING OPEERATION, FOR SPEEDS \leq 40 MPH	
701428-01	TRAFFIC CONTROL, SETUP AND REMOVAL, FREEWAY/EXPRESSWAY	
701446-09	TWO LANE CLOSURE, FREEWAY/EXPRESSWAY	
701601-09	URBAN LANE CLOSURE, MULTILANE, 1W OR 2 W WITH NONTRAVERSABLE MEDIAN	3.
701801-06	SIDEWALK, CORNER OR CROSSWALK CLOSURE	э.
701901-08	TRAFFIC CONTROL DEVICES	
704001-08	TEMPORARY CONCRETE BARRIER	4.
780001-05	TYPICAL PAVEMENT MARKINGS	
782006	GUARDRAIL AND BARRIER WALL REFLECTOR MOUNTING DETAILS	5.
		Э.

COMMITMENTS

NONE

GENERAL NOTES:

- UPON THE UNIT PRICE.

- COMMENCING WITH CONSTRUCTION.
- VARIOUS PAY ITEMS.
- PRIOR TO BEGINNING WORK.

- IMPROVEMENT.

111 S. Wacker, Dr	USER NAME = mokrent	DESIGNED - TOM	REVISED -		BRID		F.A.I RTE	SECTION	COUNTY TOTAL SHEET SHEETS NO.
Suite 3910	s	DRAWN - TOM	REVISED -	STATE OF ILLINOIS		INDEX OF SHEETS, STATE STANDARDS	94	1314.1-I	СООК 70 02
ENGINEERS & SURVEYORS Ph: 312-235-678	PLOT SCALE = 2.0000 ' / in.	CHECKED - MO	REVISED -	DEPARTMENT OF TRANSPORTATION	CONT NA	GENERAL NOTES AND COMMITMENTS			CONTRACT NO. 60M72
	PLOT DATE = $12/17/2018$	DATE - 12/12/2018	REVISED -		SCALE: N/A	SHEET I OF I SHEETS STA. TO STA.		ILLINOIS FED. A	AID PROJECT

THESE PLANS HAVE BEEN PREPARED FROM INFORMATION ACQUIRED FROM EXISTING PLANS AND NOTES RECEIVED FROM IDOT FIELD MAINTENANCE ENGINEERS.

PLAN DIMENSIONS AND DETAILS RELATIVE TO EXISTING PLANS ARE SUBJECT TO VARIATIONS FOUND IN THE FIELD. THE CONTRACTOR SHALL FIELD VERIFY EXISTING DIMENSIONS AND DETAILS AFFECTING NEW CONSTRUCTION AND MAKE NECESSARY ADJUSTMENTS PRIOR TO CONSTRUCTION OR ORDERING MATERIALS. ANY ADJUSTMENTS PROPOSED BY THE CONTRACTOR MUST BE APPROVED BY THE ENGINEER. SUCH VARIATIONS SHALL NOT BE CAUSE FOR ADDITIONAL COMPENSATION FOR A CHANGE IN THE SCOPE OF THE WORK. HOWEVER, THE CONTRACTOR WILL BE PAID FOR THE QUANTITY ACTUALLY FURNISHED BASED

FORTY-EIGHT HOURS BEFORE STARTING EXCAVATION, THE CONTRACTOR WILL CALL J.U.L.I.E. (1-800-892-0123) OR 811 FOR LOCATIONS OF THE EXISTING UTILITIES.

THE CONTRACTOR WILL NOT BE ALLOWED TO SET UP A YARD OR FIELD OFFICE ON STATE PROPERTY WITHOUT WRITTEN PERMISSION FROM THE DEPARTMENT.

SAW CUTTING PRIOR TO ANY REMOVAL ITEMS NOTED ON THE PLANS OR DIRECTED BY THE ENGINEER SHALL BE CONSIDERED INCLUDED IN THE COST OF THE ITEMS BEING REMOVED.

6. DO NOT SCALE PLANS FOR CONSTRUCTION DIMENSIONS.

7. THE CONTRACTOR SHALL USE CARE IN REMOVING OR EXCAVATING NEAR ALL EXISTING ITEMS WHICH WILL REMAIN. ANY DAMAGE DONE TO EXISTING ITEMS BY THE CONTRACTOR SHALL BE REPAIRED AT THE CONTRACTOR'S EXPENSE.

8. WHEN ARTIFICIAL LIGHTING IS UTILIZED IN NIGHT OPERATIONS, THE CONTRACTOR SHALL EXERCISE THE UTMOST PRECAUTION IN PREVENTING ADVERSE VISIBILITY TO THE MOTORING PUBLIC AS WELL AS ADJOINING RESIDENTIAL AREAS.

9. THE CONTRACTOR SHALL OBTAIN ALL NECESSARY PERMITS, AS REQUIRED, PRIOR TO

10. THE CONTRACTOR SHALL TAKE ALL NECESSARY MEASURES TO ASSURE THAT NO DEBRIS FALLS ON TO THE EDENS EXPRESSWAY. THE COST OF THIS WORK SHALL BE INCLUDED IN THE

11. THE CONTRACTOR SHALL CONTACT THE DISTRICT ONE TRAFFIC CONTROL SUPERVISOR AT (847) 705-4470 FOR ARTERIALS AND (847) 705-4151 FOR EXPRESSWAYS A MINIMUM OF 72 HOURS

12. THE RESIDENT ENGINEER SHALL CONTACT DON CHIARUGI, IDOT'S AREA TRAFFIC FIELD ENGINEER, VIA E-MAIL AT DON.CHIARUGI@ILLINOIS.GOV A MINIMUM OF TWO (2) WEEKS PRIOR TO THE PLACEMENT OF PERMANENT PAVEMENT MARKINGS.

13. ALL DAMAGE TO EXISTING PAVEMENT MARKINGS OUTSIDE THE PROPOSED IMPROVEMENTS SHOWN ON THE PLANS SHALL BE REPLACED AT THE CONTRACTOR'S EXPENSE.

14. ACCESS SHALL BE PROVIDED AT ALL TIMES TO PROPERTIES ABUTTING THE PROPOSED

15. BEFORE BEGINNING ANY WORK, THE CONTRACTOR SHALL RETAIN AND RECORD FOR FUTURE REFERENCE, ALL EXISTING PAVEMENT MARKING LINES (AND RAISED REFLECTIVE MARKERS) IN ORDER THAT THESE LOCATIONS CAN BE RE-ESTABLISHED FOR STRIPING. EXACT LOCATIONS OF ALL PAVEMENT MARKINGS SHALL BE AS DIRECTED BY THE ENGINEER.

ITEM NE RIPRAP, CLASS A4 TER FABRIC UMINOUS MATERIALS (TACK COAT) -MIX ASPHALT SURFACE REMOVAL - BUTT JOINT -MIX ASPHALT SURFACE COURSE, MIX "D", N70	UNIT SQYD SQYD SQYD POUND SQYD	TOTAL QUANTITY 218 311 523 466	90% FED 10% STATE BRIDGE 0013 SN 016-0939 218 311 523	90% FED 10% STATE SAFETY 0021
NE RIPRAP, CLASS A4 TER FABRIC UMINOUS MATERIALS (TACK COAT) -MIX ASPHALT SURFACE REMOVAL - BUTT JOINT	SQ YD SQ YD SQ YD POUND SQ YD	QUANT I TY 218 311 523	BR I DGE 0013 SN 016-0939 218 311 523	SAFETY
NE RIPRAP, CLASS A4 TER FABRIC UMINOUS MATERIALS (TACK COAT) -MIX ASPHALT SURFACE REMOVAL - BUTT JOINT	SQ YD SQ YD SQ YD POUND SQ YD	QUANT I TY 218 311 523	0013 SN 016-0939 218 311 523	
NE RIPRAP, CLASS A4 TER FABRIC UMINOUS MATERIALS (TACK COAT) -MIX ASPHALT SURFACE REMOVAL - BUTT JOINT	SQ YD SQ YD SQ YD POUND SQ YD	218 311 523	SN 016-0939 218 311 523	
TER FABRIC UMINOUS MATERIALS (TACK COAT) -MIX ASPHALT SURFACE REMOVAL - BUTT JOINT	SQ YD POUND SQ YD	311 523	218 311 523	
TER FABRIC UMINOUS MATERIALS (TACK COAT) -MIX ASPHALT SURFACE REMOVAL - BUTT JOINT	SQ YD POUND SQ YD	311 523	311 523	
UMINOUS MATERIALS (TACK COAT) -MIX ASPHALT SURFACE REMOVAL - BUTT JOINT	POUND SQ YD	523	523	
UMINOUS MATERIALS (TACK COAT) -MIX ASPHALT SURFACE REMOVAL - BUTT JOINT	POUND SQ YD	523	523	
-MIX ASPHALT SURFACE REMOVAL - BUTT JOINT	SQ YD			
		466		
		466		
-MIX ASPHALT SURFACE COURSE, MIX "D", N70	TON	1	466	
	TON	115	115	
TLAND CEMENT CONCRETE SIDEWALK 5 INCH	SQ FT	100	100	
BINATION CURB AND GUTTER REMOVAL	FOOT	326	326	
EWALK REMOVAL	SQ FT	100	100	
NT OR CRACK FILLING	POUND	26	26	
		28.6	28.6	
		20.0	20.0	
TECTIVE SHIELD	SQ YD	1452	1452	
CRETE STRUCTURES	CU YD	1.6	1.6	
CRETE SUPERSTRUCTURE	CU YD	29	29	
DGE DECK GROOVING	SQ YD	1910	1910	
	IT OR CRACK FILLING RETE REMOVAL RETE SHIELD RETE STRUCTURES RETE SUPERSTRUCTURE	IT OR CRACK FILLING POUND IT OR CRACK FILLING POUND IT OR CRACK FILLING CU YD IT OT CRACK FILLING CU YD IT OT CRACK FILLING SQ YD IT OT CRACK FILLING CU YD	IT OR CRACK FILLING POUND 26 IT OR CRACK FILLING POUND 26 INCRETE REMOVAL CU YD 28.6 INCRETE SHIELD SQ YD 1452 INCRETE STRUCTURES CU YD 1.6 INCRETE STRUCTURES CU YD 1.6	Indext Index Indext Indext

	11 S. Wacl Suite 3910 Chicago, IL Ch: 312–23
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USER NAME = tmohammed	DESIGNED - TOM	REVISED -		BRIDGE	E REPAIRS AT IL 68 (DUNDEE RD) OVER I-94	F A I RTE	SECTION	COUNTY	TOTAL SHE SHEETS N	ET 0.
Suite 3910 Chicago, IL 60606 PLOT SCALE = 2.0000 ' / in.	DRAWN - TOM	REVISED -	STATE OF ILLINOIS DEPARTMENT OF TRANSPORTATION SCALE:		SUMMARY OF QUANTITIES	94	1314.1-I	СООК	70 0	3
ERS & SURVEYORS Ph: 312-235-6783 PLOT SCALE = 2,0000 7 m. PLOT DATE = 12/6/2018	DATE - 12/12/2018	REVISED -		SCALE:	SHEET 1 OF 5 SHEETS STA. OF TO STA.		ILLINOIS FEE	D. AID PROJECT	D PROJECT	

				CONSTRUCT	ION CODE
				90% FED 10% STATE	90% FED 10% STATE
CODE			TOTAL	BRIDGE	SAFETY
NO.	ITEM	UNIT	QUANTITY	0013	0021
				SN 016-0939	
50300300	PROTECTIVE COAT	SQ YD	74	74	
50800205	REINFORCEMENT BARS, EPOXY COATED	POUND	3940	3940	
50800515	BAR SPLICERS	EACH	52	52	
52000110	PREFORMED JOINT STRIP SEAL	FOOT	188	188	
60605000	COMBINATION CONCRETE CURB AND GUTTER, TYPE B-6.24	FOOT	326	326	
67000400	ENGINEER'S FIELD OFFICE, TYPE A	CAL MO	7	7	
67100100	MOBILIZATION	L SUM	1	1	
70300100	SHORT TERM PAVEMENT MARKING	FOOT	905	905	
70300150	SHORT TERM PAVEMENT MARKING REMOVAL	SQ FT	300	300	
70300900	PAVEMENT MARKING TAPE, TYPE IV - LETTERS AND SYMBOLS	SQ FT	21	21	
70300904	PAVEMENT MARKING TAPE, TYPE IV 4"	FOOT	4511	4511	
70400100	TEMPORARY CONCRETE BARRIER	FOOT	1200	1,200	
70400200	RELOCATE TEMPORARY CONCRETE BARRIER	FOOT	1115	1115	
70600255	IMPACT ATTENUATORS, TEMPORARY (FULLY REDIRECTIVE, NARROW), TEST LEVEL 2	EACH	3	3	
,0000233	THE ACT ATTENDATORS, TEMPORART (TOLET REDIRECTIVE, NARROW), TEST LEVEL 2				



111 S. Wacker Drive,	USER NAME = tmohammed	DESIGNED - TOM	REVISED -		BRIDG	GE REPAIRS AT IL 68 (DUNDEE RD) OVER I-94	F.A.I RTE	SECTION	COUNTY TOTAL SHEET SHEETS NO.
Suite 3910 Chicago, IL 60606 & SURVEYORS Ph: 312–235–6783	PLOT SCALE = 2.0000 ' / in.	DRAWN - TOM CHECKED - MO	REVISED - REVISED -	STATE OF ILLINOIS SUMMARY OF QUANTITIES	SUMMARY OF QUANTITIES	94	1314.1-I	СООК 70 04 СОЛТВАСТ NO. 60М72	
	PLOT DATE = 12/6/2018	DATE - 12/12/2018	REVISED -		SCALE:	SHEET 2 OF 5 SHEETS STA. TO STA.		ILLINOIS FED.	AID PROJECT

				CONSTRUCTI	ON CODE
				90% FED	90% FED 10% STAT
				10% STATE	
CODE	ITEM	UNIT	TOTAL	BRIDGE 0013	SAFETY 0021
NO.		UNTI	QUANTITY	SN 016-0939	0021
70600322	IMPACT ATTENUATORS, RELOCATE (FULLY REDIRECTIVE, NARROW), TEST LEVEL 2	EACH	2	2	
78000200	THERMOPLASTIC PAVEMENT MARKING - LINE 4"	FOOT	2547	2547	
78000400	THERMOPLASTIC PAVEMENT MARKING - LINE 6"	FOOT	40	40	
78000500	THERMOPLASTIC PAVEMENT MARKING - LINE 8"	FOOT	2547	2547	
78000600	THERMOPLASTIC PAVEMENT MARKING - LINE 12"	FOOT	24	24	
78009004	MODIFIED URETHANE PAVEMENT MARKING - LINE 4"	FOOT	1308	1308	
78009008	MODIFIED URETHANE PAVEMENT MARKING - LINE 8"	FOOT	71	71	
78100100	RAISED REFLECTIVE PAVEMENT MARKER	EACH	4	4	
78200011	BARRIER WALL REFLECTORS, TYPE C	EACH	88	88	
78300200	RAISED REFLECTIVE PAVEMENT MARKER REMOVAL	EACH	4	4	
81100220	CONDUIT ATTACHED TO STRUCTURE, 3/4" DIA., PVC COATED GALVANIZED STEEL	FOOT	20		20
81100320	CONDUIT ATTACHED TO STRUCTURE, 1" DIA., PVC COATED GALVANIZED STEEL	FOOT	330		330
81100605	CONDUIT ATTACHED TO STRUCTURE, 2" DIA., PVC COATED GALVANIZED STEEL	FOOT	340		340
81100805	CONDUIT ATTACHED TO STRUCTURE, 3" DIA., PVC COATED GALVANIZED STEEL	FOOT	100		100

*= SPECIALTY ITEM

efault	111 S. Wacker Drive.	USER NAME = tmohammed	DESIGNED -	ТОМ	REVISED -		BRIDGE REPAIRS AT IL 68 (DUNDEE RD) OVER I-94			SECTION	COUNTY	TOTAL SHEET SHEETS NO.
I D I	Suite 3910 Chicago, IL 60606 Ph: 312–235–6783	DRAWN TOM REVISED -	STATE OF ILLINOIS				1314.1-I	соок	70 05			
UL P		PLOT SCALE = 2.0000 / in	CHECKED -	МО	REVISED -	DEPARTMENT OF TRANSPORTATION	SUMMARY OF QUANTITIES				CONTRACT	NO. 60M72
ΣĒ		PLOT DATE = 12/6/2018	DATE -	12/12/2018	REVISED -		SCALE:	SHEET 3 OF 5 SHEETS STA. TO STA.		ILLINOIS FED.	AID PROJECT	

				CONSTRUC	TION CODE
				90% FED 10% STATE	90% FED
				BRIDGE	10% STATI SAFETY
CODE	ITEM	UNIT	TOTAL	0013	0021
NO.			QUANTITY	SN 016-0939	0021
				210 010-0939	
81300220	JUNCTION BOX, STAINLESS STEEL, ATTACHED TO STRUCTURE, 6" X 6" X 4"	EACH	8		8
81300830	JUNCTION BOX, STAINLESS STEEL, ATTACHED TO STRUCTURE, 18" X 18" X 8"	EACH	4		4
81702110	ELECTRIC CABLE IN CONDUIT, 600V (XLP-TYPE USE) 1/C NO. 10	FOOT	1378		1378
81702130	ELECTRIC CABLE IN CONDUIT, 600V (XLP-TYPE USE) 1/C NO. 6	FOOT	1080		1080
81702140	ELECTRIC CABLE IN CONDUIT, 600V (XLP-TYPE USE) 1/C NO. 4	FOOT	3420		3420
89500510	CABINET HOUSING EQUIPMENT REMOVAL	EACH	1		1
89502300	REMOVE ELECTRIC CABLE FROM CONDUIT	FOOT	3000		3000
X0322446	CABINET HOUSING EQUIPMENT, TYPE III	EACH	1		1
X0327980	PAVEMENT MARKING REMOVAL - WATER BLASTING	SQ FT	1713	1713	
X1400249	LUMINAIRE, UNDERPASS, LED, TYPE C	EACH	8		8
X1400342	UNDERPASS LIGHTING REMOVAL	L SUM	1		1
X2700003	GROOVING FOR RECESSED PAVEMENT MARKING 8"	FOOT	141	141	
X2700004	PREFORMED PLASTIC PAVEMENT MARKING, TYPE B - LINE 7"	FOOT	141	141	
X7010216	TRAFFIC CONTROL AND PROTECTION (SPECIAL)	L SUM	1	1	

*= SPECIALTY ITEM

E: V:\0	111 S. Wacker Drive,	USER NAME = tmohammed	DESIGNED - TOM	REVISED -		BRIDGE REPAIRS AT IL 68 (DUNDEE RD) OVER I-94		F.A.I RTE	SECTION	COUNTY TOTAL SHEET SHEETS NO.
I HENGINEERS & S	Suite 3910 Chicago, IL 60606 SUBVEYOBS Ph: 312–235–6783	PLOT SCALE = 2.0000 ' / in.	CHECKED - MO	REVISED -	STATE OF ILLINOIS DEPARTMENT OF TRANSPORTATION		SUMMARY OF QUANTITIES	94	1314.1-I	СООК 70 06 СОЛТВАСТ NO. 60М72
EI MO		PLOT DATE = 12/6/2018	DATE - 12/12/2018	REVISED -		SCALE:	SHEET 4 OF 5 SHEETS STA. TO STA.		ILLINOIS FE	D. AID PROJECT

			C	ONSTRUCTION COD	E
				90% FED 10% STATE	90% FED 10% STATE
CODE			TOTAL	BRIDGE	SAFETY
NO.	ITEM	UNIT	QUANTITY	0013	0021
			QUANTITI	SN 016-0939	
X7011015	TRAFFIC CONTROL AND PROTECTION (EXPRESSWAYS)	L SUM	1	1	
Z0001800	APPROACH SLAB REPAIR (PARTIAL DEPTH)	SQ YD	19	19	
Z0001905	STRUCTURAL STEEL REPAIR	POUND	385	385	
70000014					
Z0006014	BRIDGE DECK LATEX CONCRETE OVERLAY, 2 1/2 INCHES	SQ YD	2001	2001	
Z0012130	BRIDGE DECK SCARIFICATION 3/4"	SQ YD	2001	2001	
			2001	2001	
Z0012754	STRUCTURAL REPAIR OF CONCRETE (DEPTH EQUAL TO OR LESS THAN 5 INCHES)	SQ FT	1084	1084	
Z0015595	DECK DRAIN EXTENSIONS	EACH	3	3	
Z0016001	DECK SLAB REPAIR (FULL DEPTH, TYPE I)	SQ YD	11	11	
Z0018051	DRAINAGE SCUPPERS TO BE ADJUSTED	EACH			
20010051			8	8	
Z0030850	TEMPORARY INFORMATION SIGNING	SQ FT	232	232	
Z0033028	MAINTENANCE OF LIGHTING SYSTEM	CAL MO	4		4
Z0073510	TEMPORARY TRAFFIC SIGNAL TIMING	EACH	1	1	

*= SPECIALTY ITEM

efault	111 S. Wacker Drive,	USER NAME = tmohammed	DESIGNED - TOM	REVISED -	BRIDGE REPAIRS AT IL 68 (DU		GE REPAIRS AT IL 68 (DUNDEE RD) OVER I-94	F.A.I RTE.	SECTION	COUNTY TOTAL SHEET SHEETS NO.
	Suite 3910		DRAWN - TOM	REVISED -		STATE OF ILLINOIS SUMMARY OF QUANTITIES DEPARTMENT OF TRANSPORTATION SCALE: SHEET 5 OF 5 SHEETS STA. TO STA.		94	1314.1-I	СООК 70 07
ENGINEERS & SUR	RVEYORS Ph: 312-235-6783	PLOT SCALE = 2.0000 ' / in.	CHECKED - MO	REVISED -	DEPARTMENT OF TRANSPORTATION					CONTRACT NO. 60M72
ΣΕ		PLOT DATE = 12/6/2018	DATE - 12/12/2018	REVISED -					ILLINOIS F	ED. AID PROJECT

PAVEMENT MARKING TAPE, TYPE IV SCHEDULE

			7030	0904	70300906	
LOCATION	SIDE	DESCRIPTION	TYPE	MARKING TAPE, IV 4" OOT)	PAVEMENT MARKING TAPE, TYPE IV 6" (FOOT)	
			(WHITE)	(YELLOW)	(WHITE)	
STATION TO STATION	LT/RT		LINE 4"	LINE 4"		
STAGE 1						
115+70.00 TO 116+70.00	LT	DOWNSTREAM TAPER	100	-	-	
116+70.00 TO 121+00.00	LT	TANGENT	430	-	-	
122+00.00 TO 124+00.00	LT	TANGENT	200	-	-	
114+00.00 TO 116+50.00	RT	UPSTREAM TAPER	250	-	-	
116+50.00 TO 122+68.00	RT	TANGENT	618	-	-	
122+68.00 TO 123+68.00	RT	DOWNSTREAM TAPER	100	-	-	
RAMP	LT/RT		100	100	-	
STAGE 2					-	
114+90.00 TO 116+75.00	LT	DOWNSTREAM TAPER	-	-	39	
115+20.00 TO 116+75.00	LT	DOWNSTREAM TAPER	310	-	-	
116+75.00 TO 121+00.00	LT	TANGENT	425	425	106	
121+00.00 TO 122+20.00	LT	TANGENT	240	120	-	
122+20.00 TO 123+20.00	LT	TANGENT	-	100	-	
113+75.00 TO 116+25.00	RT	UPSTREAM TAPER	-	250	-	
116+25.00 TO 122+68.00	RT	TANGENT	-	643	-	
122+68.00 TO 123+68.00	RT	DOWNSTREAM TAPER	-	100	-	
TOTAL	LT/RT		2773	1738	145	

		r	
		70400100	70400200
LOCATION	SIDE	TEMPORARY CONCRETE BARRIER (FOOT)	RELOCATE TEMPORARY CONCRETE BARRIER (FOOT)
STATION TO STATION	LT/RT		
STAGE 1			
116+75.00 TO 121+00.00	LT	425	-
121+00.00 TO 121+45.00	LT	45	-
122+54.00 TO 123+04.00	LT	50	-
123+04.00 TO 123+84.00	LT	80	-
116+25.00 TO 116+75.00	RT	50	-
116+75.00 TO 122+25.00	RT	550	-
STAGE 2			
116+75.00 TO 121+70.00	LT	-	495
121+70.00 TO 122+45.00	LT	-	75
116+25.00 TO 116+75.00	RT	-	50
116+75.00 TO 121+70.00	RT	-	495
TOTAL	LT/RT	1200	1115

PAVEMENT MARKING SCHEDULE

		7800	0200	78000400	78000500	78000600	780	0904	78009008	X2700004	X0327979
LOCATION	SIDE			THERMOPLA VEMENT MA (FOOT)	ARKING			DIFIED URET VEMENT MAR (FOOT)		PREFORMED PLASTIC PAVEMENT MARKING,	PAVEMENT MARKING REMOVAL
		(YELLOW)		(W⊢	ITE)		(YELLOW)	(WF	ITE)	TYPE B	REINO VILE
STATION TO STATION	LT/RT	LINE 4"	LINE 4"	LINE 6"	LINE 8"	LINE 12"	LINE 4"	LINE 4"	LINE 8"	LINE 7"	(SQ. FT.)
113+64.00 TO 117+85.00	LT/RT	820	305.50	40	499	-	-	-	-	-	636
117+85.00 TO 120+65.00	LT/RT	-	-	-	-	-	564	744	71	141	500
120+65.00 TO 126+00.00	LT/RT	1070	351.50	-	132	-	-	-	-	-	535
121+42.00 TO 122+51.00 (WITH RAMP GORE)	LT	-	-	-	63	24	-	-	-	-	42
TOTAL	LT/RT	1890	657	40	694	24	564	744	71	141	1713

111 S. Wacker Drive,	USER NAME = tmohammed	DESIGNED - TOM	REVISED -		BRIDG	E REPA	IRS AT IL	6
Suite 3910		DRAWN - TOM	REVISED -	STATE OF ILLINOIS			SCHEDULE	
Chicago, IL 60606 ERS & SURVEYORS Ph: 312–235–6783	PLOT SCALE = 2.0000 / in	CHECKED - MO	REVISED -	DEPARTMENT OF TRANSPORTATION			SCHEDULE	
	PLOT DATE = 12/6/2018	DATE - 12/12/2018	REVISED -		SCALE: N/A	SHEET	1 OF 1	

SHORT TERM PAVEMENT MARKING SCHEDULE

		70300100		70300150
LOCATION	SIDE	SHORT PAVEMENT LINE 4"	SHORT TERM PAVEMENT MARKING REMOVAL	
STATION TO STATION	LT/RT	YELLOW	WHITE	(SQ. FT.)
113+64.00 TO 114+90.00	LT	16	-	5
113+64.00 TO 125+92.00	LT/RT	319	319	212
113+64.00 TO 116+47.00	LT	37	-	12
115+00.00 TO 122+16.00	LT	93	-	31
117+35.00 TO 121+07.00	LT/RT	97	-	32
121+42.00 to 122+55.00	LT	15	-	5
ALONG RAMP	LT	9	-	З
TOTAL	LT/RT	586	319	300

HOT MIX ASPHALT SCHEDULE

	40600982	40603340	40600290
LOCATION	HMA SURF REM BUTT JOINT (SQ YD)	HMA SC "D" N70 (TON)	BIT MATLS TACK CT (POUND)
117+00 TO 117+35 (RT)	93	9	42
117+00 TO 117+35 (LT)	140	14	63
117+35 TO 117+94 (RT)	-	17	72
117+35 TO 117+75 (LT)	-	16	104
120+75 TO 121+07 (RT)	-	13	59
120+57 TO 121+07 (LT)	-	23	78
121+07 TO 121+42 (RT)	93	9	42
121+07 TO 121+42 (LT)	140	14	63
TOTAL	466	115	523

RAISED REF PVT MK REMOVAL AND PLACEMENT


	78300200	78100100
	RAISED REF	RAISED REF
LOCATION	PVT MK REM	PVT MKR
LOCATION	(EACH)	(EACH)
117+29 (RT)	1	1
121+26 (RT)	1	1
121+40 (RT)	1	1
121+40 (LT)	1	1
TOTAL	4	4

NOTE: ACTUAL LOCATION WILL BE SAME AS EXISTING.

CURB AND GUTTER REMOVAL AND REPLACEMENT

		44000500	6060500
LOCATION		CURB AND GUTTER REMOVAL (FOOT)	COMB. CONC. C & G, TYPE B-6.24 (FOOT)
117+00.00 TO 117+62.00	NW	62	62
120+40.00 TO 121+43.00	NE	103	103
117+00.00 TO 118+00.00	SW	100	100
120+82.00 TO 121+43.00	SE	61	61
TOTAL		326	326

L 68 (DI	JNDEE F	F.A.I RTE	SECT	ΓΙΟΝ		COUNTY	TOTAL SHEETS	SHEET NO.	
E OF QUANTITIES		94	1314	4.1-I		СООК	70	08	
			_				CONTRACT	NO. 60)M72
SHEETS	STA.	TO STA.		ILLINOIS FED. 4			D PROJECT		

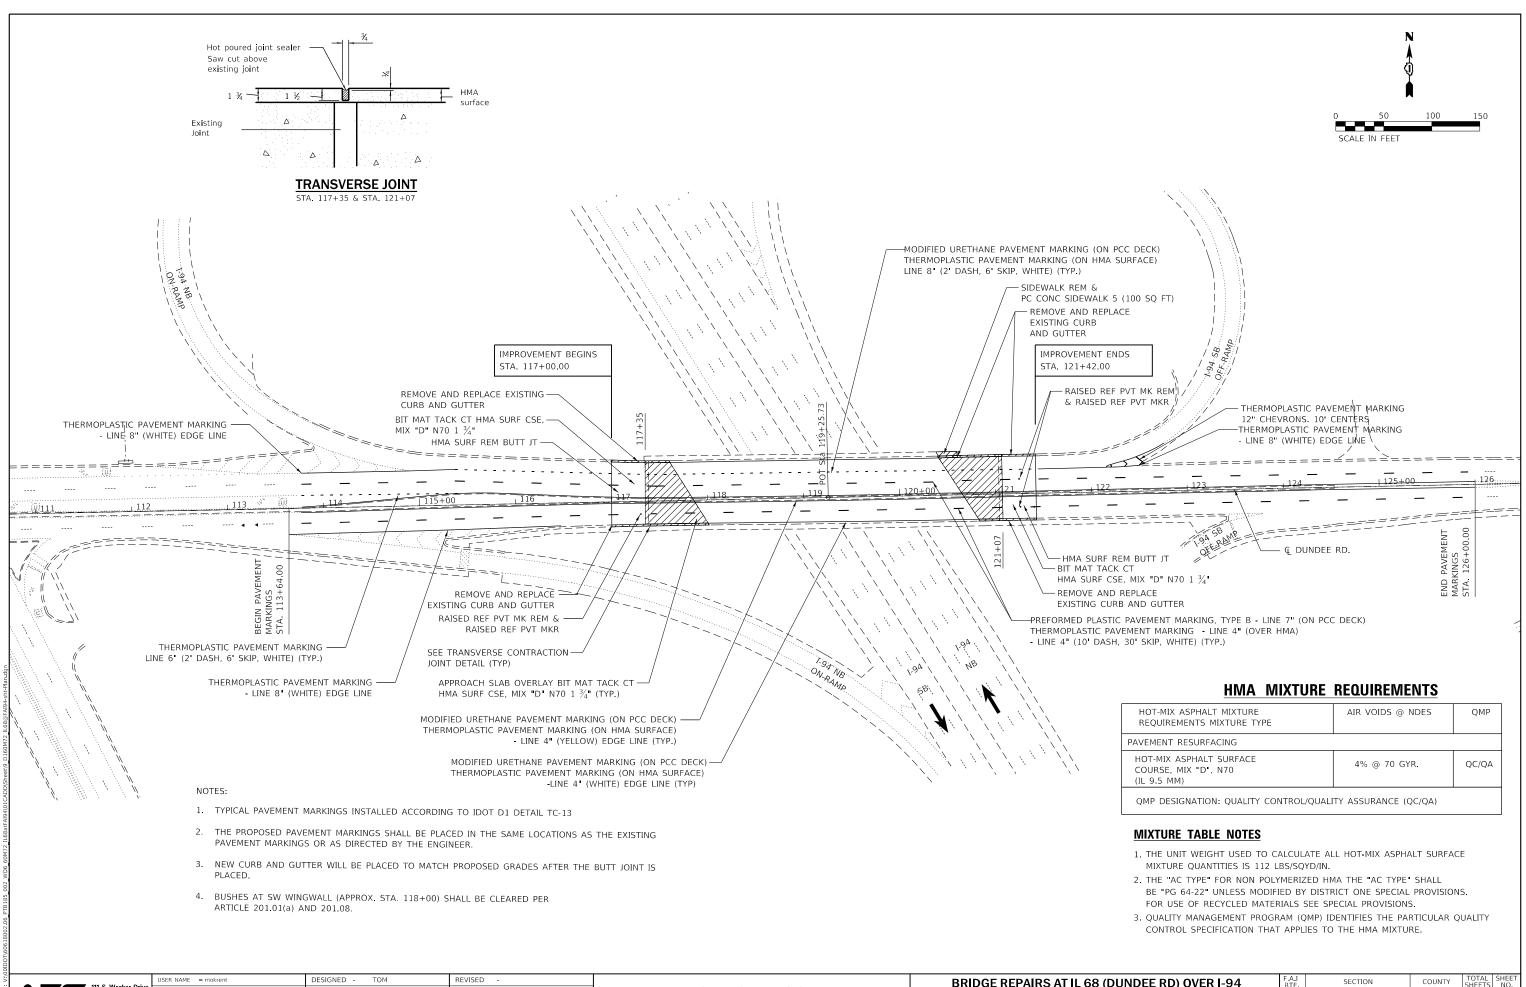

2	111 S. Wacker Drive	USER NAME = mokrent	DESIGNED -	ТОМ	REVISED -		BRID	GE REPAII	RS AT IL	L 68 (D	UNDEE RE)) OVER I-94	F.A.I BTE	SECTION	COUNTY	TOTAL SHEET SHEETS NO.
IAME	Suite 3910		DRAWN -	TOM	REVISED -	STATE OF ILLINOIS		DIAN	A DAL		T MARKIN	, <u>.</u>	94	1314.1-I	СООК	70 09
Z H EN	GINEERS & SURVEYORS Ph: 312-235-6783	PLOT SCALE = 100.0000 ' / in	CHECKED -	MO	REVISED -	DEPARTMENT OF TRANSPORTATION		FLAI	I Q FAI			G			CONTRACT	T NO. 60M72
Ē		PLOT DATE = 12/17/2018	DATE -	12/12/2018	REVISED -		SCALE:	SHEET	OF	SHEETS	STA.	TO STA.		ILLINOIS FE	D. AID PROJECT	

TRAFFIC CONTROL GENERAL NOTES

- 1. TRAFFIC CONTROL AND PROTECTION SHALL BE PERFORMED IN ACCORDANCE WITH SECTION 701 OF THE STANDARD SPECIFICATIONS FOR ROAD AND BRIDGE CONSTRUCTION
- 2. ALL LANE, RAMP AND SHOULDER CLOSURES ON THE EXPRESSWAY SHALL BE SET UP IN ACCORDANCE WITH 2018 ILLINOIS HIGHWAY STANDARDS FOR TRAFFIC CONTROL 701400, 701401, 701801, 701411, 701428, 701446, 701901, 704001 AND DISTRICT 1 TRAFFIC CONTROL DETAIL TO 17 & TO 10
- 3. TYPE A LOW INTENSITY FLASHING WARNING LIGHTS SHALL BE USED ON EACH SIGN IN ADVANCE OF THE WORK DURING HOURS OF DARKNESS. ALL WARNING SIGNS SHALL BE A MINIMUM OF 48" X 48" AND HAVE A BLACK LEGEND AND BORDER ON A FLOURESCENT ORANGE REFLECTORIZED BACKGROUND.
- 4. ALL TYPE III BARRICADES UTILIZED FOR ROAD CLOSURES SHALL HAVE TWO LOW INTENSITY FLASHING LIGHTS MOUNTED ON TOP OF EACH BARRICADE. MAINTAIN EXISTING TRAFFIC SIGNS.
- COVER ALL EXISTING TRAFFIC SPEED LIMIT SIGNS WHERE WORK ZONE SPEED 5. LIMIT CHANGES ARE IMPLEMENTED.
- WHERE ARTIFICIAL LIGHTING IS UTILIZED IN NIGHT OPERATIONS, THE CONTRACTOR 6. SHALL EXERCISE THE UTMOST PRECAUTIONS IN PREVENTING ADVERSE VISIBILITY TO THE MOTORING PUBLIC AND ADJOINING RESIDENTIAL AREAS.
- 7. EXACT LOCATION OF ALL WARNING SIGNS AND BARRICADES SHALL BE STAKED IN THE FIELD FOR APPROVAL BY THE ENGINEER PRIOR TO INSTALLATION.
- PRIOR TO START OF CONSTRUCTION, ALL REQUIRED TRAFFIC CONTROL DEVICES 8 SHALL BE IN PLACE.
- 9. THE CONTRACTOR SHALL NOTIFY THE ENGINEER 72 HOURS PRIOR TO ANY ANTICIPATED CLOSURES
- 10. A MINIMUM 11' LANE WIDTH SHALL BE MAINTAINED ON ALL INTERSTATE LANES OPEN TO TRAFFIC DURING CONSTRUCTION.
- 11. SIGN W21-1(0)-48 SHALL BE TAKEN DOWN WHEN THE WORKERS ARE NOT PRESENT
- 12. THE FURNISHING, INSTALLING, AND RELOCATION OF ALL TRAFFIC SIGNS SHALL BE IN ACCORDANCE WITH THE MANUAL ON UNIFORM TRAFFIC CONTROL DEVICES AND THE STANDARD SPECIFICATIONS. THIS WORK SHALL BE INCLUDED IN THE COST FOR TRAFFIC CONTROL AND PROTECTION, (EXPRESSWAYS). ALL CONFLICTING TRAFFIC SIGNS SHALL BE COVERED AS DIRECTED BY THE ENGINEER. THIS WORK SHALL BE INCLUDED IN THE COST TRAFFIC CONTROL AND PROTECTION (SPECIAL).
- 13. PLEASE SEE THE CONTRACT SPECIAL PROVISIONS, KEEPING THE EXPRESSWAY OPEN TO TRAFFIC SPECIAL PROVISION FOR ALLOWABLE LANE CLOSURE HOURS.
- 14. THE CONTRACTOR SHALL REQUEST AND GAIN APPROVAL FROM THE ILLINOIS DEPARTMENT OF TRANSPORTATION'S EXPRESSWAY TRAFFIC OPERATIONS ENGINEER AT WWW.IDOTLCS.COM TWENTY-FOUR (24) HOURS IN ADVANCE OF ALL DAILY LANE, RAMP AND SHOULDER CLOSURES AND 7 DAYS IN ADVANCE OF ALL PERMANENT AND WEEKEND CLOSURES ON ALL FREEWAYS AND/OR EXPRESSWAYS IN DISTRICT ONE. THIS ADVANCE NOTIFICATION IS CALCULATED BASED ON WORKWEEK OF MONDAY THROUGH FRIDAY AND SHALL NOT INCLUDE WEEKENDS OR HOLIDAYS.

15. WHEN THE CONTRACTOR IS TO PERFORM ANY WORK THAT COULD RISK THE HEALTH OR SAFETY OF NEARBY PEDESTRIANS, THE CONTRACTOR WILL IMPLEMENT APPROPRIATE MEASURES TO AVOID THE RISK. THIS CAN INCLUDE NIGHT WORK WITH SIDEWALK CLOSURES. IF THE SIDEWALK IS TO BE CLOSED, THE SIDEWALK CLOSED SIGN SHALL BE PLACED. OTHERWISE, IT IS TO BE REMOVED OR COVERED. DAYTIME CLOSURES WILL NOT BE ALLOWED AND THE CONTRACTOR WILL BE RESPONSIBLE FOR APPROPRIATE MEASURES TO PROTECT THE WORK WHILE PEDESTRIANS USE THE WALK' THIS CAN INCLUDE PLANKING OVER AREAS CURING. NO ADDITIONAL COMPENSATION WILL BE PROVIDED FOR THESE MEASURES.

PRE-STAGE

INSTALL PROTECTIVE SHIELD OVER OUTSIDE LANE AND SHOULDER PER PLAN SHEET AND STANDARDS 701401, 701411 AND 701400

IMPLEMENT STAGE 1 TRAFFIC CONTROL ON SN 016-0939 PER PLANS AND STANDARD 701601 (SEE ALSO BRIDGE STAGING PLAN FOR LANE CONFIGURATION DETAILS).

STAGE 1

CONSTRUCT BUTT JOINT IN ALL QUADRANTS EXCEPT NE QUADRANT AND REPLACE CONCRETE CURB AND GUTTER.

CONTRACTOR MAY PROCEED WITH SUBSTRUCTURE REPAIRS, INCLUDING CONCRETE AND STEEL USING PLANS FOR FAI 94 TRAFFIC CONTROL AND STANDARDS 701101. 701106, 701401, 701428, 701446 AND 701400.

STAGE 2

PROCEED WITH CONSTRUCTION ON BRIDGE DECK: SCARIFICATION, DECK REPAIR, CONCRETE REPAIR, LATEX OVERLAY, SEALING AND JOINT REPLACEMENT.

CONSTRUCT BUTT JOINT IN THE FOUR QUADRANTS

CONTRACTOR MAY PROCEED WITH SUBSTRUCTURE REPAIRS, INCLUDING CONCRETE AND STEEL USING PLANS FOR FAI 94 TRAFFIC CONTROL AND STANDARDS 701101, 701428, 701446, 701106, 701401 AND 701400.

STAGE 3

POST-STAGE

AND 701411.

															TC-01
efault	111 S. Wacker Drive.	USER NAME = tmohammed	DESIGNED -	ТОМ	REVISED -		BRI	DGE REPAIR	RS AT IL	- 68 (DI	JNDEE R	D) OVER I-94	F.A.I BTE	SECTION	COUNTY TOTAL SHEET
AME	Suite 3910		DRAWN -	TOM	REVISED -	STATE OF ILLINOIS				•		,	94	1314.1-I	СООК 70 10
LE N.	Chicago, IL 60606 ENGINEERS & SURVEYORS Ph: 312–235–6783	PLOT SCALE = 2.0000 ' / in.	CHECKED -	MO	REVISED -	DEPARTMENT OF TRANSPORTATION		TRAFFIC	CONT	ROL GE	NERAL N	UIES			CONTRACT NO. 60M72
M		PLOT DATE = 12/6/2018	DATE -	12/12/2018	REVISED -		SCALE:	SHEET	OF	SHEETS	STA.	TO STA.		ILLINOIS FF	D. AID PROJECT

SUGGESTED CONSTRUCTION SEQUENCE


INSTALL PROTECTIVE SHIELD UNDER SN 016-0939 OVER TWO INSIDE LANES AND SHOULDER OF FAI 94 PER STANDARDS 701446 AND 701400

PROCEED WITH CONSTRUCTION ON BRIDGE DECK: SCARIFICATION, DECK REPAIR, CONCRETE REPAIR, LATEX OVERLAY, SEALING AND JOINT REPLACEMENT.

IMPLEMENT STAGE 2 TRAFFIC CONTROL ON SN 016-0939.

CONSTRUCT BUTT JOINT AT NE QUADRANT (DAY OPERATION) PLACE FINAL PAVEMENT MARKING UTILIZING STANDARD 701427.

REMOVE PROTECTIVE SHIELD PER STANDARD 701400, 701401, 701446, 701428

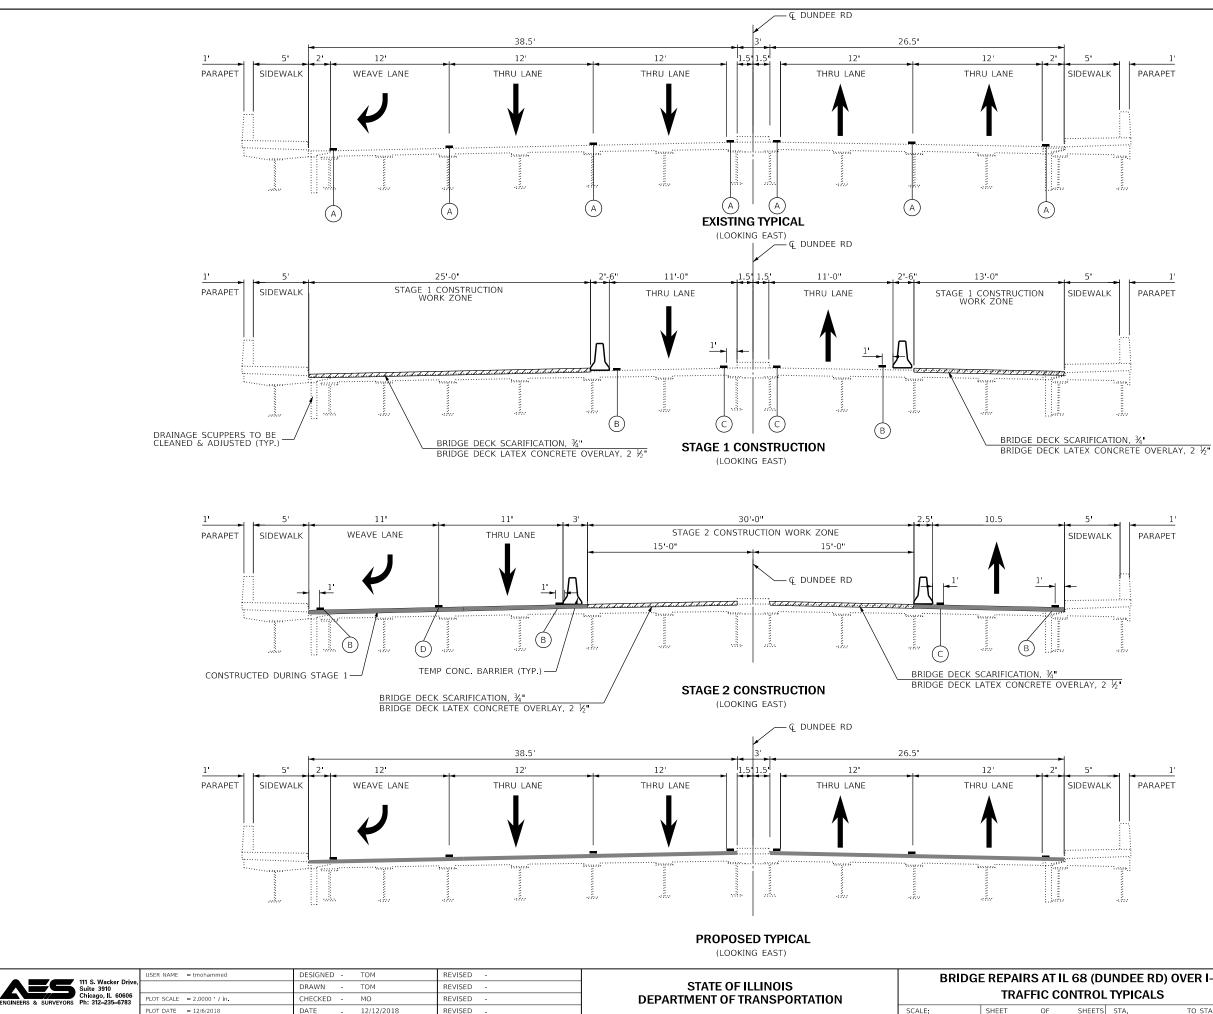


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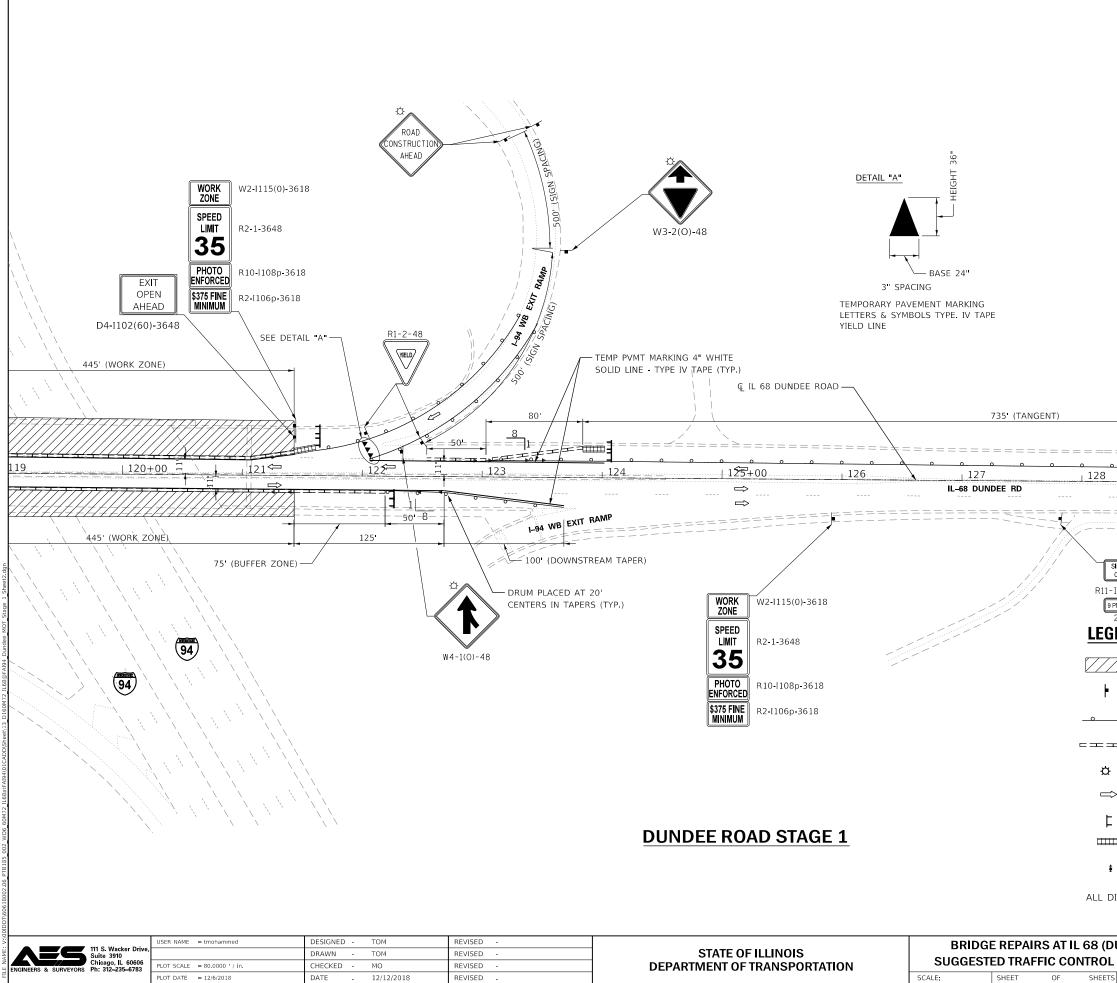
12/12/2018

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DL	JNDEE	RD) OVER I-94	F.A.I RTE	SECT	FION		COUNTY	TOTAL SHEETS	SHEET NO.
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ΓS	STA.	TO STA.			ILLINOIS	FED, A	ID PROJECT		




- TEMPORARY PAVEMENT MARKING 4" YELLOW LINE TAPE TYPE IV \bigcirc
- TEMPORARY PAVEMENT MARKING 4 WHITE LINE TAPE TYPE IV В
- (A)EXISTING PAVEMENT MARKING




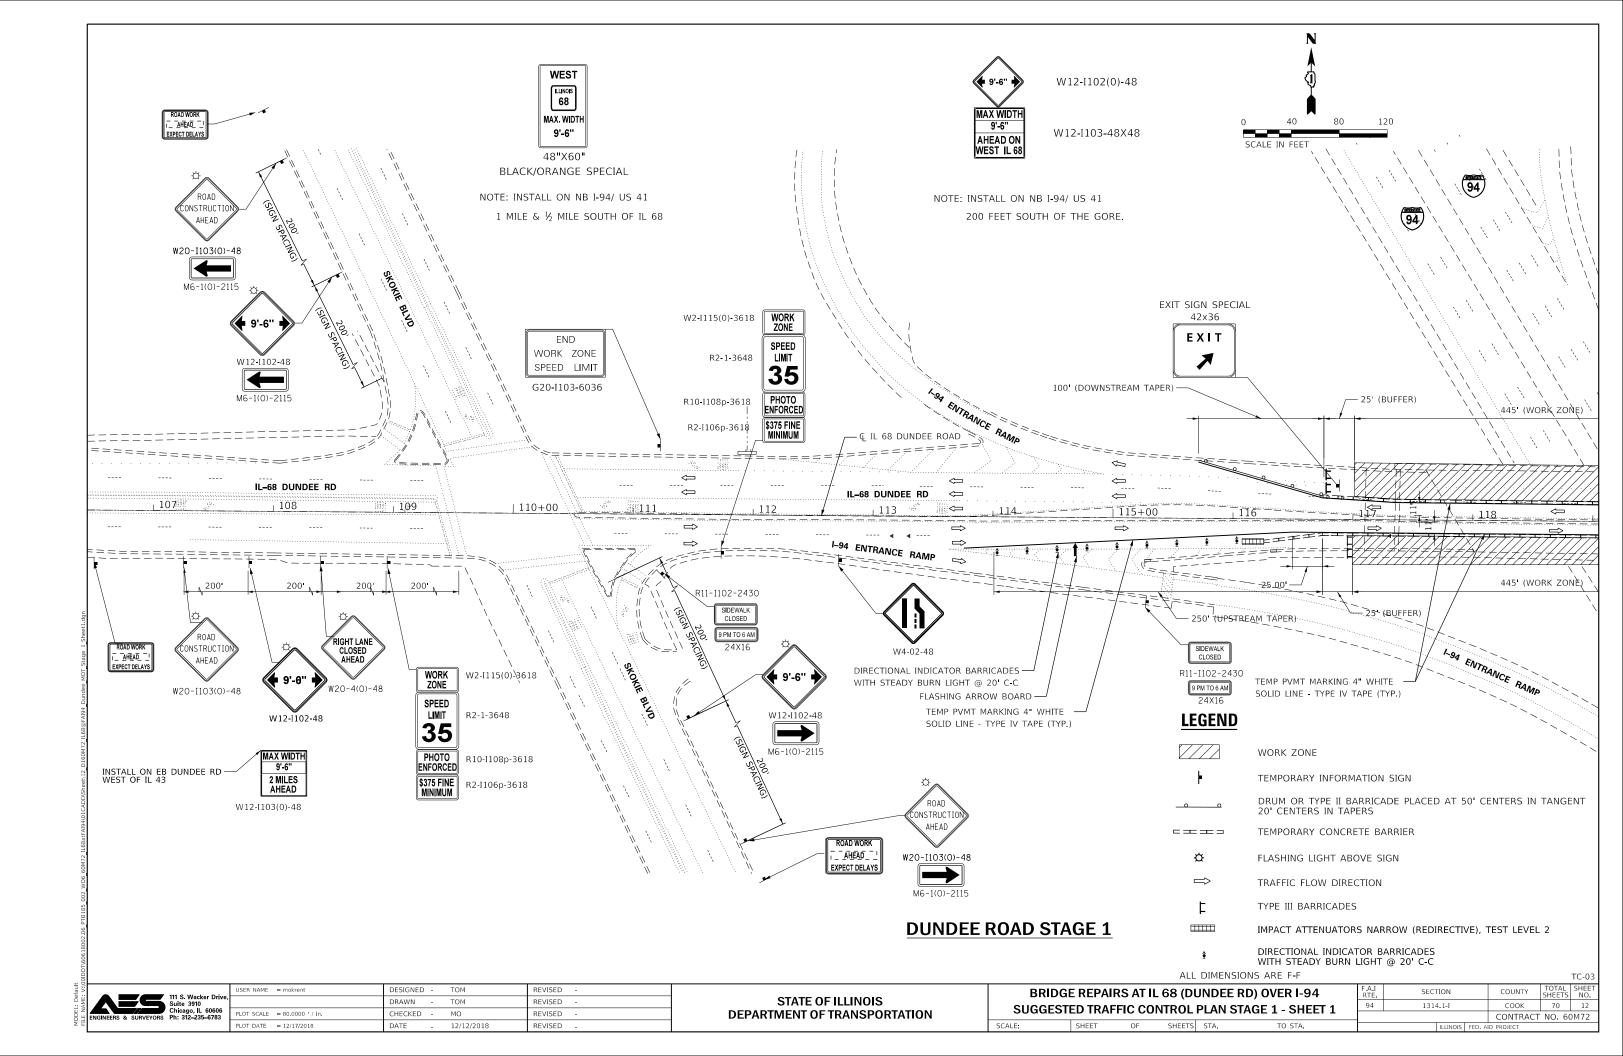


∲ DIMENSION		F.A.I			TC-04
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	DIRECTIONAL INDICATO WITH STEADY BURN LIC				
	IMPACT ATTENUATORS	NARROW	(REDIRECTIVE), TES	ST LEVEL 2	
F	TYPE III BARRICADES				
⇒	TRAFFIC FLOW DIRECT	ION			
à	FLASHING LIGHT ABOV	E SIGN			
= -	TEMPORARY CONCRET	e barrief	२		
0	DRUM OR TYPE II BAR 20' CENTERS IN TAPER		LACED AT 50' CEN	ters in ta	NGENT
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9 PM TO 6 AM 24X16					
SIDEWALK CLOSED 1-I102-243C			DRUM PLACED AT S CENTERS IN TANGE		
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		STAGE I - SHEET Z					CONTRACT	NO. 60)M72
ETS	STA.	TO STA.			ILLINOIS	FED. AI	ID PROJECT		




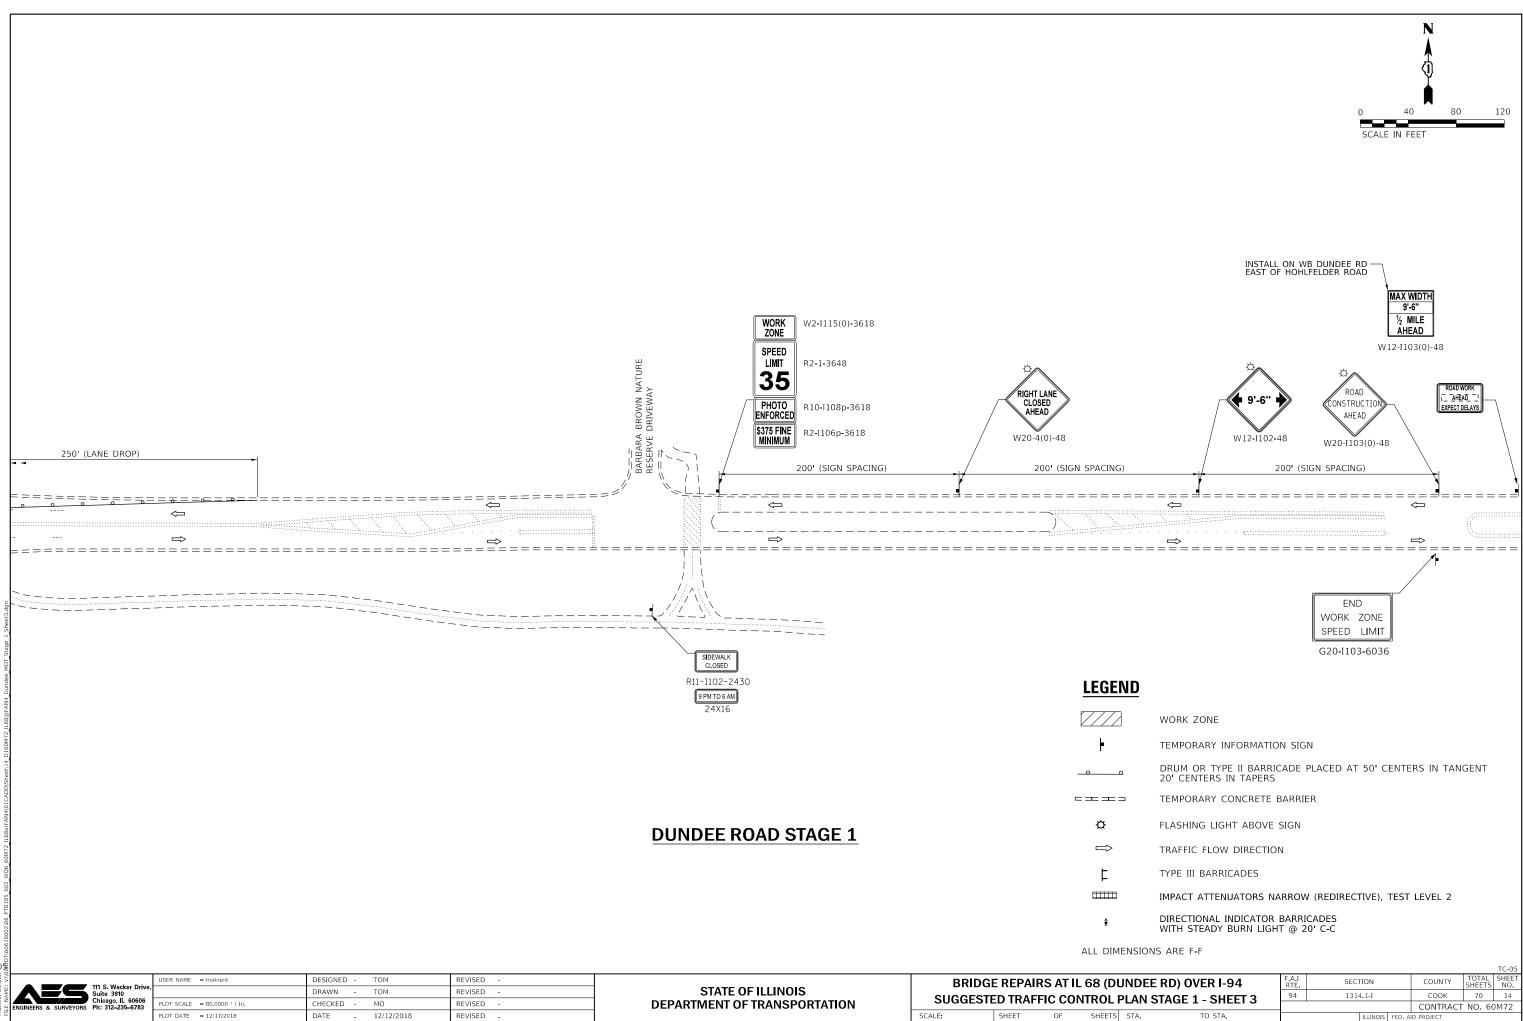

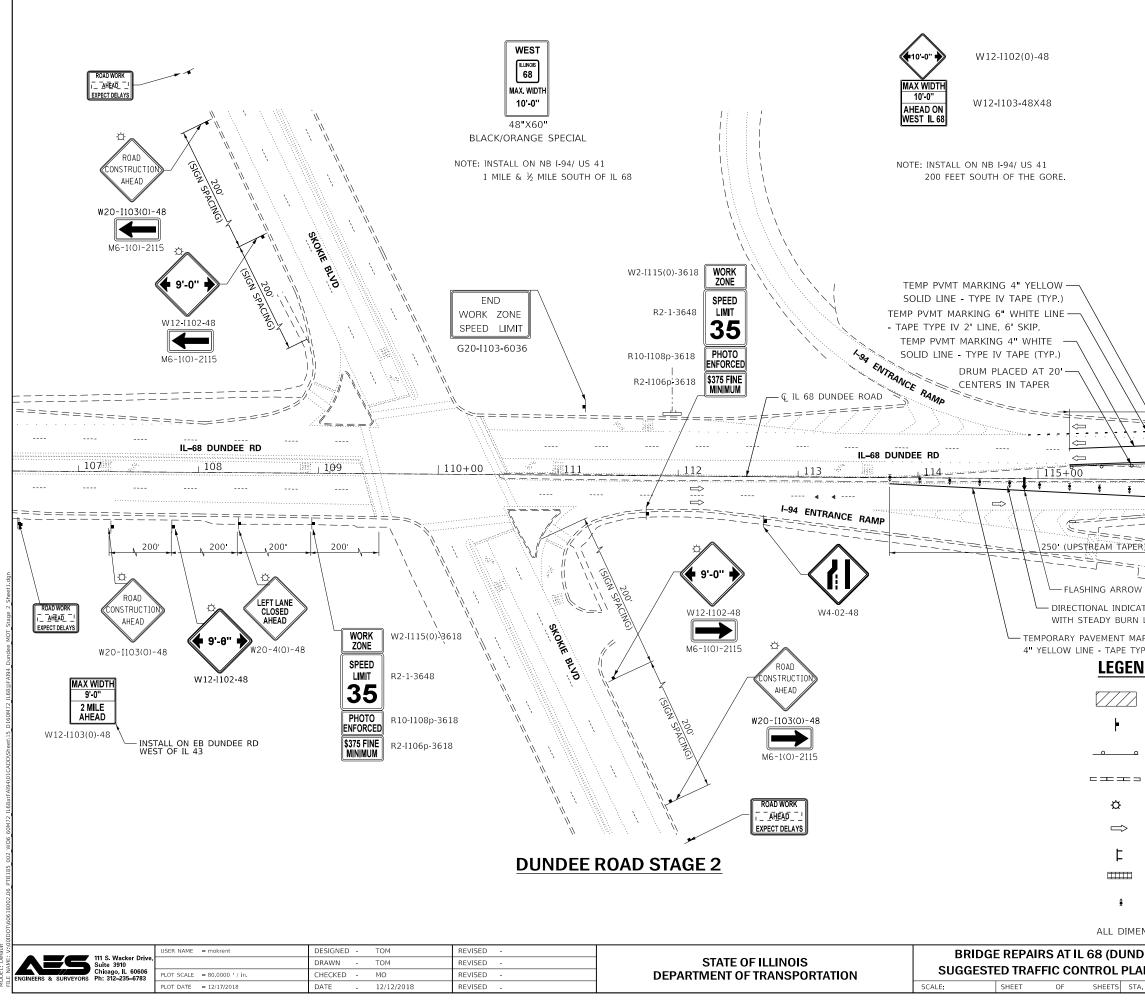
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DUNDEE R				F.A.I RTE		SECTION		COUNTY	TOTA	TC-06
L PLAN ST			Г1	94		1314.1-I		COOK CONTRAC	70	15
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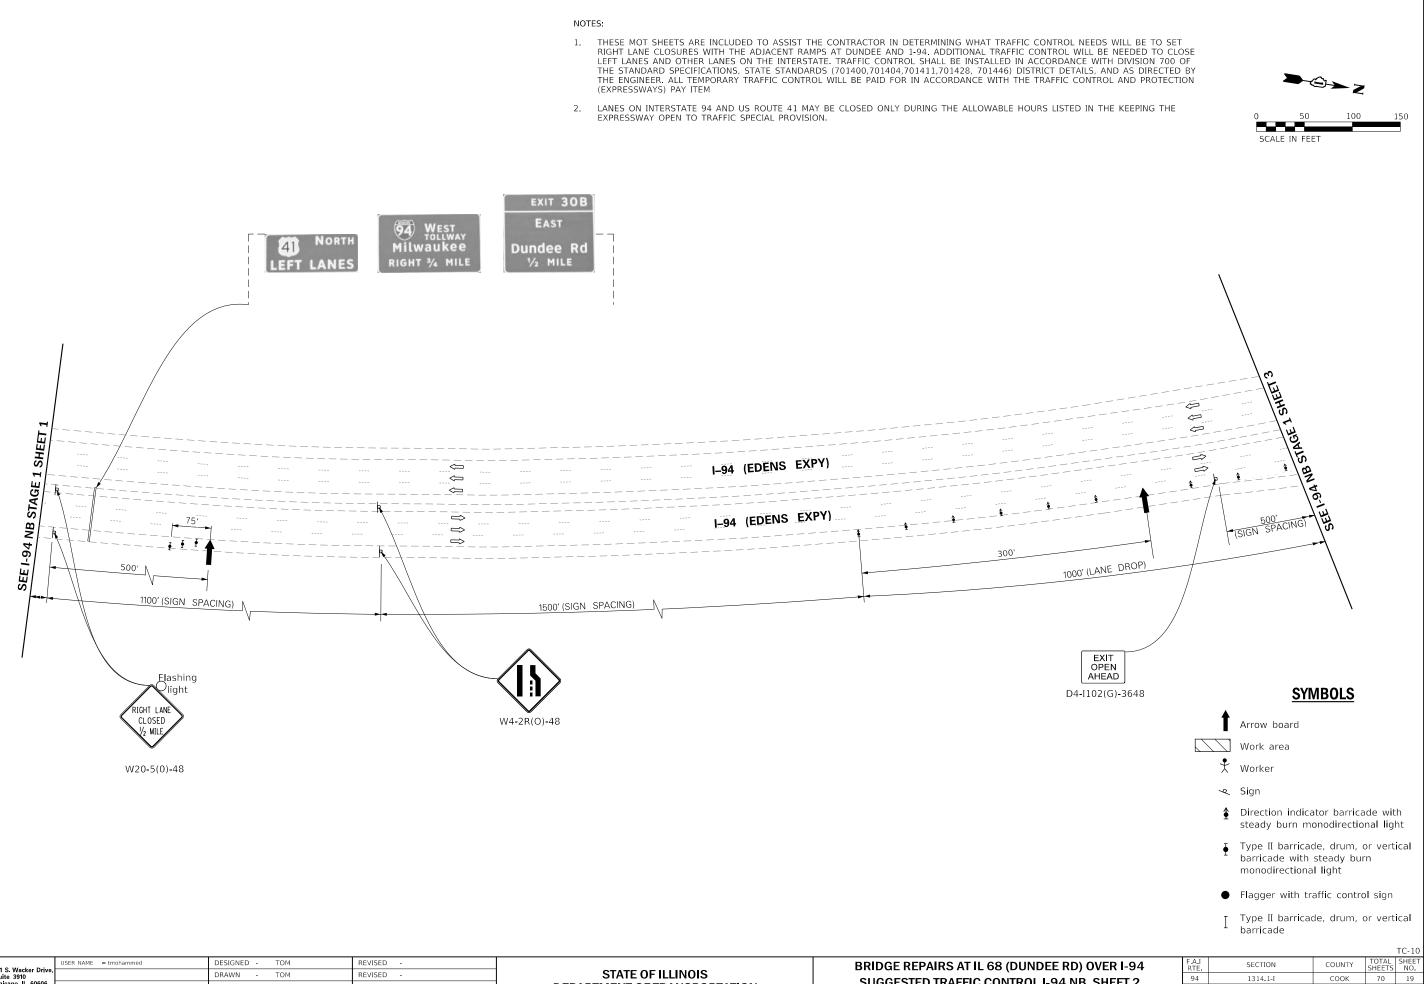
TO STA.



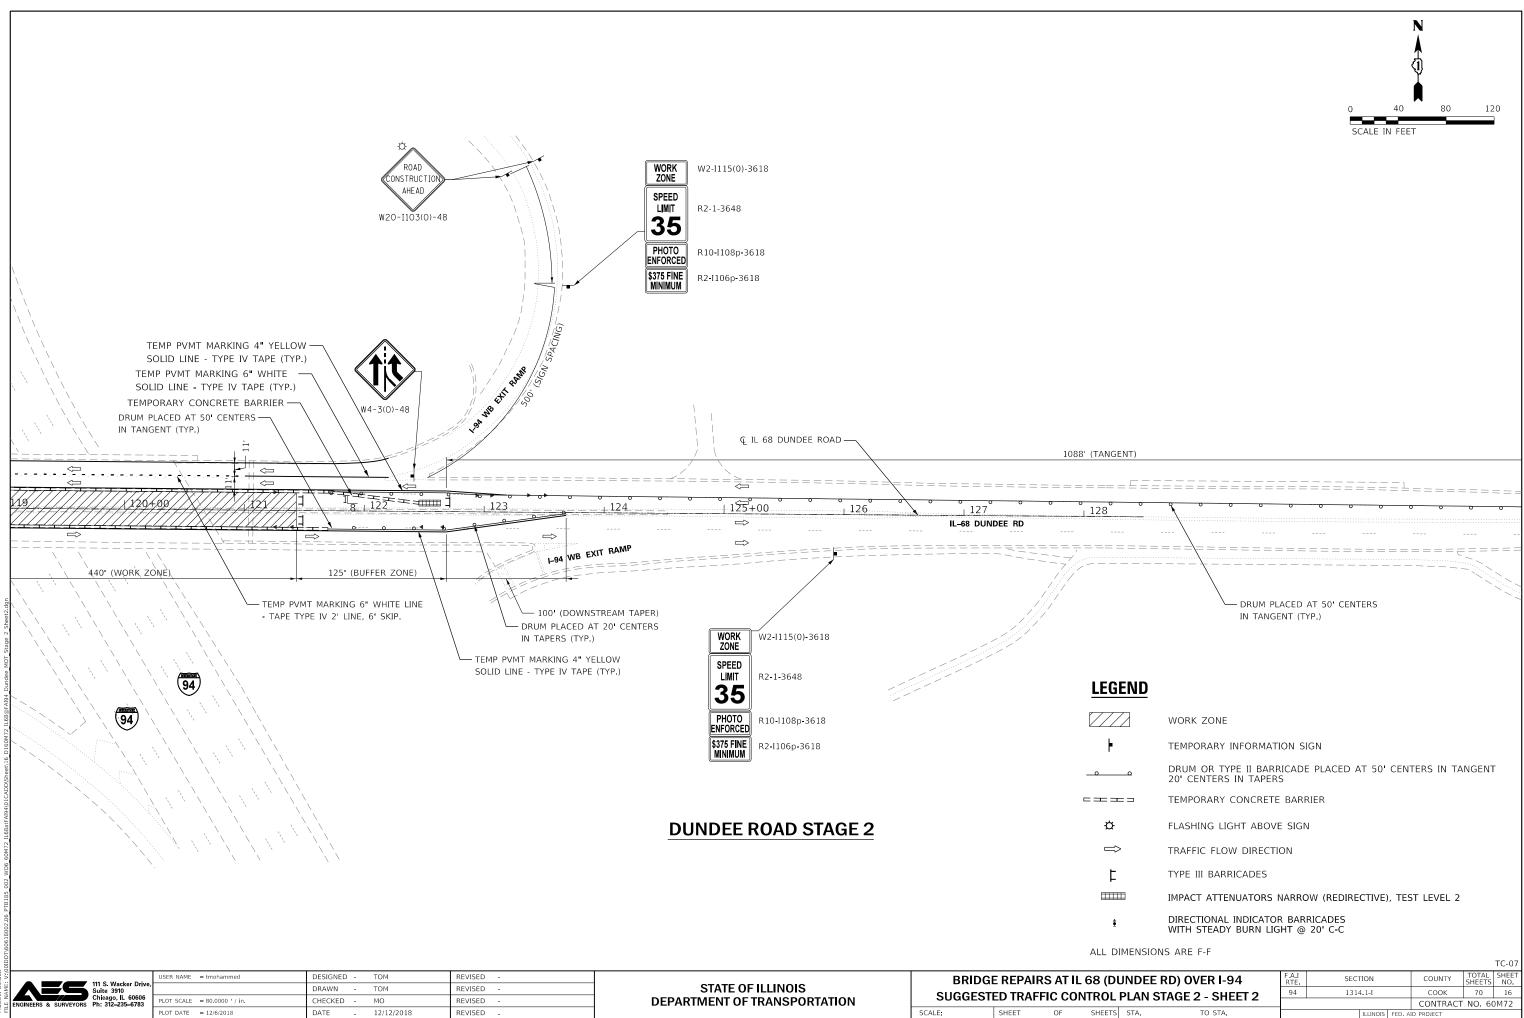

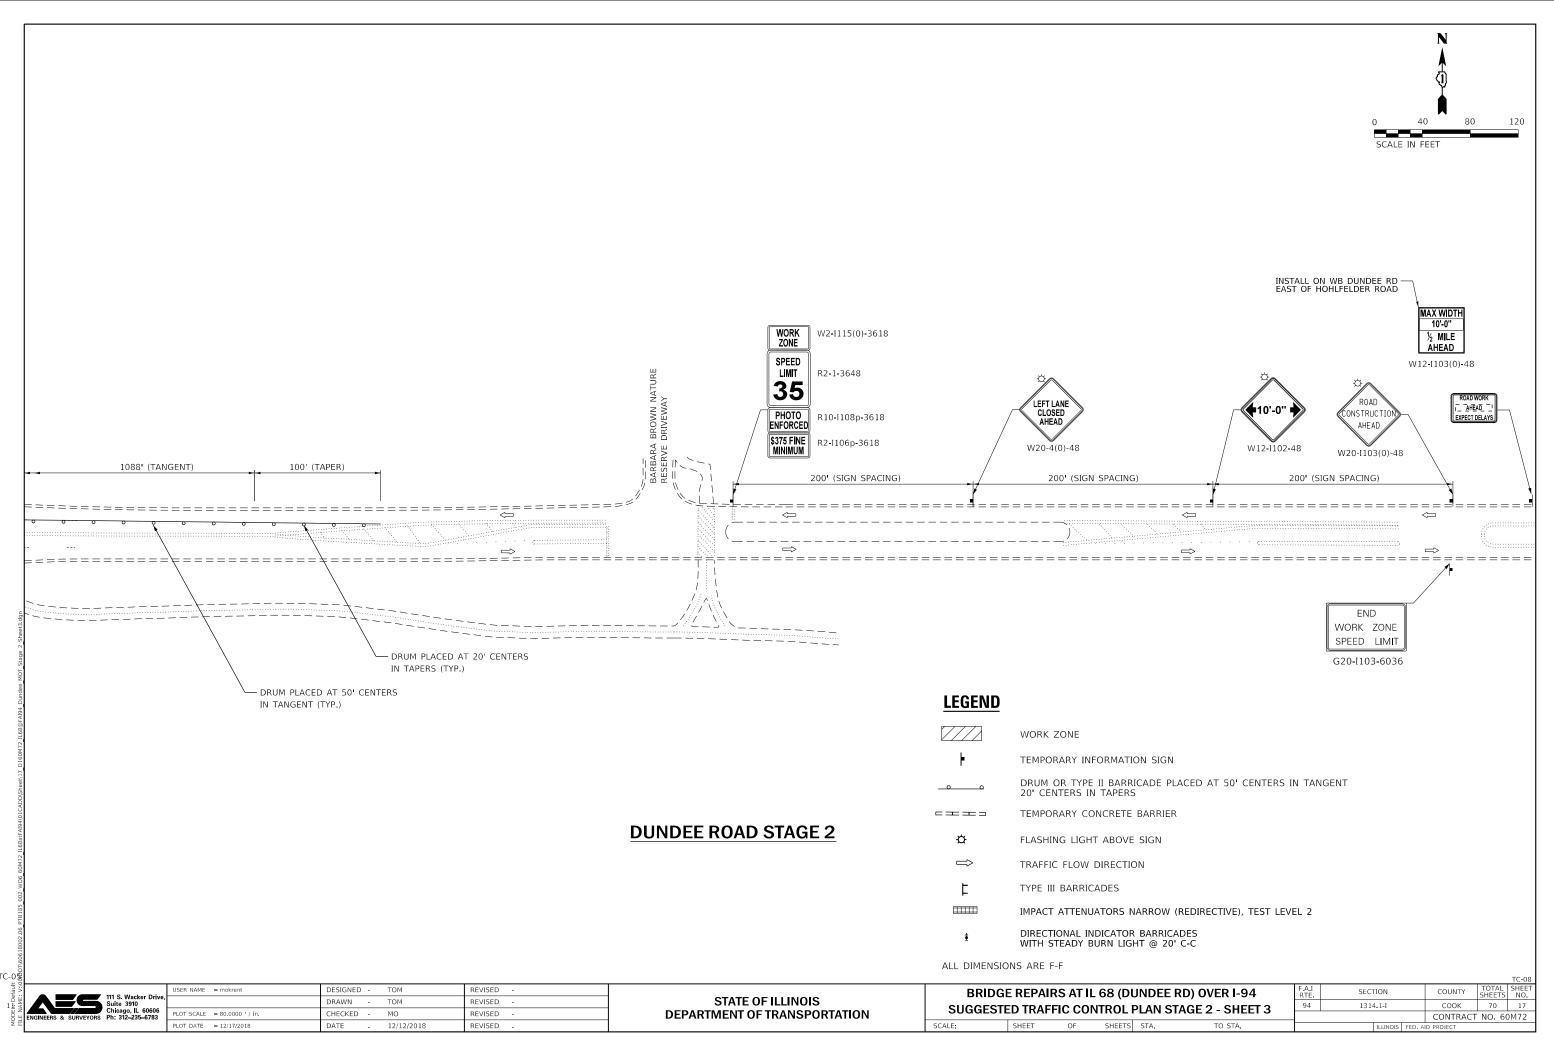
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Dl	JNDEE	RD) OVER I-94	F.A.I RTE	SEC	ΓION		COUNTY	TOTAL SHEETS	SHEET NO.
ТБ	TROL I-94 NB SHEET 1		94	131-	4.1-I		соок	70	18
			_				CONTRACT	NO. 60)M72
TS	STA.	TO STA.			ILLINOIS	FED. A	D PROJECT		

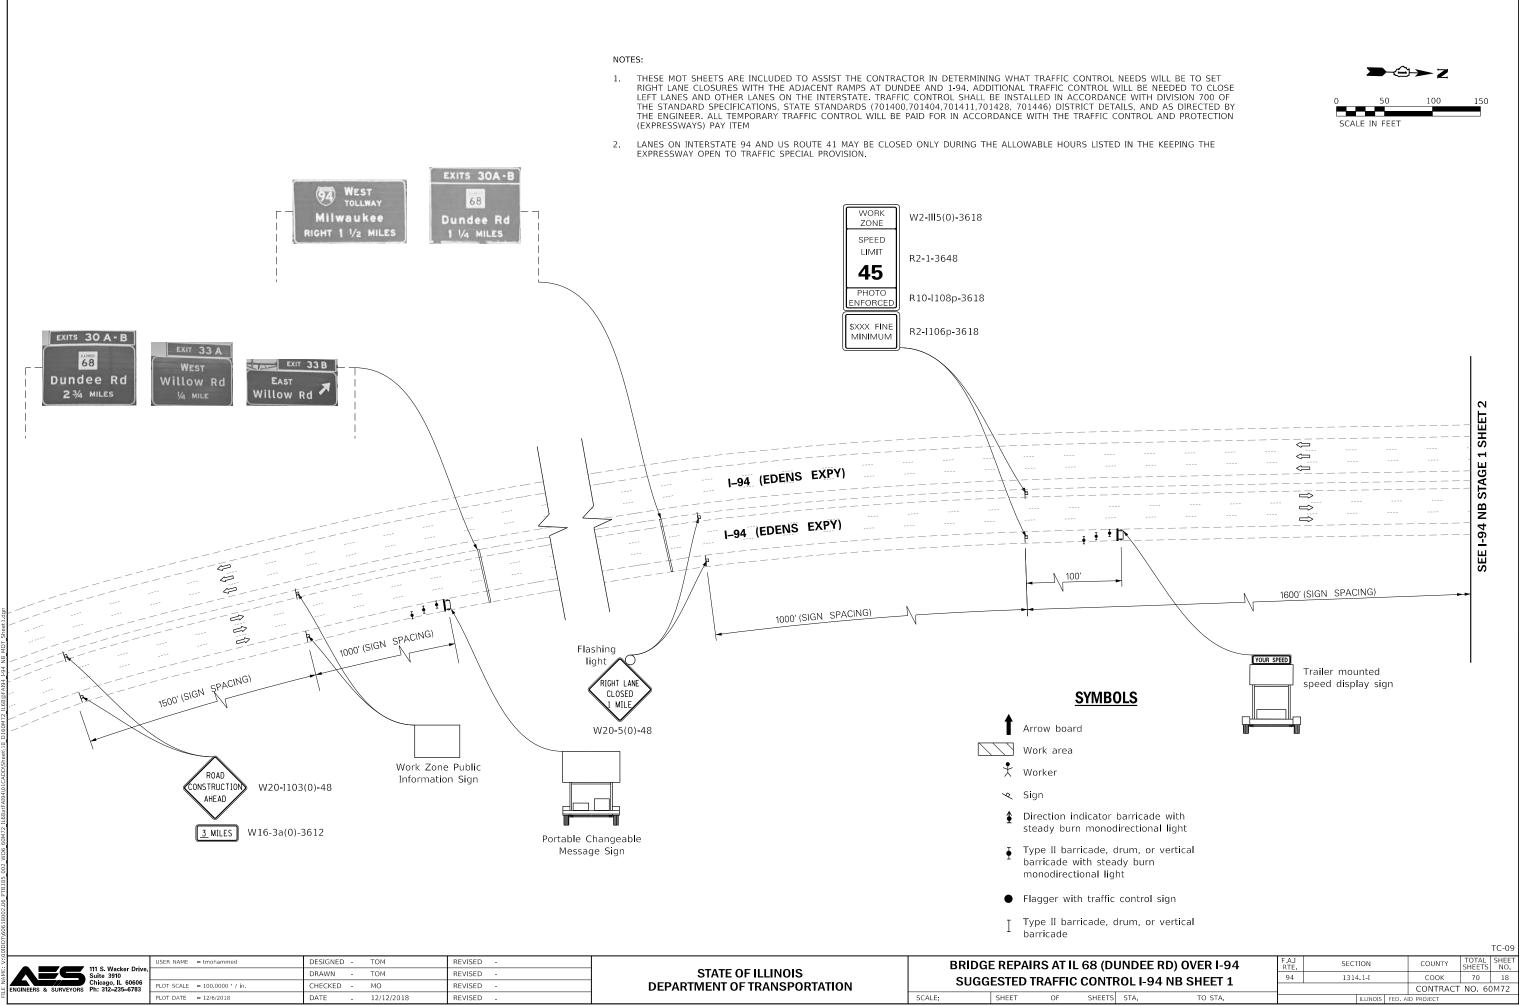
(EXPRESSWAYS) PAY ITEM




111 S. Wacker Drive.	USER NAME = tmohammed	DESIGNED -	ТОМ	REVISED -		BRIDGE REPAIRS AT IL 68 (DU							
-: De AME:	Suite 3910		DRAWN -	ТОМ	REVISED -	STATE OF ILLINOIS							
DDEI	ENGINEERS & SURVEYORS Ph: 312-235-6783	PLOT SCALE = 100.0000 ' / in.	CHECKED -	МО	REVISED -	DEPARTMENT OF TRANSPORTATION	5060	GESTED TH		ONTR	U		
MG		PLOT DATE = 12/6/2018	DATE -	12/12/2018	REVISED -		SCALE:	SHEET	OF	SHEETS	5		


ROL I-94 NB SHEET 2 CONTRACT NO. 60M72 STA. TO STA. ILLINOI

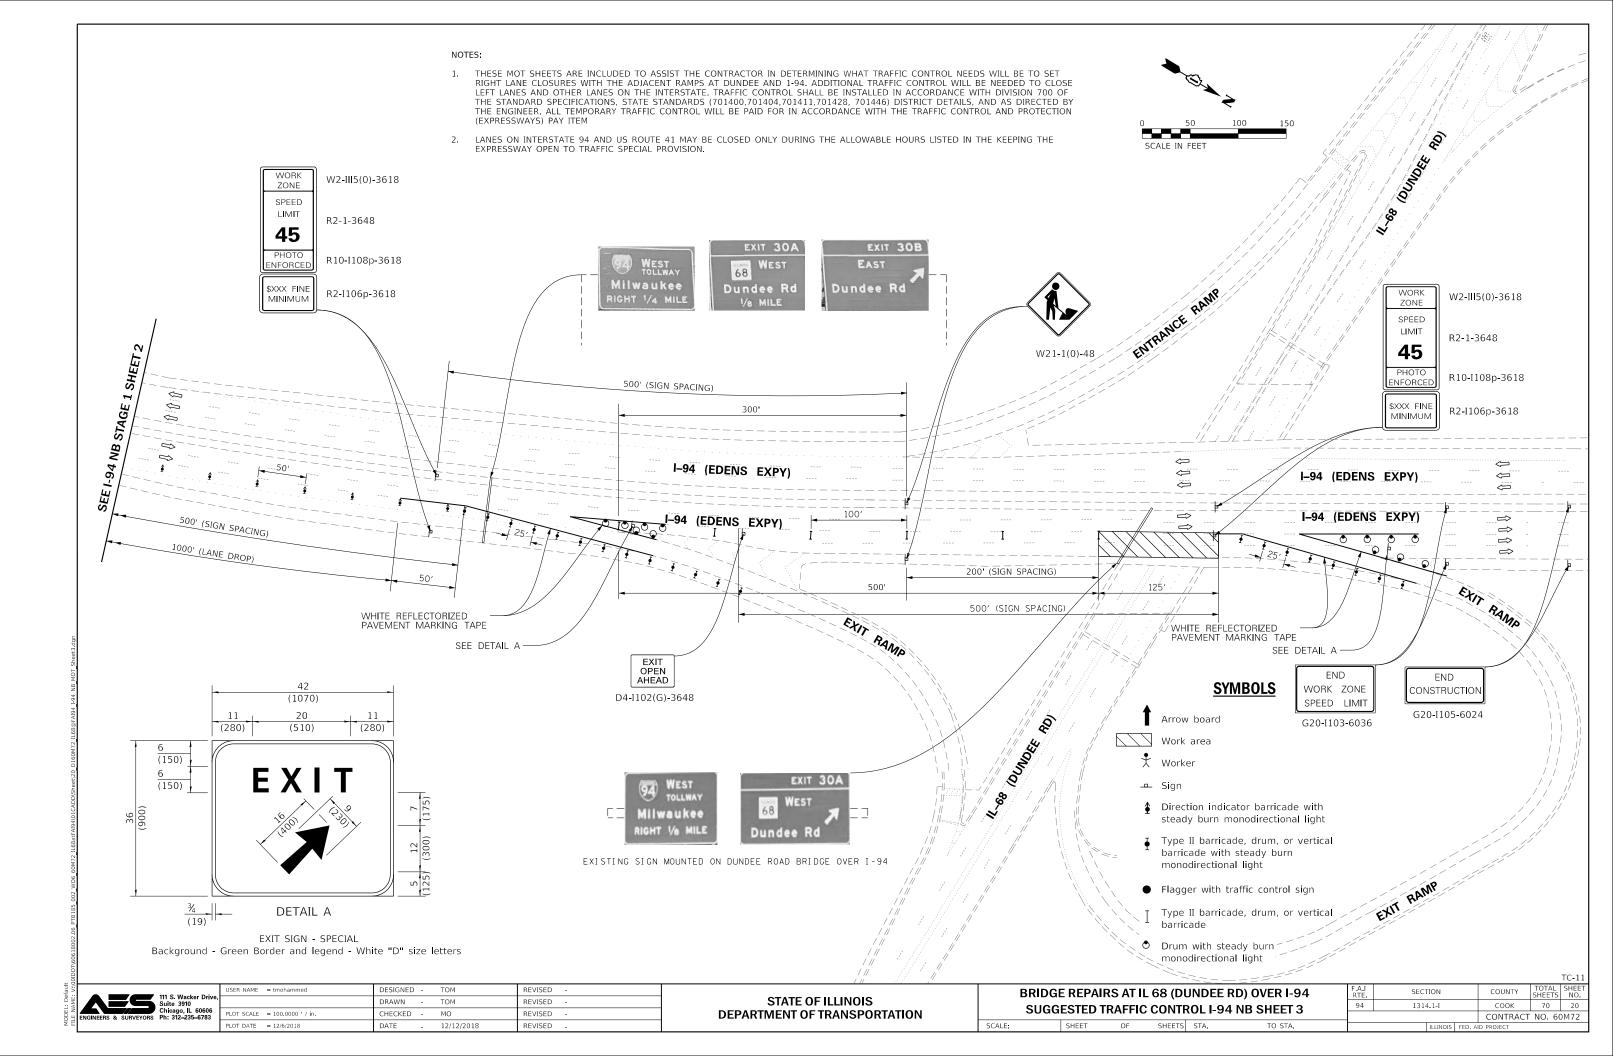


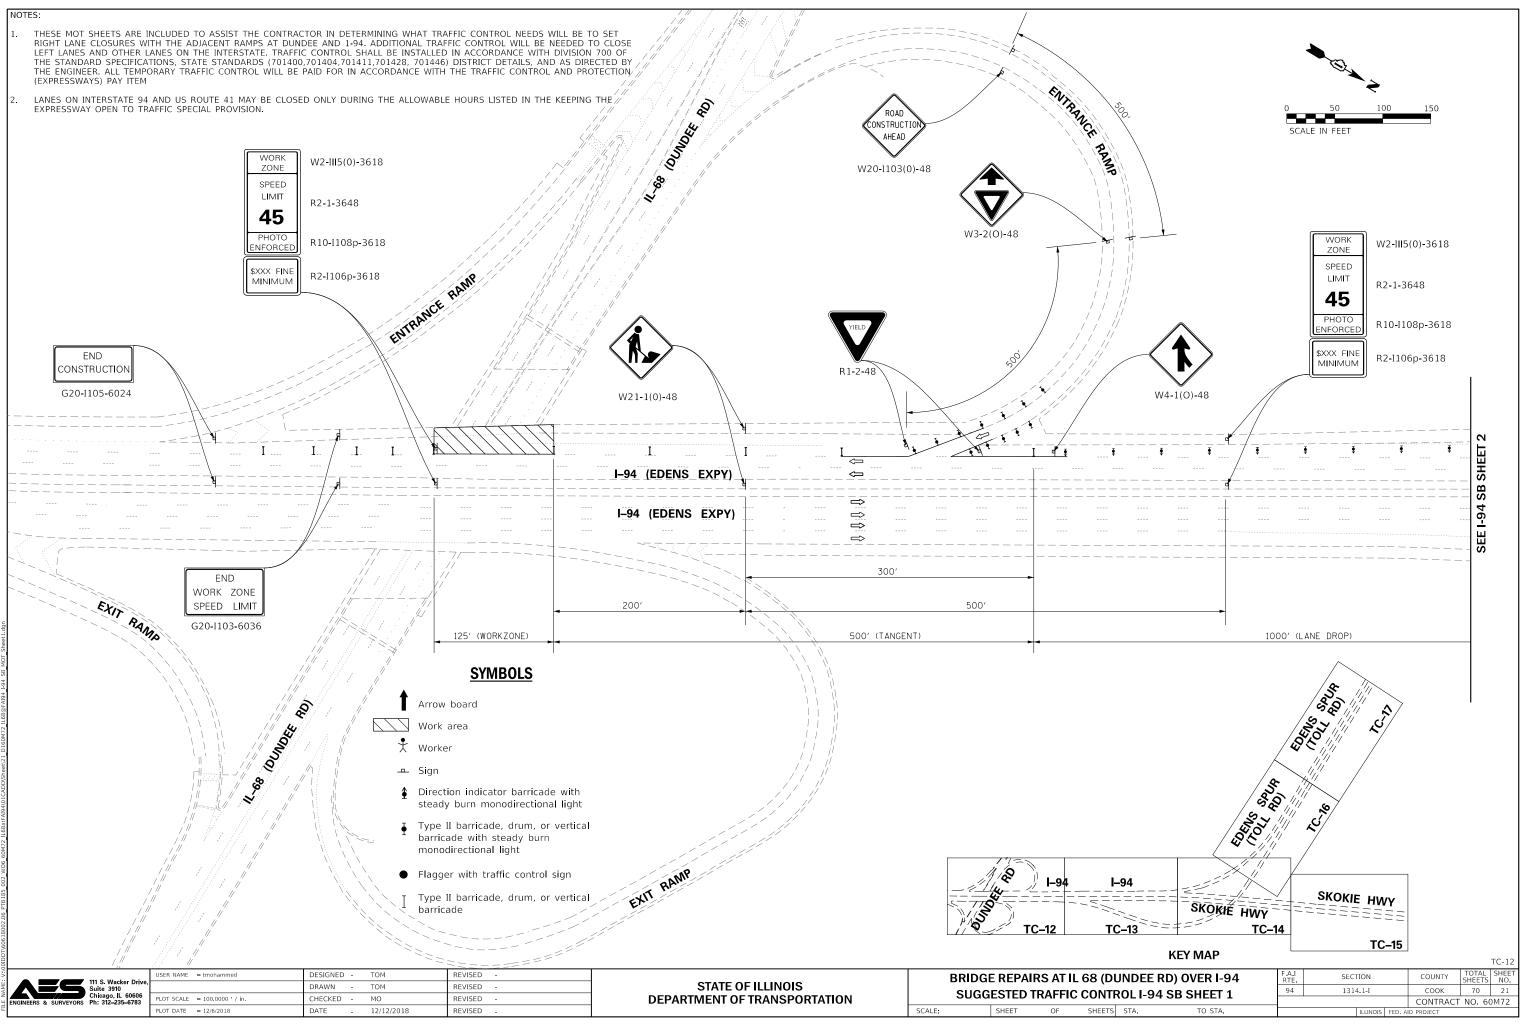


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efault : V:\C	111 S. Wacker Drive, Suite 3910	USER NAME = tmohammed	DESIGNED - TOM	REVISED -		BRIDG	E REPAIR	S AT IL	68 (DUN
-: De	Suite 3910		DRAWN - TOM	REVISED -	STATE OF ILLINOIS				•
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M		PLOT DATE = 12/6/2018	DATE - 12/12/2018	REVISED -		SCALE:	SHEET	OF	SHEETS S

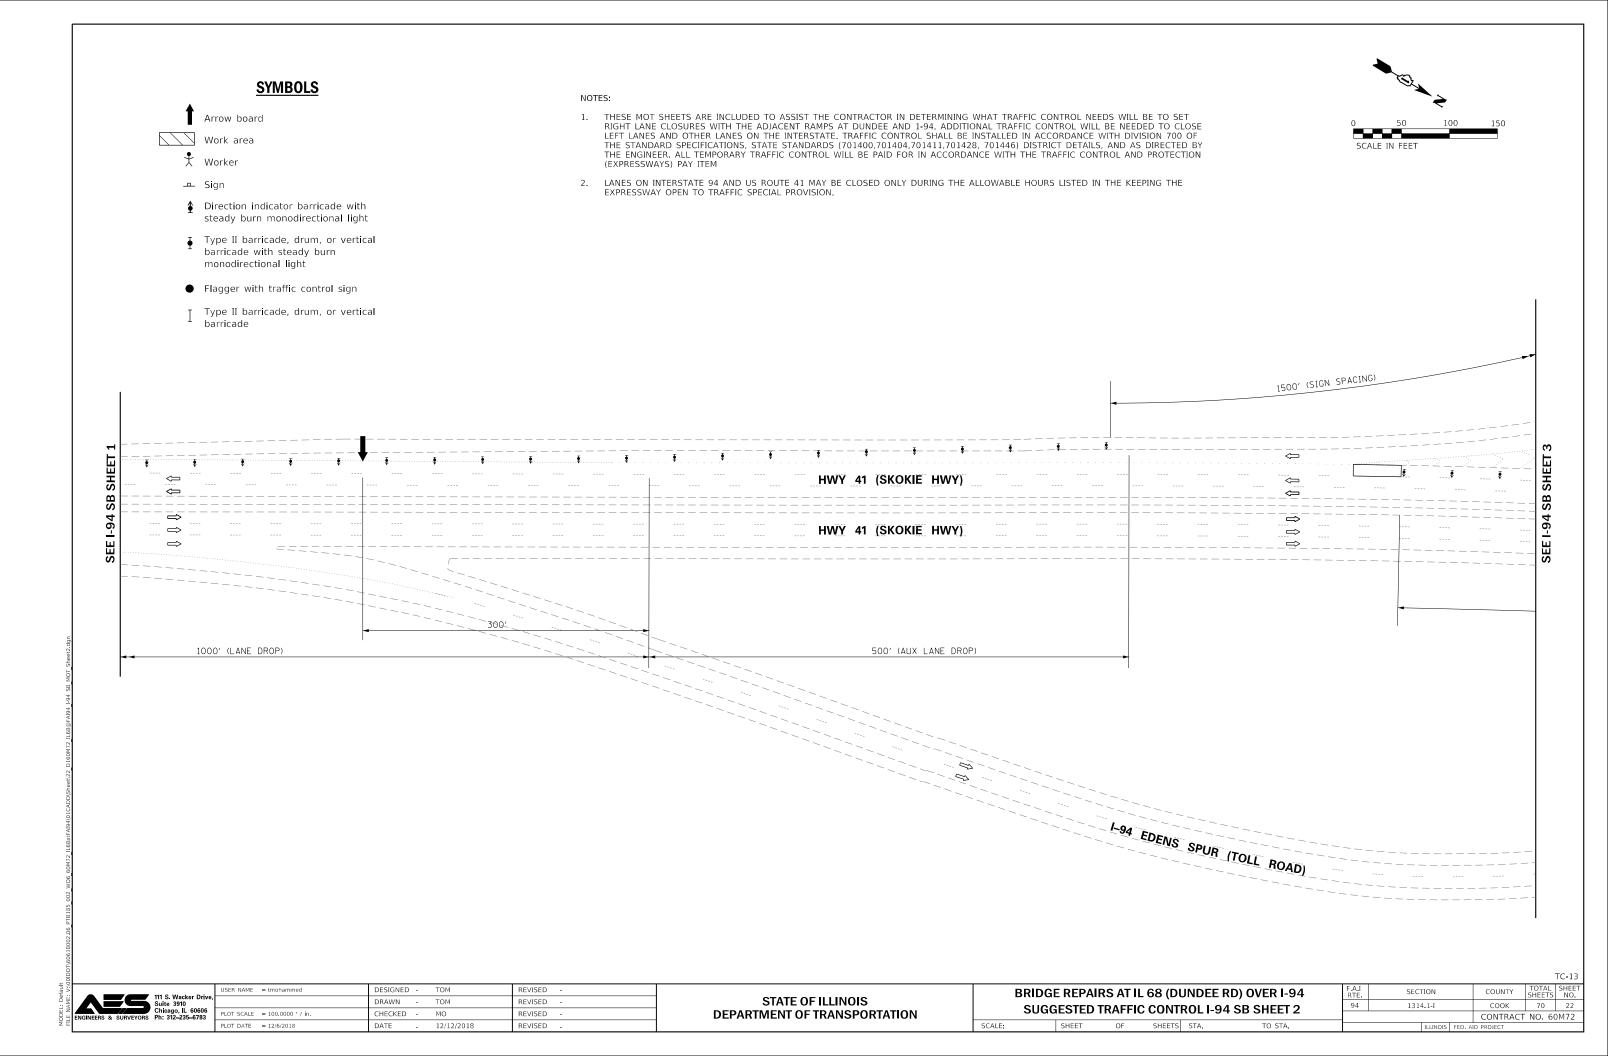


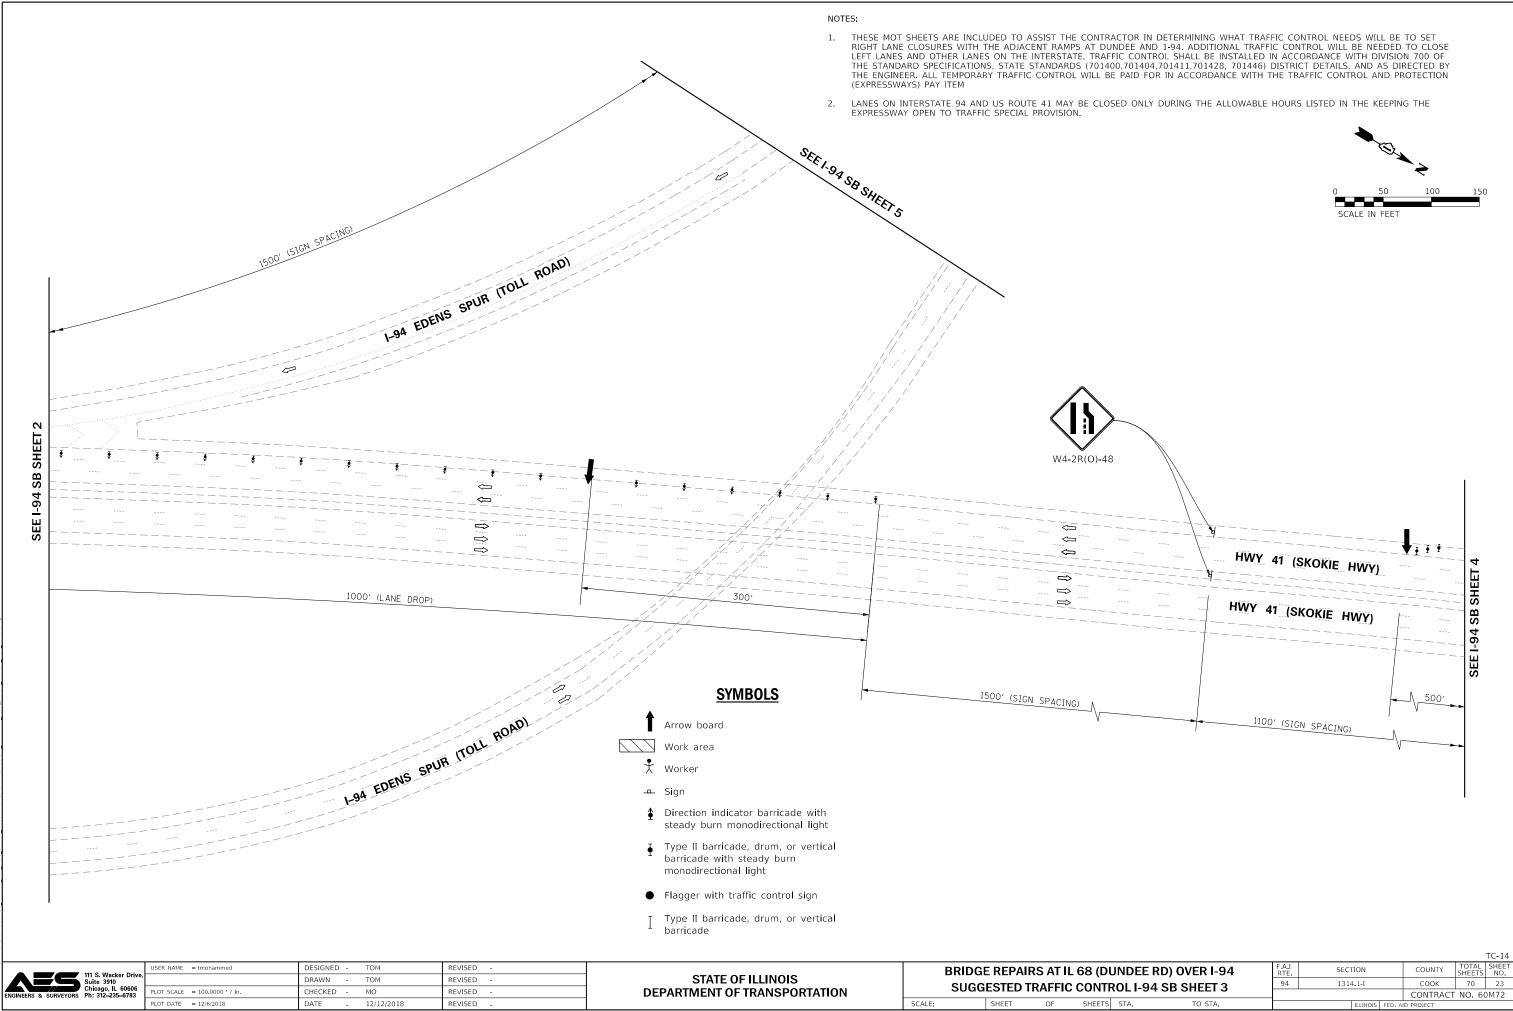STATE OF ILLINOIS DEPARTMENT OF TRANSPORTATION DRAWN -TOM REVISED OT SCALE = 100.0000 ' / in. HECKED -MO REVISED LOT DATE = 12/6/2018 DATE REVISED 12/12/2018

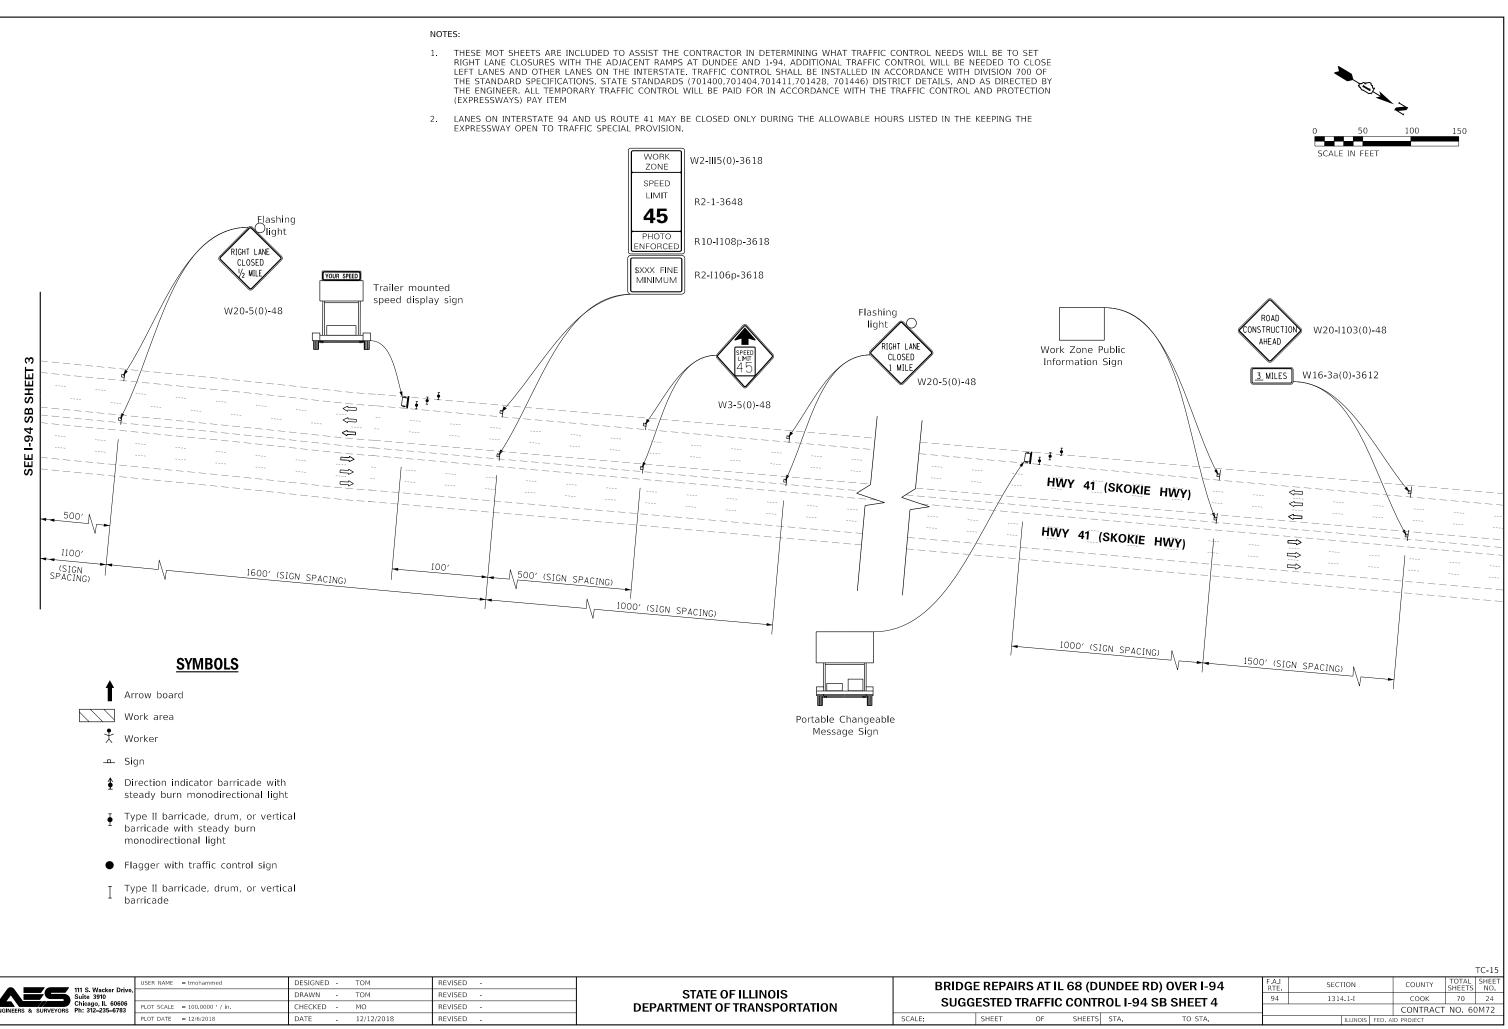
SUGGESTED TRAFFIC CONT SHEET OF SHEETS

SCALE:

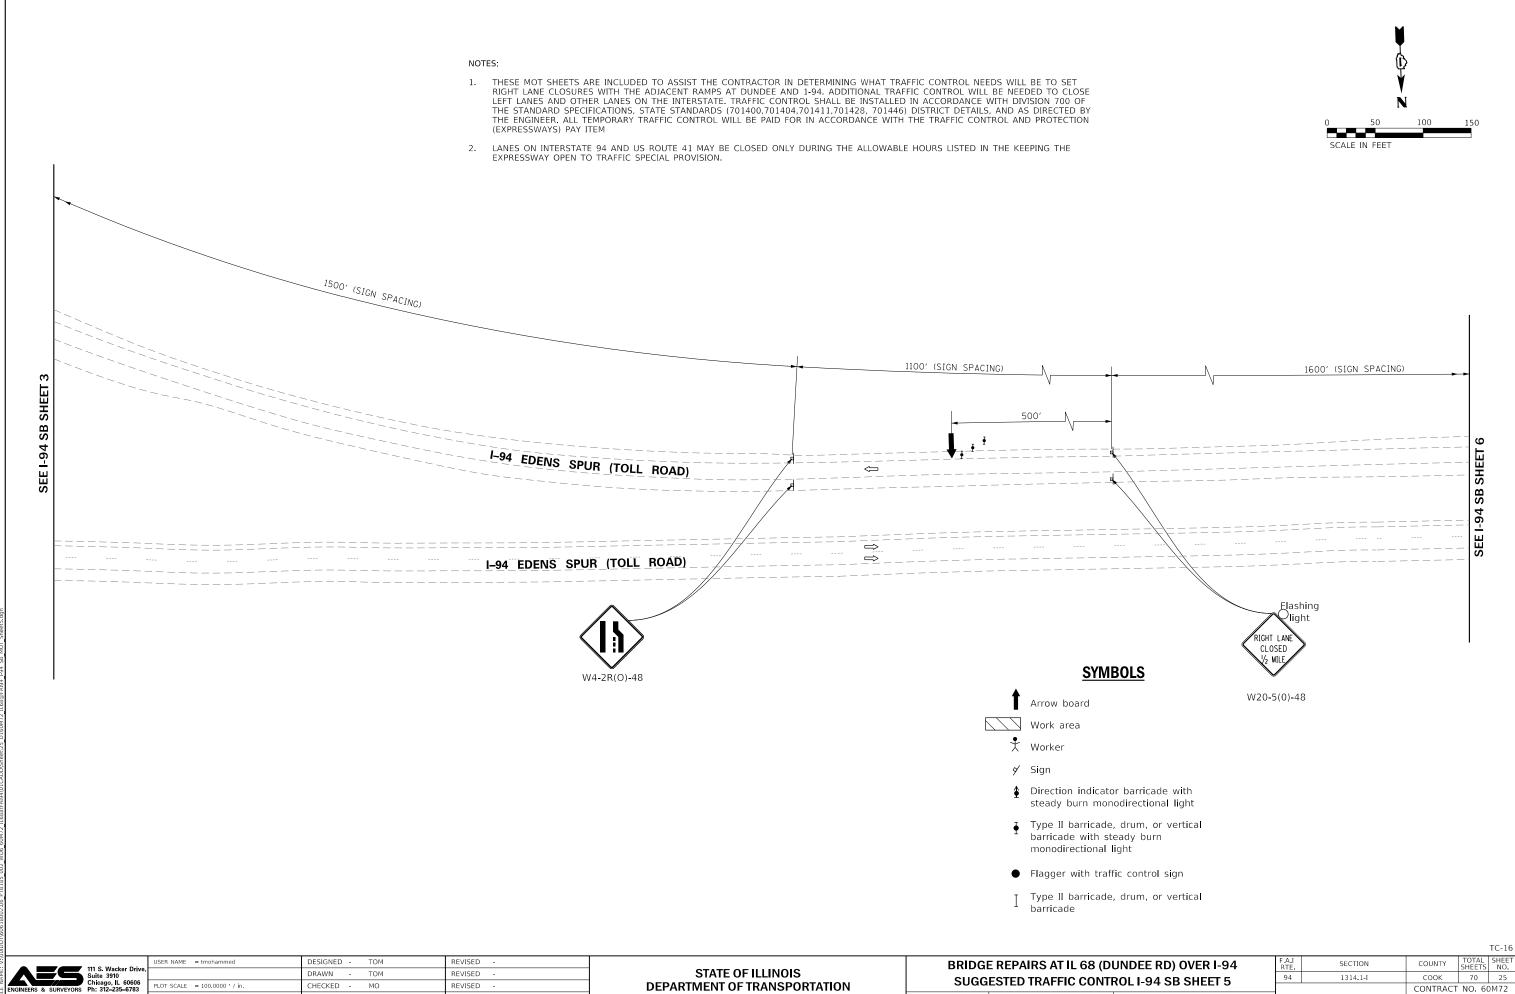DUNDEE RD) OVER I-94	F.A.I RTE	SEC	TION		COUNTY	TOTAL SHEETS	SHEET NO.
FROL I-94 SB SHEET 5	94	131	4.1-I		СООК	70	25
INCEL-34 3D SHEET 3					CONTRACT	NO. 60)M72
S STA. TO STA.			ILLINOIS	FED. A	ID PROJECT		

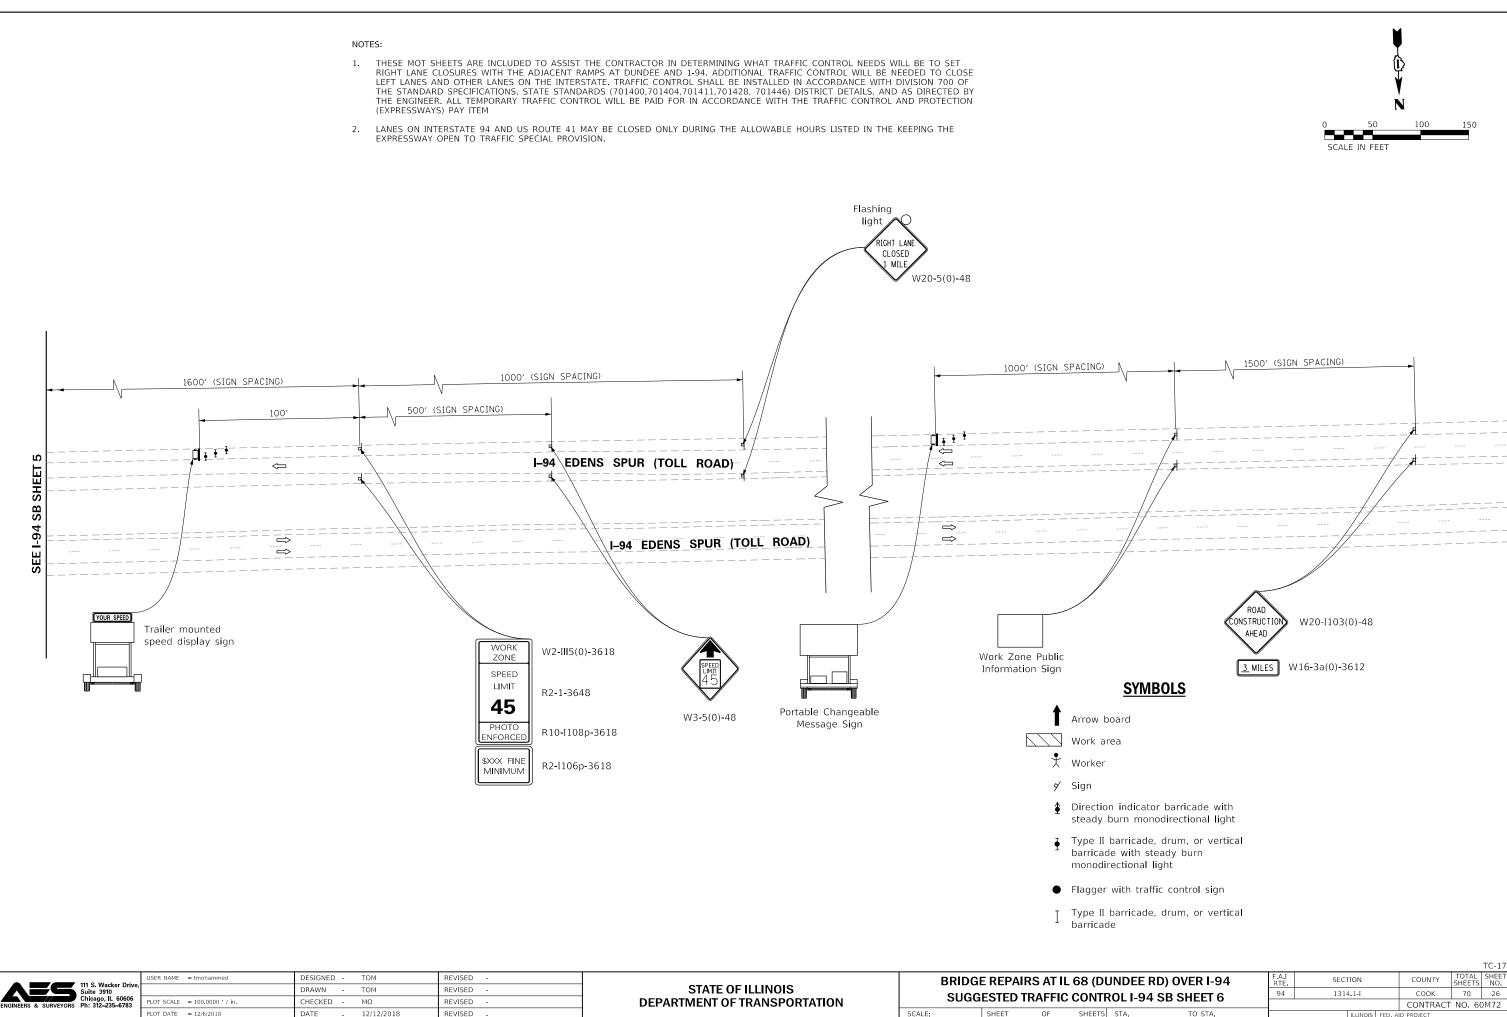

CONTRACT NO. 60M72 TO STA. 1111

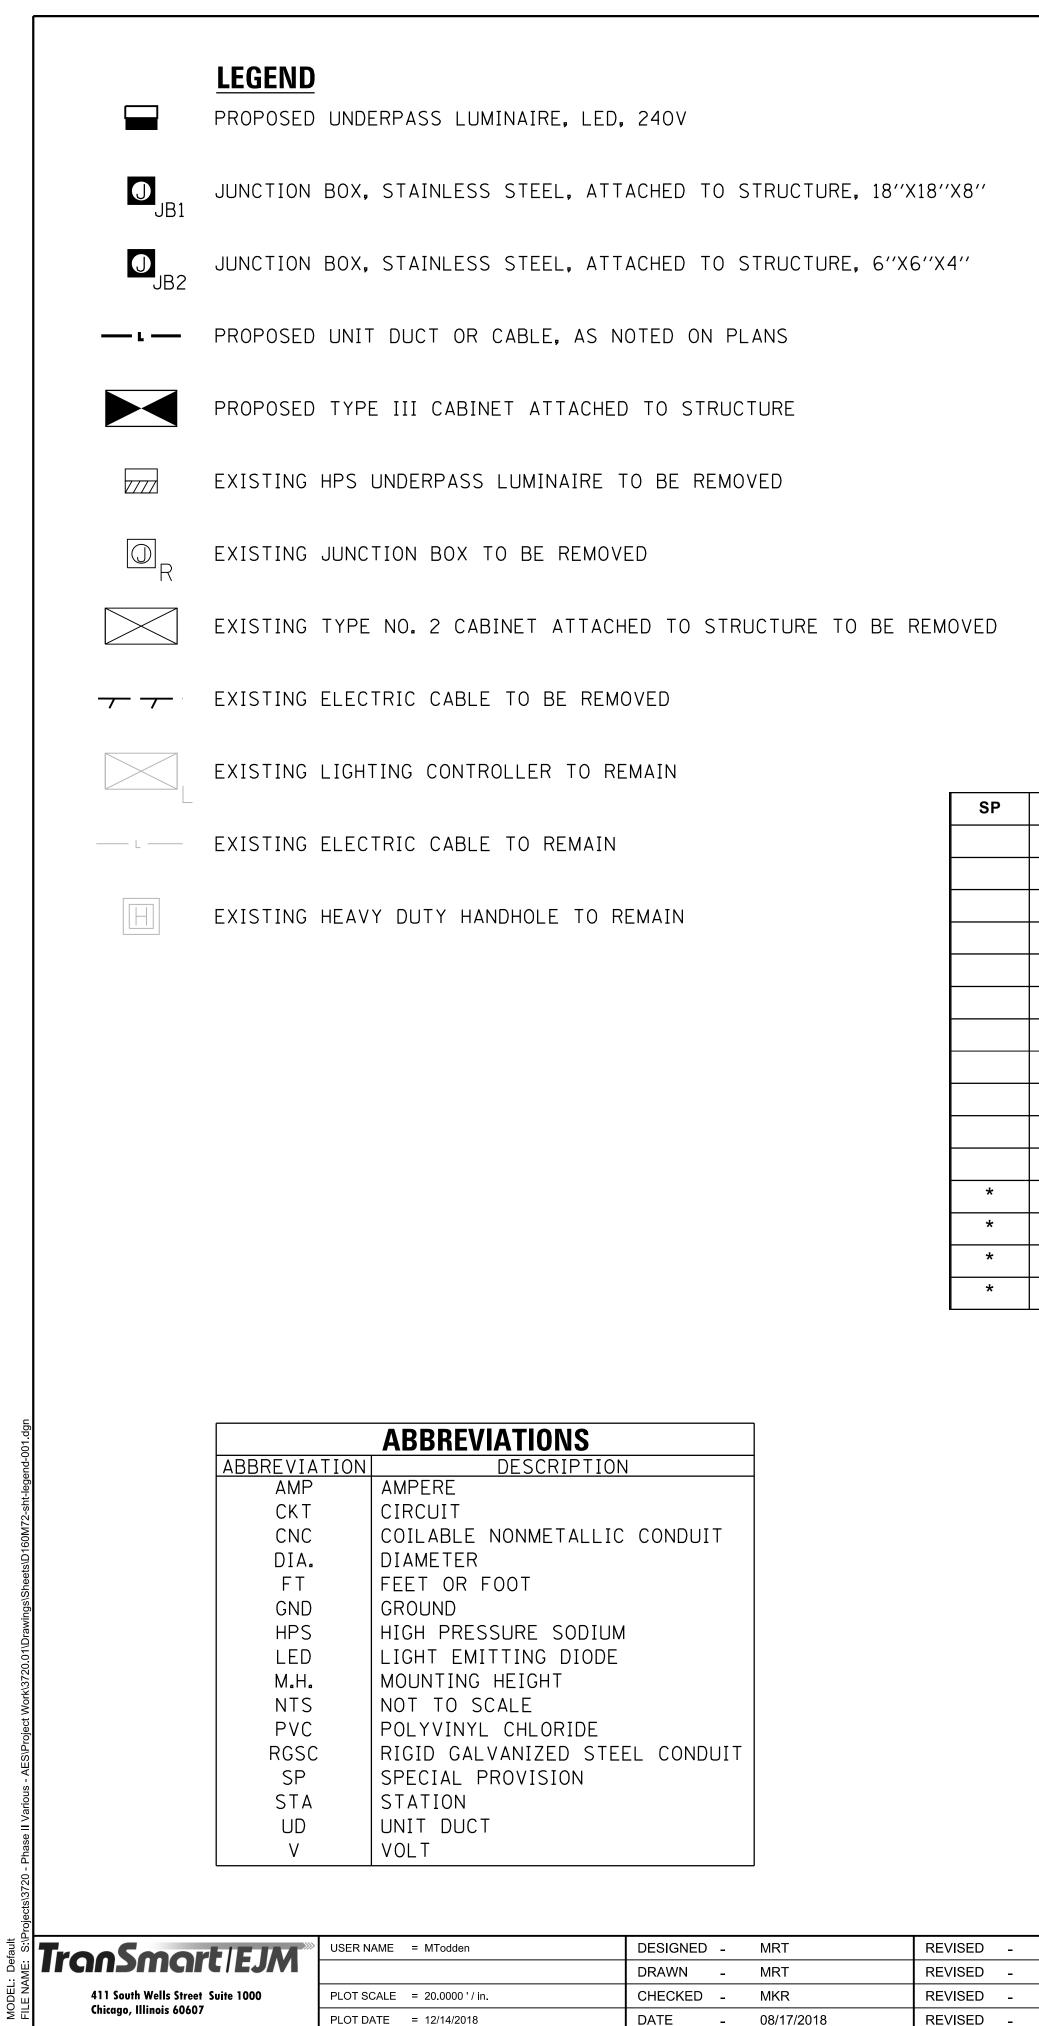

BILL OF MATERIAL

CODE NO.	ITEM	UNIT	QUANTITY
81100220	CONDUIT ATTACHED TO STRUCTURE, 3/4" DIA., PVC COATED GALVANIZED STEEL	FOOT	20
81100320	CONDUIT ATTACHED TO STRUCTURE, 1" DIA., PVC COATED GALVANIZED STEEL	FOOT	330
81100605	CONDUIT ATTACHED TO STRUCTURE, 2" DIA., PVC COATED GALVANIZED STEEL	FOOT	340
81100805	CONDUIT ATTACHED TO STRUCTURE, 3" DIA., PVC COATED GALVANIZED STEEL	FOOT	100
81300220	JUNCTION BOX, STAINLESS STEEL, ATTACHED TO STRUCTURE, 6" X 6" X 4"	EACH	8
81300830	JUNCTION BOX, STAINLESS STEEL, ATTACHED TO STRUCTURE, 18" X 18" X 8"	EACH	4
81702110	ELECTRIC CABLE IN CONDUIT, 600V (XLP-TYPE USE) 1/C NO. 10	FOOT	1,378
81702130	ELECTRIC CABLE IN CONDUIT, 600V (XLP-TYPE USE) 1/C NO. 6	FOOT	1,080
81702140	ELECTRIC CABLE IN CONDUIT, 600V (XLP-TYPE USE) 1/C NO. 4	FOOT	3,420
89500510	CABINET HOUSING EQUIPMENT REMOVAL	EACH	1
89502300	REMOVE ELECTRIC CABLE FROM CONDUIT	FOOT	3,000
X0322446	CABINET HOUSING EQUIPMENT, TYPE III	EACH	1
X1400249	LUMINAIRE, UNDERPASS, LED, TYPE C	EACH	8
X1400342	UNDERPASS LIGHTING REMOVAL	L SUM	1
Z0033028	MAINTENANCE OF LIGHTING SYSTEM	CAL MO	4

STATE OF ILLINOIS DEPARTMENT OF TRANSPORTATION	BRIDGI GENE					•
	SCALE: 1" = 20'	SHEET	1	OF	11	SHEETS

GENERAL NOTES:


1. LIGHTING WORK SHALL BE PERFORMED IN ACCORDANCE WITH THE LATEST IDOT STANDARD SPECIFICATIONS FOR ROAD AND BRIDGE CONSTRUCTION.

2. ELECTRIC CABLES IN EXISTING UNIT DUCT OR CONDUIT TO BE ABANDONED SHALL BE REMOVED AND PAID FOR AS "REMOVE ELECTRIC CABLE FROM CONDUIT'' (89502300), UNLESS OTHERWISE NOTED.


3. ALL CONDUITS AND APPURTENANCES ARE ILLUSTRATED DIAGRAMMATICALLY ON THE PLANS. THE ACTUAL LOCATIONS IN THE FIELD SHALL MEET THE APPROVAL OF THE ENGINEER.


4. THE CONTRACTOR SHALL FIELD VERIFY LOCATION OF EXISTING UNDERGROUND FACILITIES PRIOR TO COMMENCEMENT OF ANY CONSTRUCTION ACTIVITIES.

DUNDEE RD) OVER I-94			F.A.I	850			COUNTY	TOTAL	SHEET
		RTE.	RTE. SECTION				SHEETS	NO.	
. & BILL OF MATERIAL			94	94 1314.1-I			COOK	70	27
,			CONTRACT NO. 60M7			Л72			
тs	STA.	TO STA.			ILLINOIS	FED. All	D PROJECT		

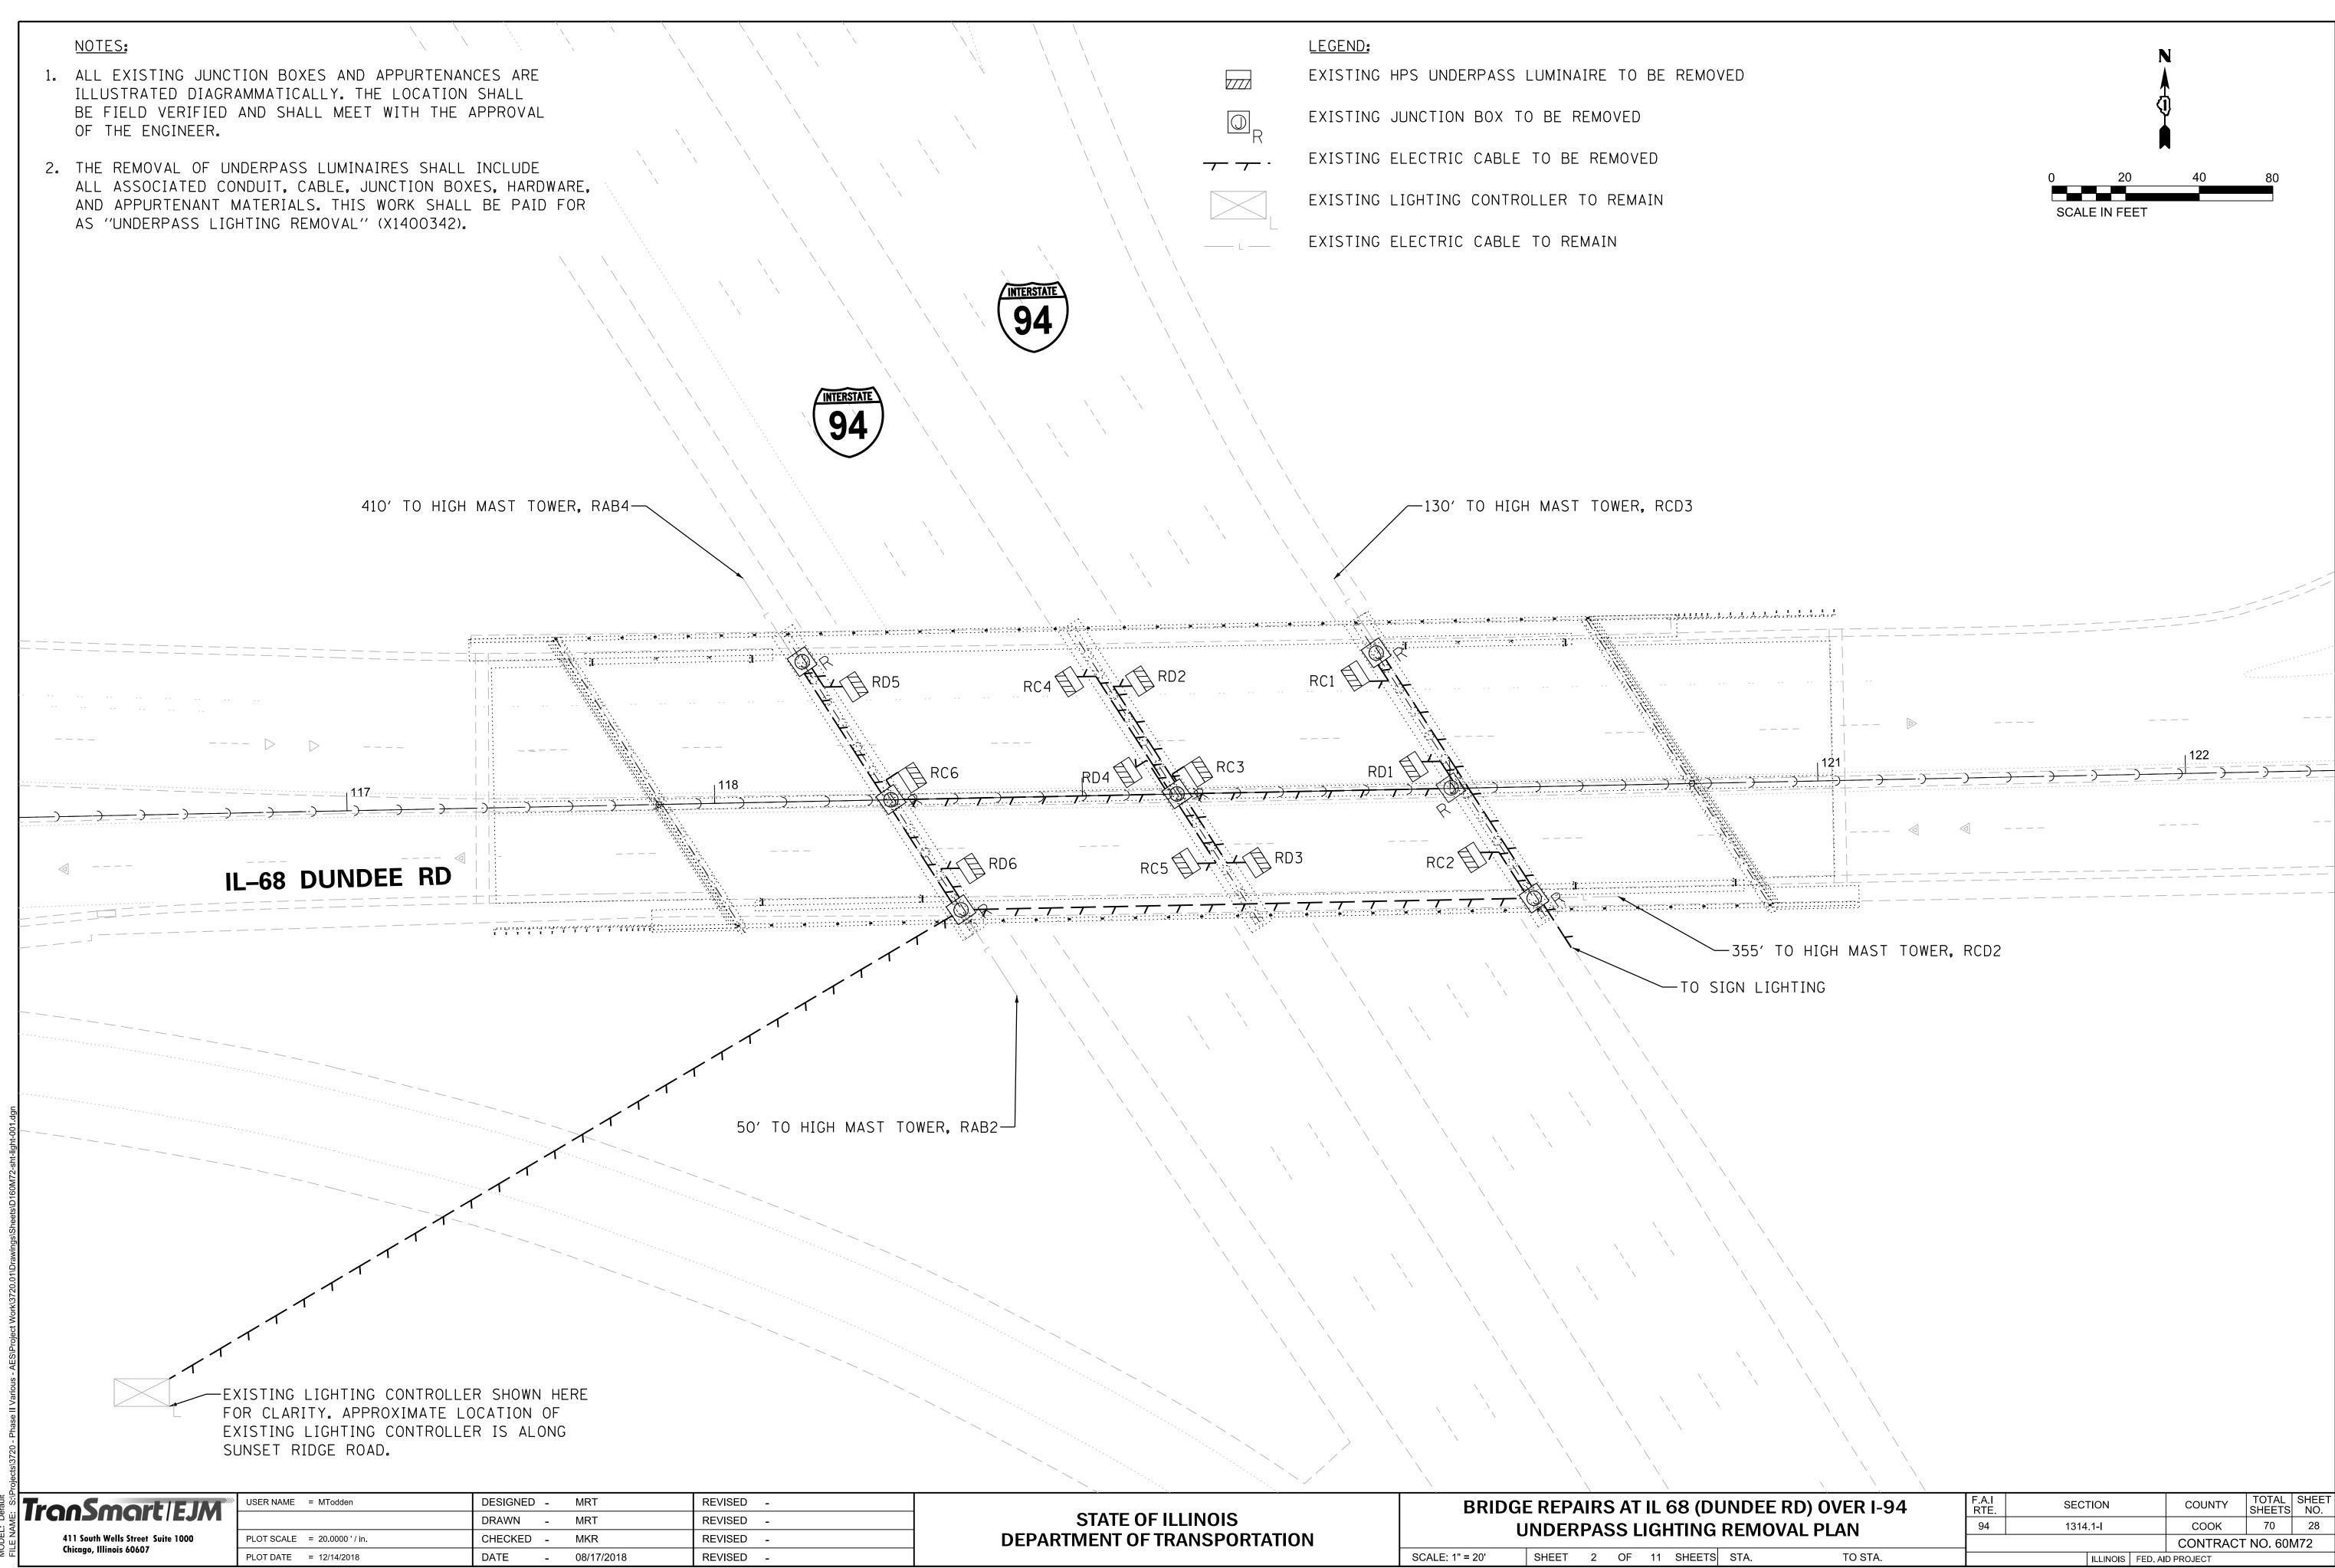



NOTES: 1. ALL EXISTING BOXES AND APPURTENANCES ARE ILLUSTRATED DIAGRAMMATICALLY. THE LOCATION SHALL BE FIELD VERIFIED AND SHALL MEET WITH THE APPROVAL OF THE ENGINEER. 2. DETACH EXISTING CONDUIT SLEEVES AND UNIT DUCTS FROM EXISTING TYPE NO. 2 CABINET. PRESERVE UNIT DUCTS FOR REINSTALLATION IN NEW CONDUIT SLEEVES (SEE ITS DETAILS ON SHEET 8). _ _ _ -_ _ _ _ _ _ _ _ _ _ _ _ _ IL-68 DUNDEE RD ____ -EXISTING LIGHTING CONTROLLER SHOWN HERE FOR CLARITY. APPROXIMATE LOCATION OF EXISTING LIGHTING CONTROLLER IS ALONG SUNSET RIDGE ROAD. USER NAME = MTodden DESIGNED -MRT REVISED -TranSmart/EJM REVISED DRAWN MRT -REVISED -CHECKED -MKR 411 South Wells Street Suite 1000 PLOT SCALE = 20.0000' / in. Chicago, Illinois 60607 DATE - 08/17/2018 REVISED -PLOT DATE = 12/16/2018

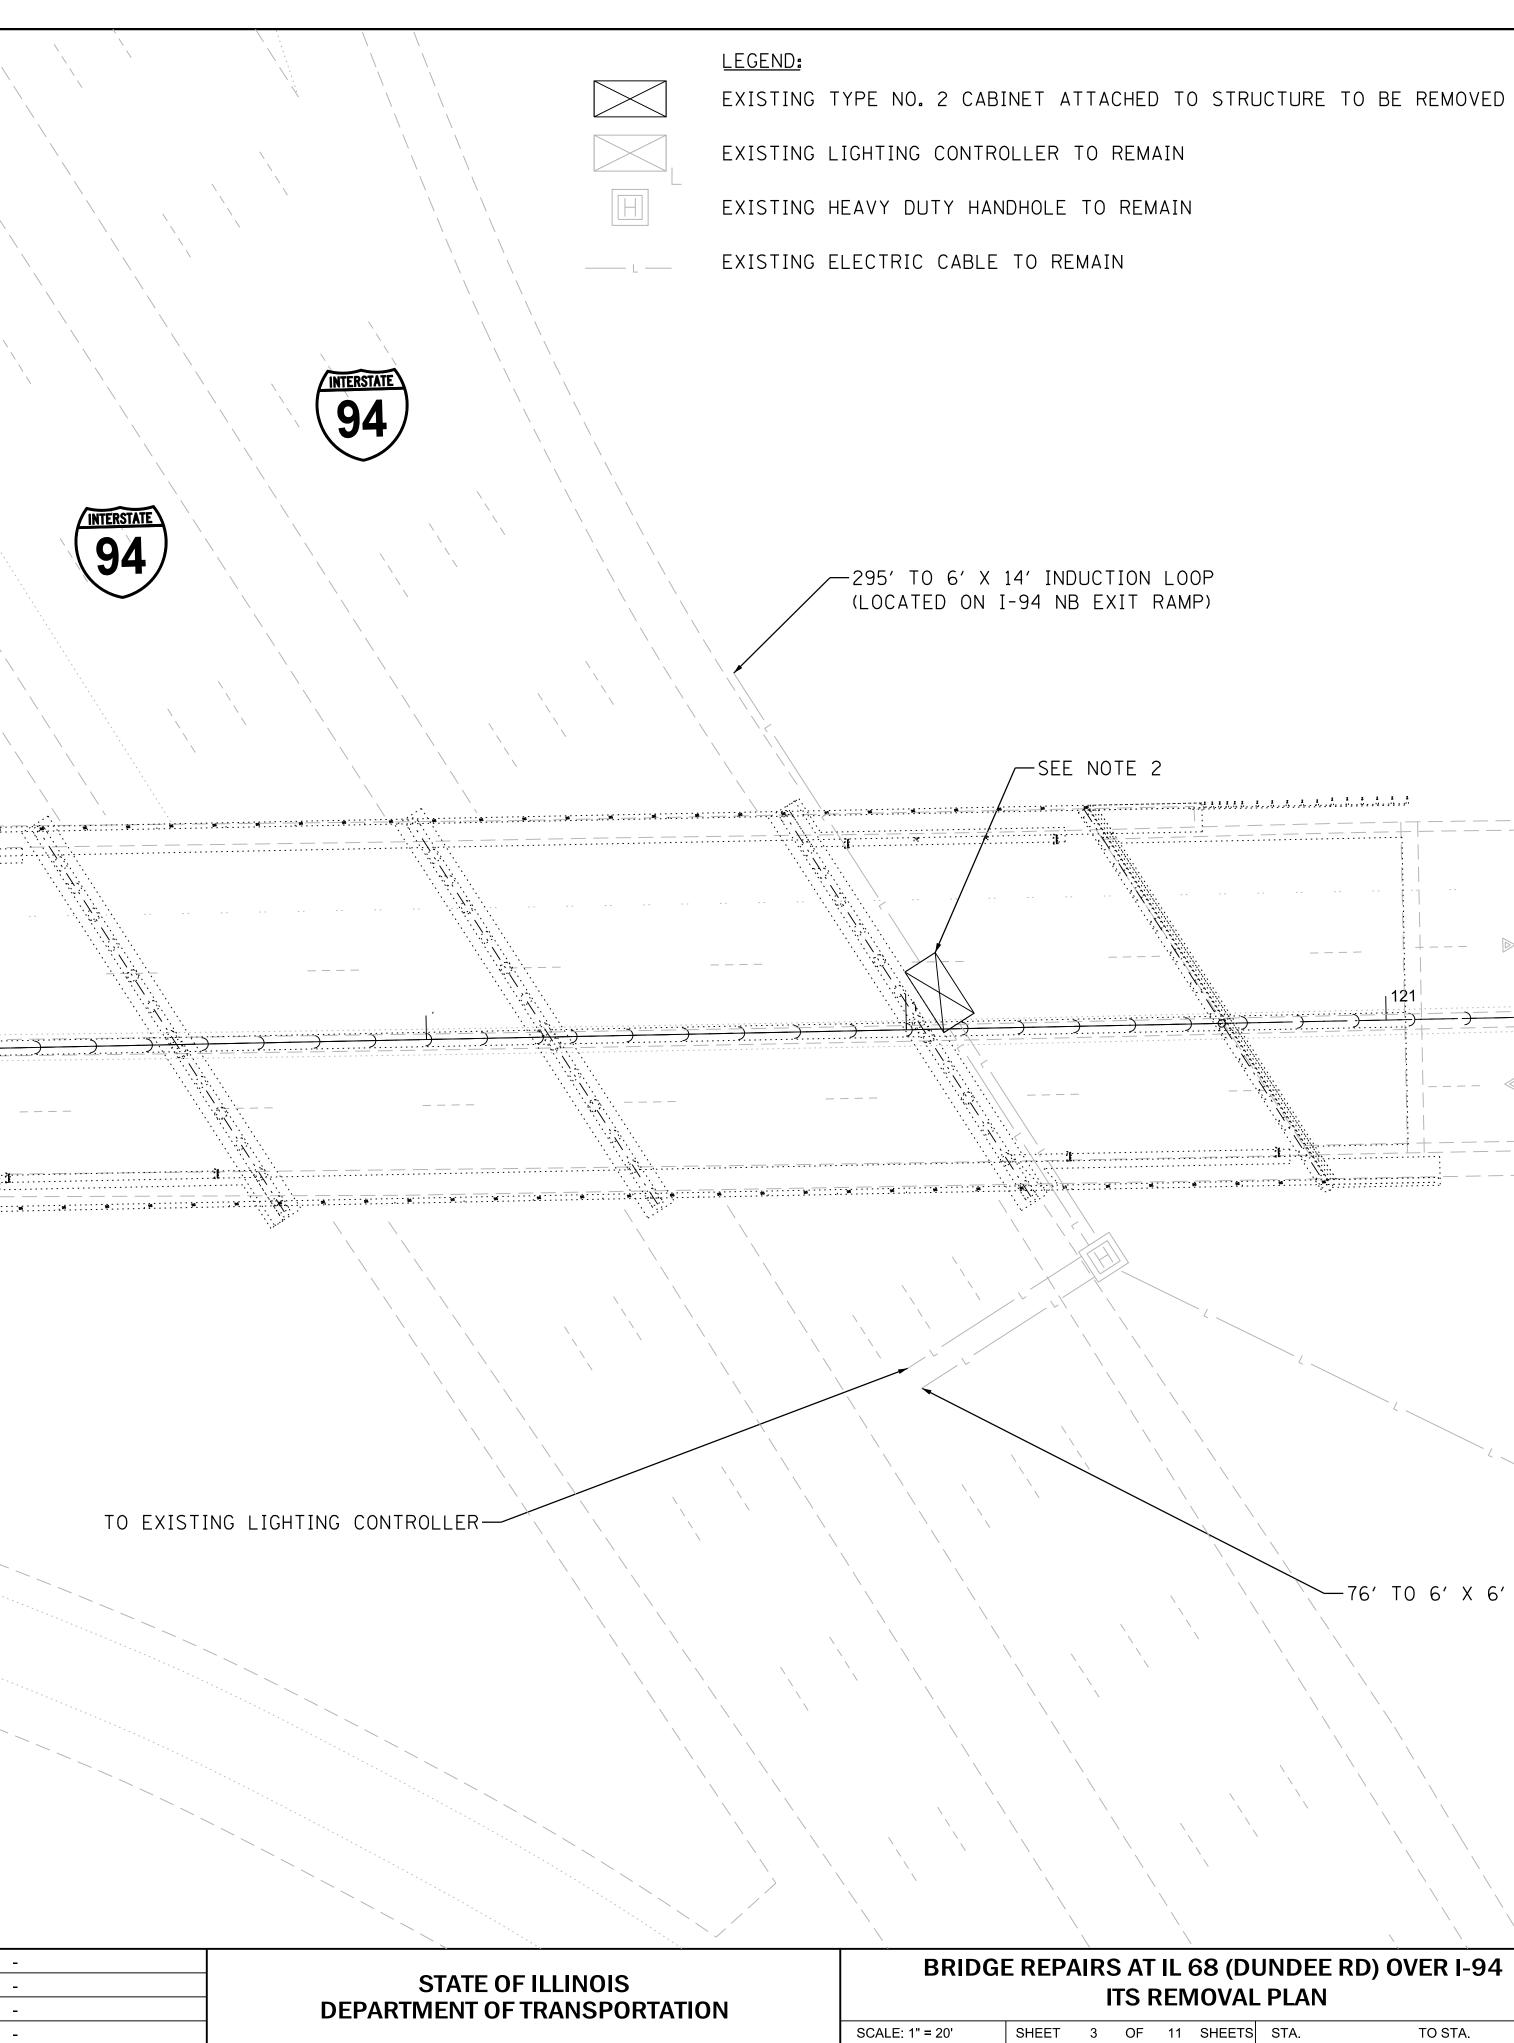


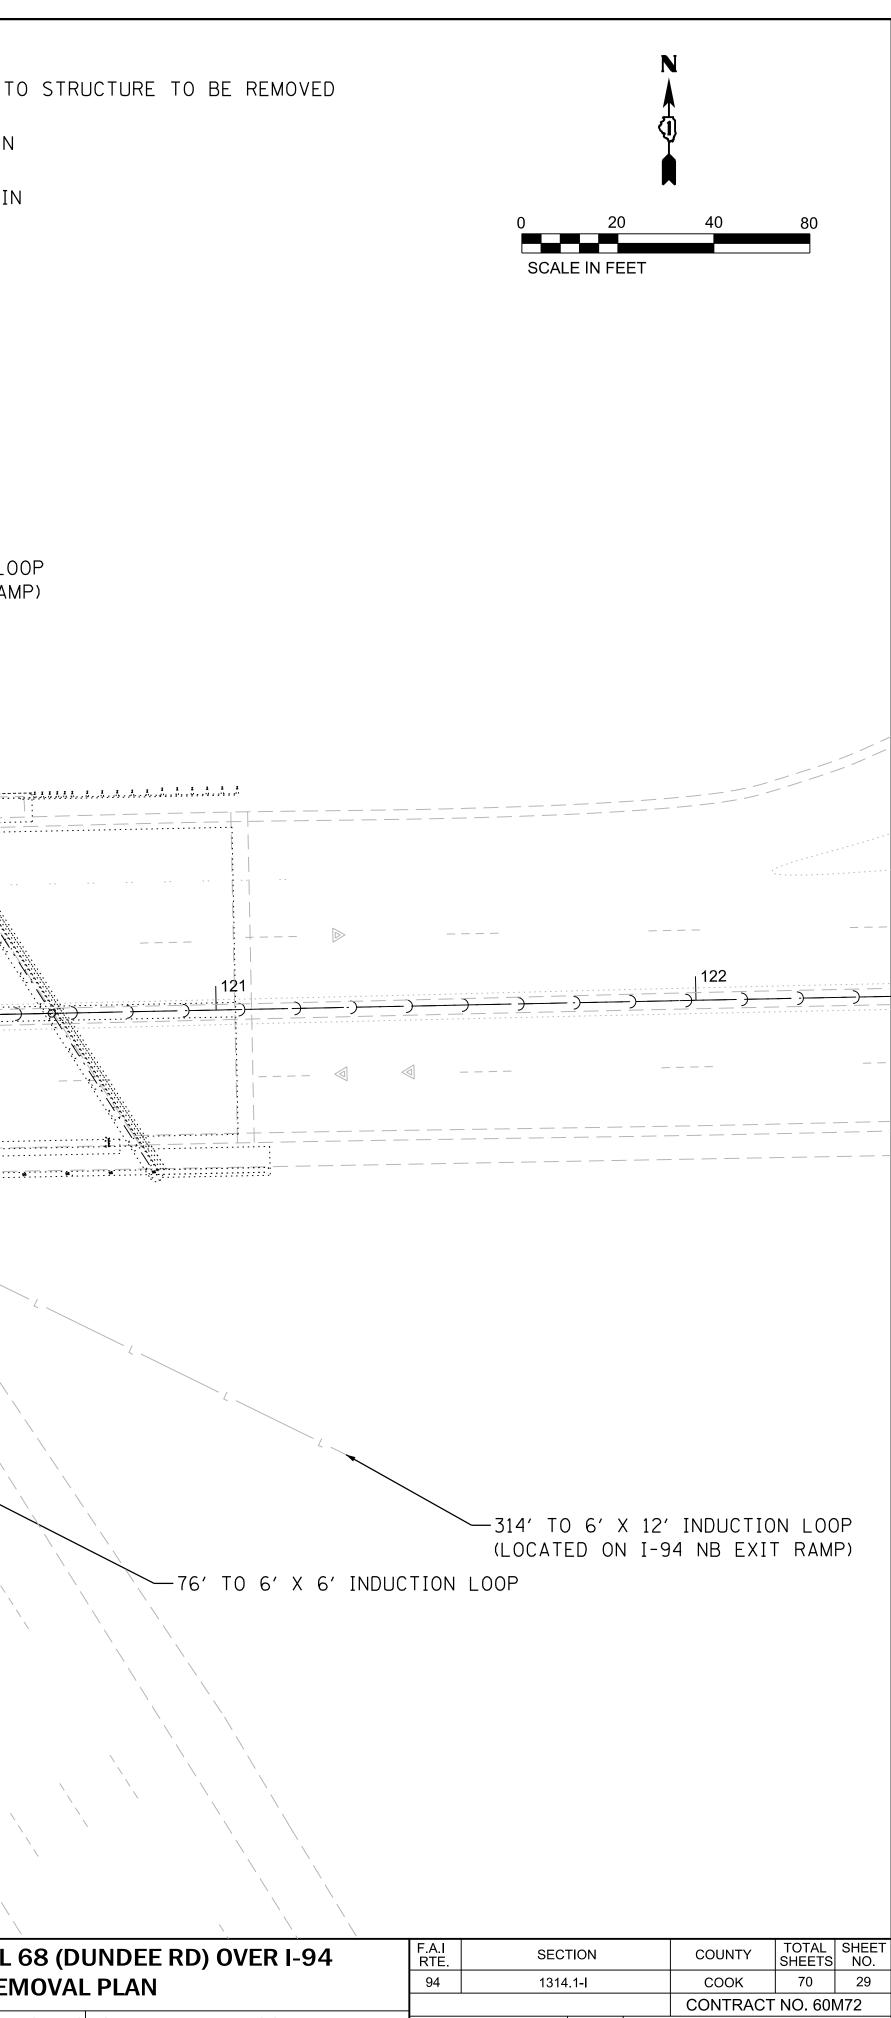


TO STA. ILLINOIS FED. AID PROJECT

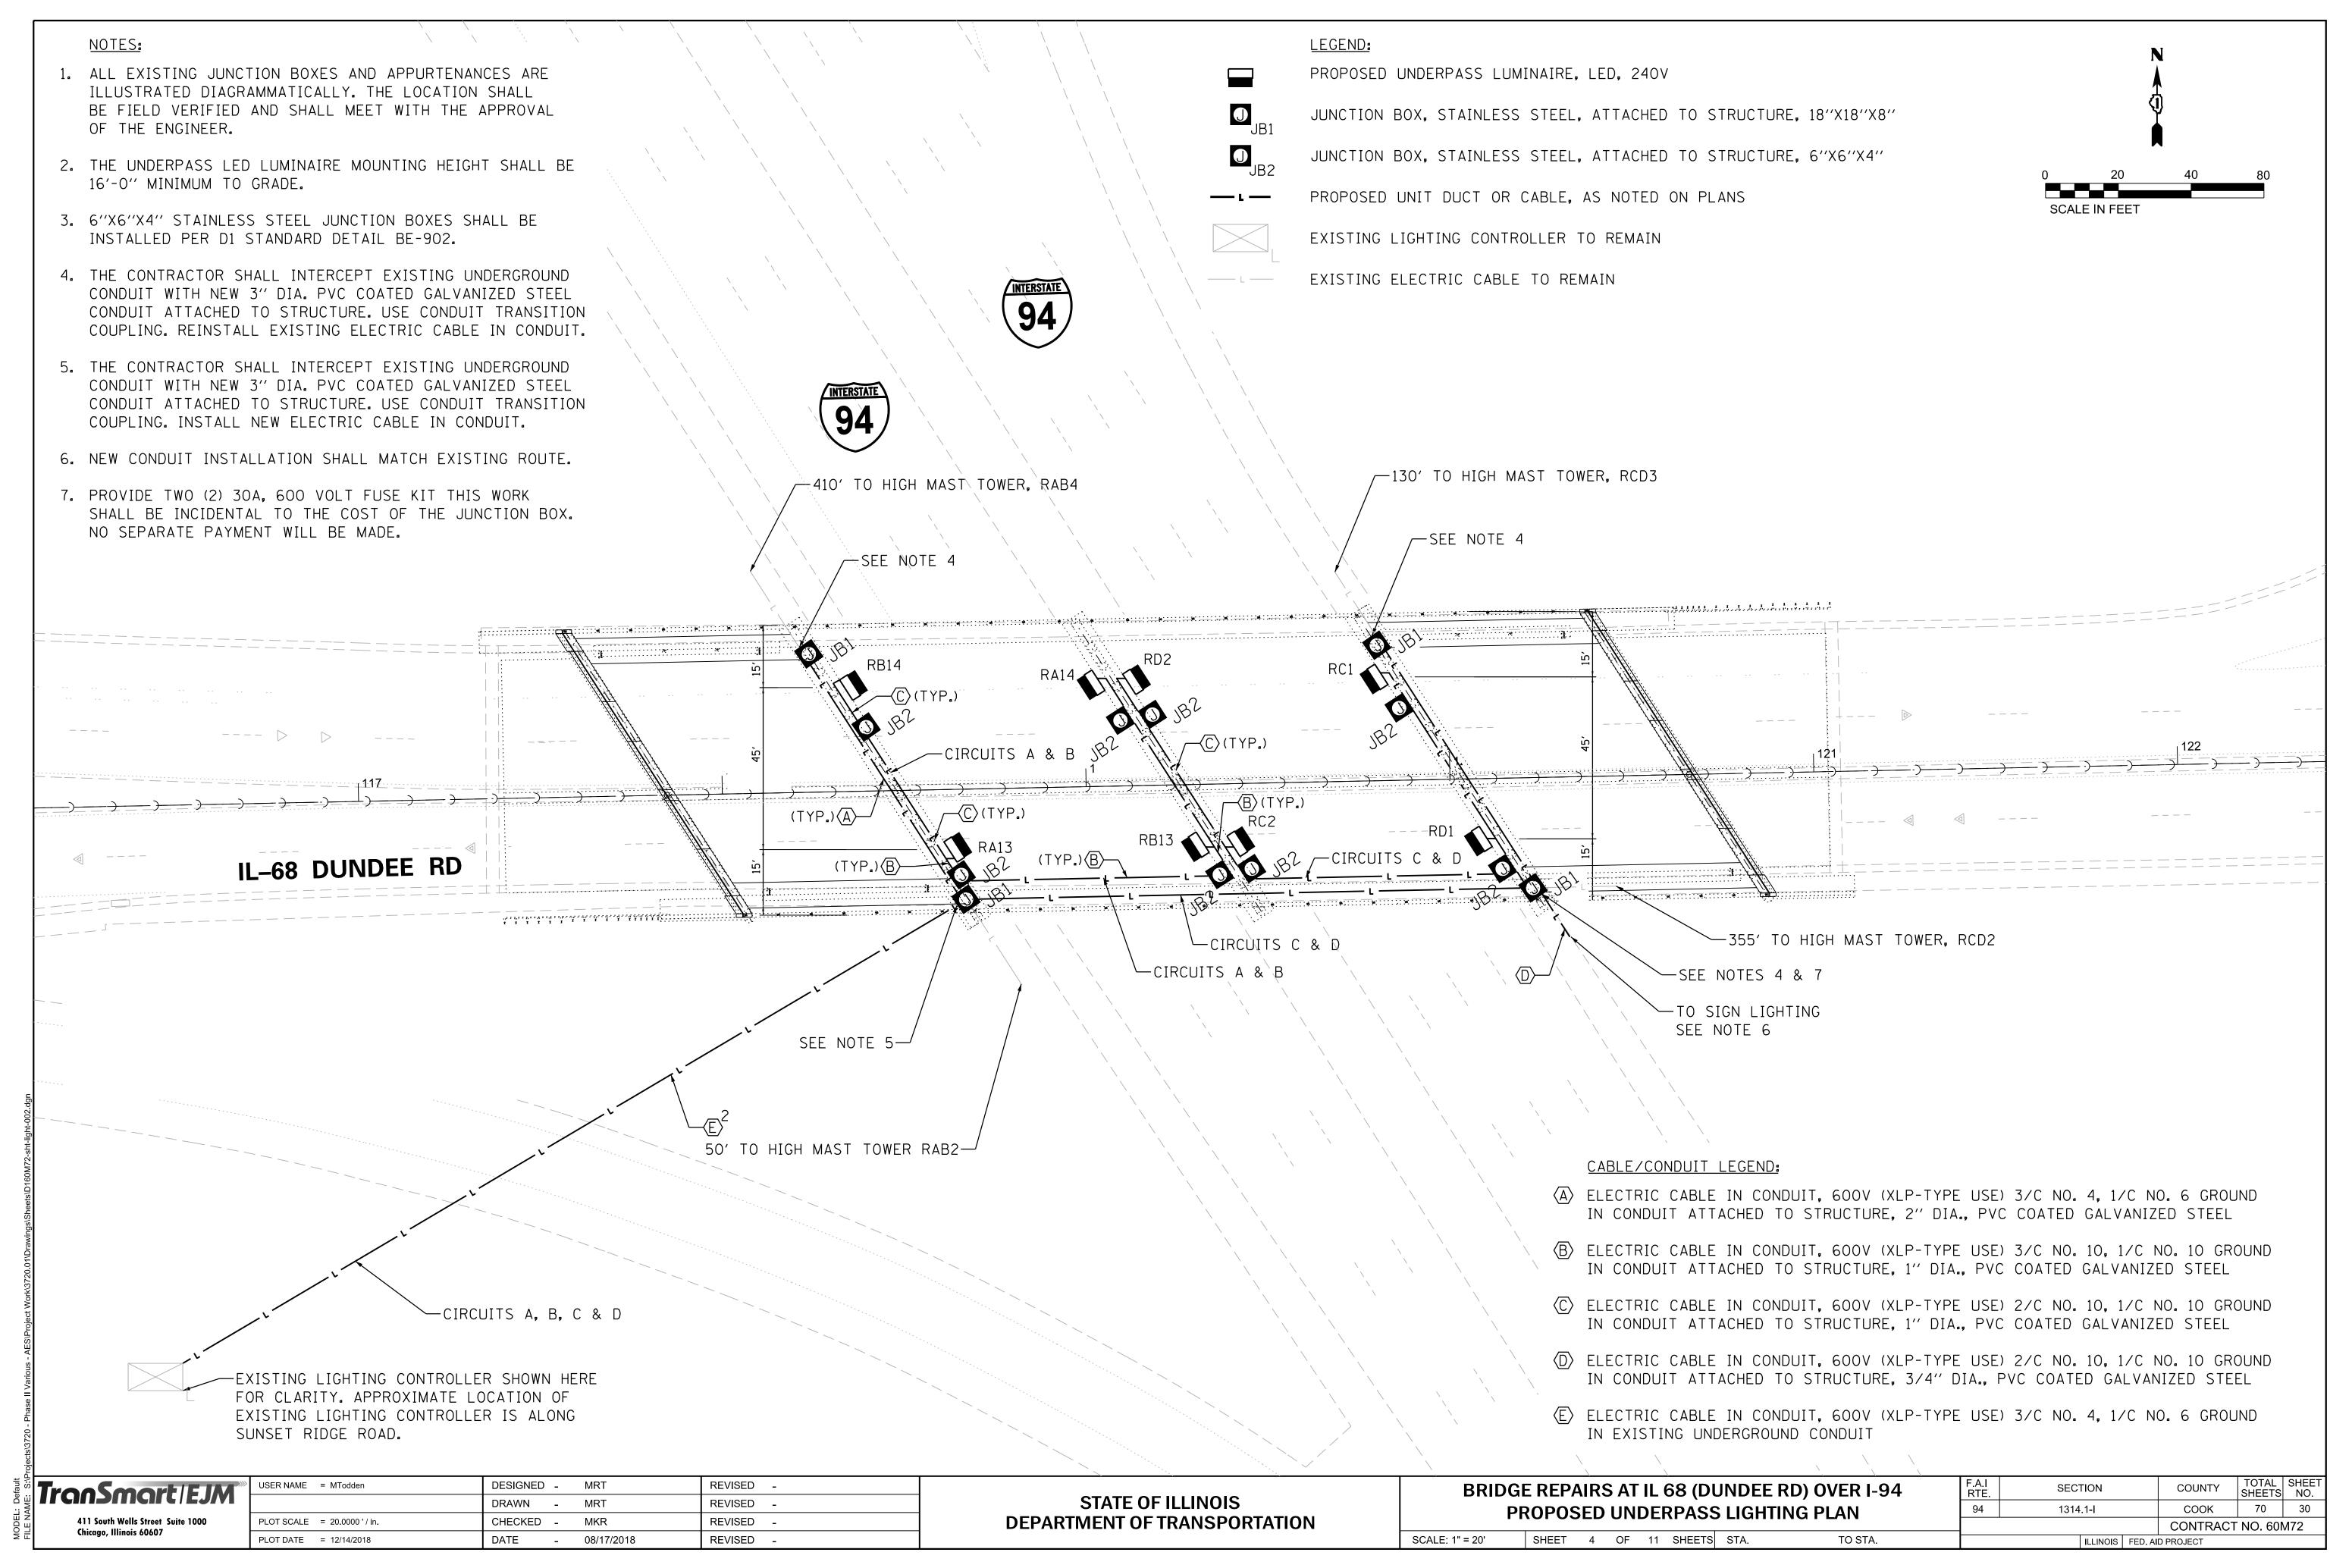

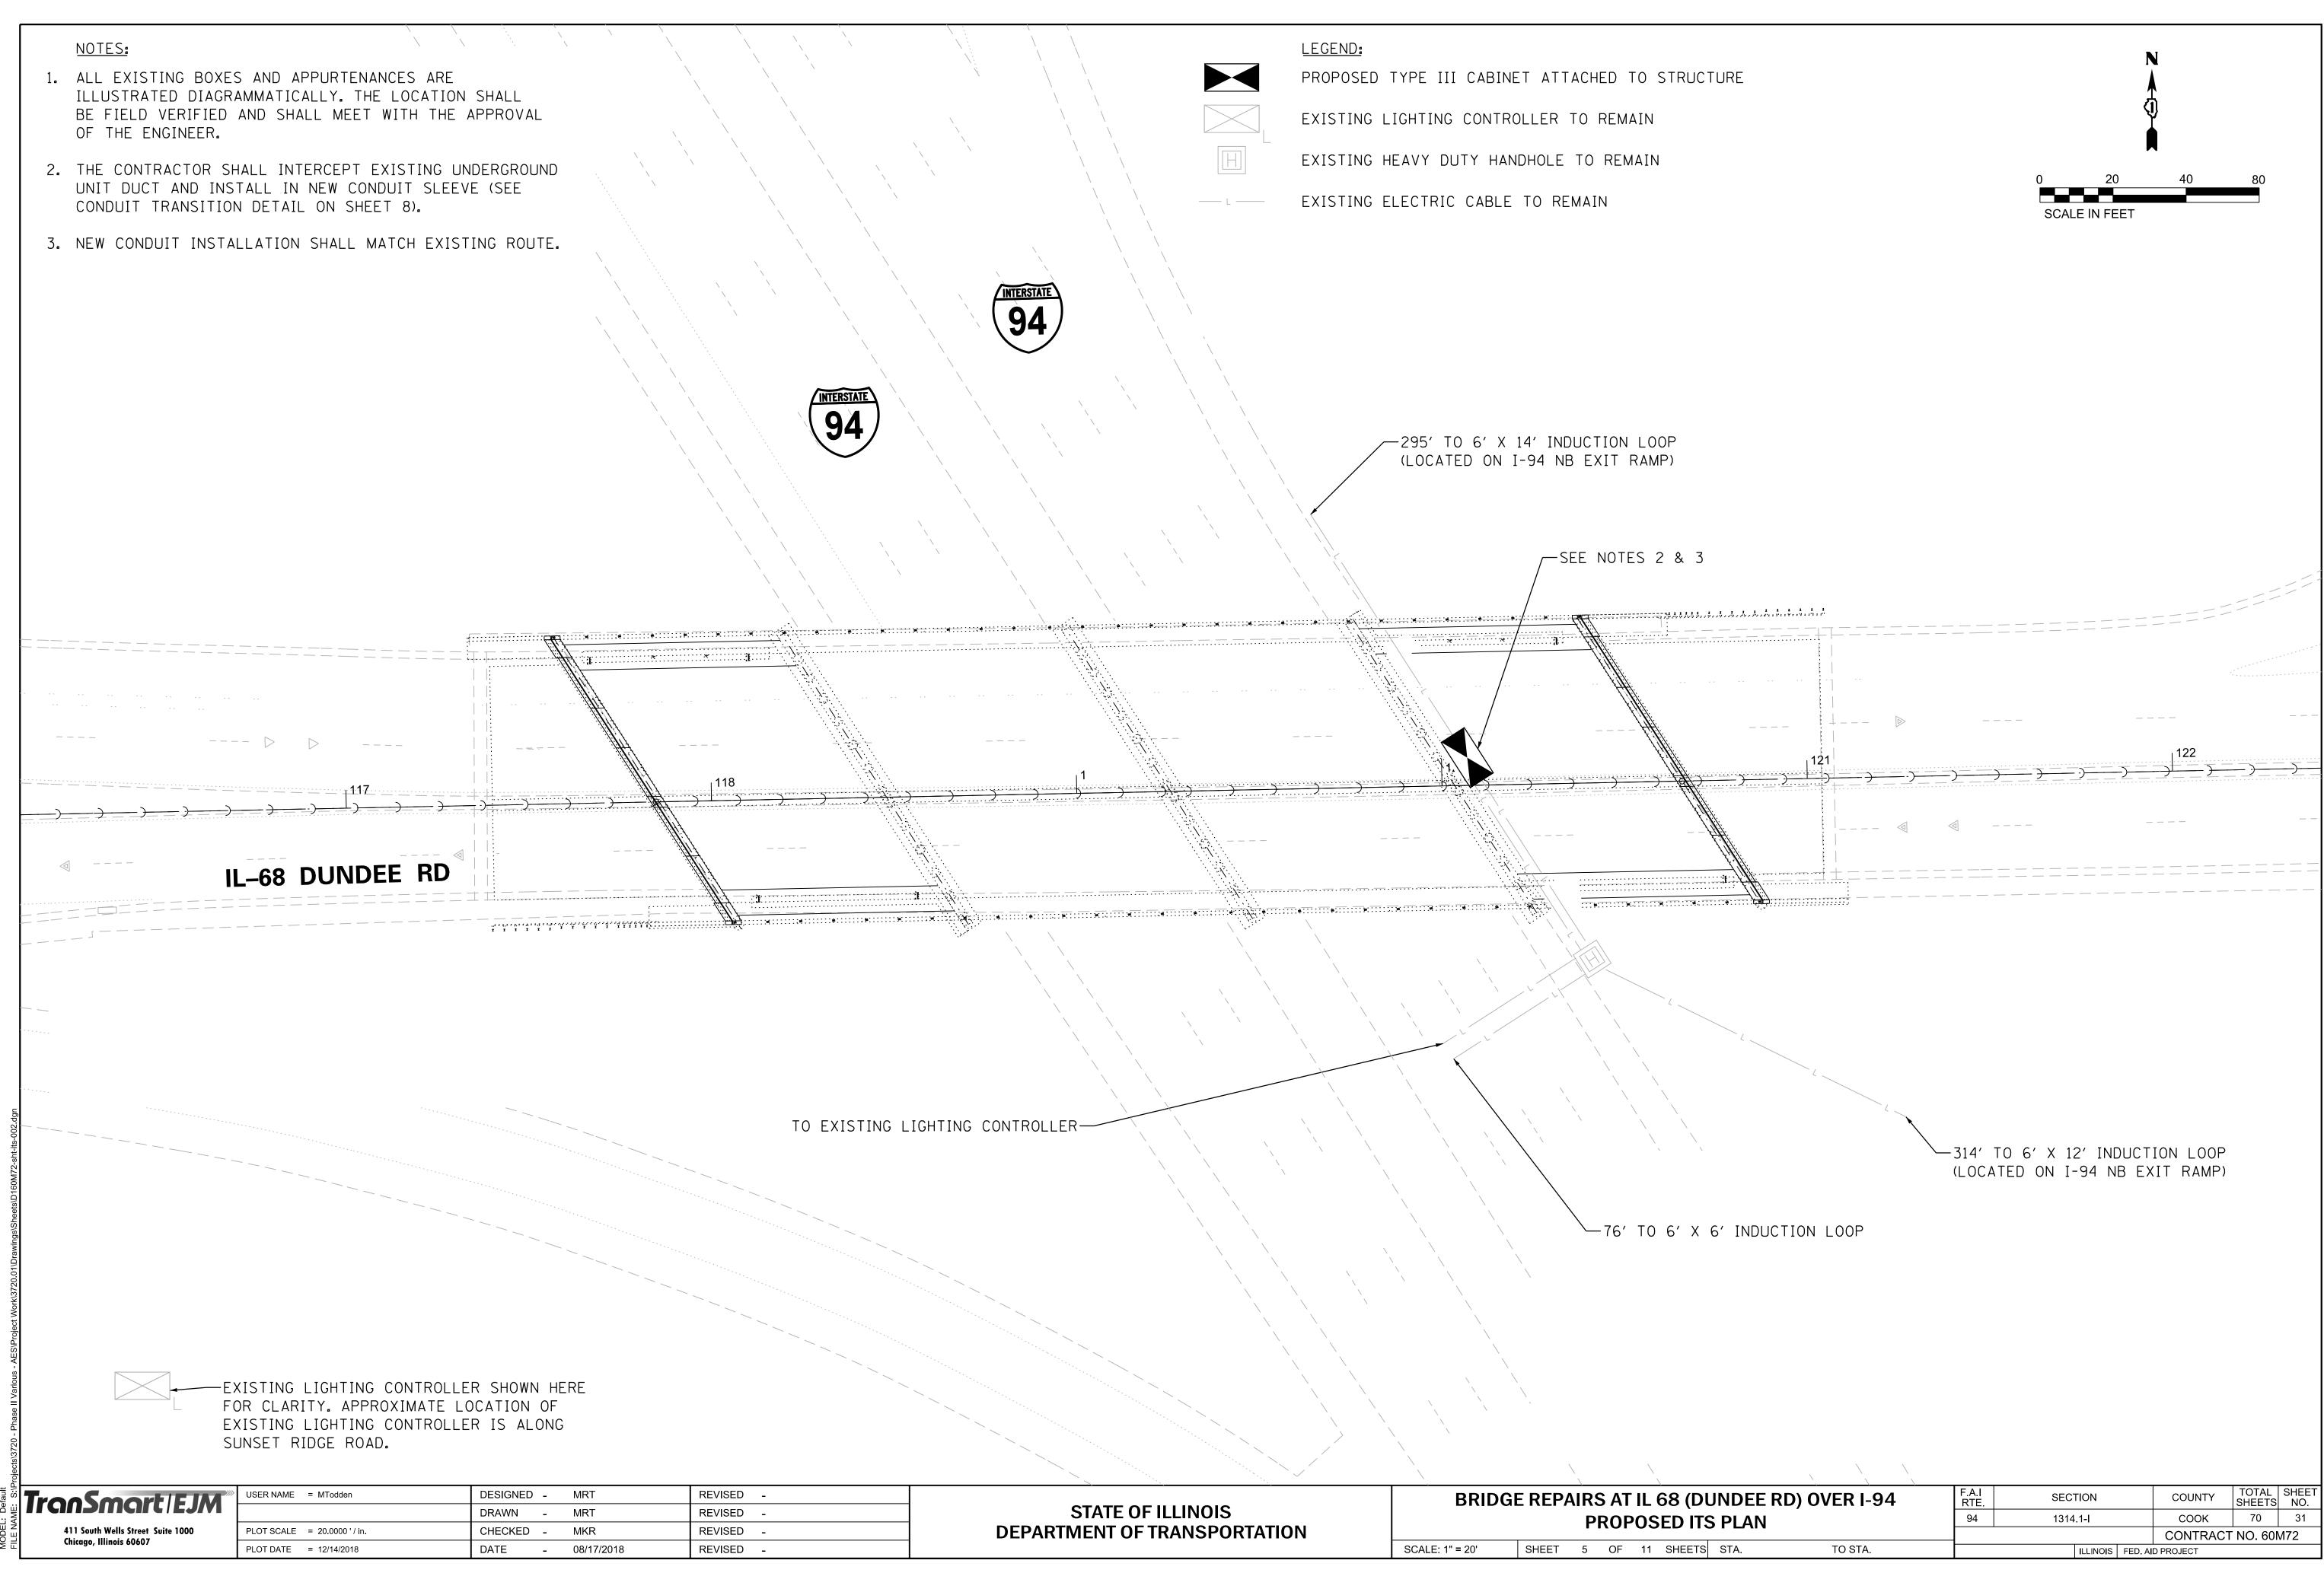

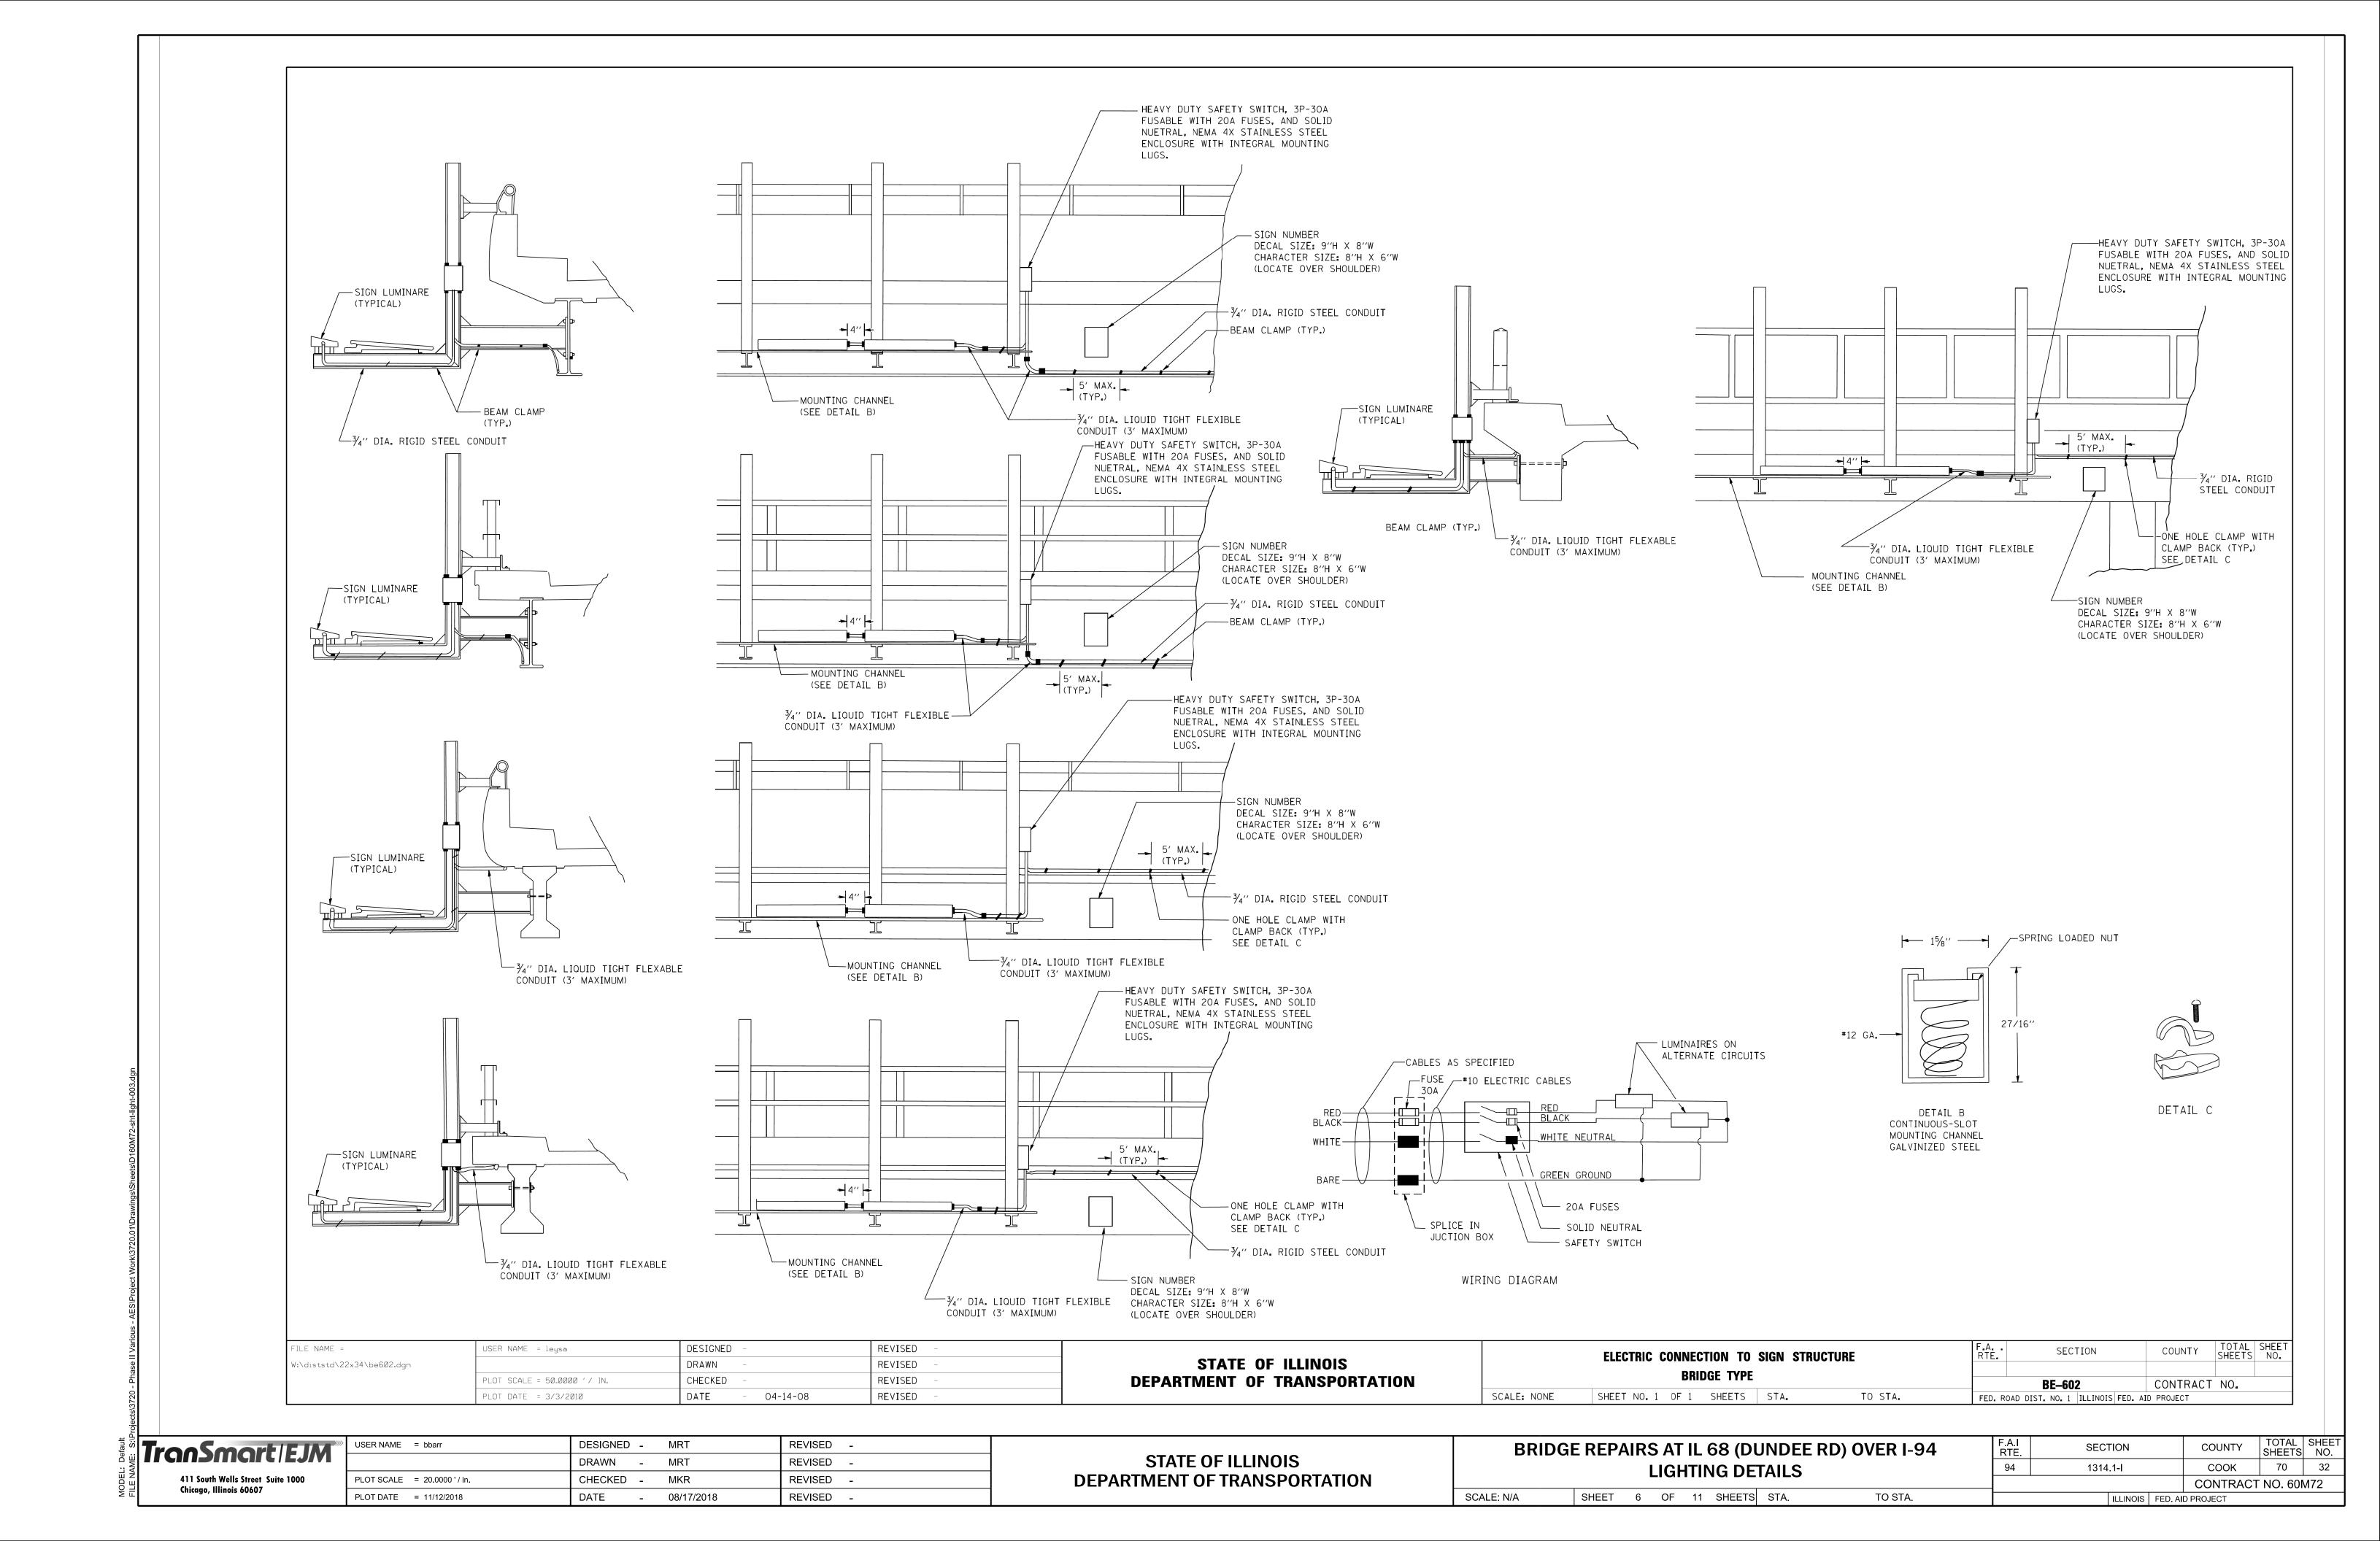

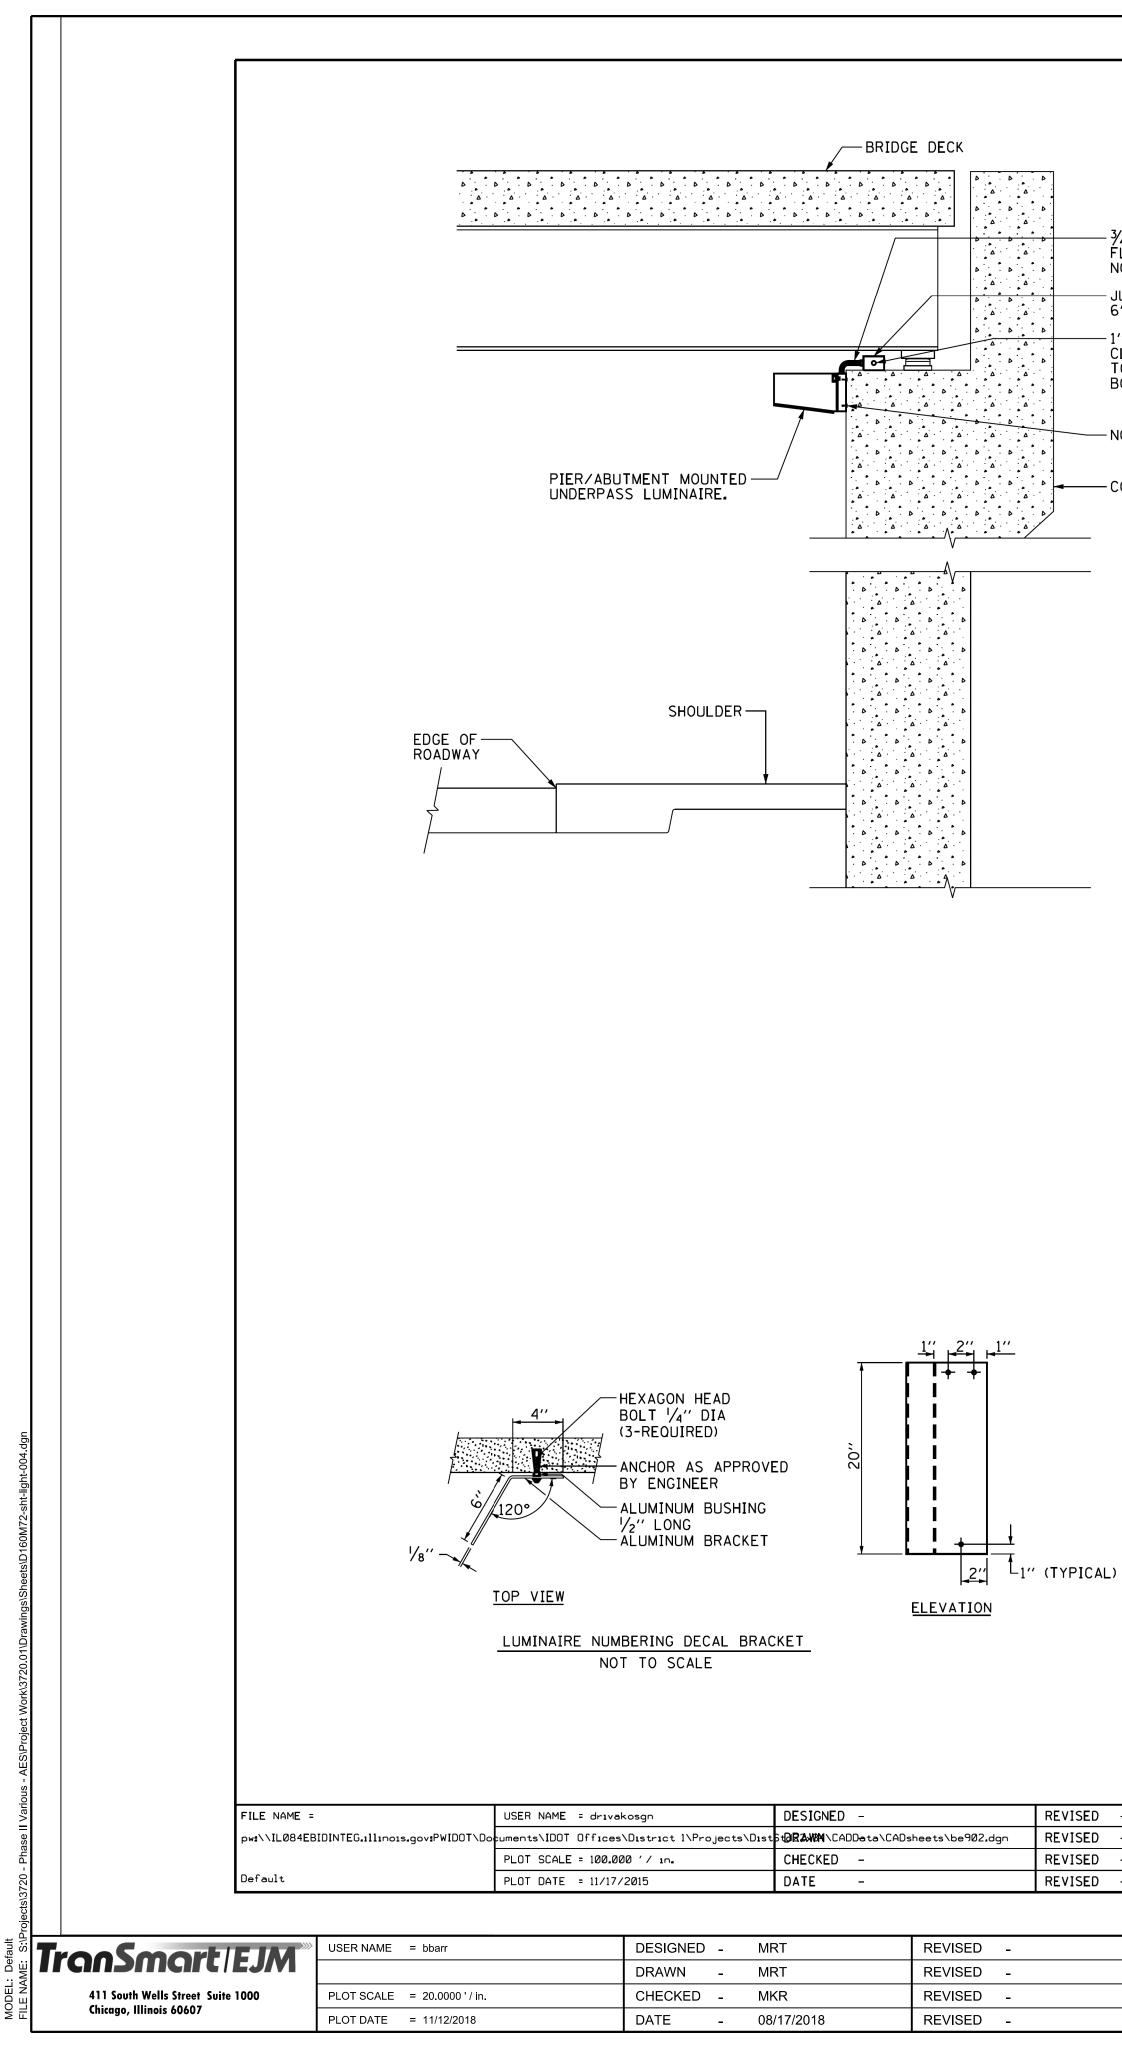

	BRIDG		S AT I	L 68 (D	UNDEEI	RD) OVER I-94	F.A.I RTE	SECTION	COUNTY	TOTAL SHEETS	SHEET NO.
 STATE OF ILLINOIS	LIGHTING DETAILS			94	1314.1-I	СООК	70	33			
DEPARTMENT OF TRANSPORTATION						CONTRAC	T NO. 60N	Л 72			
	SCALE: N/A SHEET 7 OF 11 SHEETS STA. TO STA. ILLINOIS FED. AID PROJECT										


REVISED - 01-25-05			PIER /ABU	ITME	лт і	NOI
REVISED -	STATE OF ILLINOIS					
REVISED -	DEPARTMENT OF TRANSPORTATION		LUMIN	IAKE	11/2	IAL
REVISED -		SCALE: NONE	SHEET 1	0F 1	L	SHE


PVC COATED CONDUIT BEAM CLAMP NOT TO SCALE

PVC COATED CONDUIT CLAMP NOT TO SCALE

└─ CONCRETE ABUTMENT ──

SHOULDER -

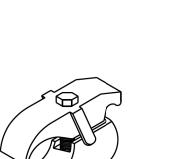

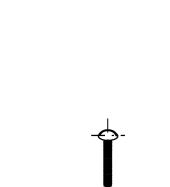



TYPICAL PIER / ABUTMENT MOUNTED UNDERPASS LIGHTING INSTALLATION DETAILS

CNC TO RGC ADAPTER-3" PVC ENCASED CONCRETE, SEE NOTE 5 24" RADIUS ELBOW (TYPICAL)


- JUNCTION BOX, SS, 6" × 6" × 4" (TYPICAL) BRIDGE DECK — · • Δ. · • · Δ· Δ ۵ ۵ ۵ ¾" DIA LIQUID TIGHT FLEXIBLE CONDUIT. NOTE 1 (TYPICAL) JUNCTION BOX, SS, 6" x 6" x 4" -1" DIA PVCC RGC CLAMPED TO STRUCTURE ≡∎ TO ADJACENT JUNCTION BOX -NOTE 3 (TYPICAL) --- PIER/ABUTMENT MOUNTED -1" DIA PVCC RGC MOUNTED ON TOP OF ABUTMENT WALL UNDERPASS LUMINAIRE. CLAMPED TO STRUCTURE - CONCRETE ABUTMENT (TYPICAL) -LUMINAIRE NUMBERING └── PVC COATED CONDUIT CLAMP, DECAL BRACKET. SEE NOTE 4 (TYPICAL)

DIRECTION OF TRAFFIC

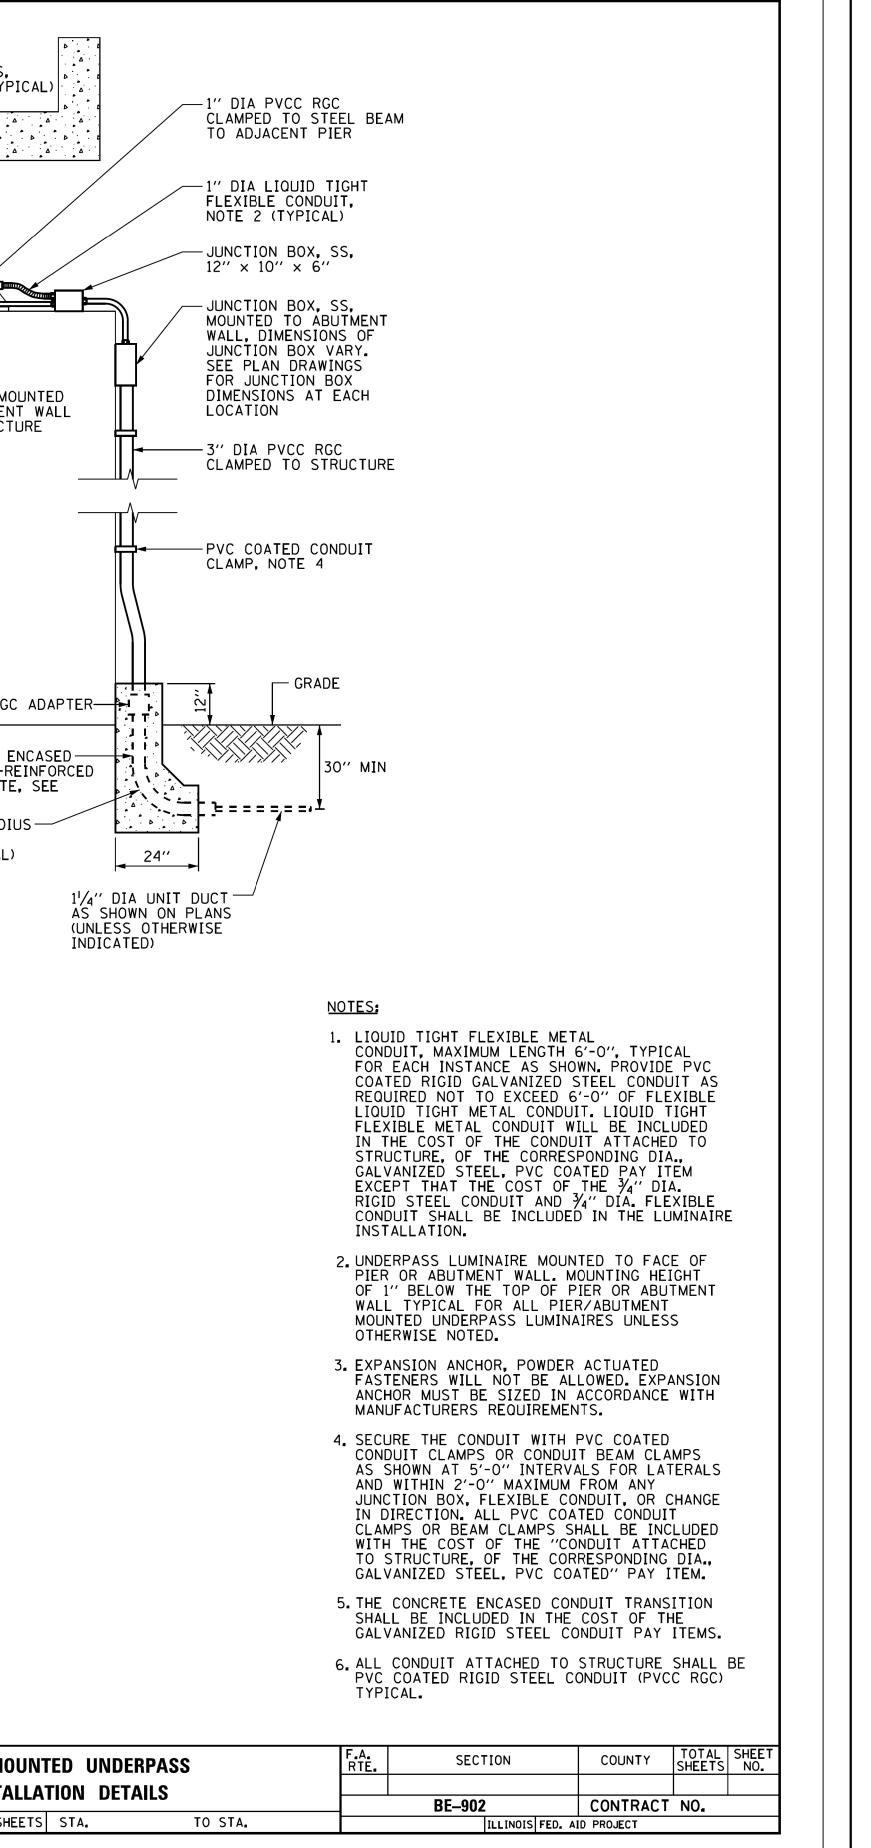

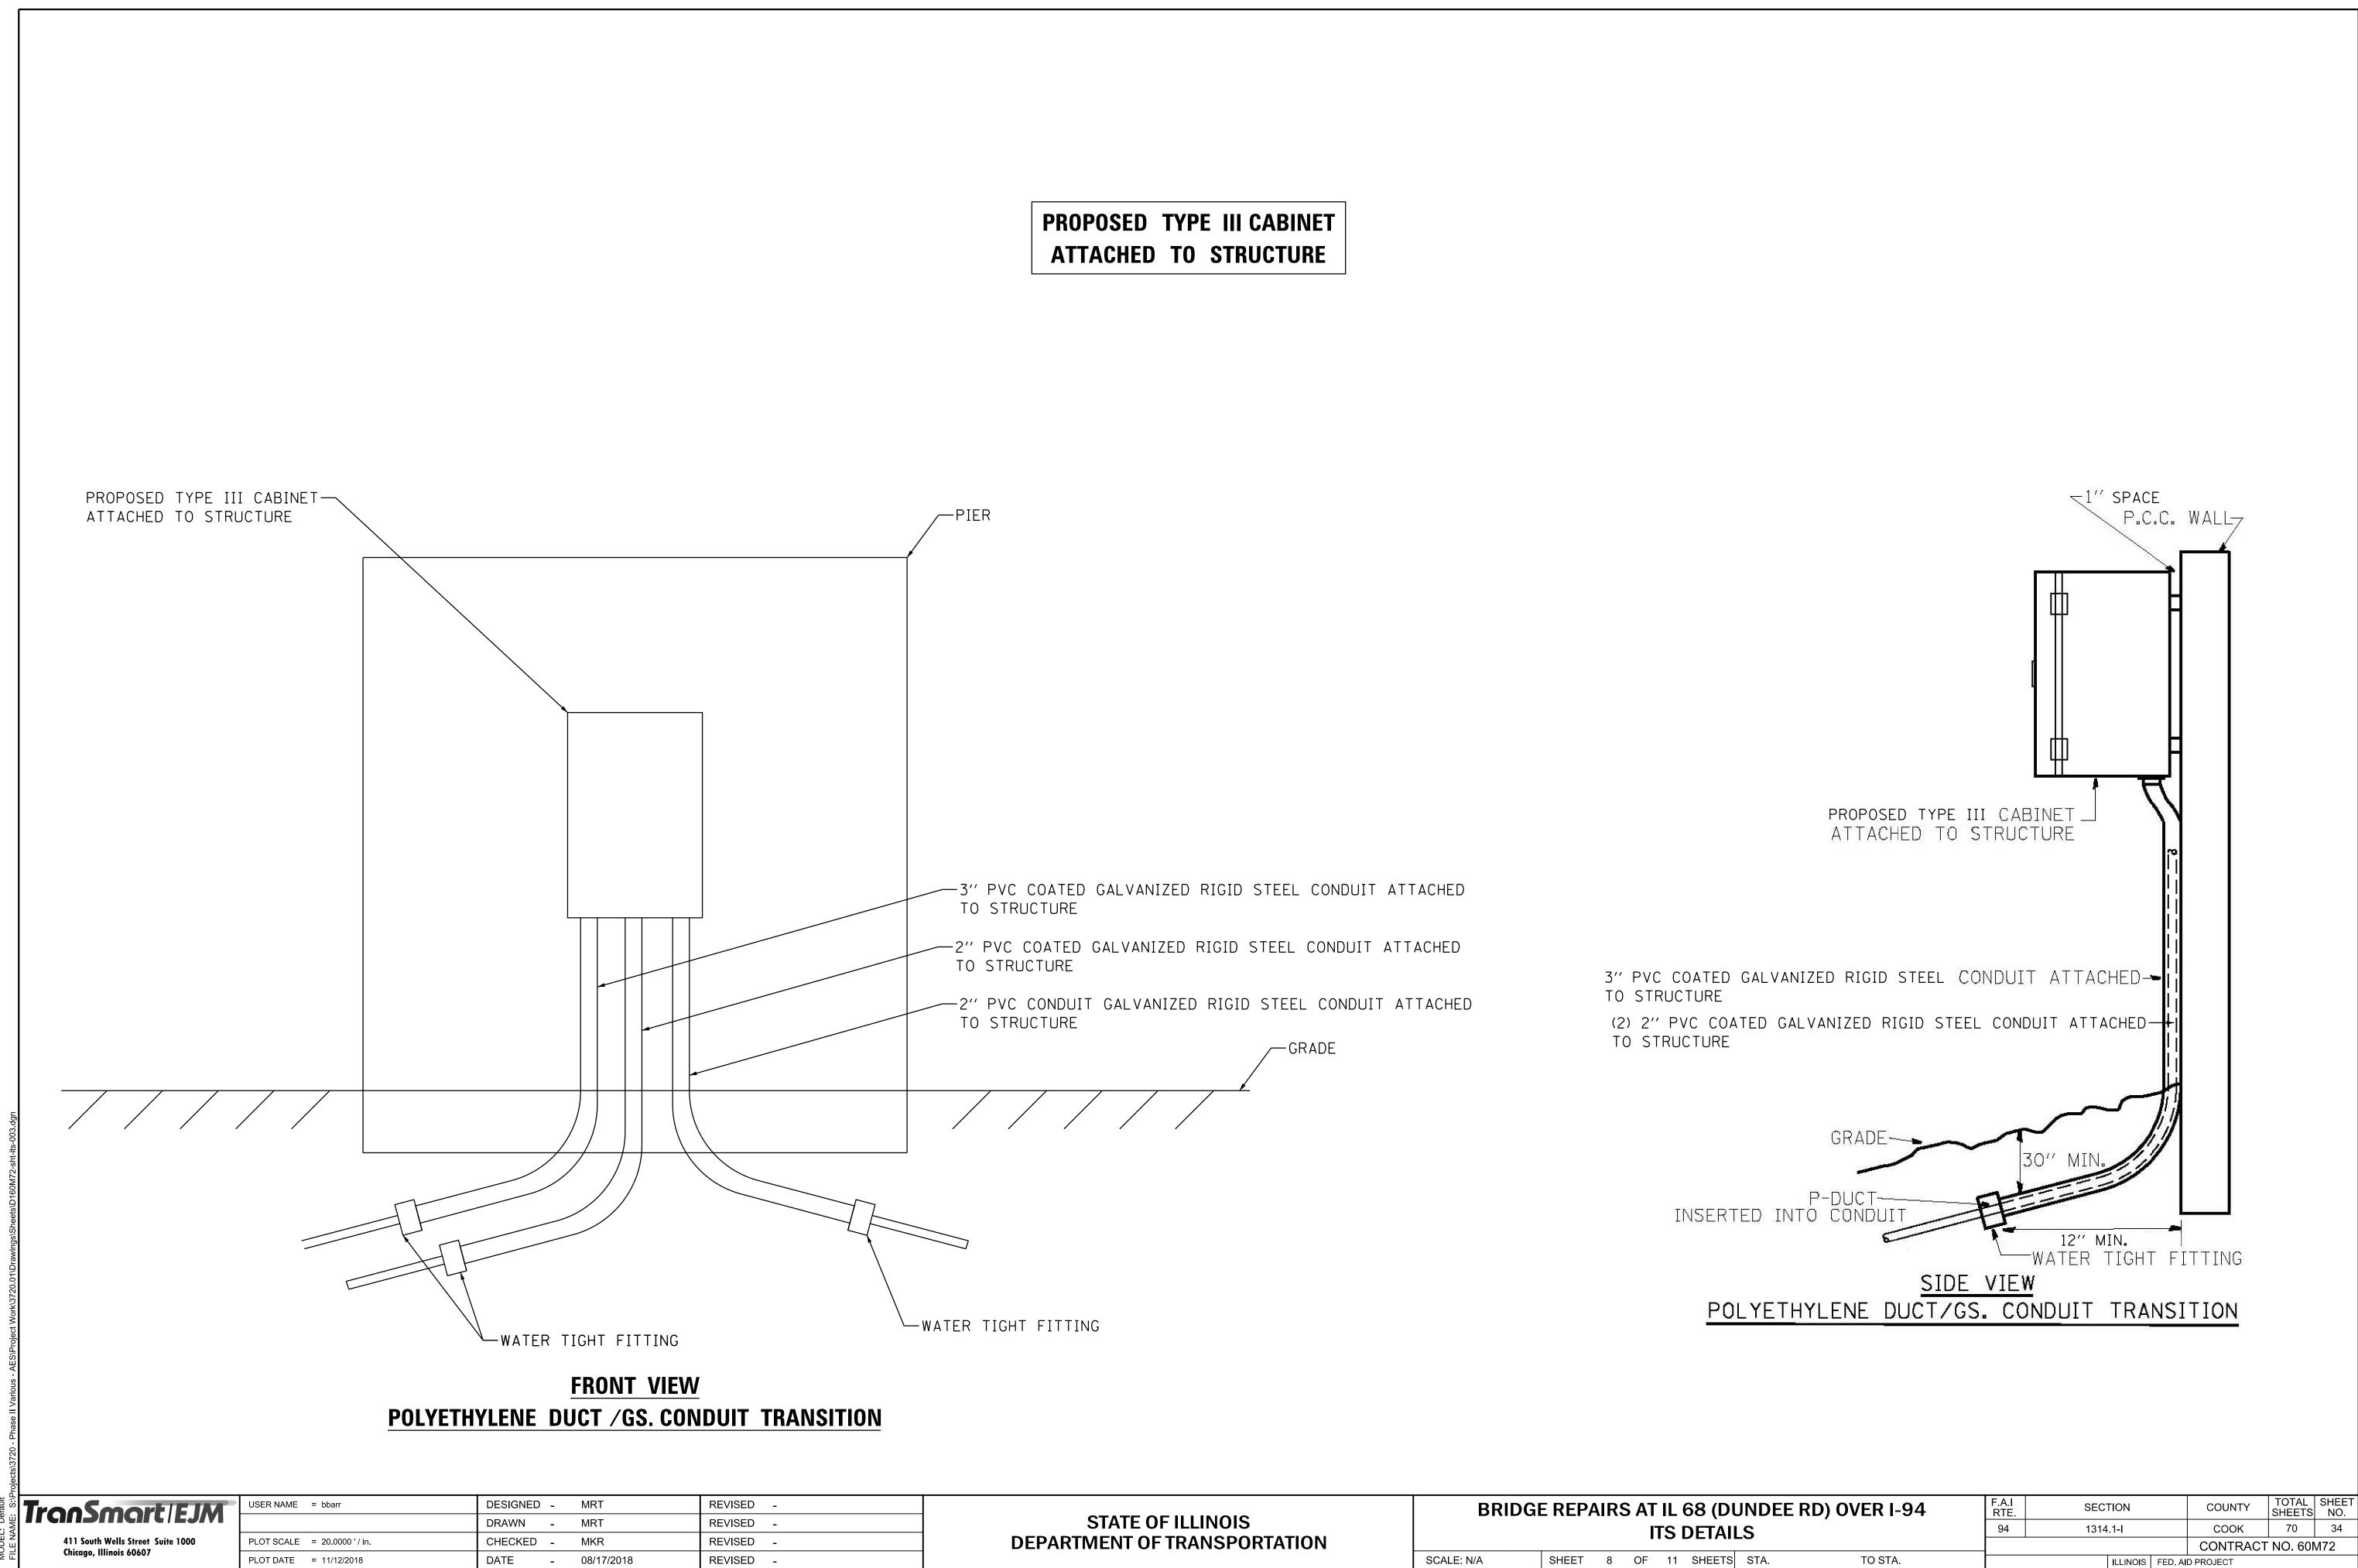

STATE OF ILLINOIS DEPARTMENT OF TRANSPORTATION	BRIDG	E REP/	AIRS			68 (D DETAI
	SCALE: N/A	SHEET	8	OF	11	SHEETS

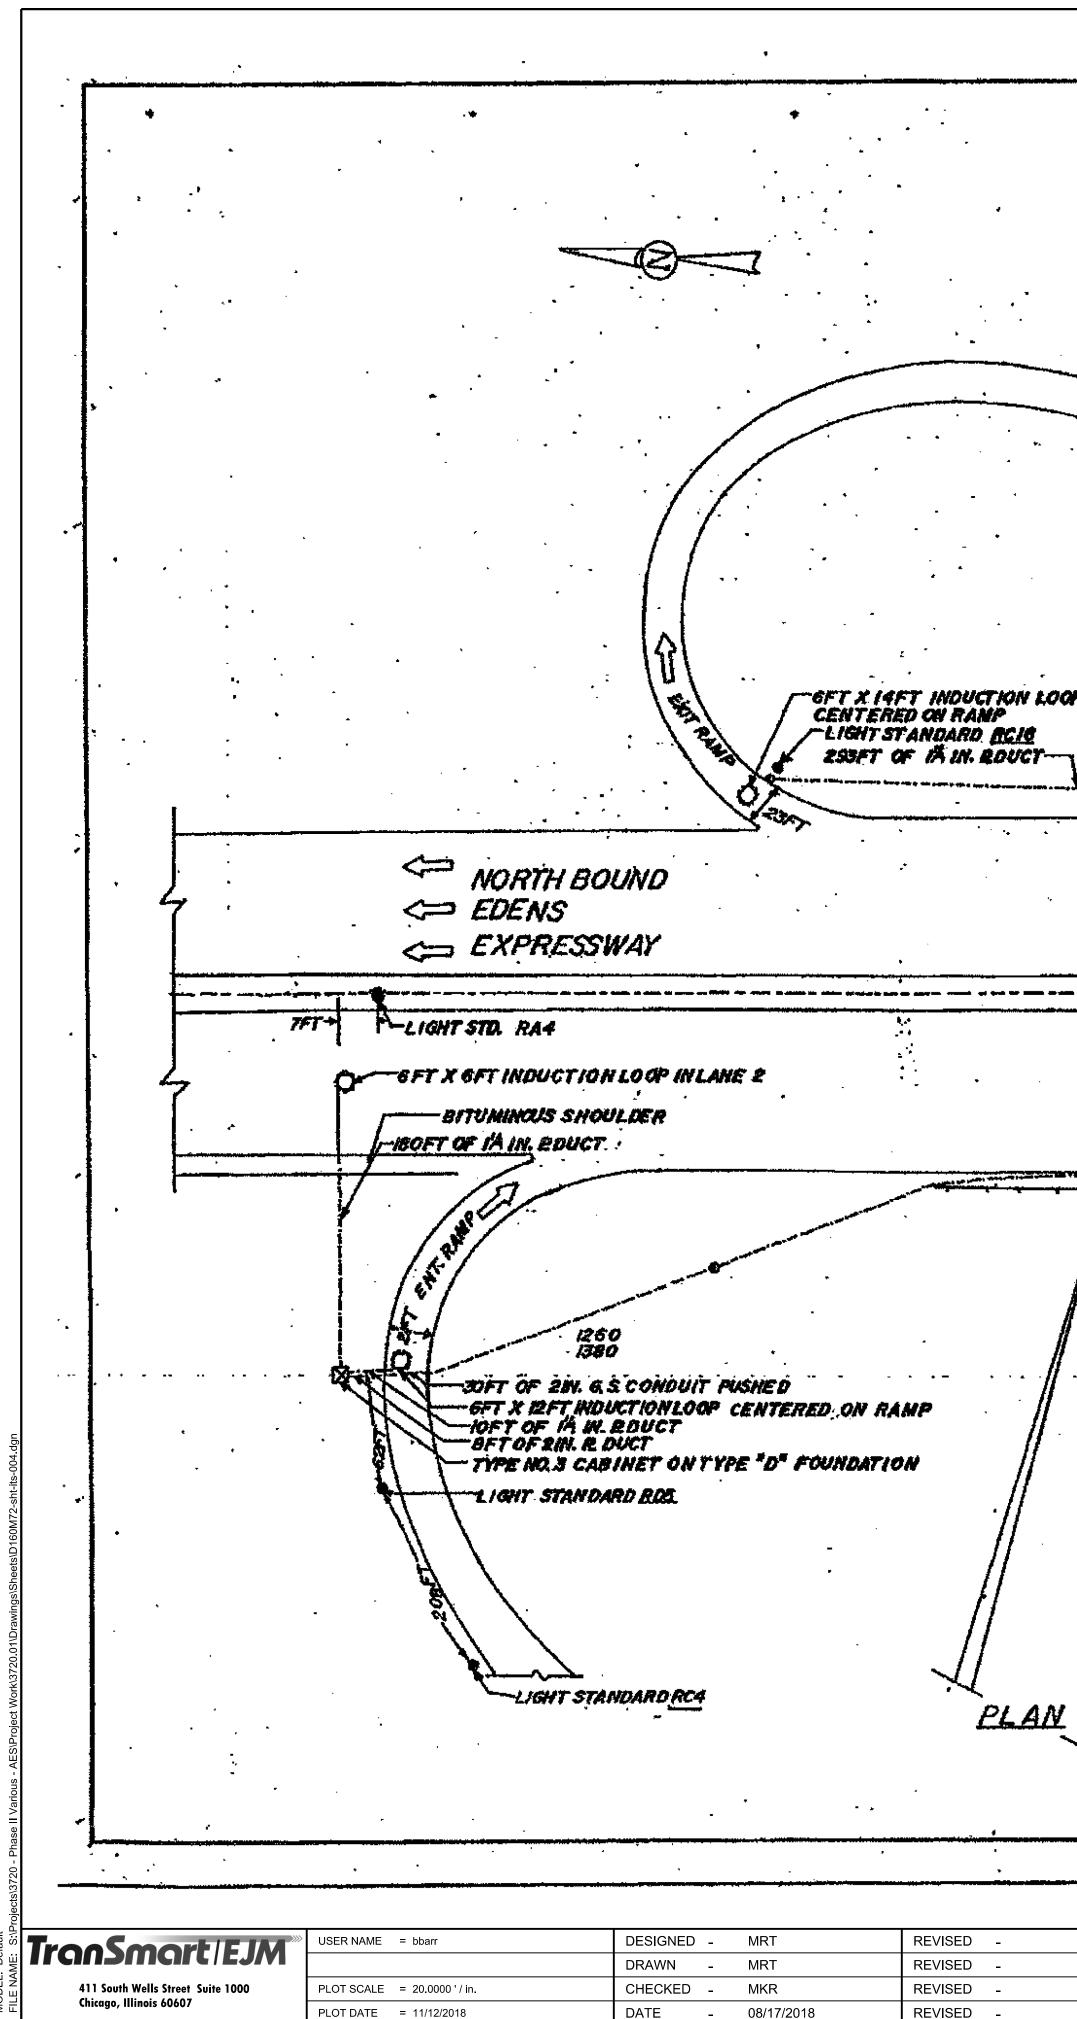


LIGHT STO ROAD. TYPE NOR CABINET ATTACHED TO STRUCTURE $\mathbf{\Omega}$ EXIT RAMP -63FT OF RIN. R.DUCT. -63FT OF IA IN. R.DUCT - 3I4 FT OF IA IN. R.DUCT GET X INFT INPUCTION LOOP 67:18 M C HEAVY DUTY HANDHOLE ----660 (30 900 ISFT OF MAIN. R.DUCT x of tinduction loop in lane e 52FT OF ZIN. B.S. CONDUIT IN THENCH \mathfrak{G} JUNCTION BOX TYPE J 588-24-HEAVY DUTY HANDHOLE 65FT OF SIN. Q.S. CONDUIT IN TRENCH UNDEE 'south bound⇔> - ESFT OF SIN. G.S. CONDUIT IN TRENCH GOFT OF 21N. G.S. CONDUIT IN TRENCH. GFT X GFT INDUCTION LOOP IN LANE 2 EDENS \Rightarrow EXPRESSWAY) /-SFT OF AN. PDUCT -25FT. OF IN IN. ROUCT يحس والمادر عين وحدود والله وجرة والمتن والمتوار المترة فيتني تتواج الجرواب والماد والمراجع المالي كمر HEAVY DUTY HANDHOLE L-775 FT OF 2IN. EDUCT 49 FT OF 3IN. & DUCT TYPE NO.3 CABINET ON TYPE "D" FOUNDATION-1020 1140 RING STFT OF 2N GS CONDUIT PUSHED STFT OF 2N. G.S. CONDUT PUSHED BFT OF 2N. ROUCT OFT OF IN. R. DUCT ENT APPT OF SIN, R_DUCT 4 V LIGHT STANDARD RCT PASTOFT OF 1/4 IN. R.DUCT 40FT OF SIN. SET OF TA IN EDUCTION LOOP -2-C NO, 14 LOOP -lot.service - LIGHTSTD. , RDO EXTRA STUBS ۰. LEGEND NOUCTION LOOP CABINET D PULL FOINT SERVICE INSTALLATION LIGHTSTD. RCI ----CONDUIT LIGHTING CABINET 🌒 LIGHT STANDARD ----- GUARD RAIL -----PVC DUCT γ. . ÷ . . **BRIDGE REPAIRS AT IL 68 (DUNDEE RD) OVER I-94**


STATE OF ILLINOIS	
DEPARTMENT OF TRANSPORTATION	

BRIDGE REPAIRS AT IL 68 (DUN ITS DETAILS

SCALE: N/A SHEET 9 OF 11 SHEETS STA.

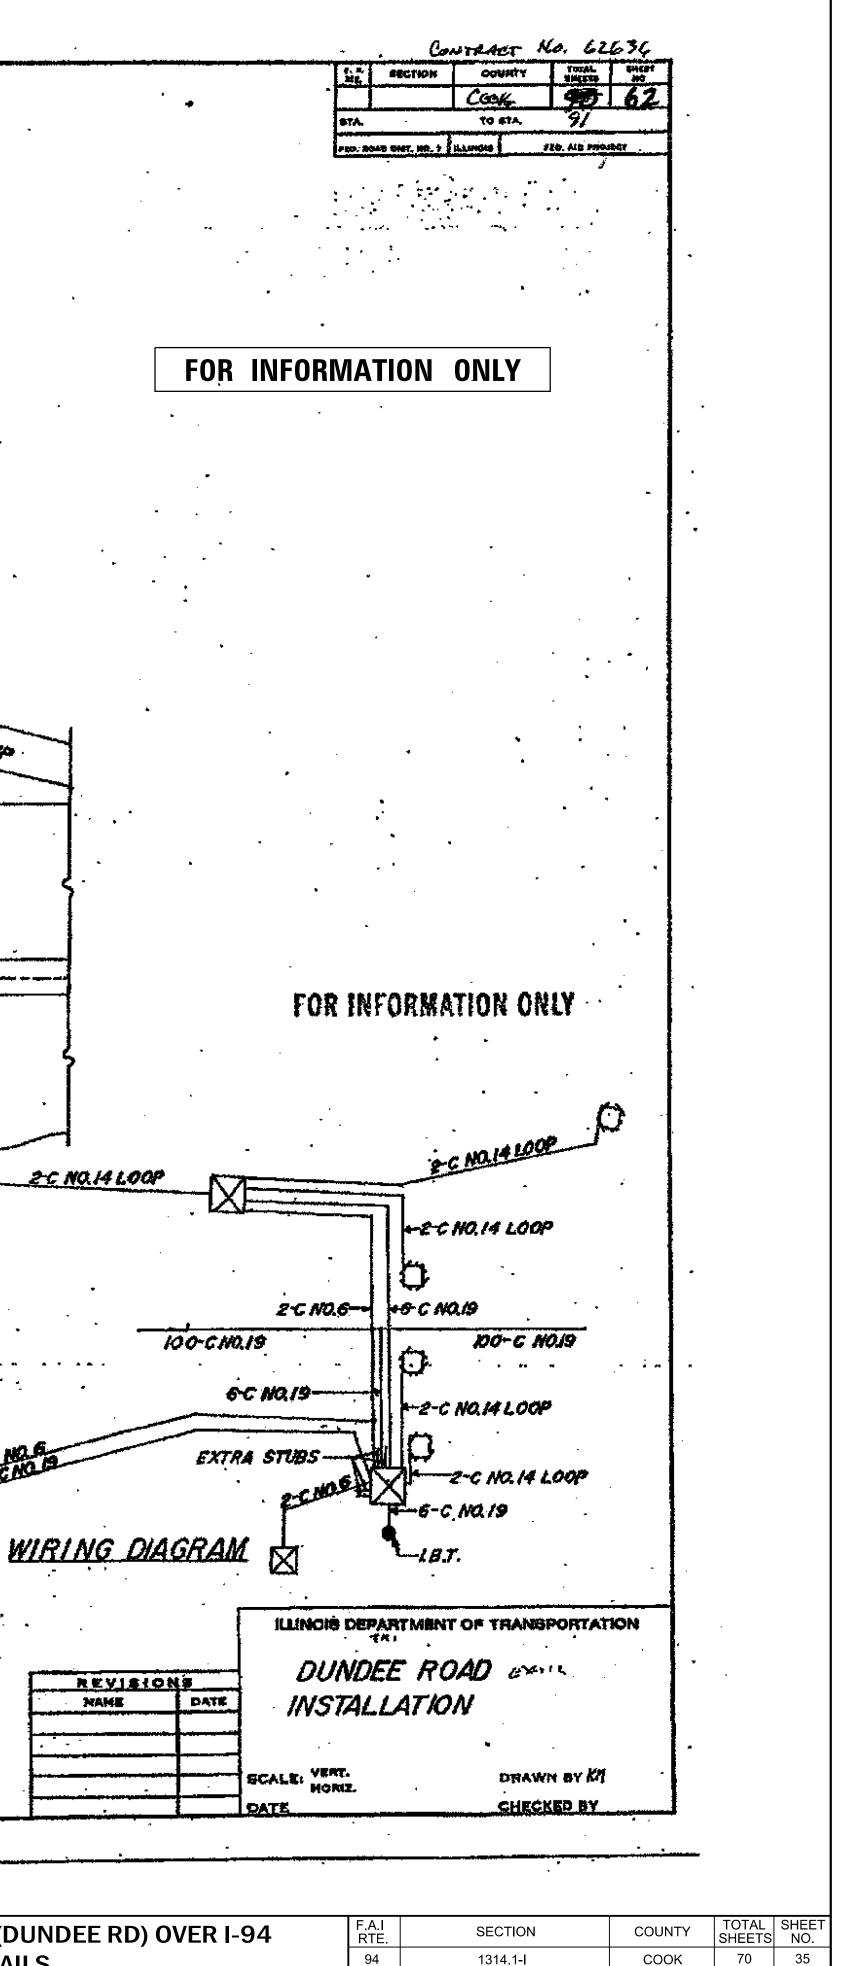

			CONTRACT NO. 60M72		
TO STA.	ILLINOIS	IOIS FED. AID PROJECT			

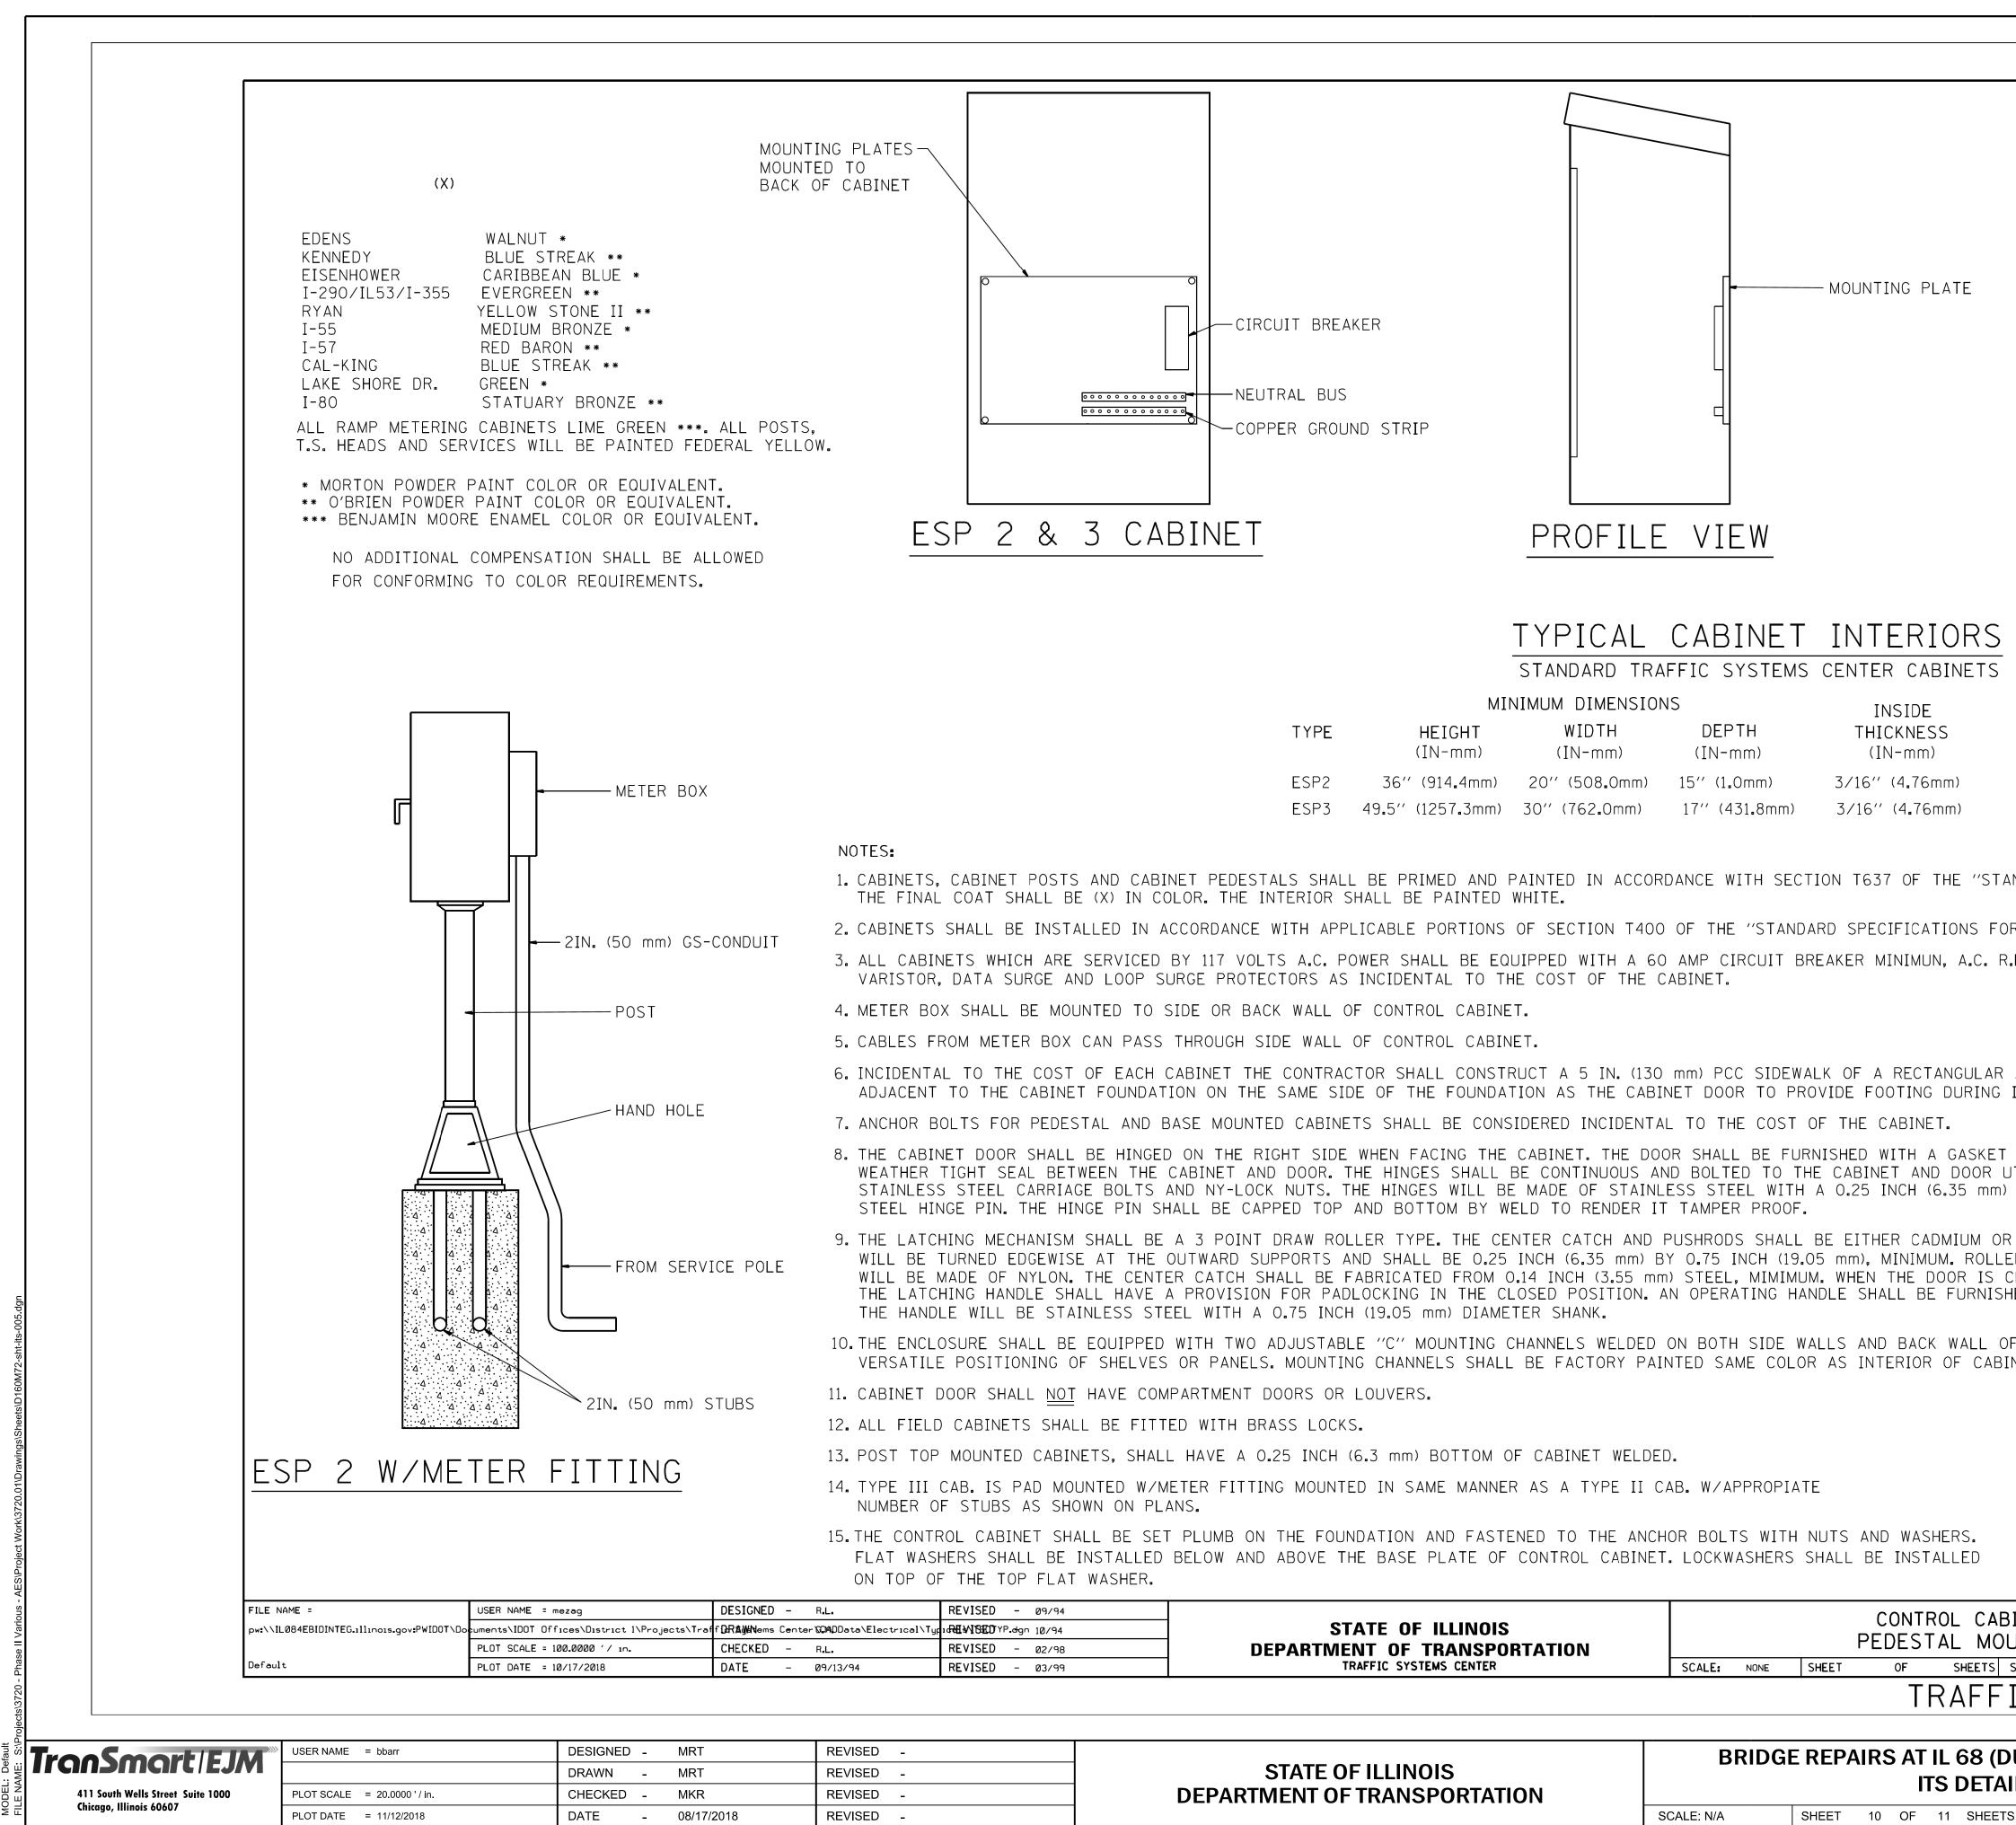

TYPICAL CABINET INTERIORS

STANDARD TRAFFIC SYSTEMS CENTER CABINETS

	IIM	NIMUM DIMENSION	NS	INSIDE
TYPE	HEIGHT (IN-mm)	WIDTH (IN-mm)	DEPTH (IN-mm)	THICKNESS (IN-mm)
ESP2	36'' (914 . 4mm)	20'' (508 . 0mm)	15′′ (1 . 0mm)	3/16" (4 . 76mm)
ESP3	49.5′′ (1257.3mm)	30′′ (762 . 0mm)	17′′ (431 . 8mm)	3/16′′ (4 . 76mm)

	REVISED – Ø9/94					CONTE	ROL CABI	ſ
τyp	10/94	STATE OF ILLINOIS						
	REVISED – Ø2/98	DEPARTMENT OF TRANSPORTATION				PEDEST	FAL MOU	1
	REVISED – 03/99	TRAFFIC SYSTEMS CENTER	SCALE:	NONE	SHEET	OF	SHEETS S	,
						יד		•


IRAFF

TO STA.

STATE OF ILLINOIS DEPARTMENT OF TRANSPORTATION	BRIDG	E REP/	AIRS			68 (DL DETAIL	
	SCALE: N/A	SHEET	10	OF	11	SHEETS	STA.


FLANGE WIDTH MINIMUM 3" (76 mm) ALL AROUND SCREENED VENT UNDERSIDE OF TOP
MATERIAL
FABRICATED ALUMINUM FABRICATED ALUMINUM
NDARD SPECIFICATIONS FOR TRAFFIC CONTROL ITEMS''.
R TRAFFIC CONTROL ITEMS". F.I. LINE FILTERING SURGE PROTECTOR,
AREA 3 FEET (915 mm) BY 4 FEET (1.25 m) IMMEDIATELY INSTALLATION AND MAINTENANCE.
THAT SHALL FORM A TILIZING 1/4-20 DIAMETER STAINLESS
ZINC PLATED, TYPE II CLASS I. PUSHRODS TRS SHALL HAVE A MINIMUM DIAMETER OF 0.875 INCH (22.22 mm) AND CLOSED AND LATCHED, IT WILL BE LOCKED. TED WITH EACH LOCK.
F THE ENCLOSURE, ALLOWING Net.
FOR INFORMATION ONLY AND USE BY CONTRACTOR
INET F.A. SECTION COUNTY TOTAL SHEET NO. JNTED CONTRACT NO.
IC SYSTEMS CENTER (TY-1TSC-400#9)
UNDEE RD) OVER I-94F.A.I RTE.SECTIONCOUNTYTOTAL SHEETSSHEE NO.941314.1-ICOOK7036

CONTRACT NO. 60M72 ILLINOIS FED. AID PROJECT

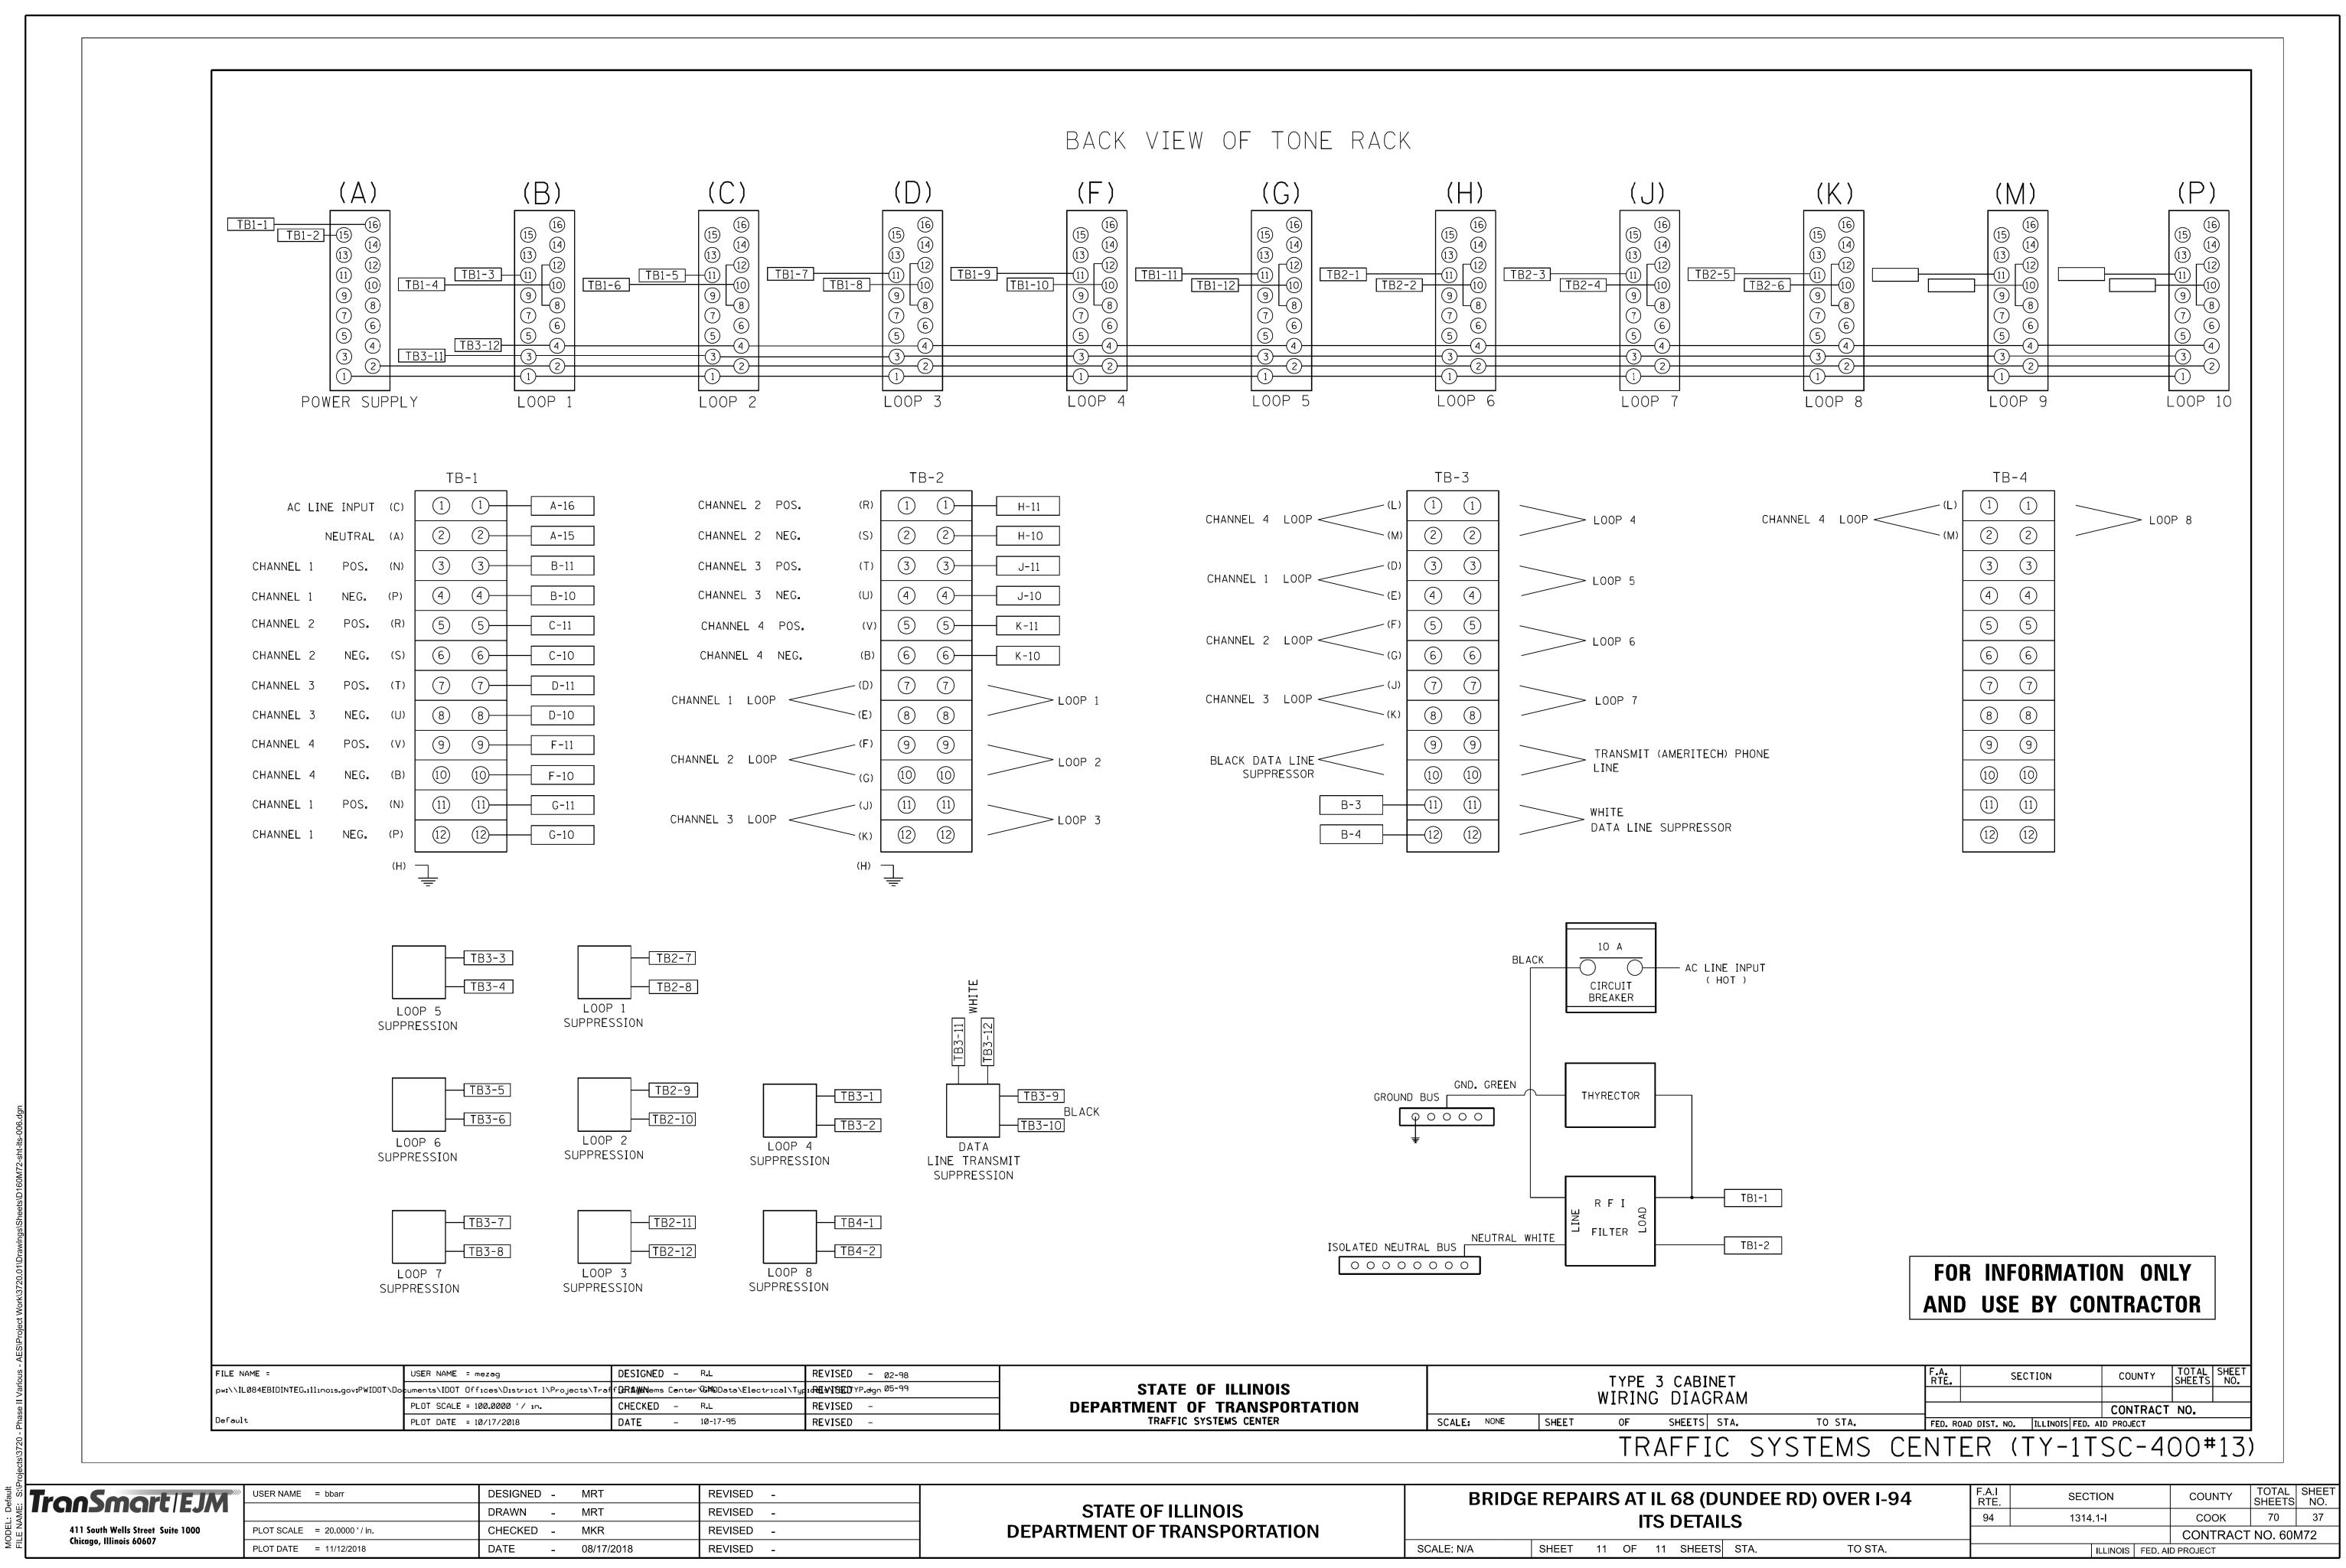

TB-3	
1 1	
22	L00P 4
3 3	
(4) (4)	LOOP 5
5 5	
6 6	L00P 6
77	
8 8	LOOP 7
99	TRANSMIT (AMERITECH
10 10	LINE
-11 (1)	WHITE
12 12	DATA LINE SUPPRESSO
	1 1 2 2 3 3 4 4 5 5 6 6 7 7 8 8 9 9 10 10 11 11

		STATE OF ILLINOIS	E	BRIDG	E REPA		IL 68 (DU
						TR	AFFIC
	REVISED - DEPARIMENT OF TRANSPORTATION TRAFFIC SYSTEMS CENTER	SCALE:	NONE	SHEET	OF	SHEETS S	
	REVISED -	DEPARTMENT OF TRANSPORTATION				WIRING	G DIAGR
∖Typ	14 41 WIGED YP.egn 05-99	STATE OF ILLINOIS					
	REVISED - Ø2-98					TYDE	3 CABINE

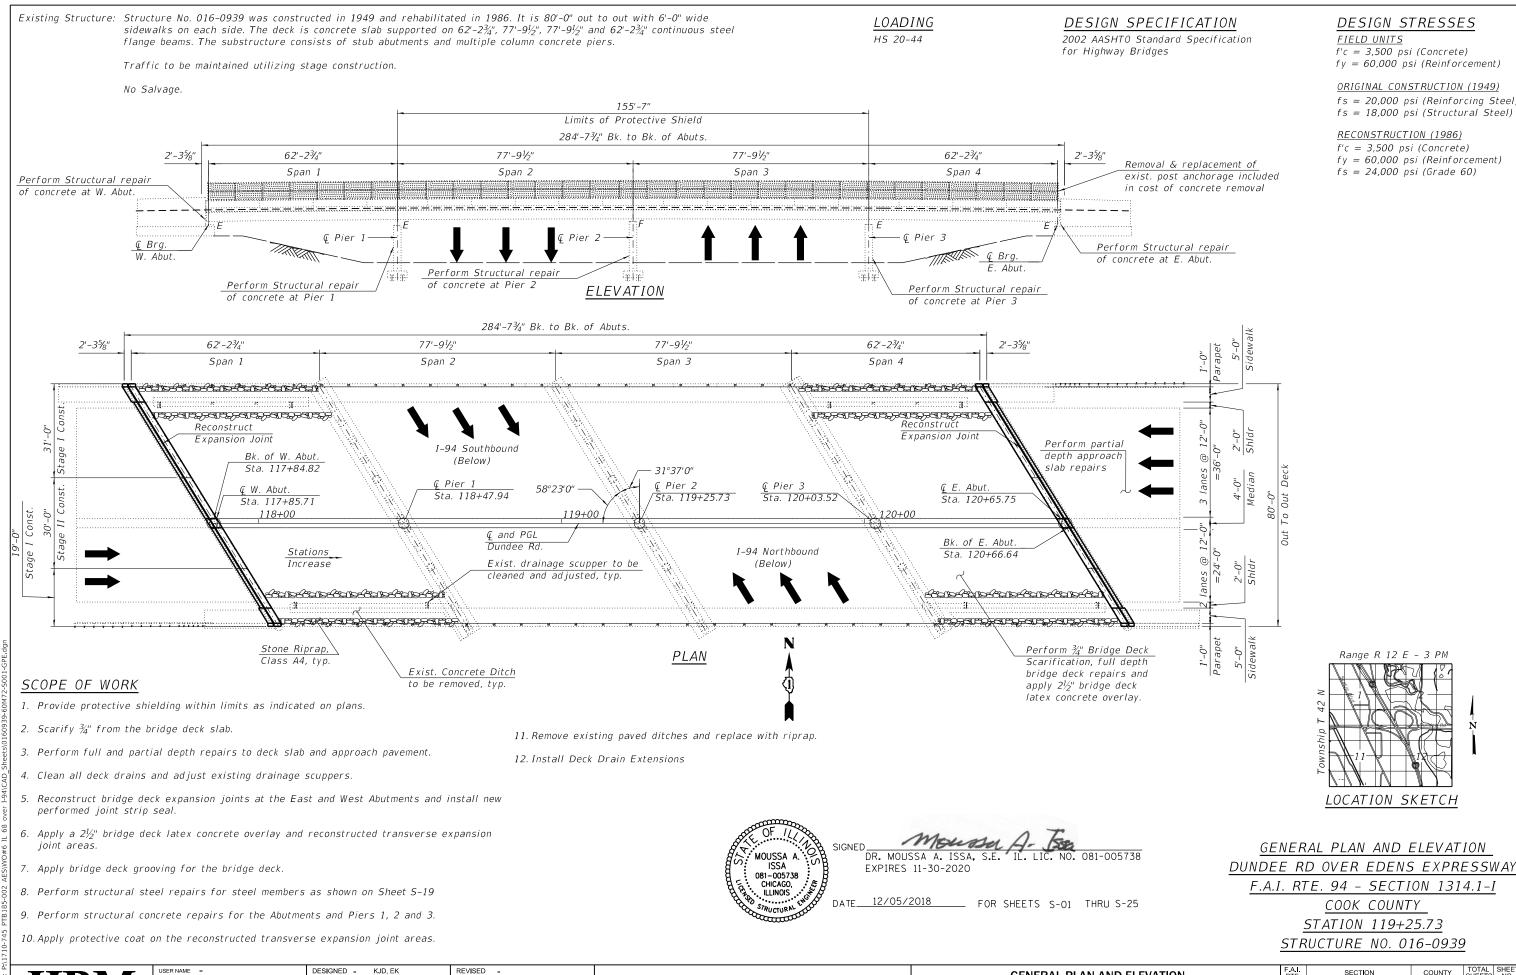

STATE OF ILLINOIS

DEPARTMENT OF TRANSPORTATION

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OT SCALE =

OT DATE =

CHECKED - MI, RTB

DRAWN - KJD, EK

- 12/05/2018

DATE

REVISED -

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GENERAL PLAN ANI S.N. 016-0939 DUNDEE RD OVE

SHEET S-01 OF S-2

fs = 20,000 psi (Reinforcing Steel)


ID ELEVATION /ER EDENS EXPRESSWAY		SECTION			COUNTY	TOTAL SHEETS	SHEET NO.
		1314.1-1			соок	70	38
					CONTRA	CT NO. 6	0M72
-25 SHEETS			ILLINOIS	FED. A	D PROJECT		

GENERAL NOTES:

- 1. Reinforcement bars designated (E) shall be epoxy coated.
- 2. The Contractor shall take all necessary precautions for the protection of passing vehicles from falling objects and/or materials until completion of the work.
- 3. Prior to pouring the new concrete deck for expansion joints reconstruction and deck slab repairs, all heavy or looser rust, loose mill scale, and other loose or potentially detrimental foreign material shall be removed from the surfaces in contact with concrete. Tightly adhered paint may remain unless otherwise noted. Removal shall be accomplished by method that will not damage the steel and the cost will be included in the pay item covering removal of the existing concrete.
- 4. The existing structural steel coating contains lead. The Contractor shall take appropriate precautions to deal with the presence of lead on this project.
- 5. Joint openings shall be adjusted according to article 520.04 of the standard specifications when the deck is poured at an ambient temperature other than 50° E.
- 6. Existing structural steel that will be in contact with new structural steel shall be cleaned and painted prior to erection as required by the Special Provision "cleaning and painting contact surface areas of existing steel structures".
- 8. Plan dimensions and details relative to existing plans are subject to nominal construction variations. The Contractor shall field verify existing dimensions and details affecting new construction and make necessary approved adjustments prior to construction or ordering of materials. Such variations shall not be cause for additional compensation for a change in scope of the work, however, the Contractor will be paid for the quantity actually furnished based at the unit price bid for the work.
- All structural steel shall be shop painted with the inorganic zinc rich primer 9. per AASHTO M300, Type 1. Cost included with Structural Steel Repair.
- 10. Existing reinforcement bars extending into the removal area shall be cleaned, straightened and incorporated into the new construction. Any reinforcement bars that are damaged during concrete removal shall be replaced with an approved bar splicer or anchorage system. Cost included with Concrete Removal.
- 11. All new fasteners shall be high strength bolts. Holes shall be subpunched or subdrilled ${}^{1}\mathcal{Y}_{16}{}^{"}$ dia. and reamed in the field to ${}^{1}\mathcal{Y}_{16}{}^{"}$ dia. for $\mathcal{Y}_{4}{}^{"}$ dia. bolts, unless otherwise noted.
- 12. Grind existing nicks, gouges and shallow cracks in the damaged beams as shown by the details included in the plans. Any cracks that cannot be removed by grinding approximately $\frac{1}{4}$ " deep shall be identified and reported to the Bureau of Bridges and Structures for further disposition. The Cost of grinding is included in Structural Steal Repair.

INDEX OF SHEETS

- S-01 General Plan and Elevation
- S-02 General Notes, Index of Sheets & Total Bill of Material
- S-03 Stage Construction
- 5-04 Temporary Concrete Barrier
- S-05 Bridge Deck Repair Plan
- S-06 W. Abutment Joint Removal and Replacement (Sheet 1 of 2)
- 5-07 W. Abutment Joint Removal and Replacement (Sheet 2 of 2)
- S-08 W. Abutment Joint Removal and Replacement details I
- S-09 W. Abutment Joint Removal and Replacement details II
- S-10 E. Abutment Joint Removal and Replacement (Sheet 1 of 2)
- S-11 E. Abutment Joint Removal and Replacement (Sheet 2 of 2)
- S-12 E. Abutment Joint Removal and Replacement details I S-13 E. Abutment Joint Removal and Replacement details II
- S-14 Preformed Joint Strip Seal Sidewalk (Sheet 1 of 3)
- S-15 Preformed Joint Strip Seal Sidewalk (Sheet 2 of 3)
- S-16 Preformed Joint Strip Seal Sidewalk (Sheet 3 of 3)
- S-17 Adjusting Drainage Scupper Details
- S-18 Framing Plan
- S-19 Structural Steel Repair Details
- S-20 West Abutment Repairs
- S-21 East Abutment Repairs
- S-22 Pier 1 Repairs
- S-23 Pier 2 Repairs
- S-24 Pier 3 Repairs
- S-25 Bar Splicers

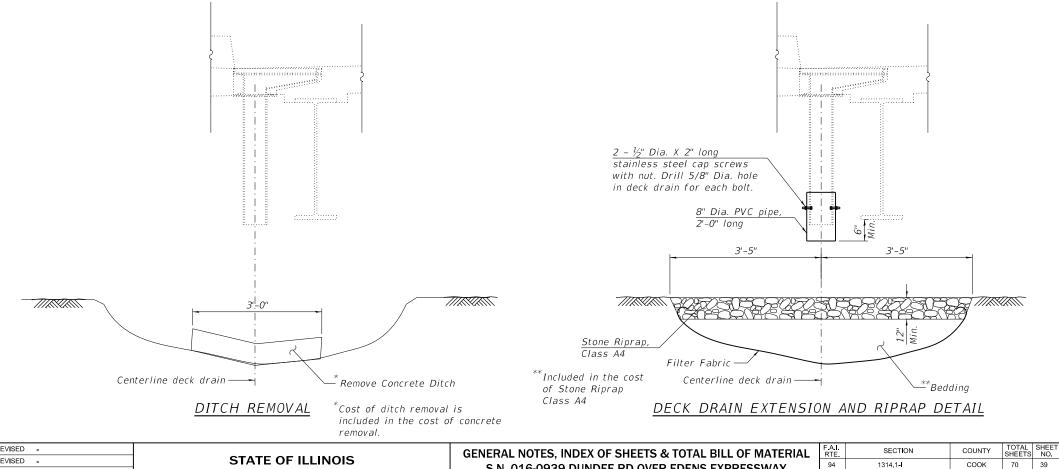

	USER NAME =	DESIGNED - KJD	REVISED -		GENERAL NOTES. INDEX OF SHEETS & TOTAL BILL OF MATERIAL	F.A.I.
HRM		CHECKED - MI, RTB	REVISED -	STATE OF ILLINOIS		94
	PLOT SCALE =	DRAWN - KJD	REVISED -	DEPARTMENT OF TRANSPORTATION	S.N. 016-0939 DUNDEE RD OVER EDENS EXPRESSWAY	
ENGINEERING GROUP, LLC	PLOT DATE =	DATE - 12/05/2018	REVISED -		SHEET S-02 OF S-25 SHEETS	
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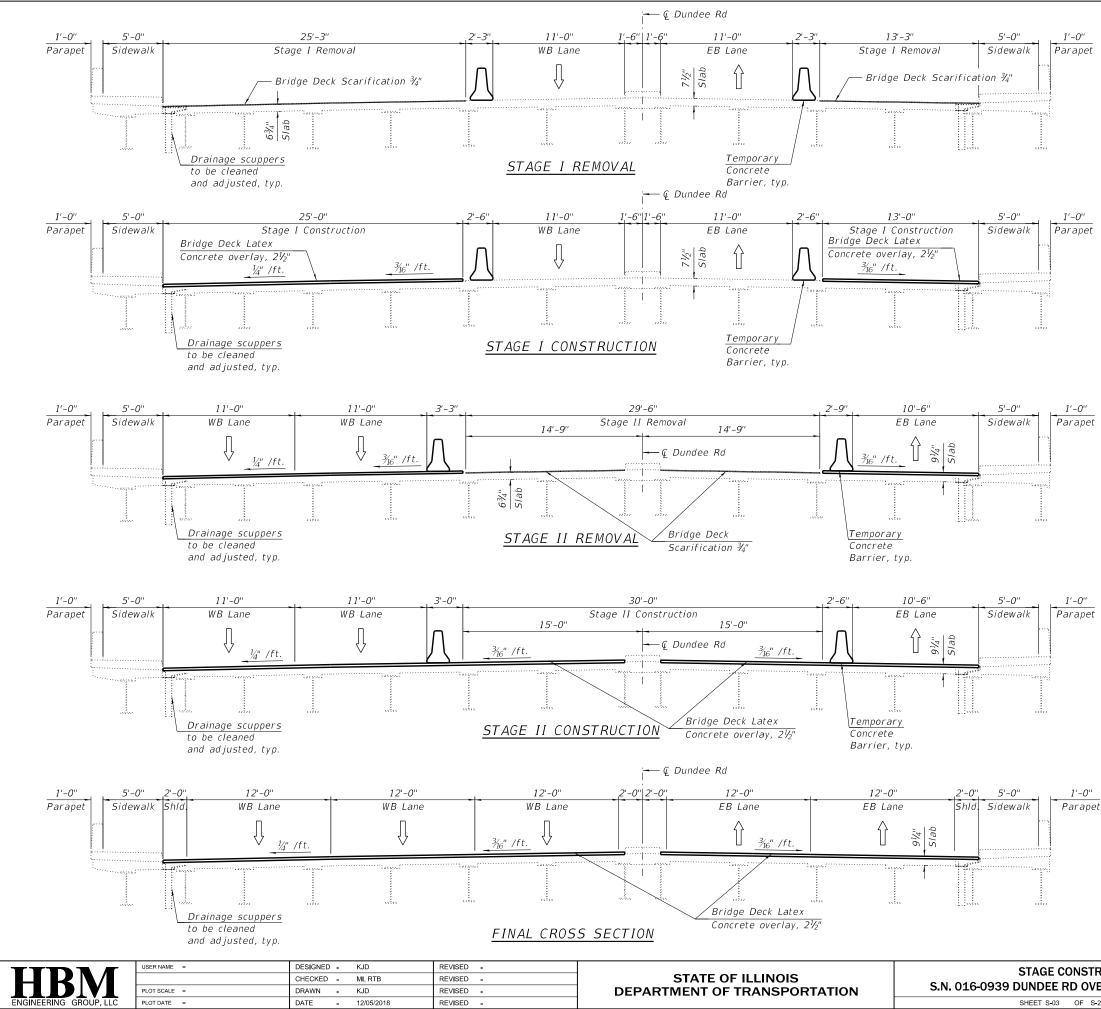
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Stone Riprap, C Filter Eabric Concrete Remov Protective Shie Concrete Struct Concrete Super Bridge Deck Gr Protective Coat Reinforcement I Bar Splicers Preformed Join Approach Slab i Structural Stee Bridge Deck La Bridge Deck Sc Structural Repa Than 5 Inches) Deck Drain Ext Deck Slab Repa Drainage Scupp

TOTAL BILL OF MATERIAL										
ITEM	UNIT	SUPER.	SUB.	TOTAL QUANTITY						
Class A4	SQ YD	-	218	218						
	SQ YD	-	311	311						
val	CU YD	27.0	1.6	28.6						
eld	SQ YD	1452	-	1452						
tures	CU YD	-	1.6	1.6						
rstructure	CU YD	29.0	-	29.0						
rooving	SQ YD	1910	-	1910						
t	SQ YD	68	6	74						
Bars, Epoxy Coated	POUND	3940	-	3940						
	EACH	52	-	52						
nt Strip Seal	FOOT	188	-	188						
Repair (Partial Depth)	SQ YD	19	-	19						
el Repair	POUND	385	-	385						
atex Concrete Overlay, 2 1/2 Inches	SQ YD	2001	-	2001						
carification 3/4"	SQ YD	2001	-	2001						
air of Concrete (Depth Equal to or Less	SQ FT	6	1078	1084						
tensions	EACH	3	-	3						
air (Full Depth, Type I)	SQ YD	8	-	11						
pers to be Adjusted	EACH	8	-	8						

CONTRACT NO. 60M72


ILLINOIS FED. AID PROJECT



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TRUCTION	N F.A.I. SECTION		COUNTY	TOTAL SHEETS	SHEET NO.		
VER EDENS EXPRESSWAY		1314.1-1			соок	70	40
					CONTRAC	CT NO. 6	0M72
S-25 SHEETS			ILLINOIS	FED. A	D PROJECT		




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with bar splicer inserts in the side of the beam, as detailed, to accommodate the installation of the retainer assemblies. A pair of bar splicers, 6" apart,

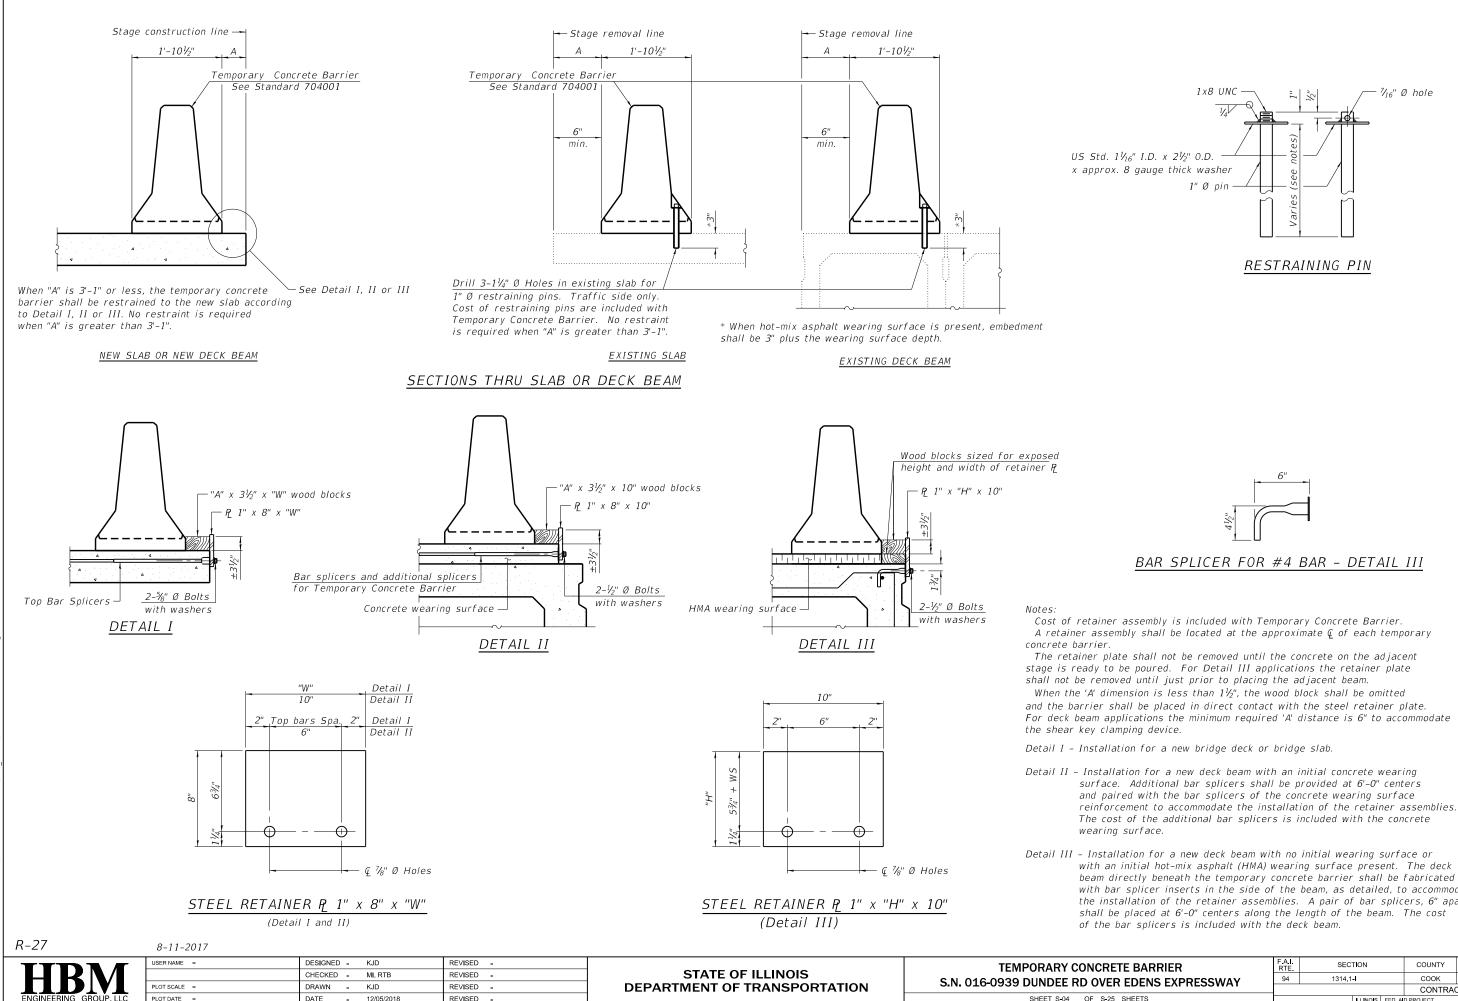RETE BARRIER	F.A.I. RTE			TOTAL SHEETS	SHEET NO.
/ER EDENS EXPRESSWAY		1314.1- I	соок	70	41
			CONTRA	CT NO. 6	60M72
3-25 SHEETS	ILLINOIS FED. AID PROJECT				


SHEET S-04 OF S-

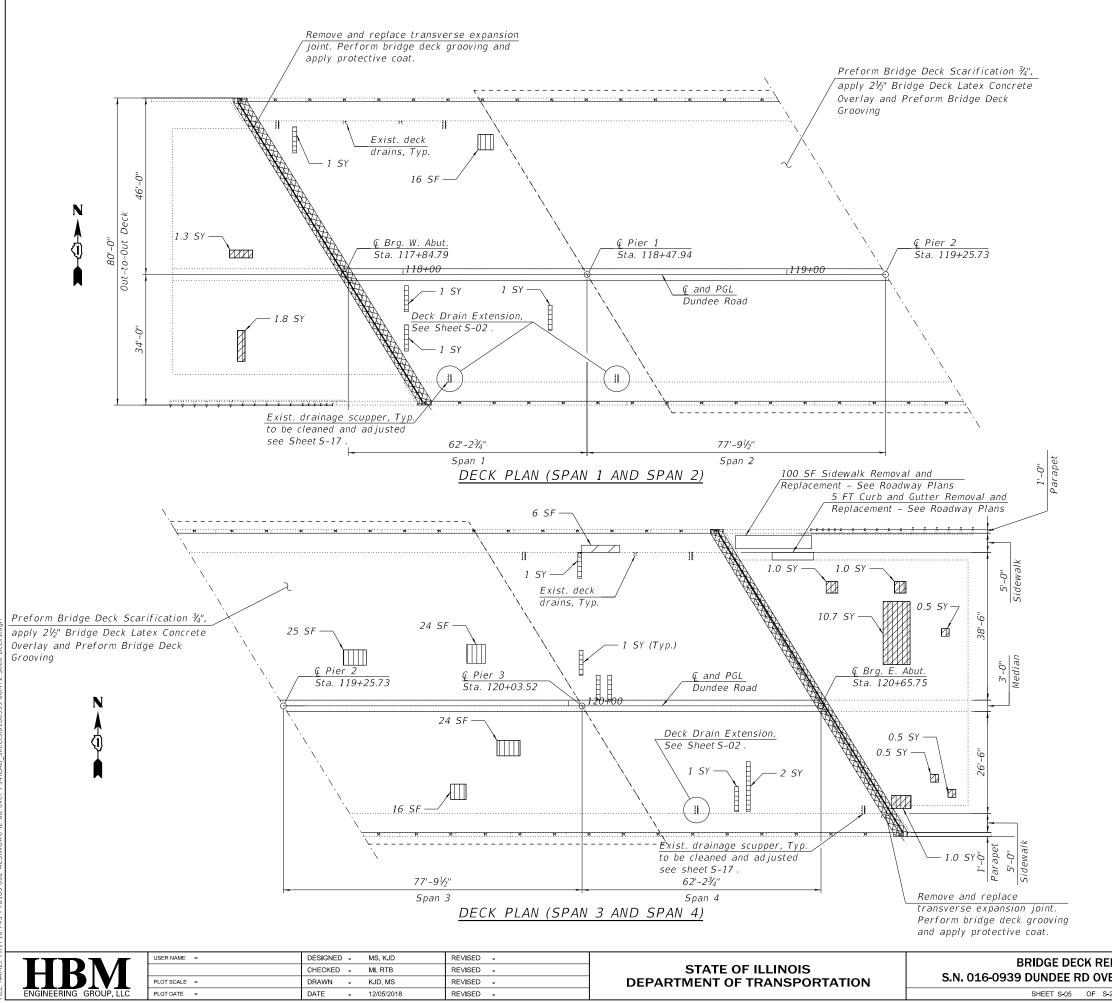

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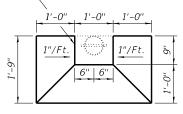
BILL OF MATERIAL

ITEM	UNIT	QUANTITY
Protective Shield	SQ YD	1452
Bridge Deck Grooving	SQ YD	1910
Approach Slab Repair (Partial Depth)	SQ YD	19
Bridge Deck Latex Concrete Overlay,	SQ YD	2001
2½ Inches		
Bridge Deck Scarification 3/4"	SQ YD	2001
Structural Repair of Concrete (Depth	SQ FT	6
Equal or Less Than 5 Inches)		
Deck Drain Extensions	EACH	3
Deck Slab Repair (Full Depth, Type I)	SQ YD	11

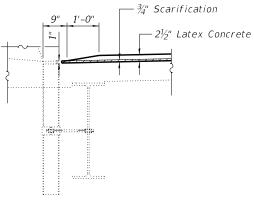

SECTION AT DECK DRAIN






TOP PLAN

NOTES:


1. Areas of deck repairs shown are estimated. The Engineer shall show actual locations of deck repairs on As-built Plans.

LEGEND

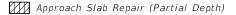

- Estimated 105 SF)
- Deck Slab Repair (Full Depth, Type I)




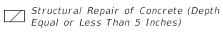

--- Protective Shield

* For Information Only to assist Contractor in bidding. See Special Provision for "Bridge Deck Latex Concrete Overlay".


EPAIR PLAN /ER EDENS EXPRESSWAY		SECTION			COUNTY	TOTAL SHEETS	SHEET NO.
		1314.1-I			соок	70	42
					CONTRA	CT NO. 6	60M72
-25 SHEETS			ILLINOIS	FED. A	D PROJECT		

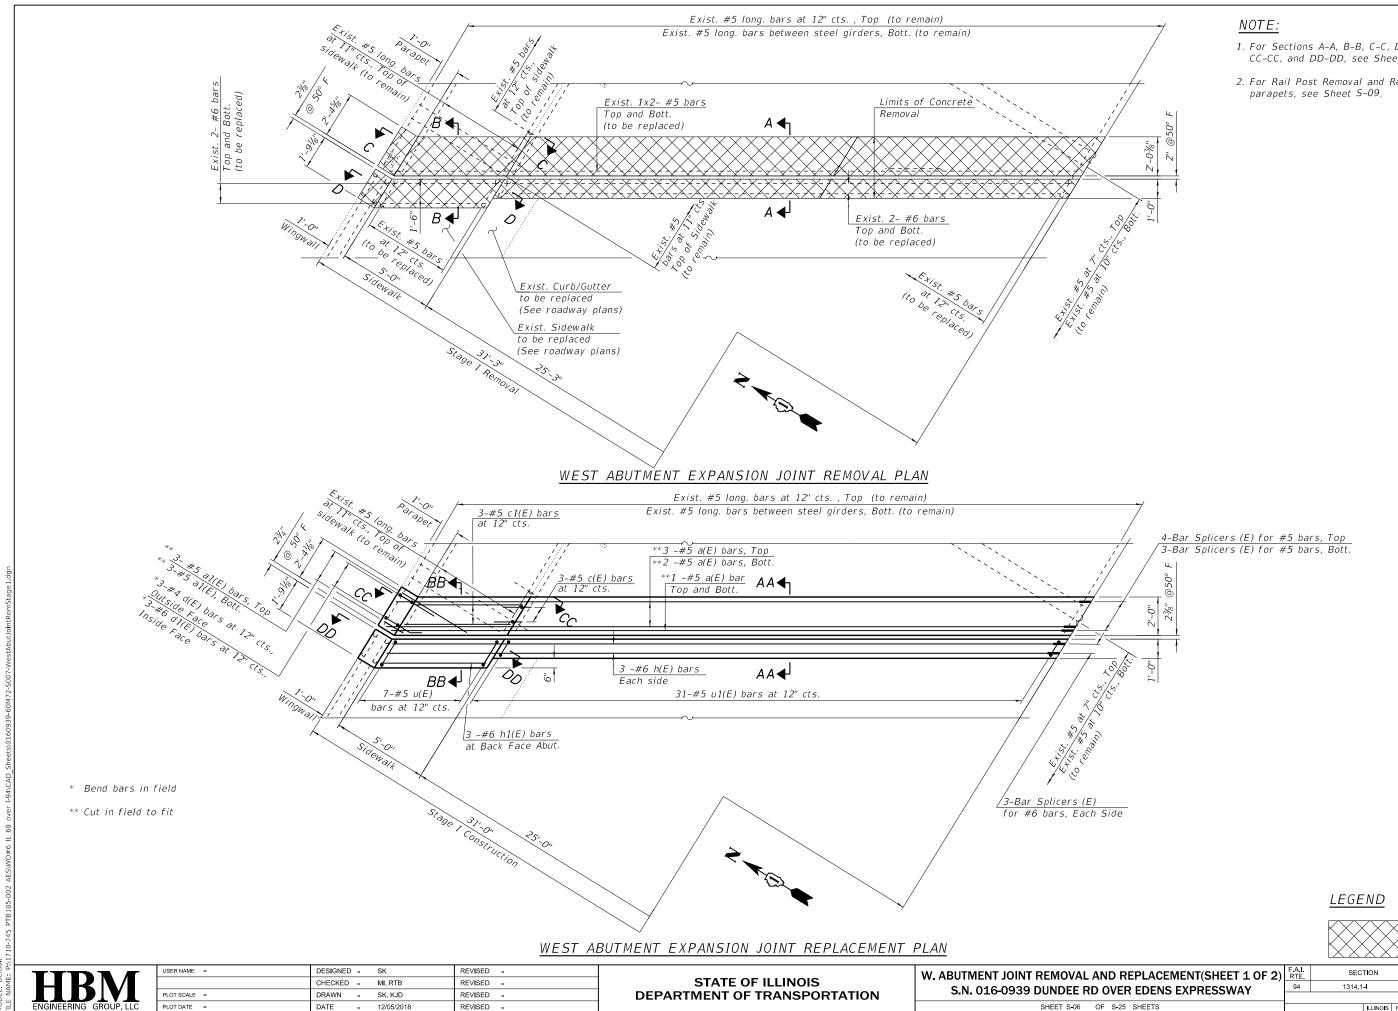


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- 1. For Sections A-A, B-B, C-C, D-D, AA-AA, BB-BB, CC-CC, and DD-DD, see Sheet S-08.
- 2. For Rail Post Removal and Replacement Details on

REPLACEMENT(SHEET 1 OF 2)		TION		COUNTY	TOTAL SHEETS	SHEET NO.
94	1314.1-			соок	70	43
				CONTRA	CT NO. 6	60M72
		ILLINOIS	FED. A	D PROJECT		
	RTE.	RTE. SEC	RTE SECTION 94 1314.1-I	RTE. SECTION 94 1314.1-1	RTE. SECTION COUNTY 94 1314,1-I COOK CONTRAC	RTE SECTION COUNTY SHEETS 94 1314.1-1 COOK 70 CONTRACT NO. 6

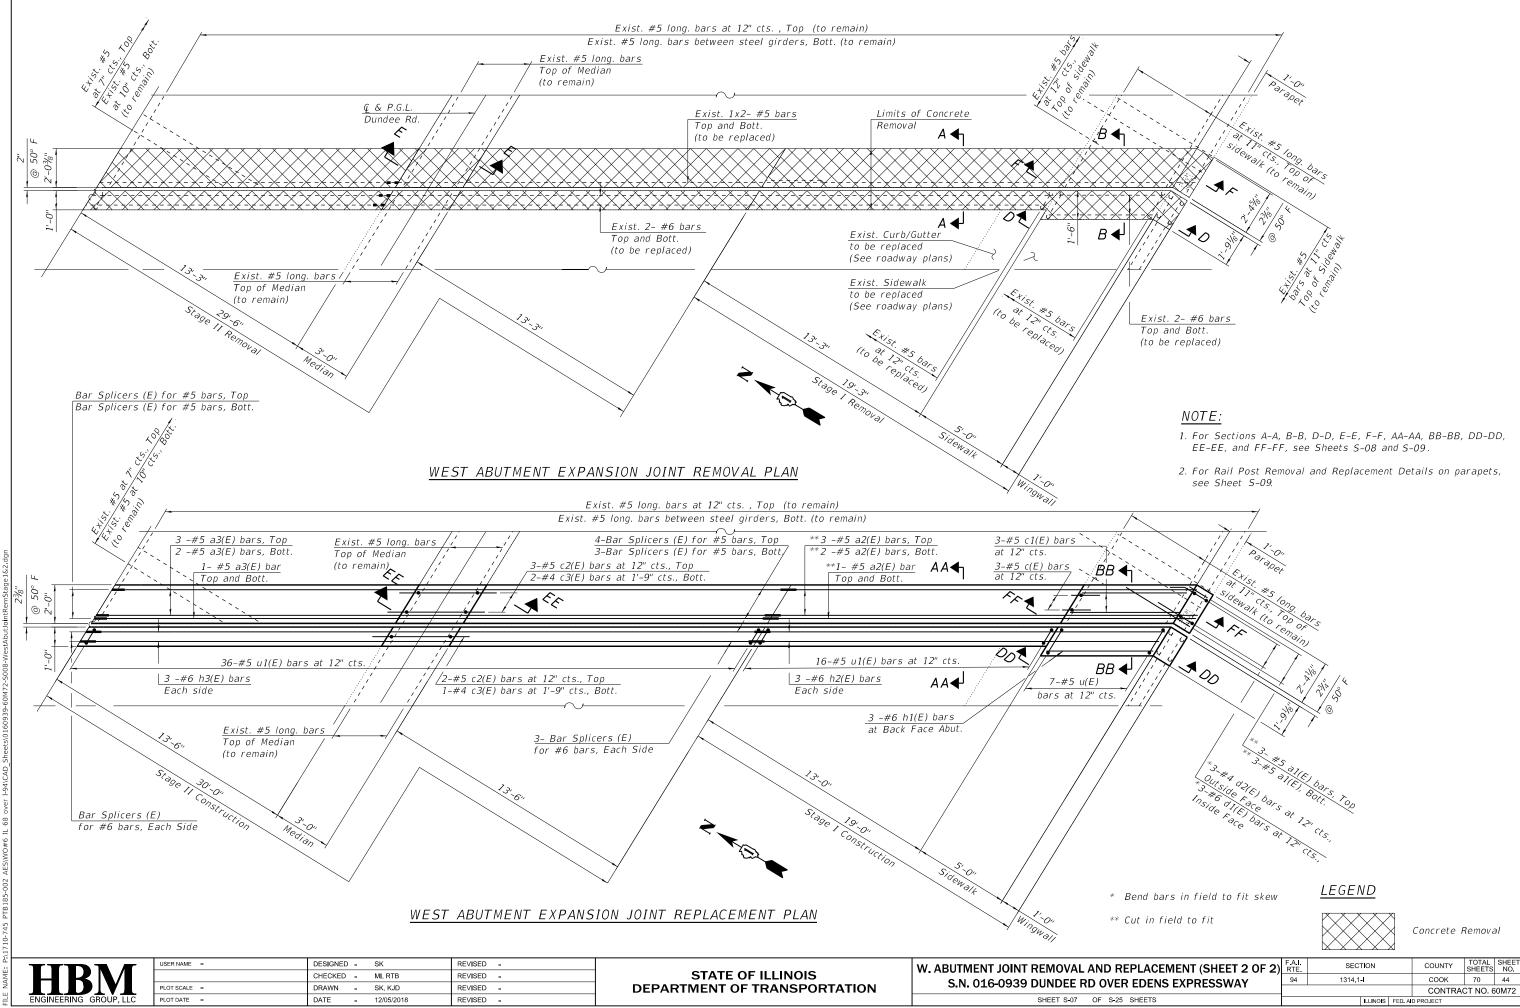


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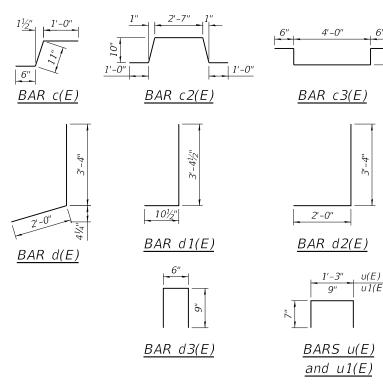
LEGEND

ND REPLACEMENT DETAILS I	F.A.I. RTE	SEC.	SECTION			TOTAL SHEETS	SHEET NO.
/ER EDENS EXPRESSWAY		1314.1-I			COOK	70	45
					CONTRA	NTRACT NO. 6	
S-25 SHEETS			ILLINOIS	FED. A	D PROJECT		

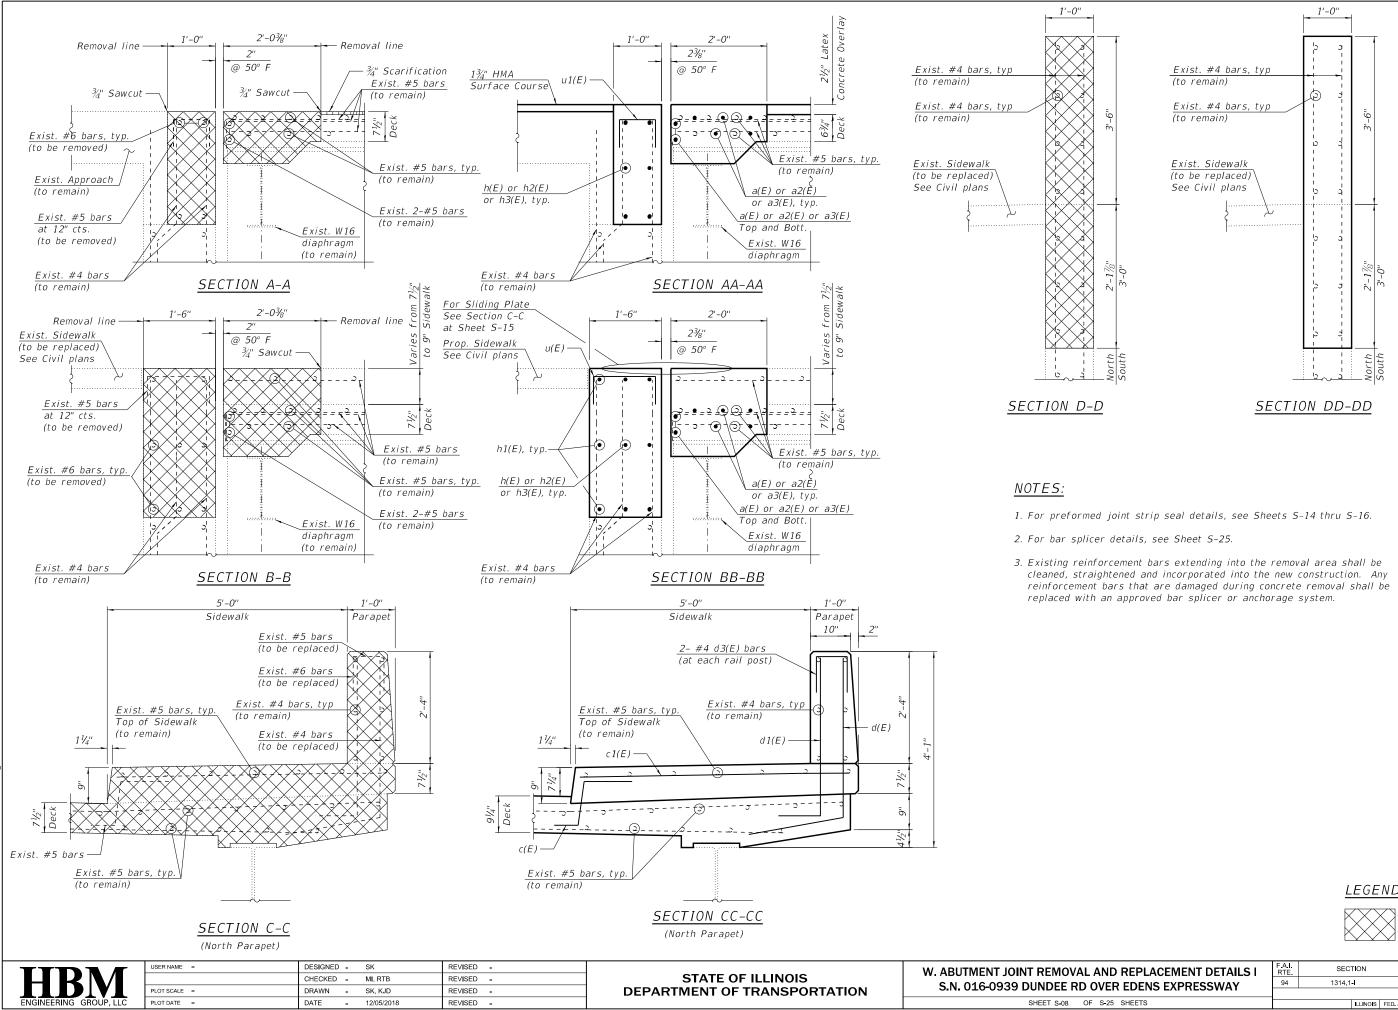

SHEET S-09 OF S-2

	B	ILL OF MAT	<u>ERIAL</u>	
Bar	No.	Size	Length	Shape
a(E)	7	#5	36'-1"	
a1(E)	12	#5	4'-3"	
a2(E)	7	#5	22'-1"	
a3(E)	7	#5	35'-0"	
c(E)	6	#5	2'-5"	<u> </u>
c1(E)	6	#5	5'-7"	
c2(E)	5	#5	6'-3"	
c3(E)	3	#4	5'-10''	
d(E)	3	41	5'-4"	1
d1(E)	6	#4 #6	4'-3"	
d2(E)	3		<u> </u>	
d3(E)	4	#4	2'-0"	
U3(E)	4	#4	2-0	
h(E)	6	#6	34'-10"	
h1(E)	6	#6	5'-7"	
h2(E)	6	#6	20'-11"	
h3(E)	6	#6	35'-0"	
u(E)	14	#5	2'-5"	
u1(E)	83	#5	1'-11"	
		<i># 5</i>		
Concrete	Removal		Cu. Yd.	14.8
Concrete			Cu. Yd.	0.8
	Superstructur	е	Cu. Yd.	15.0
Protective			Sq. Yd.	37
Reinforce	ment Bars, Ep	oxy Coated	Pound	1,970

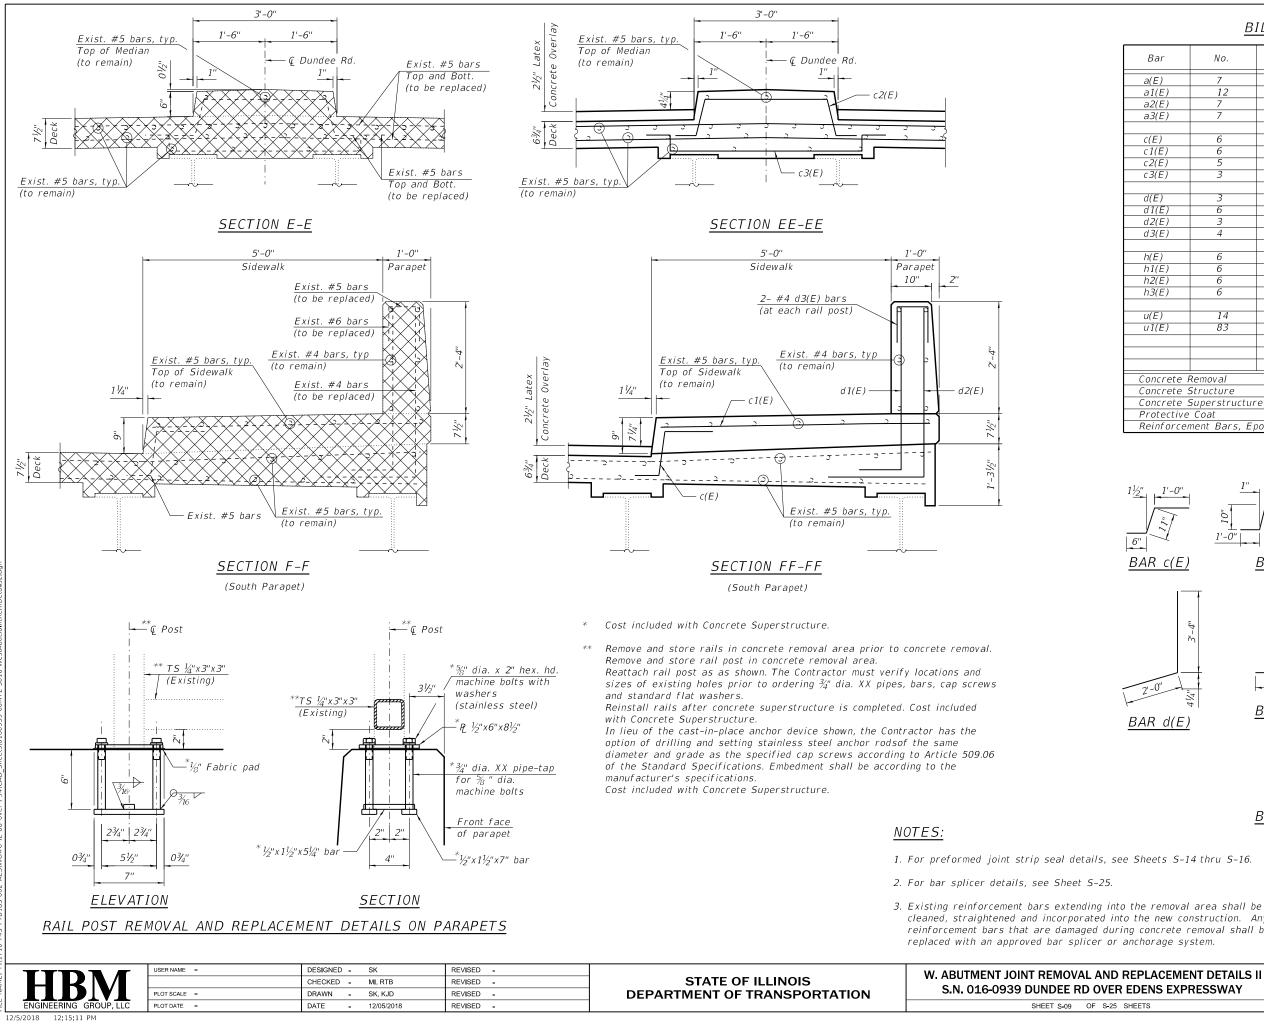


cleaned, straightened and incorporated into the new construction. Any reinforcement bars that are damaged during concrete removal shall be LEGEND



Concrete Removal

u1(E)

ND REPLACEMENT DETAILS II		SECTION		COUNTY	TOTAL SHEETS	SHEET NO.
		1314.1 -		соок	70	46
				CONTRACT NO.		60M72
3-25 SHEETS		ILLINOIS	FED. A	D PROJECT		

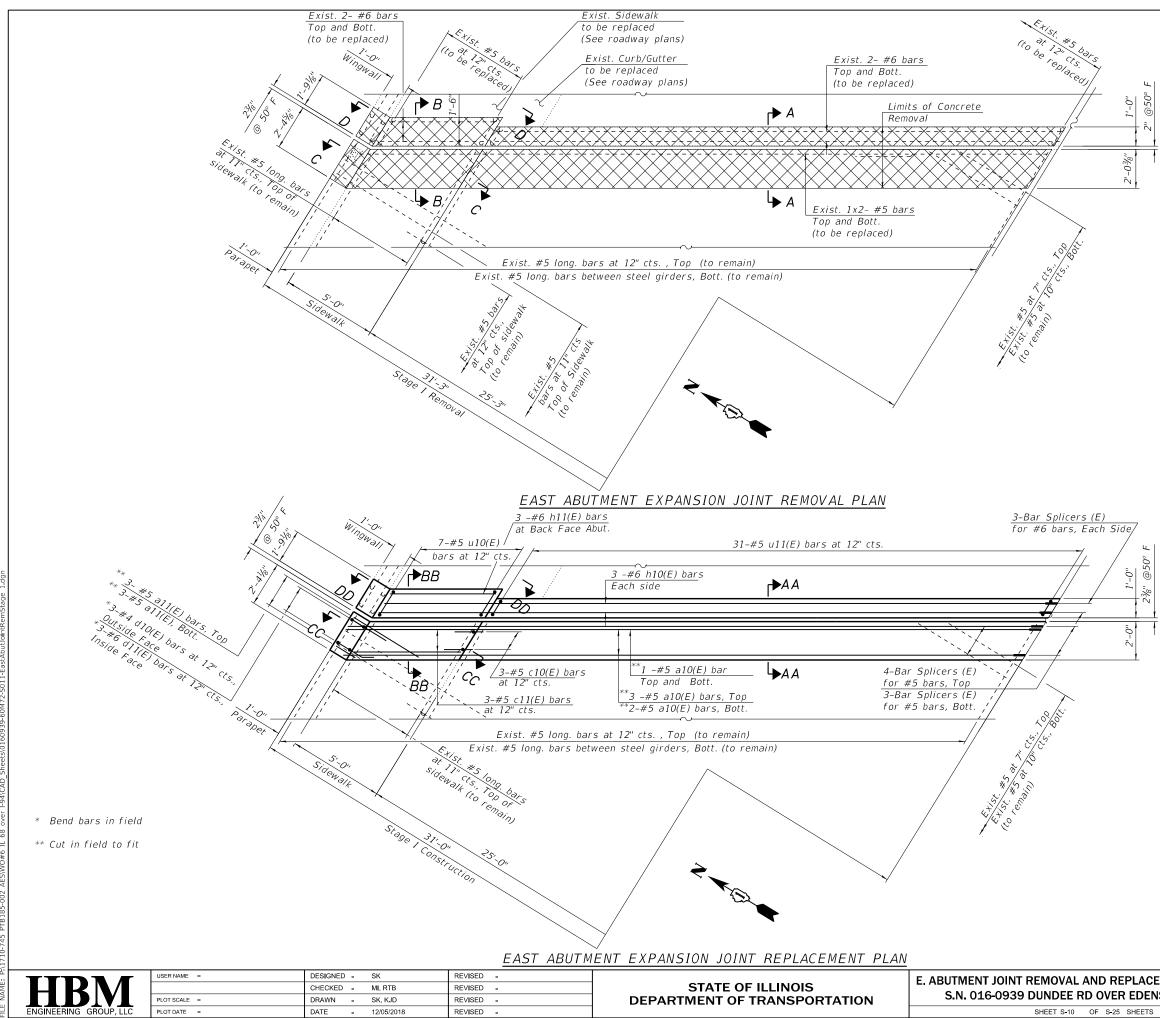

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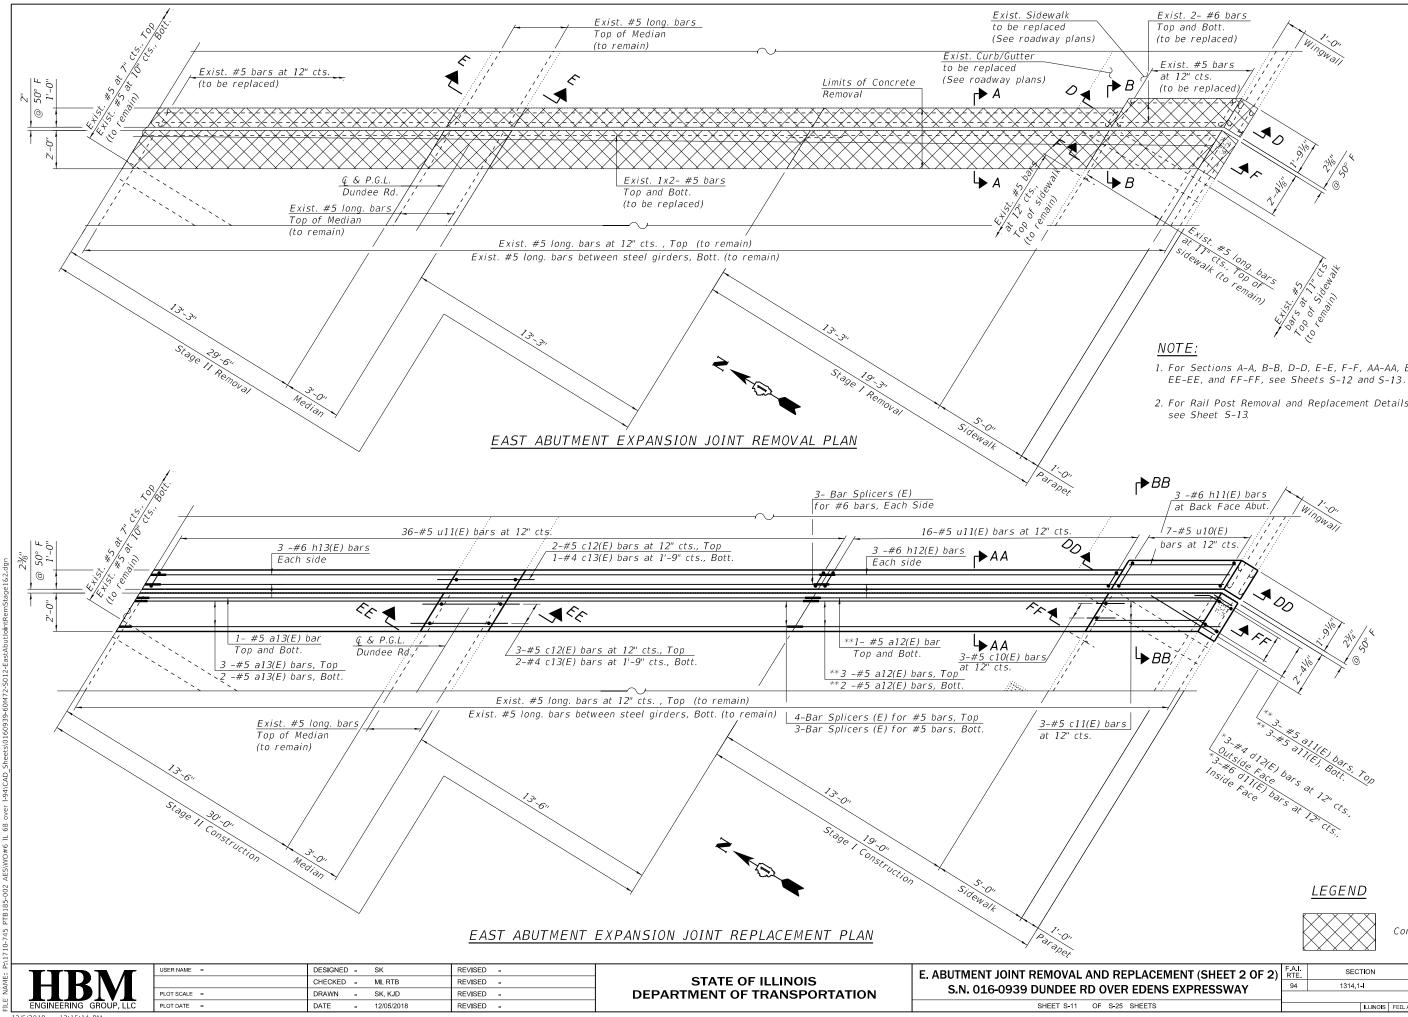
NOTE:

- 1. For Sections A-A, B-B, C-C, D-D, AA-AA, BB-BB, CC-CC, and DD-DD, see Sheet S-12.
- 2. For Rail Post Removal and Replacement Details on parapets, see Sheet S-13.






REPLACEMENT (SHEET 1 OF 2)		SEC	TION		COUNTY	TOTAL SHEETS	SHEET NO.
ER EDENS EXPRESSWAY		1314.1-1			COOK	70	47
ER EDENS EXI RESSWAT					CONTRAC	CT NO. 6	0M72
-25 SHEETS			ILLINOIS	FED. A	D PROJECT		



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- 1. For Sections A-A, B-B, D-D, E-E, F-F, AA-AA, BB-BB, DD-DD,
- 2. For Rail Post Removal and Replacement Details on parapets,


REPLACEMENT (SHEET 2 OF 2) /ER EDENS EXPRESSWAY		SEC.	TION		COUNTY	TOTAL SHEETS	SHEET NO.
		1314.1 -I			СООК	70	48
					CONTRACT NO.		0M72
3-25 SHEETS			ILLINOIS	FED. A	D PROJECT		

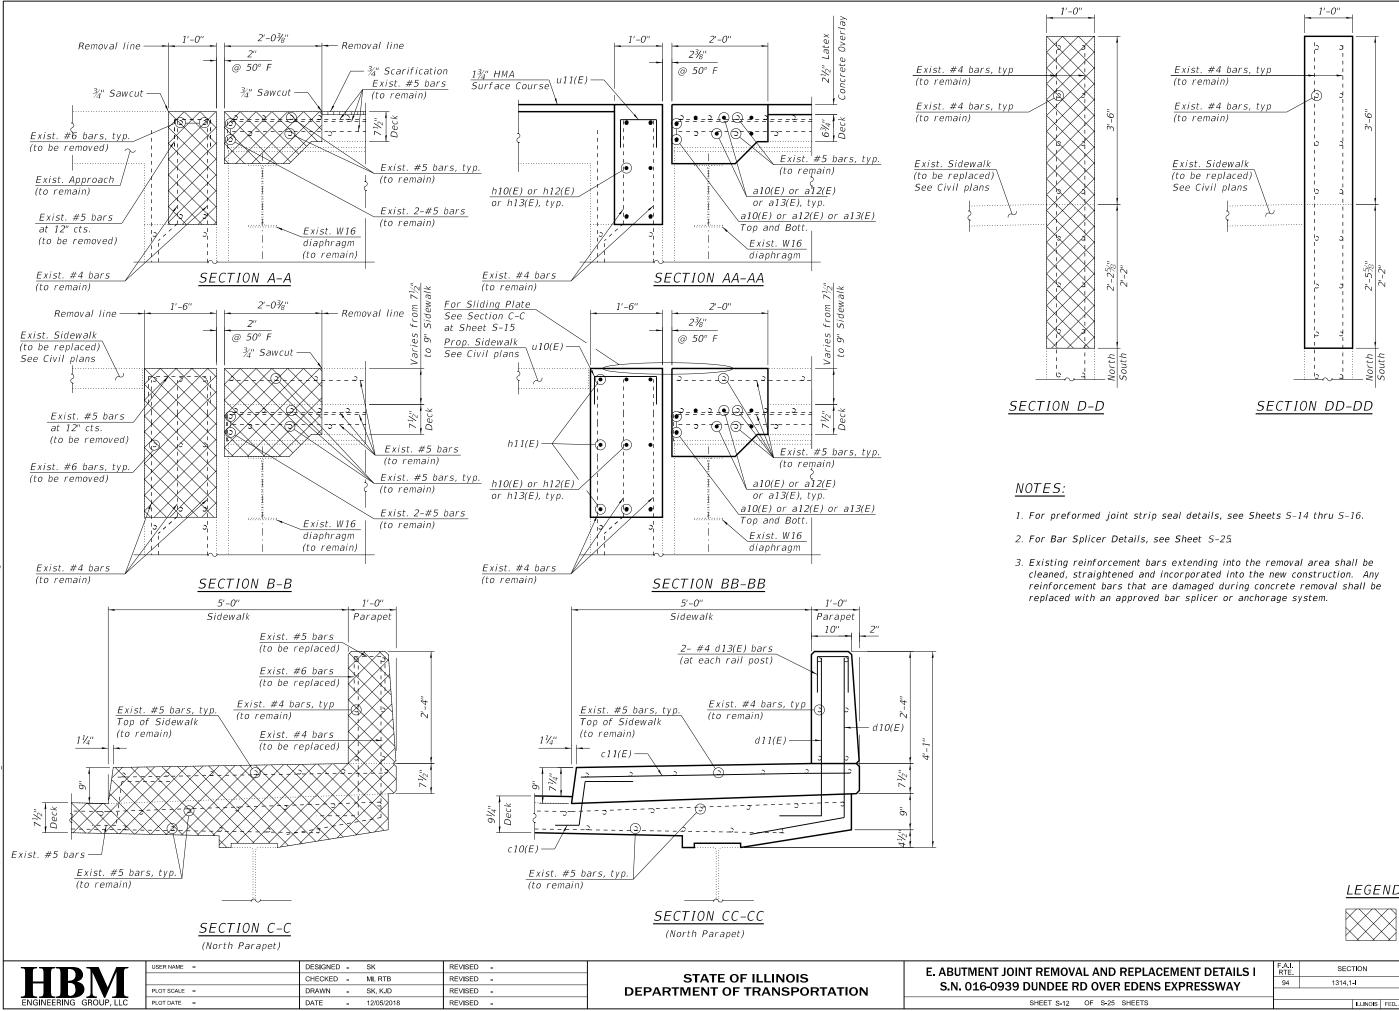

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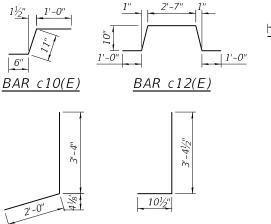
LEGEND

ND REPLACEMENT DETAILS I	F.A.I. RTE. SECTION		COUNTY	TOTAL SHEETS	SHEET NO.		
/ER EDENS EXPRESSWAY		1314.1-			COOK	70	49
					CONTRA	CT NO. 6	0M72
S-25 SHEETS			ILLINOIS	FED. A	D PROJECT		

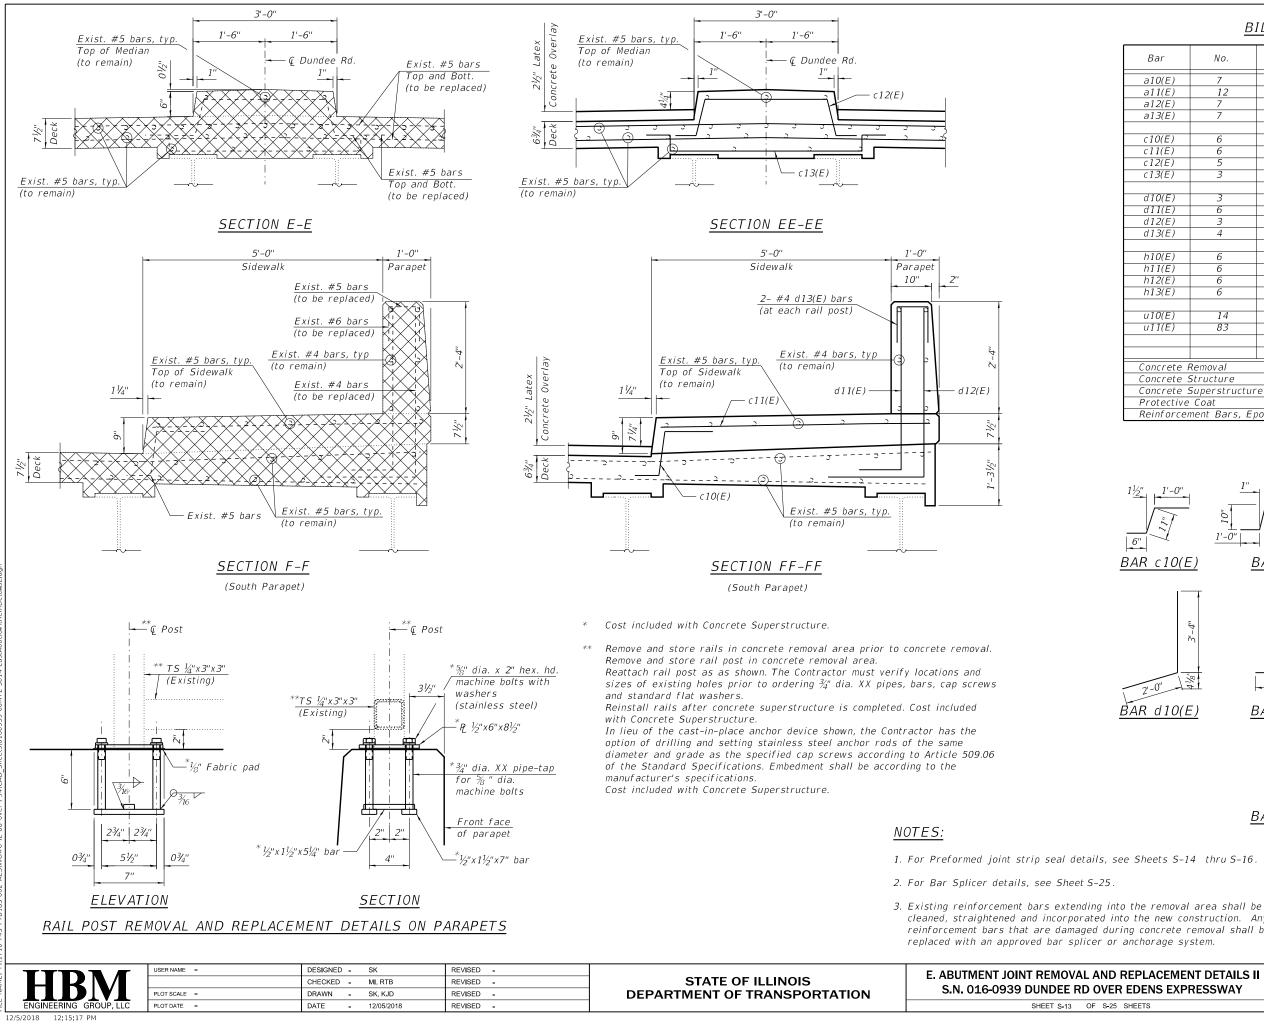

SHEET S-13 OF S-


	B	ILL OF MAT	<u>ERIAL</u>	
Bar	No.	Size	Length	Shape
a10(E)	7	#5	36'-1"	
a11(E)	12	#5	4'-3"	
a12(E)	7	#5	22'-1"	
a13(E)	7	#5	35'-0"	
c10(E)	6	#5	2'-5"	5
c11(E)	6	#5	5'-7"	
c12(E)	5	#5	6'-3''	
c13(E)	3	#4	5'-10"	
d10(E)	3	#4	5'-4"	
d11(E)	6	#6	4'-3''	
d12(E)	3	#4	5'-4"	
d13(E)	4	#4	2'-0"	
h10(E)	6	#6	34'-11"	
h11(E)	6	#6	5'-7"	
h12(E)	6	#6	20'-11"	
h13(E)	6	#6	35'-0"	
u10(E)	14	#5	2'-5"	
u11(E)	83	#5	1'-11"	
Concrete F			Cu. Yd.	13.8
Concrete S	Structure		Cu. Yd.	0.8
	Superstructur	е	Cu. Yd.	14.0
Protective			Sq. Yd.	37
Reinforcen	ment Bars, Ep	oxy Coated	Pound	1,970




BAR d11(E)




BAR d13(E)

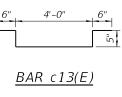

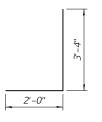

BAR d12(E)

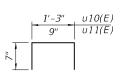


BARS u10(E) and u11(E)

BAR d10(E)

cleaned, straightened and incorporated into the new construction. Any reinforcement bars that are damaged during concrete removal shall be LEGEND



ND REPLACEMENT DETAILS II /ER EDENS EXPRESSWAY		SECTION	COUNTY	TOTAL SHEETS	SHEET NO.	
		1314.1-	соок	70	50	
			CONTR		CT NO. 6	0M72
S-25 SHEETS		ILLINOIS	FED. A	D PROJECT		

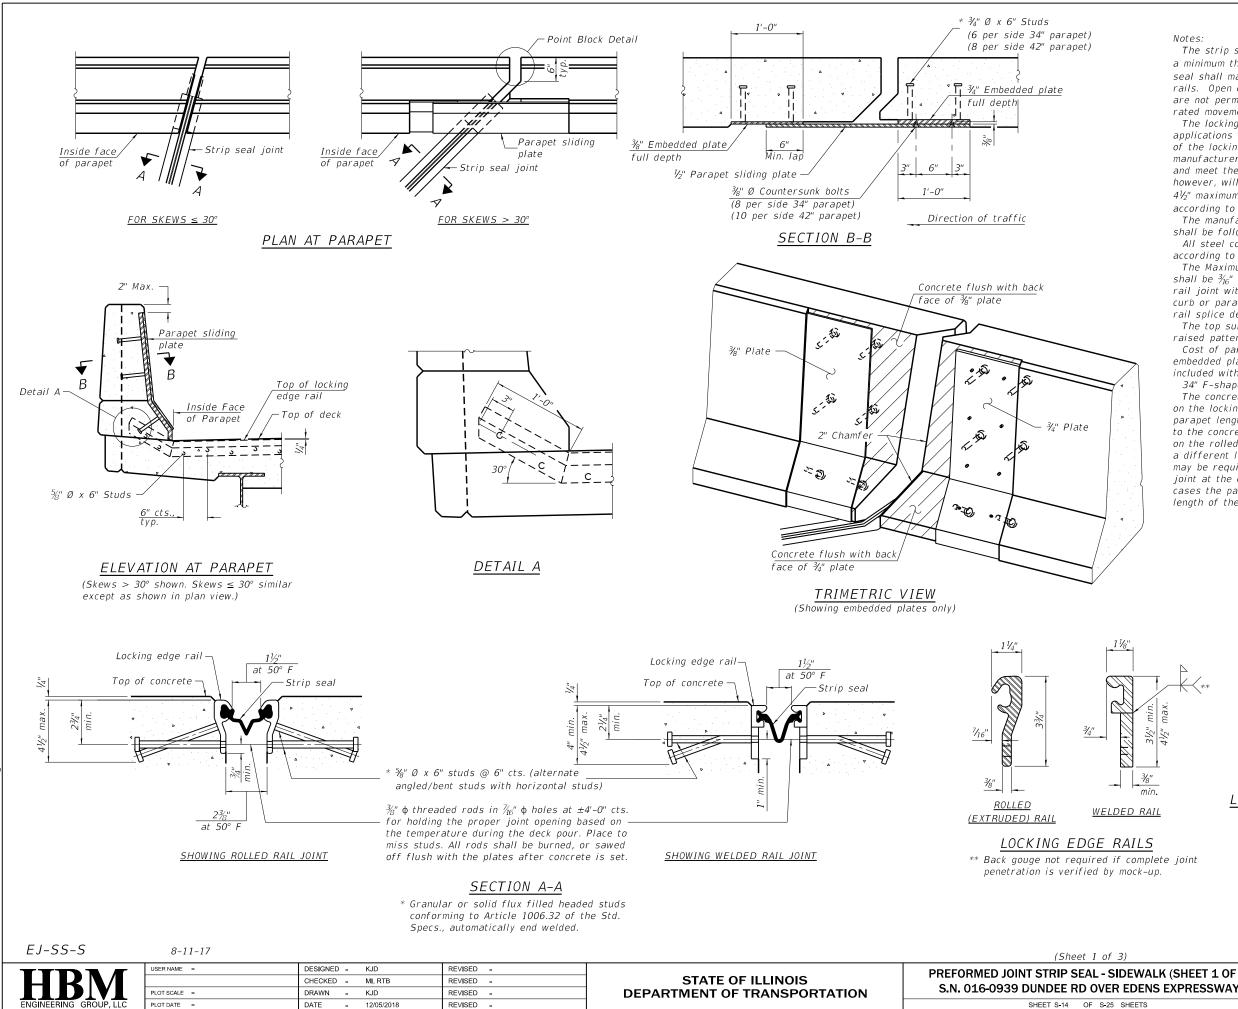

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The strip seal shall be made continuous and shall have a minimum thickness of $\frac{1}{4}$ ". The configuration of the strip seal shall match the configuration of the locking edge rails. Open or "webbed" strip seal gland configurations are not permitted. The gland shall be sized for a maximum rated movement of 4 inches.

The locking edge rails depicted are configured for typical applications and are conceptual only. The actual configuration of the locking edge rails and matching strip seal may vary from manufacturer to manufacturer provided they fit the application and meet the minimum anchorage shown. Flanged edge rails, however, will not be allowed. Locking edge rails may exceed the 4¹/₂" maximum depth provided the anchorage system is revised according to the manufacturer's recommendation.

The manufacturer's recommended installation methods shall be followed.


All steel components shall be galvanized after fabrication according to Article 520.03 of the Standard Specifications.

The Maximum space between locking edge rail segments shall be $\frac{3}{16}$ " and sealed with a suitable sealant; however, any rail joint within 10' measured perpendicular to the face of the curb or parapet shall be welded as shown in the locking edge rail splice detail.

The top surface of sidewalk sliding plates shall have a raised pattern according to ASTM A786.

Cost of parapet sliding plates, sidewalk sliding plates, embedded plates, anchorage studs, and expansion anchors included with Preformed Joint Strip Seal.

34" F-shape barrier shown, 42" F-shape similar as noted. The concrete opening below the strip seal will vary based on the locking edge rail chosen by the Contractor. Deck and parapet lengths shown elsewhere in the plans are dimensioned to the concrete opening, not the joint opening, and are based on the rolled locking edge rail. If the Contractor elects to use a different locking edge rail, dimensional adjustments may be required. One exception to this would be the strip seal joint at the end of the precast bridge approach slab. For these cases the pavement connector length shall be adjusted, not the length of the bridge approach slab.

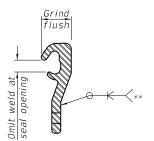

LOCKING EDGE RAIL SPLICE

The inside of the locking edge rail groove shall be free of weld residue. Rolled rail shown, welded rail similar.

BILL OF MATERIAL


Item	Unit	Total
Preformed Joint Strip Seal	Foot	188


TOTAL SHEE SHEETS NO.

70 51

SEAL - SIDEWALK (SHEET 1 OF 3)	F.A.I. RTE	SECTION	COUNTY
DD OVED EDENS EXDDESSWAV	94	1314.1-1	соок


DOVEN EDENS EXPINESSWAT				CONTRACT NO. 60M72
OF S-25 SHEETS		ILLINOIS	FED. A	D PROJECT

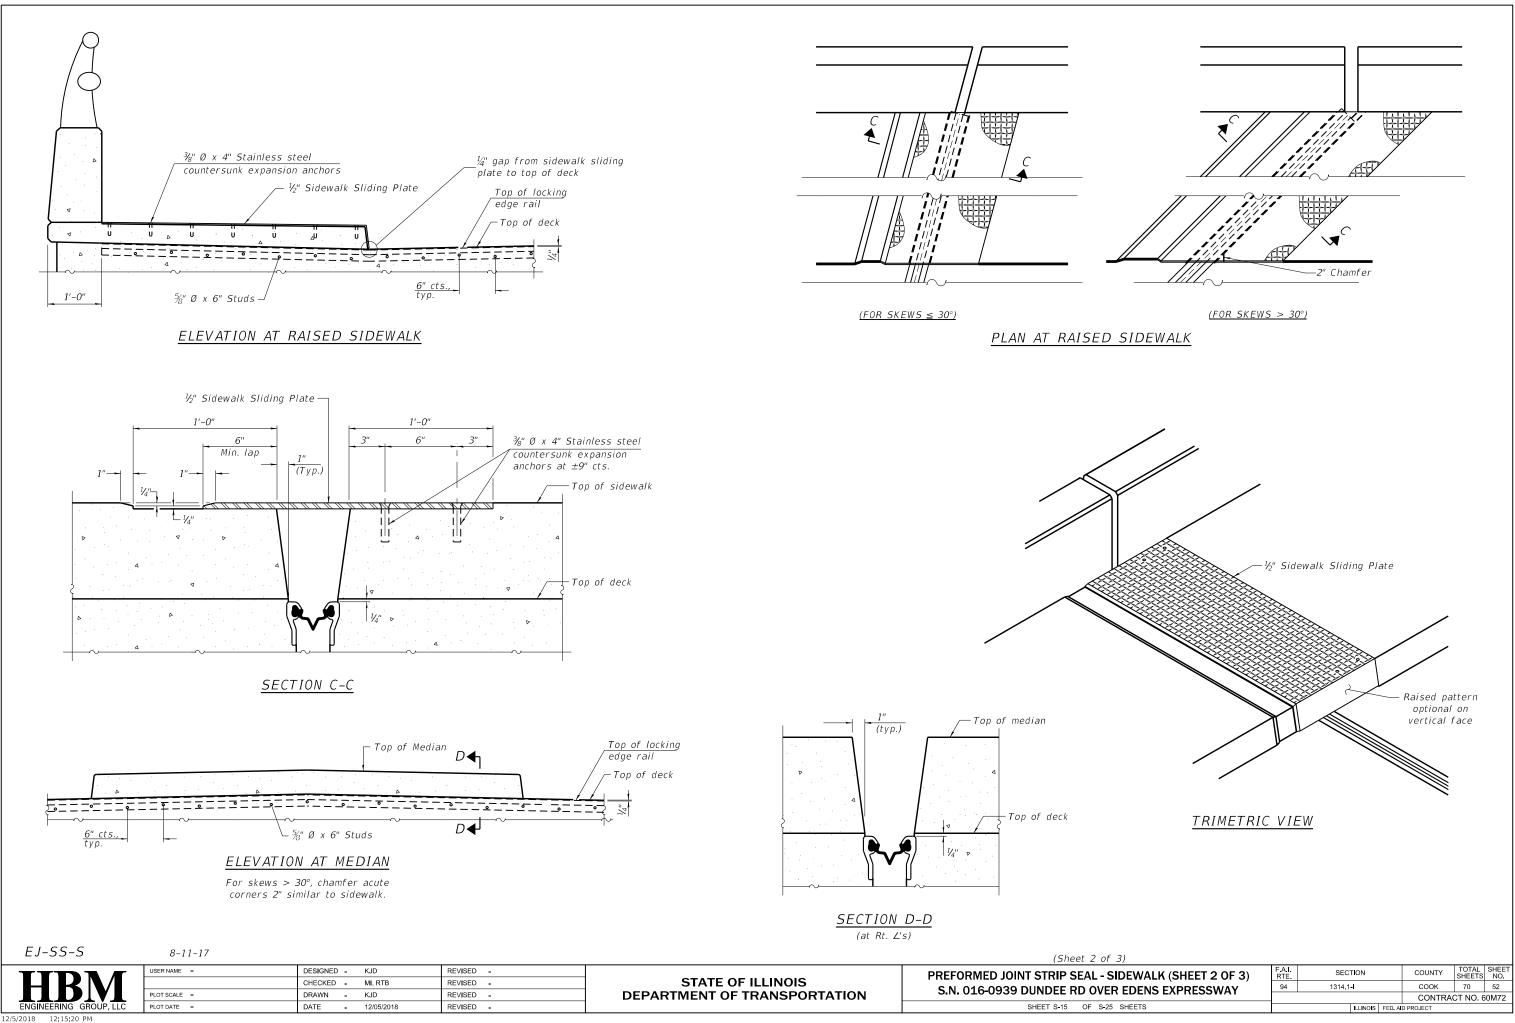

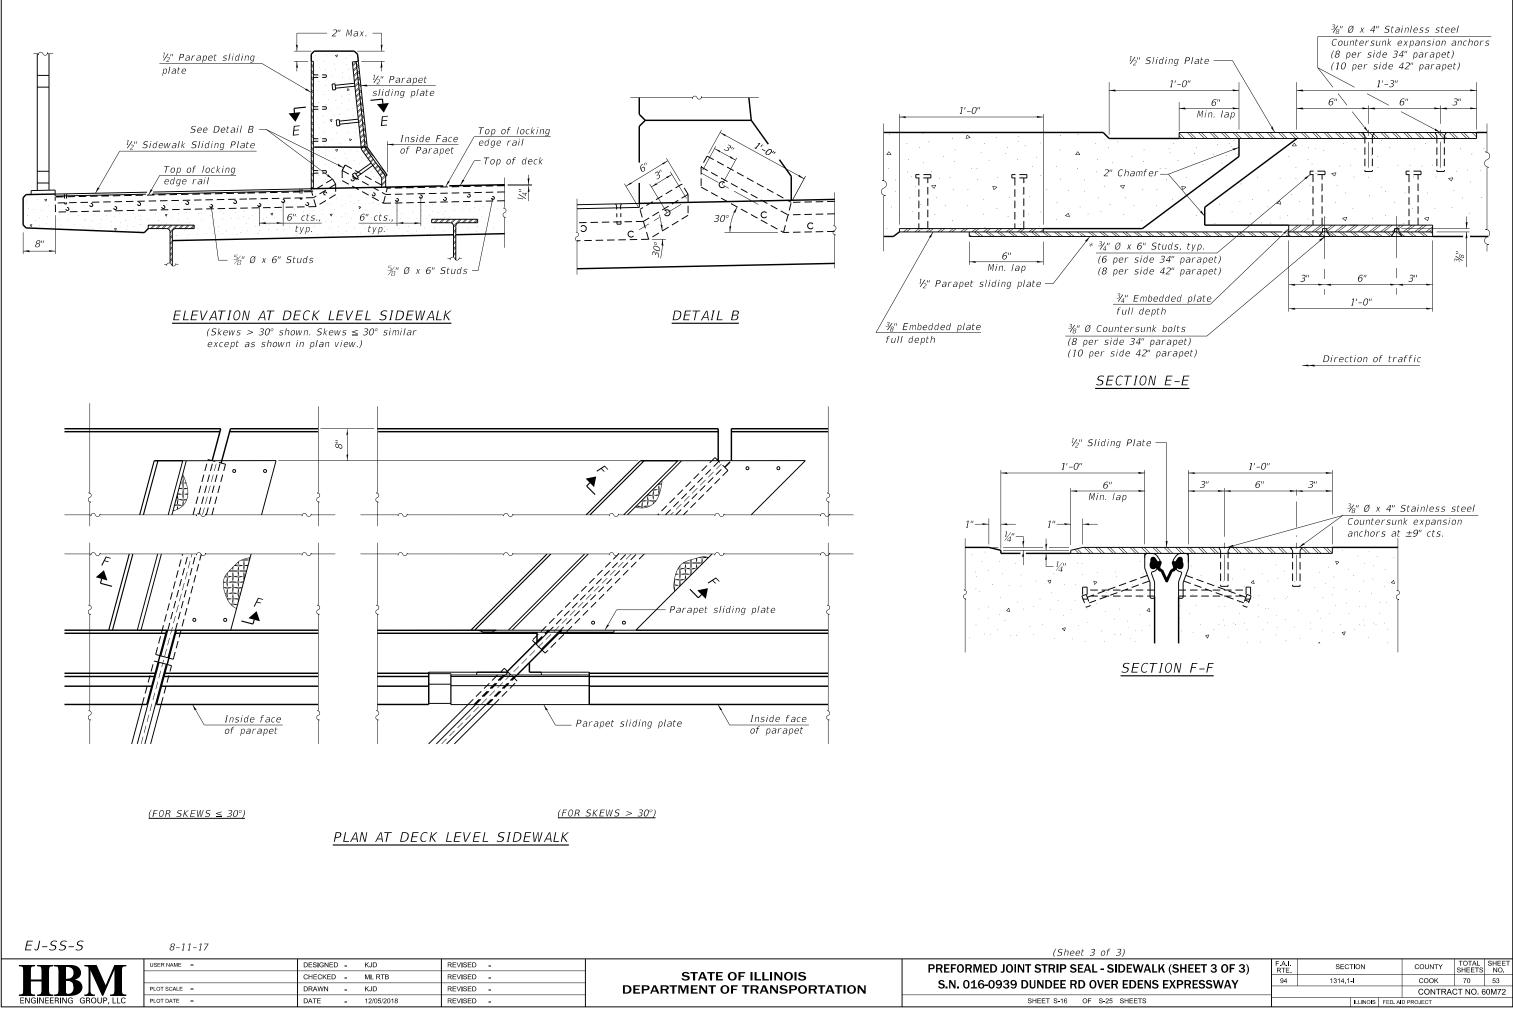

33 3	0 11 1/		
	USER NAME =	DESIGNED -	KJD

SED -	STATE OF ILLINOIS	
SED -	DEPARTMENT OF TRANSPORTATION	S.N. 016-0939 DUNDEE
SED -		SHEET S-16

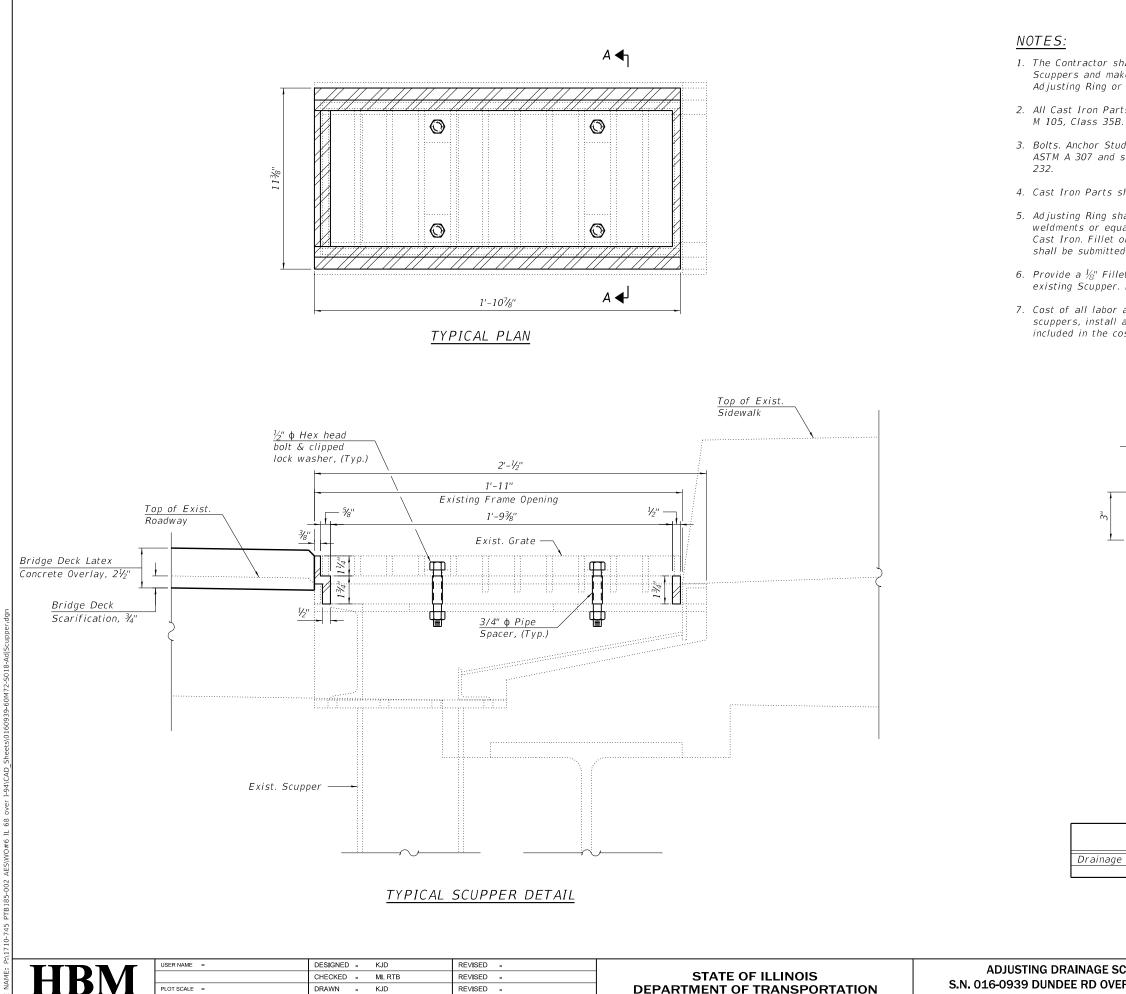

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ENGINEERING GROUP LLC

PLOT DATE =

DATE - 12/05/2018

REVISED -

S.N. 016-0939 DUNDEE RD OV

SHEET S-17 OF S-

1. The Contractor shall field verify Existing Dimensions and Details of the Existing Scuppers and make necessary adjustments prior to construction of New Adjusting Ring or ordering of material for Adjusting Drainage Scuppers.

2. All Cast Iron Parts shall be Grey Iron conforming to the requirements of AASHTO


3. Bolts. Anchor Studs, Washers and Nuts shall conform to the requirements of ASTM A 307 and shall be Galvanized according to the requirements of AASHTO M

4. Cast Iron Parts shall be unfinished.

5. Adjusting Ring shall be from Neenah and approved equal. Structural Steel weldments or equal sections and of the same configuration may be submitted for Cast Iron. Fillet or full Penetration Welds may be used for weldments. Details shall be submitted to the Engineer for approval.

6. Provide a $\frac{1}{8}$ " Fillet Weld around perimeter of new Adjusting Ring to secure to existing Scupper. Electrode shall be compatible with cast Iron.

7. Cost of all labor and materials necessary to clean all existing floor drains and scuppers, install adjusting scupper rings, remove and re-install grates is included in the cost for Drainage Scupper to be Adjusted.

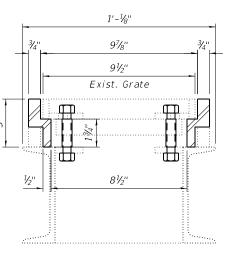


SECTION A-A

BILL OF MATERIAL

ITEM	UNIT	QUANTITY
ge Scuppers to be Adjusted	Each	8


SCUPPER DETAILS	F.A.I. RTE. SECTION		COUNTY	TOTAL SHEETS	SHEET NO.		
VER EDENS EXPRESSWAY		1314.1-			COOK	70	54
					CONTRA	CT NO. 6	0M72
S-25 SHEETS			ILLINOIS	FED. A	D PROJECT		

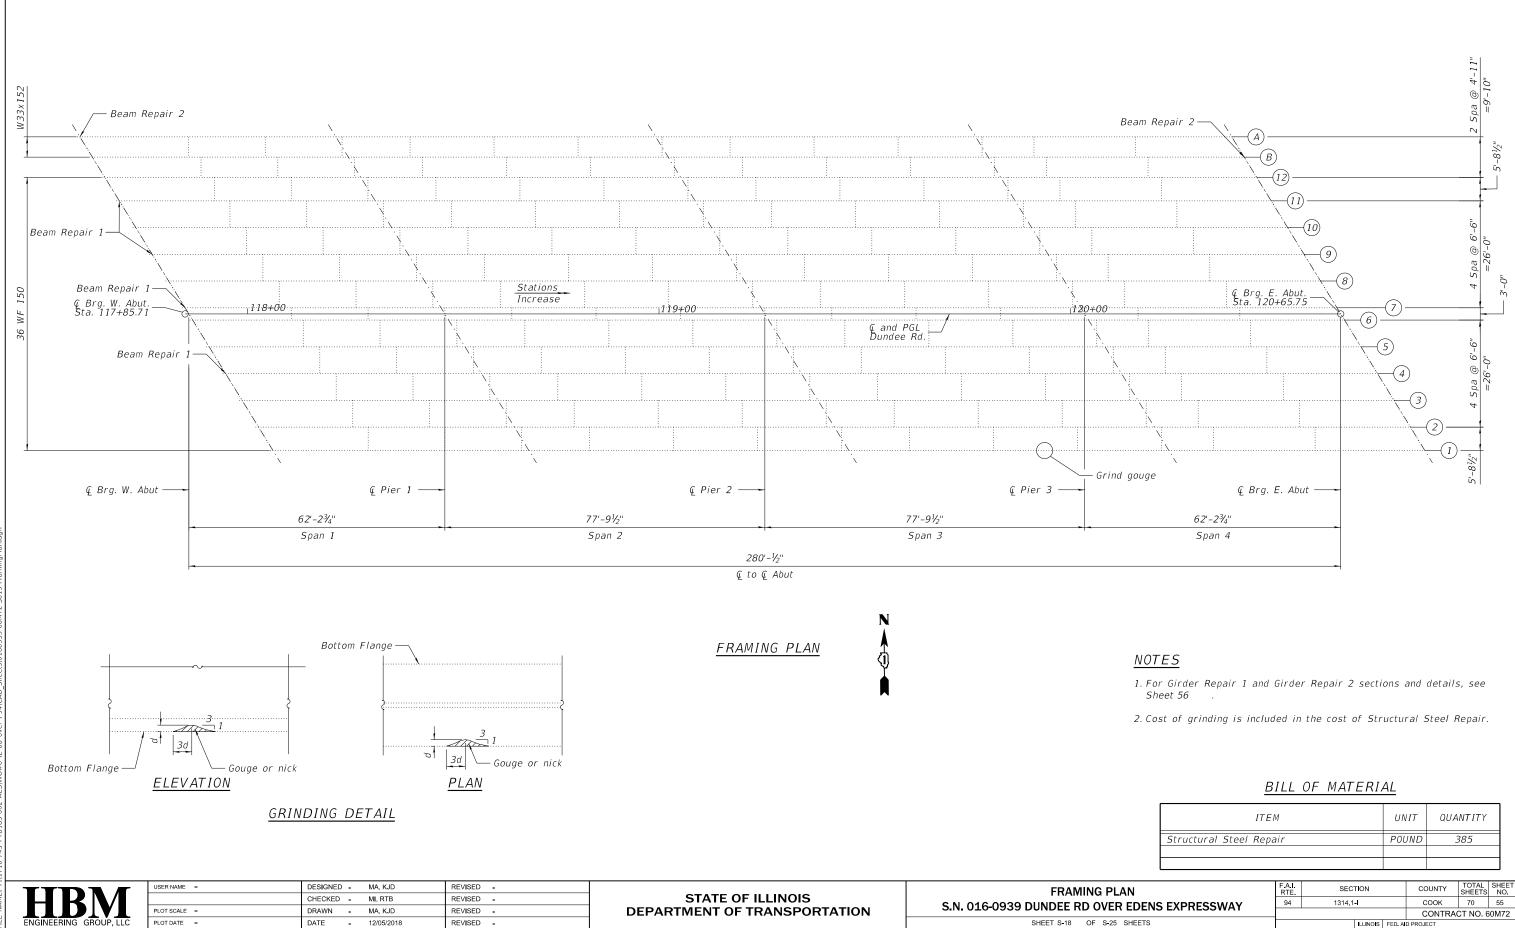

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SHEET S-18 OF S-25 SHEE

									_	
	ITEM					IT	QUA	ΝΤΙΤΥ		
	Structural Steel Repair F					POUND		385		
		F.A.I. RTE	SEC	ION		СС	UNTY	TOTAL SHEETS		EET O.
	DENS EXPRESSWAY		1314.1	1314.1-		соок		70	55	5
	EXI NESSWAT	_				С	ONTRA	CT NO. 6	60M	72
EETS		ILLINOIS FED. AID PROJECT								

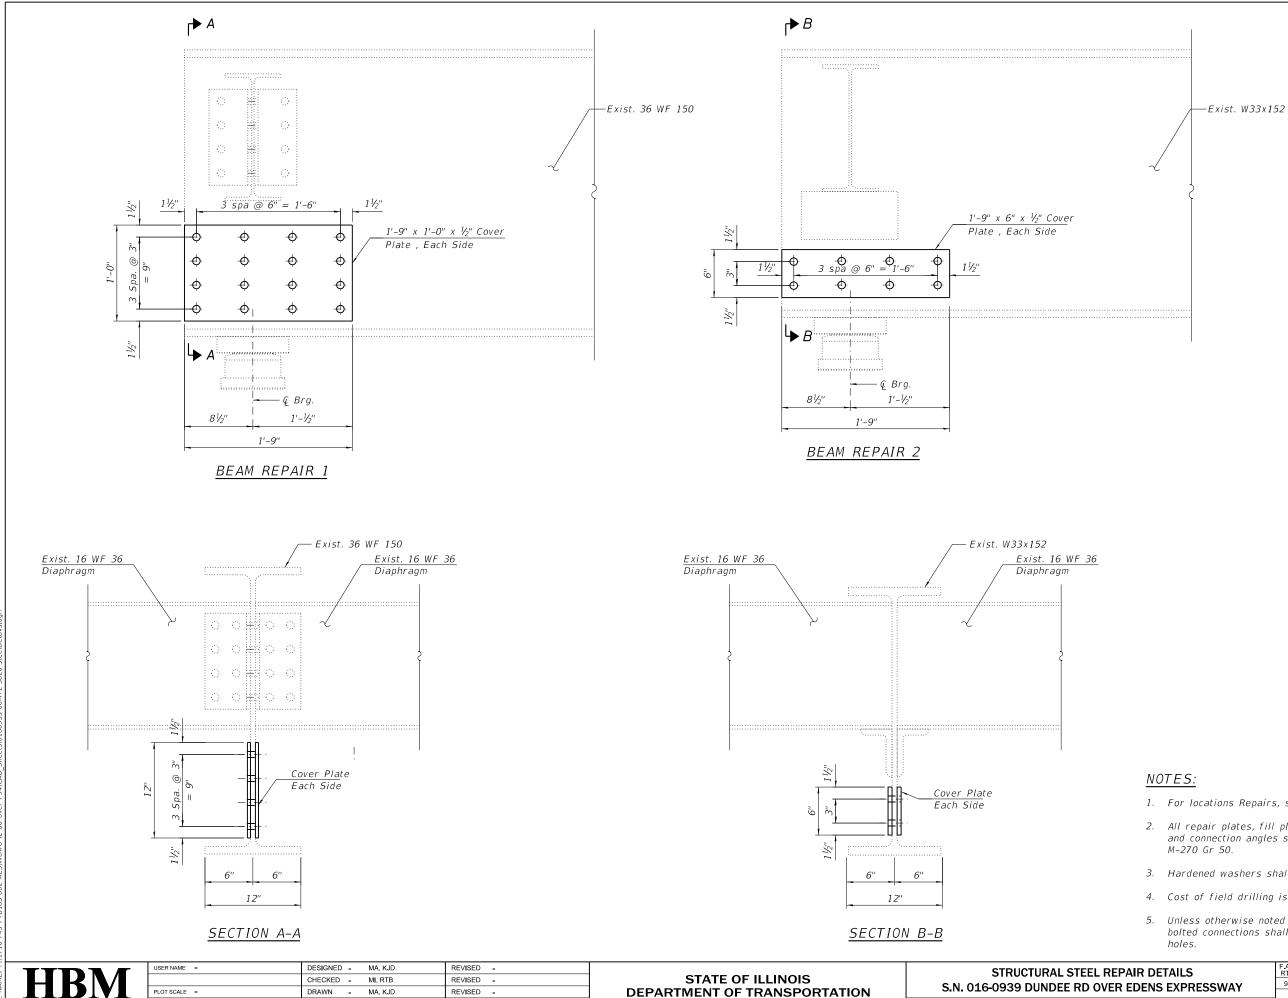

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ENGINEERING GROUP, LLC


PLOT DATE =

DATE - 12/05/2018

REVISED -

- 1. For locations Repairs, see framing plan Sheet S-18
- 2. All repair plates, fill plates, stiffener angles, connection plates and connection angles shall conform to AASHTO Classification
- 3. Hardened washers shall be required over all oversized holes.
- 4. Cost of field drilling is included with Structural Steel Repair.
- 5. Unless otherwise noted in the plans or specifications, field bolted connections shall use $\frac{3}{4}$ " high strength bolts with $\frac{13}{16}$ "

REPAIR DETAILS	F.A.I. RTE				COUNTY	TOTAL SHEETS	SHEET NO.
/ER EDENS EXPRESSWAY		1314.1 -I			соок	70	56
					CONTRA	CT NO. 6	60M72
3-25 SHEETS			ILLINOIS	FED. A	D PROJECT		

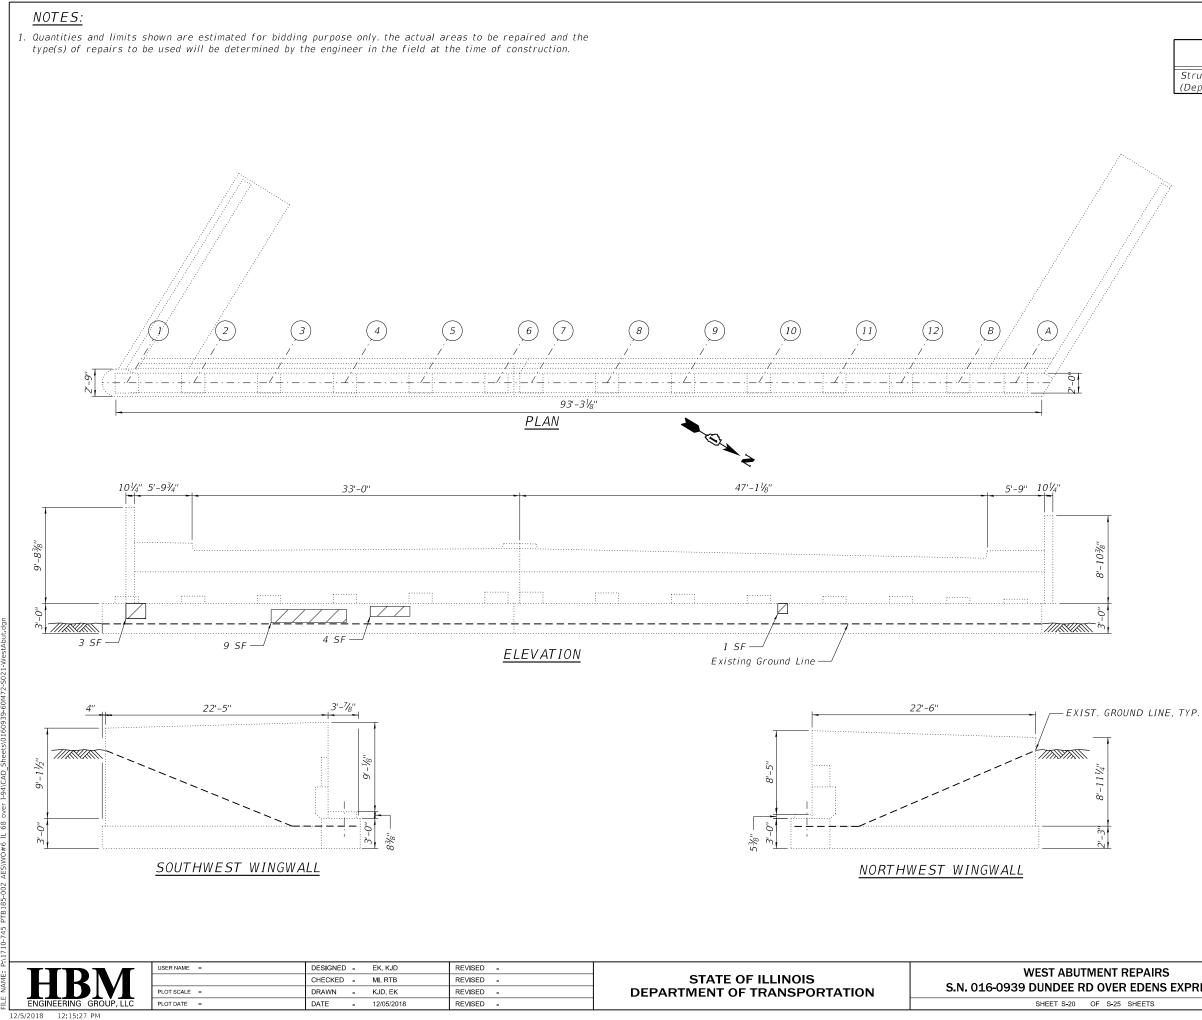

BILL OF MATERIAL

ITEM	UNIT	QUANTITY
Structural Repair of Concrete (Depth Equal to or Less than 5 inches)	Sq Ft	17

LEGENDS:


Ground line



Structural Repair of Concrete (Depth Equal to or Less than 5 inches)

SF – Square Foot

IT REPAIRS /ER EDENS EXPRESSWAY		SECTION		COUNTY	TOTAL SHEETS	SHEET NO.	
		1314.1-			соок	70	57
					CONTRA	CT NO. 6	0M72
3-25 SHEETS			ILLINOIS	FED. A	D PROJECT		

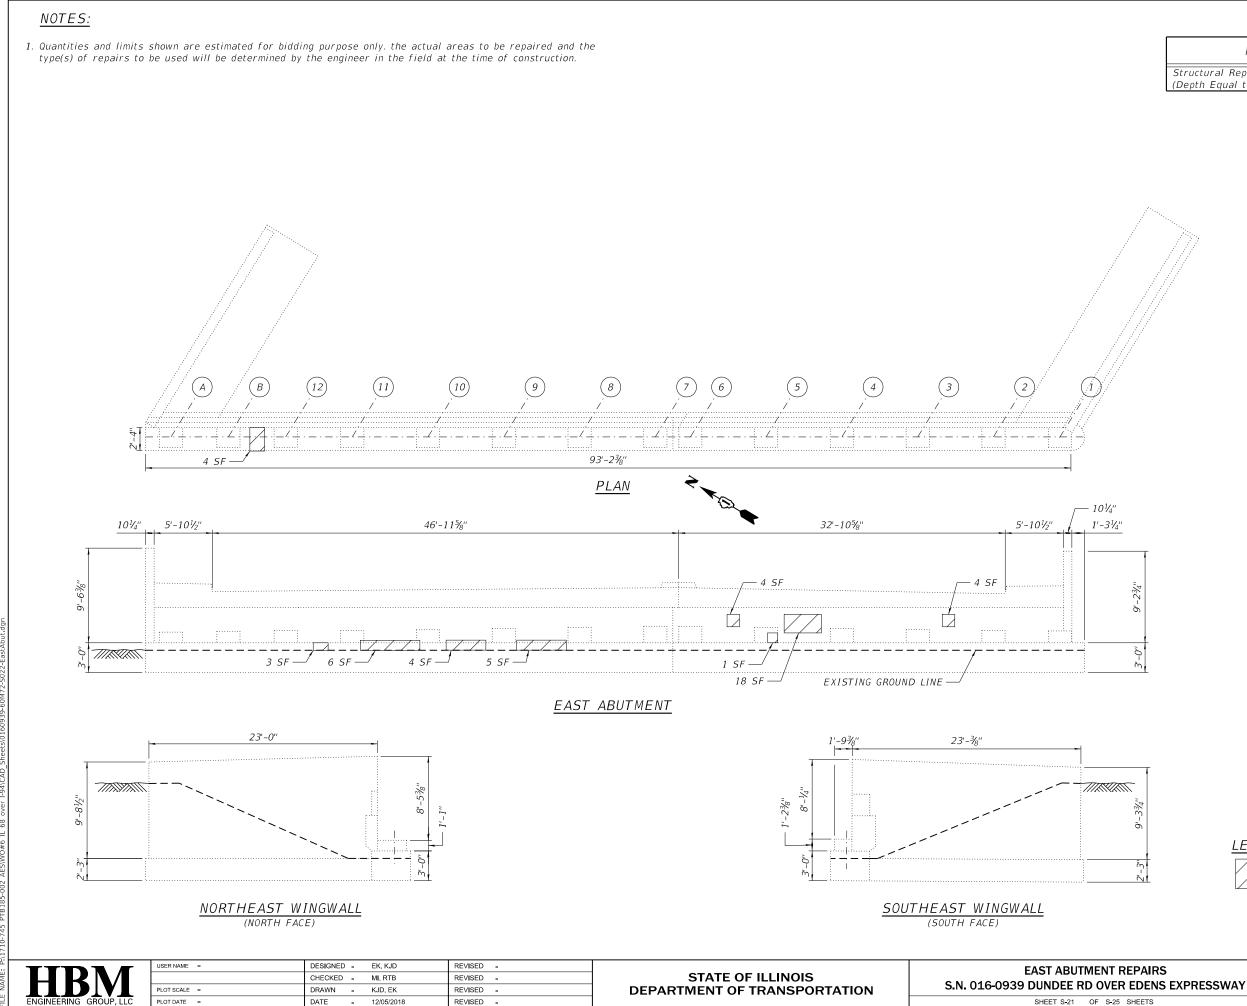

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BILL OF MATERIAL

ITEM	UNIT	BRIDGE 397 QUANTITY
Structural Repair of Concrete (Depth Equal to or Less than 5 inches)	Sq Ft	49



SF

Structural Repair of Concrete (Depth Equal to or Less than 5 inches)


Square Foot

 F.A.I. RTE.
 SECTION
 COUNTY
 TOTAL SHEETS
 SHEETS

 P4
 1314.1-1
 COOK
 70
 58

 CONTRACT NO. 60M72

 25
 SHEETS

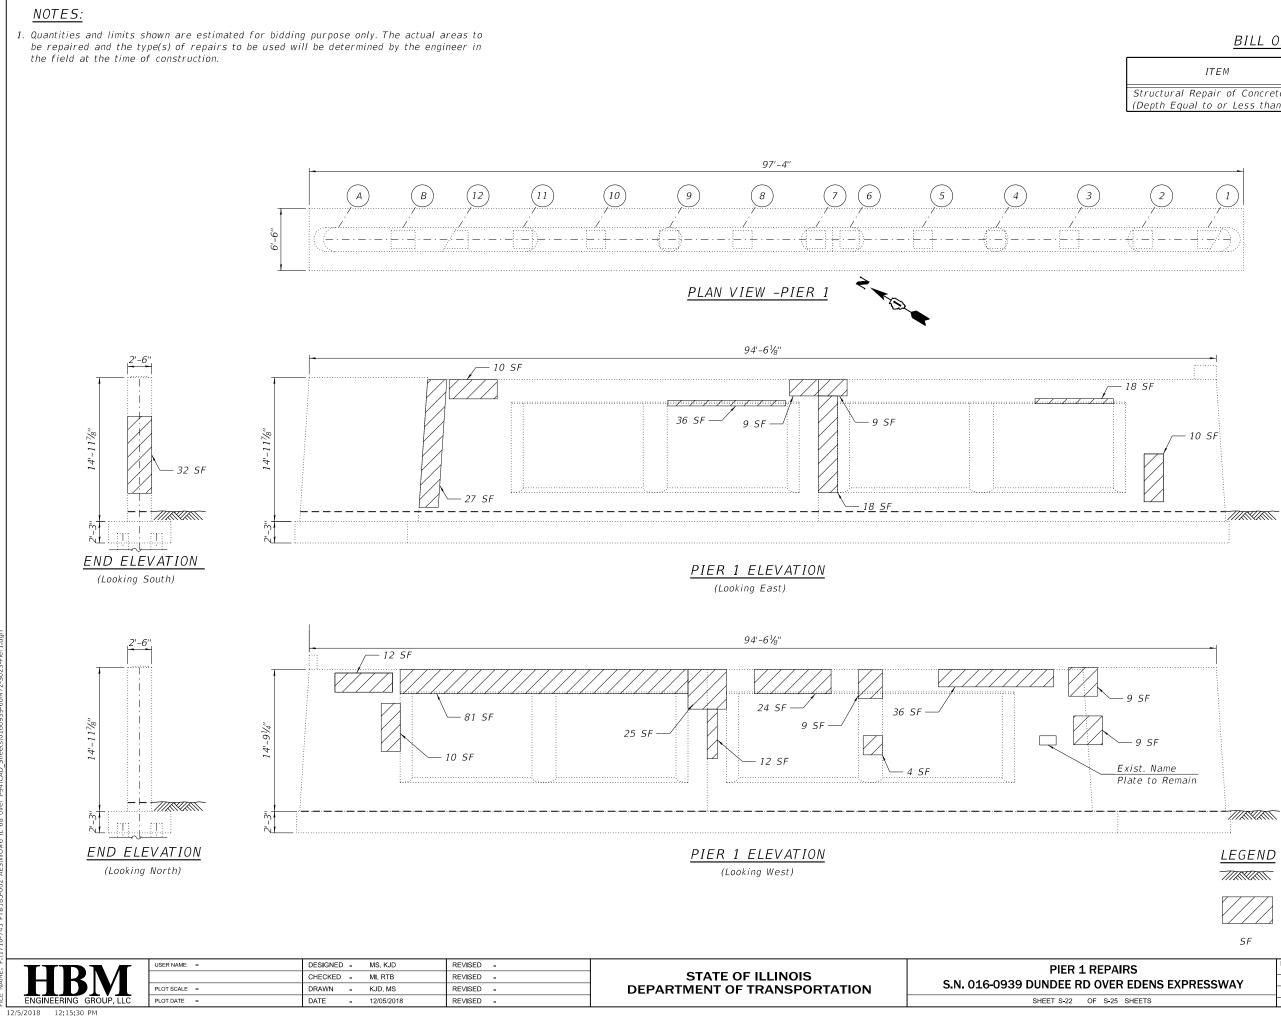

BILL	0F	MATERIAL


ITEM	UNIT	QUANTITY
Structural Repair of Concrete (Depth Equal to or Less than 5 inches)	Sq Ft	400

Ground line

Structural Repair of Concrete (Depth Equal to or Less than 5 inches)

– Square Foot

PAIRS	F.A.I. SECTION		COUNTY	TOTAL SHEETS	SHEET NO.		
/ER EDENS EXPRESSWAY		1314.1-			соок	70	59
					CONTRACT NO. 60M7		
S-25 SHEETS	ILLINOIS FED.			FED. A	D PROJECT		

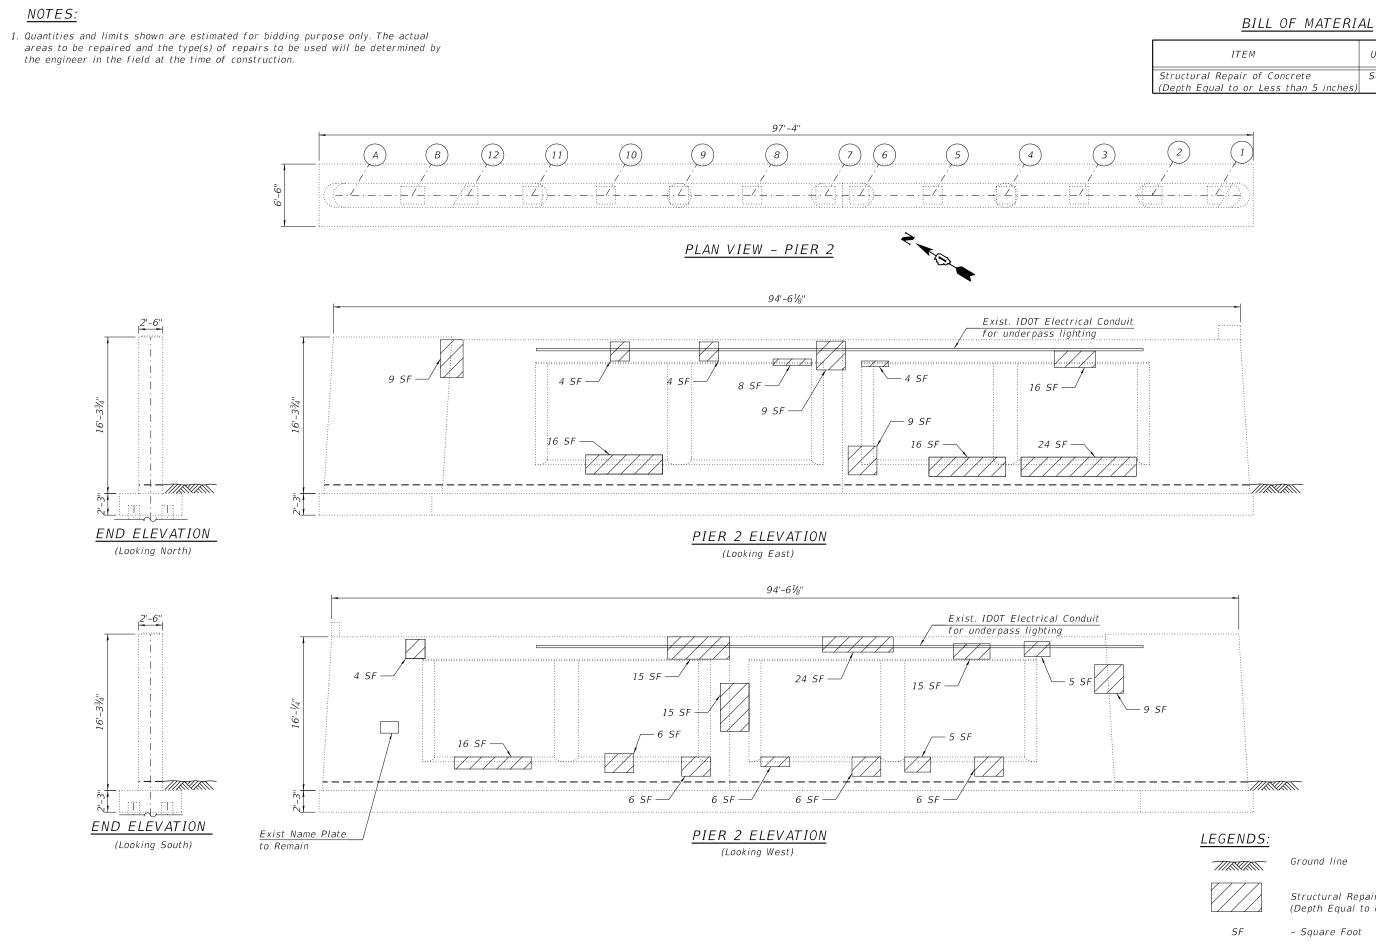

STATE OF ILLINOIS DEPARTMENT OF TRANSPORTATION

ENGINEERING GROUP, LLC 12/5/2018 12:15:31 PM

JSER NAME =

LOT SCALE =

PLOT DATE =

DESIGNED - MS, KJD

CHECKED - MI, RTB

DRAWN - KJD, MS

DATE - 12/05/2018

REVISED -

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PIER 2 REP S.N. 016-0939 DUNDEE RD OVE


<u>BILL OF MATERIAL</u>						
ITEM	UNIT	QUANTITY				
Structural Repair of Concrete (Depth Equal to or Less than 5 inches)	Sq Ft	257				

Ground line

Structural Repair of Concrete (Depth Equal to or Less than 5 inches)

– Square Foot	
---------------	--

PAIRS		F.A.I. RTE. SECTION		COUNTY	TOTAL SHEETS	SHEET NO.	
/ER EDENS EXPRESSWAY		94 1314.1-1			соок	70	60
					CONTRA	CT NO. 6	60M72
S-25 SHEETS			ILLINOIS	FED. A	D PROJECT		

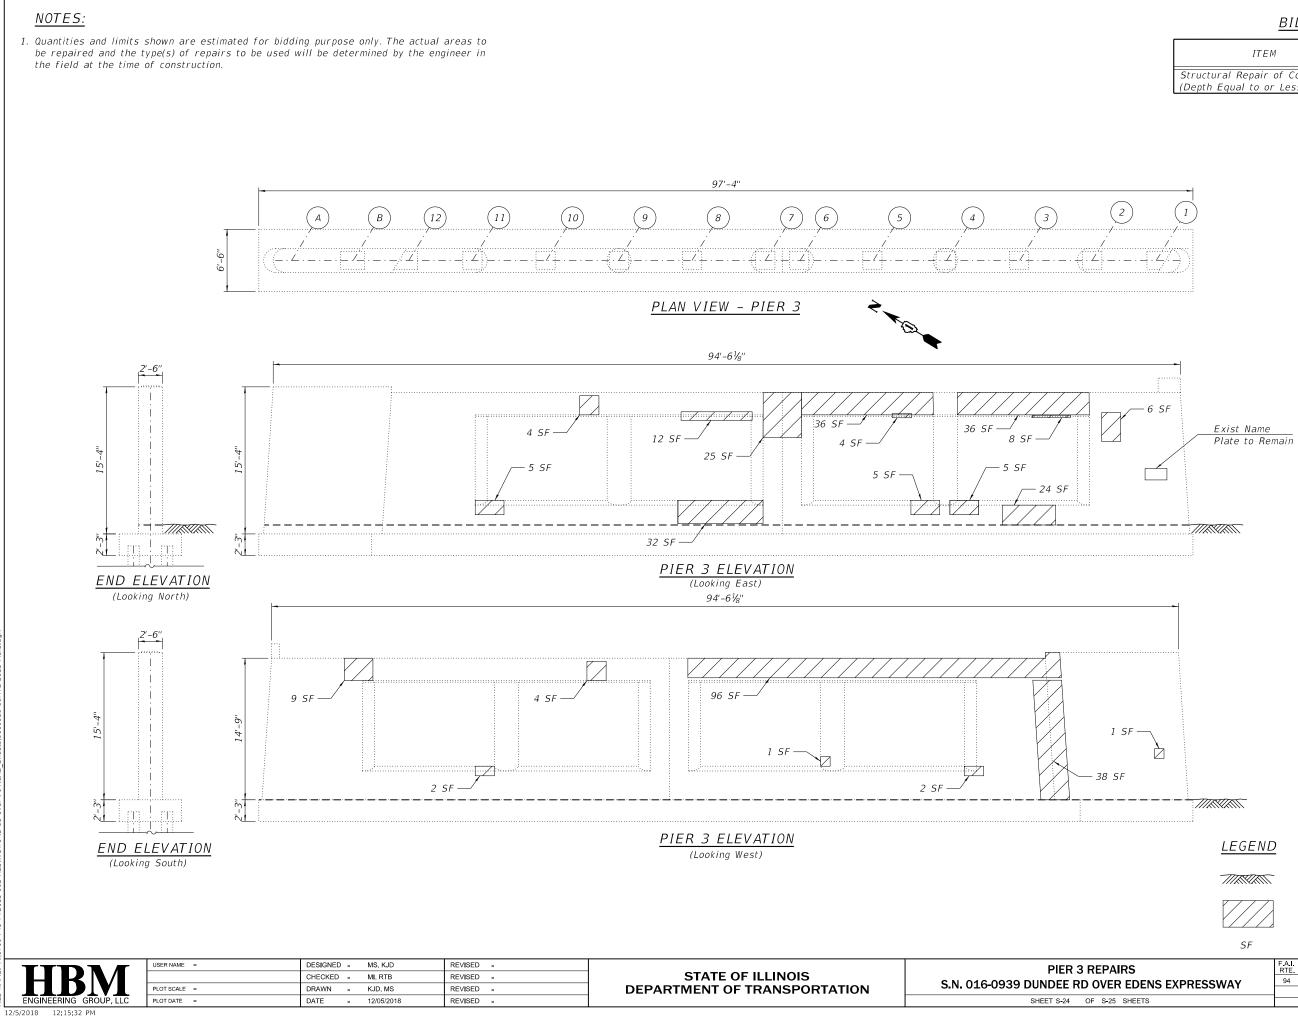

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BILL OF MATERIAL


ITEM	UNIT	QUANTITY
Structural Repair of Concrete (Depth Equal to or Less than 5 inches)	Sq Ft	355

Structural Repair of Concrete (Depth Equal to or Less than 5 inches)

– Square Foot

Ground line


PAIRS /ER EDENS EXPRESSWAY		SECTION			COUNTY	TOTAL SHEETS	SHEET NO.
		1314.1-I			соок	70	61
					CONTRA	CT NO. 6	0M72
3-25 SHEETS	ILLIN			FED. A	D PROJECT		

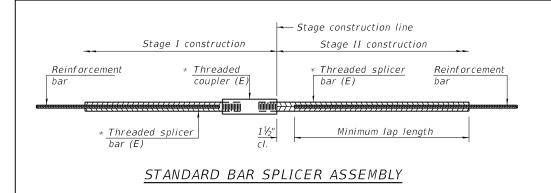

Threaded splicer bar length = min. lap length + $1\frac{1}{2}$ " + thread length

* Epoxy not required on Bar Splicer Assembly components used in conjunction with black bars.

Location	Bar size	No. assemblies required	Minimum Iap length
Deck	# 5	28	3'-6''
West Abutment	# 6	12	4'-0''
East Abutment	# 6	12	4'-0''

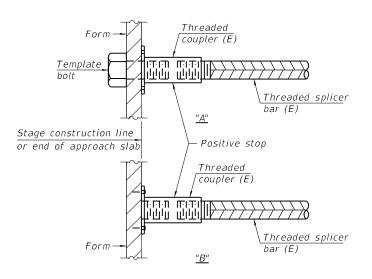


INSTALLATION AND SETTING METHODS

"A" : Set bar splicer assembly by means of a template bolt.

"B" : Set bar splicer assembly by nailing to wood forms or cementing to steel forms. (E) : Indicates epoxy coating.




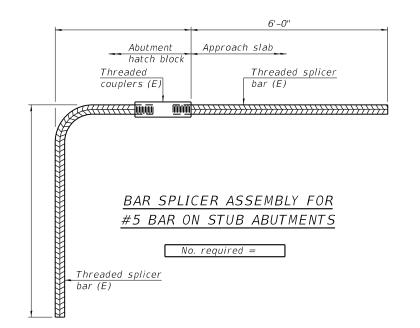

2-17-2017

efat.		USER NAME =	DESIGNED - MS, KJD	REVISED -		BAR SPLICERS
Ŭ P			CHECKED - MI, RTB	REVISED -	STATE OF ILLINOIS	
DEL:		PLOT SCALE =	DRAWN - KJD, MS	REVISED -	DEPARTMENT OF TRANSPORTATION	S.N. 016-0939 DUNDEE RD OVER
MOI	ENGINEERING GROUP, LLC	PLOT DATE =	DATE - 12/05/2018	REVISED -		SHEET S-25 OF S-25 S

BSD-1

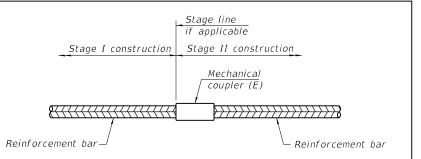

STANDARD MECHANICAL SPLICER


l a satism	Bar	No. assemblies
Location	size	required
	0.20	

NOTES


Splicer bars shall be deformed with threaded ends and have a minimum 60 ksi yield strength.


All reinforcement shall be lapped and tied to the splicer bars. Bar splicer assemblies shall be epoxy coated according to the requirements for reinforcement bars. See Section 508 of the Standard Specifications. See approved list of bar splicer assemblies and mechanical splicers for alternatives.

CERS YER EDENS EXPRESSWAY		SEC	TION		COUNTY	TOTAL SHEETS	SHEET NO.
		94 1314.1-I			соок	70	62
					CONTRAC	CT NO. 6	0M72
-25 SHEETS			ILLINOIS	FED. A	D PROJECT		

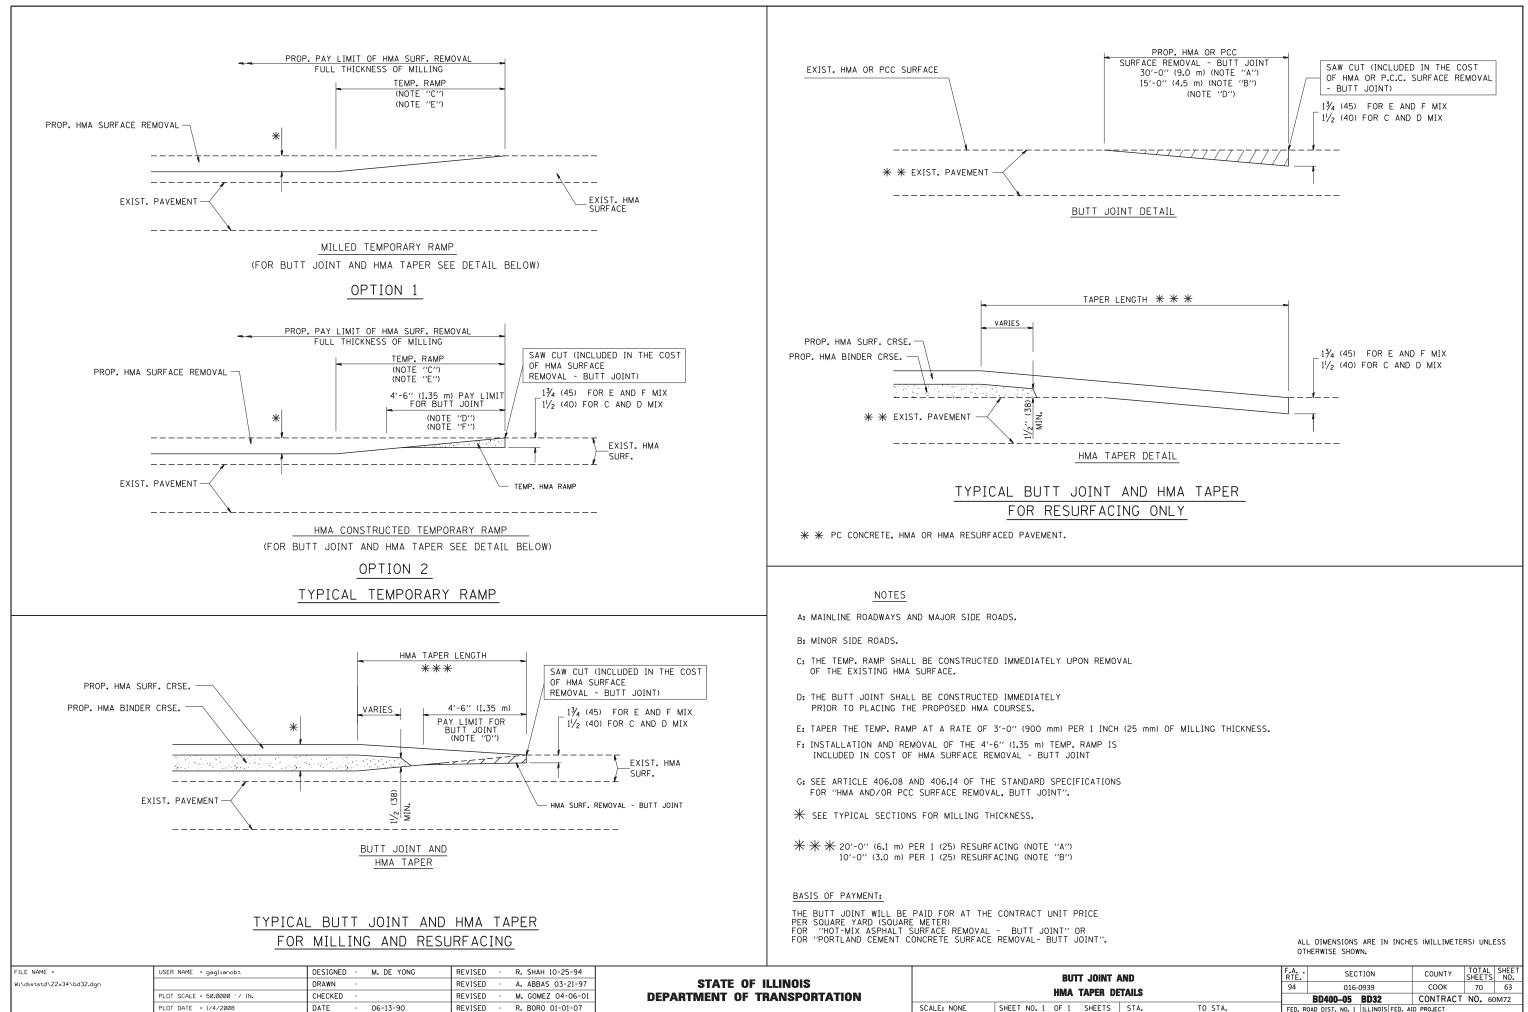

AND		F.A RTE.	SEC	TION	COUNTY	TOTAL SHEETS	SHEET NO.	
hE			94	016-0	0939	СООК	70	63
	TAILO			BD400-05		CONTRACT	NO. 60	DM72
	STA.	TO STA.	FED. RO	DAD DIST. NO. 1	ILLINOIS FED. A	ID PROJECT		

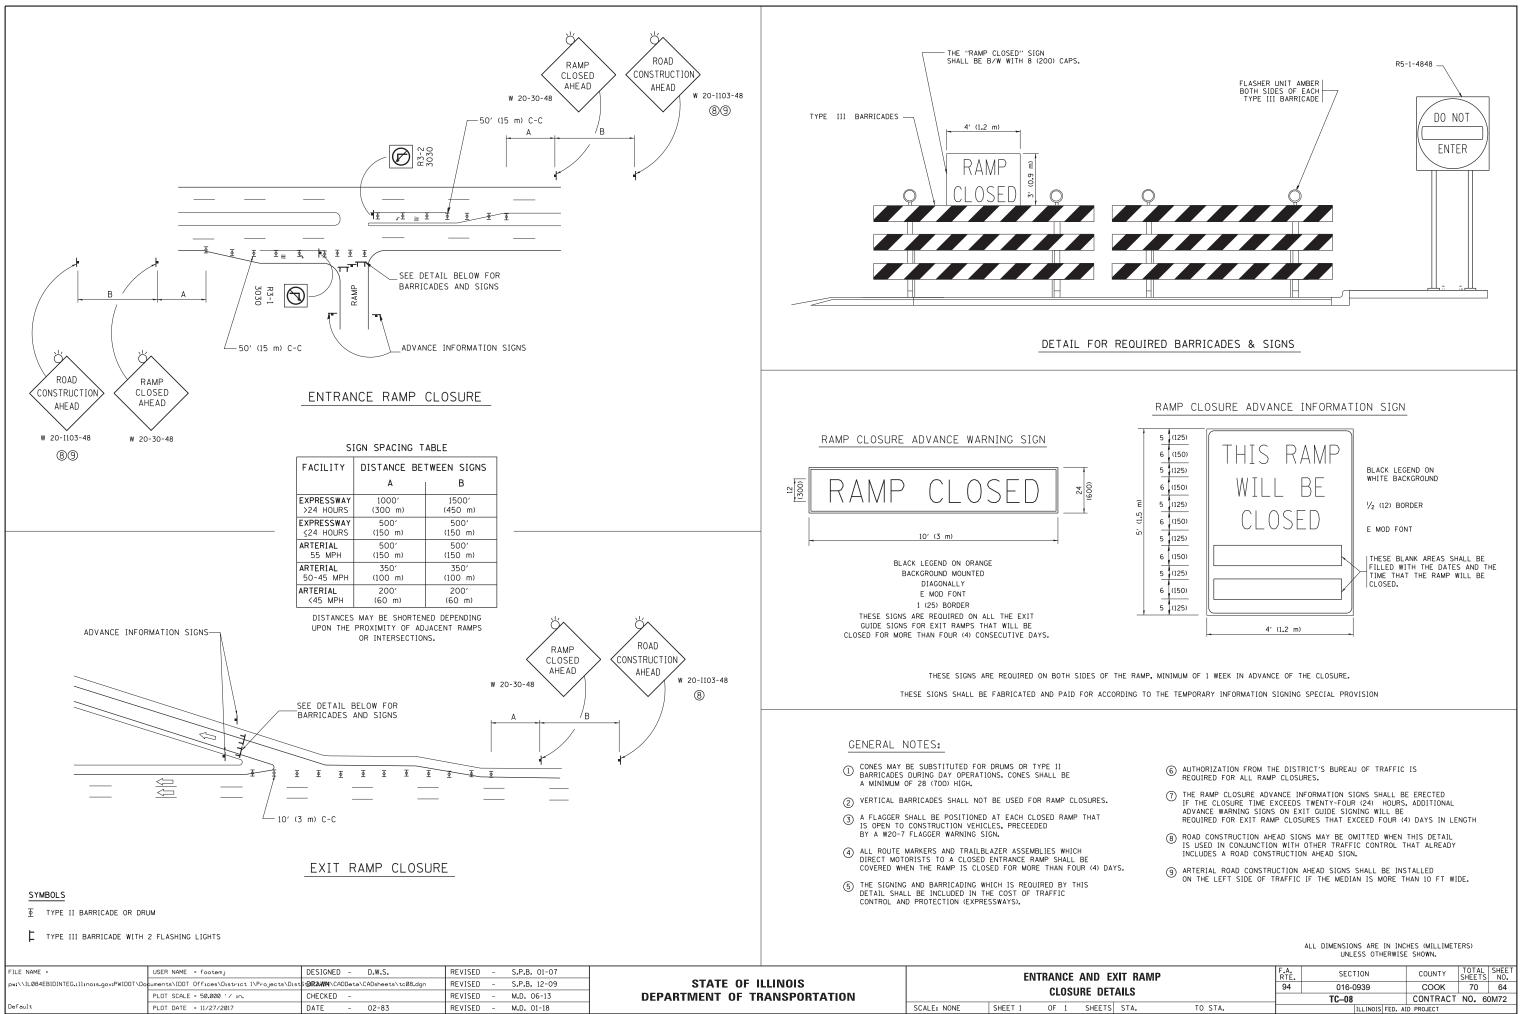

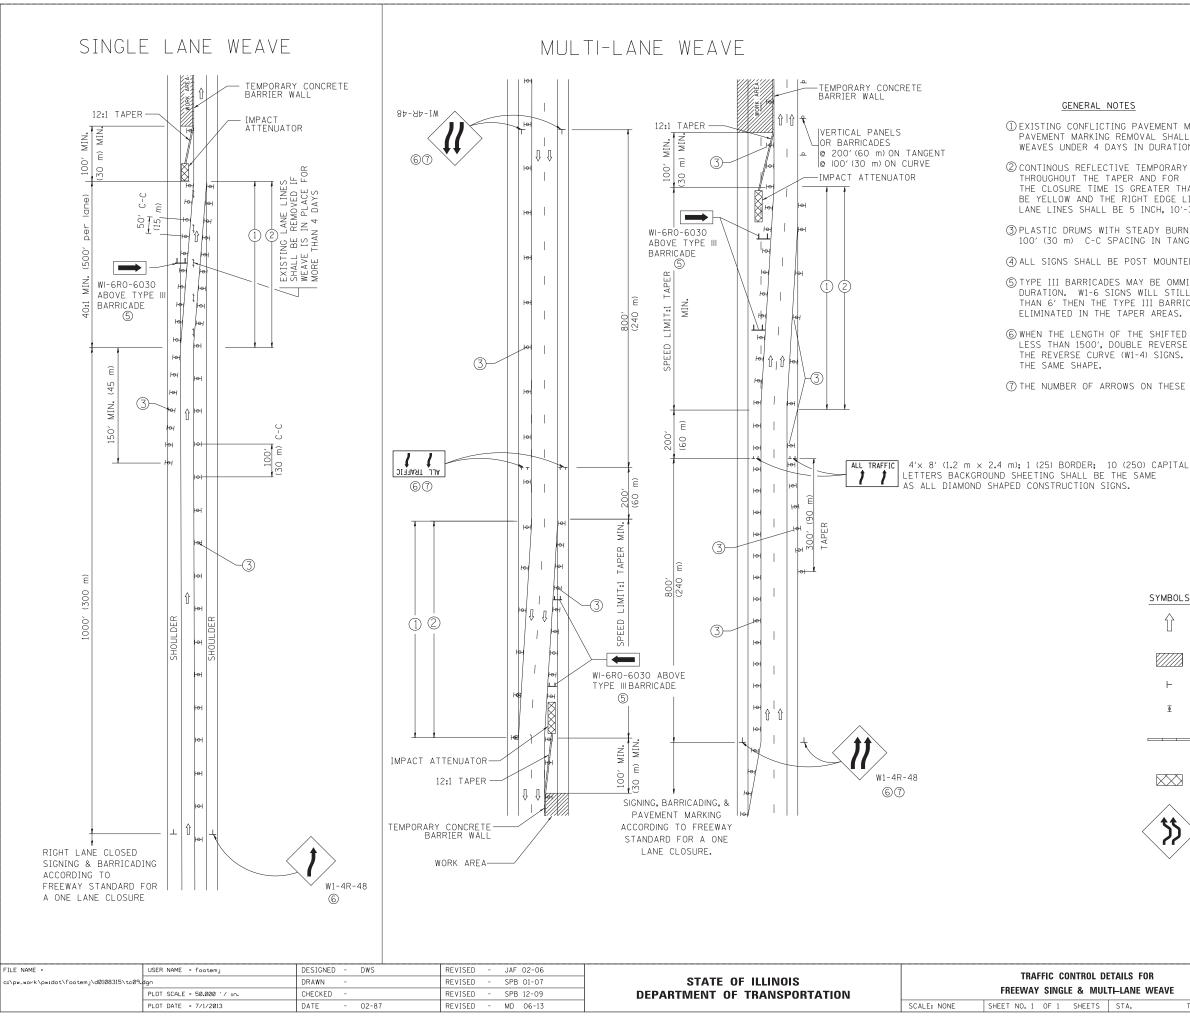

① EXISTING CONFLICTING PAVEMENT MARKING LINES SHALL BE REMOVED. PAVEMENT MARKING REMOVAL SHALL NOT BE REQUIRED FOR SINGLE LANE WEAVES UNDER 4 DAYS IN DURATION.

② CONTINOUS REFLECTIVE TEMPORARY PAVEMENT MARKING TAPE SHALL BE PLACED THROUGHOUT THE TAPER AND FOR 300' (90 m) ALONG SIDE THE WORK AREA WHERE THE CLOSURE TIME IS GREATER THAN FOURTEEN DAYS. THE LEFT EDGE LINE SHALL BE YELLOW AND THE RIGHT EDGE LINE SHALL BE WHITE. FOR MULTI-LANE WEAVES LANE LINES SHALL BE 5 INCH, 10'-30' (3 m-9 m) SKIP DASH, WHITE.

(3) PLASTIC DRUMS WITH STEADY BURN LIGHTS AT 50' (15 m) C-C SPACING IN TAPERS AND 100' (30 m) C-C SPACING IN TANGENTS.

(4) ALL SIGNS SHALL BE POST MOUNTED IF THE CLOSURE TIME EXCEEDS FOUR DAYS.

(5) TYPE III BARRICADES MAY BE OMMITTED FOR SINGLE-LANE WEAVES UNDER 24-HOURS IN DURATION. W1-6 SIGNS WILL STILL BE REQUIRED. IF THE WIDTH OF OFFSET IS LESS THAN 6' THEN THE TYPE III BARRICADE WITH ATTACHED ARROW SIGN PANEL CAN BE

(6) WHEN THE LENGTH OF THE SHIFTED SEGMENT (DISTANCE BETWEEN WEAVE POINTS) IS LESS THAN 1500', DOUBLE REVERSE CURVE SIGNS (W24-1) SHOULD BE USED INSTEAD OF THE REVERSE CURVE (W1-4) SIGNS. ARROWS ON THE 4'X8' "ALL TRAFFIC" SIGNS SHALL BE

(7) THE NUMBER OF ARROWS ON THESE SIGNS SHALL MATCH THE NUMBER OF LANES OPEN TO TRAFFIC.

SYMBOLS

- $\hat{\Pi}$ DIRECTION OF TRAFFIC
- WORK AREA
- SIGN ON PORTABLE OR PERMANENT SUPPORT
- TYPE II BARRICADE OR DRUM WITH MONO-DIRECTIONAL STEADY BURNING LIGHT

TEMPORARY CONCRETE BARRIER WALL

 \mathbb{X}

IMPACT ATTENUATOR


W24-1-48


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ALL DIMENSIONS ARE IN INCHES (MILLIMETERS) UNLESS OTHERWISE SHOWN

DETAILS FOR JLTI-LANE WEAVE		F.A RTE.	SECTION	COUNTY	TOTAL SHEETS	SHEET NO.	
		94	016-0939	COOK	70	65	
		VEAVE		TC-09	CONTRACT	NO. 6	0M72
	STA.	TO STA.	FED. R	DAD DIST. NO. 1 ILLINOIS FED. AI	D PROJECT		


		WORK AREA WORK AREA
	NOTES:	
	SHOWN ON THE DRAWII a) ONE "ROAD CON MOUNTED ON IT b) THE CLOSED POI BLOCKING WITH THE CROSS SEC 2. SIDE ROAD WITH A SF AS SHOWN ON THE DR a) ONE "ROAD CON FLASHER MOUNT OF THE MAIN RO b) THE CLOSED POI BLOCKING WITH OF THE CLOSED 3. CONES MAY BE SUBST SPACING DURING DAY IN HEIGHT. 4. WHEN THE SIDE ROAD SIGNING AND THE WOF	RTION OF THE MAIN ROUTE SHALL BE PROTECTED BY TYPE III BARRICADES, 1/2 OF THE CROSS SECTION
		All dimensions are in inches (millimeters) unless otherwise shown.
pw:\\IL084EBIDINTEG.illinois.gov:PWIDDT\Douments\IDDT Offices\District i\Projects\Dist URXWW \CADDets\CADsheets\tcl0.dgn REVISI PLOT SCALE = 50.000 // in. CHECKED - REVISI	ED - A. HOUSEH 10-15-96 ED -T. RAMMACHER 01-06-00 ED - A. SCHUETZE 07-01-13 ED - A. SCHUETZE 09-15-16 ED - A. SCHUETZE 09-15-16	TRAFFIC CONTROL AND PROTECTION FOR SIDE ROADS, INTERSECTIONS, AND DRIVEWAYS F.A. RTE. SECTION COUNTY TOTAL SHEETS SHEETS NO. SCALE: NONE SHEET 1 OF 1 SHEETS STA. TO STA. ILLINOIS FED. AID PROJECT




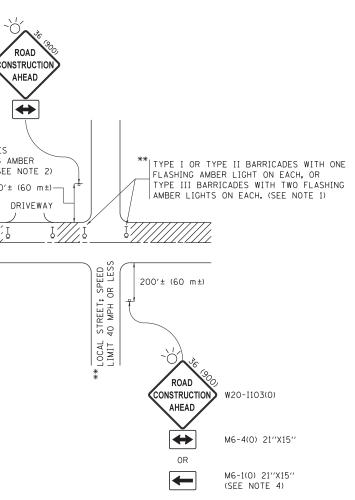

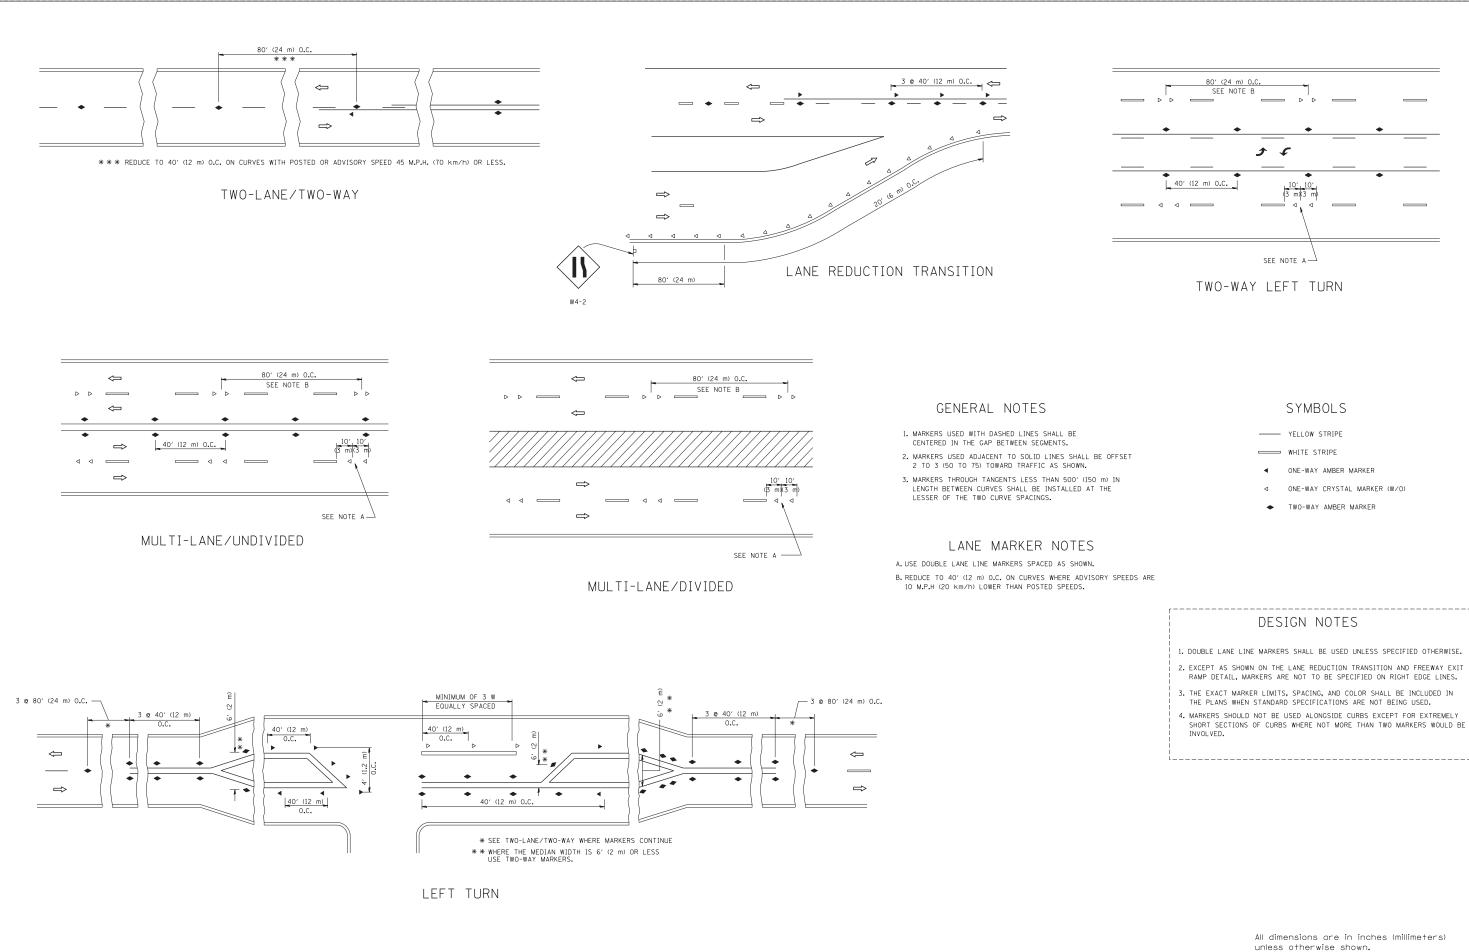FILE NAME =	USER NAME = leysa	DESIGNED - REV	/ISED - T. RAMMACHER 09-19-94		TYPICAL APPLICATIONS	F.A	SECTION	COUNTY TOTAL SHEET
c:\pw_work\pwidot\leysa\d0108315\tc11.dg	n	DRAWN - REV	/ISED -T. RAMMACHER 03-12-99	STATE OF ILLINOIS		94	016-0939	COOK 70 67
	PLOT SCALE = 50.000 '/ IN.	CHECKED - REV	/ISED -T. RAMMACHER 01-06-00	DEPARTMENT OF TRANSPORTATION	RAISED REFLECTIVE PAVEMENT MARKERS (SNOW-PLOW RESISTANT)		TC11	CONTRACT NO. 60M72
	PLOT DATE = 3/2/2011	DATE - REV	/ISED - C. JUCIUS 09-09-09		SCALE: NONE SHEET NO. 1 OF 1 SHEETS STA. TO STA.	FED. ROAD	D DIST. NO. 1 ILLINOIS FED. A	AID PROJECT

unless otherwise shown.

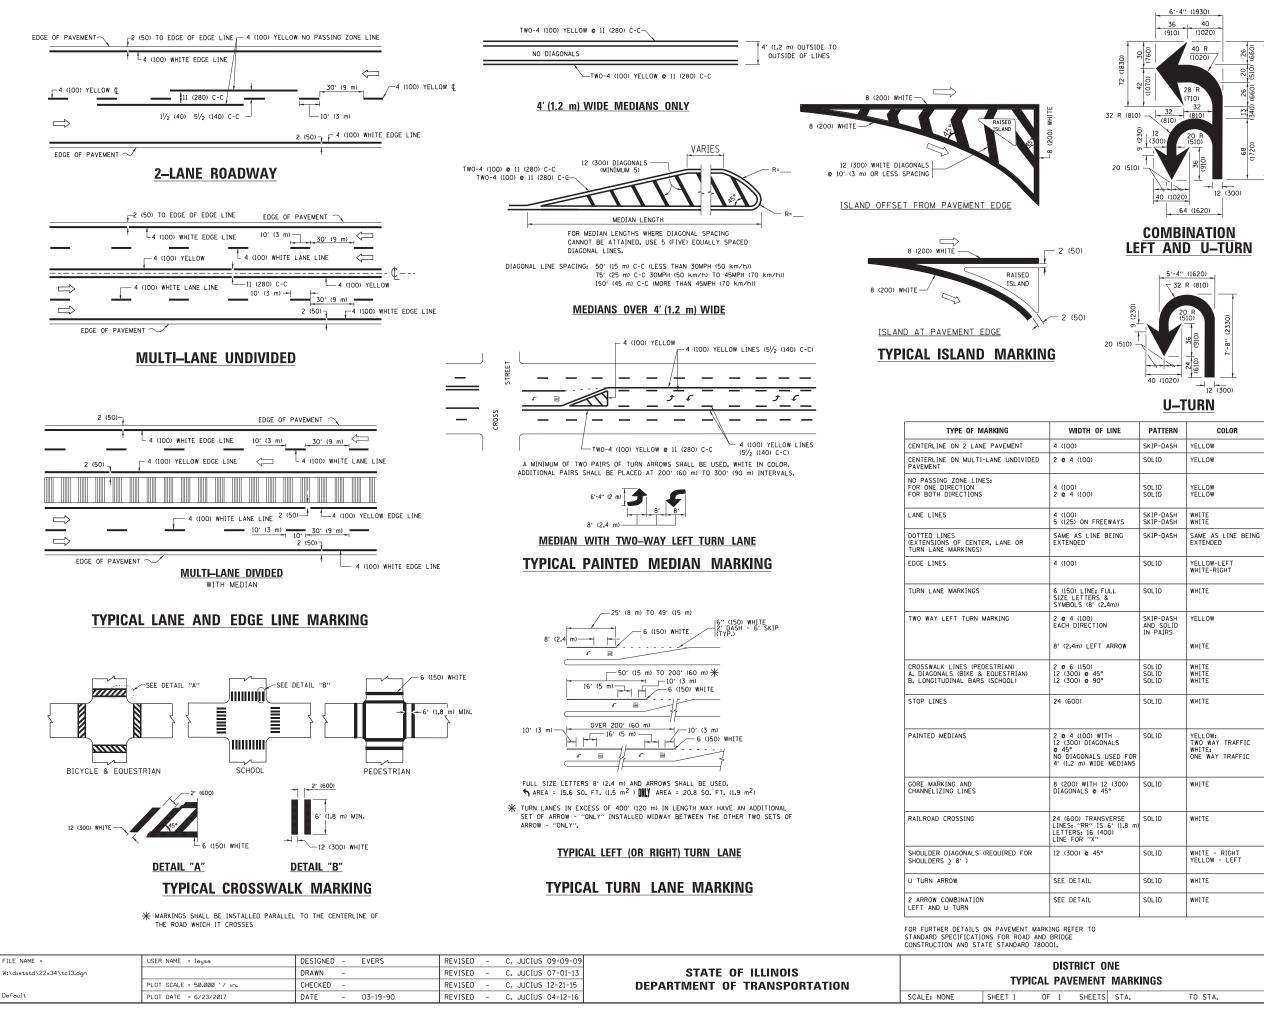

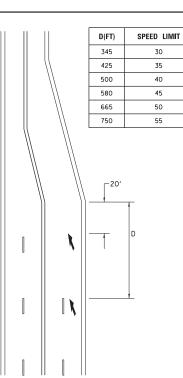


LANE REDUCTION TRANSITION

lane reduction arrows required at speeds of 45 MPH or greater or when specified in plans.

F LINE	PATTERN	COLOR	SPACING /REMARKS
	SKIP-DASH	YELLOW	10' (3 m) LINE WITH 30' (9 m) SPACE
	SOLID	YELLOW	11 (280) C-C
	SOLID SOLID	YELLOW YELLOW	5/2 (140) C-C FROM SKIP-DASH CENTERLINE 11 (280) C-C OMIT SKIP-DASH CENTERLINE BETWEEN
EEWAYS	SKIP-DASH SKIP-DASH	WHITE WHITE	10' (3 m) LINE WITH 30' (9 m) SPACE
BEING	SKIP-DASH	SAME AS LINE BEING EXTENDED	2' (600) LINE WITH 6' (1.8 m) SPACE
	SOLID	YELLOW-LEFT WHITE-RIGHT	OUTLINE MEDIANS IN YELLOW
FULL & 2.4m))	SOLID	WHITE	SEE TYPICAL TURN LANE MARKING DETAIL
ON ARROW	SKIP-DASH AND SOLID IN PAIRS	YELLOW	10' (3 m) LINE WITH 30' (9 m) SPACE FOR SKIP-DASH; 5½ (140) C-C BETWEEN SOLID LINE AND SKIP-DASH LINE SEE TYPICAL TWO-WAY LEFT TURN MARKING DETAIL
•	SOLID SOLID SOLID	WHITE WHITE WHITE	NOT LESS THAN 6' (1.8 m) APART 2' (600) APART 2' (600) APART SEE TYPICAL CROSSWALK MARKING DETAILS.
	SOLID	WHITE	PLACE 4' (1,2 m) IN ADVANCE OF AND PARALLEL TO CROSSWALK, IF PRESENT, OTHERWISE, PLACE AT DESIRED STOPPING POINT. PARALLEL TO CROSSROAD CENTERLINE, WHERE POSSIBLE
ITH DNALS USED FOR E MEDIANS	SOLID	YELLOW: TWO WAY TRAFFIC WHITE: ONE WAY TRAFFIC	11 (280) C-C FOR THE DOUBLE LINE SEE TYPICAL PAINTED MEDIAN MARKING.
20' (6 m) C-C 30MPH (50 km		DIAGONALS: 15' (4.5 m) C-C (LESS THAN 30MPH (50 km/h)) 20' (6 m) C-C 30MPH (50 km/h) TO 45MPH (70 km/h)) 30' (9 m) C-C (0VER 45MPH (70 km/h))	
SVERSE 5 6' (1.8 m) SOLID WHITE SEE STATE STANDARD 780001 AREA OF: "R"=3.6 SO. FT. (0.33 m ²) EACH "X"=54.0 SO. FT. (5.0 m ²)		AREA OF: "R"=3.6 SQ. FT. (0.33 m ²) EACH	
•	SOLID	WHITE - RIGHT YELLOW - LEFT	50' (15 m) C-C (LESS THAN 30MPH (50 km/h)) 75' (25 m) C-C (30 MPH (50 km/h) TO 45MPH (70 km/h)) 150' (45 m) C-C (0VER 45MPH (70 km/h))
	SOLID	WHITE	16.3 SF
	SOLID	WHITE	30.4 SF
		1	

All dimensions are in inches (millimeters) unless otherwise shown.


ONE IT_MARKINGS		SECTION	COUNTY	TOTAL SHEETS	SHEET NO.
		016-0939	СООК	70	68
		TC-13	CONTRACT NO. 60M72		
S STA. TO STA.	ILLINOIS FED. AID PROJECT				

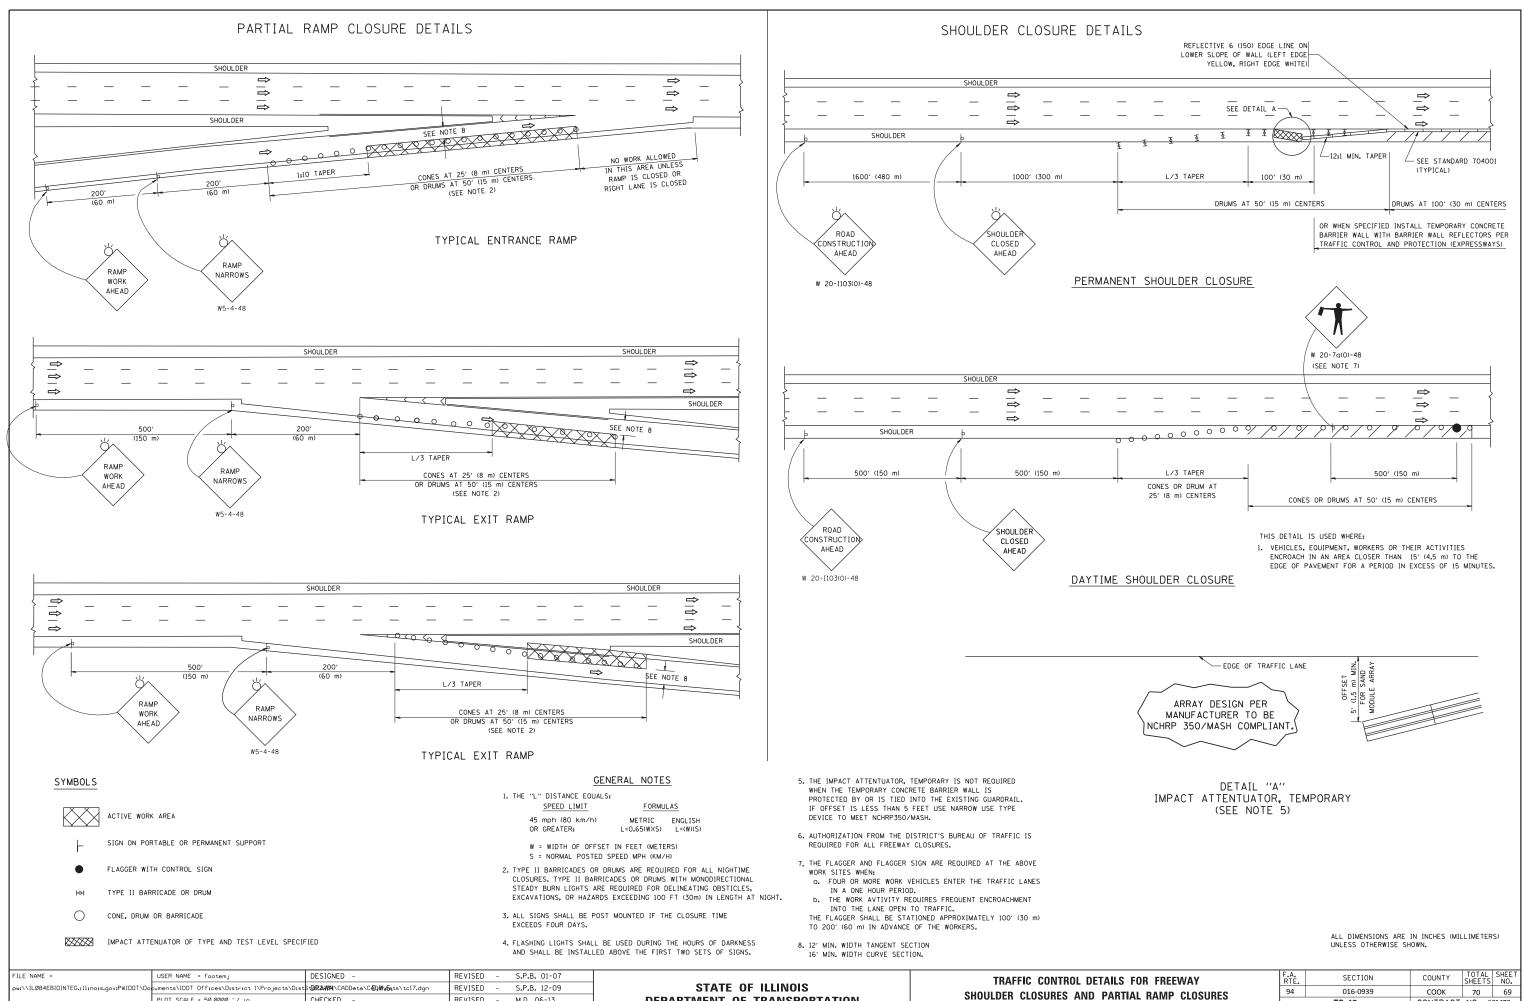

FILE NAME =	USER NAME = footemj	DESIGNED -	REVISED - S.P.B. 01-07			TRAFFIC C		
pw://IL084EBIDINTEG.1111no1s.gov:PWIDOT/Do	cuments\IDOT_Offices\District_l\Projects\Dist	St BRAWM \CADData\C ADWhe sts\tc17.dgn	REVISED - S.P.B. 12-09	STATE OF ILLINOIS	SHOULDER CLOSURES AND PA			
	PLOT SCALE = 50.0000 ' / in.	CHECKED -	REVISED - M.D. 06-13	DEPARTMENT OF TRANSPORTATION	SHU	ULDER CLOS	UKES A	IND PARI
Default	PLOT DATE = 11/27/2017	DATE - 11-96	REVISED - M.D. 01-18		SCALE: NONE	SHEET 1	OF 1	SHEETS

TC-17 S STA. TO STA

CONTRACT NO. 60M72 ULINOIS FED AID PROJECT

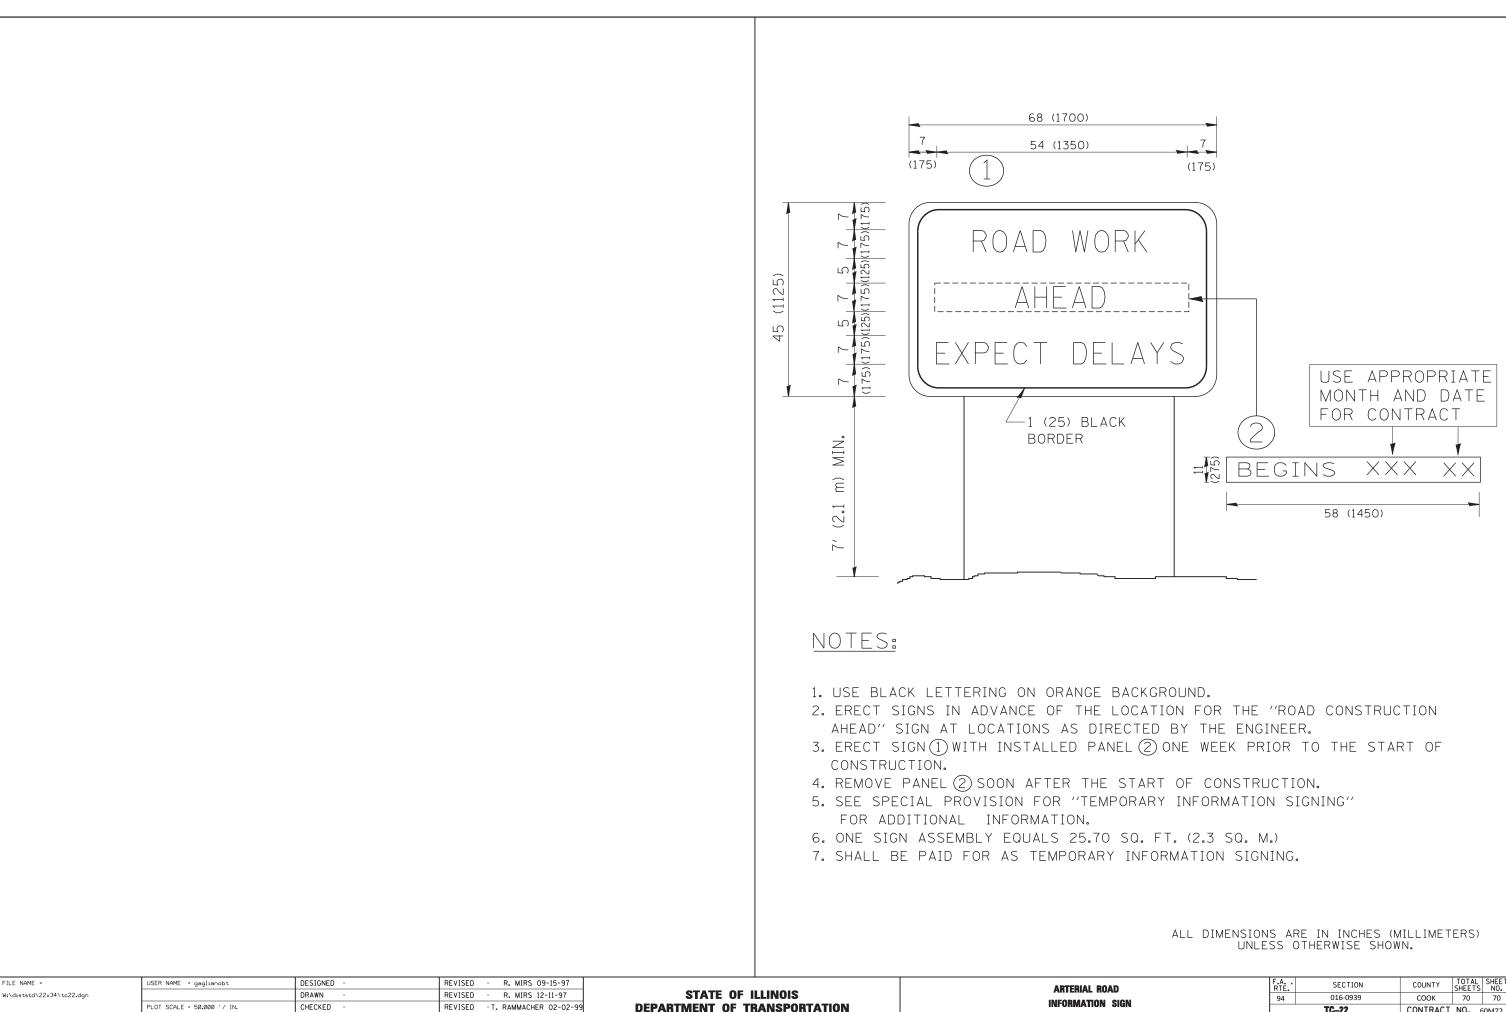

REVISED - C. JUCIUS 01-31-07

PLOT DATE = 1/4/2008

DATE

ROAD In Sign			F.A RTE.	SECTION	COUNTY	TOTAL SHEETS	SHEET NO.
			94	016-0939	COOK	70	70
				TC-22	CONTRACT	NO. 6	50M72
	STA.	TO STA.	FED. ROAD DIST. NO. 1 ILLINOIS FED. AID PROJECT				