

INDEX OF SHEETS

- COVER SHEET
- INDEX OF SHEETS, HIGHWAY STANDARDS AND GENERAL NOTES 2
- 3-4 SUMMARY OF QUANTITIES
- 5 TYPICAL SECTIONS
- SCHEDULE OF QUANTITIES 6
- PROPOSED PLAN 7
- 8-11 MAINTENANCE OF TRAFFIC
- 12 EROSION CONTROL PLAN 13 PAVEMENT MARKING PLAN
- TRAFFIC SIGNAL PLANS 14-15
- STRUCTURAL PLANS 16-24
- DETAILS FOR DEPRESSED CURB & GUTTER AND SHOULDER TREATMENT AT TBT TY. 1 SPL. (BD-34) 25
- 26 TRAFFIC CONTROL & PROTECTION FOR SIDEROADS, INTERSECTIONS & DRIVEWAYS (TC-10)
- TYPICAL APPLICATIONS RAISED REFLECTIVE PAVEMENT MARKERS (SNOW PLOW RESISTANT) (TC-11) 27 28 TYPICAL PAVEMENT MARKINGS (TC-13)
- TRAFFIC CONTROL AND PROTECTION AT TURN BAYS (TO REMAIN OPEN TO TRAFFIC (TC-14) 29
- ARTERIAL ROAD INFO SIGN (TC-22) 30

LIST OF HIGHWAY STANDARDS

STANDARD NO. DESCRIPTION

000001-07	STANDARD SYMBOLS, ABBREVIATIONS AND PATTERNS
280001-07	TEMPORARY EROSION CONTROL SYSTEMS
442201-03	CLASS C AND D PATCHES
515001-03	NAME PLATE FOR BRIDGES
630106-02	LONG-SPAN GUARDRAIL OVER CULVERT
630301-09	SHOULDER WIDENING FOR TYPE 1 (SPECIAL) GUARDRAIL TERMINALS
631011-10	TRAFFIC BARRIER TERMINAL, TYPE 2
701006-05	OFF-ROAD OPERATIONS, 2L,2W, 15' (4.5M) TO 24" (600MM) FROM PAVEMENT EDGE
701011-04	OFF-ROAD MOVING OPERATIONS, 2L, 2W, DAY ONLY
701101-05	OFF-ROAD OPERATIONS, MULTILANE, 15' (4.5M) TO 24" (600MM) FROM PAVEMENT EDGE
701301-04	LANE CLOSURE, 2L, 2W, SHORT TIME OPERATIONS
701426-09	LANE CLOSURE, MULTILANE, INTERMITTENT OR MOVING OPER., FOR SPEEDS \geq 45 MPH
701427-05	LANE CLOSURE, MULTILANE, INTERMITTENT OR MOVING OPER., FOR SPEEDS \leq 40 MPH
701606-10	URBAN SINGLE LANE CLOSURE, MULTILANE, 2W WITH MOUNTABLE MEDIAN
701701-10	URBAN LANE CLOSURE, MULTILANE INTERSECTION
701901-08	TRAFFIC CONTROL DEVICES
704001-08	TEMPORARY CONCRETE BARRIER
725001-01	OBJECT AND TERMINAL MARKERS
780001-05	TYPICAL PAVEMENT MARKINGS
782006	GUARDRAIL AND BARRIER WALL REFLECTOR MOUNTING DETAILS

COMMITMENTS

NO CLEARINGS APRIL 1 TO OCTOBER 14 OF ANY YEAR.

GENERAL NOTES

BEFORE STARTING ANY EXCAVATION, THE CONTRACTOR SHALL CALL "J.U.L.I.E." AT (800) 892-0123 OR 811 FOR FIELD LOCATIONS OF BURIED ELECTRIC, TELEPHONE, AND GAS UTILITIES, 48 HOUR NOTIFICATION IS REQUIRED.

BEFORE BEGINNING ANY WORK. THE CONTRACTOR SHALL RETAIN AND RECORD. FOR FUTURE REFERENCE, ALL EXISTING PAVEMENT MARKING LINES (AND RAISED REFLECTIVE PAVEMENT MARKERS) IN ORDER THAT THESE LOCATIONS CAN BE RE-ESTABLISHED FOR STRIPING. EXACT LOCATIONS OF ALL PAVEMENT MARKINGS SHALL BE AS DIRECTED BY THE ENGINEER.

IT IS THE CONTRACTOR'S RESPONSIBILITY TO VERIFY ALL DIMENSIONS AND CONDITIONS EXISTING IN THE FIELD PRIOR TO CONSTRUCTION AND ORDERING OF MATERIALS.

THE CONTRACTOR SHALL CONTACT THE DISTRICT ONE TRAFFIC CONTROL SUPERVISOR MRS. KALPANA KANNAN-ITOSADURGA AT (847) 705-4470 A MINIMUM OF 72 HOURS IN ADVANCE OF BEGINNING WORK.

THE RESIDENT ENGINEER SHALL CONTACT MR. WALTER CZARNY, ARTERIAL TRAFFIC FIELD ENGINEER, AT WALTER.CZARNY@ILLINOIS.GOV A MINIMUM OF TWO (2) WEEKS PRIOR TO PLACEMENT OF PERMANENT PAVEMENT MARKINGS.

THE CONTRACTOR IS REQUIRED TO PROVIDE ACCESS TO ABUTTING PROPERTY AT ALL TIMES DURING THE CONSTRUCTION OF THIS PROJECT.

DO NOT SCALE PLANS FOR CONSTRUCTION DIMENSIONS.

ALL DAMAGE TO EXISTING PAVEMENT MARKINGS OR RAISED REFLECTIVE PAVEMENT MARKERS OUTSIDE THE REMOVAL LINE SHOWN ON THE PLANS SHALL BE REPLACED AT NO ADDITIONAL COST TO THE DEPARTMENT.

THE CONTRACTOR SHALL COORDINATE CONSTRUCTION ACTIVITIES WITH UTILITY COMPANIES AND THE VILLAGE OF VERNON HILLS.

THE CONTRACTOR WILL NOT BE ALLOWED TO SET UP A YARD OR FIELD OFFICE ON STATE PROPERTY WITHOUT WRITTEN PERMISSION FROM THE DEPARTMENT

THE REMOVAL OF GUARDRAIL TERMINAL SECTIONS SHALL BE INCLUDED IN THE UNIT PRICE PER FOOT FOR "GUARDRAIL REMOVAL."

DOUBLE LANE MARKERS ARE TO BE USED AS SHOWN ON THE DISTRICT ONE DETAIL "TYPICAL APPLICATIONS - RAISED REFLECTIVE PAVEMENT MARKERS (SNOW-PLOW RESISTANT)" SHOWN IN THE PLANS.

THIS PROJECT REQUIRES A US ARMY CORPS OF ENGINEERS (USACE) 404 PERMIT THAT WILL BE SECURED BY THE DEPARTMENT. AS A CONDITION OF THIS PERMIT, THE CONTRACTOR WILL NEED TO SUBMIT AN IN-STREAM WORK PLAN TO THE DEPARTMENT FOR APPROVAL, GUIDELINES ON ACCEPTABLE IN-STREAM WORK TECHNIQUES CAN BE FOUND ON THE USACE WEBSITE. THE USACE DEFINES AND DETERMINES IN-STREAM WORK. THE COST OF ALL MATERIALS AND LABOR NECESSARY TO COMPLY WITH THE ABOVE PROVISIONS TO PREPARE AND IMPLEMENT AN IN-STREAM WORK PLAN WILL NOT BE PAID FOR SEPARATELY, BUT SHALL BE CONSIDERED AS INCLUDED IN THE UNIT BID PRICES OF THE CONTRACT AND NO ADDITIONAL COMPENSATION WILL BE ALLOWED.

THE CONTRACTOR SHALL VERIFY THE EXISTING TYPE/HEIGHT OF EXISTING GUARDRAIL BEFORE ORDERING THE NEW TERMINAL SECTION, COST INCLUDED IN THE COST OF "TRAFFIC BARRIER TERMINAL, TYPE I (SPECIAL) TANGENT".

THE CONSTRUCTION RESIDENT ENGINEER WILL CONTACT THE FOREST PRESERVE DISTRICT OF LAKE COUNTY PRIOR TO THE START OF CONSTRUCTION TO INFORM THEM OF THE INITIATION OF CONSTRUCTION ACTIVITIES NEAR THEIR PROPERTIES.

THE CONSTRUCTION RESIDENT ENGINEER WILL CONTACT PACE PRIOR TO THE START OF CONSTRUCTION TO TEMPORARILY RELOCATE A BUS STOP LOCATED JUST SOUTH OF CORPORATE WOODS.

ANY AGGREGATE SUBGRADE IMPROVEMENT CONTAMINATED AND/OR DAMAGED BY THE CONTRACTOR'S VEHICLES AND/OR EQUIPTMENTS IS TO BE REMOVED AND REPLACED AS DIRECTED BY THE ENGINEER AT CONTRACTOR EXPENSE.

THE CONTRACTOR SHALL REMOVE THE "WEIGHT LIMIT" SIGNS (2) AFTER CONSTRUCTION IS COMPLETE AND APPROVAL IS RECEIVED BY THE RESIDENT ENGINEER. THE RESIDENT ENGINEER SHALL CONTACT BRIDGE MAINTENANCE ENGINEER, AT (847)-705-4180 A MINIMUM OF 2 WEEKS PRIOR TO THE REMOVAL OF THE SIGN.



	USER NAME = Ken.drabant	DESIGNED - KJD	REVISED -		INDEX OF	SHEETS, HIGHWAY STANDARDS AND GENERAL NOTES	F.A.P SECTION	COUNTY TOTAL SHEET
2 N/I		DRAWN - KJD	REVISED -	STATE OF ILLINOIS			330 2016-052B	LAKE 30 2
	PLOT SCALE = 20.0000 ' / in.	CHECKED - RTB	REVISED -	DEPARTMENT OF TRANSPORTATION		IL 21 (MILWAUKEE AVE) OVER DITCH		CONTRACT NO. 62D38
GROUP, LLC	PLOT DATE = 1/14/2019	DATE - 01/14/2018	REVISED -		SCALE:	SHEET 1 OF 1 SHEETS STA. TO STA.	(ILLINOIS FED. /	ND PROJECT

REV. - MS

				CONSTRUCTION CO				
				80% FED 20% STA	TE] ,		1
				ROADWAY		1		
CODE			TOTAL	0004		1	CODE	
NO.	ITEM	UNIT	QUANTITY	URBAN		1	NO.	ITEM
110 .			Quantiti					
20101400	NITROGEN FERTILIZER NUTRIENT	POUND	6	6			52200010	TEMPORARY SHEET PILING
20101600	POTASSIUM FERTILIZER NUTRIENT	POUND	6	6			54003000	CONCRETE BOX CULVERTS
						-		COMBINATION CONCRETE CURB AND GUTTER,
20200100	EARTH EXCAVATION	CU YD	263	263		-	60603800	TYPE B-6.12
20201200	REMOVAL AND DISPOSAL OF UNSUITABLE		24	24			62000001	STEEL PLATE BEAM GUARDRAIL, TYPE A, 6
20201200	MATERIAL	CU YD	34	34		*	63000001	FOOT POSTS
25000210	SEEDING, CLASS 2A	ACRE	0.06	0.06		*	63000030	STRONG POST GUARDRAIL ATTACHED TO
28000400	PERIMETER EROSION BARRIER	FOOT	483	483		*	63100167	TRAFFIC BARRIER TERMINAL, TYPE 1 (SPECIAL) TANGENT
30300112	AGGREGATE SUBGRADE IMPROVEMENT 12"	SQ YD	109	109		-	63200310	GUARDRAIL REMOVAL
40603085	HOT-MIX ASPHALT BINDER COURSE, IL-19.0,	TON	7.7	7.7		-	66900200	NON-SPECIAL WASTE DISPOSAL
40005085	N70		1.1	/./			88900200	NON-SPECIAL WASTE DISPOSAL
42001300	PROTECTIVE COAT	SQ YD	39	39			66900530	SOIL DISPOSAL ANALYSIS
44000500	COMBINATION CURB AND GUTTER REMOVAL	FOOT	170	170			66901001	REGULATED SUBSTANCES PRE-CONSTRUCTION PLAN
48101620	AGGREGATE SHOULDERS, TYPE B 10"	SQ YD	120	120			66901002	ON-SITE MONITORING OF REGULATED SUBSTANCES
50100300	REMOVAL OF EXISTING STRUCTURES NO. 1	EACH	1	1			66901003	REGULATED SUBSTANCES FINAL CONSTRUCTI
			-	-				REPORT
50800105	REINFORCEMENT BARS	POUND	7870	7870			67000400	ENGINEER'S FIELD OFFICE, TYPE A
51500100	NAME PLATES	EACH	1	1			67100100	MOBILIZATION

	USER NAME = Ken.drabant	DESIGNED -	KJD	REVISED _		SUMMARY OF QUANT				
		DRAWN .	KJD	REVISED _	STATE OF ILLINOIS					
	PLOT SCALE = 20.0000 ' / in.	CHECKED -	RTB	REVISED -	DEPARTMENT OF TRANSPORTATION			LWAUK		.) UV
IGINEERING GROUP, LLC	PLOT DATE = 12/13/2018	DATE -	12/11/2018	REVISED _		SCALE:	SHEET 1	OF 2	SHEETS	STA

			CONSTRUCTION COD 80% FED 20% STAT	
				E
			ROADWAY	
		TOTAL	0004	
	UNIT	QUANTITY	URBAN	
	SQ FT	1090	1090	
	CU YD	34.5	34.5	
RB AND GUTTER,	FOOT	170	170	
		170	170	
AIL, TYPE A, 6	FOOT	187.5	187.5	
TTACHED TO				
Theneb To	FOOT	12.5	12.5	
L, TYPE 1	EACH	2	2	
	FOOT	453	453	
SAL	CU YD	241	241	
JAL		241	241	
	EACH	1	1	
	1			
E-CONSTRUCTION	LSUM	1	1	
EGULATED	CAL DA	30	30	
NAL CONSTRUCTION	LSUM	1	1	
, TYPE A	CAL MO	6	6	
	L SUM	1	1	

REV. - MS SECTION COUNTY SHEETS NO. 016-052B LAKE 30 3 CONTRACT NO. 62D38 (ILLINOIS [FED, AID PROJECT F.A.P RTE. 330 SECTION NTITIES 2016-052B OVER DITCH STA. TO STA.


WEMENT MARKING TAPE, TYPE IV 6"	UNIT SQ FT FOOT FOOT FOOT	TOTAL QUANTITY 146 8787 200 312.5	80% FED 20% ST/ ROADWAY 0004 URBAN 146 8787 200 312.5		*	CODE NO. 85000200 X0327980 X0900064	ITEM MAINTENANCE OF EXISTING TRAFFIC SIGNAL INSTALLATION PAVEMENT MARKING REMOVAL - WATER BLASTING MEMBRANE WATERPROOFING SYSTEM FOR BURI STRUCTURES
VEMENT MARKING TAPE, TYPE IV - LETTERS ID SYMBOLS VEMENT MARKING TAPE, TYPE IV 4" VEMENT MARKING TAPE, TYPE IV 6" MPORARY CONCRETE BARRIER	SQ FT FOOT FOOT	QUANT I TY	0004 URBAN 146 8787 200		*	NO. 85000200 x0327980	MAINTENANCE OF EXISTING TRAFFIC SIGNAL INSTALLATION PAVEMENT MARKING REMOVAL - WATER BLASTING MEMBRANE WATERPROOFING SYSTEM FOR BURI
VEMENT MARKING TAPE, TYPE IV - LETTERS ID SYMBOLS VEMENT MARKING TAPE, TYPE IV 4" VEMENT MARKING TAPE, TYPE IV 6" MPORARY CONCRETE BARRIER	SQ FT FOOT FOOT	QUANT I TY	URBAN 146 8787 200		*	NO. 85000200 x0327980	MAINTENANCE OF EXISTING TRAFFIC SIGNAL INSTALLATION PAVEMENT MARKING REMOVAL - WATER BLASTING MEMBRANE WATERPROOFING SYSTEM FOR BURI
VEMENT MARKING TAPE, TYPE IV - LETTERS ID SYMBOLS VEMENT MARKING TAPE, TYPE IV 4" VEMENT MARKING TAPE, TYPE IV 6" MPORARY CONCRETE BARRIER	SQ FT FOOT FOOT	146 8787 200	146 8787 200		*	85000200 X0327980	MAINTENANCE OF EXISTING TRAFFIC SIGNAL INSTALLATION PAVEMENT MARKING REMOVAL - WATER BLASTING MEMBRANE WATERPROOFING SYSTEM FOR BURI
VEMENT MARKING TAPE, TYPE IV 4" VEMENT MARKING TAPE, TYPE IV 6" MPORARY CONCRETE BARRIER	FOOT	200	8787 200		*	X0327980	INSTALLATION PAVEMENT MARKING REMOVAL - WATER BLASTING MEMBRANE WATERPROOFING SYSTEM FOR BURI
VEMENT MARKING TAPE, TYPE IV 4" VEMENT MARKING TAPE, TYPE IV 6" MPORARY CONCRETE BARRIER	FOOT	200	8787 200		*	X0327980	INSTALLATION PAVEMENT MARKING REMOVAL - WATER BLASTING MEMBRANE WATERPROOFING SYSTEM FOR BURI
WEMENT MARKING TAPE, TYPE IV 6"	FOOT	200	200				BLASTING MEMBRANE WATERPROOFING SYSTEM FOR BURI
WEMENT MARKING TAPE, TYPE IV 6"	FOOT	200	200				BLASTING MEMBRANE WATERPROOFING SYSTEM FOR BURI
MPORARY CONCRETE BARRIER	FOOT					X0900064	
LOCATE TEMPORARY CONCRETE BARRIER		312.5	312.5				
	FOOT					X2501820	SEEDING, CLASS 5 (MODIFIED)
	FOOT						
		162.5	162.5			X2511630	EROSION CONTROL BLANKET (SPECIAL)
IPACT ATTENUATORS, TEMPORARY (FULLY DIRECTIVE, NARROW), TEST LEVEL 3	EACH	3	3			X4421791	CLASS D PATCHES, TYPE IV, 12 INCH (SPECIAL)
IPACT ATTENUATORS, RELOCATE (FULLY DIRECTIVE, NARROW), TEST LEVEL 3	EACH	1	1			X7010216	TRAFFIC CONTROL AND PROTECTION, (SPECIA
RMINAL MARKER - DIRECT APPLIED	EACH	2	2			X7030005	TEMPORARY PAVEMENT MARKING REMOVAL
IERMOPLASTIC PAVEMENT MARKING - LETTERS ID SYMBOLS	SQ FT	73	73			X7040125	PINNING TEMPORARY CONCRETE BARRIER
ERMOPLASTIC PAVEMENT MARKING - LINE	FOOT	710.0	710			X7830050	RAISED REFLECTIVE PAVEMENT MARKER, REFLECTOR REMOVAL
IERMOPLASTIC PAVEMENT MARKING - LINE	FOOT	281	281			70013798	CONSTRUCTION LAYOUT
	1001	201	201			20013750	
AISED REFLECTIVE PAVEMENT MARKER	EACH	4	4			Z0030850	TEMPORARY INFORMATION SIGNING
	EACH	72	72		¥	70054400	
					*	20034400	
ARDRAIL REFLECTORS, TYPE B	EACH	5	5		*	Z0073510	TEMPORARY TRAFFIC SIGNAL TIMING
RRIER WALL REFLECTORS, TYPE C	EACH	33	33				
	RMINAL MARKER - DIRECT APPLIED ERMOPLASTIC PAVEMENT MARKING - LETTERS D SYMBOLS ERMOPLASTIC PAVEMENT MARKING - LINE ERMOPLASTIC PAVEMENT MARKING - LINE ISED REFLECTIVE PAVEMENT MARKER PLACEMENT REFLECTOR ARDRAIL REFLECTORS, TYPE B	RMINAL MARKER - DIRECT APPLIED EACH ERMOPLASTIC PAVEMENT MARKING - LETTERS SQ FT ERMOPLASTIC PAVEMENT MARKING - LINE FOOT ERMOPLASTIC PAVEMENT MARKING - LINE FOOT ISED REFLECTIVE PAVEMENT MARKING - LINE FOOT ISED REFLECTIVE PAVEMENT MARKER EACH PLACEMENT REFLECTOR EACH ARDRAIL REFLECTORS, TYPE B EACH	RMINAL MARKER - DIRECT APPLIED EACH 2 ERMOPLASTIC PAVEMENT MARKING - LETTERS SQ FT 73 ERMOPLASTIC PAVEMENT MARKING - LINE FOOT 710.0 ERMOPLASTIC PAVEMENT MARKING - LINE FOOT 281 ISED REFLECTIVE PAVEMENT MARKING - LINE FOOT 281 ISED REFLECTIVE PAVEMENT MARKER EACH 4 PLACEMENT REFLECTOR EACH 73 ARDRAIL REFLECTORS, TYPE B EACH 5	RMINAL MARKER - DIRECT APPLIED EACH 2 2 ERMOPLASTIC PAVEMENT MARKING - LETTERS SQ FT 73 73 ERMOPLASTIC PAVEMENT MARKING - LINE FOOT 710.0 710 ERMOPLASTIC PAVEMENT MARKING - LINE FOOT 710.0 710 ERMOPLASTIC PAVEMENT MARKING - LINE FOOT 281 281 ISED REFLECTIVE PAVEMENT MARKING - LINE FOOT 281 281 ISED REFLECTIVE PAVEMENT MARKER EACH 4 4 ISED REFLECTIVE PAVEMENT MARKER EACH 73 73 ARDRAIL REFLECTOR EACH 5 5	RMINAL MARKER - DIRECT APPLIED EACH 2 2 ERMOPLASTIC PAVEMENT MARKING - LETTERS SQ FT 73 73 ERMOPLASTIC PAVEMENT MARKING - LETTERS SQ FT 73 73 ERMOPLASTIC PAVEMENT MARKING - LINE FOOT 710.0 710 ERMOPLASTIC PAVEMENT MARKING - LINE FOOT 710.0 710 ERMOPLASTIC PAVEMENT MARKING - LINE FOOT 281 281 ISED REFLECTIVE PAVEMENT MARKING - LINE FOOT 281 281 ISED REFLECTIVE PAVEMENT MARKER EACH 4 4 ISED REFLECTIVE PAVEMENT MARKER EACH 73 73 ARDRAIL REFLECTORS, TYPE B EACH 5 5	RMINAL MARKER - DIRECT APPLIED EACH 2 2 RMINAL MARKER - DIRECT APPLIED EACH 2 2 ERMOPLASTIC PAVEMENT MARKING - LETTERS SQ FT 73 73 ERMOPLASTIC PAVEMENT MARKING - LINE FOOT 710.0 710 ERMOPLASTIC PAVEMENT MARKING - LINE FOOT 281 281 ISED REFLECTIVE PAVEMENT MARKING - LINE FOOT 281 281 ISED REFLECTIVE PAVEMENT MARKER EACH 4 4 ISED REFLECTIVE PAVEMENT MARKER EACH 73 73 ISED REFLECTOR EACH 5 5 RADRAIL REFLECTORS, TYPE B EACH 5 5 RRIER WALL REFLECTORS, TYPE C EACH 33 33	Image: Second symbolsImage: Second symbol symbo

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	USER NAME = Ken.drabant	DESIGNED - KJD	REVISED -			SUN	MARY (OF QU/	
2 N/I		DRAWN . KJD	REVISED -	STATE OF ILLINOIS	1				
	PLOT SCALE = 20.0000 ' / in.	CHECKED - RTB	REVISED -	DEPARTMENT OF TRANSPORTATION		IL ZI (IVII	LWAUKE	E AVE	U
GROUP, LLC	PLOT DATE = 12/13/2018	DATE _ 12/11/2018	REVISED -		SCALE:	SHEET 2	OF 2	SHEETS	S

			CONSTRUCTION CC 80% FED 20% STA	
			ROADWAY	
		TOTAL	0004	
	UNIT	QUANTITY	URBAN	
		Quintin	ORBAN	
L				
	EACH	1	1	
	SQ FT	450	450	
I ED		58	58	
	SQ YD	50	00	
	ACRE	0.06	0.06	
	SQ YD	278	278	
	SQ YD	157	157	
AL)	L SUM	1	1	
	SQ FT	1586	1586	
	EACH	69	69	
	EACH	73	73	
		, , , , , , , , , , , , , , , , , , , ,	, , ,	
	L SUM	1	1	
	SQ FT	52	52	
	CU YD	26	26	
	EACH	1	1	

U	UANTITIES /E) OVER DITCH			SECT	TON		COUNTY	TOTAL SHEETS	SHEET NO.
/F				2016-	052B		LAKE	30	4
							CONTRACT	NO. 62	2D38
sĮ	STA.	TO STA.			ILLINOIS	FED, AI	D PROJECT		

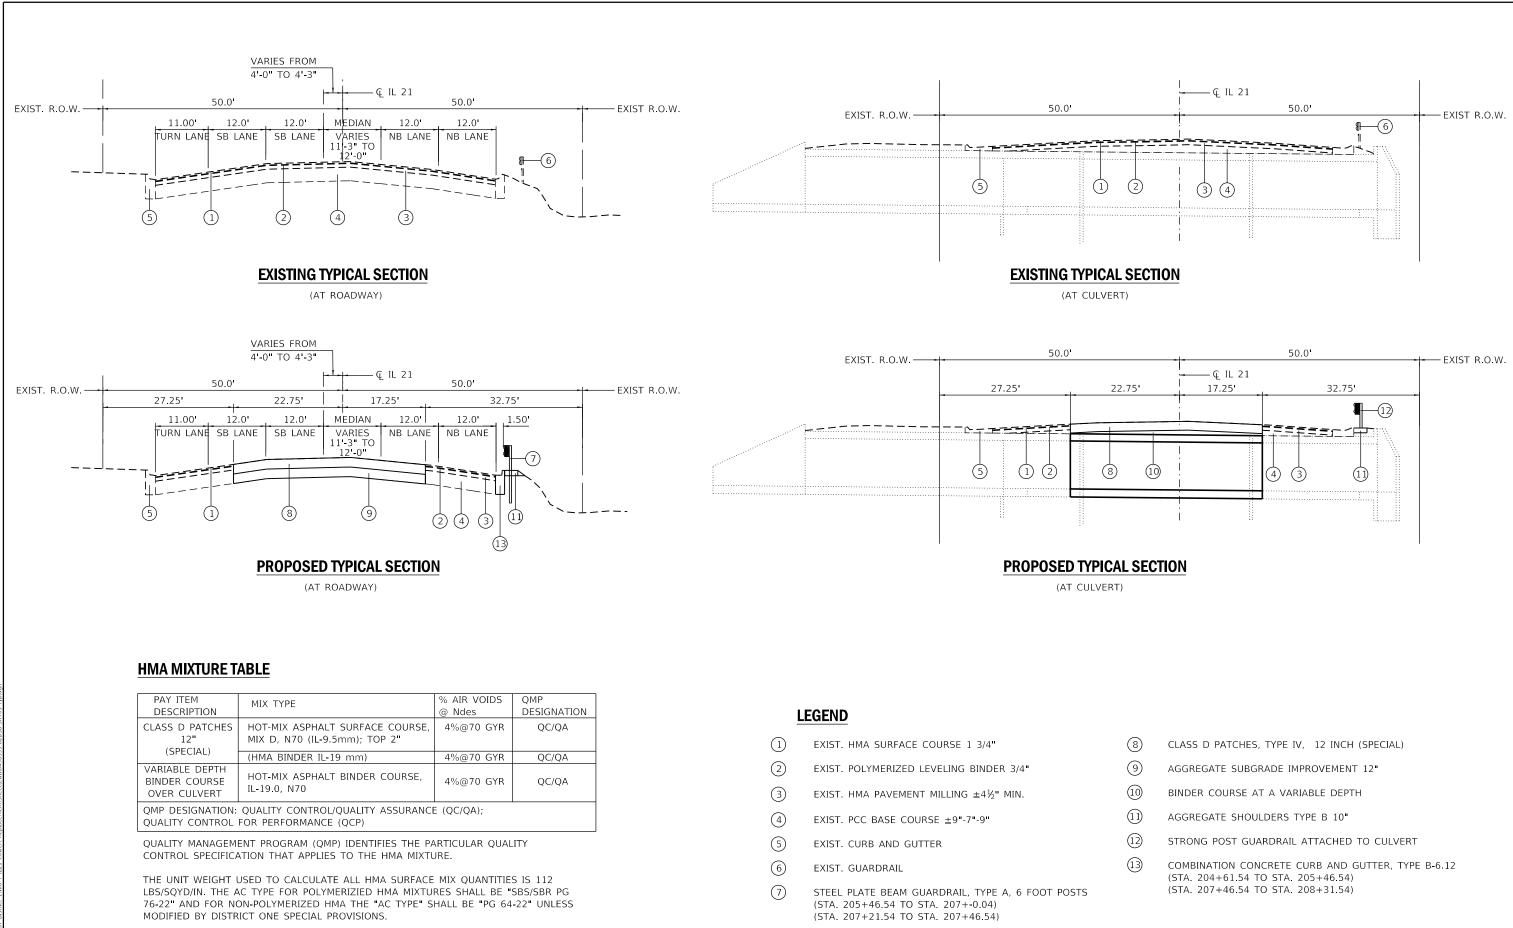

PAY ITEM DESCRIPTION	MIX TYPE	% AIR VOIDS @ Ndes	QMP DESIGNATION
CLASS D PATCHES	HOT-MIX ASPHALT SURFACE COURSE, MIX D, N70 (IL-9.5mm); TOP 2"	4%@70 GYR	QC/QA
(SPECIAL)	(HMA BINDER IL-19 mm)	4%@70 GYR	QC/QA
VARIABLE DEPTH BINDER COURSE OVER CULVERT	HOT-MIX ASPHALT BINDER COURSE, IL-19.0, N70	4%@70 GYR	QC/QA
1 .	QUALITY CONTROL/QUALITY ASSURANCI FOR PERFORMANCE (QCP)	E (QC/QA);	

FOR USE OF RECYCLE MATERIALS SEE DISTRICT ONE SPECIAL PROVISIONS.

ENGINEERING GROUP, LLC
ENGINEERING GROUP, LLC

	USER NAME = Ken drabant	DESIGNED - KJD	REVISED -			TYPICAL SECTION
2 🛯 🖊 🕹		DRAWN - KJD	REVISED -	STATE OF ILLINOIS		
	PLOT SCALE = 20.0000 ' / In.	CHECKED - RTB	REVISED -	DEPARTMENT OF TRANSPORTATION		IL 21 (MILWAUKEE AVE)
G GROUP, LLC	PLOT DATE = 12/11/2018	DATE - 12/11/2018	REVISED -		SCALE:	SHEET 1 OF 1 SHEETS

TYPICAL SECTIONS	F.A.P RTE	SECTION	COUNTY	TOTAL SHEETS	SHEET NO.
MILWAUKEE AVE) OVER DITCH	330	2016-052B	LAKE	30	5
MEWAOKEL AVE, OVEN BITCH			CONTRACT	NO. 62	2D38
OF 1 SHEETS STA. TO STA.		ILLINOIS FED. A	ID PROJECT		

EARTHWORK SCHEDULE								
	EARTH	EARTH EXCAVATION	EMBANKMENT	EARTHWORK BALANCE				
LOCATION	EXCAVATION	ADJUSTED FOR	(CU YD)	WASTE (+) OR				
	(CU YD)	SHRINKAGE (15%)		SHORTAGE (-)				
		(CU YD)		(CU YD)				
CULVERT	217	185	178	+7				
GUARDRAIL SHOULDER	46	40	33	+7				
			TOTAL	+14				

STRONG POST GUARDRAIL ATTACHED TO CULVERT							
LOCATION	STATION	то	STATION	LENG (FOO			
EAST END OF CULVERT	207+09.04		207+21.54	12.			

COMBINATION CURB AN	D GUTTER F	REMO	VAL	
LOCATION	STATION	то	STATION	LENGTH (FOOT)
SOUTH OF CULVERT BEHIND EAST CURB	204+61.54		205+46.54	85
NORTH OF CULVERT BEHIND EAST CURB	207+46.54		208+31.54	85
			TOTAL	170

COMBINATION CONCRETE CURB AND GUTTER, TYPE B-6.12							
LOCATION	STATION	то	STATION	LENGTH (FOOT)			
SOUTH OF CULVERT BEHIND EAST CURB	204+61.54		205+46.54	85			
NORTH OF CULVERT BEHIND EAST CURB	207+46.54		208+31.54	85			
			TOTAL	170			


STEEL PLATE BEAM GUARDRAIL, TYPE A, 6 FOOT POSTS							
LOCATION	STATION	то	STATION	LENGTH (FOOT)			
SOUTH OF CULVERT BEHIND EAST CURB	205+46.54		207+09.04	162.5			
NORTH OF CULVERT BEHIND EAST CURB	207+21.54		207+46.54	25			
			TOTAL	187.5			

1	GUARDRAIL REMOVAL							
	LOCATION	STATION	то	STATION	LENGTH (FOOT)			
	BEHIND EAST CURB	203+98.02		208+50.88	453			

HRM	USER NAME = Ken.drabant	DESIGNED - KJD DRAWN - KJD	REVISED - REVISED -	STATE OF ILLINOIS			HEDULE		
ENGINEERING GROUP, LLC	PLOT SCALE = 20.0000 / In. PLOT DATE = 12/11/2018	CHECKED - RTB DATE - 12/11/2018	REVISED - REVISED -	DEPARTMENT OF TRANSPORTATION	SCALE:	SHEET 1	OF 1	SHEETS	
		•	•					-	_



SCHEDULE OF QUANTITIES	F.A.P RTE	SEC	FION		COUNTY	TOTAL SHEETS	SHEET NO.
(MILWAUKEE AVE) OVER DITCH	330				LAKE	30	6
(MIEWAOREE AVE/ OVER DITOR					CONTRACT	NO. 62	D38
OF 1 SHEETS STA. TO S	TA.		ILLINOIS	FED, AI	D PROJECT		

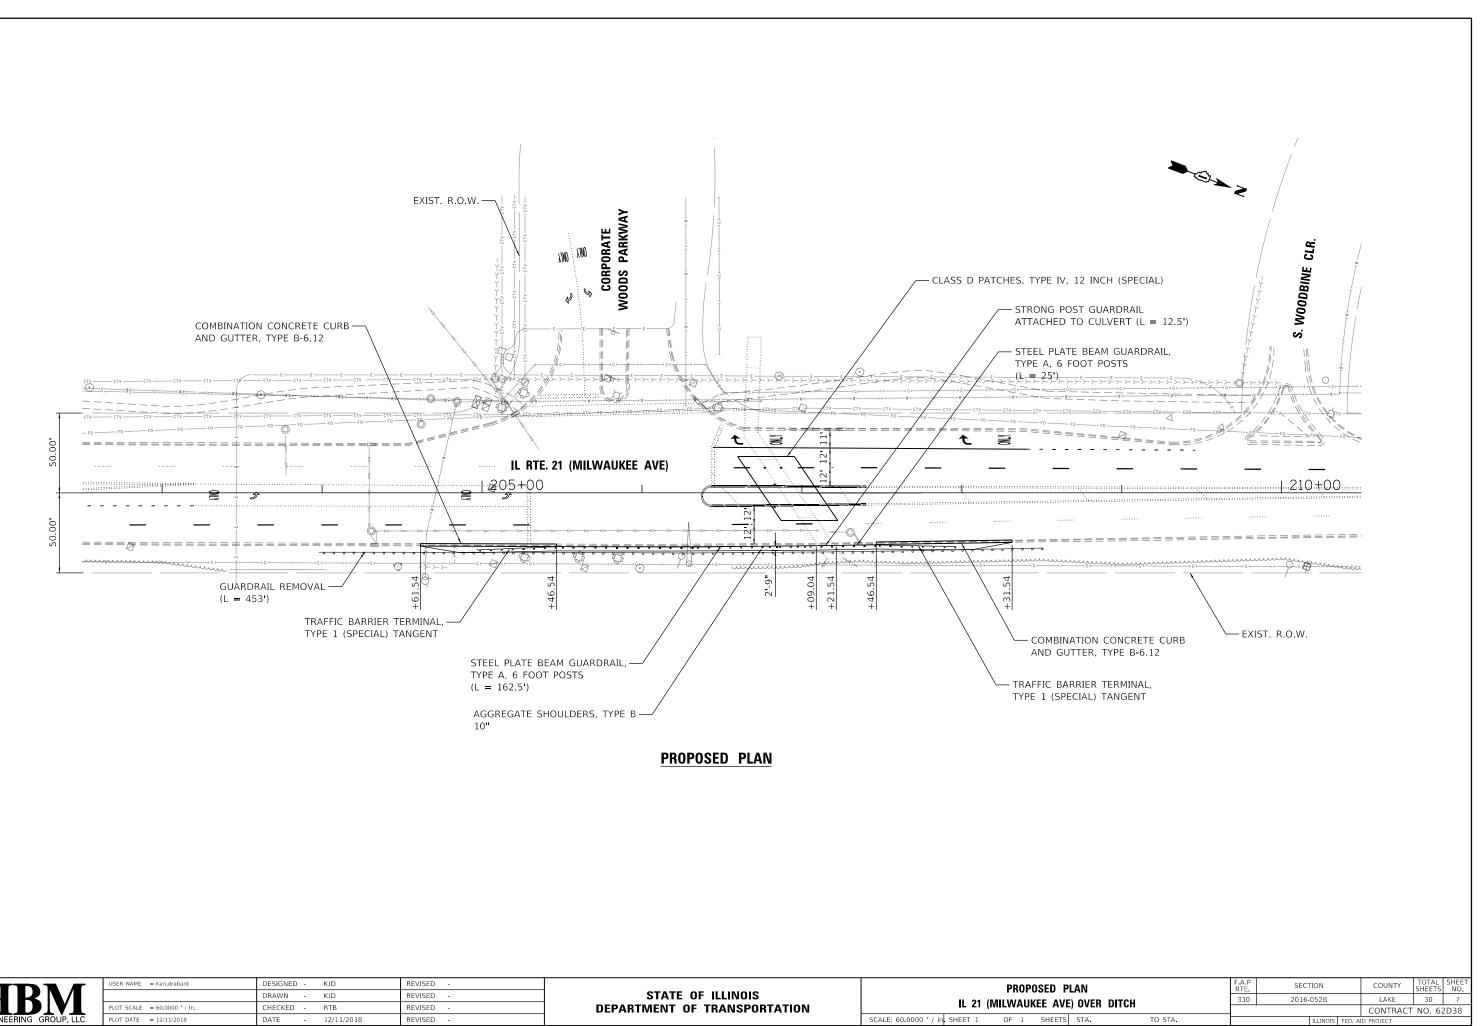



	USER NAME = Ken drabant	DESIGNED - KJD	REVISED -		PROPOSED PL
		DRAWN - KJD	REVISED -	STATE OF ILLINOIS	
Y	PLOT SCALE = 60.0000 / In.	CHECKED - RTB	REVISED -	DEPARTMENT OF TRANSPORTATION	IL 21 (MILWAUKEE AVE)
P, LLC	PLOT DATE = 12/11/2018	DATE - 12/11/2018	REVISED -		SCALE: 60.0000 ' / in SHEET 1 OF 1 SHEETS

GENERAL NOTES:

- 1. THE PERMANENT TRAFFIC CONTROL DEPICTED HERE IN IS THE MINIMUM REQUIREMENT. ADDITIONAL TRAFFIC CONTROL DEVICES AS SPECIFIED IN THE HIGHWAY STANDARDS AS SHOWN IN THE INDEX OF SHEETS AND THE SPECIAL PROVISIONS SHALL BE PLACED BY THE CONTRACTOR TO THE SATISFACTION OF THE ENGINEER. ALL TRAFFIC CONTROL DEVICES SHALL BE CONSIDERED INCLUDED IN THE COST OF TRAFFIC CONTROL AND PROTECTION, (SPECIAL) UNLESS OTHERWISE INDICATED WITHIN THESE GENERAL NOTES, PLANS OR SPECIAL PROVISIONS.
- 2. TRAFFIC CONDITIONS, ACCIDENTS, AND OTHER UNFORESEEN EMERGENCY CONDITIONS MAY REQUIRE THE ENGINEER TO RESTRICT, MODIFY OR REMOVE LANE CLOSURES OR CHANNELIZATION SHOWN IN THE PLANS. THE CONTRACTOR SHALL PROMPTLY RESPOND AT THE TIME OF NOTIFICATION BY THE ENGINEER FOR THE MAINTENANCE OF TRAFFIC CONTROL DEVICES.
- DRUMS OR TYPE II BARRICADES SHALL BE PROVIDED AS SHOWN IN THE PLANS AND SPACED 50 FEET CENTER TO CENTER IN TANGENTS, 3. 20 FEET CENTER TO CENTER IN TAPERS, AND 10 FEET CENTER TO CENTER IN RADII IN THE CONSTRUCTION WORK ZONE. ALL DRUMS AND TYPE II BARRICADES SHALL BE EQUIPPED WITH MONO-DIRECTIONAL STEADY BURN LIGHTS.
- 4. ALL EXISTING SIGNS THAT CONFLICT WITH THE TRAFFIC CONTROL PLAN SHALL BE COVERED OR REMOVED IN ACCORDANCE WITH ARTICLE 107.25 OF THE STANDARD SPECIFICATIONS
- 5. THE CONTRACTOR SHALL FURNISH, INSTALL, MAINTAIN AND REMOVE ALL SIGNS AND SIGN SUPPORTS REQUIRED FOR TRAFFIC CONTROL AND PROTECTION.
- 6. ALL TEMPORARY PAVEMENT MARKINGS SHOWING DETERIORATION AFTER 7 DAYS OF SERVICE SHALL BE REPLACED BY THE CONTRACTOR AS DIRECTED BY THE ENGINEER. SUFFICIENT QUANTITIES FOR THE INITIAL PLACEMENT AND A ONE-TIME REPLACEMENT HAVE BEEN PROVIDED FOR EACH STAGE. ALL MARKINGS THAT REQUIRE REPLACEMENT PRIOR TO 7 DAYS OF SERVICE OR REPLACEMENT AFTER THE INITIAL REPLACEMENT SHALL BE REPLACED BY THE CONTRACTOR AT HIS EXPENSE.
- 7. THE CONTRACTOR SHALL BE RESPONSIBLE FOR PROVIDING LABOR, SIGNS AND TRAFFIC CONTROL DEVICES NECESSARY FOR THE MAINTENANCE OF TRAFFIC UNLESS NOTED OTHERWISE IN THE SPECIAL PROVISIONS.
- 8. ALL TRAFFIC CONTROL DEVICES SHALL BE REMOVED, COVERED OR TURNED AWAY FROM THE TRAFFIC IMMEDIATELY WHEN THEY ARE NO LONGER NECESSARY. WHEN A SIGN IS COVERED, ITS POST SHALL HAVE A REFLECTIVE 3" x 6" DELINEATOR INSTALLED. COST OF THE DELINEATOR IS INCLUDED IN TRAFFIC CONTROL AND PROTECTION, (SPECIAL).
- 9. WORK ZONE SPEED LIMIT SHALL BE 40 MPH ON IL ROUTE 21.
- 10. THE CONTRACTOR SHALL BE REQUIRED TO MAINTAIN TRAFFIC IN ACCORDANCE WITH THE TRAFFIC CONTROL PLANS, SPECIAL PROVISIONS, APPLICABLE STATE STANDARDS, AND AS DIRECTED BY THE ENGINEER. ANY CHANGES TO THE TRAFFIC CONTROL SHALL BE SUBMITTED TO THE ENGINEER FOR APPROVAL PRIOR TO IMPLEMENTING ANY CHANGES.
- 11. THE ENGINEER SHALL BE INFORMED 48 HOURS IN ADVANCE OF ANY PROPOSED CHANGE TO THE SUGGESTED STAGE OF CONSTRUCTION AND TRAFFIC CONTROL PLAN.
- 12. THE CONTRACTOR SHALL PROVIDE ADEQUATE TEMPORARY DRAINAGE AND EROSION CONTROL PROTECTION DURING ALL PHASES OF CONSTRUCTION.
- 13. THE CONTRACTOR SHALL MAINTAIN A MINIMUM OF ONE 11' THRU-LANE IN EACH DIRECTION FOR TWO-WAY TRAFFIC FLOW UNLESS OTHERWISE SPECIFIED.
- 14. THE CONTRACTOR SHALL CONTACT THE DISTRICT ONE TRAFFIC CONTROL SUPERVISOR AT (847) 705-4470 A MINIMUM OF 72 HOURS IN ADVANCE OF BEGINNING WORK
- 15. THE CONTRACTOR SHALL BE REQUIRED TO REMOVE ALL EXISTING PAVEMENT MARKINGS WHICH CONFLICT WITH THE DESIGNATED TRAFFIC CONTROL PLAN.
- 16. TEMPORARY CONCRETE BARRIER AND TEMPORARY IMPACT ATTENUATORS SHALL BE PLACED AS INDICATED IN THE PLANS. FURNISHING, AND INSTALLING TEMPORARY CONCRETE BARRIER AND TEMPORARY IMPACT ATTENUATORS SHALL BE IN ACCORDANCE WITH IDOT SPECIAL PROVISIONS, IDOT HIGHWAY STANDARDS, STANDARD SPECIFICATIONS, AND AS DIRECTED BY THE ENGINEER.
- 17. IMMEDIATELY AFTER THE COMPLETION OF CONSTRUCTION, THE CONTRACTOR SHALL RESTORE ALL PERMANENT PAVEMENT MARKINGS, SIGNS, AND OTHER TRAFFIC CONTROL DEVICES THAT WERE COVERED, REMOVED, DAMAGED, OR OTHERWISE AFFECTED BY CONSTRUCTION.
- 18. MAINTAIN EXISTING PEDESTRIAN ACCOMMODATIONS DURING CONSTRUCTION.

PRE-STAGE

- STAGE I
- 1. INSTALL STAGE I TRAFFIC CONTROL ACCORDING TO STAGE I MOT PLANS
- 2. ERECT TEMPORARY SHEET PILING AS SHOWN IN THE PLANS. 3. REMOVE THE EXISTING CULVERT AS PER THE LIMITS SHOWN ON PLANS
- 4. CONSTRUCT THE PROPOSED CONCRETE BOX CULVERT. STAGE II

- STAGE III
- INSTALL PERMANENT PAVEMENT MARKINGS.
- 3. COMPLETE ALL UNFINISHED LANDSCAPING.

ä	A	USER NAME = lchrzesc	DESIGNED - AB	REVISED -		MAINTENANCE OF TRAFFIC – GENERAL NOTES AND	F.A.P RTF.	SECTION	COUNTY TOTAL SHEET
μ	🗼 Accurate		DRAWN - AB	REVISED -	STATE OF ILLINOIS	SUGGESTED SEQUENCE OF CONSTRUCTION	330	2016-052B	LAKE 30 8
ž	GROUP, INC.	PLOT SCALE = 20.0000 '/ in.	CHECKED - LC	REVISED -	DEPARTMENT OF TRANSPORTATION	IL 21 (MILWAUKEE AVE) OVER DITCH			CONTRACT NO. 62D38
5		PLOT DATE = 11/30/2018	DATE - 08-01-2018	REVISED -		SCALE: 1"=20' SHEET 1 OF 4 SHEETS STA. TO STA.		ILLINOIS FED. AI	D PROJECT


SEQUENCE OF CONTRUCTION

1. INSTALL EROSION CONTROL DEVICES PER THE EROSION CONTROL PLANS.

1. INSTALL STAGE II TRAFFIC CONTROL ACCORDING TO STAGE II MOT PLANS 2. REMOVE AND INSTALL THE STEEL PLATE BEAM GUARDRAIL ON THE EASTSIDE OF THE ROAD.

1. REOPEN ROADWAY AND REMOVE TEMPORARY TRAFFIC CONTROL DEVICES.

- 4. REMOVE TEMPORARY EROSION CONTROL DEVICES.

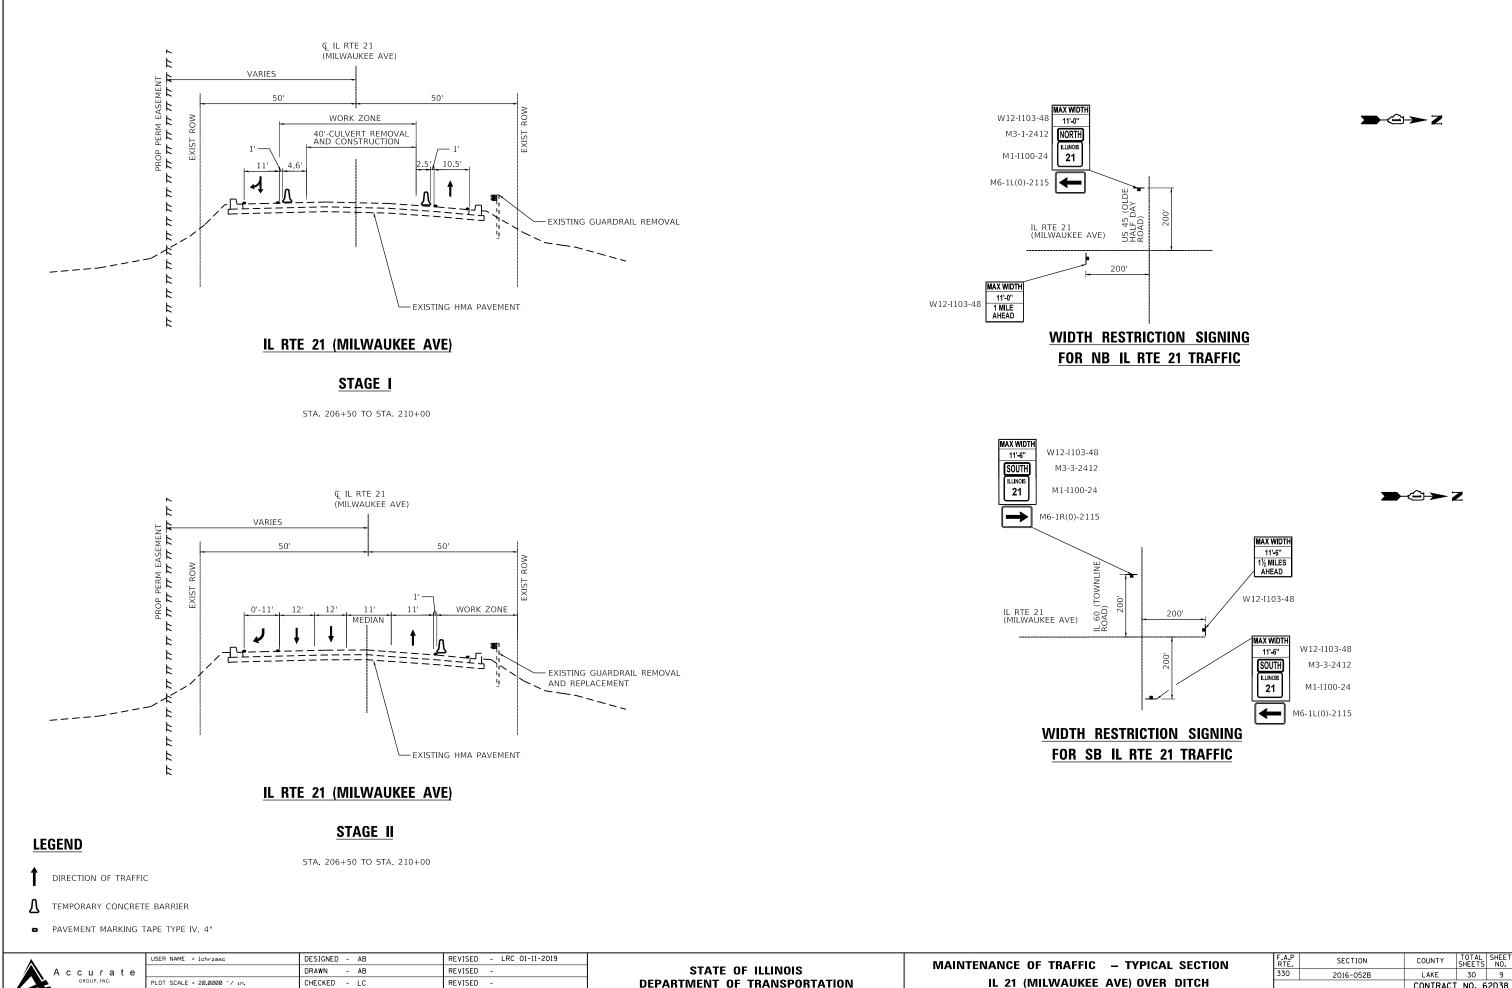



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PLOT DATE = 1/11/2019


IL 21 (MILWAUKEE SHEET OF SHEET SHEET

– TYPICAL SECTION		SECTION	COUNTY	TOTAL SHEETS	SHEET NO.
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AVE) OVER DITCH	_		CONTRACT	NO. 6	2D38
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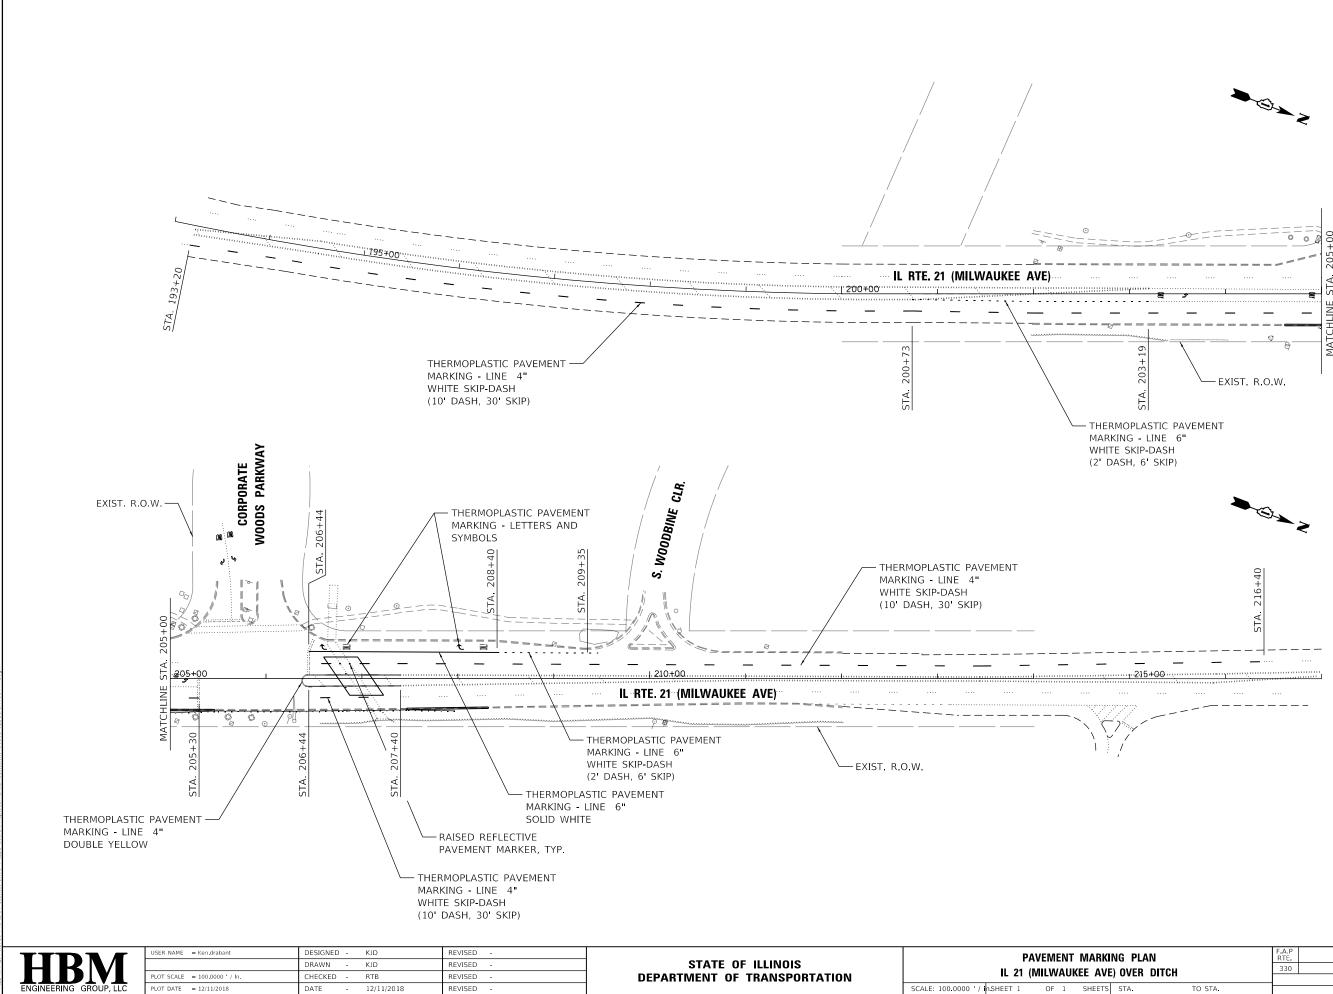


AVE) OVER DITCH		 2010 0320				-
				CONTRACT	NO.	62D3
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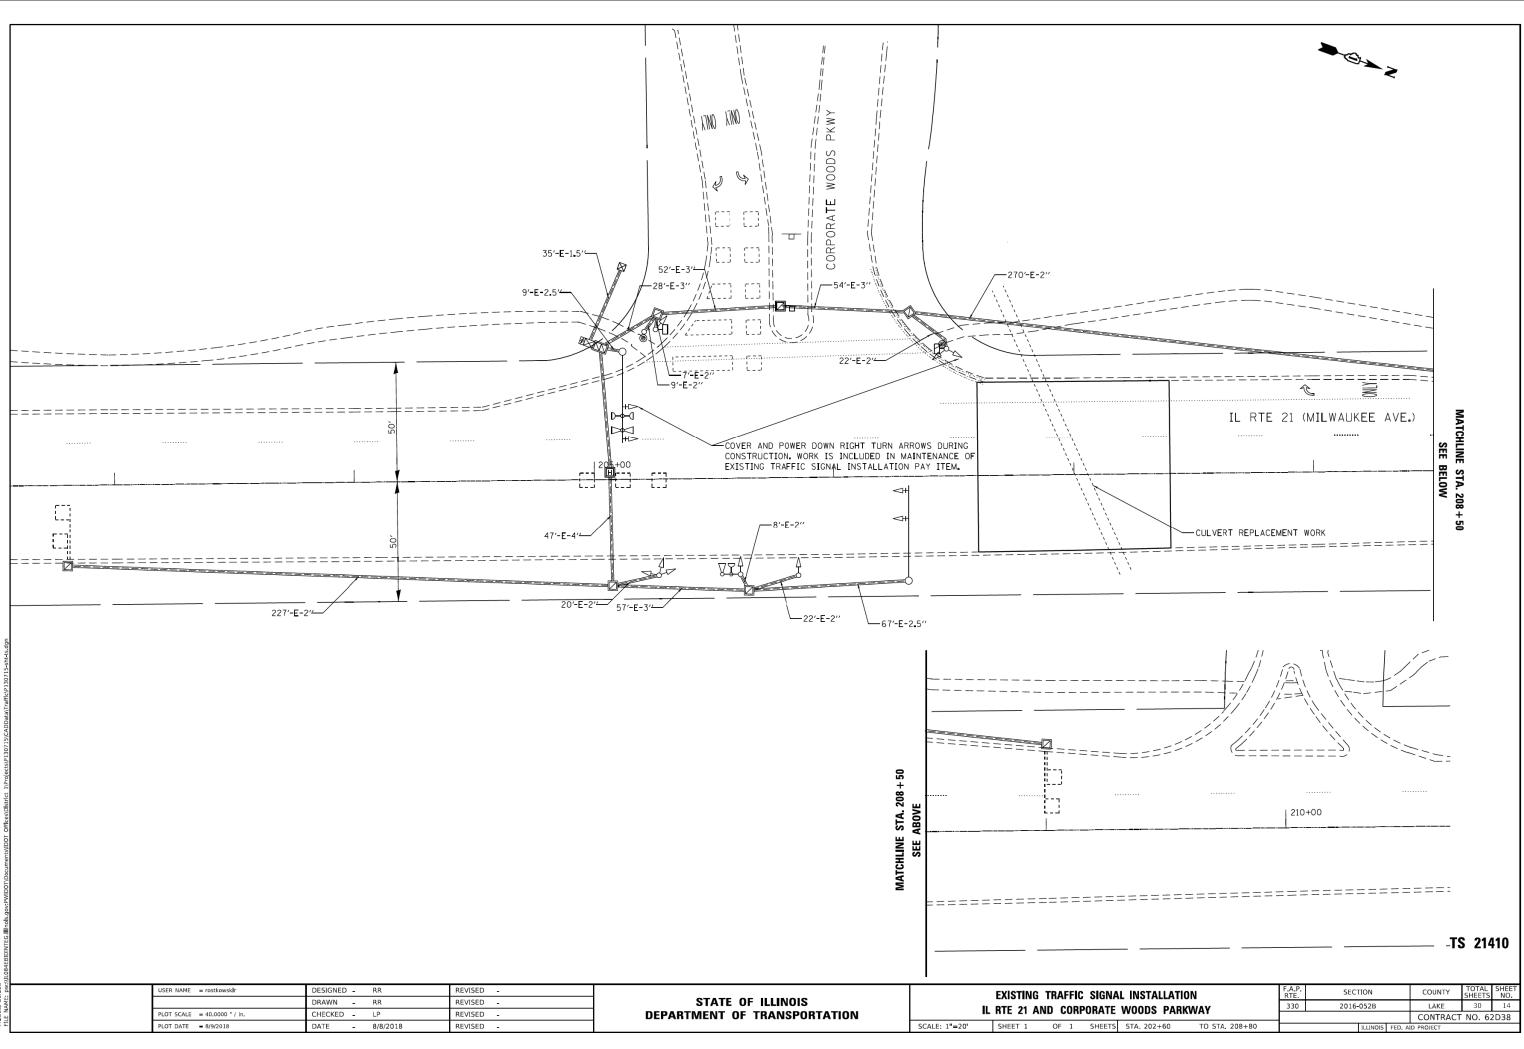
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T	ENGINEERING GROUP, LLC
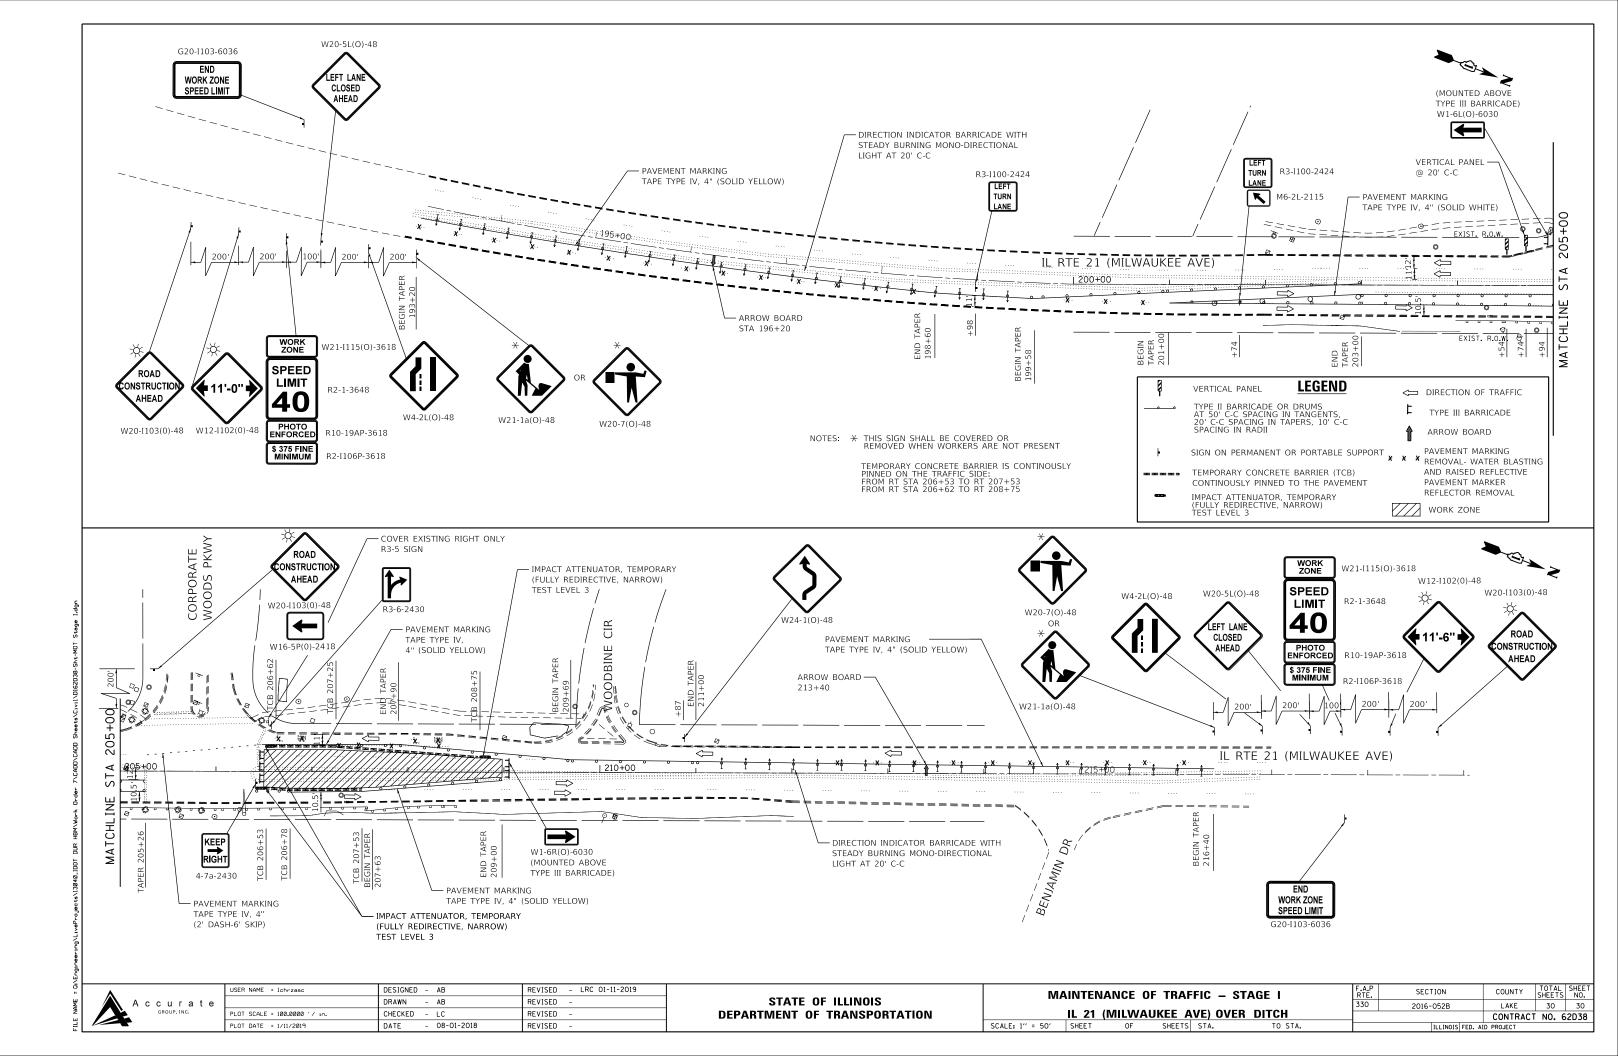
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GROUP, LLC	PLOT DATE = 12/11/2018	DATE - 12/11/2018	REVISED -		SCALE: 60.0000 ' / in. SHEET 1	OF 1 SHEETS

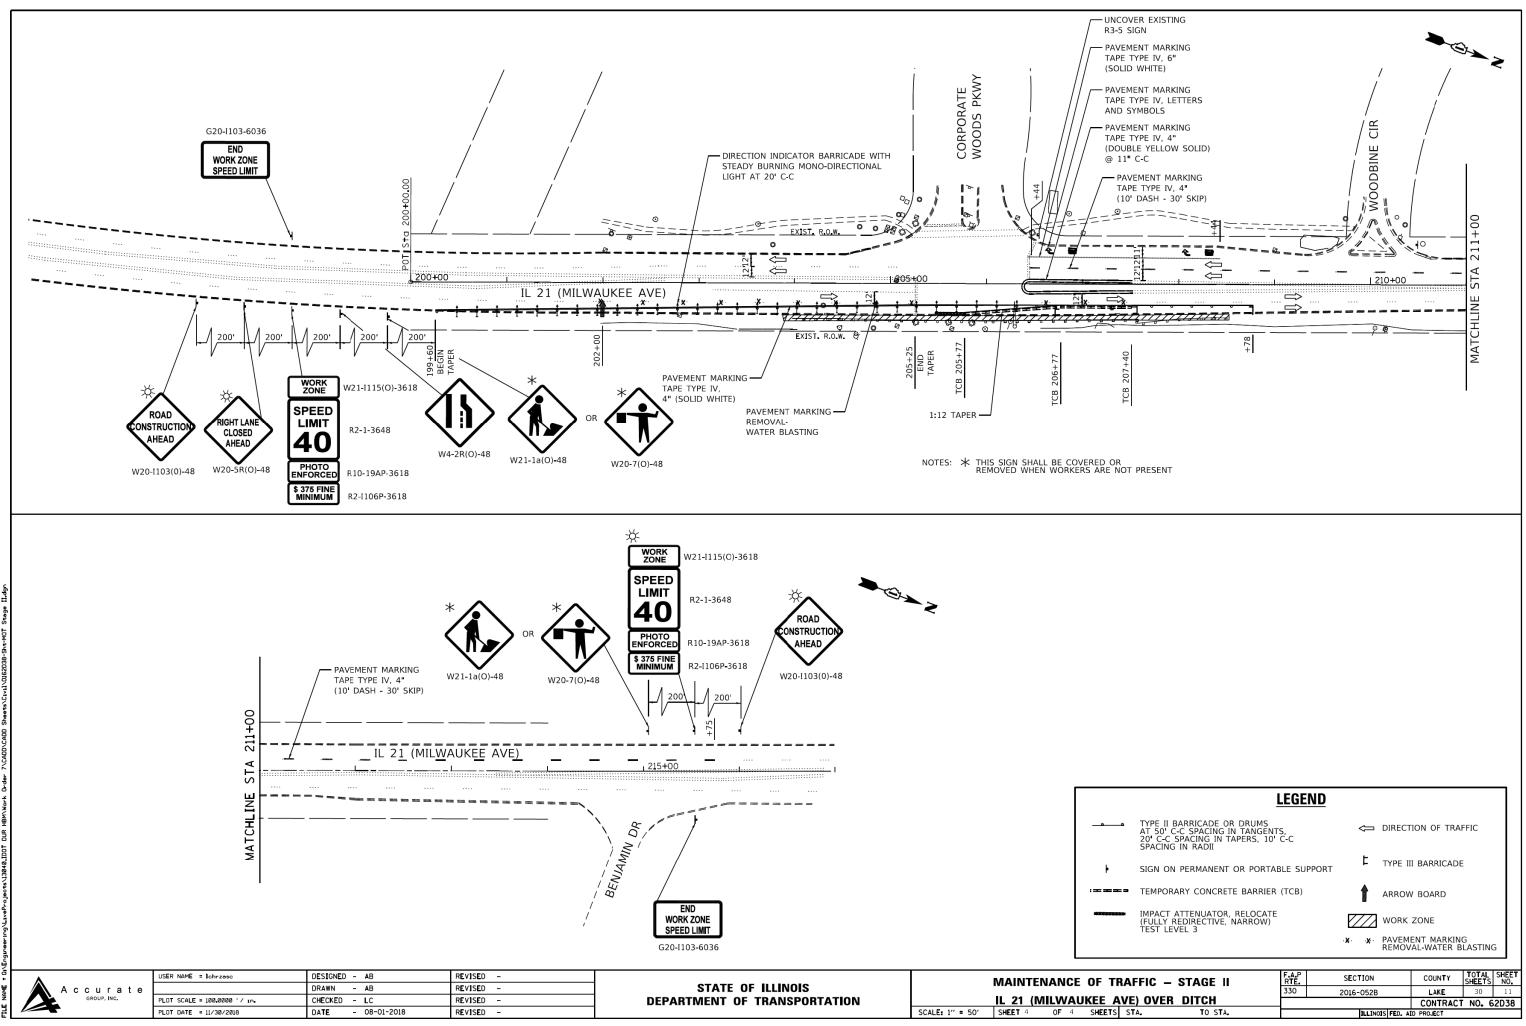

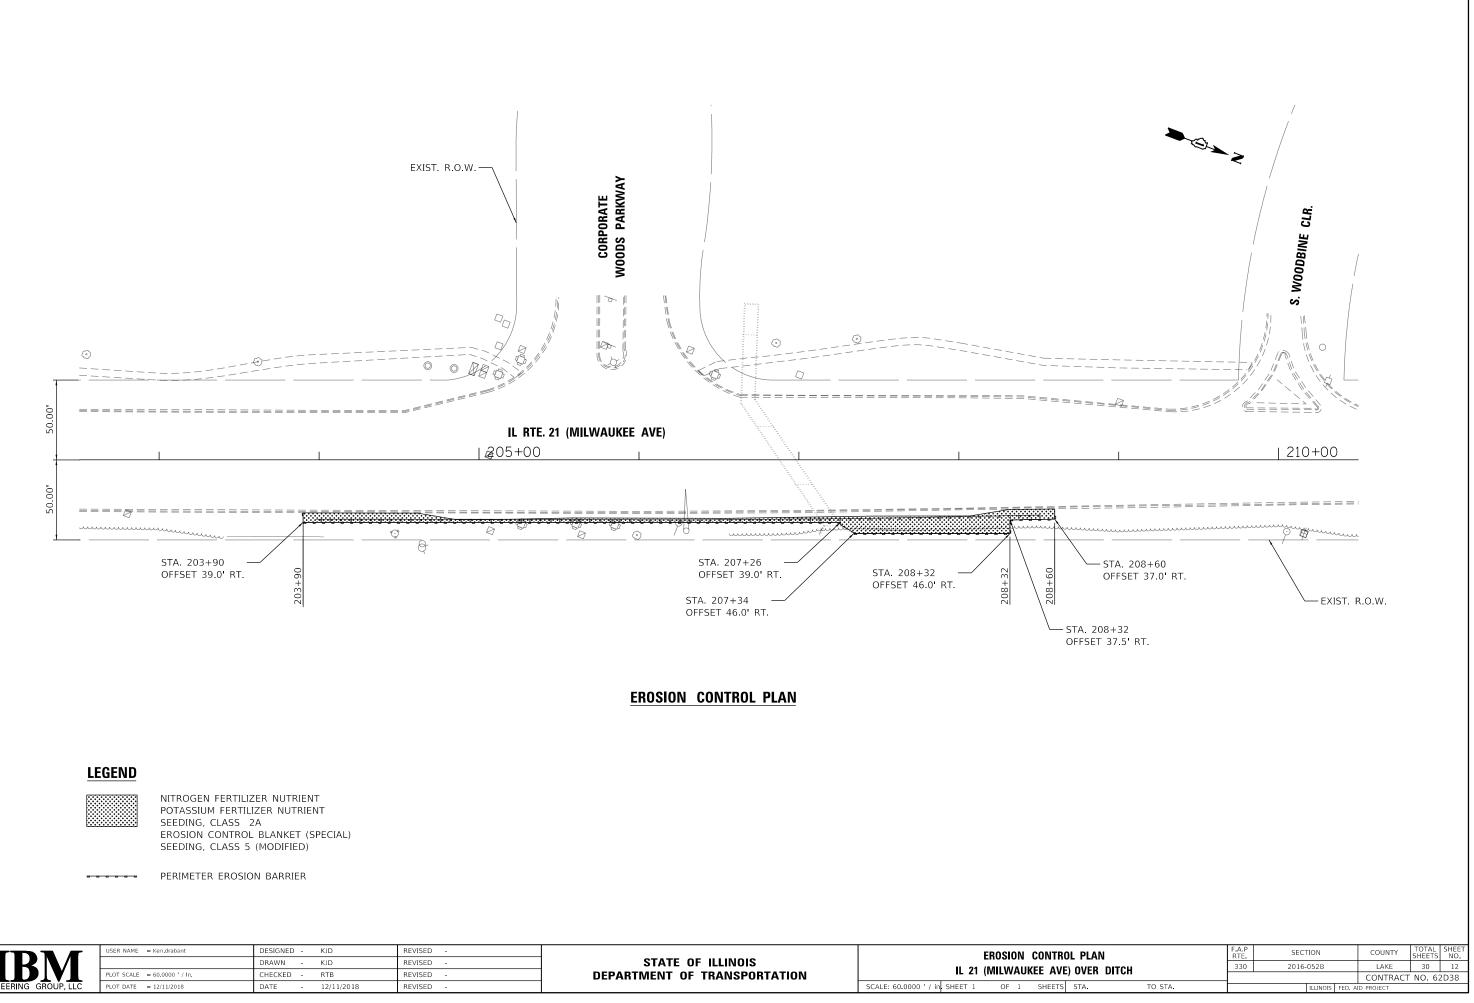


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V L.		11					CONTRACT	NO. 62	2D38
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SHT NO.1 TS

IAL INSTALLATION E WOODS PARKWAY		RTE.	SEC	ION		COUNTY	SHEETS	NO.	
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						CONTRACT	NO. 62	2D38	
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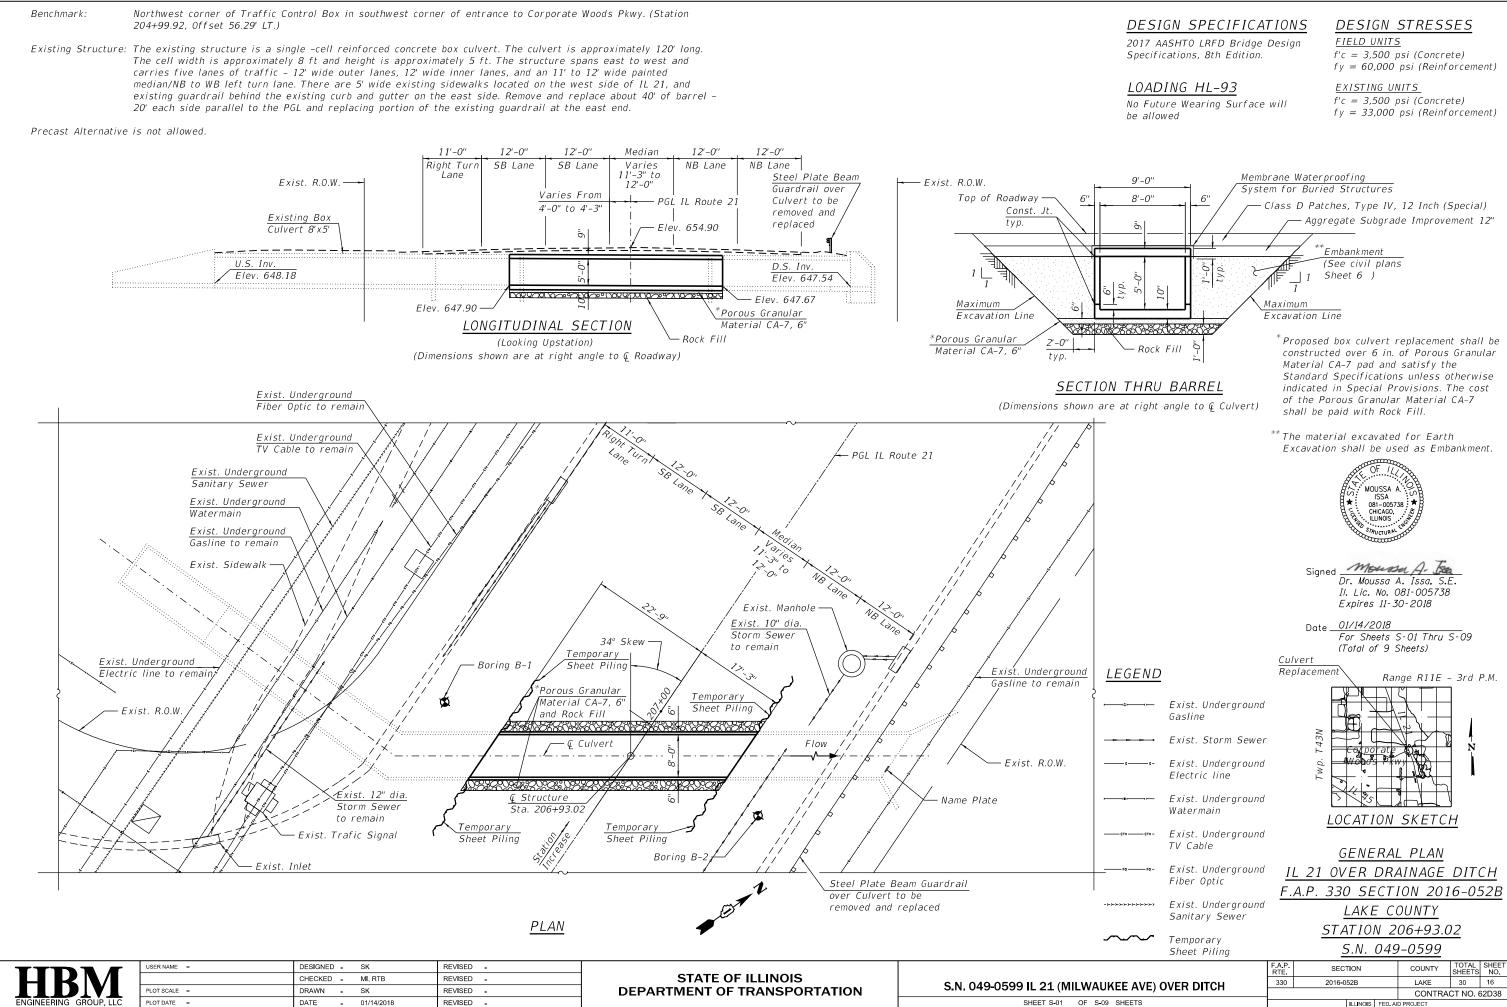
NIC.	ACCOUNT NUMBER							
Md		USER NAME = rostkowskir	DESIGNED - RR	REVISED -		EXISTING TRAFFIC SIGNAL INSTALLATION	F.A.P. SECTION	COUNTY TOTAL SHEET
AME			DRAWN - RR	REVISED -	STATE OF ILLINOIS		330 2016-052B	LAKE 30 15
U N L		PLOT SCALE = 40.0000 ' / in.	CHECKED - LP	REVISED -	DEPARTMENT OF TRANSPORTATION	IL RTE 21 AND CORPORATE WOODS PARKWAY		CONTRACT NO. 62D38
Ē		PLOT DATE = 8/9/2018	DATE - 8/8/2018	REVISED -		SCALE: NONE SHEET 1 OF 1 SHEETS STA TO STA	ILLINOIS FED. /	AID PROJECT

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COMPANY: COMMONWEALTH EDISON

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1/14/2019

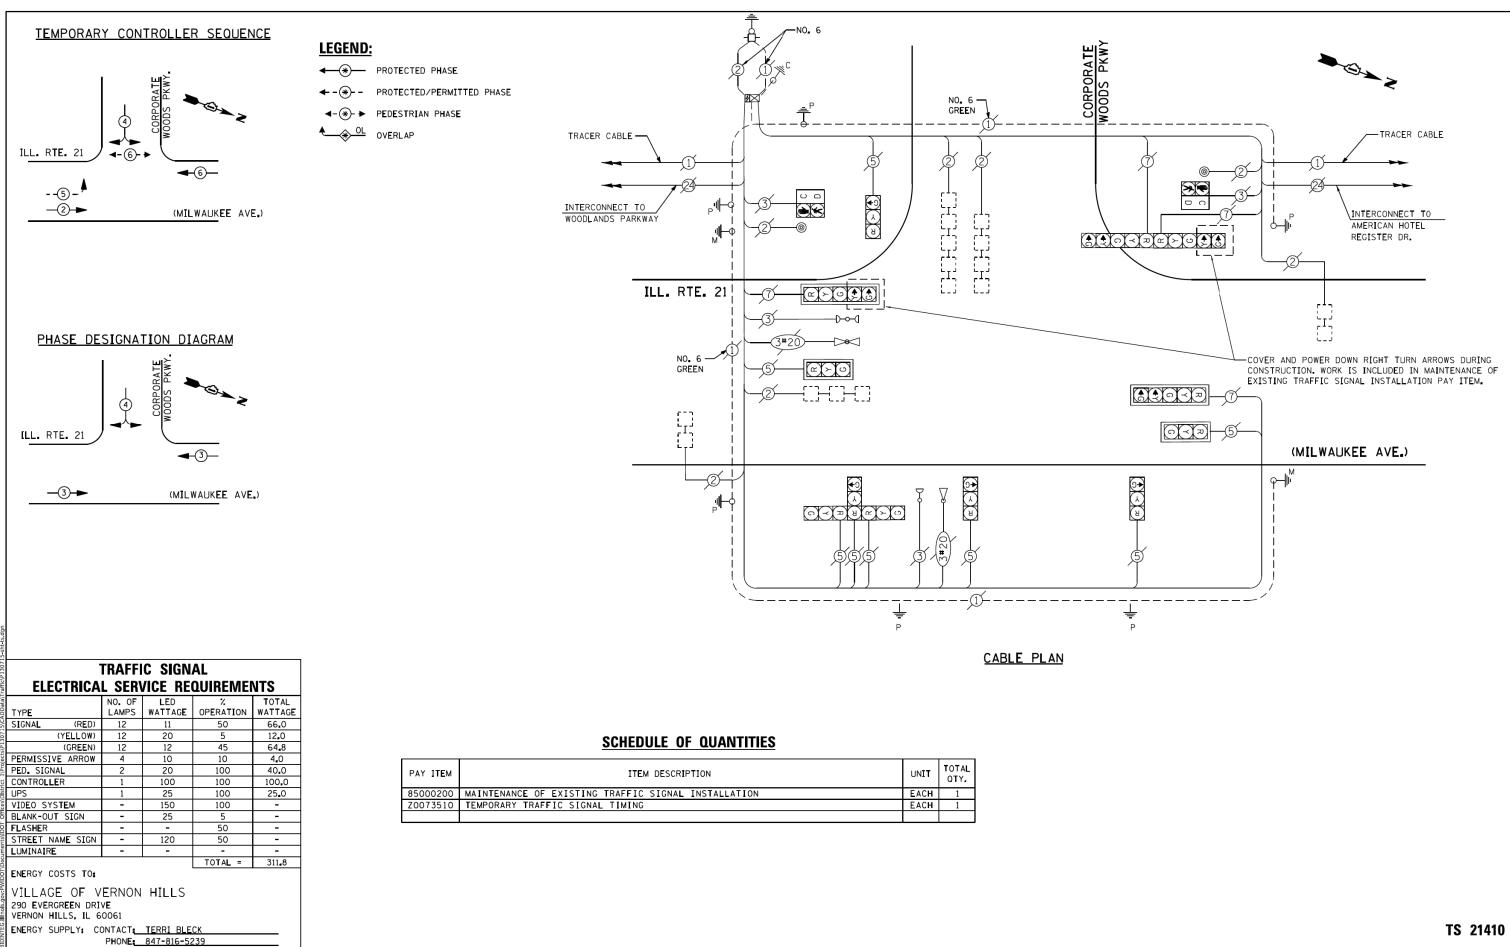GENERAL NOTES:

- 1. Plan dimensions and details relative to existing plans are subject to nominal construction variations. The Contractor shall field verify existing dimensions and details affecting new construction and make necessary approved adjustments prior to construction or ordering of materials. Such variations shall not be cause for additional compensation for a change in scope of the work, however, the Contractor will be paid for the quantity actually furnished at the unit price bid for the work.
- 2. It shall be the responsibility of the contractor to divert the stream flow during construction in order to keep the construction area free of water. The method of the water diversion shall be subjected to the approval of the Engineer and the cost shall be included with the cost of concrete box culverts.
- 3. Exposed edges shall be beveled $\frac{3}{4}$ ".

SCOPE OF WORK:

- 1. Remove and reconstruct the 40'-0" of the middle portion of culvert barrel.
- 2. Remove the steel plate beam guardrails and guardrail posts on the east side of the roadway.
- 3. Remove and reconstruct the portions of HMA pavement and median on the 40'-0" middle portion of the roadway.

INDEX OF SHEETS

- S-01 General Plan and Elevation
- S-02 General Notes, Index of Sheets, and Total Bill of Material
- S-03 Structure Removal
- S-04 Culvert Stage Construction
- S-05 Temporary Sheet Piling
- S-06 Temporary Concrete Barrier for Stage Construction
- S-07 Top and Bottom Slab Reinforcement
- S-08 Sections, Details, and Bill of Material
- S-09 Boring Logs




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ITEM	UNIT	TOTAL
Removal and Disposal of Unsuitable Material	Cu. Yd.	34
Removal of Existing Structures No. 1	Each	1
Reinforcement Bars	Pound	7,870
Name Plates	Each	1
Temporary Sheet Piling	Sq. Ft.	1,090
Concrete Box Culverts	Cu. Yd.	34.5
Membrane Waterproofing System for	Sq. Yd.	58
Buried Structures		
Rock Fill	Cu.Yd.	26




NAME PLATE See Std. 515001

AND TOTAL BILL OF MATERIAL	F A P RTE	SECTIO	ОМ	COUNTY	TOTAL SHEETS	SHEET NO.
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				CONTRA	CT NO. 6	62D38
S-09 SHEETS		ILL	LINOIS FED. AI	D PROJECT		

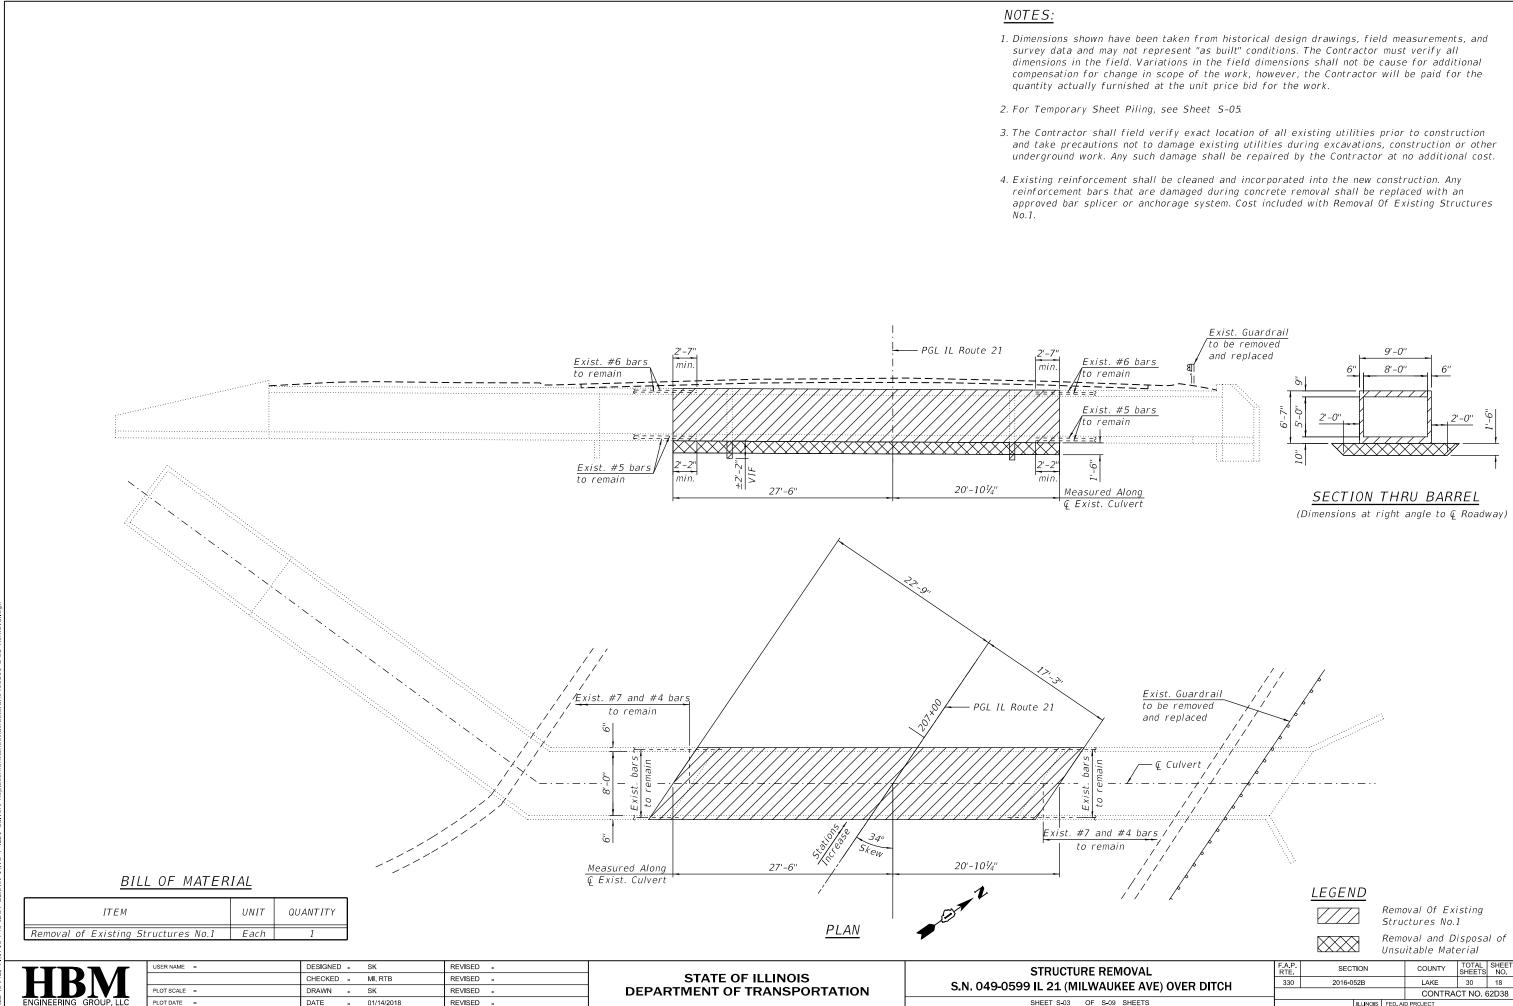

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STAGE I REMOVAL

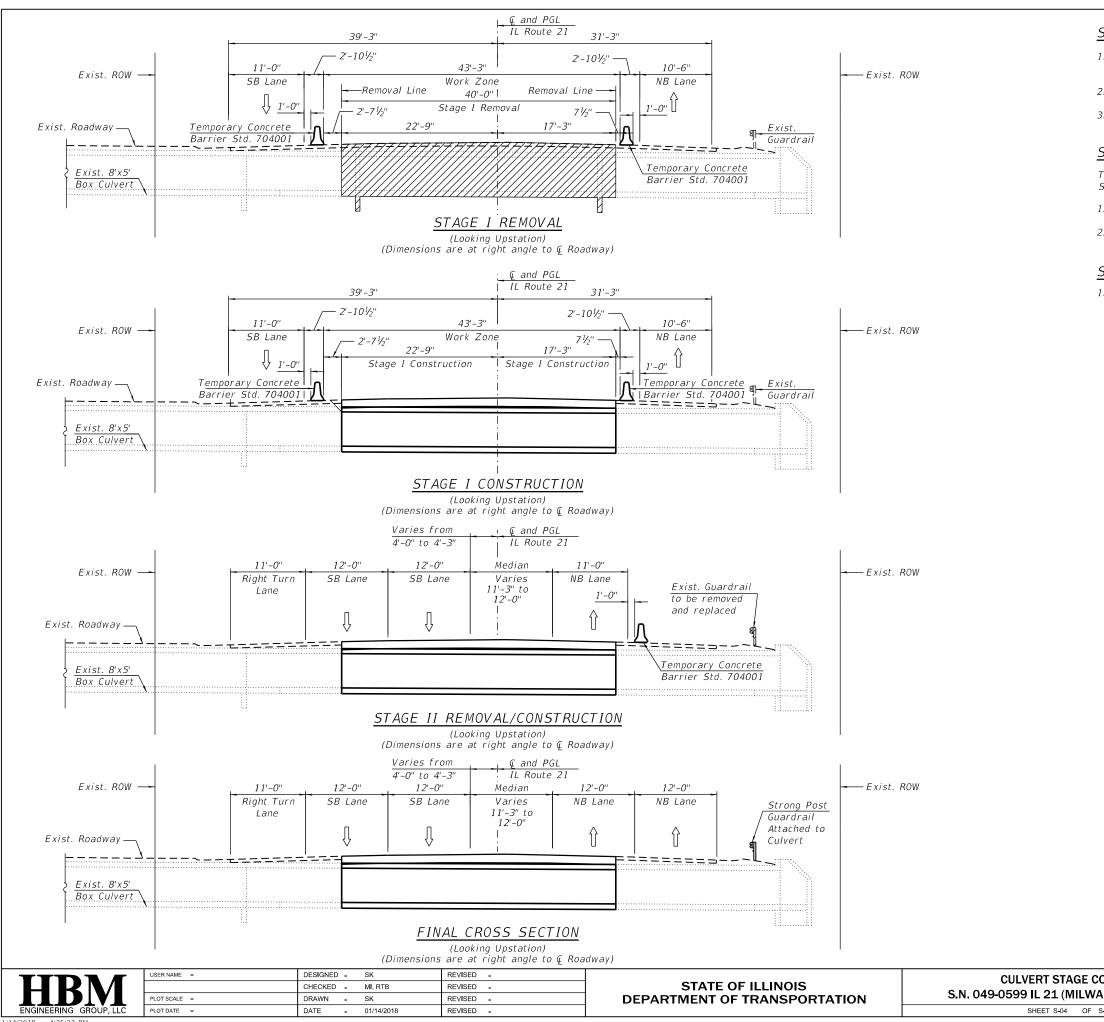- 1. Install temporary concrete barrier as shown to locate construction work area on the east side of the existing structure.
- 2. Install Temporary Sheet Piling as shown in Sheet S-05.
- 3. Remove existing culvert barrel within limits of Stage I Removal.

STAGE I CONSTRUCTION

The following construction items will be performed within the limits of Stage I Construction:

- 1. Reconstruct the culvert barrel in the limits of Stage I Construction.
- 2. Reconstruct the HMA pavement of the roadway.

STAGE II REMOVAL/CONSTRUCTION


1. Remove and install the steel plate beam guardrail and guardrail posts at the east side of the road.





Removal Of Existing Structures No.1


ONSTRUCTION	F A P RTE	SEC ⁻	TION		COUNTY	TOTAL SHEETS	SHEET NO.
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					CONTRA	CT NO. 6	62D38
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ENGINEERING GROUP, LLC	PLOT DATE =	DATE - 01/14/2018	REVISED -		SHEET S-05 OF S-09
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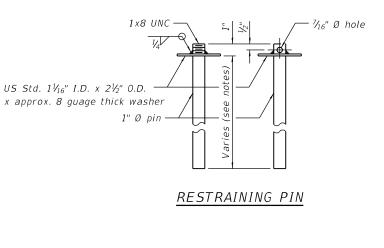
09 SHEETS

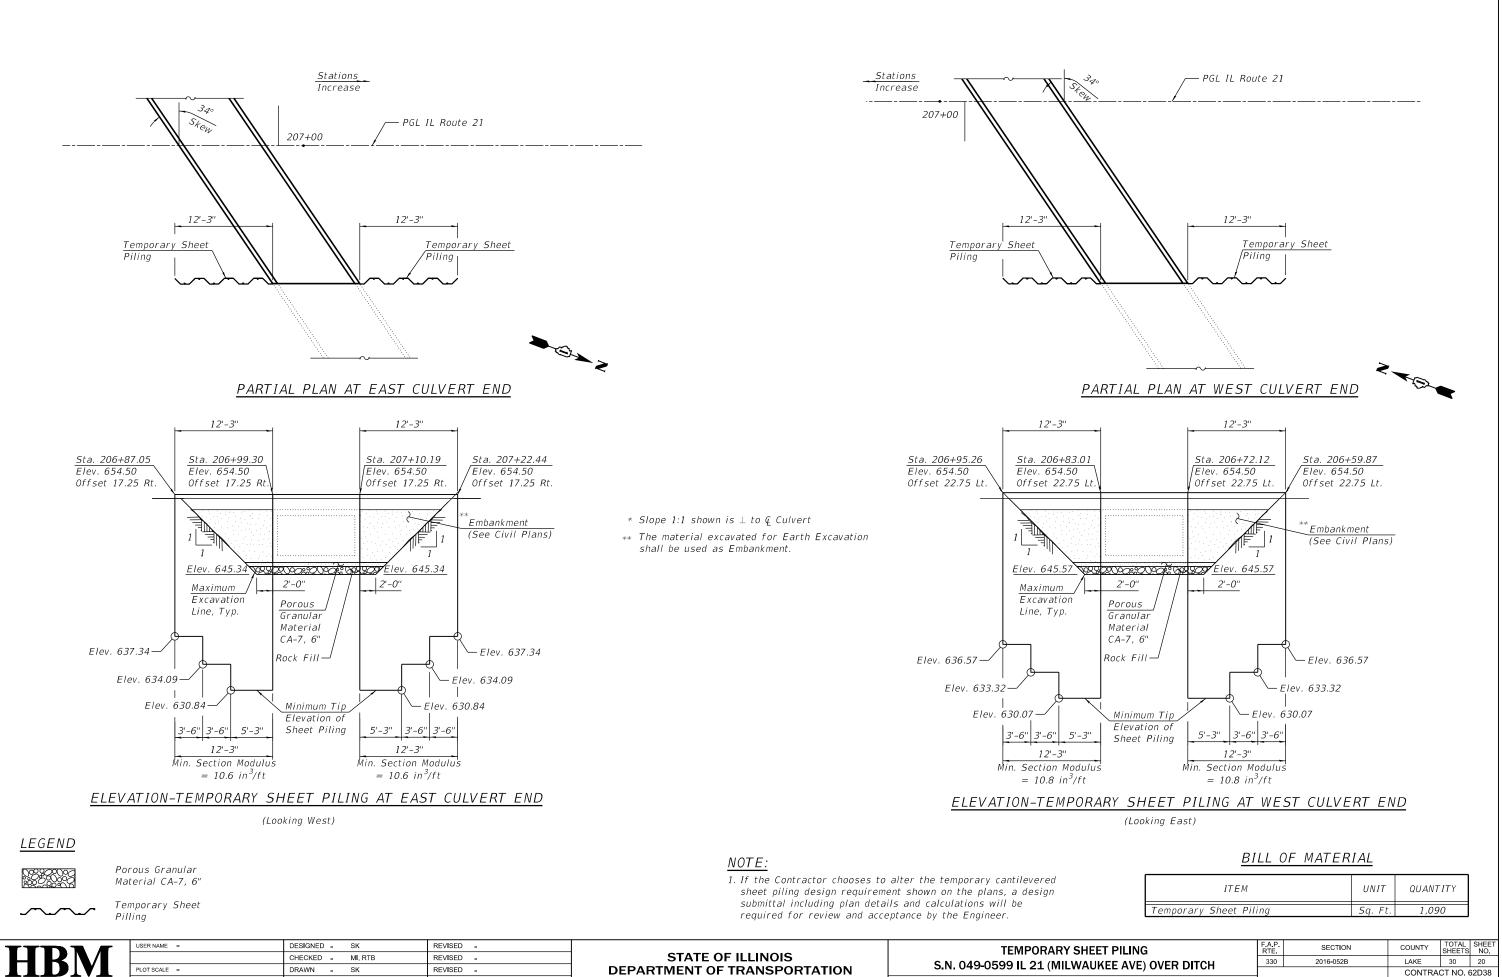
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SHEET S-06 OF S-





BAR SPLICER FOR #4 BAR - DETAIL III

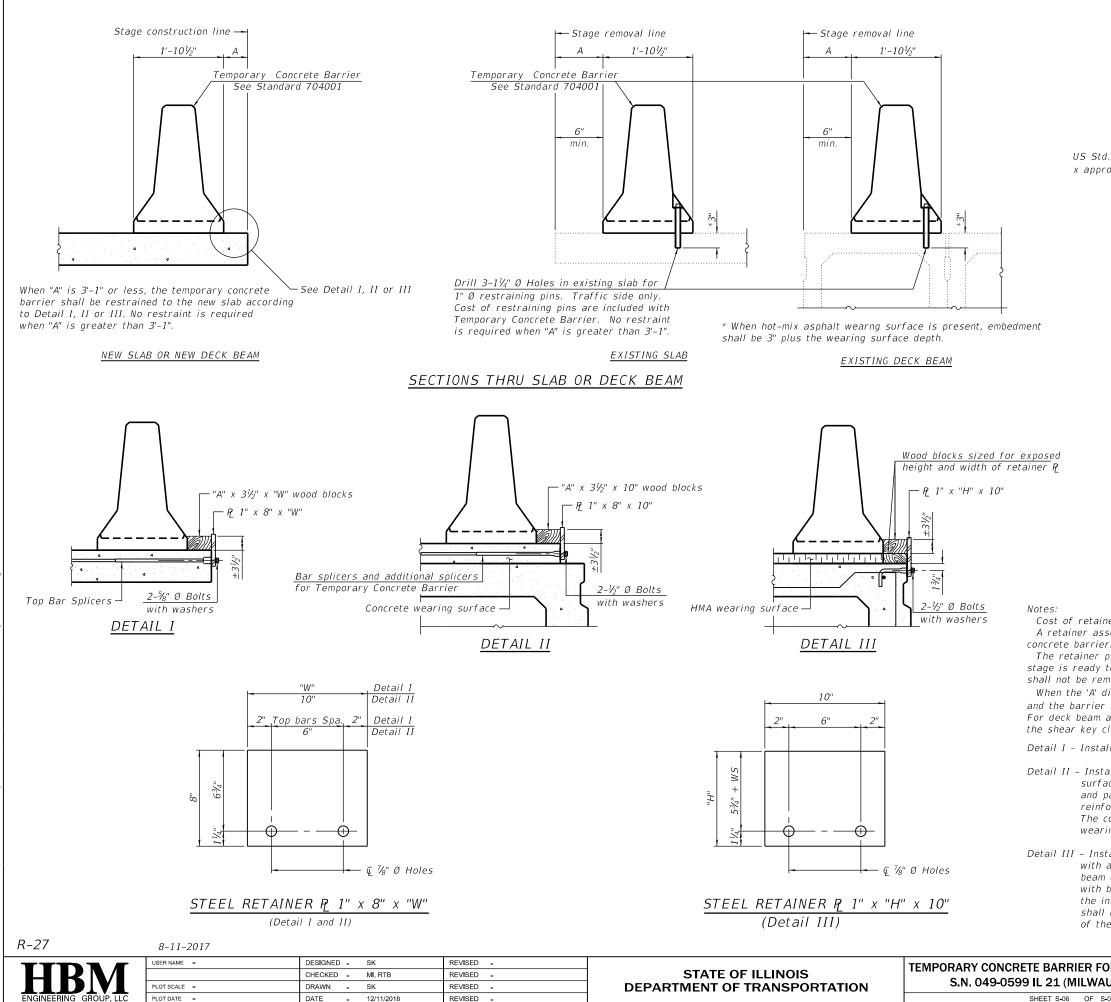Cost of retainer assembly is included with Temporary Concrete Barrier. A retainer assembly shall be located at the approximate (of each temporary oncrete barrier.

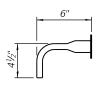The retainer plate shall not be removed until the concrete on the adjacent stage is ready to be poured. For Detail III applications the retainer plate shall not be removed until just prior to placing the adjacent beam.


When the 'A' dimension is less than $1\frac{1}{2}$ ", the wood block shall be omitted and the barrier shall be placed in direct contact with the steel retainer plate. For deck beam applications the minimum required 'A' distance is 6" to accommodate the shear key clamping device.

Detail I - Installation for a new bridge deck or bridge slab.

Detail II – Installation for a new deck beam with an initial concrete wearing surface. Additional bar splicers shall be provided at 6'-0" centers and paired with the bar splicers of the concrete wearing surface reinforcement to accommodate the installation of the retainer assemblies. The cost of the additional bar splicers is included with the concrete wearing surface.

Detail III – Installation for a new deck beam with no initial wearing surface or with an initial hot-mix asphalt (HMA) wearing surface present. The deck beam directly beneath the temporary concrete barrier shall be fabricated with bar splicer inserts in the side of the beam, as detailed, to accommodate the installation of the retainer assemblies. A pair of bar splicers, 6" apart, shall be placed at 6'-0" centers along the length of the beam. The cost of the bar splicers is included with the deck beam.

OR STAGE CONSTRUCTION	F A P RTE	SECT	TION		COUNTY	TOTAL SHEETS	SHEET NO.		
AUKEE AVE) OVER DITCH		2016-052B			LAKE	30	21		
					CONTRA	CONTRACT NO. 62D38			
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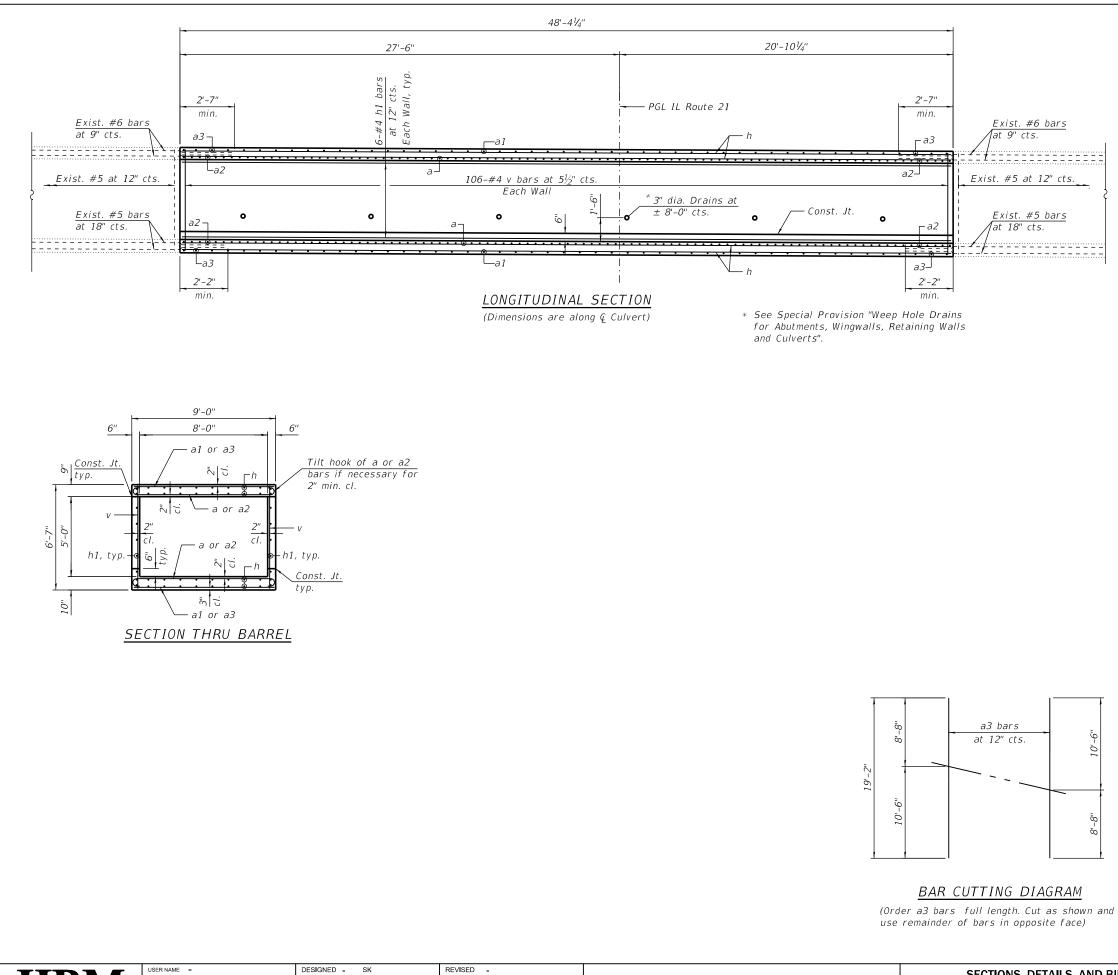
ENGINEERING GROUP, LLC

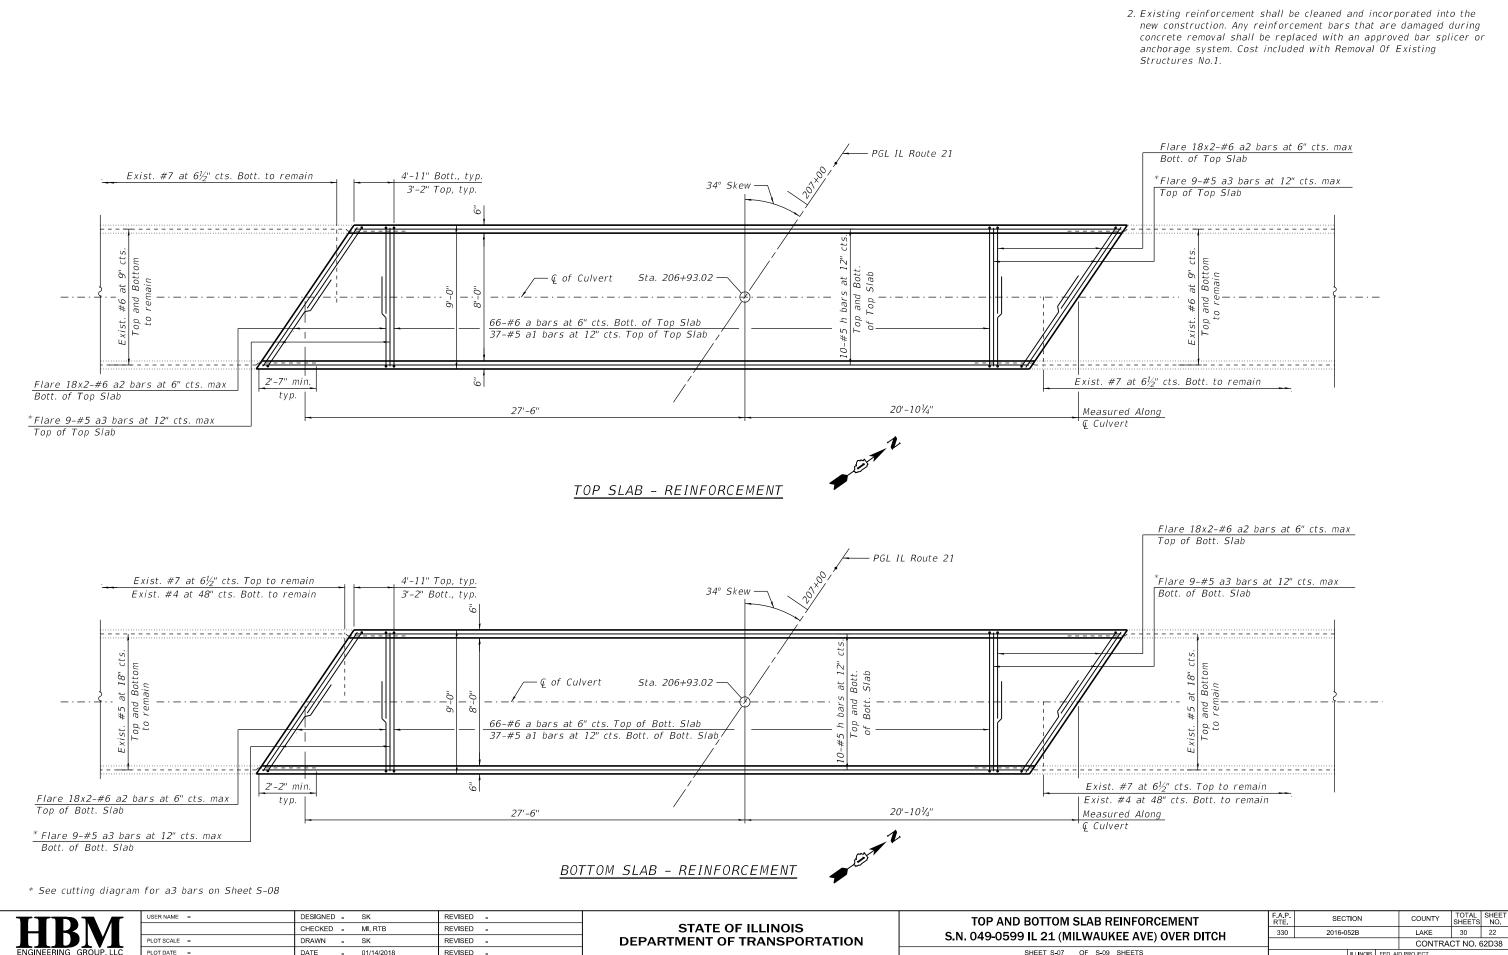SHEET S-07 OF

NOTES:

- 1. For Culvert Sections, details and Bill of Material, see Sheet S-08.
- new construction. Any reinforcement bars that are damaged during concrete removal shall be replaced with an approved bar splicer or anchorage system. Cost included with Removal Of Existing

WAUKEE AVE) OVER DITCH		330 2016-052B			LAKE	30
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OF S-09 SHEETS			ILLINOIS	FED. AI	D PROJECT	




SECTIONS, DETAILS, AND STATE OF ILLINOIS CHECKED - MI, RTB REVISED -S.N. 049-0599 IL 21 (MILWAU **DEPARTMENT OF TRANSPORTATION** PLOT SCALE = DRAWN - SK REVISED -PLOT DATE = DATE - 01/14/2018 REVISED -SHEET S-08 OF S-0 ENGINEERING GROUP, LLC


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BILL	0F	MATERIAL

Bar	No.	Size	Length	Shape
а	132	#6	10'-0''	
a1	74	#5	8'-8"	
a2	144	#6	7' <i>-3</i> ''	
a3	18	#5	19'-2"	
h	40	48'-2"		
h1	12	48'-2"		
V	212	#4	6'-3''	
Reinforcem	ent Bars	Pound	7,870	
Concrete Bo	ox Culverts	Cu.Yd.	34.5	
Membrane V	Vaterproofing	Sq. Yd.	58	
Buried Stru	icture			

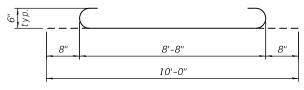


BAR a

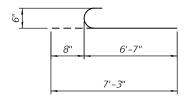

BARS a2

Minimum	Bar Laps
Bar	Lap
#5	2'-2"
#6	2'-7"

BILL OF MATERIAL		SECTION		COUNTY	TOTAL SHEETS	SHEET NO.		
UKEE AVE) OVER DITCH		2016-052B			LAKE	30	23	
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-09 SHEETS	ILLINOIS FED. A			FED. AI	ID PROJECT			

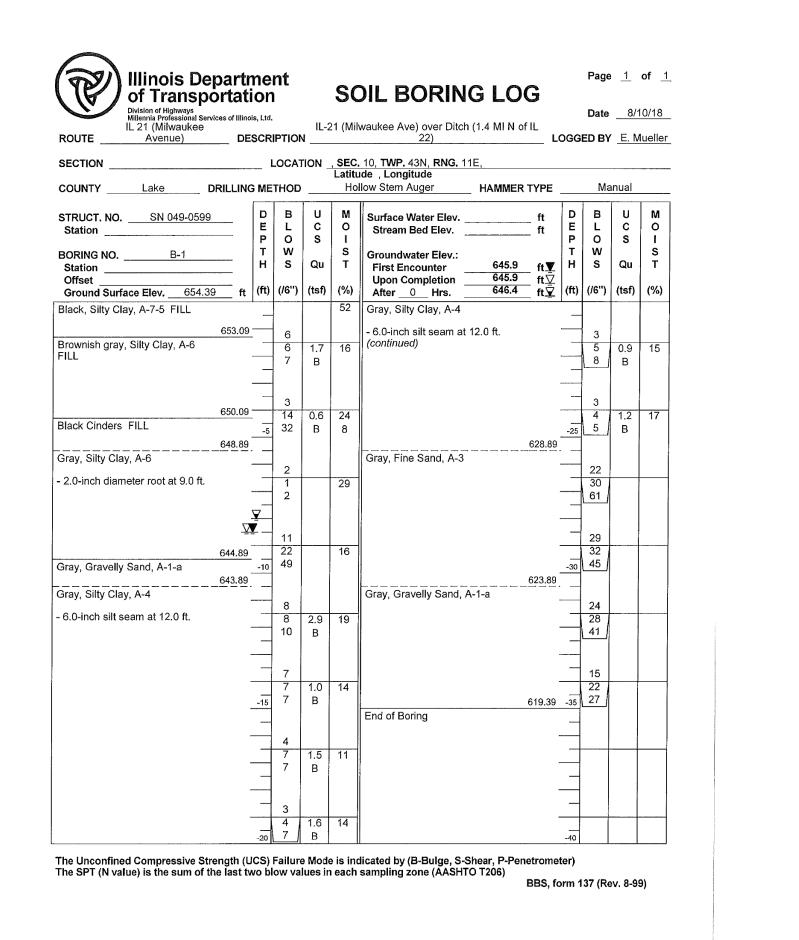


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Division of Highways Millennia Professional IL 21 (Milwauke	Services of Itlino	is, Ltđ.		11-2	21 (Mil	waukee Ave) over Ditch (1.4 MI N o 22)	of IL			8/*	
											luelle
SECTION		L	OCA1		, SEC. Latitu	10, TWP. 43N, RNG. 11E, Ide,Longitude					
COUNTY Lake	DRILLING	B ME	THOD			low Stem Auger HAMMER	RTYPE		Ma	nual	<u> </u>
STRUCT. NO. SN 049-05 Station		D E P T	B L O W	U C S	M O I S	Surface Water Elev Stream Bed Elev Groundwater Elev.:	ft ft	D E P T	B L O W	U C S	M 0 1 5
Station Offset		н	S	Qu	т	First Encounter 648.2 Upon Completion 645.7	ft	н	S	Qu	Т
Ground Surface Elev. 65	4.18 ft	(ft)	(/6'')	(tsf)	(%)	After 0 Hrs. 646.9	ft⊻ 633.68		(/6")	(tsf)	(%)
Asphalt (12.0 inches)	653.18				(Gray, Silty Clay Loam, A-4	033.00	·			
Brown, Crushed Limestone CA-06, FILL	652.18	_	18 8		14			_	6 9	1.9	15
Brown, Sand, FA-06, FILL			5							В	
			6						3		
		-5	4 4		5			-25	6 6	0.5 B	19
	<u> </u>		2						3		
		⊻	1 3		16		626.98		5 10	1.2 В	21
	646.18					Gray, Sand, A-1-a					
Gray, Sandy Clay Loam, A-4	<u>V</u> .		7					_	7		
	-	-10	8 8					-30	14 15		
		-	_								
	_		7 6	1.2	10				14 22		
		_	6	В			621.18	_/	23		
	-		2			Gray, Silty Sand, A-3			14		
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The SPT (N value) is the sum of the last two blow values in each sampling zone (AASHTO T206)

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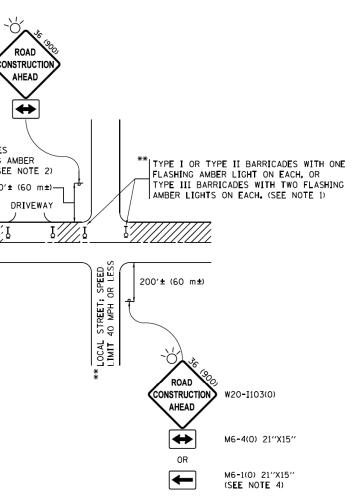
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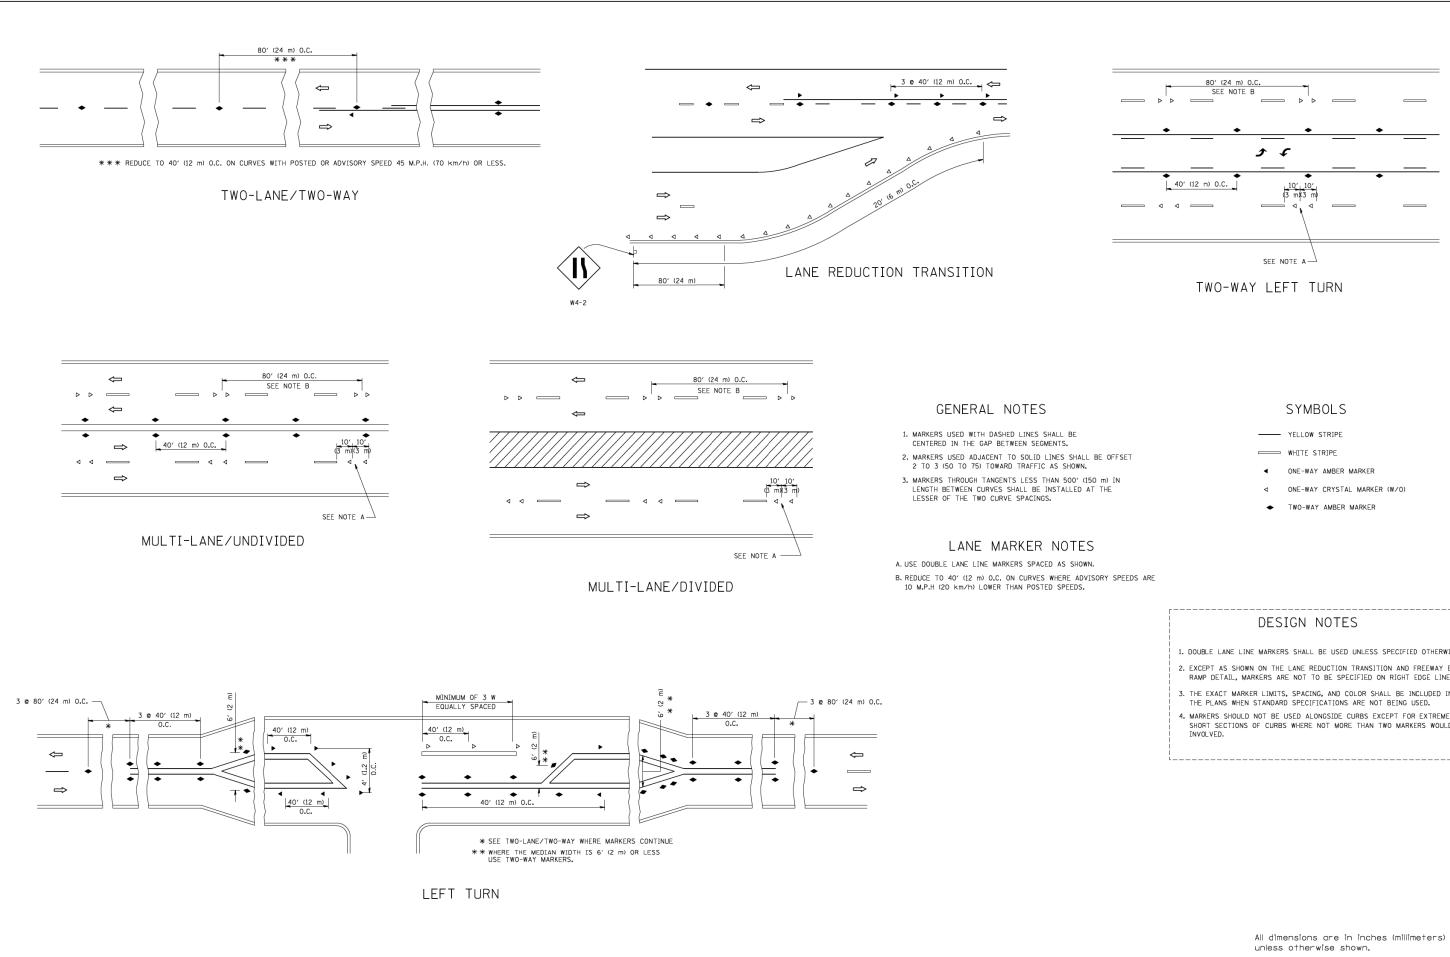
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					CONTRACT NO. 62D38			
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			Image: state of the state
		 SHOWN ON THE DRAWING AN a) ONE "ROAD CONSTRUC MOUNTED ON IT APPF b) THE CLOSED PORTION BLOCKING WITH TYPE THE CROSS SECTION 2. SIDE ROAD WITH A SPEED AS SHOWN ON THE DRAWING a) ONE "ROAD CONSTRUC FLASHER MOUNTED OF OF THE MAIN ROUTE. b) THE CLOSED PORTION BLOCKING WITH TYPE OF THE CLOSED PORTI 3. CONES MAY BE SUBSTITUTE SPACING DURING DAY OPER IN HEIGHT. 4. WHEN THE SIDE ROAD LIES 	N OF THE MAIN ROUTE SHALL BE PROTECTED BY E III BARRICADES, 1/2 OF THE CROSS SECTION
		BE USED IN LIEU OF THE I	DOUBLE HEADED ARROW (M6-4). All dimensions are in inches (millimeters) unless otherwise shown.
pw://l084EBIDINTEG.1llnois.gov;PWIDOT/Dopuments/IDOT_Offices/District_I/Projects/Dist DBRAWMY/CADDeta/CADDsheets/tc10.dgn PLOT_SCALE = 58.808 // in. CHECKED -	REVISED - A. HOUSEH 10-15-96 REVISED -T. RAMMACHER 01-06-00 REVISED - A. SCHUETZE 07-01-13 REVISED - A. SCHUETZE 09-15-16 DEPARTMENT OF		TRAFFIC CONTROL AND PROTECTION FOR SIDE ROADS, INTERSECTIONS, AND DRIVEWAYS F.A.P RTE. SECTION COUNTY TOTAL SHEETS SHE NO. SCALEL NONE SHEET 1 OF 1 SHEETS STA. TO STA. ILLINOIS FED. AID PROJECT







FILE NAME =	USER NAME = leysa	DESIGNED -	REVISED - T. RAMMACHER 09-19-94			TYDIC	CAL APPLICA	
c:\pw_work\pwidot\leysa\d0108315\tc11.dgn		DRAWN -	REVISED -T. RAMMACHER 03-12-99	STATE OF ILLINOIS				
	PLOT SCALE = 50.000 '/ IN.	CHECKED -	REVISED -T. RAMMACHER 01-06-00	DEPARTMENT OF TRANSPORTATION	RAISED R	EFLECTIVE PAVEME	NT MARKEP	IS
	PLOT DATE = 3/2/2011	DATE -	REVISED - C. JUCIUS 09-09-09		SCALE: NONE	SHEET NO. 1 OF 1	SHEETS	

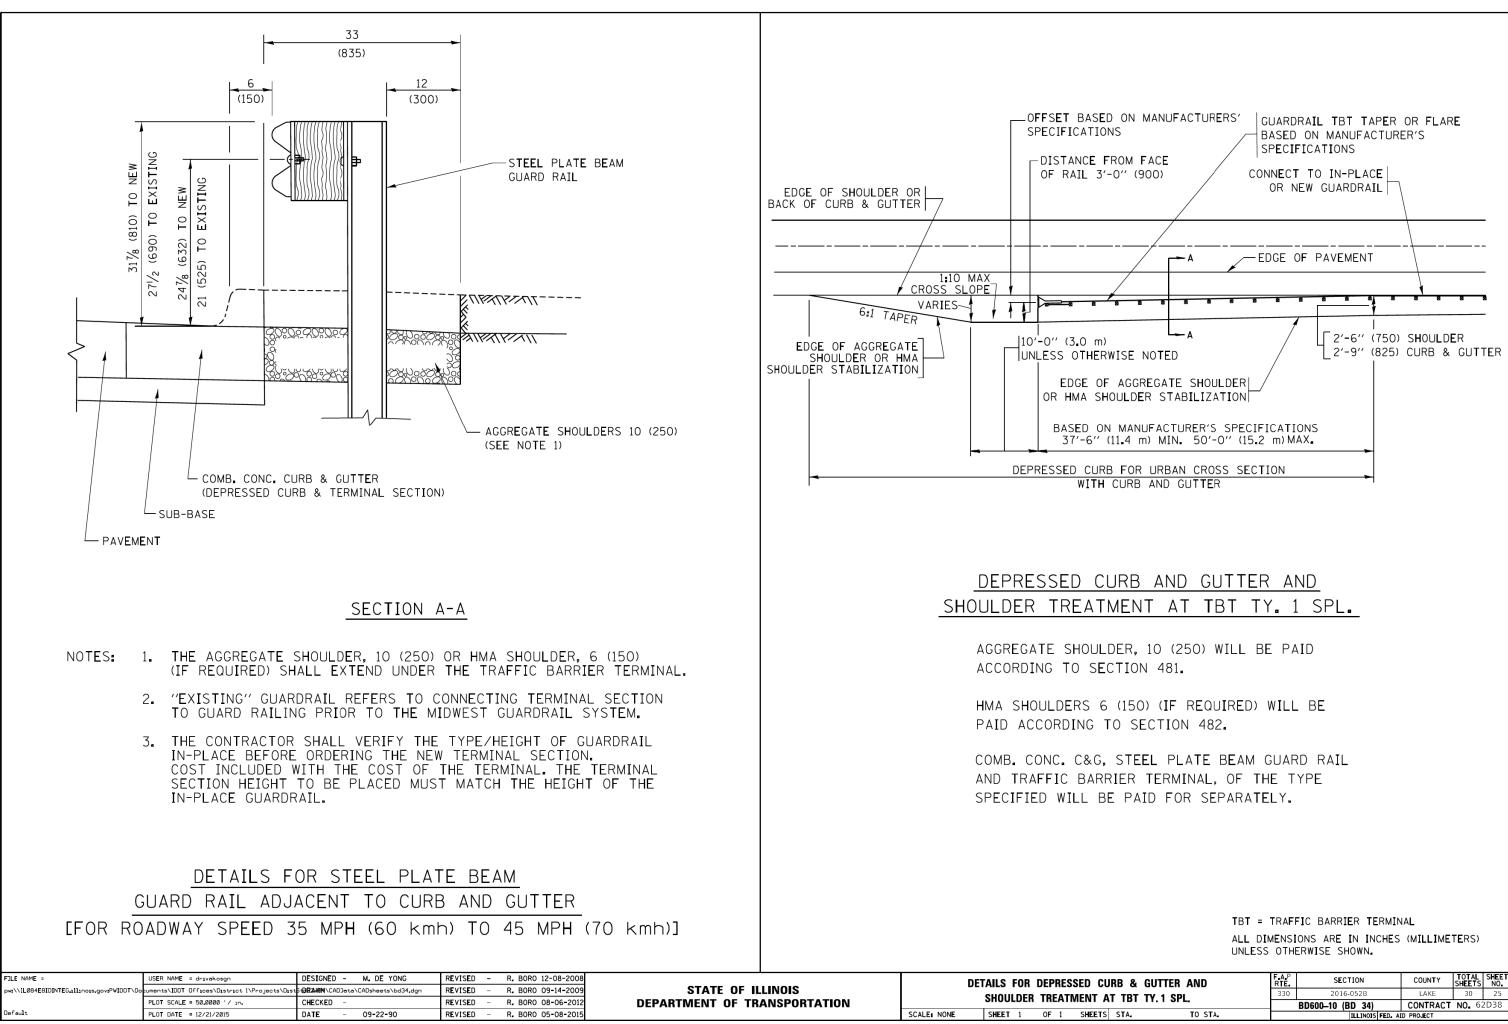1. DOUBLE LANE LINE MARKERS SHALL BE USED UNLESS SPECIFIED OTHERWISE. 2. EXCEPT AS SHOWN ON THE LANE REDUCTION TRANSITION AND FREEWAY EXIT RAMP DETAIL, MARKERS ARE NOT TO BE SPECIFIED ON RIGHT EDGE LINES. 3. THE EXACT MARKER LIMITS, SPACING, AND COLOR SHALL BE INCLUDED IN THE PLANS WHEN STANDARD SPECIFICATIONS ARE NOT BEING USED. 4. MARKERS SHOULD NOT BE USED ALONGSIDE CURBS EXCEPT FOR EXTREMELY SHORT SECTIONS OF CURBS WHERE NOT MORE THAN TWO MARKERS WOULD BE

XERS (SNOW-PLOW RESISTANT) 330 2016-052B LAKE 30 27 TC-11 CONTRACT NO. 62D38 STA. TO STA. FED. ROAD DIST. NO. 1 ILLINOIS FED. ALD PROJECT	CA	CATIONS		F.A.P. RTE.	SECTION	COUNTY	TOTAL SHEETS	SHEET NO.
TC-11 CONTRACT NO. 62D38	(FRS /SNOW_PLOW RESISTAL		DECICTANT\	330	2016-052B	LAKE	30	27
STA. TO STA. FED. ROAD DIST. NO. 1 ILLINOIS FED. AID PROJECT		RS (SNUW-PLUW RESISTANT)			TC-11	CONTRACT	NO. 62	2D38
		STA.	TO STA.	FED. R	DAD DIST. NO. 1 ILLINOIS FED. AI	D PROJECT		

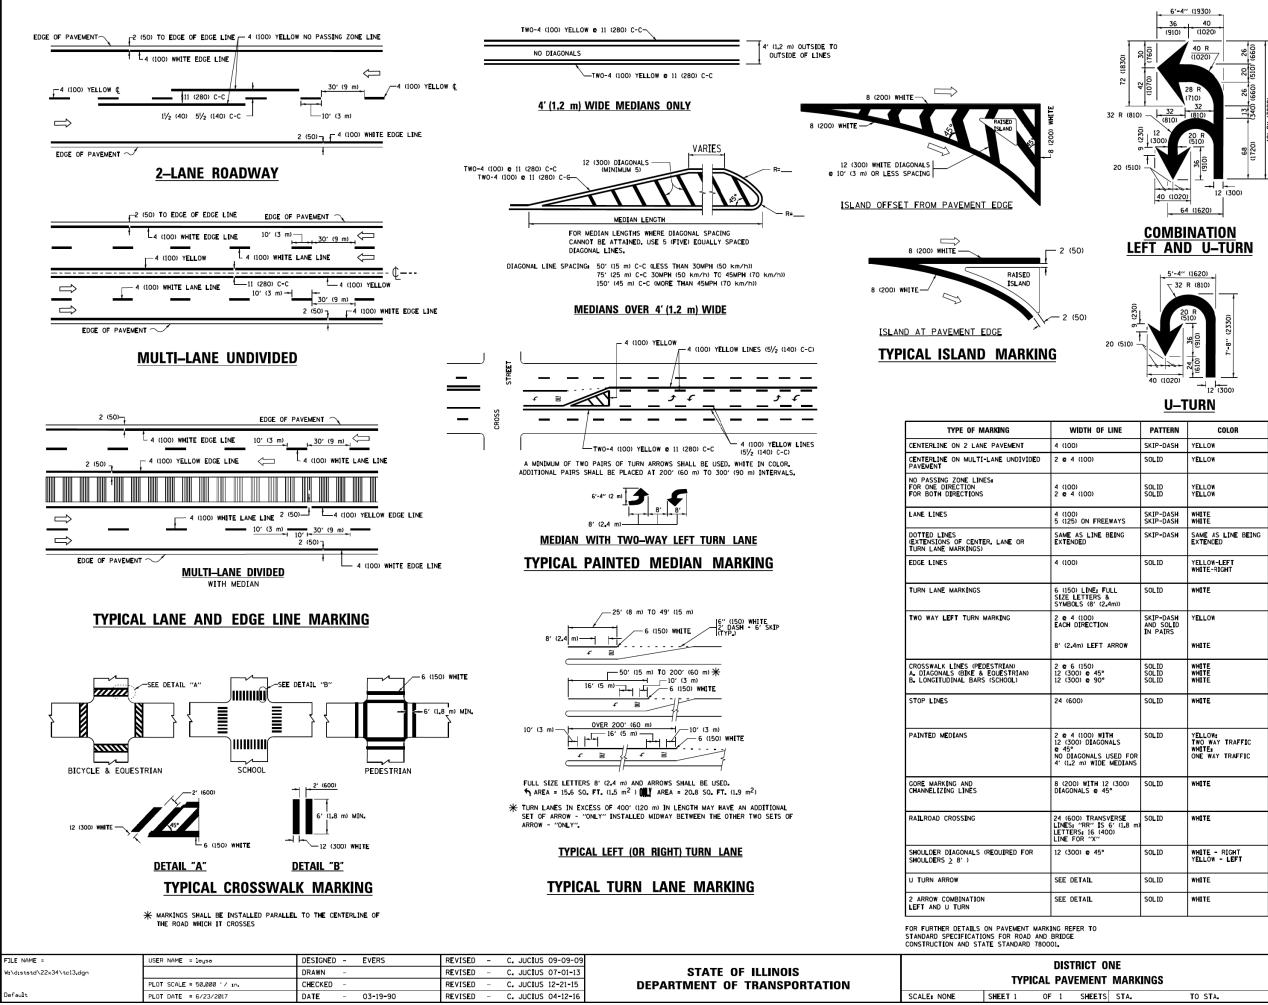

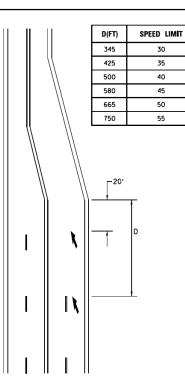

LANE REDUCTION TRANSITION


* LANE REDUCTION ARROWS REQUIRED AT SPEEDS OF 45 MPH OR GREATER OR WHEN SPECIFIED IN PLANS.


F LINE	PATTERN	COLOR	SPACING /REMARKS		
	SKIP-DASH	YELLOW	10' (3 m) LINE WITH 30' (9 m) SPACE		
	SOLID	YELLOW	11 (280) C-C		
	SOLID SOLID	YELLOW YELLOW	5½ (140) C-C FROM SKIP-DASH CENTERLINE 11 (280) C-C OMIT SKIP-DASH CENTERLINE BETWEEN		
EEWAYS	SKIP-DASH SKIP-DASH	WHITE WHITE	10' (3 m) LINE WITH 30' (9 m) SPACE		
BEING SKIP-DASH SAME AS LINE BEING			2' (600) LINE WITH 6' (1.8 m) SPACE		
	SOLID	YELLOW-LEFT WHITE-RIGHT	OUTLINE MEDIANS IN YELLOW		
FULL SOLID WHITE SEE TYP]		WHITE	SEE TYPICAL TURN LANE MARKING DETAIL		
DN SKIP-DASH AND SOLID IN PAIRS WHITE			10' (3 m) LINE WITH 30' (9 m) SPACE FOR SKIP-DASH: 5½ (140) C-C BETWEEN SOLID LINE AND SKIP-DASH LINE SEE TYPICAL TWO-WAY LEFT TURN MARKING DETAIL		
o 19	SOL ID SOL ID SOL ID	WHITE WHITE WHITE	NOT LESS THAN 6' (1.8 m) APART 2' (600) APART 2' (600) APART SEE TYPICAL CROSSWALK MARKING DETAILS.		
	SOLID	WHITE	PLACE 4' (1,2 m) IN ADVANCE OF AND PARALEL TO CROSSWALK, IF PRESENT, OTHERWISE, PLACE AT DESIRED STOPPING POINT, PARALLEL TO CROSSROAD CENTERLINE, WHERE POSSIBLE		
ITH ONALS USED FOR MEDIANS SOLID USED FOR MEDIANS SOLID TWO WAY TRAFFIC ONE WAY TRAFFIC		TWO WAY TRAFFIC WHITE:	11 (280) C-C FOR THE DOUBLE LINE See Typical painted median marking.		
12 (300) 45° SOLID WHITE		WHITE	DIAGONALS: 15' (4.5 m) C-C (LESS THAN 30MPH (50 km/h)) 20' (6 m) C-C 30MPH (50 km/h) TO 45MPH (70 km/h) 30' (9 m) C-C (0VER 45MPH (70 km/h))		
ISVERSE SOLID WHITE S 6' (1.8 m) 400)		WHITE	SEE STATE STANDARD 780001 AREA OFI "R"=3.6 SO. FT. (0.33 m ²) EACH "X"=54.0 SO. FT. (5.0 m ²)		
°	SOLID	WHITE - RIGHT Yellow - Left	50' (15 m) C-C (LESS THAN 30MPH (50 km/h)) 75' (25 m) C-C (30 MPH (50 km/h) TO 45MPH (70 km/h) 150' (45 m) C-C (0VER 45MPH (70 km/h))		
	SOLID	WHITE	16.3 SF		
	SOLID	WHITE	30.4 SF		

All dimensions are in inches (millimeters) unless otherwise shown.

ONE		F.A.P RTE.	SECTION	COUNTY	TOTAL Sheets	SHEET NO.			
IT MARKINGS			330	2016-052B	LAKE	30	28		
				TC-13	CONTRACT	NO. 61	2D38		
TS	STA.	TO STA.		ILLINOIS FED. AID PROJECT					


TURN BAY ENTRANCE AT START OF LANE CLOSURE TAPER

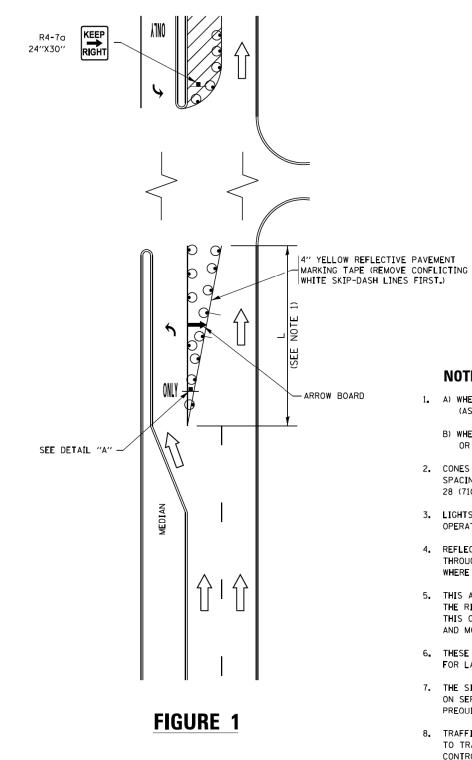

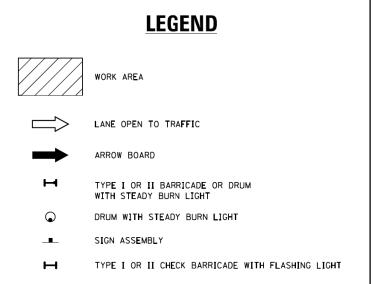


NOTES:

- 1. A) WHEN "L" IS < THE STORAGE LENGTH OF THE TURN LANE (AS SHOWN IN FIG. 1), USE FIGURE 1.
 - B) WHEN "L" IS > THE STORAGE LENGTH OF THE TURN LANE OR THE TURN LANE IS WITHIN THE LANE CLOSURE, USE FIGURE 2.
- 2. CONES MAY BE SUBSTITUTED FOR BARRICADES OR DRUMS AT HALF THE SPACING DURING DAY OPERATIONS. CONES SHALL BE A MINIMUM OF 28 (710) IN HEIGHT.
- 3. LIGHTS WILL NOT BE REQUIRED ON BARRICADES OR DRUMS FOR DAY OPERATIONS. ALL LIGHTS SHALL BE MONODIRECTIONAL.
- 4. REFLECTIVE TEMPORARY PAVEMENT MARKINGS SHALL BE PLACED THROUGHOUT THE BARRICADED AREAS OF EACH TURN BAY AS SHOWN WHERE THE CLOSURE TIME IS GREATER THAN FOURTEEN (14) DAYS.
- 5. THIS APPLICATION ALSO APPLIES WHEN WORK IS BEING PERFORMED IN THE RIGHT LANE(S) AND THE RIGHT TURN BAY IS TO REMAIN OPEN. UNDER THIS CONDITION, "RIGHT TURN LANE" R3-IIOOR 24 x 24 (600 x 600) AND M6-2R 21 × 15 (530 × 380) SHALL BE USED.
- 6. THESE CONTROLS SHALL SUPPLEMENT MAINLINE TRAFFIC CONTROL FOR LANE CLOSURES.
- 7. THE SIGNS SHALL BE MOUNTED ABOVE THE BARRICADES/DRUMS ON SEPARATE SIGN SUPPORTS THAT MEET NCHRP 350 OR MASH PREQUIREMENTS.
- 8. TRAFFIC CONTROL AND PROTECTION AT TURN BAYS (TO REMAIN OPEN TO TRAFFIC) SHALL BE INCLUDED IN THE COST OF SPECIFIED TRAFFIC CONTROL STANDARDS OR ITEMS.

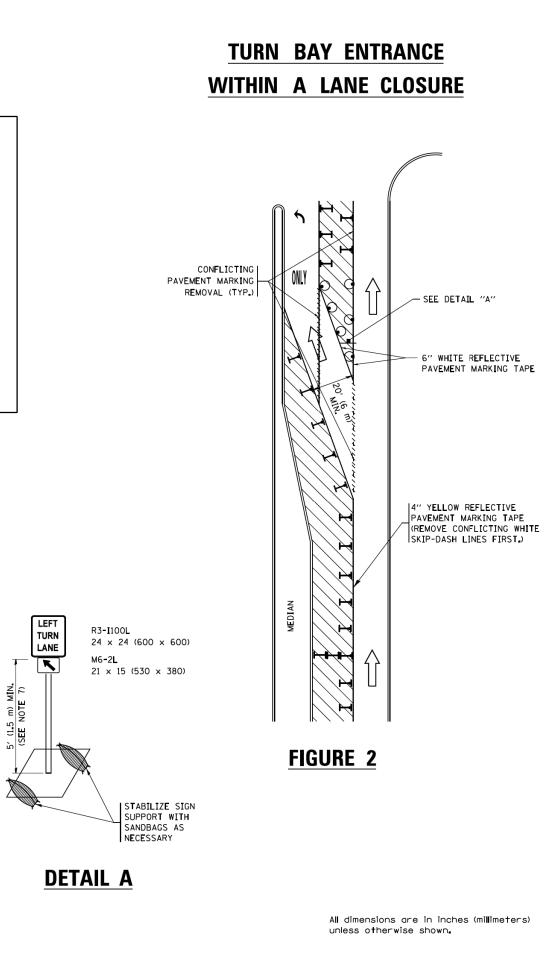

FILE NAME =	USER NAME = footemj	REVISED -T. RAMMACHER 09-08-94			TRAFFIC CONTROL AND PROTECTION AT TURN BAYS	F.A.P RTE.	SECTION	COUNTY TOTAL SHEET SHEETS NO.
pw://ILØ84EBIDINTEG_1111no18.gov:PWIDOT/Do	cuments\IDOT Offices\District 1\Projects\Dist	5 to EXISED AD Do to \CAD sHOUSEH14 bg07-95	REVISED - A. SCHUETZE 07-01-13	STATE OF ILLINOIS	(TO REMAIN OPEN TO TRAFFIC)		2016-052B	LAKE 30 29
	PLOT SCALE = 50.0000 '/ in.	REVISED - A HOUSEH 10-12-96	REVISED - A. SCHUETZE 09-15-16	DEPARTMENT OF TRANSPORTATION			TC-14	CONTRACT NO. 62D38
Default	PLOT DATE = 9/15/2016	REVISED -T. RAMMACHER 01-06-00	REVISED -		SCALEI NONE SHEET 1 OF 1 SHEETS STA. TO STA.		ILLINOIS FED. A	ID PROJECT

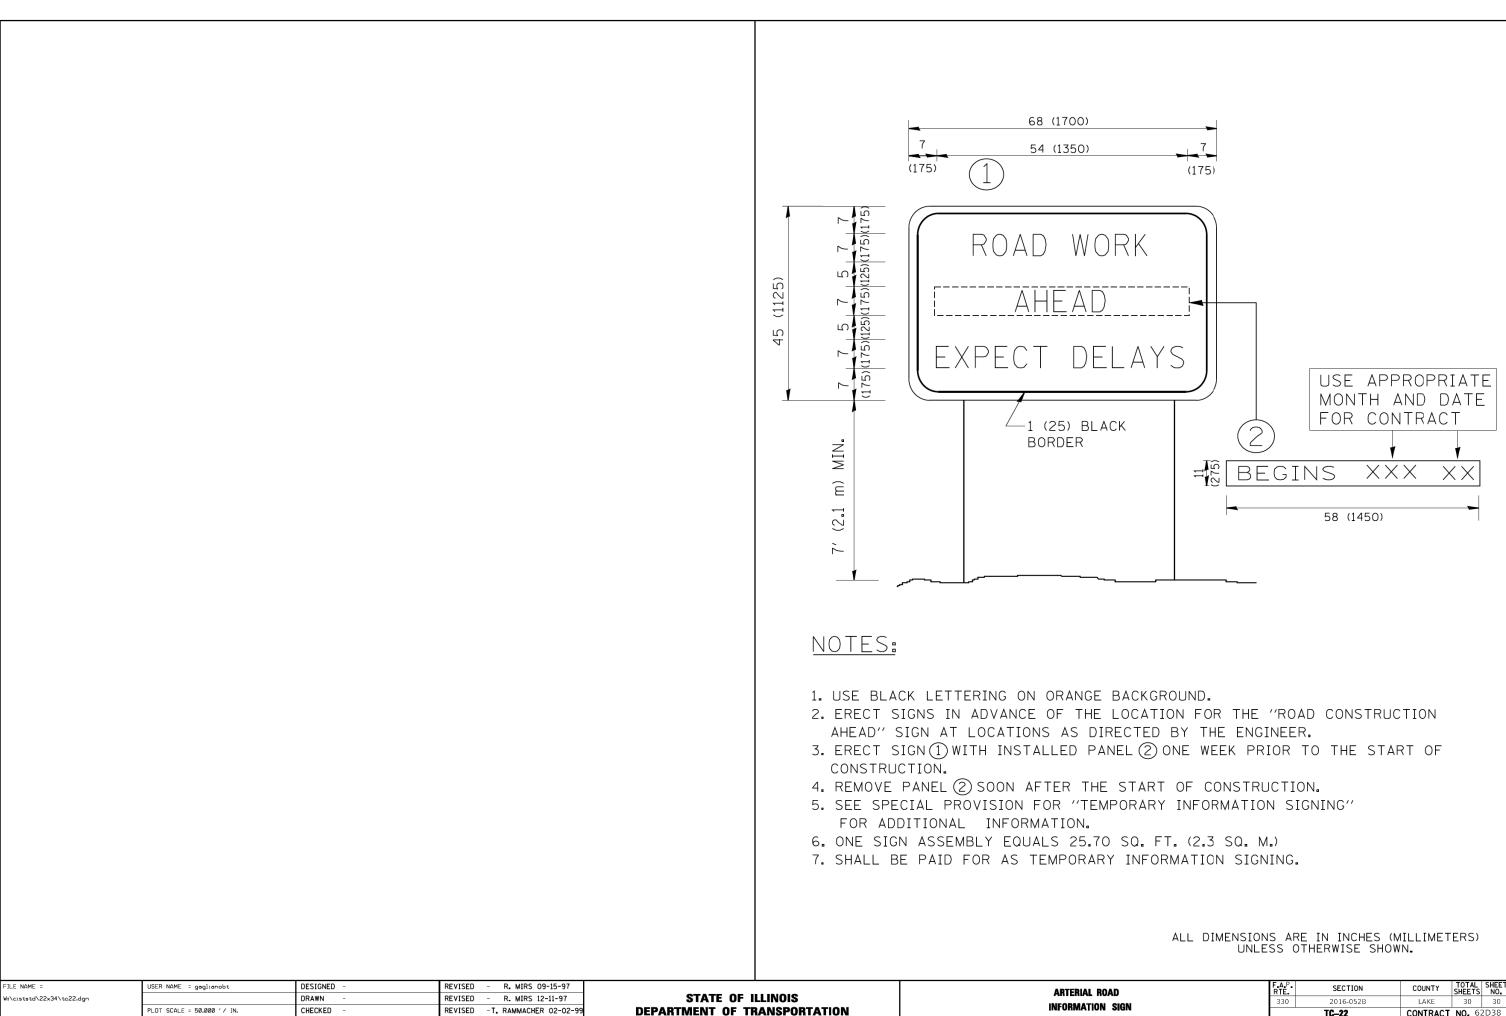

SCALE: NONE

SHEET NO. 1 OF 1 SHEETS

REVISED - C. JUCIUS 01-31-07

PLOT DATE = 1/4/2008

DATE

ROAD N SIGN		F.A.P. RTE	SECTION	COUNTY	TOTAL SHEETS	SHEET NO.			
		330	2016-052B	LAKE	30	30			
			TC-22	CONTRACT	NO. 62	2D38			
	STA.	TO STA.	FED. ROAD DIST. NO. 1 ILLINOIS FED. AID PROJECT						