03-08-2024 LETTING ITEM 008

FOR INDEX OF SHEETS, SEE SHEET NO. 2 FOR LIST OF HIGHWAY STANDARDS SEE SHEET NO. 2

**FUNCTIONAL CLASSIFICATION** CHURCH RD - MAJOR COLLECTOR SHEFFER RD - MAJOR COLLECTOR

TRAFFIC DATA CHURCH RD 2018 ADT = 10.800SHEFFER RD 2018 ADT = 4.150

0

0

SCHAUMBURG,

CARMEN E. RAMOS, P.E.,

PROGRAM

0

0

POSTED SPEED LIMIT CHURCH RD = 30 MPHSHEFFER RD = 30 MPH

**DESIGN SPEED LIMIT** CHURCH RD = 30 MPHSHEFFER RD = 30 MPH

FULL SIZE PLANS HAVE BEEN PREPARED USING STANDARD ENGINEERING SCALES. REDUCED SIZED PLANS WILL NOT CONFORM TO STANDARD SCALES. IN MAKING MEASUREMENTS ON REDUCED PLANS. THE ABOVE SCALES MAY BE USED.

J.U.L.I.E. JOINT UTILITY LOCATION INFORMATION FOR EXCAVATION 811 OR 1-800-892-0123

Dial 811 or 1-800-892-0123. Know what's below. Call before you dig.

JULIE DESIGN TICKET NUMBER: # A231651142

WITH THE FOLLOWING: COUNTY KANE COUNTY CITY-TOWNSHIP AURORA-AURORA TOWNSHIP SEC & 1/4 SEC NO. 1.14-38 N.-8 E.

CONTRACT NO. 61K23

## STATE OF ILLINOIS **DEPARTMENT OF TRANSPORTATION**

# PLANS FOR PROPOSED FEDERAL AID HIGHWAY

FAU ROUTE 2513 AND MUN 1031 (CHURCH RD. AND SHEFFER RD.) INDIAN TRAIL TO SHEFFER RD. AND CHURCH RD. TO OHIO ST.


**ROADWAY RESURFACING** 

SECTION NO.: 23-00363-00-RS

**PROJECT NO.: 63KP(575)** 


**CITY OF AURORA KANE COUNTY** 

C-91-176-23

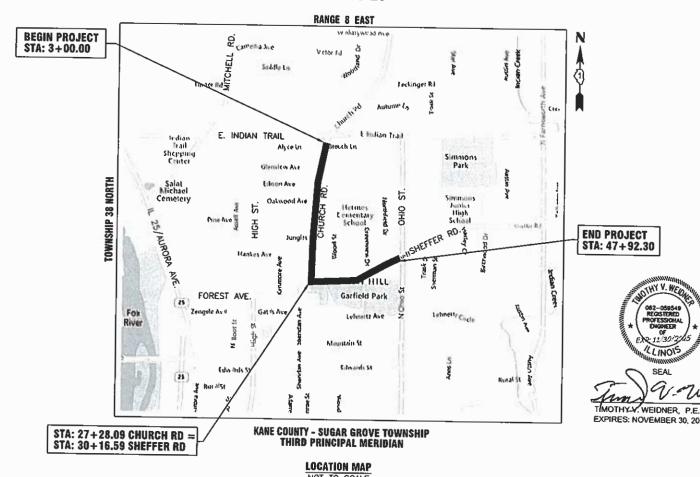

SECTION 23-00363-00-RS KANE CONTRACT NO: 61K23



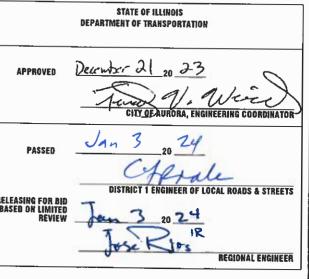

PLANS PREPARED BY THE CITY OF AURORA

**PRINTED BY THE AUTHORITY** OF THE STATE OF ILLINOIS

GROSS LENGTH OF PROJECT = 4,203.8 FEET (0.796 MILES) NET LENGTH OF PROJECT = 4,203.8 FEET (0.796 MILES)

#### **INDEX OF SHEETS**

SHEET NO.	DESCRIPTION
1	COVER SHEET
2	INDEX OF SHEETS, DETAILS, HIGHWAY STANDARDS AND GENERAL NOTES
3 - 5	SUMMARY OF QUANTITIES
6 - 7	TYPICAL SECTIONS
8 - 12	RESURFACING PLAN
13	EROSION CONTROL DETAILS
14 - 21	I.D.O.T. DISTRICT 1 DETAILS

#### ILLINOIS URBAN MANUAL EROSION CONTROL DETAILS

IUM-654SB	TEMPORARY CONCRETE WASHOUT FACILITY - STRAW BALE
IUM-561C	INLET PROTECTION - PAVED AREAS CURB PROTECTION
IUM-561D	INLET PROTECTION - PAVED AREAS DROP-IN PROTECTION

#### DISTRICT ONE DETAILS

BD-08	DETAILS FOR FRAMES AND LIDS ADJUSTMENT WITH MILLING
BD-22	PAVEMENT PATCHING FOR HMA SURFACED PAVEMENT
BD-24	CURB OR CURB AND GUTTER REMOVAL AND REPLACEMENT
BD-32	BUTT JOINT AND HMA TAPER DETAILS
TC-10	TRAFFIC CONTROL AND PROTECTION FOR SIDE ROADS, INTERSECTIONS, AND DRIVEWAYS
TC-13	DISTRICT ONE TYPICAL PAVEMENT MARKINGS
TC-16	SHORT TERM PAVEMENT MARKING LETTERS AND SYMBOLS
TC-22	ARTERIAL ROAD INFORMATION SIGN

#### **HIGHWAY STANDARDS**

000001-08	STANDARD SYMBOLS, ABBREVIATIONS AND PATTERNS
001006	DECIMAL OF AN INCH AND OF A FOOT
280001-07	TEMPORARY EROSION CONTROL SYSTEMS
420001-10	PAVEMENT JOINTS
442201-03	CLASS C AND D PATCHES
604001-05	FRAME AND LIDS TYPE 1
604051-04	FRAME AND LIDS TYPE 11
606001-08	CONCRETE CURB TYPE B AND COMBINATION CONCRETE CURB AND GUTTER
701006-05	OFF-RD OPERATIONS, 2L, 2W, 15' (4.5M) TO 24" (600 MM) FROM PAVEMENT EDGE
701301-04	LANE CLOSURE, 2L, 2W, SHORT TIME OPERATIONS
701311-03	LANE CLOSURE, 2L, 2W, MOVING OPERATIONS-DAY ONLY
701501-06	URBAN LANE CLOSURE, 2L, 2W, UNDIVIDED
701801-06	SIDEWALK, CORNER OR CROSSWALK CLOSURE
701901-09	TRAFFIC CONTROL DEVICES
780001-05	TYPICAL PAVEMENT MARKINGS

#### **GENERAL NOTES**

- ALL REFERENCES TO "STANDARD SPECIFICATIONS" IN THESE GENERAL NOTES SHALL BE INTERPRETED TO MEAN THE ILLINOIS DEPARTMENT OF TRANSPORTATION "STANDARD SPECIFICATIONS FOR ROAD AND BRIDGE CONSTRUCTION", JANUARY 1, 2022 AND SUPPLEMENTAL SPECIFICATIONS AND RECURRING SPECIAL PROVISIONS, JANUARY 1, 2024.
- 2. IT SHALL BE THE CONTRACTOR'S RESPONSIBILITY TO VERIFY ALL DIMENSIONS AND CONDITIONS EXISTING IN THE FIELD PRIOR TO CONSTRUCTION AND ORDERING OF MATERIALS. IN ADDITION, THE CONTRACTOR MUST VERIFY THE ENGINEER'S LINE AND GRADE STAKES. IN THE EVENT OF A DISCREPANCY BETWEEN THE PLANS AND FIELD CONDITIONS, THE CONTRACTOR SHALL SECURE WRITTEN INSTRUCTIONS FROM THE ENGINEER PRIOR TO PROCEEDING WITH ANY PART OF THE WORK AFFECTED BY THE IDENTIFIED DISCREPANCIES.
- BEFORE STARTING ANY EXCAVATION, THE CONTRACTOR SHALL CALL "JULIE" (JOINT UTILITY LOCATION INFORMATION FOR EXCAVATION) AT (800) 892-0123 FOR FIELD LOCATIONS OF BURIED UTILITIES (48 HOURS NOTIFICATION IS REQUIRED).
- 4. THE CONTRACTOR SHALL BE RESPONSIBLE FOR CONTACTING THE OWNER OF ALL EXISTING UTILITIES FACILITIES SO THAT THE UTILITIES AND THEIR APPURTENANCES MAY BE LOCATED AND ADJUSTED OR MOVED, IF NECESSARY, PRIOR TO THE START OF CONSTRUCTION OPERATIONS.
- 5. THE CONTRACTOR WILL NOT BE ALLOWED TO SET UP A YARD OR FIELD OFFICE ON CITY, STATE, OR PRIVATE PROPERTY WITHOUT WRITTEN PERMISSION FROM THE ENGINEER.
- 6. THE STORAGE OF EQUIPMENT AND/OR MATERIALS WITHIN THE RIGHT-OF-WAY OF ANY STREET AND/OR PARK PROPERTY SHALL REQUIRE PRIOR APPROVAL OF THE ENGINEER.
- 7. OFFSET LOCATIONS GIVEN IN THE PLANS FOR STRUCTURES, EDGE OF PAVEMENT, ETC. ARE FROM THE ROADWAY CENTERLINE.
- 8. SIDEWALK REMOVAL AND REPLACEMENT AND COMBINATION CONCRETE CURB AND GUTTER REMOVAL AND REPLACEMENT AS SHOWN ON THE PLANS IS FOR INFORMATIONAL PURPOSES ONLY. ACTUAL LOCATIONS AND QUANTITIES ARE TO BE DETERMINED AND MARKED BY THE ENGINEER PRIOR TO
- THE CONTRACTOR SHALL BE RESPONSIBLE FOR THE REPLACEMENT OF ANY DETECTOR LOOPS DAMAGED DURING CONSTRUCTION.
- 10. BUTT JOINTS WILL BE INSTALLED AT THE ENDS OF RESURFACING (WHERE RESURFACING MEETS EXISTING PAVEMENT) IN ACCORDANCE WITH THE "BUTT JOINT AND HMA TAPER DETAILS" SHEET INCLUDED IN THE PLANS.
- 11. THE CONTRACTOR SHALL VERIFY THAT ALL CRACKS, JOINTS, AND FLANGEWAYS ARE CLEAN AND DRY PRIOR TO PLACEMENT OF MIXTURE FOR CRACKS, JOINTS, AND FLANGEWAYS.
- 12. THE CONTRACTOR SHALL MAINTAIN THE SITE IN A CLEAN AND ORDERLY MANNER. DEBRIS AND SURPLUS MATERIAL SHALL BE REMOVED AND RESTORATION SHALL PROCEED AS THE WORK PROCEEDS. IF THE ENGINEER SO DIRECTS, THE CONTRACTOR SHALL STOP ALL OTHER WORK AND CONCENTRATE ON CLEAN—UP AND RESTORATION. DEBRIS AND SURPLUS MATERIAL SHALL BE DISPOSED BY THE CONTRACTOR OFF—SITE.
- 13. DRIVEWAY ENTRANCES WILL BE KEPT OPEN TO TRAFFIC AT ALL TIMES. THE CONTRACTOR WILL BE ALLOWED TO CLOSE A MAXIMUM OF HALF THE AREA OF ANY ONE ENTRANCE AT ANY TIME. IT IS ESSENTIAL THAT THE ENTRANCES REMAIN OPEN AND 'DRIVE—ABLE' FOR TWO—WAY TRAFFIC AT ALL TIMES. THE CONTRACTOR WILL BE RESPONSIBLE FOR MAINTAINING TRAFFIC CONTROL AND PROTECTION. WHERE NEW CURB AND GUTTER IS TO BE INSTALLED ACROSS A DRIVEWAY, IT IS EXPECTED THAT ONLY HALF OF THE DRIVEWAY ENTRANCE MAY BE REMOVED AND REPLACED AT ANY ONE TIME. ONLY AFTER PROPER CONCRETE CURE TIME HAS OCCURRED MAY THE CONTRACTOR BEGIN REMOVAL AND REPLACEMENT OPERATIONS ON THE REMAINING HALF OF THE CURB AND GUTTER. THE CONTRACTOR WILL NOT BE ALLOWED TO CLOSE A HALF OF DRIVEWAY ENTRANCE FOR MORE THAN 48 HOURS UNDER ANY CIRCUMSTANCE.
- 14. CONTRACTOR SHALL TAKE PRECAUTION BY PRESERVING EXISTING TREES WITHIN THE RIGHT OF WAY. IF ANY DAMAGE OCCURS, TREES SHALL BE REPLACED IN KIND PER ARTICLE 201.07 REPAIR OR REPLACEMENT OF EXISTING PLANT MATERIAL REQUIREMENTS STATED HEREIN
- 15. WHEN MILLED PAVEMENT IS OPEN TO TRAFFIC, THE MAXIMUM GRADE DIFFERENTIAL BETWEEN PASSES OF THE MILLING MACHINE SHALL NOT EXCEED 1.5 INCHES WHERE THE SPEED IS 45 MPH OR LESS, WITH WRITTEN APPROVAL FROM THE RESIDENT ENGINEER, A MAXIMUM GRADE DIFFERENTIAL OF 3 INCHES MAY BE ALLOWED IF THE EDGE OF THE MILLING IS SLOPED A MINIMUM OF 1V.3H.
- 16. ALL PHOSPHOROUS FERTILIZER NUTRIENT HAS BEEN INTENTIONALLY OMITTED FROM THE CONTRACT ON THE SODDING APPLICATION.
- 17. THE CONTRACTOR SHALL CONTACT KALPANA KANNAN-HOSADURGA, THE DISTRICT ONE TRAFFIC CONTROL SUPERVISOR AT KALPANA.KANNAN-HOSADURGA@ILLINOIS.GOV A MINIMUM 72 HOURS IN ADVANCE OF BEGINNING WORK.
- 18. THE CONTRACTOR SHALL COORDINATE WITH THE CONTRACTOR FOR IDOT CONTRACT 61H85 (INDIAN TRAIL RECONSTRUCTION).

#### LITH ITIES

- ALL UTILITY COMPANIES AND THE CITY OF AURORA SHALL BE NOTIFIED AT LEAST 3 DAYS PRIOR TO THE START OF CONSTRUCTION.
- EXISTING BROKEN FRAMES AND LIDS SHALL BE REMOVED AND DISPOSED OF BY THE CONTRACTOR AND SHALL BE REPLACED AS DIRECTED BY THE ENGINEER.
- ONLY PRECAST CONCRETE ADJUSTMENT RINGS, MAXIMUM OF 12 INCHES IN HEIGHT, WILL BE ALLOWED IN THE ADJUSTMENT OF CATCH BASINS, MANHOLES, INLETS AND VALVE VAULT STRUCTURES. COMMON BRICK WILL NOT BE ALLOWED.
- 4. THE CONTRACTOR SHALL ENSURE THAT ALL WATER SYSTEM VALVES (IN VALVE BOXES AND VALVE VAULTS) SHALL REMAIN READILY ACCESSIBLE TO THE CITY FOR EMERGENCY OPERATIONS AND NOT BURIED DURING CONSTRUCTION, UNLESS APPROVED BY THE ENGINEER. THE LOCATIONS OF ALL WATER FACILITIES SHALL BE MARKED AND READILY VISIBLE AT ALL TIMES. FOR ALL OTHER STRUCTURES THAT NEED TO BE ADJUSTED THAT ARE NOT WATER, THE CONTRACTOR CAN CHOOSE TO ADJUST THEM ACCORDING TO BD-08. THE CONTRACTOR CAN ALSO CHOOSE TO BURY WATER STRUCTURES ACCORDING TO BD-08 WITH APPROVAL BY THE ENGINEER. THE CONTRACTOR WOULD NEED TO PROVIDE A DETAILED SCHEDULE OF MILLING, PAVING, AND ADJUSTMENT TIMELINES FOR THE ENGINEER'S REVIEW. APPROVAL BY THE ENGINEER IS NOT GUARANTEED AND WOULD BE CONTINGENT ON THE CONTRACTOR BURYING WATER STRUCTURES LAST AND ADJUSTING THEM FIRST. THE CONTRACTOR IS TO DETERMINE ANY PROTECTION OR RAMPING THAT IS REQUIRED AROUND STRUCTURES IF THEY ARE NOT BURIED. OPEN LID STORM MANHOLE STRUCTURES IN THE PAVEMENT MAY NOT BE ABLE TO BE ADJUSTED ACCORDING TO BD-08.
- 5. THE INDISCRIMINATE USE OF FIRE HYDRANTS OR EXISTING STREAMS, CREEKS, WETLANDS OR PONDS IS STRICTLY PROHIBITED. THE CONTRACTOR SHALL PROVIDE A WATER TRUCK AND DRIVER AS REQUIRED TO OBTAIN AND TRANSPORT THIS WATER. THE CONTRACTOR SHALL BE RESPONSIBLE FOR OBTAINING WATER FROM AN APPROVED SOURCE. IF THIS WATER IS FROM A SOURCE OTHER THAN THEIR YARD, WRITTEN APPROVAL FROM THE AGENCY HAVING JURISDICTION FOR THE SOURCE OF THE WATER MUST BE RECEIVED BY THE ENGINEER PRIOR TO USE OF THE WATER.

#### **SIGNING AND STRIPING**

- ALL EXISTING SIGNS (INCLUDING THOSE LOCATED ON UTILITY/LIGHT POLES) THAT DO NOT
  CONFLICT WITH THE IMPROVEMENTS SHALL REMAIN IN PLACE UNLESS DIRECTED BY THE ENGINEER.
- 2. SIGNS SHALL NOT BE MOVED OR COVERED UNTIL PROGRESS OF WORK NECESSITATES IT.
- SEE IDOT DISTRICT ONE DETAILS TC-13 (DISTRICT ONE TYPICAL PAVEMENT MARKINGS), AND TC-16 (SHORT TERM PAVEMENT MARKINGS LETTERS AND SYMBOLS) AND PLAN SHEETS FOR PAVEMENT MARKING DETAILS.
- GRINDING OF PAVEMENT MARKINGS ON NEWLY CONSTRUCTED HOT-MIX ASPHALT SHALL NOT BE PERMITTED.

#### **COMMITMENTS**

NONE AS OF 11/22/2023

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STATE OF ILLINOIS
DEPARTMENT OF TRANSPORTATION

INDEX OF CUEFTO DETAIL O HIGHWAY STANDARDS AND SENERAL MOTES	FAU RTE.	SECTION		COUNTY	TOTAL SHEETS	SHEET NO.
INDEX OF SHEETS, DETAILS, HIGHWAY STANDARDS AND GENERAL NOTES	2513 1031	23-00363-00-RS	5	KANE	21	2
				CONTRA	CT NO. 6	31K23
SCALE: N.T.S.   SHEET NO. 01 OF 01 SHEETS   STA. TO STA.		ILLINOIS	FED. AID	D PROJECT		

CODE NUMBER	R ITEM DESCRIPTION		TOTAL QUANTIT 75% FEDERAL 25% LOCAL 0005	
20101400	NITROGEN FERTILIZER NUTRIENT	POUND	2	
20101600	POTASSIUM FERTILIZER NUTRIENT	POUND	2	
21101615	TOPSOIL FURNISH AND PLACE, 4"	SQ YD	97	
25200110	SODDING, SALT TOLERANT	SQ YD	97	
25200200	SUPPLEMENTAL WATERING	UNIT	5,3	
31101000	SUBBASE GRANULAR MATERIAL, TYPE B	TON	43	
40600290	BITUMINOUS MATERIALS (TACK COAT)	POUND	10175	
40600370	LONGITUDINAL JOINT SEALANT	FOOT	4140	
40600400	MIXTURE FOR CRACKS, JOINTS, AND FLANGEWAYS	TON	6.0	
40600982	HOT-MIX ASPHALT SURFACE REMOVAL - BUTT JOINT	SQ YD	159	
40603200	POLYMERIZED HOT-MIX ASPHALT BINDER COURSE, IL-4.75, N50	TON	829	
40604060	HOT-MIX ASPHALT SURFACE COURSE, IL-9.5, MIX "D", N50	TON	1689	
42400200	PORTLAND CEMENT CONCRETE SIDEWALK 5 INCH	SQ FT	825	
42400800	DETECTABLE WARNINGS	SQ FT	110	
44000100	PAVEMENT REMOVAL	SQ YD	28	
44000161	HOT-MIX ASPHALT SURFACE REMOVAL, 3"	SQ YD	15073	

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STATE OF ILLINOIS
DEPARTMENT OF TRANSPORTATION

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2513	23-00363-00-RS	KANE	21	3
 		CONTRA	CT NO.	61K23
	ILLINOIS FED. A	ND PROJECT		

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CODE NUMBE	R ITEM DESCRIPTION	UNIT	TOTAL QUANTITY 75% FEDERAL 25% LOCAL 0005
44000500	COMBINATION CURB AND GUTTER REMOVAL	FOOT	40
44000600	SIDEWALK REMOVAL	SQ FT	675
44201737	CLASS D PATCHES, TYPE I, 8 INCH	SQ YD	60
44201741	CLASS D PATCHES, TYPE II, 8 INCH	SQ YD	120
44201745	CLASS D PATCHES, TYPE III, 8 INCH	SQ YD	240
44201747	CLASS D PATCHES, TYPE IV, 8 INCH	SQ YD	180
48102100	AGGREGATE WEDGE SHOULDER, TYPE B	TON	106
60255500	MANHOLES TO BE ADJUSTED	EACH	7
60260100	INLETS TO BE ADJUSTED	EACH	26
60261300	INLETS TO BE ADJUSTED WITH NEW TYPE 11 FRAME AND GRATE	EACH	1
60265700	VALVE VAULTS TO BE ADJUSTED	EACH	8
60266600	VALVE BOXES TO BE ADJUSTED	EACH	8
60603800	COMBINATION CONCRETE CURB AND GUTTER, TYPE B-6.12	FOOT	50
67100100	MOBILIZATION CONTRACTOR CONTRACTO	L SUM	1
70102620	TRAFFIC CONTROL AND PROTECTION, STANDARD 701501	L SUM	1
70102640	TRAFFIC CONTROL AND PROTECTION, STANDARD 701801	L SUM	1

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STATE OF ILLINOIS
DEPARTMENT OF TRANSPORTATION

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2513	23-00363-00-RS	KANE	21	4				
CONTRACT NO. 61K23								
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CUMPANT NAME:
PROJECT CONTACT:
CLIENT:
DATE PLOTTED:
FILE NAME:
PLOT DRIVER:
PEN TARRE:

	CODE NUMBER	ITEM DESCRIPTION	UNIT	TOTAL QUANTITY 75% FEDERAL 25% LOCAL 0005
	70300100	SHORT TERM PAVEMENT MARKING	FOOT	1673
	70300150	SHORT TERM PAVEMENT MARKING REMOVAL	SQFT	558
t	78000100	THERMOPLASTIC PAVEMENT MARKING - LETTERS AND SYMBOLS	SQFT	37
t	78000200	THERMOPLASTIC PAVEMENT MARKING - LINE 4"	FOOT	5625
t	78000400	THERMOPLASTIC PAVEMENT MARKING - LINE 6"	FOOT	356
t	78000600	THERMOPLASTIC PAVEMENT MARKING - LINE 12"	FOOT	648
t	78000650	THERMOPLASTIC PAVEMENT MARKING - LINE 24"	FOOT	174
t	78011000	GROOVING FOR RECESSED PAVEMENT MARKING, LETTERS AND SYMBOLS	SQFT	37
t	78011025	GROOVING FOR RECESSED PAVEMENT MARKING 5"	FOOT	5625
t	78011035	GROOVING FOR RECESSED PAVEMENT MARKING 7"	FOOT	356
t	78011065	GROOVING FOR RECESSED PAVEMENT MARKING 13"	FOOT	648
t	78011125	GROOVING FOR RECESSED PAVEMENT MARKING 25"	FOOT	174
	X4400501	COMBINATION CURB AND GUTTER REMOVAL AND REPLACEMENT LESS THAN OR EQUAL TO 10 FEET	FOOT	60
	X4400503	COMBINATION CURB AND GUTTER REMOVAL AND REPLACEMENT GREATER THAN 10 FEET	FOOT	184
	X6026050	SANITARY MANHOLES TO BE ADJUSTED	EACH	15
	Z0030850	TEMPORARY INFORMATION SIGNING	SQ FT	78
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#### t INDICATES SPECIALTY ITEM

JUNET CONTRACT

JUNET

VE PLOTTED: 12/21/2

LE NAME: Church—


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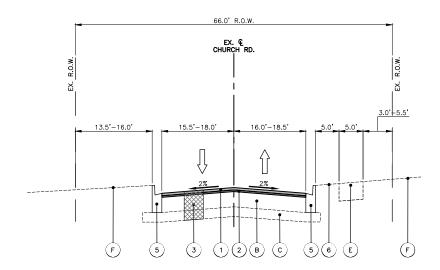
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2513	23-00363-00-RS	KANE	21	5
	CT NO. 6			
	ILLINOIS FED. A	UD PROJECT		



#### **EXISTING TYPICAL SECTION - CHURCH RD.**

STA: 3+00 - STA: 16+53

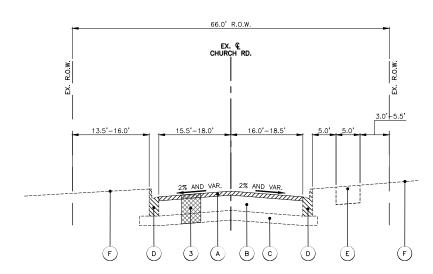

#### PROPOSED TYPICAL SECTION - CHURCH RD.

STA: 3+00 - STA: 16+53

#### **EXISTING LEGEND**

(A) HOT-MIX ASPHALT SURFACE REMOVAL 3.0"

AGGREGATE SUBBASE

COMBINATION CONCRETE CURB & GUTTER, VARIES FROM TYPE B-6.12 TO B-6.24

PORTLAND CEMENT CONCRETE SIDEWALK TO REMAIN IN PLACE

EXISTING GROUND

AGGREGATE SHOULDERS

#### **HOT-MIX ASPHALT MIXTURE REQUIREMENTS**

OPERATION	MIXTURE TYPE	AIR VOIDS	OMP					
OFLICATION	WIXTORE THE	@ NDES	QMF					
PAVEMENT RESURFACING	HOT-MIX ASPHALT SURFACE COURSE, MIX "D", IL-9.5, N50, 2"	4% @ 50 GYR.	LR1030-2					
	POLYMERIZED HOT-MIX ASPHALT BINDER COURSE, IL-4.75, N50, 1"	3.5% @ 50 GYR.	LR1030-2					
CLASS D PATCHES	HOT-MIX ASPHALT BINDER COURSE, IL-19.0, N50, 8"	4% @ 50 GYR.	LR1030-2					
OMP DESIGNATION: QUALITY CONTROL/QUALITY ASSURANCE (QC/QA) PER LR1030—2								

THE UNIT WEIGHT USED TO CALCULATE ALL HMA SURFACE MIXTURE QUANTITIES IS 112 LBS/SQ YD/IN


THE "AC TYPE" FOR POLYMERIZED HMA MIXES SHALL BE "SBS/SBR PG 76-22" AND FOR NON-POLYMERIZED HMA THE "AC TYPE" SHALL BE "PG64-22" UNLESS MODIFIED BY RECLAIMED MATERIALS SPECIFICATIONS.

THE LONGITUDINAL JOINT SEALANT SHALL BE PLACED OVER THE P HMA BC IL-4.75 N50.

# 66.0' R.O.W 0.0'-14.0' 0.0'-14.0' 0.0'-14.0' (B) (E)

#### **EXISTING TYPICAL SECTION - CHURCH RD.**

STA: 16+53 - STA: 27+50

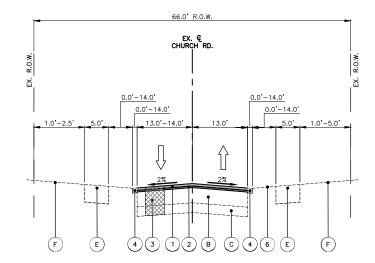

#### PROPOSED TYPICAL SECTION - CHURCH RD.

STA: 16+53 - STA: 27+50

#### PROPOSED LEGEND

HOT-MIX ASPHALT SURFACE COURSE, MIX "D", IL-9.5, N50, 2"

POLYMERIZED HOT-MIX ASPHALT BINDER COURSE, IL-4.75, N50, 1"

CLASS D PATCHES W/SUBBASE GRANULAR MATERIAL, TYPE B, 8" (SPOT REMOVAL & REPLACEMENT AS DIRECTED BY THE ENGINEER)

AGGREGATE WEDGE SHOULDER, TYPE B, 1.5" AVERAGE THICKNESS

COMBINATION CONCRETE CURB & GUTTER, VARIES FROM TYPE B-6.12 TO B-6.24 (SPOT REMOVAL & REPLACEMENT AS DIRECTED BY THE ENGINEER)

TOPSOIL FURNISH AND PLACE, 4" AND SODDING, SALT TOLERANT (IN AREAS OF LANDSCAPE RESTORATION ONLY)


- THE PATCHING QUANTITIES HAVE BEEN ESTIMATED BASED ON FIELD OBSERVATIONS DURING DESIGN. ACTUAL QUANTITIES TO BE DETERMINED DURING CONSTRUCTION BY THE ENGINEER.
- NO PROPOSED WORK WILL TAKE PLACE OUTSIDE OF THE EXISTING R.O.W.
- STATION EQUATION: STA. 27+28.09 CHURCH RD = STA. 30+16.59 SHEFFER RD

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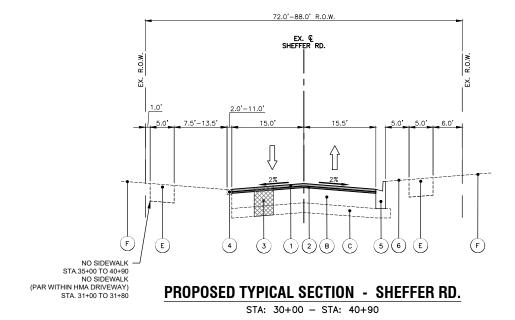
STATE OF ILLINOIS **DEPARTMENT OF TRANSPORTATION** 


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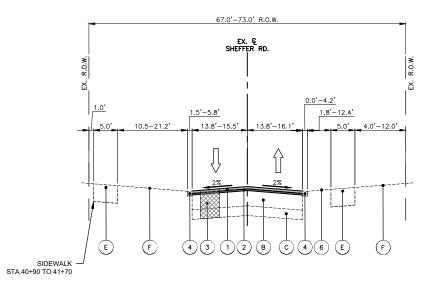
STA: 30+00 - STA: 40+90



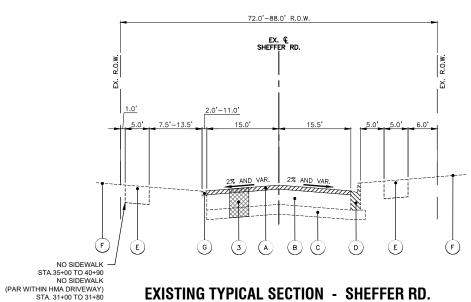

#### **EXISTING TYPICAL SECTION - SHEFFER RD.**

STA: 40+90 - STA: 47+92

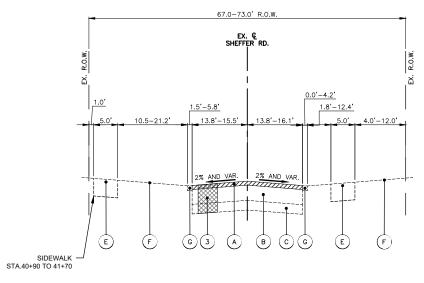

#### PROPOSED TYPICAL SECTION - SHEFFER RD.

STA: 40+90 - STA: 47+92

#### **EXISTING LEGEND**

- (A) HOT-MIX ASPHALT SURFACE REMOVAL 3.0"

PLOT SCALE = N.T.S.

PLOT DATE = 12/21/2023

- B EXISTING PAVEMENT
- C AGGREGATE SUBBASE

CHECKED - TW

- 09/18/2023

DATE

- (E) PORTLAND CEMENT CONCRETE SIDEWALK TO REMAIN IN PLACE
- (F) EXISTING GROUND
- G AGGREGATE SHOULDERS

#### NOTES:

- THE PATCHING QUANTITIES HAVE BEEN ESTIMATED BASED ON FIELD OBSERVATIONS DURING DESIGN. ACTUAL QUANTITIES TO BE DETERMINED DURING CONSTRUCTION BY THE ENGINEER.
- NO PROPOSED WORK WILL TAKE PLACE OUTSIDE OF THE EXISTING R.O.W.

**DEPARTMENT** 

• STATION EQUATION: STA. 27+28.09 CHURCH RD = STA. 30+16.59 SHEFFER RD

#### PROPOSED LEGEND

- 1 HOT-MIX ASPHALT SURFACE COURSE, MIX "D", IL-9.5, N50, 2"
- 2 POLYMERIZED HOT-MIX ASPHALT BINDER COURSE, IL-4.75, N50, 1"
- CLASS D PATCHES W/SUBBASE GRANULAR MATERIAL, TYPE B, 8" (SPOT REMOVAL & REPLACEMENT AS DIRECTED BY THE ENGINEER)
- 4 AGGREGATE WEDGE SHOULDER, TYPE B, 1.5" AVERAGE THICKNESS
- Combination concrete curb & gutter, varies from type B-6.12 to B-6.24 (SPOT REMOVAL & REPLACEMENT AS DIRECTED BY THE ENGINEER)
- 6 TOPSOIL FURNISH AND PLACE, 4" AND SODDING, SALT TOLERANT (IN AREAS OF LANDSCAPE RESTORATION ONLY)

USER NAME = HOPPM DESIGNED - AN REVISED FILE NAME = Church-Typ Sections DRAWN - MH REVISED STATE OF ILLINOIS

REVISED


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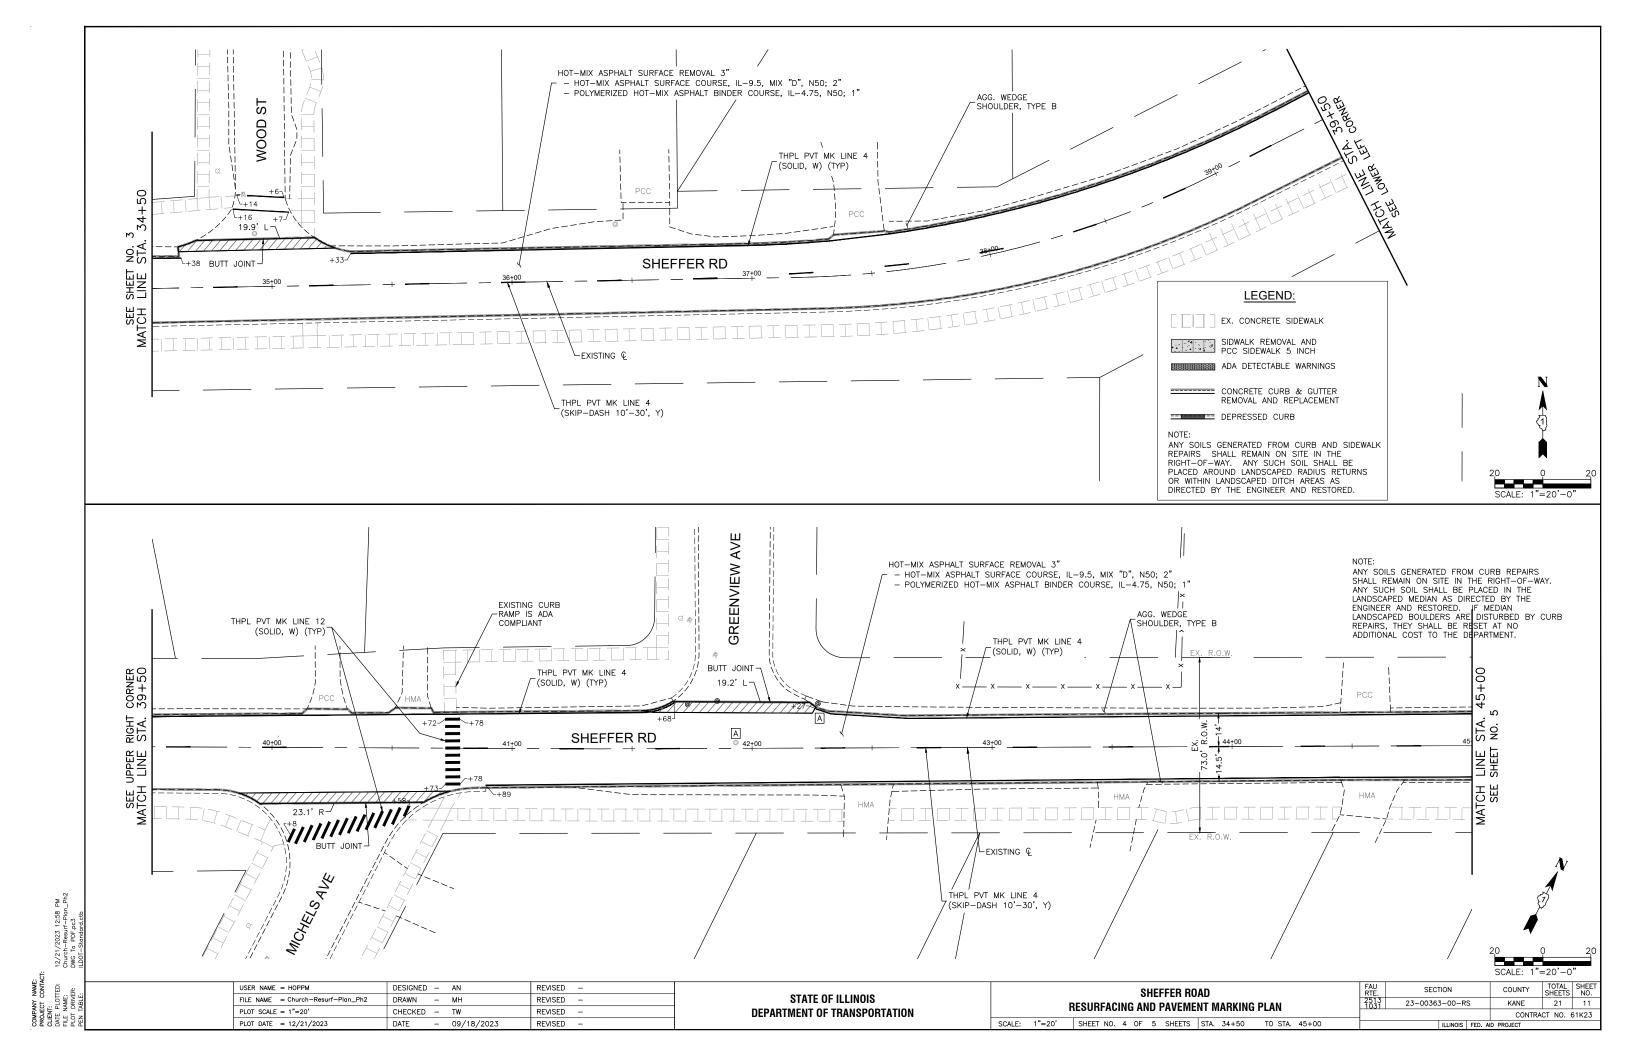
TE OF ILLINOIS		SHEFFER RO Typical sect			FAU RTE. 2513 1031	SECTION 23-00363-00-RS	COUNTY  KANE  CONTRA	SHEETS 21	SHEET NO. 7 31K23
	SCALE: N.T.S.	SHEET NO. 02 OF 02 SHEETS	STA.	TO STA.		ILLINOIS FED. AII	PROJECT		


PROJECT CONTACT:
CLENT:
DATE PLOTTED: 12/21/2
FILE NAME: OhurchPLOT DRIVER: DWG ToPEN TABLE: ILDOT—St

HOT-MIX ASPHALT SURFACE REMOVAL 3" - HOT-MIX ASPHALT SURFACE COURSE, IL-9.5, MIX "D", N50; 2" - POLYMERIZED HOT-MIX ASPHALT BINDER COURSE, IL-4.75, N50; 1" COORDINATE WITH -IDOT CONTRACT 61H85 **BEGIN PROJECT** THPL PVT MK LINE 4 (SKIP-DASH 10'-30', Y) CHURCH ROAD STA: 3+00.00 EXISTING & CHURCH RD BEGIN MILLING AND RESURFACING LEGEND: EX. CONCRETE SIDEWALK SIDWALK REMOVAL AND PCC SIDEWALK 5 INCH ADA DETECTABLE WARNINGS CONCRETE CURB & GUTTER REMOVAL AND REPLACEMENT DEPRESSED CURB ANY SOILS GENERATED FROM CURB AND SIDEWALK REPAIRS SHALL REMAIN ON SITE IN THE RIGHT—OF—WAY. ANY SUCH SOIL SHALL BE PLACED AROUND LANDSCAPED RADIUS RETURNS OR WITHIN LANDSCAPED DITCH AREAS AS DIRECTED BY THE ENGINEER AND RESTORED. HOT-MIX ASPHALT SURFACE REMOVAL 3" - — HOT-MIX ASPHALT SURFACE COURSE, IL-9.5, MIX "D", N50; 2" — POLYMERIZED HOT-MIX ASPHALT BINDER COURSE, IL-4.75, N50; 1" THPL PVT MK LINE 4 (SKIP-DASH 10'-30', Y) CORNER 5+50 CHURCH RD A -BUTT JOINT Α SEET +48-+46~ **EDISON** THPL PVT MK LINE 6 (SOLID, W) (TYP) THPL PVT MK LINE 24 AVE Z (SOLID, W) (TYP) USER NAME = HOPPM DESIGNED - AN REVISED -**CHURCH ROAD** REVISED STATE OF ILLINOIS 23-00363-00-RS KANE 21 8 RESURFACING AND PAVEMENT MARKING PLAN PLOT SCALE = 1"=20" CHECKED - TW **DEPARTMENT OF TRANSPORTATION** REVISED CONTRACT NO. 61K23 SCALE: 1"=20' SHEET NO. 1 OF 5 SHEETS STA. 1+00 TO STA. 11+00 PLOT DATE = 12/21/2023DATE - 09/18/2023 REVISED

HOT-MIX ASPHALT SURFACE REMOVAL 3" HOT-MIX ASPHALT SURFACE COURSE, IL-9.5, MIX "D", N50; 2" - POLYMERIZED HOT-MIX ASPHALT BINDER COURSE, IL-4.75, N50; 1" THPL PVT MK LINE 4 (SKIP-DASH 10'-30', Y) \_EXISTING € A CHURCH RD Α \_BUTT JOINT & Α -BUTT JOINT A A +18-THPL PVT MK LINE 6 (SOLID, W) (TYP) LEGEND: AKWOOD THPL PVT MK LINE 6 EX. CONCRETE SIDEWALK THPL PVT MK LINE 24 (SOLID, W) (TYP) (SOLID, W) (TYP) SIDWALK REMOVAL AND PCC SIDEWALK 5 INCH \_THPL PVT MK LINE 24 (SOLID, W) (TYP) Z ZE. ADA DETECTABLE WARNINGS AVE AVE ====== CONCRETE CURB & GUTTER REMOVAL AND REPLACEMENT DEPRESSED CURB ANY SOILS GENERATED FROM CURB AND SIDEWALK REPAIRS SHALL REMAIN ON SITE IN THE RIGHT-OF-WAY. ANY SUCH SOIL SHALL BE PLACED AROUND LANDSCAPED RADIUS RETURNS OR WITHIN LANDSCAPED DITCH AREAS AS HOT-MIX ASPHALT SURFACE REMOVAL 3" - HOT-MIX ASPHALT SURFACE COURSE, IL-9.5, MIX "D", N50; 2" - POLYMERIZED HOT-MIX ASPHALT BINDER COURSE, IL-4.75, N50; 1" DIRECTED BY THE ENGINEER AND RESTORED. AGG. WEDGE THPL PVT MK LINE 4  $\int (SKIP-DASH 10'-30', Y)$ SHOULDER, TYPE B AGG. WEDGE\_ SHOULDER, TYPE B THPL PVT MK LINE 4 THPL PVT MK LINE 24 「(SOLID, W) (TYP) (SOLID, W) (TYP) -BUTT JOINT THPL PVT MK LINE 12 ⊢40.6' L EXISTING & THPL PVT MK LINE 12 (SOLID, W) (TYP) \ (SOLID, W) (TYP) НМА НМА Α CHURCH RD 17+00 21+00 BUTT JOINT BUTT JOIN., -20.5' R Α НМА HMA THPL PVT MK LINE 4 THPL PVT MK LINE 24 THPL PVT MK LINE 12 (SOLID, W) (TYP) (SOLID, W) (TYP) (SOLID, W) (TYP) JUNGLES Z USER NAME = HOPPM DESIGNED - AN REVISED -SECTION **CHURCH ROAD** REVISED STATE OF ILLINOIS FILE NAME = Church-Resurf-Plan\_Ph2 23-00363-00-RS KANE 21 9 RESURFACING AND PAVEMENT MARKING PLAN PLOT SCALE = 1"=20' **DEPARTMENT OF TRANSPORTATION** CHECKED - TW REVISED CONTRACT NO. 61K23 SCALE: 1"=20' SHEET NO. 2 OF 5 SHEETS STA. 11+00 TO STA. 22+00 PLOT DATE = 12/21/2023- 09/18/2023 REVISED



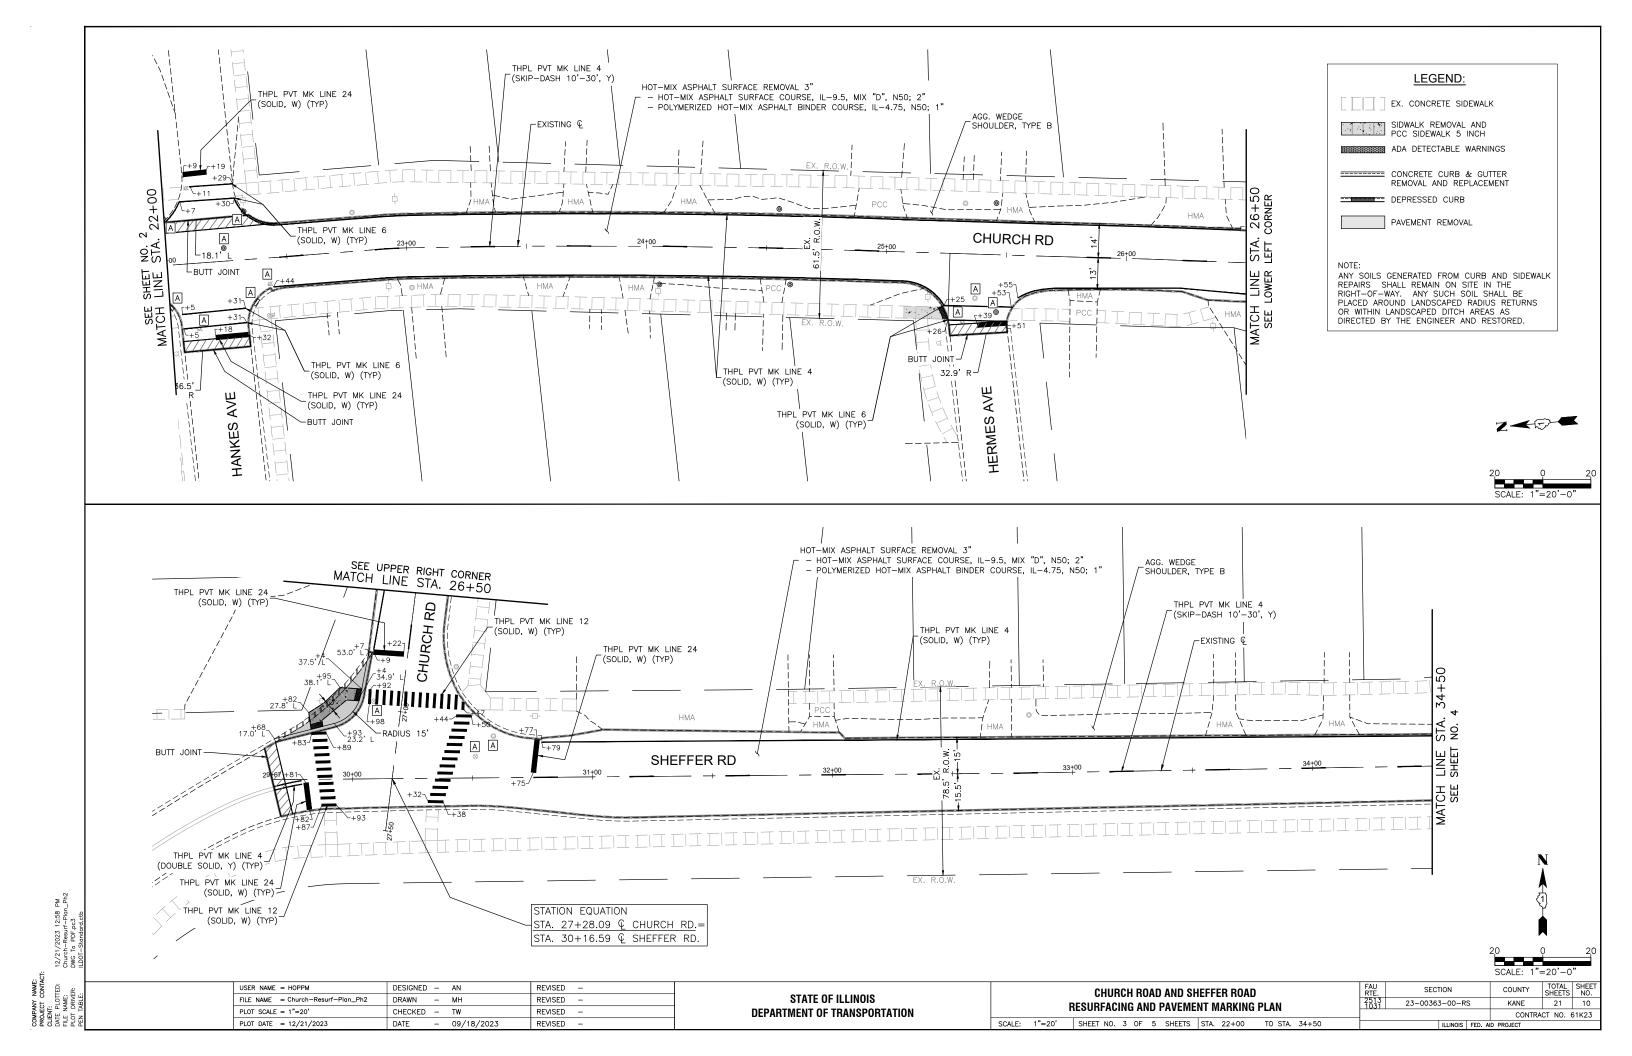

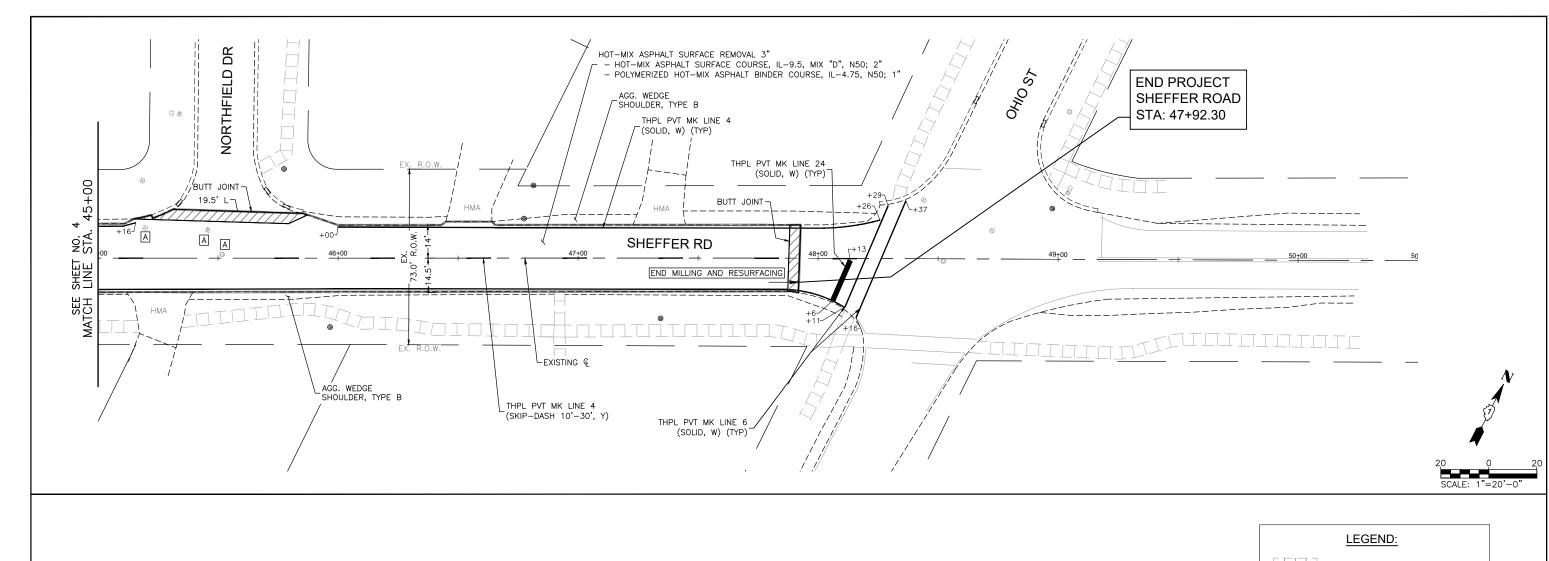

EX. CONCRETE SIDEWALK

SIDWALK REMOVAL AND PCC SIDEWALK 5 INCH

ADA DETECTABLE WARNINGS

====== CONCRETE CURB & GUTTER REMOVAL AND REPLACEMENT

DEPRESSED CURB

NOIL:
ANY SOILS GENERATED FROM CURB AND SIDEWALK
REPAIRS SHALL REMAIN ON SITE IN THE
RIGHT-OF-WAY. ANY SUCH SOIL SHALL BE
PLACED AROUND LANDSCAPED RADIUS RETURNS
OR WITHIN LANDSCAPED DITCH AREAS AS
DIRECTED BY THE ENGINEER AND RESTORED.


USER NAME = HOPPM DESIGNED - AN REVISED -FILE NAME = Church-Resurf-Plan\_Ph2 DRAWN REVISED PLOT SCALE = 1"=20" CHECKED - TW REVISED PLOT DATE = 12/21/2023 DATE - 09/18/2023 REVISED

STATE OF ILLINOIS **DEPARTMENT OF TRANSPORTATION** 

SHEFFER BLVD RESURFACING AND PAVEMENT MARKING PLAN SCALE: 1"=20' SHEET NO. 5 OF 5 SHEETS STA. 45+00 TO STA. 47+92

COUNTY TOTAL SHEET NO.

KANE 21 12 SECTION 23-00363-00-RS CONTRACT NO. 61K23

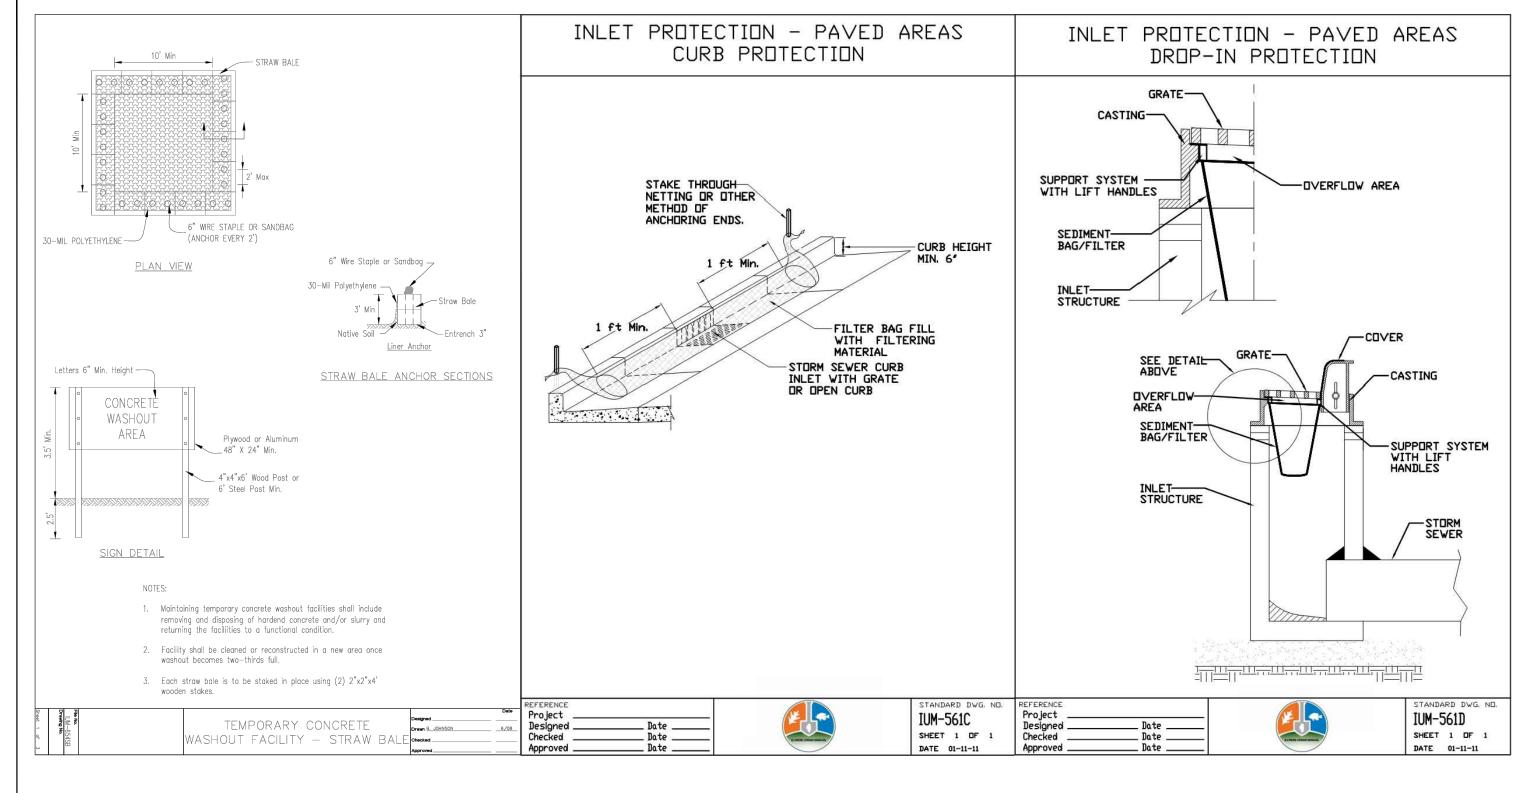

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DATE PLOTTED: 12/2
FILE NAME: Chur
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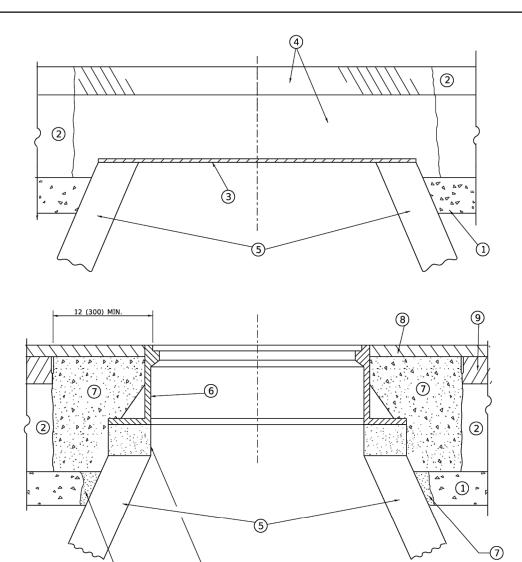
USER NAME = HOPPM	DESIGNED	-	AN	REVISED	-
FILE NAME = Church-Details	DRAWN	-	MH	REVISED	_
PLOT SCALE = N.T.S.	CHECKED	-	TW	REVISED	_
PLOT DATE = 12/21/2023	DATE	-	09/18/2023	REVISED	-

STATE OF ILLINOIS
DEPARTMENT OF TRANSPORTATION

SCALE: N.T.S.

		RTE.	SECTION			
EROSION CONTROL DETAILS						23-00363-00-RS
SHEET NO. 01	OF 01	SHEETS	STA.	TO STA.		ILLINOIS FE

KANE 21 13 CONTRACT NO. 61K23



### DETAILS FOR FRAMES AND LIDS ADJUSTMENT WITH MILLING

BRICK, MORTAR, OR CONC.

#### **NOTES**

- 1. EXISTING BROKEN FRAMES AND LIDS SHALL BE REMOVED AND DISPOSED OF BY THE CONTRACTOR AND SHALL BE REPLACED AS DIRECTED BY THE ENGINEER. REPLACEMENT FRAMES AND LIDS WILL BE PAID FOR IN ACCORDANCE WITH ARTICLE 109.04 OF THE STANDARD SPECIFICATIONS UNLESS A SEPARATE PAY ITEM HAS BEEN PROVIDED.
- IF THE EXISTING LIDS ARE OPEN, THE FRAME WILL BE ADJUSTED TO THE ELEVATION OF THE MILLED PAVEMENT SURFACE PRIOR TO THE MILLING OPERATION. THE FRAME WILL NOT BE REMOVED AND COVERED BY THE METAL PLATE.
- CITY OF CHICAGO CASTINGS ARE THE PROPERTY OF THE CITY AND THE CONTRACTOR SHALL NOTIFY THE CITY FOR REMOVAL AND DISPOSITION OF THE CASTINGS.
- 4. THE METAL PLATE USED TO COVER THE STRUCTURE SHALL REMAIN THE PROPERTY OF THE CONTRACTOR.
- THE CONTRACTOR SHALL REMOVE ALL TRAFFIC CONTROL DEVICES BY THE END OF EACH WORK SHIFT.

#### **CONSTRUCTION PROCEDURES**

#### STAGE 1 (BEFORE PAVEMENT MILLING)

- A) REMOVE A MINIMUM OF 12 (300) OF THE PAVEMENT FROM AROUND THE STRUCTURE.
- B) REMOVE THE EXISTING FRAME AND LID FROM THE STRUCTURE.C) COVER THE STRUCTURE OPENING WITH A 36 (900) DIAMETER METAL PLATE.
- D) BACKFILL WITH CRUSHED STONE AND HMA SURFACE MIX APPROVED BY THE ENGINEER. (MIN. 3 (80) HMA TO REMAIN AFTER MILLING).

#### STAGE 2 (AFTER PAVEMENT MILLING)

- A) REMOVE THE HMA SURFACE MIX AND CRUSHED STONE.
- B) INSTALL THE FRAME AND LID; ADJUST THE FRAME TO ITS FINAL SURFACE ELEVATION.
- C) THE SURROUNDING SPACE SHALL BE FILLED WITH CLASS PP-2\* CONCRETE TO THE ELEVATION OF THE SURFACE OF THE EXISTING BASE COURSE OR THE BINDER COURSE.
- \*UNLESS OTHERWISE SPECIFIED IN THE PLANS.

THE PROCEDURE EXPLAINED ABOVE SHALL CONFORM TO THE APPLICABLE PORTIONS OF SECTIONS 353, 406, 602, AND 603 OF THE STANDARD SPECIFICATIONS EXCEPT THAT "THE CONTRACTOR SHALL ADJUST THE STRUCTURES TO THE FINISHED PAVEMENT ELEVATION NO MORE THAN 5 CALENDAR DAYS PRIOR TO PLACEMENT OF THE FINAL LIFT OF SURFACE UNLESS APPROVED BY THE ENGINEER."

#### **LEGEND**

- ① SUB-BASE GRANULAR ⑥ FRAME AND LID (SEE NOTES) MATERIAL
- (2) EXISTING PAVEMENT
- (7) CLASS PP-2\* CONCRETE
- 3 36 (900) DIAMETER METAL PLATE
  - 8 PROPOSED HMA SURFACE COURSE
- 4 PROPOSED CRUSHED STONE AND HMA SURFACE MIX
- (9) PROPOSED HMA BINDER COURSE
- (5) EXISTING STRUCTURE

#### **LOCATION OF STRUCTURES**

THE CONTRACTOR WILL BE REQUIRED TO KEEP A RECORD OF THE LOCATIONS OF THE BURIED STRUCTURES ACCORDING TO THE STATION AND DISTANCE LEFT OR RIGHT OF THE CENTERLINE OF PAVEMENT. UPON COMPLETION OF THE WORK, THE CONTRACTOR WILL DELIVER THE RECORD TO THE ENGINEER.

#### **BASIS OF PAYMENT**

- 1. REMOVING FRAMES AND LIDS ON DRAINAGE AND UTILITY STRUCTURES IN THE PAVEMENT PRIOR TO MILLING, AND ADJUSTING TO FINAL GRADE PRIOR TO PLACING THE SURFACE COURSE, WILL BE PAID FOR AT THE CONTRACT UNIT PRICE EACH FOR "FRAMES AND LIDS TO BE ADJUSTED (SPECIAL)."
- 2. THIS WORK WILL NOT BE PAID FOR WHEN DRAINAGE AND UTILITY STRUCTURES ARE SPECIFIED FOR PAYMENT AS STRUCTURE RECONSTRUCTION.
- NEW FRAMES AND LIDS, WHEN SPECIFIED, WILL BE PAID FOR SEPARATELY.
- 4. WHEN STRUCTURES ARE TO BE ADJUSTED OR RECONSTRUCTED, THE LOWERING AND RAISING OF THE FRAMES AND LIDS WILL NOT BE PAID FOR SEPARATELY BUT WILL BE INCLUDED IN THE COST OF THE CORRESPONDING PAY ITEM.

ALL DIMENSIONS ARE IN INCHES (MILLIMETERS) UNLESS OTHERWISE SHOWN

DETAILS FOR
FRAMES AND LIDS ADJUSTMENT WITH MILLING
ONE SHEET 1 OF 1 SHEETS STA. TO ST

| F.A. | SECTION | COUNTY | TOTAL | SHEE | SHOOTH | SHEETS | SHOOTH | SHEETS | SHOOTH | SHEETS | SHOOTH | SHEETS | SHOOTH | SHOOTH | SHEETS | SHOOT

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STATE OF ILLINOIS
DEPARTMENT OF TRANSPORTATION

#### **METHOD OF MEASUREMENT**


REFER TO SECTION 442 OF THE STANDARD SPECIFICATIONS FOR ROAD AND BRIDGE CONSTRUCTION AND THE RECURRING SPECIAL PROVISION "PATCHING WITH HOT-MIX ASPHALT OVERLAY REMOVAL."

#### **BASIS OF PAYMENT**

- 1. REFER TO SECTION 442 OF THE STANDARD SPECIFICATIONS FOR ROAD AND BRIDGE CONSTRUCTION AND THE RECURRING SPECIAL PROVISION "PATCHING WITH HOT-MIX ASPHALT OVERLAY REMOVAL."
- SAW CUT/SCORING OF EXISTING HMA OVERLAY IS INCLUDED IN THE COST OF PAVEMENT PATCHING.
- 3. SAW CUT/SCORING OF EXISTING PAVEMENT IS INCLUDED IN THE COST OF PAVEMENT PATCHING.

★ SEE TYPICAL SECTIONS FOR

THICKNESS AND MATERIALS

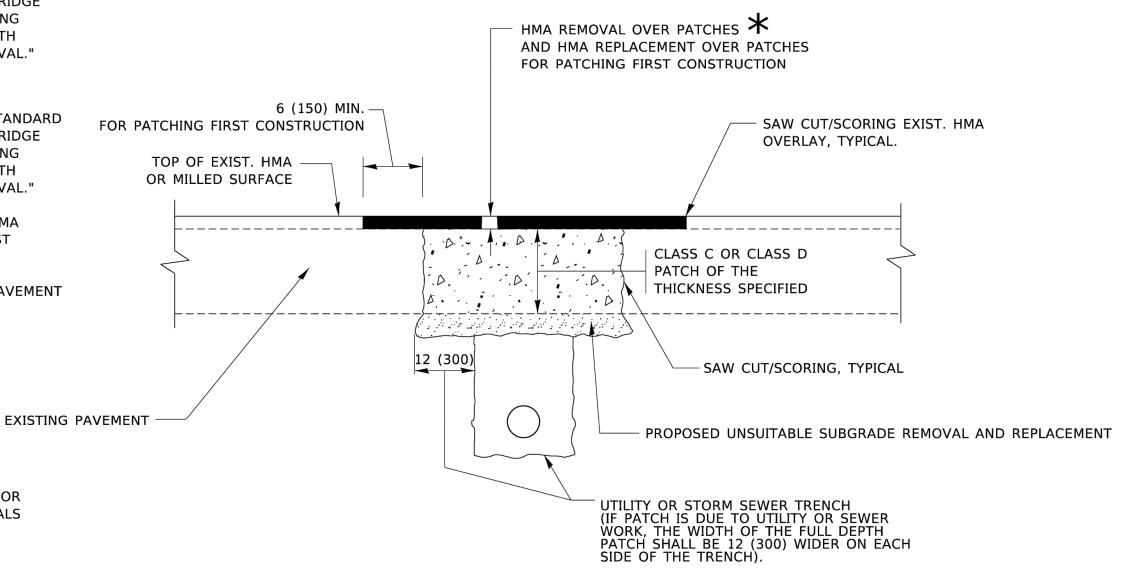

#### **SEQUENCE OF CONSTRUCTION (PATCHING FIRST)**


- 1. REMOVE THE EXISTING HMA MATERIAL OVER THE AREA TO BE PATCHED.
- 2. REMOVE AND REPLACE WITH CLASS C OR D PATCH.
- 3. REPLACE HMA MATERIAL OVER THE AREA TO BE PATCHED.

#### **SEQUENCE OF CONSTRUCTION (MILLING FIRST)**

- 1. MILL HMA FIRST IF THERE IS AT LEAST 4½ INCHES OR MORE OF HMA MATERIAL ON TOP OF THE EXISTING PAVEMENT OR IF THE PAVEMENT IS FULL DEPTH HMA. A MINIMUM OF 2 INCHES OF HMA MATERIAL SHALL BE IN PLACE AFTER MILLING.
- 2. REMOVE AND REPLACE WITH FULL DEPTH CLASS D PATCHES TO TOP OF MILLED SURFACE.

ALL DIMENSIONS ARE IN INCHES (MILLIMETERS) UNLESS OTHERWISE SHOWN.

USER NAME = Lawrence.Demanche	DESIGNED - R. SHAH	REVISED -	R. BORO 01-01-07			P	AVENEN	T PATC	HING FOR		L'ACE	SECTION	COUNTY	SHEETS	NO
	DRAWN -	REVISED -	R. BORO 09-04-07	STATE OF ILLINOIS		-					2513	23-00363-00-RS	KANF	21	15
PLOT SCALE = 100.0000 ' / in.	CHECKED -	REVISED -	K. ENG 10-27-08	DEPARTMENT OF TRANSPORTATION		HI	VIA SUK	FACED I	PAVEMENT		1001	3D400-04 (BD-22)	CONTRACT	NO. 61	K23
PLOT DATE = 11/18/2022	DATE - 10-25-94	REVISED -	K. SMITH 11-18-22		SCALE: NONE	SHEET 1	OF 1	SHEETS	STA.	TO STA.		ILLINOIS FED. A	ID PROJECT		

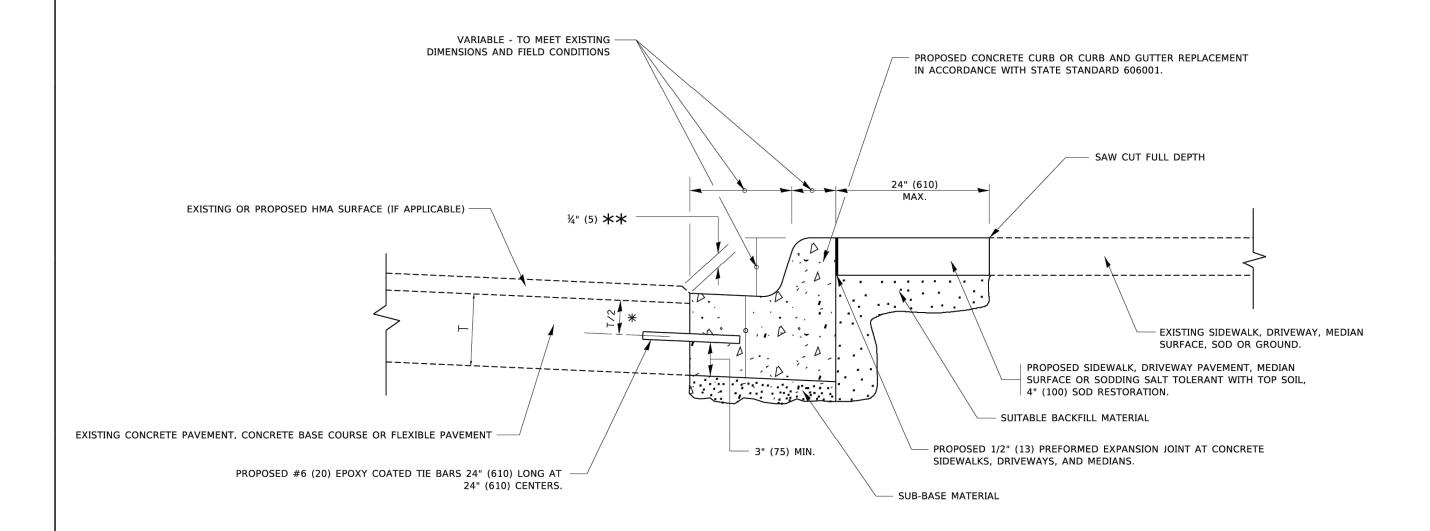


- \* 3" (75) MINIMUM FROM TOP AND BOTTOM OF THE CONCRETE PAVEMENT OR BASE COURSE.
- $\star\star$  IF THE FINAL SURFACE OF THE PAVEMENT IS CONCRETE, THE GUTTER IS TO BE FLUSH WITH THE PAVEMENT.

# **CURB OR CURB AND GUTTER REMOVAL AND REPLACEMENT**


ALL DIMENSIONS ARE IN INCHES (MILLIMETERS) UNLESS OTHERWISE SHOWN.

USER NAME = footemj	DESIGNED - A. HOUSEH	REVISED - A. ABBAS 03-21-97			CURB	R OR CU	JRB AND	GUTTER		F.A. RTF	SECTION	COUNTY	TOTAL SHEET
	DRAWN -	REVISED - M. GOMEZ 01-22-01	STATE OF ILLINOIS							2513	23-00363-00-RS	KANE	21 16
PLOT SCALE = 50.0000 ' / in.	CHECKED -	REVISED - R. BORO 12-15-09	DEPARTMENT OF TRANSPORTATION		KEIVIU	UVAL AN	ID REPLA	CEIVIENI			3D600-06 (BD-24)	CONTRACT	Γ NO. 61K23
PLOT DATE = 7/11/2019	DATE - 03-11-94	REVISED - K. SMITH 07-11-19		SCALE: NONE	SHEET 1	OF 1	SHEETS S	STA.	TO STA.		ILLINOIS FED. A	D PROJECT	

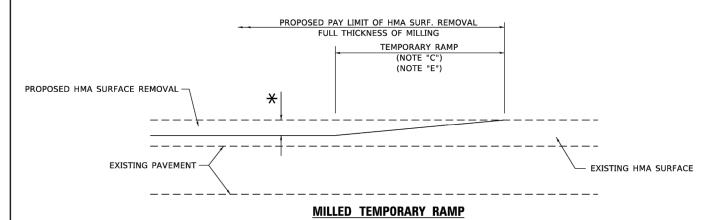


(FOR BUTT JOINT AND HMA TAPER SEE DETAIL BELOW)

#### OPTION 1

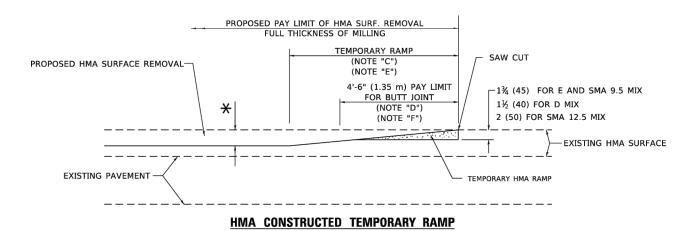



(for butt joint and hma taper see detail below)  $\begin{array}{c} \textbf{OPTION} & \textbf{2} \end{array}$ 

#### TYPICAL TEMPORARY RAMP

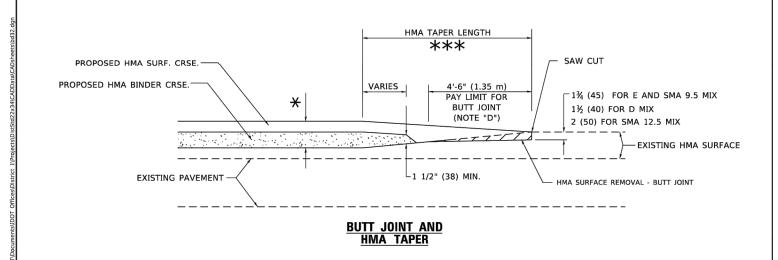

# TYPICAL BUTT JOINT AND HMA TAPER FOR MILLING AND RESURFACING

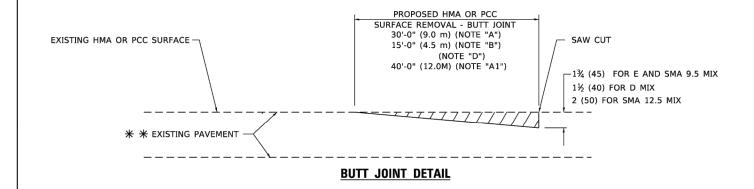

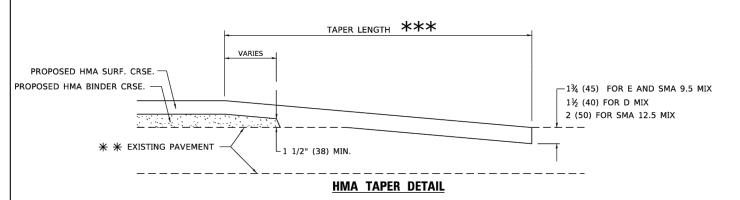

# TYPICAL BUTT JOINT AND HMA TAPER FOR RESURFACING ONLY

\*\* PC CONCRETE, HMA OR HMA RESURFACED PAVEMENT.

#### **GENERAL NOTES**

- A. MAINLINE ARTERIAL ROADWAYS AND MAJOR SIDE ROADS.
- A1. INTERSTATES
- B. MINOR SIDE ROADS.
- C. THE TEMP. RAMP SHALL BE CONSTRUCTED IMMEDIATELY UPON REMOVAL OF THE EXISTING HMA SURFACE.
- D. THE BUTT JOINT SHALL BE CONSTRUCTED IMMEDIATELY PRIOR TO PLACING THE PROPOSED HMA COURSES.
- E. TAPER THE TEMP. RAMP AT A RATE OF 3' 4" (1.02m) PER 1 INCH (25 mm) OF MILLING THICKNESS.
  - $m{\star}$  see typical sections for milling thickness.
- F. SEE ARTICLE 406.08 AND 406.14 OF THE STANDARD SPECIFICATIONS FOR "HMA AND/OR PCC SURFACE REMOVAL, BUTT JOINT".

\*\*\* 20'-0" (6.1 m) PER 1 (25) RESURFACING (NOTE "A") 10'-0" (3.0 m) PER 1 (25) RESURFACING (NOTE "B")

#### **BASIS OF PAYMENT**


- THE BUTT JOINT WILL BE PAID FOR AT THE CONTRACT UNIT PRICE PER SQUARE YARD (SQUARE METER) FOR "HOT-MIX ASPHALT SURFACE REMOVAL - BUTT JOINT" OR FOR "PORTLAND CEMENT CONCRETE SURFACE REMOVAL- BUTT JOINT".
- 2. THE TEMPORARY RAMP AND SAW CUT SHALL BE INCLUDED IN THE UNIT COST FOR HMA OR PCC SURFACE REMOVAL-BUTT JOINT.

ALL DIMENSIONS ARE IN INCHES (MILLIMETERS) UNLESS OTHERWISE SHOWN.

USER NAME = Lawrence.DeManche	DESIGNED -	M. DE YONG	REVISED	-	A. ABBAS 03-21-97
	DRAWN -		REVISED	-	M. GOMEZ 04-06-03
PLOT SCALE = 100.0000 ' / in.	CHECKED -		REVISED	-	R. BORO 01-01-07
PLOT DATE = 11/18/2022	DATE -	06-13-90	REVISED		K SMITH 11-18-22

STATE OF ILLINOIS
DEPARTMENT OF TRANSPORTATION

	BUTT JOINT	F.A. RTE.	SECTION	COUNTY	TOTAL SHEETS	SHEET NO.	
	HMA TAPER D	2513 1031	23-00363-00-RS	KANE	21	17	
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SCALE: NONE	SHEET 1 OF 1 SHEETS	STA. TO STA.		ILLINOIS FED. A	ID PROJECT		

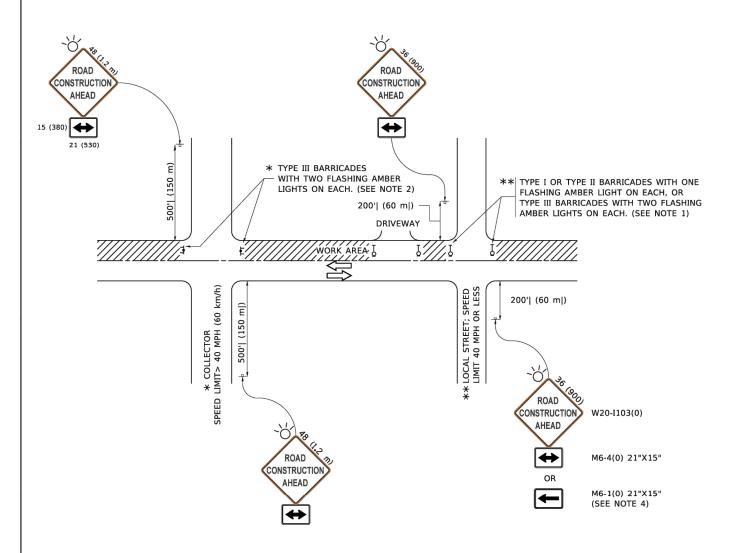

#### NOTES:

- 1. SIDE ROAD WITH A SPEED LIMIT OF 40 MPH (60 km/h) OR LESS AS SHOWN ON THE DRAWING AND AS DIRECTED BY THE ENGINEER:
- a) ONE "ROAD CONSTRUCTION AHEAD" SIGN 36 x 36 (900x900) WITH A FLASHER MOUNTED ON IT APPROXIMATELY 200' (60 m) IN ADVANCE OF THE MAIN ROUTE.
- b) THE CLOSED PORTION OF THE MAIN ROUTE SHALL BE PROTECTED BY BLOCKING WITH TYPE I, TYPE II OR TYPE III BARRICADES, 1/3 OF THE CROSS SECTION OF THE CLOSED PORTION.
- SIDE ROAD WITH A SPEED LIMIT GREATER THAN 40 MPH (60 km/h) AS SHOWN ON THE DRAWING AND AS DIRECTED BY THE ENGINEER:
  - a) ONE "ROAD CONSTRUCTION AHEAD" SIGN 48 x 48 (1.2 m x 1.2 m) WITH A FLASHER MOUNTED ON IT APPROXIMATELY 500' (150 m) IN ADVANCE OF THE MAIN ROUTE.
- THE CLOSED PORTION OF THE MAIN ROUTE SHALL BE PROTECTED BY
  b) BLOCKING WITH TYPE III BARRICADES, 1/2 OF THE CROSS SECTION
  OF THE CLOSED PORTION.
- 3. CONES MAY BE SUBSTITUTED FOR BARRICADES OR DRUMS AT HALF THE SPACING DURING DAY OPERATIONS. CONES SHALL BE A MINIMUM OF 28 (710) IN HEIGHT
- WHEN THE SIDE ROAD LIES BETWEEN THE BEGINNING OF THE MAINLINE
  4. SIGNING AND THE WORK ZONE, A SINGLE HEADED ARROW (M6-1) SHALL
  BE USED IN LIEU OF THE DOUBLE HEADED ARROW (M6-4).

SCALE: NONE

- 5. WHEN WORK IS BEING PERFORMED ON A SIDE ROAD OR DRIVEWAY, FOLLOW THE APPLICABLE STANDARD(S). THE DIRECTIONAL ARROW (M6-1 OR M6-4) SHALL BE COVERED OR REMOVED WHEN NO LONGER CONSISTENT WITH THE TRAFFIC CONTROL SET-UP.
- 6. ADVANCE WARNING SIGNS ARE TO BE OMITTED ON DRIVEWAYS UNLESS OTHERWISE SPECIFIED IN THE PLANS OR BY THE ENGINEER
- THE TRAFFIC CONTROL AND PROTECTION FOR SIDE ROADS, INTERSECTIONS, AND DRIVEWAYS SHALL BE INCLUDED IN THE COST OF SPECIFIED TRAFFIC CONTROL STANDARDS OR ITEMS.

All dimensions are in inches (millimeters) unless otherwise shown.


STATE OF ILLINOIS
DEPARTMENT OF TRANSPORTATION


TRAFFIC CONTROL AND PROTECTION FOR SIDE ROADS, INTERSECTIONS, AND DRIVEWAYS

| SHEET 1 OF 1 SHEETS STA. TO S

 
 F.A. RTE. 2513 1031
 SECTION 23-00363-00-RS
 COUNTY KANE
 TOTAL SHEETS NO.
 SHEETS NO.

 TC-10
 CONTRACT NO.
 61K23

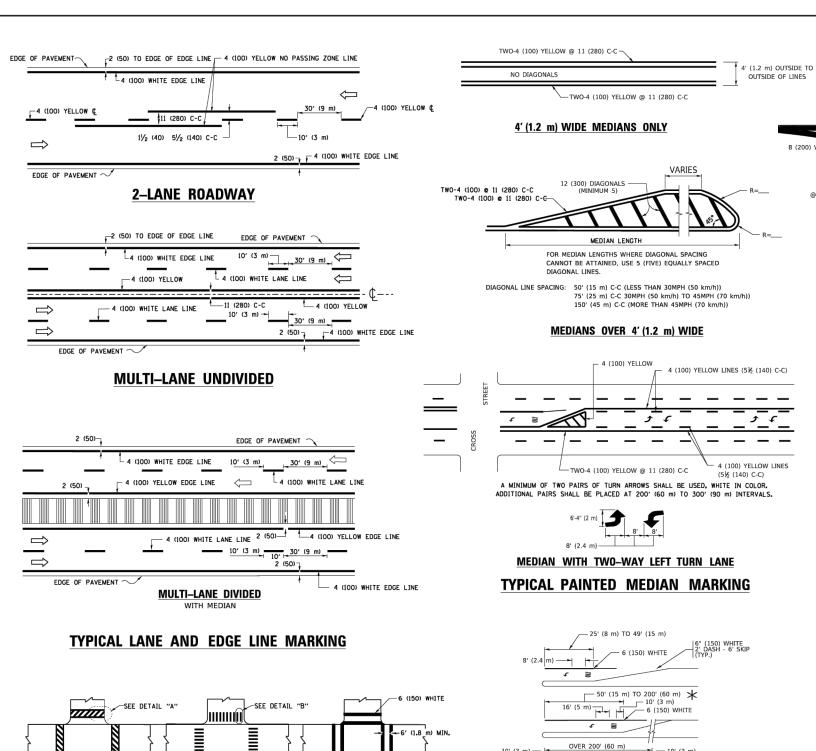


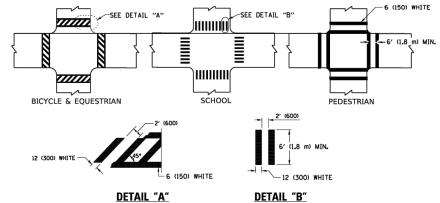

TYPICAL CROSSWALK MARKING

 $m{\star}$  MARKINGS SHALL BE INSTALLED PARALLEL TO THE CENTERLINE OF THE ROAD WHICH IT CROSSES


# @ 10' (3 m) OR LESS SPACING

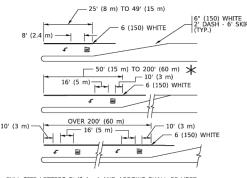

\* TURN LANES IN EXCESS OF 400' (120 m) IN LENGTH MAY HAVE AN ADDITIONAL SET OF ARROW - "ONLY" INSTALLED MIDWAY BETWEEN THE OTHER TWO SETS OF

TYPICAL LEFT (OR RIGHT) TURN LANE

#### TYPICAL TURN LANE MARKING

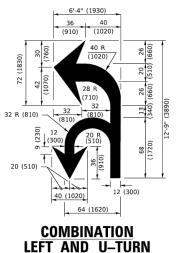

# 5'-4" (1620)

- 2 (50)

RAISED

√ 32 R (810) U-TURN

# 665 750

D(FT) | SPEED LIMIT

45

50

425

500

580

#### LANE REDUCTION TRANSITION

\* LANE REDUCTION ARROWS REQUIRED AT SPEEDS OF 45 MPH OR GREATER OR WHEN SPECIFIED IN PLANS.

		<u> </u>	O I III	
TYPE OF MARKING	WIDTH OF LINE	PATTERN	COLOR	SPACING / REMARKS
CENTERLINE ON 2 LANE PAVEMENT	4 (100)	SKIP-DASH	YELLOW	10' (3 m) LINE WITH 30' (9 m) SPACE
CENTERLINE ON MULTI-LANE UNDIVIDED PAVEMENT	2 @ 4 (100)	SOLID	YELLOW	11 (280) C-C
NO PASSING ZONE LINES: FOR ONE DIRECTION FOR BOTH DIRECTIONS	4 (100) 2 @ 4 (100)	SOLID SOLID	YELLOW YELLOW	5½ (140) C-C FROM SKIP-DASH CENTERLINE 11 (280) C-C OMIT SKIP-DASH CENTERLINE BETWEEN
LANE LINES	4 (100) 5 (125) ON FREEWAYS	SKIP-DASH SKIP-DASH	WHITE WHITE	10' (3 m) LINE WITH 30' (9 m) SPACE
DOTTED LINES (EXTENSIONS OF CENTER, LANE OR TURN LANE MARKINGS)	SAME AS LINE BEING EXTENDED	SKIP-DASH	SAME AS LINE BEING EXTENDED	2' (600) LINE WITH 6' (1.8 m) SPACE
EDGE LINES	4 (100)	SOLID	YELLOW-LEFT WHITE-RIGHT	OUTLINE MEDIANS IN YELLOW
TURN LANE MARKINGS	6 (150) LINE; FULL SIZE LETTERS & SYMBOLS (8' (2.4m))	SOLID	WHITE	SEE TYPICAL TURN LANE MARKING DETAIL
TWO WAY LEFT TURN MARKING	2 @ 4 (100) EACH DIRECTION 8' (2.4m) LEFT ARROW	SKIP-DASH AND SOLID IN PAIRS	YELLOW	10' (3 m) LINE WITH 30' (9 m) SPACE FOR SKIP-DASH; 5½ (140) C-C BETWEEN SOLID LINE AND SKIP-DASH LINE SEE TYPICAL TWO-WAY LEFT TURN MARKING DETAIL
CROSSWALK LINES (PEDESTRIAN) A. DIAGONALS (BIKE & EQUESTRIAN) B. LONGITUDINAL BARS (SCHOOL)	2 @ 6 (150) 12 (300) @ 45° 12 (300) @ 90°	SOLID SOLID SOLID	WHITE WHITE WHITE	NOT LESS THAN 6' (1.8 m) APART 2' (600) APART 2' (600) APART 5EE TYPICAL CROSSWALK MARKING DETAILS.
STOP LINES	24 (600)	SOLID	WHITE	PLACE 4' (1.2 m) IN ADVANCE OF AND PARALLEL TO CROSSWALK, IF PRESENT: OTHERWISE, PLACE AT DESIRED STOPPING POINT. PARALLEL TO CROSSROAD CENTERLINE, WHERE POSSIBLE
PAINTED MEDIANS	2 @ 4 (100) WITH 12 (300) DIAGONALS @ 45° NO DIAGONALS USED FOR 4' (1.2 m) WIDE MEDIANS	SOLID	YELLOW: TWO WAY TRAFFIC WHITE: ONE WAY TRAFFIC	11 (280) C-C FOR THE DOUBLE LINE SEE TYPICAL PAINTED MEDIAN MARKING.
GORE MARKING AND CHANNELIZING LINES	8 (200) WITH 12 (300) DIAGONALS @ 45°	SOLID	WHITE	DIAGONALS: 15' (4.5 m) C-C (LESS THAN 30MPH (50 km/h)) 20' (6 m) C-C 30MPH (50 km/h) TO 45MPH (70 km/h)) 30' (9 m) C-C (OVER 45MPH (70 km/h))
RAILROAD CROSSING	24 (600) TRANSVERSE LINES; "RR" IS 6 (1.8 m) LETTERS; 16 (400) LINE FOR "X"	SOLID	WHITE	SEE STATE STANDARD 780001 AREA OF: "R"=3.6 SQ. FT. (0.33 m ZEACH "X"=54.0 SQ. FT. (5.0 m Z
SHOULDER DIAGONALS (REQUIRED FOR SHOULDERS > 8')	12 (300) @ 45°	SOLID	WHITE - RIGHT YELLOW - LEFT	50' (15 m) C-C (LESS THAN 30MPH (50 km/h)) 75' (25 m) C-C (30 MPH (50 km/h) TO 45MPH (70 km/h)) 150' (45 m) C-C (OVER 45MPH (70 km/h))
U TURN ARROW	SEE DETAIL	SOLID	WHITE	16.3 SF
2 ARROW COMBINATION LEFT AND U TURN	SEE DETAIL	SOLID	WHITE	30.4 SF

FOR FURTHER DETAILS ON PAVEMENT MARKING REFER TO STANDARD SPECIFICATIONS FOR ROAD AND BRIDGE CONSTRUCTION AND STATE STANDARD 780001.

ISLAND OFFSET FROM PAVEMENT EDGE

8 (200) WHITE -

ISLAND AT PAVEMENT EDGE


TYPICAL ISLAND MARKING

8 (200) WHITE -

USER NAME = footemj DESIGNED -EVERS C. JUCIUS 09-09-09 DRAWN REVISED C. JUCIUS 07-01-13 CHECKED DATE REVISED -


STATE OF ILLINOIS **DEPARTMENT OF TRANSPORTATION** 

SECTION COUNTY DISTRICT ONE 23-00363-00-RS KANF 21 19 TYPICAL PAVEMENT MARKINGS CONTRACT NO. 61K23 OF 2 SHEETS STA. SHEET 1

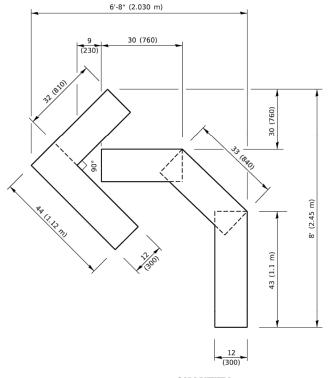


#### QUANTITY

4 (100) LINE = 45.5 ft. (13.9 m) 15.2 sq. ft. (1.41 sq. m)

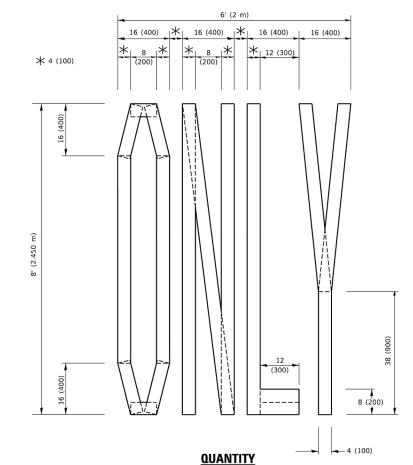

4 (100) LINE = 64.1 ft. (19.5 m) 21.4 sq. ft. (1.99 sq. m)

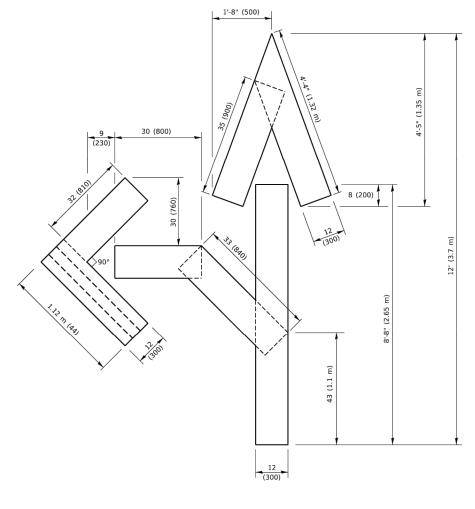


#### QUANTITY

4 (100) LINE = 82.5 ft. (25.1 m) 27.5 sq. ft. (2.53 sq. m)

#### NOTE:

ALL QUANTITIES OF PLACEMENT ARE REPRESENTED IN LINEAR FEET OF 4" LINES TO MATCH THE 4" TEMPORARY TAPE PAY ITEM AND REPRESENTS THE TOTAL QUANTITY OF 4" TAPE REQUIRED.

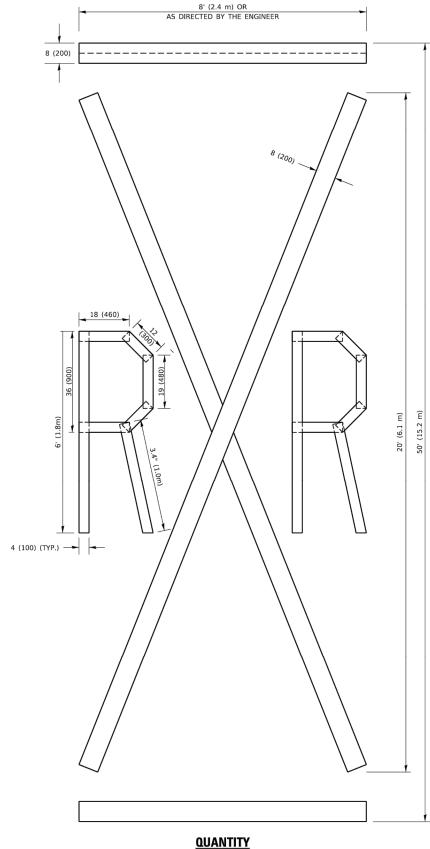

4 (100) LINE = 225.9 ft. (68.9 m) 75.3 sq. ft. (6.99 sq. m)


> All dimensions are in inches (millimeters) unless otherwise shown.

USER NAME = footemj	DESIGNED -	REVISED - T. RAMMACHER 03-02-98
	DRAWN -	REVISED - E. GOMEZ 08-28-00
PLOT SCALE = 50.0068 ' / in.	CHECKED -	REVISED - E. GOMEZ 08-28-00
PLOT DATE = 3/4/2019	DATE - 09-18-94	REVISED - A. SCHUETZE 09-15-16

STATE OF ILLINOIS **DEPARTMENT OF TRANSPORTATION** 

SHORT TE	RM	PAV	EMENT	MARKING	LETTERS	AND	SYMBOLS	
SCALE: NONE	SHEET	1	OF 1	SHEETS	STA.		TO STA.	

TOTAL SHEET NO. SECTION 23-00363-00-RS KANE CONTRACT NO. 61K23 TC-16

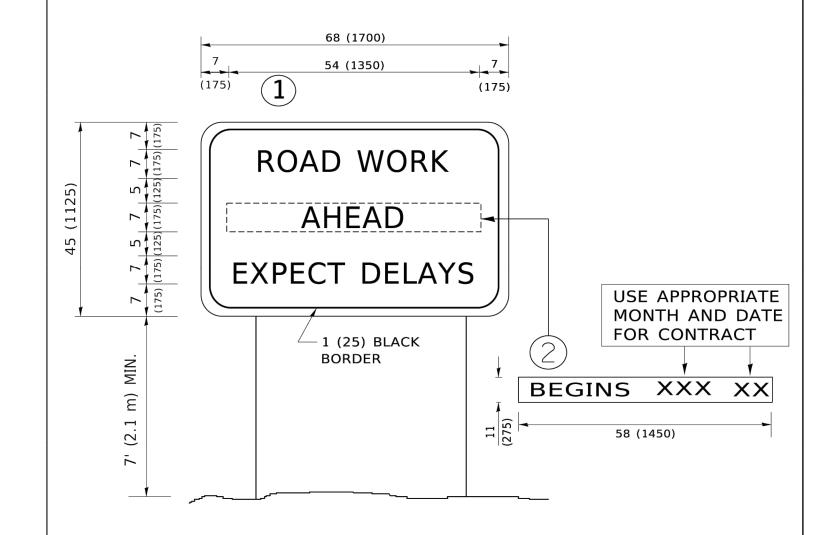

#### NOTES:

- 1. USE BLACK LETTERING ON ORANGE BACKGROUND.
- 2. ERECT SIGNS IN ADVANCE OF THE LOCATION FOR THE "ROAD CONSTRUCTION AHEAD" SIGN AT LOCATIONS AS DIRECTED BY THE ENGINEER.
- 3. ERECT SIGN 1 WITH INSTALLED PANEL 2 ONE WEEK PRIOR TO THE START OF CONSTRUCTION.
- 4. REMOVE PANEL(2)SOON AFTER THE START OF CONSTRUCTION.
- 5. SEE SPECIAL PROVISION FOR "TEMPORARY INFORMATION SIGNING" FOR ADDITIONAL INFORMATION.
- 6. ONE SIGN ASSEMBLY EQUALS 25.70 SQ. FT. (2.3 SQ. M.)
- 7. SHALL BE PAID FOR AS TEMPORARY INFORMATION SIGNING.

ALL DIMENSIONS ARE IN INCHES (MILLIMETERS) UNLESS OTHERWISE SHOWN.

USER NAME = footemj	DESIGNED -	REVISED - R. MIRS 09-15-97	·	ARTERIAL ROAD	F.A. SI	CTION	COUNTY TOTAL SHEET NO.
	DRAWN -	REVISED - R. MIRS 12-11-97	STATE OF ILLINOIS	INFORMATION SIGN	2513 1031 23-003	363-00-RS	KANE 21 21
PLOT SCALE = 50.0000 ' / in.	CHECKED -	REVISED -T. RAMMACHER 02-02-99	DEPARTMENT OF TRANSPORTATION	INFURIMATION SIGN	TC-2		CONTRACT NO. 61K23
PLOT DATE = 3/4/2019	DATE -	REVISED - C. JUCIUS 01-31-07		SCALE: NONE SHEET 1 OF 1 SHEETS STA. TO STA.			AID PROJECT