FOR INDEX OF SHEETS, SEE SHEET NO. 2

FOR LIST OF HIGHWAY STANDARDS SEE SHEET NO. 2

TRAFFIC DATA

THREE OAKS ROAD LUTTER DRIVE/SANDS ROAD

10,100 VPD (2023)

SPEED POSTED DESIGN SPEED

THREE OAKS ROAD

35 MPH 30 MPH


DESIGN DESIGNATION

FAU 4051 (THREE OAKS ROAD) - MINOR ARTERIAL (LUTTER DRIVE/SANDS ROAD) - LOCAL STREET



EXP. DATE: 11/30/25

FEHR GRAHAM

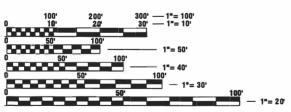

ENGINEERING SCALES. REDUCED SIZED PLANS WILL NOT CONFORM TO STANDARD SCALES. IN MAKING MEASUREMENTS ON REDUCED PLANS. THE ABOVE SCALES MAY BE USED.


JOINT UTILITY LOCATION INFORMATION FOR EXCAVATORS 1-800-892-0123 OR 811

04-26-2024 LETTING ITEM 210 **STATE OF ILLINOIS**

DEPARTMENT OF TRANSPORTATION

PLANS FOR PROPOSED FEDERAL AID HIGHWAY


FAU 4051 (THREE OAKS ROAD) THREE OAKS ROAD IMPROVEMENTS **SECTION 22-00134-00-TL** PROJECT NO. XDV1(861) **CITY OF CRYSTAL LAKE MCHENRY COUNTY** C-91-147-23

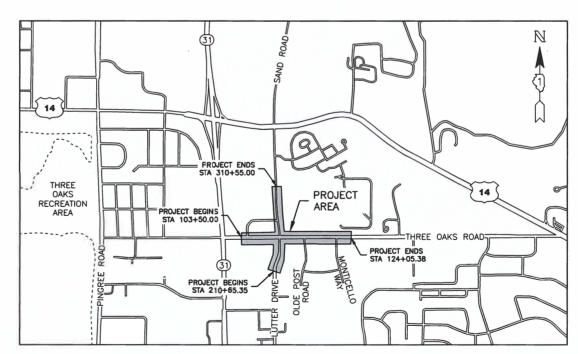

LOCATION MAP

GROSS LENGTH (THREE OAKS RD) = 2,055 FEET = 0.39 MILES NET LENGTH (THREE OAKS RD) = 2.055 FEET = 0.39 MILES GROSS LENGTH (LUTTER DRIVE/SANDS ROAD) = 1,475 FEET = 0.28 MILES NET LENGTH (LUTTER DRIVE/SANDS ROAD) = 1.475 FEET = 0.28 MILES



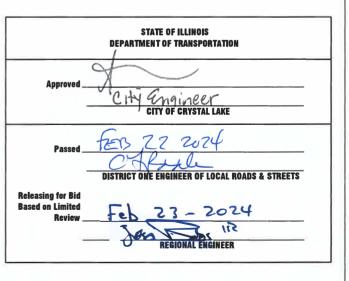

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CONTRACT NO. 61K35

	INDEX OF SHEETS
SHEET NO.	SHEET TITLE
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3	GENERAL NOTES
4	STANDARD LEGEND
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19	SCHEDULE OF QUANTITIES
20	EARTHWORK SCHEDULE
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23-28	REMOVAL PLANS
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49-54	EROSION CONTROL PLANS
55-63	DRAINAGE PLAN
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72	SIGNS DETAILS
73	INTERSECTION GRADING
7476	ADA RAMPS SHEETS
77-103	DETAILS
104-129	CROSS SECTIONS

	STATE STANDARDS	
STANDARD NO.	LIST OF DESCRIPTION	В
000001-08	STANDARD SYMBOLS, ABBREVIATIONS AND PATTERNS	_
280001-07	TEMPORARY EROSION CONTROL SYSTEMS	
424001-11	PERPENDICULAR CURB RAMPS FOR SIDEWALKS	
424005-05	DIAGONAL CURB RAMPS FOR SIDEWALKS	
424011-04	CORNER PARALLEL CURB RAMPS FOR SIDEWALKS	
424021-06	DEPRESSED CURB FOR SIDEWALKS	
424026-03	ENTRANCE/ALLEY PEDESTRIAN CROSSINGS	
602001-02	CATCH BASIN, TYPE A	
602011-02	CATCH BASIN, TYPE C	
602301-04	INLET, TYPE A	
602406~11	MANHOLE, TYPE A 6' DIAMETER	
60260106	PRECAST REINFORCED CONCRETE FLAT SLAB TOP	
602701~02	MANHOLE STEPS	В
604001-05	FRAME AND LIDS, TYPE 1	U
60405104	FRAME AND GRATE, TYPE 11	
606001 -08	CONCRETE CURB TYPE B AND COMBINATION CONCRETE CURB AND GUTTER	
70100605	OFF-ROAD OPERATIONS, 2L, 2W, 15' (4.5 m) TO 24" (600 mm) FROM PAVEMENT EDGE	
701301-04	LANE CLOSURE, 2L, 2W, SHORT TIME OPERATIONS	
701311-03	LANE CLOSURE, 2L, 2W, MOVING OPERATIONS — DAY ONLY	
70150209	URBAN LANE CLOSURE, 2L, 2W, WITH BIDIRECTIONAL TURN LANE	B
701701-10	URBAN LANE CLOSURE, MULTILANE INTERSECTION	
70180106	SIDEWALK, CORNER OR CROSSWALK CLOSURE	
701901-09	TRAFFIC CONTROL DEVICES	
704001-08	TEMPORARY CONCRETE BARRIER	
720001-01	SIGN PANEL MOUNTING DETAILS	
720006-04	SIGN PANEL ERECTION DETAILS	
720011-01	METAL POSTS FOR SIGNS, MARKERS, AND DELINEATORS	
72800101	TELESCOPING STEEL SIGN SUPPORT	
729001~01	APPLICATION OF TYPE A AND B METAL POSTS (FOR SIGNS AND MARKERS)	
731001-01	BASE FOR TELESCOPING STEEL SIGN SUPPORT	
780001-05	TYPICAL PAVEMENT MARKINGS	
781001-04	TYPICAL APPLICATIONS RAISED REFLECTIVE PAVEMENT MARKINGS	
782006~01	GUARDRAIL AN BARRIER WALL REFLECTOR MOUNTING DETAILS	
805001-01	ELECTRICAL SERVICE INSTALLATION DETAILS	
814001~03	HANDHOLES	
814006-03	DOUBLE HANDHOLES	
836001-04	LIGHT POLE FOUNDATION	
857001-01	STANDARD PHASE DESIGNATION DIAGRAMS AND PHASE SEQUENCES	
86200101	UNINTERRUPTIBLE POWER SUPPLY (UPS)	
87300102	TRAFFIC SIGNAL GROUNDING & BONDING	
877001-08	STEEL MAST ARM ASSEMBLY AND POLE 16' THROUGH 55'	
878001-11	CONCRETE FOUNDATION DETAILS	
880006-01	TRAFFIC SIGNAL MOUNTING DETAILS	
886001-01	DETECTOR LOOP INSTALLATIONS	
886006-01	TYPICAL LAYOUTS FOR DETECTION LOOPS	

DISTRICT ONE STANDARDS

BUREAU OF DESIGN DETAIL STANDARDS

DETAIL NO. LIST OF DESCRIPTION

DRIVEWAY DETAIL — DISTANCE BETWEEN R.O.W. AND FACE OF CURB GREATER THAN 15' (4.5 M)

BD07 STORM SEWER CONNECTION TO EXISTING SEWER FRAMES AND LIDS ADJUSTMENT WITH MILLING BD08

CURB AND GUTTER REMOVAL AND REPLACEMENT

BD32 BUTT JOINTS AND HMA TAPER

DEPRESSED CURB & GUTTER AND SHOULDER TREATMENT AT 18T TY 1 SPL

BD34

8036 FIRE HYDRANT TO BE MOVED

BENCHING DETAIL FOR EMBANKMENT WIDENING 8051

BUREAU OF ELECTRICAL DETAIL STANDARDS

DETAIL NO. LIST OF DESCRIPTION

ELECTRIC SERVICE INSTALLATION AERIAL, REMOTE DISCONNECT 8E220

MISCELLANEOUS ELECTRICAL DETAILS, SHEET A \sim (CABLE SPLICE, POLE WIRING, TRENCH DETAIL) BE702

BUREAU OF TRAFFIC DETAIL STANDARDS

DETAIL NO. LIST OF DESCRIPTION

TRAFFIC CONTROL AND PROTECTION FOR SIDE ROADS, INTERSECTIONS AND DRIVEWAYS

TC10

DISTRICT ONE TYPICAL PAVEMENT MARKINGS

TC14

TRAFFIC CONTROL AND PROTECTION AT TURN BAYS (TO REMAIN

TC16

SHORT-TERM PAVEMENT MARKING LETTERS AND SYMBOLS TC21 DETOUR SIGNING FOR CLOSING STATE HIGHWAYS

TC22 ARTERIAL ROAD INFORMATION SIGN

DRIVEWAY ENTRANCE SIGNING TC26

MAST ARM MOUNTED STREET NAME SIGNS

TS03 HANDHOLE TO INTERCEPT EXISTING CONDUIT

TS05 STANDARD TRAFFIC SIGNAL DESIGN DETAILS (7 SHEETS)

EMERGENCY VEHICLE PREEMPTION SEQUENCE OF OPERATION — MAIN STREET AND CROSS STREET TS08

FEHR GRAHAM

	USER NAME =BF/YJ	DESIGNED -		VL.	REVISED	~~
		DRAWN -	-	8F/YJ	REVISED	_
	PLOT SCALE - AS NOTED	CHECKED ~	~		REVISED	_
1	PLOT DATE = 3/20/24	DATE -	_	03/01/23	REVISED	_

GENERAL NOTES

- 1. ALL REFERENCES TO "STANDARD SPECIFICATIONS" IN THESE GENERAL NOTES SHALL BE INTERPRETED TO MEAN "STANDARD SPECIFICATIONS FOR ROAD AND BRIDGE CONSTRUCTION" ADOPTED BY THE ILLINOIS DEPARTMENT OF TRANSPORTATION, JANUARY 1, 2022. THE SUPPLEMENTAL SPECIFICATIONS AND RECURRING SPECIAL PROVISIONS ADOPTED JANUARY 1, 2024. ALL WORK TO BE COMPLETED IN ACCORDANCE WITH THE STANDARD SPECIFICATIONS.
- 2. IT IS THE CONTRACTOR'S RESPONSIBILITY TO ASCERTAIN EXISTING FIELD CONDITIONS PRIOR TO BIDDING ON THE PROJECT.
- BEFORE STARTING ANY EXCAVATION, THE CONTRACTOR SHALL CALL "JULIE" (JOINT UTILITY LOCATION INFORMATION FOR EXCAVATION) AT 8-1-1 IDOT AT (847) 705-4436 AND THE CITY OF CRYSTAL LAKE (847) 588-7900 FOR FIELD LOCATIONS OF BURIED UTILITIES (48 HOURS NOTFICCTION IS REQUIRED).
- 4. ALL ELEVATIONS SHOWN ON THE PLANS ARE ON THE NAVD88 DATUM.
- THE CONTRACTOR SHALL PROTECT AND CAREFULLY PRESERVE ALL SECTION OR SUBSECTION MONUMENTS, PROPERTY CORNERS, AND REFERENCE MARKERS UNTIL THE OWNER, HIS/HER AGENT, OR AN AUTHORIZED SURVEYOR HAS WITNESSED OR OTHERWISE REFERENCED THEIR LOCATIONS.
- ALL RADII FOR PROPOSED CURB AND GUTTER ARE TO THE EDGE OF PAVEMENT, UNLESS OTHERWISE NOTED. CURB AND GUTTER ELEVATIONS SHOWN ALONG RETURNS AND AT POINTS OF CURVATURE, ETC. ARE TO THE EDGE OF PAVEMENT UNLESS OTHERWISE NOTED.
- SAW CUTTING WILL BE REQUIRED FOR ALL REMOVAL ITEMS LISTED IN SECTION 440 OF THE STANDARD SPECIFICATIONS, SHOWN IN THE PLANS, AND AS DIRECTED BY THE ENGINEER.
- 8. DRIVEWAYS ARE TO BE CONSTRUCTED TO THE R.O.W. UNLESS OTHERWISE NOTED.
- 9. ABANDONED UNDERGROUND UTILITIES THAT CONFLICT WITH CONSTRUCTION SHALL BE DISPOSED OF OUTSIDE THE LIMITS OF THE RIGHT OF WAY ACCORDING TO ARTICLE 202.03 OF THE STANDARD SPECIFICATIONS AND AS DIRECTED BY THE ENGINEER.
- 10. THE ELEVATIONS SHOWN ON THE PLANS ARE FINISHED GRADES OF PROPOSED PAVEMENT, UNLESS OTHERWISE NOTED.
- 11. CURB RAMPS SHALL BE INSTALLED AT ALL INTERSECTING STREETS AND DRIVEWAYS PER CURRENT IDOT STANDARDS AT LOCATIONS WHERE SIDEWALK IS SHOWN ON THE PLAN.
- 12. CONTRACTOR SHALL BE ALLOWED TO SET UP A FIELD OFFICE AT A LOCATION APPROVED BY THE CITY OF CRYSTAL LAKE.
- 13. THE SUBGRADE STABILITY SHALL BE VERIFIED BY PROOF ROLLING WITH A FULLY LOADED TANDEM-AXEL TRUCK.
- 14. ANY AGGREGATE SUBGRADE IMPROVEMENT CONTAMINATED AND/OR DAMAGED BY THE CONTRACTOR'S VEHICLES AND/OR EQUIPMENT IS TO BE REMOVED AND REPLACED AS DIRECTED BY THE ENGINEER.
- 15. AGGREGATE SUBGRADE IMPROVEMENT (CU.YD.) HAS BEEN PROVIDED FOR USE AT THE LOCATION INDICATED FOR SOILS THAT TEND TO BE UNSTABLE AND/OR UNSUITABLE. THE ACTUAL NEED FOR REMOVAL AND REPLACEMENT WITH AGGREGATE SUBGRADE IMPROVEMENT (CU.YD.) WILL BE IN THE FIELD AT THE TIME OF CONSTRUCTION BY THE GEOTECHNICAL ENGINEER. ALL POTENTALLY UNSTABLE SOIL SHOULD BE TESTED WITH A STATIC AND/OR DYNAMIC CONE PENETROMETER AND TREATED IN ACCORDANCE WITH ATRICLE 301.04 OF THE SSRBC STANDARD AND CURRENT IDOT SUBGRADE STABILITY MANUAL. IFUNSTABLE AND/OR UNSUITABLE SOIL ARE NOT ENCOUNTER, THEN THE QUANTITY SHALL BE DEDUCTED.
- 16. EXISTING VEGETATED AREAS (TREES, SHRUBS, VEGETATIVE BUFFERS, TURF AREAS, ETC.) WHERE DISTURBANCE IS NOT OCCURRING (INCLUDING AREAS OUTSIDE THE PROJECT LIMITS) SHALL NOT BE DISTURBED TO ENSURE THAT EXISTING VEGETATION IS PRESERVED HEALTHY TO MINIMIZE SOIL EROSION AND TO ELIMINATE SOIL COMPACTION. NO MATERIALS ARE TO BE STORED OR VEHICLES DRIVEN OR PARKED WITHIN THESE UNDISTURBED AREAS AT ANY TIME.

STORM SEWERS WATER MAINS AND UTILITIES

- THE CONTRACTOR SHALL BE RESPONSIBLE FOR CONTACTING THE OWNERS OF ALL UTILITIES PRIOR TO CONSTRUCTION TO
 DETERMINE THE LOCATION OF ALL UTILITY EQUIPMENT. THE CONTRACTOR SHALL COOPERATE WITH ALL UTILITY OWNERS IN
 ACCORDANCE WITH THE STANDARD SPECIFICATIONS IF UTILITY RELOCATION, ADJUSTMENT, OR PROTECTION IS NECESSARY.
- THE LOCATION OF EXISTING DRAINAGE STRUCTURES, STORM SEWERS, WATER MAINS, SANITARY SEWERS, AND ANY OTHER PUBLIC OR PRIVATE UTILITIES AS SHOWN ON THE PLANS IS APPROXIMATE AND THEIR EXACT LOCATION IS TO BE DETERMINED IN THE FIELD BY THE CONTRACTOR.
- 3. THE CONTRACTOR SHALL BE RESPONSIBLE FOR THE PROTECTION OF ALL UNDERGROUND AND SURFACE UTILITIES EVEN THOUGH THEY MIGHT NOT BE SHOWN ON THE PLANS. ANY UTILITY PROPERTY DAMAGED DURING CONSTRUCTION SHALL BE REPAIRED OR REPLACED TO THE SATISFACTION OF THE OWNER BY THE CONTRACTOR.
- 4. ALL UTILITY COMPANIES SHALL BE NOTIFIED AT LEAST 3 DAYS PRIOR TO THE START OF CONSTRUCTION.
- 5. THE CONTRACTOR SHALL COORDINATE WITH THE CITY OF CRYSTAL LAKE IF ANY UTILITY IMPROVEMENTS ARE REQUIRED BY THE CITY WITHIN THE DURATION OF THE CONTRACT.
- 6. OFFSET LOCATIONS GIVEN IN THE PLANS FOR STRUCTURES, EDGE OF PAVEMENT, ETC. ARE FROM THE ROADWAY CENTERLINE.
- . FRAME ELEVATIONS GIVEN ON THE PLANS ARE ONLY TO ASSIST THE CONTRACTOR IN DETERMINING THE APPROXIMATE OVERALL HEIGHT OF THE STRUCTURE. FRAMES ON ALL NEW, ADJUSTED OR RECONSTRUCTED STRUCTURES WILL BE ADJUSTED TO THE FINAL ELEVATION OF THE AREA IN WHICH THEY ARE LOCATED AS PART OF THE STRUCTURE.
- 8. WHERE NEW WORK MEETS EXISTING FEATURES TO REMAIN, FIELD CHECK ALL DIMENSIONS AND ELEVATIONS BEFORE PROCEEDING WITH CONSTRUCTION. NOTIFY ENGINEER IMMEDIATELY OF ANY DISCREPANCIES.
- 9. ALL FRAMES, GRATES, LIDS, AND BOXES SCHEDULED TO BE REMOVED FROM EXISTING STRUCTURES SHALL REMAIN THE PROPERTY AND BE DELIVERED TO THE CITY OF CRYSTAL LAKE, AS APPLICABLE.
- 10. ANY LOOSE MATERIAL DEPOSITED IN THE FLOW LINE OF DRAINAGE STRUCTURES, WHICH OBSTRUCTS THE NATURAL FLOW OF WATER, SHALL BE REMOVED AT THE CLOSE OF EACH WORKING DAY. PRIOR TO ACCEPTANCE OF THE IMPROVEMENT, ALL DRAINAGE STRUCTURES SHALL BE FREE OF DIRT AND DEBRIS.
- 11. CONTRACTOR SHALL MAINTAIN THE CONVEYANCE OF ALL FLOWS DURING CONSTRUCTION OF THIS PROJECT. WHEN EXISTING DRAINAGE FACILITIES ARE DISTURBED, THE CONTRACTOR SHALL PROVIDE AND MAINTAIN TEMPORARY OUTLETS AND CONNECTIONS FOR ALL PRIVATE AND PUBLIC DRAINS, SEWERS, CULVERTS, AND OTHER DRAINAGE FACILITIES. THE CONTRACTOR SHALL PROVIDE FACILITIES TO TAKE IN ALL STORM WATER WHICH WILL BE RECEIVED BY THESE DRAINS AND SEWERS AND DISCHARGE THE SAME. THE CONTRACTOR SHALL PROVIDE AND MAINTAIN A PUMPING PLANT, IF NECESSARY, AND A TEMPORARY OUTLET AND BE PREPARED AT ALL TIMES TO DISPOSE OF THE WATER RECEIVED FROM THESE TEMPORARY CONNECTIONS UNTIL SUCH TIME THAT THE PERMANENT CONNECTIONS WITH SEWERS OR CULVERTS ARE BUILT AND IN SERVICE.

STORM SEWERS WATER MAINS AND UTILITIES CONTINUATION

- 12. ALL FRAMES WITH CLOSED LIDS TO BE FURNISHED AS PART OF THE CONTRACT FOR CONSTRUCTION, ADJUSTMENT OR RECONSTRUCTION OF ANY MANHOLE, CATCH BASIN, INLET, VALVE VAULT OR METER VAULT SHALL HAVE CAST INTO THE LID ONE OF THE FOLLOWING WORDS: ALL LIDS TO BE USED ON WATER STRUCTURES SHALL BEAR THE WORD "CITY OF CRYSTAL LAKE WATER." ALL LIDS TO BE USED ON STORM SEWER STRUCTURES SHALL BEAR THE WORD "CITY OF CRYSTAL LAKE STORM." ALL LIDS TO BE USED ON SANITARY SYSTEM STRUCTURES SHALL BEAR THE WORD "CITY OF CRYSTAL LAKE SANITARY". REFER TO THE CITY OF CRYSTAL LAKE DETAILS FOR ORDERING INFORMATION OR CONTACT THE DEPARTMENT OF PUBLIC WORDS.
- 13. ONLY PRECAST CONCRETE ADJUSTMENT RINGS, MAXIMUM OF 12" IN HEIGHT, WILL BE ALLOWED IN THE ADJUSTMENT OR RECONSTRUCTION OF CATCH BASIN, MANHOLE, INLET AND VALVE VAULT STRUCTURES. COMMON BRICK WILL NOT BE ALLOWED.
- 14. THE INDISCRIMINATE USE OF FIRE HYDRANTS OR EXISTING STREAMS, CREEKS, WETLANDS OR PONDS IS STRICTLY PROHIBITED. THE CONTRACTOR SHALL PROVIDE A WATER TRUCK AND DRIVER AS REQUIRED TO OBTAIN AND TRANSPORT THE WATER. THE CONTRACTOR SHALL BE RESPONSIBLE FOR OBTAINING WATER FROM AN APPROVED SOURCE. IF THIS WATER IS FROM A SOURCE OTHER THAN HIS/HER YARD, WRITTEN APPROVAL FROM THE AGENCY HAVING JURISDICTION FOR THE SOURCE OF THE WATER MUST BE RECEIVED BY THE ENGINEER PRIOR TO USE OF THE WATER.
- 15. PIPE UNDERDRAINS SHALL BE INSTALLED ACCORDING TO SECTION 601 OF THE SSRBC AND STANDARD 601001-05. TOP OF PIPE UNDERDRAINS SHALL BE PLACED MINIMUM 6" BELOW THE AGGREGATE SUBGRADE IMPROVEMENT LAYER.
- 16. A FLEXIBLE RUBBER BOOT THAT MEETS ASTM C923 IS REQUIRED FOR ALL CONNECTIONS. BOOTS ARE REQUIRED FOR STORM SEWERS IN COMBINED AREAS AND SANITARY SEWER IN ALL AREAS.
- 17. ALL WATER MAIN AND WATER MAIN QUALITY STORM SEWER SHALL BE DUCTILE IRON CLASS 52 CONFORMING TO ANSI/AWWA C151/A21.51-09, AND ALL DUCTILE IRON FITTINGS SHALL CONFORM TO ANSI/AWA C153/A21.53 WITH MECHANICAL JOINT GASKETS.
- 18. ALL WATER MAIN BOLTED CONNECTIONS SHALL BE TORQUED TO THE MANUFACTURER'S SPECIFICATION. THE CONTRACTOR SHALL VERIFY THE MANUFACTURER'S SPECIFICATION WITH AN APPROVED TORQUE WRENCH.
- 19. THRUST BLOCKING OR MEGA-LUGS WITH MEGA-BOND COATING SHALL BE INSTALLED ON WATER MAINS AT ALL BENDS, TEES, ELBOWS, ETC. EXCEPT 45-DEGREE VERTICAL BENDS IN WATER MAIN (THESE SHALL BE RESTRAINED WITH MEGA-LUG).
- 20. WHEN SPECIFIED, DUCTILE IRON PIPE SHALL BE ENCASED IN POLYETHYLENE AND SHALL CONFORM WITH ANSI/AWWA C105/A21.10 10 AND ASTM A674-10.
- 21. MINIMUM COVER FROM FINISHED GRADE TO TOP OF WATER MAIN SHALL BE SIX (6) FEET; MAXIMUM COVER SHALL BE EIGHT (8) FEET.
- 22. ALL WATER MAINS SHALL BE SUBJECTED TO A PRESSURE TEST AND A SEPARATE LEAKAGE TEST AT SYSTEM PRESSURE FOR 24 HOURS BY THE CONTRACTOR. HYDROSTATIC PRESSURE TEST AND LEAKAGE TEST SHALL BE BASED ON 125 PSI FOR TWO (2) HOURS. WATER MAINS SHALL BE CHLORINATED IN ACCORDANCE WITH THE STANDARD SPECIFICATIONS FOR WATER AND SEWER CONSTRUCTION IN ILLINOIS.

BACKFILL

PROVIDE TRENCH BACKFILL FOR ALL UTILITY LINES WITHIN 2' OF PAVED AREAS. BACK FILLING STORM AND SEWER
CONSTRUCTED UNDER THE ROADWAY SPECIFIED UNDER ART.550.07 (b,c) OF THE STANDARD SPECIFICATIONS WILL NOT BE
ALLOWED.

SIGNING AND STRIPING

- TWO WEEKS PRIOR TO PLACEMENT OF PERMANENT PAVEMENT MARKINGS THE ENGINEER SHALL CONTACT WALTER CZARNY, AREA TRAFFIC FIELD ENGINEER, AT WALTER.CZARNY@ILLINOIS.GOV.
- 2. SEE IDOT STANDARD DETAIL 780001, DISTRICT ONE DETAILS AND PLAN SHEETS FOR PAVEMENT MARKING DETAILS.
- 3. SIGNS SHALL NOT BE MOVED OR COVERED UNTIL PROGRESS OF WORK NECESSITATES IT.
- 4. IN ACCORDANCE WITH ARTICLE 107.25 OF THE STANDARD SPECIFICATIONS, THE CONTRACTOR WILL BE REQUIRED TO TEMPORARILY RESET ALL SUCH SIGNS THAT INTERFERE WITH HIS/HER CONSTRUCTION OPERATIONS. ALL SUCH SIGNS MUST BE MAINTAINED STRAIGHT AND CLEAN FOR THE DURATION OF THE TEMPORARY SETTING AND MUST BE RE-ERECTED AT A TEMPORARY LOCATION IN A WORKMANLIKE MANNER AND BE VISIBLE TO THE TRAFFIC FOR WHICH IT IS INTENDED.
- 5. LONGER POSTS MAY BE REQUIRED AT SOME TEMPORARY OR PERMANENT SIGN LOCATIONS TO MAINTAIN PROPER SIGN ELEVATIONS. THIS WORK SHALL BE COMPLETED IN ACCORDANCE WITH SECTION 729 OF THE STANDARD SPECIFICATIONS.
- 6. ALL SIGNS SHALL BE INSTALLED IN PERMANENT LOCATIONS AS THE ROADWAY IS COMPLETED. ALL SIGNS TO BE REMOVED SHALL REMAIN THE PROPERTY OF THE CITY OF CRYSTAL LAKE AND SHALL BE RETURNED TO THE CITY. SIGNS TEMPORARILY RELOCATED OR COVERED SHALL NOT BECOME THE PROPERTY OF THE CITY UNTIL PERMANENTLY REMOVED.
- 7. BEFORE BEGINNING ANY WORK, THE CONTRACTOR SHALL RETAIN AND RECORD FOR FUTURE REFERENCE ALL EXISTING PAVEMENT MARKING LINES (AND RAISED REFLECTIVE PAVEMENT MARKERS) IN ORDER THAT THESE LOCATIONS CAN BE RE-ESTABLISHED FOR STRIPING. EXACT LOCATIONS OF ALL PAVEMENT MARKINGS SHALL BE AS SHOWN ON THE PLANS OR AS DIRECTED BY THE FINGINFER

<u>EARTHWORK</u>

- 1. SUBGRADE SHALL BE PREPARED IN ACCORDANCE WITH ARTICLE 301.04 OF THE STANDARD SPECIFICATIONS BEFORE REMOVAL OF ANY UNSTABLE MATERIAL.
- 2. PRIOR TO ANY EMBANKMENT PLACEMENT, ALL VEGETATION AND UNSTABLE MATERIAL SHOULD BE REMOVED TO DEPTH ENCOUNTERED AND REPLACED WITH SUITABLE EMBANKMENT MATERIAL AS APPROVED BY THE ENGINEER.

TRAFFIC CONTROL

1. SEE TRAFFIC CONTROL PLANS FOR GENERAL NOTES CONCERNING TRAFFIC CONTROL AND PROTECTION.

COMMITMENTS

1. TREES THREE (3) INCHES IN DIAMETER OR GREATER AT BREAST HEIGHT SHALL NOT BE CLEARED FROM APRIL 1ST THROUGH SEPTEMBER 30TH OF ANY GIVEN YEAR.

TRAFFIC SIGNALS

- IT SHALL BE THE CONTRACTOR'S RESPONSIBILITY TO VERIFY ALL DIMENSIONS AND CONDITIONS EXISTING IN THE FIELD PRIOR TO ORDERING MATERIALS AND BEGINNING CONSTRUCTION. THIS SHALL INCLUDE LOCATING THE MAST ARM FOUNDATIONS AND VERIFYING THE MAST ARM LENGTHS.
- 2. IF THIS CONTRACT REQUIRES THE SERVICES OF AN ELECTRICAL CONTRACTOR, THE CONTRACTOR SHALL BE RESPONSIBLE AT HIS/HER OWN EXPENSE FOR LOCATING EXISTING IDOT ELECTRICAL FACILITIES PRIOR TO PERFORMING ANY WORK. IF THIS CONTRACT DOES NOT REQUIRE THE SERVICES OF AN ELECTRICAL CONTRACTOR, THE CONTRACTOR MAY REQUEST ONE FREE LOCATE FOR EXISTING IDOT ELECTRICAL FACILITIES FROM THE DISTRICT ONE ELECTRICAL MAINTENANCE CONTRACTOR PRIOR TO THE START OF ANY WORK. ADDITIONAL REQUESTS MAY BE AT THE EXPENSE OF THE CONTRACTOR. THE LOCATION OF UNDERGROUND TRAFFIC FACILITIES DOES NOT RELIEVE THE CONTRACTOR OF THEIR RESPONSIBILITY TO REPAIR ANY FACILITIES DAMAGED DURING CONSTRUCTION AT THEIR EXPENSE.
- 3. THE CONTRACTOR SHALL CHECK THE PROPOSED TRAFFIC SIGNAL EQUIPMENT LOCATIONS FOR UNDERGROUND AND OVERHEAD UTILITY CONFLICTS. THE CONTRACTOR SHALL NOTIFY THE AREA ENGINEER, THE RESIDENT ENGINEER AND ANY IMPACTED UTILITY COMPANY OF THE CONFLICT AND SHALL COORDINATE AND RESOLVE THE ISSUE PRIOR TO ORDERING MATERIALS, AND PRIOR TO POURING FOUNDATIONS.
- 4. RESTORATION OF THE TRAFFIC SIGNAL WORK AREA SHALL BE INCLUDED IN THE RELATED PAY ITEM SUCH AS FOUNDATION, CONDUIT, HANDHOLE, ETC., AND NO EXTRA COMPENSATION SHALL BE ALLOWED. ALL ROADWAY SURFACES SUCH AS SHOULDERS, MEDIAN, SIDEWALKS, PAVEMENT ETC., SHALL BE REPLACED IN KIND. ALL DAMAGE TO MOWED LAWNS SHALL BE REPLACED WITH AN APPROVED SOD, AND ALL DAMAGE TO UNMOWED FIELDS SHALL BE SEEDED IN ACCORDANCE WITH STANDARD SPECIFICATIONS 252 AND 250, RESPECTIVELY.
- 5. LOCATIONS WITH PEDESTRIAN EQUIPMENT HAVE BEEN DESIGNED TO BE ADA COMPLIANT. ANY DEVIATION FROM THE PLANS FOR TRAFFIC SIGNAL MAST ARM/POSTS THAT HAVE PEDESTRIAN EQUIPMENT WILL HAVE TO BE APPROVED BY THE ENGINEER AS COORDINATED WITH THE CITY OF CRYSTAL LAKE.


SEDIMENTATION AND EROSION CONTROL

1. SEE EROSION CONTROL PLANS FOR GENERAL NOTES CONCERNING EROSION CONTROL.

USER NAME =BF/YJ	DESIGNED	_	VL	REVISED —
	DRAWN	_	BF/YJ	REVISED —
PLOT SCALE = AS NOTED	CHECKED	_		REVISED —
PLOT DATE = 2/15/24	DATE	-	03/01/23	REVISED —

SCALE: AS NOTED SHEET 3

OFNEDAL NOTES		F.A.U. RTE.	SECTION		COUNTY	TOTAL SHEETS	SHEET NO.		
		4051	22-00134-00-TL		MCHENRY	129	3		
							CONTRACT	NO 61	K35
OF	129 SHEETS	STA.	TO STA.		IL	LINOIS FED. AI	D PROJECT		

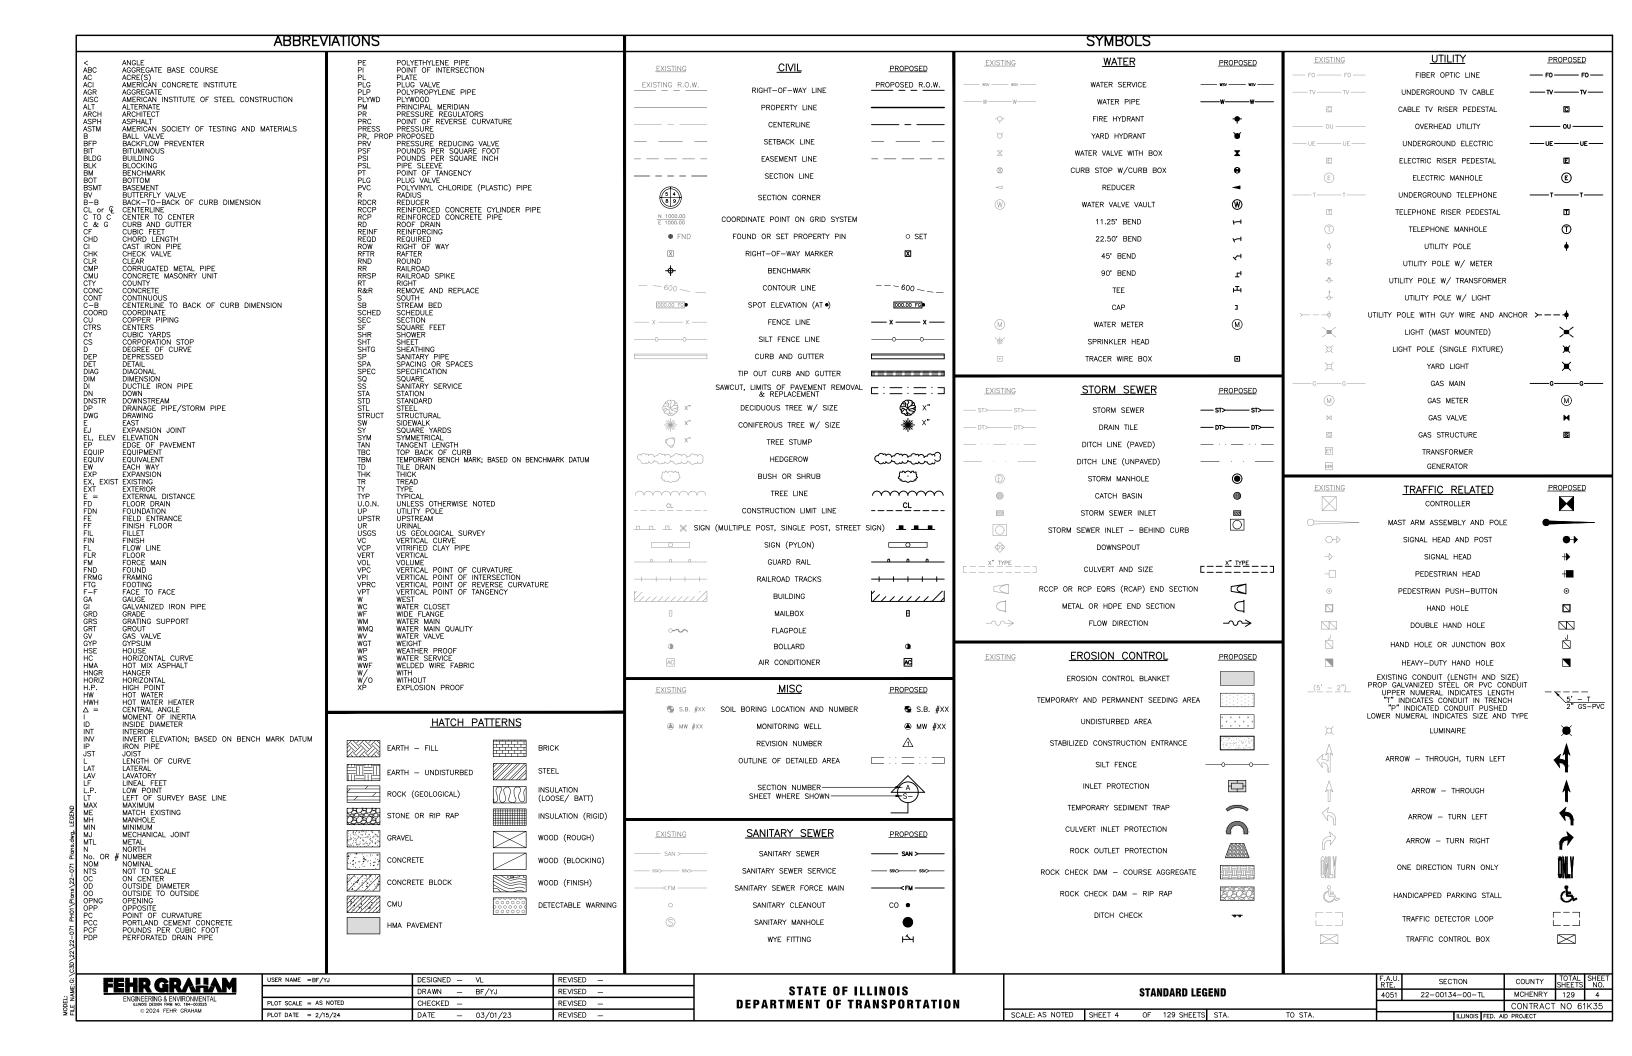

						CONSTRU	TION CODE	
PECIALTY ITEM	ITEM#	PAY ITEMS	UNIT	TOTAL	ROADWAY 80% FEDERAL 20% LOCAL 0004	LIGHTING 80% FEDERAL 20% LOCAL 0021	TRAFFIC SIGNAL 80% FEDERAL 20% LOCAL 0021	TRAINEES 80% FEDERAL 20% LOCAL 0042
	20101100	TREE TRUNK PROTECTION	EACH	6	6			
	20101400	NITROGEN FERTILIZER NUTRIENT	POUND	226.00	226.00			
	20101500	PHOSPHORUS FERTILIZER NUTRIENT	POUND	226.00	226.00			
	20101600	POTASSIUM FERTILIZER NUTRIENT	DOLIND	224.00	224.60			
	20101000	FOTASSION LENILIZER NOTRIENT	POUND	226.00	226.00			
	20200100	EARTH EXCAVATION	CU YD	3988.00	3988.00			
<u></u>				0700.00	3700.00		·	
	20800150	TRENCH BACKFILL	CU YD	257.30	257.30			
					WAR AND			
	21001000	GEOTECHNICAL FABRIC FOR GROUND STABILIZATION	SQ YD	17368.00	17368.00			
	21101625	TOPSOIL EXCAVATION AND PLACEMENT, 6"	SQ YD	9650.00	9650.00			
	25000440							
	25000110	SEEDING, CLASS 1A	ACRE	2.00	2.00			
	25100630	EROSION CONTROL BLANKET	SQ YD	0,50,00	0.50.00	•		
	23100030	ERUSION CONTROL BLANKET	3Q 1D	9650.00	9650.00			
	28000250	TEMPORARY EROSION CONTROL SEEDING	POUND	20.00	20.00			
			1 001112	20.00	20.00			
	28000315	TEMPORARY DITCH CHECKS	FOOT	76.00	76.00			
							, , , , , , , , , , , , , , , , , , ,	
	28000400	PERIMETER EROSION BARRIER	FOOT	6692.50	6692.50			
	28001100	TEMPORARY EROSION CONTROL BLANKET	SQ YD	965.00	965.00			
	28000510	INLET FILTERS	EACH	41	41			
	28100109	STONE RIPRAP, CLASS A5	SQ YD	45.00	45.00			
	20100707	STORE RIPRAP, CLASS AS	30,10	15.80	15.80			
	28200200	FILTER FABIRC	SQ YD	15.80	15.80			
				10.00	.5.00			···
-	30300001	AGGREGATE SUBGRADE IMPROVEMENT	CU YD	1105.00	1105.00			***************************************
	30300112	AGGREGATE SUBGRADE IMPROVEMENT 12"	SQ YD	6846.00	6846.00			
	35101600	AGGREGATE BASE COURSE, TYPE B 4"	SQ YD	1416.00	1416.00			
1	35101600	AGGREGATE BASE COURSE, TYPE B 4"	SQ YD	1416.00	1416.00	And the state of t		

USER NAME -BF/YJ	DESIGNED	_	VL.	REVISED	
	DRAWN		8F/YJ	REVISED	_
PLOT SCALE = AS NOTED	CHECKED	_		REVISED	_
PLOT DATE = 2/15/24	DATE		03/01/23	REVISED	_

STATE OF ILLINOIS DEPARTMENT OF TRANSPORTATION

						F.A.U. RTE.	SECTION	COUNTY	TOTAL SHEETS	SHEE!
	St	IMMA	RY OF QUA	NTITIES		4051	22-00134-00-TL	MCHENRY	129	5
								CONTRACT	NO 6:	1K35
ALE: AS NOTED	SHEET 5	OF	129 SHEETS	STA.	TO STA.		ILLINOIS FED. A	D PROJECT		

				<u> </u>			TION CODE	
SPECIALTY ITEM	ITEM#	PAY ITEMS	UNIT	TOTAL	ROADWAY 80% FEDERAL 20% LOCAL 0004	LIGHTING 80% FEDERAL 20% LOCAL 0021	TRAFFIC SIGNAL 80% FEDERAL 20% LOCAL 0021	TRAINEES 80% FEDERAL 20% LOCAL 0042
	35501316	HOT-MIX ASPHALT BASE COURSE, 8"	SQ YD	6846.00	6846.00			
	40600275	BITUMINOUS MATERIALS (PRIME COAT)	POUND	15400.00	15400.00			
	40600290	BITUMINOUS MATERIALS (TACK COAT)	POUND	8417.00	8417.00			
	40600370	LONGITUDINAL JOINT SEALANT	FOOT	7026.00	7026.00			
	40600982	HOT-MIX ASPHALT SURFACE REMOVAL - BUTT JOINT	SQ YD	124.00	124.00			
	40602985	HOT-MIX ASPHALT BINDER COURSE, IL-9.5, N70	TON	1208.00	1208.00			
	40604060	HOT-MIX ASPHALT SURFACE COURSE, IL-9.5, MIX "D", N50	TON	95.00	95.00			
	40604062	HOT-MIX ASPHALT SURFACE COURSE, IL-9.5, MIX "D", N70	TON	1349.00	1349.00			
	42400200	PORTLAND CEMENT CONCRETE SIDEWALK 5 INCH	\$Q FT	1417.00	1417.00			44-0-44-0-44-0-44-0-4-4-0-4-4-0-4-4-0-4-4-0-4-4-0-4-4-0-4-4-0-4-4-0-4-4-0-4-4-0-4-4-0-4-4-0-4-4-0-4
	42400800	DETECTABLE WARNINGS	SQ FT	209.00	209.00			
	44000100	PAVEMENT REMOVAL	SQ YD	5486.00	5486.00			
	44000155	HOT-MIX ASPHALT SURFACE REMOVAL, 1 1/2"	SQ YD	1530.00	1530.00			***
	44000161	HOT-MIX ASPHALT SURFACE REMOVAL, 3"	SQ YD	6975.00	6975.00			
	44000200	DRIVEWAY PAVEMENT REMOVAL	SQ YD	362.00	362.00			torre.
	44000500	COMBINATION CURB AND GUTTER REMOVAL	FOOT	3552.00	3552.00			
	44201741	CLASS D PATCHES, TYPE II, 8 INCH	SQ YD	59.00	59.00			
	44201745	CLASS D PATCHES, TYPE III, 8 INCH	SQ YD	65.00	65.00			
	44201747	CLASS D PATCHES, TYPE IV, 8 INCH	SQ YD	43.00	43,00			
	54213669	PRECAST REINFORCED CONCRETE FLARED END SECTIONS 24"	EACH	1	1			
	550A0050	STORM SEWERS, CLASS A, TYPE 1 12"	FOOT	166.00	166.00			

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USER NAME #BF/YJ	DESIGNED		VL	REVISED	_
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STATE OF ILLINOIS DEPARTMENT OF TRANSPORTATION

			DV 05 004			F.A.U. RTE.	SECTION	COUNTY	TOTAL SHEETS	SHEET NO.
	,	SUMMA	RY OF QUAI	NIIIIF2		4051	22-00134-00-TL	MCHENRY	129	6
								CONTRACT	. NO 6.	1K35
CALE: AS NOTED	SHEET 5	OF	129 SHEETS	STA.	TO STA.		ILUNOIS FED. A	O PROJECT		

						CONSTRUC	TION CODE	
SPECIALTY ITEM	ITEM#	PAY ITEMS	UNIT	TOTAL	ROADWAY 80% FEDERAL 20% LOCAL 0004	LIGHTING 80% FEDERAL 20% LOCAL 0021	TRAFFIC SIGNAL 80% FEDERAL 20% LOCAL 0021	TRAINEES 80% FEDERAL 20% LOCAL 0042
	550A0070	STORM SEWERS, CLASS A, TYPE 1 15"	FOOT	186.00	186.00			
	550A0090	STORM SEWERS, CLASS A, TYPE 1 18"	FOOT	248.00	248.00		, , , , , , , , , , , , , , , , , , ,	
	550A0120	STORM SEWERS, CLASS A, TYPE 1 24"	FOOT	14.00	14.00			
	550A0340	STORM SEWERS, CLASS A, TYPE 2 12"	FOOT	312.00	312.00			
	550A0360	STORM SEWERS, CLASS A, TYPE 2 15"	FOOT	95.00	95.00			
	550A0380	STORM SEWERS, CLASS A, TYPE 2 18"	FOOT	192.00	192.00			
	550A0410	STORM SEWERS, CLASS A, TYPE 2 24"	FOOT	46.00	46.00			
	550A0430	STORM SEWERS, CLASS A, TYPE 2 30"	FOOT	129.00	129.00			
	550A0450	STORM SEWERS, CLASS A, TYPE 2 36"	FOOT	270.00	270.00			4.4
	550A0730	STORM SEWERS, CLASS A, TYPE 3 30"	FOOT	205.00	205.00			
***************************************	550B0050	STORM SEWERS, CLASS B, TYPE 1 12"	FOOT	45.00	45.00			
	55100500						***************************************	
	55100500	STORM SEWER REMOVAL 12"	FOOT	298.00	298.00			
	55100700	STORM SEWER REMOVAL 15"	FOOT	444.00	444.00			
	55100900	STORM SEWER REMOVAL 18"	FOOT	137.00	137.00			
	55101200	STORM SEWER REMOVAL 24"	FOOT	211.00	211.00			
	56107400	REMOVE AND RELOCATE WATER MAIN 12"	FOOT	370.70	370.70	******		
····	56400200	FIRE HYDRANTS TO BE MOVED (SPECIAL)	EACH	3	3			
+	56400300	FIRE HYDRANT TO BE ADJUSTED	EACH	1	1			
	60200305							
	00200303	CATCH BASINS, TYPE A, 4-DIAMETER, TYPE 3 FRAME AND GRATE	EACH	13	13			
	60204005	CATCH BASINS, TYPE A, 5'-DIAMETER, TYPE 3 FRAME AND GRATE	EACH	3	3			

FEHR GRAHAM ENGINEERING & ENVIRONMENT LUNCS DESCRIPTION NO. 184-002525 © 2024 FEHR CRAHAM

USER NAME =BF/YJ	DESIGNED -	~	VL	REVISED	_
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PLOT SCALE = AS NOTED	CHECKED -	-		REVISED	_
PLOT DATE = 2/15/24	DATE -	-	03/01/23	REVISED	_

STATE OF ILLINOIS DEPARTMENT OF TRANSPORTATION

	F.A.U. SECTION COUNTY TOTAL SHEET NO.
SUMMARY OF QUANTITIES	4051 22-00134-00-TL MCHENRY 129 7
	CONTRACT NO 61K35
CALE: AS NOTED SHEET 7 OF 129 SHEETS STA. TO STA.	ILLINOIS FED. AID PROJECT

						CONSTRUC	TION CODE	
SPECIALTY ITEM	ITEM#	PAY ITEMS	UNIT	TOTAL	ROADWAY 80% FEDERAL 20% LOCAL 0004	LIGHTING 80% FEDERAL 20% LOCAL 0021	TRAFFIC SIGNAL 80% FEDERAL 20% LOCAL 0021	TRAINEES 80% FEDERAL 20% LOCAL 0042
	60207105	CATCH BASINS, TYPE C, TYPE 3 FRAME AND GRATE	EACH	9	9			
			***************************************			***************************************		
	60221100	MANHOLES, TYPE A, 5'-DIAMETER, TYPE 1 FRAME, CLOSED LID	EACH	3	3			
				_	-			
	60223800	MANHOLES, TYPE A, 6'-DIAMETER, TYPE 1 FRAME, CLOSED LID	EACH	8	8			
	00223000	MANITOGES, FILE A, O DIAMETER, FILE FIRME, CEOSED EID	LACI	0	0			
	40222040	WANTED TO THE A CLOSULETTED TODGE A COALIE AND COATE						*
	60223810	MANHOLES, TYPE A, 6'-DIAMETER, TYPE 3 FRAME AND GRATE	EACH	1	1			
	60224446	MANHOLES, TYPE A, 7'-DIAMETER, TYPE 1 FRAME, CLOSED LID	EACH	1	1			
	60255500	MANHOLES TO BE ADJUSTED	EACH	2	2			
	60260100	INLETS TO BE ADJUSTED	EACH	4	4			
	60500040	REMOVING MANHOLES	EACH	5	5			
								P
	60500060	REMOVING INLETS	EAC!!	42				
	0000000	REMOVING INLETS	EACH	12	12			
	60603800	COMBINATION CONCRETE CURB AND GUTTER, TYPE B-6.12	FOOT	5651.00	5651.00			
	67100100	MOBILIZATION	L SUM	1	1			

	70107025	CHANGEABLE MESSAGE SIGN	CAL DA	112.00	112.00			
					,,,,,,			
	70300150	SHORT TERM PAVEMENT MARKING REMOVAL	\$Q FT	2214.00	2214.00	***		
	70307120	TEMPORARY PAVEMENT MARKING - LINE 4" - TYPE IV TAPE	FOOT	12652,00	12652.00	**************************************		
	70307120	TENT OWART PAYEDERS MARKING - CINE 4 - TIPE IV TAPE	1001	12032.00	12652.00			
	H2 100010							
	72400310	REMOVE SIGN PANEL - TYPE 1	SQ FT	54.00	54.00			
	72400500	RELOCATE SIGN PANEL ASSEMBLY - TYPE A	EACH	3	3			
	72400600	RELOCATE SIGN PANEL ASSEMBLY - TYPE B	EACH	1	1			
	72400710	RELOCATE SIGN PANEL - TYPE 1	SQ FT	30.00	30.00			

+	72800100	TELESCOPING STEEL SIGN SUPPORT	FOOT	520.00	520.00			
*	, 2000100	TELESCOTING STEEL SIGN SOLI ON	1001	320.00	J20.00		Land State of the	
	79990400	THEOLON ACTIC DAVENTAL HIGHWAY A PERSONAL LIP AND A TOTAL OF THE COLUMN ACTIC DAVENTAL HIGHWAY A PERSONAL LIP AND A TOTAL OF THE COLUMN ACTIC DAVENTAL HIGHWAY A PERSONAL LIP AND A TOTAL OF THE COLUMN ACTIC DAVENTAL HIGHWAY A PERSONAL LIP AND A TOTAL OF THE COLUMN ACTIC DAVENTAL HIGHWAY A PERSONAL LIP AND A TOTAL OF THE COLUMN ACTIC DAVENTAL HIGHWAY A PERSONAL LIP AND A TOTAL OF THE COLUMN ACTIC DAVENTAL HIGHWAY A PERSONAL LIP AND A TOTAL OF THE COLUMN ACTIC DAVENTAL HIGHWAY A PERSONAL LIP AND A TOTAL DAVENTAL HIGHWAY A PERSONAL LIP AND A PE		457.50	/FR / 2			.
+	78000100	THERMOPLASTIC PAVEMENT MARKING - LETTERS AND SYMBOLS	SQ FT	457.60	457.60	I		

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ENGINEERING & ENVIRONMENTAL
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USER NAME ►BF/YJ	DESIGNED -	VL.	REVISED	_
	DRAWN -	BF/YJ	REVISED	
PLOT SCALE = AS NOTED	CHECKED -		REVISED	-
PLOT DATE = 3/21/24	DATE	03/01/23	REVISED	-

STATE OF ILLINOIS DEPARTMENT OF TRANSPORTATION

			SUMMARY OF QUANTITIES							SHEET NO.
	SUMMARY OF QUANTITIES						22-00134-00-TL	MCHENRY	129	8
								CONTRACT	NO 6	1K35
SCALE: AS NOTED	SHEET 8	OF	129 SHEETS	STA.	TO STA.		ILLINOIS FED. A	O PROJECT		

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CDECIALTY							CTION CODE	
SPECIALTY ITEM	ITEM#	PAY ITEMS	UNIT	TOTAL	ROADWAY 80% FEDERAL 20% LOCAL 0004	LIGHTING 80% FEDERAL 20% LOCAL 0021	TRAFFIC SIGNAL 80% FEDERAL 20% LOCAL 0021	TRAINEES 80% FEDERAL 20% LOCAL 0042
+	78000200	THERMOPLASTIC PAVEMENT MARKING - LINE 4"	FOOT	9274.00	9274.00			
+	78000400	THERMOPLASTIC PAVEMENT MARKING - LINE 6"	FOOT	2099.00	2099.00			
+	78000600	THERMOPLASTIC PAVEMENT MARKING - LINE 12"	FOOT	1351.00	1351.00			
	70000/50				***************************************			
+	78000650	THERMOPLASTIC PAVEMENT MARKING - LINE 24"	FOOT	151.00	151.00			
	78300201	PAVEMENT MARKING REMOVAL - GRINDING	SQ FT	2794.00	2794.00			
+	80400100	ELECTRIC SERVICE INSTALLATION	EACH	1			1	
÷	80400200	ELECTRIC UTILITY SERVICE CONNECTION	L SUM	1			1	
+	80500010	SERVICE INSTALLATION - GROUND MOUNTED	EACH	1			1	
+	81028750	UNDERGROUND CONDUIT, COILABLE NONMETALLIC CONDUIT, 2" DIA.	FOOT	64.00			64.00	
+	81028760	UNDERGROUND CONDUIT, COILABLE NONMETALLIC CONDUIT, 2 1/2" DIA.	FOOT	4.00			4.00	
+	81028770	UNDERGROUND CONDUIT, COILABLE NONMETALLIC CONDUIT, 3" DIA.	FOOT	93.00			93.00	
+	81028780	UNDERGROUND CONDUIT, COILABLE NONMETALLIC CONDUIT, 3 1/2" DIA.	FOOT	63.00			63.00	
+	81028790	UNDERGROUND CONDUIT, COILABLE NONMETALLIC CONDUIT, 4° DIA.	FOOT	546.00		***************************************	546.00	
+	81028800	UNDERGROUND CONDUIT, COILABLE NONMETALLIC CONDUIT, 5" DIA.	FOOT	6.00			6.00	
+	81400100	HANDHOLE	EACH	3			3	
+	81400300	DOUBLE HANDHOLE	EACH	1			1	
+	81702110	ELECTRICAL CABLE IN CONDUIT, 600V (XLP-TYPE USE) 1/C NO. 10	FOOT	1050.00			1050.00	
+	82110008	LUMINAIRE, LED, ROADWAY, OUTPUT DESIGNATION H	EACH	4		4		
+	84200500	REMOVAL OF LIGHTING UNIT, SALVAGE	EACH	1		1		
+	85100500	PAINT NEW TRAFFIC SIGNAL POST	EACH	5			5	***************************************

USER NAME =8F/YJ	OESIGNEO — VL	REVISED
	DRAWN — BF/YJ	REVISED -
PLOT SCALE = AS NOTED	CHECKED —	REVISED -
PLOT DATE = 2/15/24	DATE - 03/01/23	REVISED

STATE OF ILLINOIS DEPARTMENT OF TRANSPORTATION

						F.A.U. RTE.	SECTION	COUNTY	TOTAL SHEETS	SHEET NO.
	5	UMMA	RY OF QUA	MIIITES		4051	220013400-TL	MCHENRY	129	9
	·							CONTRACT	L NO 6,	IK35
CALE: AS NOTED	SHEET 9	OF	129 SHEETS	STA.	TO STA.		ILUNOIS FEO. A	ID PROJECT	A	

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						CONSTRU	TION CODE	
SPECIALTY ITEM	ITEM#	PAY ITEMS	UNIT	TOTAL	ROADWAY 80% FEDERAL 20% LOCAL 0004	LIGHTING 80% FEDERAL 20% LOCAL 0021	TRAFFIC SIGNAL 80% FEDERAL 20% LOCAL 0021	TRAINEES 80% FEDERAL 20% LOCAL 0042
+	85100800	PAINT NEW COMBINATION MAST ARM AND POLE, UNDER 40 FOOT	EACH	3	4	***************************************	3	
+	85100901	PAINT NEW COMBINATION MAST ARM AND POLE, 40 FOOT AND OVER	EACH	1			1	
+	87300925	ELECTRIC CABLE IN CONDUIT, TRACER, NO. 14 1C	FOOT	1179			1179	
+	87301215	ELECTRIC CABLE IN CONDUIT, SIGNAL NO. 14 2C	FOOT	163.00			163.00	
			1001	103.00			163.00	
+	87301225	ELECTRIC CABLE IN CONDUIT, SIGNAL NO. 14 3C	FOOT	163.00			163.00	
+	87301245	ELECTRIC CABLE IN CONDUIT, SIGNAL NO. 14 5C	FOOT	695.00			695.00	
+	87301255	ELECTRIC CABLE IN CONDUIT, SIGNAL NO. 14 7C	FOOT	1390.00	***************************************		1390.00	
+	87301805	ELECTRIC CABLE IN CONDUIT, SERVICE NO. 6 2C	FOOT	1179.00			1179.00	
+	87301900	ELECTRIC CABLE IN CONDUIT, EQUIPMENT GROUNDING CONDUCTOR, NO. 6 1C	FOOT	1179.00	***************************************		1179.00	
+	87502500	TRAFFIC SIGNAL POST, GALVANIZED STEEL 16 FT.	EACH	5.00	M Addition Appropries		5.00	
+	87702880	STEEL COMBINATION MAST ARM ASSEMBLY AND POLE, 30 FT.	EACH	1			1	
+	87702890	STEEL COMBINATION MAST ARM ASSEMBLY AND POLE, 32 FT.	EACH	1			1	
+	87702900	STEEL COMBINATION MAST ARM ASSEMBLY AND POLE, 34 FT.	EACH	1			1	
+	87702930	STEEL COMBINATION MAST ARM ASSEMBLY AND POLE, 40 FT.	EACH	1	Medical		1	
+	87800100	CONCRETE FOUNDATION, TYPE A	FOOT	18			18	
+	87800150	CONCRETE FOUNDATION, TYPE C	FOOT	3.00			3.00	
+	87800415	CONCRETE FOUNDATION, TYPE E 36-INCH DIAMETER	FOOT	50.00			50.00	
+	88040070	SIGNAL HEAD, POLYCARBONATE, LED, 1-FACE, 3-SECTION, BRACKET MOUNTED	EACH	2.00			2.00	
+	88040090	SIGNAL HEAD, POLYCARBONATE, LED, 1-FACE, 3-SECTION, MAST-ARM MOUNTED						
,	00070070	STATE TIERD, TO ET CARDONATE, LED, TETRICE, 3-SECTION, MAST-ARM MOUNTED	EACH	4			4	
+	88040150	SIGNAL HEAD, POLYCARBONATE, LED, 1-FACE, 5-SECTION, BRACKET MOUNTED	EACH	6			6	

USER NAME -BF/YJ	DESIGNED — VL	REVISED —
	DRAWN BF/YJ	REVISED —
PLOT SCALE - AS NOTED	CHECKED —	REVISED
PLOT DATE = 3/11/24	DATE - 03/01/23	REVISED -

STATE OF ILLINOIS DEPARTMENT OF TRANSPORTATION

				F.A.U. RTE.	SECTION	COUNTY	TOTAL	SHEE		
	St	JIMIMA	RY OF QUA	NTITIE:	S	4051	220013400-TL	MCHENRY	129	10
								CONTRAC	T NO 6	1K35
 SCALE; AS NOTED	SHEET 10	OF	129 SHEETS	STA.	TO STA.		ILLINOIS FED. A	D PROJECT		
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FEHR GRAHAM

ENGINEERING & ENVIRONMENTAL
LIGHT SERVING NO. 1014-201235

0 2024 FEHR GRAHAM

			, , , , , , , , , , , , , , , , , , ,			CONSTRUC	TION CODE	
SPECIALTY ITEM	ITEM#	PAY ITEMS	UNIT	TOTAL	ROADWAY 80% FEDERAL 20% LOCAL 0004	LIGHTING 80% FEDERAL 20% LOCAL 0021	TRAFFIC SIGNAL 80% FEDERAL 20% LOCAL 0021	TRAINEES 80% FEDERAL 20% LOCAL 0042
+	88040160	SIGNAL HEAD, POLYCARBONATE, LED, 1-FACE, 5-SECTION, MAST-ARM MOUNTED	EACH	6			6	
+	88102717	PEDESTRIAN SIGNAL HEAD, LED, 1-FACE, BRACKET MOUNTED WITH COUNTDOWN TIMER	EACH	2			2	
	88200400	TRACEIC CICNAL PACKRIATE FORMED DI ACTIC	64.6 11	40				
+	88200400	TRAFFIC SIGNAL BACKPLATE, FORMED PLASTIC	EACH	10			10	
+	88700200	LIGHT DETECTOR	EACH	4			4	
			*****	·				
+	88700300	LIGHT DETECTOR AMPLIFIER	EACH	1			1	
+	X0324085	EMERGENCY VEHICLE PRIORITY SYSTEM LINE SENSOR CABLE, NO. 20 3/C	FOOT	194			194	
+	X0327698	LED INTERNALLY ILLUMINATED STREET NAME SIGN	EACH	4.00			4.00	
+	X1400081	FULL-ACTUATED CONTROLLER AND TYPE SUPER P CABINET (SPECIAL)	EACH	1		Y-20,000	1	
	X1400424	ELECTRIC CABLE IN CONDUIT, STREET NAME SIGN, NO. 14 3C, TYPE SOOW	FOOT	P 40				
+	X1400424	ELECTRIC CABLE IN CONDUIT, STREET NAME SIGN, NO. 14 SC, TIPE SOOW	FOOT	540			540	
	X4021000	TEMPORARY ACCESS (PRIVATE ENTRANCE)	EACH	1.00	1.00		}	
	74021000	(Idinate and Idin	LACIT	1.00	1.00			
	X4022000	TEMPORARY ACCESS (COMMERCIAL ENTRANCE)	EACH	2	2	***************************************		
	X7010216	TRAFFIC CONTROL AND PROTECTION, (SPECIAL)	L SUM	1	1			
		·						
+	X8620200	UNINTERRUPTABLE POWER SUPPLY, SPECIAL	EACH	1			1	
+	X8760200	ACCESSIBLE PEDESTRIAN SIGNALS	EACH	2			2	
+	X8891009	VIDEO VEHICLE DETECTION SYSTEM, SINGLE APPROACH	EACH	4			4	
	WW.077.22	PLECTRIC LITTER						
+	XX007622	ELECTRIC METER	EACH	1	1			
	Z0013798	CONSTRUCTION LAYOUT	L SUM	1	1			
	20013770	CONSTRUCTION EXTOST	L JON	'	I I			
	Z0030850	TEMPORARY INFORMATION SIGNING	SQ FT	103.00	103.00			
				. ,				
	Z0056648	STORM SEWERS, TYPE 1, WATER MAIN QUALITY PIPE, 12"	FOOT	116,00	116.00			
								×
	Z0073510	TEMPORARY TRAFFIC SIGNAL TIMING	EACH	4.00			4.00	
	Z0076600	TRAINEES	HOUR	500.00				500.00
	Z0076604	TRAINEES TRAINING PROGRAM GRADUATE	HOUR	500.00				500.00
***********		TO THE PROPERTY OF THE PROPERT		230.00				300.00

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ENGINEERING & ENVIRONMENTAL
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PLOT DATE = 3/22/24	DATE	_	03/01/23	REVISED	_


STATE OF ILLINOIS DEPARTMENT OF TRANSPORTATION

.						F.A.U. RTE.	SECTION	COUNTY	TOTAL SHEETS	SHEET NO.
SUMMARY OF QUANTITIES					4051	22-00134-00-TL	MCHENRY	132	11	
				****				CONTRACT	L NO 6.	1K35
SCALE: AS NOTED	SHEET 11	OF	132 SHEETS	STA.	TO STA.		ILLINOIS FED. A	D PROJECT		


	TUDE DECLUDE	IENTO.
<u>HOT-MIX ASPHALT MIX</u>		MENIS
MIXTURE TYPE	AIR VOIDS @ NDES	<u>QMP</u>
PAVEMENT RESURFACING: THREE OAKS ROAD		
HOT-MIX ASPHALT SURFACE COURSE, IL-9.5, MIX "D", N70, 1.5"	4.0% @ 70 GYR.	LR 1030-2
HOT-MIX ASPHALT BINDER COURSE, IL-9.5, N70, 1.5"	4.0% @ 70 GYR.	LR 1030-2
PAVEMENT RESURFACING: LUTTER DRIVE		
HOT-MIX ASPHALT SURFACE COURSE, IL-9.5, MIX "D", N70, 1.5"	4.0% @ 70 GYR.	LR 1030-2
HMA PAVEMENT WIDENING: THREE OAKS ROAD		
HOT-MIX ASPHALT BASE COURSE (HMA BINDER IL-19.0), 8"	4.0% @ 70 GYR.	LR 1030-2
HMA PAVEMENT WIDENING: LUTTER DRIVE		
HOT-MIX ASPHALT BASE COURSE (HMA BINDER IL-19.0), 8"	4.0% @ 70 GYR.	LR 1030-2
HOT-MIX ASPHALT SURFACE COURSE, IL-9.5, MIX "D", N70, 1.5"	4.0% @ 70 GYR.	LR 1030-2
HMA MULTI-USE PATH		
HOT-MIX ASPHALT SURFACE COURSE, IL-9.5, MIX "D", N50, 3" (IN TWO LIFTS)	4.0% @ 50 GYR.	LR 1030-2
DRIVEWAYS		
HOT-MIX ASPHALT SURFACE COURSE, IL-9.5, MIX "D", N50, 3" (IN 2 LIFTS)	4.0% @ 50 GYR.	LR 1030-2
HMA PAVEMENT SANDS RD/OLDE POST RD/E MONTICELLO WAY		
HOT-MIX ASPHALT SURFACE COURSE, IL-9.5, MIX "D", N70, 1.5"	4.0% @ 70 GYR.	LR 1030-2
HOT-MIX ASPHALT BINDER COURSE, IL-9.5, N70, 1.5"	4.0% @ 70 GYR.	LR 1030-2
HOT-MIX ASPHALT BASE COURSE (HMA BINDER IL-19.0), 8"	4.0% @ 70 GYR.	LR 1030-2
CLASS D PATCHING		
CLASS D PATCHING (HMA BINDER IL-19.0)	4.0% @ 70 GYR.	LR 1030-2
QMP DESIGNATION: QUALITY CONTROL/Q	UALITY ASSURANCE PE	ER LR 1030-2

1. THE UNIT WEIGHT USED TO CALCULATE ALL HOT-MIX ASPHALT SURFACE MIXTURES IS 112 LBS/SQ YD/IN.

2. THE "AC TYPE" FOR POLYMERIZED HMA MIXES SHALL BE "SBS/SBR PG 76-22" AND FOR NON-POLYMERIZED HMA THE "AC TYPE" SHALL BE "PG 64-22" UNLESS MODIFIED BY RECLAIMED MATERIALS SPECIFICATIONS.

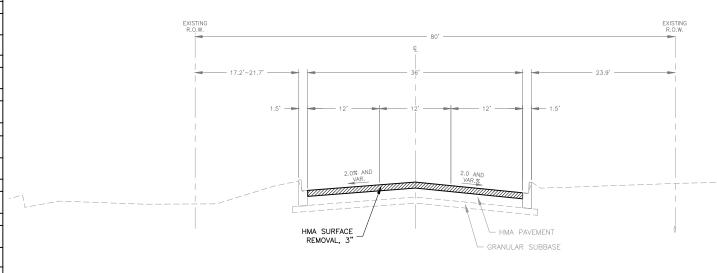

EXISTING TYPICAL SECTION
THREE OAKS ROAD
STA: 103+50 TO STA 108+82.62
NOT TO SCALE

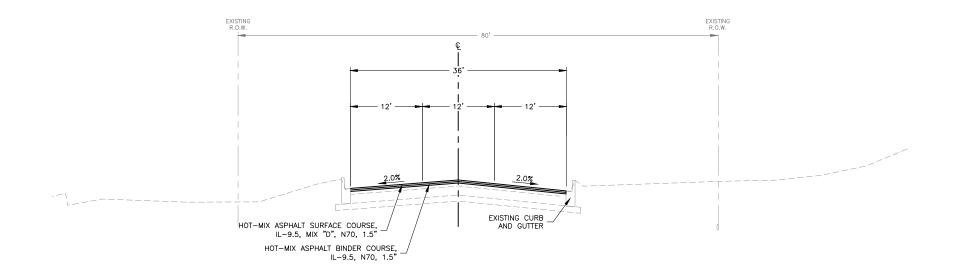

PROPOSED TYPICAL SECTION
THREE OAKS ROAD
STA: 103+50 TO STA 108+82.62
NOT TO SCALE


THE LONGITUDINAL JOINT SEALANT SHALL BE PLACED ON THE HMA BC IL-9.5 N70.

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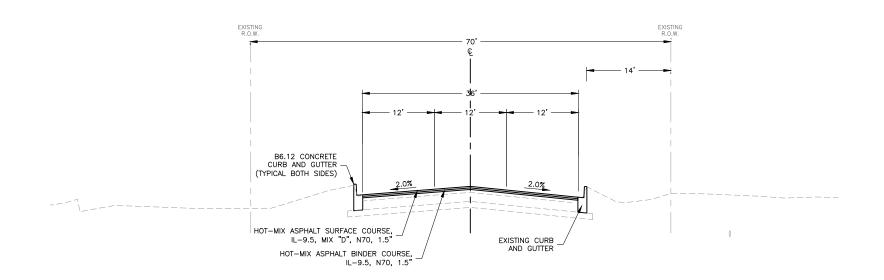
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	DRAWN — BF/YJ	REVISED —
PLOT SCALE = AS NOTED	CHECKED —	REVISED —
PLOT DATE = 2/15/24	DATE - 03/01/23	REVISED —

STAT	E OF	: ILLINOIS
DEPARTMENT	0 F	TRANSPORTATION

	F.A.U RTE.	U. SECTION	COUNTY	TOTAL SHEETS	SHEET NO.
THREE OAKS ROAD TYPICAL SECTION	4051	1 22-00134-00-TL	MCHENRY	129	12
			CONTRACT	L NO 6.	1K35
SCALE: AS NOTED SHEET 12 OF 129 SHEETS STA. TO ST		ILLINOIS FED. AID PROJECT			

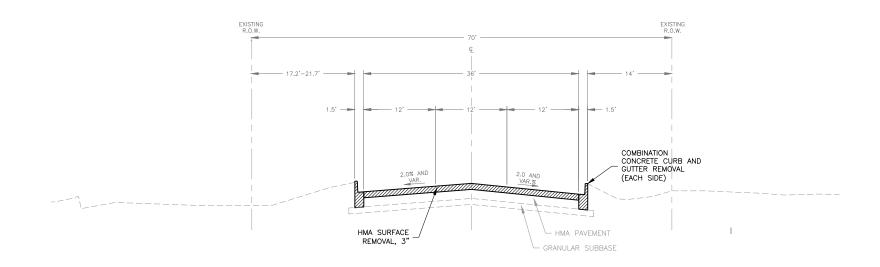

EXISTING TYPICAL SECTION
THREE OAKS ROAD
STA: 108+82.62 TO STA 109+84
NOT TO SCALE



PROPOSED TYPICAL SECTION
THREE OAKS ROAD
STA: 108+82.62 TO STA 109+84
NOT TO SCALE

THE LONGITUDINAL JOINT SEALANT SHALL BE PLACED ON THE HMA BC IL-9.5 N70.

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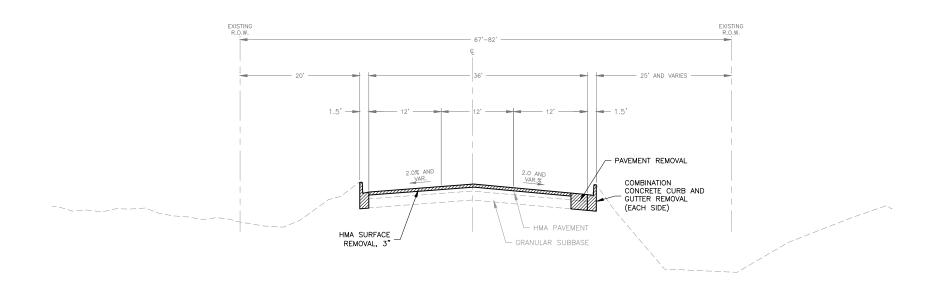
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ILLINOS DESON PRIN NO. 184-003523

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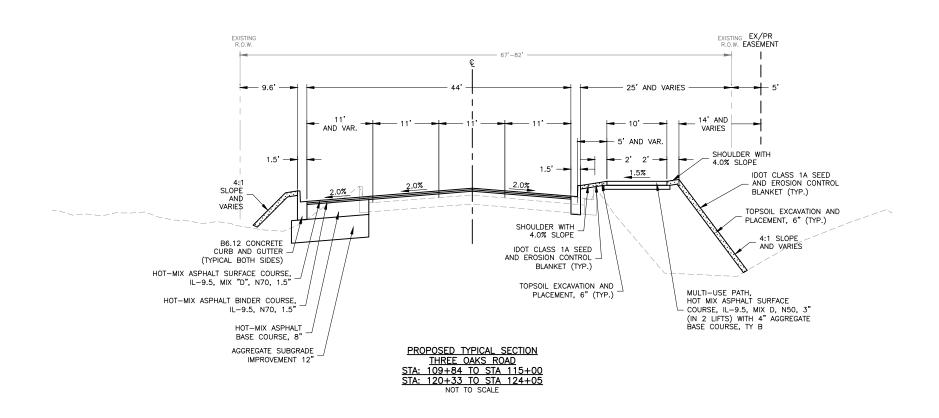
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	DRAWN - BF/YJ	REVISED —
PLOT SCALE = AS NOTED	CHECKED -	REVISED —
PLOT DATE = 2/15/24	DATE - 03/01/23	REVISED —

STATI	E 01	F ILLINOIS
DEPARTMENT	0 F	TRANSPORTATION

THREE OAKS ROAD TYPICAL SECTION							SECTION	COUNTY	TOTAL SHEETS	SHEET NO.
							22-00134-00-TL	MCHENRY	129	13
								CONTRACT	NO 61	K35
SCALE: AS NOTED	SHEET 13	OF	129 SHEETS	STA.	TO STA.		ILLINOIS FED. AID PROJECT			



EXISTING TYPICAL SECTION THREE OAKS ROAD STA: 109+84 TO STA 115+00 STA: 120+33 TO STA 124+05 NOT TO SCALE



THE LONGITUDINAL JOINT SEALANT SHALL BE PLACED ON THE HMA BC IL-9.5 N70.

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ILLINOS DESON PRIN NO. 184-003525


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	DRAWN -	BF/YJ	REVISED —
PLOT SCALE = AS NOTED	CHECKED -		REVISED —
PLOT DATE = 2/15/24	DATE -	03/01/23	REVISED —

STAT	E 01	F ILLINOIS
DEPARTMENT	0 F	TRANSPORTATION

						F.A.U. RTE.	SECTION	COUNTY	TOTAL SHEETS	SHEET NO.
	THREE	DAKS	ROAD TYPI	CAL SECTIO	N	4051	22-00134-00-TL	MCHENRY	129	14
								CONTRACT	NO 61	K35
CALE: AS NOTED	SHEET 14	OF	129 SHEETS	STA.	TO STA.		ILLINOIS FED. A	ID PROJECT		

EXISTING TYPICAL SECTION
THREE OAKS ROAD
STA: 115+00 TO STA 120+33

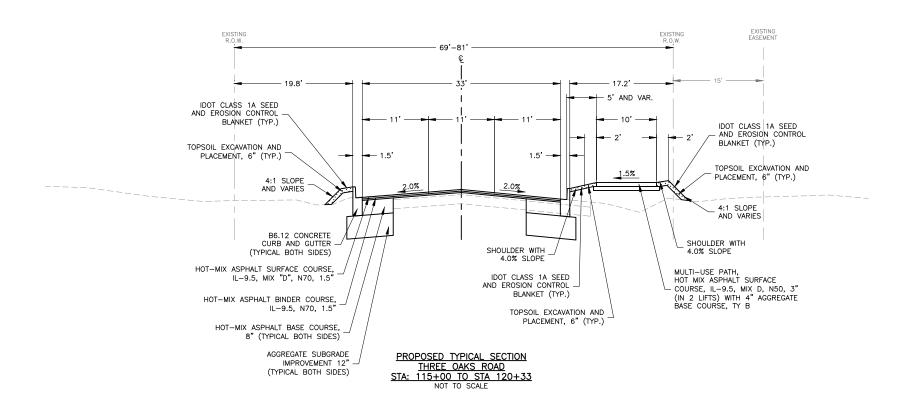

THE LONGITUDINAL JOINT SEALANT SHALL BE PLACED ON THE HMA BC IL-9.5 N70.

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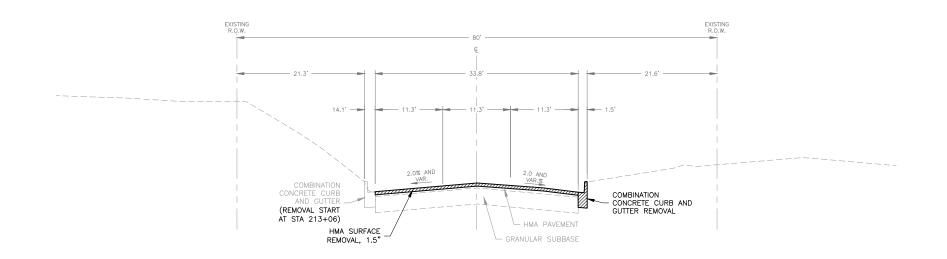
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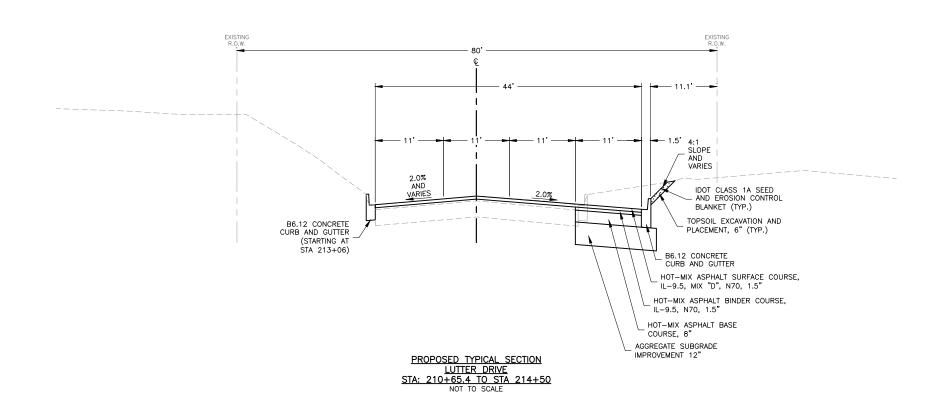
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	DRAWN	_	BF/YJ	REVISED	-
PLOT SCALE = AS NOTED	CHECKED	_		REVISED	-
PLOT DATE = 2/15/24	DATE	_	03/01/23	REVISED	-

STATI	E OF	ILLINOIS
DEPARTMENT	0 F	TRANSPORTATION

						F.A.U. RTE.	SECTION	COUNTY	TOTAL SHEETS	SHEET NO.
	THREE	OAKS	ROAD TYPI	4051	22-00134-00-TL	MCHENRY	129	15		
								CONTRACT	NO 61	K35
SCALE: AS NOTED	SHEET 15	OF	129 SHEETS	STA.	TO STA.		ILLINOIS FED. A	D PROJECT		



EXISTING TYPICAL SECTION LUTTER DRIVE STA: 210+65.4 TO STA 214+50 NOT TO SCALE



THE LONGITUDINAL JOINT SEALANT SHALL BE PLACED ON THE MILLED SURFACE.

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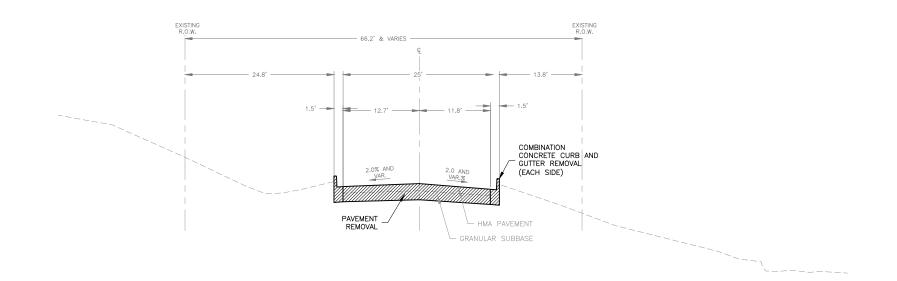
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ILLINGS BESICH FROM NO. 184-003825

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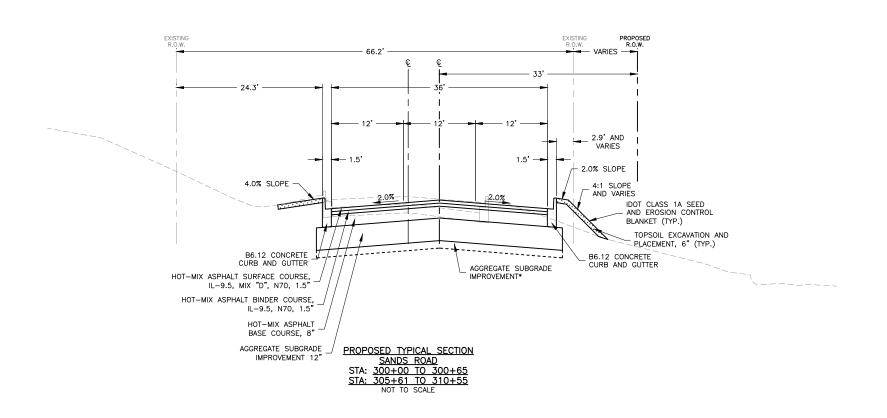
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	DRAWN	_	BF/YJ	REVISED	-
PLOT SCALE = AS NOTED	CHECKED	_		REVISED	-
PLOT DATE = $2/15/24$	DATE	_	03/01/23	REVISED	-

STAT	E 01	F ILLINOIS
DEPARTMENT	0 F	TRANSPORTATION

						F.A.U. RTE.	SECTION	COUNTY	TOTAL SHEETS	SHEET NO.
	LUTT	ER DR	IVE TYPICA	L SECTIO	N	4051	22-00134-00-TL	MCHENRY	129	16
								CONTRACT	NO 61	K35
SCALE: AS NOTED	SHEET 16	OF	129 SHEETS	STA.	TO STA.		ILLINOIS FED. AI	D PROJECT		



EXISTING TYPICAL SECTION
SANDS ROAD
STA: 300+00 TO 300+65
STA: 305+61 TO 310+55
NOT TO SCALE



THE LONGITUDINAL JOINT SEALANT SHALL BE PLACED ON THE HMA BC IL $-9.5\,$ N70.

*AGGREGATE SUBGRADE IMPROVEMENT STATION 300+00 TO 300+65 STATION 305+61 TO 307+25

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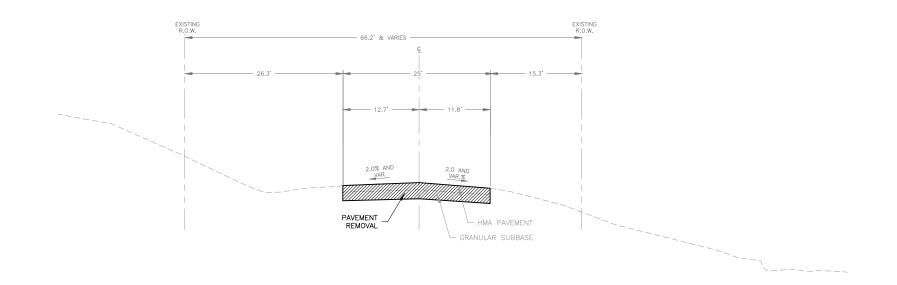
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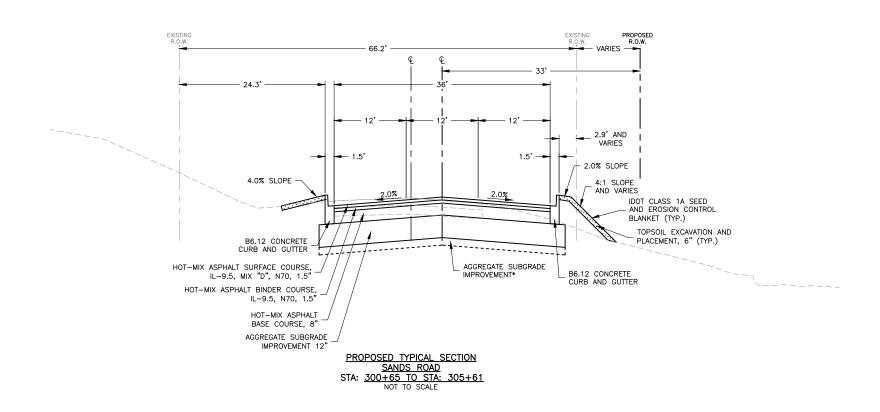
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	DRAWN - BF/Y	REVISED —
PLOT SCALE = AS NOTED	CHECKED -	REVISED —
PLOT DATE = 2/15/24	DATE - 03/01	/23 REVISED —

STATE OF ILLINOIS DEPARTMENT OF TRANSPORTATION

			F.A.U. RTE.	SECTION	COUNTY	TOTAL SHEETS	SHEET NO.
SANDS ROAD TYPICA	L SECTION		4051	22-00134-00-TL	MCHENRY	129	17
					CONTRACT	NO 61	K35
SCALE: AS NOTED SHEET 17 OF 129 SHEETS		ILLINOIS FED. A	D PROJECT				



EXISTING TYPICAL SECTION
SANDS ROAD
STA: 300+65 TO STA: 305+61
NOT TO SCALE



THE LONGITUDINAL JOINT SEALANT SHALL BE PLACED ON THE HMA BC IL-9.5 N70.

*AGGREGATE SUBGRADE IMPROVEMENT STATION 300+00 TO 300+65 STATION 305+61 TO 307+25

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ILLINOS DESON FRIN IN. 1847-030323

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USER NA	ME =BF/YJ	DESIGNED	_	VL	REVISED	_
		DRAWN	_	BF/YJ	REVISED	-
PLOT SC	ALE = AS NOTED	CHECKED	_		REVISED	-
PLOT DA	TE = 2/15/24	DATE	_	03/01/23	REVISED	-

STATE OF ILLINOIS DEPARTMENT OF TRANSPORTATION

	OAND		AD TVDICAL	OFOTION		F. <i>E</i> RT	A.U. TE.	SECTION		SHEETS	SHEET NO.
	SANL	12 KU	AD TYPICAI	. SECTION		40	051	22-00134-00-TL	MCHENRY	129	18
									CONTRACT	NO 61	K35
CALE: AS NOTED	SHEET 18	OF	129 SHEETS	STA.	TO STA.			ILLINOIS FED. AI	D PROJECT		

SCHEDULE OF QUANTITIES

	PAVING													
STATION	STATION	HOT-MIX ASPHALT BINDER COURSE, IL-9.5, N70 (TON)	HOT-MIX ASPHALT SURFACE COURSE, IL-9.5, MIX "D", N50 (TON)	HOT-MIX ASPHALT SURFACE COURSE, IL-9.5, MIX "D", N70 (TON)	COMBINATION CONCRETE CURB AND GUTTER, TYPE B-6.12 (FOOT)		BITUMINOUS MATERIALS (TACK COAT) (POUND)	LONGITUDINAL JOINT SEALANT (FOOT)	HOT-MIX ASPHALT BASE COURSE, 8" (SQ YD)	AGGREGATE SUBGRADE IMPROVEMENT (CU YD)	AGGREGATE SUBGRADE IMPROVEMENT 12" (SQ YD)	AGGREGATE BASE COURSE, TYPE B 4" (SQ YD)	PORTLAND CEMENT CONCRETE SIDEWALK 5 INCH (SQ FT)	DETECTABLE WARNINGS (SQ FT)
103+50	125+50	712	95	712	2742	2617	3893	4110	1163	97	1163	1416	1417	209
210+65	214+50	31	0	172	447	955	975	710	425	36	425	0	0	0
300+00	310+55	410	0	410	2057	10434	3131	2048	4638	920	4638	0	0	0
400+45	401+75	29	0	29	206	747	224	81	332	28	332	0	0	0
500+45	501+75	26	0	26	199	647	194	77	288	24	288	0	0	0
TO	TAL	1208	95	1349	5651	15400	8417	7026	6846	1105	6846	1416	1417	209

г							
	STATION	STATION	HOT-MIX ASPHALT SURFACE REMOVAL, 1 1/2" (SQ YD) HOT-MIX ASPHALT SURFACE REMOVAL, 3" (SQ YD)		DRIVEWAY PAVEMENT REMOVAL (SQ YD)	COMBINATION CURB AND GUTTER REMOVAL (FOOT)	PAVEMENT REMOVAL (SQ YD)
	103+50	125+50	0	6975	107	1815	70
	210+65	214+50	1530	0	42	441	0
	300+00	310+55	0	0	213	1172	5416
	500+45	501+75	0	0	0	124	0
Ī	TOTAL		1530	6975	362	3552	5486

		CLASS D PATCHES		
STATION	STATION	CLASS D PATCHES, TYPE II, 8 INCH (SQ YD)	CLASS D PATCHES, TYPE III, 8 INCH (SQ YD)	CLASS D PATCHES, TYPE IV, 8 INCH (SQ YD)
103+50	103+50 125+50		65	43
TOTAL		TOTAL 59		43

THERM	THERMOPLASTIC PAVEMENT MARKING - LETTER					
STATION	STATION	TYPE	AREA (SQ FT)			
103+50	125+50	TURN ARROW	109.2			
103+51	125+51	ONLY	145.6			
210+65	214+50	TURN ARROW	31.2			
210+66	214+51	ONLY	41.6			
300+00	310+55	TURN ARROW	109.2			
300+01	310+56	ONLY	20.8			
	TOTAL					

THERMOPLASTIC PAVEMENT MARKING - LINE 4"							
STATION	STATION	TYPE	LENGTH (FOOT)				
103+50	125+50	DOUBLE YELLOW	5330				
210+65	214+50	DOUBLE YELLOW	1141				
300+00	310+55	DOUBLE YELLOW	2255				
300+00	310+55	10'/30' DASH	324				
400+45	401+75	DOUBLE YELLOW	115				
500+45	501+75	DOUBLE YELLOW	109				
	9274						

	THERMOPLASTIC PAVEMENT MARKING - LINE 6"						
STATION	STATION	TYPE	LENGTH (FOOT)				
103+50	125+50	SOLID WHITE	933				
103+51	125+51	2'/6' DASH	290				
210+65	214+50	CROSSWALK	135				
210+65	214+50	SOLID WHITE	260				
210+66	214+51	2'/6' DASH	98				
300+00	310+55	SOLID WHITE	125				
300+01	310+56	2'/6' DASH	43				
400+45	401+75	CROSSWALK	111				
500+45	501+75	CROSSWALK	104				
	TOTAL						

THERMOPLASTIC PAVEMENT MARKING - LINE 12"						
STATION	STATION	TYPE	LENGTH (FOOT)			
103+50	125+50	CROSSWALK	80			
103+50	125+50	CROSSWALK	100			
210+65	214+50	SOLID YELLOW	474			
210+66	214+51	CROSSWALK	223			
300+00	310+55	SOLID YELLOW	59			
300+01	310+56	CROSSWALK	75			
400+45	401+75	CROSSWALK	176			
500+45	501+75	CROSSWALK	164			
	1351					

THERMOPLASTIC PAVEMENT MARKING - LINE 24"							
STATION STATION TYPE LENGTH (FOOT)							
103+50	125+50	STOP BAR	58				
210+65	214+50	STOP BAR	36				
300+00	310+55	STOP BAR	24				
400+45	401+75	STOP BAR	18				
500+45	501+75	STOP BAR	15				
	151						

USER NAME =BF/YJ	DESIGNED — VL	REVISED —
	DRAWN — BF/YJ	REVISED —
PLOT SCALE = AS NOTED	CHECKED —	REVISED —
PLOT DATE = 3/8/24	DATE - 03/01/23	REVISED —

SCHEDULE OF QUANTITIES					F.A RTI		SECTION		SHEETS	SHEET NO.	
SUIEDULE OF QUANTITIES						40)51	22-00134-00-TL	MCHENRY CONTRACT	129 NO 61	19
SCALE: AS NOTED	SHEET 19	OF	129 SHEETS	STA.	TO STA.			ILLINOIS FED. AI		NO 6	IKJS

EARTH WORK SCHEDULE

CONTR #: 61K35


	EARTH	ROCK	EARTH	ROCK		EARTH BALANCE		REM & DISP	TOPSOIL	TOPSOIL
	EXCAVATION	EXCAVATION	EXCAVATION	EXCAVATION	EMBANKMENT	WASTE (+)	FURNISHED	UNSUITABLE	EXCAVATION	FURNISH
LOCATION	(CUT)	(CUT)	ADJUSTED FOR	ADJUSTED FOR	(FILL)	OR	EXCAVATION	MATERIAL	& PLACEMENT	& PLACE, 4"
	20200100*	20200200*	SHRINKAGE	SWELL		SHORTAGE (-)	20400800*	20201200	21101505	21101615
	CU YD	CU YD	15%	10%	CU YD	CU YD	CU YD	CU YD	CU YD	SQ YD
Pre-Stage										
Three Oaks Road										
103+50 - 125+50	0	0	0	0	0	0				
Lutter Drive										
210+65 - 214+50	0	0	0	0	0	0				
Sands Road										
300+00 - 310+55	0	0	0	0	0	0				
Earth Balance Pre-Stage						0	0			
Stage 1										
Three Oaks Road										
103+50 - 125+50	659	0	560	0	252	308			2888	
Sands Road										
300+00 - 310+55	1532	0	1302	0	216	1086			2723	
Earth Balance Stage 1						1394	0			
Stage 2										
Three Oaks Road										
103+50 - 125+50	1797	0	1527	0	639	888			4039	
Earth Balance Stage 2						888	0			
TOTAL	3988	0	3390	0	1107	4566	0	0	9650	0

(C3D\22\22		
MODEL: FILE NAME: G: \	FEHR GRAHAM ENGINEERING & ENVIRONMENTAL LIJANG DESKH FINE NO. 184-003029 © 2024 FEHR GRAHAM	

USER NAME =BF/YJ	DESIGNED — VL	REVISED —
	DRAWN — BF/YJ	REVISED —
PLOT SCALE = AS NOTED	CHECKED —	REVISED —
PLOT DATE = 2/15/24	DATE 03/01/23	REVISED _

STATI	E OF	ILLINOIS
DEPARTMENT	OF	TRANSPORTATION

			F.A.U. RTE.	SECTION	COUNTY	TOTAL SHEETS	SHEET NO.
EARTHWORK SC	4051	22-00134-00-TL	MCHENRY	129	20		
					CONTRACT	NO 61	K35
SCALE: AS NOTED SHEET 20 OF 129 SHEET	S STA.	TO STA.		ILLINOIS FED. AID PROJECT			

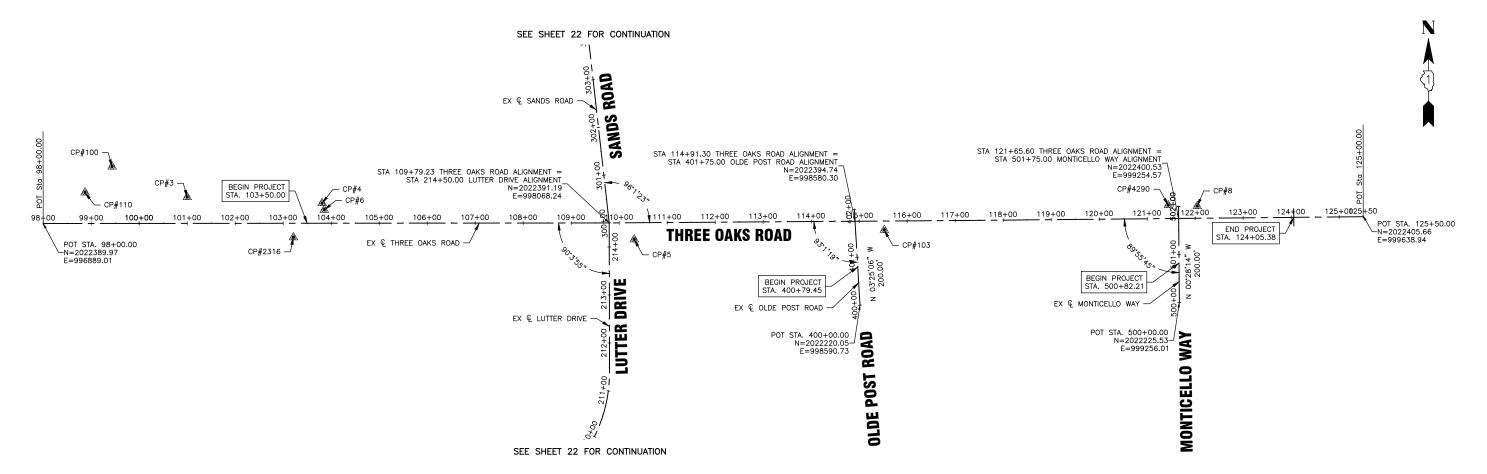

CONTROL POINT	DESCRIPTION	STATION	OFFSET	ELEV
CP#3	FND 5/8 REBAR	101+00.17	-54.47	912.58
CP#4	5/8" REBAR	103+81.10	-41.63	911.90
CP#5	CAPPED REBAR	110+31.11	34.82	906.22
CP#6	GPS CTR PNT	103+85.54	-27.74	910.10
CP#8	CP#8 CAPPED REBAR		-25.23	905.71
CP#100	CHISELED "X" IN BOC	99+43.69	-118.37	912.51
CP#103	2" MAG NAIL	115+52.07	18.71	899.66
CP#110	IDOT DISK 035-2848	98+87.36	-64.38	910.22
CP#2316	RAILROAD SPIKE	103+21.27	29.44	909.95
CP#4290	BOLT IN MUELLER	121+44.12	-27.71	907.44

NOTES:

1. SHOULD BENCHMARKS, MONUMENTS, OR CONTROL POINTS BE DESTROYED, THE CONTRACTOR SHALL BE RESPONSIBLE FOR THEIR RE-ESTABLISHMENT, WHICH SHALL BE INCLUDED IN THE LUMP SUM CONTRACT COST FOR CONSTRUCTION LAYOUT.




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USER NAME =BF/YJ	DESIGNED — VL	REVISED —
	DRAWN — BF/YJ	REVISED —
PLOT SCALE = AS NOTED	CHECKED —	REVISED —
PLOT DATE = 2/15/24	DATE - 03/01/23	REVISED —

STATE OF	: ILLINOIS
DEPARTMENT OF	TRANSPORTATION

ALIONMENT TIPS AND DENOUMABLES							A.U. TE.	SECTION	COUNTY	TOTAL SHEETS	SHEET NO.
							051	22-00134-00-TL	MCHENRY	129	21
									CONTRACT	NO 61	K35
SCALE: AS NOTED	SHEET 21	OF	129 SHEETS	STA.	TO STA.			ILLINOIS FED. AID	D PROJECT		

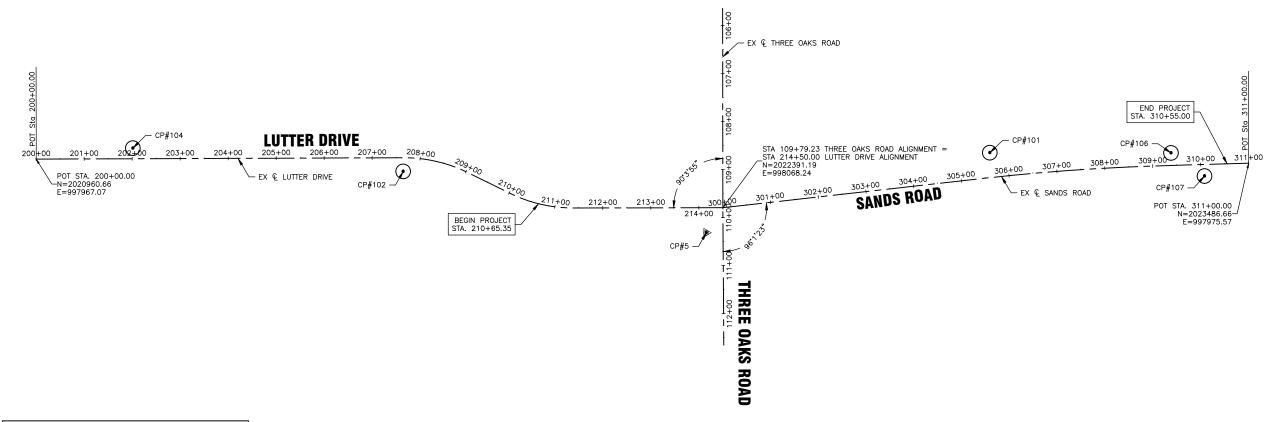

MONUMENTS SUMMARY										
CONTROL POINT	DESCRIPTION	STATION	OFFSET	ELEV						
CP#5	CAPPED REBAR	110+31.11	34.82	906.22						
CP#101	CAPPED REBAR	305+65.30	-51.71	911.15						
CP#102	CAPPED REBAR	207+64.56	28.44	899.08						
CP#104	CAPPED REBAR	202+01.57	-22.06	883.78						
CP#106	CAPPED REBAR	309+39.04	-26.06	896.77						
CP#107	CAPPED REBAR	310+07.28	24.16	891.90						

NOTES:


1. SHOULD BENCHMARKS, MONUMENTS, OR CONTROL POINTS BE DESTROYED, THE CONTRACTOR SHALL BE RESPONSIBLE FOR THEIR RE-ESTABLISHMENT, WHICH SHALL BE INCLUDED IN THE LUMP SUM CONTRACT COST FOR CONSTRUCTION LAYOUT.




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USER NA	ME =BF/YJ	DESIGNED	_	VL	REVISED	_
		DRAWN	_	BF/YJ	REVISED	-
PLOT SC	ALE = AS NOTED	CHECKED	_		REVISED	-
PLOT DA	TE = 2/15/24	DATE	_	03/01/23	REVISED	-


F. R							F.A.U. RTE.	SECTION	COUNTY	TOTAL SHEETS	SHEET NO.
	ALIGNMENT, TIES AND BENCHMARKS						4051	22-00134-00-TL	MCHENRY	129	22
									CONTRAC	T NO 61	1K35
SCALE: AS NOTED	SHEET 22	OF	129 SHEETS	STA.	TO STA.		ILLINOIS FED. AID PROJECT				

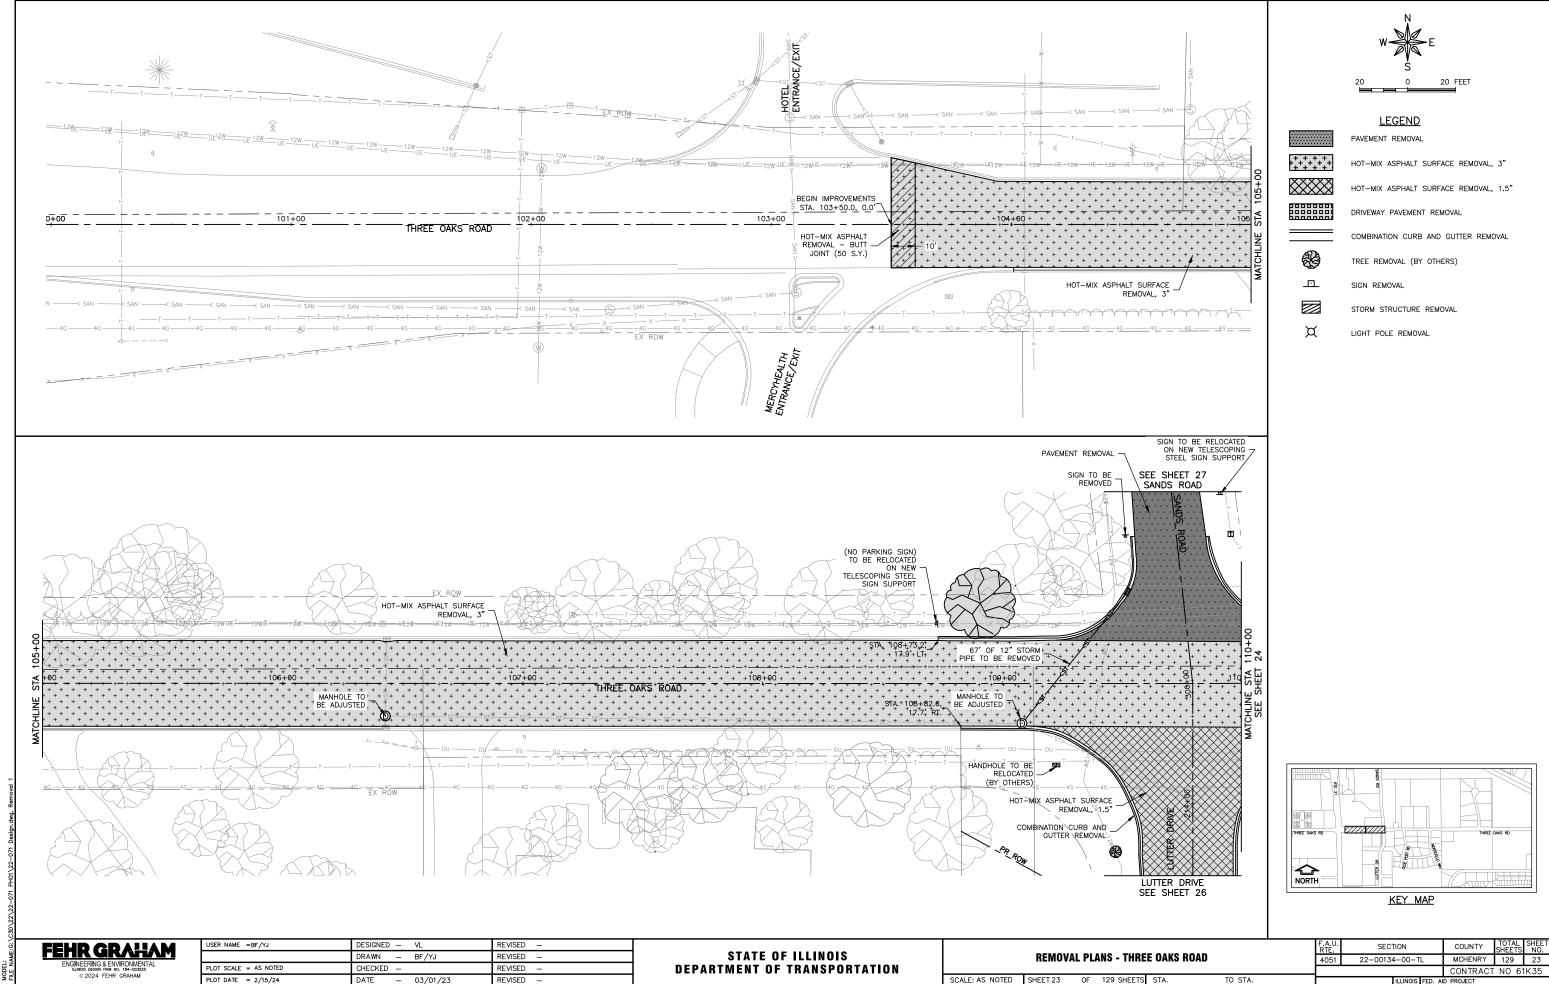

MODEL:

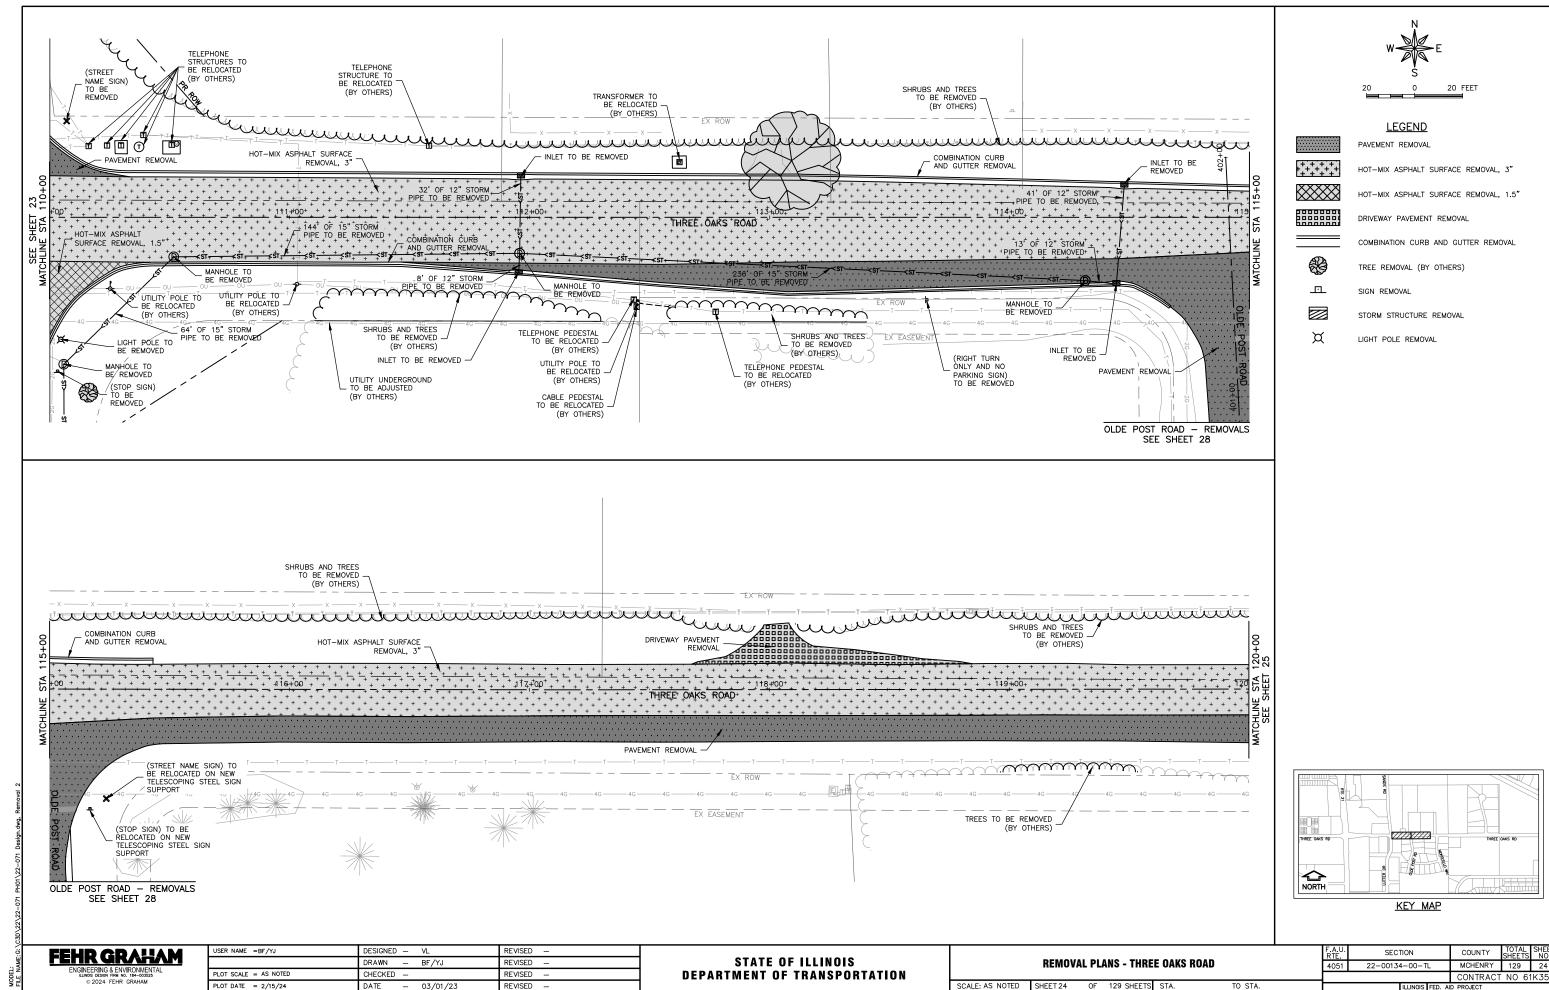

F.A.U. RTE.	SECTION	COUNTY	TOTAL SHEETS	SHEE NO.					
4051	22-00134-00-TL	MCHENRY	129	24					
CONTRACT NO 61K35									
ILLINOIS FED. AID PROJECT									

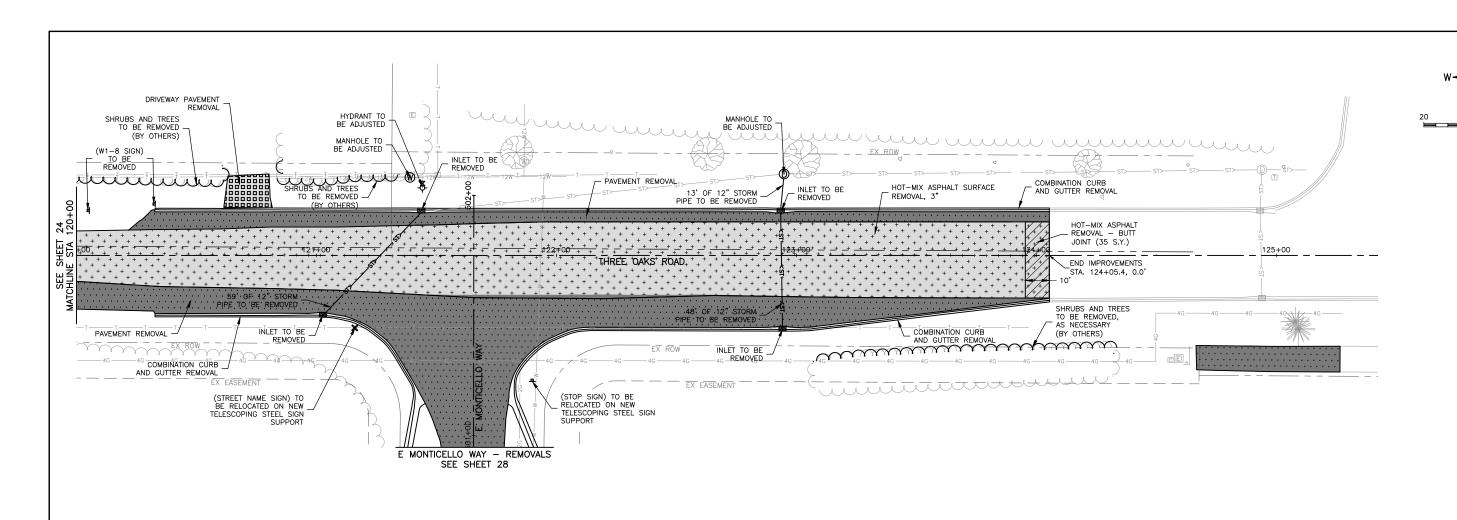



++++++

HOT-MIX ASPHALT SURFACE REMOVAL, 3"

HOT-MIX ASPHALT SURFACE REMOVAL, 1.5"

20 FEET



DRIVEWAY PAVEMENT REMOVAL

COMBINATION CURB AND GUTTER REMOVAL

TREE REMOVAL (BY OTHERS)

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SIGN REMOVAL

STORM STRUCTURE REMOVAL

LIGHT POLE REMOVAL



KEY MAP

FEHR GRALIAM


ENGINEERING & ENVIRONMENTAL
ILLINGS DESON FIRM NO. 184-00325


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	DRAWN -	_	BF/YJ	REVISED —
PLOT SCALE = AS NOTED	CHECKED -	_		REVISED —
PLOT DATE = 2/15/24	DATE -	-	03/01/23	REVISED —

STATI	: O F	FILLINOIS
DEPARTMENT	0 F	TRANSPORTATION

	REMOV	AL PLA	ANS - THRE	E OAKS ROAD	
SCALE: AS NOTED	SHEET 25	OF	129 SHEETS	STA.	TO STA.

F.A.U. RTE.	SECTION	COUNTY	TOTAL SHEETS	SHEET NO.		
4051	22-00134-00-TL	MCHENRY	129	25		
		CONTRACT NO 61K35				
ILLINOIS FED. AID PROJECT						

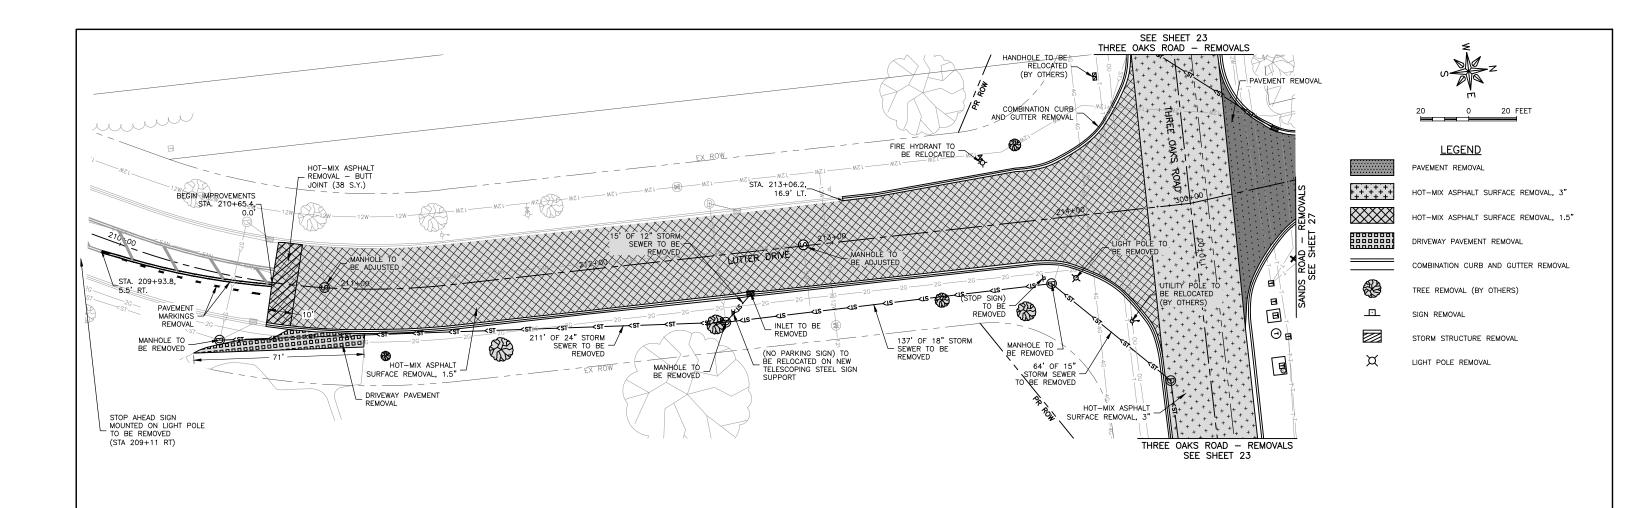

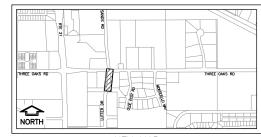

KEY MAP


EHR GRAHAM
ENGINEERING & ENVIRONMENTAL ILLINOIS DESIGN FIRM NO. 184-003525
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USER NAME =BF/YJ	DESIGNED — VL	REVISED —
	DRAWN - BF/YJ	REVISED —
PLOT SCALE = AS NOTED	CHECKED —	REVISED —
PLOT DATE = 2/15/24	DATE - 03/01/23	REVISED —

STATE OF	FILLINOIS
DEPARTMENT OF	TRANSPORTATION

REMOVAL PLANS - LUTTER DRIVE						
SCALE: AS NOTED	SHEET 26	OF	129 SHEETS	STA.	TO STA.	

F.A.U. SECTION		COUNTY	TOTAL SHEETS	SHEET NO.		
4051	4051 22-00134-00-TL		MCHENRY	129	26	
			CONTRACT	NO 61	IK35	
ILLINOIS FED. AI				D PROJECT		

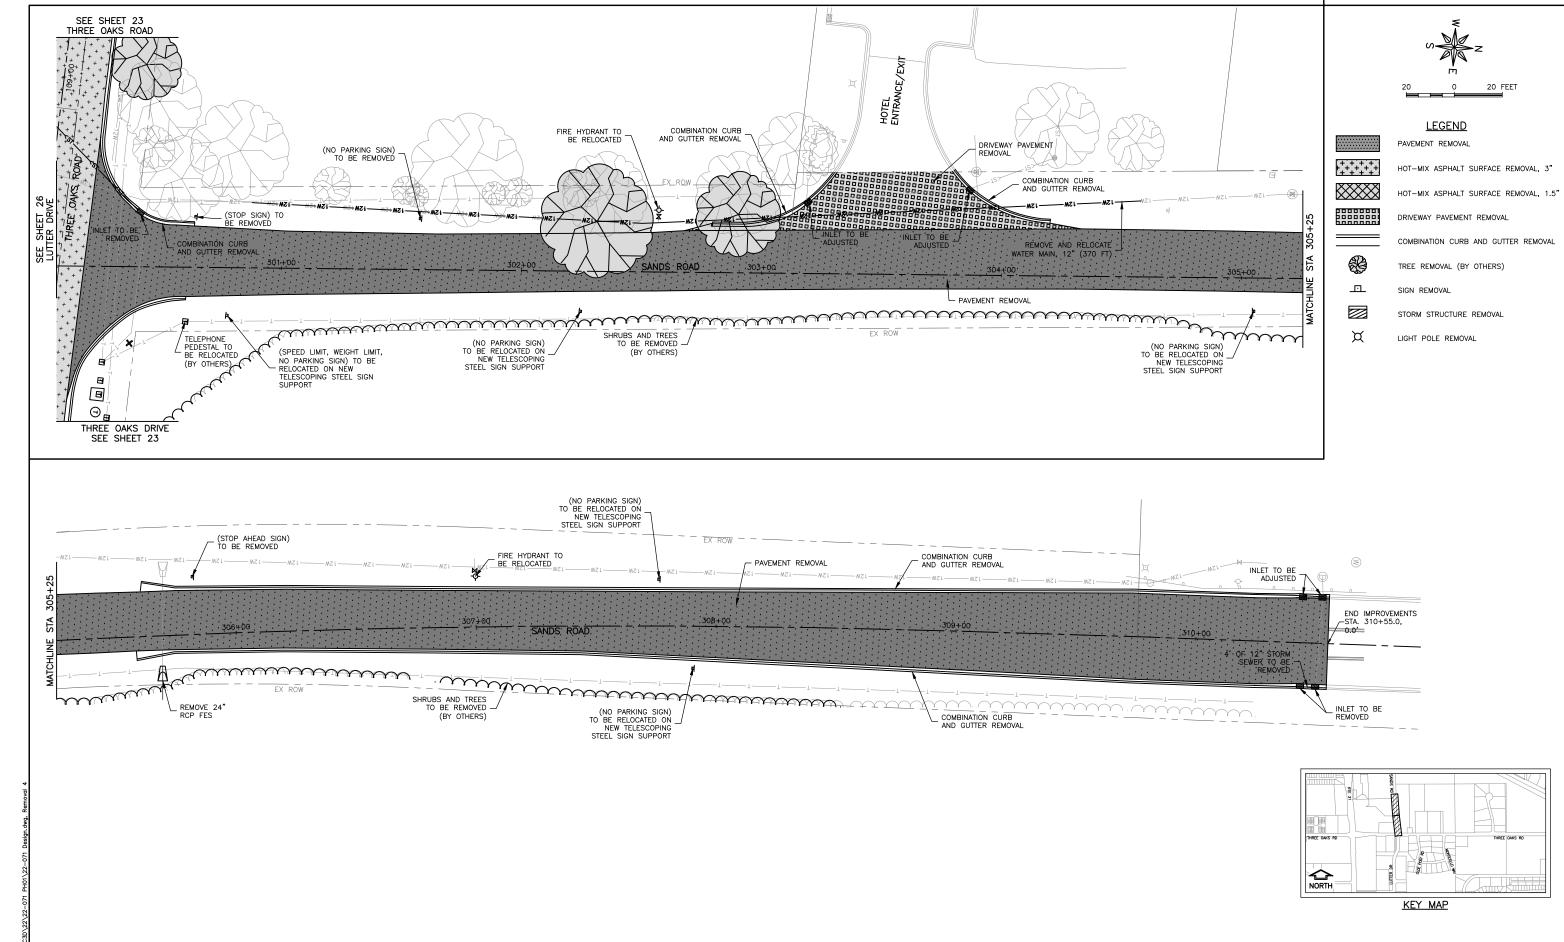


FEHR GRAHAM

JSER NAME =BF/YJ DESIGNED - VL REVISED -DRAWN BF/YJ REVISED -PLOT SCALE = AS NOTED CHECKED REVISED PLOT DATE = 2/15/24 DATE REVISED - 03/01/23

STATE OF ILLINOIS DEPARTMENT OF TRANSPORTATION

REMOVAL PLANS - SANDS ROAD SCALE: AS NOTED SHEET 27 OF 129 SHEETS STA. TO STA.

SECTION COUNTY TOTAL SHEET NO. MCHENRY 129 27 22-00134-00-TL 4051 CONTRACT NO 61K35 ILLINOIS FED. AID PROJECT

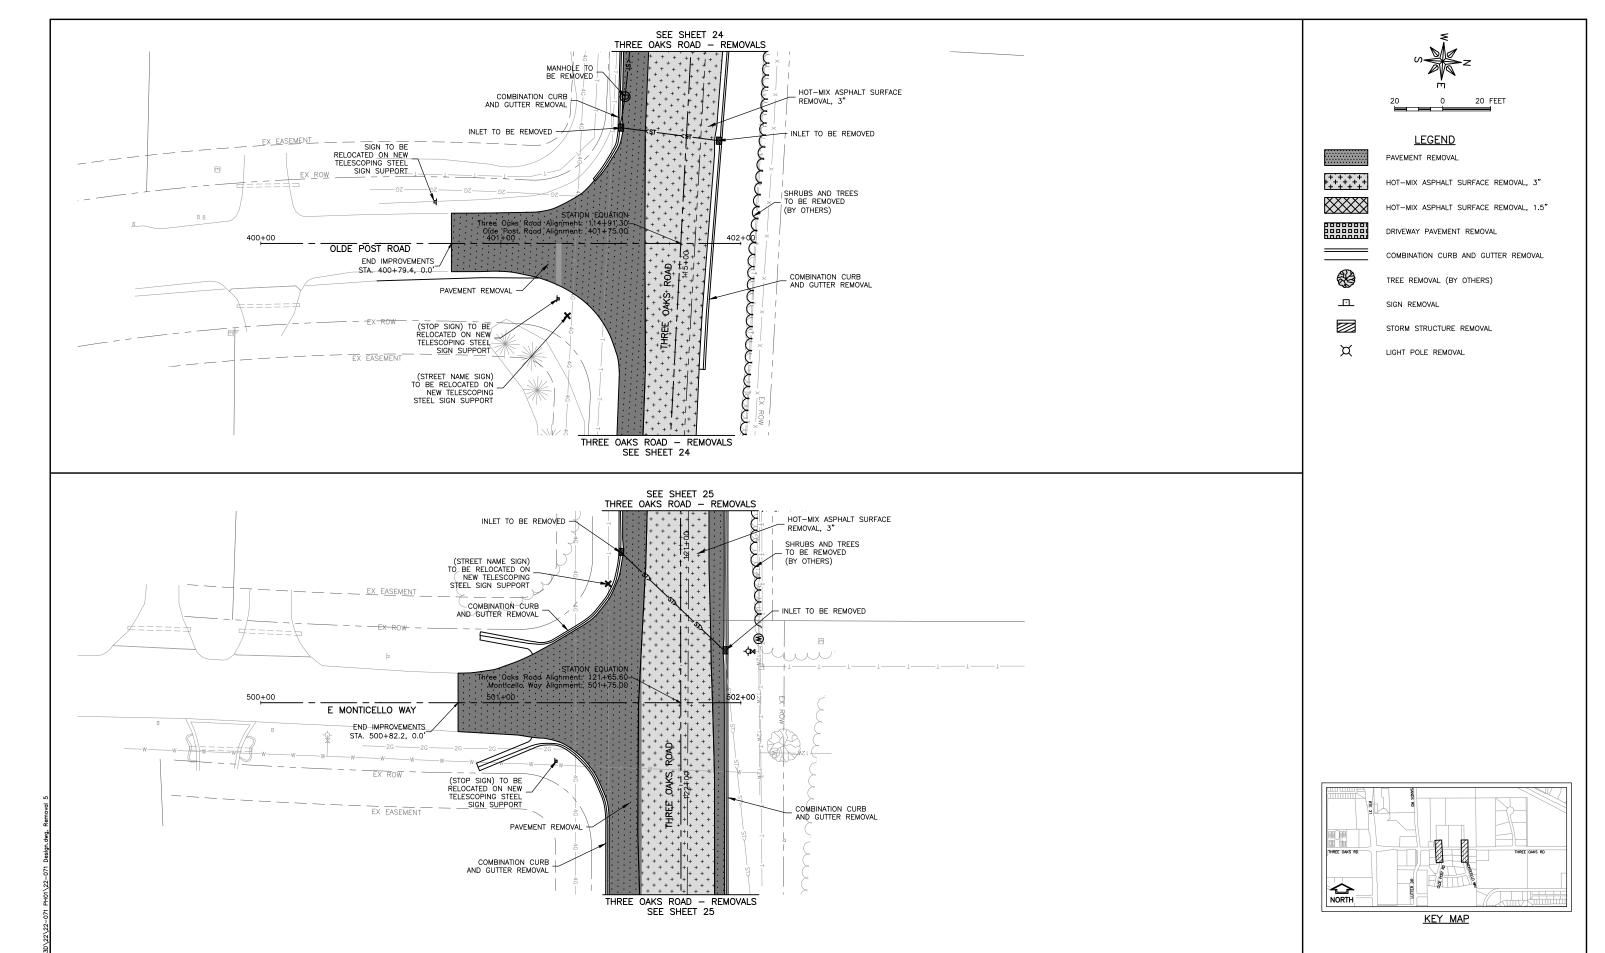

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ENGINEERING & ENVIRONMENTAL
ILINOS DESON FRM NO. 164-003525


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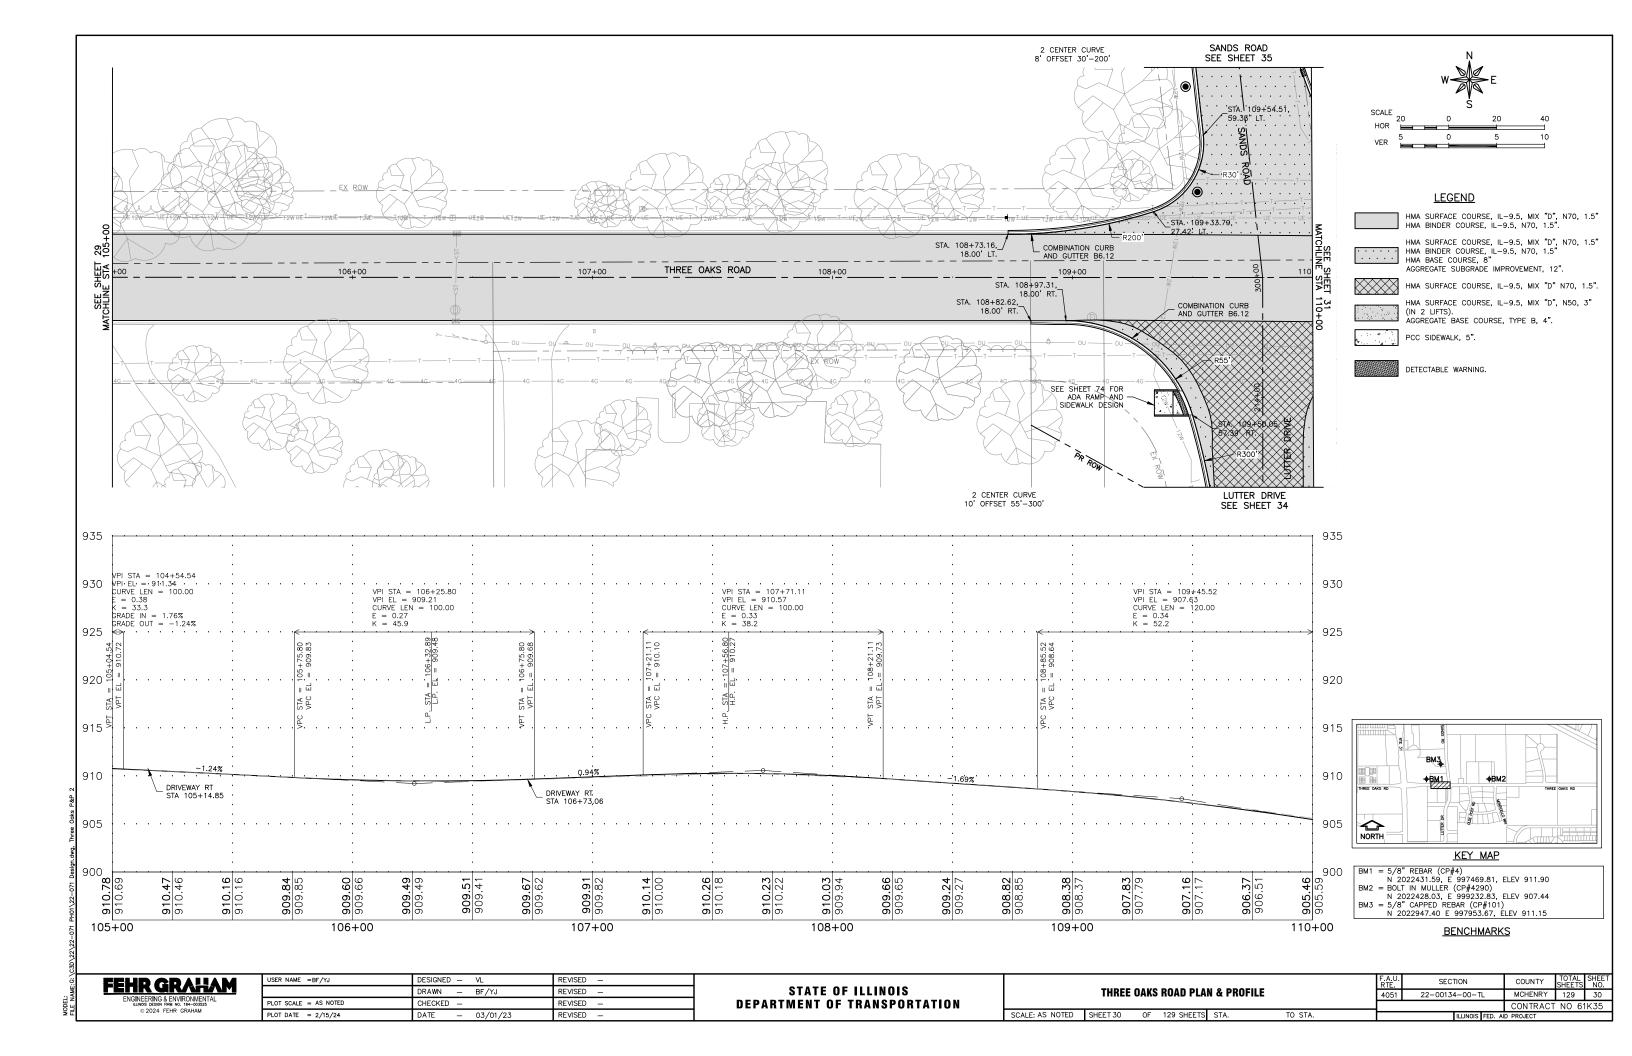
STATE OF ILLINOIS DEPARTMENT OF TRANSPORTATION


REMOVAL PLANS - OLDE POST ROAD AND MONTICELLO WAY


SCALE: AS NOTED SHEET 28 OF 129 SHEETS STA. TO STA.


	F.A.U. RTE.				COUNTY	TOTAL SHEETS	SHEET NO.
	4051	4051 22-00134-00-TL			MCHENRY	129	28
					CONTRACT	NO 61	K35
		ILLINOIS F	ED. /	٩I[PROJECT		




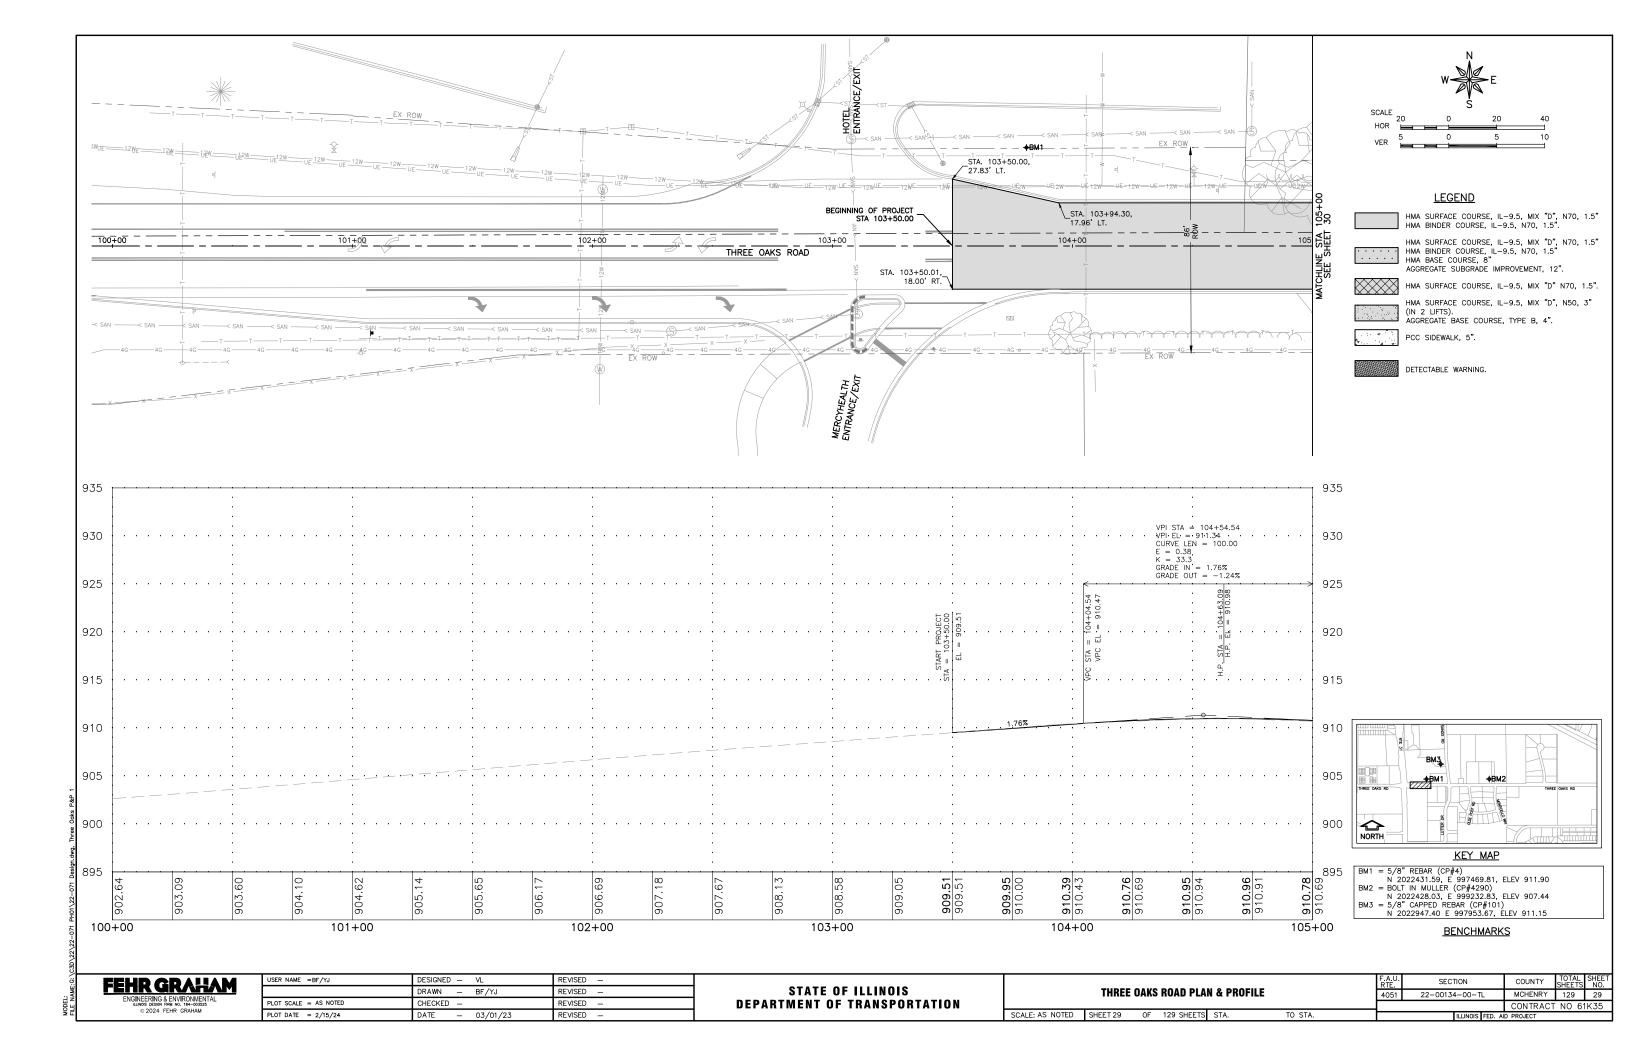


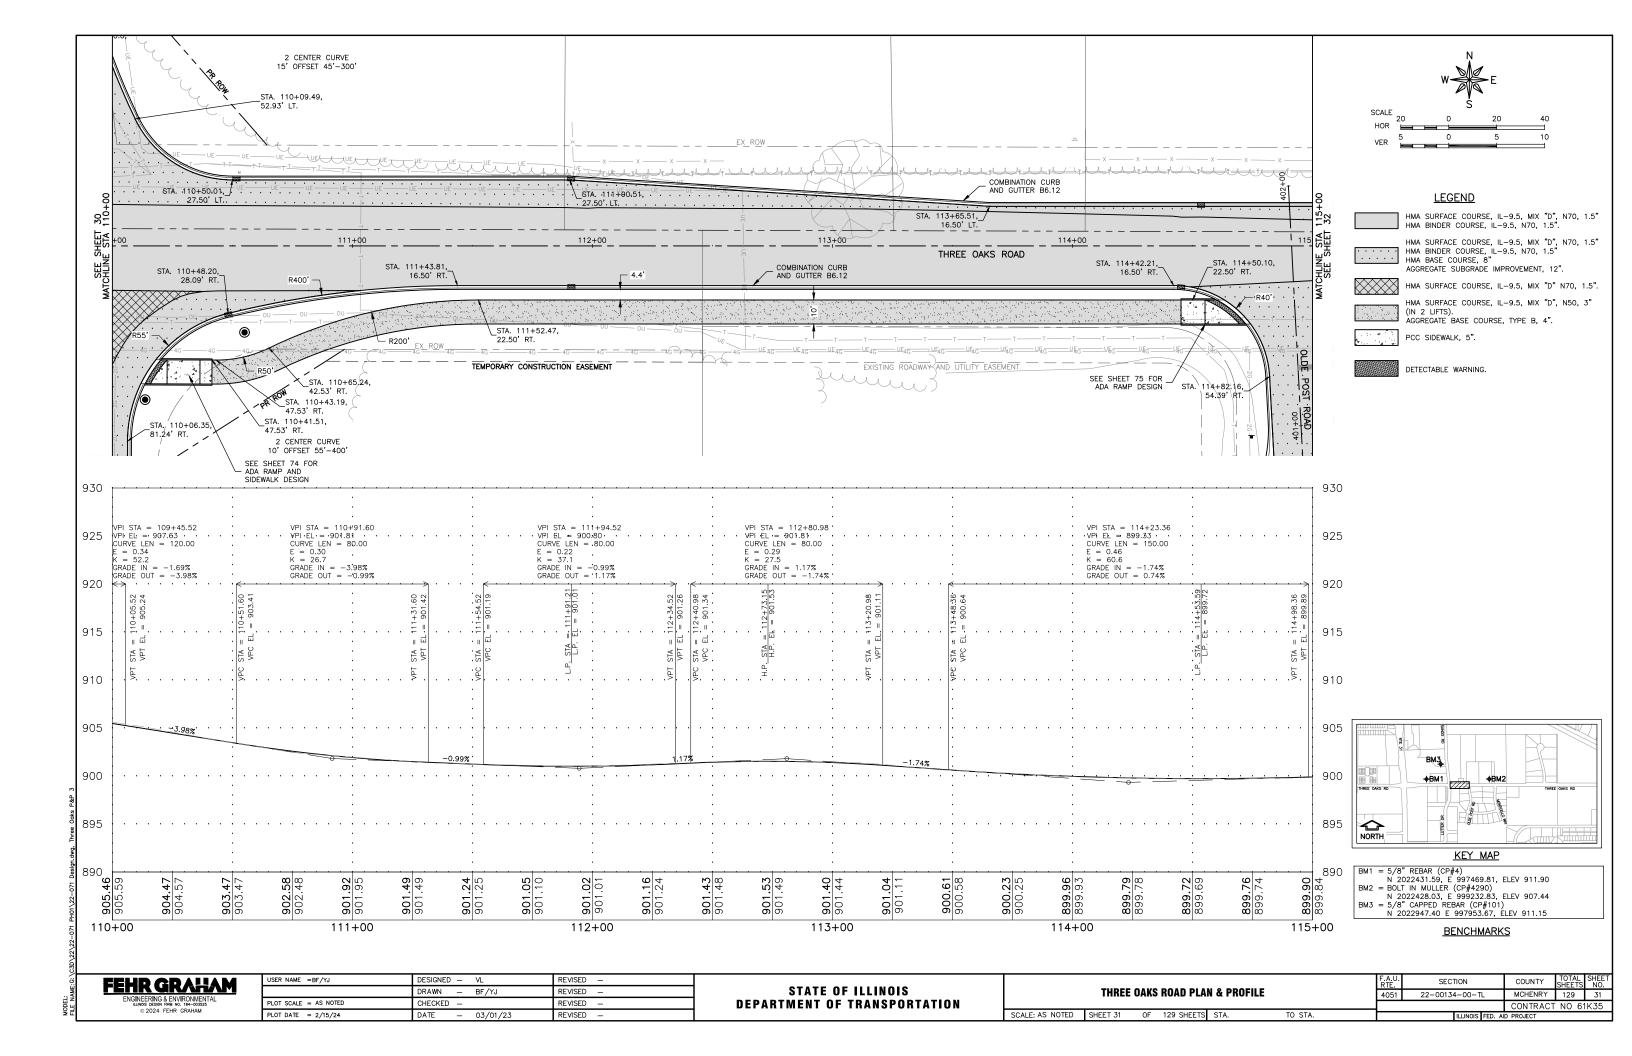

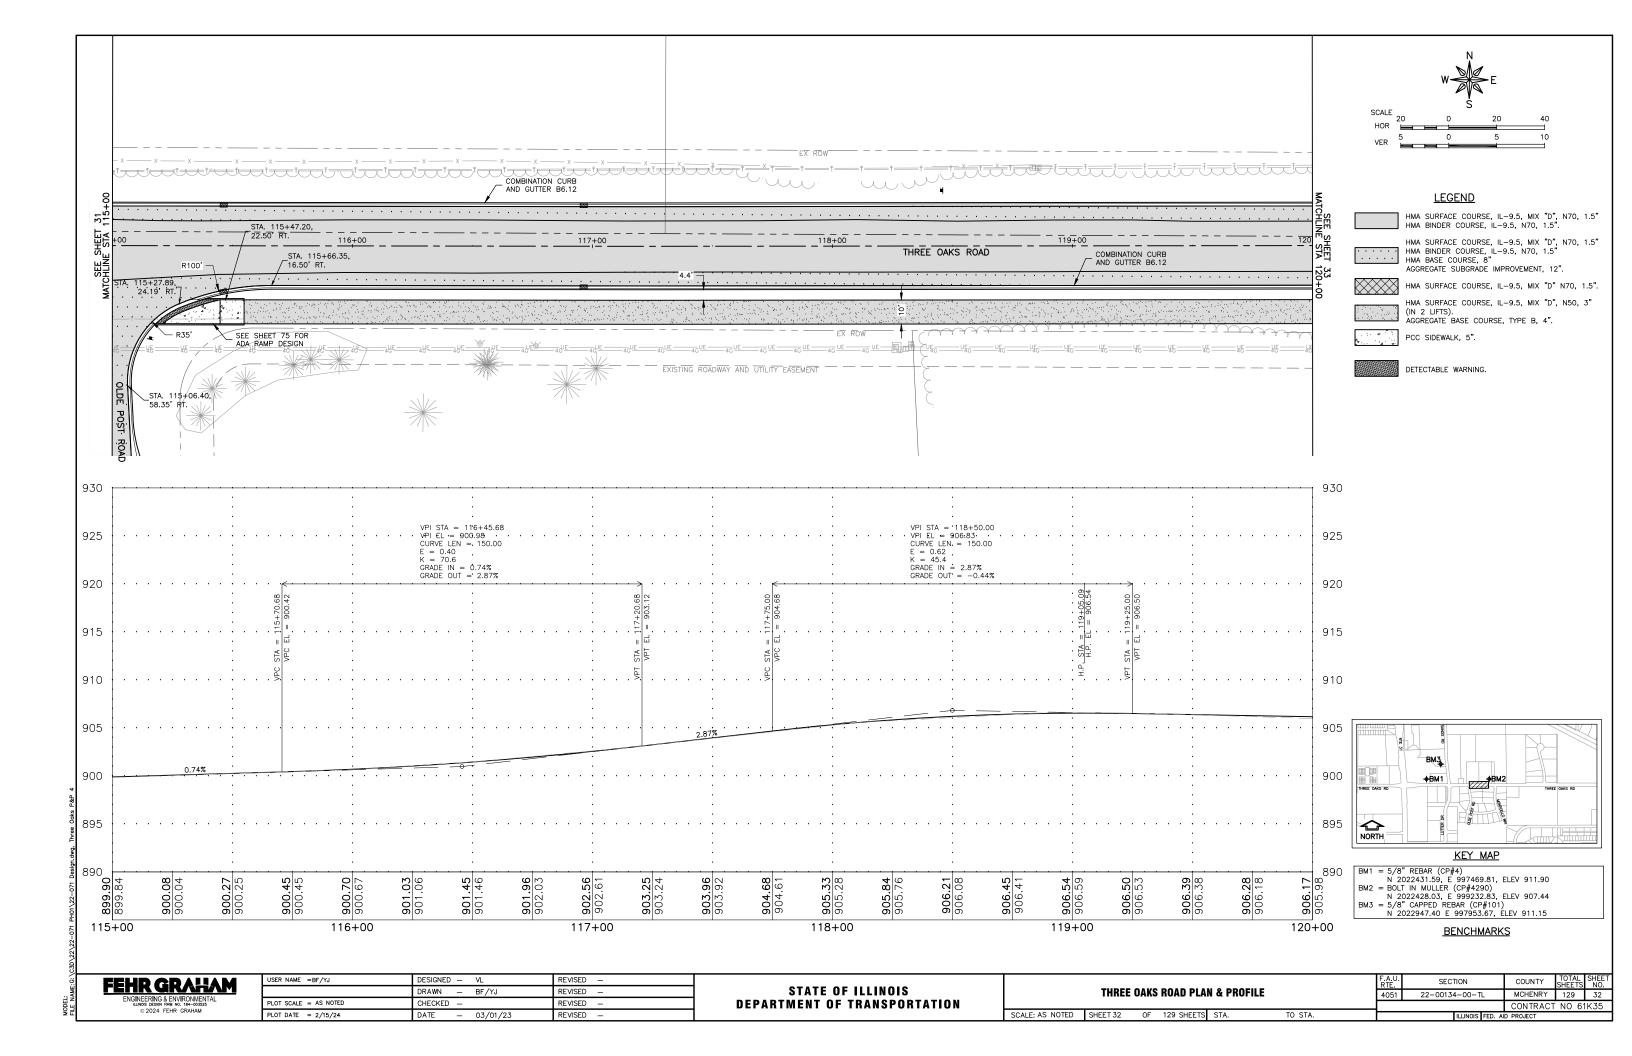

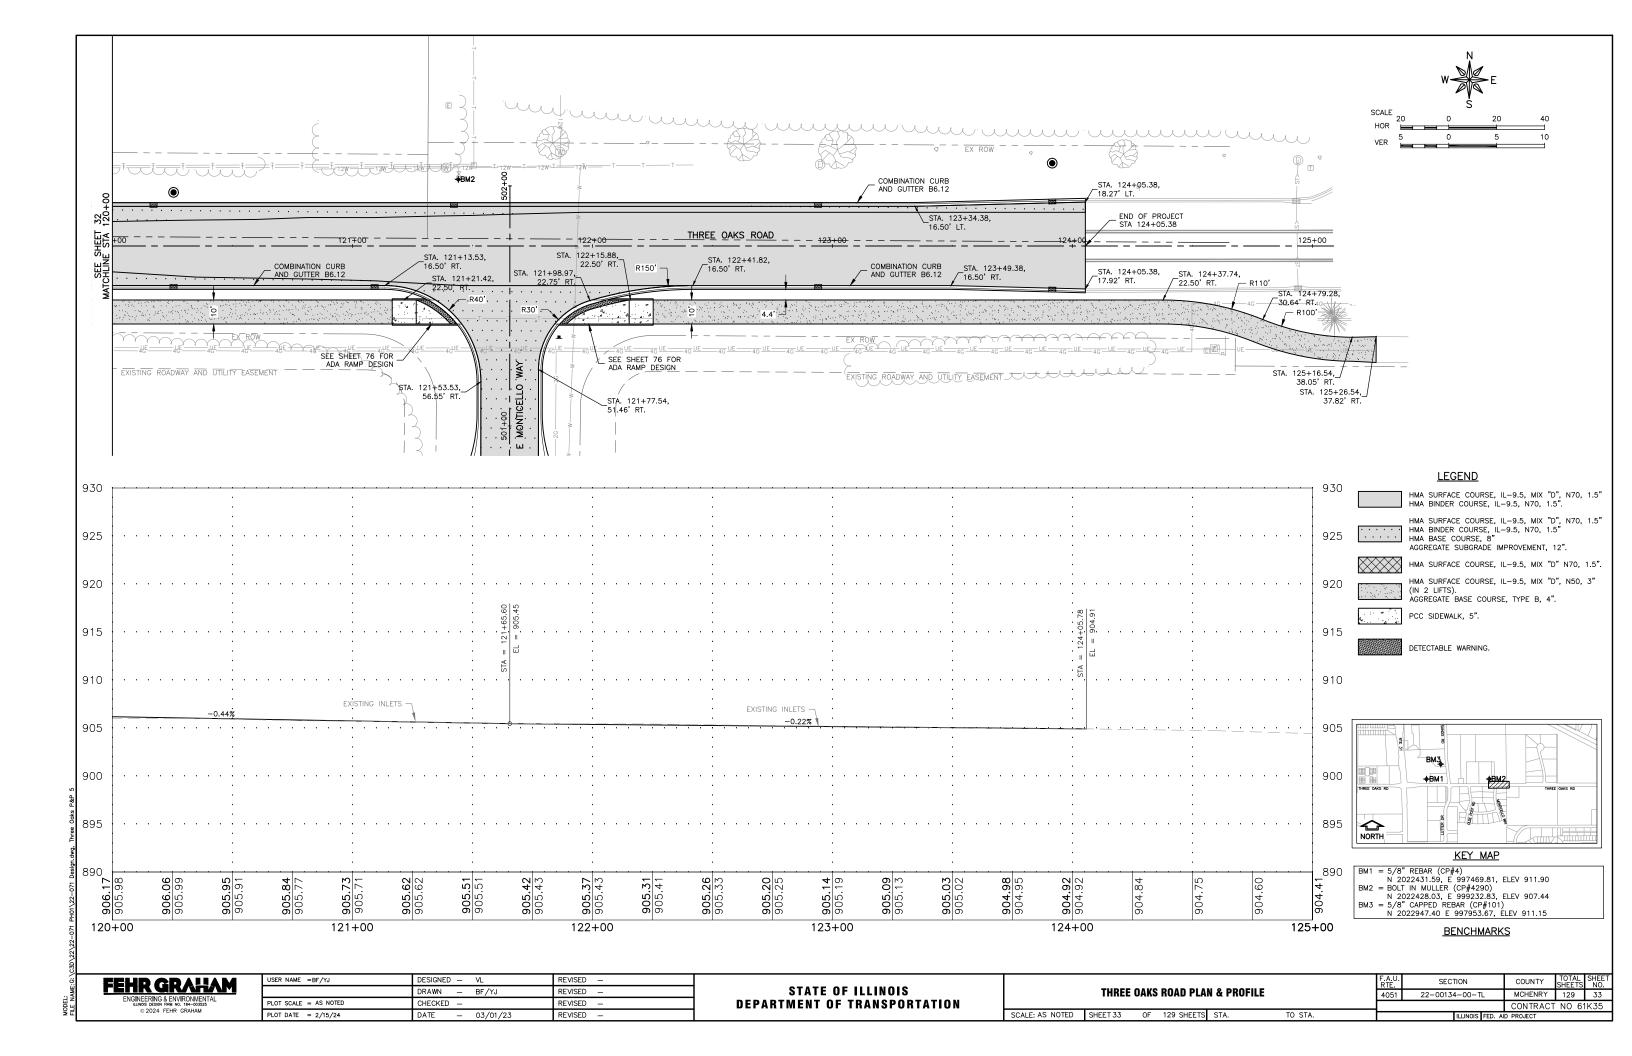

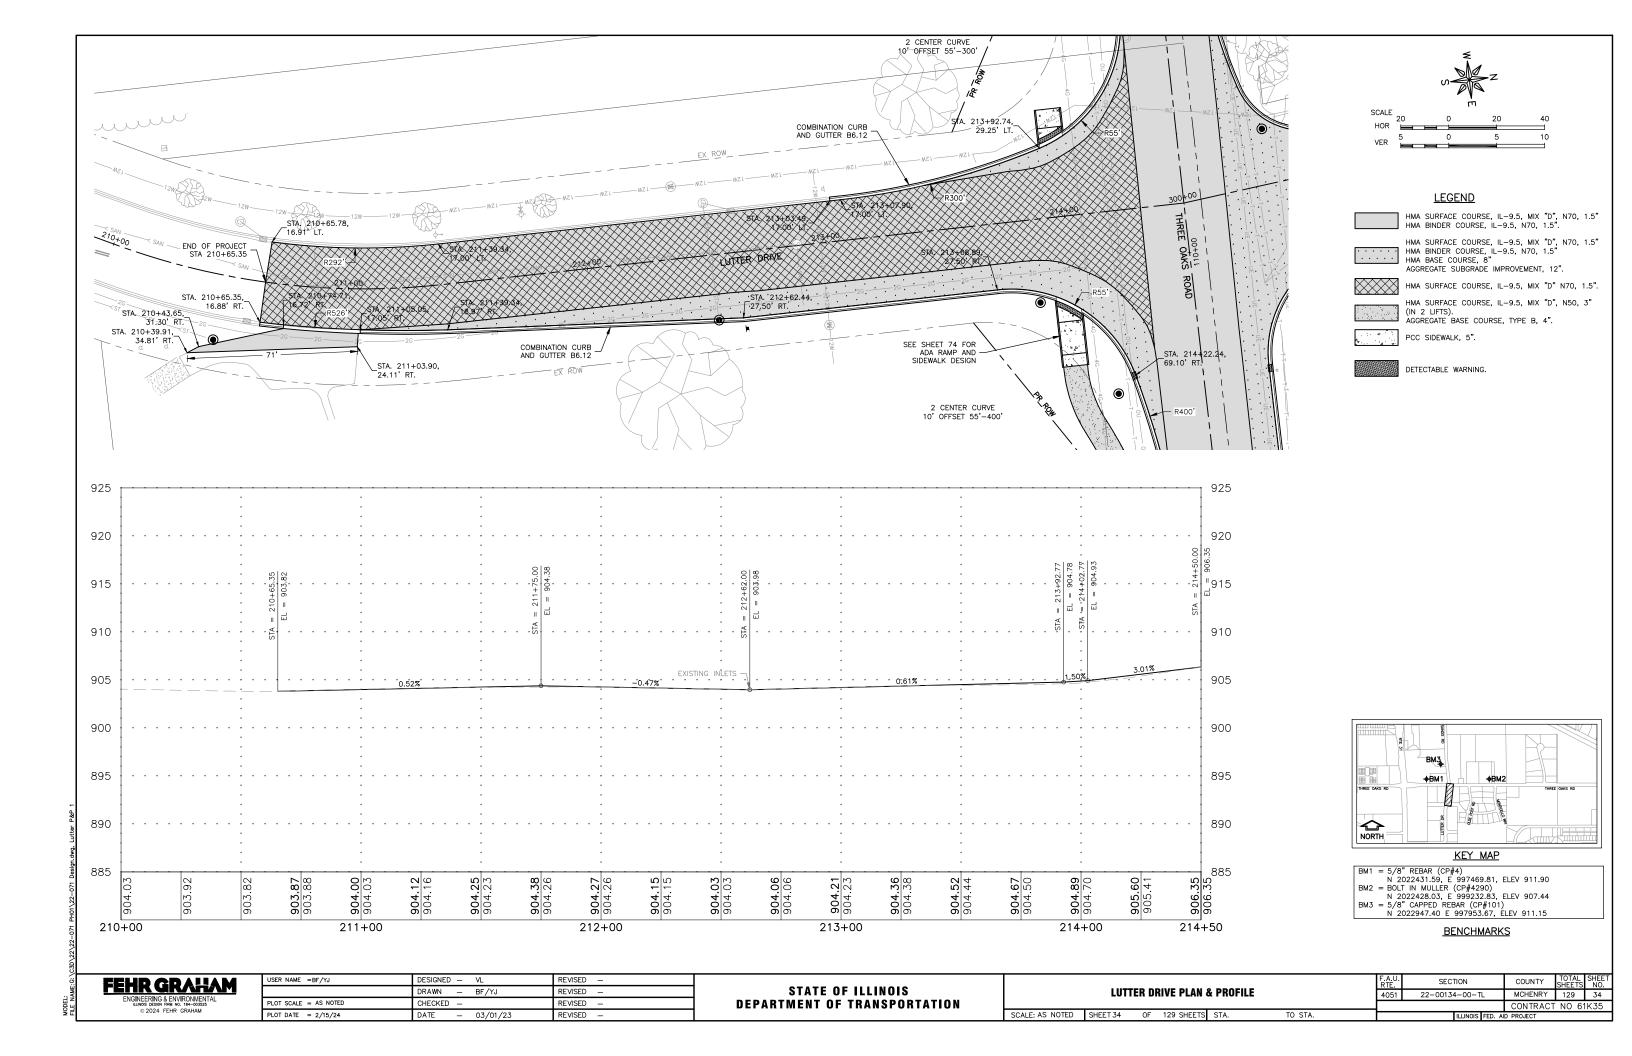

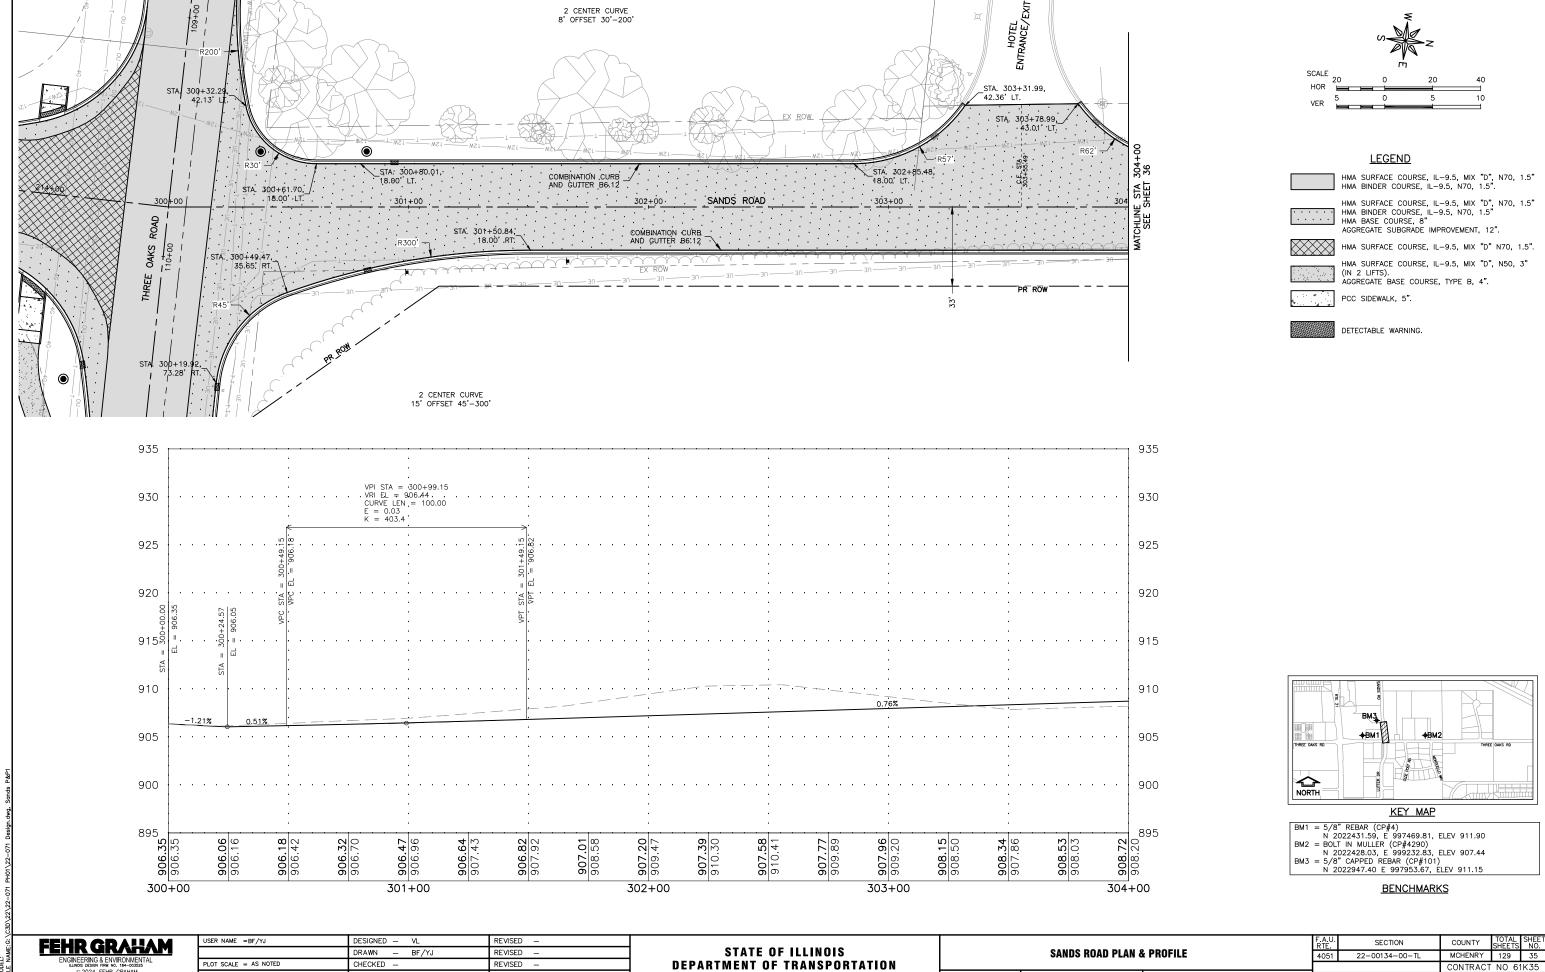

SCALE: AS NOTED SHEET 35 OF 129 SHEETS STA.


TO STA.

PLOT DATE = 2/15/24

DATE

- 03/01/23

REVISED -

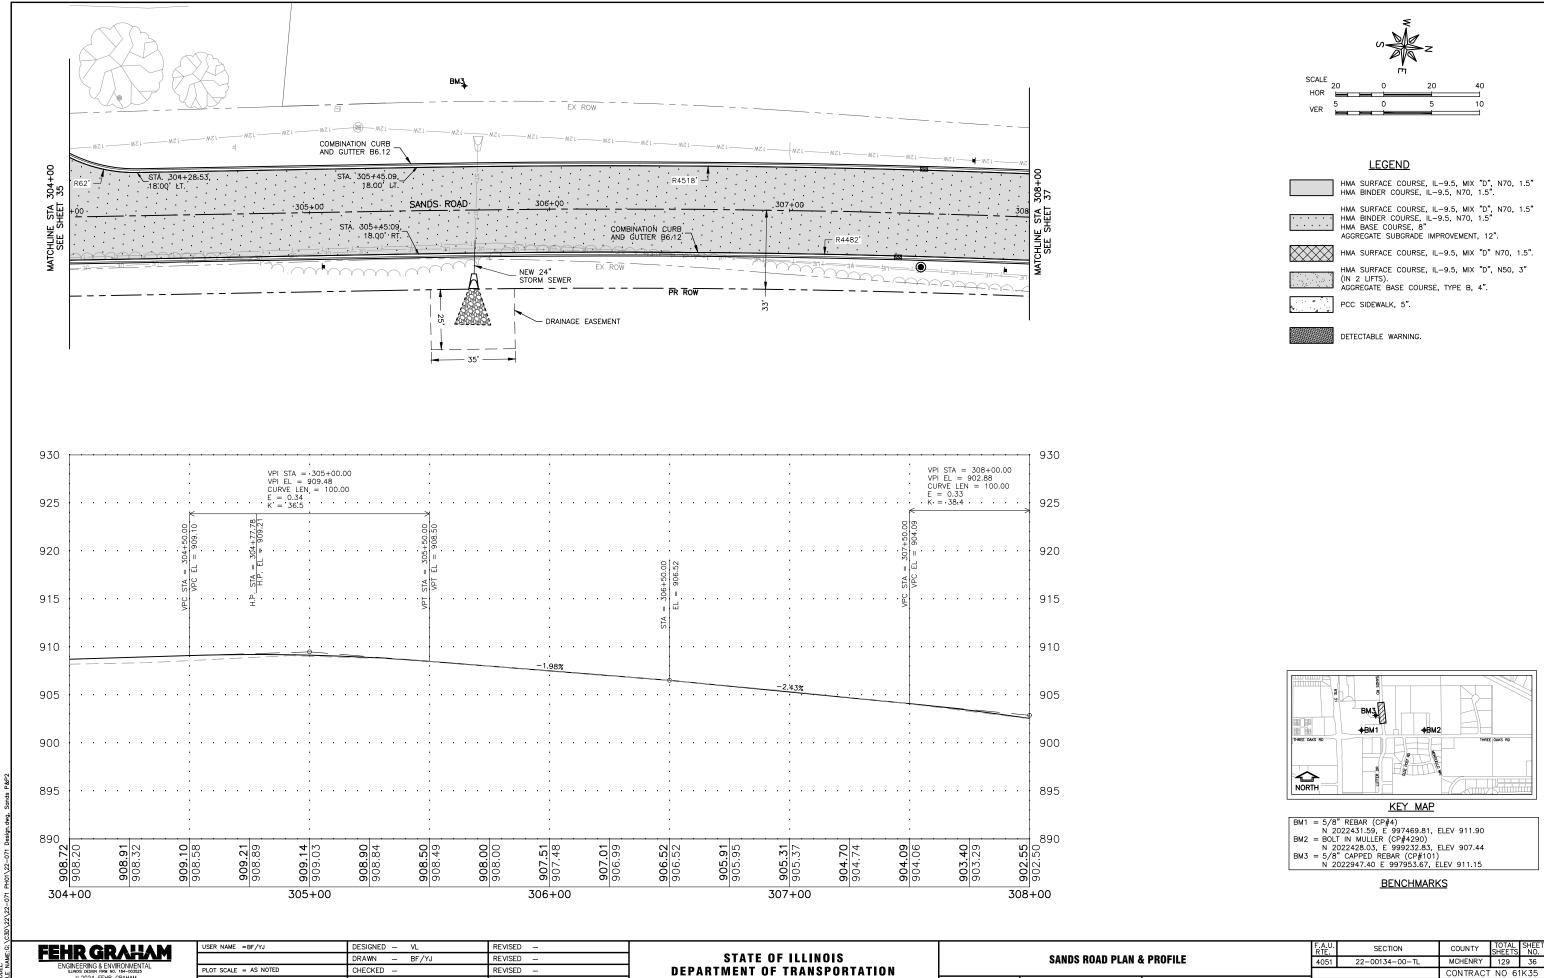

SCALE: AS NOTED SHEET 36 OF 129 SHEETS STA.


TO STA.

, Edon

PLOT DATE = 2/15/24

DATE - 03/01/23

REVISED -

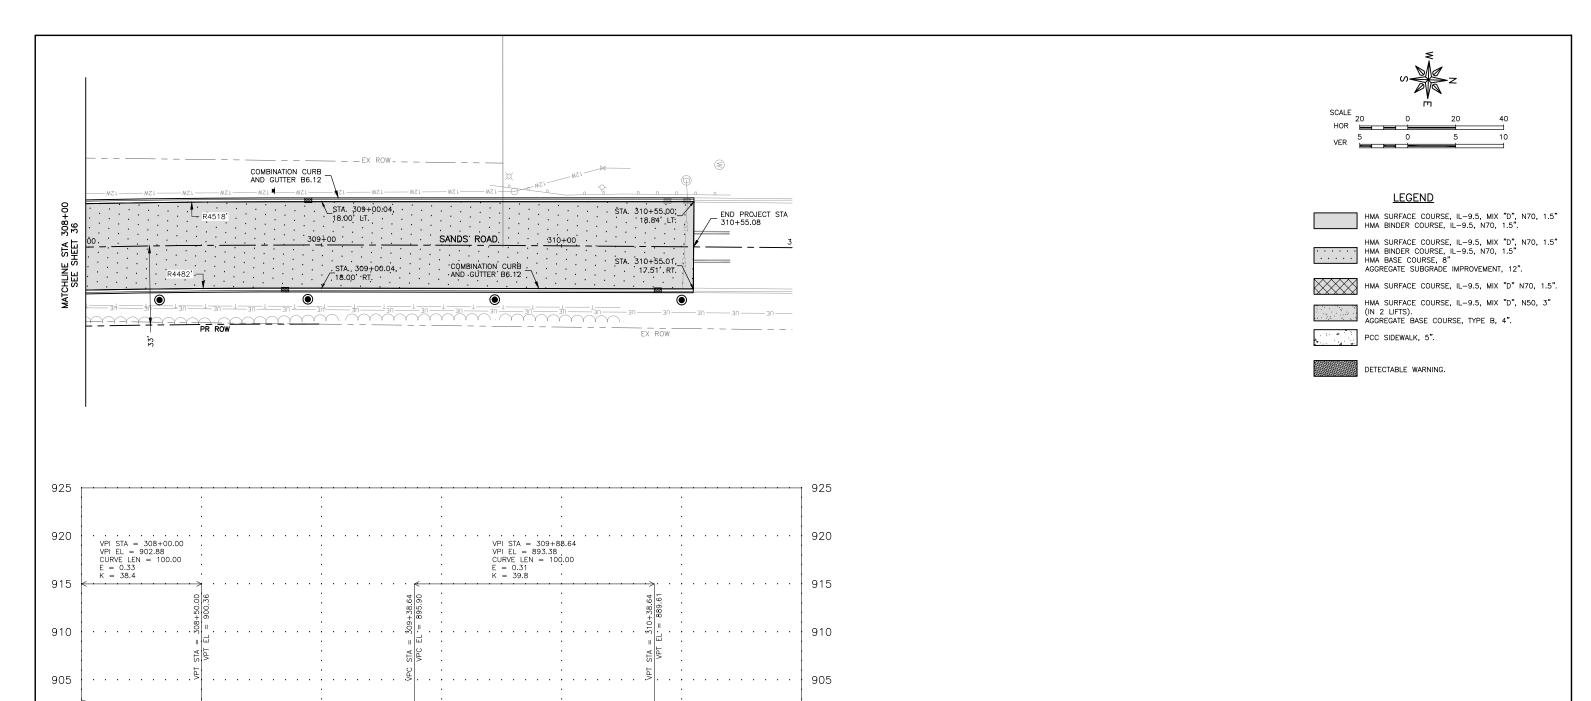



BM1 = 5/8" REBAR (CP#4) N 2022431.59, E 997469.81, ELEV 911.90 BM2 = BOLT IN MULLER (CP#4290) N 2022428.03, E 999232.83, ELEV 907.44 BM3 = 5/8" CAPPED REBAR (CP#101) N 2022947.40 E 997953.67, ELEV 911.15

BENCHMARKS

EEHD @DAUAM	USER NAME =BF/YJ
FERR YRANAM	
ENGINEERING & ENVIRONMENTAL ILLINOIS DESIGN FIRM NO. 184-003525	PLOT SCALE = AS NOTED
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899.10

8 897.8

309+00

900

895

890

902.55 1

308+00

USER NAME =BF/YJ	DESIGNED — VL	REVISED —
	DRAWN — BF/YJ	REVISED —
PLOT SCALE = AS NOTED	CHECKED —	REVISED —
PLOT DATE = 2/15/24	DATE - 03/01/23	REVISED —

892.34 892.15

310+00

STATE	OF ILLINOIS	
DEPARTMENT	OF TRANSPORTATION	ı

311+00

900

895


890

885

SANDS ROAD PLAN & PROFILE					
SHEET 37	OF	129 SHEETS	STA.	TO STA.	_

SCALE: AS NOTED

L	F.A.U. RTE.	A.U. SECTION		COUNTY	TOTAL SHEETS	SHEET NO.	
I	4051 22-00134-00-TL			MCHENRY	129	37	
1			CONTRACT	NO 6	1K35		
ſ	ILLINOIS FED. AID PROJECT						

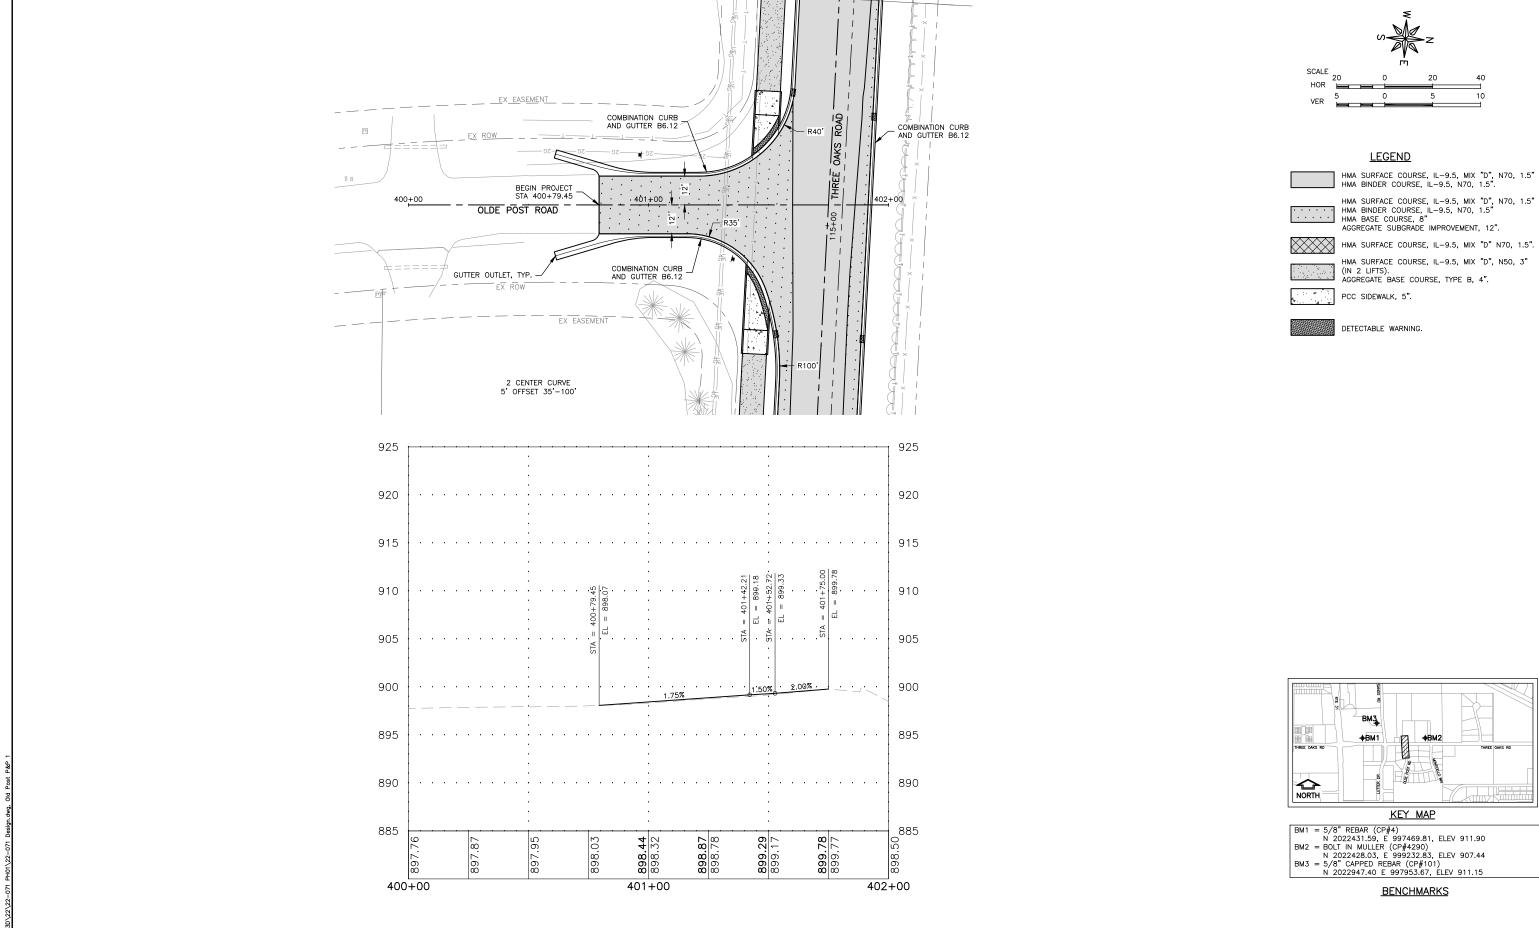

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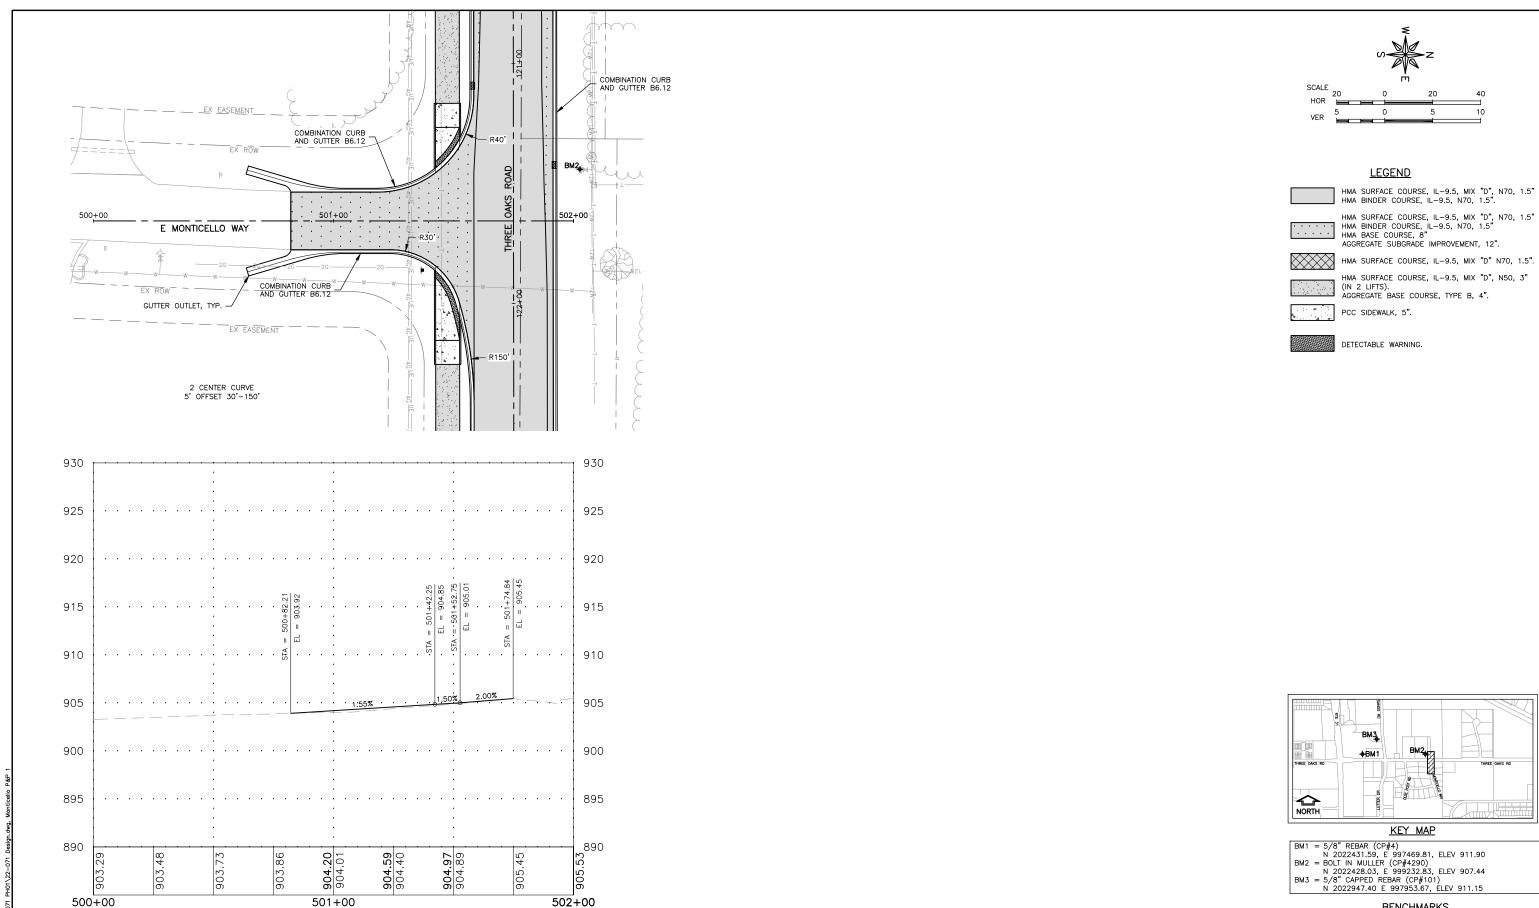
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STATE OF ILLINOIS DEPARTMENT OF TRANSPORTATION

OLDE POST ROAD PLAN & PROFILE SCALE: AS NOTED SHEET 38 OF 129 SHEETS STA.

SECTION COUNTY TOTAL SHEET NO. MCHENRY 129 38 4051 22-00134-00-TL CONTRACT NO 61K35

TO STA.



BENCHMARKS

FEHR GRAHAM

USER NAME =BF/YJ	DESIGNED	-	VL	REVISED	_
	DRAWN	_	BF/YJ	REVISED	_
PLOT SCALE = AS NOTED	CHECKED	_		REVISED	_
PLOT DATE = 2/15/24	DATE	_	03/01/23	REVISED	_

STATE OF ILLINOIS DEPARTMENT OF TRANSPORTATION

E MONTICELLO WAY PLAN & PROFILE					
SCALE: AS NOTED	SHEET 39	OF	129 SHEETS	STA.	TO STA.

F.A.U. RTE.	SECTION	COUNTY	TOTAL SHEETS	SHEET NO.		
4051 22-00134-00-TL			MCHENRY	129	39	
		CONTRACT	NO 6	1K35		
ILLINOIS FED. AID PROJECT						

THREE OAKS ROAD

SANDS ROAD SHALL BE CLOSED DURING ALL PHASES OF CONSTRUCTION. A PROPOSED DETOUR PLAN IS INCLUDED. THE CONTRACTOR SHALL REVIEW THE DETOUR PLAN AND SUBMIT ANY CHANGES TO THE PLAN TO THE ENGINEER FOR APPROVAL.

FLAGGERS ARE REQUIRED PER IDOT STANDARDS WHEN ONE LANE NEEDS TO BE CLOSED DURING DAY OPERATIONS.

STAGE 1

THREE OAKS ROAD - WIDEN ROAD AND INSTALL STORM SEWER

- INSTALL STORM SEWER INLETS AND STORM SEWER ALONG NORTH SIDE OF ROAD AND LATERALS AS FAR AS PAVEMENT REMOVAL.
- WIDEN NORTH SIDE OF ROAD.
 INSTALL CURB AND GUTTER ON NORTH SIDE OF ROAD.

SANDS ROAD (NOT ILLUSTRATED)

- PAVEMENT AND CURB & GUTTER REMOVAL.
- INSTALL STORM SEWER.

STAGE 2

THREE OAKS ROAD - INSTALL STORM SEWER AND CONSTRUCT MULTI-USE PATH

- REMOVE PAVEMENT ON THE SOUTH SIDE OF THREE OAKS
- ROAD.

 INSTALL STORM SEWER AND CURB & GUTTER ALONG THE SOUTH SIDE OF THE ROAD AND CONNECT STORM SEWER LATERALS FROM THE NORTH.

 CONSTRUCT THE MULTI-USE PATH.
- PAVEMENT REMOVAL AND RECONSTRUCTION OF OLDE POST

LUTTER DRIVE - INSTALL STORM SEWER AND WIDEN ROAD

- INSTALL STORM SEWER.
 ROADWAY WIDENING FOR RIGHT TURN LANE.
 INSTALL CURB AND GUTTER.

SANDS ROAD (NOT ILLUSTRATED)

CONSTRUCT ROAD PAVEMENT SECTION AND INSTALL CURB & GUTTER.

STAGE 3

THREE OAKS ROAD - TRAFFIC SIGNALS, RESURFACING (NOT ILLUSTRATED)


- TRAFFIC SIGNAL INSTALLATION.
 HMA RESURFACING.
 INSTALL PAVEMENT MARKINGS.


LUTTER DRIVE - MILL AND OVERLAY (NOT ILLUSTRATED)

- HMA RESURFACING.
- INSTALL PAVEMENT MARKINGS.
 SEEDING AND RESTORATION.


- HMA PAVING AND PAVEMENT MARKINGS.
 SEEDING AND RESTORATION.

SUGGESTED MAINTENANCE TRAFFIC AND CONSTRUCTION STAGING SEQUENCE OF CONSTRUCTION

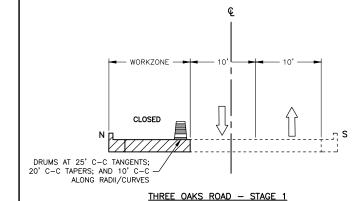

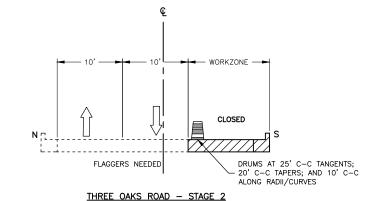

SCALE: AS NOTED

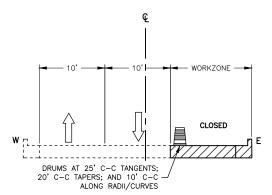

LUTTER DRIVE - STAGE 2

NOTE:

DROP-OFFS ADJACENT TO THE TRAVEL LANE SHALL BE KEPT TO A MINIMUM. PROTECTION OF THE DROP-OFF SHALL BE ACCORDING TO THE IDOT BUREAU OF SAFETY PROGRAMS AND ENGINEERING, SAFETY ENGINEERING POLICY MEMORANDUM 4-21. DROP-OFFS GREATER THAN OR EQUAL TO 12° AT LOCATIONS WHERE THE DROP-OFF IS LOCATED WITHIN 8 FT OF THE EDGE OF THE TRAVEL LANE SHALL BE BACKFILLED IN ACCORDANCE WITH TABLE 2, CONDITION II OF THE SAFETY 4-21 POLICY. THE CONTRACTOR SHALL BE RESPONSIBLE FOR ENSURING THAT THE DROP-OFF AREAS MEET THE OFFSET, HEIGHT, AND DURATION REQUIREMENTS TO USE BARRICADES AT THE END OF EACH WORKDAY. THIS MAY REQUIRE THE CONTRACTOR TO REPLACE OR PLACE SUFFICIENT MATERIAL IN THE EXCAVATION TO REDUCE THE DROP-OFF TO BE COMPLIANT WITH THE REQUIREMENTS FOR USE OF BARRICADES. NO ADDITIONAL COMPENSATION SHALL BE ALLOWED TO COMPLY WITH THIS REQUIREMENT.

THE CONTRACTOR SHALL REMOVE PAVEMENT MARKINGS THAT CONFLICT WITH TEMPORARY PAVEMENT MARKINGS FOR THE STAGE OF CONSTRUCTION.

THE CONTRACTOR SHALL CONTACT KALPANA KANNAN-HOSADURGA, THE DISTRICT ONE TRAFFIC CONTROL SUPERVISOR AT KALPANA.KANNAN-HOSADURGA@LLLINOIS.GOV A MINIMUM OF 72 HOURS IN ADVANCE OF BEGINNING WORK.

TEMPORARY INFORMATION SIGNS ON TEMPORARY SUPPORTS SHALL BE PROVIDED FOR ALL COMMERCIAL DRIVEWAYS THAT ARE LOCATED WITHIN A WORK AREA. THIS WORK SHALL BE PAID FOR PER DISTRICT 1 DETAIL TC-26. THESE SIGNS SHALL BE RELOCATED AS REQUIRED FOR EACH CONSTRUCTION STAGE AND SHALL BE PLACED AS DIRECTED BY THE ENGINEER. THIS SIGN RELOCATION WORK WILL NOT BE PAID FOR SEPARATELY AND SHALL BE INCLUDED IN THE CONTRACT UNIT PRICE PER SQUARE FOOT FOR TEMPORARY INFORMATION SIGNING.


CHANGEABLE MESSAGE SIGNS SHALL BE INSTALLED TWO WEEKS PRIOR TO ALL TRAFFIC STAGE CHANGES ON EACH APPROACH OF THE EFFECTED ROADWAY TO WARN MOTORISTS OF THE UPCOMING EVENT. THE SIGN MESSAGES SHALL BE REVISED TWO WEEKS THEREAFTER WITH MESSAGES WARNING TRAFFIC OF POTENTIAL TRAFFIC DELAYS, QUEUING AND/OR WITH MESSAGES NOTIFYING TRAFFIC TO USE ALTERNATE ROUTES. THE SIGN LOCATIONS AND MESSAGES SHALL BE DETERMINED BY THE ENGINEER.

CONTRACTOR SHALL REMOVE OR COVER ALL W21-1 (WORKERS PRESENT) AND W20-7 (FLAGGER) SIGNS, WITHIN AN HOUR, WHEN WORKERS ARE NOT PRESENT OR IF THE SIGN IS NOT APPLICABLE.

DRUMS SHALL BE PLACED AS FOLLOWS:

25' C-C TANGENTS; 20' C-C TAPERS; AND 10' C-C ALONG RADII/CURVES.

LEGEND

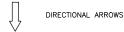





OPEN TO TRAFFIC




CLOSED TO TRAFFIC



USER NAME =BF/YJ	DESIGNED	_	VL	REVISED —	
	DRAWN	_	BF/YJ	REVISED —	
PLOT SCALE = AS NOTED	CHECKED	_		REVISED —	
PLOT DATE = 3/20/24	DATE	-	03/01/23	REVISED —	

TUDES CAVE DE TRAFFIO CONTROL NOTES			F.A.U. RTE.	SECTION	COUNTY	TOTAL SHEETS	SHEET NO.			
	THREE OAKS RD - TRAFFIC CONTROL NOTES		4051	22-00134-00-TL	MCHENRY	129	40			
								CONTRACT	L NO 6.	1K35
	SHEET 40	OF	129 SHEETS	STA.	TO STA.		ILLINOIS FED. A	ID PROJECT		

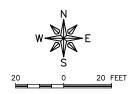














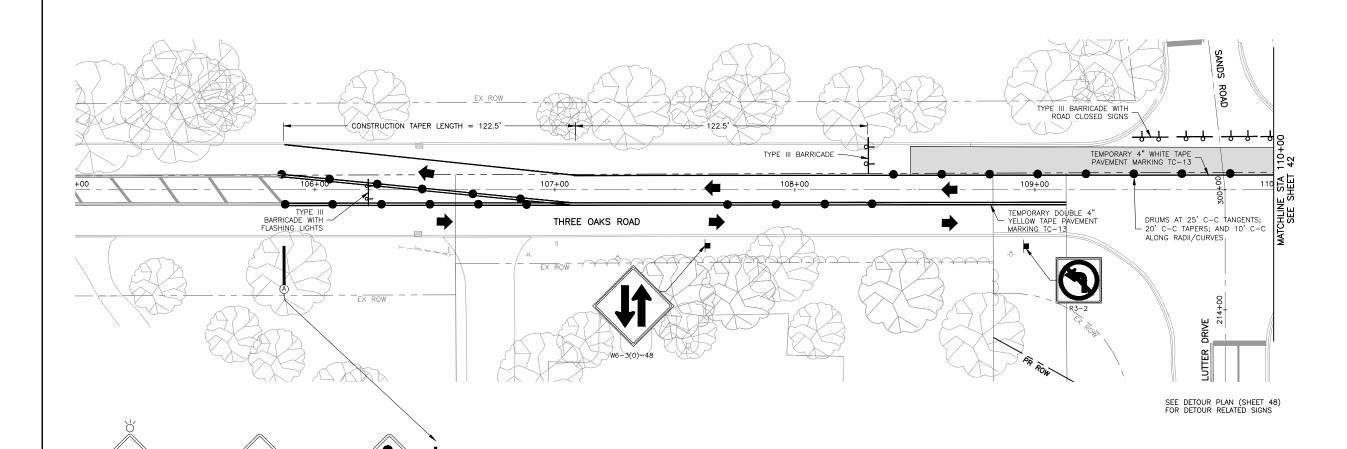



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ROAD CONSTRUCTION AHEAD

W20-I103(0)-48

CENTER LANE CLOSED AHEAD

W20-5C(0)-48

USER NAME =BF/YJ	DESIGNED — VL	REVISED —
	DRAWN - BF/YJ	REVISED —
PLOT SCALE = AS NOTED	CHECKED —	REVISED —
PLOT DATE = $3/21/24$	DATE - 03/01/23	REVISED —


WORK AREA


W21-1(0)-48


STATE O	F ILLINOIS
DEPARTMENT OF	TRANSPORTATION

	THREE OAI	KS RD	- TRAFFIC Stage 1	CONTRO	DL PLAN
SCALE: AS NOTED	SHEET 41	OF	129 SHEETS	STA.	TO STA.

F.A.U. RTE.	SECTION	COUNTY	TOTAL SHEETS	SHEET NO.			
4051	22-00134-00-TL	MCHENRY	129	41			
		CONTRACT	NO 6	1K35			
ILLINOIS FED. AID PROJECT							

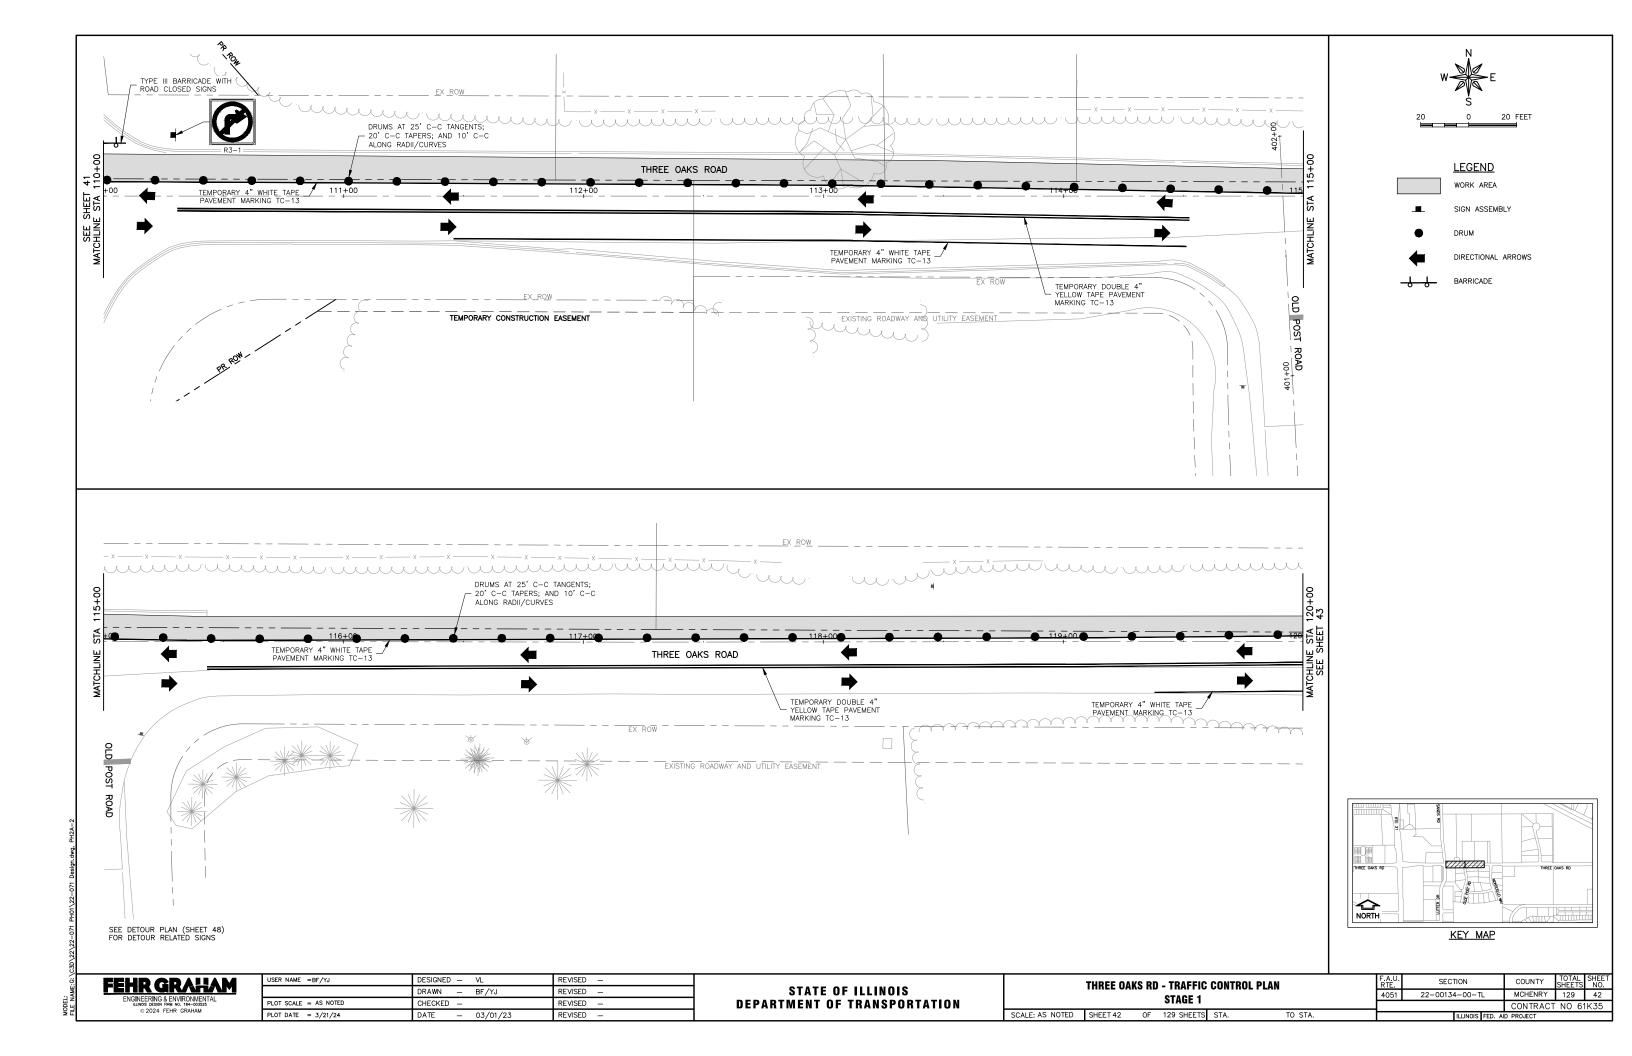

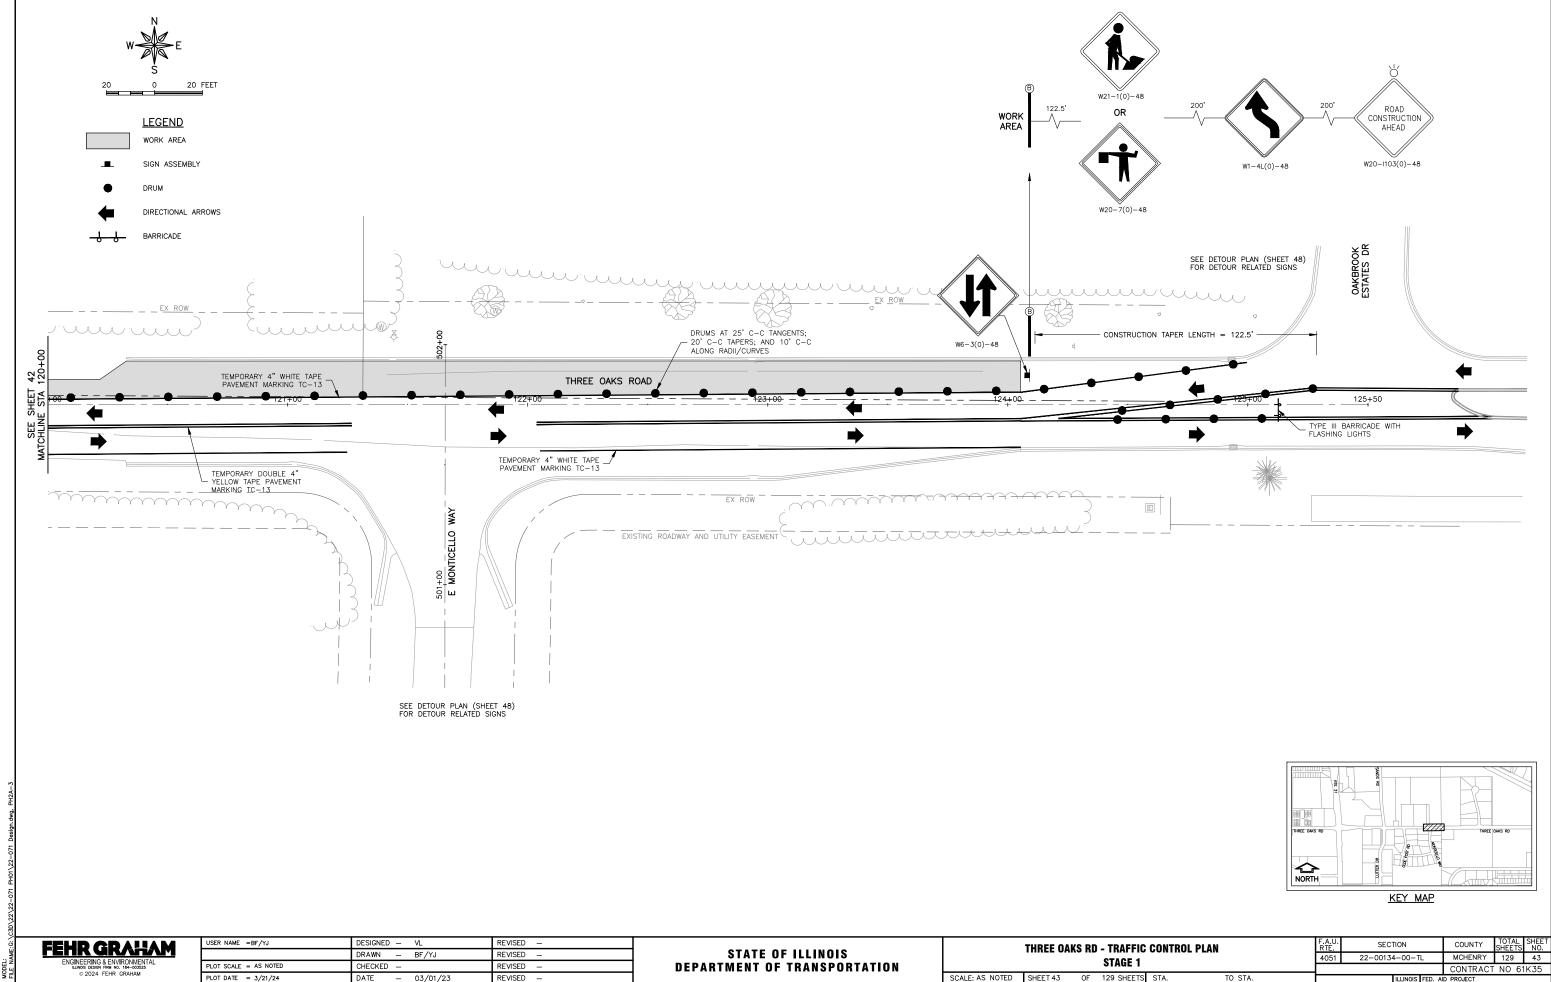

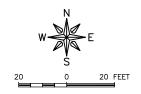




WORK AREA


SIGN ASSEMBLY

DRUM

DIRECTIONAL ARROWS

BARRICADE

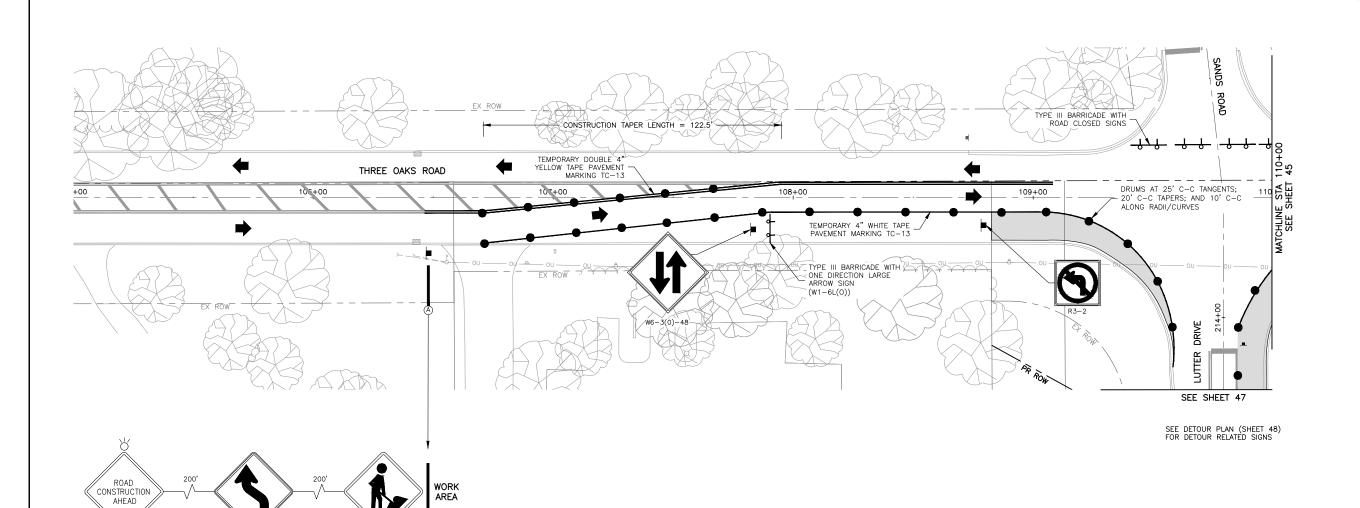

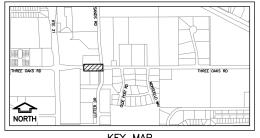

KEY MAP

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W20-I103(0)-48

W1-4L(0)-48


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PLOT SCALE = AS NOTED	CHECKED -	REVISED —	
PLOT DATE = 3/21/24	DATE - 03/0	01/23 REVISED —	


W21-1(0)-48


STATE	OF ILLINOIS	
DEPARTMENT (OF TRANSPORTATION	


	THREE OAK	S RD	- TRAFFIC STAGE 2	CONTROL PLAN	
SCALE: AS NOTED	SHEET 44	OF	129 SHEETS	STA.	TO STA.

SECTION COUNTY TOTAL SHEET NO. MCHENRY 129 44 4051 22-00134-00-TL CONTRACT NO 61K35

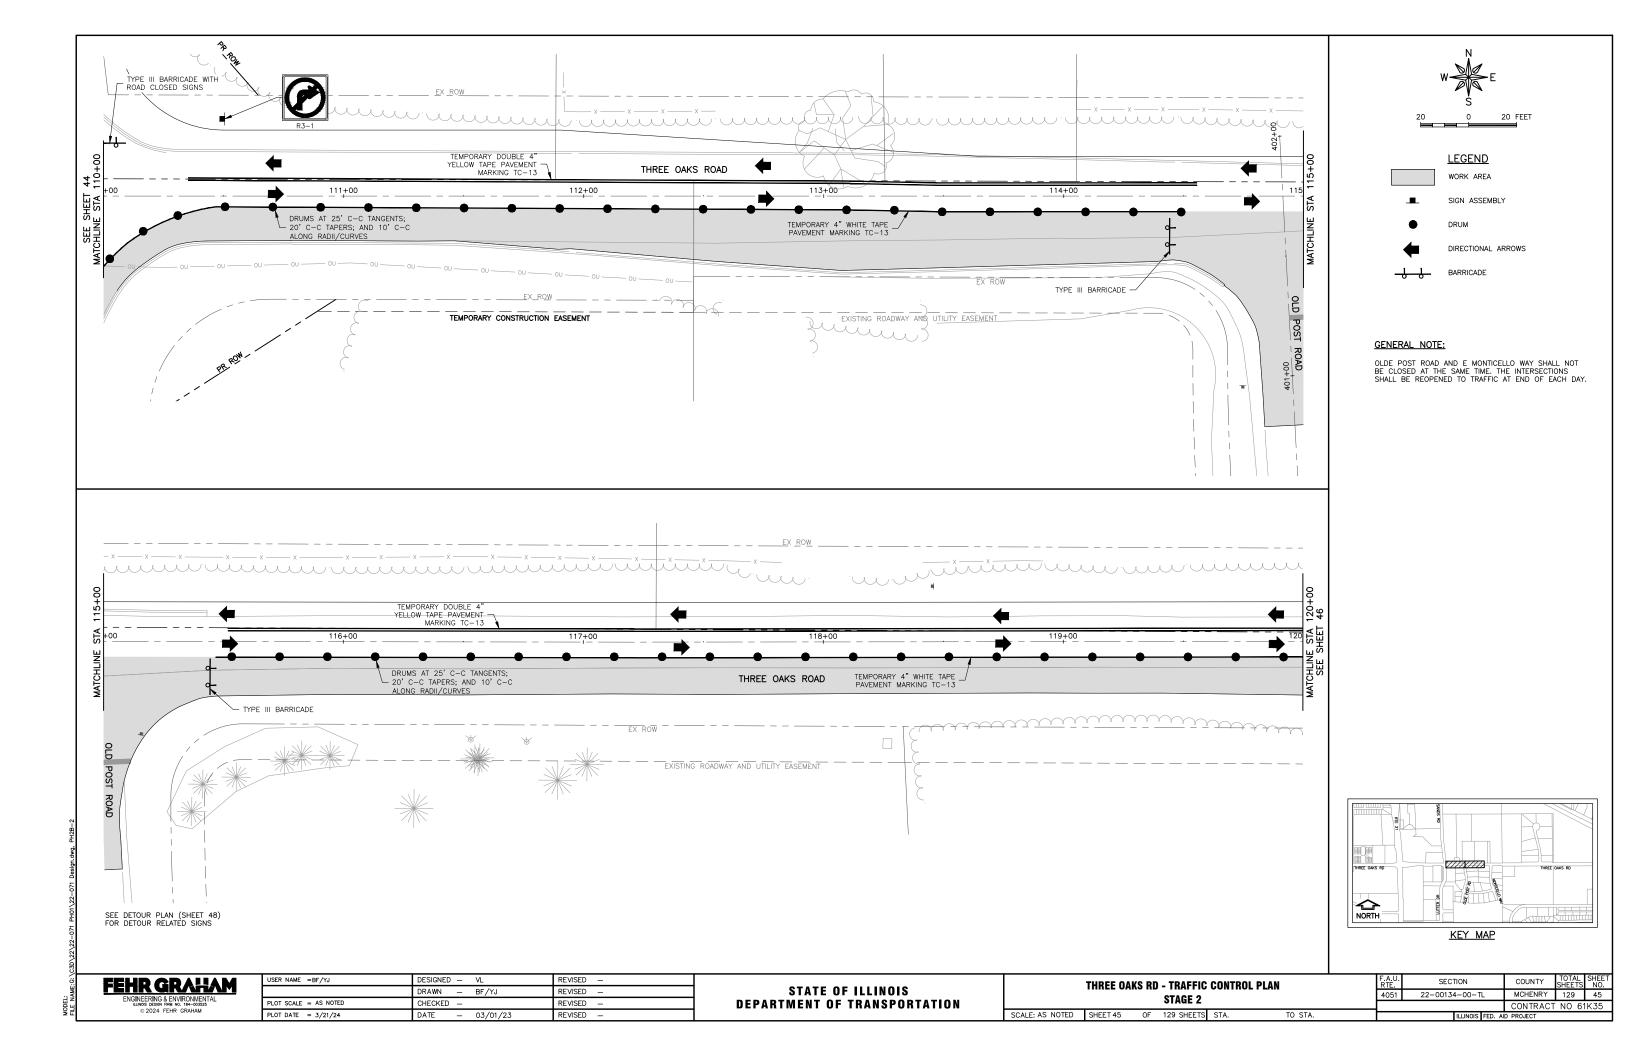

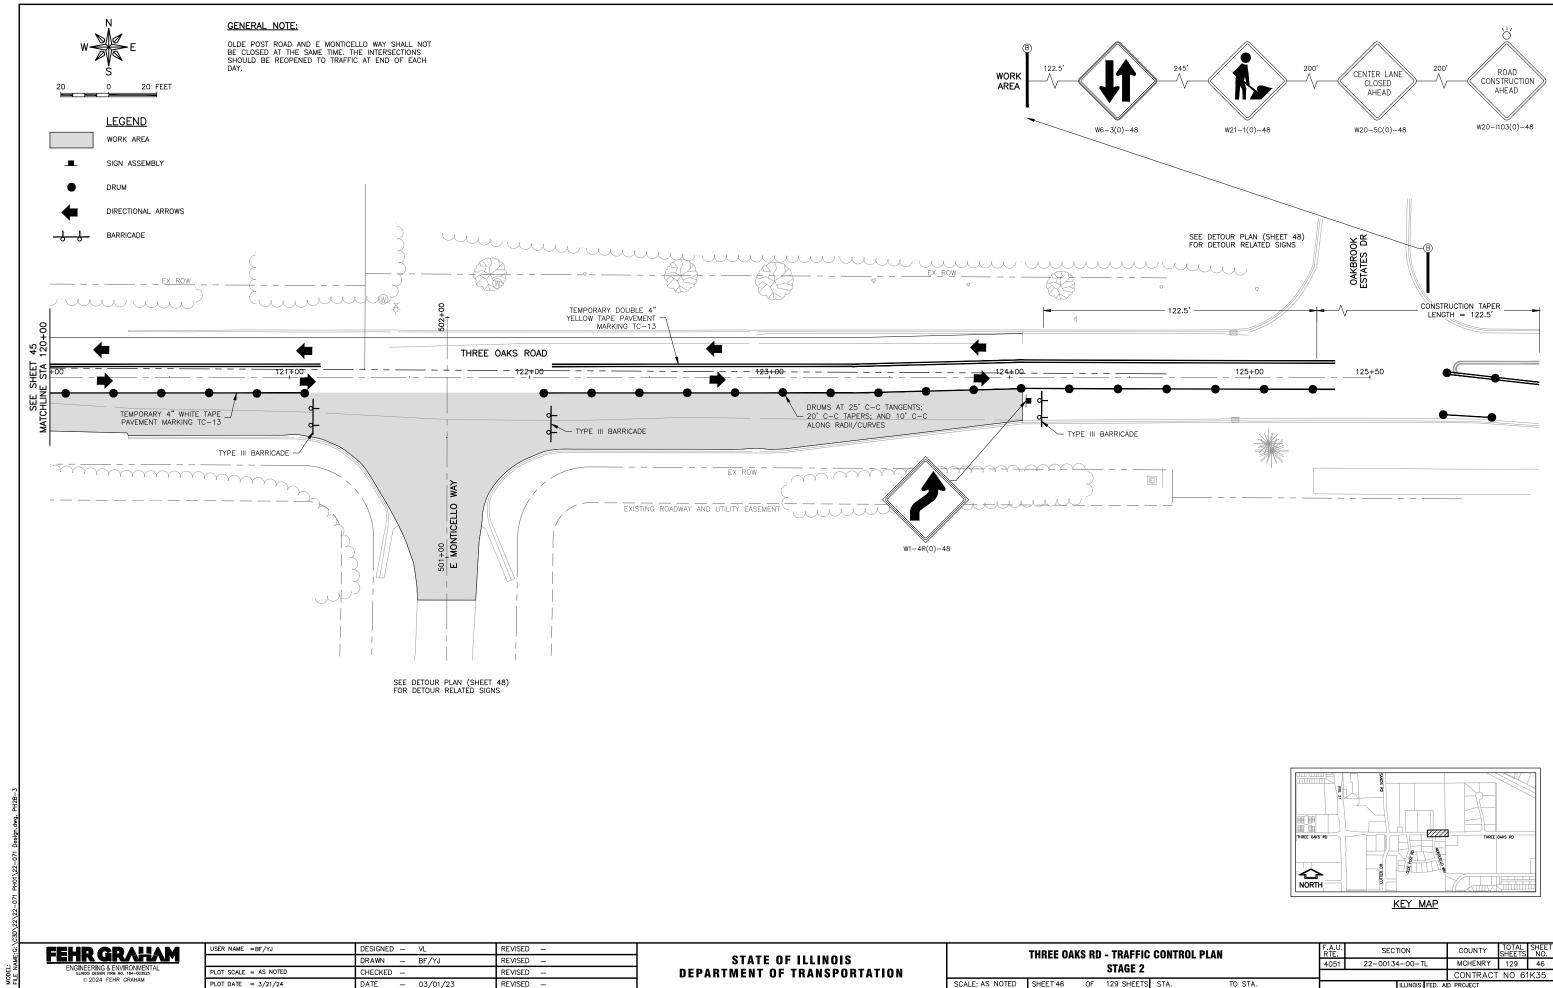

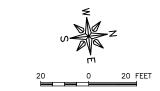

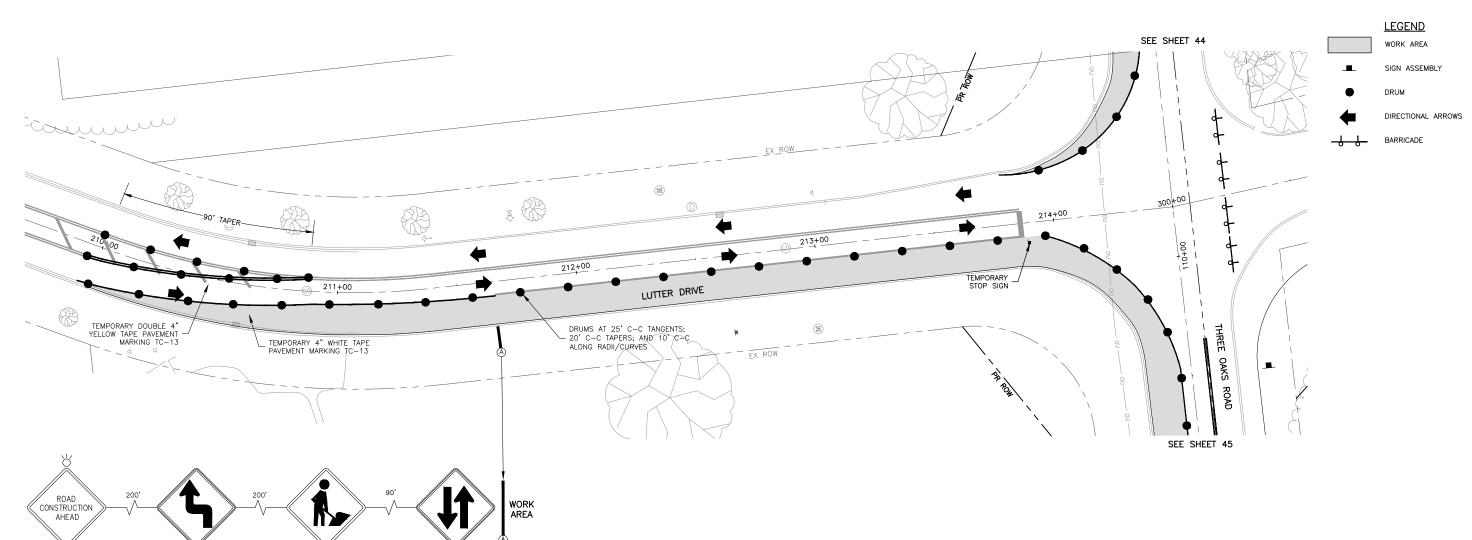



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W20-I103(0)-48

W1-3L(0)-48

W21-1(0)-48

USER NAME =BF/YJ	DESIGNED — VL	REVISED —
	DRAWN - BF/YJ	REVISED —
PLOT SCALE = AS NOTED	CHECKED —	REVISED —
PLOT DATE = $3/21/24$	DATE - 03/01/23	REVISED —


W6-3(0)-48

STATE	0 F	ILLINOIS
DEPARTMENT	OF	TRANSPORTATION

LUTTER DRIVE -			E - TRAFFIC CONTROL PLAN Stage 2			
SCALE: AS NOTED	SHEET 47	OF	129 SHEETS	STA.	TO STA.	


F.A.U. RTE.	SECTION	COUNTY	TOTAL SHEETS	SHEET NO.
4051	22-00134-00-TL	MCHENRY	129	47
		CONTRACT	NO 6	K35
	ILLINOIS FED. AI	D PROJECT		

::G:\C3D\22\22-071 PH01\22-071 Design.dv

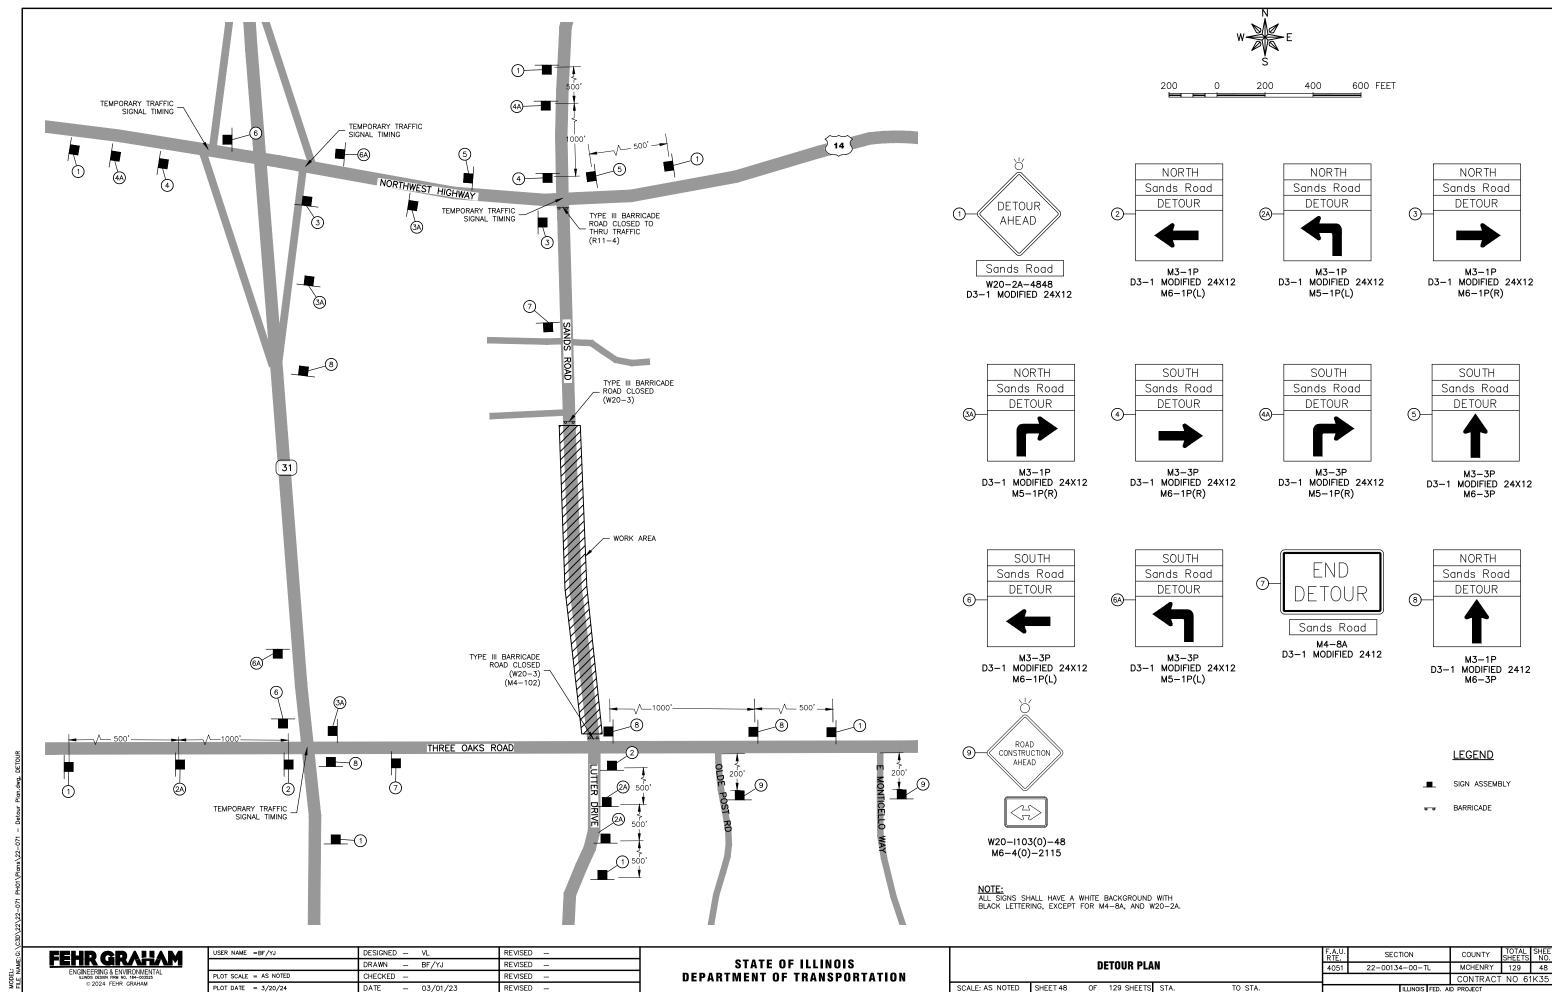

PLOT DATE = 3/20/24 DATE - 03/01/23 REVISED TO STA.

MCHENRY 129 48 CONTRACT NO 61K35 ILLINOIS FED. AID PROJECT

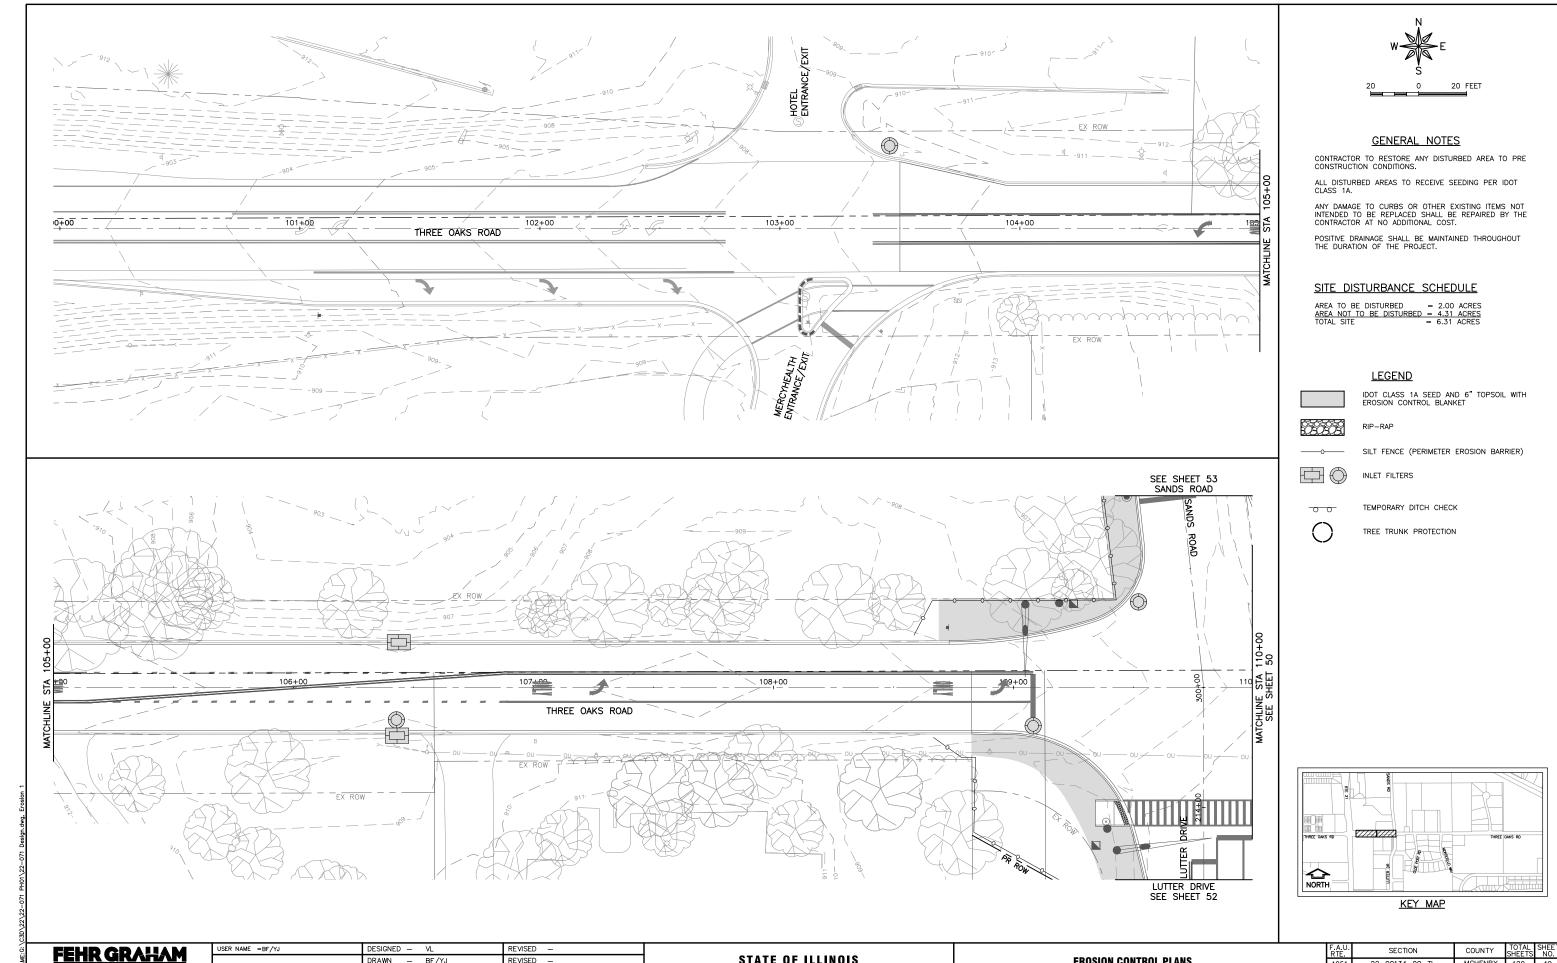

DRAWN

CHECKED

PLOT SCALE = AS NOTED

PLOT DATE = 2/15/24

BF/YJ

DATE - 03/01/23

REVISED -


REVISED


REVISED -


STATE OF ILLINOIS DEPARTMENT OF TRANSPORTATION

EROSION CONTROL PLANS SCALE: AS NOTED SHEET 49 OF 129 SHEETS STA. TO STA.

SECTION MCHENRY 129 49 4051 22-00134-00-TL CONTRACT NO 61K35

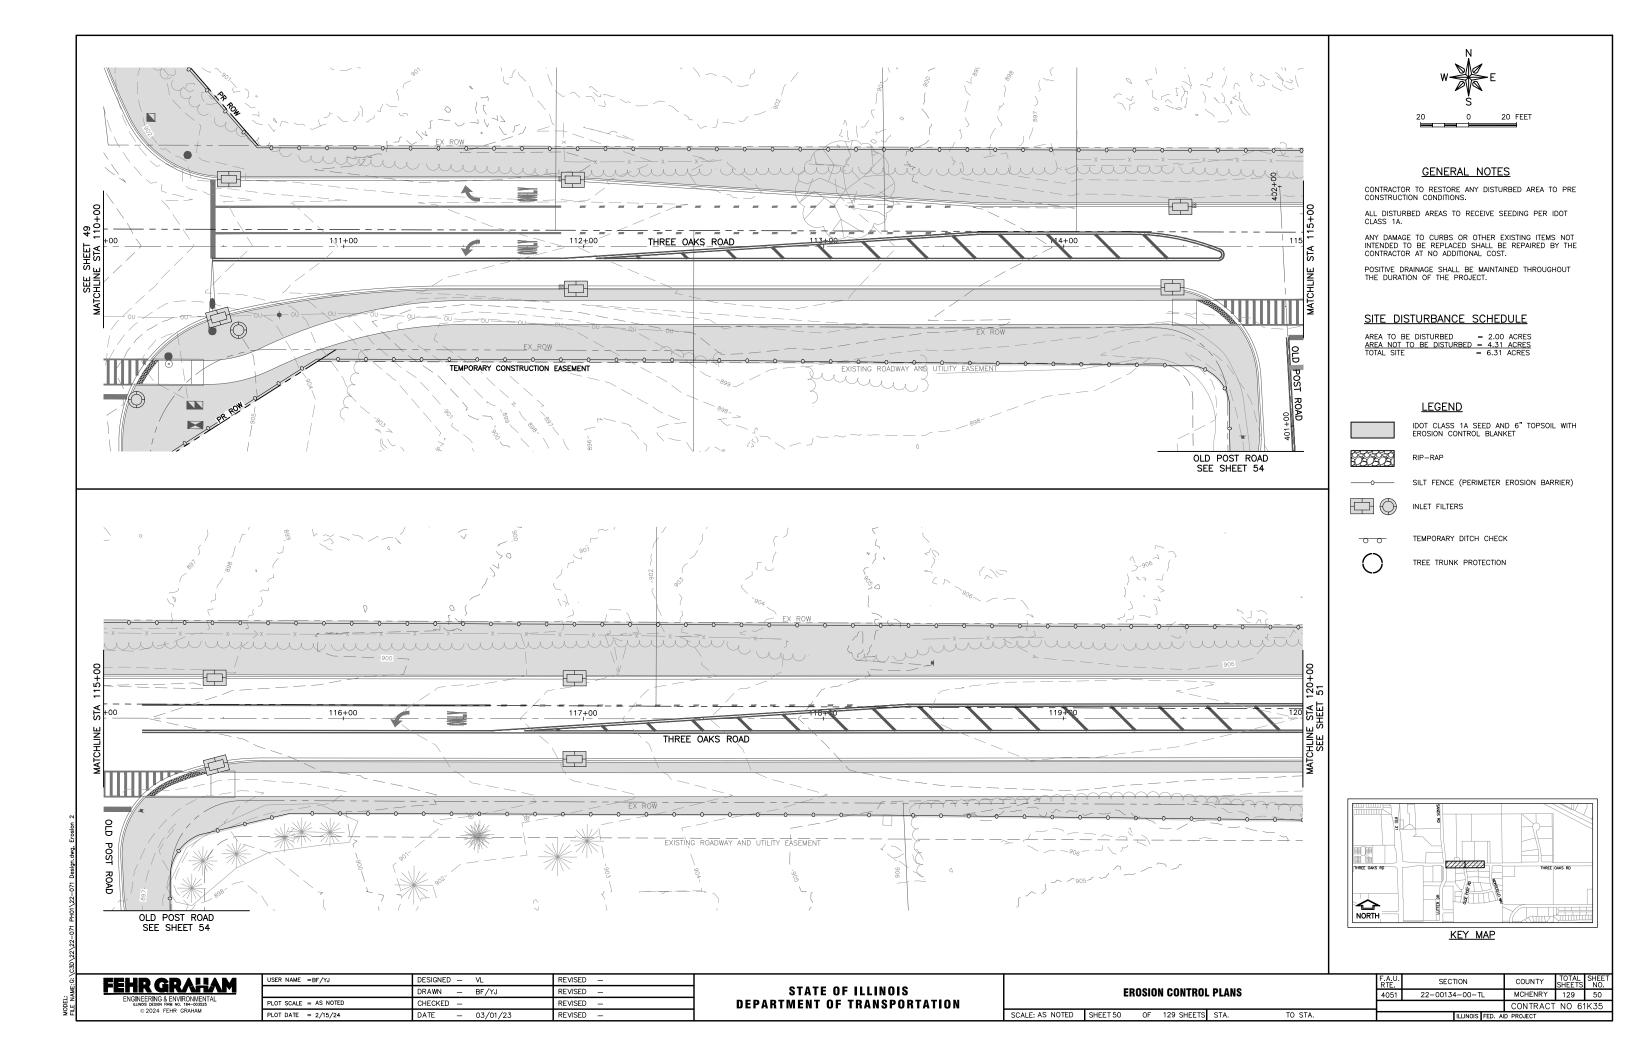

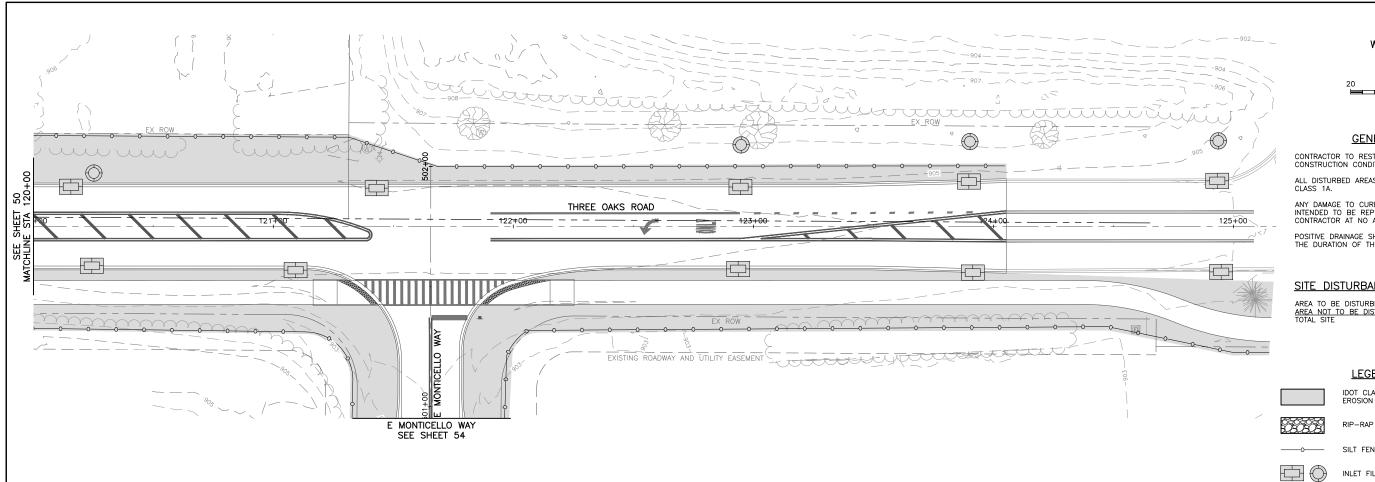

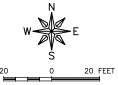

GENERAL NOTES

CONTRACTOR TO RESTORE ANY DISTURBED AREA TO PRE CONSTRUCTION CONDITIONS.

ALL DISTURBED AREAS TO RECEIVE SEEDING PER IDOT CLASS 1A.

ANY DAMAGE TO CURBS OR OTHER EXISTING ITEMS NOT INTENDED TO BE REPLACED SHALL BE REPAIRED BY THE CONTRACTOR AT NO ADDITIONAL COST.

POSITIVE DRAINAGE SHALL BE MAINTAINED THROUGHOUT THE DURATION OF THE PROJECT.

SITE DISTURBANCE SCHEDULE

AREA TO BE DISTURBED = 2.00 ACRES
AREA NOT TO BE DISTURBED = 4.31 ACRES
TOTAL SITE = 6.31 ACRES

LEGEND

IDOT CLASS 1A SEED AND 6" TOPSOIL WITH EROSION CONTROL BLANKET

SILT FENCE (PERIMETER EROSION BARRIER)

INLET FILTERS

TEMPORARY DITCH CHECK

TREE TRUNK PROTECTION



KEY MAP


FEHR GRAHAM


USER NAME =BF/YJ	DESIGNED	-	VL	REVISED	_
	DRAWN	_	BF/YJ	REVISED	-
PLOT SCALE = AS NOTED	CHECKED	_		REVISED	-
PLOT DATE = $2/15/24$	DATE	_	03/01/23	REVISED	-

STATE OF ILLINOIS DEPARTMENT OF TRANSPORTATION

	E	ROSIO	N CONTROL	PLANS	
SCALE: AS NOTED	SHEET 51	OF	129 SHEETS	STA.	TO STA

SECTION COUNTY TOTAL SHEET NO. MCHENRY 129 51 4051 22-00134-00-TL CONTRACT NO 61K35

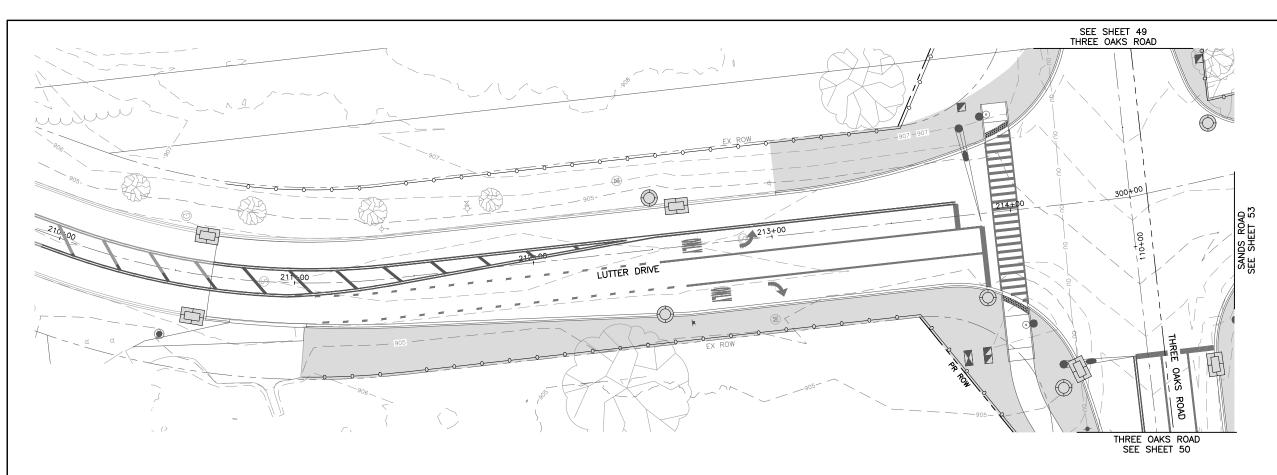

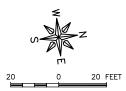

GENERAL NOTES

CONTRACTOR TO RESTORE ANY DISTURBED AREA TO PRE CONSTRUCTION CONDITIONS.

ALL DISTURBED AREAS TO RECEIVE SEEDING PER IDOT CLASS 1A. $\,$

ANY DAMAGE TO CURBS OR OTHER EXISTING ITEMS NOT INTENDED TO BE REPLACED SHALL BE REPAIRED BY THE CONTRACTOR AT NO ADDITIONAL COST.

POSITIVE DRAINAGE SHALL BE MAINTAINED THROUGHOUT THE DURATION OF THE PROJECT.

SITE DISTURBANCE SCHEDULE

AREA TO BE DISTURBED = 2.00 ACRES
AREA NOT TO BE DISTURBED = 4.31 ACRES
TOTAL SITE = 6.31 ACRES

<u>LEGEND</u>

IDOT CLASS 1A SEED AND 6" TOPSOIL WITH EROSION CONTROL BLANKET

R

SILT FENCE (PERIMETER EROSION BARRIER)



inlet filters

TEMPORARY DITCH CHECK

 \bigcirc

TREE TRUNK PROTECTION



KEY MAP

FEHR GRAHAM
ENGINEERING & ENVIRONMENTAL
ILLINGS DESIGN DO. 104-003823

USER NAME =BF/YJ	DESIGNED — VL	REVISED —
	DRAWN — BF/YJ	REVISED —
PLOT SCALE = AS NOTED	CHECKED —	REVISED —
PLOT DATE = 2/15/24	DATE - 03/01/23	REVISED —

STATE OF ILLINOIS DEPARTMENT OF TRANSPORTATION


	E	N CONTROL	. PLANS		
SCALE: AS NOTED	SHEET 52	OF	129 SHEETS	STA.	TO STA.


F.A.U. SECTION COUNTY TOTAL SHEETS NO.

4051 22-00134-00-TL MCHENRY 129 52

CONTRACT NO 61K35


| ILLINOIS | FED. AID | PROJECT

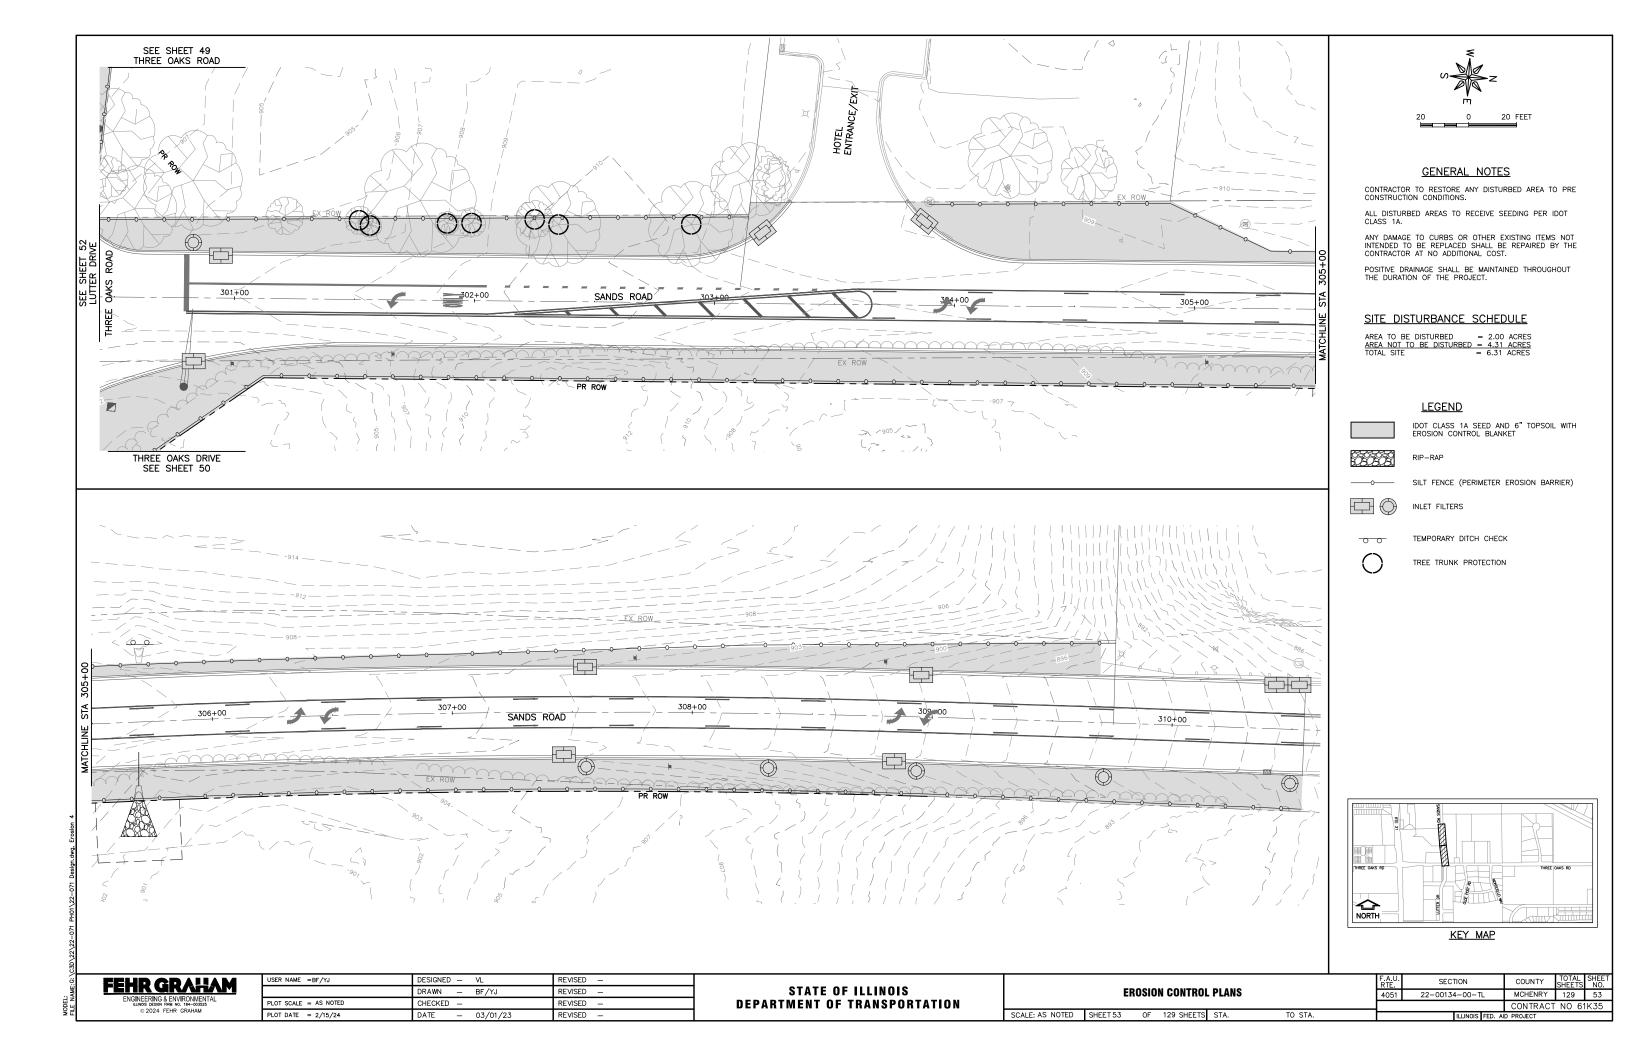

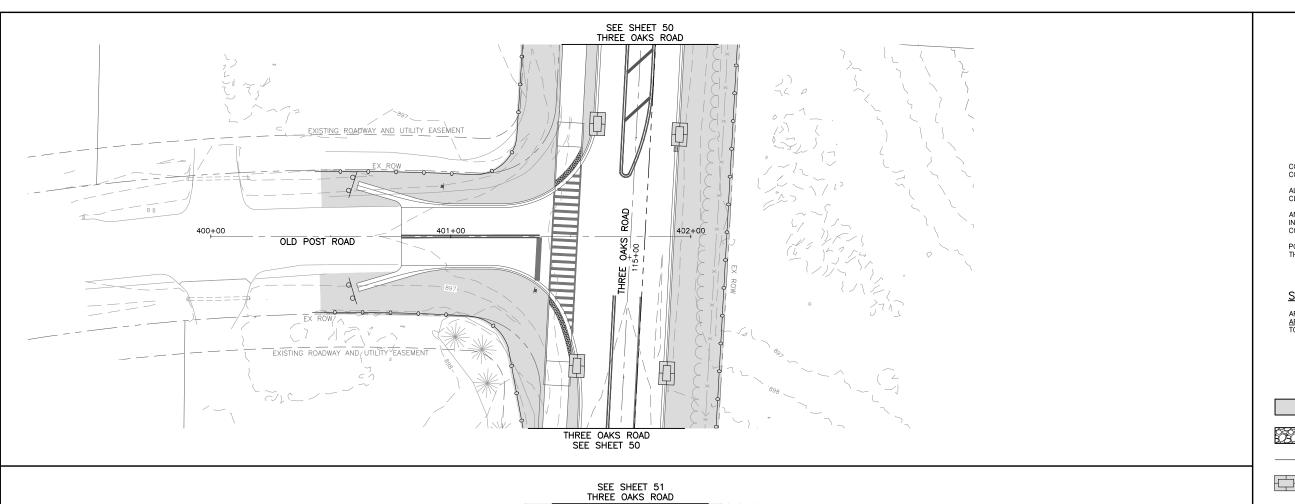

502,√00

THREE OAKS ROAD SEE SHEET 51

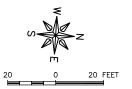

GENERAL NOTES

CONTRACTOR TO RESTORE ANY DISTURBED AREA TO PRE CONSTRUCTION CONDITIONS.

ALL DISTURBED AREAS TO RECEIVE SEEDING PER IDOT CLASS 1A. $\,$

ANY DAMAGE TO CURBS OR OTHER EXISTING ITEMS NOT INTENDED TO BE REPLACED SHALL BE REPAIRED BY THE CONTRACTOR AT NO ADDITIONAL COST.

POSITIVE DRAINAGE SHALL BE MAINTAINED THROUGHOUT THE DURATION OF THE PROJECT.

SITE DISTURBANCE SCHEDULE

AREA TO BE DISTURBED = 2.00 ACRES
AREA NOT TO BE DISTURBED = 4.31 ACRES
TOTAL SITE = 6.31 ACRES

LEGEND

IDOT CLASS 1A SEED AND 6" TOPSOIL WITH EROSION CONTROL BLANKET

SILT FENCE (PERIMETER EROSION BARRIER)




INLET FILTERS

TEMPORARY DITCH CHECK

TREE TRUNK PROTECTION



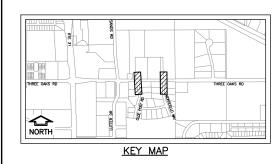

FEHR GRAHAM

500+00

E MONTICELLO WAY

EXISTING ROADWAY AND UTILITY EASEMENT

USER NAME =BF/YJ	DESIGNED	_	VL	REVISED	_
	DRAWN	_	BF/YJ	REVISED	_
PLOT SCALE = AS NOTED	CHECKED	_		REVISED	_
PLOT DATE = 2/15/24	DATE	_	03/01/23	REVISED	_


501+00


STATE OF ILLINOIS DEPARTMENT OF TRANSPORTATION


	E	ROSIOI	N CONTROI	. PLANS
SCALE: AS NOTED	SHEET 54	OF	129 SHEETS	STA.


TO STA.


F.A.U. RTE.	SECTION	COUNTY	TOTAL SHEETS	SHEET NO.			
4051	22-00134-00-TL	MCHENRY 129		54			
		CONTRACT	NO 6	1K35			
ILLINOIS FED. AID PROJECT							

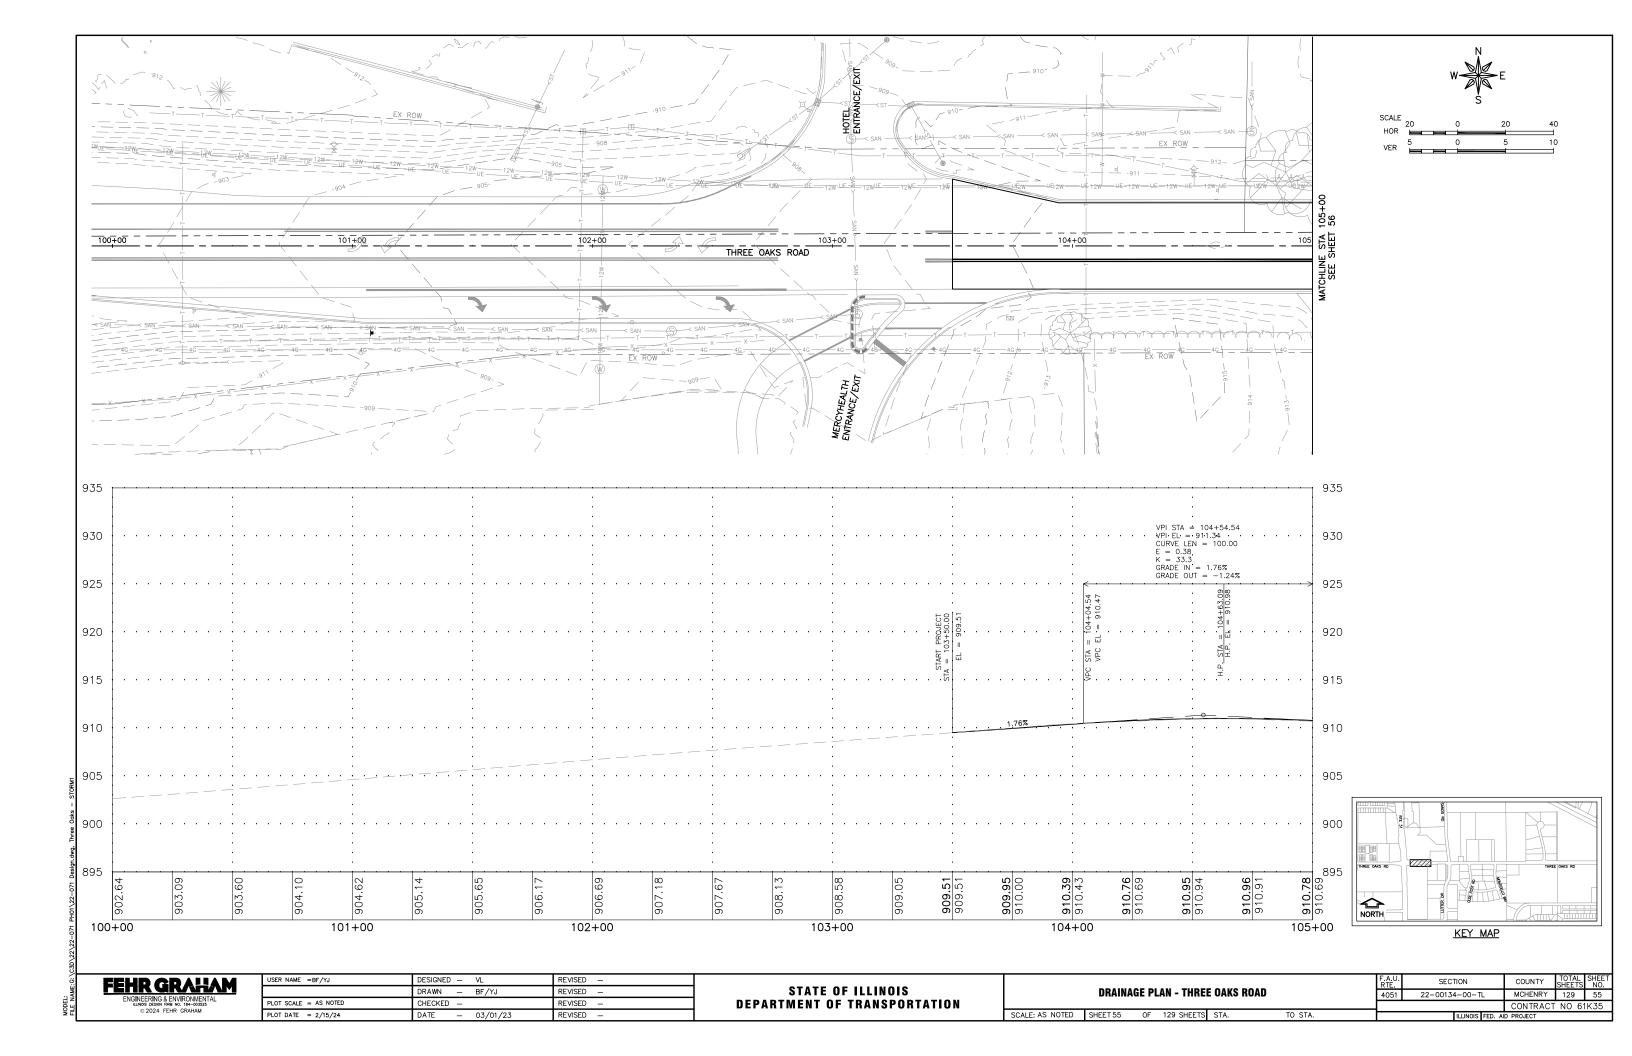


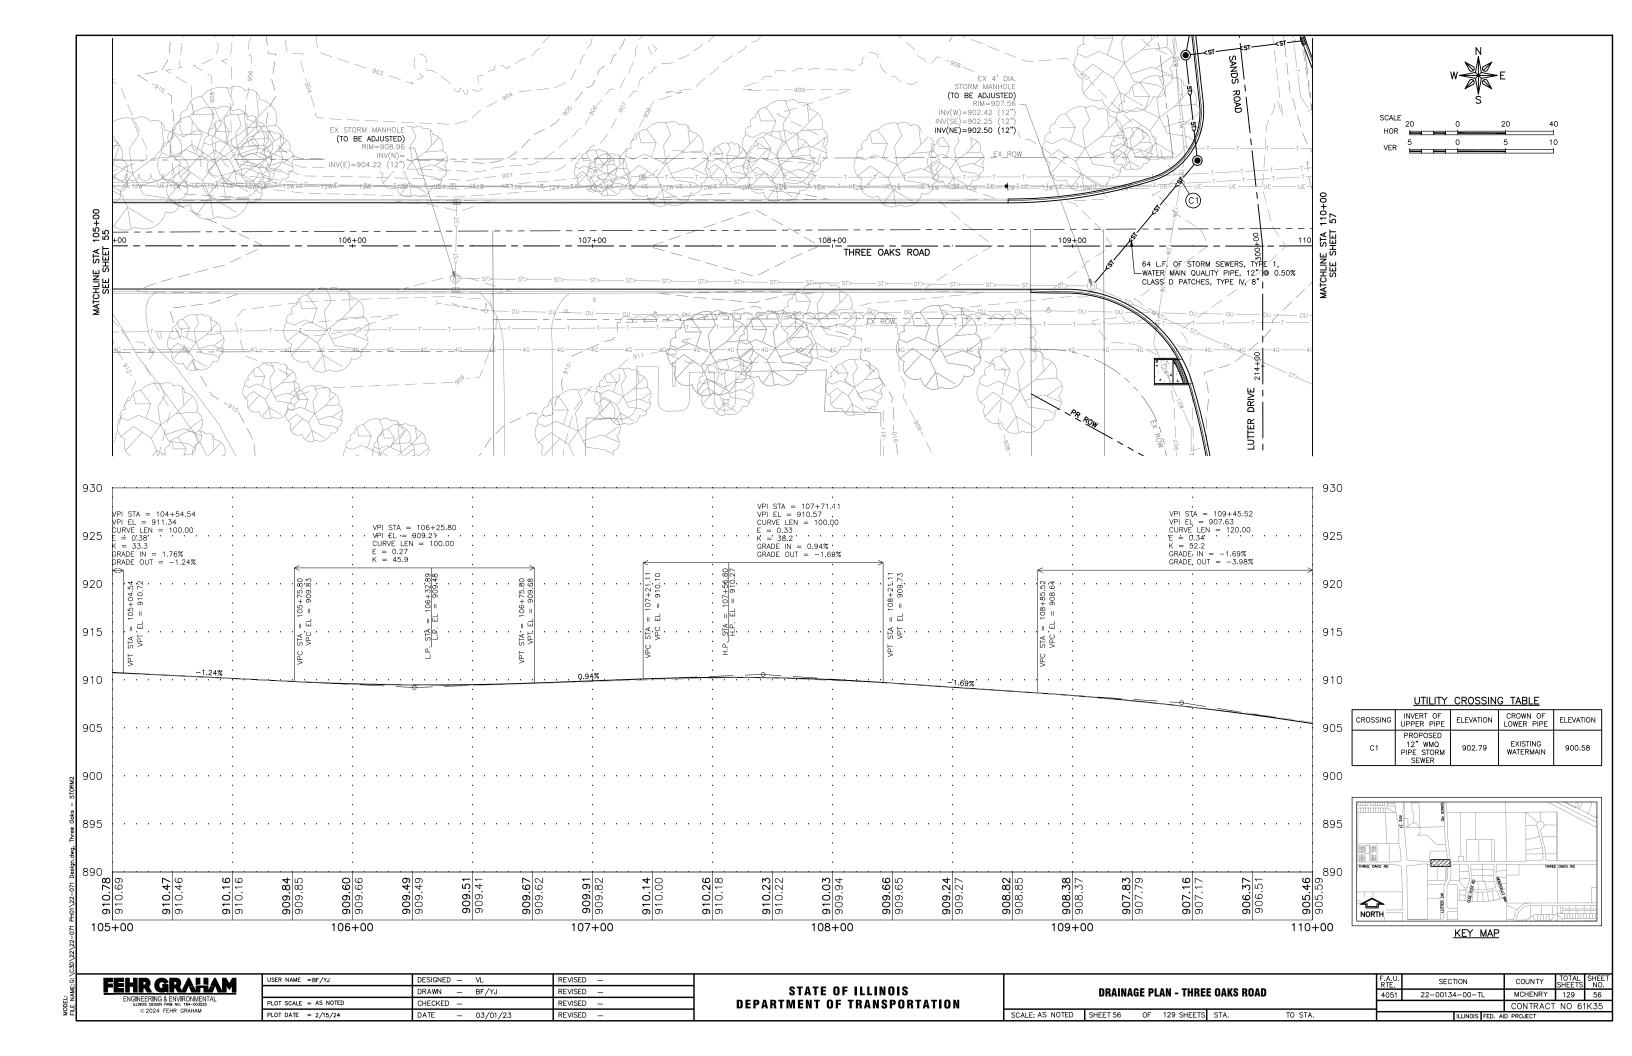


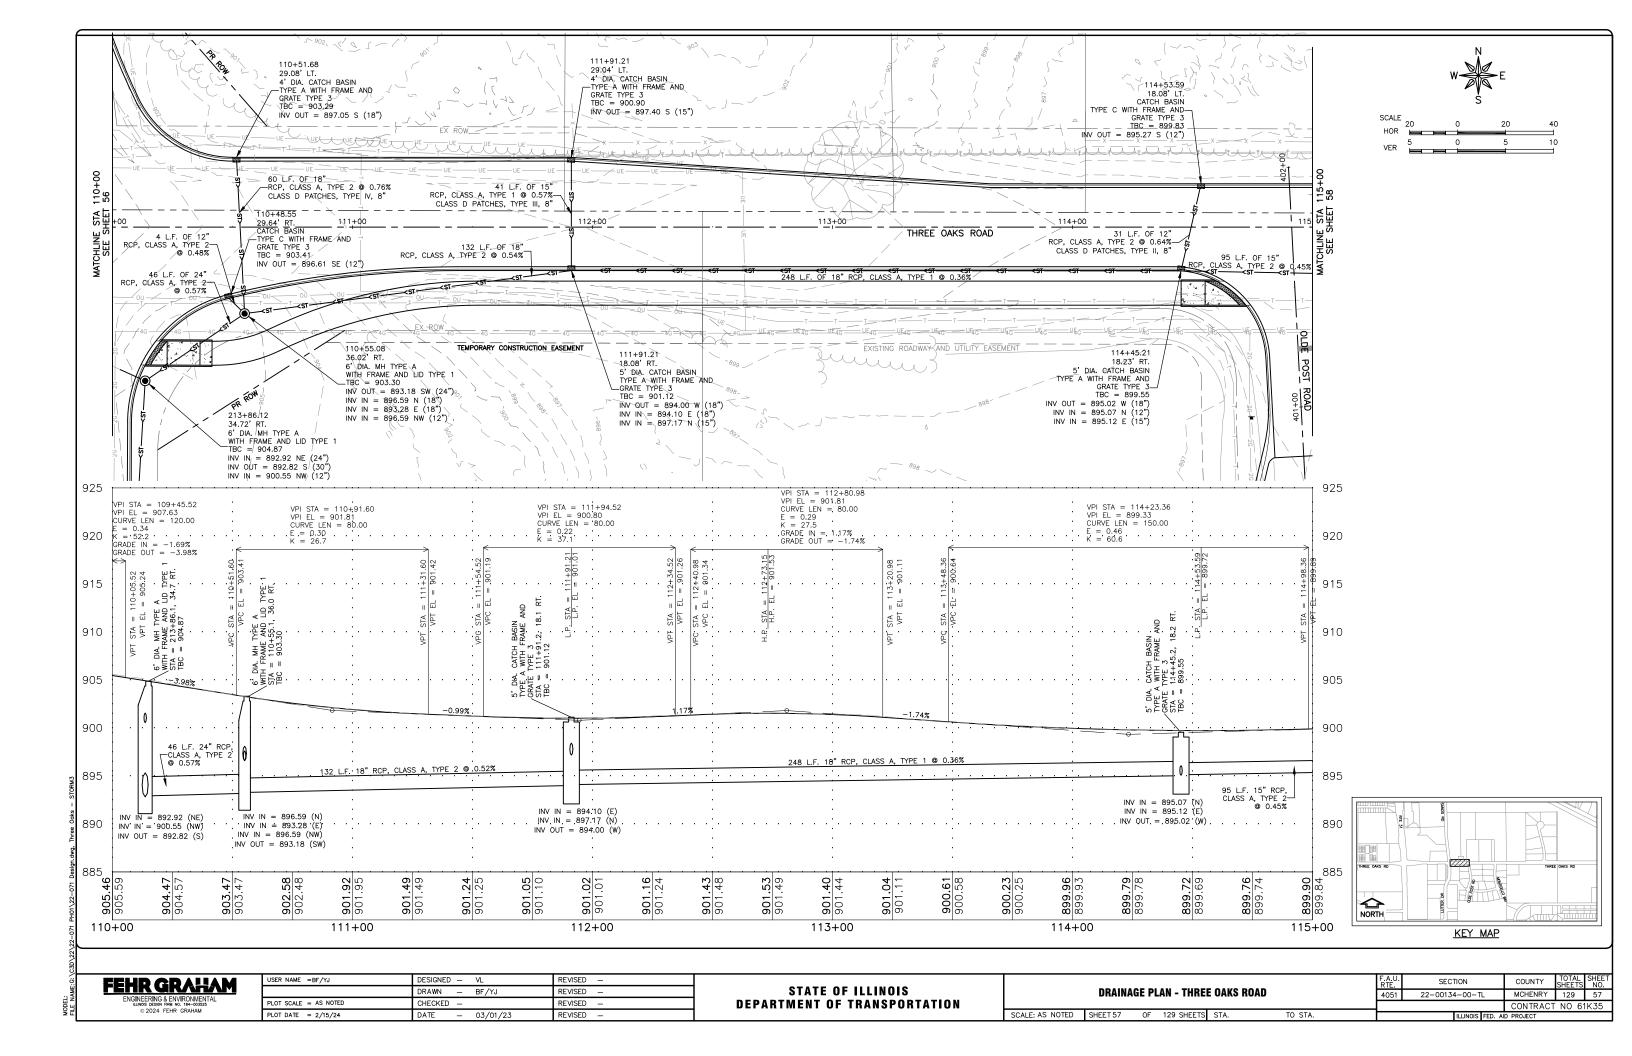


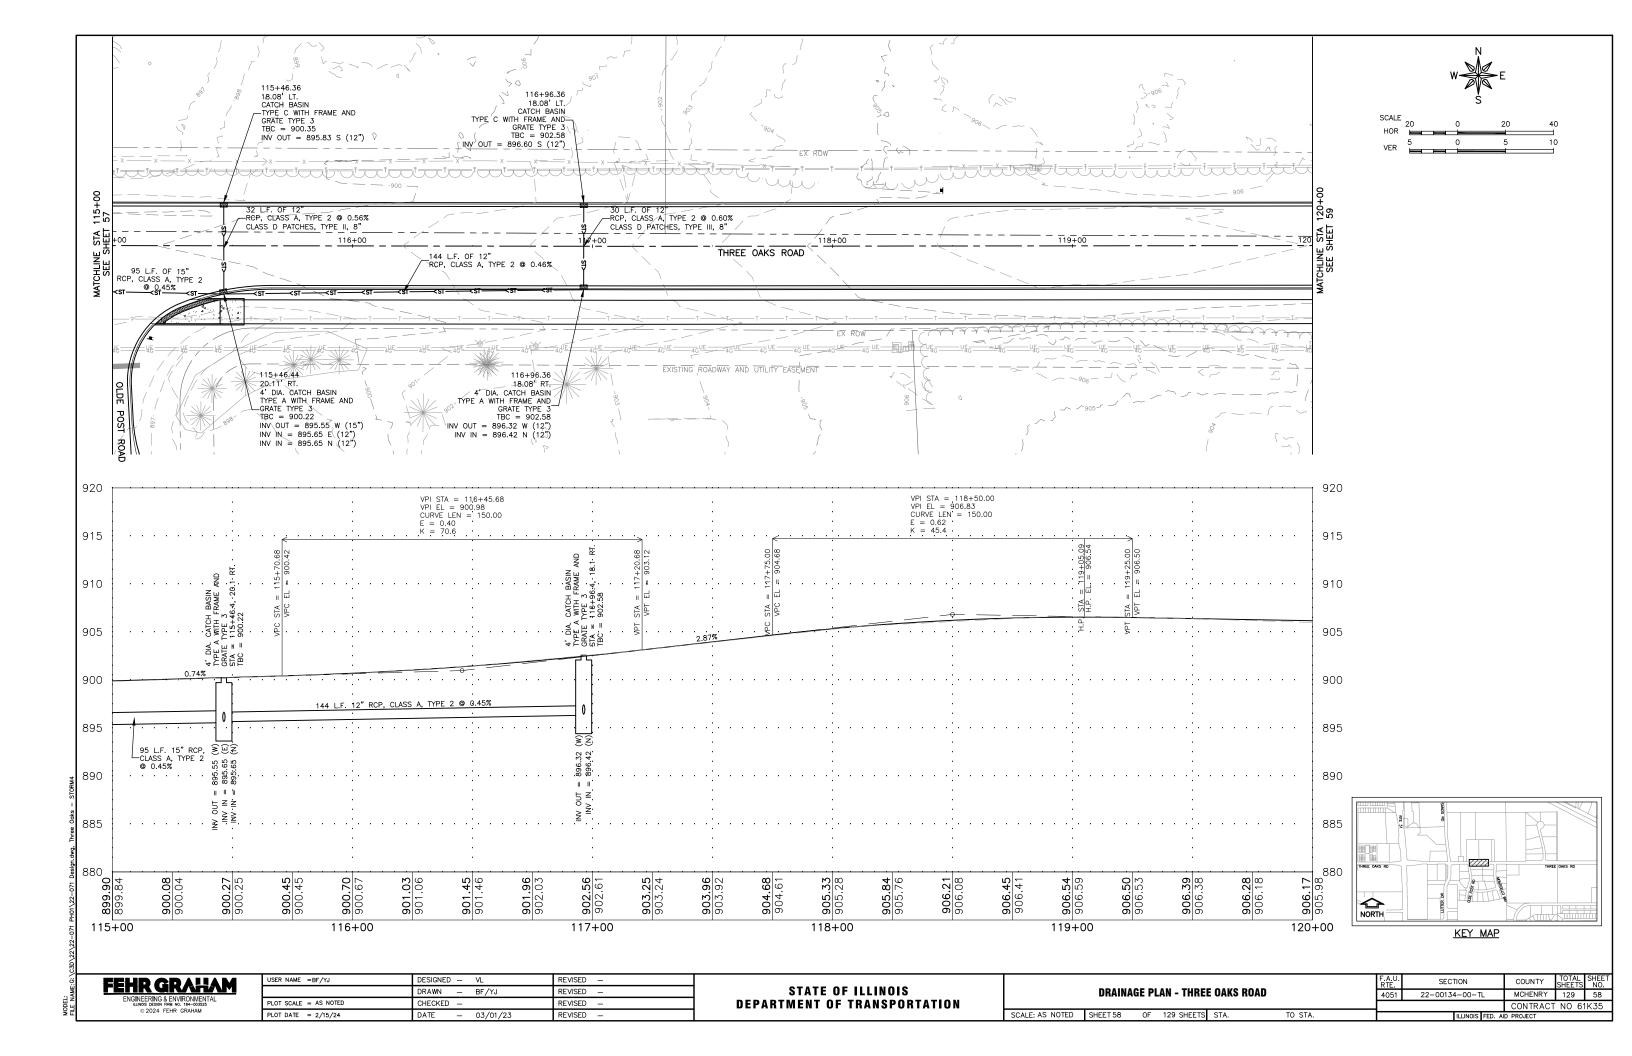


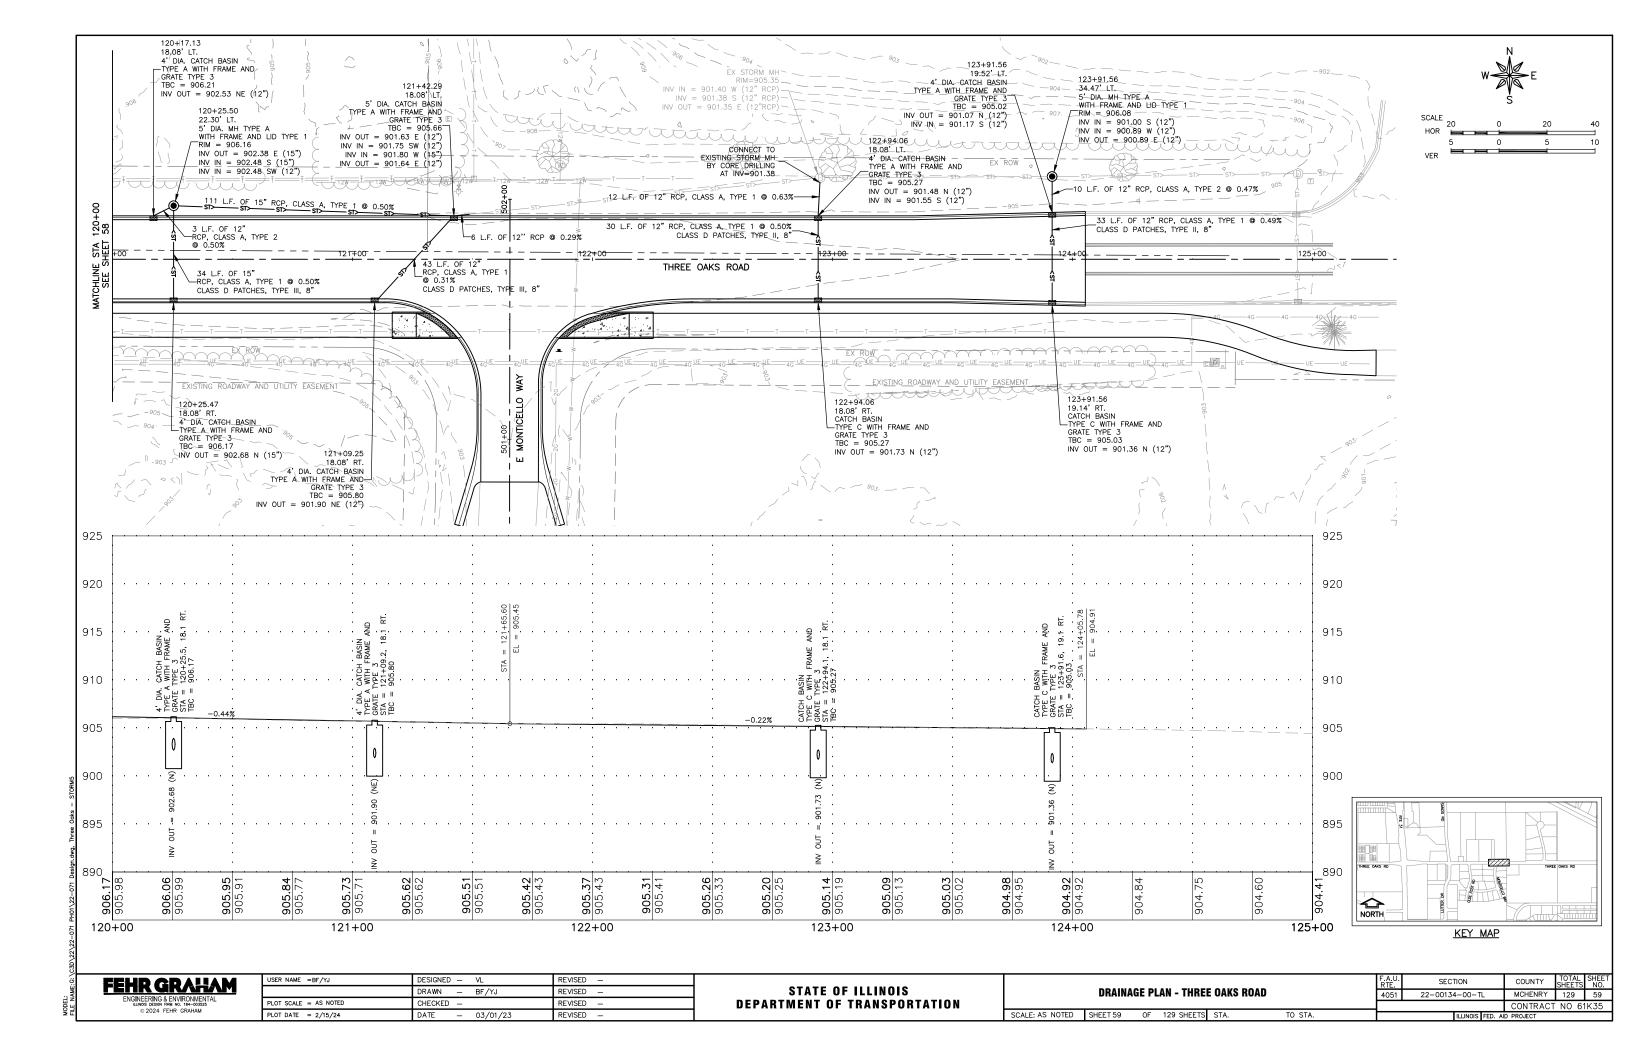


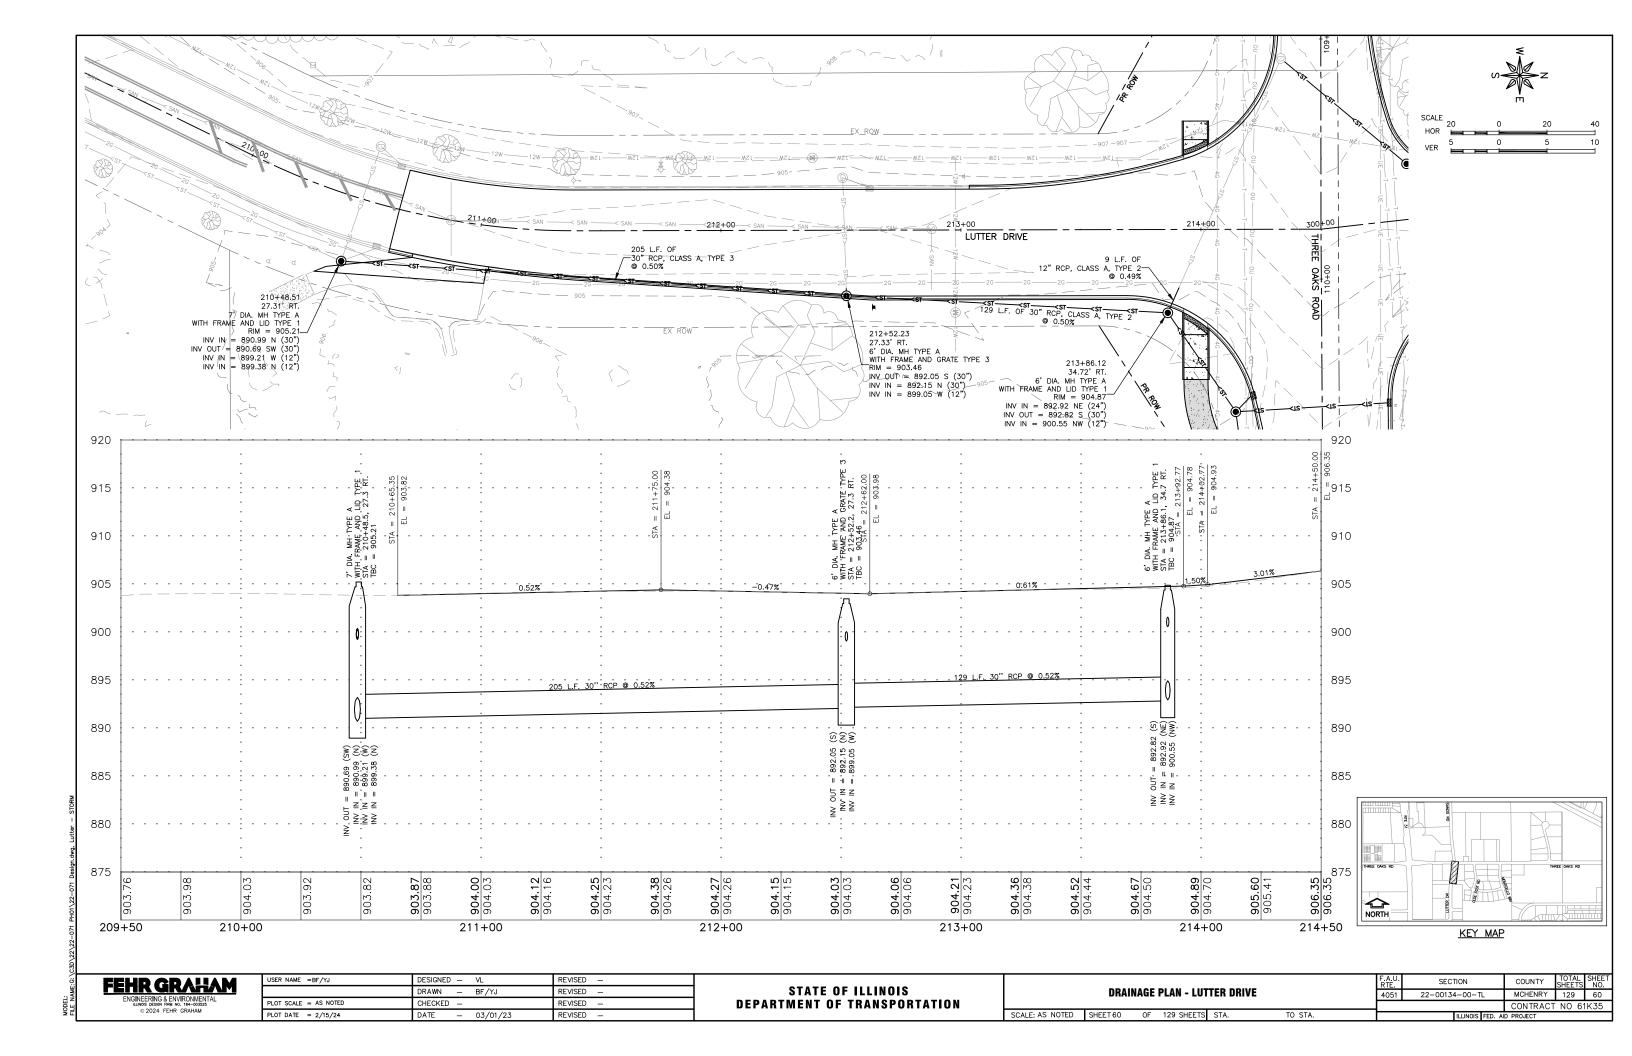


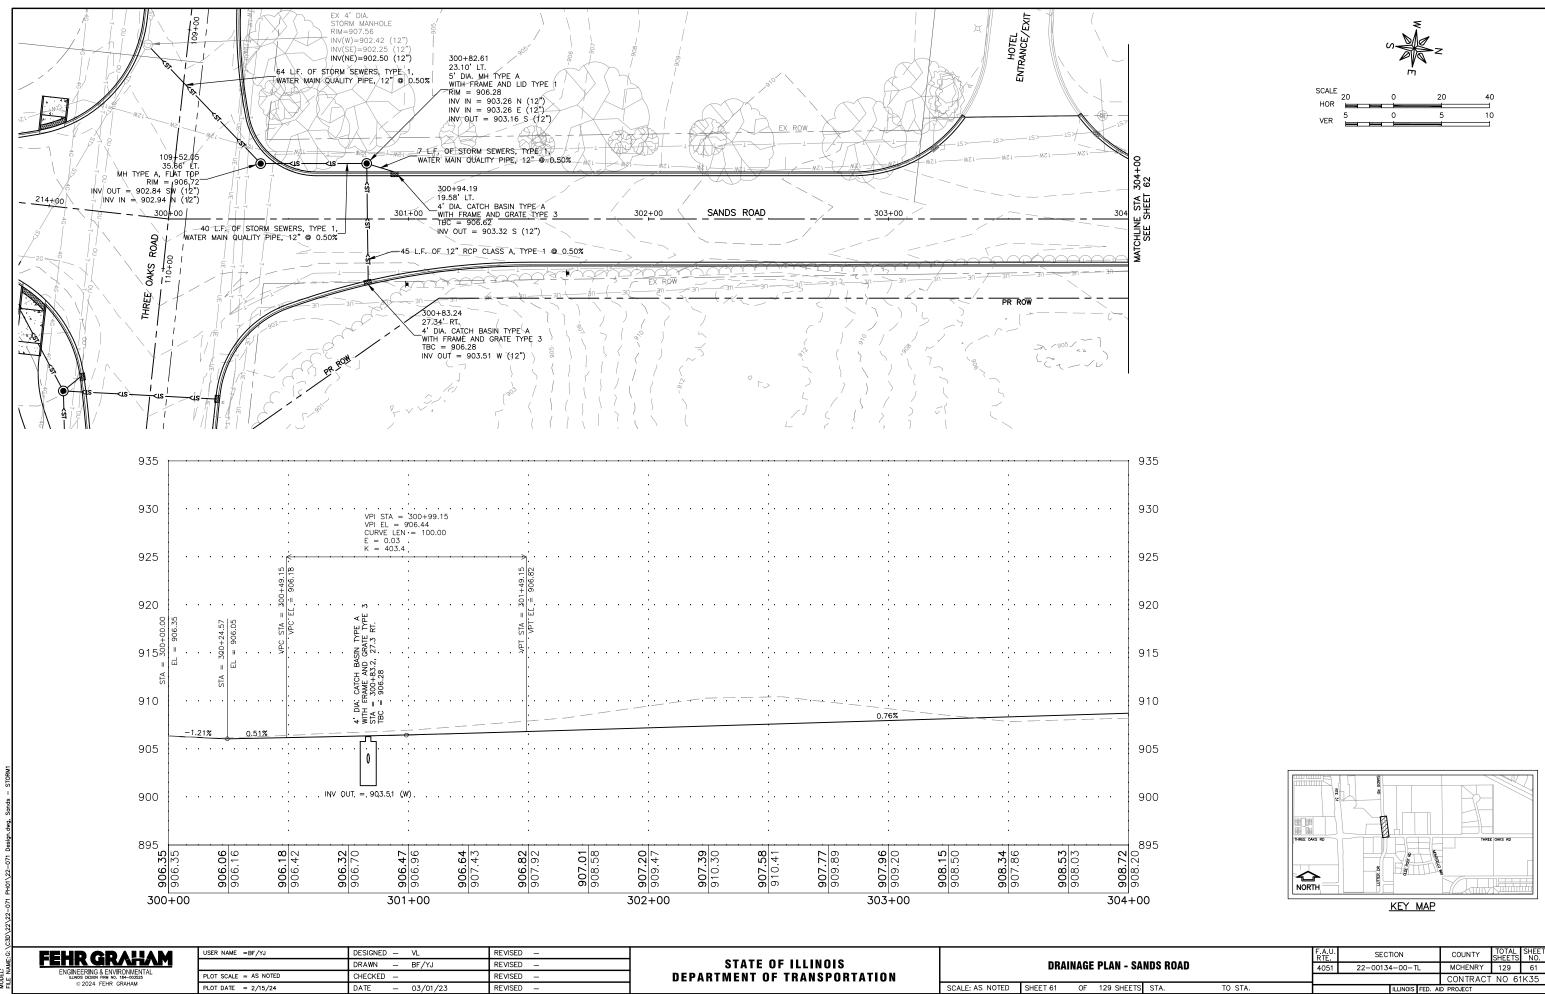


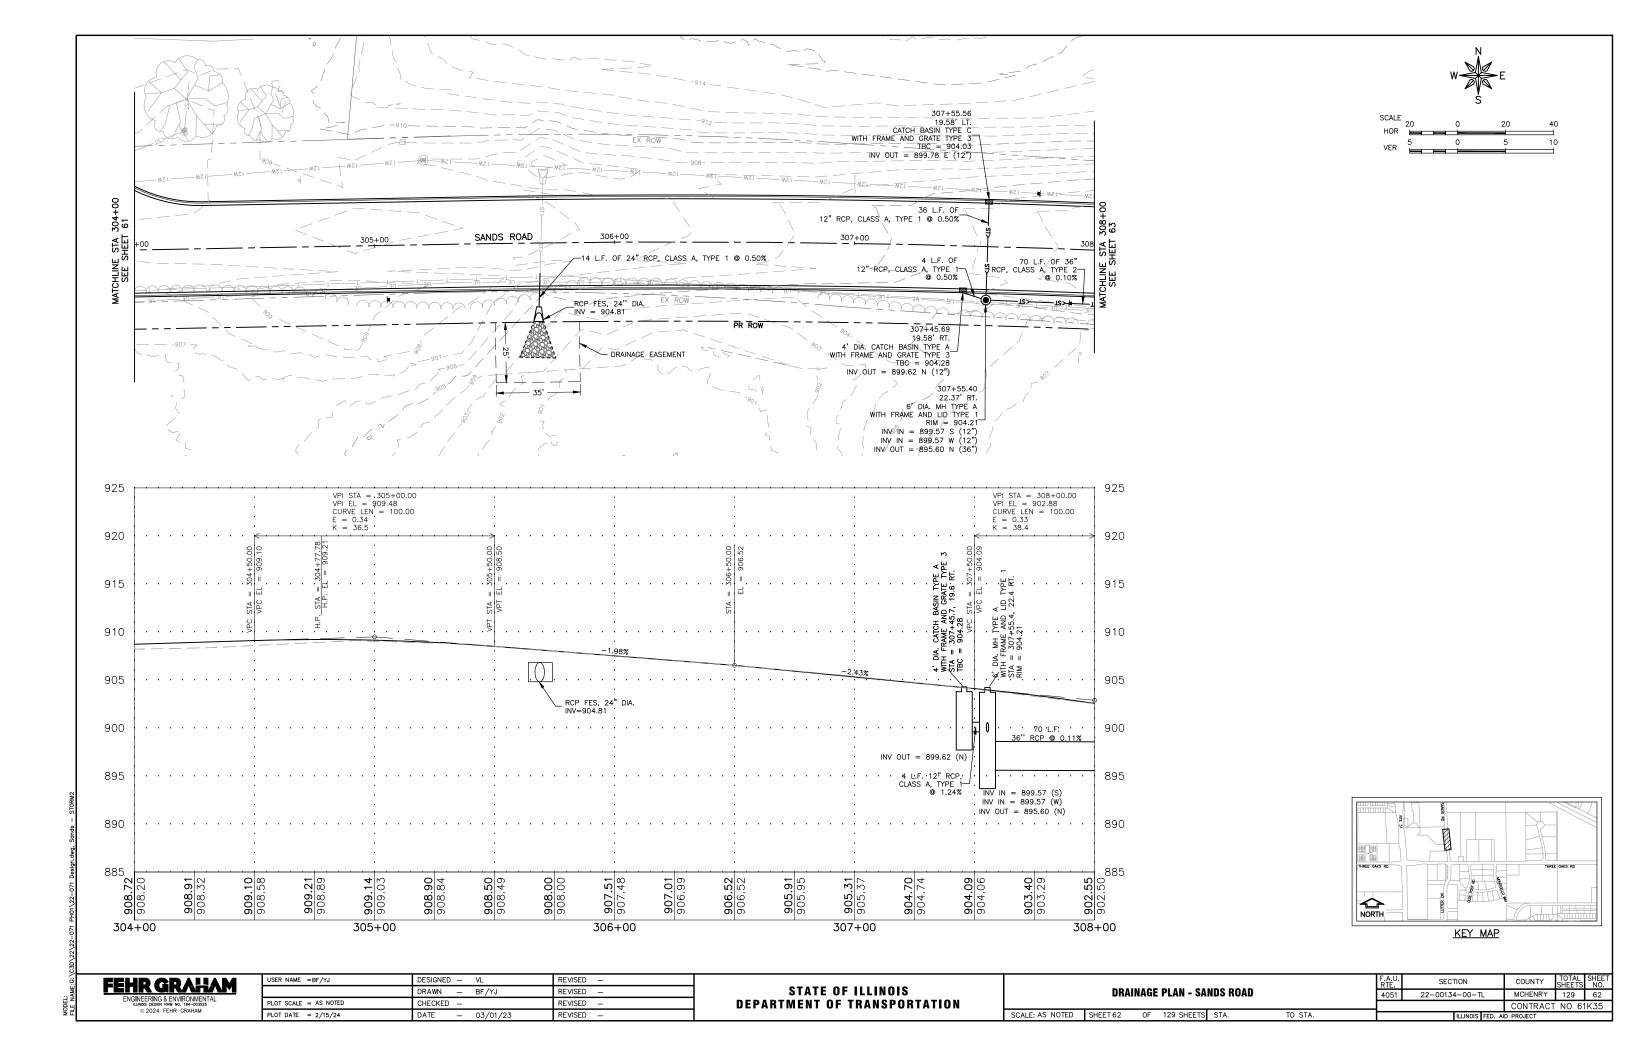

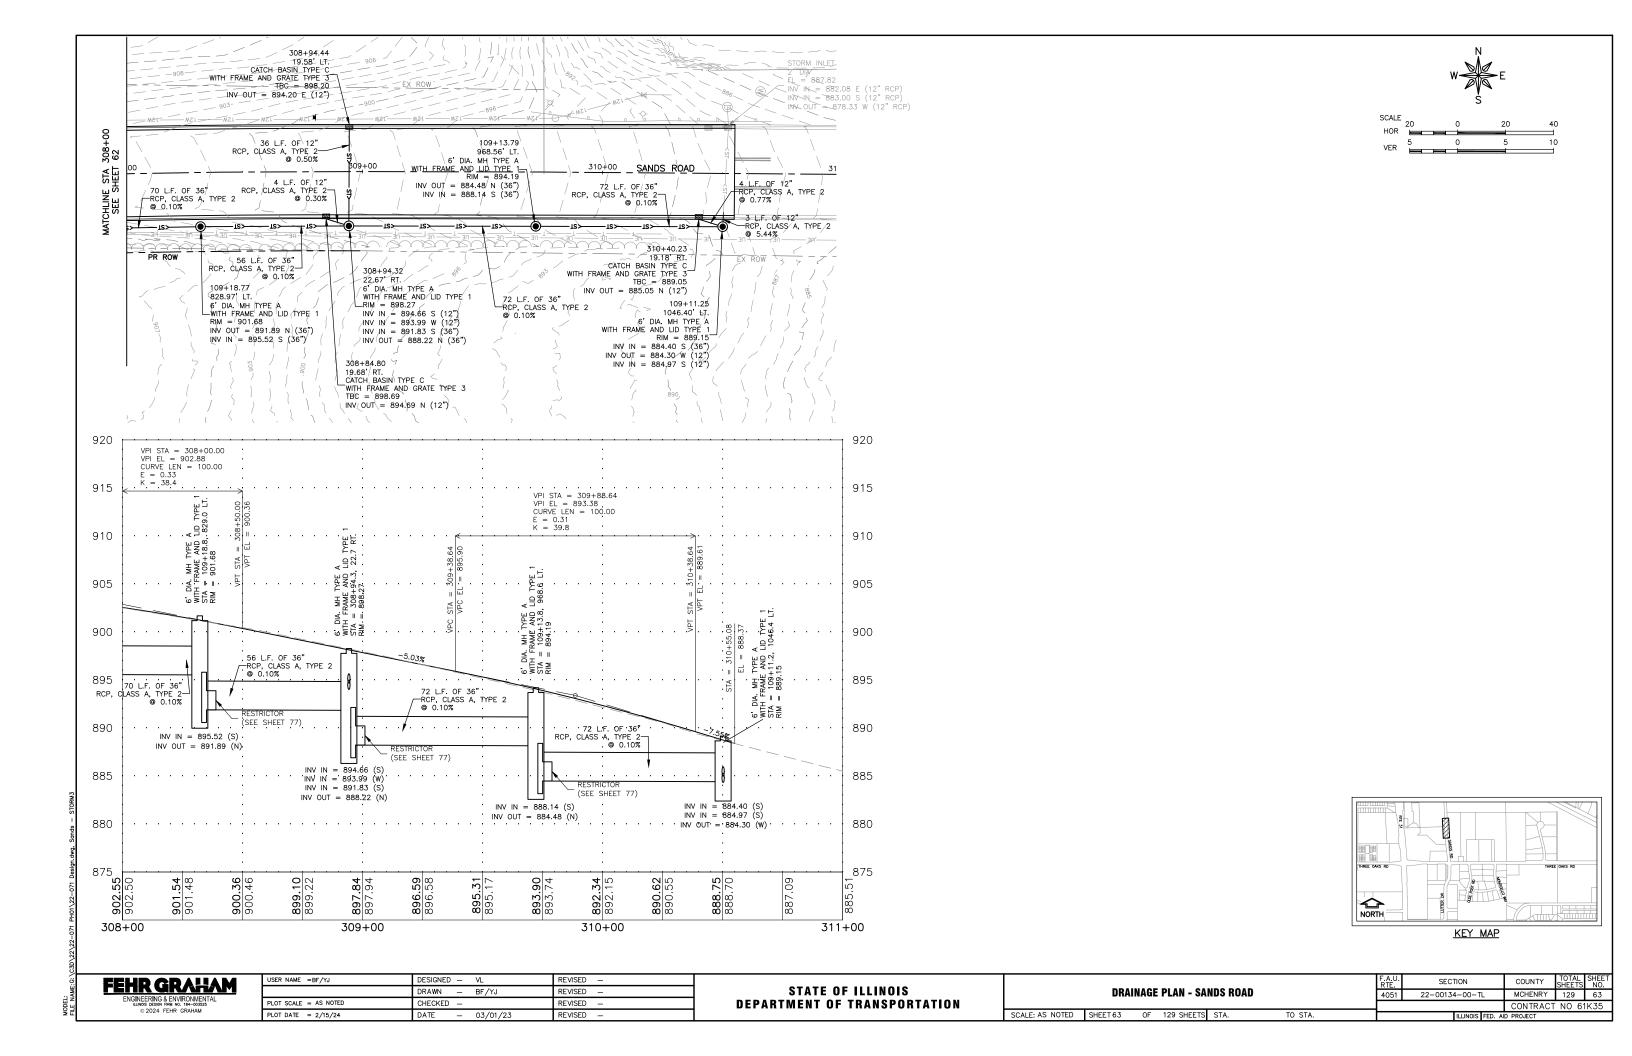

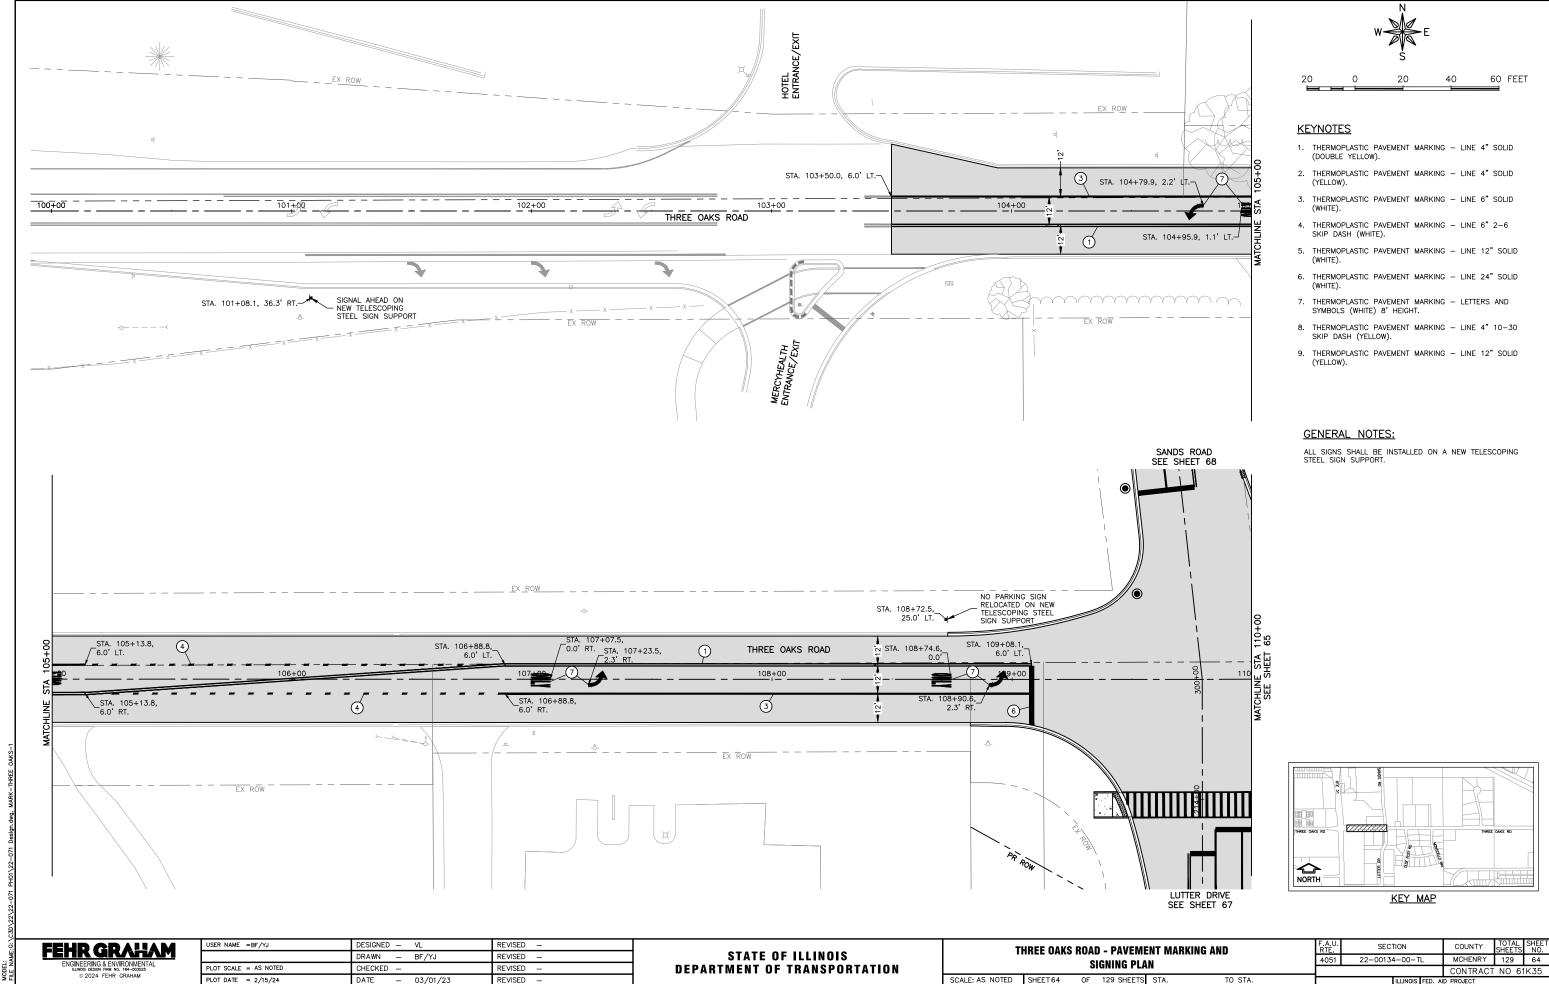

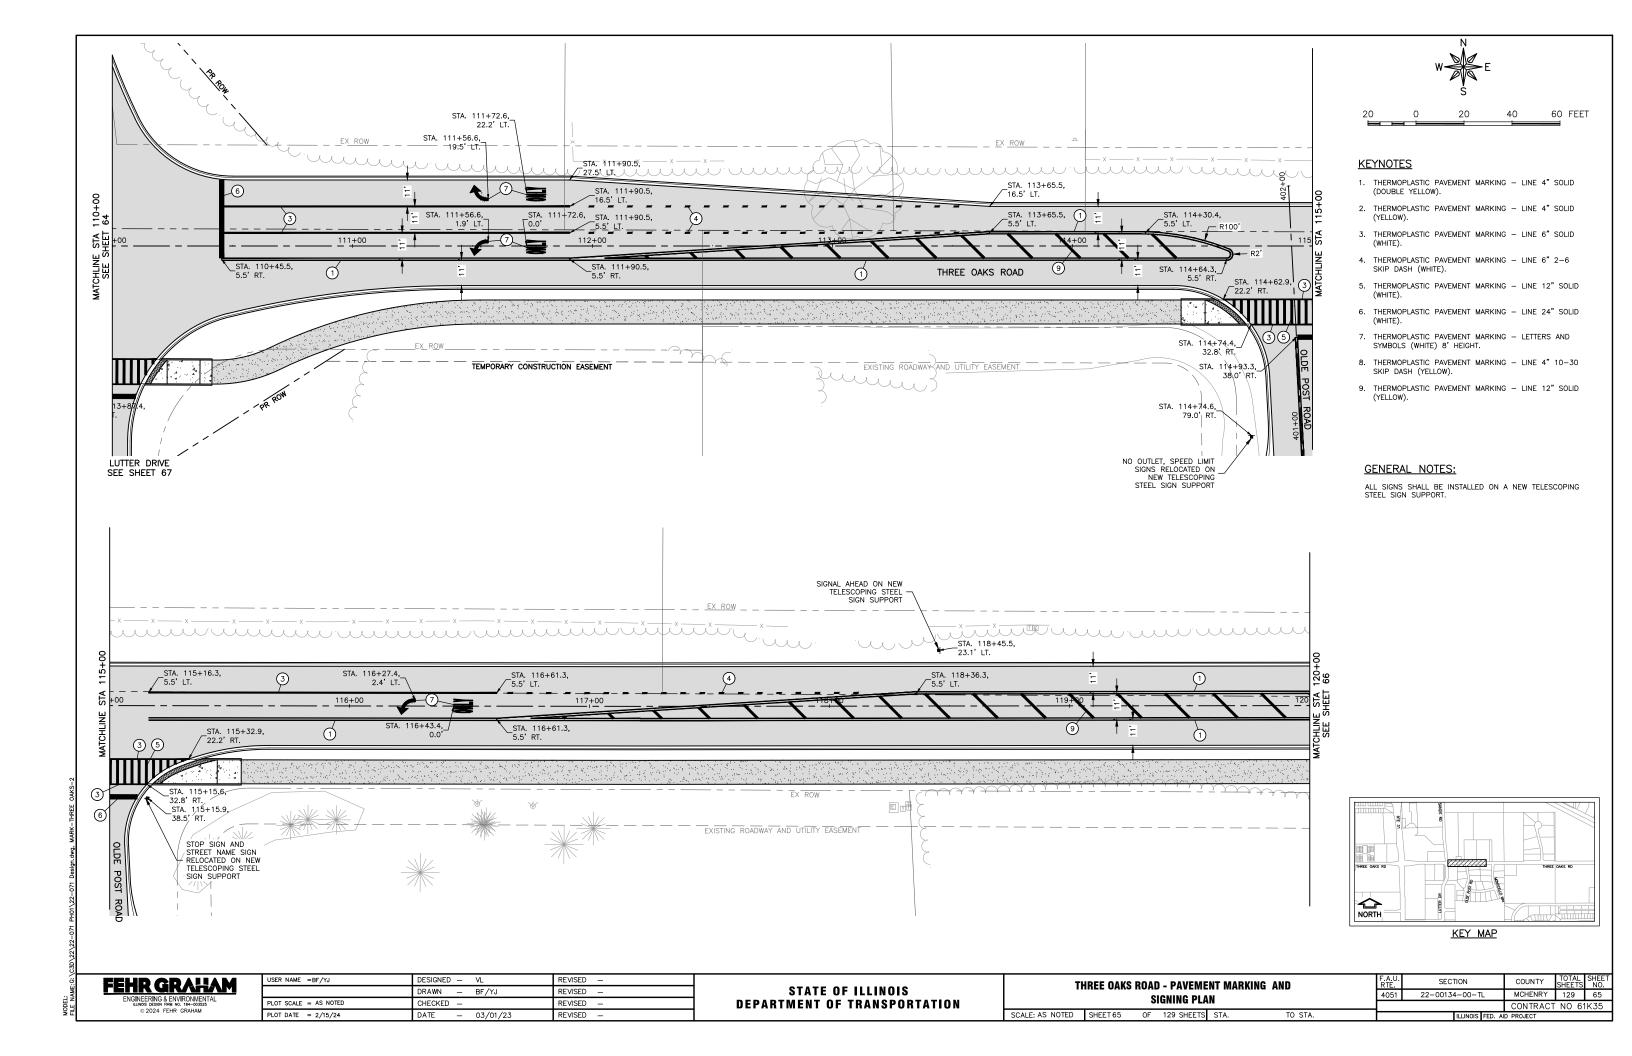

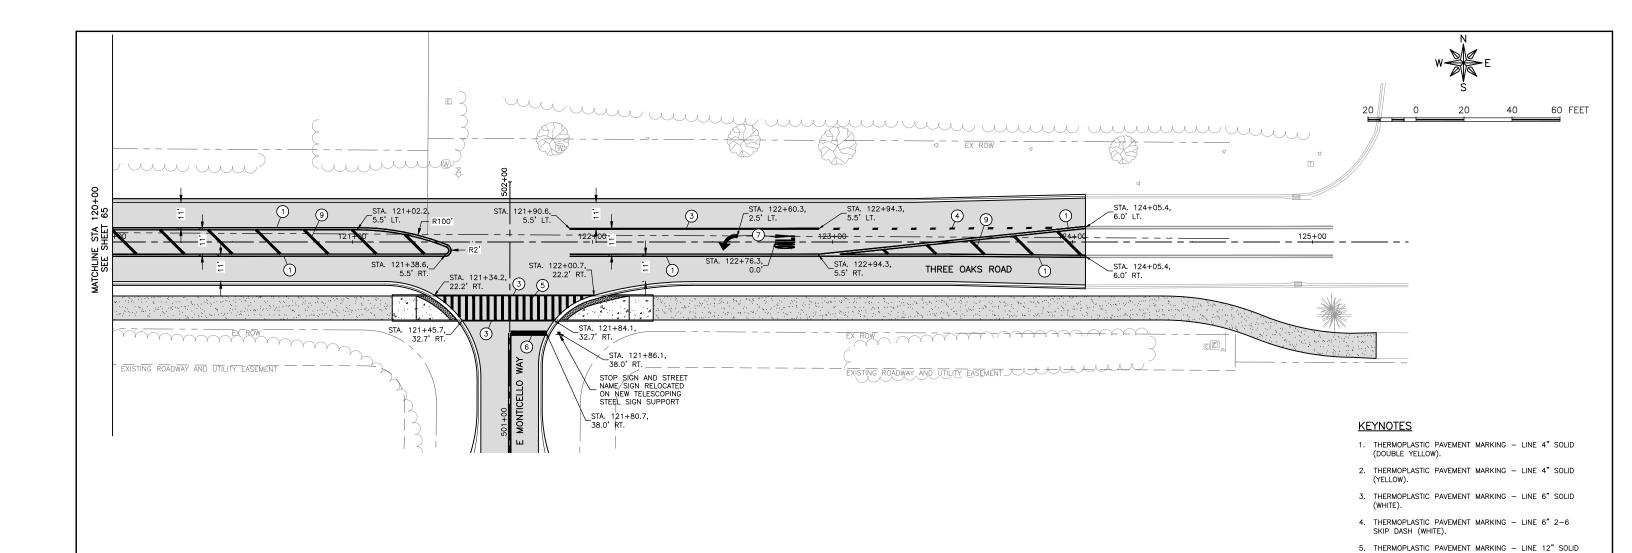

GENERAL NOTES:

SKIP DASH (YELLOW).

SYMBOLS (WHITE) 8' HEIGHT.

(WHITE).

(YELLOW).

ALL SIGNS SHALL BE INSTALLED ON A NEW TELESCOPING STEEL SIGN SUPPORT.

6. THERMOPLASTIC PAVEMENT MARKING - LINE 24" SOLID

7. THERMOPLASTIC PAVEMENT MARKING - LETTERS AND

8. THERMOPLASTIC PAVEMENT MARKING - LINE 4" 10-30

9. THERMOPLASTIC PAVEMENT MARKING - LINE 12" SOLID



KEY MAP


EHR GRAHAM
ENGINEERING & ENVIRONMENTAL ILLINOIS DESIGN FIRM NO. 184-003525
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USER NAME =BF/YJ	DESIGNED — VL	REVISED —
	DRAWN - BF/YJ	REVISED —
PLOT SCALE = AS NOTED	CHECKED —	REVISED —
PLOT DATE = 2/15/24	DATE - 03/01/23	REVISED —

STATE O	F ILLINOIS
DEPARTMENT OF	TRANSPORTATION

TI	HREE OAKS	KS ROAD - PAVEMENT M SIGNING PLAN			RKING AND
SCALE: AS NOTED	SHEET 66	OF	129 SHEETS	STA.	TO STA.

F.A.U. RTE.	SECTION	COUNTY	TOTAL SHEETS	SHEET NO.			
4051	22-00134-00-TL	MCHENRY	129	66			
		CONTRACT	NO 61	K35			
ILLINOIS FED. AID PROJECT							



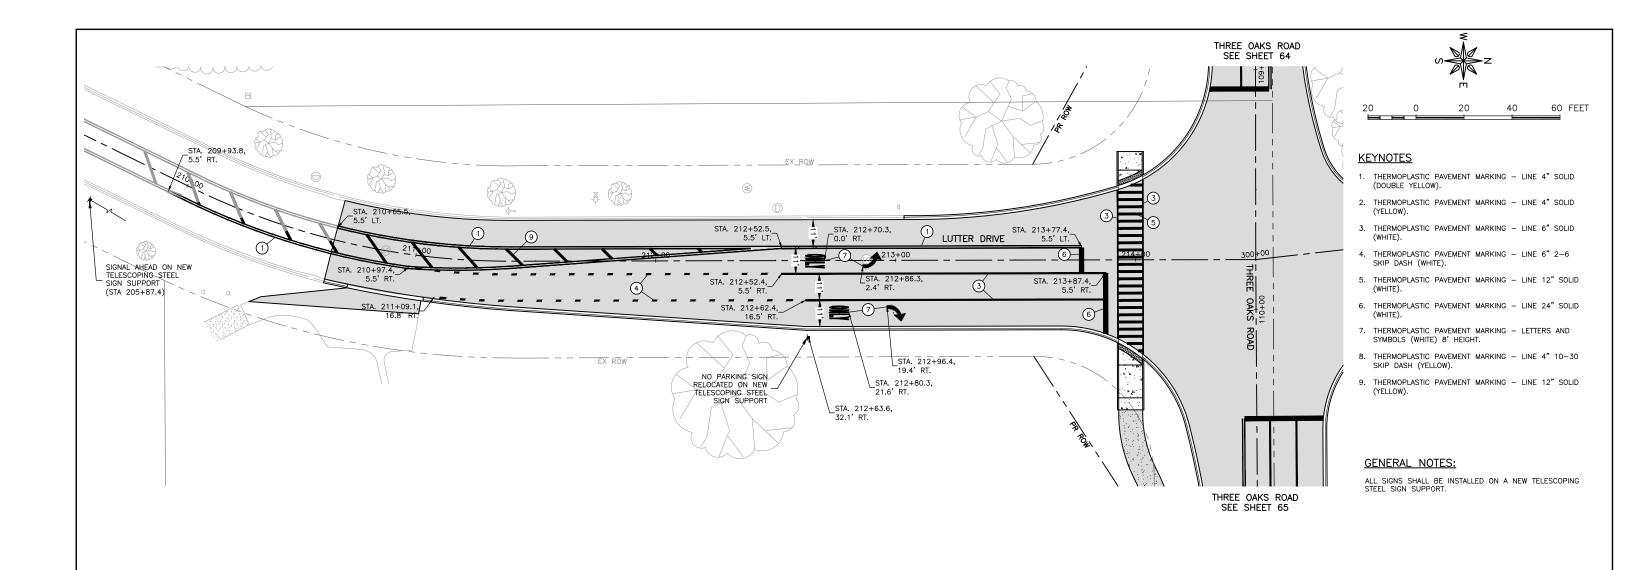


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ENGINEERING & ENVIRONMENTAL ILLINOIS DESIGN FIRM NO. 184-003525
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	DRAWN - BF/YJ	REVISED —
PLOT SCALE = AS NOTED	CHECKED —	REVISED —
PLOT DATE = 2/15/24	DATE - 03/01/23	REVISED —

STATE OF ILLINOIS						
DEPARTMENT	0 F	TRANSPORTATION				

LUTTER DRIVE - PAVEMENT MARKING AND SIGNING PLAN								
	SCALE: AS NOTED	SHEET 67	OF	129 SHEETS	STA.	TO STA.		

F.A.U. RTE.	SECTION	COUNTY	TOTAL SHEETS	SHEET NO.	
4051	22-00134-00-	MCHENRY	129	67	
		CONTRACT NO 61K35			
	ILLINOIS	FED. A	ID PROJECT	·	

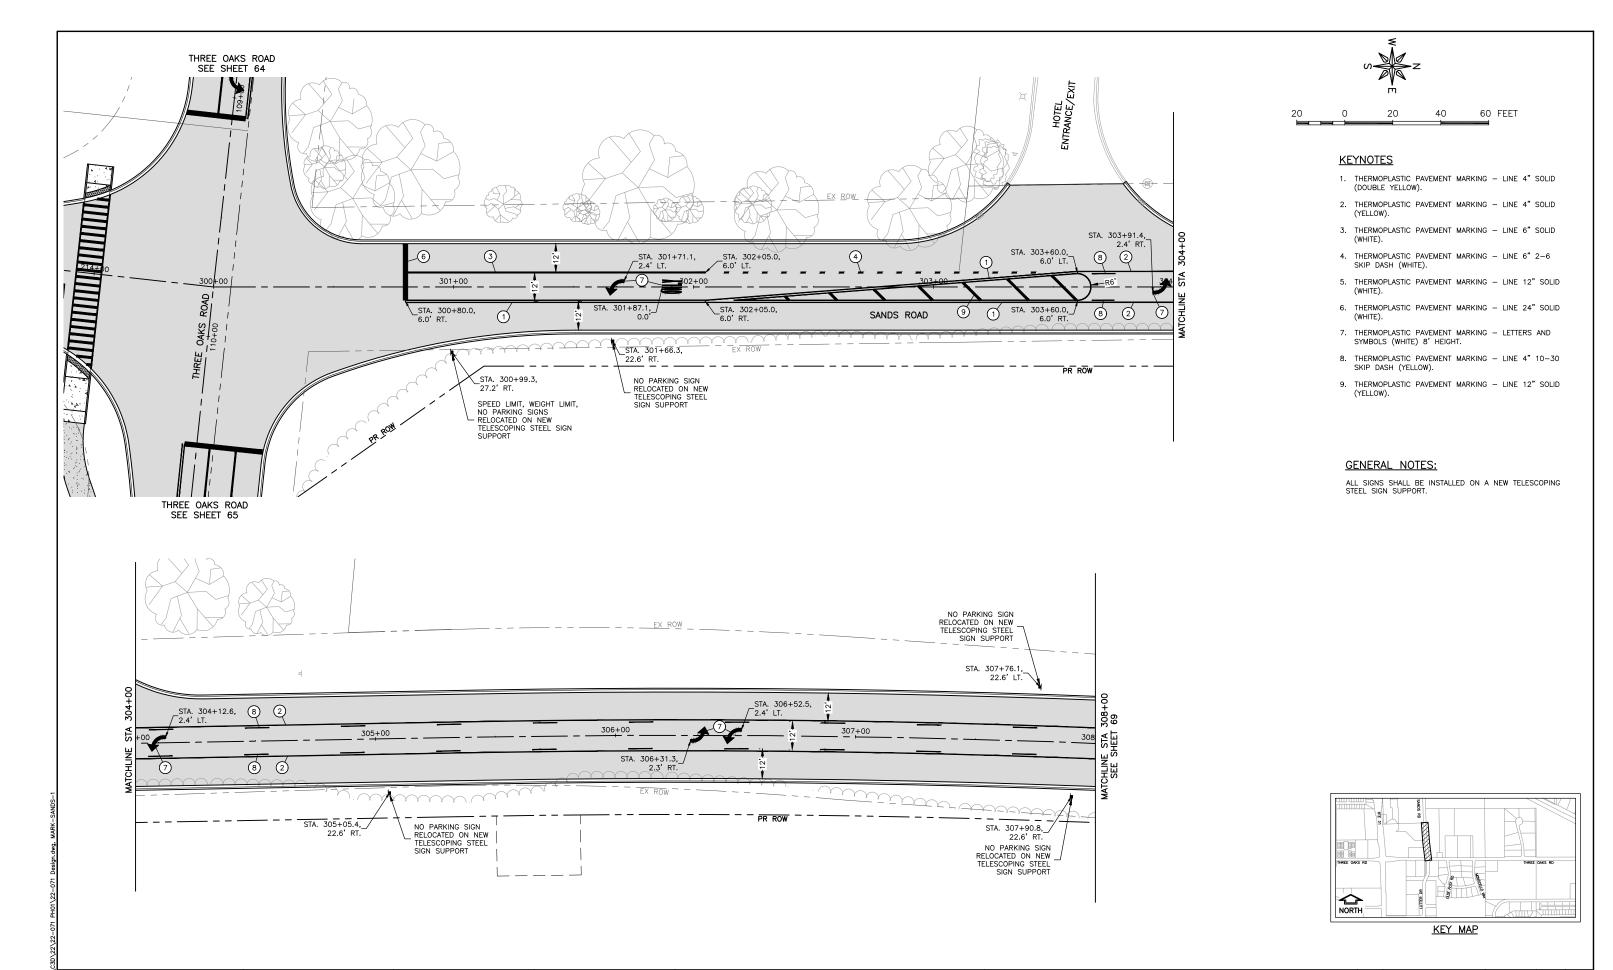

STATE OF ILLINOIS

DEPARTMENT OF TRANSPORTATION

SECTION

ILLINOIS FED. AID PROJECT

22-00134-00-TL

4051

TO STA.

SANDS ROAD - PAVEMENT MARKING AND

SIGNING PLAN

SCALE: AS NOTED SHEET 68 OF 129 SHEETS STA.

COUNTY TOTAL SHEET NO.

MCHENRY 129 68

CONTRACT NO 61K35

MODEL:

FEHR GRAHAM

JSER NAME =BF/YJ

PLOT SCALE = AS NOTED

PLOT DATE = 2/15/24

DESIGNED - VL

CHECKED

DATE

DRAWN - BF/YJ


- 03/01/23

REVISED -

REVISED -

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REVISED



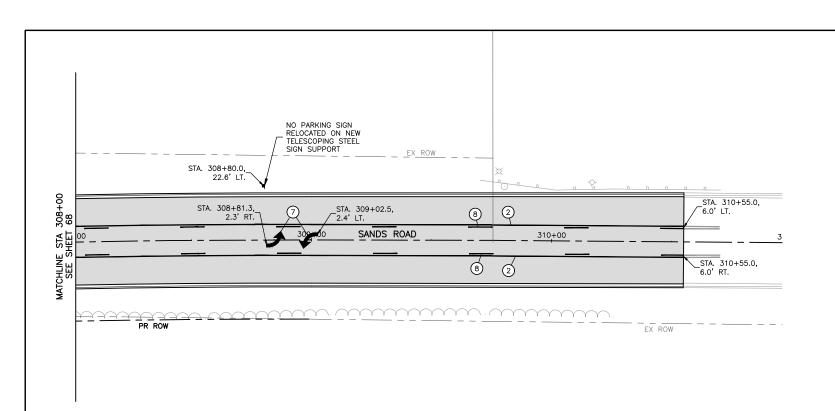

0 0 20 40 60 FEET

KEYNOTES

- THERMOPLASTIC PAVEMENT MARKING LINE 4" SOLID (DOUBLE YELLOW).
- THERMOPLASTIC PAVEMENT MARKING LINE 4" SOLID (YELLOW).
- THERMOPLASTIC PAVEMENT MARKING LINE 6" SOLID (WHITE).
- 4. THERMOPLASTIC PAVEMENT MARKING LINE 6" 2-6 SKIP DASH (WHITE).
- THERMOPLASTIC PAVEMENT MARKING LINE 12" SOLID (WHITE).

 THERMOPLASTIC PAVEMENT MARKING LINE 24" SOLID (WHITE).
- 7. THERMOPLASTIC PAVEMENT MARKING LETTERS AND SYMBOLS (WHITE) 8' HEIGHT.
- 8. THERMOPLASTIC PAVEMENT MARKING LINE 4" 10-30 SKIP DASH (YELLOW).
- 9. THERMOPLASTIC PAVEMENT MARKING LINE 12" SOLID (YELLOW).

GENERAL NOTES:

ALL SIGNS SHALL BE INSTALLED ON A NEW TELESCOPING STEEL SIGN SUPPORT.



KEY MAP

FEHR GRAHAM


ENGINEERING & ENVIRONMENTAL
ILLINGS DESON FIRM NO. 1244-003225

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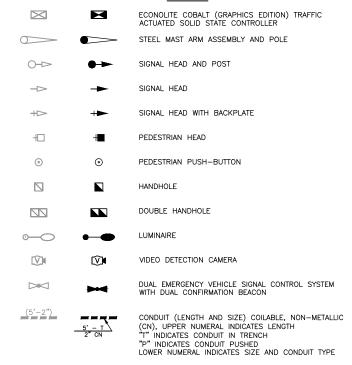
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	DRAWN - BF/YJ	REVISED —
PLOT SCALE = AS NOTED	CHECKED —	REVISED —
PLOT DATE = 2/15/24	DATE - 03/01/23	REVISED —

STATE OF ILLINOIS
DEPARTMENT OF TRANSPORTATION

SANDS ROAD - PAVEMENT MARKING AND SIGNING PLAN							
SCALE: AS NOTED	SHEET 69	OF	129 SHEETS	STA.	TO STA.		

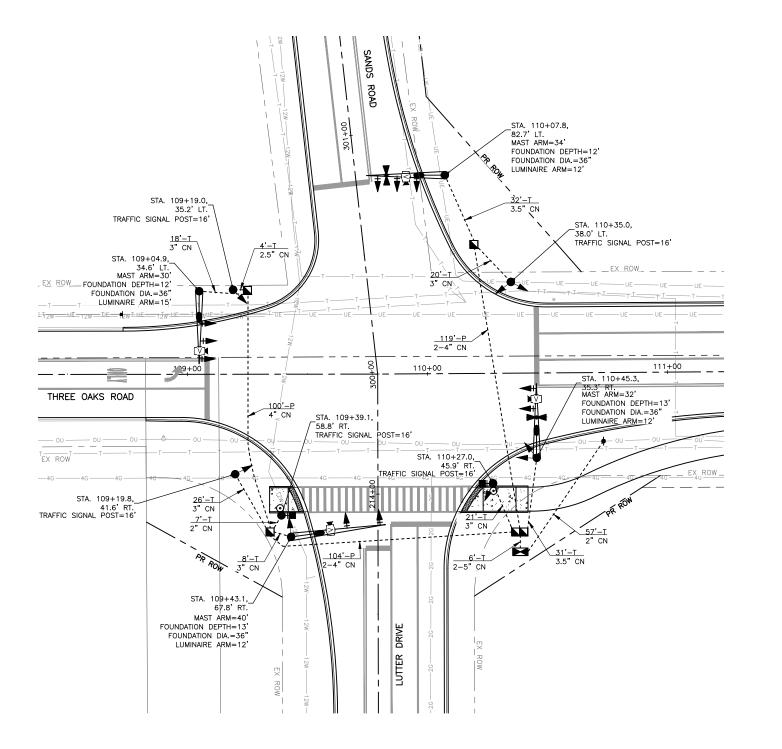

<u>LEGEND</u>



TRAFFIC SIGNAL GENERAL NOTES

THE EXACT LOCATION OF THE TRAFFIC SIGNAL EQUIPMENT IS SUBJECT TO CHANGE IN THE FIELD. THE ENGINEER AND MUNICIPALITY SHALL BE NOTIFIED AND APPROVE OF ANY CHANGES.

ALL SIGNAL CABLE SHALL BE MARKED WITH ELECTRIC TAPE FOR IDENTIFICATION PURPOSES. THIS IDENTIFICATION SHALL BE DONE AT THE CONTROLLER AND IN THE SIGNAL HEAD.

CONTRACTOR MUST SUBMIT SHOP DRAWINGS FOR TRAFFIC SIGNAL POSTS CONSISTENT WITH I.D.O.T. PRE-APPROVED DESIGNS. THE LOADING ON THE SHOP DRAWINGS MUST MEET OR EXCEED THAT SHOWN ON THE PLANS.

CONTRACTOR SHALL CONTACT COMED AND COORDINATE THE SERVICE CONNECTION AND LOCATION WITH COMED.

ALL PEDESTRIAN SIGNALS SHALL BE APS.

CHANGEABLE MESSAGE SIGNS SHALL BE INSTALLED ON EACH APPROACH TO THIS INTERSECTION TWO WEEKS PRIOR TO ACTIVATING THE SIGNAL AND SHALL REMAIN FOR TWO WEEKS AFTER SIGNAL ACTIVATION.

W3-3 SIGNAL AHEAD WARNING SIGNS WITH 18"X18" ORANGE FLAG MOUNTED ON THE TRAFFIC SIDE OF THE SIGN PANEL SHALL BE INSTALLED ON EACH LEG OF THE INTERSECTION. THE FLAG AND THE ATTACHMENT SHALL NOT OBSCURE THE FACE OF THE SIGN. THE SIGNS SHALL BE INSTALLED 800' AHEAD OF THE INTERSECTION AND INSTALLED ON TELESCOPING STEEL SIGNS SUPPORTS.



20 0 20 40 60 FEET

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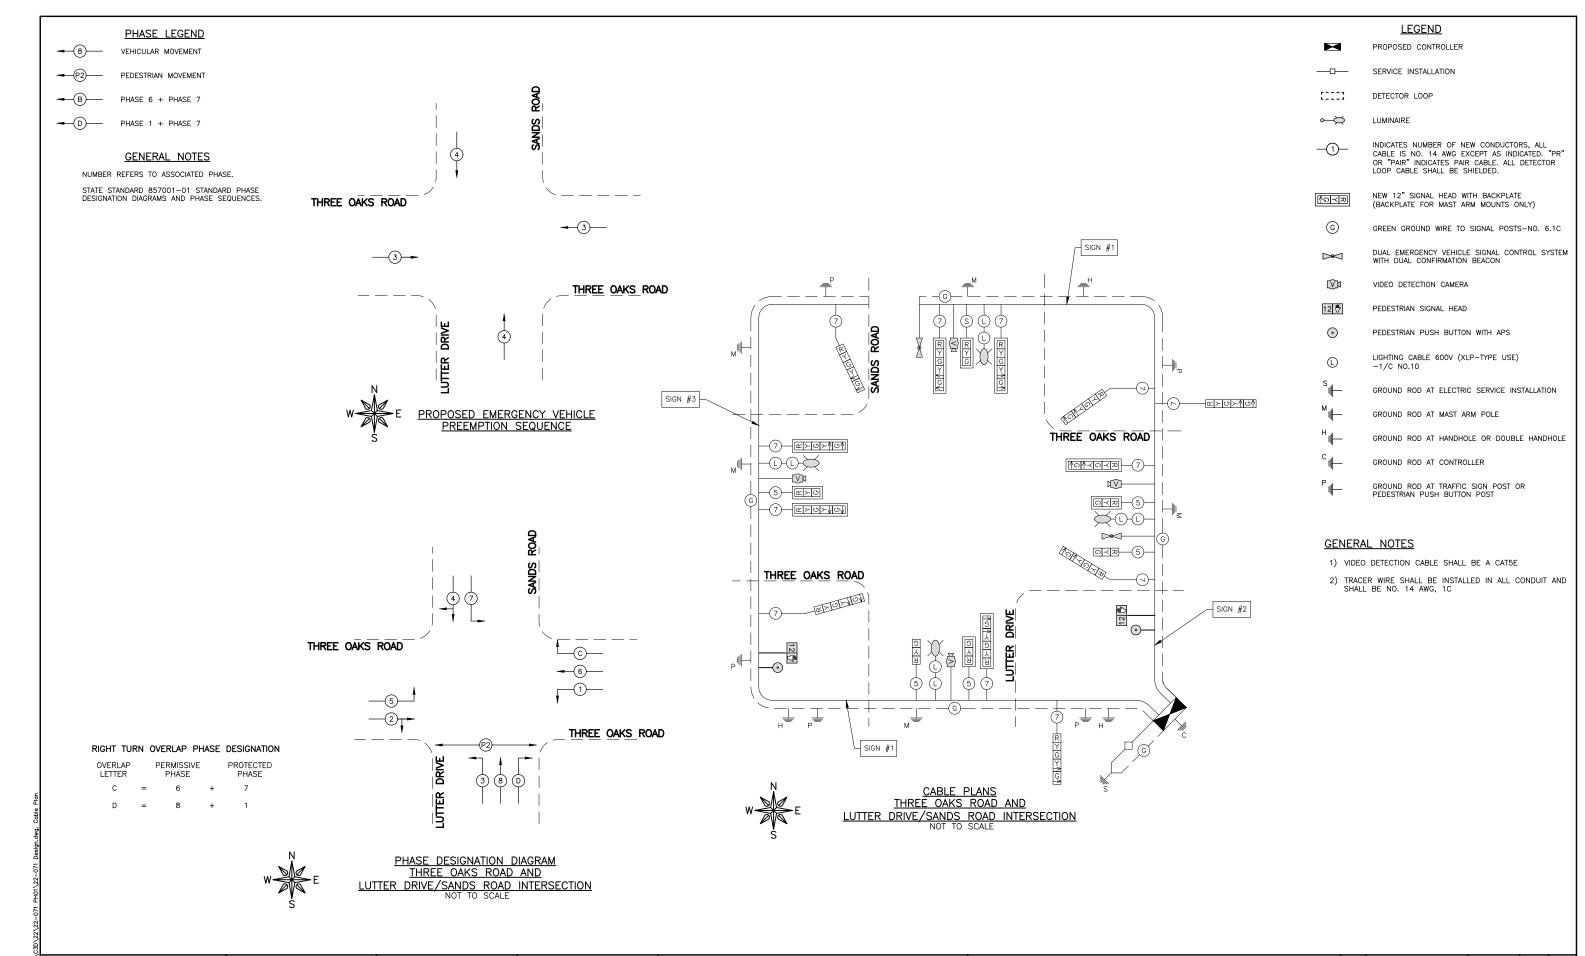
ENGINEERING & ENVIRONMENTAL
ILLINOS DESCN PRIN 10. 194-03325

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USER NAME =BF/YJ	DESIGNE	D —	VL	REVISED	_
	DRAWN	_	BF/YJ	REVISED	=
PLOT SCALE = AS NO	TED CHECKED) –		REVISED	_
PLOT DATE = 2/15/	24 DATE	_	03/01/23	REVISED	-

STATE OF ILLINOIS DEPARTMENT OF TRANSPORTATION

20000 2000							SECTION	COUNTY	TOTAL SHEETS	SHEET NO.
		5	SIGNAL PLAI		4051	22-00134-00-TL	MCHENRY	129	70	
						CONTRACT	NO 61	K35		
SCALE: AS NOTED	SHEET 70	OF	129 SHEETS	STA.	TO STA.	ILLINOIS FED. AID PROJECT				




 USER NAME
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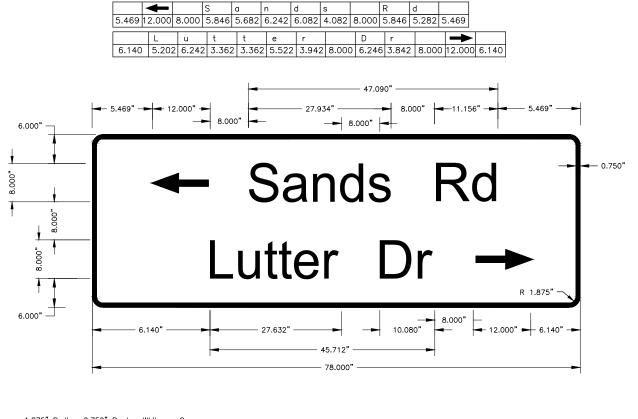
 DRAWN
 BF/YJ
 REVISED


 PLOT SCALE
 = AS NOTED
 CHECKED
 REVISED

 PLOT DATE
 = 2/15/24
 DATE
 03/01/23
 REVISED

STATE OF ILLINOIS
DEPARTMENT OF TRANSPORTATION



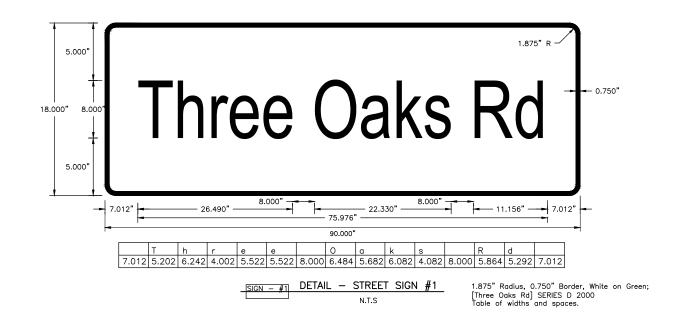

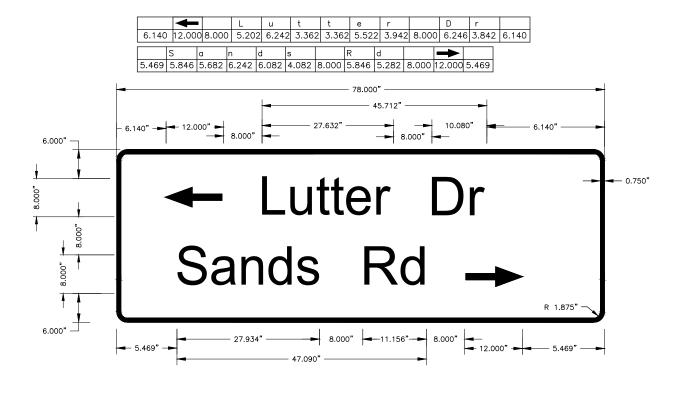

1.875" Radius, 0.750" Border, White on Green; [Lutter Dr] SERIES D 2000
Table of widths and spaces.

| DETAIL - STREET SIGN #2 | N.T.S

1.875" Radius, 0.750" Border, White on Green; [Lutter Dr] SERIES D 2000
Table of widths and spaces.

SIGN = #3

DETAIL - STREET SIGN #3

N.T.S


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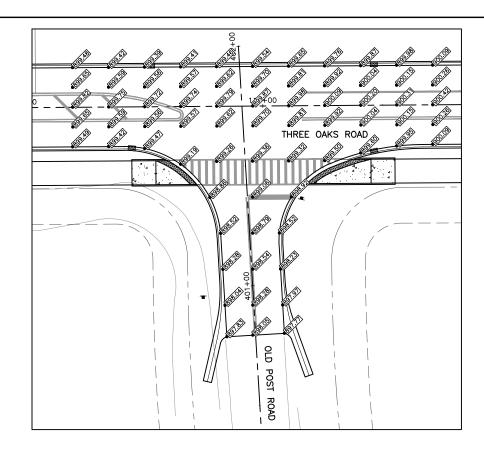
ENGINEERISE & ENVIRONMENTAL


USER NA	ME =BF/YJ	DESIGNED	_	VL	REVISED	_
		DRAWN	_	BF/YJ	REVISED	-
PLOT SC	ALE = AS NOTED	CHECKED	_		REVISED	-
PLOT DA	TE = 2/15/24	DATE	_	03/01/23	REVISED	-

STATE OF ILLINOIS DEPARTMENT OF TRANSPORTATION

SIGNS DETAILS	F.A.U. RTE. 4051	SECTION 22-00134-00-TL	COUNTY	TOTAL SHEETS 129	72
	+031	22 0010+ 00 12	CONTRACT		K35
SCALE: AS NOTED SHEET 72 OF 129 SHEETS ST	TA. TO STA.	ILLINOIS FED. AID PROJECT			



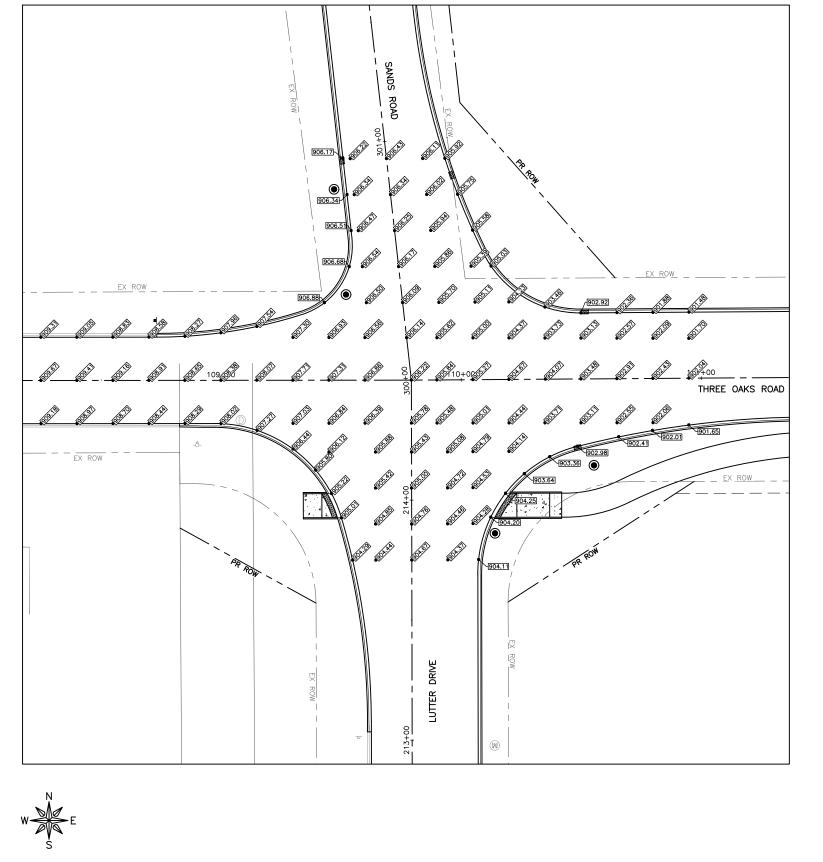

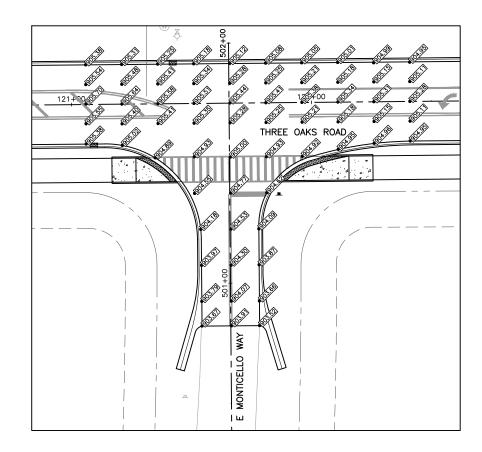



FEHR GRAHAM


ENGINEERING & ENVIRONMENTAL

LILNINGS DESIGN FIGH NO. 194-003525

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USER NAME =BF/YJ	DESIGNED — VL	REVISED —
	DRAWN - BF/YJ	REVISED —
PLOT SCALE = AS NOTED	CHECKED —	REVISED —
PLOT DATE = $2/15/24$	DATE - 03/01/23	REVISED —

							F.A.U. RTE.	SECTION	COUNTY	TOTAL SHEETS	SHEET NO.
	INTERSECTION GRADING PLAN						4051	22-00134-00-TL	MCHENRY	129	73
									CONTRACT	NO 61	K35
SCALE: AS NOTED	SHEET 73	OF	129 SHEETS	STA.	TO STA.			ILLINOIS FED. A	ID PROJECT		

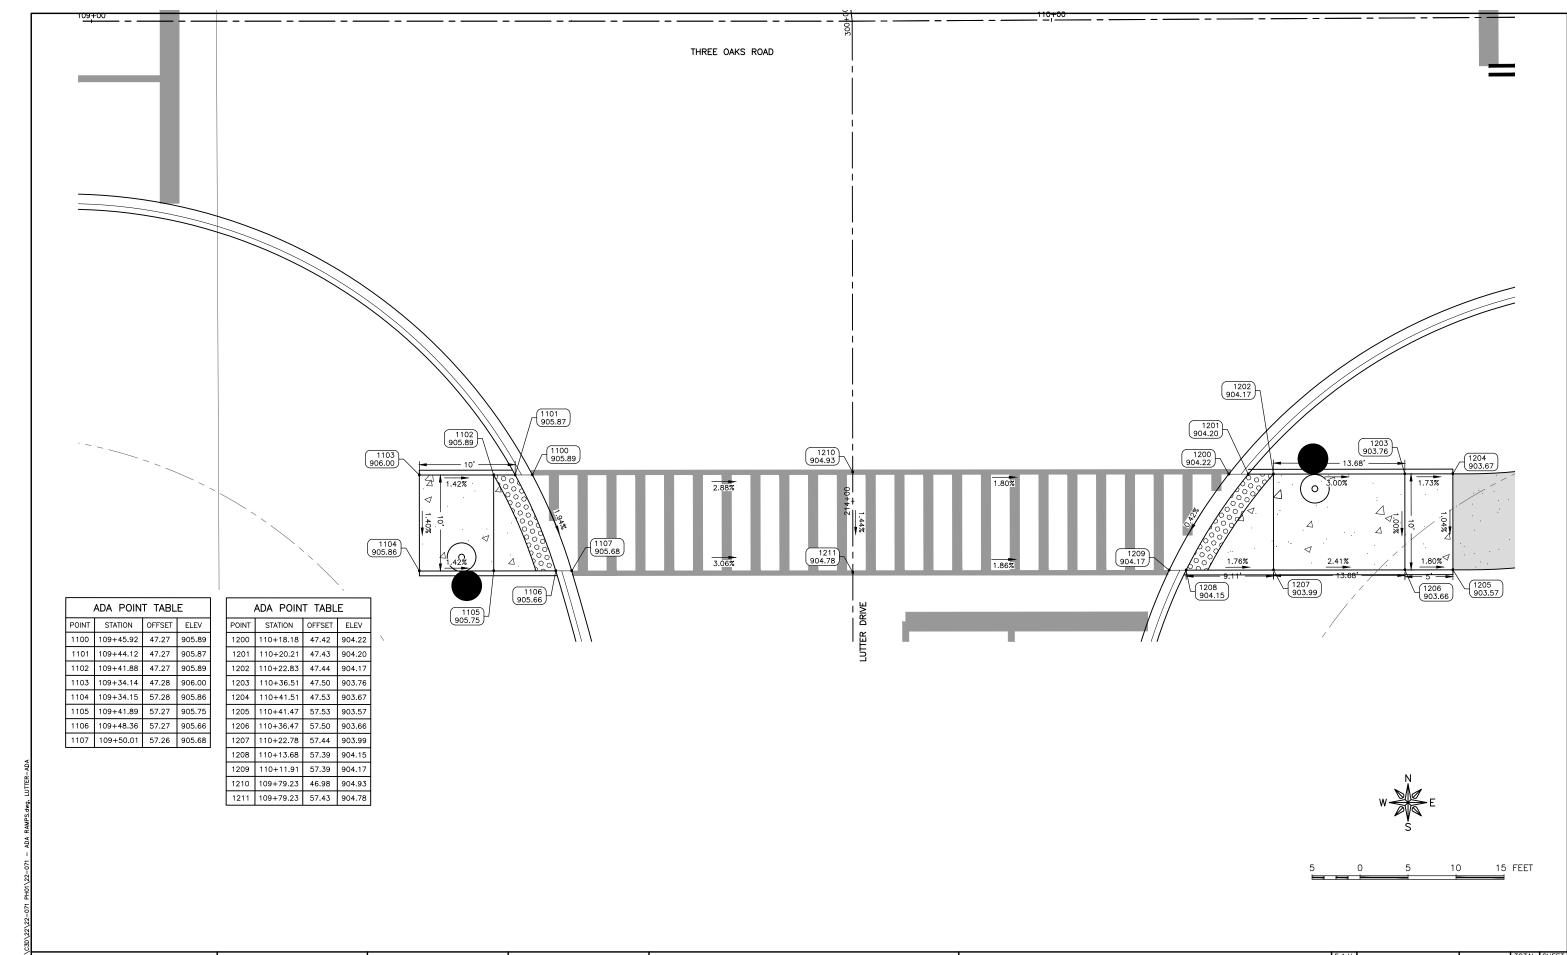

FEHR GRAHAM


ENGINEERING & ENVIRONMENTAL
ILLINOS DESON FIRM NO. 184-003523
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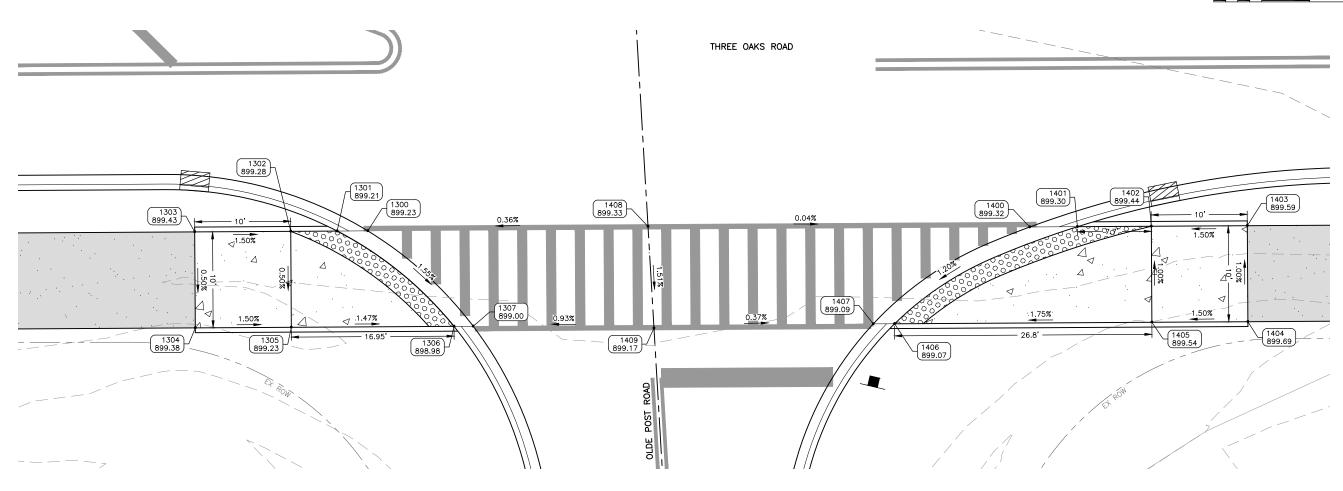
STATE OF ILLINOIS DEPARTMENT OF TRANSPORTATION

MCHENRY 129 74

CONTRACT NO 61K35





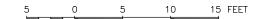

ADA POINT TABLE							
POINT	STATION	OFFSET	ELEV				
1300	114+63.29	22.50	899.23				
1301	114+60.10	22.50	899.21				
1302	114+55.26	22.50	899.28				
1303	114+45.26	22.50	899.43				
1304	114+45.26	32.50	899.38				
1305	114+55.26	32.50	899.23				
1306	114+72.21	32.50	898.98				
1307	114+74.21	32.50	899.00				

ADA POINT TABLE							
POINT	STATION	OFFSET	ELEV				
1400	115+32.23	22.50	899.32				
1401	115+37.20	22.50	899.30				
1402	115+44.90	22.50	899.44				
1403	115+54.90	22.50	899.59				
1404	115+54.90	32.50	899.69				
1405	115+44.90	32.50	899.54				
1406	115+18.10	32.50	899.07				
1407	115+15.88	32.50	899.09				
1408	114+92.48	22.21	899.33				
1409	114+93.04	32.80	899.17				


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ENGINEERING & ENVIRONMENTAL
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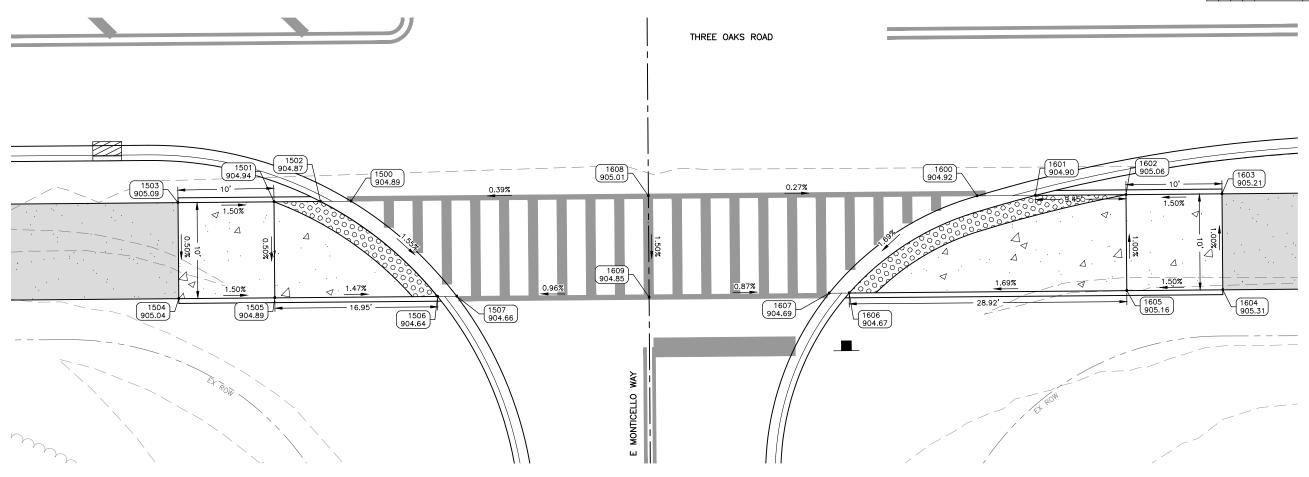
USER NAME =BF/YJ	DESIGNED — VL	REVISED —
	DRAWN — BF/YJ	REVISED —
PLOT SCALE = AS NOTED	CHECKED —	REVISED —
PLOT DATE = 2/15/24	DATE - 03/01/23	REVISED —

STATE (F ILLINOIS
DEPARTMENT O	TRANSPORTATION

	ADA DAMPS OLDS DOST DOAD					F.A.U. RTE.	SECTION	COUNTY	TOTAL SHEETS	SHEET NO.
						4051	22-00134-00-TL	MCHENRY	129	75
								CONTRACT	NO 6	1K35
	SCALE: AS NOTED	SCALE: AS NOTED SHEET 75 OF 129 SHEETS STA. TO STA.			ILLINOIS FED. A	ID PROJECT				





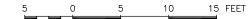

-	STATION 21+34.60	OFFSET	ELEV
-	21+34.60	22 50	
01 1:		22.00	904.89
	21+26.58	22.50	904.94
)2 1:	21+31.42	22.50	904.87
3 1:	21+16.58	22.50	905.09
)4 1:	21+16.58	32.50	905.04
)5 1:	21+26.58	32.50	904.89
)6 1:	21+43.53	32.50	904.64
7 1:	21+45.53	32.50	904.66
	3 1: 4 1: 5 1:	3 121+16.58 4 121+16.58 5 121+26.58 6 121+43.53	3 121+16.58 22.50 4 121+16.58 32.50 5 121+26.58 32.50 6 121+43.53 32.50


ADA POINT TABLE						
POINT	STATION	OFFSET	ELEV			
1600	121+99.82	22.50	904.92			
1601	122+05.88	22.50	904.90			
1602	122+15.32	22.50	905.06			
1603	122+25.32	22.50	905.21			
1604	122+25.32	32.50	905.31			
1605	122+15.32	32.50	905.16			
1606	121+86.41	32.50	904.67			
1607	121+84.32	32.50	904.69			
1608	121+65.58	22.21	905.01			
1609	121+65.56	32.77	904.85			


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ENGINEERING & ENVIRONMENTAL
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	DRAWN — BF/YJ	REVISED —
PLOT SCALE = AS NOTED	CHECKED —	REVISED —
PLOT DATE = 2/15/24	DATE - 03/01/23	REVISED —

STATE OF	ILLINOIS
DEPARTMENT OF	TRANSPORTATION

	F.A RT							.A.U. RTE. SECTION		COUNTY	TOTAL SHEETS	SHEET NO.
	ADA RAMPS - MONTICELLO WAY						4051	22-0013	4-00-TL	MCHENRY	129	76
										CONTRACT	NO 6	1K35
	SCALE: AS NOTED SHEET 76 OF 129 SHEETS STA. TO STA.						ILLINOIS FED. A	ID PROJECT				




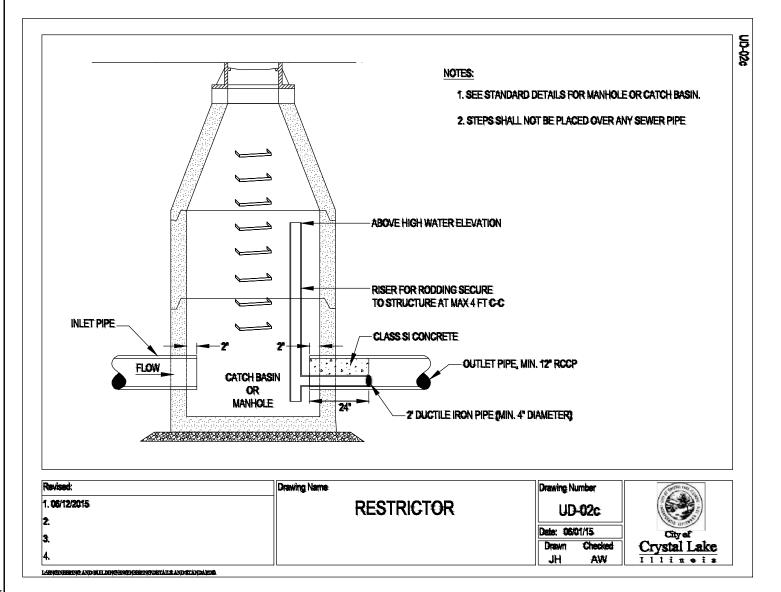


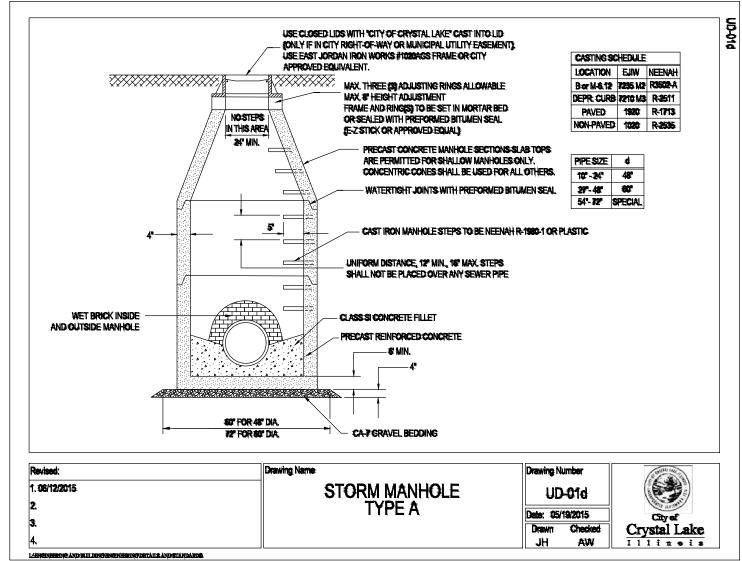

USER NAME =BF/YJ	DESIGNED	_	VL	REVISED —
	DRAWN	_	BF/YJ	REVISED —
PLOT SCALE = AS NOTED	CHECKED	_		REVISED —
PLOT DATE = $2/15/24$	DATE	_	03/01/23	REVISED —

F. R								SECTION	COUNTY	TOTAL SHEETS	SHEET NO.
				DETAILS			4051	22-00134-00-TL	MCHENRY	129	77
									CONTRACT	NO 61	1K35
S	CALE: AS NOTED	SHEET 77	OF	129 SHEETS	STA.	TO STA.		ILLINOIS FED. A	ID PROJECT		

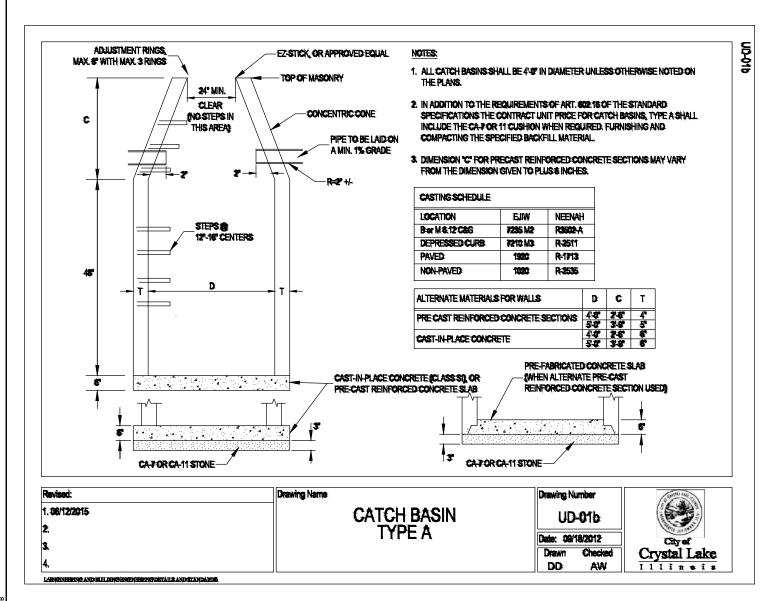

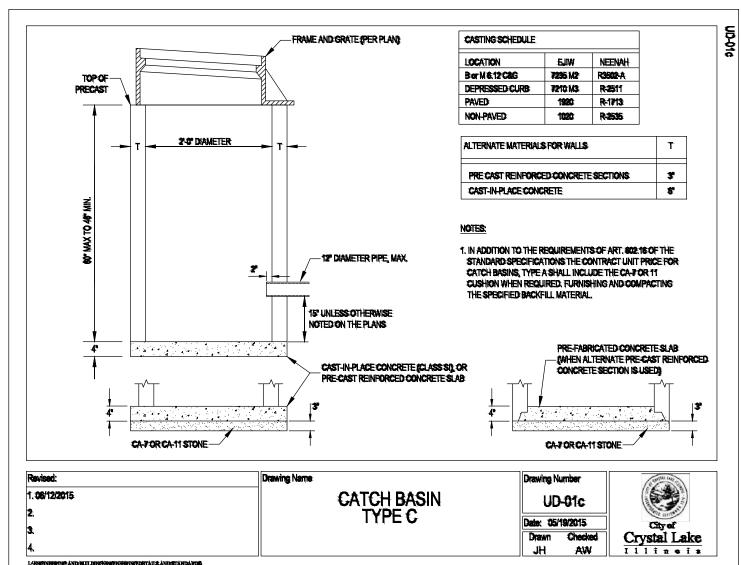




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	DRAWN	_	BF/YJ	REVISED	-
PLOT SCALE = AS NOTED	CHECKED	_		REVISED	_
PLOT DATE = 2/15/24	DATE	_	03/01/23	REVISED	-

STATE	E OF ILLINOIS	
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						F.A.U. RTE.	SECTION	COUNTY	TOTAL SHEETS	SHEET NO.
			DETAILS			4051	22-00134-00-TL	MCHENRY	129	78
								CONTRACT	NO 6	K35
SCALE: AS NOTED	SHEET 78	OF	129 SHEETS	STA.	TO STA.		ILLINOIS FED.	AID PROJECT		

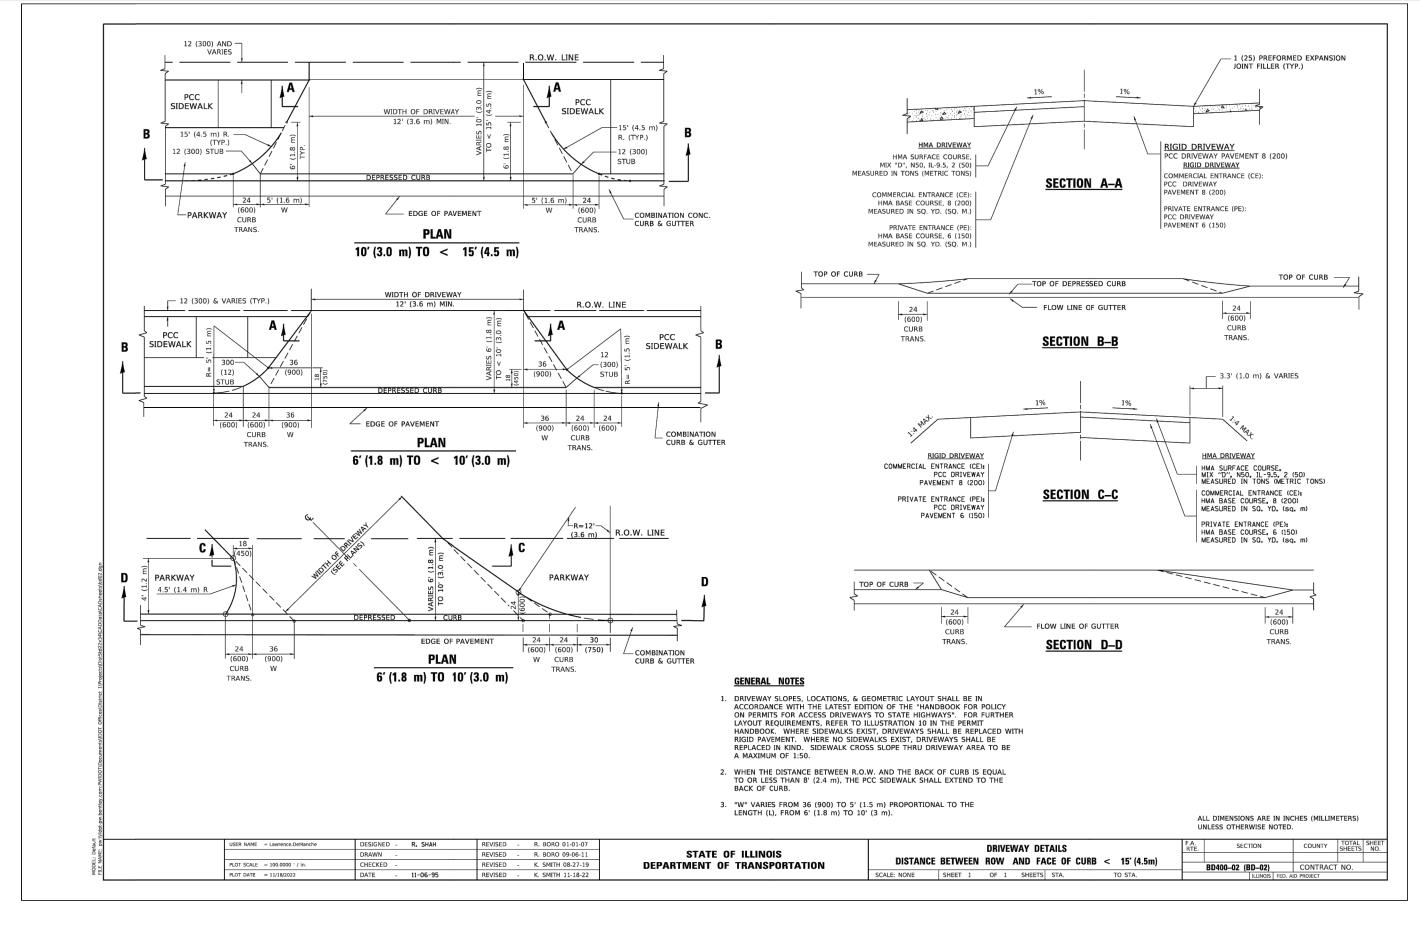

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ILLINOS DESON PRIM NO. 184-003255

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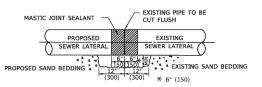
USER NAME =BF/YJ	DESIGNED	_	VL	REVISED	_
	DRAWN	_	BF/YJ	REVISED	=
PLOT SCALE = AS NOTED	CHECKED	_		REVISED	-
PLOT DATE = 2/15/24	DATE	_	03/01/23	REVISED	-


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DEPARTMENT	0 F	TRANSPORT	TATION


						F.A.U. RTE.	SECTION	COUNTY	TOTAL SHEETS	SHEET NO.
			DETAILS			4051	22-00134-00-TL	MCHENRY	129	79
								CONTRACT	NO 6	1K35
SCALE: AS NOTED	SHEET 79	OF	129 SHEETS	STA.	TO STA.		ILLINOIS FED. A	ID PROJECT		

DETAIL "A"

LATERAL CONNECTION TO EXISTING SEWER OF 27" (675) OR SMALLER



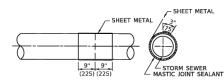

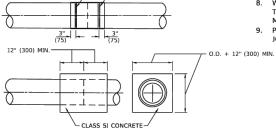


METAL BINDING

DETAIL "B"

CLASS SI CONCRETE COLLAR

CONSTRUCTION SEQUENCE

- CUT THE EXISTING END OF THE PIPE SO AS TO PRESENT A FLUSH BUTT JOINT. BRUSH AND CLEAN ALL PIPES.
- APPLY THE MASTIC JOINT SEALANT TO THE FIRST 6" (150) OF EACH PIPE.
- BUTT THE PIPES TOGETHER LEAVING A MINIMUM OF 12' x 6' (300 x 150) DEEP EXCAVATION UNDER AND AROUND EACH PIPE END.
- CUT A PIECE OF SHEET METAL GAGE NO. 19 1.1 (0.0418) 18" (450) WIDE BY THE OUTSIDE CIRCUMFERANCE OF THE PIPE PLUS 3" (75) LONG.
- 5. WRAP THE SHEET METAL AROUND THE PIPES, 9" (225) ON EACH SIDE OF THE JOINT, STARTING AT THE TOP OF THE PIPE.
- 6. LAP THE SHEET METAL AT LEAST 3" (75) AT THE TOP OF THE PIPE AND PLACE THE MASTIC JOINT SEALANT BETWEEN THE LAP.
- PLACE TWO METAL BANDS AROUND THE SHEET METAL AND TIGHTEN.
- . WIPE OFF ANY EXCESS MASTIC JOINT SEALANT THAT OOZES OUT FROM BETWEEN THE SHEET METAL AND THE PIPES.
- PLACE CLASS SI CONCRETE AROUND THE JOINT.

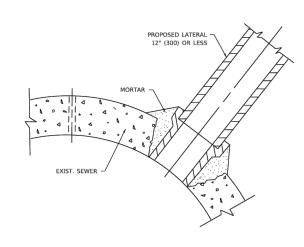

DETAIL "C"

PROPOSED LATERAL CONNECTION TO EXISTING SEWER OF 30" (750) OR LARGER

NOTES:

MATERIAL

MATERIAL USED FOR THE TEE OR WYE SECTION SHALL BE COMPATIBLE WITH THE EXISTING STORM SEWER OR THE PROPOSED STORM SEWER.

CONSTRUCTION METHODS

- I. THIS WORK SHALL BE CONSTRUCTED IN CONFORMANCE WITH THE APPLICABLE PORTIONS OF SECTION 550 OF THE STANDARD SPECIFICATIONS.
- II. CONNECTION TO AN EXISTING STORM SEWER SHALL BE BY EITHER OF THE FOLLOWING METHODS:

 A) PROPOSED STORM SEWER CONNECTION TO EXISTING SEWER OF 27" (675) OR SMALLER SEE

 DETAIL "A" AND "B".
 - B) PROPOSED STORM SEWER CONNECTION TO EXISTING SEWER OF 30" (750) OR LARGER SEE DETAIL "C".

IF THE EXISTING SEWER PIPE IS CRACKED, BROKEN OR OTHERWISE DAMAGED BY THE CONTRACTOR IN MAKING THE CIRCULAR OPENING, THE CONTRACTOR SHALL REPLACE THAT SECTION OF PIPE WITH PIPE EQUAL AND SIMILAR IN ALL RESPECTS TO THE PIPE IN THE EXISTING SEWER, IN A CAREFUL WORKMANLIKE MANNER, WITHOUT EXTRA COMPENSATION.

GENERAL

- CARE MUST BE TAKEN TO PREVENT DEBRIS FROM ENTERING THE SEWER. ALL DEBRIS WHICH ENTERS THE SEWER MUST BE REMOVED. THE SEWER MUST BE LEFT CLEAN AND UNOBSTRUCTED UPON COMPLETION OF THE CONTRACT.
- CARE MUST BE TAKEN TO PREVENT ANY PART OF THE NEW PIPE CONNECTION FROM PROJECTING INTO THE EXISTING SEWER.

BASIS OF PAYMENT

- 1. TEE OR WYE CONNECTIONS SHALL BE PAID FOR AT THE CONTRACT UNIT PRICE EACH FOR STORM SEWER TEE OR WYE OF THE TYPE AND SIZE SPECIFIED IN THE PLANS, THIS PRICE SHALL INCLUDE ALL EXCAVATION OF THE TRENCH, REMOVAL OF THE EXISTING STORM SEWER, FURNISHING AND INSTALLING THE SPECIFIED TEE OR WYE SECTION, FURNISHING AND INSTALLING THE REQUIRED CONCRETE COLLAR, AND ALL OTHER MATERIAL NECESSARY TO COMPLETE THIS WORK AS SHOWN AND SPECIFIED.
- REMOVAL AND REINSTALLATION OF EXISTING STORM SEWER ADJACENT TO THE PROPOSED TEE OR WYE SECTION, FOR THE PURPOSE OF FACILITATING THE INSTALLATION OF THE TEE OR WYE SECTION, WILL NOT BE PAID FOR SEPARATELY BUT SHALL BE INCLUDED IN THE UNIT PRICE BID FOR THE WORK.
- 3. TRENCH BACKFILL, EXCAVATION IN ROCK AND REMOVAL AND REPLACEMENT OF UNSUITABLE MATERIAL BELOW PLAN BEDDING GRADE WILL BE PAID FOR SEPARATELY.
- CONCRETE COLLAR FOR CONNECTING A PROPOSED STORM SEWER TO AN EXISTING STORM SEWER WILL NOT BE PAID PAID FOR SEPARATELY BUT SHALL BE INCLUDED IN THE COST OF THE PROPOSED STORM SEWER.

* ALL DIMENSIONS ARE IN INCHES (MILLIMETERS) UNLESS OTHERWISE SHOWN.

USER NAME = Lawrence.DeManche	DESIGNED - M. DE YONG	REVISED - R. SHAH 09-09-94			DETAIL OF STOR	M SEWER		RTE.	SECTION	COUNTY	SHEETS NO.
	DRAWN -	REVISED - R. SHAH 10-25-94	STATE OF ILLINOIS							_	10.122.0
PLOT SCALE = 100.0000 ' / in.	CHECKED -	REVISED - R. SHAH 06-12-96	DEPARTMENT OF TRANSPORTATION		CONNECTION TO EX	ISTING SEWI	EK	BD	500-01 (BD-07)	CONTRAC	T NO.
PLOT DATE = 11/18/2022	DATE - 07-25-90	REVISED - K. SMITH 11-18-22		SCALE: NONE	SHEET 1 OF 1 SHEET	TS STA.	TO STA.			AID PROJECT	


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ILLINGS SESSON PIN NO. 194-003525

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	DRAWN -	BF/YJ	REVISED —
PLOT SCALE = AS NOTED	CHECKED -		REVISED —
PLOT DATE = 2/15/24	DATE -	03/01/23	REVISED —

						F.A.U. RTE.	SECTION	COUNTY	TOTAL SHEETS	SHEET NO.
			DETAILS			4051	22-00134-00-TL	MCHENRY	129	80
								CONTRACT	NO 6	1K35
SCALE: AS NOTED	SHEET 80	OF	129 SHEETS	STA.	TO STA.		ILLINOIS FED. AI	D PROJECT		



DETAILS FOR FRAMES AND LIDS ADJUSTMENT WITH MILLING

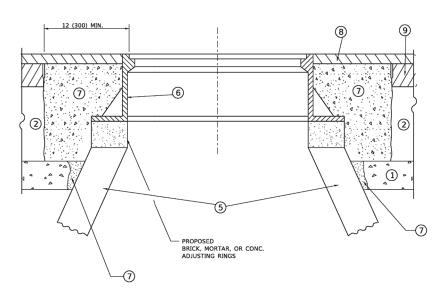NOTES

- 1. EXISTING BROKEN FRAMES AND LIDS SHALL BE REMOVED AND DISPOSED OF BY THE CONTRACTOR AND SHALL BE REPLACED AS DIRECTED BY THE ENGINEER. REPLACEMENT FRAMES AND LIDS WILL BE PAID FOR IN ACCORDANCE WITH ARTICLE 109.04 OF THE STANDARD SPECIFICATIONS UNLESS A SEPARATE PAY ITEM HAS BEEN PROVIDED.
- 2. IF THE EXISTING LIDS ARE OPEN, THE FRAME WILL BE ADJUSTED TO THE ELEVATION OF THE MILLED PAVEMENT SURFACE PRIOR TO THE MILLING OPERATION. THE FRAME WILL NOT BE REMOVED AND COVERED BY THE METAL PLATE.
- 3. CITY OF CHICAGO CASTINGS ARE THE PROPERTY OF THE CITY AND THE CONTRACTOR SHALL NOTIFY THE CITY FOR REMOVAL AND DISPOSITION OF THE CASTINGS.
- 4. THE METAL PLATE USED TO COVER THE STRUCTURE SHALL REMAIN THE PROPERTY OF THE CONTRACTOR.
- 5. THE CONTRACTOR SHALL REMOVE ALL TRAFFIC CONTROL DEVICES BY THE END OF EACH WORK SHIFT.

CONSTRUCTION PROCEDURES

STAGE 1 (BEFORE PAVEMENT MILLING)

- A) REMOVE A MINIMUM OF 12 (300) OF THE PAVEMENT FROM AROUND THE STRUCTURE.
- B) REMOVE THE EXISTING FRAME AND LID FROM THE STRUCTURE. C) COVER THE STRUCTURE OPENING WITH A 36 (900) DIAMETER
- D) BACKFILL WITH CRUSHED STONE AND HMA SURFACE MIX APPROVED BY THE ENGINEER. (MIN. 3 (80) HMA TO REMAIN AFTER MILLING).

METAL PLATE.

- STAGE 2 (AFTER PAVEMENT MILLING)

 A) REMOVE THE HMA SURFACE MIX AND CRUSHED STONE.
 - B) INSTALL THE FRAME AND LID; ADJUST THE FRAME TO ITS FINAL SURFACE ELEVATION.
 - C) THE SURROUNDING SPACE SHALL BE FILLED WITH CLASS PP-2* CONCRETE TO THE ELEVATION OF THE SURFACE OF THE EXISTING BASE COURSE OR THE BINDER COURSE.
 - *UNLESS OTHERWISE SPECIFIED IN THE PLANS.

THE PROCEDURE EXPLAINED ABOVE SHALL CONFORM TO THE APPLICABLE PORTIONS OF SECTIONS 353, 406, 602, AND 603 OF THE STANDARD SPECIFICATIONS EXCEPT THAT "THE CONTRACTOR SHALL ADJUST THE STRUCTURES TO THE FINISHED PAVEMENT ELEVATION NO MORE THAN 5 CALENDAR DAYS PRIOR TO PLACEMENT OF THE FINAL LIFT OF SURFACE UNLESS APPROVED BY THE ENGINEER."

- 1 SUB-BASE GRANULAR MATERIAL
- (6) FRAME AND LID (SEE NOTES)
- 2 EXISTING PAVEMENT

(5) EXISTING STRUCTURE

- 7 CLASS PP-2* CONCRETE
- 3 36 (900) DIAMETER METAL PLATE
 - (8) PROPOSED HMA SURFACE COURSE
- (4) PROPOSED CRUSHED STONE AND HMA SURFACE MIX
- 9 PROPOSED HMA BINDER COURSE
- **LOCATION OF STRUCTURES**

THE CONTRACTOR WILL BE REQUIRED TO KEEP A RECORD OF THE LOCATIONS OF THE BURIED STRUCTURES ACCORDING TO THE STATION AND DISTANCE LEFT OR RIGHT OF THE CENTERLINE OF PAVEMENT. UPON COMPLETION OF THE WORK, THE CONTRACTOR WILL DELIVER THE RECORD TO THE ENGINEER.

BASIS OF PAYMENT

- 1. REMOVING FRAMES AND LIDS ON DRAINAGE AND UTILITY STRUCTURES IN THE PAVEMENT PRIOR TO MILLING, AND ADJUSTING TO FINAL GRADE PRIOR TO PLACING THE SURFACE COURSE, WILL BE PAID FOR AT THE CONTRACT UNIT PRICE EACH FOR "FRAMES AND LIDS TO BE ADJUSTED (SPECIAL)."
- 2. THIS WORK WILL NOT BE PAID FOR WHEN DRAINAGE AND UTILITY STRUCTURES ARE SPECIFIED FOR PAYMENT AS STRUCTURE RECONSTRUCTION.
- 3. NEW FRAMES AND LIDS, WHEN SPECIFIED, WILL BE PAID FOR SEPARATELY.
- 4. WHEN STRUCTURES ARE TO BE ADJUSTED OR RECONSTRUCTED, THE LOWERING AND RAISING OF THE FRAMES AND LIDS WILL NOT BE PAID FOR SEPARATELY BUT WILL BE INCLUDED IN THE COST OF THE CORRESPONDING PAY ITEM.


ALL DIMENSIONS ARE IN INCHES (MILLIMETERS) UNLESS OTHERWISE SHOWN

USER NAME = Lawrence.DeManche	DESIGNED - R. SHAH	REVISED - R. BORO 03-09-11		DETAILS	FOR	F.A. RTF	SECTION	COUNTY	TOTAL SHEET
	DRAWN -	REVISED - R. BORO 12-06-11	STATE OF ILLINOIS		STMENT WITH MILLING	1112			STILLETS NO.
PLOT SCALE = 100.0000 ' / in.	CHECKED -	REVISED - K. SMITH 11-18-22	DEPARTMENT OF TRANSPORTATION	FRAMES AND LIDS ADJU	STIVIENT WITH WILLING		BD600-03 (BD-08)	CONTRACT	NO.
PLOT DATE = 9/15/2023	DATE - 10-25-94	REVISED - K. SMITH 09-15-23		SCALE: NONE SHEET 1 OF 1 SHE	ETS STA. TO STA.		ILLINOIS FED. A	ID PROJECT	
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SCALE:

USER NAME =BF/YJ	DESIGNED	_	VL	REVISED	_
	DRAWN	_	BF/YJ	REVISED	=
PLOT SCALE = AS NOTED	CHECKED	_		REVISED	-
PLOT DATE = 2/15/24	DATE	_	03/01/23	REVISED	_

						F.A.U. RTE.	SECTION	COUNTY	TOTAL SHEETS	SHEET NO.
			DETAILS		4051	22-00134-00-TL	MCHENRY	129	81	
								CONTRACT	NO 61	K35
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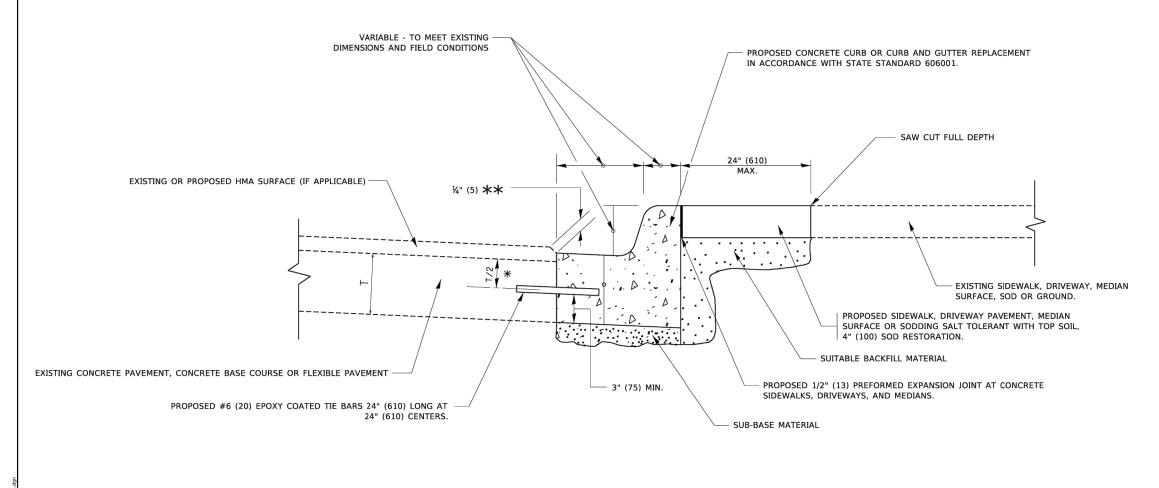
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LILINGS DESOR FRIN IO. 184-0-03292

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	DRAWN — BF/YJ	REVISED —
PLOT SCALE = AS NOTED	CHECKED —	REVISED —
PLOT DATE = 3/22/24	DATE - 03/01/23	REVISED —

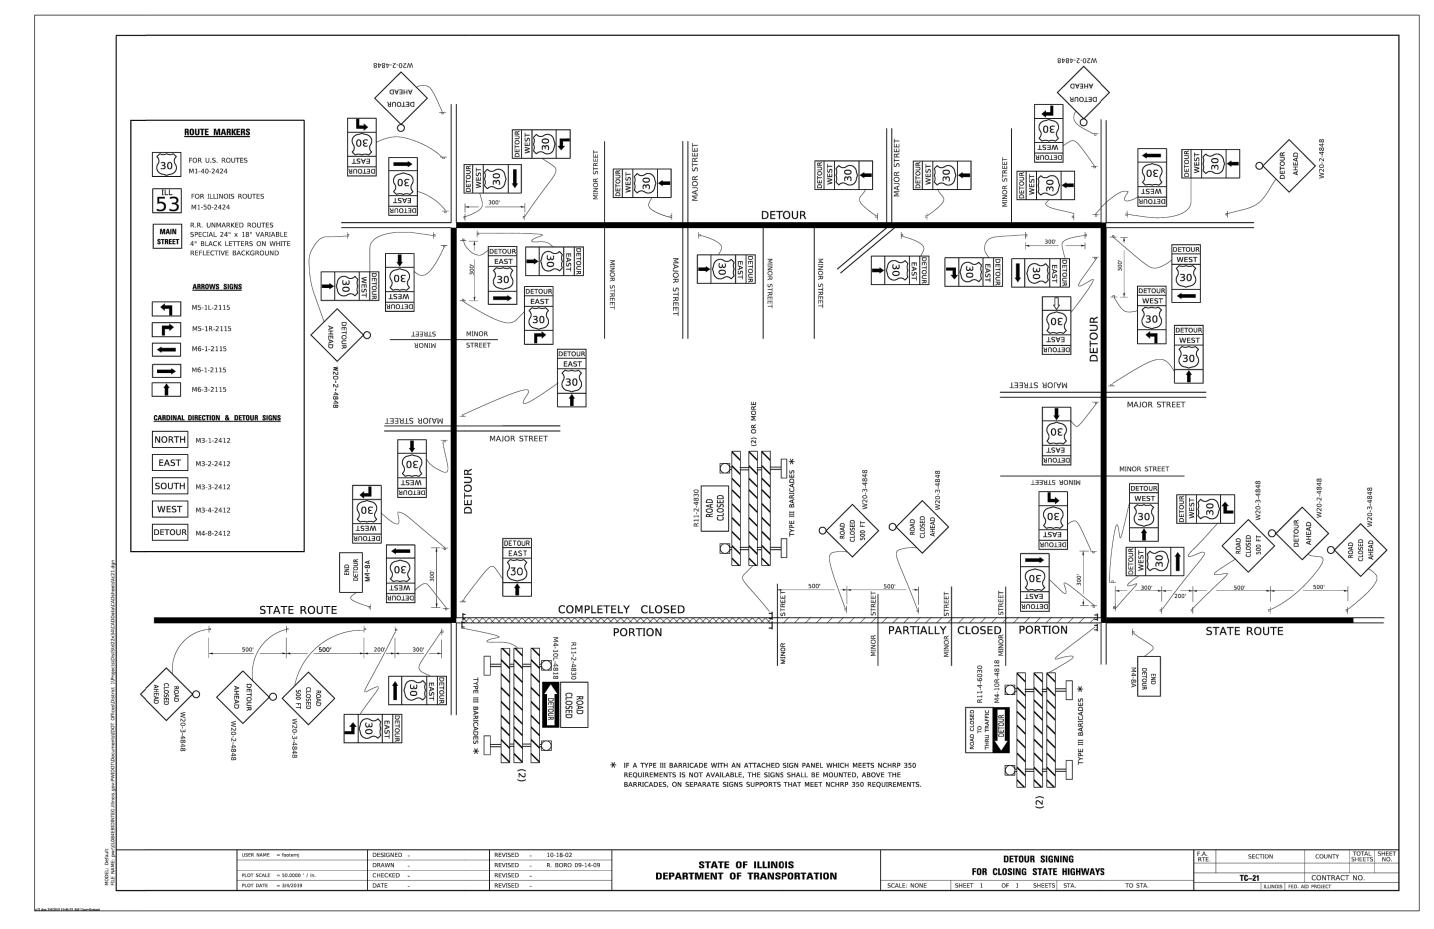STATI	E 01	F ILLINOIS
DEPARTMENT	0F	TRANSPORTATION

							F.A.U. RTE.	SECTION	COUNTY	TOTAL SHEETS	SHEET NO.
				DETAILS	4051	22-00134-00-TL	MCHENRY	132	81A		
L									CONTRACT	NO 61	K35
	SCALE: AS NOTED SHEET81A OF 132 SHEETS STA. TO STA.							ILLINOIS FED. A	D PROJECT		



 \divideontimes 3" (75) MINIMUM FROM TOP AND BOTTOM OF THE CONCRETE PAVEMENT OR BASE COURSE.

** IF THE FINAL SURFACE OF THE PAVEMENT IS CONCRETE, THE GUTTER IS TO BE FLUSH WITH THE PAVEMENT.

CURB OR CURB AND GUTTER REMOVAL AND REPLACEMENT

ALL DIMENSIONS ARE IN INCHES (MILLIMETERS) UNLESS OTHERWISE SHOWN.


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	DRAWN -	REVISED - M. GOMEZ 01-22-01	STATE OF ILLINOIS									+	5112215 1151
PLOT SCALE = 50.0000 ' / in.	CHECKED -	REVISED - R. BORO 12-15-09	DEPARTMENT OF TRANSPORTATION		KEI	IOVAL I	AND KI	EPLACEMENT			BD600-06 (BD-24)	CONTRAC	T NO.
PLOT DATE = 7/11/2019	DATE - 03-11-94	REVISED - K. SMITH 07-11-19		SCALE: NONE	SHEET 1	OF 1	SHEET	TS STA.	TO STA.		ILLINOIS FED.	AID PROJECT	
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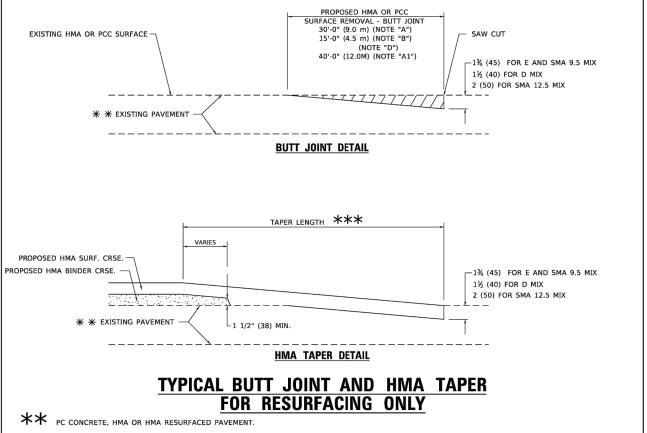
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USER NAME =BF/YJ	DESIGNED -	VL	REVISED —
	DRAWN —	BF/YJ	REVISED —
PLOT SCALE = AS NOTED	CHECKED -		REVISED —
PLOT DATE = 2/15/24	DATE -	03/01/23	REVISED —

STAT	E 01	F ILLINOIS
DEPARTMENT	0F	TRANSPORTATION

	DETAILS									
DETAILS		405	1 22-00134-00	D—TL MO	CHENRY	129	82			
				CO	NTRACT	NO 61	K35			
CALE: AS NOTED SHEET 82 OF 129 SHEETS	STA. TO	STA.	ILLIN	IOIS FED. AID PRO	DJECT					



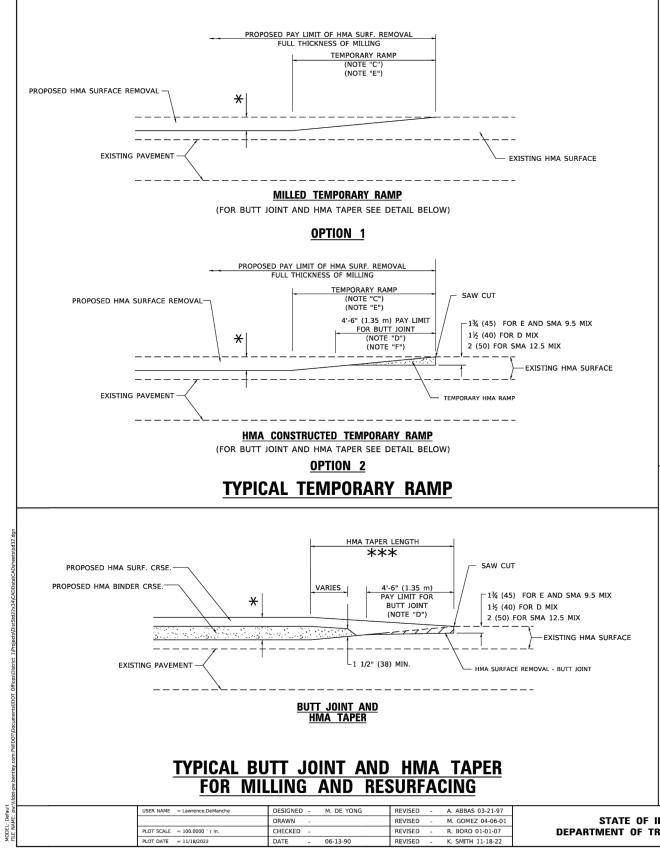

GENERAL NOTES

- A. MAINLINE ARTERIAL ROADWAYS AND MAJOR SIDE ROADS.
- A1. INTERSTATES
- B. MINOR SIDE ROADS.
- C. THE TEMP. RAMP SHALL BE CONSTRUCTED IMMEDIATELY UPON REMOVAL OF THE EXISTING HMA SURFACE.
- D. THE BUTT JOINT SHALL BE CONSTRUCTED IMMEDIATELY PRIOR TO PLACING THE PROPOSED HMA COURSES.
- E. TAPER THE TEMP. RAMP AT A RATE OF 3' 4" (1.02m) PER 1 INCH (25 mm) OF MILLING THICKNESS.

 ** SEE TYPICAL SECTIONS FOR MILLING THICKNESS.
- F. SEE ARTICLE 406.08 AND 406.14 OF THE STANDARD SPECIFICATIONS FOR "HMA AND/OR PCC SURFACE REMOVAL, BUTT JOINT".
- *** 20'-0" (6.1 m) PER 1 (25) RESURFACING (NOTE "A") 10'-0" (3.0 m) PER 1 (25) RESURFACING (NOTE "B")

BASIS OF PAYMENT

- THE BUTT JOINT WILL BE PAID FOR AT THE CONTRACT UNIT PRICE PER SQUARE YARD (SQUARE METER)
 FOR "HOT-MIX ASPHALT SURFACE REMOVAL - BUTT JOINT" OR FOR "PORTLAND CEMENT CONCRETE SURFACE REMOVAL- BUTT JOINT".
- 2. THE TEMPORARY RAMP AND SAW CUT SHALL BE INCLUDED IN THE UNIT COST FOR HMA OR PCC SURFACE REMOVAL-BUTT JOINT

ALL DIMENSIONS ARE IN INCHES (MILLIMETERS) UNLESS OTHERWISE SHOWN.

USER NAME = Lawrence.DeManche	DESIGNED - M. DE YONG	REVISED - A. ABBAS 03-21-97			BUTT JOINT AND		F.A. RTE.	SECTION	COUNTY TO	TOTAL SHEET SHEETS NO.
	DRAWN -	REVISED - M. GOMEZ 04-06-01	STATE OF ILLINOIS		HMA TAPER DETAILS					
PLOT SCALE = 100.0000 ' / in.	CHECKED -	REVISED - R. BORO 01-01-07	DEPARTMENT OF TRANSPORTATION		HIMA TAPER DETAILS		В	D400-05 BD-32	CONTRACT N	VO.
PLOT DATE = 11/18/2022	DATE - 06-13-90	REVISED - K. SMITH 11-18-22		SCALE: NONE SHE	EET 1 OF 1 SHEETS STA.	TO STA.			ID PROJECT	

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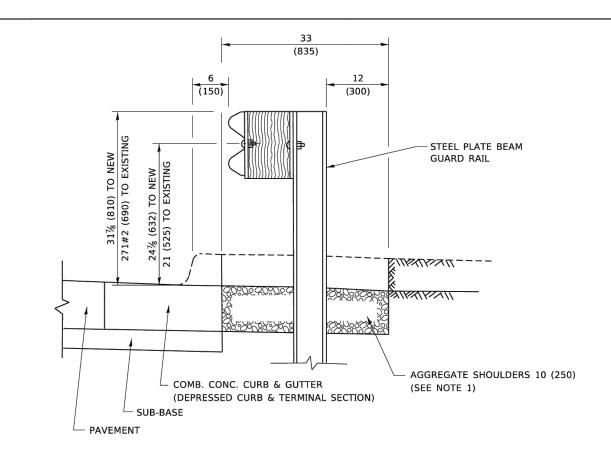
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	DRAWN	_	BF/YJ	REVISED	-
PLOT SCALE = AS NOTED	CHECKED	_		REVISED	-
PLOT DATE = 2/15/24	DATE	_	03/01/23	REVISED	-

STAT	E 01	F ILLINOIS
DEPARTMENT	0F	TRANSPORTATION

		F.A.U. RTE.	SECTION	COUNTY	TOTAL SHEETS	SHEET NO.
DETAILS		4051	22-00134-00-TL	MCHENRY	129	83
				CONTRACT	NO 6	1K35
CALE: AS NOTED SHEET 83 OF 129 SHEETS STA.	TO STA.		ILLINOIS FED. AID PROJECT			



SECTION A-A


NOTES:

- THE AGGREGATE SHOULDER, 10 (250) OR HMA SHOULDER, 6 (150) (IF REQUIRED) SHALL EXTEND UNDER THE TRAFFIC BARRIER TERMINAL.
- 2. "EXISTING" GUARDRAIL REFERS TO CONNECTING TERMINAL SECTION TO GUARD RAILING PRIOR TO THE MIDWEST GUARDRAIL SYSTEM.
- 3. THE CONTRACTOR SHALL VERIFY THE TYPE/HEIGHT OF GUARDRAIL IN-PLACE BEFORE ORDERING THE NEW TERMINAL SECTION.
 COST INCLUDED WITH THE COST OF THE TERMINAL. THE EXISTING GUARDRAIL HEIGHT SHALL TRANSISTION TO MATCH THE NEW TERMINAL END SECTION AND SHALL BE PAID FOR AS VERTICAL ADJUSTMENT OF EXISTING GUADRAIL.

DETAILS FOR STEEL PLATE BEAM

GUARD RAIL ADJACENT TO CURB AND GUTTER

[FOR ROADWAY SPEED 35 MPH (60 kmh) TO 45 MPH (70 kmh)]

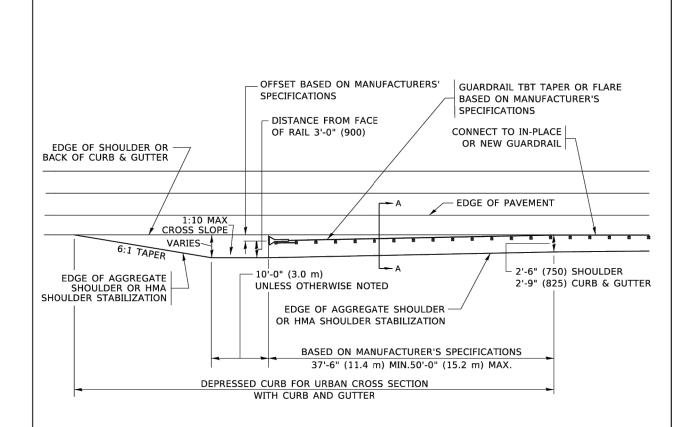

DEPRESSED CURB AND GUTTER AND SHOULDER TREATMENT AT TBT TY. 1 SPL.

AGGREGATE SHOULDER, 10 (250) WILL BE PAID ACCORDING TO SECTION 481.

HMA SHOULDERS 6 (150) (IF REQUIRED) WILL BE PAID ACCORDING TO SECTION 482.

COMB. CONC. C&G, STEEL PLATE BEAM GUARD RAIL AND TRAFFIC BARRIER TERMINAL, OF THE TYPE SPECIFIED WILL BE PAID FOR SEPARATELY.

TBT = TRAFFIC BARRIER TERMINAL
ALL DIMENSIONS ARE IN INCHES (MILLIMETERS)
UNLESS OTHERWISE SHOWN.

DETAILS FOR DEPRESSED CURB & GUTTER AND SHOULDER TREATMENT AT TBT TY.1 SPL.

SCALE: NONE SHEET 1 OF 1 SHEETS STA. TO STA.

FA. SECTION COUNTY TOTAL SHEE NO.

BD600-10 (BD-34) CONTRACT NO.

| ILLINOIS FED. AID PROJECT

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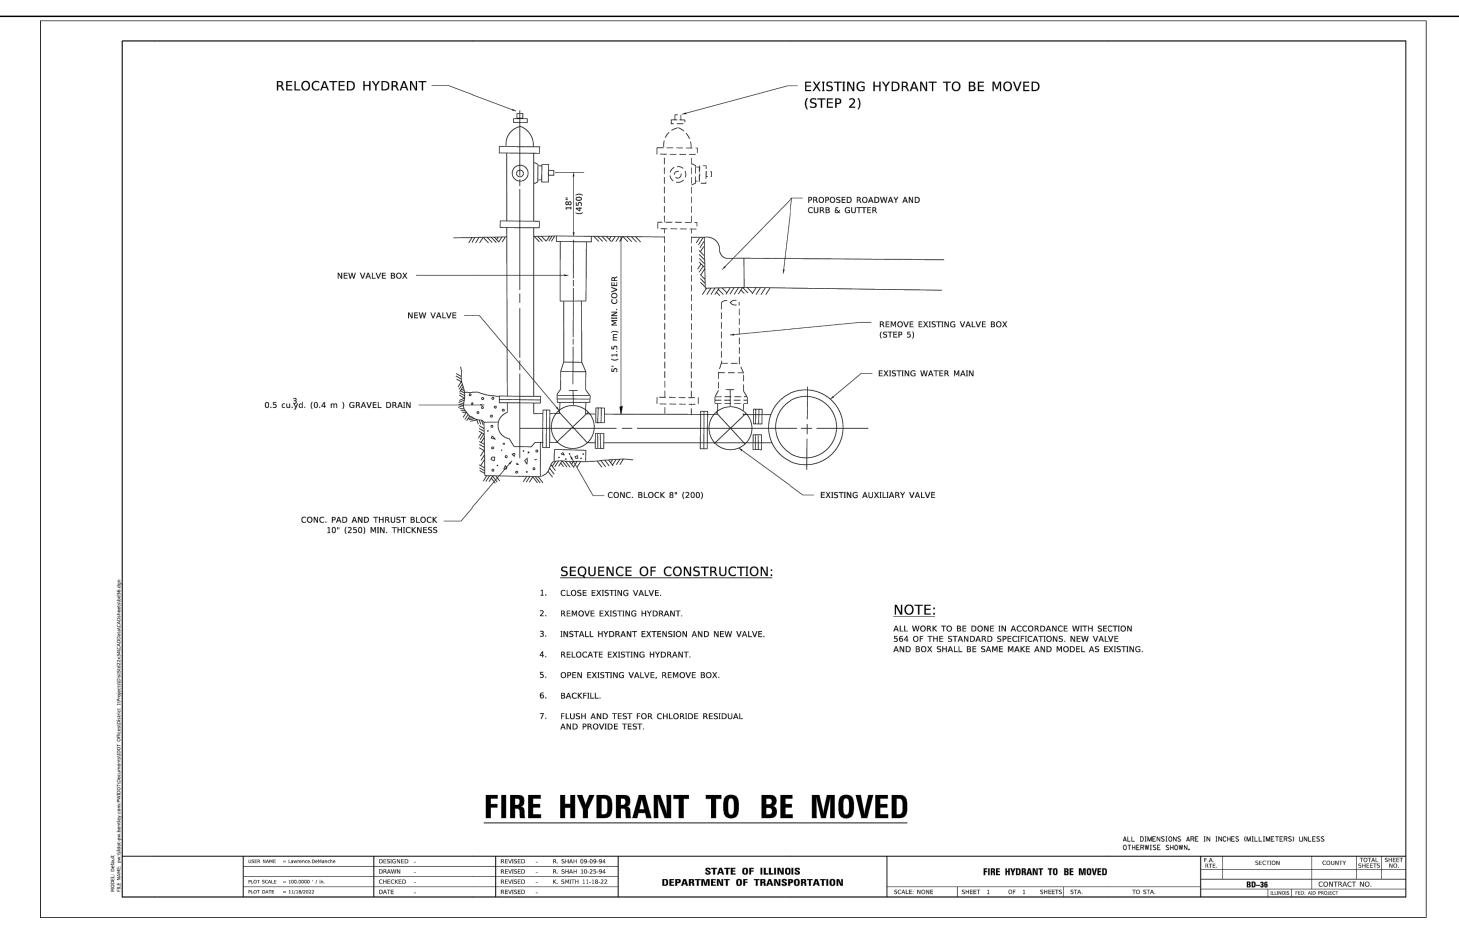
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PLOT DATE = 2/15/24	DATE -	03/01/23	REVISED —

STATI	E 01	F ILLINOIS
DEPARTMENT	0F	TRANSPORTATION

				F.A.U. RTE.	SECTION	COUNTY	TOTAL SHEETS	SHEET NO.
	DETAILS			4051	22-00134-00-TL	MCHENRY	129	84
						CONTRACT	NO 6	1K35
SCALE: AS NOTED SHEET 84 OF	129 SHEETS	STA.	TO STA.		ILLINOIS FED. AID PROJECT			




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PLOT SCALE = AS NOTED	CHECKED -		REVISED —
PLOT DATE = $2/15/24$	DATE -	03/01/23	REVISED —

Ī							F.A.U. RTE.	SECTION	COUNTY	TOTAL SHEETS	SHEET NO.
ı				DETAILS	4051	22-00134-00-TL	MCHENRY	129	85		
ı									CONTRACT	NO 6	K35
	SCALE: AS NOTED	SHEET 85	OF	129 SHEETS	STA.	TO STA.	ILLINOIS FED. AID PROJECT				




APPLICATION

THIS DETAIL APPLIES FOR LOW VOLTAGE ELECTRIC SERVICE (660 V OR LESS) FROM AN OVERHEAD UTILITY SUPPLY TO SEPERATLY-MOUNTED SERVICE EQUIPMENT.

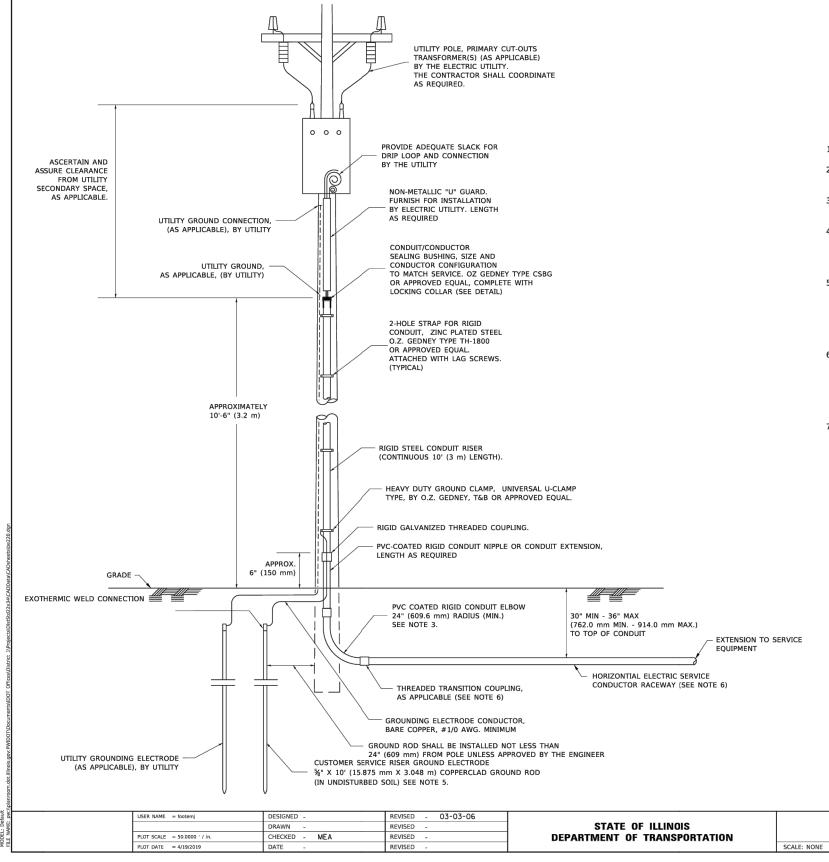NOTES

- 1. SERVICE VOLTAGE SHALL BE AS INDICATED ELSEWHERE IN THE DRAWINGS.
- 2. UNLESS OTHERWISE INDICATED, ITEMS AND WORK SHALL BE INCLUDED AND PAID AS PART OF THE ELECTRIC UTILITY SERVICE INSTALLATION PAY ITEM
- 3. CONDUIT AND CONNECTOR DIAMETER SHALL MATCH THE DIAMETER OF THE SERVICE CONDUCTOR RACEWAY AS INDICATED ON THE PLANS.
- 4. PVC COATED RACEWAYS AND ACCESSORIES SHALL BE CAREFULLY INSTALLED WITH MFR RECOMMENDED TOOLS AND PROCEDURES TO AVOID DAMAGE. ANY DAMAGE SHALL BE REPAIRED WITH COMPATIBLE PVC TOUCH-UP MATERIAL TO THE SATISFACTION OF THE ENGINEER OR THE DAMAGED MATERIAL SHALL BE REPLACED AT NO ADDITIONAL COST.
- 5. THE CONTRACTOR SHALL OBTAIN INSPECTION AND APPROVAL BY THE ENGINEER OF SERVICE RISER GROUND ELECTRODE, RISER ELBOW NIPPLE AND CONNECTION TO SERVICE CONDUCTOR RACEWAY EXTENSION BEFORE BACKFILL AND SHALL ALSO OBTAIN INSPECTION OF SERVICE RISER AND SEALING BUSHING BEFORE UTILITY "U" GUARD INSTALLATION AND
- 6. THE HORIZONTAL ELECTRIC SERVICE CONDUCTOR RACEWAY SHALL BE AS INDICATED AND SHALL BE MEASURED SEPARATELY FOR PAYMENT. WHEN THE RACEWAY IS PVC-COATED RIGID GALVANIZED STEEL, THE COUPLING SHALL BE THE SAME. WHEN THE RACEWAY IS PVC CONDUIT (IN CONCRETE), THE COUPLING SHALL BE A METALIC TO NON METALIC ADAPTER. WHEN THE RACEWAY IS ENCASED IN CONCRETE, THE CONCRETE SHALL EXTEND TO COVER THE COUPLING.
- 7. PLANS AND DETAILS INDICATE THE GENERAL NATURE AND REQUIREMENTS. THEY DO NOT SHOW EVERY ACCESSORY AND ATTACHMENT, AND THEY DO NOT RELIEVE THE CONTRACTOR OF THE REQUIREMENTS OF THE SPECIFICATIONS AND SPECIAL PROVISIONS TO ASCERTAIN UTILITY REQUIREMENTS AND TO COORDINATE ACCORDINGLY, FURNISHING ALL ITEMS AND WORK NOT PROVIDED BY THE UTILITY, BUT NECESSARY FOR A COMPLETE SERVICE INSTALLATION IS REQUIRED AND SHALL BE INCLUDED IN THE ELECTRIC UTILITY SERVICE INSTALLATION PAY ITEM.

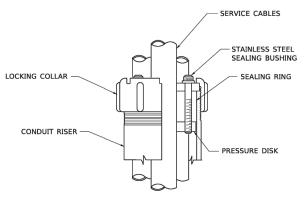


SEALING BUSHING DETAIL

ELECTRIC SERVICE INSTALLATION								F.A. RTE.	F.A. SECTION			COUNTY		SHEE NO.
		ΔFF	ΙΔΙ	RFN	INTE DI	SCONNECT								
		ALI	ual,	IILI	NOIL DI	SCOMMEDI		BE-220 CONTRACT NO.					NO.	
SCALE: NONE	SHEET	1	OF	1	SHEETS	STA.	TO STA.			ILLINOIS	FED. A	ID PROJECT		

USER NAME =BF/YJ	DESIGNED	-	VL	REVISED	_
	DRAWN	_	BF/YJ	REVISED	-
PLOT SCALE = AS NOTED	CHECKED	_		REVISED	-
PLOT DATE = $2/15/24$	DATE	_	03/01/23	REVISED	-

		F.A.U. RTE.	SECTION	COUNTY	TOTAL SHEETS	SHEET NO.
DETAILS	4051	22-00134-00-TL	MCHENRY	129	86	
				CONTRACT	NO 61	K35
SCALE: AS NOTED SHEET 86 OF 129 SHEETS	STA. TO STA.	ILLINOIS FED. AID PROJECT				

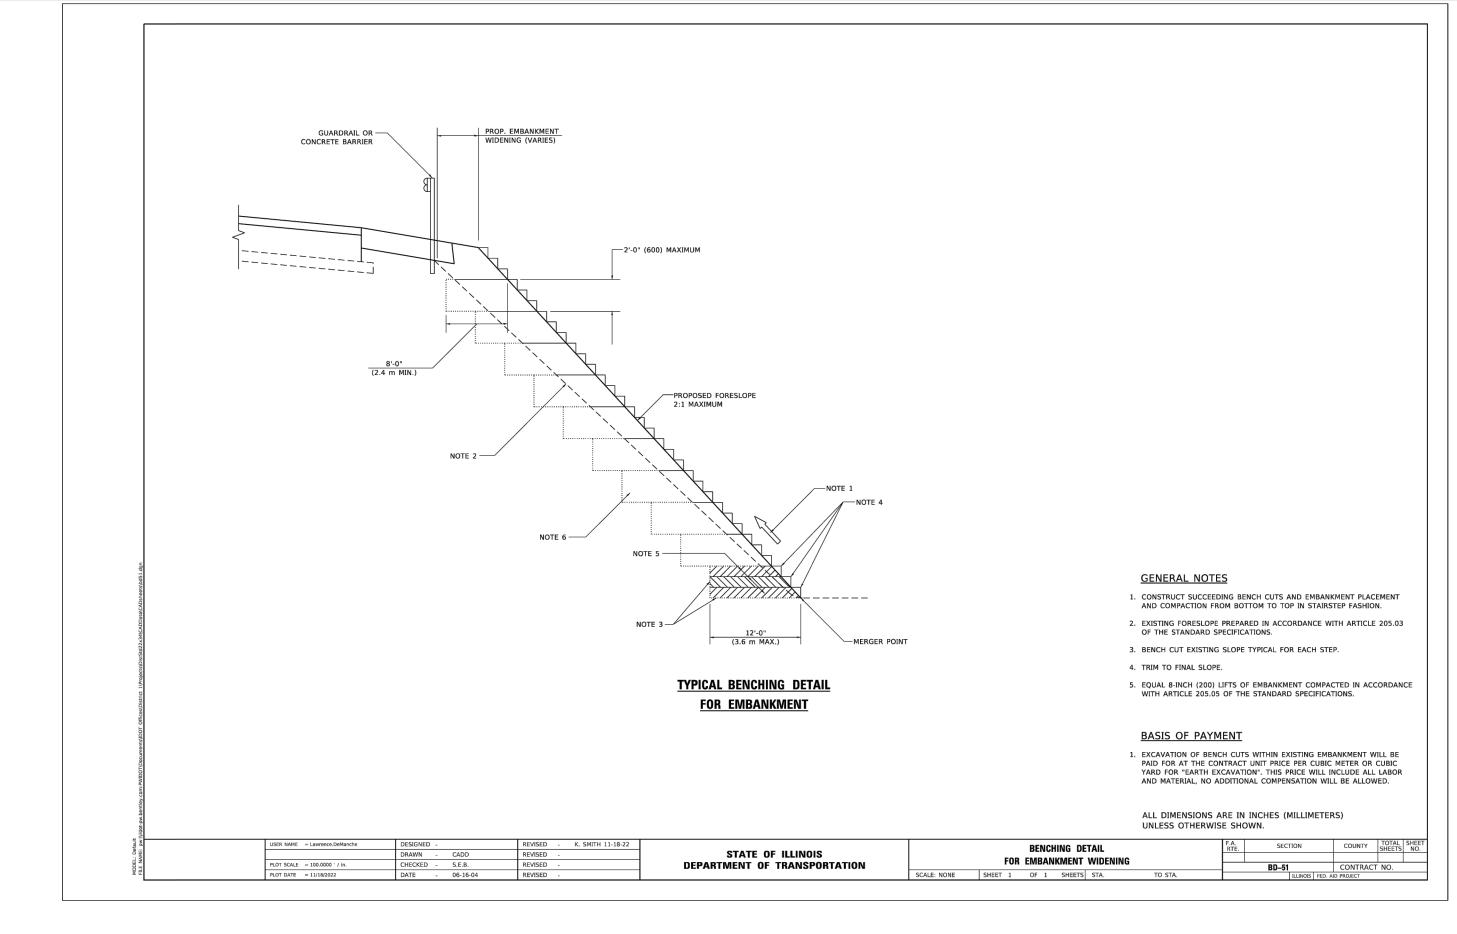


FEHR GRAHAM

ENGINEERING & ENVIRONMENTAL
ILLINOS DESON FRIN IN JEH-COSS25

© 2024 FEHR GRAHAM

USER NAME =BF/YJ	DESIGNED — VL	REVISED —
	DRAWN - BF/YJ	REVISED —
PLOT SCALE = AS NOTED	CHECKED —	REVISED —
PLOT DATE = 2/15/24	DATE - 03/01/23	REVISED —

	F.A.U. RTE.	SECTION	COUNTY	TOTAL SHEETS	SHEET NO.	
DETAILS	4051	22-00134-00-TL	MCHENRY	129	87	
				CONTRACT	NO 61	K35
SCALE: AS NOTED SHEET 87 OF 129 SHEETS S	A. TO STA.		ILLINOIS FED. AI	D PROJECT		

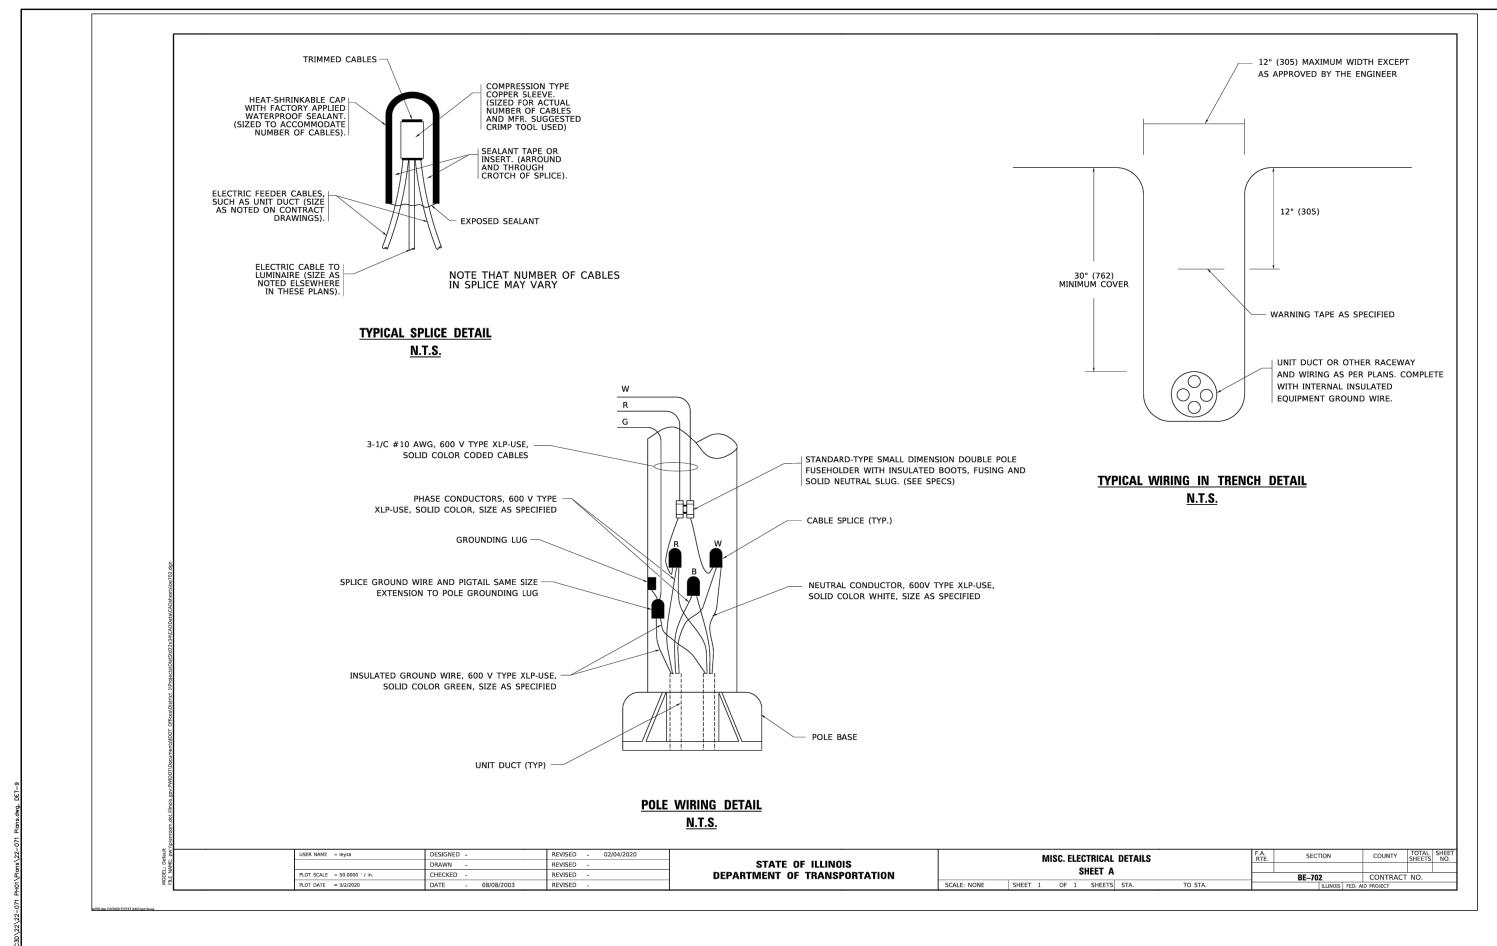


EHR GRAHAM

ENGINEERING & ENVIRONMENTAL
ILLINOS DESIGN FIRM NO. 184-003525

USER NAME =BF/YJ	DESIGNED	-	VL	REVISED —
	DRAWN	_	BF/YJ	REVISED —
PLOT SCALE = AS NOTED	CHECKED	_		REVISED —
PLOT DATE = $2/15/24$	DATE	_	03/01/23	REVISED —

STAT	E 0	F ILLINOIS
DEPARTMENT	0 F	TRANSPORTATION

F						F.A.U RTE.	F.A.U. SECTION		COUNTY TOTAL SHEETS		SHEET NO.
			DETAILS			4051	1	22-00134-00-TL	MCHENRY	129	88
								CONTRACT	NO 61	K35	
SCALE: AS NOTED	SHEET 88	OF	129 SHEETS	STA.	TO STA.		ILLINOIS FED. AID PROJECT				

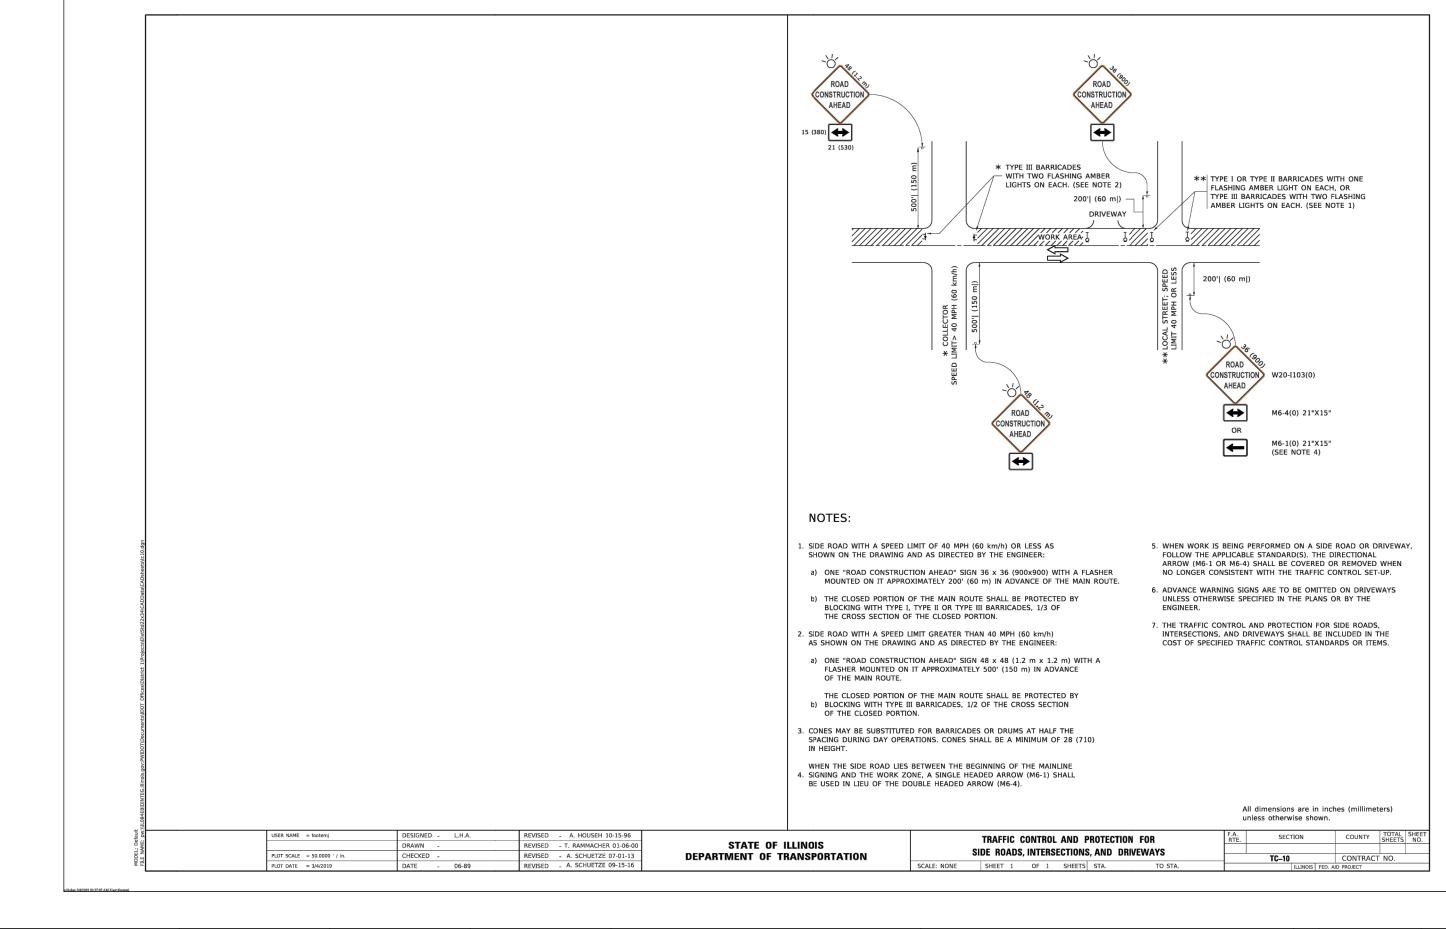


FEHR GRALIAM

ENGINEERING & ENVIRONMENTAL
LILMOS DESON FRIN IN. 18-0-03323

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USER NAME =BF/YJ	DESIGNED	_	VL	REVISED	_
	DRAWN	_	BF/YJ	REVISED	=
PLOT SCALE = AS NOTED	CHECKED	_		REVISED	-
PLOT DATE = 2/15/24	DATE	_	03/01/23	REVISED	-

						F.A.U. RTE.	SECTION	COUNTY
			DETAILS			4051	22-00134-00-TL	MCHENRY
								CONTRACT
SCALE: AS NOTED	SHEET 89	OF	129 SHEETS	STA.	TO STA.		ILLINOIS FED. AI	D PROJECT

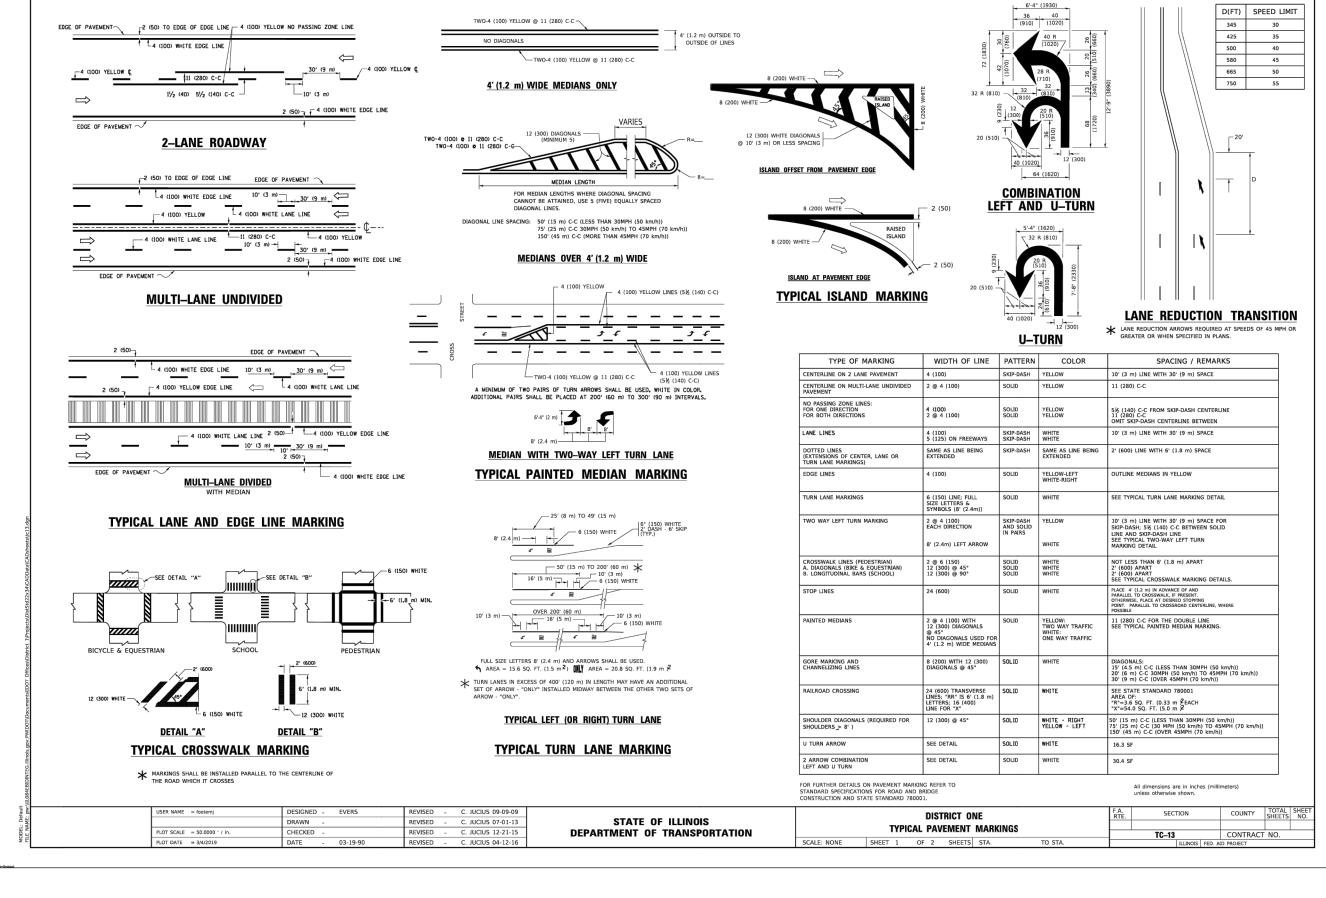

FEHR GRAHAM


ENGINEERING & ENVIRONMENTAL
ILLINOIS DESON FIRM NO. 164-003029

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USER NAME =BF/YJ	DESIGNED	_	VL	REVISED	_
	DRAWN	_	BF/YJ	REVISED	-
PLOT SCALE = AS NOTED	CHECKED	_		REVISED	_
PLOT DATE = $2/15/24$	DATE	_	03/01/23	REVISED	-

STATI	E OF	: ILLINO	IS
DEPARTMENT	0 F	TRANSP	ORTATION

						F.A.U. RTE.	SECTION	COUNTY	TOTAL SHEETS	SHEET NO.
			DETAILS			4051	22-00134-00-TL	MCHENRY	129	90
								CONTRACT	NO 61	K35
SCALE: AS NOTED	SHEET 90	OF	129 SHEETS	STA.	TO STA.		ILLINOIS FED. AI	D PROJECT		

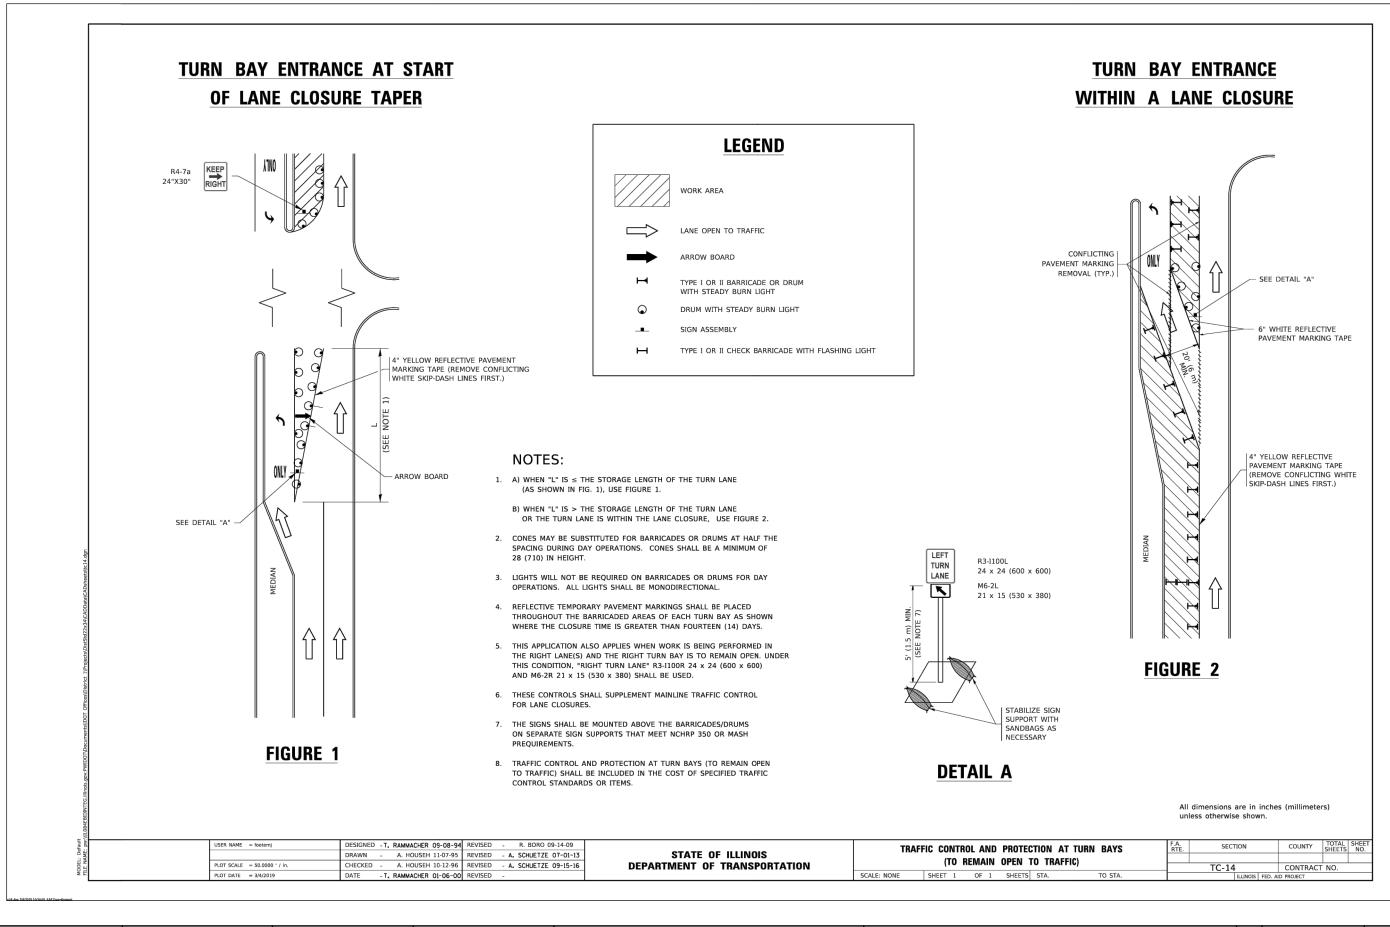

FEHR GRALIAM

ENGINEERING & ENVIRONMENTAL
ILLINOIS DESIGN PIRIN NO. 184-003025

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 USER NAME
 =BF/YJ
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 VL
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 —


 DRAWN
 — BF/YJ
 REVISED
 —

 PLOT SCALE
 = AS NOTED
 CHECKED
 —
 REVISED
 —

 PLOT DATE
 = 3/22/24
 DATE
 —
 03/01/23
 REVISED
 —

STATE OF ILLINOIS DEPARTMENT OF TRANSPORTATION

| F.A.U. | SECTION | COUNTY | STATE | SHEET | SECTION | COUNTY | STATE | SHEET | SOURCE | SECTION | COUNTY | STATE | SHEET | SOURCE | SECTION | COUNTY | STATE | STATE | STATE | STATE | SECTION | COUNTY | STATE | SECTION | COUNTY | STATE | SECTION | COUNTY | STATE | STATE | SECTION | COUNTY | STATE | SECTION | COUNTY | STATE | STATE | SECTION | COUNTY | STATE | SECTION | COUNTY | STATE | STATE | SECTION | COUNTY | STATE | SECTION | COUNTY | STATE | STATE | SECTION | COUNTY | STATE | STATE | SECTION | COUNTY | STATE | SECTION | COUNTY | STATE | STATE

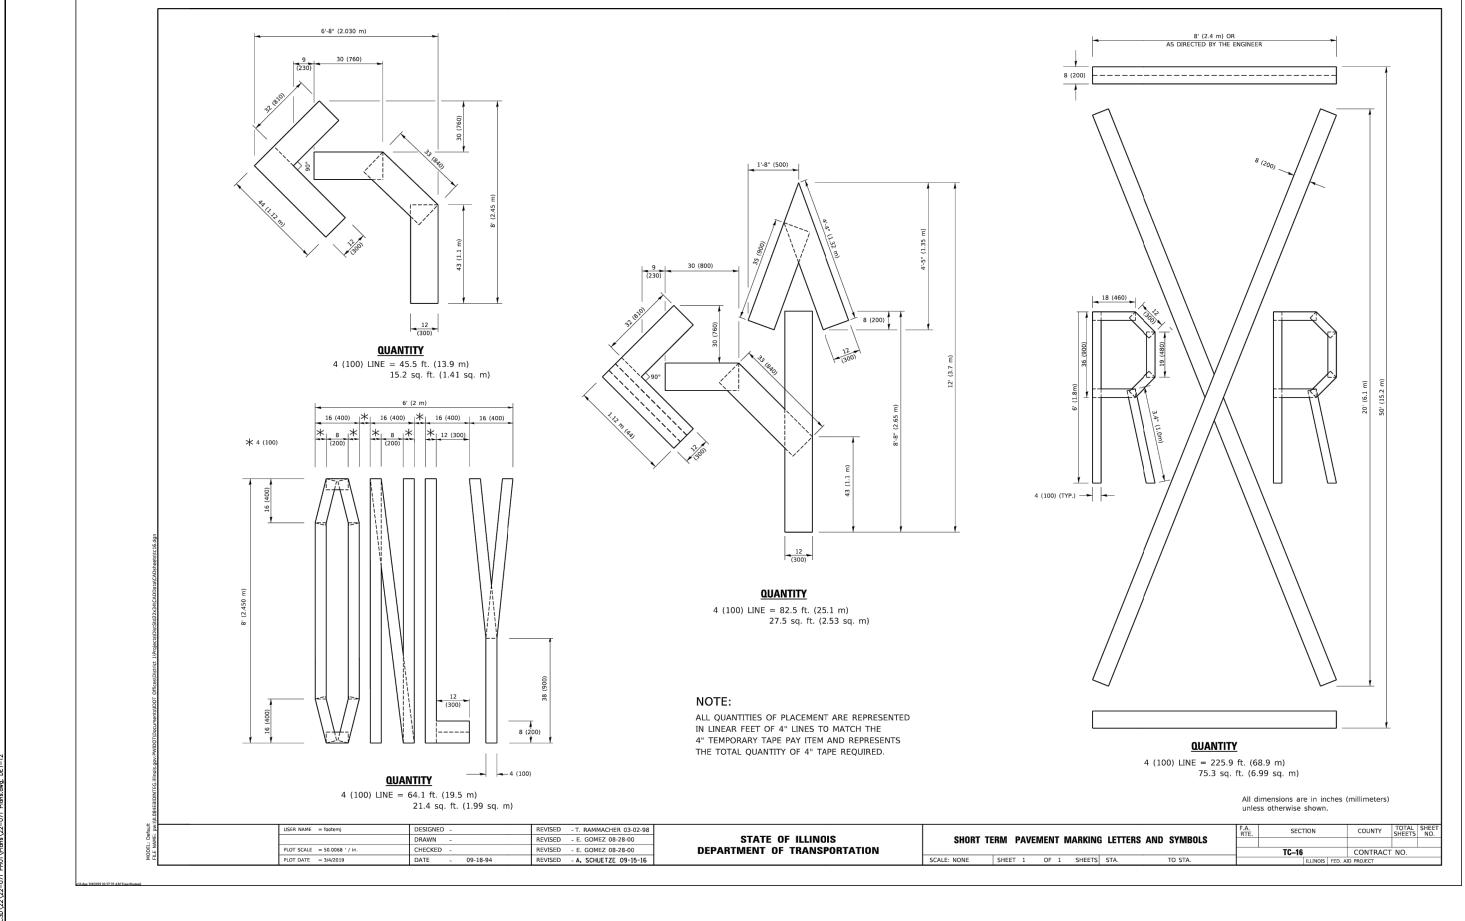


FEHR GRALAM

ENGINEERING & ENVIRONMENTAL
ILLINOS DESON PION 100. 1804-003525

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USER NAME =BF/YJ	DESIGNED -		VL	REVISED	_
	DRAWN -	-	BF/YJ	REVISED	-
PLOT SCALE = AS NOTED	CHECKED -	-		REVISED	_
PLOT DATE = 2/15/24	DATE -	-	03/01/23	REVISED	-

						F.A.U. RTE.	SECTION	COUNTY	TOTAL SHEETS	SHEET NO.
			DETAILS			4051	22-00134-00-TL	MCHENRY	129	91
								CONTRACT	NO 6	K35
CALE: AS NOTED S	SHEET 91 (OF	129 SHEETS	STA.	TO STA.		ILLINOIS FED. A	D PROJECT		

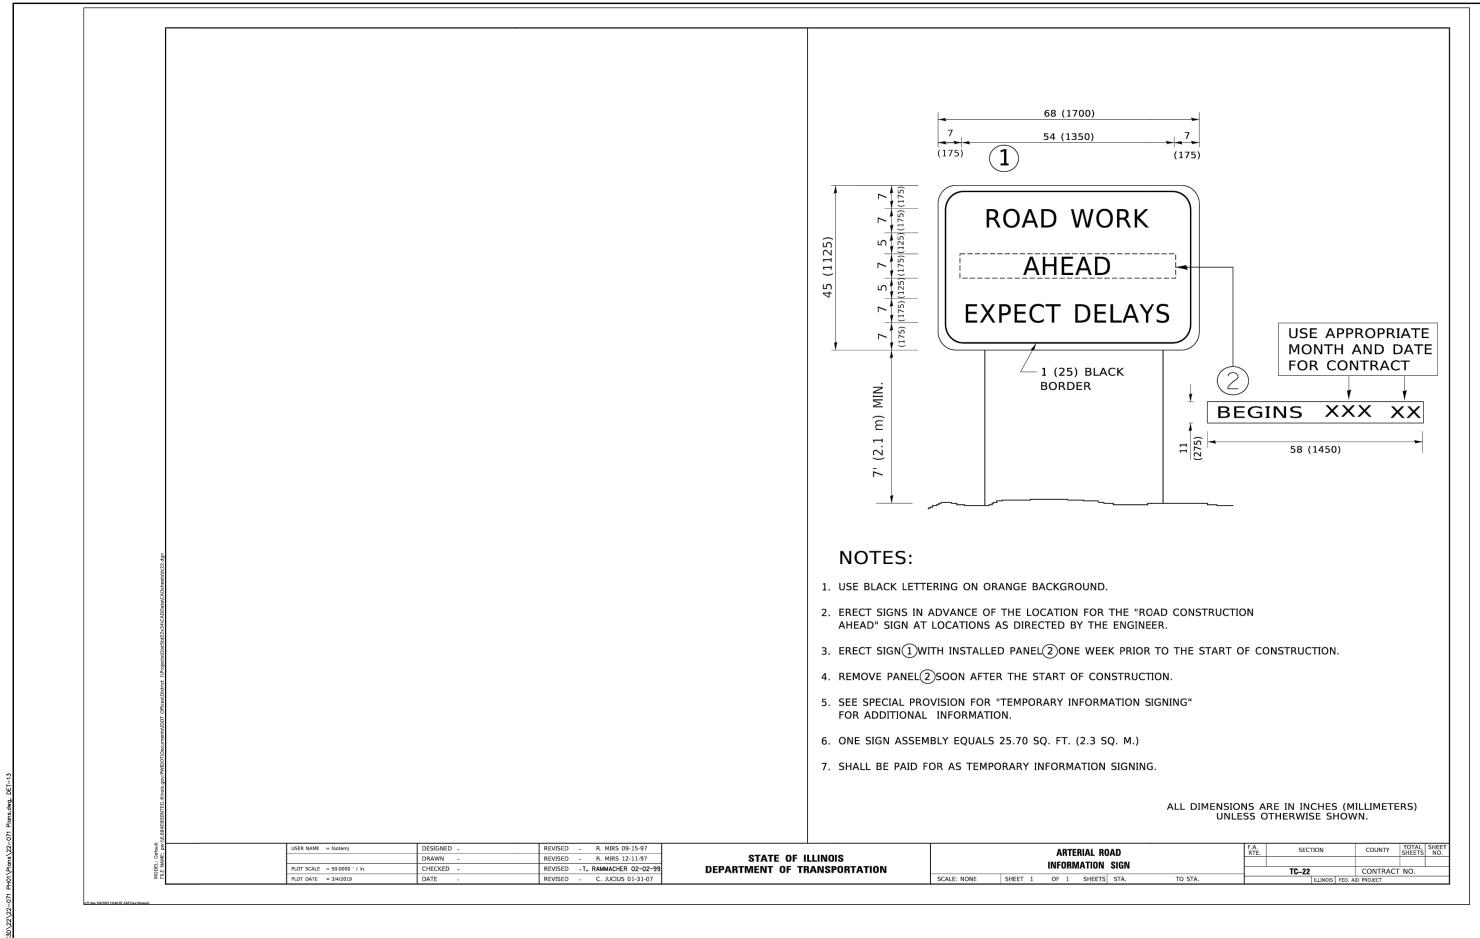


FEHR GRAHAM
ENGINEERING & ENVIRONMENTAL ILLINOIS DESIGN FIRM NO. 184-003525
© 2024 FEHR GRAHAM

USER NAME =BF/YJ	DESIGNED — VL	REVISED —
	DRAWN — BF/YJ	REVISED —
PLOT SCALE = AS NOTED	CHECKED —	REVISED —
PLOT DATE = 2/15/24	DATE - 03/01/23	REVISED —

STATI	E 01	F ILLINOIS
DEPARTMENT	0 F	TRANSPORTATION

		F.A.U. RTE.	SECTION	COUNTY	TOTAL SHEETS	SHEET NO.
DETAILS		4051	22-00134-00-TL	MCHENRY	129	92
				CONTRACT	NO 61	1K35
LE: AS NOTED SHEET 92 OF 129 SHEETS STA.	TO STA.		ILLINOIS FED. A	D PROJECT		

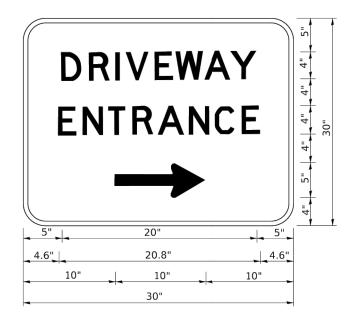

3.0" RADIUS, 0.5" BORDER, WHITE ON GREEN; REFLECTORIZED "DRIVEWAY" D; "ENTRANCE" D; STANDARD ARROW CUSTOM 12.0" \times 5.0"

NOTES:

- 1. HALF OF THE SIGNS WILL REQUIRE A LEFT HAND FACING ARROW.
- 2. TWO SIGNS SHALL BE USED AT EACH COMMERCIAL ENTRANCE PLACED BACK-TO-BACK: ONE WITH A RIGHT HAND ARROW (SHOWN) SHALL BE PLACED ON THE NEAR RIGHT SIDE THE DRIVEWAY AND ONE WITH A LEFT HAND ARROW SHALL BE PLACED ON THE FAR LEFT SIDE OF THE DRIVEWAY.
- 3. SIGNS TO BE PAID FOR AS ITEM "TEMPORARY INFORMATION SIGNING".

USER NAME = leysa	DESIGNED -	REVISED	-	C. JUCIUS 02-15-07
	DRAWN -	REVISED	-	
PLOT SCALE = 50.0000 ' / in.	CHECKED -	REVISED	-	
PLOT DATE = 8/6/2021	DATE -	REVISED	-	

STATE OF ILLINOIS
DEPARTMENT OF TRANSPORTATION

	_							F.A. RTE.	SEC	TION		COUNTY	SHEETS	NO.
	ı	DRIVE	:WA	YE	NTRANC	CE SIGNING	i							
									TC-26			CONTRACT	NO.	
SCALE: NONE	SHEET	1	OF	1	SHEETS	STA.	TO STA.			ILLINOIS	FED. A	ID PROJECT		

FEHR GRAHAM


USER NAME =BF/YJ	DESIGNED — VL	REVISED —
	DRAWN — BF/YJ	REVISED —
PLOT SCALE = AS NOTED	CHECKED —	REVISED —
PLOT DATE = 3/22/24	DATE - 03/01/23	REVISED —


STATI	E OF	ILLINOIS	
DEPARTMENT	0 F	TRANSPORT	TATION

	F.A.U. RTE.	SECTION	COUNTY	TOTAL SHEETS	SHEET NO.
DETAILS	4051	22-00134-00-TL	MCHENRY	132	92A
			CONTRACT	NO 61	1K35
SCALE: AS NOTED SHEET92A OF 132 SHEETS STA. TO STA.		ILLINOIS FED. A	D PROJECT		

SIGN PANEL - TYPE 1 OR TYPE 2

Sample Rd

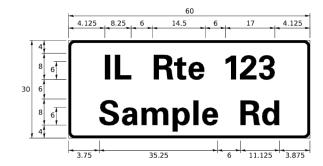

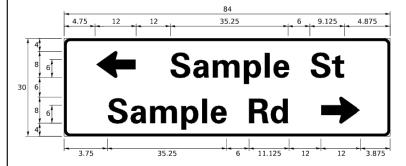

DESIGN	AREA	SIGN PANEL	SHEETING	QTY.
SERIES	(SQ FT)	TYPE	TYPE	REQUIRED
D OR C	-	1 OR 2	ZZ	-

COMMON STREET NAME ABBREVIATIONS AND WIDTHS

NAME	ABBREVATION	WIDTH	(INCH)
NAME	ADDREVATION	SERIES "C"	SERIES "D"
AVENUE	Ave	15.000	18.250
BOULEVARD	Blvd	17.125	20.000
CIRCLE	Cir	11.125	13.000
COURT	Ct	8. 250	9.625
DRIVE	Dr	8.625	10.125
HIGHWAY	Hwy	18.375	22.000
ILLINOIS	IL	7. 000	8. 250
LANE	Ln	9.125	10.750
PARKWAY	Pkwy	23. 375	27. 375
PLACE	PΙ	7. 125	7. 750
ROAD	Rd	9.625	11.125
ROUTE	Rte	12.625	14.500
STREET	St	8.000	9.125
TERRACE	Ter	12.625	14.625
TRAIL	Tr	7. 750	9.125
UNITED STATES	US	10.375	12.250

GENERAL NOTES

- 1. WHERE MAST ARM MOUNTED STREET NAME SIGNS ARE SPECIFIED, THE MAST ARM ASSEMBLY AND POLES SHALL BE DESIGNED TO SUPPORT THE LOADINGS CALLED FOR ON STANDARDS 877001, 877002, 877002, 877011 AND 877012, AS APPLICABLE, PLUS TWO (2) SIGN PANELS 2'-6" x 8'-0" MOUNTED AS SHOWN. THE DESIGN SHALL BE IN ACCORDANCE WITH THE REQUIREMENTS OF THE CURRENT "STANDARD SPECIFICATIONS FOR STRUCTURAL SUPPORTS FOR HIGHWAY SIGNS, LUMINAIRES, AND TRAFFIC SIGNALS" AS PUBLISHED BY THE AMERICAN ASSOCIATION OF STATE HIGHWAY AND TRANSPORTATION OFFICIALS FOR 80 M.P.H. WIND VELOCITY.
- ALL SIGNS SHALL CONSIST OF A WHITE LEGEND AND BORDER (TYPE ZZ SHEETING) ON A GREEN BACKGROUND (TYPE ZZ SHEETING)
- THE SIGN LENGTH SHALL BE IN 6-INCH INCREMENTS, BUT THE OVERALL LENGTH SHALL NOT EXCEED 8'-0". ALL BORDERS IF
 POSSIBLE, BUT MAY BE REDUCED TO 5" WHEN SPACING IS CRITICAL. A MINIMUM OF 2-1/2" SHALL BE INCLUDED BETWEEN
 THE WORD AND THE RIGHT AND LEFT EDGES OF THE SIGN.
- 4. A PREFERRED METHOD FOR THE SIGN DESIGN IS TO USE SERIES "D" LETTER ON A ONE-LINE SIGN 18" IN HEIGHT AND A MAXIMUM OF 8"-0" IN WIDTH. IF SERIES "D" DOES NOT FIT ON A 8"-0" SIGN, THEN SERIES "C" SHOULD BE TRIED. IF SERIES "C" DOES NOT FIT ON A 8"-0" SIGN, A 30" HIGH TWO-LINE SIGN CAN BE USED. THE CROSSROAD DESIGNATION AS TO STREET, AVENUE, ETC. SHOULD BE SPELLED OUT ON THE SECOND LINE, IF THE ABBREVIATION CANNOT FIT ON THE FIRST LINE.
- LED ILLUMINATED STREET NAME SIGNS CAN BE USED IN PLACE OF REGULAR SIGN PANELS BUT ANY SPECIAL WORDING AND SYMBOLOGY MUST BE APPROVED BY THE DEPARTMENT. GENERAL DESIGN REQUIREMENT AS LISTED ABOVE (COLOR, FONT, SIZE, ETC.) MUST BE FOLLOWED.
- 6. SIGNFIX ALUMINUM CHANNEL FRAMING SYSTEM SHALL BE USED FOR ALL SIGNS ATTACHED TO SIGNAL POLES AND POSTS.

LOCAL SUPPLIERS: PARTS LISTING:


J.O. HERBERT COMPANY, INC SIGN CHANNEL PART #HPN053 (MED. CHANNEL)
MIDLOTHIAN, VA SIGN SCREWS 1/4" x 14 x 1" H.W.H. #3
SELF TAPPING WITH NEOPRENE WASHER

WESTERN REMAC, INC. BRACKETS PART #HPN034 (UNIVERSAL)
WOODRIDGE, IL CHANNEL CLAMPS WITH STAINLESS STEEL STRAPPING


OTHER BRANDS OF MOUNTING HARDWARE ARE ACCEPTABLE, BASED UPON THE DEPARTMENT'S APPROVAL AND COMPATIBILITY WITH THE CHANNEL/BRACKET OF THE ABOVE PRODUCT.

MOUNTING LOCATION

ARM OR POLE MOUNTED

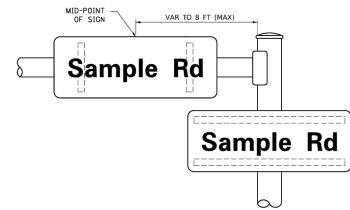

SUPPORTING CHANNELS

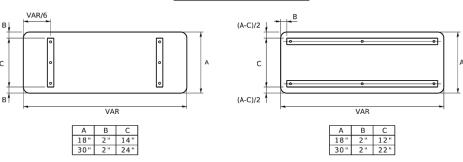

STANDARD ALPHABETS SPACING CHART

(8") UPPER CASE AND (6") LOWER CASE

	FHWA SEI	RIES "C"			FHWA SE	RIES "D"	
CHARACTER	(INCH)	WIDTH (INCH)	RIGHT SPACING (INCH)	CHARACTER	LEFT SPACING (INCH)	WIDTH (INCH)	RIGHT SPACING (INCH)
Α	0.240	5. 122	0.240	Α	0.240	6.804	0.240
В	0.880	4. 482	0.480	В	0.960	5.446	0.400
С	0.720	4.482	0.720	С	0.800	5.446	0.800
D	0.880	4. 482	0.720	D	0.960	5.446	0.800
E	0.880	4.082	0.480	E	0.960	4.962	0.400
F	0.880	4.082	0.240	F	0.960	4.962	0.240
G H	0.720	4.482	0.720	G H	0.800	5. 446 5. 446	0.800
I	0.880	4.482 1.120	0.880	I	0.960 0.960	1. 280	0.960
J	0. 240	4. 082	0.880	J	0. 240	5. 122	0.960
K	0.880	4. 482	0.480	K	0.960	5. 604	0.400
L	0.880	4. 082	0. 240	L	0.960	4. 962	0.240
М	0.880	5. 284	0.880	М	0.960	6. 244	0.960
N	0.880	4. 482	0.880	N	0.960	5.446	0.960
0	0.720	4. 722	0.720	0	0.800	5. 684	0.800
P	0.880	4.482	0.720	P	0.960	5.446	0.240
Q	0.720	4. 722	0.720	Q	0.800	5. 684	0.800
R	0.880	4.482	0.480	R	0.960	5.446	0.400
S	0.480	4. 482	0.480	S	0.400	5.446	0.400
T	0.240	4.082	0.240	Т	0.240	4.962	0.240
U	0.880	4.482	0.880	U	0.960	5.446	0.960
٧	0.240	4.962	0.240	V	0.240	6.084	0.240
W	0.240	6.084	0.240	W	0.240	7.124	0.240
X	0.240	4. 722	0.240	Х	0.400	5.446	0.400
Υ	0.240	5. 122	0.240	Υ	0.240	6.884	0.240
Z	0.480	4.482	0.480	Z	0.400	5.446	0.400
а	0.320	3. 842	0.640	a	0.400	4.562	0.720
Ь	0.720	4.082	0.480	b	0.800	4.802	0.480
С	0.480	4.002	0.240	C .	0.480	4. 722	0.240
d	0.480	4.082	0.720	d	0.480	4.802	0.800
e f	0.480	4.082	0.320	e f	0.480	4. 722	0.320
	0.320	2.480	0.160		0.320	2.882	0.160
g	0.480	4.082 4.082	0.720	g h	0.480	4.802	0.800
h İ	0.720	1.120	0.720	i	0.800	1. 280	0.800
j	0.000	2. 320	0.720	j	0.000	2.642	0.800
k	0.720	4. 322	0.160	k	0.800	5. 122	0.160
1	0.720	1.120	0.720	ı.	0.800	1.280	0.800
m	0.720	6. 724	0.640	m	0.800	7. 926	0.720
n	0.720	4.082	0.640	n	0.800	4. 722	0.720
0	0.480	4.082	0.480	0	0.480	4.882	0.480
Р	0.720	4.082	0.480	р	0.800	4.802	0.480
q	0.480	4.082	0.720	q	0.480	4.802	0.800
r	0.720	2.642	0.160	r	0.800	3.042	0.160
S	0.320	3. 362	0.240	S	0.320	3.762	0.240
t	0.080	2.882	0.080	t	0.080	3. 202	0.080
u	0.640	4.082	0.720	u	0.720	4.722	0.800
٧	0.160	4.722	0.160	V	0.160	5.684	0.160
W	0.160	7.524	0.160	w	0.160	9.046	0.160
×	0.000	5. 202	0.000	х	0.000	6. 244	0.000
У	0.160	4. 962	0.160	у	0.160	6.004	0.160
Z	0.240	3. 362	0.240	Z	0.240	4.002	0.240
1	0.720	1.680	0.880	1	0.800	2.000	0.960
2	0.480	4.482	0.480	2	0.800	5.446	0.800
3	0.480	4.482	0.480	3	1.440	5.446	0.800
4	0.240	4. 962	0.720	4 5	0.160	6.004	0, 960
5	0.480	4. 482 4. 482	0.480	6	0.800	5.446	0.800
6 7	0.720	4.482	0.720	7	0.800 0.560	5.446	0.800
8	0. 480	4.482	0. 480	8	0.800	5.446	0.800
	0.480	4.482	0.480	9	0.800	5, 446	0.800
	0.720	4. 722	0.720	0	0.800	5. 684	0.800
9	0				0.240	2.802	
0	0.240	2.802	0.240		0.240	Z. BUZ	0.240

	_	_	

PLOT SCALE = 50.0000 ' / in.
PLOT DATE = 3/4/2019

JSER NAME = footemj


STATE OF ILLINOIS
DEPARTMENT OF TRANSPORTATION

DISTRICT ONE
MAST ARM MOUNTED STREET NAME SIGNS
SCALE: SHEET OF SHEETS STA. TO

FEHR GRAHAM

USER NAME =BF/YJ	DESIGNE	D —	VL	REVISED	_
	DRAWN	_	BF/YJ	REVISED	-
PLOT SCALE = AS NO	TED CHECKED) –		REVISED	-
PLOT DATE = 2/15/	DATE DATE	_	03/01/23	REVISED	-

_							F.A.U. RTE.	SECTION	COUNTY	TOTAL SHEETS	SHEET NO.
				DETAILS			4051	22-00134-00-TL	MCHENRY	129	93
									CONTRACT	NO 61	K35
	SCALE: AS NOTED	SHEET 93	OF	129 SHEETS	STA.	TO STA.		ILLINOIS FED. AI	D PROJECT		

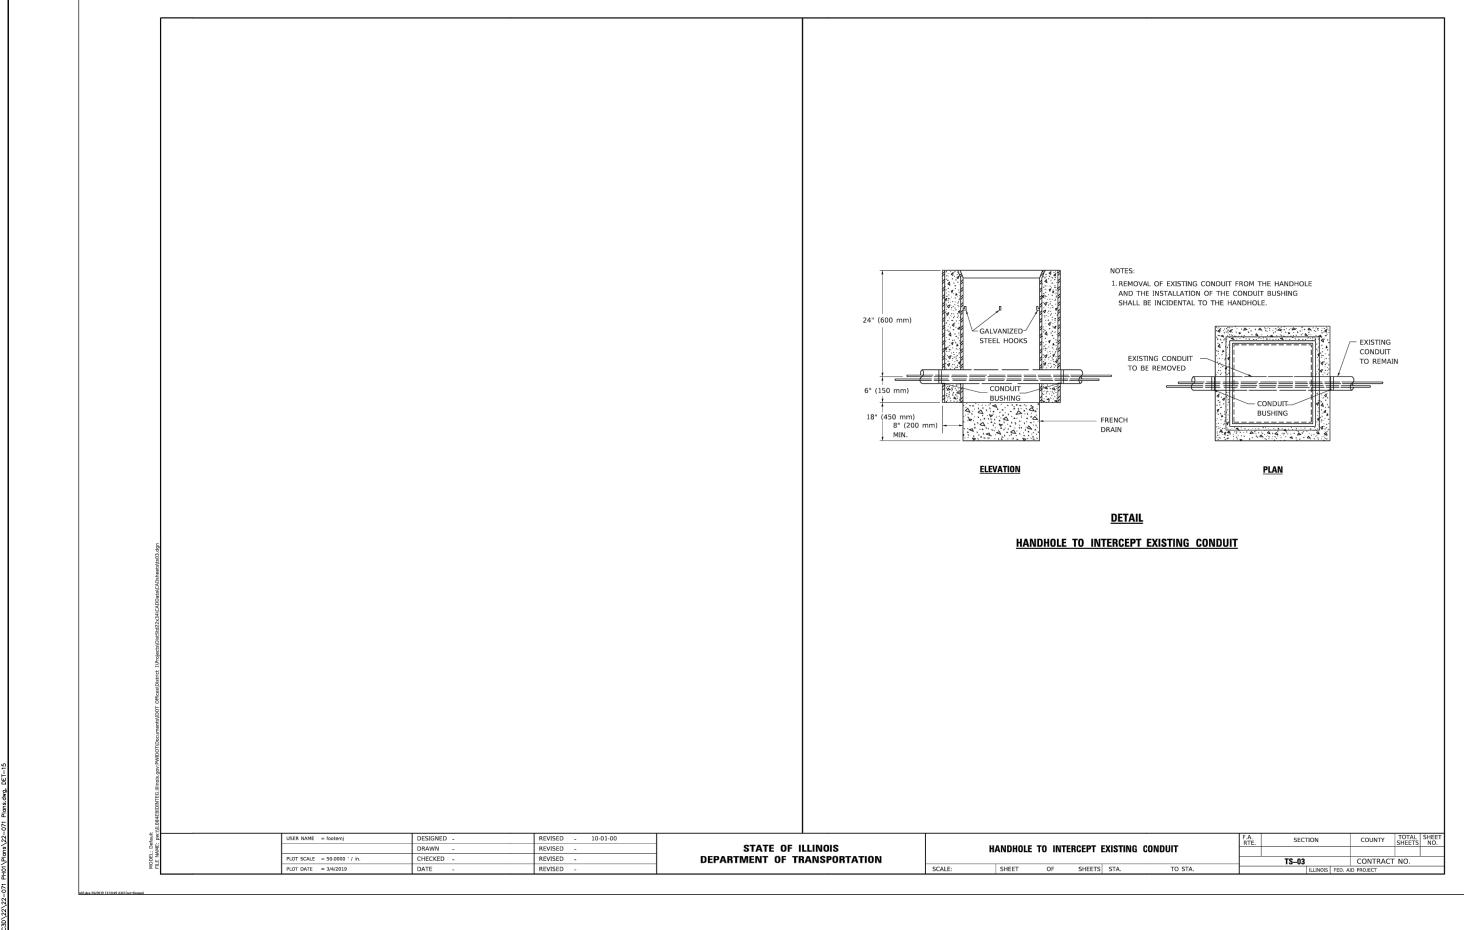

FEHR GRALIAM

ENGINEERING & ENVIRONMENTAL
ILLINGS DESON FROM NO. 184-003523

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USER NAME =BF/YJ	DESIGNED	_	VL	REVISED	_
	DRAWN	_	BF/YJ	REVISED	-
PLOT SCALE = AS NOTED	CHECKED	_		REVISED	-
PLOT DATE = 2/15/24	DATE	_	03/01/23	REVISED	_


STAT	E 01	F ILLINOIS
DEPARTMENT	0F	TRANSPORTATION

						F.A.U. RTE.	SECTION	COUNTY	TOTAL SHEETS	SHEET NO.
			DETAILS			4051	22-00134-00-TL	MCHENRY	129	94
								CONTRACT	NO 61	K35
SCALE: AS NOTED	SHEET 94	OF	129 SHEETS	STA.	TO STA.		ILLINOIS FED. A	ID PROJECT		


LOOP DETECTOR NOTES

- EACH PAIR OF LOOP WIRES SHALL BE PLACED IN A SEPARATE EMPTY COILABLE NONMETALLIC CONDUIT FROM THE EDGE OF PAVEMENT TO THE HANDHOLE. SPACING BETWEEN THE HOLES DRILLED IN THE PAVEMENT SHALL NOT BE LESS THAN 6" (150 mm). EMPTY COILABLE NONMETALLIC CONDUIT SHALL BE INCLUDED IN THE COST OF THE LOOP WIRE.
- THE NUMBER OF LOOP TURNS SHALL BE AS RECOMMENDED BY THE AMPLIFIER MANUFACTURER.
 ALL ADJACENT SIDES OF THE LOOPS SHALL BE INSTALLED IN SUCH A WAY THAT THE CURRENT
 FLOW IS IN THE SAME DIRECTION TO REINFORCE ITS MAGNETIC FIELDS FOR SMALL VEHICLE
 DETECTION.
- 3. EACH LOOP LEAD-IN SHALL BE IDENTIFIED AND PERMANENTLY TAGGED IN THE HANDHOLE. EACH LEAD-IN CABLE TAG SHALL INDICATE THE LOCATION OF THE LOOP, LOOP ROTATION (CLOCKWISE/COUNTERCLOCKWISE), LOOP LEAD-IN DIRECTION (IN OR OUT), LOOP CABLE NUMBER AND LOCATION IN CABINET, AND NUMBER OF TURNS IN THE DETECTOR LOOPS IN WATER PROOF INK AS INDICATED ON THE DISTRICT 1 STANDARD TRAFFIC SIGNAL DESIGN DETAIL. THE CONTRACTOR SHALL MARK LOOP LOCATIONS ON RECORD DRAWINGS AND PRESENT TO THE ENGINEER AFTER FINAL INSPECTION. LOOPS SHALL BE MARKED BY LANE AND LOOP NUMBER. SEE DETAIL BELOW.
- 4. ALL LOOP CABLE SHALL BE FASTENED WITH PLASTIC TIE WRAP TO THE HANDHOLE HOOKS.
- 5. IN ASPHALT PAVEMENT, LOOPS SHOULD BE PLACED IN THE BINDER AND DIVEHOLES MARKED AT THE CURB WITH A SAW-CUT. THE SAW-CUT SHALL BE CUT IN ACCORDANCE WITH LOCAL AND E.P.A. DUST CONTROL REQUIREMENTS. DETECTOR LOOP(S) SHALL NOT BE INSTALLED IN WET CONDITIONS AND THE SAW-CUTS MUST BE FREE OF DEBRIS AND RESIDUE SUCH AS DUST AND WATER WHICH IS TO BE ACHIEVED BY THE USE OF COMPRESSED AIR, WIRE BRUSHING AND HEAT DRYING ACCORDING TO SEALANT MANUFACTURER REQUIREMENTS. THE DETECTOR WIRE SHALL BE HELD IN PLACE BY THE USE OF FORM WEDGES. WEDGES SHALL BE SPACED NO MORE THAN 18" (450 mm) APART.
- LOOP SPLICES SHALL BE SOLDERED USING A SOLDERING IRON. BLOW TORCHES OR OTHER DEVICES WHICH OXIDIZE COPPER CABLE SHALL NOT BE ALLOWED FOR SOLDERING OPERATIONS. SEE DETAIL BELOW RIGHT.
- 7. PREFORMED DETECTOR LOOPS SHALL BE USED, AS SHOWN ON THE PLANS, WHERE NEW CONCRETE PAVEMENT IS PROPOSED. THE INSTALLATION OF PREFORMED LOOPS SHALL BE IN ACCORDANCE WITH THE DISTRICT 1 SPECIFICATIONS OR AS DIRECTED BY THE ENGINEER.

LOOP LEAD-IN CABLE TAG

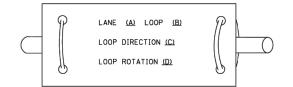



- A. LANE 1 IS THE LANE CLOSEST TO THE CENTERLINE OF THE ROADWAY
- B. LOOP #1 IS THE LOOP IN THE LANE CLOSEST TO THE INTERSECTION.
- C. LABEL LOOP CABLE "IN" OR LOOP CABLE "OUT".
- D. LABEL LOOP CABLE CLOCKWISE OR LOOP CABLE COUNTERCLOCKWISE.

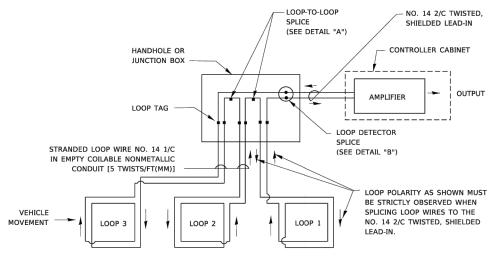

DETECTOR LOOP WIRING SCHEMATIC

- LOOPS SHALL BE SPLICED IN SERIES.
 SAW-CUTS SHALL BE A MINIMUM WIDTH OF 5/16" (8 mm).
- SAW-CUT DEPTHS SHALL BE 3" (75 mm). IF IN CONCRETE,
- THE SAW-CUT DEPTH SHALL BE TO THE TOP OF THE REINFORCEMENT.
- LOOP CORNERS SHALL BE DRILLED WITH A 2" (50 mm) DIAMETER CORE.

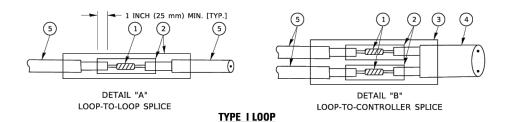

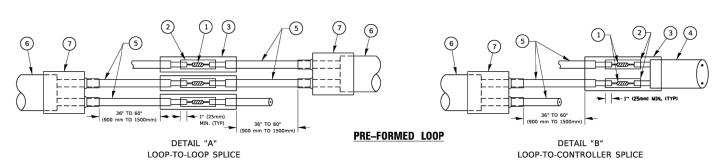

LOOP DETECTOR SPLICE

- (1) WESTERN UNION SPLICE SOLDERED WITH ROSIN CORE FLUX. ALL EXPOSED SURFACES OF THE SOLDER SHALL BE SMOOTH. THE WESTERN UNION SPLICES SHALL BE STAGGERED.
- (2) WCSMW 30/100 HEAT SHRINK TUBE, MINIMUM LENGTH 3" (75 mm), UNDERWATER GRADE.
- 3 WCS 200/750 HEAT SHRINK TUBE, MINIMUM LENGHT 6" (150 mm), UNDERWATER GRADE.
- 4 NO. 14 2/C TWISTED, SHIELDED CABLE.

- 5 LOOP CONDUCTOR WITH FLEXIBLE PLASTIC TUBE. PRE-FORMED LOOP
- 6 XL POLYOLEFIN 2 CONDUCTOR
- 7) BREAKOUT SEALS. TYCO CBR-2 OR APPROVED EQUAL


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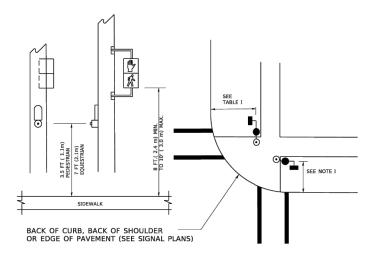
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								CONTRAC	L NO 6.	K35
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MAST ARM MOUNTED SIGNALS IN EXISTING, PROPOSED OR FUTURE SIDEWALK/BICYCLE PATH AREA. INTERSECTION SHOWN WITH PEDESTRIAN SIGNALS AND




- 2. REFER TO THE TRAFFIC SIGNAL EQUIPMENT OFFSET TABLE.
- PROVIDE A LEVEL ALL-WEATHER SURFACE (CONCRETE SIDEWALK, ASPHALT BICYCLE PATH SURFACE OR MATCHING MATERIAL TO THE ADJACENT SURFACE) UP TO THE MAST ARM SHAFT OR THE SIGNAL POST.
- THE FACE OF THE PEDESTRIAN PUSHBUTTON SHALL BE PARALLEL TO THE CROSSWALK TO BE USED.
- 5. THE LOCATIONS AND INSTALLATION OF PEDESTRIAN SIGNAL HEADS AND PEDESTRIAN PUSHBUTTONS SHALL MEET THE REQUIREMENTS OF THE MUTCD AND INFORMATION FOUND IN THE "AMERICANS WITH DISABILITIES ACT ACCESSIBILITY GUIDELINES FOR BUILDINGS AND FACILITIES."

PEDESTRIAN SIGNAL POST AND PEDESTRIAN PUSH BUTTON POST

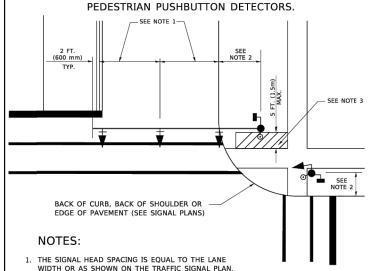

NOTES:

- 1. REFER TO THE TRAFFIC SIGNAL EQUIPMENT OFFSET TABLE.
- PROVIDE A LEVEL ALL-WEATHER SURFACE (CONCRETE SIDEWALK, ASPHALT BICYCLE PATH SURFACE OR MATCHING MATERIAL TO THE ADJACENT SURFACE) UP TO THE PEDESTRIAN SIGNAL POST OR THE PEDESTRIAN PUSH BUTTON POST.
- THE FACE OF THE PEDESTRIAN PUSHBUTTON SHALL BE PARALLEL TO THE CROSSWALK TO BE USED.
- 4. THE LOCATIONS AND INSTALLATION OF PEDESTRIAN SIGNAL HEADS AND PEDESTRIAN PUSHBUTTONS SHALL MEET THE REQUIREMENTS OF THE MUTCD AND INFORMATION FOUND IN THE "AMERICANS WITH DISABILITIES ACT ACCESSIBILITY GUIDELINES FOR BUILDINGS AND FACILITIES."

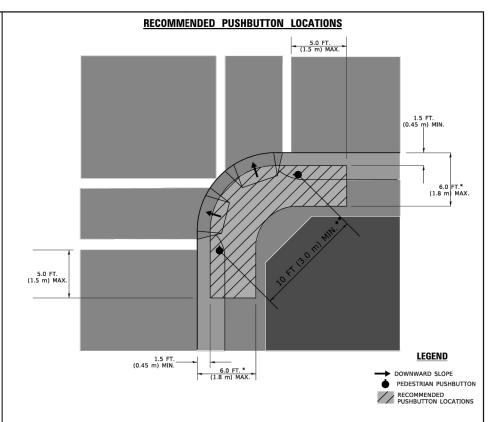

- * WHERE THERE ARE CONSTRAINTS THAT MAKE IT IMPRACTICAL TO PLACE THE PEDESTRIAN PUSHBUTTON BETWEEN 1.5 FT (0.45 m) AND 6 FT (1.8 m) FROM THE EDGE OF THE CURB, SHOULDER, OR PAVEMENT, IT SHOULD NOT BE FURTHER THAN 10 FT (3 m) FROM THE EDGE OF CURB, SHOULDER, OR PAVEMENT.
- ** WHERE THERE ARE CONSTRAINTS ON A PARTICULAR CORNER THAT MAKE IT IMPRACTICAL TO PROVIDE THE 10 FT (3 m) SEPERATION BETWEEN THE TWO PEDESTRIAN PUSHBUTTONS, THE PUSHBUTTONS MAY BE PLACED CLOSER TOGETHER OR ON THE SAME POLE.

NOTES:

- PEDESTRIAN SIGNAL HEADS SHALL BE MOUNTED WITH THE BOTTOM OF THE SIGNAL HOUSING INCLUDING BRACKETS NOT LESS THAN 8 FT (2.4 m) OR MORE THAN 10 FT (3 m) ABOVE SIDEWALK LEVEL, AND SHALL BE POSITIONED AND ADJUSTED TO PROVIDE MAXIMUM VISIBILITY AT THE BEGINNING OF THE CONTROLLED CROSSWALK.
- THE BOTTOM OF THE SIGNAL HOUSING (INCLUDING BRACKETS) OF A VEHICULAR SIGNAL FACE THAT IS NOT LOCATED OVER A HIGHWAY SHALL BE AT LEAST 8 FT (2.4 m) BUT NOT MORE THAN 19 FT (5.8 m) ABOVE THE SIDEWALK OR, IF THERE IS NO SIDEWALK, ABOVE THE PAVEMENT GRADE AT THE CENTER OF THE ROADWAY.
- 3. THE BOTTOM OF THE SIGNAL HOUSING AND ANY RELATED ATTACHMENTS TO A SIGNAL FACE LOCATED OVER ANY PORTION OF A HIGHWAY SHALL BE ACCORDING TO CURRENT STATE STANDARDS 877001, 877002, 877006, 877011 AND 877012 WITH A MINIMUM OF 16 FT (5.0 m) AND A MAXIMUM OF 18 FT. (5.5 m) FROM THE HIGHEST POINT OF PAYEMENT.
- 4. THE BOTTOM OF THE TEMPORARY SPAN WIRE MOUNTED SIGNAL HOUSING AND ANY RELATED ATTACHMENTS TO A SIGNAL FACE LOCATED OVER ANY PORTION OF A HIGHWAY SHALL BE ACCORDING TO CURRENT STATE STANDARD 880001 WITH A MINIMUM OF 17 FT (5.18 m) FROM THE HIGHEST POINT OF PAVEMENT.
- THE TOP OF THE SIGNAL HOUSING OF A SIGNAL FACE LOCATED OVER ANY PORTION OF A HIGHWAY SHALL NOT BE MORE THAN 25.6 FT (7.8 m) ABOVE THE PAYEMENT

TRAFFIC SIGNAL EQUIPMENT OFFSET

	THE STORY E EQUITIENT OF TO	
TRAFFIC SIGNAL EQUIPMENT	COMBINATION CONCRETE CURB AND GUTTER (MINIMUM DISTANCE FROM BACK OF CURB TO CENTERLINE OF FOUNDATION)	SHOULDER/NON-CURBED AREA (MINIMUM DISTANCE FROM EDGE OF PAVEMENT TO CENTERLINE OF FOUNDATION)
TRAFFIC SIGNAL MAST ARM POLE	6 FT (1.8m)	SHOULDER WIDTH + 2 FT (0.6m), MINIMUM 10 FT (3.0m)
TRAFFIC SIGNAL POST	4 FT (1.2m)	SHOULDER WIDTH + 2 FT (0.6m), MINIMUM 10 FT (3.0m)
PEDESTRIAN SIGNAL POST	4 FT (1.2m)	SHOULDER WIDTH + 2 FT (0.6m), MINIMUM 10 FT (3.0m)
PEDESTRIAN PUSHBUTTON POST	4 FT (1.2m)	SHOULDER WIDTH + 2 FT (0.6m), MINIMUM 10 FT (3.0m)
TEMPORARY WOOD POLE	6 FT (1.8m)	SHOULDER WIDTH + 2 FT (0.6m), MINIMUM 10 FT (3.0m)
CONTROLLER CABINET	6 FT (1.8m) MINIMUM DISTANCE SEE NOTE 2	SHOULDER WIDTH + 6 FT (1.8m), MINIMUM 16 FT (4.9m) SEE NOTE 3.
SERVICE INSTALLATION, GROUND MOUNT	6 FT (1.8m) MINIMUM DISTANCE SEE NOTE 2	SHOULDER WIDTH + 6 FT (1.8m), MINIMUM 16 FT (4.9m) SEE NOTE 3.

NOTES:

- 1. CONTACT THE "AREA TRAFFIC SIGNAL MAINTENANCE AND OPERATIONS ENGINEER" FOR ASSISTANCE IN LOCATING THE TRAFFIC SIGNAL EQUIPMENT WHEN THERE ARE CONFLICTS WITH DITCHES OR THE MINIMUM OFFSET DISTANCES CANNOT BE MET.
- 2. MINIMUM DISTANCE FROM THE BACK OF CURB TO THE ROADWAY SIDE OF THE FOUNDATION.
- 3. MINIMUM DISTANCE FROM THE EDGE OF PAVEMENT TOTHE ROADWAY SIDE OF THE FOUNDATION.
- 4. ANY CHANGES TO THE OFFSETS OF THE FOUNDATIONS, FROM THE MINIMUM DISTANCES LISTED IN THE "TRAFFIC SIGNAL EQUIPMENT OFFSET" CHART AND THE TRAFFIC SIGNAL INSTALLATION PLAN, COULD EFFECT THE PLACEMENT OF THE SIGNAL HEADS, PEDESTRIAN SIGNAL HEADS AND THE PEDESTRIAN PUSHBUTTONS. THE SIGNAL HEAD PLACEMENT ON THE MAST ARMS SHALL REMAIN AS PER THE TRAFFIC SIGNAL INSTALLATION PLAN AND THE "TRAFFIC SIGNAL MAST ARM AND SIGNAL POST" DETAIL ABOVE. THE PROPOSED MAST ARM LENGTHS MAY NEED TO BE REVISED TO MEET THE ABOVE REQUIREMENTS. THE PEDESTRIAN SIGNAL HEADS AND PEDESTRIAN PUSHBUTTONS MUST MEET THE REQUIREMENTS UNDER THE DETAILS ON THIS SHEET.


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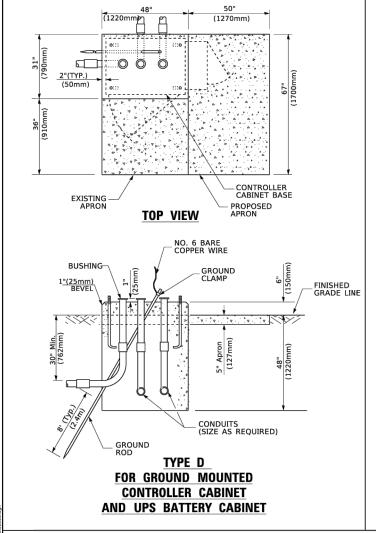
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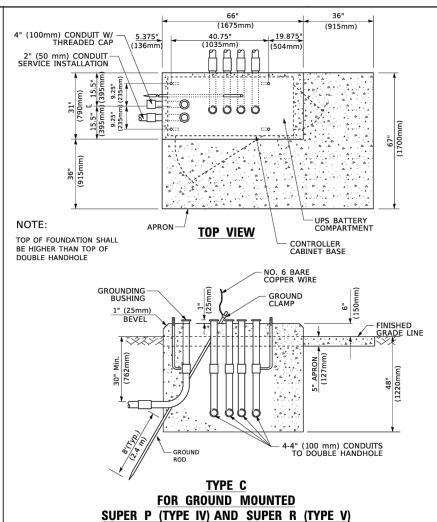


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ENGINEERING & ENVIRONMENTAL ILLINOIS DESIGN FIRM NO. 184-003525
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CONTROLLER CABINETS

65" (SEE NOTE 4) (1651mm) 2" x 6" (51mm x 152mm) WOOD FRAMING (TYP.) TRAFFIC SIGNAL-CONTROLLER CABINET UPS CABINET 2" x 6" (51mm x 152mm) TREATED WOOD NOTES: TREATED WOOD POSTS BASED ON CONTROLLER CABINET TYPE IV WITH BASE DIMENSIONS OF 26" x 44" (660mm x 1118mm).
 ADJUST PLATFORM SIZE TO FIT CABINET BASE DIMENSIONS BEING SUPPLIED

- BASED ON UNINTERRUPTIBLE POWER SUPPLY CABINET WITH BASE DIMENSIONS OF 16" x 25" (406mm x 635mm).
 ADJUST PLATFORM SIZE TO FIT CABINET BASE DIMENSIONS BEING SUPPLIED.
- 3. PLATFORM SIZE FOR CONTROLLER CABINET TYPE IV.
- 4. PLATFORM SIZE FOR CONTROLLER CABINET TYPE IV AND UNINTERRUPTIBLE POWER SUPPLY CABINET
- 5. DRILLED HOLES THROUGH THE PLATFORM BASE TO MATCH THE CONTROLLER CABINET BOLT TEMPLATE. FASTEN THE CONTROLLER CABINET TO THE PLATFORM WITH CARRIAGE BOLTS, WASHERS AND NUTS.
- 6. FASTEN ALL SUPPORT WOOD FRAMING TO THE WOOD POSTS WITH 2 LAG SCREWS FOR EACH CONNECTION..

TEMPORARY SIGNAL CONTROLLER **WOOD SUPPORT PLATFORM**

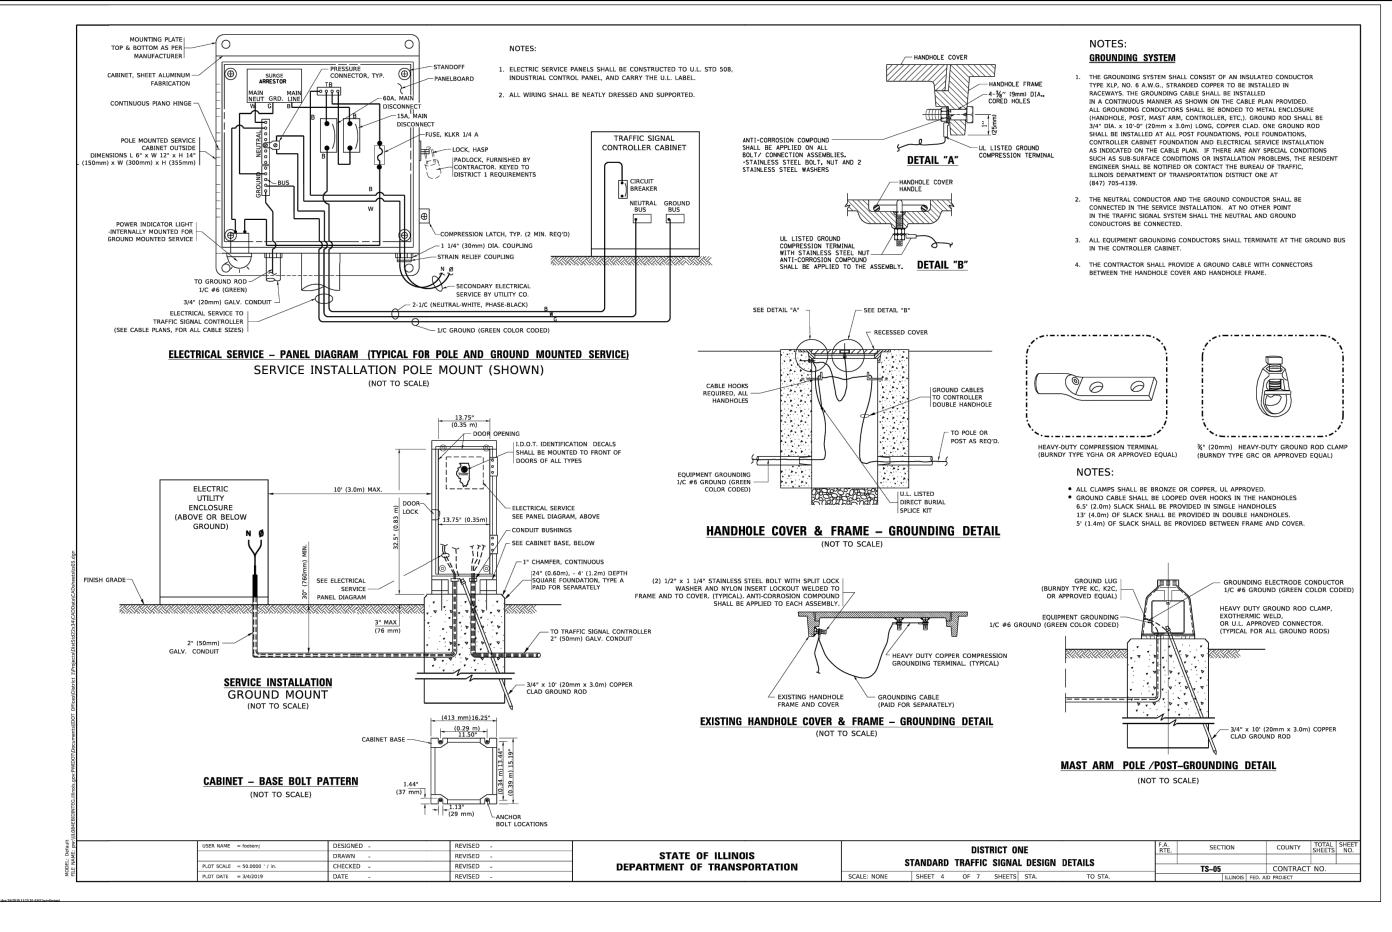CABLE SLACK LENGTH	FEET	METER
HANDHOLE	6.5	2.0
DOUBLE HANDHOLE	13.0	4.0
SIGNAL POST	2.0	0.6
MAST ARM	2.0	0.6
CONTROLLER CABINET	1.5	0.5
FIBER OPTIC AT CABINET	13.0	4.0
ELECTRIC SERVICE AT (CABINET OR SERVICE LOCATION)	1.5	0.5
GROUND CABLE (SIGNAL POST, MAST ARM, CABINET)	1.5	0.5
GROUND CABLE (BETWEEN FRAME AND COVER)	5.0	1.6

CABLE SLACK

VERTICAL CABLE LENGTH	FEET	METER
MAST ARM POLE (MAST ARM MOUNTED SIGNAL HEAD)		
(L = MAST ARM LENGTH - DISTANCE TO SIGNAL HEAD FROM END OF ARM)	20.0+L	6.0+L
BRACKET MOUNTED (MAST ARM POLE OR SIGNAL POLE)	13.0	4.0
PEDESTRIAN PUSH BUTTON	6.0	2.0
SERVICE INSTALLATION POLE MOUNT TO SERVICE DROP	13.5	4.1
SERVICE INSTALLATION POLE MOUNT TO GROUND	13.5	4.1
SERVICE INSTALLATION GROUND MOUNT	6.0	2.0
FOUNDATION (SIGNAL POST, MAST ARM POLE, CONTROLLER CABINET, SERVICE-GROUND MOUNT)	3.0	1.0

VERTICAL CABLE LENGTH

FOUNDATION	DEPTH
TYPE A - Signal Post	4'-0" (1.2m)
TYPE C - CONTROLLER W/ UPS	4'-0" (1.2m)
TYPE D - CONTROLLER	4'-0" (1.2m)
SERVICE INSTALLATION, GROUND MOUNT, TYPE A - SQUARE	4'-0" (1.2m)

DEPTH OF FOUNDATION

Mast Arm Length	① Foundation Depth	Foundation Diameter	Spiral Diameter	Quantity of Rebars	Size of Rebars
Less than 30' (9.1 m)	10'-0" (3.0 m)	30" (750mm)	24" (600mm)	8	6(19)
Greater than or equal to	13'-6" (4.1 m)	30" (750mm)	24" (600mm)	8	6(19)
30' (9.1 m) and less than 40' (12.2 m)	11'-0'' (3.4 m)	36" (900mm)	30" (750mm)	12	7(22)
Greater than or equal to 40' (12.2 m) and less than 50' (15.2 m)	13'-0'' (4 _* 0 m)	36" (900mm)	30" (750mm)	12	7(22)
Greater than or equal to 50' (15.2 m) and up to 55' (16.8 m)	15'-0" (4.6 m)	36" (900mm)	30" (750mm)	12	7(22)
Greater than or equal to 56' (16.8 m) and less than 65' (19.8 m)	21'-0" (6 _* 4 m)	42" (1060mm)	36" (900mm)	16	8(25)
Greater than or equal to 65' (19.8 m) and up to 75' (22.9 m)	25'-0" (7.6 m)	42" (1060mm)	36" (900mm)	16	8(25)

- 2. Combination mast arm assemblies under 55 feet (16.8 m) shall use 36" (900 mm) diameter foundations.
- 3. Combination mast arm assemblies under 56 feet (16.8 m) through 75 feet (22.9 m) shall use 42" (1060 mm) diameter foundations
- 4. For most arm assemblies with dual arms refer to state standard 878001..


DEPTH OF MAST ARM FOUNDATIONS, TYPE E

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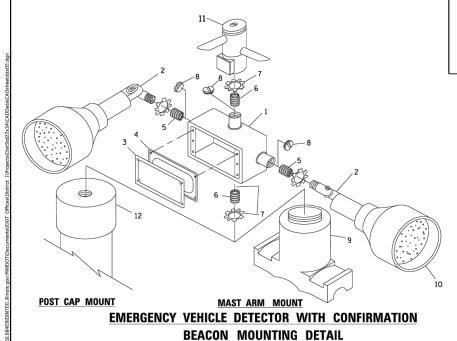
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- CONDUIT DEPTH SHALL BE A MINIMUM OF 30" (760mm) BELOW THE BOTTOM OF THE DRAINAGE DITCH OR ANY SLOPING GROUND
- 2. THE MINIMUM CONDUIT DEPTH APPLIES TO ALL CONDUIT PLACED UNDER ROADWAY PAVEMENT, MULTI-USE PATHS, SIDEWALKS AND SOIL SURFACES.
- 3. THE MINIMUM CONDUIT DEPTH APPLIES TO ALL HANDHOLES, HEAVY DUTY HANDHOLES AND DOUBLE HANDHOLES.

USER NAME = footemj

HANDHOLE WITH MINIMUM CONDUIT DEPTH

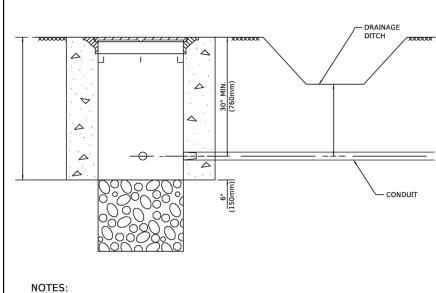

66" (1675mm) 36" (915mm) 19.875" (504mm) 40.75" (1035mm) PROPOSED-CONTROLLER CABINET BASE **TOP VIEW** APRON -NO. 3 DOWEL 18" (450mm NO. 6 BARE COPPER WIRE LONG (8 REQ.) _GROUND CLAMP EXISTING-ANCHOR BOLTS FINISHED GRADE LINE 12" (300mm) 12" (300mm) (225mm) (225mm) EXISTING CONDUITS EXISTING GROUND ROD MODIFY EXISTING TYPE "D" FOUNDATION

TO TYPE "C" FOUNDATION

(NOT TO SCALE)

IDENTIFICATION OUTLET BOX- GALV. 21 CU.IN. (0.000344 CU-M)
LAMP HOLDER AND COVER

NOTES: AL TO THE DIAMETER OF THE MAST ARM POLE AT THE TOP OF THE SHROUD. IE TIGHT TO THE MAST ARM POLE. R SHALL VERIFIED THE ABOVE DIMENSIONS BASED ON MAST ARM REQUIREMENTS. HEIGHT OF THE SHROUD SHALL COVER THE ANCHOR BOLTS, NUTS AND MAST ARM POLE BASE. NOTE: SUPPORT EXISTING CABINET AND CONTROL EQUIPMENT ABOVE FOUNDATION TO KEEP TRAFFIC SIGNAL FUNCTIONING WHILE FOUNDATION MODIFICATION WORK IS PROCEEDING. - DIMENSION 4" (100mm) LARGER THAN CONTROLLER CABINET BASE DIMENSION, BOTH DIRECTIONS BREAK DOWN EXISTING FOUNDATION 12" (300mm) _12" (300 9" (225mm) 9" (225mm) EXISTING CONDUIT — 2" (50mm), 4" (100mm) & 4" (100mm) NEW TYPE "D" (MODIFIED) FOUNDATION EXISTING TYPE D (CONTROLLER) FOUNDATION MODIFY EXISTING TYPE "D" FOUNDATION

0.25"-

7" (178mm) - 12" (300m

SHROUD

MATERIAL

WEIGHT

53 lbs (24kg)

68 lbs (31 kg)

- ASTM A-123 HOT DIPPED GALVANIZED

11 DETECTOR UNIT 12 POST CAP [18 FT. (5.4 m) POST MIN.]

NOTES:

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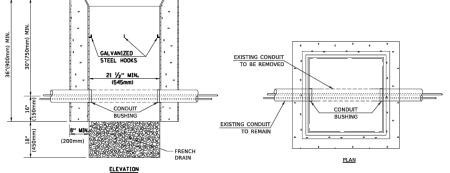
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- 1. ALL ELECTRICAL ITEMS, EXCEPT ITEMS #2 AND #11 SHALL BE ALUMINUM OR GALVANIZED
- 2. ITEM #1- OZ/GEDNEY FSX-1-50 OR EQUIVALENT ITEM #2- MULBERRY CON-O-SHADE LAMP SHIELD OR EQUIVALENT ITEM #9- "BAND-IT" SADDLE BRACKET OR EQUIVALENT
- 3. WHEN POST MOUNTING IS SPECIFIED, ITEM #9 SHALL NOT BE REQUIRED. THE DETECTION UNIT SHALL BE MOUNTED DIRECTLY ON TOP OF THE CAP BY DRILLING AND TAPPING A 3/4 "(19 mm) HOLE WITH PIPE THREADS. THE POST CAP SHALL EITHER BE SCREWED TO THE TOP OF THE POST OR A MINIMUM OF 3 TIGHTENING SCREWS SHALL BE REQUIRED ON EACH CAP.

STATE OF ILLINOIS

DEPARTMENT OF TRANSPORTATION



NOTES:

VARIES

VARIES

VARIES

9.5"(241mm

10.75"(273mm

13.0"(330m VARIES | 18.5"(470m 19"(483m

- 1. HANDHOLE CONSTRUCTED PER STATE STANDARD 814001.
- REMOVAL OF THE EXISTING CONDUIT FROM THE HANDHOLE AND THE INSTALLATION
 OF THE CONDUIT BUSHINGS SHALL BE INCLUDED WITH THE COST OF THE HANDHOLE.

HANDHOLE TO INTERCEPT EXISTING CONDUIT

DISTRICT ONE							NE		RTE.	:	ECTION	COUNTY	SHEETS		
	S.	TANDA	RD	TRAI	FIC	SIGNA	I DESIGN	DETAILS							
	STANDARD TRAFFIC SIG					Oldina	L DEGIGIT	, DEGIGIT DETAILS			-05	CONTRACT NO.			
SCALE: NONE		SHEET	6	OF	7	SHEETS	STA.	TO STA.			ILLINO	FED. A	ID PROJECT		
								•							


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USER NAME =BF/YJ	DESIGNED	_	VL	REVISED	-
	DRAWN	_	BF/YJ	REVISED	_
PLOT SCALE = AS NOTED	CHECKED	_		REVISED	-
PLOT DATE = 2/15/24	DATE	_	03/01/23	REVISED	_

CHECKED

DATE

				F.A.U. RTE.	SECTION		TOTAL SHEETS	SHEET NO.		
			DETAILS	4051	22-00134-00-TL	MCHENRY 129 99				
								CONTRACT	NO 61	K35
SCALE: AS NOTED	SHEET 99	OF	129 SHEETS	TO STA.		ILLINOIS FED. AII	PROJECT			

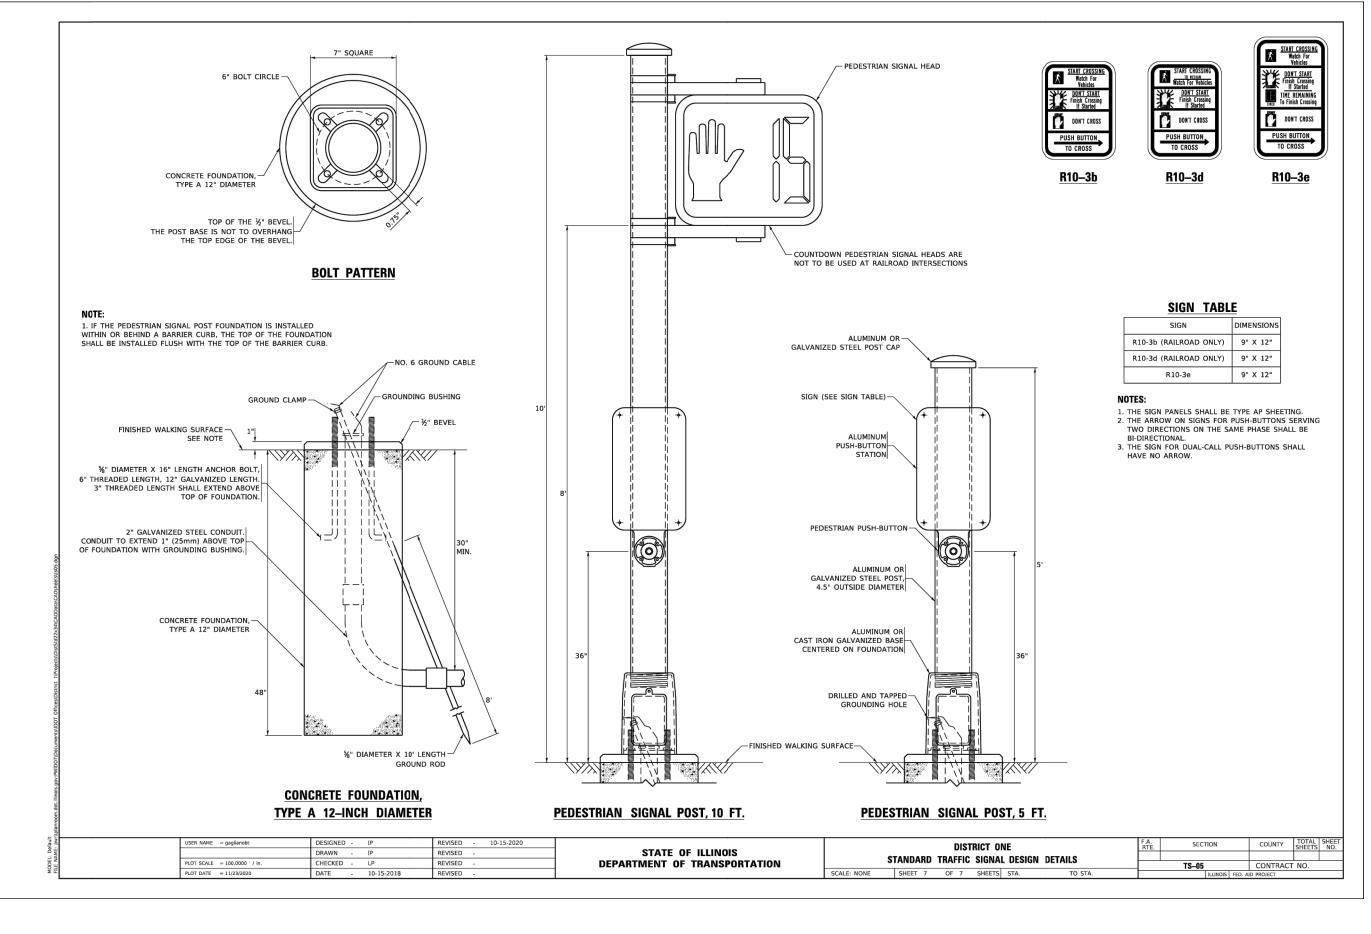

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ENGINEERING & ENVIRONMENTAL
ILLINGS DESIGN FIRM NO. 184-003525

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	DRAWN	_	BF/YJ	REVISED	-
PLOT SCALE = AS NOTED	CHECKED	_		REVISED	-
PLOT DATE = $2/15/24$	DATE	_	03/01/23	REVISED	-

STATI	E 01	F ILLINOIS
DEPARTMENT	0 F	TRANSPORTATION

						F.A.U. RTE.	SECTION	COUNTY	TOTAL SHEETS	SHEET NO.
			DETAILS			4051	22-00134-00-TL	MCHENRY	129	100
								CONTRACT	NO 61	1K35
SCALE: AS NOTED	SHEET100	OF	129 SHEETS	STA.	TO STA.		ILLINOIS FED. A	D PROJECT		

LOOPS NEXT TO SHOULDERS PROVIDE A PAVEMENT REPLACEMENT NOTE WHICH SHOULD EQUAL 3' (900 mm) X WIDTH OF PAVED SHOULDER. PAVED OR NON-PAVED SHOULDER Ξ:**[**] ++/++M+ (1.5 m) (1.8 m) (1.5 m) 1" (25 mm) UNΓ DUCT-TRENCHED (3.0 m) TO E/P ** \times = (600 mm) \star \star Unit duct is to be shown on plan sheets BUT SHALL NOT BE INCLUDED IN THE PAY ITEMS.

* = (1.8m)

CROSS STREET

** = (1.5m)

LOOPS ARE SAW-CUT TO THE EDGE OF PAVEMENT. 1" (25 mm) UNIT

ISER NAME = footemj

PLOT DATE = 3/4/2019

STRAIGHT SAW

IN PAVEMENT

(TYP)

CUTS TO HEAVY-

DUTY HANDHOLE

DUCT IS RUN BETWEEN

EDGE OF PAVEMENT

AND HANDHOLE.


(TYP. FOR LOOPS THAT TERMINATE

IN HANDHOLES

LEFT TURN LANES WITH MEDIANS VOLUME DENSITY ("FAR OUT" DETECTION) ON SAME APPROACH

(PROTECTED / PERMITTED LEFT TURN PHASING)

HANDHOLE LOCATION MAY VARY DEPENDING ON GEOMETRICS AND DESIGN OF TRAFFIC SIGNALS. HEAVY-DUTY HANDHOLES TO BE USED WHEN THE MEDIAN IS MOUNTABLE. REFER TO STANDARD 814001 TO ENSURE THAT HANDHOLE FITS IN MEDIAN.

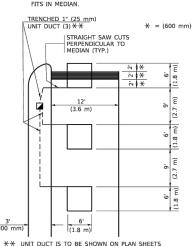

BUT SHALL NOT BE INCLUDED IN THE PAY ITEMS.


PLAN SHEET FOR DETECTOR LOOP REPLACEMENT

NOTE: DUAL LEFT TURNS NOT SHOWN REFER TO

LEFT TURN LANES WITHOUT MEDIANS

VOLUME DENSITY ("FAR OUT" DETECTION) ON SAME APPROACH

(PROTECTED / PERMITTED LEFT TURN PHASING)

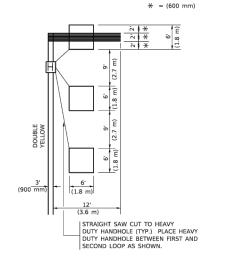


NOTE: DUAL LEFT TURNS NOT SHOWN REFER TO PLAN SHEET FOR DETECTOR LOOP REPLACEMENT

SCALE: NONE

SCALE:

ARTERIAL-VOLUME DENSITY ("FAR OUT" DETECTION) CROSS STREET-NON VOLUME DENSITY ("FAR OUT" DETECTION) CROSS STREET-NON VOLUME DENSITY ("UPTIGHT" PRESENCE DETECTION)

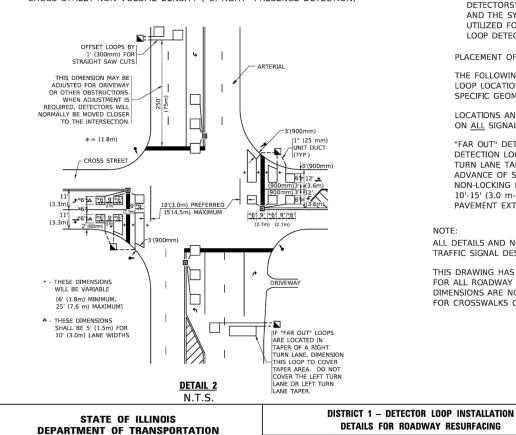

NOTES:

VEHICLES LOOP DETECTORS

- * ALL LEAD IN CABLE SHALL BE TWO CONDUCTOR NO. 14 TWISTED,
- * EACH DETECTOR LOOP SHALL HAVE ITS OWN SAW CUT FROM THE LOOP TO THE EDGE OF PAVEMENT OR TO A HANDHOLE IN THE PAVEMENT.
- * EACH DETECTOR LOOP SHALL HAVE ITS OWN ONE INCH (25 mm) UNIT DUCT BETWEEN THE EDGE OF PAVEMENT AND THE FIRST HANDHOLE OR JUNCTION BOX, EACH UNIT DUCT RUN SHALL BE SHOWN ON THE PLANS BY THE DESIGNER, BUT SHALL NOT BE PAID FOR SEPARATLY. THIS ITEM IS INCIDENTAL TO THE PAY ITEM FOR DETECTOR LOOPS.
- * ONE DIMENSION OF ALL DETECTOR LOOPS SHALL BE SIX FEET (1.8 m)
- * EACH LANE OF NON-LOCKING, PRESENCE DETECTION AND EACH LANE OF A DOUBLE LEFT TURN LANE REQUIRES A SEPARATE INDUCTIVE LOOP DETECTOR AND LEAD IN CABLE.
- * WHEN NON-LOCKING, PRESENCE DETECTION IS USED, MORE THAN ONE LOOP PER LANE IS REQUIRED BEHIND THE STOP BAR (i.e. 1-1/2, 1-3/4, 2).
- * WHEN SYSTEM LOOPS ARE REQUIRED ON AN APPROACH OF AN INTERSECTION, THE LOOPS USED FOR VOLUME DENSITY AND INTERSECTION TIMING SHALL ALSO BE USED AS SYSTEM DETECTORS. EACH ONE OF THESE TYPE OF LOOPS REQUIRES A SEPARATE TWO CONDUCTOR NO. 14 TWISTED SHIELDED CABLE AND A SEPARATE INDUCTIVE LOOP DETECTOR WHEN NEW CONTROLLERS ARE UTILIZED. THE DESIGNER SHALL LABEL THESE TYPES OF LOOPS AS "INTERSECTION AND SAMPLING (SYSTEM) DETECTORS" ON THE SIGNAL LAYOUT, THE INTERCONNECT PLAN AND THE SYSTEM CABLE PLAN. WHEN AN EXISTING CONTROLLER IS UTILIZED FOR THIS TYPE OF DETECTION, THE PAY ITEM "INDUCTIVE LOOP DETECTOR WITH SYSTEM OUTPUT" SHOULD BE USED.

PLACEMENT OF DETECTORS

THE FOLLOWING FIGURES REPRESENT THE MOST COMMON DETECTOR LOOP LOCATIONS AND SIZES. ADJUSTMENTS WILL BE NECESSARY FOR

LOCATIONS AND DEMENSIONS OF DETECTOR LOOPS ARE REQUIRED ON ALL SIGNAL LAYOUT PLAN SHEETS

"FAR OUT" DETECTION REFERS TO LOCKING, PRESENCE TYPE DETECTION LOCATED IN THRU LANES, RIGHT TURN LANES, AND RIGHT TURN LANE TAPER AREAS (IF APPLICABLE), USUALLY 250' (75 m) IN ADVANCE OF STOP BARS, "UPTIGHT" DETECTION REFERS TO NON-LOCKING PRESENCE TYPE DETECTION LOCATED IN ALL LANES AND 10'-15' (3.0 m-4.5 m) BEHIND THE CROSSING STREET'S EDGE OF PAVEMENT EXTENDED.

SHEET 1 OF 1 SHEETS STA

ALL DETAILS AND NOTES SHOWN ARE FROM THE I.D.O.T. DISTRICT 1 TRAFFIC SIGNAL DESIGN GUIDELINES DATED JANUARY 1995

THIS DRAWING HAS BEEN PREPARED TO ASSIST THE RESIDENT ENGINEER FOR ALL ROADWAY RESURFACING OR S.M.A.R.T. PROJECTS WHERE THE DIMENSIONS ARE NOT SHOWN ON THE PLANS AND THE FINAL LOCATIONS FOR CROSSWALKS OR STOP BARS ARE NOT DETERMINED.

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PLOT DATE = 2/15/24	DATE -	 03/01/23	REVISED	_

DETAIL 1

N.T.S.

DATE

DESIGNED -

CHECKED -

R.K.F.

ARTERIAL-VOLUME DENSITY ("FAR OUT" DETECTION)

DO NOT INSTALL

IOFF SET LOOPS BY

STRAIGHT SAW CUTS.

REVISED -

REVISED

REVISED

REVISED

[TYP.-12' (3.6m) LANES]

> STATE OF ILLINOIS **DEPARTMENT OF TRANSPORTATION**

	F.A.U. RTE.	SECTION	COUNTY	TOTAL SHEETS	SHEET NO.			
DETAILS		4051	22-00134-00-TL	MCHENRY	129	101		
				CONTRACT	NO 61	IK35		
: AS NOTED SHEET101 OF 129 SHEETS STA.	TO STA.		ILLINOIS FED. AID PROJECT					

SECTION

TS-07

COUNTY TOTAL SHEET NO.

CONTRACT NO.

CHANGE FROM NORMAL SEQUENCE OF OPERATION INTERVAL NUMBER

EMERGENCY VEHICLE PREEMPTION SEQUENCE
OF OPERATION INTERVAL NUMBER
CHANGE TO EMERGENCY VEHICLE PREEMPTION

MAIN STREET E/B END MAST ARM AND FAR LEFT SIGNALS

MAIN STREET W/B END MAST ARM AND FAR LEFT SIGNALS

CROSS STREET S/B
END MAST ARM AND FAR LEFT SIGNALS

CROSS STREET N/B END MAST ARM AND FAR LEFT SIGNALS

PEDESTRIAN SIGNALS CROSSING CROSS STREET ON NORTHSIDE OF MAIN STREET

PEDESTRIAN SIGNALS CROSSING CROSS STREET ON SOUTHSIDE OF MAIN STREET

PEDESTRIAN SIGNALS CROSSING MAIN STREET ON EASTSIDE OF CROSS STREET

PEDESTRIAN SIGNALS CROSSING MAIN STREET ON WESTSIDE OF CROSS STREET

MAIN STREET FAR RIGHT SIGNAL

MAIN STREET FAR RIGHT SIGNAL

CROSS STREET FAR RIGHT SIGNAL

CROSS STREET FAR RIGHT SIGNAL

					NUMBER 3	NUMBER 4	
		26		26			CLEAR TO
	1CC	1DD	1EE	1FF	2	3	NORMAL SEQUENCE
	1DD	1EE	2	3			♦
	R	R	R	R	G	R	♦
	R	R	R	R	G	R	♦
	R	R	R	R	G	R	♦
	R	R	R	R	G	R	♦
	G	Y	R	G	R	G	♦
	G	Y	R	G	R	G	♦
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PREEMPTOR PREEMPTOR

MERGENCY VEHICLE SEQUENCE SHALL PROVIDE THE PROPER CLEARANCE INTERVAL TO RESUME THE NORMAL SEQUENCE OF OPERATION OR PROPER CLEARANCE INTERVAL TO DISPLAY A DIFFERENT EMERGENCY INTERVAL AFTER EMERGENCY VEHICLE 2 OR 3 IS TERMINATED.

IDOT\Documents\IDOT Offices\District 1\Projects\DistStd22x`

STATE OF ILLINOIS DEPARTMENT OF TRANSPORTATION

11

SEQUENCE OF OPERATION - MAIN STREET AND CROSS STREET

SCALE: SHEET 1 OF 2 SHEETS STA. TO STA.

F.A. SECTION COUNTY TOTAL SHEETS NO.

TS-08 CONTRACT NO.

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PLOT DATE = 2/15/24	DATE - 03/01/23	REVISED —

STATE OF ILLINOIS DEPARTMENT OF TRANSPORTATION

1					F.A.U. RTE.	SECTION	COUNTY TOTAL SHE				
	i			DETAILS	4051	22-00134-00-TL	MCHENRY 129 102				
									CONTRACT	NO 61	K35
	SCALE: AS NOTED	SHEET102	OF	129 SHEETS	STA.	TO STA.					

FILE NAME: G: \C3D\22\22-

PROPOSED SEQUENCE OF OPERATION

PROPOSED RAILROAD PREEMPTION SEQUENCE OF OPERATION

CHANGE FROM NORMAL SEQUENCE OF OPERATION INTERVAL NUMBER

OPERATION INTERVAL NUMBER

CHANGE TO RAILROAD PREEMPTION

PEDESTRIAN SIGNALS CROSSING CROSS

PEDESTRIAN SIGNALS CROSSING MAIN STREET ON EASTSIDE OF CROSS STREET

PEDESTRIAN SIGNALS CROSSING MAIN STREET ON WESTSIDE OF CROSS STREET

INTERNALLY ILLUMINATED NRT SIGNS

INTERNALLY ILLUMINATED NLT SIGNS

CHANGE FROM EMERGENCY VEHICLE PREEMPTION SEQUENCE OF OPERATION INTERVAL NUMBER RAILROAD PREEMPTION SEQUENCE OF

MOVEMENT		و_ 5	. • 1	ι		- 6 - 1			5			2 -	> ← 6			Ĺ	,			•	֓֞֞֝֓֞֓֓֞֝֓֓֓֓֓֓֓֓֓֓֓֓֓֟֟ ֓֓֞֓֞֓֓֓֞֓֓֞֓֓֞֓֓֓֓֓֓֓֓֓	‡				1	⁷			‡ ‡	†	,	F
PHASE		1 -	+ 5			1 + 6			2 + 5			2 -	+ 6			3 -	+ 7				3 + 8					4 + 7				4 -	+ 8		L
INTERVAL	1	2	3	4	5	6	7	8	9	10	11	12	13A	13B	14	15	16	17	18	19	20A	20B	21	22	23	24A	24B	25	26	27	28A	28B	S
CHANGE TO		1+6	2+5	2+6	0	*/	2+6	*/	•/	2+6	/		3+ 3+ 4+ 4+	⊦8 ⊦7		1+5 1+6 2+5 2+6 4+8	3+8	4+7	*/	*/	1- 1- 2- 2-	+6 +5	4+8	•	*/	1- 2-	+5 +6 +5 +6	4+8			1- 2-	+5 +6 +5 +6	н
MAIN STREET E/B END MAST ARM AND FAR LEFT SIGNALS	R → G	R • Y	R → G	R ⊸ Y	R	R	R	G - G	G - G	G ⊸ Y	G	G	Y	R	R	R	R	R	R	R	R	R	R	R	R	R	R	R	R	R	R	R	R
MAIN STREET E/B FAR RIGHT SIGNAL	R	R	R	R	R	R	R	G	G	G	G	G	Υ	R	R	R	R	R	R	R	R	R	R	R	R	R	R	R	R	R	R	R	R
MAIN STREET W/B END MAST ARM AND FAR LEFT SIGNALS	R → G	R - G	R ⊸ Y	R ⊸ Y	G → G	G → G	G → Y	R	R	R	G	G	Υ	R	R	R	R	R	R	R	R	R	R	R	R	R	R	R	R	R	R	R	R
MAIN STREET W/B FAR RIGHT SIGNAL	R	R	R	R	G	G	G	R	R	R	G	G	Υ	R	R	R	R	R	R	R	R	R	R	R	R	R	R	R	R	R	R	R	R
CROSS STREET S/B END MAST ARM AND FAR LEFT SIGNALS	R	R	R	R	R	R	R	R	R	R	R	R	R	R	R ⊸ G	R — Y	R ⊸ Y	R ⊸ G	R	R	R	R	R	G → G	G → G	Υ	R	G ⊸ Y	G	G	Υ	R	R
CROSS STREET S/B FAR RIGHT SIGNAL	R	R	R	R	R	R	R	R	R	R	R	R	R	R	R	R	R	R	R	R	R	R	R	G	G	Υ	R	G	G	G	Υ	R	R
CROSS STREET N/B END MAST ARM AND FAR LEFT SIGNALS	R	R	R	R	R	R	R	R	R	R	R	R	R	R	R ⊸ G	R — Y	R ⊸-G	R ⊸ Y	G → G	G ⊸ G	Υ	R	G ⊸ Y	R	R	R	R	R	G	G	Υ	R	R
CROSS STREET N/B FAR RIGHT SIGNAL	R	R	R	R	R	R	R	R	R	R	R	R	R	R	R	R	R	R	G	G	Υ	R	G	R	R	R	R	R	G	G	Υ	R	R
PEDESTRIAN SIGNALS CROSSING CROSS STREET ON NORTHSIDE OF MAIN STREET	н	н	н	н	*Р	**FH	н	н	н	н	*Р	**FH	н	н	н	н	н	Н	н	н	н	н	н	н	н	н	н	н	н	н	н	н	D
PEDESTRIAN SIGNALS CROSSING CROSS STREET ON SOUTHSIDE OF MAIN STREET	н	н	н	н	н	н	н	*р	**FH	Н	*р	**FH	н	н	н	н	н	н	н	н	н	н	н	н	н	н	н	н	н	н	н	н	A
PEDESTRIAN SIGNALS CROSSING MAIN STREET ON EASTSIDE OF CROSS STREET	н	н	н	н	н	н	н	н	н	Н	н	н	н	Н	н	н	Н	Н	*Р	**FH	н	н	н	н	н	Н	Н	н	*Р	**FH	Н	Н	R
PEDESTRIAN SIGNALS CROSSING MAIN STREET ON WESTSIDE OF CROSS STREET	н	н	н	н	н	н	н	н	н	н	н	н	н	н	н	н	Н	н	н	н	н	н	Н	*Р	**FH	Н	н	н	*Р	**FH	Н	н	К

PREEMPTOR PREEMPTOR PREEMPTOR NUMBER 3 NUMBER 4 NUMBER 2

1N 1P 1Q 1R 1S

1Q

* TO APPEAR ONLY UPON PUSHBUTTON ACTIVATION

** FLASHING $^{\prime\prime}$ is to terminate at the completion of the PEDESTRIAN INTERVAL CLEARANCE. THIS" OR FLASHING" TINTERVAL MAY FINISH TIMIMG IN THE

 $oldsymbol{\Theta}$ BIDIRECTIONAL STRAIGHT THROUGH MOVEMENT IF THE LEFT ARROW TIME IS NOT SUFFICIENT TO COMPLETE "A" OR FLASHING "TINTERVALS. "Mand Flashing" Timings to be set only on phases where "M"and flashing" Tare indicated in the sequence of OPERATION.

P = ILLUMINATED PERSON = WALK

FH = ILLUMINATED FLASHING HAND = FLASHING DON'T WALK

H = ILLUMINATED SOLID HAND = DON'T WALK

PHASE 2+6 SHALL BE PLACED ON RECALL.

NLT = "NO LEFT TURN" OR

NRT = "NO RIGHT TURN" OR

NORMAL SEQUENCE SEQUENCE OF OPERATION INTERVAL NUMBER MAIN STREET E/B END MAST ARM AND FAR LEFT SIGNALS Δ MAIN STREET FAR RIGHT SIGNAL E/B Δ MAIN STREET W/B END MAST ARM AND FAR LEFT SIGNALS MAIN STREET FAR RIGHT SIGNAL Δ CROSS STREET S/B END MAST ARM AND FAR LEFT SIGNALS Δ CROSS STREET FAR RIGHT SIGNAL S/B Δ CROSS STREET N/B END MAST ARM AND FAR LEFT SIGNALS Δ CROSS STREET FAR RIGHT SIGNAL Δ PEDESTRIAN SIGNALS CROSSING CROSS STREET ON NORTHSIDE OF MAIN STREET Δ

H H FH FH H

NRT | NRT | NRT | NRT | NRT | NRT | NRT | NRT | NRT | NRT | NRT | NRT | NRT | NRT | NRT | NRT | NRT | NRT |

NLT | NLT | NLT | NLT | NLT | NLT | NLT | NLT | NLT | NLT | NLT

18

A RAILROAD PREEMPTION SEQUENCE SHALL PROVIDE THE PROPER CLEARANCE INTERVAL TO RESUME THE NORMAL SEQUENCE OF OPERATION OR PROPER CLEARANCE INTERVAL TO DISPLAY AN EMERGENCY VEHICLE INTERVAL (IF APPLICABLE) AFTER RAILROAD PREEMPTION INTERVAL 5 IS TERMINATED.

USER NAME = footemj DESIGNED -REVISED -CHECKED -REVISED -

STATE OF ILLINOIS **DEPARTMENT OF TRANSPORTATION**

NRT NRT NRT

NRT

NLT

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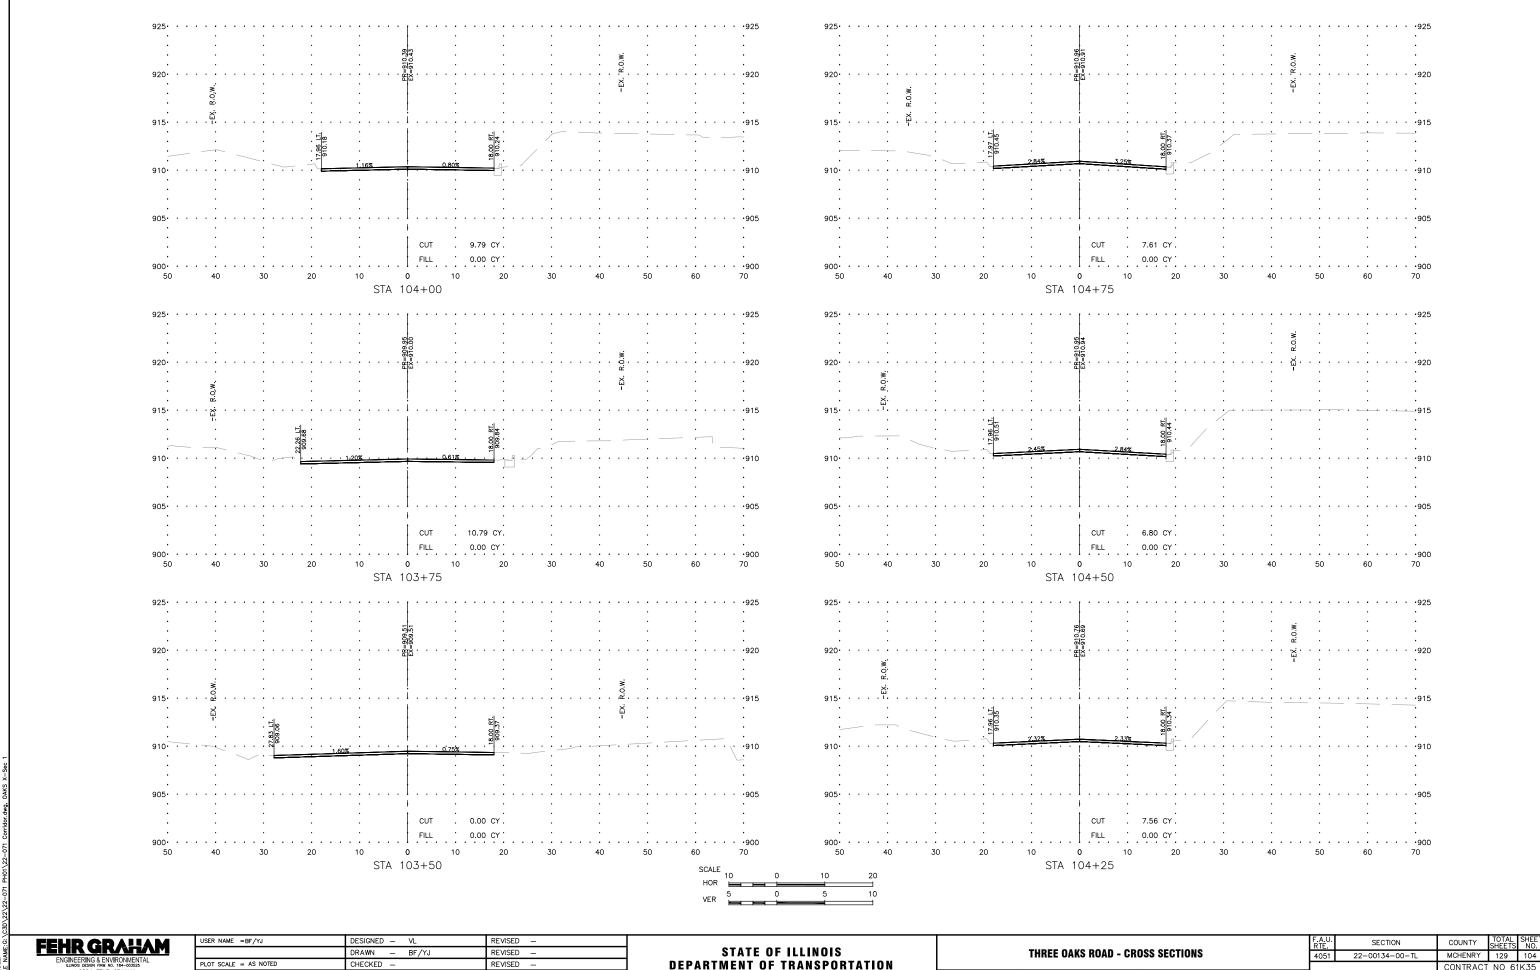
EMERGENCY VEHICLE PREEMPTION SEQUENCE OF OPERATION - MAIN STREET AND CROSS STREET SHEET 2 OF 2 SHEETS STA.

SECTION

COUNTY TOTAL SHEET NO. CONTRACT NO.

USER NAME =BF/YJ	DESIGNED -	VL	REVISED	_
	DRAWN -	BF/YJ	REVISED	=
PLOT SCALE = AS NOTED	CHECKED -		REVISED	-
PLOT DATE = 2/15/24	DATE -	 03/01/23	REVISED	_

				F.A.U. SECTION		COUNTY	TOTAL SHEETS	SHEET NO.		
DETAILS				4051	22-00134-00-TL	MCHENRY	129	103		
						CONTRACT	NO 61	K35		
SCALE: AS NOTED	SHEET103	OF	129 SHEETS	STA.	TO STA.		ILLINOIS FED. AI	D PROJECT		




SCALE: AS NOTED SHEET104 OF 129 SHEETS STA.

TO STA.

PLOT DATE = 2/15/24

DATE - 03/01/23

REVISED -

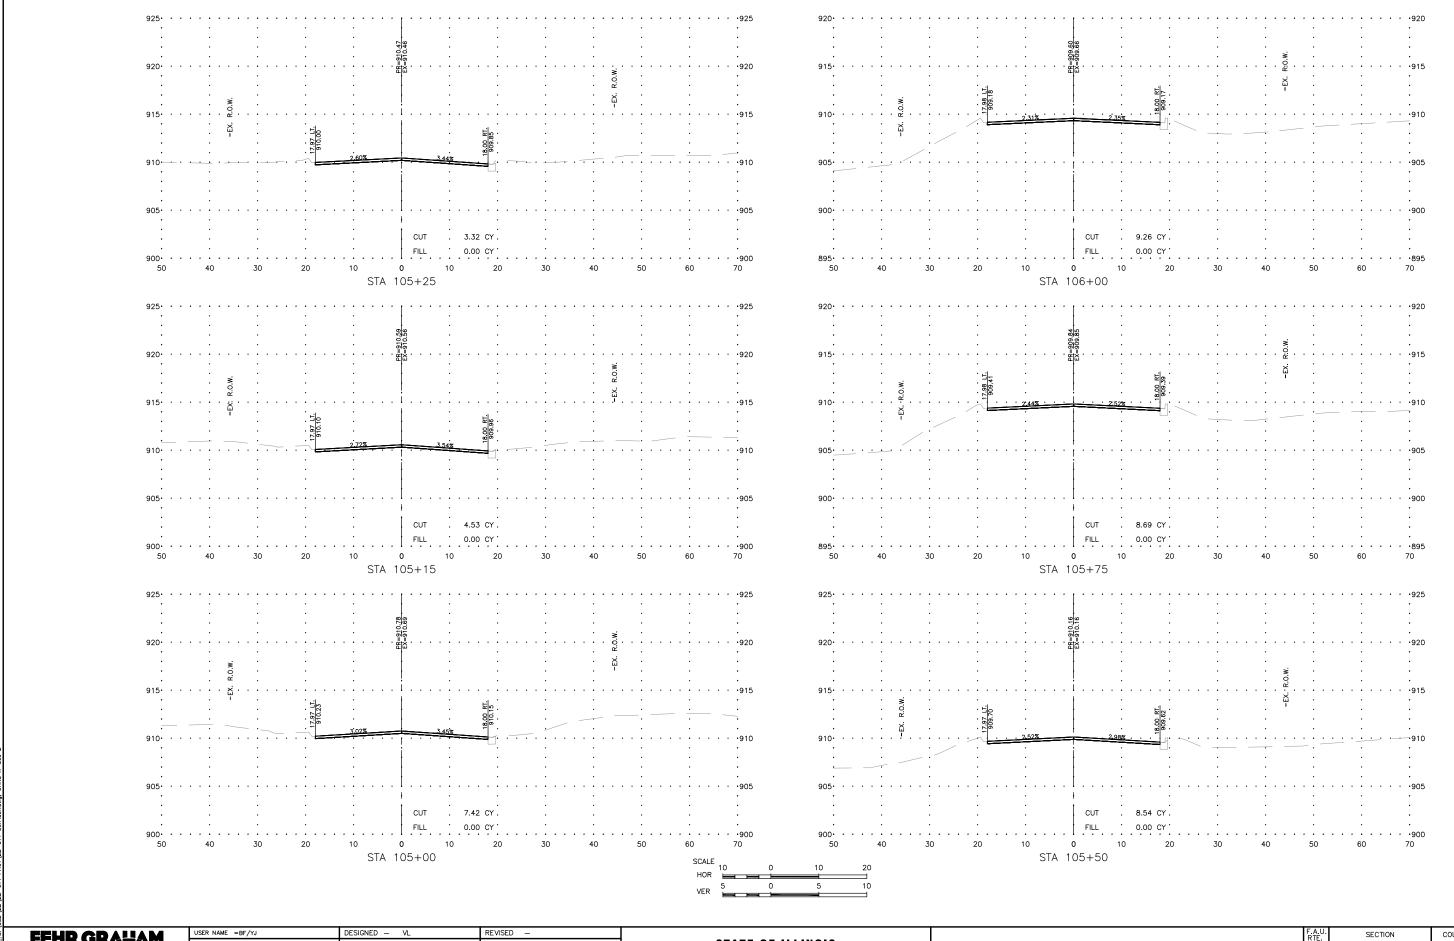

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ILINOS DESGRI FIRI NO. 184-00528


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USER NAME =BF/YJ	DESIGNED -	VL	REVISED —
	DRAWN -	BF/YJ	REVISED —
PLOT SCALE = AS NOTED	CHECKED -		REVISED —
PLOT DATE = 2/15/24	DATE -	03/01/23	REVISED —

STATI	E OF ILLINOIS	
DEPARTMENT	OF TRANSPORTATION	

SCALE: AS


	F.A.U. RTE.	SECTION	COUNTY	TOTAL SHEETS	SHEET NO.	
THREE OAKS ROAD - CROS	4051	22-00134-00-TL	MCHENRY	129	105	
	CONTRACT NO 61K35				K35	
NOTED SHEET105 OF 129 SHEETS S	A. TO STA.	ILLINOIS FED. AID PROJECT				

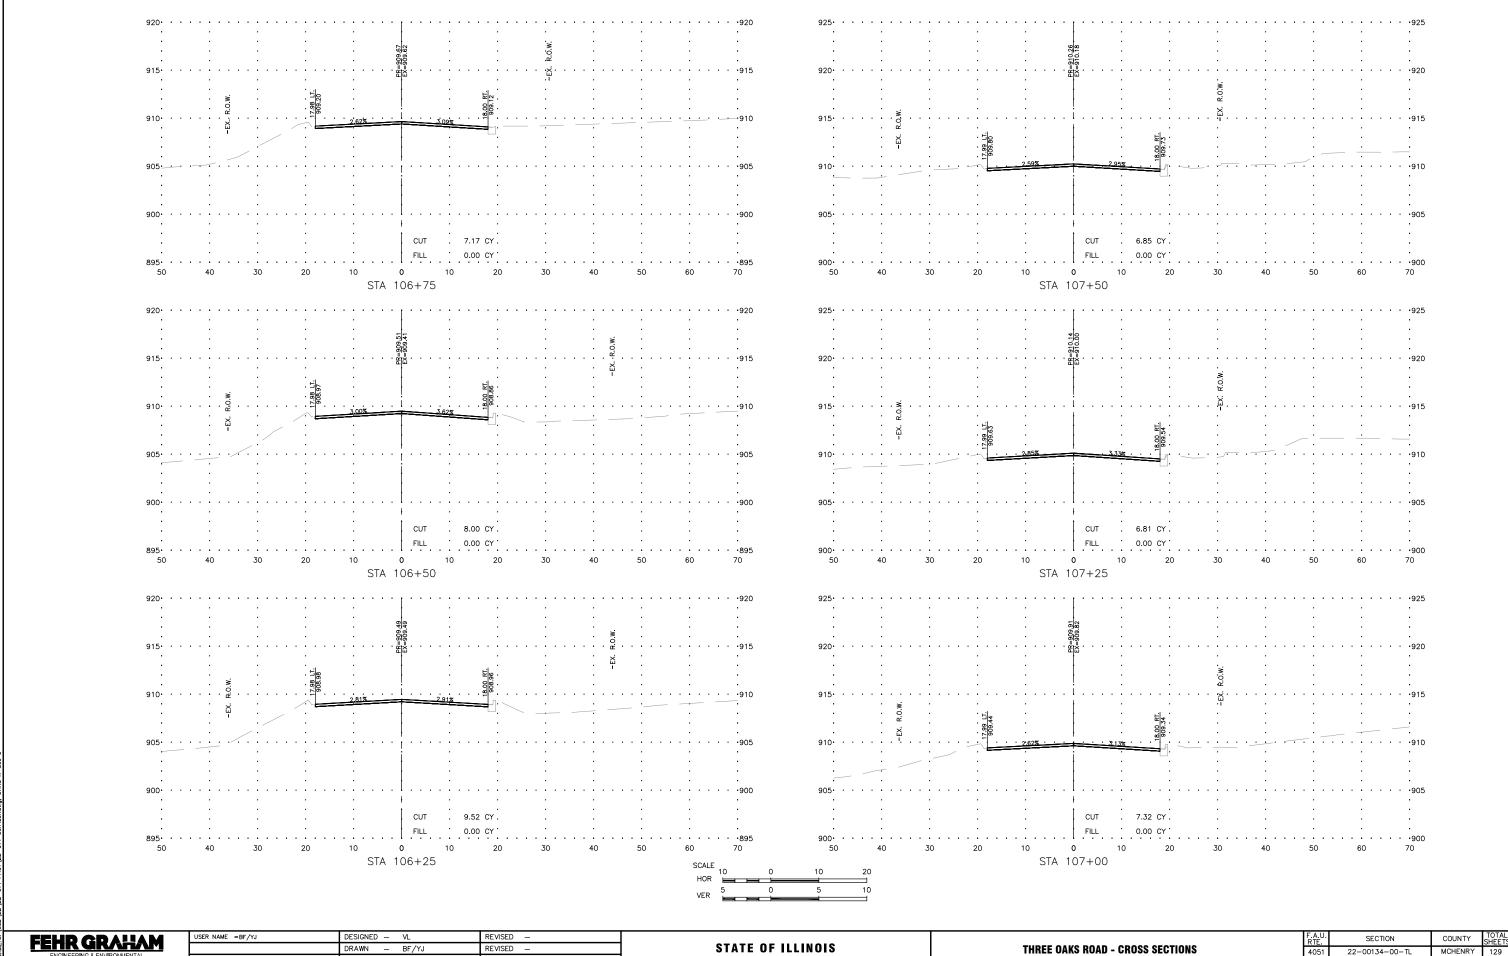

DRAWN REVISED -REVISED PLOT DATE = 2/15/24 DATE - 03/01/23 REVISED

DEPARTMENT OF TRANSPORTATION

THREE OAKS ROAD - CROSS SECTIONS 22-00134-00-TL SCALE: AS NOTED SHEET106 OF 129 SHEETS STA. TO STA.

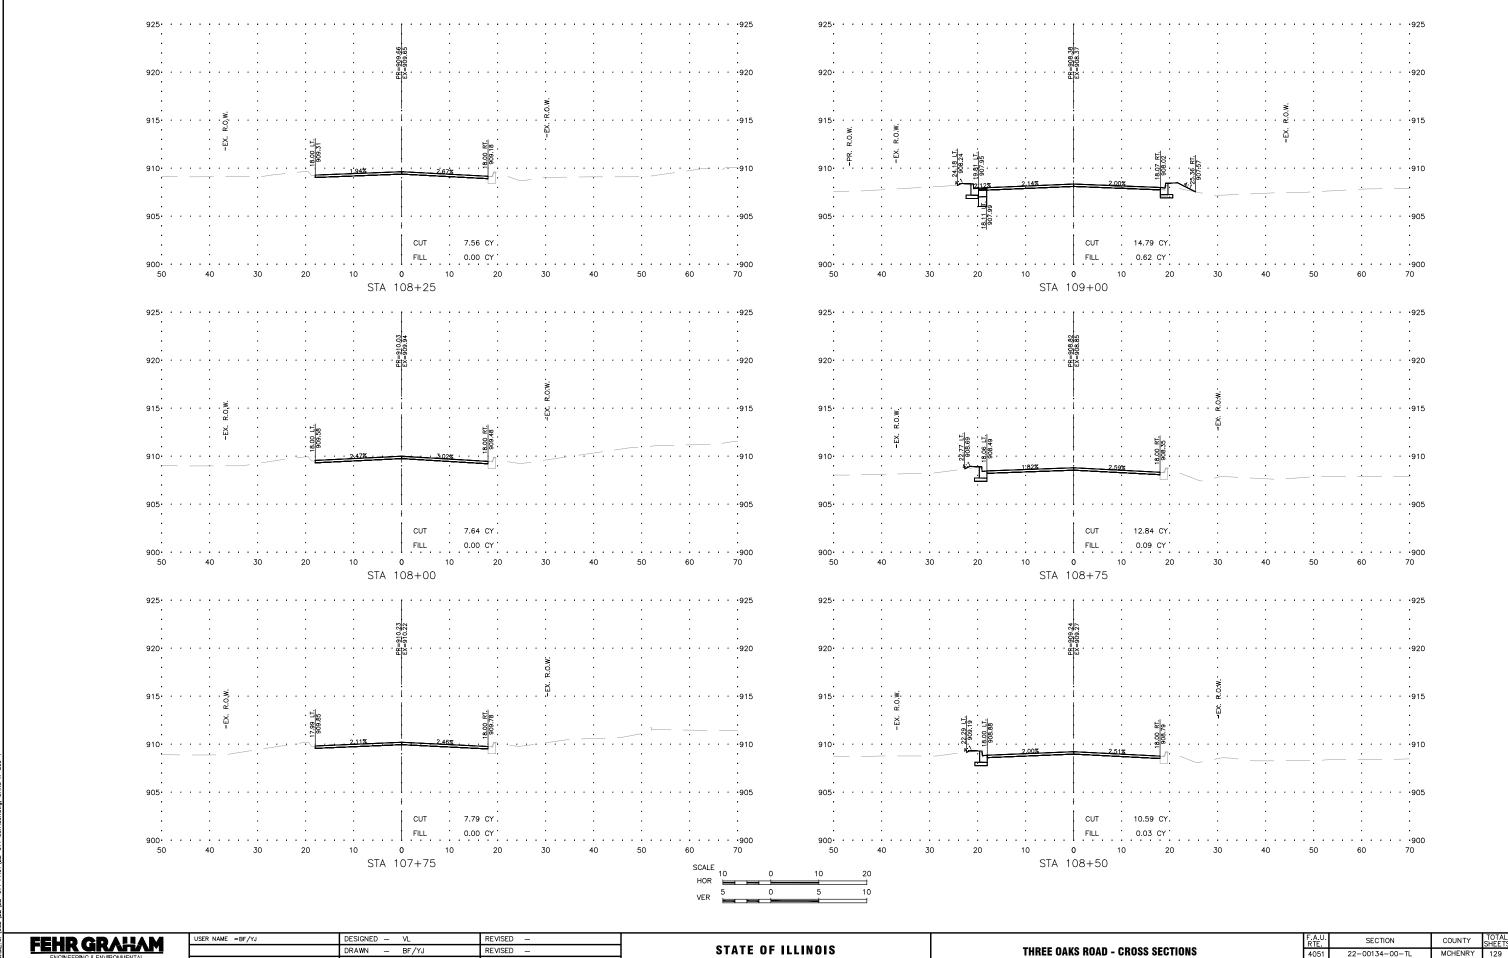

DEPARTMENT OF TRANSPORTATION

SCALE: AS NOTED SHEET107 OF 129 SHEETS STA.

TO STA.

FILE NAME: G:


CHECKED -

DATE - 03/01/23

PLOT DATE = 2/15/24

REVISED

REVISED -

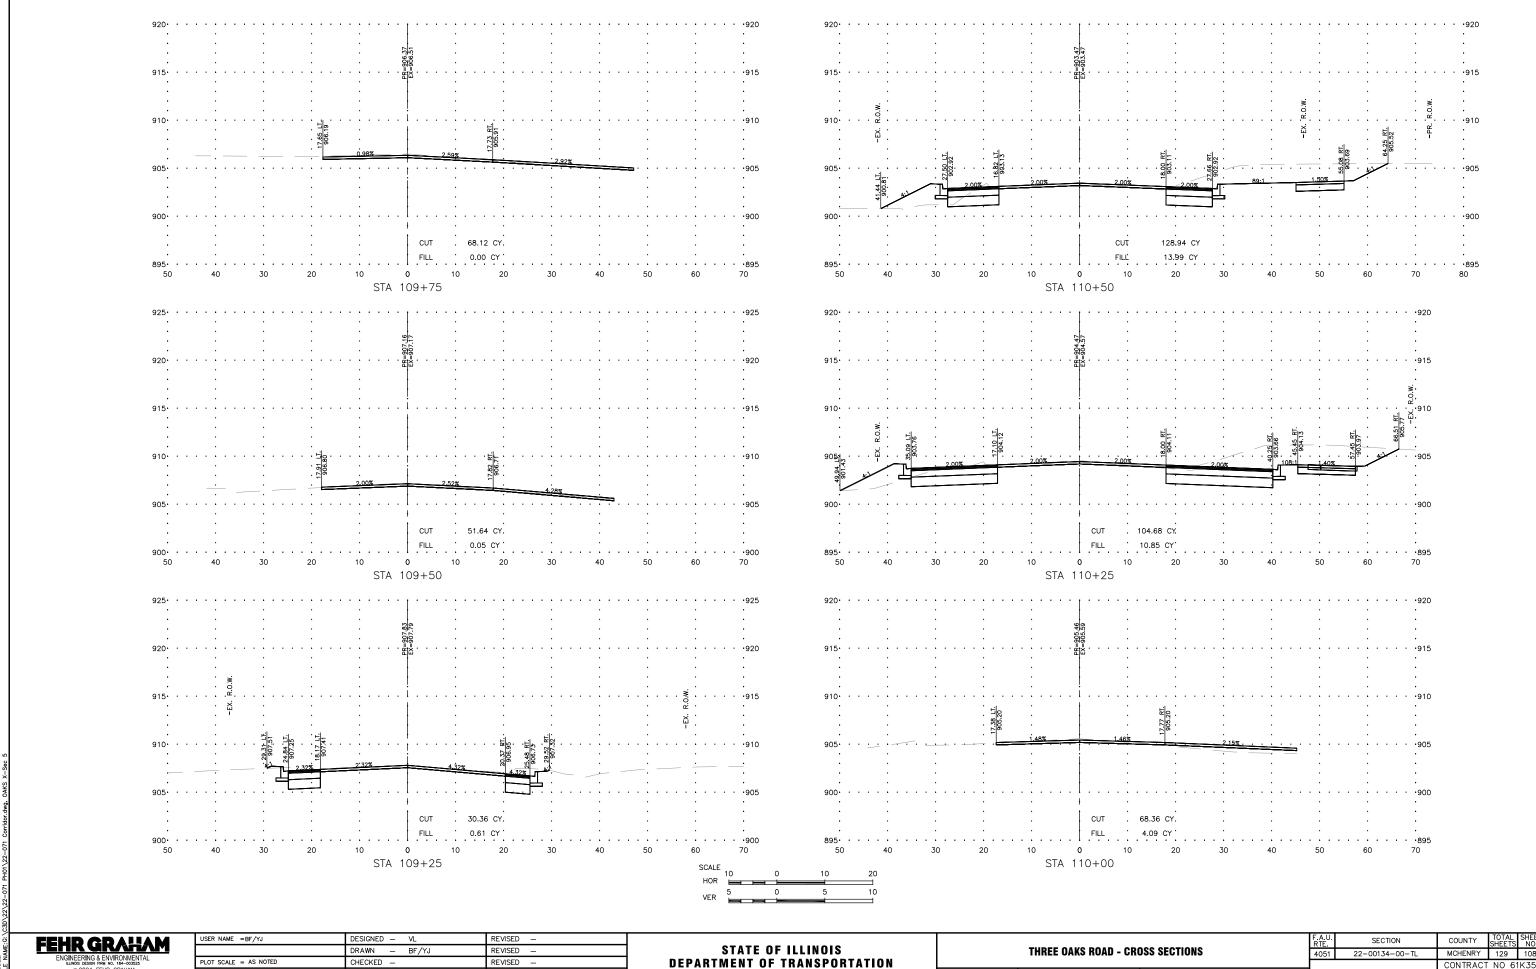


SCALE: AS NOTED SHEET108 OF 129 SHEETS STA.

TO STA.

PLOT DATE = 2/15/24

DATE - 03/01/23

REVISED -

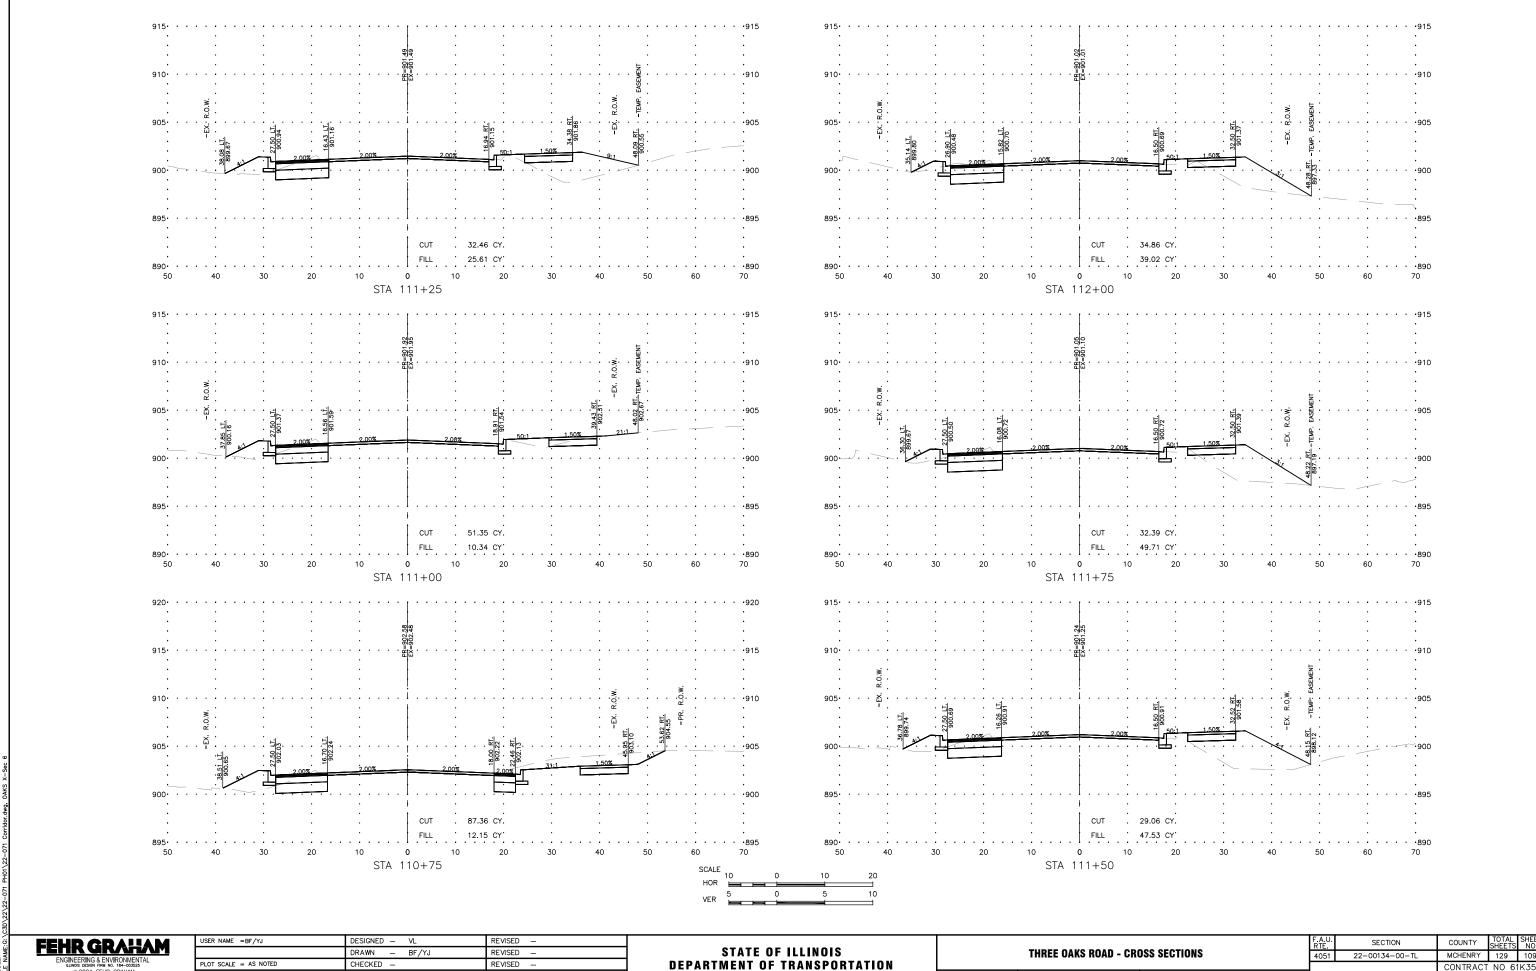


SCALE: AS NOTED SHEET109 OF 129 SHEETS STA.

TO STA.

PLOT DATE = 2/15/24

DATE - 03/01/23

REVISED -

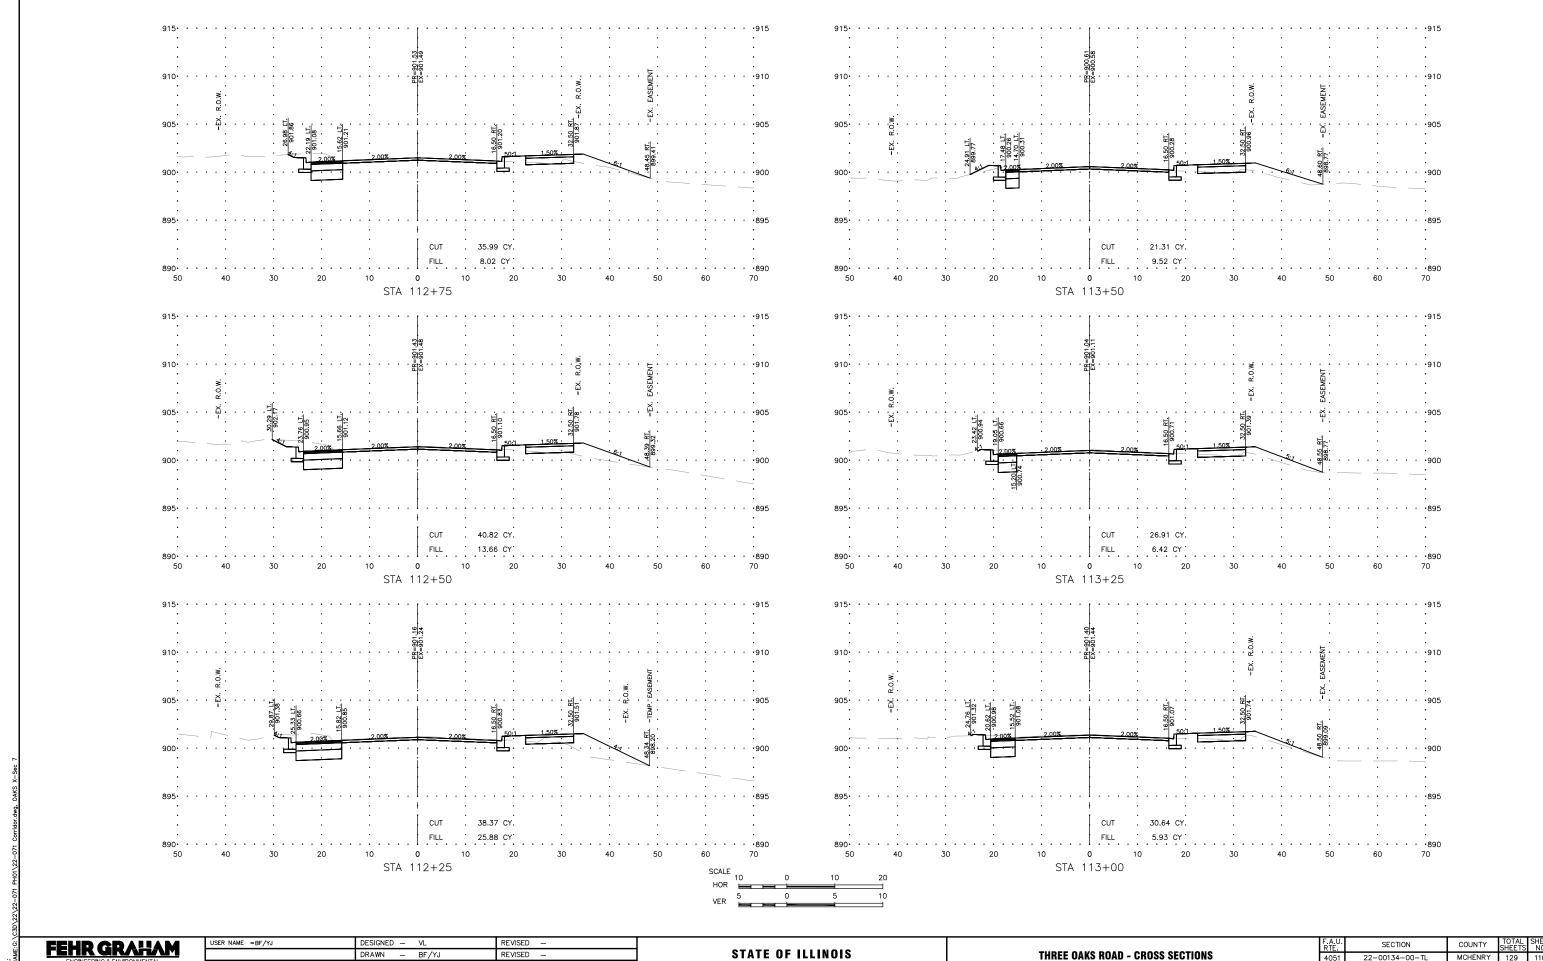


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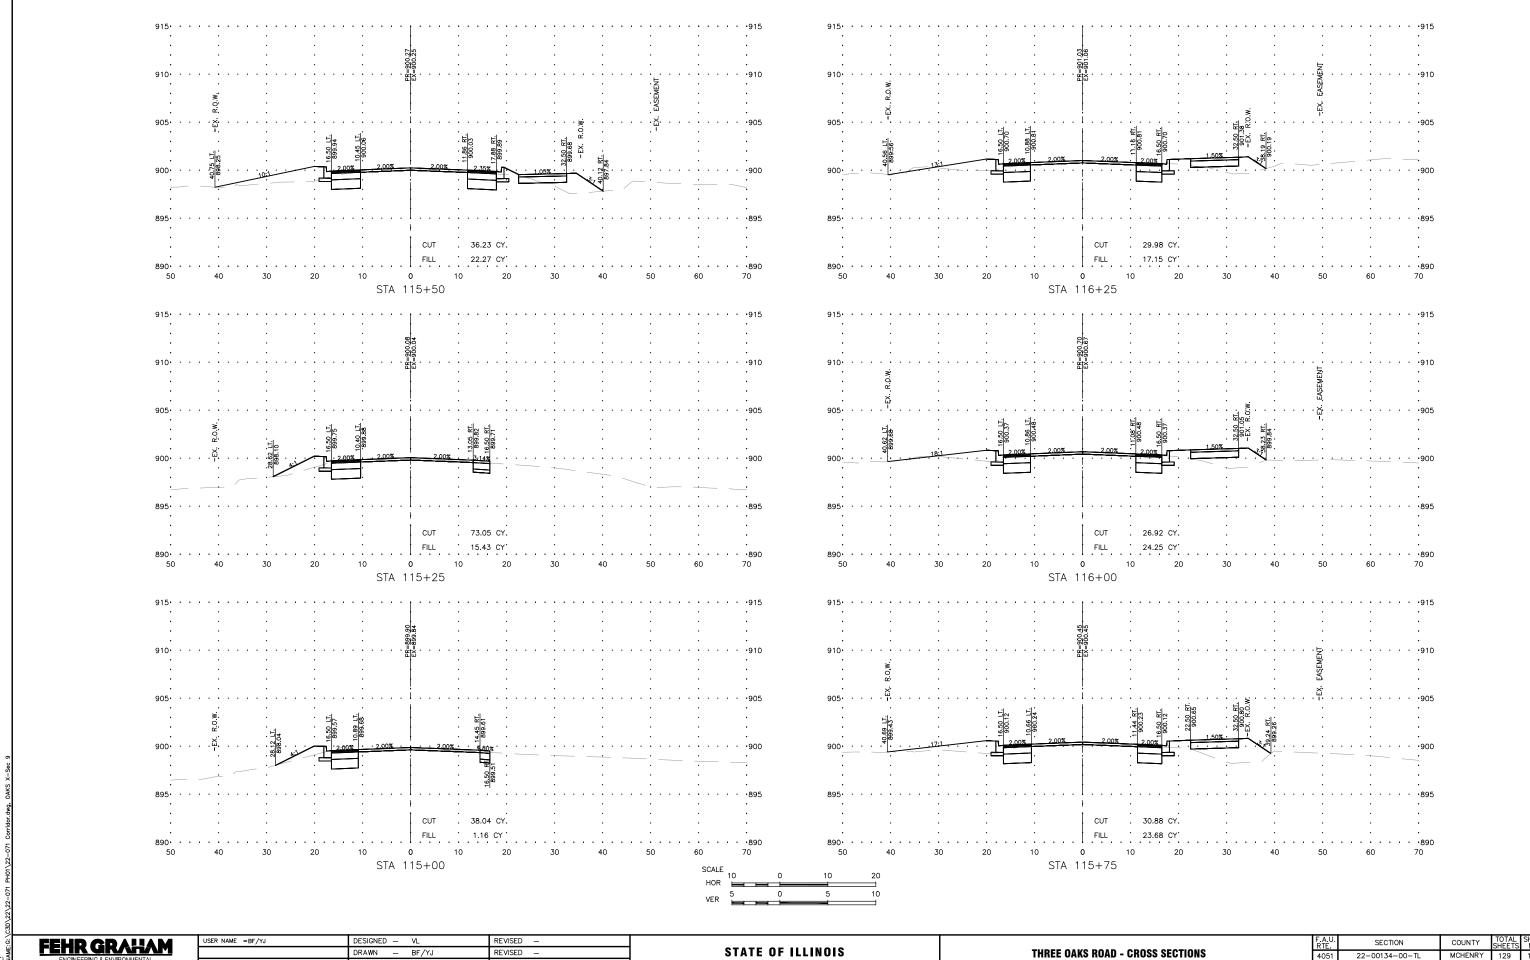
SCALE: AS NOTED SHEET111 OF 129 SHEETS STA.

TO STA.

PLOT DATE = 2/15/24

DATE - 03/01/23

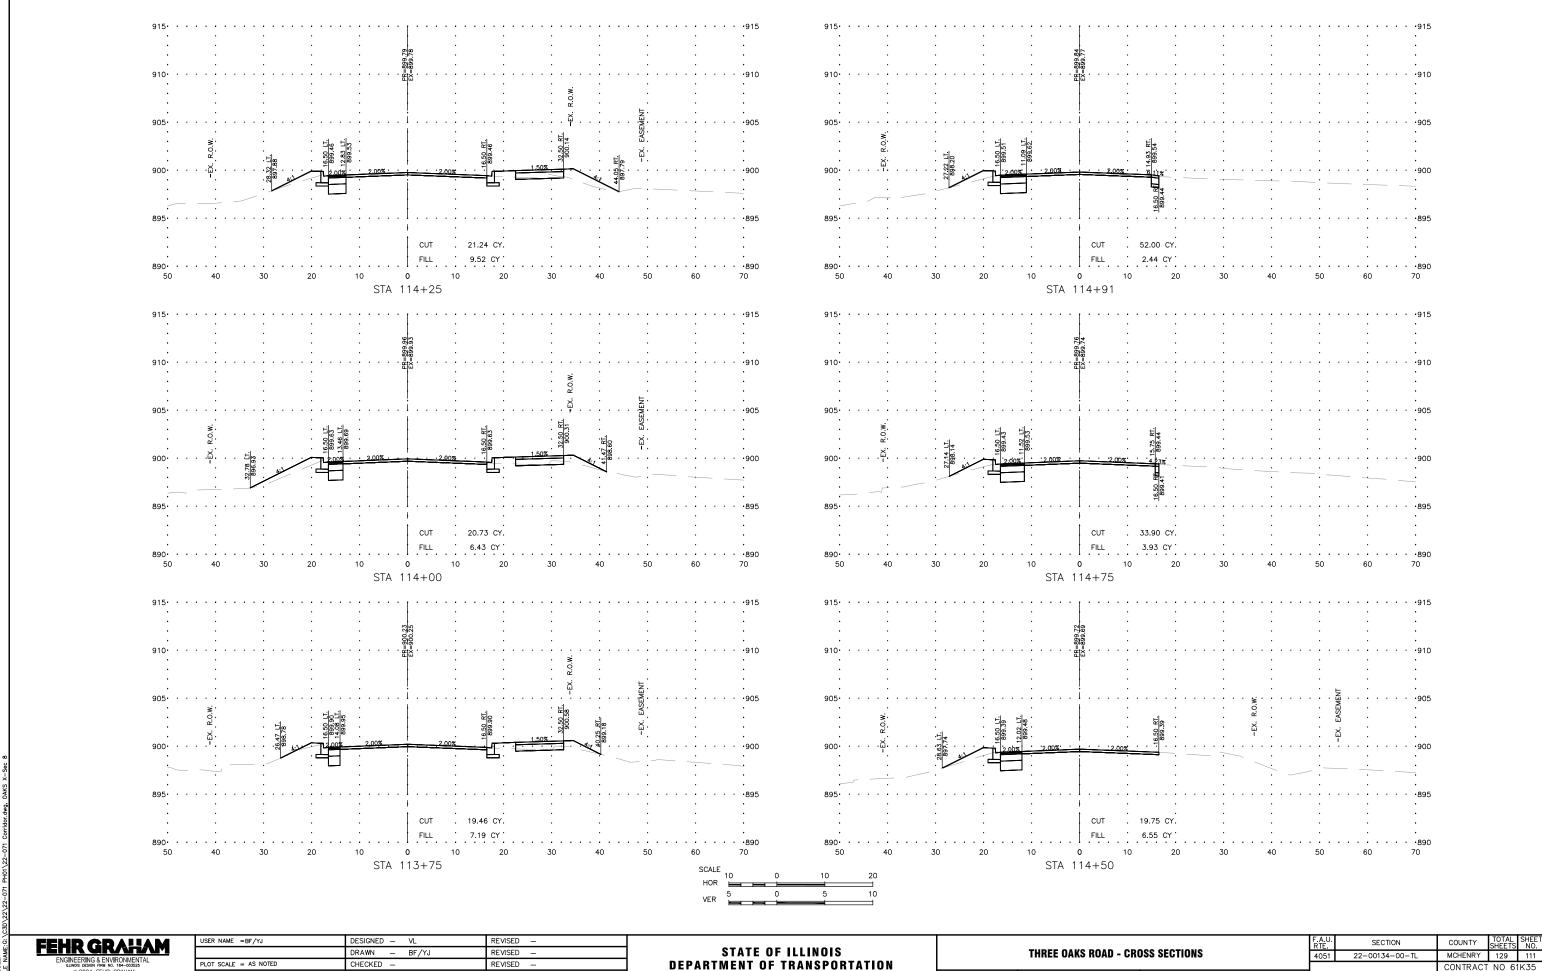
REVISED



BF/YJ REVISED PLOT DATE = 2/15/24 DATE - 03/01/23 REVISED

DEPARTMENT OF TRANSPORTATION


THREE OAKS ROAD - CROSS SECTIONS 22-00134-00-TL SCALE: AS NOTED SHEET112 OF 129 SHEETS STA. TO STA.

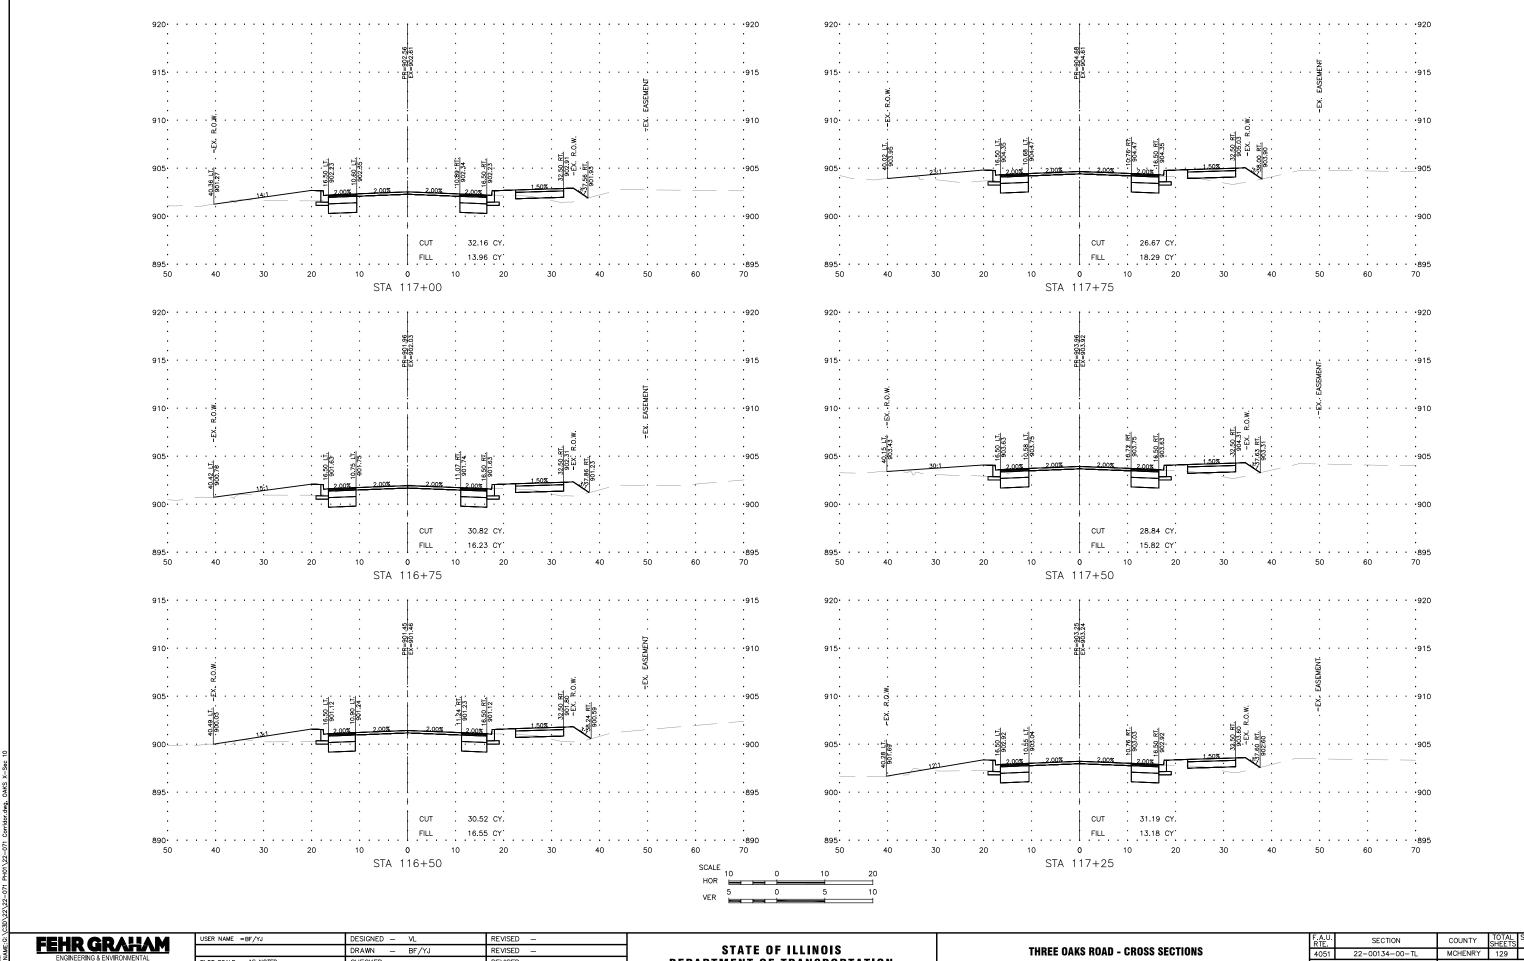

REVISED PLOT DATE = 2/15/24 DATE - 03/01/23 REVISED

DEPARTMENT OF TRANSPORTATION


SCALE: AS NOTED SHEET113 OF 129 SHEETS STA. TO STA.

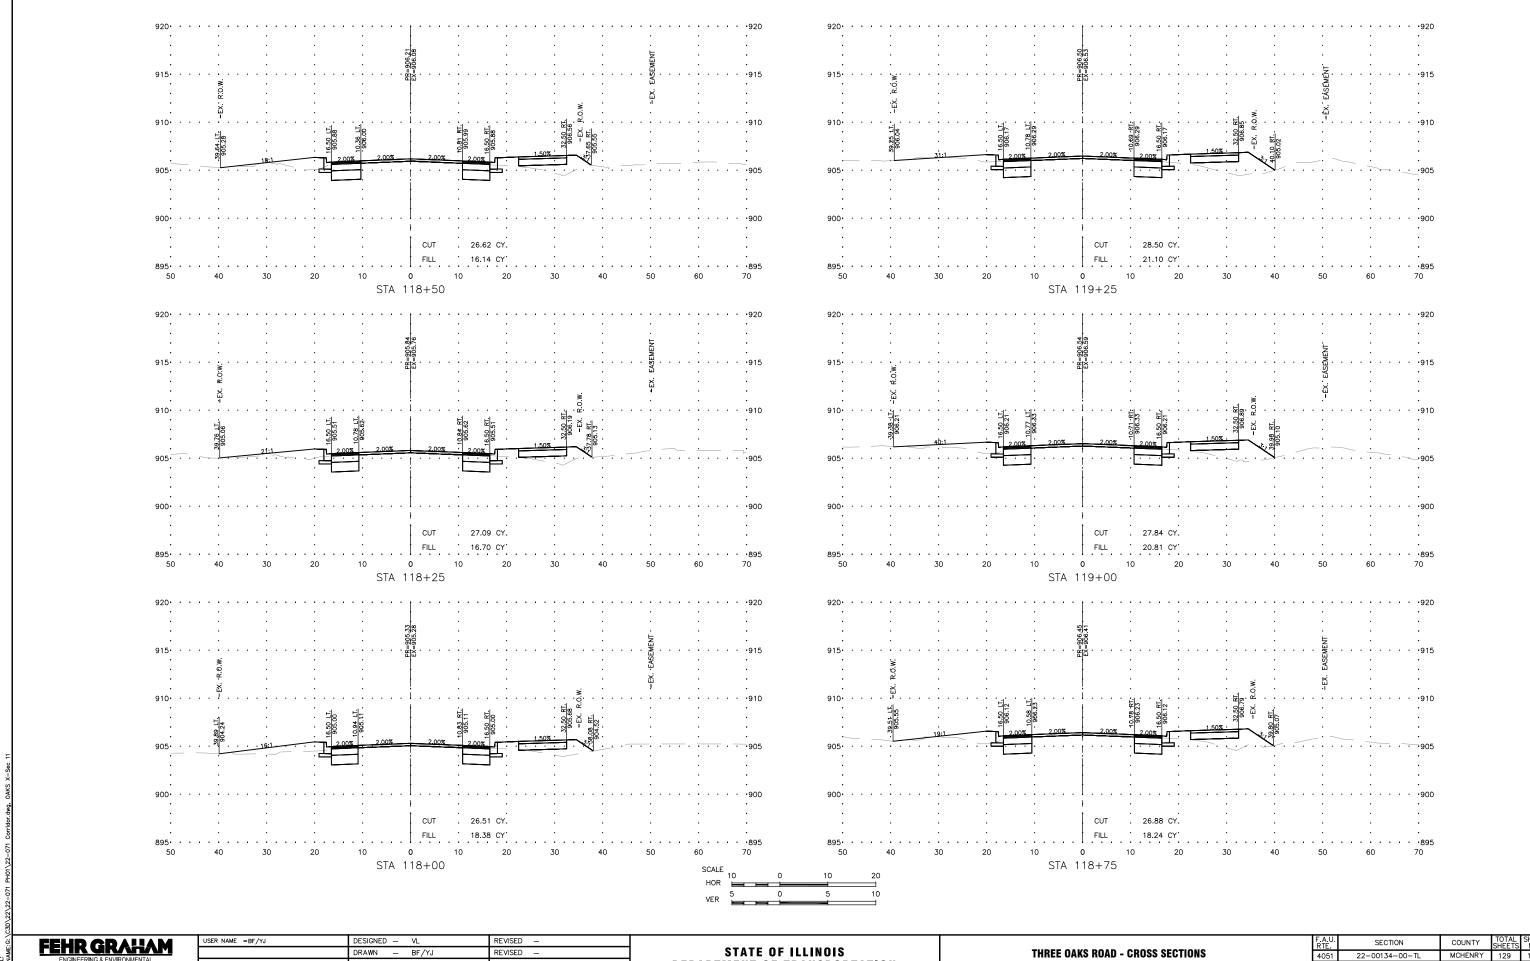

REVISED PLOT DATE = 2/15/24 DATE - 03/01/23 REVISED

DEPARTMENT OF TRANSPORTATION

SCALE: AS NOTED SHEET114 OF 129 SHEETS STA. TO STA.

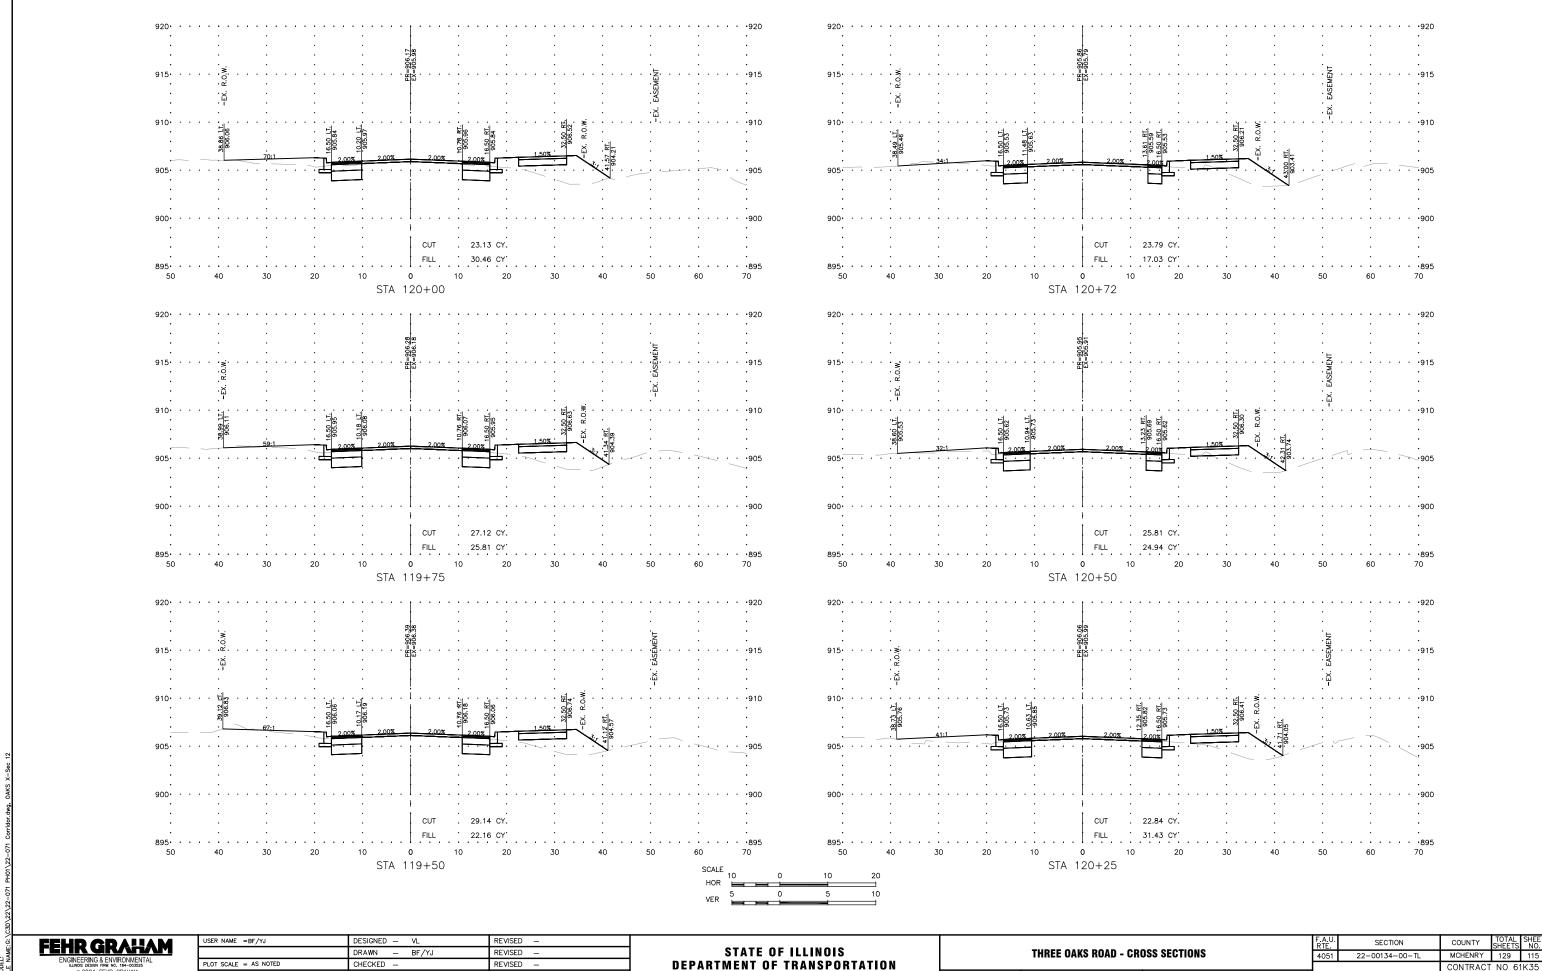


SCALE: AS NOTED SHEET115 OF 129 SHEETS STA.

TO STA.

PLOT DATE = 2/15/24

DATE - 03/01/23


REVISED

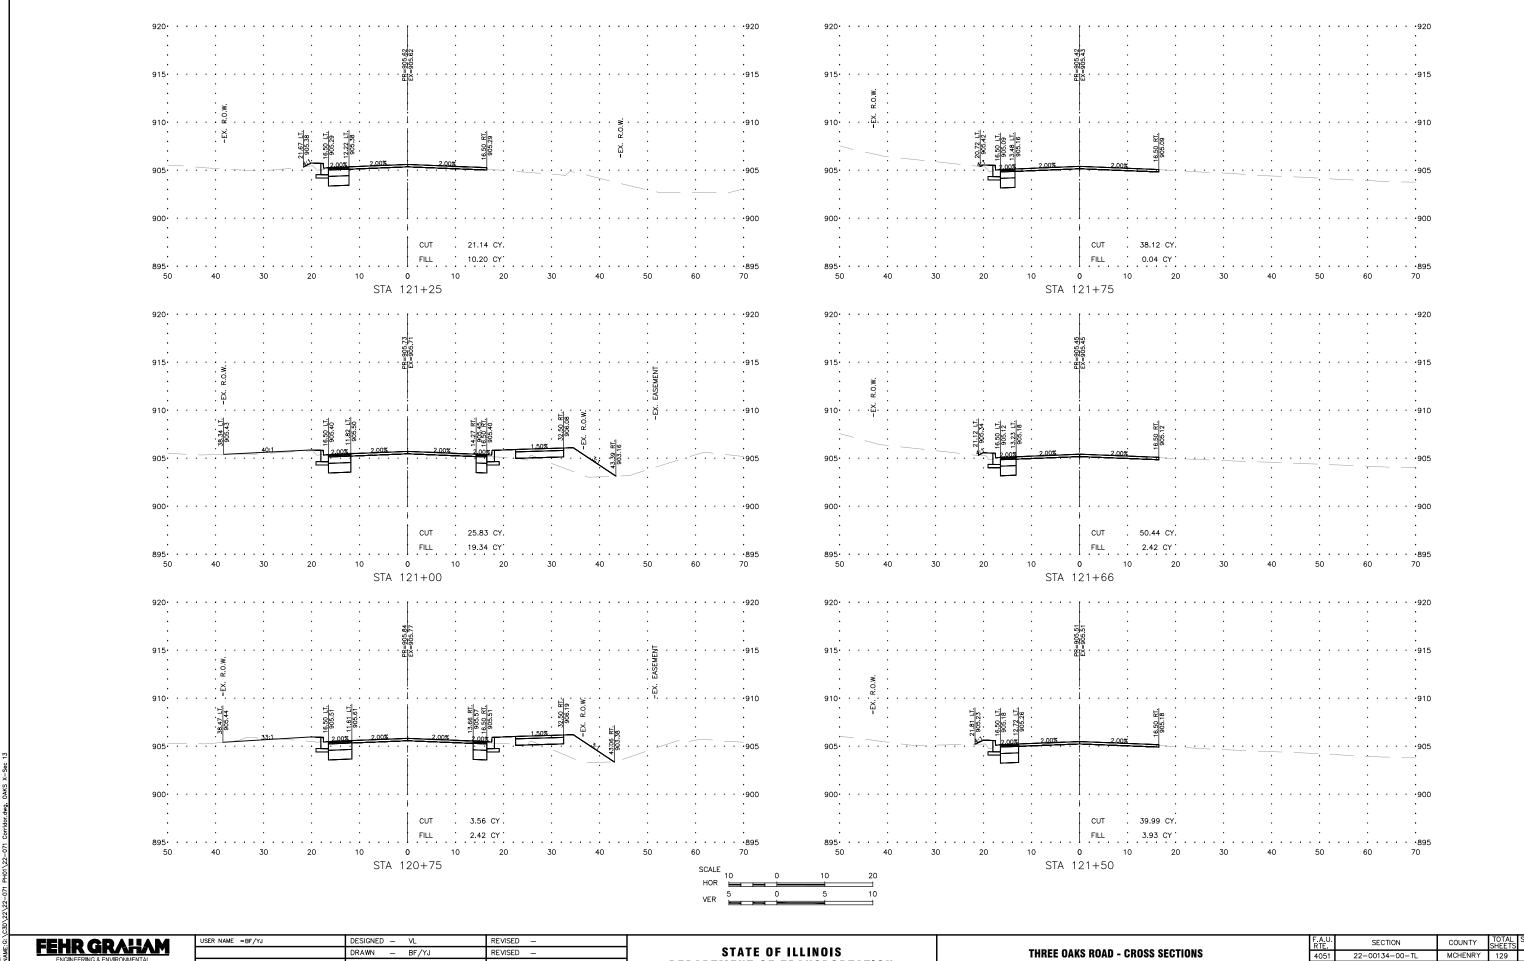

REVISED PLOT DATE = 2/15/24 DATE - 03/01/23 REVISED

DEPARTMENT OF TRANSPORTATION

						RTE.	SECTION
	THREE C	IAKS I	ROAD - CRO	ISS SECT	TONS	4051	22-00134-00-TL
						_	
SCALE: AS NOTED	SHEET116	OF	129 SHEETS	STA.	TO STA.		ILLINOIS F
	SCALE: AS NOTED					THREE OAKS ROAD - CROSS SECTIONS SCALE: AS NOTED SHEET116 OF 129 SHEETS STA. TO STA.	THREE OAKS ROAD - CROSS SECTIONS 4051

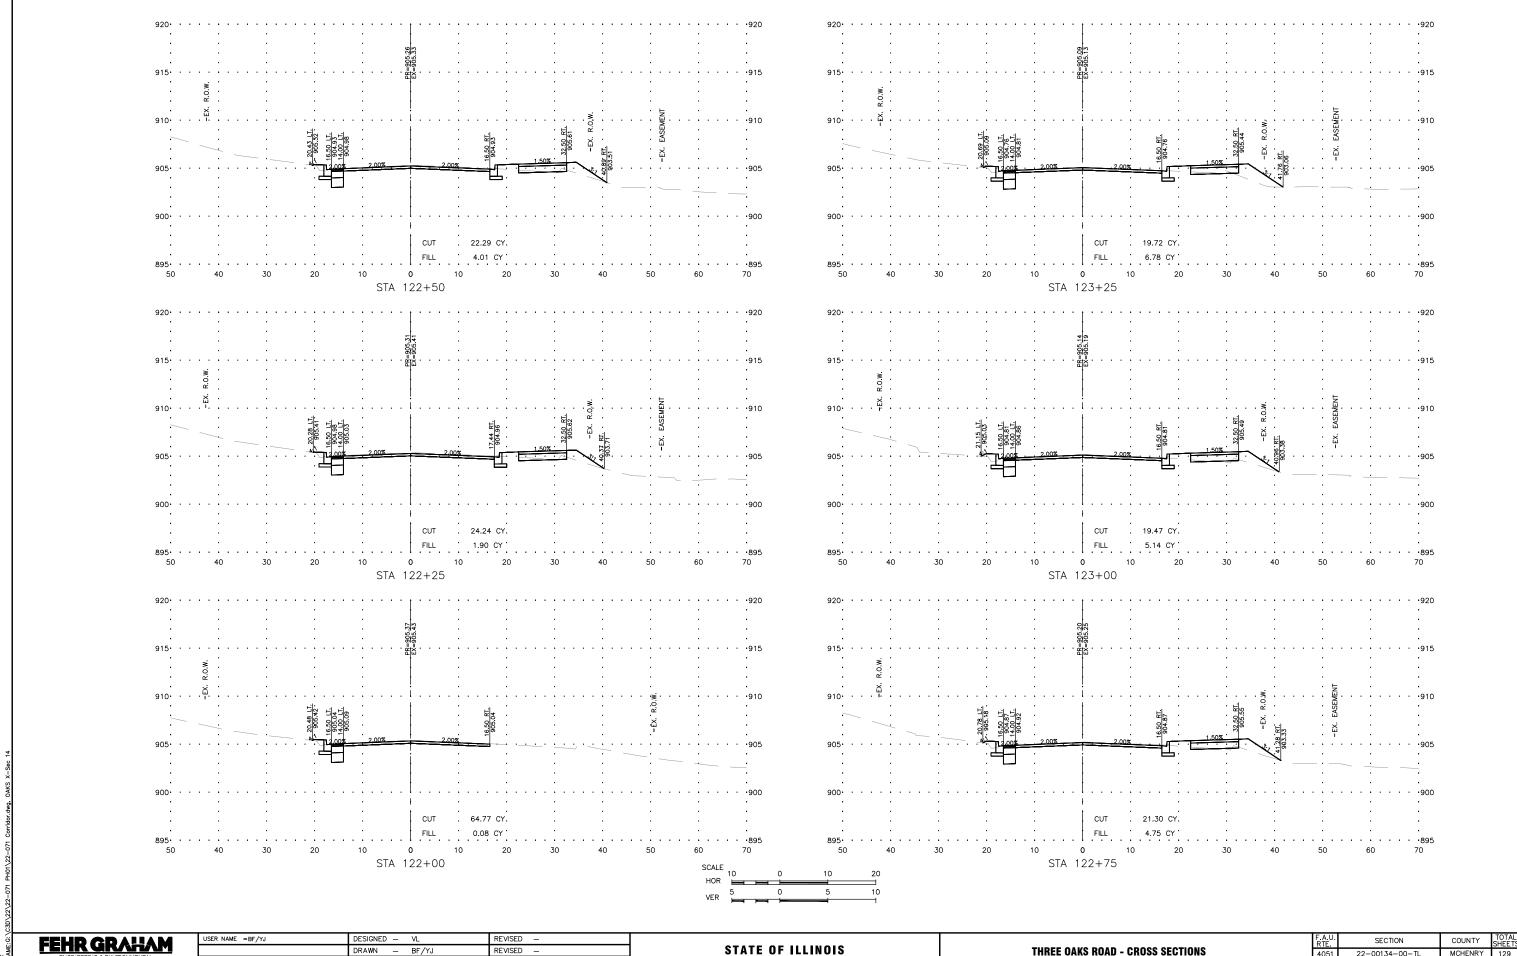


FEHR GRAGA

ENGINEERING & ENVIRONMENTAL
ILLINGS DESIGN FIRW NO. 184-003525

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| DRAWN - BF/YJ REVISED - | PLOT SCALE = AS NOTED | CHECKED - | PLOT DATE = 2/15/24 | DATE - 03/01/23 | REVISED - |

STATE OF ILLINOIS
DEPARTMENT OF TRANSPORTATION

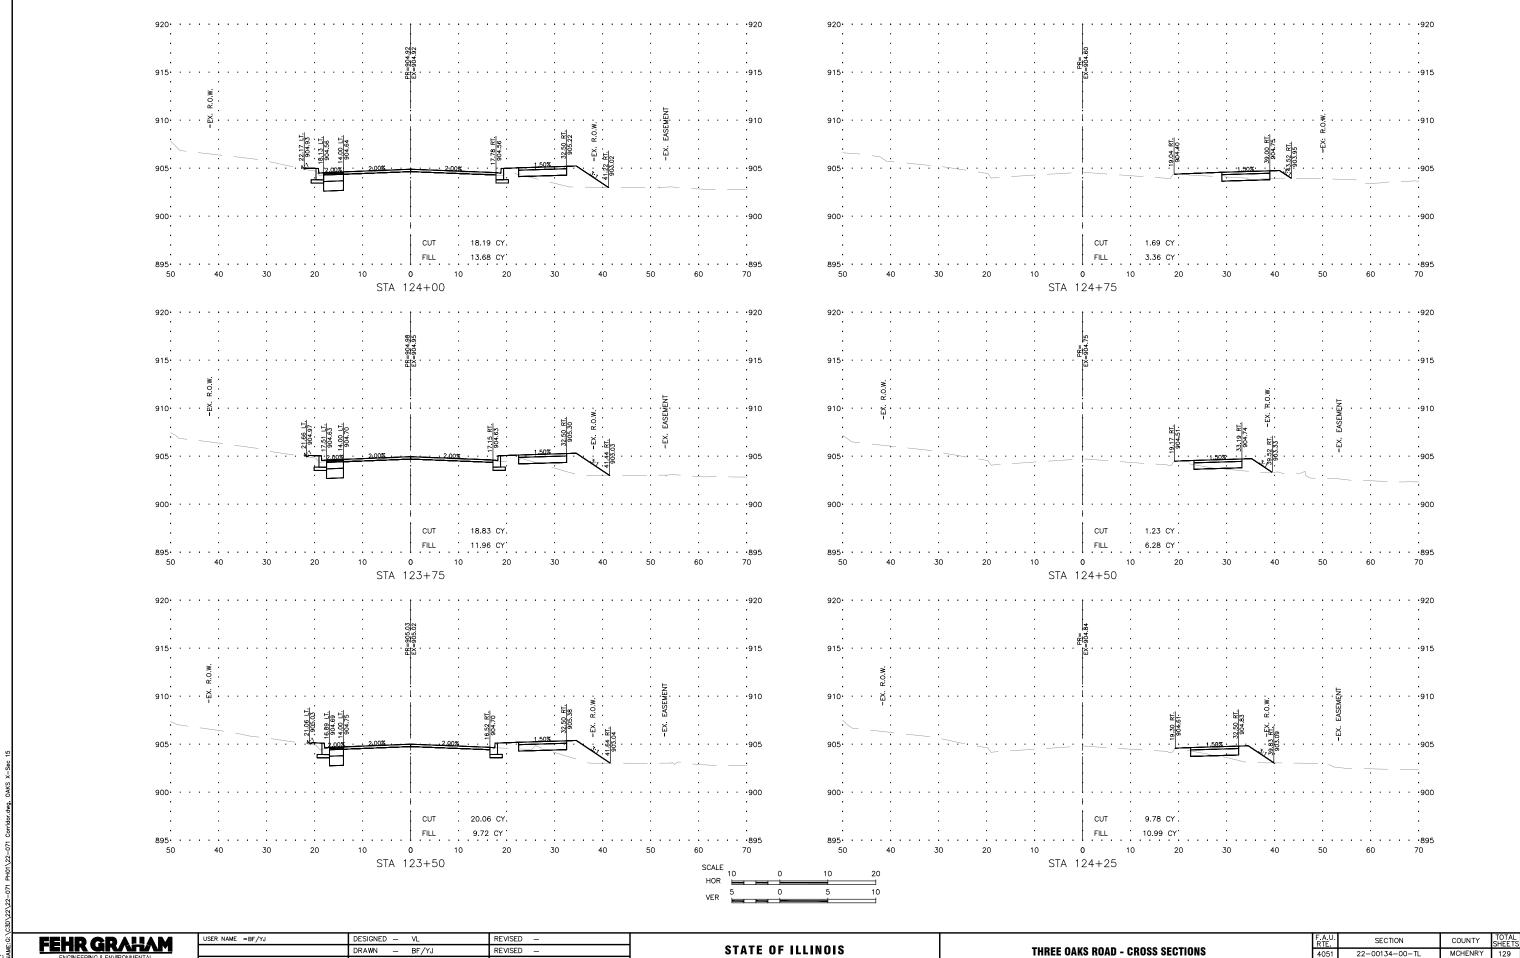


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| DRAWN - BF/YJ REVISED - | PLOT SCALE = AS NOTED | CHECKED - | REVISED - | PLOT DATE = 2/15/24 | DATE - 03/01/23 | REVISED - |

STATE OF ILLINOIS DEPARTMENT OF TRANSPORTATION
 THREE OAKS ROAD - CROSS SECTIONS
 RTE.
 SECTION
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 SCALE: AS NOTED
 SHEET118
 OF 129 SHEETS
 STA.
 TO STA.
 ILLINOIS FED. AID PROPERTY OF THE PROPERTY



FEHR GRAHAM

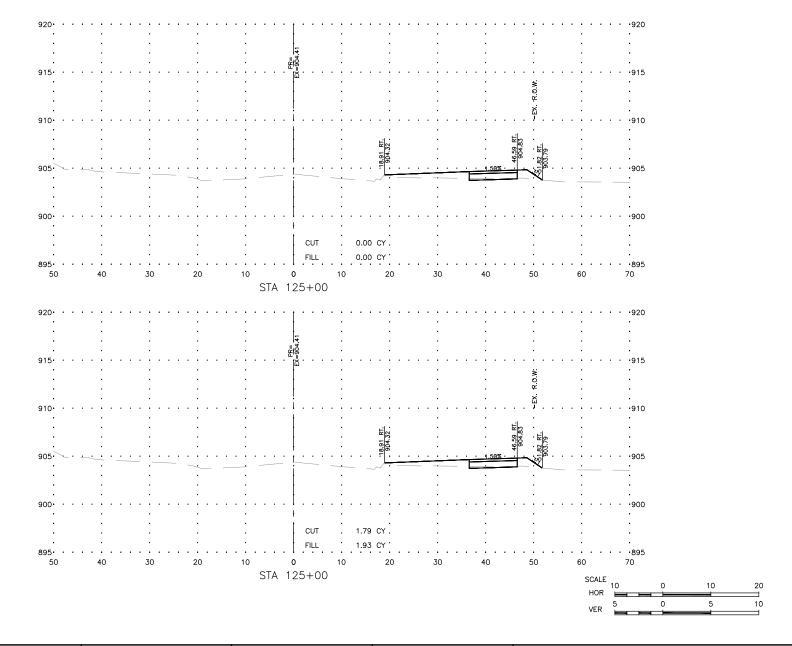
ENGINEERING & ENVIRONMENTAL
ILLINOS DESIGN PRIN NO. 194–003525
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USER NAME =BF/YJ	DESIGNED	_	VL	REVISED	_
	DRAWN	_	BF/YJ	REVISED	_
PLOT SCALE = AS NOTED	CHECKED	_		REVISED	_
PLOT DATE = $2/15/24$	DATE	_	03/01/23	REVISED	_

STATE OF ILLINOIS DEPARTMENT OF TRANSPORTATION

					_		F.A.U. RTE.	SECTION	COUNTY	TOTAL SHEETS	SHEET NO.
	THREE O	AKS	ROAD - CRO	SS SECTION	S	[4051	22-00134-00-TL	MCHENRY	129	119
									CONTRACT	NO 61	K35
SCALE: AS NOTED	SHEET119	OF	129 SHEETS	STA.	TO STA.			ILLINOIS FED. AI	D PROJECT		


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REVISED PLOT DATE = 2/15/24 DATE - 03/01/23 REVISED -

DEPARTMENT OF TRANSPORTATION

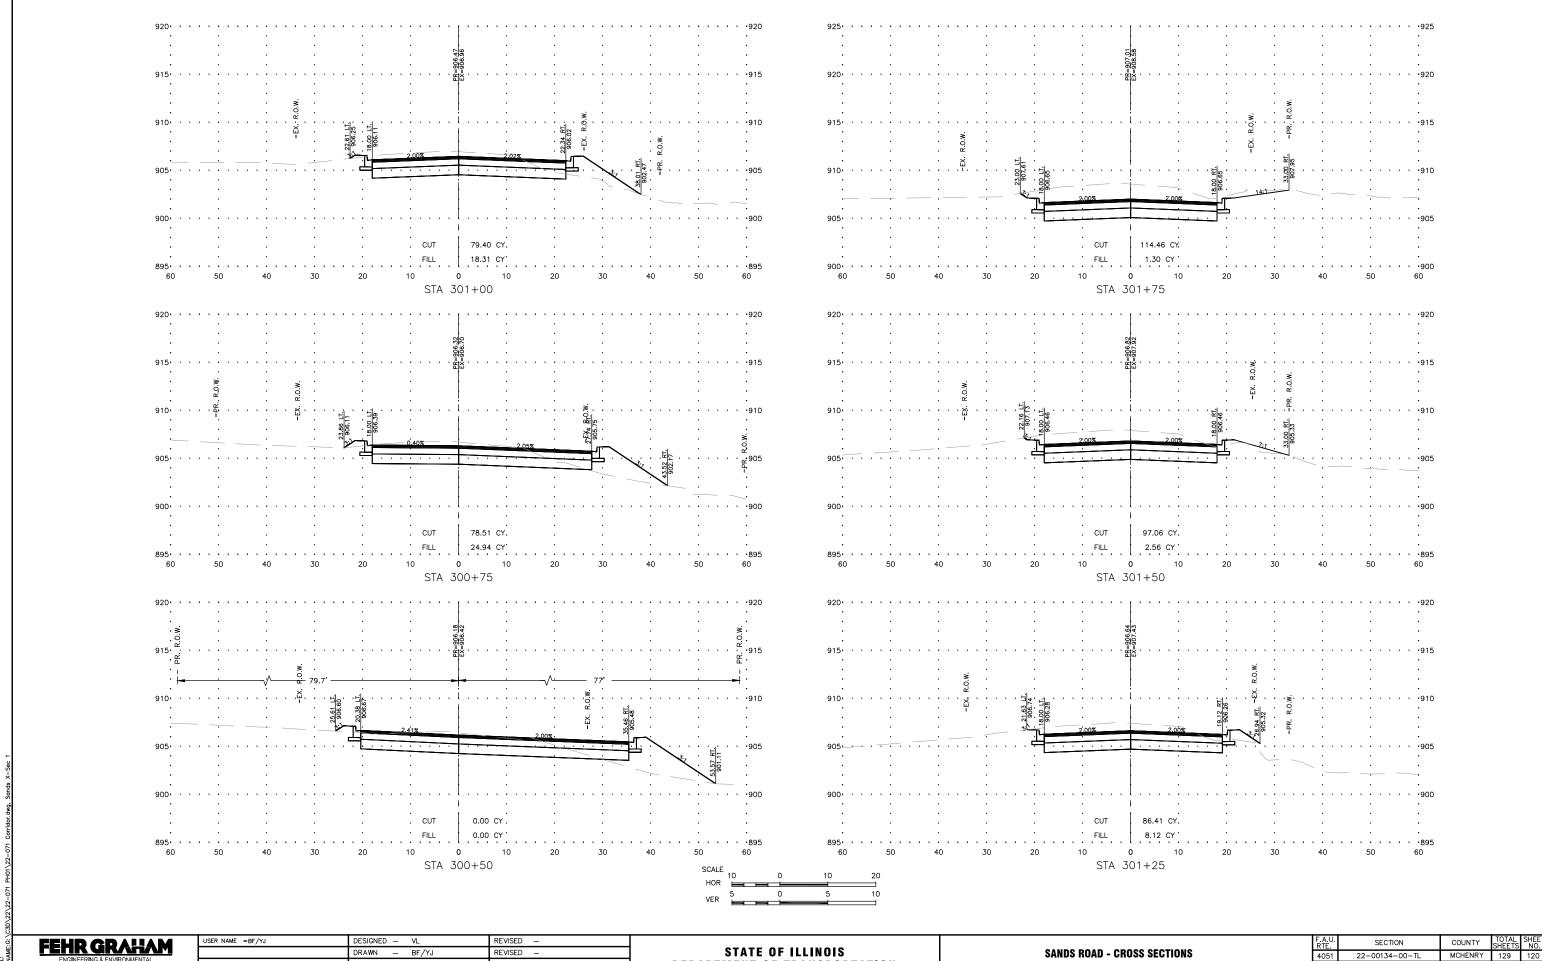							RTE.	SECTION
		SAND	IS RO	AD - CROSS	SECTIO	NS	4051	22-00134-00-
	SCALE: AS NOTED	SHEET120	OF	129 SHEETS	STA.	TO STA.		ILLINOIS
_								




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 PLOT SCALE = AS NOTED
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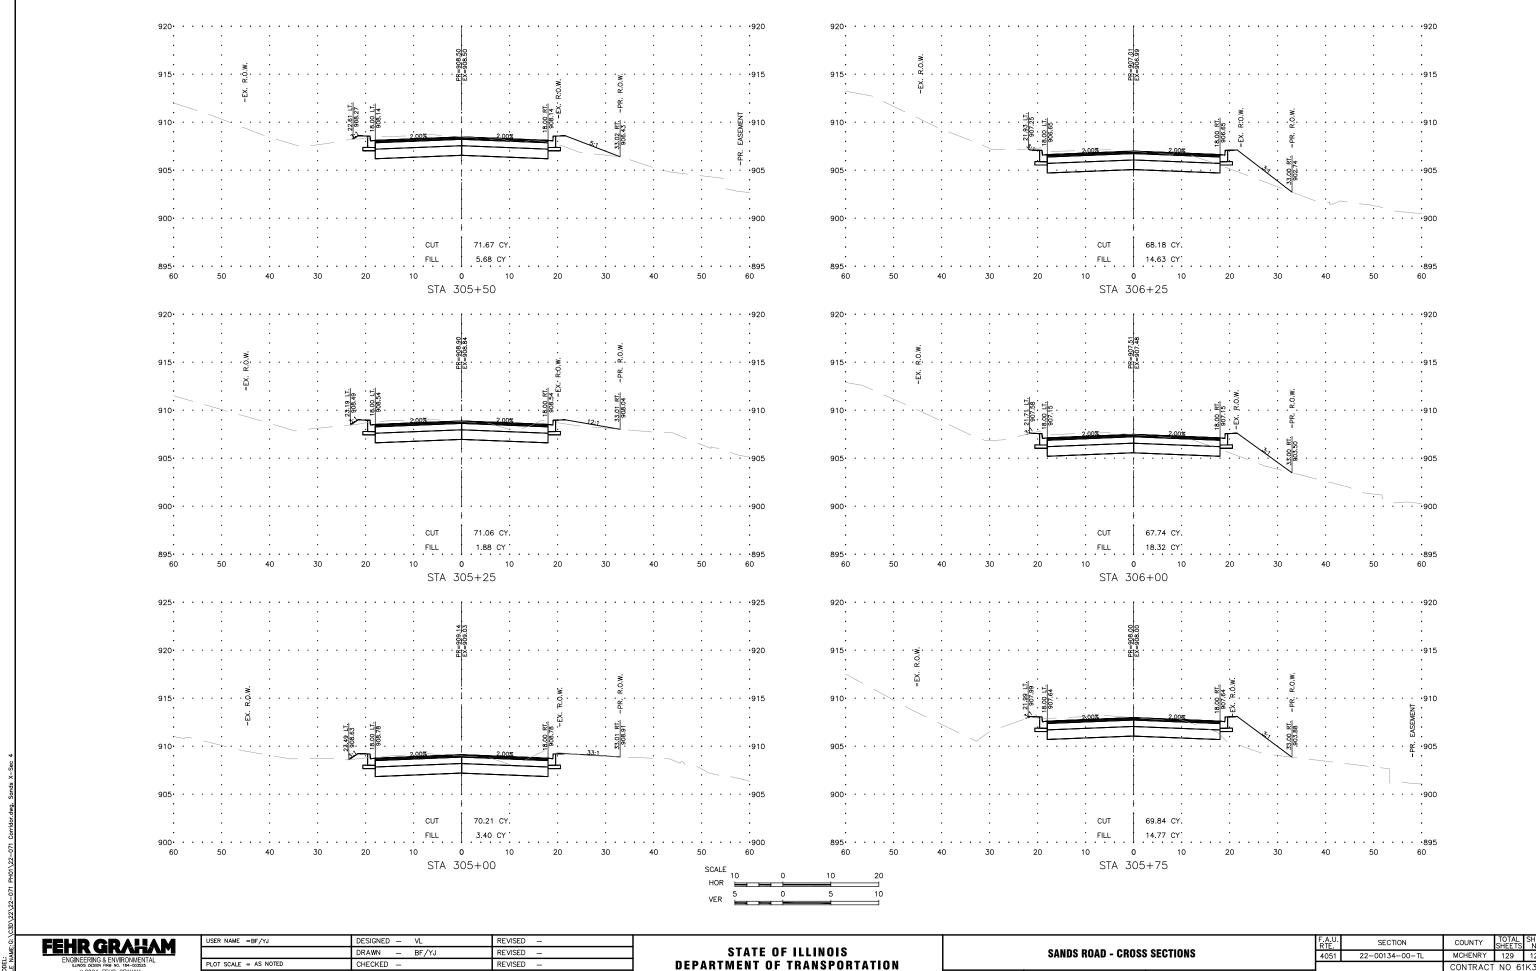
DEPARTMENT OF TRANSPORTATION

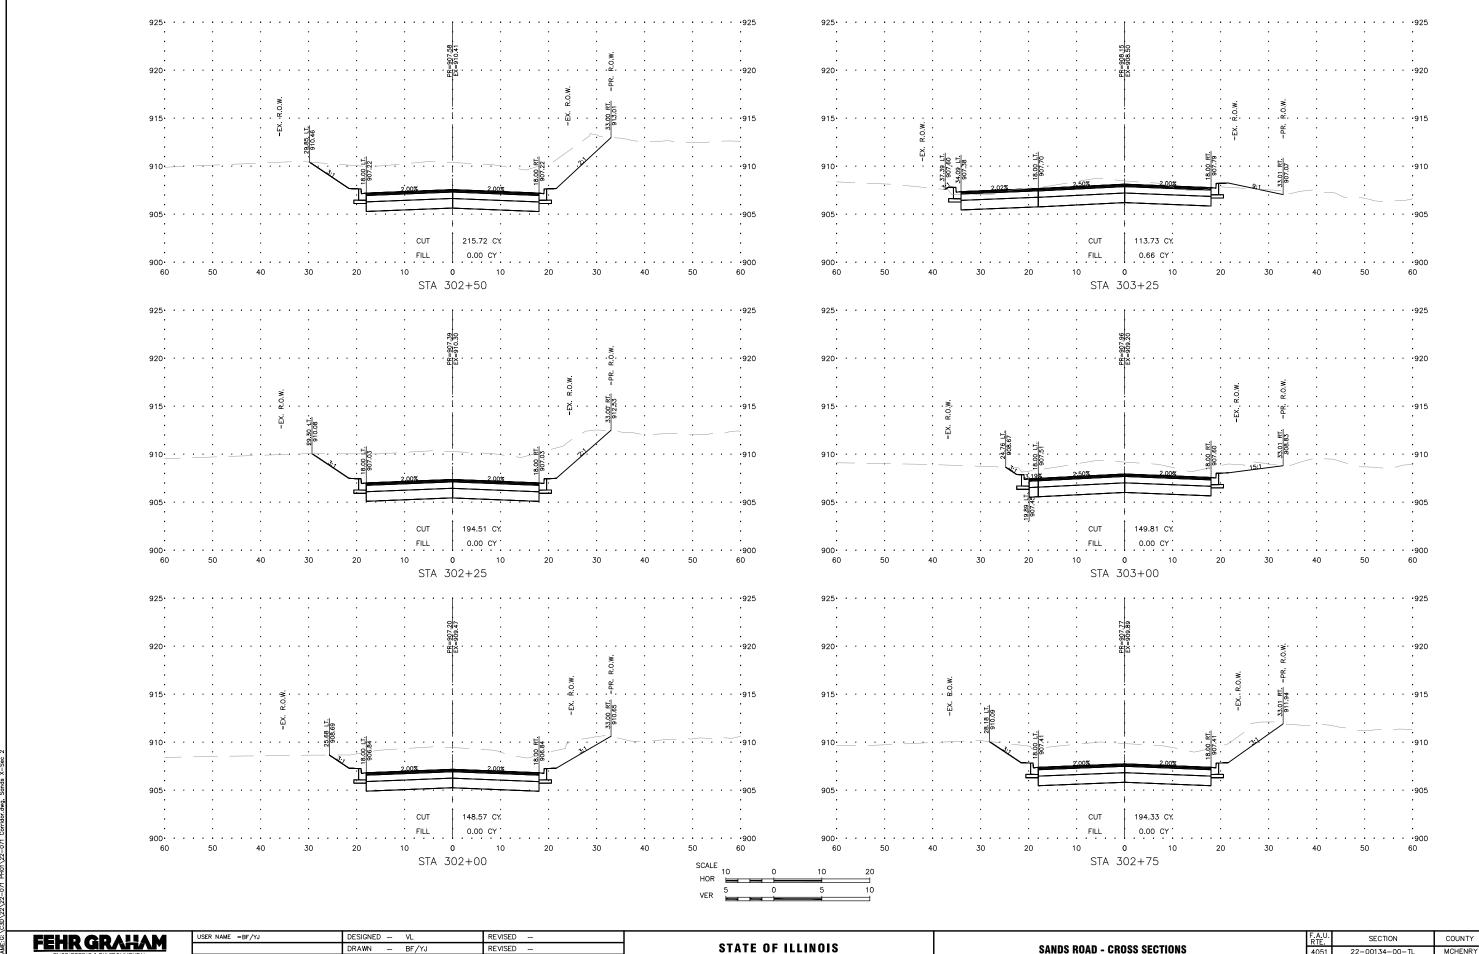

USER NAME =BF/YJ	DESIGNED — VL	REVISED —
	DRAWN — BF/YJ	REVISED —
PLOT SCALE = AS NOTED	CHECKED —	REVISED —
PLOT DATE = 2/15/24	DATE - 03/01/23	REVISED —

DEPARTMENT OF TRANSPORTATION

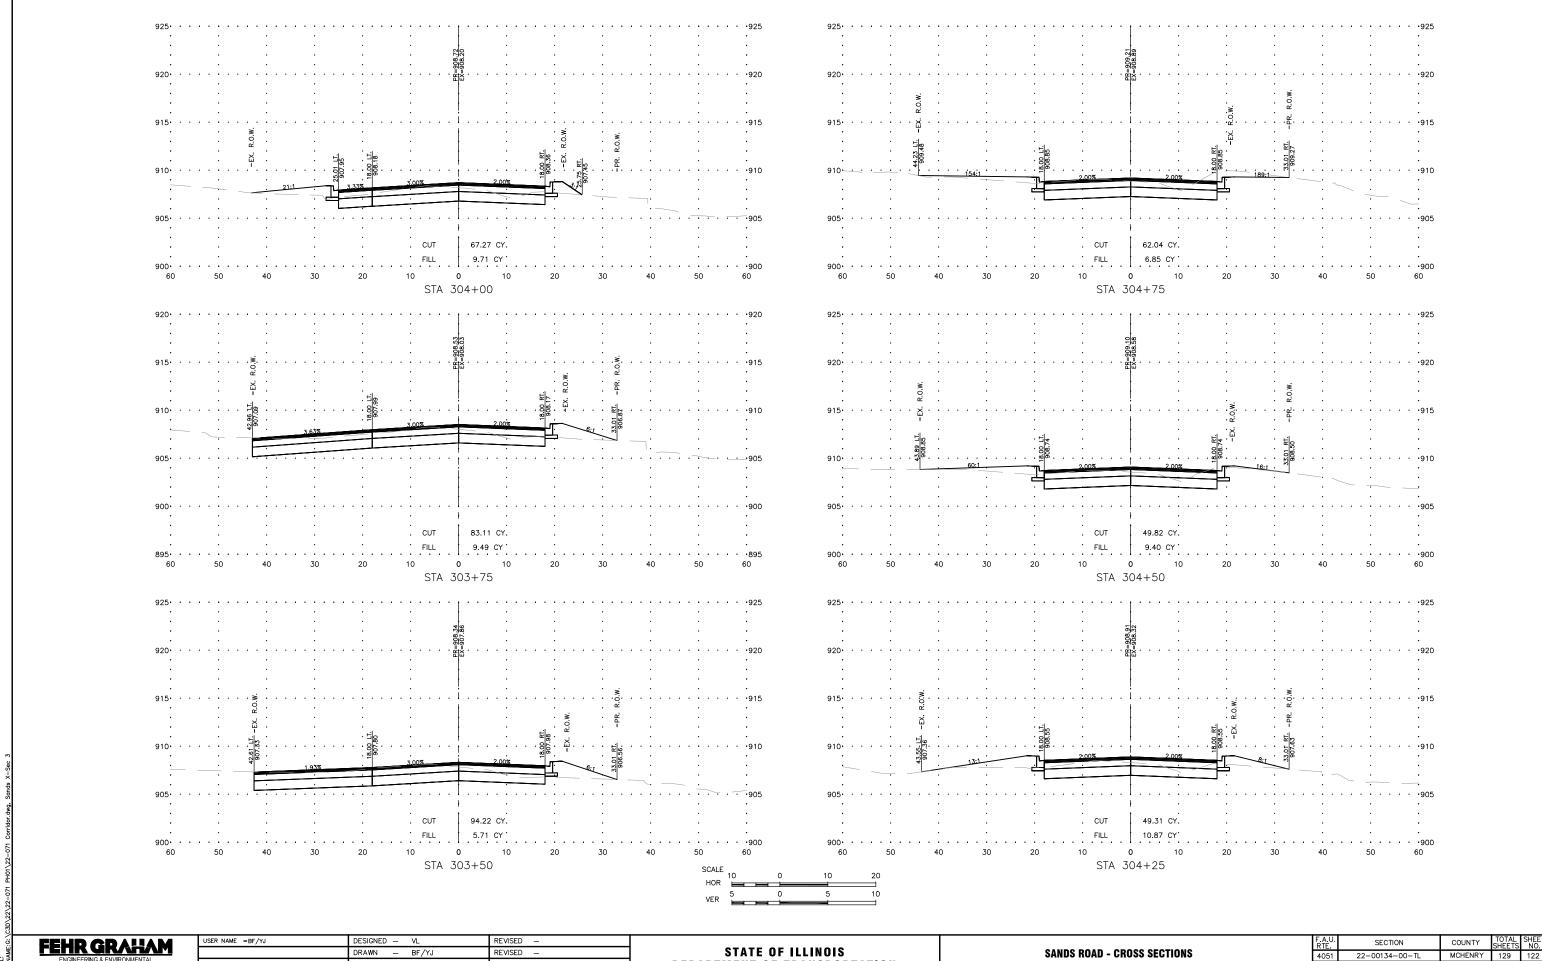SANDS ROAD - CROSS SECTIONS 4051 2 SCALE: AS NOTED SHEET122 OF 129 SHEETS STA. TO STA.							RTE.	
SCALE: AS NOTED SHEET122 OF 129 SHEETS STA. TO STA.		SAND	IS RO	AD - CROSS	SECTIO	INS	4051	:
SCALE: AS NOTED SHEET122 OF 129 SHEETS STA. TO STA.								-
	SCALE: AS NOTED	SHEET122	OF	129 SHEETS	STA.	TO STA.		




SCALE: AS NOTED SHEET123 OF 129 SHEETS STA.

TO STA.

PLOT DATE = 2/15/24

DATE - 03/01/23

REVISED

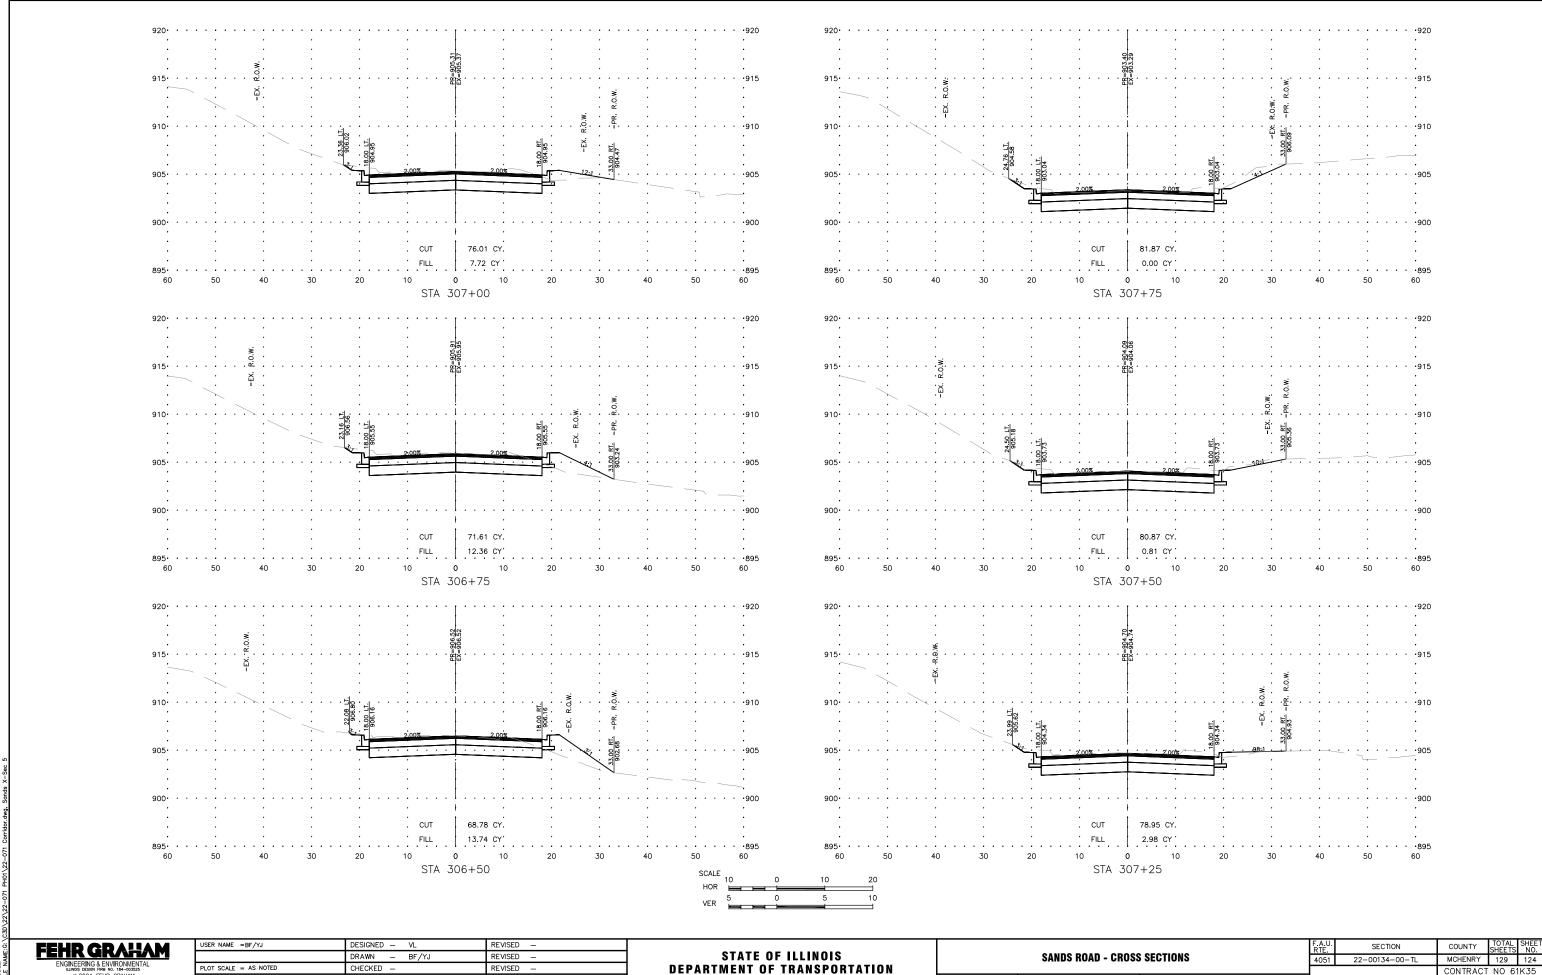


SCALE: AS NOTED SHEET124 OF 129 SHEETS STA.

TO STA.

PLOT DATE = 2/15/24

DATE - 03/01/23

REVISED

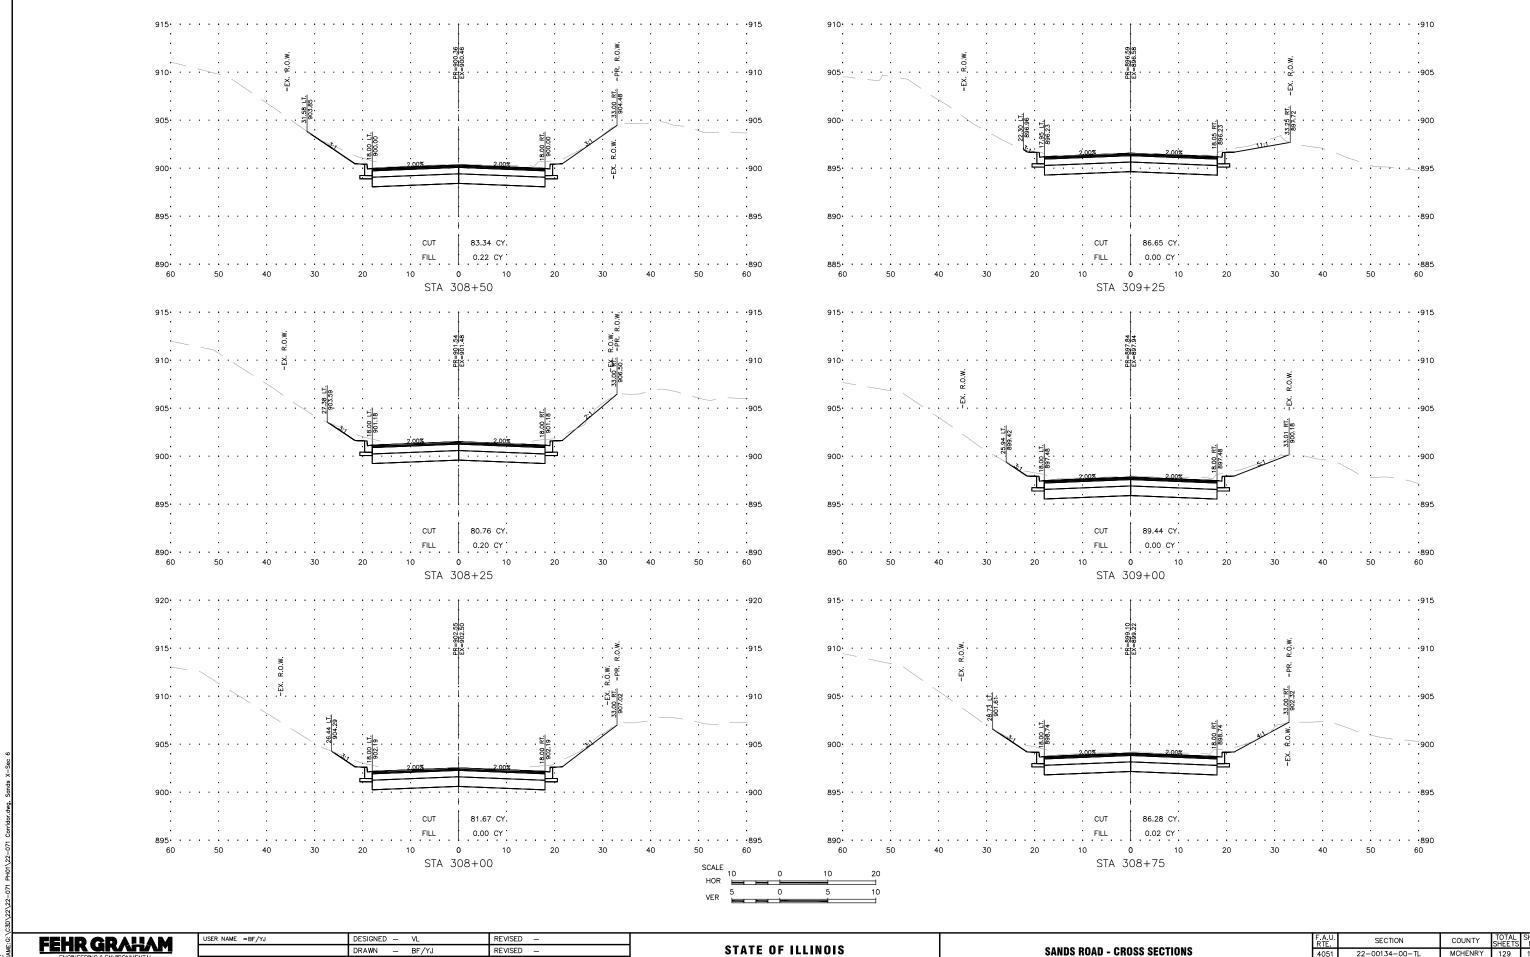


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| DRAWN - BF/YJ REVISED - | PLOT SCALE = AS NOTED | CHECKED - | REVISED - | PLOT DATE = 2/15/24 | DATE - 03/01/23 | REVISED - |

STATE OF ILLINOIS DEPARTMENT OF TRANSPORTATION

SANDS ROAD - CROSS SECTIONS								
	SCALE: AS NOTED	SHEET125	OF	129 SHEETS	STA.	TO STA.		




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STATE OF ILLINOIS DEPARTMENT OF TRANSPORTATION

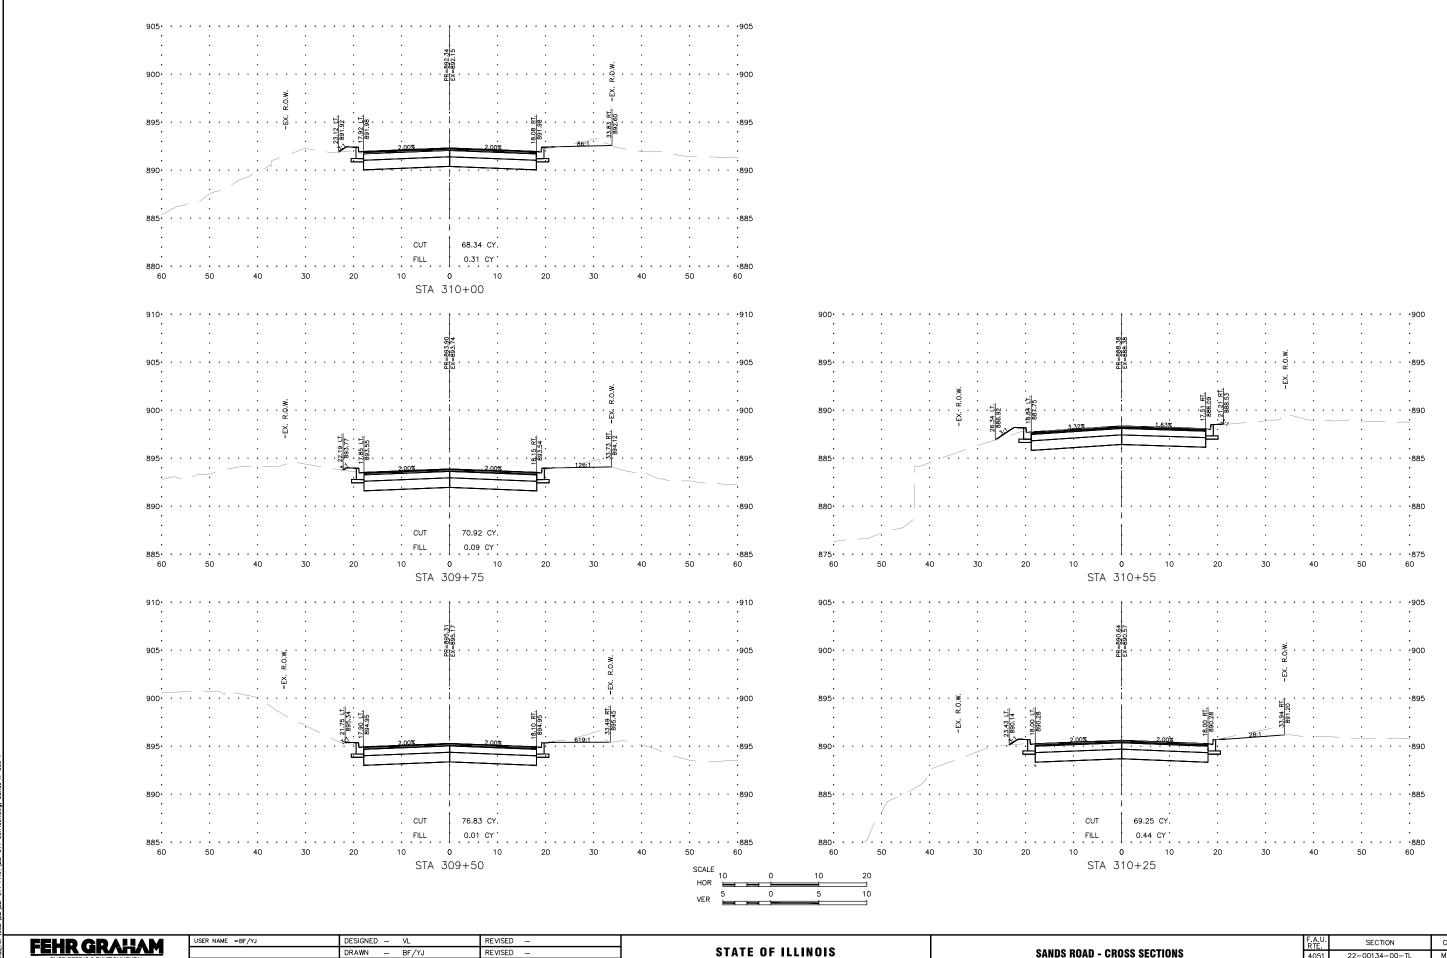
	SAND	S RO	AD - CROSS	SECTION	IS	4051	Ŀ
SCALE: AS NOTED	SHEET126	OF	129 SHEETS	STA.	TO STA.		_



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DEPARTMENT OF TRANSPORTATION

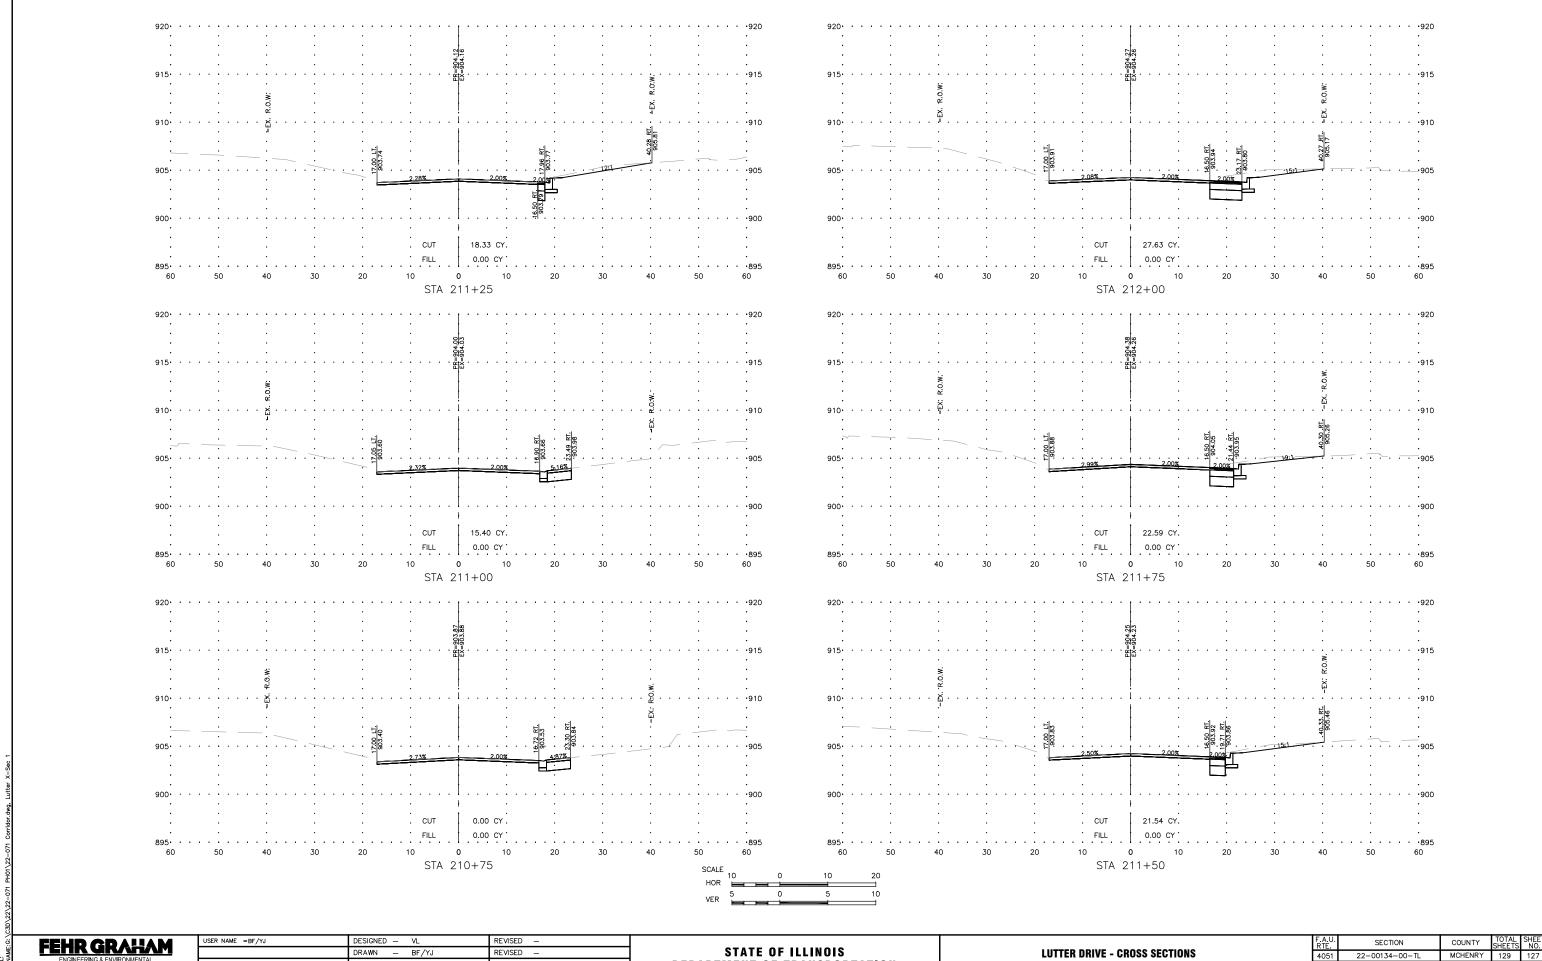SCALE: AS NOTED SHEET127 OF 129 SHEETS STA. TO STA.

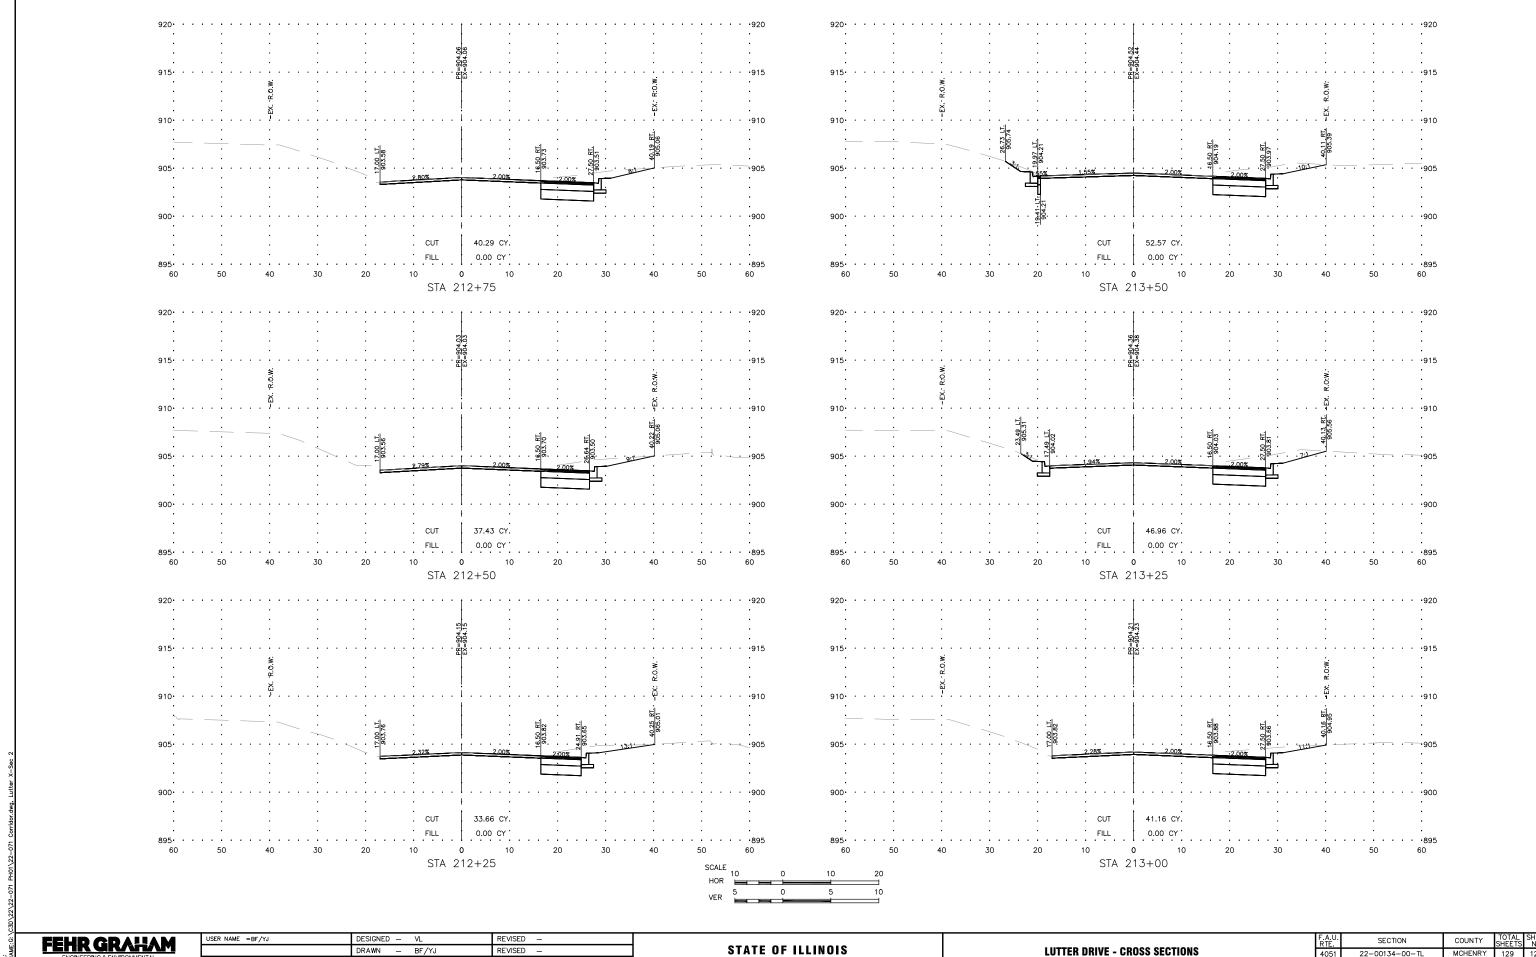


REVISED PLOT DATE = 2/15/24 DATE - 03/01/23 REVISED

DEPARTMENT OF TRANSPORTATION

	LUTTE	R DR	VE - CROS	S SECTIO	NS	4051	22-
CALE: AS NOTED	SHEET128	OF	129 SHEETS	STA.	TO STA.		

MCHENRY 129

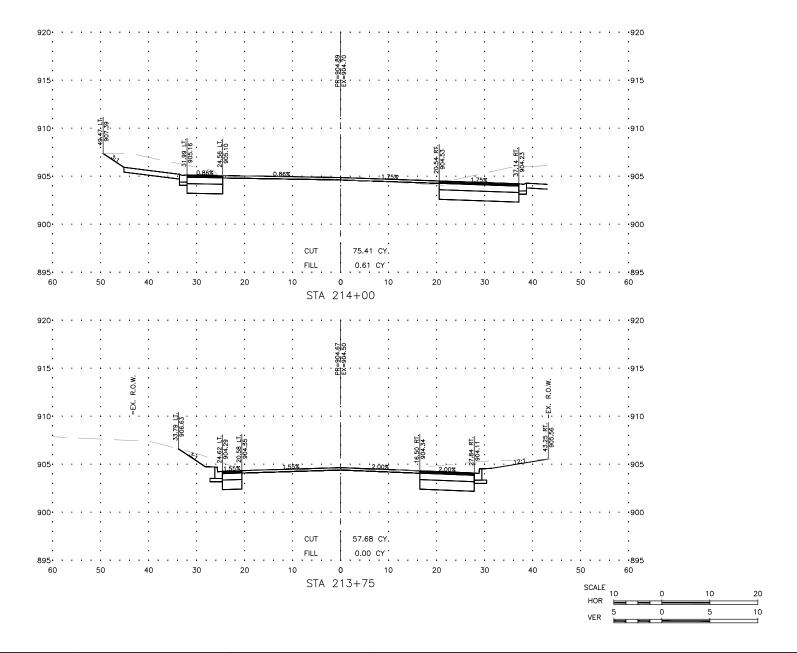

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	DRAWN -	_	BF/YJ	REVISED —
PLOT SCALE = AS NOTED	CHECKED -	_		REVISED —
PLOT DATE = 2/15/24	DATE -	-	03/01/23	REVISED —

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DEPARTMENT	0F	TRANSPORTATION

						F.A.U. RTE.	SECTION	COUNTY	TOTAL SHEETS	SHEET NO.
	LUTTE	R DR	IVE - CROSS	S SECTIONS	5	4051	22-00134-00-TL	MCHENRY	129	129
								CONTRACT	NO 6	1K35
SCALE: AS NOTED SHEET129 OF 129 SHEETS STA. TO STA.							ILLINOIS FED. A	ND PROJECT		

E NAME: G: \C3D\22\22-071 PH