STATE OF ILLINOIS

DEPARTMENT OF TRANSPORTATION

21-00041-00-RS DUPAGE ILLINOIS CONTRACT NO. 61 33

INDEX_OF_SHEETS

SEE SHEET NO. 2

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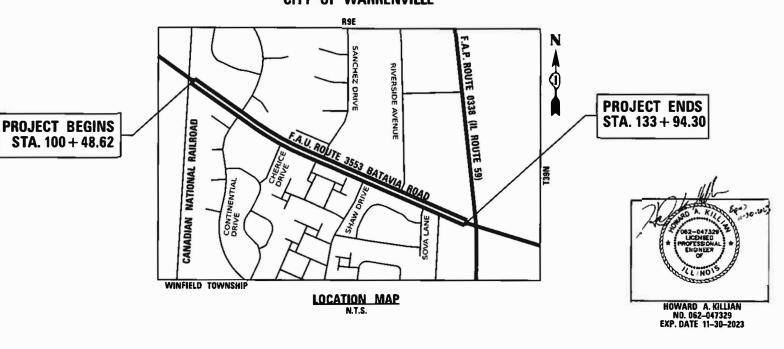
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PLANS FOR PROPOSED FEDERAL AID HIGHWAY

F.A.U. ROUTE 3553 (BATAVIA ROAD) **F.A.P. ROUTE 0338 (IL ROUTE 59) ROADWAY RESURFACING SECTION NO.: 21-00041-00-RS PROJECT NO.: D75Y(626)** CITY OF WARRENVILLE **DUPAGE COUNTY** C-91-134-22


CANADIAN NATIONAL RAILROAD TO

CITY OF WARRENVILLE



GROSS LENGTH = 3,345.68 FT. = 0.63 MILE NET LENGTH = 3,345.68 FT. = 0.63 MILE



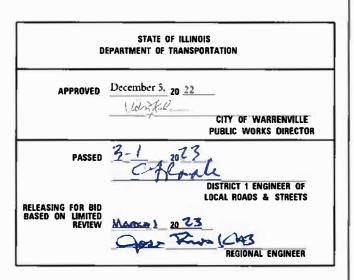

PRINTED BY THE AUTHORITY OF THE STATE OF ILLINOIS

DESIGN DESIGNATION:

BATAVIA ROAD: MINOR ARTERIAL

TRAFFIC_DATA:

BATAVIA ROAD:

ADT: 3,000 (2020)

SPEED LIMIT:

POSTED - 35 M.P.H. DESIGN - 35 M.P.H.

FULL SIZE PLANS HAVE REEN PREPARED LISING STANDARD ENGINEERING SCALES. REDUCED SIZED PLANS WILL NOT CONFORM TO STANDARD SCALES. IN MAKING MEASUREMENTS ON REDUCED PLANS, THE ABOVE SCALES MAY BE USED.

J.U.L.I.E. JOINT UTILITY LOCATION INFORMATION FOR EXCAVATION 1-800-892-0123 OR 811

AID PROGRAM ENGINEERING RESOURCE ASSOCIATES

E. RAMOS, P.E. SCHAUMBURG, IL

CARMEN

CONTRACT NO. 61J33

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24	DISTRICT ONE - DETAILS FOR FRAMES AND LIDS ADJUSTMENT W

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DISTRICT ONE - SHORT TERM PAVEMENT MARKINGS LETTERS AND SYMBOLS (TC-16) 30

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HIGHWAY STANDARDS

000001-08	STANDARD SYMBOLS, ABBREVIATIONS AND PATTERNS
001001-02	AREAS OF REINFORCEMENT BARS
001006	DECIMAL OF AN INCH AND OF A FOOT
280001-07	TEMPORARY EROSION CONTROL SYSTEMS
424001-11	PERPENDICULAR CURB RAMPS FOR SIDEWALKS
424006-05	DIAGONAL CURB RAMPS FOR SIDEWALKS
424011-04	CORNER PARALLEL CURB RAMPS FOR SIDEWALKS
424016-05	MID-BLOCK CURB RAMPS FOR SIDEWALK
424021-06	DEPRESSED CORNER FOR SIDEWALKS
424026-03	ENTRANCE / ALLEY PEDESTRIAN CROSSING
442201-03	CLASS C AND D PATCHES
604001-05	FRAME AND LIDS TYPE 1
604036-03	GRATE TYPE 8
606001-08	CONCRETE CURB TYPE B AND COMBINATION CONCRETE CURB AND GUTTER
606306-04	CORRUGATED PC CONCRETE MEDIANS
701001-02	OFF-ROAD OPERATIONS, 2L, 2W, MORE THAN 15' AWAY
701006-05	OFF-ROAD OPERATIONS, 2L, 2W, 15' TO 24" FROM PAVEMENT EDGE
701301-04	LANE CLOSURE, 2L, 2W, SHORT TIME OPERATIONS
701311-03	LANE CLOSURE, 2L, 2W, MOVING OPERATIONS - DAY ONLY
701501-06	URBAN LANE CLOSURE, 2L, 2W, UNDIVIDED
701701-10	URBAN LANE CLOSURE, MULTILANE INTERSECTION
701801-06	SIDEWALK, CORNER OR CROSSWALK CLOSURE
701901-08	TRAFFIC CONTROL DEVICES
780001-05	TYPICAL PAVEMENT MARKINGS
781001-04	TYPICAL APPLICATIONS RAISED REFLECTIVE PAVEMENT MARKERS

GENERAL NOTES

THE CONTRACTOR SHALL CONTACT THE FOLLOWING A MINIMUM OF 72 HOURS IN ADVANCE OF BEGINING WORK:

- PUBLIC WORKS DIRECTOR AT THE CITY OF WARRENVILLE AT (630) 393-9050
- ENGINEERING RESOURCE ASSOCIATES AT (630) 393-3060
- DISTRICT ONE TRAFFIC CONTROL SUPERVISOR KALPANA KANNAN-HOSADURGA AT KALPANA.KANNAN-HOSADURGA@ILLINOIS.GOV

BEFORE STARTING ANY WORK THE CONTRACTOR SHALL CALL J.U.L.I.E. AT (800) 892-0123 FOR FIELD LOCATIONS OF BUIRIED ELECTRIC, TELEPHONE, CABLE, AND GAS FACILITIES. A MINIMUM OF 48 HOURS NOTICE REQUIRED.

IT IS THE CONTRACTOR'S SOLE RESPONSIBILITY TO COORDINATE WITH THE CANADIAN NATIONAL RAILROAD WHENEVER CONSTRUCTION ACTIVITY IS WITHIN 25 FT OF THE RAILROAD ROW. THE CONTRACTOR SHALL RETAIN FLAGMEN EMPLOYED AND DESIGNATED BY THE CANADIAN NATIONAL RAILROAD TO MONITOR ON-GOING TRAIN TRAFFIC AND ADVISE CONTRACTOR PERSONNEL WHEN ACTIVITY ON OR NEAR THE RAILROAD RIGHT-OF-WAY MAY PROCEED. THIS ITEM WILL BE PAID FOR ACCORDING TO ARTICLE 107.12 AND WILL BE REIMBURSED ACCORDING TO ARTICLE 109.05.

THE CONTRACTORS SHALL COORDINATE WITH ENBRIDGE WHEN COMPLETING WORK NEAR THE OIL PIPELINE. WORK NEAR THE PIPELINE SHALL BE COMPLETED IN ACCORDANCE WITH THE CROSSING APPLICATION REQUIREMENTS, INCLUDING BUT NOT LIMITED TO THE FOLLOWING.

ALL PROPOSED EXISTING PAVEMENT REMOVAL OVER ANY ENBRIDGE PIPELINE SHALL BE COMPLETED BY DOZER, SHOVEL EXCAVATOR OR SIMILAR CONSTRUCTION MACHINERY, (MILLING IS PERMITTED.) NO HAMMERING REMOVAL METHODOLOGY WILL BE ALLOWED WITHIN TEN (10) FEET OF THE PIPELINE.

THE CONTRACTOR WILL HAVE LIMITED ACCESS FOR STORAGE OF EQUIPMENT AND/OR MATERIALS. STAGING OF EQUIPMENT AND/OR MATERIALS WITHIN THE ROW SHALL BE GRANTED ON A LIMITED BASIS TO ACCOMODATE DAILY CONSTRUCTION ACTIVITIES WITH PRIOR APPROVAL BY THE RESIDENT ENGINEER. OVERNIGHT STORAGE WITHIN THE ROW IS PROHIBITED.

IT SHALL BE THE CONTRACTOR'S RESPONSIBILITY TO VERIFY ALL DIMENSIONS AND CONDITIONS EXISTING PRIOR TO THE START OF WORK. ANY DISCREPANCIES FROM INFORMATION SHOWN ON THE PLANS SHALL BE REPORTED TO THE RESIDENT ENGINEER.

BEFORE BEGINING ANY WORK, THE CONTRCTOR SHALL RETAIN AND RECORD FOR FURTURE REFERENCE, ALL EXISTING PAVEMENT MARKING LINES, LETTERS AND SYMBOLS, AND RAISED REFLECTIVE PAVEMENT MARKERS IN ORDER THAT THESE LOCATIONS CAN BE RE-ESTABLISHED FOR RE-INSTALLATION. THE EXACT LOCATIONS OF ALL PAVEMENT MARKINGS SHALL BE APPROVED BY THE RESIDENT ENGINEER PRIOR TO RE-INSTALLATION.

CONTRACTOR SHALL TAKE PRECAUTION BY PRESERVING EXISTING TREES WITHIN THE RIGHT OF WAY. IF ANY DAMAGE OCCURS, TREES SHALL BE REPLACES IN KIND PER ARTICLE 201.07 REPAIR OR REPLACEMENT OF EXISTING PLANT MATERIAL REQUIREMENTS STATED HEREIN.

	USER NAME = rbellot	DESIGNED : rcb	REVISED -
		DRAWN rcb	REVISED -
	PLOT SCALE = 0.167 ' / in.	CHECKED - HK	REVISED -
j	PLOT DATE = 2/27/2023	DATE 2/24/2023	REVISED -

SCALE:

INDEX OF SHEETS, HIGHWAY STANDARDS, AND GENERAL NOTES					F.A.U. RTE.			COUNTY	TOTAL SHEETS	SHEET NO.				
					3553	21-00041-00-RS			DuPAGE	31	2			
	,		AND	UL.	.ITLIIAL	HUILS						CONTRACT	NO. 61	33
	SHEET	1	OF	1	SHEETS	STA.	TO STA.			ILLINOIS	FED. Al	D PROJECT		

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SPECIALTY	SP	CODE NUMBER	ITEM DESCRIPTION	PAY UNIT	TOTAL QUANTITY	ROADWAY RESURFACING 0005 URBAN	TRAINEES 0042 URBAN
		20200100	EARTH EXCAVATION	CU YD	200	200	
		25100630	EROSION CONTROL BLANKET	SQ YD	680	680	
	*	25200200	SUPPLEMENTAL WATERING	UNIT	10	10	
		28000510	INLET FILTERS	EACH	22	22	
		28000250	TEMPORARY EROSION CONTROL SEEDING	POUND	5	5	
		31101200	SUBBASE GRANULAR MATERIAL, TYPE B 4"	SQ YD	1,110	1,110	· · · · · · · · · · · · · · · · · · ·
		35501308	HOT-MIX ASPHALT BASE COURSE, 6"	SQ YD	130	130	
			·				
		35501316	HOT-MIX ASPHALT BASE COURSE, 8"	SQ YD	170	170	
		40201000	AGGREGATE FOR TEMPORARY ACCESS	TON	240	240	
				-	-		•
		40600290	BITUMINOUS MATERIALS (TACK COAT)	POUND	6,300	6,300	
		40600370	LONGITUDINAL JOINT SEALANT	FOOT	5,700	5,700	
,,		40600400	MIXTURE FOR CRACKS, JOINTS, AND FLANGEWAYS	TON	10	10	
		40600900	HOT-MIX ASPHALT BINDER COURSE (HAND METHOD), N50	TON	5	5	
		40600982	HOT-MIX ASPHALT SURFACE REMOVAL - BUTT JOINT	SQ YD	130	130	
		40603200	POLYMERIZED HOT-MIX ASPHALT BINDER COURSE, IL-4.75, N50	TON	710	710	
		40604060	HOT-MIX ASPHALT SURFACE COURSE, IL-9.5, MIX "D", N50	TON	1,450	1,450	
					* '		

EN	GINEERING DURCE ASSOCIATES
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USER NAME = rbeflot	DESIGNED - rcb	REVISED -
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PLOT DATE == 2/27/2023	DATE 2/24/2023	REVISED -

STATE OF ILLINOIS DEPARTMENT OF TRANSPORTATION

SCALE:

								RTÉ.	58
	SUMMARY OF QUANTITIES							3553	21-000
	SHEET	1	QF	5	SHEETS	STA.	TO STA.		

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SPECIALTY	SP	CODE NUMBER	ITEM DESCRIPTION	PAY UNIT	TOTAL QUANTITY	ROADWAY RESURFACING 0005 URBAN	TRAINEES 0042 URBAN
		42001300	PROTECTIVE COAT	SQ YD	1,130	1,130	
	*	42300500	PORTLAND CEMENT CONCRETE DRIVEWAY PAVEMENT, 9 INCH	SQ YD	195	195	
	. *	42400200	PORTLAND CEMENT CONCRETE SIDEWALK 5 INCH	SQ FT	4,400	4,400	
	*	40.400.400					
	•	42400400	PORTLAND CEMENT CONCRETE SIDEWALK 7 INCH	SQ FT	200	200	
	*	42400435	PORTLAND CEMENT CONCRETE SIDEWALK 10 INCH	SQ FT	920	920	
		42400433	PORTLAND CEMENT CONCRETE SIDEWALK TO INCH	aQ F1	920	920	
		42400800	DETECTABLE WARNINGS	SQ FT	360	360	
		44000161	HOT-MIX ASPHALT SURFACE REMOVAL, 3"	SQ YD	12,300	12,300	
					,		
		44000200	DRIVEWAY PAVEMENT REMOVAL	SQ YD	540	540	
		44000600	SIDEWALK REMOVAL	SQ FT	4,730	4,730	
		44003100	MEDIAN REMOVAL	SQ FT	110	110	
		44201690	CLASS D PATCHES, TYPE I, 4 INCH	SQ YD	200	200	
		44201692	CLASS D PATCHES, TYPE II, 4 INCH	SQ YD	200	200	
		44004004	CLACO D DATOUES TYPE III. A INCIL	CO VD	200	200	
		44201694	CLASS D PATCHES, TYPE III, 4 INCH	SQ YD	200	200	
		44201696	CLASS D PATCHES, TYPE IV, 4 INCH	SQ YD	400	400	
		77201030	ob do b 1711 one o, 111 ETV, 4114011	30(1)	400		
		48101200	AGGREGATE SHOULDERS, TYPE B	TON	220	220	
	1	·····	1	<u> </u>	I	<u> </u>	

ENGINEERING RESOURCE ASSOCIATES

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STATE OF ILLINOIS					
DEPARTMENT OF TRANSPORTATION					

SCALE:

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SHEET	2	OF 5	SHEETS	STA.	TO STA.	Г

	F.A.U. RTE.	SECTION	COUNTY	TOTAL SHEETS	SHEET NO.				
	3553	21-00041-00-R5	DuPAGE	31	4				
			CONTRACT NO. 61J33						
	ILLINOIS FED. AID PROJECT								
Long Section Number									

	,			7		}	
SPECIALTY	SP	CODE NUMBER	ITEM DESCRIPTION	PAY UNIT	TOTAL QUANTITY	ROADWAY RESURFACING 0005 URBAN	TRAINEES 0042 URBAN
		60250200	CATCH BASINS TO BE ADJUSTED	EACH	2	2	· ·
		60251200	CATCH BASINS TO BE ADJUSTED WITH NEW TYPE 8 GRATE	EACH	2	2	
		00231200	CATCITIBATING TO BE ADSOLLED WITH NEW TITLE BOTATE	D. TOTT		2	
		60255500	MANHOLES TO BE ADJUSTED	EACH	4	4	
		60260100	INLETS TO BE ADJUSTED	EACH	1	1	
		60624600	CORRUGATED MEDIAN	SQ FT	90	90	
*							
*		66900200	NON-SPECIAL WASTE DISPOSAL	CU YD	100	100	
*		66900530	SOIL DISPOSAL ANALYSIS	EACH	1	1	
		00300330	SOLE DIGFOGAL AVALTOIS	LACIT	. '	<u>'</u>	
*		66901001	REGULATED SUBSTANCES PRE-CONSTRUCTION PLAN	L SUM	1	1	
*		66901003	REGULATED SUBSTANCES FINAL CONSTRUCTION REPORT	LSUM	1	1	
*		66901006	REGULATED SUBSTANCES MONITORING	CAL DA	5	5	
		67100100	MOBILIZATION	L SUM	1	1	
		70102620	TRAFFIC CONTROL AND PROTECTION, STANDARD 701501	L SUM	1	1	
		10102020	TO STATE OF A POST TO TESTION, STATEDARD 101001	LOON	,	'	
		70102635	TRAFFIC CONTROL AND PROTECTION, STANDARD 701701	L SUM	1	1	
		70102640	TRAFFIC CONTROL AND PROTECTION, STANDARD 701801	L SUM	1	1	
		70300100	SHORT TERM PAVEMENT MARKING	FOOT	1,500	1,500	
					<u>-</u>		
		70300150	SHORT TERM PAVEMENT MARKING REMOVAL	SQ FT	50	50	
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ENGINEERING RESOURCE ASSOCIATES

USER NAME = rbellot	DESIGNED - rcb	REVISED -
	DRAWN + rcb	REVISED -
PLOT SCALE = 0.167 '/in.	CHECKED - HK	REVISED -
PLOT DATE == 2/27/2023	DATE 2/24/2023	REVISED -

STATE OF ILLINOIS
DEPARTMENT OF TRANSPORTATION

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	SUMMA	RY OF	QUANTIT	ES
SHEET 3	OF.	5 SHE	ETS STA	TO STA

_	F.A.U. RTE.	SECTION	COUNTY	TOTAL SHEETS	SHEET NO.
	3553	21-00041-00-RS	DuPAGE	31	5
_			CONTRACT	NO. 61	33
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	7				20% LOCAL		
SPECIALTY	SP	CODE NUMBER	ITEM DESCRIPTION	PAY UNIT	TOTAL QUANTITY	ROADWAY RESURFACING 0005 URBAN	TRAINEES 0042 URBAN
		70300211	TEMPORARY PAVEMENT MARKING LETTERS AND SYMBOLS - PAINT	SQ FT	325	325	
		70300221	TEMPORARY PAVEMENT MARKING - LINE 4"- PAINT	FOOT	9,700	9,700	
				7.00.	0,100	0,700	
		70300241	TEMPORARY PAVEMENT MARKING - LINE 6"- PAINT	FOOT	690	690	
		70300261	TEMPORARY PAVEMENT MARKING - LINE 12"- PAINT	FOOT	1,000	1,000	
raktir ka serora errotamono - gagaja orrat				1 001	1,000	1,000	
		70300281	TEMPORARY PAVEMENT MARKING - LINE 24"- PAINT	FOOT	120	120	
*		78000100	THERMOPLASTIC PAVEMENT MARKING - LETTERS AND SYMBOLS	SQ FT	325	325	
							······
*		78000200	THERMOPLASTIC PAVEMENT MARKING - LINE 4"	FOOT	9,700	9,700	
*		78000400	THERMOPLASTIC PAVEMENT MARKING - LINE 6"	FOOT	1,290	1,290	
*		78000600	THERMOPLASTIC PAVEMENT MARKING - LINE 12"	FOOT	1,000	1,000	
*		78000650	THERMOPLASTIC PAVEMENT MARKING - LINE 24"	FOOT	120	120	
*		78100100	RAISED REFLECTIVE PAVEMENT MARKER	EACH	107	107	
					101	107	
		78300200	RAISED REFLECTIVE PAVEMENT MARKER REMOVAL	EACH	107	107	
		78300201	PAVEMENT MARKING REMOVAL - GRINDING	SQ FT	120	120	
						-	
		89502380	REMOVE EXISTING HANDHOLE	EACH	1	1	
	*	X2110104	TOPSOIL FURNISH AND PLACE, 4" (SPECIAL)	SQ YD	680	680	
	*	X2500920	SEEDING, CLASS 1A (SPECIAL)	ACRE	0.14	0.14	

ENGINEERING RESOURCE ASSOCIATES

USER NAME = rbeliot	DESIGNED + rcb	REVISED -
	DRAWN - rcb	REVISED -
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5CALE:

	SUMMARY OF QUANTITIES								SECTION	COUNTY TOTAL SH		SHEET NO.
									3553 21-00041-00-R5 (31	6
										CONTRAC	F NO. 61)	33
	SHEET	4	OF	5	SHEETS	STA.	TO STA.	ILLINOIS FED. AID PROJECT				
								Ann Sa	ction Number			

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SPECIALTY	SP	CODE NUMBER	ITEM DESCRIPTION	PAY UNIT	TOTAL QUANTITY	ROADWAY RESURFACING 0005 URBAN	TRAINEES 0042 URBAN	
	*	X4400221	CURB REMOVAL AND REPLACEMENT LESS THAN OR EQUAL TO 10 FEET	FOOT	50	50		
	*	X4400223	CURB REMOVAL AND REPLACEMENT GREATER THAN 10 FEET	FOOT	60	60		
	*	X4400501	COMBINATION CURB AND GUTTER REMOVAL AND REPLACEMENT LESS THAN OR EQUAL TO 10 FEET	FOOT	50	50		
	*	X4400503	COMBINATION CURB AND GUTTER REMOVAL AND REPLACEMENT GREATER THAN 10 FEET	FOOT	1,250	1,250		
				1001	1,200	1,200		
	*	X6026056	SANITARY MANHOLES TO BE ADJUSTED WITH NEW TYPE 1 FRAME, CLOSED LID	EACH	2			
		7,0020000	ONATACT MANIFOLIS TO BE ADJUSTED WITH NEW TIPE T FRANCE, GEOSED LID	EACH		2		
	*	X6030310	EDAMES AND LIPS TO BE ADJUSTED (SPECIAL)	54011	_	_		
		V0020210	FRAMES AND LIDS TO BE ADJUSTED (SPECIAL)	EACH	2	2		
	*	70040700						
		Z0013798	CONSTRUCTION LAYOUT	L SUM	1	1		
	*	Z0030850	TEMPORARY INFORMATION SIGNING	SQ FT	52	52		
	*	Z0048665	RAILROAD PROTECTIVE LIABILITY INSURANCE	LSUM	1	1		
	*	Z0076600	TRAINEES	HOUR	500		500	
	*	Z0076604	TRAINEES TRAINING PROGRAM GRADUATE	HOUR	500		500	
					***************************************		***************************************	


ENGINEERING RESOURCE ASSOCIATES

USER NAME = rbelfot	DESIGNED -	rcb	REVISED	-
	DRAWN -	rcb	REVISED	~
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 PLOT DATE == 2/27/2023	DATE 2/2	24/2023	REVISED	*

STATE OF ILLINOIS DEPARTMENT OF TRANSPORTATION


SCALE;

SHEET 5	OF 5	SHEETS	STA.	TO STA.		22-00041
\$	F.A.U. RTE. 3553	21-00041				

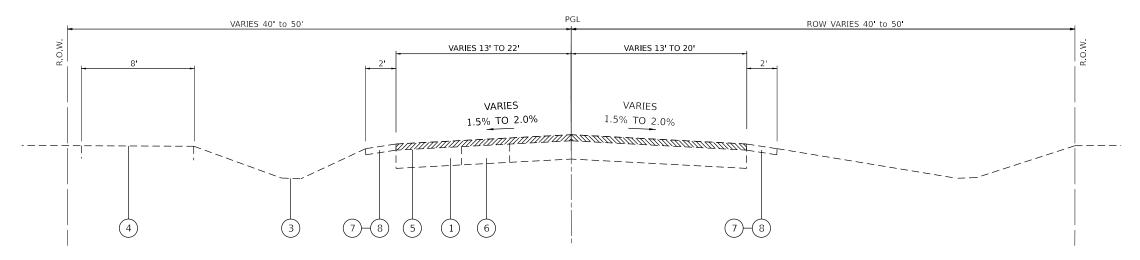

EXISITING TYPICAL SECTION BATAVIA ROAD

STA. 100+48.62 TO STA. 128+38.82, LT. STA. 100+48.62 TO STA. 128+92.91, RT.

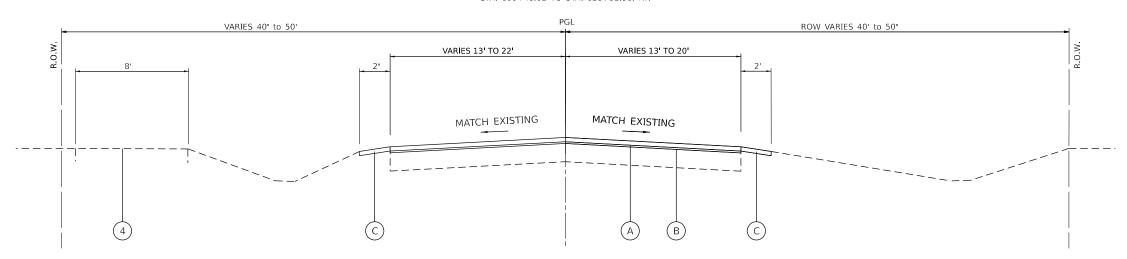

PROPOSED TYPICAL SECTION

BATAVIA ROAD

STA. 100+48.62 TO STA. 128+38.82, LT. STA. 100+48.62 TO STA. 128+92.91, RT.

HOT-MIX ASPHALT MIXTURE REQUIREMENTS

MIXTURE TYPE	AIR VOIDS @Ndes	QMP
PAVEMENT RESURFACING		
HOT-MIX ASPHALT SURFACE COURSE, IL-9.5, MIX "D", N50	4% @ 50 Gyr.	LR1030-2
POLYMERIZED HOT-MIX ASPHALT BINDER COURSE, IL-4.75, N50	3.5% @ 50 Gyr.	LR1030-2
PAVEMENT PATCHING - CLASS D PATCHES		
HOT-MIX ASPHALT BINDER, IL-19mm	4% @ 50 Gyr.	LR1030-2
HAND METHOD BINDER		
HOT-MIX ASPHALT BINDER COURSE (HAND METHOD), N50 (IL-9.5)	4% @ 50 Gyr.	LR1030-2
HMA DRIVEWAY PAVEMENT		
HOT-MIX ASPHALT SURFACE COURSE, IL-9.5, MIX "D", N50, 2"	4% @ 50 Gyr.	LR1030-2
HMA BASE COURSE (HMA BINDER, IL-19mm); PE-6" AND CE-8"	4% @ 50 Gyr.	LR1030-2
QMP DESIGNNATION: QUALITY CONTROL / QUANLITY ASSURANCE (QC/QA) PER LR 1030-2		

NOTES

- 1 -THE UNIT WEIGHT USED TO CALCULATE ALL HMA SURFACE MIXTURE QUANTITIES IS 112 LBS/SQ YD/IN.
- 2 THE "AC TYPE" FOR POLYMERIZED HMA MIXES SHALL BE "SBS/SBR PG 76-22" AND FOR NON-POLYMERIZED HMA THE "AC TYPE" SHALL BE "PG 64-22" UNLESS MODIFIED BY RECLAIMED MATERIALS SPECIFICATIONS
- 3 THE LONGITUDINAL JOINT SEALANT SHALL BE PLACED OVER THE POLYMERIZED HMA BINDER COURSE, IL-4.75, N50.

EXISTING AND REMOVAL LEGEND

- 1 EXISTING HMA PAVEMENT (7")
- 2 EXISTING CONCRETE CURB AND GUTTER
- 3 EXISTING GROUND
- 4 EXISTING PCC SIDEWALK
- 5 HOT-MIX ASPHALT SURFACE REMOVAL, 3" (SQ YD)
- 6 CLASS D PATCHES, 4" (SQ YD) (AT LOCATIONS DIRECTED BY THE ENGINEER)
- 7 EXISTING AGGREGATE SHOULDER
- 8 EARTH EXCAVATION

PROPOSED LEGEND

- A HOT-MIX ASHPALT SURFACE COURSE MIX "D", IL-9.5,
 N50 (2") (TON)
- B POLYMERIZED HOT-MIX ASPHALT BINDER COURSE, $IL\text{-}4.75, \ N50 \ (1 \ \) \ (TON)$
- C AGGREGATE SHOULDERS, TYPE B (TON) (AT LOCATIONS DIRECTED BY THE ENGINEER)

NOTES

A QUANTITY FOR THE FOLLOWING ITEMS HAVE BEEN INCLUDED IN THE CONTRACT FOR USE AS DIRECTED BY THE ENGINEER DURING CONTRUCTION:


- SIDEWALK REMOVAL (SQ FT)
- PORTLAND CEMENT CONCRETE SIDEWALK 5 INCH (SQ FT)
- PORTLAND CEMENT CONCRETE SIDEWALK 7 INCH (SQ FT)
- PORTLAND CEMENT CONCRETE SIDEWALK 10 INCH (SQ FT)
- COMBINATION CURB AND GUTTER REMOVAL AND REPLACEMENT LESS THAN OR EQUAL TO 10 FEET (FOOT)
- COMBINATION CURB AND GUTTER REMOVAL AND REPLACEMENT GREATER THAN 10 FEET (FOOT)
- CURB REMOVAL AND REPLACEMENT LESS THAN OR EQUAL
- CURB REMOVAL AND REPLACEMENT GREATER THAN 10 FEET (FOOT)

ENGINEERING RESOURCE ASSOCIATES

USER NAME = rbellot	DESIGNED - rcb	REVISED -
	DRAWN - rcb	REVISED -
PLOT SCALE = 0.167 ' / In	CHECKED - HK	REVISED -
PLOT DATE = 2/28/2023	DATE 2/24/2023	REVISED -

STATE OF ILLINOIS
DEPARTMENT OF TRANSPORTATION


						F.A.U. RTE.	SECTION	COUNTY	TOTAL SHEETS	SHEET NO.	
TYPICAL SECTIONS							21-00041-00-RS		DuPAGE	31	8
									CONTRACT	NO. 61	33
	SHEET 1	OF 2	SHEETS	STA.	TO STA.		ILLINOIS	FED. A	D PROIECT		

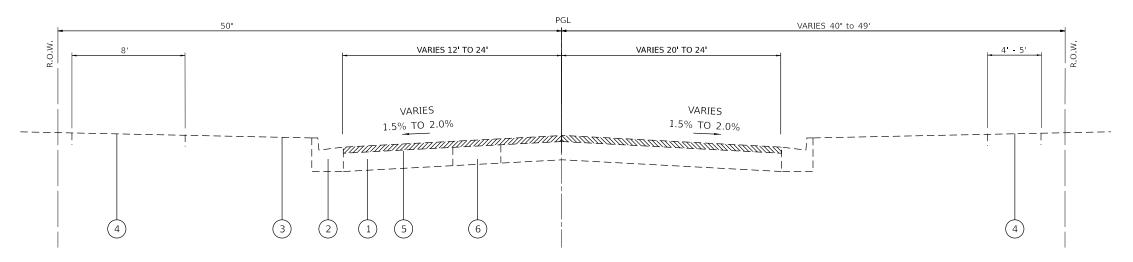

EXISTING TYPICAL SECTION

BATAVIA ROAD

STA. 128+38.82, LT. TO STA. 133+94.30 STA. 128+92.91, RT. TO STA. 133+94.30

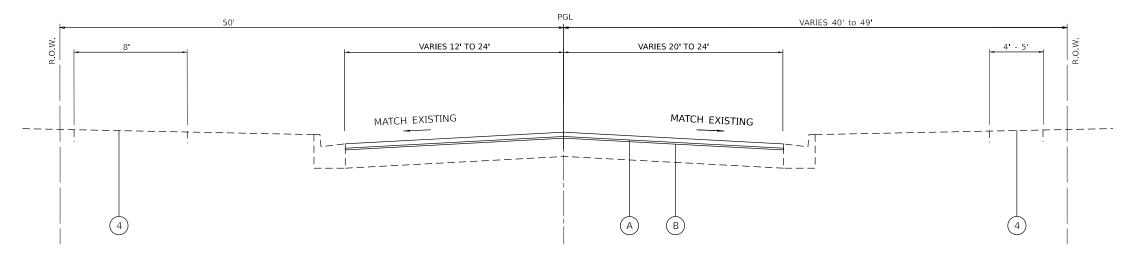

PROPOSED TYPICAL SECTION

BATAVIA ROAD

STA. 128+38.82, LT. TO STA. 133+94.30 STA. 128+92.91, RT. TO STA. 133+94.30

EXISTING AND REMOVAL LEGEND

- 1 EXISTING HMA PAVEMENT (7")
- 2 EXISTING CONCRETE CURB AND GUTTER
- 3 EXISTING GROUND
- 4 EXISTING PCC SIDEWALK
- 5 HOT-MIX ASPHALT SURFACE REMOVAL, 3" (SQ YD)
- 6 CLASS D PATCHES, 4" (SQ YD) (AT LOCATIONS DIRECTED BY THE ENGINEER)
- 7 EXISTING AGGREGATE SHOULDER
- 8 EARTH EXCAVATION

PROPOSED LEGEND

- A HOT-MIX ASHPALT SURFACE COURSE MIX "D", IL-9.5, N50 (2") (TON)
- B POLYMERIZED HOT-MIX ASPHALT BINDER COURSE, IL-4.75, N50 (1") (TON)
- C AGGREGATE SHOULDERS, TYPE B (TON) (AT LOCATIONS DIRECTED BY THE ENGINEER)

NOTES

A QUANTITY FOR THE FOLLOWING ITEMS HAVE BEEN INCLUDED IN THE CONTRACT FOR USE AS DIRECTED BY THE ENGINEER DURING CONTRUCTION:

- SIDEWALK REMOVAL (SQ FT)
- PORTLAND CEMENT CONCRETE SIDEWALK 5 INCH (SQ FT)
- PORTLAND CEMENT CONCRETE SIDEWALK 7 INCH (SQ FT)
- PORTLAND CEMENT CONCRETE SIDEWALK 10 INCH (SQ FT)
- COMBINATION CURB AND GUTTER REMOVAL AND REPLACEMENT LESS THAN OR EQUAL TO 10 FEET (FOOT)
- COMBINATION CURB AND GUTTER REMOVAL AND REPLACEMENT GREATER THAN 10 FEET (FOOT)
- CURB REMOVAL AND REPLACEMENT LESS THAN OR EQUAL TO 10 FEET (FOOT)
- CURB REMOVAL AND REPLACEMENT GREATER THAN 10 FEET (FOOT)


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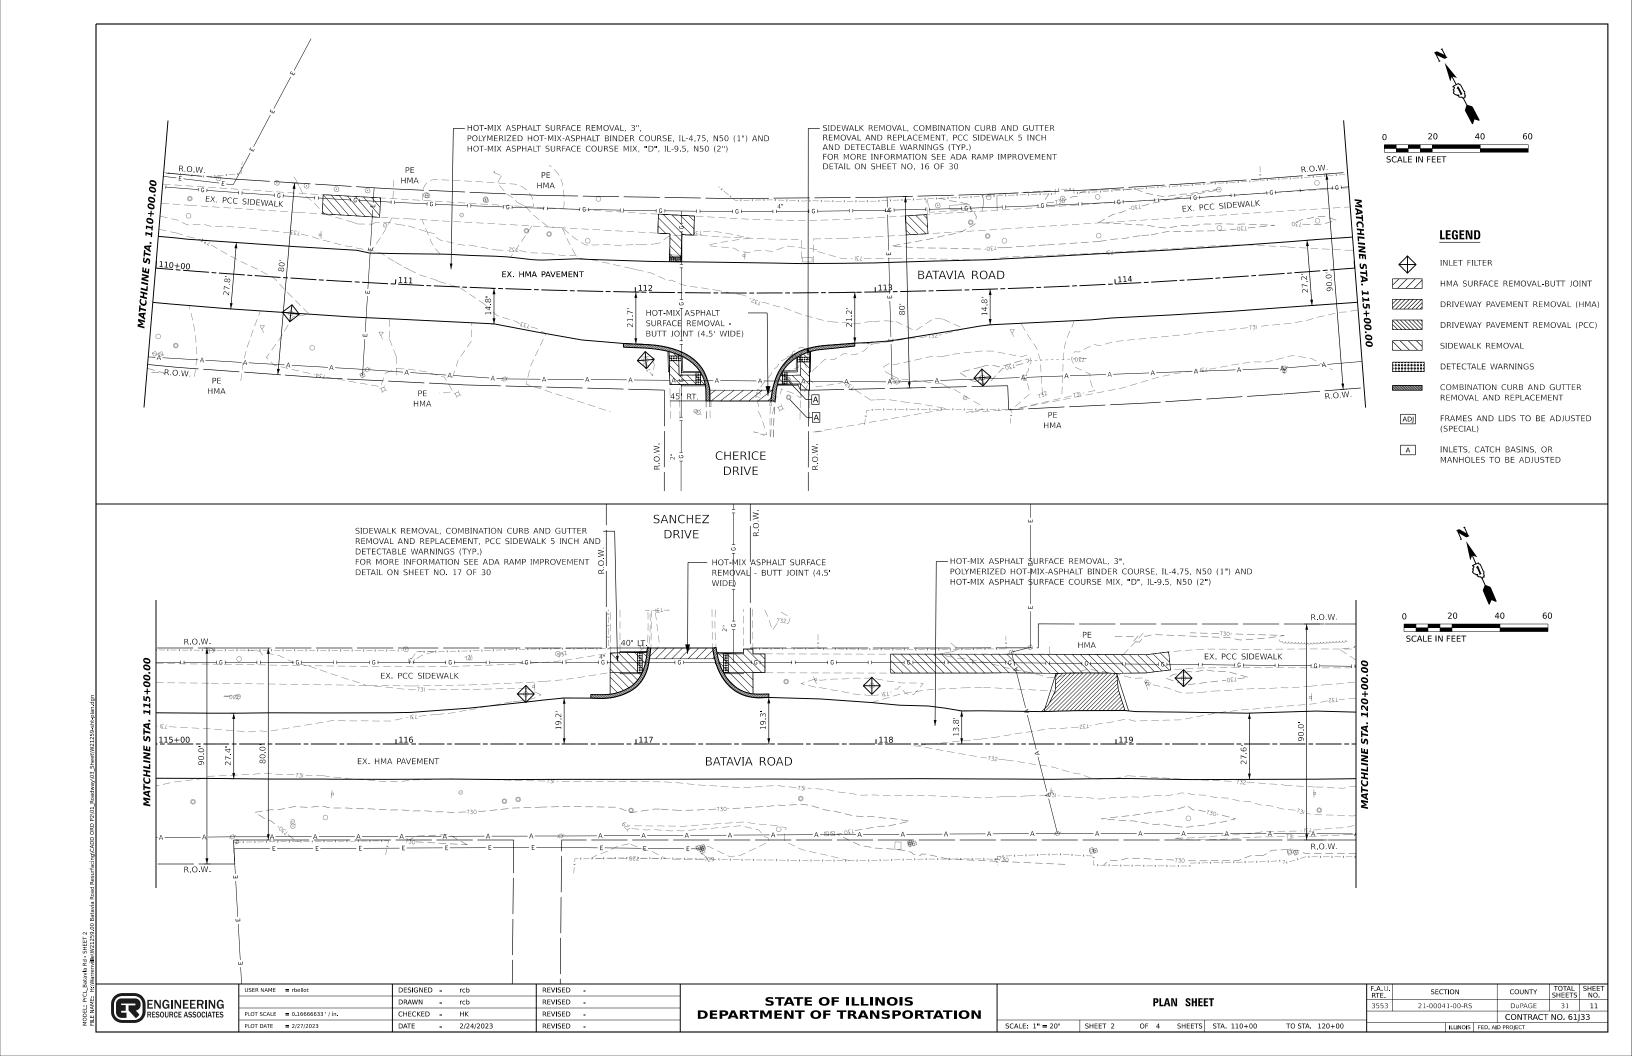
STATE OF ILLINOIS DEPARTMENT OF TRANSPORTATION


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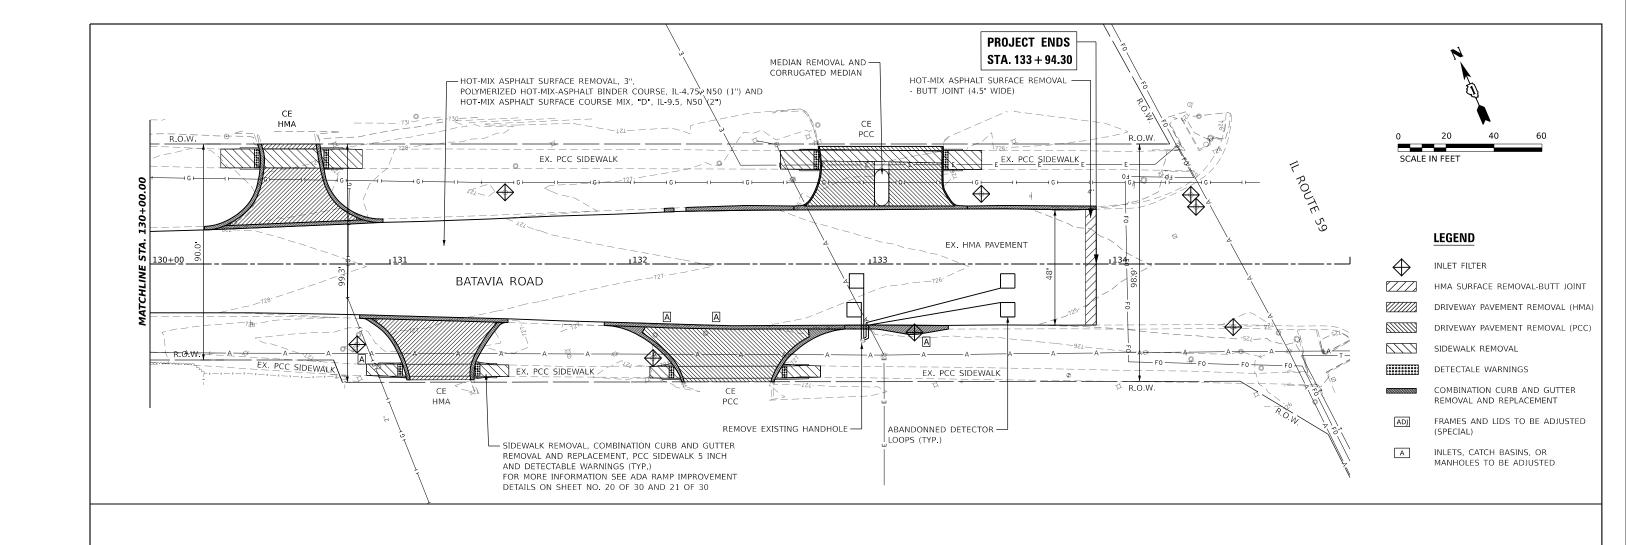
SCALE:

SECTION COUNTY 31 9 21-00041-00-RS DuPAGE CONTRACT NO. 61J33





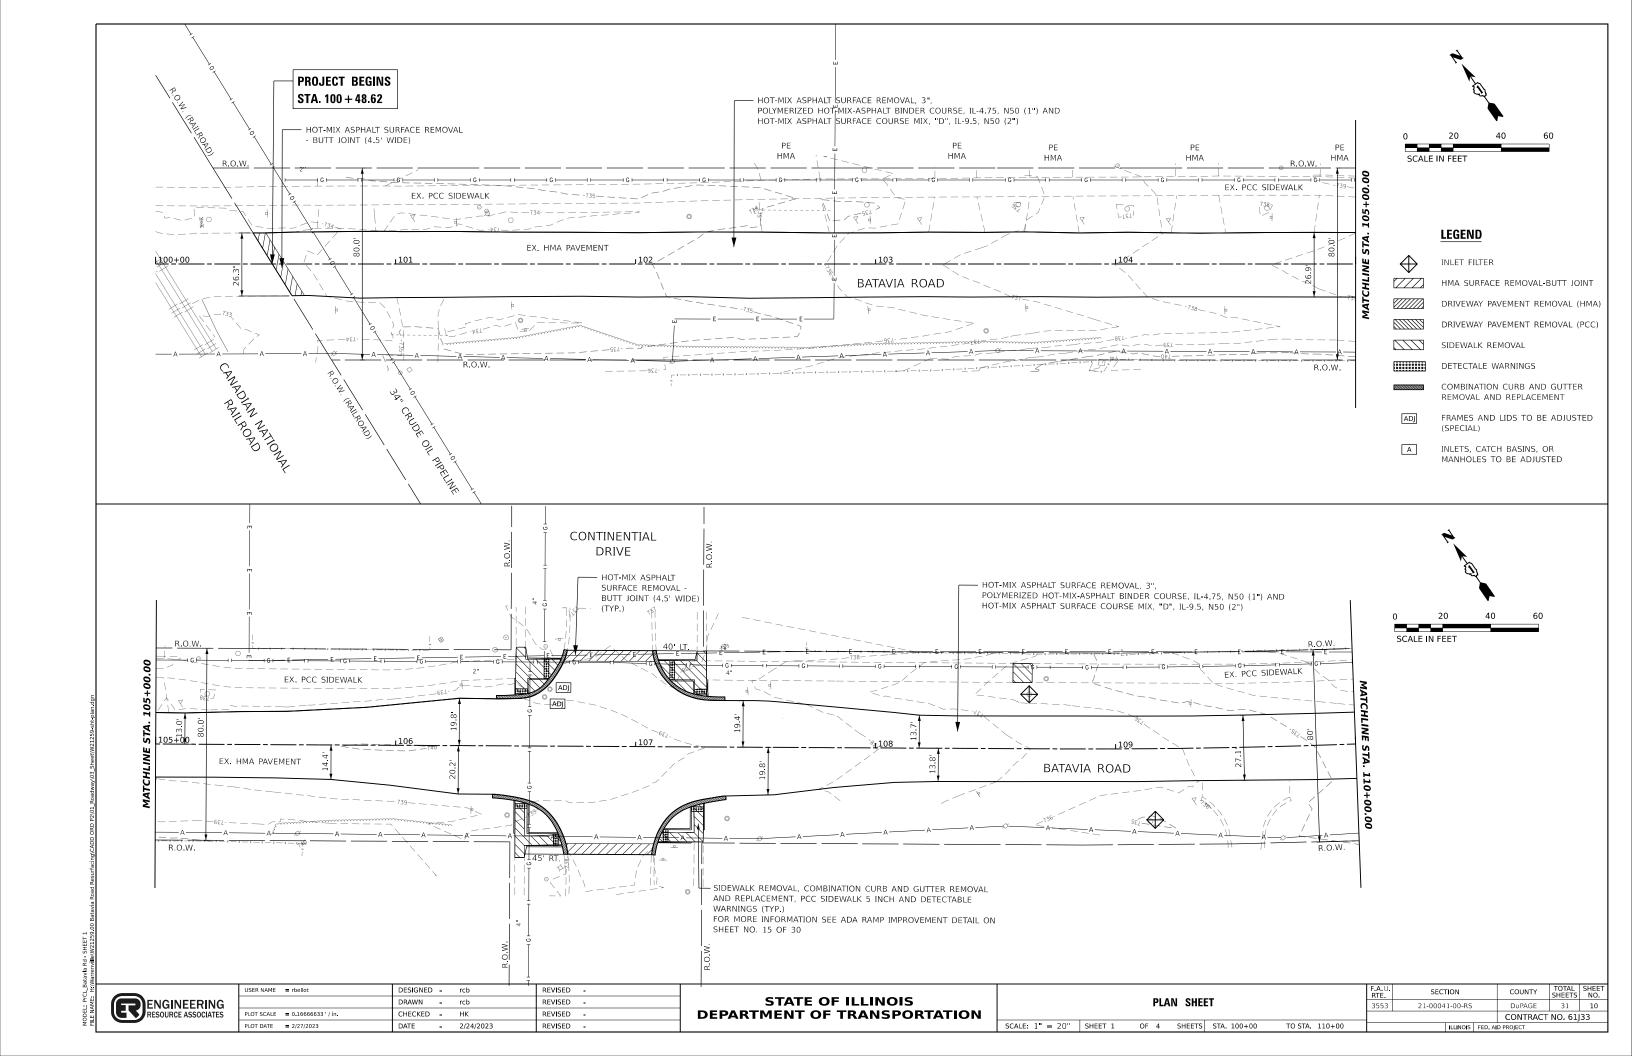

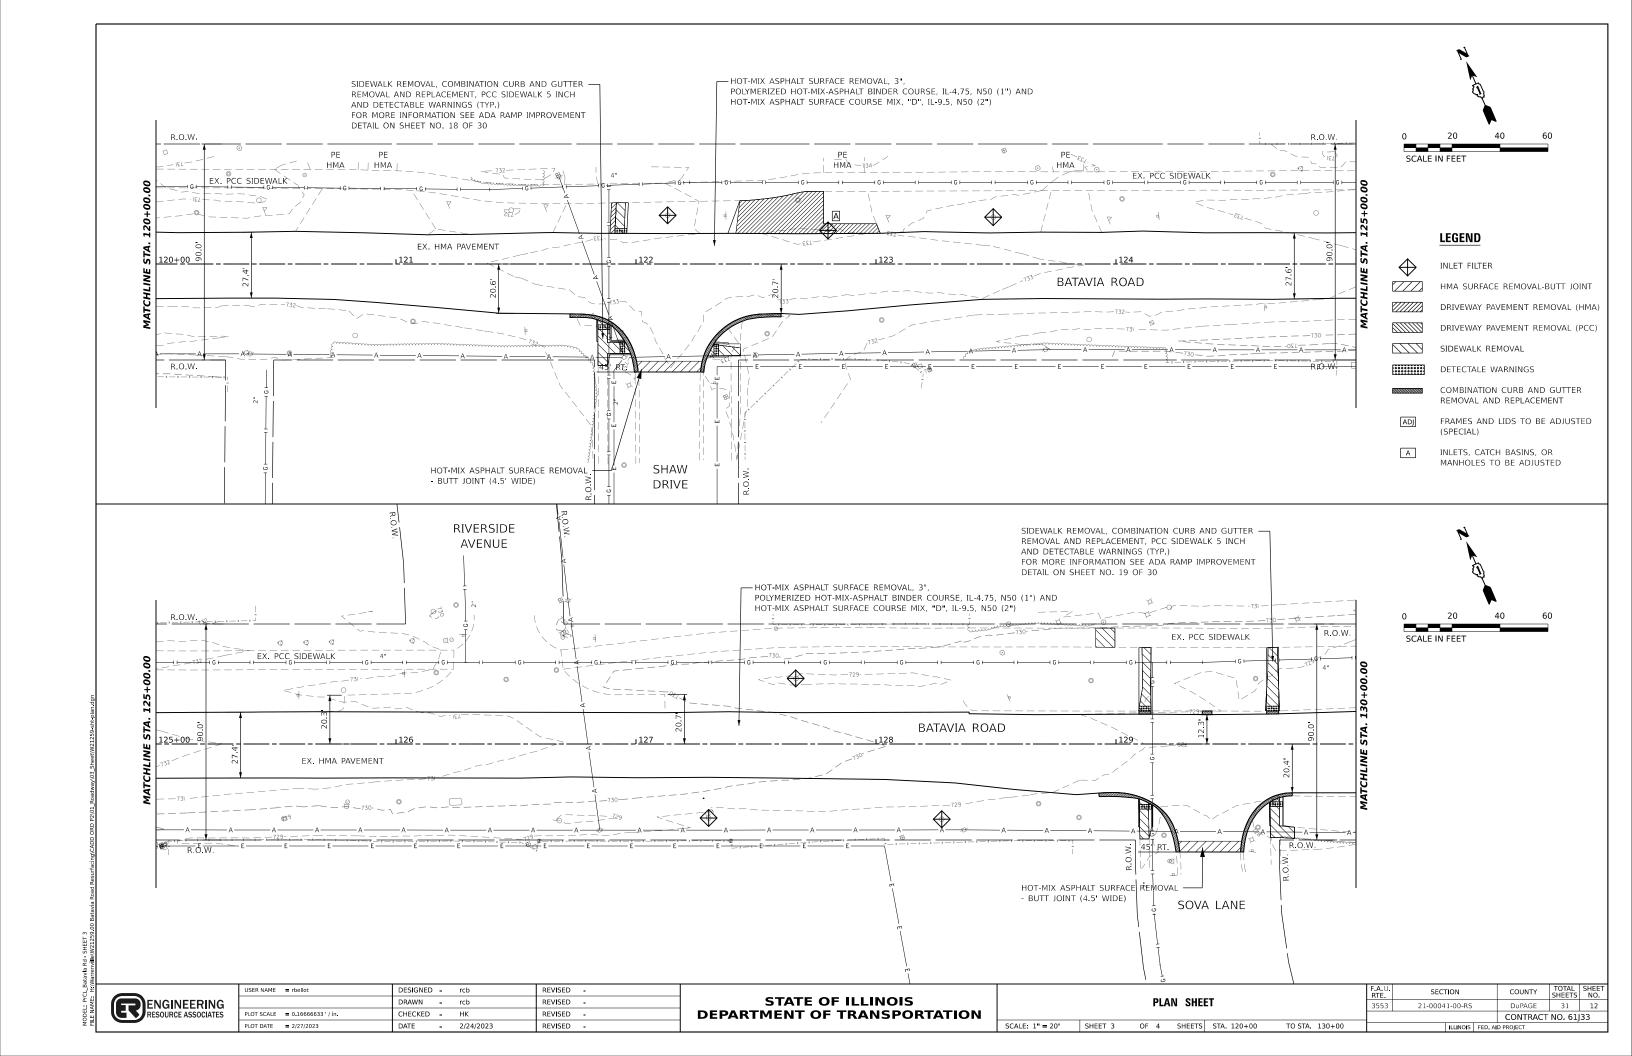


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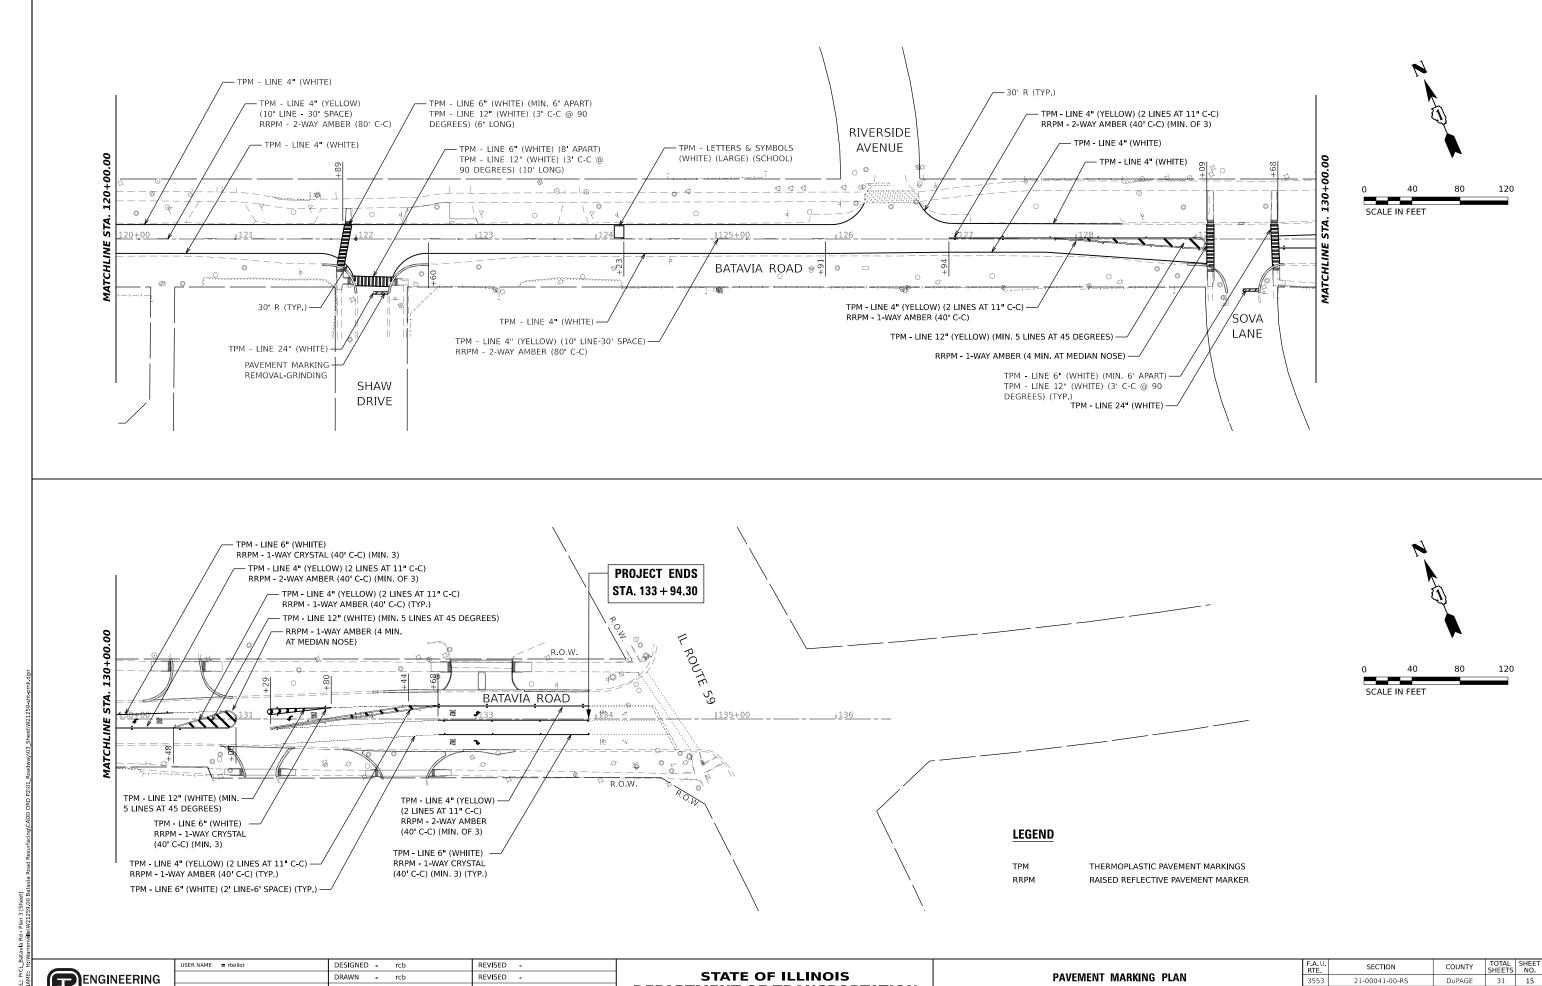
STATE OF ILLINOIS DEPARTMENT OF TRANSPORTATION

SCALE: 1" = 20'

	DIANI CHEET					RTE	5
						3553	21-00
	SHEET 4	OF 4	SHEETS	STA. 130+00	TO STA. 135+00		

| F.A. U. | SECTION | COUNTY | TOTAL SHEETS | NO. |
| 3553 | 21-00041-00-RS | DuPAGE | 31 | 13 |
| CONTRACT NO. 61J33 |



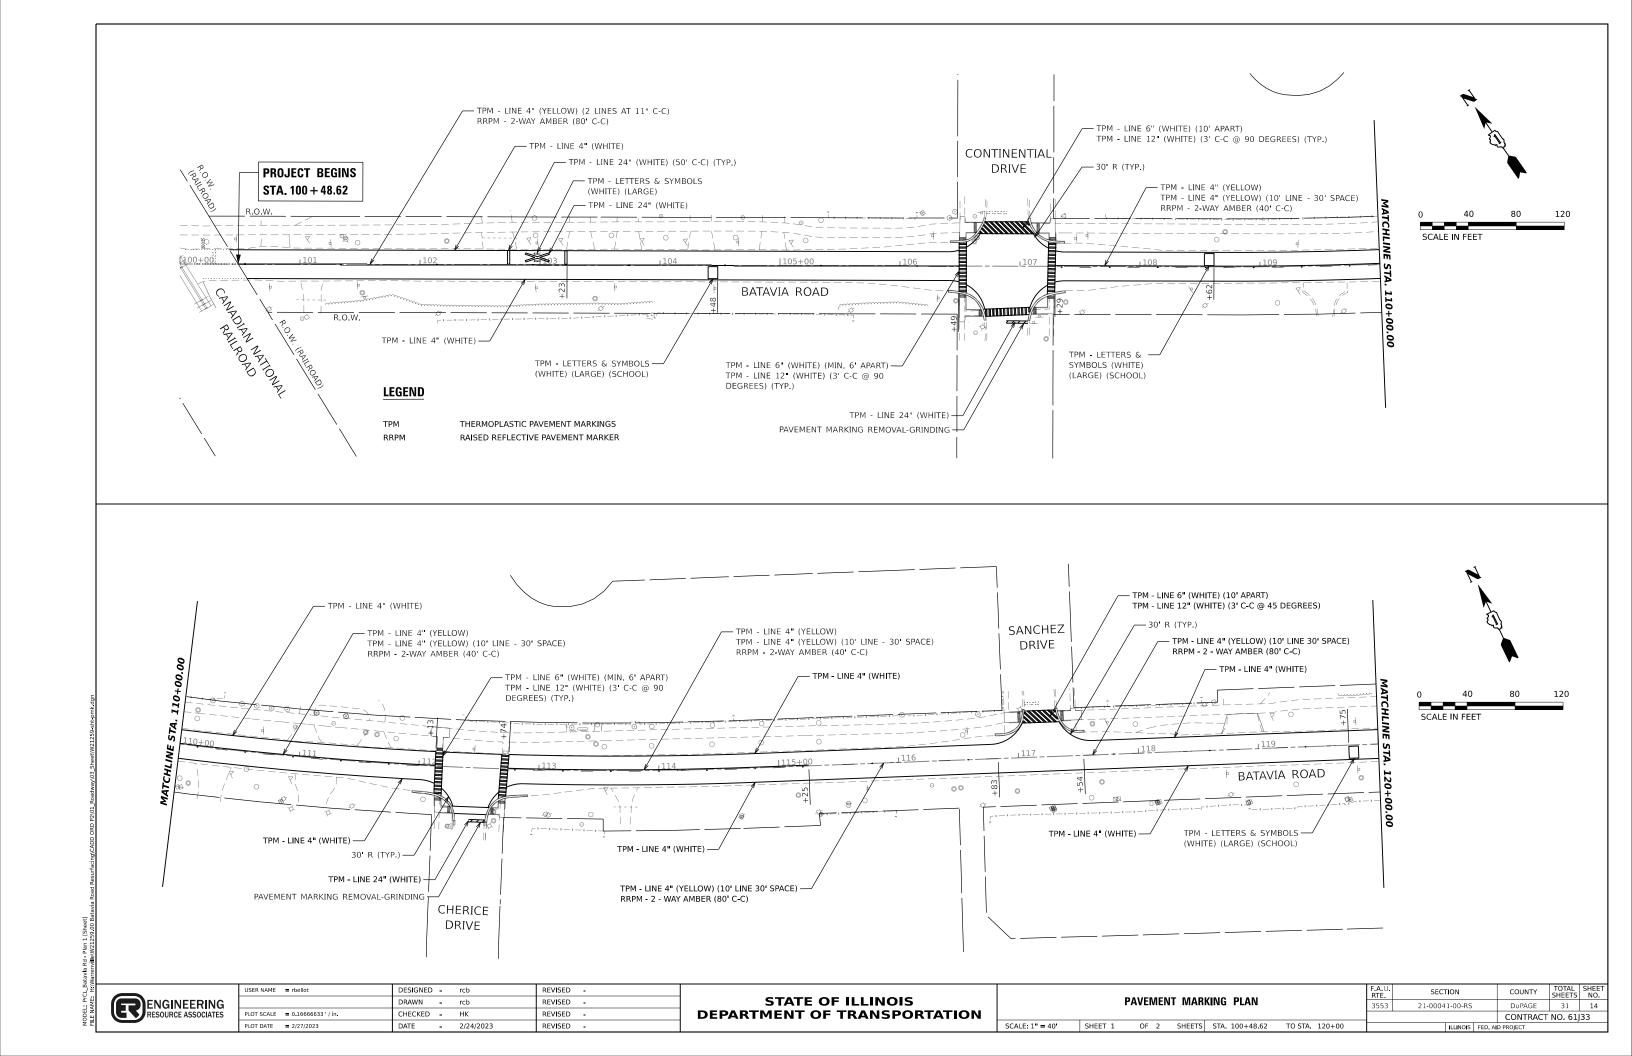


ENGINEERING RESOURCE ASSOCIATES

CHECKED - HK REVISED LOT DATE = 2/27/2023 REVISED - 2/24/2023

DEPARTMENT OF TRANSPORTATION

SCALE: 1" = 40' SHEET 2 OF 2 SHEETS STA. 120+00 TO STA. 133+94.30


21-00041-00-RS CONTRACT NO. 61J33

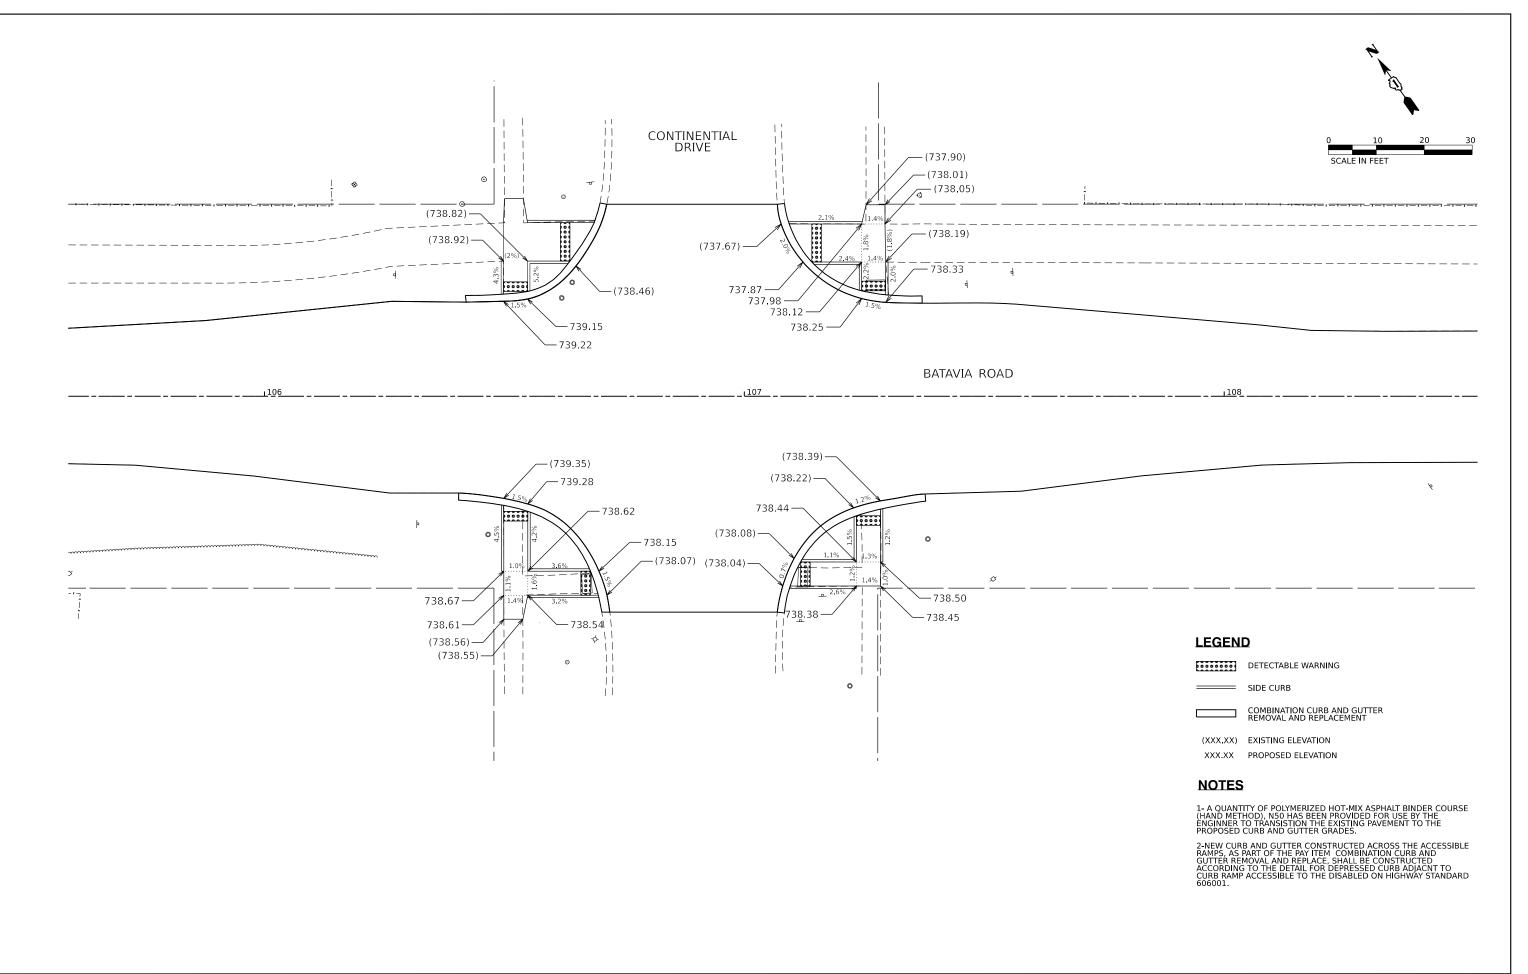

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STATE OF ILLINOIS
DEPARTMENT OF TRANSPORTATION

	ADA	RAMP	IMPROVE	AIL	
	BATAVIA	ROAD	AND CO	NTINENTAL	. DRIVE
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ENGINEERING RESOURCE ASSOCIATES


STATE OF ILLINOIS DEPARTMENT OF TRANSPORTATION

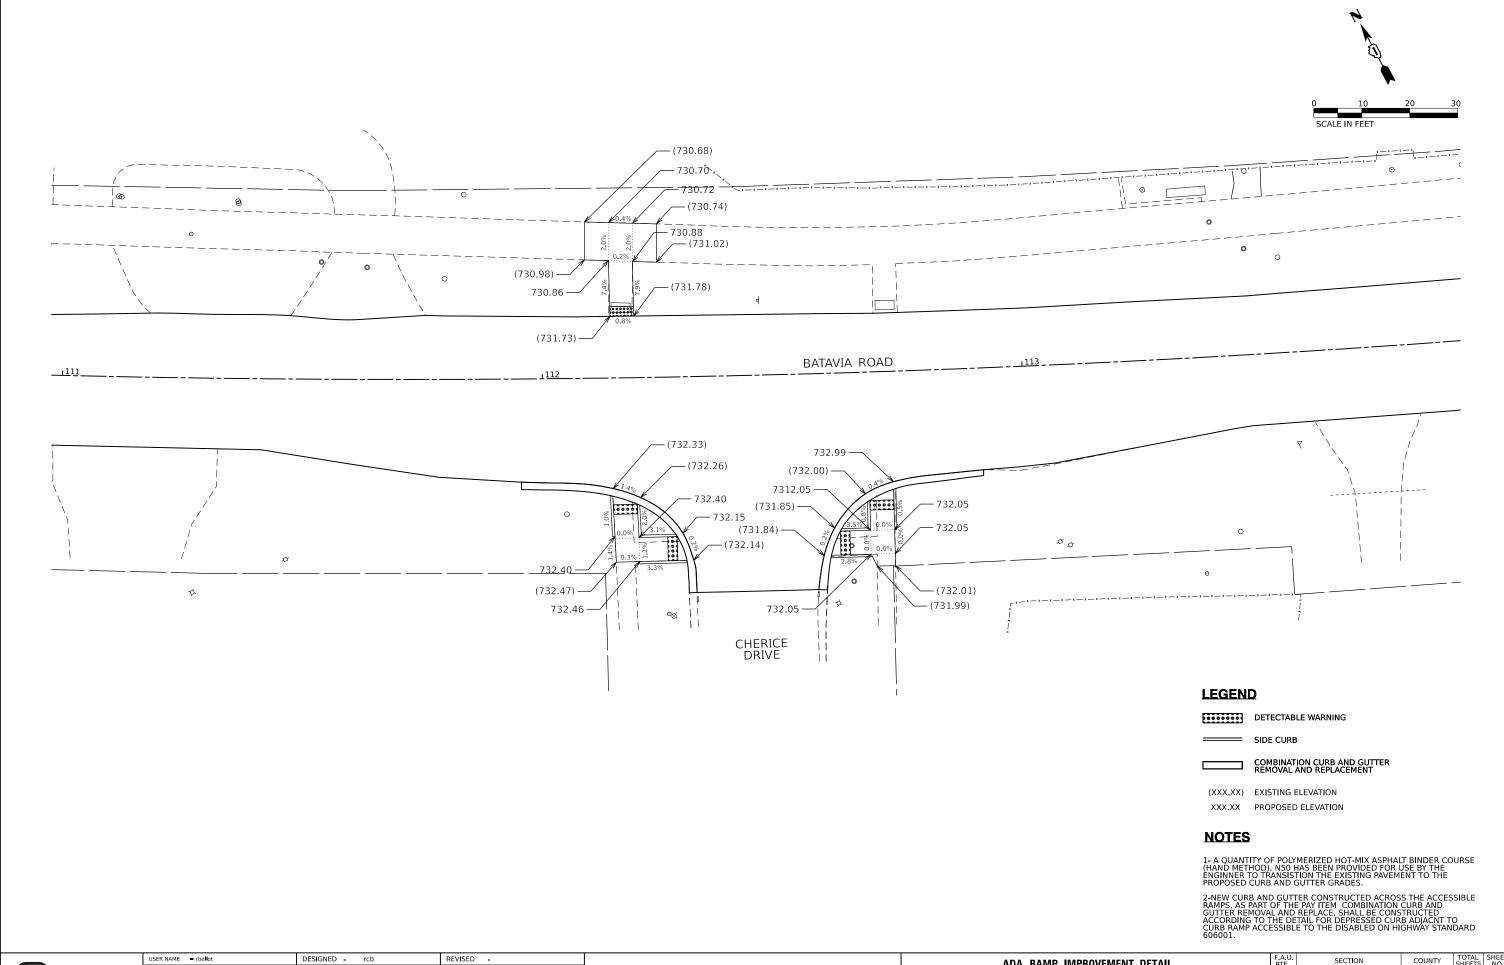ADA RAMP IMPROVEMENT DETAIL
BATAVIA ROAD AT CHERICE DRIVE

SHEET 2 OF 7 SHEETS STA. TO

SCALE: 1"=10'

Long Section Number

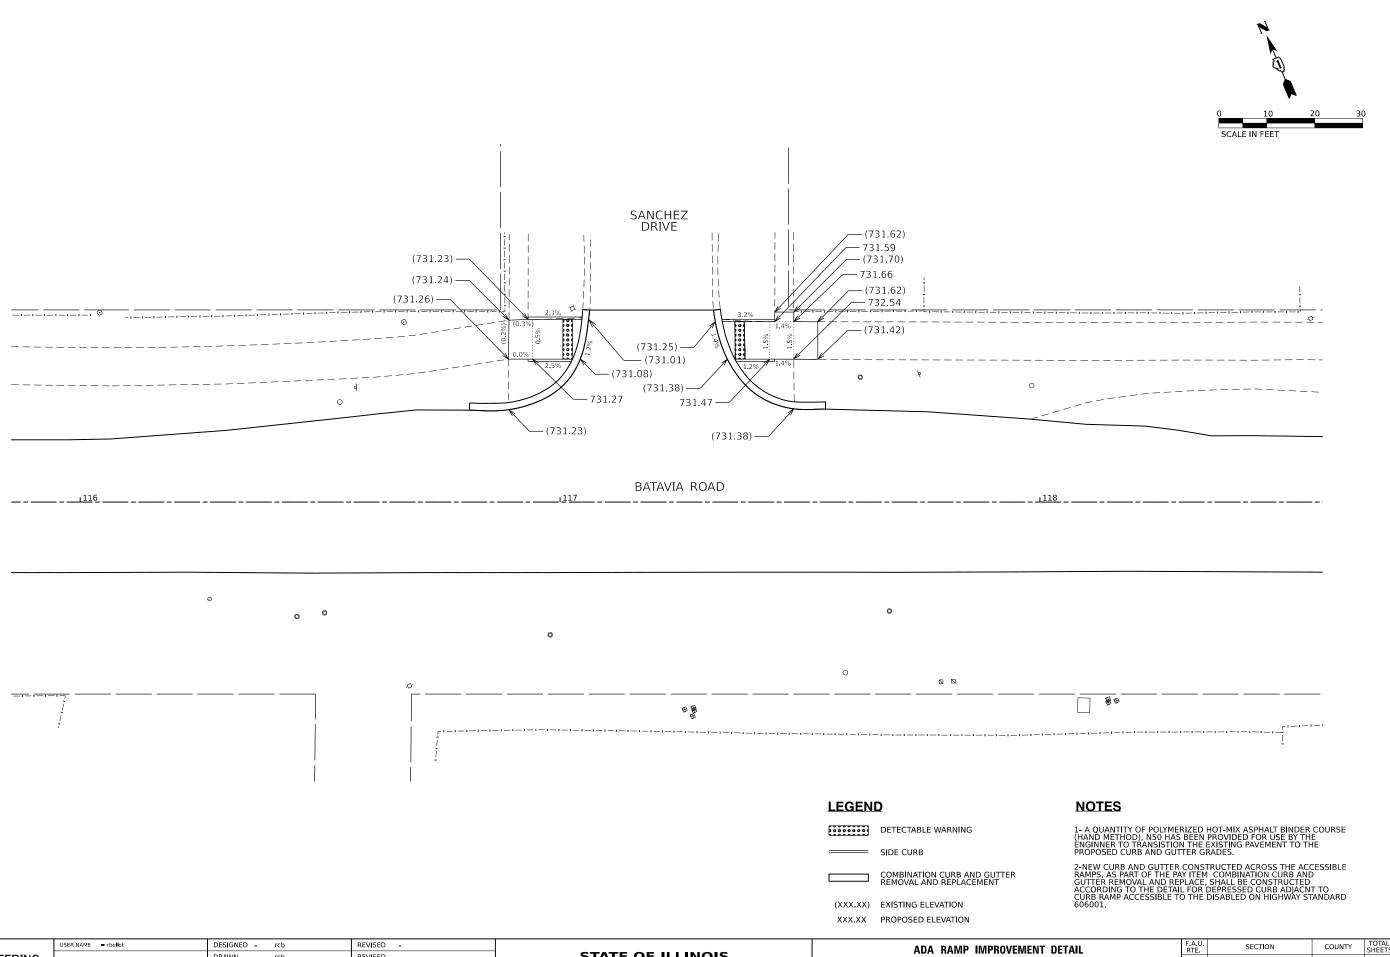


ENGINEERING RESOURCE ASSOCIATES


STATE OF ILLINOIS DEPARTMENT OF TRANSPORTATION ADA RAMP IMPROVEMENT DETAIL
BATAVIA ROAD AT SANCHEZ DRIVE

SHEET 3 OF 7 SHEETS STA.


SCALE: 1"=10"

Long Section Number

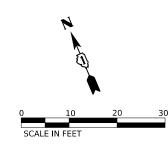

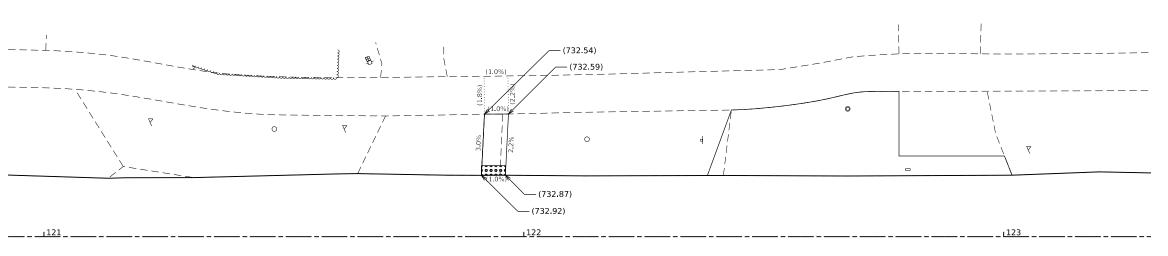

BATAVIA ROAD

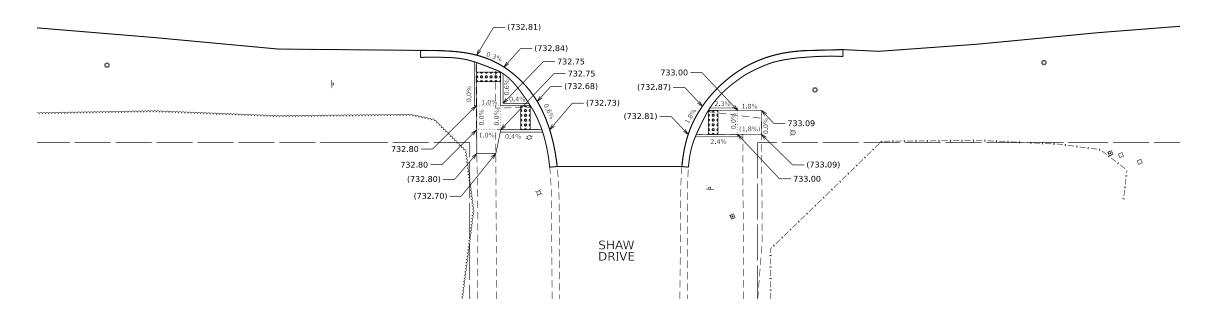

LEGEND

DETECTABLE WARNING

SIDE C

COMBINATION CURB AND GUTTER REMOVAL AND REPLACEMENT

(XXX.XX) EXISTING ELEVATION
XXX.XX PROPOSED ELEVATION

NOTES

1- A QUANTITY OF POLYMERIZED HOT-MIX ASPHALT BINDER COURSE (HAND METHOD), NSO HAS BEEN PROVIDED FOR USE BY THE ENGINNER TO TRANSISTION THE EXISTING PAVEMENT TO THE PROPOSED CURB AND GUTTER GRADES.

2-NEW CURB AND GUTTER CONSTRUCTED ACROSS THE ACCESSIBLE RAMPS, AS PART OF THE PAY ITEM COMBINATION CURB AND GUTTER REMOVAL AND REPLACE, SHALL BE CONSTRUCTED ACCORDING TO THE DETAIL FOR DEPRESSED CURB ADJACNT TO CURB RAMP ACCESSIBLE TO THE DISABLED ON HIGHWAY STANDARD 606001.




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PLOT DATE = 2/27/2023	DATE 2/24/2023	REVISED -


STATE OF ILLINOIS
DEPARTMENT OF TRANSPORTATION


SCALE: 1*=10*

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SHEET 4	OF 7	SHEETS STA	_	TO STA.

F.A.U. RTE	SECTION		COUNTY	TOTAL SHEETS	SHEE
3553	21-00041-00-RS	DuPAGE	31	19	
			CONTRACT	NO. 61J	33

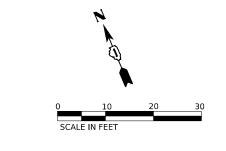

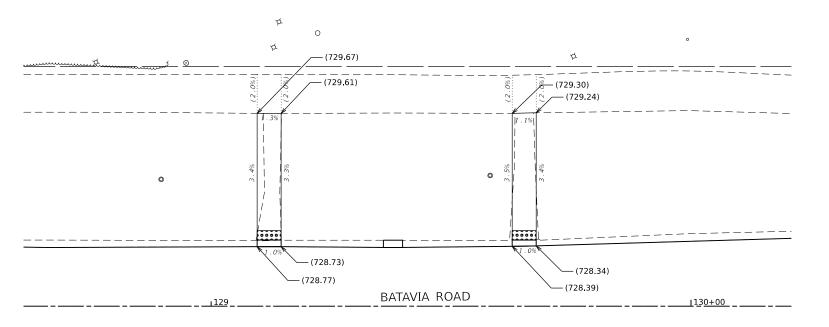

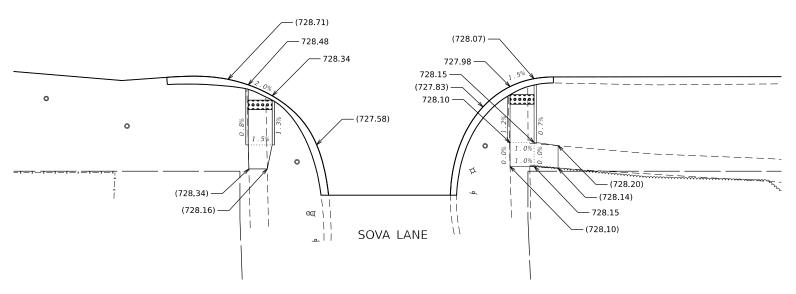

LEGEND

SCALE: 1"=10'

DETECTABLE WARNING

===== SIDE

COMBINATION CURB AND GURE AND GURE AND GURE AND REPLACEMEN

(XXX.XX) EXISTING ELEVATION
XXX.XX PROPOSED ELEVATION

NOTES

1- A QUANTITY OF POLYMERIZED HOT-MIX ASPHALT BINDER COURSE (HAND METHOD), N50 HAS BEEN PROVIDED FOR USE BY THE ENGINNER TO TRANSISTION THE EXISTING PAVEMENT TO THE PROPOSED CURB AND GUTTER GRADES.


2-NEW CURB AND GUTTER CONSTRUCTED ACROSS THE ACCESSIBLE RAMPS, AS PART OF THE PAY ITEM COMBINATION CURB AND GUTTER REMOVAL AND REPLACE, SHALL BE CONSTRUCTED ACCORDING TO THE DETAIL FOR DEPRESSED CURB ADJACNT TO CURB RAMP ACCESSIBLE TO THE DISABLED ON HIGHWAY STANDARD 606001.




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F.A.U. RTE	SECTION	COUNTY	TOTAL SHEETS	SH	
3553 21-00041-00-RS			DuPAGE	31	2
			CONTRACT	NO. 61	33
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LEGEND

DETECTABLE WARNING

===== SIDE CURB

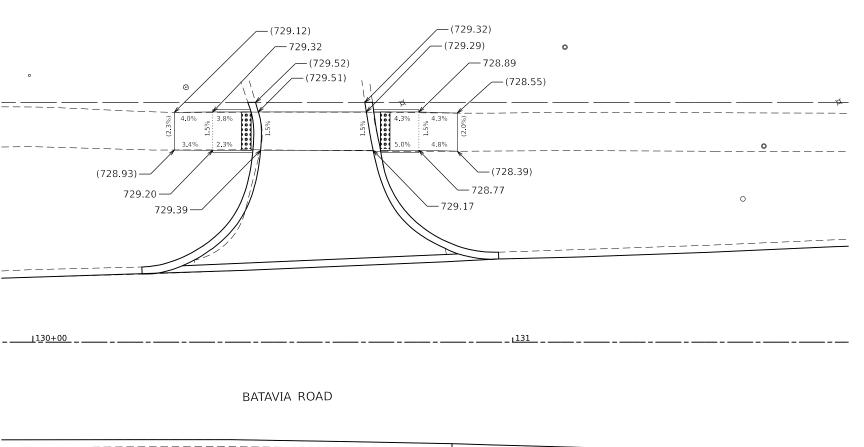COMBINATION CURB AND GUTTER REMOVAL AND REPLACEMENT

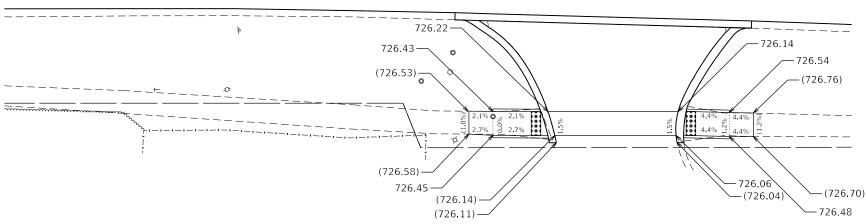(XXX.XX) EXISTING ELEVATION
XXX.XX PROPOSED ELEVATION

NOTES

1- A QUANTITY OF POLYMERIZED HOT-MIX ASPHALT BINDER COURSE (HAND METHOD), N50 HAS BEEN PROVIDED FOR USE BY THE ENGINNER TO TRANSISTION THE EXISTING PAVEMENT TO THE PROPOSED CURB AND GUTTER GRADES.

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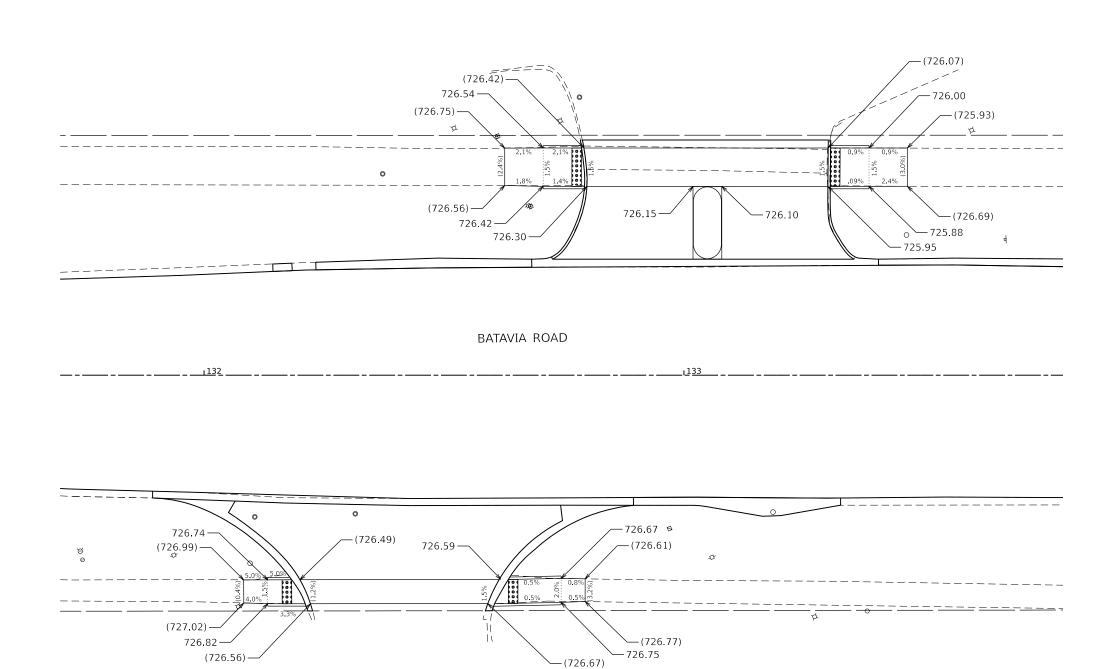
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	DRAWN - rcb	REVISED -
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STATE OF ILLINOIS	l
DEPARTMENT OF TRANSPORTATION	ŀ
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SCALE: 1"=10"	SHEET 6	OF	7	SHEETS	STA.	TO STA.

F.A.U. RTE	SECTION		COUNTY	TOTAL SHEETS	SHE
3553	21-00041-00-RS	DuPAGE	31	21	
			CONTRACT	NO. 61	33
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NOTES

DETECTABLE WARNING

1- A QUANTITY OF POLYMERIZED HOT-MIX ASPHALT BINDER COURSE (HAND METHOD), N50 HAS BEEN PROVIDED FOR USE BY THE ENGINNER TO TRANSISTION THE EXISTING PAVEMENT TO THE PROPOSED CURB AND GUTTER GRADES.

TO STA.

2-NEW CURB AND GUTTER CONSTRUCTED ACROSS THE ACCESSIBLE RAMPS, AS PART OF THE PAY ITEM. COMBINATION CURB AND GUTTER REMOVAL AND REPLACE, SHALL BE CONSTRUCTED ACCORDING TO THE DETAIL FOR DEPRESSED CURB ADJACNT TO CURB RAMP ACCESSIBLE TO THE DISABLED ON HIGHWAY STANDARD 606001.



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STATE OF ILLINOIS
DEPARTMENT OF TRANSPORTATION

					VIENT DETAIL
SCALE: 1"=10"	SHEET 7	OF	7	SHEETS	STA.


COMBINATION CURB AND GUTTER REMOVAL AND REPLACEMENT

(XXX.XX) EXISTING ELEVATION
XXX.XX PROPOSED ELEVATION

LEGEND

F.A.U. RTE.	U. SECTION		COUNTY	TOTAL SHEETS	SHE
3553	21-00041-00-RS		DuPAGE	31	22
			CONTRACT	NO. 61	33

SCALE IN FEET

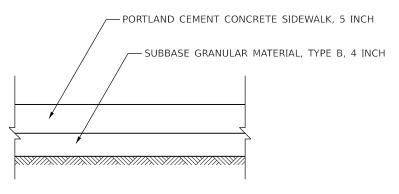


PORTLAND CEMENT CONCRETE SIDEWALK


NOTES:

PORTLAND CEMENT CONCRETE SIDEWALK, 7 INCH TO BE USED ACROSS PRIVATE ENTRANCES


PORTLAND CEMENT CONCRETE SIDEWALK, 10 INCH TO BE USED ACROSS COMMERCIAL ENTRANCES

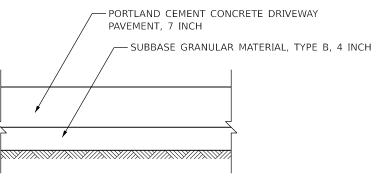


PRIVATE ENTRANCE (PE) PORTLAND CEMENT CONCRETE

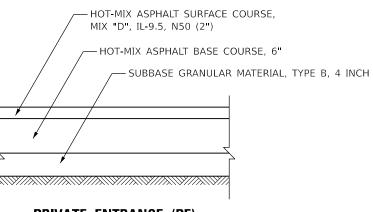


PRIVATE ENTRANCE (PE) **HOT-MIX ASPHALT**

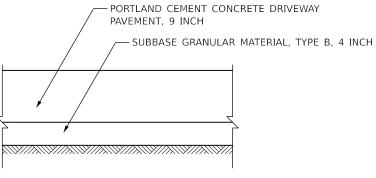

COMMERCIAL ENTRANCE (CE) PORTLAND CEMENT CONCRETE

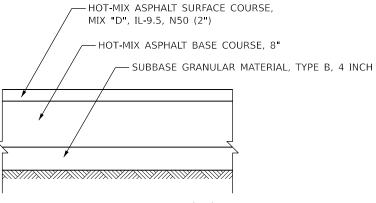

COMMERCIAL ENTRANCE (CE) HOT-MIX ASPHALT

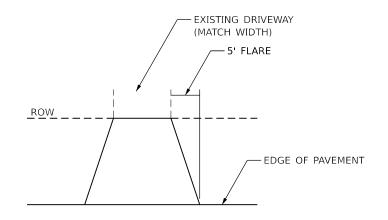


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PRIVATE ENTRANCE (PE) **HOT-MIX ASPHALT**



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PLOT DATE = 2/27/2023	DATE 2/24/2023	REVISED -

Long Section Number

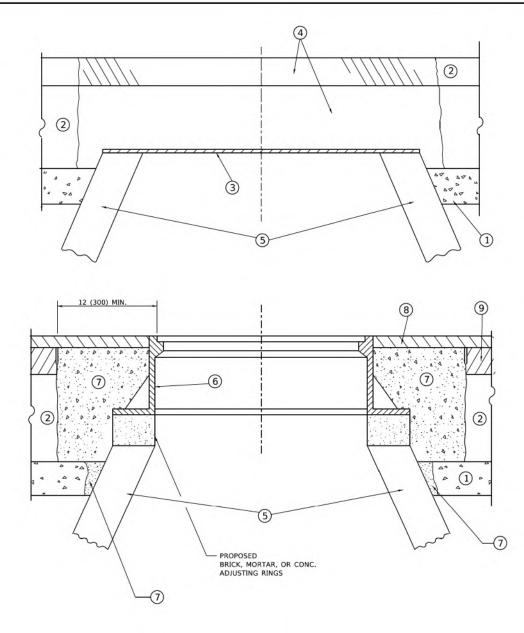

DETAILS FOR FRAMES AND LIDS ADJUSTMENT WITH MILLING

NOTES

- EXISTING BROKEN FRAMES AND LIDS SHALL BE REMOVED AND DISPOSED OF BY THE CONTRACTOR AND SHALL BE REPLACED AS DIRECTED BY THE ENGINEER. REPLACEMENT FRAMES AND LIDS WILL BE PAID FOR IN ACCORDANCE WITH ARTICLE 109.04 OF THE STANDARD SPECIFICATIONS UNLESS A SEPARATE PAY ITEM HAS BEEN PROVIDED.
- IF THE EXISTING LIDS ARE OPEN, THE FRAME WILL BE ADJUSTED TO THE ELEVATION OF THE MILLED PAVEMENT SURFACE PRIOR TO THE MILLING OPERATION. THE FRAME WILL NOT BE REMOVED AND COVERED BY THE METAL PLATE.
- CITY OF CHICAGO CASTINGS ARE THE PROPERTY OF THE CITY AND THE CONTRACTOR SHALL NOTIFY THE CITY FOR REMOVAL AND DISPOSITION OF THE CASTINGS.
- THE METAL PLATE USED TO COVER THE STRUCTURE SHALL REMAIN THE PROPERTY OF THE CONTRACTOR.

CONSTRUCTION PROCEDURES

STAGE 1 (BEFORE PAVEMENT MILLING)

- A) REMOVE A MINIMUM OF 12 (300) OF THE PAVEMENT FROM AROUND THE STRUCTURE.
- B) REMOVE THE EXISTING FRAME AND LID FROM THE STRUCTURE.
- C) COVER THE STRUCTURE OPENING WITH A 36 (900) DIAMETER METAL PLATE.
- D) BACKFILL WITH CRUSHED STONE AND HMA SURFACE MIX APPROVED BY THE ENGINEER. (MIN. 1 1/2 (40) HMA TO REMAIN AFTER MILLING).

STAGE 2 (AFTER PAVEMENT MILLING)

- A) REMOVE THE HMA SURFACE MIX AND CRUSHED STONE.
- B) INSTALL THE FRAME AND LID; ADJUST THE FRAME TO ITS FINAL SURFACE ELEVATION.
- C) THE SURROUNDING SPACE SHALL BE FILLED WITH CLASS*PP-1 CONCRETE TO THE ELEVATION OF THE SURFACE OF THE EXISTING BASE COURSE OR THE BINDER COURSE.
- *UNLESS OTHERWISE SPECIFIED IN THE PLANS.

THE PROCEDURE EXPLAINED ABOVE SHALL CONFORM TO THE APPLICABLE PORTIONS OF SECTIONS 353, 406, 602, AND 603 OF THE STANDARD SPECIFICATIONS EXCEPT THAT "THE CONTRACTOR SHALL ADJUST THE STRUCTURES TO THE FINISHED PAVEMENT ELEVATION NO MORE THAN 5 CALENDAR DAYS PRIOR TO PLACEMENT OF THE FINAL LIFT OF SURFACE UNLESS APPROVED BY THE ENGINEER."

LEGEND

- SUB-BASE GRANULAR
 MATERIAL
- (6) FRAME AND LID (SEE NOTES)
- 2 EXISTING PAVEMENT
- (7) CLASS*PP-1 CONCRETE
- 3 36 (900) DIAMETER METAL PLATE
 - (8) PROPOSED HMA SURFACE COURSE
- PROPOSED CRUSHED STONE AND HMA SURFACE MIX
- (5) EXISTING STRUCTURE

9 PROPOSED HMA BINDER COURSE

LOCATION OF STRUCTURES


THE CONTRACTOR WILL BE REQUIRED TO KEEP A RECORD OF THE LOCATIONS OF THE BURIED STRUCTURES ACCORDING TO THE STATION AND DISTANCE LEFT OR RIGHT OF THE CENTERLINE OF PAVEMENT, UPON COMPLETION OF THE WORK, THE CONTRACTOR WILL DELIVER THE RECORD TO THE ENGINEER.

BASIS OF PAYMENT

- REMOVING FRAMES AND LIDS ON DRAINAGE AND UTILITY STRUCTURES IN THE PAVEMENT PRIOR TO MILLING, AND ADJUSTING TO FINAL GRADE PRIOR TO PLACING THE SURFACE COURSE, WILL BE PAID FOR AT THE CONTRACT UNIT PRICE EACH FOR "FRAMES AND LIDS TO BE ADJUSTED (SPECIAL)."
- THIS WORK WILL NOT BE PAID FOR WHEN DRAINAGE AND UTILITY STRUCTURES ARE SPECIFIED FOR PAYMENT AS STRUCTURE RECONSTRUCTION.
- NEW FRAMES AND LIDS, WHEN SPECIFIED, WILL BE PAID FOR SEPARATELY.
- 4. WHEN STRUCTURES ARE TO BE ADJUSTED OR RECONSTRUCTED, THE LOWERING AND RAISING OF THE FRAMES AND LIDS WILL NOT BE PAID FOR SEPARATELY BUT WILL BE INCLUDED IN THE COST OF THE CORRESPONDING PAY ITEM.

ALL DIMENSIONS ARE IN INCHES (MILLIMETERS) UNLESS OTHERWISE SHOWN

USER NAME = Lawrence.DeManche	DESIGNED - R. SHAH	REVISED - R. BORO 01-01-07		DETAILS FOR F.A. RTE. SECTION COUNTY	TOTAL SHEET
	DRAWN -	REVISED - R. BORO 03-09-11	STATE OF ILLINOIS	FRAMES AND LIDS ADJUSTMENT WITH MILLING 3553 22-00041-00-RS DUPAGE	31 24
PLOT SCALE = 100.0000 ' / in.	CHECKED -	REVISED - R. BORO 12-06-11	DEPARTMENT OF TRANSPORTATION	FRAMES AND LIDS ADJUSTMENT WITH WILLING BD600-03 (BD-08) CONTRAC	T NO. 61J33
PLOT DATE = 11/18/2022	DATE - 10-25-94	REVISED - K. SMITH 11-18-22		SCALE: NONE SHEET 1 OF 1 SHEETS STA. TO STA. JILLINOIS FED. AID PROJECT	

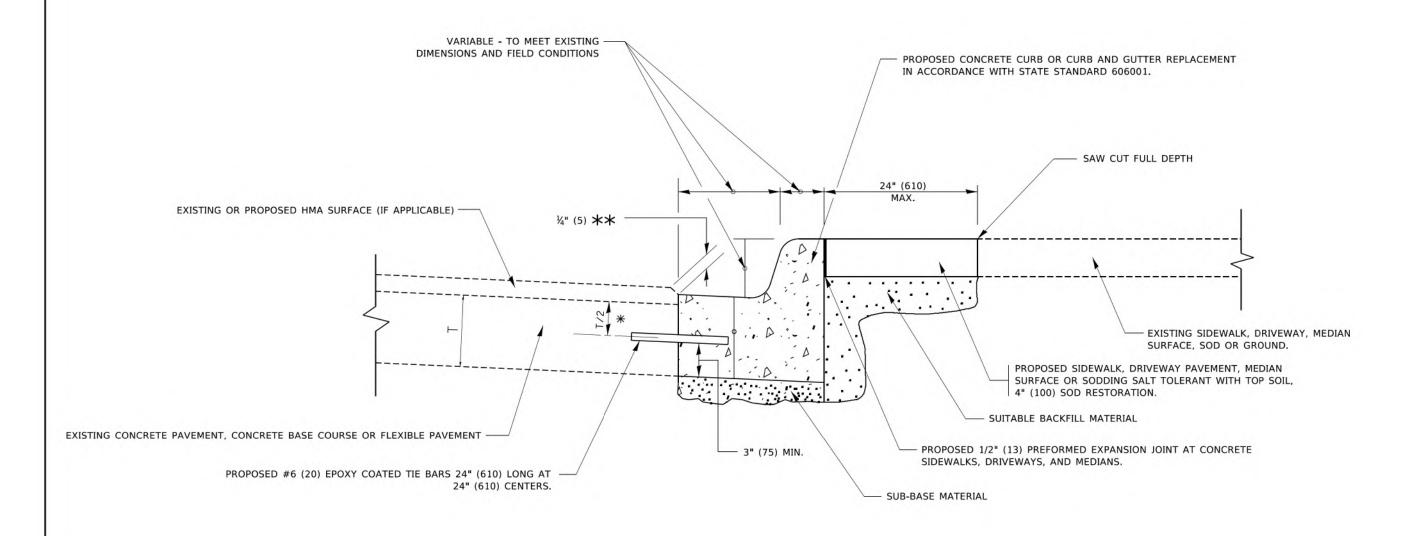

- X 3" (75) MINIMUM FROM TOP AND BOTTOM OF THE CONCRETE PAVEMENT OR BASE COURSE.
- $\star\star$ IF THE FINAL SURFACE OF THE PAVEMENT IS CONCRETE, THE GUTTER IS TO BE FLUSH WITH THE PAVEMENT.

CURB OR CURB AND GUTTER REMOVAL AND REPLACEMENT


ALL DIMENSIONS ARE IN INCHES (MILLIMETERS) UNLESS OTHERWISE SHOWN.

USER NAME = footemj	DESIGNED - A. HOUSEH	REVISED - A. A.	BBAS 03-21-97
	DRAWN -	REVISED - M. G	OMEZ 01-22-01
PLOT SCALE = 50.0000 ' / in.	CHECKED -	REVISED - R. B	ORO 12-15-09
PLOT DATE = 7/11/2019	DATE - 03-11-94	REVISED - K. SI	VITH 07-11-19

STATE OF ILLINOIS
DEPARTMENT OF TRANSPORTATION

CURB OR CURB AND GUTTER
REMOVAL AND REPLACEMENT


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MILLED TEMPORARY RAMP

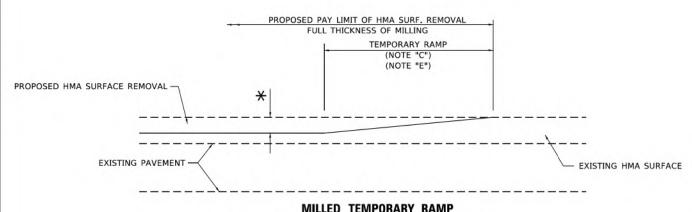(FOR BUTT JOINT AND HMA TAPER SEE DETAIL BELOW)

OPTION 1




HMA CONSTRUCTED TEMPORARY RAMP

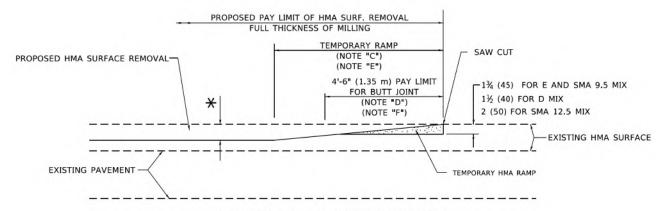(FOR BUTT JOINT AND HMA TAPER SEE DETAIL BELOW)

OPTION 2

TYPICAL TEMPORARY RAMP

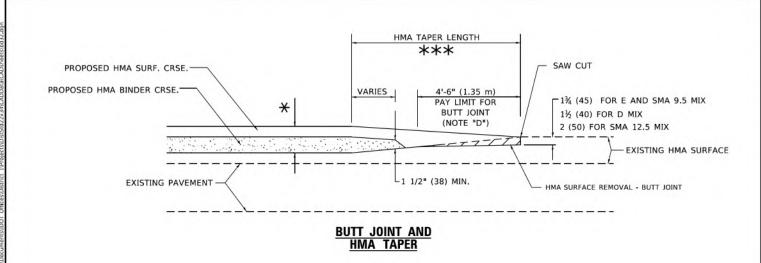


TYPICAL BUTT JOINT AND HMA TAPER FOR MILLING AND RESURFACING

USER NAME = Lawrence, DeManche DESIGNED - M. DE YONG REVISED - A. ABBAS 03-21-97 DRAWN REVISED - M. GOMEZ 04-06-01 PLOT SCALE = 100.0000 ' / in. CHECKED -REVISED -R. BORO 01-01-07 REVISED - K. SMITH 11-18-22 LOT DATE = 11/18/2022 DATE

STATE OF ILLINOIS **DEPARTMENT OF TRANSPORTATION**

BUTT JOINT AND 22-00041-00-RS HMA TAPER DETAILS BD400-05 BD-32 OF 1 SHEETS STA, SHEET 1 TO STA.

PROPOSED HMA OR PCC SURFACE REMOVAL - BUTT JOINT 30'-0" (9.0 m) (NOTE "A") EXISTING HMA OR PCC SURFACE -SAW CUT 15'-0" (4.5 m) (NOTE "B") (NOTE "D") 40'-0" (12.0M) (NOTE "A1") -1¾ (45) FOR E AND SMA 9.5 MIX 1½ (40) FOR D MIX 2 (50) FOR SMA 12.5 MIX * * EXISTING PAVEMENT **BUTT JOINT DETAIL**

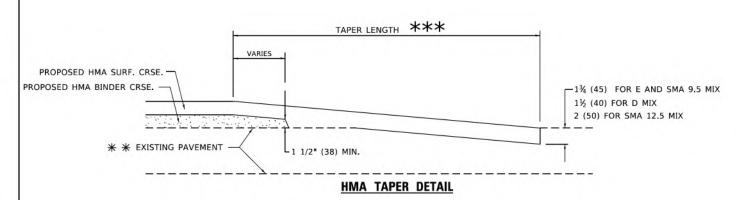

TYPICAL BUTT JOINT AND HMA TAPER FOR RESURFACING ONLY

** PC CONCRETE, HMA OR HMA RESURFACED PAVEMENT.

GENERAL NOTES

- A. MAINLINE ARTERIAL ROADWAYS AND MAJOR SIDE ROADS.
- A1. INTERSTATES
- B. MINOR SIDE ROADS.
- C. THE TEMP. RAMP SHALL BE CONSTRUCTED IMMEDIATELY UPON REMOVAL OF THE EXISTING HMA SURFACE.
- D. THE BUTT JOINT SHALL BE CONSTRUCTED IMMEDIATELY PRIOR TO PLACING THE PROPOSED HMA COURSES.
- E. TAPER THE TEMP. RAMP AT A RATE OF 3' 4" (1.02m) PER 1 INCH (25 mm) OF MILLING THICKNESS.
 - * SEE TYPICAL SECTIONS FOR MILLING THICKNESS.
- F. SEE ARTICLE 406.08 AND 406.14 OF THE STANDARD SPECIFICATIONS FOR "HMA AND/OR PCC SURFACE REMOVAL, BUTT JOINT".
- *** 20'-0" (6.1 m) PER 1 (25) RESURFACING (NOTE "A") 10'-0" (3.0 m) PER 1 (25) RESURFACING (NOTE "B")

BASIS OF PAYMENT

- THE BUTT JOINT WILL BE PAID FOR AT THE CONTRACT UNIT PRICE PER SQUARE YARD (SQUARE METER) FOR "HOT-MIX ASPHALT SURFACE REMOVAL BUTT JOINT" OR FOR "PORTLAND CEMENT CONCRETE SURFACE REMOVAL- BUTT JOINT"
- THE TEMPORARY RAMP AND SAW CUT SHALL BE INCLUDED IN THE UNIT COST FOR HMA OR PCC SURFACE REMOVAL-BUTT JOINT


SCALE: NONE

ALL DIMENSIONS ARE IN INCHES (MILLIMETERS) UNLESS OTHERWISE SHOWN.

COUNTY

DuPAGE 31 26

CONTRACT NO. 61J33

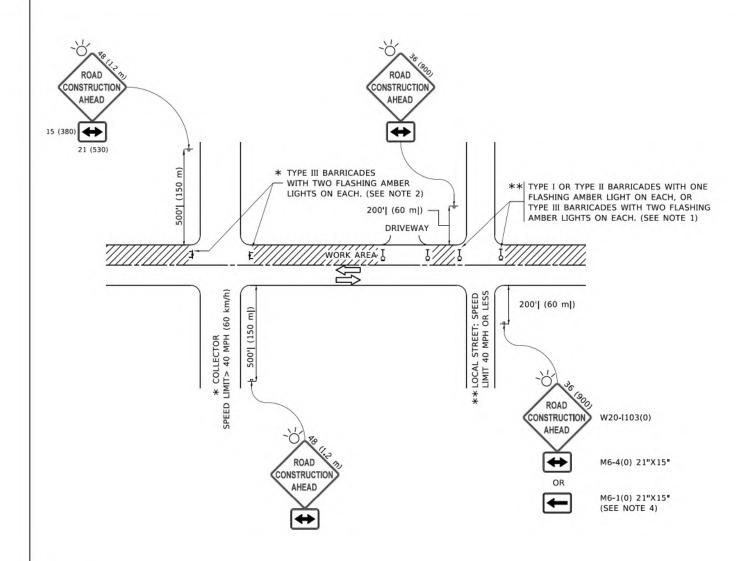

NOTES:

- SIDE ROAD WITH A SPEED LIMIT OF 40 MPH (60 km/h) OR LESS AS SHOWN ON THE DRAWING AND AS DIRECTED BY THE ENGINEER:
- a) ONE "ROAD CONSTRUCTION AHEAD" SIGN 36 x 36 (900x900) WITH A FLASHER MOUNTED ON IT APPROXIMATELY 200' (60 m) IN ADVANCE OF THE MAIN ROUTE.
- b) THE CLOSED PORTION OF THE MAIN ROUTE SHALL BE PROTECTED BY BLOCKING WITH TYPE I, TYPE II OR TYPE III BARRICADES, 1/3 OF THE CROSS SECTION OF THE CLOSED PORTION.
- SIDE ROAD WITH A SPEED LIMIT GREATER THAN 40 MPH (60 km/h) AS SHOWN ON THE DRAWING AND AS DIRECTED BY THE ENGINEER:
- a) ONE "ROAD CONSTRUCTION AHEAD" SIGN 48 x 48 (1.2 m x 1.2 m) WITH A FLASHER MOUNTED ON IT APPROXIMATELY 500' (150 m) IN ADVANCE OF THE MAIN ROUTE.
- THE CLOSED PORTION OF THE MAIN ROUTE SHALL BE PROTECTED BY
 b) BLOCKING WITH TYPE III BARRICADES, 1/2 OF THE CROSS SECTION
 OF THE CLOSED PORTION.
- 3. CONES MAY BE SUBSTITUTED FOR BARRICADES OR DRUMS AT HALF THE SPACING DURING DAY OPERATIONS. CONES SHALL BE A MINIMUM OF 28 (710) IN HEIGHT
- WHEN THE SIDE ROAD LIES BETWEEN THE BEGINNING OF THE MAINLINE
 4. SIGNING AND THE WORK ZONE, A SINGLE HEADED ARROW (M6-1) SHALL
 BE USED IN LIEU OF THE DOUBLE HEADED ARROW (M6-4).

- WHEN WORK IS BEING PERFORMED ON A SIDE ROAD OR DRIVEWAY, FOLLOW THE APPLICABLE STANDARD(S). THE DIRECTIONAL ARROW (M6-1 OR M6-4) SHALL BE COVERED OR REMOVED WHEN NO LONGER CONSISTENT WITH THE TRAFFIC CONTROL SET-UP.
- ADVANCE WARNING SIGNS ARE TO BE OMITTED ON DRIVEWAYS UNLESS OTHERWISE SPECIFIED IN THE PLANS OR BY THE ENGINEER.
- THE TRAFFIC CONTROL AND PROTECTION FOR SIDE ROADS, INTERSECTIONS, AND DRIVEWAYS SHALL BE INCLUDED IN THE COST OF SPECIFIED TRAFFIC CONTROL STANDARDS OR ITEMS.


All dimensions are in inches (millimeters) unless otherwise shown.

USER NAME = footemj	DESIGNED - L.H.A.	REVISED - A. HOUSEH 10-15-96
	DRAWN -	REVISED - T. RAMMACHER 01-06-00
PLOT SCALE = 50.0000 * / in.	CHECKED -	REVISED - A. SCHUETZE 07-01-13
PLOT DATE = 3/4/2019	DATE - 06-89	REVISED _ A. SCHUETZE 09-15-16

STATE OF ILLINOIS
DEPARTMENT OF TRANSPORTATION

				TECTION FOR ND DRIVEWAYS
SCALE: NONE	SHEET 1	OF 1	SHEETS ST.	A. TO STA.


F.A. RTE.	SECTION		COUNTY	TOTAL SHEETS	SHE		
3553	22-00041-00-RS	DuPAGE	31	2			
	TC-10	CONTRACT NO. 61J					
	ILLINOIS	FED. A	ID PROJECT				

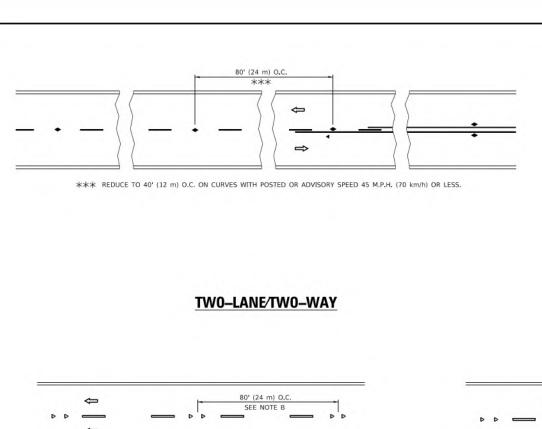

 \Rightarrow

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MULTI-LANE/UNDIVIDED

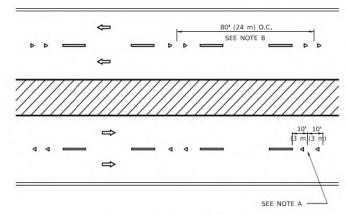


MULTI-LANE/DIVIDED

SEE FIGURE 3B-14 MUTCD

LANE REDUCTION TRANSITION

 \Rightarrow

3 @ 40' (12 m) O.C.

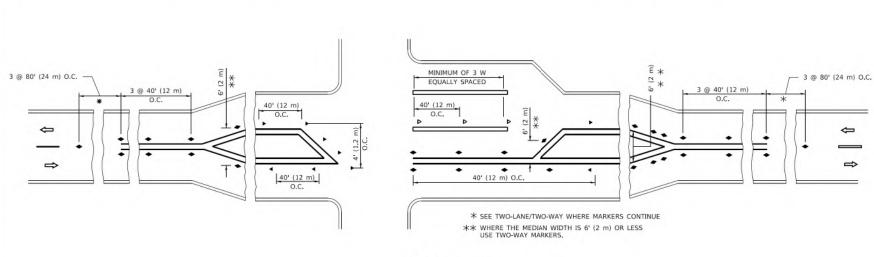

TURN LANES

SEE NOTE B 1 5 40' (12 m) O.C. SEE NOTE A -TWO-WAY LEFT TURN

GENERAL NOTES

- 1. MARKERS USED WITH DASHED LINES SHALL BE CENTERED IN THE GAP BETWEEN SEGMENTS.
- 2. MARKERS USED ADJACENT TO SOLID LINES SHALL BE OFFSET 2 TO 3 (50 TO 75) TOWARD TRAFFIC AS SHOWN.
- MARKERS THROUGH TANGENTS LESS THAN 500' (150 m) IN LENGTH BETWEEN CURVES SHALL BE INSTALLED AT THE LESSER OF THE TWO CURVE SPACINGS.
- 4. MARKERS ARE TO BE USED ADJACENT TO BOTH SOLID WHITE LINES IN DUAL LEFT TURN LANES

LANE MARKER NOTES

- A. USE DOUBLE LANE LINE MARKERS SPACED AS SHOWN.
- B. REDUCE TO 40' (12 m) O.C. ON CURVES WHERE ADVISORY SPEEDS ARE 10 M.P.H (20 km/h) LOWER THAN POSTED SPEEDS.

DESIGN NOTES

- 1. DOUBLE LANE LINE MARKERS SHALL BE USED UNLESS SPECIFIED OTHERWISE.
- RAMP DETAIL, MARKERS ARE NOT TO BE SPECIFIED ON RIGHT EDGE LINES.
- SHORT SECTIONS OF CURBS WHERE NOT MORE THAN TWO MARKERS WOULD BE INVOLVED.

All dimensions are in inches (millimeters) unless otherwise shown.

USER NAME = footemj	DESIGNED -	REVISED - T. RAMMACHER 03-12-9
	DRAWN -	REVISED -T. RAMMACHER 01-06-0
PLOT SCALE = 50,0000 * / in.	CHECKED -	REVISED - C. JUCIUS 09-09-09
PLOT DATE = 3/4/2019	DATE -	REVISED - C. JUCIUS 07-01-13

SEE NOTE A -

STATE OF ILLINOIS **DEPARTMENT OF TRANSPORTATION**

			TYPICAL	APPLICA	TION	IS	
RAISED	REFLECTIVE	P	AVEMENT	MARKER	S (S	NOW-PLOW	RESISTANT)
SCALE: NONE	SHEET	- 1	OF 1	SHEETS	STA	TO	STA

DuPAGE 31 28 3553 22-00041-00-RS CONTRACT NO, 61J33 TC-11

SYMBOLS

ONE-WAY AMBER MARKER


TWO-WAY AMBER MARKER


■ ONE-WAY CRYSTAL MARKER (W/O)

YELLOW STRIPE

WHITE STRIPE

- 2. EXCEPT AS SHOWN ON THE LANE REDUCTION TRANSITION AND FREEWAY EXIT
- 3. THE EXACT MARKER LIMITS, SPACING, AND COLOR SHALL BE INCLUDED IN
- 4. MARKERS SHOULD NOT BE USED ALONGSIDE CURBS EXCEPT FOR EXTREMELY

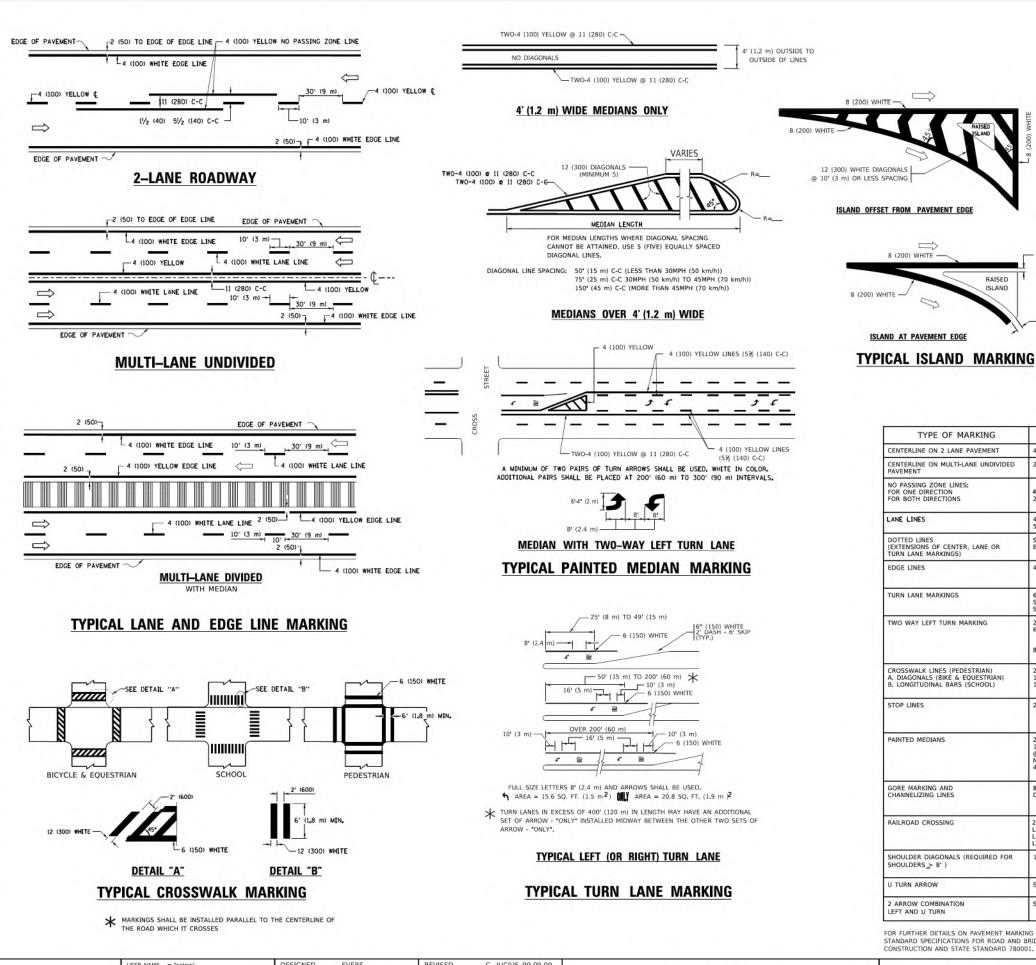

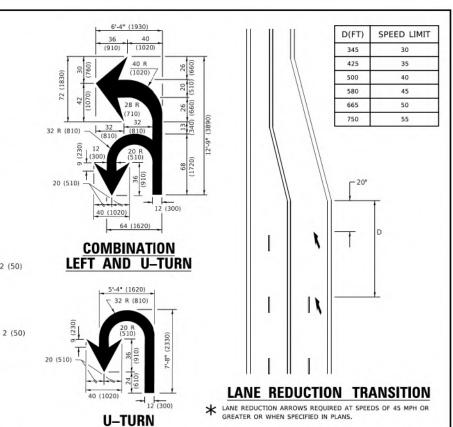

TYPE OF MARKING	WIDTH OF LINE	PATTERN	COLOR	SPACING / REMARKS
CENTERLINE ON 2 LANE PAVEMENT	4 (100)	SKIP-DASH	YELLOW	10' (3 m) LINE WITH 30' (9 m) SPACE
CENTERLINE ON MULTI-LANE UNDIVIDED PAVEMENT	2 @ 4 (100)	SOLID	YELLOW	11 (280) C-C
NO PASSING ZONE LINES: FOR ONE DIRECTION FOR BOTH DIRECTIONS	4 (100) 2 @ 4 (100)	SOLID SOLID	YELLOW YELLOW	5½ (140) C-C FROM SKIP-DASH CENTERLINE 11 (280) C-C OMIT SKIP-DASH CENTERLINE BETWEEN
LANE LINES	4 (100) 5 (125) ON FREEWAYS	SKIP-DASH SKIP-DASH	WHITE WHITE	10' (3 m) LINE WITH 30' (9 m) SPACE
DOTTED LINES (EXTENSIONS OF CENTER, LANE OR TURN LANE MARKINGS)	SAME AS LINE BEING EXTENDED	SKIP-DASH	SAME AS LINE BEING EXTENDED	2' (600) LINE WITH 6' (1.8 m) SPACE
EDGE LINES	4 (100)	SOLID	YELLOW-LEFT WHITE-RIGHT	OUTLINE MEDIANS IN YELLOW
TURN LANE MARKINGS	6 (150) LINE; FULL SIZE LETTERS & SYMBOLS (8' (2.4m))	SOLID	WHITE	SEE TYPICAL TURN LANE MARKING DETAIL
TWO WAY LEFT TURN MARKING	2 @ 4 (100) EACH DIRECTION 8' (2.4m) LEFT ARROW	SKIP-DASH AND SOLID IN PAIRS	YELLOW	10' (3 m) LINE WITH 30' (9 m) SPACE FOR SKIP-DASH; 5½ (140) C-C BETWEEN SOLID LINE AND SKIP-DASH LINE SEE TYPICAL TWO-WAY LEFT TURN MARKING DETAIL
CROSSWALK LINES (PEDESTRIAN) A. DIAGONALS (BIKE & EQUESTRIAN) B. LONGITUDINAL BARS (SCHOOL)	2 @ 6 (150) 12 (300) @ 45° 12 (300) @ 90°	SOLID SOLID SOLID	WHITE WHITE WHITE	NOT LESS THAN 6' (1.8 m) APART 2' (600) APART 2' (600) APART 5EE TYPICAL CROSSWALK MARKING DETAILS.
STOP LINES	24 (600)	SOLID	WHITE	PLACE 4* (1,2 m) IN ADVANCE OF AND PARALLEL TO CROSSWALK, IF PRESENT. OTHERWISE, PLACE AT DESIRED STOPPING POINT. PARALLEL TO CROSSROAD CENTERLINE, WHERE POSSIBLE
PAINTED MEDIANS	2 @ 4 (100) WITH 12 (300) DIAGONALS @ 45° NO DIAGONALS USED FOR 4' (1.2 m) WIDE MEDIANS	SOLID	YELLOW: TWO WAY TRAFFIC WHITE: ONE WAY TRAFFIC	11 (280) C-C FOR THE DOUBLE LINE SEE TYPICAL PAINTED MEDIAN MARKING.
GORE MARKING AND CHANNELIZING LINES	8 (200) WITH 12 (300) DIAGONALS @ 45°	SOLID	WHITE	DIAGONALS: 15' (4.5 m) C-C (LESS THAN 30MPH (50 km/h)) 20' (6 m) C-C 30MPH (50 km/h) TO 45MPH (70 km/h)) 30' (9 m) C-C (OVER 45MPH (70 km/h))
RAILROAD CROSSING	24 (600) TRANSVERSE LINES; "RR" IS 6' (1.8 m) LETTERS; 16 (400) LINE FOR "X"	SOLID	WHITE	SEE STATE STANDARD 780001 AREA OF: "R"=3.6 SQ, FT. (0.33 m) ² EACH "X"=54.0 SQ, FT. (5.0 m) ²
SHOULDER DIAGONALS (REQUIRED FOR SHOULDERS > 8')	12 (300) @ 45°	SOLID	WHITE - RIGHT YELLOW - LEFT	50' (15 m) C-C (LESS THAN 30MPH (50 km/h)) 75' (25 m) C-C (30 MPH (50 km/h) TO 45MPH (70 km/h)) 150' (45 m) C-C (OVER 45MPH (70 km/h))
U TURN ARROW	SEE DETAIL	SOLID	WHITE	16,3 SF
2 ARROW COMBINATION LEFT AND U TURN	SEE DETAIL	SOLID	WHITE	30,4 SF

FOR FURTHER DETAILS ON PAVEMENT MARKING REFER TO STANDARD SPECIFICATIONS FOR ROAD AND BRIDGE CONSTRUCTION AND STATE STANDARD 780001.

SCALE: NONE


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All dimensions are in inches (millimeters) unless otherwise shown.


DRAWN -	REVISED - C. JUCIUS 07-01-13
CHECKED -	REVISED - C. JUCIUS 12-21-15
DATE - 03-19-90	REVISED - C. JUCIUS 04-12-16
	CHECKED -

STATE OF ILLINOIS **DEPARTMENT OF TRANSPORTATION**


DISTRICT ONE								F.A. RTE.	F.A. RTE. SECTION COUNTY TOT SHE							
	TYPICAL PAVEMENT MARKINGS						c	3553	22-00041-00-RS	DuPAGE	31	29				
	TIFICAL PAVEINENT INIANNINGS								TC-13	CONTRAC	NO. 61	33				
	SHEET	1	OF	2	SHEETS	STA.	TO STA.		ILLINOIS FED.	AID PROJECT						

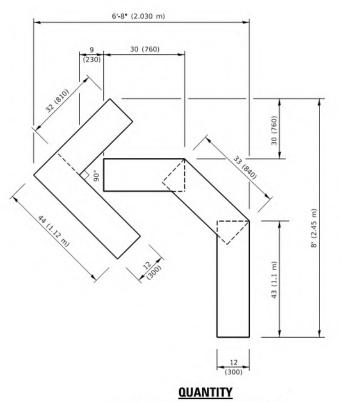

4 (100) LINE = 45.5 ft. (13.9 m) 15.2 sq. ft. (1.41 sq. m)

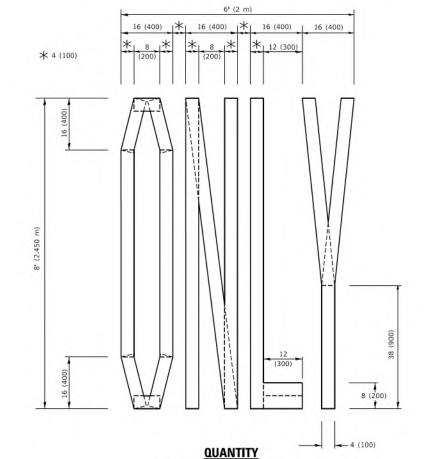

4 (100) LINE = 64.1 ft. (19.5 m) 21.4 sq. ft. (1.99 sq. m)

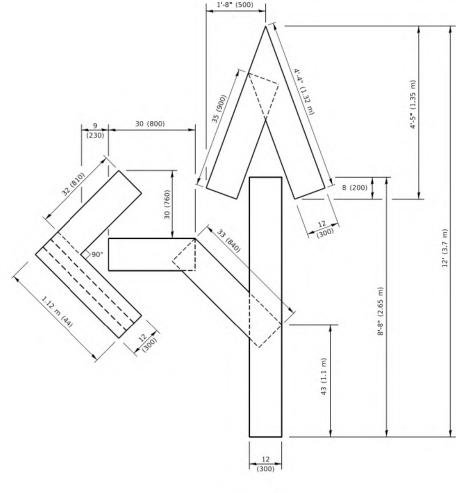


QUANTITY

4 (100) LINE = 82.5 ft. (25.1 m) 27.5 sq. ft. (2.53 sq. m)

NOTE:

ALL QUANTITIES OF PLACEMENT ARE REPRESENTED IN LINEAR FEET OF 4" LINES TO MATCH THE 4" TEMPORARY TAPE PAY ITEM AND REPRESENTS THE TOTAL QUANTITY OF 4" TAPE REQUIRED.

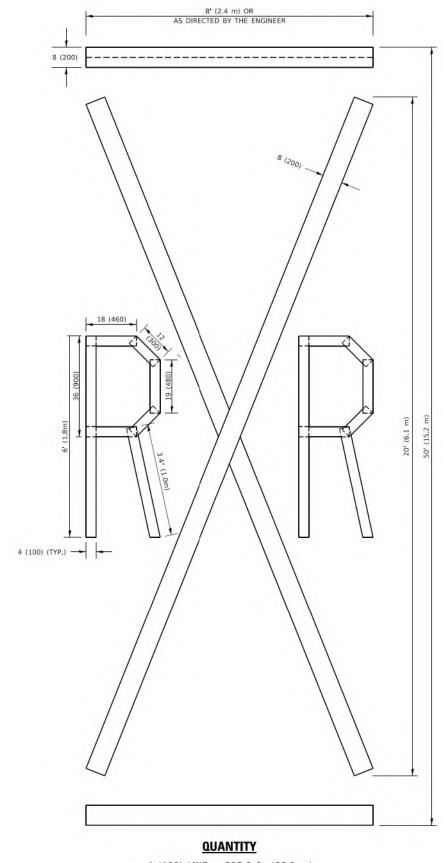

4 (100) LINE = 225.9 ft. (68.9 m) 75.3 sq. ft. (6.99 sq. m)


All dimensions are in inches (millimeters) unless otherwise shown.

STATE OF ILLINOIS
DEPARTMENT OF TRANSPORTATION

SHORT TERM PAVEMENT MARKING LETTERS AND SYMBOLS

SCALE: NONE SHEET 1 OF 1 SHEETS STA. TO STA.

F.A. RTE. SECTION COUNTY TOTAL SHEETS NO. 3553 22-00041-00-RS DUPAGE 31 30 TC-16 CONTRACT NO. 61J33

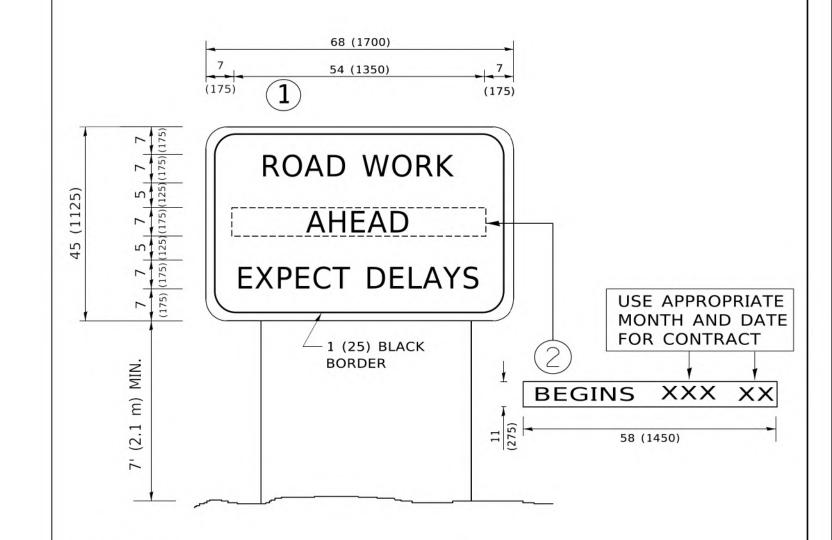

NOTES:

- 1. USE BLACK LETTERING ON ORANGE BACKGROUND.
- 2. ERECT SIGNS IN ADVANCE OF THE LOCATION FOR THE "ROAD CONSTRUCTION AHEAD" SIGN AT LOCATIONS AS DIRECTED BY THE ENGINEER.
- 3. ERECT SIGN 1 WITH INSTALLED PANEL 2 ONE WEEK PRIOR TO THE START OF CONSTRUCTION.
- 4. REMOVE PANEL(2)SOON AFTER THE START OF CONSTRUCTION.
- 5. SEE SPECIAL PROVISION FOR "TEMPORARY INFORMATION SIGNING" FOR ADDITIONAL INFORMATION.
- 6. ONE SIGN ASSEMBLY EQUALS 25.70 SQ. FT. (2.3 SQ. M.)
- 7. SHALL BE PAID FOR AS TEMPORARY INFORMATION SIGNING.

ALL DIMENSIONS ARE IN INCHES (MILLIMETERS) UNLESS OTHERWISE SHOWN.

 USER NAME = footemj	DESIGNED -	REVISED - R. MIRS 09-15-97			ΔRT	ERIAL ROA	ΔD		F.A. RTF	SECTION	COUNTY	TOTAL SHEET
77.034	DRAWN -	REVISED - R, MIRS 12-11-97	STATE OF ILLINOIS	INFORMATION SIGN					3553	22-00041-00-RS	DuPAGE	31 31
PLOT SCALE = 50,0000 * / in.	CHECKED -	REVISED -T. RAMMACHER 02-02-99	DEPARTMENT OF TRANSPORTATION						TC-22		CONTRACT	NO, 61J33
PLOT DATE = 3/4/2019	DATE -	REVISED - C. JUCIUS 01-31-07		SCALE: NONE	SHEET 1 OF 1	SHEETS	STA.	TO STA.		ILLINOIS FED. A	AID PROJECT	