STATE OF ILLINOIS


DEPARTMENT OF TRANSPORTATION

FOR INDEX OF SHEETS AND HIGHWAY STANDARDS, SEE SHEET NO. 2

PROPOSED HIGHWAY PLANS

FAP ROUTE 599 (US 67)
SECTION D2 SW 2020-2
PROJECT STP-LTDU(457)
ADA IMPROVEMENTS
2ND AVE TO 5TH AVE IN ROCK ISLAND
ROCK ISLAND COUNTY

TOWNSHIP: ROCK ISLAND SECTION: 35

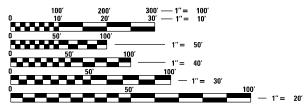

FULL SIZE PLANS HAVE BEEN PREPARED USING STANDARD ENGINEERING SCALES. REDUCED SIZED PLANS WILL NOT CONFORM TO STANDARD SCALES. IN MAKING MEASUREMENTS ON REDUCED PLANS, THE ABOVE SCALES MAY BE USED.


J.U.L.I.E.
JOINT UTILITY LOCATION INFORMATION FOR EXCAVATORS
1–800–892–0123
OR 811

PROJECT ENGINEER: MICHAEL KUEHN
PROJECT MANAGER: BRAD CUSHMAN 815–284–5996

EMAIL: BRAD.CUSHMAN@ILLINOIS.GOV

CONTRACT NO. 64P59

 \bigcirc

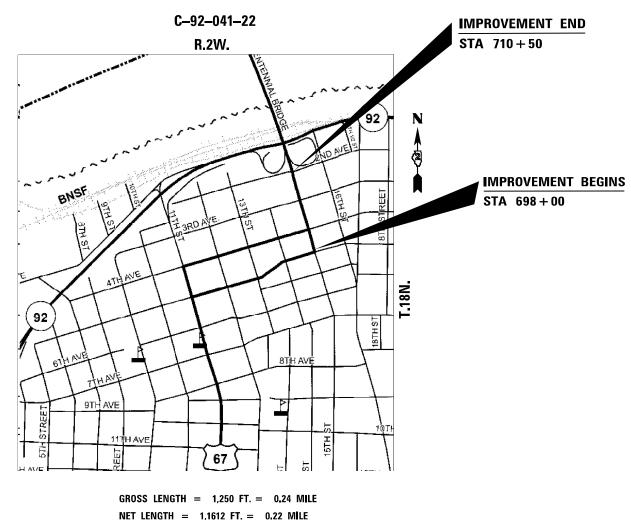

D-92-063-20



STATE OF ILLINOIS
DEPARTMENT OF TRANSPORTATION

SUBMITTED

11/29

20

REGIONAL ENGINEER

March 24, 2023

ENGINEER OF DESIGN AND ENVIRONMENT

March 24, 2023

PRINTED BY THE AUTHORITY OF THE STATE OF ILLINOIS

INDEX OF SHEETS

HIGHWAY STANDARDS

2		INDEX / HIGHWAY STANDARDS
3 -	7	SUMMARY OF QUANTITIES
8		GENERAL NOTES
9 -	12	SCHEDULE OF QUANTITIES
13 -	16	HORIZONTAL & VERTICAL CONTROL
17 -	23	PLAN SHEETS
24 -	39	ADA DETAIL SHEETS
40 -	48	TRAFFIC SIGNAL PLANS
49 -	54	RIGHT OF WAY AND EASEMENT PLAT
55		CATCH BASIN OR INLETS TO BE ADJUSTED OR RECONSTRUCTED (17.4)
		SIDEWALK AND DRIVEWAY PAVEMENT PAY AREAS (35.4)
56		ENTRANCE APPROACHES - URBAN AREA (25.1)
57		ADA CURB RAMP PAVEMENT REMOVAL AND REPLACEMENT (26.1)
58 -	60	TYPICAL PAVEMENT MARKINGS (41.1)

COVER SHEET

000001-08	STANDARD SYMBOLS, ABBREVIATIONS AND PATTERNS
001001-02	AREAS OF REINFORCEMENT BARS
001006	DECIMAL OF AN INCH AND A FOOT
424001-11	PERPENDICULAR CURB RAMPS FOR SIDEWALKS
424006-05	DIAGONAL CURB RAMPS FOR SIDEWALKS
424011-04	CORNER PARALLEL CURB RAMPS FOR SIDEWALKS
424016-05	MID-BLOCK CURB RAMPS FOR SIDEWALKS
424021-06	DEPRESSED CORNER FOR SIDEWALKS
442201-03	CLASS C AND D PATCHES
602301-04	INLET, TYPE A
602306-03	INLET, TYPE B
602601-06	PRECAST REINFORCED CONCRETE FLAT SLAB TOP
604006-05	FRAME AND GRATE, TYPE 3
606001-08	CONCRETE CURB TYPE B AND COMBINATION CONCRETE CURB AND GUTTER
701006-05	OFF-ROAD OPERATIONS, 2L, 2W, 15' (4.5M) TO 24" (600 MM) FROM PAVEMENT EDGE
701427-05	LANE CLOSURE, MULTILANE, INTERMITTENT OR MOVING OPERATION, FOR SPEEDS ≤ 40MPH
701456-05	PARTIAL EXIT RAMP CLOSURE FREEWAY/EXPRESSWAY
701501-06	URBAN LANE CLOSURE, 2L, 2W, UNDIVIDED
701701-10	URBAN LANE CLOSURE, MULTILANE INTERSECTION
701801-06	SIDEWALK, CORNER OR CROSSWALK CLOSURE
701901-08	TRAFFIC CONTROL DEVICES
720011-01	METAL POST FOR SIGNS, MARKERS AND DELINEATORS
728001-01	TELESCOPING STEEL SIGN SUPPORT
729001-01	APPLICATIONS OF TYPES A & B METAL POSTS (FOR SIGNS AND MARKERS)
731001-01	BASE FOR TELESCOPING STEEL SIGN SUPPORT
780001-05	TYPICAL PAVEMENT MARKINGS
814001-03	HANDHOLES
814006-03	DOUBLE HANDHOLES
857001 - 01	STANDARD PHASE DESIGNATION DIAGRAMS AND PHASE SEQUENCES
876001-04	PEDESTRIAN PUSH BUTTON POST
877001-08	STEEL MAST ARM ASSEMBLY AND POLE 16' THROUGH 55'
877011-10	STEEL COMBINATION MAST ARM ASSEMBLY AND POLE 16' THROUGH 55'
878001-11	CONCRETE FOUNDATION DETAILS
880006-01	TRAFFIC SIGNAL MOUNTING DETAILS

		•	
PLOT DATE = Nov-29-2022 06:49:59 AM	DATE	REVISED -	
PLOT SCALE = 100.0000 / in.	CHECKED	REVISED -	
	DRAWN -	REVISED -	
USER NAME = Brad.Cushman	DESIGNED	REVISED -	

STATE OF ILLINOIS DEPARTMENT OF TRANSPORTATION

SCALE: _

COUNTY TOTAL SHEET NO.

SW 2020-2 ROCK ISLAND 60 2

CONTRACT NO. 64P59

ILLINOIS FED. AID PROJECT INDEX / HIGHWAY STANDARDS D2 SW 2020-2 SHEET ___ OF __ SHEETS STA. _____

	_			ADA PED RAMPS	TRAFFIC SIGNALS	TRAFFIC SIGNALS	ROADWAY
CODE			TOTAL	0021	0021	0021	0021
NO .	ITEM	UNIT	QUANTITY	URBAN	URBAN 4TH Ave.	URBAN 3rd. & 5th Ave	URBAN
20200100	EARTH EXCAVATION	CU YD	90	90			
21101615	TOPSOIL FURNISH AND PLACE, 4"	SQ YD	89	89			
25200110	SODDING, SALT TOLERANT	SQ YD	89	89			
25200200	SUPPLEMENTAL WATERING	UNIT	1	1			
_							
28000510	INLET FILTERS	EACH	4	4			
40600290	BITUMINOUS MATERIALS (TACK COAT)	POUND	32	32			
40800050	INCIDENTAL HOT-MIX ASPHALT SURFACING	TON	6	6	_	_	
42300300	PORTLAND CEMENT CONCRETE DRIVEWAY PAVEMENT, 7 INCH	SQ YD	37	37			
					_	_	
42400200	PORTLAND CEMENT CONCRETE SIDEWALK 5 INCH	SQ FT	6301	6301			
42400800	DETECTABLE WARNINGS	SQ FT	338	338			_
_		_					
44000161	HOT-MIX ASPHALT SURFACE REMOVAL, 3"	SQ YD	35	35			
						_	
44000200	DRIVEWAY PAVEMENT REMOVAL	SQ YD	35	35			
_					_	_	
44000500	COMBINATION CURB AND GUTTER REMOVAL	FOOT	818	818		_	
44000600	SIDEWALK REMOVAL	SQ FT	5318	5318	_		

80% FEDERAL

20% STATE

MODEL: Default FILE NAME: pw://ildot-pw.bent * SPECIALTY ITEMS

STATE OF ILLINOIS DEPARTMENT OF TRANSPORTATION

 SUMMARY OF QUANTITES
 F.A.P. RTE.
 SECTION
 COUNTY SHEETS
 SHEET NO. SHEETS
 SHEET NO. GO 3

 SCALE:
 SHEET
 OF SHEETS
 STA.
 TO STA.
 ILLINOIS FED. AID PROJECT
 TO STA.
 ILLINOIS FED. AID PROJECT
 TO STA.
 ILLINOIS FED. AID PROJECT
 TO STA.
 TO

CONSTRUCTION CODE

5% Rock Island

80% FEDERAL/15% STATE 80% FEDERAL/10% STATE 100% CITY OF ROCK ISLAND

10% Rock Island

					COI	NSTRUCTION CODE		
					80% FEDERAL	80% FEDERAL/15% STATE	80% FEDERAL/10% STATE	100% CITY OF ROCK ISLAND
					20% STATE	5% Rock Island	10% Rock Island	
)		ADA PED RAMPS	TRAFFIC SIGNALS	TRAFFIC SIGNALS	ROADWAY
	CODE			TOTAL	0021	0021	0021	0021
	NO.	ITEM	UNIT	QUANTITY	URBAN	URBAN 4TH Ave.	URBAN 3rd. & 5th Ave	URBAN
	44201341	CLASS C PATCHES, TYPE II, 9 INCH	SQ YD	30	30			
				3				
	60255500	MANHOLES TO BE ADJUSTED	EACH	3				3
	60260100	INLETS TO BE ADJUSTED	EACH	4				4
	60605000	COMBINATION CONCRETE CURB AND GUTTER, TYPE B-6.24	FOOT	796	796			
*	66900200	NON-SPECIAL WASTE DISPOSAL	CU YD	90	90			
*	66900530	SOIL DISPOSAL ANALYSIS	EACH	3	3			
*	66901001	REGULATED SUBSTANCES PRE-CONSTRUCTION PLAN	L SUM	1	1			
1	00901001	REGULATED SUBSTANCES PRE-CONSTRUCTION FEAN	L 30M	1	1			
*	66901003	REGULATED SUBSTANCES FINAL CONSTRUCTION REPORT	L SUM	1	1			
*	66901006	REGULATED SUBSTANCES MONITORING	CAL DA	15	15			
	67000400	ENGINEER'S FIELD OFFICE, TYPE A	CAL MO	3	3			
	671.001.00							
	67100100	MOBILIZATION	L SUM	1	1			
	70100825	TRAFFIC CONTROL AND PROTECTION, STANDARD 701456	L SUM	1	1			
	70102621	TRAFFIC CONTROL AND PROTECTION, STANDARD 701501	EACH	1	1			
					2			
	70102637	TRAFFIC CONTROL AND PROTECTION, STANDARD 701701	EACH	1	1			

CONSTRUCTION CODE

* SPECIALTY ITEMS

USER NAME = Brad.Cushman	DESIGNED	REVISED =							F.A.P.	SECTION	COUNTY	TOTAL SHEET
	DRAWN	REVISED	STATE OF ILLINOIS		SUMMARY OF QUANTITES		599	D2 SW 2020-2	ROCK ISLAND	60 4		
PLOT SCALE = 100.0000 / in.	CHECKED	REVISED	DEPARTMENT OF TRANSPORTATION								CONTRACT	NO. 64P59
PLOT DATE = Nov-22-2022 01:02:26 PM	DATE	REVISED		SCALE:	SHEET	OF	SHEETS STA	TO STA		LILLINOIS EED	AID PROJECT	

					CON	ISTRUCTION CODE	
		Т		80% FEDERAL 20% STATE ADA PED RAMPS	5% Rock Is∣and	80% FEDERAL/10% STATE 10% Rock Island TRAFFIC SIGNALS	100% CITY OF ROCK ISLAN
COL	CODE		TOTAL	0021	0021	0021	0021
NO		UNIT	QUANTITY	URBAN	URBAN 4TH Ave.	URBAN 3rd. & 5th Ave	URBAN
			,				
70102	02640 TRAFFIC CONTROL AND PROTECTION, STANDARD 701801	L SUM	1	1			
70103	03815 TRAFFIC CONTROL SURVEILLANCE	CAL DA	30	30			
78000	00400 THERMOPLASTIC PAVEMENT MARKING - LINE 6"	FOOT	1464	1464			
78000	00650 THERMOPLASTIC PAVEMENT MARKING - LINE 24"	FOOT	291	291	_	_	
78011	11035 GROOVING FOR RECESSED PAVEMENT MARKING 7"	FOOT	1464	1464			
78011	11125 GROOVING FOR RECESSED PAVEMENT MARKING 25"	FOOT	291	291			
78300	00201 PAVEMENT MARKING REMOVAL - GRINDING	SQ FT	1326	1326			
81028	28740 UNDERGROUND CONDUIT, COILABLE NONMETALLIC CONDUIT, 1 1/2" DIA.	FOOT	177		23	154	
81028	28760 UNDERGROUND CONDUIT, COILABLE NONMETALLIC CONDUIT, 2 1/2" DIA.	FOOT	75		22	53	
81702	02110 ELECTRIC CABLE IN CONDUIT, 600V (XLP-TYPE USE) 1/C NO. 10	FOOT	486		105	381	
85000	00200 MAINTENANCE OF EXISTING TRAFFIC SIGNAL INSTALLATION	EACH	3		1	2	
85700	00200 FULL-ACTUATED CONTROLLER AND TYPE IV CABINET	EACH	2		1	1	
87301	01215 ELECTRIC CABLE IN CONDUIT. SIGNAL NO. 14 2C	FOOT	2112		770	1342	
87301	01225 ELECTRIC CABLE IN CONDUIT, SIGNAL NO. 14 3C	FOOT	270		51	219	

* SPECIALTY ITEMS

USER NAME = Brad.Cushman	DESIGNED	REVISED -
	DRAWN	REVISED
PLOT SCALE = 100.0000 / in.	CHECKED	REVISED
PLOT DATE = Nov-22-2022 01:04:00 PM	DATE -	REVISED -

SCALE: ___

01111		, 05 011	4 NITITEO		F.A.P. RTE	SECT	ПОИ		COUNTY	TOTAL SHEETS	SHEET NO.
SUMMARY OF QUANTITES						D2 SW	2020-2		ROCK ISLAND	60	5
									CONTRACT	NO. 64	1P59
SHEET	OF	SHEETS	STA.	TO STA.			TELINOIS	FED A	ID PROJECT		

			CONSTRUCTION CODE							
					80% FEDERAL			100% CITY OF ROCK ISLAN		
			1		20% STATE	5% Rock Island	10% Rock Island			
	0055				ADA PED RAMPS	TRAFFIC SIGNALS	TRAFFIC SIGNALS	ROADWAY		
	CODE		l	TOTAL	0021	0021	0021	0021		
	NO .	ITEM	UNIT	QUANTITY	URBAN	URBAN 4TH Ave.	URBAN 3rd. & 5th Ave	URBAN		
(87	7301245	ELECTRIC CABLE IN CONDUIT, SIGNAL NO. 14 5C	FOOT	576		121	455			
< 87	7301255	ELECIRIC CABLE IN CONDUIT, SIGNAL NO. 14 /C	F001	155		0	155			
< 87	7900200	DRILL EXISTING HANDHOLE	EACH	23		5	18			
< 88	8102845	PEDESTRIAN SIGNAL HEAD, POLYCARBONATE, LED, 2 FACE, BRACKET MOUNTED WITH COUNT DOWN TIMER	EACH	12		4	8			
`						,				
< 89	9501300	RELOCATE EXISTING MAST ARM ASSEMBLY AND POLE	EACH	4		1	3			
(89	9502210	MODIFY EXISTING CONTROLLER CABINET	EACH	1			1			
< 89	9502375	REMOVE EXISTING TRAFFIC SIGNAL EQUIPMENT	EACH	3		1	2			
< 89	9502385	REMOVE EXISTING CONCRETE FOUNDATION	EACH	4		1	3			
< X(0321973	MODIFY EXISTING SERVICE INSTALLATION	EACH	1			1			
	-									
< X(0322951	CABLE SPLICE SPECIAL	EACH	34		6	28			
- X1	1400378	PEDESTRIAN SIGNAL POST, 5 FT.	EACH	17		4	13			
	1400370	TEEESTRIAN STORME TOST, STORM	LACIT			,				
< X8	8140205	MODIFY EXISTING CONCRETE HANDHOLE	EACH	12		4	8			
< X8	8500102	MAINTENANCE OF FIBER OPTIC CABLE (FOC) NETWORK	MO	1		0.33	0.67			
< X8	8760200	ACCESSIBLE PEDESTRIAN SIGNALS	EACH	24		8	16			
-			_		_	_				

* SPECIALTY ITEMS

USER NAME = Brad.Cushman	DESIGNED	REVISED
	DRAWN	REVISED
PLOT SCALE = 100.0000 / in.	CHECKED	REVISED
PLOT DATE = Nov-22-2022 01:06:18 PM	DATE -	REVISED -

	F.A.P. RTE.	SECTION		COUNTY		SHEET NO.					
	SUMMARY OF QUANTITES							599 D2 SW 2020-2			6
				CONTRACT	NO. 64	1P59					
SCALE:	SHEET	OF	SHEETS	STA	TO STA	ILLINOIS FED. AID PROJECT					

						CON	ISTRUCTION CODE	
								100% CITY OF ROCK ISLAND
		·	_		20% STATE	5% Rock Island	10% Rock Island	
					ADA PED RAMPS	TRAFFIC SIGNALS	TRAFFIC SIGNALS	ROADWAY
	CODE			TOTAL	0021	0021	0021	0021
	NO.	ITEM	UNIT	QUANTITY	URBAN	URBAN 4TH Ave.	URBAN 3rd. & 5th Ave	URBAN
*	X8780107	CONCRETE FOUNDATION (SPECIAL)	FOOT	55		14	41	
*	X8950105	REMOVE EXISTING TRAFFIC CONTROLLER AND CABINET	EACH	2		1	1	
	Z0013798	CONSTRUCTION LAYOUT	L SUM	1	1			
			_					
*	Z0025505	PROPERTY MARKERS	EACH	28	28			
*	Z0033072	VIDEO VEHICLE DETECTION SYSTEM	EACH	2		1	1	

* SPECIALTY ITEMS

STATE OF ILLINOIS DEPARTMENT OF TRANSPORTATION

GENERAL NOTES

Fertilizer Nutrients shall be applied at the rate specified in Sections 250 and 252 of the Standard Specifications. This shall be included in the cost of the SEEDING or SODDING.

The Contractor shall be responsible for collecting and maintaining an electronic log of all stakeout survey that is performed on the job, either by him/her or any sub-contractor performing the stakeout. Upon request, all logs shall be submitted to the Department. No additional compensation will be allowed for this work, but shall be considered included in the cost for CONSTRUCTION LAYOUT.

The following listed utilities located within the project limits or immediately adjacent to the project construction limits are members of JULIE:

Geneseo Telephone Co.	309/944-8025
MidAmerican Energy Co.	563/333-8706
MidAmerican Energy Co.	309/793-3704
Mediacom	309/743-4750
Windstream	414/313-9032
City of Rock Island	309/732-2238
AT&T	630/573-5465
Bluebird Network	847/650-1348
Modern Woodmen of America	309/793-5614

IDOT is not a member of JULIE. If you are near any overhead lighting, intersection lighting or traffic signals, contact the IDOT Traffic Office at 815/284-5469 at least 48 hours prior to work.

It shall be the Contractor's responsibility to contact the municipality to determine approved methods of utility structure adjustment. Utility structures may include, but are not limited to, manholes, water valves, handholes, etc. All materials and work necessary to complete adjustments per municipality requirements shall be considered included in the cost of the associated adjustment pay item.

Pavement Marking shall be done according to Standard 780001, except as follows:

- 1. All words, such as ONLY, shall be 8 feet high.
- 2. All non-freeway arrows shall be the large size.
- 3. The distance between yellow no-passing lines shall be 8 inches, not 7 inches, as shown in the detail of Typical Lane and Edge Lines.
- 4. Centerline Skip Dash Pavement Marking on multi-lane divided, multi-lane undivided, and one-way roadway shall be according to District Standard 41.1.

	USER NAME =	DESIGNED - Engineering Systems	REVISED -
FILE NAME CARGO ON BOOM		DRAWN -	REVISED -
FILE NAME = 64P59.GN.DOCX	PLOT SCALE =	CHECKED -	REVISED -
	PLOT DATE = 11/9/2022 3:18 PM	DATE - 9/28/2022 2:38 PM	REVISED -

STATE OF ILLINOIS	
DEPARTMENT OF TRANSPORTATION	

SHEET NO.

					ROUTE	SECTION	ON	COUNTY	TOTAL SHEETS	SHEET NO.
GENE	RAL N	OTES			FAP 599	D2 SW 20)20-2	Rock Island	60	8
SEITENAE ITOTES								CONTRACT NO	. 64P59	
٥٢	CHEETC	CTA	TO CI	•			II I INOIC	EED AID DOO!	CT	

20200100	EARTH EXC	AVATION									
	CU YD	LOCATION	OFFSET	REMARKS	28000510	INLET FIL	TERS				
		698+00 - 710+50	OFFSET	Estimate of Various ADA Ramp locations		EACH	LOCATION	OFFSET	REMA	RKS	
		TOTAL		Estimate of Valious ADA Namp locations		1	701+91	26.5' LT	NW Corner of 4	 h Ave & US 67	
	90	TOTAL				1	701+92	33.5' RT	NE Corner of 4t	n Ave & US 67	
24404645	TORSON EN	DNICH AND DI ACE 4"				1	709+04	38.8' RT	SE Corner of 2n	d Ave & US 67	
21101615	TOPSOIL FU	RNISH AND PLACE, 4"				1	709+05	29.3' LT	SW Corner of 2r		
	CO VD	LOCATION	OFFOFT	DEMARKO		4	TOTAL				
	SQ YD	LOCATION	<u>OFFSET</u>	REMARKS			J				
		698+20 - 698+49	RT	SW Comer of 5th Ave & US 67	40600290	BITUMINO	US MATERIALS (TACK CO	AT)			
	4.2	699+00 - 699+10	RT	NE Corner of 5th Ave & US 67		2 0		,			
	0.8	699+02 - 699+25	LT	NW Corner of 5th Ave & US 67		POUND	LOCATION	OFFSET	REMA	RKS	
	8.4	50+21 - 50+53	RT	SW Corner of 5th Ave & US 67		10	701+85 - 702+10	LT	NW Corner of 2r	 _	
	0.5	699+56 - 699+71	LT	SW Corner of 4th Ave & US 67		22	705+85 - 706+19	RT	NW Corner of 3		
		701+15 - 701+43	RT	SE Corner of 4th Ave & US 67		32	TOTAL	IXI	14W Conner or Si	a AVC & OO OT	
		701+87 - 702+14	LT	NW Corner of 4th Ave & US 67		32] TOTAL				
		702+07 - 702+14	RT	NE Corner of 4th Ave & US 67	40900050	INCIDENT	AL HOT MIV ACDUALT CHD	EACING			
	0.1	705+20 - 705+24	RT	SE Corner of 3rd Ave & US 67	40800050	INCIDENT	AL HOT-MIX ASPHALT SUR	FACING			
	6.9	705+16 - 705+36	LT	SW Corner of 3rd Ave & US 67							
	2.3	706+00 - 706+15	LT	NW Corner of 3rd Ave & US 67		TON	LOCATION	OFFSET	REMA		
	0.4	706+04 - 706+05	RT	NE Corner of 3rd Ave & US 67		2	701+85 - 702+10	LT	NW Corner of 2r		
	2.1	709+00 - 709+20	LT	SW Corner of 2nd Ave & US 67		4	705+85 - 706+19	RT	NW Comer of 3	d Ave & US 67	
	51.3	709+50 - 710+25	RT	E 2nd Ave Crosswalk to Centennial Bridge Park & NE 2nd Ave.		6	TOTAL				
	89	TOTAL			4000000	DODT! AN	D CEMENT CONCRETE DR	VENAV DAVEMENT Z	NOU		
25200110	SODDING, S.	ALT TOLERANT			42300300	PURILAN	D CEMENT CONCRETE DRI				
						SQ YD	LOCATION	OFFSET	REMA	 _	
	SQ YD	LOCATION	OFFSET	<u>REMARKS</u>		37	39+24 - 39+62 7	LT	NW 4th Ave Ac	e Mumer Clinic	
	1.4	698+20 - 698+49	RT	SW Corner of 5th Ave & US 67		37	TOTAL				
	4.2	699+00 - 699+10	RT	NE Corner of 5th Ave & US 67							
	0.8	699+02 - 699+25	LT	NW Corner of 5th Ave & US 67	42400200	PORTLAN	D CEMENT CONCRETE SID	EWALK, 5 INCH			
	8.4	50+21 - 50+53	RT	SW Corner of 5th Ave & US 67							
	0.5	699+56 - 699+71	LT	SW Corner of 4th Ave & US 67		SQ FT	LOCATION	OFFSET	REMA	<u>RKS</u>	
	0.9	701+15 - 701+43	RT	SE Corner of 4th Ave & US 67		234	50+29 - 50+51	RT	SE Corner of 5t	1 Ave & US 67	
	9.4	701+87 - 702+14	LT	NW Corner of 4th Ave & US 67		250	50+35 - 50+55	LT	NE Corner of 5t	1 Ave & US 67	
		702+07 - 702+14	RT	NE Corner of 4th Ave & US 67		239	698+20 - 698+47	RT	SW Corner of 5	h Ave & US 67	
		705+20 - 705+24	RT	SE Corner of 3rd Ave & US 67		411	698+32 - 699+25	LT	NW Corner of 5	h Ave & US 67	
		705+16 - 705+36	LT	SW Corner of 3rd Ave & US 67		473	701+06 - 701+35	LT	SW Corner of 4	h Ave & US 67	
		706+00 - 706+15	LT	NW Corner of 3rd Ave & US 67		303	701+16 - 701+41	RT	SE Corner of 4t	1 Ave & US 67	
		706+04 - 706+05	RT	NE Corner of 3rd Ave & US 67		344	701+85 - 702+14	RT	NE Corner of 4t	n Ave & US 67	
		709+00 - 709+20	LT	SW Corner of 2nd Ave & US 67		321	701+88 - 702+15	LT	NW Corner of 4	h Ave & US 67	
		709+50 - 710+25	RT	E 2nd Ave Crosswalk to Centennial Bridge Park & NE 2nd Ave.		998	704+63 - 705+36	LT	SW Comer of 3r	d Ave & US 67	
		TOTAL	IXI	E Zha Ave Glosswan to Gentennia Bhage Fair & NE Zha Ave.		442	705+08 - 705+38	RT	SE Corner of 3r	d Ave & US 67	
	09	TOTAL				424	705+88 - 706+19	RT	NE Corner of 3r		
	OUDDI EMEN	TAL WATERNO				388	705+93 - 706+14	LT	NW Corner of 3		
25200200	SUPPLEMEN	ITAL WATERING				492	708+71 - 709+10	RT	SE Corner of 2n		
		LOCATION	055055	DEMAN()		417	708+71 - 709+24	LT	SW Corner of 2r		
	<u>UNIT</u>	LOCATION	<u>OFFSET</u>	REMARKS		178	709+19 - 709+27	RT	E 2nd Ave Crosswalk to		
		698+20 - 698+49	RT	SW Corner of 5th Ave & US 67		155	709+19 - 709+27 709+51 - 709+81	RT	E 2nd Ave Crosswalk to	-	
		699+00 - 699+10	RT	NE Corner of 5th Ave & US 67							
	0.007	699+02 - 699+25	LT	NW Comer of 5th Ave & US 67		232	710+11 - 710+45	RT	E 2nd Ave Crosswalk to	Gentenniai bridge Park	
	0.076	50+21 - 50+53	RT	SW Corner of 5th Ave & US 67		6301	TOTAL				
	0.004	699+56 - 699+71	LT	SW Corner of 4th Ave & US 67							
	800.0	701+15 - 701+43	RT	SE Corner of 4th Ave & US 67							
	0.085	701+87 - 702+14	LT	NW Corner of 4th Ave & US 67							
	0.001	702+07 - 702+14	RT	NE Corner of 4th Ave & US 67							
		705+20 - 705+24	RT	SE Corner of 3rd Ave & US 67							
		705+16 - 705+36	LT	SW Corner of 3rd Ave & US 67							
		706+00 - 706+15	LT	NW Corner of 3rd Ave & US 67							
		706+04 - 706+05	RT	NE Corner of 3rd Ave & US 67							
		709+00 - 709+20	LT	SW Corner of 2nd Ave & US 67							
		709+50 - 710+25	RT	E 2nd Ave Crosswalk to Centennial Bridge Park & NE 2nd Ave.							
		TOTAL	13.1	E 2.14 AVG GIGGSWAIK to Geriterinial bridge Faik & NE 2114 AVG.							
	1 0.8								T.		COUNTY TOTAL
		= Brad.Cushman	DESIGNED	REVISED	CTATE OF ULUNOIS				l'	A.P. SECTION	COUNTY SHEETS
	USER NAME	= Brad Cushman = 100.0000 / in	DESIGNED DRAWN CHECKED	REVISED	STATE OF ILLINOIS ARTMENT OF TRANSPORTATION		SCHED	ULE OF QUANTITES		A.P. SECTION 599 D2 SW 2020-2	COUNTY TOTAL SHEETS ROCK ISLAND 60 CONTRACT NO. 64P

42400800	DETECTAE	LE WARNINGS			44000500	COMBINAT	TION CURB AND GUTTER RE	EMOVAL	
	SQ FT	LOCATION	OFFSET	REMARKS		FOOT	LOCATION	OFFSET	REMARKS
	26	50+29 - 50+42	RT	SE Corner of 5th Ave & US 67		38	50+21 - 50+53	RT	SE Corner of 5th Ave & US 67
	18	50+36 - 50+44	LT	NE Corner of 5th Ave & US 67		24	50+35 - 50+56	LT	NE Comer of 5th Ave & US 67
	18	698+37 - 699+02	LT	NW Corner of 5th Ave & US 67		42	698+13 - 699+08	LT	NW Comer of 5th Ave & US 67
	24	698+45 - 698+37	LT	SW Corner of 5th Ave & US 67		41	698+16 - 698+49	RT	SW Comer of 5th Ave & US 67
	11		LT	SW Corner of 4th Ave & US 67		48	701+07 - 701+35	LT	SW Comer of 4th Ave & US 67
	10		LT			37	701+15 - 701+44	RT	SE Comer of 4th Ave & US 67
	12	701+31 - 701+33 701+24 - 701+30	RT	SW Comer of 4th Ave & US 67 SE Corner of 4th Ave & US 67		35	701+83 - 702+14	RT	NE Corner of 4th Ave & US 67
	12	701+34 - 701+36	RT	SE Corner of 4th Ave & US 67		73	701+87 - 702+10	LT	NW Comer of 4th Ave & US 67
			RT			87	704+63 - 705+37	LT	SW Corner of 3rd Ave & US 67
	10	701+89 - 701+91 701+95 - 702+00		NE Corner of 4th Ave & US 67		54	705+04 - 705+38	RT	SE Corner of 3rd Ave & US 67
	11		RT	NE Corner of 4th Ave & US 67		47	705+87 - 706+19	RT	NE Corner of 3rd Ave & US 67
	10	701+90 - 701+92	LT	NW Corner of 4th Ave & US 67		51	705+93 - 706+14	LT	NW Comer of 3rd Ave & US 67
	10	701+94 - 702+00	LT	NW Corner of 4th Ave & US 67		59	708+70 - 709+25	LT	SW Corner of 2nd Ave & US 67
	24	705+21 - 705+31	RT	SE Corner of 3rd Ave & US 67		41	708+70 - 709+07	RT	SE Corner of 2nd Ave & US 67
	22	705+24 - 705+32	LT	SW Corner of 3rd Ave & US 67		30	709+24 - 709+32	RT	E 2nd Ave Crosswalk to Centennial Bridge Park
	10	705+33 - 705+35	LT	SW Corner of 3rd Ave & US 67		37	709+50	RT	E 2nd Ave Crosswalk to Centennial Bridge Park
	31	705+94 - 706+04	LT	NW Corner of 3rd Ave & US 67		36	709+72 - 709+92	RT	E 2nd Ave Crosswalk to Centennial Bridge Park
	18	705+96 - 706+04	RT	NE Corner of 3rd Ave & US 67		38	709+99 - 710+21	RT	E 2nd Ave Crosswalk to Centennial Bridge Park
	10	708+89 - 708+94	LT	SW Corner of 2nd Ave & US 67		818	TOTAL		
	11	708+89 - 708+94	RT	SE Corner of 2nd Ave & US 67]		
	10	709+25 - 709+28	RT	E 2nd Ave Crosswalk to Centennial Bridge Pa	44000600	SIDEWALK	REMOVAL		
	10	709+51 - 709+53	RT 	E 2nd Ave Crosswalk to Centennial Bridge Pa	ark				
	10	709+76 - 709+78	RT 	E 2nd Ave Crosswalk to Centennial Bridge Pa		SQ FT	LOCATION	OFFSET	REMARKS
	10	710+15 - 710+17	RT	E 2nd Ave Crosswalk to Centennial Bridge Pa	ark	272	50+25 - 50+51	RT	SE Comer of 5th Ave & US 67
	338	TOTAL				257	50+33 - 50+55	LT	NE Corner of 5th Ave & US 67
						257	698+16 - 699+05	LT	NW Comer of 5th Ave & US 67
44000161	HOT-MIX AS	SPHALT SURFACE REMOV	AL, 3"			198	698+20 - 698+45	RT	SW Comer of 5th Ave & US 67
						196	705+06 - 701+28	LT	SW Comer of 4th Ave & US 67
	<u>SQ YD</u>	LOCATION	OFFSET	REMARKS		303	701+16 - 701+41	RT	SE Comer of 4th Ave & US 67
	11	701+85 - 702+10	LT	NW Corner of 2nd Ave & US 67		328	701+85 - 702+14	RT	NE Corner of 4th Ave & US 67
	24	705+85 - 706+19	RT	NW Comer of 3rd Ave & US 67		272	701+88 - 702+15	LT	NW Corner of 4th Ave & US 67
	35	TOTAL				584	704+63 - 705+37	LT	SW Corner of 3rd Ave & US 67
						284	705+08 - 705+32	RT	SE Corner of 3rd Ave & US 67
44000200	DRIVEWAY	PAVEMENT REMOVAL				421	705+88 - 706+19	RT	NE Corner of 3rd Ave & US 67
						344	705+93 - 706+15	LT	NW Corner of 3rd Ave & US 67
	<u>SQ YD</u>	LOCATION	<u>OFFSET</u>	<u>REMARKS</u>		314	708+71 - 709+24	LT	SW Corner of 2nd Ave & US 67
	35	39+34 - 39+61	LT	NW 4th Ave Ace Nuffler Clinic		496	708+71 - 709+10	RT	SE Corner of 2nd Ave & US 67
	35	TOTAL				170	709+18 - 709+31	RT	E 2nd Ave Crosswalk to Centennial Bridge Park
						238	709+51 - 709+85	RT	E 2nd Ave Crosswalk to Centennial Bridge Park
						384	710+00 - 710+45	RT	E 2nd Ave Crosswalk to Centennial Bridge Park
						5318	TOTAL	IXI	E 21d / We Grosswalk to Ochtermia Bridge Fank
						0010] TOTAL		
					44201341	CLASS C F	PATCHES, TYPE II, 9 INCH		
						SQ YD	LOCATION	OFFSET	REMARKS
						14	708+69 - 709+27	LT	NW 2nd Ave. & US 67
						8	709+74 - 710+19	RT	NE 2nd Ave & On Ramp to Bridge
						9	709+74 - 710+19	RT	NE 2nd Ave & On Ramp to Bridge
						30	TOTAL		
					60255500	MANHOLE	S TO BE ADJUSTED		
						EACH	LOCATION	OFFSET	REMARKS
						1	50+45	19.8' RT	SE Corner of 5th Ave & US 67 (Storm Sewer)
						1	50+44	24.0' LT	NE Corner of 5th Ave & US 67 (Storm Sewer)
						1	708+77	31.7' RT	SE Corner of 2nd Ave & US 67 (Storm Sewer)
						3	TOTAL		
	1		L projection	100,000		-			[FAB] TATAL ALBERT
	USER N.	AME = Brad.Cushman	DESIGNED	REVISED REVISED	STATE OF ILLINOIS		SCI	HEDULE OF Q	UANTITES F.A.P. SECTION COUNTY TOTAL SHEET SHOET NO.
	PLOT SO	ALE = 100.0000 / in.	CHECKED -	REVISED -	DEPARTMENT OF TRANSPORTATION				CONTRACT NO. 64P59
	PLOT D	TE = Nov-21-2022 01:37:53 PM	DATE	REVISED			SCALE: SHEET	OF SHEETS	STA TO STA ILLINOIS FED. AID PROJECT

					7801
	EACH	LOCATION	OFFSET	<u>REMARKS</u>	
	1	701+91	26.5' LT	NW Corner of 4th Ave & US 67	
	1	701+92	33.5' RT	NE Corner of 4th Ave & US 67	
	1	709+04	38.8' RT	SE Corner of 2nd Ave & US 67	
	1	709+05 ¬	29.3' LT	SW Corner of 2nd Ave & US 67	
	4	TOTAL			
0605000	COMBINA	TION CONCRETE CU	RB AND GUTTER, TYPI	E B-6.24	
	FOOT	LOCATION	OFFSET	REMARKS	7801
	38	50+21 - 50+	+53 RT	SE Corner of 5th Ave & US 67	
	24	50+35 - 50+	+56 LT	NE Corner of 5th Ave & US 67	
	42	698+13 - 699	+08 LT	NW Corner of 5th Ave & US 67	
	41	698+16 - 698	+49 RT	SW Corner of 5th Ave & US 67	
	48	701+07 - 701	+35 LT	SW Corner of 4th Ave & US 67	
	37	701+15 - 701	+44 RT	SE Corner of 4th Ave & US 67	
	39	701+83 - 702	+14 RT	NE Corner of 4th Ave & US 67	
	47	701+87 - 702	+10 LT	NW Comer of 4th Ave & US 67	
	87	704+63 - 705		SW Corner of 3rd Ave & US 67	
	54	705+04 - 705		SE Corner of 3rd Ave & US 67	
	47	705+87 - 706		NE Corner of 3rd Ave & US 67	
	51	705+93 - 706	+14 LT	NW Corner of 3rd Ave & US 67	
	59	708+70 - 709	+25 LT	SW Corner of 2nd Ave & US 67	
	41	708+70 - 709	+07 RT	SE Corner of 2nd Ave & US 67	
	30	709+24 - 709		E 2nd Ave Crosswalk to Centennial Bridge Park	7830
	37	709+50 -	RT	E 2nd Ave Crosswalk to Centennial Bridge Park	
	36	709+72 - 709	+92 RT	E 2nd Ave Crosswalk to Centennial Bridge Park	
	38	709+99 - 710	+21 RT	E 2nd Ave Crosswalk to Centennial Bridge Park	
	38 796	709+99 - 710 TOTAL	+21 RT		
3000400	796	7			
8000400	796	TOTAL			
8000400	796 THERMOP	TOTAL	MARKING - LINE 6" OFFSET	E 2nd Ave Crosswalk to Centennial Bridge Park	
8000400	796 THERMOP	TOTAL PLASTIC PAVEMENT LOCATION	MARKING - LINE 6" OFFSET +03	E 2nd Ave Crosswalk to Centennial Bridge Park REMARKS	
8000400	796 THERMOP FOOT 387	TOTAL PLASTIC PAVEMENT LOCATION 698+65 - 699	MARKING - LINE 6" OFFSET +03 +01	E 2nd Ave Crosswalk to Centennial Bridge Park REMARKS 5th Ave & US 67 Crosswalks (White)	
8000400	796 THERMOP FOOT 387 388	TOTAL *LASTIC PAVEMENT LOCATION 698+65 - 699 701+22 - 702	MARKING - LINE 6" OFFSET +03 +01 +05	E 2nd Ave Crosswalk to Centennial Bridge Park REMARKS 5th Ave & US 67 Crosswalks (White) 4th Ave & US 67 Crosswalks (White)	
8000400	796 THERMOP FOOT 387 388 489	TOTAL LOCATION 698+65 - 699 701+22 - 702 705+23 - 706	MARKING - LINE 6" OFFSET +03 +01 +05 +95	E 2nd Ave Crosswalk to Centennial Bridge Park REMARKS 5th Ave & US 67 Crosswalks (White) 4th Ave & US 67 Crosswalks (White) 3rd Ave & US 67 Crosswalks (White)	
8000400	796 THERMOP FOOT 387 388 489 113 37 49	LOCATION 698+65 - 699 701+22 - 702 705+23 - 706 708+88 - 708 709+29 - 709 709+83 - 710	MARKING - LINE 6" OFFSET +03 +01 +05 +95 +49 RT	E 2nd Ave Crosswalk to Centennial Bridge Park REMARKS 5th Ave & US 67 Crosswalks (White) 4th Ave & US 67 Crosswalks (White) 3rd Ave & US 67 Crosswalks (White) 2nd Ave South Side WB/EB Crosswalk (White)	
8000400	796 THERMOP FOOT 387 388 489 113 37	LOCATION 698+65 - 699 701+22 - 702 705+23 - 706 708+88 - 708 709+29 - 709	MARKING - LINE 6" OFFSET +03 +01 +05 +95 +49 RT	E 2nd Ave Crosswalk to Centennial Bridge Park REMARKS 5th Ave & US 67 Crosswalks (White) 4th Ave & US 67 Crosswalks (White) 3rd Ave & US 67 Crosswalks (White) 2nd Ave South Side WB/EB Crosswalk (White) 2nd Ave South Side WB/EB Crosswalk (White)	
	796 THERMOP FOOT 387 388 489 113 37 49 1464	LOCATION 698+65 - 699 701+22 - 702 705+23 - 706 708+88 - 708 709+29 - 709 709+83 - 710 TOTAL	MARKING - LINE 6" OFFSET +03 +01 +05 +95 +49 RT	E 2nd Ave Crosswalk to Centennial Bridge Park REMARKS 5th Ave & US 67 Crosswalks (White) 4th Ave & US 67 Crosswalks (White) 3rd Ave & US 67 Crosswalks (White) 2nd Ave South Side WB/EB Crosswalk (White) 2nd Ave South Side WB/EB Crosswalk (White)	
	796 THERMOP FOOT 387 388 489 113 37 49 1464 THERMOP	TOTAL LOCATION 698+65 - 699 701+22 - 702 705+23 - 706 708+88 - 708 709+29 - 709 709+83 - 710 TOTAL LOCATION LOCATION LOCATION LOCATION	OFFSET OFFSET OFFSET OFFSET OFFSET OFFSET	REMARKS 5th Ave & US 67 Crosswalks (White) 4th Ave & US 67 Crosswalks (White) 3rd Ave & US 67 Crosswalks (White) 3rd Ave & US 67 Crosswalks (White) 2nd Ave South Side WB/EB Crosswalk (White) 2nd Ave South Side WB/EB Crosswalk (White) E 2nd Ave Crosswalks to Centennial Bridge Park (White)	
	796 THERMOP FOOT 387 388 489 113 37 49 1464 THERMOP	TOTAL	MARKING - LINE 6" OFFSET +03 +01 +05 +95 +49 RT +05 RT MARKING - LINE 24" OFFSET +20 RT	REMARKS 5th Ave & US 67 Crosswalks (White) 4th Ave & US 67 Crosswalks (White) 3rd Ave & US 67 Crosswalks (White) 2rd Ave South Side WB/EB Crosswalk (White) 2nd Ave South Side WB/EB Crosswalk (White) E 2nd Ave Crosswalks to Centennial Bridge Park (White) REMARKS 15th St & 5th Ave NB Stop Bar (White)	
	796 THERMOP FOOT 387 388 489 113 37 49 1464 THERMOP FOOT 20 44	TOTAL	MARKING - LINE 6" OFFSET +03 +01 +05 +95 +49 RT +05 RT MARKING - LINE 24" OFFSET +20 RT +32	REMARKS 5th Ave & US 67 Crosswalks (White) 4th Ave & US 67 Crosswalks (White) 3rd Ave & US 67 Crosswalks (White) 2rd Ave South Side WB/EB Crosswalk (White) 2nd Ave South Side WB/EB Crosswalk (White) 2nd Ave Crosswalks to Centennial Bridge Park (White) E 2nd Ave Crosswalks to Centennial Bridge Park (White) REMARKS 15th St & 5th Ave NB Stop Bar (White) West Side of US 67 & 5th Ave WB/EB Stop Bar (White)	
	796 THERMOP FOOT 387 388 489 113 37 49 1464 THERMOP FOOT 20 44 22	TOTAL	MARKING - LINE 6" OFFSET +03 +01 +05 +95 +49 RT +05 RT MARKING - LINE 24" OFFSET +20 RT +32 +09 LT	REMARKS 5th Ave & US 67 Crosswalks (White) 4th Ave & US 67 Crosswalks (White) 3rd Ave & US 67 Crosswalks (White) 3rd Ave & US 67 Crosswalks (White) 2rd Ave South Side WB/EB Crosswalk (White) 2nd Ave South Side WB/EB Crosswalk (White) E 2nd Ave Crosswalks to Centennial Bridge Park (White) REMARKS 15th St & 5th Ave NB Stop Bar (White) West Side of US 67 & 5th Ave WB/EB Stop Bar (White)	
	796 THERMOP FOOT 387 388 489 113 37 49 1464 THERMOP FOOT 20 44 22 27	TOTAL	MARKING - LINE 6" OFFSET +03 +01 +05 +95 +49 RT +05 RT MARKING - LINE 24" OFFSET +20 RT +32 +09 LT +18 RT	REMARKS 5th Ave & US 67 Crosswalks (White) 4th Ave & US 67 Crosswalks (White) 3rd Ave & US 67 Crosswalks (White) 3rd Ave South Side WB/EB Crosswalk (White) 2nd Ave South Side WB/EB Crosswalk (White) 2nd Ave Crosswalks to Centennial Bridge Park (White) E 2nd Ave Crosswalks to Centennial Bridge Park (White) West Side of US 67 & 5th Ave NB Stop Bar (White) US 67 & 5th Ave SB Stop Bar (White) US 67 & 4th Ave NB Stop Bar (White)	
	796 THERMOP FOOT 387 388 489 113 37 49 1464 THERMOP FOOT 20 44 22 27 38	TOTAL	MARKING - LINE 6" OFFSET +03 +01 +05 +95 +49 RT +05 RT MARKING - LINE 24" OFFSET +20 RT +32 +09 LT +18 RT +18 RT	REMARKS 5th Ave & US 67 Crosswalks (White) 4th Ave & US 67 Crosswalks (White) 3rd Ave & US 67 Crosswalks (White) 3rd Ave South Side WB/EB Crosswalk (White) 2nd Ave South Side WB/EB Crosswalk (White) 2nd Ave South Side WB/EB Crosswalk (White) E 2nd Ave Crosswalks to Centennial Bridge Park (White) E 2nd Ave Crosswalks to Centennial Bridge Park (White) West Side of US 67 & 5th Ave WB/EB Stop Bar (White) US 67 & 5th Ave SB Stop Bar (White) US 67 & 4th Ave NB Stop Bar (White) East Side of US 67 & 4th Ave WB/EB Stop Bar (White)	
	796 THERMOP FOOT 387 388 489 113 37 49 1464 THERMOP FOOT 20 44 22 27 38 21	TOTAL	MARKING - LINE 6" OFFSET +03 +01 +05 +95 +49 RT +05 RT MARKING - LINE 24" OFFSET +20 RT +32 +09 LT +18 RT +82 RT +07 LT	REMARKS 5th Ave & US 67 Crosswalks (White) 4th Ave & US 67 Crosswalks (White) 3rd Ave & US 67 Crosswalks (White) 3rd Ave & US 67 Crosswalks (White) 2rd Ave South Side WB/EB Crosswalk (White) 2nd Ave South Side WB/EB Crosswalk (White) E 2nd Ave Crosswalks to Centennial Bridge Park (White) E 2nd Ave Crosswalks to Centennial Bridge Park (White) West Side of US 67 & 5th Ave WB/EB Stop Bar (White) US 67 & 5th Ave SB Stop Bar (White) US 67 & 4th Ave NB Stop Bar (White) East Side of US 67 & 4th Ave WB/EB Stop Bar (White) US 67 & 4th Ave SB Stop Bar (White)	
	796 THERMOP FOOT 387 388 489 113 37 49 1464 THERMOP FOOT 20 44 22 27 38 21 35	TOTAL	MARKING - LINE 6" OFFSET +03 +01 +05 +95 +49 RT +05 RT MARKING - LINE 24" COFFSET +20 RT +32 +09 LT +18 RT +82 RT +07 LT +19 RT	REMARKS 5th Ave & US 67 Crosswalks (White) 4th Ave & US 67 Crosswalks (White) 3rd Ave & US 67 Crosswalks (White) 3rd Ave South Side WB/EB Crosswalk (White) 2nd Ave South Side WB/EB Crosswalk (White) 2nd Ave South Side WB/EB Crosswalk (White) E 2nd Ave Crosswalks to Centennial Bridge Park (White) E 2nd Ave Crosswalks to Centennial Bridge Park (White) West Side of US 67 & 5th Ave WB/EB Stop Bar (White) US 67 & 5th Ave SB Stop Bar (White) US 67 & 4th Ave NB Stop Bar (White) East Side of US 67 & 4th Ave WB/EB Stop Bar (White) US 67 & 4th Ave SB Stop Bar (White) US 67 & 4th Ave SB Stop Bar (White) US 67 & 3rd Ave NB Stop Bar (White)	
	796 THERMOP FOOT 387 388 489 113 37 49 1464 THERMOP FOOT 20 44 22 27 38 21 35 24	TOTAL LOCATION 698+65 - 699 701+22 - 702 705+23 - 706 708+88 - 708 709+29 - 709 TOTAL LOCATION 50+00 - 50+698+30 - 698 699+07 - 699 701+16 - 701 701+44 - 701 702+05 - 705 705+39 - 705 705+39 - 705 705+39 - 705 705 - 705	MARKING - LINE 6" OFFSET +03 +01 +05 +95 +49 RT +05 RT MARKING - LINE 24" OFFSET +20 RT +32 +09 LT +18 RT +82 RT +82 RT +07 LT +19 RT +19 RT +166 LT	REMARKS 5th Ave & US 67 Crosswalks (White) 4th Ave & US 67 Crosswalks (White) 3rd Ave & US 67 Crosswalks (White) 2rd Ave South Side WB/EB Crosswalk (White) 2nd Ave South Side WB/EB Crosswalk (White) 2nd Ave South Side WB/EB Crosswalk (White) E 2nd Ave Crosswalks to Centennial Bridge Park (White) E 2nd Ave Crosswalks to Centennial Bridge Park (White) West Side of US 67 & 5th Ave NB Stop Bar (White) US 67 & 5th Ave SB Stop Bar (White) US 67 & 4th Ave NB Stop Bar (White) East Side of US 67 & 4th Ave WB/EB Stop Bar (White) US 67 & 4th Ave SB Stop Bar (White) US 67 & 3rd Ave NB Stop Bar (White) US 67 & 3rd Ave BB Stop Bar (White) US 67 & 3rd Ave EB Stop Bar (White)	
8000400 8000650	796 THERMOP FOOT 387 388 489 113 37 49 1464 THERMOP FOOT 20 44 22 27 38 21 35	TOTAL	MARKING - LINE 6" OFFSET +03 +01 +05 +95 +49 RT +05 RT MARKING - LINE 24" OFFSET +20 RT +32 +09 LT +18 RT +82 RT +07 LT +19 RT +19 RT +19 RT +160 LT +188 RT	REMARKS 5th Ave & US 67 Crosswalks (White) 4th Ave & US 67 Crosswalks (White) 3rd Ave & US 67 Crosswalks (White) 3rd Ave South Side WB/EB Crosswalk (White) 2nd Ave South Side WB/EB Crosswalk (White) 2nd Ave South Side WB/EB Crosswalk (White) E 2nd Ave Crosswalks to Centennial Bridge Park (White) E 2nd Ave Crosswalks to Centennial Bridge Park (White) West Side of US 67 & 5th Ave WB/EB Stop Bar (White) US 67 & 5th Ave SB Stop Bar (White) US 67 & 4th Ave NB Stop Bar (White) East Side of US 67 & 4th Ave WB/EB Stop Bar (White) US 67 & 4th Ave SB Stop Bar (White) US 67 & 4th Ave SB Stop Bar (White) US 67 & 3rd Ave NB Stop Bar (White)	
	796 THERMOP FOOT 387 388 489 113 37 49 1464 THERMOP FOOT 20 44 22 27 38 21 35 24	TOTAL LOCATION 698+65 - 699 701+22 - 702 705+23 - 706 708+88 - 708 709+29 - 709 TOTAL LOCATION 50+00 - 50+698+30 - 698 699+07 - 699 701+16 - 701 701+44 - 701 702+05 - 705 705+39 - 705 705+39 - 705 705+39 - 705 705 - 705	MARKING - LINE 6" OFFSET +03 +01 +05 +95 +49 RT +05 RT MARKING - LINE 24" OFFSET +20 RT +32 +09 LT +18 RT +82 RT +07 LT +19 RT +19 RT +106 LT +88 RT	REMARKS 5th Ave & US 67 Crosswalks (White) 4th Ave & US 67 Crosswalks (White) 3rd Ave & US 67 Crosswalks (White) 2rd Ave South Side WB/EB Crosswalk (White) 2nd Ave South Side WB/EB Crosswalk (White) 2nd Ave South Side WB/EB Crosswalk (White) E 2nd Ave Crosswalks to Centennial Bridge Park (White) E 2nd Ave Crosswalks to Centennial Bridge Park (White) West Side of US 67 & 5th Ave NB Stop Bar (White) US 67 & 5th Ave SB Stop Bar (White) US 67 & 4th Ave NB Stop Bar (White) East Side of US 67 & 4th Ave WB/EB Stop Bar (White) US 67 & 4th Ave SB Stop Bar (White) US 67 & 3rd Ave NB Stop Bar (White) US 67 & 3rd Ave BB Stop Bar (White) US 67 & 3rd Ave EB Stop Bar (White)	

<u>FOOT</u>	LO	CAT	ION	<u>OFFSET</u>	REMARKS
387	698+65	-	699+03		5th Ave & US 67 Crosswalks (White)
388	701+22	-	702+01		4th Ave & US 67 Crosswalks (White)
489	705+23	-	706+05		3rd Ave & US 67 Crosswalks (White)
113	708+88	-	708+95		2nd Ave South Side WB/EB Crosswalk (White)
37	709+29	-	709+49	RT	2nd Ave South Side WB/EB Crosswalk (White)
49	709+83	-	710+05	RT	E 2nd Ave Crosswalks to Centennial Bridge Park (Whi
1464] TOTAL				
ROOVING	FOR REC	ESS	ED PAVEME	ENT MARKING 25'	n
<u>FOOT</u>	LO	CAT	<u>ION</u>	OFFSET	<u>REMARKS</u>
20	50+00	-	50+20	RT	15th St & 5th Ave NB Stop Bar (White)
44	698+30	-	698+32		West Side of US 67 & 5th Ave WB/EB Stop Bar (White
22	699+07	-	699+09	LT	US 67 & 5th Ave SB Stop Bar (White)
27	701+16	-	701+18	RT	US 67 & 4th Ave NB Stop Bar (White)
38	701+44	-	701+82	RT	East Side of US 67 & 4th Ave WB/EB Stop Bar (White
21	702+05	-	702+07	LT	US 67 & 4th Ave SB Stop Bar (White)
35	705+17	-	705+19	RT	US 67 & 3rd Ave NB Stop Bar (White)
24	705+39	-	705+66	LT	US 67 & 3rd Ave EB Stop Bar (White)
26	705+62	-	705+88	RT	US 67 & 3rd Ave WB Stop Bar (White)
34	706+09	_	706+11	LT	US 67 & 3rd Ave SB Stop Bar (White)
34	100.00				
291	TOTAL		MOVAL - GF	RINDING	
291 AVEMENT SQ FT	TOTAL TMARKING		MOVAL - GF	RINDING OFFSET	<u>REMARKS</u>
291 AVEMENT SQ FT 57	TOTAL TMARKING	G RE	MOVAL - GF I <u>ON</u> 69+75		5th Ave & US 67 Crosswalks (White)
291 AVEMENT SQ FT 57 39	TOTAL T MARKING LOI 59+69 50+38	CAT	MOVAL - GF ION 69+75 50+44		5th Ave & US 67 Crosswalks (White) 5th Ave & US 67 Crosswalks (White)
291 AVEMENT 57 39 48	T MARKING 59+69 50+38 698+31	CAT - - -	MOVAL - GF 10N 69+75 50+44 698+37		5th Ave & US 67 Crosswalks (White) 5th Ave & US 67 Crosswalks (White) 5th Ave & US 67 Crosswalks (White)
291 AVEMENT 57 39 48 62	T MARKING 59+69 50+38 698+31 698+65	CAT - - - -	MOVAL - GF 1ON 69+75 50+44 698+37 699+03		5th Ave & US 67 Crosswalks (White) 5th Ave & US 67 Crosswalks (White) 5th Ave & US 67 Crosswalks (White) 5th Ave & US 67 Crosswalks (White)
291 AVEMENT 57 39 48 62 57	TOTAL LOC 59+69 50+38 698+31 698+65 701+27	CAT - - - -	MOVAL - GF 1ON 69+75 50+44 698+37 699+03 701+33	OFFSET	5th Ave & US 67 Crosswalks (White) 4th Ave & US 67 Crosswalks (White)
291 AVEMENT 57 39 48 62 57 55	TOTAL LOC 59+69 50+38 698+31 698+65 701+27 701+32	CAT	MOVAL - GF 1ON 69+75 50+44 698+37 699+03 701+33 701+90	<u>OFFSET</u> LT	5th Ave & US 67 Crosswalks (White) 4th Ave & US 67 Crosswalks (White) 4th Ave & US 67 Crosswalks (White)
291 AVEMENT 57 39 48 62 57 55 49	59+69 50+38 698+31 698+65 701+27 701+32 701+37	CAT - - - -	MOVAL - GF 10N 69+75 50+44 698+37 699+03 701+33 701+90 701+91	OFFSET	5th Ave & US 67 Crosswalks (White) 4th Ave & US 67 Crosswalks (White) 4th Ave & US 67 Crosswalks (White) 4th Ave & US 67 Crosswalks (White)
291 AVEMENT 57 39 48 62 57 55 49 60	59+69 50+38 698+31 698+65 701+27 701+32 701+37 701+91	CAT	MOVAL - GF 10N 69+75 50+44 698+37 699+03 701+33 701+90 701+91 701+96	<u>OFFSET</u> LT	5th Ave & US 67 Crosswalks (White) 4th Ave & US 67 Crosswalks (White)
291 AVEMENT 57 39 48 62 57 55 49 60 62	59+69 50+38 698+31 698+65 701+27 701+32 701+37 701+91 705+24	CAT	MOVAL - GF 69+75 50+44 698+37 699+03 701+33 701+90 701+91 701+96 705+30	<u>OFFSET</u> LT RT	5th Ave & US 67 Crosswalks (White) 4th Ave & US 67 Crosswalks (White) 3rd Ave & US 67 Crosswalks (White)
291 AVEMENT 57 39 48 62 57 55 49 60 62 65	59+69 50+38 698+31 698+65 701+27 701+32 701+37 701+91 705+24 705+30	CAT	MOVAL - GR 69+75 50+44 698+37 699+03 701+33 701+90 701+91 701+96 705+30 705+98	OFFSET LT RT	5th Ave & US 67 Crosswalks (White) 4th Ave & US 67 Crosswalks (White) 3rd Ave & US 67 Crosswalks (White) 3rd Ave & US 67 Crosswalks (White)
291 AVEMENT 57 39 48 62 57 55 49 60 62 65 63	59+69 50+38 698+31 698+65 701+27 701+32 701+37 701+91 705+24 705+30 705+30	CAT	MOVAL - GR 69+75 50+44 698+37 699+03 701+33 701+90 701+91 701+96 705+30 705+98 705+98	<u>OFFSET</u> LT RT	5th Ave & US 67 Crosswalks (White) 4th Ave & US 67 Crosswalks (White) 3rd Ave & US 67 Crosswalks (White)
291 AVEMENT 57 39 48 62 57 55 49 60 62 65 63 63	TOTAL LOC 59+69 50+38 698+31 698+65 701+27 701+32 701+37 701+91 705+24 705+30 705+30 705+98	CAT	MOVAL - GR 69+75 50+44 698+37 699+03 701+33 701+90 701+91 701+96 705+30 705+98 705+98 706+05	OFFSET LT RT	5th Ave & US 67 Crosswalks (White) 4th Ave & US 67 Crosswalks (White) 3rd Ave & US 67 Crosswalks (White)
291 AVEMENT 57 39 48 62 57 55 49 60 62 65 63 63 61	59+69 50+38 698+31 698+65 701+27 701+32 701+37 701+91 705+24 705+30 705+30 705+98 708+91	CAT	MOVAL - GF	OFFSET LT RT LT	5th Ave & US 67 Crosswalks (White) 4th Ave & US 67 Crosswalks (White) 3rd Ave & US 67 Crosswalks (White)
291 AVEMENT 57 39 48 62 57 55 49 60 62 65 63 63 61 41	59+69 50+38 698+65 701+27 701+32 701+37 701+91 705+24 705+30 705+98 708+91 50+00	CAT	MOVAL - GF 1ON 69+75 50+44 698+37 699+03 701+90 701+91 701+96 705+30 705+98 705+98 706+05 708+96 50+20	OFFSET LT RT	5th Ave & US 67 Crosswalks (White) 4th Ave & US 67 Crosswalks (White) 3rd Ave & US 67 Crosswalks (White) 15th St & 5th Ave NB Stop Bar (White)
291 AVEMENT 57 39 48 62 57 55 49 60 62 65 63 63 61 41 89	59+69 50+38 698+31 698+65 701+27 701+32 701+37 701+91 705+24 705+30 705+30 705+98 708+91 50+00 698+30	CAT	MOVAL - GF 1ON 69+75 50+44 698+37 699+03 701+33 701+90 701+91 701+96 705+30 705+98 705+98 706+05 708+96 50+20 698+32	OFFSET LT RT LT RT LT	5th Ave & US 67 Crosswalks (White) 4th Ave & US 67 Crosswalks (White) 3rd Ave & US 67 Crosswalks (White) 15th St & 5th Ave NB Stop Bar (White) West Side of US 67 & 5th Ave WB/EB Stop Bar (White)
291 AVEMENT 57 39 48 62 57 55 49 60 62 65 63 63 61 41 09 44	59+69 50+38 698+31 698+65 701+27 701+32 701+37 701+91 705+24 705+30 705+30 705+98 708+91 50+00 698+30 699+07	CAT	MOVAL - GF 10N 69+75 50+44 698+37 699+03 701+33 701+90 701+91 701+96 705+30 705+98 705+98 705+98 706+05 708+96 50+20 690+32 699+09	OFFSET LT RT LT RT LT	5th Ave & US 67 Crosswalks (White) 4th Ave & US 67 Crosswalks (White) 3rd Ave & US 67 Crosswalks (White) 4th Ave & US 67 Crosswalks (White) 5th Ave & US 67 Crosswalks (White) 4th Ave & US 67 Crosswalks (White) 5th Ave & US 67 Crosswalks (White) 4th Ave & US 67 Crosswalks (White) 5th Ave & US 67 Crosswalks (White) 4th Ave & US 67 Crosswalks (White) 5th Ave & US 67 Crosswalks (White)
291 AVEMENT 57 39 48 62 57 55 49 60 62 65 63 63 61 41 09 44 55	59+69 50+38 698+31 698+65 701+27 701+32 701+37 701+91 705+24 705+30 705+30 705+98 708+91 50+00 698+30 699+07 701+16	CAT	MOVAL - GF ION 69+75 50+44 698+37 699+03 701+90 701+91 701+96 705+30 705+98 705+98 706+05 708+96 50+20 690+32 699+09 701+18	OFFSET LT RT LT RT LT RT	5th Ave & US 67 Crosswalks (White) 4th Ave & US 67 Crosswalks (White) 3rd Ave & US 67 Crosswalks (White) 4th Ave & US 67 Crosswalks (White) 5th Ave & US 67 Crosswalks (White) 4th Ave & US 67 Crosswalks (White) 5th Ave & US 67 Crosswalks (White) 4th Ave & US 67 Crosswalks (White) 5th Ave & US 67 Crosswalks (White) 5th Ave & US 67 Crosswalks (White) 4th Ave & US 67 Crosswalks (White) 5th Ave & US 67 Crosswalks (White) 5th Ave & US 67 Crosswalks (White) 6th Ave & US 67 Crosswalks (US 67 & US
291 AVEMENT 57 39 48 62 57 55 49 60 62 65 63 63 61 41 89 44 55 75	59+69 50+38 698+31 698+65 701+27 701+32 701+37 701+91 705+24 705+30 705+30 705+98 708+91 50+00 698+30 699+07 701+16 701+44	CAT	MOVAL - GF ION 69+75 50+44 698+37 699+03 701+90 701+91 701+96 705+30 705+98 705+98 706+05 708+96 50+20 690+32 699+09 701+18 701+82	OFFSET LT RT LT RT LT RT RT	5th Ave & US 67 Crosswalks (White) 4th Ave & US 67 Crosswalks (White) 3rd Ave & US 67 Crosswalks (White) 15th St & 5th Ave NB Stop Bar (White) West Side of US 67 & 5th Ave WB/EB Stop Bar (White) US 67 & 5th Ave NB Stop Bar (White) East Side of US 67 & 4th Ave NB Stop Bar (White)
291 AVEMENT 57 39 48 62 57 55 49 60 62 65 63 63 61 41 89 44 55 75 42	TOTAL LOC 59+69 50+38 698+31 698+65 701+27 701+32 701+37 701+91 705+24 705+30 705+30 705+98 708+91 50+00 698+30 699+07 701+16 701+44 702+05	CAT	MOVAL - GF ION 69+75 50+44 698+37 699+03 701+33 701+90 701+91 701+96 705+30 705+98 705+98 706+05 708+96 50+20 690+32 699+09 701+18 701+82 702+07	OFFSET LT RT LT RT LT RT LT RT LT RT LT RT LT	5th Ave & US 67 Crosswalks (White) 4th Ave & US 67 Crosswalks (White) 3rd Ave & US 67 Crosswalks (White) 15th St & 5th Ave NB Stop Bar (White) West Side of US 67 & 5th Ave WB/EB Stop Bar (White) US 67 & 4th Ave NB Stop Bar (White) East Side of US 67 & 4th Ave WB/EB Stop Bar (White)
291 AVEMENT 57 39 48 62 57 55 49 60 62 65 63 63 61 41 09 44 55 75 42 70	TOTAL LOC 59+69 50+38 698+31 698+65 701+27 701+32 701+37 701+91 705+24 705+30 705+30 705+98 708+91 50+00 698+30 699+07 701+16 701+44 702+05 705+17	CAT	MOVAL - GF ION 69+75 50+44 698+37 699+03 701+90 701+91 701+96 705+30 705+98 705+98 706+05 708+96 50+20 690+32 699+09 701+18 701+82	OFFSET LT RT LT RT LT RT LT RT RT R	5th Ave & US 67 Crosswalks (White) 4th Ave & US 67 Crosswalks (White) 3rd Ave & US 67 Crosswalks (White) 15th St & 5th Ave NB Stop Bar (White) West Side of US 67 & 5th Ave WB/EB Stop Bar (White) US 67 & 4th Ave NB Stop Bar (White) East Side of US 67 & 4th Ave WB/EB Stop Bar (White) US 67 & 4th Ave SB Stop Bar (White) US 67 & 4th Ave SB Stop Bar (White) US 67 & 4th Ave SB Stop Bar (White)
291 AVEMENT 57 39 48 62 57 55 49 60 62 65 63 61 41 89 44 55 75 42 70 49	TOTAL LOC 59+69 50+38 698+31 698+65 701+27 701+32 701+37 701+91 705+24 705+30 705+30 705+98 708+91 50+00 698+30 699+07 701+16 701+44 702+05	CAT	MOVAL - GF ION 69+75 50+44 698+37 699+03 701+33 701+90 701+91 701+96 705+30 705+98 705+98 706+05 708+96 50+20 690+32 699+09 701+18 701+82 702+07 705+19 705+66	OFFSET LT RT LT RT LT RT LT RT LT RT LT RT LT RT	5th Ave & US 67 Crosswalks (White) 4th Ave & US 67 Crosswalks (White) 4th Ave & US 67 Crosswalks (White) 4th Ave & US 67 Crosswalks (White) 3rd Ave & US 67 Crosswalks (White) 15th St & 5th Crosswalks (White) 2nd Ave South Side WB/EB Crosswalk (White) 15th St & 5th Ave NB Stop Bar (White) West Side of US 67 & 5th Ave WB/EB Stop Bar (White) US 67 & 4th Ave NB Stop Bar (White) East Side of US 67 & 4th Ave WB/EB Stop Bar (White) US 67 & 4th Ave SB Stop Bar (White) US 67 & 3rd Ave NB Stop Bar (White) US 67 & 3rd Ave NB Stop Bar (White)
291 AVEMENT 57 39 48 62 57 55 49 60 62 65 63 63 61 41 09 44 55 75 42 70	TOTAL LOC 59+69 50+38 698+31 698+65 701+27 701+32 701+37 701+91 705+24 705+30 705+30 705+98 708+91 50+00 698+30 699+07 701+16 701+44 702+05 705+17	CAT	MOVAL - GF ION 69+75 50+44 698+37 699+03 701+33 701+90 701+91 701+96 705+30 705+98 705+98 706+05 708+96 50+20 690+32 699+09 701+18 701+82 702+07 705+19	OFFSET LT RT LT RT LT RT LT RT RT R	5th Ave & US 67 Crosswalks (White) 4th Ave & US 67 Crosswalks (White) 4th Ave & US 67 Crosswalks (White) 4th Ave & US 67 Crosswalks (White) 3rd Ave & US 67 Crosswalks (White) 15th St & 5th Ave NB Stop Bar (White) West Side of US 67 & 5th Ave WB/EB Stop Bar (White) US 67 & 5th Ave NB Stop Bar (White) East Side of US 67 & 4th Ave WB/EB Stop Bar (White) US 67 & 4th Ave SB Stop Bar (White) US 67 & 4th Ave SB Stop Bar (White) US 67 & 3rd Ave NB Stop Bar (White)

GROOVING FOR RECESSED PAVEMENT MARKING 7"

Z0025505 PROPERTY MARKERS

<u>EACH</u>	LOCATION	OFFSET	REMARKS
1	698+29.3	29.8' RT	SW Comor of 5th Ave & US 67
1	698+29.3	30.2' RT	SW Comer of 5th Ave & US 67
1	698+34.3	30.2' RT	SW Comer of 5th Ave & US 67
1	50+43.2	33.5' RT	SE Corner of 5th Ave & US 67
1	50+48.0	33.5' RT	SE Corner of 5th Ave & US 67
1	50+52.0	30.0' RT	SE Corner of 5th Ave & US 67
1	698+15.0	30.2' LT	NW Comer of 5th Ave & US 67
1	698+34.5	33.0' LT	NW Comer of 5th Ave & US 67
1	50+43.4	31.8' LT	NE Corner of 5th Ave & US 67
1	50+44.6	30.5' LT	NE Corner of 5th Ave & US 67
1	50+55.0	30.5' LT	NE Corner of 5th Ave & US 67
1	50+55.0	30.0' LT	NE Corner of 5th Ave & US 67
1	701+18.0	37.0' LT	SW Comer of 4th Ave & US 67
1	701+20.6	40.0' LT	SW Comer of 4th Ave & US 67
1	702+32.2	45.1' RT	NE Corner of 4th Ave & US 67
1	702+15.0	42.1' RT	NE Corner of 4th Ave & US 67
1	702+15.0	45.0' RT	NE Corner of 4th Ave & US 67
1	705+11.7	39.5' RT	SE Corner of 3rd Ave & US 67
1	705+11.7	41.1' RT	SE Corner of 3rd Ave & US 67
1	705+18.0	41.1' RT	SE Corner of 3rd Ave & US 67
1	705+18.0	47.5' RT	SE Corner of 3rd Ave & US 67
1	705+23.7	47.5' RT	SE Corner of 3rd Ave & US 67
1	705+22.0	40.6' LT	SW Corner of 3rd Ave & US 67
1	705+21.7	60.1' LT	SW Corner of 3rd Ave & US 67
1	705+23.9	60.1' LT	SW Corner of 3rd Ave & US 67
1	708+43.6	44.3' RT	SE Corner of 2nd Ave & US 67
1	708+43.5	45.6' RT	SE Corner of 2nd Ave & US 67
1	708+36.9	45.6' RT	SE Corner of 2nd Ave & US 67
28	TOTAL		


USER NAME = Brad Cushman	DESIGNED	REVISED	
	DRAWN	REVISED	
PLOT SCALE = 100.0000 / in.	CHECKED	REVISED	
DLOT DATE - Nov 21 2022 01:20:52 DM	DATE	DEVICED	

STATE OF ILLINOIS
DEPARTMENT OF TRANSPORTATION

	F.A.P. RTE.	SECTION	COUNTY	TOTAL SHEETS	SHEET NO.
SCHEDULE OF QUANTITES	599	D2 SW 2020-2	ROCK ISLAND	60	12
			CONTRACT	NO. 64	P59
SCALE: SHEET OF SHEETS STA TO STA		ILLINOIS FEE	D. AID PROJECT		

t-pw.bentley.com:PWIDOT\Documents\IDOT_Offices\District_2\Projects\64P59\Program_Development\

MODEL: Default

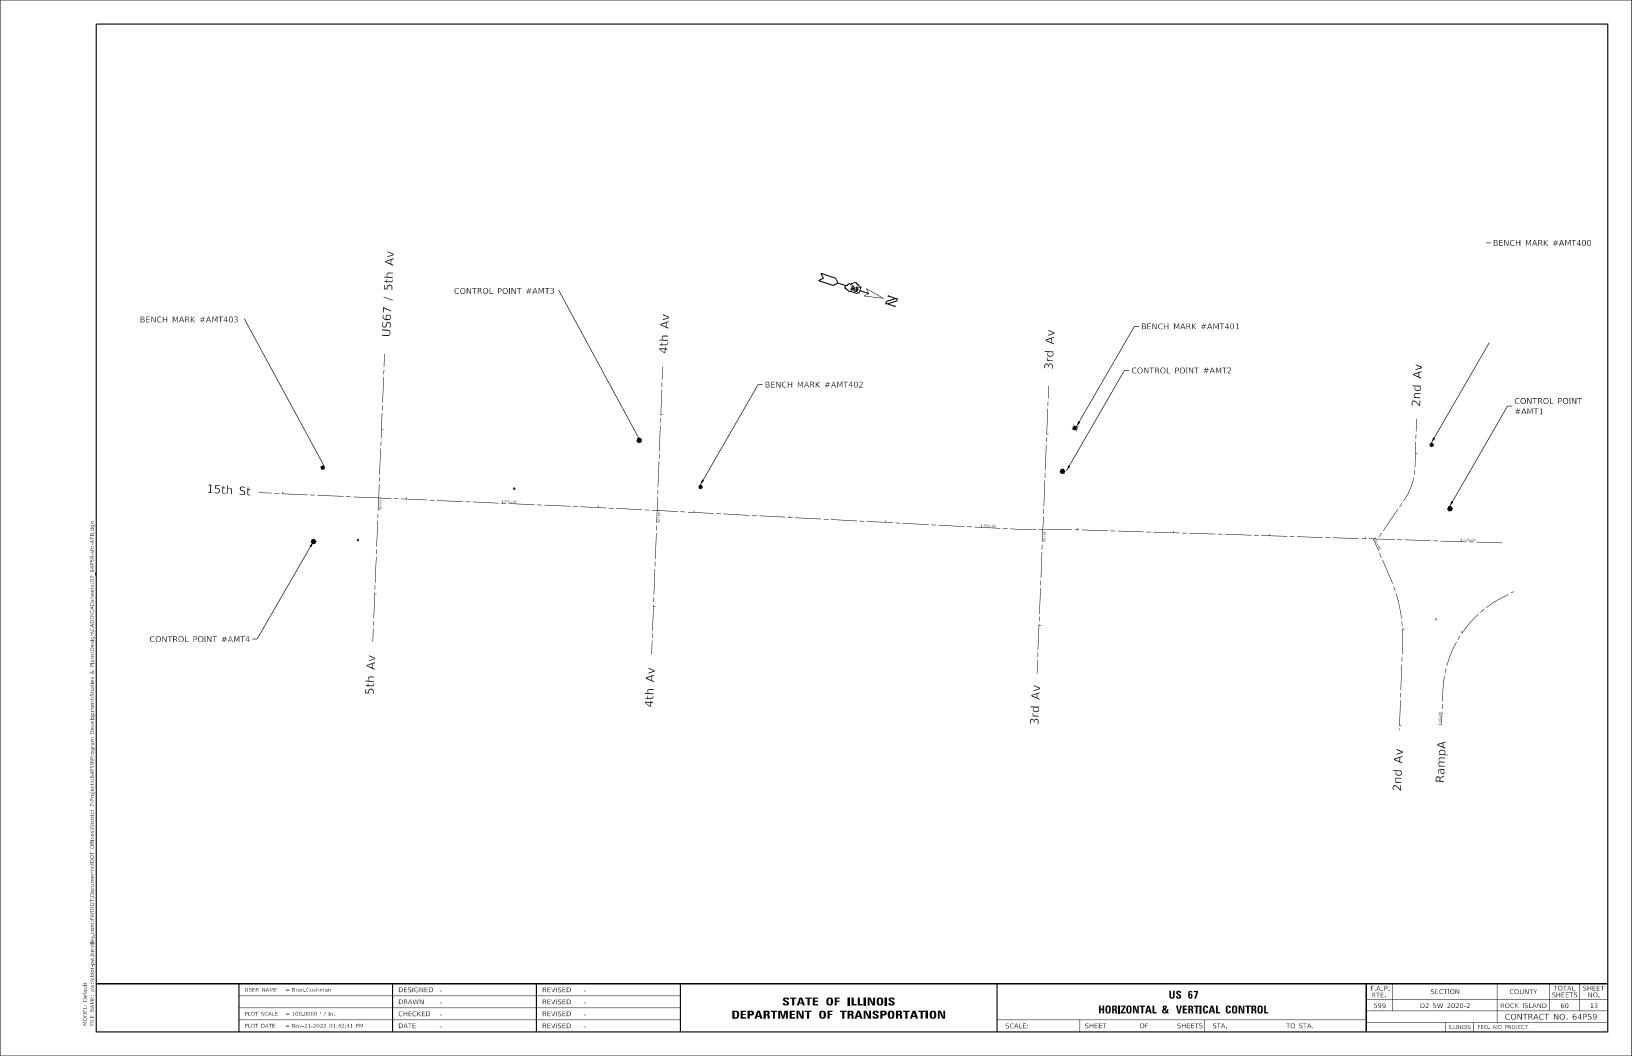

Chain US67 contains: T1000 T1001 T1011 T1012 T1013 T1014

Beginning chain US67 description

Point T1000 N 1,763,275.1665 E 2,183,758.0330 Sta 697+21.09

Course from T1000 to T1001 N 73° 42' 25.33" E Dist 150.0000'

Point T1001 N 1,763,317.2488 E 2,183,902.0089 Sta 698+71.09

Course from T1001 to T1011 N 16° 09' 25.09" W Dist 224.2831'

Point T1011 N 1,763,532.6734 E 2,183,839.5977 Sta 700+95.37

Course from T1011 to T1012 N 15° 40' 33.80" W Dist 452.8629'

Point T1012 N 1,763,968.6920 E 2,183,717.2350 Sta 705+48.24

Course from T1012 to T1013 N 18° 48' 15.47" W Dist 44.8370'

Point T1013 N 1,764,011.1358 E 2,183,702.7824 Sta 705+93.07

Course from T1013 to T1014 N 16° 52' 39.90" W Dist 452.2685'

Point T1014 N 1,764,443.9235 E 2,183,571.4750 Sta 710+45.34

Chain 15THST contains: T1009 T1010 T1016

Ending chain US67 description

Beginning chain 15THST description

Ending chain 15THST description

Point T1009 N 1,763,197.1416 E 2,183,936.6386 Sta 58+75.00


Course from T1009 to T1010 N 15° 57' 04.15" W Dist 44.6188'

Point T1010 N 1,763,240.0424 E 2,183,924.3766 Sta 59+19.62


Course from T1010 to T1016 N 16° 09' 25.09" W Dist 80.3812'

Point T1016 N 1,763,317.2488 E 2,183,902.0089 Sta 60+00.00


HORIZONTAL CONTROL POINT #AMT1

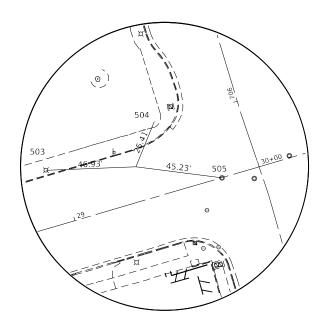

HORIZONTAL CONTROL POINT #AMT2

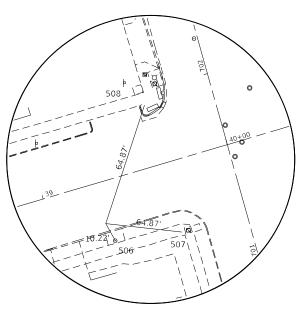

HORIZONTAL CONTROL POINT #AMT3

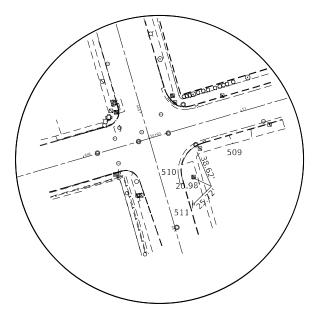

HORIZONTAL CONTROL POINT #AMT4

STATE OF ILLINOIS
DEPARTMENT OF TRANSPORTATION

 US 67
 F.A.P. RTE.
 SECTI RTE.

 HORIZONTAL & VERTICAL CONTROL
 599
 D2 SW 2

 SHEET
 OF
 SHEETS
 STA.
 TO STA.
 TO

MODEL: Default File NAME: pwc/ylidot-ow bentle

	BENCH MARKS										
POINT	NORTH	EAST	ELEVATION	CHAIN	STATION	OFFSET	DESCRIPTION				
AMT400	1764339.2380	2183498.8720	563.6273	US67	709+66.25	99.8691' LT	VERTICAL CONTROL STATION, LIGHT POLE				
AMT401	1763981.0390	2183601.1440	564.1571	US67	705+93.78	105.9985' LT	VERTICAL CONTROL STATION, LIGHT POLE				
AMT402	AMT402 1763631.4110 2183783.8350 5		563.4551	US67	702+05.51	27.0099' LT	VERTICAL CONTROL STATION, FIRE HYDRANT				
AMT403	1763251.8720	2183890.6940	559.2447	US67	698+41.89	59.5769' RT	VERTICAL CONTROL STATION, CHISELED SQUARE				

	HORIZONTAL CONTROL POINTS										
POINT	POINT NORTH EAST ELEVATION			CHAIN	STATION	OFFSET	DESCRIPTION				
65723060	1765983.8200	2210976.4000	567.3300	US67	698+71.09	27205.3902' R	TNGS MONUMENT, PERM. SURVEY MARKER				
68803501	1746783.2180	2173364.9120	572.5600	US67	OUT OF CHAIN		NGS MONUMENT, PERM. SURVEY MARKER				
68803506	1764657.0440	2183592.7970	562.1400	US67	OUT OF CHAIN		NGS MONUMENT, PERM. SURVEY MARKER				
AMT1	1764378.5760	2183555.8590	565.6524	US67	709+87.34	33.9157' LT	GPS CONTROL POINT, REBAR				
AMT2	1763983.5540	2183647.9570	564.2270	US67	705+84.64	60.7897' LT	GPS CONTROL POINT, PK NAIL				
AMT3	1763555,2650	2183758,3760	560.8203	US67	701+39.07	72.0964' LT	GPS CONTROL POINT, PK NAIL				
AMT4	1763267.3720	2183966.7360	560.0176	US67	698+71.09	81.7147' RT	GPS CONTROL POINT, REBAR				

			I	REFERENCE	TIES	
POINT	POINT NORTH EAST CHAIN		CHAIN	STATION	OFFSET	DESCRIPTION
500	1764362.8990	2183564.3610	US67	709+69.87	30.3315' LT	LIGHT POLE
501	1764365.1550	2183597.3410	US67	709+62.46	1.883' RT	MANHOLE
502	1764422.0810	2183610.1240	US67	710+13.22	30.6427' RT	LIGHT POLE
503	1763981.7660	2183601.0950	US67	705+94.49	105.8343' LT	LIGHT POLE
504	1764007.0890	2183657.5380	US67	706+02.34	44.4705' LT	TRAFFIC SIGNAL CANTILEVER
505	1763977.7560	2183692.8170	US67	705+64.69	20.193' LT	MANHOLE
506	1763546.3230	2183763.3310	US67	701+29.12	69.7418' LT	WATER VALVE
507	1763550,8300	2183798.0710	US67	701+24.08	35,0762' LT	TRAFFIC SIGNAL CANTILEVER
508	1763616.9110	2183778.5850	US67	701+92.96	35.9825' LT	TRAFFIC SIGNAL CANTILEVER
509	1763303.3970	2183951.5910	US67	698+71.09	51.4806' RT	TRAFFIC SIGNAL CANTILEVER
510	1763277.0850	2183948.1820	US67	698+71.09	61.1971' RT	HANDHOLE
511	1763248.8640	2183948.0360	US67	698+71.09	82.4316' RT	SIGN

 USER NAME
 = Brad.Cushman
 DESIGNED
 REVISED

 DRAWN
 REVISED

 PLOT SCALE
 = 100,0000 ' / in.
 CHECKED
 REVISED

 PLOT DATE
 = Nov-21-2022 01:43:42 PM
 DATE
 REVISED

STATE OF ILLINOIS DEPARTMENT OF TRANSPORTATION

SCALE:

stadut : pw:\\\lidat-pw.bentley.com:PV/IDOT\Documents\IDOT Offices\District 2\Projects\64P59\Progra Chain 2NDAV EAST contains: T1019 CUR T210 T1020

Beginning chain 2NDAV EAST description

Point T1019 N 1,764,312,9611 E 2,183,611,2089 Sta 20+00.00

Course from T1019 to PC T210 N 47° 50' 00.64" E Dist 43.7371'

Curve Data

Curve T210

P.I. Station 20+79.89 N 1,764,366.5924 E 2,183,670.4255 Delta = $25^{\circ} 44' 24.70'' (RT)$ Degree = 36° 12' 24.79" Tangent = 36.1562'Length = 71.0920'Radius = 158.2455' External = 4.0780Long Chord = 70.4956' Mid. Ord. = 3.9755P.C. Station 20+43.74 N 1,764,342.3213 E 2,183,643.6267 P.T. Station 21+14.83 N 1,764,376.8167 E 2,183,705.1060 C.C. N 1,764,225.0301 E 2,183,749.8549

Course from PT T210 to T1020 N 73° 34' 25,33" E Dist 90,0000'

Point T1020 N 1,764,402,2671 E 2,183,791,4325 Sta 22+04,83

_____ Ending chain 2NDAV EAST description

Chain 2NDAV_WEST contains: T1018 CUR T200 T1017

Beginning chain 2NDAV WEST description

Point T1018 N 1,764,315.5062 E 2,183,478.1098 Sta 18+63.71

Course from T1018 to PC T200 N 73° 06' 58.59" E Dist 50.0000'

Curve Data

Curve T200

P.I. Station 19+32.85 N 1,764,335.5852 E 2,183,544.2651 Delta = $32^{\circ} 31' 42.24'' (RT)$ Degree = $87^{\circ} 21' 17.40"$ Tangent = 19.1353'Length = 37.2371'Radius = 65.5897External = 2.7343Long Chord = 36.7390'Mid. Ord. = 2.6249' P.C. Station 19+13.71 N 1.764.330.0278 E 2.183.525.9546 P.T. Station 19+50.95 N 1,764,330.4250 E 2,183,562.6915 C.C. N 1,764,267.2652 E 2,183,545.0039

Course from PT T200 to T1017 S 74° 21' 19.17" E Dist 49.0491'

Point T1017 N 1,764,317.1979 E 2,183,609.9234 Sta 20+00.00

_____ Ending chain 2NDAV WEST description

Chain 3RDAV contains: T1006 T1007 T1008

Beginning chain 3RDAV description

Point T1006 N 1,763,941.4086 E 2,183,568.2154 Sta 28+50.00

Course from T1006 to T1007 N 73° 40' 11.81" E Dist 150.0000'

Point T1007 N 1,763,983.5841 E 2,183,712.1641 Sta 30+00.00

Course from T1007 to T1008 N 73° 40' 11.81" E Dist 150.0000'

Point T1008 N 1,764,025.7596 E 2,183,856.1128 Sta 31+50.00

_____ Ending chain 3RDAV description

Chain 4THAV contains: T1003 T1004 T1005

Beginning chain 4THAV description

Point T1003 N 1,763,553.9089 E 2,183,677.8577 Sta 38+50.00

Course from T1003 to T1004 N 73° 32' 49.17" E Dist 150.0000'

Point T1004 N 1,763,596.3932 E 2,183,821.7156 Sta 40+00.00

Course from T1004 to T1005 N 73° 32' 49.17" E Dist 150.0000'

Point T1005 N 1,763,638.8776 E 2,183,965.5734 Sta 41+50.00

_____ Ending chain 4THAV description

Chain 5THAV contains: T1015 T1002

Beginning chain 5THAV description

Point T1015 N 1,763,317.2488 E 2,183,902.0089 Sta 50+00.00

Course from T1015 to T1002 N 73° 42' 25.33" E Dist 150.0000'

Point T1002 N 1,763,359.3311 E 2,184,045.9849 Sta 51+50.00

Ending chain 5THAV description

Chain RAMPA contains: T1022 CUR T220 T1021

Beginning chain RAMPA description

Point T1022 N 1,764,442.1494 E 2,183,771.6590 Sta 70+00.00

Course from T1022 to PC T220 S 73° 33' 46.58" W Dist 35.0000'

Curve Data

Curve T220 P.I. Station 71+00.74 N 1,764,413.6440 E 2,183,675.0365 Delta = $59^{\circ} 47' 16.01'' (RT)$ Degree = $50^{\circ} 06' 15.60"$ Tangent = 65.7396'Length = 119.3266'Radius = 114.3529External = 17.5497Long Chord = 113.9859'Mid. Ord. = 15.2147P.C. Station 70+35.00 N 1,764,432.2458 E 2,183,738.0894 P.T. Station 71+54.33 N 1,764,458.7718 E 2,183,627.2329 C.C. N 1,764,541.9253 E 2,183,705.7319

Course from PT T220 to T1021 N 46° 38' 57.41" W Dist 15.0000'

Point T1021 N 1,764,469,0687 E 2,183,616,3254 Sta 71+69,33

_____ Ending chain RAMPA description

JSER NAME = Brad.Cushman DESIGNED REVISED DRAWN REVISED HECKED REVISED PLOT DATE = Nov-21-2022 01:44:07 PM REVISED DATE


STATE OF ILLINOIS **DEPARTMENT OF TRANSPORTATION**


SECTION COUNTY US 67 599 D2 SW 2020-2 ROCK ISLAND 60 16 HORIZONTAL & VERTICAL CONTROL CONTRACT NO. 64P59 TO STA.


OF

SCALE:


SHEETS STA.

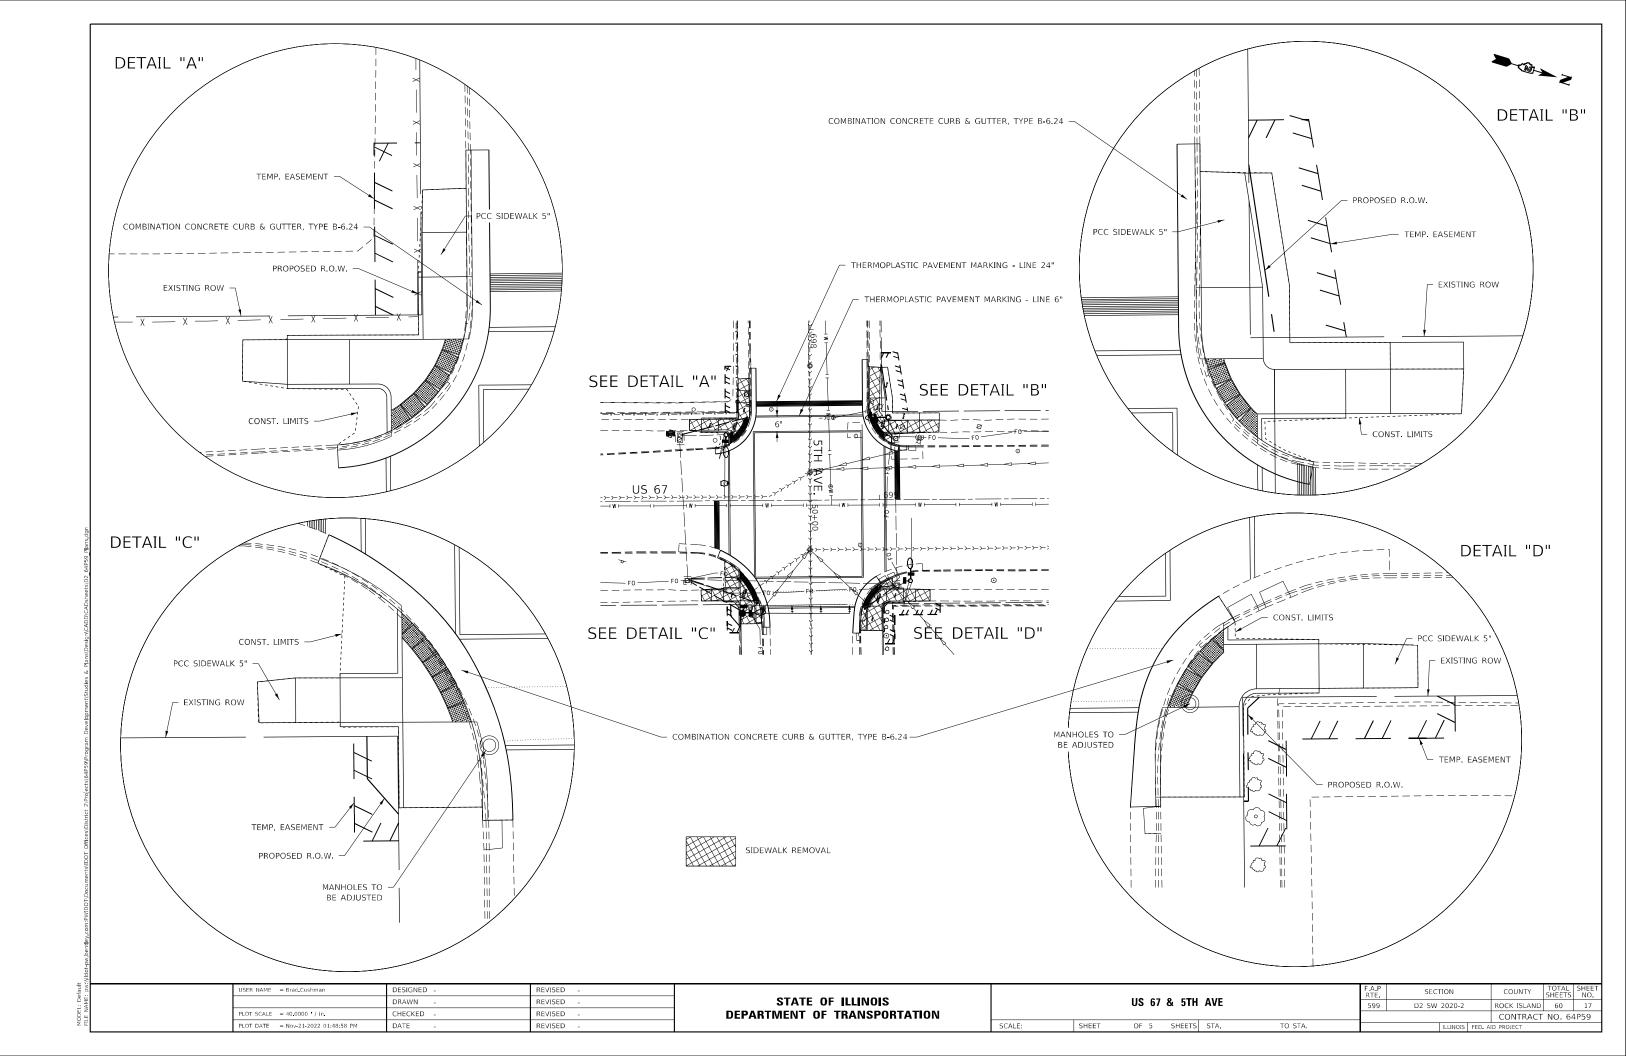


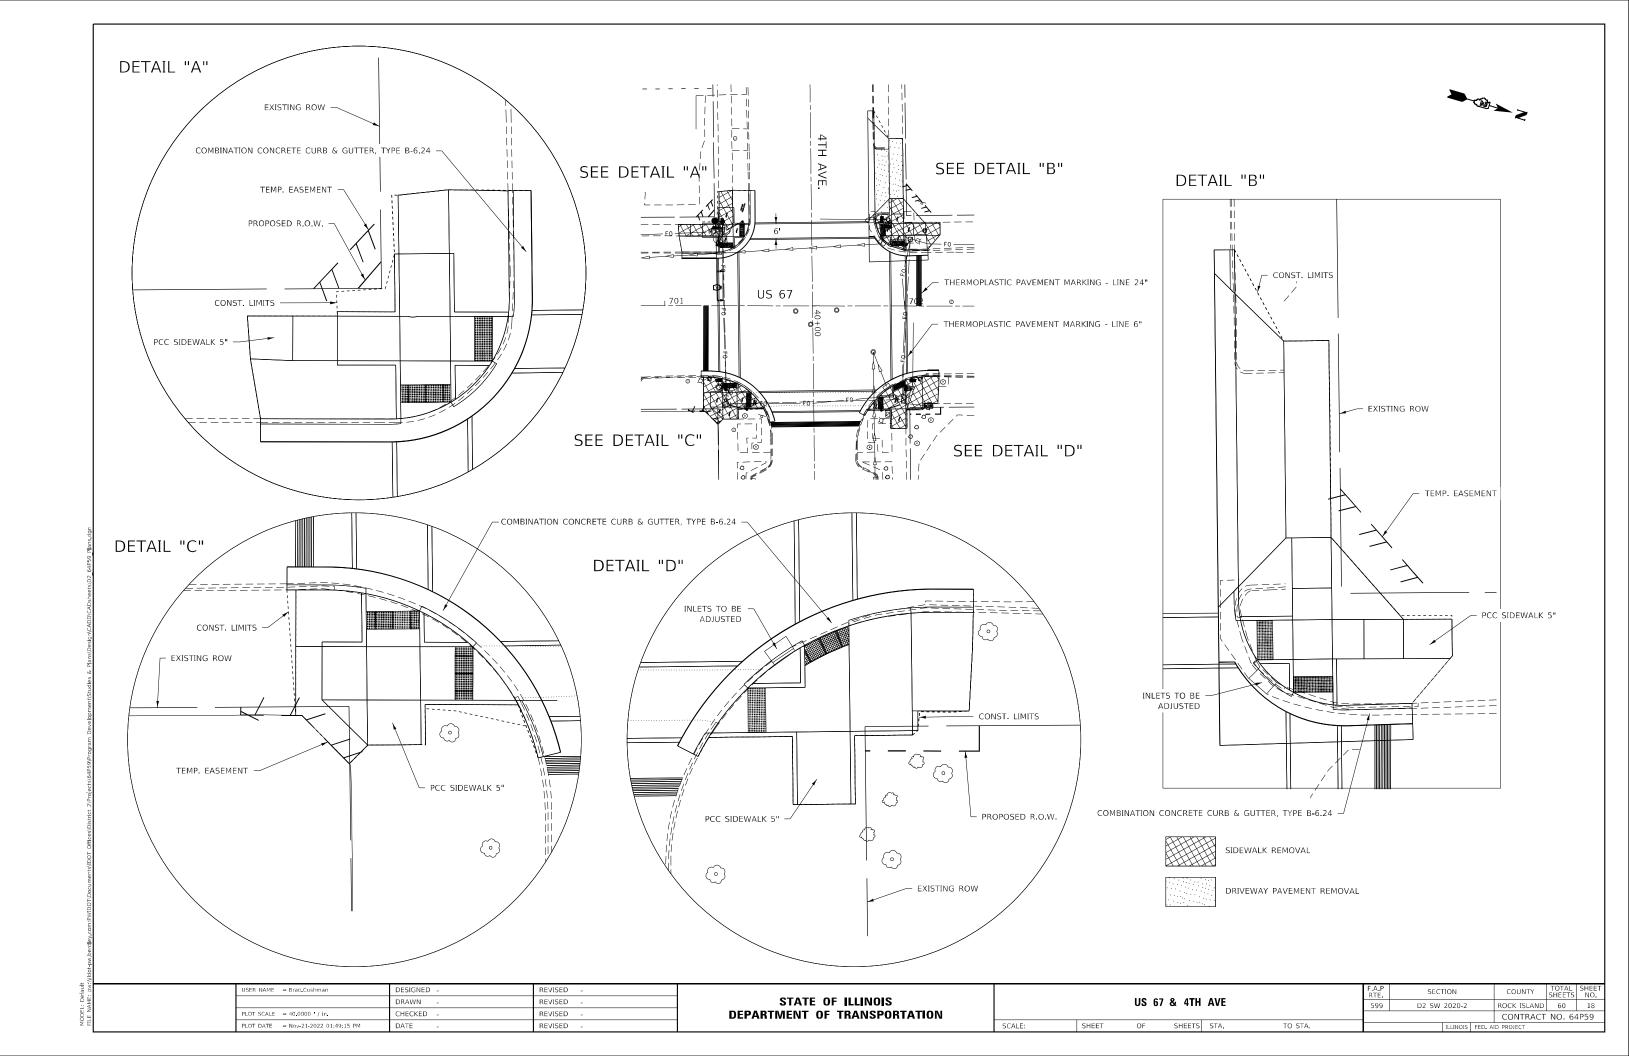


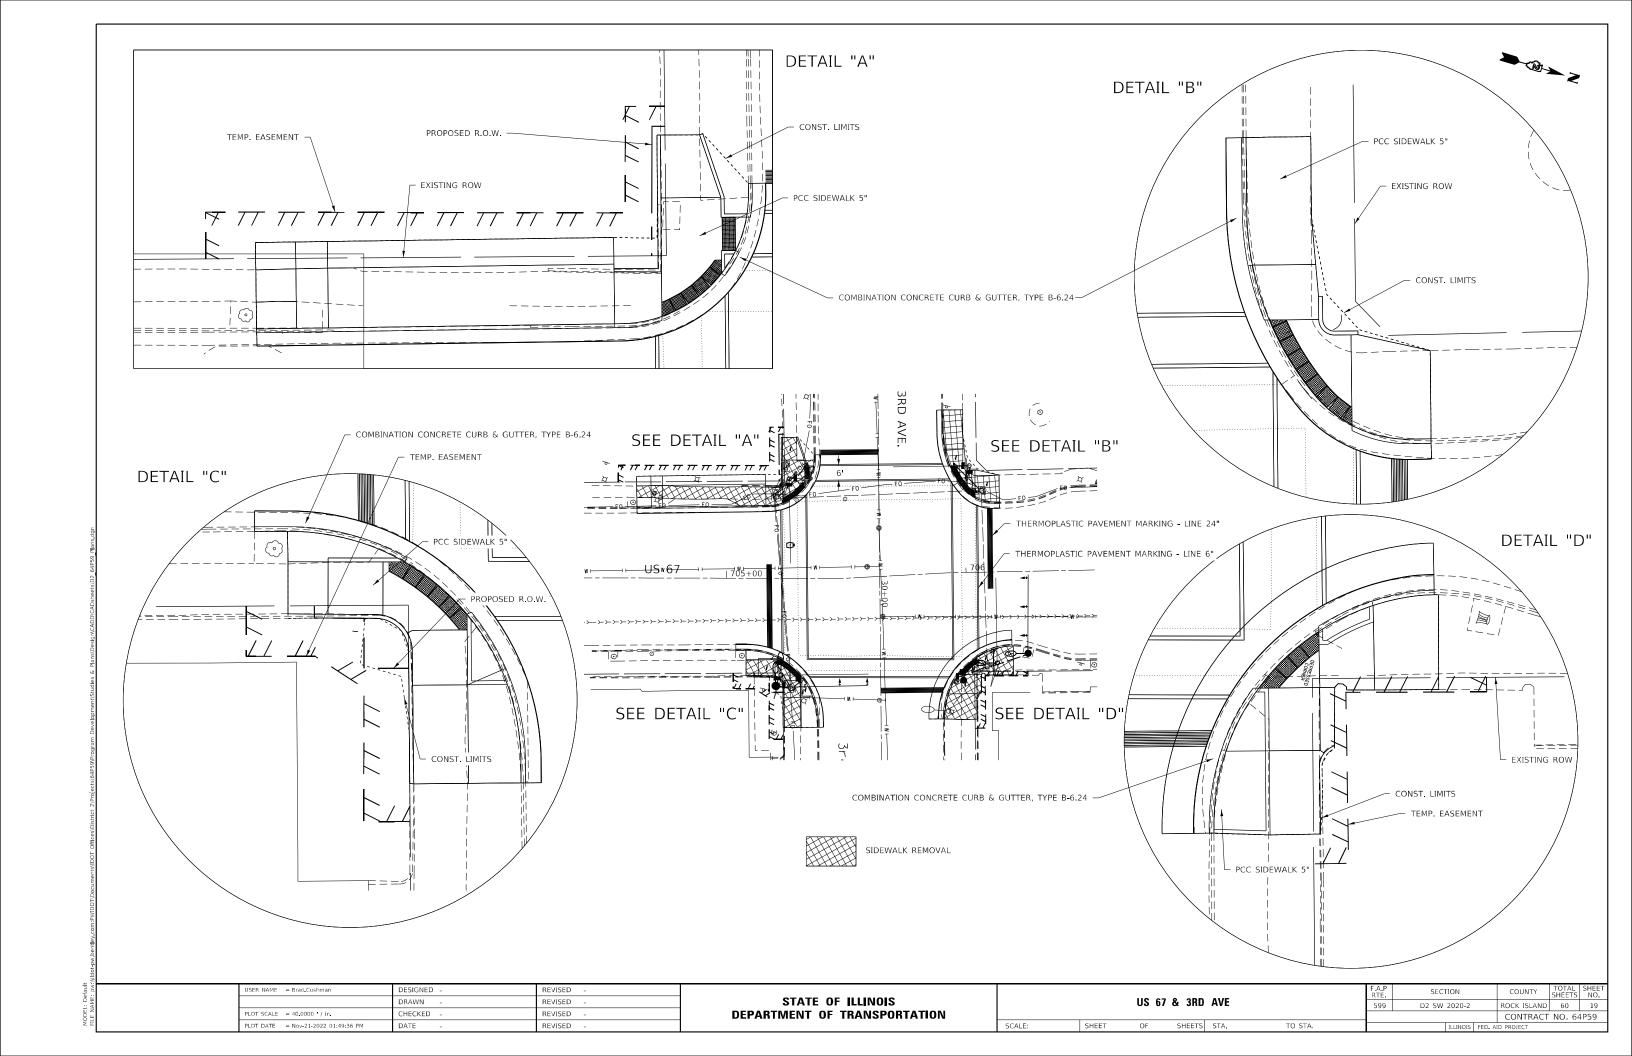



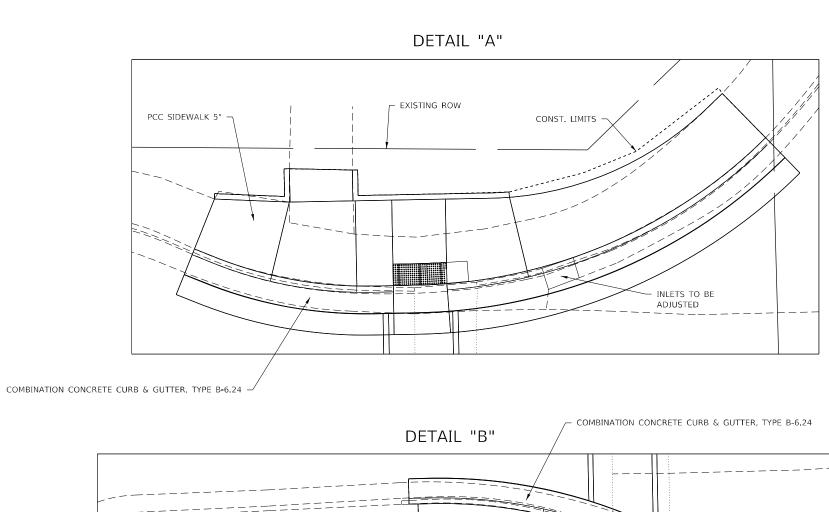

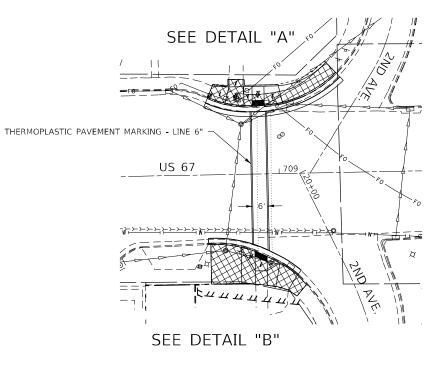

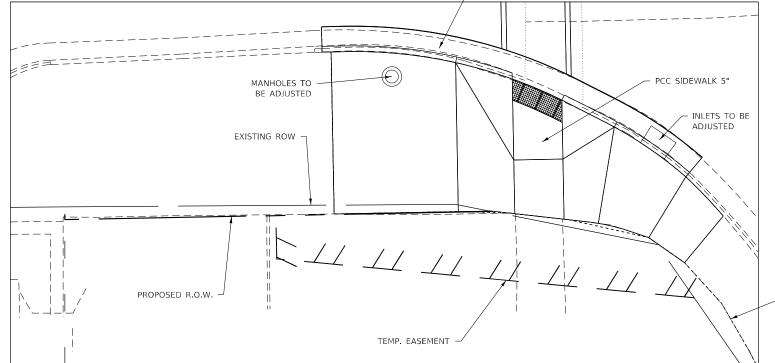



USER NAME = Brad Cushman	DESIGNED -	REVISED -
	DRAWN -	REVISED -
PLOT SCALE = 40.0000 / in.	CHECKED -	REVISED -
PLOT DATE = Nov-21-2022 01:49:55 PM	DATE -	REVISED -

STATE OF ILLINOIS
DEPARTMENT OF TRANSPORTATION


CONST. LIMITS

	IIC C7 9 2ND AVE						SECTION	COUNTY	TOTAL SHEETS	SHEET NO.
US 67 & 2ND AVE						599	D2 SW 2020-2	ROCK ISLAND	60	20
								CONTRACT	NO. 64	1P59
CALE:	SHEET	OF	SHEETS	STA.	TO STA.		ILLINOIS FED.	AID PROJECT		





DETAIL "A"

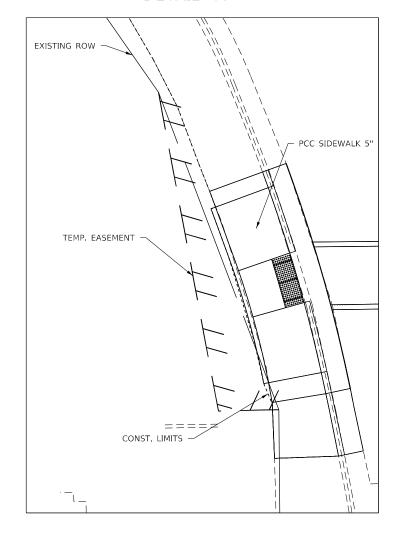

CLASS C PATCHES, TYPE II, 9"


SEE DETAIL "B"

SEE DETAIL "C"


SEE DETAIL "C"

THERMOPLASTIC PAVEMENT MARKING - LINE 6"

DETAIL "B"

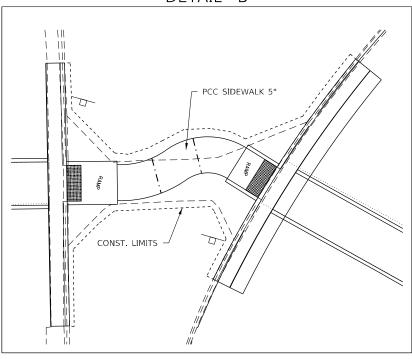


DETAIL "C"

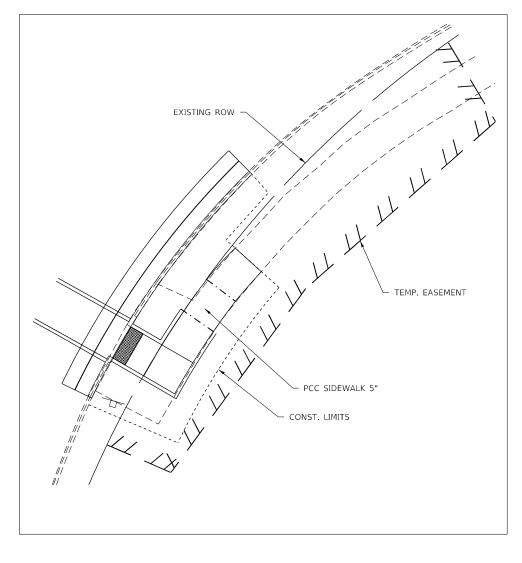



USER NAME = Brad Cushman	DESIGNED -	REVISED -
	DRAWN -	REVISED -
PLOT SCALE = 40.0000 / in.	CHECKED -	REVISED -
PLOT DATE = Nov-21-2022 01:50:15 PM	DATE -	REVISED -

STATE OF ILLINOIS	
DEPARTMENT OF TRANSPORTATION	

	IIC 67 9. 2ND AVE						SECT	ION		COUNTY	TOTAL SHEETS	SHEET NO.
US 67 & 2ND AVE					599	D2 SW 2	2020-2		ROCK ISLAND	60	21	
										CONTRACT	NO. 64	IP59
	SHEET	OF	SHEETS	STA.	TO STA.			ILLINOIS	FED. AI	D PROJECT		

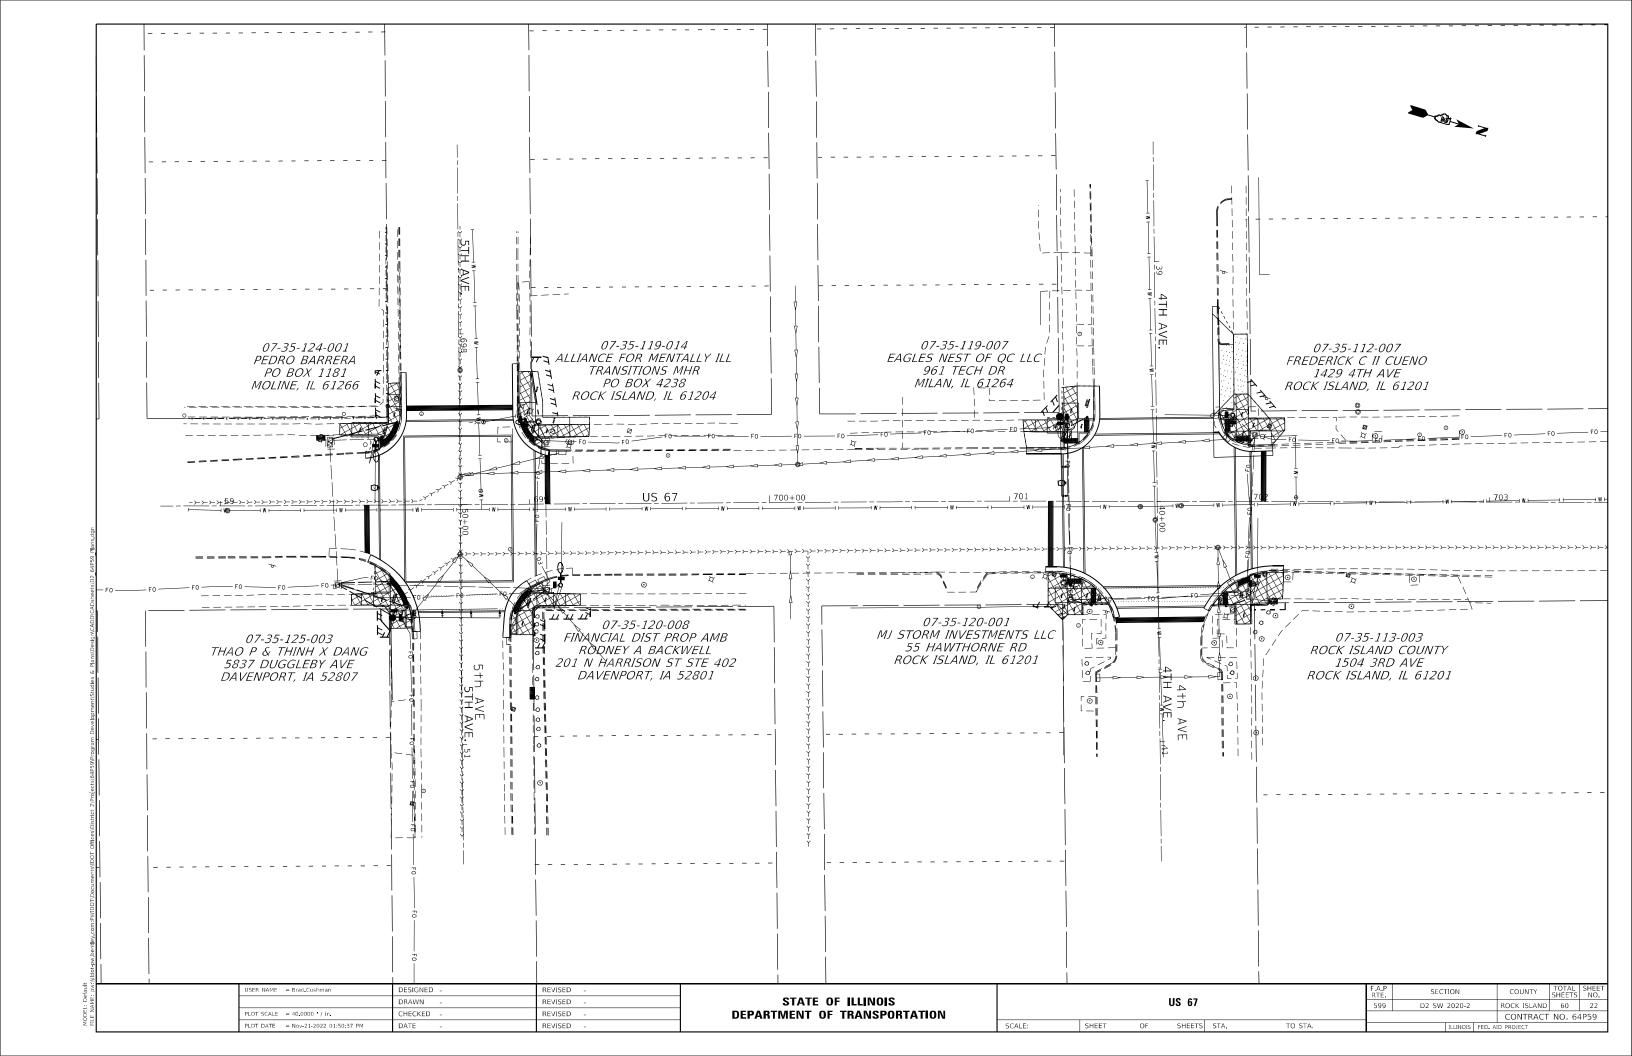

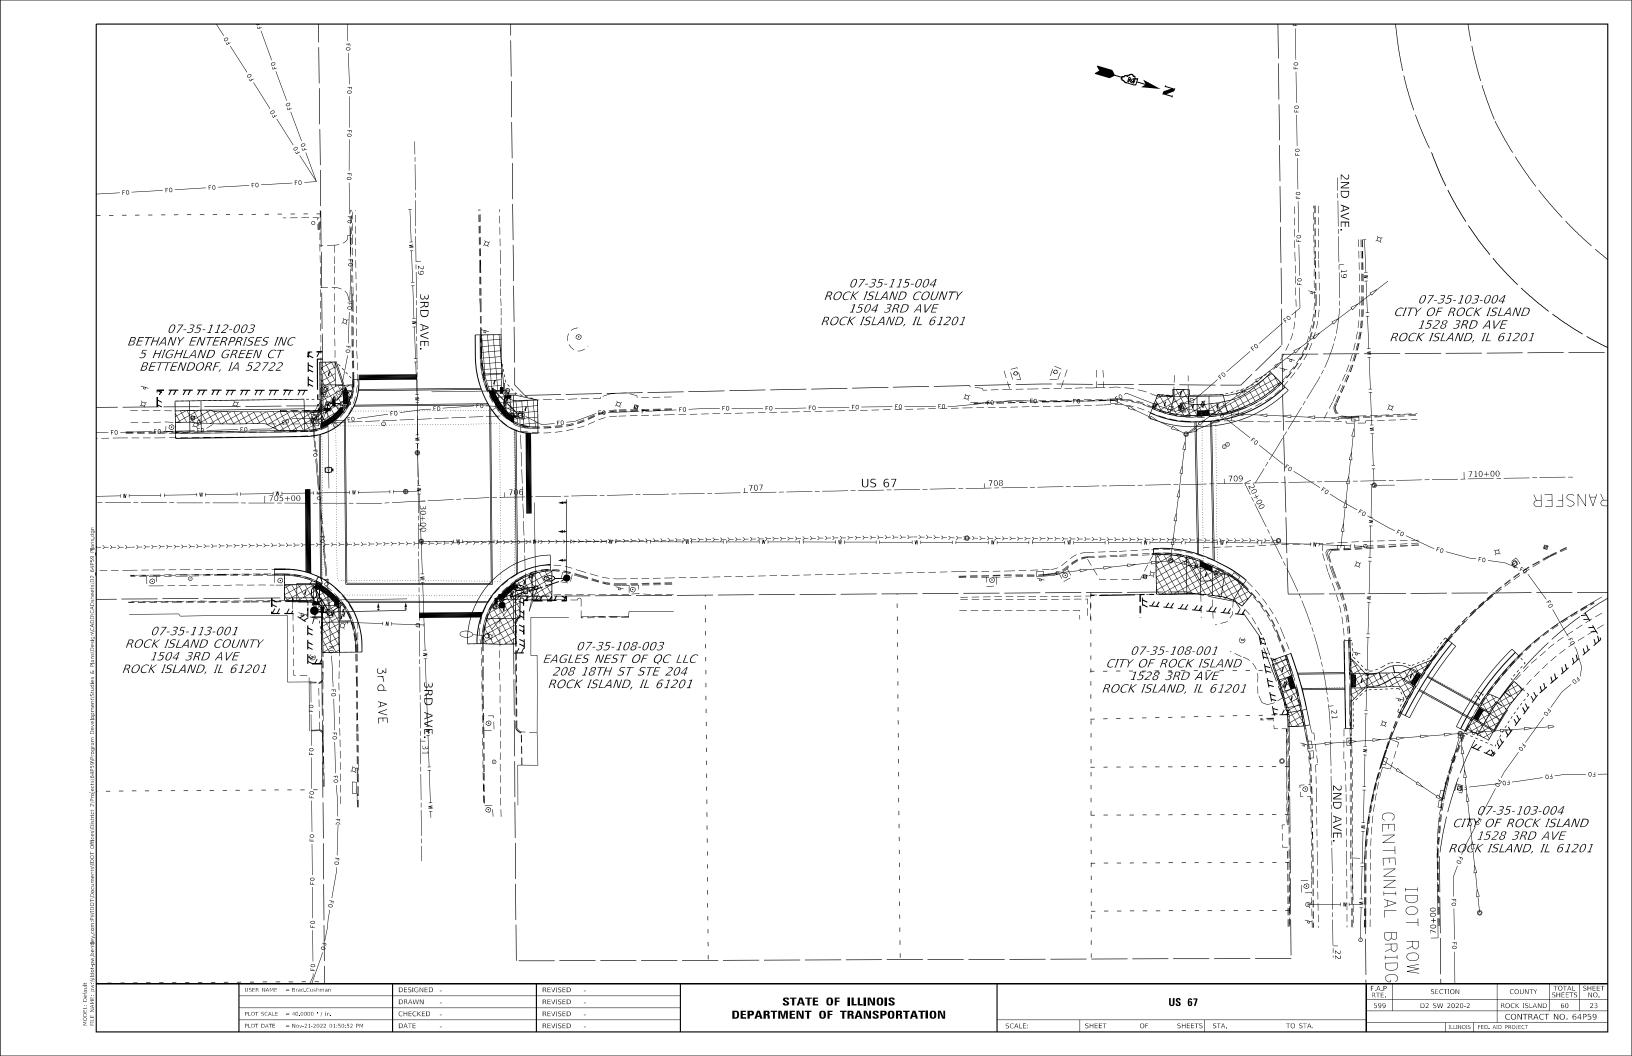

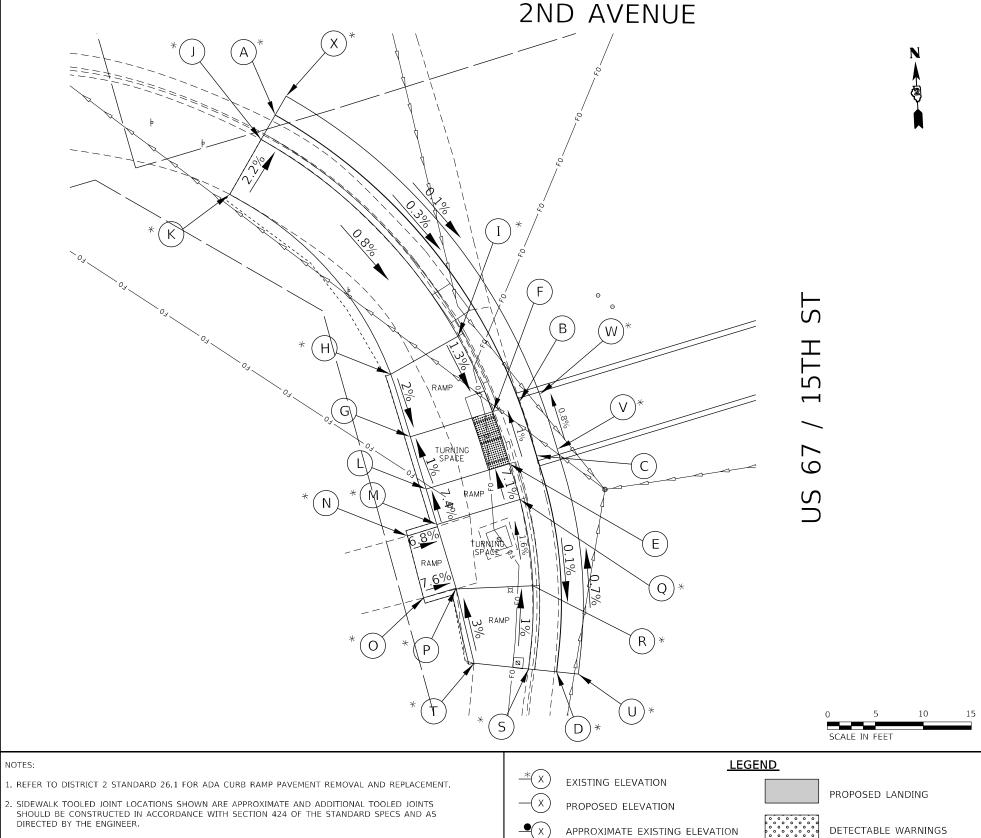

SW QUAD 2ND AVENUE

POINT	STATION	OFFSET	SIDE	ELEVATION
Α	709+26.07	39.84	LT	562.83
В	708+94.44	26.09	LT	562.93
С	708+89.30	26.00	LT	562.98
D	708+69.81	29.98	LT	562.97
Е	708+89.29	28.59	LT	562.96
F	708+94.30	28.66	LT	562.91
G	708+94.30	36.56	LT	563.02
Н	709+00.30	36.61	LT	563.14
Ι	709+01.83	29.71	LT	563.04
J	709+24.30	41.72	LT	563.18
K	709+20.34	45.94	LT	563.31
L	708+89.30	36.56	LT	563.07
М	708+85.90	36.56	LT	563.32
N	708+85.68	39.43	LT	563.54
0	708+79.82	39.67	LT	563.53
Р	708+79.74	36.56	LT	563.32
Q	708+85.90	28.62	LT	563.20
R	708+77.99	29.77	LT	563.33
S	708+70.82	32.36	LT	563.41
T	708+72.77	36.98	LT	563.53
U	708+69.03	28.14	LT	563.02
V	708+89.30	24.00	LT	562.88
W	708+94.57	24.09	LT	562.84
Χ	709+27.44	38.38	LT	562.89

- B. FLOW LINE ELEVATION PERPENDICULAR TO CURB IS 0.04' LOWER THAN BACK OF CURB. SEE STANDARD 606001.
- 4. AT DEPRESSED CURBS ADJACENT TO CURB RAMPS ACCESSIBLE TO THE DISABLED, THE PERPENDICULAR GUTTER FLAG SLOPE SHALL BE -4.0% UNLESS NOTED OTHERWISE.
- 5. LIMITS OF PAVEMENT PATCH TO BE COORDINATED WITH ENGINEER TO ACHIEVE 5.0% MAX. CROSSWALK RUNNING SLOPE AND 5.0% MAX. COUNTERSLOPE.





DETECTABLE WARNINGS



PEDESTRIAN PUSH-BUTTON



INCIDENTAL HMA SURFACING SEE NOTES 1 & 5

NOT PART OF PEDESTRIAN ACCESS ROUTE

LEGEND

SEE TRAFFIC SIGNALS SHEETS FOR UTILITY HANDHOLE WORK

USER NAME = Brad.Cushman	DESIGNED -	REVISED -
	DRAWN -	REVISED -
PLOT SCALE = 10.0000 / in.	CHECKED -	REVISED -
PLOT DATE = Nov-21-2022 01:52:40 PM	DATE -	REVISED -

STATE OF ILLINOIS **DEPARTMENT OF TRANSPORTATION**

→X.X% SIDEWALK / PAVEMENT GRADE

) EXISTING ELEVATION / SLOPE

----- PROPOSED CONSTRUCTION LIMITS


---- PROPOSED TOOLED JOINT (APPROX.)

U	US 67 /15TH STREET AND SW 2ND AVENUE							
	ADA RAMP DETAIL SHEET							
	SHEE	Γ OF	SHEETS	STA.	TO STA.			

F.A.P. RTE	SECTION		COUNTY	TOTAL SHEETS	SHEET NO.
559	D2 SW 2020-2		ROCK ISLAND	60	24
			CONTRACT	NO. 64	1P59
	ILLINOIS	FED. A	ID PROJECT		

SE QUAD 2ND AVENUE

POINT	STATION	OFFSET	SIDE	ELEVATION
Α	708+70.01	26.49	RT	563.12
В	708+88.80	29.24	RT	563.00
С	708+94.80	31.77	RT	562.93
D	709+08.46	40.50	RT	562.74
Е	708+94.30	34.41	RT	562.75
F	708+89.30	32.17	RT	562.96
G	708+89.30	40.41	RT	563.35
Н	708+94.30	40.41	RT	563.41
I	708+94.30	46.53	RT	563.48
J	708+89.30	45.87	RT	563.41
K	708+86.91	45.55	RT	563.42
L	708+83.57	45.55	RT	563.44
М	708+83.57	30.40	RT	563.39
N	708+70.93	29.07	RT	563.41
0	708+70.93	45.55	RT	563.50
Р	708+97.77	47.01	RT	563.50
Q	708+99.59	37.25	RT	563.35
R	709+02.20	38.89	RT	563.29
S	709+04.57	40.63	RT	563.23
Т	709+06.75	42.44	RT	563.18
U	709+02.86	48.56	RT	563.52
V	708+77.06	31.68	RT	563.47
W	709+03.34	37.19	RT	562.73
Χ	709+05.83	38.99	RT	562.72

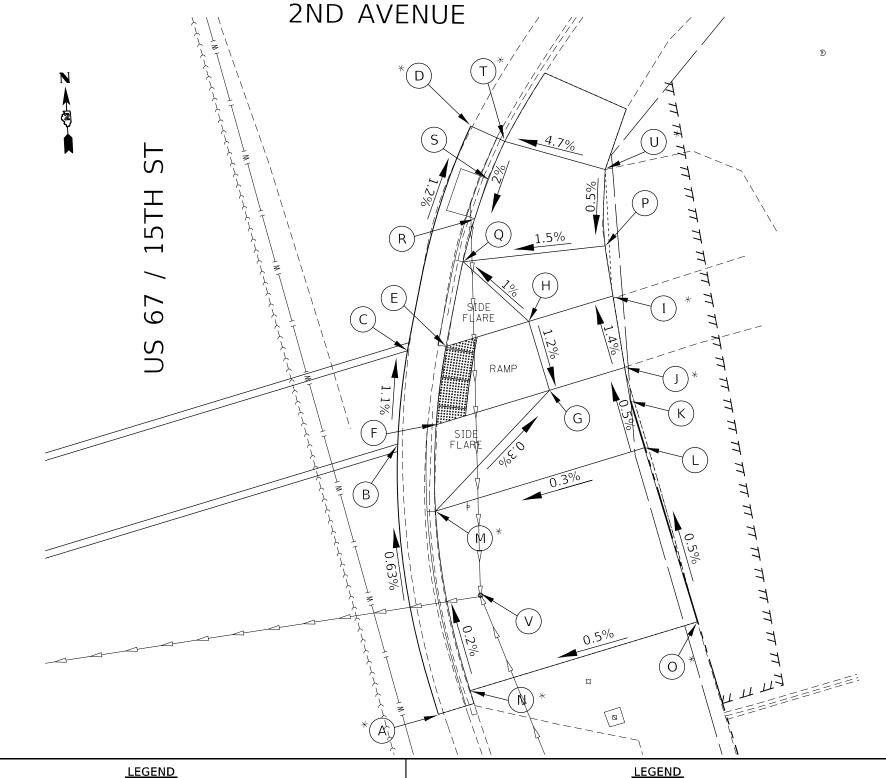

- 1. REFER TO DISTRICT 2 STANDARD 26.1 FOR ADA CURB RAMP PAVEMENT REMOVAL AND REPLACEMENT.
- 2. SIDEWALK TOOLED JOINT LOCATIONS SHOWN ARE APPROXIMATE AND ADDITIONAL TOOLED JOINTS SHOULD BE CONSTRUCTED IN ACCORDANCE WITH SECTION 424 OF THE STANDARD SPECS AND AS DIRECTED BY THE ENGINEER.
- . FLOW LINE ELEVATION PERPENDICULAR TO CURB IS 0.04' LOWER THAN BACK OF CURB. SEE STANDARD 606001.
- 1. AT DEPRESSED CURBS ADJACENT TO CURB RAMPS ACCESSIBLE TO THE DISABLED, THE PERPENDICULAR GUTTER FLAG SLOPE SHALL BE -4.0% UNLESS NOTED OTHERWISE.
- 5. LIMITS OF PAVEMENT PATCH TO BE COORDINATED WITH ENGINEER TO ACHIEVE 5.0% MAX. CROSSWALK RUNNING SLOPE AND 5.0% MAX. COUNTERSLOPE.

EXISTING ELEVATION

PROPOSED ELEVATION

→X.X% SIDEWALK / PAVEMENT GRADE

) EXISTING ELEVATION / SLOPE

----- PROPOSED CONSTRUCTION LIMITS

---- PROPOSED TOOLED JOINT (APPROX.)

APPROXIMATE EXISTING ELEVATION



PROPOSED LANDING



DETECTABLE WARNINGS



PEDESTRIAN PUSH-BUTTON



INCIDENTAL HMA SURFACING SEE NOTES 1 & 5

NOT PART OF PEDESTRIAN ACCESS ROUTE

LEGEND

SEE TRAFFIC SIGNALS SHEETS FOR UTILITY HANDHOLE WORK

USER NAME = Brad.Cushman	DESIGNED -	REVISED -
	DRAWN -	REVISED -
PLOT SCALE = 10.0000 / in.	CHECKED -	REVISED -
PLOT DATE = Nov-21-2022 01:53:02 PM	DATE -	REVISED -

STATE OF ILLINOIS **DEPARTMENT OF TRANSPORTATION**

ι	JS 67	 STREET RAMP			 AVENUE	
	SHEET	OF	SHEETS	STA	TO	STA.


SECTION D2 SW 2020-2 ROCK ISLAND 60 25 CONTRACT NO. 64P59

USER NAME	= Brad.Cus
PLOT SCALE	= 10.0000

SEE QUAD 2ND AVENUE

POINT	STATION	OFFSET	SIDE	ELEVATION
Α	709+26.41	71.31	RT	563.14
В	709+29.12	79.88	RT	563.22
С	709+30.75	86.01	RT	563.26
D	709+33.86	101.18	RT	563.51
E	709+28.02	85.73	RT	563.22
F	709+26.64	80.58	RT	563.18
G	709+21.30	82.31	RT	563.24
Н	709+19.03	75.69	RT	563.67
1	709+24.53	73.79	RT	563.49
J	709+23.97	72.16	RT	563.47
K	709+18.46	74.05	RT	563.64
L	709+22.70	87.11	RT	563.28
М	709+24.12	93.95	RT	563.79
N	709+24.50	96.01	RT	563.94
0	709+30.07	95.19	RT	563.86
Р	709+29.65	93.00	RT	563.71
Q	709+48.62	85.67	RT	563.85
R	709+48.63	80.64	RT	563.80
S	709+48.64	66.45	RT	563.67
T	709+51.22	80.67	RT	563.84
U	709+51.22	85.67	RT	563.89
V	709+58.21	85.73	RT	564.09
W	709+58.23	80.74	RT	564.04
X	709+48.63	103.00	RT	563.88
Υ	709+31.27	101.68	RT	563.73
Z	709+24.64	101.77	RT	563.97

ST

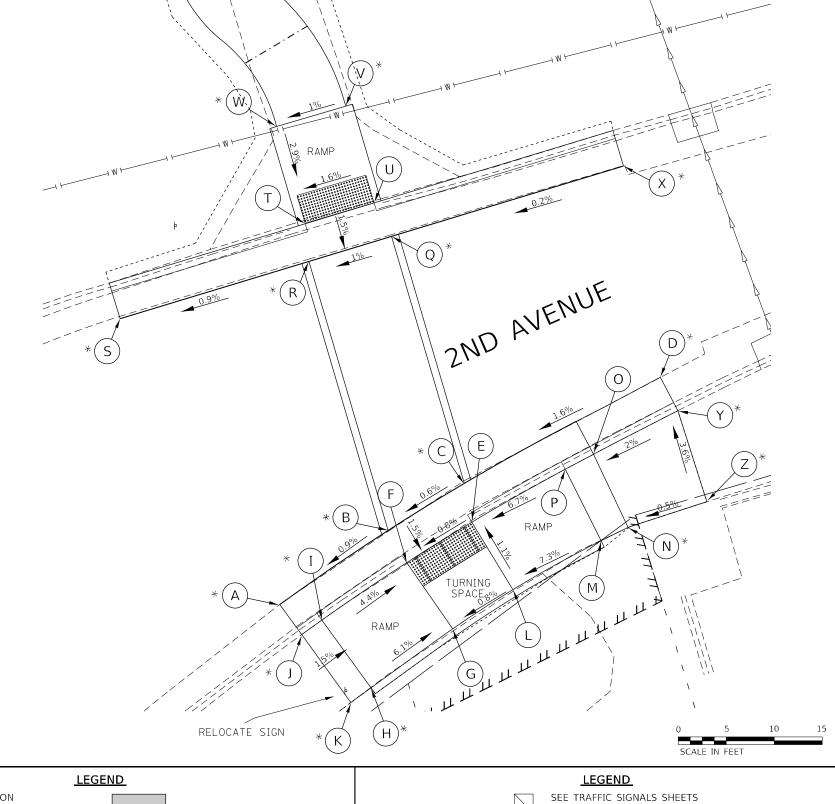

- 1. REFER TO DISTRICT 2 STANDARD 26.1 FOR ADA CURB RAMP PAVEMENT REMOVAL AND REPLACEMENT.
- SIDEWALK TOOLED JOINT LOCATIONS SHOWN ARE APPROXIMATE AND ADDITIONAL TOOLED JOINTS SHOULD BE CONSTRUCTED IN ACCORDANCE WITH SECTION 424 OF THE STANDARD SPECS AND AS DIRECTED BY THE ENGINEER.
- . FLOW LINE ELEVATION PERPENDICULAR TO CURB IS 0.04' LOWER THAN BACK OF CURB. SEE STANDARD 606001.
- 1. AT DEPRESSED CURBS ADJACENT TO CURB RAMPS ACCESSIBLE TO THE DISABLED, THE PERPENDICULAR GUTTER FLAG SLOPE SHALL BE -4.0% UNLESS NOTED OTHERWISE.
- 5. LIMITS OF PAVEMENT PATCH TO BE COORDINATED WITH ENGINEER TO ACHIEVE 5.0% MAX. CROSSWALK RUNNING SLOPE AND 5.0% MAX. COUNTERSLOPE.

EXISTING ELEVATION PROPOSED ELEVATION

X.X% SIDEWALK / PAVEMENT GRADE

) EXISTING ELEVATION / SLOPE

----- PROPOSED CONSTRUCTION LIMITS

---- PROPOSED TOOLED JOINT (APPROX.)

APPROXIMATE EXISTING ELEVATION



PROPOSED LANDING





DETECTABLE WARNINGS



PEDESTRIAN PUSH-BUTTON



INCIDENTAL HMA SURFACING SEE NOTES 1 & 5

NOT PART OF PEDESTRIAN ACCESS ROUTE


FOR UTILITY HANDHOLE WORK

USER NAME = Brad.Cushman	DESIGNED -	REVISED -	
	DRAWN -	REVISED -	
PLOT SCALE = 10.0000 / in.	CHECKED -	REVISED -	
PLOT DATE = Nov-21-2022 01:53:26 PM	DATE -	REVISED -	

US	67 /15TH	STREET	ΓAND	SEE 2ND	AVENUE	A.P. RTE	SECTION		COUNTY	TOTAL SHEETS	SHEET NO.
	۸۵۸	ВАМЕ	DETA	IL SHEET		559	D2 SW 2020-2		ROCK ISLAND	60	26
	AUF	i it/Alvii	DLIA	L SIILLI					CONTRACT	NO. 64	1P59
SH	FET	OF	SHEETS	STA	TO STA.		TILIMOIS	EED AI	D DDOLECT		

NE QUAD 2ND AVENUE

POINT	STATION	OFFSET	SIDE	ELEVATION
A	709+58.25	80.73	RT	564.04
В	709+58.21	85.73	RT	564.09
С	709+73.52	82.92	RT	564.47
D	709+76.25	78.73	RT	564.52
E	709+80.46	81.45	RT	564.59
F	709+77.74	85.66	RT	564.51
G	709+71.82	97.16	RT	MATCH EX
Н	709+73.59	98.08	RT	564.24
ı	709+79.74	87.33	RT	564.47
J	709+83.02	82.30	RT	564.57
K	709+93.65	82.29	RT	565.20
L	709+92.13	67.02	RT	MATCH EX
M	709+95.18	69.62	RT	565.12
N	709+84.75	83.31	RT	564.53
0	709+81.47	88.34	RT	564.37
P	709+75.37	99.00	RT	564.13
Q	709+94.82	103.11	RT	563.44
R	709+97.69	97.80	RT	563.60
S	710+00.81	92.67	RT	563.78
T	710+18.60	71.20	RT	565.03
U	710+19.98	72.65	RT	564.93
V	710+02.54	93.68	RT	563.68
W	709+99.42	98.80	RT	563.60
Х	709+96.60	104.02	RT	563.36
Υ	709+98.38	104.92	RT	563.31
Z	710+01.91	99.66	RT	563.56
AA	710+04.52	95.39	RT	563.64
ВВ	710+21.35	74.10	RT	564.84
CC	710+08.79	97.98	RT	563.95
DD	710+06.20	102.26	RT	563.90
EE	710+10.46	104.84	RT	563.95
FF	710+13.07	100.57	RT	564.00
GG	710+22.80	88.08	RT	565.11
НН	710+19.25	84.76	RT	565.03

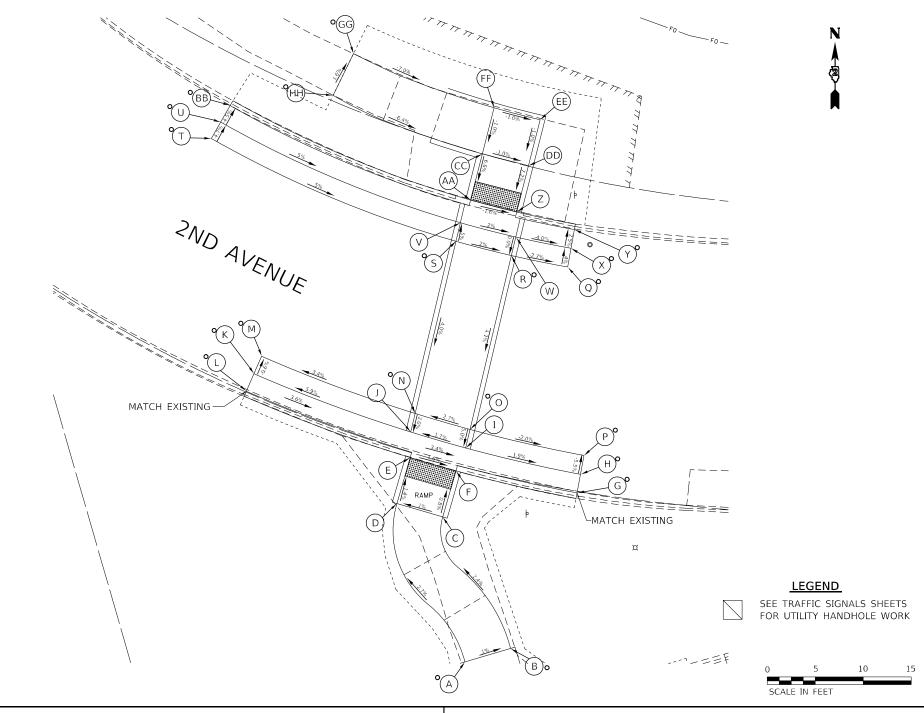



APPROXIMATE EXISTING ELEVATION

X.X% SIDEWALK / PAVEMENT GRADE

) EXISTING ELEVATION / SLOPE

----- PROPOSED CONSTRUCTION LIMITS

---- PROPOSED TOOLED JOINT (APPROX.)

ST

5TH

67

PROPOSED LANDING

DETECTABLE WARNINGS

PEDESTRIAN PUSH-BUTTON

SEE NOTES 1 & 5


INCIDENTAL HMA SURFACING

NOT PART OF PEDESTRIAN ACCESS ROUTE

- 1. REFER TO DISTRICT 2 STANDARD 26.1 FOR ADA CURB RAMP PAVEMENT REMOVAL AND REPLACEMENT.
- . SIDEWALK TOOLED JOINT LOCATIONS SHOWN ARE APPROXIMATE AND ADDITIONAL TOOLED JOINTS SHOULD BE CONSTRUCTED IN ACCORDANCE WITH SECTION 424 OF THE STANDARD SPECS AND AS DIRECTED BY THE ENGINEER.
- . FLOW LINE ELEVATION PERPENDICULAR TO CURB IS 0.04' LOWER THAN BACK OF CURB. SEE STANDARD 606001.
- 4. AT DEPRESSED CURBS ADJACENT TO CURB RAMPS ACCESSIBLE TO THE DISABLED, THE PERPENDICULAR GUTTER FLAG SLOPE SHALL BE -4.0% UNLESS NOTED OTHERWISE.
- 5. LIMITS OF PAVEMENT PATCH TO BE COORDINATED WITH ENGINEER TO ACHIEVE 5.0% MAX. CROSSWALK RUNNING SLOPE AND 5.0% MAX. COUNTERSLOPE.

USER NAME = Brad.Cushman	DESIGNED -	REVISED -
	DRAWN -	REVISED -
PLOT SCALE = 10.0000 / in.	CHECKED -	REVISED -
PLOT DATE = Nov-21-2022 01:53:49 PM	DATE -	REVISED -

ι	JS 67	/15TH STREE	T AND	NE 2ND A	VENUE	F.A.P. RTE	SECTION	COUNTY	TOTAL SHEETS	SHEET NO.
		ADA RAMP	DETA	II CHEET		559	D2 SW 2020-2	ROCK ISLAND	60	27
		ADA IIAWII	DLIA	IL SIILLI				CONTRACT	NO. 6	1P59
	CHEET	O.E.	CHEETC	CTA	TO CTA					

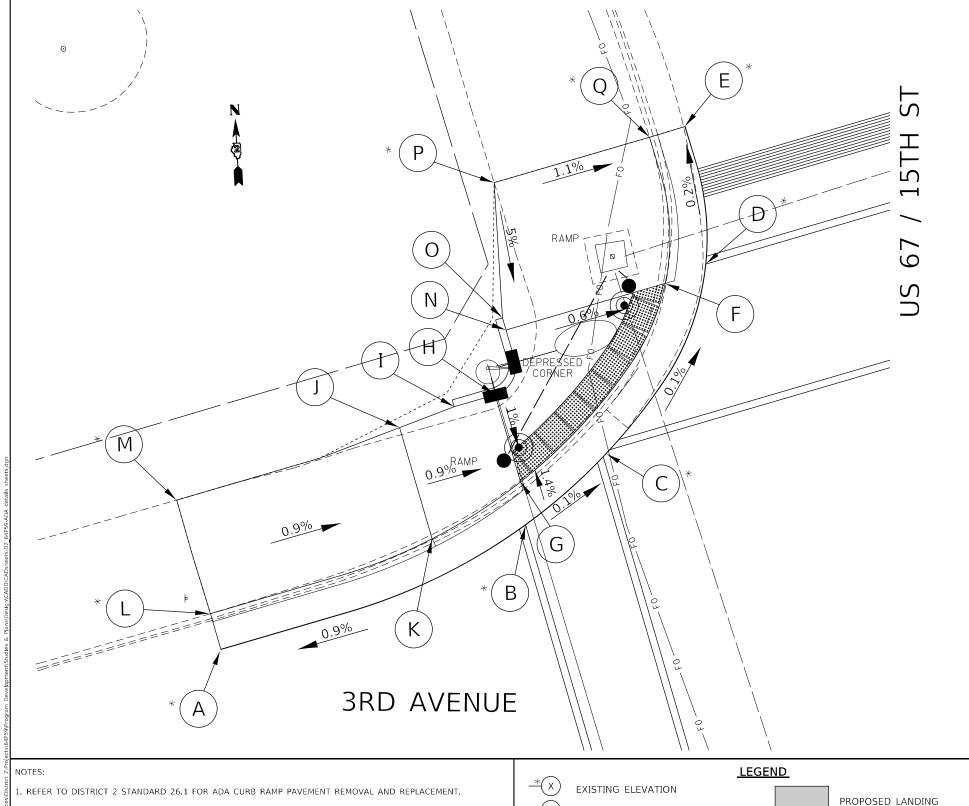

NW QUAD 3RD AVENUE

POINT	STATION	OFFSET	SIDE	ELEVATION
A	705+91.31	67.99	LT	564.00
В	705+92.68	45.16	LT	564.21
С	705+94.30	38.29	LT	564.20
D	706+04.86	27.89	LT	564.19
E	706+14.43	26.49	LT	564.17
F	706+04.39	30.97	LT	564.23
G	705+94.12	44.55	LT	564.19
Н	706+00.42	44.53	LT	564.25
	706+00.45	47.49	LT	564.27
J	706+00.16	51.54	LT	564.31
K	705+93.07	51.62	LT	564.21
L	705+93.07	67.88	LT	564.25
M	705+99.84	67.82	LT	564.45
N	706+04.50	42.49	LT	564.26
0	706+05.38	42.49	LT	564.30
P	706+14.53	40.31	LT	564.77
Q	706+14.43	29.08	LT	564.65



2. SIDEWALK TOOLED JOINT LOCATIONS SHOWN ARE APPROXIMATE AND ADDITIONAL TOOLED JOINTS SHOULD BE CONSTRUCTED IN ACCORDANCE WITH SECTION 424 OF THE STANDARD SPECS AND AS DIRECTED BY THE ENGINEER.

. FLOW LINE ELEVATION PERPENDICULAR TO CURB IS 0.04' LOWER THAN BACK OF CURB. SEE STANDARD 606001.

4. AT DEPRESSED CURBS ADJACENT TO CURB RAMPS ACCESSIBLE TO THE DISABLED, THE PERPENDICULAR GUTTER FLAG SLOPE SHALL BE -4.0% UNLESS NOTED OTHERWISE.

5. LIMITS OF PAVEMENT PATCH TO BE COORDINATED WITH ENGINEER TO ACHIEVE 5.0% MAX. CROSSWALK RUNNING SLOPE AND 5.0% MAX. COUNTERSLOPE.



APPROXIMATE EXISTING ELEVATION

X.X% SIDEWALK / PAVEMENT GRADE

) EXISTING ELEVATION / SLOPE

----- PROPOSED CONSTRUCTION LIMITS

---- PROPOSED TOOLED JOINT (APPROX.)





DETECTABLE WARNINGS



PEDESTRIAN PUSH-BUTTON



INCIDENTAL HMA SURFACING SEE NOTES 1 & 5

NOT PART OF PEDESTRIAN ACCESS ROUTE


<u>LEGEND</u>

SEE TRAFFIC SIGNALS SHEETS FOR UTILITY HANDHOLE WORK

USER NAME = Brad Cushman	DESIGNED -	REVISED -
	DRAWN -	REVISED -
PLOT SCALE = 10.0000 / in.	CHECKED -	REVISED -
PLOT DATE = Nov-21-2022 01:54:16 PM	DATE -	REVISED -

U	S 67 /	 		NW 31	 AVENUE	
	SHEET	OF	SHEETS	STA.	TO STA.	

F.A.P. RTE	SECT	ПОИ		COUNTY	TOTAL SHEETS	SHEET NO.		
559	D2 SW	2020-2		ROCK ISLAND	60	28		
				CONTRACT NO. 64P59				
		ILLINOIS	FED. A	ID PROJECT				

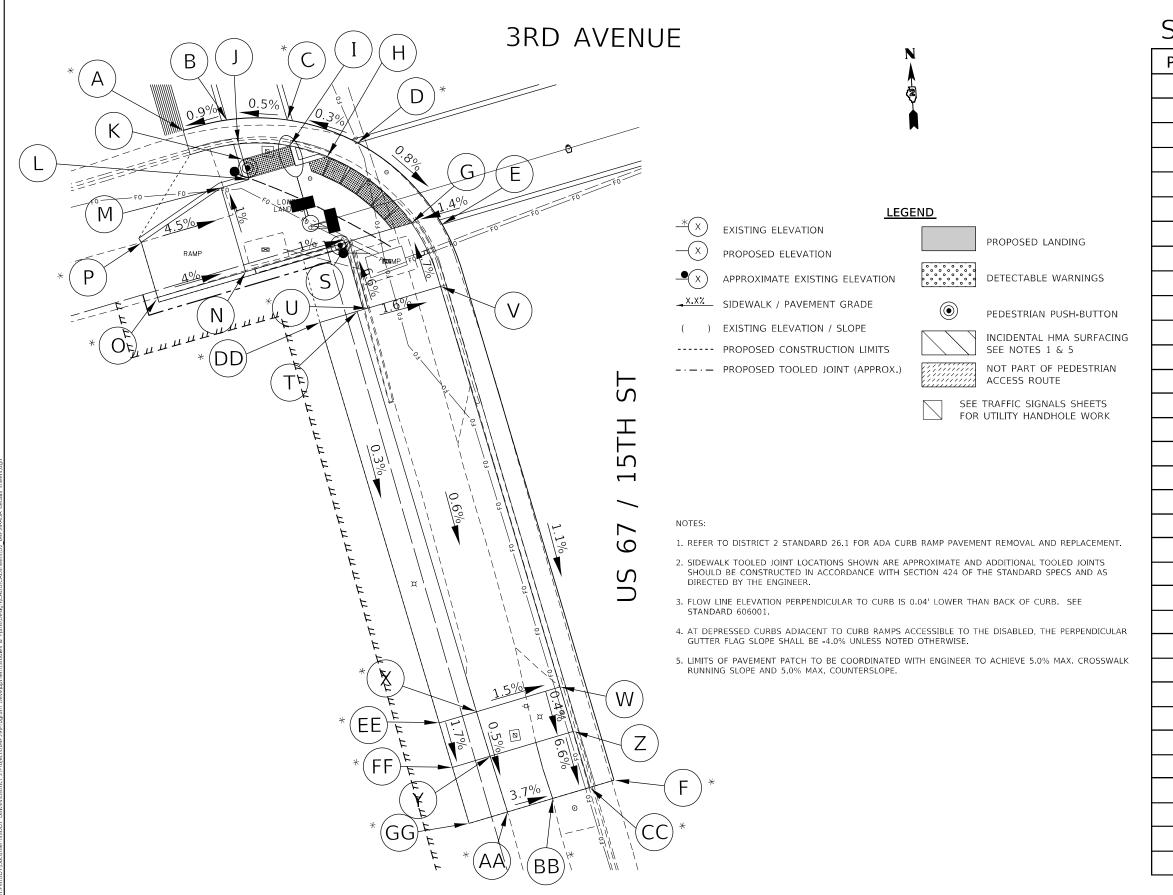

SW QUAD 3RD AVENUE

	SVI QUILD SILD INVENUE									
POINT	STATION	OFFSET	SIDE	ELEVATION						
Α	705+39.09	51.51	LT	564.00						
В	705+38.92	46.93	LT	564.04						
С	705+37.24	40.91	LT	564.07						
D	705+33.52	35.13	LT	564.09						
E	705+23.09	28.61	LT	564.04						
F	704+73.53	27.07	LT	563.49						
G	705+23.56	31.47	LT	564.00						
Н	705+32.49	37.94	LT	564.04						
1	705+34.61	41.39	LT	564.03						
J	705+36.23	46.40	LT	564.00						
K	705+34.56	46.38	LT	564.02						
L	705+32.40	46.36	LT	564.05						
M	705+32.36	49.36	LT	564.08						
N	705+23.35	49.26	LT	564.17						
0	705+23.25	58.70	LT	564.55						
Р	705+29.16	58.77	LT	564.53						
Q	705+32.45	41.36	LT	564.06						
R	705+32.47	39.94	LT	564.06						
S	705+23.48	37.87	LT	564.06						
Т	705+16.33	39.31	LT	564.55						
U	705+16.35	38.16	LT	564.53						
V	705+16.48	30.35	LT	564.41						
W	704+73.49	29.65	LT	564.16						
X	704+73.34	38.61	LT	564.29						
Υ	704+68.55	38.50	LT	564.26						
Z	704+68.70	29.57	LT	564.14						
AA	704+62.55	38.34	LT	564.23						
BB	704+62.64	33.48	LT	564.05						
CC	704+62.67	29.58	LT	563.74						
DD	705+16.27	43.31	LT	564.41						
EE	704+73.28	42.61	LT	564.53						
FF	704+68.49	42.53	LT	564.45						
GG	704+62.48	42.44	LT	564.34						



USER NAME = Brad.Cushman	DESIGNED -	REVISED -
	DRAWN -	REVISED -
PLOT SCALE = 10.0000 / in.	CHECKED -	REVISED -
PLOT DATE = Nov-21-2022 01:54:38 PM	DATE	REVISED.

SE QUAD 3RD AVENUE

POINT	STATION	OFFSET	SIDE	ELEVATION
Α	705+04.03	27.49	RT	563.65
В	705+23.77	31.33	RT	563.77
С	705+34.58	40.85	RT	563.88
D	705+40.61	62.02	RT	564.01
E	705+31.11	40.58	RT	563.83
F	705+23.18	33.96	RT	563.73
G	705+20.40	33.96	RT	563.76
Н	705+20.40	40.73	RT	563.83
I	705+23.53	43.00	RT	563.89
J	705+24.13	42.66	RT	563.88
К	705+31.13	42.58	RT	563.85
L	705+31.21	49.58	RT	564.30
М	705+35.52	47.69	RT	564.30
N	705+24.21	49.66	RT	564.36
0	705+24.35	62.20	RT	564.61
Р	705+31.35	62.12	RT	564.46
Q	705+13.40	40.62	RT	564.33
R	705+13.40	33.96	RT	564.26
S	705+08.30	33.96	RT	564.19
Т	705+08.32	40.56	RT	564.38
U	705+08.22	30.08	RT	564.06
V	705+38.03	62.05	RT	564.26



NOTES:

3RD AVENUE


1. REFER TO DISTRICT 2 STANDARD 26.1 FOR ADA CURB RAMP PAVEMENT REMOVAL AND REPLACEMENT.


2. SIDEWALK TOOLED JOINT LOCATIONS SHOWN ARE APPROXIMATE AND ADDITIONAL TOOLED JOINTS SHOULD BE CONSTRUCTED IN ACCORDANCE WITH SECTION 424 OF THE STANDARD SPECS AND AS DIRECTED BY THE ENGINEER.

3. FLOW LINE ELEVATION PERPENDICULAR TO CURB IS 0.04' LOWER THAN BACK OF CURB. SEE STANDARD 606001.

4. AT DEPRESSED CURBS ADJACENT TO CURB RAMPS ACCESSIBLE TO THE DISABLED, THE PERPENDICULAR GUTTER FLAG SLOPE SHALL BE -4.0% UNLESS NOTED OTHERWISE.

5. LIMITS OF PAVEMENT PATCH TO BE COORDINATED WITH ENGINEER TO ACHIEVE 5.0% MAX. CROSSWALK RUNNING SLOPE AND 5.0% MAX. COUNTERSLOPE.

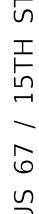

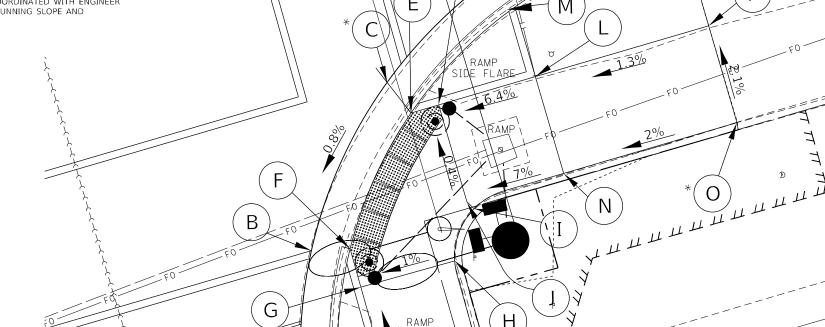

<u>LEGEND</u>

EXISTING ELEVATION

PROPOSED ELEVATION

APPROXIMATE EXISTING ELEVATION

→X.X% SIDEWALK / PAVEMENT GRADE

EXISTING ELEVATION / SLOPE ----- PROPOSED CONSTRUCTION LIMITS

-·-· PROPOSED TOOLED JOINT (APPROX.)



PROPOSED LANDING




DETECTABLE WARNINGS



PEDESTRIAN PUSH-BUTTON



INCIDENTAL HMA SURFACING SEE NOTES 1 & 5

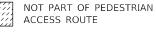



SEE TRAFFIC SIGNALS SHEETS FOR UTILITY HANDHOLE WORK



STATE OF ILLINOIS **DEPARTMENT OF TRANSPORTATION**

ι	JS	67	/15TH	STREET	AND	SE	3RD	AVENUE	
			ADA	RAMP	DETA	IL S	HEET		

SECTION D2 SW 2020-2 ROCK ISLAND 60 30 CONTRACT NO. 64P59

NE QUAD 3RD AVENUE

POINT	STATION	OFFSET	SIDE	ELEVATION
Α	705+85.30	60.59	RT	564.18
В	705+90.83	43.24	RT	564.49
С	706+04.29	32.13	RT	564.49
D	706+18.56	28.44	RT	564.04
E	706+03.76	35.42	RT	564.47
F	705+96.00	42.48	RT	564.46
G	705+89.97	50.36	RT	564.55
Н	705+87.88	60.70	RT	564.40
l	706+03.51	61.21	RT	565.05
J	706+03.68	50.55	RT	564.70
K	706+04.15	50.93	RT	564.73
L	706+05.46	49.88	RT	564.76
М	706+05.65	42.57	RT	564.66
N	706+03.76	42.55	RT	564.58
0	706+06.10	42.11	RT	564.67
Р	706+07.20	42.93	RT	564.64
Q	706+10.76	42.98	RT	564.65
R	706+10.76	32.23	RT	564.53
S	706+19.09	31.04	RT	564.44
Т	706+18.90	43.10	RT	564.66
U	705+81.31	60.42	RT	564.32
٧	705+86.27	42.98	RT	564.26
W	706+04.32	27.65	RT	564.19
Х	706+18.56	24.44	RT	564.19



NOTES:

- 1. REFER TO DISTRICT 2 STANDARD 26.1 FOR ADA CURB RAMP PAVEMENT REMOVAL AND REPLACEMENT.
- 2. SIDEWALK TOOLED JOINT LOCATIONS SHOWN ARE APPROXIMATE AND ADDITIONAL TOOLED JOINTS SHOULD BE CONSTRUCTED IN ACCORDANCE WITH SECTION 424 OF THE STANDARD SPECS AND AS DIRECTED BY THE ENGINEER.
- 3. FLOW LINE ELEVATION PERPENDICULAR TO CURB IS 0.04' LOWER THAN BACK OF CURB. SEE STANDARD 606001.
- 1. AT DEPRESSED CURBS ADJACENT TO CURB RAMPS ACCESSIBLE TO THE DISABLED, THE PERPENDICULAR GUTTER FLAG SLOPE SHALL BE -4.0% UNLESS NOTED OTHERWISE.
- 5. LIMITS OF PAVEMENT PATCH TO BE COORDINATED WITH ENGINEER TO ACHIEVE 5.0% MAX. CROSSWALK RUNNING SLOPE AND 5.0% MAX. COUNTERSLOPE.

EXISTING ELEVATION PROPOSED ELEVATION APPROXIMATE EXISTING ELEVATION XX.XXX. SIDEWALK / PAVEMENT GRADE

SIDEWALK / PAVEMENT GRADE

) EXISTING ELEVATION / SLOPE

----- PROPOSED CONSTRUCTION LIMITS

---- PROPOSED TOOLED JOINT (APPROX.)

PEDESTRIAN PUSH-BUTTON

INCIDENTAL HMA SURFACING SEE NOTES 1 & 5

NOT PART OF PEDESTRIAN ACCESS ROUTE

<u>LEGEND</u>


SEE TRAFFIC SIGNALS SHEETS FOR UTILITY HANDHOLE WORK

USER NAME = Brad.Cushman	DESIGNED -	REVISED -
	DRAWN -	REVISED -
PLOT SCALE = 10.0000 / in.	CHECKED -	REVISED -
PLOT DATE = Nov-21-2022 01:55:27 PM	DATE -	REVISED -

STATE OF ILLINOIS
DEPARTMENT OF TRANSPORTATION

Į	JS 67	/15TH	STREE	T AND	NE 3RD	AVENUE		F.A.P. RTE	SE	CTIO	N	COUNTY	TOTAL SHEETS	
	ADA RAMP DETAIL SHEET					559	D2 SV	W 20	20-2	ROCK ISLAND	60	31		
										CONTRACT	NO. 64	1P59		
	SHEET	-	OF	SHEETS	STA	T(O STA.			TI I	INOIS FED /	VID PROJECT		

MODEL: Default FILE NAME: pw:\\ildot+p

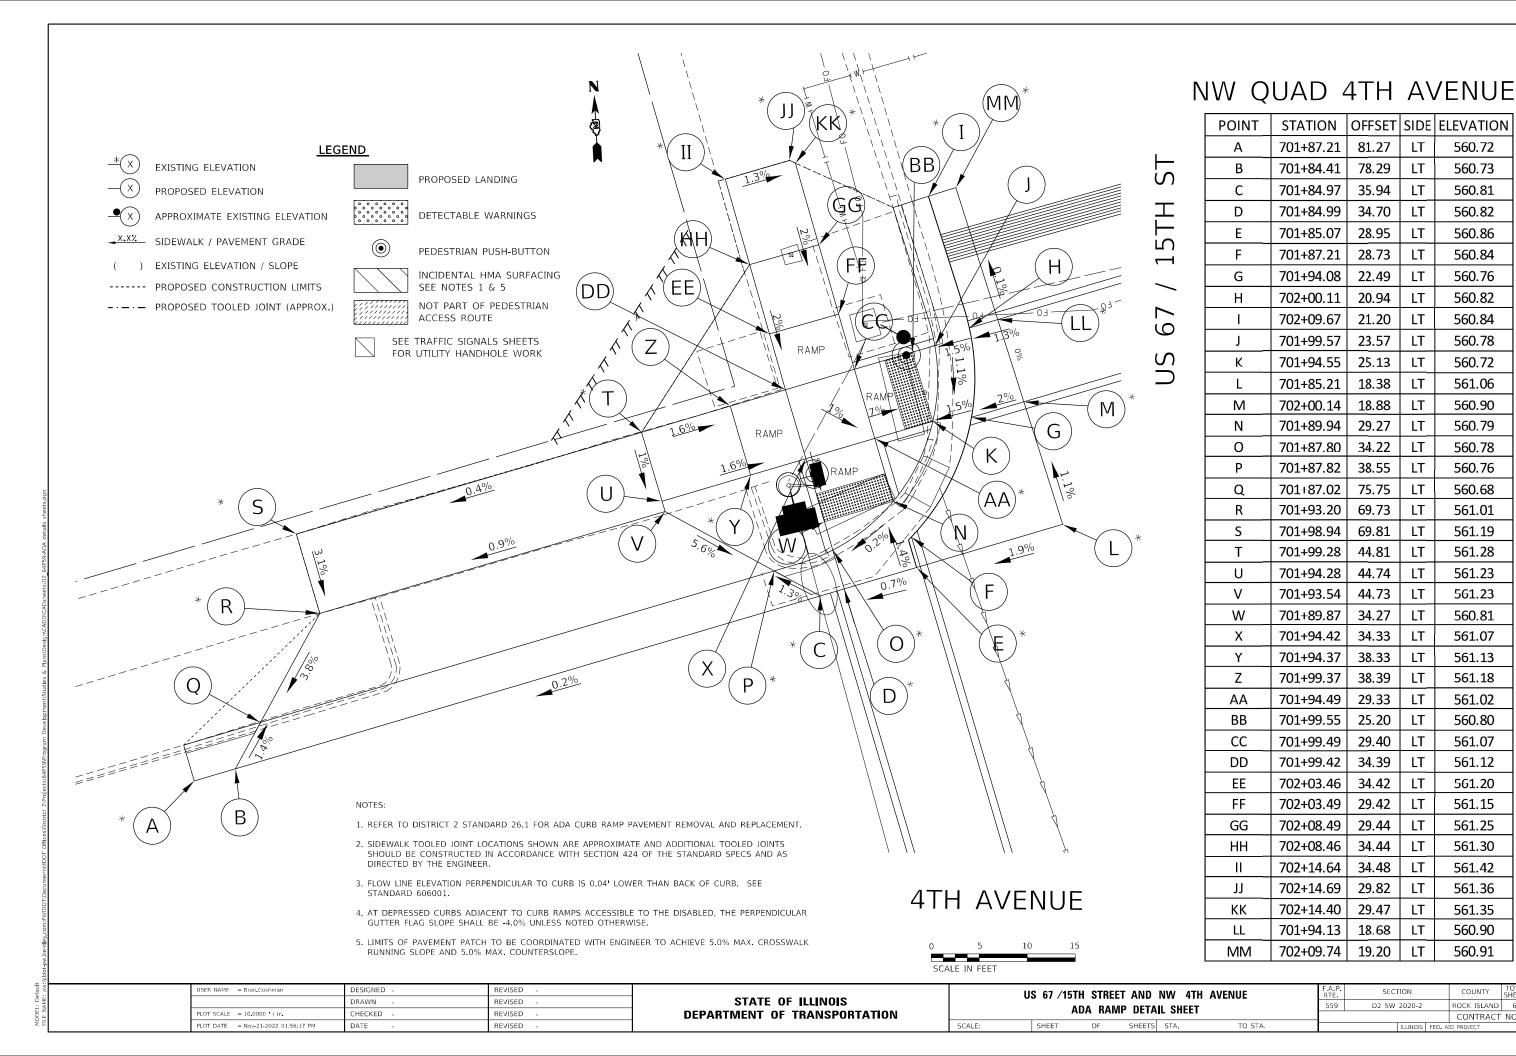

560.72

560.73

560.81

560.82

560.86

560.84

560.76

560.82

560.84

560.78

560.72

561.06

560.90

560.79

560.78

560.76

560.68

561.01

561.19

561.28

561.23

561.23

560.81

561.07

561.13

561.18

561.02

560.80

561.07

561.12

561.20

561.15

561.25

561.30

561.42

561.36

561.35

560.90

560.91

ROCK ISLAND 60 32

CONTRACT NO. 64P59

LT

4TH AVENUE K 0.4% PROPOSED GROUND Χ 1.5% RAMP LEGEND EXISTING ELEVATION PROPOSED LANDING PROPOSED ELEVATION APPROXIMATE EXISTING ELEVATION DETECTABLE WARNINGS → X.X½ SIDEWALK / PAVEMENT GRADE PEDESTRIAN PUSH-BUTTON) EXISTING ELEVATION / SLOPE INCIDENTAL HMA SURFACING ----- PROPOSED CONSTRUCTION LIMITS SEE NOTES 1 & 5 NOT PART OF PEDESTRIAN -·-·- PROPOSED TOOLED JOINT (APPROX.) ACCESS ROUTE SEE TRAFFIC SIGNALS SHEETS SCALE IN FEET FOR UTILITY HANDHOLE WORK JSER NAME = Brad.Cushman DESIGNED REVISED REVISED DRAWN CHECKED REVISED DEP/

PLOT DATE = Nov-21-2022 01:56:42 PM

DATE

SW QUAD 4TH AVENUE

POINT	STATION	OFFSET	SIDE	ELEVATION
Α	701+37.40	48.03	LT	560.80
В	701+37.47	34.05	LT	560.82
С	701+35.58	28.03	LT	560.78
D	701+30.32	22.35	LT	560.67
E	701+22.35	19.77	LT	560.51
F	701+07.05	19.75	LT	560.29
G	701+22.82	22.39	LT	560.42
Н	701+22.79	24.16	LT	560.41
1	701+28.46	24.23	LT	560.51
J	701+33.09	28.87	LT	560.60
K	701+34.85	33.87	LT	560.71
L	701+33.09	33.87	LT	560.80
M	701+28.33	33.87	LT	561.03
N	701+28.39	28.87	LT	560.83
0	701+22.73	28.87	LT	560.90
Р	701+22.66	33.87	LT	561.11
Q	701+15.66	33.87	LT	560.99
R	701+15.66	28.87	LT	560.90
S	701+10.66	33.87	LT	560.99
Т	701+10.66	28.87	LT	560.88
U	701+05.91	29.04	LT	560.82
V	701+05.56	33.87	LT	561.01
W	701+22.57	40.87	LT	561.05
X	701+28.23	40.95	LT	561.04
Υ	701+28.13	48.10	LT	561.10
Z	701+22.48	47.47	LT	561.12

NOTES:

S

- 1. REFER TO DISTRICT 2 STANDARD 26.1 FOR ADA CURB RAMP PAVEMENT REMOVAL AND REPLACEMENT.
- 2. SIDEWALK TOOLED JOINT LOCATIONS SHOWN ARE APPROXIMATE AND ADDITIONAL TOOLED JOINTS SHOULD BE CONSTRUCTED IN ACCORDANCE WITH SECTION 424 OF THE STANDARD SPECS AND AS DIRECTED BY THE ENGINEER.
- 3. FLOW LINE ELEVATION PERPENDICULAR TO CURB IS 0.04' LOWER THAN BACK OF CURB. SEE STANDARD 606001.
- 4. AT DEPRESSED CURBS ADJACENT TO CURB RAMPS ACCESSIBLE TO THE DISABLED, THE PERPENDICULAR GUTTER FLAG SLOPE SHALL BE -4.0% UNLESS NOTED OTHERWISE.
- 5. LIMITS OF PAVEMENT PATCH TO BE COORDINATED WITH ENGINEER TO ACHIEVE 5.0% MAX. CROSSWALK RUNNING SLOPE AND 5.0% MAX. COUNTERSLOPE.

OTATE OF HUMOIO	U	US 67 /15TH STREET AND SW 4TH AVENUE							COUNTY	TOTAL SHEETS	SHEET NO.
STATE OF ILLINOIS PARTMENT OF TRANSPORTATION	ADA RAMP DETAIL SHEET						559	D2 SW 2020-2	ROCK ISLAND	60	33
	ADA HAWII DETAJE SHEET					CONTRACT NO. 64P59			P59		
	SCALE:	SHEET	OF	SHEETS	STA.	TO STA.		ILLINOIS FED. AI	D PROJECT		

SE QUAD 4TH AVENUE

POINT	STATION	OFFSET	SIDE	ELEVATION
Α	701+15.17	27.32	RT	560.48
В	701+22.99	27.53	RT	560.67
С	701+31.03	29.83	RT	560.77
D	701+39.15	35.64	RT	560.87
Е	701+44.66	44.08	RT	560.90
F	701+45.93	48.09	RT	560.93
G	701+40.88	42.25	RT	561.09
Н	701+36.07	36.25	RT	560.88
I	701+30.06	32.23	RT	560.78
J	701+24.03	30.30	RT	560.68
K	701+24.06	32.31	RT	560.76
L	701+24.11	36.25	RT	560.96
М	701+30.11	36.25	RT	560.93
N	701+36.07	42.25	RT	561.10
0	701+30.19	42.25	RT	561.16
Р	701+30.26	47.25	RT	561.41
Q	701+24.26	47.33	RT	561.38
R	701+24.19	42.25	RT	561.09
S	701+19.11	42.25	RT	561.22
Т	701+19.11	36.25	RT	560.99
U	701+16.17	36.25	RT	560.98
V	701+16.17	44.00	RT	561.37
W	701+16.86	44.02	RT	561.40
X	701+22.21	49.41	RT	561.45






EXISTING ELEVATION PROPOSED ELEVATION

EXISTING ELEVATION / SLOPE

-·-· PROPOSED TOOLED JOINT (APPROX.)

PROPOSED CONSTRUCTION LIMITS

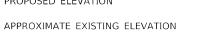



PEDESTRIAN PUSH-BUTTON



INCIDENTAL HMA SURFACING SEE NOTES 1 & 5

NOT PART OF PEDESTRIAN ACCESS ROUTE

SEE TRAFFIC SIGNALS SHEETS FOR UTILITY HANDHOLE WORK 2. SIDEWALK TOOLED JOINT LOCATIONS SHOWN ARE APPROXIMATE AND ADDITIONAL TOOLED JOINTS SHOULD BE CONSTRUCTED IN ACCORDANCE WITH SECTION 424 OF THE STANDARD SPECS AND AS DIRECTED BY THE ENGINEER.

3. FLOW LINE ELEVATION PERPENDICULAR TO CURB IS 0.04' LOWER THAN BACK OF CURB. SEE

4. AT DEPRESSED CURBS ADJACENT TO CURB RAMPS ACCESSIBLE TO THE DISABLED, THE PERPENDICULAR GUTTER FLAG SLOPE SHALL BE -4.0% UNLESS NOTED OTHERWISE.

5. LIMITS OF PAVEMENT PATCH TO BE COORDINATED WITH ENGINEER TO ACHIEVE 5.0% MAX. CROSSWALK RUNNING SLOPE AND 5.0% MAX. COUNTERSLOPE.



USER NAME = Brad.Cushman	DESIGNED -	REVISED -
	DRAWN -	REVISED -
PLOT SCALE = 10.0000 / in.	CHECKED -	REVISED -
PLOT DATE = Nov-21-2022 01:57:18 PM	DATE -	REVISED -


STATE OF ILLINOIS **DEPARTMENT OF TRANSPORTATION**

US 67 /15TH STREET AND SE 4TH AVENUE						F.A.P. RTE	
	ADA RAMP DETAIL SHEET						[
					•		
	SHEET	OF	SHEETS	STA.	TO STA.		

SECTION D2 SW 2020-2 ROCK ISLAND 60 34 CONTRACT NO. 64P59

NE QUAD 4TH AVENUE

POINT	STATION	OFFSET	SIDE	ELEVATION
Α	702+14.30	26.83	RT	561.01
В	702+00.77	28.10	RT	560.85
С	701+94.80	30.52	RT	560.79
D	701+87.83	35.48	RT	560.74
Е	701+81.59	43.57	RT	560.80
F	701+84.91	43.02	RT	560.75
G	701+89.05	42.97	RT	560.75
Н	701+88.98	37.97	RT	560.70
ı	701+95.36	33.16	RT	560.75
J	702+00.33	30.95	RT	560.81
K	701+95.42	37.88	RT	560.73
L	701+94.49	42.89	RT	560.83
M	702+00.49	42.81	RT	560.92
N	702+00.60	50.97	RT	561.52
0	701+94.60	51.05	RT	561.39
Р	702+07.49	42.72	RT	561.55
Q	702+08.09	42.71	RT	561.71
R	702+08.08	40.50	RT	561.60
S	702+11.91	40.50	RT	561.61
Т	702+13.86	40.50	RT	561.66
U	702+14.30	29.41	RT	561.43
V	702+07.27	29.53	RT	561.31
W	702+14.21	33.41	RT	561.49
Х	701+81.11	44.48	RT	560.85

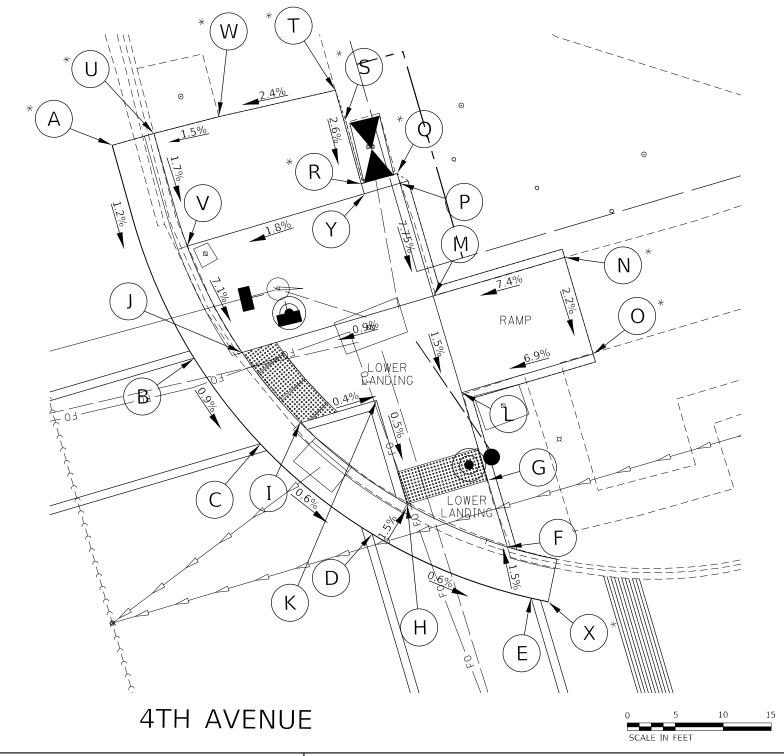

- 1. REFER TO DISTRICT 2 STANDARD 26.1 FOR ADA CURB RAMP PAVEMENT REMOVAL AND REPLACEMENT.
- 2. SIDEWALK TOOLED JOINT LOCATIONS SHOWN ARE APPROXIMATE AND ADDITIONAL TOOLED JOINTS SHOULD BE CONSTRUCTED IN ACCORDANCE WITH SECTION 424 OF THE STANDARD SPECS AND AS DIRECTED BY THE ENGINEER.
- . FLOW LINE ELEVATION PERPENDICULAR TO CURB IS 0.04' LOWER THAN BACK OF CURB. SEE STANDARD 606001.
- 1. AT DEPRESSED CURBS ADJACENT TO CURB RAMPS ACCESSIBLE TO THE DISABLED, THE PERPENDICULAR GUTTER FLAG SLOPE SHALL BE -4.0% UNLESS NOTED OTHERWISE.
- 5. LIMITS OF PAVEMENT PATCH TO BE COORDINATED WITH ENGINEER TO ACHIEVE 5.0% MAX. CROSSWALK RUNNING SLOPE AND 5.0% MAX. COUNTERSLOPE.

LEGEND EXISTING ELEVATION



PROPOSED ELEVATION

X.X% SIDEWALK / PAVEMENT GRADE

) EXISTING ELEVATION / SLOPE

----- PROPOSED CONSTRUCTION LIMITS

---- PROPOSED TOOLED JOINT (APPROX.)

APPROXIMATE EXISTING ELEVATION



PROPOSED LANDING



DETECTABLE WARNINGS



PEDESTRIAN PUSH-BUTTON



INCIDENTAL HMA SURFACING SEE NOTES 1 & 5

ACCESS ROUTE

NOT PART OF PEDESTRIAN

<u>LEGEND</u>




SEE TRAFFIC SIGNALS SHEETS FOR UTILITY HANDHOLE WORK

ROCK ISLAND 60 35

CONTRACT NO. 64P59

USER NAME = Brad.Cushman	DESIGNED -	REVISED -
	DRAWN -	REVISED -
PLOT SCALE = 10.0000 / in.	CHECKED -	REVISED -
PLOT DATE = Nov-21-2022 01:57:49 PM	DATE -	REVISED -

S 67 /15TH STREET AND NE 4TH AVENUE						SECTIO	NC	
	ADA RAMI	559	D2 SW 2	020-2				
	ADA IIAIVII	DLIA	IL SIILLI					
SHEET	OF	SHEETS	STA.	TO STA.		IL	LINOIS	FI

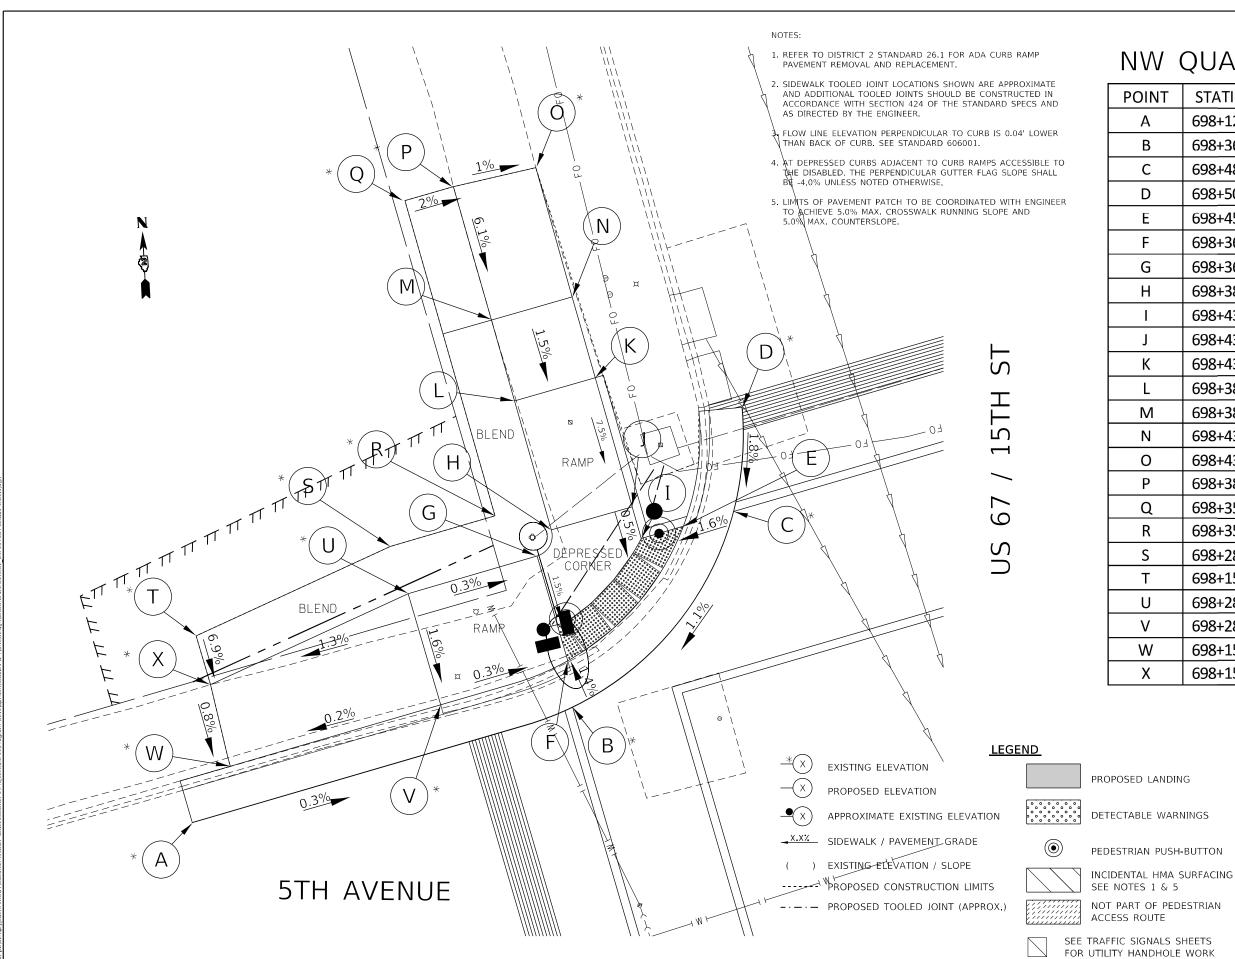

DESIGNED

HECKED

DRAWN

PLOT DATE = Nov-21-2022 01:58:18 PM

REVISED

REVISED

REVISED

NW QUAD 5TH AVENUE

	~			
POINT	STATION	OFFSET	SIDE	ELEVATION
Α	698+12.62	22.18	LT	558.30
В	698+36.28	22.43	LT	558.38
С	698+48.76	31.13	LT	558.55
D	698+50.95	36.75	LT	558.66
E	698+45.65	31.13	LT	558.50
F	698+36.78	25.15	LT	558.34
G	698+36.78	31.67	LT	558.44
Н	698+38.03	33.13	LT	558.46
I	698+43.03	31.13	LT	558.53
J	698+43.03	33.13	LT	558.54
К	698+43.03	41.13	LT	559.01
L	698+38.03	41.13	LT	559.06
М	698+38.03	46.13	LT	559.11
N	698+43.03	46.13	LT	559.06
0	698+43.03	54.39	LT	559.56
Р	698+38.03	54.39	LT	559.61
Q	698+35.03	46.13	LT	559.49
R	698+35.04	34.67	LT	559.30
S	698+28.56	34.67	LT	559.15
Т	698+15.96	32.80	LT	558.84
U	698+28.78	31.67	LT	558.80
V	698+28.78	24.77	LT	558.69
W	698+15.73	24.77	LT	558.67
X	698+15.96	29.77	LT	558.63


NOTE: STA AND OFF FOR ALL POINTS EAST
OF JOINT F-G WERE ESTIMATED
FOLLOWING THE US 67/5TH AV
ALIGNMENT FROM WEST TO EAST AT
THE INTERSECTION DUE TO A CONFLICT
IN CONTINUITY ALONG THE RADIUS.



STATE OF ILLINOIS
DEPARTMENT OF TRANSPORTATION

US 67 /15TH STREET AND NW 5TH AVENUE ADA RAMP DETAIL SHEET

F.A.P. RTE	SECTION		COUNTY	TOTAL SHEETS	SHEET NO.
559	D2 SW 2020-2		ROCK ISLAND	60	36
			CONTRACT	NO. 64	1P59
	TLUNOIS	FED Δ	D PROJECT		

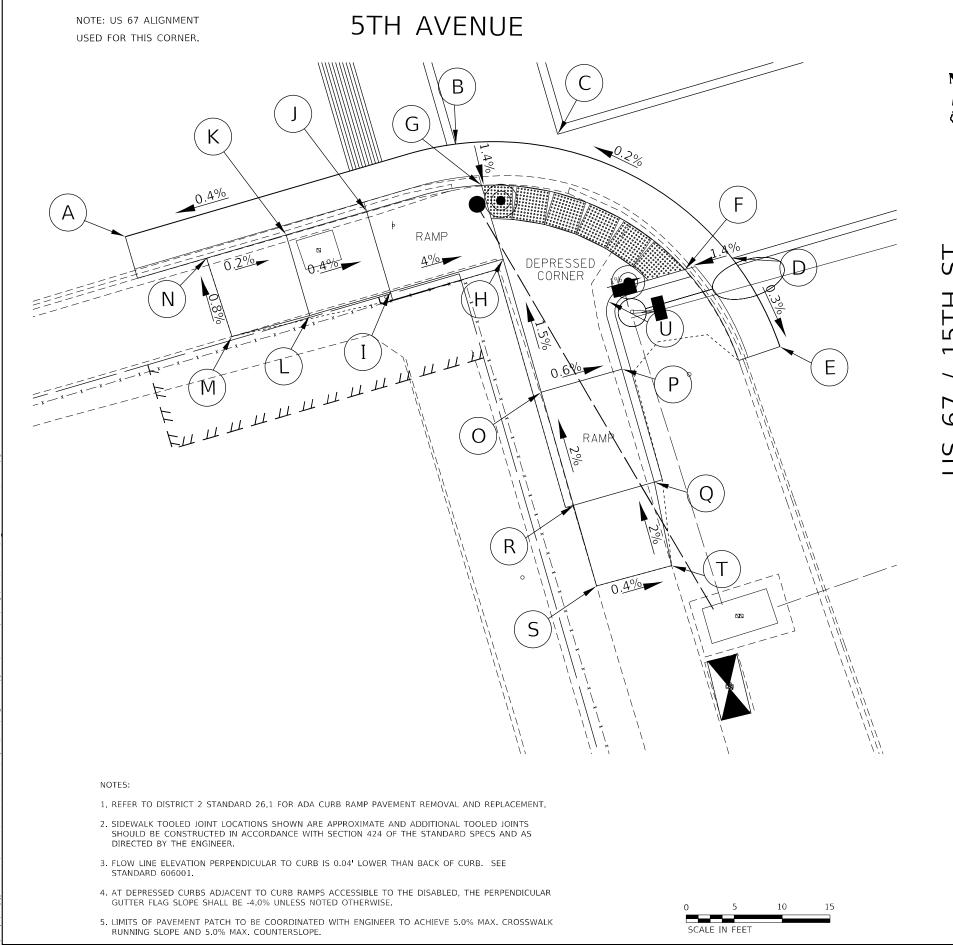

REVISED

REVISED

REVISED

DRAWN

CHECKED

DATE

PLOT DATE = Nov-21-2022 01:58:46 PM

SW QUAD 5TH AVENUE

POINT	STATION	OFFSET	SIDE	ELEVATION
Α	698+15.86	22.09	LT	558.31
В	698+36.28	22.32	LT	558.40
С	698+42.28	23.46	LT	558.42
D	698+50.21	33.46	LT	558.43
Е	698+51.43	39.30	LT	558.41
F	698+47.28	33.31	LT	558.39
G	698+37.08	25.11	LT	558.36
Н	698+37.08	29.67	LT	558.41
I	698+30.08	29.67	LT	558.69
J	698+30.08	24.67	LT	558.64
K	698+25.08	24.67	LT	558.66
L	698+25.08	29.67	LT	558.71
М	698+20.29	29.57	LT	558.71
N	698+20.15	24.67	LT	558.67
0	698+37.03	37.92	LT	558.53
Р	698+42.03	37.95	LT	558.50
Q	698+41.99	44.95	LT	558.64
R	698+36.99	44.92	LT	558.66
S	698+36.96	49.92	LT	558.76
Т	698+41.59	50.01	LT	558.74
U	698+42.39	33.86	LT	558.44

LEGEND

EXISTING ELEVATION PROPOSED ELEVATION



APPROXIMATE EXISTING ELEVATION



PROPOSED LANDING



→X.X% SIDEWALK / PAVEMENT GRADE

EXISTING ELEVATION / SLOPE

----- PROPOSED CONSTRUCTION LIMITS

-·-·- PROPOSED TOOLED JOINT (APPROX.)



DETECTABLE WARNINGS



PEDESTRIAN PUSH-BUTTON



INCIDENTAL HMA SURFACING SEE NOTES 1 & 5



NOT PART OF PEDESTRIAN ACCESS ROUTE



SEE TRAFFIC SIGNALS SHEETS FOR UTILITY HANDHOLE WORK

STATE	E 01	FILLINOIS
DEPARTMENT	0F	TRANSPORTATION


P.	SECTION		COUNTY	TOTAL SHEETS	SHEET NO.
59	D2 SW 2020-2		ROCK ISLAND	60	37
			CONTRACT	NO. 64	1P59
	TLUNOIS	FFD. A	D PROJECT		

SE QUAD 5TH AVENUE

POINT	STATION	OFFSET	SIDE	ELEVATION
Α	50+20.56	37.57	RT	558.51
В	50+25.60	29.47	RT	558.54
С	50+32.41	23.03	RT	558.60
D	50+41.76	18.66	RT	558.64
E	50+52.78	17.18	RT	558.71
F	50+41.73	21.75	RT	558.59
G	50+29.40	29.46	RT	558.48
Н	50+36.68	29.46	RT	558.58
ı	50+41.68	29.46	RT	558.66
J	50+41.64	36.49	RT	559.16
K	50+36.64	36.46	RT	559.11
L	50+36.61	41.46	RT	559.16
M	50+41.61	41.49	RT	559.21
N	50+41.59	45.61	RT	559.32
0	50+37.01	45.76	RT	559.45
Р	50+51.29	29.46	RT	559.07
Q	50+51.29	20.59	RT	558.86

NOTE: 5TH AV ALIGNMENT USED FOR THIS CORNER.

LEGEND

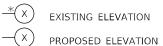

EXISTING ELEVATION



APPROXIMATE EXISTING ELEVATION



→ X.X% SIDEWALK / PAVEMENT GRADE



----- PROPOSED CONSTRUCTION LIMITS



---- PROPOSED TOOLED JOINT (APPROX.)



PEDESTRIAN PUSH-BUTTON

DETECTABLE WARNINGS

PROPOSED LANDING

DRAWN

CHECKED

INCIDENTAL HMA SURFACING SEE NOTES 1 & 5

NOT PART OF PEDESTRIAN ACCESS ROUTE


REVISED

REVISED



PLOT DATE = Nov-21-2022 01:59:10 PM

SEE TRAFFIC SIGNALS SHEETS FOR UTILITY HANDHOLE WORK

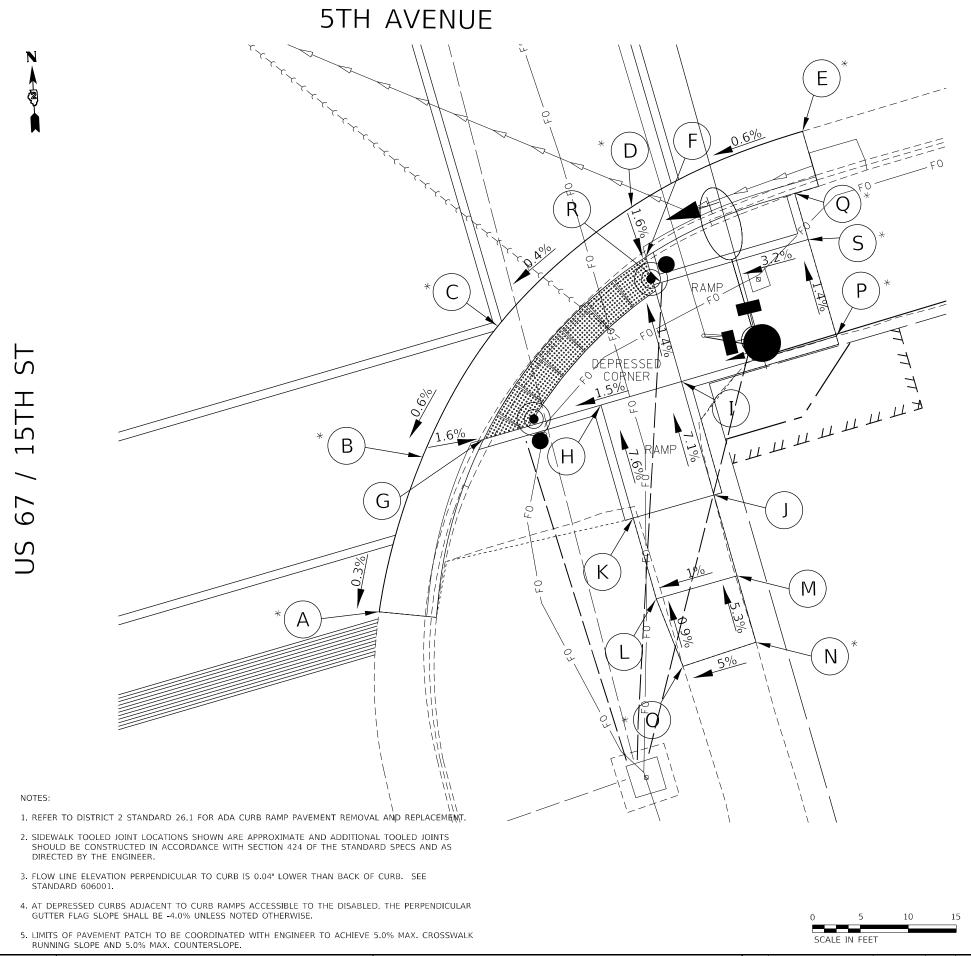

US 67 /15TH STREET AND SE 5TH AVENUE ADA RAMP DETAIL SHEET SHEETS STA.

SECTION D2 SW 2020-2 ROCK ISLAND 60 CONTRACT NO. 64P59

STATE OF ILLINOIS **DEPARTMENT OF TRANSPORTATION**

NE QUAD 5TH AVENUE

POINT	STATION	OFFSET	SIDE	ELEVATION
A	50+31.96	27.35	RT	558.55
В	50+44.41	18.29	RT	558.54
С	50+55.56	17.23	RT	558.54
D	50+44.41	21.52	RT	558.49
E	50+35.75	27.86	RT	558.49
F	50+37.40	27.86	RT	558.51
G	50+37.41	31.55	RT	558.57
Н	50+42.41	31.54	RT	558.62
	50+44.41	29.54	RT	558.61
J	50+54.53	29.54	RT	558.91
K	50+54.47	20.65	RT	558.81
L	50+42.42	38.54	RT	559.11
М	50+37.42	38.55	RT	559.06
N	50+37.43	43.55	RT	559.11
0	50+42.43	43.54	RT	559.16
Р	50+42.45	49.65	RT	559.34
Q	50+37.66	49.66	RT	559.32

NOTE: 5TH AV ALIGNMENT

USED FOR THIS CORNER.

RAMP. RAMP D 5TH AVENUE **LEGEND**

- 1. REFER TO DISTRICT 2 STANDARD 26.1 FOR ADA CURB RAMP PAVEMENT REMOVAL AND REPLACEMENT.
- SIDEWALK TOOLED JOINT LOCATIONS SHOWN ARE APPROXIMATE AND ADDITIONAL TOOLED JOINTS SHOULD BE CONSTRUCTED IN ACCORDANCE WITH SECTION 424 OF THE STANDARD SPECS AND AS DIRECTED BY THE ENGINEER.
- . FLOW LINE ELEVATION PERPENDICULAR TO CURB IS 0.04' LOWER THAN BACK OF CURB. SEE STANDARD 606001.
- 1. AT DEPRESSED CURBS ADJACENT TO CURB RAMPS ACCESSIBLE TO THE DISABLED, THE PERPENDICULAR GUTTER FLAG SLOPE SHALL BE -4.0% UNLESS NOTED OTHERWISE.
- 5. LIMITS OF PAVEMENT PATCH TO BE COORDINATED WITH ENGINEER TO ACHIEVE 5.0% MAX. CROSSWALK RUNNING SLOPE AND 5.0% MAX. COUNTERSLOPE.



S

 \mathbf{C}











PROPOSED LANDING



DETECTABLE WARNINGS



PEDESTRIAN PUSH-BUTTON



INCIDENTAL HMA SURFACING SEE NOTES 1 & 5

NOT PART OF PEDESTRIAN ACCESS ROUTE

	SF
$ \setminus $	
	EΩ

EE TRAFFIC SIGNALS SHEETS FOR UTILITY HANDHOLE WORK

USER NAME = Brad.Cushman	DESIGNED -	REVISED -
	DRAWN -	REVISED -
PLOT SCALE = 10.0000 / in.	CHECKED -	REVISED -
PLOT DATE = Nov-21-2022 01:59:33 PM	DATE -	REVISED -

STATE OF ILLINOIS **DEPARTMENT OF TRANSPORTATION**

ι	JS 6	7 /15TH	STREET	AND	NE	5TH	AVENUE	
		ADA	RAMP	DETAI	L SI	HEET		
\neg								

1	F.A.P. RTE			COUNTY	TOTAL SHEETS	SHEET NO.
ı	559	D2 SW 2020-2		ROCK ISLAND	60	39
4				CONTRACT	NO. 6	1P59
ı		TILIMOIS	EED A	ID PROJECT		

PAY CODE	ПЕМ	UNIT	US 67 & 3RD AVE		US 67 & 5TH AVE	TOTAL
81028740	UNDERGROUND CONDUIT, COILABLE NONMETALLIC CONDUIT, 1 1/2" DIA.	FOOT	57	23	97	177
81028760	UNDERGROUND CONDUIT, COILABLE NONMETALLIC CONDUIT, 2 1/2" DIA.	FOOT	18	22	35	75
81702110	ELECTRIC CABLE IN CONDUIT, 600V (XLP TYPE USE) 1/C NO 10	FOOT	234	105	147	486
85000200	MAINTENANCE OF EXISTING TRAFFIC SIGNAL INSTALLATION	EACH	1	1	1	3
85700200	FULL-ACTUATED CONTROLLER AND TYPE IV CABINET	EACH	0	1	1	2
87301215	ELECTRIC CABLE IN CONDUIT, SIGNAL, NO 14 2C	FOOT	170	770	1172	2112
87301225	ELECTRIC CABLE IN CONDUIT, SIGNAL, NO 14 3C	FOOT	126	51	93	270
87301245	ELECTRIC CABLE IN CONDUIT, SIGNAL, NO 14 5C	FOOT	258	121	197	576
87301255	ELECTRIC CABLE IN CONDUIT, SIGNAL, NO 14 7C	FOOT	108	0	47	155
87900200	DRILL EXISTING HANDHOLE	EACH	10	5	8	23
88102845	PEDESTRIAN SIGNAL HEAD, POLYCARBONATE, LED, 2-FACE, BRACKET MOUNTED WITH COUNTDOWN TIMER	EACH	4	4	4	12
89501300	RELOCATE EXISTING MAST ARM ASSEMBLY AND POLE	EACH	2	1	1	4

vatchplot\64P59\D2_64P59-sht-ts

USER NAME = Brad.Cushman	DESIGNED -	REVISED -
	DRAWN -	REVISED -
PLOT SCALE = 40.0000 / in.	CHECKED -	REVISED -
PLOT DATE = Nov-21-2022 12:29:06 PM	DATE -	REVISED -

STATE O	F ILLINOIS
DEPARTMENT OF	TRANSPORTATION

SCALE:

		IC SIGNA 67 at 31		
SHEET	OF	SHEETS	STA.	TO STA.

PAY CODE	ITEM	UNIT	US 67 & 3RD AVE		US 67 & 5TH AVE	11()1()1
89502210	MODIFY EXISTING CONTROLLER CABINET	EACH	1	0	0	1
89502375	REMOVE EXISTING TRAFFIC SIGNAL EQUIPMENT	EACH	1	1	1	3
89502385	REMOVE EXISTING CONCRETE FOUNDATION	EACH	2	1	1	4
X0322951	CABLE SPLICE SPECIAL	EACH	18	6	10	34
X8780107	CONCRETE FOUNDATIONS (SPECIAL)	FOOT	27	14	14	55
X8760200	ACCESSIBLE PEDESTRIAN SIGNAL	EACH	8	8	8	24
X8950105	REMOVE EXISTING TRAFFIC CONTROLLER AND CABINET	EACH	0	1	1	2
X8140205	MODIFY EXISTING CONCRETE HANDHOLE	EACH	4	4	4	12
X0321973	MODIFY EXISTING SERICE INSTALLATION	EACH	1	0	0	1
X8500102	MAINTENANCE OF EXISTING FIBER OPTIC CABLE (FOC) NETWORK	MO	0.34	0.33	0.33	1
X1400378	PEDESTRIAN SIGNAL POST, 5 FT.	EACH	7	4	6	17
Z0033072	VIDEO VEHICLE DETECTION SYSTEM	EACH	0	1	1	2

plot\64P59\D2_64P59-sht-ts_dgn

USER NAME = Brad.Cushman	DESIGNED -	REVISED -
	DRAWN -	REVISED -
PLOT SCALE = 40.0000 / in.	CHECKED -	REVISED -
PLOT DATE = Nov-21-2022 01:09:00 PM	DATE -	REVISED -


STATE OF ILLINOIS
DEPARTMENT OF TRANSPORTATION

	TRAFFIC	SIGN	IAL PLAN	
T	ABULATIONS	0F (DUANTITIES	
CHEET	OE .	сыссто	CTA	_

TO STA.

SCALE:

F.A.P. RTE	SECTION		COUNTY	TOTAL SHEETS	SHE
599	D2 SW 2020-2		ROCK ISLAND	60	41
			CONTRACT	NO. 64	1P59
	ILLINOIS	FED. A	D PROJECT		

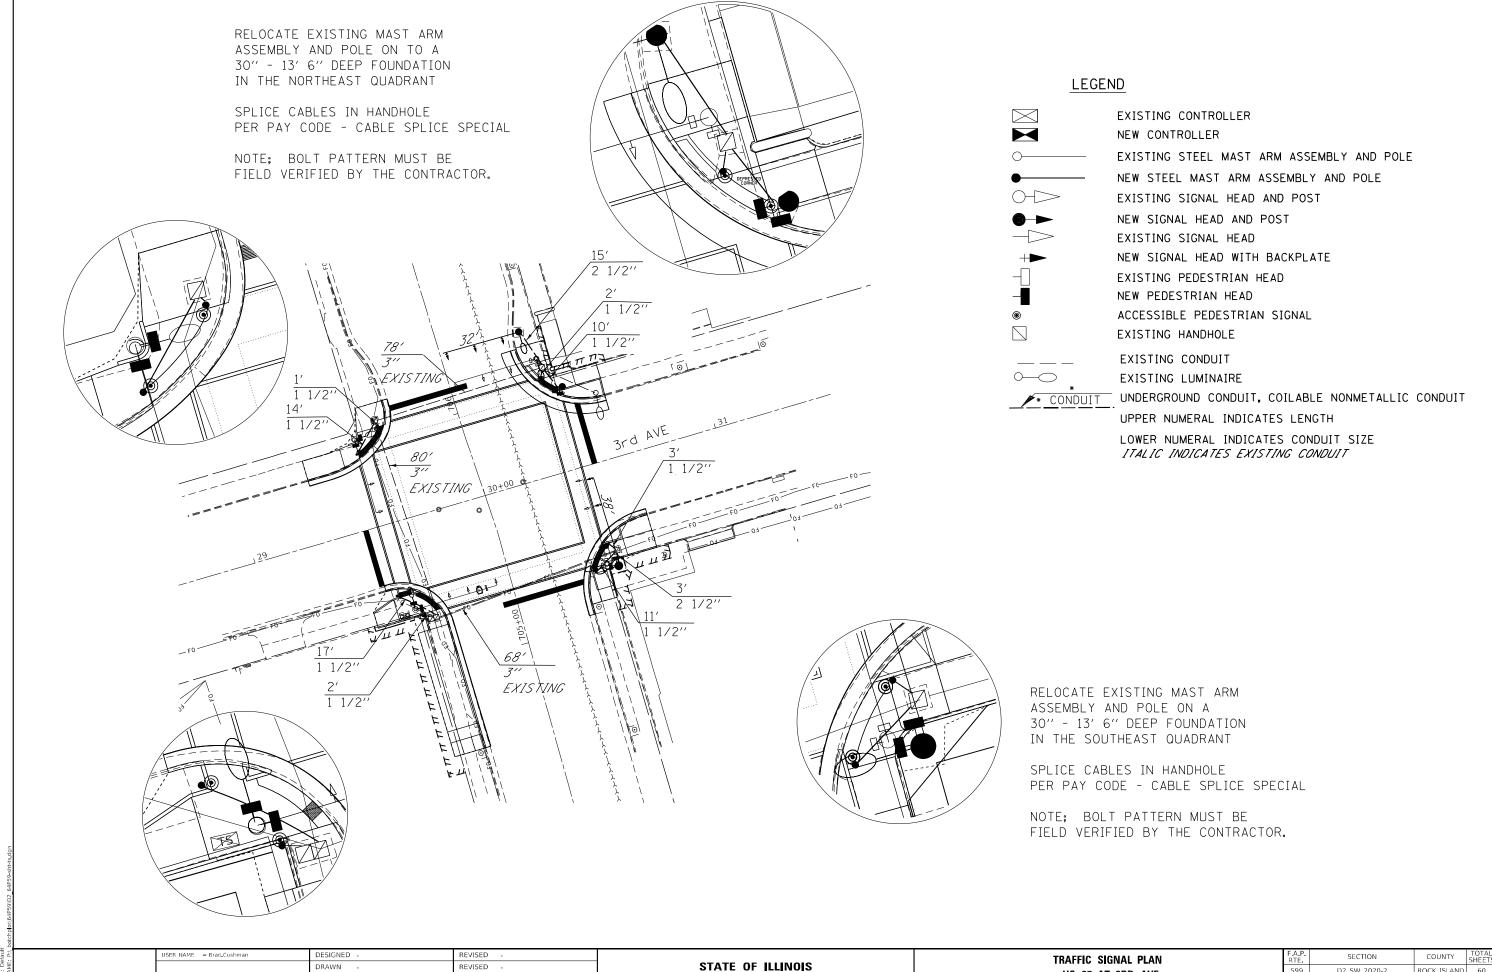

MODEL: Default

HECKED

PLOT DATE = Nov-21-2022 01:09:45 PM

REVISED


STATE OF ILLINOIS
DEPARTMENT OF TRANSPORTATION

TRAFFIC SIGNAL PLAN
US 67 AT 3RD AVE


SHEET OF SHEETS STA. TO STA.

D2 SW 2020-2 ROCK ISLAND 60 42

CONTRACT NO. 64P59

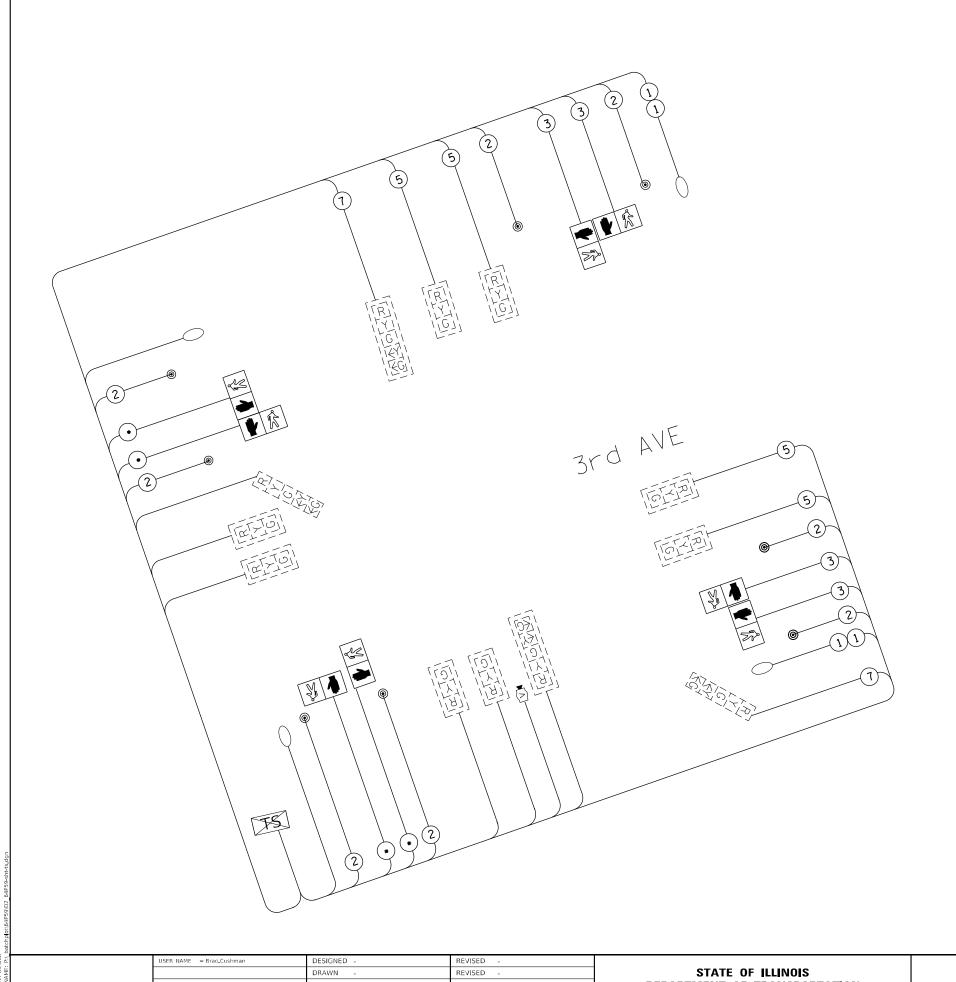

PHASE DESIGNATION DIAGRAM

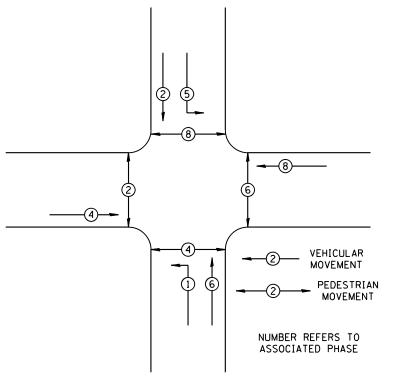

REFER TO STANDARD 857001

LEGEND

INDICATES USING EXISTING WIRING



INDICATES NUMBER OF NEW CONDUCTORS.
ALL CABLE IS NO. 14 EXCEPT AS INDICATED. "P" INDICATES PAIR CABLE



EXISTING LED SIGNAL HEAD WITH OR WITHOUT BACKPLATE



EXISTING VIDEO DETECTION SYSTEM (GRIDSMART)



VIDEO DETECTION SYSTEM (GRIDSMART)



NEW PEDESTRIAN HEAD, LED WITH COUNTDOWN



ACCESSIBLE PEDESTRIAN SIGNAL



EXISTING LUMINAIRE (AND RELOCATED)

ROCK ISLAND 60 43


CONTRACT NO. 64P59

USER NAME = Brad.Cushman	DESIGNED -	REVISED -
	DRAWN -	REVISED -
PLOT SCALE = 40.0000 / in.	CHECKED -	REVISED -
PLOT DATE = Nov-21-2022 01:10:09 PM	DATE -	REVISED -

DEPARTMENT OF TRANSPORTATION

SCALE:

TRAFFIC SIGNAL CABLE PLAN					F.A.P. RTE	SECT	ПОИ		
US 67 AT 3RD AVE				599	D2 SW	2020-2			
03 07 AT SHU AVE									
	SHEET	OF	SHEETS	STA.	TO STA.			ILLINOIS	FED. A

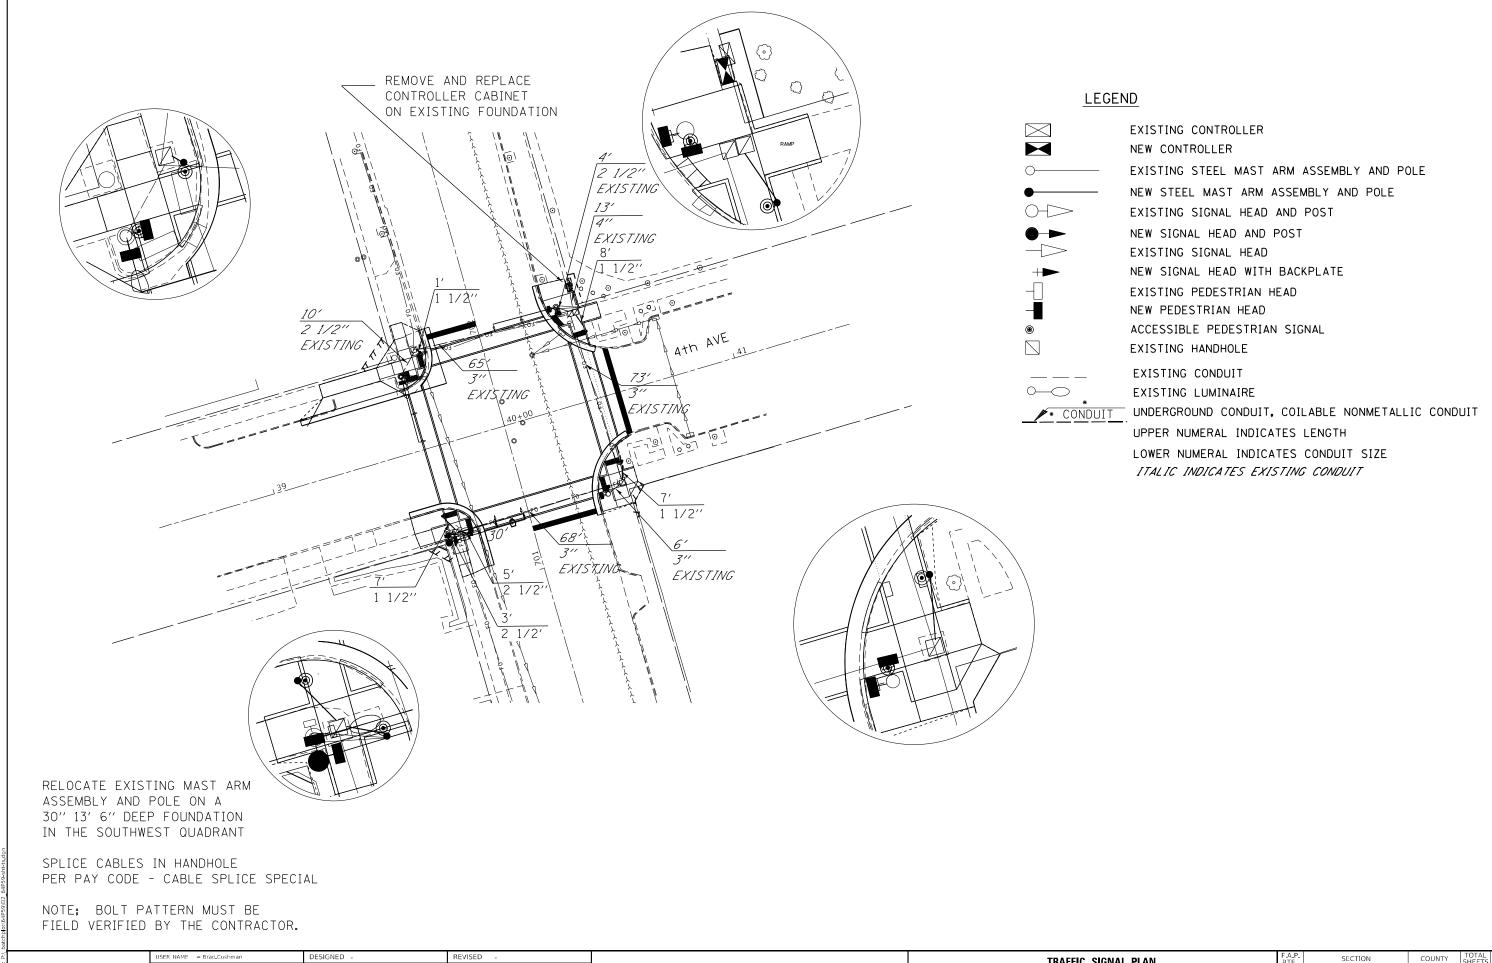

MODEL: Default

PLOT DATE = Nov-21-2022 01:10:28 PM


 DRAWN
 REVISED

 CHECKED
 REVISED
 DEF

STATE OF ILLINOIS
DEPARTMENT OF TRANSPORTATION

TRAFFIC SIGNAL PLAN
US 67 AT 4TH AVE


OF SHEETS STA. TO STA.

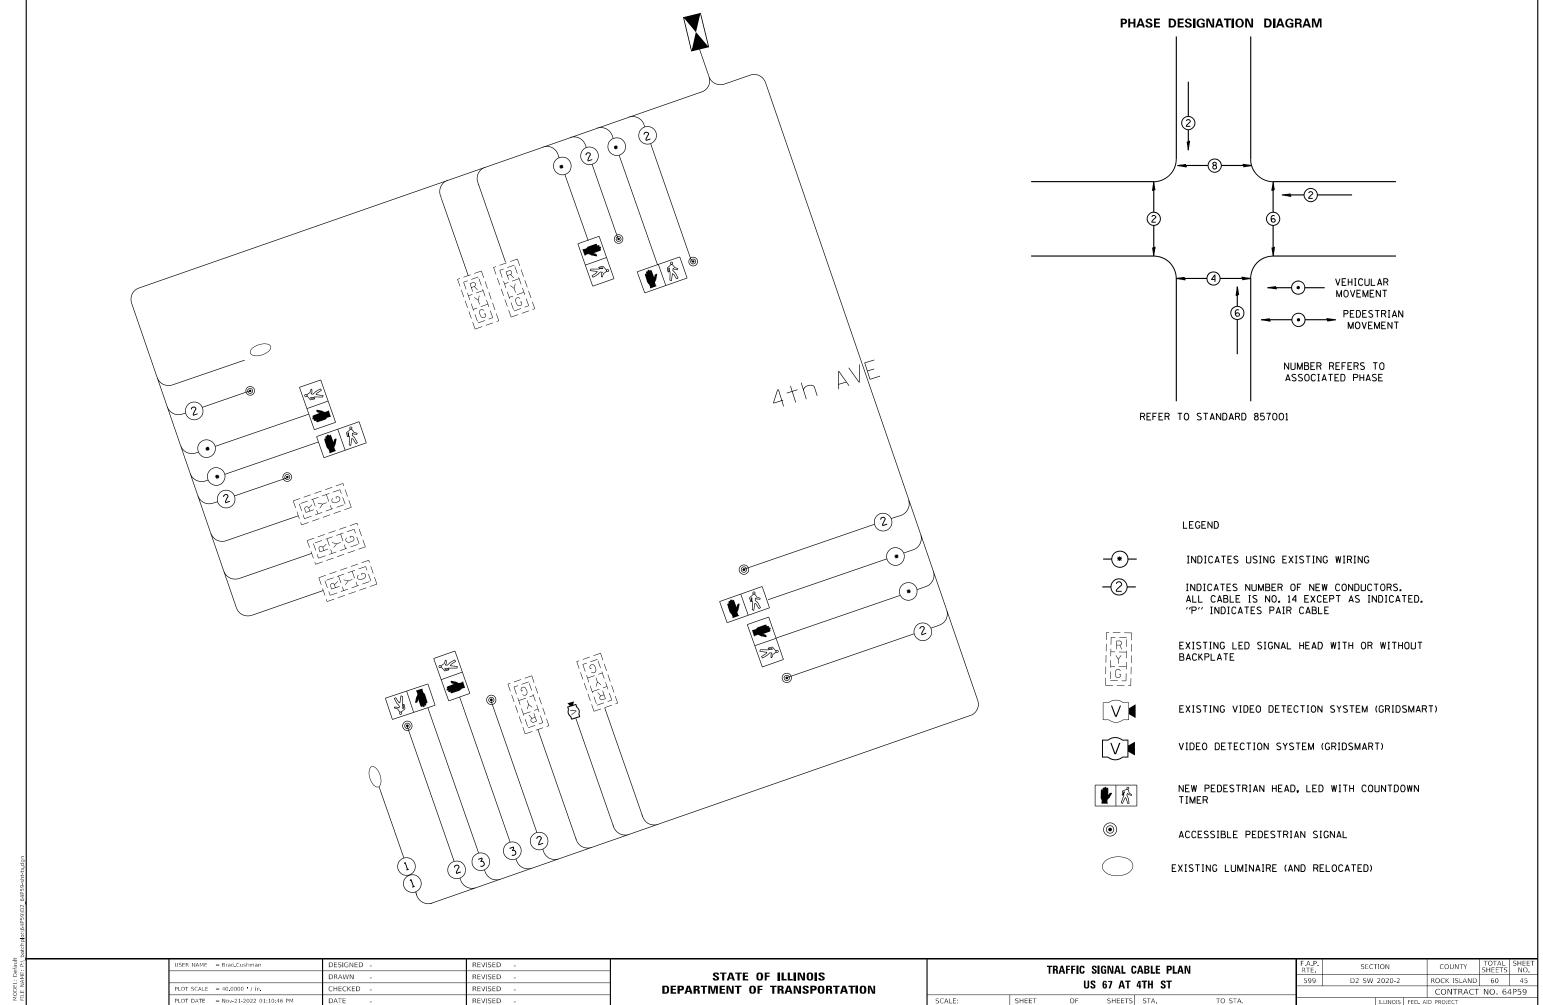

DATE

DEPARTMENT OF TRANSPORTATION

SHEET OF SHEETS STA. CONTRACT NO. 64P59

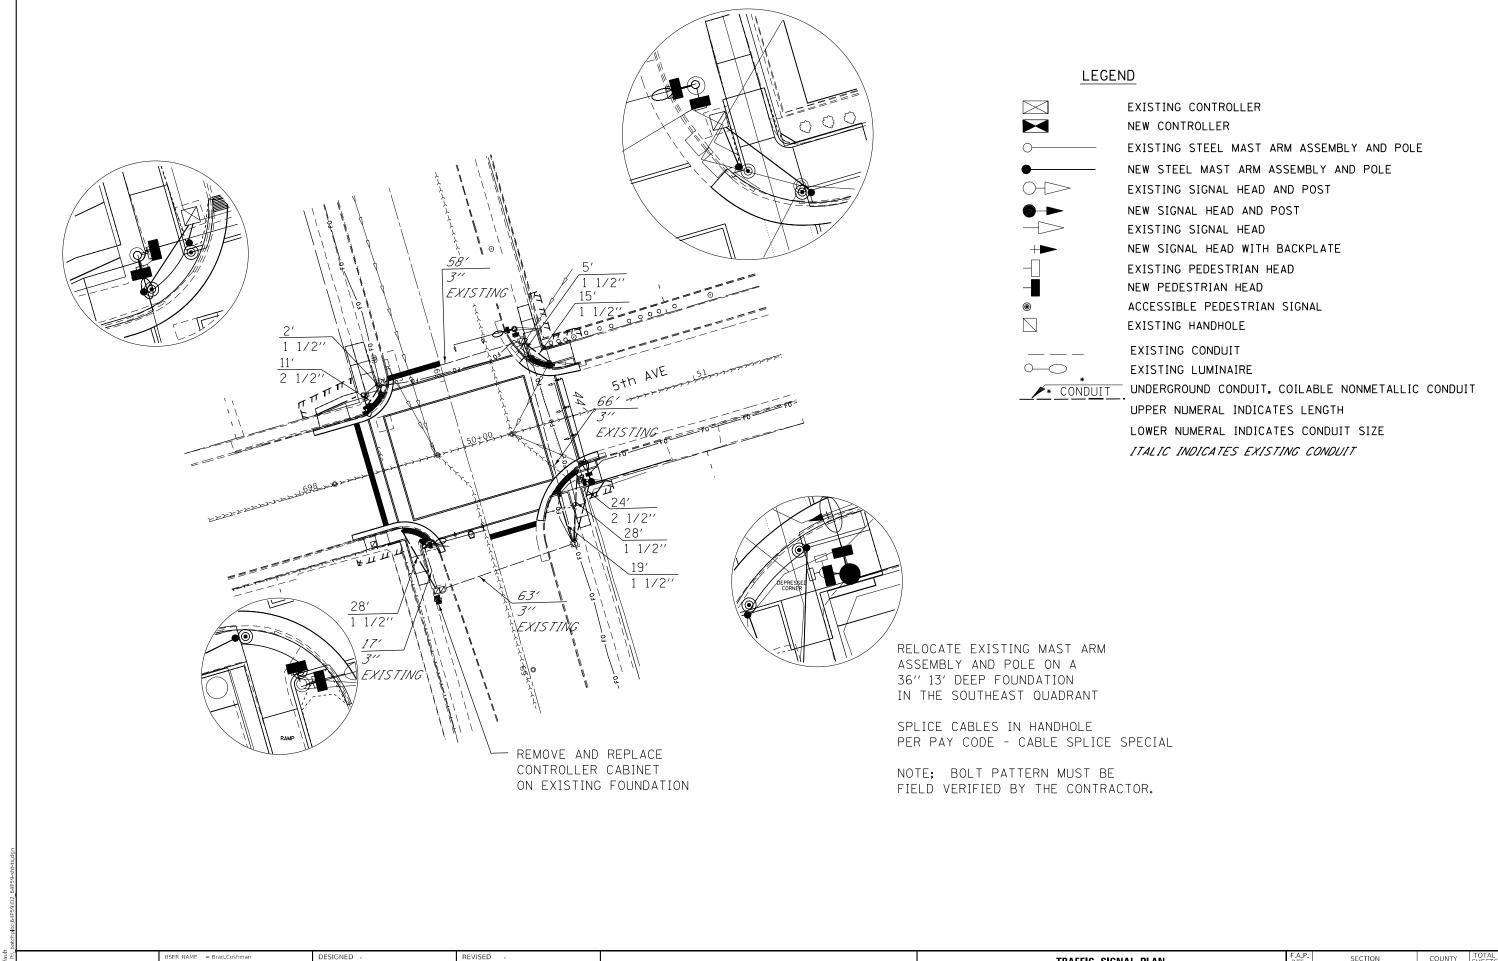


MODEL: Default

| DRAWN - REVISED - STATE OF ILLINOIS | DEPARTMENT OF TRANSPORTATION | DRIVER - NOV-21-2022 01:11:07 PM | DATE - REVISED - | DEPARTMENT OF TRANSPORTATION | DATE - NOV-21-2022 01:11:07 PM | DATE - NOV-21-2022 01:11:07 PM | DATE | DATE | DATE | DEPARTMENT OF TRANSPORTATION | DEPARTMENT OF TRANSPORTATION | DATE | DEPARTMENT OF TRANSPORTATION | DATE | DEPARTMENT OF TRANSPORTATION | DEPARTMENT OF TR

			IC SIGNA 67 AT 5		
SCALE:	SHEET	OF	SHEETS	STA.	

TO STA.

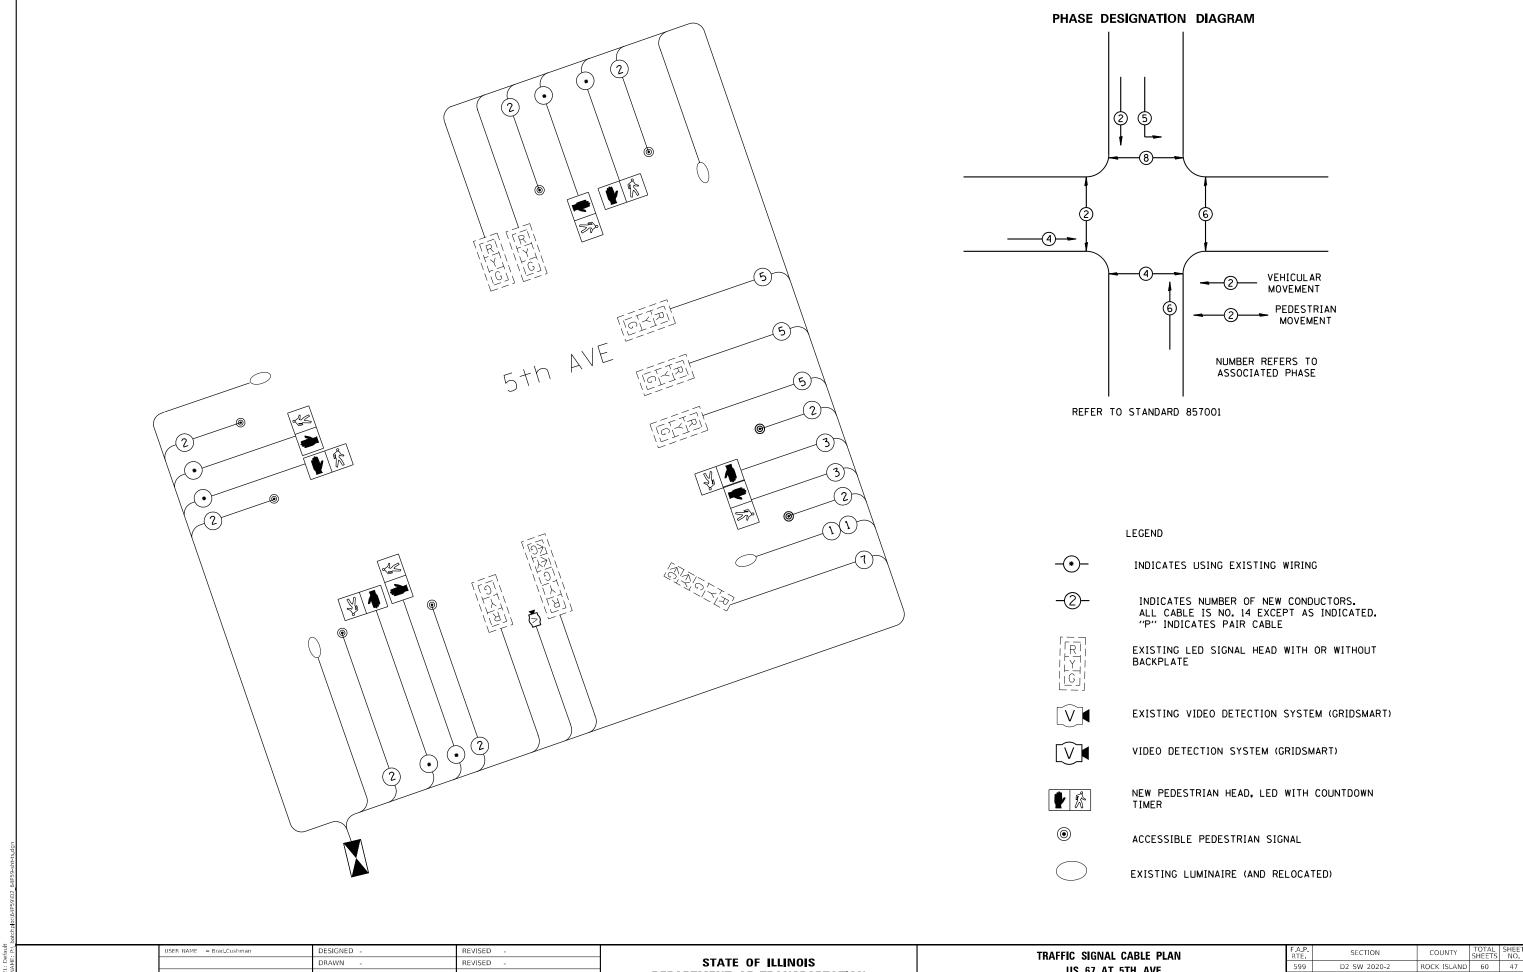

DEPARTMENT OF TRANSPORTATION

US 67 AT 5TH AVE

TO STA.

OF SHEETS STA.

SHEET

CONTRACT NO. 64P59

CHECKED

DATE


PLOT DATE = Nov-21-2022 01:11:23 PM

REVISED

REVISED

Mast Arm Lenth	Dim. "A"	Dim "B"	Number of No. 5 Rebars
Less Than 30'	24"	20"	6
30' and Longer	30"	26"	8

TOP VIEW

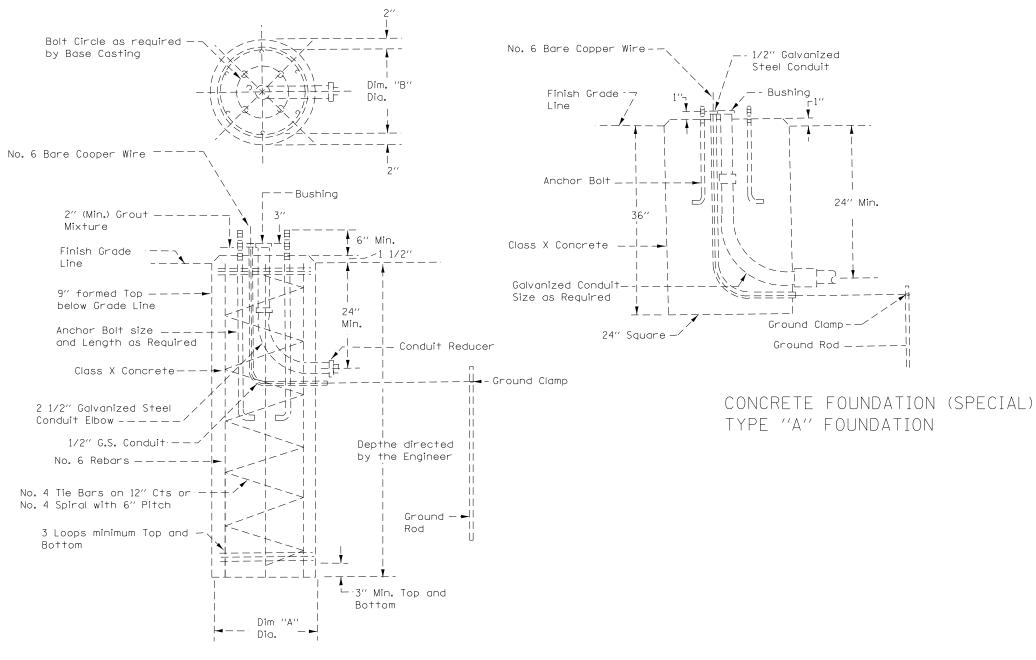

SCALE:

CONCRETE FOUNDATION (SPECIAL)
TYPE "E" FOUNDATION

USER NAME = Brad.Cushman	DESIGNED -	REVISED -
	DRAWN -	REVISED -
PLOT SCALE = 40.0000 / in.	CHECKED -	REVISED -
PLOT DATE = Nov-21-2022 01:11:47 PM	DATE -	REVISED -

STATE OF ILLINOIS
DEPARTMENT OF TRANSPORTATION


					F.A.P. RTE	SECTION		COUNTY	TOTAL SHEETS	SHEET NO.
MODI	IFIED F	ON DETAILS	599	D2 SW 2020-2	ROCK ISLAND	60	48			
								CONTRACT	NO. 64	1P59
SHEET	OF	SHEETS	STA.	TO STA.		ILLINOIS	FED. AI	D PROJECT		

STATE OF ILLINOIS **DEPARTMENT OF TRANSPORTATION**

38											
SHEET INDEX											
SHEET NO.	STATION to STATION	DESCRIPTION									
1		COVERSHEET									
2		LEGENDS & STATEMENTS									
3	697+21 to 703+00	ROW PLAT									
4	705+00 to 710+00	ROW PLAT									
5	697+21 to 703+00	TEMP. EASE. PLAT									
6	704+55 to 710+00	TEMP FASE PLAT									

PLAT OF HIGHWAYS

FAP ROUTE 599 **SECTION D2 SW 2020-2 ROCK ISLAND COUNTY** JOB NO. R-92-002-21

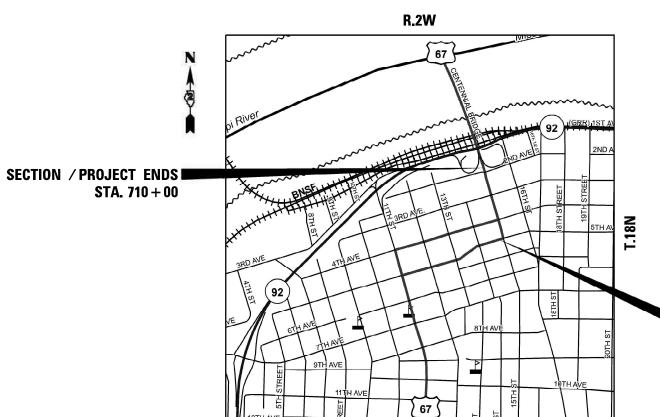

STEPHENSON | WINNEBAGO | BOONE JO DAVIESS CARROLL OGLE WHITESIDE LEE **ROCK ISLAND** HENRY **DISTRICT 2** * DISTRICT HEADQUARTERS

LOCATION OF SECTION INDICATED THUS: -

SPACE RESERVED FOR RECORDING OFFICER

SECTION / PROJECT BEGINS STA. 698 + 15

JIMMY D. ROSE - ILLINOIS PROFESSIONAL LAND SURVEYOR NO. 35-2775 CURRENT EXPIRATION DATE: NOVEMBER 30, 2022

PREPARED BY:

USER NAME = scott.spayer	DESIGNED	REVISED =
	DRAWN	REVISED -
PLOT SCALE = 2.0000 / in.	CHECKED	REVISED -
PLOT DATE = Nov-02-2022 04:56:43 PM	DATE	REVISED +

JOB# R-92-002-21 DRAWER FOLDER CONTRACT NO. 64P59		PLAT OF H	F.A.P. RTE.	SECTION	COUNTY	TOTAL SHEETS	SHEET NO.	
	LAND	SECTION 35	T 18N, R 2W OF 4TH P.M.	599	D2 SW 2020-2	ROCK ISLAND	60	49
	JOB#	R-92-002-21	DRAWER FOLDER			CONTRACT	NO. 64	1P59
SCALE: NTS SHEET 1 OF 6 SHEETS STA. 698+15 TO STA. 710+00 ILLINOIS FED. AID PROJECT	SCALE: NTS	SHEET 1 OF 6 SHEETS	STA. 698+15 TO STA. 710+00		ILLINOIS FED. A	ID PROJECT		

LEGEND FOR EXISTING TOPOGRAPHIC SYMBOLS

TRAFFIC SIGNAL GULFBOX	0	DRAINAGE FLOW LINE	FL
TRAFFIC SIGNAL HANDHOLE		RIP RAP	
TRAFFIC SIGNAL SIGNAL POST	0	HEADWALL	_
TRAFFIC SIGNAL STEEL MAST ARM	0	CULVERT END SECTION	△
TRAFFIC SIGNAL PEDESTRIAN PUSH BUTTON	•	DRAINAGE MANHOLE	0
TRAFFIC SIGNAL WOODEN POLE	⊗	INLET	
TRAFFIC SIGNAL VEHICLE DETECTION PRIORITY	⋖	ROADWAY DITCH FLOW	- √>
TRAFFIC SIGNAL VEHICLE DETECTION MAGNET	-	VEGETATION LINE	~~~~
TRAFFIC SIGNAL JUNCTION BOX	0	STUMP	重
TRAFFIC SIGNAL CONTROLLER	⊠	SHRUB	0
TRAFFIC SIGNAL HEAVY DUTY HANDHOLE	H	EVERGREEN TREE	©
RAILROAD CANTILEVER MAST ARM	XOX X	DECIDUOUS TREE	0
RAILROAD CROSSBUCK	X -	WOODS/BUSH LINE	
RAILROAD TRACK	#####	TRAFFIC SIGN	þ
RAILROAD TRACK (ABANDONED)	-+	GUARDRAIL POST	0
RAILROAD CROSSGATE	⊻0 ∑─	GUARDRAIL	0 0 0 0 0 0 0
RAILROAD CONTROL BOX	\boxtimes	FIELD LINE	E
RAILROAD FLASHING SIGNAL	Xo X	LEVEE/NOISE BARRIER	
UTILITY TELEPHONE SPLICE BOX	⊞	FENCE	-1-1-1-1-1-1-1
UTILITY POWER POLE	-0-	MAIL BOX	P
UTILITY TRAFFIC SIGNAL	•	ADVERTISING SIGN	þ
UTILITY LIGHT POLE	¤	MARSH	يتلند
UTILITY FIRE HYDRANT	Q	LIGHTING HANDHOLE	
UTILITY MANHOLE	0	LIGHTING POWER POLE	-0-
UTILITY TELEPHONE POLE	-0-	LIGHTING JUNCTION BOX	
UTILITY GUY ANCHOR	\leftarrow	LIGHTING HEAVYDUTY HANDHOLE	H
UTILITY PIPELINE WARNING SIGN	þ	LIGHTING CONTROLLER	⊠
UTILITY HANDHOLE		LIGHTING PULL POINT	P
UTILITY SPLICE BOX	⊞	HIGHWAY LIGHTING ELECTRICAL GROUND	→
UTILITY JUNCTION BOX	(HIGHWAY LIGHTING SINGLE UNIT	\bigcirc
UTILITY HEAVY DUTY HANDHOLE	H	HIGHWAY LIGHTING DOUBLE UNIT	\bigcirc
UTILITY DOUBLE HANDHOLE		EXISTING CONCRETE BARRIER	
UTILITY CONTROLLER	\boxtimes	EXISTING CREEK OR DITCH	
UTILITY WATER METER	0	EXISTING EDGE OF PAVEMENT	

BASIS OF COORDINATE & BEARING STATEMENT

ALL COORDINATES, BEARINGS AND DISTANCES SHOWN HEREON ARE BASED ON ILLINOIS STATE PLANE (WEST ZONE) NAD83 (2011 ADJUSTMENT)

GROUND DISTANCE = GRID DISTANCE DIVIDED BY PROJECT COMBINATION FACTOR OF 0.99992872

AREAS SHOWN BASED ON GROUND DISTANCES

TOPOGRAPHIC STATEMENT

THE TOPOGRAPHY SHOWN HEREON WAS PROVIDED TO THE SURVEYOR BY THE ILLINOIS DEPARTMENT OF TRANSPORTATION. THE SURVEYOR VISUALLY FIELD VERIFIED THE EXISTENCE OF THE TOPOGRAPHY SHOWN HEREON. IN ADDITION, THE SURVEYOR PHYSICALLY LOCATED IN THE FIELD THE FOLLOWING ITEMS ON __/_/_:

PREPARED BY:



RIGHT OF WAY LEGEND





— – — – EXISTING CENTERLINE ---- FORMER RIGHT OF WAY LINE ---- BUILDING SETBACK LINE - —————— EXISTING ACCESS CONTROL LINE

____ AC ____ EXISTING RIGHT OF WAY & ACCESS CONTROL LINE - - - - - - - - PROPOSED RIGHT OF WAY & ACCESS CONTROL LINE — AC — PROPOSED ACCESS CONTROL LINE

- - - PROPOSED RIGHT-OF-WAY LINE 77 77 77 77 77 77 PROPOSED TEMPORARY EASEMENT LINE PROPOSED PERMANENT EASEMENT LINE --- SECTION LINE

— - - — QUARTER SECTION LINE — – — QUARTER QUARTER SECTION LINE PROPERTY LINE (TITLE) - - - - - - RECORDED PLAT/DEED LINE

APL APPARENT PROPERTY LINE SAME OWNERSHIP 121.45 MEASURED DIMENSION (121.45') RECORDED DIMENSION FOUND STONE

FOUND IRON PIPE OR IRON ROD AT 0 CORNER UNLESS OTHERWISE NOTED SET 5/8 INCH IRON ROD WITH PLASTIC CAP IDENTIFIED BY SURVEYORS LICENSE NUMBER AT

CORNER UNLESS OTHERWISE NOTED PERMANENT SURVEY MONUMENT, I.D.O.T. STD. 667101

(TO BE SET BY OTHERS) SET 5/8 INCH IRON ROD AS SURVEY Δ CONTROL UNLESS OTHERWISE NOTED

FOUND CUT CROSS SET CUT CROSS

STAKING OF PROPOSED RIGHT OF WAY AND PERMANENT EASEMENT CORNERS. SET 5/8 INCH METAL ROD WITH DEPARTMENT OF TRANSPORTATION SURVEY ALUMINUM CAP TO MONUMENT THE POSITION SHOWN. IDENTIFIED BY INSCRIPTION DATA AND SURVEYORS LICENSE NUMBER.

STAKING OF PROPOSED RIGHT OF WAY AND PERMANENT EASEMENT CORNERS IN CULTIVATED AREA. A MINIMUM OF 20 INCHES BELOW THE GROUND SURFACE. SET 5/8 INCH METAL ROD WITH DIVISION OF HIGHWAY SURVEY ALUMINUM CAP TO MONUMENT THE POSITION SHOWN. IDENTIFIED BY INSCRIPTION DATA AND SURVEYORS

LEGEND FOR ABBREVIATIONS

ACCESS CONTROL AC. ACRE AVE AVENUE BK BOOK BLVD BOULEVARD CENTERLINE CAB CABINET СН COUNTY HIGHWAY CHAIN Ch CP CONTROL POINT CPS COTTON PICKER SPINDLE DB DEED BOOK EAST EXISTING ΕX FΑ FEDERAL AID FEDERAL AID INTERSTATE FΔP FEDERAL AID PRIMARY FAS FEDERAL AID SECONDARY FEDERAL AID URBAN FAU FND FOUND ha HECTARE IRON PIPE IRON ROD LT LEFT METER SQUARE METERS NORTH NOW OR FORMERLY

NAIL AND BOTTLE CAP N & BC N & C NAIL AND CAP NAIL AND WASHER N & W NE NORTHEAST NORTHWEST PB PLAT BOOK PAGE POINT OF BEGINNING POB POINT OF COMMENCEMENT POC POT POINT ON TANGENT PROPERTY LINE PROPOSED RANGE RD ROAD REC RECORD RIGHT OF WAY ROW

> RAILROAD RAILROAD SPIKE

RIGHT

ROUTE

SOUTH STATE BOND ISSUE SE SOUTHEAST SEC SECTION SQ FT SQUARE FEET STATE ROUTE SR ST STREET STA STATION SMK SURVEY MARKER SW SOUTHWEST TOWNSHIP

TOWNSHIP ROAD

U.S. GEOLOGICAL SURVEY WEST

USGS

RR

RRS

RTE

RT

PROPOSED PARCEL NUMBER LEGEND



PROPOSED FEE SIMPLE ACQUISITION PROPOSED PERMANENT EASEMENT PROPOSED TEMPORARY EASEMENT PROPOSED DEDICATION PROPOSED ACCESS CONTROL LINE


CURVE ABBREVIATIONS


POINT OF CURVATURE POINT OF INTERSECTION PT POINT OF TANGENCY POINT OF REVERSE CURVE POINT OF COMPOUND CURVE PCC RADIUS OF CURVE LENGTH OF CURVE CB CHORD BEARING CHORD LENGTH DEGREE OF CURVE EXTERNAL ORDINATE DELTA


JIMMY D. ROSE - ILLINOIS PROFESSIONAL LAND SURVEYOR NO. 35-2775 CURRENT EXPIRATION DATE: NOVEMBER 30, 2022


USER NAME = Angel.Rodriguez2	DESIGNED -	REVISED -
	DRAWN -	REVISED -
PLOT SCALE = 1.0000 1 / in.	CHECKED -	REVISED -
PLOT DATE = Nov-03-2022 09:37:58 AM	DATE -	REVISED -

	PLAT OF H	IGH	WAYS		F.A.P. RTE	SEC	TION		COUNTY	TOTAL SHEETS	SHEET NO.
LAND	SECTION 35		T 18N, R 2V	W OF 4TH P.M.	599	D2 SW	2020-2		ROCK ISLAND	60	50
JOB#	R-92-002-21		DRAWER	FOLDER					CONTRACT	NO. 64	1P59
SCALE: NTS	SHEET 2 OF 6 SHEETS						ILLINOIS	FED. A	ID PROJECT		

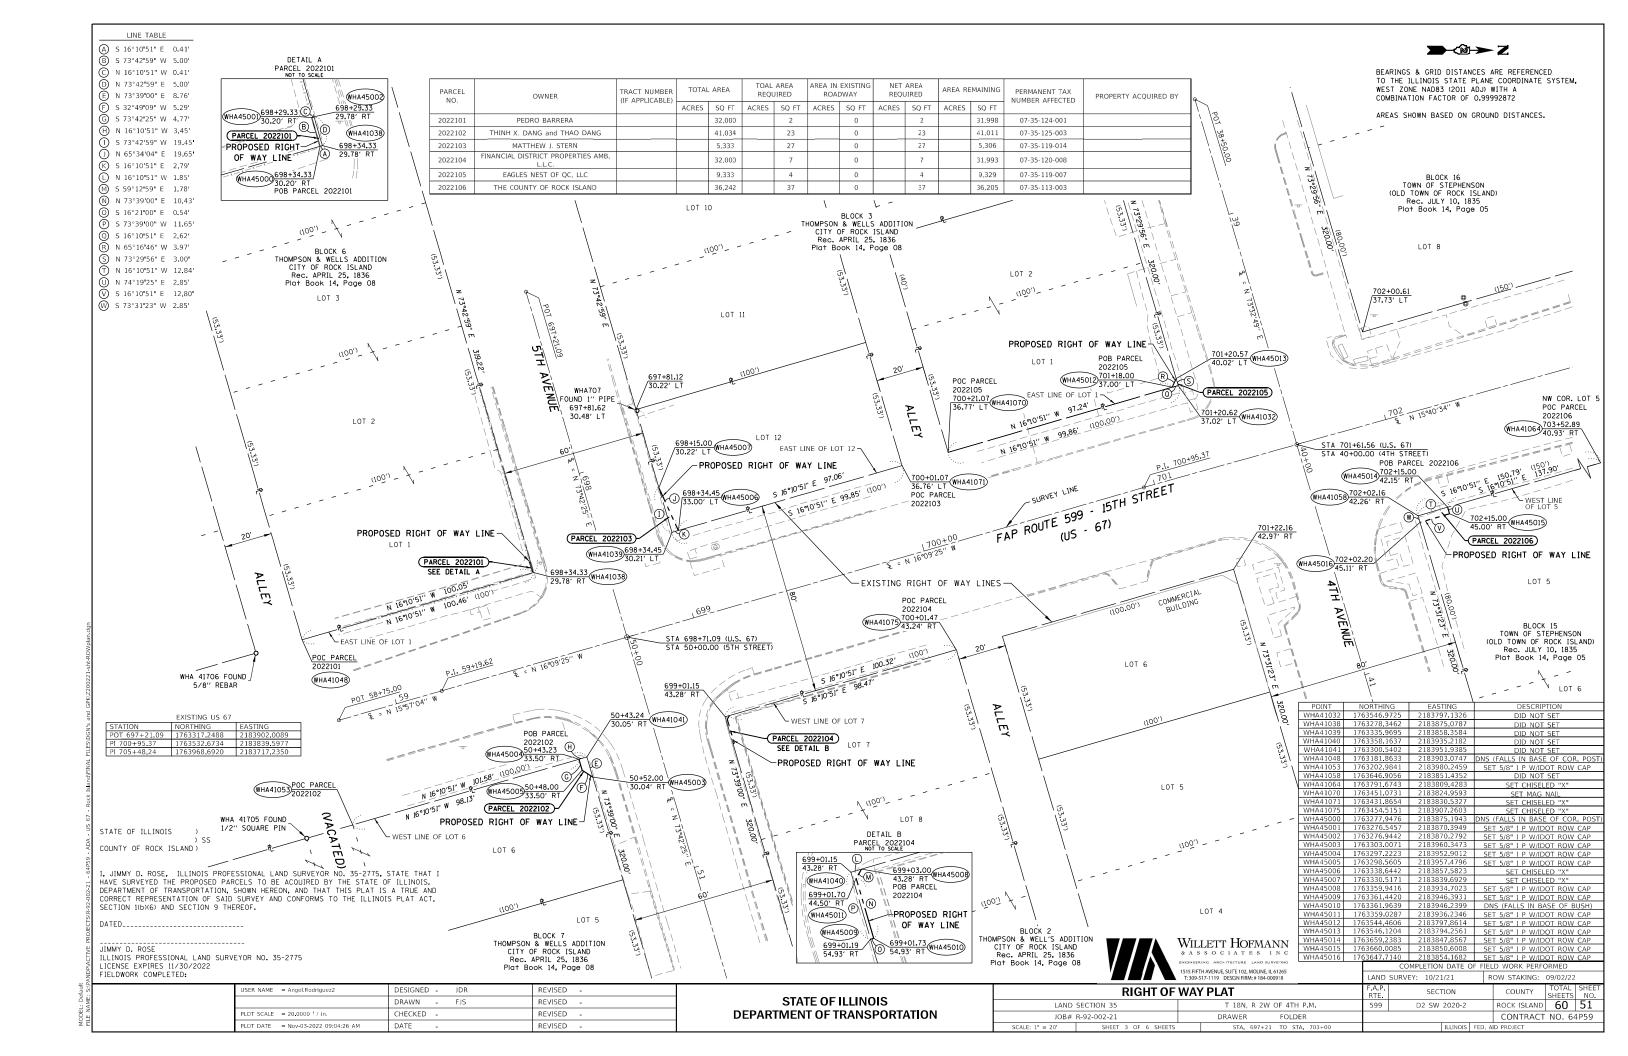

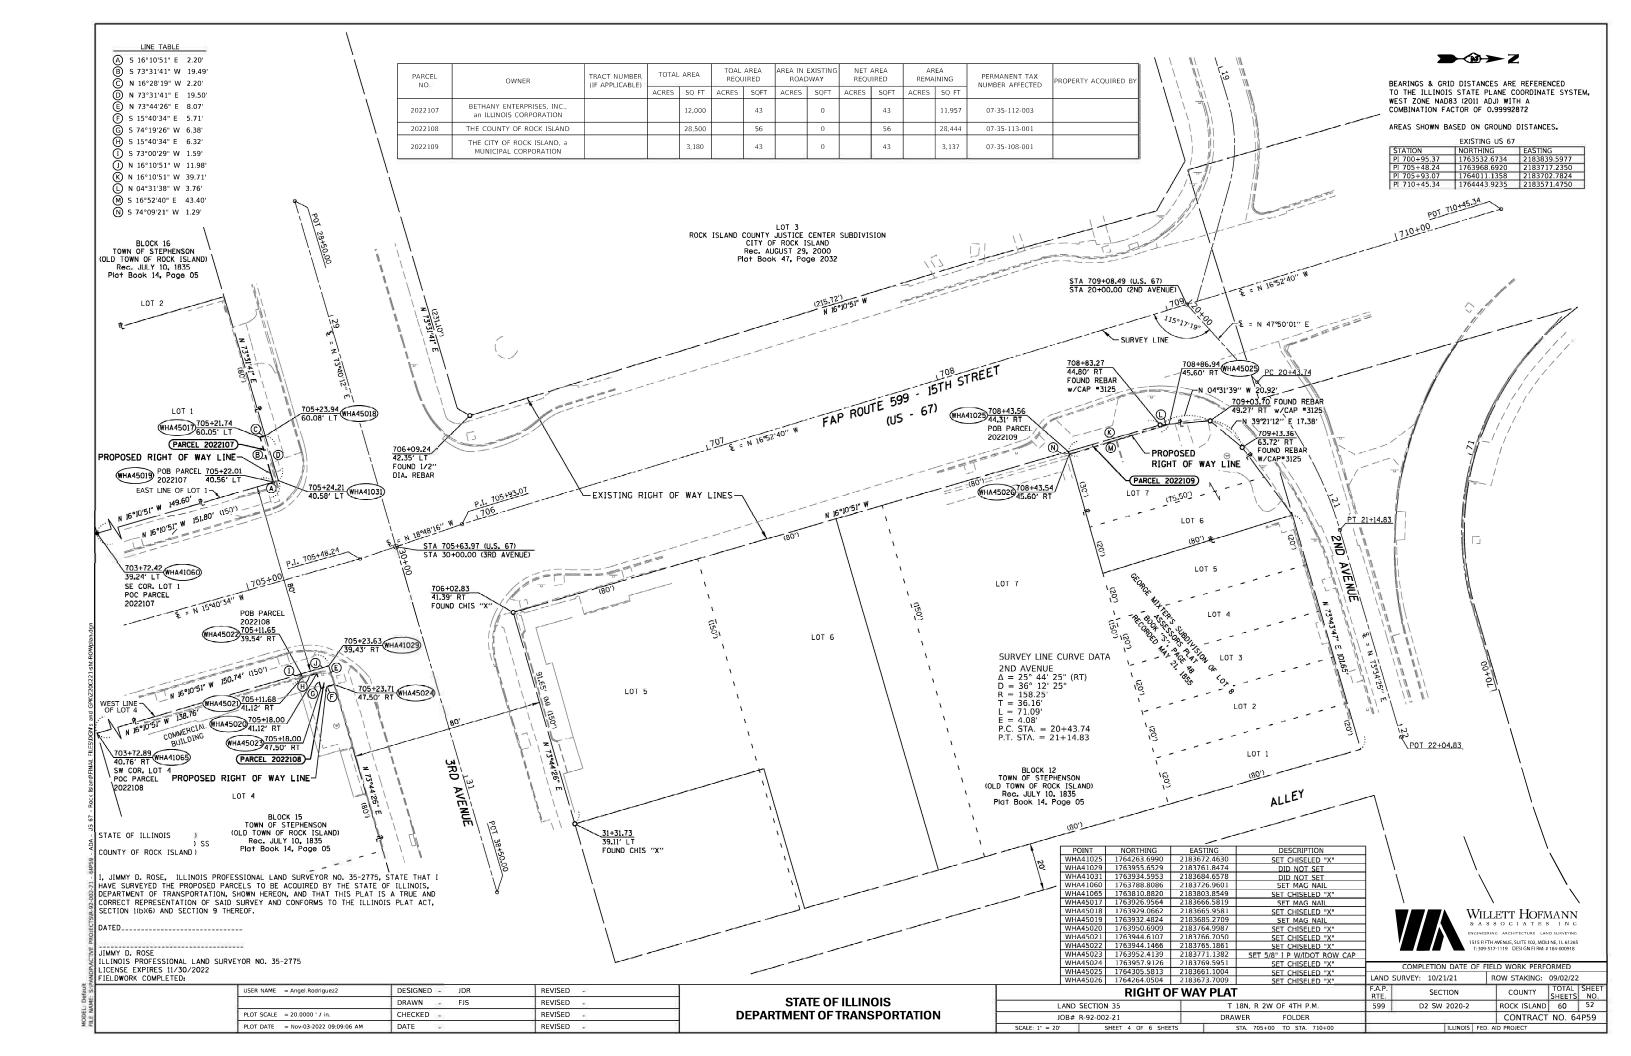

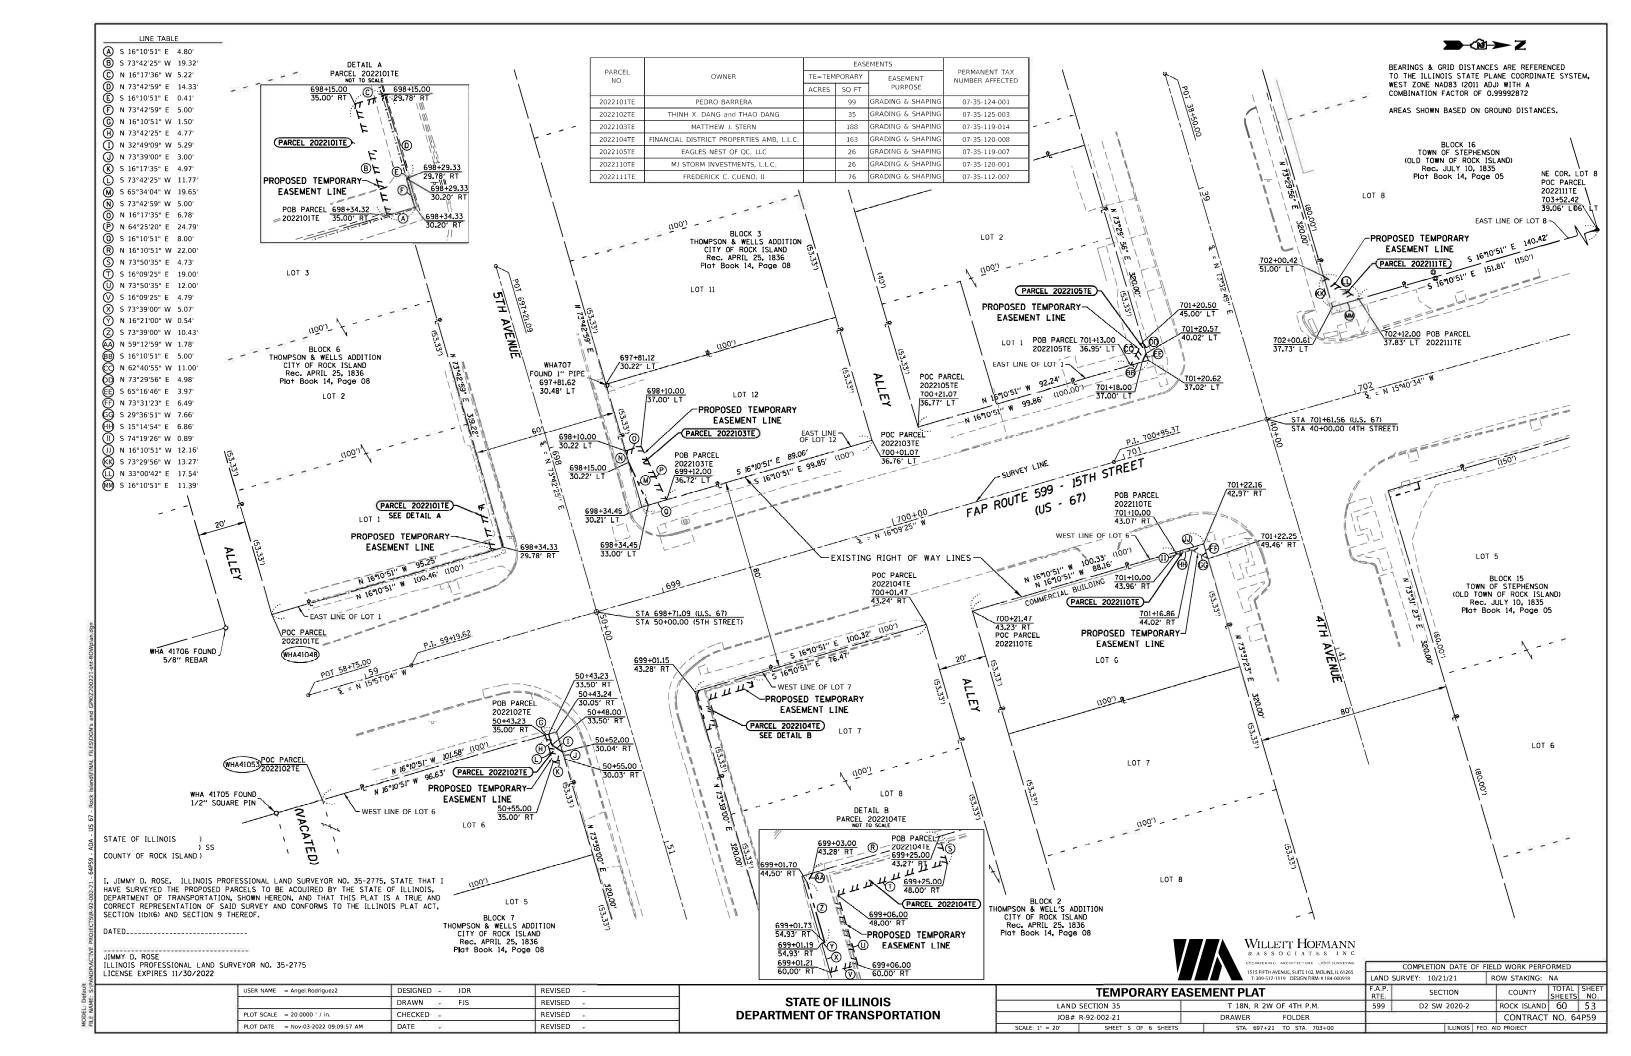

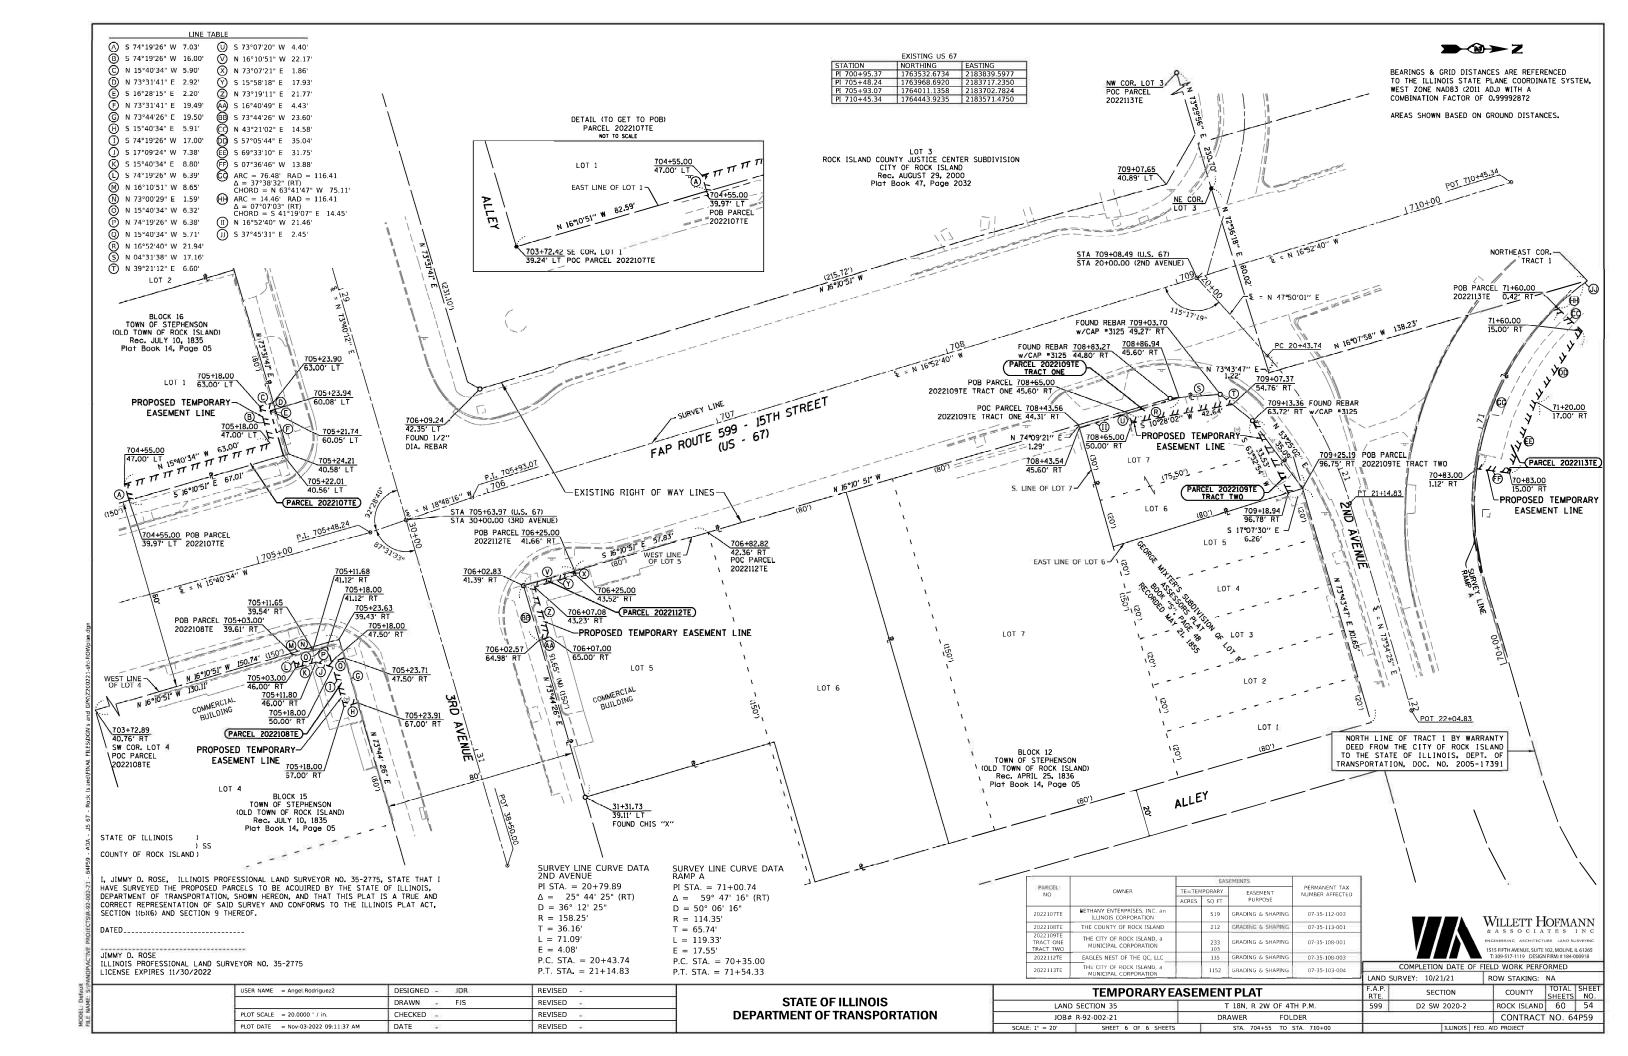

CATCH BASIN OR INLETS TO BE ADJUSTED OR RECONSTRUCTED

(DETAILS FOR CURB & GUTTER REPLACEMENT)

CONCRETE CURB AND GUTTER SHALL BE CONSTRUCTED IN ACCORDANCE WITH SECTION 606 OF THE STANDARD SPECIFICATIONS, SUPPLEMENTAL SPECIFICATIONS, STANDARD 606001 AND THIS DRAWING.

CLASS SI CONCRETE SHALL BE USED THROUGHOUT. A HOLE 1-1/2 IN DIAMETER AND 9 DEEP SHALL BE DRILLED IN THE EXISTING CONCRETE CURB AS SHOWN. A 1-1/4 X 18 SMOOTH DOWEL BAR SHALL BE GROUTED IN THE HOLE LONGITUDINALLY.

JOINTS OF A TYPE SIMILAR TO THAT IN THE UNDER-LYING PAVEMENT (EXPANSION OR CONTRACTION) SHALL BE INSTALLED IN THE CONCRETE CURB IN ALIGNMENT WITH THE JOINTS IN THE PAVEMENT.


THE PROPOSED CONFIGURATION OF THE CURB AND GUTTER SHALL MATCH THAT REMOVED.

THE LOCATION OF THE DOWEL BAR SHALL BE DETERMINED BY THE ENGINEER.

ALL EXISTING TIE BARS IN EDGE OF PAVEMENT SLAB THRU REPLACEMENT AREA SHALL BE CUT OFF.


THE WORK SHALL BE DONE IN ACCORDANCE WITH SECTION 602 OF THE STANDARD SPECIFICATIONS AND INCLUDES THE REMOVAL AND REPLACEMENT OF SOD, CONCRETE PAVEMENT AND/OR CURB AND GUTTER ADJACENT TO CATCH BASINS OR INJETS TO BE ADJUSTED OR RECONSTRUCTED AND SHALL BE INCLUDED IN THE PAY ITEM OF CATCH BASINS OR INLETS TO BE ADJUSTED OR RECONSTRUCTED

REVISED - 9-30-11

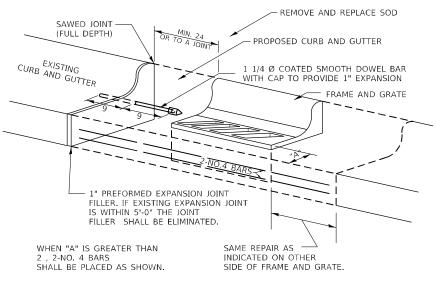

ALL DIMENSIONS ARE IN INCHES UNLESS OTHERWISE NOTED.

SIDEWALK AND DRIVEWAY **PAVEMENT PAY AREAS**

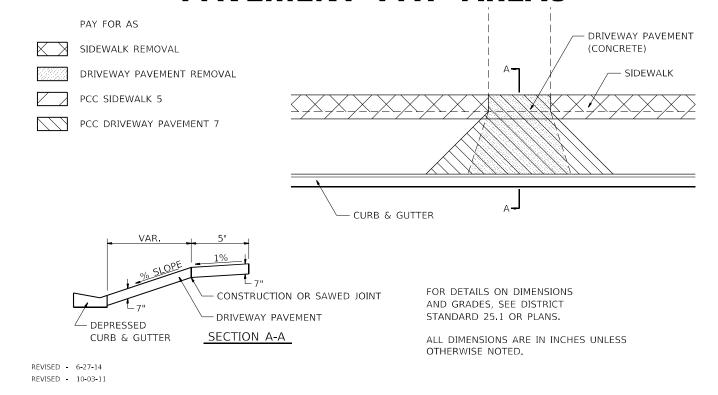


17.4

35.4


CATCH	BASIN	OR	INLETS	T0	BE ADJUSTED	OR	RECONSTRUCTED	

SIDEWALK AND DRIVEWAY PAVEMENT PAY AREAS


REVISED SECTION REVISED -**REGION 2 / DISTRICT 2 STANDARD** D2 SW 2020-2 ROCK ISLAND 60 55 REVISED CONTRACT NO. 64P59 SCALE: 100.0000 / inSHEET OF SHEETS STA. TO STA. REVISED -

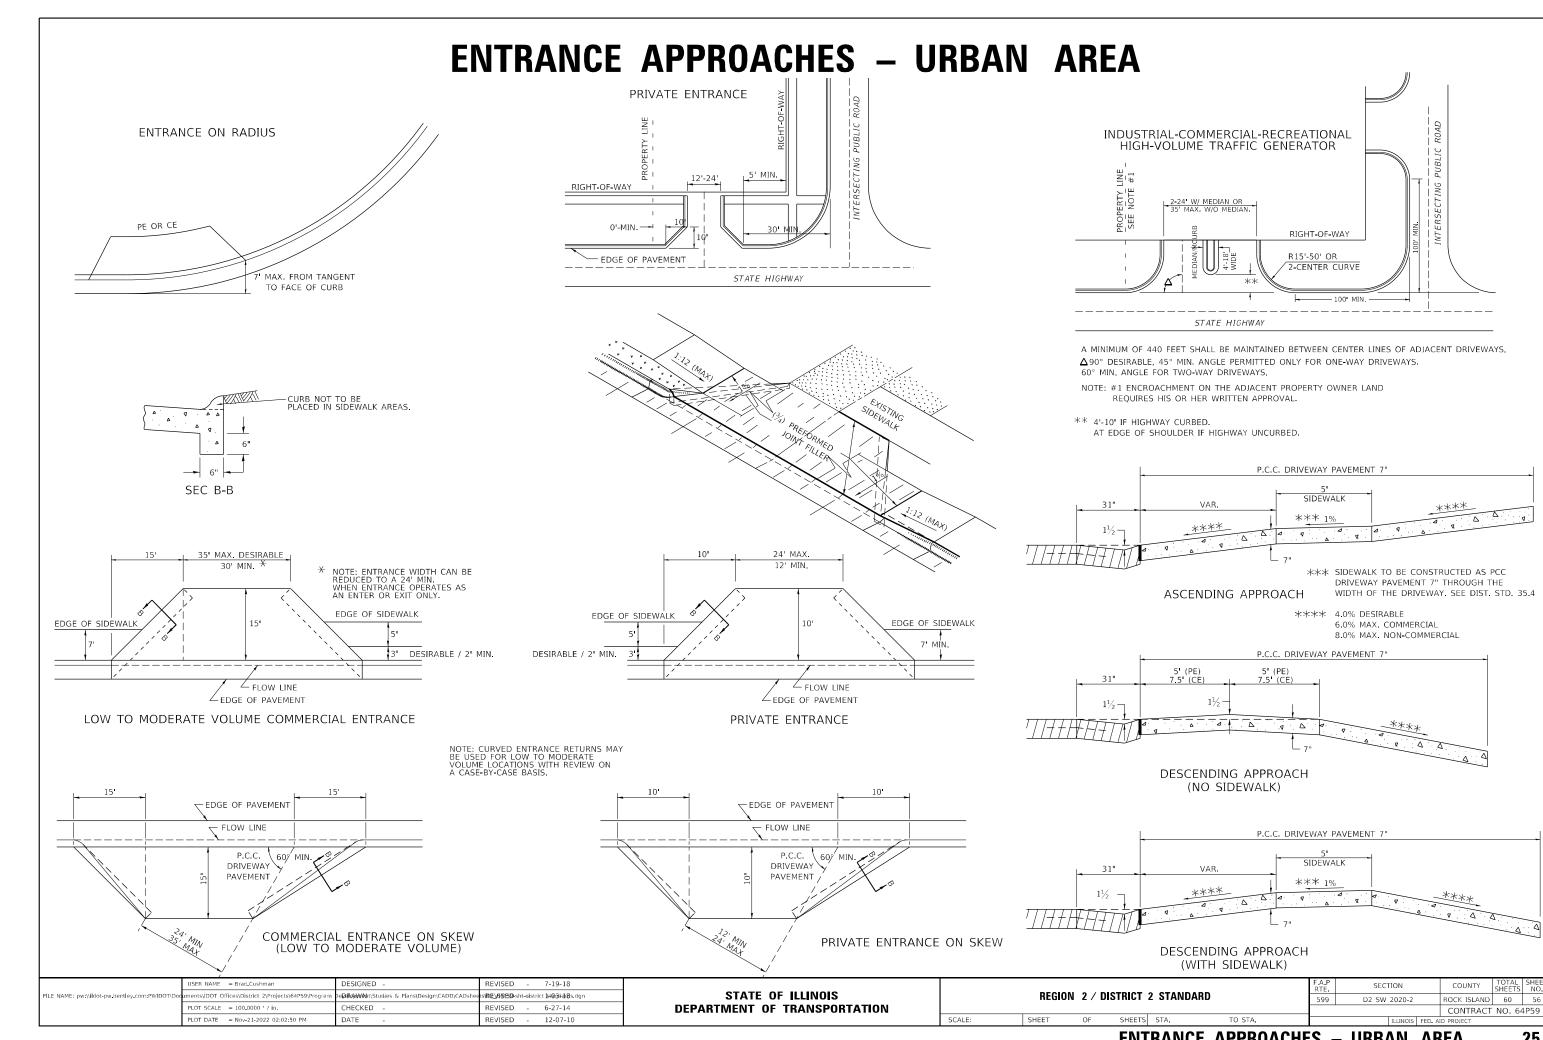

ADA CURB RAMP PAVEMENT REMOVAL AND REPLACEMENT

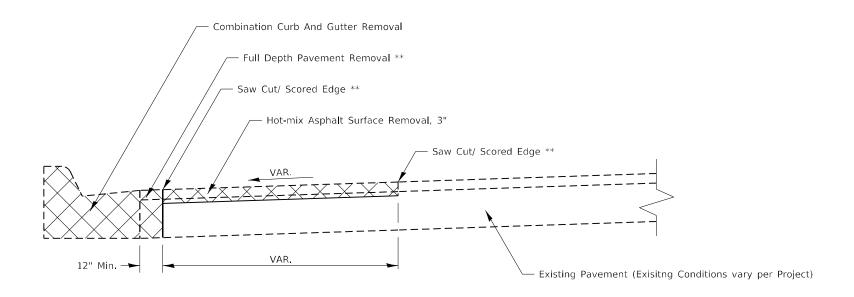

PAVEMENT REMOVAL

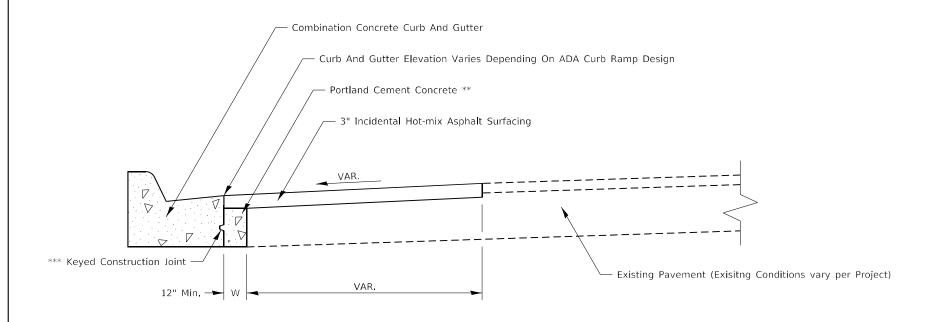

PAVEMENT REPLACEMENT

GENERAL NOTES:

SEE STANDARD 606001 FOR CONCRETE CURB AND COMBINATION CURB AND GUTTER DETAILS NOT SHOWN.

SEE STANDARD 420001 FOR KEYED CONSTRUCTION JOINT DETAILS

SAW CUTTING/ SCORING SHALL BE INCLUDED IN THE UNIT COST OF HOT-MIX ASPHALT SURFACE REMOVAL.

FULL DEPTH PAVEMENT REMOVAL SHALL BE INCLUDED IN THE UNIT COST OF COMBINATION CURB AND GUTTER REMOVAL.

PORTLAND CEMENT CONCRETE NEEDED TO FILL IN THE FORMWORK AREA IN FRONT OF THE COMBINATION CURB AND GUTTER SHALL BE INCLUDED IN THE UNIT COST OF COMBINATION CONCRETE CURB AND GUTTER.

IF THERE IS A CHANGE IN RADIUS AND THE DISTANCE BETWEEN THE NEW COMBINATION CURB AND GUTTER AND THE EXISTING PAVEMENT IS 4FT OF GREATER, THE PCC IN FRONT OF THE CURB AND GUTTER SHALL BE TIED TO THE NEW COMBINATION CURB AND GUTTER AND THE EXISTING PAVEMENT WITH TIE BARS. TIE BARS SHALL BE INCLUDED IN THE UNIT COST OF COMBINATION CONCRETE CURB AND GUTTER.

CONSTRUCTION SEQUENCE

- 1. REMOVE EXISTING FULL DEPTH PAVEMENT AND CURB AND GUTTER
- 2. FORM AND POUR COMBINATION CONCRETE CURB AND GUTTER
- 3. REPLACE FULL DEPTH PAVEMENT WITH PORTLAND CEMENT CONCRETE

 (UP TO 3" FROM FINISHED SURFACE ELVATION TO ALLOW FOR HMA OVERLAY)
- 4. HOT-MIX ASPHALT REMOVAL AND REPLACEMENT.

NOTES

- ALL DIMENSIONS ARE IN INCHES UNLESS OTHERWISE NOTED
- ** COST INCLUDED IN OTHER PAY ITEMS PER GENERAL NOTES
- *** IF W > 24" TIE BARS SHALL BE USED INSTEAD OF A KEYED CONSTRUCTION JOINT

	USER NAME = Brad Cushman	DESIGNED -	REVISED - 1-10-22								F.A.P RTE	SECTION	COUNTY	TOTAL SH	EET
FILE NAME: pw:\\ildot-pw.bentley.com:PWIDOT\Doc	uments\IDOT Offices\District 2\Projects\64P59\Program	De DaRANN/A nt\Studies & Plans\Design\CADD\CADshe	ets IRE_VISED -sht-district standards.dgn	STATE OF ILLINOIS		REGION	N 2 / DIS		STANDARD		599	D2 SW 2020-2	BOCK ISLAND	60 4	57
	PLOT SCALE = 100.0000 / in.	CHECKED -	REVISED -	DEPARTMENT OF TRANSPORTATION									CONTRACT	NO. 64P5	9
	PLOT DATE = Nov-21-2022 02:03:07 PM	DATE -	REVISED -		SCALE:	SHEET	OF	SHEETS S	STA.	TO STA.		ILLINOIS FED.	AID PROJECT		-

TYPICAL PAVEMENT MARKINGS

TYPICAL MARKING FOR

PAINTED ISLANDS

8 WHITE


- 45° ANGLE

12 WHITE

- 8 WHITE


MEDIAN PAVEMENT MARKING

TYPICAL PAVEMENT MARKING FOR FLUSH MEDIAN AT LEFT TURN LANE

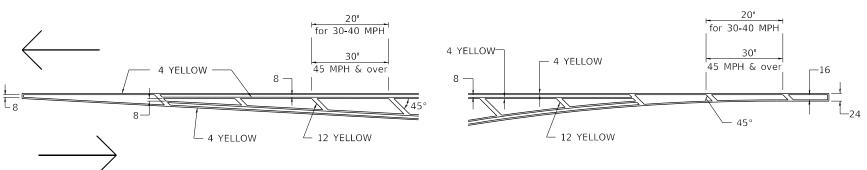

-8 WHITE

- 24 WHITE

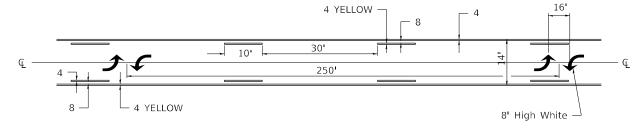

** ALL DIMENSIONS ARE IN INCHES UNLESS OTHERWISE NOTED.

TYPICAL ISLAND OFFSET SHOULDER WIDTH


24 WHITE-

8 WHITE

NOTE: * 45° TO LOCAL TAN. 24 WHITE STOP BAR 8 WHITE

STANDARD CROSSWALK MARKING

See Schedules for Locations

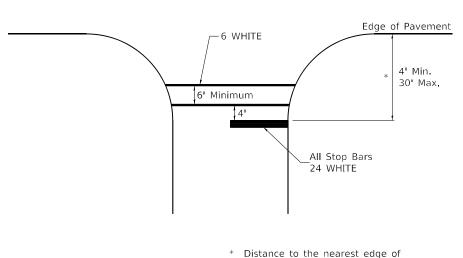

the intersecting roadway in the absence of a marked crosswalk.

5 Diagonals

Minimum

- 12 WHITE


STATE OF ILLINOIS DEPARTMENT OF TRANSPORTATION

 $\langle \Box$

THROUGH TRAFFIC


	REC	GION	2 /	' DI	STRICT	2 :	STANDARD	
CCALE	CHEET	1	0.5	-	CHEETC	-	T 6	 CTA

F.A.P RTE	SECTION		COUNTY	TOTAL SHEETS	SHEET NO.
599	D2 SW 2020-2		ROCK ISLAND	60	58
			CONTRACT	NO. 64	1P59
	TILINOIS	EED A	ID BROJECT		

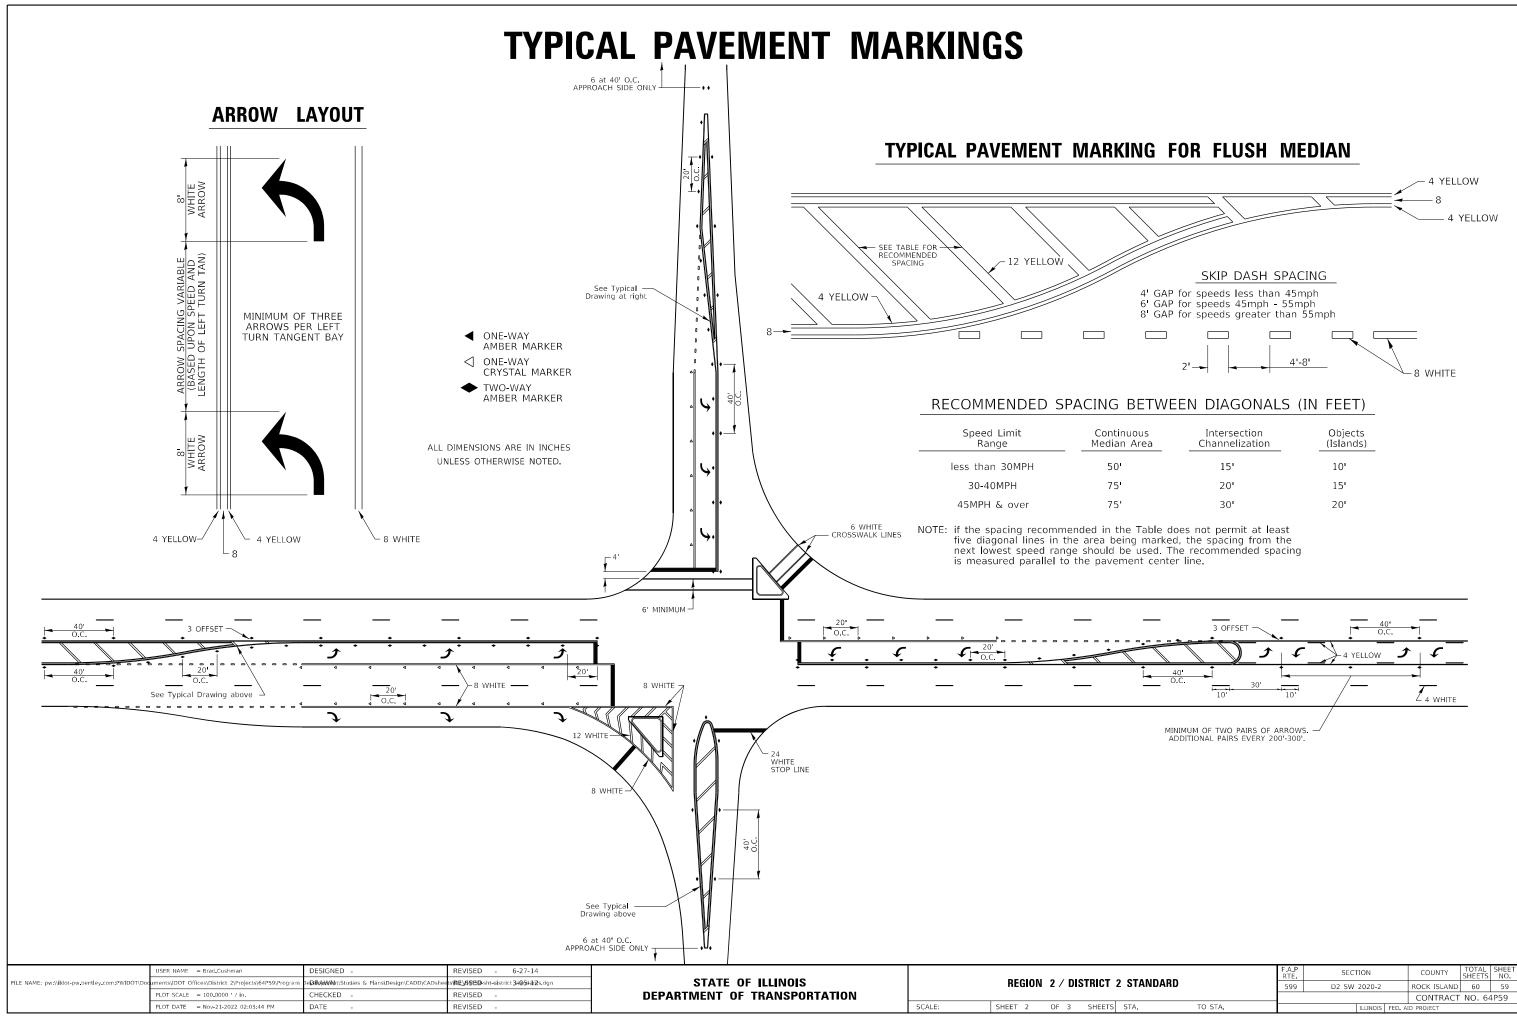


TYPICAL PAVEMENT MARKINGS

TYPICAL PARKING SPACING

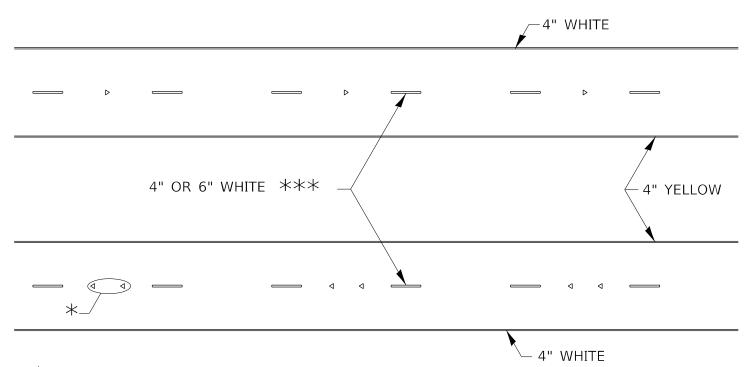

* SEE HIGHWAY STANDARD 781001 FOR SPACING DETAILS. USE DOUBLE MARKERS WHEN ADT \geq 20,000.

MULTI-LANE / DIVIDED

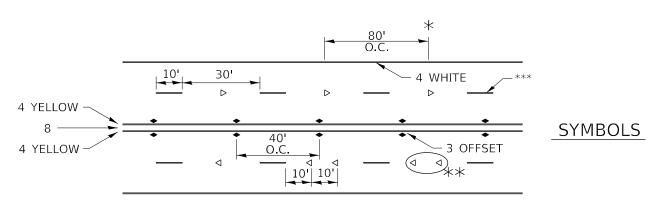

- * REDUCE TO 40' O.C. ON CURVES WHERE ADVISORY SPEEDS ARE 10 MPH LOWER THAN POSTED SPEEDS.
- ** USE DOUBLE MARKERS WHEN ADT ≥ 20,000

*** CENTERLINE SKIP DASH PAVEMENT MARKING SPEED LIMIT LESS THAN 40 MPH USE 4" LINE. SPEED LIMIT 40 MPH AND OVER USE 6" LINE.

MULTI-LANE / UNDIVIDED & ONE WAY

(FOR MULTI-LANE UNDIVIDED HIGHWAYS USE THIS DETAIL NOT HIGHWAY STANDARD 781001)

	USER NAME = Brad Cushman	DESIGNED -	REVISED - 6-27-14
FILE NAME: pw:\\ildot-pw.bentley.com:PWIDOT\Doc	uments\IDOT Offices\District 2\Projects\64P59\Program	De ፲፲፰፻/፲/////e\ ht\Studies & Plans\Design\CADD\CADshee	ts /RE_/d/\$BD -sht-district8+2 <i>i</i> 7d4dr3s.dgn
	PLOT SCALE = 100.0000 / in.	CHECKED -	REVISED - 11-28-12
	PLOT DATE = Nov-21-2022 02:03:57 PM	DATE -	REVISED -

STATE OF ILLINOIS DEPARTMENT OF TRANSPORTATION

| F.A.P | SECTION | COUNTY | TOTAL | SHEET | SHEET | SHOOK | SHEET | SHEET | SHOOK | SHEET | SHOOK | SHEET | SHOOK | SHEET | SHOOK | S

22'-25' 4 WHITE 20' Min. No Parking Zone 22'-25' 20' Min. Face of Curb 30' Min. Approach to Signal 20' Min. Face of Curb 20' Min. Approach to Signal

TYPICAL PAVEMENT MARKING FOR TWO LANE SECTION - NO PASSING ZONES

No Parking Zone

