04-29-2022 LETTING ITEM 090

STATE OF ILLINOIS DEPARTMENT OF TRANSPORTATION

PLANS FOR PROPOSED FEDERAL AID HIGHWAY

FOR INDEX OF SHEETS SEE SHEET NO. 2

ILLINOIS PRAIRIE PATH IL ROUTE 56 (BUTTERFIELD ROAD) AND ROCKWELL STREET TO IL ROUTE 56 (BUTTERFIELD ROAD) AND BATAVIA ROAD

TRAILHEAD IMPROVEMENTS

SECTION No.: 19-00039-00-BT

PROJECT No.: ZF8R(670)

TRAILHEAD IMPROVEMENTS

DUPAGE COUNTY C-91-095-20

3RD PM PROJECT BEGINS 6+00 STAFFORD PLACE ROCKWELL STREET * WARRENVILLE ROAD WINFIELD TOWNSHIP

LOCATION MAP

GROSS LENGTH = 460.00NET LENGTH = 460.00'

19-00039-00-87

STATE OF TLINOIS
DEPARTMENT OF TRANSPORTATION DIPAGE COUNTY COUNTY ANGINE February 4 KE HI RELEASING FOR BID

LOCATION OF SECTION INDICATED THUS: -

PRINTED BY THE AUTHORITY OF THE STATE OF ILLINOIS



PROJECT LOCATED IN THE CITY OF WARRENVILLE

FULL SIZE PLANS HAVE BEEN PREPARED USING STANDARD ENGINEERING SCALES. REDUCED SIZED PLANS WILL NOT CONFORM TO STANDARD SCALES. IN MAKING MEASUREMENTS ON REDUCED PLANS, THE ABOVE SCALES MAY BE USED.

JOINT UTILITY LOCATION INFORMATION FOR EXCAVATION 1-800-892-0123

OR 811 PROJECT MANAGER: JOHN F. MAYER, P.E. PROJECT ENGINEER: ANDREW R. KUSTUSCH, P.E.

CONTRACT NO. 61H18

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LAYOUT AND MATERIAL PLAN

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28-49

000001-08	STANDARD SYMBOLS, ABBREVIATIONS, AND PATTERNS
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720001-01	SIGN PANEL MOUNTING DETAILS
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LEGEND

	= EX. PROPERTY LINE
	= EX. LOT LINE
	= EX. EASEMENT LINE
	= EX. SANITARY LINE
***************************************	= EX. WOOD FENCE
	= EX. WATER LINE
	= EX. OVERHEAD WIRE
***************************************	= EX. WOOD FENCE
	= EX. CONCRETE CURB & GUTTER
	= EX. TREE/BRUSH LINE
780	= EX. 1 FOOT CONTOURS
0	= FOUND IRON PIPE OR ROD
€	= EX. ELECTRICAL METER
\$	= EX. ELECTRIC PEDESTAL
E C	= EX. AIR CONDITIONING UNIT
Q	= EX. FIRE HYDRANT/AUX. VALVE
\otimes	= EX. VALVE BOX
P	= EX. MAILBOX
100,00	= EX. SPOT ELEVATION
**	= EX. CONIFEROUS TREE
	= EX. DECIDUOUS TREE
₿	= EX. SHRUB

ABBREVIATIONS

A CH	ARC LENGTH CHORD
CONC.	CONCRETE
E	EAST
FIP	FOUND IRON PIPE
FIR	FOUND IRON ROD
N	NORTH
R	RADIUS
R.O.W.	RIGHT OF WAY
S	SOUTH
W	WEST
B.S.L.	BUILDING SETBACK LINE
DOC.	DOCUMENT
(XXX.XX)	RECORD INFORMATION
XXX.XX	MEASURED INFORMATION

GENERAL NOTES

- 1. THE CONTRACTOR SHALL CONTACT THE ENGINEER AND TRAFFIC CONTROL SUPERVISOR AT KALPANA KANNAN-HOSADURGA@ILLINOIS.GOV A MINIMUM OF 72 HOURS IN ADVANCE OF BEGINNING WORK. WORK SHALL BEGIN AFTER AUGUST 7, 2022.
- 2. CONTRACTOR TO HAVE LIMITED ACCESS FOR STORAGE OF EQUIPMENT AND/OR MATERIALS. STAGING OF EQUIPMENT AND/OR MATERIALS WITHIN RIGHT OF WAYS (R.O.W.) SHALL BE GRANTED ON A LIMITED BASIS TO ACCOMODATE DAILY CONSTRUCTION ACTIVITIES WITH PRIOR APPROVAL BY THE ENGINEER. OVERNIGHT STORAGE IN R.O.W. IS PROHIBITED. CONTRACTOR MAY STORE MATERIALS AND EQUIPMENT AT THE CITY OF WARRENVILLE'S PUBLIC WORKS YARD LOCATED AT 38346 MIGNIN DRIVE WITH PRIOR APPROVAL FROM THE PUBLIC WORKS DIRECTOR (TEL. NO. 630-393-9050). STORAGE AT THE PUBLIC WORKS YARD IS AT CONTRACTOR'S RISK.
- SIDEWALK CLOSURES SHALL BE GRANTED ON A LIMITED BASIS TO ACCOMMODATE DAILY
 CONSTRUCTION ACTIVITIES WITH PRIOR APPROVAL BY THE ENGINEER. CONTRACTOR
 SHALL FOLLOW IDOT STANDARD 701801-06 TO REDIRECT PEDESTRIAN TRAFFIC
 ACCORDINGLY
- 4. VERIFY SITE CONDITIONS AND INFORMATION ON DRAWINGS. PROMPTLY REPORT ANY CONCEALED CONDITIONS, MISTAKES, DISCREPANCIES OR DEVIATIONS FROM THE INFORMATION SHOWN IN THE CONTRACT DOCUMENTS. CHANGE ORDERS/EXTRA WORK AND AUTHORIZATION ARE COVERED BY STANDARD SPECIFICATIONS.
- 5. THE CONTRACTOR WILL BE REQUIRED TO DISPOSE OF ALL MATERIALS EXCAVATED OR REMOVED DUE TO CONSTRUCTION OPERATIONS. ALL EXCESS EXCAVATED MATERIAL SHALL BE REMOVED FROM SITE ON THE DAY IT IS EXCAVATED. HAULING OR TRUCKING THE MATERIAL TO LOCATIONS, SHALL BE PROVIDED BY THE CONTRACTOR, OUTSIDE THE LIMITS OF IMPROVEMENT.
- CITY OF WARRENVILLE WILL PROVIDE THE CONTRACTOR WITH WATER AND WATER METER, AND BATHROOM FACILITIES AT THE PUBLIC WORKS YARD LOCATED AT 3S346 MIGNIN DRIVE
- 7. BEFORE STARTING ANY EXCAVATION, THE CONTRACTOR SHALL CALL "JULIE" (811) AT 800-892-0123 FOR FIELD LOCATIONS OF BURIED ELECTRIC, TELEPHONE AND GAS FACILITIES, 488 HOURS NOTIFICATION IS REQUIRED).
- 8. ALL WORK SHALL BE IN ACCORDANCE WITH THE IDOT "STANDARD SPECIFICATIONS FOR ROAD AND BRIDGE CONSTRUCTION" (JANUARY 1, 2022), THE CITY OF WARRENVILLE CODE OF ORDINANCES, THE COUNTY OF DUPAGE CODE OF ORDINANCES, AND THE "STANDARD SPECIFICATIONS FOR WATER AND SEWER MAIN CONSTRUCTION IN ILLINOIS", (LATEST FOITION)
- 9. THE EROSION & SEDIMENT CONTROL PRACTICES SHALL BE ACCORDING TO THE ILLINOIS URBAN MANUAL (LATEST EDITION).
- 10. NO WORK SHALL COMMENCE UNTIL TRAFFIC CONTROL REQUIREMENTS ARE MET.
- 11. ALL SOIL EROSION AND SEDIMENT CONTROL DEVICES SHALL BE INSTALLED PRIOR TO UPLAND DISTURBANCE.
- 12. THE CONTRACTOR SHALL PERFORM ALL CONSTRUCTION LAYOUT REQUIRED TO COMPLETE THE WORK.
- 13. PHOSPHORUS FERTILIZER HAS BEEN INTENTIONALLY OMITTED FROM THE CONTRACT. A PHOSPHORUS-FREE FERTILIZER SHALL BE USED. (MIDDLE NUMBER SHOULD EQUAL 0).

STORM SEWERS, STRUCTURES, & UTILITIES

- THE CONTRACTOR SHALL BE RESPONSIBLE FOR CONTACTING LOCAL AGENCIES
 MAINTAINING SANITARY SEWERS, WATERMAINS, AND ELECTRICAL FACILITIES TO VERIFY
 THE MATERIALS AND METHODS ALLOWED FOR THE ADJUSTMENT OR PROTECTION OF THE
 UTILITY INVOLVED.
- 2. SPECIFIC ATTENTION IS CALLED TO THE EXISTING HIGH-VOLTAGE OVERHEAD TRANSMISSION LINES OWNED BY COMED.
- 3. THE LOCATION AND ELEVATION OF EXISTING UTILITIES ARE APPROXIMATE. THE EXACT LOCATIONS AND ELEVATIONS ARE TO BE VERIFIED BY THE CONTRACTOR THROUGH THE OWNER OF THE UTILITY

DuPAGE COUNTY DIVISION OF TRANSPORTATION NOTES

- 1. DISTURBED AREAS OF THE COUNTY'S RIGHT OF WAY SHALL BE REGRADED AND RESTORED WITH TOPSOIL AND CLASS 2A SALT TOLERANT SEED (WITH EROSION CONTROL BLANKET OR HYDRO SEEDING) OR SOD (SALT TOLERANT AND STAKED IN PLACE) UNLESS SHOWN OTHERWISE ON THE PLANTING PLAN.
- 2. ANY DAMAGE TO PATH SURFACES BY CONSTRUCTION TRAFFIC OR DURING CONSTRUCTION SHALL BE REPLACED AS COORDINATED WITH THE DUPAGE COUNTY DIVISION OF TRANSPORTATION AND AS DIRECTED BY THE ENGINEER.
- CONTACT DUPAGE COUNTY DOT (630-407-6900) A MINIMUM OF 48 HRS PRIOR TO START OF CONSTRUCTION TO ARRANGE FOR INSPECTIONS OF AND AT THE COMPLETION OF THE DESCRIBED WORK WITHIN THE COUNTY'S RIGHT-OF-WAY.
- 4. ALL WORK WITHIN THE DUPAGE COUNTY DOT RIGHT-OF-WAY SHALL MEET THE LOCAL REQUIREMENTS OF THE COUNTY.

SEDIMENT & EROSION CONTROL NOTES

- DURING CONSTRUCTION, AREAS OUTSIDE THE CONSTRUCTION LIMITS SHALL BE PROTECTED. THE CONTRACTOR SHALL NOT USE THIS AREA FOR STAGING, PARKING OF VEHICLES OF CONSTRUCTION EQUIPMENT, STORAGE OF MATERIALS OR OTHER CONSTRUCTION RELATED ACTIVITIES.
- CONSTRUCTION EQUIPMENT SHALL BE STORED AND FUELED ONLY AT OWNER APPROVED LOCATIONS. ALL NECESSARY MEASURES SHALL BE TAKEN TO CONTAIN ANY FUEL OR OTHER POLLUTANT IN ACCORDANCE WITH EPA WATER QUALITY REGULATIONS. LEAKING EQUIPMENT OR SUPPLIES SHALL BE IMMEDIATELY REPAIRED OR REMOVED FROM THE SITE
- TEMPORARY SEDIMENT CONTROL SYSTEMS SHALL BE LEFT IN PLACE WITH PROPER
 MAINTENANCE UNTIL PERMANENT EROSION CONTROL IS IN PLACE AND WORKING
 PROPERLY AND ALL PERMANENT VEGETATION IS GROWING AND THRIVING.
- EROSION CONTROL MEASURES SHALL BE INSTALLED PRIOR TO START OF CONSTRUCTION.
- 5. ALL EROSION CONTROL MEASURES MUST BE INSPECTED WEEKLY AND AFTER EACH $\frac{1}{2}$ RAIN EVENT.
- IN AREAS WHERE WORK IS COMPLETE, PERMANENT STABILIZATION SHALL OCCUR WITHIN 7 DAYS OF COMPLETION, AND IN AREAS WHERE WORK HAS TEMPORARILY CEASED FOR 14 DAYS OR MORE, TEMPORARY STABILIZATION SHALL OCCUR BY THE 7TH DAY AFTER WORK HAS CEASED.
- 7. TEMPORARY EROSION CONTROL SEEDING SHALL BE APPLIED AT A RATE OF 50 LBS/ACRES.
- WINTER SHUTDOWN SHALL BE ADDRESSED EARLY IN THE FALL GROWING SEASON SO
 THAT SLOPES AND OTHER BARE EARTH AREAS MAY BE STABILIZED WITH TEMPORARY
 AND/OR PERMANENT VEGETATIVE COVER FOR PROPER EROSION AND SEDIMENT
- ALL ADJACENT STREETS MUST BE KEPT CLEAR OF DEBRIS, INSPECTED DAILY AND CLEANED WHEN NECESSARY AND AS DIRECTED BY ENGINEER.
- 10. UNLESS OTHERWISE INDICATED, ALL VEGETATIVE AND STRUCTURAL EROSION AND SEDIMENT CONTROL PRACTICES WILL BE CONSTRUCTED ACCORDING TO MINIMUM STANDARDS AND SPECIFICATIONS IN THE MOST RECENT ILLINOIS URBAN MANUAL.
- 11. THE CONTRACTOR IS RESPONSIBLE FOR INSTALLATION OF ANY ADDITIONAL EROSION CONTROL MEASURES NECESSARY TO PREVENT EROSION AND SEDIMENTATION AS DETERMINED BY THE ENGINEER, CITY OF WARRENVILLE, OR DUPAGE COUNTY.
- 12. IT IS THE RESPONSIBILITY OF THE GENERAL CONTRACTOR TO INFORM ANY SUB-CONTRACTOR(S) WHO MAY PERFORM WORK ON THIS PROJECT, OF THE REQUIREMENTS IN IMPLEMENTING AND MAINTAINING THESE EROSION CONTROL ITEMS AND ASSURE COMPLIANCE WITH ALL APPLICABLE LOCAL, STATE AND FEDERAL REGULATIONS.
- 13. SEDIMENT COLLECTED DURING CONSTRUCTION BY THE VARIOUS TEMPORARY SEDIMENT CONTROL SYSTEMS SHALL BE DISPOSED OF ON THE SITE ON A REGULAR BASIS, AS DIRECTED BY THE ENGINEER. THE COST OF THIS MAINTENANCE SHALL BE INCLUDED IN THE COST OF THE EROSION CONTROL SYSTEMS AND SHALL NOT BE PAID FOR SEPARATELY.
- 14. ALL DROP INLETS ON AND ADJACENT TO THE SITE MUST HAVE A SEDIMENT TRAPPING OR CONTAINMENT DEVICE INSTALLED DURING CONSTRUCTION ACTIVITIES. FILTER FABRIC ON ITS OWN IS NOT AN APPROVED METHOD. A MANUFACTURER'S SPEC SHOULD BE USED FOR PREFABRICATED DROP INLET PROTECTION AND SHOULD BE AS NOTED IN THE ILLINOIS URBAN MANUAL STANDARD 861 FOR INLET PROTECTION.
- 15. THE DRAWINGS, SPECIFICATIONS AND SPECIAL PROVISIONS WILL ENSURE THAT EXISTING VEGETATION IS PRESERVED WHERE ATTAINABLE AND DISTURBED PORTIONS OF THE SITE WILL BE STABILIZED. STABILIZATION PRACTICES INCLUDE TEMPORARY SEEDING, PERMANENT SEEDING, PROTECTION OF TREES, PRESERVATION OF NATURAL VEGETATION, AND OTHER APPROPRIATE MEASURES AS DIRECTED BY THE ENGINEER. AREAS OF EXISTING VEGETATION OUTSIDE THE PROPOSED CONSTRUCTION LIMITS SHALL BE PROTECTED FROM CONSTRUCTION ACTIVITIES.

SCALE: NONE

WATER SERVIC

- For water services 2-inch diameter and less shall be Type "K" copper only with a minimum size of one-inch (1") diameter.
- All brass is preferred to have compression fittings. Compression fittings must be of the stainless full circle ring retainage. No set screws are allowed. Flair fitting are acceptable.
- B-Boxes shall be of the arch pattern design with a telescoping one and one quarter-inch (1-1/4") iron pipe upper section, pentagon nut access, enlarged base for 1-1/2" roundways and larger, manufactured in the USA.
- Tapping saddle at minimum shall be epoxy coated ductile with two stainless steel bands. All stainless steel saddles are acceptable. Manufactured in USA.
- 5. All repair clamps shall be full circle stainless steel.
- 6. Depth of bury for water services to be 5'-6" (minimum) to 6'-6" (maximum).

SANITARY SEWER

- All sanitary sewer and sanitary sewer service pipe shall be SDR 26 ASTM D-2241 and fittings shall meet the requirements of ASTM D-3139. <u>Note:</u> This is a pressure rated pipe.
- 2. Sanitary sewer services shall be a minimum of 6-inches in diameter.
- All sanitary sewers shall be air and mandrel tested, and televised, including private commercial lines between inspection manhole and the public sanitary sewer. Copies of DVDs and reports shall be provided to the City.
- Sanitary sewer manholes shall have openings for the pipe connections cast into the wall of the structure. Rubber gasketed coupling (boot) with stainless steel bands / retainers shall be per ASTM C-923.
- 5. When connecting to an existing manhole, the hole must be cored and a rubber gasketed coupling (bod) with stainless steel bands / retainers shall be per ASTM C-923. The bench shall be removed and repoured, if necessary. Rubber boots/seals must be used where pipes enter manholes. The internal connection shall be dressed up with non-shrink hydraulic cement. Hydraulic cement, mortar, and concrete must be of the strength and water-tightness quality as specified in the ASTM standards
- When connecting a new sanitary service to an existing sanitary sewer main without an existing wye, contact Public Works to determine which one of the two following methods shall be used:
- a. A section of the main shall be cut out to install a new wye. Connection between the existing sanitary sewer and the new wye shall be made with non-shear mission couplings with two stainless steel bands to a point where the coupling cannot shift.
- b. Core the existing main and make the connection with a watertight lateral fitting.
- Sanitary manholes shall be pre-cast concrete units. For sanitary sewers 18-inch diameter or less, the manhole shall be 48-inch inside diameter. For sanitary sewers 21-inch diameter and larger, the manhole shall be 60-inch inside diameter.
- Frames and lids shall have the word "SANITARY" cast in the cover. The lid shall be a self- sealing solid lid with watertight gasket and concealed pickhole.
- 9. All commercial buildings shall have an inspection manhole
- 10. Manhole sections and adjusting rings shall be sealed with butyl rope.
- 11. Sanitary manholes shall have a poured concrete bench
- 12. Rings / steps shall be installed in manholes unless specifically prohibited
- 13. External chimney seals will be required with all sanitary manholes. The frame, chimney, and top "lip" of the cone section shall be required to be sealed with a chimney seal. This should be observed by the City prior to backfilling.
- 14. No ground water will be allowed to enter the sanitary sewer during or after
- 15. No more than twelve inches (12") of adjusting rings are allowed.

Trailhead 706 STP [

SPECIALTY ITEM	SPECIAL PROVISIONS	CODE NUMBER	ITEM	UNIT OF MEASURE	QUANTITY	CONSTRUCTION CODE 0028 FEDERAL 75% / LOCAL 25%	CONSTRUCTION CODE 0042 FEDERAL 75% / LOCAL 25%	LOCAL 100%
		20101000	TEMPORARY FENCE	FOOT	900	900		
×		20101200	TREE ROOT PRUNING		3	3		
×		20101300	TREE PRUNING (1 TO 10 INCH DIAMETER)	EACH	1	1		
Х	х	20101700	SUPPLEMENTAL WATERING	UNIT	40	40		
		20400800	FURNISHED EXCAVATION	CU YD	150	150		
		20800150	TRENCH BACKFILL	CU YD	35	35		
	x	21101615	TOPSOIL FURNISH AND PLACE, 4"	SQ YD	3,162	3,162		
	x	21101645	TOPSOIL FURNISH AND PLACE, 12"	SQ YD	357	357		
×		25000210	SEEDING, CLASS 2A	ACRE	0,50	0.50		
×		25000400	NITROGEN FERTILIZER NUTRIENT	POUND	50	50		
X		25000600	POTASSIUM FERTILIZER NUTRIENT	POUND	50	50		
×		25100115	MULCH, METHOD 2	ACRE	0.25	0.25		
×		25100630	EROSION CONTROL BLANKET	SQ YD	3,162	3,162	,	
		28000250	TEMPORARY EROSION CONTROL SEEDING	POUND	100	100		
		28000400	PERIMETER EROSION BARRIER	FOOT	900	900		
		28000510	INLET FILTERS	EACH	8	8		
		40601005	HOT-MIX ASPHALT REPLACEMENT OVER PATCHES	TON	7.3	7.3		
		42400200	PORTLAND CEMENT CONCRETE SIDEWALK 5 INCH	SQ FT	5,025	5,025		
		42400400	PORTLAND CEMENT CONCRETE SIDEWALK 7 INCH	SQ FT	770	770		
		42400800	DETECTABLE WARNINGS	SQ FT	100	100		
	L			L	.1	<u> </u>	L	

ILE NAME: H: \War	ENGINEERING RESOURCE ASSOCIATES
문호	

	USER NAME = azielinski	DESIGNED -	A.Z.	REVISED -
ì		DRAWN -	A.J.	REVISED
3	PLOT SCALE = \$SCALE\$	CHECKED -	J.M.	REVISED -
•	PLOT DATE = 1/17/2022	DATE -	12/13/2021	REVISED -

STATE OF ILLINOIS
DEPARTMENT OF TRANSPORTATION

	SUMMARY OF Q		F.A.P. RTE.	SECTIO	N		COUNTY	TOTAL SHEETS	SHEET NO.
	365	365 19-00039-00-BT			DUPAGE	49	3		
							CONTRAC	T NO.: 6	1H18
CALE: NONE	SHEET NO. 1 OF 8 SHEETS	STA, — TO STA. —		ILLINOIS FED. AID PROJECT					

SPECIALTY ITEM	SPECIAL PROVISIONS	CODE NUMBER	ITEM	UNIT OF MEASURE	QUANTITY	CONSTRUCTION CODE 0028 FEDERAL 75% / LOCAL 25%	CONSTRUCTION CODE 0042 FEDERAL 75% / LOCAL 25%	LOCAL 100%
		44000300	CURB REMOVAL	FOOT	FOOT 276 276			
		44000500	COMBINATION CURB AND GUTTER REMOVAL	FOOT	48	48		
		44000600	SIDEWALK REMOVAL	SQ FT	3,212	3,212		
		44002208	HOT-MIX ASPHALT REMOVAL OVER PATCHES, 2"	SQ YD	65	65		
		44201692	CLASS D PATCHES, TYPE II, 4 INCH	SQ YD	7,3	7.3		
		44201696	CLASS D PATCHES, TYPE IV, 4 INCH	SQ YD	59	59		
×	х	50901760	PIPE HANDRAIL	FOOT	120	120		
		550A0040	STORM SEWERS, CLASS A, TYPE 1, 10"	FOOT	75	75		
								,
×	X	56200200	WATER SERVICE LINE, 3/4"	FOOT	25	25		
		60100925	PIPE DRAINS 8"	FOOT	52	52		
		60207605	CATCH BASINS, TYPE C, TYPE 8 GRATE	EACH	3	3		
		60250200	CATCH BASINS TO BE ADJUSTED	EACH	2	2		
		60255700	MANHOLES TO BE ADJUSTED WITH NEW TYPE 1 FRAME, OPEN LID	EACH	1	1		
		60500050	REMOVING CATCH BASINS	EACH	1	1		
		60600605	CONCRETE CURB, TYPE B	FOOT	94	94		
		60603800	COMBINATION CONCRETE CURB AND GUTTER, TYPE B-6.12	FOOT	48	48		
		67100100	MOBILIZATION	L SUM	1	1		
		70102620	TRAFFIC CONTROL AND PROTECTION, STANDARD 701501	L SUM	1	1		
		70102640	TRAFFIC CONTROL AND PROTECTION, STANDARD 701801	L SUM	1	1		
Х		72000100	SIGN PANEL - TYPE 1	SQ FT	4	4		

ENGINEERING RESOURCE ASSOCIATES

USER NAME = azielinski	DESIGNED -	A.Z.	REVISED -
	DRAWN -	A.J.	REVISED
PLOT SCALE = \$SCALE\$	CHECKED -	J.M.	REVISED
PLOT DATE = 2/2/2022	DATE -	12/13/2021	REVISED

STATE OF ILLINOIS
DEPARTMENT OF TRANSPORTATION

			F.A.P. RTE.	SECTION	COUNTY	SHEETS	SHEET NO.
	SUMMARY OF QUA	NTITIES	365	19-00039-00-BT	DUPAGE	49	4
					CONTRAC	T NO.: 6	1H18
ALE: NONE	SHEET NO. 2 OF 8 SHEETS	STA, — TO STA. —		ILLINOIS F	ED. AID PROJECT		

SPECIALTY ITEM	SPECIAL PROVISIONS	CODE NUMBER	ITEM	UNIT OF MEASURE	QUANTITY	CONSTRUCTION CODE 0028 FEDERAL 75% / LOCAL 25%	CONSTRUCTION CODE 0042 FEDERAL 75% / LOCAL 25%	LOCAL 100%
		78300202	PAVEMENT MARKING REMOVAL - WATER BLASTING	SQ FT	200	200		
X		81028170	UNDERGROUND CONDUIT, GALVANIZED STEEL, 1" DIA.	FOOT	41			41
		84702444	ELECTRICAL CABLE IN CONDUIT, 600V (XLP-TYPE USE) 2-12/C, 1-12/C GROUND	FOOT	41			41
×		81702441	ELECTRICAL CABLE IN CONDOTT, 300V (ALF-TIPE 03E) 2-1210, 1-1210 GROUND	F001	71			71
	X	Z0003850	BENCHES	EACH	1	1		
		2000000						
	×	Z0003855	BICYCLE RACKS	EACH	5	5		
	×	Z0012455	CONCRETE STEP REMOVAL	EACH	1	1		
	Х	Z0013798	CONSTRUCTION LAYOUT	L SUM	1	1		
	X	Z0039700	PICNIC TABLE	EACH	2.00	2.00		
	х	20076600	TRAINEES	HOUR	500		500	
	X	Z0076604	TRAINEES TRAINING PROGRAM GRADUATE	HOUR	500		500	

×		A2005920	TREE, PLATANUS X ACERIFOLIA 'BLOODGOOD', (BLOODGOOD LONDON PLANETREE), 2 1/2" CALLIPER, BALLED AND BURLAPPED	EACH	1.00	1.00		
			SHRUB, ARONIA MELANOCARPA AUTUMN MAGIC, (AUTUMN MAGIC BLACK CHOKEBERRY), 2' HEIGHT, BALLED					
Х		C2000652	AND BURLAPPED	EACH	25	25		
×		C2002324	SHRUB, DIERVILLA LONICERA (BUSH HONEY SUCKLE), 2' HEIGHT, BALLED AND BURLAPPED	EACH	30	30		
~		C2015302	SHRUB, JUNIPERUS CHINENSIS KALLAY'S COMPACTA, (KALLAY COMPACT JUNIPER), 5-GALLON	EACH	21	21		
Х								
<u>,</u>		C2C04675	SHRUB, PHYSOCARPA OPULIFOLIUS DONNA MAY (LITTLE DEVIL NINEBARK), 2-1/2' HEIGHT, CONTAINER	EACH	19	19		
×		C2C04675	OTHER THEORY OF THE OTHER WATER WATER THE DEVIL MINEBANNY, 2-112 THEORY, CONTAINER	LACH	13	19		
×		C2C09784	SHRUB, SPIREA BETULIFOLIA TOR (TOR BIRCHLEAF SPIREA), 2' HEIGHT, CONTAINER	EACH	21.0	21.0		
^		2200704					***************************************	
×	×	K0012990	PERENNIAL PLANTS, ORNAMENTAL TYPE, GALLON POT	UNIT	6	6	-	
7								
Х	X	K0026850	PERENNIAL PLANT CARE	SQ YD	92.0	92.0		
Х	х	K0029634	WEED CONTROL, PRE-EMERGENT GRANULAR HERBICIDE	POUND	10	10		

(ER)	ENGINEERING RESOURCE ASSOCIATES
	RESOURCE ASSOCIATES

USER NAME = azielinski	DESIGNED - A.Z.	REVISED -
	DRAWN - A.J.	REVISED -
PLOT SCALE = \$SCALE\$	CHECKED ~ J.M.	REVISED -
PLOT DATE = 1/17/2022	DATE - 12/13/2021	REVISED -

STATE OF ILLINOIS
DEPARTMENT OF TRANSPORTATION

			F.A.P. RTE.	·	SECTION			COUNTY	TOTAL SHEETS	SHEET NO.
	SUMMARY OF QUA	ANTITIES	365		19-00039-00-B	Т		DUPAGE	49	5
								CONTRACT	NO.: 6	1H18
SCALE: NONE	SHEET NO. 3 OF 8 SHEETS	STA, — TO STA. —			ILLING	IS F	ED, AID	PROJECT		

SPECIALTY ITEM	SPECIAL PROVISIONS	CODE NUMBER	ITEM	UNIT OF MEASURE	QUANTITY	CONSTRUCTION CODE 0028 FEDERAL 75% / LOCAL 25%	CONSTRUCTION CODE 0042 FEDERAL 75% / LOCAL 25%	LOCAL 100%
	х	X0100029	EXPLORATORY EXCAVATION	FOOT	80	80	·	
,,,,,,,,,,,,,,,,,,,,,,,,,,,,,,,,,,,,,,,	х	X0320067	BENCH REMOVAL	EACH	3	3		
	Х	X0322917	PROPOSED STORM SEWER CONNECTION TO EXISTING MANHOLE	EACH	1	1		
	х	X0324450	SEGMENTAL CONCRETE BLOCK WALL, SPECIAL	SQ FT	150	150		
×	х	X0325130	TUBULAR TRAFFIC SIGN POST	EACH	2	2		A Paragraphy (Paragraphy)
	х	X0325786	STONE SEATING	SQ FT	74	74		
		- 1,3 1			·			
X	х	X0325789	INTERPRETIVE SIGNAGE COMPLETE	EACH	1	1		
x	х	X0325970	SOIL CONDITIONER 3"	SQ YD	357	357		
,,								
	Х	X1700067	STAMPED COLORED PORTLAND CEMENT CONCRETE SIDEWALK, 5 INCH	SQ FT	516.00	516,00		
	х	X1800024	DECORATIVE STONE	SQ FT	295	295		
			·					
	х	X2020410	EARTH EXCAVATION, SPECIAL	CU YD	275	275		
×	х	X2501820	SEEDING, CLASS 5 (MODIFIED)	ACRE	0.25	0.25		
×	х	X2502014	SEEDING, CLASS 4A (MODIFIED)	ACRE	0.25	0.25		
,								
	х	X3400004	RETAINING WALL REMOVAL	FOOT	75	75		
	x	X4240430	PORTLAND CEMENT CONCRETE SIDEWALK 5 INCH, SPECIAL	SQ FT	1,730	1,730		
	x	X4240450	PORTLAND CEMENT CONCRETE SIDEWALK 7 INCH, SPECIAL	SQ FT	300	300		
	x	X4404400	PAVEMENT REMOVAL (SPECIAL)	SQ YD	213.0	213.0		
	^		, ,					
	х	X8300001	LIGHT POLE, SPECIAL	EACH	1			1
X	^	7,000001						
	x	X8360120	LIGHT POLE FOUNDATION, SPECIAL	EACH	1			1
X	^	A0000120	ELOTT CLE TO SOUTH OF LOW IE					
		VVOCCEC	TDACH DECEDTACIES	EACH	4	4		
	Х	XX000959	TRASH RECEPTACLES	LAOIT				

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Trailhead	ENGINEERING
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	RESOURCE ASSOCIATES
믮	

	USER NAME = azielinski	DESIGNED -	A.Z.	REVISED -
ì		DRAWN -	A.J.	REVISED
	PLOT SCALE = \$SCALE\$	CHECKED -	J.M.	REVISED
	PLOT DATE = 1/17/2022	DATE -	12/13/2021	REVISED

STATE OF ILLINOIS	
DEPARTMENT OF TRANSPORTATION	

			F.A.P. RTE.	SECTION		COUNTY	SHEETS	
SUMMARY OF QUANTITIES				19-00039-00-BT		DUPAGE	49	6
						CONTRACT	NO.: 6	1H18
CALE: NONE	SHEET NO. 4 OF 8 SHEETS	STA. — TO STA. —		ILLINOIS	FED. AID F	ROJECT		


SPECIALTY ITEM	SPECIAL PROVISIONS	CODE NUMBER	ITEM	UNIT OF MEASURE	QUANTITY	CONSTRUCTION CODE 0028 FEDERAL 75% / LOCAL 25%	CONSTRUCTION CODE 0042 FEDERAL 75% / LOCAL 25%	LOCAL 100%
×	х	XX001683	INFORMATION KIOSK	EACH	1	1		
	×	XX005845	MODULAR CONCRETE PAVERS (SPECIAL)	SQ FT	150	150		
Х	х	XX006670	TRAIL HEAD SIGN, COMPLETE	EACH	2	2		
·	х	XX006921	PRECAST MEDALLIONS	EACH	1	1		
×	×	XX009020	LUMINAIRE, LED, TYPE 3, SPECIAL	EACH	1			1
×	x	XX009045	DRINKING FOUNTAIN	EACH	1	1		
Х	х	XX009334	BICYCLE REPAIR STATION	EACH	1	1		
×	Х	XX009525	RESTROOM BUILDING	LSUM	1	1		

ENGINEERING RESOURCE ASSOCIATES

USER NAME = azielinski	DESIGNED - A.Z.	REVISED -
	DRAWN - A.J.	REVISED
PLOT SCALE = \$SCALE\$	CHECKED - J.M.	REVISED
PLOT DATE = 2/2/2022	DATE - 12/13/2021	REVISED


STATE OF ILLINOIS	
DEPARTMENT OF TRANSPORTATION	

			F.A.P. RTE.	SECTION	COUNTY	TOTAL SHEETS	
SUMMARY OF QUANTITIES			365	19-00039-00-BT	DUPAGE	49	7
					CONTRAC	T NO.: 6	1H18
ALE: NONE	SHEET NO. 5 OF 8 SHEETS	STA. — TO STA. —		ILLINOIS FED, AID PROJECT			

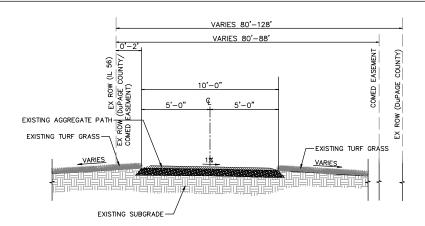

EXISTING TYPICAL SECTION

STA. 006+00 TO STA. 006+56 STA. 006+66 TO STA. 010+37

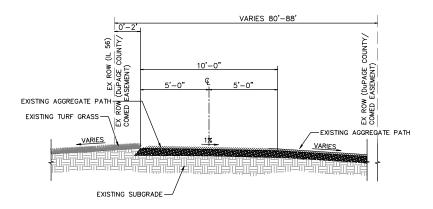

EXISTING TYPICAL SECTION NOT TO SCALE

STA. 006+56 TO STA. 006+66 STA. 010+37 TO STA. 010+60


HOT-MIX ASPHALT MIXTURE REQUIREMENTS

PATCHING

PAY ITEM DESCRIPTION	AIR VOIDS @ Ndes	QMP
CLASS D PATCHES, TYPE II, 4" (HMA BINDER IL-19.0 N50)	4% @ 50 Gyr.	LR 1030-2
CLASS D PATCHES, TYPE IV, 4" (HMA BINDER IL-19.0 N50)	4% @ 50 Gyr.	LR 1030-2
HMA REPLACEMENT OVER PATCHES (HMA SURFACE IL-9.5, MIX "D" N50)	4% @ 50 Gyr.	LR 1030-2


THE UNIT WEIGHT USED TO CALCULATE ALL HMA SURFACE MIXTURE QUANTITIES IS 112 LBS/SQ YD-IN.

THE "AC TYPE" FOR POLYMERIZED HMA MIXES SHALL BE "SBS/SBR PG 76-22" AND FOR NON-POLYMERIZED HMA THE "AC TYPE" SHALL BE "PG 64-22" UNLESS MODIFIED BY RECLAIMED MATERIALS SPECIFICATIONS

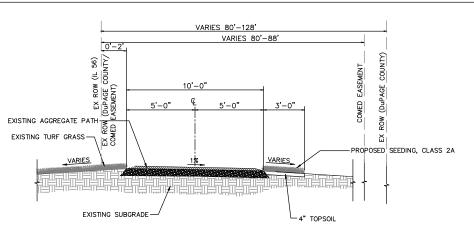


PROPOSED TYPICAL SECTION NOT TO SCALE

STA. 006+00.00 TO STA. 006+39.44 STA. 006+54.34 TO STA. 006+62.88 STA. 006+70.88 TO STA. 008+60.44 STA. 008+68.44 TO STA. 009+70.95 STA. 009+78.95 TO STA. 001+48.16

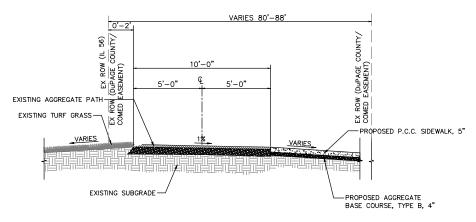

PROPOSED TYPICAL SECTION NOT TO SCALE

STA. 006+39.44 TO STA. 006+54.34 STA. 006+62.88 TO STA. 006+70.88 STA. 008+60.44 TO STA. 008+68.44 STA. 009+70.95 TO STA. 009+78.95 STA. 010+48.16 TO STA. 010+60.00

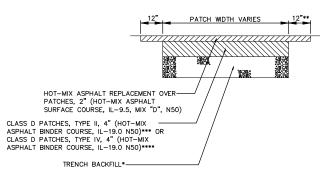

*FOR PATCHING ALONG EXISTING CURB: EXISTING AGGREGATE BASE
**FOR PATCHING ALONG EXISTING CURB: NO 12" EXTENSION OF SURFACE COURSE.
***FOR PATCHING ON THE WEST SIDE OF THE PARKING LOT FOR PROPOSED STORM SEWER
****FOR PATCHING ON THE NORTH AND EAST SIDES OF THE PARKING LOT

PAVEMENT PATCH DETAIL


NOT TO SCALE

ENGINEERING RESOURCE ASSOCIATES RESOURCE ASSOCIATES

	USER NAME = azielinski	DESIGNED -	A.Z.	REVISED -		
ì		DRAWN -	A.J.	REVISED -		
	PLOT SCALE = \$SCALE\$	CHECKED -	J.M.	REVISED -	_	
	PLOT DATE = 2/10/2022	DATE -	12/13/2021	REVISED -		

STATE OF ILLINOIS **DEPARTMENT OF TRANSPORTATION**

TVDICAL SECTIONS		F.A.P. RTE.	F.A.P. SECTION		COUNTY	TOTAL SHEETS				
		365	19-00039-00-BT		DUPAGE	49	8			
								CONTRAC	T NO.: 6	1H18
ΙE	SHEET NO. 1 OF 1 SHEETS	STA TO STA				ILLINOIS	FED. All	D PROJECT		

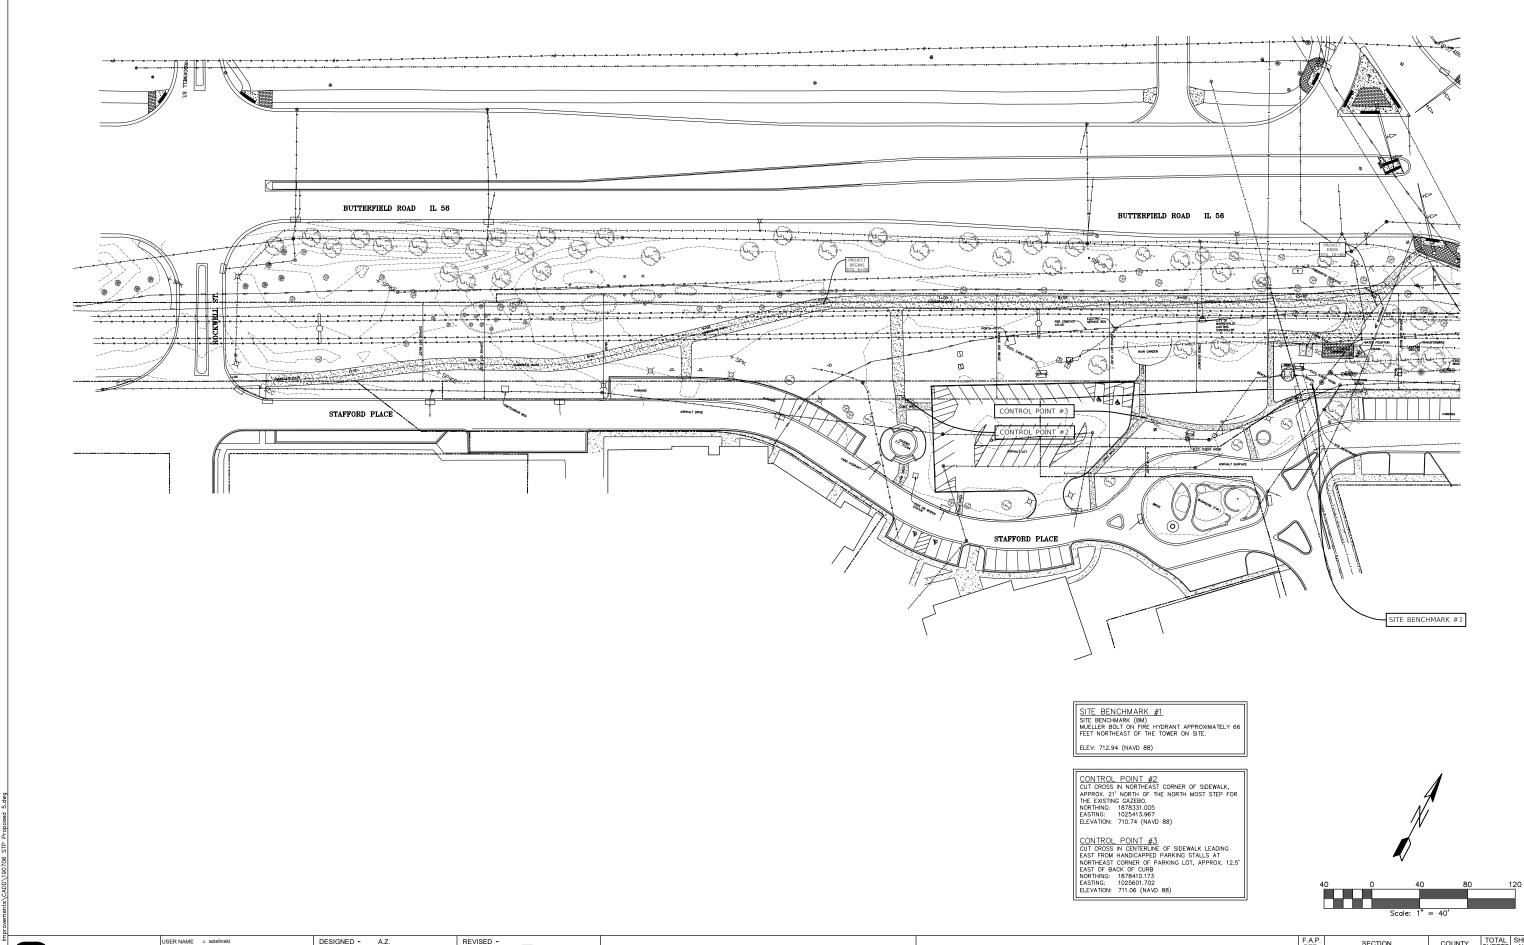


ENGINEERING RESOURCE ASSOCIATES

STATE OF ILLINOIS
DEPARTMENT OF TRANSPORTATION

ALIGNMENT AND BENCHMARKS

SHEET NO. 1 OF 1 SHEETS STA. 6+00 TO STA. 1/2

SCALE: 1"=40'

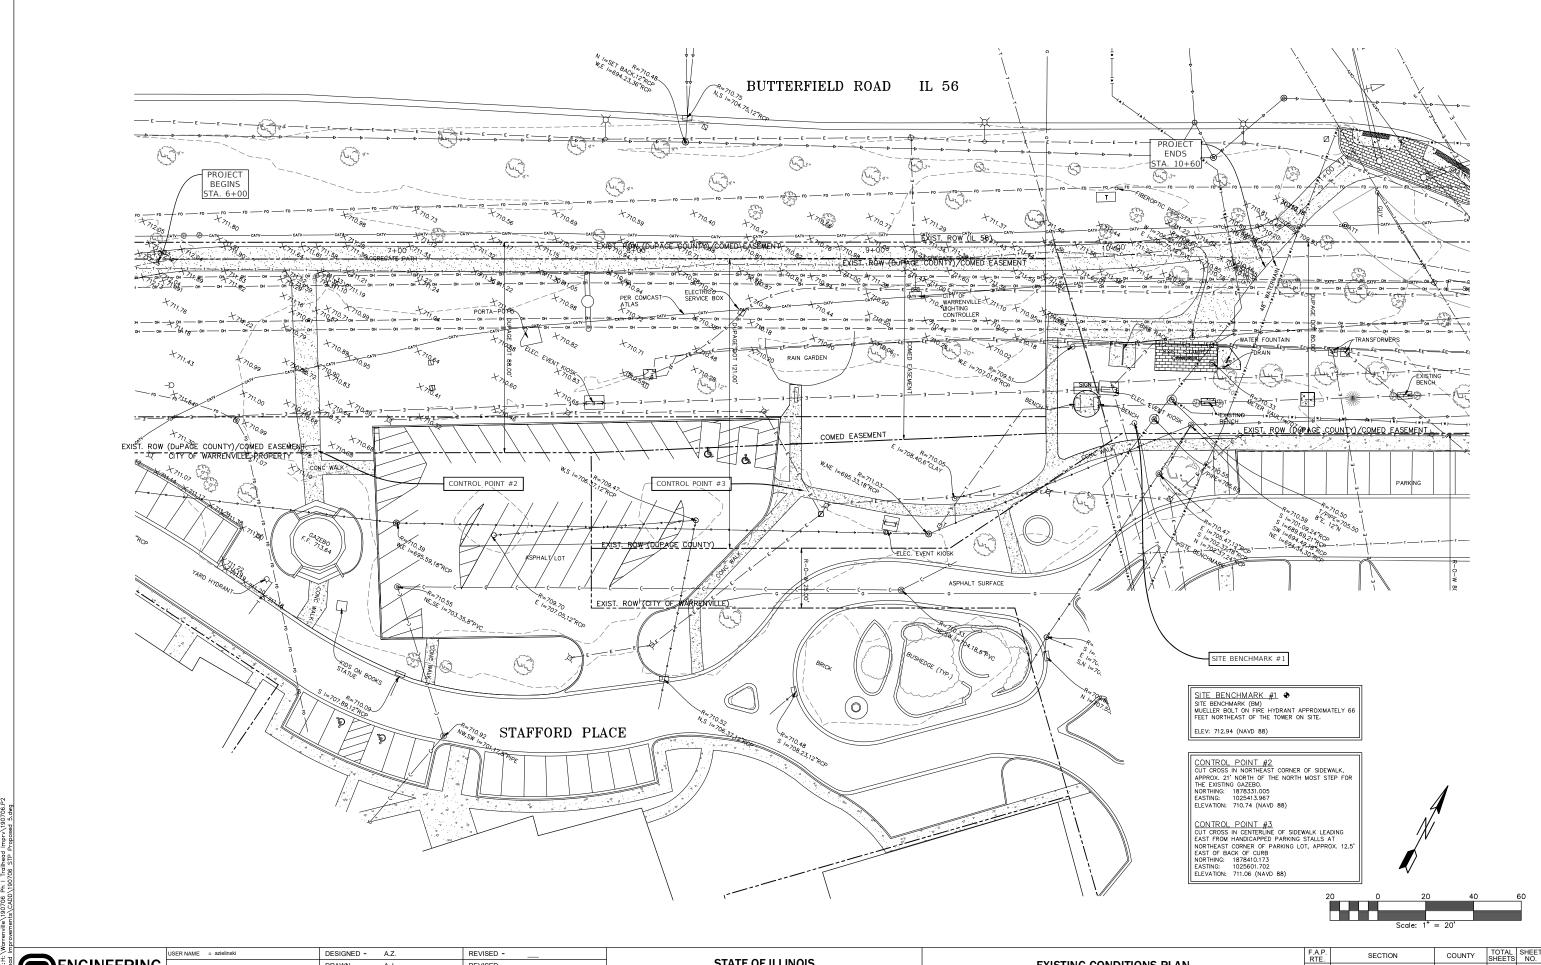

ENGINEERING
RESOURCE ASSOCIATES

USER NAME = azlelinski

PLOT SCALE = \$SCALES
PLOT DATE = 2/10/2022

STATE OF ILLINOIS
DEPARTMENT OF TRANSPORTATION


EXISTING CONDITIONS PLAN

SHEET NO. 1 OF 1 SHEETS STA. 6+00 TO STA. 10+60

SCALE: 1"=20'


F.A.P. RTE. SECTION COUNTY TOTAL SHEETS NO. 365 19-00039-00-BT DUPAGE 49 10

CONTRACT NO.: 61H18

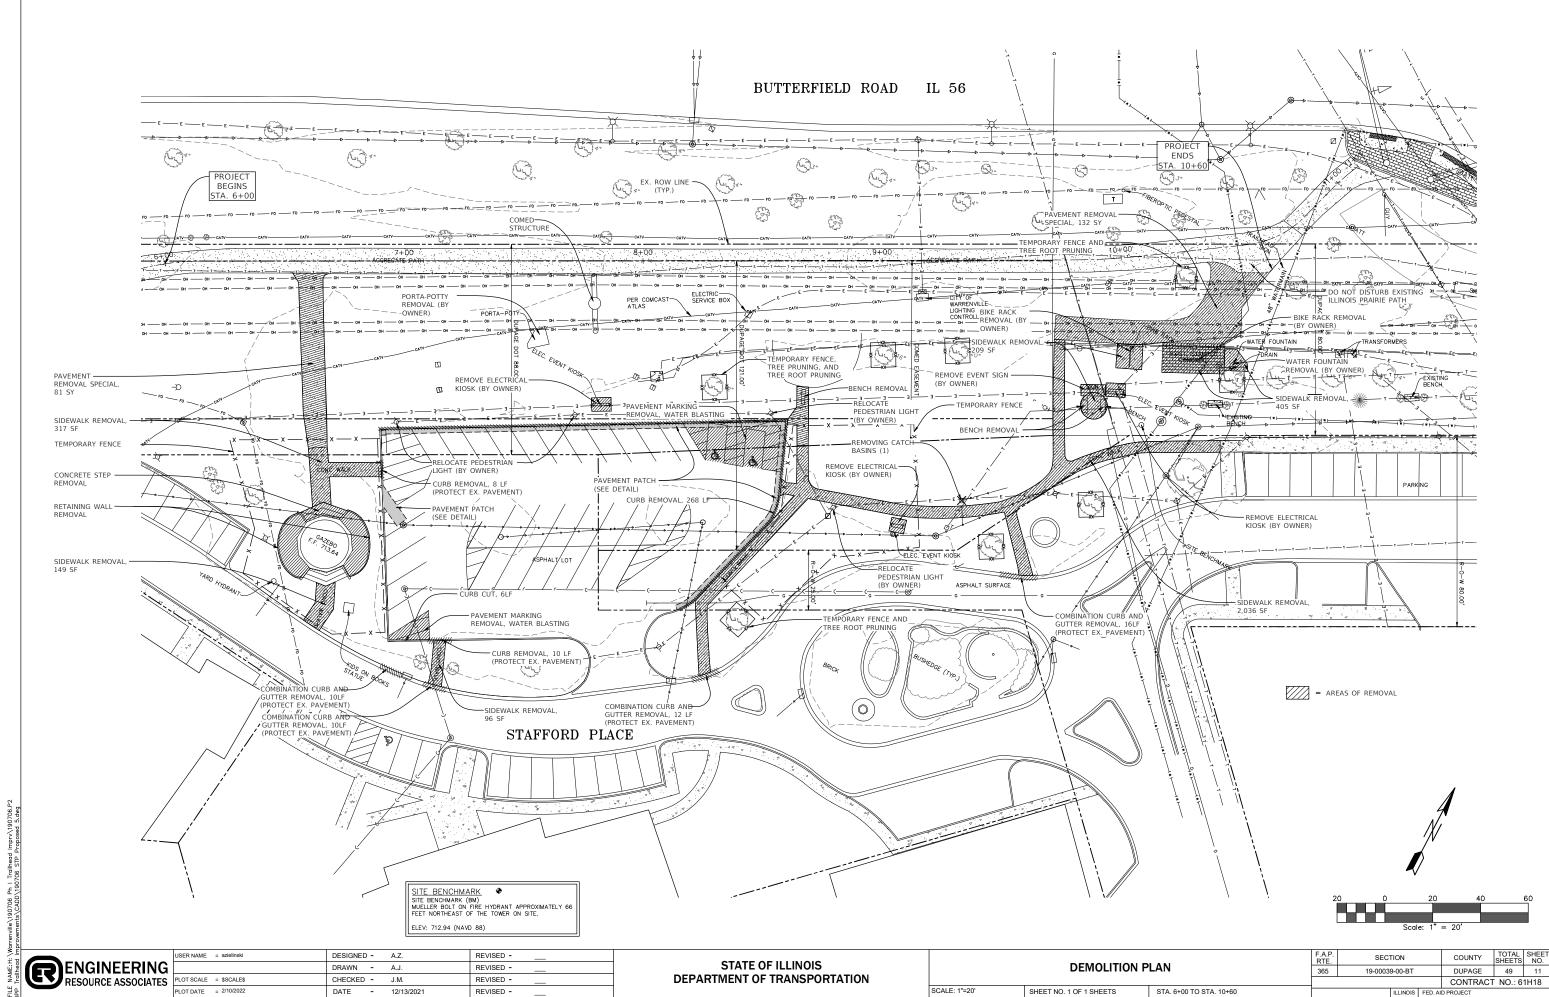

DATE - 12/13/2021

SHEET NO. 1 OF 1 SHEETS STA. 6+00 TO STA. 10+60

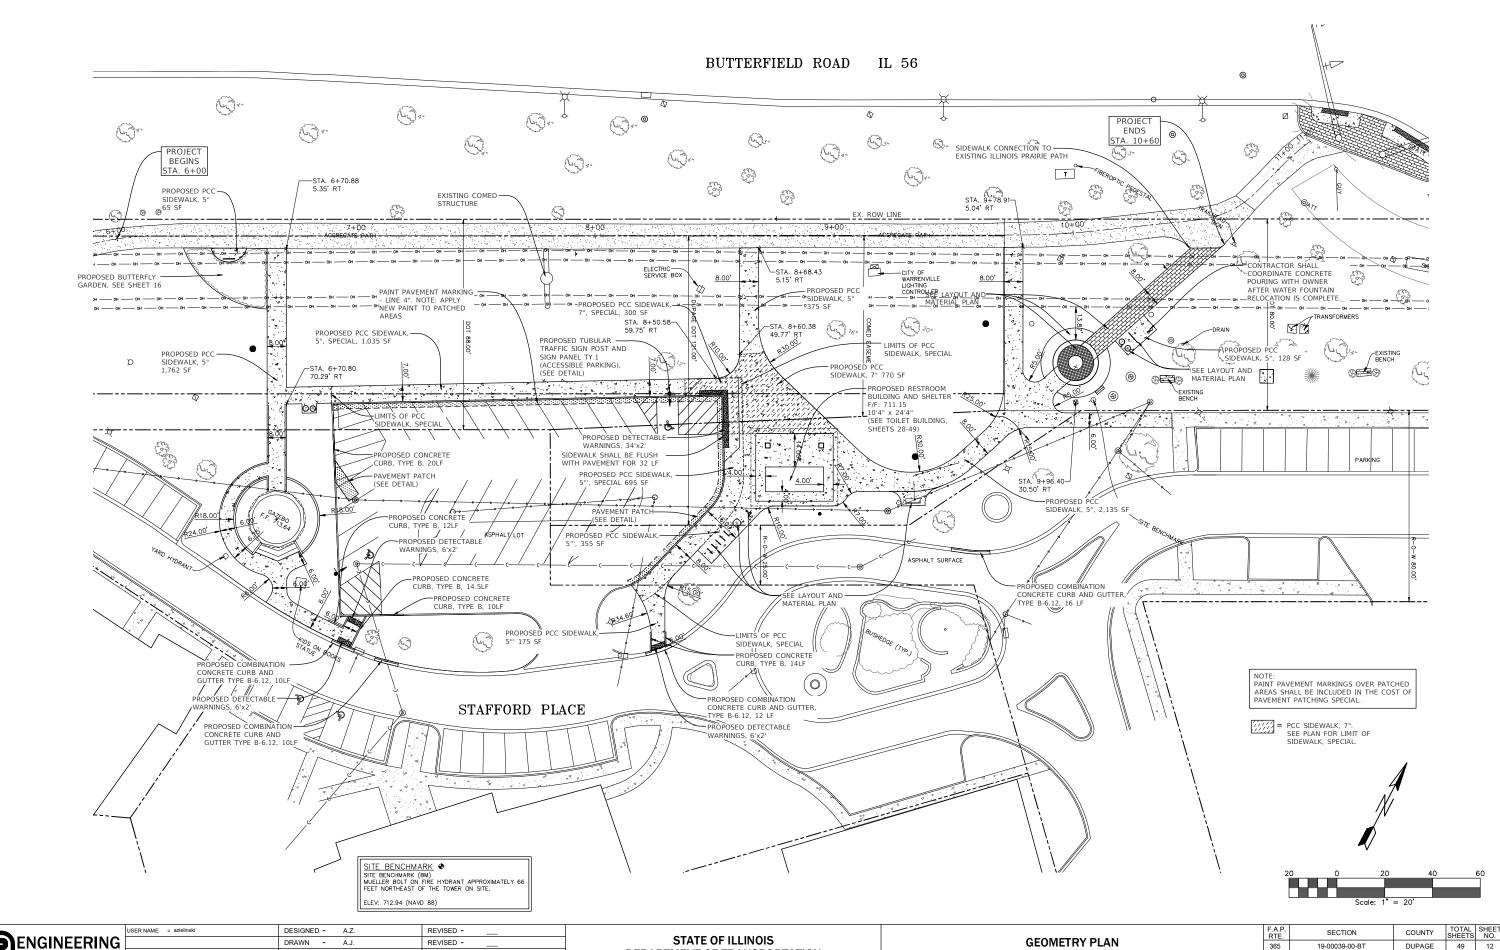


iLE NAME:H: \Warrenville\190706 Ph I Trailhead Imprv\190706 PP Trailhead Improvements\CADD\190706 STP Proposed 5.dw

ENGINEERING
RESOURCE ASSOCIATES

PLOT SCALE = SSCALES
PLOT DATE = 2/10/2022

DEPARTMENT OF TRANSPORTATION

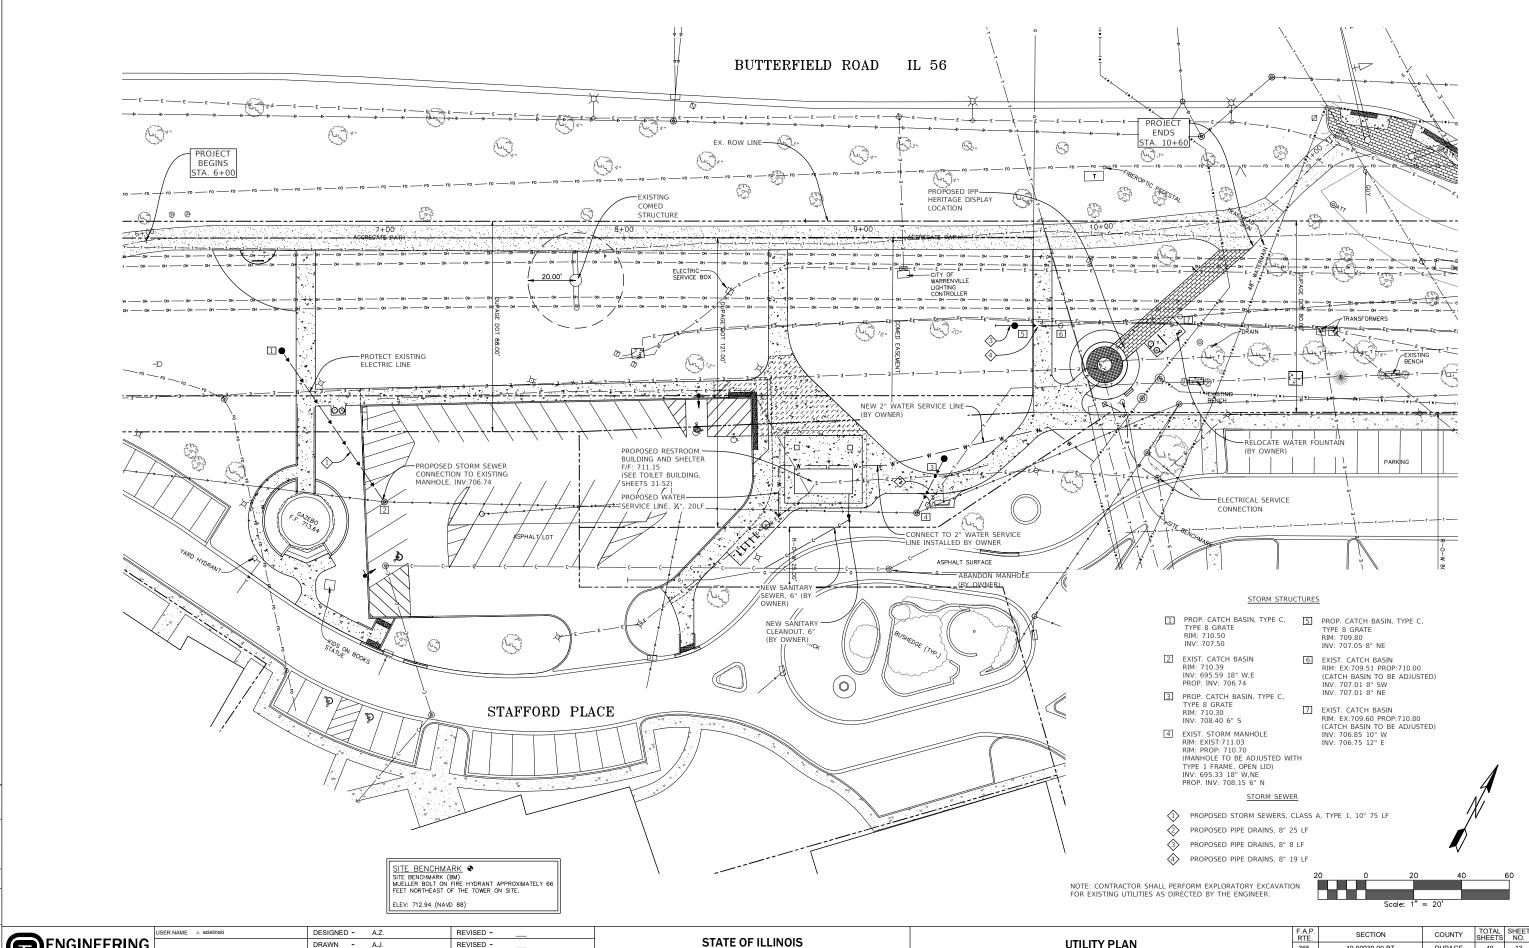

ENGINEERING RESOURCE ASSOCIATES


DRAWN -REVISED -A.J. RESOURCE ASSOCIATES PLOT SCALE = \$SCALE\$ CHECKED -J.M. REVISED -DATE - 12/13/2021 REVISED -


DEPARTMENT OF TRANSPORTATION


UTILITY PLAN SHEET NO. 1 OF 1 SHEETS STA. 6+00 TO STA. 10+60


SCALE: 1"=20'

DUPAGE 49 13 19-00039-00-BT 365 CONTRACT NO.: 61H18

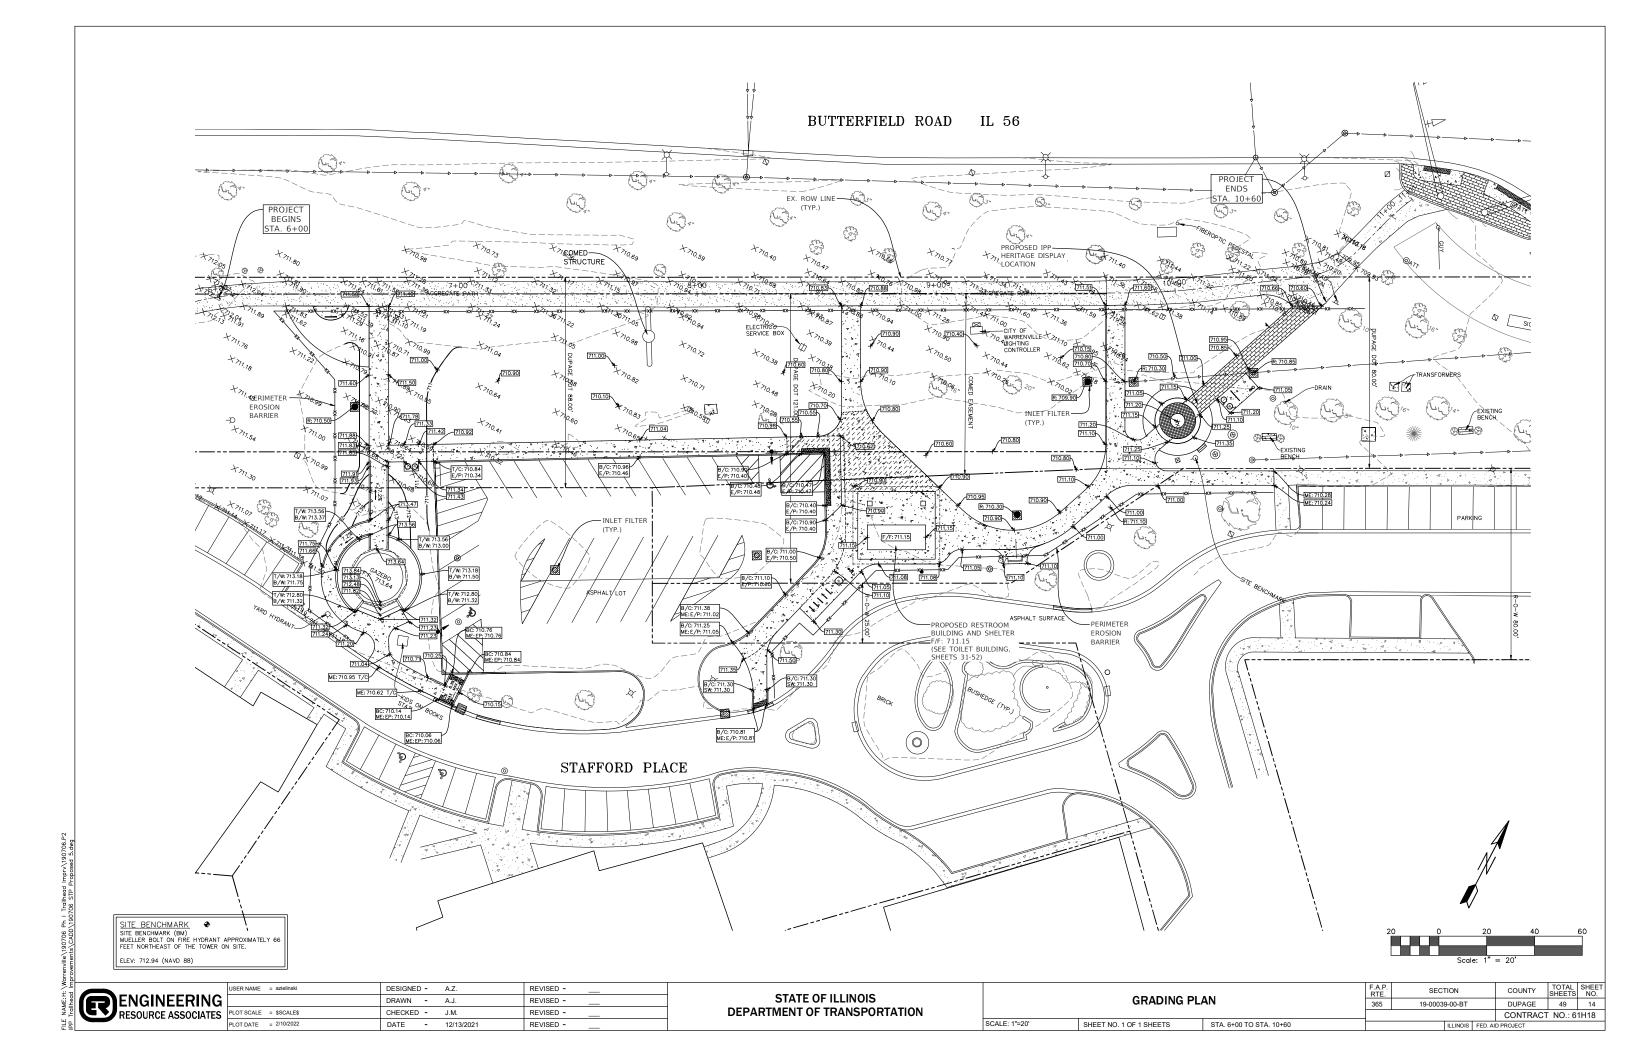

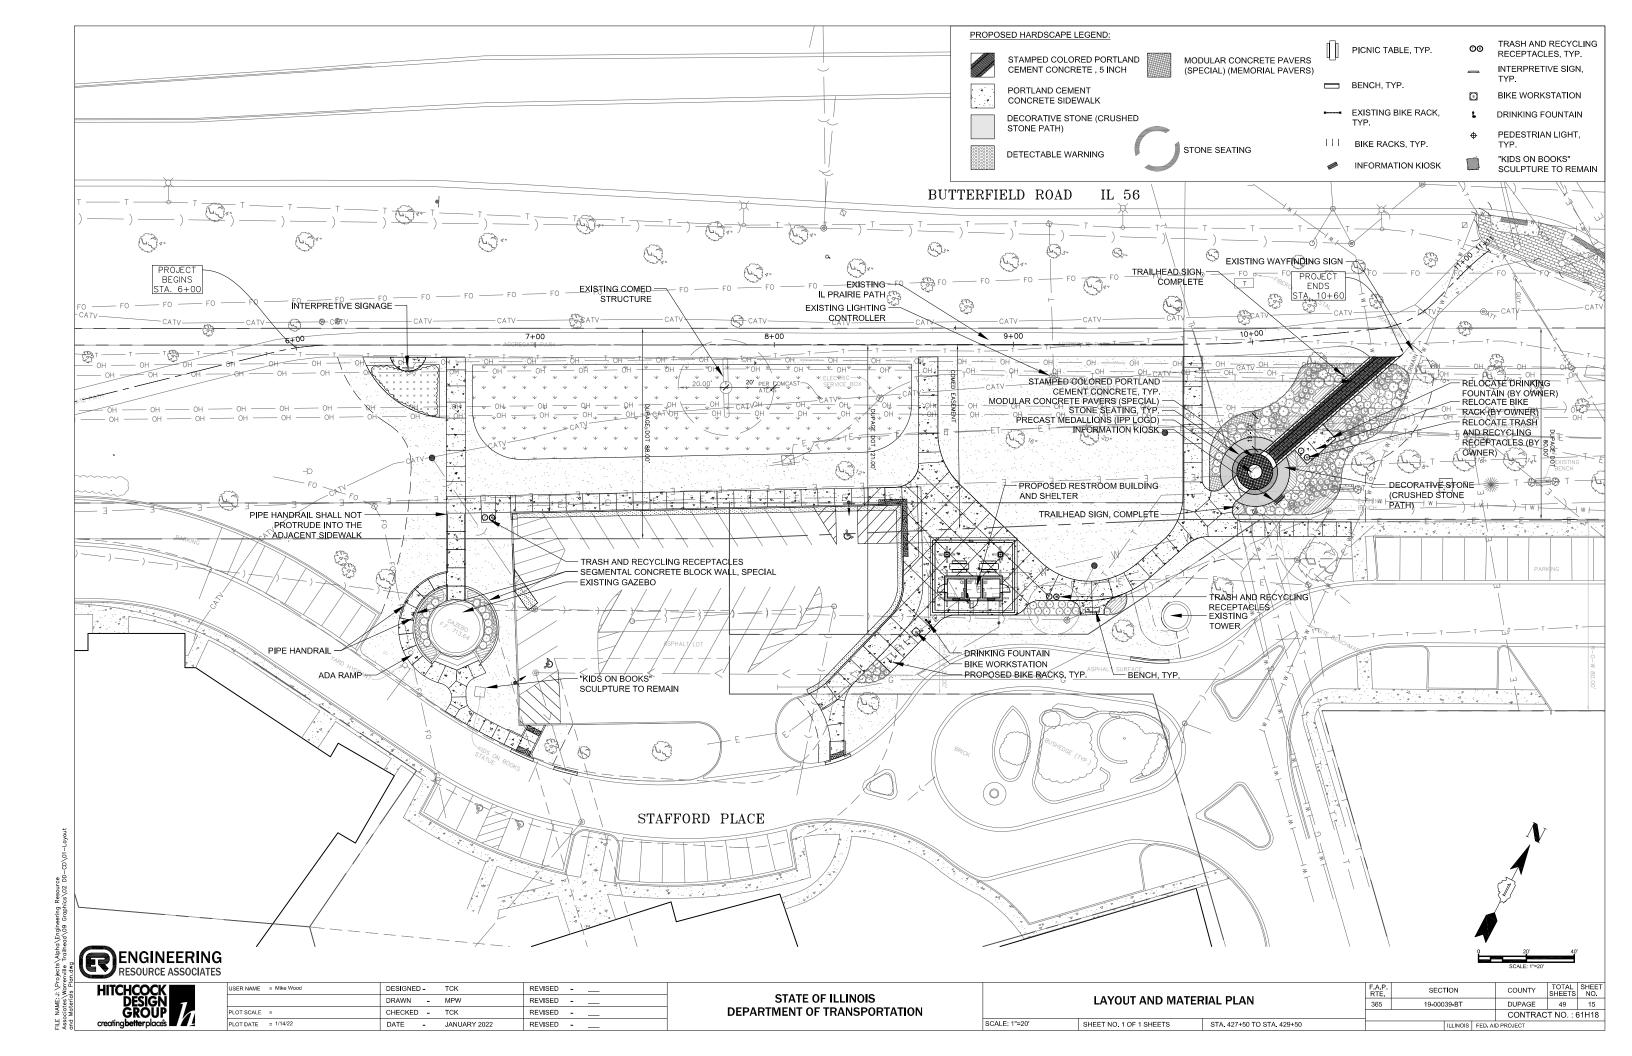

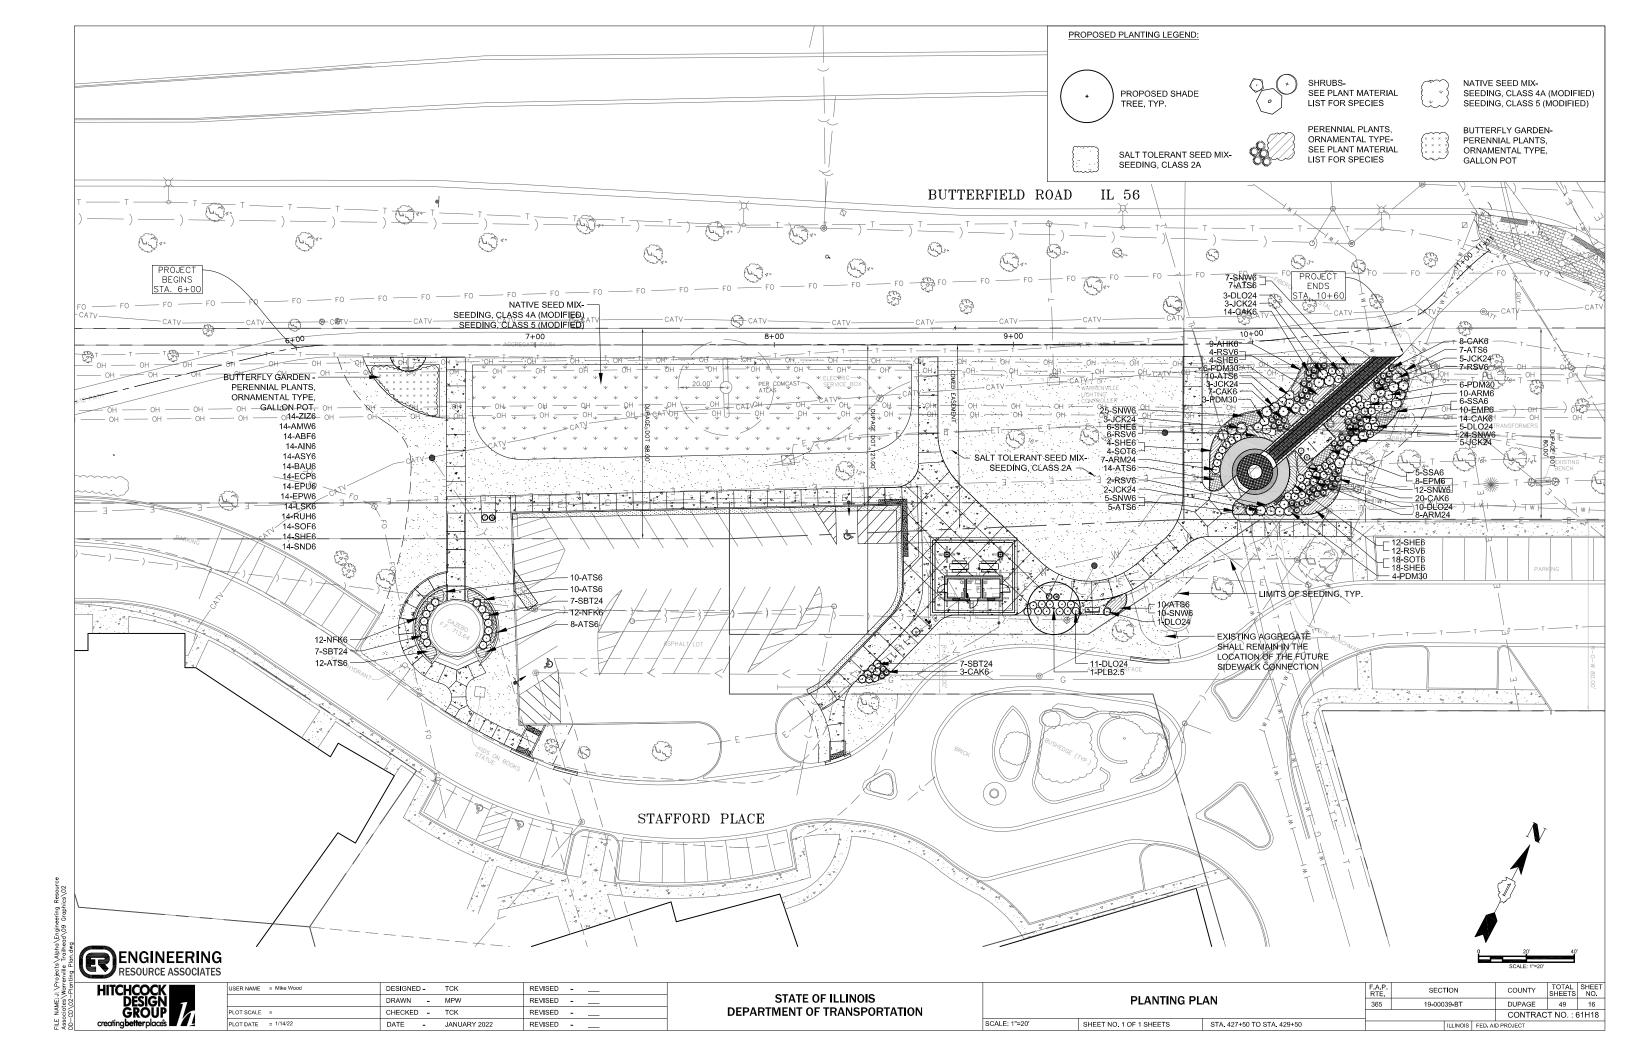

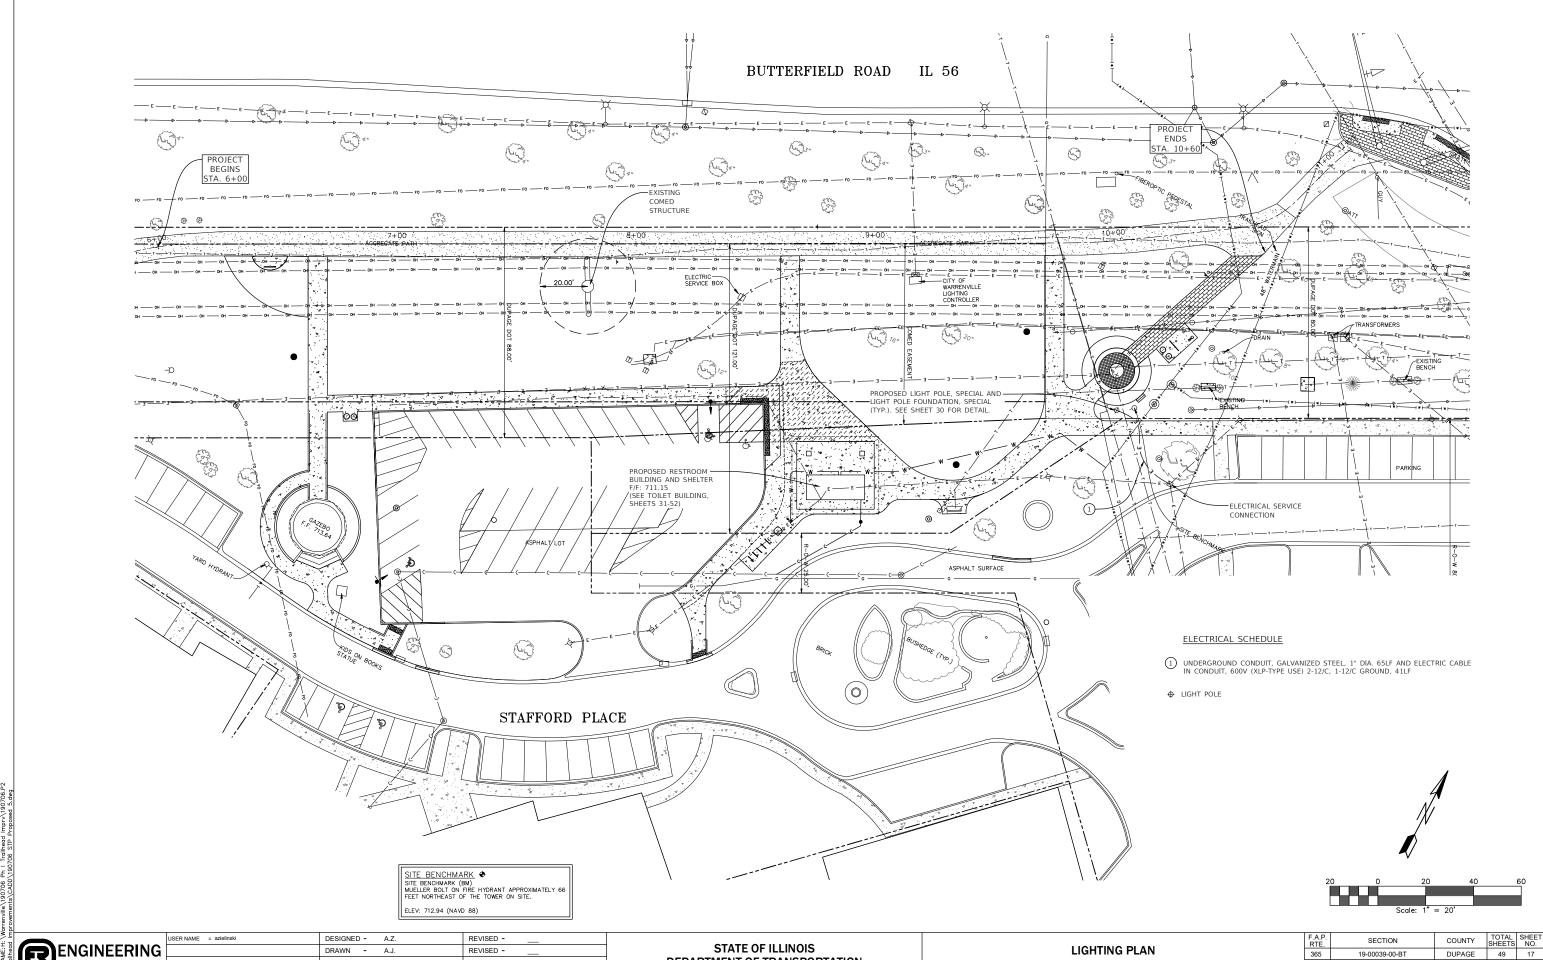

ENGINEERING RESOURCE ASSOCIATES RESOURCE ASSOCIATES

PLOT SCALE = \$SCALE\$


PLOT DATE = 2/10/2022

DRAWN -REVISED -A.J. CHECKED -J.M. REVISED -DATE - 12/13/2021 REVISED -

DEPARTMENT OF TRANSPORTATION

LIGHTING PLAN SCALE: 1"=20' SHEET NO. 1 OF 1 SHEETS STA. 6+00 TO STA. 10+60

19-00039-00-BT CONTRACT NO.: 61H18

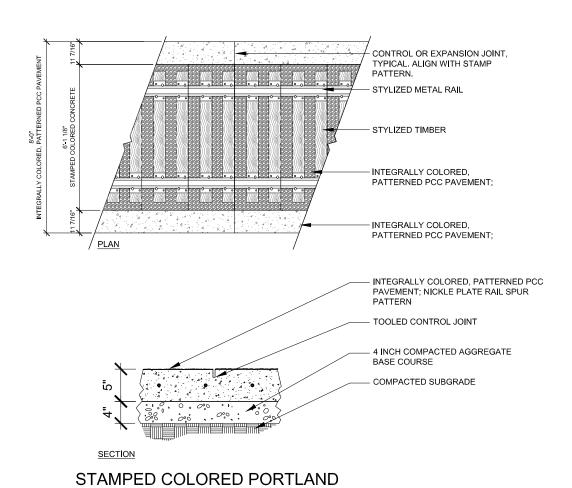


DECORATIVE STONE (CRUSHED STONE PATH) FINISH GRADE HEIGHT VARIES - 3' MAX., SEE GRADING PLANS FOR SPECIFIC HEIGHTS COPING UNIT ADHESIVE GEOGRID REINFORCEMENT AS REQUIRED - INSTALL PER MANUFACTURERS RECOMMENDATIONS- EXTEND MIN. 4' INTO GRADE STANDARD WALL UNIT GRANULAR BACKFILL FILTER FABRIC 4" PERFORATED PVC PIPE, FABRIC LINED FINISH GRADE COMPACTED GRANULAR BASE COMPACTED SUBGRADE NOTE: PVC PIPE TO DAYLIGHT THROUGH UNIT WALL. MANUFACTURER: UNILOCK PRODUCT: RIVERCREST NOTE: CONTRACTOR TO PROVIDE STAMPED ENGINEERING DRAWINGS FOR REVIEW AND COLOR: TBD APPROVAL.

- LIMESTONE SCREENINGS

COMPACTED AGGREGATE

COMPACTED SUBGRADE

BASE COARSE

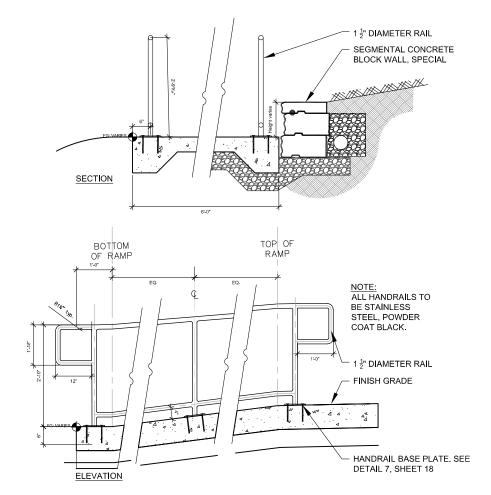

SEGMENTAL CONCRETE BLOCK WALL, SCALE: 3/4" = 1'-0

CUSTOM HIGH PRESSURE LAMINATE SIGN; INSTALL PER MANUFACTURERS' POST AND ASSOCIATED ALUMINUM POST CONNECTION PLATES TO BE ANCHOR BOLT POWDER COATED COLOR: BLACK ATTACHMENT PER MANUFACTURERS' RECOMMENDATIONS **** ADJACENT CONCRETE PAVING CONCRETE FOOTING COMPACTED GENERAL NOTES: 1 - GRAPHICS AND NOTES AGGREGATE BASE SHALL BE PROVIDED BY CITY 2 - SEE SPECIAL PROVISIONS COURSE, CA-6 FOR ADDITIONAL INFORMATION FRONT ELEVATION SIDE ELEVATION

3/8" PLATE 1-1/2" Ø POST 1/2" DIA. HILTI KWIK BOLT, GALVANIZED, 5 1/2" EMBEDMENT

HANDRAIL BASE PLATE

PIPE HANDRAIL

UNIT PAVER W/ SAND SWEPT JOINTS 1" SAND LEVELING BED FINISH GRADE FILTER FABRIC COMPACTED AGGREGATE BASE COARSE

CEMENT CONCRETE SIDEWALK, 5 INCH

MODULAR CONCRETE PAVERS (SPECIAL) (MEMORIAL PAVERS)



SCALE: NTS



U:	SER NAME = Mike Wood	DESIGNED -	TCK	REVISED
		DRAWN -	MPW	REVISED
PΙ	LOT SCALE =	CHECKED -	TCK	REVISED
PΙ	LOT DATE = 1/14/22	DATE -	JANUARY 2022	REVISED

COMPACTED SUBGRADE


STATE OF ILLINOIS **DEPARTMENT OF TRANSPORTATION**

							- 1	
		F.A.P. RTE	SECTION	COUNTY	TOTAL SHEETS			
		365	19-00039-BT	DUPAGE	49	18		
					CONTRAC	T NO. : 6	31H18	
	SHEET NO. 1 OF 7 SHEETS	STA, 427+50 TO STA, 429+50		ILLINOIS FEE	, AID PROJECT		-	


INTERPRETIVE SIGNAGE, COMPLETE


Scale: 1/2" = 1'-0"

SCALE: AS NOTED

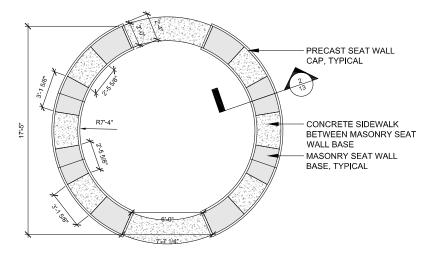




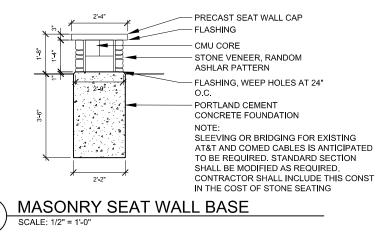

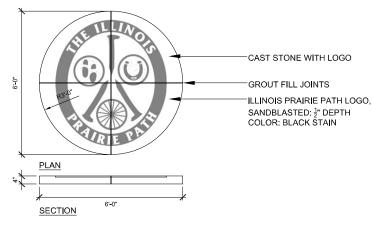



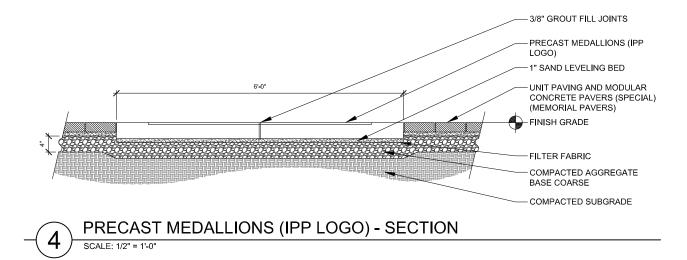





ER NAME = Mike Wood	DESIGNED - TCK	REVISED
	DRAWN - MPW	REVISED
OT SCALE =	CHECKED - TCK	REVISED
OT DATE = 1/14/22	DATE - JANUARY 2022	REVISED

SCALE: AS NOTED

		F.A.P. RTE			COUNTY	TOTAL SHEETS	SHEET NO.		
		365	19-00039-BT		DUPAGE	49	19		
						CONTRAC	T NO. : 6	61H18	
	SHEET NO. 2 OF 7 SHEETS	STA, 427+50 TO STA, 429+50				ILLINOIS FED. AID PROJECT			

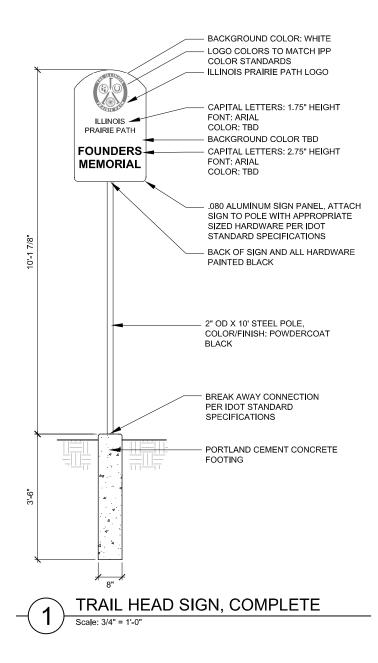

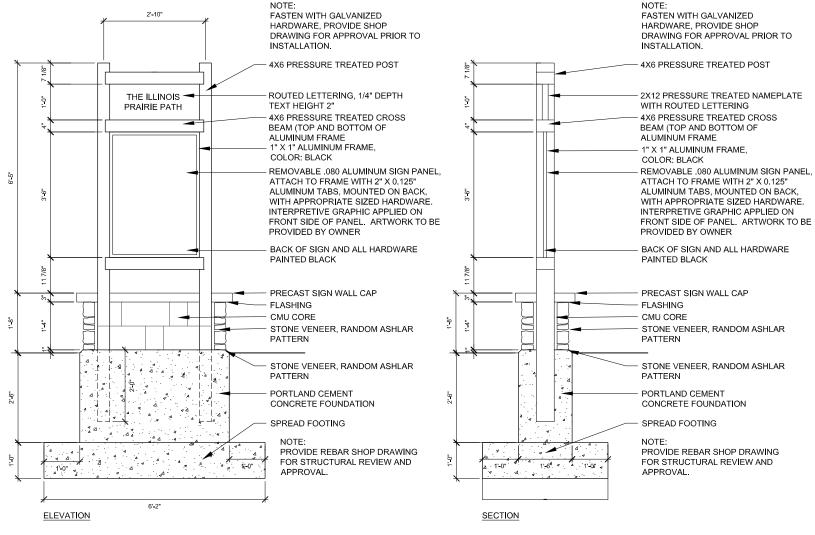

SCALE: AS NOTED





	100001111
HCOCK DESIGN GROUP Detterplaces	h

SER NAME = Mike Wood	DESIGNED - TCK	REVISED
	DRAWN - MPW	REVISED
LOT SCALE =	CHECKED - TCK	REVISED
LOT DATE = 1/14/22	DATE - JANUARY 2022	REVISED

STATE OF ILLINOIS DEPARTMENT OF TRANSPORTATION

ACMOTRUCTION R	CONSTRUCTION DETAILS	F.A.P. RTE	SEC ⁻	ΓΙΟΝ		COUNTY	TOTAL SHEETS	SHEET NO.	
CONSTRUCTION D	ETAILS	365	19-00039-BT			DUPAGE	49	20	
EET NO. 3 OF 7 SHEETS STA. 427+50 TO STA. 429+50						CONTRACT NO.: 61H18			
				ILLINOIS	FED. AI				



<u>Description</u>: Solar Charging Bench Manufacturer: Superior Amenities

1050 Columbia Drive Carrollton, GA 30117 866-268-1701 https://webcoat.com

Item: Size: SolarChargeBench 6' length, surface mount Frame Style: Casino Collection, horizontal strap


metal design

Material: 1.5" square powder coated legs and arms, textured polyethylene seat and back

Color:

Components: Solar panel attached to back with 2 dual 2.0 rapid-charge USB ports



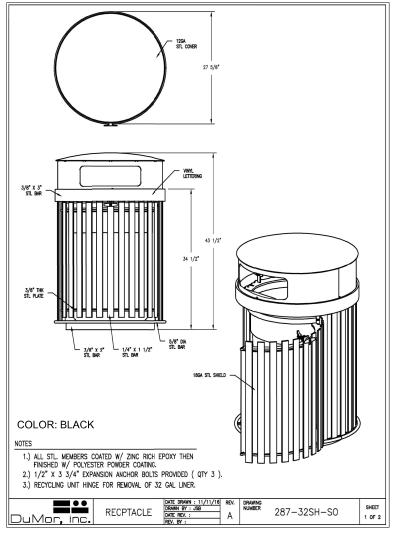







	USER NAME	-
1	PLOT SCALE	-
1	PLOT DATE	-

SER NAME = Mike Wood	DESIGNED - TCK	REVISED
	DRAWN - MPW	REVISED
OT SCALE =	CHECKED - TCK	REVISED
OT DATE = 1/14/22	DATE - JANUARY 2022	REVISED

CONSTRUCTION DETAILS					SECTION			TOTAL SHEETS	SHEET NO.
CONSTRUCTION DETAILS			365	19-00039-BT			DUPAGE	49	21
						CONTRACT NO.: 61H1			
SCALE: AS NOTED	SHEET NO. 4 OF 7 SHEETS	STA. 427+50 TO STA. 429+50			ILLINOIS	FED. AI	D PROJECT		

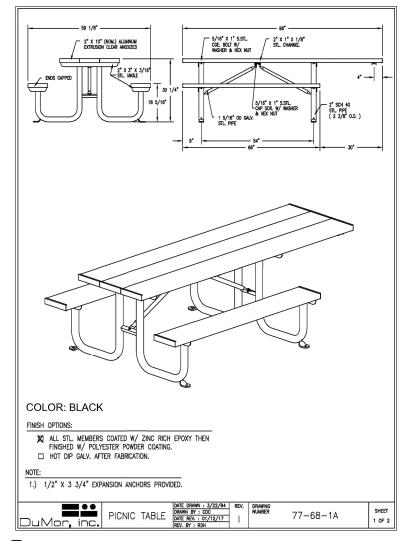



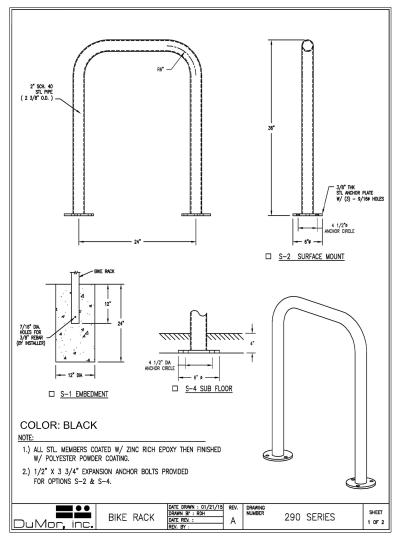







SER NAME = Mike Wood	DESIGNED - TCK	REVISED
	DRAWN - MPW	REVISED
LOT SCALE =	CHECKED - TCK	REVISED
LOT DATE = 1/14/22	DATE - JANUARY 2022	REVISED

STATE OF ILLINOIS DEPARTMENT OF TRANSPORTATION

CONSTRUCTION DETAILS				SEC	TION		COUNTY	TOTAL SHEETS		
CONSTRUCTION DETAILS			365	19-000	19-00039-BT			49	22	
							CONTRAC	T NO. : 6	31H18	
SCALE: AS NOTED	SHEET NO. 5 OF 7 SHEETS	STA, 427+50 TO STA, 429+50	ILLINOIS			FED. AI	D PROJECT			

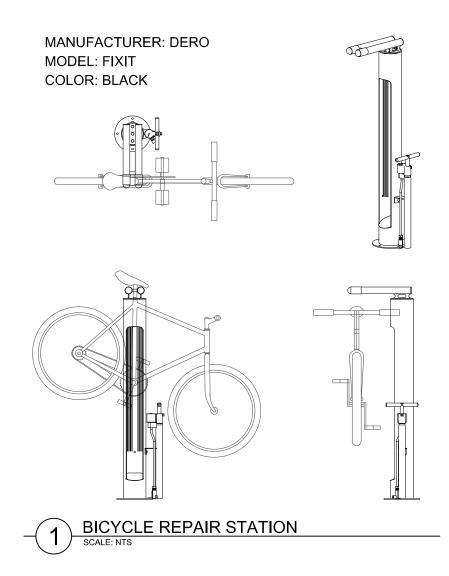

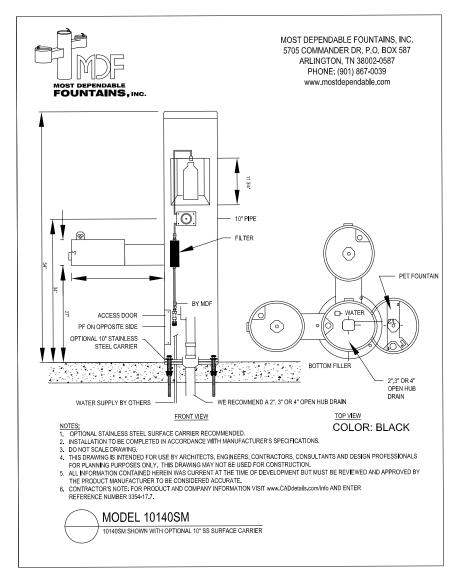




SCALE: AS NOTED




SER NAME = Mike Wood	DESIGNED - TCK	REVISED
	DRAWN - MPW	REVISED
LOT SCALE =	CHECKED - TCK	REVISED
OT DATE = 1/14/22	DATE - JANUARY 2022	REVISED

STATE OF ILLINOIS DEPARTMENT OF TRANSPORTATION


	CONSTRUCTION DETAILS		F.A.P. RTE.	SECTION		COUNTY	TOTAL SHEETS	SHEET NO.	
			365	19-00039-BT	DUPAGE	49	23		
				CONTRACT NO.: 61H18					
	SHEET NO. 6 OF 7 SHEETS	STA. 427+50 TO STA. 429+50		ILLINOIS	FED. A	PROJECT			

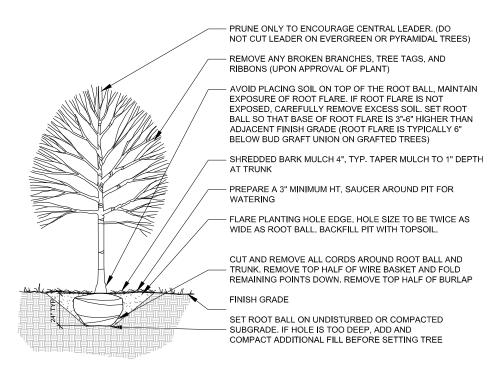

DECIDUOUS TREE PLANTING

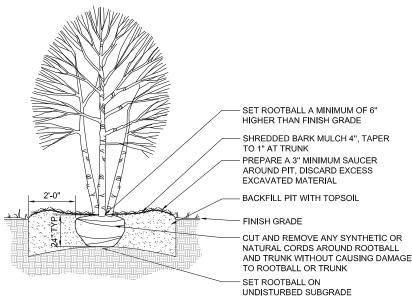

ORNAMENTAL TREE PLANTING SCALE: NTS

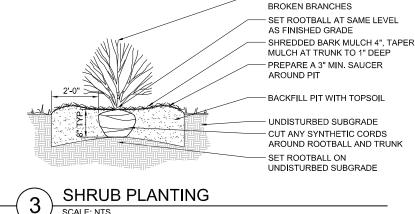

LIMIT PRUNING TO DEAD AND

SET PLANTS AT SAME LEVEL AS GROWN IN CONTAINER FURNISH AND PLACE TOPSOIL TO A DEPTH OF 12" AND SOIL CONDITIONER TO A DEPTH OF 3" IN ALL PLANTING AREAS SHREDDED BARK MULCH 2". WORK MULCH UNDER BRANCHES RAISE PLANT BED 2" ABOVE FINISH GRADE UNDISTURBED SUBGRADE



SEE PLANTING PLAN



ALL PERENNIALS TO BE PAID FOR AS PERENNIAL PLANTS, ORNAMENTAL TYPE, GALLON POT (1 UNIT = 100 PLANTS)

TOTAL PERENNIALS: TOTAL UNITS:

597

5.97

PLANTING NOTES

- 1. SEED TO LIMITS OF DISTURBANCE FOR RESTORATION ONLY. CONTRACTOR IS RESPONSIBLE FOR RESTORATION OF ANY UNAUTHORIZED DISRUPTION OUTSIDE OF DESIGNATED CONSTRUCTION AREA.
- 2. CONTRACTOR IS RESPONSIBLE FOR EROSION CONTROL IN ALL DISTURBED AREAS. ALL DISTURBED AREAS ARE TO BE PROTECTED WITHIN 24 HOURS. DO NOT DISTURB MORE AREA THAN CAN BE COMPLETED AND PROTECTED WITHIN 24 HOURS.
- 3. PLACE TOPSOIL TO A DEPTH OF 4 INCHES FOR ALL SEED AREAS. PLACE TOPSOIL TO A DEPTH OF 12 INCHES AND SOIL CONDITIONER TO A DEPTH OF 3" FOR ALL PLANTING BED AND BUTTERFLY GARDEN AREAS.
- 4. PERENNIAL MIXES IN PLANTING BEDS AND BUTTERFLY GARDEN TO BE INSTALLED IN GROUPINGS OF 3, 5, OR 7 AND TO BE SPREAD EVENLY BUT RANDOMLY THROUGHOUT THE PLANTING AREA, SEE PLANT MATERIAL LIST FOR SPACING.
- 5. PROVIDE EROSION CONTROL BLANKET FOR ALL SEEDING CLASS 2A AREAS. PROVIDE MULCH METHOD 2 FOR ALL SEEDING CLASS 4A (MODIFIED) AND SEEDING CLASS 5 (MODIFIED)
- 6. REFER TO THE SPECIAL PROVISIONS FOR ADDITIONAL CONDITIONS, STANDARDS AND NOTES.




	USER NAME = Mike Wood	DESIGNED -	TCK	REVISED
		DRAWN -	MPW	REVISED
7	PLOT SCALE =	CHECKED -	TCK	REVISED -
4	PLOT DATE = 1/14/22	DATE -	JANUARY 2022	REVISED -


STATE OF ILLINOIS **DEPARTMENT OF TRANSPORTATION**

SCALE: AS NOTED

AANATRIJATIAN R	CONSTRUCTION DETAILS	F.A.P. RTE	SECT	ION		COUNTY	TOTAL SHEETS	SHEET NO.			
CONSTRUCTION D	CONSTRUCTION DETAILS		19-00039-BT			DUPAGE	48	24			
						CONTRACT NO.: 61H18					
SHEET NO. 7 OF 7 SHEETS STA. 427+50 TO STA. 429+50				ILLINOIS	EED All	D PROJECT					

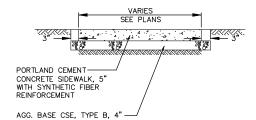

P.C.C. SIDEWALK, 5" DETAIL

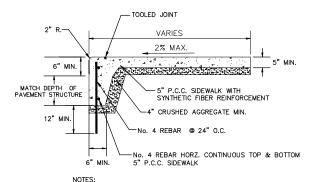


NOTES:


1. CLASS SI CONCRETE SHALL BE USED THROUGHOUT (UNLESS OTHERWISE NOTED)

2. MAXIMUM SIDEWALK EXPANSION JOINT SPACING IS 40-FEET.

P.C.C. SIDEWALK, 5", SPECIAL DETAIL

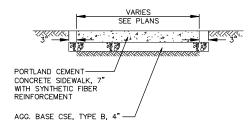

P.C.C. SIDEWALK, 7" DETAIL

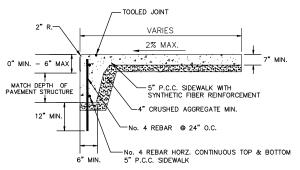

NOTES:

CLASS SI CONCRETE SHALL BE USED THROUGHOUT (UNLESS OTHERWISE NOTED)

2 MAXIMUM SIDEWALK EXPANSION JOINT SPACING IS 40-FEET.

P.C.C. SIDEWALK, 7", SPECIAL DETAIL

R7-8 SIGN
COLORS

LETITERS & BORDER = BLUE
WHITE SYMBOL ON BLUE
BACKGROUND
SIGN BACKGROUND = WHITE RESERVED PARKING R7-I101P PLAQUE COLORS LETTERS & BORDER = GREEN REFLECTORIZED SIGN BACKGROUND = WHITE, REFLECTORIZED \$250 FINE - 2" O.D. GALVANIZED STEEL TUBULAR TRAFFIC SIGN POST WITH BLACK POWDER COAT -LINE OF GRADE


ACCESSIBLE SIGN DETAIL NOT TO SCALE




USER NAME = azielinski	DESIGNED - A.Z.	REVISED	
	DRAWN - A.J.	REVISED	
PLOT SCALE = \$SCALE\$	CHECKED - J.M.	REVISED	
PLOT DATE = 2/10/2022	DATE - 12/13/2021	REVISED -	

STATE OF ILLINOIS **DEPARTMENT OF TRANSPORTATION**

		F.A.P. RTE.	SEC	TION		COUNTY	TOTAL SHEETS	SHEET NO.			
	CONSTRUCTION DETAILS			365	19-0003	19-00039-00-BT			49	49 25	
								CONTRACT NO.: 61H18			
SCALE: NONE SHEET NO. 8 OF 10 SHEETS STA TO STA ILLINOIS FED. AID PROJECT											

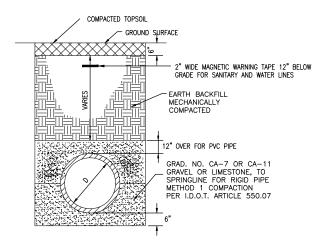

TRENCH SECTION IN UNPAVED AREAS

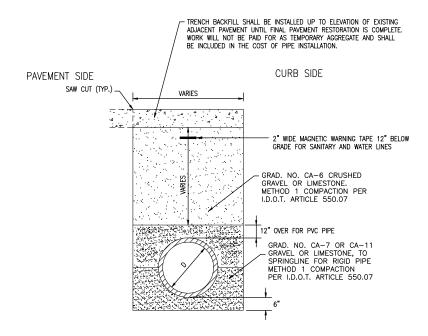


NOTES:

ALL TRENCHES SHALL BE SAWCUT AND THE COST SHALL BE INCLUDED IN THE COST OF THE PIPE.


REMOVE ONLY SUFFICIENT PAVEMENT TO PERFORM PIPE INSTALLATION AND COORDINATE WITH ENGINEER.

TRENCH SECTION IN PAVED AREAS

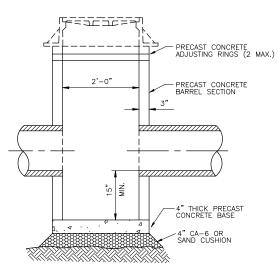

CATCH BASIN, TYPE C

- 1. PRECAST-REINFORCED CONCRETE RISER RINGS AND CONES SHALL COMPLY WITH TEST STRENGTH - A.S.T.M. C-39. ADJUSTMENT RINGS SHALL NOT EXCEED 8" IN HEIGHT.
- 2. MINIMUM WALL THICKNESS SHALL BE 5" AND MINIMUM CIRCULAR REINFORCEMENT SHALL BE 0.18 SQUARE INCH PER FOOT.
- THE BOTTOM MAY BE EITHER PRECAST AS INTEGRAL PART OR CAST IN PLACE WITH CLASS "SI" CONCRETE.
- 4. MANHOLE WALL THICKNESS "T" SHALL BE AS SHOWN IN THE LIST BELOW.
- 5. ALL STEPS SHALL BE CAST IRON.
- 6. ALL JOINTS BETWEEN PRE-CAST ELEMENTS, ADJUSTING RINGS AND MANHOLE FRAMES ON ALL UNDERGROUND STRUCTURES, SHALL BE SET IN PLACE WITH A RUBBER JOINT SEALANT, AND ALL JOINTS TO BE TUCKPOINTED WITH HYDRAULIC CEMENT.
- 7. FOR LOCATIONS WITH A BEEHIVE GRATE, SIX—INCHES OF ADJUSTING RINGS SHALL BE INCLUDED ON TOP OF THE SLAB TO ALLOW TOPSOIL PLACEMENT AND GRASS ESTABLISHMENT ABOVE THE SLAB.
- 8. IN GENERAL, USE TYE 8 GRATE IN LAWN AREAS.IN LAWN AREAS WHERE TREES ARE PRESENT, IN PUBLIC RICHT-OF-WAY, AND IN DITCHES, USE STOOL TYPE GRATE. CONTRACTOR SHALL CONFIRM GRATE TYPES WITH ENGINEER.

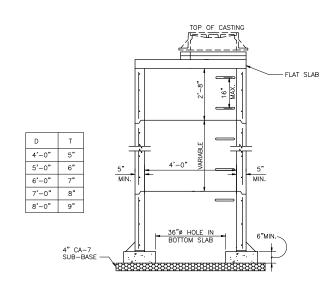

INLET SPECIAL NOT TO SCALE


DESIGNED -A.Z. REVISED -ENGINEERING RESOURCE ASSOCIATES DRAWN -REVISED -A.J. RESOURCE ASSOCIATES 🗄 PLOT SCALE = \$SCALE\$ CHECKED -J.M. REVISED -12/13/2021 REVISED -

STATE OF ILLINOIS **DEPARTMENT OF TRANSPORTATION**

CONSTRUCTION DETAILS			F.A.P. RTE.	SECT	ION		COUNTY	TOTAL SHEETS	SHEET NO.		
			365	19-00039-00-BT		DUPAGE	49	26			
								CONTRAC	T NO.: 6	1H18	
	SHEET NO. 9 OF 10 SHEETS	STA TO STA				ILLINOIS	FED. AI	D PROJECT			

DATE 01-11-11

INLET PROTECTION - PAVED AREAS DROP-IN PROTECTION GRATE-CASTING-SUPPORT SYSTEM — WITH LIFT HANDLES -OVERFLOW AREA SEDIMENT BAG/FILTER STRUCTURE —C□VER GRATE-SEE DETAI⊢ AB□∨E -CASTING □VERFL□V AREA -SUPPORT SYSTEM WITH LIFT HANDLES INLET—— STRUCTURE MADTS-SEWER Project Designed Checked STANDARD DWG. NO. IUM-561D SHEET 1 OF 1

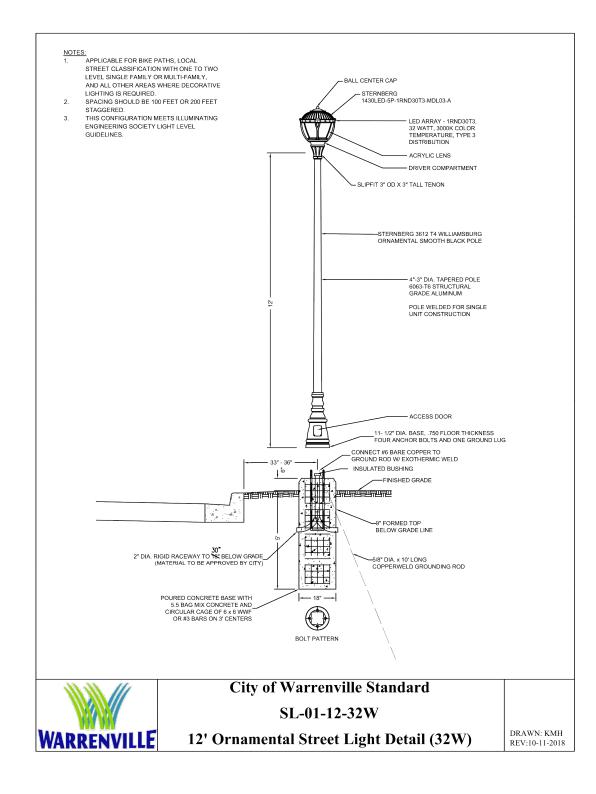

	I
ENGINEERING BESOURCE ASSOCIATES	ļ
RESOURCE ASSOCIATES	ŀ

USER NAME = azielinski	DESIGNED - A.Z.	REVISED
	DRAWN - A.J.	REVISED -
PLOT SCALE = \$SCALE\$	CHECKED - J.M.	REVISED -
PLOT DATE = 1/17/2022	DATE - 12/13/2021	REVISED -

	OONICT DUCTION D		F.A.P. RTE.	SECTION		COUNTY	TOTAL SHEETS	SHEET NO.
CONSTRUCTION DETAILS				19-00039-00-BT		DUPAGE	49	27
				•		CONTRACT	NO.: 6	1H18
SCALE: NONE	SHEET NO. 10 OF 10 SHEETS	STA TO STA		ILLINOIS	FED. AID	PROJECT		

A. GENERAL NOTES

- ALL CONTRACTORS ARE REQUIRED TO MSIT THE SITE AND BE KNOWLEDGEABLE REGARDING EXISTING CONDITIONS AND THEIR EFFECT ON THE PROPOSED WORK. CONTRACTORS SHALL VERIFY AND BE RESPONSIBLE FOR, ANY CONDITIONS REQUIRING MODIFICATION BEFORE PROCEEDING WITH THE PROJECT.
- 2. NOTIFY THE OWNER'S REPRESENTATIVE A MINIMUM OF 72 HOURS PRIOR TO THE INTERRUPTION OF ANY UTILITY.
- 3. PROTECT AND KEEP IN SERVICE ACTIVE UNDERGROUND UTILITIES, PIPES, OR CONDUITS, WHETHER INDICATED ON THE DRAWINGS OR NOT, UNLESS SPECIFICALLY CALLED FOR TO BE REMOVED, RELOCATED, OR DISCONNECTED AND
- 4. CONTRACTORS AND SUBCONTRACTORS SHALL COORDINATE THEIR WORK WITH THAT OF OTHER TRADES.
- 5. NO WORK WILL BE PERMITTED TO BE INSTALLED WITHOUT RECEIPT AND SUBSEQUENT REVIEW OF FULL AND COMPLETE SUBMITTALS BY THE ARCHITECT/ENGINEER.
- 6. DO NOT SCALE DRAWINGS, DIMENSIONS INDICATED TAKE PRECEDENCE OVER SCALE.
- VERIFY ALL DIMENSIONS AND ELEVATIONS IN THE FIELD. WHERE DISCREPANCIES ARE FOUND BETWEEN DIMENSIONS OR ELEVATIONS SHOWN AND ACTUAL FIELD CONDITIONS, NOTIFY ARCHITECT/ENGINEER.
- 8. WHERE CONFLICTS MAY EXIST BETWEEN THE REQUIREMENTS OF PORTIONS OF THE CONTRACT DOCUMENTS, THE GREATER QUANTITY, HIGHER QUALITY OR MORE STRINGENT REQUIREMENT SHALL GOVERN. THEREFORE, BY EXECUTING A CONTRACT FOR CONSTRUCTION, THE CONTRACTOR AGREES THAT, FIT RASSED NO QUESTIONS GEADEN US SUCH CONFLICTS DURING THE BIDDING PROCESS, AND IN THE ABSENCE OF A CLARIFYING ADDENDUM ISSUED DURING THE BIDDING PROCESS, IT HAS VOLUNTEERED TO COMPLY WITH THE MORE EXPENSIVE REQUIREMENT AS PART OF ITS BASE BID AND IS NOT ENTITLED TO ANY ADDITIONAL COMPENSATION TO RESOLVE THE CONFLICT.
- THE CONTRACT DOCUMENTS REQUIRE THE CONTRACTOR TO FURNISH AND INSTALL COMPLETE PRODUCTS, SYSTEMS AND SERVICES. BY EXECUTING A CONTRACT FOR CONSTRUCTION, THE CONTRACTOR AGRESS THAT THE DRAWNIGS SET FORTH THE DESIGN INTENT AND, THEREFORE, MAY NOT EXPRESSLY DEPICT EVERY LENGTH, SEGMENT, PIECE, PART, COMPONENT OR UNIT OF A PRODUCT, SYSTEM OR SERVICE. THE CONTRACTOR FURTHER AGREST THAT, AS PART OF ITS BID, IT MUST FURNISH AND INSTALL EVERY LENGTH, SEGMENT, PIECE, PART, COMPONENT OR UNIT OF A PRODUCT, SYSTEM OR SERVICE AND, CONSEQUENTLY, THE CONTRACTOR IS NOT ENTITLE OT ANY ADDITIONAL COMPENSATION FOR ANY LENGTH, SEGMENT, PIECE, PART COMPONENT OR UNIT OF A PRODUCT, SYSTEM OR SERVICE BY

B: MISCELLANEOUS AND DEMOLITION NOTES

- 1. COORDINATE PENETRATIONS AND OR SLEEVES REQUIRED IN WALLS FLOORS CEILINGS OR ROOFS FOR IECHANICAL AND ELECTRICAL WORK REQUIRED BY ARCHITECTURAL, MECHANICAL, ELECTRICAL, ANI
- SEAL WITH UL APPROVED MATERIALS PENETRATIONS OF DUCTWORK, CONDUIT AND PIPES THROUGH FIRE-RATED ASSEMBLIES, TO MAINTAIN THE RATING INTEGRITY OF THOSE ASSEMBLIES. PROVIDE FIRE DAMPERS AS INDICATED ON THE DRAWINGS.
- SEAL WITH ACOUSTICAL SEALANT PENETRATIONS OF DUCTWORK, CONDUIT AND PIPES THROUGH NON-RATED FLOORS, FULL-HEIGHT WALLS/PARTITIONS, ACOUSTICALLY INSULATED WALLS/PARTITIONS, AND SOUND-RATED WALLS/PARTITIONS, TO MAINTAIN THE ACOUSTICAL INTEGRITY OF THOSE ASSEMBLIES.
- 4. APPLY APPROPRIATE & COMPATIBLE SEALANT MATERIALS AS REQUIRED TO SEPARATE DISSIMILAR METALS, FILL GAPS IN EXISTING ASSEMBLIES OR WHERE NEW AND EXISTING ASSEMBLIES MEET OR WHERE OTHERWISE REQUIRED BY THE SPECIFICATIONS
- BRING ANY UNFORESEEN OR CONFLICTING CONDITIONS TO THE IMMEDIATE ATTENTION OF THE ARCHITECT/ENGINEER BEFORE PROCEEDING WITH THE WORK.
- 6. REPAIR, PATCH, OR REPLACE FINISH MATERIALS OR VISIBLE ASSEMBLIES THAT ARE SOILED, CUT OR DAMAGED IN ANY FASHION DURING THE COURSE OF THE WORK. PERFORM PATCHING SUCH THAT EDGES BLEND INTO CONTIGUOUS SURFACES SMOOTHLY, MATCHING TEXTURE AND COLOR OF ADJACENT

TOILET BUILDING ONLY

REQUIRED PLAN COVER SHEET INFORMATION FOR REVIEW UNDER 2015 INTERNATIONAL CODES, STATE OF ILLINOIS ACCESSIBILITY CODE. AND THE STATE OF ILLINOIS PLUMBING CODE CODE REVIEW DATA

GENERAL STATEMENT OF OVERALL PROJECT SCOPE AND INTENT:

PROJECT CONSISTS OF CONSTRUCTION OF A TOILET BUILDING FOR A PARK FACILITY. THE BUILDING IS UNOCCUPIED OTHER THAN WHEN USING OR SERVICING THE TOILET FACILITIES.

- A. USE AND OCCUPANCY GROUP(S) CLASSIFICATION: U
- B. TYPE OF CONSTRUCTION: VB
- C. SQUARE FOOTAGE OF BUILDING: 835 S.F.; INCLUDING COVERED AREAS, BUT NOT INCLUDING PERIMETER OVERHANG. NOT SPRINKLERED; NOT ALARMED
- D. OCCUPANT LOAD BASED ON INTERNATIONAL BUILDING CODE: 0
- F. OCCUPANT LOAD BASED ON ILLINOIS PLUMBING CODE: 0
- F. THE DESIGN PROFESSIONALS IN RESPONSIBLE CHARGE ARE IDENTIFIED IN THE SEALS AND CERTIFICATES AREA, BELOW.

GENERAL

- GENERAL NOTES & DRAWING INDEX
- ACCESSIBILITY REQUIREMENTS

ARCHITECTURAL & STRUCTURAL

- IMAGES
- FLOOR PLAN
- REFLECTED CEILING PLAN
- BUILDING SECTIONS
- EXTERIOR ELEVATIONS **EXTERIOR FLEVATIONS**
- WALL SECTIONS
- WALL SECTIONS
- DETAILS
- DETAILS AND SCHEDULES
- FOUNDATION PLAN ROOF FRAMING AND BEAM PLAN
- STRUCTURAL DETAILS

MECHANICAL

MECHANICAL PLAN

PLUMBING

- PLUMBING UNDERGROUND PLAN PLUMBING FLOOR PLAN
- PLUMBING DETAILS

ELECTRICAL

ELECTRICAL POWER AND LIGHTING PLAN ELECTRICAL SCHEDULES AND DETAILS

APPLICABLE CODES

2015 INTERNATIONAL BUILDING CODE 2015 INTERNATIONAL MECHANICAL CODE 2015 INTERNATIONAL FUEL AND GAS CODE 2015 INTERNATIONAL EXISTING BUILDING CODE 2015 INTERNATIONAL FIRE CODE

2014 NATIONAL ELECTRICAL CODE LOCAL AMENDMENTS TO THE ABOVE CODES

2014 ILLINOIS PLUMBING CODE 2018 INTERNATIONAL ENERGY CONSERVATION CODE 2018 ILLINOIS ACCESSIBILITY CODE

SEALS & CERTIFICATIONS

I HAVE PREPARED, OR CAUSED TO BE PREPARED UNDER MY DIRECT SUPERVISION, THE ATTACHED PLANS AND SPECIFICATIONS AND STATE THAT TO THE BEST OF MY KNOWLEDGE AND BELIEF, AND TO THE EXTENT OF MY CONTRACTUAL OBLIGATION. THEY ARE IN COMPLIANCE WITH IBC 2015 EDITION. THE ENVIRONMENTAL BARRIERS ACT AND THE ILLINOIS ACCESSIBILITY

KLUBER, INC. ILLINOIS PROFESSIONAL DESIGN FIRM LICENSE #184-001284




SHEETS 1-16

SCALE: NONE



SHEETS 1-2 & 10-16 (STRUCTURAL DETAILS)

STA, 8+66 TO STA, 9+01

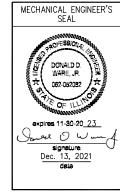

SHEETS 1-2 & 17-20



SHEETS 1-2 & 21-22

Kluber



USER NAME = Parnell Tesoro	DESIGNED - CJH	REVISED
	DRAWN - CJH	REVISED
PLOT SCALE = 1" = 1'-0"	CHECKED - CJH	REVISED
PLOT DATE = 12/13/2021	DATE - 12/13/2021	REVISED -


STATE OF ILLINOIS


WARRENVILLE TRAILHEAD TOILET BUILDING **GENERAL NOTES & DRAWING INDEX**

SHEET NO. 1 OF 22 SHEETS

F.A.P RTE			COUNTY	TOTAL SHEETS	SHEE NO.	
N/A	A 19-00039-BT			DUPAGE	49	28
			CONTRAC	T NO. 61	H18	
		ILLINOIS	FED. A	D PROJECT		

DEPARTMENT OF TRANSPORTATION

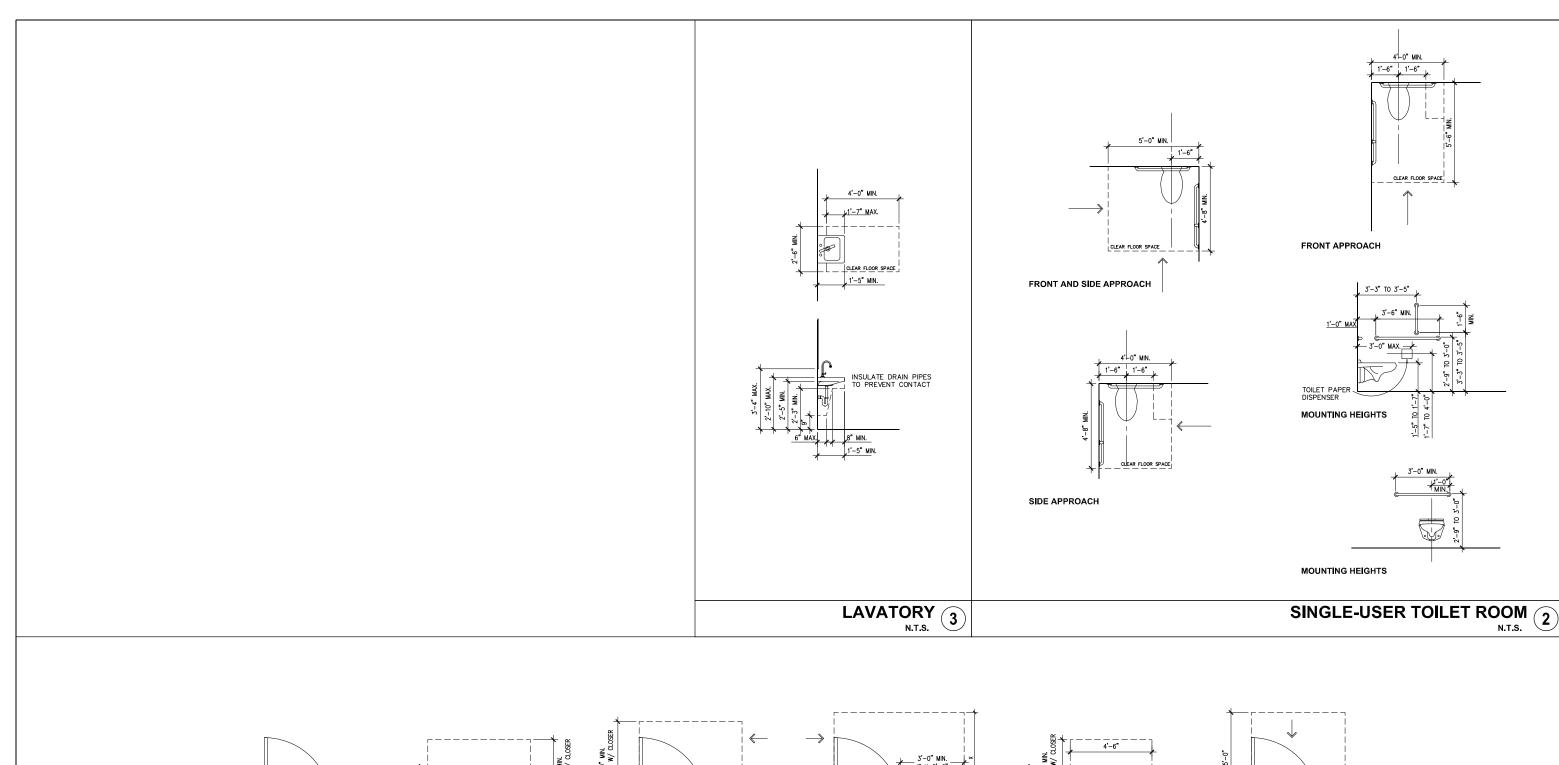

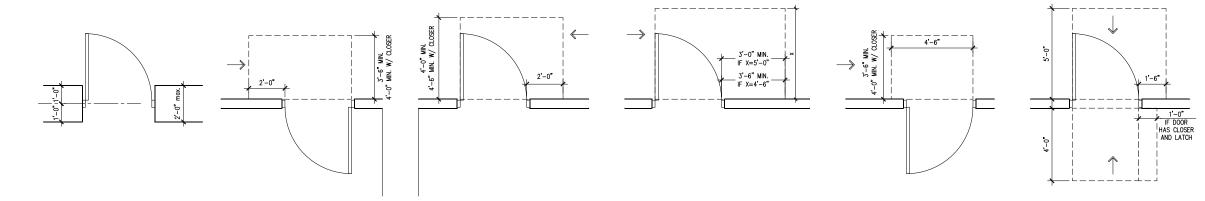

Kluber

WARRENVILLE TRAILHEAD TOILET BUILDING ACCESSIBILITY REQUIREMENTS


DOOR CLEARANCES 1 F.A.P. RTE. COUNTY TOTAL SHEET NO. SECTION 19-00039-BT DUPAGE 49 29 CONTRACT NO. 61H18

ENGINEERING RESOURCE ASSOCIATES

ER NAME = Parnell Tesoro REVISED -DESIGNED - CJH DRAWN - CJH REVISED -CHECKED - CJH PLOT SCALE = 3/8" = 1'-0" REVISED -DATE - 12/13/2021 LOT DATE = 12/13/2021 REVISED -

STATE OF ILLINOIS DEPARTMENT OF TRANSPORTATION

SHEET NO. 2 OF 22 SHEETS STA. 8+66 TO STA. 9+01 SCALE: AS INDICATED

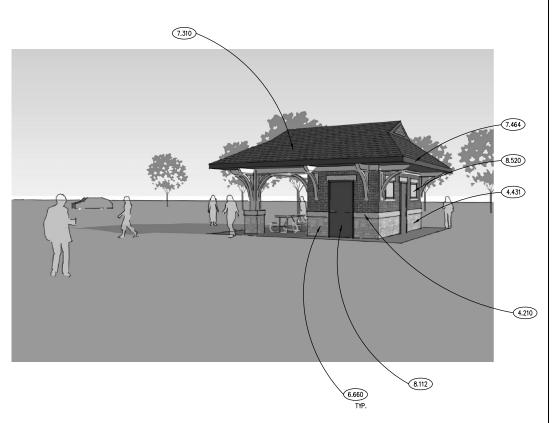


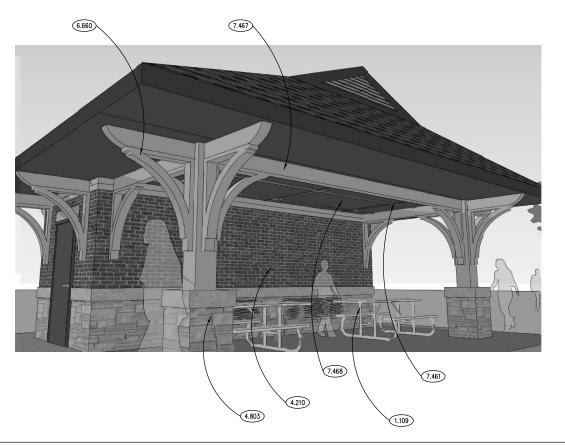


IMAGE SCALE: NTS

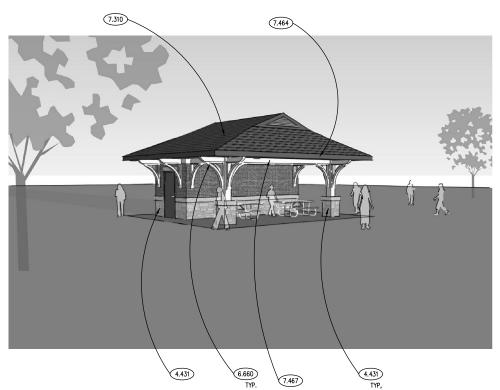

7.310 6.660 TYP. 4.431

GENERAL NOTES

KEYNOTES

1.109 OWNER-PROVIDED ITEM (N.I.C.): PICNIC TABLE.

7.310 ASPHALT SHINGLE ROOFING SYSTEM: REFER TO SPECIFICATIONS.

2X FRAMING; REFER TO SPECIFICATIONS.

1. REFER TO DRAWING 1 FOR PROJECT GENERAL NOTES FOR TOILET BUILDING.

Kluber

IMAGE (3) SCALE: NTS

IMAGE SCALE: NTS



WARRENVILLE TRAILHEAD TOILET BUILDING **IMAGES**

SECTION DUPAGE 49 CONTRACT NO. 61H18

SER NAME = Parnell Tesoro DESIGNED - CJH REVISED -DRAWN - CJH REVISED -PLOT SCALE = 1/4" = 1'-0" CHECKED - CJH REVISED -PLOT DATE = 12/13/2021 DATE - 12/13/2021 REVISED -

STATE OF ILLINOIS DEPARTMENT OF TRANSPORTATION

SCALE: AS INDICATED SHEET NO. 3 OF 22 SHEETS

STA. 8+66 TO STA. 9+01

30

KEYNOTES ARE NOT ALWAYS REPEATED ACROSS ALL DRAWINGS ON THIS SHEET. AN UN-KEYNOTED ITEM ON THIS SHEET IS THE SAME AS A KEYNOTED ITEM ON THIS SHEET HAVING THE SAME GRAPHIC APPEARANCE.

4.210 BRICK MASONRY: MODULAR TYPE "B-1"; REFER TO SPECIFICATIONS.
4.431 STONE MASONRY VENEER: 3-1/2" (NOM.) THK; ASHLAR BOND; SAW-CUT BACKS. REFER TO SPECIFICATIONS. 4.803 MASONRY ASSEMBLY: MASONRY PIER. REFER TO PLANS AND SCHEDULES FOR DETAILED INFORMATION. 6.660 CUSTOM SIMULATED ORNAMENTAL WOODWORK: BASIS OF DESIGN: FYPON INC., COMPOSITE PVC PLASTIC ENCASED DECORATIVE BRACKET; SIZE: 30 X 30 X 6; MODEL NUMBER: BKT30X30 OR CUSTOM SHAPED PRODUCTS TO MATCH BASIS OF DESIGN UNIT BY HARDIE BOYS OR EKENA MILLWORK; TYPICAL OF 24; SECURE TO STRUCTURE WITH MANUFACTURERS RECOMMENDED FASTENERS AND ADHESIVES. WHERE FASTRENERS ARE USED, COUNTERSINK AND PLUG HOLES WITH WOOD BUTTON PLUGS PRIOR TO PAINTING.

ASTRICT SIGNING. ROUTING STORM. PACEN TO STORM STORM.

461 FIBER CEMENT SIDING: TRIM BOARD; ROUGHSAWN: 3½" WIDE X 3/4" THK; REFER TO SPECIFICATIONS.

7.464 FIBER CEMENT SIDING: TRIM BOARD; ROUGHSAWN: 9½" WIDE X 3/4" THK; REFER TO SPECIFICATIONS.

7.467 FIBER CEMENT SIDING: SOFFIT PARIES; ECDARMILL: 1/4" THICK SOLID; USED TO ENCAGE STRUCTURAL

BEAM MEMBERS AND TO CONCEAL STRUCTURAL BEAM MEMBERS AND TO CREATE FALSE BEAM CONSTRUCTION OVER

7.468 FIBER CEMENT SIDING: SOFFIT PANELS; CEDARMILL: 1/4" THICK SOLID; REFER TO SPECIFICATIONS.

STEEL DOOR: INSULATED. REFER TO DOOR, FRAME AND BORROWED LIGHT SCHEDULE.
 CLAD WOOD WINDOWS: FIXED PICTURE WINDOW UNIT TYPE WITH INSULATED, TEMPERED AND NON-WISION FROSTED GLASS; MUTTINS AS INDICATED. PRIMED WOOD INTERIOR FOR FIELD PAINT FINISH; REFER TO SPECIFICATIONS.

ENGINEERING RESOURCE ASSOCIATES

IMAGE 4

SCALE: NTS

KEYNOTES

KEYNOTES ARE TYPICALLY NOT DUPLICATED WITHIN A GIVEN DETAIL. AN UN-KEYNOTED ITEM IN A DETAIL IS THE SAME AS A KEYNOTED ITEM HAVING THE SAME APPEARANCE WITHIN THE SAME DETAIL.

- 1.109 OWNER-PROVIDED ITEM (N.I.C.): PICNIC TABLE.
- 1.411 60" DIA. CLEAR TURNING SPACE FOR WHEELCHAIR.
- 4.303 CONCRETE BLOCK MASONRY: 2" (NOM.) THK.; RUNNING BOND AT LOCATION OF TOILET WALL CARRIER UNIT TO ALLOW FOR WALL MOUNTED TOILET AND CONTROL VALVE INSTALLATION.
- 4.803 MASONRY ASSEMBLY: MASONRY PIER. REFER TO PLANS AND SCHEDULES FOR DETAILED INFORMATION.
- 8.722 KNOX BOX BY GENERAL CONTRACTOR: FULLY-RECESSED IN MASONRY; COORDINATE MOUNTING LOCATION AT
- 22.120 PLUMBING PIPING SPECIALTY: FLOOR DRAIN; REFER TO PLUMBING DRAWINGS; SLOPE FLOOR TO DRAIN AS
- INDICATED.

 22.400 PLUMBING FIXTURE: WALL MOUNTED TOILET; REFER TO PLUMBING DRAWINGS.
- 22.401 PLUMBING FIXTURE: WALL MOUNTED LAVATORY; REFER TO PLUMBING DRAWINGS.
 22.402 PLUMBING FIXTURE ACCESSORY: VANDAL—RESISTANT, ADA—COMPLIANT, 1—PIECE LAVATORY PIPING
- SHEILD/ENCLOSURE; WHITE, IMPACT-RESISTANT PVC; PROVIDE FACTORY PRECUT MODEL TO MATCH LAVATORY, OR CAREFULLY AND NEATLY SCRIBE TOP EDGE TO FIT SNUGLY AROUND AND ALL ALONG UNDERSIDE OF LAVATORY BASIN; INSTALL USING TAMPER-RESISTANT SECURITY-TYPE FASTENERS; TYP. AT ALL LAVATORIES IN ALL RESTROOMS: PRODUCT: TRUEBRO LAV SHIELD, MANUFACTURED BY IPS CORPORATION: www.ipscorp.com.
- 22.410 PLUMBING EQUIPMENT: ELECTRIC WATER HEATER MOUNTED ON UNISTRUT WALL BRACKETS, MOUNTED 6 FEET ABOVE FINISHED FLOOR: REFER TO PLUMBING DRAWINGS.
- 26.008 ELECTRICAL PANELBOARD; REFER TO ELECTRICAL DRAWINGS. 26.009 ELECTRICAL METER; REFER TO ELECTRICAL DRAWINGS.
- 32.131 CONCRETE PAVING: PEDESTRIAN WALK; REFER TO DETAILS.

TOILET ACCESSORY SCHEDULE

MARK	DESCRIPTION	CAT. NO.	REMARKS	MOUNTING HEIGHTS
A	S.S. GRAB BAR – 36"	3800-36	SNAP-ON FLANGE COVER	SEE SHEET G201
В	S.S. GRAB BAR – 42"	3800-42	SNAP-ON FLANGE COVER	SEE SHEET G201
С	S.S. GRAB BAR - 18" (VERTICAL)	3800-18	SNAP-ON FLANGE COVER	SEE SHEET G201
D	JUMBO TOILET ROLL DISPENSER	MODEL 0046	2	
E	AUTOMATIC FOAM DISPENSER	MODEL 20365	SURF. MTD.	44" MAXIMUM CONTROLS
F	SECURITY FRAMED MIRROR	MODEL 105-14	12" X 16" SURFACE MTD., 2	
G	ELECTRIC HAND DRYER	MODEL XL-SB	BRUSHED CHROME SURFACE MTD.	MT. 40" A.F.F. TO NOZZLE
Н	S.S. SHELF W/ MOP & BROOM HOLDER	1308-4		72" TO SHELF
J	BABY CHANGING STATION	KB200-05	SURF. MTD.	34" FROM TOP OF COUNTER WHEN OPEN

TOILET ACCESSORY GENERAL NOTES

- A.S.I. CATALOG NUMBERS ARE USED FOR REFERENCE ONLY, UNLESS OTHERWISE NOTED; REFER TO SPECIFICATIONS FOR ACCEPTABLE MANUFACTURERES.
- MOUNTING HEIGHTS PER ADA-AG (AMERICAN'S WITH DISABILITIES ACT ACCESSIBILITIES GUIDELINES).
 MOUNTING HEIGHTS ARE FROM FINISHED FLOOR TO HEIGHT INDICATED.

TOILET ACCESSORY REMARKS

- 1. BOBRICK CATALOG NUMBERS, USED FOR REFERENCE ONLY.
- 2. DUROLLA MODEL NUMBERS, USED FOR REFERENCE ONLY.

ROOM SCHEDULE

RM. NO. ROOM NAME R	RM. NO. ROOM NAME
---------------------	-------------------

UNISEX TOILET ROOM

101 UTILITY ROOM 102 UNISEX TOILET ROOM

GENERAL NOTES

1. REFER TO DRAWING 1 FOR PROJECT GENERAL NOTES FOR TOILET BUILDING.



SER NAME = Parnell Tesoro DESIGNED - CJH REVISED -DRAWN - PJT REVISED -PLOT SCALE = 1/4" = 1'-0" CHECKED - CJH REVISED -RESOURCE ASSOCIATES PLOT DATE = 12/13/2021 DATE - 12/13/2021 REVISED -

STATE OF ILLINOIS **DEPARTMENT OF TRANSPORTATION** WARRENVILLE TRAILHEAD TOILET BUILDING FLOOR PLAN

FLOOR PLAN (1)

SCALE: 1/4" = 1'-0"

SECTION DUPAGE 49 CONTRACT NO. 61H18

SCALE: AS INDICATED SHEET NO. 4 OF 22 SHEETS STA. 8+66 TO STA. 9+01

KEYNOTES ARE TYPICALLY NOT DUPLICATED WITHIN A GIVEN DETAIL. AN UN-KEYNOTED ITEM IN A DETAIL IS THE SAME AS A KEYNOTED ITEM HAVING THE SAME APPEARANCE WITHIN THE SAME DETAIL.

2. ROOFING CONTRACTOR PROVIDE STACK BOOTS ON MECHANICAL AND PLUMBING VENTS.


ENGINEERING RESOURCE ASSOCIATES

JSER NAME = Parnell Tesoro DESIGNED - CJH REVISED -DRAWN - PJT REVISED -PLOT SCALE = 1/4" = 1'-0" CHECKED - CJH REVISED -PLOT DATE = 12/13/2021 DATE - 12/13/2021 REVISED -

STATE OF ILLINOIS **DEPARTMENT OF TRANSPORTATION**

WARRENVILLE TRAILHEAD TOILET BUILDING ROOF PLAN SCALE: AS INDICATED SHEET NO. 5 OF 22 SHEETS STA. 8+66 TO STA. 9+01

SECTION DUPAGE 49 32 CONTRACT NO. 61H18

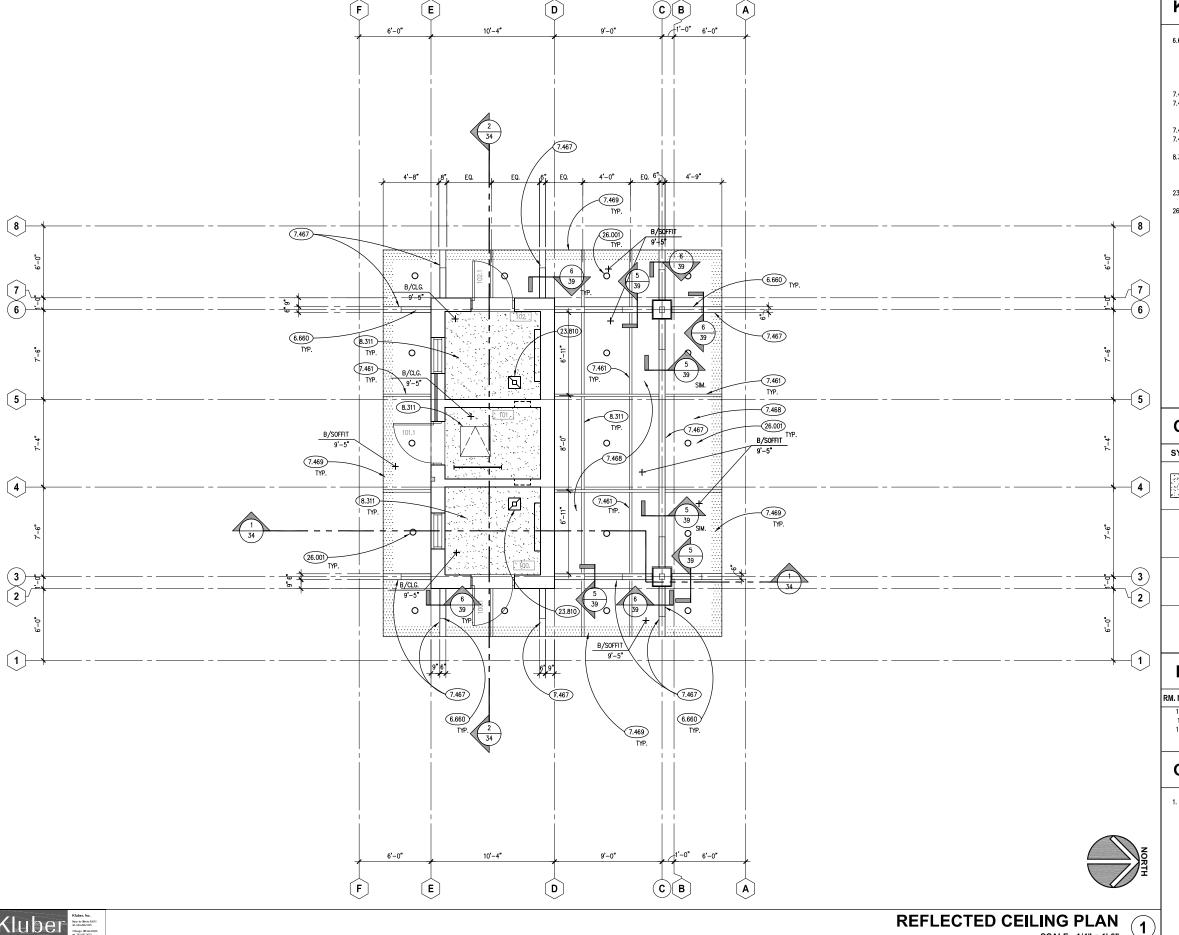

KEYNOTES

KEYNOTES ARE TYPICALLY NOT DUPLICATED WITHIN A GIVEN DETAIL. AN UN-KEYNOTED ITEM IN A DETAIL IS THE SAME AS A KEYNOTED ITEM HAVING THE SAME APPEARANCE WITHIN THE SAME DETAIL.

- 6.660 CUSTOM SIMULATED ORNAMENTAL WOODWORK: BASIS OF DESIGN: FYPON INC., COMPOSITE PVC PLASTIC ENCASED DECORATIVE BRACKET; SIZE: 30 X 30 X 6; MODEL NUMBER: BKT30X30 OR CUSTOM SHAPED PRODUCTS TO MATCH BASIS OF DESIGN UNIT BY HARDIE BOYS OR EKENA MILLWORK; TYPICAL OF 24; SECURE TO STRUCTURE WITH MANUFACTURERS RECOMMENDED FASTENERS AND ADHESIVES. WHERE FASTRENERS ARE USED, COUNTERSIN AND PLUG HOLES WITH WOOD BUTTON PLUGS PRIOR TO PAINTING
- 7.461 FIBER CEMENT SIDING: TRIM BOARD; ROUGHSAWN: 3½" WIDE X 3/4" THK.; REFER TO SPECIFICATIONS. 7.467 FIBER CEMENT SIDING: SOFFIT PANELS; CEDARMILL: 1/4" THICK SOLID; USED TO ENCASE STRUCTURAL BEAM MEMBERS AND TO CONCEAL STRUCTURAL BEAM MEMBERS AND TO CREATE FALSE BEAM CONSTRUCTION OVE
- 2X FRAMING: REFER TO SPECIFICATIONS. 7.468 FIBER CEMENT SIDING: SOFFIT PANELS; CEDARMILL: 1/4" THICK SOLID; REFER TO SPECIFICATIONS.
- 7.469 FIBER CEMENT SIDING: SOFFIT PANELS; CEDARMILL: 1/4: THICK VENTED; REFER TO SPECIFICATIONS.
- 8.311 ACCESS DOOR: 30"X30", HINGED, WITH FLANGED FRAME FOR CEILING MOUNTING; PRIMED STEEL; PROVIDE SUPPLEMENTAL ROUGH CARPENTRY WOOD FRAMING BETWEEN TRUSSES TO CREATE ROUGH OPENING FOR MOUNTING DOOR; SCREWDRIVER-OPERATED CAM LATCH; REFER TO SPECIFICATIONS.
- 23.810 ELECTRIC CABINET UNIT HEATER: CEILING MOUNTED. REFER TO MECHANICAL DRAWINGS.
- 26.001 LIGHT FIXTURE: EXTERIOR, RECESSED CAN LIGHT WITH LENS. REFER TO ELECTRICAL DRAWINGS.

CEILING LEGEND

SYMBOL	DESCRIPTION	SYMBOL	DESCRIPTION
	GYPSUM BOARD	回	MECHANICAL DIFFUSER: EXHAUST
		0	DOWN LIGHT FIXTURES
		<u> </u>	LIGHT FIXTURE: INDUSTRIAL STRIP

ROOM SCHEDULE

RM. NO.	ROOM NAME	RM. NO.	ROOM NAME
100	UNISEX TOILET ROOM		
101	UTILITY ROOM		
102	UNISEX TOILET ROOM		

GENERAL NOTES

1. REFER TO DRAWING 1 FOR PROJECT GENERAL NOTES FOR TOILET BUILDING.



ENGINEERING RESOURCE ASSOCIATES

SER NAME = Parnell Tesoro DESIGNED - CJH REVISED -DRAWN - PJT REVISED -PLOT SCALE = 1/4" = 1'-0" CHECKED - CJH REVISED -PLOT DATE = 12/13/2021 DATE - 12/13/2021 REVISED -

STATE OF ILLINOIS


WARRENVILLE TRAILHEAD TOILET BUILDING REFLECTED CEILING PLAN

SCALE: 1/4" = 1'-0"


SCALE: AS INDICATED SHEET NO. 6 OF 22 SHEETS STA. 8+66 TO STA. 9+01

SECTION DUPAGE 49 CONTRACT NO. 61H18

DEPARTMENT OF TRANSPORTATION

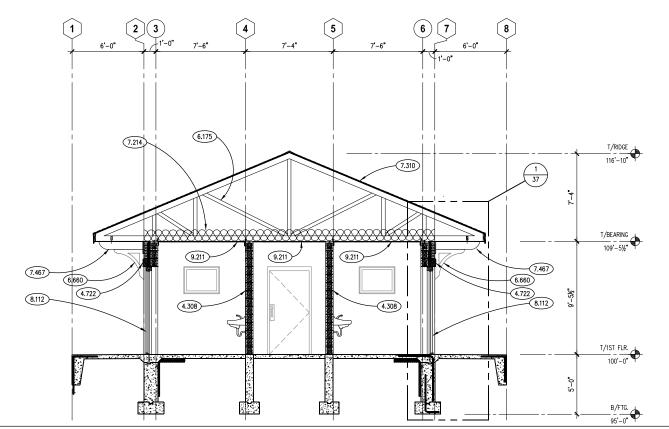

BUILDING SECTION SCALE: 1/4" = 1'-0"

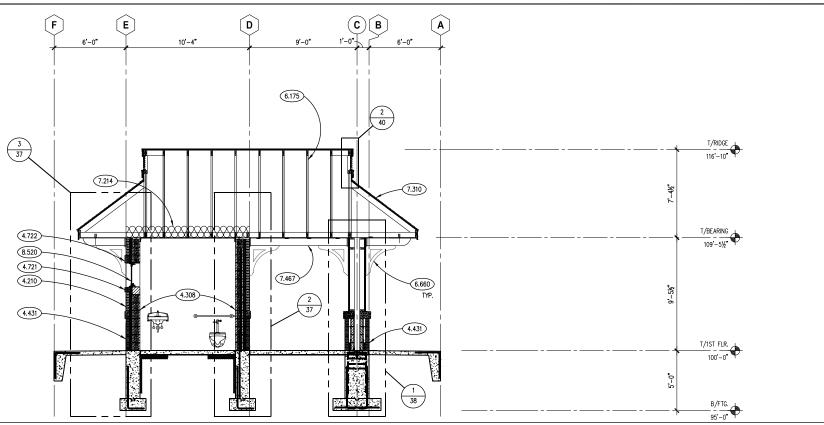

KEYNOTES

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- 4.210 BRICK MASONRY: MODULAR TYPE "B-1": REFER TO SPECIFICATIONS.
- 4.308 CONCRETE BLOCK MASONRY: 8" (NOM.) THK.; RUNNING BOND.
- 4.431 STONE MASONRY: SILL COURSE; SIZE AND CONFIGURATION AS INDICATED; PROVIDE CAST DRIP AT ALL
- OVERHANG EDGES; SLOPE TOP TO DRAIN AS SHOWN; PROVIDE UNITS WITH FINISHED ENDS AT BUTT-JOINTED CORNERS; RAKE OUT MORTAR AND PROVIDE BOND BREAKER AND JOINT SEALANT AT ALL HEAD AND TOP JOINTS.
- 4.722 CAST STONE MASONRY: HEADER COURSE; 8" HIGH (NOM.) X OPENING WIDTH PLUS 6" BEARING EACH END X 4" (NOM.) THK.; PROVIDE CAST DRIP AT ALL OVERHANG EDGES; REFER TO SPECIFICATIONS.
- 6.175 PRE-FABRICATED WOOD TRUSSES: 6:12 PITCH @ 24" O.C.; REFER TO SPECIFICATIONS.
- 6.660 CUSTOM SIMULATED ORNAMENTAL WOODWORK: BASIS OF DESIGN: FYPON INC., COMPOSITE PVC PLASTIC ENCASED DECORATIVE BRACKET; SIZE: 30 X 30 X 6; MODEL NUMBER: BKT30X30 OR CUSTOM SHAPED PRODUCTS TO MATCH BASIS OF DESIGN UNIT BY HARDIE BOYS OR EKENA MILLWORK; TYPICAL OF 24; SECURE TO STRUCTURE WITH MANUFACTURERS RECOMMENDED FASTENERS AND ADHESIVES. WHERE FASTRENERS ARE USED, COUNTERSINH AND PLUG HOLES WITH WOOD BUTTON PLUGS PRIOR TO PAINTING.
- 7.214 INSULATION: THERMAL BATT; KRAFT FACED; ATTIC BATT; 12" THICKNESS; R-38.
- 7.310 ASPHALT SHINGLE ROOFING SYSTEM: REFER TO SPECIFICATIONS.
 7.467 FIBER CEMENT SIDING: SOFFIT PANELS; CEDARMILL: 1/4" THICK SOLID; USED TO ENCASE STRUCTURAL BEAM MEMBERS AND TO CONCEAL STRUCTURAL BEAM MEMBERS AND TO CREATE FALSE BEAM CONSTRUCTION OVER 2X FRAMING: REFER TO SPECIFICATIONS.
- 8.112 STEEL DOOR: INSULATED. REFER TO DOOR, FRAME AND BORROWED LIGHT SCHEDULE.
 8.520 CLAD WOOD WINDOWS: FIXED PICTURE WINDOW UNIT TYPE WITH INSULATED, TEMPERED AND NON-VISION FROSTED GLASS; MUTTINS AS INDICATED. PRIMED WOOD INTERIOR FOR FIELD PAINT FINISH; REFER TO SPECIFICATIONS.
- 9.211 GYPSUM BOARD: 5/8" THICK; MOISTURE RESISTANT.

GENERAL NOTES

1. REFER TO DRAWING 1 FOR PROJECT GENERAL NOTES FOR TOILET BUILDING.


BUILDING SECTION (1)

SCALE: 1/4" = 1'-0"




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WEST ELEVATION SCALE: 1/4" = 1'-0"

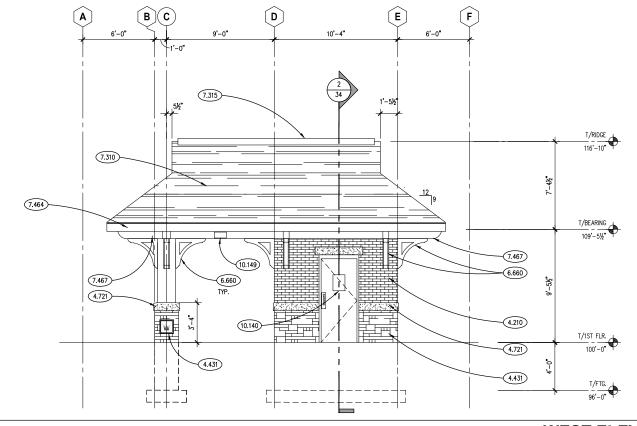

KEYNOTES

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- 4.210 BRICK MASONRY: MODULAR TYPE "B-1"; REFER TO SPECIFICATIONS.
 4.431 STONE MASONRY VENEER: 3-1/2" (NOM.) THK; ASHLAR BOND; SAW-CUT BACKS. REFER TO SPECIFICATIONS.
- 4.721 CAST STONE MASONRY: SILL COURSE, SIZE AND CONFIGURATION AS INDICATED; PROVIDE CAST DRIP AT ALL OVERHANG EDGES; SLOPE TOP TO DRAIN AS SHOWN; PROVIDE UNITS WITH FINISHED ENDS AT BUTT—JOINTED CORNERS; RAKE OUT MORTAR AND PROVIDE BOND BREAKER AND JOINT SEALANT AT ALL HEAD AND TOP JOINTS.
- 4.723 CAST STONE MASONRY: CAST MEDALLION WITH TWO COLOR INSCRIBED OWNER LOGO: REFER TO SPECIFICATIONS.
- 6.660 CUSTOM SIMULATED ORNAMENTAL WOODWORK: BASIS OF DESIGN: FYPON INC., COMPOSITE PVC PLASTIC ENCASED DECORATIVE BRACKET; SIZE: 30 X 30 X 6; MODEL NUMBER: BKT30X30 OR CUSTOM SHAPED PRODUCTS TO MATCH BASIS OF DESIGN UNIT BY HARDIE BOYS OR EKENA MILLWORK; TYPICAL OF 24: SECURE TO STRUCTURE WITH MANUFACTURERS RECOMMENDED FASTENERS AND ADHESIVES. WHERE FASTRENERS ARE USED, COUNTERSINE AND PLUG HOLES WITH WOOD BUTTON PLUGS PRIOR TO PAINTING.
- 7.310 ASPHALT SHINGLE ROOFING SYSTEM: REFER TO SPECIFICATIONS.
 7.315 ASPHALT SHINGLES ACCESSORY: SHINGLE OVER RIDGE VENT; CONTINUOUS.
- 7.464 FIBER CEMENT SIDING: TRIM BOARD; ROUGHSAWN: 9¼" WIDE X 3/4" THK.; REFER TO SPECIFICATIONS.
 7.467 FIBER CEMENT SIDING: SOFFIT PANELS; CEDARMILL: 1/4" THICK SOLID; USED TO ENCASE STRUCTURAL
- BEAM MEMBERS AND TO CONCEAL STRUCTURAL BEAM MEMBERS AND TO CREATE FALSE BEAM CONSTRUCTION OVER 2X FRAMING; REFER TO SPECIFICATIONS.
- 10.140 SIGNAGE: FLAT SIGN; GENDER NEUTRAL; 6" X 9" SIZE. "RESTROOM" WORDING WITH UNIVERSAL SYMBOLS.
- 10.149 IGNAGE: EXTERIOR DIMENSIONAL LETTERING ON STANDOFFS; SURFACE MOUNTED, NON-LIT, 6" HIGH; REFER TO SPECIFICATIONS.

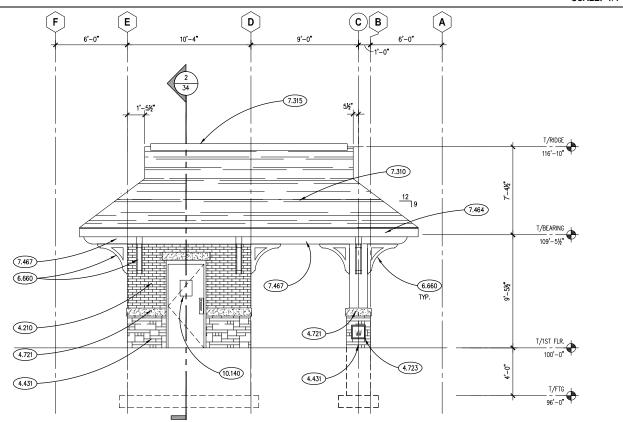GENERAL NOTES

- 1. REFER TO DRAWING 1 FOR PROJECT GENERAL NOTES FOR TOILET BUILDING.
- COORDINATE LOCATIONS OF WALL-MOUNTED MECHANICAL, PLUMBING AND ELECTRICAL ITEMS TO ENSURE NO OVERLAP.

EAST ELEVATION (1)

SCALE: 1/4" = 1'-0"

00ALL: 1/4 = 1-0	
WARRENVILLE TRAILHEAD TOILET	BUILDING
EXTERIOR ELEVATIONS	


SECTION DUPAGE 49 35 CONTRACT NO. 61H18

ENGINEERING PEROPETER RESOURCE ASSOCIATES


Kluber

REVISED -SER NAME = Parnell Tesoro DESIGNED - CJH DRAWN - PJT REVISED -PLOT SCALE = 1/4" = 1'-0" CHECKED - CJH REVISED -PLOT DATE = 12/13/2021 DATE - 12/13/2021 REVISED -

STATE OF ILLINOIS **DEPARTMENT OF TRANSPORTATION**

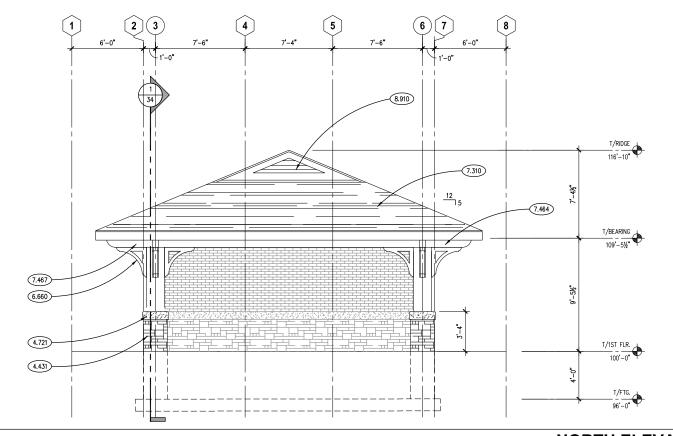

NORTH ELEVATION SCALE: 1/4" = 1'-0"

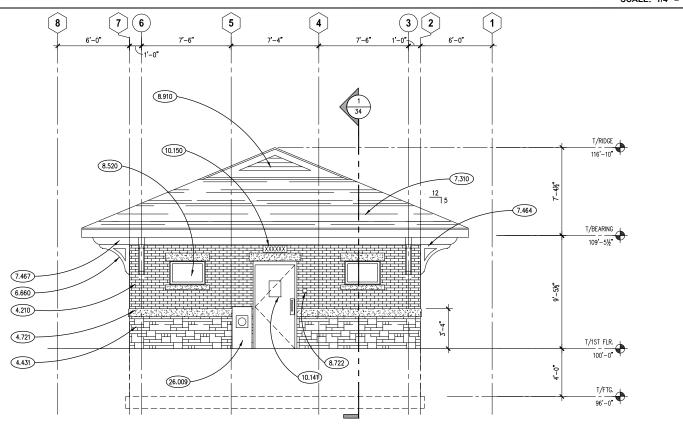

KEYNOTES

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- 4.210 BRICK MASONRY: MODULAR TYPE "B-1": REFER TO SPECIFICATIONS.
- 4.431 STONE MASONRY VENEER: 3-1/2" (NOM.) THK.; ASHLAR BOND; SAW-CUT BACKS. REFER TO SPECIFICATIONS. 4.721 CAST STONE MASONRY: SILL COURSE, SIZE AND CONFIGURATION AS INDICATED; PROVIDE CAST DRIP AT ALL OVERHANG EDGES; SLOPE TOP TO DRAIN AS SHOWN; PROVIDE UNITS WITH FINISHED ENDS AT BUTT—JOINTED CORNERS; RAKE OUT MORTAR AND PROVIDE BOND BREAKER AND JOINT SEALANT AT ALL HEAD AND TOP JOINTS.
- 6.660 CUSTOM SIMULATED ORNAMENTAL WOODWORK: BASIS OF DESIGN: FYPON INC., COMPOSITE PVC PLASTIC ENCASED DECORATIVE BRACKET; SIZE: 30 X 30 X 6; MODEL NUMBER: BKT30X30 OR CUSTOM SHAPED PRODUCTS TO MATCH BASIS OF DESIGN UNIT BY HARDIE BOYS OR EKENA MILLWORK; TYPICAL OF 24; SECURE TO STRUCTURE WITH MANUFACTURERS RECOMMENDED FASTENERS AND ADHESIVES. WHERE FASTRENERS ARE USED, COUNTERSINA AND PLUG HOLES WITH WOOD BUTTON PLUGS PRIOR TO PAINTING.
- 7.310 ASPHALT SHINGLE ROOFING SYSTEM: REFER TO SPECIFICATIONS.
- 7.464 FIBER CEMENT SIDING: TRIM BOARD; ROUGHSAWN: 9¼" WIDE X 3/4" THK.; REFER TO SPECIFICATIONS.
 7.467 FIBER CEMENT SIDING: SOFFIT PANELS; CEDARMILL: 1/4" THICK SOLID; USED TO ENCASE STRUCTURAL
- BEAM MEMBERS AND TO CONCEAL STRUCTURAL BEAM MEMBERS AND TO CREATE FALSE BEAM CONSTRUCTION OVER 2X FRAMING: REFER TO SPECIFICATIONS.
- 8.520 CLAD WOOD WINDOWS: FIXED PICTURE WINDOW UNIT TYPE WITH INSULATED, TEMPERED AND NON-VISION FROSTED GLASS; MUTTINS AS INDICATED. PRIMED WOOD INTERIOR FOR FIELD PAINT FINISH; REFER TO SPECIFICATIONS.
- 8.722 KNOX BOX BY GENERAL CONTRACTOR: FULLY-RECESSED IN MASONRY; COORDINATE MOUNTING LOCATION AT BUILDING ENTRANCE WITH AUTHORITY HAVING JURISDICTION.

 8.910 WALL LOUVER/VENT - GABLE TYPE: STATIONARY DRAINABLE BLADES; FLANGED FRAME; INSECT SCREEN; REFER
- TO SPECIFICATIONS. SIZE AS SHOWN.
- 10.141 SIGNAGE: FLAT SIGN; EQUIPMENT ROOM; 6" X 9" SIZE. "EQUIPMENT ROOM" WORDING. DOOR MOUNTED.
- 10.150 SIGNAGE: SIX CHARACTERS; ADDRESS TO BE DETERMINED; GEMINI INC. OR APPROVED EQUAL; CAST ALUMINUM 6" HIGH; DARK BRONZE ANODIZED; FIELD VERIFY W/ OWNER FOR FINAL LOCATION.

26.009 ELECTRICAL METER; REFER TO ELECTRICAL DRAWINGS.

GENERAL NOTES

- 1. REFER TO DRAWING 1 FOR PROJECT GENERAL NOTES FOR TOILET BUILDING.
- COORDINATE LOCATIONS OF WALL-MOUNTED MECHANICAL, PLUMBING AND ELECTRICAL ITEMS TO ENSURE NO OVERLAP.

SOUTH ELEVATION (1)

SCALE: AS INDICATED SHEET NO. 9 OF 22 SHEETS STA. 8+66 TO STA. 9+01


SCALE: 1/4" = 1'-0"


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	ENGINEERING RESOURCE ASSOCIATES	Ρ
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USER NAME = Parnell Tesoro	DESIGNED - CJH	REVISED
	DRAWN - PJT	REVISED
PLOT SCALE = 1/4" = 1'-0"	CHECKED - CJH	REVISED
PLOT DATE = 12/13/2021	DATE - 12/13/2021	REVISED
	PLOT SCALE = 1/4" = 1'-0"	DRAWN - PJT PLOT SCALE = 1/4" = 1'-0" CHECKED - CJH

STATE OF ILLINOIS **DEPARTMENT OF TRANSPORTATION** WARRENVILLE TRAILHEAD TOILET BUILDING **EXTERIOR ELEVATIONS**

F.A.P. RTE	SECTION			COUNTY	TOTAL SHEETS	SHE
N/A	19-00039-BT			DUPAGE	49	3
			CONTRACT NO. 61H18			
		ILLINOIS	FED. A	D PROJECT		



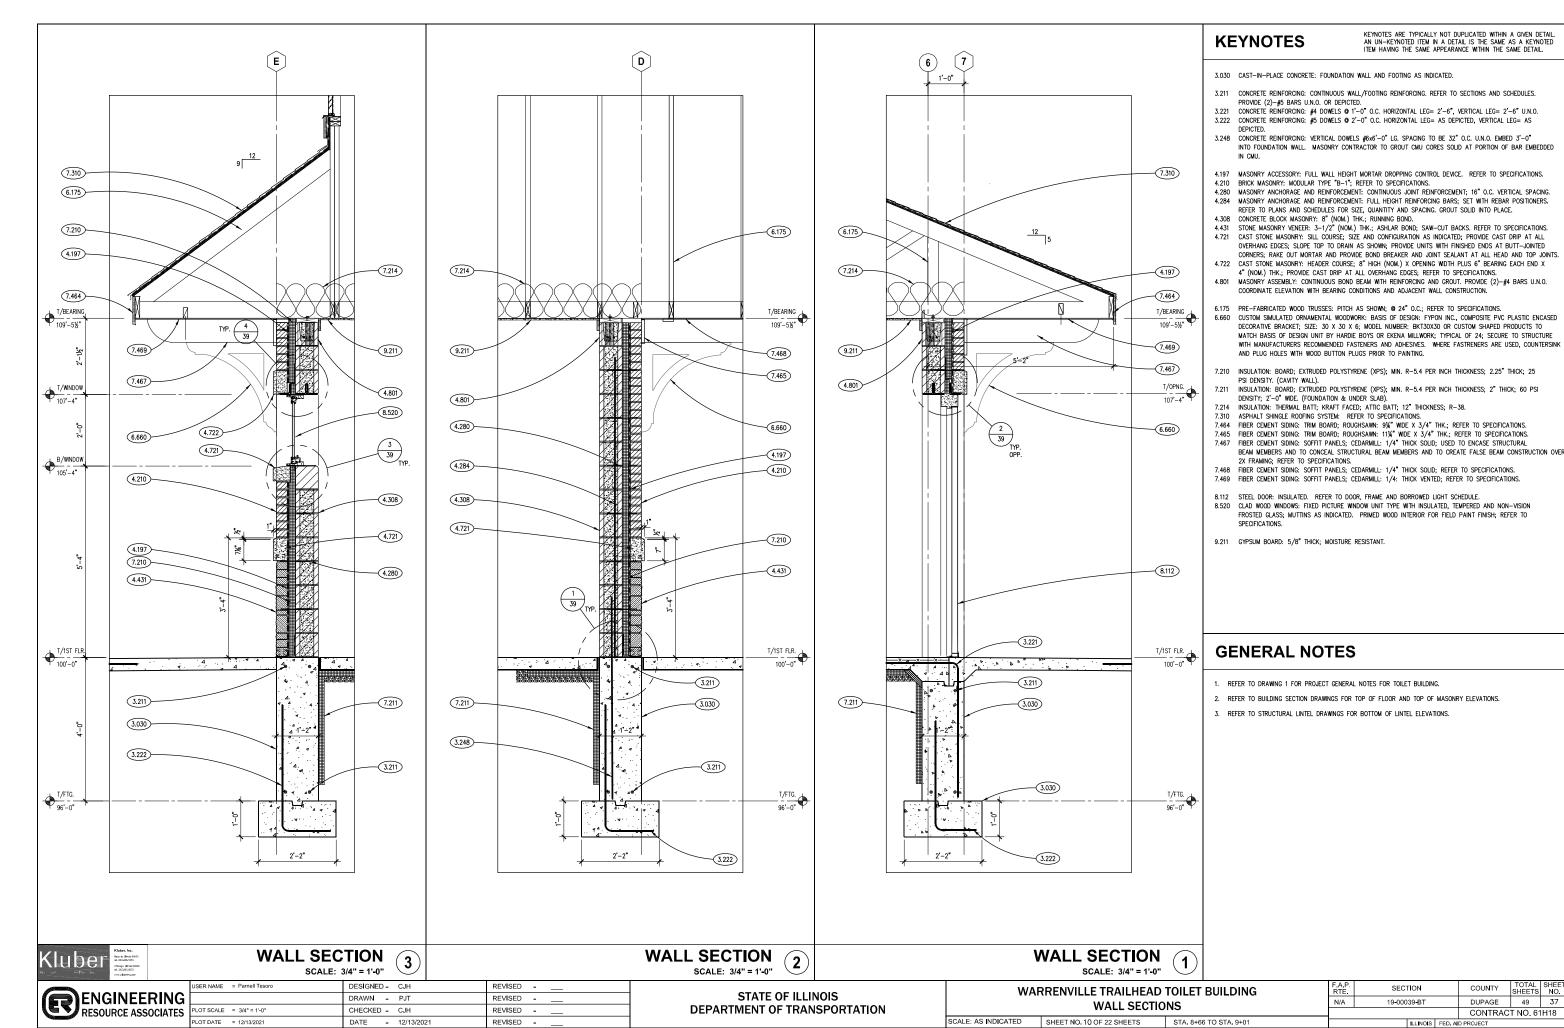

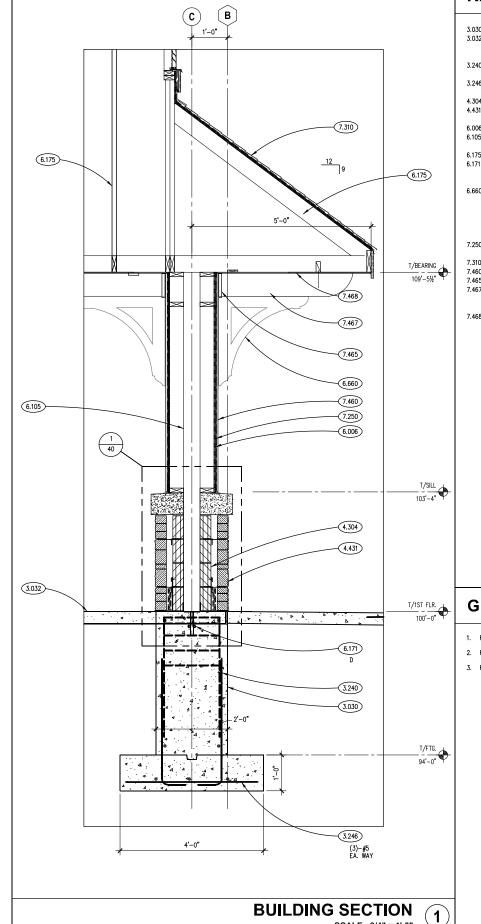KEYNOTES ARE TYPICALLY NOT DUPLICATED WITHIN A GIVEN DETAIL. AN UN-KEYNOTED ITEM IN A DETAIL IS THE SAME AS A KEYNOTED ITEM HAVING THE SAME APPEARANCE WITHIN THE SAME DETAIL.

- 3.030 CAST-IN-PLACE CONCRETE: FOUNDATION WALL AND FOOTING AS INDICATED.
- 3.032 CAST-IN-PLACE CONCRETE: SLAB-ON-GRADE INFILL; 5" THICK, MIN.; DOWEL INTO EXISTING ADJACENT SLAB USING 2'-0" LONG #4 BARS AT 1'-0" O.C.
- 3.240 CONCRETE REINFORCING: #5 VERTICAL BARS HOOKED INTO FOOTING (QUANTITY AS DEPICTED) AND #3 TIES

 © FOLLOWING SPACING...(3) © 2", (1) © 4", R © 12" U.N.O. PIER DIMENSIONS AS NOTED.

- 4.304 CONCRETE BLOCK MASONRY: 4" (NOM.) THK.; RUNNING BOND.
- 4.431 STONE MASONRY VENEER: 3-1/2" (NOM.) THK.; ASHLAR BOND; SAW-CUT BACKS. REFER TO SPECIFICATIONS.
- 6.006 ROUGH CARPENTRY: PLYWOOD: 1/2" THICK; REFER TO SPECIFICATIONS FOR TREATMENT.
 6.105 WOOD FRAMING: FULL HEIGHT POST/COLUMN. 6" X 6" (NOM.) SEE PLAN, SCHEDULE AND DETAILS FOR SPECIES
- AND QUANTITY.

 6.175 PRE-FABRICATED WOOD TRUSSES: PITCH AS SHOWN; @ 24" O.C.; REFER TO SPECIFICATIONS.
- 6.171 WOOD FRAMING ACCESSORY: LIGHT GAUGE WOOD CONSTRUCTION CONNECTOR AS NOTED MANUFACTURED BY SIMPSC STRONG—TIE OR EQUAL. INSTALL PER MANUFACTURER'S RECOMMENDATIONS. PROVIDE NAIL TYPE AND QUANTITIES RESULTING IN THE MAXIMUM TABULATED CAPACITIES.
- 6.660 CUSTOM SIMULATED ORNAMENTAL WOODWORK: BASIS OF DESIGN: FYPON INC., COMPOSITE PVC PLASTIC ENCASED DECORATIVE BRACKET; SIZE: 30 X 30 X 6; MODEL NUMBER: BKT30X30 OR CUSTOM SHAPED PRODUCTS TO MATCH BASIS OF DESIGN UNIT BY HARDIE BOYS OR EKENA MILLWORK; TYPICAL OF 24: SECURE TO STRUCTURE WITH MANUFACTURERS RECOMMENDED FASTENERS AND ADHESIVES. WHERE FASTRENERS ARE USED, COUNTERSINK AND PLUG HOLES WITH WOOD BUTTON PLUGS PRIOR TO PAINTING.
- 7.250 WEATHER BARRIER: AIR BARRIER COATING; INSTALL TO OUTER FACE OF CONCRETE MASONRY UNITS AT CAVITY WALL CONSTRUCTION. REFER TO SPECIFICATIONS.
- 7.310 ASPHALT SHINGLE ROOFING SYSTEM: REFER TO SPECIFICATIONS.
- 7.460 FIBER CEMENT SIDING: 5/16" THK, PANEL SIDING.
- 7.465 FIBER CEMENT SIDING: TRIM BOARD; ROUGHSAWN: 111/4" WIDE X 3/4" THK.; REFER TO SPECIFICATIONS. 7.467 FIBER CEMENT SIDING: SOFFIT PANELS: CEDARMILL: 1/4" THICK SOLID: USED TO ENCASE STRUCTURAL
- BEAM MEMBERS AND TO CONCEAL STRUCTURAL BEAM MEMBERS AND TO CREATE FALSE BEAM CONSTRUCTION OVER 2X FRAMING: REFER TO SPECIFICATIONS.
- 7.468 FIBER CEMENT SIDING: SOFFIT PANELS; CEDARMILL: 1/4" THICK SOLID; REFER TO SPECIFICATIONS.

GENERAL NOTES

- 1. REFER TO DRAWING 1 FOR PROJECT GENERAL NOTES FOR TOILET BUILDING.
- 2. REFER TO BUILDING SECTION DRAWINGS FOR TOP OF FLOOR AND TOP OF MASONRY ELEVATIONS.
- 3. REFER TO STRUCTURAL LINTEL DRAWINGS FOR BOTTOM OF LINTEL ELEVATIONS.

SCALE: 3/4" = 1'-0"

SCALE: AS INDICATED SHEET NO. 11 OF 22 SHEETS STA. 8+66 TO STA. 9+01






	USER NAME = Parnell Tesoro	DESIGNED - CJH	REVISED
ì		DRAWN - PJT	REVISED
3	PLOT SCALE = 3/4" = 1'-0"	CHECKED - CJH	REVISED
	PLOT DATE = 12/13/2021	DATE - 12/13/2021	REVISED

STATE OF ILLINOIS **DEPARTMENT OF TRANSPORTATION** WARRENVILLE TRAILHEAD TOILET BUILDING WALL SECTIONS

SECTION DUPAGE 49 38 CONTRACT NO. 61H18

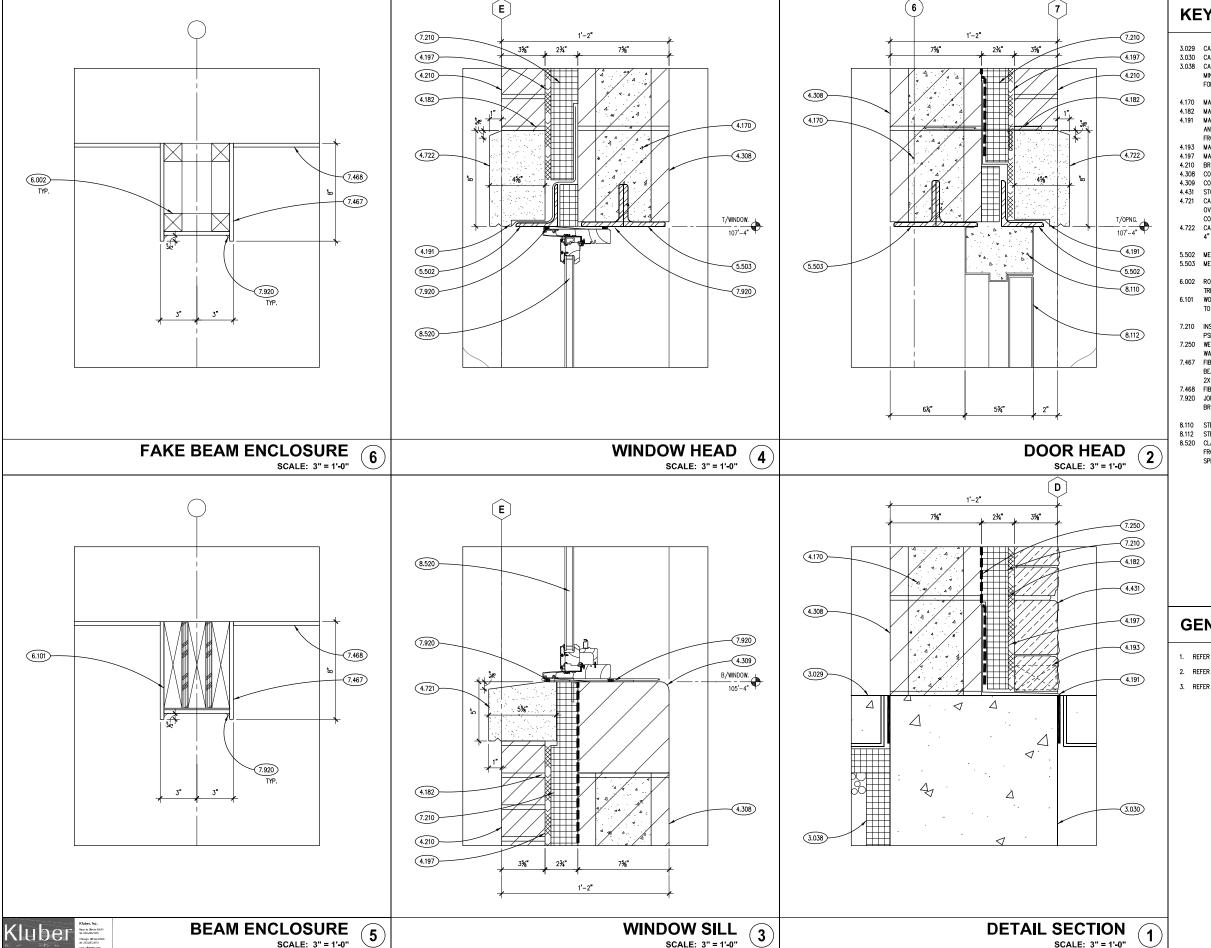

KEYNOTES ARE TYPICALLY NOT DUPLICATED WITHIN A GIVEN DETAIL. AN UN-KEYNOTED ITEM IN A DETAIL IS THE SAME AS A KEYNOTED ITEM HAVING THE SAME APPEARANCE WITHIN THE SAME DETAIL.

- 3 029 CAST-IN-PLACE CONCRETE FLOOR SLAB
- 3.030 CAST-IN-PLACE CONCRETE: FOUNDATION WALL AND FOOTING AS INDICATED.
- 3.038 CAST-IN-PLACE CONCRETE ACCESSORY: RIGID BOARD INSULATION; 2º THK. EXTRUDED POLYSTYRENE (XPS);
 MIN. R-5.4 PER INCH THICKNESS; 60 PSI COMPRESSIVE STRENGTH FOR HORIZONTAL APPLICATIONS; 25 PSI FOR VERTICAL APPLICATIONS.
- 4.170 MASONRY GROUT: CONTINUOUS GROUTED SOLID MASONRY COURSES. REFER TO SPECIFICATIONS.
- 4.182 MASONRY ANCHORAGE AND REINFORCEMENT: FLEXIBLE MASONRY TIE.
- 4.191 MASONRY ACCESSORY: THROUGH-WALL FLASHING; RUBBERIZED ASPHALT SHEET WITH TERMINATION BAR AT TOP AND STAINLESS STEEL DRIP EDGE AT BOTTOM; HOLD BACK RUBBERIZED ASPHALT SHEET AT LEAST 1 INCH FROM EXTERIOR FACE OF WALL.
- 4.193 MASONRY ACCESSORY: WEEP VENT.
 4.197 MASONRY ACCESSORY: FULL WALL HEIGHT MORTAR DROPPING CONTROL DEVICE. REFER TO SPECIFICATIONS.
- 4.210 BRICK MASONRY: MODULAR TYPE "B-1"; REFER TO SPECIFICATIONS.
 4.308 CONCRETE BLOCK MASONRY: 8" (NOM.) THK.; RUNNING BOND.
- 4.309 CONCRETE BLOCK MASONRY: 8" (NOM.) THK; SOLID W/ BULLNOSE EDGE.
 4.431 STONE MASONRY VENEER: 3-1/2" (NOM.) THK.; ASHLAR BOND; SAW-CUT BACKS. REFER TO SPECIFICATIONS.
- 4.721 CAST STONE MASONRY: SILL COURSE; SIZE AND CONFIGURATION AS INDICATED; PROVIDE CAST DRIP AT ALL OVERHANG EDGES: SLOPE TOP TO DRAIN AS SHOWN: PROVIDE UNITS WITH FINISHED ENDS AT BUTT-JOINTED
- CORNERS; RAKE OUT MORTAR AND PROVIDE BOND BREAKER AND JOINT SEALANT AT ALL HEAD AND TOP JOINTS. 4.722 CAST STONE MASONRY: HEADER COURSE: 8" HIGH (NOM.) X OPENING WIDTH PLUS 6" BEARING EACH END X 4" (NOM.) THK.; PROVIDE CAST DRIP AT ALL OVERHANG EDGES; REFER TO SPECIFICATIONS.
- 5.502 METAL FABRICATION: SINGLE STEEL LINTEL; L3X3X1/4; GALVANIZED; 6" BEARING EA. END.
- 5.503 METAL FABRICATION: DOUBLE STEEL LINTEL; L3X3X1/4; GALVANIZED; 6" BEARING EA. END.
- 6.002 ROUGH CARPENTRY: WOOD BLOCKING; DIMENSIONAL LUMBER; SIZE AS REQUIRED; REFER TO SCHEDULE FOR TREATMENT.
- 6.101 WOOD FRAMING: BEAM/HEADER. SEE PLAN, SCHEDULE AND DETAILS FOR SIZE AND SPECIES. FURR OUT SIDES TO DIMENSIONS SHOWN TO ALLOW FOR FOR FIBER CEMENT SIDING ENCASEMENT.
- 7.210 INSULATION: BOARD; EXTRUDED POLYSTYRENE (XPS); MIN. R-5.4 PER INCH THICKNESS; 2.25" THICK; 25 PSI DENSITY. (CAVITY WALL).
- 7.250 WEATHER BARRIER: AIR BARRIER COATING: INSTALL TO OUTER FACE OF CONCRETE MASONRY UNITS AT CAVITY WALL CONSTRUCTION. REFER TO SPECIFICATIONS.
- 7.467 FIBER CEMENT SIDING: SOFFIT PANELS; CEDARMILL: 1/4" THICK SOLID; USED TO ENCASE STRUCTURAL BEAM MEMBERS AND TO CONCEAL STRUCTURAL BEAM MEMBERS AND TO CREATE FALSE BEAM CONSTRUCTION OVER 2X FRAMING; REFER TO SPECIFICATIONS.
- 7.468 FIBER CEMENT SIDING: SOFFIT PANELS: CEDARMILL: 1/4" THICK SOLID: REFER TO SPECIFICATIONS. 7.920 JOINT SEALANT: REFER TO SCHEDULE IN SPECIFICATION SECTION 07 92 00; PROVIDE BACKER ROD OR BOND
- 8.110 STEEL DOOR FRAME: GROUTED SOLID. REFER TO DOOR, FRAME AND BORROWED LIGHT SCHEDULE.
 8.112 STEEL DOOR: INSULATED. REFER TO DOOR, FRAME AND BORROWED LIGHT SCHEDULE.
- 8.520 CLAD WOOD WINDOWS: FIXED PICTURE WINDOW UNIT TYPE WITH INSULATED, TEMPERED AND NON-VISION FROSTED GLASS; MUTTINS AS INDICATED. PRIMED WOOD INTERIOR FOR FIELD PAINT FINISH; REFER TO

GENERAL NOTES

- 1. REFER TO DRAWING 1 FOR PROJECT GENERAL NOTES FOR TOILET BUILDING.
- 2. REFER TO BUILDING SECTION DRAWINGS FOR TOP OF FLOOR AND TOP OF MASONRY ELEVATIONS.
- 3. REFER TO STRUCTURAL LINTEL DRAWINGS FOR BOTTOM OF LINTEL ELEVATIONS.

ENGINEERING RESOURCE ASSOCIATES

DESIGNED - CJH JSER NAME = Parnell Tesoro REVISED -DRAWN - PJT REVISED -PLOT SCALE = 3" = 1'-0" CHECKED - CJH REVISED -PLOT DATE = 12/13/2021 DATE - 12/13/2021 REVISED -

STATE OF ILLINOIS DEPARTMENT OF TRANSPORTATION WARRENVILLE TRAILHEAD TOILET BUILDING DETAILS

STA. 8+66 TO STA. 9+01

SHEET NO. 12 OF 22 SHEETS

SCALE: 3" = 1'-0"

SECTION DUPAGE 49 39 CONTRACT NO. 61H18

TREATMENT.

SPECIFICATIONS

TO SPECIFICATIONS. SIZE AS SHOWN. 8.911 WALL LOUVER ACCESSORY: SILL PAN WITH END DAMS.

WITH DOORS WHERE APPLICABLE.

FROM EXTERIOR FACE OF WALL. MASONRY ACCESSORY: WEEP VENT. 4.194 MASONRY ACCESSORY: MORTAR DROPPING CONTROL DEVICE. MASONRY ACCESSORY: TERMINATION BAR WITH SEALANT.

4.304 CONCRETE BLOCK MASONRY: 4" (NOM.) THK.; RUNNING BOND.

3.360 CAST-IN-PLACE CONCRETE JOINT DEVICE/FILLER: SLAB ISOLATION JOINT FILLER. COORDINATE LOCATIONS

4.191 MASONRY ACCESSORY: THROUGH-WALL FLASHING: RUBBERIZED ASPHALT SHEET WITH TERMINATION BAR AT TOP

AND STAINLESS STEEL DRIP EDGE AT BOTTOM; HOLD BACK RUBBERIZED ASPHALT SHEET AT LEAST 1 INCH

STONE MASONRY VENEER: 3-1/2" (NOM.) THK.; ASHLAR BOND; SAW-CUT BACKS. REFER TO SPECIFICATIONS. 4.721 CAST STONE MASONRY: SILL COURSE; SIZE AND CONFIGURATION AS INDICATED; PROVIDE CAST DRIP AT ALL OVERHANG EDGES; SLOPE TOP TO DRAIN AS SHOWN; PROVIDE UNITS WITH FINISHED ENDS AT BUTT—JOINTED CORNERS; RAKE OUT MORTAR AND PROVIDE BOND BREAKER AND JOINT SEALANT AT ALL HEAD AND TOP JOINTS.

6.002 ROUGH CARPENTRY: WOOD BLOCKING; DIMENSIONAL LUMBER; SIZE AS REQUIRED; REFER TO SCHEDULE FOR

6.105 WOOD FRAMING: FULL HEIGHT POST/COLUMN. 6" X 6" (NOM.) SEE PLAN, SCHEDULE AND DETAILS FOR SPECIES 6.115 WOOD FRAMING: 5/8" THICK APA RATED SHEATHING. FASTENER TYPE, SPACING: 10d NAILS @ 6" O.C.

7.250 WEATHER BARRIER: AIR BARRIER COATING; INSTALL TO OUTER FACE OF CONCRETE MASONRY UNITS AT CAVITY

7.468 FIBER CEMENT SIDING: SOFFIT PANELS; CEDARMILL: 1/4" THICK SOLID; REFER TO SPECIFICATIONS. 7.470 FIBER CEMENT SIDING ACCESSORY: PREFINISHED SHEET METAL FLASHING; SILL FLASHING SET INTO BED OF SEALANT ON UNDERSIDE OF FLASHING. VERTICAL FLASHING LEG SHALL BE 4 INCHES MINIMUM. TUCK

8.110 STEEL DOOR FRAME: GROUTED SOLID. REFER TO DOOR, FRAME AND BORROWED LIGHT SCHEDULE.

STEEL DOOR: INSULATED. REFER TO DOOR, FRAME AND BORROWED LIGHT SCHEDULE. 8.520 CLAD WOOD WINDOWS: FIXED PICTURE WINDOW UNIT TYPE WITH INSULATED, TEMPERED AND NON-VISION

7.920 JOINT SEALANT: REFER TO SCHEDULE IN SPECIFICATION SECTION 07 92 00; PROVIDE BACKER ROD OR BOND

FROSTED GLASS; MUTTINS AS INDICATED. PRIMED WOOD INTERIOR FOR FIELD PAINT FINISH; REFER TO

8.910 WALL LOUVER/VENT - GABLE TYPE: STATIONARY DRAINABLE BLADES; FLANGED FRAME; INSECT SCREEN; REFER

FLASHING UNDER WEATHER BARRIER AND TAPE OFF TO FLASHING. TYPICAL.

ASPHALT SHINGLES METAL FLASHING: RAKE EDGE FLASHING; MATERIAL, THICKNESS AND FINISH AS SPECIFIED. 7.318 ASPHALT SHINGLES METAL FLASHING: BASE FLASHING; MATERIAL, THICKNESS AND FINISH AS SPECIFIED.
7.463 FIBER CEMENT SIDING: TRIM BOARD; ROUGHSAWN: 7¼" WIDE X 3/4" THK.; REFER TO SPECIFICATIONS.

WOOD FRAMING ACCESSORY: LIGHT GAUGE WOOD CONSTRUCTION CONNECTOR AS NOTED MANUFACTURED BY SIMPSO STRONG-TIE OR EQUAL. INSTALL PER MANUFACTURER'S RECOMMENDATIONS. PROVIDE NAIL TYPE AND QUANTITIES

6.006 ROUGH CARPENTRY: PLYWOOD: 1/2" THICK; REFER TO SPECIFICATIONS FOR TREATMENT.

(EDGES), 12" (FIELD). REFER TO SPECIFICATIONS FOR TREATMENT.

ASPHALT SHINGLE ROOFING SYSTEM: REFER TO SPECIFICATIONS.

RESULTING IN THE MAXIMUM TABULATED CAPACITIES.

WALL CONSTRUCTION. REFER TO SPECIFICATIONS.

7.313 ASPHALT SHINGLES SHEET MATERIAL LINDERLAYMENT

FRAME DETAILS STEEL DOORS WOOD DOORS PE MAT. GA. FINISH GLASS GA MDL CORE GRD CORE VENEER CUT MATCH 1 3'-4" 7'-0" 1-3/4" F LHR S 1 3'-4" 7'-0" 1-3/4" F LHR S 1 3'-4" 7'-0" 1-3/4" F RHR S UNISEX TOILET ROOM
UTILITY ROOM 1/40 UNISEX TOILET ROOM 2/42

HARDWARE SCHEDULE

;	SET NO.	HINGES	LOCK SET	EXIT DEVICE	CLOSER	HOLDER	STOP	THRES- HOLD	KICK PLATE	MOP PLATE	WEATHER STRIPPING		PUSH/ PULL	REMOV. MULLION	REMARKS
	1	CONTINUOUS	YES*	-	YES	-	IN CLOSER	YES	YES	-	YES	YES	YES	-	1. NOTE: EXTRA HEAVY DUTY & THERMALLY INSULATED DOOR. DOOR SHALL HAVE FULL CLOSURE TOP - NO RECESS.
	2	CONTINUOUS	YES*	-	YES	-	IN CLOSER	YES	YES	-	YES	YES	YES	-	2. NOTE: EXTRA HEAVY DUTY & THERMALLY INSULATED DOOR. DOOR SHALL HAVE FULL CLOSURE TOP - NO RECESS.
Г															

HARDWARE SCHEDULE REMARKS

EAST

FIN. CC.


- 1. ENTRY MORTISE DEAD LOCK WITH "OCCUPIED" INDICATOR AND ADA INTERIOR THUMB TURN AND DOOR CYLINDER EXTERIOR. HEAVY DUTY DOOR CLOSER WITH SPRING STOP ARM, EXTERIOR OFFSET PULL TRIM WITH INTERIOR PUSH PLATE. CONTINUOUS HINGES, THERMAL BREAK ADA THRESHOLD WITH STOP, DOOR SWEEP AND WEATHERSTRIPPING. REFER TO SPECIFICATIONS FOR DOOR HARDWARE MOUNTING HEIGHTS.
- 2. ENTRY MORTISE DEAD LOCK WITH "LOCKED" INDICATOR AND ADA INTERIOR THUMB TURN AND DOOR CYLINDER EXTERIOR. HEAVY DUTY DOOR CLOSER WITH SPRING STOP ARM, EXTERIOR OFFSET PULL TRIM WITH INTERIOR PUSH PLATE. CONTINUOUS HINGES, THERMAL BREAK ADA THRESHOLD WITH STOP, DOOR SWEEP AND WEATHERSTRIPPING. REFER TO SPECIFICATIONS FOR DOOR HARDWARE MOUNTING HEIGHTS.

FIN. CC.

ROOM FINISH SCHEDULE

CC.

FIN.

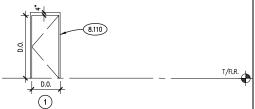




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F

FRAME TYPES

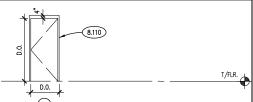

WINDOW TYPES



FINISH TYPES

FLOOR

FIN. CC.

BASE


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FIN.

AREA	FIN.	DESCRIPTION	AREA	FIN.	DESCRIPTION
FLOOR	F1	FLUID-APPLIED FLOORING	CEILING	C1	GYP. BD.: 5/8" THK.; MOISTURE RESISTANT
	F2	SEALED CONCRETE			RESISTANT
BASE	B1	INTEGRAL FLUID-APPLIED; 6" HIGH COVE	PAINT	P1	LATEX - "SEMI-GLOSS" - CMU WALLS
	B2	VINYL; 4" HIGH COVE		P2	LATEX - "FLAT" - INTERIOR CEILINGS
				P3	LATEX - "SATIN" - DOOR AND FRAMES
GLASS	SG1	SEALED, INSULATED GLASS			

FINISH SCHEDULE REMARKS

1. COLOR SELECTIONS WILL BE DETERMINED AT A LATER DATE AND ISSUED BY ARCHITECT'S SUPPLEMENTAL

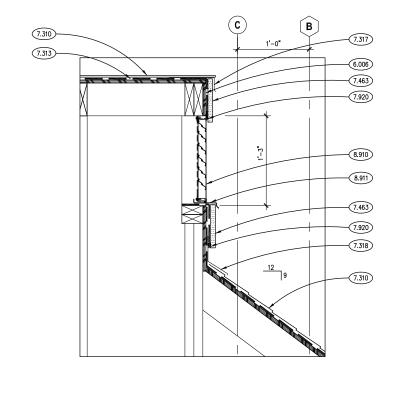


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CEILING

FIN. CC.

C1/P2

C1/P2

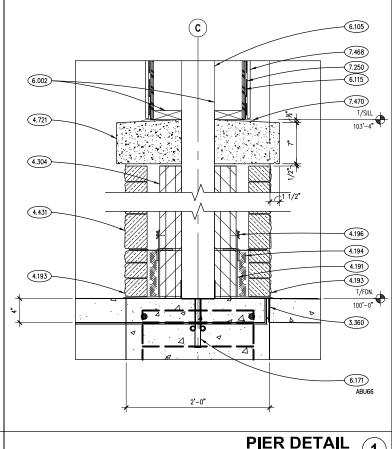

DOOR SCHEDULE ABBREVIATIONS

DOOR / FRAME MATERIAL		STEEL DOOR GAGE			OD DOOR GRADE	WOOD DOOR VENEER CUTS		
AL	ALUMINUM	20	LEVEL 1 - STD. DUTY	Р	PREMIUM	PS	PLAIN SLICED	
STL	STEEL	18	LEVEL 2 - HEAVY DUTY	С	CUSTOM	QS	QUARTER SLICED	
WD	WOOD	16	LEVEL 3 - EXTRA HVY. DUTY	Ε	ECONOMY	RC	RIFT CUT	
SPE	CIAL DOOR TYPES	14	LEVEL 4 - MAXIMUM DUTY	wo	OD DOOR CORE	R	ROTARY CUT	
AC	ACCORDION	STE	EL DOOR MODEL	HC	HONEYCOMB			
AP	ACCESS PANEL	1	FULL FLUSH	MB	MINERAL BOARD	woo	D DOOR VENEER MATCHING	
DK	DARKROOM REVOLVING	2	SEAMLESS	PC5	5-PLY PARTICLE BOARD	BK	BOOK MATCH	
HS	OVERHEAD HIGH-SPEED	3	STILE & RAIL	SC	SOUND-RATED	SL	SLIP MATCH	
OR	OVERHEAD ROLLING	STE	STEEL DOOR CORE				RANDOM MATCH	
OS	OVERHEAD SECTIONAL	нс	HONEYCOMB	WOOD DOOR VENEER		E	END MATCH	
R۷	REVOLVING	MB	MINERAL BOARD	BW	BIRCH - WHITE (SAPWOOD)	CON	CONTINUOUS MATCH	
SG	OVERHEAD SECURITY GRILLE	PS	POLYSTYRENE	HB	PRIMED HARDBOARD	RUN	RUNNING MATCH	
DOG	OR / FRAME FINISHES	PU	POLYURETHANE	HPDL	DECORATIVE LAMINATE	BAL	BALANCE MATCH	
Α	ANODIZED	SS	STEEL STIFFENERS	MW	MAPLE - WHITE (SAPWOOD)	CB	CENTER BALANCE MATCH	
P_	PAINTED - SEE FIN. SCHED.			OR	RED OAK	Р	PAIR MATCH	
S_	STAINED - SEE FIN. SCHED.			OW	WHITE OAK	S	SET MATCH	
				P0	POPLAR			
			The state of the s				, and the second	

GENERAL NOTES

- 1. REFER TO DRAWING 1 FOR PROJECT GENERAL NOTES FOR TOILET BUILDING.
- 2. REFER TO BUILDING SECTION DRAWINGS FOR TOP OF FLOOR AND TOP OF MASONRY ELEVATIONS.
- 3. REFER TO STRUCTURAL LINTEL DRAWINGS FOR BOTTOM OF LINTEL ELEVATIONS.

Klubei

UNISEX TOILET ROOM

UNISEX TOILET ROOM

UTILITY ROOM

ENGINEERING RESOURCE ASSOCIATES

SER NAME = Parnell Tesoro DESIGNED - CJH REVISED -DRAWN - PJT REVISED PLOT SCALE = 11/2" = 1'-0" CHECKED - CJH REVISED -PLOT DATE = 12/13/2021 DATE - 12/13/2021 REVISED -

STATE OF ILLINOIS **DEPARTMENT OF TRANSPORTATION**

LOUVER DETAIL 2


SCALE: 11/2" = 11-0"

WARRENVILLE TRAILHEAD TOILET BUILDING **DETAILS & SCHEDULES**

SCALE: 11/2" = 11-0"

SECTION DUPAGE 49 40 CONTRACT NO. 61H18

SCALE: 11/2"=1-0" SHEET NO. 13 OF 22 SHEETS STA. 8+66 TO STA. 9+01

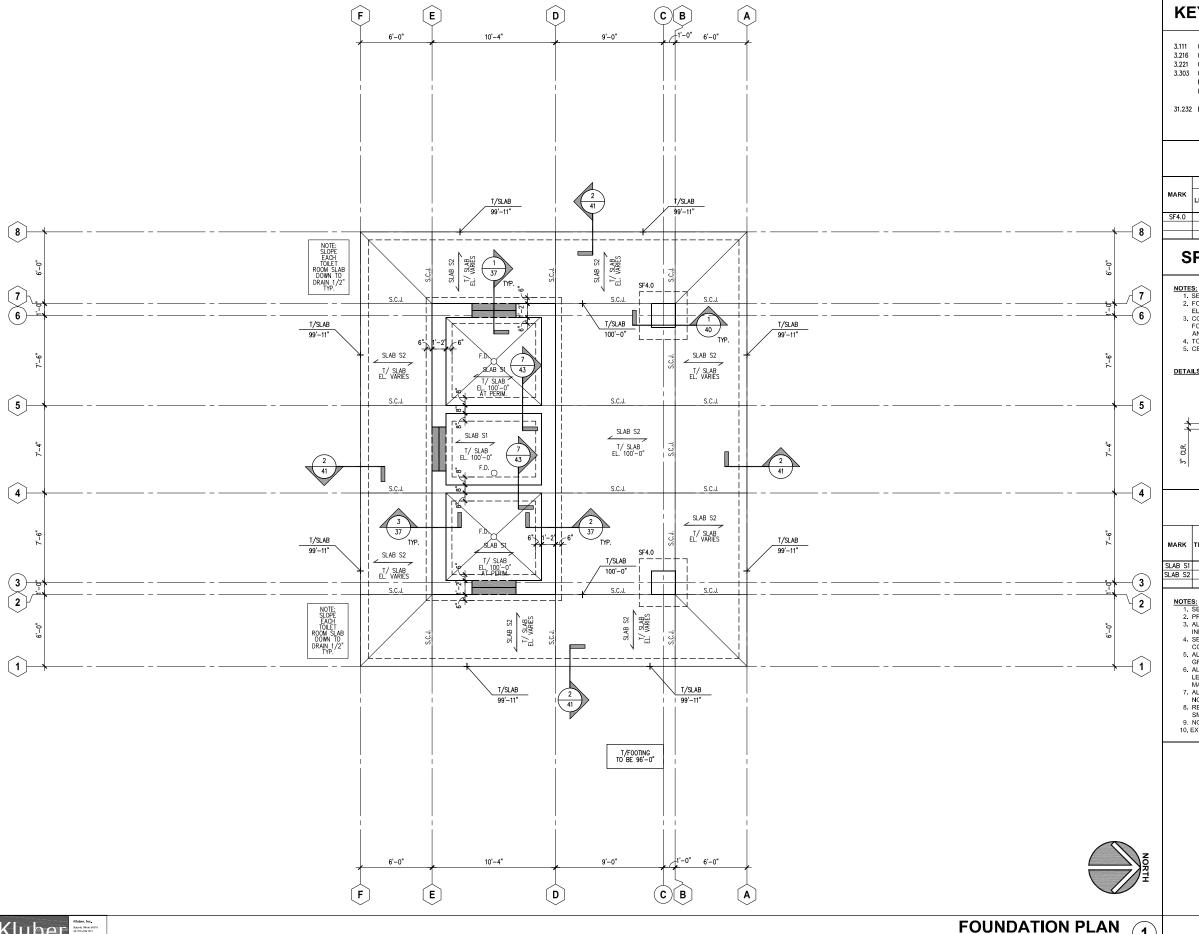

KEYNOTES ARE TYPICALLY NOT DUPLICATED WITHIN A GIVEN DETAIL. AN UN-KEYNOTED ITEM IN A DETAIL IS THE SAME AS A KEYNOTED ITEM HAVING THE SAME APPEARANCE WITHIN THE SAME DETAIL.

- 3.111 CONCRETE FORMING AND ACCESSORIES: CONTINUOUS 3/4" CHAMFER U.N.O.
- 3.216 CONCRETE REINFORCING: CONTINUOUS REINFORCING BAR. #5 U.N.O. QUANTITY AS DEPICTED.
- 3.221 CONCRETE REINFORCING: #4 DOWELS @ 1'-0" O.C. HORIZONTAL LEGE 2'-6", VERTICAL LEGE 2'-6" U.N.O. 3.303 CAST-IN-PLACE CONCRETE: EXTERIOR SLAB-ON-GRADE. REFER TO SPECIFICATIONS FOR MIX TYPE AND FINISH.
- REINFORCE WITH WWF-6x6 W2.1 x W2.1. SLOPE AWAY FROM BUILDING. ELEVATION AT DOOR AT MATCH INTERIOR SLAB/FINISH FLOOR ELEVATION.

31.232 EXCAVATION FILL: ENGINEERED GRANULAR FILL.


SPREAD FOOTING SCHEDULE

I		DI	MENSION	s	REINFORCING STEEL			
	MARK	LENGTH	WIDTH (B)	THICK	BOTTOM LENGTH (L)	BOTTOM WIDTH (B)	ТОР	SPECIAL COMMENTS
Ī	SF4.0	4'-0"	4'-0"	1'-0"	(4)-#5	(4)-#5	NO	
I								

SPREAD FOOTING NOTES AND DETAILS

- NOTES:

 1. SEE PLAN FOR FOOTING LOCATIONS.
 2. FOOTINGS TO BEAR ON UNDISTURBED SOILS/ENGINEERED FILL ASSUMED TO BE AT THE DESIGN ELEVATIONS NOTED ON THE PLANS.
 3. CONTRACTOR TO HAVE A QUALIFIED SOIL TESTING AGENCY CONFIRM THE SOIL AT THE BASE OF THE FOOTING EXCAVATIONS PRIOR TO CASTING THE CONCRETE. ALL UNSUITABLE MATERIALS TO BE REMOVED AND REPLACED IN ACCORDANCE WITH THE PROJECT SOILS REPORT.
 4. TOP STEEL REINFORCING (WHEN REQUIRED) TO MATCH BOTTOM U.N.O. WITH FULL DEPTH HOOKED ENDS.
 5. CENTERLINE OF FOOTING TO BE CENTERED ON COLUMNS, PIERS AND WALLS U.N.O. ON PLAN.

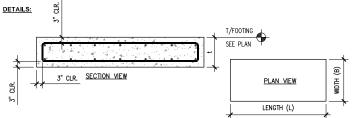

SLAB SCHEDULE AND NOTES

MARK	THICK (t)	CONCRETE STRENGTH (f'c)	CONCRETE TYPE (NW or LW)	REINFORCING STEEL	GENERAL LOCATIONS	SPECIAL COMMENTS OR ADDITIONAL LOCATIONS
SLAB S1	5"	4,500 PSI	NW	WWF-6x6 W2.1xW2.1	INTERIOR SLAB ON GRADE	SEE SPEC SECTION 033000 FOR MIX
SLAB S2	5"	3,500 PSI	NW	WWF-6x6 W2.1xW2.1	EXTERIOR SLAB ON GRADE, STOOPS	SEE SPEC SECTION 321313 FOR WIX

- NOTES:

 1. SEE PROJECT SPECIFICATIONS FOR DETAILED MIX DESIGNS.
 2. PREPARE ALL SLAB ON GRADE SUB-GRADES AS INDICATED ON SHEET S010.
 3. ALL SLABS ON GRADE TO BE PLACED OVER 6" OF CLEAN, WELL GRADED GRANULAR MATERIALS AS

- INDICATED ON SHEET 5010.

 4. SEE PLANS AND DETAILS FOR ALL LOCATIONS OF REINFORCING STEEL, CONTRACTION JOINTS, CONSTRUCTION JOINTS AND ISOLATION JOINTS.

 5. ALL INTERIOR SLAB ON GRADE AREAS REQUIRE A 10 MIL, VAPOR BARRIER PLACED DIRECTLY OVER THE GRANULAR SUB-BASE U.N.O. SEE PROJECT SPECIFICATIONS FOR ADDITIONAL INFORMATION.

 6. ALL WWF REINFORCING TO BE IN FLAT SHEETS ONLY, PLACEMENT (I.E. SUPPORT SPACING, LAP SPLICE LENGTINS, ETC.) TO BE IN ACCORDANCE WITH THE STRUCTURAL WELDED WIRE REINFORCEMENT MANUAL OF STANDARD PRACTICE: (WWR-S00); WIRE REINFORCEMENT INSTITUTE; LATEST EDITION.


 7. ALL REINFORCING STEEL TO BE SUPPORTED AS REQUIRED TO MAINTAIN THE DETAILED POSITIONS NOTED ON THE CONTRACT DOCUMENTS DURING PLACEMENT OF THE CONCRETE.

 8. REINFORCING BARS SHALL BE ASTM A615 GRADE 60, DEFORMED. ALL WWF SHALL BE ASTM A185, SMOOTH.

- SMOUTH.

 9. NORMAL WEIGHT CONCRETE (NW) SHALL HAVE A MAXIMUM DENSITY OF 145 PCF.

 10. EXTERIOR CONCRETE TO HAVE 6% AIR ENTRAINMENT.

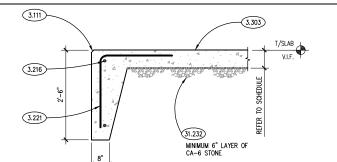

Kluber

DESIGNED - JMB REVISED -DRAWN - PJT REVISED LOT SCALE = 1/4" = 1'-0" CHECKED - CJH/JMB REVISED -

REVISED -

DATE - 12/13/2021

STATE OF ILLINOIS

WARRENVILLE TRAILHEAD TOILET BUILDING **FOUNDATION PLAN**

SCALE: 1/4" = 1'-0"

SCALE: AS INDICATED SHEET NO. 14 OF 22 SHEETS STA. 8+66 TO STA. 9+01

SCALE: N.T.S. TOTAL SHEET NO. SECTION COUNTY 19-00039-BT CONTRACT NO. 61H18


DETAIL SECTION

DUPAGE 49 41 N/A


ENGINEERING RESOURCE ASSOCIATES


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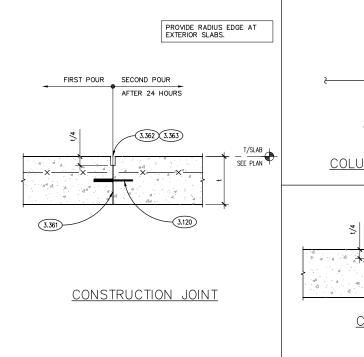
DEPARTMENT OF TRANSPORTATION

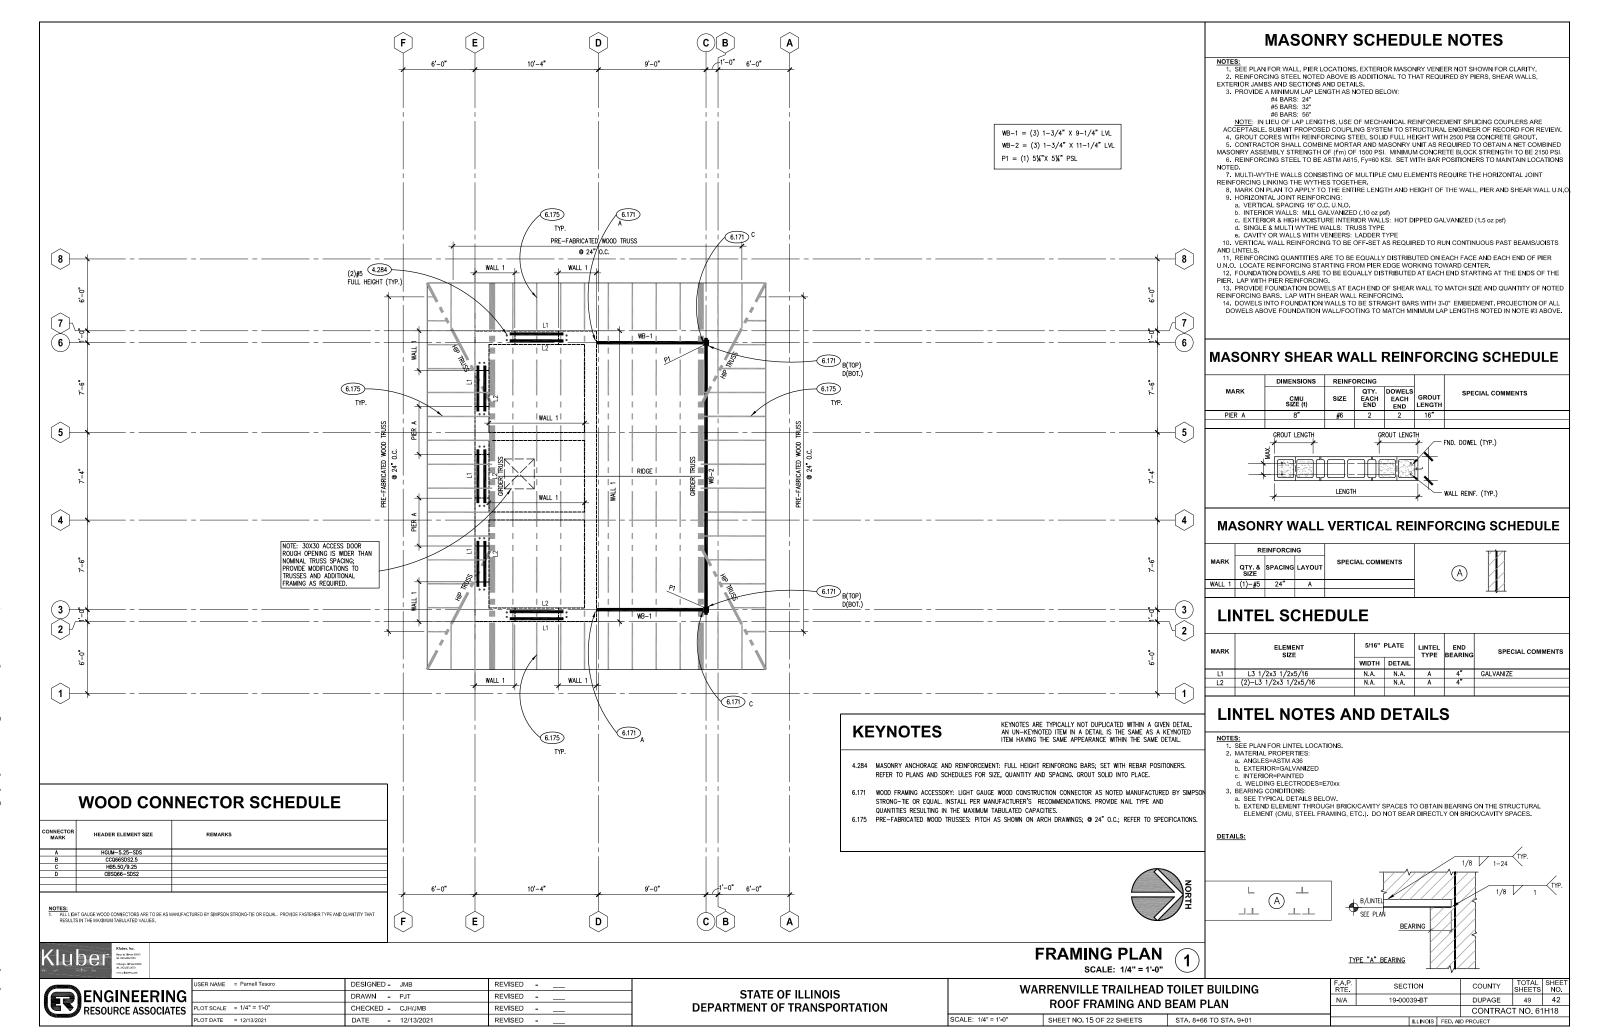



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TYP. SLAB RE-ENTRANT CORNER BAR DETAIL SCALE: 3/4" = 1'-0"

(3)

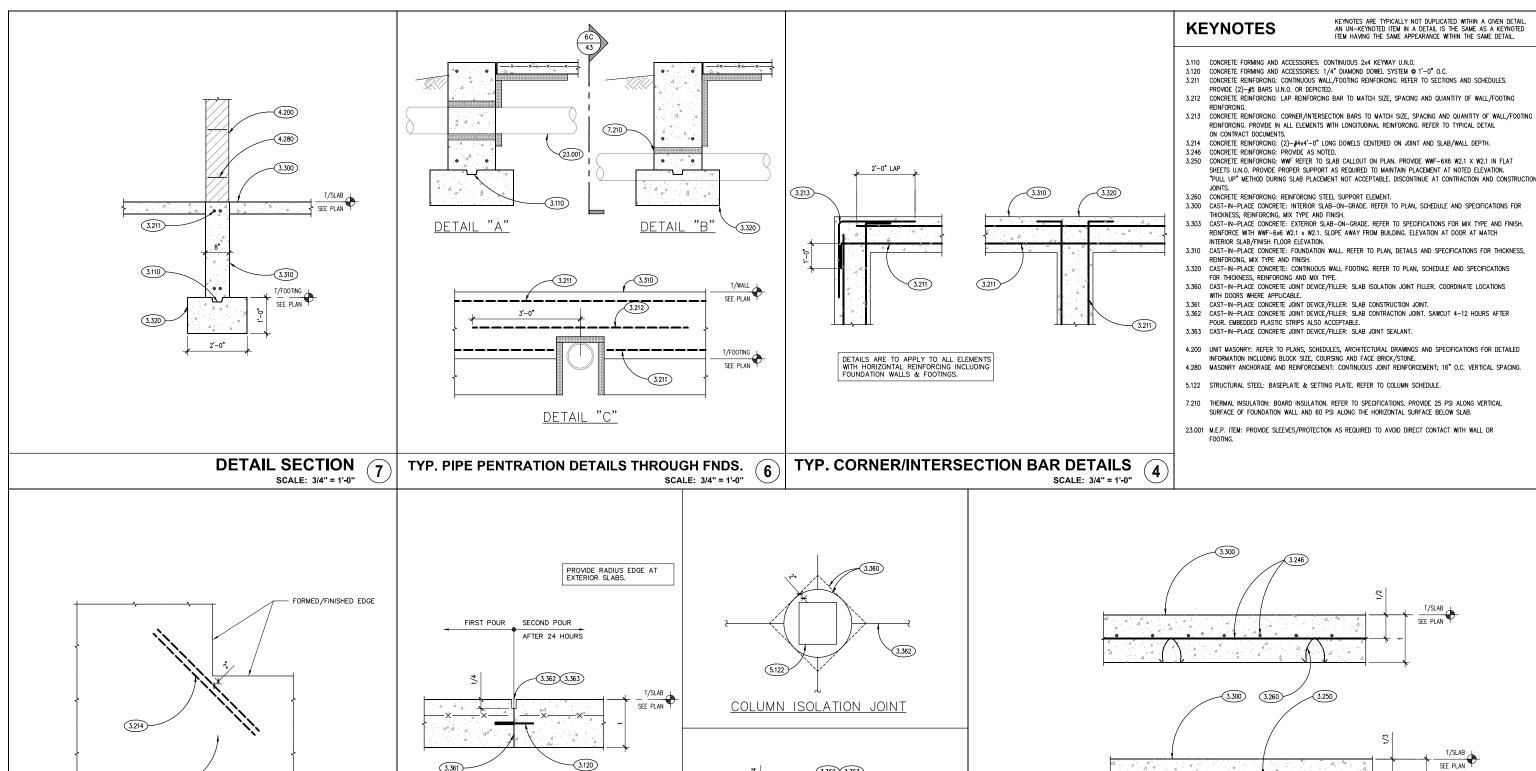TYPICAL SLAB JOINT DETAILS SCALE: 3/4" = 1'-0"

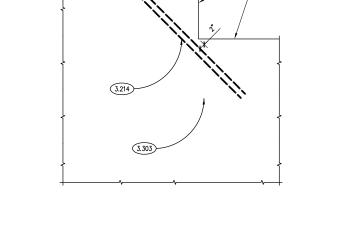TYPICAL SLAB ON GRADE DETAIL

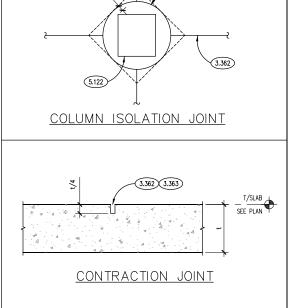SCALE: 3/4" = 1'-0"

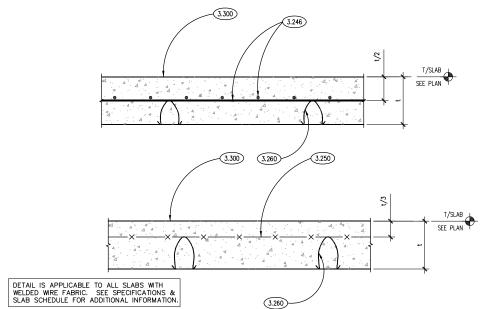

USER NAME = Parnell Tesoro	DESIGNED - JMB	REVISED
	DRAWN - PJT	REVISED
PLOT SCALE = 3/4" = 1'-0"	CHECKED - CJH/JMB	REVISED
PLOT DATE = 12/13/2021	DATE - 12/13/2021	REVISED
•		

STATE OF ILLINOIS **DEPARTMENT OF TRANSPORTATION** WARRENVILLE TRAILHEAD TOILET BUILDING STRUCTURAL DETAILS

SECTION DUPAGE 49 43 CONTRACT NO. 61H18

SCALE: 3/4"= 1'-0" SHEET NO. 16 OF 22 SHEETS

STA. 8+66 TO STA. 9+01

KEYNOTES ARE TYPICALLY NOT DUPLICATED WITHIN A GIVEN DETAIL. AN UN-KEYNOTED ITEM IN A DETAIL IS THE SAME AS A KEYNOTED ITEM HAVING THE SAME APPEARANCE WITHIN THE SAME DETAIL.

23.100 PROVIDE DUCTWORK FROM CEILING EXHAUST FAN UP TO GABLE WALL LOUVER AND TERMINATE THROUGH LOUVER. EXHAUST FANS SHALL BE ACTIVATED BY OCCUPANCY SENSOR. REFER TO ELECTRICAL DRAWINGS.

FAN SCHEDULE

MARK	TEF
MODEL	GC-146
AIR FLOW RATE (CFM)	80
EXTERNAL STATIC PRESS (IN WG)	0.33
DRIVE TYPE	DIRECT
MOTOR SIZE (WATTS)	33.4
ELECTRICAL (V/PH/HZ)	120/1/60
AREA SERVED	TOILET ROOMS
REMARKS	1

1. MODEL BASED ON LOREN COOK.

ELECTRIC UNIT HEATER SCHEDULE

MARK	CUH
MODEL	CDF-542-RE
AIR FLOW RATE (CFM)	300
ELECTRIC HEATER (KW)	2.0
AIR TEMPERATURE RISE (°F)	42
SUPPLY FAN (HP)	-
ELECTRICAL (V/PH/HZ)	240/1/60
FULL LOAD AMPS	8.3
REMARKS	1, 2

- MODEL BASED ON QMARK.
 PROVIDE TRIM RING FOR MOUNTING IN PERMANENT CEILING, INTERNAL THERMOSTAT AND DISCONNECT.

ROOM SCHEDULE

RM. NO.	ROOM NAME	RM. NO.	ROOM NAME
---------	-----------	---------	-----------

UNISEX TOILET ROOM

101 UTILITY ROOM 102 UNISEX TOILET ROOM

GENERAL NOTES

- 1. REFER TO DRAWING SHEET 1 FOR PROJECT GENERAL NOTES.
- ALL DUCTWORK IS SHOWN DIAGRAMMATICALLY AND DO NOT SHOW ALL REQUIRED FITTINGS, OFFSETS, DROPS AND RISES. THE CONTRACTOR IS RESPONSIBLE TO PROVIDE ALL MATERIAL AND LABOR FOR A COMPLETE AND WORKING SYSTEM. COORDINATE WITH OTHER TRADES FOR SPACE AVAILABLE AND RELATIVE LOCATIONS OF EQUIPMENT, PIPING, DUCTWORK, ETC.
- ALL TAPES AND MASTICS USED TO SEAL DUCTWORK LISTED AND LABELED IN ACCORDANCE WITH UL 181A SHALL BE MARKED ACCORDINGLY. ALL TAPES AND MASTICS USED TO SEAL FLEXIBLE DUCTS AND AIR CONNECTORS SHALL COMPLY WITH UL 181B AND MARKED ACCORDINGLY.
- 4. SPACE ALLOCATION, COORDINATION WITH ELECTRICAL, ARCHITECTURAL & OTHER MECHANICAL COMPONENTS HAVE BEEN MADE WITH RESPECT TO ALL EQUIPMENT SCHEDULED ON THESE DRAWINGS AND IN THE SPECIFICATIONS OF THE FIRST NAMED MANUFACTURER ONLY. OTHER MANUFACTURERS ARE ACCEPTABLE PROVIDED THEY MEET PERFORMANCE REQUIREMENTS AND AFOREMENTIONED COORDINATION.
- 5. OBTAIN AND PAY ALL COSTS FOR PERMITS, LICENSES, CERTIFICATE FILING AND ALL INSPECTIONS BY AUTHORITIES HAVING JURISDICTION.

Kluber

ENGINEERING RESOURCE ASSOCIATES

JSER NAME = Parnell Tesoro DESIGNED - DDW REVISED -REVISED -PLOT SCALE = 1/4" = 1'-0" CHECKED - DDW REVISED -PLOT DATE = 12/13/2021 DATE - 12/13/2021 REVISED -

STATE OF ILLINOIS **DEPARTMENT OF TRANSPORTATION** WARRENVILLE TRAILHEAD TOILET BUILDING **MECHANICAL PLAN**

SCALE: 1/4" = 1'-0"

SECTION DUPAGE 49 CONTRACT NO. 61H18

SCALE: AS INDICATED SHEET NO. 17 OF 22 SHEETS STA. 8+66 TO STA. 9+01

KEYNOTES ARE TYPICALLY NOT DUPLICATED WITHIN A GIVEN DETAIL. AN UN-KEYNOTED ITEM IN A DETAIL IS THE SAME AS A KEYNOTED ITEM HAVING THE SAME APPEARANCE WITHIN THE SAME DETAIL.

22.103 PROVIDE CASING AROUND WATER PIPES UNDER BUILDING. CASING SHALL BE TWO TIMES THE SIZE OF THE WATER PIPES. SEAL CASING AT FLOOR LEVEL AND AT FOUNDATION WALL.

ROOM SCHEDULE

RM. NO.	ROOM NAME	RM. NO.	ROOM NAME
---------	-----------	---------	-----------

100 UNISEX TOILET ROOM

101 UTILITY ROOM 102 UNISEX TOILET ROOM

GENERAL NOTES

- 1. REFER TO DRAWING COVER SHEET 1 FOR PROJECT GENERAL NOTES.
- 2. ALL SANITARY, WASTE AND STORM PIPES UP TO AND INCLUDING 3 INCHES SHALL SLOPE AT 1/4 INCH PER FOOT, 4 INCHES AND LARGER SHALL SLOPE AT 1/8 INCH PER FOOT, UNLESS OTHERWISE NOTED.
- ALL PIPING IS SHOWN DIAGRAMMATICALLY AND DOES NOT SHOW ALL OFFSETS, DROPS AND RISES. THE
 CONTRACTOR IS RESPONSIBLE TO PROVIDE ALL MATERIAL AND LABOR FOR A COMPLETE AND WORKING SYSTEM.
- OBTAIN AND PAY ALL COSTS FOR PERMITS, LICENSES, CERTIFICATE FILING AND INSPECTIONS BY AUTHORITIES
 HAVING JURISDICTION.
- COORDINATE ROUGH-INS FOR AND INSTALLATION OF PLUMBING FIXTURES WITH ACCESSIBILITY AND MOUNTING INFORMATION CONTAINED ON ARCHITECTURAL DRAWINGS.
- COORDINATE LOCATIONS OF ROUGH-INS FOR SINKS WITH CASEWORK ELEVATIONS CONTAINED ON ARCHITECTURAL DRAWINGS.
- 7. DRAINAGE AND VENT SYSTEM SHALL BE PRESSURE TESTED WITH WATER OR AIR.
- ALL BACKFLOW PREVENTER ASSEMBLIES SHALL BE TESTED AND APPROVED BY A CROSS CONNECTION CONTROL DEVICE INSPECTOR (CCCDI) BEFORE INITIAL OPERATION, AND AT LEAST ANNUALLY THEREAFTER.
- 9. PROVIDE DRAIN VALVES AT ALL LOW POINTS IN PIPING TO ALLOW FOR DRAINING THE SYSTEM COMPLETELY.

SCALE: 1/4" = 1'-0"

ENGINEERING RESOURCE ASSOCIATES

JSER NAME = Parnell Tesoro DESIGNED - KL REVISED -DRAWN - KL REVISED -PLOT SCALE = 1/4" = 1'-0" CHECKED - DDW REVISED -PLOT DATE = 12/13/2021 DATE - 12/13/2021 REVISED -

STATE OF ILLINOIS DEPARTMENT OF TRANSPORTATION WARRENVILLE TRAILHEAD TOILET BUILDING PLUMBING UNDERGROUND PLAN

SECTION DUPAGE 49 CONTRACT NO. 61H18

SCALE: AS INDICATED SHEET NO. 18 OF 22 SHEETS STA. 8+66 TO STA. 9+01

KEYNOTES ARE TYPICALLY NOT DUPLICATED WITHIN A GIVEN DETAIL. AN UN-KEYNOTED ITEM IN A DETAIL IS THE SAME AS A KEYNOTED ITEM HAVING THE SAME APPEARANCE WITHIN THE SAME DETAIL.

- 22.100 PROVIDE WATER SERVICE AND METER FOR BUILDING, COORDINATE WITH CITY FOR WATER METER. PROVIDE DRAIN DOWN VALVE DOWNSTREAM OF METER. COORDINATE EXACT LOCATION WITH OWNER.
- 22.101 PROVIDE HEAT TRAPS ON THE OUTLET AND INLET OF THE WATER HEATER AND INSULATE HOT WATER PIPING WITH 1 INCH FIBERGLASS INSULATION.
- 22.102 PROVIDE WATER PIPES SUCH THAT THEY ARE NOT LOCATED OVER ELECTRICAL PANEL IN CORNER OF ROOM. IF PIPES ARE INSTALLED OVER PANEL, DRIP PAN AND DRAIN PIPE SHALL BE REQUIRED.

ROOM SCHEDULE

RM. NO. RM. NO. ROOM NAME ROOM NAME

UNISEX TOILET ROOM

101 UTILITY ROOM 102 UNISEX TOILET ROOM

GENERAL NOTES

- 1. REFER TO DRAWING COVER SHEET 1 FOR PROJECT GENERAL NOTES.
- 2. ALL SANITARY, WASTE AND STORM PIPES UP TO AND INCLUDING 3 INCHES SHALL SLOPE AT 1/4 INCH PER FOOT, 4 INCHES AND LARGER SHALL SLOPE AT 1/8 INCH PER FOOT, UNLESS OTHERWISE NOTED.
- ALL PIPING IS SHOWN DIAGRAMMATICALLY AND DOES NOT SHOW ALL OFFSETS, DROPS AND RISES. THE CONTRACTOR IS RESPONSIBLE TO PROVIDE ALL MATERIAL AND LABOR FOR A COMPLETE AND WORKING SYSTEM.
- OBTAIN AND PAY ALL COSTS FOR PERMITS, LICENSES, CERTIFICATE FILING AND INSPECTIONS BY AUTHORITIES
 HAVING JURISDICTION.
- COORDINATE ROUGH-INS FOR AND INSTALLATION OF PLUMBING FIXTURES WITH ACCESSIBILITY AND MOUNTING INFORMATION CONTAINED ON ARCHITECTURAL DRAWINGS.
- COORDINATE LOCATIONS OF ROUGH-INS FOR SINKS WITH CASEWORK ELEVATIONS CONTAINED ON ARCHITECTURAL DRAWNOS.
- 7. DRAINAGE AND VENT SYSTEM SHALL BE PRESSURE TESTED WITH WATER OR AIR.
- ALL BACKFLOW PREVENTER ASSEMBLIES SHALL BE TESTED AND APPROVED BY A CROSS CONNECTION CONTROL DEVICE INSPECTOR (CCCDI) BEFORE INITIAL OPERATION, AND AT LEAST ANNUALLY THEREAFTER.
- 9. PROVIDE DRAIN VALVES AT ALL LOW POINTS IN PIPING TO ALLOW FOR DRAINING THE SYSTEM COMPLETELY.



SCALE: 1/4" = 1'-0"


SCALE: AS INDICATED SHEET NO. 19 OF 22 SHEETS STA. 8+66 TO STA. 9+01



	USER NAME = Parnell Tesoro	DESIGNED - KL	REVISED
ì		DRAWN - KL	REVISED
	PLOT SCALE = 1/4" = 1'-0"	CHECKED - DDW	REVISED
	PLOT DATE = 12/13/2021	DATE - 12/13/2021	REVISED

STATE OF ILLINOIS **DEPARTMENT OF TRANSPORTATION** WARRENVILLE TRAILHEAD TOILET BUILDING PLUMBING FLOOR PLAN

SECTION DUPAGE 49 CONTRACT NO. 61H18

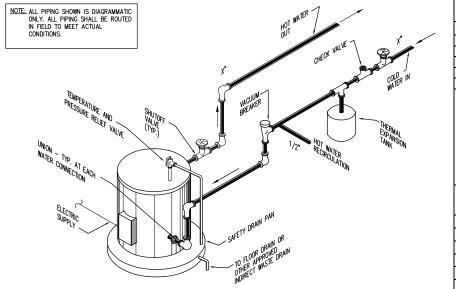

ELECTRIC WATER HEATER DETAIL

PLUMBING FIXTURE SCHEDULE

TAG	DESCRIPTION	COLD	нот	WASTE	VENT	REMARKS
WC	WATER CLOSET-WALL MOUNTED	1"	-	4"	2"	ADAAG COMPLIANT
LAV	LAVATORY-WALL HUNG	1/2"	1/2"	1-1/2"	1-1/4"	ADAAG COMPLIANT
MB	MOP BASIN	1/2"	1/2"	3"	1-1/2"	
HB	HOSE BIB	1/2"	-	-	-	
HYD	HYDRANT, FREEZE-RESISTANT	1/2"	-	-	-	

- ALL PLUMBING MATERIALS AND INSTALLATIONS SHALL BE IN STRICT ACCORDANCE WITH ALL STATE AND LOCAL PLUMBING RULES AND REGULATIONS CURRENTLY IN EFFECT, GOVERNED BY THE ADMINISTRATIVE AUTHORITY HAVING JURISDICTION.
- 2. THE PLUMBING CONTRACTOR IS RESPONSIBLE FOR THE INSTALLATION OF ALL TRAPS AND CLEANOUTS AS NECESSARY OF THE LOCALITY.
- 3. THE OPENINGS IN WALLS FOR THE PASSAGE OF PIPES SHALL BE TOTALLY FIRE SEALED TO THE SATISFACTION OF THE PLUMBING INSPECTOR AND/OR THE AUTHORITY HAVING JURISDICTION.

ELECTRIC WATER HEATER SCHEDULE


MARK	EWH
MODEL	DEL-10
TYPE	STORAGE
RECOVERY @ 100 DEGREE F RISE	10
HEATING ELEMENT (kW)	2.5
ELECTRICAL (V/PH/HZ)	240/1/60
SERVICE	POTABLE
REMARKS	1

MODEL BASED ON A.O. SMITH


PUMP SCHEDULE


MARK	HWRP
MODEL	e3-4
WATER FLOW RATE (GPM)	1.0
HEAD (FT)	4.0
ТҮРЕ	INLINE
MOTOR SIZE (W)	5 - 28 ECM
ELECTIRCAL (V/PH/HZ)	120/1/60
MOTOR SPEED (RPM)	_
SERVICE	HW RECIRCULATION
REMARKS	1

MODEL BASED ON B&G.

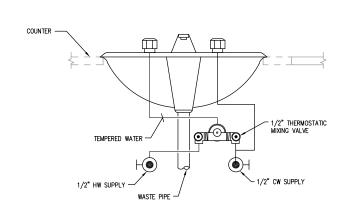

 MIXING VALVE SHALL COMPLY WITH ASSE 1070.
 MIXING VALVE SHALL HAVE A MAXIMUM SETTING OF FINISHED FLOOR

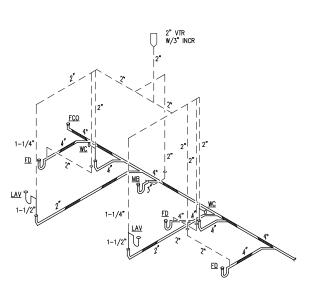

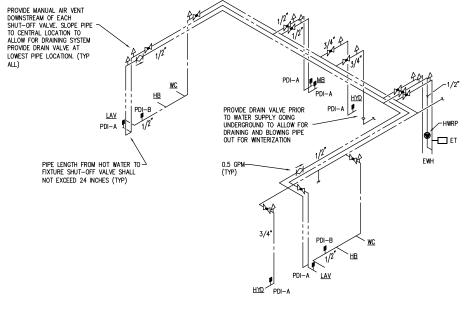

RISER DIAGRAM

3

SCALE: AS INDICATED SHEET NO. 20 OF 22 SHEETS

LOCAL MIXING VALVE DETAIL

SCALE: NTS

ENGINEERING PEROUPER 1997 RESOURCE ASSOCIATES

	USER NAME = Parnell Tesoro	DESIGNED - KL	REVISED	
ί		DRAWN - KL	REVISED	
S	PLOT SCALE = 1/2" = 1'-0"	CHECKED - DDW	REVISED	
	PLOT DATE = 12/13/2021	DATE - 12/13/2021	REVISED	

STATE OF ILLINOIS DEPARTMENT OF TRANSPORTATION WARRENVILLE TRAILHEAD TOILET BUILDING **PLUMBING DETAILS**

STA. 8+66 TO STA. 9+01

A.P. RTE	SEC ⁻	ΓΙΟΝ	COUNTY	TOTAL SHEETS	SHEE NO.
N/A	19-000	39 - BT	DUPAGE	49	47
			CONTRAC	T NO. 61	H18

ILLINOIS FED. AID PROJECT

WASTE & VENT

DOMESTIC WATER

KEYNOTES ARE TYPICALLY NOT DUPLICATED WITHIN A GIVEN DETAIL. AN UN-KEYNOTED ITEM IN A DETAIL IS THE SAME AS A KEYNOTED ITEM HAVING THE SAME APPEARANCE WITHIN THE SAME DETAIL.

26.300 PROVIDE CEILING MOUNTED OCCUPANCY SENSOR WITH WIREGUARD, MOUNT CENTER OF CEILING IN ROOM.

26.301 PROVIDE CONNECTION TO HAND DRYER. PROVIDE 2#12,1#12G.,3/4"C. TO PANELBOARD.

26.302 PROVIDE 3" EMPTY GRS CONDUIT, STUBBED AND CAPPED 2' PAST FOUNDATION FOR UTILITY SERVICE LATERAL.
UTILITY SERVICE LATERAL AND CONNECTION BY OTHERS.

26.303 PROVIDE QTY. 4, NEMA L14-50R RECEPTACLES. PROVIDE NEMA 3R PULL BOX WITH LOCKABLE COVER FOR RECEPTACLES (12"X12"X6" NOMINAL). VERIFY EXACT RECEPTACLE CONFIGURATION WITH OWNER'S EXISTING

26.304 PROVIDE 30A/2P DISCONNECT SWITCH FOR WATER HEATER. PROVIDE 2#12.1#12G.1/2°C. TO PANELBOARD.
26.305 PROVIDE 1 1/4" EMPTY GRS CONDUIT, STUBBED AND CAPPED 2" PAST FOUNDATION FOR FUTURE POWER REQUIREMENTS.

26.307 PROVIDE CONTACTOR, PHOTOCELL, AND TIMECLOCK FOR EXTERIOR LIGHTING CONTROL. PHOTOCELL ON,

TIMECLOCK OFF WITH MANUAL OVERRIDE IN UTILITY ROOM.

26.308 PROVIDE SINGLE POLE TOGGLE SWITCH FOR FINAL CONNECTION TO AUTO FLUSH/AUTO FAUCET TRANSFORMER.

COORDINATE EXACT LOCATION OF TRANSFORMER WITH PLUMBING CONTRACTOR PRIOR TO INSTALLATION.
26.309 PROVIDE OUTLET BOX TYPE LAMPHOLDER IN ATTIC. PROVIDE LED LAMP FOR EACH. PROVIDE SINGLE POLE,

ILLUMINATED (WHILE LIGHTING IS ON) TOGGLE SWITCH IN ATTIC LOCATED WITHIN UTILITY ROOM. 26.310 PROVIDE GFCI, WEATHERPROOF DUPLEX RECEPTACLE WITH DUAL USB (ONE USB-A AND ONE USB-C) (BASIS

ROOM SCHEDULE

	RM. NO.	ROOM NAME	RM. NO.	ROOM NAME			
J	100	UNISEX TOILET ROOM					
	101	UTILITY ROOM					
	102	UNISEX TOILET ROOM					

ELECTRICAL GENERAL NOTES

- INTENT OF DRAWINGS: THESE DRAWINGS ARE INTENDED TO RELAY TO CONTRACTOR A DESIGN INTENT. INCLUDE IN BID ALL LABOR AND MATERIALS NECESSARY FOR A COMPLETE AND OPERATIONAL SYSTEM AS REASONABLY INFERABLE, AS DETERMINED BY ARCHITECT, TO ACCOMPLISH THE INTENT OF THESE DRAWING
- REFER TO ARCHITECTURAL, PLUMBING, PLANS, SHOP DRAWINGS AND MANUFACTURERS INSTALLATION INSTRUCTIONS FOR ADDITIONAL INFORMATION ON EXACT POWER, WIRING & ROUGH—IN REQUIREMENTS AND LOCATIONS OF DEVICES.
- 3 ROUTE ALL POWER CIRCUITS TO PANEL 'PP1'
- . UNLESS NOTED OTHERWISE, ALL HOMERUNS SHALL CONSIST OF A MAXIMUM OF 2 CIRCUITS (PHASE A & B, NEUTRAL & GROUND) IN 1/2"C. MINIMUM WIRE SIZE SHALL BE #12 AWG. WIRE SIZE FOR HOMERUN CIRCUITS SHALL BE 2#12, 1#12N & 1#12G.).
- SECURE ALL JUNCTION BOXES TO BUILDING STRUCTURE PER NEC REQUIREMENTS.
- 6. SECURE CONDUIT TO BUILDING STRUCTURE WITHIN 3' OF JUNCTION BOXES AND A MAXIMUM OF 10' ON

SCALE: 1/4" = 1'-0"


ENGINEERING RESOURCE ASSOCIATES

SER NAME = Parnell Tesoro DESIGNED - ATR REVISED -DRAWN - ATR REVISED -PLOT SCALE = 1/4" = 1'-0" CHECKED - MTK REVISED -PLOT DATE = 12/13/2021 DATE - 12/13/2021 REVISED -

STATE OF ILLINOIS **DEPARTMENT OF TRANSPORTATION** WARRENVILLE TRAILHEAD TOILET BUILDING **ELECTRICAL POWER & LIGHTING PLAN**

SECTION DUPAGE 49 48 CONTRACT NO. 61H18

SCALE: AS INDICATED SHEET NO. 21 OF 22 SHEETS STA. 8+66 TO STA. 9+01

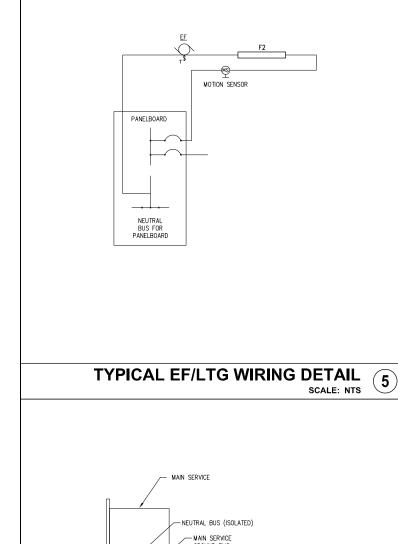



LIGHTING FIXTURE SCHEDULE 3 N.T.S.

INDICATES ISOLATED GROUND CONDUCTOR.

SYMBOL

CEILING WALL FLOOR

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POWER EQUIPMENT & DEVICES SAFETY SWITCH. N=NON-FUSED (AMPS/POLES/ENCLOSURE). \Box F=FUSED (AMPS/FUSE/POLES/ENCLOSURE). MAGNETIC MOTOR STARTER. NEMA SIZE AS NOTED. \boxtimes COMBINATION MAGNETIC MOTOR STARTER AND FUSED DISCONNECT SW. (AMPS/FUSE/POLES/NEMA SIZE). \boxtimes MOTOR. HP= HORSE-POWER RATING. (HP) (HP) (HP) ELECTRIC HEAT OUTLET Δ Δ PANEL 240V & BELOW.

DESCRIPTION

SELF CONTAINED EMERGENCY BATTERY PACK W/ BATTERY BACK-UP

SEE LIGHTING FIXTURE SCHEDULE.
SINGLE POLE TOGGLE SWITCH. 15A OR 20A AS REQUIRED. 120/277V
a=SWITCHING CONTROL, P=PILOT LIGHT, K=KEYED SW., LV=LOW VOLTAGE

3-WAY TOGGLE SWITCH. 15A OR 20A AS REQUIRED. 120/277V

LIGHTING CONTROL DIMMER SWITCH. SIZE AS INDICATED.

VACANCY SENSOR SWITCH. MANUAL ON CONTROL WITH AUTOMATIC SHUT OFF AFTER 30 MINUTES OF VACANCY.

OCCUPANCY SENSOR SWITCH. AUTOMATIC ON CONTROL WITH AUTOMATIC SHUT OFF AFTER 30 MINUTES OF VACANCY.

DUPLEX RECEPTACLE. 20A 125V 2P 3W GRD. NEMA5-20R. @18"AFF D=DEDICATED CIRCUIT. 'I' = MTD. @48"AFF, OR @6" ABOVE COUNTER.

GFCI(GROUND FAULT CIRCUIT INTERRUPTER) PROTECTED RECEPTACLE. WP=WEATHER PROOF. 20A 125V 2P 3W GRD. NEMA5-20R. @18"AFF

GFCI(GROUND FAULT CIRCUIT INTERRUPTER) PROTECTED RECEPTACLE MTD. @48"AFF, OR @6" ABOVE COUNTER.

WRING IN CONDUIT CONCEALED ABOVE CEILING, IN WALL AND UNDER FLOOR OR UNDERGROUND.

20A 125V 2P 3W GRD. NEMA5-20R. PO=POP UP RECEPTACLE

WIRING DEVICES & OUTLETS

SPECIAL PURPOSE SINGLE RECEPTACLE. @18"AFF

WIRING IN CONDUIT EXPOSED ON CEILING OR WALL. HILL JHILL BRANCH CIRCUIT WIRING IN CONDUIT HOMERUN TO PANEL. ONE ARROW PER HOMERUN. SLASHES INDICATE NUMBER OF CONDUCTORS. INDICATES GROUND CONDUCTOR.

MATCH CONFIGURATION TO EQUIPMENT.

DOUBLE DUPLEX RECEPTACLE. @18"AFF

FLEXIBLE CONDUIT CONNECTION.

4' LED STRIP FIXTURE TYPE. SEE LIGHT FIXTURE SCHEDULE. A= FIXTURE TYPE, 2= CIRCUIT ASSIGNMENT, o=SWITCH LEG

LUMINARIES 4' FIXTURE TYPE. SEE LIGHT FIXTURE

MOMENTARY CONTACT SWITCH.

SCHEDULE.

3=3 WAY DIMMER

26.0)

CP

MISCELLANEOUS

HVAC EQUIPMENT IDENTIFICATION

EQUIPMENT CONTROL PANEL

KEYNOTE IDENTIFICATION

NEUTRAL BUS (ISOLATED) MAIN SERVICE GROUND BUS	
GROUND RING OR CONCRETE ENCASED ELECTRODE. OF BARE COPPER CONDUCTOR A DEPTH BELOW THE	

PANEL: PP1			100A/2P MAIN CIRCUIT BREAKER				
CKT.	BRKR	DESCRIPTION	PH/	ASE B	DESCRIPTION	BRKR	CKT.
		-	1000			+	
1	2P20	ELECTRIC WATER HEATER	1250		CUH-1	2P20	2
3	1			1000 1250		1	4
5	1P20*	HAND DRYER	1000		CUH-2	2P20	6
7	1P20*	HAND DRYER		1000 1400		1	8
9	1P20	HWRP-1	1000 28		CUH-3	2P20	10
11	1P20	EXTERIOR RECEPTACLES		1000 360		1	12
13	1P20	EXTERIOR RECEPTACLES	90 360		LTG, EF - WOMEN'S	1P20	14
15	1P20**	EXTERIOR LIGHTING		90 462	LTG, EF - MEN'S	1P20	16
17	1P20	LTG, REC - UT LITY ROOM	250 381		AUTO FLUSH/AUTO FAUCET	1P20	18
19	1P20	RECEPTACLE - "OILET ROOM		1980 180	ATTIC LIGHTING	1P20	20
21	1P20	RECEPTACLE - "OILET ROOM	180		SPARE	1P20	22
23	1P20	SPARE		0 0	SPARE	1P20	24
25	-	-SPACE-			-SPACE-	-	26
27	-	-SPACE-			-SPACE-	-	28
29	-	-SPACE-			-SPACE-	-	30
31	-	-SPACE-			-SPACE-	-	32
33	-	-SPACE-			-SPACE-	-	34
35	2P50	NEMA 14-50R		180 180	NEMA 14-50R	2P50	36
37	1		180			1	38
39	2P50	NEMA 14-50R		180 180	NEMA 14-50R	2P50	40
41	1		180			1	42
OLTA(120 / 240 VOLT, 1PHASE,	3WIRE		NOTES:		
	PHASE A				1. NEMA1 ENCLOSURE, GROUND		
OTAL	PHASE B	8722			2. LOCKABLE COVER, SURFACE		
					3. SERVICE ENTRANCE RATED, 2		
					* CIRCUIT BREAKER SHALL BE L	OCKABLE	IN THE
		CALCU_ATE	D AMPS:	65.3	OFF POSITION.		
					** ROUTE VIA TIMECLOCK		

200A 240V 1Ø 3W UTILITY METER ₩. IN NEMA3R ENCL 3#2,#8G,1 1/4"C. -SEE DETAIL THIS SHEET BOND AT SERVICE ENTRANCE EQUIPMENT 1 1/4" EMPTY GRS CONDUIT STUBBED AND CAPPED SEE ELECTRICAL LIGHTING AND POWER PLAN SHEET

-3-250KCMIL,#2G,3"C. (BY OWNER)
PROVIDE 3" EMPTY GRS CONDUIT SUBBED AND CAPPED

SEE ELECTRICAL LIGHTING AND POWER PLAN SHEET 48

GROUNDING ELECTRODE DETAIL SCALE: N.T.S.

EARTHS SURFACE OF NOT LESS THAN 2-1/2', #4 AWG

SCALE: NTS

DANEL - DD4

PANEL SCHEDULE

400A /OD MAIN CIDCUIT DDEAKED

UTILITY PAD-MOUNT XFMR

S:120/240 1 PHASE, 3 WIRE, WYE

ELECTRICAL ONE LINE RISER DIAGRAM

ELECTRICAL SYMBOLS LIST

Kluber

		USER NAME	= Parnell Te
	ENGINEERING		
	RESOURCE ASSOCIATES		= 1/4" = 1'-
		PLOT DATE	= 12/13/202

DRAWN - ATR REVISED	
CHECKED - MTK REVISED	
DATE - 12/13/2021 REVISED	
CHECKED - MTK REVISED -	_

STATE OF ILLINOIS **DEPARTMENT OF TRANSPORTATION**

WARRENVILLE TRAILHEAD TOILET BUILDING ELECTRICAL SCHEDULES & DETAILS				
SCALE:	AS INDICATED	SHEET NO. 22 OF 22 SHEETS	STA. 8+66 TO STA. 9+01	

SECTION DUPAGE 49 49 CONTRACT NO. 61H18