EROSION CONTROL LEGEND TEMPORARY EROSION CONTROL SEEDING TEMPORARY DITCH CHECK AND MULCH METHOD 2 TEMPORARY EROSION CONTROL SEEDING TEMPORARY DITCH CHECK INSTALLED AND TEMPORARY EROSION CONTROL BLANKET IN PREVIOUS STAGE PERMANENT SEEDING (SEE NOTE 3) INLET & PIPE PROTECTION TEMPORARY EROSION CONTROL SEEDING OR PERMANENT INLET & PIPE PROTECTION INSTALLED SEEDING INSTALLED IN A PREVIOUS STAGE IN PREVIOUS STAGE TEMPORARY PAVEMENT FLOW DIRECTION (SEE NOTE 4) -√> PERIMETER EROSION BARRIER (SEE NOTE 2) PROPOSED STORM SEWER (SEE NOTE 1) PERIMETER EROSION BARRIER INSTALLED PROPOSED STORM SEWER INSTALLED IN PREVIOUS STAGE IN PREVIOUS STAGE INLET FILTER TEMPORARY PIPE CULVERT PERMANENT DRAINAGE STRUCTURE (27) INLET FILTER INSTALLED IN PREVIOUS STAGE

CHECKED JCM

DATE

12/14/2012

REVISED

REVISED

NUMBER (SEE NOTE 1)

NOTES

- 1. SEE PROPOSED DRAINAGE PLANS FOR STORM SEWER INFORMATION.
- 2. PERIMETER EROSION BARRIER SHALL BE ERECTED ADJACENT TO R.O.W., EASEMENT, AND CONSTRUCTION LIMITS AND AS DIRECTED BY THE ENGINEER.
- 3. SEE LANDSCAPING PLANS FOR LANDSCAPING REQUIREMENTS.
- 4. SEE PRE-STAGE CROSS SECTIONS FOR GRADING INFORMATION.
- 5. REMOVE INLETS/CATCH BASINS/MANHOLES TO MAINTAIN FLOW.

DUPAGE

734 428


CONTRACT NO. 60R31

338

ILLINOIS ROUTE 59

SCALE: AS SHOWN SHEET NO. 3 OF 40 SHEETS STA. 4010+00 TO STA. 4023+00

(112 & 113) WRS-6

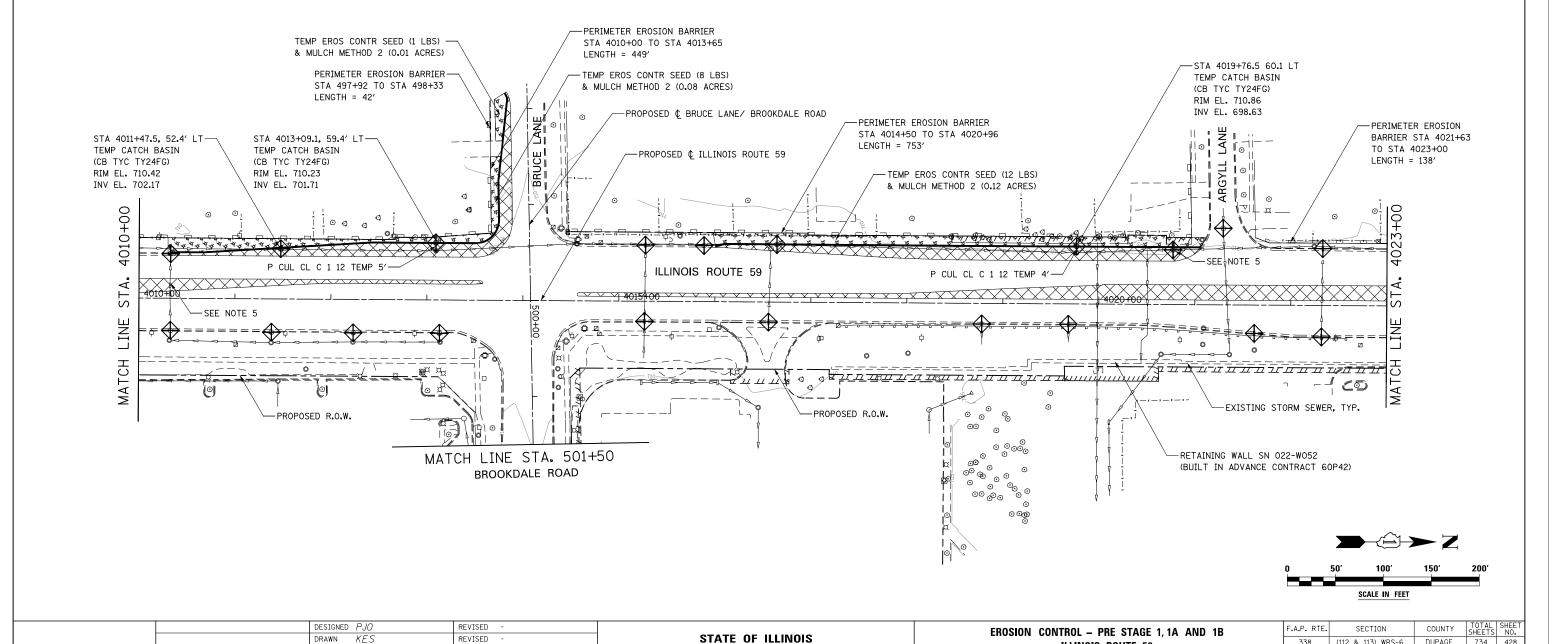

DEPARTMENT OF TRANSPORTATION