## EROSION CONTROL LEGEND TEMPORARY EROSION CONTROL SEEDING TEMPORARY DITCH CHECK AND MULCH METHOD 2 TEMPORARY EROSION CONTROL SEEDING TEMPORARY DITCH CHECK INSTALLED AND TEMPORARY EROSION CONTROL BLANKET IN PREVIOUS STAGE PERMANENT SEEDING (SEE NOTE 3) INLET & PIPE PROTECTION INLET & PIPE PROTECTION INSTALLED TEMPORARY EROSION CONTROL SEEDING OR PERMANENT SEEDING INSTALLED IN A PREVIOUS STAGE IN PREVIOUS STAGE TEMPORARY PAVEMENT FLOW DIRECTION (SEE NOTE 4) PERIMETER EROSION BARRIER (SEE NOTE 2) PROPOSED STORM SEWER (SEE NOTE 1) PERIMETER EROSION BARRIER INSTALLED PROPOSED STORM SEWER INSTALLED IN PREVIOUS STAGE IN PREVIOUS STAGE

CHECKED JCM

DATE 12/14/2012

REVISED

REVISED

TEMPORARY PIPE CULVERT

NUMBER (SEE NOTE 1)

PERMANENT DRAINAGE STRUCTURE

INLET FILTER

INLET FILTER INSTALLED IN PREVIOUS STAGE

## NOTES

- 1. SEE PROPOSED DRAINAGE PLANS FOR STORM SEWER INFORMATION.
- 2. PERIMETER EROSION BARRIER SHALL BE ERECTED ADJACENT TO R.O.W., EASEMENT, AND CONSTRUCTION LIMITS AND AS DIRECTED BY THE ENGINEER.
- 3. SEE LANDSCAPING PLANS FOR LANDSCAPING REQUIREMENTS.
- 4. SEE PRE-STAGE CROSS SECTIONS FOR GRADING INFORMATION.

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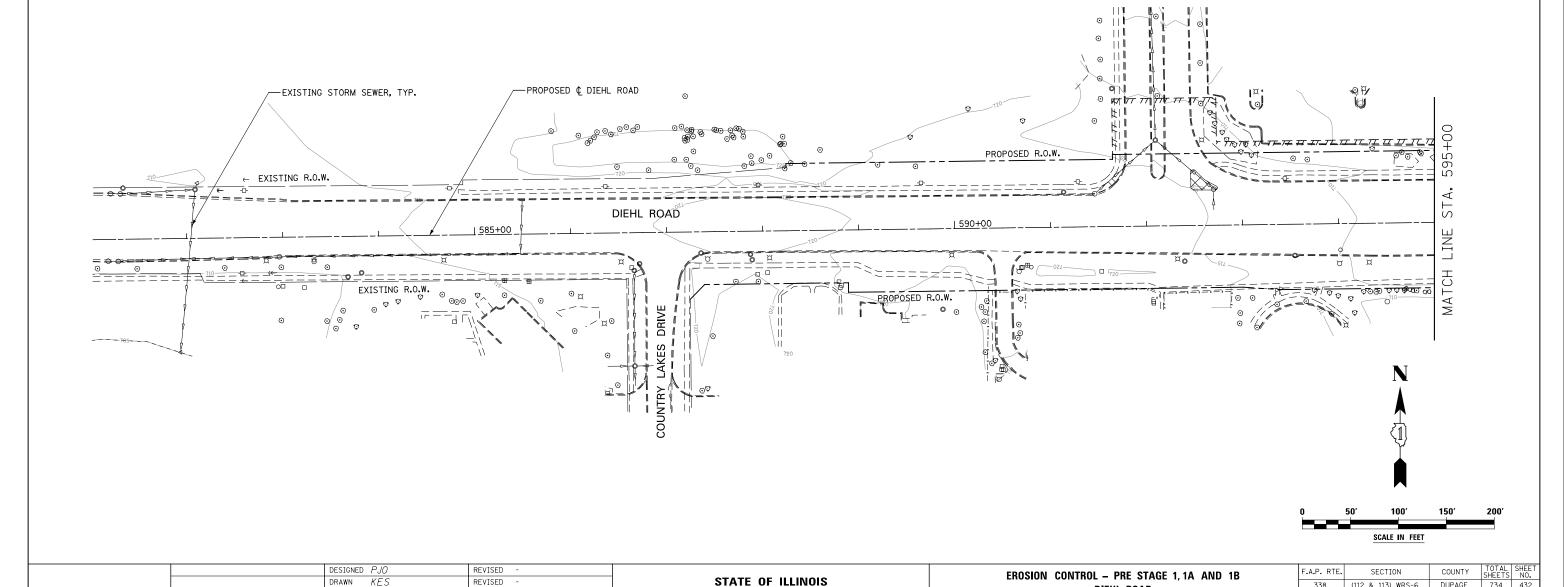
DIEHL ROAD

SCALE: AS SHOWN SHEET NO. 7 OF 40 SHEETS STA. 581+00 TO STA. 595+00

(112 & 113) WRS-6 DUPAGE

734 432

CONTRACT NO. 60R31



**DEPARTMENT OF TRANSPORTATION**