
## EROSION CONTROL LEGEND

2 4 4 4 4 4 4 4 4 4 4 4	TEMPORARY EROSION CONTROL SEEDING AND MULCH METHOD 2	-\$-	TEMPORARY DITCH CHECK	1. SEE PROPOSED DRAINAGE PLANS FOR STORM SEWER INFORMATION.				
	TEMPORARY EROSION CONTROL SEEDING AND TEMPORARY EROSION CONTROL BLANKET	{\$}	TEMPORARY DITCH CHECK INSTALLED IN PREVIOUS STAGE	<ol> <li>PERIMETER EROSION BARRIER SHALL BE ERECTED ADJACENT TO R.O.W., EASEMENT, AND CONSTRUCTION LIMITS AND AS DIRECTED</li> </ol>				
	PERMANENT SEEDING (SEE NOTE 3)	⊕	INLET & PIPE PROTECTION	BY THE ENGINEER.				
	TEMPORARY EROSION CONTROL SEEDING OR PERMANENT SEEDING INSTALLED IN A PREVIOUS STAGE	÷	INLET & PIPE PROTECTION INSTALLED IN PREVIOUS STAGE	3. SEE LANDSCAPING PLANS FOR LANDSCAPING REQUIREMENTS.				
	TEMPORARY PAVEMENT	\->	FLOW DIRECTION (SEE NOTE 4)	4. SEE STAGE 3 CROSS SECTIONS FOR GRADING INFORMATION.				
	PERIMETER EROSION BARRIER (SEE NOTE 2)	<b>&gt;</b> >	PROPOSED STORM SEWER (SEE NOTE 1)	5. PROPOSED STRUCTURE SHALL BE BURIED AND TEMPORARILY COVERED/CLOSED WITH STEEL PLATE OF THICKNESS SPECIFIED AND APPROVED BY THE ENGINEER. PAYMENT FOR THIS TEMPORARY				
<del></del>	PERIMETER EROSION BARRIER INSTALLED IN PREVIOUS STAGE	<b>bb</b>	PROPOSED STORM SEWER INSTALLED IN PREVIOUS STAGE	COVER INSTALLATION AND REMOVAL SHALL BE CONSIDERED INCLUDED IN THE COST OF THE PROPOSED STRUCTURE.				
$\Leftrightarrow$	INLET FILTER	<b>&gt;</b> >	TEMPORARY PIPE CULVERT					
$\Leftrightarrow$	INLET FILTER INSTALLED IN PREVIOUS STAGE	(27)	PERMANENT DRAINAGE STRUCTURE NUMBER (SEE NOTE 1)					
(*) - SEE NOTE 5								

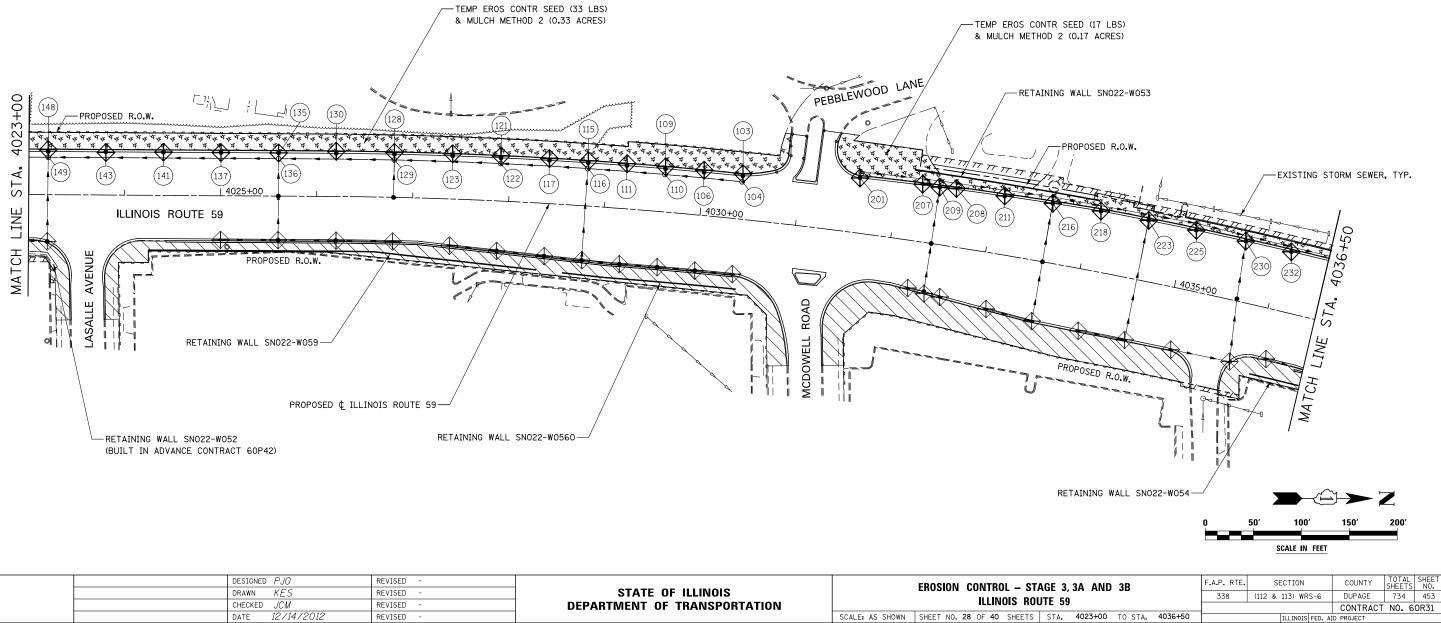

NOTES

	DESIGNED PJO	REVISED -	STATE OF ILLINOIS DEPARTMENT OF TRANSPORTATION	EROSION CONTROL – STAG Illinois Rout
	DRAWN KES CHECKED JCM	REVISED - REVISED -		
	DATE 12/14/2012	REVISED -		SCALE: AS SHOWN SHEET NO. 28 OF 40 SHEETS