## EROSION CONTROL LEGEND TEMPORARY EROSION CONTROL SEEDING TEMPORARY DITCH CHECK AND MULCH METHOD 2 TEMPORARY EROSION CONTROL SEEDING TEMPORARY DITCH CHECK INSTALLED AND TEMPORARY EROSION CONTROL BLANKET IN PREVIOUS STAGE PERMANENT SEEDING (SEE NOTE 3) INLET & PIPE PROTECTION TEMPORARY EROSION CONTROL SEEDING OR PERMANENT INLET & PIPE PROTECTION INSTALLED SEEDING INSTALLED IN A PREVIOUS STAGE IN PREVIOUS STAGE TEMPORARY PAVEMENT FLOW DIRECTION (SEE NOTE 4) PERIMETER EROSION BARRIER (SEE NOTE 2) PROPOSED STORM SEWER (SEE NOTE 1) PROPOSED STORM SEWER INSTALLED PERIMETER EROSION BARRIER INSTALLED IN PREVIOUS STAGE IN PREVIOUS STAGE TEMPORARY PIPE CULVERT INLET FILTER

(27)


INLET FILTER INSTALLED IN PREVIOUS STAGE

PERMANENT DRAINAGE STRUCTURE

NUMBER (SEE NOTE 1)

## NOTES

- 1. SEE PROPOSED DRAINAGE PLANS FOR STORM SEWER INFORMATION.
- PERIMETER EROSION BARRIER SHALL BE ERECTED ADJACENT TO R.O.W., EASEMENT, AND CONSTRUCTION LIMITS AND AS DIRECTED BY THE ENGINEER.
- 3. SEE LANDSCAPING PLANS FOR LANDSCAPING REQUIREMENTS.
- 4. SEE STAGE 4 CROSS SECTIONS FOR GRADING INFORMATION.

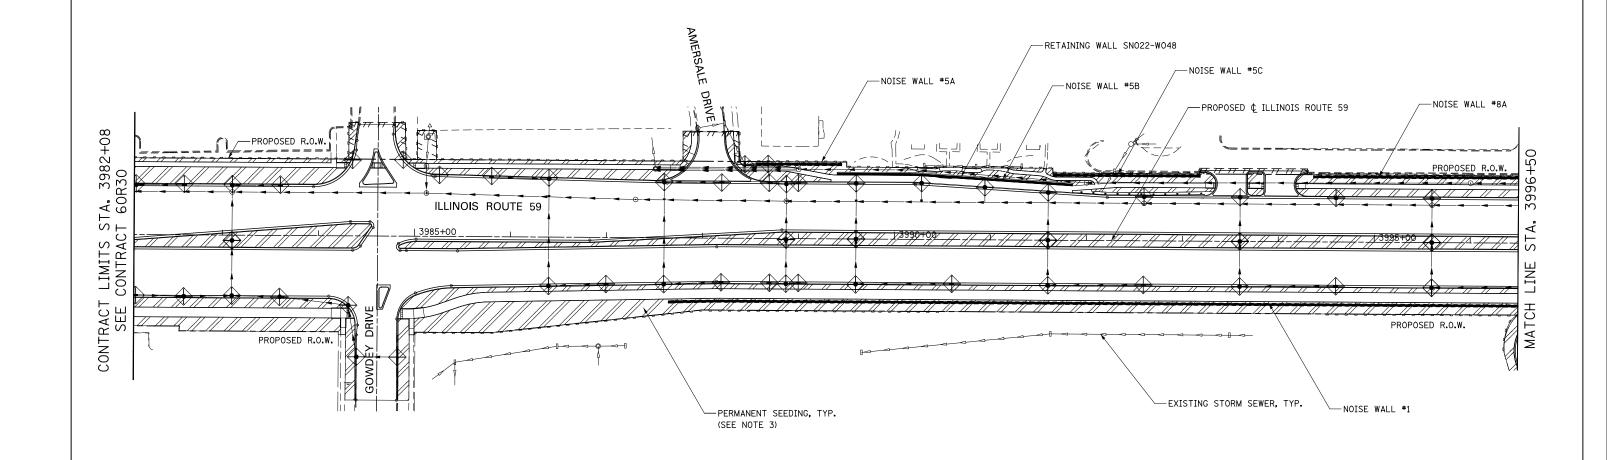

	DESIGNED PJO	REVISED -	STATE OF ILLINOIS DEPARTMENT OF TRANSPORTATION S	EROSION CONTROL - STAGE 4,4A AND 4B	F.A.P. RTE.	SECTION	COUNTY	TOTAL SHEETS	SHEET NO.
	DRAWN KES	REVISED -		ILLINOIS ROUTE 59		(112 & 113) WRS-6	DUPAGE	734	458
	CHECKED JCM	REVISED -				CONTRACT N			OR31
	DATE 12/14/2012	REVISED -		SCALE: AS SHOWN SHEET NO. 33 OF 40 SHEETS STA. 3982+08 TO STA. 3996+50		ILLINOIS FED. AID PROJECT			

SCALE IN FEET