
EROSION CONTROL LEGEND

* 4 * 4 * 4 * 4	TEMPORARY EROSION CONTROL SEEDING AND MULCH METHOD 2	-\$-	TEMPORARY DITCH CHECK
	TEMPORARY EROSION CONTROL SEEDING AND TEMPORARY EROSION CONTROL BLANKET		TEMPORARY DITCH CHECK INSTALLED IN PREVIOUS STAGE
	PERMANENT SEEDING (SEE NOTE 3)	⊕	INLET & PIPE PROTECTION
	TEMPORARY EROSION CONTROL SEEDING OR PERMANENT SEEDING INSTALLED IN A PREVIOUS STAGE		INLET & PIPE PROTECTION INSTALLED IN PREVIOUS STAGE
	TEMPORARY PAVEMENT	-~>	FLOW DIRECTION (SEE NOTE 4)
- <u></u>	PERIMETER EROSION BARRIER (SEE NOTE 2)		PROPOSED STORM SEWER (SEE NOTE 1)
	PERIMETER EROSION BARRIER INSTALLED IN PREVIOUS STAGE	-	PROPOSED STORM SEWER INSTALLED IN PREVIOUS STAGE
\Leftrightarrow	INLET FILTER	> >	TEMPORARY PIPE CULVERT
\Leftrightarrow	INLET FILTER INSTALLED IN PREVIOUS STAGE	(27)	PERMANENT DRAINAGE STRUCTURE NUMBER (SEE NOTE 1)

NOTES

- 1. SEE PROPOSED DRAINAGE PLANS FOR STORM SEWER INFORMATION.
- 2. PERIMETER EROSION BARRIER SHALL BE ERECTED ADJACENT TO R.O.W., EASEMENT, AND CONSTRUCTION LIMITS AND AS DIRECTED BY THE ENGINEER.
- 3. SEE LANDSCAPING PLANS FOR LANDSCAPING REQUIREMENTS.
- 4. SEE STAGE 4 CROSS SECTIONS FOR GRADING INFORMATION.

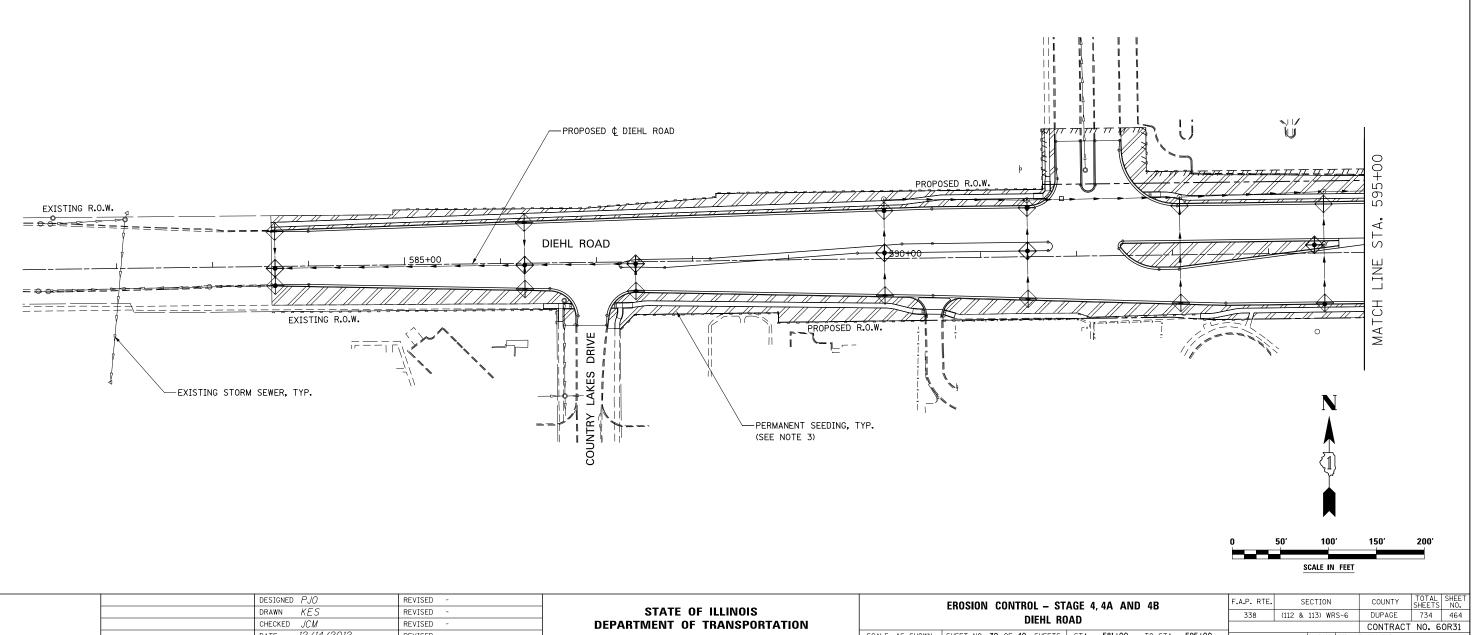

DESIGNED PJO	REVISED -		EROSION CONTROL – STAGE 4, 4A AND 4B
DRAWN KES	REVISED -	STATE OF ILLINOIS	
CHECKED JCM	REVISED -	DEPARTMENT OF TRANSPORTATION	DIEHL ROAD
DATE 12/14/2012	REVISED -		SCALE: AS SHOWN SHEET NO. 39 OF 40 SHEETS STA. 581+00 TO STA. 595+00



ILLINOIS FED. AID PROJECT