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- BOWMAN PUMP STATION STRUCTURAL DETAILS
- 7 BOWMAN PUMP STATION PIPE SUPPORT PLANS
- BOWMAN PUMP STATION PIPE SUPPORT ELEVATION

HIGHWAY STANDARDS

000001-07 STANDARD SYMBOLS, ABBREVIATIONS AND PATTERNS

STATE OF ILLINOIS

DEPARTMENT OF TRANSPORTATION

PROPOSED HIGHWAY PLANS

FAI ROUTE 70 /FAP 594 (I-055/064/IL 203) SECTION 82-2-1PS-4, 61-PS-1 BOWMAN & McCAMBRIDGE AVENUE PUMP STATION BUILDING IMPROVEMENTS ST. CLAIR & MADISON COUNTIES

C-98-043-19

BOWMAN
PUMP STATION


POR STATION

RECAMBRIDGE AVE.
PUMP STATION

MCCAMBRIDGE AVE.
PUMP STATION

& A S S O C I A T E S. P. C.

Engineers - Architects - Surveyors
616 N. 24th St. Quincy, linois 62301 217.223,3670
STATE OF ILLINOIS DESIGN FIRM - 1842738

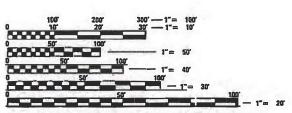

FULL SIZE PLANS HAVE BEEN PREPARED USING STANDARD ENGINEERING SCALES. REDUCED SIZED PLANS WILL NOT CONFORM TO STANDARD SCALES. IN MAKING MEASUREMENTS ON REDUCED PLANS, THE ABOVE SCALES MAY BE USED,

J.U.L.I.E. JOINT UTILITY LOCATION INFORMATION FOR EXCAVATION 1–800–892–0123 OR 811

PROJECT ENGINEER: HERVE GELIN PROJECT MANAGER: PHILLIP SAWYER

618-346-3179 618-346-3275

CONTRACT NO. 76M22

Gross Length = N Net Length = N/A

REGISTERED

PROFESSIONAL

ENGINEER

REDISTERED PROFESSIONAL ENGINEER STATE OF ILLINOIS NO. 062-063295 AARON M. SCHAFER
LICENSED STRUCTURAL ENGINEER
STATE OF ILLINOIS NO. 081-007926

081-007926

LICENSED

ENGINEER


F.A.I. SECTION COUNTY TOTAL SHEET MO.

- 82-2-IPS-4, 61-PS-1 - 9 9 1

| hilmois | CONTRACT NO. - |
F.FAI. 70/FAP. 598 | 98 ST. CLAIR & MADISON.

D-98-031-19



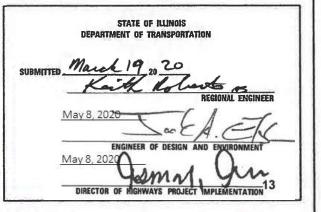

PRINTED BY THE AUTHORITY OF THE STATE OF ILLINOIS

REV. - MS

MBC36 PM

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DESIGN CRITERIA

1. BUILDING CODES: IBC 2012

GENERAL NOTES

- PLAN DIMENSIONS AND DETAILS RELATIVE TO EXISTING STRUCTURES HAVE BEEN TAKEN FROM EXISTING PLANS AND ARE SUBJECT TO NOMINAL CONSTRUCTION VARIATIONS. IT SHALL BE THE CONTRACTOR'S RESPONSIBILITY TO VERIFY SUCH DIMENSIONS AND DETAILS IN THE FIELD, AND MAKE NECESSARY APPROVED ADJUSTMENTS PRIOR TO CONSTRUCTION OR ORDERING MATERIALS.
- 2. THE CONTRACTOR SHALL SECURE ANY LOCAL, STATE, COUNTY PERMITS NEEDED FOR THIS PROJECT.
- 3. THE CONTRACTOR SHALL PERFORM ALL CONSTRUCTION FOR THE PROJECT IN A MANNER AND SEQUENCE THAT ARE BASED ON ACCEPTED INDUSTRY STANDARDS THAT RECOGNIZE THE INTERACTION OF THE COMPONENTS THAT COMPRISE THE STRUCTURE, WITHOUT CAUSING DISTRESS, UNANTICIPATED MOVEMENTS OR IRREGULAR LOAD PATHS AS A RESULT OF THE CONSTRUCTION MEANS AND METHODS EMPLOYED.
- 4. CONSTRUCTION LOADS SHALL NOT EXCEED DESIGN LIVE LOAD. THE CONTRACTOR IS RESPONSIBLE FOR ALL DESIGN REQUIRED TO SUPPORT CONSTRUCTION EQUIPMENT USED IN CONSTRUCTING THIS PROJECT. SHORING AND RESHORING IS THE RESPONSIBILITY OF THE CONTRACTOR AND SHALL BE INCLUDED WITH THE COST OF FURNISHING AND ERECTING STRUCTURAL STEEL, SPECIAL.
- 5. UTILITIES LOCATIONS / INFORMATION ON PLANS

ILLINOIS STATE LAW REQUIRES A 48-HOUR NOTICE TO BE GIVEN TO UTILITIES BEFORE DIGGING. FIELD MARKING OF FACILITIES MAY BE OBTAINED BY CONTACTING J.U.L.I.E. OR FOR NON-MEMBERS, THE UTILITY COMPANY DIRECTLY. AGENCIES KNOWN TO HAVE FACILITIES WITHIN THE PROJECT AREA ARE AS FOLLOWS:

- * Ameren Illinois (GAS & ELECTRIC)
- * AT&T Illinois (COMMUNICATIONS)
- * CenturyLink, Inc. (COMMUNICATIONS)
- * City of East St. Louis (LIGHTING)
- * ILLINOIS AMERICAN WATER CO. (WATER)

MEMBERS OF J.U.L.I.E. CALL TOLL FREE (800) 892-0123 OR 811 AND ARE INDICATED BY *. NON-J.U.L.I.E. MEMBERS MUST BE NOTIFIED INDIVIDUALLY

- 6. IT IS THE CONTRACTOR'S RESPONSIBILITY TO ENFORCE ALL APPLICABLE SAFETY CODES AND REGULATIONS DURING ALL PHASES OF CONSTRUCTION.
- 7. ALL CONTRACTORS ARE REQUIRED TO EXAMINE THE DRAWINGS AND SPECIAL PROVISIONS CAREFULLY, VISIT THE SITE AND FULLY INFORM THEMSELVES AS TO ALL EXISTING CONDITIONS AND LIMITATIONS, PRIOR TO AGREEING TO PERFORM THE WORK. FAILURE TO VISIT THE SITE AND FAMILIARIZE THEMSELVES WITH THE EXISTING CONDITIONS AND LIMITATIONS WILL IN NO WAY RELIEVE THE CONTRACTOR FROM FURNISHING ANY MATERIALS OR PERFORMING ANY WORK IN ACCORDANCE WITH THE DRAWINGS AND SPECIFICATIONS WITHOUT ADDITIONAL COST TO THE OWNER.
- 8. DURING CONSTRUCTION THE CONTRACTOR SHALL BE RESPONSIBLE FOR MAINTENANCE OF THE EXISTING PUMP STATION BUILDING.
- 9. DRAWINGS ARE NOT TO SCALE.
- 10. THE DEPARTMENT RESERVES THE RIGHT TO NOTIFY THE CONTRACTOR TO CHANGE THE CONSTRUCTION SCHEDULE IF NEEDED TO ENSURE PROPER DEWATERING NEEDS FOR THE DEPARTMENT.
- 11. THE DEPARTMENT STRONGLY ENCOURAGES THE PRIME CONTRACTOR AND THEIR APPROVED SUB-CONTRACTORS TO HIRE MINORITY, WOMEN AND DISADVANTAGED INDIVIDUALS FROM ITS FEDERALLY FUNDED HIGHWAY CONSTRUCTION CAREERS TRAINING PROGRAM (HCCTP) TO HELP MEET WORKFORCE AND TRAINEE GOALS. THIS PROGRAM IS TRAINING MINORITIES, WOMEN AND DISADVANTAGED INDIVIDUALS IN HIGHWAY CONSTRUCTION RELATED SKILLS, E.G., MATH FOR THE TRADES, JOB READINESS, TECHNICAL SKILLS COURSEWORK (CARPENTRY, CONCRETE FLATWORK, BLUEPRINT READING, SITE PLANS, SITE WORK, TOOLS USE, ETC.) AND OSHA 10 HOUR CERTIFICATION TO PREPARE THEM FOR A CAREER IN THE HIGHWAY CONSTRUCTION TRADES, GRADUATES ARE WELL TRAINED AND READY TO BECOME PRODUCTIVE ENTRY LEVEL CONSTRUCTION WORKERS. CONTACT THE DISTRICT 8 EEO OFFICE AT 618-346-3360 AND/OR THE HCTP COORDINATOR AT 618-874-6528 TO LEARN MORE ABOUT THE PROGRAM AND FOR ASSISTANCE IN MEETING WORKFORCE AND TRAINEE GOALS.

STRUCTURAL STEEL

- DETAILING, FABRICATION AND ERECTION SHALL CONFORM TO THE AISC SPECIFICATIONS AND STANDARD CODE OF PRACTICE.
- 2. STEEL FABRICATION AND ERECTION SHALL FOLLOW OSHA REQUIRMENTS.
- ALL WELDING SHALL BE IN ACCORDANCE WITH THE "STRUCTURAL WELDING CODE", AWS D1.1, LATEST EDITION.
- 4. STRUCTURAL STEEL SHALL CONFORM TO THE FOLLOWING GRADES:
 - a. WT SHAPES ASTM A992 GRADE 50 (Fy=50ksi)
- b. PLATES, RODS, AND BARS ASTM A36 (Fy=36 ksi)
- c. PIPES ASTM A53 (Fy=35ksi)
- d. BOLTS ASTM 325-n e. WASHERS - ASTM F436
- NUTS ASTM A563
- THREADED ANCHOR RODS ASTM F1554 GRADE 36 (Fy=36ksi)
- h. WELDING ELECTRODES E70xx
- i. GROUT FOR BASE PLATES PREPACKED, NON-METALLIC, NO-GASEOUS, AND NON-SHRINK PER CRD C621 AND ASTM C1107 AT FLUID CONSISTENCY

(FLOW CONE) OF 20-30 SECONDS. 28 DAY COMPRESSIVE STRENGTH = 7000 psl

- 1. MATERIAL: CARBON STEEL
- FINISH: HOT DIPPED GALVANIZED
- 3. APPROVAL: COMPLIES WITH FEDERAL SPECIFICATION A-A-1192A (TYPE 1), WW-H-171-E (TYPE 1), ANSI/MSS SP-69 AND MSS SP-58 (TYPE 1)
- 5. ALL STEEL SHALL BE HOT DIPPED GALVANIZED, UNLESS NOTED OTHERWISE. SEE SPECIAL PROVISION.
- 6. REPAIR GALVANIZED SURFACES PER ASTM A780.
- 7. ALL STEEL SHALL BE FURNISHED IN ACCORDANCE WITH SECTION 505 OF THE STANDARD SPECIFICATIONS FOR ROAD AND BRIDGE CONSTRUCTION.
- 8. EPOXY ANCHORS SHALL FOLLOW SECTION 584 OF THE STANDARD SPECIFICATIONS.

	KLINGNER
\$_	& ASSOCIATES, P.C.
\$FILEL	Engineers • Architects • Surveyors 616 N.24TH ST. QUINCY, ILLINOIS 62301 217.223,3670 STATE OF ILLINOIS DESIGN FIRM NO. 184-2738

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STATE	: OI	F ILLINOIS
DEPARTMENT	0F	TRANSPORTATION

Ī	CENERAL NOTES					F.A.I. RTE.	SECTION	COUNTY	TOTAL SHEETS	SHEET NO.	
ı	GENERAL NOTES				VAR	82-2-1PS-4, 61-PS-1	ST. CLAIR/MADISON	9	2		
l							CONTRACT	NO.	76M22		
١	SCALE:	SHEET	OF	SHEETS	STA.	TO STA.		ILLINOIS FED.	AID PROJECT		

ILLINOIS DEPARTMENT OF TRANSPORTATION

SUMMARY OF QUANTITIES

			100% STATE URBAN	CONSTR	UCTION TYPE CODE
				ST. CLAIR	MADISON
CODE NO.	ITEM	UNIT	TOTAL QUANTITY	0044	0044
50500405	FURNISHING AND ERECTING STRUCTURAL STEEL	POUND	1,215	930	285
67100100	MOBILIZATION	L SUM	1	0.7	0.3
X0335700	PUMP STATION GENERAL WORK	L SUM	1	1	
Z0001904	STRUCTURAL STEEL REMOVAL	L SUM	1	0.6	0.4


17 - Bowman & McCambridge Pump Stations\CADD Sheets\D876M22-sh


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3011	KLINGNER	USE
001	& ASSOCIATES, P.C.	
	Engineers • Architects • Surveyors	PLO
5	616 N.24TH ST. QUINCY, ILLINOIS 62301 217 223 3670 STATE OF ILLINOIS DESIGN FIRM NO. 184-2738	PLO


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	SUMMA	ARY OF	QUANTIT	ES
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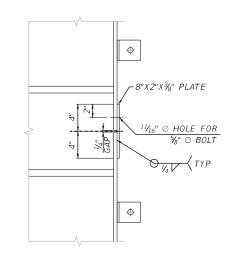
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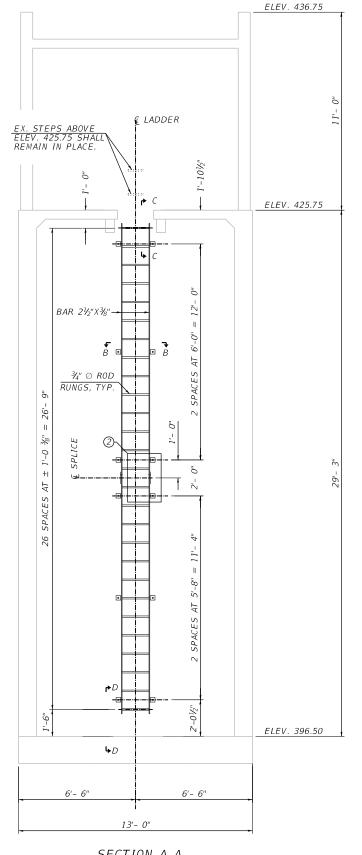


DETAIL 1 - BRACKET

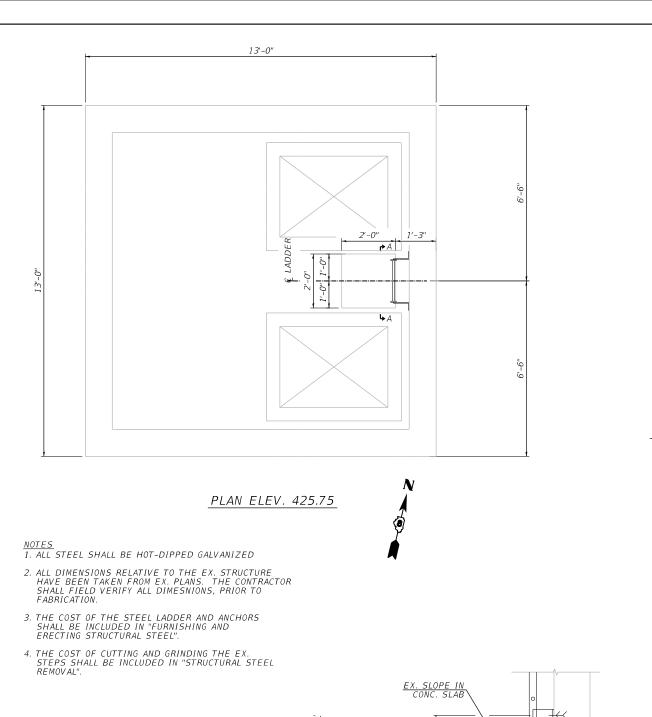

SCALE:

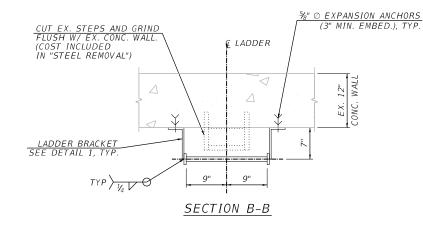DETAIL 2 - LADDER SPLICE

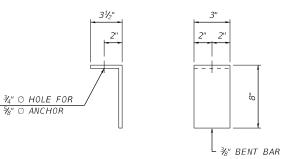

SECTION A-A

SECTION C-C BILL OF MATERIAL

Item	Unit	Quantity
Furnishing and Erecting Structural Steel	Pound	285

Item	Unit	Quantity
Furnishing and Erecting Structural Steel	Pound	285

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SECTION D-D


STATE OF ILLINOIS **DEPARTMENT OF TRANSPORTATION**


McCAMBRIDGE AVENUE PUMP STATION						SECTION
PLAN AND STRUCTURAL DETAILS					VAR	82-2-1PS-4, 61-PS
	LAN AND					
SHEET	OF	SHEETS	STA.	TO STA.		ILLINOIS


TOTAL SHEET NO. COUNTY ST. CLAIR/MADISON CONTRACT NO. 76M22

EASSOCIATES, P.C.

CUT EX. STEPS AND GRIND FLUSH W/ EX. CONC. WALL. (COST INCLUDED IN "STEEL REMOVAL")

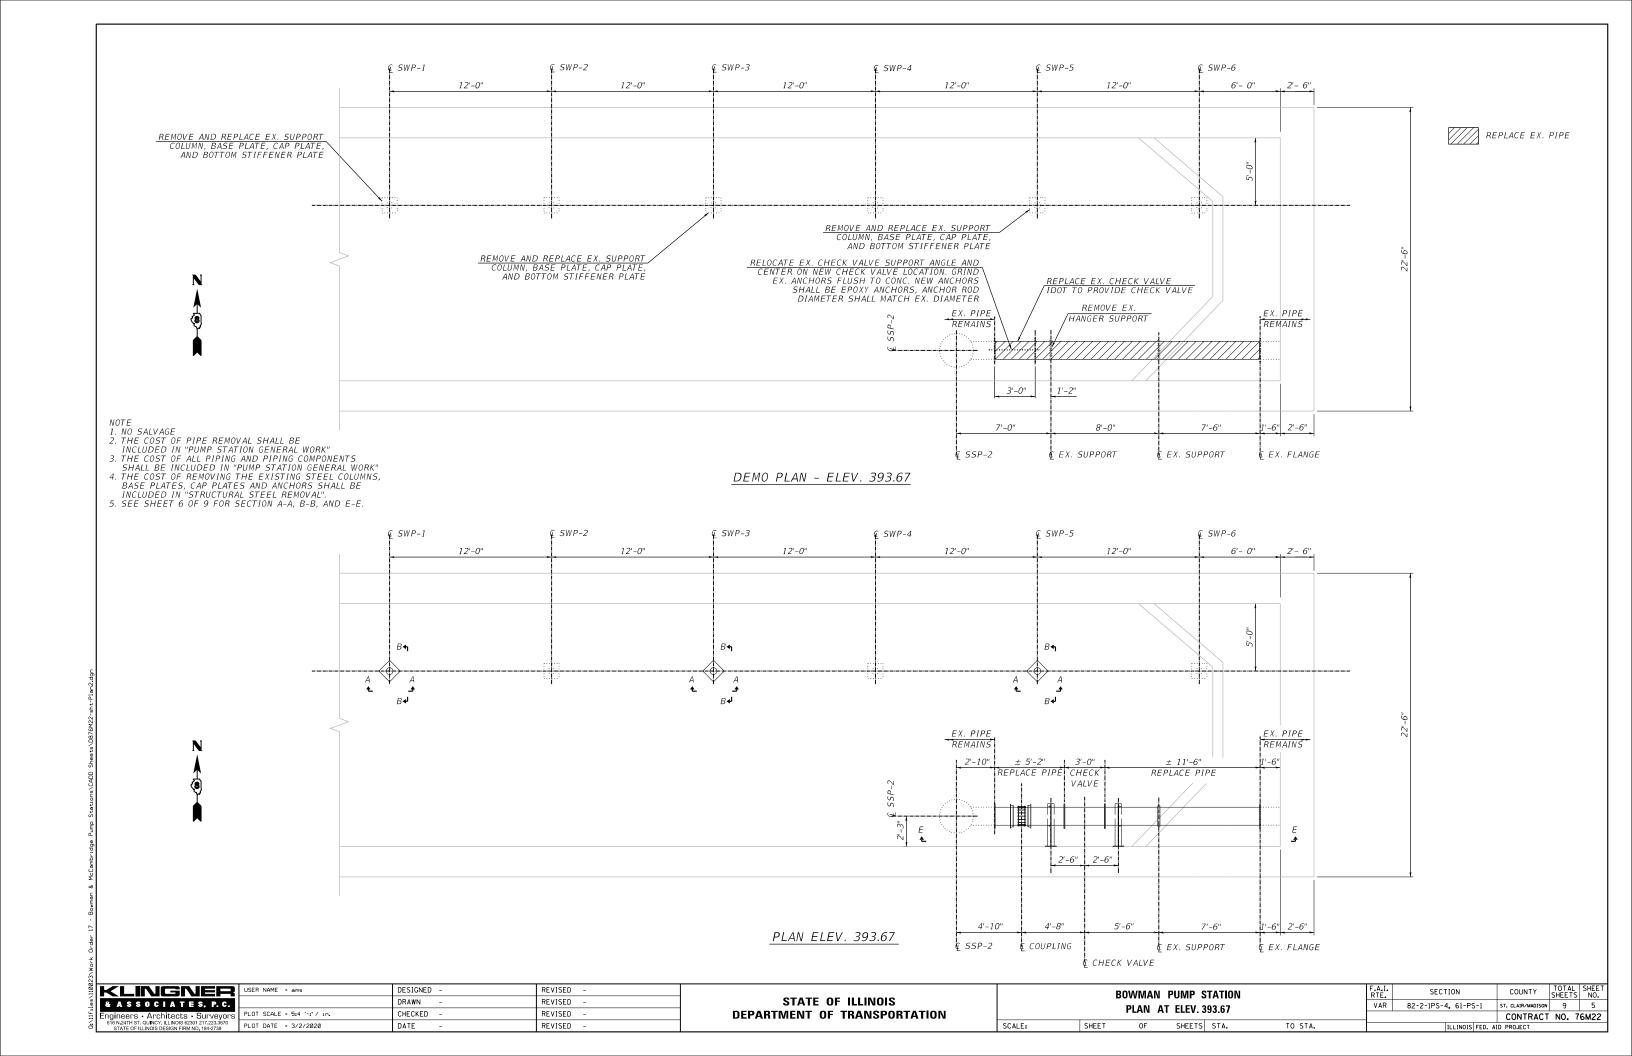

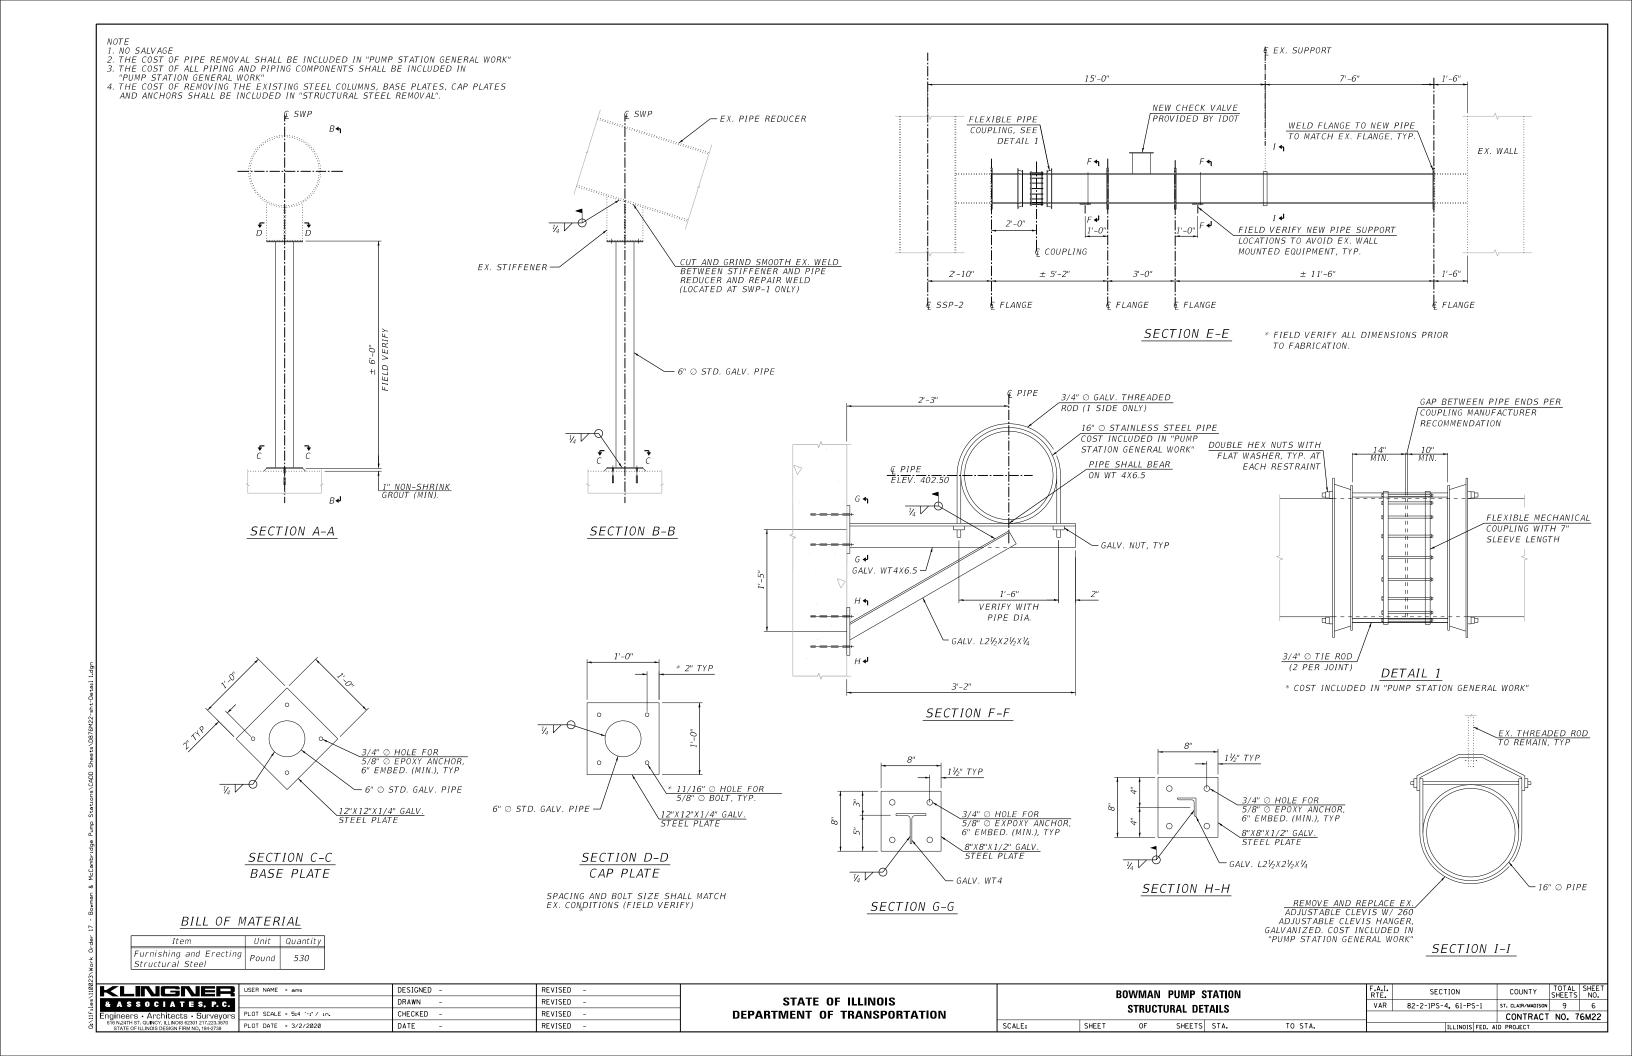

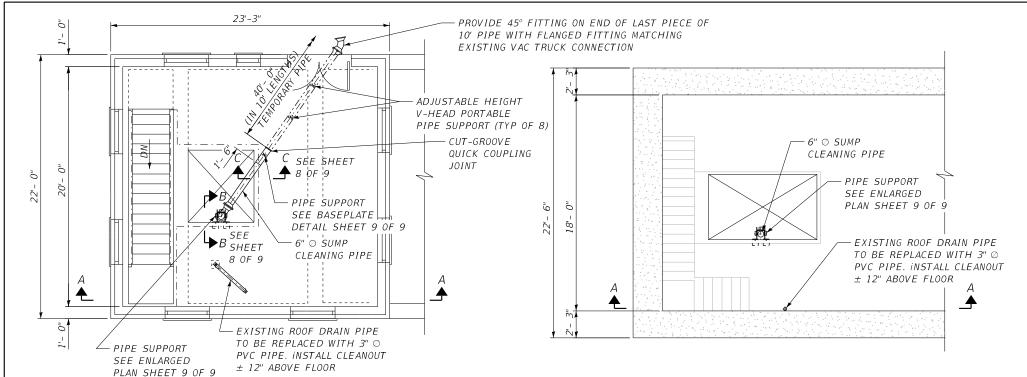



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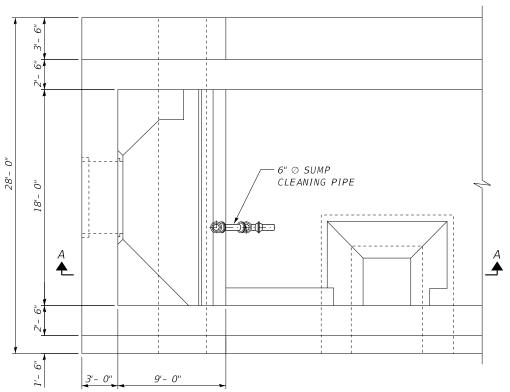
- 1. NO SALVAGE
- 2. THE COST OF PIPE REMOVAL SHALL BE INCLUDED IN "PUMP STATION GENERAL WORK"
- 3. THE COST OF ALL PIPING AND PIPING COMPONENTS SHALL BE INCLUDED IN "PUMP STATION GENERAL WORK"
- 4. THE COST OF STEEL PIPE SUPPORTS SHALL BE INCLUDED IN "FURNISHING AND ERECTING STRUCTURAL STEEL"
- 5. SEE SHEET 8 OF 9 FOR SECTION A-A.
- 6. SEE SHEET 9 OF 9 FOR ENLARGED PLANS AND STRUCTURAL DETAILS.



PLAN @ EL 393.67



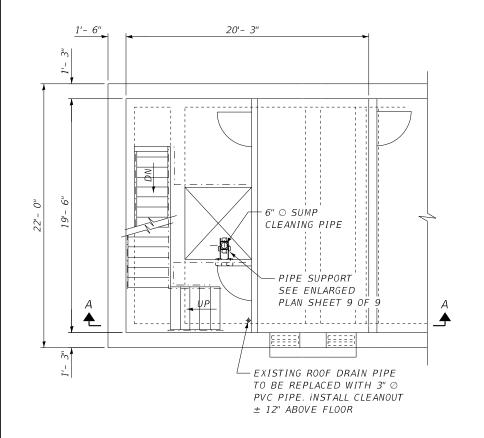

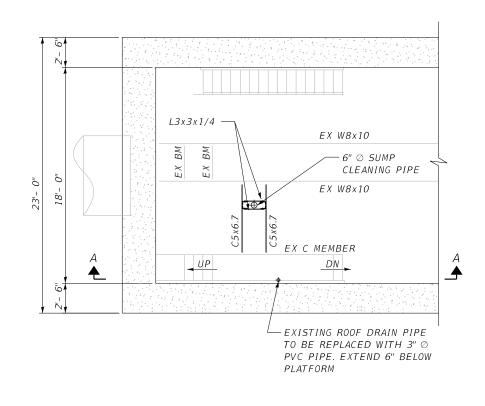

PLAN @ EL 408.0

PLAN @ EL 380.0

PLAN @ EL 366.0


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es	& ASSOCIATES, P.C.	
=	Engineers • Architects • Surveyors	PL
5	616 N.24TH ST. QUINCY, ILLINOIS 62301 217.223.3670 STATE OF ILLINOIS DESIGN FIRM NO. 184-2738	PL


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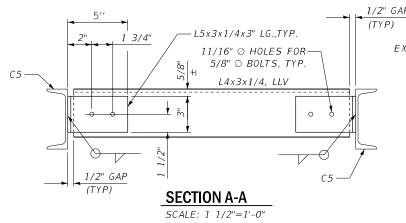
STATE OF ILLINOIS
DEPARTMENT OF TRANSPORTATION


		В	OWMAN PIPE SU		STATION PLANS	
SCALE:	1/4"=1'-0"	SHEET	OF	SHEETS	STA.	TO STA.

	THE TWO IS FED. AT	ID DROJECT		
		CONTRACT	NO. 7	6M22
VAR 82-2-1PS-4, 61-PS-1		ST. CLAIR/MADISON	9	7
F.A.I. RTE.	SECTION	COUNTY	TOTAL SHEETS	SHEET NO.



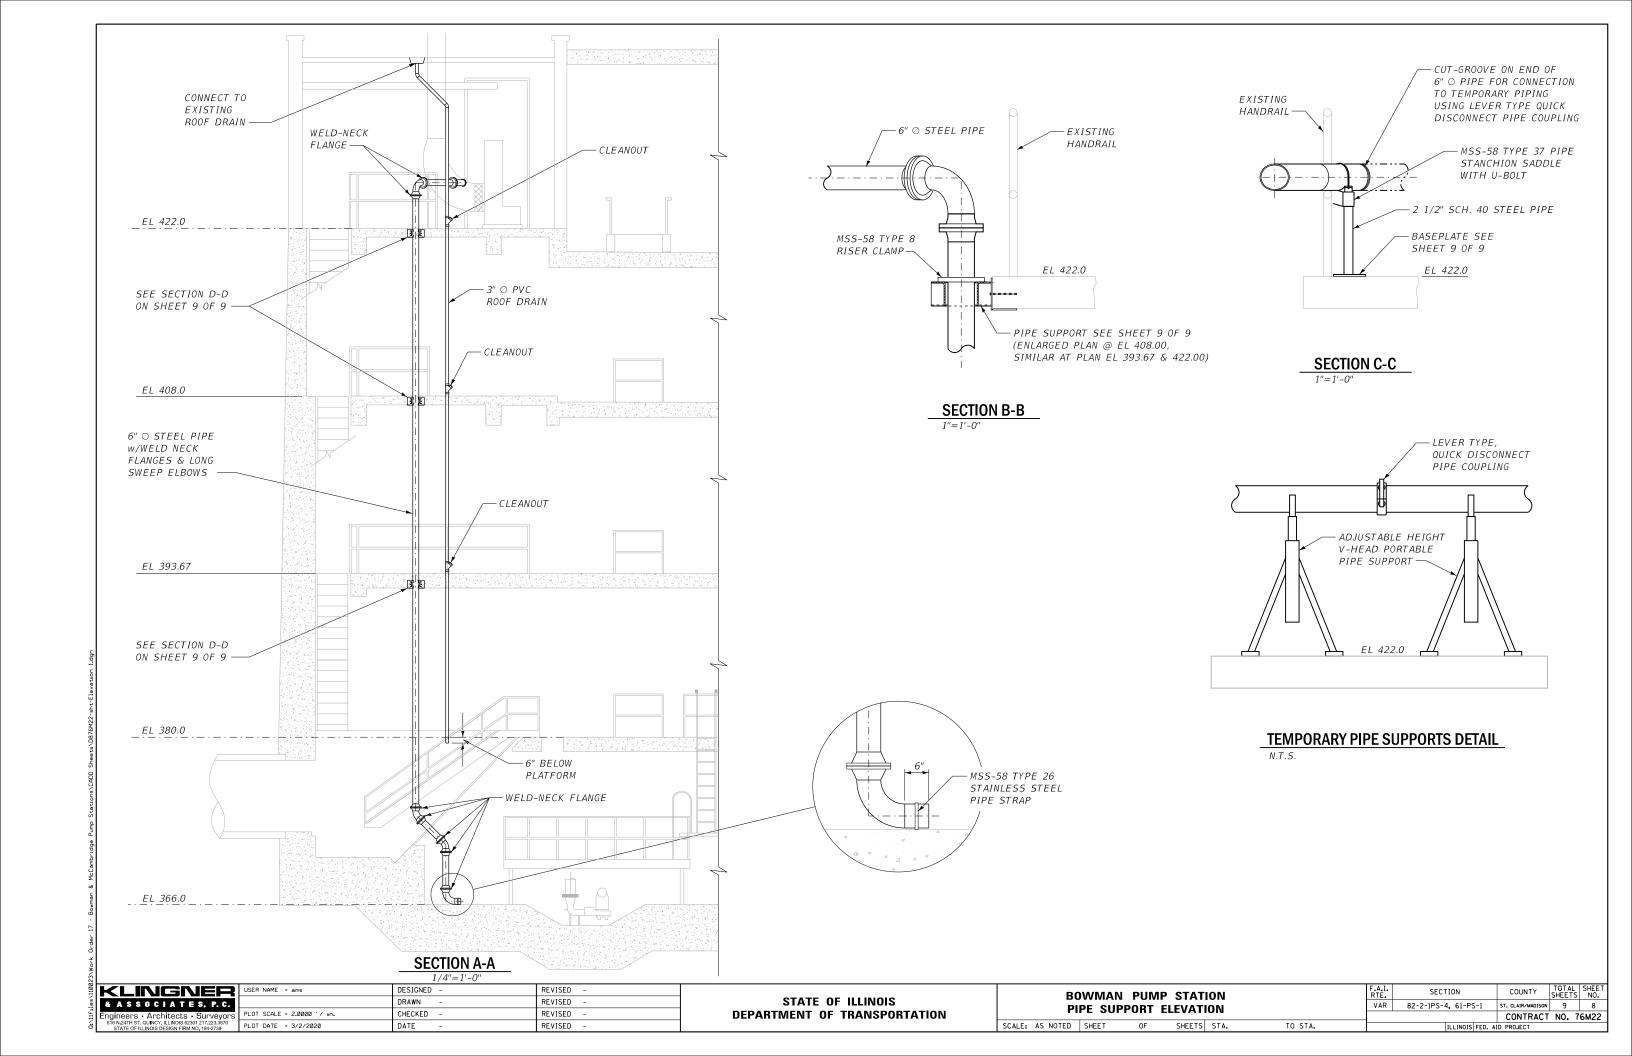

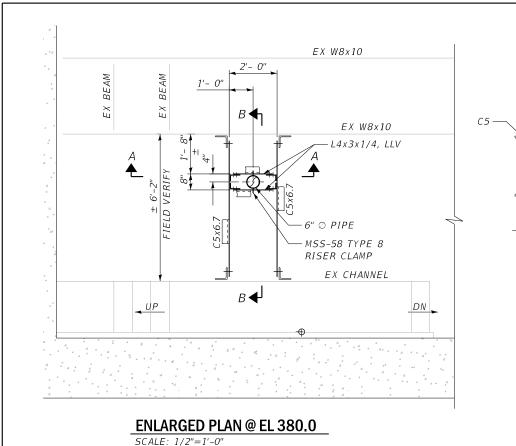

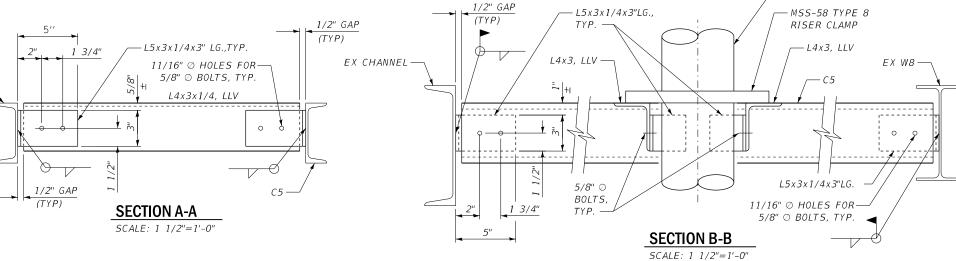


NOTE

- 1. NO SALVAGE
- 2. THE COST OF PIPE REMOVAL SHALL BE INCLUDED IN "PUMP STATION GENERAL WORK"
- 3. THE COST OF ALL PIPING AND PIPING COMPONENTS SHALL BE INCLUDED IN "PUMP STATION GENERAL WORK"
- 4. THE COST OF STEEL PIPE SUPPORTS SHALL BE INCLUDED IN "FURNISHING AND ERECTING STRUCTURAL STEEL"
- 5. SEE SHEET 8 OF 9 FOR SECTION A-A.

BILL OF MATERIAL

Item	Unit	Quantity
Furnishing and Erecting Structural Steel	Pound	400

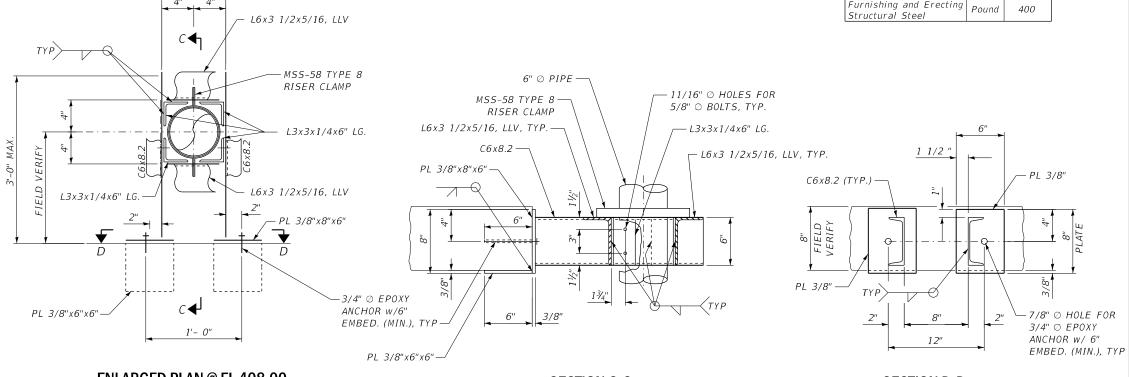

ENLARGED PLAN @ EL 408.00 **SIMILAR AT PLAN EL 393.67 AND 422.00** SCALE: 1"=1'-0"

SECTION C-C SCALE: 1 1/2"=1'-0" SECTION D-D SCALE: 1 1/2"=1'-0"

SCALE:

- 2 1/2" SCH. 40 3/4" ∅ HOLES FOR-STEEL PIPE 5/8" ⊘ THREADED ANCHOR RODS, TYP \bigcirc PL 1/2" PIPE SUPPORT

SECTION B-B (OPTION)

SCALE: 1 1/2"=1'-0"

-6" ∅ PIPE

OR

- L5x3x1/4

6" ∅ PIPE

MSS-58 TYPE 8

L4x3, LLV -

TOP ELEVATION TO

MATCH TOP EX W8

5/8" ⊘ BOLTS, TYP.-

RISER CLAMP

BASEPLATE DETAIL AT PLAN EL 422.0

SCALE: 1 1/2"=1'-0"

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les/i	& ASSOCIATES, P.C.	
0:\116	Engineers • Architects • Surveyors	F
ä	616 N.24TH ST. QUINCY, ILLINOIS 62301 217 223 3670 STATE OF ILLINOIS DESIGN FIRM NO. 184-2738	F

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STATE OF ILLINOIS **DEPARTMENT OF TRANSPORTATION**

PII			PUMP STRUCT		ION DETAILS	
	SHEET	OF	SHEETS	STA.	TO	STA.

F.A.I. RTE.	SECTION		COUNTY	TOTAL SHEETS	SHEET NO.
VAR	82-2-1PS-4, 61-PS	-1	ST. CLAIR/MADISON	9	9
		CONTRACT	NO. 7	6M22	
	ILLINOIS	FED. A	D PROJECT		