


# PROPOSED

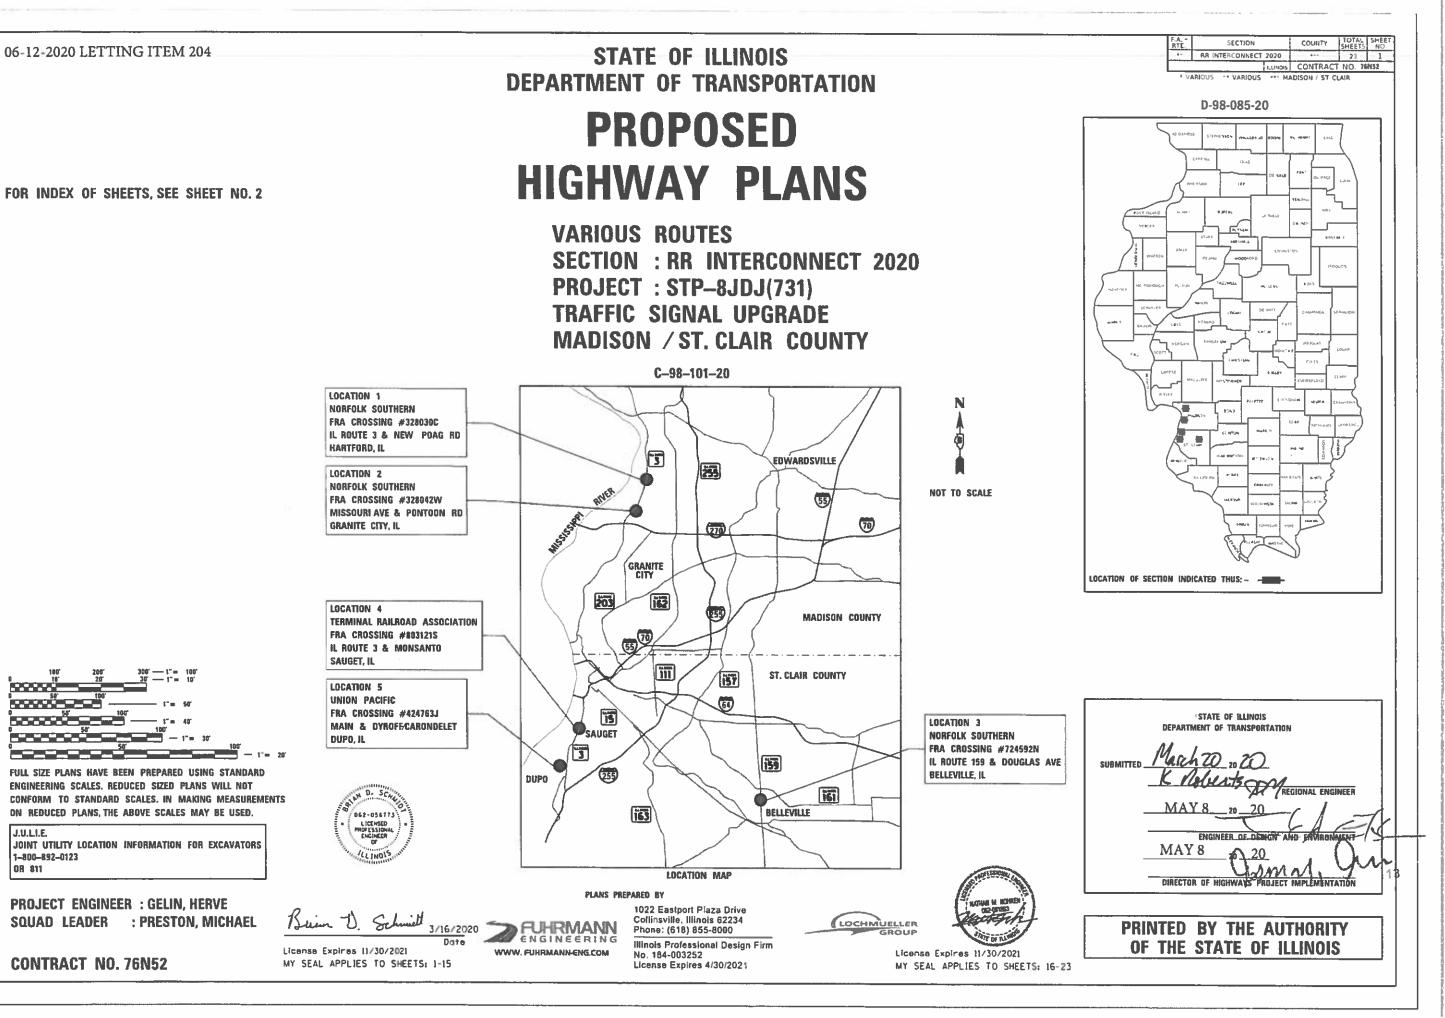

INDEX	OF SHEETS
1	COVER SHEET
2	INDEX OF SHEETS, HIGHWAY STANDARDS, AND GENERAL NOTES
3	SUMMARY OF QUANTITIES
	NORFOLK SOUTHERN
	LOCATION 1 - FRA CROSSING #328030C - IL ROUTE 3 & NEW POAG ROAD (HARTFORD)
4	TRAFFIC SIGNAL MODIFICATION PLAN
5	TRAFFIC SIGNAL CABLE PLAN
6	TRAFFIC SIGNAL SEQUENCE OF OPERATION
7	RAILROAD PREEMPTION SEQUENCE OF OPERATION
	LOCATION 2 - FRA CROSSING #328042W - MISSOURI AVENUE & PONTOON ROAD (GRANITE C
8	TRAFFIC SIGNAL MODIFICATION PLAN
9	TRAFFIC SIGNAL CABLE PLAN
10	TRAFFIC SIGNAL SEQUENCE OF OPERATION
11	RAILROAD PREEMPTION SEQUENCE OF OPERATION
	LOCATION 3 - FRA CROSSING #724592N - IL ROUTE 159 & DOUGLAS AVENUE (BELLEVILLE)
12	TRAFFIC SIGNAL MODIFICATION PLAN
13	TRAFFIC SIGNAL CABLE PLAN
14	TRAFFIC SIGNAL SEQUENCE OF OPERATION
15	RAILROAD PREEMPTION SEQUENCE OF OPERATION
	TERMINAL RAILROAD ASSOCIATION
	LOCATION 4 - FRA CROSSING #8031215 - IL 3 & MONSANTO (SAUGET)
16	TRAFFIC SIGNAL MODIFICATION PLAN
17	TRAFFIC SIGNAL CABLE PLAN
18	TRAFFIC SIGNAL SEQUENCE OF OPERATION
19	RAILROAD PREEMPTION SEQUENCE OF OPERATION
	UNION PACIFIC
	LOCATION 5 - FRA CROSSING #424763J - MAIN & DYROFF/CORONDOLET (DUPO)
20	TRAFFIC SIGNAL MODIFICATION PLAN
21	TRAFFIC SIGNAL CABLE PLAN
22	TRAFFIC SIGNAL SEQUENCE OF OPERATION
23	RAILROAD PREEMPTION SEQUENCE OF OPERATION

### HIGHWAY STANDARDS

000001-07	STANDARD SYMBOLS, ABBREVIATIONS AND PATTERNS
001006	DECIMAL OF AN INCH AND OF A FOOT
701001-02	OFF-ROAD OPERATIONS, 2L, 2W, MORE THAN 15' (4.5 m) AWAY
701006-05	OFF-ROAD OPERATIONS, 2L, 2W, 15' (4.5 m) TO 24" (600 mm) FROM PAVEMENT EDG
701101-05	OFF-ROAD OPERATIONS, MULTILANE, 15 FT (4.5 m) TO 24 IN (600 mm) FROM PAVEMI
701106-02	OFF-ROAD OPERATIONS, MULTILANE, MORE THAN 15 FT (4.5 m) AWAY
701426-09	LANE CLOSURE, MULTILANE, INTERMITTENT OR MOVING OPERATIONS, FOR SPEEDS $\geq$
701427-05	LANE CLOSURE, MULTILANE, INTERMITTENT OR MOVING OPERATIONS, FOR SPEEDS $\leq$
701701-10	URBAN LANE CLOSURE, MULTILANE INTERSECTION
701901-08	TRAFFIC CONTROL DEVICES
720001-01	SIGN PANEL MOUNTING DETAILS
720006-04	SIGN PANEL ERECTION DETAILS
728001-01	TELESCOPING STEEL SIGN SUPPORT
857001-01	STANDARD PHASE DESIGNATION DIAGRAMS AND PHASE SEQUENCES
857006-01	SUPERVISED RAILROAD INTERCONNECT CIRCUIT
862001-01	UNINTERRUPTABLE POWER SUPPLY (UPS)
880006-01	TRAFFIC SIGNAL MOUNTING DETAILS
	701101-05 701106-02 701426-09 701427-05 701701-10 701901-08 720001-01 728001-01 857001-01 857006-01 862001-01

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### GENERAL NOTES

- NO WORK SHALL COMMENCE UNTIL THE PROPOSED TRAFFIC CONTROL IS IN PLACE AND HAS BEEN APPROVED BY THE ENGINEER.
- 2 THE CONTRACTOR SHALL VERIFY ALL DIMENSIONS AND CONDITIONS IN THE FIELD PRIOR TO CONSTRUCTION AND ORDERING MATERIALS.
- ABANDONED UNDERGROUND UTILITIES THAT CONFLICT WITH CONSTRUCTION SHALL BE DIPOSED OF OUTSIDE THE LIMITS OF THE RIGHT OF WAY. ACCORDING TO THE 3 ARTICLE 202.30 OF THE STANDARD SPECIFICATION AND AS DIRECTED BY THE ENGINEER. THIS WORK WILL NOT BE BE PAID FOR SEPERATELY, BUT SHALL BE INCLUDED IN THE COSTS OF THE UNDERGROUND CONDUIT.
- 4 THE SCALE SHOWN ON THE DRAWINGS APPLIES ONLY TO FULL SIZE PLANS AND NOT TO THE REDUCED SIZE PLANS. REDUCED SIZE PLANS CAN BE PRINTED TO SCALE FOR USE IN THE FIELD.
- 5 NS RAILROAD AND UP RAILROAD FLAGGERS SHALL BE PRESENT WHEN WORKING WITHIN 25' OF THE RAILROAD TRACKS. THE CONTRACTOR SHALL COORDINATE WITH NS OR THE UP RAILROAD TO ASSURE FLAGGERS ARE PRESENT DURING CONSTRUCTION. NO ADDITIONAL COMPENSATION WILL BE ALLOWED.
- 6 EXISTING UTILITIES ARE SHOWN ON THE PLANS ACCORDING TO INFORMATION OBTAINED FROM THE LOCAL AGENCIES. OWNERS, AND FIELD SURVEYS. THE ACCURACY AND COMPLETENESS OF SAID INFORMATION IS NOT GUARANTEED. IT SHALL BE THE CONTRACTOR'S RESPONSIBILITY TO VERIFY THE EXISTENCE. NATURE AND EXACT LOCATIONS OF ALL UTILITY LINES AND APPURTENANCES WITH THE LIMITS OF IMPROVEMENTS.
- THE CONTRACTOR SHALL COORDINATE WITH NS FOR RIGHT OF ENTRY PERTAINING TO WORK WITHIN RAILROAD R.O.W.
- 7 THE RESIDENT ENGINEER SHALL VERIFY THE EXISTENCE OF HIGHWAY LIGHTING AND/OR INTELLIGENT TRANSPORTATION SYSTEMS (I.T.S.) UTILITIES WITHIN THE PROJECT LIMITS. IF HIGHWAY LIGHTING AND OR I.T.S. EXISTS WITHIN THE PROJECT LIMITS, AND IF THESE ITEMS REQUIRE LOCATING, THE CONTRACTOR SHALL BE DIRECTED TO DO SO ACCORDING TO SECTION 803 OF THE STANDARD SPECIFICATIONS. THIS WORK SHALL BE PAID FOR ACCORDING TO ARTICLE 109.04 OF THE STANDARD SPECIFICATIONS.
- THE DEPARTMENT STRONGLY ENCOURAGES THE PRIME CONTRACTOR AND THEIR APPROVED SUBCONTRACTORS TO HIRE MINORITY, WOMEN AND DISADVANTAGED 8 INDIVIDUALS FROM ITS FEDERALLY FUNDED HIGHWAY CONSTRUCTION CAREERS TRAINING PROGRAM (HCCTP) TO HELP MEET WORKFORCE AND TRAINEE GOALS. THIS PROGRAM IS TRAINING MINORITIES, WOMEN AND DISADVANTAGED INDIVIDUALS IN HIGHWAY CONSTRUCTION-RELATED SKILLS, E.G., MATH FOR THE TRADES, JOB READINESS, TECHNICAL SKILLS COURSE WORK (CARPENTRY, CONCRETE FLATWORK, BLUEPRINT READING, SITE PLANS, SITE WORK, TOOLS USE, ETC.) AND OSHA 10 HOUR CERTIFICATION. TO PREPARE THEM FOR A CAREER IN THE HIGHWAY CONSTRUCTION TRADES. GRADUATES ARE WELL-TRAINED AND READY TO BECOME PRODUCTIVE ENTRY-LEVEL CONSTRUCTION WORKERS. CONTACT THE DISTRICT 8 EEO OFFICE AT 618-346-3360 AND/OR THE HCCTP COORDINATOR AT 618-874-6528 TO LEARN MORE ABOUT THE PROGRAM AND FOR ASSISTANCE IN MEETING WORKFORCE AND TRAINEE GOALS.
- MEMBERS OF J.U.L.I.E CALL TOLL FREE (800) 892-1023 OR 811. NON-J.U.L.I.E. MEMBERS MUST BE NOTIFIED INDIVIDUALLY. 9
- ILLINOIS STATE LAW REQUIRES A 48-HOUR NOTICE BE GIVEN TO ALL UTILITIES WITHIN THE PROJECT AREA BEFORE DIGGING. FIELD MARKING OF FACILITIES MAY BE 10 OBTAINED BY CONTACTING J.U.L.I.E. OR FOR NON-MEMBERS, THE UTILITY COMPANY DIRECTLY. THE FOLLOWING UTILITIES ARE KNOWN TO HAVE FACILITIES WITHIN THE PROJECT AREA AS FOLLOWS:

COMMUNICATIONS 21 PROGRESS PARKWAY	<u>AMEREN ILLINOIS</u> GAS & ELECTRIC 1050 WEST BOULEVARD BELLEVILLE, IL 62221-4169	GAS & ELECTRIC
CAHOKIA PUBLIC WATER DISTRICT STORM AND SANTARY SEWER 2525 MOUSETTE LN CAHOKIA, IL 62206	CABLE TV 101 NORTHWEST PLAZA	SANITARY SEWER
<u>CITY OF GRANITE CITY</u> SNAITARY SEWER PUBLIC WORKS DEPARTMENT 2301 ADAMS ST GRANITE CITY, IL 62040-3394	CLEARWAVE COMMUNICATIONS TWO N VINE ST P.O. BOX 808 HARRISBURG, IL 62946	COMMUNICATIONS 5300 NORTHSHORE COVE
ILLINOIS AMERICAN WATER WATER 100 N WATER WORKS DR BELLEVILLE, IL 62223-9040	INDUSTRIAL GAS PRODUCTS PIPELINE 2301 FALLING SPRINGS RD SAUGET, IL 62201	COMMUNICATIONS
<u>SPIRE NGL</u> PIPELINE 4119 SHREWSBURY AVE SHREWSBURY, MO 63119	<u>ST LOUIS PIPELINE OPERATING</u> PIPELINE 1381 ROBBINS RD P.O. BOX 154	<u>SUGAR LOAF TOWNSHIP SEW</u> SANITARY SEWER 2174 JESSE EAST CARONDELET, IL 62241

HARTFORD, IL 62048

WINDSTREAM KDL

COMMUNICATIONS

102 E. SHAFER

FORSYTH, IL 62535

SCALE: NTS

VILLAGE OF SAUGET ELECTRIC & SANITARY SEWER 2897 FALLING SPRINGS RD SAUGET, IL 62206

OGE MENT EDGE

≥ 45 MPH  $\leq$  40 MPH

INDEX OF SHEETS	F.A. * RTE.	SECTION	COUNTY	TOTAL SHEETS	SHEET NO.
GENERAL NOTES	**	RR INTERCONNECT 2020	***	23	2
HIGHWAY STANDARDS			CONTRACT	NO. 7	76N52
SHEET 1 OF 1 SHEETS STA. TO STA.		ILLINOIS FED	AID PROJECT		
	* \/		MADICON / CT C		

STATE	E 01	F ILLINOIS
DEPARTMENT	OF	TRANSPORTATION

<u>CITY)</u>

LINOIS ECTRIC ER STREET 378 62062-0378

AM PARTNERS ATIONS

UNICATIONS ATIONS

VNSHIP SEWER SEWER E EAST

AT&T COMMUNICATIONS 160 W DIVISION ST MARYVILLE, IL 62062

CITY OF COLUMBIA STORM AND SANTARY SEWER 208 S.RAPP AVE. P.O. BOX 467 COLUMBIA, IL 62236-0467

> EXTENET SYSTEMS COMMUNICATIONS 3030 WARRENVILLE RD SUITE 340 LISLE, IL 60532

LINDE NORTH AMERICA GAS 1200 S DELMAR AVE P.O. BOX 37

VILLAGE OF DUPO WATER & SANITARY SEWER 107 N SECOND ST DUPO, IL 62239

HARTFORD, IL 62048

BUCKEYE PARTNERS L.P. PIPELINE 220 E HAWTHORNE ST HARTFORD, IL 62048

CITY OF EDWARDSVILLE WATER & SANITARY SEWER PUBLIC WORKS 200 E PARK ST EDWARDSVILLE, IL 62025-0407

HARRISONVILLE TELEPHONE CO COMMUNICATIONS 214 S. MAIN ST P.O. BOX 149 WATERLOO, IL 62298-0149

MCI NETWORK SERVICES COMMUNICATIONS 730 W HENRY ST INDIANAPOLIS, IN 46225

VILLAGE OF HARTFORD STORM AND SANITARY SEWER 140 W HAWTHORNE HARTFORD, IL 620048

### SIIMMARY O

			301111	
		CODE NO	ІТЕМ	
		67100100	MOBILIZATION	
		70102635	TRAFFIC CONTROL AND PROTI	ECTION, STANDA
	*	72000100	SIGN PANEL - TYPE 1	
	*	72000200	SIGN PANEL - TYPE 2	
		72800100	TELESCOPING STEEL SIGN SU	PPORT
		85000200	MAINTENANCE OF EXISTING TF	RAFFIC SIGNAL IN
		87301255	ELECTRIC CABLE IN CONDUIT,	SIGNAL NO. 14 7
		87301750	ELECTRIC CABLE IN CONDUIT,	RAILROAD, NO. 1
		88040150	SIGNAL HEAD, POLYCARBONAT	ΓE, LED, 1-FACE, ξ
		89100400	ILLUMINATED SIGN, LED	
		89502300	REMOVE ELECTRIC CABLE FRO	OM CONDUIT
		89502375	REMOVE EXISTING TRAFFIC SI	GNAL EQUIPMEN
		X1400144	UNINTERRUPTABLE POWER SU	JPPLYAND CABIN
		X1400214	SPARE RAILROAD, FULL ACTUA	ATED CONTROLLI
		X1400399	VIDEO DETECTION SYSTEM CC	)MPLETE
		X8571215	RAILROAD, FULL-ACTUATED CO	ONTROLLER AND
		X8950105	REMOVE EXISTING TRAFFIC CO	ONTROLLER AND
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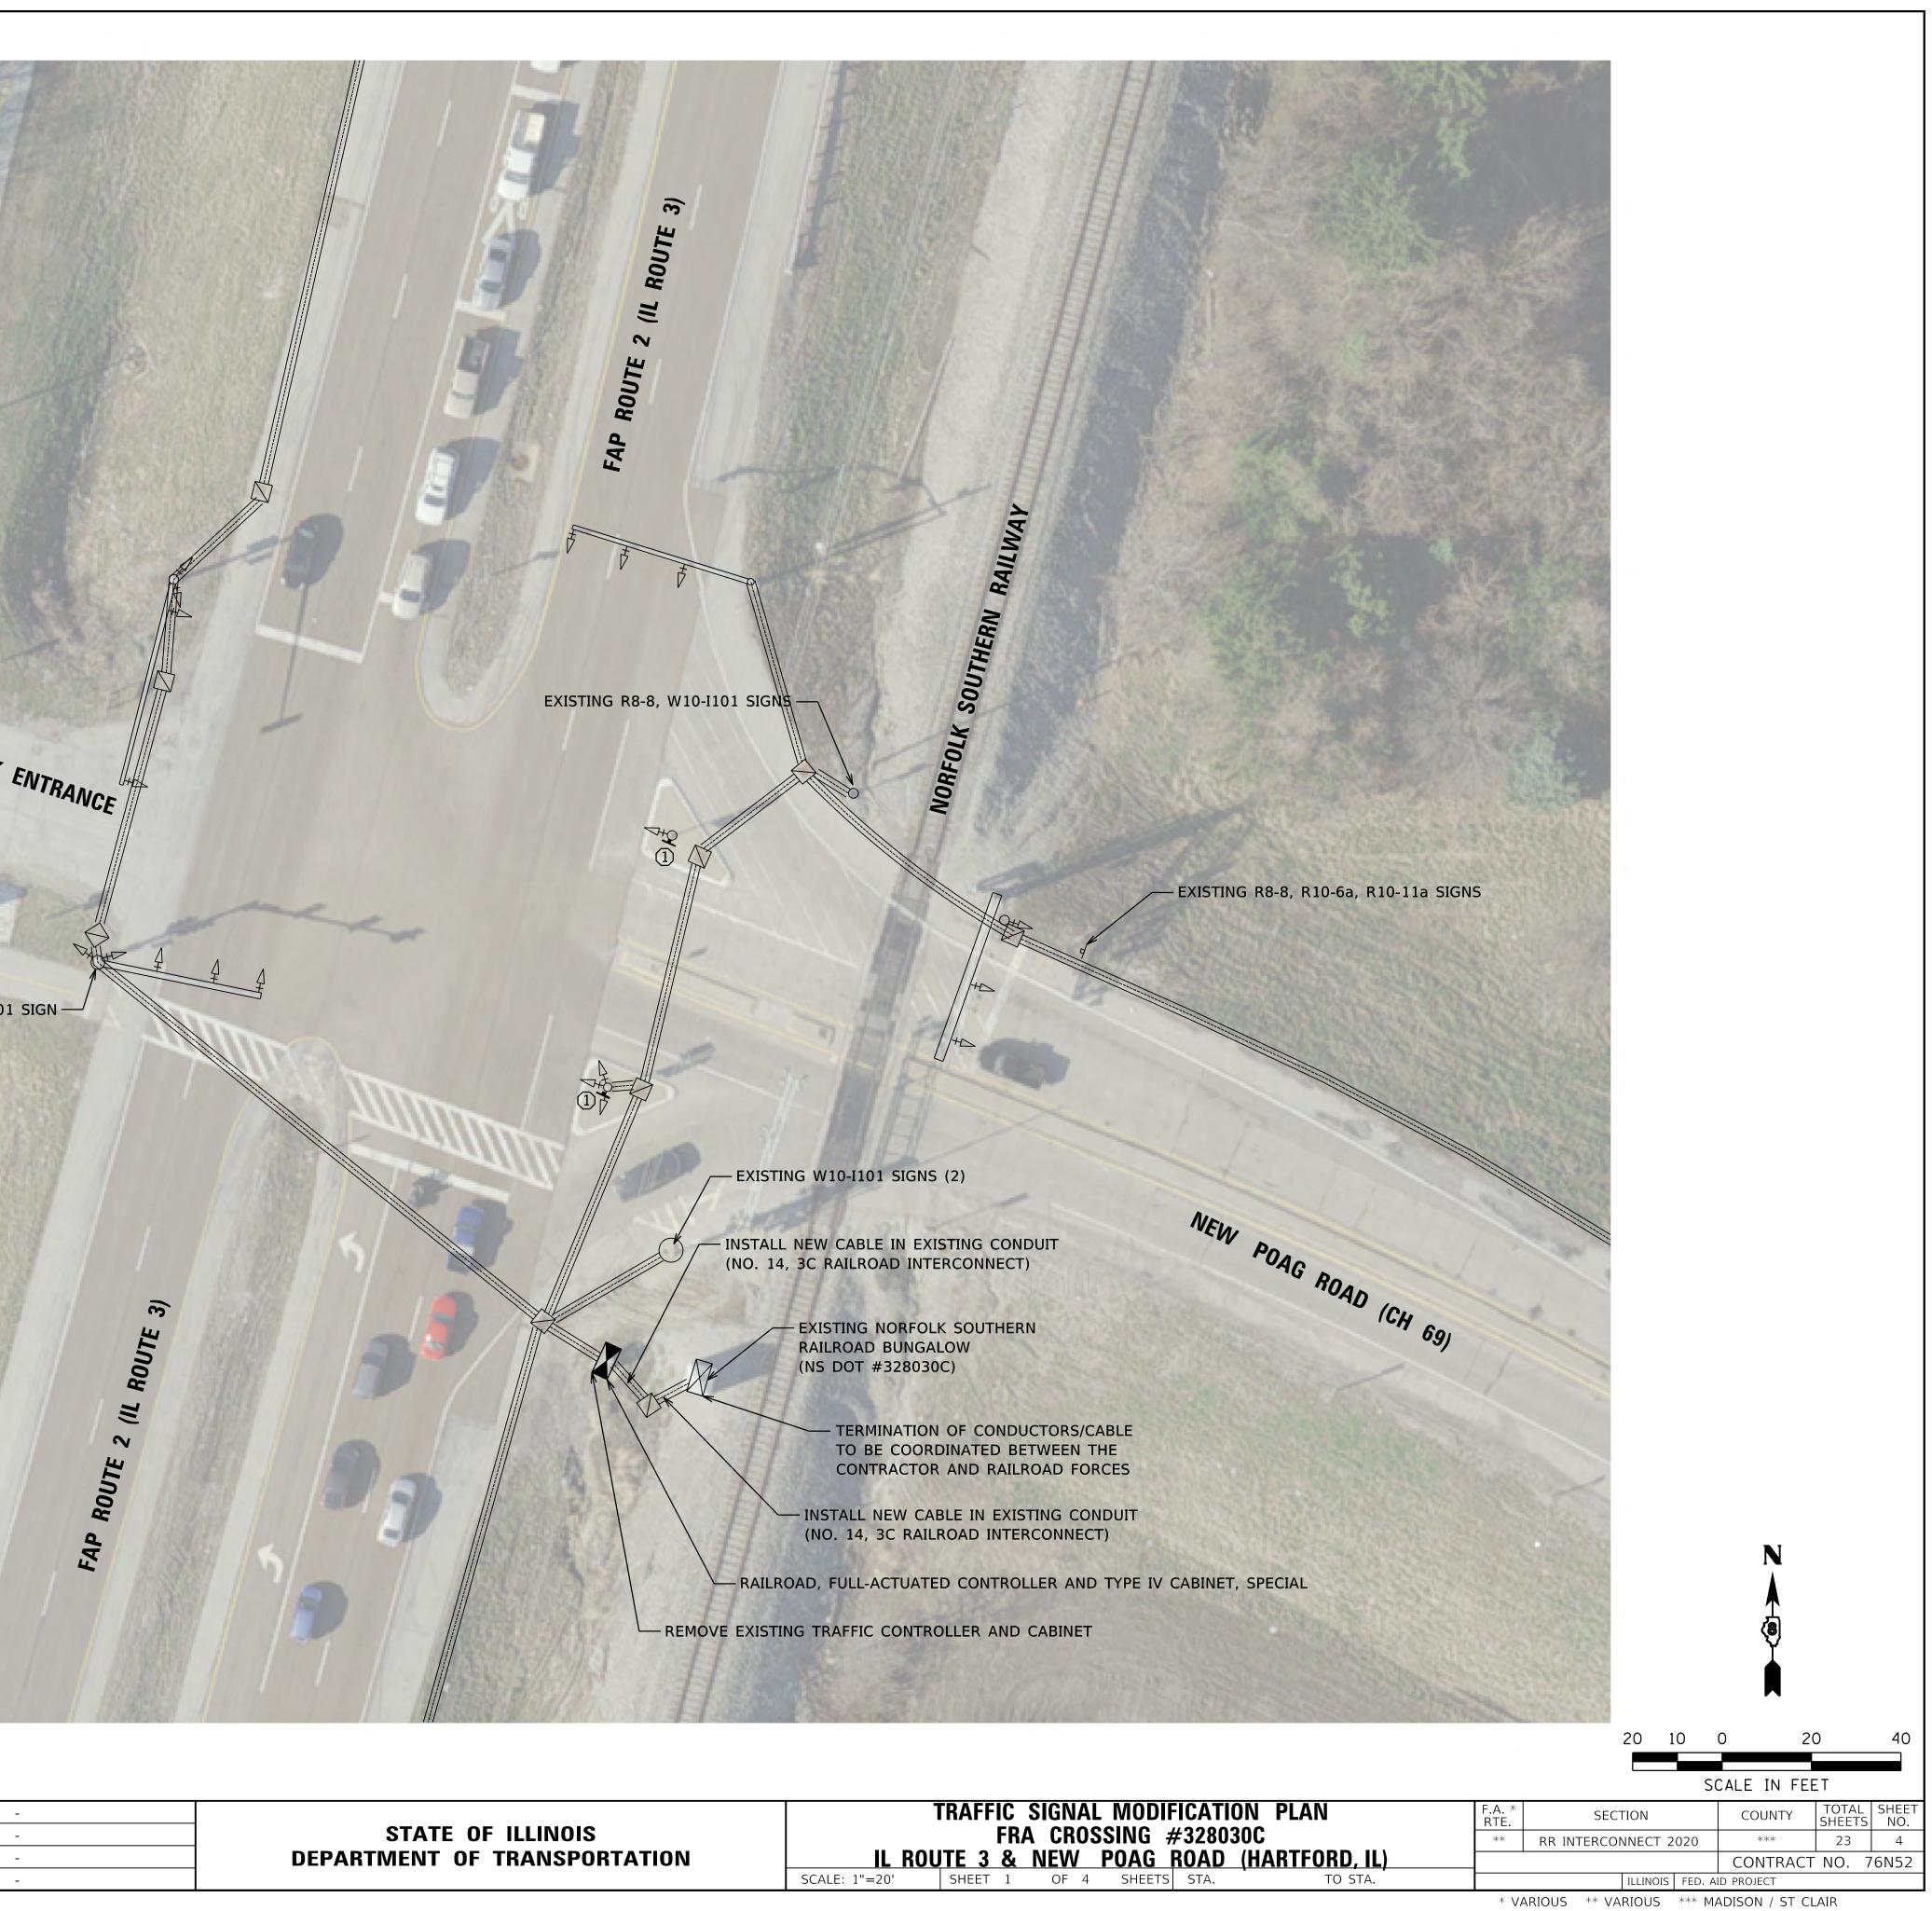
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4 3C	FOOT	620	50	330	60	90	90			
5-SECTION, BRACKET MOUNTED	EACH	5	0	3	0	2	0	-		
	EACH	14	2	4	2	4	2			
	FOOT	620	50	330	60	90	90			
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ER , SPECIAL	EACH	5	1	1	1	1	1			
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TYPE IV CABINET, SPECIAL	EACH	5	1	1	1	1	1			
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STATE OF ILLINOIS
DEPARTMENT OF TRANSPORTATION


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NOTE: A	ALL TRAFFIC SIGNAL	CONTROLLER EQUIPMENT F	OR THIS PROJECT SHALL BE "EC	CONOLITE".
RESTOR PAY ITE SHALL I	MS AND NO EXTRA BE REPLACED IN KIN	FFIC SIGNAL WORK AREA SH COMPENSATION SHALL BE A	ALL BE INCLUDED WITH THE RE ALLOWED. ANY DAMAGE TO PAV AREAS SHALL BE SEEDED IN ACC 5.	EMENT CORDANCE
THE EX UNTIL A		ITERCONNECT WILL BE MAIN TERCONNECT CABLE IS INST	TAINED THROUGHOUT THE WOR ALLED FRON THE NEW CONTRO	
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<b>TRAF</b>		DLE HANDHOLE AD CONTROL CABINET C SIGNAL CONTROLLER		
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STATE OF ILLINOIS		FR/	A CRO	SSING 🗧
DEPARTMENT OF TRANSPORTATION	IL ROU	JTE 3 &	NEW	POAG
	SCALE: 1"=20'	SHEET 1	OF 4	SHEETS



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ILLINOIS ROUTE 3 FAR LEFT AND LEFT MAST ARM SIGNAL	S/B G	G	G	Y T	R	Y	R	G	Y	R	R	R	R	R	R	R	R	R	R	R	R	R	R <del>-</del>	R	R	R	R	R	R	R	R	R
ILLINOIS ROUTE 3 NEAR RIGHT AND MIDDLE AND RIGHT MAST ARM SIGNALS	S/B R	R	R	R	R	R	R	G	G	G	R	R	R	R	G	Y	Y	R	G	G	Y	R	R	R	R	R	R	R	R	R	R	R
ILLINOIS ROUTE 3 FAR LEFT AND LEFT MAST ARM SIGNAL	N/B G	Y -	R	G	G	Ý	R	R ◀	R	R	G	G	Y -	R	R	R	R	R	R	R	R	R	R	R	R	R	R	R	R	R	R	R
ILLINOIS ROUTE 3 NEAR RIGHT AND MIDDLE AND RIGHT MAST ARM SIGNALS	N/B R	R	R	R	R	R	R	R	R	R	G	G	G	G	G	Y	Y	R	Y	R	G	G	R	R	R	R	R	R	R	R	R	R
NEW POAG ROAD (PRE-SIGNAL) ALL SIGNALS	W/B R	R	R	R	R	R	R	R	R	R	R	R	R	R	R	R	R	R	R	R	R	R	G	Y	R	R	R	R	R	R	R	R
NEW POAG ROAD (WEST OF TRACKS) FAR LEFT AND LEFT MAST ARM SIGNAL	W/B R	R	R	R	R	R	R	R	R	R	R	R	R	R	R	R	R	R	R	R	R	R	G G	G G	G G	Y	R	R	R	R	R	R
NEW POAG ROAD (WEST OF TRACKS) RIGHT MAST ARM SIGNAL	W/B R	R	R	R	R	R	R	R	R	R	R	R	R	R	R	R	R	R	R	R	R	R	G	G	G	Y	R	R	R	R	R	R
PARK ENTRANCE FAR LEFT SIGNAL	E/B R	R	R	R	R	R	R	R	R	R	R	R	R	R	R	R	R	R	R	R	R	R	R	R	R	R	R	G G	G G	Y	R	R
PARK ENTRANCE FAR RIGHT AND NEAR RIGHT SIGNAL	E/B R	R	R	R	R	R	R	R	R	R	R	R	R	R	R	R	R	R	R	R	R	R	R	R	R	R	R	G	G	Y	R	R
PEDESTRIAN SIGNALS CROSSING IL 3 ON SOUTH SIDE OF NEW POAG ROAD	Н	Н	Н	Н	Н	Н	Н	Н	Н	Н	Н	Н	Н	Н	Н	Н	н	Н	Н	Н	н	Н	Н	Н	Н	Н	Н	*P	**FH	Н	Н	חעם
PEDESTRIAN SIGNALS CROSSING NEW POAG ROAD ON EAST SIDE OF IL 3	Н	Н	н	Н	Н	Н	Н	Н	Н	Н	*P	**FH	Н	н	*Р	**FH	Н	н	Н	Н	Н	Н	Н	Н	Н	Н	Н	Н	Н	Н	Н	DARK

PHASES 2 AND 6 SHALL BE PLACED ON RECALL

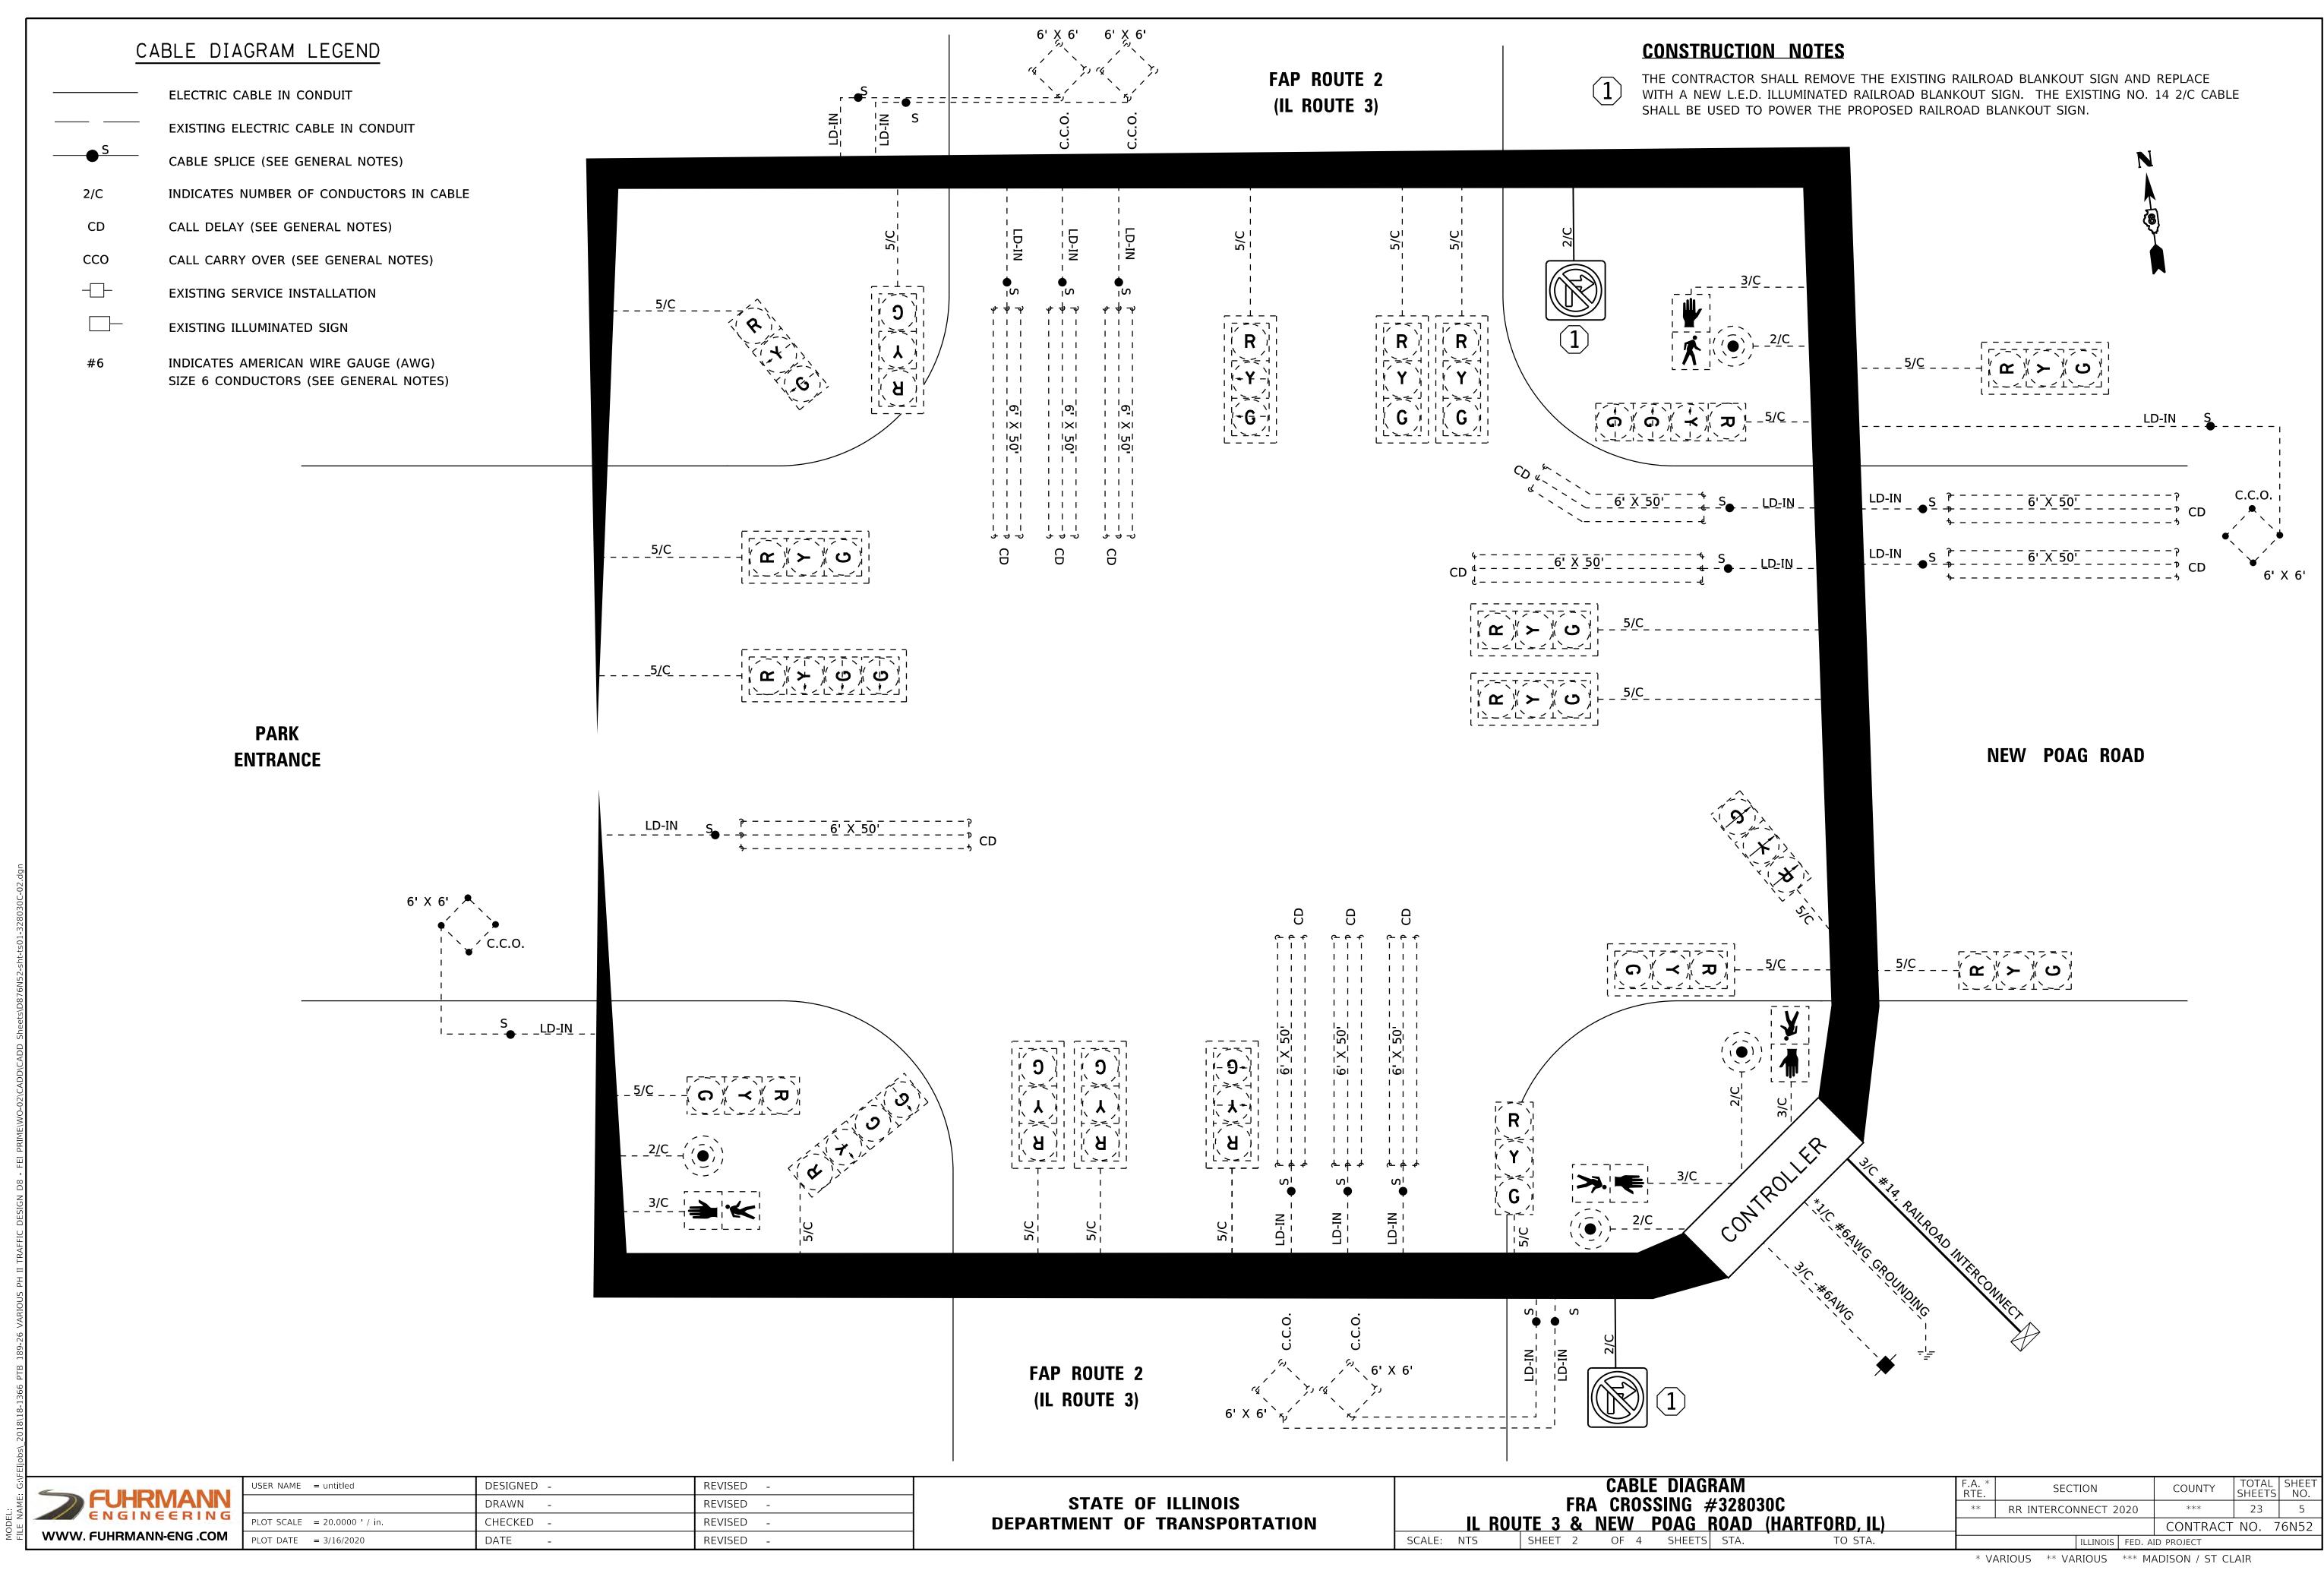

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## **TRAFFIC SIGNAL SEQUENCE OF OPERATION**

- P = ILLUMINATED PERSON = WALK
- H = ILLUMINATED SOLID HAND = DON'T WALK
- \* TO APPEAR ONLY UPON PUSHBUTTON ACTUATION

	TR/					F.A. * RTE.	SECTION	COUNTY	TOTAL SHEETS	SHEET NO.
STATE OF ILLINOIS		FRA		SING #3280		**	RR INTERCONNECT 2020	***	23	6
DEPARTMENT OF TRANSPORTATION	SCALE: NTS	<b>JTE 3 &amp;</b> SHEET 3	NEW OF 4	POAG ROAD SHEETS STA.	(HARTFORD, IL) TO STA.		ILLINOIS FED. AI		<sup>-</sup> NO. 7	6N52
	1	1				* \/				

FH = ILLUMINATED FLASHING HAND = FLASHING DON'T WALK

\*\* "FH" TO TERMINATE AT THE COMPLETION OF THE PEDESTRIAL INTERVAL CLEARANCE

														PREEMPTOR NUMBER 2				
CHANGE FROM NORMAL SEQUENCE OF OPERATION INTERVAL NUMBER			1		5		7	1	0	1	5	1	7					
RAILROAD PREEMPTION SEQUENCE OF OPERATION INTERVAL NUMBER		1A	1B	1C	1D	1E	1F	1G	1H	1L	1M	1N	1P	2	З	4	5	CLEAR TO
CHANGE TO RAILROAD PREEMPTION SEQUENCE OF OPERATION NUMBER		1B	2	1D	2	1F	2	1H	2	1M	2	1P	2	3	4	5		NORMAL SEQUENCE
ILLINOIS ROUTE 3 FAR LEFT AND LEFT MAST ARM SIGNAL	S/B	Y	R	Y	R	R	R	R	R	R	R	R	R	R	R	R	R	$\bigtriangleup$
ILLINOIS ROUTE 3 NEAR RIGHT AND MIDDLE AND RIGHT MAST ARM SIGNALS	S/B	R	R	Y	R	R	R	Y	R	R	R	R	R	R	R	R	G	$\bigtriangleup$
ILLINOIS ROUTE 3 FAR LEFT AND LEFT MAST ARM SIGNAL	N/B	Y	R	R	R	Y T	R	R	R	R	R	R	R	R	R	R	R	$\bigtriangleup$
ILLINOIS ROUTE 3 NEAR RIGHT AND MIDDLE AND RIGHT MAST ARM SIGNALS	N/B	R	R	R	R	Y	R	Y	R	R	R	R	R	R	R	R	G	$\bigtriangleup$
NEW POAG ROAD (PRE-SIGNAL) ALL SIGNALS	W/B	R	R	R	R	R	R	R	R	Y	R	R	R	R	R	R	R	$\bigtriangleup$
NEW POAG ROAD (WEST OF TRACKS) FAR LEFT AND LEFT MAST ARM SIGNAL	W/B	R	R	R	R	R	R	R	R	G G	G G	R	R	G G	Y	R	R	$\bigtriangleup$
NEW POAG ROAD (WEST OF TRACKS) RIGHT MAST ARM SIGNAL	W/B	R	R	R	R	R	R	R	R	G	G	R	R	G	Y	R	R	$\bigtriangleup$
PARK ENTRANCE FAR LEFT SIGNAL	E/B	R	R	R	R	R	R	R	R	R	R	Y	R	R	R	R	R	$\bigtriangleup$
PARK ENTRANCE FAR RIGHT AND NEAR RIGHT SIGNAL	E/B	R	R	R	R	R	R	R	R	R	R	Y	R	R	R	R	R	$\bigtriangleup$
INTERNALLY ILLUMINATED NO RIGHT TURN SIGNS		NRT	NRT	NRT	NRT	NRT	NRT	NRT	NRT	NRT	NRT	NRT	NRT	NRT	NRT	NRT	NRT	$\bigtriangleup$
PEDESTRIAN SIGNALS CROSSING IL 3 ON SOUTH SIDE OF NEW POAG ROAD		н	н	Н	н	Н	н	н	Н	н	н	FH	Н	Н	Н	Н	Н	
PEDESTRIAN SIGNALS CROSSING NEW POAG ROAD ON EAST SIDE OF IL 3		н	н	Н	н	FH	н	FH	Н	н	н	Н	Н	Н	Н	Н	Н	
																	HOLD	

- THE RAILROAD PREEMPTION SEQUENCE SHALL BE CAPABLE OF CYCLING BETWEEN PHASES 1+6, AND 2+6 UNTIL PREEMPTION IS TERMINATED
- $\triangle$  RAILROAD PREEMPTION SEQUENCE SHALL PROVIDE THE PROPER CLEARANCE INTERVAL TO RESUME THE NORMAL SEQUENCE OF OPERATION AFTER RAILROAD INTERVAL 5 IS TERMINATED

NOTES:

- 1. ONCE PREEMPTION HAS BEEN CALLED, THE TRACK CLEAR SIGNAL DISPLAY SHALL APPEAR IMMEDIATELY AFTER ALL NECESSARY VEHICULAR CLEARANCES HAVE BEEN PROVIDED.
- 2. THE RAILROAD PREEMPTION SEQUENCE OF OPERATION SHALL HAVE PRIORITY OVER ALL OTHER SEQUENCES OF OPERATION.

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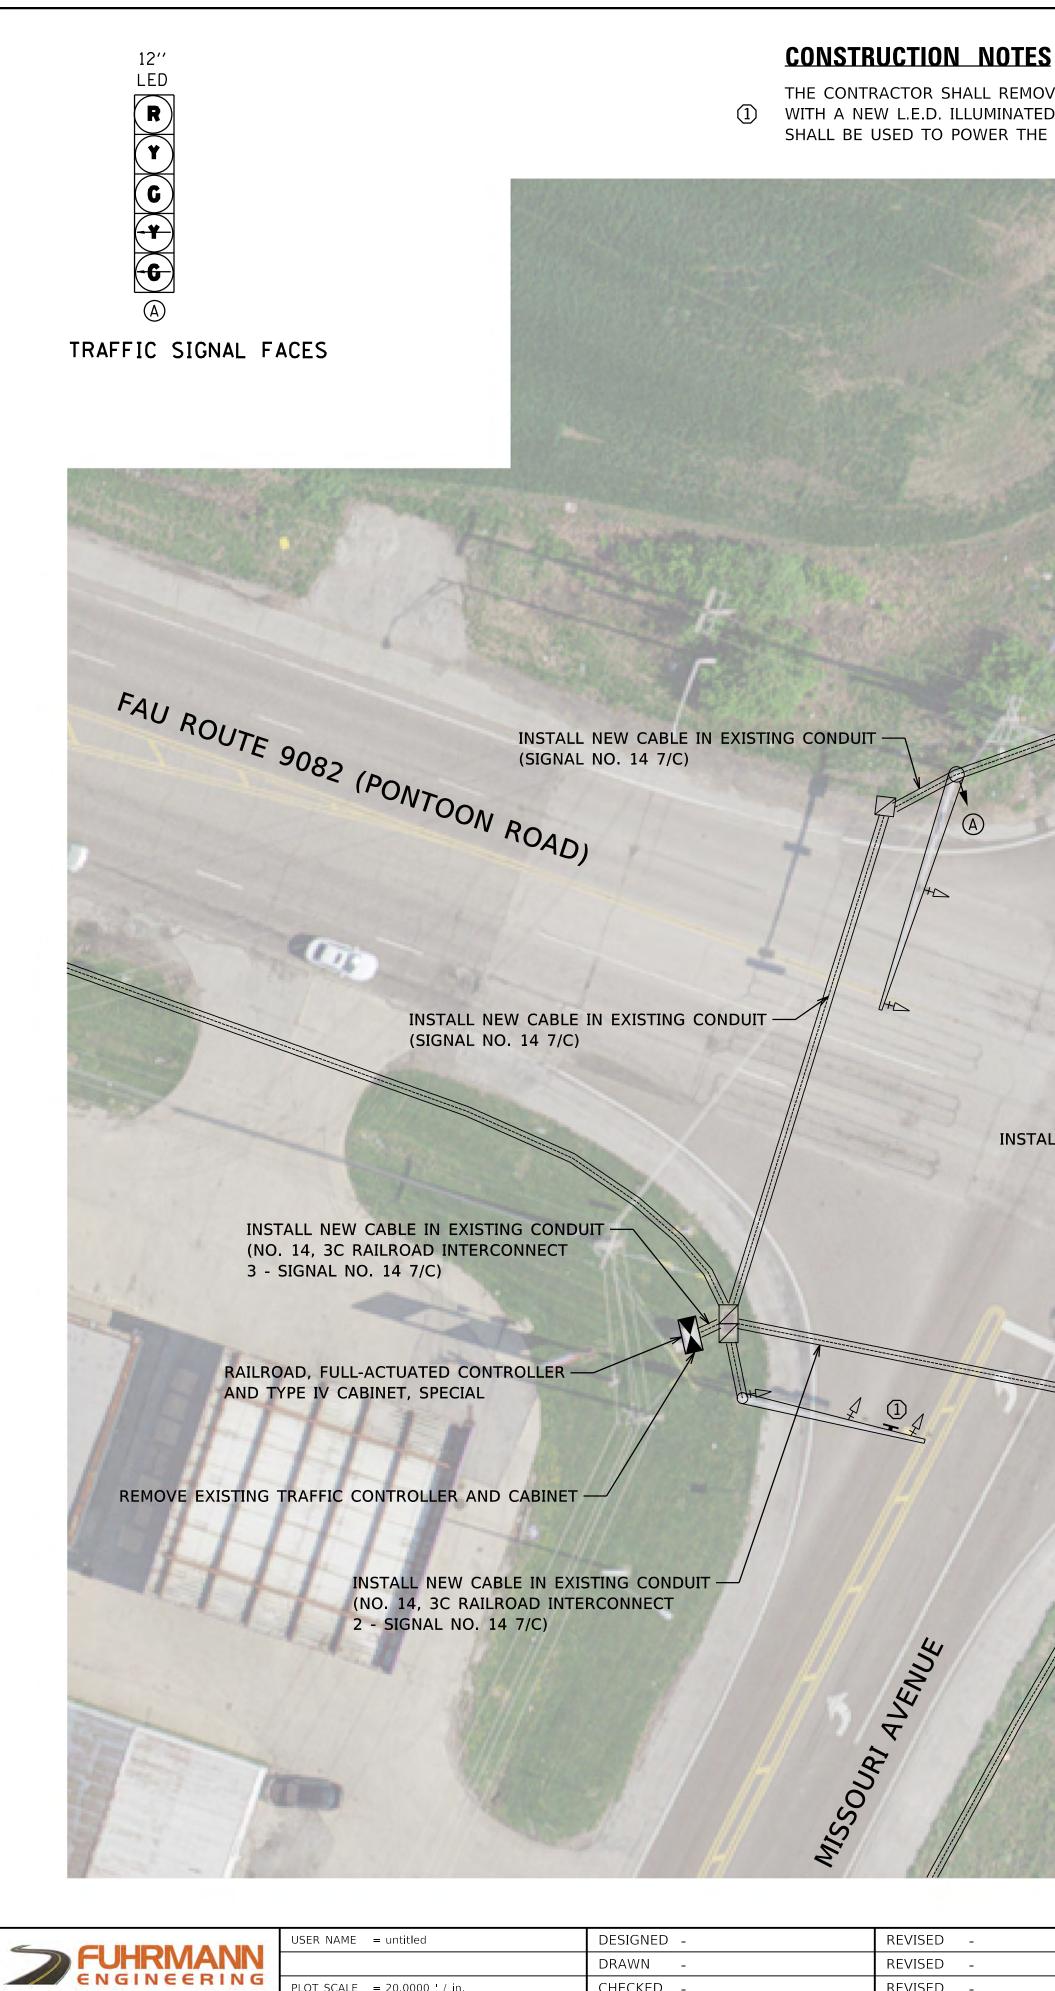
P = ILLUMINATED PERSON = WALK

FH = ILLUMINATED FLASHING HAND = FLASHING DON'T WALK

H = ILLUMINATED SOLID HAND = DON'T WALK

	RAILRO	AD PRE	EMPTIO	N SEC
STATE OF ILLINOIS		FR/	A CROS	SSING
DEPARTMENT OF TRANSPORTATION	IL ROL	<u>JTE 3 &amp;</u>	NEW	POAG
	SCALE: NTS	SHEET 4	OF 4	SHEET

		OF OPERATION	F.A. * RTE.	SEC1	ΓΙΟΝ		COUNTY	TOTAL SHEETS	SHEET NO.
	<b>#3280</b> 3		**	RR INTERCOM	NNECT 2	020	***	23	7
	ROAD	(HARTFORD, IL)					CONTRACT	NO. 7	6N52
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THE CONTRACTOR SHALL REMOVE THE EXISTING RAILROAD BLANKOUT SIGN AND REPLACE WITH A NEW L.E.D. ILLUMINATED RAILROAD BLANKOUT SIGN. THE EXISTING NO. 14 2/C CABLE SHALL BE USED TO POWER THE PROPOSED RAILROAD BLANKOUT SIGN.

DEPARTM

### **TRAFFIC SIGNAL LEGEND**

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EXISTING HANDHOLE	

- $\sum$ EXISTING DOUBLE HANDHOLE
- $\ge$ EXISTING RAILROAD CONTROL CABINET
- PROPOSED TRAFFIC SIGNAL CONTROLLER
  - EXISTING UNDERGROUND CONDUIT

MISSOURI AVENUE **EXISTING NORFOLK SOUTHERN -**RAILROAD BUNGALOW (NS DOT #328042W) TERMINATION OF CONDUCTORS/CABLE -TO BE COORDINATED BETWEEN THE CONTRACTOR AND RAILROAD FORCES - INSTALL NEW W25-2 SIGN (A) INSTALL NEW CABLE IN EXISTING CONDUIT (SIGNAL NO. 14 7/C) - INSTALL NEW CABLE IN EXISTING CONDUIT (NO. 14, 3C RAILROAD INTERCONNECT) EXISTING R8-8 SIGN - INSTALL NEW R8-8 & R10-11A SIGN POST ASSEMBLY INSTALL NEW W25-2 SIGN -NORFOLK SOUTHERN RAILINGY - INSTALL NEW CABLE IN EXISTING CONDUIT (NO. 14, 3C RAILROAD INTERCONNECT SIGNAL NO 14, 7C) INSTALL NEW CABLE IN EXISTING CONDUIT (SIGNAL NO. 14 7/C)

	TRAFFIC SIGNAL MOD
TATE OF ILLINOIS	FRA CROSSING
ENT OF TRANSPORTATION	MISSOURI AVENUE & PONTOON
	SCALE: 1"=20' SHEET 1 OF 4 SHEET

### **TRAFFIC SIGNAL GENERAL NOTES**

1. IT SHALL BE THE CONTRACTOR'S RESPONSIBILITY TO VERIFY ALL DIMENSIONS AND CONDITIONS EXISTING IN THE FIELD PRIOR TO ORDERING MATERIALS AND **BEGINNING CONSTRUCTION.** 

2. THE EXACT LOCATION OF ALL UTILITIES SHALL BE FIELD VERIFIED BY THE CONTRACTOR BEFORE ORDERING ANY MATERIALS AND STARTING ANY WORK, FOR LOCATIONS OF UTILITIES, LOCALLY OWNED EQUIPMENT, AND IDOT UNDERGROUND FACILITIES, CONTACT THE LOCAL COUNTIES, MUNICIPALITIES AND IDOT FOR LOCATES. THE CONTRACTOR SHALL CALL "JULIE" AT (800) 892-0123.

3. THE CONTRACTOR SHALL CONTACT THE NORFOLK SOUTHERN RAILWAY AT (478) 832-0958 (JOEL VAN AKKEREN, C&S SUPERVISOR). JOEL.VANAKKEREN@NSCORP.COM 4. THE CONTRACTOR SHALL COORDINATE WITH NORFOLK SOUTHERN (NS) RAILROAD BEFORE STARTING ANY WORK ON NS PROPERTY. CONTRACTOR SHALL BE RESPONSIBLE FOR OBTAINING AND FOLLOWING CURRENT SPECIFICATIONS FOR PIPELINE OCCUPANCY OF

NORFOLK SOUTHERN CORPORATION PROPERTY. (NS DOT #328030C) 5. THE CONTRACTOR SHALL COORDINATE CONSTRUCTION ACTIVITIES WITH UTILITY COMPANIES, LOCAL GOVERNMENT AGENCIES, IDOT, AND NS RAILWAY.

6. COORDINATE ALL WORK WITH THE RAILROAD FORCES. SEE SPECIAL PROVISION "RAILROAD COORDINATION AND FLAGGERS."

7. THE ILLINOIS DEPARTMENT OF TRANSPORTATION SHALL BE NOTIFIED AT LEAST 72 HOURS PRIOR TO REPLACING OF AND TURNING ON OF THE CONTROLLER UNIT. 8. THE CONTRACTOR SHALL PROVIDE A SELF-ADHERED PHASE DIAGRAM ON THE INSIDE OF THE CONTROLLER CABINET DOOR.

9. RAILROAD, FULL-ACTUATED CONTROLLER AND TYPE IV CABINET, SPECIAL SHALL INCLUDE VEHICLE DETECTOR AMPS, REMOTE MONITORING, AND AN INTERSECTION MONITOR. 10. IT SHALL BE THE CONTRACTOR'S RESPONSIBILITY TO MAINTAIN THE EXISTING TRAFFIC SIGNAL INSTALLATION DURING THE WORK.

11. THE CONTRACTOR SHALL DOWNLOAD THE EXISTING TRAFFIC CONTROLLER DATABASES AND PROVIDE A COPY TO IDOT AND ICC STAFF PRIOR TO SHOP TESTING OF THE NEW TRAFFIC CONTROLLER EQUIPMENT.

THE FOLLOWING ITEMS SHALL BE REMOVED BY THE CONTRACTOR AND SHALL REMAIN THE PROPERTY OF THE AGENCY LISTED BELOW. THE CONTRACTOR SHALL SAFELY STORE AND ARRANGE FOR THE PICK UP OF ALL EQUIPMENT TO BE RETURNED TO THE LISTED AGENCY AS PER THE SPECIAL PROVISION.

AGENCY: ILLINOIS DEPARTMENT OF TRANSPORTATION DISTRICT 8 1 EACH CONTROLLER AND CABINET (COMPLETE)

NOTE: ALL TRAFFIC SIGNAL CONTROLLER EQUIPMENT FOR THIS PROJECT SHALL BE "ECONOLITE".


**RESTORATION OF WORK AREA:** 

RESTORATION OF THE TRAFFIC SIGNAL WORK AREA SHALL BE INCLUDED WITH THE RELATED PAY ITEMS AND NO EXTRA COMPENSATION SHALL BE ALLOWED. ANY DAMAGE TO PAVEMENT SHALL BE REPLACED IN KIND. ANY DAMAGE TO TURF AREAS SHALL BE SEEDED IN ACCORDANCE WITH SECTION 252 OF THE STANDARD SPECIFICATIONS.


STAGING OF RAILROAD INTERCONNECT WORK:

THE EXISTING RAILROAD INTERCONNECT WILL BE MAINTAINED THROUGHOUT THE WORK UNTIL A NEW RAILROAD INTERCONNECT CABLE IS INSTALLED FRON THE NEW CONTROLLER TO THE RIALROAD BUNGALOW AS SHOWN.

ANY DAMAGE DONE TO THE EXISTING SIGNAL ITEMS OR APURTENANCES SHALL BE REPAIRED OR REPLACED BY THE CONTRACTOR, PER SECTION 895.02 OF THE STANDARD SPECIFICATIONS.

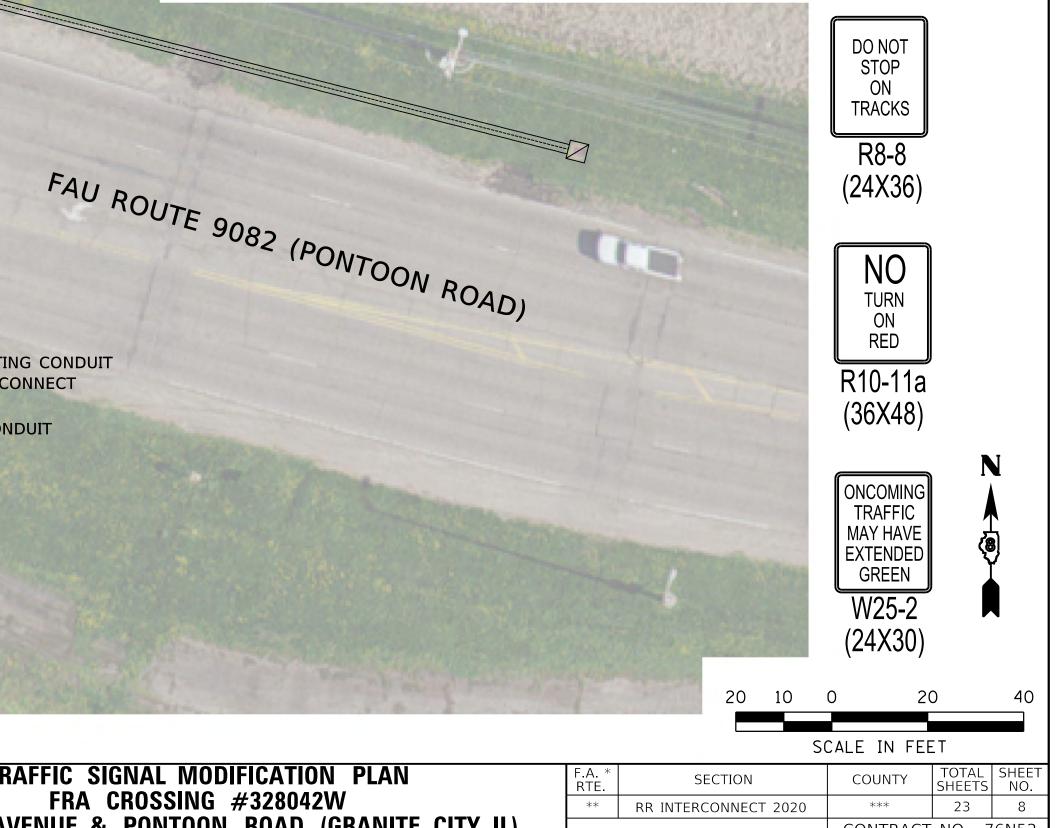

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MOVEMENT		5	- - 1			2						+ + + + + + + + + + + + + + + + + + +			7 –	J		ſ	3							L F	- 8 - 3			- , , ,					4		+	8
PHASE			1 + 5			2	+ 5		1 +	6	2	2 + 6	;				3 +	7							3 +	- 8					4	+ 7	,		Z	1 + 8		
INTERVAL	1	2A 2E	3 3A 3	3B 4	A 4B	5	6A	6B	7 84	A 8E	3 9	10A [	10B	11 12/	4 12B	13A	13B 13C	13D 1	4A ]	14B 140	C 14D	15	16A 1	6B 16	5C 16	D 174	A 17B	17C	17D	18	19A	19B	20A 20	В 21	l 22A	22B 2	22C2	22D
CHANGE TO		2 + 5	1 +	6 2	2 + 6		2 +	6	2	+ 6		3 + 4 + 3 + 4 +	7	3	+ 8		4 + 7		1 +	- 5, 2 - - 6, 2 - 4 + 8	+ 6			1 + 2 + 1 + 2 +	5 6		4	+8			1 + 2 + 1 + 2 +	5 6	4+8			1 + 2 + 1 + 2 +	5 6	
MISSOURI AVE LEFT MAST ARM SIGNAL	S/B R G	R R G (	R F		R Y	G G	G Y	G F	R R	R	G	Y	R	R R	R	R	R R	RR	2	R R	R	R	R F	R R	R	R	R	R	R	R	R	R	R R	R	R	RI	R	R F
MISSOURI AVE RIGHT MAST ARM AND NEAR RIGHT SIGNALS	S/B R	RR	R	RF	RR	G	G	G	R R	R	G	Y	R	R R	R	R	R R	R	R	R R	R	R	R	R	R R	R	R	R	R	R	R	R	R R	R	R	R	R	R
MISSOURI AVE LEFT MAST ARM SIGNAL	N/B R G	R R Y	G	G	R Y	R	R		G G	Y	G	Y	R	R R	R	R	R R	RF	R	R R	R	R	R F	R R	R	R	R	R	R	R	R	R	R R	R	R	RI	R	R F
MISSOURI AVE RIGHT MAST ARM AND NEAR RIGHT SIGNALS	N/B R	RR	R	RF	RR	R	R	R	G G	G	G	Y	R	R R	R	R	R R	R	R	R R	R	R	R	R	R R	R	R	R	R	R	R	R	R R	R	R	R	R	R
PONTOON ROAD (PRE-SIGNAL) LEFT MAST ARM AND NEAR LEFT SIGNALS	W/B R	R R	R F	R R	R	R	R	R F	R R	R	R	R	R	R R G C	R G G	R Y	R R	RR	₹ Y	R R	R	G G		R R	R	G	, R -	R	R	R	R	R	R R	G	Y	RI	R	RF
PONTOON ROAD (PRE-SIGNAL) RIGHT MAST ARM AND NEAR RIGHT SIGNALS	W/B R	R R	R	R F	R R	R	R	R	R R	R	R	R	R	R R	R	R	R R	R	R	R R	R	G	Y	RI	R R	G	G	G	G	R	R	R	R R	G	Y	R	R	R
PONTOON ROAD (WEST OF TRACKS) LEFT MAST ARM AND FAR LEFT SIGNALS	W/B R	R R	R F	R R	R	R	R	R F	R R	R	R	R	R	R R G C	R G G	R G	R R G Y		G G	R R G Y	R.	G G	G ( G		Y R	G	G G G	G Y	R	R	R	R	R R	G	G	G	Y	RI
PONTOON ROAD (WEST OF TRACKS) RIGHT MAST ARM SIGNAL		R R	R	R F	R R	R	R	R	R R	R	R	R	R	R R	R	R	R R	R	R	R R	R	G	G	G `	Y R	G	G	G	G	R	R	R	R R	G	G	G	Y	R
PONTOON ROAD LEFT MAST ARM SIGNAL	E/B R	R R	RF	R R	R	R	R	R F	R R	R	R	R	R	R R G Y		R G	R R G G		₹ G	R R G Y		R	R F	R R	R	R	R	R	R	G G	Y	R	G G	G	G	G	Y	RF
PONTOON ROAD RIGHT MAST ARM AND NEAR RIGHT SIGNALS	E/B R	R R	R	RF	R R	R	R	R	R R	R	R	R	R	R R	R	R	R R		R	R R	R	R	R	RI	R R	R	R	R	R	G	Y	R	G G	G	G	G	Y	R

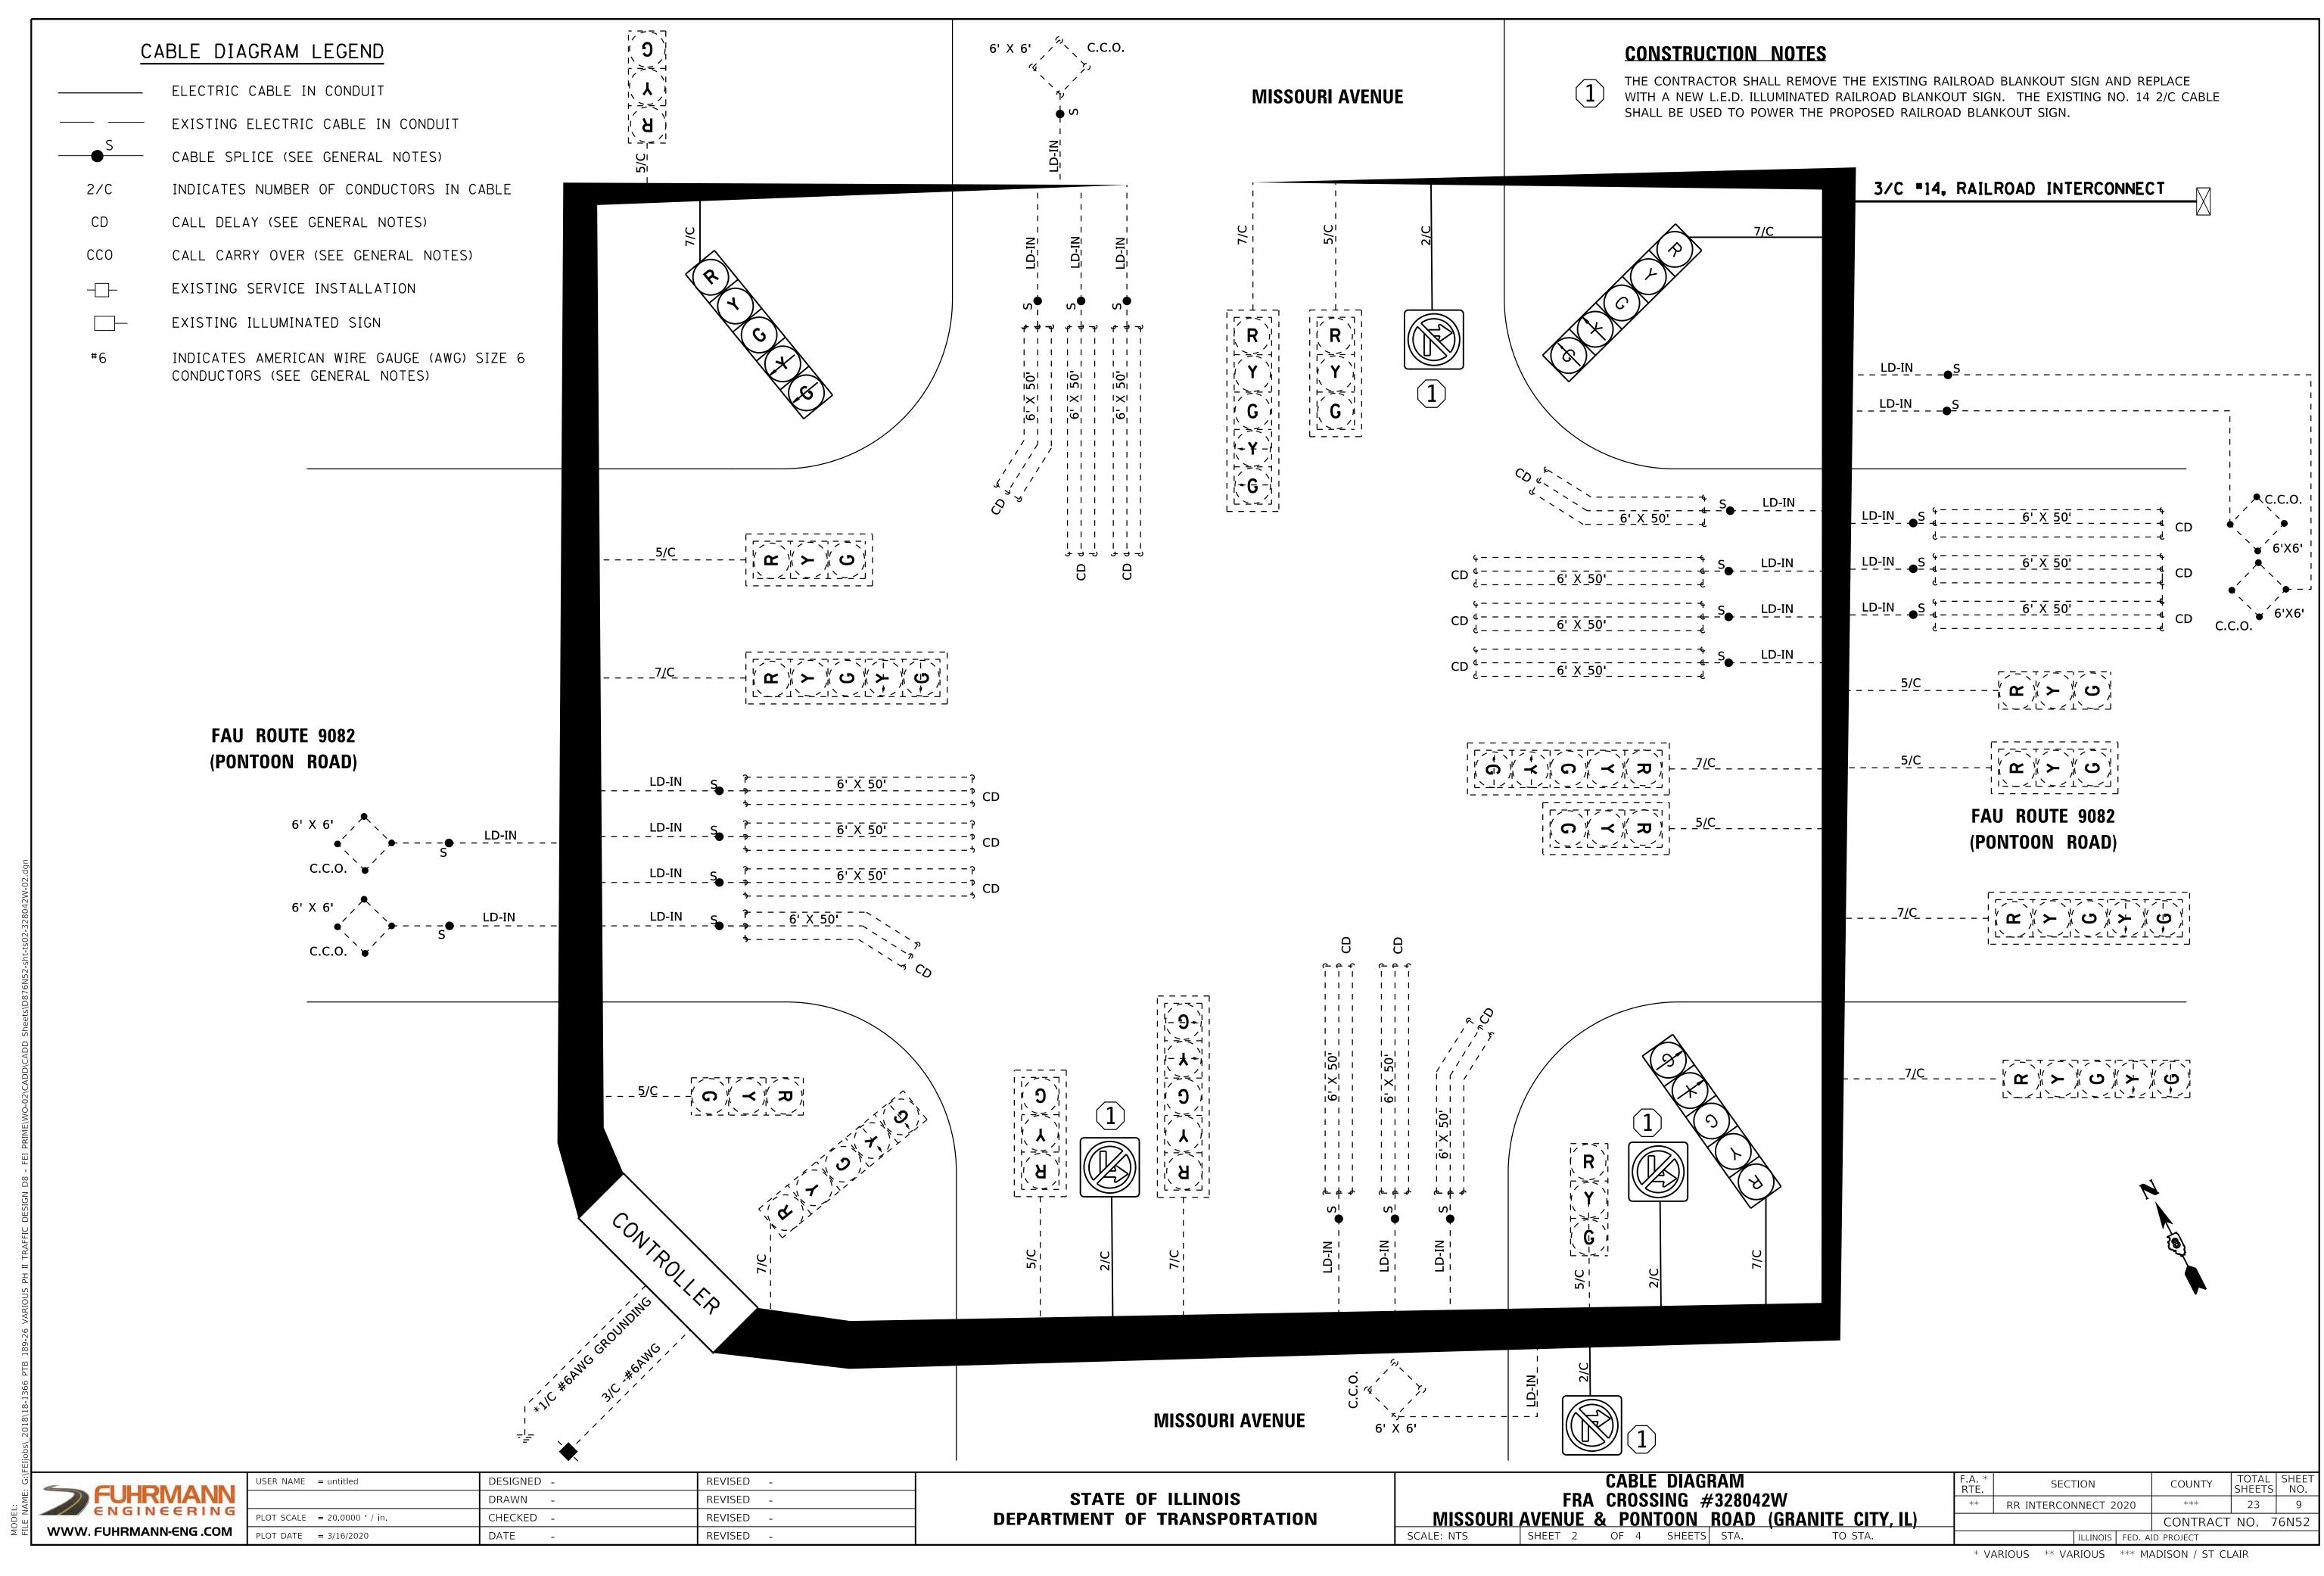PHASES 2 AND 6 SHALL BE PLACED ON RECALL



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## TRAFFIC SIGNAL SEQUENCE OF OPERATION

STATE OF ILLINOIS	
DEPARTMENT OF TRANSPORTATION	MISSOU

NCE OF OPERATION	F.A. * RTE	SECT	TON		COUNTY TOTAL SHEET SHEETS NO.				
#328042W	**	RR INTERCON	NECT 2	020	***	23	10		
I <u>ROAD (GRANITE CITY, IL)</u>					CONTRACT	NO. 7	′6N52		
TS STA. TO STA.			ILLINOIS	FED. AI	d project				
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																		PREEMPTOR NUMBER 2	]			
CHANGE FROM NORMAL SEQUENCE OF OPERATION INTERVAL NUMBER		1			ō	-	7		9	]	. 1	]	15	1	.8	2	21					
RAILROAD PREEMPTION SEQUENCE OF OPERATION INTERVAL NUMBER		1A	1B	1C	1D	1E	1F	1G	1H	1L	1M	1N	1P	1R	15	1T	10	2	3	4	5	CLEAR TO
CHANGE TO RAILROAD PREEMPTION SEQUENCE OF OPERATION NUMBER		1B	2	1D	2	1F	2	1H	2	1M	2	1P	2	1S	2	1U	2	3	4	5		NORMAL SEQUENCE
MISSOURI AVE LEFT MAST ARM SIGNAL	S/B	R Y	R	Y Y	R	R	R	Y	R	R	R	R	R	R	R	R	R	R	R	R	G	
MISSOURI AVE NEAR RIGHT AND RIGHT MAST ARM SIGNALS	S/B	R	R	Y	R	R	R	Y	R	R	R	R	R	R	R	R	R	R	R	R	G	
MISSOURI AVE LEFT MAST ARM SIGNAL	N/B	R Y	R	R	R	Y Y	R	Y	R	R	R	R	R	R	R	R	R	R	R	R	G	
MISSOURI AVE NEAR RIGHT AND RIGHT MAST ARM SIGNALS	N/B	R	R	R	R	Y	R	Y	R	R	R	R	R	R	R	R	R	R	R	R	G	
PONTOON ROAD (PRE-SIGNAL) LEFT AND LEFT POST MOUNT SIGNALS	W/B	R	R	R	R	R	R	R	R	R Y	R	Y Y	R	R	R	Y	R	R	R	R	R	
PONTOON ROAD (PRE-SIGNAL) RIGHT AND RIGHT POST MOUNT SIGNALS	W/B	R	R	R	R	R	R	R	R	R	R	Y	R	R	R	Y	R	R	R	R	R	
PONTOON ROAD (WEST OF TRACKS) FAR LEFT AND LEFT MAST ARM SIGNALS	W/B	R	R	R	R	R	R	R	R	R G	R G	G G	G G	R	R	G	G	G G	Y	R	R	
PONTOON ROAD (WEST OF TRACKS) RIGHT MAST ARM SIGNAL	W/B	R	R	R	R	R	R	R	R	R	R	G	G	R	R	G	G	G	Y	R	R	
PONTOON ROAD LEFT MAST ARM SIGNAL	E/B	R	R	R	R	R	R	R	R	R Y	R	R	R	Y Y	R	Y	R	R	R	R	R	
PONTOON ROAD NEAR RIGHT AND RIGHT MAST ARM SIGNALS	E/B	R	R	R	R	R	R	R	R	R	R	R	R	Y	R	Y	R	R	R	R	R	
INTERNALLY ILLUMINATED NO RIGHT TURN SIGNS		NRT	NRT	NRT	NRT	NRT	NRT	NRT	NRT	NRT	NRT	NRT	NRT	NRT	NRT	NRT	NRT	NRT	NRT	NRT	NRT	
INTERNALLY ILLUMINATED NO LEFT TURN SIGNS		NLT	NLT	NLT	NLT	NLT	NLT	NLT	NLT	NLT	NLT	NLT	NLT	NLT	NLT	NLT	NLT	NLT	NLT	NLT	NLT	
																					HOLC	

- ☐ THE RAILROAD PREEMPTION SEQUENCE SHALL BE CAPABLE OF CYCLING BETWEEN PHASES 1+6, AND 2+6 UNTIL PREEMPTION IS TERMINATED
- $\triangle$  RAILROAD PREEMPTION SEQUENCE SHALL PROVIDE THE PROPER CLEARANCE INTERVAL TO RESUME THE NORMAL SEQUENCE OF OPERATION AFTER RAILROAD INTERVAL 5 IS TERMINATED

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NOTES: 1. ONCE PREEMPTION HAS BEEN CALLED, THE TRACK CLEAR SIGNAL DISPLAY SHALL APPEAR IMMEDIATELY AFTER ALL NECESSARY VEHICULAR CLEARANCES HAVE BEEN PROVIDED.

2. THE RAILROAD PREEMPTION SEQUENCE OF OPERATION SHALL HAVE PRIORITY OVER ALL OTHER SEQUENCES OF OPERATION.

	RAILR	OAD PRE	EMPTION	N SEC
STATE OF ILLINOIS DEPARTMENT OF TRANSPORTATION				
	SCALE: NTS	AVENUE SHEET 4	<b>A PUN</b> OF 4	SHEET

		OF OPERATION	F.A. * RTE.	SECT	ΓΙΟΝ		COUNTY	TOTAL SHEETS	SHEET NO.
	32804		**	RR INTERCO	NNECT 2	020	***	23	11
	<u>ROAD</u>	<u>(GRANITE CITY, IL)</u>					CONTRACT	NO. 7	'6N52
TS	STA.	TO STA.			ILLINOIS	FED. AI	D PROJECT		
			* VA	ARIOUS ** VA	RIOUS	*** MA	ADISON / ST CL	AIR	

TRAFI	FIC SIGNAL GENE	ERAL NOTES		
		TOR'S RESPONSIBILITY TO HE FIELD PRIOR TO ORDERI		\ND
BEGI	NNING CONSTRUCTION			
		ALL UTILITIES SHALL BE FIEL ERING ANY MATERIALS AND		OR
	•	OCALLY OWNED EQUIPMENT OCAL COUNTIES, MUNICIPA	•	
		CALL "JULIE" AT (800) 892-0		JATES.
		CONTACT THE NORFOLK SOU SUPERVISOR). JOEL.VANAKK	•	) 832-0958
4. THE (	CONTRACTOR SHALL C	COORDINATE WITH NORFOLK	SOUTHERN (NS) RAILROA	
		ORK ON NS PROPERTY. CON DWING CURRENT SPECIFICA		
		ORATION PROPERTY. (NS DO		/
		COORDINATE CONSTRUCTION NMENT AGENCIES, IDOT, AN		
	RDINATE ALL WORK WI ROAD COORDINATION	ITH THE RAILROAD FORCES. AND FLAGGERS."	SEE SPECIAL PROVISION	
		OF TRANSPORTATION SHAL		72
		ROVIDE A SELF-ADHERED P		NSIDE
	HE CONTROLLER CABIN ROAD. FULL-ACTUATED	NET DOOR. CONTROLLER AND TYPE IV	CABINET. SPECIAL SHALL	. INCLUDE
VEHIC	CLE DETECTOR AMPS,	REMOTE MONITORING, AND	AN INTERSECTION MONIT	FOR.
	AL INSTALLATION DURI	TOR'S RESPONSIBILITY TO N ING THE WORK.	MAINTAIN THE EXISTING T	KAFFIC
		OWNLOAD THE EXISTING T AND ICC STAFF PRIOR TO S		
	ROLLER EQUIPMENT.			
		ALL BE REMOVED BY THE C	ONTRACTOR AND	
THE I		ENCY LISTED BELOW. THE C	CONTRACTOR	
	L SAFELY STORE ARRANGE FOR THE PIC	CK UP OF ALL EQUIPMENT T	O BE RETURNED	
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	ICY AS PER THE SPECI			
		IENT OF TRANSPORTATION D CABINET (COMPLETE)	DISTRICT 8	
	: ALL TRAFFIC SIGNAL ECT SHALL BE "ECONO	CONTROLLER EQUIPMENT F	OR THIS	
REST	ORATION OF WORK AR	RFA:		
REST	ORATION OF THE TRAF	FIC SIGNAL WORK AREA SH	HALL BE	
	JDED WITH THE RELAT TEMS AND NO EXTRA	COMPENSATION SHALL BE	ALLOWED. ANY	
	AGE TO PAVEMENT I BE REPLACED IN KIN	ID. ANY DAMAGE TO TURF /	ARFAS SHALL BE	
SEED	ED IN ACCORDANCE			
VVIIH	SECTION 252 OF THE	STANDARD SPECIFICATIONS	5.	
	ING OF RAILROAD INT EXISTING RAILROAD IN	ERCONNECT WORK: ITERCONNECT WILL BE MAIN	NTAINED	INSTALI (NO. 14
THRC	UGHOUT THE WORK			(10. 1-
	NEW CONTROLLER TO	TERCONNECT CABLE IS INST	TALLED FRON	
THE I	RIALROAD BUNGALOW	AS SHOWN.		EXISTING
		E EXISTING SIGNAL ITEMS C	DR	RAILROAD (NS DOT a
	TENANCES SHALL BE F EPLACED BY THE CON	REPAIRED TRACTOR, PER SECTION 895	5.02 OF THE	
STAN	DARD SPECIFICATIONS			
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	FIC SIGNAL LEGE	:NU		CONTRACTOR AN
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	EXISTING DOUBLE HA	ANDHOLE		RAILROAD, FULL-ACTUATED CONT
$\bowtie$	EXISTING RAILROAD	CONTROL CABINET		REMOVE EXIS
	PROPOSED TRAFFIC S	SIGNAL CONTROLLER		
	EXISTING UNDERGRO	UND CONDUIT		
	CONSTRUCTION			
(1) V	VITH A NEW L.E.D. ILLU	LL REMOVE THE EXISTING RAINATED RAILROAD BLANK	OUT SIGN. THE EXISTING	
S	SHALL BE USED TO POW	WER THE PROPOSED RAILRO	AD BLANKOUT SIGN.	
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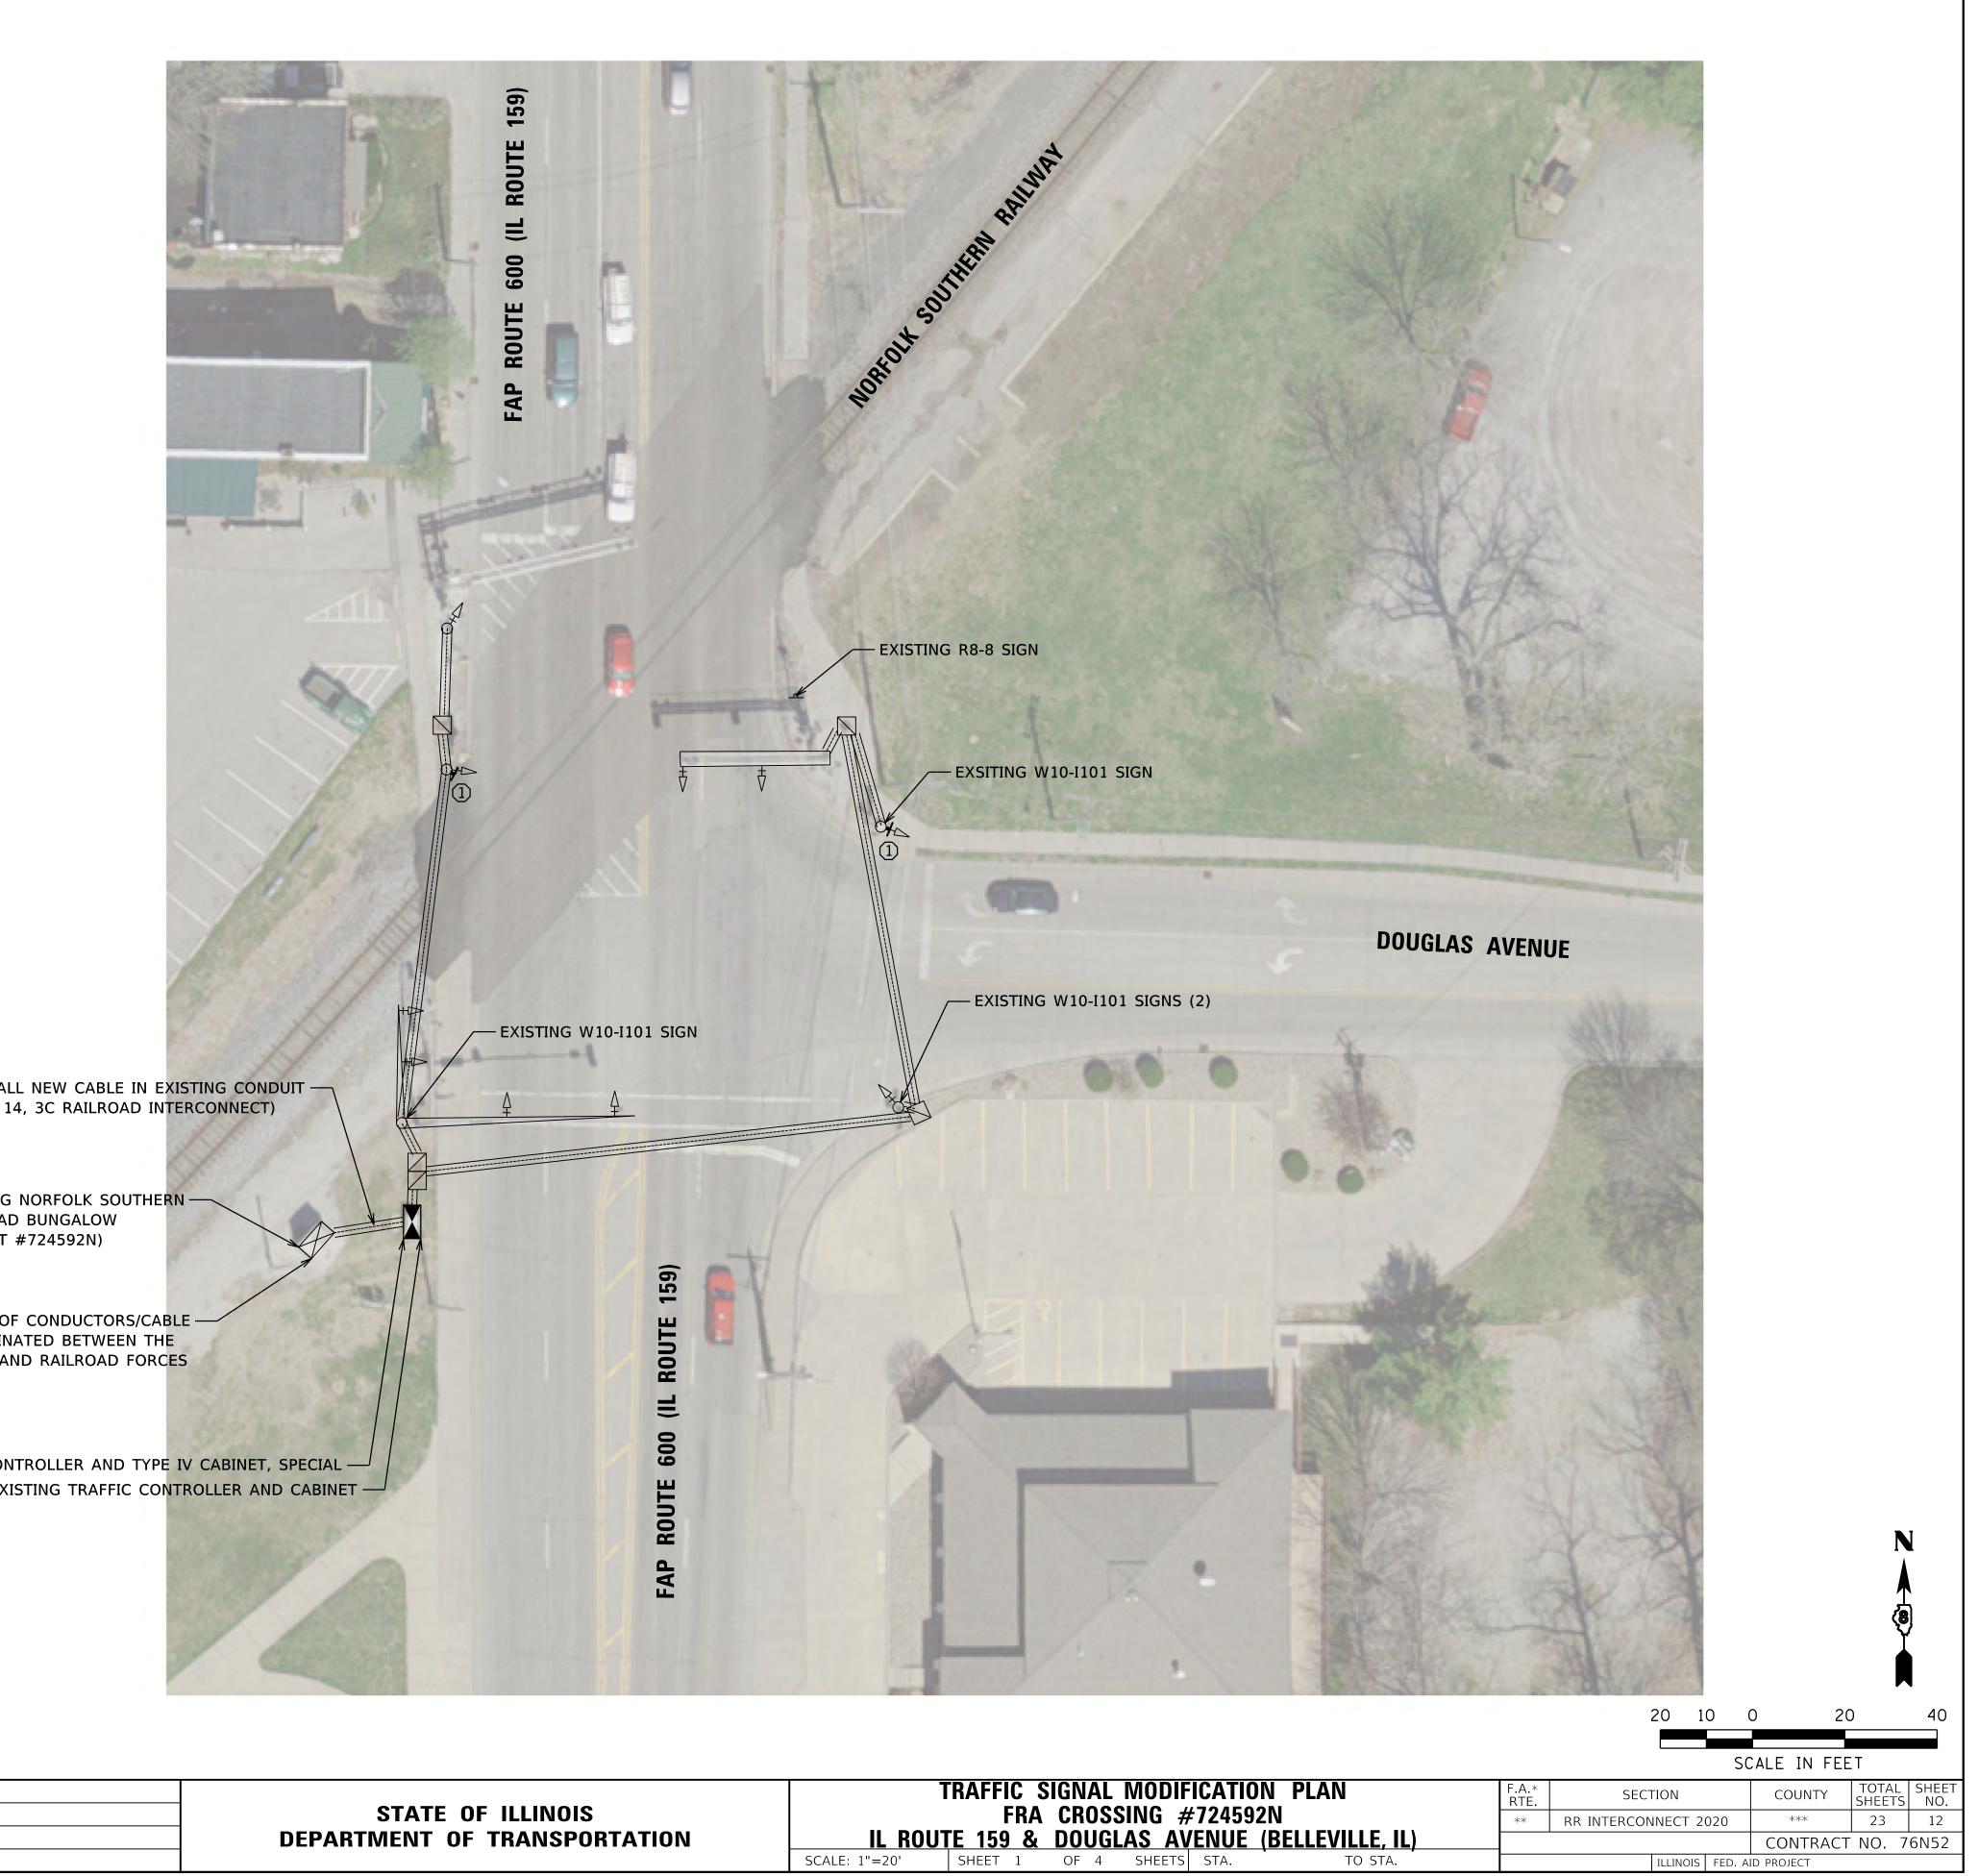
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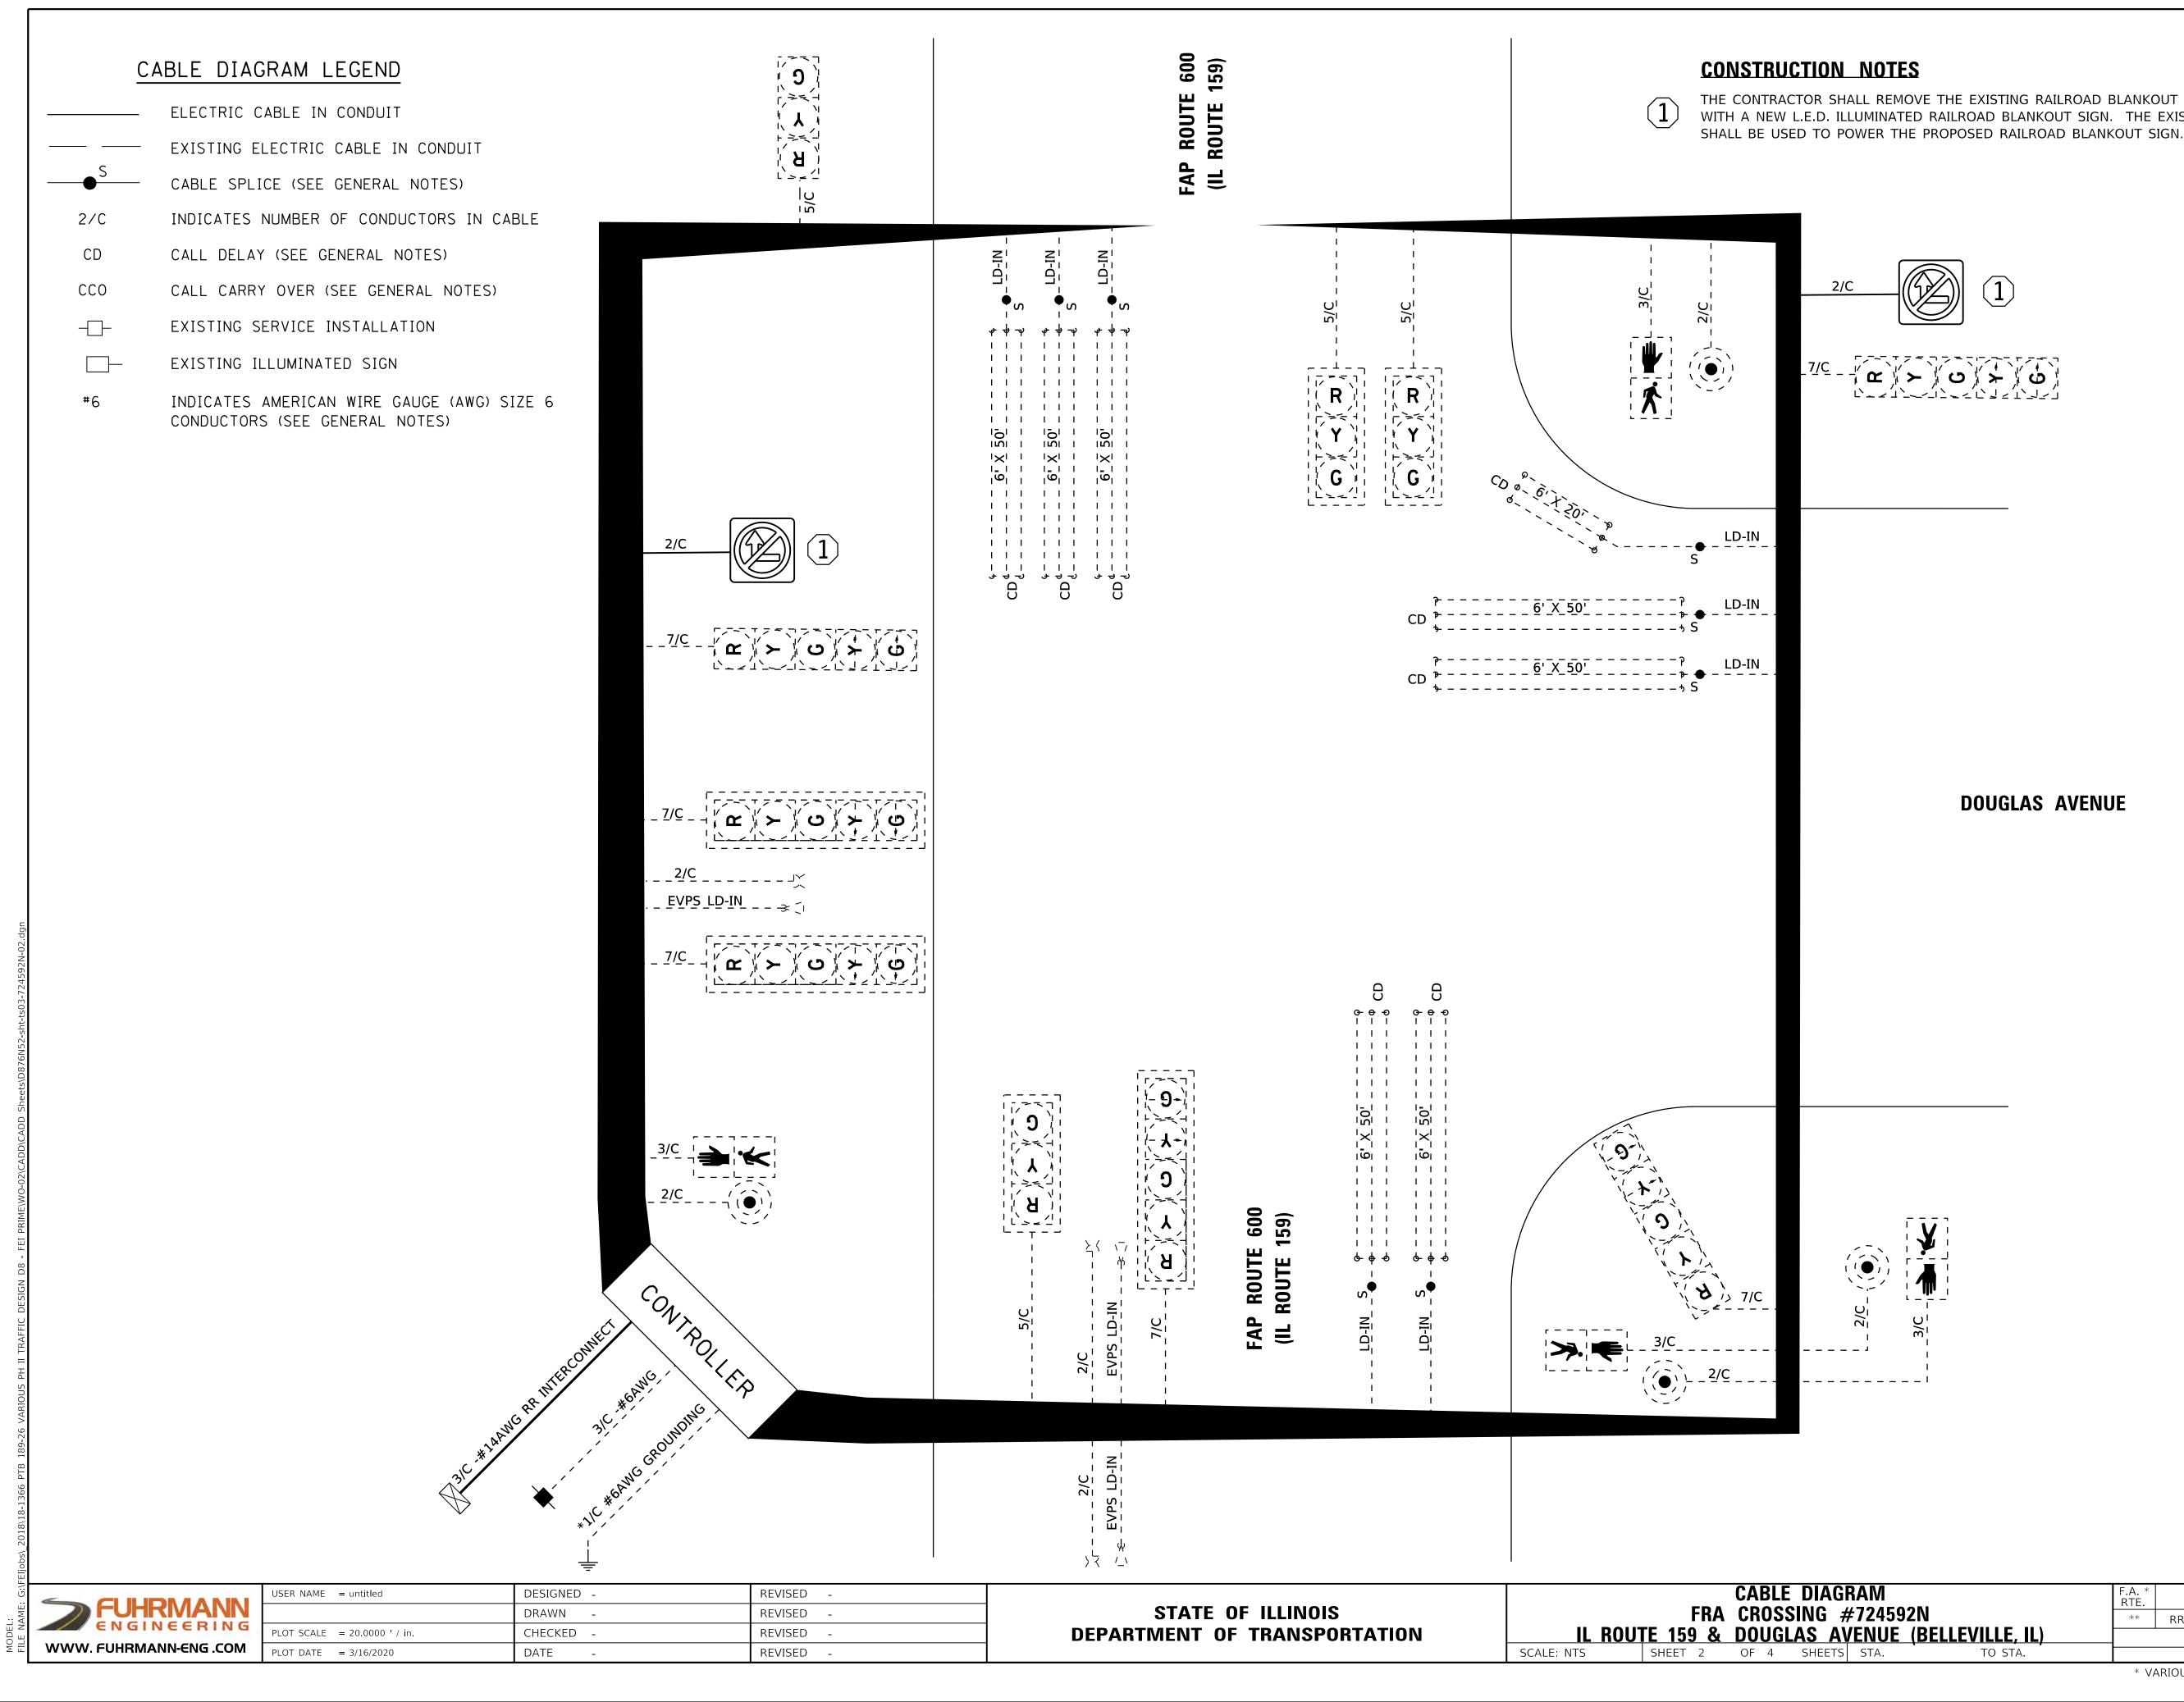
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REVISED -



	STATE OF ILLINOIS DEPARTMENT OF TRANSPORTATION	TRAFFIC SIGNAL FRA CROS ITE 159 & DOU(	SSING
		1	

CONTRACT NO. 76N52 ILLINOIS FED. AID PROJECT \* VARIOUS \*\* VARIOUS \*\*\* MADISON / ST CLAIR



THE CONTRACTOR SHALL REMOVE THE EXISTING RAILROAD BLANKOUT SIGN AND REPLACE WITH A NEW L.E.D. ILLUMINATED RAILROAD BLANKOUT SIGN. THE EXISTING NO. 14 2/C CABLE



**DOUGLAS AVENUE** 

GRAM	F.A. * RTE	SECT	ΓΙΟΝ		COUNTY	TOTAL SHEETS	SHEET NO.
#724592N	**	RR INTERCO	NNECT 2	020	***	23	13
AVENUE (BELLEVILLE, IL)					CONTRACT	NO. 7	6N52
TS STA. TO STA.			ILLINOIS	FED. AI	D PROJECT		
	* VA	ARIOUS ** VA	RIOUS	*** M/	ADISON / ST CL	AIR	

## TRAFFIC SIGNAL SEQUENCE OF OPERATION

MOVEMENT
PHASE
INTERVAL
CHANGE TO
ILLINOIS ROUTE 159 FAR LEFT AND LEFT MAST ARM SIGNA
ILLINOIS ROUTE 159 RIGHT MAST ARM SIGNAL
ILLINOIS ROUTE 159 NEAR RIGHT SIGNAL (PRE-SIGNAL)
ILLINOIS ROUTE 159 LEFT AND RIGHT RR CANTILEVER SIGN
DOUGLAS AVE MAST ARM SIGNALS
DOUGLAS AVE FAR RIGHT AND NEAR RIGHT SIGNALS
PEDESTRIAN SIGNALS CROSSING DOUG ON EAST SIDE OF IL 159
PEDESTRIAN SIGNALS CROSSING IL 15 ON SOUTH SIDE OF DOUGLAS AVENUE

PHASES 2 AND 6 SHALL BE PLACED ON RECALL



	USER NAME = untitled	DESIGNED -	REVISED -
Ν		DRAWN -	REVISED -
G	PLOT SCALE = $1.0000$ ' / in.	CHECKED -	REVISED -
M	PLOT DATE = $3/16/2020$	DATE -	REVISED -

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		2	2 + 5	5		Γ	2 -	+ 6	[			Γ	I	4+7	1					4 -	+ 8			
		1	2A	2B	3	4	5A	5B	6A	6B	7	8A	8B	9A	9B	10A	10B	11	12	13A	13B	14A	14B	
			2 -	+ 6			2 -	+ 5	4 - 4 -			4 -	+ 8	2 -	+ 5	2 +	- 6			2 -	+ 5	2 -	+ 6	
NAL	S/B	G G	GY	G	G	G	G	G	Y	R	R	R	R	R	R	R	R	R	R	R	R	R	R	R
	S/B	G	G	G	G	G	G	G	Y	R	R	R	R	R	R	R	R	R	R	R	R	R	R	R
	S/B	G	G	G	G	G	G	G	Y	R	R	R	R	R	R	R	R	R	R	R	R	R	R	R
GNALS	N/B	R	R	R	G	G	Y	R	Y	R	R	R	R	R	R	R	R	R	R	R	R	R	R	R
V	V/B	R	R	R	R	R	R	R	R	R	G G	G Y	G	Y Y	R	Y Y	R	G	G	Y	R	Y	R	R
V LS	V/B	R G	R Y	R	R	R	R	R	R	R	G G	G G	G G	Y G	R G	Y Y	R	G G	G G	Y G	R G	Y Y	R	R
UGLAS AVENUE		Н	Н	Н	*P	FH	Н	Н	Н	Н	Н	Н	Н	Н	н	Н	Н	Н	Н	Н	Н	Н	Н	
159 IUE		Н	Н	Н	Н	Н	Н	Н	Н	Н	Н	Н	н	н	н	Н	Н	*P	FH	Н	Н	Η	Н	DARK

P = ILLUMINATED PERSON = WALK

FH = ILLUMINATED FLASHING HAND = FLASHING DON'T WALK

H = ILLUMINATED SOLID HAND = DON'T WALK

\* TO APPEAR ONLY UPON PUSHBUTTON ACTUATION
 \*\* "FH" TO TERMINATE AT THE COMPLETION OF THE PEDESTRIAL INTERVAL CLEARANCE

	TR/	AFFIC SIG	NAL SI	EQUEN
STATE OF ILLINOIS		FRA	CROS	SING ;
DEPARTMENT OF TRANSPORTATION	IL ROU	TE 159 &	DOUG	LAS A
	SCALE: NTS	SHEET 3	OF 4	SHEETS

= FLASHING DON'T WALK ON'T WALK

NCE OF OPERATION	F.A. * RTE.	SEC		COUNTY	TOTAL SHEETS	SHEET NO.	
#724592N	**	RR INTERCO	NNECT 2	020	***	23	14
<u>AVENUE (BELLEVILLE</u>	<u>, IL)                                    </u>				CONTRACT	NO. 7	6N52
TS STA. TO ST	Α.		ILLINOIS	FED. AI	d project		
	ale A		DIOLIC	stesteste N.A. (	DIGON ( GT CI		

										PREEMPTOR NUMBER 2				
CHANGE FROM NORMAL SEQUENCE OF OPERATION INTERVAL NUMBER		1			3	-	7	1	1					
RAILROAD PREEMPTION SEQUENCE OF OPERATION INTERVAL NUMBER	14	2	1B	1C	1D	1E	1F	1G	1H	2	3	4	5	CLEAR TO
CHANGE TO RAILROAD PREEMPTION SEQUENCE OF OPERATION NUMBER	16	3	2	1D	2	1F	2	1H	2	3	4	5		NORMAL SEQUENCE
ILLINOIS ROUTE 159 FAR LEFT AND LEFT MAST ARM SIGNAL	3 G	G	G G	G	G	R	R	R	R	G G	Y Y	R	R	$\bigtriangleup$
ILLINOIS ROUTE 159 S/I RIGHT MAST ARM SIGNAL	<sup>3</sup> G	ì	G	G	G	R	R	R	R	G	Y	R	R	$\bigtriangleup$
ILLINOIS ROUTE 159 S/I NEAR RIGHT SIGNAL (PRE-SIGNAL)	3 Y		R	Y	R	R	R	R	R	R	R	R	R	$\bigtriangleup$
ILLINOIS ROUTE 159 LEFT AND RIGHT RAILROAD CANTILEVER SIGNALS	<sup>3</sup> R		R	Y	R	R	R	R	R	R	R	R	R	$\bigtriangleup$
DOUGLAS AVE W/I LEFT MAST ARM SIGNALS	3 R		R	R	R	Y Y	R	Y	R	R	R	R	R G	$\bigtriangleup$
DOUGLAS AVE W/I FAR RIGHT AND NEAR RIGHT SIGNALS	3 R	Ý	R	R	R	Y Y	R	Y Y	R	R	R	R	R	$\bigtriangleup$
INTERNALLY ILLUMINATED NO RIGHT TURN SIGNS	NR		VRT	NRT	NRT	NRT	NRT	NRT	NRT	NRT	NRT	NRT	NRT	$\triangle$
PEDESTRIAN SIGNALS CROSSING DOUGLAS AVENUE ON EAST SIDE OF IL 159	Н		Н	FH	н	Н	н	Н	Н	Н	н	н	Н	$\bigtriangleup$
PEDESTRIAN SIGNALS CROSSING IL 159 ON SOUTH SIDE OF DOUGLAS AVENUE	Н		Н	Н	Н	Н	н	FH	Н	Н	Н	н	Н	$\triangle$
	-	•											HOLD	

△ RAILROAD PREEMPTION SEQUENCE SHALL PROVIDE THE PROPER CLEARANCE INTERVAL TO RESUME THE NORMAL SEQUENCE OF OPERATION AFTER RAILROAD INTERVAL 5 IS TERMINATED




	USER NAME = untitled	DESIGNED -	REVISED -
V		DRAWN -	REVISED -
G	PLOT SCALE = $1.0000$ ' / in.	CHECKED -	REVISED -
M	PLOT DATE = $3/16/2020$	DATE -	REVISED -


NOTES:

- 1. ONCE PREEMPTION HAS BEEN CALLED, THE TRACK CLEAR SIGNAL DISPLAY SHALL APPEAR IMMEDIATELY AFTER ALL NECESSARY VEHICULAR CLEARANCES HAVE BEEN PROVIDED.
- 2. THE RAILROAD PREEMPTION SEQUENCE OF OPERATION SHALL HAVE PRIORITY OVER ALL OTHER SEQUENCES OF OPERATION.
  - P = ILLUMINATED PERSON = WALK
- FH = ILLUMINATED FLASHING HAND = FLASHING DON'T WALK
- H = ILLUMINATED SOLID HAND = DON'T WALK

	RAILRO	AD PREE		
 STATE OF ILLINOIS DEPARTMENT OF TRANSPORTATION	IL ROU	гка ТЕ 159 &	CROSS DOUGL	
	SCALE: NTS	SHEET 4	OF 4	SHEETS

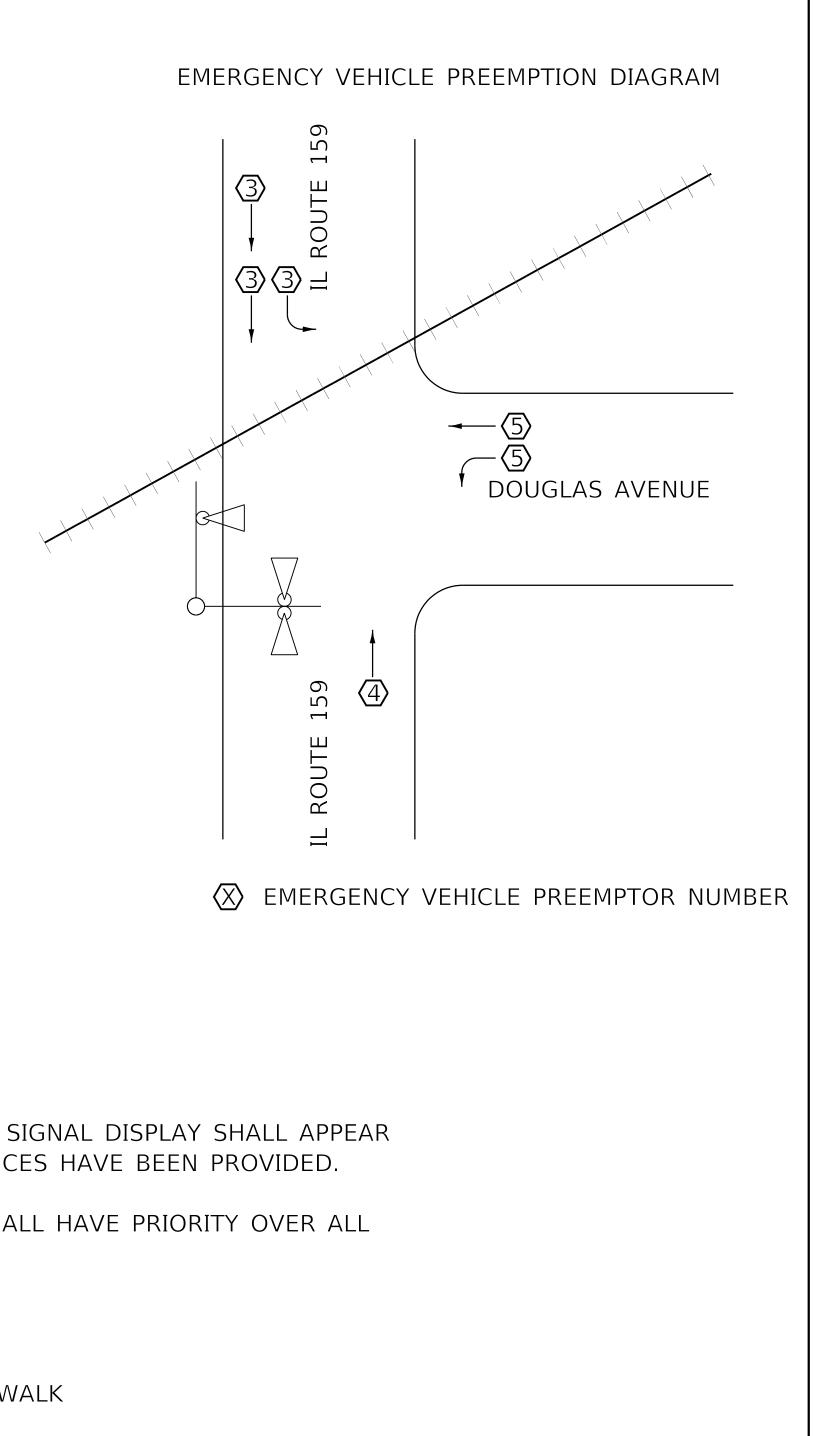


QUENCE OF OPERATION			F.A. * RTE	SECT	ION	COUNTY	TOTAL SHEETS	SHEET NO.	
#724592N				RR INTERCON	NECT 2	020	***	23	15
AVENUE (BELLEVILLE, IL)					CONTRACT	NO. 7	6N52		
ΤS	STA.	TO STA.			ILLINOIS	FED. AI	D PROJECT		
			* V4	ARIOUS ** VA	RIOUS	*** MA	ADISON / ST CL	AIR	

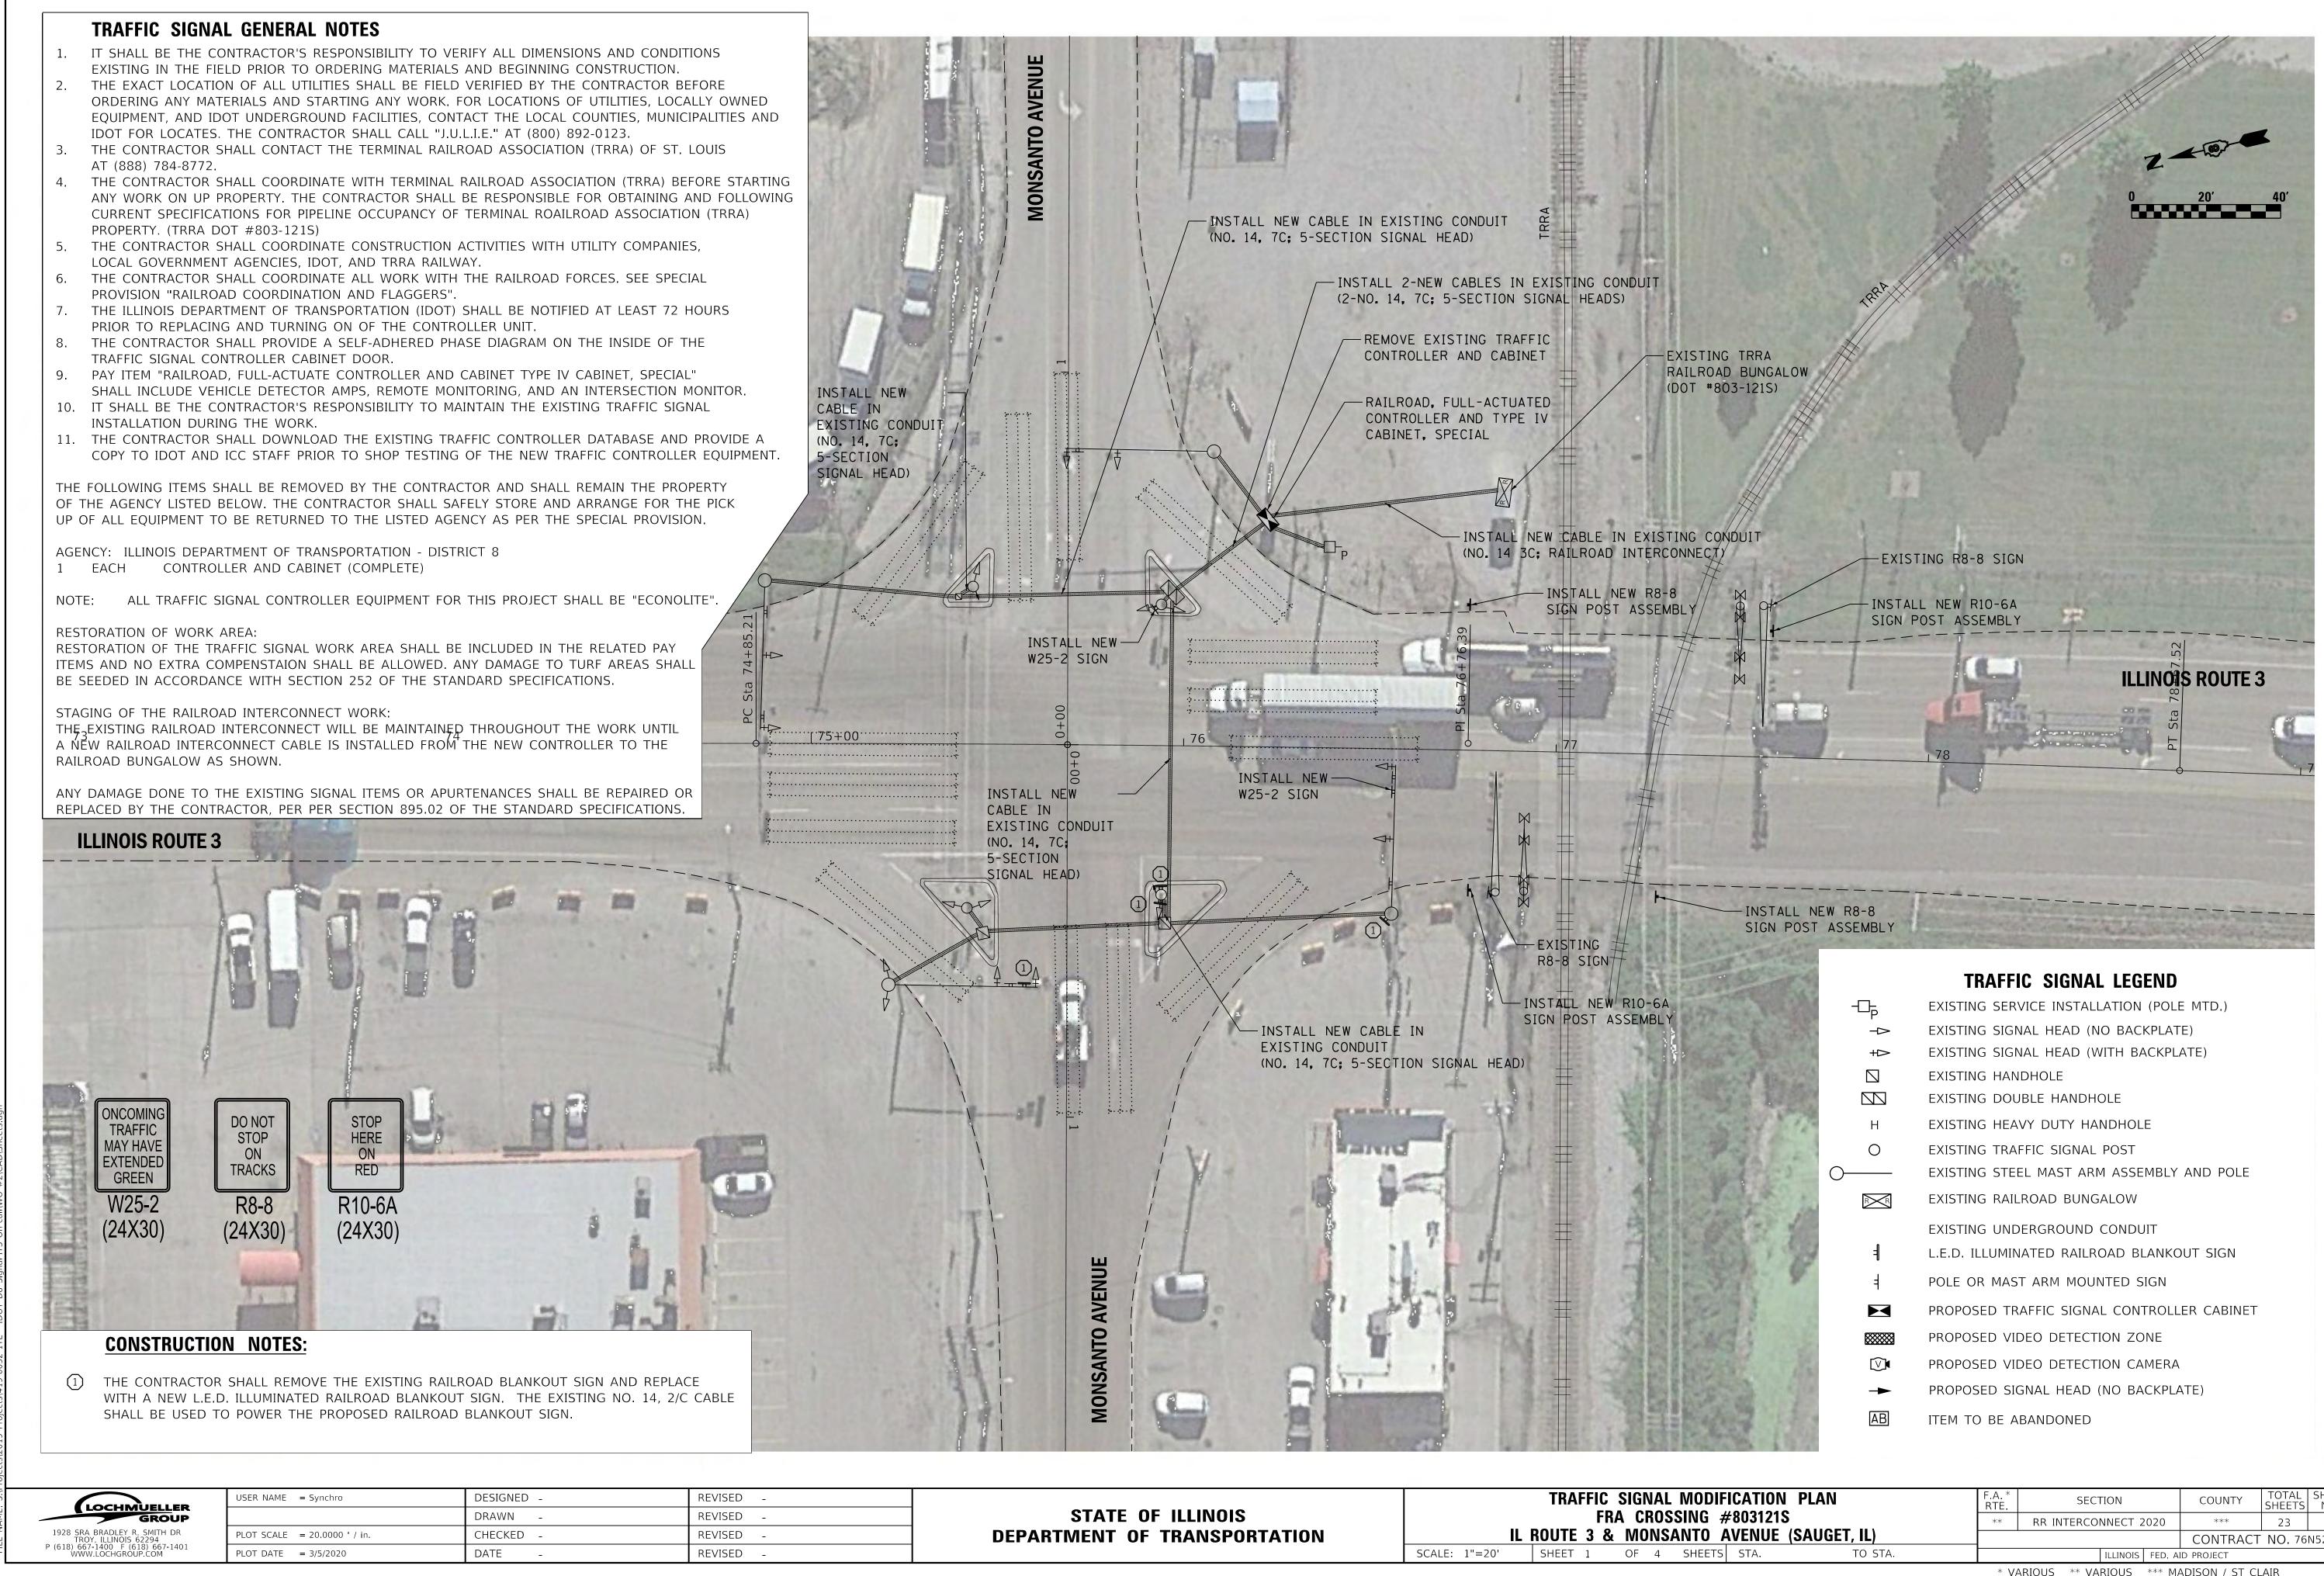

STATE OF ILLINOIS
DEPARTMENT OF TRANSPORTATION

		TRAFFIC SIGNAL LEGEND	
	-0	EXISTING SERVICE INSTALLATION (POLE MTD.)	
	->	EXISTING SIGNAL HEAD (NO BACKPLATE)	
	+1>	EXISTING SIGNAL HEAD (WITH BACKPLATE)	
		EXISTING HANDHOLE	
Lag		EXISTING DOUBLE HANDHOLE	
CN TR	н	EXISTING HEAVY DUTY HANDHOLE	
Fiz ?	0	EXISTING TRAFFIC SIGNAL POST	
100-	0	EXISTING STEEL MAST ARM ASSEMBLY AND POLE	
53 12		EXISTING RAILROAD BUNGALOW	
		EXISTING UNDERGROUND CONDUIT	
1.99	ŧ	L.E.D. ILLUMINATED RAILROAD BLANKOUT SIGN	
8	4	POLE OR MAST ARM MOUNTED SIGN	
		PROPOSED TRAFFIC SIGNAL CONTROLLER CABINET	
		PROPOSED VIDEO DETECTION ZONE	
	$\bigtriangledown$	PROPOSED VIDEO DETECTION CAMERA	
	-	PROPOSED SIGNAL HEAD (NO BACKPLATE)	
	AB	ITEM TO BE ABANDONED	
15%			

IFICATION PLAN			F.A.* RTE	SECT	FION		COUNTY	TOTAL SHEETS	SHEET NO.
#803121S				** RR INTERCONNECT 2020 ***					
<u> </u>	VENUE	(SAUGET, IL)	_				CONTRACT	NO. 76	N52
ΓS	STA.	TO STA.			ILLINOIS	FED. AI	d project		
			* V/	ARIOUS ** VA	RIOUS *	*** MA	ADISON / ST CL	AIR	

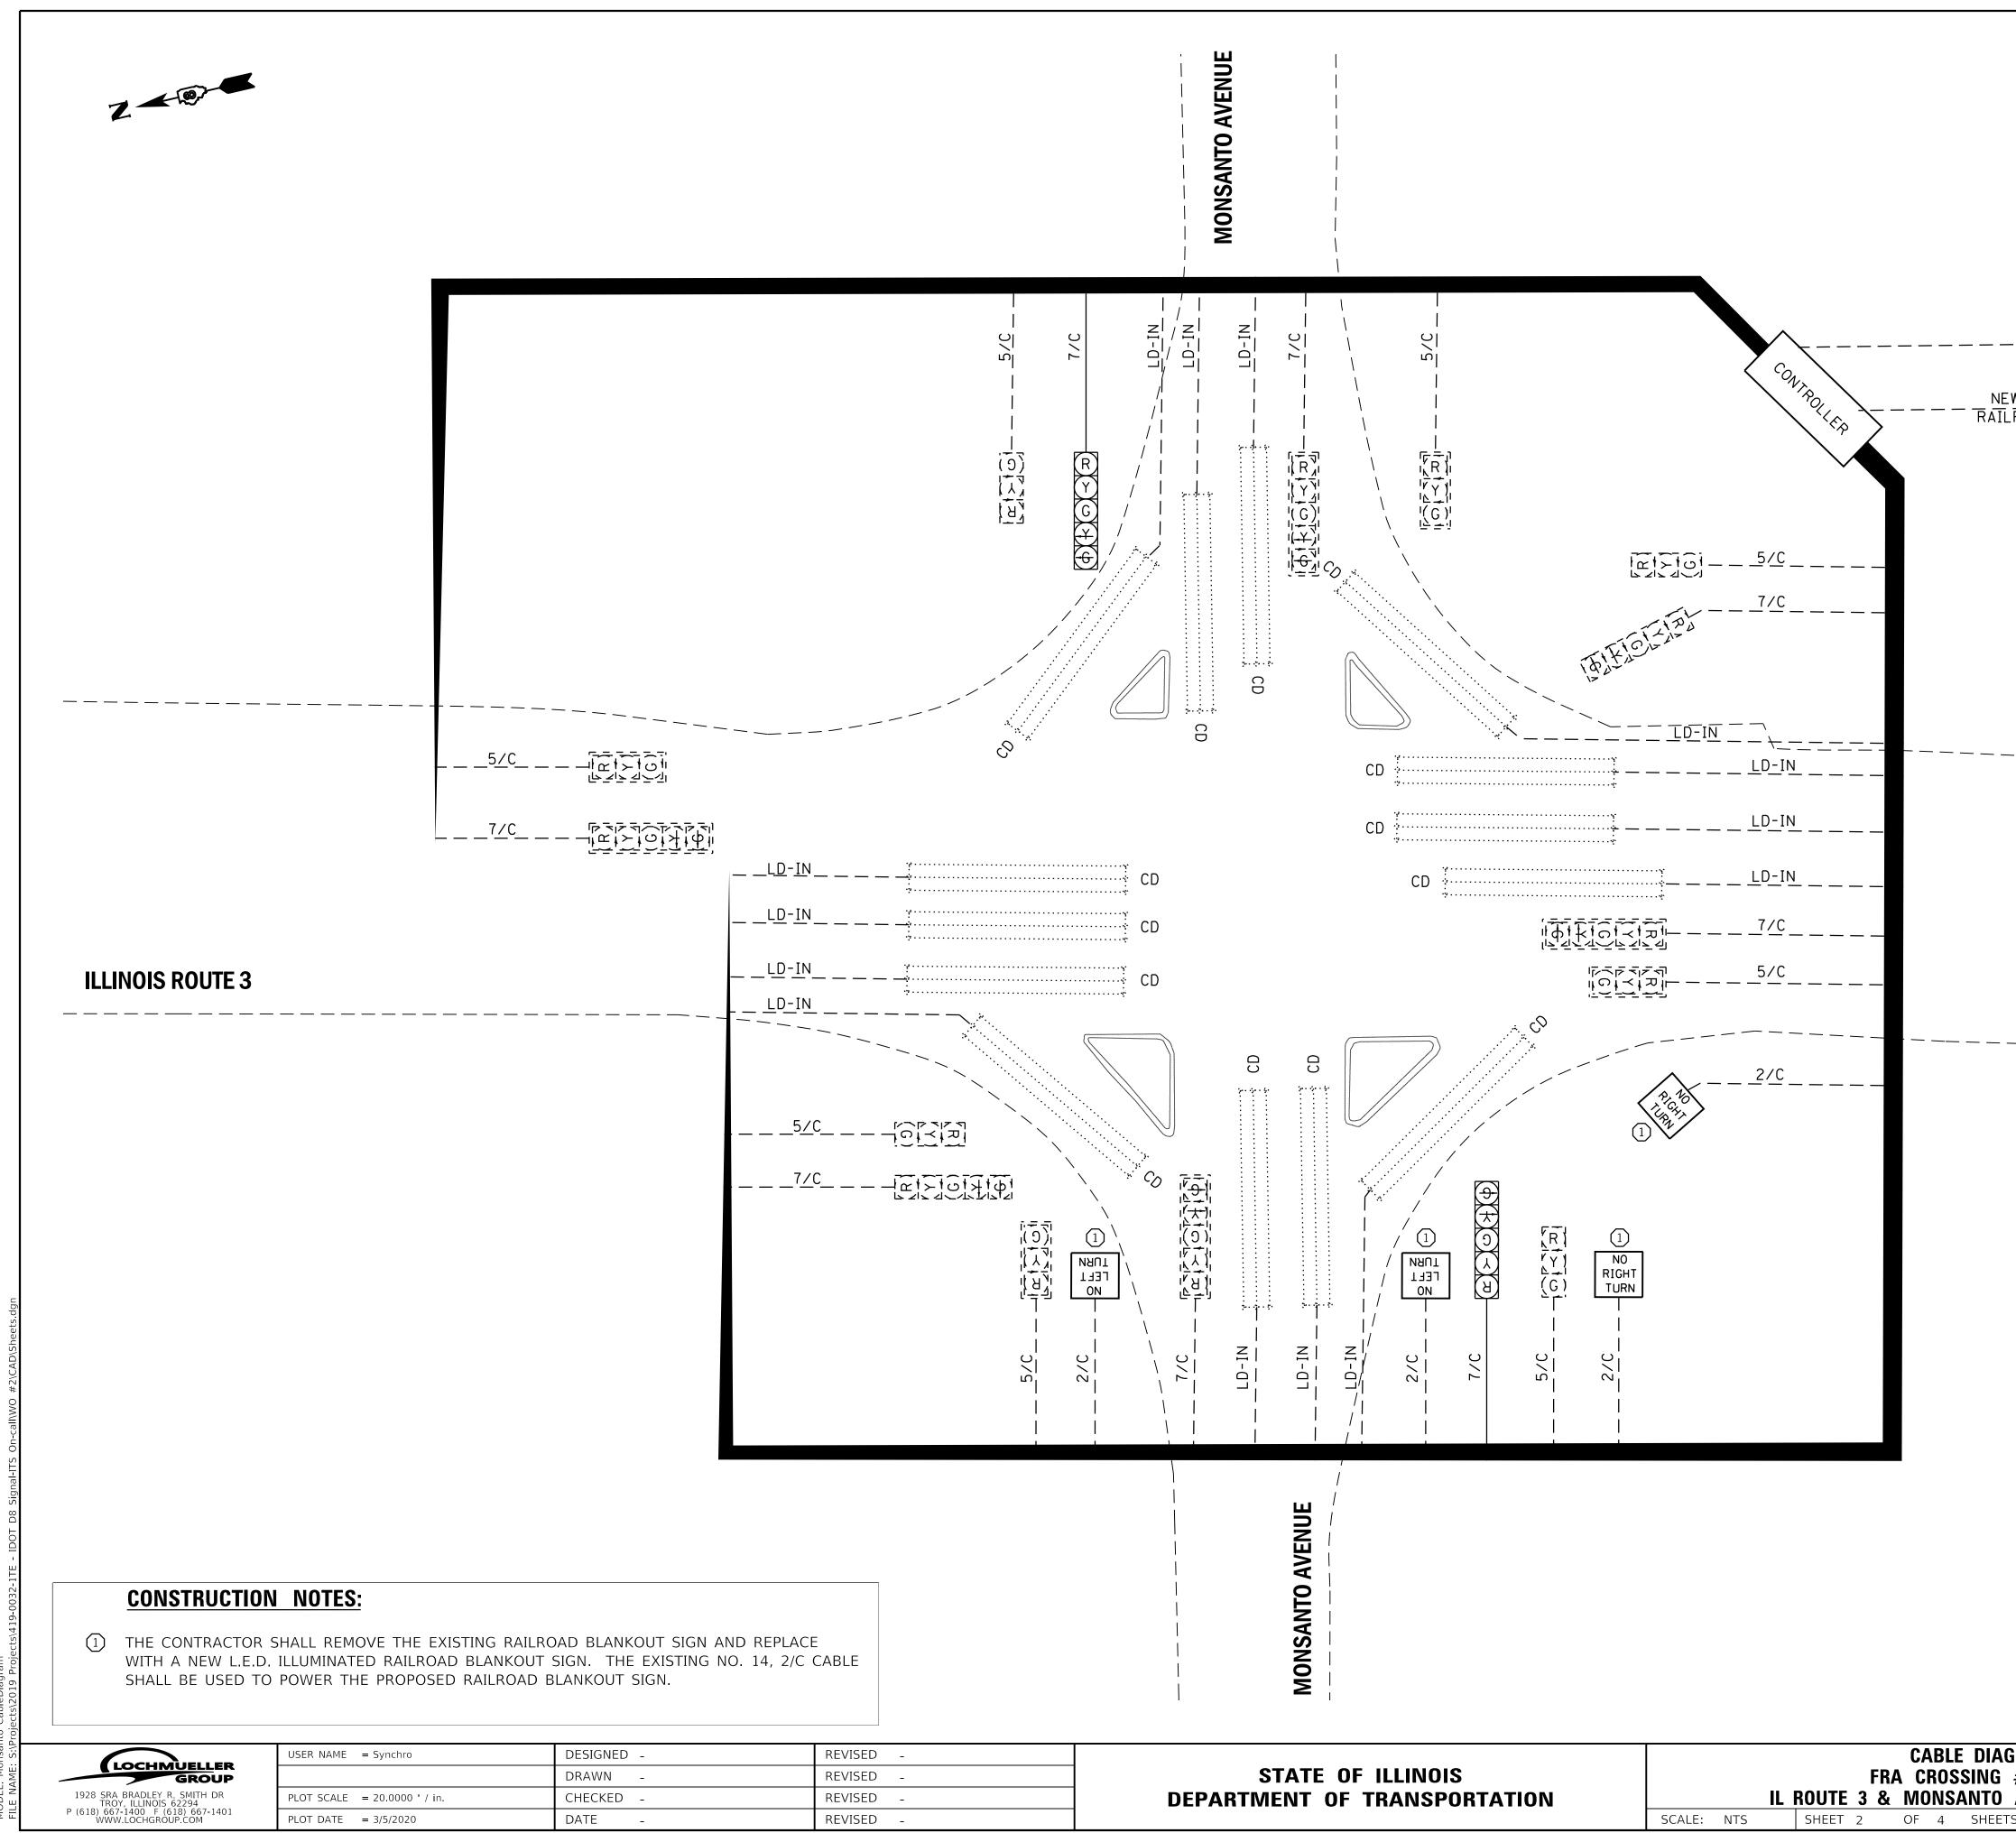

DEL: Monsanto Cable E NAME: S:\Projects\2

\_2/C\_#6\_AWG\_\_\_\_\_

NEW CABLE (NO. 14 3C; - - R R RAILROAD INTERCONNECT)

### **ILLINOIS ROUTE 3**

### TRAFFIC SIGNAL LEGEND

	EXISTING SERVICE INSTALLATION (POLE MTD.)
2/C	INDICATES NUMBER OF CONDUCTORS IN CABLE
CD	CALL DELAY (SEE GENERAL NOTES)
LD-IN	ELECTRIC CABLE LEAD-IN 1 PAIR
<b>#</b> 6	INDICATES AMERICAN WIRE GAUGE (AWG) SIZE, 6 CONDUCTORS
	ELECTRIC CABLE IN CONDUIT
	EXISTING ELECTRIC CABLE IN CONDUIT
Y	EXISTING LOOP DETECTION ZONE
NO RIGHT TURN	PROPOSED L.E.D. ILLUMINATED RAILROAD BLANKOUT SIGN
RIGHT	PROPOSED L.E.D. ILLUMINATED RAILROAD BLANKOUT SIGN

GRAM		FA* RTE	SEC	ΓΙΟΝ		COUNTY	TOTAL SHEETS	SHEET NO.	
#803121S			**	RR INTERCO	NNECT 2	2020	***	23	17
<u> </u>	VENUE	(SAUGET, IL)					CONTRACT	NO. 76	N52
TS	STA.	TO STA.			ILLINOIS	FED. AI	ID PROJECT		
			* V/	ARIOUS ** VA	RIOUS	*** MA	ADISON / ST CL	_AIR	

MOVEMENT						) 5	 ‡		-	Y	► ++++	+		- 5	2					3	 			- 7					- 7			3 8				8	∲	<b>↓</b> 4 <b>↓</b> 4	F L A
PHASE					1 +	5				1	+ 6		2	+ 5	5	2	2 + 6	5				3 + 7	7					4 +	7				3 + 8	3			4 +	8	Т S   Н Н
INTERVAL		1	2A	2B	3A	38	3 4A	4	B 5	6 6	5A (	5В	7	8A	8B	9	10A	10B	11	12A	12B	13A	13B	14A	14B	15	16A	16B	17A	17B	18	19A	19B	20A	20B	21	22A	22B	,
CHANGE TO			1	+ 6	2	+ 5	2	+ 6	5		2 +	6		2 -	+ 6					4 -	+ 7	3 -	+ 8	1 2 2	+ 5 + 6 + 5 + 6 + 8		4 -	+ 8	1 - 2 -	+ 5 + 6 + 5 + 6		4 -	+ 8	1 - 2 -	+ 5 + 6 + 5 + 6		1 2	+ 5 + 6 + 5 + 6	
ILLINOIS ROUTE 3 LEFT MAST ARM AND FAR LEFT SIGNALS	S/B	R G	R G				R Y			G		G	R	R	R	G	Y	R	R	R	R	R	R	R	R	R	R	R	R	R	R	R	R	R	R	R	R	R	R
ILLINOIS ROUTE 3 RIGHT MAST ARM AND NEAR RIGHT SIGNALS	S/B	R	R	R	R	R	R	R		Ĵ	G	G	R	R	R	G	Y	R	R	R	R	R	R	R	R	R	R	R	R	R	R	R	R	R	R	R	R	R	R
ILLINOIS ROUTE 3 LEFT MAST ARM AND FAR LEFT SIGNALS	N/B	R G	R Y	R	R G		R G Y	, R -	K F	K	R	R	G G	G Y	G	G	Y	R	R	R	R	R	R	R	R	R	R	R	R	R	R	R	R	R	R	R	R	R	R
ILLINOIS ROUTE 3 RIGHT MAST ARM AND NEAR RIGHT SIGNALS	N/B	R	R	R	R	R	R	R	K F	K	R	R	G	G	G	G	Y	R	R	R	R	R	R	R	R	R	R	R	R	R	R	R	R	R	R	R	R	R	R
MONSANTO AVENUE LEFT MAST ARM SIGNAL	W/B	R	R	R	R	R	R	R	R F	K	R	R	R	R	R	R	R	R	R G	R G	G	R Y	R	R Y	R	G G	G Y	G	Y Y	R	R	R	R	R	R	G	Y	R	R
MONSANTO AVENUE RIGHT MAST ARM AND NEAR RIGHT SIGNALS	W/B	R	R	R	R	R	R	R	R F	K	R	R	R	R	R	R	R	R	R	R	R	R	R	R	R	G	G	G	Y	R	R	R	R	R	R	G	Y	R	R
MONSANTO AVENUE LEFT MAST ARM SIGNAL	E/B	R	R	R	R	R	R	R	R F	R	R	R	R	R	R	R	R	R	R G	R Y	R	R G	R G		R	R	R	R	R	R	G G	G Y	G	Y Y	R	G	Y	R	R
MONSANTO AVENUE RIGHT MAST ARM AND NEAR RIGHT SIGNALS	E/B	R	R	R	R	R	R	R	R F		R	R	R	R	R	R	R	R	R	R	R	R	R	R	R	R	R	R	R	R	G	G	G	Y	R	G	Y	R	R

MAANC# OWWLEY-AO STI-Leanis BO TOAL

NOTES: 1. PHASES 2 AND 6 SHALL BE PLACED ON RECALL.

	USER NAME = Synchro	DESIGNED -	REVISED -
GROUP		DRAWN -	REVISED -
1928 SRA BRADLEY R. SMITH DR TROY, ILLINOIS 62294	PLOT SCALE = 1.0000 ' / in.	CHECKED -	REVISED -
P (618) 667-1400 F (618) 667-1401 WWW.LOCHGROUP.COM	PLOT DATE = 3/5/2020	DATE -	REVISED -

### TRAFFIC SIGNAL SEQUENCE OF OPERATION

STATE OF ILLINOIS DEPARTMENT OF TRANSPORTATION		TRAFFIC F Route 3	RA CRO	SSING
	SCALE:	SHEET 3	OF 4	SHEETS

NCE OF OPERATION			SEC	FION		COUNTY	TOTAL SHEETS	SHEET NO.
•• • • • • • • • •		**	RR INTERCO	NNECT 2	020	***	23	18
J AVENUE (	SAUGET, IL)					CONTRACT	NO. 7	6N52
TS STA.	TO STA.			ILLINOIS	FED. AI	ID PROJECT		

																	PREEMPTOR NUMBER 2				
CHANGE FROM NORMAL SEQUENCE OF OPERATION INTERVAL NUMBER			1		5	7		9	1	. 1	1	15	1	8	2	21					
RAILROAD PREEMPTION SEQUENCE OF OPERATION INTERVAL NUMBER		1A	1B	1C	1D	1E	1F	1G	1H	1J	1K	1L	1M	1N	1P	1Q	2	3	4	5	
CHANGE TO RAILROAD PREEMPTION SEQUENCE OF OPERATION NUMBER		1B	2	1D	2	2	1H	2	1M	2	1P	2	15	2	1U	2	3	4	5		- NC SEC
MAIN STREET MAST ARM SIGNALS	S/B	R Y	R	Y Y	R	R	Y	R	R	R	R	R	R	R	R	R	R	R	R	R	
ILLINOIS ROUTE 3 RIGHT MAST ARM AND NEAR RIGHT SIGNALS	S/B	R	R	Y	R	R	Y	R	R	R	R	R	R	R	R	R	R	R	R	R	
ILLINOIS ROUTE 3 LEFT MAST ARM AND FAR LEFT SIGNALS	N/B	R G	R G	R	R	G G	G	G	R	R	R	R	R	R	R	R	G G	Y Y	R	R	
ILLINOIS ROUTE 3 RIGHT MAST ARM AND NEAR RIGHT SIGNALS	N/B	R	R	R	R	G	G	G	R	R	R	R	R	R	R	R	G	Y	R	R	
MONSANTO AVENUE LEFT MAST ARM AND FAR LEFT SIGNALS	W/B	R	R	R	R	R	R	R	R Y	R	Y Y	R	R	R	Y	R	R	R	R	G	
MONSANTO AVENUE RIGHT MAST ARM AND NEAR RIGHT SIGNAL	W/B	R	R	R	R	R	R	R	R	R	Y	R	R	R	Y	R	R	R	R	G	
MONSANTO AVENUE LEFT MAST ARM AND FAR LEFT SIGNALS	E/B	R	R	R	R	R	R	R	R Y	R	R	R	Y Y	R	Y	R	R	R	R	G	
MONSANTO AVENUE RIGHT MAST ARM AND NEAR RIGHT SIGNALS	E/B	R	R	R	R	R	R	R	R	R	R	R	Y	R	Y	R	R	R	R	G	
INTERNALLY ILLUMINATED NO RIGHT TURN SIGNS		NRT	NRT	NRT	NRT	NRT	NRT	NRT	NRT	NRT	NRT	NRT	NRT	NRT	NRT	NRT	NRT	NRT	NRT	NRT	
INTERNALLY ILLUMINATED NO LEFT TURN SIGNS		NLT	NLT	NLT	NLT	NLT	NLT	NLT	NLT	NLT	NLT	NLT	NLT	NLT	NLT	NLT	NLT	NLT	NLT	NLT	
		-		·			•	•		-	•	•			-				•	HOLD	)

☐ THE RAILROAD PREEMPTION SEQUENCE SHALL BE CAPABLE OF CYCLING BETWEEN PHASES 1, 3, 4, AND 8 UNTIL PREEMPTION IS TERMINATED

△ RAILROAD PREEMPTION SEQUENCE SHALL PROVIDE THE PROPER CLEARANCE INTERVAL TO RESUME THE NORMAL SEQUENCE OF OPERATION AFTER RAILROAD INTERVAL 5 IS TERMINATED


5				
S \I		USER NAME = Synchro	DESIGNED -	REVISED -
AME	GROUP		DRAWN -	REVISED -
ILE N	1928 SRA BRADLEY R. SMITH DR TROY, ILLINOIS 62294	PLOT SCALE = 1.0000 ' / in.	CHECKED -	REVISED -
FIL	P (618) 667-1400 F (618) 667-1401 WWW.LOCHGROUP.COM	PLOT DATE = 3/5/2020	DATE -	REVISED -

NOTES:


1. ONCE PREEMPTION HAS BEEN CALLED, THE TRACK CLEAR SIGNAL DISPLAY SHALL APPEAR IMMEDIATELY AFTER ALL NECESSARY VEHICULAR CLEARANCES HAVE BEEN PROVIDED.

2. THE RAILROAD PREEMPTION SEQUENCE OF OPERATION SHALL HAVE PRIORITY OVER ALL OTHER SEQUENCES OF OPERATION.

	BA		PREEMPTIO	
 STATE OF ILLINOIS			FRA CROS	SSING
DEPARTMENT OF TRANSPORTATION	1	. KUUIE	<u>3 &amp; MONS</u>	ANIU
	SCALE:	SHEET 4	OF 4	SHEETS

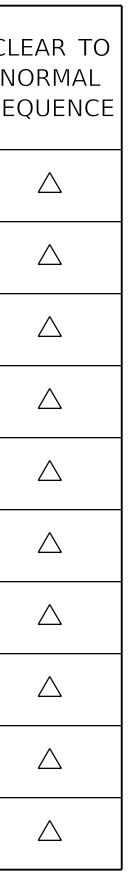

EQUENCE OF OPERATION			F.A. * RTE	SECT	TION		COUNTY	TOTAL SHEETS	SHEET NO.
	#803121		**	** RR INTERCONNECT 2020				23	19
	AVENUE	(SAUGET, IL)					CONTRACT	NO. 7	6N52
TS	STA.	TO STA.			ILLINOIS	FED. A	ID PROJECT		
			* V/	ARIOUS ** VA	RIOUS	*** MA	ADISON / ST CL	AIR	

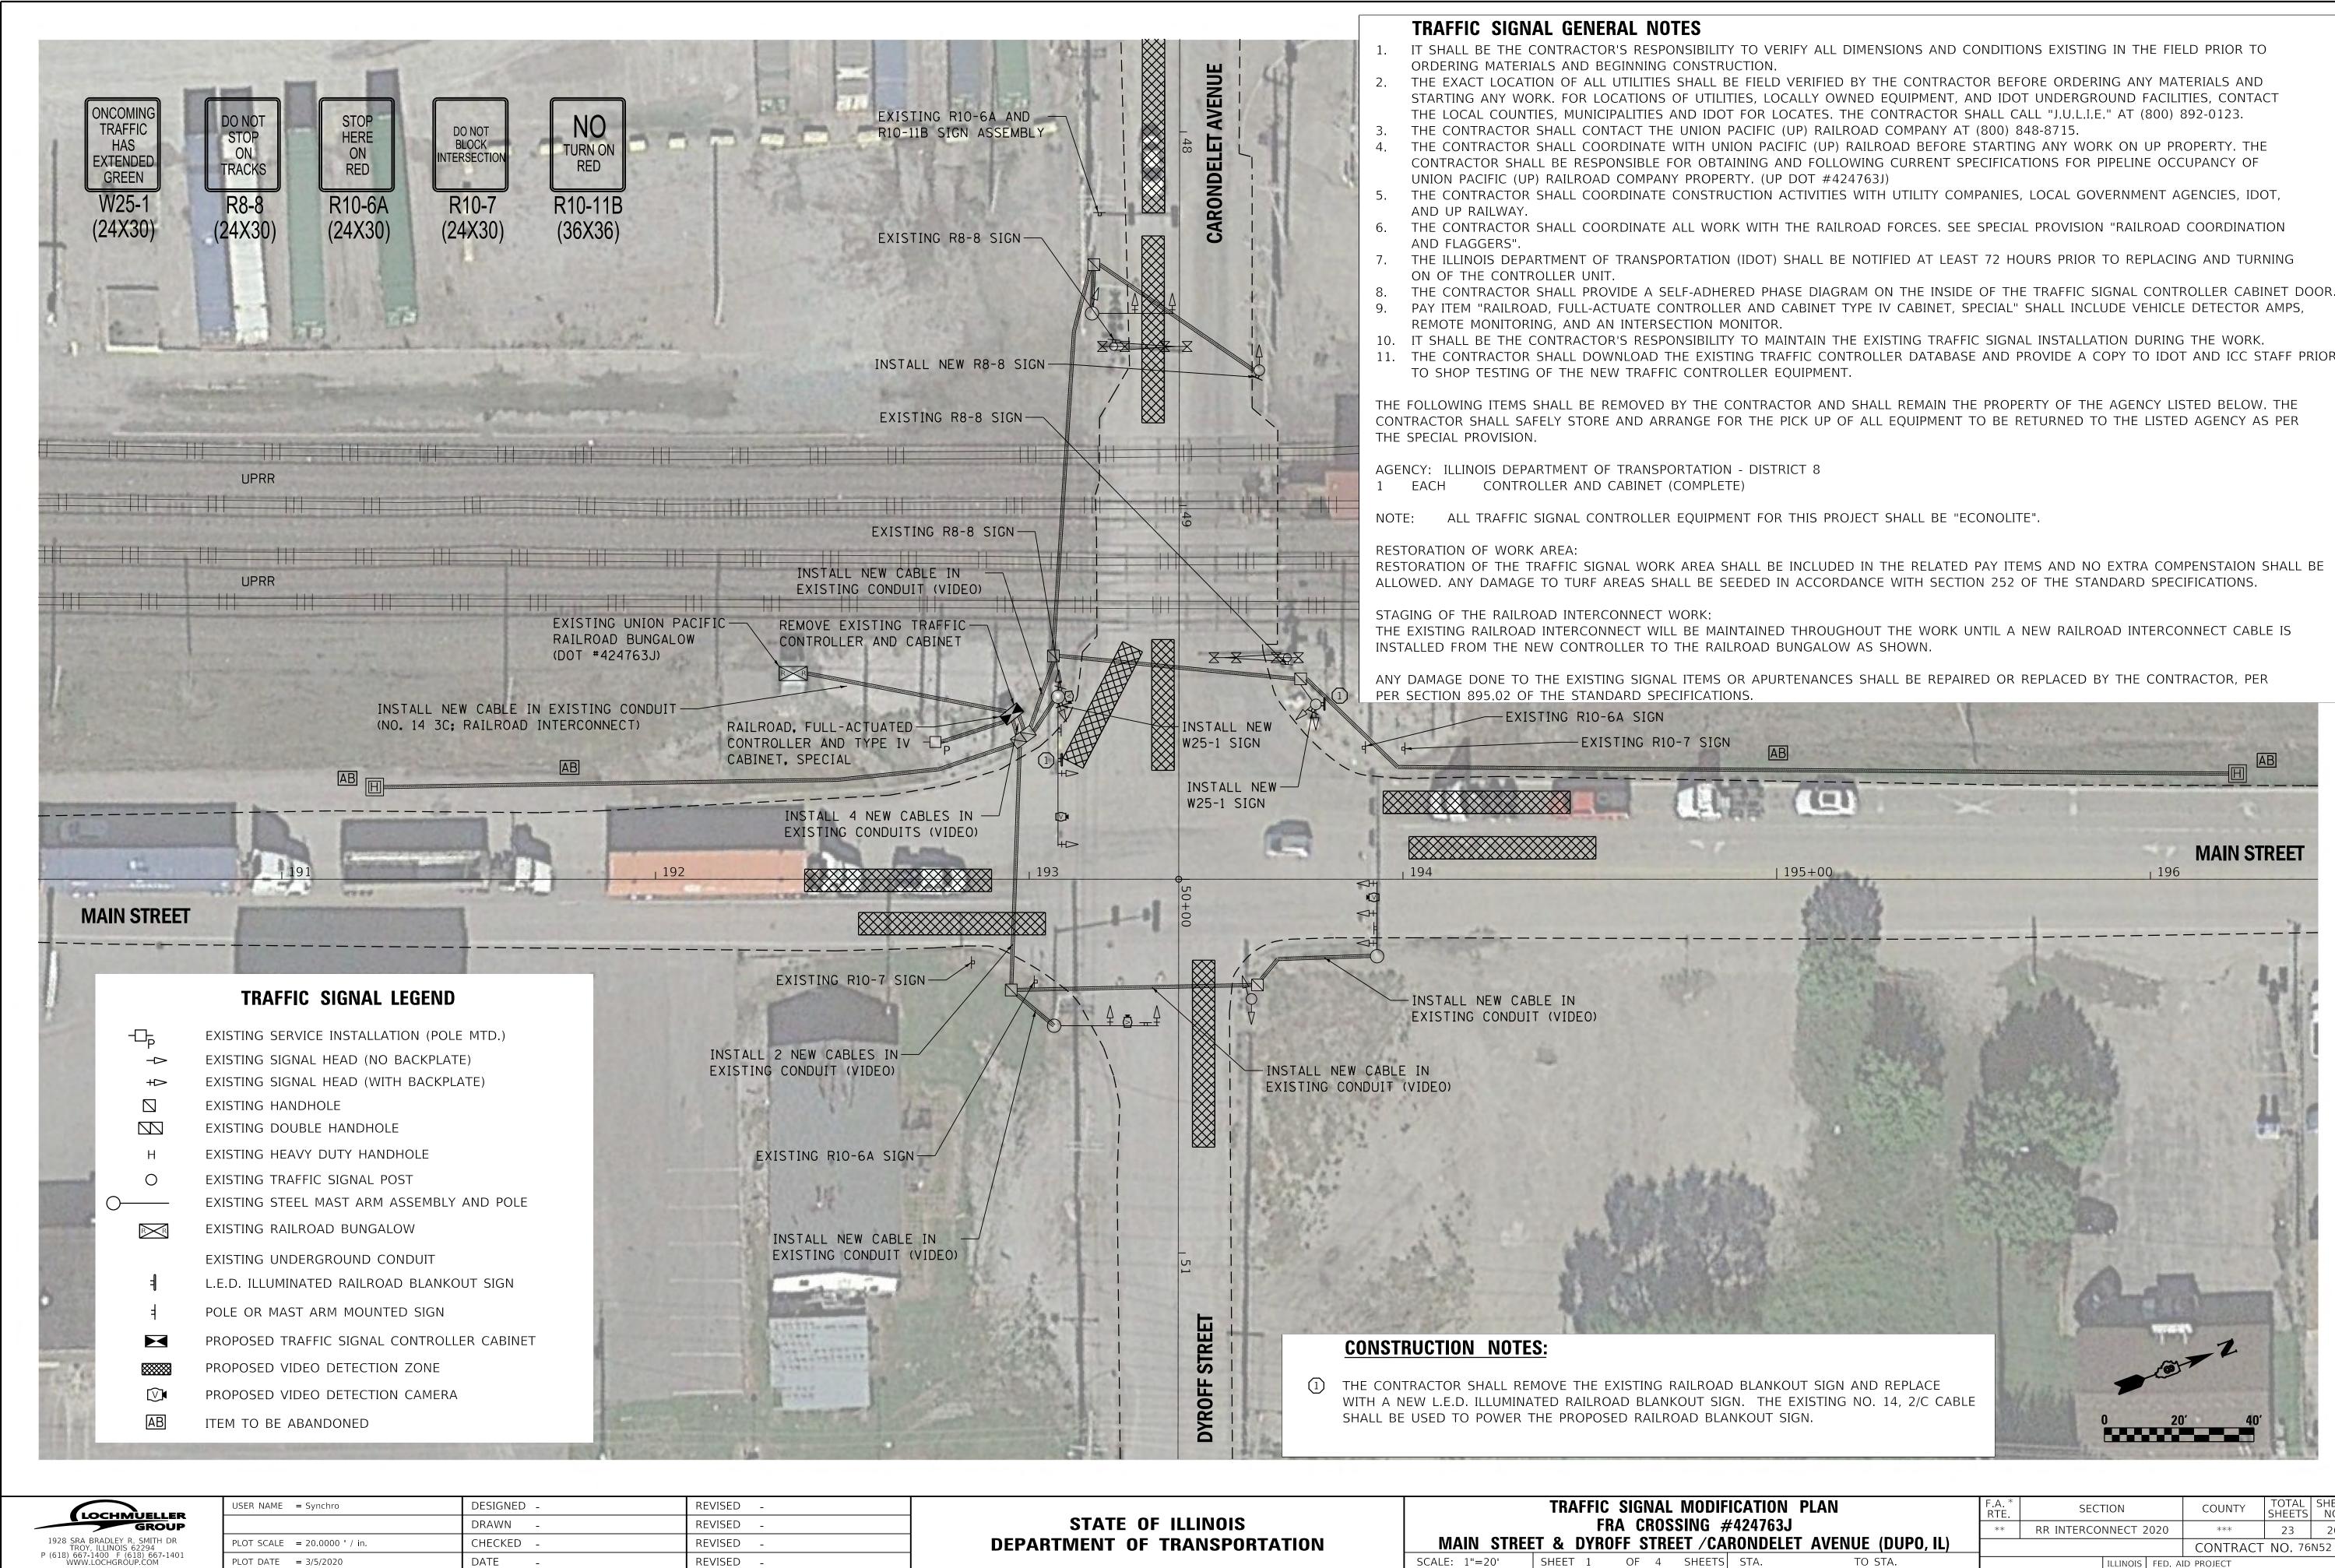


	TRAFFIC SIGNAL MOI	)IFIC
STATE OF ILLINOIS	FRA CROSSING	#4
DEPARTMENT OF TRANSPORTATION	MAIN STREET & DYROFF STREET /	CARC
	SCALE: 1"=20' SHEET 1 OF 4 SHEE	TS !


DATE

REVISED

PLOT DATE = 3/5/2020

IFICATION PLAN	F.A.* RTE	SECT	ΓΙΟΝ		COUNTY	TOTAL SHEETS	SHEET NO.
#424763J	**	RR INTERCO	NNECT 2	.020	***	23	20
ARONDELET AVENUE (DUPO, IL)					CONTRACT	NO. 76	N52
TS STA. TO STA.			ILLINOIS	FED. AI	d project		
	* V/	ARIOUS ** VA	RIOUS	*** MA	ADISON / ST CL	AIR	

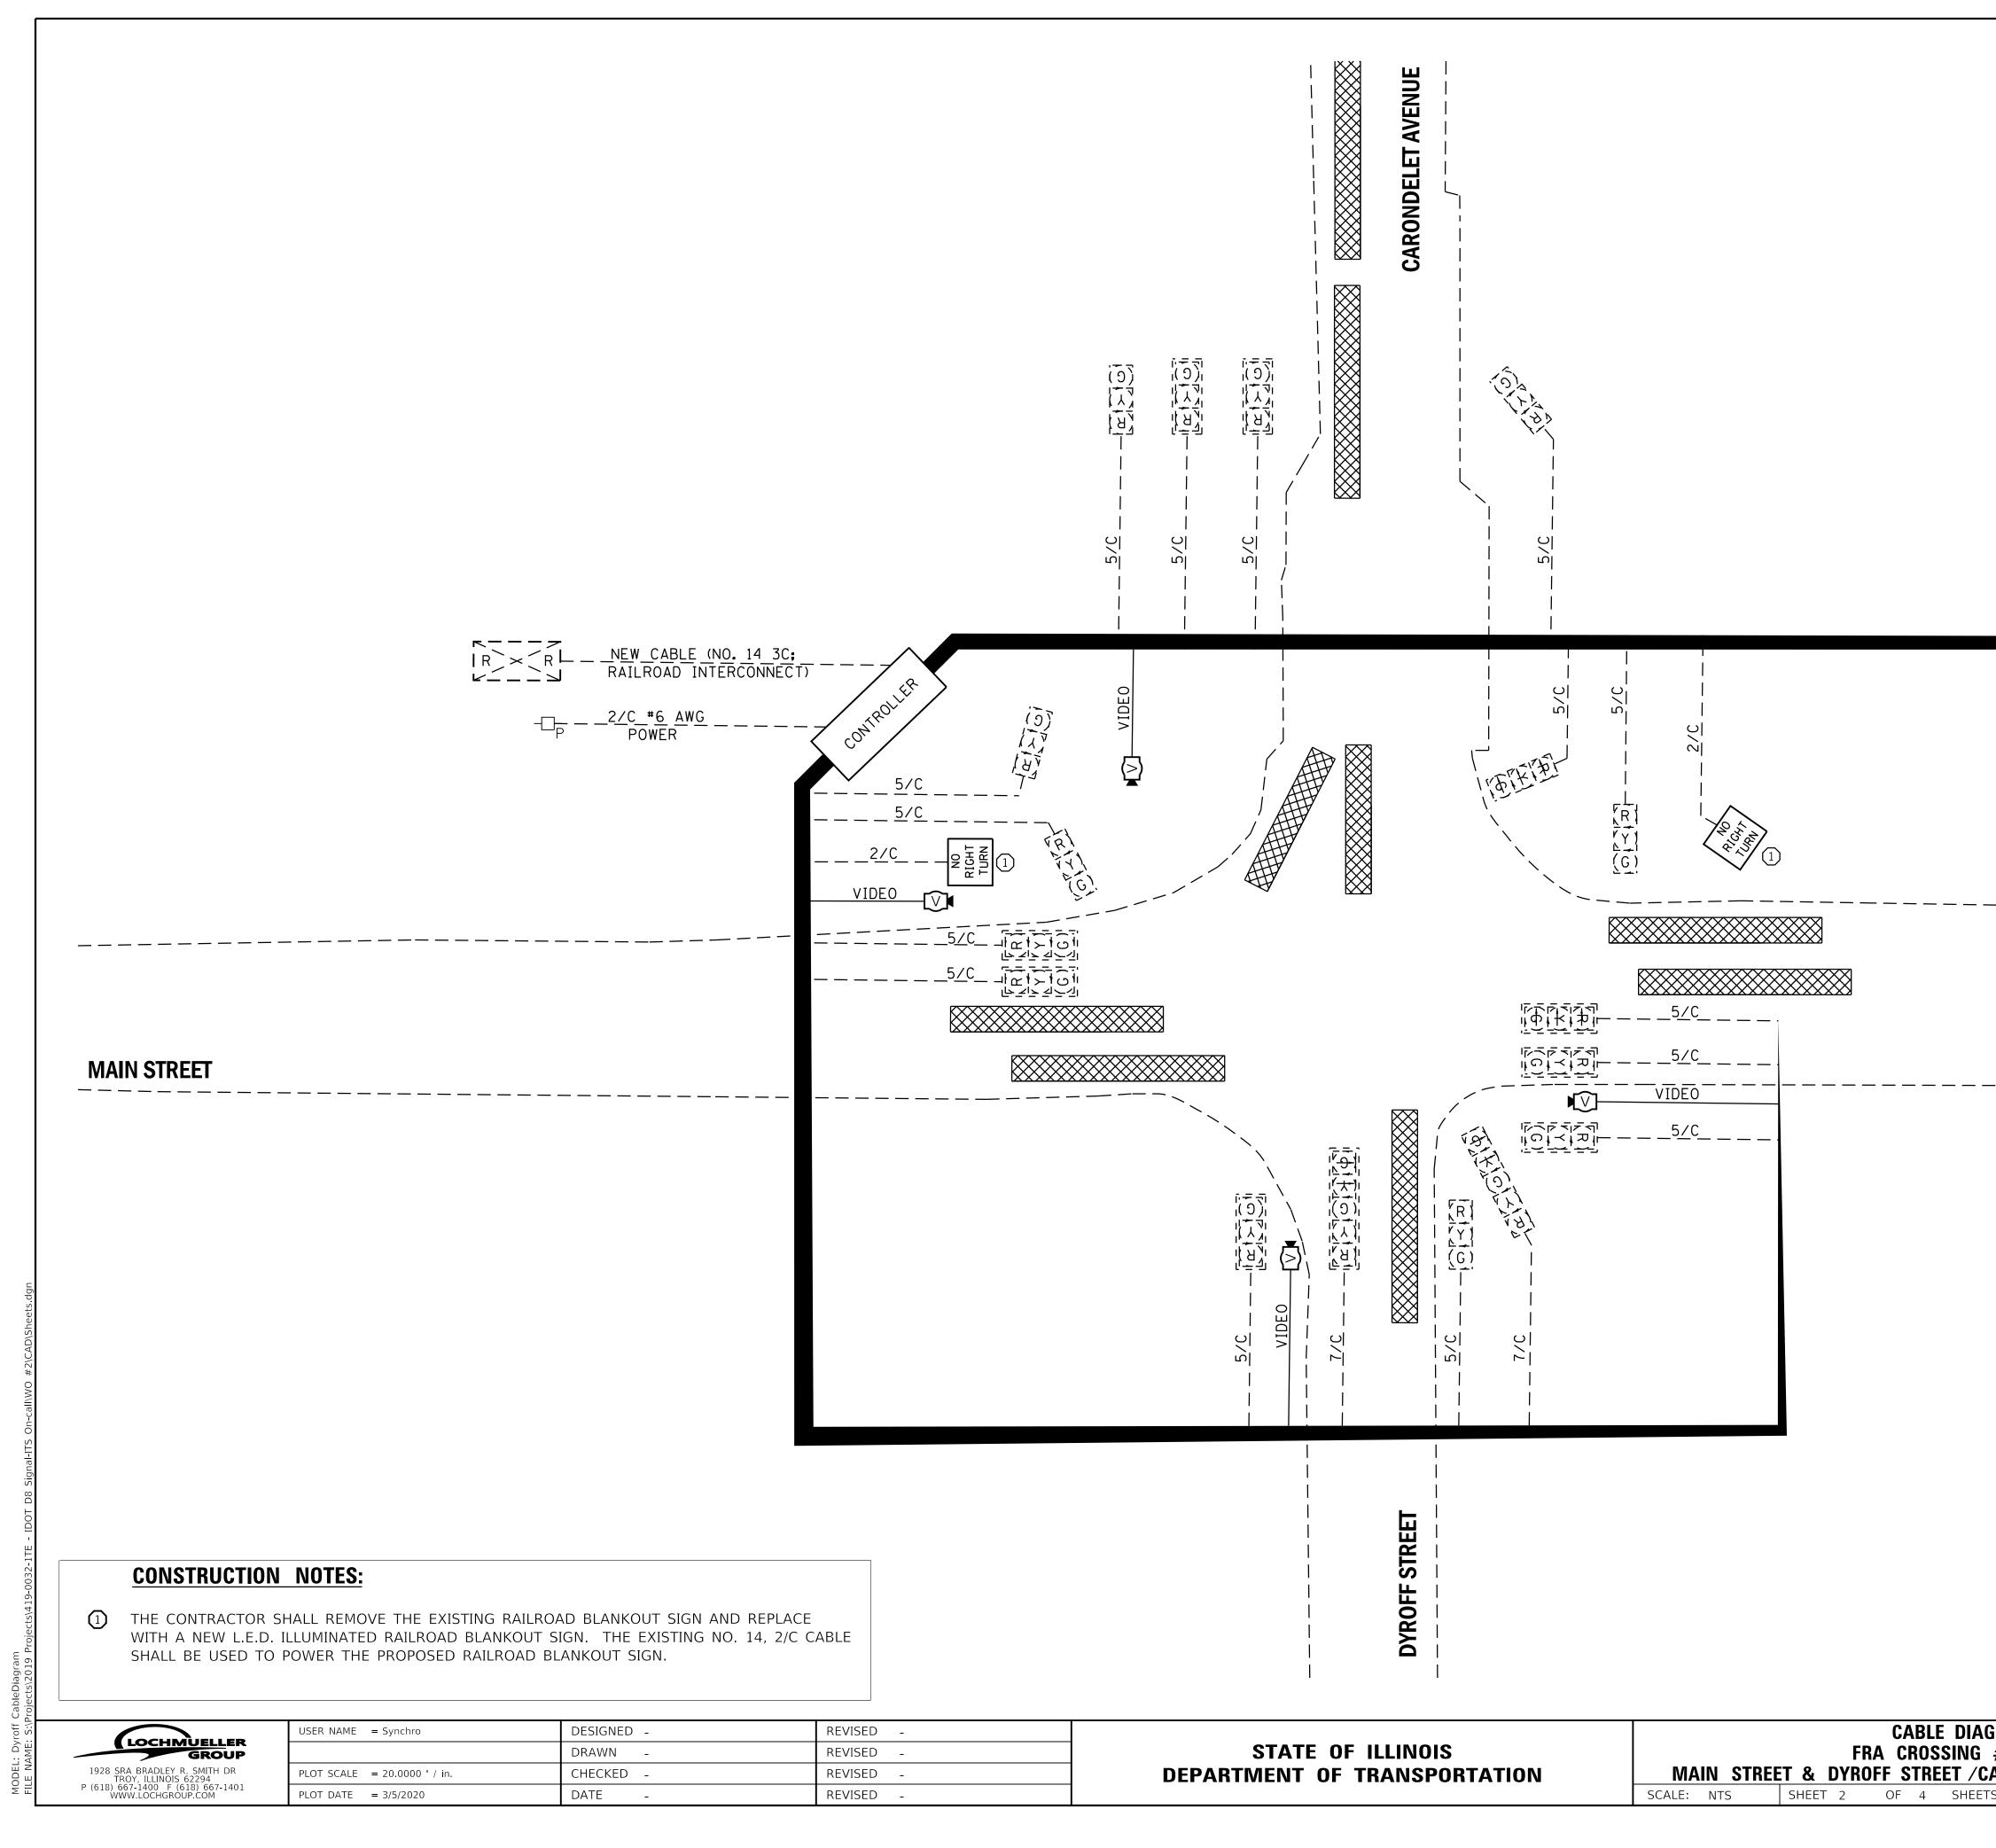

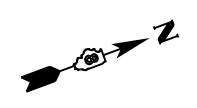

### MAIN STREET


### TRAFFIC SIGNAL LEGEND

-07 P	EXISTING SERVICE INSTALLATION (POLE MTD.)
2/C	INDICATES NUMBER OF CONDUCTORS IN CABLE
<b>#</b> 6	INDICATES AMERICAN WIRE GAUGE (AWG) SIZE, 6 CONDUCTORS
	ELECTRIC CABLE IN CONDUIT
	EXISTING ELECTRIC CABLE IN CONDUIT
NO RIGHT TURN	PROPOSED L.E.D. ILLUMINATED RAILROAD BLANKOUT SIGN
$\mathbf{\nabla}$	PROPOSED VIDEO DETECTION CAMERA
	PROPOSED VIDEO DETECTION ZONE

GRAM #424763J			F.A.* RTE	SECTION	COUNTY	TOTAL SHEETS	SHEET NO.			
			**	RR INTERCONNECT 2	2020	***	23	21		
CARONDELET AVENUE (DUPO, IL)						CONTRACT	NO. 76	N52		
TS	STA.	TO STA.	ILLINOIS FED. AID PROJECT							
			* V4	ARIOUS ** VARIOUS	*** M4	ADISON / ST CL	AIR			

## **TRAFFIC SIGNAL SEQUENCE OF OPERATION**

MOVEMENT
PHASE
INTERVAL
CHANGE TO
MAIN STREET MAST ARM SIGNALS
MAIN STREET FAR LEFT SIGNAL AND LEFT M
MAIN STREET CENTER AND RIGHT MAST ARI
DYROFF STREET ALL SIGNALS
CARONDELET AVENUE (EAST O LEFT MAST ARM AND FAR LEFT SIGNALS
CARONDELET AVENUE (EAST O RIGHT MAST ARM AND NEAR RIGHT SIGNALS
CARONDELET AVENUE (WEST ALL SIGNALS
NOTES: 1. PHASES 2 AND 6 SHALL BE
2. PHASE 7 SHALL LAG PHASE

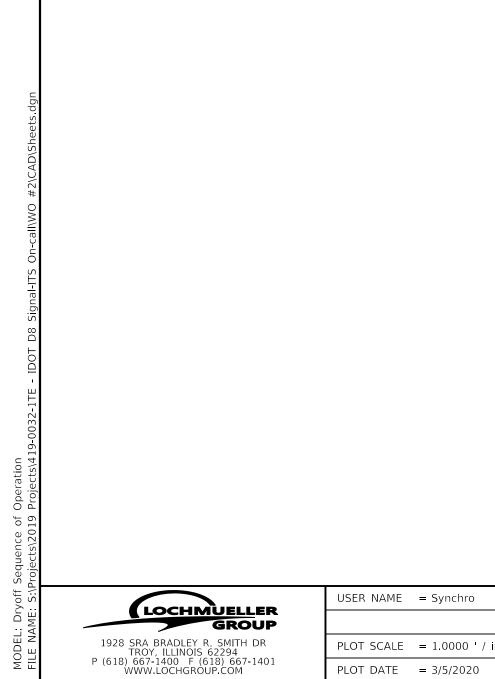

USER NAME = Synchro	DESIGNED -	REVISED -
	DRAWN -	REVISED -
PLOT SCALE = $1.0000$ ' / in.	CHECKED -	REVISED -
PLOT DATE = 3/5/2020	DATE -	REVISED -

				6			2	<b>†</b> 6	*	3		— 8 )LA				_		F L A
		-	1 + 6	5		Ź	2 + 6	5			3 + 8	3		3 +	- 7			S H
		1	2A	2B	3	4A	4B	5A	5B	6	7A	7B	8	9A	9B	9C	9D	
			2 -	+ 6		1 -	+ 6	3 - 3 -	⊦ 8 ⊦ 7		3 -	+ 7			1 +			
	S/B	R	R	R	G	Y	R	Y	R	R	R	R	R	R	R	R	R	R
FT MAST ARM SIGI	N/B NAL	G	Y	R	R	R	R	R	R	R	R	R	R	R	R	R	R	R
ARM SIGNALS	N/B	G	G	G	G	G	G	Y	R	R	R	R	R	R	R	R	R	R
	W/B	R	R	R	R	R	R	R	R	G	Y	R	R	R	R	R	R	R
ST OF TRACKS)	E/B	R	R	R	R	R	R	R	R	G	G	G	G G	G G	G G	Y Y	R	R
ST OF TRACKS)	E/B	R	R	R	R	R	R	R	R	G	G	G	G	G	G	Y	R	R
EST OF TRACKS)	E/B	R	R	R	R	R	R	R	R	G	G	G	G	Y	R	R	R	R
			1	1	1	1								1				

PLACED ON RECALL.

8. THE CONTROLLER SHALL BE PROGRAMMED TO ALWAYS SERVICE PHASE 7 AFTER PHASE 8.

STATE OF ILLINOIS DEPARTMENT OF TRANSPORTATION	T MAIN STREE		A CROS	SING
	SCALE:	SHEET 3	OF 4	SHEETS

9D	F L A S H
R	R
R	R
R	R
R	R
R	R
R	R
R	R

NCE OF OPERATION	F.A. * RTE	SECT	TION	COUNTY	TOTAL SHEETS	SHEET NO.	
#424763J	**	RR INTERCOM	NNECT 20	***	23	22	
ARONDELET AVENUE (DUPO, IL)					CONTRACT	NO. 7	6N52
TS STA. TO STA.			ILLINOIS	FED. AI	d project		
	* V/	ARIOUS ** VA	RIOUS	*** MA	DISON / ST CL	AIR	

										PREEMPTOR NUMBER 2				
CHANGE FROM NORMAL SEQUENCE OF OPERATION INTERVAL NUMBER		1			3		6		8					
RAILROAD PREEMPTION SEQUENCE OF OPERATION INTERVAL NUMBER	1	A	1B	1C	1D	1E	1F	1G	1H	2	3	4	5	CLEAR TO
CHANGE TO RAILROAD PREEMPTION SEQUENCE OF OPERATION NUMBER	1	В	2	1D	2	1F	2	1H	2	3	4	5	6	NORMAL SEQUENCE
MAIN STREET S, MAST ARM SIGNALS	BF	٦	R	Y	R	R	R	R	R	R	R	R	G	$\bigtriangleup$
MAIN STREET N, LEFT MAST ARM AND FAR LEFT SIGNALS	B	Y ►	R	R	R	R	R	R	R	R	R	R	R	$\bigtriangleup$
MAIN STREET N, CENTER AND RIGHT MAST ARM SIGNALS	B	Y	R	Y	R	R	R	R	R	R	R	R	G	$\bigtriangleup$
DYROFF STREET W, ALL SIGNALS	BF	٦	R	R	R	Y	R	R	R	R	R	R	R	$\bigtriangleup$
CARONDELET AVENUE (EAST OF TRACKS) E, LEFT MAST ARM AND FAR LEFT SIGNALS	BF	٦	R	R	R	G	G	G G	G G	G G	Y Y	R	R	$\bigtriangleup$
CARONDELET AVENUE (EAST OF TRACKS) E, RIGHT MAST ARM AND NEAR RIGHT SIGNAL	BF	٦	R	R	R	G	G	G	G	G	Y	R	R	$\bigtriangleup$
CARONDELET AVENUE (WEST OF TRACKS) E, ALL SIGNALS	BF	٦	R	R	R	Y	R	Y	R	R	R	R	R	$\bigtriangleup$
INTERNALLY ILLUMINATED NO RIGHT TURN SIGNS	NF	RT	NRT	NRT	NRT	NRT	NRT	NRT	NRT	NRT	NRT	NRT	NRT	$\bigtriangleup$
	•												HOLD	

△ RAILROAD PREEMPTION SEQUENCE SHALL PROVIDE THE PROPER CLEARANCE INTERVAL TO RESUME THE NORMAL SEQUENCE OF OPERATION AFTER RAILROAD INTERVAL 5 IS TERMINATED

FILE NAME: S:\P		USER NAME = Synchro	DESIGNED -	REVISED -
			DRAWN -	REVISED -
	1928 SRA BRADLEY R. SMITH DR TROY, ILLINOIS 62294	PLOT SCALE = 1.0000 ' / in.	CHECKED -	REVISED -
	P (618) 667-1400 F (618) 667-1401 WWW.LOCHGROUP.COM	PLOT DATE = 3/5/2020	DATE -	REVISED -

NOTES:

- 1. ONCE PREEMPTION HAS BEEN CALLED, THE TRACK CLEAR SIGNAL DISPLAY SHALL APPEAR IMMEDIATELY AFTER ALL NECESSARY VEHICULAR CLEARANCES HAVE BEEN PROVIDED.
- 2. THE RAILROAD PREEMPTION SEQUENCE OF OPERATION SHALL HAVE PRIORITY OVER ALL OTHER SEQUENCES OF OPERATION.

STATE OF ILLINOIS DEPARTMENT OF TRANSPORTATION	RA MAIN STRI	=	RA CRO	SSING
	SCALE:	SHEET 4	OF 4	SHEETS

		OPERATION	F.A. * RTE	SECT	TION		COUNTY	TOTAL SHEETS	SHEET NO.
	#424763J		**	RR INTERCOM	NECT 2	020	***	23	23
CA	KUNDELEI	AVENUE (DUPO, IL)					CONTRACT	NO. 7	'6N52
TS	STA.	TO STA.			ILLINOIS	FED. AI	D PROJECT		
			* \//		RIOUS	*** M/		AIR	