06-15-12 LETTING ITEM 004

FOR INDEX OF SHEETS, SEE SHEET NO. 2

 \circ

 \circ

 \circ

 \circ

STATE OF ILLINOIS

DEPARTMENT OF TRANSPORTATION

DIVISION OF HIGHWAYS

PROPOSED HIGHWAY PLANS

F.A.P. ROUTE 348 (HARLEM AVE)
OVER MIDLOTHIAN CREEK
SECTION 3127-2-SB-I
BRIDGE DECK OVERLAY
STRUCTURE NO. 016-0963
COOK COUNTY

C-91-156-11

EXISTING ADT = 36100 (2009) SPEED LIMIT = 40 MPH

PROJECT IS IN THE VILLAGE OF TINLEY PARK.

0 100' 200' 300' — 1" = 100'
0 50' 100' — 1" = 50'
0 50' 100' — 1" = 40'
0 50' 100' — 1" = 30'
0 50' 100' — 1" = 20'

FULL SIZE PLANS HAVE BEEN PREPARED USING STANDARD ENGINEERING SCALES. REDUCED SIZED PLANS WILL NOT CONFORM TO STANDARD SCALES. IN MAKING MEASUREMENTS ON REDUCED PLANS, THE ABOVE SCALES MAY BE USED.

J.U.L.I.E.
JOINT UTILITY LOCATION INFORMATION FOR EXCAVATION
1-800-892-0123
OR 811

PROFESSIONAL PROFE

ROBERT TESSIATORE DATE: 3/30/2012 EXP.: 11/30/2013 SHEET: 1-6



ROBERT TESSIATORE

DATE: 3/30/2012

EXP.: 11/30/2012


SHEET: 8-12

PROJECT ENGINEER: ROBERT BORO 847–705–4237
PROJECT MANAGER: ISSAM RAYYAN 847–705–4178

ORLAND TOWNSHIP SEC 25 – SE 1/4 R12E

T36N

BREMEN TOWNSHIP SEC 30 - SW 1/4 R13E

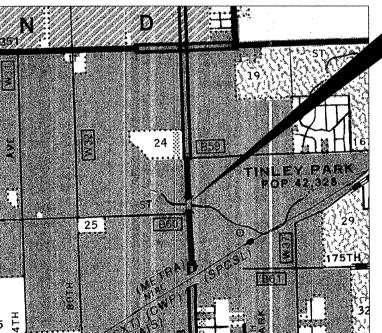

GROSS LENGTH = 113 FT. = 0.021 MILE NET LENGTH = 113 FT. = 0.021 MILE BRIDGE REPAIR SN: 016-0963 BEGIN STA 285+92 END STA 287+08



THOMAS P. PAOLICCHI, P.E.

DATE: 3/30/2012

EXP.: 11/30/2013

SHEET: 7


* ABNA


F.A.P. SECTION COUNTY TOTAL SHEET NO.

348 3127-2-SB-I COOK 19 1

RILINGIS CONTRACT NO. 60M71

D-91-156-11

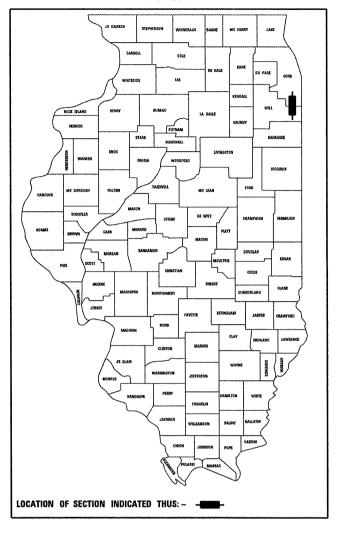

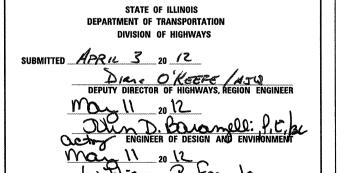

PRINTED BY THE AUTHORITY OF THE STATE OF ILLINOIS

CONTRACT NO. 60M71

HIGHWAY STANDARDS

TC-22 ARTERIAL ROAD INFORMATION SIGN

TC-26 DRIVEWAY ENTRANCE SIGNING

ITTER

HOT-MIX ASPHALT MIXTURE REQUIREMENT	S
MIXTURE TYPE	PERCENT AIR VOIDS @ Ndes
HOT-MIX ASPHALT SURFACE COURSE, MIX "D", N70, (IL 9.5mm), (1/2")	4% @ 70 Gyr.
TEMPORARY PAVEMENT:	
HOT-MIX ASPHALT SURFACE COURSE, MIX "D", N50, (IL 9.5mm), (2")	4% @ 50 Gyr.
HOT-MIX ASPHALT BINDER COURSE, IL 19.0, N50, (10")	4% @ 50 Gyr.

THE UNIT WEIGHT USED TO CALCULATE ALL HMA SURFACE MIXTURE QUANTITIES IS 112 LBS/SQ YD/IN.

THE "AC TYPE" FOR POLYMERIZED HMA MIXES SHALL BE " SBS/SBR PG 76 - 22" AND FOR NON-POLYMERIZED HMA THE "AC TYPE" SHALL BE "PG 64-22" UNLESS MODIFIED BY DISTRICT ONE SPECIAL PROVISIONS. FOR "PERCENT OF RAP" SEE SPECIAL PROVISIONS.

GENERAL NOTES

- BEFORE STARTING ANY EXCAVATION, THE CONTRACTOR SHALL CALL "J.U.L.I.E." AT (800) 892-0123 FOR FIELD LOCATIONS OF BURIED ELECTRIC. TELEPHONE, AND GAS UTILITIES. (48 HOUR NOTIFICATION IS REQUIRED.)
- 2. THE CONTRACTOR SHALL COORDINATE CONSTRUCTION ACTIVITIES WITH UTILITY COMPANIES, AND THE LOCAL MUNICIPALITY.
- 3. THE CONTRACTOR WILL NOT BE ALLOWED TO SET UP A YARD OR FIELD OFFICE ON STATE PROPERTY WITHOUT WRITTEN PERMISSION FROM THE
- 4. ALL DAMAGE TO EXISTING PAVEMENT MARKING OR RAISED REFLECTIVE PAVEMENT MARKERS OUTSIDE THE REMOVAL LINE SHOWN ON THE PLANS SHALL BE REPLACED AT THE CONTRACTOR'S EXPENSE.
- 5. WHEN MILLED PAVEMENT IS OPEN TO TRAFFIC THE MAXIMUM GRADE DIFFERENTIAL BETWEEN PASSES OF THE MILLING MACHINE SHALL NOT EXCEED 11/2 INCHES WHERE THE SPEED LIMIT IS 45 MPH. WITH WRITTEN APPROVAL FROM THE ENGINEER, A MAXIMUM GRADE DIFFERENTIAL OF 3 INCHES MAY BE ALLOWED IF THE EDGE OF THE MILLING IS SLOPED A MINIMUM 1:3 (V:H).
- 6. BUTT JOINTS WILL BE INSTALLED AT THE ENDS OF ALL RESURFACING (WHERE RESURFACING MEETS EXISTING PAVEMENT.) IN ACCORDANCE WITH "BUTT JOINT AND HOT-MIX ASPHALT TAPER DETAILS" SHEET INCLUDED IN THE PLANS, UNLESS OTHERWISE SPECIFIED.
- 7. BEFORE BEGINNING ANY WORK, THE CONTRACTOR SHALL RETAIN AND RECORD (FOR FUTURE REFERENCES), ALL EXISTING PAVEMENT MARKING LINES AND RAISED REFLECTIVE PAVEMENT MARKERS IN ORDER THAT THESE LOCATIONS CAN BE RE-ESTABLISHED FOR STRIPING, EXACT LOCATIONS OF ALL STRIPING SHALL BE AS DIRECTED BY THE ENGINEER.
- 8. THE ENGINEER SHALL CONTACT PATRICE HARRIS, TRAFFIC FIELD TECHNICIAN, AT (708) 597-9800 A MINIMUM OF TWO WEEKS PRIOR TO PLACEMENT OF PERMANENT PAVEMENT MARKINGS.
- 9. DO NOT SCALE PLANS FOR CONSTRUCTION DIMENSIONS.
- 10. THESE PLANS HAVE BEEN PREPARED FROM NOTES RECEIVED FROM IDOT BRIDGE INSPECTORS IN MARCH 2009.
- 11. PLAN DIMENSIONS AND DETAILS RELATIVE TO EXISTING PLANS ARE SUBJECT TO ROUTINE VARIATIONS, THE CONTRACTOR SHALL FIELD VERIFY EXISTING DIMENSIONS AND DETAILS AFFECTING NEW CONSTRUCTION AND MAKE NECESSARY APPROVED ADJUSTMENTS PRIOR TO CONSTRUCTION OR ORDERING MATERIALS. SUCH VARIATION SHALL NOT BE CAUSE FOR ADDITIONAL COMPENSATION FOR A CHANGE IN THE SCOPE OF THE WORK, HOWEVER, THE CONTRACTOR WILL BE PAID FOR THE QUANTITY ACTUALLY FURNISHED BASED AT THE UNIT PRICE BID FOR THE WORK.
- 12. CONTRACTOR SHALL MILL BEFORE PATCHING.
- 13. SEEDING, CLASS 2A AND ALL FERTILIZER SHALL BE INCULDED IN THE COST OF TOPSOIL FURNISH AND PLACE, 4".
- 14. THE SEEDING DATES FOR BARE EARTH SEEDING OF MIXTURE CLASS 2A SHALL BE FROM APRIL 1 TO JUNE 1 AND FROM AUGUST 15 TO SEPTEMBER 30. ALL SEEDING NOT SOWN ACCORDINGLY TO SPECIFIED SEASONAL DATE SHALL REQUIRE PRIOR WRITTEN APPROVAL FROM THE ENGINEER. FAILURE TO SECURE SUCH APPROVAL SHALL RESULT IN REJECTION OF THE SEEDING AND REPLACEMENT BY THE CONTRACTOR AT HIS/HER EXPENSE.

MAINTENANCE OF TRAFFIC GENERAL NOTES

- THE ENGINEER SHALL BE INFORMED 48 HOURS IN ADVANCE OF ANY CHANGES TO THE MOT PLANS.
- 2. ALL EXISTING PAVEMENT MARKING IN CONFLICT WITH THE MAINTENANCE OF TRAFFIC STRIPING SHALL BE REMOVED. THIS WORK WILL BE PAID FOR AT THE CONTRACT LINIT PRICE PER SOLIARE FOOT, "PAVEMENT MARKING REMOVAL"
- 3. THE CONTRACTOR SHALL REMOVE ALL TEMPORARY PAVEMENT MARKING TAPE WHICH CONFLICT WITH THE NEXT STAGE OR FINAL STRIPING. REMOVAL OF TEMPORARY PAVEMENT MARKING TAPE WILL BE PAID FOR AT THE CONTRACT UNIT PRICE PER SQUARE FOOT, "WORK ZONE PAVEMENT MARKING REMOVAL".
- 4. ALL TRAFFIC CONTROL DEVICES USED FOR THE MAINTENANCE OF TRAFFIC, AS DETAILED ON THE PLANS, OR HIGHWAY STANDARD SHALL BE REFLECTORIZED PRIOR TO INSTALLATION AND CLEANED AS SPECIFIED IN MAINTENANCE OF TRAFFIC SPECIAL PROVISIONS OR AS DIRECTED BY THE ENGINEER.
- 5. ALL DRUMS, VERTICAL PANELS AND BARRICADES ADJACENT TO THE EDGE OF TRAVELED WAY SHALL BE EQUIPPED WITH STEADY-BURNING MONO-DIRECTIONAL LIGHTS.
- ALL EXISTING SIGNS WITHIN THE LIMITS OF MAINTENANCE OF TRAFFIC SHALL BE MAINTAINED IN ACCORDANCE WITH ARTICLE 107.25 OF THE IDOT STANDARD SPECIFICATIONS.
- 7. ALL TEMPORARY INFORMATION SIGNS SHALL BE PAID FOR SEPARATELY AT THE CONTRACT UNIT PRICE PER SQUARE FOOT FOR "TEMPORARY INFORMATION SIGNING"
- 8. FOR ADDITIONAL BRIDGE CONSTRUCTION STAGING INFORMATION, SEE STRUCTURAL PLANS.
- CONTRACTOR SHALL LOCATE AND PROVIDE ALL APPROACH SIGNAGE PER REFERENCED HIGHWAY STANDARDS, SIGN LOCATIONS SHOWN ARE SCHEMATIC ONLY.
- 10. TRAFFIC CONDITIONS, ACCIDENTS, AND OTHER UNFORESEEN EMERGENCY CONDITIONS MAY REQUIRE THE ENGINEER TO RESTRICT, MODIFY, OR REMOVE LANE CLOSURES OF CHANNELIZATION SHOWN IN THE PLANS. THE CONTRACTOR SHALL MAKE THE NECESSARY ADJUSTMENTS AS DIRECTED BY THE ENGINEER WITHOUT DELAY. THE CONTRACTOR SHALL RESPOND TO ANY REQUEST MADE BY THE ENGINEER FOR CORRECTION WITHIN TWO HOURS FROM THE TIME OF NOTIFICATION.
- THE RESIDENT ENGINEER SHALL CONTACT THE DISTRICT ONE TRAFFIC CONTROL SUPERVISOR AT (847) 705-4470 A MINIMUM OF 72 HOURS IN ADVANCE OF THE PLACEMENT OF ANY TEMPORARY TRAFFIC CONTROL DEVICE.

Wight

USER NAME =	DESIGNED	-	KAC	REVISED	-	
	CHECKED	~	BRT	REVISED	~	ĺ
PLOT SCALE =	DRAWN	-	CEY	REVISED	A9	ĺ
PLOT DATE = 3/28/2012	CHECKED	-	BJM	REVISED	~	ĺ

SUMMARY OF QUANTITIES

Spacialty.	CODE			URBAN	TYPE CODE 0014
Specialty Item	NUMBER	ΠΕΜ	UNIT	TOTAL QUANTITY	SN 016-0963
					100% STATE
	20800150	TRENCH BACKFILL	CUYD	9.5	9.5
*	21101615	TOPSOIL FURNISH AND PLACE, 4"	SQ YD	113.6	113.6
*	25100630	EROSION CONTROL BLANKET	SQ YD	113.6	113.6
	40600100	BITUMINOUS MATERIALS (PRIME COAT)	GALLON	83	83
	40600982	HOT-MIX ASPHALT SURFACE REMOVAL - BUTT JOINT	SQ YD	483	483
	40603340	HOT-MIX ASPHALT SURFACE COURSE, MIX "D", N70	TON	73	73
	42400200	PORTLAND CEMENT CONCRETE SIDEWALK 5 INCH	SQFT	100	100
	44000100	PAVEMENT REMOVAL	SQYD	151.1	151.1
	44000500	COMBINATION CURB AND GUTTER REMOVAL	FOOT	17	17
	44000600	SIDEWALK REMOVAL	SQFT	100	100
	44003100	MEDIAN REMOVAL	SQFT	151.1	151.1
	50300100	FLOOR DRAINS	EACH	2	2
	50300260	BRIDGE DECK GROOVING	SQ YD	120	120
	50300300	PROTECTIVE COAT	SQ YD	74	74
	550A0340	STORM SEWER, CLASS A, TYPE 2 12"	FOOT	8	8
	60237470	INLET, TYPE A, TYPE 24 FRAME AND GRATE	EACH	2	2
	60500060	REMOVING INLETS	EACH	2	2
	60603800	COMBINATION CONCRETE CURB AND GUTTER, TYPE B-6.12	FOOT	146	146
	60605000	COMBINATION CONCRETE CURB AND GUTTER, TYPE B-6.24	FOOT	17	17
	60619600	CONCRETE MEDIAN, TYPE SB-6.12	SQFT	119	119
*	63000001	STEEL PLATE BEAM GUARDRAIL, TYPE A, 6 FOOT POSTS	FOOT	275.0	275.0
*	63100045	TRAFFIC BARRIER TERMINAL, TYPE 2	EACH	2	2
*	63100070	TRAFFIC BARRIER TERMINAL, TYPE 5	EACH	4	4
*	63100167	TRAFFIC BARRIER TERMINAL, TYPE 1 (SPECIAL) TANGENT	EACH	2	2
*	63200310 GUARDRAIL REMOVAL 67000400 ENGINEER'S FIELD OFFICE, TYPE A		FOOT	454	454
			CAL MO	3	3
67100100 MOBILIZATION		MOBILIZATION	LSUM	1	1
	70103815	TRAFFIC CONTROL SURVEILLANCE	CAL DA	15	15
	70106800	CHANGEABLE MESSAGE SIGN	CAL MO	8	8
* DESIGNED	Specialty Item	REVISED -			

Wight

_	USER NAME =	DESIGNED	-	KAC	REVISED	*	
		CHECKED	-	BRT	REVISED	-	ĺ
	PLOT SCALE =	DRAWN		CEY	REVISED	-	
	PLOT DATE : 3/27/2012	CHECKED	-	ВЈМ	REVISED	-	1

STATE OF ILLINOIS
DEPARTMENT OF TRANSPORTATION

S	UMM	ARY	1	OF ()UA	ITN	TIES	
IL	ROUT	re 4	3	(HA	RL	EM	AVE)	
	SHEET	NO.	1	OF	2	SHE	ETS	

F.A.P. RTE.	SECTION	COUNTY	TOTAL	SHEET NO.				
348	3127-2-SB-I	COOK	19	3				
		CONTRAC	T NO. 6	OM71				
ILLINOIS FED. AID PROJECT								

SUMMARY OF QUANTITIES

Specialty Item	CODE NUMBER	ITEM	UNIT	URBA _A) TOTAL QUANTITY	CONSTRUCTION TYPE CODE 0014 SN 016-0963 100% STATE
	70300100	SHORT TERM PAVEMENT MARKING	FOOT	28	28
	70301000	WORK ZONE PAVEMENT MARKING REMOVAL	SQFT	3488	3488
*	78000100	THERMOPLASTIC PAVEMENT MARKING - LETTERS AND SYMBOLS	SQ FT	36.4	36.4
*	78000200	THERMOPLASTIC PAVEMENT MARKING - LINE 4"	FOOT	1979	1979
*	78000400	THERMOPLASTIC PAVEMENT MARKING - LINE 6"	FOOT	60	60
*	78000600	THERMOPLASTIC PAVEMENT MARKING - LINE 12"	FOOT	84	84
*	78008210	POLYUREA PAVEMENT MARKING TYPE 1 - LINE 4"	FOOT	20	20
*	78100100	RAISED REFLECTIVE PAVEMENT MARKER	EACH	29	29
*	78100105	RAISED REFLECTIVE PAVEMENT MARKER (BRIDGE)	EACH	4	4
*	78200410	GUARDRAIL MARKERS, TYPE A	EACH	16	16
*	78201000	TERMINAL MARKER - DIRECT APPLIED	EACH	2	2
	78300100	PAVEMENT MARKING REMOVAL	SQFT	76.7	76.7
	78300200	RAISED REFLECTIVE PAVEMENT MARKER REMOVAL	EACH	33	33
	Z0001800	APPROACH SLAB REPAIR (PARTIAL DEPTH)	SQ YD	22	22
	Z0006012	BRIDGE DECK LATEX CONCRETE OVERLAY, 2 1/4 INCHES	SQ YD	124	124
	Z0012130	BRIDGE DECK SCARIFICATION 3/4"	SQ YD	130	130
	Z0012754	STRUCTURAL REPAIR OF CONCRETE (DEPTH EQUAL TO OR LESS THAN 5 INCHES)	SQFT	92	92
	Z0016002	DECK SLAB REPAIR (FULL DEPTH, TYPE II)	SQ YD	4	4
	Z0021922	SILICONE JOINT SEALER	FOOT	22	22
	Z0030850	TEMPORARY INFORMATION SIGNING	SQFT	70.2	70.2
	Z0041895	POLYMER CONCRETE	CUFT	10.4	10.4
	Z0062456	TEMPORARY PAVEMENT	SQ YD	151.1	151.1
*	A2005020	TREE, GYMNOCLADUS DIOICUS (KENTUCKY COFFEETREE), 2-1/2" CALIPER, BALLED AND BURLAPPED	EACH	2	2
*	X7010216	TRAFFIC CONTROL AND PROTECTION, (SPECIAL)	LSUM	1	1
*	X7030030 Specialty Item	WET REFLECTIVE TEMPORARY TAPE TYPE III, 4 INCH	FOOT	10463	10463


Wight

	USER NAME =	DESIGNED -	KAC	REVISED ~	Г
		CHECKED -	BRT	REVISED -	
1	PLOT SCALE =	DRAWN -	CEY	REVISED ~	
	PLOT DATE = 3/27/2012	CHECKED -	B.IM	REVISED -	

STATE OF ILLINOIS
DEPARTMENT OF TRANSPORTATION

SUMMARY			•	OF	QUA	NTI	TIES	
IL	ROUT	FE 4	3	(HA	۱RLI	EM	AVE)	
*****	SHEET	NO.	2	OF	2	SHE	ETS	

A.P.	SECTION	COUNTY	TOTAL SHEETS	SHEET NO.			
348	3127-2-5B-I	СООК	19	4			
		CONTRACT	NO. 6	ОМ71			
ILLINOIS FED. AID PROJECT							

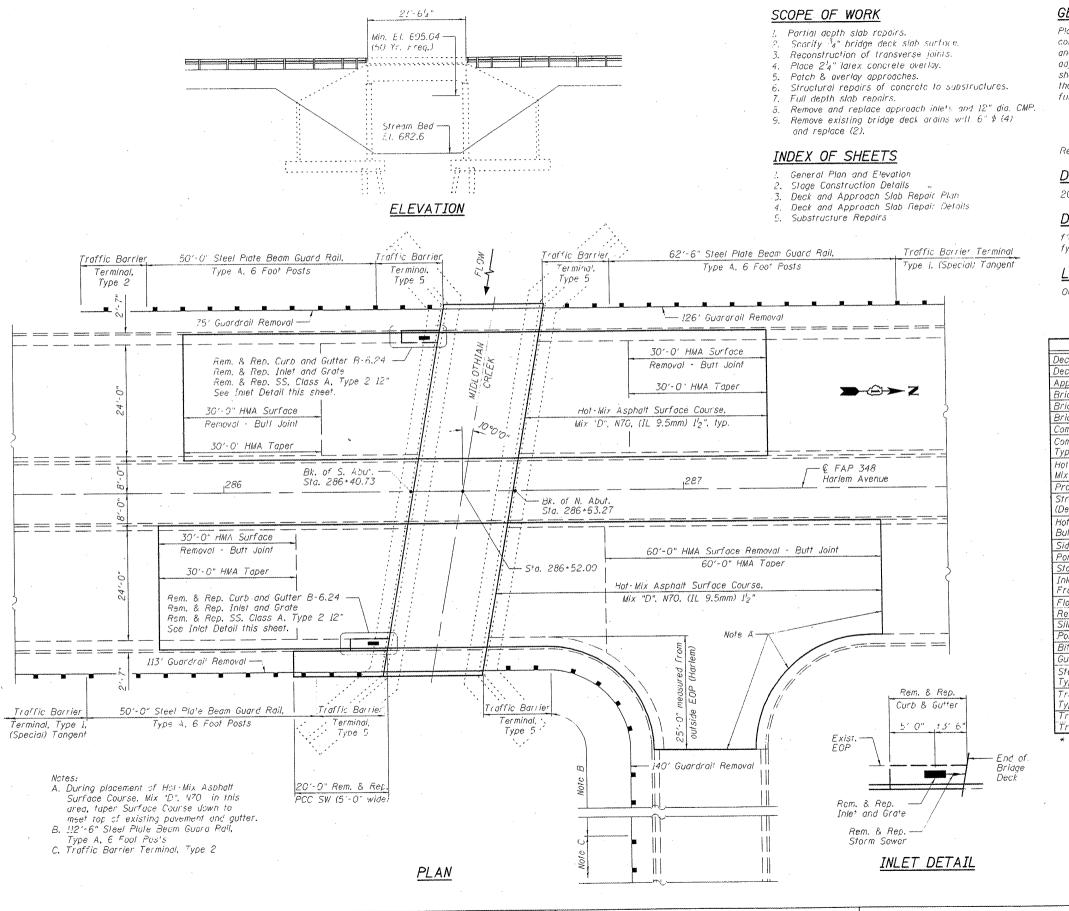

GENERAL NOTES

Plan dimensions and details relative to existing plans are subject to nominal construction variations. The Contractor shall field verify existing dimensions and details affecting new construction and make necessary approved adjustments prior to construction or ordering of materials. Such variations shall not be cause for additional compensation for a change in scope of the work, however the Contractor will be paid for the quantity actually furnished at the unit price bid for the work.

Reinforcement bars designated (E) shall be epoxy coated.

DESIGN SPECIFICATIONS

2002 AASHTO Standard Specifications for Highway Bridges, 17th Edition

DESIGN STRESSES

f'c = 3,500 psi fy = 60,000 psi

LOADING HS20-44

Original Construction

TOTAL BILL OF MATERIAL

ITEM	UNIT	SUPER	SUB	TOTAL
Deck Slab Repair (Partial) *	Sq. Yd.	40		40
Deck Slab Repair (Full Depth, Type II)	Sq. Yd.	4		4
Approach Slab Repair (Partial Depth)	Sg. Yd.	22		22
Bridge Deck Grooving	Sg. Yd.	120		120
Bridge Deck Scarification 34"	Sq. Yd.	130		130
Bridge Deck Latex Concrete Overlay, 21/4"	Sq. Yd.	124		124
Combination Curb and Gutter Removal	Foot	17		17
Combination Concrete Curb and Gutter. Type B-6.24	Foot	17		17
Hot-Mix Asphalt Surface Course, Mix "D", N7O	Ton	73		73
Protective Coat	Sq. Yd.	74		74
Structural Repair of Concrete (Depth Equal To or Less Than 5 Inches)	Sq. Ft.		. 92 .	92
Hot-Mix-Asphalt Surface Removal - Bult Joint	Sq. Yd.	483		483
Sidewalk Removal	Sq. Ft.	100		100
Portland Cement Concrete Sidewalk 5 Inch	Sq. Fi.	100		100
Storm Sewer, Class A, Type 2 12"	Foot	8		8
Inlet. Type A. Type 24 Frame and Grafe	Each	2		2
Floor Drains	Each	2 .		2
Removing Inlets	Each			2
Silicone Joint Sealer	Foot	22		22
Polymer Concrete	Cu. Ft.	10.4		10.4
Bituminous Materials (Prime Coat)	Galion	83		83
Guardrail Removal	Foot	454	1	454
Steel Plate Beam Guard Raii. Type A, 6 Foot Posts	Fooi	275		275
Traffic Barrier Terminal. Type I (Special) Tangent	Each	2		2
Traffic Barrier Terminal, Type 2	Each	2		2
Traffic Barrier Terminal, Type 5	Each	1		1

* For Information Only

GENERAL PLAN AND ELEVATION

IL 43 (HARLEM AVENUE)

OVER MIDLOTHIAN CREEK


F.A.P. RT. 348 - SEC. 3127-2-SB-I


COOK COUNTY


STATION 286+52.00


STRUCTURE NO. 016-0963

		DESIGNED - BRT	REVISED -		GENERAL PLAN AND ELEVATION	RTE. SECTION	COUNTY SHEETS NO.
	USEF HAME	DESIGNED - BRI	DEVICED -	STATE OF ILLINOIS		348 3127-2-SB-1	COOK 19 8
Wight		CHECKED - BJW	UCA13CD	DEPARTMENT OF TRANSPORTATION	STRUCTURE NO. 016-0963		CONTRACT NO. 60M71
wigin	PLOT SCALE : 1":10"	DRAWN - CET	REVISED -	DEPARTMENT OF THANSFORTATION	SHEET NO. 1 OF 5 SHEETS	ILLINOIS FED. A	D PROJECT
LJ	FLOT DATE = 3/27/2012	CHECKED BJM	REVISED		<u> </u>		

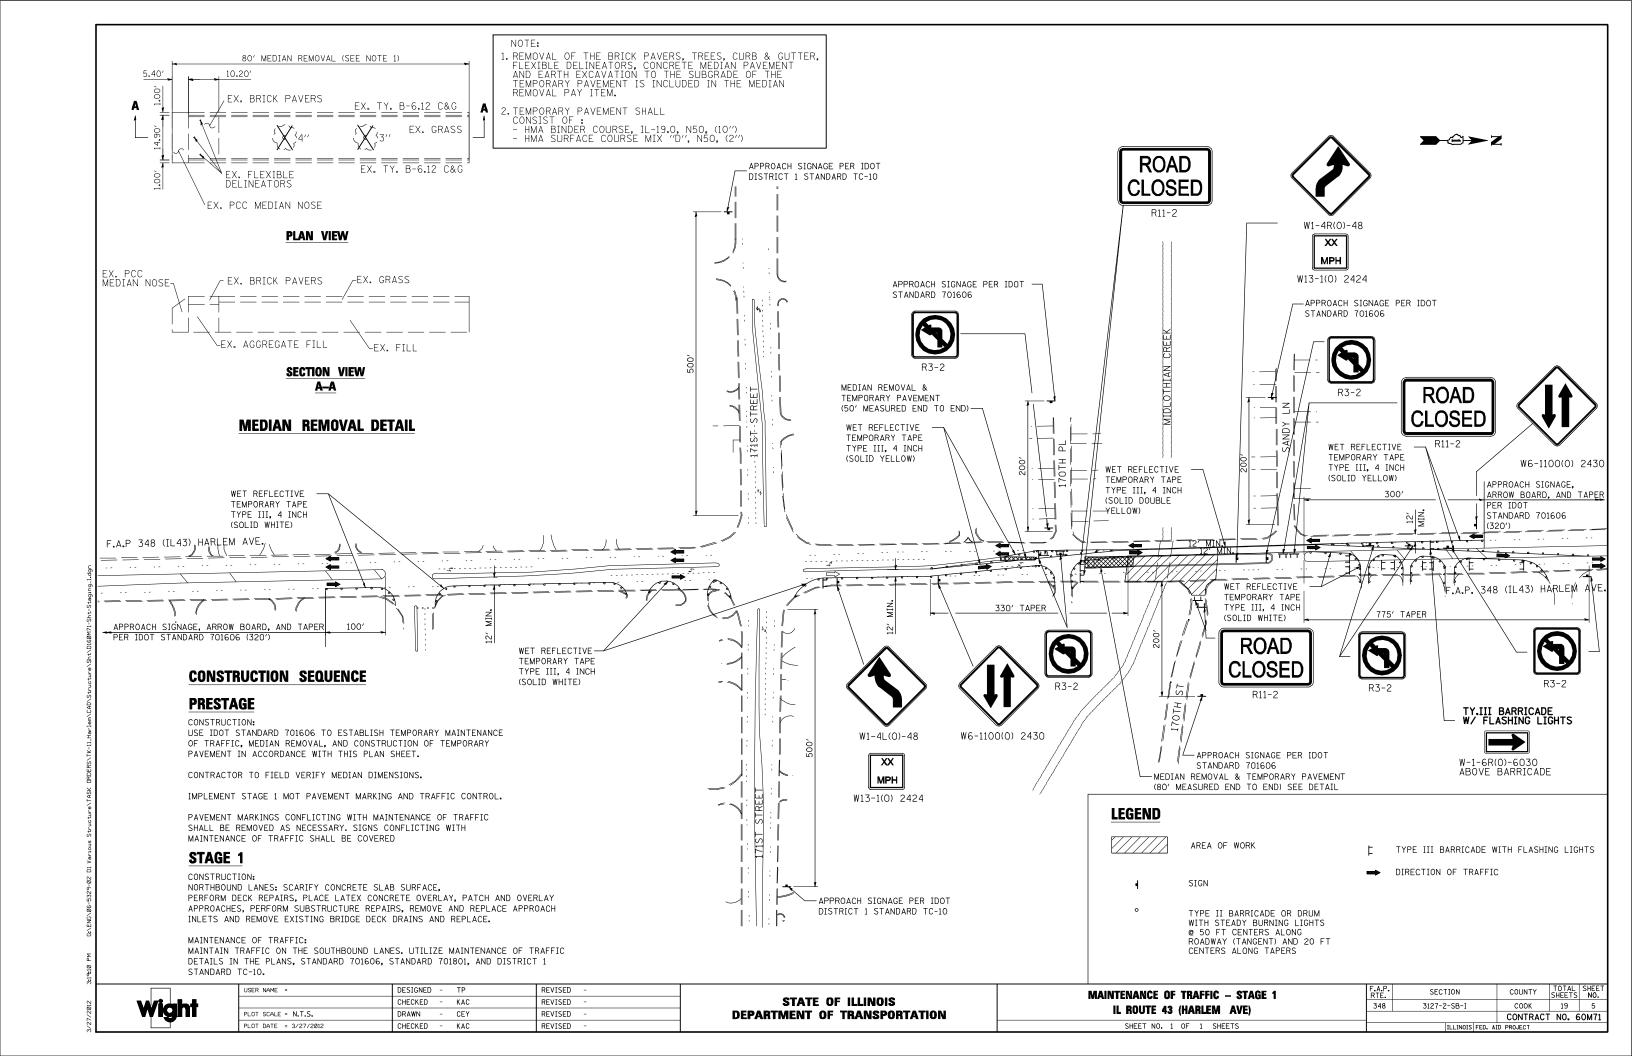


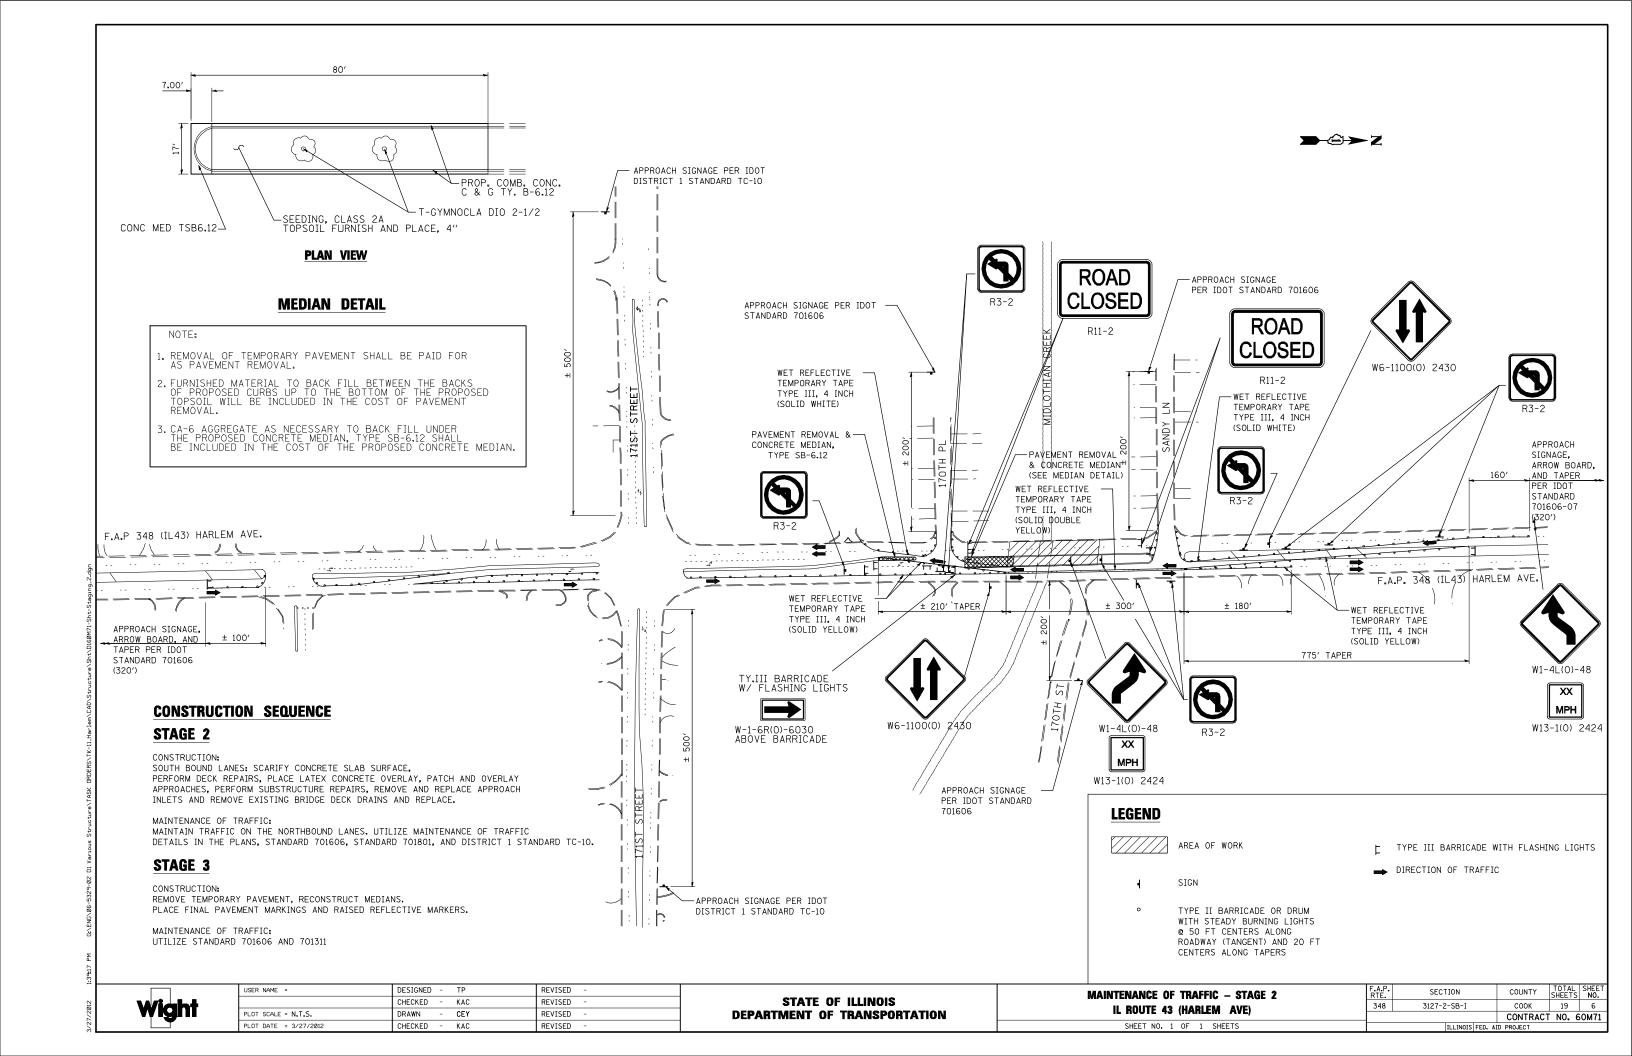

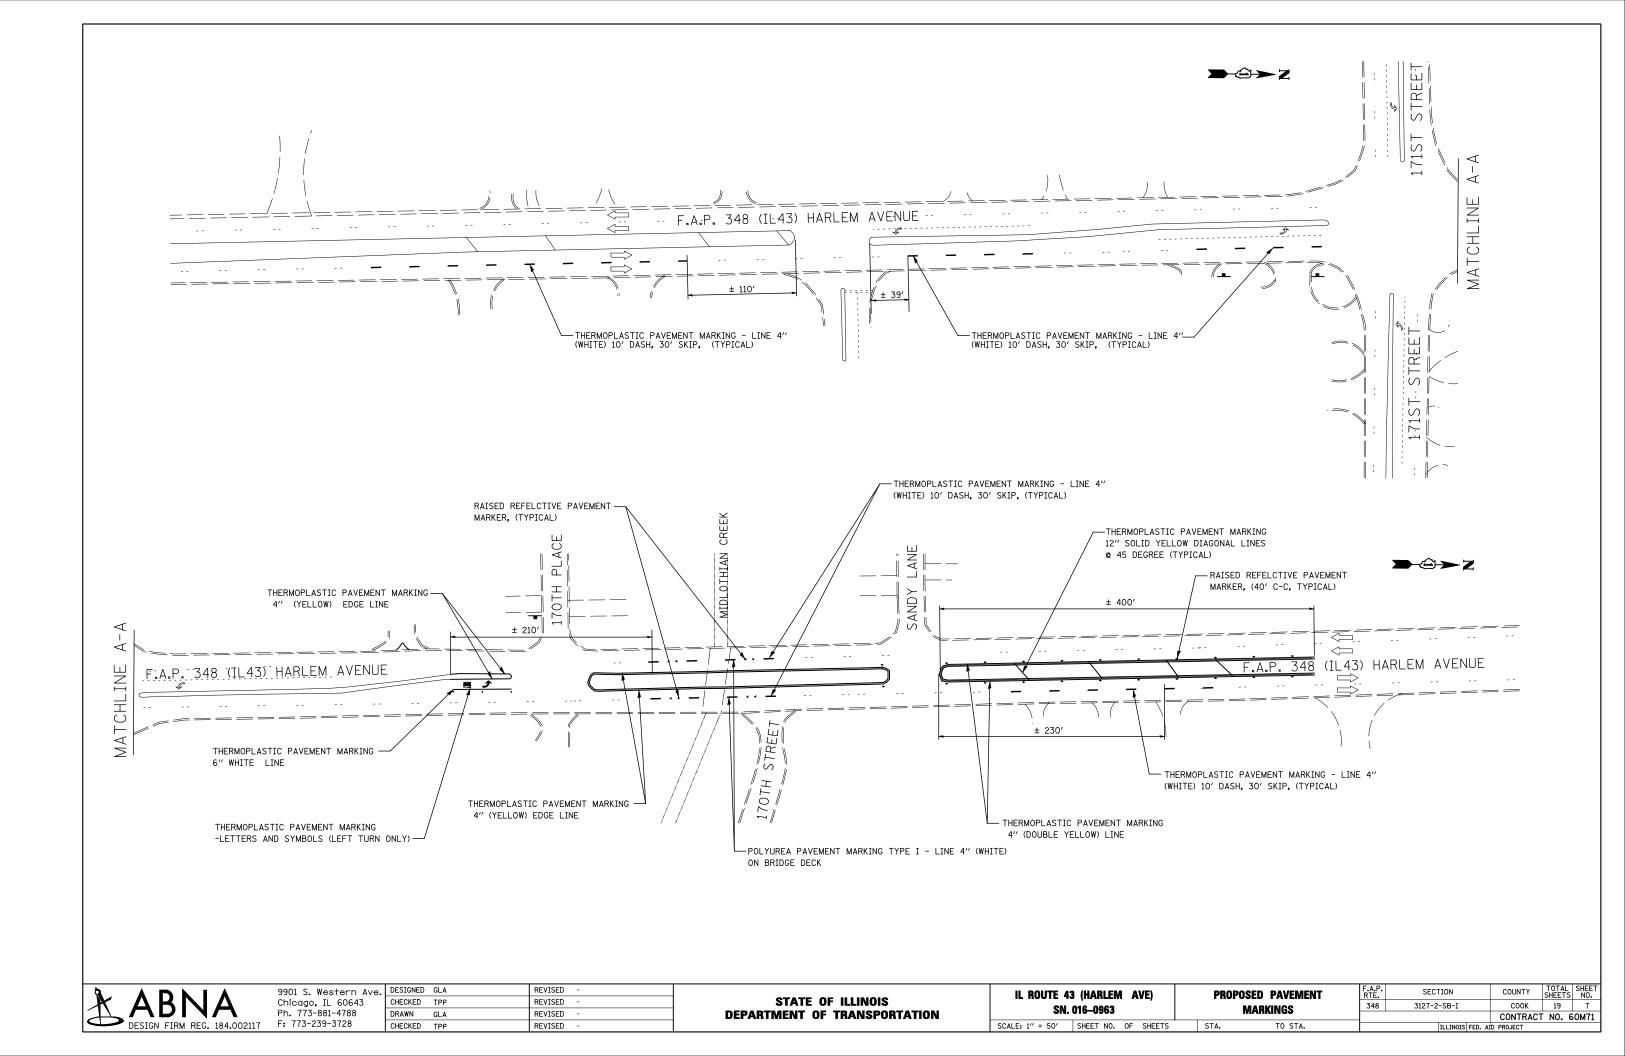

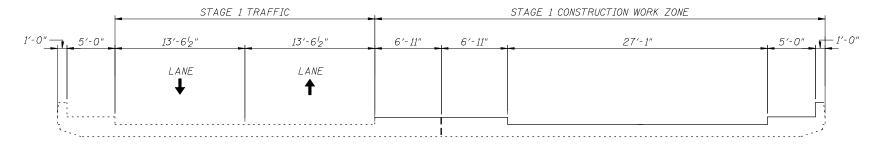


STAGE 1 - CROSS SECTION LOOKING NORTH

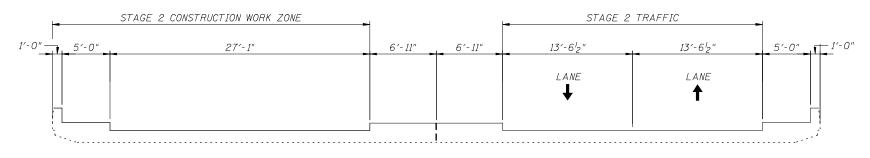



STAGE 2 - CROSS SECTION

LOOKING NORTH

USER NAME =	DESIGNED - BRT	REVISED -		STAGE CONSTRUCTION DETAILS	F.A.P. RTE.	SECTION	COUNTY S	TOTAL SHEETS
	CHECKED - BJM	REVISED -	STATE OF ILLINOIS	STRUCTURE NO. 040, 0000	348	3127-2-SB-I	соок	19
PLOT SCALE =	DRAWN - CEY	REVISED -	DEPARTMENT OF TRANSPORTATION	STRUCTURE NO. 016-0963	J			NO. 60
PLOT DATE = 3/27/2012	CHECKED - BJM	REVISED -		SHEET NO. 2 OF 5 SHEETS		ILLINOIS FED. A	AID PROJECT	

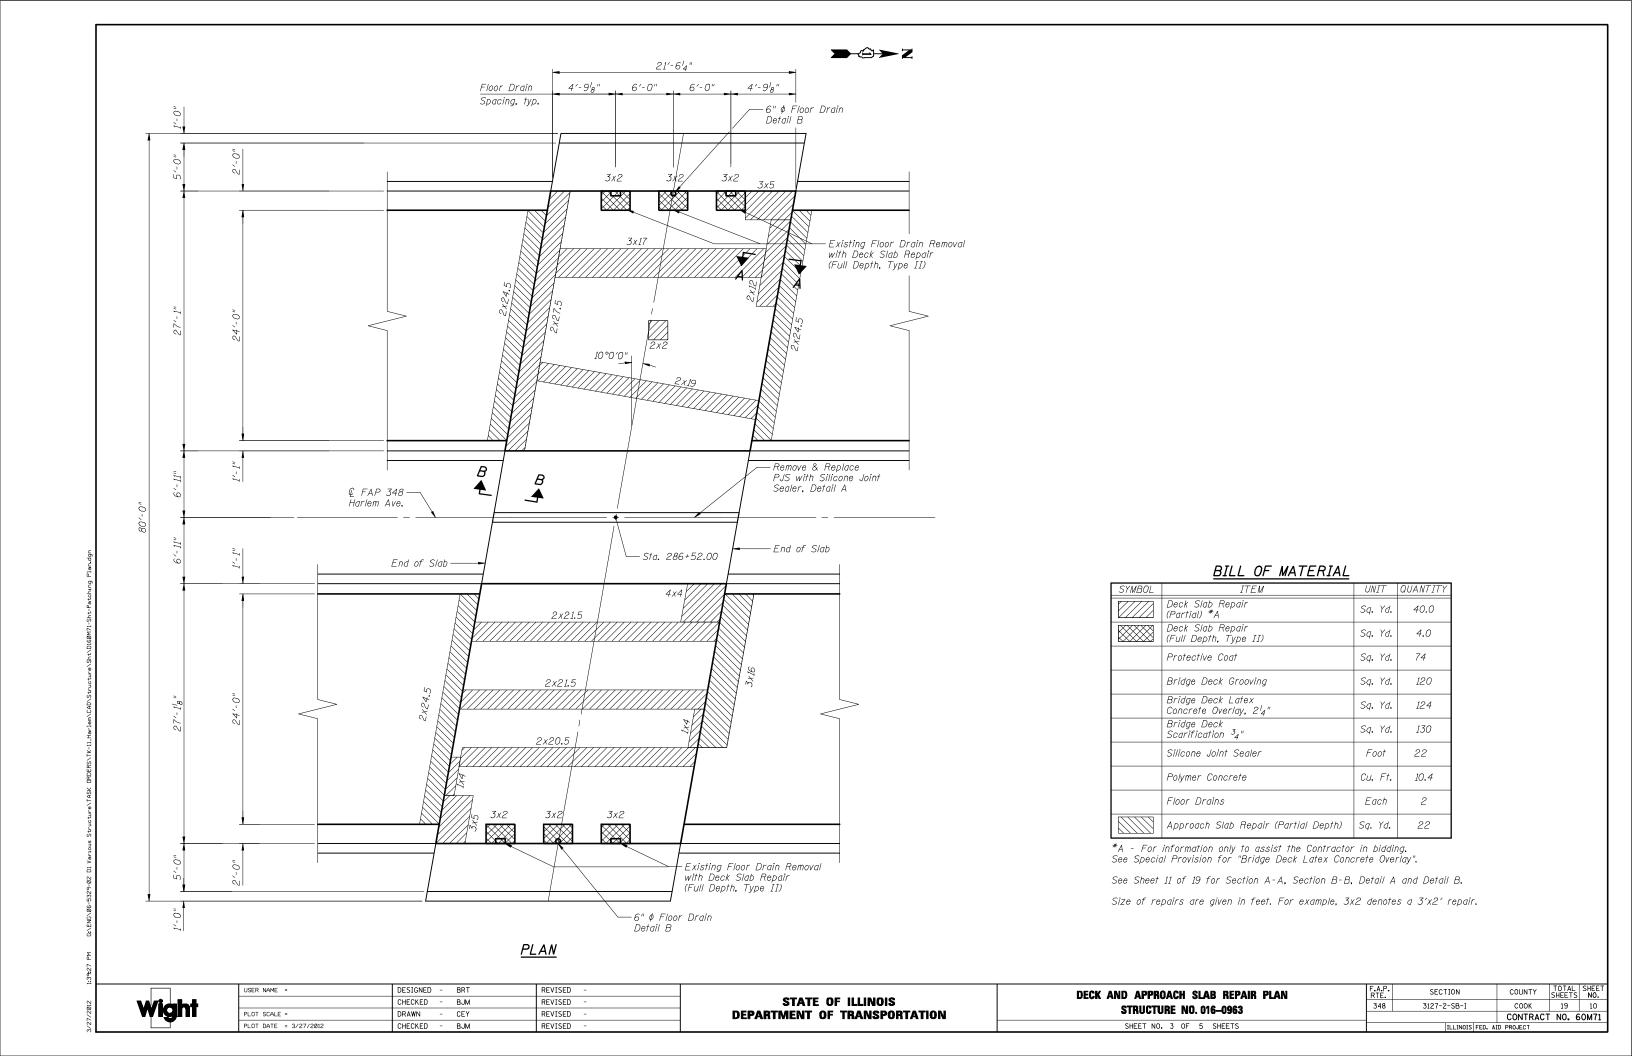

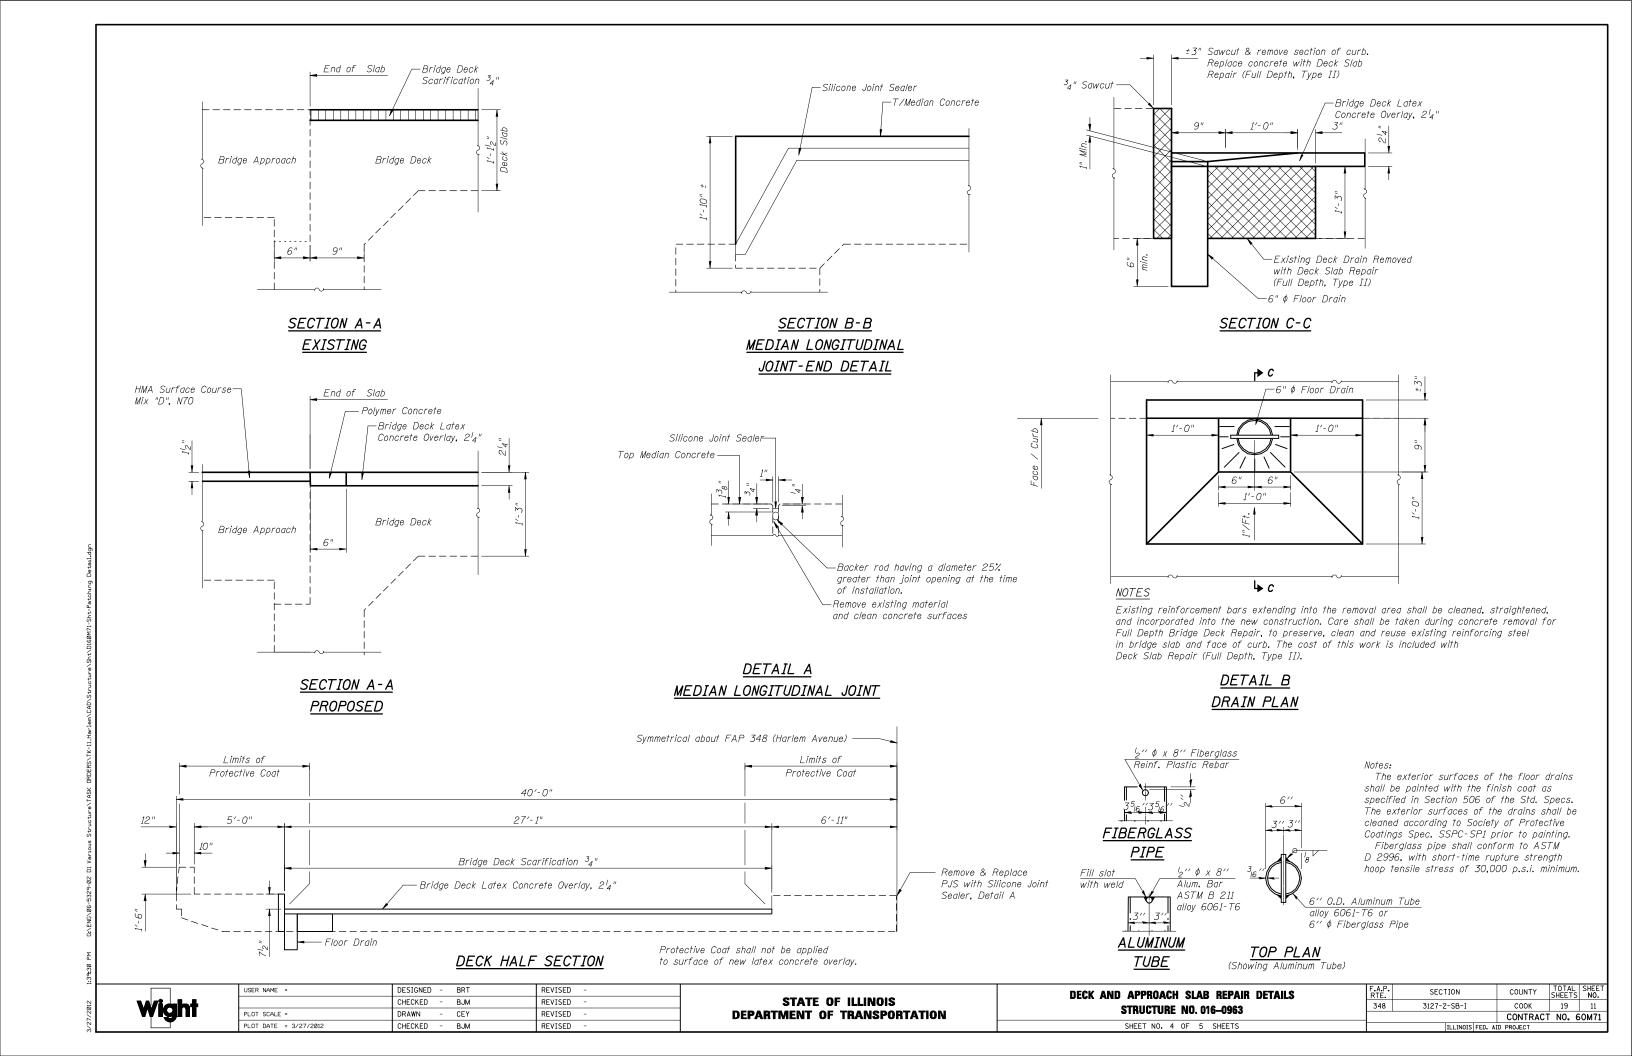

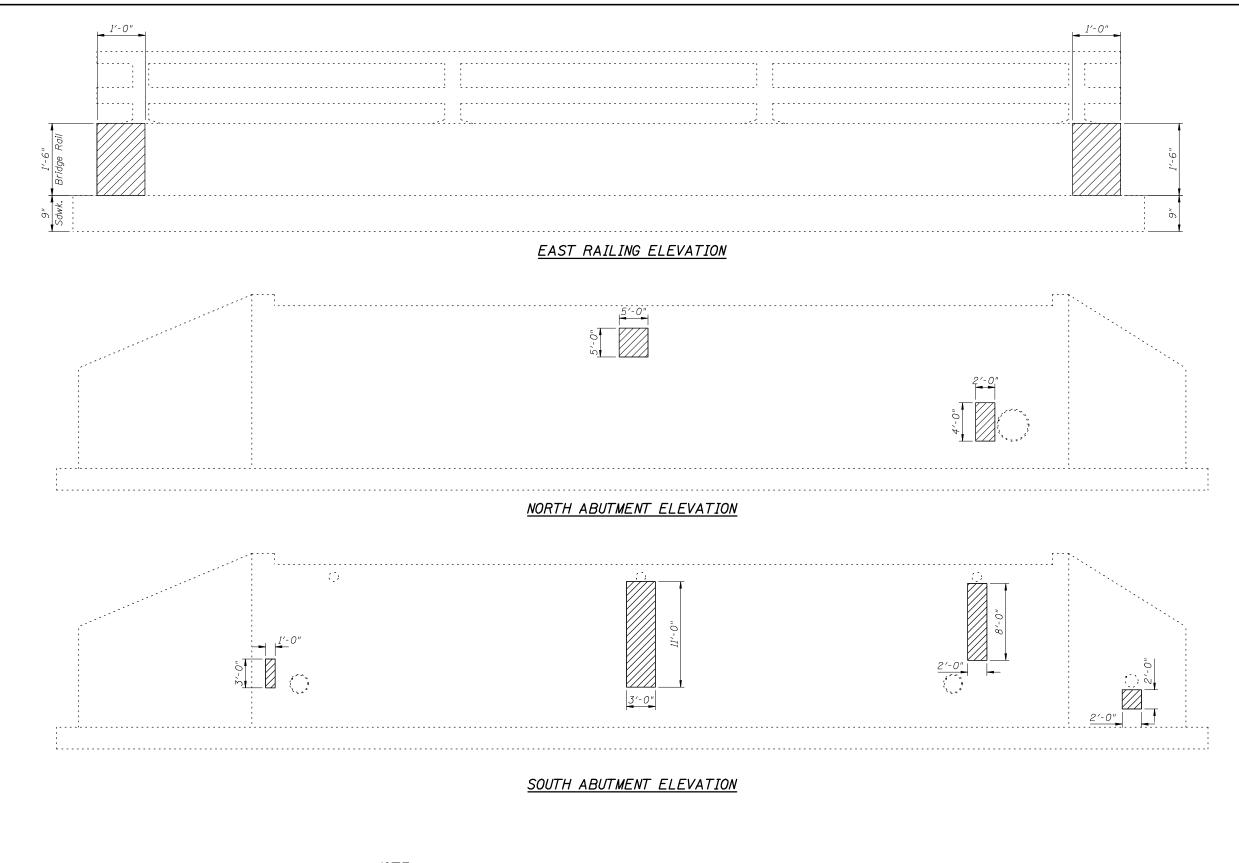

<u>NOTE</u>

The limits and locations of repair shown on this sheet are taken from the most recent survey performed by the District in March 2009.

BILL OF MATERIAL

SYMBOL	ITEM	UNIT	QUANTITY
	Structural Repair of Concrete (Depth Equal To or Less Than 5 Inches)	Sq. Ft.	92




USER NAME =	DESIGNED	-	BRT	REVISED -
	CHECKED	-	ВЈМ	REVISED -
PLOT SCALE = 1'=5'	DRAWN	-	CEY	REVISED -
PLOT DATE = 3/27/2012	CHECKED	-	ВЈМ	REVISED -

STATE OF ILLINOIS
DEPARTMENT OF TRANSPORTATION

STR	UCT	lUI	RE I	REP	AIRS	
STRUC	TUI	RE	NO	. 01	6-0963	
CHEET	NΩ	_	ΛE	_	CHEETS	

OPTION 1


(FOR BUTT JOINT AND HMA TAPER SEE DETAIL BELOW)

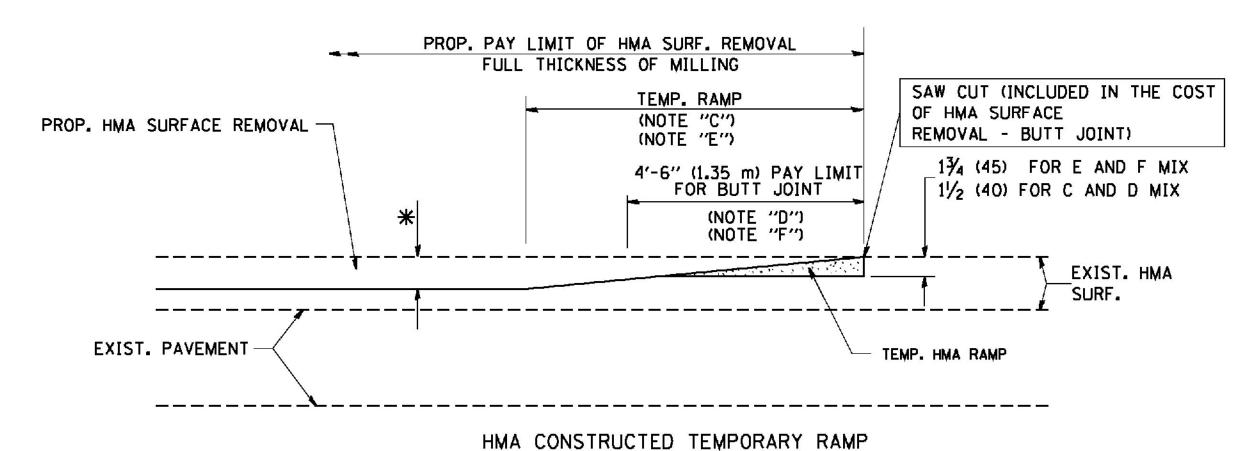


(FOR BUTT JOINT AND HMA TAPER SEE DETAIL BELOW)


OPTION 2

TYPICAL TEMPORARY RAMP

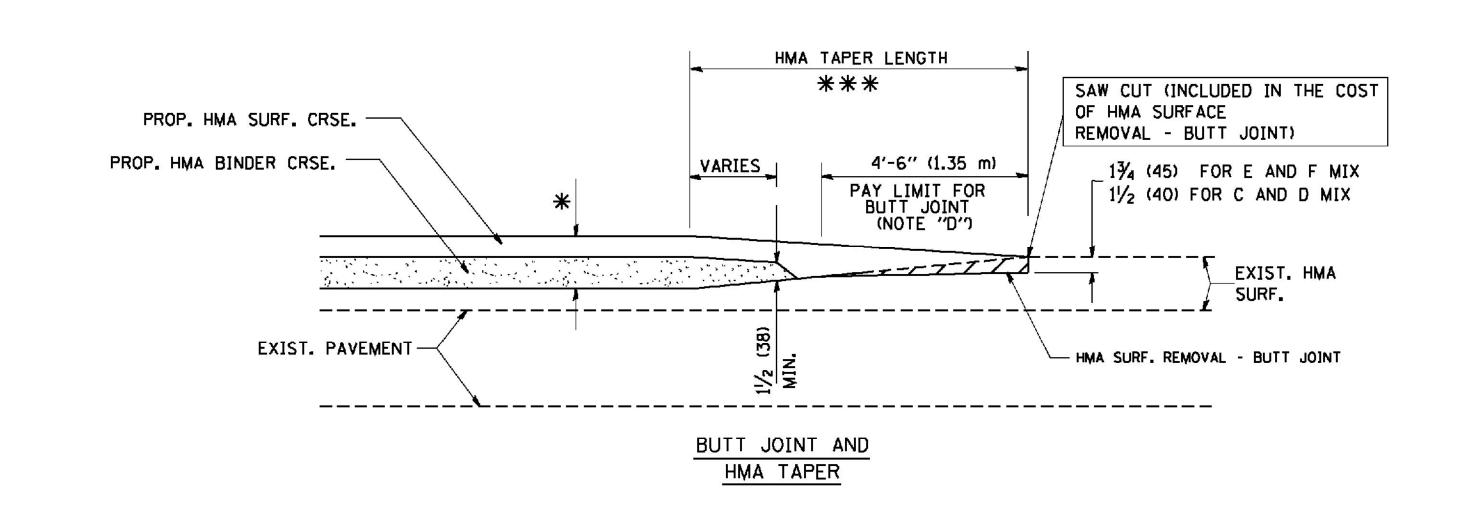

TYPICAL BUTT JOINT AND HMA TAPER FOR MILLING AND RESURFACING

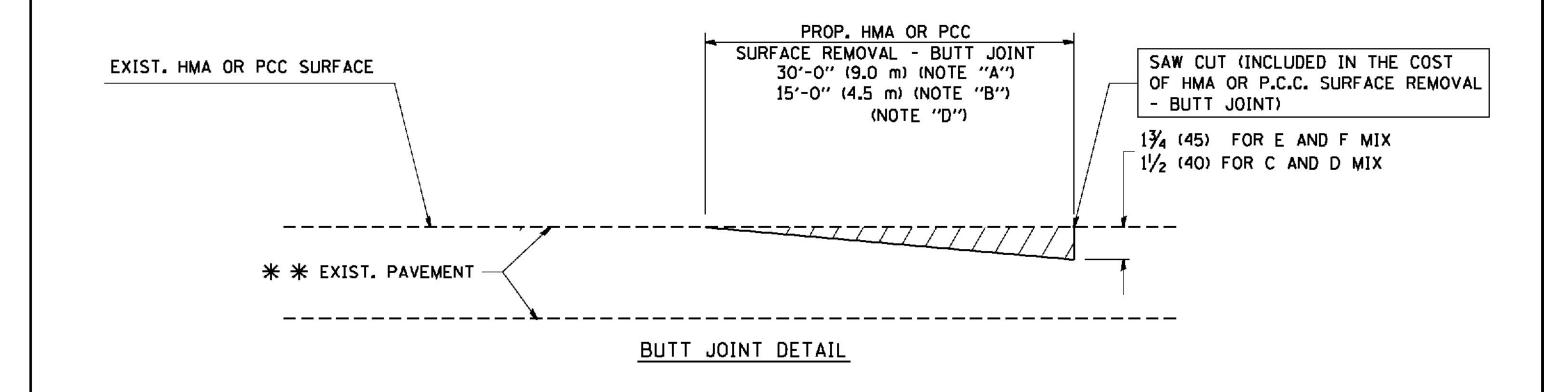

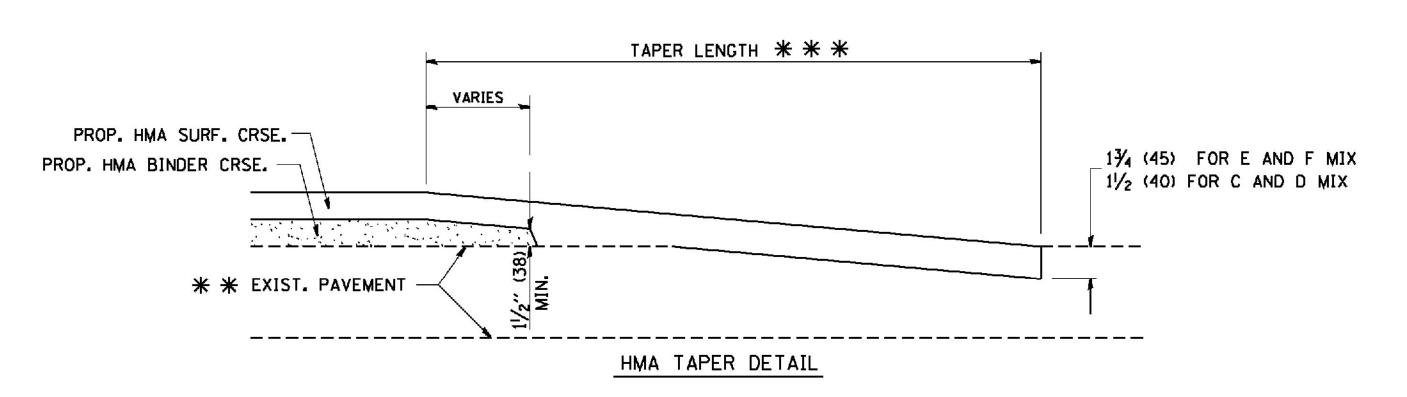

TYPICAL BUTT JOINT AND HMA TAPER FOR RESURFACING ONLY

* * PC CONCRETE, HMA OR HMA RESURFACED PAVEMENT.

NOTES

- A: MAINLINE ROADWAYS AND MAJOR SIDE ROADS.
- B: MINOR SIDE ROADS.
- C: THE TEMP. RAMP SHALL BE CONSTRUCTED IMMEDIATELY UPON REMOVAL OF THE EXISTING HMA SURFACE.
- D: THE BUTT JOINT SHALL BE CONSTRUCTED IMMEDIATELY PRIOR TO PLACING THE PROPOSED HMA COURSES.
- E: TAPER THE TEMP. RAMP AT A RATE OF 3'-0" (900 mm) PER 1 INCH (25 mm) OF MILLING THICKNESS.
- F: INSTALLATION AND REMOVAL OF THE 4'-6" (1.35 m) TEMP. RAMP IS INCLUDED IN COST OF HMA SURFACE REMOVAL BUTT JOINT
- G: SEE ARTICLE 406.08 AND 406.14 OF THE STANDARD SPECIFICATIONS FOR "HMA AND/OR PCC SURFACE REMOVAL, BUTT JOINT".
- * SEE TYPICAL SECTIONS FOR MILLING THICKNESS.
- ** ** ** 20'-0" (6.1 m) PER 1 (25) RESURFACING (NOTE "A") 10'-0" (3.0 m) PER 1 (25) RESURFACING (NOTE "B")

BASIS OF PAYMENT:

THE BUTT JOINT WILL BE PAID FOR AT THE CONTRACT UNIT PRICE PER SQUARE YARD (SQUARE METER)
FOR "HOT-MIX ASPHALT SURFACE REMOVAL - BUTT JOINT" OR FOR "PORTLAND CEMENT CONCRETE SURFACE REMOVAL- BUTT JOINT".

SCALE: NONE

ALL DIMENSIONS ARE IN INCHES (MILLIMETERS) UNLESS OTHERWISE SHOWN.



USER NAME = geglienabt	DESIGNED - M. DE YONG	REVISED	-	R. SHAH 10-25-94
	CHECKED -	REVISED	-	A. ABBAS 03-21-97
PLOT SCALE = 50.0000 '/ IN.	DRAWN	REVISED	-	M. GOMEZ 04-06-01
PLOT DATE = 19/48/20018	CHECKED - 06-13-90	REVISED	-	R. BORO 01-01-07

STATE OF ILLINOIS
DEPARTMENT OF TRANSPORTATION

BUTT JOINT	RTE.	SECTION	COUNT
HMA TAPER DETAILS	348	3127-2-SB-I	СООК
IIIVIA TAI LII DETAILS		BD400-05 BD32	CONTR
SHEET NO. 1 OF 1 SHEETS	FED. R	OAD DIST. NO. 1 ILLINOIS FED.	AID PROJECT

A.P. SECTION COUNTY TOTAL SHEET NO. 48 3127-2-SB-I COOK 19 13

CONTRACT NO. 60M71

TRAFFIC CONTROL AND PROTECTION FOR SIDE ROADS, INTERSECTIONS, AND DRIVEWAYS

NOTES:

- A. FOR NO LANE RESTRICTION ON THE SIDE ROAD OR DRIVEWAYS
- 1. SIDE ROAD WITH A SPEED LIMIT OF 40 MPH (60 km/h) OR LESS AS SHOWN ON THE DRAWING AND AS DIRECTED BY THE ENGINEER:
- ONE ROAD CONSTRUCTION AHEAD SIGN 36 x 36 (900x900) WITH A FLASHER AND FLAG MOUNTED ON IT APPROXIMATELY 200' (60 m) IN ADVANCE OF THE MAIN ROUTE.
- b) THE CLOSED PORTION OF THE MAIN ROUTE SHALL BE PROTECTED BY BLOCKING WITH TYPE I, TYPE II OR TYPE III BARRICADES, 1/3 OF THE CROSS SECTION OF THE CLOSED PORTION.
- 2. SIDE ROAD WITH A SPEED LIMIT GREATER THAN 40 MPH (60 km/h)
 AS SHOWN ON THE DRAWING AND AS DIRECTED BY THE ENGINEER:
- a) ONE ROAD CONSTRUCTION AHEAD SIGN 48 x 48 (1.2 m x 1.2 m) WITH A FLASHER MOUNTED ON 1T APPROXIMATELY 500' (150 m) IN ADVANCE OF THE MAIN ROUTE.
- b) THE CLOSED PORTION OF THE MAIN ROUTE SHALL BE PROTECTED BY BLOCKING WITH TYPE III BARRICADES, 1/2 OF THE CROSS SECTION OF THE CLOSED PORTION.
- 3. WHEN THE SIDE ROAD LIES BETWEEN THE BEGINNING OF THE MAINLINE SIGNING AND THE WORK ZONE, A SINGLE HEADED ARROW (M6-1) SHALL BE USED IN LIEU OF THE DOUBLE HEADED ARROW (M6-4).

SCALE: NONE


- B. FOR A LANE CLOSURE ON A SIDE ROAD OR DRIVEWAY:
- USE APPLICABLE PORTIONS OF THE TYPICAL APPLICATION OF TRAFFIC CONTROL DEVICES (STD. 701501, STD. 701606 OR THE APPROPRIATE STANDARD). THE SPACING OF SIGNS AND BARRICADES SHALL BE ADJUSTED FOR FIELD CONDITIONS AS DIRECTED BY THE ENGINEER. THE DIRECTIONAL ARROW SHALL BE COVERED OR REMOVED WHEN NO LONGER CONSISTENT WITH THE SIDE ROAD LANE CLOSURE.
- C. ADVANCE WARNING SIGNS ARE TO BE OMITTED ON DRIVEWAY UNLESS OTHERWISE NOTED.
- D. THE TRAFFIC CONTROL AND PROTECTION FOR SIDE ROADS, INTERSECTIONS.

 AND DRIVEWAYS SHALL BE INCIDENTAL TO THE COST OF SPECIFIED TRAFFIC CONTROL STANDARDS OR ITEMS.

All dimensions are in millimeters (inches) unless otherwise shown.





USER NAME = gaglianobt	DESIGNED - LHA	REVISED -	J. OBERLE 10-18-95
	CHECKED -	REVISED -	A. HOUSEH 03-06-96
PLOT SCALE = 50.000 '/ IN.	DRAWN	REVISED -	A. HOUSEH 10-15-96
PLOT DATE = 18/48/23/11/8	CHECKED - 06-89	REVISED -	T. RAMMACHER 01-06-0

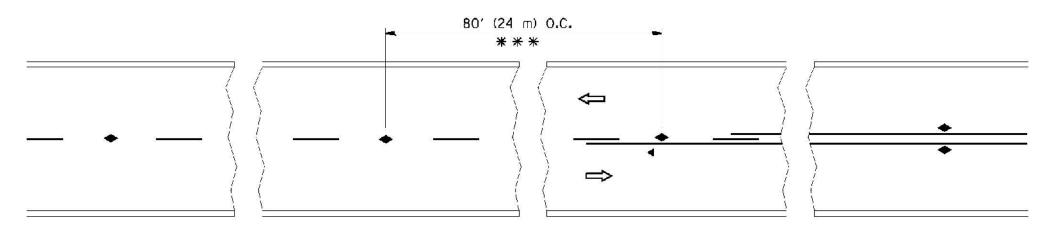


* * REDUCE TO 40' (12 m) O.C. ON CURVES WITH POSTED OR ADVISORY SPEED 45 M.P.H. (70 km/h) OR LESS.

TWO-LANE/TWO-WAY

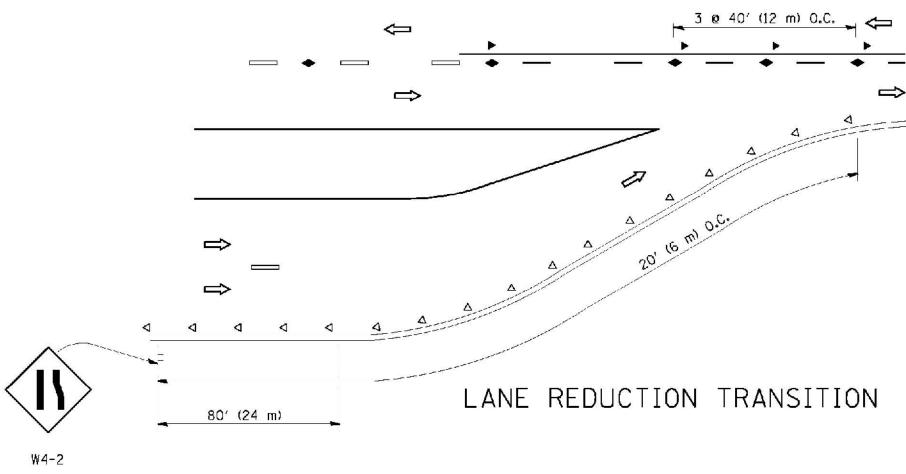


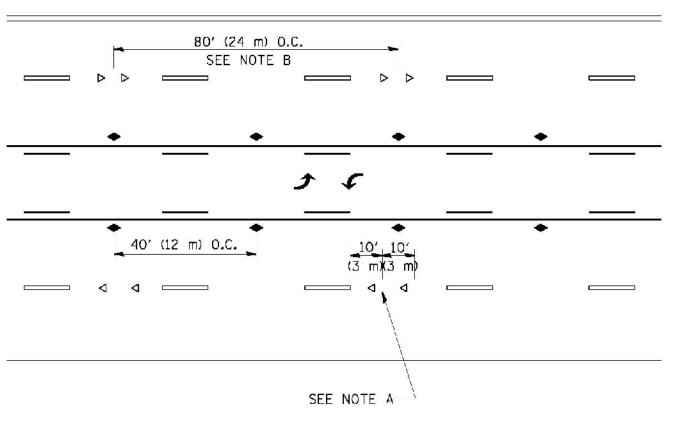

TWO-WAY LEFT TURN

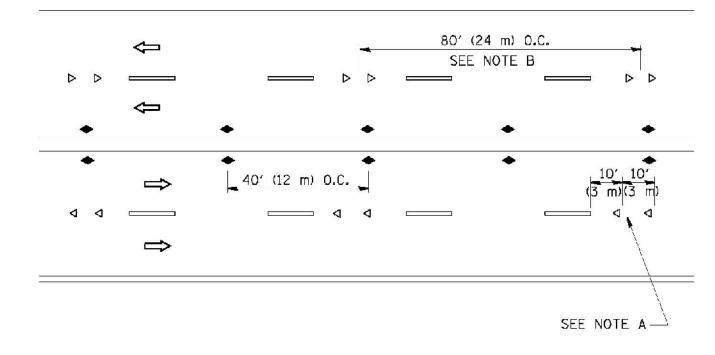

MULTI-LANE/UNDIVIDED

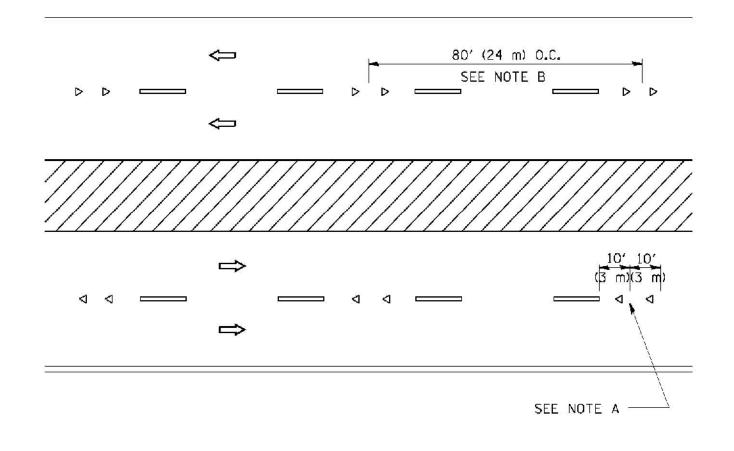

MULTI-LANE/DIVIDED

GENERAL NOTES

- MARKERS USED WITH DASHED LINES SHALL BE CENTERED IN THE GAP BETWEEN SEGMENTS.
- 2. MARKERS USED ADJACENT TO SOLID LINES SHALL BE OFFSET 2 TO 3 (50 TO 75) TOWARD TRAFFIC AS SHOWN.
- 3. MARKERS THROUGH TANGENTS LESS THAN 500' (150 m) IN LENGTH BETWEEN CURVES SHALL BE INSTALLED AT THE LESSER OF THE TWO CURVE SPACINGS.

LANE MARKER NOTES

A. USE DOUBLE LANE LINE MARKERS SPACED AS SHOWN.

B. REDUCE TO 40' (12 m) O.C. ON CURVES WHERE ADVISORY SPEEDS ARE 10 M.P.H (20 km/h) LOWER THAN POSTED SPEEDS.

SYMBOLS


---- YELLOW STRIPE

WHITE STRIPE

- ONE-WAY AMBER MARKER
- ONE-WAY CRYSTAL MARKER (₩/O)
- TWO-WAY AMBER MARKER

DESIGN NOTES

- 1. DOUBLE LANE LINE MARKERS SHALL BE USED UNLESS SPECIFIED OTHERWISE.
- 2. EXCEPT AS SHOWN ON THE LANE REDUCTION TRANSITION AND FREEWAY EXIT RAMP DETAIL, MARKERS ARE NOT TO BE SPECIFIED ON RIGHT EDGE LINES.
- 3. THE EXACT MARKER LIMITS, SPACING, AND COLOR SHOULD BE INCLUDED IN THE PLANS.
- 4. MARKERS SHOULD NOT BE USED ALONGSIDE CURBS EXCEPT FOR EXTREMELY SHORT SECTIONS OF CURBS WHERE NOT MORE THAN TWO MARKERS WOULD BE INVOLVED.

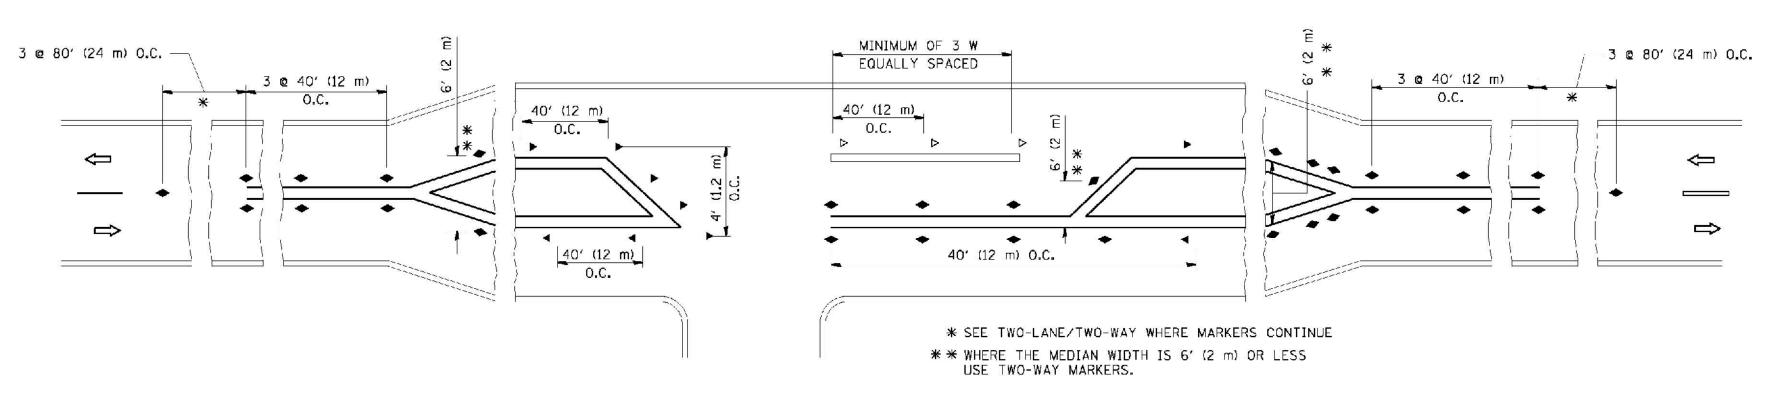


LEFT TURN


All dimensions are in inches (millimeters) unless otherwise shown.




USER NAME = dm.vakosgn	DESIGNED -	REVISED	-T. RAMMACHER	09-19-94
	CHECKED -	REVISED	-T. RAMMACHER	03-12-99
PLOT SCALE = DW.WWK '/ IN.	DRAWN -	REVISED	-T. RAMMACHER	01-06-00
PLOT DATE = 8/8/2009	CHECKED -	REVISED	- C. JUCIUS	09-09-09

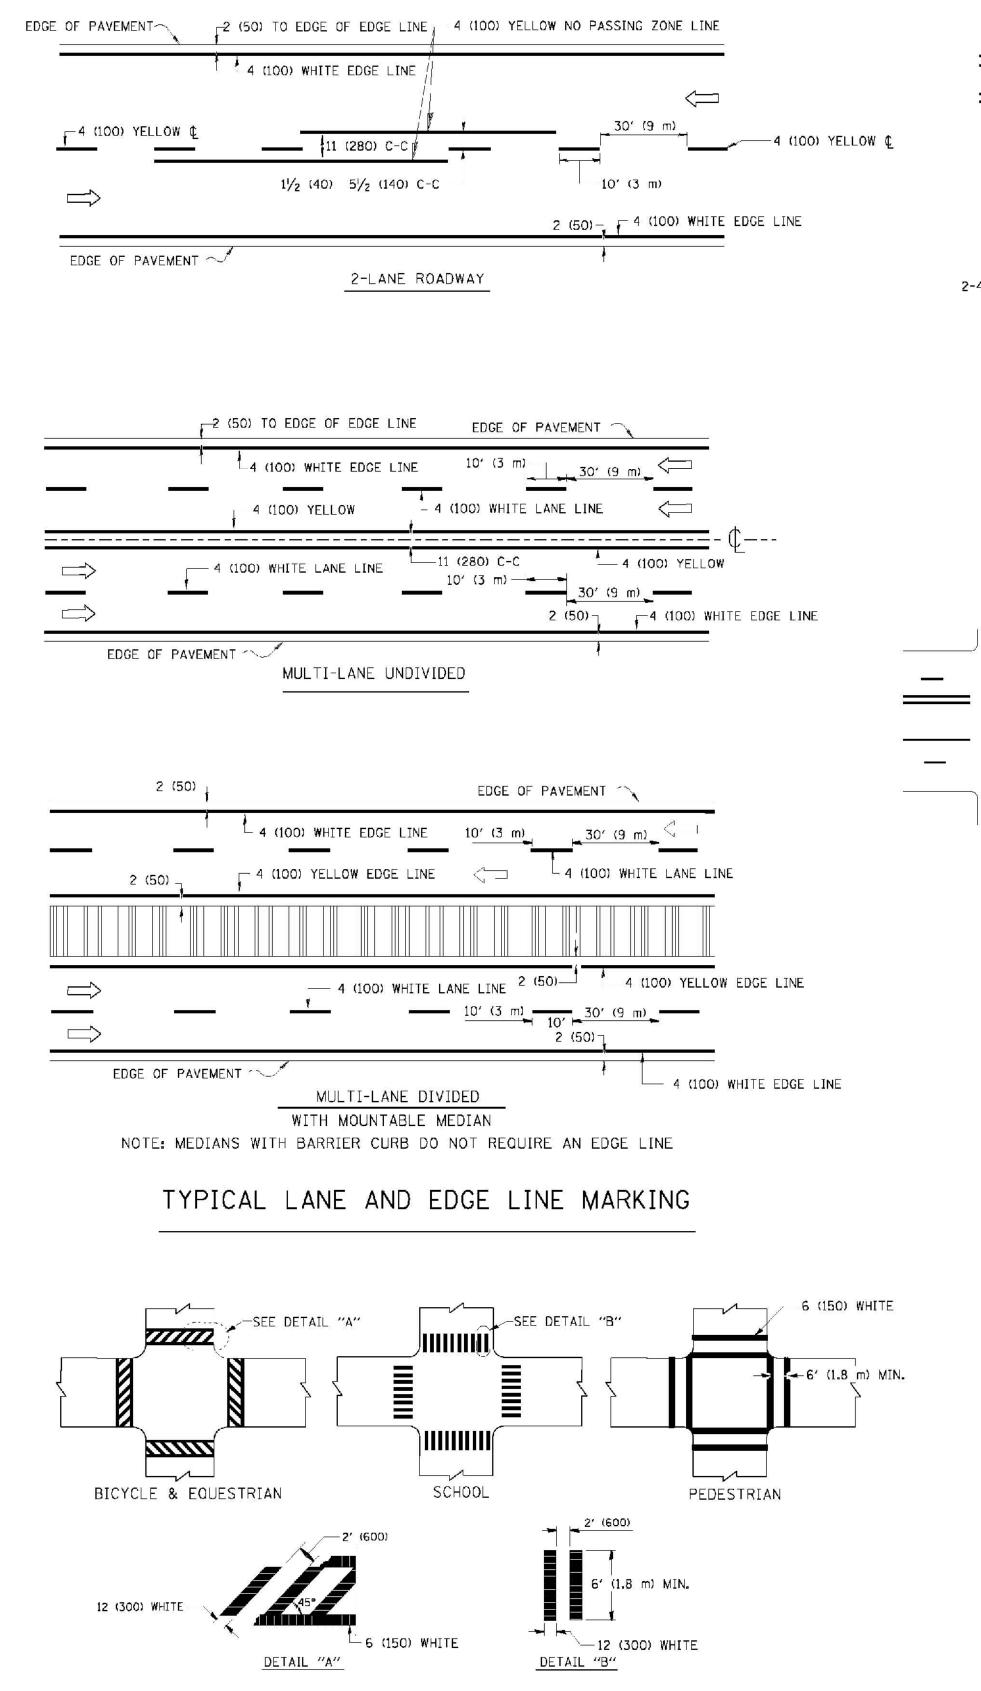

TYPICAL CROSSWALK MARKING

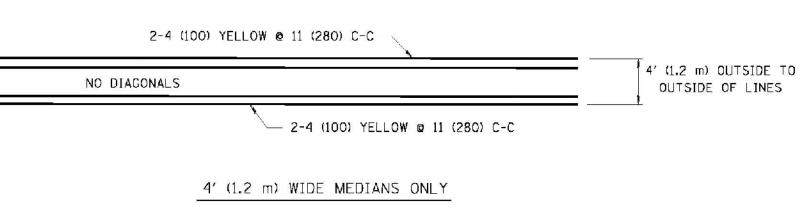

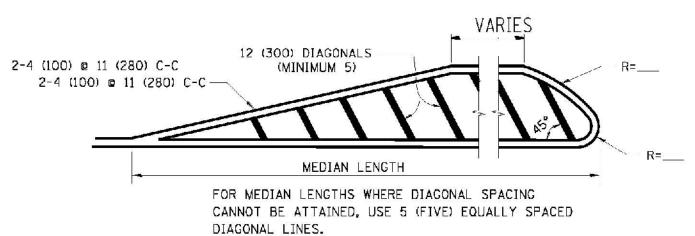


DIAGONAL LINE SPACING: 50' (15 m) C-C (LESS THAN 30MPH (50 km/h)) 75' (25 m) C-C 30MPH (50 km/h) TO 45MPH (70 km/h)) 150' (45 m) C-C (MORE THAN 45MPH (70 km/h))

4 (100) YELLOW LINES (51/2 (140) C-C)

MEDIANS OVER 4' (1.2 m) WIDE _ 4 (100) YELLOW LINES (51/2 (140) C-C)

A MINIMUM OF TWO PAIRS OF TURN ARROWS SHALL BE USED, WHITE IN COLOR. ADDITIONAL PAIRS SHALL BE PLACED AT 200' (60 m) TO 300' (90 m) INTERVALS.

2-4 (100) YELLOW @ 11 (280) C-C

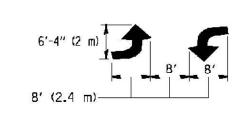

MEDIAN WITH TWO-WAY LEFT TURN LANE

TYPICAL PAINTED MEDIAN MARKING


25' (8 m) TO 49' (15 m) ___50′ (15 m) TO 200′ (60 m) | 16' (5 m) 6 (150) WHITE OVER 200' (60 m)


FULL SIZE LETTERS 8' (2.4 m) AND ARROWS SHALL BE USED. \uparrow AREA = 15.6 SQ. FT. (1.5 m²) (NLY AREA = 20.8 SQ. FT. (1.9 m²)

* TURN LANES IN EXCESS OF 400' (120 m) IN LENGTH MAY HAVE AN ADDITIONAL SET OF ARROW - "ONLY" INSTALLED MIDWAY BETWEEN THE OTHER TWO SETS OF ARROW - "ONLY".

TYPICAL LEFT (OR RIGHT) TURN LANE

TYPICAL TURN LANE MARKING

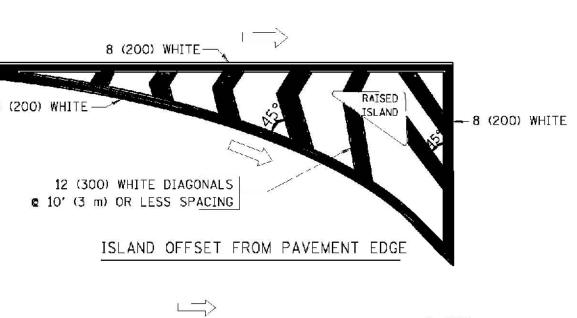

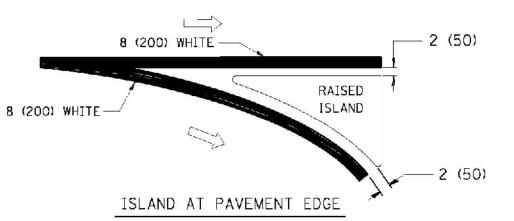

TYPICAL ISLAND MARKING

TYPE OF MARKING	WIDTH OF LINE	PATTERN	COLOR	SPACING / REMARKS
CENTERLINE ON 2 LANE PAVEMENT	4 (100)	SKIP-DASH	YELLOW	10' (3 m) LINE WITH 30' (9 m) SPACE
CENTERLINE ON MULTI-LANE UNDIVIDED PAVEMENT	2 @ 4 (100)	SOLID	YELLOW	11 (280) C-C
NO PASSING ZONE LINES: FOR ONE DIRECTION FOR BOTH DIRECTIONS	4 (100) 2 c 4 (100)	SOLID SOLID	YELLOW YELLOW	5/2 (140) C-C FROM SKIP-DASH CENTERLINE 11 (280) C-C OMIT SKIP-DASH CENTERLINE BETWEEN
LANE LINES	4 (100) 5 (125) ON FREEWAYS	SKIP-DASH SKIP-DASH	WHITE WHITE	10' (3 m) LINE WITH 30' (9 m) SPACE
DOTTED LINES (EXTENSIONS OF CENTER, LANE OR TURN LANE MARKINGS)	SAME AS LINE BEING EXTENDED	SKIP-DASH	SAME AS LINE BEING EXTENDED	2' (600) LINE WITH 6' (1.8 m) SPACE
EDGE LINES	4 (100)	SOLID	YELLOW-LEFT WHITE-RIGHT	OUTLINE MOUNTABLE MEDIANS IN YELLOW; EDGE LINES ARE NOT USED NEXT TO BARRIER CURB
TURN LANE MARKINGS	6 (150) LINE; FULL SIZE LETTERS & SYMBOLS (8' (2.4m))	SOLID	WHITE	SEE TYPICAL TURN LANE MARKING DETAIL
TWO WAY LEFT TURN MARKING	2 @ 4 (100) EACH DIRECTION	SKIP-DASH AND SOLID	YELLOW	10' (3 m) LINE WITH 30' (9 m) SPACE FOR SKIP-DASH; 51/2 (140) C-C BETWEEN SOLID LINE AND SKIP-DASH LINE
	8' (2.4m) LEFT ARROW	IN PAIRS	WHITE	SEE TYPICAL TWO-WAY LEFT TURN MARKING DETAIL
CROSSWALK LINES (PEDESTRIAN) A. DIAGONALS (BIKE & EQUESTRIAN) B. LONGITUDINAL BARS (SCHOOL)	2 c 6 (150) 12 (300) c 45° 12 (300) c 90°	SOLID SOLID SOLID	WHITE WHITE WHITE	NOT LESS THAN 6' (1.8 m) APART 2' (600) APART 2' (600) APART SEE TYPICAL CROSSWALK MARKING DETAILS.
STOP LINES	24 (600)	SOLID	WHITE	PLACE 4' (1.2 m) IN ADVANCE OF AND PARALLEL TO CROSSWALK, IF PRESENT. OTHERWISE, PLACE AT DESIRED STOPPING POINT. PARALLEL TO CROSSROAD CENTERLINE, WHERE POSSIBLE
PAINTED MEDIANS	2 @ 4 (100) WITH 12 (300) DIAGONALS	SOLID	YELLOW: TWO WAY TRAFFIC	11 (280) C-C FOR THE DOUBLE LINE
	@ 45° NO DIAGONALS USED FOR 4' (1.2 m) WIDE MEDIANS		WHITE: ONE WAY TRAFFIC	SEE TYPICAL PAINTED MEDIAN MARKING.
GORE MARKING AND CHANNELIZING LINES	8 (200) WITH 12 (300) DIAGONALS @ 45°	SOLID	WHITE	DIAGONALS: 15' (4.5 m) C-C (LESS THAN 30MPH (50 km/h)) 20' (6 m) C-C 30MPH (50 km/h) TO 45MPH (70 km/h)) 30' (9 m) C-C (OVER 45MPH (70 km/h))
RAILROAD CROSSING	24 (600) TRANSVERSE LINES; "RR" IS 6' (1.8 m) LETTERS; 16 (400) LINE FOR "X"	SOLID	WHITE	SEE STATE STANDARD 780001 AREA OF: "R"=3.6 SO. FT. (0.33 m ²) EACH "X"=54.0 SO. FT. (5.0 m ²)
SHOULDER DIAGONALS	12 (300) @ 45°	SOLID	WHITE - RIGHT YELLOW - LEFT	50' (15 m) C-C (LESS THAN 30MPH (50 km/h)) 75' (25 m) C-C (30 MPH (50 km/h) TO 45MPH (70 km/h)) 150' (45 m) C-C (0VER 45MPH (70 km/h))

FOR FURTHER DETAILS ON PAVEMENT MARKING REFER TO STANDARD SPECIFICATIONS FOR ROAD AND BRIDGE CONSTRUCTION AND STATE STANDARD 780001.

SCALE: NONE

All dimensions are in inches (millimeters)

Wight

DESIGNED **EVERS** -T. RAMMACHER 10-27-94 USER NAME = drivakosgn CHECKED -C. JUCIUS 09-09-09 PLOT SCALE = 57.700 '/ IN. DRAWN REVISED CHECKED 03-19-90 REVISED PLOT DATE = 8/8/2005


STATE OF ILLINOIS DEPARTMENT OF TRANSPORTATION

SECTION DISTRICT ONE 3127-2-SB-I TYPICAL PAVEMENT MARKINGS TC-13

unless otherwise shown.

SHEET NO. 1 OF 1 SHEETS

COUNTY COOK 19 16 CONTRACT NO. 60M71 FED. ROAD DIST. NO. 1 ILLINOIS FED. AID PROJECT

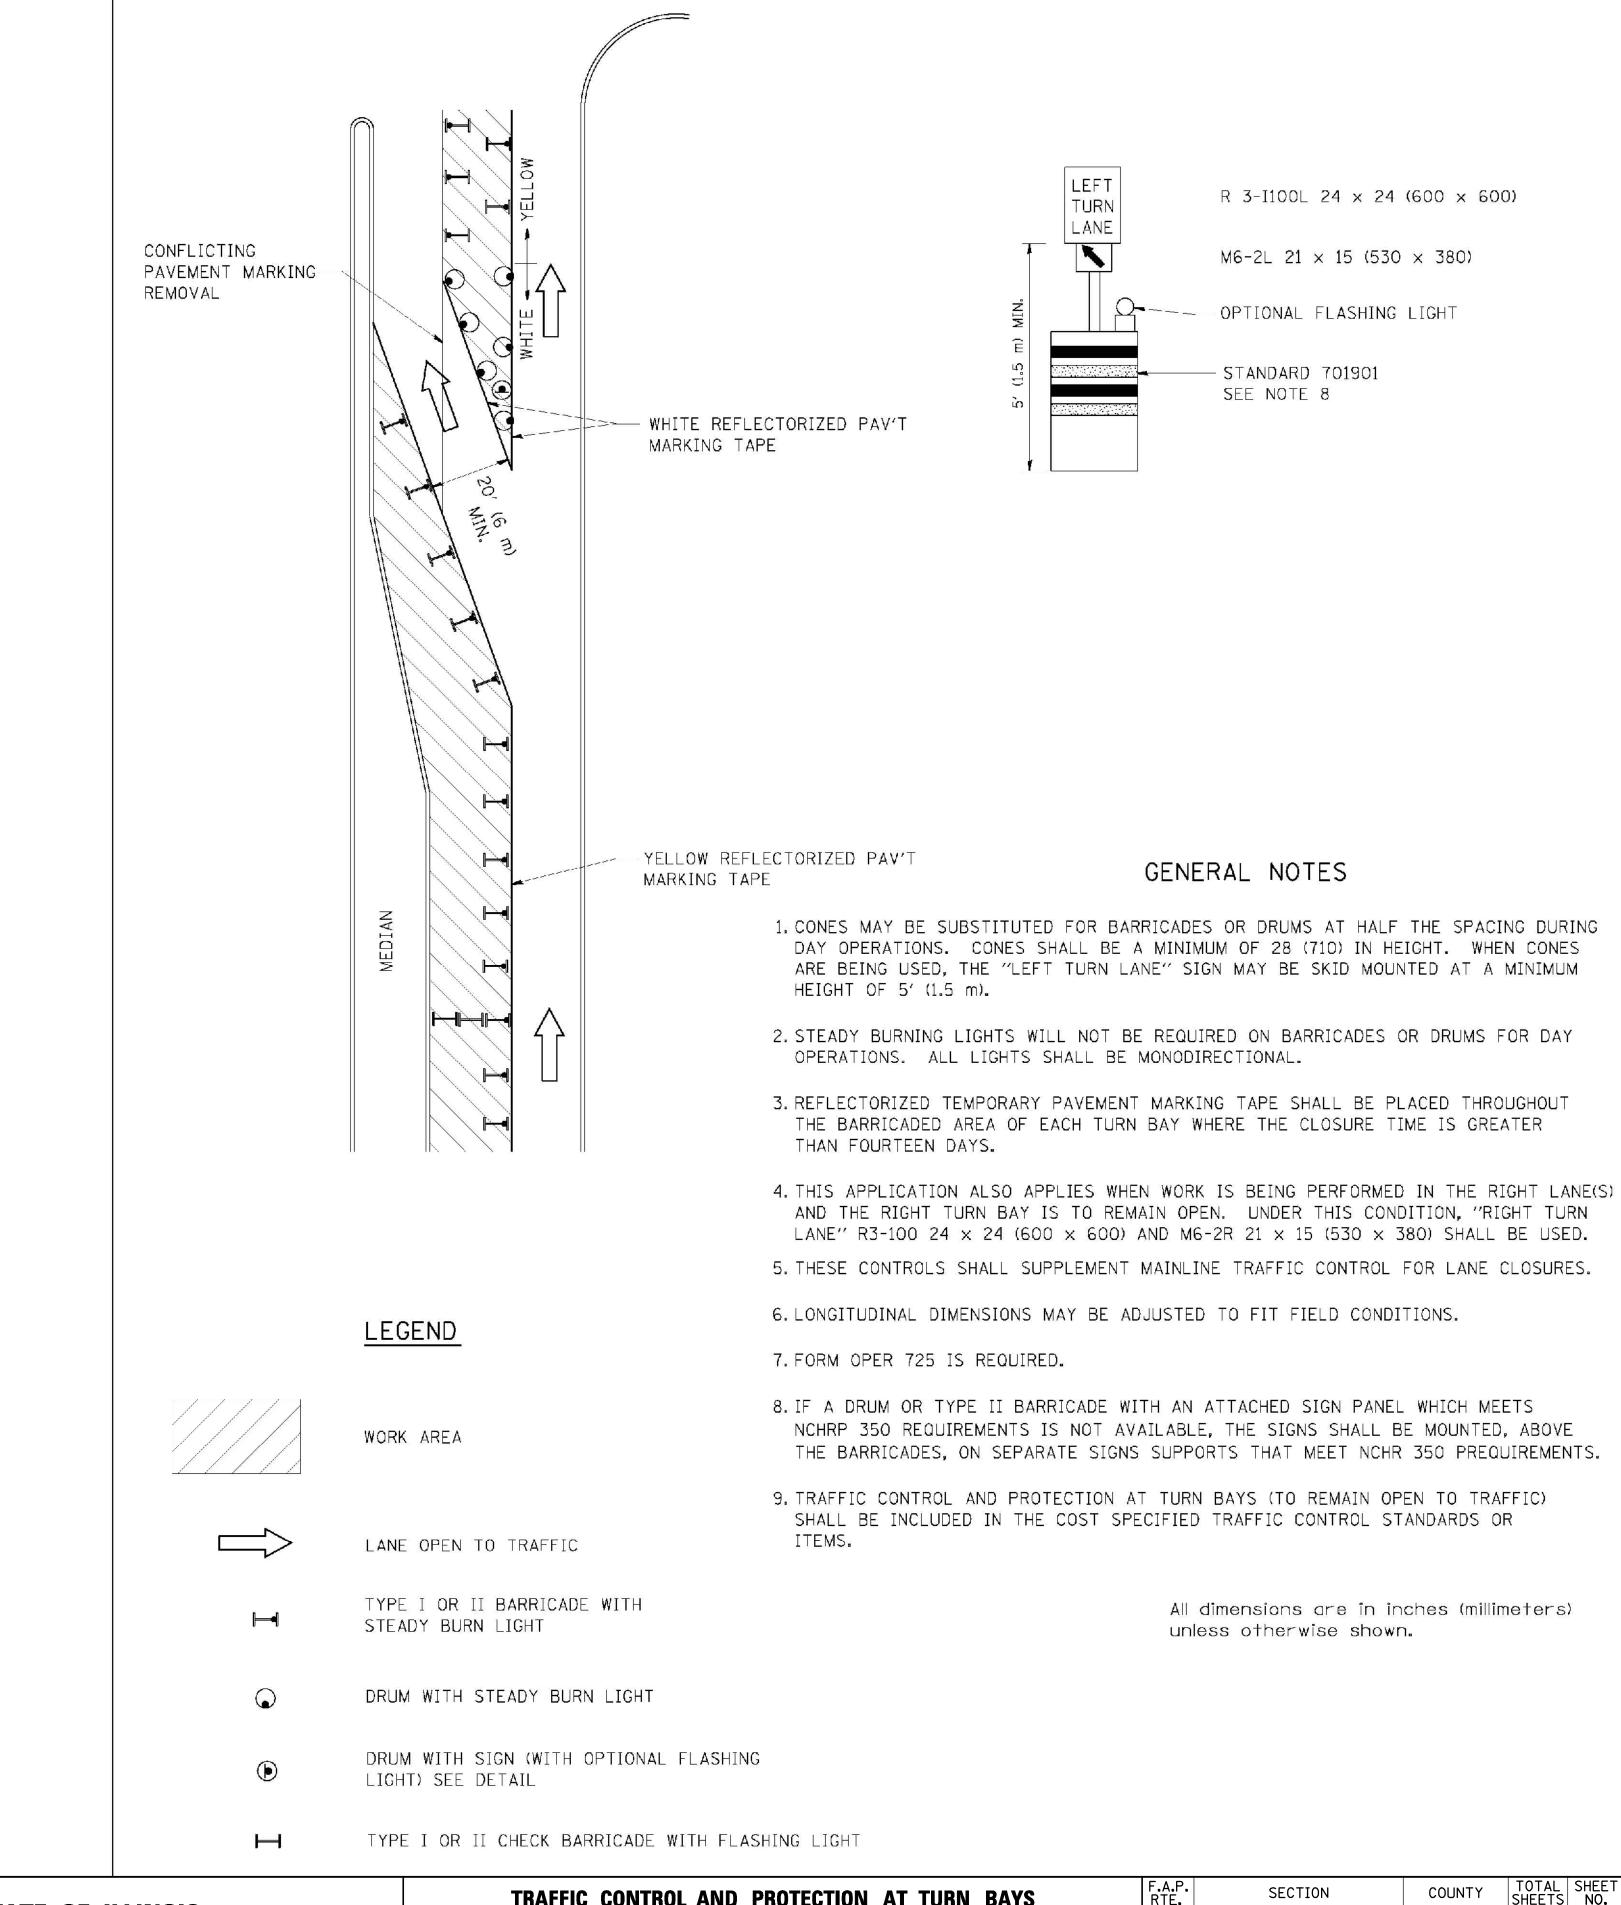




DESIGNED -T. RAMMACHER 09-08-94 REVISED - R. BORO 09-14-09 USER NAME = daryakosgn CHECKED - A. HOUSEH 11-07-95 REVISED - A. HOUSEH 10-12-96 REVISED PLOT SCALE = 49.0000 '/ IN. PLOT DATE = 8/184/200109 CHECKED -T. RAMMACHER 01-06-00 REVISED

STATE OF ILLINOIS DEPARTMENT OF TRANSPORTATION

TRAFFIC CONTROL AND PROTECTION AT TURN BAYS (TO REMAIN OPEN TO TRAFFIC) SCALE: NONE SHEET NO. 1 OF 1 SHEETS

TOTAL SHEET NO. 19 17 3127-2-SB-I COOK TC-14 CONTRACT NO. 60M71 FED. ROAD DIST. NO. 1 ILLINOIS FED. AID PROJECT

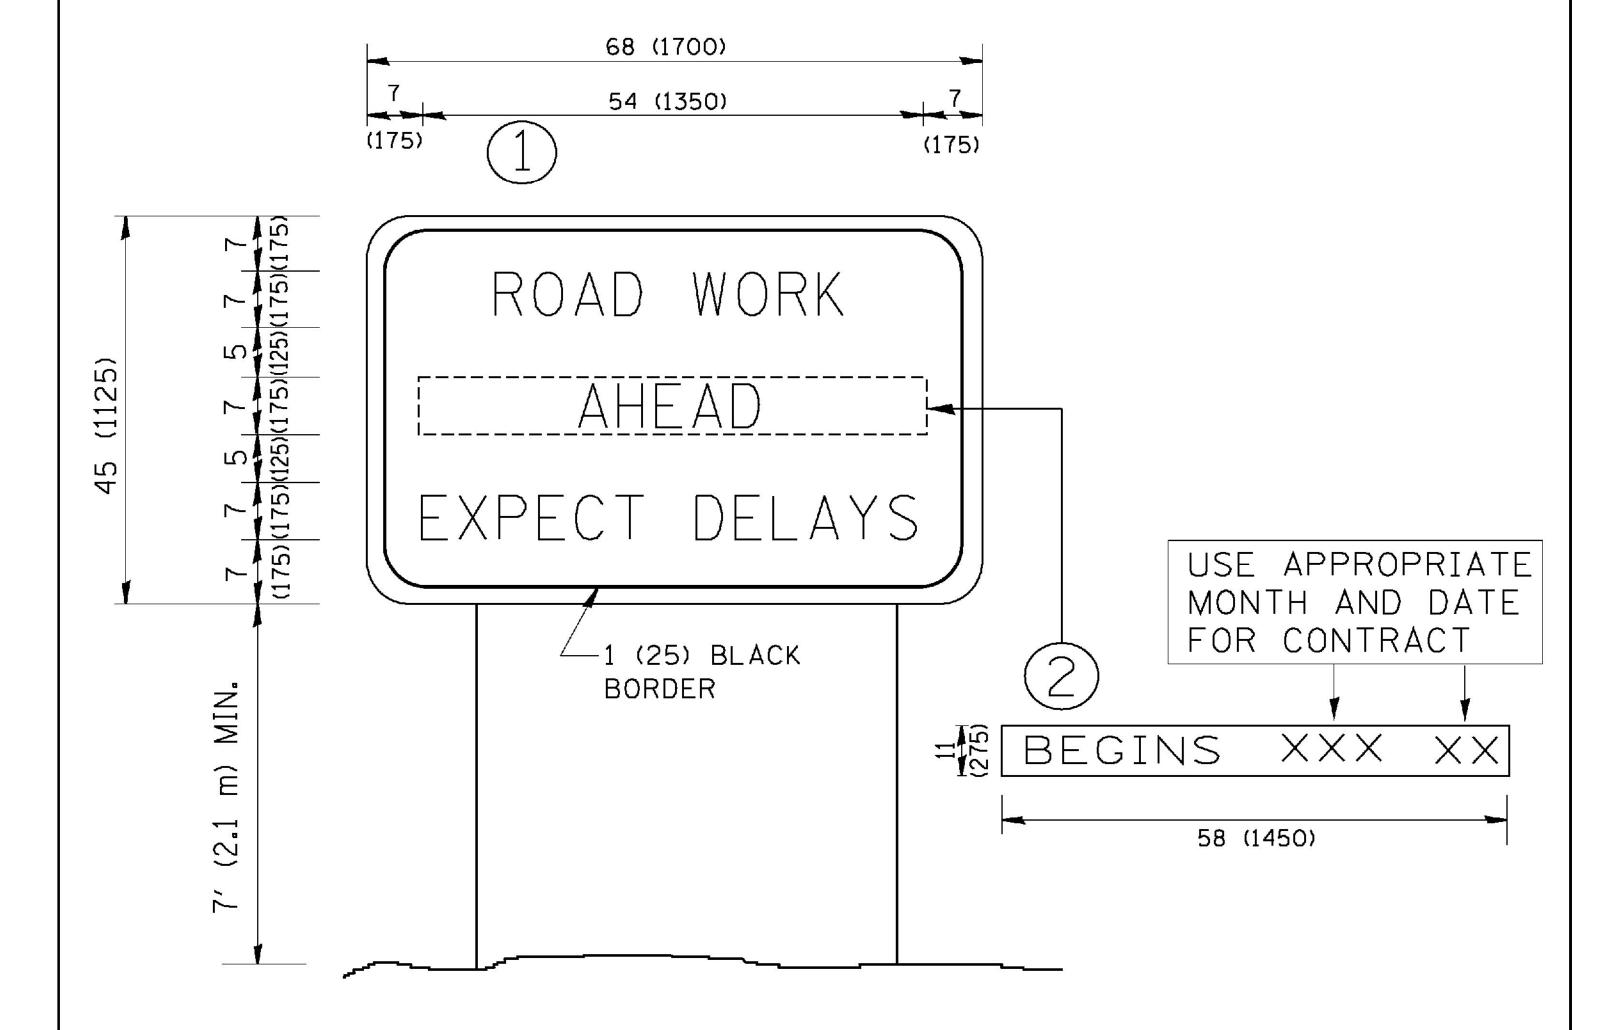

NOTES:

1. USE BLACK LETTERING ON ORANGE BACKGROUND.


SCALE: NONE

- 2. ERECT SIGNS IN ADVANCE OF THE LOCATION FOR THE "ROAD CONSTRUCTION AHEAD" SIGN AT LOCATIONS AS DIRECTED BY THE ENGINEER.
- 3. ERECT SIGN (1) WITH INSTALLED PANEL (2) ONE WEEK PRIOR TO THE START OF CONSTRUCTION.
- 4. REMOVE PANEL 2 SOON AFTER THE START OF CONSTRUCTION.
- 5. SEE SPECIAL PROVISION FOR "TEMPORARY INFORMATION SIGNING" FOR ADDITIONAL INFORMATION.
- 6. ONE SIGN ASSEMBLY EQUALS 25.70 SQ. FT. (2.3 SQ. M.)
- 7. SHALL BE PAID FOR AS TEMPORARY INFORMATION SIGNING.

ALL DIMENSIONS ARE IN INCHES (MILLIMETERS)
UNLESS OTHERWISE SHOWN.



USER NAME = geglienabt	DESIGNED -	REVISED	- R. MIRS 09-15-97
-	CHECKED -	REVISED	- R. MIRS 12-11-97
PLOT SCALE = 50.000 '/ IN.	DRAWN -	REVISED	-T. RAMMACHER 02-02-9
PLOT DATE = 18/46/20008	CHECKED -	REVISED	- C. JUCIUS 01-31-07

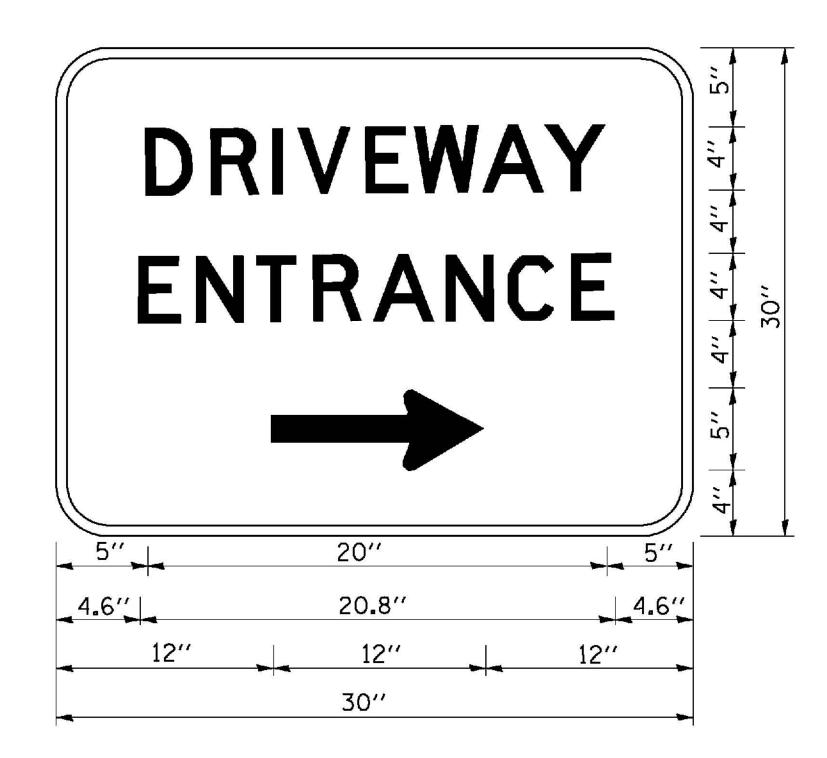

3.0" RADIUS, 0.5" BORDER, WHITE ON GREEN; REFLECTORIZED "DRIVEWAY" D; "ENTRANCE" D; STANDARD ARROW CUSTOM 12.0" x 5.0"

NOTES:

- 1. HALF OF THE SIGNS WILL REQUIRE A LEFT HAND FACING ARROW.
- 2. TWO SIGNS SHALL BE USED AT EACH COMMERCIAL ENTRANCE PLACED BACK-TO-BACK: ONE WITH A RIGHT HAND ARROW (SHOWN) SHALL BE PLACED ON THE NEAR RIGHT SIDE THE DRIVEWAY AND ONE WITH A LEFT HAND ARROW SHALL BE PLACED ON THE FAR LEFT SIDE OF THE DRIVEWAY.
- 3. SIGNS TO BE PAID FOR AS ITEM "TEMPORARY INFORMATION SIGNING".

Wight

USER NAME = gaglianobt	DESIGNED -	REVISED -	C. JUCIUS 02-15-0
	CHECKED -	REVISED -	
PLOT SCALE = 50.000 '/ IN.	DRAWN -	REVISED -	
PLOT DATE = 18/48/20008	CHECKED -	REVISED -	

STATE OF ILLINOIS
DEPARTMENT OF TRANSPORTATION

SCALE: NONE