ROAD CLASSIFICATION = MAJOR COLLECTOR 2017 ADT = 1050 VPD DESIGN SPEED 40 MPH-3R DESIGN STANDARDS POSTED SPEED: 55 MPH

HIGHWAY STANDARDS

STANDARD SYMBOLS, ABBREVIATIONS AND PATTERNS 000001-06 001006 DECIMAL OF AN INCH AND OF A FOOT TEMPORARY EROSION CONTROL SYSTEMS 280001-07 642006 SHOULDER RUMBLE STRIPS, 8in. LANE CLOSURE, 2L. 2W. DAY ONLY, FOR SPEEDS EQUAL OR GREATER THAN 45 MPH 701201-04 LANE CLOSURE, 2L, 2W, SLOW MOVING OPERATIONS DAY ONLY, 701306-04 FOR SPEEDS EQUAL OR GREATER THAN 45 MPH LANE CLOSURE 2L, 2W MOVING OPERATIONS-DAY ONLY 701311-03 TRAFFIC CONTROL DEVICES 701901-07 SIGN PANEL MOUNTING DETAILS 720001-01 SIGN PANEL ERECTION DETAILS 720006-04 TELESCOPING STEEL SIGN SUPPORT 728001-01 TYPICAL PAVEMENT MARKINGS 780001-05 TYPICAL APPLICATIONS RAISED REFLECTIVE PAVEMENT MARKERS 781001-04

VERT. 1" = 5'

DEPARTMENT OF TRANSPORTATION PLANS FOR PROPOSED FEDERAL AID HIGHWAY STR & HSIP FUNDING

STATE OF ILLINOIS

FAS 857 - AMES ROAD - C.H. 5 AMES ROAD RESURFACING SECTION 16-00051-02-RS PROJECT NO. 2KZY (942)

> COUNTY OF MONROE JOB NO. C-98-339-16

1" = 100'

T5S

INDEX OF SHEETS

PLAN:

SHEET NUMBER	DESCRIPTION
1	COVER
2	SUMMARY OF QUANTITIES AND GENERAL NOTES
3	TYPICAL SECTIONS
4-20	PLAN & PROFILE
21-24	DETAILS AND SCHEDULES
25-72	CROSS SECTIONS

MAILBOX TURNOUT FOR LOCAL ROADS

SECTIONS: HORIZ. 1" = 5

R9W R8W T3S TR 1 (RANDOLPH) RAN -LOST ACRES **BEGIN CONSTRUCTION** STA. 0+00 T4S HORSE CREEK BRIDGE STRUCTURE 067-3132 STA. 109+13.66 STA. 111+15.33 I g S T END CONSTRUCTION STA. 251+95.83 TRENAUL NO. DRAWN BY MET BAE & AWM

COUNTY

UTILITIES

BLR 24-2

SCALES:

ELECTRIC - MONROE COUNTY ELECTRIC CO-OP - (618) 939-7171 GAS - CITY OF RED BUD - (618) 282-3339 TELEPHONE - HARRISONVILLE TELEPHONE COMPANY - (888) 482-8353 CALL J.U.L.I.E. BEFORE YOU DIG 800-892-0123

LOCATION MAP

SCALE: 1" = 1.5 MILE GROSS LENGTH = 25,195.83 FEET = 4.772 MILES NET LENGTH = 25,195.83 FEET = 4.772 MILES

PROFESSIONAL DESIGN CERTIFICATION These plans were propared by me or a full time member of my start under my personal supervision 3-15-18

CHECKED BY 5382 AWM BAF

REGISTERED :

DATE 01-16-18

Illinois Registered Professional Engineer No. 055382 Expiration Date: 11/30/19

TOTAL SHEET ROUTE NO SECTION COUNTY SHEETS FAS 857 16-00051 MONROE 72

FEDERAL AID PROJECT CONTRACT 97673



STATE OF ILLINOIS DEPARTMENT OF TRANSPORTATION

APPROVED_ March Monroe County Engineer Monroe County Highway Department

2018 Passed acting District 8 Engineer Local Roads and Streets

Released for Bid Based on

PRINTED BY THE AUTHORITY OF THE STATE OF ILLINOIS

		SUMMARY OF QU	ANTITII	ES		
	CODE NO.	ITEM	UNIT	TOTAL QUANTITY	STR FUNDS	HSIP FUNDS
	20200100	EARTH EXCAVATION	CU. YD.	101		101
	20400800	FURNISHED EXCAVATION	CU. YD.	1286	1071	215
	28000250	TEMPORARY EROSION CONTROL SEEDING	POUND	210	175	35
	28000305	TEMPORARY DITCH CHECKS	FOOT	343	286	57
	28000400	PERIMETER EROSION BARRIER	FOOT	3050	2540	510
	28000500	INLET AND PIPE PROTECTION	EACH	8	8	***
	40200800	AGGREGATE SURFACE COURSE, TYPE B	TON	100	100	
-	40300200	BITUMINOUS MATERIALS (PRIME COAT)	TON	25	25	
	40300400	BITUMINOUS MATERIALS (COVER AND SEAL COATS)	TON	20.8	20.8	
	40300600	SEAL COAT AGGREGATE	TON	252	252	
	40600290	BITUMINOUS MATERIALS (TACK COAT)	POUND	27776	25212	2564
	40600625	LEVELING BINDER (MACHINE METHOD), N70	TON	2306	1705	601
	40600982	40600982 HOT-MIX ASPHALT SURFACE REMOVAL - BUTT JOINT		525	525	
	40600990	TEMPORARY RAMP	SQ. YD.	70	70	
	40603340	HOT-MIX ASPHALT SURFACE COURSE, MIX "D", N70	TON	5186	5186	
	40800050	INCIDENTAL HOT-MIX ASPHALT SURFACING	TON	126	110	16
	48102100	AGGREGATE WEDGE SHOULDER, TYPE B	TON	3186	3186	Wer state
	48203100	HOT-MIX ASPHALT SHOULDERS	TON	820		820
	64200108	SHOULDER RUMBLE STRIPS, 8 INCH	FOOT	4662		4662
	67100100	MOBILIZATION	L SUM	1.0	0.85	0.15
	70300100	SHORT TERM PAVEMENT MARKING	FOOT	3484	3484	
	70300150	SHORT TERM PAVEMENT MARKING REMOVAL	SQ. FT.	840	840	-10-10-1
	70300220	TEMPORARY PAVEMENT MARKING - LINE 4"	FOOT	89159	89159	
٠	72000100	SIGN PANEL - TYPE 1	SQ. FT.	52		52
×	72800100	TELESCOPING STEEL SIGN SUPPORT	FOOT	80		80
	78001110	PAINT PAVEMENT MARKING - LINE 4"	FOOT	89159	89159	
•	78100100	RAISED REFLECTIVE PAVEMENT MARKER	EACH	534	396	138
	X2501000	SEEDING, CLASS 2 (SPECIAL)	ACRE	2.5	2.10	0.40
ļ	X7010216	TRAFFIC CONTROL AND PROTECTION (SPECIAL)	L SUM	1.0	0.85	0.15
ľ	X0327979	PAVEMENT MARKING REMOVAL - GRINDING	FOOT	89159	89159	

* SPECIALTY ITEMS

FEDERAL AID PROJECT CONTRACT 97673

GENERAL NOTES

- 1. THE CONTRACTOR SHALL VERIFY ALL DIMENSIONS AND CONDITIONS IN THE FIELD PRIOR TO CONSTRUCTION AND ORDERING MATERIAL.
- 2. THE CONTRACTOR IS RESPONSIBLE FOR CONTACTING MONROE COUNTY (48) HOURS IN ADVANCE PRIOR TO COMMENCEMENT OF ANY CONSTRUCTION ACTIVITIES OR WORK REQUIRING INSPECTION OR APPROVAL. A COUNTY REPRESENTATIVE CAN BE REACHED AT (618) 939-8681 EXT. 212, FROM 7:30 AM TO 4:30 PM.
- 3. ALL TRAFFIC CONTROL (INCLUDING, BUT NOT LIMITED TO WORK ZONE, TEMPORARY AND PERMANENT) SHALL BE FURNISHED, INSTALLED, MAINTAINED, RELOCATED AND/OR REMOVED IN ACCORDANCE WITH SECTION 701 OF THE LATEST EDITION OF THE IDOT STANDARD SPECIFICATIONS FOR ROAD AND BRIDGE CONSTRUCTION AND THE LATEST EDITION OF THE MANUAL ON UNIFORM TRAFFIC CONTROL DEVICES.
- 4. NO OVERNIGHT LANE CLOSURES ON AMES ROAD SHALL BE ALLOWED.
- 5. TRAFFIC CONTROL SIGNS SHALL BE 48" FLUORESCENT ORANGE RETRO-REFLECTIVE UNLESS OTHERWISE NOTED.
- 6. ALL TEMPORARY PAVEMENT MARKINGS SHALL BE PLACED IN SUCH A MANNER SO AS NOT TO INTERFERE WITH THE PLACEMENT OF PERMANENT PAVEMENT MARKINGS
- 7. APRONS OF SIDEROADS, DRIVES AND MAILBOX TURNOUTS PAVED WITH EXTENDABLE SCREED WIDENERS SHALL BE CONSIDERED AN INTEGRAL PART OF MAINLINE PAVING AND WILL NOT BE MEASURED FOR PAYMENT AS INCIDENTAL HOT—MIX ASPHALT SURFACING, BUT AS EITHER LEVELING BINDER (MACHINE METHOD), N70 OR HMA SURFACE COURSE, MIX "D", N70.
- 8. ALL EXCAVATION/DROPOFFS ADJACENT TO THE EDGE OF PAVEMENT SHALL BE PROTECTED BY TYPE 1 OR 2 BARRICADES WITH STEADY BURN LIGHTS. REFER TO ARTICLE 701.07 OF THE STANDARD SPECIFICATIONS.
- 9. ACCESS SHALL BE PROVIDED FROM PRIVATE ENTRANCES AND SIDEROADS AT ALL LOCATIONS DURING ALL STAGES.
- 10. REMOVAL OF EXISTING AGGREGATE SHOULDER REQUIRED FOR HMA SHALL BE INCLUDED IN THE QUANTITY FOR EARTH EX. MATERIAL MAY BE USED WITHIN EMBANKMENT PER THE STANDARD SPECIFICATIONS SECTION 205.
- 11. SEAL COAT SHOULDERS SHALL CONSIST OF A PRIME, BITUMINOUS SEAL COAT AND AGGREGATE SEAL COAT.
- 12. PAINT PAVEMENT MARKINGS SHALL MATCH EXISTING.
- 13. RIGHT OF WAY WIDTH VARIES. CONTRACTOR SHALL VERIFY RIGHT OF WAY WITH LOCAL AGENCY AND RECEIVE PERMISSION FROM THE LAND OWNER PRIOR TO LEAVING THE ESTABLISHED RIGHT OF WAY FOR ANY REASON. REFER TO SPECIAL PROVISION PAGE 9 FOR MORE DETAIL.
- 14. IN ORDER TO MINIMIZE THE "BUMP" AT SIDE ROAD/DRIVE LOCATIONS, AT THE END OF EACH DAY OF PAVING, THE CONTRACTOR SHALL COMPLETE INCIDENTAL HMA AT ANY SIDE ROAD/ENTRANCE THAT HAS A GREATER THAN 2" BUMP AT AMES ROAD, UNLESS THE APRON IS PERFORMED PER NOTE 7 ABOVE. THE SIDEROAD/ENTRANCE GRADE SHALL CLOSELY MATCH THAT SHOWN IN THESE PLANS.

FACTORS USED FOR QUANTITY CALCULATIONS ARE AS FOLLOWS:

ALL HOT MIX ASPHALT - 112.0 LBS/SQ YD PER 1" THICKNESS

BITUMINOUS MATERIAL (TACK COAT) OVER AGED NON MILLED ASPHALT - 0.05 LB/SQ FT

BITUMINOUS MATERIAL (TACK COAT) OVER HMA LIFTS - 0.025 LB/SQ FT

AGGREGATE BASE/SURFACE - 2.05 TON/CU YD

BITUMINOUS MATERIALS (PRIME COAT) ON SHOULDER - 0.3 GAL/SQ YD

BITUMINOUS MATERIAL (COVER AND SEAL COAT) ON SHOULDER - 0.25 GAL/SQ YD

SEAL COAT AGGREGATE ON SHOULDER - 25 LBS/SQ YD


SALVAGE: NONE

COMMITMENTS: NONE

AMES ROAD RESURFACING GENERAL NOTES AND SUMMARY OF QUANTITIES SEC 16-00051-02-RS MONROE COUNTY, ILLINOIS

PROPOSED SUPERELEVATED SECTION CURVE WITH HOT-MIX ASPHALT SHOULDERS

CURVE NO. 3 FULL S.E. (8.0%) STA. 62+98.44 TO STA. 65+80.87 S.E. TRANSITION STA. 61+04.44 TO STA. 62+98.44 AND STA. 65+80.87 TO STA. 67+74.87 CURVE NO. 4 FULL S.E. (7.0%) STA. 74+90.00 TO STA. 76+82.93 S.E. TRANSITION STA. 73+17.00 TO STA. 74+90.00 AND STA. 76+82.93 TO STA. 78+55.93 CURVE NO. 12 FULL S.E. (7.0%) STA. 181+38.15 TO STA. 182+59.60 S.E. TRANSITION STA. 179+96.15 TO STA. 181+38.15 AND STA. 182+59.60 TO STA. 184+01.60 CURVE NO. 13 FULL S.E. (6.5%) STA. 187+57.65 TO STA. 191+47.31 S.E. TRANSITION STA. 185+94.65 TO STA. 187+57.65 AND STA. 191+47.31 TO STA. 193+10.31

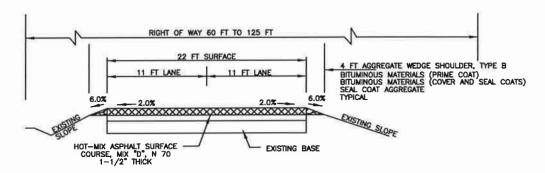

PROPOSED TYPICAL SECTION


TANGENT

STA. 0+00.00 TO STA. 14+17.33 STA. 22+46.18 TO STA. 29+51.62 STA. 35+93.47 TO STA. 61+04.44 STA. 67+74.87 TO STA. 73+17.00 STA. 78+55.93 TO STA. 81+78.84 STA. 86+52.78 TO STA. 105+19.89 STA. 111+15.33 TO STA. 113+04.91 STA. 121+48.33 TO STA. 124+66.96 STA. 130+70.88 TO STA. 141+45.51 STA, 147+29.94 TO STA, 155+51.40 STA. 168+30.02 TO STA. 179+96.15 STA. 184+01.60 TO STA. 185+94.65 STA. 193+10.31 TO STA. 193+56.50 STA. 198+78.65 TO STA. 202+05.55 STA 211+49.78 TO STA 214+63.75 STA, 221+46.31 TO STA, 222+90.17 STA. 230+23.21 TO STA. 251+95.83


REFER TO CROSS SECTIONS SHEETS 25-72 FOR MORE DETAIL SECTIONS INCLUDE ONLY STATIONS ON CURVE, TANGENT SECTIONS SHALL FOLLOW THESE TYPICAL SECTIONS.



STA. 0+00 TO STA. 109+13.66 STA. 111+15.33 TO STA. 251+95.83

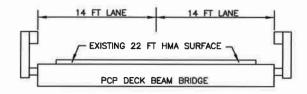

EXISTING BRIDGE SECTION STA. 109+13.66 TO STA. 111+15.33

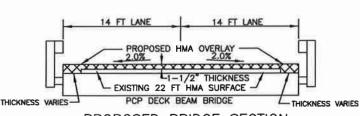

ROUTE NO SECTION

FAS 857

16-00051

-02-RS

COUNTY TOTAL SHEET NO.

72


MONROE

CONTRACT 97673

FEDERAL AID PROJECT

3

PROPOSED BRIDGE SECTION STA. 109+13.66 TO STA. 111+15.33

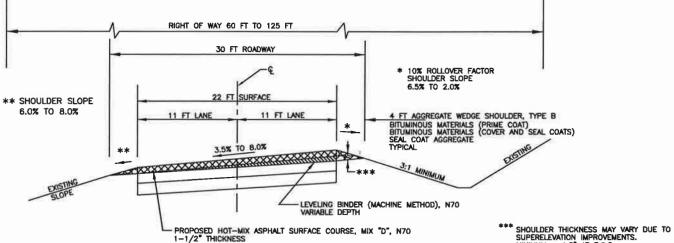

PROPOSED SUPERELEVATED SECTION

CURVE WITH AGGREGATE SHOULDERS

CURVE NO. 1 FULL S.E. (6.0%) STA. 15+70.33 TO STA. 20+93.18 S.E. TRANSITION STA 14+17.33 TO STA 15+70.33 AND STA 20+93.18 TO STA 22+46.18 CURVE NO. 2 FULL S.E. (7.5%) STA 31+35.62 TO STA 34+09.47

S.E. TRANSITION STA 29+51.62 TO STA 31+35.62 AND STA. 34+09.47 TO STA. 35+93.47 CURVE NO. 5 FULL S.E. (4.0%) STA. 82+99.84 TO STA. 85+31.78

S.E. TRANSITION STA 81+78.84 TO STA 82+99.84 AND STA. 85+31.78 TO STA. 86+52.78

CURVE NO. 6 FULL S.E. (3.5%) STA. 106+29.89 TO STA. 108+10.43
S.E. TRANSITION STA. 105+19.89 TO STA. 106+29.89 AND STA. 108+10.43 TO STA. 109+13.66
CURVE NO. 7 FULL S.E. (4.0%) STA. 114+25.91 TO STA. 120+27.33
S.E. TRANSITION STA. 113+04.91 TO STA. 114+25.91 AND STA. 120+27.33 TO STA. 121+48.33

CURVE NO. 8 FULL S.E. (5.5%) STA. 126+20.96 TO STA. 129+16.88

S.E. TRANSITION STA. 124+66.96 TO STA. 126+20.96 AND STA. 129+16.88 TO STA. 130+70.88 CURVE NO. 9 FULL S.E. (3.5%) STA. 142+55.51 TO STA. 146+19.94 S.E. TRANSITION STA. 141+45.51 TO STA. 142+55.51 AND STA. 146+19.94 TO STA. 147+29.94

CURVE NO. 10 FULL S.E. (6.0%) STA. 157+04.40 TO STA. 161+92.95 S.E. TRANSITION STA. 155+51.40 TO STA. 157+04.40 AND STA. 161+92.95 TO STA. 163+45.95

CURVE NO. 11 FULL S.E. (3.5%) STA. 164+55.95 TO STA. 167+20.02
S.E. TRANSITION STA. 163+45.95 TO STA. 164+55.95 AND STA. 167+20.02 TO STA. 168+30.02
CURVE NO. 14 FULL S.E. (6.0%) STA. 195+21.50 TO STA. 197+13.65
S.E. TRANSITION STA. 193+56.50 TO STA. 195+21.50 AND STA. 197+13.65 TO STA. 198+78.65


CURVE NO. 15 FULL S.E. (4.5%) STA. 203+37.55 TO STA. 210+17.78 S.E. TRANSITION STA. 202+05.55 TO STA. 203+37.55 AND STA. 210+17.78 TO STA. 211+49.78 CURVE NO. 16 FULL S.E. (7.5%) STA. 216+73.75 TO STA. 219+36.31 S.E. TRANSITION STA. 214+63.75 TO STA. 216+73.75 AND STA. 219+36.31 TO STA. 221+46.31


CURVE NO. 17 FULL S.E. (8.0%) STA. 225+00.17 TO STA. 228+13.21


S.E. TRANSITION STA. 222+90.17 TO STA. 225+00.17 AND STA. 228+13.21 TO STA. 230+23.21


MINIMUM = 1.5" AT E.O.P.
MAXIMUM = 8" AT E.O.P.


AMES ROAD RESURFACING TYPICAL SECTIONS SEC 16-00051-02-RS MONROE COUNTY, ILLINOIS

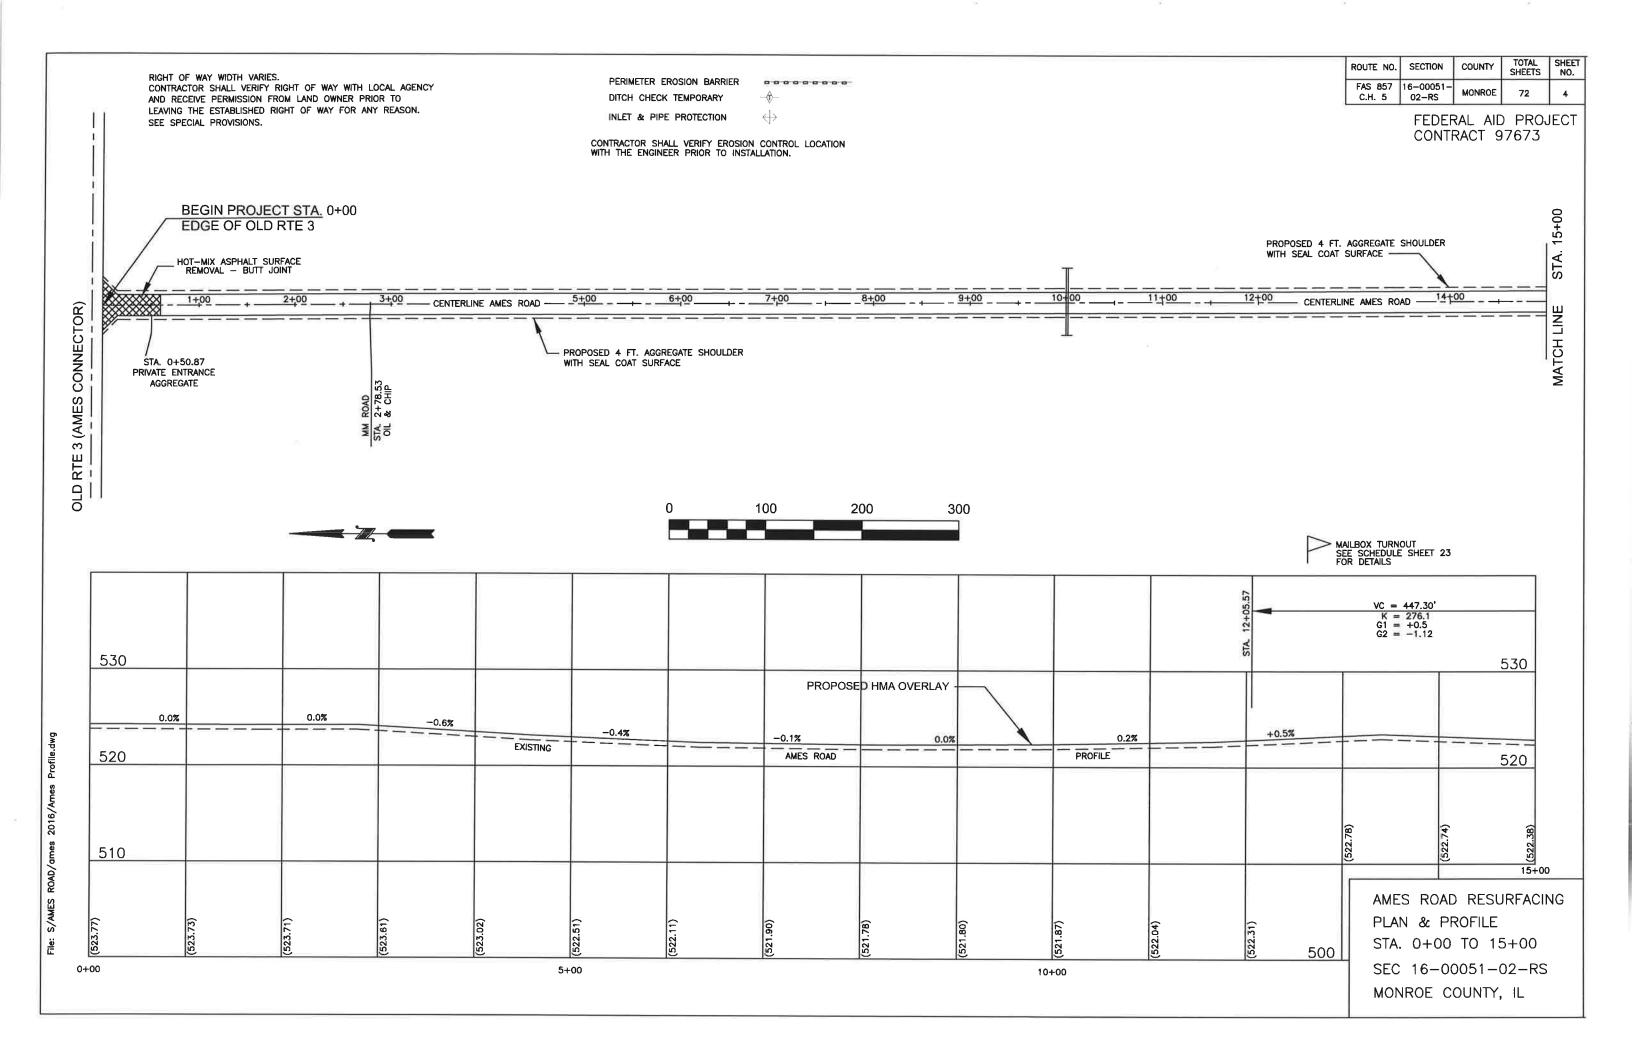


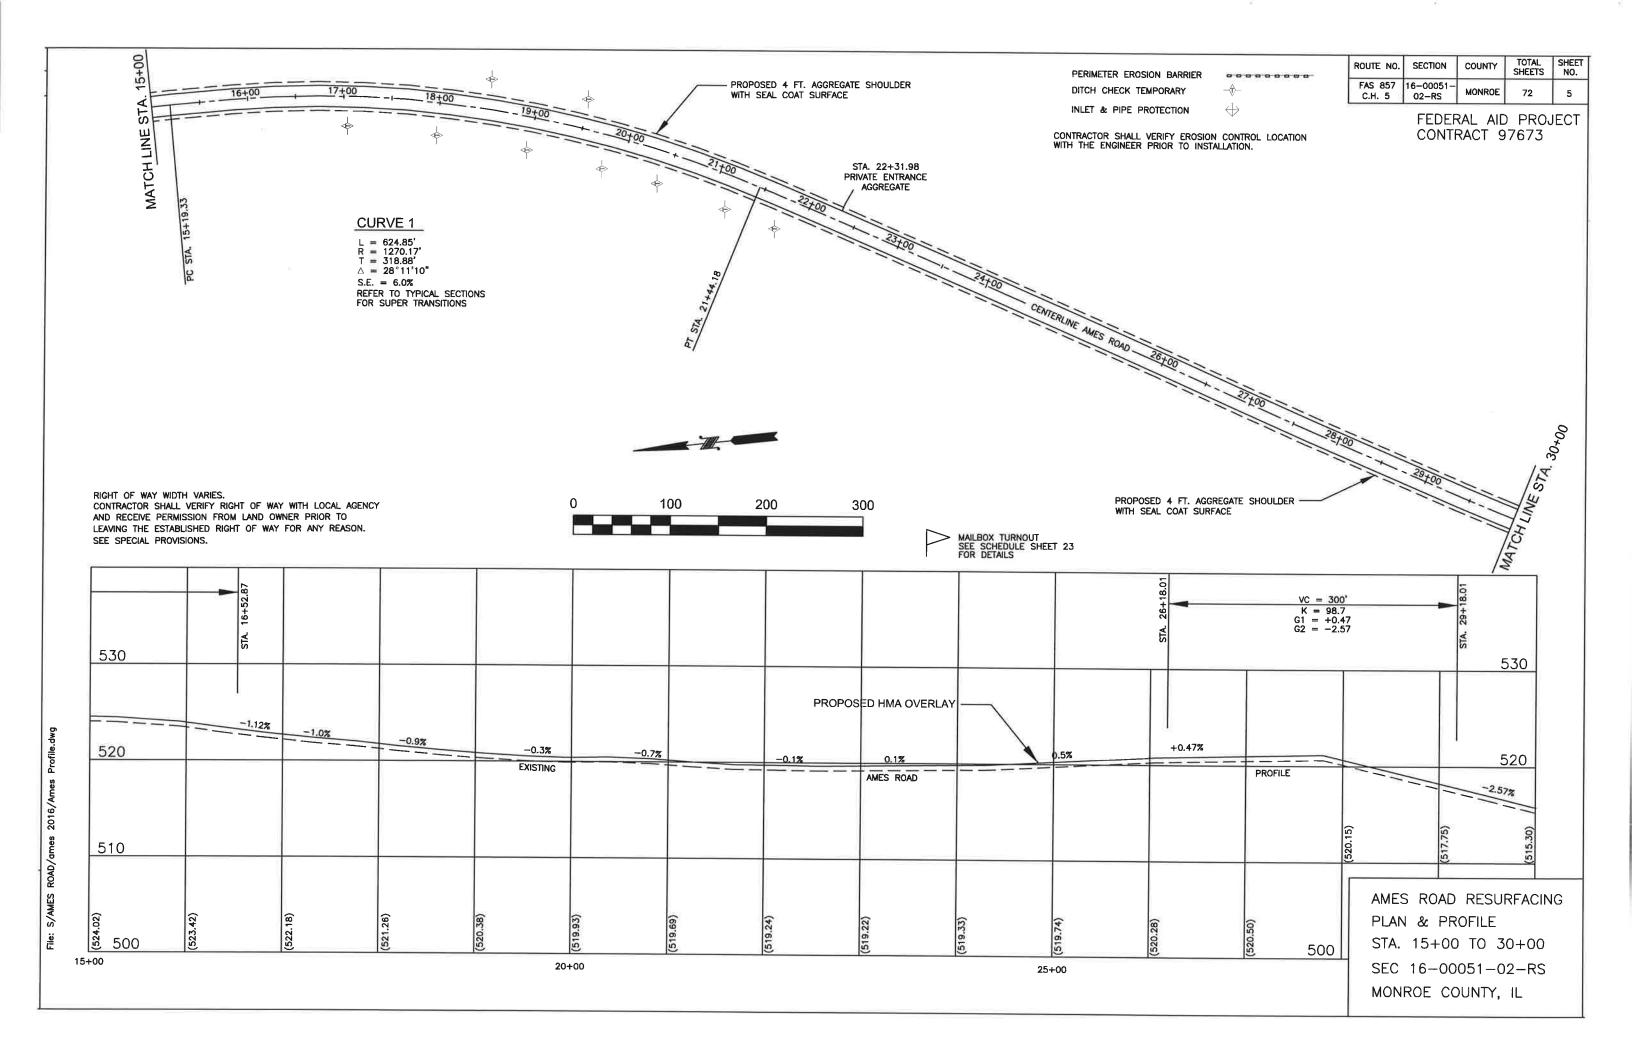

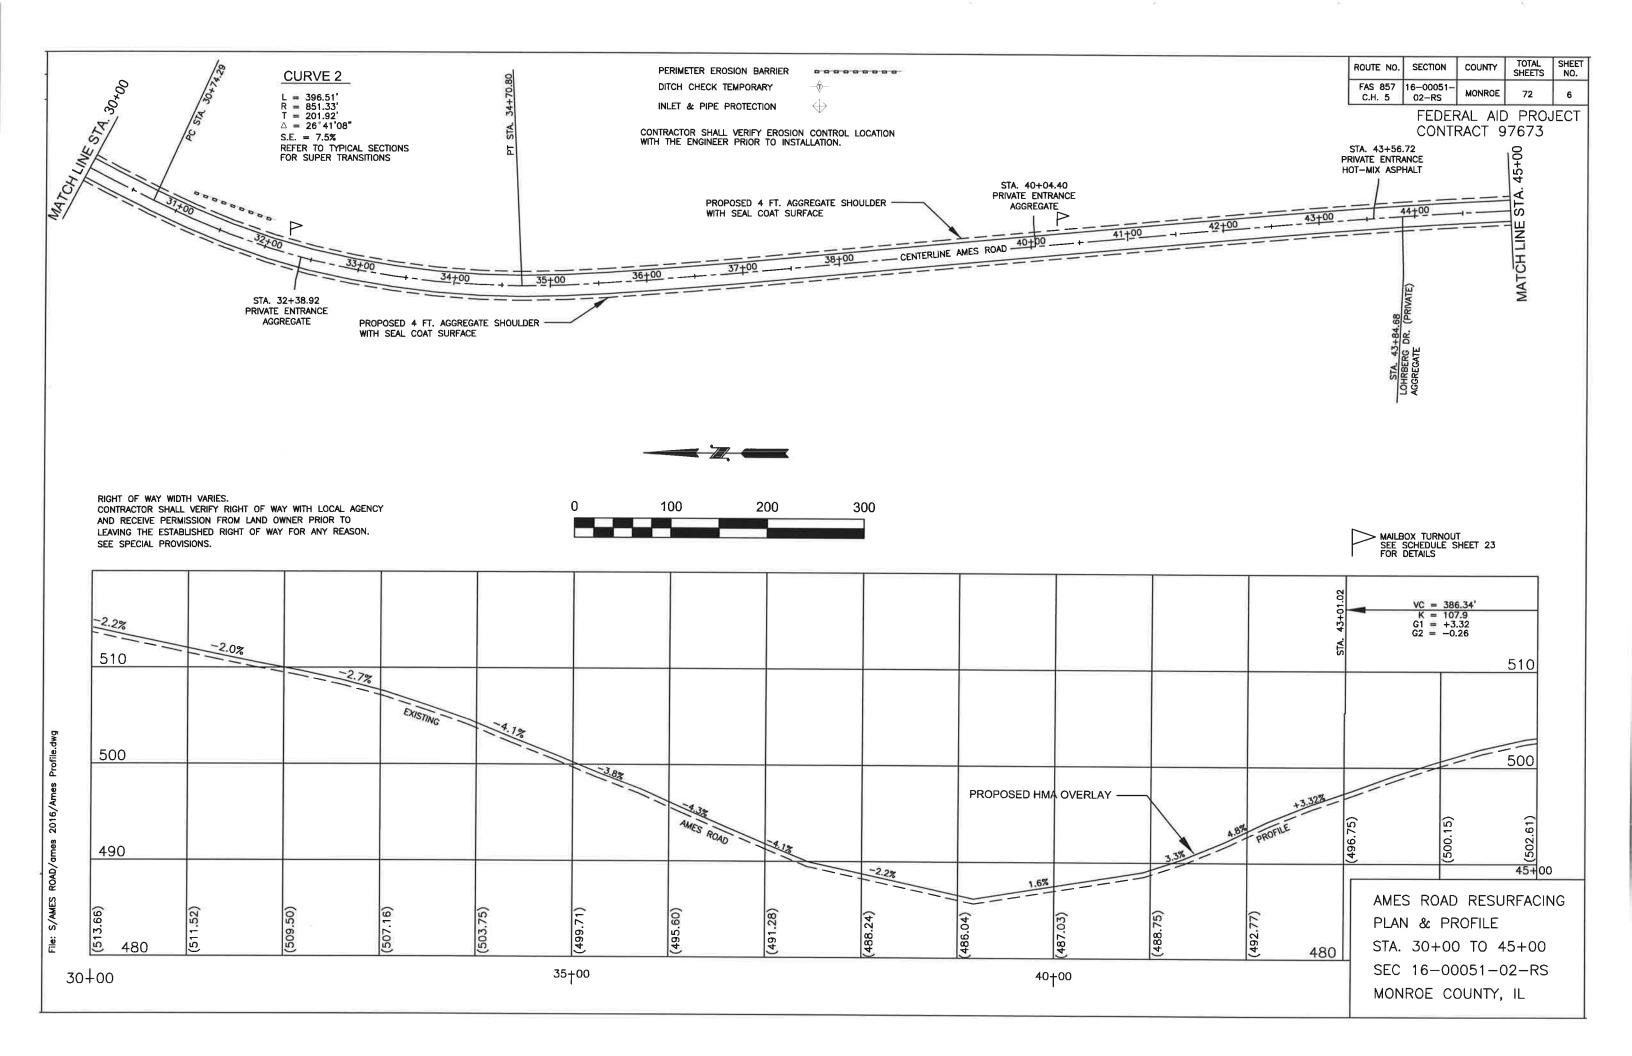


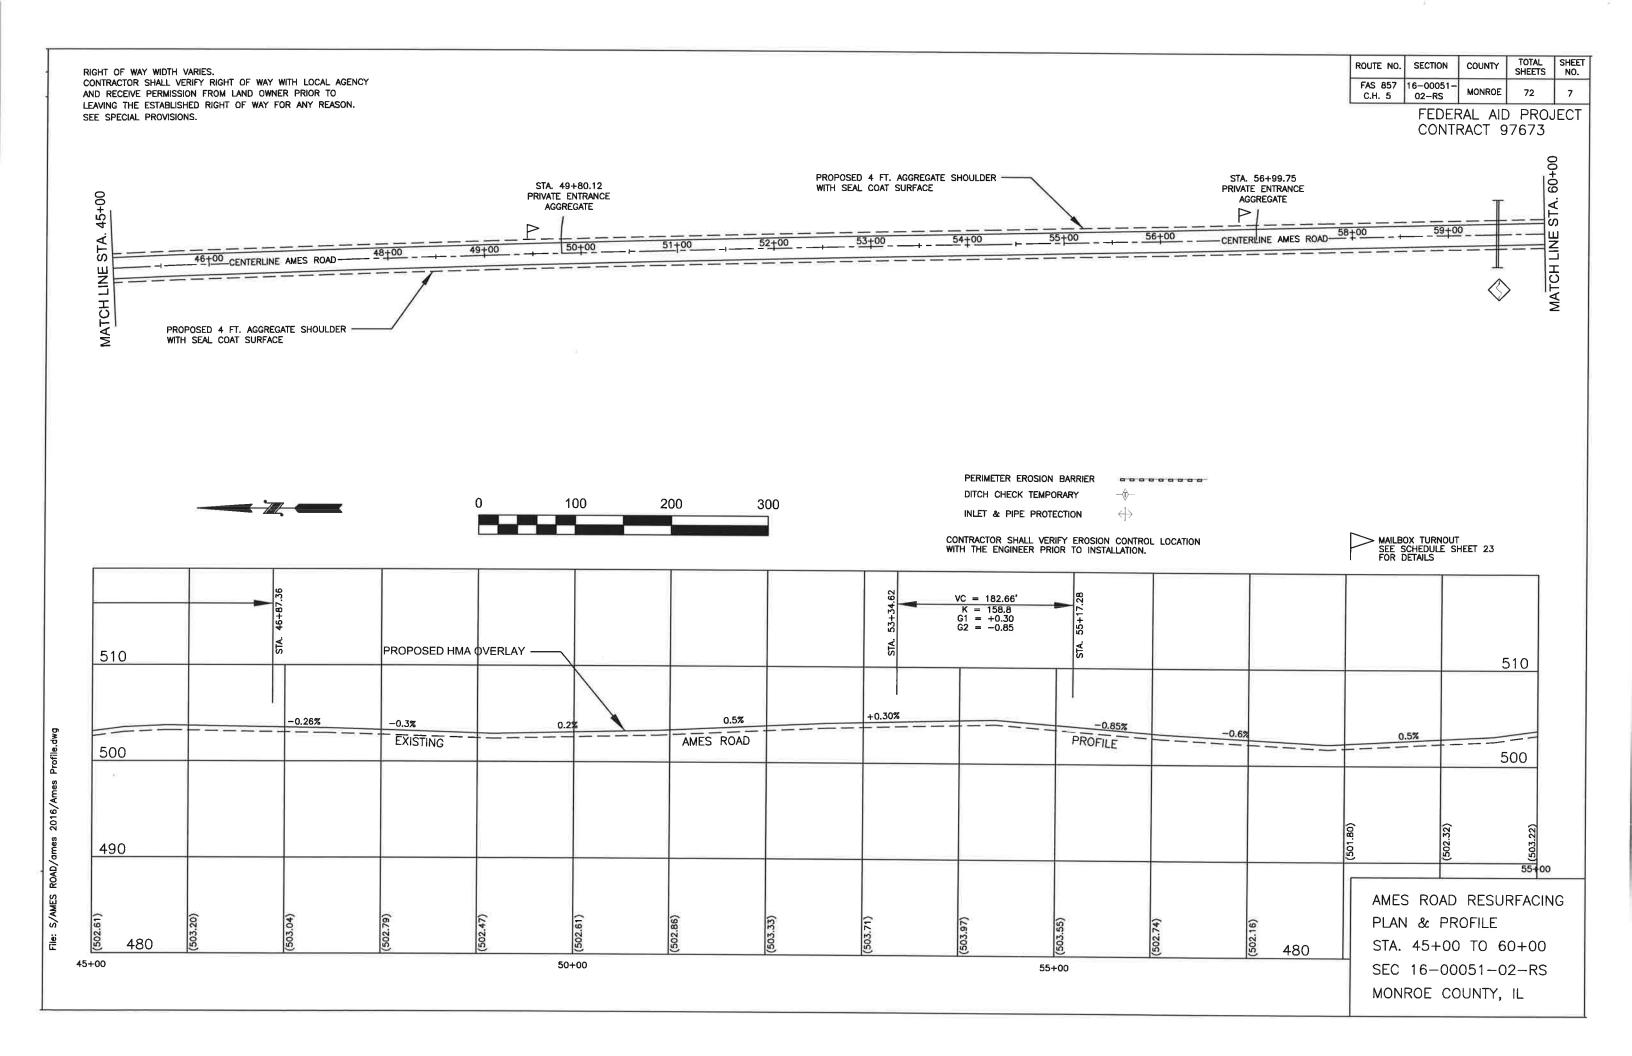


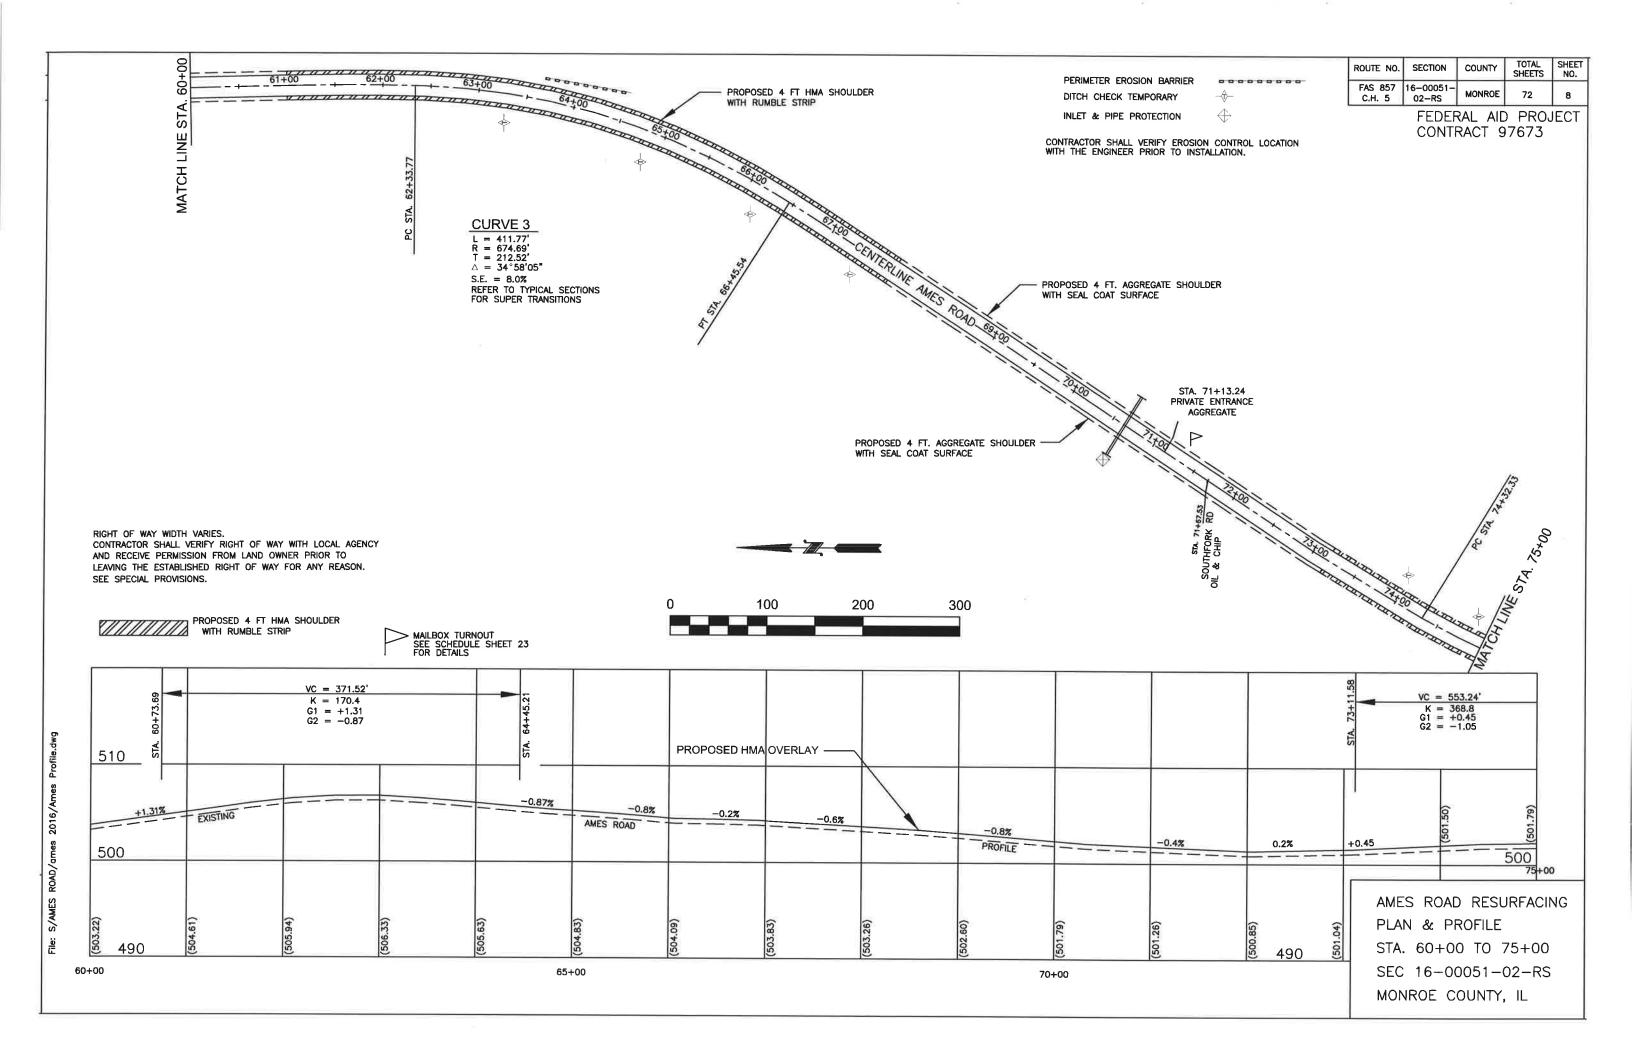


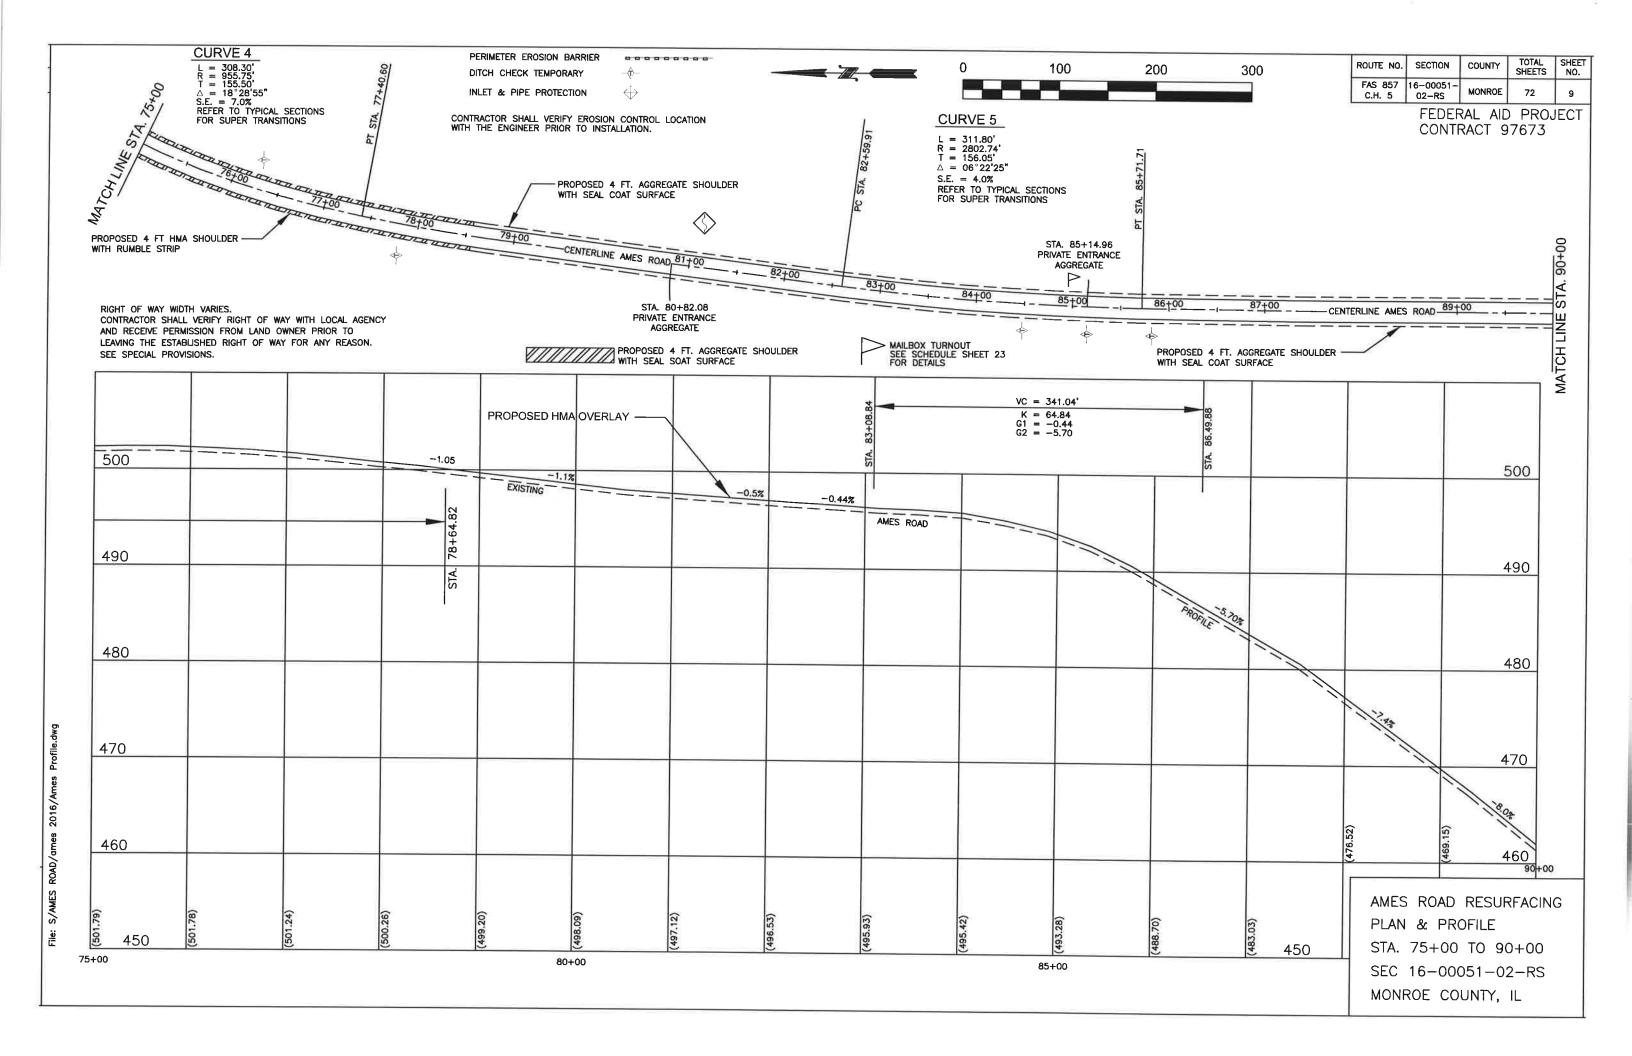



TOTAL SHEETS SHEET NO. RIGHT OF WAY WIDTH VARIES. ROUTE NO. SECTION COUNTY PERIMETER EROSION BARRIER CONTRACTOR SHALL VERIFY RIGHT OF WAY WITH LOCAL AGENCY FAS 857 16-00051 AND RECEIVE PERMISSION FROM LAND OWNER PRIOR TO DITCH CHECK TEMPORARY 72 10 LEAVING THE ESTABLISHED RIGHT OF WAY FOR ANY REASON. C.H. 5 02-RS INLET & PIPE PROTECTION SEE SPECIAL PROVISIONS. FEDERAL AID PROJECT CONTRACT 97673 CONTRACTOR SHALL VERIFY EROSION CONTROL LOCATION WITH THE ENGINEER PRIOR TO INSTALLATION. 00+06 STA. 98+67.62 WHITE PINE LANE (PRIVATE) STA. 105+00 PROPOSED 4 FT. AGGREGATE SHOULDER AGGREGATE WITH SEAL COAT SURFACE MATCH LINE MATCH PROPOSED 4 FT. AGGREGATE SHOULDER WITH SEAL COAT SURFACE 100 200 300 MAILBOX TURNOUT
SEE SCHEDULE SHEET 23
FOR DETAILS 460 460 450 450 PROPOSED HMA OVERLAY 440 440 0.0% 0.1% 0.1% -0.1% 0.0% AMES ROAD PROFILE 430 430 AMES ROAD RESURFACING PLAN & PROFILE STA. 90+00 TO 105+00 420 90+00 95+00 100+00 SEC 16-00051-02-RS MONROE COUNTY, IL

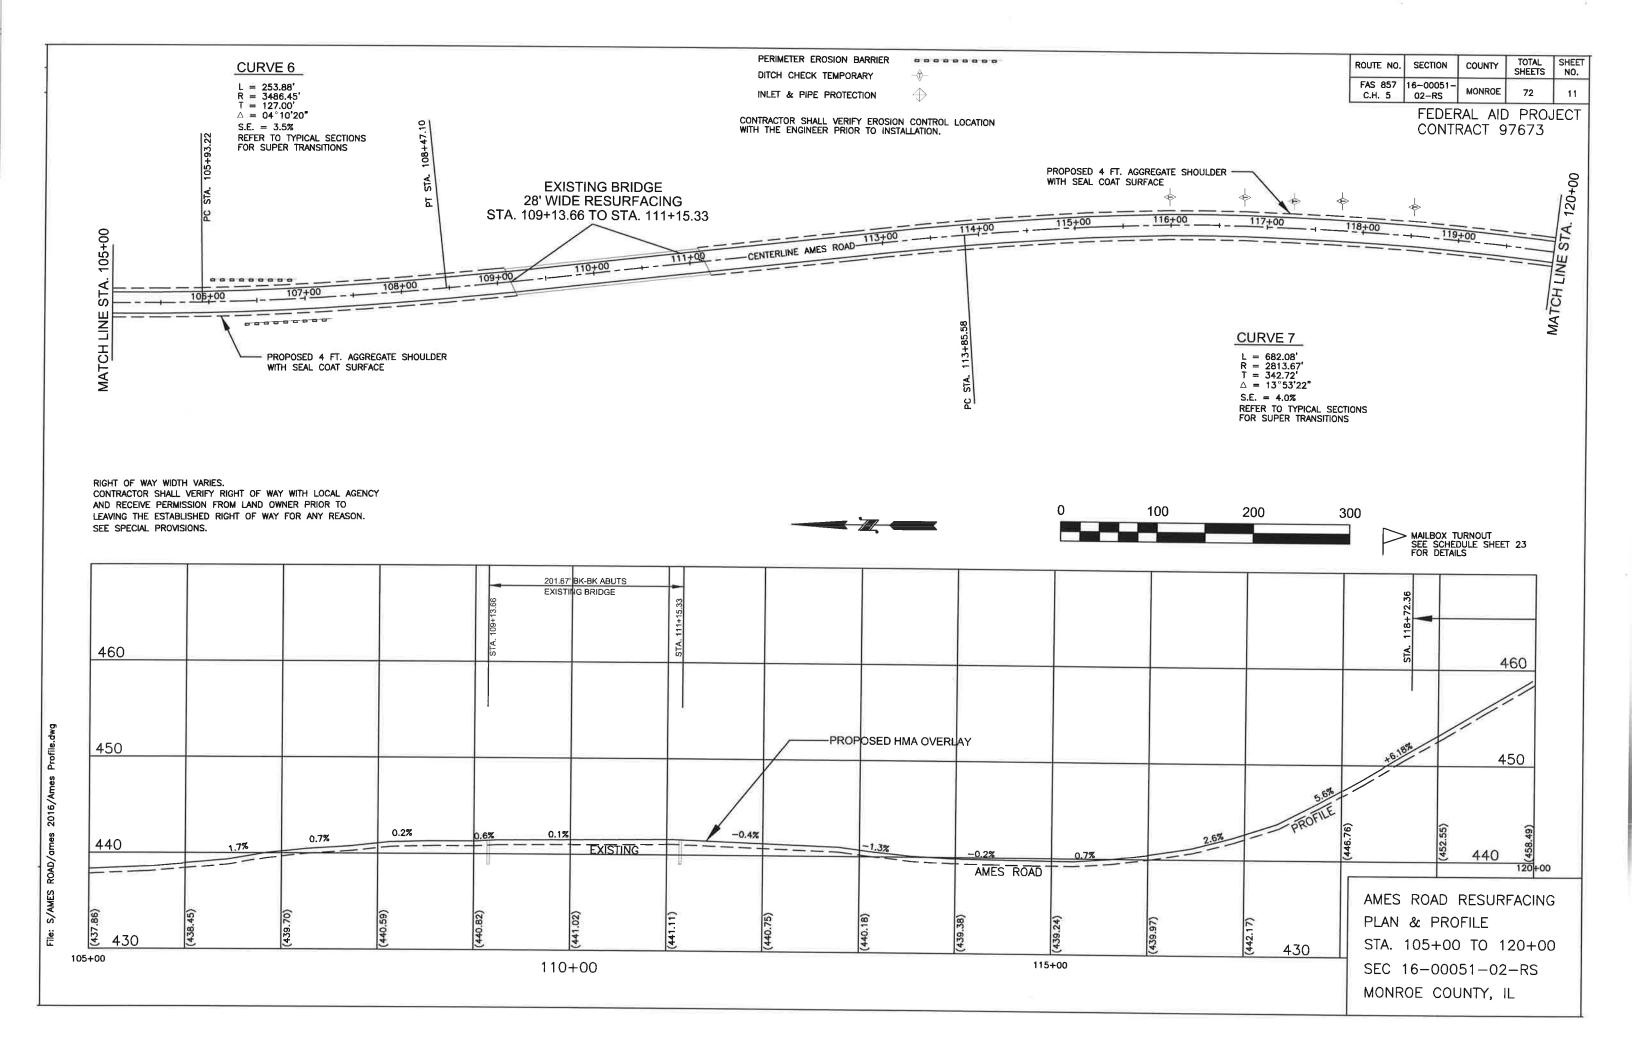


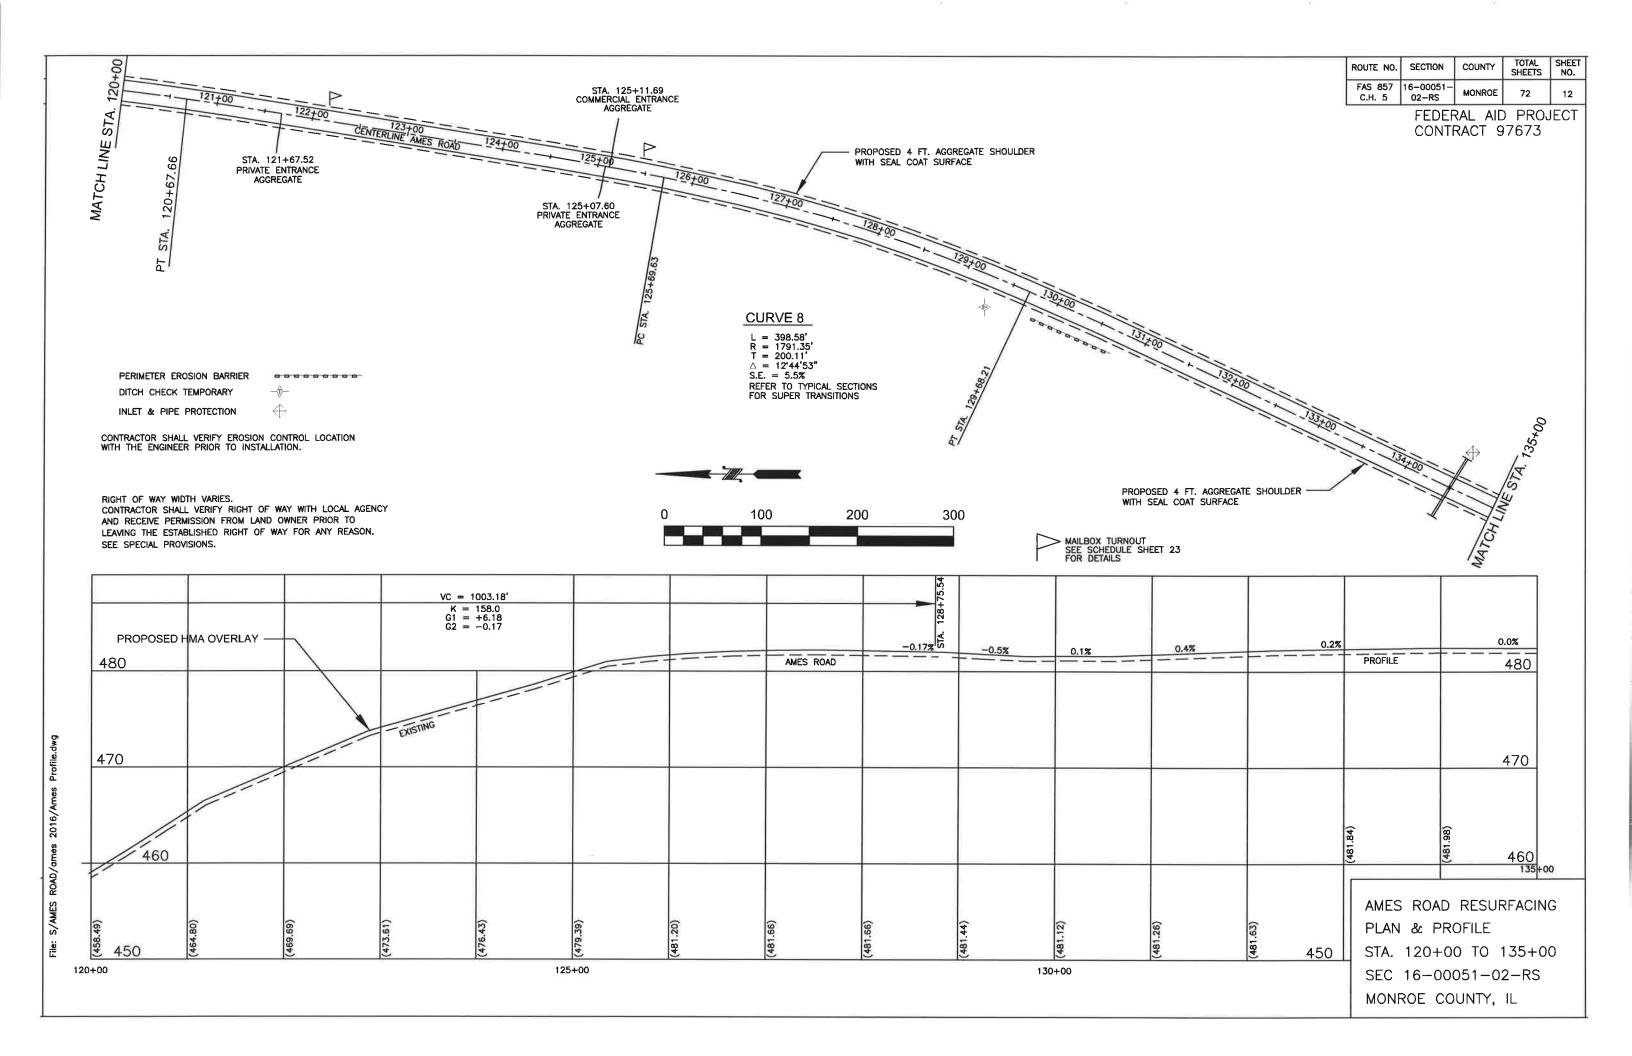


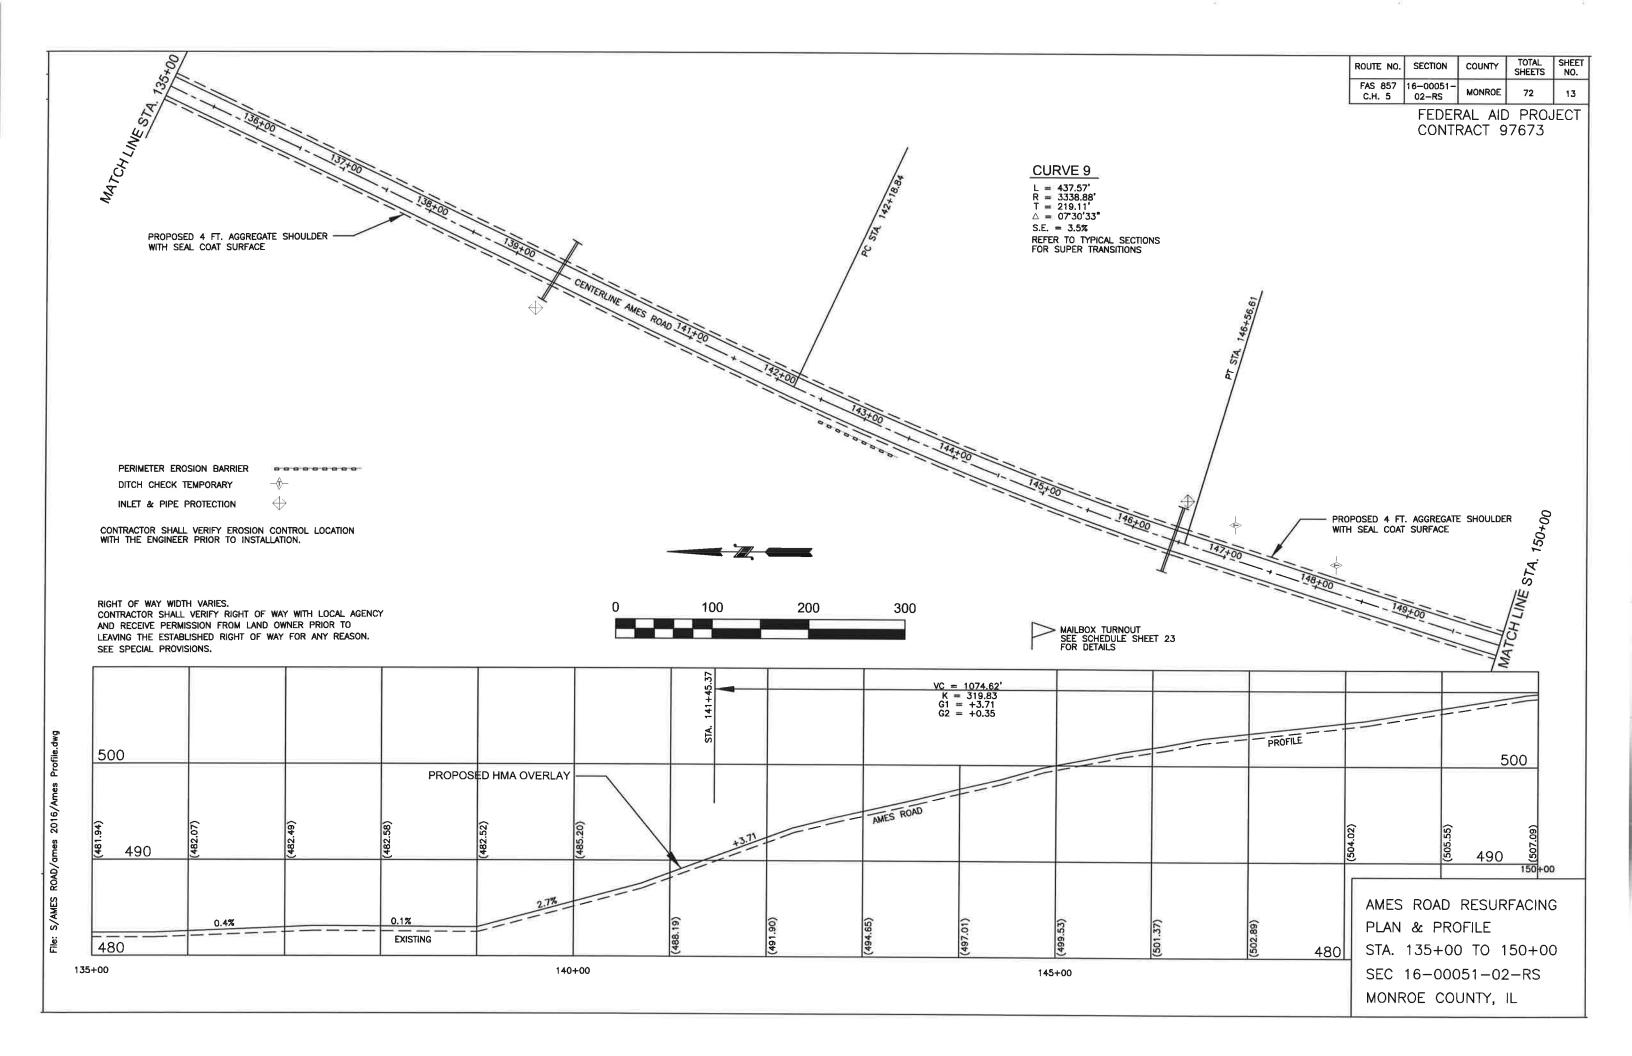


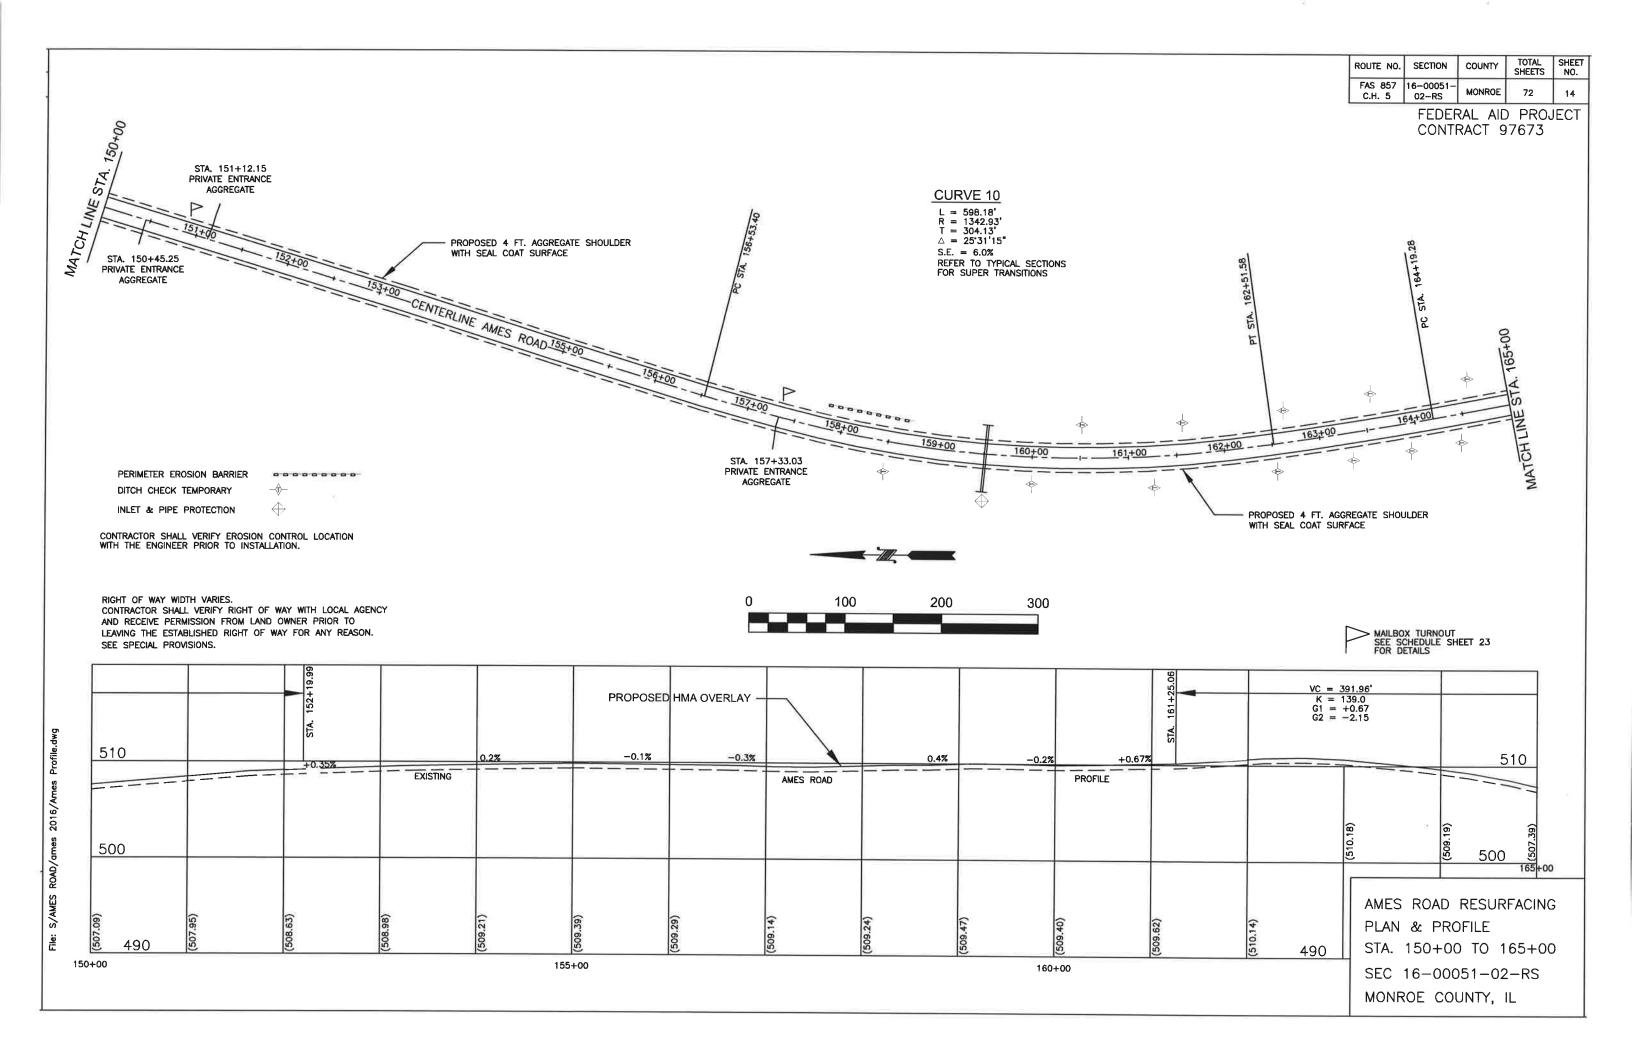


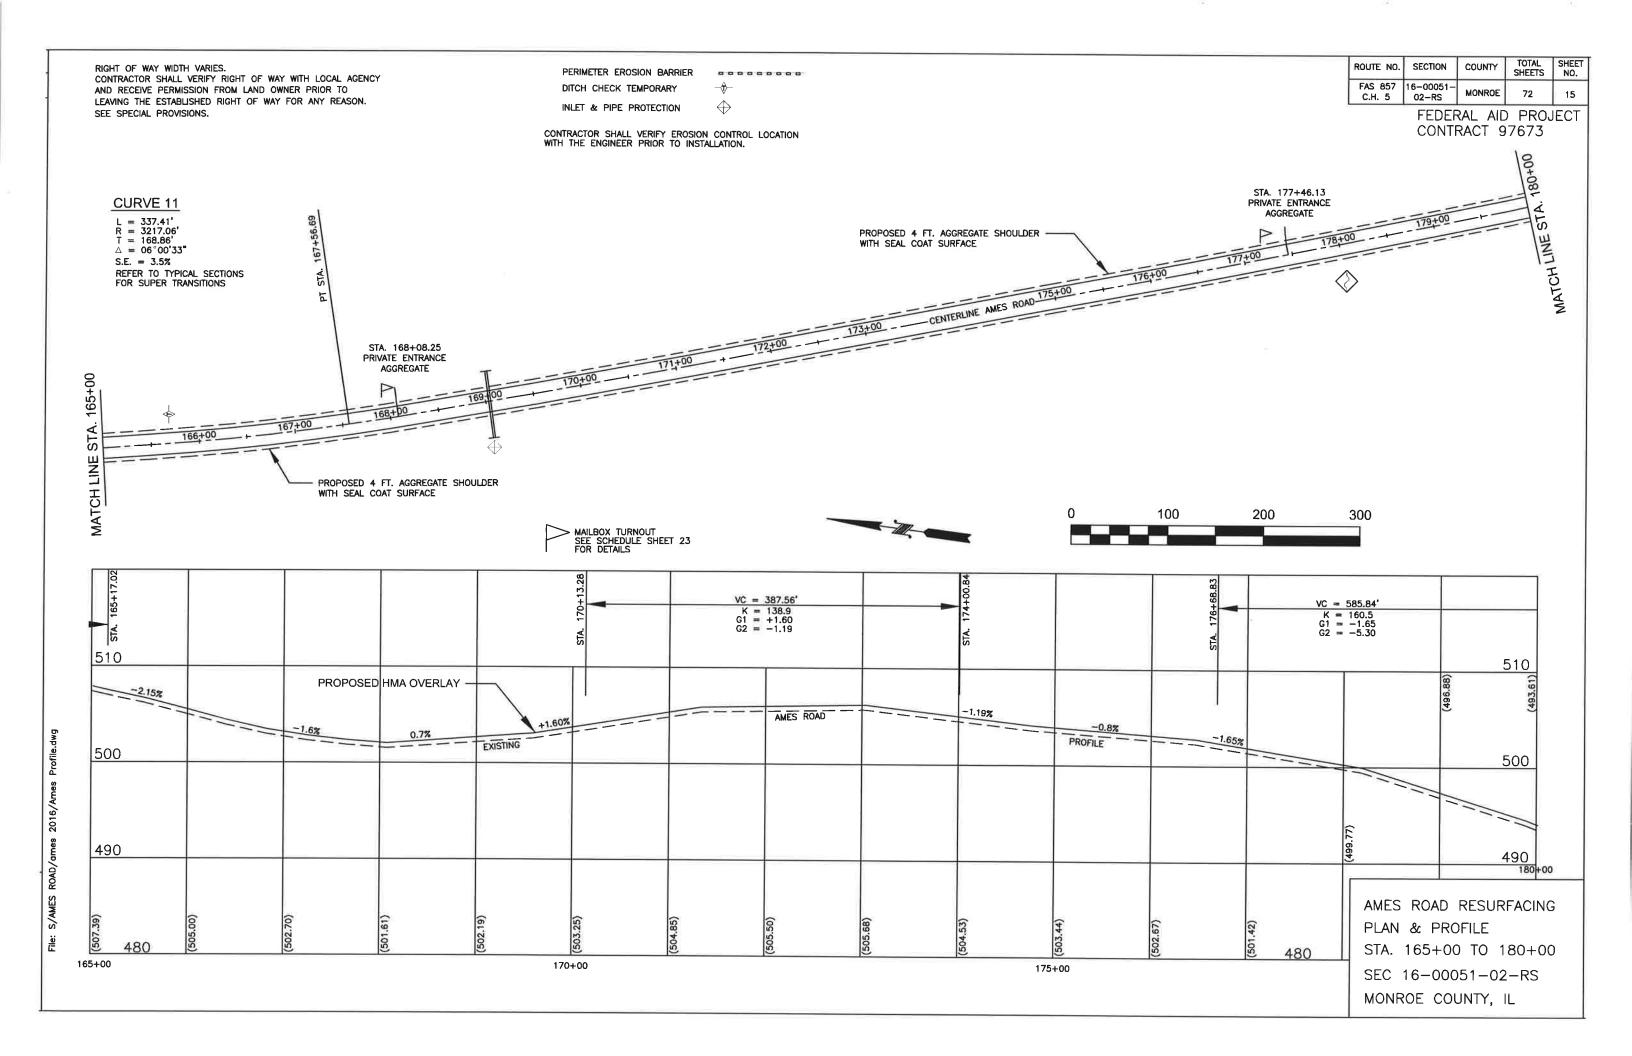


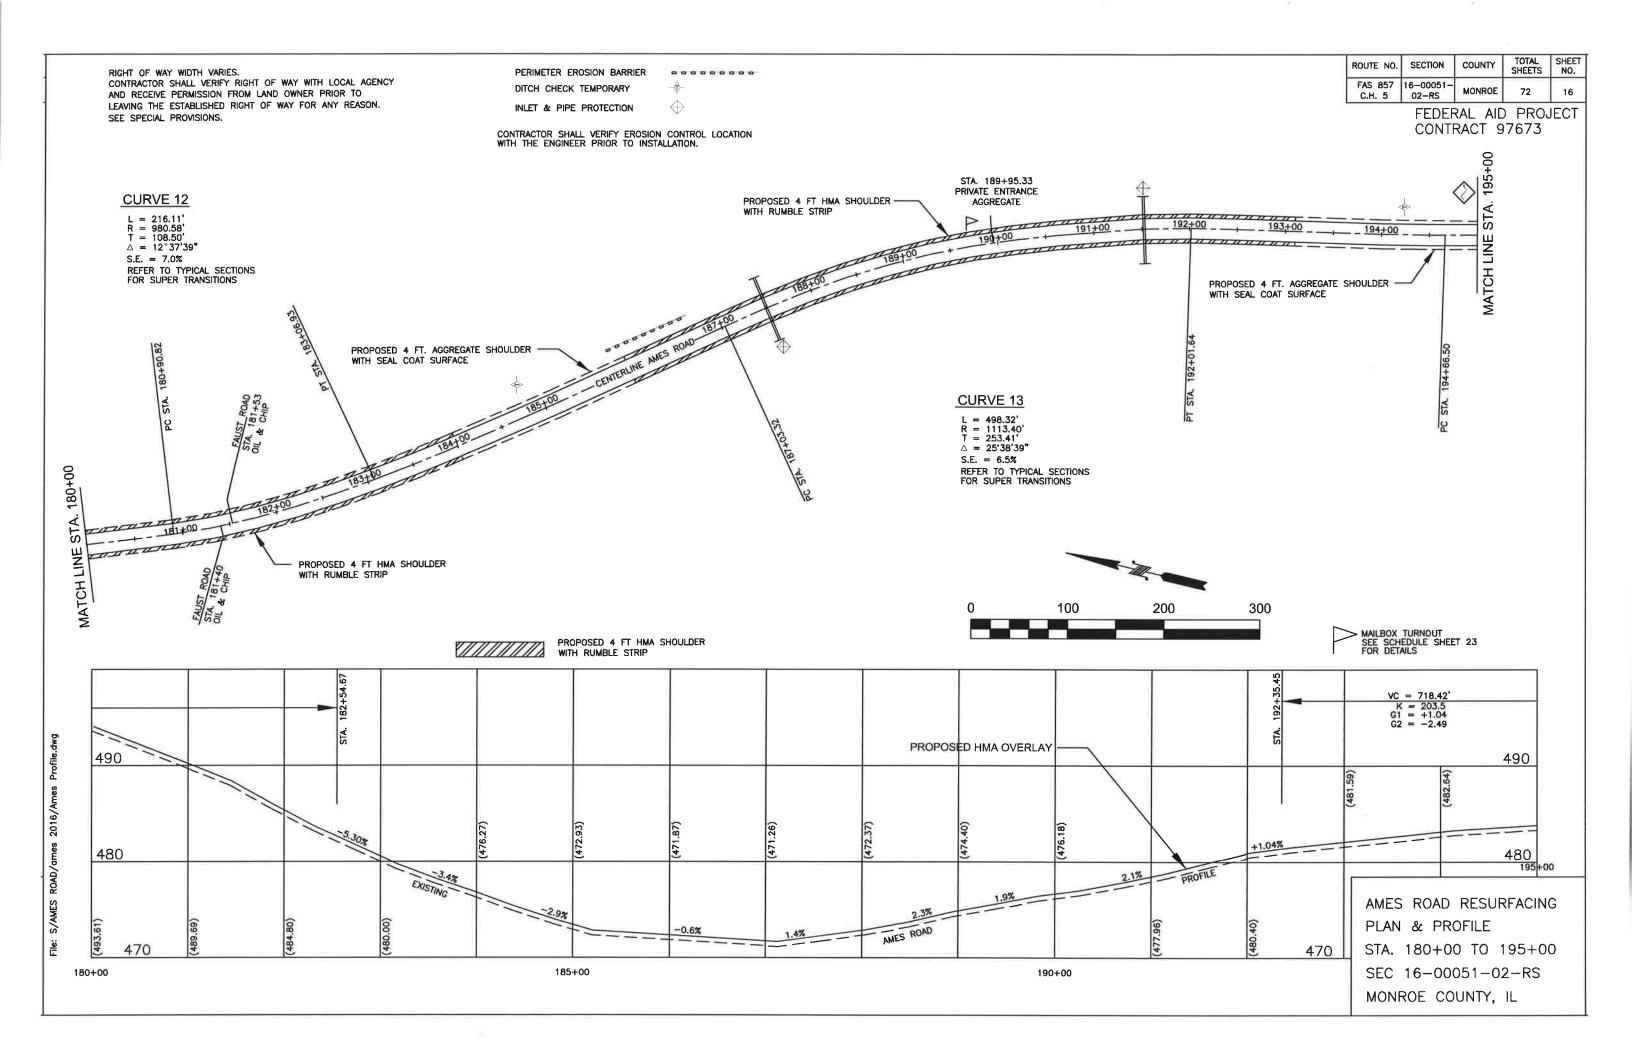

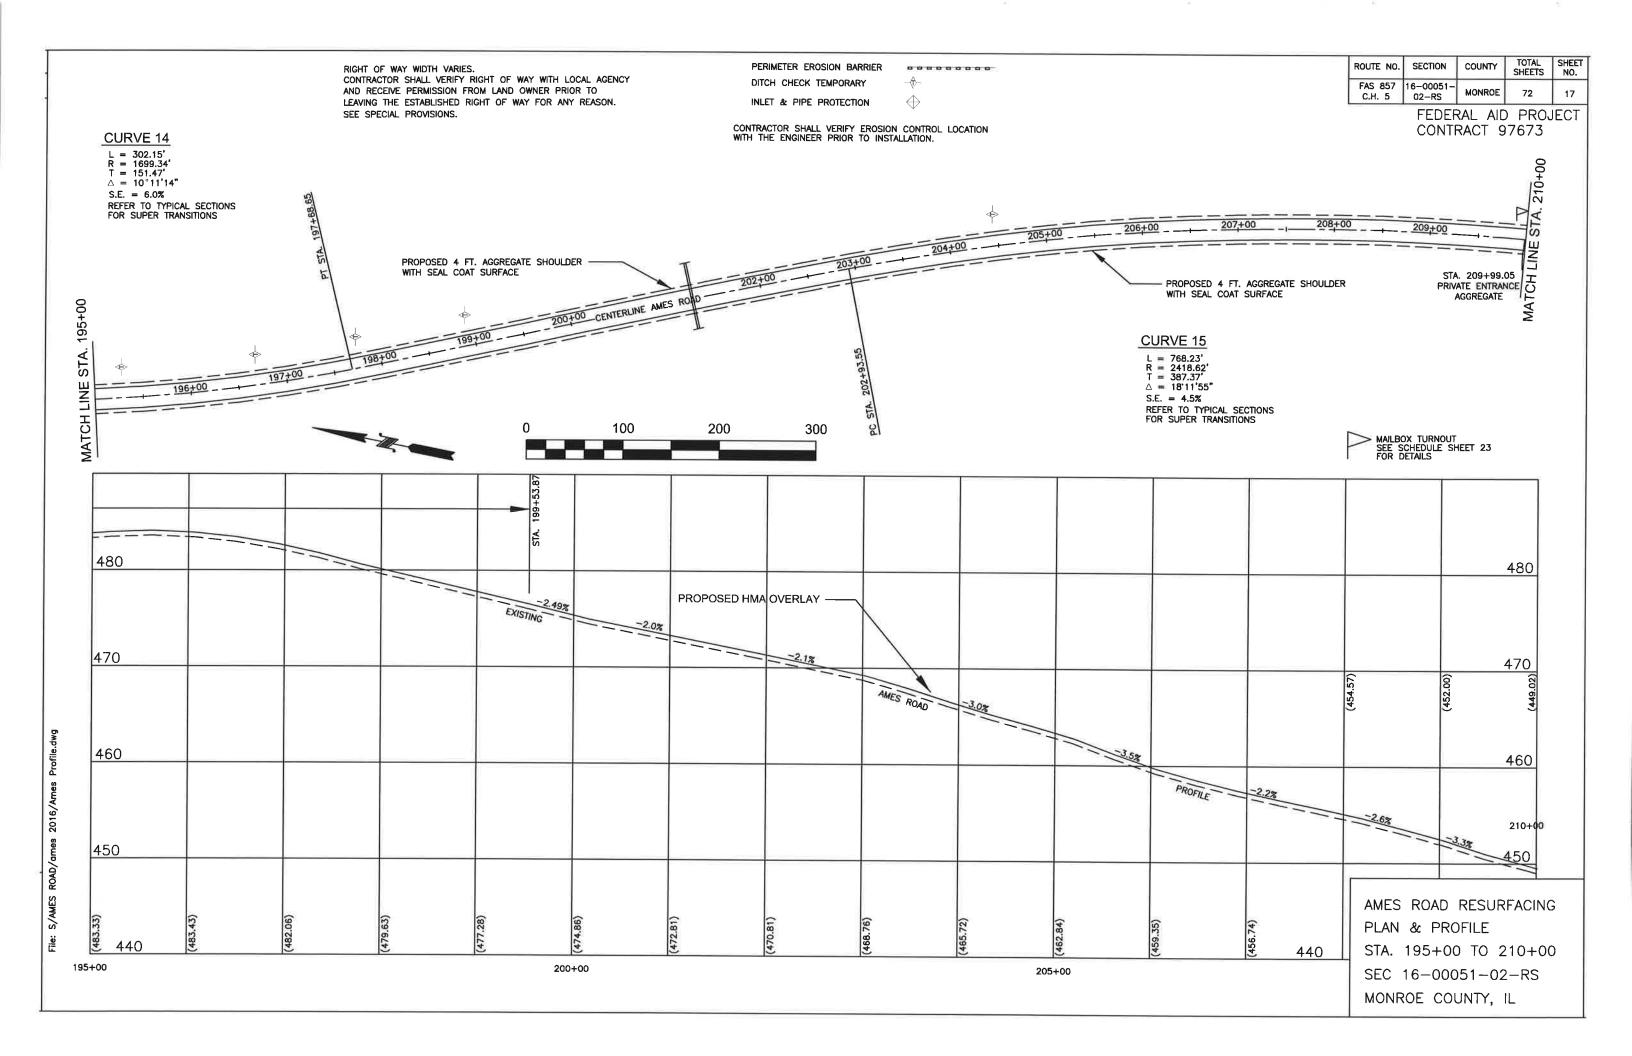

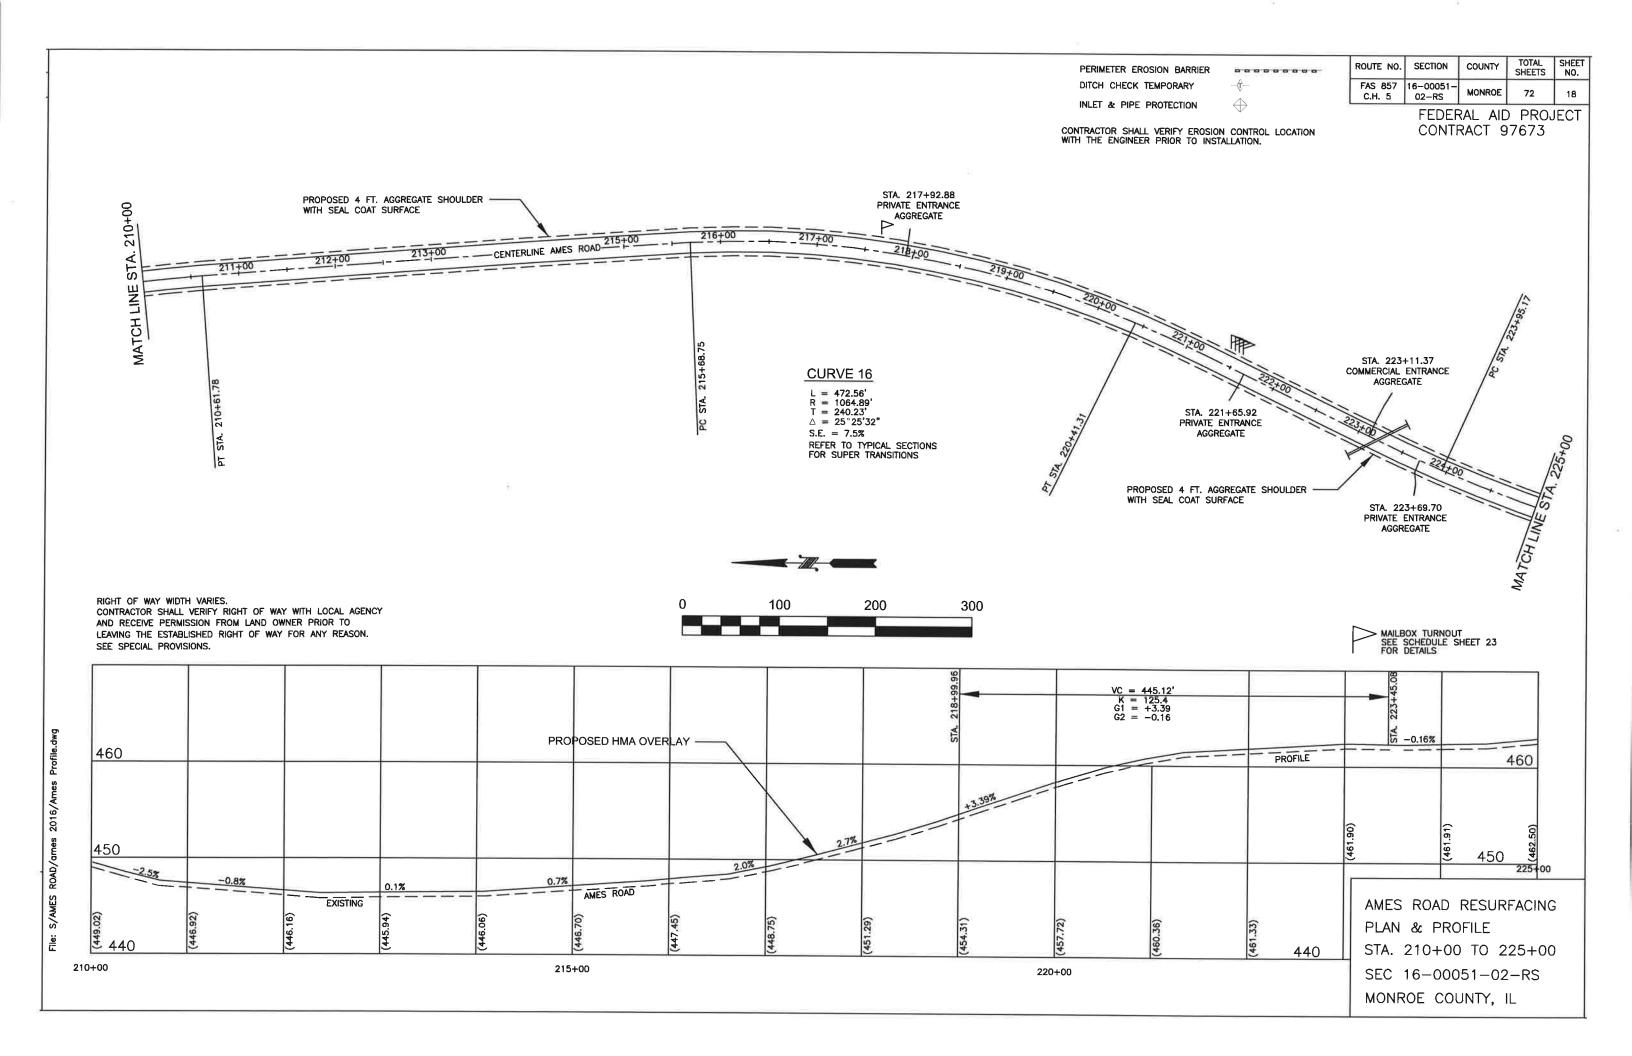

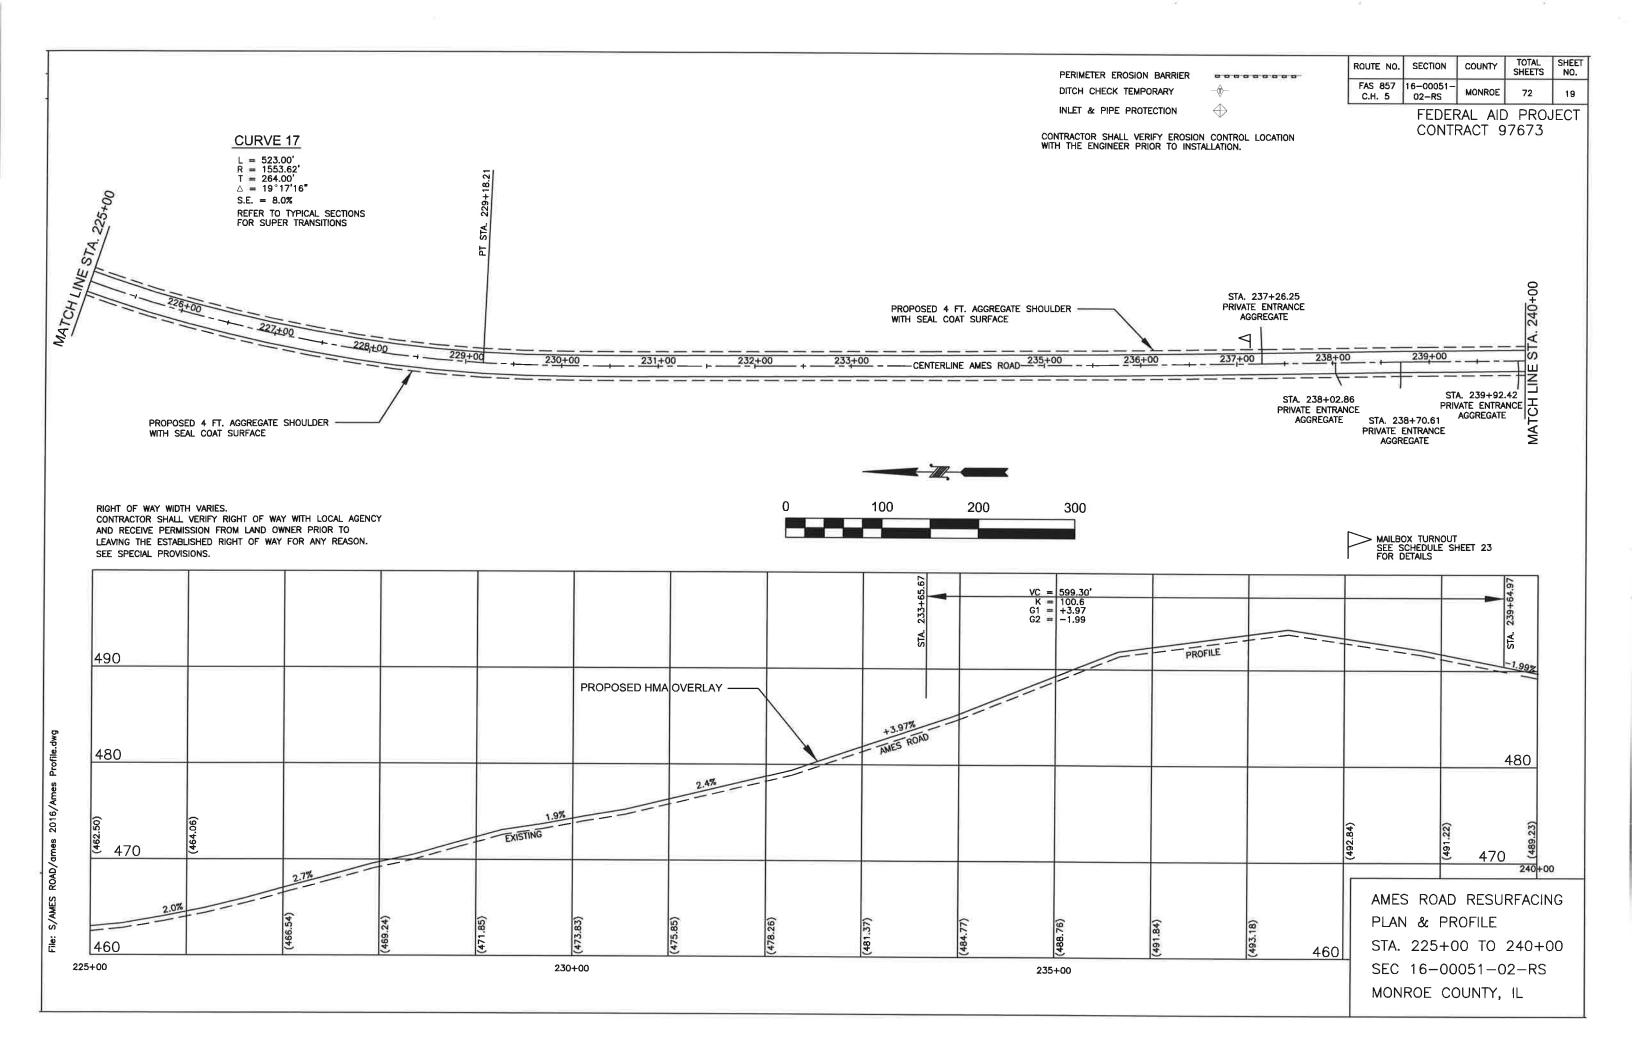

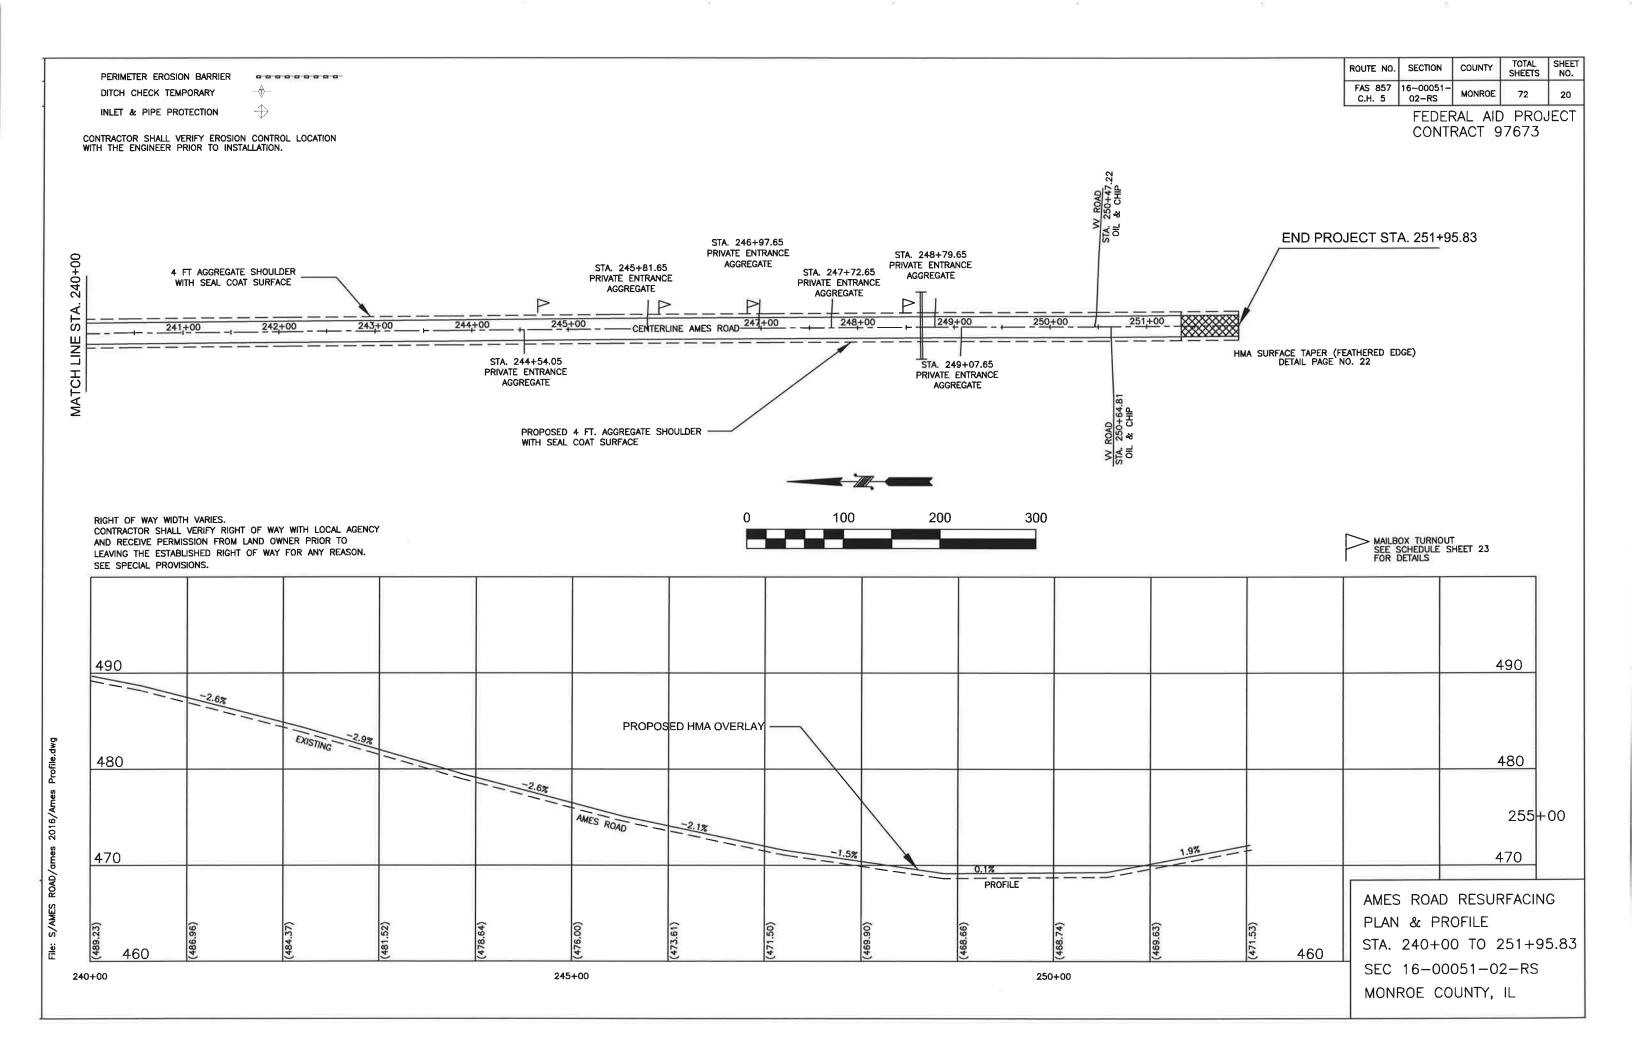


SIDEROAD SCHEDULE

	ROUTE NO	SECTION	COUNTY	TOTAL SHEETS	SHEET NO.	
I	FAS 857 C.H. 5	16-00051 -02-RS	MONROE	72	21	

FEDERAL AID PROJECT CONTRACT NO. 97673

LOCATION STATION	SIDE LT/RT	EXISTING SURFACE	IMPROVED LENGTH (FT.)	EXISTING WIDTH (FT.)	INCIDENTAL HOT MIX ASPHALT SURFACING (TONS)	AGGREGATE SURFACE COURSE, TYPE B (TONS)	ROAD NAME
2+78.53	RIGHT	OIL & CHIP	8.0	22.0	3		MM ROAD
43+84.68	RIGHT	AGGREGATE	8.0	14.0	2	3.0	LOHRBERG LANE
71+67.53	RIGHT	OIL & CHIP	32.0	18.0	20		SOUTHFORK ROAD
98+67.62	LEFT	AGGREGATE	8.0	14.0	2	3.0	WHITE PINE LANE
181+40.00	RIGHT	OIL & CHIP	17.0	20.0	7		FAUST ROAD
181+40.00	LEFT	OIL & CHIP	6.0	22.0	2		FAUST ROAD
250+47.22	LEFT	OIL & CHIP	16.0	22.0	15		VV ROAD
250+64.81	RIGHT	OIL & CHIP	6.0	26.0	3		VV ROAD
				TOTAL	54	6.0	


REFER TO CROSS SECTIONS FOR SIDE ROAD PROFILES.

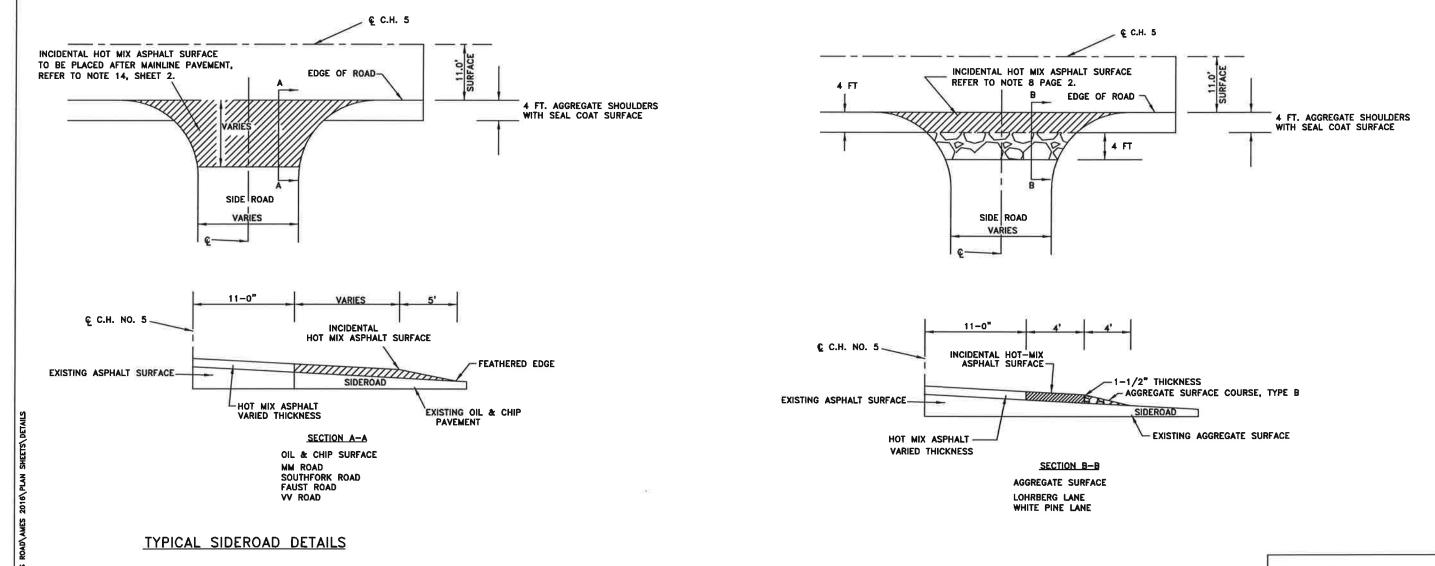


AMES ROAD RESURFACING
SIDEROAD SCHEDULE
AND DETAIL
SEC 16-00051-02-RS
MONROE COUNTY, ILLINOIS

SIGN SCHEDULE

STATION	SIGN	SIGN PANEL- TYPE 1 (SQ FT)	TELESCOPING STEEL SIGN SUPPORT (SQ FT)	DESCRIPTION
59+50 RIGHT 59+50 RIGHT	W1-4R W13-1P	9 4	20	36" × 36" REVERSE CURVE RIGHT
80+50 LEFT 80+50 LEFT	W1-4R W13-1P	9 4	20	36" x 36" REVERSE CURVE RIGHT 24" x 24" 45 MPH PLAQUE
178+00 RIGHT 178+00 RIGHT	W1-4L W13-1P	9 4	20	36" x 36" REVERSE CURVE LEFT 24" x 24" 45 MPH PLAQUE
195+00 LEFT 195+00 LEFT	W1-4L W13-1P	9 4	20	36" x 36" REVERSE CURVE LEFT 24" x 24" 45 MPH PLAQUE
TOTALS		52	80	

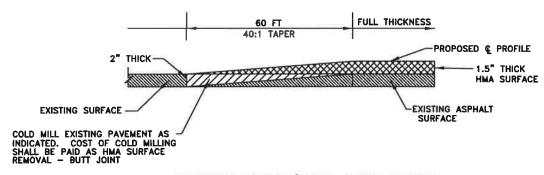

ASPHALT TAPER/BUTT JOINT DETAIL STA. 0+00 TO STA. 0+60

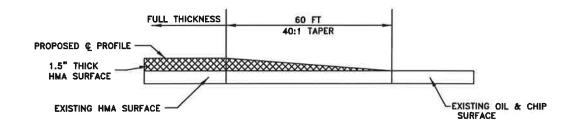

ASPHALT TAPER/FEATHERED EDGE DETAIL STA. 251+35.83 TO STA. 251+95.83

ASPHALT TAPER WILL NOT BE PAID FOR SEPERATELY, BUT SHALL BE INCLUDED IN THE COST PER TON FOR HMA SURFACE COURSE

ROUTE NO	SECTION	COUNTY	TOTAL SHEETS	SHEET NO.
FAS 857 C.H. 5	16-00051 -02-RS	MONROE	72	22

FEDERAL AID PROJECT CONTRACT 97673

HOT-MIX ASPHALT MIXTURE REQUIREMENTS									
LOCATION(S)	ALL								
MIXTURE USE(S)	SURFACE	LEVELING BINDER	INCIDENTAL	SHOULDERS					
AC/PG	PG 64-22	PG 64-22	PG 64-22	PG 64-22					
DESIGN AIR VOIDS	4.0% • Ndes=70	4.0% • Ndes=70	4.0% • Ndes=70	4.0% • Ndes=50					
MIXTURE COMPOSITION 9.5 (GRADATION MIXTURE)									
FRICTION AGGREGATE	MIXTURE D	MIXTURE C	MIXTURE C	MIXTURE C					

MAINLINE SURFACING SUMMARY

LOCATION STATION - STATION	HOT-MIX ASPHALT SURFACE COURSE, MIX "D" N70	LEVELING BINDER (MACHINE METHOD), N70	HOT-MIX ASPHALT SHOULDERS	BITUMINOUS MATERIALS (COVER AND SEAL COATS) A-1 TREATMENT	SEAL COAT AGGREGATE	BITUMINOUS MATERIALS (PRIME COAT)	HOT-MIX ASPHALT SURFACE REMOVAL - BUTT JOINT	AGGREGATE WEDGE SHOULDER, TYPE B	BITUMINOUS MATERIALS (TACK COAT)	AGGREGATE (TACK COAT)	STRIPS, 8 INCH
UNIT	TON	TON	TON	TON	TON	TON	SQ YD	TON	POUND	TON	FOOT
STA. 0+00 TO STA. 61+04.44	1254	300		5.6	67.8	6.7	525	684	6715	29.8	
STA. 61+04.44 TO STA. 67+74.87	138	194	250						737	3.3	1341
STA. 67+74.87 TO STA. 78+55.93	222	104	186	0.5	6.0	0.6		41	1189	5.3	1078
STA. 78+55.93 TO STA. 113+04.91	720	205		3.0	36.1	3.6		432	3854	17.1	
STA. 113+04.91 TO STA. 141+45.51	583	303		2.6	31.6	3.2		515	3125	13.9	
STA. 141+45.51 TO STA. 179+96.15	791	492		3.5	42.9	4.2		745	4236	18.8	0=m
STA. 179+96.15 TO STA. 185+94.65	123	116	138	0.2	2.2	0.2		15	658	2.9	811
STA. 185+94.65 TO STA. 193+56.50	156	187	246	0.1	0.5	0.1		4	838	3.7	1432
STA. 193+56.50 TO STA. 211+49.78	368	405		1.6	19.9	2.0		443	1973	8.8	
STA. 211+49.78 TO STA. 251+95.83	831			3.7	45.0	4.4		307	4451	19.8	
PROJECT TOTALS	5186	2306	820	20.8	252.0	25.0	525	3186	27776	123.4	4662

AGGREGATE (TACK COAT) FOR INFORMATIONAL PURPOSES ONLY

AMES ROAD RESURFACING DETAILS AND SCHEDULES SEC 16-00051-02-RS MONROE COUNTY, ILLINOIS

ENTRANCE SCHEDULE

LOCATION STATION	SIDE LT/RT	TYPE OF ENTRANCE	EXISTING SURFACE	LENGTH FOOT	WIDTH FOOT	INCIDENTAL HOT-MIX ASPHALT SURFACING TONS	BIT. MAT'L. (TACK COAT) POUND	AGGREGATE (TACK COAT) POUND	AGGREGATE SURFACE COURSI TYPE B (TONS)
0+50.87	RIGHT	PRIVATE	AGGREGATE	8.00	10.0	1.0	5.6	49.8	2.0
22+31.98	LEFT	PRIVATE	AGGREGATE	8.00	12.0	0.8	4.4	39.1	3.5
32+38.92	RIGHT	PRIVATE	AGGREGATE	8.00	10.0	1.1	6.0	53.3	3.7
40+04.40	LEFT	PRIVATE	AGGREGATE	8.00	12.0	1.3	6.8	60.4	2.4
43+56.72	LEFT	PRIVATE	HMA	8.00	12.0	1.3	6.8	60.4	0.0
49+80.12	LEFT	PRIVATE	AGGREGATE	8.00	8.0	1.2	6.4	56.8	1.6
56+99.75	LEFT	PRIVATE	AGGREGATE	8.00	10.5	1.2	6.4	56.8	2.4
71+13.24	LEFT	PRIVATE	AGGREGATE	8.00	12.0	1.3	7.2	64.0	4.6
80+82.08	RIGHT	PRIVATE	AGGREGATE	8.00	10.5	1.3	7.2	64.0	2.6
85+14.96	LEFT	PRIVATE	AGGREGATE	8.00	10.0	1.4	7.6	67.5	2.1
94+00.00	LEFT	PRIVATE	AGGREGATE	8.00	18.0	0.9	4.8	42.7	3.3
121+67.52	RIGHT	PRIVATE	AGGREGATE	8.00	20.0	1.6	8.4	74.7	3.5
125+07.60	RIGHT	PRIVATE	AGGREGATE	8.00	22.0	1.4	7.6	67.6	5.5
125+11.69	LEFT	COMMERCIAL	AGGREGATE	8.00	22.0	2.0	10.8	96.0	4.7
150+45.25	RIGHT	PRIVATE	AGGREGATE	8.00	14.0	1.5	8.0	71.2	2.4
151+12.15	LEFT	PRIVATE	AGGREGATE	8.00	19.0	1.9	10.0	88.8	3.2
157+33.03	RIGHT	PRIVATE	AGGREGATE	8.00	12.0	1.3	7.2	64.0	2.4
168+08.25	LEFT	PRIVATE	AGGREGATE	8.00	12.0	1.6	8.8	78.4	2.5
177+46.13	LEFT	PRIVATE	AGGREGATE	8.00	15.0	1.9	10.0	88.8	2.6
189+95.33	LEFT	PRIVATE	AGGREGATE	8.00	10.0	1.4	7.6	67.5	2.4
209+99.05	RIGHT	PRIVATE	AGGREGATE	8.00	10.0	1.4	7.6	67.5	2.5
217+92.88	LEFT	PRIVATE	AGGREGATE	8.00	12.0	1.6	8.4	74.7	2.3
221+65.92	RIGHT	PRIVATE	AGGREGATE	8.00	11.0	2.1	11.2	99.6	2.3
223+11.37	LEFT	COMMERCIAL	AGGREGATE	8.00	31.0	3.0	16.0	142.2	3.9
223+69.70	RIGHT	PRIVATE	AGGREGATE	8.00	10.0	1.4	8.0	71.2	1.8
237+26.25	LEFT	PRIVATE	AGGREGATE	8.00	10.0	1.0	6.0	53.4	1.9
238+02.86	RIGHT	PRIVATE	AGGREGATE	8.00	10.0	1.3			
238+70.61	RIGHT	PRIVATE	AGGREGATE	8.00	12.0	1.3	6.8 6.8	60.4	1.8
239+92.42	RIGHT	PRIVATE	AGGREGATE	8.00	11.0	1.3		60.4	2.0
244+54.05	RIGHT	PRIVATE	AGGREGATE	8.00	12.0		7.2	64.0	2.1
245+81.65	LEFT	PRIVATE	AGGREGATE	8.00	11.0	1.4 1.2	7.6	67.6	2.0
246+97.65	LEFT	PRIVATE	AGGREGATE	8.00	21.0		6.4	56.8	2.1
247+72.65	LEFT	PRIVATE	AGGREGATE	8.00	12.0	1.2	6.4	56.8	3.7
248+79.65		PRIVATE				1.0	5.6	49.8	2.0
249+07.65	LEFT RIGHT	PRIVATE	AGGREGATE	8.00	26.0	1.2	6.7	60.4	3.8
Z43TU/.03	KIGHI	TRIVALL	AGGREGATE	8.00	16.0	1.2	6.7	60.4	2.5
TOTAL						49.0	265.0	2357.0	94.0

ROUTE NO	SECTION	COUNTY	TOTAL SHEETS	SHEET NO.
FAS 857 C.H. 5	16-00051 -02-RS	MONROE	72	23


MAILBOX TURNOUT SCHEDULE


FEDERAL AID PROJECT CONTRACT NO. 97673

LOCATION STATION	SIDE LT/RT	INCIDENTAL HOT MIX ASPHALT SURFACING TONS	BIT. MAT'L (TACK COAT) POUNDS	AGGREGATE (TACK COAT) POUNDS
70 1 00 50				
32+22.56	LEFT	1.2	6.6	58.7
40+28.52	LEFT	1.0	5.6	49.6
49+44.50	LEFT	1.2	6.6	58.7
56+81.63	LEFT	0.9	5.0	44.4
71+32.26	LEFT	1.0	5.6	49.6
84+94.56	LEFT	0.9	5.0	44.4
122+15.47	LEFT	1.2	6.6	58.7
125+45.21	LEFT	1.0	5.6	49.6
150+89.04	LEFT	0.9	5.0	44.4
157+33.41	LEFT	1.2	6.6	58.7
167+97.58	LEFT	0.9	5.0	44.4
177+19.88	LEFT	0.9	5.0	44.4
189+70.37	LEFT	0.9	5.0	44.4
210+01.36	LEFT	1.2	6.6	58.7
217+65.01	LEFT	0.9	5.0	44.4
221+42.63	LEFT	1.2	6.6	58.7
221+47.43	LEFT	0.2	1.0	9.0
221+51.79	LEFT	0.2	1.0	9.0
221+56.40	LEFT	1.2	6.6	58.7
237+13.87	LEFT	0.9	5.0	44.4
244+68.49	LEFT	1.2	6.6	58.7
245+93.85	LEFT	1.0	5.6	49.6
246+85.65	LEFT	0.9	5.4	44.4
248+46.65	LEFT	0.9	5.4	44.4
	TOTAL	23.0	128.0	1130.0


REFER TO STANDARD BLR 24-2 FOR TURNOUT DETAILS
AGGREGATE (TACK COAT) FOR INFORMATIONAL PURPOSES ONLY

AGGREGATE (TACK COAT) FOR INFORMATIONAL PURPOSES ONLY

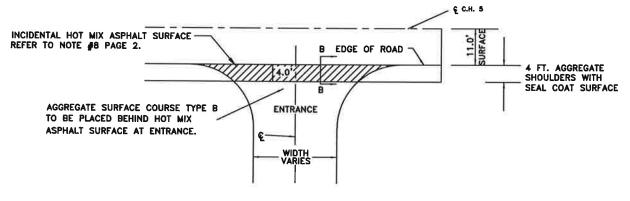

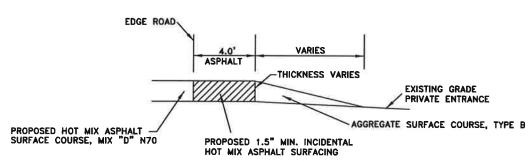

SECTION B-B
TYPICAL SECTION PRIVATE ENTRANCE
AGGREGATE DRIVES

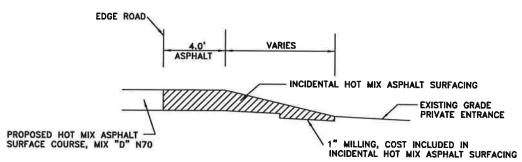

SECTION B-B
TYPICAL SECTION PRIVATE ENTRANCE
ASPHALT DRIVES
STA. 43+56.72

AMES ROAD RESURFACING ENTRANCE SCHEDULE AND DETAIL SEC 16-00051-02-RS MONROE COUNTY, ILLINOIS

ROUTE NO SECTION COUNTY IUIAL SHEETS SMLEI NO. FAS 857 C.H. 5 16-00051 -02-RS MONROE 72 24

FEDERAL AID PROJECT CONTRACT NO. 97673

EARTHWORK AND EROSION CONTROL SCHEDULE

STATION	EARTH EXCAVATION (CU YD)	EARTH EXCAVATION ADJUSTED FOR 25% SHRINKAGE (CU YD)	FURNISHED EXCAVATION (CU YD)	EARTHWORK BALANCE WASTE(+) OR SHORTAGE(-) (CU YD)	TEMPORARY EROSION CONTROL SEEDING (POUND)	TEMPORARY DITCH CHECKS (FOOT)	PERIMETER EROSION BARRIER (FOOT)	INLET AND PIPE PROTECTION (EACH)	SEEDING, CLASS 2 SPECIAL (ACRE)
AMES ROAD									
0+00 TO 61+04.44	0.0	0.0	128.5	-128.5	25.0	70.0	100.0	0.0	0.25
61+04.44 TO 67+74.87	40.0	30.0	75.7	-45.7	12.0	28.0	200.0	0.0	0.15
67+74.87 TO 78+55.93	18.0	13.5	78.9	-65.4	14.0	28.0	0.0	1.0	0.15
78+55.93 TO 113+04.91	0.0	0.0	148.9	-148.9	28.0	21.0	1400.0	0.0	0.30
113+04.91 TO 141+45.51	0.0	0.0	222.9	-222.9	37.0	42.0	400.0	2.0	0.40
141+45.51 TO 179+96.15	0.0	0.0	354.8	-354.8	48.0	105.0	500.0	3.0	0.50
179+96.15 TO 185+94.65	23.0	17.3	21.0	-3.7	5.0	7.0	0.0	0.0	0.10
185+94.65 TO 193+56.50	20.0	15.0	39.4	-24.4	15.0	0.0	450.0	2.0	0.15
193+56.50 TO 211+49.78	0.0	0.0	215.9	-215.9	26.0	42.0	0.0	0.0	0.25
211+49.78 TO 251+95.83	0.0	0.0	0.0	0.0	0.0	0.0	0.0	0.0	0.00
TOTALS	101.0	75.8*	1286.0	1210.2*	210.0	343.0	3050.0	8.0	2.25

^{*} FOR INFORMATIONAL PURPOSES ONLY

PAVEMENT MARKINGS SCHEDULE

	PAINT	PAINT PAVEMENT MARKING - LINE 4"						TEMPORARY PAVEMENT MARKING - LINE 4"						SHORT TERM
	PAINT SKIP-DASH YELLOW 4" (FT)	YEL	AINT OLID LOW 4" FT)	PAINT SOLID WHITE 4" (FT)		RAISED REFLECTIVE PAVEMENT MARKERS (EA)		SKIP-DASH YELLOW 4" YELLOW 4" (FT)		SOLID WHITE 4" (FT)		SHORT TERM PAVEMENT MARKING (FT)	PAVEMENT MARKING REMOVAL (SQ FT)	
STATION	CENTERLINE	NO PASS	ING ZONE RT	EDGE I	LINES	AMBER (2 WAY)	(1 WAY)	CENTERLINE	NO PASS	ING ZONE	EDGE LT	LINES	CENTERLINE	CENTERLINE
AMES ROAD														
0+00 TO 6+87	170			593	530	9	- -	170			593	530	68.70	23.00
6+87 TO 17+80	273	344	1093	1093	1093	17		273		1093	1093	1093	145.60	36.00
17+80 TO 44+29		2649	2649	2649	2649	43			2649	2649	2649	2649	375.70	88.00
44+29 TO 54+12	246	983		983	983	12		246	983		983	983	98.30	33.00
54+12 TO 54+95	21			83	83	1		21			83	83	8.30	3.00
54+95 TO 65+03	252		1008	1008	1008	16	20	252		1008	1008	1008	140.70	34.00
65+03 TO 85+31		2028	2028	2028	1926	35	42		2028	2028	2028	1926	339.10	67.00
85+31 TO 97+53	300	1202	7-22	1202	1202	15		300	1202		1202	1202	134.40	41.00
97+53 TO 108+53.33	275			1100	1100	18		275			1100	1100	143.30	36.00
108+53.33 TO 110+55	50			201	201	3		50			201	201	26.20	7.00
110+55 TO 112+58	51			203	203	3		51	77.7		203	203	20.30	7.00
112+58 TO 122+53	249		995	995	995	22		249		995	995	995	183.80	33.00
122+53 TO 126+84		431	431	431	431	7			431	431	431	431	64.80	14.00
126+84 TO 137+15	258	1031		1031	1031	17		258	1031		1031	1031	141.80	34.00
137+15 TO 138+77	41			162	162	2		41			162	162	16.20	6.00
138+77 TO 146+76	200		799	799	799	16		200		799	799	799	132.90	27.00
146+76 TO 207+20		6044	6044	5960	5982	106	56		6044	6044	5960	5982	953.30	202.00
207+20 TO 224+70		1750	1750	1750	1750	22			1750	1750	1750	1750	218.00	58.00
224+70 TO 237+57		1272	1272	1272	1272	27			1272	1272	1272	1272	128.70	43.00
237+57 TO 250+39	322	1286	1000	1286	1286	23		322	1286		1286	1286	128.20	43.00
250+39 TO 251+95.83	40			94	57	2		40			94	57	15.70	5.00
SUBTOTALS	2748	36745 49666		416	118	2748	3 36745		49666					
TOTALS		89159					34	89159				3484.00	840.00	

AMES ROAD RESURFACING
EARTHWORK, EROSION AND
PAVEMENT MARKING SCHEDULE
SEC 16-00051-02-RS
MONROE COUNTY, ILLINOIS

