06-16-2023 LETTING ITEM 042


STATE OF ILLINOIS **DEPARTMENT OF TRANSPORTATION**

FOR INDEX OF SHEETS, SEE SHEET NO. 2 FOR SUMMARY OF QUANTITIES, SEE SHEET NO. 3-7

PROPOSED **HIGHWAY PLANS**

FAP 801 (ILL 10) **SECTION 4BR PROJECT NHPP-550N(100) BRIDGE REPLACEMENT CHAMPAIGN COUNTY**

> C-95-042-10 **COPPER SLOUGH E OF DUNCAN RD**

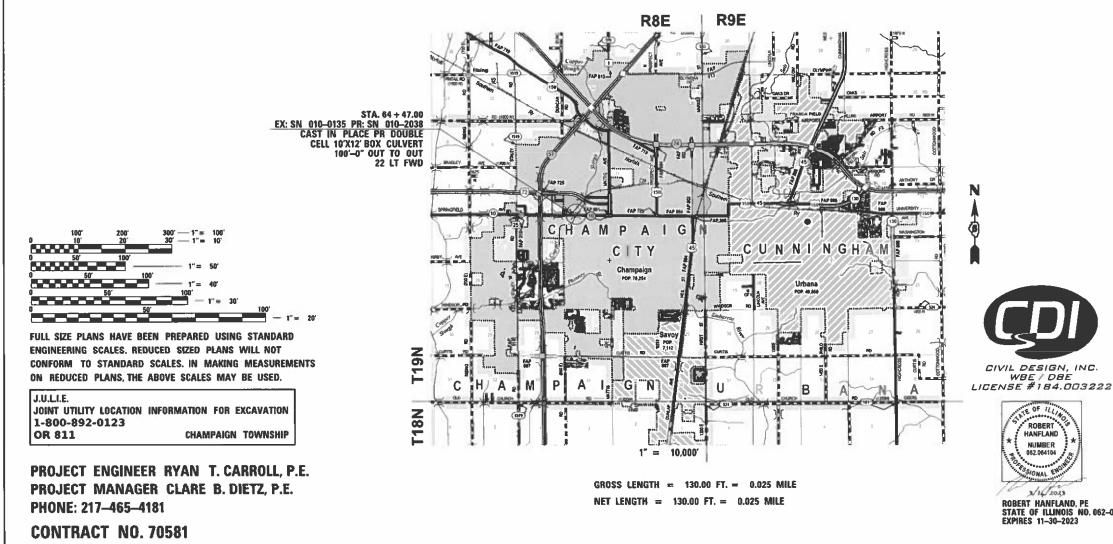


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ROBERT

HANFLAND NUMBER

2/16/2023

REV. 5/22/23

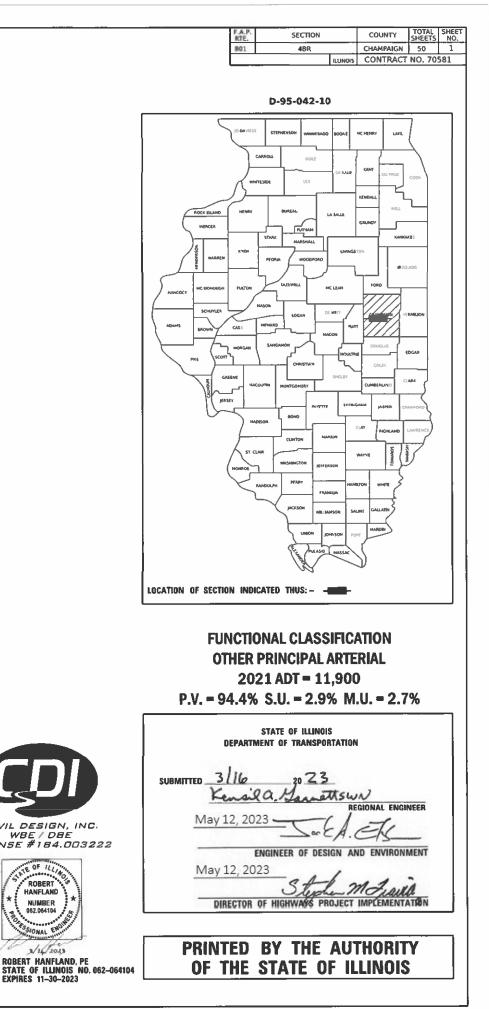HIGHWAY STANDARDS

000001-08	STANDARD SYMBOLS, ABBREVIATIONS AND PATTERNS
001001-02	AREAS OF REINFORCEMENT BARS
001006	DECIMAL OF AN INCH AND OF A FOOT
442201-03	CLASS C AND D PATCHES
424001-11	PERPENDICULAR CURB RAMPS FOR SIDEWALKS
515001-04	NAME PLATE FOR BRIDGES
542301-03	PRECAST REINFORCED CONCRETE FLARED END SECTION
602401-07	PRECAST MANHOLE TYPE A 4' (1.22 m) DIAMETER
602601-06	PRECAST REINFORCED CONCRETE FLAT SLAB TOP
602701-02	MANHOLE STEPS
604001-05	FRAME AND LID TYPE 1
606001-08	CONCRETE CURB TYPE B AND COMBINATION CONCRETE CURB AND GUTTER
701001-02	OFF-ROAD OPERATIONS, 2L, 2W, 15' (4.5 m) AWAY
701006-05	OFF-ROAD OPERATIONS, 2L, 2W, 15' (4.5 m) TO 24" (600 mm) FROM PAVEMENT EDGE
701011-04	OFF-RD MOVING OPERATIONS, 2L, 2W, DAY ONLY
701311-03	LANE CLOSURE 2L, 2W, MOVING OPERATIONS - DAY ONLY
701502-09	URBAN LANE CLOSURE, 2L, 2W, WITH BIDIRECTIONAL LEFT TURN LANE
701801-06	SIDEWALK, CORNER OR CROSSWALK CLOSURE
701901-08	TRAFFIC CONTROL DEVICES
780001-05	TYPICAL PAVEMENT MARKINGS
781001-04	TYPICAL APPLICATIONS RAISED REFLECTIVE PAVEMENT MARKERS

INDEX OF SHEETS


1COVER SHEET2INDEX OF SHEETS/LIST OF STANDARDS/GENERAL NOTES3-8SUMMARY OF QUANTITIES9TYPICAL SECTIONS10-11SCHEDULE OF QUANTITIES12ALIGNMENT, CONTROL POINTS, & BENCHMARKS13PLAN & PROFILE14REMOVAL PLAN15DRAINAGE PLAN & PROFILE16ENTRANCE PLAN17SIDEWALK DETAILS18-22DETOUR23RIGHT OF WAY24-34STRUCTURE 010-2038 SHEETS35-36DISTRICT 5 DETAIL NO. 40800050C37DISTRICT 5 DETAIL NO. 6424851038DISTRICT 5 DETAIL NO. 702000040-43DISTRICT 5 DETAIL NO. 7800AAAA44-49CROSS SECTIONS50CHANNEL CROSS SECTIONS	SHEET NO.	DESCRIPTION
3-8SUMMARY OF QUANTITIES9TYPICAL SECTIONS10-11SCHEDULE OF QUANTITIES12ALIGNMENT, CONTROL POINTS, & BENCHMARKS13PLAN & PROFILE14REMOVAL PLAN15DRAINAGE PLAN & PROFILE16ENTRANCE PLAN17SIDEWALK DETAILS18-22DETOUR23RIGHT OF WAY24-34STRUCTURE 010-208 SHEETS35-36DISTRICT 5 DETAIL NO. 40800050C37DISTRICT 5 DETAIL NO. 5424851038DISTRICT 5 DETAIL NO. 702000040-43DISTRICT 5 DETAIL NO. 702000040-43DISTRICT 5 DETAIL NO. 7800AAAA44-49CROSS SECTIONS	-	
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15 DRAINAGE PLAN & PROFILE 16 ENTRANCE PLAN 17 SIDEWALK DETAILS 18-22 DETOUR 23 RIGHT OF WAY 24-34 STRUCTURE 010-2038 SHEETS 35-36 DISTRICT 5 DETAIL NO. 40800050C 37 DISTRICT 5 DETAIL NO. 54248510 38 DISTRICT 5 DETAIL NO. 60600095A 39 DISTRICT 5 DETAIL NO. 70200000 40-43 DISTRICT 5 DETAIL NO. 7800AAAA 44-49 CROSS SECTIONS	13	PLAN & PROFILE
16 ENTRANCE PLAN 17 SIDEWALK DETAILS 18-22 DETOUR 23 RIGHT OF WAY 24-34 STRUCTURE 010-2038 SHEETS 35-36 DISTRICT 5 DETAIL NO. 40800050C 37 DISTRICT 5 DETAIL NO. 54248510 38 DISTRICT 5 DETAIL NO. 60600095A 39 DISTRICT 5 DETAIL NO. 70200000 40-43 DISTRICT 5 DETAIL NO. 7800AAAA 44-49 CROSS SECTIONS	14	REMOVAL PLAN
17 SIDEWALK DETAILS 18-22 DETOUR 23 RIGHT OF WAY 24-34 STRUCTURE 010-2038 SHEETS 35-36 DISTRICT 5 DETAIL NO. 40800050C 37 DISTRICT 5 DETAIL NO. 54248510 38 DISTRICT 5 DETAIL NO. 60600095A 39 DISTRICT 5 DETAIL NO. 70200000 40-43 DISTRICT 5 DETAIL NO. 7800AAAA 44-49 CROSS SECTIONS	15	DRAINAGE PLAN & PROFILE
18-22 DETOUR 23 RIGHT OF WAY 24-34 STRUCTURE 010-2038 SHEETS 35-36 DISTRICT 5 DETAIL NO. 40800050C 37 DISTRICT 5 DETAIL NO. 54248510 38 DISTRICT 5 DETAIL NO. 60600095A 39 DISTRICT 5 DETAIL NO. 70200000 40-43 DISTRICT 5 DETAIL NO. 7800AAAA 44-49 CROSS SECTIONS	16	ENTRANCE PLAN
23 RIGHT OF WAY 24-34 STRUCTURE 010-2038 SHEETS 35-36 DISTRICT 5 DETAIL NO. 40800050C 37 DISTRICT 5 DETAIL NO. 54248510 38 DISTRICT 5 DETAIL NO. 60600095A 39 DISTRICT 5 DETAIL NO. 70200000 40-43 DISTRICT 5 DETAIL NO. 7800AAAA 44-49 CROSS SECTIONS	17	SIDEWALK DETAILS
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44-49 CROSS SECTIONS	39	DISTRICT 5 DETAIL NO, 70200000
	40-43	DISTRICT 5 DETAIL NO. 7800AAAA
50 CHANNEL CROSS SECTIONS	44-49	CROSS SECTIONS
	50	CHANNEL CROSS SECTIONS

COMMITMENTS

PARCEL NO. 5171202TE

AS A RESULT OF RIGHT-OF-WAY NEGOTIATIONS, THE PROPERTY OWNER, MR. VICTOR FUENTES, HAS SELECTED [LIST TREE DESCRIPTIONS & QUANTITIES OF EACH] AS REPLACEMENTS FOR TREES TO BE REMOVED DURING CONSTRUCTION OPERATIONS. FOR PLACEMENT OF THESE TREES, MR. FUENTES CAN BE REACHED AT THE FOLLOWING PHONE NUMBER: (217) 202-7327



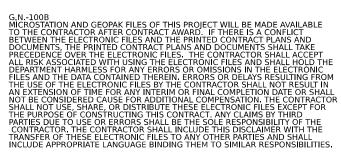

G.N.-105.09A ALL ELEVATIONS SHOWN IN THE PLANS ARE BASED ON NORTH AMERICAN VERTICAL DATUM OF 1988. (NAVD 88)

G.N.-201 TREES THAT INTERFERE WITH THE CONSTRUCTION OPERATIONS SHALL BE REMOVED AS DIRECTED BY THE ENGINEER. ANY TREE DUE TO ITS LOCATION AND DEEMED SUITABLE FOR SAVING BY THE ENGINEER SHALL BE PROTECTED DURING CLEARING AND SUBSEQUENT CONSTRUCTION OPERATIONS.

G.N. -406H MIXTURE REQUIREMENTS THE FOLLOWING MIXTURE REQUIREMENTS ARE APPLICABLE FOR THIS PROJECT:

Location	IL 10
Mixture Use	Incidental & Temporary
	Pavement
AC/PG	SBS PG 70-22
Design Air Voids	4.0% @ Ndes=70
Mix Comp(Gradation)	IL 9.5
Friction Aggregate	Mix D
Mixture Weight	112
Quality Management Program	QC/QA
Sublot Size	3000
Material Transfer Device (Required ?)	NO

G.N.-440B

THE EXISTING TIE BARS BETWEEN THE EXISTING PAVEMENT AND EXISTING MEDIANS, GUTTERS AND/OR COMBINATION CURB AND GUTTERS THAT ARE FOUND SUITABLE FOR REUSE SHALL BE CLEANED, STRAIGHTENED AND INCORPORATED INTO THE NEW CONSTRUCTION. ANY EXISTING TIE BARS THAT ARE FOUND UNSUITABLE TO BE INCORPORATED INTO THE PROPOSED CONSTRUCTION DUE TO EXCESSIVE RUSTING OR DISTRESS SHALL BE REMOVED FLUSH WITH THE FACE OF THE EXISTING CONCRETE AND DISPOSED OF OUTSIDE THE LIMITS OF THE RIGHT-OF-WAY IN ACCORDANCE WITH ARTICLE 202.03 OF THE STANDARD SPECIFICATIONS.

THIS WORK WILL NOT BE PAID FOR SEPARATELY BUT SHALL BE CONSIDERED INCLUDED IN THE VARIOUS REMOVAL PAY ITEMS AND NO ADDITIONAL COMPENSATION WILL BE ALLOWED.

G.N.- 542.07

AT LOCATIONS WHERE END SECTIONS ARE SPECIFIED, CAST-IN-PLACE CONCRETE HEADWALLS WILL NOT BE ALLOWED.

G.N.- 781

THE FINAL PAVEMENT MARKINGS SHALL BE IN PLACE PRIOR TO PLACING THE RAISED REFLECTIVE PAVEMENT MARKERS.

EXISTING TOPSOIL IN THE AREAS OF EARTH EXCAVATION SHALL BE STRIPPED AND STORED FOR USE FOR FINAL GRADING. THIS WORK SHALL BE INCIDENTAL TO EARTH EXCAVATION.



CIVIL DESIGN INC.	USER NAME = rhanfland	DESIGNED -	REVISED - RLH 5/8/2023	STATE OF ILLINOIS	INDEX OF SHEETS, GENERAL NOT	ES, HIGHWAY STANDARDS	F.A.P. RTE	SECTION	COUNTY TOTAL SHEET SHEETS NO.
WBE DBE		DRAWN -	REVISED -		& COMMITM	•	801	4BR	CHAMPAIGN 50 2
LIC. #184.003222	PLOT SCALE = 0.16666633 '/ in.	CHECKED -	REVISED -	DEPARTMENT OF TRANSPORTATION	a committe		_		CONTRACT NO. 70581
	PLOT DATE = 5/10/2023	DATE -	REVISED -		SCALE: 1" = 1' SHEET 1 OF 1 SHEET	S STA. TO STA.		ILLINOIS FE	.D. AID PROJECT

]	FAP 801 (ILL 10)
			ľ	FED 80%
				STATE 20%
				CHAMPAIGN COUNTY
				URBAN
				BOX CULVERT
CODE			TOTAL	0010
NO.	ITEM	UNIT	QUANTITY	010-2038
			QUANTIT	010-2050
0100110	TREE REMOVAL (6 TO 15 UNITS DIAMETER)	UNIT	14	14
0100110				± •
20200100	EARTH EXCAVATION	CU YD	110	110
20400800	FURNISHED EXCAVATION	CU YD	63	63
0700220	POROUS GRANULAR EMBANKMENT	CU YD	964	964
5000210	SEEDING, CLASS 2A	ACRE	0.25	0.25
5000400	NITROGEN FERTILIZER NUTRIENT	POUND	26	26
5000500	PHOSPHORUS FERTILIZER NUTRIENT	POUND	26	26
5000600	POTASSIUM FERTILIZER NUTRIENT	POUND	26	26
			20	2.0
5100115	MULCH, METHOD 2	ACRE	0.25	0.25
5200100	SODDING	SQ YD	278	278
25200200	SUPPLEMENTAL WATERING	UNIT	1	1
8000250	TEMPORARY EROSION CONTROL SEEDING	POUND	350	350
· · · · · · · · · · · · · · · · · · ·				`
8000400	PERIMETER EROSION BARRIER	FOOT	100	100
0000500				
8000500	INLET AND PIPE PROTECTION	EACH	2	2

* SPECIALTY ITEM



		USER NAME = rhanfland	DESIGNED -	REVISED -		1	
	GIVIL DESIGN,ING. WBE DBE		DRAWN -	REVISED -	STATE OF ILLINOIS	1	SUMMARY OF QU
DI LIVIL DESIGN,INC. WBE DBE EFFINGHAM, IL LIC. #184.003222	PLOT SCALE = 0.16666633 ' / in.	CHECKED -	REVISED -	DEPARTMENT OF TRANSPORTATION	1		
	210. ***04.000222	PLOT DATE = 3/14/2023	DATE -	REVISED -		SCALE: 1" = 1'-0"	SHEET 1 OF 6 SHEETS

 F.A.P. RTE:
 SECTION
 COUNTY
 TOTAL SHEETS
 SHEET NO.

 801
 4BR
 CHAMPAIGN
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 CONTRACT NO. 70581

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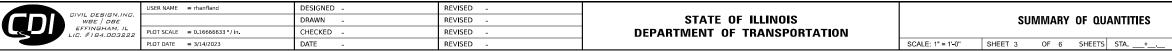
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 ILLINOIS
 FED. AID PROJECT

		1	_	FAP 801 (ILL 10) FED 80% STATE 20% CHAMPAIGN COUNTY URBAN
CODE NO.	ITEM	UNIT	TOTAL QUANTITY	BOX CULVERT 0010 010-2038
28100109	STONE RIPRAP, CLASS A5	SQ YD	134	134
28200200	FILTER FABRIC	SQ YD	134	134
28400100	GABIONS	CU YD	33	33
31101900	SUBBASE GRANULAR MATERIAL, TYPE C	TON	94	94
10800025	BITUMINOUS MATERIALS (PRIME COAT)	POUND	461	461
10800050	INCIDENTAL HOT-MIX ASPHALT SURFACING	TON	46	46
12300200	PORTLAND CEMENT CONCRETE DRIVEWAY PAVEMENT, 6 INCH	SQ YD	107	107
42400200	PORTLAND CEMENT CONCRETE SIDEWALK 5 INCH	SQ FT	1490	1490
42400800	DETECTABLE WARNINGS	SQ FT	20	20
44000200	DRIVEWAY PAVEMENT REMOVAL	SQ YD	321	321
44000500	COMBINATION CURB AND GUTTER REMOVAL	FOOT	289	289
44000600	SIDEWALK REMOVAL	SQ FT	398	398
14201371	CLASS C PATCHES, TYPE IV, 11 INCH	SQ YD	520	520
50100300	REMOVAL OF EXISTING STRUCTURES NO. 1	EACH	1	1
SPECIALTY ITEM				

USER NAME = manifand DESIGNED - REVISED -	SECTION COUNTY ISVANTSEIS I
WHE I DEE DRAWN - REVISED - STATE OF ILLINOIS SUMMARY OF QUANTITIES	ao1 I 4BR CHAMPAIGN I so I 4
EFFINGHAM, IL I.G. #784.0032Z PLOTSCALE = 0.16666633 // h. CHECKED - REVISED - DEPARTMENT OF TRANSPORTATION	CONTRACT NO. 70581
PLOT DATE = 3/14/2023 DATE REVISED SCALE: 1" = 1 0" I SHEET 2 OF 6 SHEETS I STA_ + TO STA.	_ + ILLINOIS FED. AID PROJECT

				FAP 801 (ILL 10) FED 80% STATE 20% CHAMPAIGN COUNTY
CODE			TOTAL	URBAN BOX CULVERT 0010
NO.	ITEM	UNIT	QUANTITY	010-2038
50100400	REMOVAL OF EXISTING STRUCTURES NO. 2	EACH	1	1
50105220	PIPE CULVERT REMOVAL	FOOT	128	128
0200450	REMOVAL AND DISPOSAL OF UNSUITABLE MATERIAL FOR STRUCTURES	CU YD	99	99
50800105	REINFORCEMENT BARS	POUND	77,960	77,960
0901720	BICYCLE RAILING	FOOT	140	140
1500100	NAME PLATES	EACH	1	1
2200015	PERMANENT SHEET PILING	SQ FT	195	195
64003000	CONCRETE BOX CULVERTS	CU YD	377.2	377.2
			57712	
421D018	PIPE CULVERTS, CLASS D, TYPE 1 18" (TEMPORARY)	FOOT	40	40
4213663	PRECAST REINFORCED CONCRETE FLARED END SECTIONS 18"	EACH	2	2
4248510	CONCRETE COLLAR	CU YD	1.3	1.3
50A0340	STORM SEWERS, CLASS A, TYPE 2 12"	FOOT	22	22
50A0380	STORM SEWERS, CLASS A, TYPE 2 18"	FOOT	156	156
50A0410	STORM SEWERS, CLASS A, TYPE 2 24"	FOOT	13	13

* SPECIALT ITEM



 FA.P. RTE.
 SECTION
 COUNTY
 TOTAL SHEETS
 SHEET NO.

 801
 4BR
 CHAMPAIGN
 50
 5

 CONTRACT NO. 70581

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 TO STA. __+_.
 ILLINOIS
 FED. AID PROJECT

]	FAP 801 (ILL 10)
			ľ	FED 80%
				STATE 20%
				CHAMPAIGN COUNTY
				URBAN
				BOX CULVERT
CODE			TOTAL	0010
NO.	ITEM	UNIT	QUANTITY	010-2038
			QUINTIT	010 2000
50A0500	STORM SEWERS, CLASS A, TYPE 2 60"	FOOT	13	13
55100500	STORM SEWER REMOVAL 12"	FOOT	12	12
59100100	GEOCOMPOSITE WALL DRAIN	SQ YD	296	296
	MANHOLES, TYPE A, 5'-DIAMETER, TYPE 1 FRAME, CLOSED LID		1	1
50221100	MANHOLES, TYPE A, S'-DIAMETER, TYPE I FRAME, CLOSED LID	EACH	1	1
50600095	CLASS SI CONCRETE (OUTLET)	CU YD	1.2	1.2
50603800	COMBINATION CONCRETE CURB AND GUTTER, TYPE B-6.12	FOOT	40	40
50605000	COMBINATION CONCRETE CURB AND GUTTER, TYPE B-6.24	FOOT	305	305
53200310	GUARDRAIL REMOVAL	FOOT	159	159
57000500	ENGINEER'S FIELD OFFICE, TYPE B	CAL MO	4	4
57100100	MOBILIZATION	L SUM	1	1
0107025	CHANGEABLE MESSAGE SIGN	CAL DA	14	14
	CHORT TERM DAVEMENT MARKING	FOOT	48	48
70300100	SHORT TERM PAVEMENT MARKING	FUUT	40	40
0300150	SHORT TERM PAVEMENT MARKING REMOVAL	SQ FT	16	16
0300211	TEMPORARY PAVEMENT MARKING LETTERS AND SYMBOLS - PAINT	SQ FT	62	62

* SPECIALTY ITEM

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	F.A.P. RTE	SECTION		COUNTY	TOTAL SHEETS	SHEET NO.
UANTITIES	801	4BR		CHAMPAIGN	50	6
				CONTRACT	NO. 705	581
S STA+ TO STA+		ILLIN	IOIS FED. AI	PROJECT		

				-	FAP 801 (ILL 1 FED 80% STATE 20% CHAMPAIGN COUN
	CODE NO.	ITEM	UNIT	TOTAL QUANTITY	URBAN BOX CULVERT 0010 010-2038
,	70300221	TEMPORARY PAVEMENT MARKING - LINE 4" - PAINT	FOOT	325	325
*	72400200	REMOVE SIGN PANEL ASSEMBLY - TYPE B	EACH	2	2
*	72400500	RELOCATE SIGN PANEL ASSEMBLY - TYPE A	EACH	2	2
* ,	78008300	POLYUREA PAVEMENT MARKING TYPE 11 - LETTERS AND SYMBOLS	SQ FT	62	62
* [78008310	POLYUREA PAVEMENT MARKING TYPE II - LINE 4"	FOOT	325	325
* [78011000	GROOVING FOR RECESSED PAVEMENT MARKING, LETTERS AND SYMBOLS	SQ FT	62	62
* _	78011025	GROOVING FOR RECESSED PAVEMENT MARKING 5"	FOOT	325	325
*	78100100	RAISED REFLECTIVE PAVEMENT MARKER	EACH	6	6
Ī	A2000216	TREE, ACER X FREEMANII MARMO (MARMO FREEMAN MAPLE), 2" CALIPER, BALLED AND BURLAPPED	EACH	2	2
Σ	X0323265	REMOVE EXISTING RIPRAP	SQ YD	114	114
	A2005016	TREE, GYMNOCLADUS DIOICUS (KENTUCKY COFFEETREE), 2" CALIPER, BALLED AND BURLAPPED	EACH	2	2
Þ	X0900064	MEMBRANE WATERPROOFING SYSTEM FOR BURIED STRUCTURES	SQ YD	296	296
	B2010042	TREE, CHIONANTHUS VIRGINIICUS (WHITE FRINGETREE), 2" CALIPER, TREE FORM, BALLED AND BURLAPPED	EACH	2	2
Σ	X2840105	GABION REMOVAL	CU YD	36	36
Σ	X5427602	REMOVE EXISTING FLARED END SECTION	EACH	2	2
2	X7010216	TRAFFIC CONTROL AND PROTECTION, (SPECIAL)	l SUM	1	1
Z	Z0013798	CONSTRUCTION LAYOUT	L SUM	1	1

*	SPECI
	ITEM

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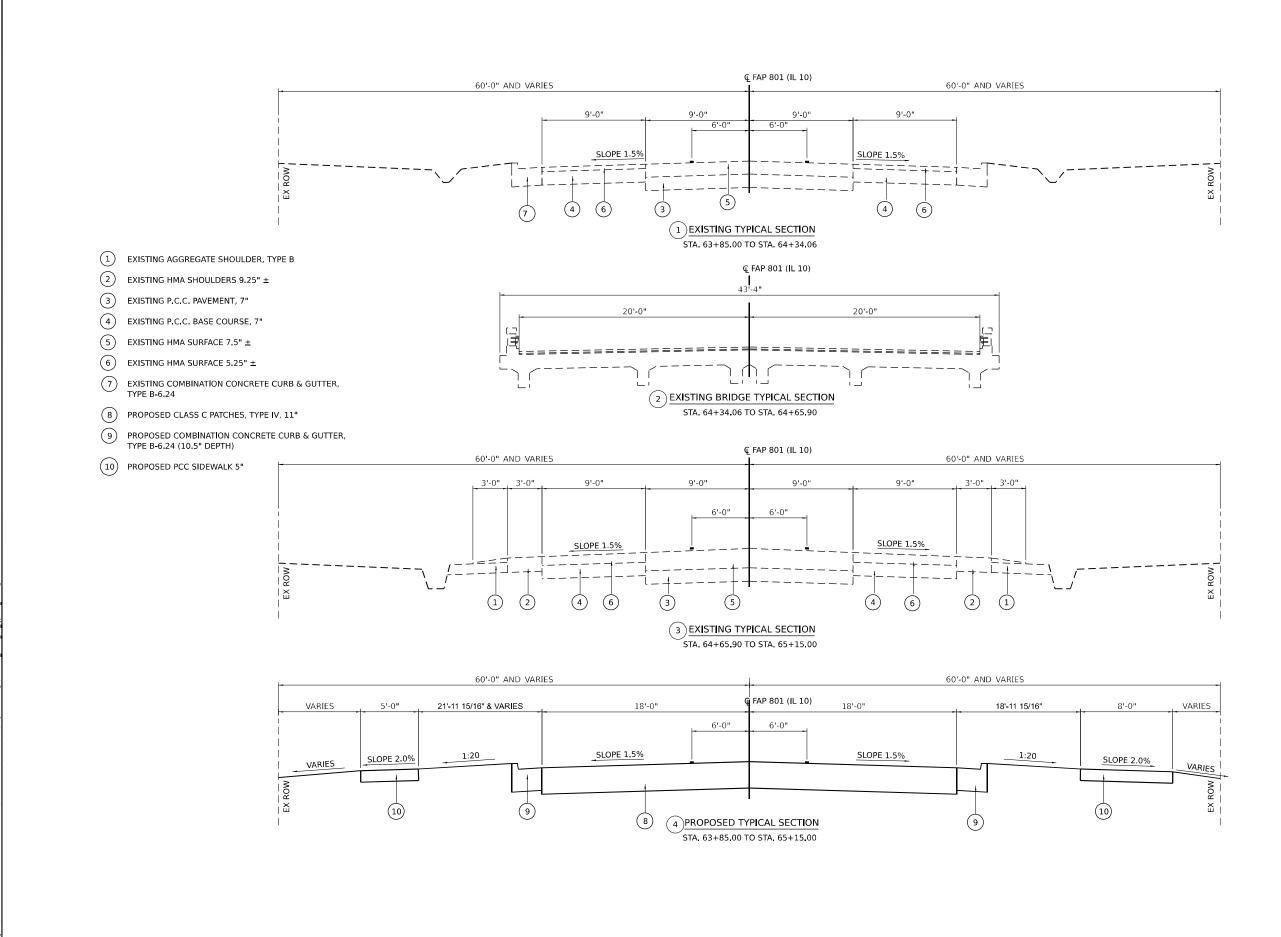
			Ĺ	FAP 801 (ILL 10)
				FED 80% STATE 20% CHAMPAIGN COUNTY URBAN
				BOX CULVERT
CODE			TOTAL	0010
NO.	ITEM	UNIT	QUANTITY	010-2038
20016702	DETOUR SIGNING	L SUM	1	1
20038700	PERMANENT BENCH MARKS	EACH	1	1
20054517	ROCK FILL - FOUNDATION	TON	158	158
Z0062456	TEMPORARY PAVEMENT	SQ YD	403	403
PECIALTY IT				

* SPECIALTY ITEM



		USER NAME = rhanfland	DESIGNED -	REVISED -				
'n'	GIVIL DESIGN,INC. WBE DBE		DRAWN -	REVISED -	STATE OF ILLINOIS		SUMMARY	OF QUA
ועי	EFFINGHAM, IL LIC. #184.003222	PLOT SCALE = 0.16666633 ' / in.	CHECKED -	REVISED -	DEPARTMENT OF TRANSPORTATION			
	2.0	PLOT DATE = 3/14/2023	DATE -	REVISED -		SCALE: 1" = 1'-0"	SHEET 6 OF 6	SHEETS

	F.A.P. RTE	SECT	ION		COUNTY	TOTAL SHEETS	SHEET NO.
UANTITIES	801	4B	R		CHAMPAIGN	50	8
					CONTRACT	NO. 705	581
TS STA+ TO STA+			ILLINOIS	FED, AI	D PROJECT		



	USER NAME = rhanfland	DESIGNED -	REVISED -						F A P. RTF	SECTION	COUNTY	TOTAL	SHEET
WBE DBE		DRAWN -	REVISED -	STATE OF ILLINOIS			TYPICAL SECTIONS		801	4BR	CHAMPAIGN	50	9
EFFINGHAM, IL LIC. #184.003222	PLOT SCALE = 0.16666633 '/in.	CHECKED -	REVISED -	DEPARTMENT OF TRANSPORTATION							CONTRACT	NO. 70'	581
	PLOT DATE = 3/14/2023	DATE -	REVISED -		SCALE: 1" = 1'	SHEET 1	OF 1 SHEETS STA.	TO STA.		ILLINOIS FED. A	D PROJECT		

					ENTRAN	CE SCHEDULE			
					31101900	40800025	40800050	42300200	
STATION	SIDE	THROAT	LEGHTH (EOP	AREA	SUBBASE GRANULAR	BITUMINOUS	INCIDENTAL HOT-MIX	PORTLAND CEMENT	Г
		WIDTH	TO BACK OF		MATERIAL, TYPE C	MATERIALS	ASPHALT SURFACING	CONCRETE DRIVEWAY	
			ENTRANCE)			(PRIME COAT)	(4" THICK)	PAVEMENT, 6 INCH	
		FEET	FEET	SQ YD	TON	POUND	TON	SQ YD	Γ
63+98	LT	30.3	25.5	107.0				107.0	
64+93	RT	23.0	24.0	85.0	38.7	191.3	19.0		Γ
65+07	LT	30.2	28.4	119.5	54.4	268.9	26.8		
61+94	LT	20.0	93.0	222.9					
65+46	LT	20.0	41.0	85.9					Г
65+68	RT	20.0	58.1	93.3					
				TOTAL	93.1	460.2	45.8	107.0	Γ
				USE	94	461	46	107	
					TON	POUND	TON	SQ YD	

								REI	MOVAL SCHE	DULE				
			20100110	44000200	44000500	44000600	50105220	55100500	63200310	72400200	72400500	X0322936	X0323265	
STATION	TO STATION	SIDE	TREE REMOVAL	DRIVEWAY	COMBINATION CURB	SIDEWALK	PIPE	STORM	GUARDRAIL	REMOVE SIGN	REMOVE SIGN	REMOVE EXISTING	REMOVE	COMMENT
			(6 TO 15 UNITS	PAVEMENT	AND GUTTER	REMOVAL	CULVERT	SEWER	REMOVAL	PANEL ASSEMBLY	- PANEL ASSEMBLY -	FLARED END	EXISTING	
			DIAMTER)	REMOVAL	REMOVAL		REMOVAL	REMOVAL, 12"		TYPE B	TYPE A	SECTION	RIPRAP	
			UNIT	SQ YD	FOOT	SQ FT	FOOT	FOOT	FOOT	EACH	EACH	EACH	SQ YD	
60+99		RT								1				WEIGHT LIMIT SIGN
61+74	62+21	LT			47									EXIST. 6.24 C&G
61+74	62+21	LT			47									DEPRESSED 6.24 C&G PUT IN FOR TEMP ENT.
61+84	62+04	LT			20									EXIST. 6.12 C&G IN PARKING LOT
61+84	62+04	LT			20									DEPRESSED 6.12 C&G PUT IN FOR TEMP ENT.
61+83	62+05	LT				88								
61+88		44' LT	7											
61+95		85' LT	7											
63+70	63+97	RT				135								
63+75	64+28	RT							57					
63+85	64+28	RT			43									EXIST. 6.24 C&G
64+40		LT											47	GROUTED RIP RAP
64+62	64+74	RT				60								
63+72	64+39	LT			67									EXIST. 6.24 C&G
63+98		LT		121	45	115			41					C.E. PCC, EXIST. 6.12 C&G
64+63		RT									1			SPEED LIMIT SIGN
64+75		LT											67	GROUTED RIP RAP
64+77		LT									1			SPEED LIMIT SIGN
64+93		RT		86					32					C.E. HMA
65+07		LT		114					29					C.E. HMA
64+07		RT						12						LENGTH INLCUDES END SECTION
64+04		42' RT										1		24" END SECTION
64+40		39' LT										1		60" END SECTION
64+48	64+55	RT					58							18" CMP
64+74	65+44	LT					70							18" CMP
69+97		LT								1				WEIGHT LIMIT SIGN
		TOTAL		321	289	398	128	12	159	2	2	2	114	
			UNIT	SQ YD	FOOT	SQ FT	FOOT	FOOT	FOOT	EACH	EACH	EACH	SQ YD	

				EARTHWORK		
			20200100	EXCVATION ADJUSTED		EARTHWORK
OTATION	-	STATION	EARTH EXCAVATION	ADJUSTED FOR	EMBANKMENT	BALANCE WASTE (+)
STATION	10	STATION		SHRINKAGE 25%		OR SHORTAGE (-)
			CU YD	CU YD	CU YD	CU YD
61+94 LT			60	45	60	-15
63+85		64+17	2	2	44	-42
64+77		65+15	25	19	1	18
65+46 LT			10	8	22	-14
65+68 RT			13	10	20	-10
		TOTAL	110	84	147	- 63
			CU YD	CU YD	CU YD	CU YD

		PAT	CHING SCHEDULE	
			44201371	STATION
STATION	то	STATION	CLASS C PATCHES, TYPE IV, 11 INCH	
			SQ YD	61+83
63+85		65+15	520	64+16
		TOTAL	520	63+70
			SQ YD	



		USER NAME = rhanfland	DESIGNED -	REVISED -					
D	CIVIL DESIGN,INC. WBE DBE		DRAWN -	REVISED -	STATE OF ILLINOIS		SCHEDULES OF Q		
	EFFINGHAM, IL LIC. #184.003222	PLOT SCALE = 0.16666633 '/in.	CHECKED -	REVISED -	DEPARTMENT OF TRANSPORTATION				
		PLOT DATE = 3/14/2023	DATE -	REVISED -		SCALE: 1"=5'	SHEET 1	OF 2	SHEETS

Z0062456
TEMPORARY
PAVEMENT
SQ YD
222.9
85.9
93.3
402.1
403
SQ YD

[
			SIDEV	VALK SCHEDULE		
				42400200	42400800	
				PORTLAND CEMENT	DETECTABLE	
STATION	то	STATION	SIDE	CONCRETE SIDEWALK	WARNINGS	
				5 INCH		
				SQ FT	SQ FT	
61+83		62+05	LT	88		
64+16		64+99	LT	514	20	
63+70		64+75	RT	888		
		TOTAL		1490	20	
				SQ FT	SQ FT	

	E. SECT			COUNTY	SHEETS	SHEET NO.
UANTITIES 801	1 4B	4BR CHAMPAIGN			50	10
				CONTRACT	NO. 705	i81
S STA+ TO STA+	ILLINOIS FED. A			PROJECT		

							DRAINAGE	SCHEDULE			
				54213663	54248510	5422D018	550A0340	550A0380	550A0410	550A0500	60221100
STATION	то	STATION	SIDE	PRECAST REINFORCED CONCRETE FLARED END SECTIONS 18"	CONCRETE COLLAR	PIPE CULVERTS, CLASS D, TYPE 1 18" (TEMPORARY)	STORM SEWERS, CLASS A, TYPE 2 12"	STORM SEWERS, CLASS A, TYPE 2 18"	STORM SEWERS, CLASS A, TYPE 2 24"	STORM SEWERS, CLASS A, TYPE 2 60"	MANHOLES, TYPE A, 5'- DIAMETER, TYPE 1 FRAME CLOSED LID
				EACH	CU YD	FOOT	FOOT	FOOT	FOOT	FOOT	EACH
64+04			42' RT								1
64+08			RT				22				
64+04		64+09	RT						13		
64+41		64+51	LT		1.3					13	
64+45		65+06	RT	1				62			
64+75		65+68		1				94			
65+68			RT			40					
			TOTAL	2	1.3	40	22	156	13	13	1
				EACH	CU YD	FOOT	FOOT	FOOT	FOOT	FOOT	EACH


					PAVEMENT MARKING	S SCHEDULE			
			78008300	78008310	70300211	70300221	78011000	78011025	78100100
STATION	TO STATION	SIDE	POLYUREA PAVEMENT MARKING TYPE II - LETTERS AND SYMBOLS	POLYUREA PAVEMENT MARKING TYPE II - LINE 4"	TEMPORARY PAVEMENT MARKING LETTERS AND SYMBOLS - PAINT	TEMPORARY PAVEMENT MARKING - LINE 4"- PAINT	GROOVING FOR RECESSED PAVEMENT MARKING, LETTERS AND SYMBOLS	GROOVING FOR RECESSED PAVEMENT MARKING 5"	RAISED REFLECTIVE PAVEMENT MARKER
			SQ FT	FOOT	SQ FT	FOOT	00 FT	FOOT	FAOL
			WHITE	YELLOW	WHITE	YELLOW	SQ FT	FOOT	EACH
63+85	65+15	LT	<u></u>	163	62	163	<u></u>	163	3
63+85	65+15	RT	62	163		163	62	163	3
	TOTAL		62	325	62	325	62	325	6
			SQ FT	FOOT	SQ FT	FOOT	SQ FT	FOOT	EACH

						CURB AND GUTTER SCHEDU	LE			
				60600095	60603800	60605000				
STATION	то	STATION	SIDE	CLASS SI CONCRETE (OUTLET)	COMBINATION CONCRETE CURB AND GUTTER, TYPE B-6.12	COMBINATION CONCRETE CURB AND GUTTER, TYPE B-6.24	COMMENT			
							CU YD	FOOT	FOOT	
61+74		62+21	LT			47	DEPRESSED GUTTER FOR TEMP. ENT			
61+74		62+21	LT			47	REPLACING CURB AND GUTTER AFTER TEMP. EN			
61+84		62+04	LT		20		DEPRESSED GUTTER FOR TEMP. ENTRANCE			
61+84		62+04	LT		20		REPLACING CURB AND GUTTER AFTER TEMP. EN			
63+85		64+53	RT			68				
64+53		64+58	RT	0.6						
63+72		64+68	LT			96				
64+68		64+72	LT	0.6						
64+16		64+34	LT			47	63+98 LT C.E.			
			TOTAL	1.2	40	305				
				CU YD	FOOT	FOOT				


AL ST.
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28000400 PERIMETER EROSION BARRIER FEET	28000500 INLET AND PIPE PROTECTION EACH	28000250 TEMPORARY EROSION CONTROL SEEDING POUND	COMMENT
EROSION BARRIER	PIPE PROTECTION	EROSION CONTROL SEEDING	COMMENT
FEET	EACH	POUND	
100			AS NEEDED FOR TOPSOIL STOCKPIPLE
		350	0.25 ACRES (10 APPLICATIONS)
	1		
	1		
100	2	350	
FEET	EACH	POUND	
	100	1 1 100 2	350 1 1 100 2 350

		USER NAME = rhanfland	DESIGNED -	REVISED -					
Ţ	CIVIL DESIGN,INC. WBE DBE		DRAWN -	REVISED -	STATE OF ILLINOIS	SCHEDULES			OF QUAI
	EFFINGHAM, IL LIC. #184.003222	PLOT SCALE = 0.16666633 ' / in.	CHECKED -	REVISED -	DEPARTMENT OF TRANSPORTATION	1			
		PLOT DATE = 3/14/2023	DATE -	REVISED -		SCALE: 1"=5'	SHEET 2	OF 2	SHEETS
_		PLOT DATE = $3/14/2023$	DATE -	REVISED -		SCALE: 1"=5"	SHEET 2	OF 2	SHEET

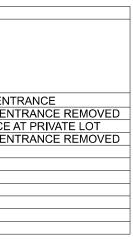

	F.A.P. RTE	SECTION		COUNTY	TOTAL SHEETS	SHEET NO.
QUANTITIES	801 4BR CHAMP			CHAMPAIGN	50	11
				CONTRACT	NO. 705	581
EETS STA+ TO STA+		ILLINOIS	FED. AI	D PROJECT		
		ILLINOIS	FED. All	D PROJECT		

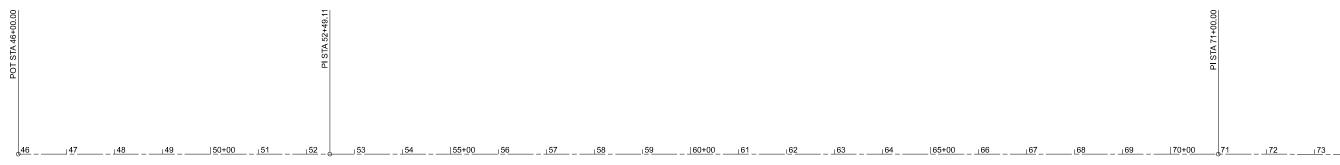


BENCHMARK

BM 4487 - CHISELED "X" TOP CENTER BOLT OF FH LOCATED IN THE SW QUAD OF DUNCAN RD & RIDGEWOOD CT (IDOT #4482-7) S DUNCAN ROAD STA. 6+64.40 38.3' LT ELEV.730.75'	BM ISL QU IL 1
BM LIN1- CHISELED "X" TOP CENTER BOLT OF FH BETWEEN IN & OUT ENTRANCE TO KFC; FIRST FH EAST OF KENWOOD RD, SOUTH OF IL 10 IL 10 STA. 47+93.10 34.9' LT ELEV. 750.04'	TBI QU S. [
	ТΒМ
BM LIN2 - CHISELED SQUARE SOUTHERLY CORNER	OF
OF TRAFFIC CONTROL BOX FDN LOCATED IN THE NW QUAD OF IL 10 & KENWOOD ROAD, INT.	N. [
IL 10 STA. 52+86.10 55.7' RT ELEV. 745.96'	CHI LO(
BM LIN3 - CHISELED SQUARE TOP OF SE WINGWALL:	& IL
SN 010-0135; BRIDGE IS LOCATED 20'±	IL 1
E. OF KAUFFMAN LAKE ENT.	
IL 10 STA. 64+39.5 22.1' LT ELEV. 730.31'	CHI PL/
BM4481 - CHISELED SQUARE ON SW CORNER OF	& 0
CONTROLLED ENVIRONMENT TELEPHONE BOX FDN LOCATED ON THE N. SIDE OF IL10 35'± N. OF EDGE OF PAVEMENT, 270'± W. OF CN RR CROSSING, & 670'± W. OF DUNCAN RD. (IDOT #4482-1) IL 10 STA. 72+05.4 61.0' RT ELEV. 737.40'	ELE

ŀ	ALIGNMENT COC	RDINATED - IL 1	0
STATION	NORTHING	EASTING	DESCRIPTION
46+00.00	1255107.633	998170.194	P.O.T.
52+49.11	1255115.620	997521.134	P.I.
71+00.00	1255138.394	995670.382	P.I.
73+83.00	1255142.569	995387.413	P.O.T.

	CONTRO	L POINTS	
POINT NAME	NORTHING	EASTING	ELEVATION
300	1254490.953	996638.5483	733.78
301	1254476.2300	996831.8669	736.776
302	1256231.988	997536.0234	739.431
303	1256017.531	997538.7745	745.429

CONTROL POINT
,
1 OF 1 SHEETS
Г ,

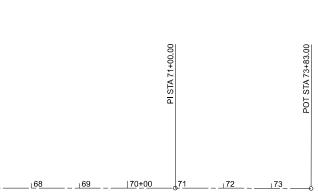

M

N

BM LIN4 - CHISELED SQUARE ON NE COR. OF HH FDN IN ISLAND W/ STOP LIGHT & RR CROSSING SIGNAL IN THE SW QUAD OF IL 10 AND DUNCAN RD. INT. IL 10 STA. 83+95.1 24.9' LT ELEV. 734.14'


TBM1 - CHISELED "X" TOP CNTR BOLT FH LOCATED IN NW QUAD OF S. DUNCAN RD. & BLAIR DR., 800' S. OF IL 10 DUNCAN STA 2+14.3 42.7' LT ELEV. 728.04'


BM2 - CHISELE "X" IN W NW BOLT TOP OF FH IN N. QUAD F S. DUNCAN RD & LAGER DR., 720'± N. OF IL 10 DUNCAN STA 17+25.4 34.5' RT ELEV. 741.99'

HISELED "X" ON NW WINGWALL OF BRIDGE (SN 010-0247) OCATED ON IL 10 OVER CREEK BETWEEN PRARIE GARDENS ILLINOIS BRICK CO. 0.1 MI. W. OF DUNCAN RD. (IDOT #4482-3) 10 STA. 84+37.0 27.4' RT ELEV. 730.12'


CHISELED "X" IN MH RIM LOCATED IN CONC. ENT. TO PLASTIPAX INC.; N. SIDE OF IL 10; 0.3 MI. W. OF DUNCAN RD. & 0.1 MI. E. OF I-57 OVERPASS (IDOT #4482-4) LEV. 732.53'


	F.A.P. RTE	SECTION	COUNTY	TOTAL SHEETS	SHEET NO.
NTS & BENCHMARKS	801	4BR	CHAMPAIGN	50	12
			CONTRACT	NO. 705	581
TS STA+ TO STA+		ILLINOIS FED. A	D PROJECT		

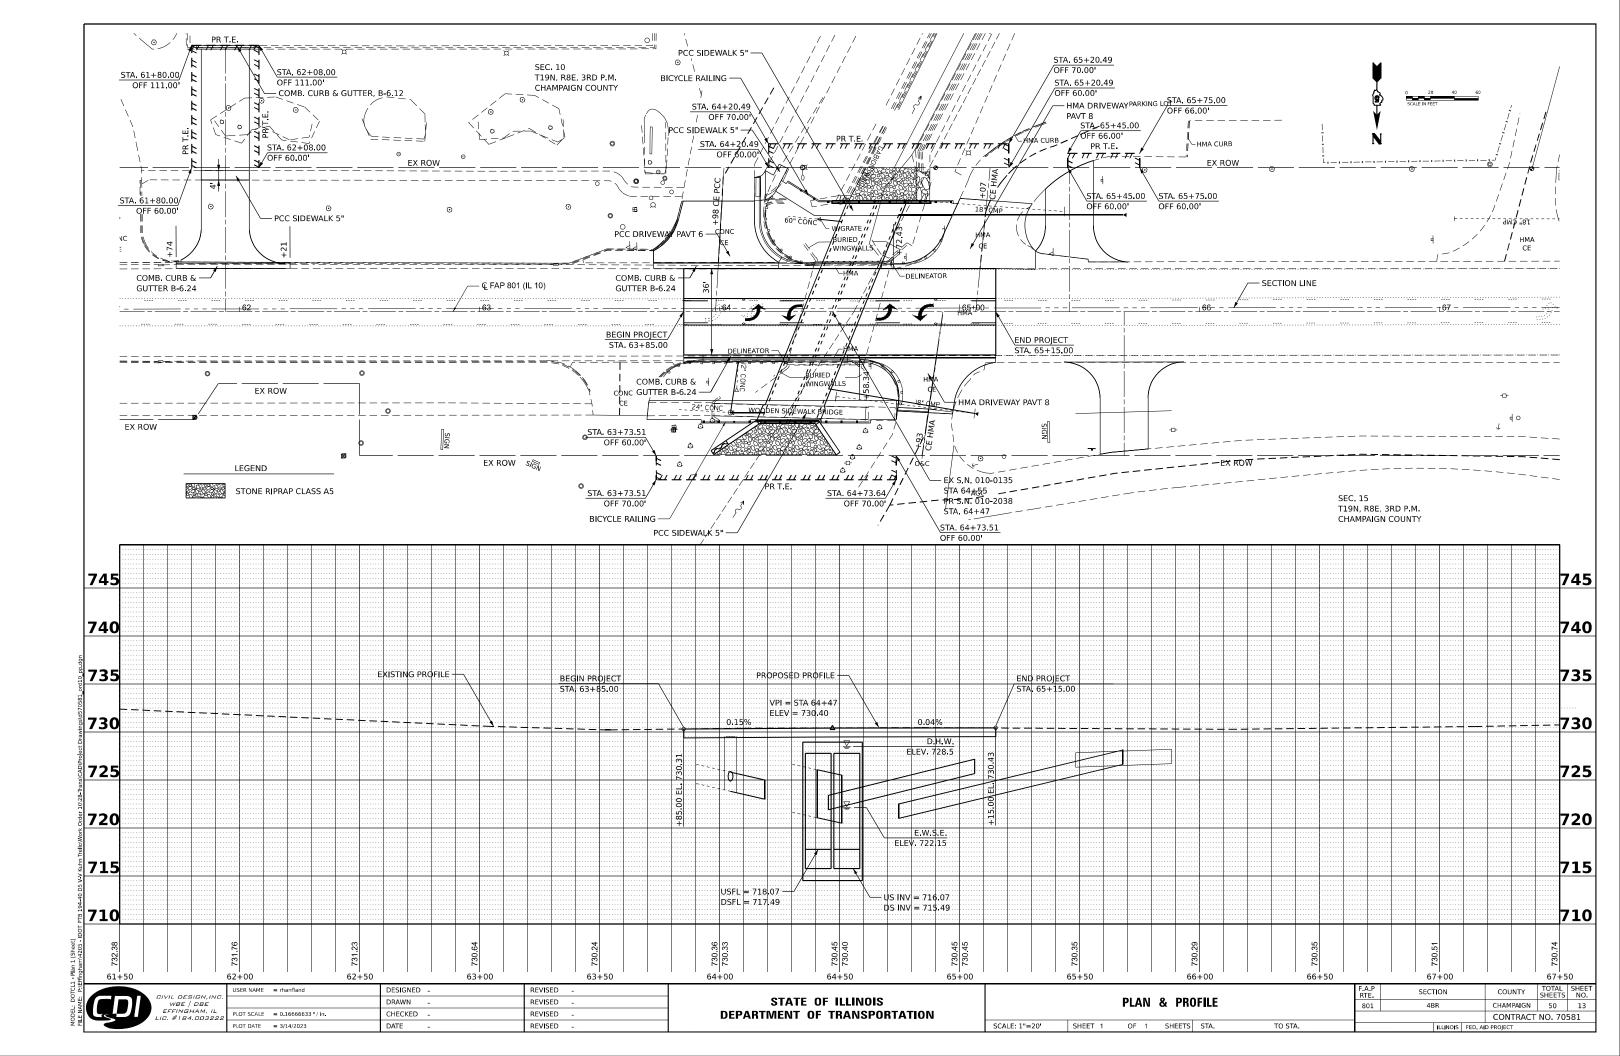


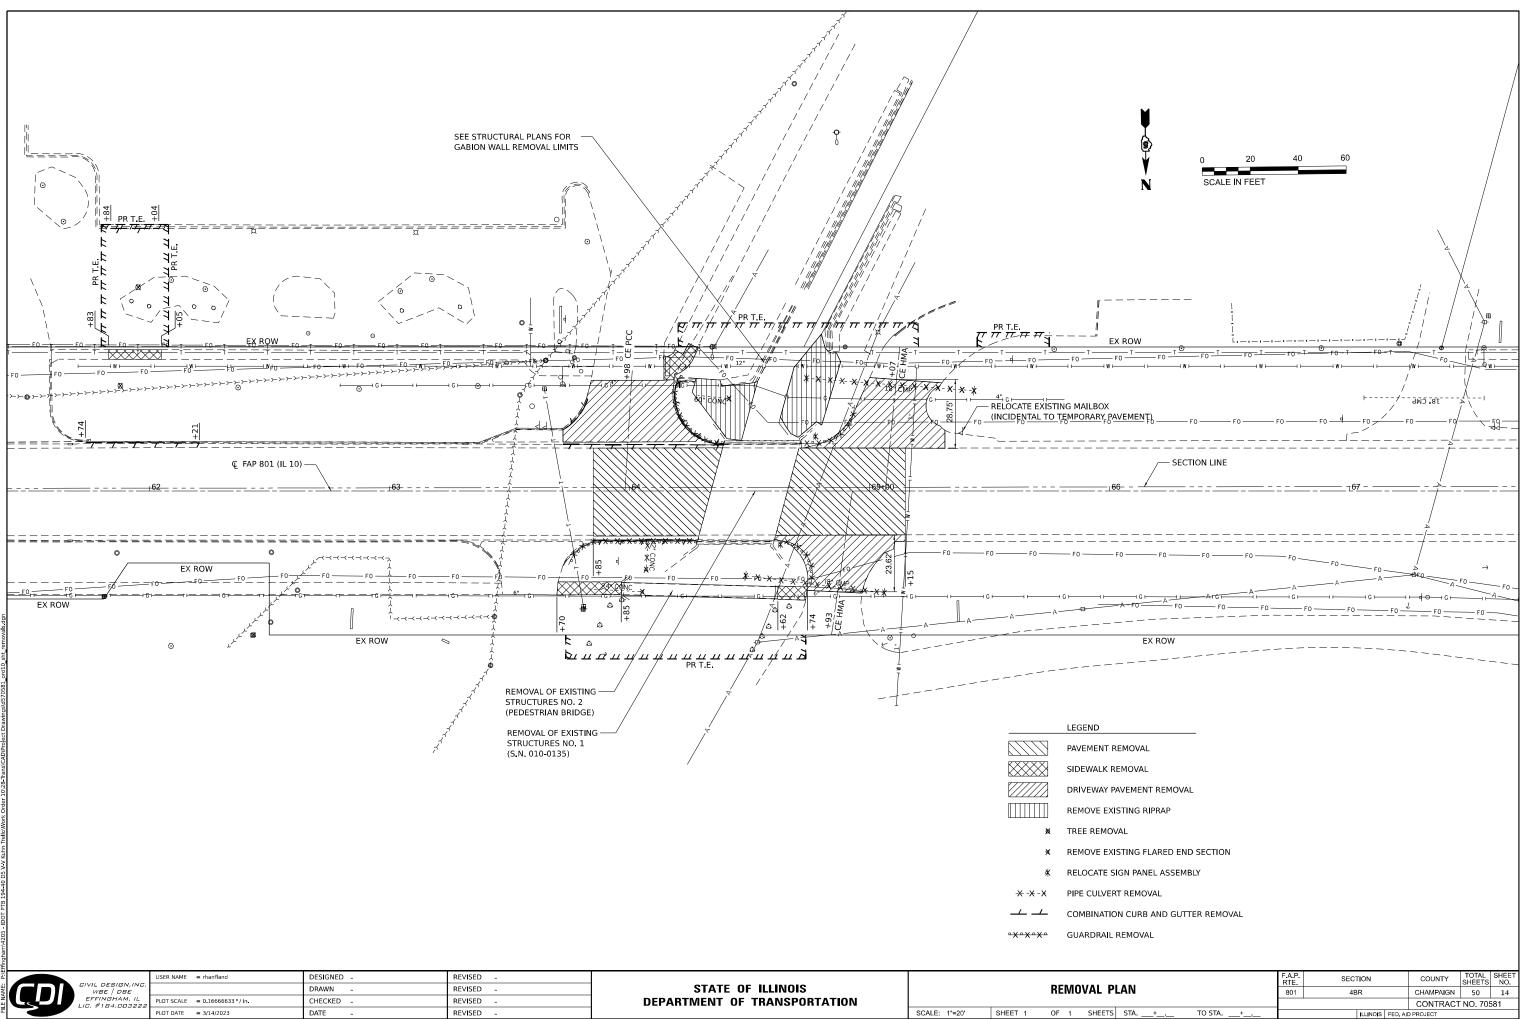


SCALE: 1"=20' SHEET 1 OF 1 SHEETS STA. __+_.

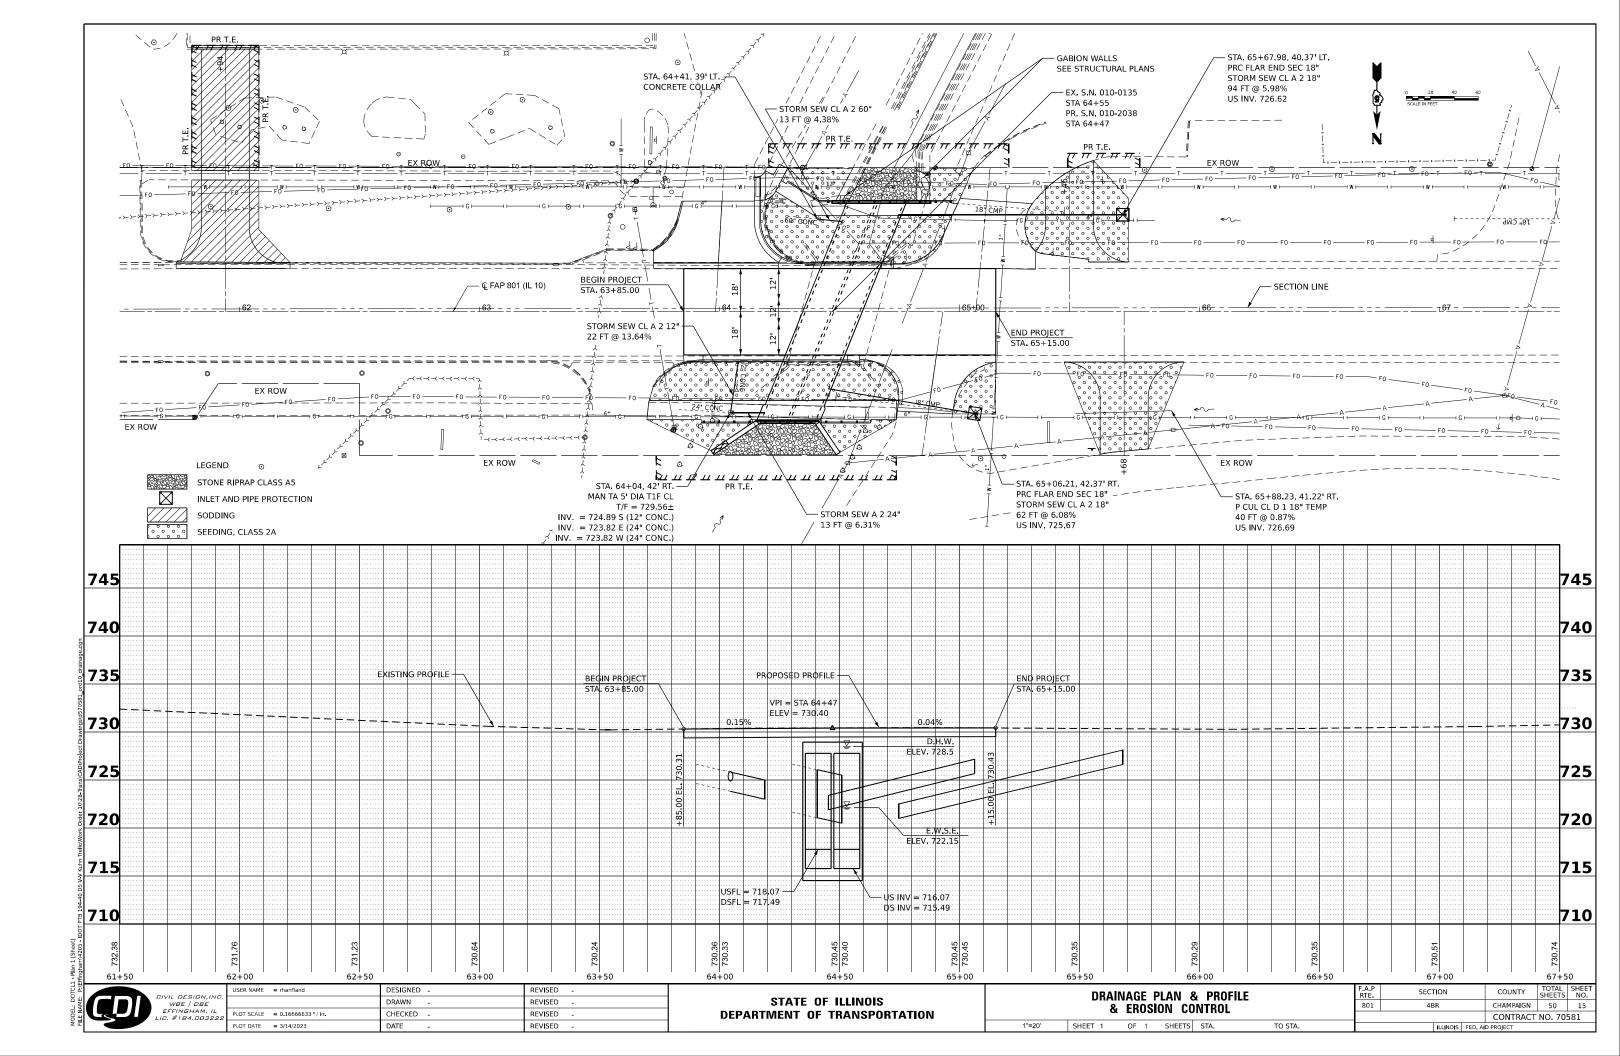

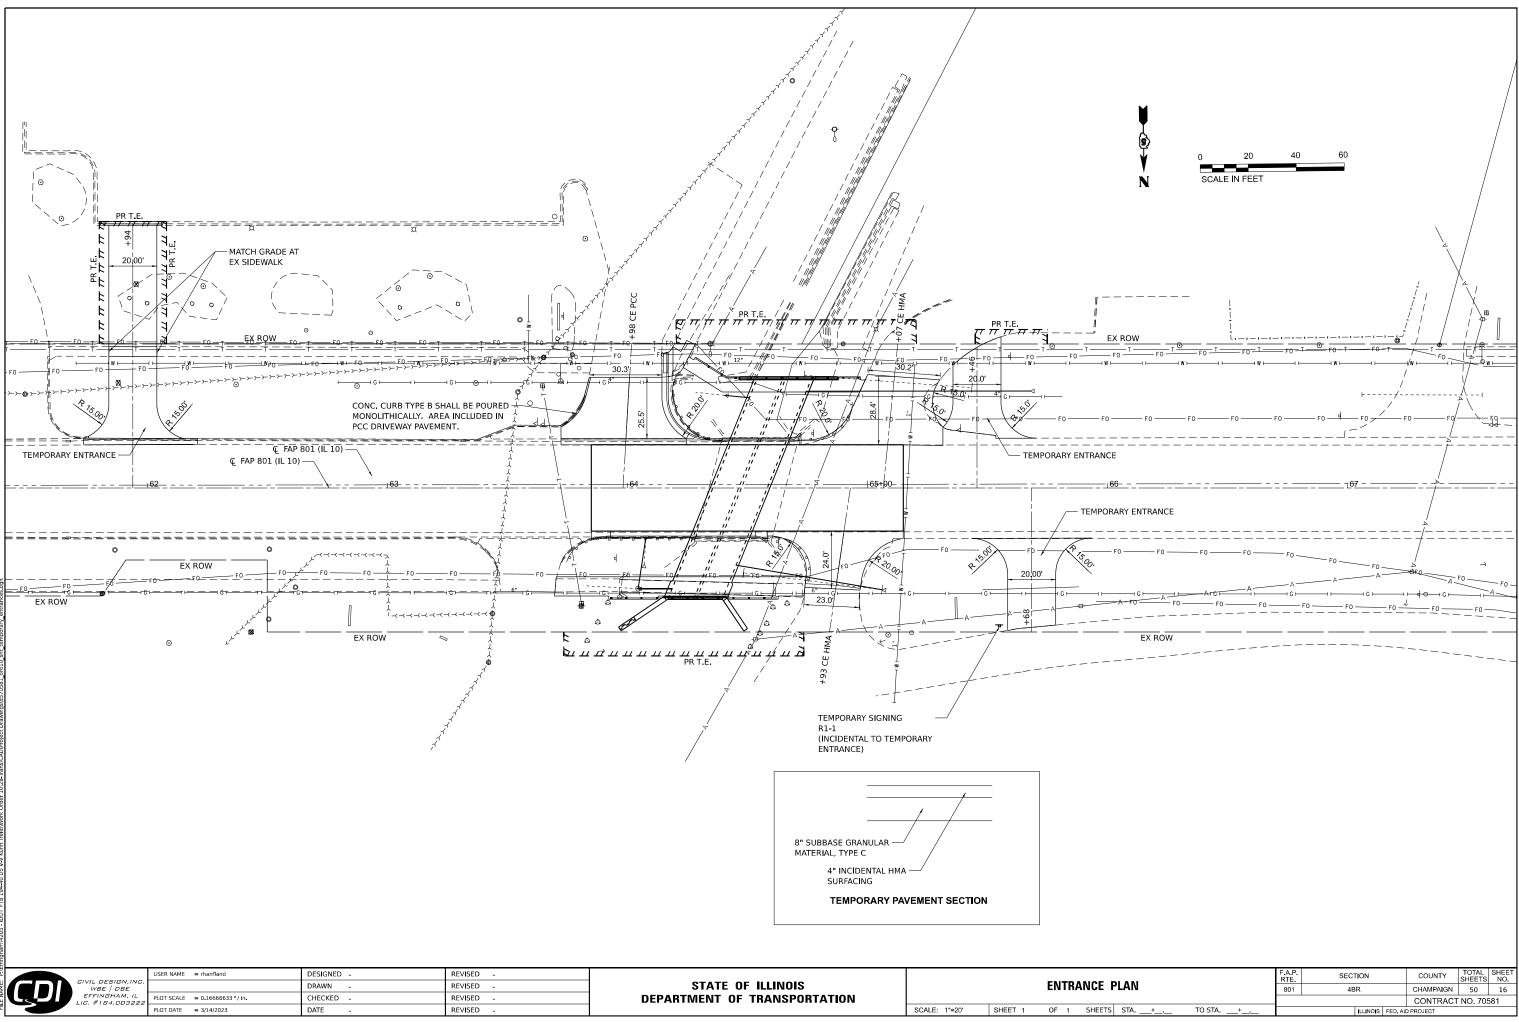


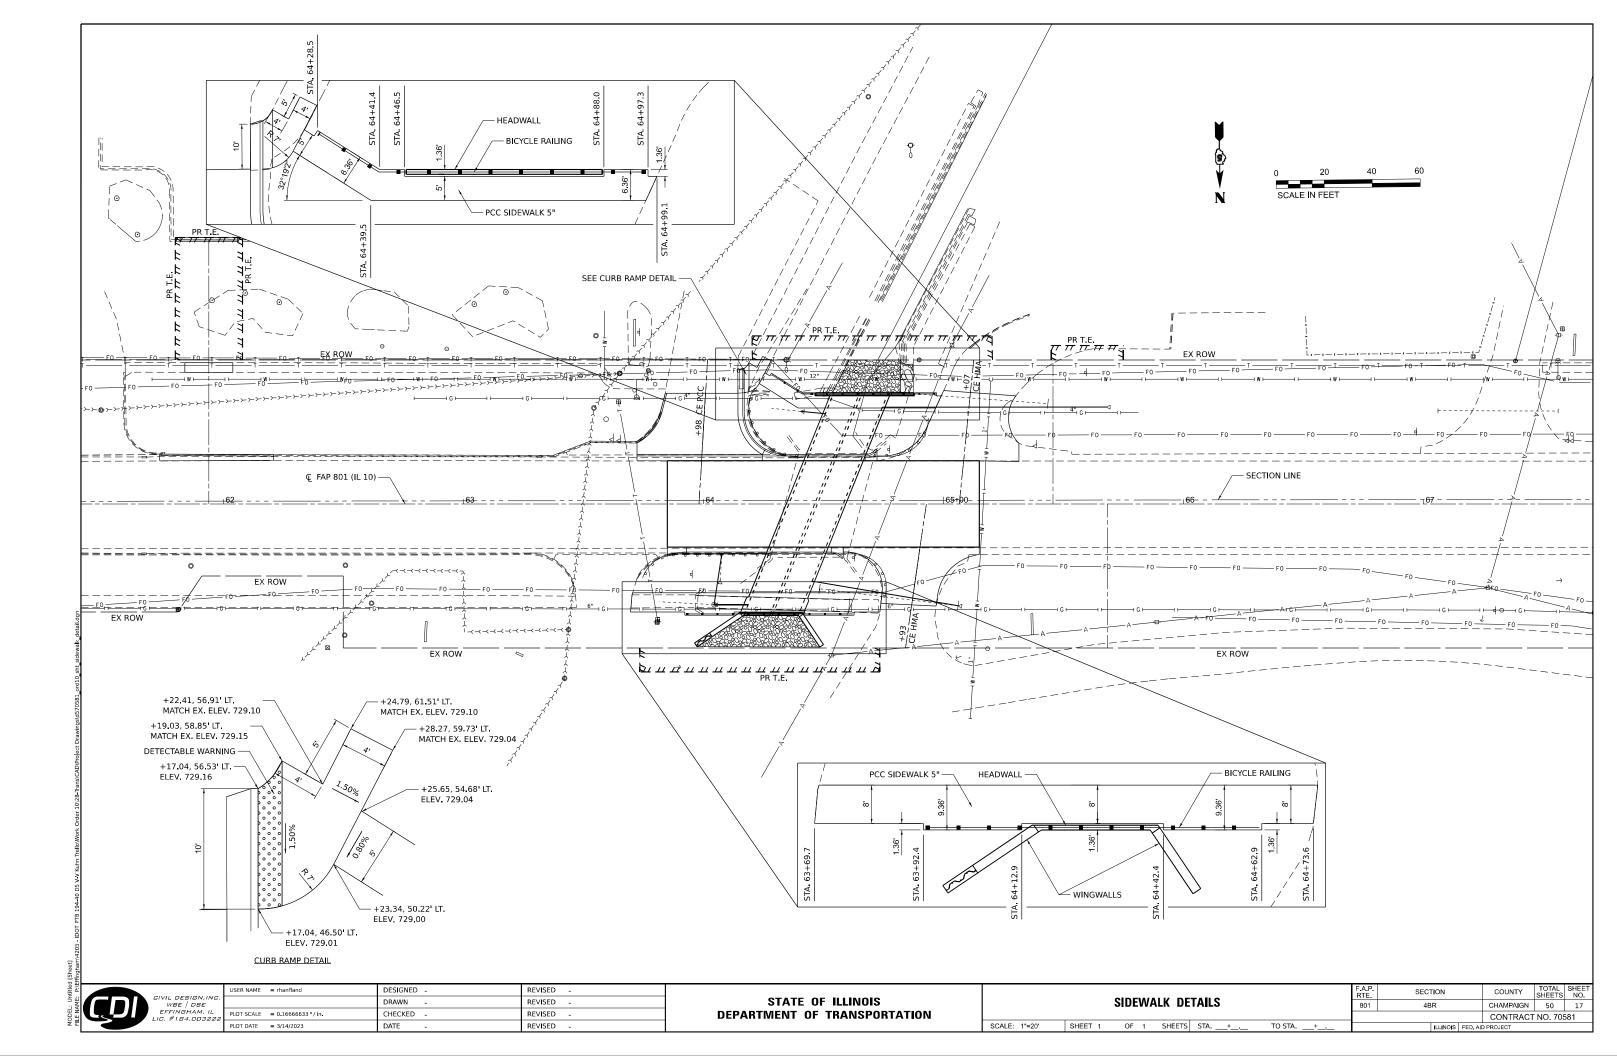

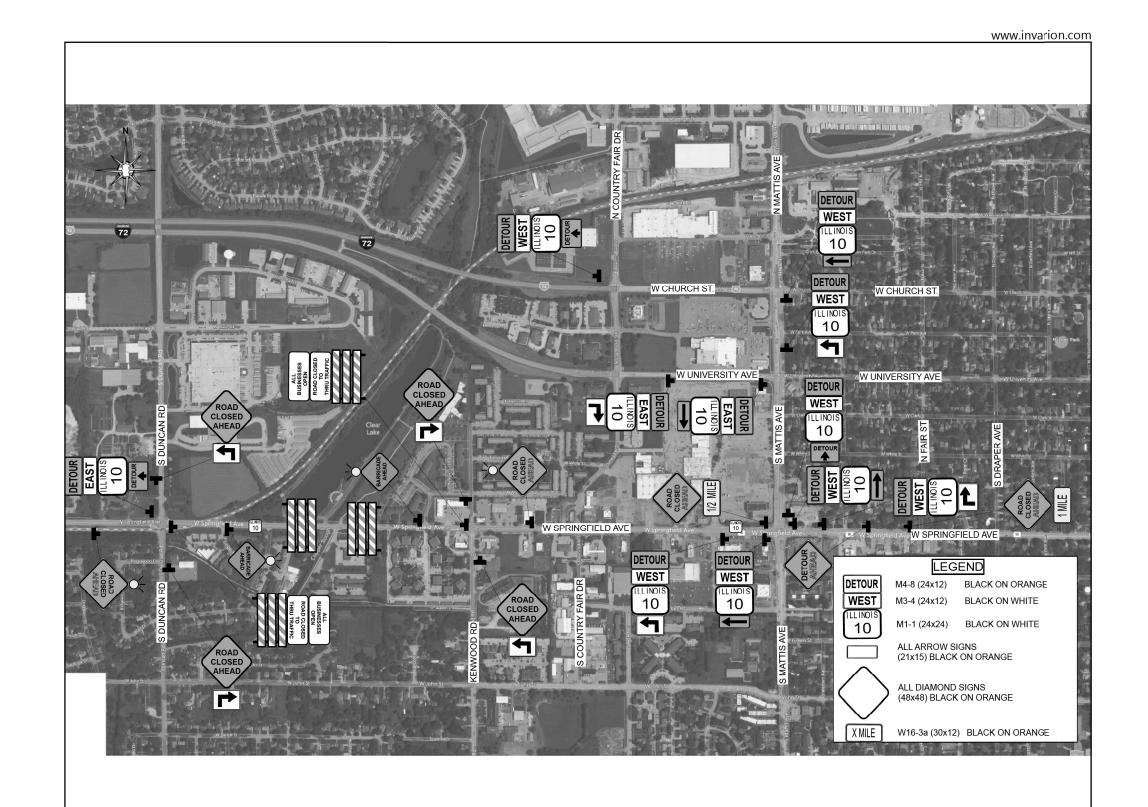

NOTE: SEE DISTRICT STANDARD 70200000 FOR ADDITIONAL ROAD CLOSURE DETAILS

		USER NAME = rhanfland	DESIGNED -	REVISED -						F.A.P. RTE	SECTION	COUNTY	TOTAL SHEETS	SHEET NO
	WBE DBE		DRAWN -	REVISED -	STATE OF ILLINOIS			DETOUR		801	4BR	CHAMPAIGN	50	18
Ľ	EFFINGHAM, IL LIC, #184.003222	PLOT SCALE = 0.166666633 ' / in.	CHECKED -	REVISED -	DEPARTMENT OF TRANSPORTATION							CONTRACT	NO 705	581
		PLOT DATE = 3/14/2023	DATE -	REVISED -		SCALE:	SHEET 1	OF 5 SHEETS STA.	TO STA.		ILLINOIS FED.	AID PROJECT		

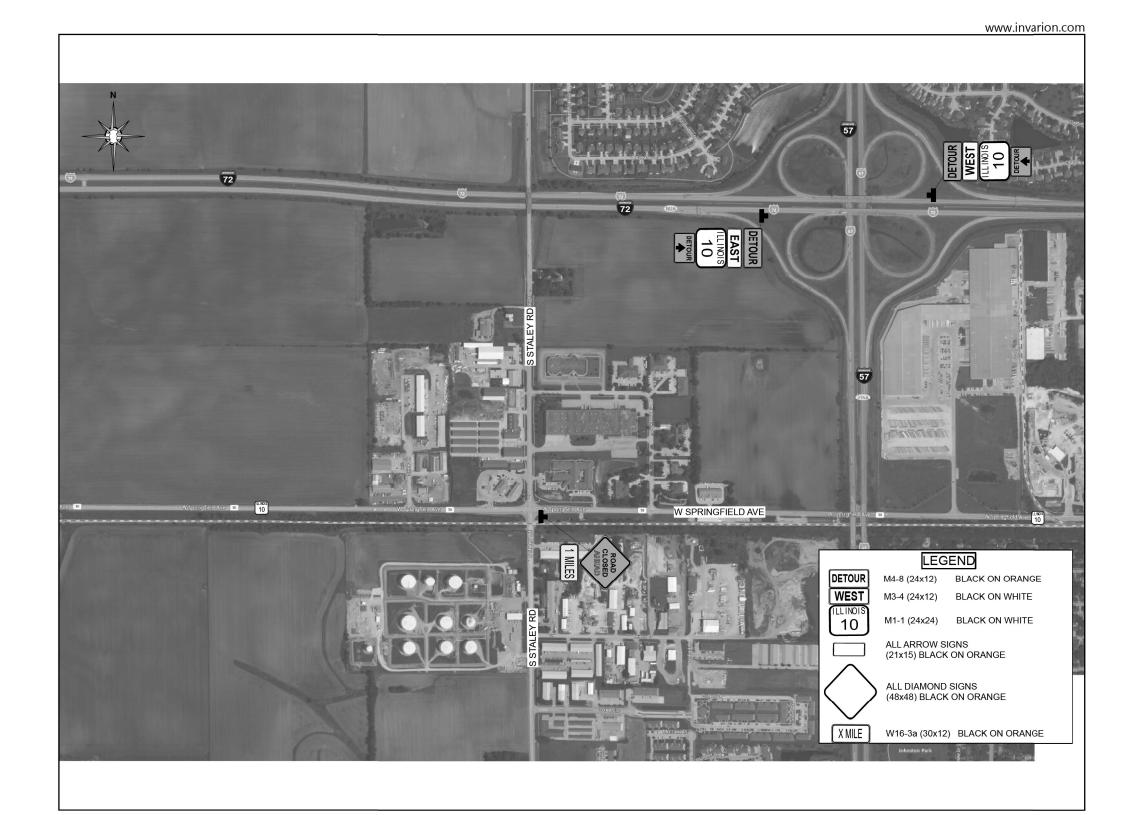



	USER NAME = rhanfland	DESIGNED -	REVISED -							F.A.P. BTE	SECTION	COUNTY	TOTAL SHEETS	SHEET
CIVIL DESIGN,INC. WBE DBE		DRAWN -	REVISED -	STATE OF ILLINOIS		DETOUR					4BR	CHAMPAIGN	50	19
EFFINGHAM, IL	PLOT SCALE = 0.16666633 '/ in.	CHECKED -	REVISED -	DEPARTMENT OF TRANSPORTATION								CONTRAC	T NO. 70	581
210. // 104.000222	PLOT DATE = 3/14/2023	DATE -	REVISED -		SCALE:	SHEET 2	OF 5 SHEETS	STA.	TO STA.		ILLINOIS F	ED. AID PROJECT		





	USER NAME = rhanfland	DESIGNED -	REVISED -								F.A.P. RTF	SECTION	COUNTY	TOTAL SHEET SHEETS NO.
CIVIL DESIGN,INC. WBE DBE		DRAWN -	REVISED -	STATE OF ILLINOIS			DET	OUR			801	4BR	CHAMPAIG	SN 50 20
EFFINGHAM, IL LIC. #184.003222	PLOT SCALE = 0.16666633 ' / in.	CHECKED -	REVISED -	DEPARTMENT OF TRANSPORTATION									CONTRA	CT NO. 70581
	PLOT DATE = 3/14/2023	DATE -	REVISED -		SCALE:	SHEET 3	OF 5 SH	HEETS	STA.	TO STA.		ILLINOIS FI	D. AID PROJECT	


www.invarion.com


4x12)	BLACK ON ORANGE
4x12)	BLACK ON WHITE



WBE DBE EFFINGHAM, IL	USER NAME = rhanfland	DESIGNED -	REVISED -								
C D	CIVIL DESIGN, INC. WBE DBE EFFINGHAM, IL LIC. #184.003222		DRAWN -	REVISED -	STATE OF ILLINOIS						
		PLOT SCALE = 0.16666633 ' / in.	CHECKED -	REVISED -	DEPARTMENT OF TRANSPORTATION						
		PLOT DATE = 3/14/2023	DATE -	REVISED -		SCALE:	SHEET 4	OF 5	SHEETS		
									-		

			F.A.P. RTE	SECTION		COUNTY	TOTAL SHEETS	SHEET NO.
ETOUR				4BR		CHAMPAIGN	50	21
						CONTRACT	NO. 70	581
SHEETS	STA.	TO STA.		ILLINOIS	FED. A	D PROJECT		

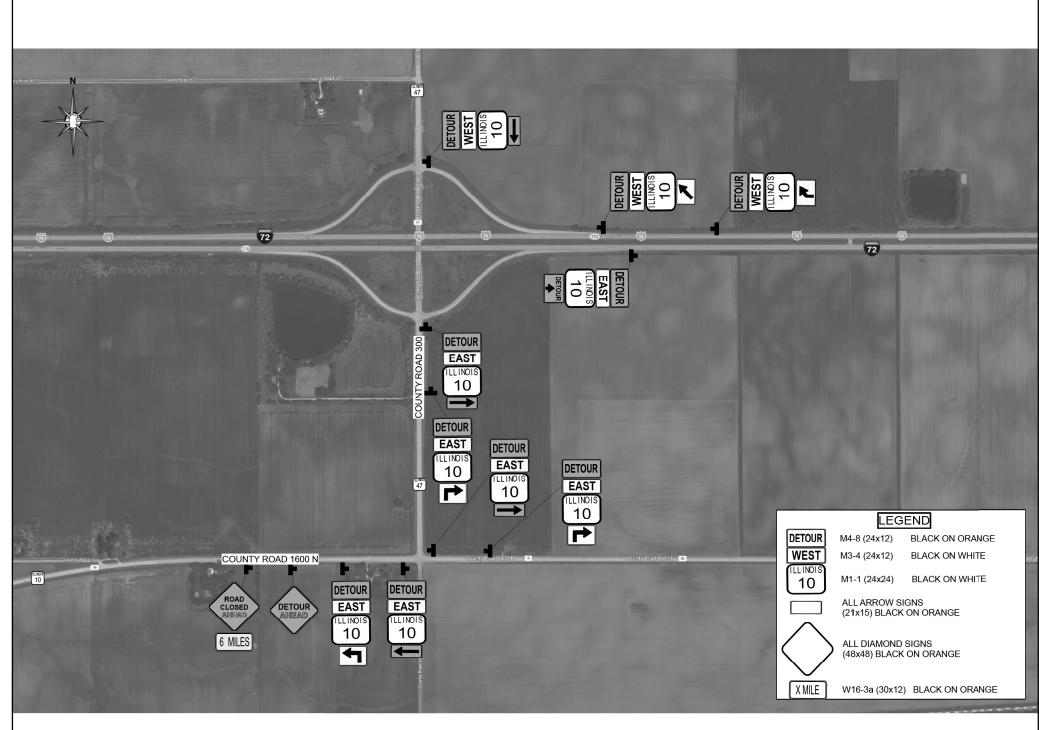


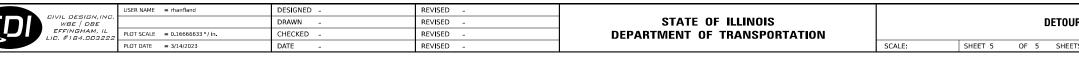



www.invarion.com

24x12)	BLACK ON ORANGE
24x12)	BLACK ON WHITE

			F.A.P. RTE	SECT	TION		COUNTY	TOTAL SHEETS	SHEET NO.
R			801	48	BR		CHAMPAIGN	50	22
_			_				CONTRACT	NO. 705	581
TS	STA.	TO STA.			ILLINOIS	FED. A	D PROJECT		
_									

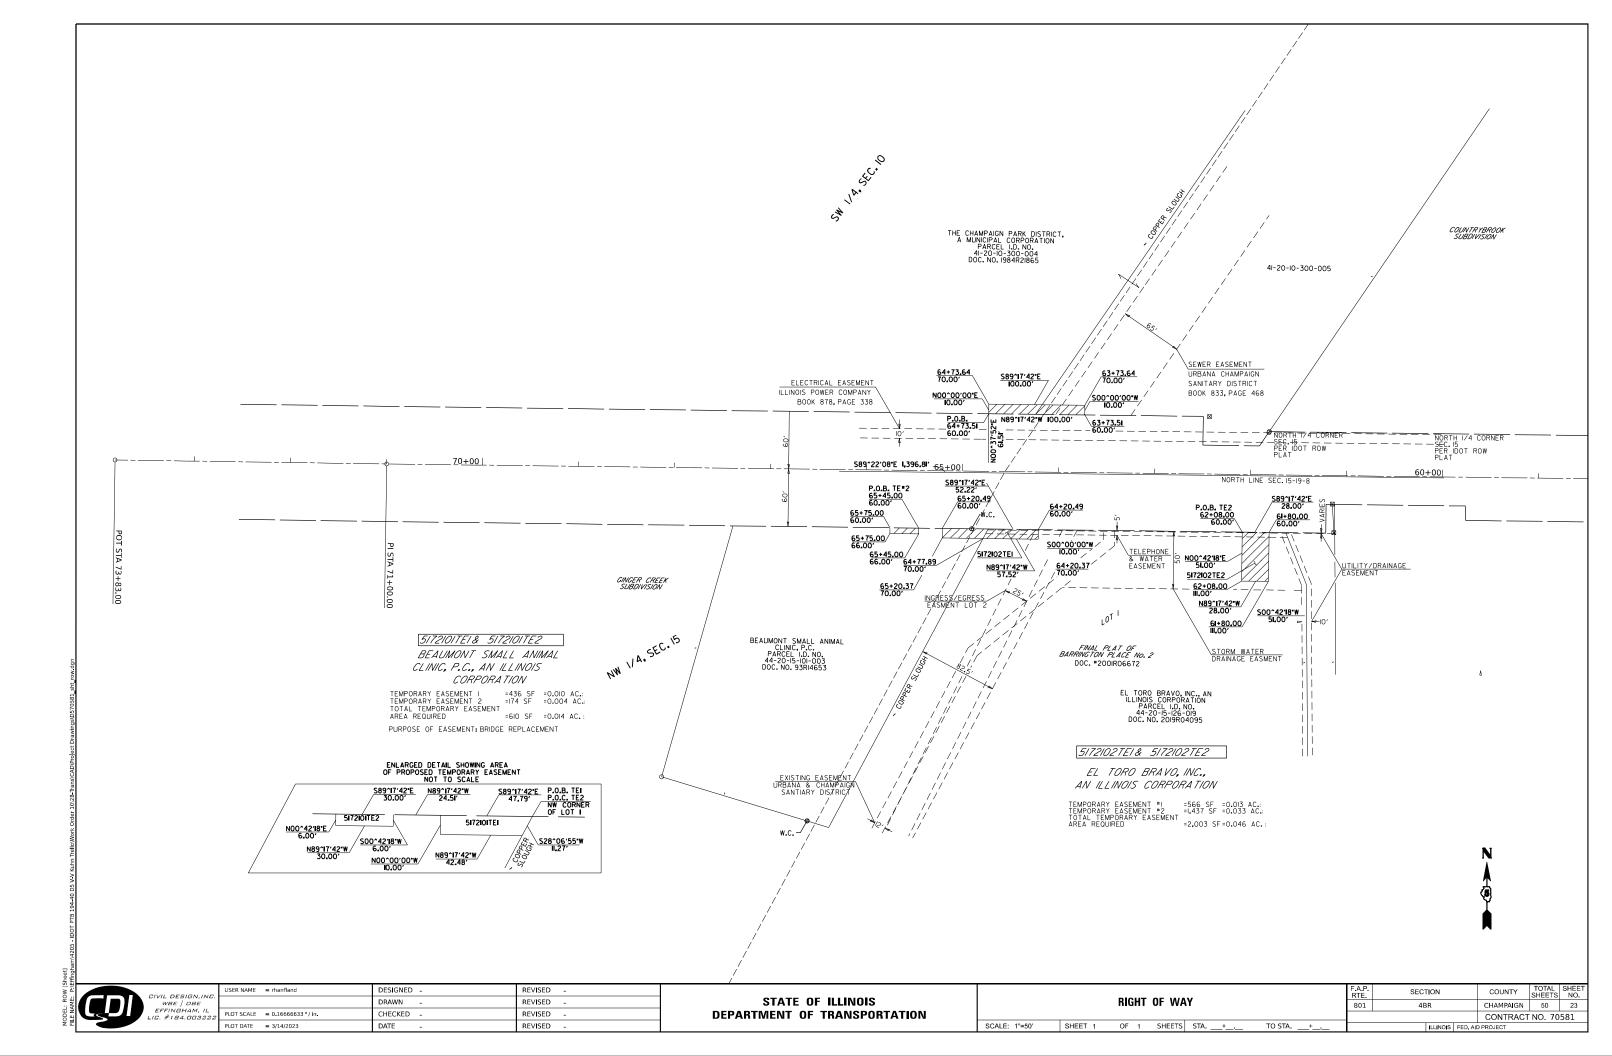

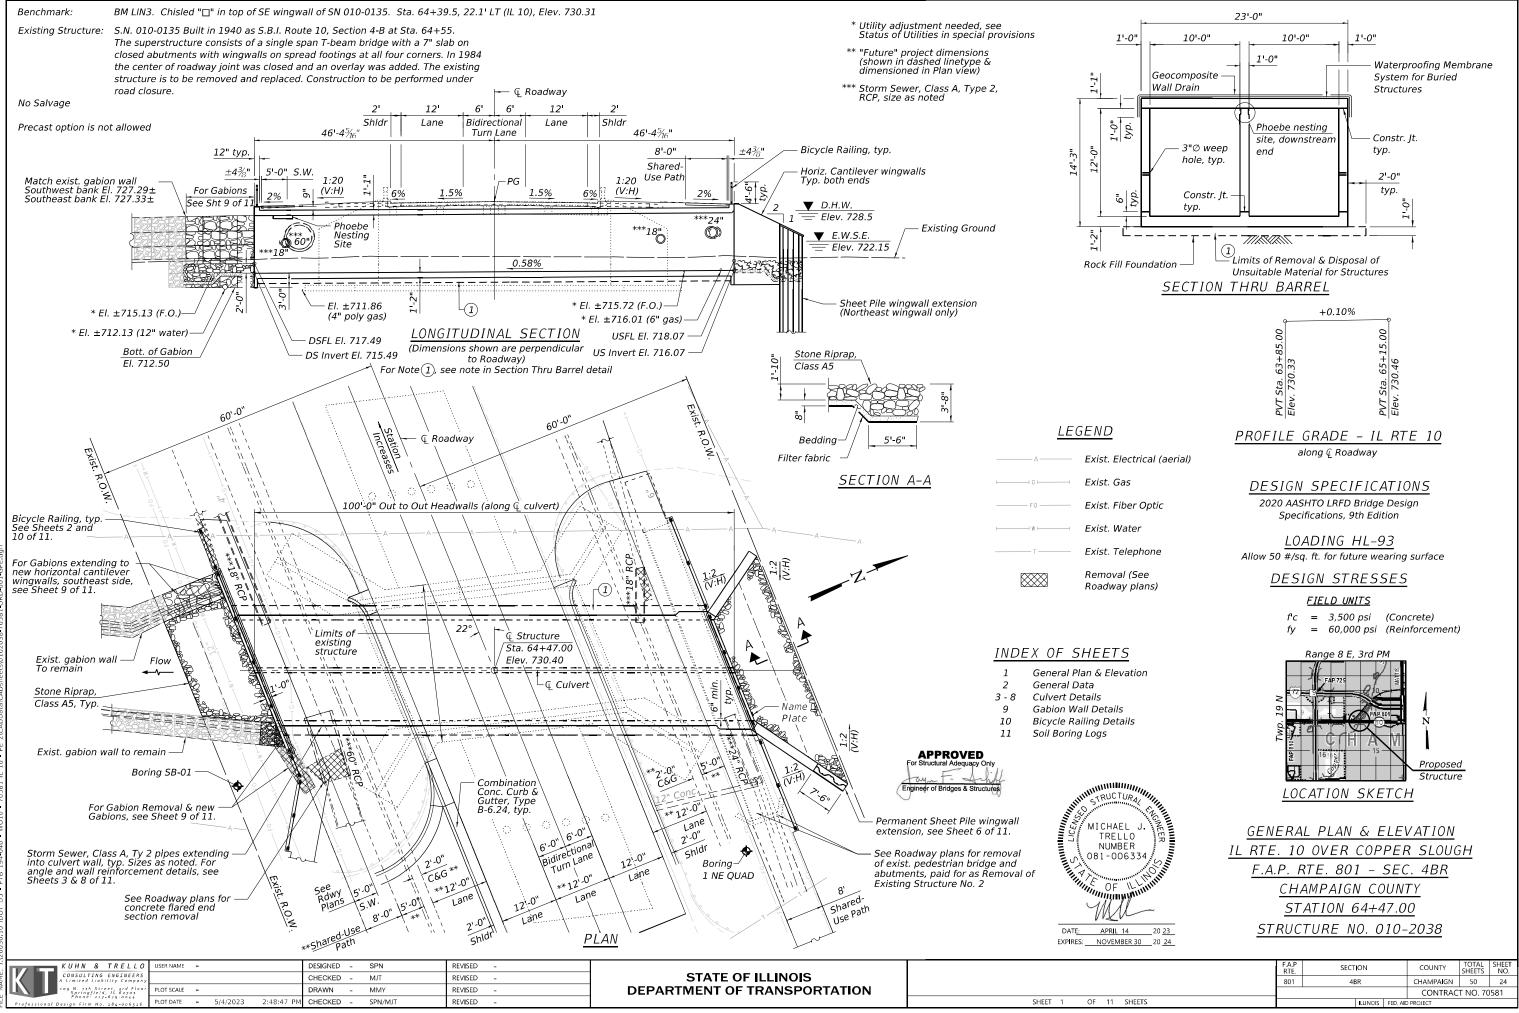

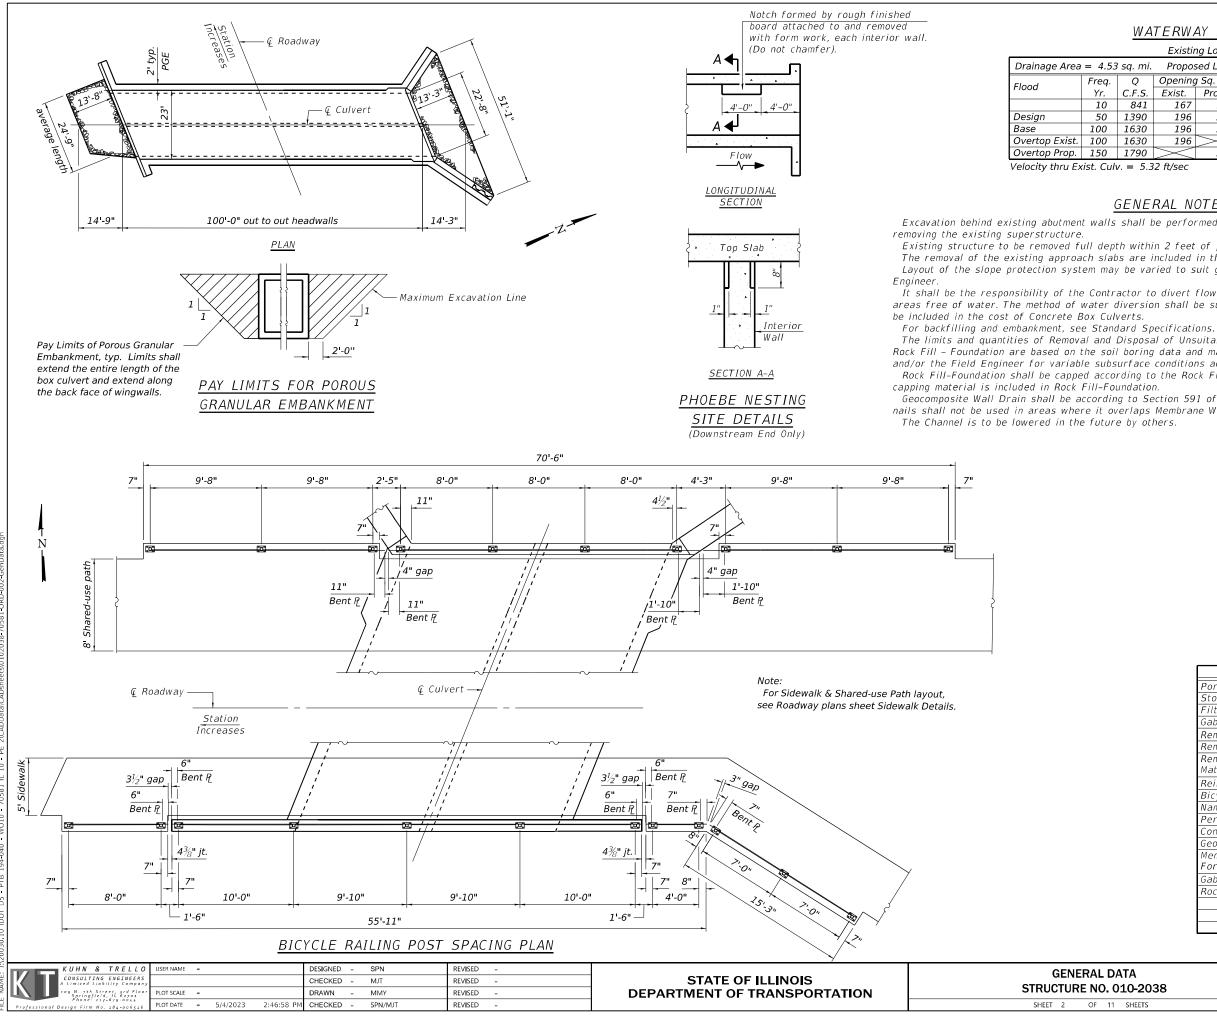

|--|

		Existir	ng Low Gi	rade Ele	v. = 73	0.36 @ 3	Sta. 65+	-68.78				
53	3 sq. mi. Proposed Low Grade Elev. = 730.36 @ Sta. 65+69											
	Q	Opening	g Sq. Ft.	Nat.	Head	- Ft.	Headwater El.					
	C.F.S.	Exist.	Prop.	H.W.E.	Exist.	Prop.	Exist.	Prop.				
	841	167	161	726.1	0.1	0.0	726.2	726.1				
	1390	196	200	728.5	0.6	0.2	729.1	728.7				
	1630	196	200	729.3	1.0	0.7	730.3	730.0				
	1630	196	$>\!$	729.3	1.0	\times	730.3	\times				
	1790	$\!$	200	729.8	\times	0.8	\times	730.6				
1.		24/222	10.	w Malaa!	المربعة الم			10 4/20				

10 yr Velocity thru Prop. Culv. = 5.19 ft/sec

GENERAL NOTES

Excavation behind existing abutment walls shall be performed to balance front and back soil pressure before

Existing structure to be removed full depth within 2 feet of proposed culvert barrel and wingwall footprint. The removal of the existing approach slabs are included in the cost of "Removal of Existing Structures No. 1". Layout of the slope protection system may be varied to suit ground conditions in the field as directed by the

It shall be the responsibility of the Contractor to divert flow during construction in order to keep construction areas free of water. The method of water diversion shall be subject to the approval of the Engineer and shall

The limits and quantities of Removal and Disposal of Unsuitable Materials for Structures and replacement with Rock Fill - Foundation are based on the soil boring data and may be modified by the District Geotechnical Engineer and/or the Field Engineer for variable subsurface conditions actually encountered in the field.

Rock Fill-Foundation shall be capped according to the Rock Fill-Foundation Special Provision. The cost of the

Geocomposite Wall Drain shall be according to Section 591 of the Standard Specifications, except that concrete nails shall not be used in areas where it overlaps Membrane Waterproofing System for Buried Structures.


> STATION 64+47.00 BUILT 20__ BY STATE OF ILLINOIS IL RTE. 10 SEC. 4BR LOADING HL-93 STRUCTURE NO. 010-2038

> > NAME PLATE See Std. 515001

TOTAL BILL OF MATERIAL


ITEM	UNIT	TOTAL
Porous Granular Embankment	Cu. Yd.	964
Stone Riprap, Class A5	Sq. Yd.	134
Filter Fabric	Sq. Yd.	134
Gabions	Cu. Yd.	33
Removal of Existing Structures No. 1	Each	1
Removal of Existing Structures No. 2	Each	1
Removal and Disposal of Unsuitable Material for Structures	Cu. Yd.	99
Reinforcement Bars	Pound	77,960
Bicycle Railing	Foot	140
Name Plates	Each	1
Permanent Sheet Piling	Sq. Ft.	195
Concrete Box Culverts	Cu.Yd.	377.2
Geocomposite Wall Drain	Sq. Yd.	296
Membrane Waterproofing System For Buried Structures	Sq. Yd.	296
Gabion Removal	Cu. Yd.	36
Rock Fill-Foundation	Ton	158

ΟΑΤΑ	F.A.P RTF.	F.A.P SECTION			COUNTY	TOTAL SHEETS	SHEET NO.
010-2038		4BR			CHAMPAIGN	50	25
010 2000					CONTRAC	T NO. 70	581
1 SHEETS			ILLINOIS	FED. AIC	PROJECT		

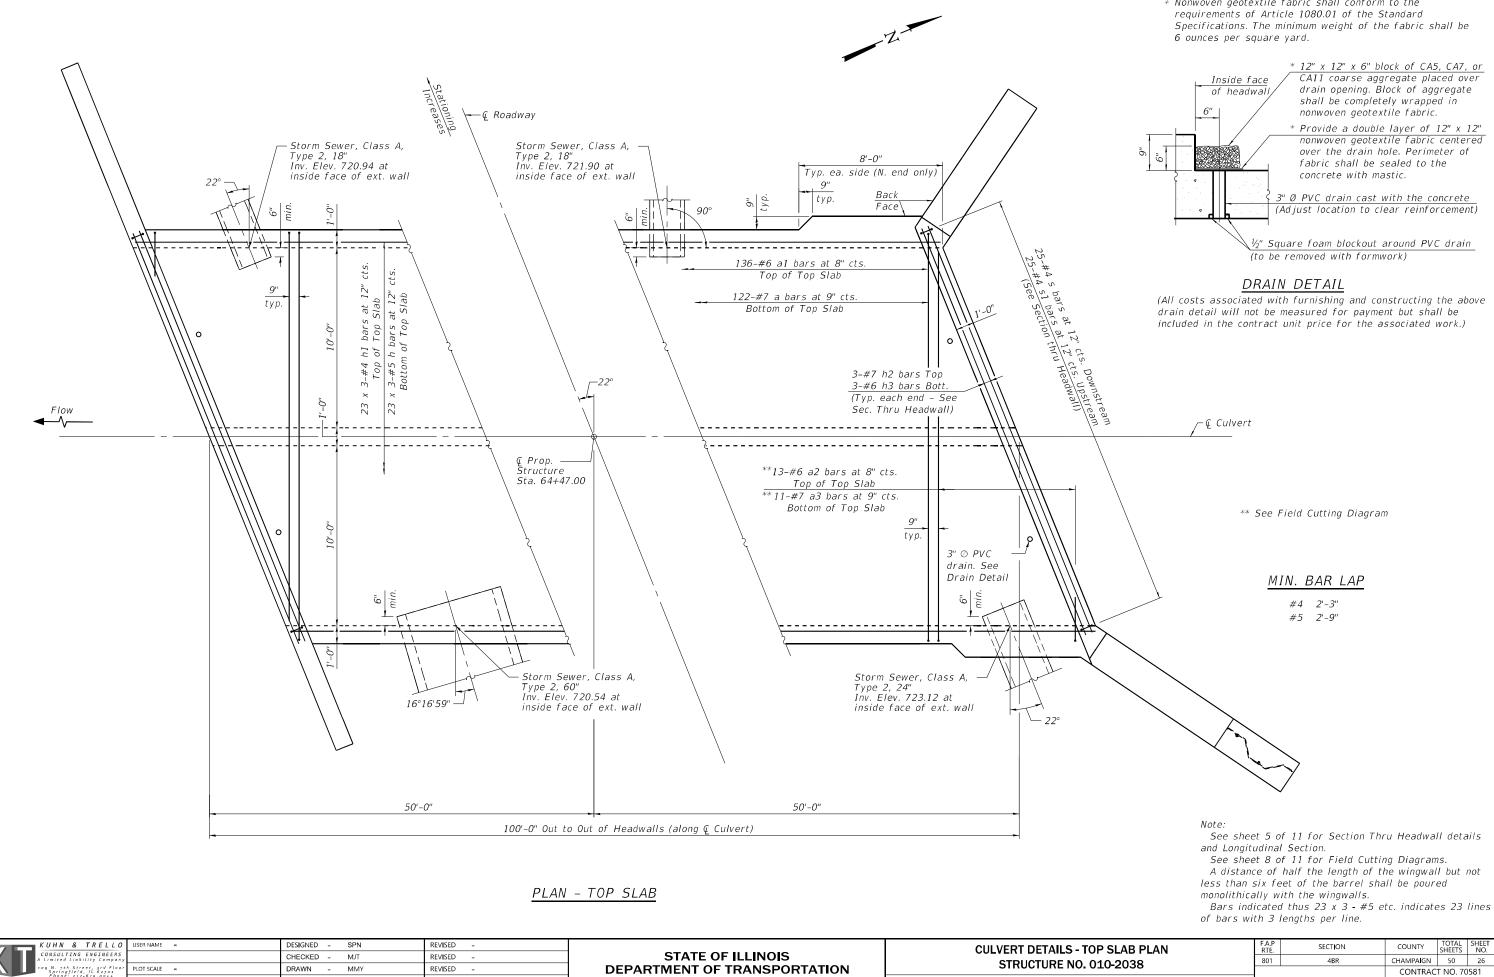


DEL: Defau	KUHN & TRELLO CONSULTING ENGINEERS A Limited Liability Company 199 N. 7th Street, 3rd Floor Springfield, 16 2070	USER NAME = PLOT SCALE =	DESIGNED - SPN CHECKED - MJT DRAWN - MMY	REVISED - REVISED - REVISED -	STATE OF ILLINOIS DEPARTMENT OF TRANSPORTATION	CULVERT DETAILS - TOP STRUCTURE NO. 010
MOI	Phoné: 217-679-0044 Professional Design Firm No. 184-006516	PLOT DATE = 5/4/2023 2:49:56 PM	CHECKED - SPN/MJT	REVISED -		SHEET 3 OF 11 SI


* Nonwoven geotextile fabric shall conform to the requirements of Article 1080.01 of the Standard

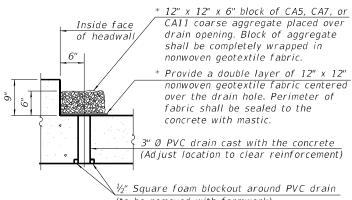

SHEETS


ILLINOIS FED. AID PROJECT

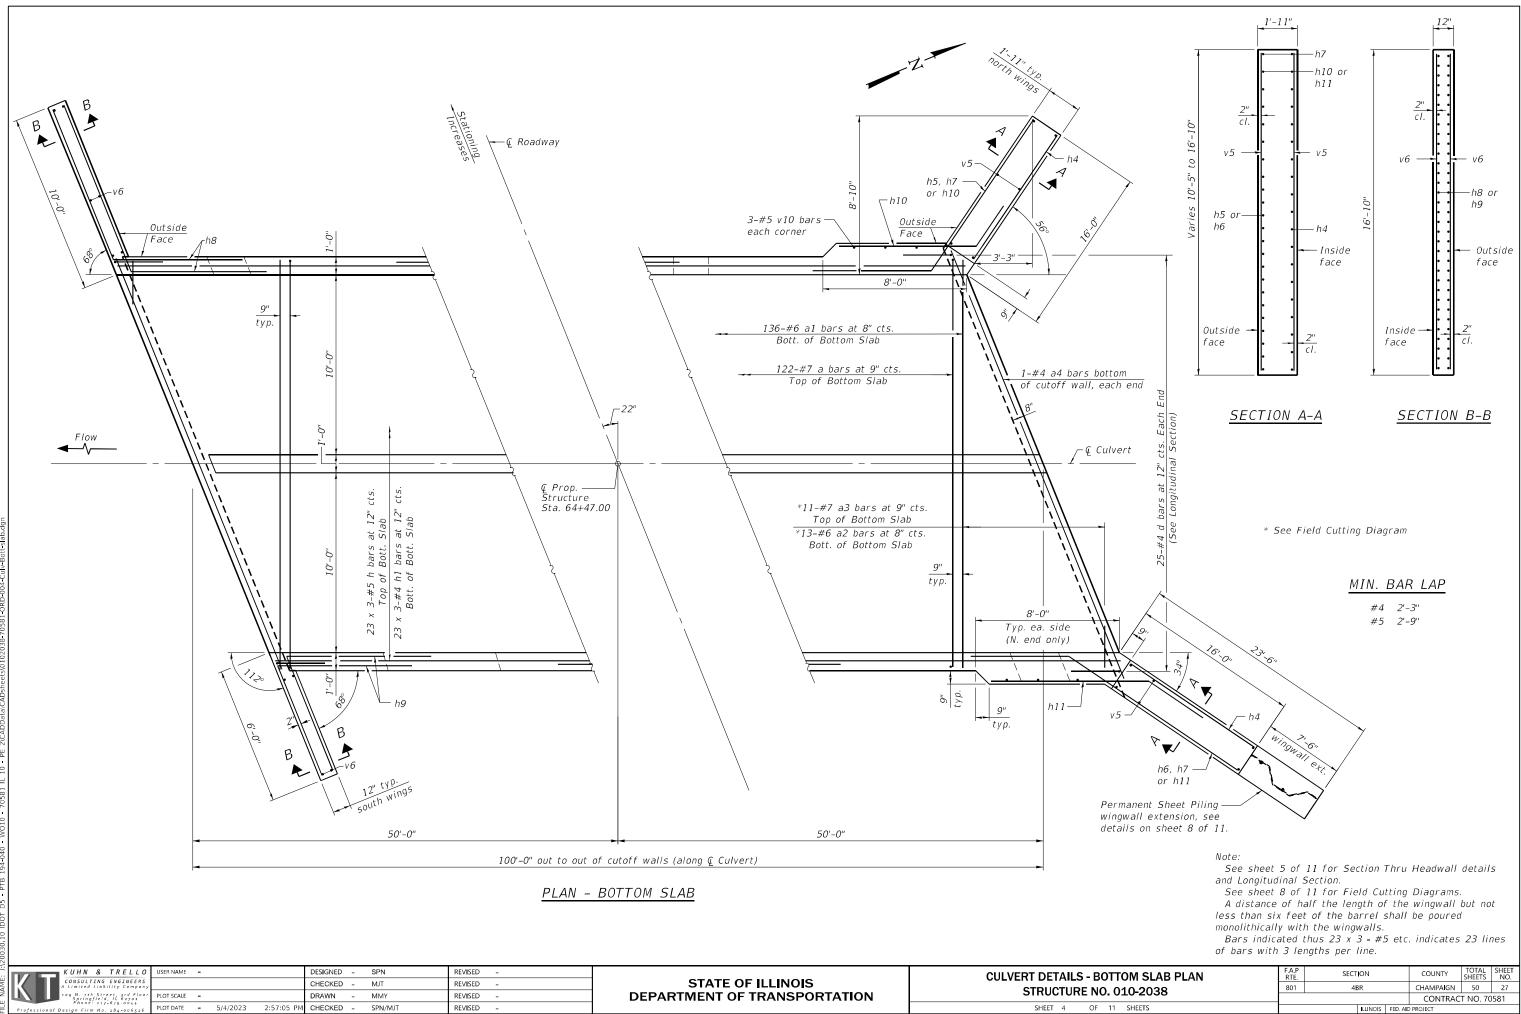

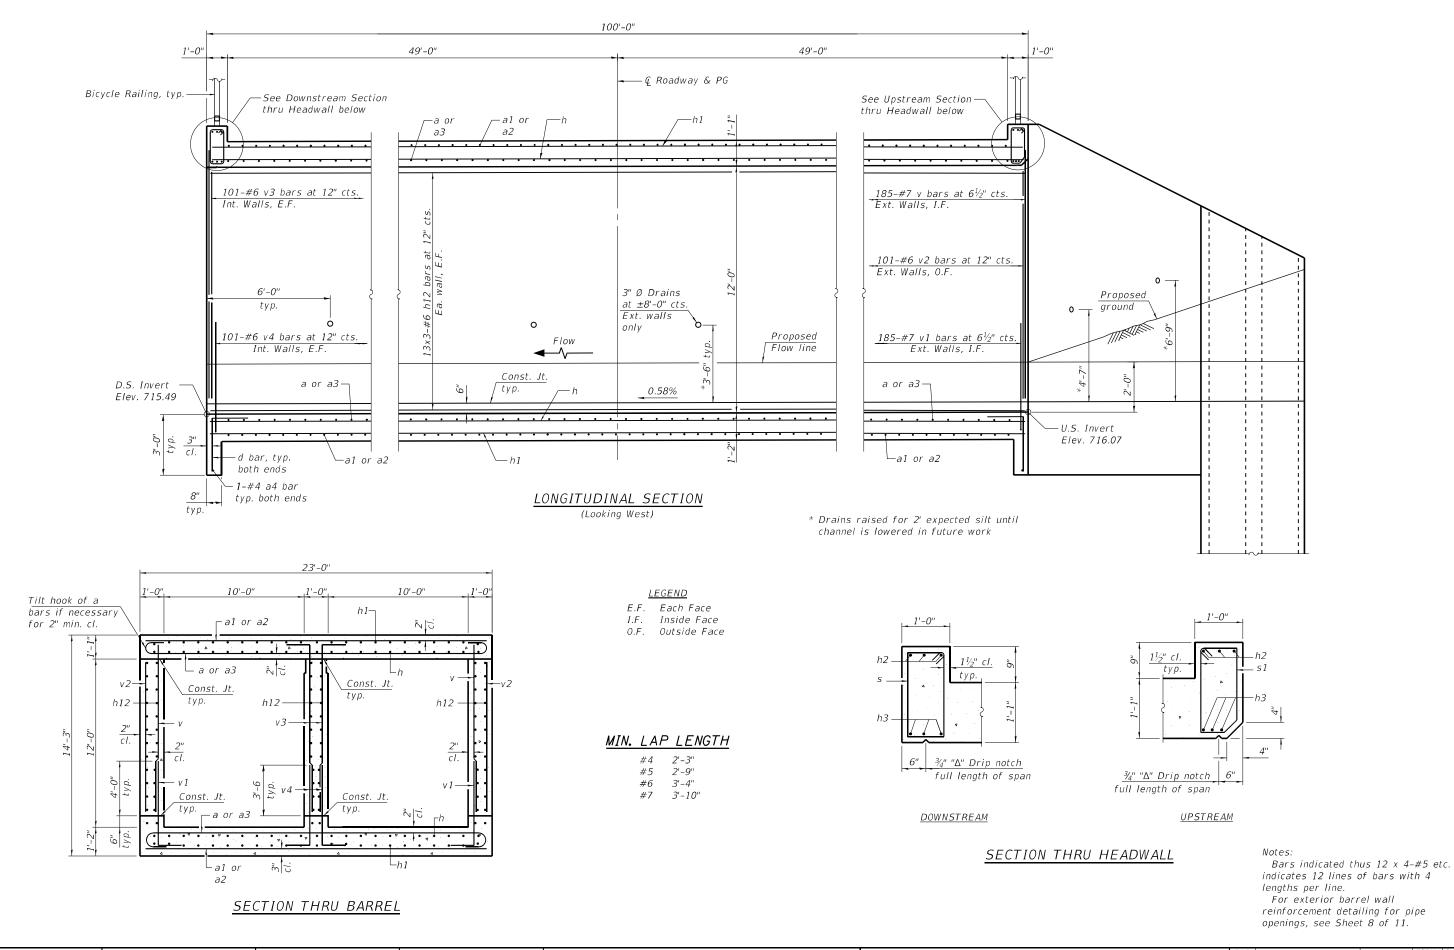

efaul : J:\:		KUHN & TRELLO	SER NAME = DESIGNED - SPN REVISED - CULVERT DETAILS		F.A.P S	ECTION	COUNTY TOT	AL SHEET			
	CONSULTING ENGINEERS A Limited Liability Company 209 N, 7th Street, 3cd Floor Phonoglield, for 63701 Phonoglield, for 63701		CHECKED - MJT	REVISED -	STATE OF ILLINOIS	STRUCTURE NO. 010-2038	801	4BR	CHAMPAIGN 50	J 28	
E N		PLOT SCALE =	DRAWN - MMY	REVISED -	DEPARTMENT OF TRANSPORTATION	STRUCTURE NO. 010-2038	I		CONTRACT NO). 70581	
N H	Professional Design Firm No. 184-006516		PLOT DATE = 5/4/2023 2:58:14 PM	= 5/4/2023 2:58:14 PM CHECKED - SPN/MJT REVISED -			SHEET 5 OF 11 SHEETS	ILLINOIS FED. A		ID PROJECT	


For exterior barrel wall reinforcement detailing for pipe openings, see Sheet 8 of 11.

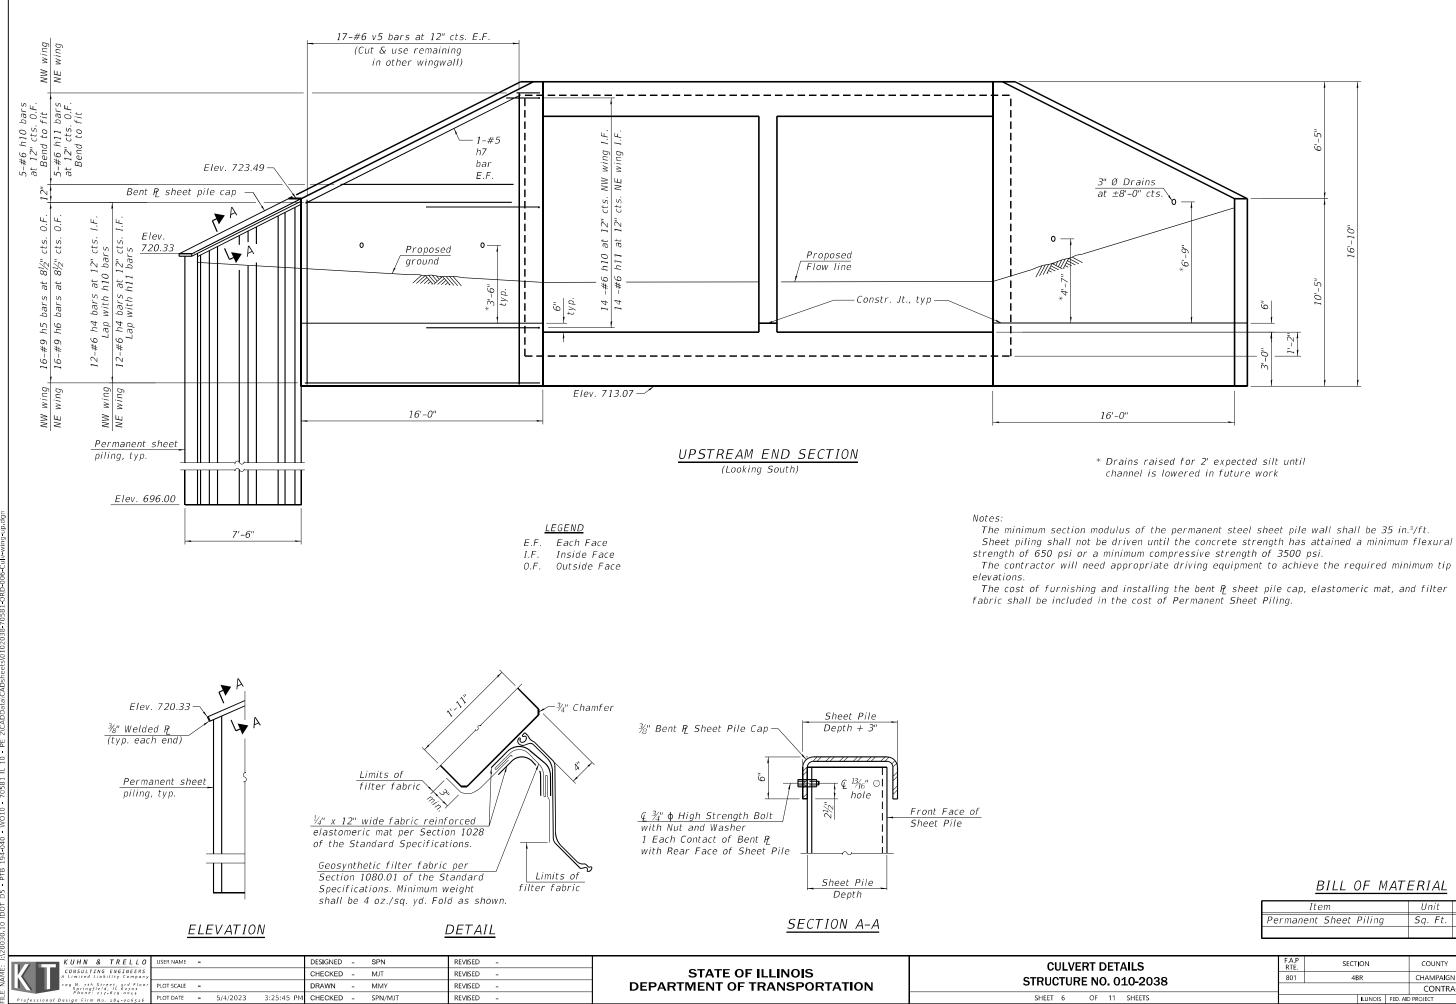


BILL OF MATERIAL

Item	Unit	Quantity
Permanent Sheet Piling	Sq. Ft.	195

ETAILS	F.A.P RTE.	SECT	ON		COUNTY	TOTAL SHEETS	SHEET NO.
. 010-2038	801	4BR			CHAMPAIGN	50	29
. 010-2038					CONTRAC	T NO. 70	581
11 SHEETS			ILLINOIS	FED. AID	PROJECT		

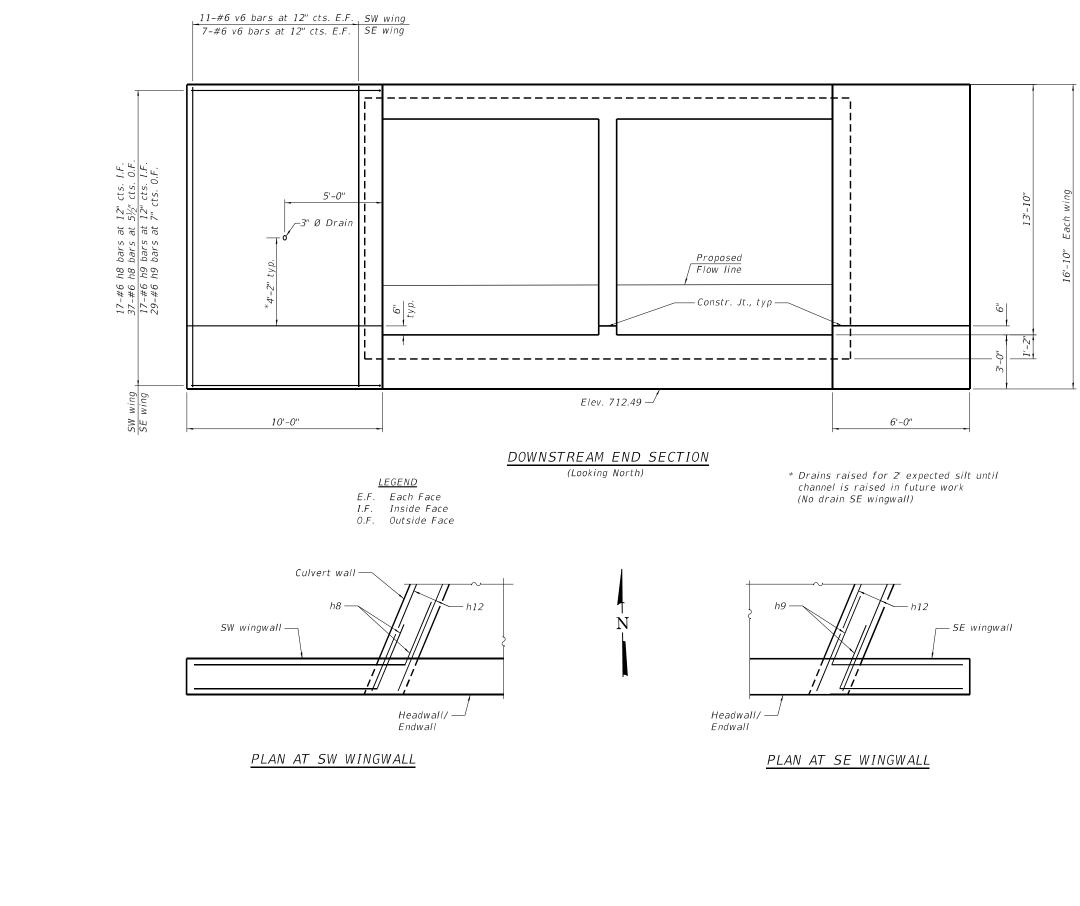

22							54.5			I.C.C.T.
: . I	KUHN & TRELLO	USER NAME =	DESIGNED – SPN	REVISED -		CULVERT DETAILS	F.A.P	SECTION	COUNTY IUTAL SH	
5 문	CONSULTING ENGINEERS	CONSULTING ENGINEERS		REVISED -	STATE OF ILLINOIS		RTE.	100		20.
i≰I	Non N ath Street and Elege	DI OTICO IL	CHECKED - MJT	REVISED -		STRUCTURE NO. 010-2038	801	4BR	CHAMPAIGN 50 :	,0
i E I I	Springfield, IL 62701 Phone: 217-679-0044	PLOT SCALE =	DRAWN - MMY	REVISED -	DEPARTMENT OF TRANSPORTATION				CONTRACT NO. 7058	
2 2 1	Professional Design Firm No. 184-006516	PLOT DATE = 5/4/2023 3:16:37 PM	CHECKED - SPN/MJT	REVISED -		SHEET 7 OF 11 SHEETS		ILLINOIS FED. AID	PROJECT	

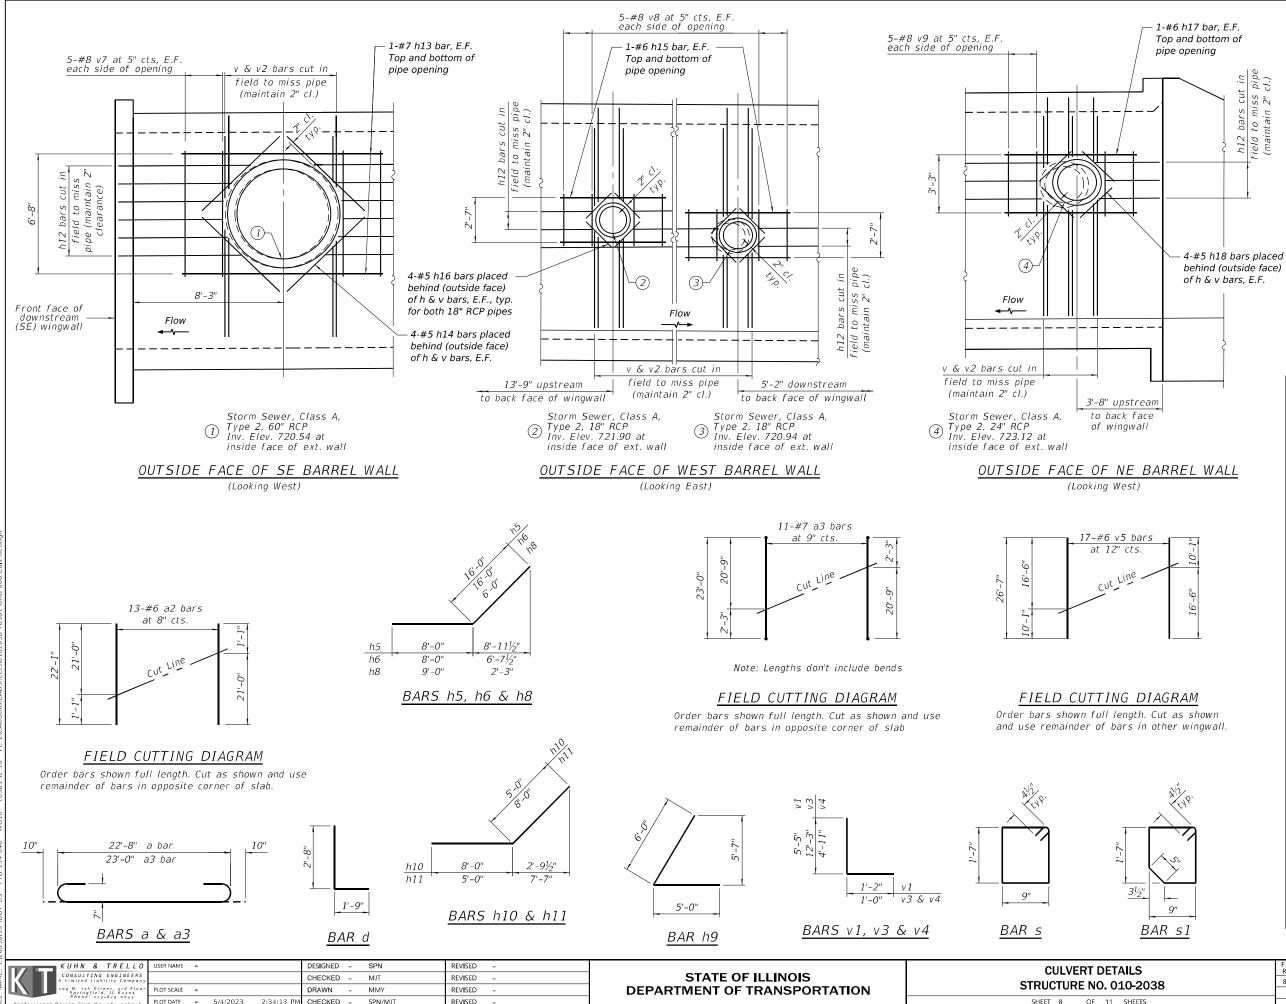

SHEET 8 OF 11 SHEETS

SHEET NO. SECTION COUNTY SHEETS 801 4BR CHAMPAIGN 50 31 CONTRACT NO. 70581 ILLINOIS FED. AID PROJECT

Notes:


Pipe sections shall be cast in the exterior culvert walls at the location shown. The ends shall extend a minimum of 6 inches past the inside face of walls. The pipes shall extend through and beyond the outside face a sufficient distance to allow connections. The Contractor shall carefully


construct the walls around the pipes to prevent leakage along the surfaces. The Contractor shall seal any voids between the culvert walls and sections with non-shrink grout per Article 1024.02 of the Standard Specifications. The cost of the connection shall not

be paid for separately but shall be included in the length of pipe culvert or storm sewer of the class, type, and size shown.


BILL OF MATERIAL

Bar No. Size Length Shape a 244 #7 24'-4"		DILL	UF MA	AI E KI	AL
a1 272 #6 $22'-8''$ a2 26 #6 $22'-1''$ a3 22 #7 $24'-8''$ a4 2 #4 $24'-5''$ d 50 #4 $4'-5''$ h 138 #5 $35'-3''$ h1 138 #4 $34'-9''$ h2 6 #7 $24'-5''$ h3 6 #6 $24'-5''$ h4 24 #6 $15'-8''$ h5 16 #9 $24'-0''$ h6 16 #9 $24'-0''$ h7 4 #5 $16'-4''$ h8 54 #6 $15'-0''$ h10 19 #6 $13'-0''$ h11 19 #6 $35'-6''$ h12 234 #6 $35'-6''$ h13 4 #7 $11'-2''$ h14 8 #5 $2'-0''$ h13 4 #7 $11'-2''$ h14 8 #5	Bar	No.	Size	Length	Shape
a2 26 #6 $22'-1"$ a3 22 #7 $24'-8"$ a4 2 #4 $24'-5"$ d 50 #4 $4'-5"$ h 138 #5 $35'-3"$ h1 138 #4 $34'-9"$ h2 6 #7 $24'-5"$ h3 6 #6 $24'-5"$ h4 24 #6 $15'-8"$ h5 16 #9 $24'-0"$ h6 16 #9 $24'-0"$ h7 4 #5 $16'-4"$ h8 54 #6 $15'-0"$ h10 19 #6 $35'-6"$ h11 19 #6 $13'-0"$ h12 234 #6 $35'-6"$ h13 4 #7 $11'-2"$ h14 8 #5 $6'-0"$ h15 8 #6 $7'-8"$ h14 8 #5 $2'-6"$ h15 8 #6 $7'-8"$	а	244	#7	24'-4"	
a2 26 #6 $22'-1"$ a3 22 #7 $24'-8"$ a4 2 #4 $24'-5"$ d 50 #4 $4'-5"$ h 138 #5 $35'-3"$ h1 138 #4 $34'-9"$ h2 6 #7 $24'-5"$ h3 6 #6 $24'-5"$ h4 24 #6 $15'-8"$ h5 16 #9 $24'-0"$ h6 16 #9 $24'-0"$ h7 4 #5 $16'-4"$ h8 54 #6 $15'-0"$ h10 19 #6 $35'-6"$ h11 19 #6 $13'-0"$ h12 234 #6 $35'-6"$ h13 4 #7 $11'-2"$ h14 8 #5 $6'-0"$ h15 8 #6 $7'-8"$ h14 8 #5 $2'-6"$ h13 4 #7 $11'-2"$	a1	272	#6	22'-8"	
a3 22 #7 $24'-8''$ $24'-8''$ a4 2 #4 $24'-5''$ $$	a2	26	#6	22'-1"	
d 50 #4 $4'-5''$ L h 138 #5 $35'-3''$	a3	22	#7		
h 138 #5 $35'-3"$ h1 138 #4 $34'-9"$ h2 6 #7 $24'-5"$ h3 6 #6 $24'-5"$ h4 24 #6 $15'-8"$ h5 16 #9 $24'-0"$ \checkmark h6 16 #9 $24'-0"$ \checkmark h6 16 #9 $24'-0"$ \checkmark h7 4 #5 $16'-4"$ \frown h8 54 #6 $15'-0"$ \checkmark h10 19 #6 $13'-0"$ \checkmark h11 19 #6 $13'-0"$ \checkmark h12 234 #6 $35'-6"$ \frown h13 4 #7 $11'-2"$ \frown h14 8 #5 $6'-0"$ \frown h15 8 #6 $7'-8"$ \frown h14 8 #5 $2'-5"$ \Box s 25 #4 $5'-5"$ \Box s1 25 <td>а4</td> <td>2</td> <td></td> <td>24'-5"</td> <td></td>	а4	2		24'-5"	
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h1 138 #4 $34'-9"$ h2 6 #7 $24'-5"$ h3 6 #6 $24'-5"$ h3 6 #6 $24'-5"$ h5 16 #9 $24'-0"$ h5 16 #9 $24'-0"$ h6 16 #9 $24'-0"$ h7 4 #5 16'-4" h8 54 #6 15'-0" h9 46 #6 11'-0" h10 19 #6 35'-6" h13 4 #7 11'-2" h14 8 #5 6'-0" h13 4 #7 11'-2" h14 8 #5 2'-0" h15 8 #6 7'-8" h16 16 #5 2'-0" h17 4 #6 8'-6" s 25 #4 5'-5" s1 25 #4 5'-1" v1 370 #7 6'-7" v2	h	120	#5	251 21	
h2 6 #7 $24'-5"$ h3 6 #6 $24'-5"$ h4 24 #6 $15'-8"$ h5 16 #9 $24'-0"$ \checkmark h6 16 #9 $24'-0"$ \checkmark h7 4 #5 $16'-4"$ \checkmark h8 54 #6 $15'-0"$ \checkmark h9 46 #6 $11'-0"$ \checkmark h10 19 #6 $13'-0"$ \checkmark h11 19 #6 $13'-0"$ \checkmark h13 4 #7 $11'-2"$ \sim h13 4 #7 $11'-2"$ \sim h14 8 #5 $6'-0"$ \sim h15 8 #6 $7'-8"$ \sim h16 16 #5 $2'-0"$ \sim h17 4 #6 $8'-6"$ \sim h18 8 #5 $2'-6"$ \sim v1 370 #7 $12'-3"$ \sim <t< td=""><td></td><td></td><td></td><td></td><td></td></t<>					
h3 6 #6 $24'-5"$ h4 24 #6 $15'-8"$ h5 16 #9 $24'-0"$ \checkmark h6 16 #9 $24'-0"$ \checkmark h7 4 #5 $16'-4"$ \checkmark h8 54 #6 $15'-0"$ \checkmark h9 46 #6 $11'-0"$ \checkmark h10 19 #6 $13'-0"$ \checkmark h11 19 #6 $13'-0"$ \checkmark h12 234 #6 $35'-6"$ \frown h13 4 #7 $11'-2"$ \frown h14 8 #5 $6'-0"$ \frown h15 8 #6 $7'-8"$ \frown h16 16 #5 $2'-0"$ \frown h18 8 #5 $2'-6"$ \Box s 25 #4 $5'-5"$ \Box s1 370 #7 $12'-3"$ \Box v1 370 #7 $12'-3"$ \Box					
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h5 16 #9 $24'-0"$					
h6 16 #9 $24'-0"$					
h7 4 #5 $16'-4"$ h8 54 #6 $15'-0"$					
h8 54 #6 $15'-0"$ h9 46 #6 $11'-0"$ \measuredangle h10 19 #6 $13'-0"$ $_$ h11 19 #6 $13'-0"$ $_$ h12 234 #6 $35'-6"$ $_$ h13 4 #7 $11'-2"$ $_$ h14 8 #5 $6'-0"$ $_$ h15 8 #6 $7'-8"$ $_$ h16 16 #5 $2'-0"$ $_$ h17 4 #6 $8'-6"$ $_$ h18 8 #5 $2'-6"$ $_$ s 25 #4 $5'-5"$ \square s1 25 #4 $5'-3"$ \square v 370 #7 $6'-7"$ $_$ v2 202 #6 $11'-2"$ $_$ v3 202 #6 $11'-2"$ $_$ v4 202 #6 $15'-11"$ $_$ v5 34 #6 </td <td></td> <td></td> <td></td> <td></td> <td></td>					
h9 46 #6 $11'-0"$ \checkmark h10 19 #6 $13'-0"$ \checkmark h11 19 #6 $13'-0"$ \checkmark h12 234 #6 $35'-6"$ \checkmark h13 4 #7 $11'-2"$ \sim h14 8 #5 $6'-0"$ \sim h15 8 #6 $7'-8"$ \sim h16 16 #5 $2'-0"$ \sim h17 4 #6 $8'-6"$ \sim h18 8 #5 $2'-6"$ \sim s 25 #4 $5'-5"$ \Box v 370 #7 $12'-3"$ \Box v1 370 #7 $6'-7"$ L v2 202 #6 $11'-2"$ \Box v3 202 #6 $13'-3"$ \Box v4 202 #6 $5'-11"$ L v5 34 #6 $26'-7"$ \Box v4 202 #6 </td <td></td> <td></td> <td></td> <td></td> <td></td>					
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h12 234 #6 $35'-6"$ h13 4 #7 $11'-2"$ h14 8 #5 $6'-0"$ h15 8 #6 $7'-8"$ h16 16 #5 $2'-0"$ h17 4 #6 $8'-6"$ h18 8 #5 $2'-0"$ s 25 #4 $5'-5"$ \Box s 25 #4 $5'-3"$ \Box v 370 #7 $12'-3"$ \Box v2 202 #6 $11'-2"$ \Box v3 202 #6 $13'-3"$ \Box v4 202 #6 $15'-3"$ \Box v5 34 #6 $26'-7"$ \Box v5 34 #6 $26'-7"$ \Box v5 34 #6 $26'-7"$ \Box v6 36 #6 $16'-6"$ \Box v7 20 #8 $3'-8"$ \Box v9 20 #8 $3'-8"$ </td <td></td> <td></td> <td></td> <td></td> <td></td>					
h13 4 #7 11'-2" h14 8 #5 6'-0" h15 8 #6 7'-8" h16 16 #5 2'-0" h17 4 #6 8'-6" h18 8 #5 2'-0" s 25 #4 5'-5" s1 25 #4 5'-3" v1 370 #7 6'-7" v2 202 #6 11'-2" v3 202 #6 13'-3" v4 202 #6 16'-6" v7 20 #8 7'-0" v6 36 #6 16'-6" v7 20 #8 3'-8" v10 6 #5 12'-3" v6 36 #6 16'-6" v7 20 #8 3'-8" v10 6 #5 12'-3" v10 6 #5 12'-3" v10 6 #5 12'-3" v10 6					
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h15 8 #6 7'-8" h16 16 #5 2'-0" h17 4 #6 8'-6" h18 8 #5 2'-6" s 25 #4 5'-5" 1 s1 25 #4 5'-3" 1 v 370 #7 6'-7" 1 v2 202 #6 11'-2" 1 v3 202 #6 13'-3" 1 v4 202 #6 5'-11" 1 v5 34 #6 26'-7" 1 v5 34 #6 16'-6" 1 v7 20 #8 3'-0" 1 v8 40 #8 3'-0" 1 v9 20 #8 3'-8" 1 v10 6 #5 12'-3" <t< td=""><td></td><td></td><td></td><td></td><td></td></t<>					
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h17 4 #6 8'-6" h18 8 #5 2'-6" s 25 #4 5'-5" 1 s1 25 #4 5'-3" 1 v 370 #7 12'-3" 1 v 370 #7 6'-7" 1 v2 202 #6 11'-2" 1 v3 202 #6 5'-11" 1 v5 34 #6 26'-7" 1 v5 34 #6 26'-7" 1 v6 36 #6 16'-6" 1 v7 20 #8 3'-0" 1 v8 40 #8 3'-0" 1 v9 20 #8 3'-8" 1 Concrete Box Culverts Cu. Yd. 377.2 Reinforcement Bars Pound 77.960 Bars indicated thus 1 x 3-#4 etc. indic		-			
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s1 25 #4 5'-3" Image: Constraint of the second seco	h18	8	#5	2'-6"	
s1 25 #4 5'-3" Image: Constraint of the second seco		25			
v 370 #7 12'-3" v1 370 #7 6'-7" L v2 202 #6 11'-2"					
v1 370 #7 6'-7" L v2 202 #6 11'-2"	s I	25	#4	5'-3''	U
v2 202 #6 11'-2" v3 202 #6 13'-3"] v4 202 #6 5'-11" L v5 34 #6 26'-7"	V	370	#7	12'-3"	
v3 202 #6 13'-3" 1 v4 202 #6 5'-11" L v5 34 #6 26'-7"	v 1	370	#7	6'-7"	L
v4 202 #6 5'-11" L v5 34 #6 26'-7"	v2	202	#6	11'-2"	
v4 202 #6 5'-11" L v5 34 #6 26'-7"	v3	202	#6	13'-3"	٦
v5 34 #6 26'-7" v6 36 #6 16'-6" v7 20 #8 7'-0" v8 40 #8 3'-0" v9 20 #8 3'-8" v10 6 #5 12'-3" Concrete Box Culverts Cu. Yd. 377.2 Reinforcement Bars Pound 77,960 Bars indicated thus 1 x 3-#4 etc. indic 1x 3-#4 etc.	v 4	202	#6		L
v6 36 #6 16'-6" v7 20 #8 7'-0" v8 40 #8 3'-0" v9 20 #8 3'-8" v10 6 #5 12'-3" concrete Box Culverts Cu. Yd. 377.2 Reinforcement Bars Pound 77,960 Bars indicated thus 1 x 3-#4 etc. indic					
v7 20 #8 7'-0" v8 40 #8 3'-0" v9 20 #8 3'-8" v10 6 #5 12'-3" Concrete Box Culverts Cu. Yd. 377.2 Reinforcement Bars Pound 77,960 Bars indicated thus 1 x 3-#4 etc. indic					
v8 40 #8 3'-0" v9 20 #8 3'-8" v10 6 #5 12'-3" Concrete Box Culverts Cu. Yd. 377.2 Reinforcement Bars Pound 77,960 Bars indicated thus 1 x 3-#4 etc. indic					
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Concrete Box Culverts Cu. Yd. 377.2 Reinforcement Bars Pound 77,960 Bars indicated thus 1 x 3-#4 etc. indic					
Reinforcement Bars Pound 77,960 Bars indicated thus 1 x 3-#4 etc. indic					
Reinforcement Bars Pound 77,960 Bars indicated thus 1 x 3-#4 etc. indic	Concre	te Box	Culverts	Cu. Yd.	377.2
Bars indicated thus 1 x 3-#4 etc. indic					
	1 line	of bars			

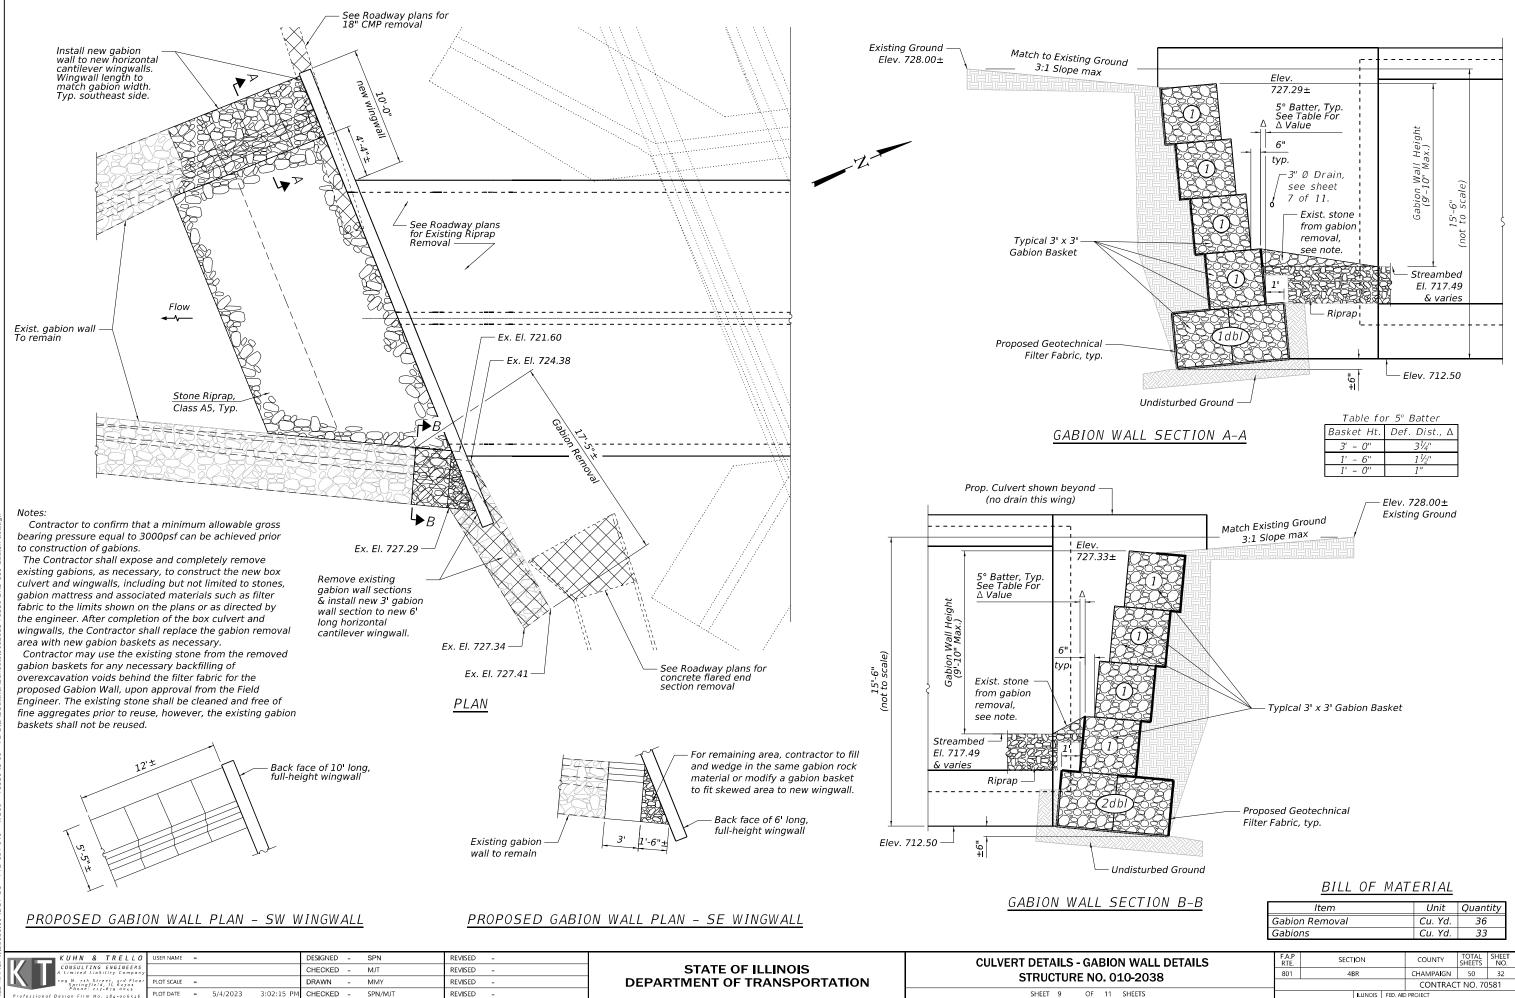

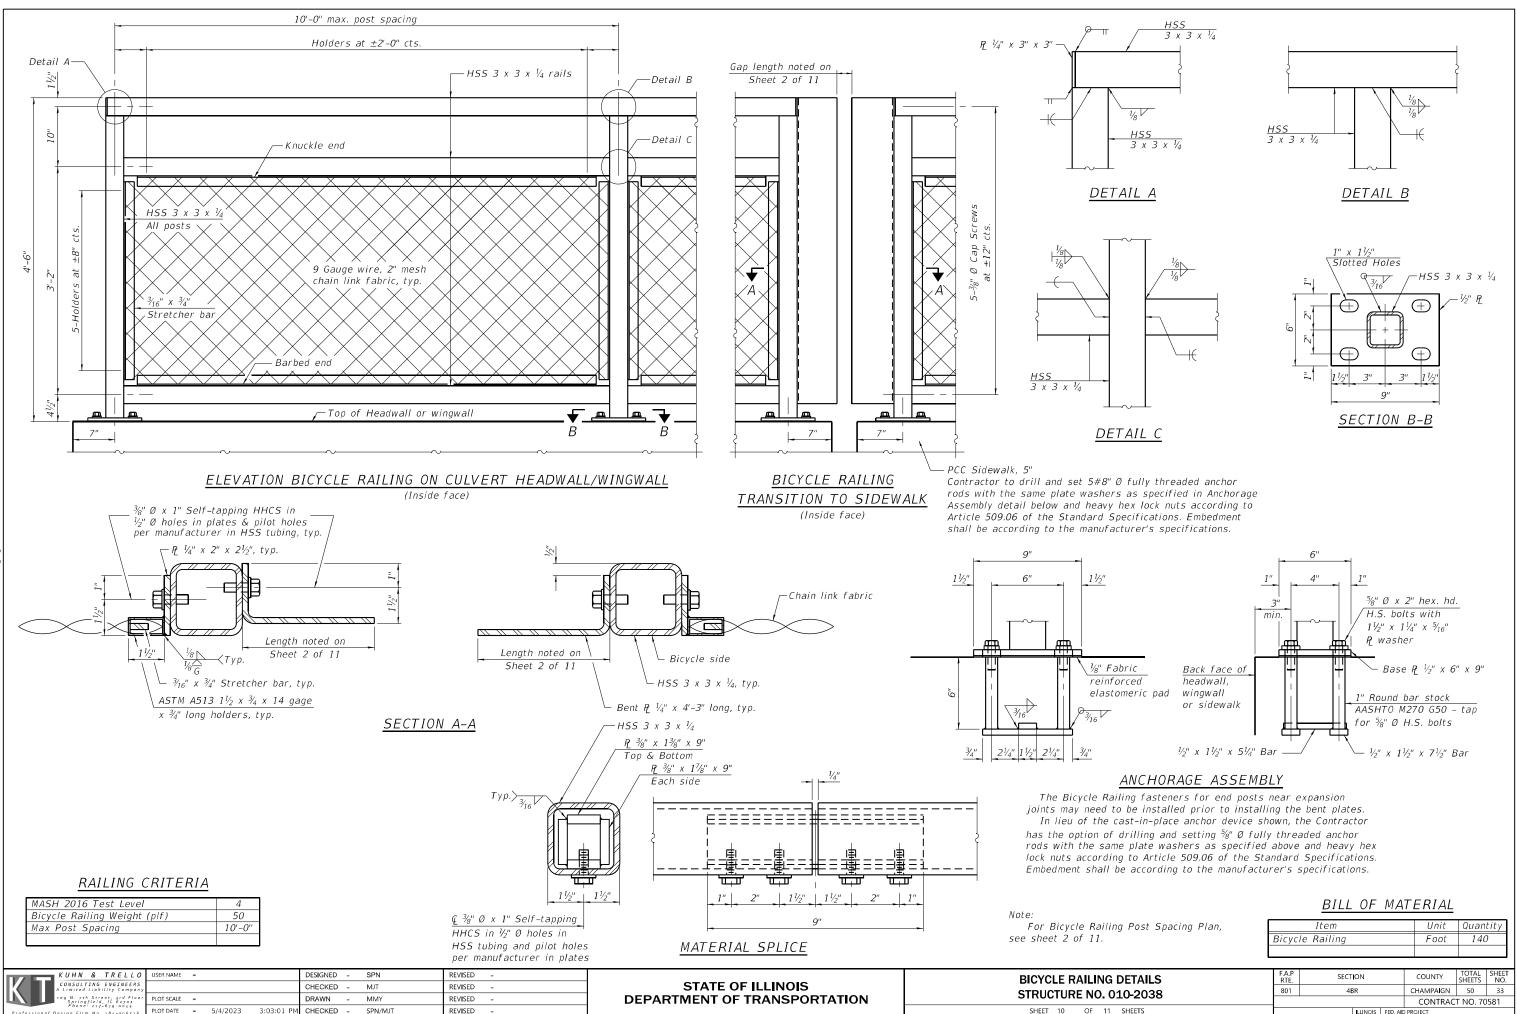

iling Post Spacing Plan,	Item				Unit	Quan	tity
	Bicyc	le Railing			Foot	140)
IG DETAILS	F.A.P RTE.	SECT	ON		COUNTY	TOTAL SHEETS	SHEET NO.
. 010-2038	801	4E	BR		CHAMPAIGN	50	33
. 010-2038					CONTRAC	T NO. 70	581
11 SHEETS			ILLINOIS	FED. AIC	PROJECT		

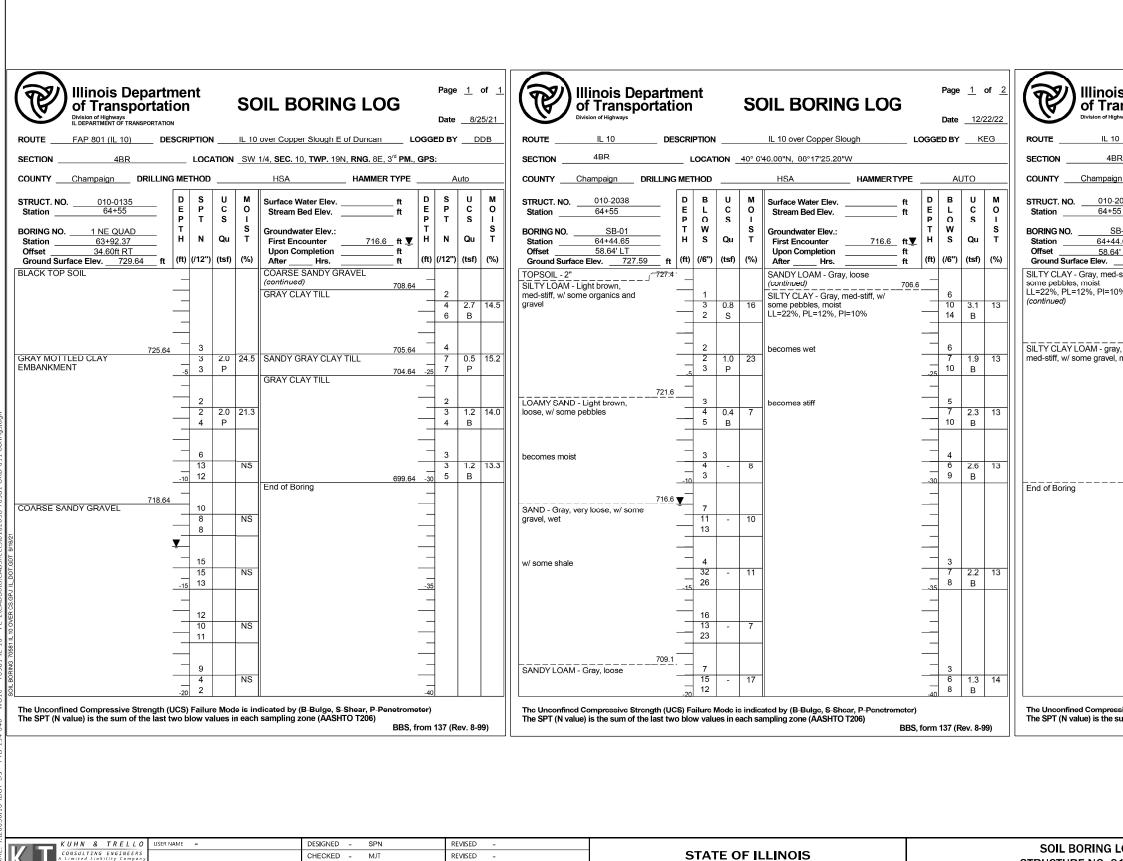

N. 7th Street, 3rd Flo Springfield, IL 62702 Phone: 227-679-0044 LOT SCALE =

DRAWN

PLOT DATE = 5/4/2023 3:05:55 PM CHECKED -

MM


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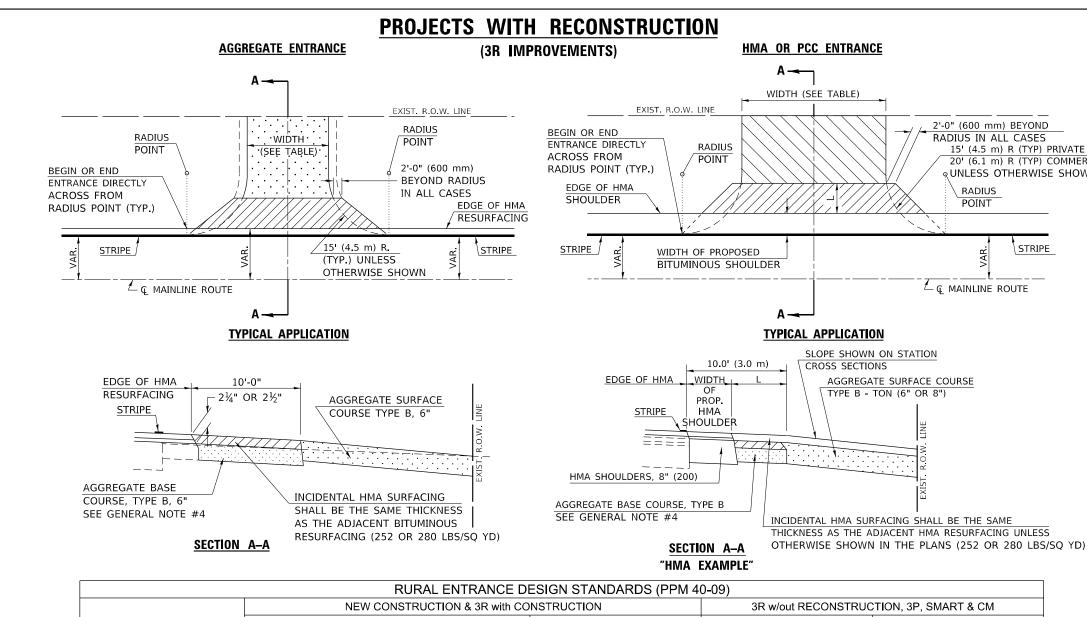
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	DES	CDI				IL 10 over Coppe	or Clouch		1.000			<u>22/22</u>
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aign DRILL				_		HSA			/PF	AU	то	
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+55 SB-01 -44.65 64' LT	ft	E P T H	L O W S	C S Qu (tsf)	Ю I S T (%)	Surface Water El Stream Bed Ele Groundwater Ele First Encounter Upon Completic After Hr	v v.: on	716.6				
ed-stiff, w/		_					<u> </u>					
10% 6, ray, el, moist	<u>84.1</u>		5 7 10	1.1 B	13							
6			2 5 8	1.0 B	13							
essive Strength	(UC	S) Fa	ailure I	Node is	s indica	ated by (B-Bulge, S	S-Shear, P	-Penetrom	eter)			
e sum of the las	t two	o blov	w valu	es in e	ach sa	mpling zone (AAS	HTO T206))	BBS, form	137 (R	ev. 8-9	99)
												-
LOGS						F.A.P RTE.	SECTION		COUNTY	/ TO	OTAL IEETS	SHEET NO.
010-2038						801	4BR		CHAMPA	GN	50	34
1 SHEETS							ILUN	NOIS FED. A	D PROJECT			,501

PROJECTS WITHOUT RECONSTRUCTION



AL ENTRANCES	
	SHEET NO.
COMMERCIAL RURAL) 801 4BR CHAMPAIGN 50	35
CONTRACT NO. 705	581
TS STA. TO STA. ILLINOIS FED AID PROJECT	

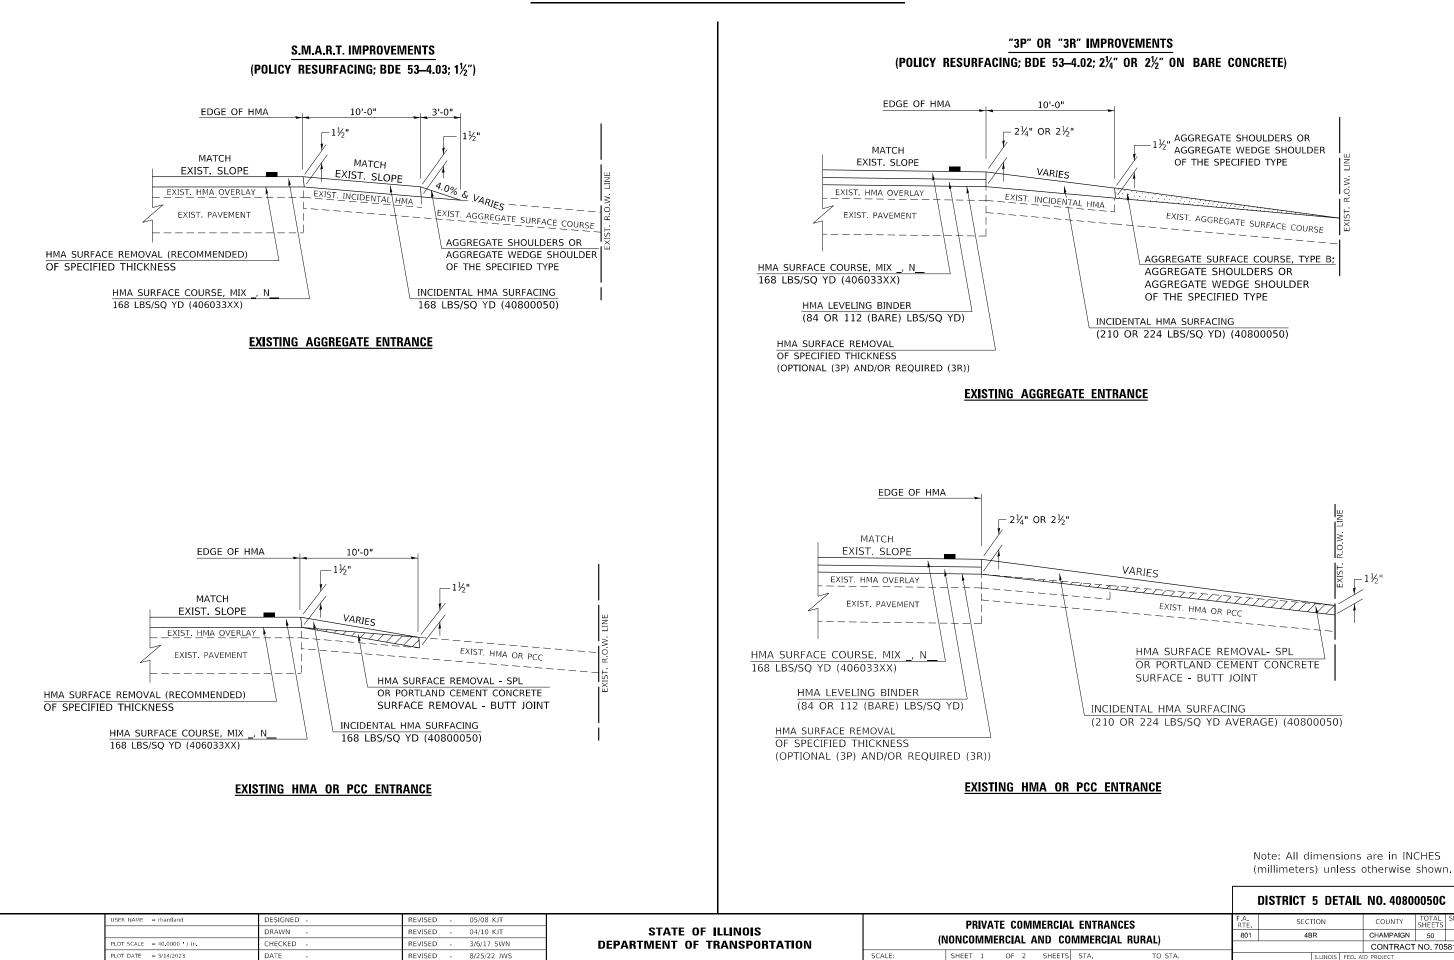


		1.01			-0101101			0 00)						APRON WITHOUT PROPER APPROVAL		
NEW CONSTRUCTION & 3R with CO						ON		3R w/out RECONSTRUCTION, 3P, SMART & CM NONCOMMERCIAL				СМ	THROUGH THE BUREAU OF OPERATIONS "POLICY ON PERMITS FOR ACCESS DRIVEWAYS TO STATE			
	NONCOMMERCIAL															
			FIELD	N/FARM												
PRIVATE & FIELD		ELD	IMPLEMENTS		COMMERCIAL		PRIVATE & FIELD		COMMERC		IAL		RE APPROPRIATE ACCESS POLICIES ARE			
min.	des.	max.	min.	max.	min.	des.	max.	min. des	s. max.	min.	des.	max.		LL NEW ACCESS SHALL BE APPLIED H THE BUREAU OF OPERATIONS PERMI		
12	16	24	24	30	1 LANE, 1 WAY						1 LANE, 1 WAY			ATION PROCESS. PLAN PREPARATION		
					14	14 16 24								RANDUMS 40-09 ALONG WITH DISTRICT		
					2 LANE, 2 WAY				2 LANE, 2 WAY		/AY		F IMPLEMENTATION MEMO 104/01			
					24	30	35		I					PROCEDURE.		
15	25	40	30		20	30	50	resurface existing	configuration	, existing ag	gregate or ea	arth				
2	2		2		1	3		entrances shall h	ave the contin	uation of ag	gregate shou	ders				
2	4	6	4		2	4	6	placed behind the	em							
0	2 to 5	10 or 12	2 to 5	10 or 12	0	2 to 5	8 or 10	-								
1:10	1:6	1:4	1:6	1:4	1:10	1:6	1:4									
			2		2 an 4		taper from hma re	surfacing thick	ness (2 1/2"	, 2 1/4" or 1 ´	/2")					
	2		2		5014			to 1 1/2" to minimize aggregate shoulder								
	6		6		0			if applicable, use it	applicable, use items: Preparation of Base & Aggregate							
	0	0 0			0			Base Repair; see	ase Repair; see PPM 30-02					Note: All dimensions are in INCHES (millimeters) unless otherwise showr		
	6						6 or 8							(Infiniteters) unless otherwise shown.		
	0						0010							DISTRICT 5 DETAIL NO. 40800050C		
DRAWN - REVISED - 04/10 CHECKED - REVISED - 3/6/10			- 05/08 K	05/08 KJT								001414500	F.A.	E SECTION COUNTY SHEETS N		
														RTE. SHEETS NO. 801 4BR CHAMPAIGN 50 36		
						DEPARTMENT OF TRAN			6CA					ILLINOIS FED. AID PROJECT		
1	min. 12 15 2 2 0 1:10 DESIGNED - DRAWN -	Image: main main main main main main main main	NONCOMMER PRIVATE & FIELD min. des. max. 12 16 24 12 16 24 12 25 40 2 2 4 2 4 6 0 2 to 5 10 or 12 1:10 1:6 1:4 DESIGNED - REVISED DRAWN - REVISED CHECKED - REVISED REVISED	NONCOMMERCIAL FIELD IMPLE min. des. max. min. 12 16 24 24 15 25 40 30 2 2 2 2 2 4 6 4 0 2 to 5 10 or 12 2 to 5 1:10 1:6 1:4 1:6 DESIGNED - REVISED - 05/08 K DAWN - REVISED - 05/08 K	NONCOMMERCIAL FIELD W/FARM PRIVATE & FIELD FIELD W/FARM min. des. max. min. max. 12 16 24 24 30 12 16 24 24 30 12 25 40 30 - 2 2 2 2 - 2 4 6 4 - 0 2 to 5 10 or 12 2 to 5 10 or 12 1:10 1:6 1:4 1:6 1:4 DESIGNED - DESIGNED - C REVISED - 05/08 KJT DRAWN - REVISED - 04/10 KJT CHECKED - REVISED - 3/6/17 SWN	NONCOMMERCIAL PRIVATE & FIELD FIELD W/FARM IMPLEMENTS CC min. des. max. min. max. min. 1 12 16 24 24 30 14 2 12 16 24 24 30 14 2 12 16 24 24 30 14 2 12 16 24 24 30 14 2 12 16 24 24 30 14 2 12 16 124 24 30 20 2 2 1 1 2 2 2 10 or 12 2 to 5 10 or 12 0 1	FIELD W/FARM IMPLEMENTS COMMERCI/ MIRENTS min. des. max. min. max. min. des. 12 16 24 24 30 14 16 12 16 24 24 30 14 16 12 16 24 24 30 14 16 12 16 24 24 30 14 16 12 16 24 24 30 14 16 12 16 24 24 30 20 30 15 25 40 30 20 30 2 2 2 1 3 2 4 6 4 2 4 0 2 to 5 10 or 12 0 2 to 5 10 or 12 0 2 to 5 110 1:6 1:4 1:10 1:6 1:6 1:4 1:10 1:6	NONCOMMERCIAL FIELD W/FARM IMPLEMENTS COMMERCIAL min. des. max. min. max. min. des. max. 12 16 24 24 30 14 16 24 12 16 24 24 30 14 16 24 12 16 24 24 30 14 16 24 12 16 24 24 30 35 14 16 24 12 16 24 24 30 35 14 16 24 12 2 2 2 1 3 35 16 13 11 13 11 13 11 </td <td>NONCOMMERCIAL NONCOMMERCIAL NONCOMMERCIAL NONCOMMERCIAL NONCOMMERCIAL PRIVATE min. des. max. min. max. min. des. 12 16 24 24 24 30 14 16 24 12 16 24 24 30 20 30 50 resurface existing entrances shall h placed behind the placed behind</td> <td>NONCOMMERCIAL NONCOMMERCIAL PRIVATE & FIELD FIELD W/FARM IMPLEMENTS COMMERCIAL PRIVATE & FIELD min. des. max. min. max. min. des. max. max.</td> <td>NONCOMMERCIAL NONCOMMERCIAL NONCOMMERCIAL PRIVATE & FIELD IMPLEMENTS COMMERCIAL PRIVATE & FIELD min. des. max. min. max. min. des. des. des. des. des. des. des.</td> <td>NONCOMMERCIAL FIELD W/FARM NONCOMMERCIAL NONCOMMERCIAL min. des. max. min. max. min. des. des.</td> <td>NONCOMMERCIAL NONCOMMERCIAL NONCOMMERCIAL PRIVATE & FIELD FIELD W/FARM IMPLEMENTS COMMERCIAL PRIVATE & FIELD COMMERCIAL min, des, max, ital, des, des, max, ital, des, des, des,</td> <td>NONCOMMERCIAL SR wide Recions FROCTION, 3-, SMART & CW NONCOMMERCIAL PRIVATE & FIELD IMPLEMENTS COMMERCIAL PRIVATE & FIELD COMMERCIAL TO ASSURE A min, des. max. min. max. min. des. max. des</td>	NONCOMMERCIAL NONCOMMERCIAL NONCOMMERCIAL NONCOMMERCIAL NONCOMMERCIAL PRIVATE min. des. max. min. max. min. des. 12 16 24 24 24 30 14 16 24 12 16 24 24 30 20 30 50 resurface existing entrances shall h placed behind the placed behind	NONCOMMERCIAL NONCOMMERCIAL PRIVATE & FIELD FIELD W/FARM IMPLEMENTS COMMERCIAL PRIVATE & FIELD min. des. max. min. max. min. des. max. max.	NONCOMMERCIAL NONCOMMERCIAL NONCOMMERCIAL PRIVATE & FIELD IMPLEMENTS COMMERCIAL PRIVATE & FIELD min. des. max. min. max. min. des. des. des. des. des. des. des.	NONCOMMERCIAL FIELD W/FARM NONCOMMERCIAL NONCOMMERCIAL min. des. max. min. max. min. des. des.	NONCOMMERCIAL NONCOMMERCIAL NONCOMMERCIAL PRIVATE & FIELD FIELD W/FARM IMPLEMENTS COMMERCIAL PRIVATE & FIELD COMMERCIAL min, des, max, ital, des, des, max, ital, des, des, des,	NONCOMMERCIAL SR wide Recions FROCTION, 3-, SMART & CW NONCOMMERCIAL PRIVATE & FIELD IMPLEMENTS COMMERCIAL PRIVATE & FIELD COMMERCIAL TO ASSURE A min, des. max. min. max. min. des. max. des		

1D
S
) PRIVATE
) COMMERCIAL
ISE SHOWN

GENERAL NOTES

- 1. THE EXISTING SURFACE SHALL BE PREPARED IN ACCORDANCE WITH SECTION 408 OF THE STANDARD SPECIFICATIONS.
- 2. ANY NECESSARY WORK BEHIND THE HMA SHOULDER OR THE INCIDENTAL HMA SURFACING SHALL BE AS SHOWN IN THE PLANS AND/OR AS DIRECTED BY THE ENGINEER.
- 3. EARTH EXCAVATION REQUIRED FOR THE CONSTRUCTION OF THE AGGREGATE SURFACE COURSE SHALL BE INCLUDED IN THE COST OF AGGREGATE SURFACE COURSE.
- 4. AGGREGATE BASE COURSE, TYPE B, 6" (150 mm) MIN. SHALL BE USED WHERE IN THE OPINION OF THE ENGINEER THERE IS NOT SUFFICIENT BASE MATERIAL FOR THE PROPOSED ENTRANCES, THIS MATERIAL SHALL GENERALLY BE USED TO WIDEN ANY EXISTING RETURN OR TO CONSTRUCT NEW
- 5. ENTRANCES WHERE NONE NOW EXISTS.
- 6. THE AGGREGATE BASE COURSE SHALL BE CONSTRUCTED 12" (300 mm) WIDER THAN THE SURFACE DIMENSIONS AS SHOWN ABOVE.
- 7. EXISTING FIELD ENTRANCES OF AGGREGATE OR EARTH WITH NO HMA APRON SHALL NOT RECEIVE A NEW HMA APRON WITHOUT PROPER APPROVAL

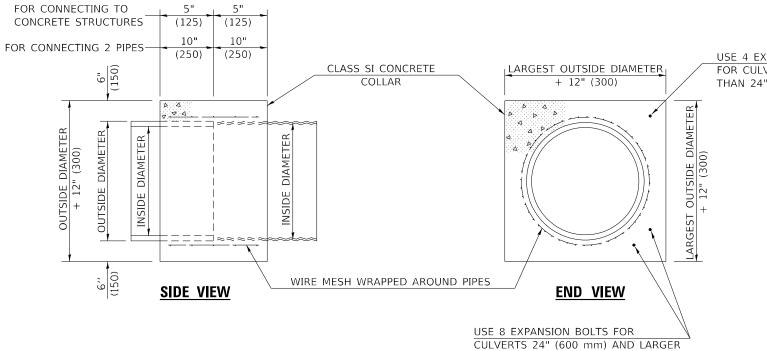

QUANTITIES FO	DR METAL PIPES
INSIDE DIAMETER OF PIPE	ESTIMATED CLASS SI CONCRETE REQUIRED
INCH (mm)	20" (500 mm) WIDTH CU.YD. (m ³)
4" (100)	0.12 (0.09)
6" (150) 8" (200)	0.14 (0.11) 0.16 (0.12)
10" (250)	0.19 (0.14)
12" (300)	0.21 (0.16)
15" (375)	0.25 (0.19)
18" (450) 24" (600)	0.29 (0.22) 0.38 (0.29)
30" (750)	0.47 (0.36)
36" (900)	0.59 (0.45)
42" (1050)	0.69 (0.53)
48" (1200)	0.81 (0.62)
54" (1350) 60" (1500)	0.93 (0.71) 1.05 (0.81)

QUANTITIES FOR	CONCRETE PIPES				
INSIDE DIAMETER	ESTIMATED				
OF PIPE	CLASS SI CONCRETE				
	REQUIRED				
	20" (500 mm) WIDTH				
INCH (mm)	CU.YD. (m ³)				
4" (100)	0.14 (0.11)				
6" (150)	0.16 (0.12)				
8" (200)	0.19 (0.14)				
10" (250)	0.22 (0.17)				
12" (300)	0.25 (0.19)				
15" (375)	0.30 (0.23)				
18" (450)	0.35 (0.27)				
24" (600)	0.45 (0.35)				
30" (750)	0.57 (0.43)				
36" (900)	0.69 (0.53)				
42" (1050)	0.83 (0.63)				
48" (1200)	0.97 (0.74)				
54" (1350)	1.12 (0.86)				
60" (1500)	1.28 (0.98)				

						DIS	TRICT 5 DETA	L NO. 54248	3510
USER NAME = rhanfland	DESIGNED -	REVISED - 12/06				F.A. RTE	SECTION	COUNTY TOTA	AL SHEET
	DRAWN -	REVISED -	STATE OF ILLINOIS CONCRETE COLLAR		CONCRETE COLLAR SCALE: SHEET 1 OF 1 SHEETS STA. TO STA.	4BR	CHAMPAIGN 50	37	
PLOT SCALE = 40.0000 / in	CHECKED -	REVISED -	DEPARTMENT OF TRANSPORTATION					CONTRACT NO. 7	70581
PLOT DATE = 3/14/2023	DATE -	REVISED -		SCALE:	SHEET 1 OF 1 SHEETS STA. TO STA.		ILLINOIS FED. /	ID PROJECT	

USE 4 EXPANSION BOLTS FOR CULVERTS SMALLER THAN 24" (600 mm)

GENERAL NOTES

1. CLASS SI CONCRETE SHALL BE USED THROUGHOUT.


2. WHEN CONCRETE COLLARS ARE USED TO CONNECT PIPES OF DIFFERENT OUTSIDE DIAMETERS, THE CONCRETE COLLAR SHALL BE FORMED USING THE LARGEST OUTSIDE DIAMETER (SEE END VIEW).

3. THE WIRE MESH SHALL WEIGH NOT LESS THAN 54#/100 SQ. FT. (2.63 kg/m²).

4. WHEN CONCRETE COLLARS ARE CONSTRUCTED ADJACENT TO AN EXISTING CONCRETE STRUCTURE (HEADWALLS, ETC.) EXPANSION BOLTS, SHALL BE USED AND WILL BE PAID FOR AT THE CONTRACT UNIT PRICE, EACH, FOR EXPANSION BOLTS OF THE SIZE SPECIFIED IN THE PLANS.

5. CONCRETE COLLARS WILL BE PAID FOR AT THE CONTRACT UNIT PRICE, PER CUBIC YARD (CUBIC METER), FOR CONCRETE COLLARS INCLUDING ALL MATERIAL AND LABOR SPECIFIED TO COMPLETE THE WORK IN PLACE.

Note: All dimensions are in INCHES (millimeters) unless otherwise shown.

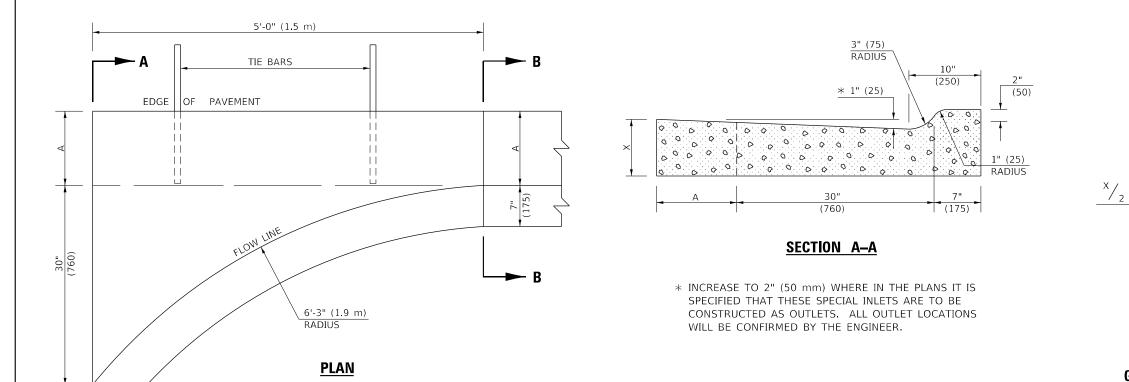


1. CLASS SI CONCR

- (OUTLET).
- ARTICLE 1006.11(b).

	B-6.12 B-9.12		.12	B-6.18		B-9.18		B-6.24		B-9.24		
	(B-1	5.30)	(B-2	2.30)	(B-15.45)		(B-2	2.45)	(B-15.60)		(B-2	2.60)
А	12"	12"	12"	12"	18"	18"	18"	18"	24"	24"	24"	24"
A	(300)	(300)	(300)	(300)	(450)	(450)	(450)	(450)	(600)	(600)	(600)	(600)
В	6"	6"	9"	9"	6"	6"	9"	9"	6"	6"	9"	9"
	(150)	(150)	(225)	(225)	(150)	(150)	(225)	(225)	(150)	(150)	(225)	(225)
х	9"	10"	9"	10"	9"	10"	9"	10"	9"	10"	9"	10"
^	(225)	(250)	(225)	(250)	(225)	(250)	(225)	(250)	(225)	(250)		(250)
CU. YD.	0.37	0.42	0.38	0.42	0.44	0.49	0.45	0.50	0.51	0.56	0.52	0.57
(m ³)	(0.28)	(0.32)	(0.29)	(0.32)	(0.34)	(0.37)	(0.34)	(0.38)	(0.39)	(0.43)	(0.40)	(0.44)
CLASS SI												
CONCRETE												

(OUTLET)

						DISTRIC	T 5 DETAIL	NO. 60600095A
USER NAME = rhanfland	DESIGNED -	REVISED - 11/06				F.A. BTE	SECTION	COUNTY TOTAL SHEET
	DRAWN -	REVISED -	STATE OF ILLINOIS INLET – COMBINATION CONCRETE CURB & GUTTER (BARRIER CURB)				4BR	CHAMPAIGN 50 38
PLOT SCALE = 40.0000 / in	CHECKED -	REVISED -	DEPARTMENT OF TRANSPORTATION					CONTRACT NO. 70581
PLOT DATE = 3/14/2023	DATE -	REVISED -		INLET – COMBINATION CONCRETE CURB & GUTTER (BARRIER CURB)				

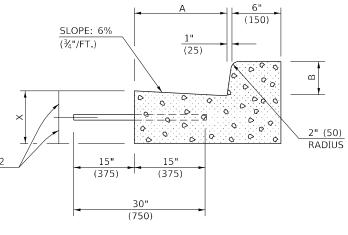



GENERAL NOTES

RETE SHALL BE USED THROUGHOUT.

2. TIE BARS SHALL BE NO. 6 (NO. 20) AT 24" (600 mm) CENTERS UNLESS OTHERWISE SHOWN. SPECIAL INLETS AND OUTLETS SHALL BE TIED TO THE PAVEMENT IN ACCORDANCE WITH DETAILS FOR LONGITUDINAL CONSTRUCTION JOINT SHOWN ON STANDARD 420001.


3. TIE BARS SHOWN ABOVE WILL NOT BE PAID FOR SEPARATELY BUT SHALL BE CONSIDERED AS INCIDENTAL TO CLASS SI CONCRETE


4. WHEN SPECIAL INLET IS CONSTRUCTED ADJACENT TO FLEXIBLE PAVEMENT, THE TIE BARS SHALL BE OMITTED AND ALL CONSTRUCTION JOINTS SHALL BE PROVIDED WITH A DOWEL BAR CONFORMING TO


5. THIS WORK WILL BE PAID FOR AT THE CONTRACT UNIT PRICE PER CU. YD. (m³) FOR CLASS SI CONCRETE (OUTLET) WHICH PRICE SHALL INCLUDE ALL LABOR AND MATERIAL AS SPECIFIED AND NO ADDITIONAL COMPENSATION WILL BE ALLOWED.

> Note: All dimensions are in INCHES (millimeters) unless otherwise shown.

ROAD CLOSURE

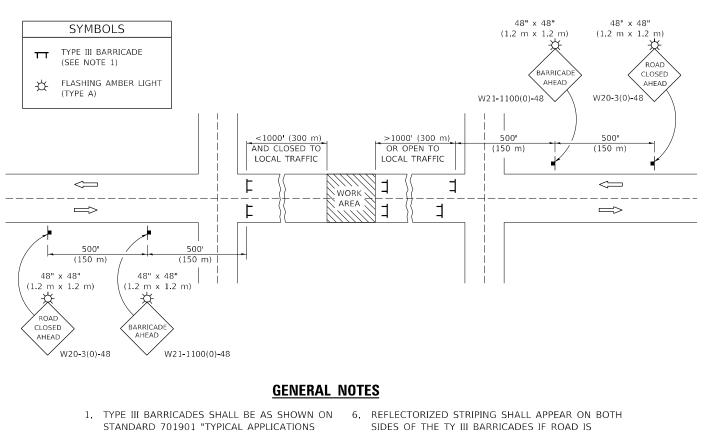

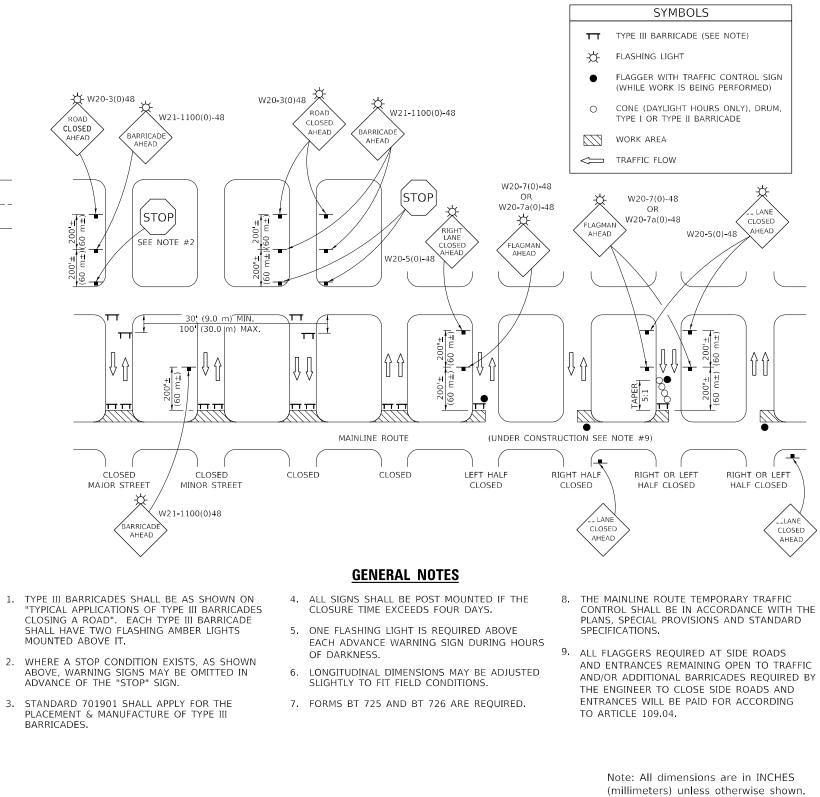

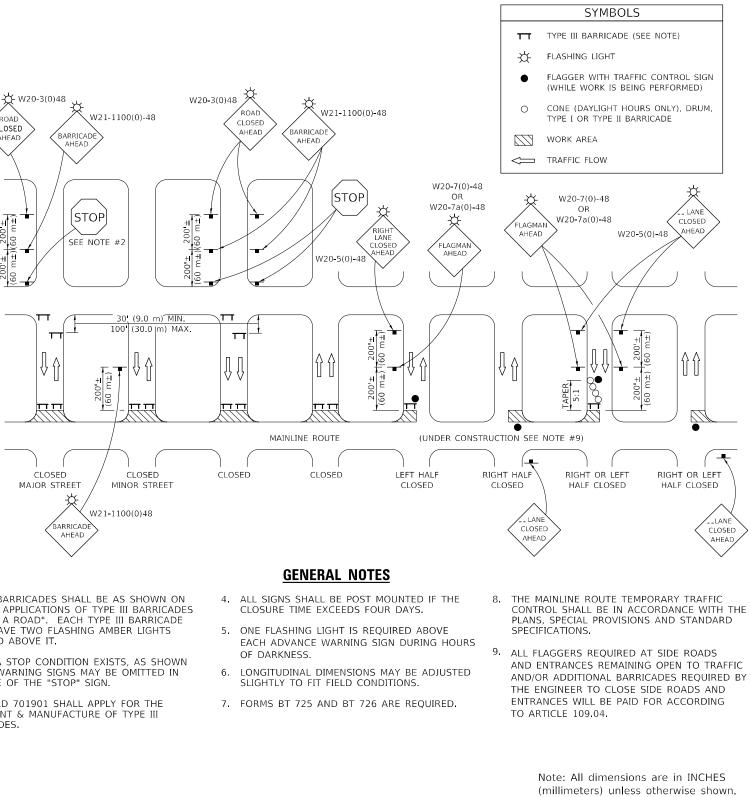


						DISTRIC	T 5 DETA	NIL NO. 70200000
USER NAME = rhanfland	DESIGNED -	REVISED - 11/06			TRAFFIC CONTROL & PROTECTION DEVICES	F.A. S	SECTION	COUNTY TOTAL SHEET SHEETS NO.
	DRAWN -	REVISED - 12/07	STATE OF ILLINOIS	TRAFFIC CONTROL & PROTECTION DEVI (ROAD & SIDEROAD / STREET CLOSUR		801	4BR	CHAMPAIGN 50 39
PLOT SCALE = 40.0000 / in	CHECKED -	REVISED - 09/09 KJT	DEPARTMENT OF TRANSPORTATION		(RUAD & SIDEKUAD / SIREEI CLUSUKES)			CONTRACT NO. 70851
PLOT DATE = 3/14/2023	DATE -	REVISED -		SCALE:	SHEET 1 OF 1 SHEETS STA. TO STA.		ILLINOIS FED.	AID PROJECT
•	•		-					


- OF TYPE III BARRICADES CLOSING A ROAD". EACH TYPE III BARRICADE SHALL HAVE TWO FLASHING AMBER LIGHTS MOUNTED ABOVE IT.
- 2. IF THE ROAD IS OPEN TO LOCAL TRAFFIC OR EXCEEDS 1000' (300 m), ANOTHER SET OF TYPE III BARRICADES, EQUIPPED AS IN NOTE 1 ABOVE, SHALL BE PLACED AT EACH END OF THE WORK AREA.
- 3. WHEN A STOP CONDITION EXISTS, NO SIGNS ARE REQUIRED IN ADVANCE OF THE "STOP" SIGN WHEN THE ROAD IS CLOSED WITHIN 100' (30 m) OF THE INTERSECTION.
- 4. STANDARD 701901 SHALL APPLY FOR THE
- 5. IF A TYPE III BARRICADE WITH AN ATTACHED SIGN PANEL WHICH MEETS NCHRP 350 IS NOT AVAILABLE. THE SIGNS MAY BE MOUNTED ON AN NCHRP 350 TEMPORARY SIGN SUPPORT DIRECTLY IN FRONT OF THE BARRICADE.

- OPEN TO LOCAL TRAFFIC.
- 7. ALL SIGNS SHALL BE POST MOUNTED IF THE CLOSURE TIME EXCEEDS FOUR DAYS.
- 8. A MINIMUM OF TWO FLASHING LIGHTS SHALL BE USED AT NIGHT ON EACH APPROACH IN ADVANCE OF THE WORK AREA. FLASHING LIGHTS SHALL BE INSTALLED ABOVE THE FIRST TWO SIGNS IN THE SERIES.
- 9. LONGITUDINAL DIMENSIONS MAY BE ADJUSTED SLIGHTLY TO FIT FIELD CONDITIONS.
- 10. FORMS BT. 725 AND BT. 726 ARE REQUIRED.
- PLACEMENT & DESIGN OF TYPE III BARRICADES. 11. WHEN A SIDEROAD INTERSECTS THE HIGHWAY ON WHICH WORK IS BEING PERFORMED, ADDITIONAL TRAFFIC DEVICES SHALL BE ERECTED AND PROVIDED AS DIRECTED BY THE ENGINEER.
 - 12. AN ADDITIONAL SIGN MAY BE REQUIRED AT A MAJOR INTERSECTING ROAD IN ADVANCE OF THE CLOSURE. THE ADDITIONAL SIGN SHALL GIVE THE DISTANCE TO THE BARRICADE IN MILES OR FRACTIONS OF A MILE.
- "TYPICAL APPLICATIONS OF TYPE III BARRICADES CLOSING A ROAD". EACH TYPE III BARRICADE SHALL HAVE TWO FLASHING AMBER LIGHTS MOUNTED ABOVE IT.
- PLACEMENT & MANUFACTURE OF TYPE III BARRICADES.

SIDEROAD / STREET CLOSURE

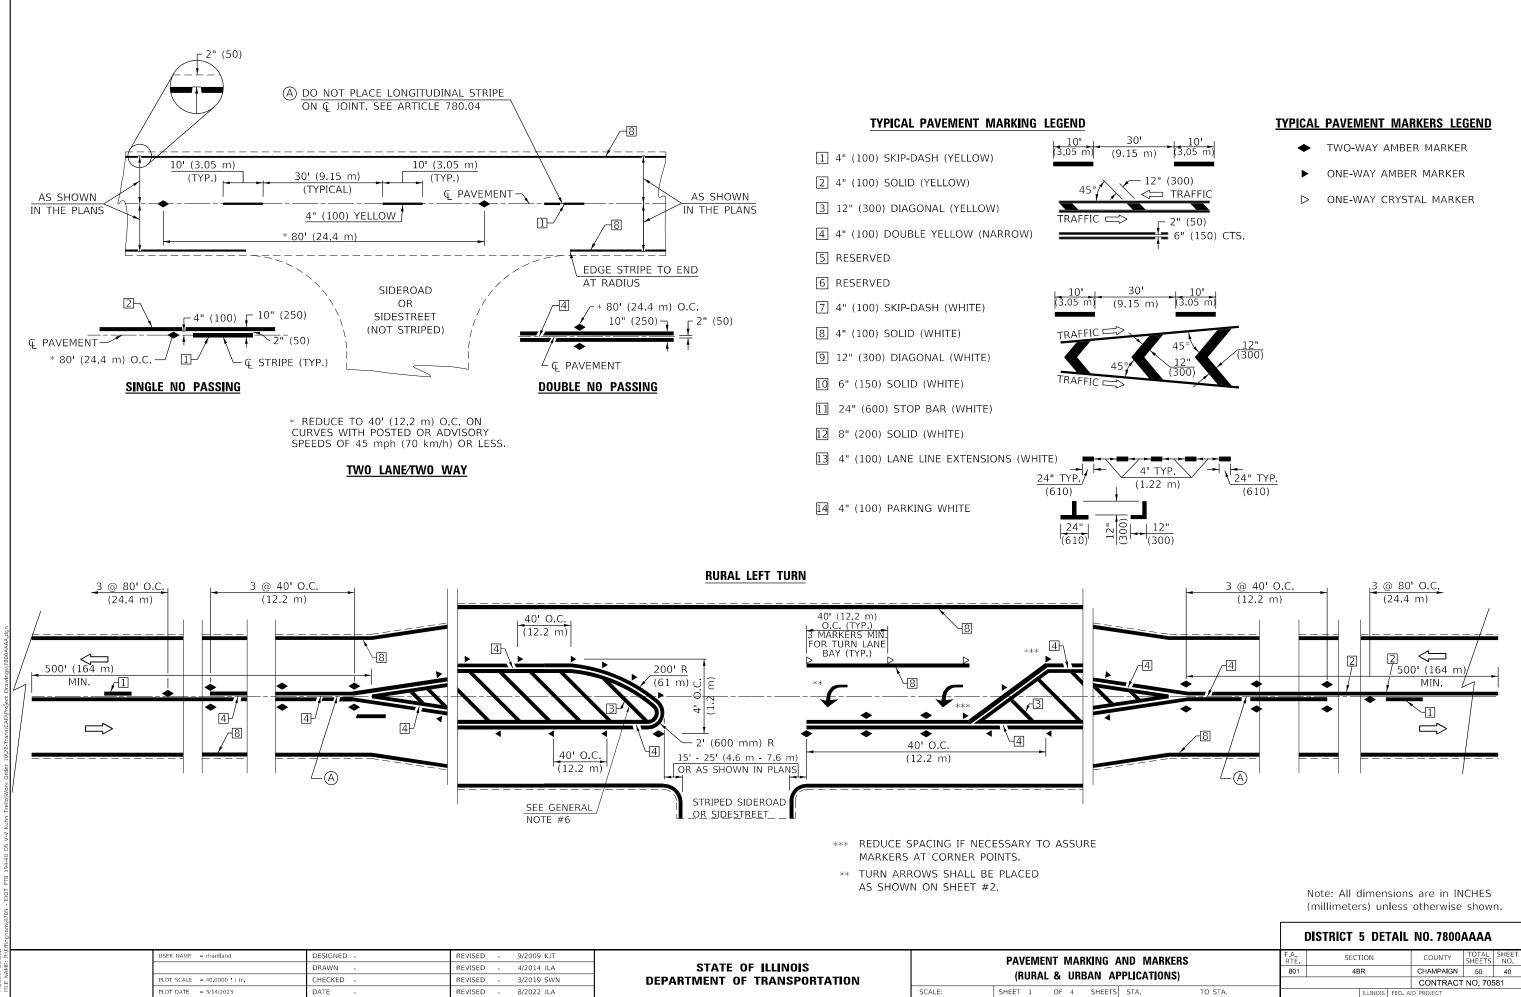


DISTRICT 5 DETAIL NO. 7						NO. 7800	AAAA	
AND MARKERS			SECT	ION		COUNTY	TOTAL SHEETS	SHEET NO.
APPLICATIONS)		801	801 4BR			CHAMPAIGN	50	40
CONTRACT NO. 705					581			
TS STA.	TO STA.			ILLINOIS	FED. A	D PROJECT		

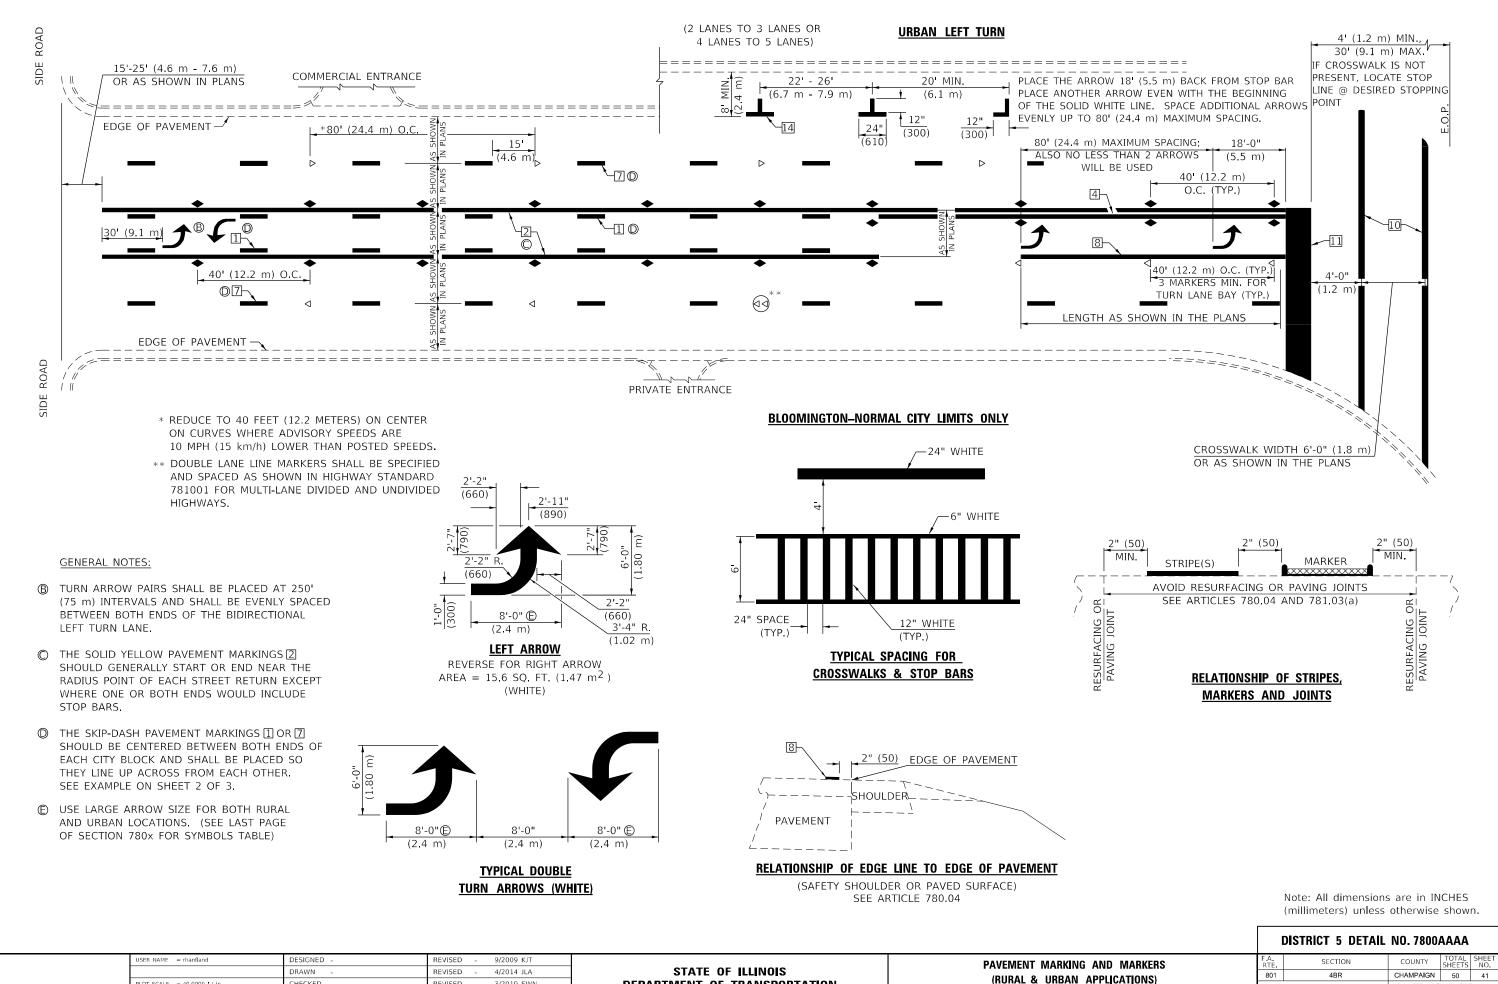


USER NAME = rhanfland	DESIGNED - DRAWN -	REVISED - 9/2009 KJT REVISED - 4/2014 JLA	STATE OF ILLINOIS		PAVEMENT MARKING A
PLOT SCALE = 40.0000 / in.	CHECKED -	REVISED - 3/2019 SWN	DEPARTMENT OF TRANSPORTATION		(RURAL & URBAN AP
PLOT DATE = 3/14/2023	DATE -	REVISED - 8/2022 JLA		SCALE:	SHEET 2 OF 4 SHEETS

S STA. TO STA.

CONTRACT NO. 70581 ILLINOIS FEE

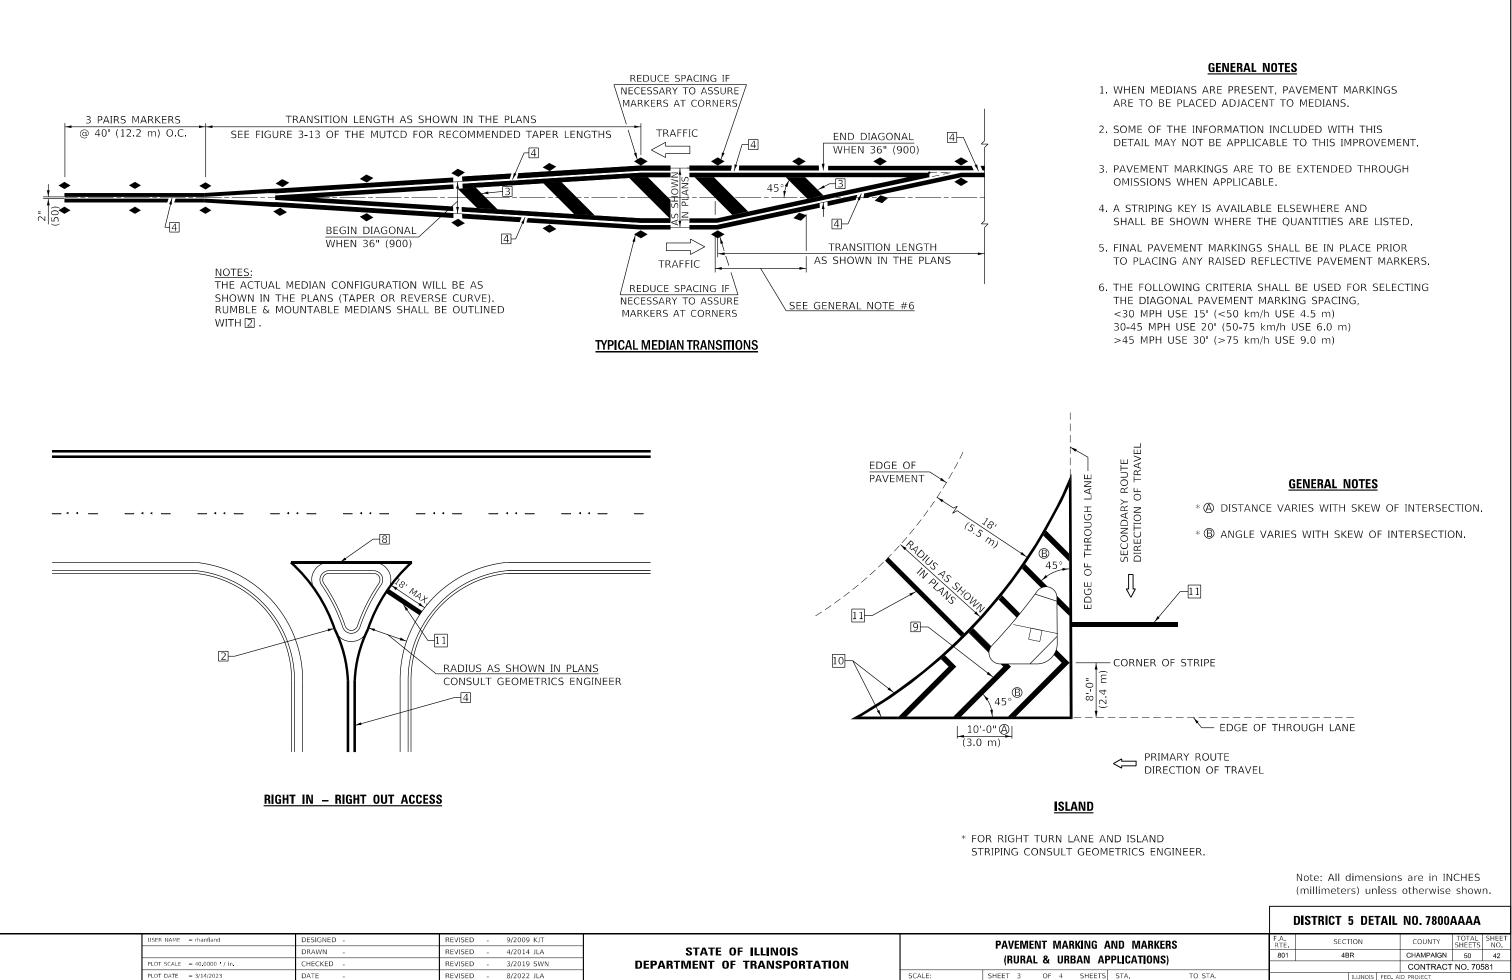

	DISTRICT 5 DETAIL	NO. 7800	AAAA		
F.A. RTE	SECTION	COUNTY	TOTAL SHEETS	SHEET NO.	
801	4BR	CHAMPAIGN	50	42	
APPLICATIONS) CONTRACT NO. 705				581	
ILLINOIS FED AID PROJECT					
	F.A. RTE	F.A. SECTION RTE. 801 48R	F.A. SECTION COUNTY RTE 801 4BR CHAMPAIGN CONTRACT	RTE SECTION COUNTY SHEETS 801 4BR CHAMPAIGN 50 CONTRACT NO. 705	

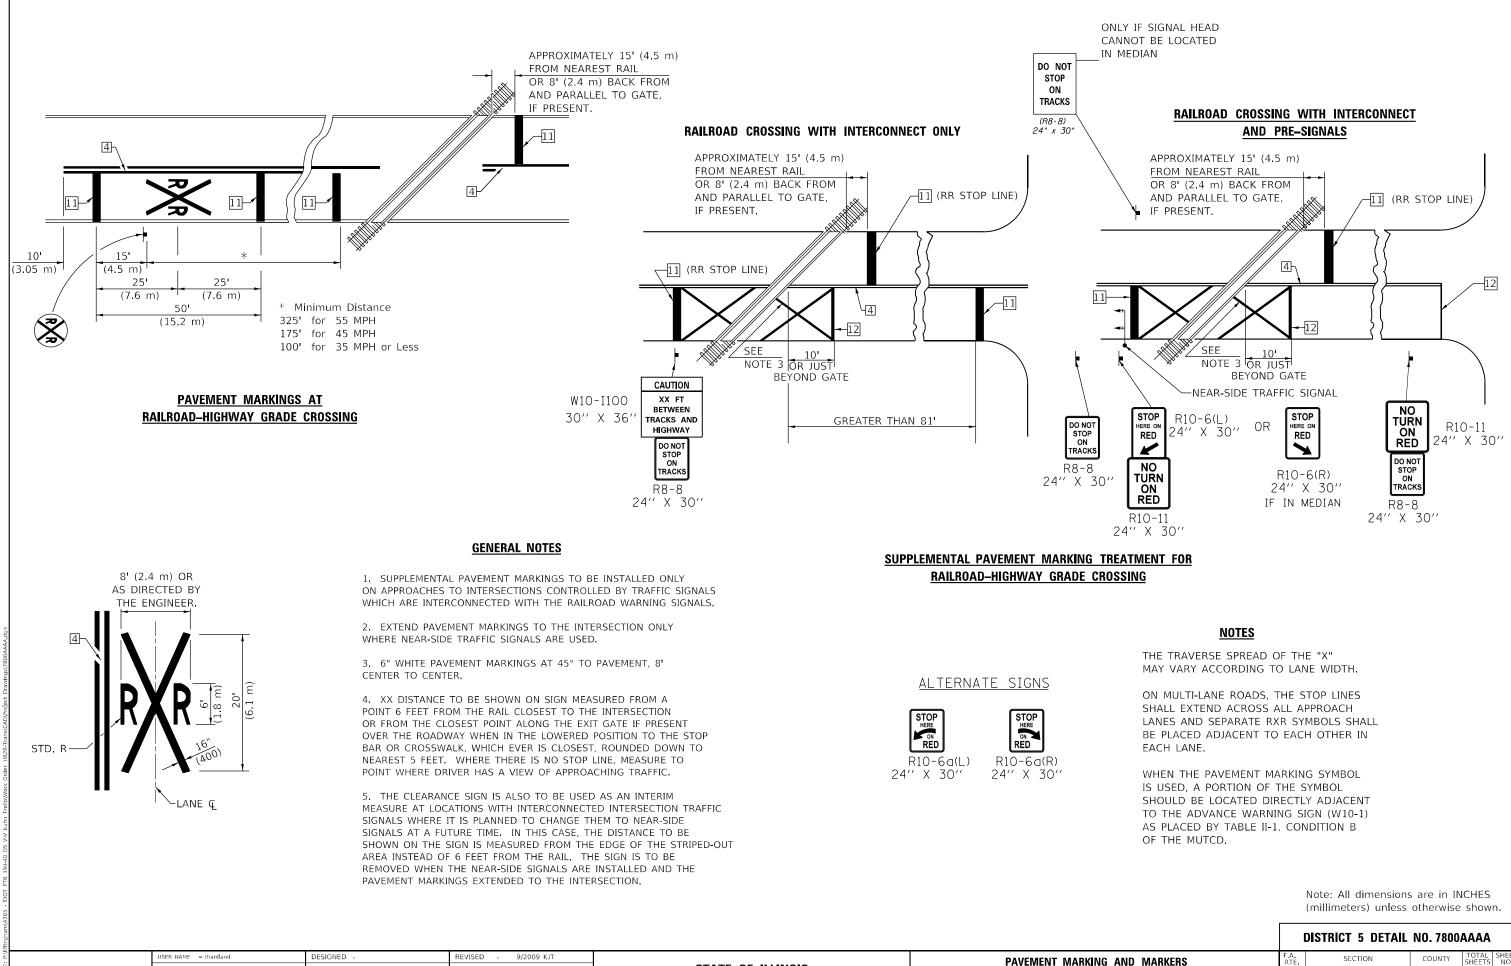

USER NAME = rhanfland	DESIGNED -	REVISED - 9/2009 KJT			PAVEMENT MARKING	<u></u>
	DRAWN -	REVISED - 4/2014 JLA	STATE OF ILLINOIS			
PLOT SCALE = 40.0000 / in.	CHECKED -	REVISED - 3/2019 SWN	DEPARTMENT OF TRANSPORTATION		(RURAL & URBAN A	۲P
PLOT DATE = 3/14/2023	DATE -	REVISED - 8/2022 JLA		SCALE:	SHEET 4 OF 4 SHEETS	·


DISTRICT 5 DETAIL NO. 7800AAAA						
AND MARKERS	F.A. RTE	SECTION	COUNTY	TOTAL SHEETS	SHEET NO.	
APPLICATIONS)		4BR	CHAMPAIGN	50	43	
	CONTRACT NO. 70581					
TS STA. TO STA.	ILLINOIS FED. AID PROJECT					

DATE
 FINAL
 SURVEYED

 SURVEY
 PLOTTED

 NOTE BOOK
 TEMPLATE


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CROSS SECTION SHEET 1 OF 6 SHEET

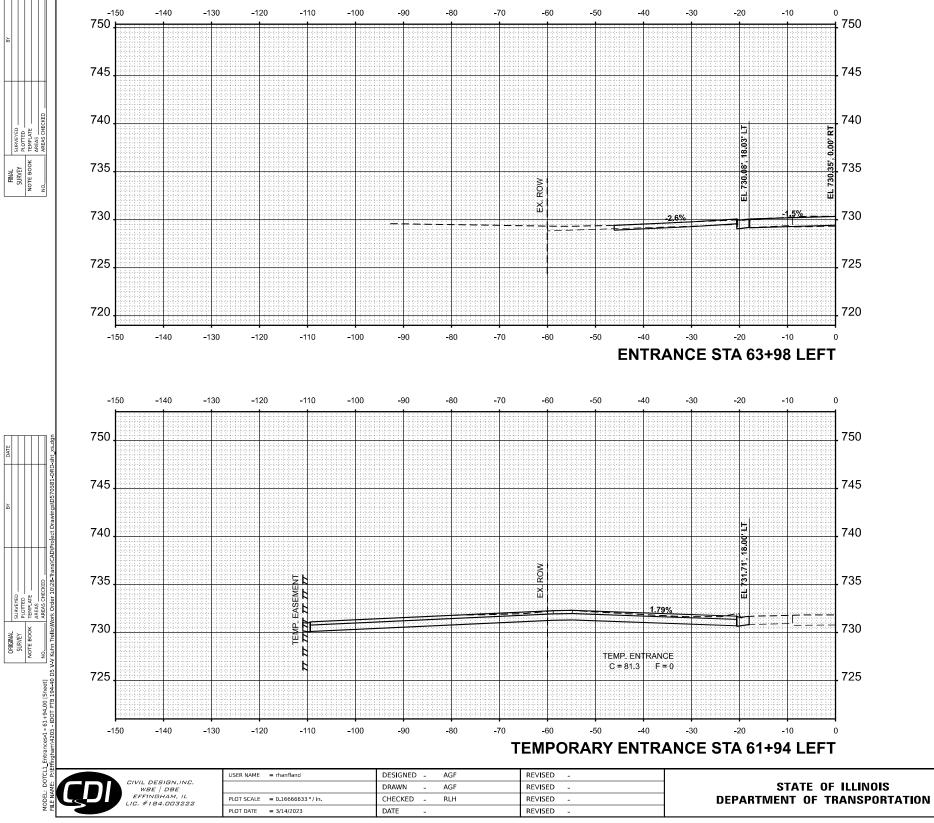SCALE:

			F.A.P. RTE	SECTION			COUNTY	TOTAL SHEETS	SHEET NO.
DNS		801	4BR		CHAMPAIGN	50	44		
							CONTRACT	NO. 705	581
TS	STA.	TO STA.			ILLINOIS	FED. A	AID PROJECT		



-150

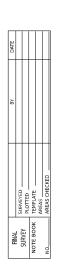-140

-130

-120

-110

-100

-90

-80

-70

-60

-50

-40

-30

-20

-10

0

10


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50

60



70	80	90	100	110	120	130	140	¹⁵⁰	
								. 745	
								. 740	
								735	
								. 730	
1N 77								725	
EASEMENT									
								. 720	
77								715	
								175	
								710	
70	80	90	100	110	120	130	140	150	
						SIA	64+00		
CTIONS				F.A.P RTE 801	SECTIC 4BR	N	COUNTY	TOTAL SHEE SHEETS NO.	
	ΤΑ.	TO ST	<u> </u>				CONTRACT	50 45 NO.70581	
		10 31/	•	ILLINOIS FED. AID PROJECT					


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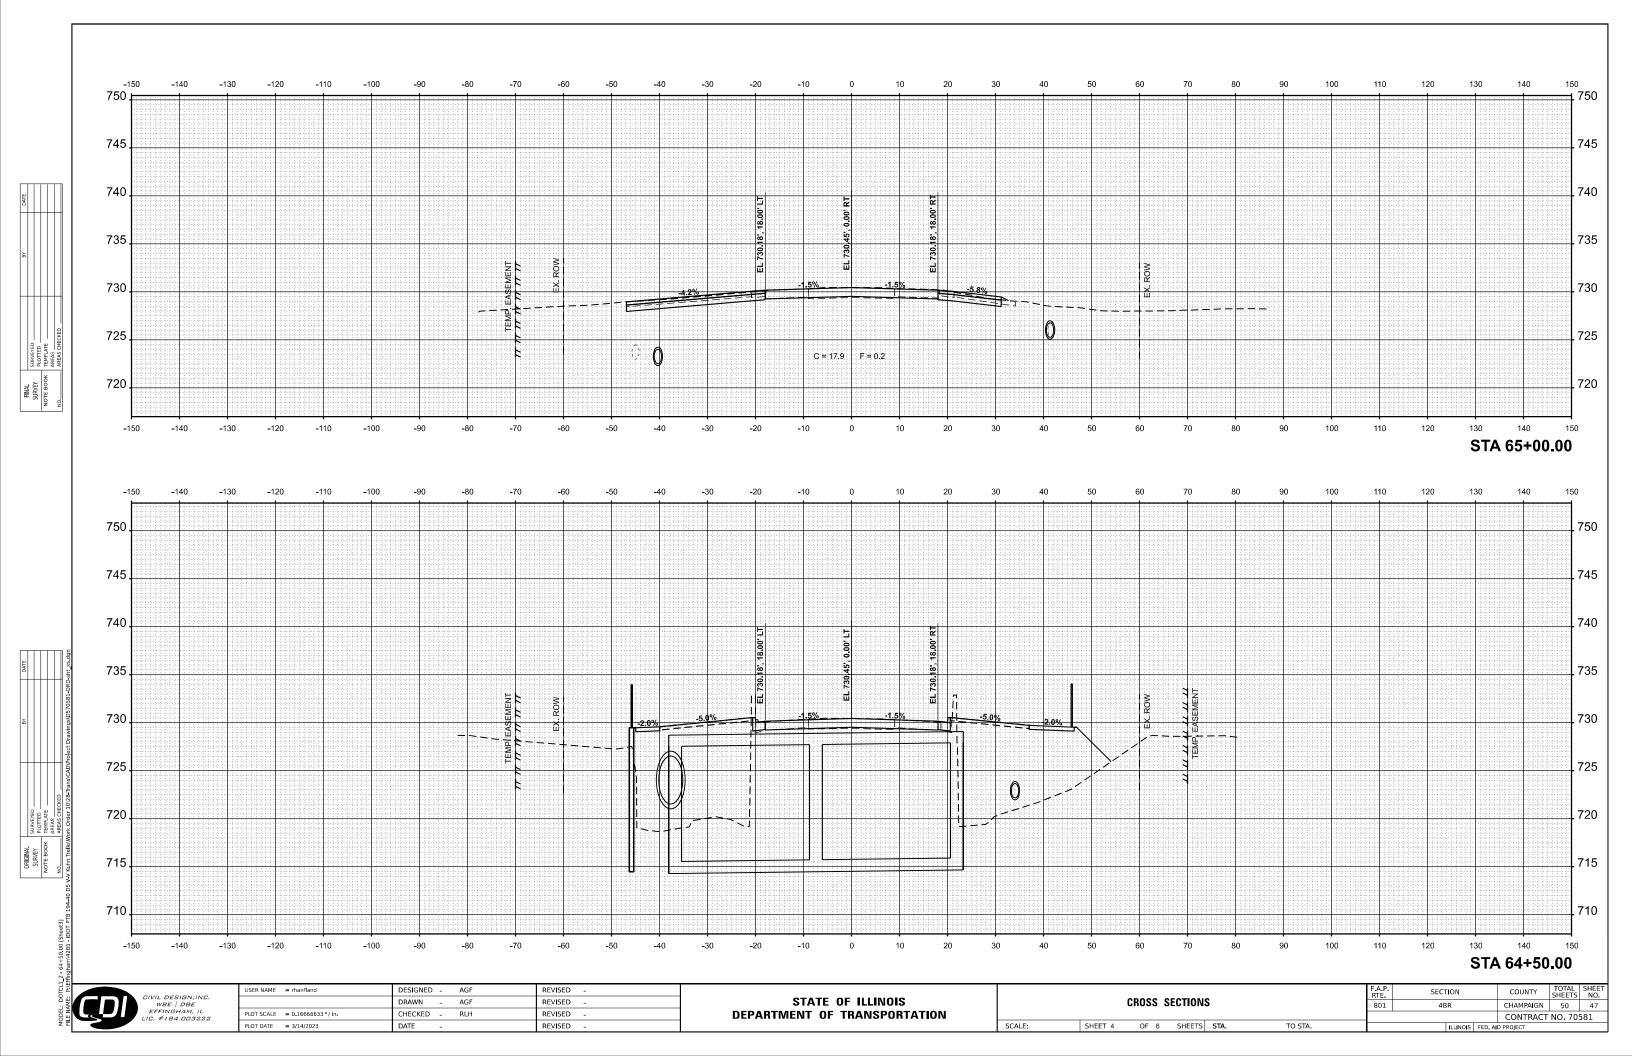
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 AREAS
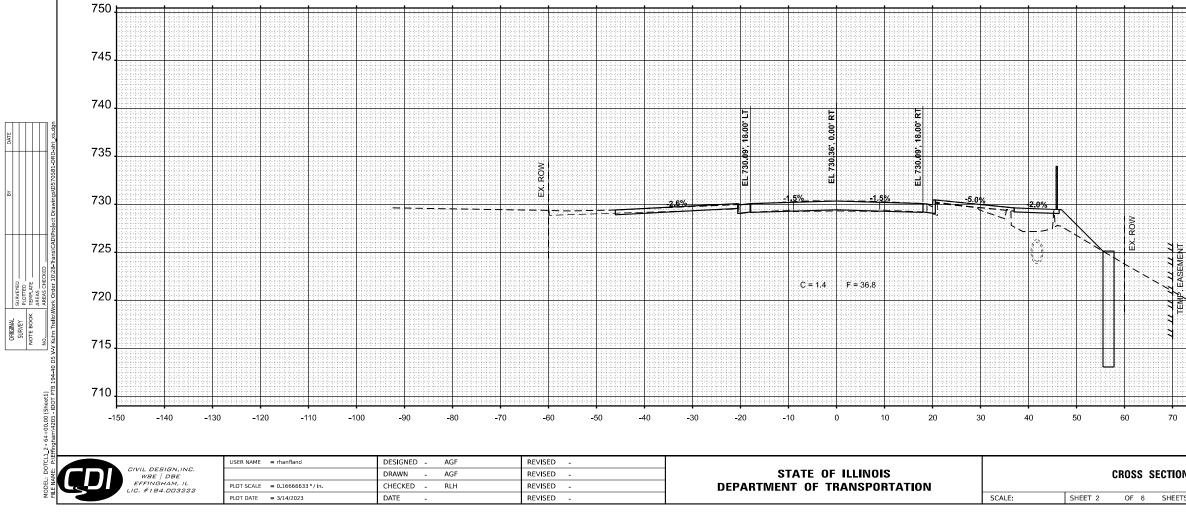
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SCALE: SHEET 3 OF 6 SHEETS STA. PLOT DATE = 3/14/2023 REVISED -DATE




DATE
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 SURVEYE

 NOTE BOOK
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 NO
 AREAS CHECKED

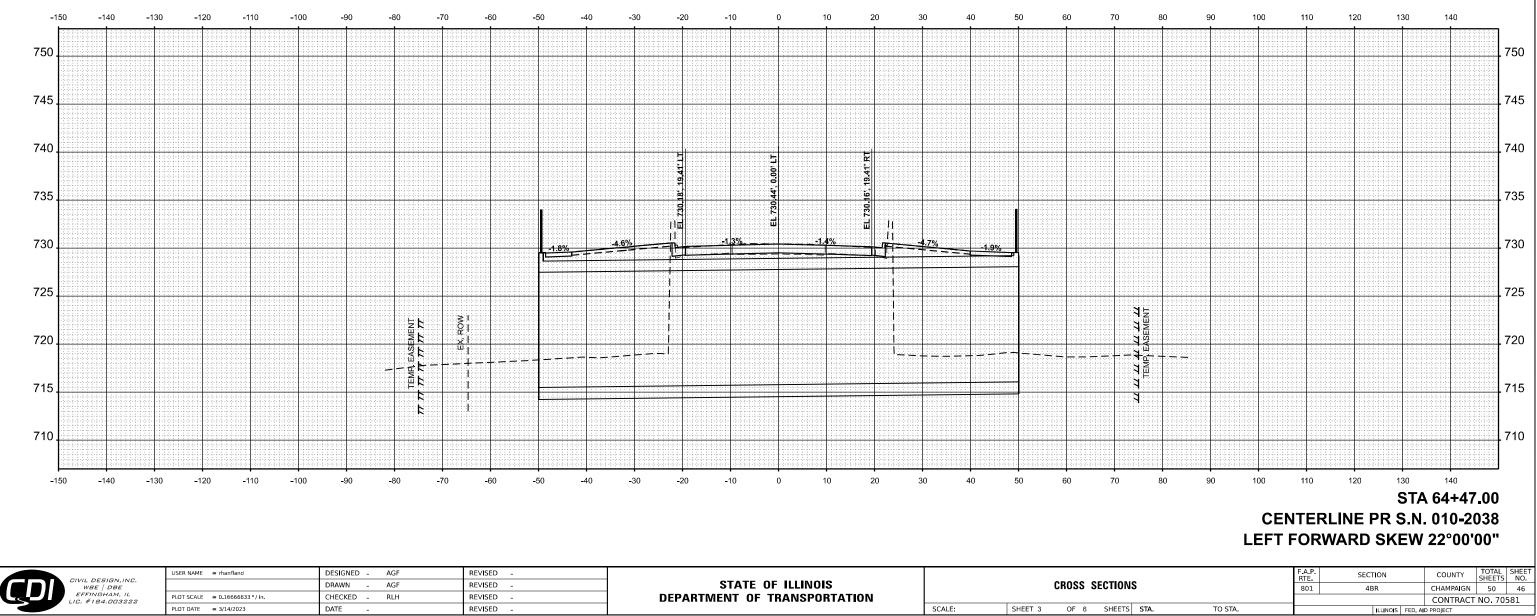


SCALE:

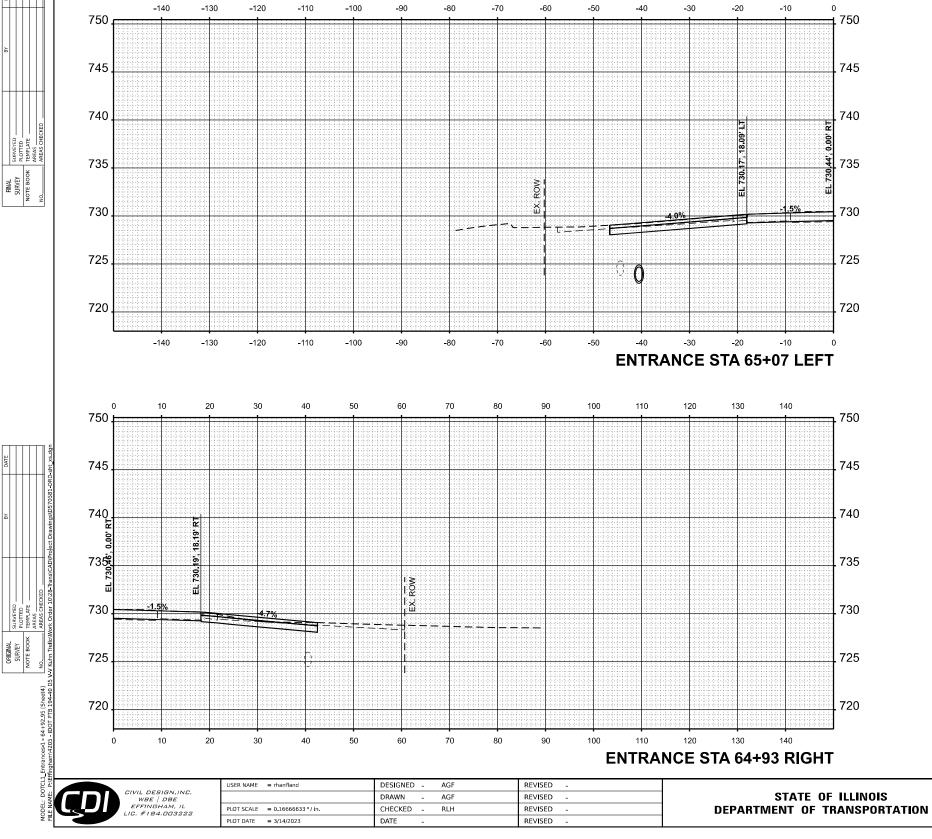			F.A.P. RTE	SECTION			COUNTY	TOTAL SHEETS	SHEET NO.	
DNS		801	4BR		CHAMPAIGN	50	48			
							CONTRACT	NO. 705	581	
TS	STA.	TO STA.		1	LLINOIS	FED. AI	AID PROJECT			


FINAL SURVEY SURVEY NOTE BOOK TEMPRATE AREAS ARE

ORIGINAL SURVEY BLOTTE BOOK NOTE BOOK AREAS NO.______AREAS OREC

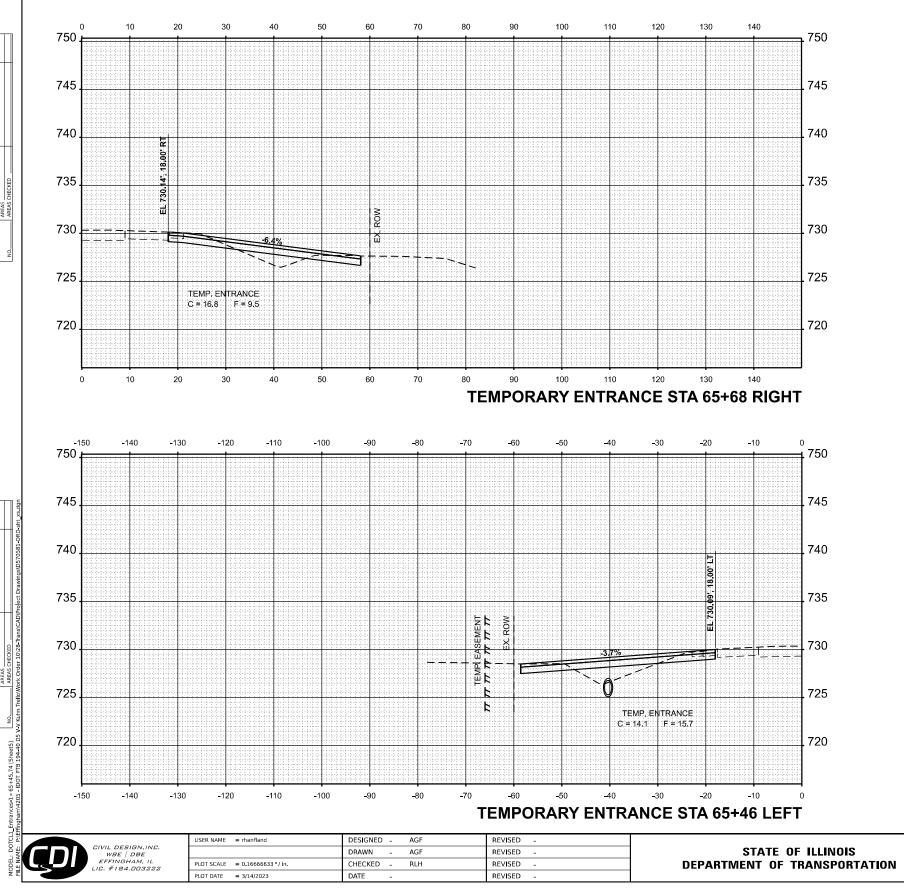

SCALE:

DNS		F.A.P. RTE	SECTION			COUNTY	TOTAL SHEETS	SHEET NO.		
		801	4BR		CHAMPAIGN	50	49			
							CONTRACT	NO. 705	581	
TS	STA.	TO STA.		I	LLINOIS	FED. A	AID PROJECT			

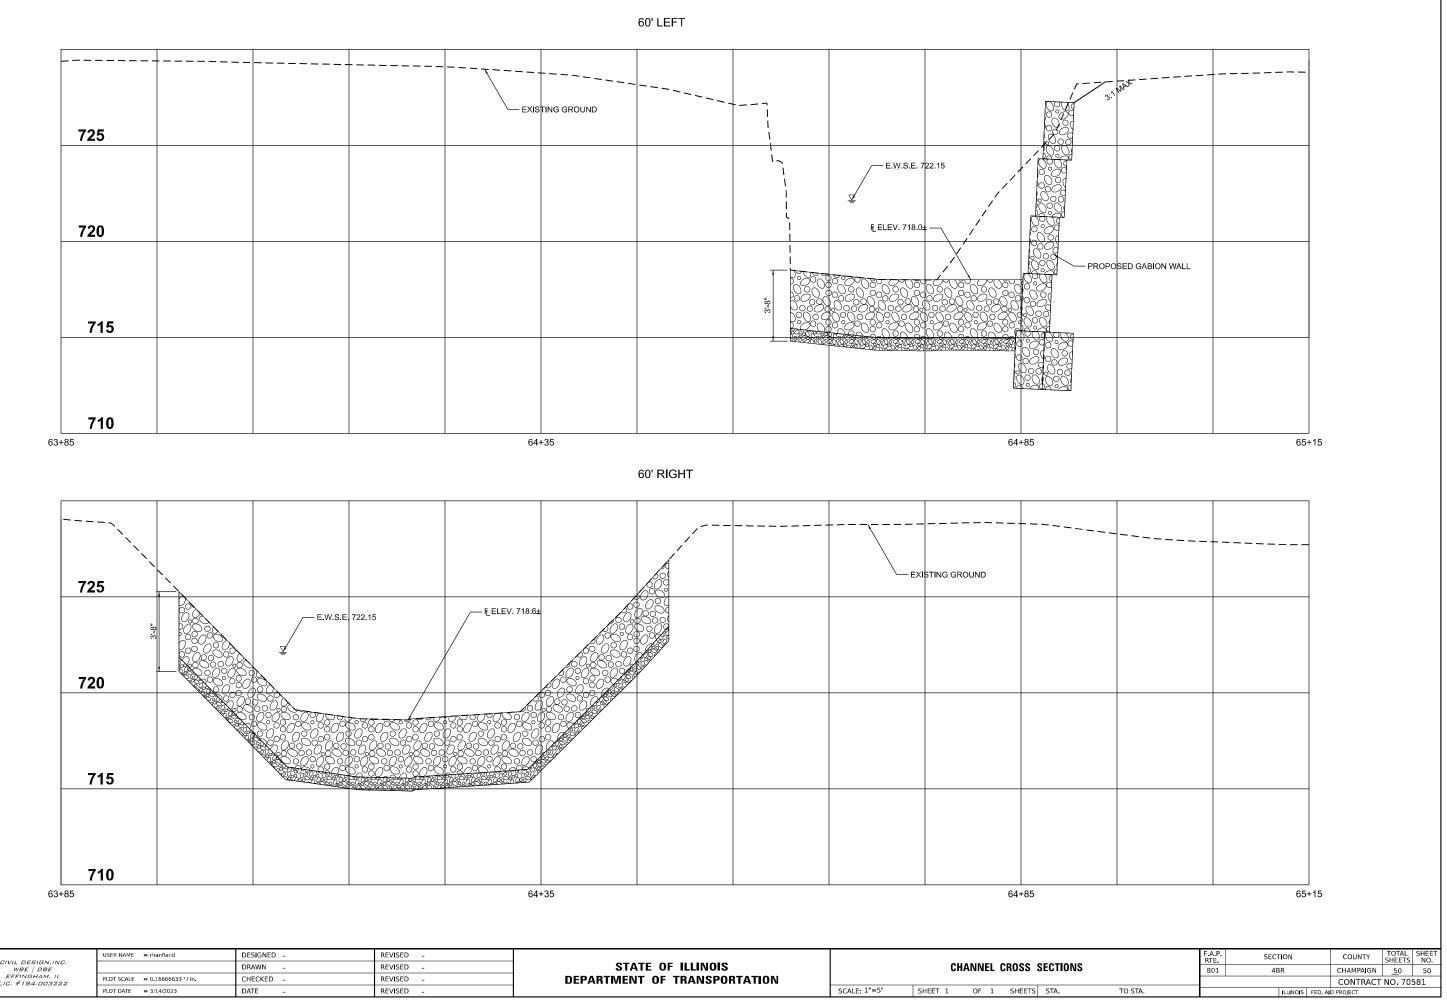

PLOT DATE = 3/14/2023

DATE

REVISED -

SCALE: 1"=5' SHEET 1 OF 1 SHEETS

		001	4610			circumation		
_						CONTRACT	NO. 70	58
5	STA. TO STA.		ILL	LINOIS	FED. AL	D PROJECT	-	
							-	