

SUMMARY OF QUANTITIES

H01 H05

CODE NUMBER	ITEM DESCRIPTION	UNIT	TOTAL	URBAN - 90% FEDERAL, 10% STATE								100% CITY
				DAN RYAN J000-2A	FRONT. RD I000-2A	LIGHTING Y030-1E	I.T.S. Y032-1F	SIGNALS Y031-1F	SIGNING Y002-1C	RETAINING WALLS Y007	76TH ST. BRIDGE X771-2A	
X0325030	TRENCH AND BACKFILL FOR 2 OR 4 DUCTS	FOOT	448						448			
* E20200G1	VINE-PARTHENOISSUS QUINQUEFOLIA (VIRGINIA CREEPER), 1-GALLON POT	EACH	1304	1304								
* K0030400	PERENNIAL PLANTS, DAYLILIES	UNIT	13	13								
X0300057	MANHOLES, TYPE A, 6'-DIAMETER, TYPE 1 FRAME, CLOSED LID, RESTRICTOR PLATE	EACH	3	3								
* X0301295	ELECTRICAL MANHOLE REMOVAL	EACH	8			4		4				
* X0301898	ELECTRICAL MANHOLES 3' x 4' x 4' WITH 24" FRAME AND LID	EACH	8			2		6				
X0320001	PVC CONDUIT IN TRENCH 2" (SCHEDULE #40)	FOOT	219			219						
* X0320080	ROD AND CLEAN DUCT IN EXISTING CONDUIT SYSTEM	FOOT	610					610				
X0320815	SLEEPER SLAB	SQ YD	206	206								
X0321072	BRIDGE FENCE RAILING	FOOT	694							694		
* X0321519	CONDUIT SUPPORT SYSTEM	L SUM	1					1				
* X0322256	TEMPORARY INFORMATION SIGNING	SQ FT	144		144							
* X0322425	CIRCUIT BREAKER, 1-POLE, 70 AMPERE, 480 VOLT IN EXISTING STREET LIGHT CONTROLLER	EACH	2					2				
X0322679	CONCRETE FOUNDATION FOR TYPE "P" BASE MOUNTED TRAFFIC SIGNAL CONTROLLER	EACH	2					2				
* X0322706	ELECTRIC CABLE IN CONDUIT NO. 12 10/C	FOOT	512					512				
* X0322741	LIGHT POLE, STEEL, 34.5 FT. M.H., 12 FT. MAST ARM, 3 GAUGE 12 1/2" DIA., 16.5" BOLT CIRCLE, 1 1/2" ANCHOR RODS	EACH	1					1				
* X0322859	WEED CONTROL, PRE-EMERGENT GRANULAR HERBICIDE	POUND	20	20								
X0323426	SEDIMENT CONTROL, DRAINAGE STRUCTURE INLET FILTER CLEANING	EACH	30		30							
X0323574	MAINTENANCE OF LIGHTING SYSTEM	CAL MO	18			18						
X0323710	REMOVE CONDUIT ATTACHED TO STRUCTURE	FOOT	760			760						
X0323830	DRAINAGE SCUPPERS DS-11	EACH	10							10		
* X0323907	COMMUNICATIONS VAULT, TYPE C1	EACH	6				6					
X0324112	BARRIER BASE	FOOT	1039	939	100							
* X0324198	REMOVAL OF ASBESTOS CEMENT CONDUIT	FOOT	795			795						
* X0324210	CONDUIT ENCASED, REINFORCED CONCRETE, 4-4" DIA. CNC, 2 WIDE X 2 HIGH	FOOT	160			160						
* X0324212	CONDUIT ENCASED, REINFORCED CONCRETE, 6-4" DIA. CNC 2 WIDE X 3 HIGH	FOOT	40			40						
* X0325052	CONDUIT ENCASED, REINFORCED CONCRETE, 5-4" DIA. CNC AND 1-2" DIA. CNC, 2 WIDE X 3 HIGH	FOOT	34			34						
* X0325053	CONDUIT ENCASED, REINFORCED CONCRETE, 6-4" DIA. CNC AND 2-2" DIA. CNC, 2 WIDE X 4 HIGH	FOOT	35			35						
* X0325054	CONDUIT ENCASED, REINFORCED CONCRETE, 5-4" DIA. CNC AND 3-2" DIA. CNC, 2 WIDE X 4 HIGH	FOOT	431			431						
X0324225	CONTROLLER, TRAFFIC, 16 LOAD BAY, P CABINET	EACH	2					2				
* X0324414	CONDUIT ENCASED, REINFORCED CONCRETE, 1-3" DIA. CNC	FOOT	48			48						
X0324420	PVC CONDUIT IN TRENCH 4" (SCHEDULE #40)	FOOT	68					68				

* - SPECIALTY ITEM
 □ - IDOT PAY CODE SFTY-3N
 △ - IDOT PAY CODE Y080

REVISIONS	
NAME	DATE
REVISED	05/06/05
REVISED	04/15/05

ILLINOIS DEPARTMENT OF TRANSPORTATION
 F.A.I. 94 (DAN RYAN EXPRESSWAY)

SUMMARY OF QUANTITIES
 SHEET 10 OF 13

SCALE: NONE DRAWN BY: JPA
 DATE: MARCH 25, 2005 CHECKED BY: MPG

TYLIN INTERNATIONAL

△ Rev. 6-1-05

COMBINATION CONCRETE CURB AND GUTTER REMOVAL

RAMP/WALL	ALIGNMENT	FROM		TO		COMB CURB GUTTER REM (FOOT)
		STATION	OFFSET	STATION	OFFSET	
HALSTED EXIT	SB I-57	95+37.3	108.8 LT	97+61.2	94.9 LT	225
HALSTED EXIT	SB I-57	97+61.2	94.9 LT	102+47.2	36.2 LT	493
HALSTED EXIT	SB I-57	97+63.8	117.1 LT	98+32.5	120.2 LT	70
HALSTED EXIT	SB I-57	97+63.8	117.1 LT	106+54.2	34.0 LT	896
WALL 67	SB I-57	107+16.2	101.2 LT	115+70.7	114.1 LT	867
WENTWORTH EXIT	SB I-57	133+41.7	195.9 LT	135+52.7	148.5 LT	198
WENTWORTH EXIT	SB I-57	135+52.7	148.5 LT	140+85.6	35.6 LT	525
WENTWORTH EXIT	SB I-57	135+61.2	169.2 LT	136+20.9	164.3 LT	57
WENTWORTH EXIT	SB I-57	135+61.2	169.2 LT	147+84.1	33.2 LT	1196
WENTWORTH EXIT	SB I-57	140+16.3	34.5 LT	140+85.6	35.6 LT	70
WALL 33	SB I-94	1203+27.3	138.5 LT	1205+34.2	128.2 LT	202
95TH ST CTA	SB I-94	1206+51.8	130.3 LT	1206+57.8	130.4 LT	6
95TH EXIT	SB I-94	1210+22.4	118.1 LT	1214+90.2	114.2 LT	471
95TH EXIT	SB I-94	1214+90.2	114.2 LT	1221+20.0	65.7 LT	639
95TH EXIT	SB I-94	1214+91.7	137.7 LT	1215+91.6	139.1 LT	101
95TH EXIT	SB I-94	1214+91.7	137.7 LT	1226+12.2	62.9 LT	1125
WALL 36	SB I-94	1220+22.8	169.5 LT	1220+27.1	169.4 LT	5
WALL 36	SB I-94	1220+22.6	138.5 LT	1231+63.5	133.2 LT	1141
WALL 37	SB I-94	1233+65.5	132.8 LT	1235+15.5	132.9 LT	150
87TH ENTRANCE	SB I-94	1243+63.7	52.5 LT	1249+18.9	55.0 LT	557
87TH ENTRANCE	SB I-94	1243+63.9	52.8 LT	1249+83.6	107.7 LT	627
87TH ENTRANCE	SB I-94	1243+76.8	72.6 LT	1249+80.7	131.9 LT	609
87TH ENTRANCE	SB I-94	1248+02.5	134.0 LT	1249+80.7	131.9 LT	180
87TH ENTRANCE	SB I-94	1249+83.9	107.7 LT	1258+52.1	112.8 LT	870
87TH EXIT	SB I-94	1265+01.2	68.0 LT	1265+94.5	68.0 LT	97
87TH EXIT	SB I-94	1265+24.9	127.4 LT	1266+79.2	120.8 LT	155
87TH EXIT	SB I-94	1266+79.2	120.8 LT	1272+90.6	73.6 LT	615
87TH EXIT	SB I-94	1266+82.8	143.3 LT	1267+27.7	145.6 LT	46
87TH EXIT	SB I-94	1266+82.8	143.3 LT	1276+28.2	68.4 LT	953
87TH EXIT	SB I-94	1270+14.6	136.5 LT	1273+74.3	131.5 LT	360
76TH-79TH C-D	SB I-94	1328+77.4	143.83LT	1330+63.0	162.6LT	190
76TH-79TH C-D	SB I-94	1325+86.0	61.17LT	1328+77.4	143.83LT	307
76TH-79TH C-D	SB I-94	1317+92.0	125.77LT	1328+70.3	164.43LT	1098
76TH-79TH C-D	SB I-94	1317+92.0	125.77	1328+70.3	164.43LT	1091
76TH-79TH C-D	SB I-94	1317+84.3	105.25LT	1320+61.6	67.46LT	279
76TH-79TH C-D	SB I-94	1334+16.5	60.11LT	1336+72.9	60.58LT	256
76TH-79TH C-D	SB I-94	1325+86.0	61.17LT	1331+92.8	61.90LT	612
76TH-79TH C-D	SB I-94	1317+33.0	73.77LT	1320+62.0	67.27LT	336
76TH-79TH C-D	SB I-94	1313+23.9	120.37LT	1317+84.0	105.29LT	456
71ST-75TH C-D	SB I-94	1343+41.8	72.4 LT	1351+08.7	63.9 LT	778
71ST-75TH C-D	SB I-94	1344+14.9	159.3 LT	1346+47.5	154.7 LT	233
71ST-75TH C-D	SB I-94	1346+47.5	154.7 LT	1351+08.7	63.9 LT	472
71ST-75TH C-D	SB I-94	1346+51.8	177.8 LT	1347+03.8	179.3 LT	53
71ST-75TH C-D	SB I-94	1346+51.8	177.8 LT	1354+15.6	61.3 LT	776
71ST-75TH C-D	SB I-94	1354+15.6	61.3 LT	1361+24.0	169.7 LT	722
71ST-75TH C-D	SB I-94	1356+97.3	61.5 LT	1364+03.8	60.2 LT	708
71ST-75TH C-D	SB I-94	1356+97.3	61.5 LT	1361+29.4	146.5 LT	442
71ST-75TH C-D	SB I-94	1361+00.9	173.1 LT	1361+24.0	169.7 LT	25
71ST-75TH C-D	SB I-94	1361+29.4	146.5 LT	1364+69.4	172.7 LT	343
1000-2A TOTAL						7495
J000-2A TOTAL						15188
TOTAL						22683

NOTE:
"ALIGNMENT" REFERS TO PROPOSED ALIGNMENTS

BITUMINOUS SURFACE REMOVAL 1/2"

RAMP/WALL	ALIGNMENT	FROM		TO		PROPOSED * BC SC SUPER "D" N70 (SQ YD)	PROPOSED * PCC BSE CSE 9 (SQ YD)	PROPOSED * PCC BSE CSE 10 1/2 (SQ YD)	BIT SURF REM 1 1/2 (SQ YD)
		STATION	OFFSET	STATION	OFFSET				
HALSTED EXIT	HAL EXIT	7448+21.7	HAL EXIT	7448+72.9		63		23	40
HALSTED EXIT	HAL EXIT	7448+72.9	HAL EXIT	7451+16.3		540	354		186
WALL 67	SB I-57	107+16.2	SB I-57	115+69.3		1057		946	111
WENTWORTH EXIT	WENT EXIT	7429+76.1	WENT EXIT	7430+17.1		49		18	31
WENTWORTH EXIT	WENT EXIT	7430+17.1	WENT EXIT	7432+30.0		426	248		178
WALL 33	SB I-94	1203+27.2	SB I-94	1205+34.2		245		223	22
95TH EXIT	95TH EXIT	7411+69.4	95TH EXIT	7412+40.2		98		32	66
95TH EXIT	95TH EXIT	7412+40.2	95TH EXIT	7417+38.2		1649	855		794
WALL 36	SB I-94	1220+22.6	SB I-94	1231+63.5		1395		1268	127
WALL 37	SB I-94	1233+65.5	SB I-94	1235+15.5		183		167	17
87TH ENTRANCE	87TH ENT	7196+68.6	87TH ENT	7201+48.2		1163	1110		53
87TH ENTRANCE	87TH ENT	7201+48.2	87TH ENT	7207+17.2		696		633	63
87th EXIT	87TH EXIT	7188+43.4	87TH EXIT	7188+95.5		58		26	32
87th EXIT	87TH EXIT	7188+95.5	87TH EXIT	7190+45.8		506	406		100
87th EXIT	87TH EXIT	7181+98.0	87th EXIT	7185+57.3		642		602	40
76TH-79TH C-D	76-79 C-D	7503+39.6	76-79 C-D	7504+42.0		386	331		55
76TH-79TH C-D	76-79 C-D	7504+40.4	76-79 C-D	7517+83.8		3772		1814	1958
76TH-79TH C-D	76-79 C-D	7517+83.7	76-79 C-D	7520+81.4		1688	611		1077
71ST-75TH C-D	71-75 C-D	7118+17.1	71-75 C-D	7120+62.6		688	358		330
71ST-75TH C-D	71-75 C-D	7120+62.6	71-75 C-D	7121+84.0		216		57	159
71ST-75TH C-D	71-75 C-D	7132+05.6	71-75 C-D	7132+91.7		171		19	152
71ST-75TH C-D	71-75 C-D	7135+91.8	71-75 C-D	7136+32.6		43			43
71ST-75TH C-D	71-75 C-D	7136+32.6	71-75 C-D	7138+79.7		818	408		410
1000-2A TOTAL						16551	4273	5827	6451
J000-2A TOTAL									
TOTAL						16551	4273	5827	6451

* - VALUES FROM PROPOSED PAVEMENT QUANTITIES
THE QUANTITY OF BITUMINOUS SURFACE REMOVAL IS EQUAL TO THE DIFFERENCE BETWEEN THE AREA COVERED BY BITUMINOUS SURFACE COURSE AND THE AREA OF PCC BASE COURSE.

GUARDRAIL REMOVAL

RAMP/WALL	ALIGNMENT	FROM		TO		GUARDRAIL REMOV (FOOT)
		STATION	OFFSET	STATION	OFFSET	
WALL 67	SB I-57	109+93.2	98.7 LT	110+45.5	98.8 LT	53
WALL 67	SB I-57	115+22.0	101.1 LT	115+69.8	101.2 LT	48
WALL 67	SB I-57	115+71.3	103.2 LT	115+71.5	143.4 LT	41
WALL 68	SB I-57	142+29.7	102.1 LT	142+84.0	101.0 LT	52
95TH EXIT	SB I-94	1212+39.7	115.8 LT	1212+93.8	116.1 LT	55
WALL 36	SB I-94	1219+18.4	136.7 LT	1219+57.7	136.2 LT	40
WALL 36	SB I-94	1225+67.6	130.8 LT	1226+20.8	130.6 LT	54
87TH EXIT	SB I-94	1272+31.4	124.5 LT	1272+81.9	124.3 LT	51
76TH-79TH C-D	SB I-94	1315+56.0	115.06LT	1316+08.5	11387LT	52
76TH-79TH C-D	SB I-94	1325+54.5	147.97LT	1326+06.3	151.98LT	53
76TH-79TH C-D	SB I-94	1322+24.4	129.30LT	1322+75.1	131.45LT	51
76TH-79TH C-D	SB I-94	1323+13.8	69.51LT	1324+67.8	73.97LT	154
76TH-79TH C-D	SB I-94	1318+90.9	123.44LT	1319+41.7	122.39LT	51
71ST-75TH C-D	SB I-94	1345+41.5	152.1 LT	1345+91.8	151.7 LT	51
1000-2A TOTAL						600
J000-2A TOTAL						0
TOTAL						600

CHAIN LINK FENCE REMOVAL (CTA)

RAMP/WALL	ALIGNMENT	FROM		TO		CH LK FENCE REMOV-CTA (FOOT)
		STATION	OFFSET	STATION	OFFSET	
OVERHEAD SIGN	SB I-94	1223+60.0	8.2 RT	1224+30.0	8.6 RT	70
OVERHEAD SIGN	SB I-94	1251+03.0	8.3 RT	1251+73.1	8.4 RT	70
OVERHEAD SIGN	SB I-94	1276+32.0	7.9 RT	1276+92.0	7.9 RT	60
OVERHEAD SIGN	SB I-94	1355+51.0	10.0 RT	1356+21.1	10.0 RT	70
1000-2A TOTAL						
J000-2A TOTAL						270
TOTAL						270

TREE REMOVAL (OVER 15 UNITS)

RAMP/WALL	ALIGNMENT	LOCATION		TREE REMOV OVER 15 (UNIT)
		STATION	OFFSET	
WALL 67	SB I-57	110+80.91	93.5LT	16
WALL 67	SB I-57	111+14.36	81.3LT	20
WALL 67	SB I-57	111+46.53	95.3LT	32
WALL 67	SB I-57	111+67.22	95.0LT	24
WALL 67	SB I-57	112+15.86	92.9LT	20
WALL 67	SB I-57	112+22.36	92.9LT	20
WALL 67	SB I-57	113+04.59	96.9LT	24
WALL 67	SB I-57	114+39.91	97.6LT	20
WALL 67	SB I-57	114+81.38	96.8LT	18
WALL 67	SB I-57	115+43.12	73.3LT	17
WALL 33	SB I-94	1205+07.69	102.1LT	18
WALL 33	SB I-94	1205+19.55	84.3LT	18
WALL 36	SB I-94	1222+40.35	131.3LT	36
WALL 36	SB I-94	1224+14.04	129.3LT	22
WALL 36	SB I-94	1225+40.83	128.1LT	16
WALL 36	SB I-94	1226+64.20	101.4LT	18
WALL 36	SB I-94	1226+82.06	97.3LT	20
WALL 36	SB I-94	1227+06.02	128.4LT	16
WALL 36	SB I-94	1227+62.44	128.3LT	18
WALL 36	SB I-94	1227+66.48	128.3LT	18
WALL 36	SB I-94	1228+80.63	127.3LT	16
WALL 36	SB I-94	1229+33.34	127.9LT	17
WALL 36	SB I-94	1231+62.11	127.1LT	30
WALL 37	SB I-94	1233+71.91	108.5LT	16
WALL 37	SB I-94	1234+72.93	127.1LT	16
87TH EXIT	SB I-94	1274+60.95	114.3LT	20
87TH EXIT	SB I-94	1274+77.38	116.2LT	18
87TH EXIT	SB I-94	1275+03.37	103.1LT	20
87TH EXIT	SB I-94	1275+64.97	108.6LT	17
87TH EXIT	SB I-94	1275+72.78	111.4LT	17
76-79 C-D	SB I-94	1315+33.27	106.2LT	16
76-79 C-D	SB I-94	1315+72.09	111.2LT	16
76-79 C-D	SB I-94	1316+37.69	110.3LT	26
76-79 C-D	SB I-94	1319+54.22	120.0LT	16
76-79 C-D	SB I-94	1320+10.44	120.2LT	16
76-79 C-D	SB I-94	1322+53.03	128.6LT	24
76-79 C-D	SB I-94	1324+43.72	130.6LT	18
76-79 C-D	SB I-94	1325+70.90	129.0LT	17
76-79 C-D	SB I-94	1331+75.93	115.7LT	16
76-79 C-D	SB I-94	1334+17.27	133.3LT	18
76-79 C-D	SB I-94	1333+70.33	127.9LT	16
71-75 C-D	SB I-94	1351+43.53	148.5LT	16
71-75 C-D	SB I-94	1353+29.87	145.8LT	16
71-75 C-D	SB I-94	1354+44.06	144.9LT	18
71-75 C-D	SB I-94	1364+30.89	144.1LT	16
71-75 C-D	SB I-94	1364+35.46	125.8LT	18
TOTAL (>15 UNITS)				881

REVISIONS	
NAME	DATE

CONCRETE BARRIER REMOVAL

RAMP/WALL	ALIGNMENT	FROM		TO		CONC BARRIER REMOV (FOOT)
		STATION	OFFSET	STATION	OFFSET	
OVERHEAD SIGN	SB I-94	1223+64.6	6.7 RT	1224+25.4	6.9 RT	61
WALL 36	SB I-94	1226+13.1	64.6 LT	1227+71.0	64.6 LT	158
OVERHEAD SIGN	SB I-94	1251+07.7	6.8 RT	1251+68.3	6.9 RT	61
OVERHEAD SIGN	SB I-94	1276+37.0	6.4 RT	1276+87.0	6.4 RT	50
76TH-79TH C-D	SB I-94	1316+37.1	73.56LT	1317+33.0	74.19LT	95
76TH-79TH C-D	SB I-94	1332+78.6	62.88LT	1334+16.6	60.96LT	138
76TH-79TH C-D	SB I-94	1323+14.1	62.02LT	1323+71.9	76.08LT	60
71ST-75TH C-D	SB I-94	1353+28.0	69.2 LT	1354+81.7	69.9 LT	154
OVERHEAD SIGN	SB I-94	1355+55.7	8.5 RT	1356+16.3	8.4 RT	61
I000-2A TOTAL						
J000-2A TOTAL						838
TOTAL						838

CHAIN LINK FENCE REMOVAL

RAMP/WALL	ALIGNMENT	FROM		TO		CH LK FENCE REMOV (FOOT)
		STATION	OFFSET	STATION	OFFSET	
HALSTED EXIT	SB I-57	95+37.0	99.7 LT	97+60.1	85.6 LT	224
HALSTED EXIT	SB I-57	97+60.1	85.6 LT	98+78.9	72.6 LT	120
WALL 67	SB I-57	107+16.6	92.9 LT	116+46.2	97.1 LT	930
WENTWORTH EXIT	SB I-57	131+32.9	-101.38	136+50.5	-109.69	511
WENTWORTH EXIT	SB I-57	136+10.1	160.6 LT	136+77.4	152.9 LT	63
WALL 33	SB I-94	1203+06.1	133.1 LT	1205+29.3	120.2 LT	218
95TH EXIT	SB I-94	1210+22.3	113.1 LT	1214+89.8	108.7 LT	468
95TH EXIT	SB I-94	1214+89.8	108.7 LT	1216+43.1	98.2 LT	154
95TH EXIT	SB I-94	1215+93.9	134.2 LT	1217+82.0	135.2 LT	189
WALL 36	SB I-94	1222+28.9	132.9 LT	1229+83.2	129.1 LT	755
WALL 37	SB I-94	1234+42.8	128.4 LT	1235+15.5	128.3 LT	73
HMLT 60KL4	SB I-94	1245+78.6	125.7 LT	1246+23.6	125.8 LT	45
87TH ENTRANCE	SB I-94	1247+78.8	125.8 LT	1248+62.6	125.7 LT	84
87TH ENTRANCE	SB I-94	1248+19.1	85.9 LT	1249+84.3	103.1 LT	167
87TH ENTRANCE	SB I-94	1249+84.3	103.1 LT	1258+51.7	114.8 LT	877
87TH EXIT	SB I-94	1265+00.6	118.6 LT	1266+78.2	111.7 LT	178
87TH EXIT	SB I-94	1266+78.2	111.7 LT	1269+05.8	91.4 LT	229
87TH EXIT	SB I-94	1268+50.6	135.4 LT	1273+94.4	123.5 LT	545
76TH-79TH C-D	SB I-94	1313+25.1	115.37LT	1317+82.3	100.84LT	453
76TH-79TH C-D	SB I-94	1317+82.2	100.84LT	1319+11.4	84.16LT	129
76TH-79TH C-D	SB I-94	1328+80.1	136.09LT	1331+88.5	155.20LT	314
76TH-79TH C-D	SB I-94	1327+82.0	110.34LT	1328+80.1	136.09LT	103
76TH-79TH C-D	SB I-94	1318+67.5	122.54LT	1328+19.0	159.89LT	956
71ST-75TH C-D	SB I-94	1343+90.0	151.4 LT	1346+46.4	146.6 LT	257
71ST-75TH C-D	SB I-94	1346+46.4	146.6 LT	1347+83.5	122.8 LT	140
71ST-75TH C-D	SB I-94	1347+42.1	170.6 LT	1347+83.4	171.1 LT	42
71ST-75TH C-D	SB I-94	1360+25.3	118.1 LT	1361+30.9	138.7 LT	108
71ST-75TH C-D	SB I-94	1361+30.9	138.7 LT	1364+72.8	164.2 LT	344
I000-2A TOTAL						7015
J000-2A TOTAL						1661
TOTAL						8676

SIDEWALK REMOVAL

RAMP/WALL	ALIGNMENT	OFFSET	FROM STATION	TO STATION	SIDEWALK REMOVAL (SQ FT)
WALL 72	SB I-94	LT	1313+16.5	1313+24.0	89
95TH ST CTA	SB I-94	LT	1206+43.9	1206+71.4	151
93RD STREET	SB I-94	LT	1220+20.7	1220+26.7	20
WALL 36	SB I-94	LT	1232+23.5	1232+36.8	68
WALL 37	SB I-94	LT	1232+92.4	1233+05.5	66
87TH ENTRANCE	SB I-94	LT	1258+46.0	1258+59.8	201
I000-2A TOTAL					594
J000-2A TOTAL					
TOTAL					594

PAVEMENT REMOVAL




RAMP/WALL	DESCRIPTION OF EXISTING LOCATION	ALIGNMENT	FROM STATION	TO STATION	PAVEMENT REM (SQ YD)
HALSTED EXIT	RAMP TERMINAL AT W. 98th PLACE	SB I-57	95+37.2	97+64.6	333
HALSTED EXIT	HALSTED STREET EXIT RAMP	SB I-57	97+61.2	102+55.7	1181
HALSTED EXIT	SOUTH SIDE OF W. 98th PLACE	SB I-57	97+63.8	98+32.5	40
HALSTED EXIT	RAMP TERMINAL AT SOUTHBOUND I-57	SB I-57	102+53.2	104+86.4	321
WALL 67	SOUTH SIDE OF W. 98th PLACE	SB I-57	107+16.2	115+70.8	940
WENTWORTH EXIT	RAMP TERMINAL AT S. LAFAYETTE AV.	SB I-57	133+41.8	135+61.4	240
WENTWORTH EXIT	WENTWORTH AVENUE EXIT RAMP	SB I-57	135+53.0	140+87.7	1110
WENTWORTH EXIT	EAST SIDE OF S. LAFAYETTE AV.	SB I-57	135+60.9	136+21.7	24
WENTWORTH EXIT	RAMP TERMINAL AT SOUTHBOUND I-57	SB I-57	140+79.6	142+64.8	366
WENTWORTH EXIT	RAMP TERMINAL AT SOUTHBOUND I-57	SB I-57	142+64.7	143+18.7	
WENTWORTH EXIT	RAMP TERMINAL AT SOUTHBOUND I-57	SB I-57	143+18.6	143+60.5	8
WALL 33	EAST SIDE OF S. LAFAYETTE AV.	SB I-94	1203+27.4	1205+34.2	226
95TH EXIT	MEDIAN RECEIVING PIT	SB I-94	1210+28.3	1210+41.3	15
95TH EXIT	RAMP TERMINAL AT S. LAFAYETTE AV.	SB I-94	1210+22.4	1214+91.7	823
95TH EXIT	95TH STREET EXIT RAMP	SB I-94	1214+90.2	1221+24.3	1480
95TH EXIT	EAST SIDE OF S. LAFAYETTE AV.	SB I-94	1214+91.7	1215+91.6	46
95TH EXIT	RAMP TERMINAL AT SOUTHBOUND I-94	SB I-94	1221+22.5	1225+42.0	689
WALL 36	EAST SIDE OF S. LAFAYETTE AV.	SB I-94	1220+22.6	1231+63.5	1283
WALL 37	MEDIAN RECEIVING PIT	SB I-94	1233+64.9	1233+77.9	12
WALL 37	EAST SIDE OF S. LAFAYETTE AV.	SB I-94	1233+65.5	1235+15.5	166
87TH ENTRANCE	87TH STREET ENTRANCE RAMP	SB I-94	1243+63.1	1249+34.9	360
87TH ENTRANCE	87TH STREET ENTRANCE RAMP	SB I-94	1245+34.9	1245+84.9	
87TH ENTRANCE	87TH STREET ENTRANCE RAMP	SB I-94	1245+84.9	1249+83.7	956
87TH ENTRANCE	EAST SIDE OF S. LAFAYETTE AV.	SB I-94	1248+02.4	1249+81.1	198
87TH ENTRANCE	RAMP TERMINAL AT S. LAFAYETTE AV.	SB I-94	1249+81.1	1258+52.1	1353
87TH EXIT	RAMP TERMINAL AT S. LAFAYETTE AV.	SB I-94	1265+24.9	1266+81.9	435
87TH EXIT	87TH STREET EXIT RAMP	SB I-94	1266+79.2	1272+20.9	1287
87TH EXIT	87TH STREET EXIT RAMP	SB I-94	1272+20.8	1272.70.91	
87TH EXIT	87TH STREET EXIT RAMP	SB I-94	1272+70.9	1272+93.7	50
87TH EXIT	EAST SIDE OF S. LAFAYETTE AV.	SB I-94	1266+81.9	1267+27.7	23
87TH EXIT	EAST SIDE OF S. LAFAYETTE AV.	SB I-94	1270+14.7	1273+74.3	599
87TH EXIT	WEST SIDE OF SOUTHBOUND I-94	SB I-94	1271+49.8	1272+22.3	16
87TH EXIT	RAMP TERMINAL AT SOUTHBOUND I-94	SB I-94	1272+90.6	1276+28.2	580
76TH-79TH C-D	RAMP TERMINAL AT S. LAFAYETTE AV.	SB I-94	1313+24.0	1313+77.4	34
76TH-79TH C-D	RAMP TERMINAL AT S. LAFAYETTE AV.	SB I-94	1313+77.3	1314+28.0	
76TH-79TH C-D	RAMP TERMINAL AT S. LAFAYETTE AV.	SB I-94	1314+27.8	1317+93.1	1046
76TH-79TH C-D	79TH STREET EXIT RAMP	SB I-94	1317+50.0	1317+84.3	152
76TH-79TH C-D	79TH STREET EXIT RAMP	SB I-94	1317+84.3	1320+64.9	630
76TH-79TH C-D	EAST SIDE OF S. LAFAYETTE AV.	SB I-94	1317+92.6	1328+70.8	1484
76TH-79TH C-D	EXIT RAMP TERMINAL AT SB I-94	SB I-94	1316+37.1	1323+00.0	816
76TH-79TH C-D	ENTRANCE RAMP TERMINAL AT SB I-94	SB I-94	1322+99.8	1325+48.2	248
76TH-79TH C-D	ENTRANCE RAMP TERMINAL AT SB I-94	SB I-94	1325+48.2	1325+99.1	
76TH-79TH C-D	75TH STREET ENTRANCE RAMP	SB I-94	1325+99.0	1328+70.6	672
76TH-79TH C-D	RAMP TERMINAL AT S. LAFAYETTE AV.	SB I-94	1328+70.6	1330+62.8	487
71ST-75TH C-D	RAMP TERMINAL AT S. LAFAYETTE AV.	SB I-94	1344+14.9	1346+50.7	386
71ST-75TH C-D	75TH STREET EXIT RAMP	SB I-94	1346+47.7	1351+15.2	1098
71ST-75TH C-D	EAST SIDE OF S. LAFAYETTE AV.	SB I-94	1346+50.7	1347+03.8	25
71ST-75TH C-D	EXIT RAMP TERMINAL AT SB I-94	SB I-94	1351+09.3	1354+15.6	260
71ST-75TH C-D	ENTRANCE RAMP TERMINAL AT SB I-94	SB I-94	1354+15.6	1356+96.6	166
71ST-75TH C-D	71ST STREET ENTRANCE RAMP	SB I-94	1356+92.7	1358+67.7	394
71ST-75TH C-D	71ST STREET ENTRANCE RAMP	SB I-94	1358+67.5	1359+17.6	
71ST-75TH C-D	71ST STREET ENTRANCE RAMP	SB I-94	1359+17.4	1361+29.4	507
71ST-75TH C-D	EAST SIDE OF S. LAFAYETTE AV.	SB I-94	1361+00.9	1361+24.2	13
71ST-75TH C-D	RAMP TERMINAL AT S. LAFAYETTE AV.	SB I-94	1361+24.2	1364+69.4	367
I000-2A TOTAL					10571
J000-2A TOTAL					13374
TOTAL					23945

PAVED SHOULDER REMOVAL

RAMP/WALL	ALIGNMENT	OFFSET	FROM STATION	TO STATION	PAVED SHLD REMOVAL (SQ YD)
HALSTED EXIT	SB I-57	98+22.5	97+65.6	LT	35
HALSTED EXIT	SB I-57	102+47.2	102+25.7	LT	8
HALSTED EXIT	SB I-57	106+03.8	103+67.5	LT	97
HALSTED EXIT	SB I-57	106+54.2	105+99.1	LT	10
WALL 67	SB I-57	115+71.3	113+56.3	LT	103
WENTWORTH EXIT	SB I-57	136+38.8	135+61.6	LT	72
WENTWORTH EXIT	SB I-57	140+84.5	140+16.3	LT	75
WALL 68	SB I-57	142+83.1	139+25.0	LT	
95TH EXIT	SB I-94	1213+18.1	1205+33.5	RT	524
95TH EXIT	SB I-94	1214+90.2	1210+22.4	LT	303
95TH EXIT	SB I-94	1215+57.6	1214+89.9	LT	30
95TH EXIT	SB I-94	1216+15.0	1214+92.3	LT	86
95TH EXIT	SB I-94	1221+20.7	1220+02.5	LT	121
95TH EXIT	SB I-94	1221+23.0	1221+19.5	LT	2
95TH EXIT	SB I-94	1227+77.8	1225+60.1	LT	64
WALL 36	SB I-94	1232+23.5	1219+12.3	LT	514
WALL 37	SB I-94	1233+77.9	1233+64.9	RT	10
WALL 37	SB I-94	1235+15.5	1233+05.5	LT	70
87TH ENTRANCE	SB I-94	1245+34.9	1243+70.1	LT	92
87TH ENTRANCE	SB I-94	1245+84.9	1245+34.8	LT	
87TH ENTRANCE	SB I-94	1247+11.6	1245+84.8	LT	129
87TH ENTRANCE	SB I-94	1249+18.9	1249+11.2	LT	3
87TH ENTRANCE	SB I-94	1249+80.7	1249+24.0	LT	41
87TH ENTRANCE	SB I-94	1258+53.0	1253+09.5	RT	447
87TH EXIT	SB I-94	1265+61.8	1265+01.2	LT	39
87TH EXIT	SB I-94	1665+94.5	1365+61.8	LT	
87TH EXIT	SB I-94	1267+57.8	1266+83.6	LT	53
87TH EXIT	SB I-94	1272+21.0	1271+34.2	LT	120
87TH EXIT	SB I-94	1272+20.9	1271+74.6	LT	
87TH EXIT	SB I-94	1272+85.3	1272+20.9	LT	
87TH EXIT	SB I-94	1276+28.2	1276+05.3	LT	13
76TH-79TH C-D	SB I-94	1320+62.6	1313+23.9	LT	533
76TH-79TH C-D	SB I-94	1319+44.7	1316+37.1	LT	298
76TH-79TH C-D	SB I-94	1328+69.7	1328+22.6	LT	50
76TH-79TH C-D	SB I-94	1324+69.4	1323+15.8	LT	588
76TH-79TH C-D	SB I-94	1325+99.1	1325+84.6	LT	
76TH-79TH C-D	SB I-94	1325+99.1	1325+86.2	LT	
76TH-79TH C-D	SB I-94	1326+54.6	1325+99.1	LT	8
76TH-79TH C-D	SB I-94	1326+82.3	1325+99.1	LT	130
76TH-79TH C-D	SB I-94	1336+72.9	1325+99.1	LT	676
76TH-79TH C-D	SB I-94	1321+80.5	1317+92.3	LT	195
71ST-75TH C-D	SB I-94	1349+79.3	1343+41.8	LT	923
71ST-75TH C-D	SB I-94	1347+39.5	1346+52.4	LT	82
71ST-75TH C-D	SB I-94	1351+03.7	1349+58.8	LT	269
71ST-75TH C-D	SB I-94	1354+83.2	1353+27.2	LT	111
71ST-75TH C-D	SB I-94	1358+21.4	1356+98.0	LT	179
71ST-75TH C-D	SB I-94	1361+22.0	1360+58.5	LT	75
I000-2A TOTAL					1678
J000-2A TOTAL					5598
TOTAL					7276

F.A.I. RTE.	SECTION	COUNTY	TOTAL SHEETS	SHEET NO.
94	*	COOK	907	37
STA. 1200+00.00		TO STA. 1365+00		
FED. ROAD DIST. NO.		ILLINOIS FED. AID PROJECT		
(1516.1, 1717 & 1818) R-9		62695		

F.A.I. RTE.	SECTION	COUNTY	TOTAL SHEETS	SHEET NO.
94		COOK	907	103
STA. 1200+00.00 TO STA. 1365+00				
FED. ROAD DIST. NO.		ILLINOIS	FED. AID PROJECT	
* (1516, 1717 & 1818) E-9		62695		

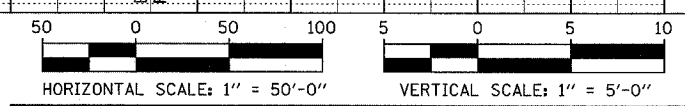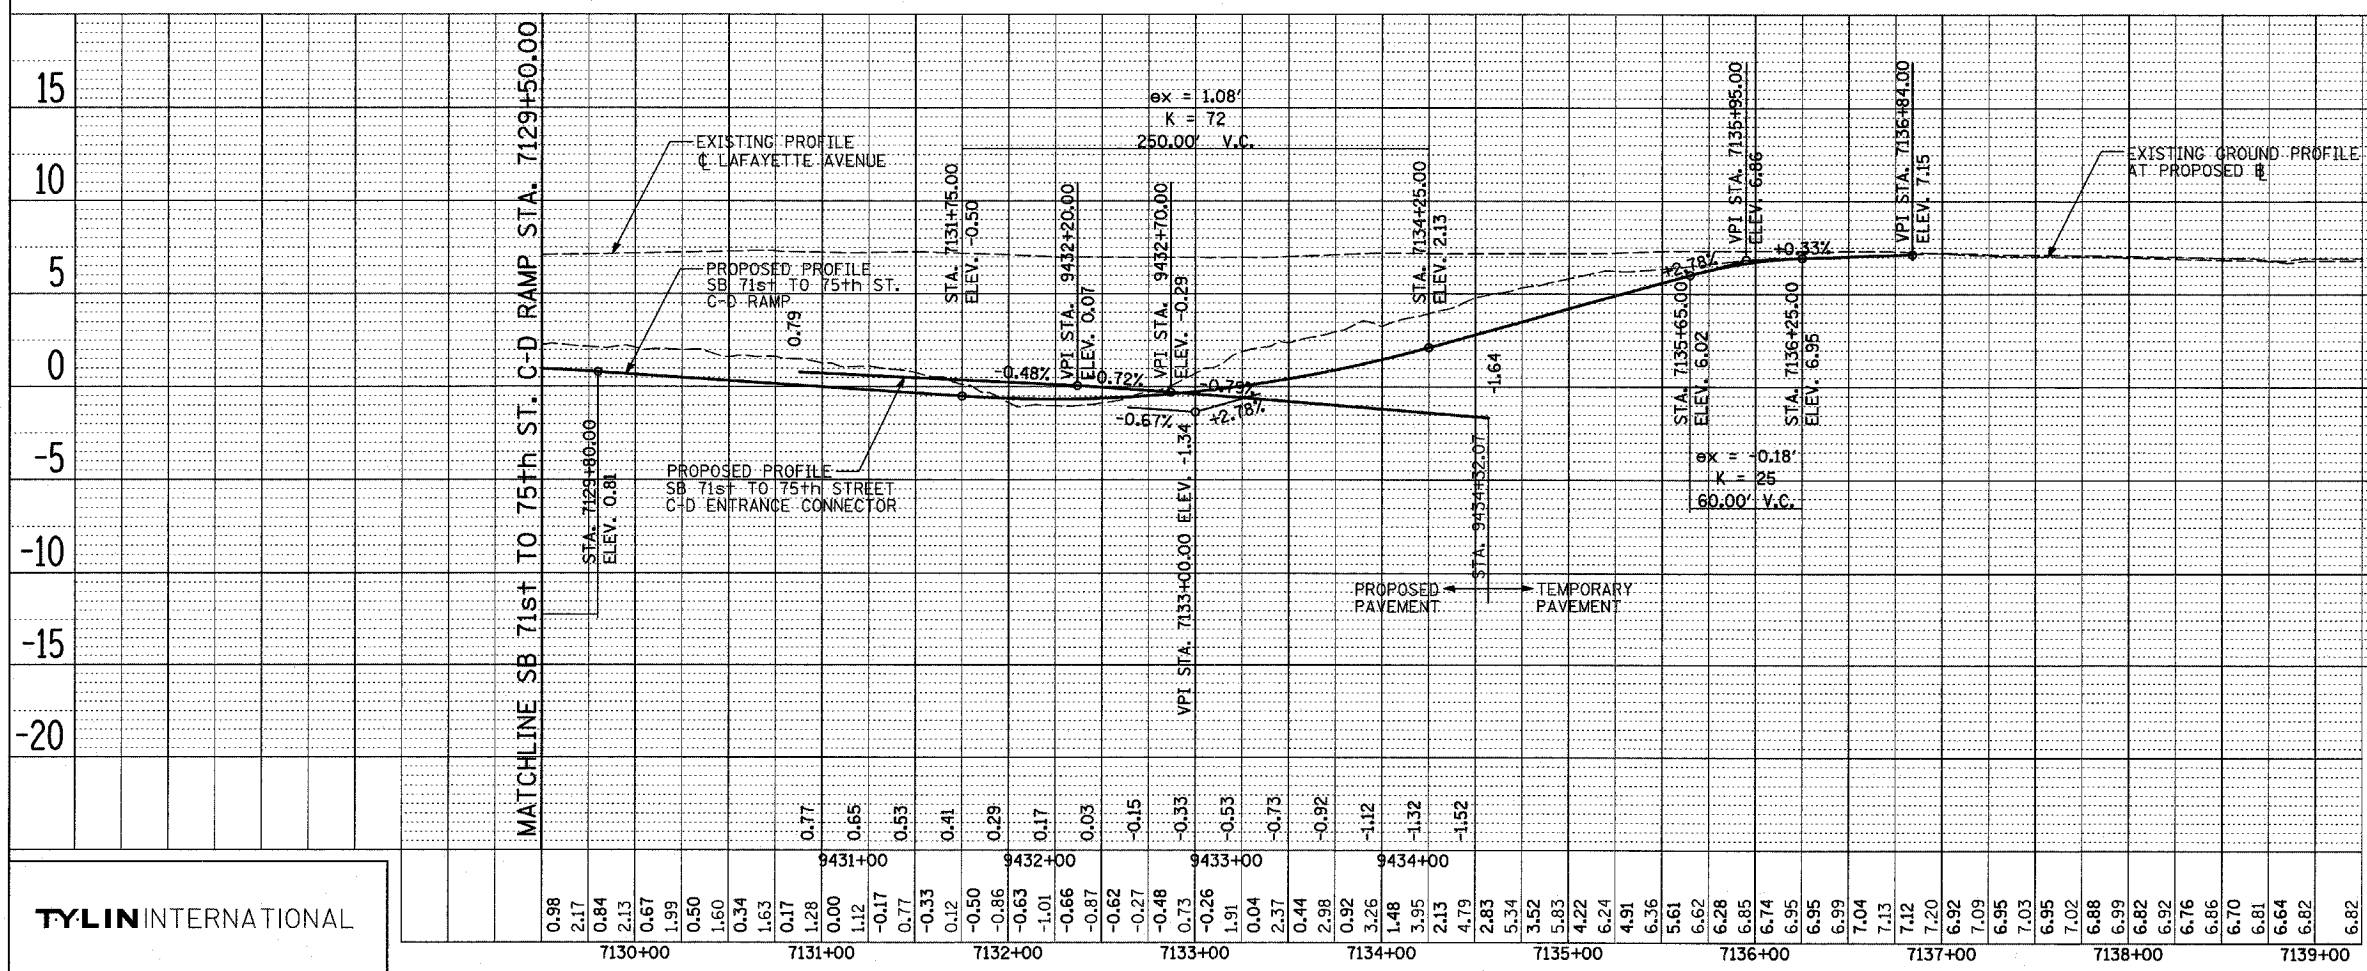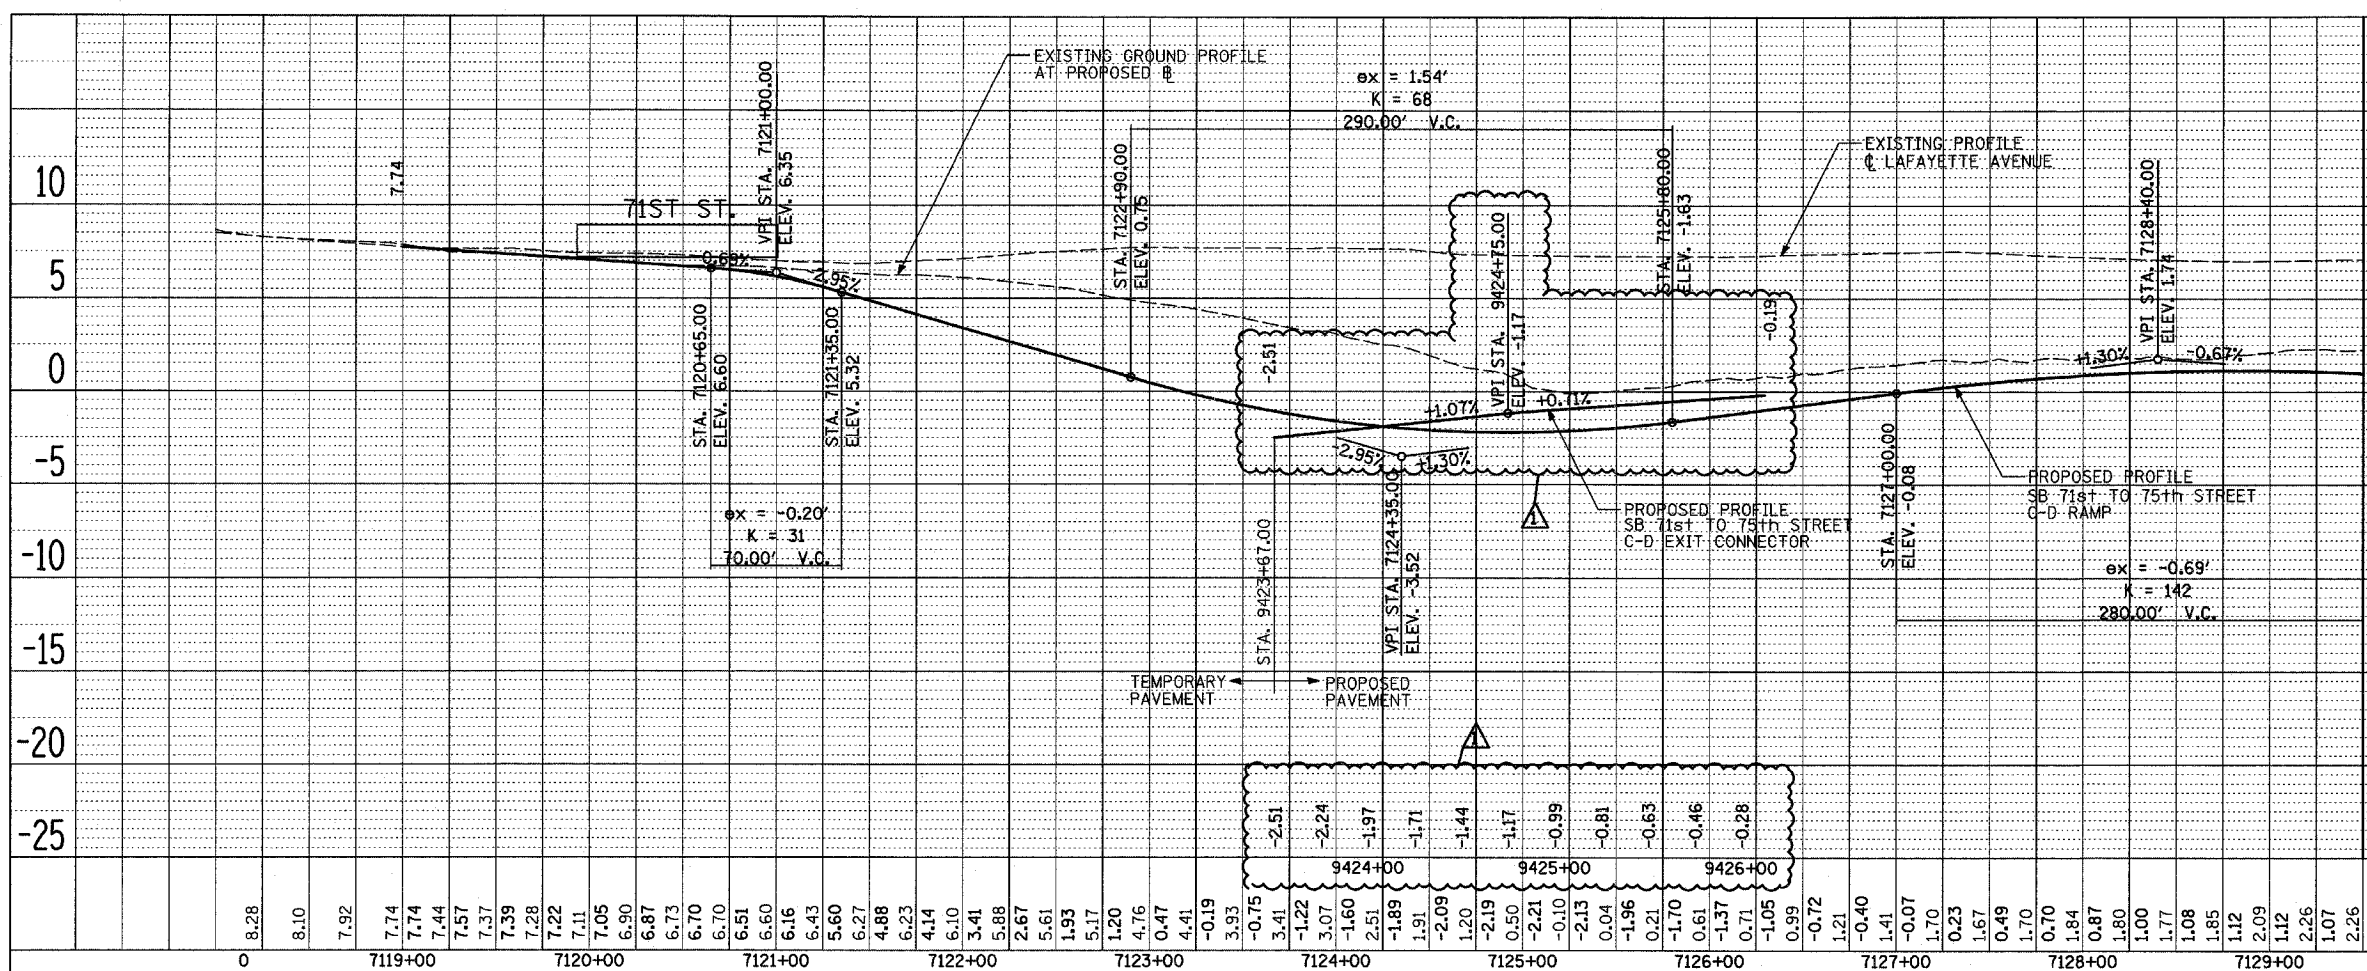

REVISIONS	
NAME	DATE

ILLINOIS DEPARTMENT OF TRANSPORTATION
F.A.I. 94 (DAN RYAN EXPRESSWAY)

EXISTING AND PROPOSED PROFILE
SB 71st TO 75th STREET C-D RAMP

SCALE: 1"=50' HORIZ.
1"=5' VERT.

DATE: MARCH 25, 2005

DRAWN BY: JPM
CHECKED BY: MPG

TYLIN INTERNATIONAL



PLAN
NO. _____
DATE _____

REVISIONS
PLOTTED _____
ALIGNED _____
CHECKED _____
CADD FILE NAME _____

PLAN
NO. _____
DATE _____

REVISIONS
PLOTTED _____
ALIGNED _____
CHECKED _____
CADD FILE NAME _____

ADDENDUM 1 05/27/05

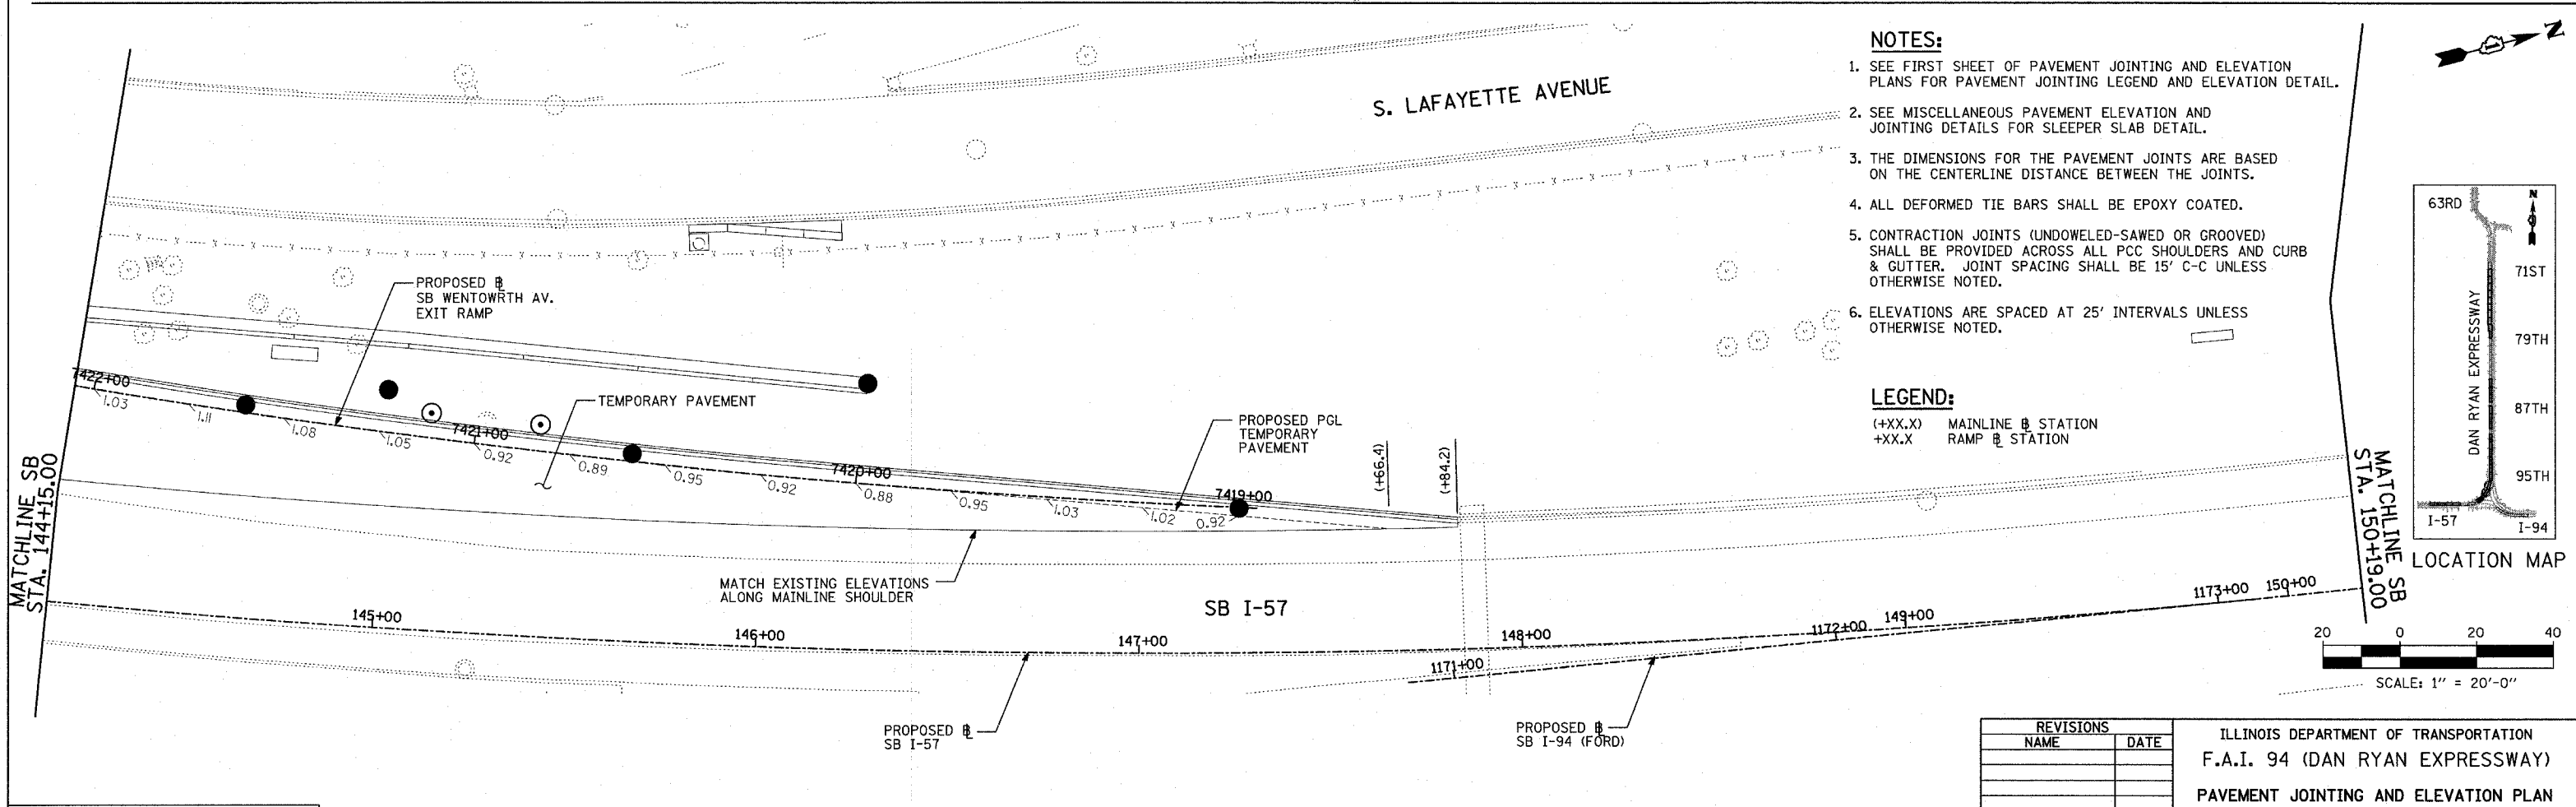
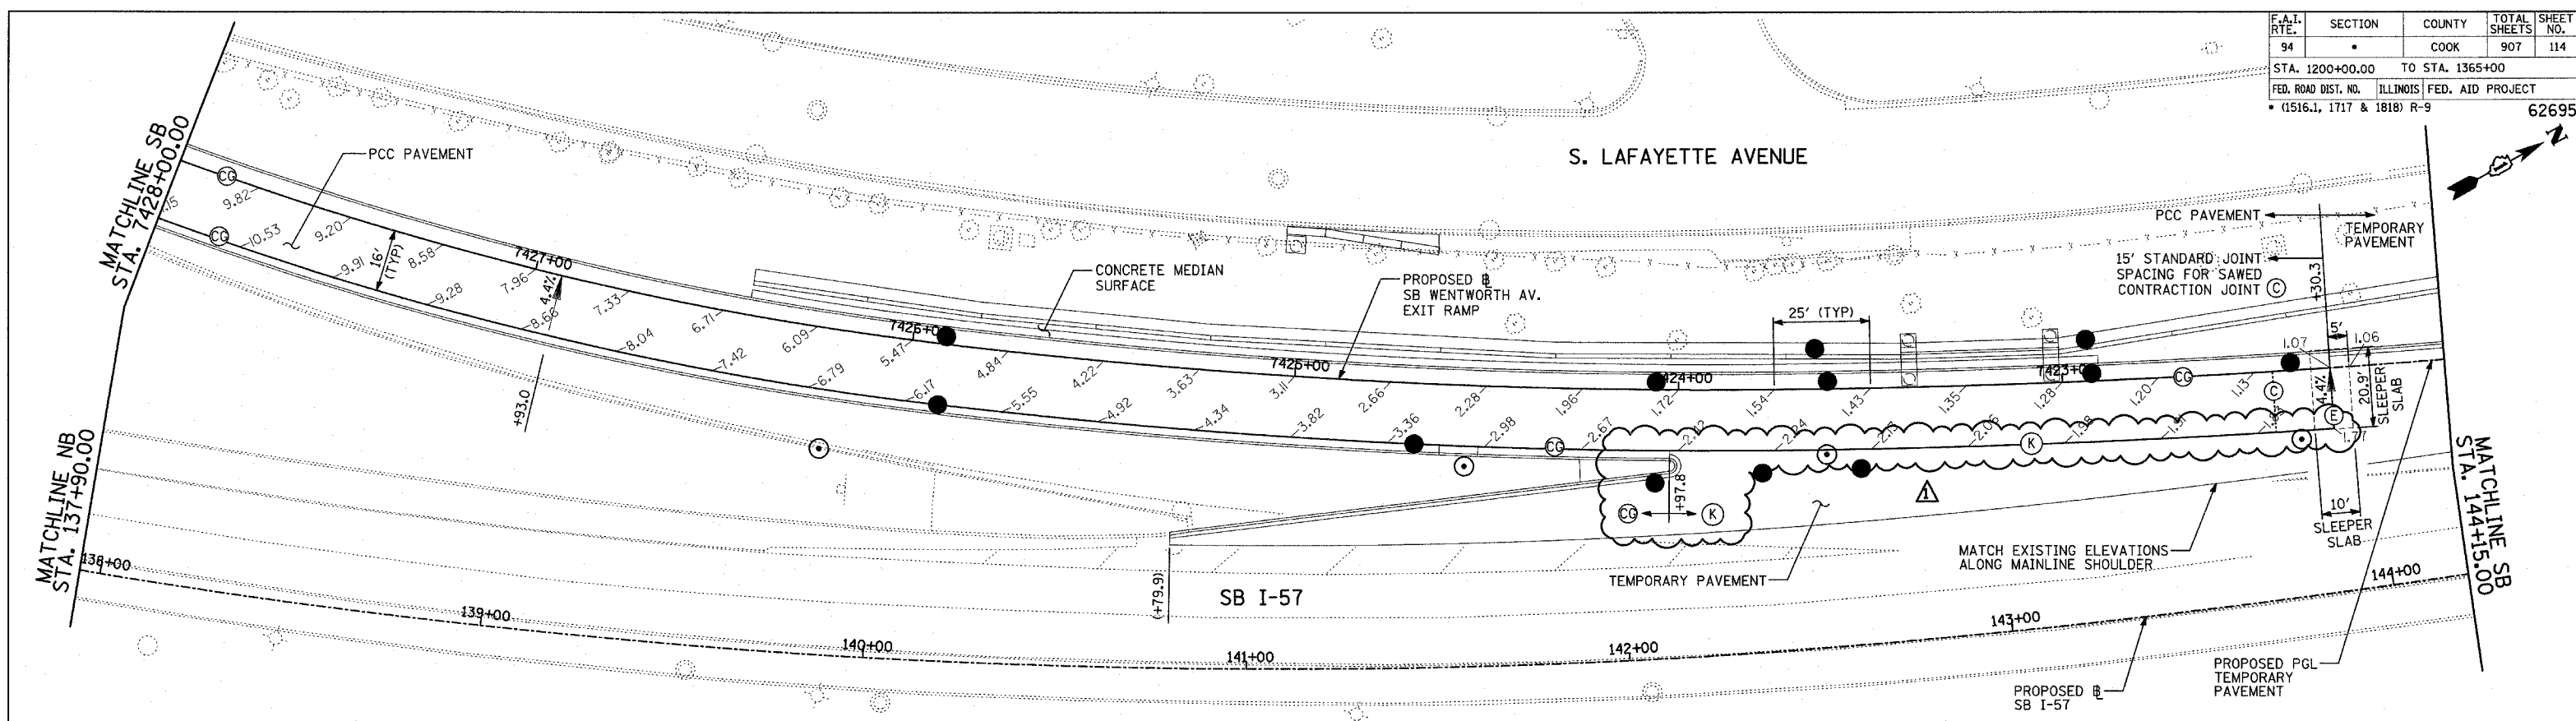


NOTES:

- SEE FIRST SHEET OF PAVEMENT JOINTING AND ELEVATION PLANS FOR PAVEMENT JOINTING LEGEND AND ELEVATION DETAIL.
- SEE MISCELLANEOUS PAVEMENT ELEVATION AND JOINTING DETAILS FOR SLEEPER SLAB DETAIL.
- THE DIMENSIONS FOR THE PAVEMENT JOINTS ARE BASED ON THE CENTERLINE DISTANCE BETWEEN THE JOINTS.
- ALL DEFORMED TIE BARS SHALL BE EPOXY COATED.
- CONTRACTION JOINTS (UNDOWELED-SAWED OR GROOVED) SHALL BE PROVIDED ACROSS ALL PCC SHOULDERS AND CURB & GUTTER. JOINT SPACING SHALL BE 15' C-C UNLESS OTHERWISE NOTED.
- ELEVATIONS ARE SPACED AT 25' INTERVALS UNLESS OTHERWISE NOTED.

LEGEND:

- (+XX.X) MAINLINE @ STATION
- +XX.X RAMP @ STATION

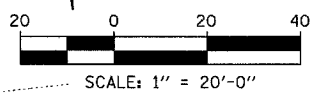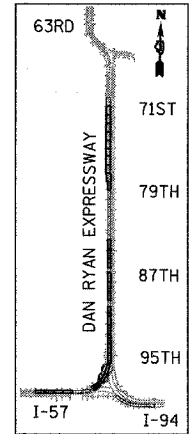

REVISIONS	
NAME	DATE


ILLINOIS DEPARTMENT OF TRANSPORTATION
 F.A.I. 94 (DAN RYAN EXPRESSWAY)
 PAVEMENT JOINTING AND ELEVATION PLAN
 SB WENTWORTH AVENUE EXIT RAMP
 SB I-57 STA. 137+90.00 TO 150+19.00

SCALE: 1"=20'
 DATE: MARCH 25, 2005
 DRAWN BY: JPM
 CHECKED BY: JPM, MAG




TYLIN INTERNATIONAL

ADDENDUM 1 05/27/05

F.A.I. RTE.	SECTION	COUNTY	TOTAL SHEETS	SHEET NO.
94		COOK	907	116
STA. 1200+00.00 TO STA. 1365+00				
FED. ROAD DIST. NO.		ILLINOIS FED. AID PROJECT		
(1516.1, 1717 & 1818) R-9		62695		

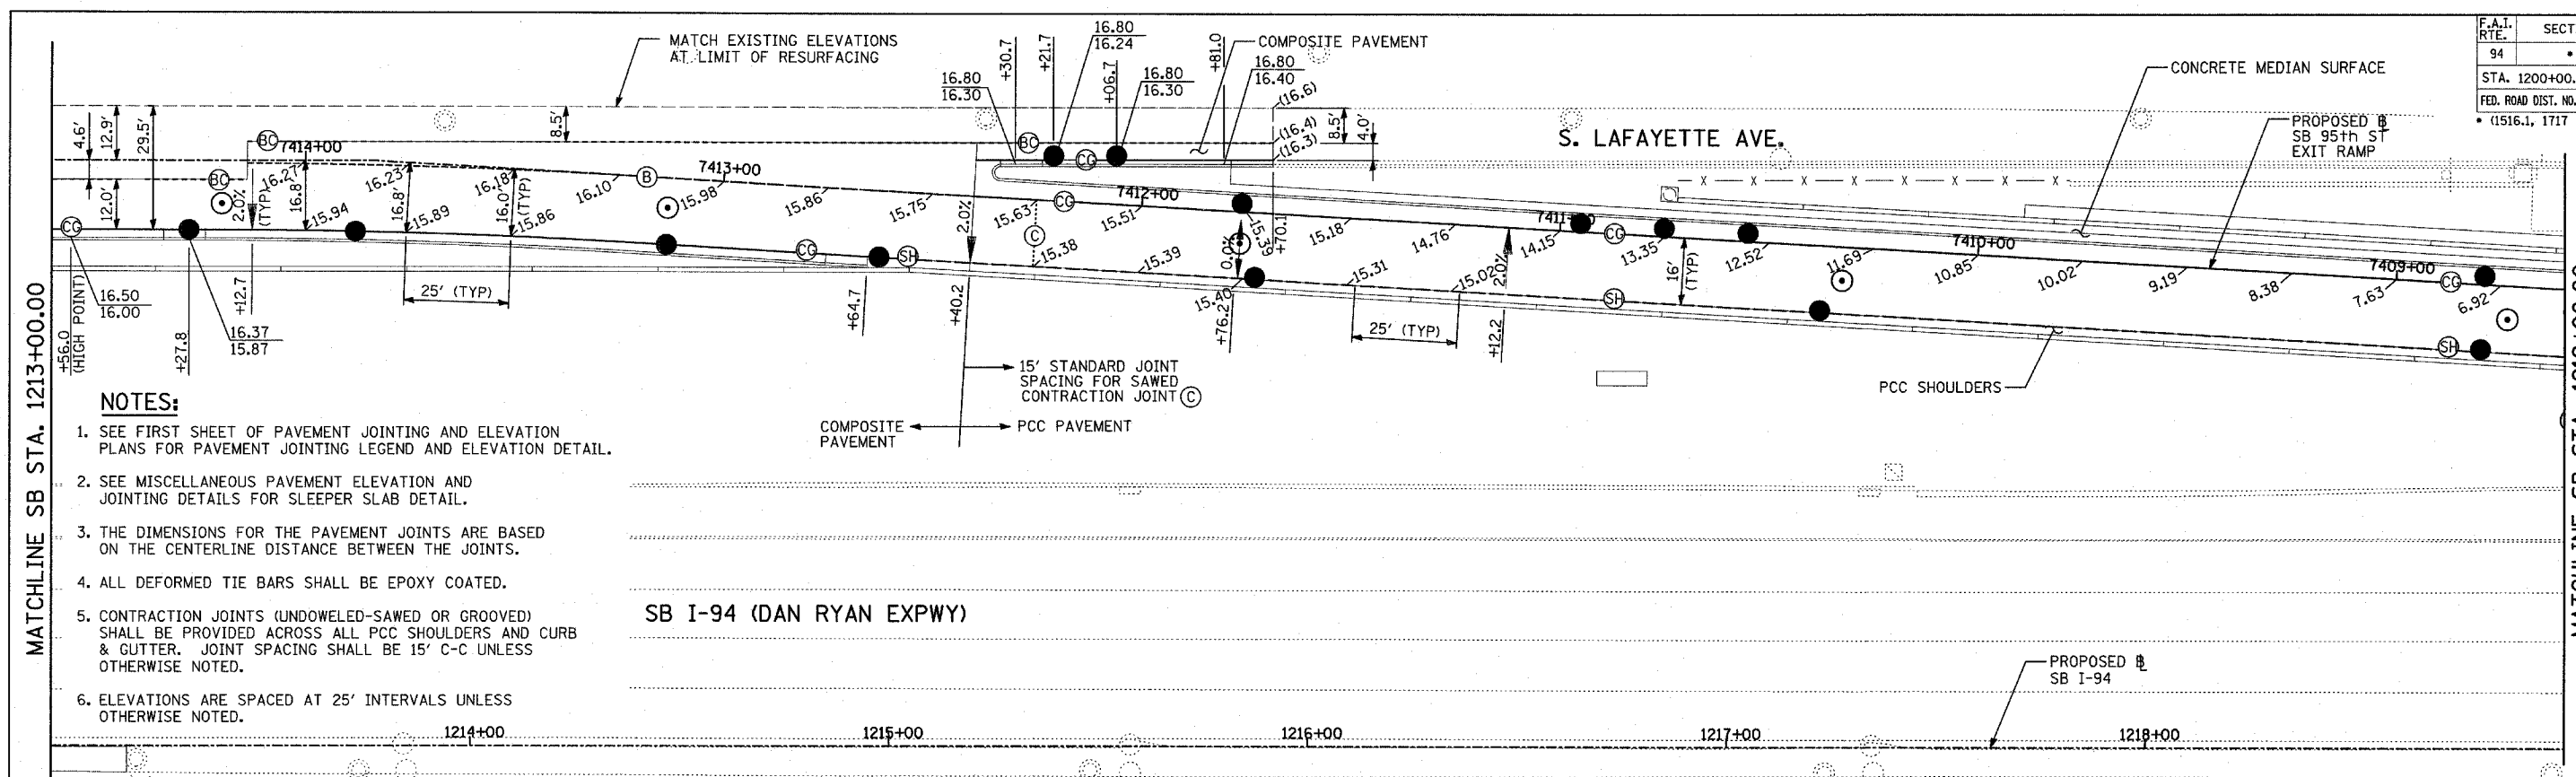

- NOTES:**
- SEE FIRST SHEET OF PAVEMENT JOINTING AND ELEVATION PLANS FOR PAVEMENT JOINTING LEGEND AND ELEVATION DETAIL.
 - SEE MISCELLANEOUS PAVEMENT ELEVATION AND JOINTING DETAILS FOR SLEEPER SLAB DETAIL.
 - THE DIMENSIONS FOR THE PAVEMENT JOINTS ARE BASED ON THE CENTERLINE DISTANCE BETWEEN THE JOINTS.
 - ALL DEFORMED TIE BARS SHALL BE EPOXY COATED.
 - CONTRACTION JOINTS (UNDOWELED-SAWED OR GROOVED) SHALL BE PROVIDED ACROSS ALL PCC SHOULDERS AND CURB & GUTTER. JOINT SPACING SHALL BE 15' C-C UNLESS OTHERWISE NOTED.
 - ELEVATIONS ARE SPACED AT 25' INTERVALS UNLESS OTHERWISE NOTED.

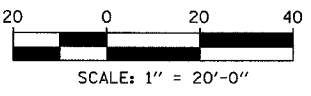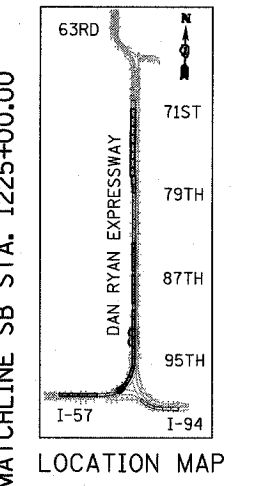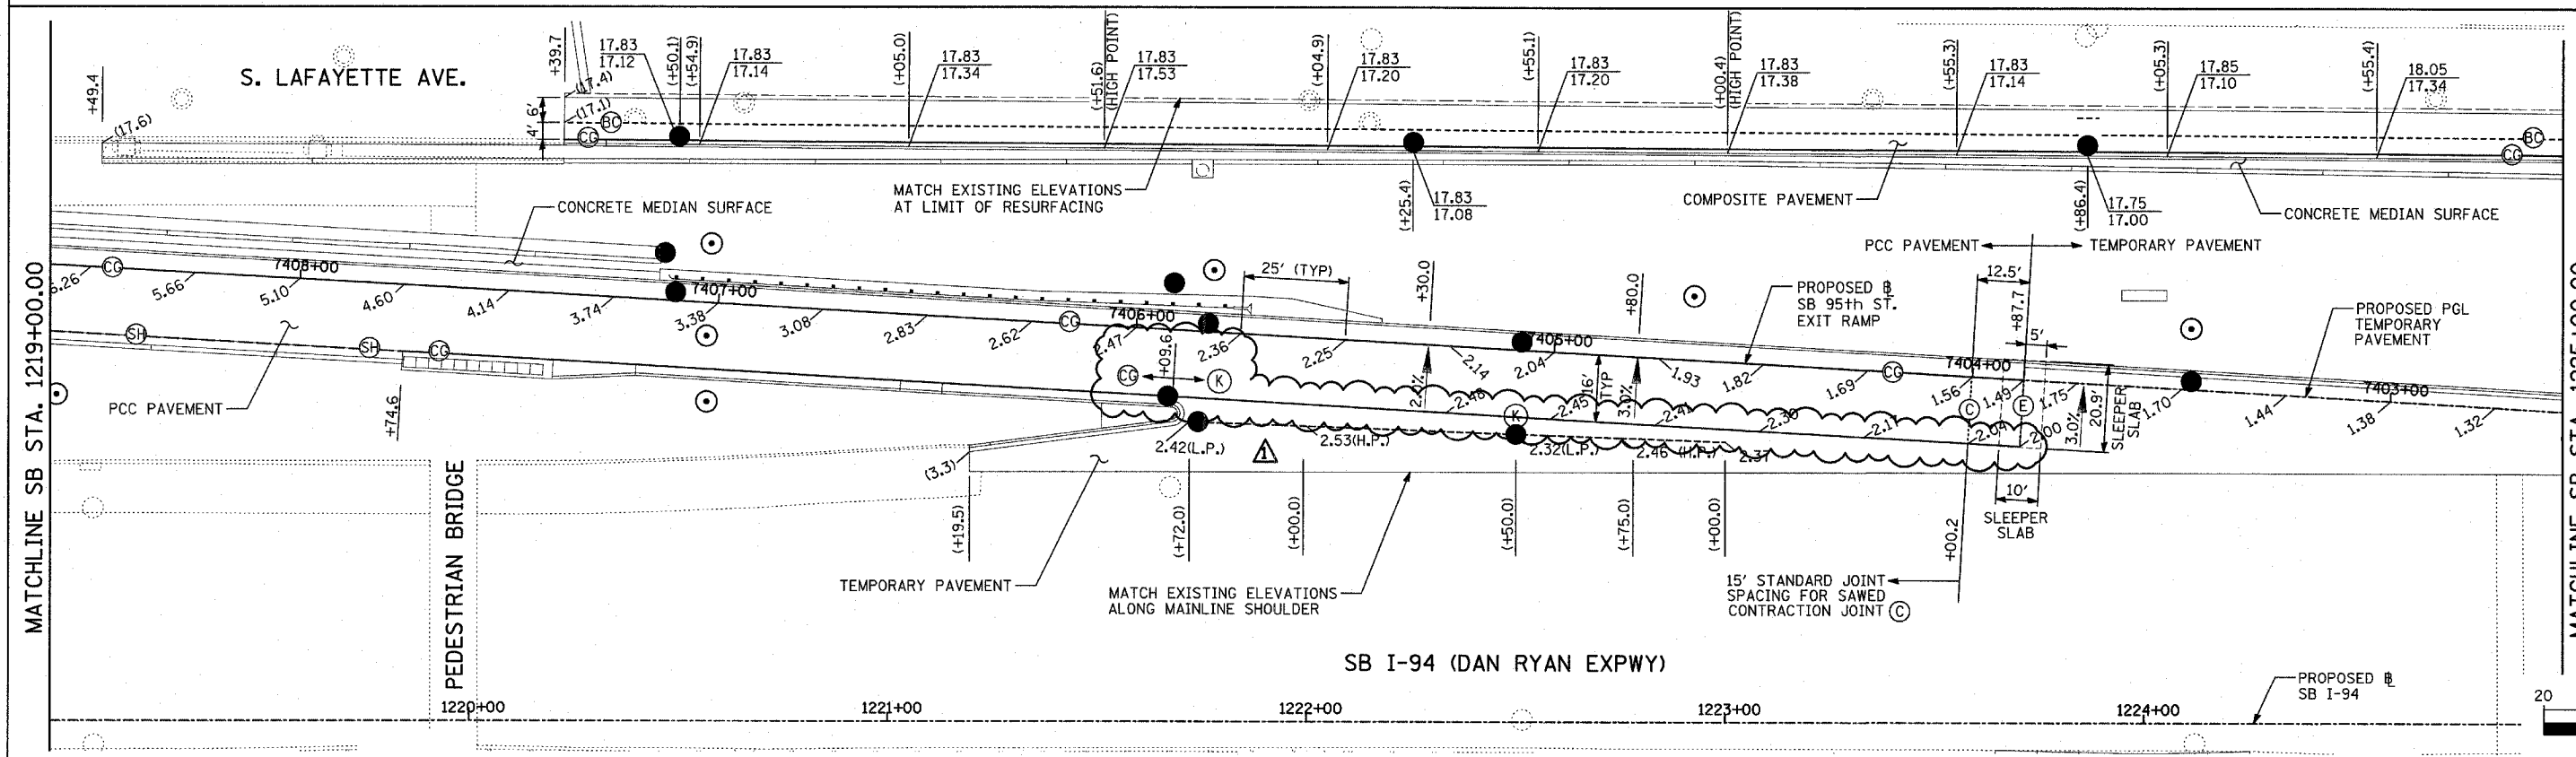

LEGEND:
 (+XX.X) MAINLINE # STATION
 +XX.X RAMP # STATION




REVISIONS	
NAME	DATE

ILLINOIS DEPARTMENT OF TRANSPORTATION
 F.A.I. 94 (DAN RYAN EXPRESSWAY)
 PAVEMENT JOINTING AND ELEVATION PLAN
 SB 95th STREET EXIT RAMP
 SB I-94 STA. 1213+00.00 TO 1225+00.00

SCALE: 1"=20'
 DATE: MARCH 25, 2005
 DRAWN BY: JPM
 CHECKED BY: JPM, MAG

TYLIN INTERNATIONAL

ADDENDUM 1 05/27/05

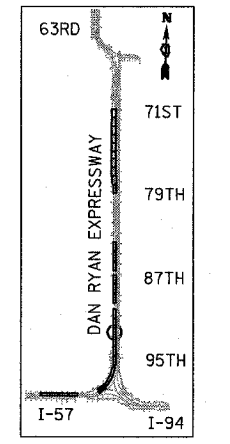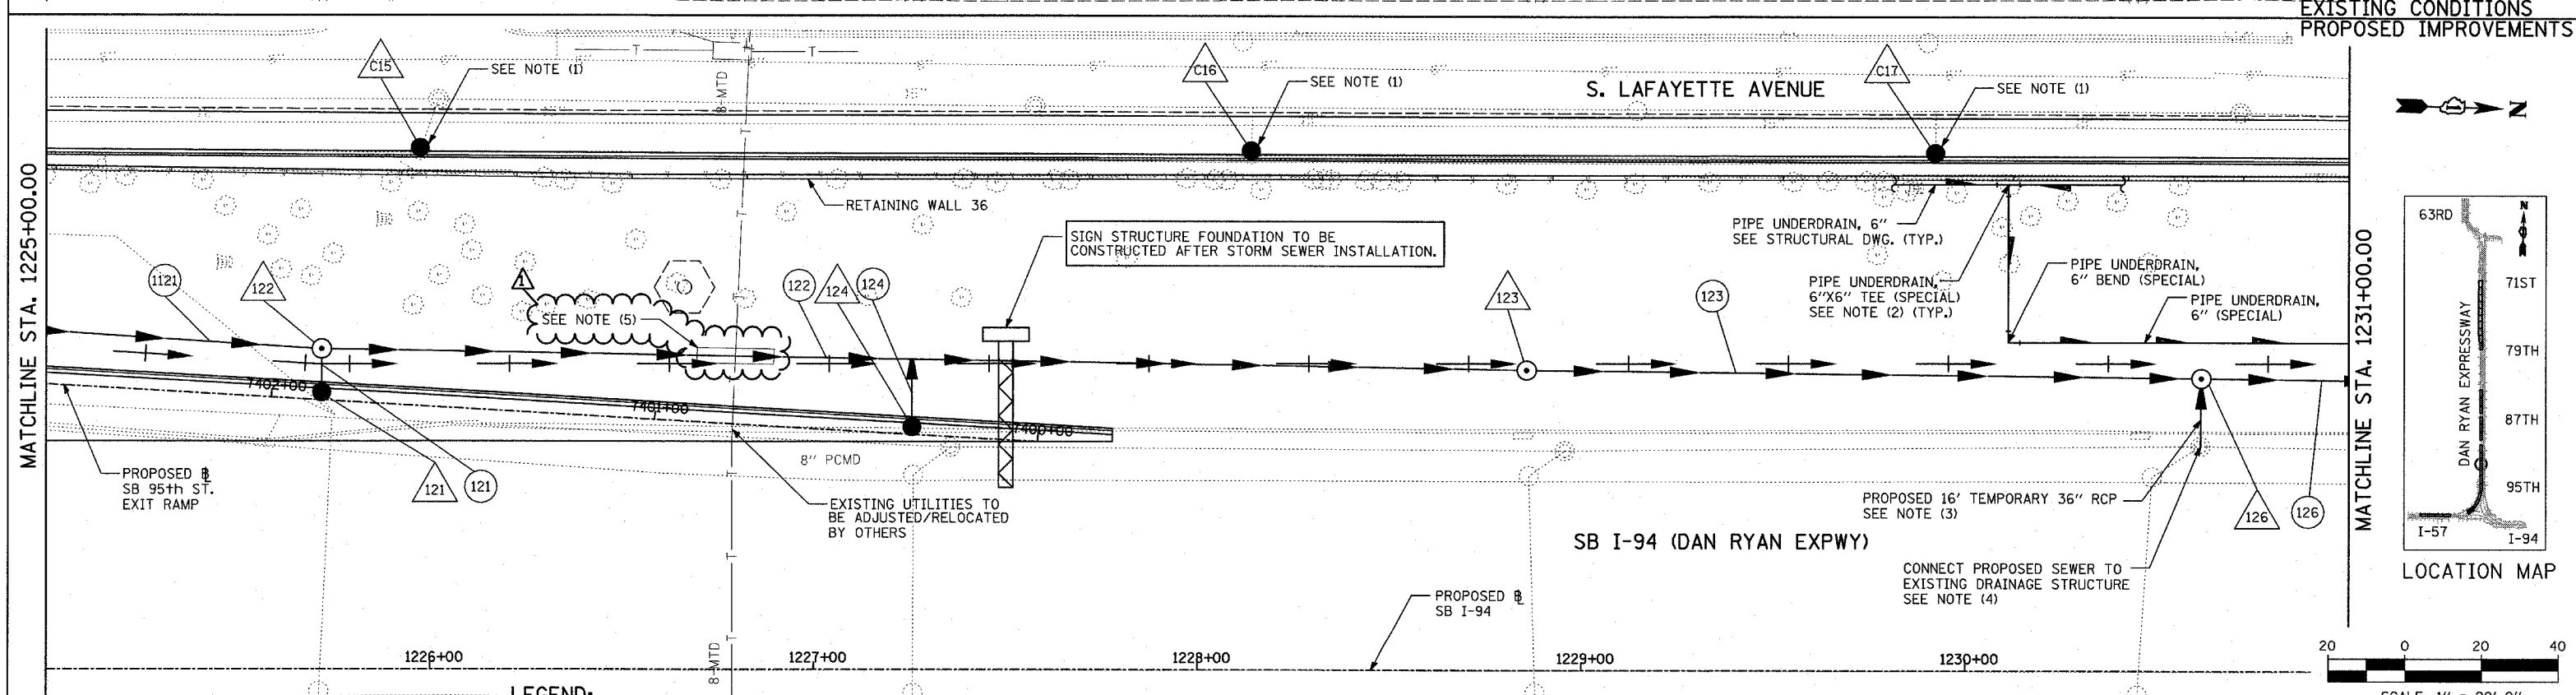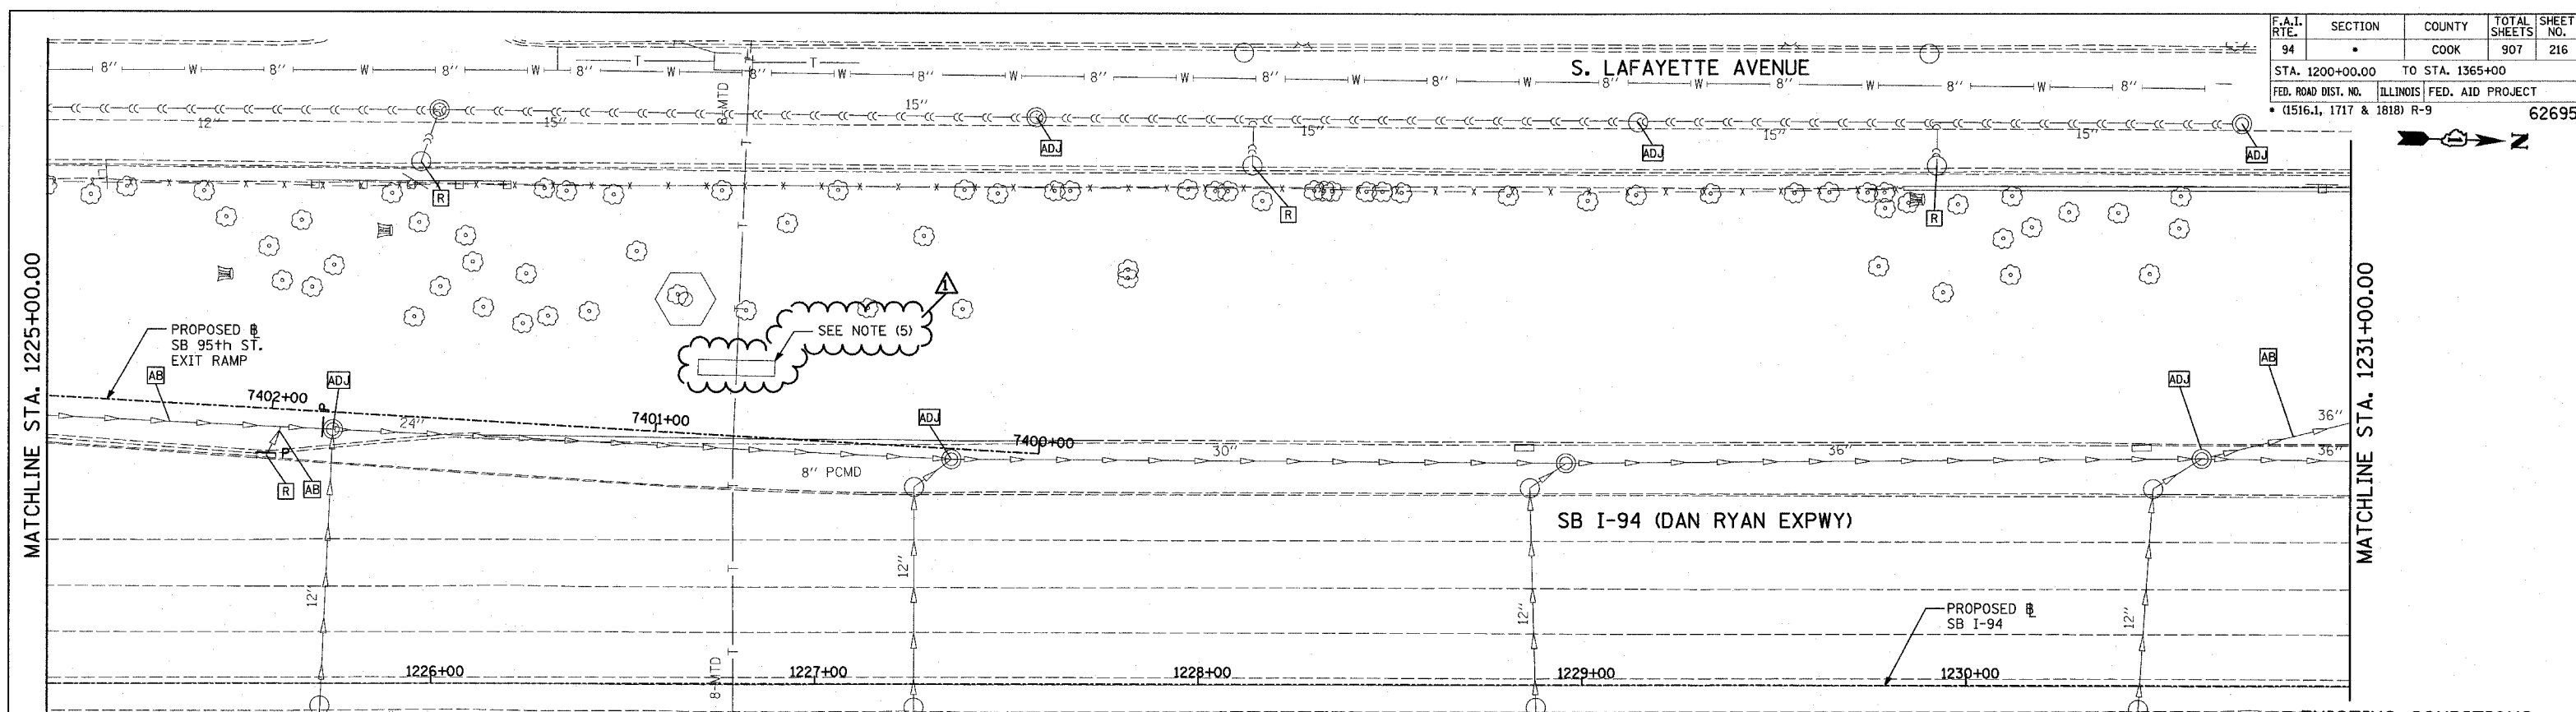

LEGEND:

	EXISTING COMBINED SEWER		HIGH MAST LIGHT TOWER FOUNDATION (BY OTHERS - SEE CONTRACT 62583)
	PROPOSED STORM SEWER NUMBER (X=SHEET NO., Y=PIPE NO.)		HIGH MAST LIGHT TOWER FOUNDATION, WALL MOUNTED
	PROPOSED STRUCTURE NUMBER (X=SHEET NO., Y=STRUCTURE NO.)		HIGH MAST LIGHT TOWER FOUNDATION (BY OTHERS - SEE CONTRACT 62583)
	PIPE STUBOUT TO BE PLUGGED		F.V. FIELD VERIFY
	UTILITY REMOVAL		
	UTILITY REMOVAL PLUG		

- NOTES:**
- CONNECT TO EXISTING CDMW COMBINED SEWER. SEE COMBINED SEWER DRAINAGE SCHEDULE FOR DETAILS (TYP.).
 - ALL TEES AND ELBOWS/BENDS FOR PUD, 6" (SPECIAL) SHALL BE INCLUDED IN COST OF PUD, 6" (SPECIAL).
 - SURVEY DATA NOT AVAILABLE. CONTRACTOR SHALL VERIFY FIELD CONDITIONS PRIOR TO CONSTRUCTION.
 - CORE DRILL AND CONNECT TO EXISTING DRAINAGE STRUCTURE. CONNECTION COST SHALL BE INCLUDED IN THE COST TO CONSTRUCT THE STORM SEWER.
 - EXISTING STEEL CASING, 48" TO BE INSTALLED BY OTHERS DURING UTILITY ADJUSTMENTS AND PRIOR TO SEWER CONSTRUCTION. PROPOSED SEWER PIPE TO BE CENTERED (APPROX.) IN CASING PIPE. BEDDING MATERIAL AND FILLING OF VOID SPACE BETWEEN SEWER AND CASING PIPE TO BE APPROVED BY ENGINEER. COST SHALL BE INCLUDED IN SEWER PAY ITEM.

REVISIONS

NAME	DATE
ADDENDUM 1	05/27/05
REVISED	04/15/05

ILLINOIS DEPARTMENT OF TRANSPORTATION
F.A.I. 94 (DAN RYAN EXPRESSWAY)
DRAINAGE AND UTILITY PLANS
SB 95th STREET EXIT RAMP
SB I-94 STA. 1225+00.00 TO 1231+00.00

SCALE: 1"=20'
DATE: MARCH 25, 2005
DRAWN BY: MB
CHECKED BY: DA

TYLIN INTERNATIONAL

DRAINAGE STRUCTURE SCHEDULE (CONT.)

STRUCTURE NUMBER	STATION	OFFSET	STRUCTURE TYPE		DIA.	FRAME & LID	TOP OF FRAME	N INV.	E INV.	S INV.	W INV.
			MH	CB							
91	1210+29.60	73.5 LT	PLUG					-9.86			
92	7415+04.00	9.6 LT	A		4'	T1F CL	16.17	10.19	10.59		
93	7415+08.83	18.6 LT		A(1)	4'	T1F OL	15.91				10.66
94	7414+67.82	18.6 LT		A(1)	4'	T1F OL	15.84				10.59
95	NOT USED										
96	1210+47.50	73.4 LT		C	2'	T1F OL	0.15		-2.47		
97	1210+37.33	80.6 LT	A		5'	T1F CL	1.55	-7.89	-9.89	-9.88	
98	1212+07.56	80.6 LT	A		5'	T1F CL	-1.56	-7.64		-7.64	
99	1210+37.00	67.8 LT	A(2)		6'	T1F CL	0.56		-9.90		-9.90
910	1210+34.78	2.3 RT	A		7'	T1F CL	-1.33				-10.00
101	7414+27.81	18.6 LT		A(1)	4'	T1F OL	15.87			10.39	10.39
102	7413+88.11	19.0 LT		A(1)	4'	T1F OL	15.79				10.21
103	7413+13.06	18.0 LT		A(1)	4'	T1F OL	15.60				10.35
104	7413+13.06	7.1 LT	A		5'	T1F CL	15.90	7.37	10.32	9.37	
105	7412+61.98	18.0 LT		A(1)	4'	T1F OL	15.36				9.36
106	1215+39.25	139.0 LT		A(1)	4'	T1F OL	16.17		10.65		
107	1215+54.25	139.0 LT		A(1)	4'	T1F OL	16.20		10.95		
108	7411+72.14	18.0 LT		A	4'	T20 F&G	15.26				10.01
109	7411+76.16	4.0 RT		A	4'	T20 F&G	15.24		9.99		
1010	7410+95.16	4.0 RT		A	4'	T20 F&G	13.84	8.59			
1011	7410+75.16	4.0 RT		A	4'	T20 F&G	13.19	7.21	7.21	7.94	
1012	7410+55.16	4.0 RT		A	4'	T20 F&G	12.53			7.28	
1013	7410+32.08	8.0 LT	A		5'	T1F CL	12.08	2.10	5.25	4.10	
1014	7408+78.99	4.0 RT		A	4'	T20 F&G	6.87		1.62		
1015	7408+78.99	18.0 LT		A	4'	T20 F&G	7.23				1.23
1016	7410+37.03	18.0 LT		A	4'	T20 F&G	12.29				6.29
1017	1217+22.86	80.3 LT	A		5'	T1F CL	1.65	-6.72		-6.72	
1018	1213+83.86	80.3 LT	A		5'	T1F CL	-0.75	-7.38		-7.38	
1019	NOT USED										
1020	NOT USED										
1021	7414+19.99	10.3 LT	A		5'	T1F CL	16.01	9.83		9.83	9.18(S)
1022	7411+76.16	7.6 LT	A		5'	T1F CL	15.40	5.75	8.57	5.81	8.57
1023	7408+73.01	8.0 LT	A		5'	T1F CL	7.03	-0.63	0.20	-0.56	0.20
111	NOT USED										
112	7407+02.36	8.0 LT	A		5'	T1F CL	3.58		-5.30	-3.49	
113	7407+10.36	4.0 RT		A	4'	T20 F&G	3.36	-1.89			
114	1220+46.79	112.3 LT		C	2'	T1F OL	4.30	-1.01			
115	1220+57.86	114.6 LT	A		5'	T1F CL	4.75	-5.67	-2.08	-2.08	
116	7405+91.56	18.0 LT		A	4'	T20 F&G	2.63	-3.00	-3.00		
117	7405+82.85	4.0 RT		A	4'	T20 F&G	2.23		-3.77		-3.77
118	7405+07.86	4.0 RT		A	4'	T20 F&G	1.91		-3.34		-3.34
119	1222+92.59	102.3 LT	A		5'	T1F CL	1.00	-7.57	-4.30	-6.57	
1110	1221+74.07	72.0 LT		A	4'	T1F OL	2.42			-3.03	-3.03
1111	7403+47.79	4.0 RT		A	4'	T20 F&G	1.51		-4.49		-4.49
1112	1222+50.01	69.1 LT		A	4'	T1F OL	2.32				-2.93
1113	1220+56.70	77.7 LT	A		5'	T1F CL	4.17			-5.37	-5.37
1114	1221+68.40	105.2 LT		C	2'	T1F OL	1.94	-3.89			
1115	NOT USED										
1116	NOT USED										
1117	NOT USED										
1118	1219+01.53	78.4 LT	A		5'	T1F CL	3.59	-6.03		-6.03	
1119	NOT USED										
1120	1221+77.93	108.3 RT	A		5'	T1F CL	2.82	-6.13	-4.01	-6.13	-4.01(S)
1121	1224+11.23	94.6 LT	A		5'	T1F CL	1.05	-7.99		-7.98	

STORM SEWER SCHEDULE (CONT.)

PIPE NUMBER	UPSTREAM STATION	DOWNSTREAM STATION	TYPE	DIA. (IN)	LENGTH (FT)	SLOPE (%)	T.B. (CU.YD)
92	7415+04.00	7414+19.99	2	12	80.0	0.45	50.6
93	7415+08.83	7415+04.00	2	12	5.0	1.46	5.1
94	7414+67.82	7414+27.81	2	12	36.0	0.55	36.6
95	NOT USED	-	-	-	-	-	-
96	1210+47.50	1210+37.33	2	12	9.0	8.70	0.0
97	1212+07.56	1210+37.33	2	36	166.0	0.50	0.0
98	NOT USED	-	-	-	-	-	-
99	1210+37.33	1210+37.00	2	36	8.0	0.15	0.0
910	1210+37.00	1210+34.78	2	36	64.0	0.16	0.0
101	7414+27.81	7414+19.99	2	12	7.0	20.17	7.1
102	7413+88.11	7413+88.11	2	12	5.0	10.20	5.1
103	7413+13.06	7413+13.06	2	12	5.0	0.60	5.1
104	7413+13.06	7411+76.16	2	24	132.0	1.18	117.0
105	7412+61.98	7412+53.46	2	12	11.0	0.44(3)	11.2
106	1215+39.25	1215+39.25	2	12	19.0	0.44(5)	19.3
107	1215+54.25	1215+39.25	2	12	15.0	0.44	15.3
108	7411+72.14	7411+76.16	2	12	5.0	28.80	5.1
109	7411+76.16	7411+76.16	2	12	6.0	23.66	6.1
1010	7410+95.16	7410+75.16	2	12	16.0	4.06	16.3
1011	7410+75.16	7410+75.16	2	12	9.0	0.44(4)	9.2
1012	7410+55.16	7410+75.16	2	12	16.0	0.44	16.3
1013	7410+32.08	7408+73.01	2	24	155.0	1.72	128.0
1014	7408+78.99	7408+73.01	2	12	8.0	5.25	8.1
1015	7408+78.99	7408+73.01	2	12	6.0	17.17	6.1
1016	7410+37.03	7410+32.08	2	12	5.0	20.80	5.1
1017	1217+22.86	1213+83.86	2	36	334.0	0.20	0.0
1018	1213+83.86	1212+07.56	2	36	172.0	0.15	99.2
1019	1219+01.53	1217+22.86	2	27	175.0	0.40	37.8
1020	NOT USED	-	-	-	-	-	-
1021	7414+19.99	7413+13.06	2	12	102.0	0.45	25.1
1022	7411+76.16	7410+32.08	2	24	140.0	1.18	118.4
1023	7408+73.01	7407+02.36	2	24	166.0	1.72	61.1
111	NOT USED	-	-	-	-	-	-
112	NOT USED	-	-	-	-	-	-
113	7407+10.36	1220+57.86	2	12	11.0	1.73	6.9
114	1220+46.79	1220+57.86	2	12	8.0	13.38	0.0
115	1220+57.86	1221+77.93	2	27	116.0	0.40	0.0
116	7405+91.56	1221+74.07	2	12	6.0	0.44	6.1
117	7405+82.85	1221+77.93	2	12	9.0	2.66	6.9
118	7405+07.86	7405+07.71	2	12	12.0	0.44(4)	2.6
119	1222+92.59	1224+11.23	2	27	114.0	0.36	0.0
1110	1221+74.07	7405+82.85	2	12	20.0	3.70	20.3
1111	7403+47.79	1224+11.23	2	18	9.0	14.33	2.6
1112	1222+50.01	7405+07.86	2	12	18.0	2.41	18.3
1113	7407+02.36	1220+56.70	2	27	11.0	0.64	10.3
1114	1221+68.40	1221+77.93	2	12	7.0	2.00	0.0
1115	NOT USED	-	-	-	-	-	-
1116	7404+80.10	1222+92.59	2	12	39.0	0.44	32.6
1117	7403+72.53	7403+47.79	2	18	26.0	2.50	26.4
1118	1220+56.70	1219+01.53	2	27	151.0	0.44	132.5
1119	NOT USED	-	-	-	-	-	-
1120	1221+77.93	1222+92.59	2	27	111.0	0.40	0.0
1121	1224+11.23	1225+71.76	2	27	156.0	0.36	0.0
1122	7405+98.31	7405+91.56	2	12	10.0	0.44	10.2

- NOTES:**
- INDICATES CATCH BASIN WITH HALF TRAP, 4' DIAMETER, TYPE 1 FRAME & OPEN LID OR TYPE 20 FRAME & GRATE.
 - INDICATES MANHOLE, TYPE A, 6' DIAMETER, TYPE 1 FRAME, CLOSED LID, RESTRICTOR PLATE.
 - INDICATES SEWER LATERAL WITH 45° CONNECTION. SEE SHEET "DETAIL OF STORM SEWER CONNECTIONS TO SEWER."
 - INDICATES SEWER LATERAL WITH 30° CONNECTION. SEE SHEET "DETAIL OF STORM SEWER CONNECTIONS TO SEWER."
 - INDICATES SEWER LATERAL WITH 60° CONNECTION. SEE SHEET "DETAIL OF STORM SEWER CONNECTIONS TO SEWER."
 - INDICATES MANHOLE TYPE A WITH FLAT SLAB TOP, IDOT STANDARD 602601.

CASING SIZES

PIPE SIZE	CASING SIZE (OD)*	CASING WALL THICKNESS
12"	30"	0.500"
24"	42"	0.625"
30"	48"	0.688"
36"	48"	0.688"


*ALL STEEL CASING SHALL MEET OR EXCEED ASTM A-139, GRADE B.

SEE THE DRAINAGE & UTILITY PLANS FOR LOCATION OF ALL STRUCTURES.

CATCH BASIN STATIONS ARE MEASURED TO CENTER OF STRUCTURE.

CATCH BASIN OFFSETS ARE MEASURED TO FLOWLINE OF CASTING. (SEE BELOW)

FLOWLINE OF CASTING IS LOCATED AT 1/2 OF STRUCTURE FOR CATCH BASINS LOCATED IN SWALE AND GORE AREAS.

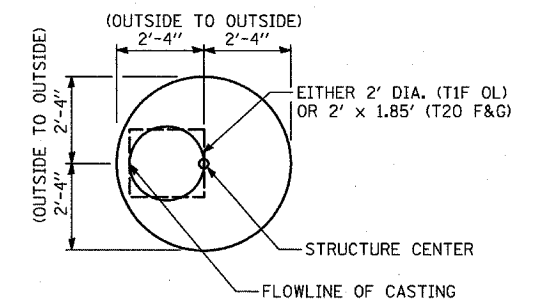

CATCH BASIN



(PRECAST REINFORCED CONCRETE SECTION)

MANHOLE STATIONS AND OFFSETS ARE MEASURED TO CENTER OF STRUCTURE. (SEE BELOW)

F.A.I. RTE.	SECTION	COUNTY	TOTAL SHEETS	SHEET NO.
94		COOK	907	368
STA. 142+00.00 TO STA. 1204+00.00				
FED. ROAD DIST. NO.		ILLINOIS	FED. AID PROJECT	
(1516,1,1717 & 1818) R-9		62695		

NOTES:

- SEE DRAWINGS EI-100 AND EI-101 FOR ELECTRICAL SYMBOLS AND ABBREVIATIONS.
- COORDINATE ALL WORK WITH IDOT CONTRACTS 62583 AND 62694.
- UNLESS NOTED OTHERWISE, ALL ITEMS AND WORK SHOWN IN HEAVY LINE WEIGHT ON THIS DRAWING ARE PROPOSED NEW ITEMS AND WORK.
- SIGN STRUCTURE SHALL BE PROVIDED UNDER THIS CONTRACT. SIGN LUMINAIRES, DISCONNECT SWITCH, WIRING AND CONNECTIONS SHALL BE PROVIDED BY OTHERS UNDER CONTRACT 62583. SIGN A7 SHALL BE LIT BEFORE WENTORTH RAMP IS OPENED.
- REFER TO STRUCTURAL DRAWINGS AND EI-104 FOR CONDUIT INSTALLATION DETAILS FOR LIGHT TOWER FOUNDATIONS MOUNTED ON WALL.

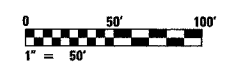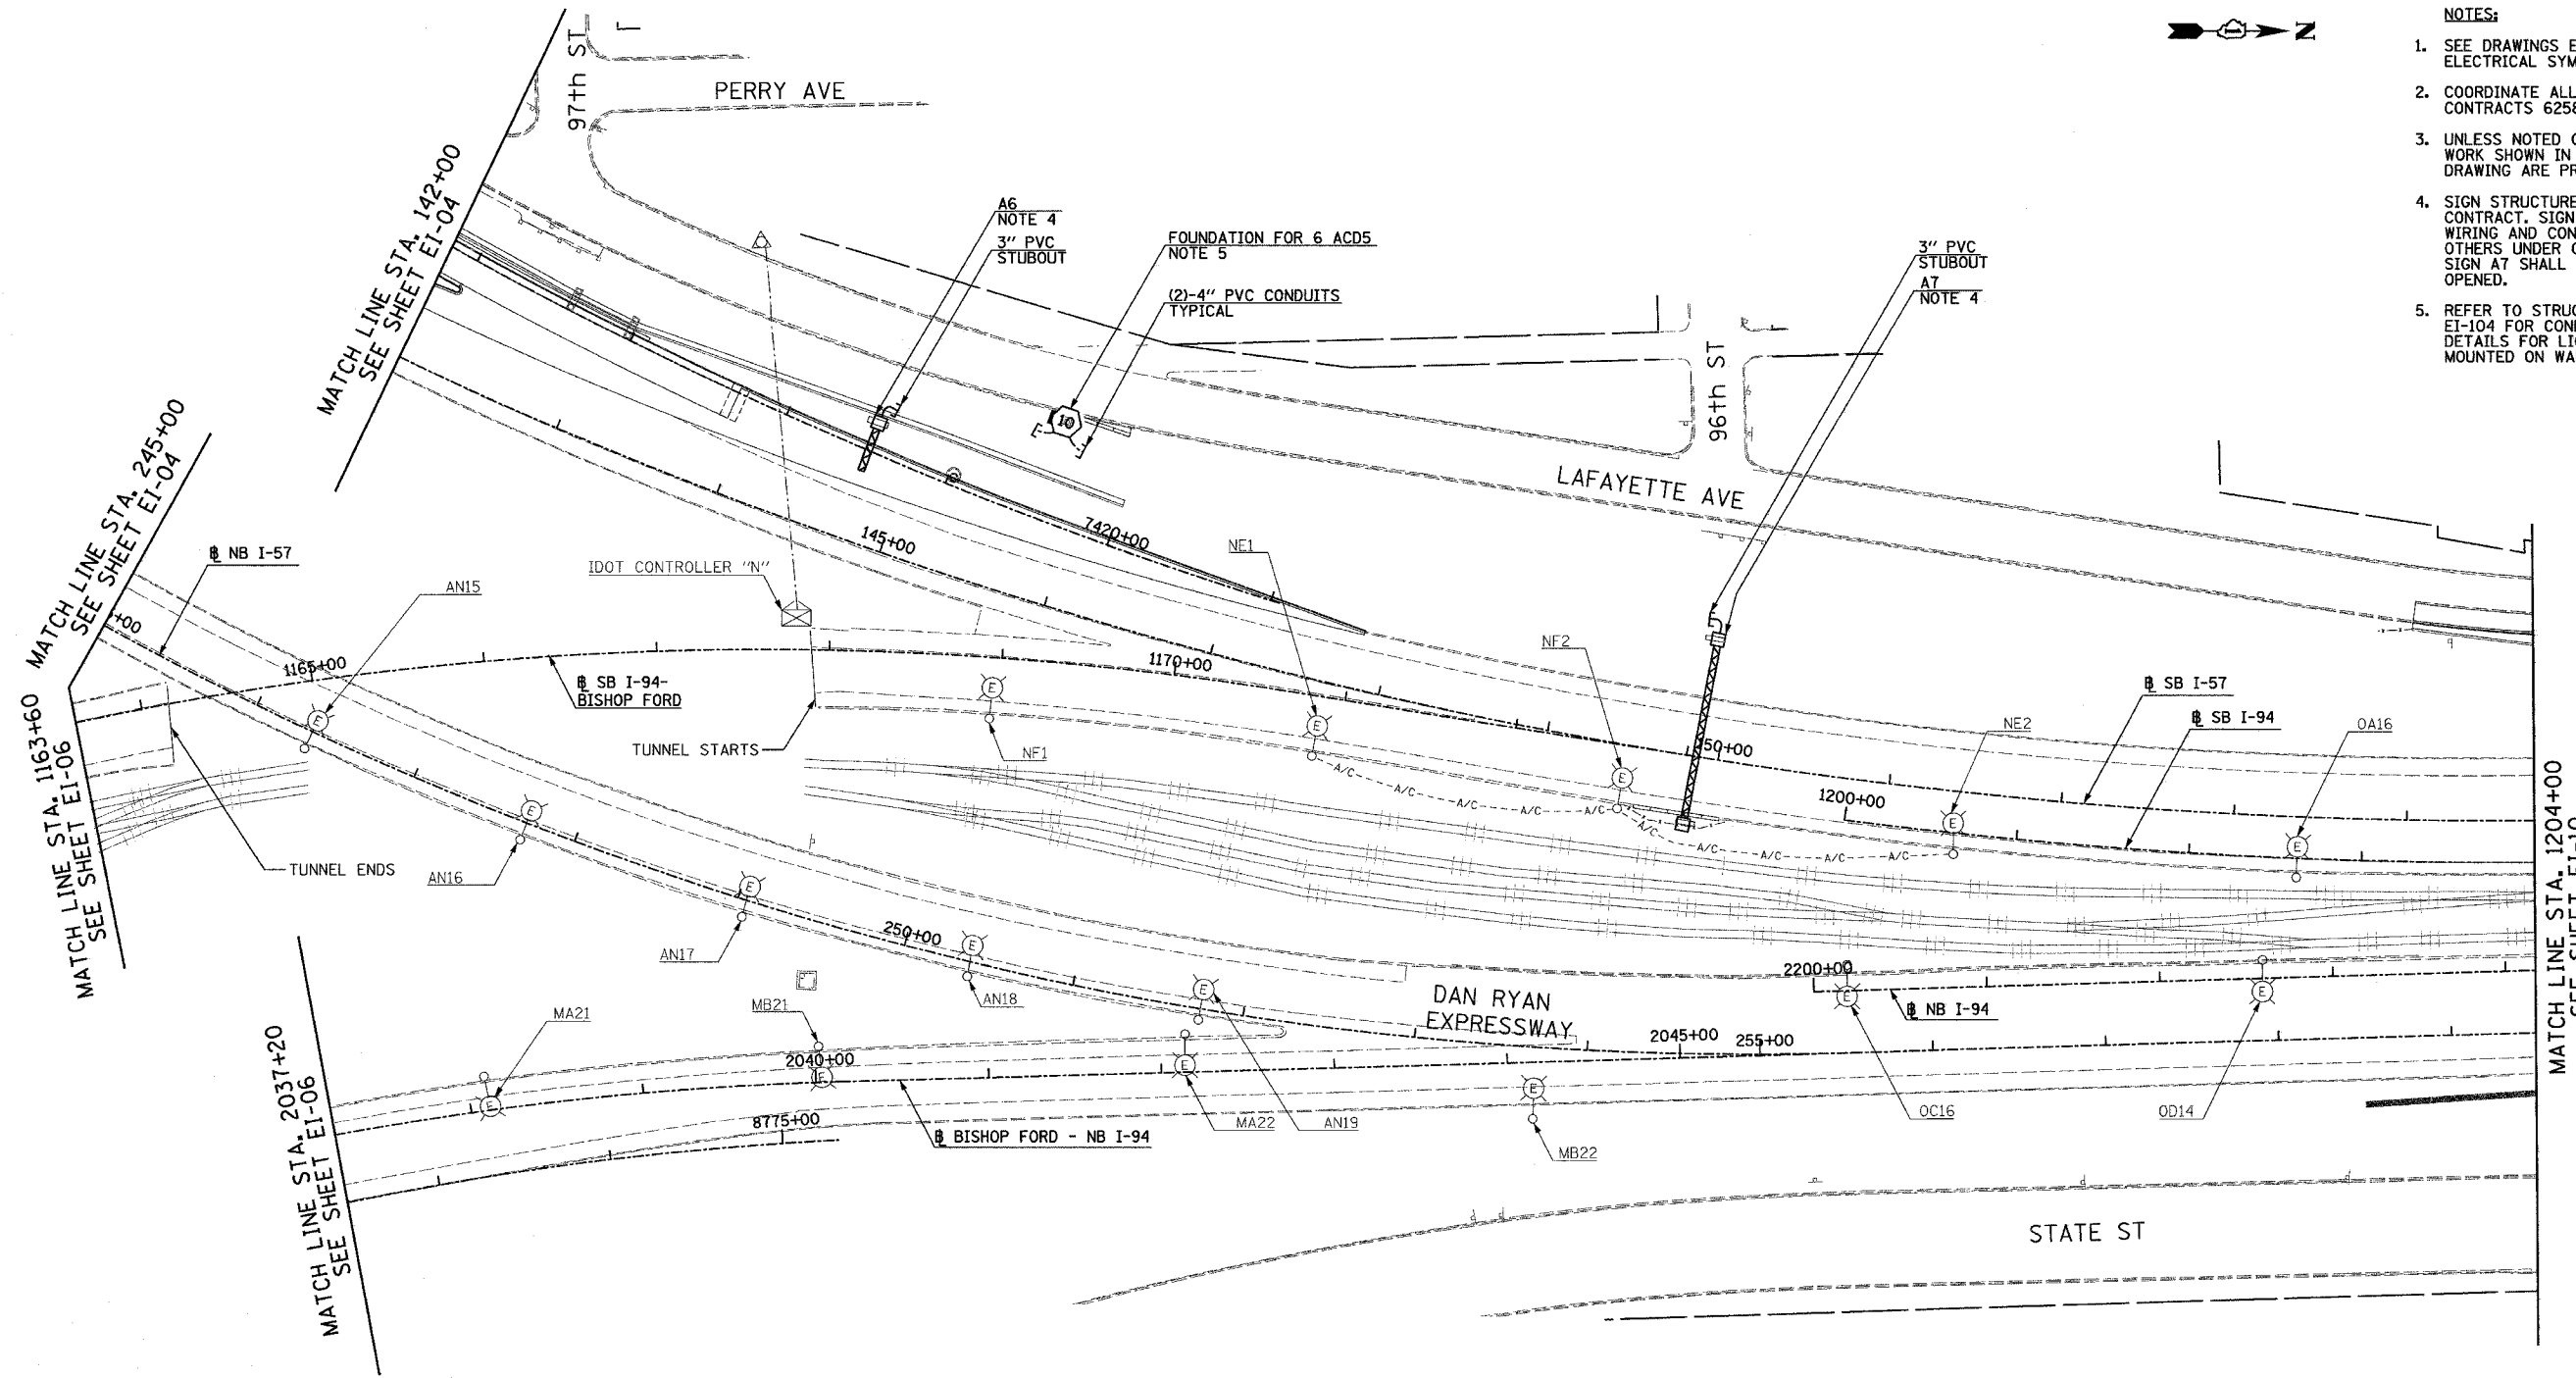

17B/EI-09

REVISIONS		
REVISED	NAME	DATE
		5/06/05

ILLINOIS DEPARTMENT OF TRANSPORTATION
F.A.I. 94 (DAN RYAN EXPRESSWAY)

ELECTRICAL INFRASTRUCTURE PLANS
PROPOSED IMPROVEMENTS

SCALE: 1"=50' DRAWN BY: VG
DATE: MARCH 25, 2005 CHECKED BY: TM

APPENDUM 1 5/21/05


SINGH
SINGH & ASSOCIATES, INC.
CONSULTING ENGINEERS

300 W. ADAMS ST.
CHICAGO, IL 60606
TEL: (312) 629-0240
FAX: (312) 629-8449

5/26/2005 4:07:45 PM

F.A.I. RTE.	SECTION	COUNTY	TOTAL SHEETS	SHEET NO.
94	*	COOK	907	372
STA. 1243+00.00		TO STA. 1255+70.00		
FED. ROAD DIST. NO.		ILLINOIS FED. AID PROJECT		
* (1516.1, 1717 & 1818) R-9		62695		

- NOTES:**
- SEE DRAWINGS EI-100 AND EI-101 FOR ELECTRICAL SYMBOLS AND ABBREVIATIONS.
 - COORDINATE ALL WORK WITH IDOT CONTRACTS 62583 AND 62694.
 - UNLESS NOTED OTHERWISE, ALL ITEMS AND WORK SHOWN IN HEAVY LINE WEIGHT ON THIS DRAWING ARE PROPOSED NEW ITEMS AND WORK.
 - REFER TO STRUCTURAL DRAWINGS AND EI-104 FOR CONDUIT INSTALLATION DETAILS FOR LIGHT TOWER FOUNDATION MOUNTED ON WALL.
 - REFER TO SHEETS EI-103, EI-106 AND EI-110 FOR HANDHOLE DETAILS.
 - REFER TO SHEET EI-107 FOR COMMUNICATIONS VAULT CI DETAILS.
 - REFER TO SHEETS EI-106, EI-110 AND EI-114 FOR RAMP METERING DETAILS.
 - REFER TO SHEET EI-XX FOR FLASHER WALL TYPE FOUNDATION DETAIL.
 - SIGN STRUCTURE SHALL BE PROVIDED UNDER THIS CONTRACT. SIGN LUMINAIRES, DISCONNECT SWITCH, WIRING AND CONNECTIONS SHALL BE PROVIDED UNDER CONTRACT 62583.
 - REFER TO SHEETS EI-102 AND ME-04 FOR DUCTBANK INSTALLATION DETAILS.

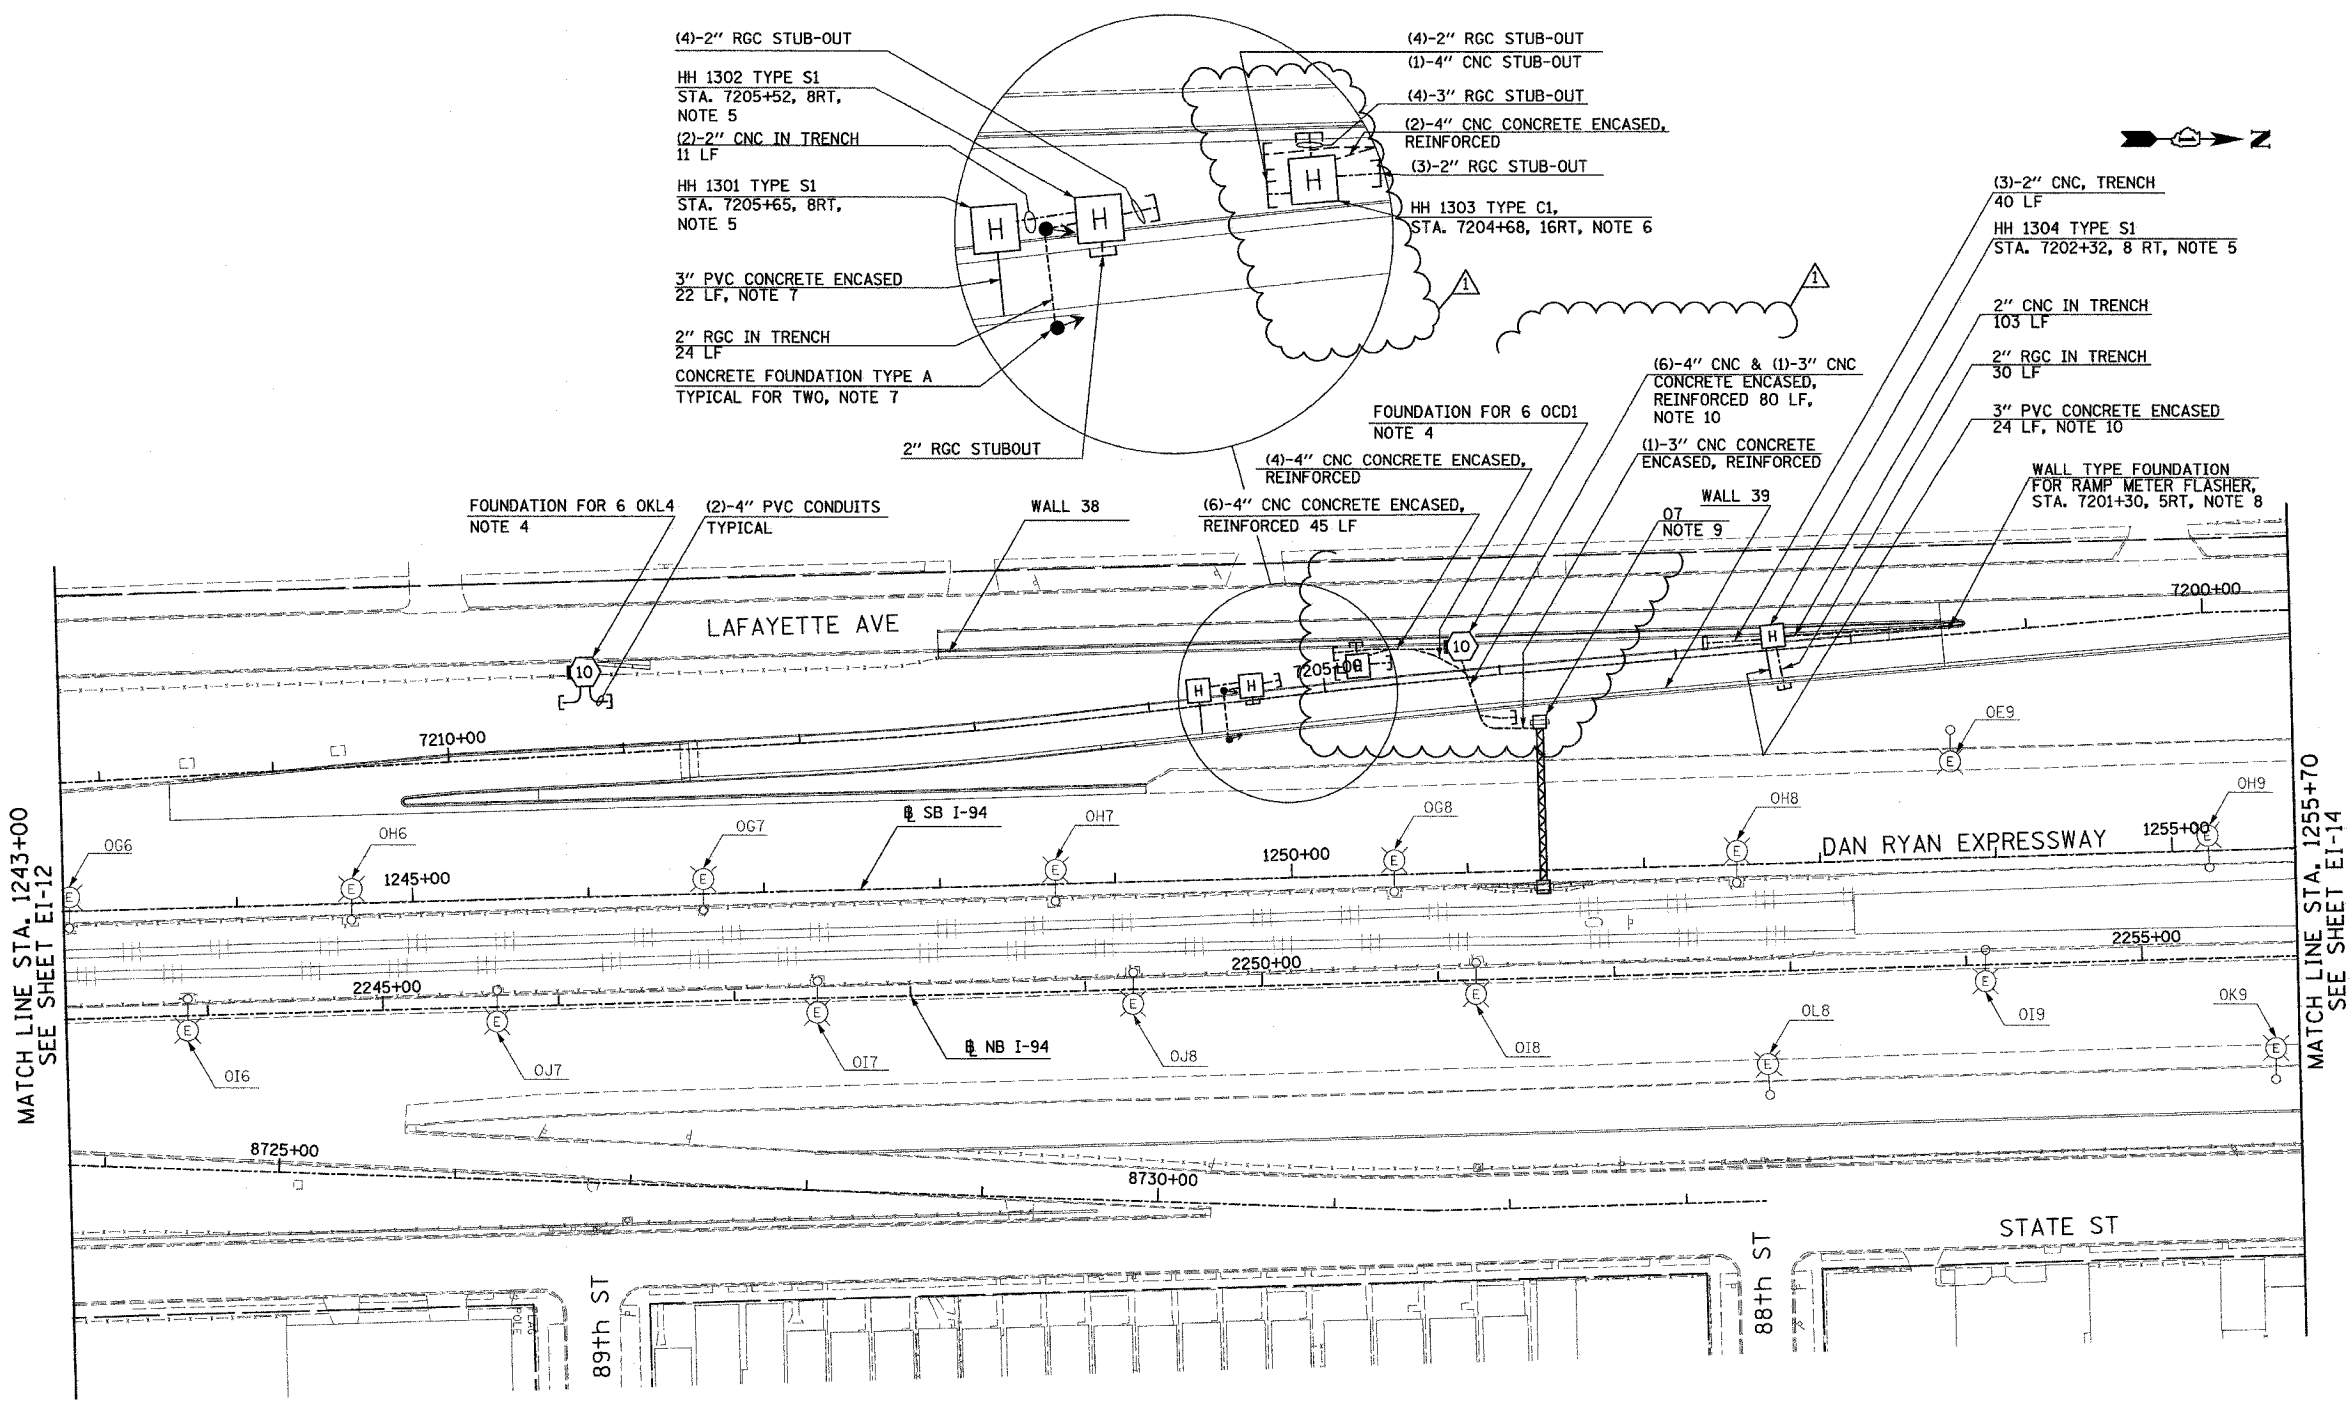

MATCH LINE STA. 1243+00
SEE SHEET EI-12

MATCH LINE STA. 1255+70
SEE SHEET EI-14



17B/EI-13

REVISIONS		
NO.	NAME	DATE
1	ADDENDUM 1	05/27/05

ILLINOIS DEPARTMENT OF TRANSPORTATION
F.A.I. 94 (DAN RYAN EXPRESSWAY)

ELECTRICAL INFRASTRUCTURE PLANS
PROPOSED IMPROVEMENTS


SCALE: 1"=50'
DATE: MARCH 25, 2005

DRAWN BY: VG
CHECKED BY: TM


SINGH 300 W. ADAMS ST.
CHICAGO, IL 60606
SINGH & ASSOCIATES, INC. TEL: (312) 629-0240
CONSULTING ENGINEERS FAX: (312) 629-8449

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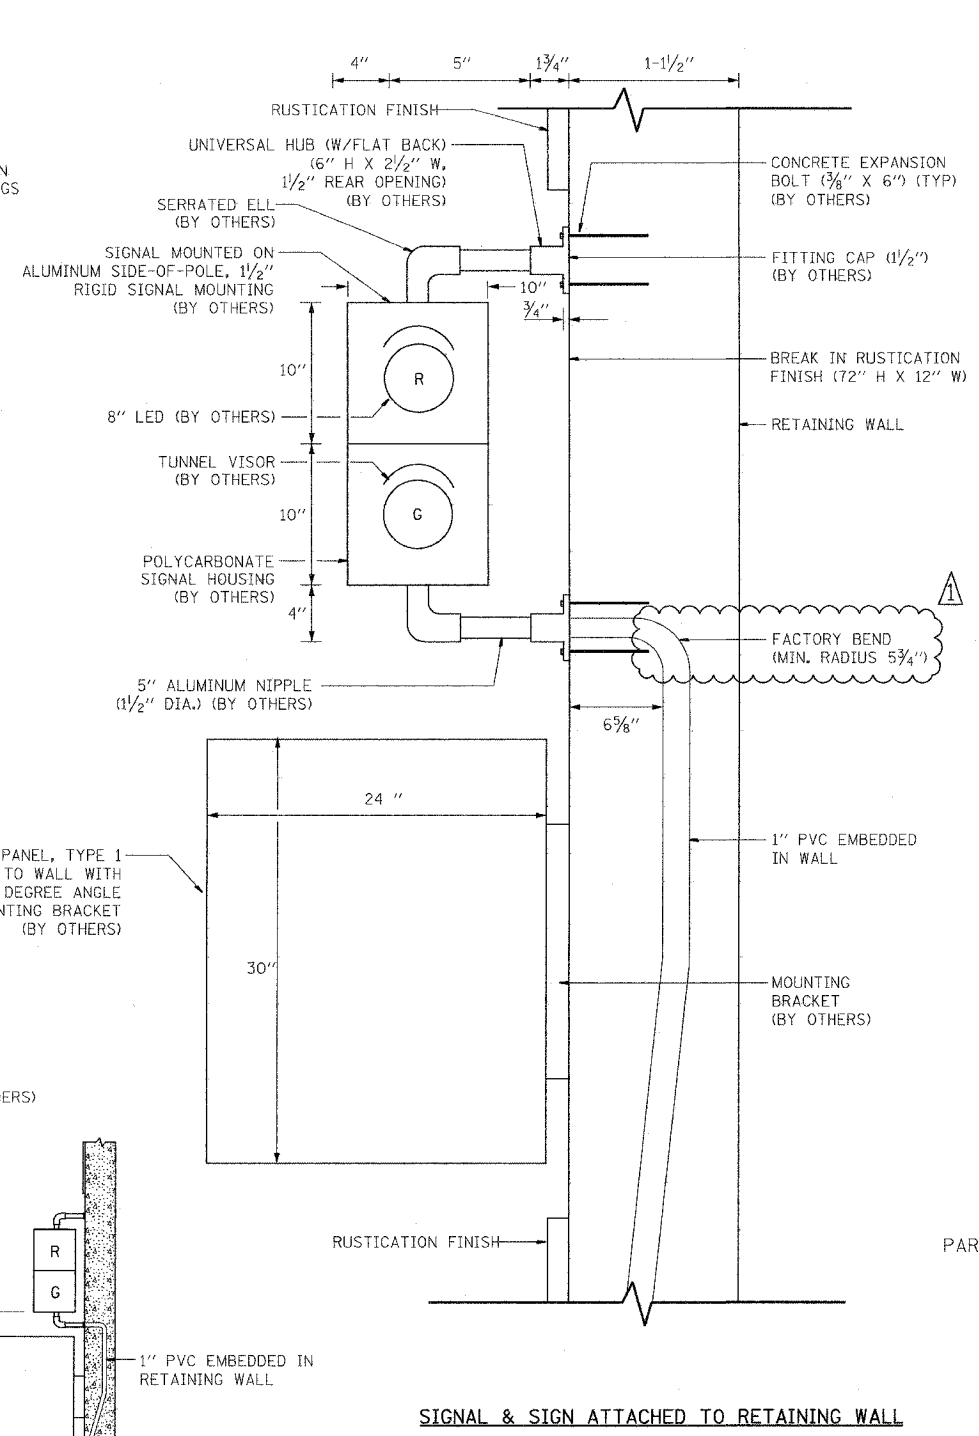
F.A.I. RTE.	SECTION	COUNTY	TOTAL SHEETS	SHEET NO.
94		COOK	907	421
STA. --- TO STA. --- 421				
FED. ROAD DIST. NO. 1 ILLINOIS FED. AID PROJECT				
(1516,1,1717 & 1818) R-9				
62695				

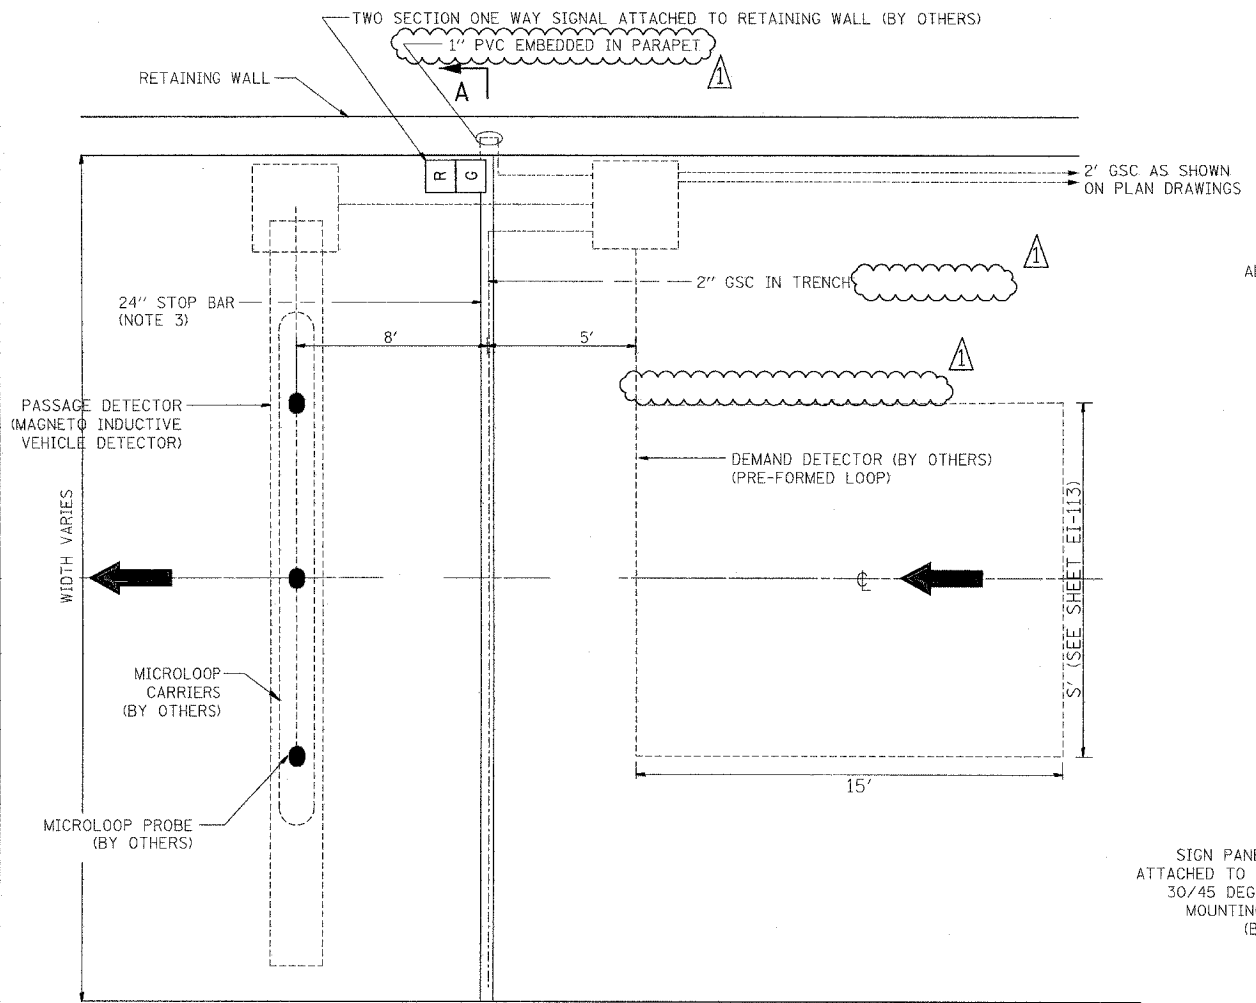

TYPICAL DETECTION LAYOUT

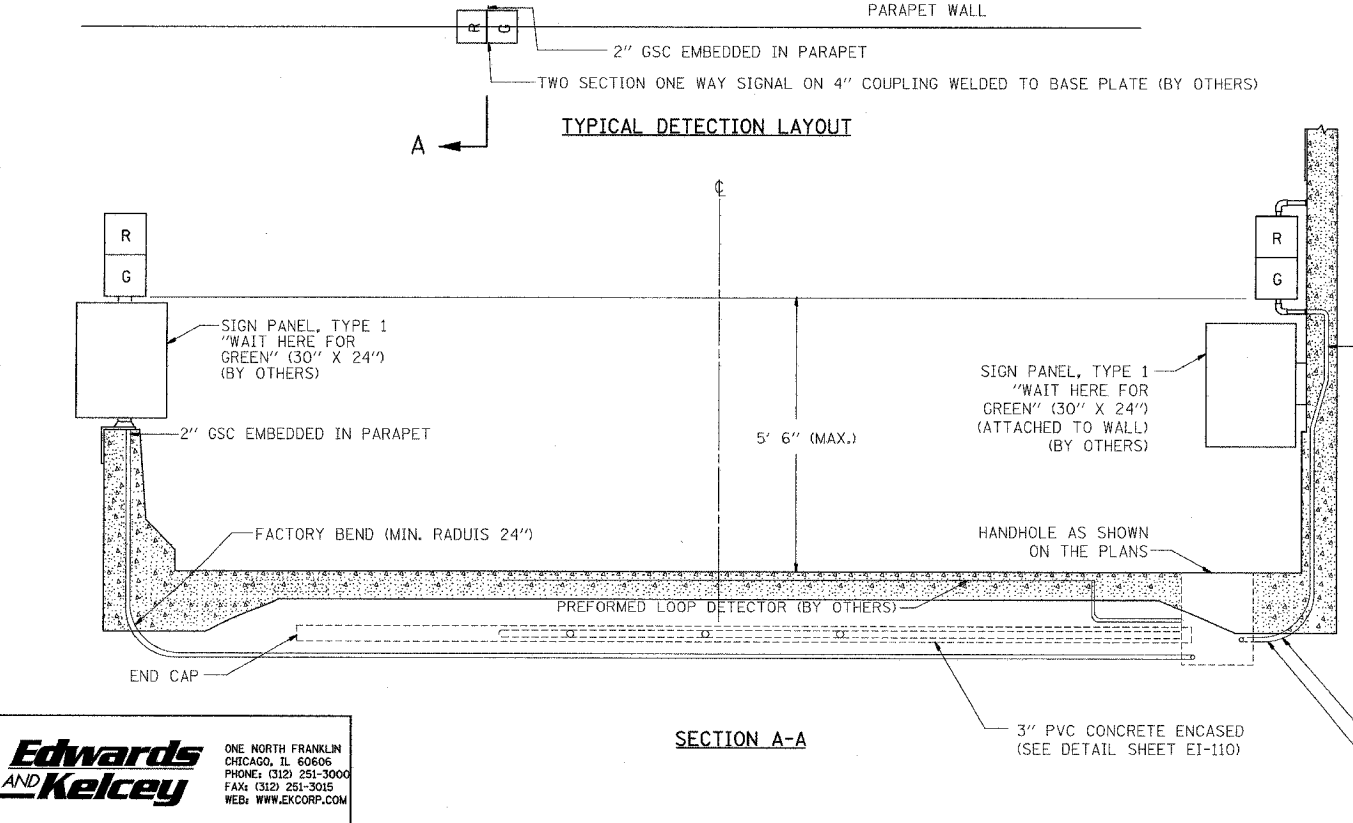


SECTION A-A



SIGNAL & SIGN ATTACHED TO RETAINING WALL

- NOTES:
1. CONDUIT AND HANDHOLE MUST BE FURNISHED AND INSTALLED UNDER THIS CONTRACT. ALL CABLES, PROBES, SIGNALS, SIGNS, AND OTHER EQUIPMENT WILL BE FURNISHED AND INSTALLED BY OTHERS UNDER CONTRACT NUMBER 62583.
 2. CONDUIT MUST BE STUBBED OUT OF CONCRETE A MINIMUM OF 3".
 3. CENTERLINE OF STOP BAR AND TRAFFIC SIGNALS SHALL BE LOCATED AT THE STATION SHOWN ON THE PLANS.

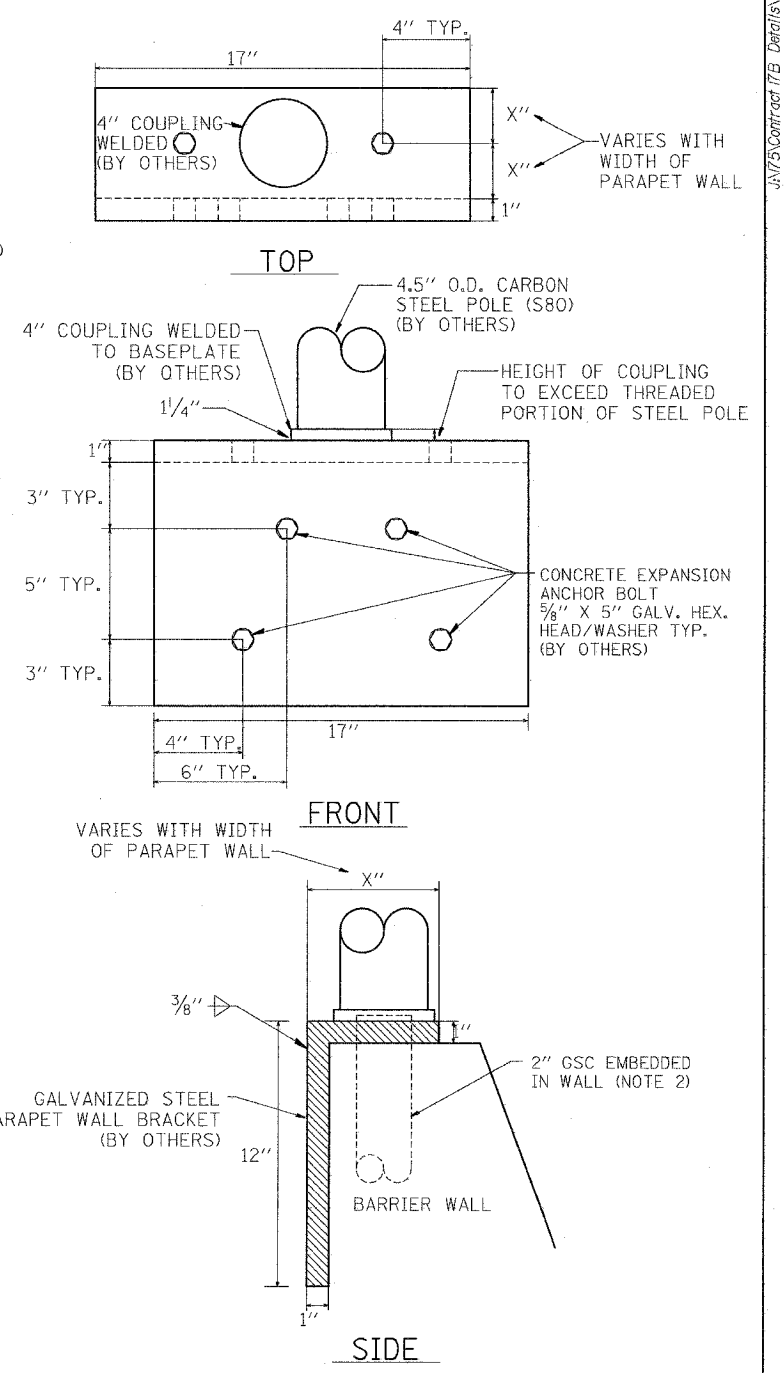

SIGNAL MOUNTED ON PARAPET WALL

17B/EI-114

Edwards and Kelcey
 ONE NORTH FRANKLIN
 CHICAGO, IL 60606
 PHONE: (312) 251-3000
 FAX: (312) 251-3015
 WEB: WWW.EKCORP.COM

REVISIONS	
NAME	DATE
ADDENDUM 1	5/21/05


ILLINOIS DEPARTMENT OF TRANSPORTATION
 F.A.I. 90/94 (DAN RYAN EXPRESSWAY)

TYPICAL RAMP METERING
 BARRIER WALL AND
 RETAINING WALL INSTALLATION


SCALE: NTS
 DATE: MARCH 25, 2005

DRAWN BY: NB
 CHECKED BY: CTC

5/26/2005 4:00:51 PM J:\75\Contract\17B_Detail\Review\00\17B-EI-114-517

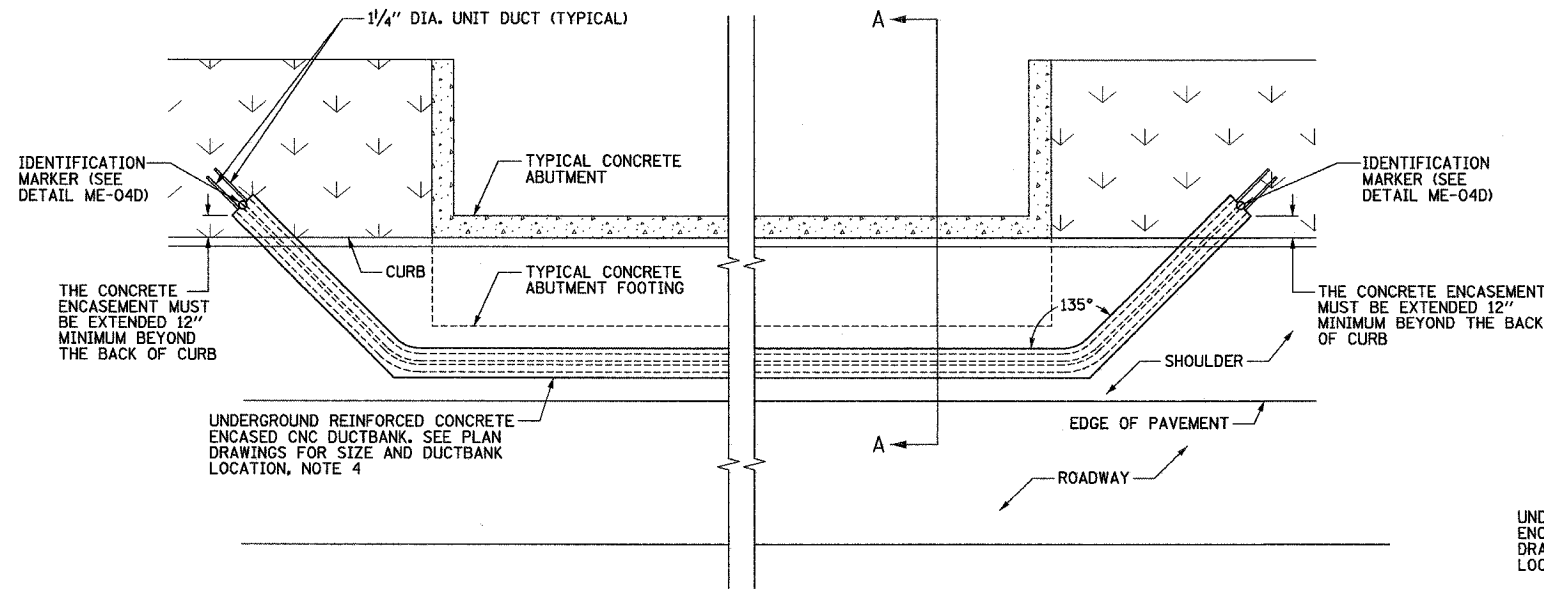



ME-04A DUCTBANK ROUTING AROUND ABUTMENT
 SCALE: 1/4" = 1'-0"
 DETAIL FOR REFERENCE ONLY, NOT INCLUDED IN THIS CONTRACT

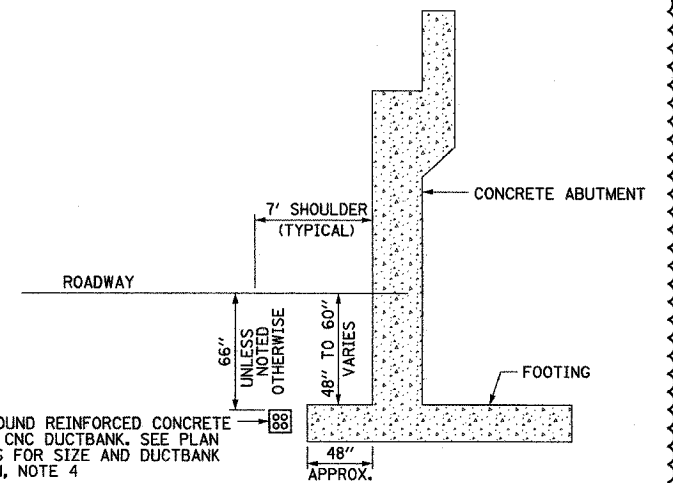


ME-04B DUCTBANK INSTALLATION DETAIL A-A
 NOT TO SCALE
 DETAIL FOR REFERENCE ONLY, NOT INCLUDED IN THIS CONTRACT

WALL	STATION	H
* 68	144+04.53	9'-2"
* 34	1216+84.52	7'-4"
* 39	1251+00.00	5'-2"
* 39	1252+81.08	9'-3"


5 INCH DIA. CIRCLE
 1 INCH HIGH LETTERS
 3/4 INCH WIDE LETTERS
 1/16 INCH STROKE WIDTH
 2 1/2 INCH ARROW LENGTH

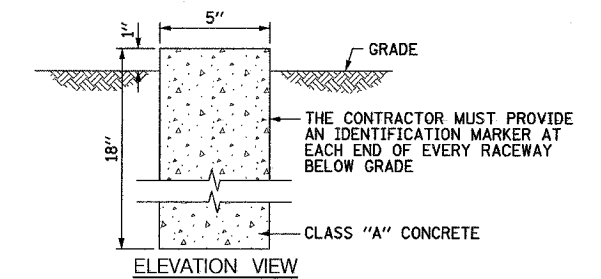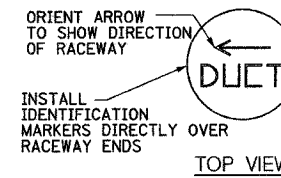

ME-04D IDENTIFICATION MARKER DETAIL
 SCALE: 3" = 1'-0"

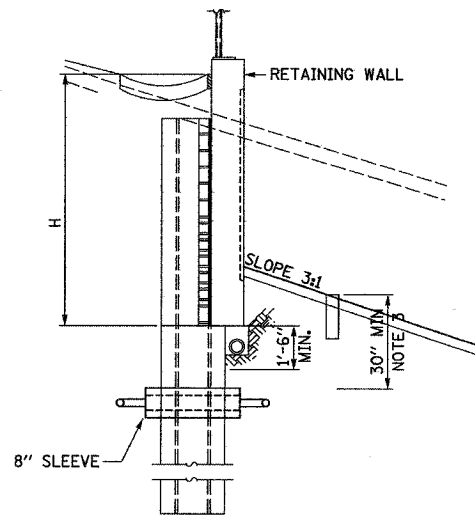

ME-04E CONCRETE ENCASED CNC UNDER WALL 68 INSTALLATION DETAIL
 NOT TO SCALE

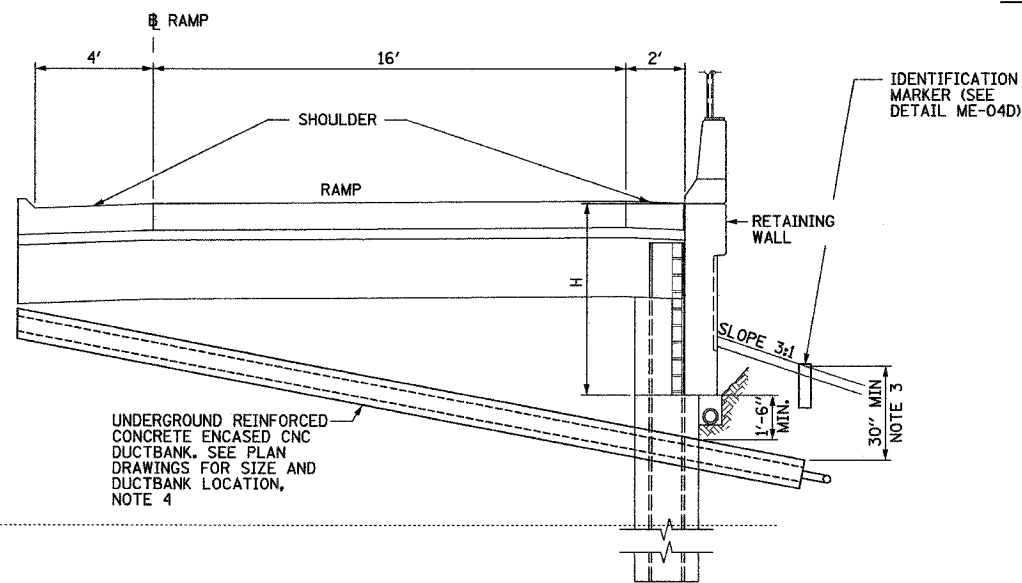


ME-04C TYPICAL CONCRETE ENCASED CNC UNDER RAMP INSTALLATION DETAIL
 NOT TO SCALE
 TYPICAL FOR WALLS 34 & 39

NOTES:

- SEE DRAWINGS ME-01 AND ME-02 FOR ELECTRICAL SYMBOLS AND ABBREVIATIONS.
- SEE PLAN DRAWINGS FOR THE PROPOSED CONDUIT ROUTING.
- DUCTBANK DEPTH MUST BE ADJUSTED SUCH THAT THE TOP OF CONCRETE ENCASEMENT IS INSTALLED UNDER THE BOTTOM OF RETAINING WALL CONCRETE FACING. THE DUCTBANK DEPTH MUST BE 30 INCHES MINIMUM.
- SEE DRAWING ME-11 FOR ELECTRICAL CONCRETE DUCTBANK DETAILS.
- SEE PLAN DRAWINGS FOR ANY DEVIATIONS IN DUCTBANK DEPTH.

17B/ME-04

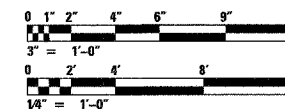

REVISIONS		ILLINOIS DEPARTMENT OF TRANSPORTATION	
NAME	DATE	F.A.I. 90/94 (DAN RYAN EXPRESSWAY)	
		DUCTBANK INSTALLATION DETAILS UNDER RAMPS AND AROUND ABUTMENTS	
		SCALE: AS SHOWN	DRAWN BY: CJM
		DATE: MARCH 25, 2005	CHECKED BY: WDS
ADDENDUM 1	05/27/05		

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