INDEX OF SHEETS


- 1 COVER SHEET
- 2 GENERAL NOTES
- 3-5 SUMMARY OF QUANTITIES
- 6 TYPICAL SECTIONS
- 7 SCHEDULE OF QUANTITIES
- 8 ALIGNMENT & BENCHMARK DATA
- 9-12 TRAFFIC CONTROL & PROTECTION
- 13-14 PLAN & PROFILE

15-23 S.N. 001-0014 PLANS

- 24 MISC DETAILS BRIDGE APPROACH PAVEMENT (SP)
- 25 MISC DETAILS TRAFFIC BARRIER TERMINAL, TY 6A (SP)
- 26 MISC DETAILS ENTRANCE DETAILS
- 27-28 CROSS SECTIONS

HIGHWAY STANDARDS

000001-04	701006- <i>02</i>
001001- <i>01</i>	701011 - <i>0</i> /
420401-05	701301- <i>02</i>
515001 - 02	701306 - <i>01</i>
630001-07	701311 - OZ
630301-0H	701321-08
631032-03	701326 - OZ
635006 - <i>DZ</i>	702001 - 06
635011-01	704001-03
701001 . 01	780001-01

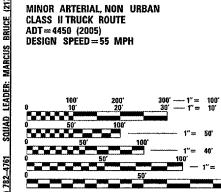

DESIGN DESIGNATION

FULL SIZE PLANS HAVE BEEN PREPARED USING STANDARD ENGINEERING SCALES. REDUCED SIZED PLANS WILL NOT CONFORM TO STANDARD SCALES. IN MAKING MEASUREMENTS ON REDUCED PLANS, THE ABOVE SCALES MAY BE USED.

J.U.L.I.E. JOINT UTILITY LOCATION INFORMATION FOR EXCAVATION 1-811-892-0123

FAP 502 (IL 57)


CONTRACT NO. 72873

ADAMS COUNTY

STATE OF ILLINOIS DEPARTMENT OF TRANSPORTATION DIVISION OF HIGHWAYS **PROPOSED HIGHWAY PLANS**

FAP ROUTE 502 (IL RTE. 57) SECTION 54BR-1 PROJECT : BHF-0502 (014) ADAMS COUNTY BRIDGE RECONSTRUCTION OVER GHOST HOLLOW CREEK

C-96-568-07

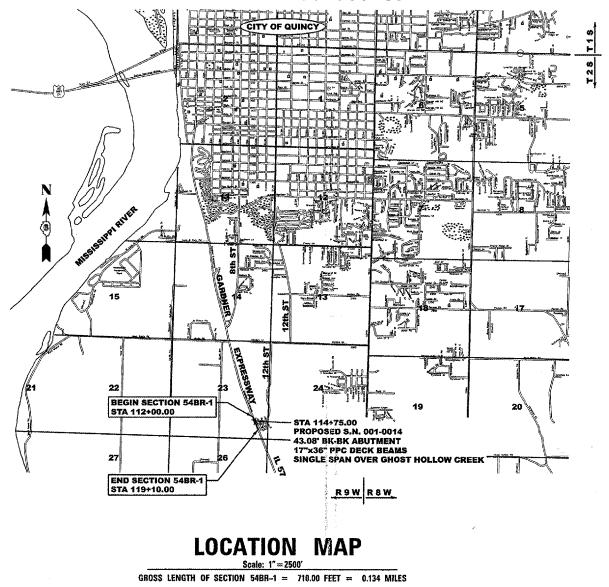

NET LENGTH OF SECTION 54BR-1 = 710.00 FEET = 0.134 MILES

SECTION 54BR-1

CONTRACT NO. 7287 F.A.P. RTE. 502 TOTAL SHEET SECTION COUNTY 54BR-1 ADAMS 28 D-96-526-04 HENRI OGLE LEE HITESIDE HENRY BUREAU KANKAKE Requests NC I FAS DE WIT GREEN CLAR: LOCATION OF SECTION INDICATED THUS: -STATE OF ILLINOIS DEPARTMENT OF TRANSPORTATION DIVISION OF HIGHWAYS SUBMITTE THE FUCINEER New JEE. BAN KLINGNEF 062-053338 & ASSOCIATES, P.C. LICENSED PROFESSIONAL STEVE E. BANGE ars / Architects REGISTERED PROFESSIONAL ENGINEER ENGINEER 616 North 24th Street (2)11 223-3670 Dulney, Illinois 62301 FAX: 223-3600 Internet Address: www.kilingner.c STATE OF ILLINOIS DESIGN FIRM * 184273 LLINOIS IN THE REAL OF THE REA **PRINTED BY THE AUTHORITY** OF THE STATE OF ILLINOIS

RATES OF APPLICATION TABLE

AGGREGATE (SURFACE, BASE, BASE, OR BACKFILL) 2.05 TON/CU YD SUBBASE GRANULAR MATERIAL, TYPE C 1.80 TON/CU YD STONE DUMPED RIPRAP 1.50 TON/CU YD

BITUMINOUS CONCRETE: BITUMINOUS MATERIALS (PRIME COAT) BITUMINOUS MATERIALS (PRIME COAT) AGGREGATE PRIME COAT BITUMINOUS CONCRETE SURFACE / BINDER

SEEDING AREAS: NITROGEN FERTILIZER NUTRIENT PHOSPHOROUS FERTILIZER NUTRIENT POTASSIUM FERTILIZER NUTRIENT AGRICULTURAL GROUND LIMESTONE MULCH TEMPORARY EROSION CONTROL SEEDING

SODDING AREAS: NITROGEN FERTILIZER NUTRIENT PHOSPHOROUS FERTILIZER NUTRIENT POTASSIUM FERTILIZER NUTRIENT AGRICULTURAL GROUND LIMESTONE SUPPLEMENTAL WATERING

LIME FOR LIME MODIFIED SOILS, 12" WATER FOR LIME MODIFIED SOILS, 12"

0.00038 TON/SQ YD (on pavement) 0.001425 TON/SQ YD (on aggregate) 0.002 TON/SQ YD 0.055 TON/SQ YD=IN



0.0186 LBS/S0 YD 0.0011 LBS/S0 YD 0.0074 LBS/S0 YD 0.000046 TON/SQ YD 0.009 UNITS/SQ YD (3 appl. a 3GAL/ SQ YD)

0.02 TON/SQ YD 0.007 UNITS/SQ YD (1 UNIT = 1000 GAL)

GENERAL NOTES

THE NOMINAL THICKNESS FOR BASE AND SURFACE COURSES ARE SHOWN ON THE TYPICAL SECTIONS, STANDARDS, SCHEDULES, OR SPECIAL DETAILS. THE CONSTRUCTED THICKNESS OF THE ABOVE ITEMS SHALL NOT BE LESS THAN 90 PERCENT OF THE NOMINAL THICKNESS AT ANY LOCATION.

THE THICKNESS OF BITUMINOUS MIXTURE SHOWN ON THE PLANS IS THE NOMINAL THICKNESS. DEVIATIONS FROM THE NOMINAL THICKNESS WILL BE PERMITTED WHEN SUCH DEVIATIONS OCCUR DUE TO IRREGULARITIES IN THE EXISTING SURFACE OR BASE ON WHICH THE BITUMINOUS MIXTURE IS PLACED.

- 2. WHERE SECTION OR SUBSECTION MONUMENTS ARE ENCOUNTERED, THE ENGINEER SHALL BE NOTIFIED BEFORE SUCH MONUMENTS ARE REMOVED. THE CONTRACTOR SHALL PROTECT AND CAREFULLY PRESERVE ALL PROPERTY MARKERS AND MONUMENTS UNTIL THE OWNER AND AN AUTHORIZED SURVEYOR OR AGENT, HAS WITNESSED OR OTHERWISE REFERENCED THEIR LOCATION.
- 3. ALL ELEVATIONS SHOWN REFER TO THE U.S.G.S. DATUM AT SEA LEVEL, UNLESS OTHERWISE NOTED.
- 4. UTILITIES ARE SHOWN IN ACCORDANCE WITH THE BEST AVAILABLE INFORMATION, AND THEIR TRUE LOCATION IS NOT GUARANTEED TO BE AS SHOWN ON THE PLANS. IT WILL BE THE CONTRACTOR'S RESPONSIBILITY TO DETERMINE THE EXACT LOCATION OF ALL UTILITIES AND CARRY OUT HIS OR HER OPERATIONS ACCORDINGLY.
- 5. THE FOLLOWING UTILITIES HAVE FACILITIES WITHIN THE LIMITS OF CONSTRUCTION:

AMERITECH	TELEPHONE	601 BROADWAY, QUINCY IL	217-224-9961
MCLEOD USA	TELEPHONE	510 MAINE ST. QUINCY, IL	217-228-7900
AMEREN CIPS	ELECTRICAL	700 JERSEY, QUINCY, IL	1-800-789-2477
AMEREN CIPS	GAS	700 JERSEY, QUINCY, IL	1-800-789-2477
INSIGHT COMMUNICATIONS	CABLE	2930 STATE ST. QUINCY, IL	217-222~53BB
MILL CREEK WATER DISTRICT	WATER	6415 HICKORY GROVE NORTH, QUINCY, IL	217-224-9343

6. ADJUSTMENTS OF UTILITY LOCATIONS SHALL BE MADE BY THE OWNER, UNLESS OTHERWISE NOTED.

- 7. SEEDING SHALL BE DONE ON ALL AREAS THAT ARE DISTURBED BY CONSTRUCTION OPERATIONS AS DIRECTED BY THE ENGINEER. SEEDING SHALL BE PAID FOR ONLY WITHIN THE EXISTING RIGHT-OF-WAY LIMITS. ALL AREAS DISTURBED BY THE CONTRACTOR OUTSIDE THE PROPOSED CONSTRUCTION LIMITS SHALL BE SEEDED AS DIRECTED BY THE ENGINEER, AT THE CONTRACTOR'S EXPENSE. SEEDING WILL NOT BE PERMITTED AT ANY TIME WHEN THE GROUND IS FROZEN. WET, OR IN AN UNTILABLE CONDITION. SEEDING CLASS 2 SHALL BE USED ON AREAS FLATTER THAN 3:1, SEEDING CLASS 3 SHALL BE USED ON AREAS 3:1 AND STEEPER.
- 8. ANY REFERENCE TO A STANDARD IN THESE PLANS SHALL BE INTERPRETED TO MEAN THE EDITION, AS INDICATED BY THE SUB-NUMBER ON THE COVER SHEET.
- 9. ALL DETAILS IN THESE PLANS SHALL GOVERN THE CONSTRUCTION OF THIS PROJECT, AND IN CASE OF CONFLICT WITH ANY STANDARD DRAWINGS INCLUDED, THE SAID DETAILS SHALL GOVERN.
- 10. THE EXISTING ROAD SIGNS THAT INTERFERE WITH CONSTRUCTION SHALL BE REMOVED AND RELOCATED AS DIRECTED BY THE ENGINEER. THIS WORK WILL NOT BE PAID FOR SEPARATELY BUT SHALL BE CONSIDERED AS PART OF THE CONTRACT AND NO COMPENSATION WILL BE ALLOWED.
- 11. EXISTING MAILBOXES SHALL BE TEMPORARILY RELOCATED FOR CONTINUED OPERATION AS NECESSARY DURING CONSTRUCTION. MAIL BOXES SHALL BE RELOCATED TO THEIR FINAL LOCATION AFTER CONSTRUCTION AS DIRECTED BY THE ENGINEER. THIS WORK WILL NOT BE PAID FOR SEPARATELY BUT SHALL BE CONSIDERED AS PART OF THE CONTRACT AND NO COMPENSATION WILL BE ALLOWED.
- 12. THE CONTRACTOR SHALL BE RESPONSIBLE FOR PROTECTING UTILITY PROPERTY FROM CONSTRUCTION OPERATIONS AS OUTLINED IN ARTICLE 107.31 OF THE STANDARD SPECIFICATIONS.
- 13. FOR STABILIZATION, ALL TYPE III BARRICADES SHALL REQUIRE A MINIMUM OF FOUR SAND BAGS PER BARRICADE.
- 14. ANY REFERENCE TO "BITUMINOUS" SHOULD BE INTERPRETED TO MEAN "HOT MIX" TO REFLECT THE NEW STANDARD SPECIFICATIONS FOR ROAD AND BRIDGE CONSTRUCTION ADOPTED JANUARY 1, 2007, UNLESS OTHERWISE SPECIFIED IN THE SPECIFICATIONS.
- 15. ANY DAMAGE TO THE UNDERGROUND FACILITIES CAUSED BY THE CONTRACTOR SHALL BE REPAIRED TO THE SATISFACTION OF THE DEPARTMENT AT THE CONTRACTOR'S EXPENSE. INCLUDING TEMPORARY REPAIRS WHICH MAY BE REDURED TO KEEP THE FACILITY OPERATIONAL WHILE MATERIAL IS BEING OBTAINED TO MAKE PERMANENT REPAIRS.
- 16. ACCESS TO ALL PROPERTIES AND SIDE ROADS SHALL BE MAINTAINED AT ALL TIMES.
- 17. GUARDRAIL MARKERS SHALL BE ATTACHED TO THE RAIL OF THE PROPOSED "TRAFFIC BARRIER TERMINAL TYPE 1 SPECIAL" RAIL ELEMENTS, MARKERS IN THE AREA OF THE TRAFFIC BARRIER TERMINAL TYPE 1 SPECIAL SHALL BE MOUNTED ON THE TOP OF THE NEAREST POST.
- 18. ALL SAW CUTS REQUIRED FOR PAVEMENT, SHOULDER, SURFACE, AND STRUCTURE REMOVALS SHALL NOT BE MEASURED FOR PAYMENT. THE COST OF SAW CUTS WILL BE INCLUDED IN THE COST OF THE RESPECTIVE PAY ITEMS.
- 19. REMOVAL OF RAISED REFLECTIVE MARKERS SHALL NOT BE MEASURED FOR PAYMENT. THE COST OF REMOVING THE RAISED REFLECTIVE PAVEMENT MARKERS SHALL BE INCLUDED IN THE COST OF THE PAY ITEM FOR BITUMINDUS SURFACE REMOVAL. NEW RAISED REFLECTIVE PAVEMENT MARKERS SHALL BE FURNISHED AND INSTALLED BY OTHERS UNDER A FUTURE CONTRACT.

EXAM OPER EXAN PROG EXAN

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		CONTRACT	NO. 728	373
F.A.P. RTE.	SECTION	COUNTY	TOTAL	SHEET NO.
502	54BR~1	ADAMS	28	2
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FED. ROA	I DIST, NO. 11.	INDIS FED. AID	PROJECT	

DISTRICT SIX
INED June 26 2007
INED June 28 20 07 RAM IMPLEMENTATION ENGINEER
INED 20 07
RAM DEVELOPMENT ENGINEER
REVISIONS ILLINOIS DEPARTMENT OF TRANSPORTATION
GENERAL NOTES FAP 502 (IL 57) SECTION 54BR-1 ADAMS COUNTY
SCALE: VERT. DRAWN BY HORIZ. DRAWN BY DATE 6/28/2007 CHECKED BY EBB

				80% FED.			EDERAL TION AND S
	SUMMARY OF QUANTITIES			20% STATE	X080-2A		
CODE NO.	ITEM	SP. PROV.	UNIT	TOTAL QUANTITIES			
20200100	EARTH EXCAVATION	31.1101	CU YD	30	30		
20200500	EARTH EXCAVATION (WIDENING)		CU YD	135	135		
25000200	SEEDING, CLASS 2		ACRE	0.3	0.3		
25000300	SEEDING, CLASS 3		ACRE	0.1	0.1		
25000400	NITROGEN FERTILIZER NUTRIENT		POUND	36	36		
25000500	PHOSPHORUS FERTILIZER NUTRIENT		POUND	36	36	·····	
25000600	POTASSIUM FERTILIZER NUTRIENT		POUND	36	36		
25000700	AGRICULTURAL GROUND LIMESTONE		TON	0.8	0.8		
25100105	MULCH, METHOD 1		ACRE	0.4	0.4		
20100100			ACTL				
28000250	TEMPORARY EROSION CONTROL SEEDING		POUND	40	40		
31100300	SUB-BASE GRANULAR MATERIAL, TYPE A 4"		SO YD	212	212		
35501324	HOT-MIX ASPHALT BASE COURSE. 10"		SO YD	312	312		
35561524				JIZ	512		
35600716	HOT-MIX ASPHALT BASE COURSE WIDENING, 10"		SO YD	269	269		
40200100	AGGREGATE SURFACE COURSE, TYPE A		TON	47	47		
40600200	BITUMINOUS MATERIALS (PRIME COAT)		TON				
40600200	DITUMINUUS MATERIALS (FRIME CUAT)		T.ON	1.0	1.0		
40600300	AGGREGATE (PRIME COAT)		TON	4.9	4,9		
40600990	TEMPORARY RAMP		SO YD	105	105		
10007010							
40603540	POLYMERIZED HOT-MIX ASPHALT SURFACE COURSE, MIX "D", N70		TON	199	199		
40800050	INCIDENTAL HOT-MIX ASPHALT SURFACING		TON	27	27		
42001400	BRIDGE APPROACH PAVEMENT (SPECIAL)		SQ YD	220	220		
42001470			CO VD				
42001430	BRIDGE APPROACH PAVEMENT CONNECTOR (FLEXIBLE)		SO YD	44	44		
44000100	PAVEMENT REMOVAL		SQ YD	241	241		
44000155	HOT-MIX ASPHALT SURFACE REMOVAL, 1 1/2"		SO YD	2364	2364		
44000200	DRIVEWAY PAVEMENT REMOVAL		SO YD	31	31		
44004250	PAVED SHOULDER REMOVAL	· · · · · · · · · · · · · · · · · · ·	SQ YD	532	532		
48101200	AGGREGATE SHOULDERS, TYPE B		TON	37	37		
50101500	REMOVAL OF EXISTING SUPERSTRUCTURES		EACH	1	1		

PLOT DATE = 7/2/2037 FILE NAME = c1/Projects/d652681/Mingner-PLOT SCALE = 185.8824 * / JM. SFILE8

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					F.A.P. RTE.	SECTION		ONTRACT COUNTY	NO. 72 TOTAL SHEETS	B73
					502	54BR~1		ADAMS	28	3
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					AD	AMS 1	01 001	INTY		
				SCALE: VERT, HORIZ				DRAWN	BY S	SEB
				DATE 6/28	/2007			CHECKE		

	SUMMARY OF QUANTITIES			80% FED. 20% STATE	X080~2A	CONSTRUCT	DERAL
CODE N		CD DDAY	1117	TOTAL			
CODE N 5030020		SP. PROV.	UNIT SO YD	OUANTITIES	421		
				421			
5030030	DO PROTECTIVE COAT		SQ YD	······································	H2		
5040030	05 PRECAST PRESTRESSED CONCRETE DECK BEAMS (17" DEPTH)		SO FT	1408	1408		
5080020	05 REINFORCEMENT BARS, EPOXY COATED		POUND	2015	2015		
508005	15 BAR SPLICERS		EACH	44	44		
509010	50 STEEL RAILING, TYPE SM		FOOT	86	86		
5150010	00 NAME PLATES		EACH	1	1		
¥ 6300000	OO STEEL PLATE BEAM GUARD RAIL, TYPE A		FOOT	243.8	243.8		
* 6310008	B7 TRAFFIC BARRIER TERMINAL, TYPE 6A	*	EACH	3	3		
* 6310016	57 TRAFFIC BARRIER TERMINAL TYPE 1, SPECIAL (TANGENT)	1	ЕАСН	1	1	·····	
¥ 6310016	59 TRAFFIC BARRIER TERMINAL TYPE 1, SPECIAL (FLARED)		EACH	3	3		
6320031	10 GUARDRAIL REMOVAL		FOOT	463	46.7		
			F001	465	463		
6700040	00 ENGINEER'S FIELD OFFICE, TYPE A		CAL MO	8	8		
6710010	00 MOBILIZATION		L SUM	1	1		
7010046	TRAFFIC CONTROL AND PROTECTION, STANDARD 701306		L SUM	1	1		
7010050	OO TRAFFIC CONTROL AND PROTECTION, STANDARD 701326		L SUM	1	1		
7010120	D5 TRAFFIC CONTROL AND PROTECTION, STANDARD 701321 (SPECIAL)		EACH	1	1		
7010381	15 TRAFFIC CONTROL SURVEILLANCE		CAL DA	7	7		
7010650			EACH				
				•	!		
7030010	DO SHORT-TERM PAVEMENT MARKING		FOOT	72	72		
7030023	30 TEMPORARY PAVEMENT MARKING - LINE 5"		FOOT	1600	1600		
7030028	BO TEMPORARY PAVEMENT MARKING - LINE 24"		FOOT	18	18		
7030063	30 TEMPORARY PAINT PAVEMENT MARKING LINE 5"		FOOT	3342	3342		
7030066	60 TEMPORARY PAINT PAVEMENT MARKING LINE 24"		FOOT	45	45		
7030100	DO WORK ZONE PAVEMENT MARKING REMOVAL		SQ FT	2209	2209		
7040010	DO TEMPORARY CONCRETE BARRIER	· · · · · · · · · · · · · · · · · · ·	FOOT	481	481		
7040020	00 RELOCATE TEMPORARY CONCRETE BARRIER		FOOT	481	481		

PLOT DATE = 7/2/2007 FILE WANE = cn?P-o_jecs\d852684\Wingnew_โ/ PLOT SCALE = 185,8824 '/)%

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* SPECIALTY ITEMS

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				F.A.P.	SECTION		NTRACT	NO. 728 TOTAL SHEETS	73 Shee
				F.A.P. RTE. 502	54BR-1		ADAMS	SHEETS 28	NO. 4
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-			SCALE: VERT. HORIZ. DATE 6/28	N	DNE			BY SEB	
			DATE 6/28.	/2007			CHECKED) BY	E.BB


									F.A.P. SECTION 502 54BR-1	CONTRACT NO. 72 COUNTY TOTA ADAMS 28 O STA. DIS FED. AID PROJE
A				80% FED.		% FEDERAL CONSTRUCTION AND	% STATE SAFETY TYPE CODE	*****		
CODE 110	SUMMARY OF QUANTITIES	SP. PROV.	UNIT	20% STATE TOTAL QUANTITIES	X080-2A					
CODE NO. 78001120	PAINT PAVEMENT MARKING - LINE 5"	SP. PROV.	FOOT	1600	1600					
78001180	PAINT PAVEMENT MARKING - LINE 24"		FOOT	18	18		· · · · · · · · · · · · · · · · · · ·			
78200410	GUARDRAIL MARKERS, TYPE A		EACH	10	10					
78201000	TERMINAL MARKER - DIRECT APPLIED	1	EACH	4	4					
X0325305	STRUCTURAL REPAIR OF CONCRETE (DEPTH EQUAL TO OR LESS THAN 5 INCHES)		SQ FT	50	50					
X5030305	CONCRETE WEARING SURFACE, 5"	4	SQ YD	157	157					
x7200201	WIDTH RESTRICTION SIGNING	4	L SUM	1	1					
XX005496	TRAFFIC BARRIER TERMINAL TYPE 6A (SPECIAL)		EACH	1	1					
20001900	ASBESTOS BEARING PAD REMOVAL		EACH	24	24					
Z0013798	CONSTRUCTION LAYOUT		LSUM	1	1					
20030250	IMPACT ATTENUATORS, TEMPORARY (NON- REDIRECTIVE), TEST LEVEL 3		EACH	5	2					
		· · · · · · · · · · · · · · · · · · ·								
20030260	IMPACT ATTENUATORS, TEMPORARY (FULLY REDIRECTIVE, NARROW), TEST LEVEL 3		EACH	2	2			· · · · · · · · · · · · · · · · · · ·		
20030330	IMPACT ATTENUATORS, RELOCATE (FULLY REDIRECTIVE), TEST LEVEL 3		EACH	2	2					
Z0030350	IMPACT ATTENUATORS, RELOCATE (NON- REDIRECTIVE), TEST LEVEL 3	1	EACH	2	2					
20073500	TEMPORARY SUPPORT SYSTEM	v	LSUM	1	1					

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PLOT DATE = 7/2/2007 FILE NAME = c1/Projects/d552604/ PLOT 5CALE = 105.0024 '/ jN,

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DATE = 7/2/2007 NAME = c1/Projects/465260 SCALE = 105.8824 '/ IN.

PLOT FILE PLOT

			С	ONTRACT	NO. 728	873	
	.A.P. TE.	SECTION		COUNTY	TOTAL SHEETS	SHEET NO.	
! !	502	54BR-1		ADAMS	28	6	
-	TA.			O STA.			
FE	D. ROAD	DIST. NO.	ILLINO	IS FED. AID	PROJECT		
LEGEND							
E1 EXISTING 9"-6"-6" PAVEMENT							
E2 EXISTING HOT-MIX ASPHALT BASE COURSE WID	DENIN	G					
E3 EXISTING HOT-MIX ASPHALT SURFACE AND BIN	DER	COURSE,	4¾	'' AND VAF	RIES		
(E4) EXISTING HOT-MIX ASPHALT SHOULDERS, 8"	E4 EXISTING HOT-MIX ASPHALT SHOULDERS, 8"						
(E5) EXISTING CONCRETE V-GUTTER, TYPE A							
(E6) EXISTING HOT MIX ASPHALT SURFACE AND BIN	NDER	COURSE,	, 6″	AND VARIE	ES		
E7 EXISTING REINFORCED PCC BASE COURSE							
<u></u>							
1 PROPOSED HOT-MIX ASPHALT SURFACE REMOVA	AL, 17	2					
(2) PROPOSED POLYMERIZED HOT-MIX ASPHALT SU	IRFACE	E COURS	6E, M	IX "D", N	70,11,	/2′′	
3 PROPOSED HOT-MIX ASPHALT BASE COURSE, 10 PROPOSED HOT-MIX ASPHALT BASE COURSE WI)'' (W) Idenin	IDTH > NG, 10''	6′) 0 (WID	R TH < 6')			
(4) PROPOSED AGGREGATE SHOULDER, TYPE B							
5 PROPOSED AGGREGATE SHOULDER, TYPE B, 6"							
6 PROPOSED PAINT PAVEMENT MARKING - LINE	5''						

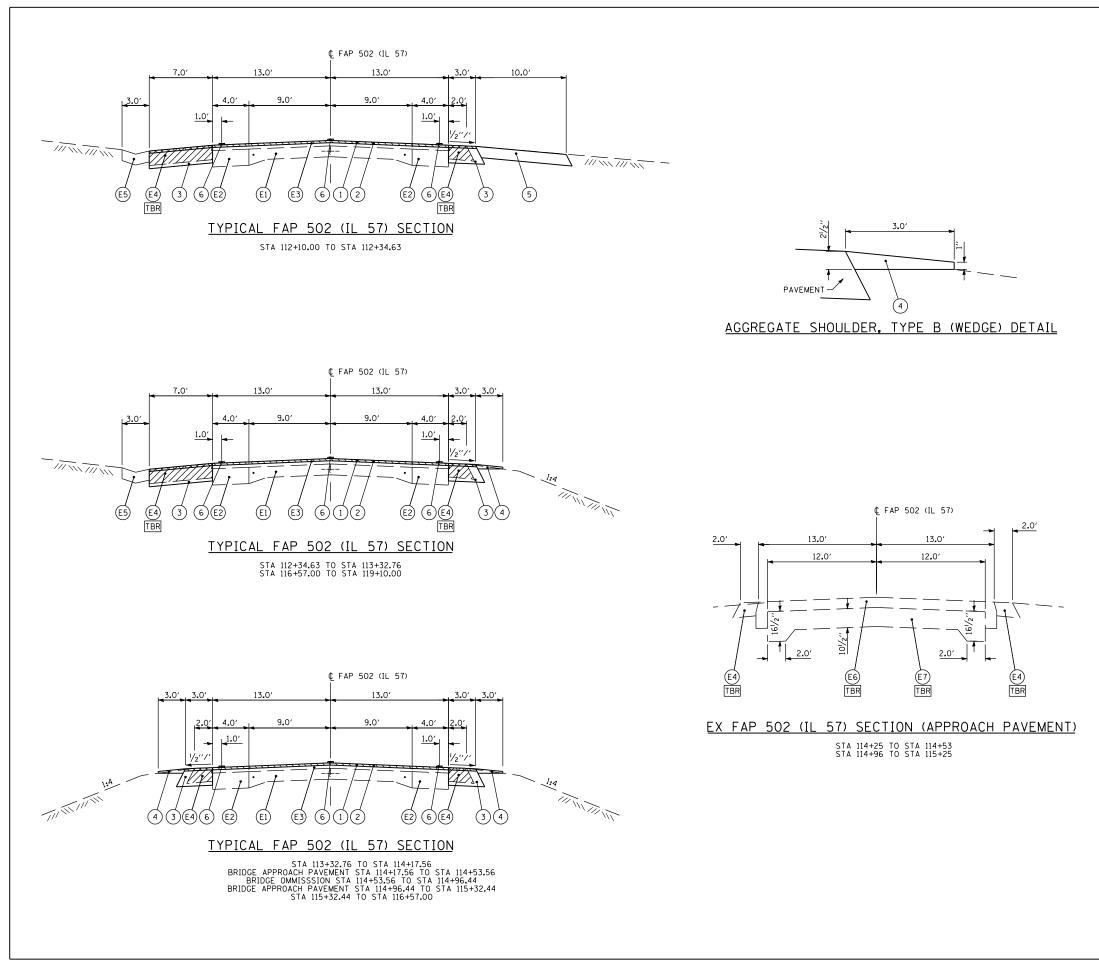MIXTURE REQUIREMENTS

MIXTURE NUMBER:	1	2
LOCATIONS:	IL 57	IL 57
MIXTURE USES:	HMA SURFACE COURSE	HMA BASE CS (WIDENING)
AC/PG:	SBS PG70-22	PG64-22
DESIGN AIR VOIDS:	4.0% @ N DESIGN = 70	4.0% @ N DESIGN = 70
MIXTURE COMPOSITION (GRADATION MIXTURE):	IL 9.5 or 12.5	IL 19 . 0
FRICTION AGGREGATE:	MIX "D"	NZA

REVISIONS		ILLINOIS DEPARTMENT O	
NAME	DATE	ILLINOIS DEI ARTMENT C	INANSI ONTATION
		TYPICAL S	ECTIONS
		FAP 502	(IL 57)
		SECTION	54BR-1
		ADAMS C	OUNTY
		SCALE: VERT. NONE	DRAWN BY SEB
		DATE 6/28/2007	CHECKED BY EBB

_____GUARDRAIL SCHEDULE

	63000000	63100087	63100167	63100169	XX005496	78201000	78200410
LOCATION	STEEL PLATE BEAM GUARD RAIL, TYPE A	TRAFFIC BARRIER TERMINAL TYPE 6A	TRAFFIC BARRIER TERMINAL TYPE 1, SP (TANGENT)	TRAFFIC BARRIER TERMINAL TYPE 1, SP (FLARED)	TRAFFIC BARRIER TERMINAL TYPE 6A (SPECIAL)	TERMINAL MARKER - DIRECT APPLIED	GUARDRAIL MARKERS, TYPE A
	FOOT	EACH	EACH	EACH	EACH	EACH	EACH
STA 112+60.2 TO STA 113+10.2 LT	-	-	1	-	-	1	
STA 113+10.2 TO STA 114+22.7 LT	112.5	-	-	-	-	-	3
STA 114+22.7 TO STA 114+67.9 LT	-	1	-	-	-	-	
STA 112+62.1 TO STA 113+12.1 RT	-	-	-	1	-	1	
STA 113+12.1 TO STA 113+99.6 RT	87.5	-	-	-	-	-	3
STA 113+99.6 TO STA 114+44.8 RT	-	1	-	-	-	-	
STA 114+82.1 TO STA 115+17.9 RT	-	-	-	-	1	-	2
STA 115+17.9 TO STA 115+67.9 RT	-	-	-	1	-	1	
STA 115+05.2 TO STA 115+50.4 LT	-	1	-	-	-	-	
STA 115+50.4 TO STA 115+94.2 LT	43.8	-	-	-	-	-	2
STA 115+94.2 TO STA 116+44.2 LT	-	-	-	1	-	1	
TOTALS:	243.8	3	1	3	1	4	10

						CONTRACT		
					F.A.P. RTE. SECTION	COUNTY	TOTAL SHEETS	SHEET
					502 54BR-1	ADAMS	28	7
					STA.	TO STA.		
					FED. ROAD DIST. NO. ILLI	INOIS FED. AID	PROJECT	r
REMOVAL SCHED	ULE				·			
		44000100	44000155	44000200	44004250]		
LOCATION		PAVEMENT REMOVAL	HOT-MIX ASPHALT SURFACE REMOVAL, 1 1/2"	DRIVEWAY PAVEMENT REMOVAL	PAVED SHOULDER REMOVAL			
		SQ YD	SQ YD	SQ YD	SQ YD]		
112+00.0 TO 114+17.6	LT	-	460.7	-	123.8			
	RT	-	376.8	-	47.9]		
114+17.6 TO 114+53.6	LT	59.2	-	-	8.2]		
	RT	62.5	-	-	-			
114+90.4 TO 115+26.4	LT	58.8	-	-	5.1			
	RT	60.6	-	-	-]		
115+26.4 TO 119+10.0	LT	-	845.6	-	252.2]		
	RT	-	681.2	30.8	95.2			
TOTALS:		241	2364	31	532			

PAVING SCHEDULE

TAVINO JUNEDO													
		31100300	35501324	25000400	40600200	40600300	40603540	42001400	42001430	48101200		20200100	20200500
LOCATION		SUB-BASE GRANULAR MATERIAL, TYPE A 4''	HOT-MIX ASPHALT BASE COURSE, 10"	HOT-MIX ASPHALT BASE COURSE WIDENING, 10''	BITUMINOUS MATERIALS (PRIME COAT)	AGGREGATE (PRIME COAT)	POLY HOT-MIX ASPHALT SURFACE, MIX "D", N70	BRIDGE APPROACH PAVEMENT (SPECIAL)	BRIDGE APPROACH PVMT CONNECTOR (FLEXIBLE)	AGGREGATE SHOULDERS, TYPE B	LOCATION	EARTH EXCAVATION	EARTH EXCAVATION (WIDENING)
		SQ YD	SQ YD	SQ YD	TON	TON	TON	SQ YD	SQ YD	TON		CU YD	CU YD
112+00.0 TO 114+17.6	LT	-	107.9	32.0	0.2	0.9	38.7	-	-	2.8	112+00 TO 114+27 LT	-	10.8
	RT	-	-	69.1	0.2	0.8	31.7	-	-	15.9	NORTH APPROACH LT	7.5	-
114+17.6 TO 114+53.6	LT	53.0	-	-	-	-	-	55.0	11.0	1.5	SOUTH APPROACH LT	7.5	-
	RT	53.0	-	-	-	-	-	55.0	11.0	0.8	115+41 TO 119+10 LT	-	18.8
114+90.4 TO 115+26.4	LT	53.0	-	-	-	-	-	55.0	11.0	0.7	112+00 TO 114+08 RT	-	36.0
	RT	53.0	-	-	-	-	-	55.0	11.0	1.6	NORTH APPROACH RT	7.5	-
115+26.4 TO 119+10.0	LT	-	204.5	38.7	0.3	1.7	70.9	-	-	4.2	SOUTH APPROACH RT	7.5	-
	RT	-	-	129.2	0.3	1.5	57.2	-	-	9.5	115+23 TO 119+10 RT	-	69.6
TOTALS:		212	312	269	1.0	4.9	199	220	44	37	TOTALS	30	135

SEEDING SCHEDULE

	25000200	25000300	25000400	25000500	25000600	25000700	25100105	28000250	
LOCATION	SEEDING, CLASS 2	SEEDING, CLASS 3	NITROGEN FERTILIZER NUTRIENT	PHOSPHORUS FERTILIZER NUTRIENT	POTASSIUM FERTILIZER NUTRIENT	AGRICUL TURAL GROUND LIMESTONE	MULCH, METHOD 1	TEMPORARY EROSION CONTROL SEEDING	LOCATION
	ACRE	ACRE	POUND	POUND	POUND	TON	ACRE	POUND	
112+00 TO 114+63 LT	0.06	-	5.4	5.4	5.4	0.12	0.06	6	STA 112+00
114+63 TO 1115+13 LT	-	0.05	4.5	4.5	4.5	0.10	0.05	5	NORTH BRIDGE APPROACH
115+13 TO 119+10 LT	0.09	-	8.1	8.1	8.1	0.18	0.09	9	SOUTH BRIDGE APPROACH
									STA 119+10
112+00 TO 114+39 RT	0.05	-	4.5	4.5	4.5	0.10	0.05	5	SOUTH 12TH STREET
114+39 TO 114+85 RT	-	0.05	4.5	4.5	4.5	0.10	0.05	5	
114+85 TO 119+10 RT	0.10	-	9.0	9.0	9.0	0.20	0.10	10	TOTALS:
TOTALS:	0.3	0.1	36	36	36	0.8	0.4	40	

PAVEMENT STRIPING SCHEDULE

FAVENIENI SIR	II ING SCHEI							
			01120	78001180	70300100	70300230	70300280	70300280
LOCATION	PAINT P. MARKING WHITE	- LINE 5"	PAINT PAVEMENT MARKING - LINE 24''	SHORT-TERM PAVEMENT MARKING	TEMPORARY PAVEMENT MARKING - LINE 5''	TEMPORARY PAVEMENT MARKING - LINE 24''	WORK ZONE PAVEMENT MARKING REMOVAL	
		FO	ОТ	FOOT	FOOT	FOOT	FOOT	SQ FT
112+00.0 TO 119+10.0	LT	-	710	18	-	710	18	331.8
	¢	180	-	-	72	180	-	99.0
	RT	-	710	-	-	710	-	295.8
STAGE CONSTRUCTION		-	-	-	-	-	-	1482.5
TOTALS:		16	00	18	72	1600	18	2209

ENTRANCE SCHEDULE

	40200100	40800050
LOCATION	AGGREGATE SURFACE COURSE, TYPE A	INCIDENTAL HOT-MIX ASPHALT SURFACING
	TON	TON
112+37.5 RT AGG CE	10.0	10.9
115+90.4 RT BIT PE	20.0	12.5
116+47.3 RT AGG PE	17.0	4.0
TOTALS:	47	27


TEMPORARY RAMP SCHEDULE

EARTHWORK SCHEDULE

20200100
TEMPORARY RAMP
SQ YD
20.2
22.1
22.1
20.0
20.4
105

	63200310
LOCATION	GUARDRAIL REMOVAL
	FOOT
112+64 TO 114+42 RT	178
113+62 TO 114+65 LT	103
114+84 TO 115+63 RT	79
115+07 TO 116+10 LT	103
TOTALS:	463


LS:			463	
1	REVISIONS		ILLINOIS DEPARTMENT OF TRANSPORTATIO	NN
	NAME	DATE	ILLINOIS DEFARIMENT OF TRANSFORTATIO	
			SCHEDULE OF QUANTITIES	S
			EAP 502 (11 57)	-
			FAF DUZ (IL DI)	
			SECTION 54BR-1	
			ADAMS COUNTY	
			SCALE: HORIZ. NONE DRAWN BY S	EB
			DATE 6/28/2007 CHECKED BY	EBB

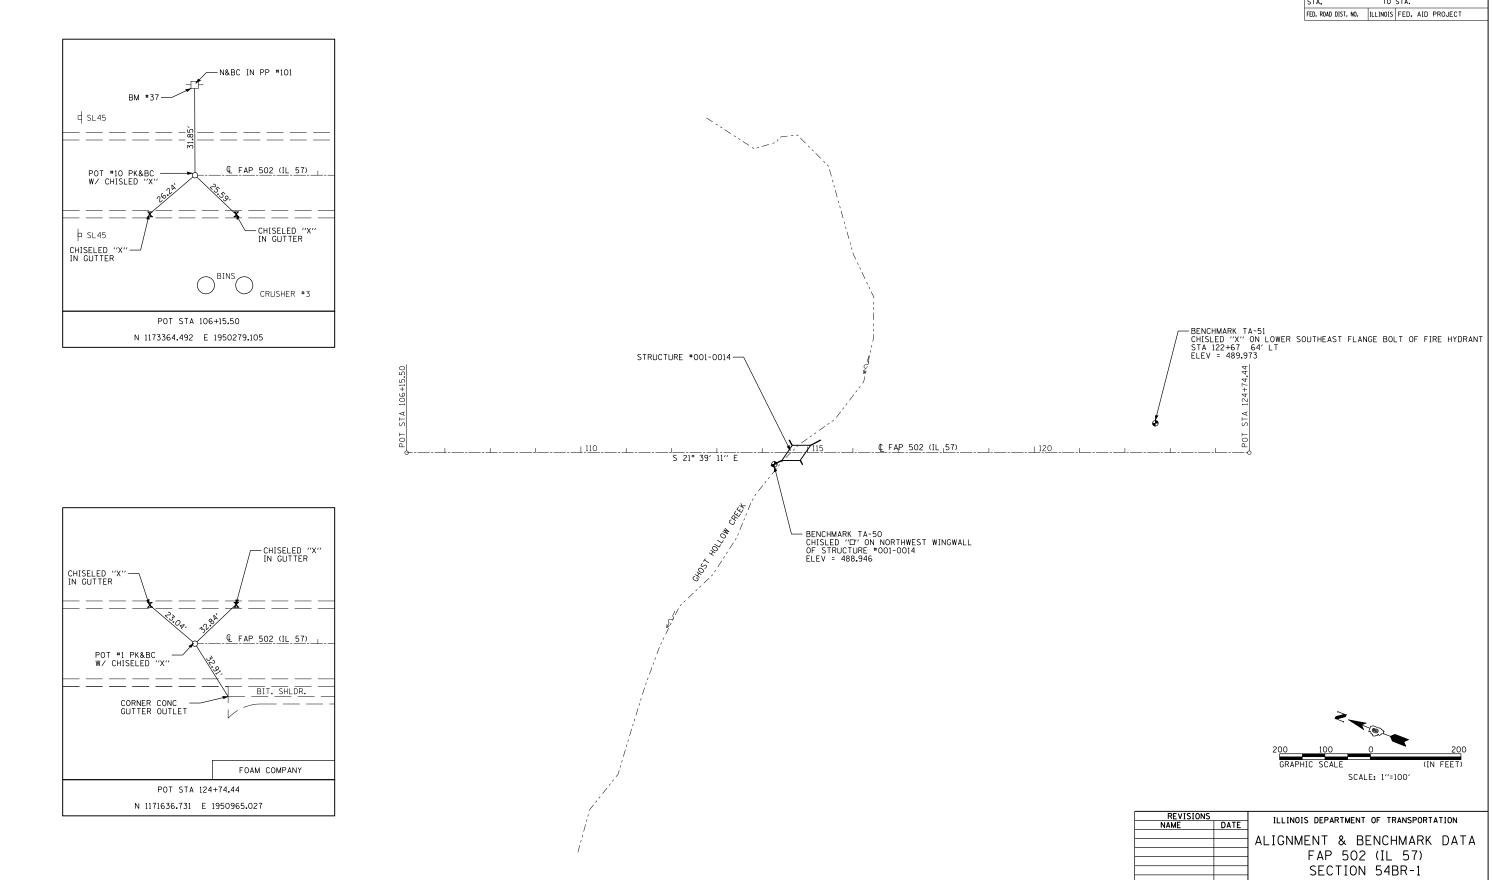

		CC	NTRA	T 1	NO. 728	373
F.A.P. RTE.	SECTION		COUNTY		TOTAL SHEETS	SHEET NO.
502	54BR-1		ADAM	s	28	8
STA.		TO	STA.			
FED. ROA	D DIST. NO.	ILLINOIS	FED.	AID	PROJECT	


	2.		-	
200	100	0		200
GRAPHI	C SCALE		(IN	I FEET)
	S	CALE: 1"=	100'	

REVISIONS NAME DATE	ILLINOIS DEPARTMENT OF TRANSPORTATION							
	-							
	ALIGNMENT & BENCHMARK DATA							
	FAP 502 (IL 57)							
	SECTION 54BR-1							
	ADAMS COUNTY							
	SCALE: VERT. 1"=100' DRAWN BY BDJ							
	DATE 6/28/2007 CHECKED BY EBB							

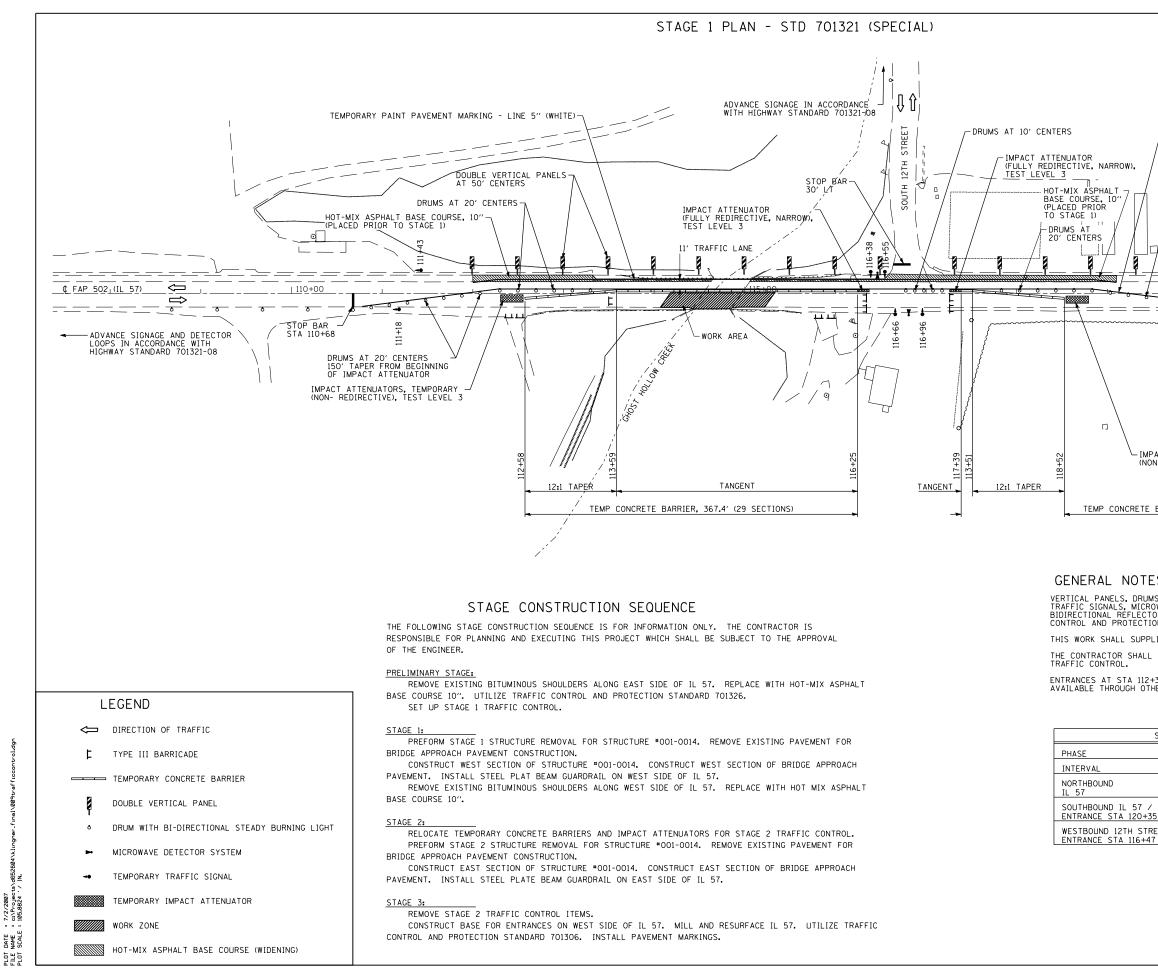


			CONTRACT	NO 728	173
	F.A.P. RTE.	SECTION	COUNTY		SHEET NO.
	502	54BR-1	ADAMS	28	9
	STA.		TO STA.		
	FED. ROAL	/ UISI. NU. ILLI	NOIS FED. AID	PRUJECI	
- TENDODADY DATEST DAVENEST MODI					
TEMPORARY PAINT PAVEMENT MARKI	NU - LINE 5" (YE				
DRUMS AT 20' CENTERS					
OF IMPACT ATTENUATOR					
	/ LOOPS IN	SIGNAGE AND ACCORDANCE	E WITH		→
	/ HIGHWAY S	TANDARD 70	01321-08		
STOP BAR	/		1		
/ STA 120+43		÷) [-		_
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NO TURN ON RED				- == =	
	24'')		E Contraction of the second se		
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PACT ATTENUATORS, TEMPORARY	100 50 GRAPHIC SC	D O	,	1C IN FEET	
DN- REDIRECTIVE), TEST LEVEL 3	GRAPHIC SC	SCALE:	1''=50'	IN FEEL	'
BARRIER, 114.0' (9 SECTIONS)					
ES					
		SIGNS			
MS WITH STEADY BURNING LIGHTS, TYPE OWAVE DETECTOR SYSTEMS, DETECTOR L ORS SHALL BE INCLUDED IN THE COST (OOPS, AND TYPE	C C C C			
ION, STANDARD 701321 (SPECIAL)"	UT THE FAT TIEM	I INAFFIC			
LIMENT AND BE IN ACCORDANCE WITH HI	GHWAY STANDARD	701321.			
PLACE MAX WIDTH SIGNS BEFORE IMPLE	EMENTING ANT ST	AGE			
+37.5 RT AND STA 115+90.4 RT SHALL B	BE CLOSED. ACCE	SS SHAL BE			
HER ENTRANCES ON THE PROPERTIES.					
SEQUENCE OF OPERATIONS					
1 2 3 4 5 6 7 8 9					
G Y R R R R R R R					
35 RT R R R G Y R R R R					
7 RT R R R R R G Y R					
REVISIONS	ILLINOIS DEP	ARTMENT OF	TRANSPOR	TATION	
NAME DATE					
	RAFFIC CO	NIROL 9 502 (1		IEUI.	
		502 (1) TION 5			
		AMS CO			
	SCALE, VERT. 1"=	50'	DRAWN E	BY SEB	
	DATE 6/28/2007	50'	CHECKED		EBB

STAGE 2 PLAN - STD 701321 (SPECIAL)

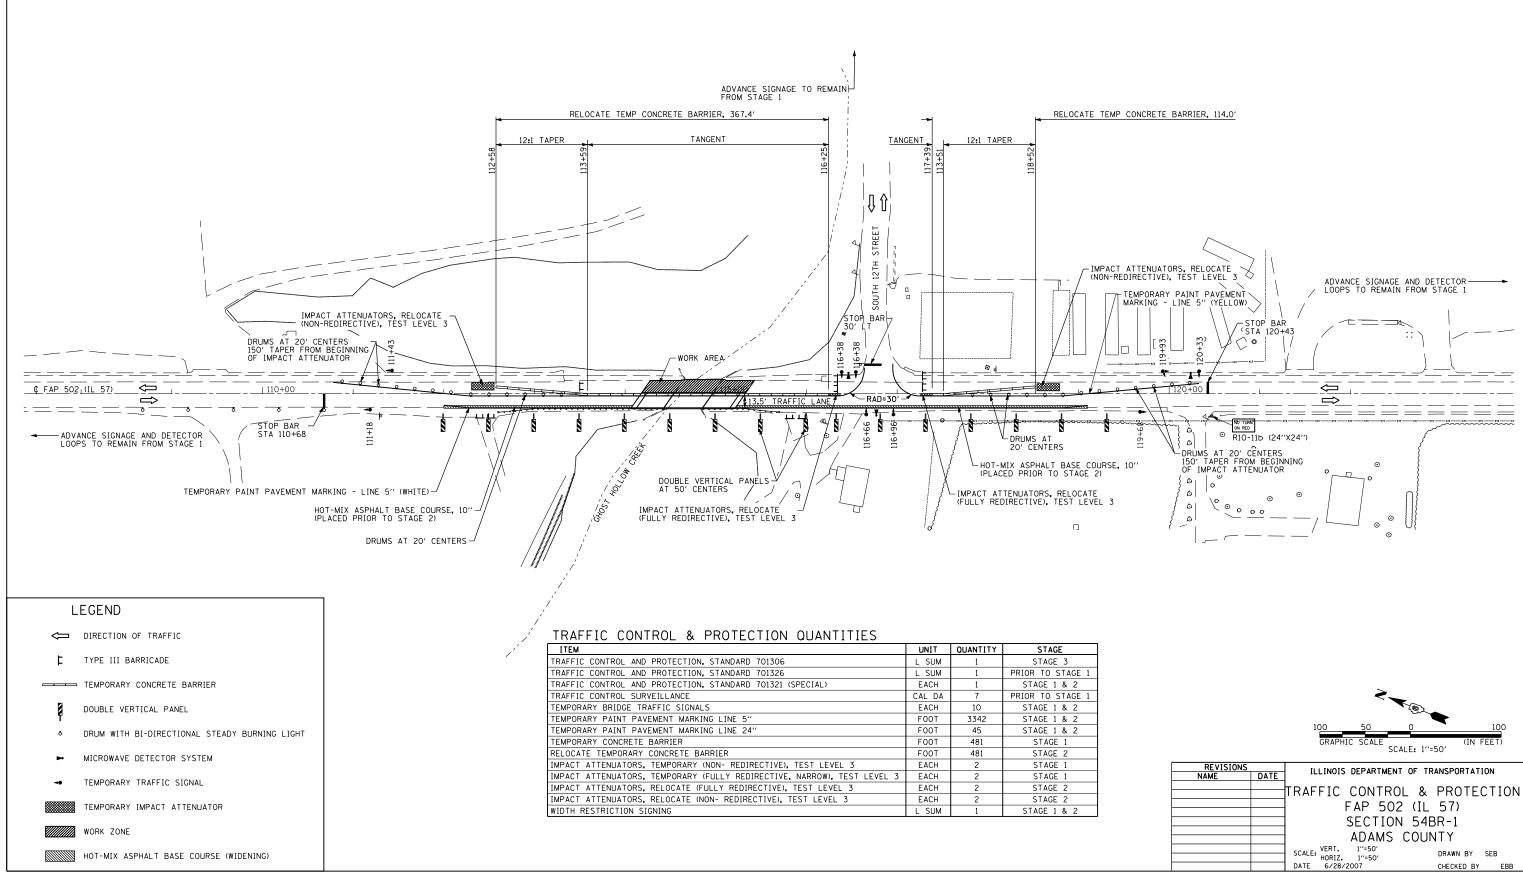

TAP. SECTION COUNTY TOTAL SHEET NO.	
	F.A.P. RTE.
502 54BR-1 ADAMS 28 10	502
STA. TO STA.	STA.
ED. ROAD DIST. NO. ILLINOIS FED. AID PROJECT	FED. ROA
ED. ROAD DIST. NO. LEINOIS FED. AID FROJECT	TED. NUP

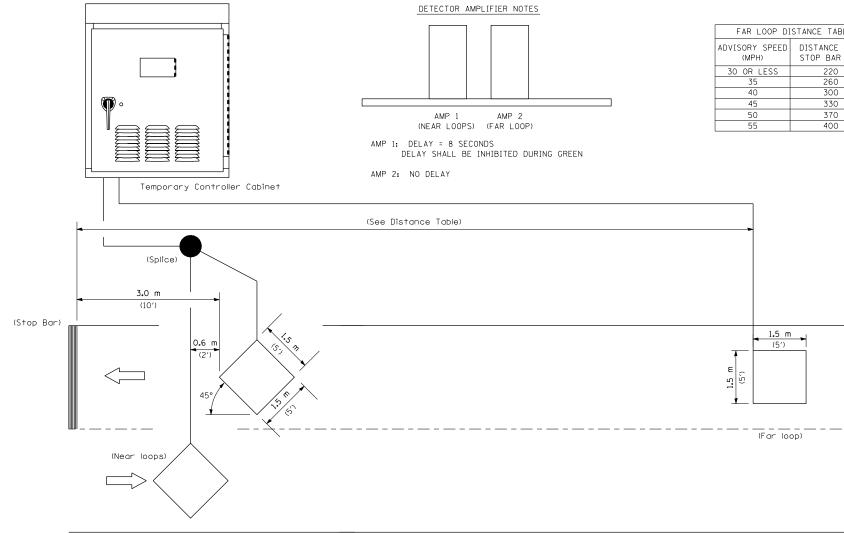

NOTE: All loops centered in lane.


INDUCTION LOOP DETECTOR

				NTRACI	T N/	N 720	72
			U.	INTRACI			
F.A RTE	A.P. FE.	SECTION		COUNTY	s	TOTAL SHEETS	SHEET NO.
50	502	54BR-1		ADAMS		28	11
ST	TA.		ΤC	STA.			
FED.	D. ROA	AD DIST. NO.	ILLINOI	FED. A	ID PI	ROJECT	

ABLE
CE FROM AR (FT.)
20
50
00
30
70
10


TEMPORARY BRIDGE TRAFFIC SIGNAL LOOP PLACEMENT DETAIL SHEET


REVISIONS		ILLINOIS DEPARTMENT OF T	RANSPORTATION
NAME	DATE		
		TRAFFIC CONTROL &	PROTECTION
		FAP 502 (IL	57)
		SECTION 54	1 1
		SECTION 34	
		ADAMS COU	
		ADAMS COU	
		SCALE: VERT. NONE	DRAWN BY DIST. 6
		HORIZ. NONE	DRAWN BI DIST. 6
		DATE 6/28/2007	CHECKED BY EBB

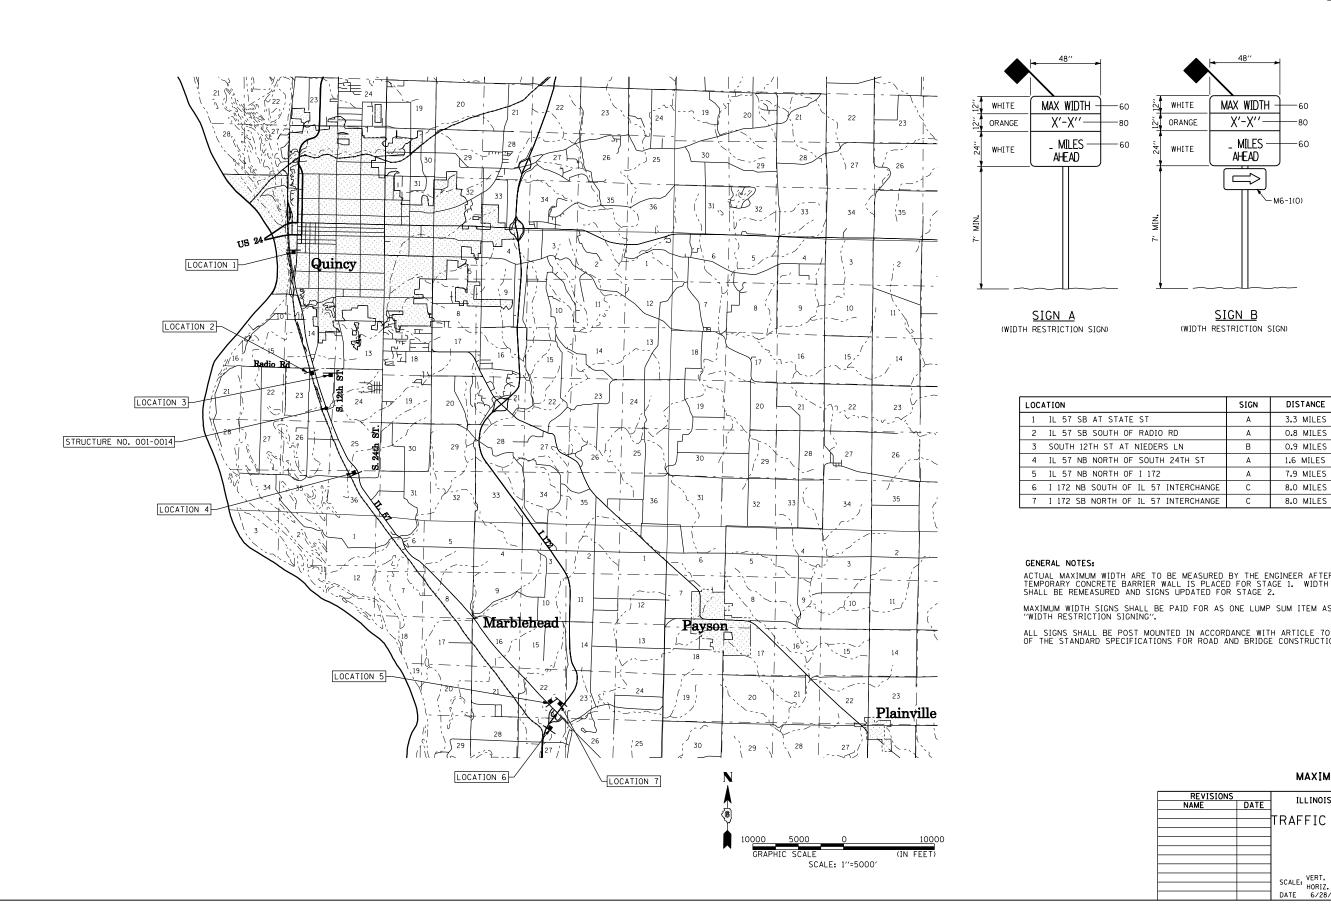

526I IN. 7/2/2007 ci/Projects 10588.2353 . . . DATE NAME SCALE PLOT FILE PLOT

			С	ONTRA	сти	٥٥.	728	173
	F.A.P. RTE.	SECTION		COUNT	Y	TOT SHE		SHEET NO.
	502	54BR-1		ADA	ADAMS		8	12
STA. TO STA.								
	FED. ROA	D DIST. NO.	ILLINO	S FED.	AID	PR0.	JECT	

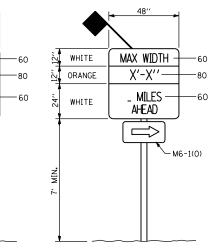

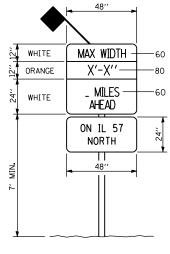

<u>SIGN C</u> (WIDTH RESTRICTION SIGN)

	SIGN	DISTANCE
I STATE ST	А	3.3 MILES
OUTH OF RADIO RD	А	0.8 MILES
ST AT NIEDERS LN	В	0.9 MILES
ORTH OF SOUTH 24TH ST	А	1.6 MILES
DRTH OF I 172	А	7.9 MILES
OUTH OF IL 57 INTERCHANGE	С	8.0 MILES
DIV OF N FR NITEROUNNOF	0	

<u>SIGN B</u>

(WIDTH RESTRICTION SIGN)


ACTUAL MAXIMUM WIDTH ARE TO BE MEASURED BY THE ENGINEER AFTER TEMPORARY CONCRETE BARRIER WALL IS PLACED FOR STAGE 1. WIDTH SHALL BE REMEASURED AND SIGNS UPDATED FOR STAGE 2.


MAXIMUM WIDTH SIGNS SHALL BE PAID FOR AS ONE LUMP SUM ITEM AS "WIDTH RESTRICTION SIGNING".


ALL SIGNS SHALL BE POST MOUNTED IN ACCORDANCE WITH ARTICLE 701.14 OF THE STANDARD SPECIFICATIONS FOR ROAD AND BRIDGE CONSTRUCTION.

MAXIMUM WIDTH SIGNING DETAILS

REVISIONS		ILLINOIS DEPARTMENT OF TRANSPORTATION
NAME	DATE	
		TRAFFIC CONTROL & PROTECTION
		FAP 502 (IL 57)
		SECTION 54BR-1
		ADAMS COUNTY
		SCALE: VERT. 1''=5000' DRAWN BY SEB
		DATE 6/28/2007 CHECKED BY EBB

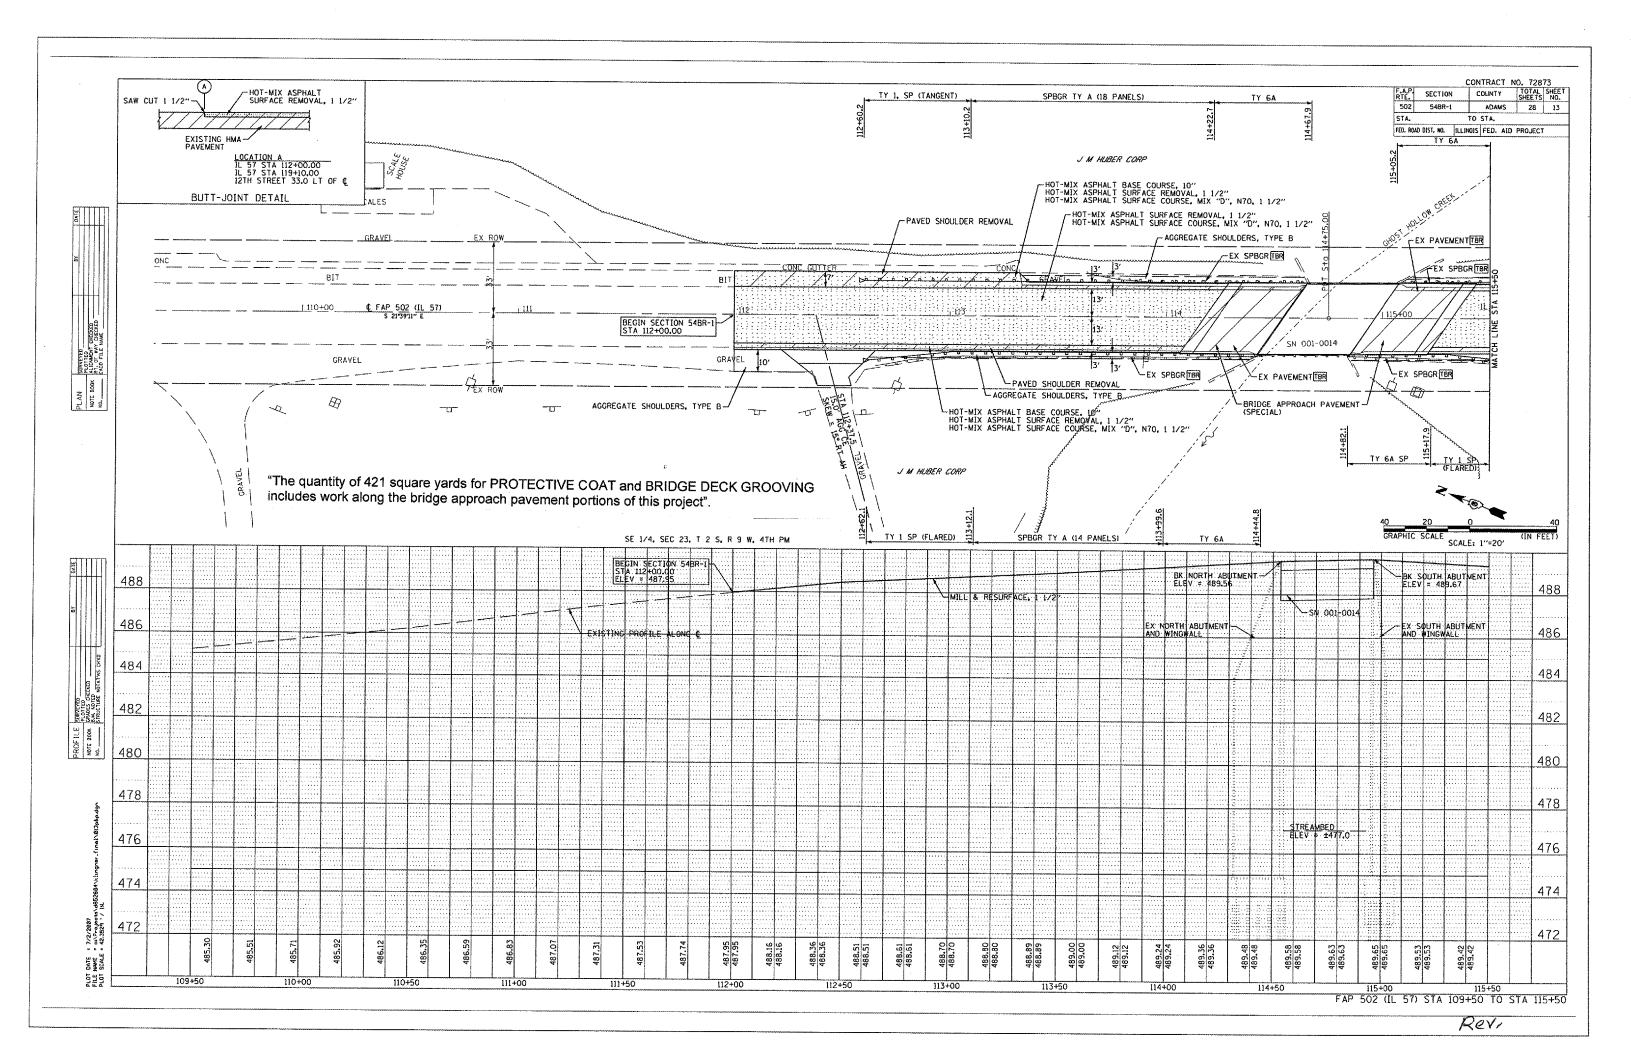

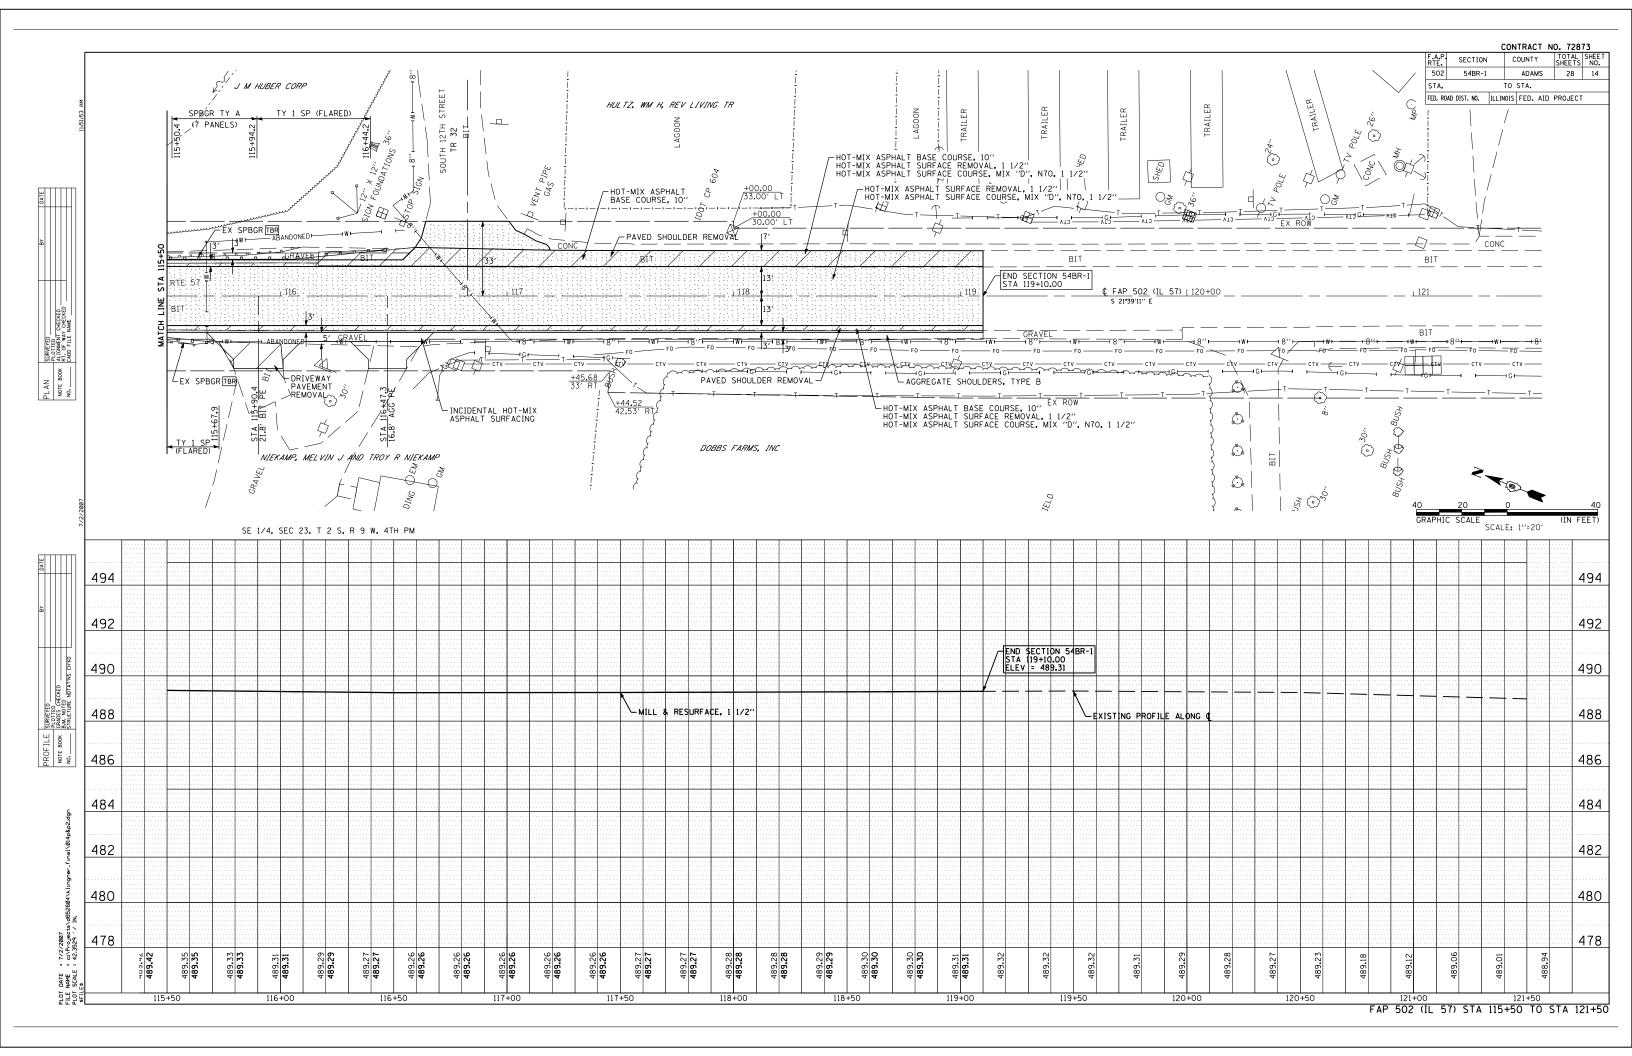

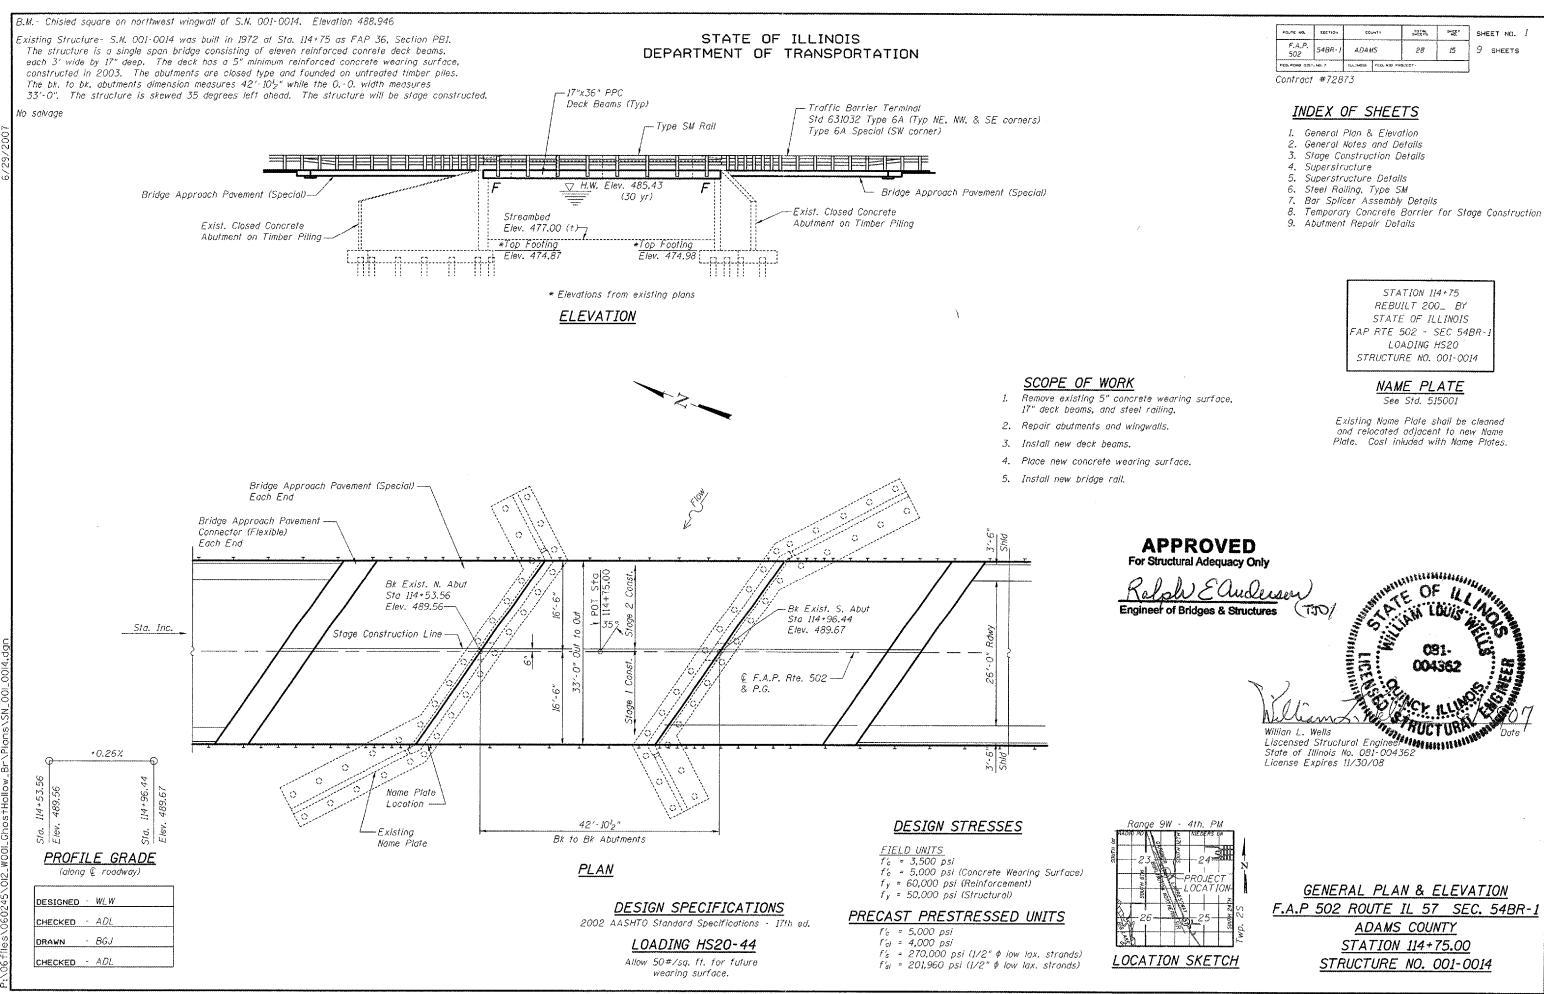

POUTE NO.	5807104	ec	00474	SHEETS	SHEE: NO.	SHE	EET NO.
F.A.P. 502	54BR · I	ADA	HS	28	15	9	SHEETS
FED. ROAD 019	T. NO. 7	144 IND15	FED. AID	PROJECT -		1	

STATE OF ILLINOIS DEPARTMENT OF TRANSPORTATION

Unit

Each

Sq. Yd.

Sq. Ft.

Pound

Foot

Each

Each

Sq. ft.

Total

157

2015

1408

157

157


86

44

24

50

1

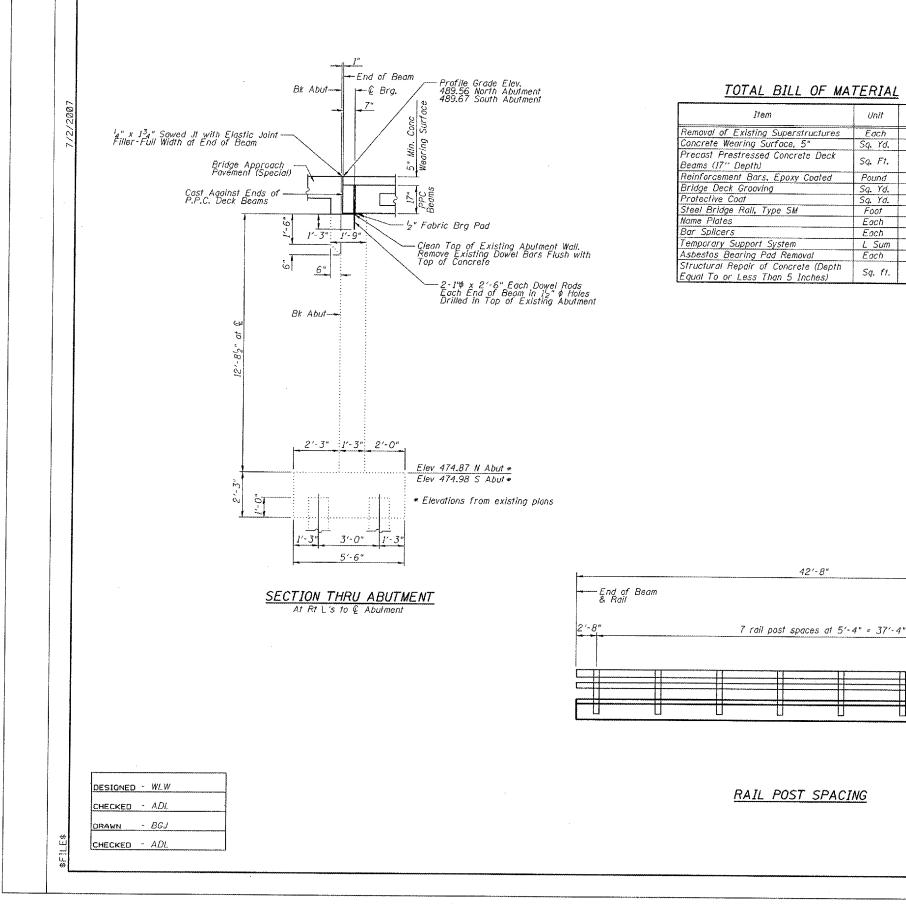

movement of the beams. will not be permitted.

-End of Beam & Rail

21-8

ROUTE NO.	SECTION	co		SHC QTS	SHEET NO.	зн	EET NO.	2
F.A.P. 502	54BR-1	ADAI	1S	28	<i>J</i> 6	9	SHEETS	\$
FED, ROAD DIST.	. NO. 7	ILLINGIS	FED. 410 PR	03601-				

Contract #72873

GENERAL NOTES

The cut strands at each beam end shall be given two coats of zinc dust spray or paint meeting the requirements of ASTM A 780. The zinc dust spray or paint shall be applied before corrosion appears and allowed to dry according to the manufacture's specifications. prior to another coat of zinc. A concrete sealer meeting the requirements of Section 587 of the Standard Specifications shall be applied to the exterior face and 9" in on the underside of the fascia beams. This work shall be performed by the producer and included with the cost of the beam.

Repair of abutments shall be completed prior to placement of new deck beams. The minimum thickness of the Concrete overlay shall be 5" and varies as required to adjust for the new profile grade and beam camber.

The contractor is advised that the existing PPC Deck Beams are in deteriorated condition with reduced load carrying capacity. It is the contractor's responsibility to account for the condition of the beams when developing construction procedures for removal and replacement of the superstructure.

If the contractor's procedure for existing beam removal or placement of new beams involves placement of cranes or other heavy equipment on the new beams, a detailed procedure shall be submitted to the Engineer for approval. The procedure shall include

calculations, prepared and sealed by an Illinois Licensed Structural Engineer, verifying that the equipment and procedures used will not overstress the new beams. To distribute load to multiple beams and protect the concrete, in all cases a double layer mat of heavy timbers shall be used at all times under crane tracks or wheels and any outriggers in the down position. If necessary, shims shall be used under the crane mat to ensure uniform contact with the underlying beams. Prior to placement of the timber mats the following shall be done: placement and tightening of transverse tie assemblies, grouting and curing the dowel rods 24 hours minimum and grouting and curing the shear keys. A temporary means of lateral restraint will be required for fascia beams at expansion ends of the beams to prevent


The rail anchorage shall be cast with the beam and the wearing surface shall be cast in the field. Formwork necessary for the wearing surface may be secured utilizing the bottom rail anchoroge inserts and/or additional inserts cast into the beam. Drilling into the beam

Reinforcement bars shall conform to the requirements of ASTM A706 Grade 60 (IL Modified). See Special Provisions.

Plan dimensions and details relative to existing structure have been taken from existing plans and field surveys and are subject to nominal construction variations. It shall be the Contractor's responsibility to verify such dimensions and details in the field and make necessary approved adjustments prior to construction or ordering of materials. Such variations shall not be cause for additional compensation for a change in the scope of the work, however, the Contractor will be paid for the quantity actually furnished at the unit price for the work. All construction joints shall be bonded.

Reinforcement bars designated (E) shall be epoxy coated.

GENERAL NOTES AND DETAILS F.A.P 502 ROUTE IL 57 SEC. 54BR-1 ADAMS COUNTY STATION 114+75.00 STRUCTURE NO. 001-0014

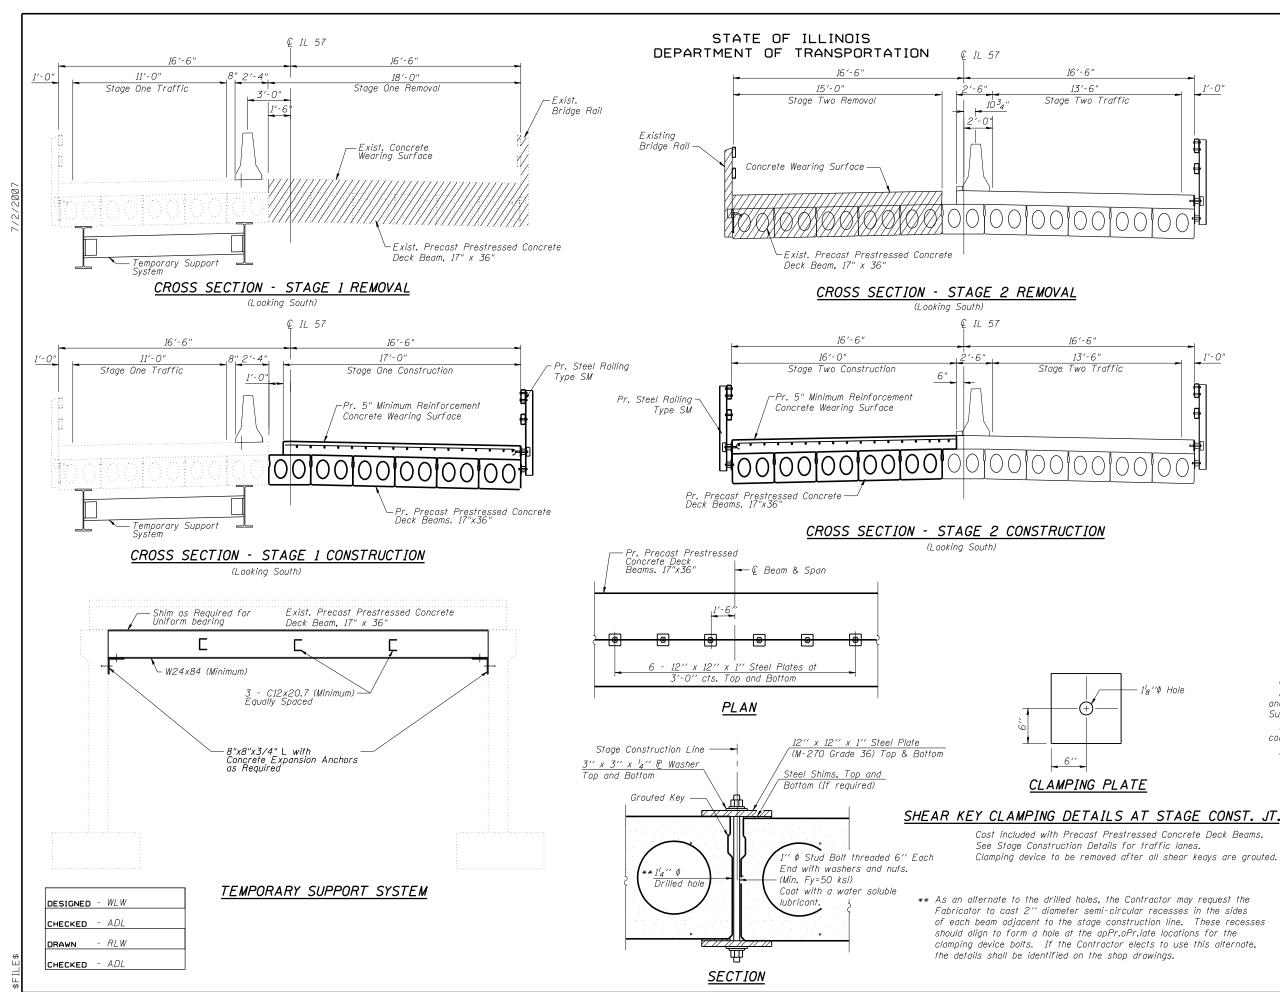

ROUTE NO.	SECTION	co	JNTY	TOTAL SHEETS	SHEET NO.
F.A.P. 502	54BR - 1	ADAM	IS	28	17
FED. ROAD DIST	ND. 7	ILLINDIS	FED. AID Pr.	OJECT-	

Contract #72873

NOTES:


Hatch areas indicate "Removal of Existing Superstructure". Removal of existing steel railing, concrete wearing surface, and deck beams, are included with "Removal of Existing Superstructure".

See roadway plans for quantity and location of temporary concrete barrier.

All dimensions given for existing structure are approximate.


STAGE CONSTRUCTION DETAILS F.A.P 502 ROUTE IL 57 SEC. 54BR-ADAMS COUNTY STATION 114+75.00 STRUCTURE NO. 001-0014


SHEET NO. 3 9 SHEETS

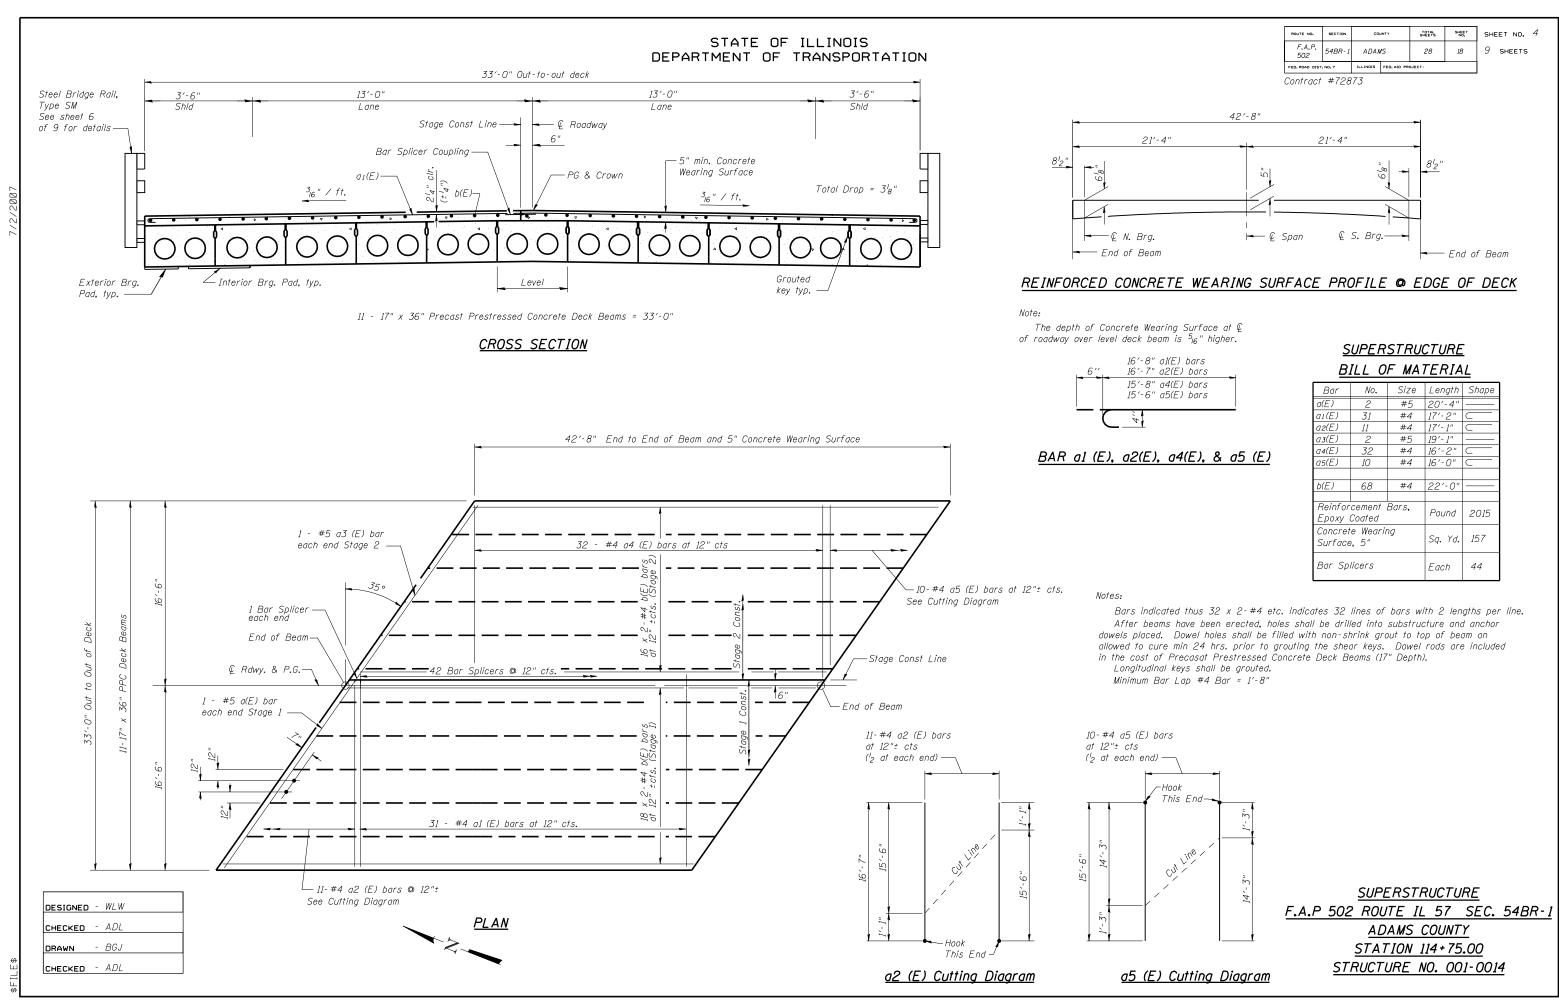


a1(E) a2(E)	
а4(Е) а5(Е)	

				_
Bar	No.	Size	Length	Shape
a(E)	2	#5	20'-4"	
aı(E)	31	#4	17'-2"	
a2(E)	11	#4	17'-1"	
a3(E)	2	#5	19′-1″	
a4(E)	32	#4	16′-2″	
a5(E)	10	#4	16′-0″	
b(E)	68	#4	22'-0"	
Reinfor Epoxy	cement . Coated	Pound	2015	
Concret Surface	e Wearir e, 5"	Sq. Yd.	157	
Bar Sp	licers	Each	44	

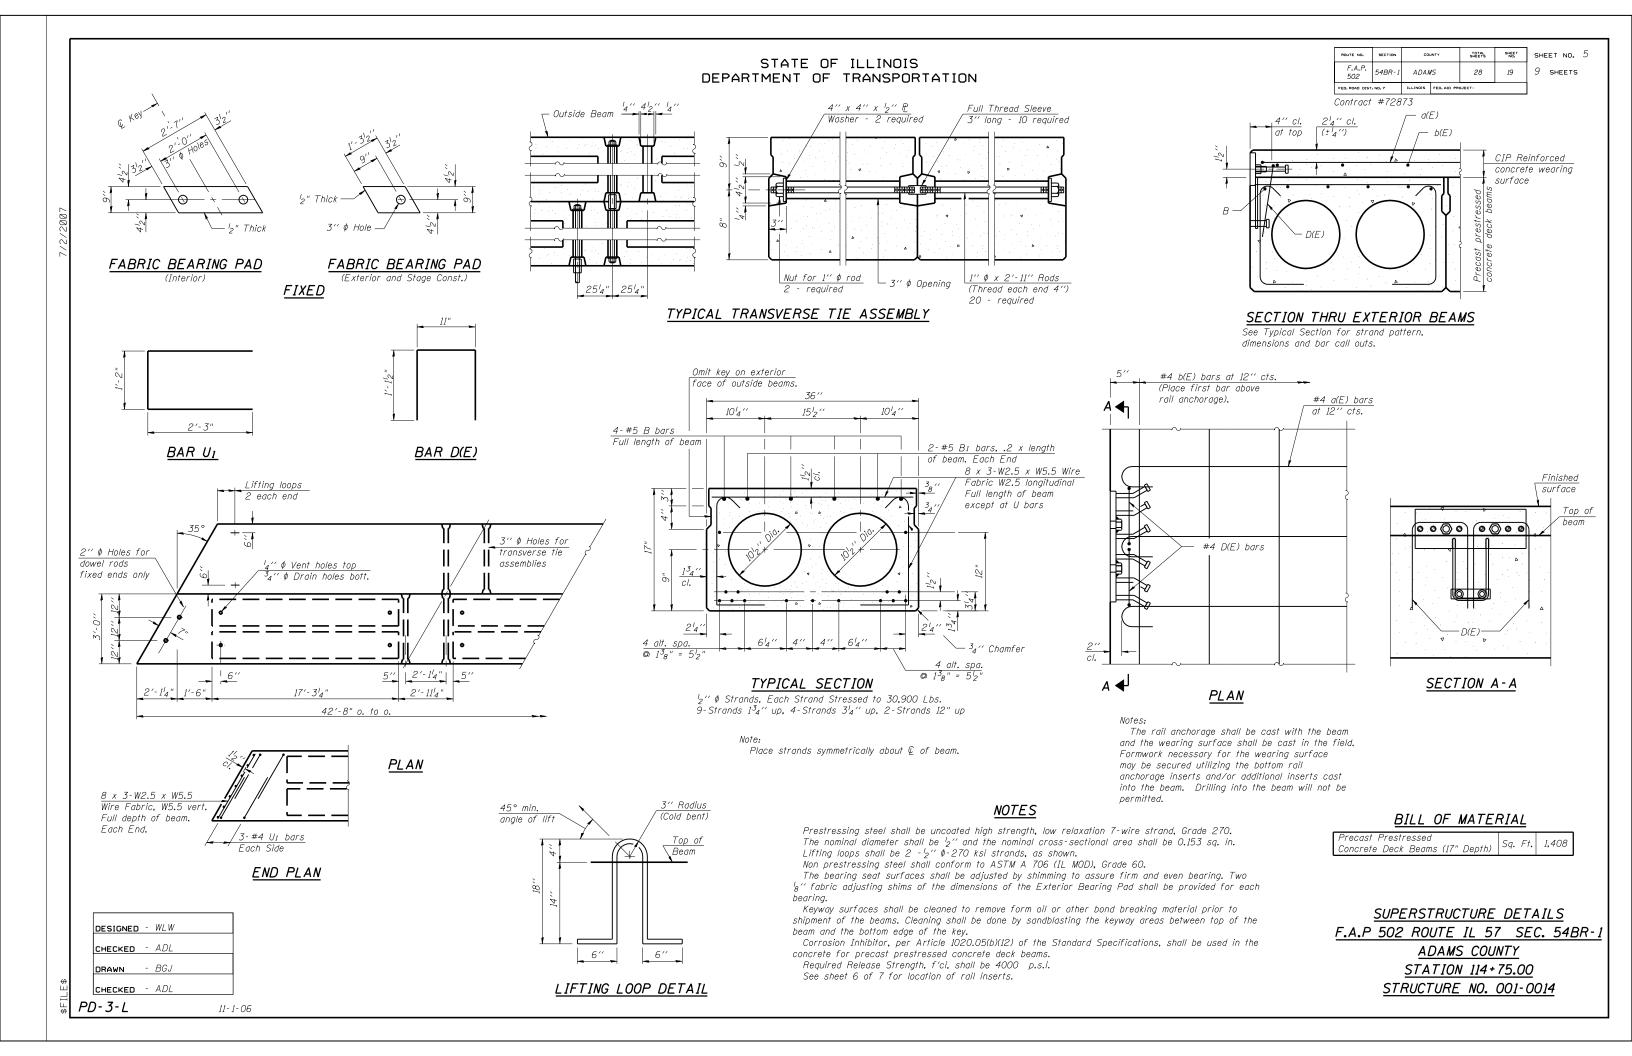

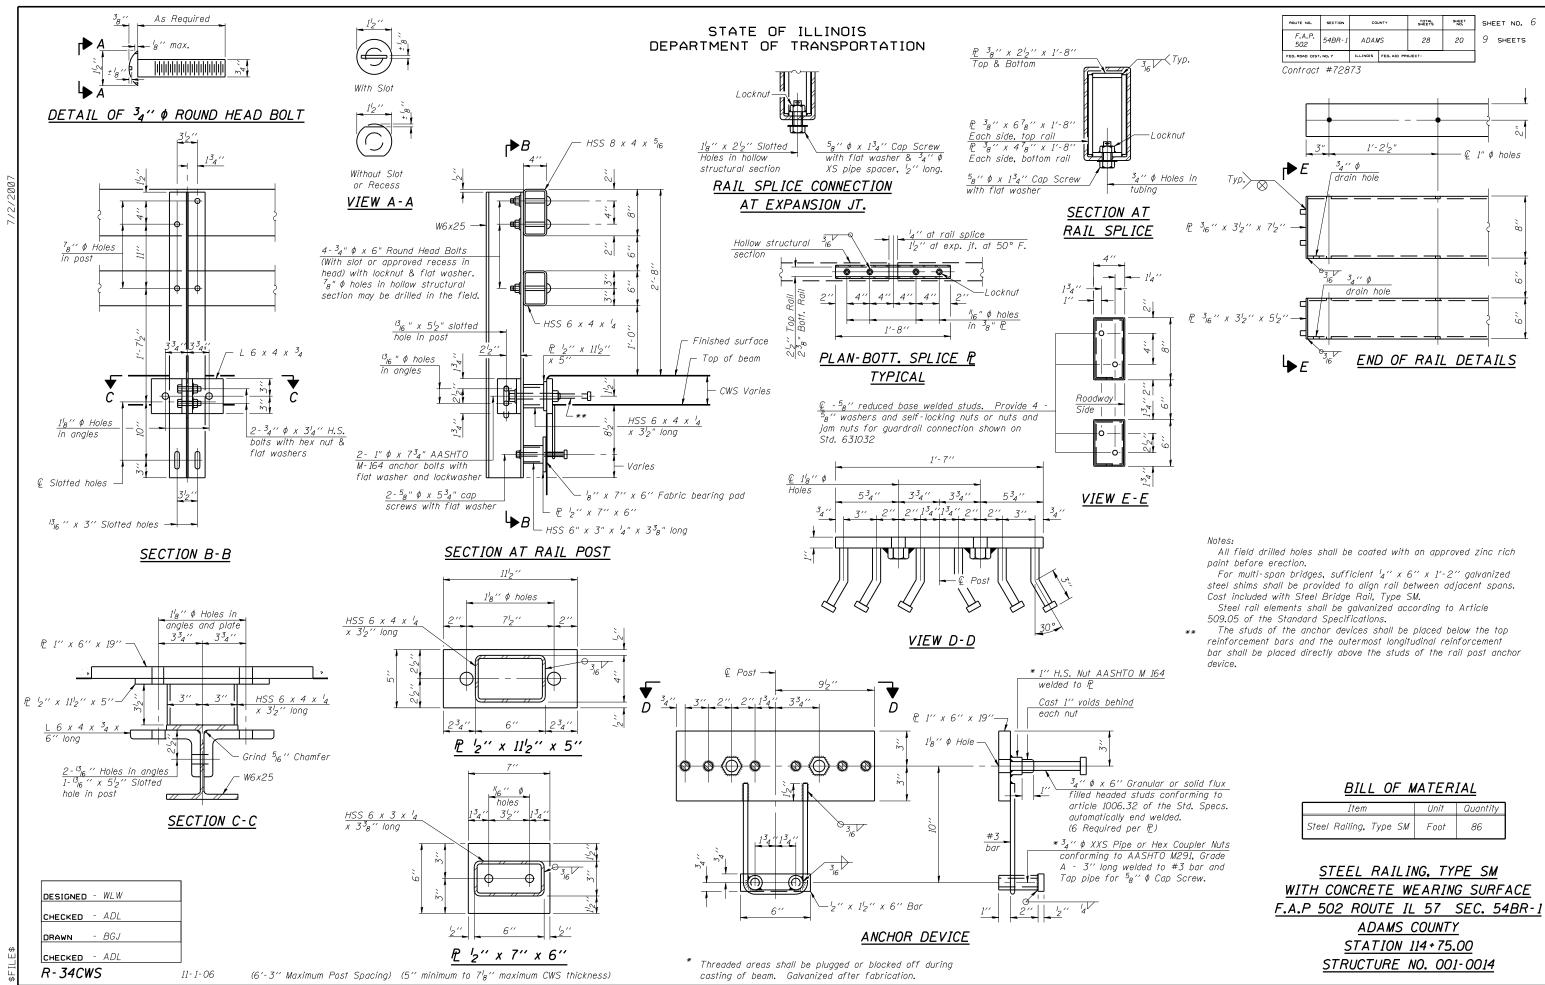

anular or solid flux_ uds conforming to	<u>BILL OF M</u>	IATER.	<u>IAL</u>	
of the Std. Specs.	Item	Unit	Quantity	
d welded. 一	Steel Railing, Type SM	Foot	86	
	<u>STEEL RAILIN</u> WITH CONCRETE WI A.P 502 ROUTE IL ADAMS (STATION I	EARIN 57 COUNT 1 14 + 75.	<u>G SURF</u> <u>SEC. 54</u> <u>/</u> 00	

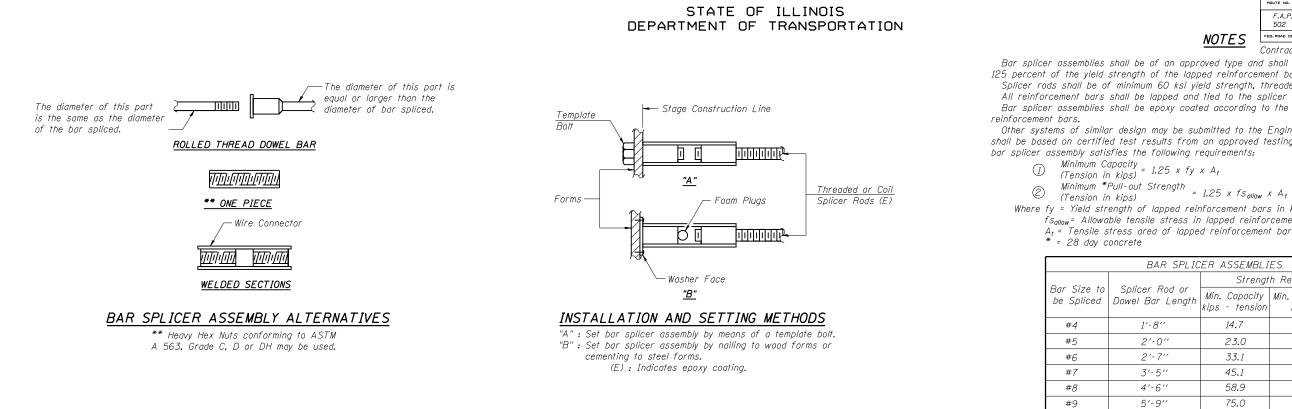

Bar splicer assemblies shall be according to Section 508 of the Standard Specifications, except as noted. The furnishing and installation of bar splicer assemblies will be measured and paid for at the contract unit price each for "BAR SPLICERS."

Stage	Ι	Cor

#10

#11

Reinforcement	Thread
Bars	Loop

_	WLW
-	ADL
-	BGJ
-	ADL

11-1-06

Ę

ROUTE NO.	SECTION	COUNTY		TOTAL SHEETS	SHEET NO.
F.A.P. 502	54BR-1	ADAMS		28	21
FED. ROAD DIST. NO. 7		ILLINDIS	FED. AID PROJECT-		

NOTES

Contract #72873 Bar splicer assemblies shall be of an approved type and shall develop in tension at least 125 percent of the yield strength of the lapped reinforcement bars. Splicer rods shall be of minimum 60 ksi yield strength, threaded or coiled full length. All reinforcement bars shall be lapped and tied to the splicer rods or dowel bars. Bar splicer assemblies shall be epoxy coated according to the requirements for

Other systems of similar design may be submitted to the Engineer for approval. Approval shall be based on certified test results from an approved testing laboratory that the proposed


9'-0''

Where fy = Yield strength of lapped reinforcement bars in ksi.

fs_{allow} = Allowable tensile stress in lapped reinforcement bars in ksi (Service Load) $A_{\rm f}$ = Tensile stress area of lapped reinforcement bars. * = 28 day concrete

crete		
BAR SPLIC	ER ASSEMBLI	ËS
	Strengt	h Requirements
Splicer Rod or owel Bar Length	Min. Capacity kips - tension	Min. Pull-Out Strength kips – tension
1'-8''	14.7	5.9
2'-0''	23.0	9.2
2'-7''	33.1	13.3
3'-5''	45.1	18.0
4'-6''	58.9	23.6
5'-9''	75.0	30.0
7'-3''	95.0	38.0

117.4

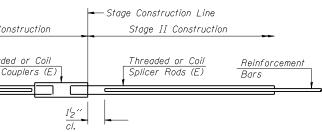

46.8


STANDARD

Bar Size	No. Assemblies Required	Location
#4	42	Stage Const Line
#5	2	Stage Const Line

BAR SPLICER ASSEMBLY DETAILS F.A.P 502 ROUTE IL 57 SEC. 54BR-ADAMS COUNTY STATION 114+75.00 STRUCTURE NO. 001-0014

SHEET NO. 7

9 SHEETS

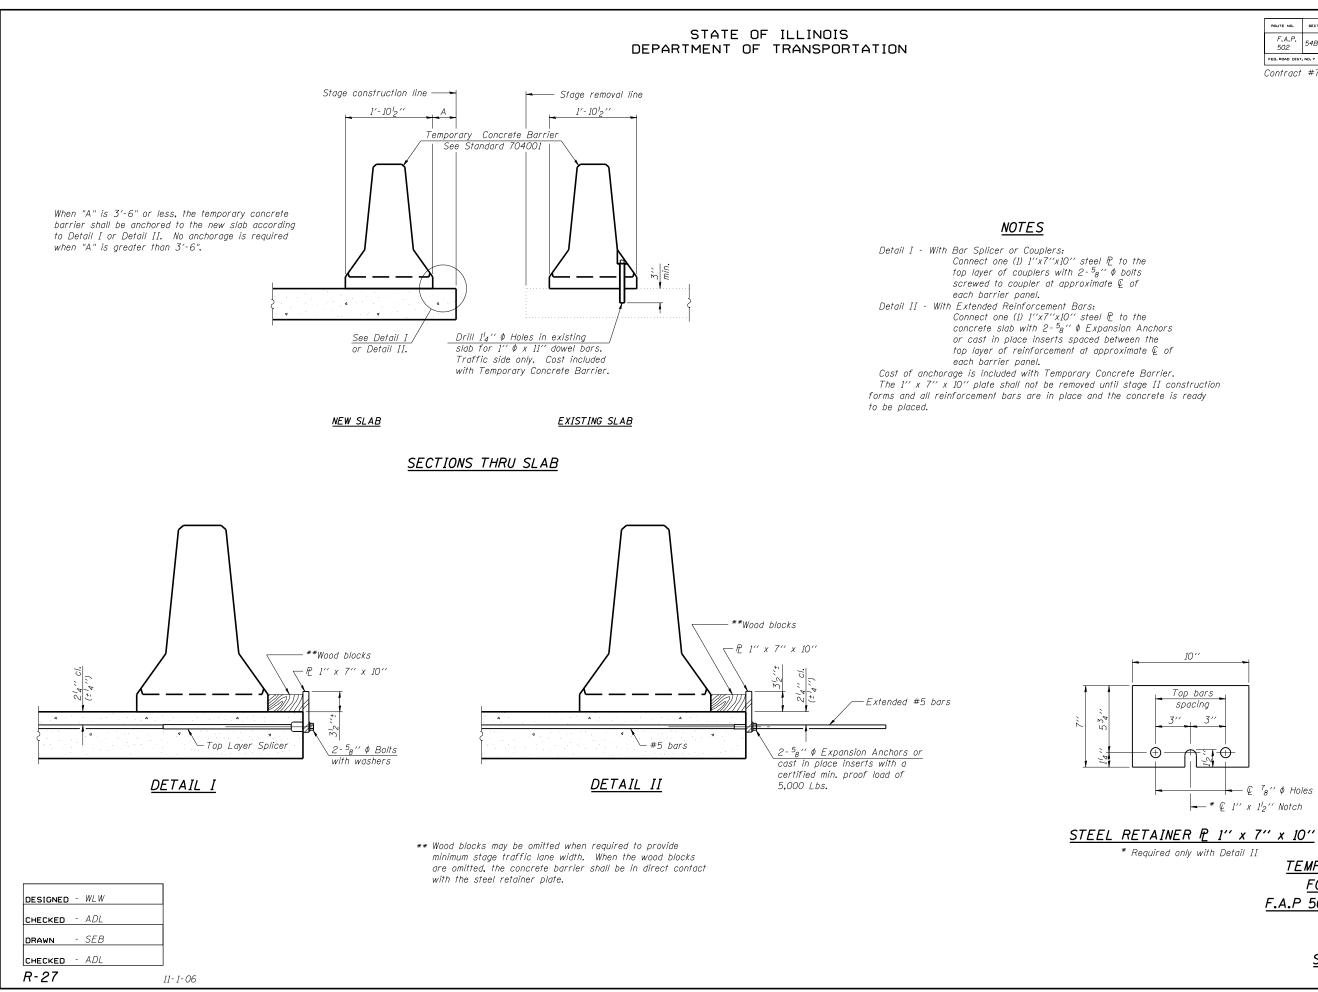


ROUTE NO.	SECTION	COUNTY		TOTAL SHEETS	SHEET NO.	
F.A.P. 502	54BR-1	ADAMS		28	22	
FED. ROAD DIST. NO. 7		ILLINDIS FED. AID PROJECT-				

Contract #72873

TEMPORARY CONCRETE BARRIER FOR STAGE CONSTRUCTION F.A.P 502 ROUTE IL 57 SEC. 54BR-1 ADAMS COUNTY STATION 114+75.00 STRUCTURE NO. 001-0014

SHEET NO. 8

9 SHEETS

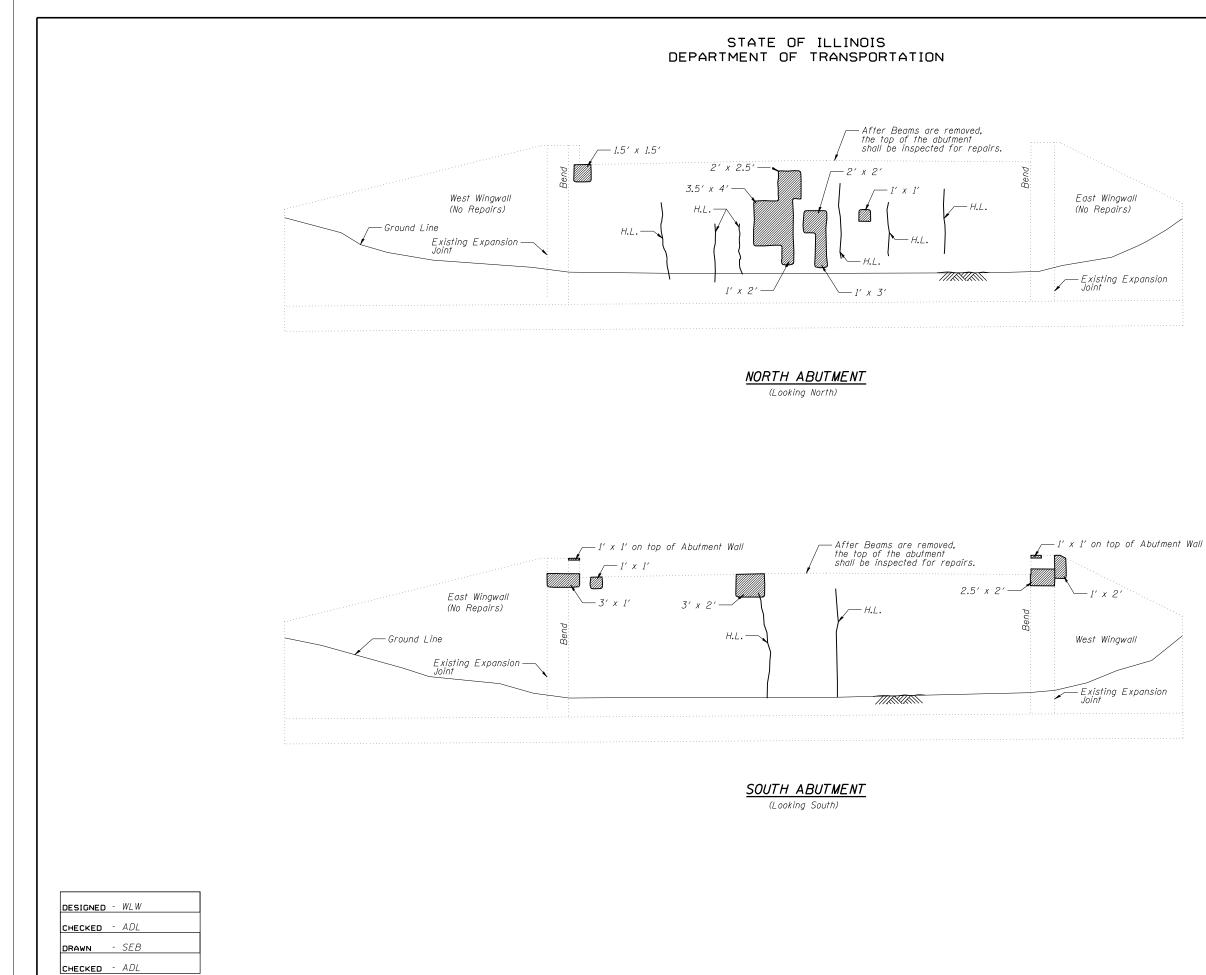

ROUTE NO.	SECTION	COUNTY		TOTAL SHEETS	SHEET NO.
F.A.P. 502	54BR-1	ADAMS		28	23
FED. ROAD DIST. NO. 7		ILLINDIS	FED. ALD PROJECT-		

Contract #72873

BILL OF MATERIAL- NORTH ABUTMENT

Item	Unit	Total
Structural Repair of Concrete (Depth equal to or less than 5 in.)	Sq. Ft.	31

<u>LEGEND</u>

Structural Repair of Concrete (Depth equal to or less than 5 in.)

H.L.

Hairline Crack - Not to be sealed

Note: Crack widths are ${}^{l}_{8}$ " ${}^{t}_{l6}$ " unless otherwise noted.




BILL OF MATERIAL - SOUTH ABUTMENT

Item	Unit	Total
Structural Repair of Concrete (Depth equal to or less than 5 in.)	Sq. Ft.	19

ABUTMENT REPAIR DETAILS F.A.P 502 ROUTE IL 57 SEC. 54BR-1 ADAMS COUNTY STATION 114+75.00 STRUCTURE NO. 001-0014

SHEET NO. 9 9 SHEETS

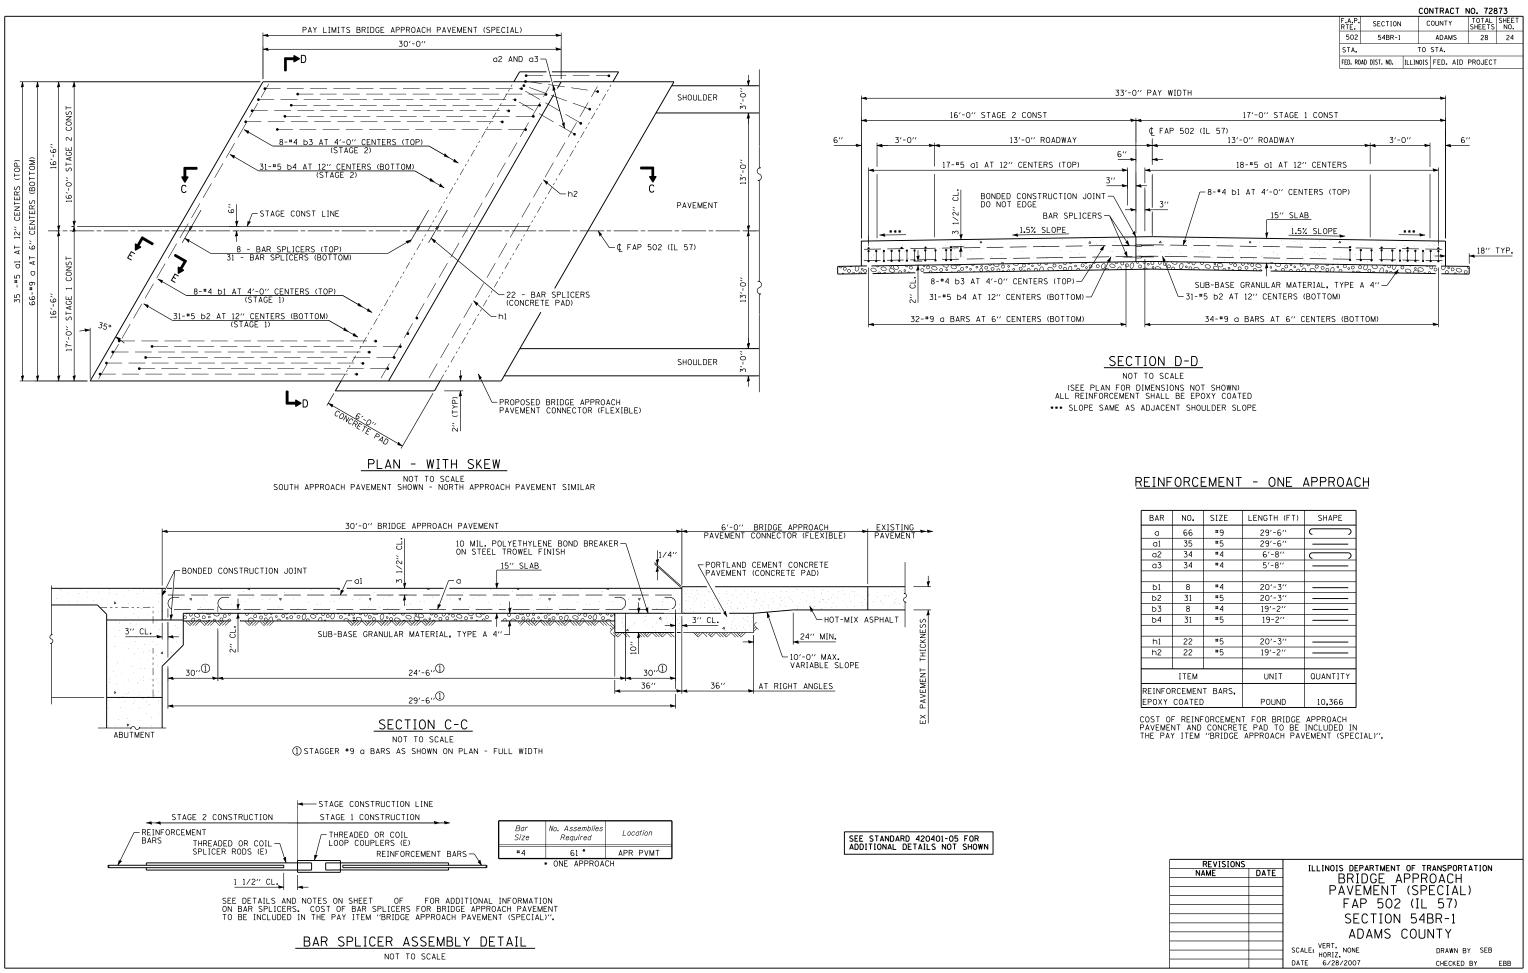


192 I

7/2/2007 ci/Project 105.8824 ' . . . DATE NAME SCALE

PLOT FILE PLOT

BAR	NO.	SIZE	LENGTH (FT)	SHAPE
a	66	# 9	29'-6''	
al	35	#5	29'-6''	
a2	34	#4	6'-8''	
a3	34	#4	5'-8''	
b1	8	#4	20'-3''	
b2	31	#5	20'-3''	
b3	8	#4	19'-2''	
b4	31	# 5	19-2''	
hl	22	#5	20'-3''	
h2	22	# 5	19'-2''	
ITEM		UNIT	QUANTITY	
REINFO	REINFORCEMENT BARS,			
EPOXY COATED			POUND	10,366

REVISIONS		ILLINOIS DEPARTMENT OF	
NAME	DATE	BRIDGE APPR	
		PAVEMENT (SF	
			ECIAL)
		EAP 502 (II	57)
			_ 317
		SECTION 54	IBR-1
		ADAMS COL	
		ADAMS CUL	JINTT
		SCALE: VERT. NONE	DRAWN BY SEB
		HORIZ.	DRAWN BY SEB
		DATE 6/28/2007	CHECKED BY EBB

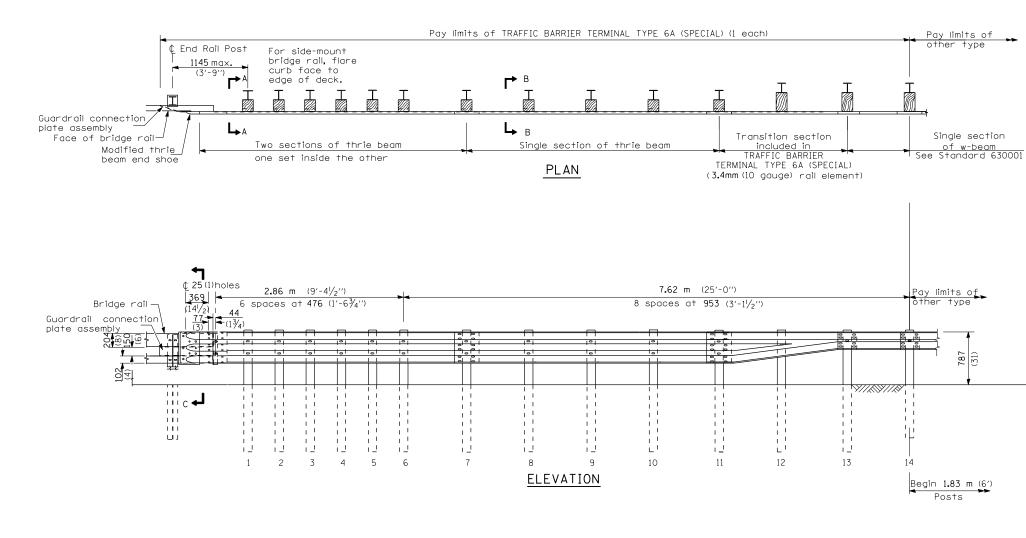


DETAIL OF TRAFFIC BARRIER TERMINAL, TYPE 6A (SPECIAL)

	CO	NTRACT	NO. 728	73
A.P. SECTION	С	OUNTY	TOTAL SHEETS	SHEET NO.
502 54BR-1		ADAMS	28	25
ΓΑ.	TO	STA.		
D. ROAD DIST. NO.	ILLINOIS	FED. AID	PROJECT	
50 50	2 54BR-1	P- SECTION C D2 54BR-1 A. TO	P. SECTION COUNTY D2 54BR-1 ADAMS A. TO STA.	SECTION COUNT SHEETS 52 54BR-1 ADAMS 28 A. TO STA. TO STA.

SEE STANDARD 631032 FOR DETAILS NOT SHOWN.

REVISIONS		ILLINOIS DEPARTMENT (
NAME	DATE	ILLINOIS DEI ARTMENT C	DI TRANSFORTATION
		MISCELLANEOL	JS DETAILS
		FAP 502	(IL 57)
		SECTION	54BR-1
		ADAMS C	OUNTY
		SCALE: VERT. NONE	DRAWN BY SEB
		DATE 6/28/2007	CHECKED BY EBB

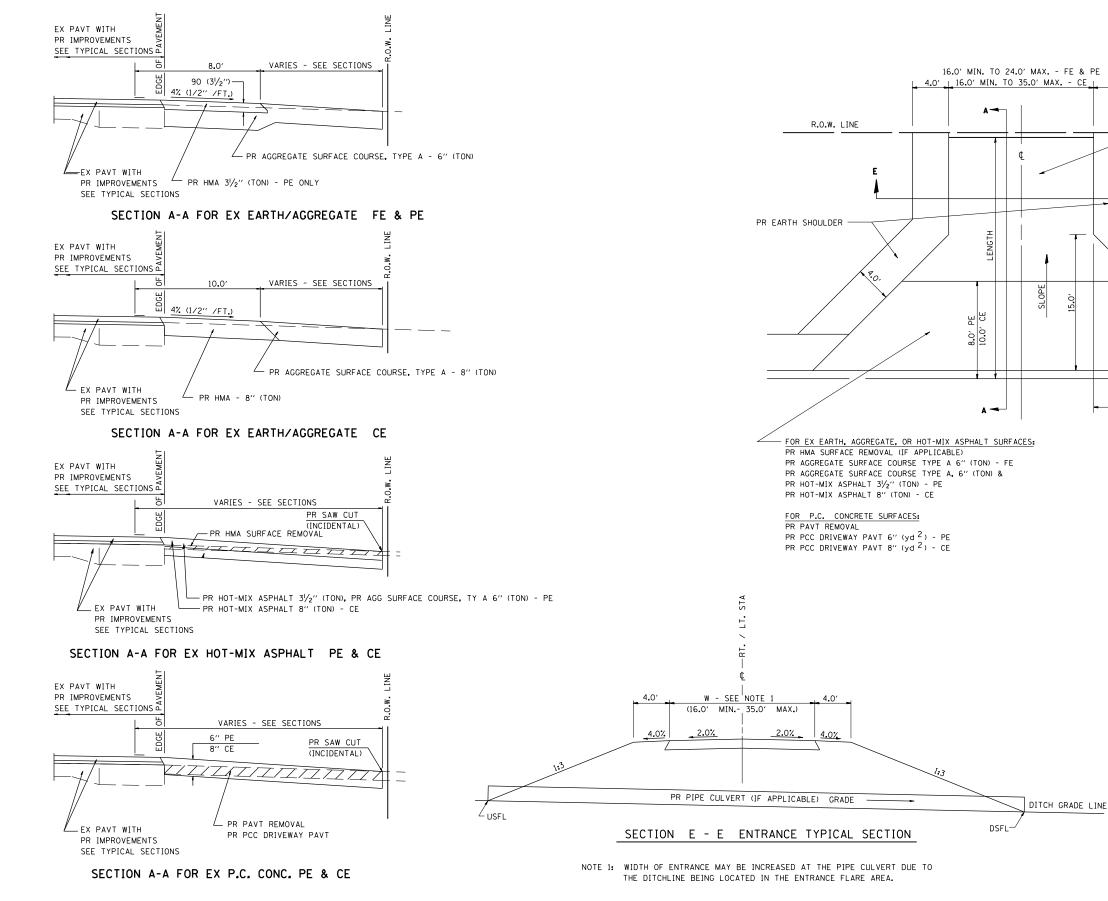

7/2/200/ ci/Projec 105.8826 DATE VAME SCALE PLOT PLOT

		F.A.P. RTE	SECTION	COUNTY	TOTAL	B73 SHEET NO.
		502	54BR-1	ADAMS	28	26
		STA.		TO STA.		
		FED. ROAD	DIST. NO. ILLI	NOIS FED. AID	PROJECT	r
E						
4.0'						
	MATCH EX SURFACE	TYPE (AGGRE	GATE OR BE	ETTER)		
	NOTE: THIS TREATME					
	THE EDGE OF	PAVEMENT	FOR FE ONL	Υ.		
	FOR EX EARTH, OR A	GGREGATE S				
_	PR AGGREGATE SURFA			' (TON) - FE	& PE	
E	PR AGGREGATE SURFA	ACE COURSE	TYPE A, 8'	'(TON) - CE		
			ACES.			
-+	FOR EX HOT-MIX ASP PR HMA SURFACE REM		AUES:			
Į	PR AGGREGATE SURFA		. TYPE A, 6	.0" (TON) -	PE	
	PR HOT-MIX ASPHALT	- / L	_			
\setminus	PR HOT-MIX ASPHALT	8" (TON -	CE			
	FOR EX P.C. CONCRE	TE SURFACE	ς.			
	PR PAVT REMOVAL		_			
A.O.	PR PCC DRIVEWAY PA					
\sim	PR PCC DRIVEWAY PA	AVEMENT 8"	(yd ²) - C	E		
\backslash	\backslash					
λ		- SHOULDER	LINE			
/ `						
/45°						
ļ		EDGE OF F	AVEMENT			
•						
	\E	EDGE LINE,	PAVEMENT	MARKING		

GENERAL NOTES:

THE RESIDENT ENGINEER WILL DETERMINE THE EXACT TYPE OF IMPROVEMENT TO BE COMPLETED FOR ALL ENTRANCES, SIDEROADS AND MAILBOX TURNOUTS ON THIS PROJECT.

THE PLAN DETAILS AND SCHEDULES SHOULD BE USED AS A GUIDE FOR THE ENGINEER TO IMPLEMENT THE FINAL DESIGN. THE ENGINEER MAY DECIDE TO SALVAGE PORTIONS OF THE EXISTING ENTRANCE PAVEMENT STRUCTURE; THEREFORE, REDUCING PAY ITEM QUANTITIES. NO ADDITIONAL PAYMENT WILL BE ALLOWED FOR THIS REDUCTION IN QUANTITIES.

ANY WORK THE ENGINEER REQUIRES WHICH IS NOT COVERED BY A PAY ITEM CONTAINED IN THE PLANS WILL BE PAID FOR IN ACCORDANCE WITH ARTICLE 109.04 OF THE STANDARD SPECIFICATIONS.

HOT-MIX ASPHALT REQUIRED TO CONSTRUCT THE ENTRANCES SHALL BE IN ACCORDANCE WITH THE APPLICABLE PORTIONS OF SECTION 406 AND 408 OF THE STANDARD SPECIFICATIONS AND AS DIRECTED BY THE ENGINEER.

WHEN THE HOT-MIX ASPHALT PROPOSED FOR THE IMPROVEMENT IS THICKER THAN 3 INCHES AND REQUIRE PLACEMENT IN MORE THAN ONE LIFT. THE BOTTOM LIFT(S) SHALL MEET THE REQUIREMENTS OF HOT-MIX ASPHALT BASE COURSE IN SECTION 406 OF THE STANDARD SPECIFICATIONS AND THE TOP LIFT OF 2 INCHES SHALL MEET THE APPLICABLE REQUIREMENTS OF HOT-MIX ASPHALT SURFACE COURSE OF SECTION 406 OF THE STANDARD SPECIFICATIONS. SURFACE COURSE MIXTURE SHALL BE MIX "C".

THIS WORK WILL BE PAID FOR AT THE CONTRACT UNIT PRICE PER TON FOR "INCIDENTAL HOT-MIX ASPHALT SURFACING" WHICH SHALL INCLUDE ALL MATERIALS, EQUIPMENT, AND LABOR INVOLVED.

ENTRANCE DETAILS

REVISIONS		ILLINOIS DEPARTMENT OF TRA		
NAME	DATE	TEETHOTS DEFAILTMENT OF THA		
		MISCELLANEOUS [DETAILS	
		FAP 502 (IL	57)	
		SECTION 54B	R-1	
		ADAMS COUN	ΤY	
		SCALE: VERT. NONE HORIZ.	DRAWN BY SEB	
			CHECKED BY E	BB

