FOR INDEX OF SHEETS, SEE SHEET NO. 2

IMPROVEMENT IS LOCATED IN THE

TRAFFIC DATA

P.V. = 93.0% S.U. = 3.5% M.U. = 3.5%

FULL SIZE PLANS HAVE BEEN PREPARED USING STANDARD

JOINT UTILITY LOCATION INFORMATION FOR EXCAVATION

CONFORM TO STANDARD SCALES. IN MAKING MEASUREMENTS ON REDUCED PLANS, THE ABOVE SCALES MAY BE USED.

ENGINEERING SCALES. REDUCED SIZED PLANS WILL NOT

POSTED SPEED = 35 MPH

DESIGN SPEED = 35 MPH

VILLAGE OF EAST HAZEL CREST &

VILLAGE OF HAZEL CREST

2014 ADT = 10450

FOR LIST OF HIGHWAY STANDARDS, SEE SHEET NO. 2

FUNCTIONAL CLASSIFICATION: URBAN MINOR ARTERIAL

### STATE OF ILLINOIS **DEPARTMENT OF TRANSPORTATION**

## 2014-093B

#### P-91-408-15 D-91-126-15



EFK Moen, LLC Civil Engineering Design 125 South Warter Dr. Suite 2026 Chicago, H. 60626 Phone 312-326-4065

STATE OF ILLINOIS DEPARTMENT OF TRANSPORTATION DIVISION OF HIGHWAYS

PRINTED BY THE AUTHORITY OF THE STATE OF ILLINOIS

# **PROPOSED** HIGHWAY PLANS

AT DITCH (0.17MI NORTH OF GOVERNORS HWY) **SECTION 2014-083B** FEDERAL PROJECT NHPP-M1YX(015) **CULVERT REPLACEMENT COOK COUNTY** C-91-126-15

**FAU ROUTE 2843 (DIXIE HWY)** 

IMPROVEMENT LIMIT **CULVERT REPLACEMENT** EXIST. SN 016-2211 PROP. SN 016-2292 IMPROVEMENT LIMIT

STA 11+00

STA 14+62.28

STA 16+00

LOCATION MAP NOT TO SCALE License Expires 11/10/2015 The seal above is volid for Sheets 1 13 & 29 19 CHRIS UNNEMAN

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PROJECT ENGINEER: JEAN ALIX BRICE (847)705-4552

PROJECT MANAGER: MATTHEW ROTHENBERG, PE (847)705-4230

CONTRACT NO. 62A28

1-800-892-0123 OR 811

REV. 7/30/18

GROSS LENGTH = 500.00 FT. = 0.095 MILE NET LENGTH = 500.00 FT. = 0.095 MILE

THORNTON TOWNSHIP

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  - B TYPICAL SECTIONS
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#### LIST OF IDOT HIGHWAY STANDARDS

- 280001-07 TEMPORARY EROSION CONTROL SYSTEMS
- 420001 -09 PAVEMENT JOINTS
- 483001-05 PCC SHOULDER
- 515001-03 NAME PLATE FOR BRIDGES
- 606001-07 CONCRETE CURB TYPE B AND COMBINATION CONCRETE CURB
- AND GUTTER
- 630001-12 STEEL PLATE BEAM GUARDRAIL
- 630106-02 LONG-SPAN GUARDRAIL OVER CULVERT
- 630301-08 SHOULDER WIDENING FOR TYPE 1 (SPECIAL) GUARDRAIL TERMINALS
- 631011-10 TRAFFIC BARRIER TERMINAL, TYPE 2
- 635001-02 DELINEATORS
- 664001-02 CHAIN LINK FENCE
- 701101-05 MULTILANE, 15' (4.5M) TO 24" (600mm) FROM PAVEMENT EDGE MUL
- 701106-02 TILANE, MORE THAN 15' (4.5M) AWAY
- 701901-07 TRAFFIC CONTROL DEVICES
- 725001-01 OBJECT AND TERMINAL MARKERS
- 782006 GUARDRAIL AND BARRIER WALL REFLECTOR MOUNTING DETAILS

#### **GENERAL NOTES**

- BEFORE STARTING ANY EXCAVATION, THE CONTRACTOR SHALL CALL "J.U.L.I.E."
  AT (800) 892-0123 OR 811 FOR FIELD LOCATIONS OF BURIED ELECTRIC, TELEPHONE,
  AND GAS UTILITIES. 48 HOUR NOTIFICATION IS REQUIRED.
- 2. NOTIFY THE VILLAGES AT LEAST 48 HOURS IN ADVANCE OF CONSTRUCTION.
- 3. THE CONTRACTOR WILL NOT BE ALLOWED TO SET UP A YARD OR FIELD OFFICE ON STATE PROPERTY WITHOUT WRITTEN PERMISSION FROM THE DEPARTMENT.
- 4. BEFORE BEGINNING ANY WORK, THE CONTRACTOR SHALL RETAIN AND RECORD, FOR FUTURE REFERENCE, ALL EXISTING PAVEMENT MARKING LINES (AND RAISED REFLECTIVE PAVEMENT MARKERS) IN ORDER THAT THESE LOCATIONS CAN BE RE-ESTABLISHED FOR STRIPING, EXACT LOCATIONS OF ALL PAVEMENT MARKINGS SHALL BE AS DIRECTED BY THE FNGINFER.
- 5. IT IS THE CONTRACTOR'S RESPONSIBILITY TO VERIFY ALL DIMENSIONS AND CONDITIONS EXISTING IN THE FIELD PRIOR TO CONSTRUCTION AND ORDERING OF MATERIALS.
- 6. THE CONTRACTOR SHALL CONTACT THE DISTRICT ONE TRAFFIC CONTROL SUPERVISOR AT (847) 705-4470 A MINIMUM OF 72 HOURS IN ADVANCE OF BEGINNING WORK.
- 7. THE RESIDENT ENGINEER SHALL CONTACT PATRICE HARRIS, AREA TRAFFIC FIELD TECHNICIAN, AT PATRICE.HARRIS@ILLINOIS.GOV A MINIMUM OF TWO (2) WEEKS PRIOR TO THE PLACEMENT OF PERMANENT PAVEMENT MARKINGS.
- THESE PLANS HAVE BEEN PREPARED FROM NOTES RECEIVED FROM THE BUREAU OF MAINTENANCE.
- 9. THE CONTRACTOR IS REQUIRED TO PROVIDE ACCESS TO ABUTTING PROPERTY AT ALL TIMES DURING THE CONSTRUCTION OF THIS PROJECT.
- 10. DO NOT SCALE PLANS FOR CONSTRUCTION DIMENSIONS.
- 11. THIS PROJECT REQUIRES A U.S. ARMY CORPS OF ENGINEERS (USACE) 404 PERMIT THAT WILL BE SECURED BY THE DEPARTMENT. ALL CONDITIONS OF THE 404 PERMIT, FOUND IN THE SPECIAL PROVISIONS, MUST BE FOLLOWED. THE COST OF ALL MATERIALS AND LABOR NECESSARY TO COMPLY WITH THE 404 PERMIT WILL NOT BE PAID FOR SEPARATELY BUT SHALL BE CONSIDERED AS INCLUDED IN THE UNIT BID PRICES OF THE CONTRACT AND NO ADDITIONAL COMPENSATION WILL BE ALLOWED. EARTH EXCAVATION PAY ITEM INCLUDES PLACING AND COMPACTING EMBANKMENT AND LEGAL OFFSITE DISPOSAL OF EXCESS MATERIAL.
- 12. ALL DAMAGE TO EXISTING PAVEMENT MARKINGS OR RAISED REFLECTIVE PAVEMENT MARKERS OUTSIDE THE REMOVAL LINE SHOWN ON THE PLANS SHALL BE REPLACED AT NO ADDITIONAL COST TO THE DEPARTMENT.
- 13. ALL UTILITIES, SCHOOL DISTRICTS, LOCAL POLICE, AND FIRE DEPARTMENTS SHALL BE NOTIFIED BY THE CONTRACTOR PRIOR TO THE START OF CONSTRUCTION.
- 14. THE CONTRACTOR SHALL USE CARE IN GRADING OR EXCAVATING NEAR ANY AND ALL EXISTING ITEMS THAT WILL NOT BE REMOVED, ANY DAMAGE DONE TO THE EXISTING ITEMS BY THE CONTRACTOR SHALL BE REPAIRED OR REPLACED TO THE SATISFACTION OF THE ENGINEER AT THE CONTRACTOR'S OWN FXPENSE.
- 15. TREES NOT MARKED FOR REMOVAL SHALL BE CONSIDERED AS DESIGNATED TO BE SAVED AND SHALL BE PROTECTED UNDER THE PROVISIONS OF ARTICLE 201.05 OF THE STANDARD SPECIFICATIONS.

#### DRAINAGE AND UTILITIES GENERAL NOTES

- 1. THE CONTRACTOR SHALL MAINTAIN THE SURFACE DRAINAGE OF ALL ROADWAYS DURING CONSTRUCTION OF THIS PROJECT. WHEN EXISTING DRAINAGE FACILITIES ARE DISTURBED, THE CONTRACTOR SHALL PROVIDE AND MAINTAIN TEMPORARY OUTLETS AND CONNECTIONS FOR ALL PRIVATE OR PUBLIC DRAINS, SEWERS, INLETS, AND CATCH BASINS. THE CONTRACTOR SHALL PROVIDE FACILITIES TO TAKE IN ALL STORM WATER, WHICH WILL BE RECEIVED BY THESE DRAINS AND SEWERS AND DISCHARGE SAME. THE CONTRACTOR SHALL PROVIDE AND MAINTAIN A TEMPORARY OUTLET AND BE PREPARED AT ALL TIMES TO DISPOSE OF THE WATER RECEIVED FROM ALL THESE TEMPORARY CONNECTIONS UNTIL INSTALLATION IS COMPLETE, INCLUDING PAVEMENT. THIS WORK SHALL NOT BE PAID FOR DIRECTLY BUT SHALL BE CONSIDERED INCLUDED IN THE CONTRACT. COORDINATION WITH ALL AGENCIES INVOLVED IS REQUIRED.
- 2. THE LOCATION AND ELEVATION OF EXISTING UTILITIES ARE APPROXIMATE AND ARE PROVIDED BY THE OWNERS. THE EXACT LOCATIONS AND ELEVATIONS ARE TO BE VERIFIED BY THE CONTRACTOR THROUGH THE OWNERS OF THE UTILITIES.
- 3. THE COST OF MAKING STORM SEWER CONNECTIONS TO EXISTING SEWER SHALL BE INCLUDED IN THE CONTRACT UNIT PRICE FOR THE STORM SEWER BEING CONNECTED.

#### **EROSION CONTROL AND LANDSCAPING GENERAL NOTES**

- 1. ALL WASTE GENERATED AS A RESULT OF THE PROJECT INCLUDING DISCARDED BUILDING MATERIALS, CONCRETE TRUCK WASHOUT, CHEMICALS, LITTER, SANITARY WASTE, OR ANY OTHER WASTE SHALL BE PROPERLY DISPOSED OF AND BE PREVENTED FROM BEING CARRIED OFF THE SITE BY EITHER WIND OR WATER.
- THE CONCTRACTOR SHALL INSTALL PERIMETER EROSION BARRIER PRIOR TO STRIPPING OF VEGETATION.
- 3. RUNOFF FROM EXCAVATED AREAS SHALL LEAVE THE SITE THROUGH SEDIMENT CONTROL DEVICES SHOWN IN IDOT STD. 280001, AND/OR NRCS DETAILS FROM THE MOST RECENT VERSION OF THE ILLINOIS URBAN MANUAL.
- 4. THE CONTRACTOR SHALL SURROUND ANY NECESSARY EARTH STOCKPILES WITH PERIMETER EROSION BARRIER.
- 5. ALL EROSION CONTROL MEASURES SHOULD BE CHECKED WEEKLY AND AFTER EACH RAINFALL 0.5 INCHES OR GREATER. ADDITIONALLY DURING WINTER MONTHS, ALL MEASURES SHOULD BE CHECKED AFTER EACH SNOWMELT.
- 6. THE REVISED PERMIT REQUIRES THAT STABILIZATION OF DISTURBED AREAS MUST BE INITIAITED WITHIN ONE (1) WORKING DAY OF THE TEMPORARY OR PERMANENT CESSATION OF EARTH DISTURBING ACTIVITIES AND SHALL BE COMPLETED AS SOON AS POSSIBLE BUT NO LATER THAN 14 DAYS FROM THE INITIATION OF STABILIZATION OF WORK IN AN AREA.
- 7. ALL EXPOSED IDLE EARTH, INCLUDING EARTH STOCKPILES, WILL BE SEEDED WITH TEMPORARY EROSION CONTROL SEEDING. THE APPLICATION RATE FOR TEMPORARY EROSION CONTROL SEEDING IS 100 POUNDS PER ACRE FOR THREE APPLICATIONS.
- 8. ALL TEMPORARY EROSION AND SEDIMENT CONTROL MEASURES SHALL BE REMOVED WITHIN 30 DAYS OF ACHIEVING PERMANENT SOIL STABILIZATION. TRAPPED SEDIMENT AND OTHER DISTURBED SOILS RESULTING FROM TEMPORARY MEASURES SHALL BE PROPERLY DISPOSED OF AND THE AREA PERMANENTLY STABILIZED.

#### **COMMITMENTS**

NONE.

#### **EARTHWORK**

| EARTHWORK SCHEDULE                                    |                     |
|---|---------------------|
| LOCATION  | EARTH<br>EXCAVATION |
|   | (CU YD)             |
| BARRIER WALL AND BASE ON EAST SIDE OF DIXIE HWY       | 80                  |
| CURB AND GUTTER REMOVAL AND REPLACEMENT               | 3                   |
| SUBGRADE IMPROVEMENT BEYOND CULVERT EXCAVATION LIMITS | 7                   |
|   |                     |
| TOTAL   | 90                  |

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|          |   |         |           | CONSTR CORE  | CONSTR. CODE   |
|----------|---|---------|-----------|--------------|----------------|
|          |   |         | 80% FED   | CONSTR. CODE | CONSTR. CODE   |
|          |   |         | 20% STATE |              |                |
|          |   |         |           | ROADWAY      | BOX CULVERT    |
| CODE     |   |         | TOTAL     | 0004         | 0004           |
| NO.      | ITEM  | UNIT    | QUANTITY  | URBAN        | S. N. 016-2292 |
|          |   |         |           |              |                |
| 20100110 | TREE REMOVAL AC TO 15 UNITE DIAMETERS       | LINITT  | 4.2       | 40           |                |
| 20100110 | TREE REMOVAL (6 TO 15 UNITS DIAMETER)       | UNIT    | 42        | 42           |                |
|          |   |         |           |              |                |
| 20100210 | TREE REMOVAL (OVER 15 UNITS DIAMETER)       | UNIT    | 22        | 22           |                |
| 20100210 | THE REMOVAL VOVER 15 DIVITS DIAMETERS       | ONTT    | 22        | 22           |                |
|          |   |         |           |              |                |
| 20101000 | TEMPORARY FENCE                             | FOOT    | 4         | 4            |                |
| 20101000 |   |         |           | ·            |                |
|          |   |         |           |              |                |
| 20101350 | TREE PRUNING (OVER 10 INCH DIAMETER)        | EACH    | 1         | 1            |                |
|          |   |         |           |              |                |
|          |   |         |           |              |                |
| 20200100 | EARTH EXCAVATION                            | CU YD   | 89        | 89           |                |
|          |   |         |           |              |                |
|          |   |         |           |              |                |
| 20201200 | REMOVAL AND DISPOSAL OF UNSUITABLE MATERIAL | CU YD   | 119       | 56           | 63             |
|          |   |         |           |              |                |
|          |   |         |           |              |                |
| 20700220 | POROUS GRANULAR EMBANKMENT                  | CU YD   | 333       |              | 333            |
|          |   |         |           |              |                |
|          |   |         |           |              |                |
| 20800150 | TRENCH BACKFILL                             | CU YD   | 15        | 15           |                |
|          |   |         |           |              |                |
|          |   |         |           |              |                |
| 21101625 | TOPSOIL FURNISH AND PLACE, 6"               | SQ YD   | 332       | 332          |                |
|          |   |         |           |              |                |
| 2500000  |   |         |           |              |                |
| 25000210 | SEEDING, CLASS 2A                           | ACRE    | 0.03      | 0.03         |                |
|          |   |         |           |              |                |
| 25000400 | NITROGEN FERTILIZER NUTRIENT                | POUND   | 7         | 7            |                |
| 23000400 | NITHOGEN TENTETZEN NOTKIENT                 | T OUND  | 1         | 1            |                |
|          |   |         |           |              |                |
| 25000500 | PHOSPHORUS FERTILIZER NUTRIENT              | POUND   | 7         | 7            |                |
|          |   | 1 03.10 |           |              |                |
|          |   |         |           |              |                |
| 25000600 | POTASSIUM FERTILIZER NUTRIENT               | POUND   | 7         | 7            |                |
|          |   |         |           |              |                |
|          |   |         |           |              |                |
| 25200200 | SUPPLEMENTAL WATERING                       | UNIT    | 10        | 10           |                |
|          |   |         |           |              |                |
|          |   |         |           |              |                |
|          |   |         |           |              |                |

| USER NAME = RGall             | DESIGNED | - | RG         | REVISED - | l |
|-------------------------------|----------|---|------------|-----------|---|
|                               | DRAWN    | - | KW         | REVISED - | l |
| PLOT SCALE = 100.0000 ' / in. | CHECKED  | - | JH         | REVISED - | l |
| PLOT DATE = 6/26/2018         | DATE     | - | 04/27/2018 | REVISED - | L |

SCALE:

COUNTY TOTAL SHEET NO.

COOK 30 3

CONTRACT NO. 62A28

<sup>\*</sup> SPECIAL PROVISION REQUIRED
\*\* DENOTES SPECIALTY ITEM

|          |  |       | 80% FED   | CONSTR. CODE    | CONSTR. CODE   |
|----------|--|-------|-----------|-----------------|----------------|
|          |  |       | 20% STATE |                 |                |
| CODE     | 1754   |       | TOTAL     | ROADWAY<br>0004 | BOX CULVERT    |
| NO.      | ITEM   | UNIT  | QUANTITY  | URBAN           | S. N. 016-2292 |
| 28000250 | TEMPORARY EROSION CONTROL SEEDING            | POUND | 21        | 21              |                |
| 28000400 | PERIMETER EROSION BARRIER                    | FOOT  | 558       | 558             |                |
| 28200200 | FILTER FABRIC                                | SQ YD | 85        |                 | 85             |
| 30300112 | AGGREGATE SUBGRADE IMPROVEMENT 12"           | SQ YD | 292       | 292             |                |
| 40600290 | BITUMINOUS MATERIALS (TACK COAT)             | POUND | 61        | 61              |                |
| 40603085 | HOT-MIX ASPHALT BINDER COURSE, IL-19.0, N70  | TON   | 96        | 96              |                |
| 40603340 | HOT-MIX ASPHALT SURFACE COURSE, MIX "D", N70 | TON   | 16        | 16              |                |
| 42001300 | PROTECTIVE COAT                              | SQ YD | 444       | 424             | 20             |
|          |  |       |           |                 |                |
| 44000100 | PAVEMENT REMOVAL                             | SQ YD | 183       | 183             |                |
| 44213200 | SAW CUTS                                     | FOOT  | 394       | 394             |                |
| 48101600 | AGGREGATE SHOULDERS, TYPE B 8"               | SQ YD | 90        | 90              |                |
|          |  |       |           |                 |                |
| 50100100 | REMOVAL OF EXISTING STRUCTURES               | EACH  | 1         |                 | 1              |
| 50800105 | REINFORCEMENT BARS                           | POUND | 11120     |                 | 11120          |
| 51500100 | NAME PLATES                                  | EACH  | 1         |                 | 1              |
|          |  |       |           |                 |                |

SCALE:

CONTRACT NO. 62A28

<sup>\*</sup> SPECIAL PROVISION REQUIRED
\*\* DENOTES SPECIALTY ITEM

SECTION
 COUNTY
 TOTAL SHEETS NO.

 2014-083B
 COOK
 30
 4

|     |             |  |        | 80% FED           | CONSTR. CODE             | CONSTR. CODE                          |
|-----|-------------|--|--------|-------------------|--------------------------|---------------------------------------|
|     |             |  | 2      | 20% STATE         |                          |                                       |
|     | CODE<br>NO. | ITEM   | UNIT   | TOTAL<br>QUANTITY | ROADWAY<br>0004<br>URBAN | BOX CULVERT<br>0004<br>S. N. 016-2292 |
|     |             |  |        |                   |                          |                                       |
|     | 54003000    | CONCRETE BOX CULVERTS  | CU YD  | 55.6              |                          | 55.6                                  |
|     | 550A0120    | STORM SEWERS, CLASS A, TYPE 1 24"                            | FOOT   | 40                | 40                       |                                       |
|     | 33040120    | STORM SERENS, SEASS A, THE LET                               | 1 001  |                   |                          |                                       |
|     | 55101200    | STORM SEWER REMOVAL 24"                                      | FOOT   | 50                | 50                       |                                       |
| **  | 63100045    | TRAFFIC BARRIER TERMINAL, TYPE 2                             | EACH   | 1                 | 1                        |                                       |
|     |             |  |        |                   |                          |                                       |
| **  | 63100167    | TRAFFIC BARRIER TERMINAL, TYPE 1 (SPECIAL) TANGENT           | EACH   | 1                 | 1                        |                                       |
|     | 63200310    | GUARDRAIL REMOVAL  | FOOT   | 354               | 354                      |                                       |
|     |             |  |        |                   |                          |                                       |
|     | 63700180    | CONCRETE BARRIER, SINGLE FACE, 44 INCH HEIGHT                | FOOT   | 278               | 278                      |                                       |
|     | 63700900    | CONCRETE BARRIER BASE  | FOOT   | 337               | 337                      |                                       |
|     | 03100300    | CONCRETE BARRIER BASE  | 1001   | 331               | 331                      |                                       |
|     | 64300260    | IMPACT ATTENUATORS (FULLY REDIRECTIVE, NARROW), TEST LEVEL 3 | EACH   | 2                 | 2                        |                                       |
|     |             |  |        |                   |                          |                                       |
|     | 66400305    | CHAIN LINK FENCE, 6'   | FOOT   | 38                | 38                       |                                       |
| **  | 66900200    | NON-SPECIAL WASTE DISPOSAL                                   | CU YD  | 110               | 110                      |                                       |
| **  | 66900450    | SPECIAL WASTE PLANS AND REPORTS                              | L SUM  | 1                 | 1                        |                                       |
| - 中 | 00300430    | SILUTAL MASIE FLANS AND REFURIS                              | L SUM  | 1                 | 1                        |                                       |
| **  | 66900530    | SOIL DISPOSAL ANALYSIS                                       | EACH   | 1                 | 1                        |                                       |
|     | 67000400    | ENGINEER'S FIELD OFFICE, TYPE A                              | CAL MO | 6                 | 6                        |                                       |
|     |             |  |        |                   |                          |                                       |

SCALE:

<sup>\*</sup> SPECIAL PROVISION REQUIRED
\*\* DENOTES SPECIALTY ITEM

|    |             |  |           | 80% FED           | CONSTR. CODE             | CONSTR. CODE                          |
|----|-------------|--|-----------|-------------------|--------------------------|---------------------------------------|
|    |             |  | 20% STATE |                   |                          |                                       |
|    | CODE<br>NO. | ITEM   | UNIT      | TOTAL<br>QUANTITY | ROADWAY<br>0004<br>URBAN | BOX CULVERT<br>0004<br>S. N. 016-2292 |
|    | NU.         | TIEM   | UNII      | QUANTITY          | URBAN                    | 5. N. 016-2292                        |
|    | 67100100    | MOBILIZATION   | L SUM     | 1                 | 1                        |                                       |
| ** | 72501000    | TERMINAL MARKER - DIRECT APPLIED   | EACH      | 2                 | 2                        |                                       |
| ** | 78000200    | THERMOPLASTIC PAVEMENT MARKING - LINE 4"                                       | FOOT      | 431               | 431                      |                                       |
| ** | 78100100    | RAISED REFLECTIVE PAVEMENT MARKER  | EACH      | 6                 | 6                        |                                       |
| ** | 78200005    | GUARDRAIL REFLECTORS, TYPE A   | EACH      | 4                 | 4                        |                                       |
| ** | 78200011    | BARRIER WALL REFLECTORS, TYPE C  | EACH      | 4                 | 4                        |                                       |
|    | 78300200    | RAISED REFLECTIVE PAVEMENT MARKER REMOVAL                                      | EACH      | 6                 | 6                        |                                       |
| ** | A2002916    | TREE, CELTIS OCCIDENTALIS (COMMON HACKBERRY), 2" CALIPER, BALLED AND BURLAPPED | EACH      | 4                 | 4                        |                                       |
| ** | K0013000    | PERENNIAL PLANTS, PRAIRIE TYPE, 2" DIAMETER BY 4" DEEP PLUG                    | UNIT      | 9                 | 9                        |                                       |
| .: | K0029614    | WEED CONTROL, AQUATIC  | GALLON    | 5                 | 5                        |                                       |
| ** | X2510635    | HEAVY DUTY EROSION CONTROL BLANKET, SPECIAL                                    | SQ YD     | 332               | 332                      |                                       |
| ** | X2502014    | SEEDING, CLASS 4A (MODIFIED)   | ACRE      | 0.02              | 0.02                     |                                       |
| *  | X2502024    | SEEDING, CLASS 4B (MODIFIED)   | ACRE      | 0.02              | 0.02                     |                                       |
| ** | X2503315    | INTERSEEDING, CLASS 4A (MODIFIED)  | ACRE      | 0.05              | 0.05                     |                                       |
|    |             |  |           |                   |                          |                                       |

CHECKED - JH

DATE - 04/27/2018

REVISED -

REVISED -

PLOT SCALE = 100.0000 '/ in.

PLOT DATE = 6/26/2018

\* SPECIAL PROVISION REQUIRED
\*\* DENOTES SPECIALTY ITEM

COUNTY TOTAL SHEET NO.

COOK 30 6

CONTRACT NO. 62A28 F.A.U. RTE. 2843 USER NAME = RGall DESIGNED - RG REVISED -SECTION DIXIE HIGHWAY OVER DITCH STATE OF ILLINOIS DRAWN - KW REVISED -2014-083B

SCALE:

SHEET

**DEPARTMENT OF TRANSPORTATION** 

SUMMARY OF QUANTITIES

TO STA.

OF SHEETS STA.

|     |           |   |       | 80% FED   | CONSTR. CODE  | CONSTR. CODE           |
|-----|-----------|---|-------|-----------|---------------|------------------------|
|     |           |   |       | 20% STATE |               |                        |
|     | CODE      |   |       | TOTAL     | ROADWAY       | BOX CULVERT            |
|     | NO.       | ITEM  | UNIT  | QUANTITY  | 0004<br>URBAN | 0004<br>S. N. 016-2292 |
|     |           |   |       |           |               |                        |
| .:  | X2503318  | INTERSEEDING, CLASS 4B (MODIFIED)                             | ACRE  | 0. 05     | 0.05          |                        |
|     |           |   |       |           |               |                        |
| •   | X0327980  | PAVEMENT MARKING REMOVAL - WATER BLASTING                     | SQ FT | 102       | 102           |                        |
|     | X0900064  | MEMBRANE WATERPROOFING SYSTEM FOR BURIED STRUCTURES           | SQ YD | 91        |               | 91                     |
|     |           |   |       |           |               |                        |
| •   | X4810200  | AGGREGATE SHOULDER REMOVAL                                    | CU YD | 14        | 14            |                        |
| *** | X5538200  | STORM SEWERS TO BE CLEANED 24"                                | FOOT  | 432       | 432           |                        |
|     |           |   |       |           |               |                        |
| •   | X6640300  | CHAIN LINK FENCE REMOVAL                                      | FOOT  | 36        | 36            |                        |
|     |           |   |       |           |               |                        |
| •   | X7010216  | TRAFFIC CONTROL AND PROTECTION, (SPECIAL)                     | L SUM | 1         | 1             |                        |
| •   | Z0004562  | COMBINATION CURB AND GUTTER REMOVAL AND REPLACEMENT           | FOOT  | 40        | 40            |                        |
|     |           |   |       |           |               |                        |
| •   | Z0013798  | CONSTRUCTION LAYOUT   | L SUM | 1         | 1             |                        |
|     |           |   |       |           |               |                        |
| *** | Z0018500  | DRAINAGE STRUCTURES TO BE CLEANED                             | EACH  | 1         | 1             |                        |
| •   | Z0030850  | TEMPORARY INFORMATION SIGNING                                 | SQ FT | 44        | 44            |                        |
|     |           |   |       |           |               |                        |
| •   | Z0073510  | TEMPORARY TRAFFIC SIGNAL TIMING                               | EACH  | 5         | 5             |                        |
|     | #X2300018 | LONG SPAN GUARDRAIL OVER CULVERT (SPECIAL), 12 FOOT 6 IN SPAN | FOOT  | 37. 5     | 37.5          |                        |
| • • | 72500010  | 25.10 S. AN SOMEWAIT STEEL SOLVENT VSIESTAET, 12 1001 STAN    | 1 001 |           | 31.3          |                        |
|     |           |   |       |           |               |                        |
|     |           |   |       |           |               |                        |


\* SPECIAL PROVISION REQUIRED

• DENOTES SPECIALTY ITEM

\*\*\* 100% STATE


SECTION

SCALE:

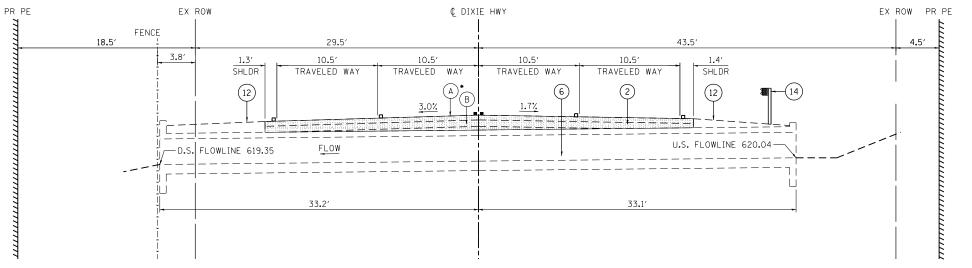

#### **EXISTING TYPICAL SECTION**

(AT CULVERT LOOKING NORTH) STA. 14+48.27 TO STA. 14+76.27

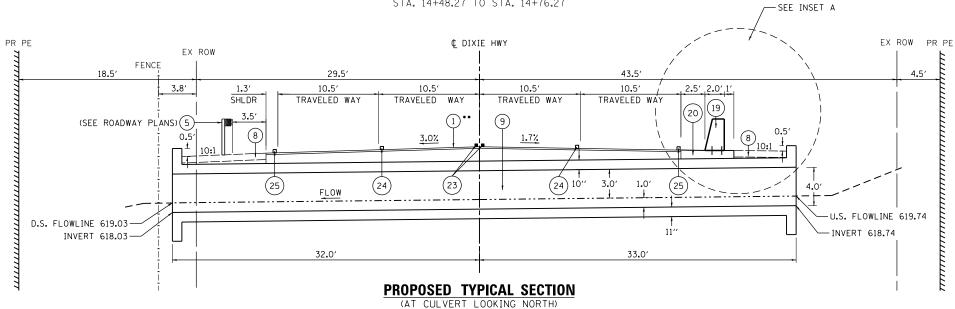

STA. 14+48.27 TO STA. 14+76.27

• SEE SOIL BORING LOGS FOR EXISTING PAVEMENT THICKNESS.


•• DEPTH OF HMA BINDER COURSE PLACED OVER CULVERT VARIES FROM 18" MAX. AT CENTER OF CULVERT TO 10" MIN. AT EDGE OF PAVEMENT. DEPTH OF HMA BINDER COURSE AT ALL OTHER LOCATIONS SHALL BE 12".

\*\*\* AGGREGATE SUBGRADE IMPROVEMENT, 12" NOT PLACED OVER CULVERT. SEE CULVERT DETAILS.

#### **MIXTURES TABLE**

|    | MIXTURE TYPE   | AIR VOIDS<br>@ Ndes | QUALITY MANAGEMENT<br>PROGRAM (QMP) |
|----|--|---------------------|-------------------------------------|
|    | PROPOSED PAVEMENT  |                     |                                     |
|    | HOT-MIX-ASPHALT SURFACE COURSE, MIX D", N70; 2" (IL-9.5 MM)        | 4% @ 70 Gyr.        | QC/QA                               |
| ** | HOT-MIX-ASPHALT BINDER COURSE, IL-19.0, VARIES (10" MIN., 18" MAX) | 4% @ 70 Gyr.        | QC/QA                               |
|    | OMP DESIGNATION: QUALITY CONTROL/QUALITY ASSURANCE (QC/QA)         |                     |                                     |

- 1. THE UNIT WEIGHT USED TO CALCULATE ALL HMA SURFACE MIXTURE QUANTITIES IS 112 LBS/SQYD/IN.
- 2. FOR NON-POLYMERIZED HMA THE "AC TYPE" SHALL BE "PG 64-22" UNLESS MODIFIED BY DISTRICT ONE SPECIAL PROVISIONS.
- 3. FOR USE OF RECYCLED MATERIALS SEE DISTRICT ONE SPECIAL PROVISIONS.
- 4. QUALITY MANAGEMENT PROGRAM (QMP) IDENTIFIES THE PARTICULAR QUALITY CONTROL SPECIFICATION THAT APPLIES TO THE HMA MIXTURE.

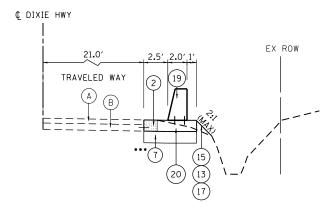

#### INSET A

(PROPOSED GRADING FOR BARRIER WALL) STA 11+67.38 TO STA 14+56.47 STA 14+65.49 TO STA 15+04.28

#### LEGEND

- A EXISTING HMA PAVEMENT, 6"
- B) EXISTING PCC BASE COURSE, 8"
- 1) HMA SURFACE COURSE, MIX "D", N70 HMA BINDER COURSE, IL-19.0, N70
- 2) PAVEMENT REMOVAL
- (3) TRAFFIC BARRIER TERMINAL, TYPE 1 (SPECIAL) TANGENT
- (4) TRAFFIC BARRIER TERMINAL, TYPE 2
- (5) LONG SPAN GUARDRAIL OVER CULVERT (SPECIAL), 12 FOOT
- (6) REMOVAL OF EXISTING STRUCTURES
- (7) AGGREGATE SUBGRADE IMPROVEMENT, 12"
- (8) AGGREGATE SHOULDERS, TYPE B 8"
- 9 CONCRETE BOX CULVERTS
- (10) POROUS GRANULAR EMBANKEMENT
- 11) IMPACT ATTENUATORS (FULLY REDIRECTIVE, NARROW), TEST LEVEL 3
- (12) AGGREGATE SHOULDER REMOVAL
- (13) SEEDING, CLASS 4A (MODIFIED)
- (14) GUARDRAIL REMOVAL
- (15) HEAVY DUTY EROSION CONTROL BLANKET, SPECIAL
- (16) PERIMETER EROSION BARRIER
- (17) TOPSOIL FURNISH AND PLACE, 6"
- (18) COMBINATION CURB AND GUTTER REMOVAL AND REPLACEMENT
- (19) CONCRETE BARRIER, SINGLE FACE, 44 INCH HEIGHT
- (20) CONCRETE BARRIER BASE
- (21) CHAIN LINK FENCE REMOVAL CHAIN LINK FENCE, 6'
- CHAIN LINK FLINCE, 6
- (22) STORM SEWER REMOVAL 24"
- THERMOPLASTIC PAVEMENT MARKING LINE 4" (SOLID DOUBLE YELLOW)
  RAISED REFLECTIVE PAVEMENT MARKER (40' O.C. TWO-WAY AMBER)
- THERMOPLASTIC PAVEMENT MARKING LINE 4" (30' SKIP 10' DASH WHITE)
  RAISED REFLECTIVE PAVEMENT MARKER (40' O.C. DOUBLE ONE-WAY CRYSTAL)
- (25) THERMOPLASTIC PAVEMENT MARKING LINE 4" (SOLID WHITE)
- (26) STORM SEWERS, CLASS A, TYPE 1 24"
- 27) STORM SEWERS TO BE CLEANED 24"
- (28) DRAINAGE STRUCTURES TO BE CLEANED
- PAVEMENT REMOVAL

NOT TO SCALE


| USER NAME = RGall            | DESIGNED - RG     | REVISED - |                              |        | D     | IXIE HIGI | HWAY N   | VER DITCH |         | F.A.U.<br>RTF | SECTION         | COUNTY    | TOTAL<br>SHEETS | SHEET<br>NO. |
|------------------------------|-------------------|-----------|------------------------------|--------|-------|-----------|----------|-----------|---------|---------------|-----------------|-----------|-----------------|--------------|
|                              | DRAWN - KW        | REVISED - | STATE OF ILLINOIS            |        |       |           |          |           |         | 2843          | 2014-083B       | соок      | 30              | 8            |
| PLOT SCALE = 100.0000 '/ in. | CHECKED - JH      | REVISED - | DEPARTMENT OF TRANSPORTATION |        |       | TYPIC     | CAL SECT | HONS      |         |               |                 | CONTRACT  |                 | 2A28         |
| PLOT DATE = 6/26/2018        | DATE - 04/27/2018 | REVISED - |                              | SCALE: | SHEET | OF        | SHEETS   | STA.      | TO STA. |               | ILLINOIS FED. A | D PROJECT |                 |              |


VERTICAL CONTROL WAS ESTABLISHED USING THE ONLINE POSITIONING USER SERVICE (OPUS) AND OPERATED BY THE NATIONAL GEODETIC SURVEY (NGS). OBSERVATIONS WERE MADE USING AN EPOCH MODEL 50 ROVER (S/N 5224833036) AND A CELLULAR EQUIPPED SPECTRA PRECISION RANGER. VERTICAL CONTROL IS REPORTED ON NAVD-88 DATUM. FIELD WORK WAS PERFORMED DURING APRIL, 2015.


PROJECT BENCHMARK ( NAVD-88 DATUM )

TBM (ELEVATION = 625.14)


LOCATED AT THE NORTHEAST CORNER OF DIXIE HIGHWAY AND 174TH STREET.
CUT SQUARE ON SOUTHWEST CORNER OF A 11.7' X 10.7' CONCRETE PAD FOR AT&T PULLBOXES AND MARKED "17311 DIXIE".

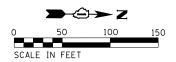

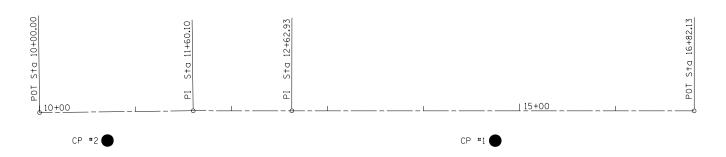

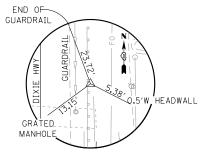

CONTROL POINT #1
IR W/CAP
DIXIE HWY STA 14+74.90, 31.06' RT
N: 1788252.1643
E: 1167014.3845
EL: 624.28

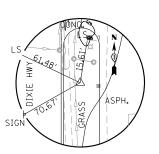



CONTROL POINT #2 IR W/CAP DIXIE HWY STA 10+70.46, 29.95' RT N: 1787848.1069 E: 1167018.8565 EL: 624.78

| TIE POINTS |
|------------|
|------------|

| ALIGNMENT COORDINATES - DIXIE HWY |           |            |            |  |  |  |  |  |  |
|-----------------------------------|-----------|------------|------------|--|--|--|--|--|--|
| POINT                             | STATION   | EASTING    |            |  |  |  |  |  |  |
| POB                               | 10+00.00  | 1787776.98 | 1166990.54 |  |  |  |  |  |  |
| PI                                | 11+60.10  | 1787937.03 | 1166986.85 |  |  |  |  |  |  |
| PI                                | 12+62.93  | 1788039.86 | 1166985.71 |  |  |  |  |  |  |
| POT                               | 123+01.45 | 1788039.86 | 1166985.71 |  |  |  |  |  |  |

| USER NAME = RGall            | DESIGNED - RG  |     | REVISED - |                              |  | DIXIE HIGHWAY OVER DITCH |  |  |  | F.A.U<br>RTF | SECTION | COUNTY           | TOTAL SHEET<br>SHEETS NO. |             |
|------------------------------|----------------|-----|-----------|------------------------------|--|--------------------------|--|--|--|--------------|---------|------------------|---------------------------|-------------|
|                              | DRAWN - KW     |     | REVISED - | STATE OF ILLINOIS            |  | ALIGNMENT AND TIES       |  |  |  |              | 2843    | 2014-083B        | COOK                      | 30 9        |
| PLOT SCALE = 100.0000 '/ in. | CHECKED - JH   |     | REVISED - | DEPARTMENT OF TRANSPORTATION |  | ALIGNMENT AND TIES       |  |  |  |              |         |                  |                           | T NO. 62A28 |
| PLOT DATE = 6/26/2018        | DATE - 04/27/2 | 018 | REVISED - |                              | SCALE: 1"=50" SHEET OF SHEETS STA. TO STA. |                          |  |  |  |              |         | ILLINOIS FED. AI | D PROJECT                 |             |

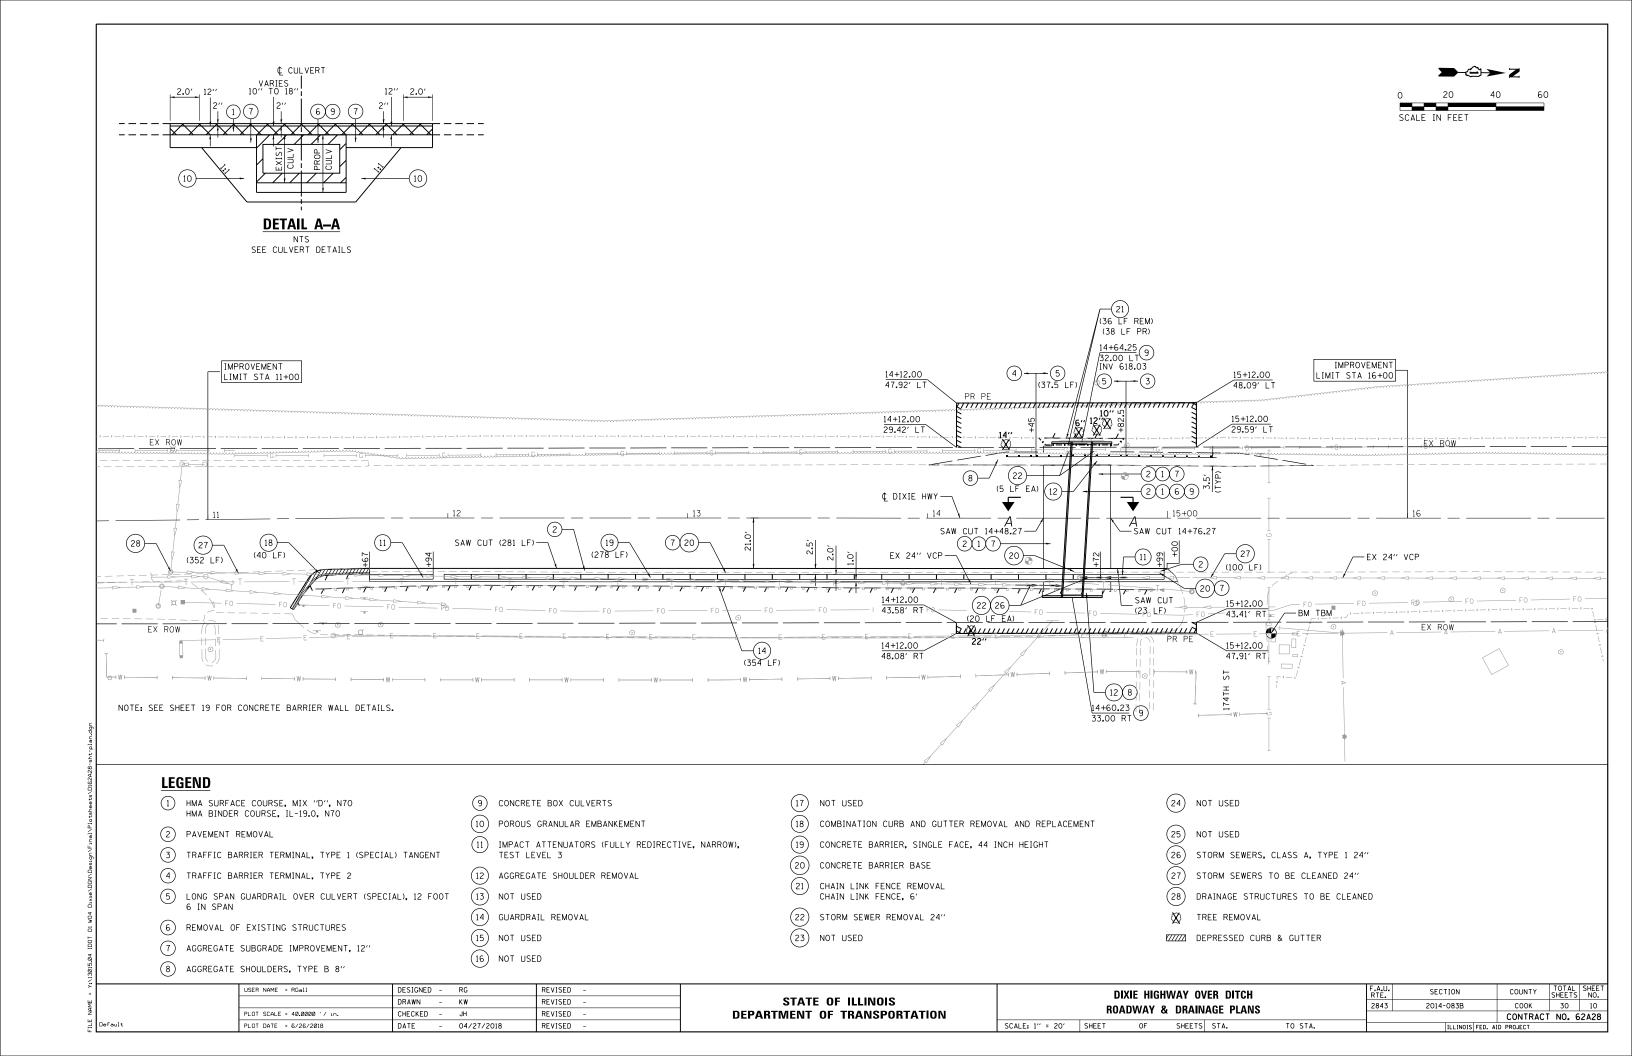

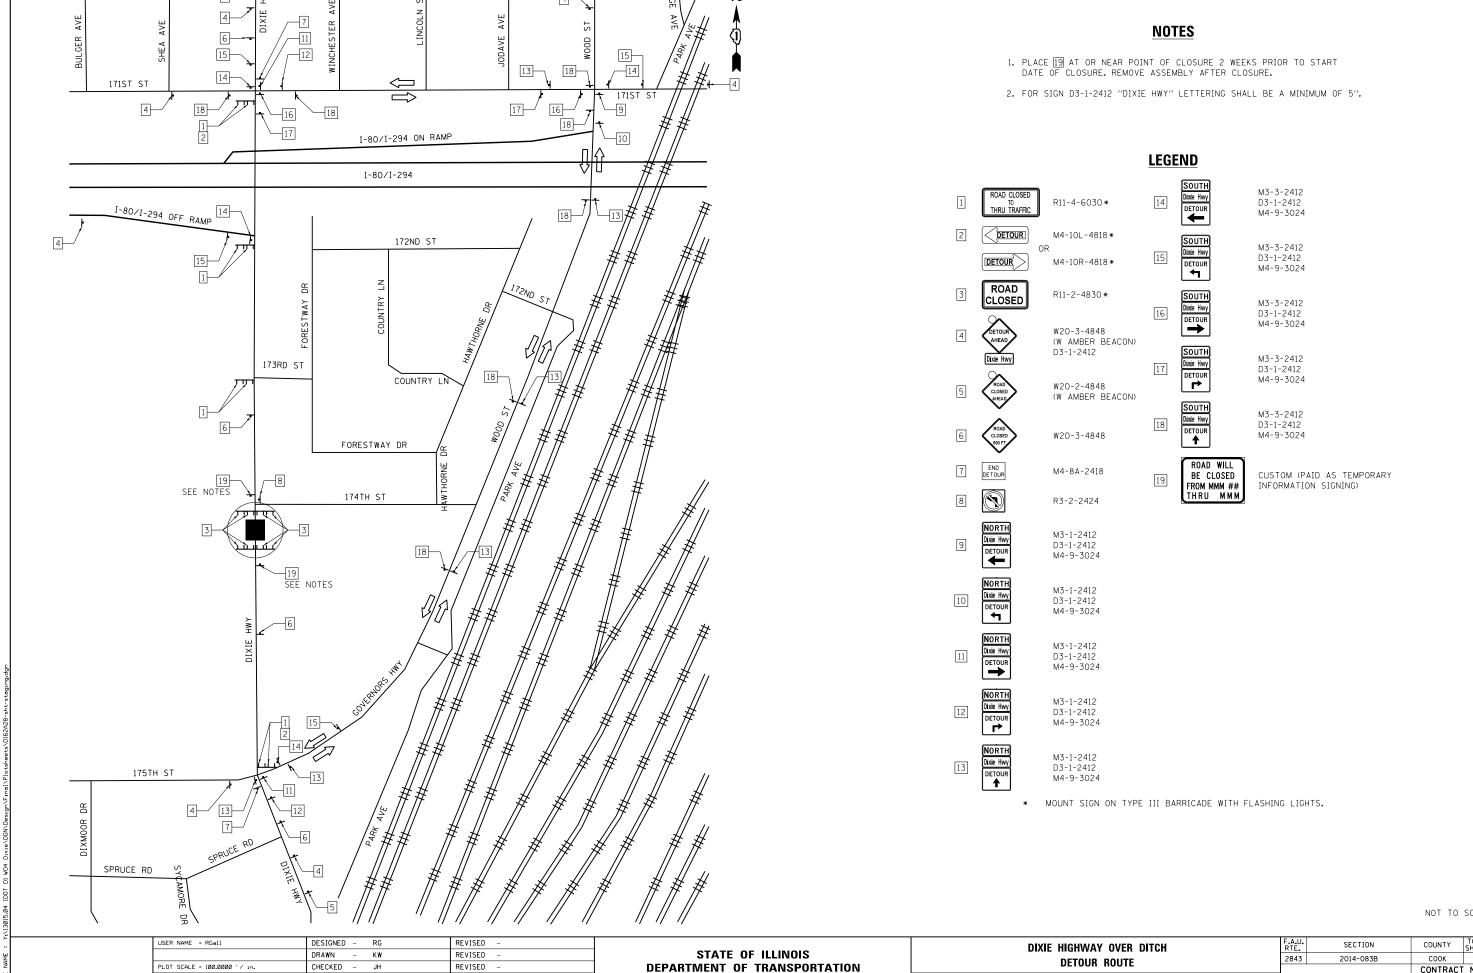

REVISED


DATE

- 04/27/2018

PLOT DATE = 6/26/2018

NOT TO SCALE

30 CONTRACT NO. 62A28 SCALE: SHEET SHEETS STA. TO STA.

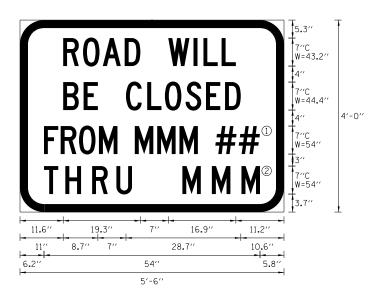

6.0" RADIUS, 1.3" BORDER, BLACK ON ORANGE; "ROAD WILL" C 2K; "BE CLOSED" C 2K; RECTANGLE ORANGE; RECTANGLE ORANGE; "HIGHWAY C" FONT


① OVERLAY PANEL ① TO CONTAIN STARTING DATE OF FULL CLOSURE AND DETOUR IMPLEMENTATION (I.E. "FROM APR 2")
② OVERLAY PANEL ② TO CONTAIN ENDING MONTH OF FULL CLOSURE AND DETOUR (I.E. "THRU JULY"). OMIT THE DATE ON PANEL ② MONTH ONLY.


ERECT SIGN ASSEMBLY (POST-MOUNTED) WITH PANELS ① AND ② IN PLACE ON ROAD TO BE CLOSED IN EACH DIRECTION NEAR POINT OF CLOSURE OR WITHIN SECTION TO BE FULLY CLOSED TWO (2) WEEKS PRIOR TO START DATE OF FULL CLOSURE. REMOVE ASSEMBLY AFTER CLOSURE.

| USER NAME = RGall             | DESIGNED | - | RG         | REVISED - |  |
|-------------------------------|----------|---|------------|-----------|--|
|                               | DRAWN    | - | KW         | REVISED - |  |
| PLOT SCALE = 100.0000 ' / in. | CHECKED  | - | JH         | REVISED - |  |
| PLOT DATE = 6/26/2018         | DATE     | - | 04/27/2018 | REVISED - |  |
|                               |          |   |            |           |  |


| STATE OF      | ILLINOIS       |
|---------------|----------------|
| DEPARTMENT OF | TRANSPORTATION |

|   |        |       | 2121 |          | F.A.U.<br>RTE. | SECTION   | COUNTY   | TOTAL<br>SHEETS  |           |  |  |
|---|--------|-------|------|----------|----------------|-----------|----------|------------------|-----------|--|--|
|   |        |       | SIGN | IING DET | 2843           | 2014-083B | COOK     | 30               | 12        |  |  |
| L |        |       |      |          |                |           | CONTRACT | NO.              | 62A28     |  |  |
|   | SCALE: | SHEET | OF   | SHEETS   | STA.           | TO STA.   |          | ILLINOIS FED. AI | D PROJECT |  |  |

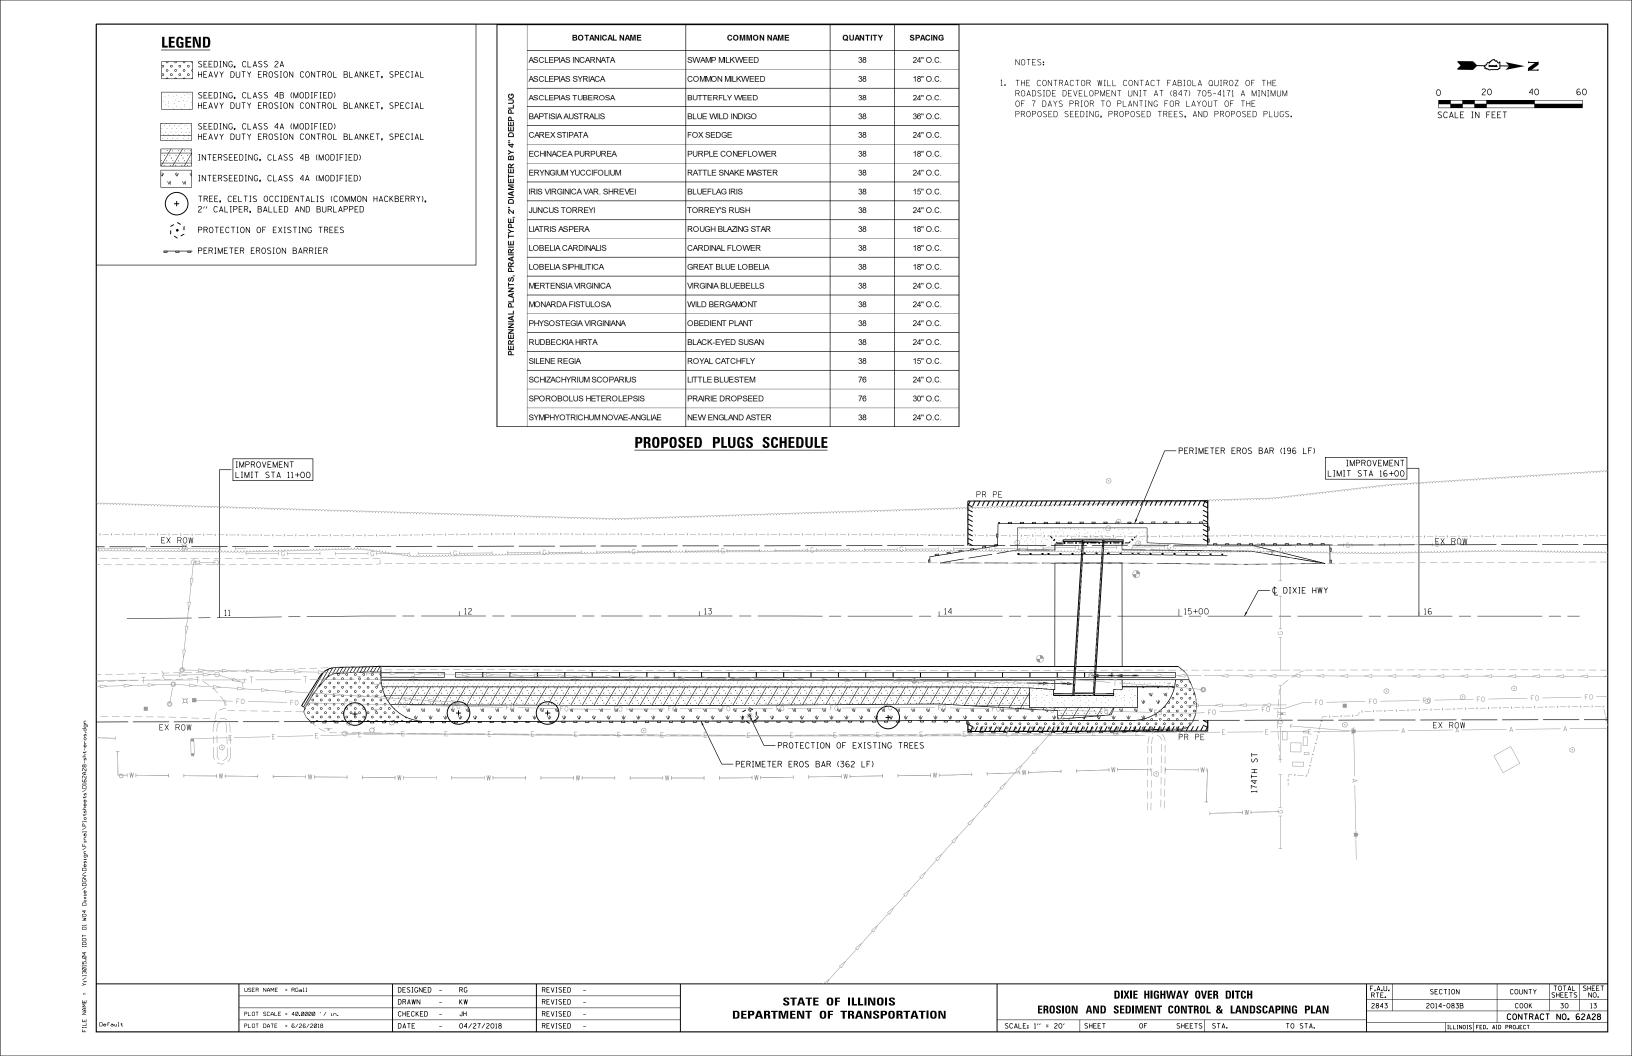

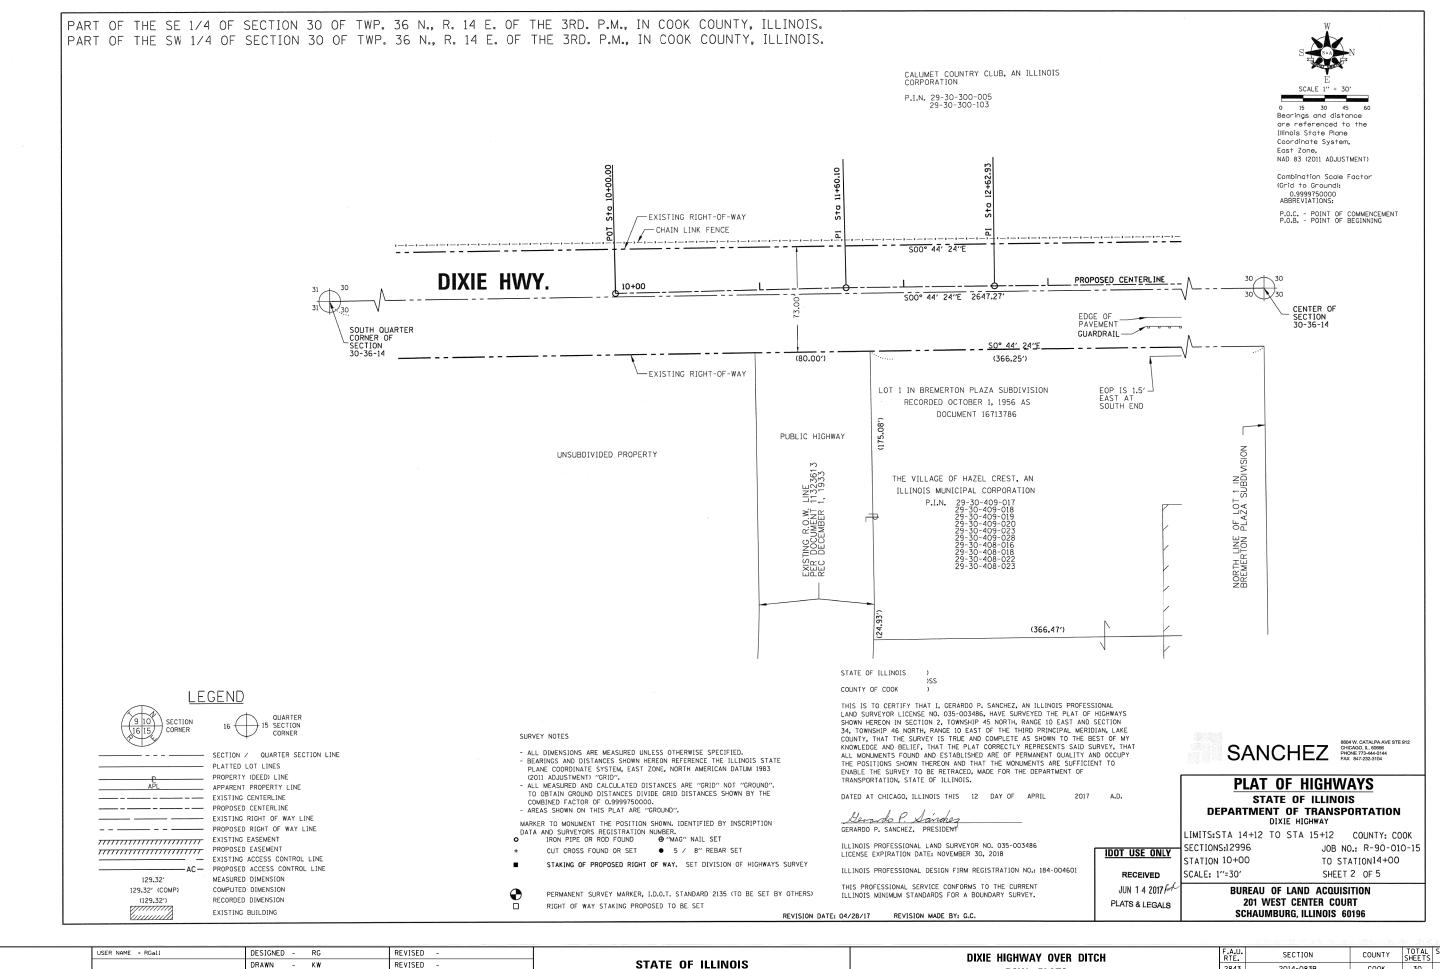


2843 2014-083B COOK 30 14 **ROW PLATS** CHECKED -REVISED **DEPARTMENT OF TRANSPORTATION** CONTRACT NO. 62A28 SCALE: 1" = 20' SHEET SHEETS STA. TO STA. PLOT DATE = 6/26/2018 OF DATE - 04/27/2018 REVISED

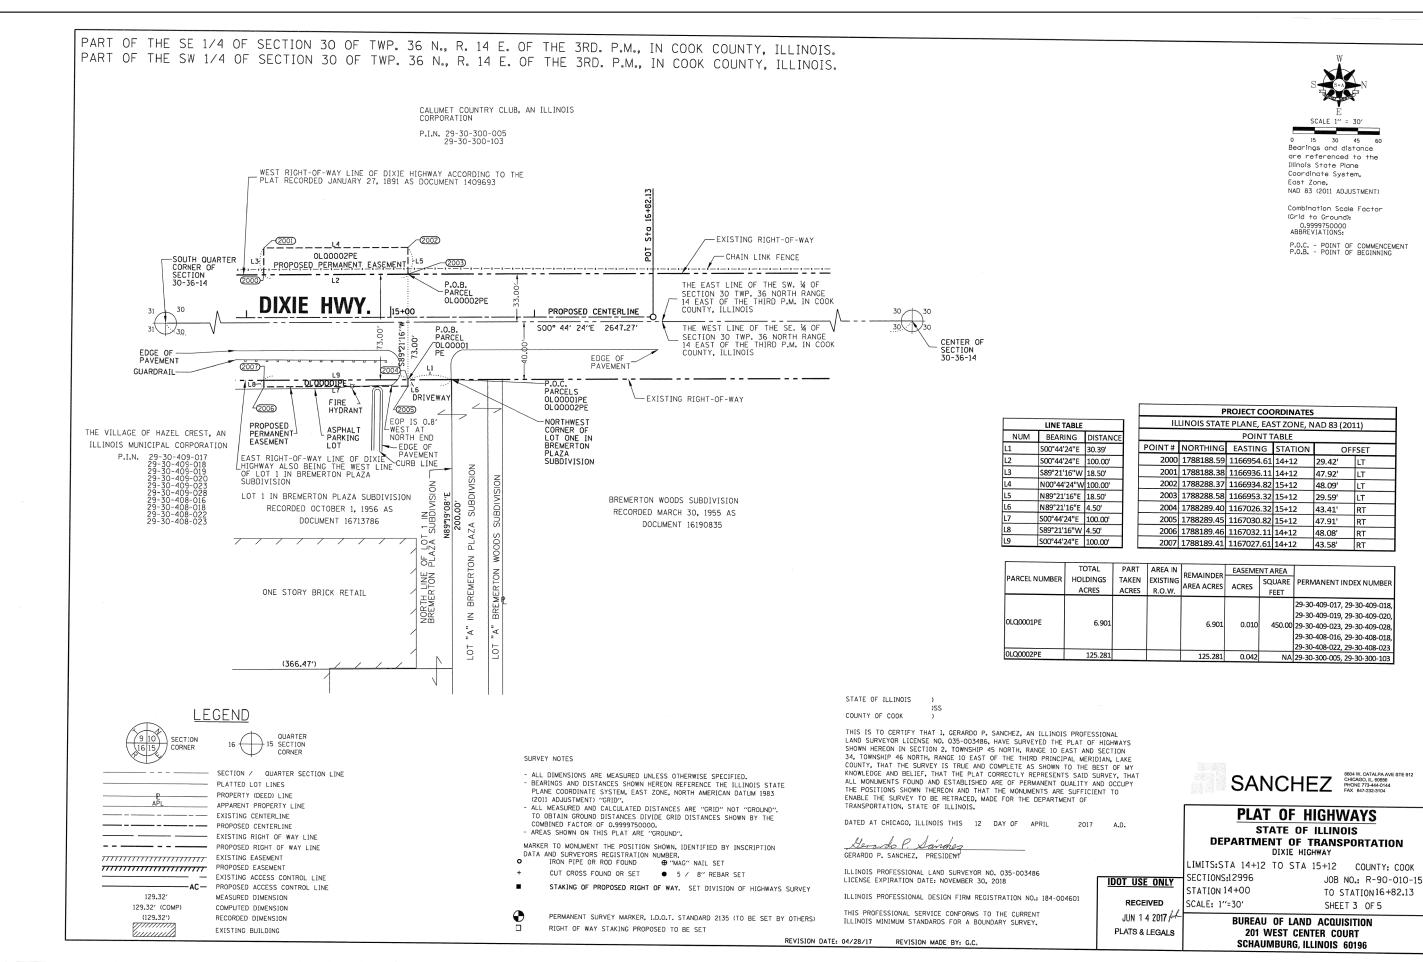

USER NAME = RGall DESIGNED - RG REVISED SECTION COUNTY **DIXIE HIGHWAY OVER DITCH** STATE OF ILLINOIS DRAWN - KW REVISED 2843 2014-083B COOK **ROW PLATS** CHECKED REVISED **DEPARTMENT OF TRANSPORTATION** CONTRACT NO. 62A28 SCALE: 1" = 20' SHEET TO STA. SHEETS STA PLOT DATE = 6/26/2018 DATE - 04/27/2018 REVISED OF

30 15

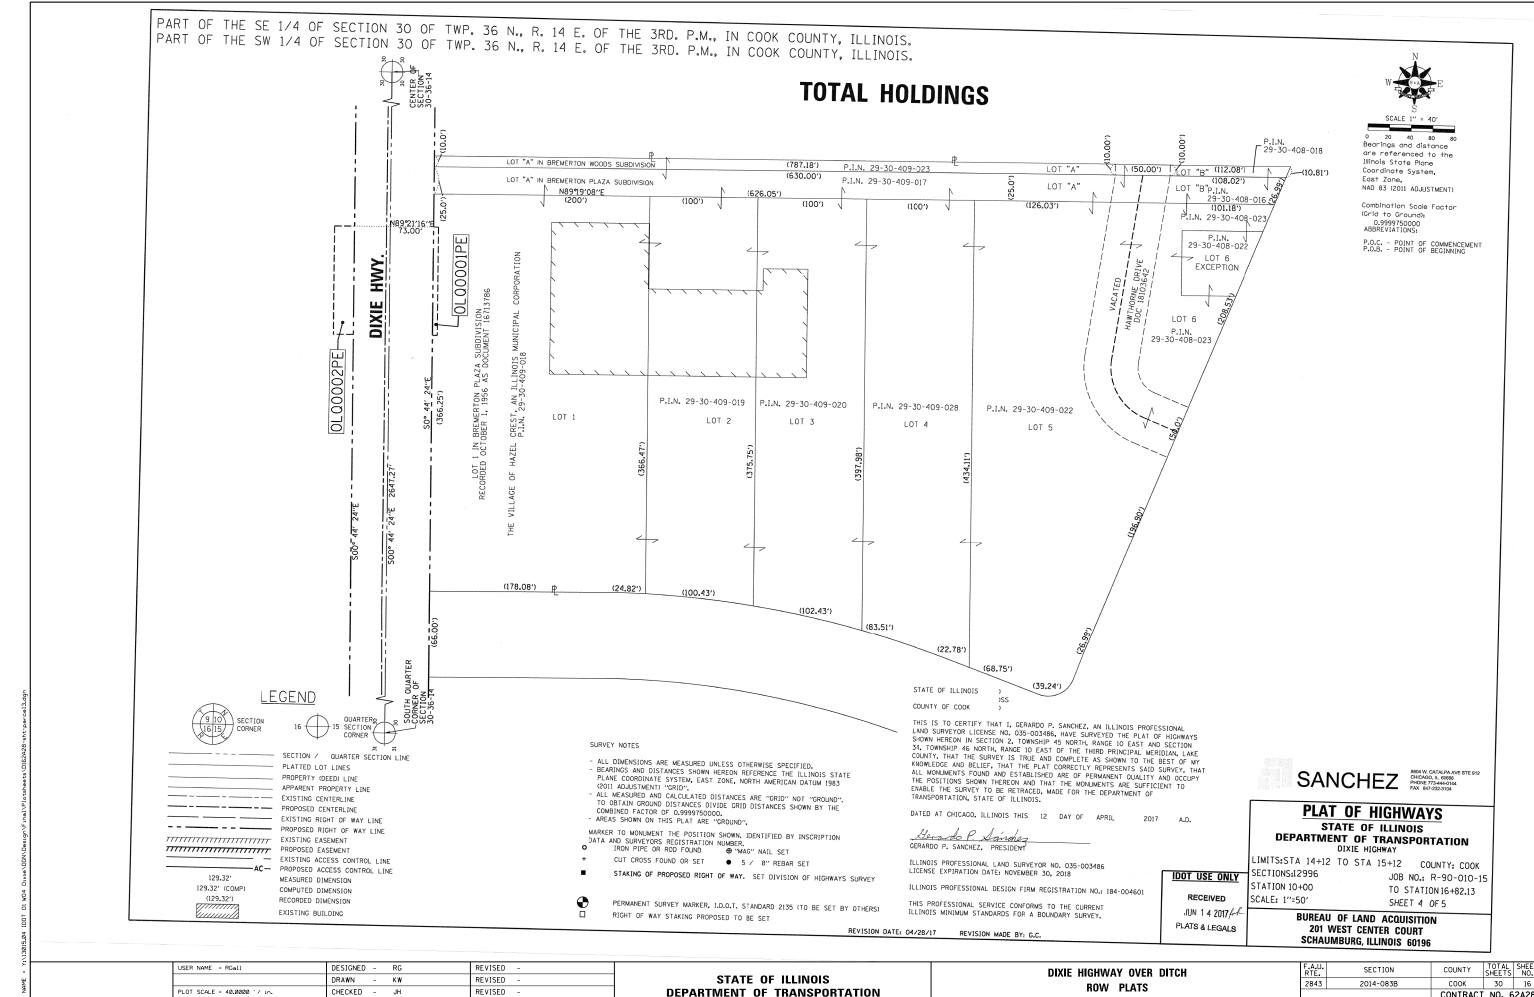

SCALE: 1" = 20' SHEET

SHEETS STA.

OF

TO STA.


CONTRACT NO. 62A28

PLOT DATE = 6/26/2018

DATE

04/27/2018

REVISED

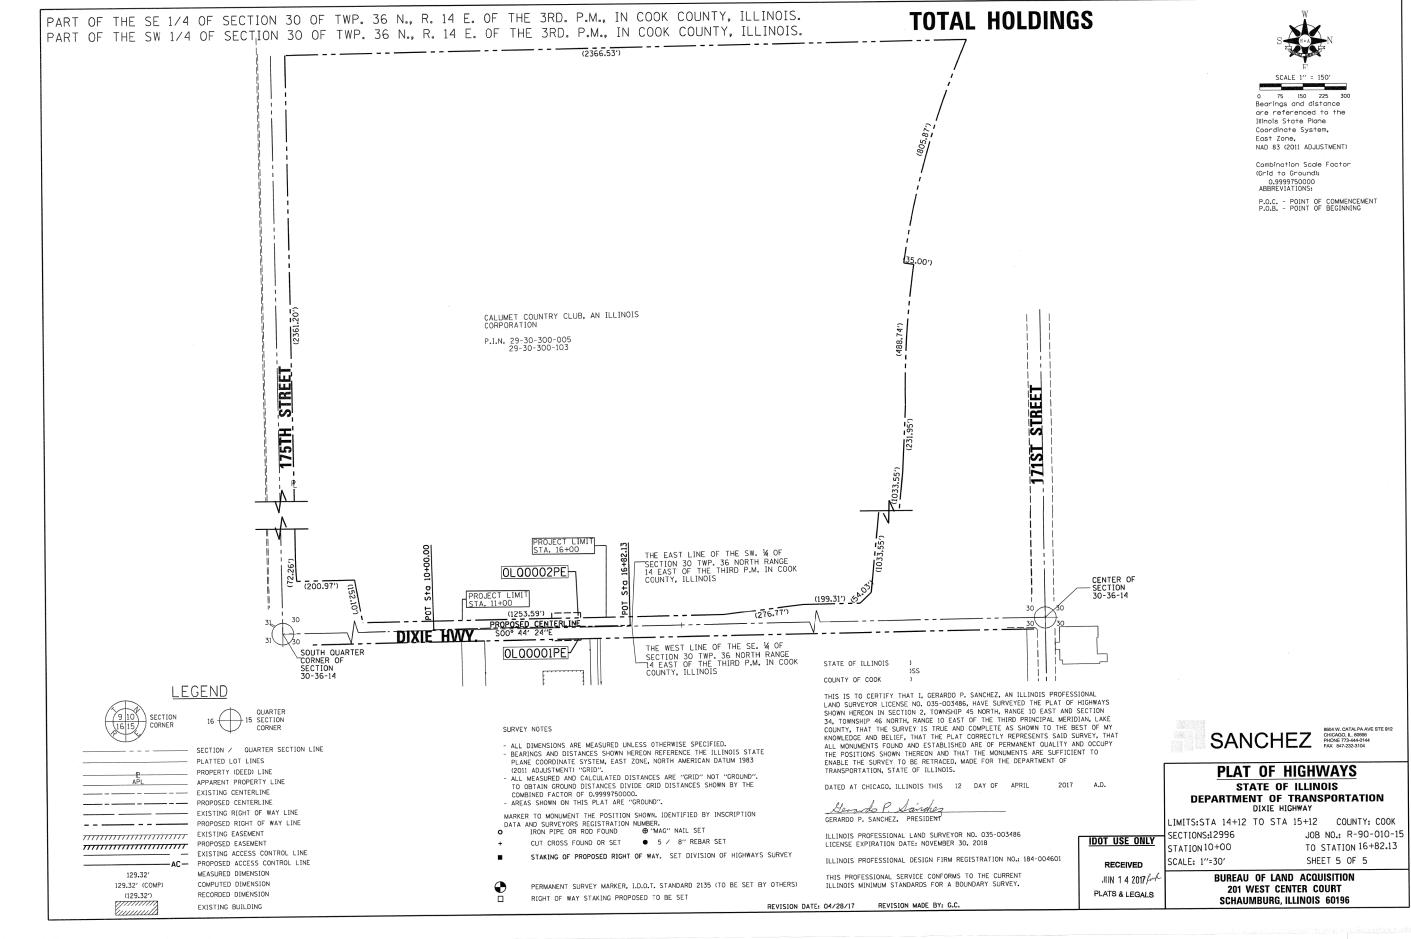


USER NAME = RGall DESIGNED - RG REVISED DRAWN - KW REVISED CHECKED -REVISED PLOT DATE = 6/26/2018 DATE - 04/27/2018 REVISED


STATE OF ILLINOIS **DEPARTMENT OF TRANSPORTATION** 

**DIXIE HIGHWAY OVER DITCH ROW PLATS** SCALE: 1" = 20' SHEET SHEETS STA. OF

TO STA.

SECTION COUNTY 2843 2014-083B COOK 30 17 CONTRACT NO. 62A28

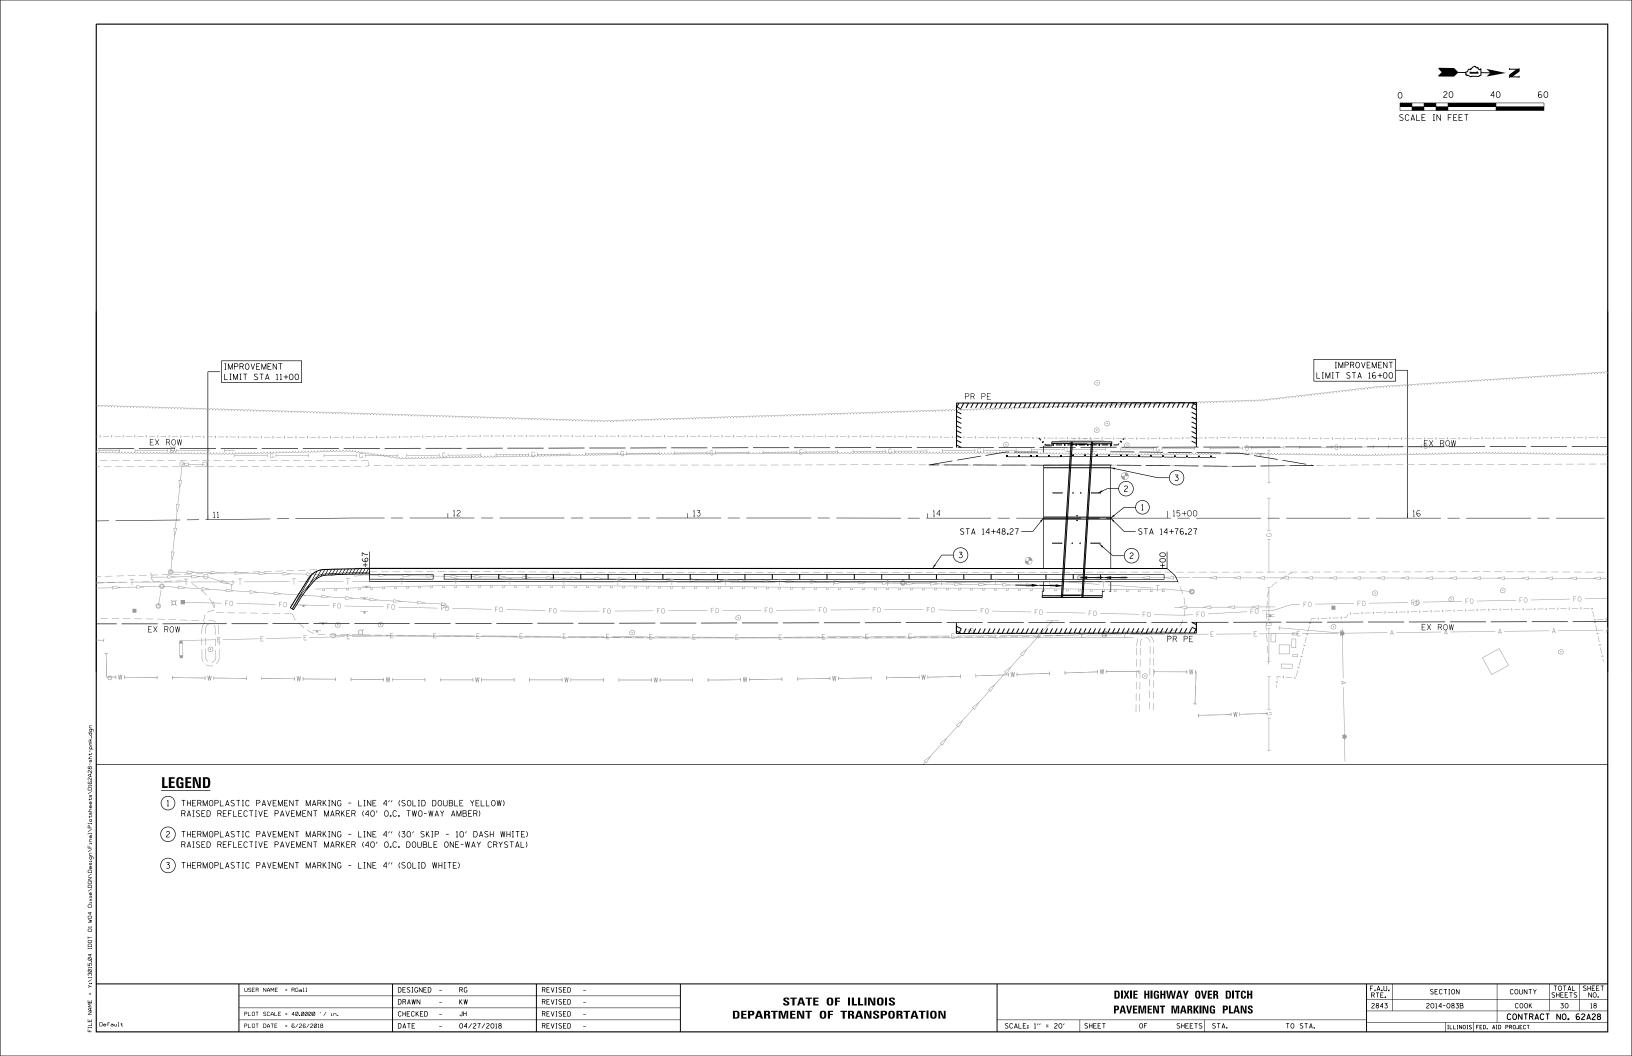


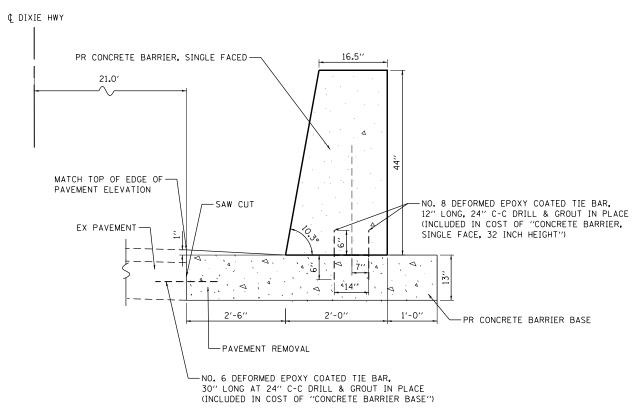


## CONCRETE BARRIER TYPICAL CROSS-SECTION

| LOCATION | STATION  |
|----------|----------|
| 01       | 12+10.00 |
| 02       | 12+25.00 |
| 03       | 12+40.00 |
| 04       | 12+55.00 |
| 05       | 12+70.00 |
| 06       | 12+85.00 |
| 07       | 13+00.00 |
| 08       | 13+15.00 |
| 09       | 13+30.00 |
| 10       | 13+45.00 |
| 11       | 13+60.00 |
| 12       | 13+75.00 |
| 13       | 13+90.00 |
| 14       | 14+05.00 |
| 15       | 14+20.00 |
| 16       | 14+35.00 |
| 17       | 14+50.00 |
| 18       | 14+65.00 |


## DRAINAGE SLOT SCHEDULE

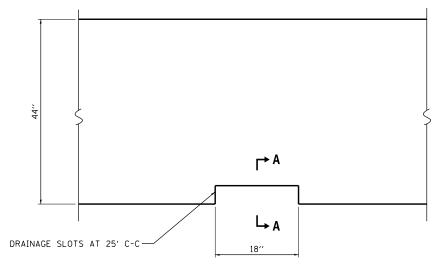

## CONCRETE BARRIER ELEVATION

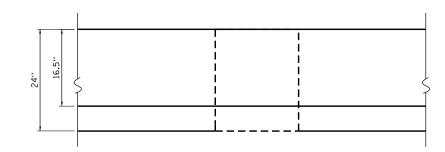

## CONCRETE BARRIER PLAN

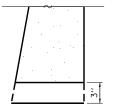


## SECTION A-A DRAINAGE SLOT

DRAINAGE SLOTS TO BE SPACED 15 FT C-C AT THE LOCATIONS SHOWN IN THE DRAINAGE SLOT SCHEDULE

| USER NAME = RGall            | DESIGNED - | RG         | REVISED - |                              |                 | וצוח   | E HI |
|------------------------------|------------|------------|-----------|------------------------------|-----------------|--------|------|
|                              | DRAWN -    | KW         | REVISED - | STATE OF ILLINOIS            |                 |        |      |
| PLOT SCALE = 40.0000 ' / in. | CHECKED -  | JH         | REVISED - | DEPARTMENT OF TRANSPORTATION |                 | CONCRE | CIE  |
| PLOT DATE = 6/26/2018        | DATE -     | 04/27/2018 | REVISED - |                              | SCALE: 1" = 20' | SHEET  | OF   |

|  | DI                            | XIE HIGI | HWAY OV | ER DITCH |         | F.A.U.<br>RTE. | SECTION         | COUNTY    | TOTAL<br>SHEETS | SHEET<br>NO. |
|--|-------------------------------|----------|---------|----------|---------|----------------|-----------------|-----------|-----------------|--------------|
|  | CONCRETE BARRIER WALL DETAILS |          |         |          |         |                | 2014-083B       | соок      | 30              | 19           |
|  |                               |          |         |          |         |                | CONTRACT NO. 62 |           |                 |              |
|  | SHEET                         | OF       | SHEETS  | STA.     | TO STA. |                | ILLINOIS FED. A | D PROJECT |                 |              |

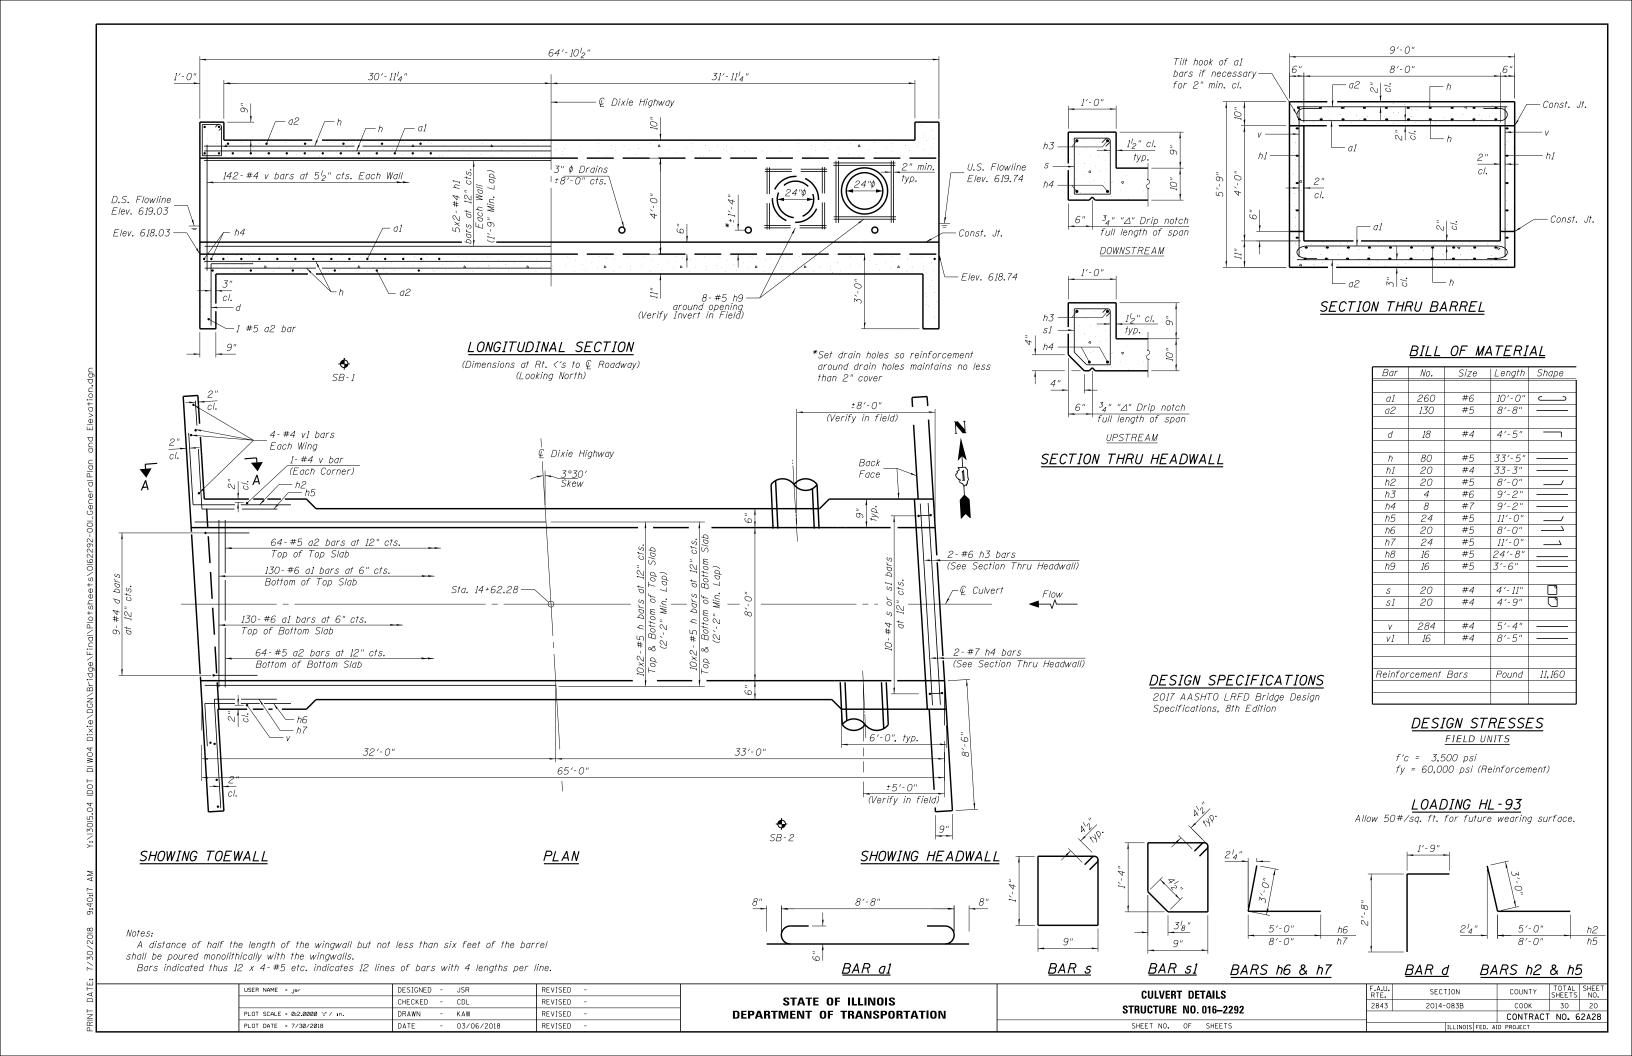

#### GENERAL NOTES

Precast alternate is not allowed.

Layout of the slope protection system may be varied to suit ground conditions in the field as directed by the Engineer.

It shall be the responisibility of the Contractor to divert the stream flow during construction in order to keep the construction area free of water. The method of the water diversion shall be subjected to the approval of the Engineer and the cost shall be included with the cost of the Concrete Box Culverts.

Compaction via machine vibrators is not allowed over the culvert. Hand compaction method only.

STATION 14+62.28
BUILT BY
STATE OF ILLINOIS
F.A.U. RTE. 2843
SEC. 2014-083B
LOADING HL-93
STRUCTURE NO. 016-2292


NAME PLATE
See Std. 515001


#### SECTION THRU BARREL

(Looking West)

The limits and quantities of Undercut removal and replacement shown are based on the recommendations of the Structural Geotechnical Report (SGR) and may be modified by the District Geotechnical and Field Engineer for variable subsurface conditions encountered in the field.

Excavation for construction of the box culvert, and wingwalls including the excavation necessary to construct the porous granular embankment, is included in Removal of Existing Structures.

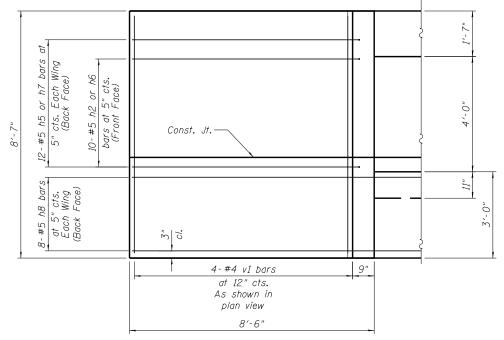

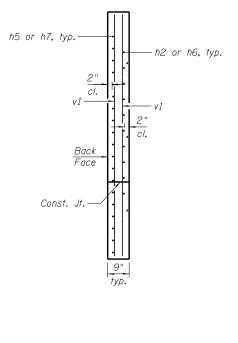

SECTION THRU WINGWALLS

#### ELEVATION OF NW AND SE WINGWALL

(NE and SW Similar)

#### SECTION A-A

#### WATERWAY INFORMATION

| Drainage Area = 32.45 Acres<br>Existing Low Grade Elev. 624.66<br>Proposed Low Grade Elev. 624.66 |       |                          |        |         |          |            |               |  |  |  |  |  |
|---|-------|--------------------------|--------|---------|----------|------------|---------------|--|--|--|--|--|
| Flood   | Freq. | reg. Q Natrual Opening S |        | Sq. Ft. | Headwate | er El. Ft. |               |  |  |  |  |  |
| 1 1000  | Yr.   | C.F.S.                   | H.W.E. | Exist.  | Prop.    | Exist.     | Prop.         |  |  |  |  |  |
| Ten-Year  | 10    | 60.4                     | 622.1  | 16.5    | 18.9     | 623.31     | 623.32        |  |  |  |  |  |
| Design  | 50    | 98.7                     | 623.0  | 23.7    | 26.1     | 623.73     | <i>623.75</i> |  |  |  |  |  |
| Base  | 100   | 119.7                    | 623.3  | 26.1    | 28.5     | 623.97     | 624.00        |  |  |  |  |  |
| Overtopping   |       |                          |        |         |          |            |               |  |  |  |  |  |
| Max. Calc.  | 500   | 155.8                    | 623.7  | 29.2    | 31.6     | 624.76     | 624.78        |  |  |  |  |  |

10-year Velocity through Existing Culvert = 2.52 ft/s 2-year Peak Flow = 210 cfs
10-year Velocity through Proposed Culvert = 2.52 ft/s 2-year Peak Elevation = 621.97

#### TOTAL BILL OF MATERIAL

| TTCH   | / / / / T.T. | TOTA:           |
|--|--------------|-----------------|
| ITEM   | UNIT         | TOTAL           |
| Removal and Disposal of<br>Unsuitable Material         | Cu. Yd.      | 63              |
| Porous Granular Embankment                             | Cu. Yd.      | 333             |
| Filter Fabric  | Sq. Yd.      | 85              |
| Removal of Existing Structures                         | Each         | 1               |
| Reinforcement Bars                                     | Pound        | 11 <b>,</b> 160 |
| Name Plates  | Each         | 1               |
| Concrete Box Culverts                                  | Cu. Yd.      | 55.6            |
| Membrane Waterproofing System for<br>Buried Structures | Sq. Yd.      | 91              |
|  |              |                 |
|  |              |                 |

STATE OF ILLINOIS
DEPARTMENT OF TRANSPORTATION

 CULVERT DETAILS
 F.A.U. RTE.
 SECTION
 COUNTY
 TOTAL SHEETS NO.

 STRUCTURE
 NO. 016–2292
 2843
 2014-083B
 COOK
 30
 21

 SHEET NO.
 OF SHEETS
 ILLINOIS FED. AID PROJECT
 NO. 62A28



SILTY CLAY LOAM-gray-hard

CLAY LOAM-gray-very stiff

SAND-gray-medium dense to

dense

GSI Job No. <u>15042</u>

### **SOIL BORING LOG**

SILTY SAND-gray-medium dense

SILT-gray-medium dense

SILTY CLAY-gray-very stiff

24 End Of Boring @ -40.0'. Boring backfilled with cuttings.

Page <u>1</u> of <u>1</u>

Date 4/8/15 DESCRIPTION FAU 2843 Dixie Highway Culvert, Hazel Crest, II. \_\_\_\_ LOGGED BY \_\_\_\_MD\_\_ **SECTION** LOCATION SW 1/4, SEC. 30, TWP. T36N, RNG. R14E, 3<sup>rd</sup> PM 2014-083B COUNTY \_\_\_ DRILLING METHOD Hollow Stem Auger/Rotary HAMMER TYPE CME Automatic B C Surface Water Elev. n/a ft C 0 E 0 Stream Bed Elev. <u>n/a</u> ft 0 S P 0 S 1 W BORING NO. Groundwater Elev.: S Qu Н Qu Т T S Station First Encounter Dry To -10.0' ft Offset **Upon Completion** <u>n/a</u> ft (ft) (/6") (tsf) (%) Ground Surface Elev. | (ft) | (/6") | (tsf) | (%) After \_\_\_\_ Hrs. 6.0" ASPHALT 8.0" CONCRETE SAND-gray-medium dense to dense (continued) SILTY CLAY-black-medium stiff 1 0.3 28 33 18 2 Р 40

CLAY-dark brown & gray-stiff SAND & GRAVEL-gray-medium 10 3 1.3 26 12 11 3 В 14 -25 CLAY LOAM-brown & gray-hard SILTY CLAY LOAM-gray-medium 3 14 5 5.8 12 8 В 7 CLAY-gray-hard SILTY LOAM-gray-medium dense 4 8 5.1 13 10 В 12

The Unconfined Compressive Strength (UCS) Failure Mode is indicated by (B-Bulge, S-Shear, P-Penetrometer) The SPT (N value) is the sum of the last two blow values in each sampling zone (AASHTO T206)

5

3

6 B

10

13

15

15

26 24

8

9 B

4.4

5 2.1 14

20

BBS, from 137 (Rev. 8-99)

10

11

13

13

12

11

8

6

8

16

21

22

2.3 20

В

Geo Services, Inc.
Geolechnical Environmental & Civil Engineering
805 Aminetal Court; Suril 204
Neperville, Illustis B0555
(200) 355-82856

GSI Job No. <u>15042</u>

### **SOIL BORING LOG**

Page <u>1</u> of <u>1</u>

Date <u>4/8/15</u>


| ROUTE                     | FAU 2843                          | DE   | SCRI        | PTION    |             | Dixi        | e Highway Culvert, Haz                                   | el Crest, II.    | _ L                | OGGE        | D BY        |             | ND          |
|---------------------------|-----------------------------------|------|-------------|----------|-------------|-------------|--|------------------|--------------------|-------------|-------------|-------------|-------------|
| SECTION                   | 2014-083B                         |      | 1           | LOCAT    | ION _       | SW 1/       | 4, SEC. 30, TWP. T36N                                    | I, RNG. R14E, 3  | B <sup>rd</sup> PM |             |             |             |             |
| COUNTY _                  | Cook DRIL                         | LUNG | ME          | ПОО      |             | Hollow      | Stem Auger/Rotary  | _ HAMMERT        | YPE .              |             | CME A       | utoma       | tic         |
| STRUCT. No Station        | 0. 016-2292                       | _    | D<br>E<br>P | 0        | U<br>C<br>S | M<br>O<br>I | Surface Water Elev.<br>Stream Bed Elev.                  | n/a<br>n/a       | ft<br>ft           | D<br>E<br>P | B<br>L<br>O | U<br>C<br>S | M<br>0<br>1 |
| Station _                 | ). SB-2                           | _    | H           |          | Qu<br>4-0   | S<br>T      | Groundwater Elev.:<br>First Encounter<br>Upon Completion | n/a              | ft                 |             | S<br>(CT)   | Qu          | S<br>T      |
| Ground St                 | Irface Elev.<br>ALT 8.0" CONCRETE | _ ft | (ft)        | (/6")    | (tsf)       | (%)         | After Hrs. SAND-gray-dense (cc                           |                  | ft                 | (ft)        | (/6")       | (tsf)       | (%)         |
|                           |                                   |      | _           | 3        |             |             | SAND & GRAVEL-gra  |                  |                    |             | 7           |             |             |
| SILTY CLAY                | Y-black-medium stiff              |      | _           | 3 2      | 0.5<br>P    | 20          | 30/130   |                  |                    | _           | 9<br>12     |             | 14          |
| CLAY-dark<br>medium stiff | brown & gray-soft to              |      | _           | 1        |             |             | SILT-gray-medium de                                      | ense             |                    |             | 15          |             |             |
|                           |                                   |      | -5          | 2 2      | 0.8<br>B    | 28          |  |                  |                    | -25         | 10<br>5     |             | 15          |
|                           |                                   |      | <u>_</u>    | 0        |             |             |  |                  |                    | _           | 7           |             |             |
|                           |                                   |      | _           | 1 2      | 0.1<br>B    | 35          |  |                  |                    | _           | 5<br>5      |             | 18          |
| CLAY LOAN                 | M-gray-very stiff to hard         |      | _           | 3        |             |             | SILTY SAND-gray-me                                       | edium dense      |                    | _           | 10          |             |             |
|                           |                                   |      | -10         | 7<br>11  | 5.5<br>B    | 19          |  |                  | ,                  | -30         | 8<br>10     |             | 18          |
|                           |                                   |      |             | 4        |             |             | SILT-gray-medium de                                      | ense             |                    | _           | 7           |             |             |
|                           |                                   |      | _           | 5<br>8   | 2.4<br>B    | 15          |  |                  |                    | _           | 8 7         |             | 20          |
|                           |                                   |      | _           | 4        |             |             |  |                  | ,                  |             | 4           |             |             |
|                           |                                   |      | -15         | 6<br>7   | 2.2<br>B    | 15          |  |                  |                    | - <u>35</u> | 5<br>7      |             | 22          |
| SAND-gray-                | dense                             |      |             | 11       |             |             | SILTY LOAM-gray-me                                       | edium dense      |                    |             | 7           |             |             |
|                           |                                   |      |             | 23<br>38 |             | 20          |  |                  |                    |             | 8           |             | 21          |
|                           |                                   |      | _           | 13       |             |             | CLAY LOAM -gray-ve                                       |                  |                    |             | 4           |             |             |
|                           |                                   |      | -20         | 18<br>17 |             | 21          | End Of Boring @ -40.<br>backfilled with cuttings         | 0'. Boring<br>s. |                    | -40         | 7<br>7      | 2.2<br>B    | 21          |


The Unconfined Compressive Strength (UCS) Failure Mode is indicated by (B-Bulge, S-Shear, P-Penetrometer) The SPT (N value) is the sum of the last two blow values in each sampling zone (AASHTO T206)


BBS, from 137 (Rev. 8-99)

| USER NAME = RGall            | DESIGNED | - | RG         | REVISED - |
|------------------------------|----------|---|------------|-----------|
|                              | DRAWN    | - | KW         | REVISED - |
| PLOT SCALE = 100.0000 '/ in. | CHECKED  | - | JH         | REVISED - |
| PLOT DATE = 6/26/2018        | DATE     | - | 04/27/2018 | REVISED - |

|                  |       |    |        |      |         | F.A.U.<br>RTE. | SECTION    | cou           | NTY , | TOTAL<br>SHEETS | SHEE! |
|------------------|-------|----|--------|------|---------|----------------|------------|---------------|-------|-----------------|-------|
| SOIL BORING LOGS |       |    |        |      |         |                | 2014-083B  | CO            | ок    | 30              | 22    |
|                  |       |    |        |      |         |                |            | CON           | TRACT | NO. 6           | 62A28 |
| CALE:            | SHEET | OF | SHEETS | STA. | TO STA. |                | ILLINOIS F | ED. AID PROJE | CT    |                 |       |

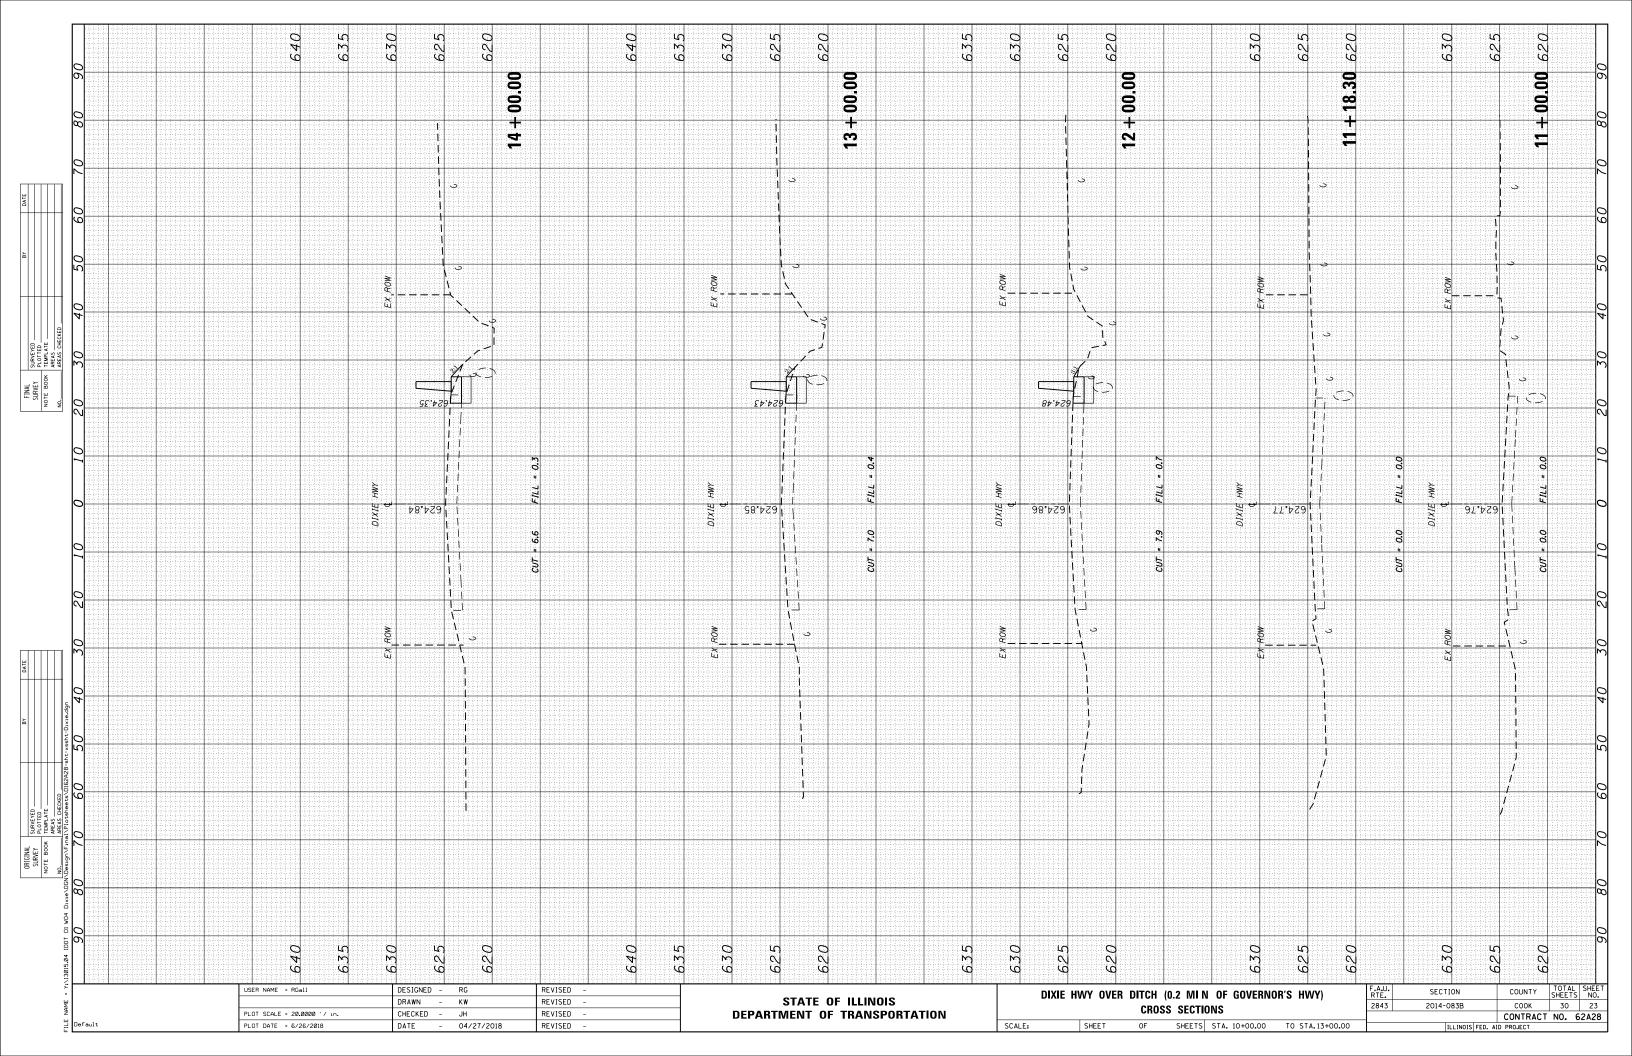


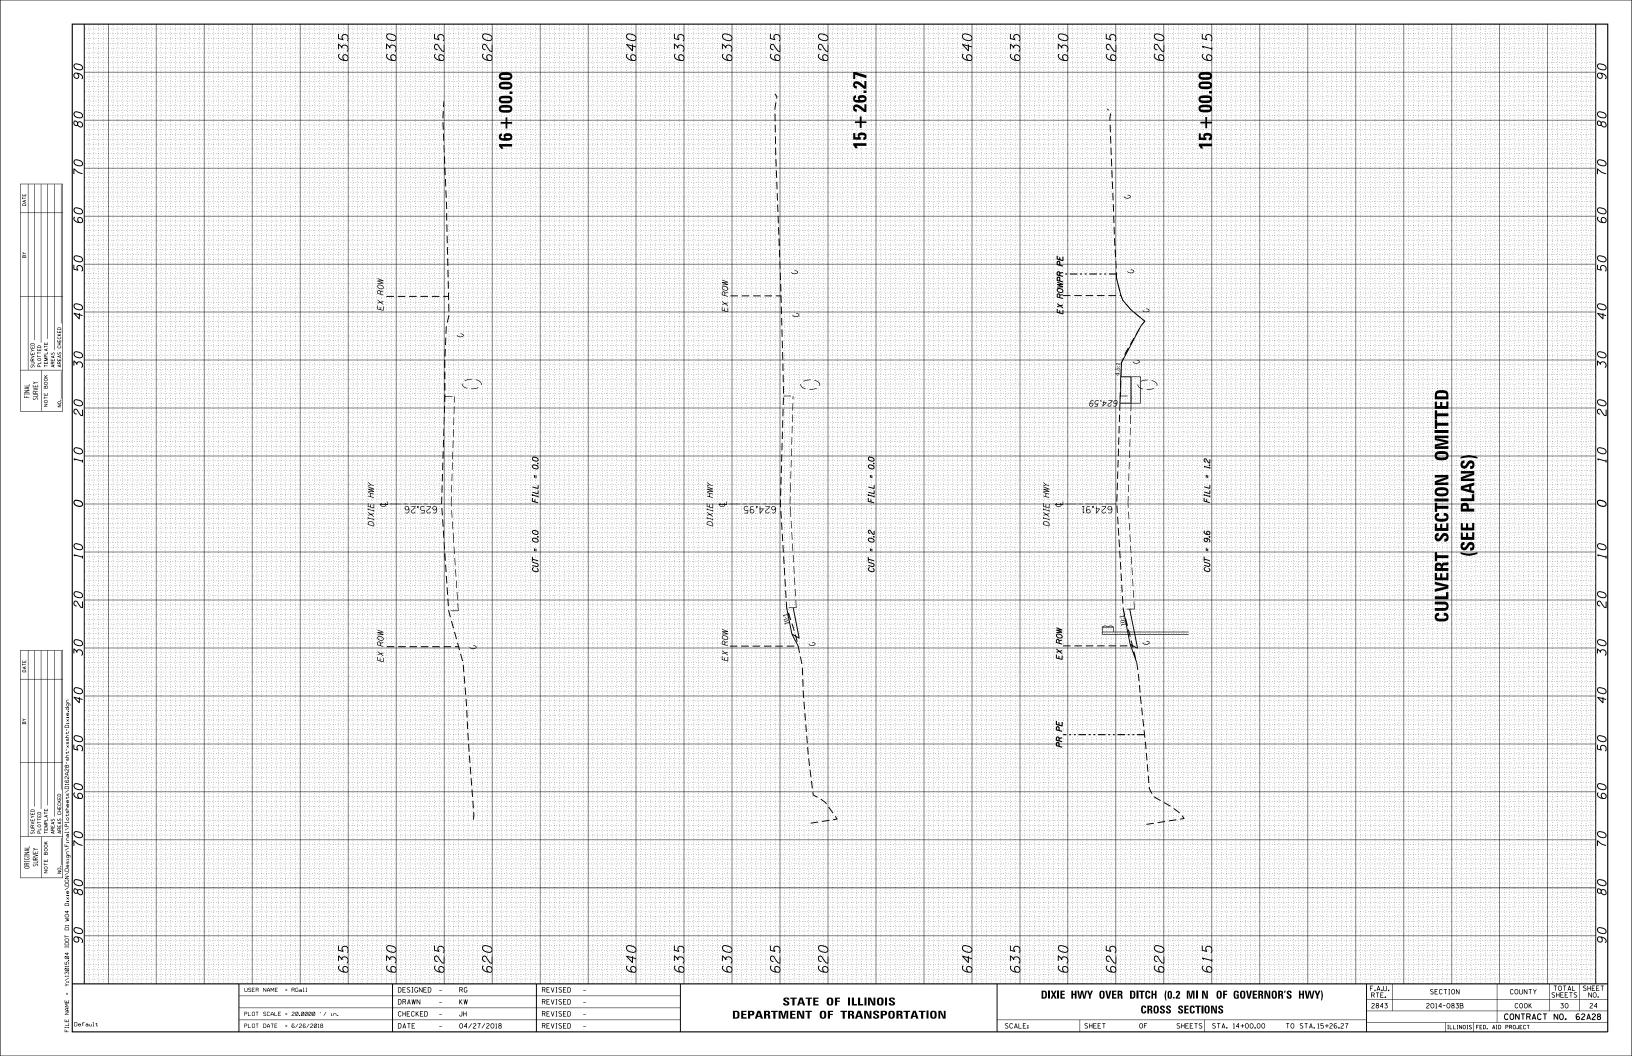


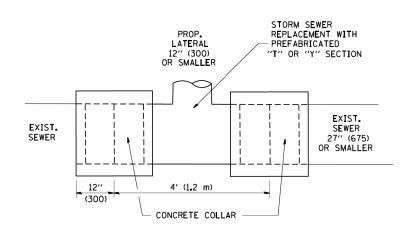

#### DETAIL "A"

LATERAL CONNECTION TO EXISTING SEWER
OF 27" (675) OR SMALLER

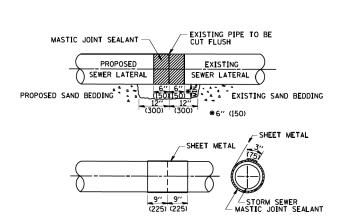

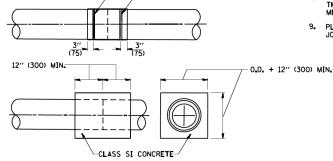


METAL BINDING

<u>DETAIL "B"</u> CLASS SI CONCRETE COLLAR

#### CONSTRUCTION SEQUENCE

- CUI THE EXISTING END OF THE PIPE SO AS TO PRESENT A FLUSH BUTT JOINT, BRUSH AND CLEAN ALL PIPES.
- 2. APPLY THE MASTIC JOINT SEALANT TO THE FIRST 6" (150) OF EACH PIPE.
- 3. BUTT THE PIPES TOGETHER LEAVING A MINIMUM OF 12' × 6' (300 × 150) DEEP EXCAVATION UNDER AND AROUND EACH PIPE END.
- 4. CUT A PIECE OF SHEET METAL GAGE NO. 19 1.1 (0.0418) 18" (450) WIDE BY THE OUTSIDE CIRCUMFERANCE OF THE PIPE PLUS 3" (75) LONG.
- WRAP THE SHEET METAL AROUND THE PIPES, 9" (225) ON EACH SIDE OF THE JOINT, STARTING AT THE TOP OF THE PIPE.
- 6. LAP THE SHEET METAL AT LEAST 3" (75) AT THE TOP OF THE PIPE AND PLACE THE MASTIC JOINT SEALANT BETWEEN THE LAP.
- 7. PLACE TWO METAL BANDS AROUND THE SHEET METAL AND TIGHTEN.
- 8. WIPE OFF ANY EXCESS MASTIC JOINT SEALANT THAT OOZES OUT FROM BETWEEN THE SHEET METAL AND THE PIPES.
- 9. PLACE CLASS SI CONCRETE AROUND THE JOINT.

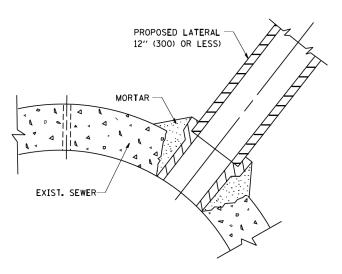

#### DETAIL "C"

PROPOSED LATERAL
CONNECTION TO EXISTING SEWER
OF 30" (750) OR LARGER

#### **NOTES**

#### MATERIA

MATERIAL USED FOR THE TEE OR WYE SECTION SHALL BE COMPATIBLE WITH THE EXISTING STORM SEWER OR THE PROPOSED STORM SEWER,

#### CONSTRUCTION METHODS

- THIS WORK SHALL BE CONSTRUCTED IN CONFORMANCE WITH THE APPLICABLE PORTIONS OF SECTION 550 OF THE STANDARD SPECIFICATIONS.
- II. CONNECTION TO AN EXISTING STORM SEWER SHALL BE BY EITHER OF THE FOLLOWING METHODS:
  - A) PROPOSED STORM SEWER CONNECTION TO EXISTING SEWER OF 27" (675) OR SMALLER SEE DETAIL "A" AND "B".

    B) PROPOSED STORM SEWER CONNECTION TO EXISTING SEWER OF 30" (750) OR LARGER SEE

IF THE EXISTING SEWER PIPE IS CRACKED, BROKEN OR OTHERWISE DAMAGED BY THE CONTRACTOR IN MAKING THE CIRCULAR OPENING, THE CONTRACTOR SHALL REPLACE THAT SECTION OF PIPE WITH PIPE EQUAL AND SIMILAR IN ALL RESPECTS TO THE PIPE IN THE EXISTING SEWER, IN A CAREFUL WORKMANLIKE MANNER, WITHOUT EXTRA COMPENSATION.

#### GENERAL

CARE MUST BE TAKEN TO PREVENT DEBRIS FROM ENTERING THE SEWER. ALL DEBRIS WHICH ENTERS THE SEWER MUST BE REMOVED. THE SEWER MUST BE LEFT CLEAN AND UNOBSTRUCTED UPON COMPLETION OF THE CONTRACT.

CARE MUST BE TAKEN TO PREVENT ANY PART OF THE NEW PIPE CONNECTION FROM PROJECTING INTO THE EXISTING SEWER.

#### BASIS OF PAYMENT

TEE OR WYE CONNECTIONS SHALL BE PAID FOR AT THE CONTRACT UNIT PRICE EACH FOR STORM SEWER TEE OR WYE OF THE TYPE AND SIZE SPECIFIED IN THE PLANS, THIS PRICE SHALL INCLUDE ALL EXCAVATION OF THE TRENCH, REMOVAL OF THE EXISTING STORM SEWER, FURNISHING AND INSTALLING THE SPECIFIED TEE OR WYE SECTION, FURNISHING AND INSTALLING THE REQUIRED CONCRETE COLLAR, AND ALL OTHER MATERIAL NECESSARY TO COMPLETE THIS WORK AS SHOWN AND SPECIFIED.


REMOVAL AND REINSTALLATION OF EXISTING STORM SEWER ADJACENT TO THE PROPOSED TEE OR WYE SECTION, FOR THE PURPOSE OF FACILITATING THE INSTALLATION OF THE TEE OR WYE SECTION, WILL NOT BE PAID FOR SEPARATELY BUT SHALL BE INCLUDED IN THE UNIT PRICE BID FOR THE WORK.

TRENCH BACKFILL, EXCAVATION IN ROCK AND REMOVAL AND REPLACEMENT OF UNSUITABLE MATERIAL BELOW PLAN BEDDING GRADE WILL BE PAID FOR SEPARATELY.

CONCRETE COLLAR FOR CONNECTING A PROPOSED STORM SEWER TO AN EXISTING STORM SEWER WILL NOT BE PAID PAID FOR SEPARATELY BUT SHALL BE INCLUDED IN THE COST OF THE PROPOSED STORM SEWER.

ALL DIMENSIONS ARE IN INCHES (MILLIMETERS) UNLESS OTHERWISE SHOWN.

| FILE NAME =               | USER NAME = gaglianobt      | DESIGNED - M. DE YONG | REVISED - M. DE YONG 05-08-92 |                              | DETAIL OF STORM SEWER                            | F.A.U. SECTION                        | COUNTY TOTAL SHEET |
|---------------------------|-----------------------------|-----------------------|-------------------------------|------------------------------|--|---------------------------------------|--------------------|
| W:\diststd\22x34\bd@7.dgn |                             | DRAWN -               | REVISED - R. SHAH 09-09-94    | STATE OF ILLINOIS            |  | 2843 2014-083B                        | COOK 30 25         |
|                           | PLOT SCALE = 50.000 ' / IN. | CHECKED -             | REVISED - R. SHAH 10-25-94    | DEPARTMENT OF TRANSPORTATION | CONNECTION TO EXISTING SEWER                     | BD500-01 (BD-7)                       | CONTRACT NO. 62A28 |
|                           | PLOT DATE = 1/4/2008        | DATE - 07-25-90       | REVISED - R. SHAH 06-12-96    |                              | SCALE: NONE SHEET NO. 1 OF 1 SHEETS STA. TO STA. | FED. ROAD DIST. NO. 1 ILLINOIS FED. A | ID PROJECT         |

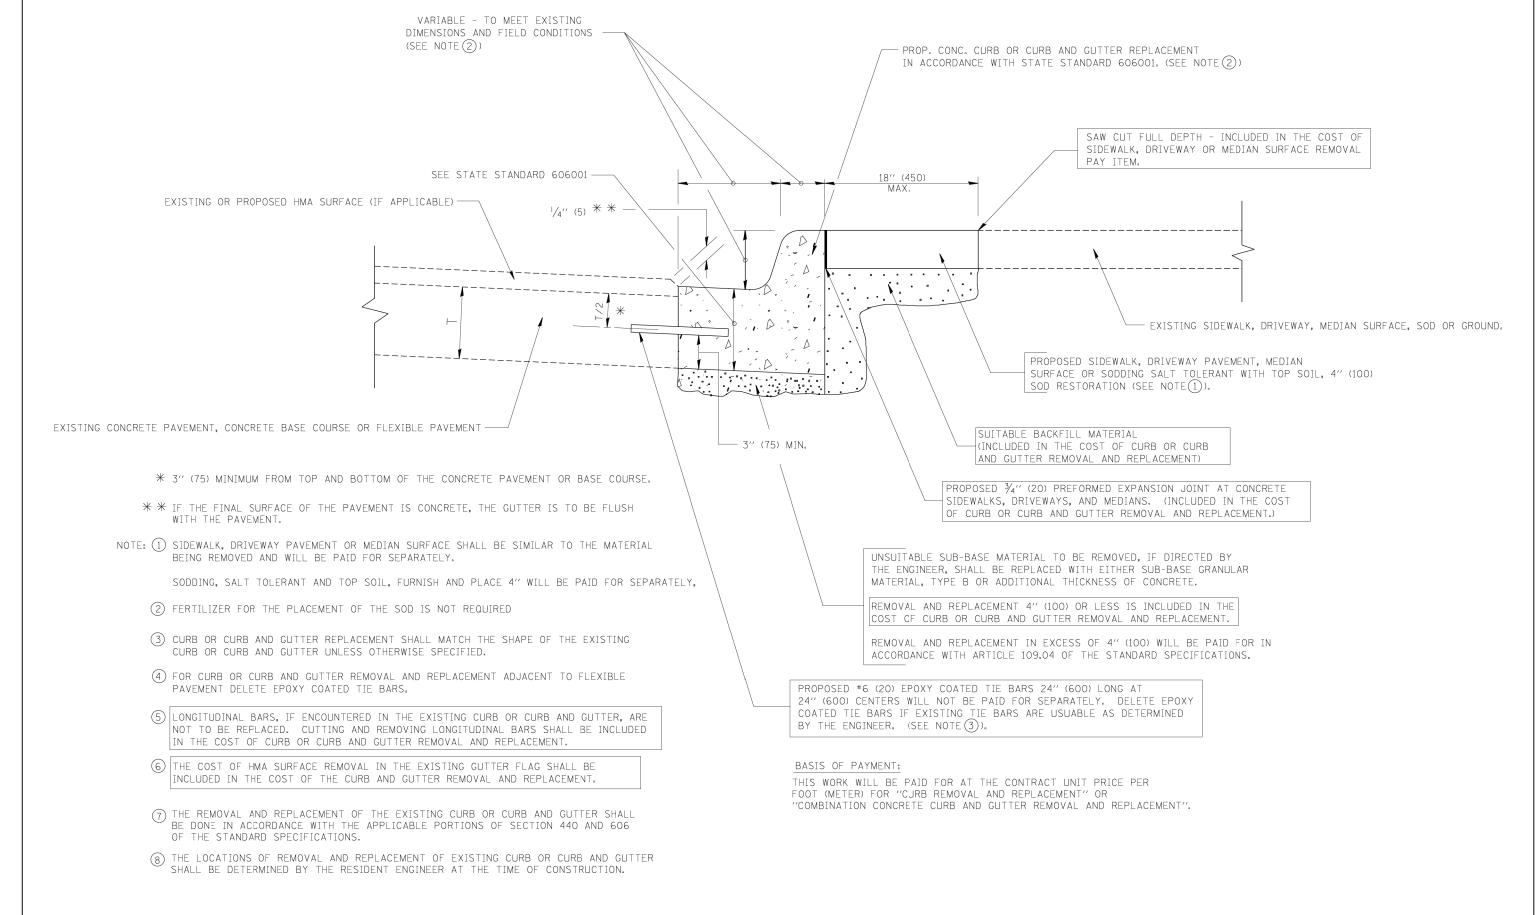

### CURB OR CURB AND GUTTER REMOVAL AND REPLACEMENT


SCALE: NONE

ALL DIMENSIONS ARE IN INCHES (MILLIMETERS) UNLESS OTHERWISE SHOWN.

| FILE NAME =                              | USER NAME = drivakosgn     | DESIGNED - A. HOUSEH | REVISED - | R. SHAH 10-03-96  |
|--|----------------------------|----------------------|-----------|-------------------|
| c:\pw_work\pwidot\drivakosgn\d0108315\bd | 24.dgn                     | DRAWN -              | REVISED - | A. ABBAS 03-21-97 |
|  | PLOT SCALE = 50.000 '/ IN. | CHECKED -            | REVISED - | M. GOMEZ 01-22-01 |
|  | PLOT DATE = 12/15/2009     | DATE - 03-11-94      | REVISED - | R. BORO 12-15-09  |

STATE OF ILLINOIS
DEPARTMENT OF TRANSPORTATION


|  | CURB OR CURB AND GUTTER REMOVAL AND REPLACEMENT |        |      |         | F.A.U<br>RTE. | SECTION                         | COUNTY     | TOTAL<br>SHEETS | SHEE<br>NO. |
|--|---|--------|------|---------|---------------|---------------------------------|------------|-----------------|-------------|
|  |   |        |      |         | 2843          | 2014-083B                       | соок       | 30              | 26          |
|  | REMOVAL AND REPLACEMENT                         |        |      |         |               | BD600-06 (BD-24)                | CONTRACT   | NO. 6           | 2A28        |
|  | SHEET NO. 1 OF 1                                | SHEETS | STA. | TO STA. | FED. RO       | OAD DIST. NO. 1 ILLINOIS FED. A | ID PROJECT |                 |             |

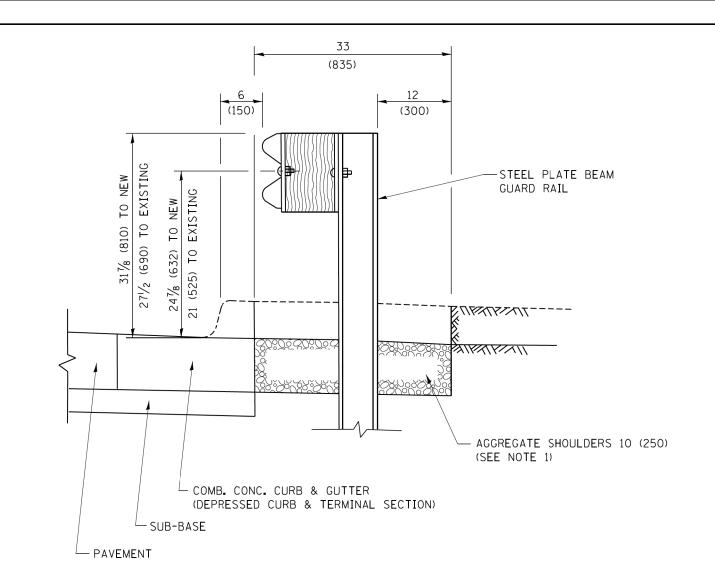

### SECTION A-A

- NOTES: 1. THE AGGREGATE SHOULDER, 10 (250) OR HMA SHOULDER, 6 (150) (IF REQUIRED) SHALL EXTEND UNDER THE TRAFFIC BARRIER TERMINAL.
  - 2. "EXISTING" GUARDRAIL REFERS TO CONNECTING TERMINAL SECTION TO GUARD RAILING PRIOR TO THE MIDWEST GUARDRAIL SYSTEM.
  - 3. THE CONTRACTOR SHALL VERIFY THE TYPE/HEIGHT OF GUARDRAIL IN-PLACE BEFORE ORDERING THE NEW TERMINAL SECTION. COST INCLUDED WITH THE COST OF THE TERMINAL. THE TERMINAL SECTION HEIGHT TO BE PLACED MUST MATCH THE HEIGHT OF THE IN-PLACE GUARDRAIL.

DETAILS FOR STEEL PLATE BEAM GUARD RAIL ADJACENT TO CURB AND GUTTER [FOR ROADWAY SPEED 35 MPH (60 kmh) TO 45 MPH (70 kmh)]

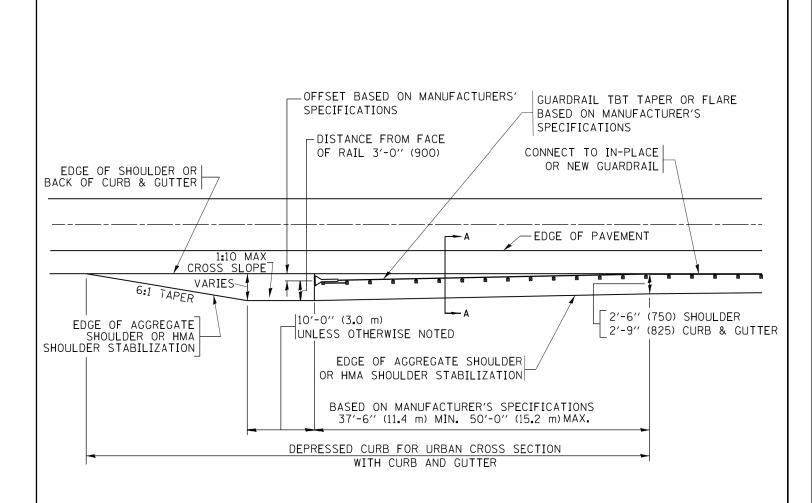

### DEPRESSED CURB AND GUTTER AND SHOULDER TREATMENT AT TBT TY. 1 SPL.

AGGREGATE SHOULDER, 10 (250) WILL BE PAID ACCORDING TO SECTION 481.

HMA SHOULDERS 6 (150) (IF REQUIRED) WILL BE PAID ACCORDING TO SECTION 482.

COMB. CONC. C&G, STEEL PLATE BEAM GUARD RAIL AND TRAFFIC BARRIER TERMINAL, OF THE TYPE SPECIFIED WILL BE PAID FOR SEPARATELY.


> TBT = TRAFFIC BARRIER TERMINAL ALL DIMENSIONS ARE IN INCHES (MILLIMETERS) UNLESS OTHERWISE SHOWN.

DESIGNED - M. DE YONG REVISED - R. BORO 12-08-2008 FILE NAME = USER NAME = drivakosqn w:\\ILØ84EBIDINTEG.ıllınoı ents\IDOT Offices\District 1\Projects\D taRAWM\CADData\CADsheets\bd34.dgr REVISED - R. BORO 09-14-200 PLOT SCALE = 50.0000 '/ 10. CHECKED -REVISED -R. BORO 08-06-2012 PLOT DATE = 12/21/2015 DATE 09-22-90 REVISED -R. BORO 05-08-201

STATE OF ILLINOIS DEPARTMENT OF TRANSPORTATION


DETAILS FOR DEPRESSED CURB & GUTTER AND SHOULDER TREATMENT AT TBT TY. 1 SPL. SHEET 1 OF 1 SHEETS STA. SCALE NONE


TOTAL SHEET NO. 30 27 SECTION СООК 2014-083B BD600-10 (BD 34) CONTRACT NO. 62A28

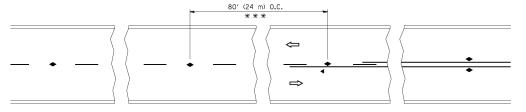


\*\*\* REDUCE TO 40' (12 m) O.C. ON CURVES WITH POSTED OR ADVISORY SPEED 45 M.P.H. (70 km/h) OR LESS.

#### TWO-LANE/TWO-WAY

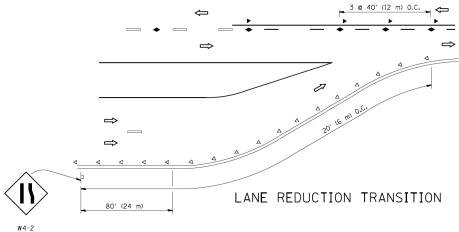


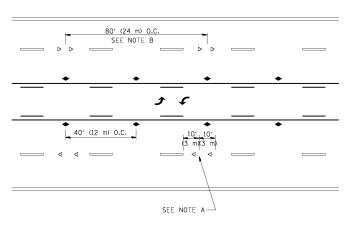

TWO-WAY LEFT TURN

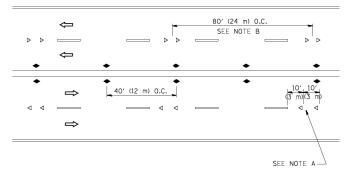

MULTI-LANE/UNDIVIDED

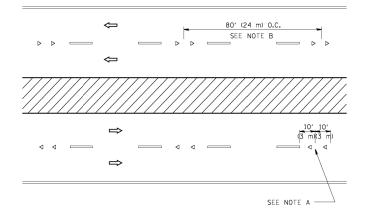

MULTI-LANE/DIVIDED

#### GENERAL NOTES

- MARKERS USED WITH DASHED LINES SHALL BE CENTERED IN THE GAP BETWEEN SEGMENTS.
- 2. MARKERS USED ADJACENT TO SOLID LINES SHALL BE OFFSET 2 TO 3 (50 TO 75) TOWARD TRAFFIC AS SHOWN.
- 3. MARKERS THROUGH TANGENTS LESS THAN 500' (150 m) IN LENGTH BETWEEN CURVES SHALL BE INSTALLED AT THE LESSER OF THE TWO CURVE SPACINGS.

#### LANE MARKER NOTES

A. USE DOUBLE LANE LINE MARKERS SPACED AS SHOWN.

B. REDUCE TO 40' (12 m) O.C. ON CURVES WHERE ADVISORY SPEEDS ARE 10 M.P.H (20 km/h) LOWER THAN POSTED SPEEDS.

#### SYMBOLS

---- YELLOW STRIPE

── WHITE STRIF

- ONE-WAY AMBER MARKER
- ONE-WAY CRYSTAL MARKER (₩/O)
- ◆ TWO-WAY AMBER MARKER

#### DESIGN NOTES


- 1. DOUBLE LANE LINE MARKERS SHALL BE USED UNLESS SPECIFIED OTHERWISE.
- 2. EXCEPT AS SHOWN ON THE LANE REDUCTION TRANSITION AND FREEWAY EXIT RAMP DETAIL, MARKERS ARE NOT TO BE SPECIFIED ON RIGHT EDGE LINES.
- 3. THE EXACT MARKER LIMITS, SPACING, AND COLOR SHALL BE INCLUDED IN THE PLANS WHEN STANDARD SPECIFICATIONS ARE NOT BEING USED.
- 4. MARKERS SHOULD NOT BE USED ALONGSIDE CURBS EXCEPT FOR EXTREMELY SHORT SECTIONS OF CURBS WHERE NOT MORE THAN TWO MARKERS WOULD BE INVOLVED.

#### 

LEFT TURN

All dimensions are in inches (millimeters) unless otherwise shown.

| FILE NAME =                               | USER NAME = leysa          | DESIGNED - | REVISED -T. RAMMACHER 09-19-94 |                              | TYPICAL APPLICATIONS                                     | RTF SEC               | ECTION              | COUNTY      | SHEETS NO. |
|---|----------------------------|------------|--------------------------------|------------------------------|--|-----------------------|---------------------|-------------|------------|
| c:\pw_work\pwidot\leysa\d0108315\tc11.dgn |                            | DRAWN -    | REVISED -T. RAMMACHER 03-12-99 | STATE OF ILLINOIS            |  | 2843 2014             | 14-083B             | соок        | 30 28      |
|   | PLOT SCALE = 50.000 '/ IN. | CHECKED -  | REVISED -T. RAMMACHER 01-06-00 | DEPARTMENT OF TRANSPORTATION | RAISED REFLECTIVE PAVEMENT MARKERS (SNOW-PLOW RESISTANT) | TC-11                 |                     | CONTRACT N  | NO. 62A28  |
|   | PLOT DATE = 3/2/2011       | DATE -     | REVISED - C. JUCIUS 09-09-09   |                              | SCALE: NONE SHEET NO. 1 OF 1 SHEETS STA. TO STA.         | FED. ROAD DIST. NO. 1 | 1 ILLINOIS FED. AID | AID PROJECT |            |

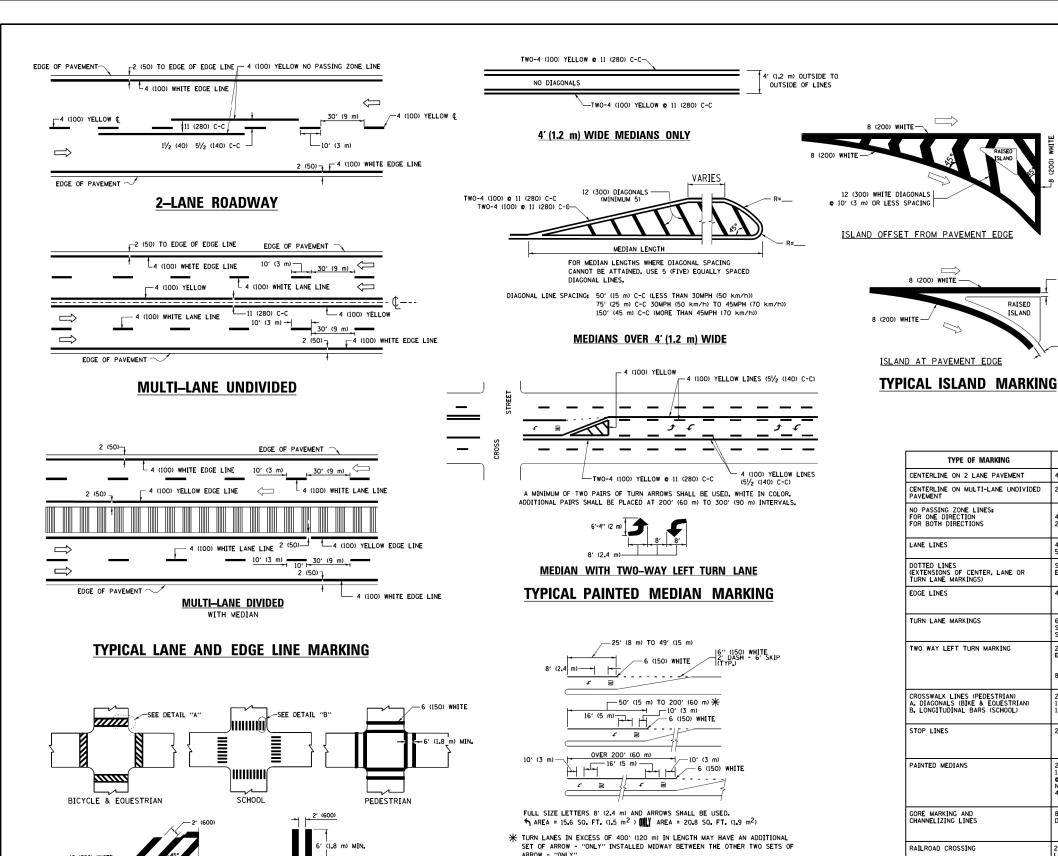

TYPICAL LEFT (OR RIGHT) TURN LANE TYPICAL TURN LANE MARKING

6'-4" (1930) D(FT) SPEED LIMIT 500 580 665 50 750 55 40 (1020) **COMBINATION** LEFT AND U-TURN 5'-4" (1620) ₹ 32 R (810)

#### LANE REDUCTION TRANSITION

\* LANE REDUCTION ARROWS REQUIRED AT SPEEDS OF 45 MPH OR GREATER OR WHEN SPECIFIED IN PLANS.

| TYPE OF MARKING   | WIDTH OF LINE   | PATTERN                            | COLOR   | SPACING /REMARKS   |
|---|---|------------------------------------|---|--|
| CENTERLINE ON 2 LANE PAVEMENT   | 4 (100)   | SKIP-DASH                          | YELLOW  | 10' (3 m) LINE WITH 30' (9 m) SPACE  |
| CENTERLINE ON MULTI-LANE UNDIVIDED PAVEMENT   | 2 @ 4 (100)   | SOLID                              | YELLOW  | 11 (280) C-C   |
| NO PASSING ZONE LINES:<br>FOR ONE DIRECTION<br>FOR BOTH DIRECTIONS                          | 4 (100)<br>2 @ 4 (100)  | SOLID<br>SOLID                     | YELLOW<br>YELLOW  | 5½ (140) C-C FROM SKIP-DASH CENTERLINE<br>11 (280) C-C<br>OMIT SKIP-DASH CENTERLINE BETWEEN  |
| LANE LINES  | 4 (100)<br>5 (125) ON FREEWAYS  | SKIP-DASH<br>SKIP-DASH             | WHITE<br>WHITE  | 10' (3 m) LINE WITH 30' (9 m) SPACE  |
| DOTTED LINES (EXTENSIONS OF CENTER, LANE OR TURN LANE MARKINGS)                             | SAME AS LINE BEING EXTENDED   | SKIP-DASH                          | SAME AS LINE BEING<br>EXTENDED                          | 2' (600) LINE WITH 6' (1.8 m) SPACE  |
| EDGE LINES  | 4 (100)   | SOLID                              | YELLOW-LEFT<br>WHITE-RIGHT                              | OUTLINE MEDIANS IN YELLOW  |
| TURN LANE MARKINGS  | 6 (150) LINE; FULL<br>SIZE LETTERS &<br>SYMBOLS (8' (2.4m))   | SOLID                              | WHITE   | SEE TYPICAL TURN LANE MARKING DETAIL   |
| TWO WAY LEFT TURN MARKING   | 2 @ 4 (100)<br>EACH DIRECTION<br>8' (2.4m) LEFT ARROW   | SKIP-DASH<br>AND SOLID<br>IN PAIRS | YELLOW WHITE  | 10' (3 m) LINE WITH 30' (9 m) SPACE FOR SKIP-DASH; 5½ (140) C-C BETWEEN SOLID LINE AND SKIP-DASH LINE SEE TYPICAL TWO-WAY LEFT TURN MARKING DETAIL                 |
| CROSSWALK LINES (PEDESTRIAN) A. DIAGONALS (BIKE & EQUESTRIAN) B. LONGITUDINAL BARS (SCHOOL) | 2 <b>e</b> 6 (150)<br>12 (300) <b>e</b> 45°<br>12 (300) <b>e</b> 90°                                | SOLID<br>SOLID<br>SOLID            | WHITE<br>WHITE<br>WHITE                                 | NOT LESS THAN 6' (1.8 m) APART<br>2' (600) APART<br>2' (600) APART<br>5EE TYPICAL CROSSWALK MARKING DETAILS.   |
| STOP LINES  | 24 (600)  | SOLID                              | WHITE   | PLACE 4' (1.2 m) IN ADVANCE OF AND PARALLEL TO CROSSWALK, IF PRESENT. OTHERMISE, PLACE AT DESIRED STOPPING POINT. PARALLEL TO CROSSROAD CENTERLINE, WHERE POSSIBLE |
| PAINTED MEDIANS   | 2 @ 4 (100) WITH<br>12 (300) DIAGONALS<br>@ 45°<br>NO DIAGONALS USED FOR<br>4' (1.2 m) WIDE MEDIANS | SOLID                              | YELLOW:<br>TWO WAY TRAFFIC<br>WHITE:<br>ONE WAY TRAFFIC | 11 (280) C-C FOR THE DOUBLE LINE<br>SEE TYPICAL PAINTED MEDIAN MARKING.  |
| GORE MARKING AND<br>CHANNELIZING LINES  | 8 (200) WITH 12 (300)<br>DIAGONALS @ 45°  | SOLID                              | WHITE   | DIACONALS: 15' (4,5 m) C-C (LESS THAN 30MPH (50 km/h)) 20' (6 m) C-C 30MPH (50 km/h) TO 45MPH (70 km/h)) 30' (9 m) C-C (0VER 45MPH (70 km/h))                      |
| RAILROAD CROSSING   | 24 (600) TRANSVERSE<br>LINES; "RR" IS 6' (1.8 m)<br>LETTERS; 16 (400)<br>LINE FOR "X"               | SOLID                              | WHITE   | SEE STATE STANDARD 780001<br>AREA OF:<br>"R"53.6 SO, FT. (0.33 m²) EACH<br>"X"54.0 SO, FT. (5.0 m²)  |
| SHOULDER DIAGONALS (REQUIRED FOR SHOULDERS > 8')  | 12 (300) <b>@</b> 45°   | SOLID                              | WHITE - RIGHT<br>YELLOW - LEFT                          | 50' (15 m) C-C (LESS THAN 30MPH (50 km/h))<br>75' (25 m) C-C (30 MPH (50 km/h) T0 45MPH (70 km/h))<br>150' (45 m) C-C (0VER 45MPH (70 km/h))                       |
| U TURN ARROW  | SEE DETAIL  | SOLID                              | WHITE   | 16,3 SF  |
| 2 ARROW COMBINATION<br>LEFT AND U TURN  | SEE DETAIL  | SOLID                              | WHITE   | 30.4 SF  |

**U\_TURN** 

FOR FURTHER DETAILS ON PAVEMENT MARKING REFER TO STANDARD SPECIFICATIONS FOR ROAD AND BRIDGE CONSTRUCTION AND STATE STANDARD 780001.

SCALE:

\_\_ 2 (50)

2 (50)

RAISED

8 (200) WHITE -

All dimensions are in inches (millimeters) unless otherwise shown.

| FILE NAME =               | USER NAME = leysa          | DESIGNED - EVERS | REVISED - | C. JUCIUS 09-09-09 |
|---------------------------|----------------------------|------------------|-----------|--------------------|
| W:\diststd\22x34\tcl3.dgn |                            | DRAWN -          | REVISED - | C. JUCIUS 07-01-13 |
|                           | PLOT SCALE = 50.000 '/ in. | CHECKED -        | REVISED - | C. JUCIUS 12-21-15 |
| Default                   | PLOT DATE = 6/23/2017      | DATE - 03-19-90  | REVISED - | C. JUCTUS 04-12-16 |

TYPICAL CROSSWALK MARKING

\* MARKINGS SHALL BE INSTALLED PARALLEL TO THE CENTERLINE OF THE ROAD WHICH IT CROSSES

-12 (300) WHITE

DETAIL "B"

- 6 (150) WHITE

DETAIL "A"

**STATE OF ILLINOIS DEPARTMENT OF TRANSPORTATION** 

| DISTRICT ONE TYPICAL PAVEMENT MARKINGS |  |  |  |  |  |  | F.A.U.<br>RTE. | SECTION         | COUNTY     | TOTAL<br>SHEETS | SHEET<br>NO. |
|--|--|--|--|--|--|--|----------------|-----------------|------------|-----------------|--------------|
|  |  |  |  |  |  |  | 2843           | 2014-083B       | соок       | 30              | 29           |
| ITFIGAL PAVEINENT INIARKINGS           |  |  |  |  |  |  |                | TC-13           | CONTRACT   | NO. 6           | 52A28        |
| NONE SHEET 1 OF 1 SHEETS STA. TO STA.  |  |  |  |  |  |  |                | ILLINOIS FED. A | ID PROJECT |                 |              |

