# STATE OF ILLINOIS **DEPARTMENT OF TRANSPORTATION**

1681 23-00095-00-RS FED. ROAD DIST. NO. 1 ILLINOIS FED. AID PROJECT 8RCG(039

CONTRACT NO. 61J72

# PLANS FOR PROPOSED FEDERAL AID HIGHWAY

FOR INDEX OF SHEETS, SEE SHEET NO. 2 FOR HIGHWAY STANDARDS, SEE SHEET NO. 2 **FAU ROUTE 1681 (EDGEWATER DRIVE / VILLAGE DRIVE) PULASKI ROAD TO BRIAR LANE ROADWAY RESURFACING** 

**SECTION NO.: 23-00095-00-RS** 

POSTED SPEED LIMIT-**DESIGN SPEED-**

**EDGEWATER DRIVE / VILLAGE DRIVE** 

**PULASKI ROAD TO BRIAR LANE** 

TRAFFIC (2018 ADT)-

FUNCTIONAL CLASSIFICATION-


MINOR COLLECTOR

1,250

**20 MPH** 

**20 MPH** 

PROJECT NO.: 8RCG(039) **VILLAGE of HAZEL CREST COOK COUNTY** JOB NO.: C-91-162-23

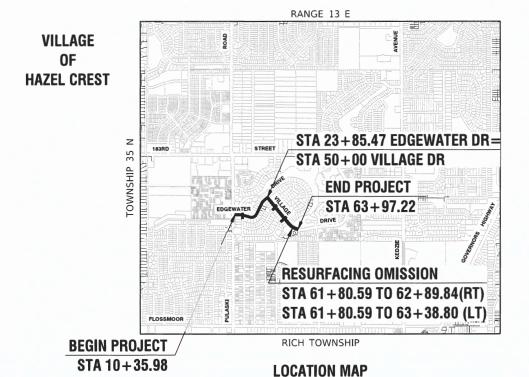

**NOT TO SCALE** 

GROSS LENGTH= 3,159.43 FEET= 0.60 MILES

NET LENGTH= 3,050.18 FEET= 0.58 MILES

LOCATION OF SECTION INDICATED THUS: -

PRINTED BY THE AUTHORITY OF THE STATE OF ILLINOIS

ENGINEERING SCALES, REDUCED SIZED PLANS WILL NOT CONFORM TO STANDARD SCALES, IN MAKING MEASUREMENTS ON REDUCED PLANS. THE ABOVE SCALES MAY BE USED.

JOINT UTILITY LOCATION INFORMATION FOR EXCAVATION 1 - 800 - 892 - 0123 OR 811

CONTRACT NO. 61J72

22B0763-COVB-01 - C01

AID PROGRAM ENGINEER:

#### INDEX OF SHEETS

- 1 COVER SHEET
- INDEX OF SHEETS, HIGHWAY STANDARDS AND GENERAL NOTES
- 3-5 SUMMARY OF QUANTITIES
- 6 TYPICAL CROSS SECTIONS
- 7-8 ALIGNMENT AND TIES
- 9-10 PROPOSED IMPROVEMENT PLAN
- 11-12 PAVEMENT MARKING AND SIGNAGE PLAN
- 13 ADA RAMP DETAILS
- 14-19 IDOT DISTRICT 1 STANDARDS

#### HIGHWAY STANDARDS

000001-08	STANDARD SYMBOLS, ABBREVIATIONS AND PATTERNS
424001-11	PERPENDICULAR CURB RAMPS FOR SIDEWALKS
442201-03	CLASS C AND D PATCHES
604001-05	FRAME AND LIDS TYPE 1
606001-08	CONCRETE CURB TYPE B AND COMBINATION CONCRETE CURB AND GUTTER
701001-02	OFF ROAD OPERATIONS, 2L, 2W, MORE THAN 15' (4.5m) AWAY
701006-05	OFF ROAD OPERATIONS, 2L, 2W, 15'(4.5m) TO 24"(600mm) FROM PAVEMENT EDGE
701011-04	OFF ROAD MOVING OPERATIONS, 2L,2W, DAY ONLY
701301-04	LANE CLOSURE, 2L, 2W, SHORT TIME OPERATIONS
701311-03	LANE CLOSURE, 2L, 2W, MOVING OPERATIONS - DAY ONLY
701501-06	URBAN LANE CLOSURE, 2L, 2W, UNDIVIDED
701801-06	SIDEWALK, CORNER OR CROSSWALK CLOSURE
701901-08	TRAFFIC CONTROL DEVICES

#### DISTRICT ONE DETAILS

BD-08	FRAMES AND LIDS ADJUSTMENT WITH MILLING
BD-22	PAVEMENT PATCHING FOR HMA SURFACED PAVEMENT
BD-32	BUTT JOINTS AND HMA TAPER
TC-10	TRAFFIC CONTROL AND PROTECTION FOR SIDE ROADS, INTERSECTIONS AND DRIVEWAYS
TC-13	DISTRICT ONE TYPICAL PAVEMENT MARKINGS
TC-16	SHORT TERM PAVEMENT MARKING LETTERS AND SYMBOLS

#### **GENERAL NOTES**

- ITEMS OF WORK LISTED IN THE SUMMARY OF QUANTITIES NOT SPECIFICALLY CALLED OUT ON THE PLANS SHALL BE PERFORMED AS DIRECTED BY THE ENGINEER.
- 2. THE ROBINSON ENGINEERING, LTD. FIELD OFFICE (708-331-6700), AND THE PUBLIC WORKS DIRECTOR, AT THE VILLAGE OF HAZEL CREST (708-335-9600 EXT. 200), SHALL BE NOTIFIED THREE (3) WORKING DAYS BEFORE CONSTRUCTION BEGINS.
- BEFORE STARTING ANY EXCAVATION THE CONTRACTOR SHALL CALL "J.U.L.I.E." AT (800) 892-0123 OR 811 AND (312) 744-7000 FOR FIELD LOCATIONS OF BURIED ELECTRIC, TELEPHONE AND GAS UTILITIES. (48 HOUR NOTIFICATION REQUIRED)
- 4. UTILITIES INDICATED ON THE PLANS ARE PROVIDED FOR THE CONTRACTOR'S USE AND ARE BASED UPON INFORMATION AVAILABLE AT THE TIME OF THE ADVERTISEMENT FOR BIDS. THE OWNER AND ENGINEER DO NOT GUARANTEE THE ACCURACY OF UTILITY INFORMATION.
- 5. IT SHALL BE THE CONTRACTOR'S RESPONSIBILITY TO VERIFY ALL DIMENSIONS AND CONDITIONS EXISTING IN THE FIELD PRIOR TO CONSTRUCTION AND ORDERING OF MATERIALS.
- 6. THE THICKNESS OF HMA MIXTURE STATED IN THE SPECIFICATIONS IS THE NOMINAL THICKNESS. DEVIATIONS FROM THE NOMINAL THICKNESS WILL BE PERMITTED WHEN SUCH DEVIATIONS OCCUR DUE TO IRREGULARITIES IN THE EXISTING SURFACE OR BASE ON WHICH THE HMA SUBFACE IS PLACED.
- 7. ANY LOOSE MATERIAL DEPOSITED IN THE FLOW LINE OF DITCHES, GUTTERS OR OTHER DRAINAGE STRUCTURES SHALL BE REMOVED BY THE END OF EACH DAY BY THE CONTRACTOR.
- 8. CLASS D PATCHING QUANTITIES FOR THIS CONTRACT SHALL BE PERFORMED AT THE DIRECTION OF THE ENGINEER AFTER PAVEMENT MILLING.
- 9. CONTRACTOR SHALL TAKE PRECAUTION BY PRESERVING EXISTING TREES WITHIN THE RIGHT OF WAY. IF ANY DAMAGE OCCURS, TREES SHALL BE REPLACED IN KIND PER ARTICLE 201.07 REPAIR OR REPLACEMENT OF EXISTING PLANT MATERIAL REQUIREMENTS STATED HEREIN.
- 10. NO PAVEMENT PATCHING SHALL BE PERMITTED AFTER FRIDAY AT 3:00 PM OF EACH AND EVERY WEEK AND NO HOLES WILL BE ALLOWED TO REMAIN OPEN OVERNIGHT OR OVER THE WEFKEND.
- 11. ALL EQUIPMENT SHALL BE REMOVED OFF THE VILLAGE STREETS DURING ALL HOLIDAY WEEKENDS AS COORDINATED WITH THE VILLAGE.
- 12. HMA PAVING SHALL BE PERFORMED WITH HOT JOINTS.

SCALE: NONE

- 13. THE CONTRACTOR SHALL CONTACT KALPANA KANNAN-HOSADURGA, THE DISTRICT ONE TRAFFIC CONTROL SUPERVISOR, AT KALPANA.KANNAN-HOSADURGA@ILLINOIS.GOV A MINIMUM OF 72 HOURS IN ADVANCE OF BEGINNING WORK.
- 14. THE "ROAD CONSTRUCTION AHEAD" SIGNS SHALL REMAIN INSTALLED UNTIL THE COMPLETION OF THE PROJECT OR WHEN NO ROADWAY HAZARDS REMAIN WITHIN THE WORK ZONE.

FILE NAME = 22R0763-INDX-01 - P01	USER NAME =	DESIGNED — CH	REVISED —	
		CHECKED — WPD	REVISED —	STATE OF ILLINOIS
	PLOT SCALE =	DRAWN — BG	REVISED —	DEPARTMENT OF TRANSPORTATION
	PLOT DATE = 07-11-23	CHECKED — AG	REVISED —	

EDGEWATER DRIVE / VILLAGE		F.A.U RTE.	SECT	ION		COUNTY	TOTAL SHEETS	SHEET NO.
ROADWAY RESURFACIN		1681	23-0009	5-00-RS		соок	19	2
INDEX OF SHEETS, STANDARDS & GENERAL NOTES						CONTRACT	NO. 61J7	'2
SHEET NO. 2 OF 19 SHEETS STA.	TO STA.	FFD. BO	AD DIST. NO. 1	ILLINOIS	FFD. Al	D PROJECT 8RCG	(039)	

SPECIALTY ITEM	PAY CODE	PAY ITEM DESCRIPTION	UNIT	TOTAL QUANTITY	ROADWAY 0005	SAFETY 0021	TRAINEES 0042
				QUANTITI	URBAN	URBAN	URBAN
					FED 80%/LOCAL 20%	FED 80%/LOCAL 20%	FED 80%/LOCAL 20
	20200100	EARTH EXCAVATION	CU YD	20		20	
	21101615	TOPSOIL FURNISH AND PLACE, 4"	SQ YD	635	635		
	25200110	SODDING, SALT TOLERANT	SQ YD	635	635		
	25200200	SUPPLEMENTAL WATERING	UNIT	35	35		
	28000250	TEMPORARY EROSION CONTROL SEEDING	POUND	14	14		
			100.0	1 7	***		
	28000510	INLET FILTERS	EACH	24	24		
	35101600	AGGREGATE BASE COURSE, TYPE B 4"	SQ YD	670		670	
			***************************************				
	35800100	PREPARATION OF BASE	SQ YD	5,710	5,710		
	35800200	AGGREGATE BASE REPAIR	TON	640	640		
	33800200	AGGREGATE DAGE REPAIR	TON	640	640		
	40201000	AGGREGATE FOR TEMPORARY ACCESS	TON	20	20		
	40600275	BITUMINOUS MATERIALS (PRIME COAT)	POUND	12,850	12,850		
	40600290	BITUMINOUS MATERIALS (TACK COAT)	POUND	4,615	4,615		
	40000770	LONGITUDINAL JOINT CEALANT		0.555			
	40600370	LONGITUDINAL JOINT SEALANT	FOOT	2,830	2,830		
	40600982	HOT-MIX ASPHALT SURFACE REMOVAL BUTT JOINT	SQ YD	210	210		
	40602978	HOT-MIX ASPHALT BINDER COURSE, IL-9.5, N50	TON	965	965		
	40604060	HOT-MIX ASPHALT SURFACE COURSE, IL-9.5, MIX "D", N50	TON	895	895		
	40700700	PORTIAND CENEAT CONCRETE DONGWAY DANGAGET 7 INCH					
	42300300	PORTLAND CEMENT CONCRETE DRIVEWAY PAVEMENT, 7 INCH	SQ YD	95	95		

FILE NAME = 22R0763-QUAN-01 - P01	USER NAME =	DESIGNED CH	REVISED			EDGEWATER DRIVE / VILLAGE DRIVE	F.A.U	SECTION	COUNTY	TOTAL S	HEET
		CHECKED — SDK	REVISED —	STATE OF ILLINOIS		ROADWAY RESURFACING	1681	23-00095-00-RS	соок	19	3
	PLOTSCALE =	DRAWN BG	REVISED —	DEPARTMENT OF TRANSPORTATION		SUMMARY OF QUANTITIES	1		CONTRACT	F NO. 61J72	
	PLOT DATE = 07-11-23	CHECKED AG	REVISED —		SCALE: NONE	SHEET NO, 3 OF 19 SHEETS STA. TO STA.	FED, ROAL	D DIST. NO. 1 ILLUNOIS FED. A	AD PROJECT BROWN		$\dashv$

						CONSTRUCTION CODE	
SPECIALTY	D.134 -48-			TOTAL	ROADWAY	SAFETY	TRAINEES
SPECIALTY ITEM	PAY CODE	PAY ITEM DESCRIPTION	TINU	TOTAL QUANTITY	0005	0021	0042
				İ	URBAN	URBAN	URBAN
					FED 80%/LOCAL 20%	FED 80%/LOCAL 20%	FED 80%/LOCAL 20
	42400200	PORTLAND CEMENT CONCRETE SIDEWALK 5 INCH	SQ FT	5,145		5,145	
	42400800	DETECTABLE WARNINGS	SQ FT	310		310	
				010		510	
	44000160	HOT-MIX ASPHALT SURFACE REMOVAL, 2 3/4"	SQ YD	5,710	5,710		
			34 10	3,710	5,710		
	44000161	HOT-MIX ASPHALT SURFACE REMOVAL, 3"	50 V0	4.070	4.070		
		HOT-MIX ASFRACE REMOVAL, 3	SQ YD	4,930	4,930		
	4400000						
	44000200	DRIVEWAY PAVEMENT REMOVAL	SQ YD	130	130		
	4400000	CONTINUATION OF THE WITTER SERVICE					
	44000500	COMBINATION CURB AND GUTTER REMOVAL	FOOT	965	965		
	44000600	SIDEWALK REMOVAL	SQ FT	4,990		4,990	
					:		
	44201713	CLASS O PATCHES, TYPE I, 6 INCH	SQ YD	100	100		
	44201717	CLASS D PATCHES, TYPE II, 6 INCH	SQ YD	150	150		
				1			
	44201721	CLASS D PATCHES, TYPE III, 6 INCH	SQ YD	200	200		
	44001707	CLASS D DATCHES TYPE IV. 6 INCH.					
	44201723	CLASS D PATCHES, TYPE IV, 6 INCH	SQ YD	250	250		
		MUVE POWER TO BE ADMINISTED					
	60266600	VALVE BOXES TO BE ADJUSTED	EACH	5	5		
<u> </u>	0010000	FRANCE AND LIDE TYPE 4 COCKLUD					
	60406000	FRAMES AND LIDS, TYPE 1, OPEN LID	EACH	1	1		
	60603800	COMBINATION CONCRETE CURB AND GUTTER, TYPE B-6.12	FOOT	45	45		
							,
	60608300	COMBINATION CONCRETE CURB AND GUTTER, TYPE M-2.12	FOOT	920	920		
	67100100	MOBILIZATION	LSUM	1	1		
:							
	70102620	TRAFFIC CONTROL AND PROTECTION, STANDARD 701501	LSUM	1	1		

FILE NAME = 22R0763-QUAN-01 - P02	USER NAME =	DESIGNED — CH	REVISED
		CHECKED — SDK	REVISED
	PLOT SCALE =	DRAWN BG	REVISED —
<u> </u>	PLOT DATE = 07-11-23	CHECKED AG	REVISED —

STATE OF ILLINOIS
DEPARTMENT OF TRANSPORTATION

EDGEWATER DRIVE / VILLAGE DRIVE ROADWAY RESURFACING										
			AY RESUR RY OF QUA							
SCALE: NONE	SHEET NO. 4	OF 19	SHEETS	STA.	TO STA.					

	F.A.U RTE.		SEC	TION	COUNTY		SHEETS	NO,	
	1681	23	-0009	95-00-RS		соок	Ī	19	4
_						CONTRAC	CTN	IO. 61J7	'2
	FED, ROA	AD DIST. NO.	1	ILUNOIS	FED. A	ID PROJECT BE	RCG(	039)	


						CONSTRUCTION CODE		
SPECIALTY	247 0005			TOTAL	ROADWAY	SAFETY	TRAINEES	
SPECIALTY ITEM	PAY CODE	PAY ITEM DESCRIPTION	UNIT	TOTAL QUANTITY	0005	0021	0042	
					URBAN	URBAN	URBAN	
					FED 80%/LOCAL 20%	FED 80%/LOCAL 20%	FED 80%/LOCAL 20%	
	70102640	TRAFFIC CONTROL AND PROTECTION, STANDARD 701801	LSUM	1	1			
	70700400						1	
	70300100	SHORT TERM PAVEMENT MARKING	FOOT	1,500		1,500		
	70300150	SHORT TERM PAVEMENT MARKING REMOVAL	SQ FT	500		500		
X	72000100	SIGN PANEL TYPE 1	SQ FT	65		65		
	70400400						<u> </u>	
	72400100	REMOVE SIGN PANEL ASSEMBLY TYPE A	EACH	10		10		
X	72800100	TELESCOPING STEEL SIGN SUPPORT	FOOT	150		150		
X	78000200	THERMOPLASTIC PAVEMENT MARKING - LINE 4"	FOOT	310		310		
							ı	
X	78000400	THERMOPLASTIC PAVEMENT MARKING - LINE 6"	FOOT	680		680		
X	78000600	THERMOPLASTIC PAVEMENT MARKING - LINE 12"	FOOT	450		450		
X	78000650	THERMOPLASTIC PAVEMENT MARKING - LINE 24"	FOOT	235		235		
	Z0004514	HOT-MIX ASPHALT DRIVEWAY PAVEMENT, 4"						
	20004514	HOI-MIX ASPRIALI DRIVEWAT PAVEMENI, 4	SQ YD	35	35			
	Z0017400	DRAINAGE & UTILITY STRUCTURES TO BE ADJUSTED	EACH	33	33			
	Z0017700	DRAINAGE & UTILITY STRUCTURES TO BE RECONSTRUCTED	EACH	1	1			
	20076600	TRAINEES	110110					
	250,0000		HOUR	500			500	
	Z0076604	TRAINEES TRAINING PROGRAM GRADUATE	HOUR	500			500	

FILE NAME = 22R0763-QUAN-01 - P00	USER NAME =	DESIGNED CH	REVISED ·
		CHECKED — SDK	REVISED —
	PLOT SCALE =	DRAWN BG	REVISED
	PLOT DATE = 07-11-23	CHECKED AG	REVISED

STATE OF ILLINOIS
DEPARTMENT OF TRANSPORTATION


_					ILLAGE D				
	ROADWAY RESURFACING SUMMARY OF QUANTITIES								
	SCALE: NONE	SHEET NO. 5	OF 19	SHEETS	STA.	TO STA.	_		

F.A.U RTE.				COUNTY	TOTAL SHEETS	SHEET NO.	
1681	1681 23-00095-00-RS			COOK	19	5	
				CONTRACT NO. 61J72			
FED. RO.	AD DIST, NO.	1	D PROJECT BRCG	(039)			

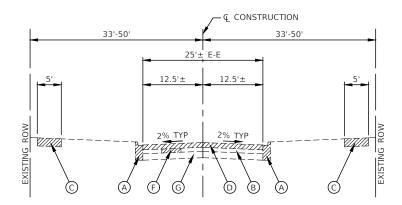

#### **EXISTING TYPICAL SECTION**

EDGEWATER DRIVE STA 10+35.98 TO STA 24+34.64

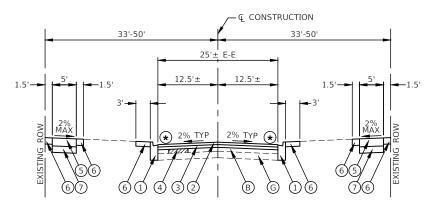

FINISHED PAVEMENT SURFACE SHALL BE 1/4" ABOVE TOP OF GUTTER

# PROPOSED TYPICAL SECTION EDGEWATER DRIVE STA 10+35.98 TO STA 24+34.64

#### **EXISTING LEGEND**

(A) EXISTING CURB AND GUTTER

EXISTING BITUMINOUS PAVEMENT, ±2.25" - 8"

C EXSISTING PCC SIDEWALK

D HOT-MIX ASPHALT SURFACE REMOVAL, 3"

E HOT-MIX ASPHALT SURFACE REMOVAL, 2.75"

F) PAVEMENT REMOVAL FOR CLASS D PATCHES, 6 INCH

G EXISTING AGGREGATE BASE, ±4"

EXISTING AGGREGATE BASE, ±6"

H

B

ITEM TO BE REMOVED
(AS DIRECTED BY THE ENGINEER)

NOTE:

FILE NAME

LONGITUDINAL JOINT SEALANT SHALL BE PLACED OVER THE HOT-MIX ASPHALT BINDER COURSE IL-9.5, N50.

#### PROPOSED LEGEND

COMBINATION CONCRETE CURB AND GUTTER, TYPE B-6.12 OR M-2.12 (TO BE REPLACED AS DIRECTED BY THE ENGINEER)

2) HOT-MIX ASPHALT SURFACE COURSE, IL-9.5, MIX "D", N50, 1 1/2"

HOT-MIX ASPHALT BINDER COURSE, IL-9.5, N50, 1 3/4"

HOT-MIX ASPHALT BINDER COURSE, IL-9.5, N50, 1 1/2"

CLASS D PATCHES, 6 INCH

(TO BE REPLACED AS DIRECTED BY THE ENGINEER)

5 PORTLAND CEMENT CONCRETE SIDEWALK, 5" OR
PORTLAND CEMENT CONCRETE SIDEWALK, 7" AT DRIVEWAYS
(TO BE REPLACED AS DIRECTED BY THE ENGINEER)


TOPSOIL FURNISH AND PLACE, 4" AND SODDING, SALT TOLERANT

(7) AGGREGATE BASE COURSE, TYPE B 4"

# Q CONSTRUCTION 40'-50' 33'± E-E 16.5' 16.5' 2% TYP 2% TYP 2% TYP 2% TYP A C

#### **EXISTING TYPICAL SECTION**

VILLAGE DRIVE STA 50+15.08 TO STA 63+97.22 OMISSION = STA 61+80.59 TO STA 62+89.94 RT AND STA 61+80.59 TO STA 63+38.80 LT

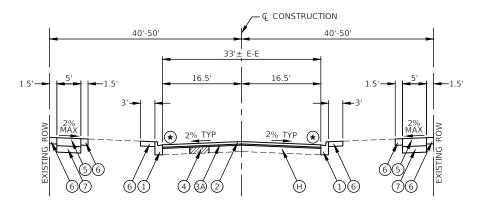

\* FINISHED PAVEMENT SURFACE SHALL BE 1/4" ABOVE TOP OF GUTTER

#### PROPOSED TYPICAL SECTION

VILLAGE DRIVE STA 50+15.08 TO STA 63+97.22 OMISSION = STA 61+80.59 TO STA 62+89.94 RT AND STA 61+80.59 TO STA 63+38.80 LT


HOT-MIX ASPHALT MIXTURE REQU	IREMENTS	
MIXTURE TYPE	AIR VOIDS @ NDES	QMP
PAVEMENT RESURFACING	·	
HOT-MIX ASPHALT SURFACE COURSE, IL-9.5, MIX "D", N50, 1 1/2"	4% @ 50 Gyr.	LR 1030-2
HOT-MIX ASPHALT BINDER COURSE, IL-9.5, N50, 1 3/4" OR 1 1/2"	4% @ 50 Gyr.	LR 1030-2
HOT-MIX ASPHALT DRIVEWAY PAVEMENT, 4"		
HOT-MIX ASPHALT SURFACE COURSE, IL-9.5, MIX "D", N50, 1 1/2"	4% @ 50 Gyr.	LR 1030-2
HOT-MIX ASPHALT BINDER COURSE, IL-19.0, N50, 2 1/2"	4% @ 50 Gyr.	LR 1030-2
CLASS D PATCHES, 6 INCH	·	
HOT-MIX ASPHALT BINDER COURSE, IL-19.0mm, N70 (6")	4% @ 70 Gyr.	LR 1030-2
QMP DESIGNATIONS: QUALITY CONTROL/QUALITY ASSURANCE (QC/QA) PER LOCAL R	OADS SPECIFICATION 1030-2	


NOTE:

UNIT WEIGHT USED TO CALCULATE ALL HMA SURFACE MIXTURE QUANTITIES IS 112 LBS/SQ YD/IN.

THE "AC TYPE" FOR POLYMERIZED HMA MIXES SHALL BE "SBS/SBR PG 76-22" AND FOR NON-POLYMERIZED HMA THE "AC TYPE" SHALL BE "PG 64-22" UNLESS MODIFIED BY RECLAIMED MATERIALS SPECIFICATIONS.

AME = 22R0763-TYPX-01 - P01	USER NAME =	DESIGNED — CH	REVISED —			EDGEWATER DRIVE / VILLAGE DRIVE	F.A	SECTION	COUNTY	TOTAL	SHEET
		CHECKED — SDK	REVISED —	STATE OF ILLINOIS		ROADWAY RESURFACING	1681	23-00095-00-RS	соок	19	6
	PLOT SCALE =	DRAWN — BG	REVISED —	DEPARTMENT OF TRANSPORTATION		TYPICAL CROSS SECTIONS			CONTRACT	 ΓΝΟ. 61J7	$\frac{1}{2}$
	DI OT DATE - 07 11 22	CHECKED BC	BEVICED		SCALE:	CHEET NO 6 OF 10 CHEETS CTA TO CTA					

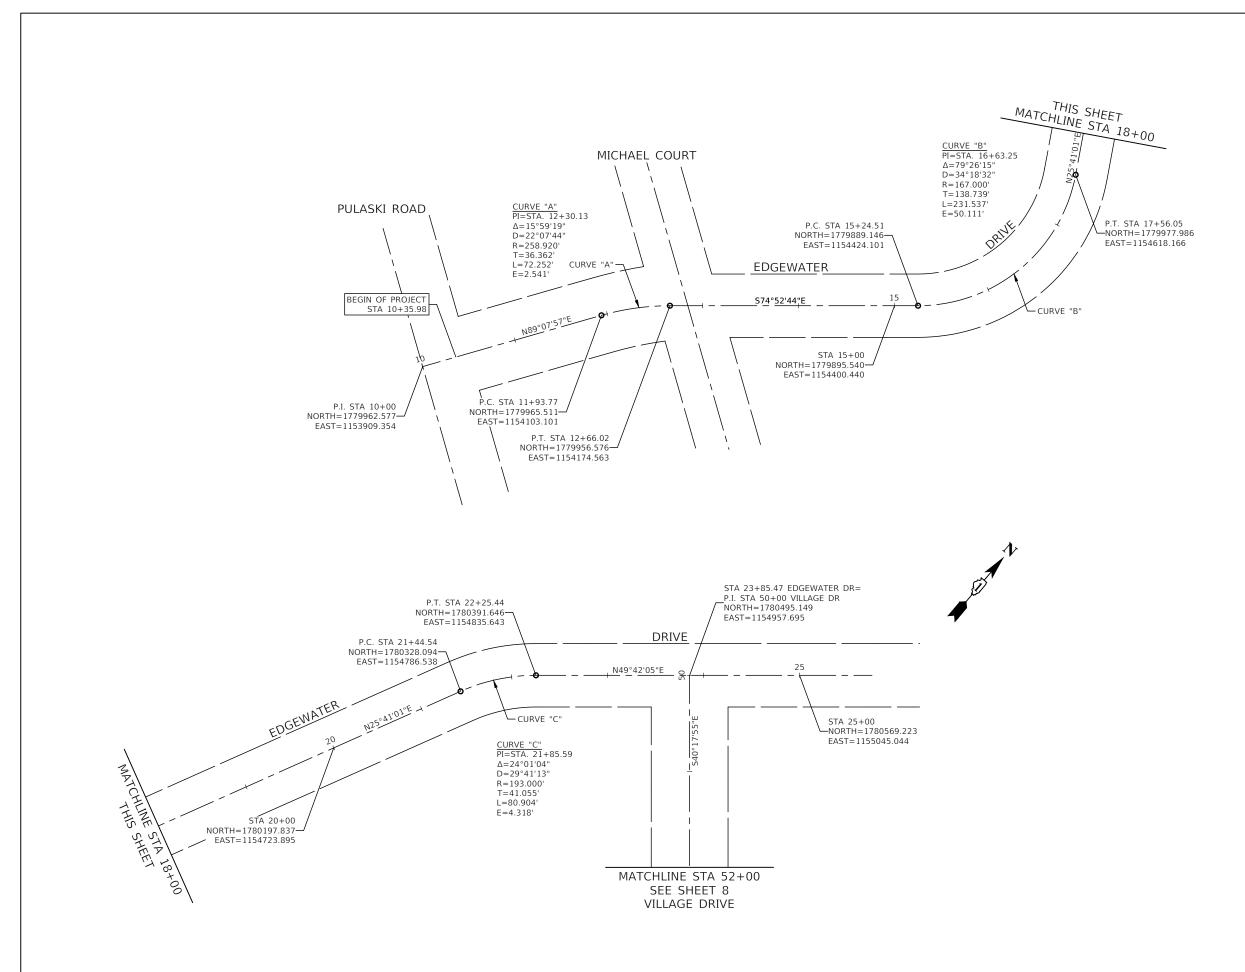

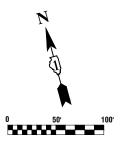

#### NOTES


- COORDINATES ARE BASED ON ILLINOIS
   STATE PLANE EASTERN ZONE NORTH
   AMERICAN DATUM 1983
- 2. SURVEY FEET UNITS WERE USED.

COUNTY TOTAL SHEET NO.

COOK 19 7 FILE NAME = 22R0763-TIES-01 - P01 USER NAME = DESIGNED — CH EDGEWATER DRIVE / VILLAGE DRIVE REVISED SECTION STATE OF ILLINOIS CHECKED - SDK REVISED ROADWAY RESURFACING 1681 23-00095-00-RS ALIGNMENT AND TIES PLOT SCALE = DRAWN — BG REVISED DEPARTMENT OF TRANSPORTATION CONTRACT NO. 61J72 PLOT DATE = 07-11-23 SCALE: SHEET NO. 7 OF 19 SHEETS STA. TO STA. CHECKED — AG REVISED -






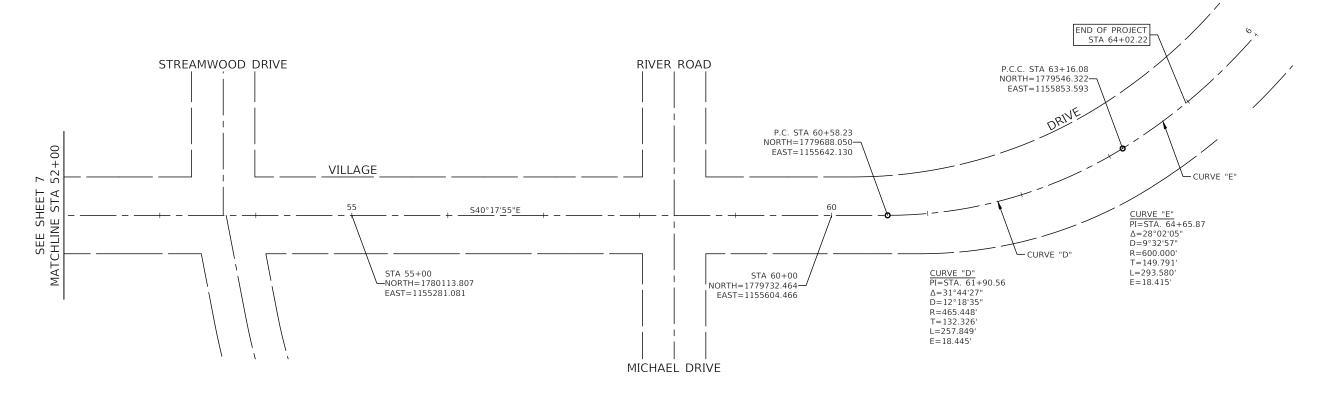


#### NOTES

- 1. COORDINATES ARE BASED ON ILLINOIS STATE PLANE EASTERN ZONE NORTH AMERICAN DATUM 1983
- 2. SURVEY FEET UNITS WERE USED.


FILE NAME = 22R0763-TIES-01 - P02	USER NAME =	DESIGNED — CH	REVISED —			EDGEWATER DRIVE / VILLAGE DRIVE				F.A RTE.	SECTION	COUNTY	TOTAL	SHEET NO.
		CHECKED — SDK	REVISED —	STATE OF ILLINOIS	ROADWAY RESURFACING 1681 23-00		23-00095-00-RS	соок	19	8				
	PLOT SCALE =	DRAWN — BG	REVISED —	DEPARTMENT OF TRANSPORTATION	ALIGNMENT AND TIES			CONTRACT	NO 61.17					
	PLOT DATE = 07-11-23	CHECKED — AG	REVISED —		SCALE: 1"=50'	SHEET NO. 8 OF 19 SHEETS STA. TO STA.		FED. ROAD DIS	ST. NO. 1 ILLINOIS FE	D. AID PROJECT 8RCC		$\vdash$		

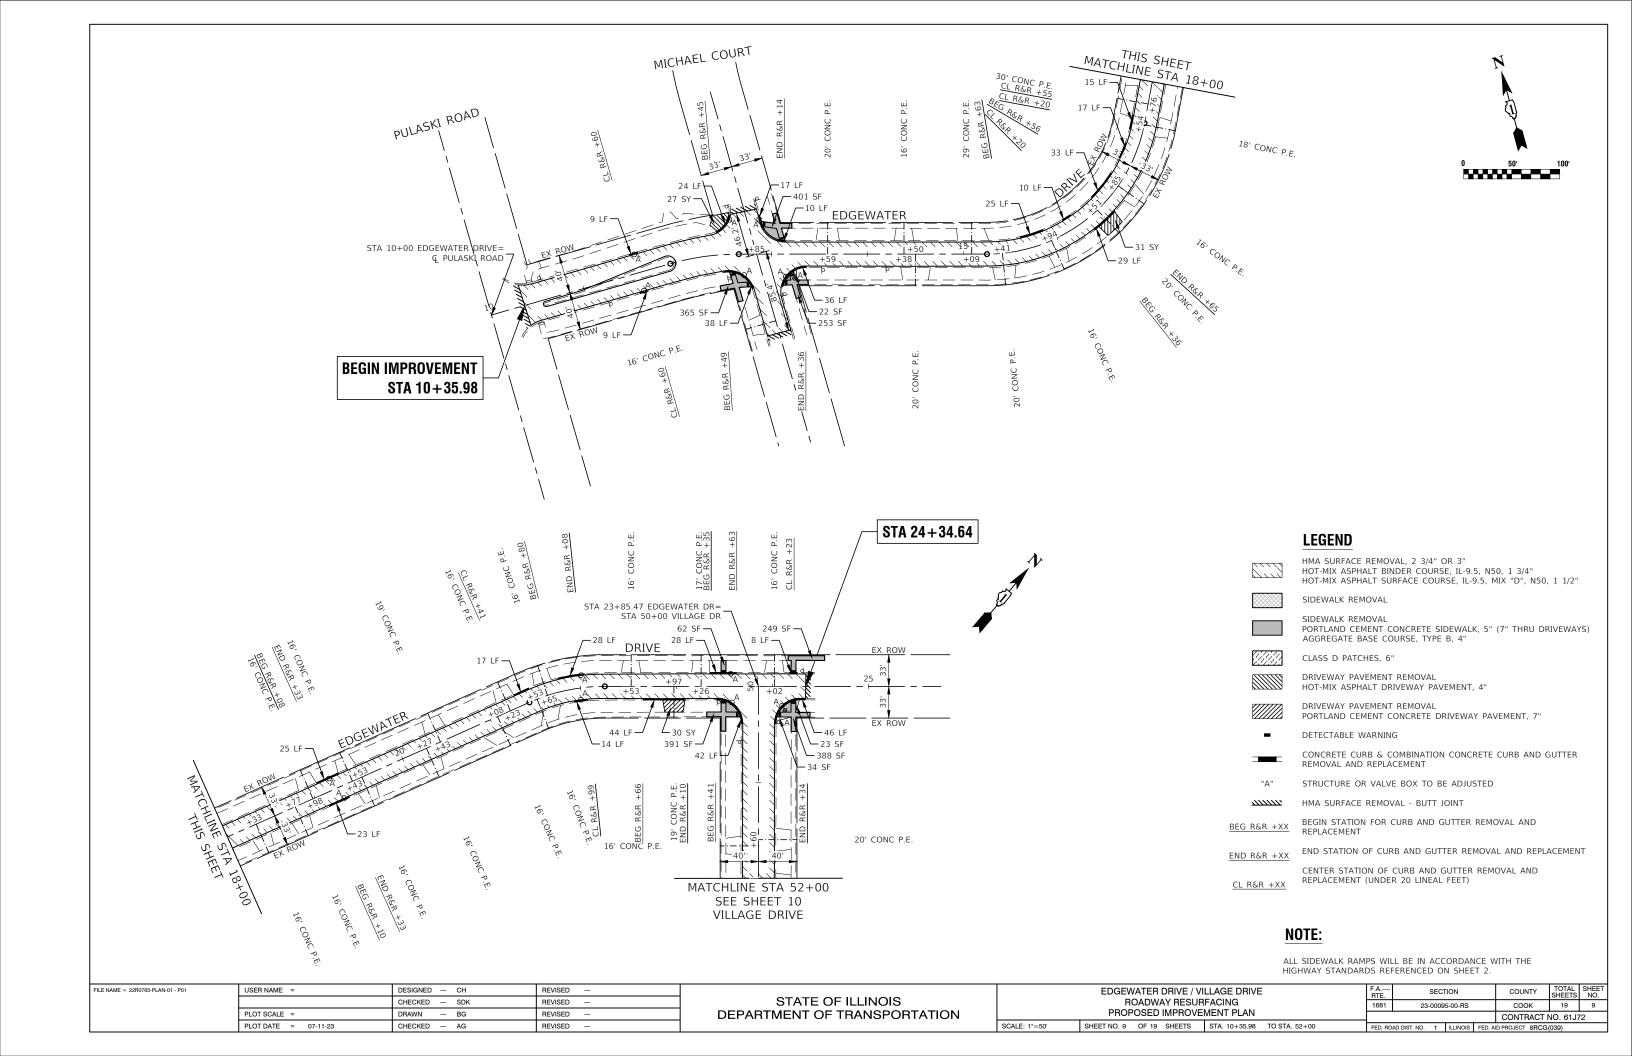


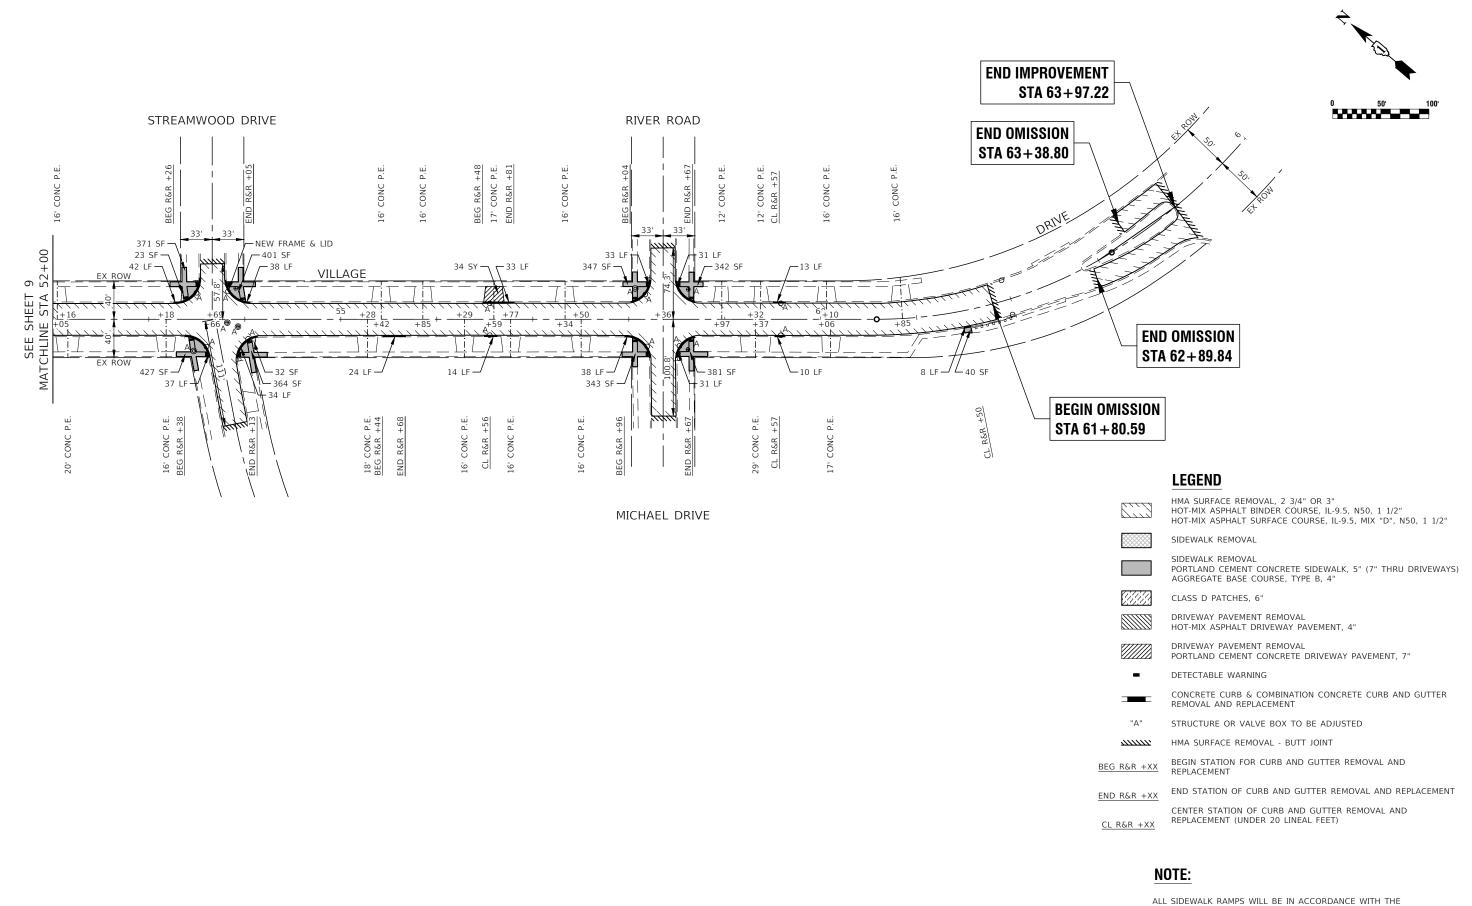

ALL SIDEWALK RAMPS WILL BE IN ACCORDANCE WITH THI HIGHWAY STANDARDS REFERENCED ON SHEET 2.

FILE NAME = 22R0763-PLAN-01 - P02	USER NAME =	DESIGNED — CH	REVISED —		EDGEWATER DRIVE / VILLAGE DRIVE	F.A	SECTION	COUNTY	TOTAL SHEET	T
		CHECKED — SDK	REVISED —	STATE OF ILLINOIS	ROADWAY RESURFACING	1681	23-00095-00-RS	соок	19 10	┨
	PLOT SCALE =	DRAWN — BG	REVISED —	DEPARTMENT OF TRANSPORTATION	PROPOSED IMPROVEMENT PLAN			CONTRACT N	VO. 61J72	┨
	PLOT DATE = 07-11-23	CHECKED — AG	REVISED —		SCALE: 1"=50' SHEET NO. 10 OF 19 SHEETS STA. 52+00 TO STA. 63+97.22	FED ROAD DIS	IST NO. 1 ILLINOIS FED AL	D PROJECT SRCG(	030)	┪

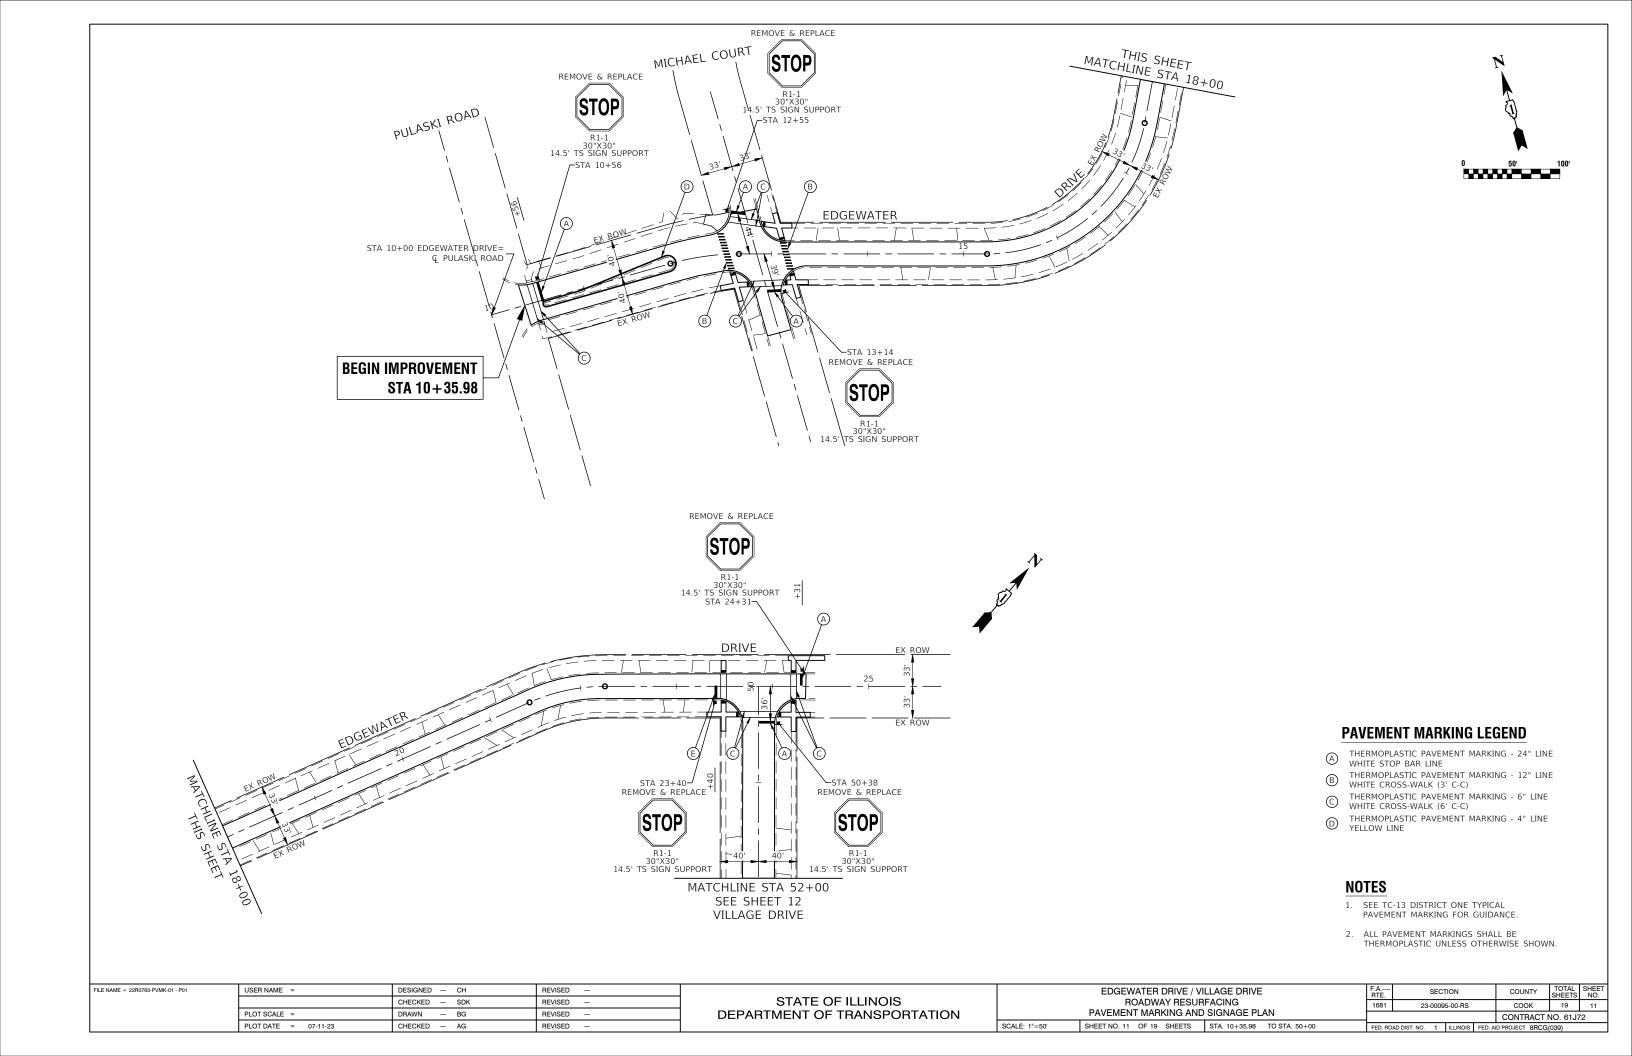

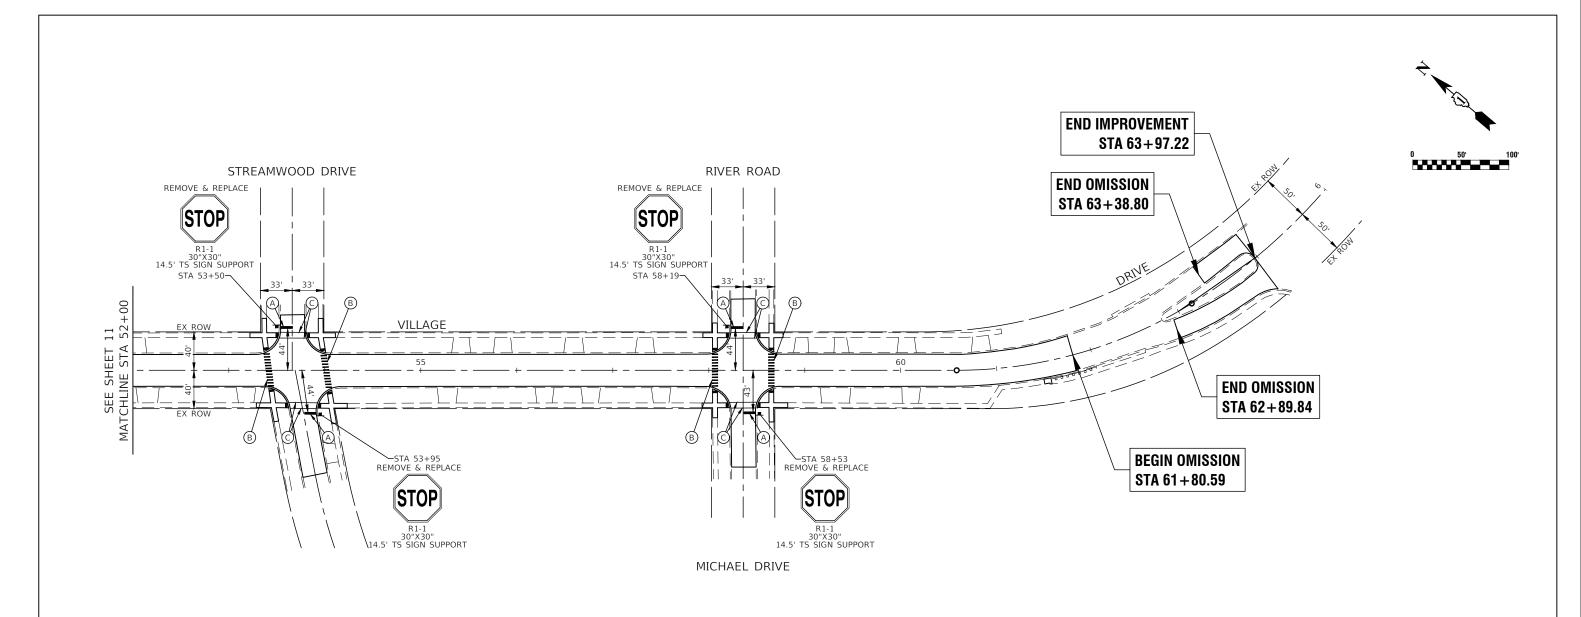

#### PAVEMENT MARKING LEGEND


- THERMOPLASTIC PAVEMENT MARKING 24" LINE WHITE STOP BAR LINE

  B THERMOPLASTIC PAVEMENT MARKING 12" LINE WHITE CROSS-WALK (3' C-C)
- THERMOPLASTIC PAVEMENT MARKING 6" LINE WHITE CROSS-WALK (6' C-C)
- THERMOPLASTIC PAVEMENT MARKING 4" LINE YELLOW LINE

#### NOTES

- SEE TC-13 DISTRICT ONE TYPICAL PAVEMENT MARKING FOR GUIDANCE.
- 2. ALL PAVEMENT MARKINGS SHALL BE THERMOPLASTIC UNLESS OTHERWISE SHOWN.

FILE NAME = 22R0763-PVMK-01 - P02	USER NAME =	DESIGNED — CH	REVISED —		EDGEWATER DRIVE / VILLAGE DRIVE   FA		F.A RTE.	SECTION	COUNTY	TOTAL SHEETS	SHEET NO.
		CHECKED — SDK	REVISED —	STATE OF ILLINOIS			23-00095-00-RS	соок	19	12	
	PLOT SCALE =	DRAWN — BG	REVISED —	DEPARTMENT OF TRANSPORTATION				CONTRACT NO. 61J72		72	
	PLOT DATE = 07-11-23	CHECKED — AG	REVISED —		SCALE: 1"=50'	SHEET NO. 12 OF 19 SHEETS STA. 52+00 TO STA. 63+97.22	FED. ROAD	D DIST. NO. 1 ILLINOIS FED.	AID PROJECT 8RCC		

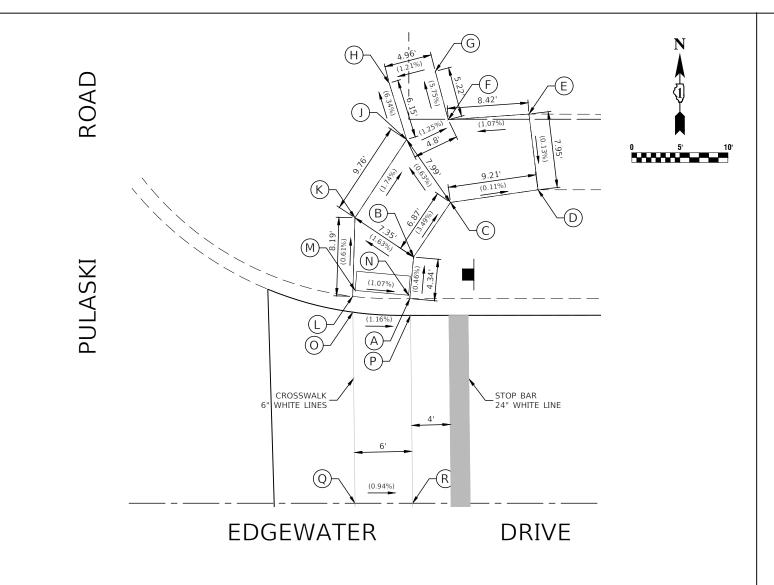

## **FIGURE 1 NE CORNER**

	STATION	OFFSET	ELEVATION	DESCRIPTION
А	10+50.10	21.32' LT	698.97	TC, CW
В	10+50.49	25.65' LT	CW	
С	10+54.34	31.34' LT	698.71	CW
D	10+63.46	32.65' LT	698.70	CW
E	10+62.51	40.54' LT	698.69	CW
F	10+54.10	39.95' LT	698.60	CW
G	10+52.76	44.99' LT	698.30	CW
Н	10+47.96	43.76' LT	698.27	CW
J	10+49.77	37.88' LT	698.66	CW


	STATION	OFFSET	ELEVATION	DESCRIPTION
К	10+44.39	29.74' LT	698.83	CW
L	10+44.15	21.55' LT	698.95	TC, CW
М	10+44.41	22.16' LT	698.91	ADA
N	10+49.98	21.67' LT	698.97	ADA
0	10+44.17	19.90' LT	698.81	EP
Р	10+50.18	19.57' LT	698.74	EP
Q	10+44.39	0.00' RT	699.33	BIT
R	10+50.39	0.00' RT	699.27	BIT

REVISED —

REVISED

REVISED


REVISED —

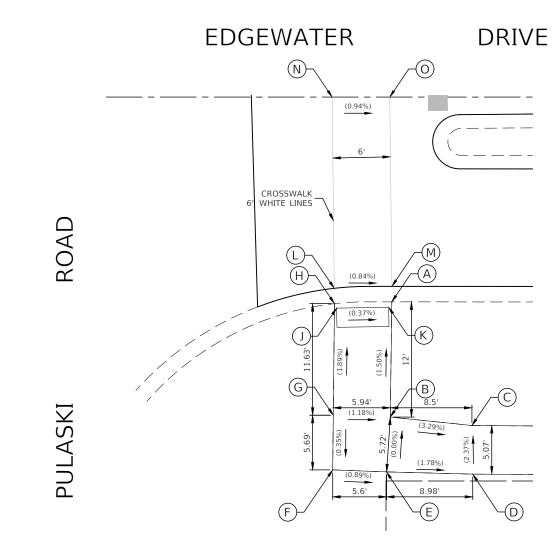

## FIGURE 2 SE CORNER

	STATION	OFFSET	ELEVATION	DESCRIPTION
А	10+50.60	21.34' RT	698.92	TC, CW
В	10+50.44	33.34' RT	699.10	CW
С	10+58.95	34.22' RT	698.82	CW
D	10+59.03	39.28' RT	698.94	CW
E	10+50.05	39.05' RT	699.10	CW
F	10+44.45	38.84' RT	699.15	CW
G	10+44.51	33.15' RT	699.17	CW


	STATION	OFFSET	ELEVATION	DESCRIPTION
Н	10+44.63	21.52' RT	698.95	TC, CW
J	10+44.63	21.81' RT	698.98	ADA
K	10+50.28	21.90' RT	698.96	ADA
L	10+44.62	19.92' RT	698.91	EP
М	10+50.61	19.72' RT	698.86	EP
N	10+44.39	0.00' RT	699.33	BIT
0	10+50.39	0.00' RT	699.27	BIT

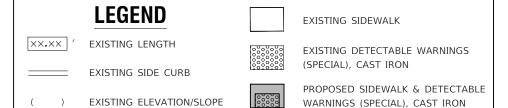

CHECKED — AG

PLOT DATE = 07-11-23

STATE OF ILLINOIS DEPARTMENT OF TRANSPORTATION

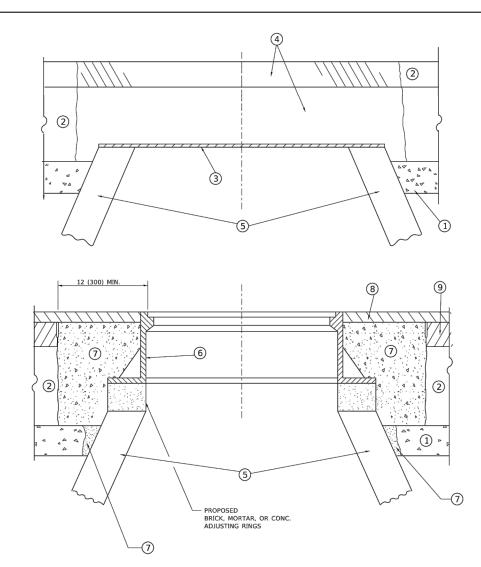

# DETAILS FOR FRAMES AND LIDS ADJUSTMENT WITH MILLING

#### NOTES

- 1. EXISTING BROKEN FRAMES AND LIDS SHALL BE REMOVED AND DISPOSED OF BY THE CONTRACTOR AND SHALL BE REPLACED AS DIRECTED BY THE ENGINEER. REPLACEMENT FRAMES AND LIDS WILL BE PAID FOR IN ACCORDANCE WITH ARTICLE 109.04 OF THE STANDARD SPECIFICATIONS UNLESS A SEPARATE PAY ITEM HAS BEEN PROVIDED.
- IF THE EXISTING LIDS ARE OPEN, THE FRAME WILL BE ADJUSTED TO THE ELEVATION OF THE MILLED PAVEMENT SURFACE PRIOR TO THE MILLING OPERATION. THE FRAME WILL NOT BE REMOVED AND COVERED BY THE METAL PLATE.
- CITY OF CHICAGO CASTINGS ARE THE PROPERTY OF THE CITY AND THE CONTRACTOR SHALL NOTIFY THE CITY FOR REMOVAL AND DISPOSITION OF THE CASTINGS.
- THE METAL PLATE USED TO COVER THE STRUCTURE SHALL REMAIN THE PROPERTY OF THE CONTRACTOR.

### CONSTRUCTION PROCEDURES

STAGE 1 (BEFORE PAVEMENT MILLING)

- A) REMOVE A MINIMUM OF 12 (300) OF THE PAVEMENT FROM AROUND THE STRUCTURE.
- B) REMOVE THE EXISTING FRAME AND LID FROM THE STRUCTURE.
- C) COVER THE STRUCTURE OPENING WITH A 36 (900) DIAMETER METAL PLATE.
- D) BACKFILL WITH CRUSHED STONE AND HMA SURFACE MIX APPROVED BY THE ENGINEER. (MIN. 1 1/2 (40) HMA TO REMAIN AFTER MILLING).

#### STAGE 2 (AFTER PAVEMENT MILLING)

- A) REMOVE THE HMA SURFACE MIX AND CRUSHED STONE.
- B) INSTALL THE FRAME AND LID; ADJUST THE FRAME TO ITS FINAL SURFACE ELEVATION.
- C) THE SURROUNDING SPACE SHALL BE FILLED WITH CLASS\*PP-1 CONCRETE TO THE ELEVATION OF THE SURFACE OF THE EXISTING BASE COURSE OR THE BINDER COURSE.
- \*UNLESS OTHERWISE SPECIFIED IN THE PLANS.

THE PROCEDURE EXPLAINED ABOVE SHALL CONFORM TO THE APPLICABLE PORTIONS OF SECTIONS 353, 406, 602, AND 603 OF THE STANDARD SPECIFICATIONS EXCEPT THAT "THE CONTRACTOR SHALL ADJUST THE STRUCTURES TO THE FINISHED PAVEMENT ELEVATION NO MORE THAN 5 CALENDAR DAYS PRIOR TO PLACEMENT OF THE FINAL LIFT OF SURFACE UNLESS APPROVED BY THE ENGINEER."

#### LEGENI

- ① SUB-BASE GRANULAR MATERIAL
- (6) FRAME AND LID (SEE NOTES)
- 2 EXISTING PAVEMENT
- 7 CLASS\*PP-1 CONCRETE
- 3 36 (900) DIAMETER METAL PLATE
- 8 PROPOSED HMA SURFACE COURSE
- 4 PROPOSED CRUSHED STONE AND HMA SURFACE MIX
- G TROPOSED TIMA SORTAC
- (5) EXISTING STRUCTURE
- PROPOSED HMA BINDER COURSE

#### **LOCATION OF STRUCTURES**

THE CONTRACTOR WILL BE REQUIRED TO KEEP A RECORD OF THE LOCATIONS OF THE BURIED STRUCTURES ACCORDING TO THE STATION AND DISTANCE LEFT OR RIGHT OF THE CENTERLINE OF PAVEMENT. UPON COMPLETION OF THE WORK, THE CONTRACTOR WILL DELIVER THE RECORD TO THE ENGINEER.

#### BASIS OF PAYMENT

- REMOVING FRAMES AND LIDS ON DRAINAGE AND UTILITY STRUCTURES IN THE PAVEMENT PRIOR TO MILLING, AND ADJUSTING TO FINAL GRADE PRIOR TO PLACING THE SURFACE COURSE, WILL BE PAID FOR AT THE CONTRACT UNIT PRICE EACH FOR "FRAMES AND LIDS TO BE ADJUSTED (SPECIAL)."
- 2. THIS WORK WILL NOT BE PAID FOR WHEN DRAINAGE AND UTILITY STRUCTURES ARE SPECIFIED FOR PAYMENT AS STRUCTURE RECONSTRUCTION.
- NEW FRAMES AND LIDS, WHEN SPECIFIED, WILL BE PAID FOR SEPARATELY.
- 4. WHEN STRUCTURES ARE TO BE ADJUSTED OR RECONSTRUCTED, THE LOWERING AND RAISING OF THE FRAMES AND LIDS WILL NOT BE PAID FOR SEPARATELY BUT WILL BE INCLUDED IN THE COST OF THE CORRESPONDING PAY ITEM.

ALL DIMENSIONS ARE IN INCHES (MILLIMETERS) UNLESS OTHERWISE SHOWN

USER NAME = Lawrence.DeManche	DESIGNED - R. SHAH	REVISED - R. BORO 01-01-07			DETAILS FOR	F.A.	SECTION	COUNTY	TOTAL S	HEET
	DRAWN -	REVISED - R. BORO 03-09-11	STATE OF ILLINOIS			IXIL.		<del></del>	SHEETS	140.
PLOT SCALE = 100.0000 ' / in.	CHECKED -	REVISED - R. BORO 12-06-11	DEPARTMENT OF TRANSPORTATION	FK/	AMES AND LIDS ADJUSTMENT WITH MILLING		BD600-03 (BD-08)	CONTRACT	NO.	
PLOT DATE = 11/18/2022	DATE - 10-25-94	REVISED - K. SMITH 11-18-22		SCALE: NONE	SHEET 1 OF 1 SHEETS STA. TO STA.		ILLINOIS FED. A	AID PROJECT		

FILE NAME = 22R0763-DTLS-01 - BD08	USER NAME =	DESIGNED —	REVISED —						F.A	SECTION	COUNTY	TOTAL	SHEET
		CHECKED —	REVISED —	STATE OF ILLINOIS		DISTRICT 1 DE			1681	23-00095-00-RS	соок	19	14
	PLOT SCALE =	DRAWN —	REVISED —	DEPARTMENT OF TRANSPORTATION					<b>—</b>		CONTRACT	NO. 61J7	72
	PLOT DATE =	CHECKED —	REVISED —		SCALE:	SHEET NO. 14 OF 19 SHEETS	STA.	TO STA.	FED. ROA	AD DIST. NO. 1 ILLINOIS FED. A	D PROJECT 8RCG	2(030)	

#### METHOD OF MEASUREMENT

REFER TO SECTION 442 OF THE STANDARD SPECIFICATIONS FOR ROAD AND BRIDGE CONSTRUCTION AND THE RECURRING SPECIAL PROVISION "PATCHING WITH HOT-MIX ASPHALT OVERLAY REMOVAL."

#### **BASIS OF PAYMENT**

- 1. REFER TO SECTION 442 OF THE STANDARD SPECIFICATIONS FOR ROAD AND BRIDGE CONSTRUCTION AND THE RECURRING SPECIAL PROVISION "PATCHING WITH HOT-MIX ASPHALT OVERLAY REMOVAL."
- SAW CUT/SCORING OF EXISTING HMA OVERLAY IS INCLUDED IN THE COST OF PAVEMENT PATCHING.
- 3. SAW CUT/SCORING OF EXISTING PAVEMENT IS INCLUDED IN THE COST OF PAVEMENT PATCHING.

**★** SEE TYPICAL SECTIONS FOR

THICKNESS AND MATERIALS

HMA REMOVAL OVER PATCHES \* AND HMA REPLACEMENT OVER PATCHES FOR PATCHING FIRST CONSTRUCTION 6 (150) MIN. – SAW CUT/SCORING EXIST. HMA FOR PATCHING FIRST CONSTRUCTION OVERLAY, TYPICAL. TOP OF EXIST. HMA OR MILLED SURFACE CLASS C OR CLASS D PATCH OF THE THICKNESS SPECIFIED · D 12 (300) SAW CUT/SCORING, TYPICAL **EXISTING PAVEMENT** PROPOSED UNSUITABLE SUBGRADE REMOVAL AND REPLACEMENT UTILITY OR STORM SEWER TRENCH
(IF PATCH IS DUE TO UTILITY OR SEWER
WORK, THE WIDTH OF THE FULL DEPTH
PATCH SHALL BE 12 (300) WIDER ON EACH
SIDE OF THE TRENCH).

#### SEQUENCE OF CONSTRUCTION (PATCHING FIRST)

- 1. REMOVE THE EXISTING HMA MATERIAL OVER THE AREA TO BE PATCHED.
- 2. REMOVE AND REPLACE WITH CLASS C OR D PATCH.
- 3. REPLACE HMA MATERIAL OVER THE AREA TO BE PATCHED.

#### SEQUENCE OF CONSTRUCTION (MILLING FIRST)

- 1. MILL HMA FIRST IF THERE IS AT LEAST 4½ INCHES OR MORE OF HMA MATERIAL ON TOP OF THE EXISTING PAVEMENT OR IF THE PAVEMENT IS FULL DEPTH HMA. A MINIMUM OF 2 INCHES OF HMA MATERIAL SHALL BE IN PLACE AFTER MILLING.
- 2. REMOVE AND REPLACE WITH FULL DEPTH CLASS D PATCHES TO TOP OF MILLED SURFACE.

ALL DIMENSIONS ARE IN INCHES (MILLIMETERS) UNLESS OTHERWISE SHOWN.

USER NAME = Lawrence.DeManche	DESIGNED - R. SHAH	REVISED - R. BORO 01-01-07		PAVEMENT PATCHING FOR		F	F.A. RTF	SECTION	COUNTY	TOTAL SHEET
	DRAWN -	REVISED - R. BORO 09-04-07	STATE OF ILLINOIS			l'	IXIL.			SHEETS NO.
PLOT SCALE = 100.0000 ' / in.	CHECKED -	REVISED - K. ENG 10-27-08	DEPARTMENT OF TRANSPORTATION	HMA SURFACED PAVEMENT				0400-04 (BD-22)	CONTRACT	NO.
PLOT DATE = 11/18/2022	DATE - 10-25-94	REVISED - K. SMITH 11-18-22		SCALE: NONE	SHEET 1 OF 1 SHEETS STA. T	O STA.		ILLINOIS FED.	AID PROJECT	

Ī	FILE NAME = 22R0763-DTLS-01 - BD22	USER NAME =	DESIGNED —	REVISED —						F.A BTF	SECTION	COUNTY	TOTAL	SHEET
			CHECKED —	REVISED —	STATE OF ILLINOIS		DISTRICT 1 DE			1681	23-00095-00-RS	соок	19	15
		PLOT SCALE =	DRAWN —	REVISED —	DEPARTMENT OF TRANSPORTATION					-		CONTRACT	NO. 61J7	2
		PLOT DATE =	CHECKED —	REVISED —		SCALE:	SHEET NO. 15 OF 19 SHEETS	STA.	TO STA.	FED. ROAD	DIST. NO. 1 ILLINOIS FED. A	ID PROJECT 8RC		

