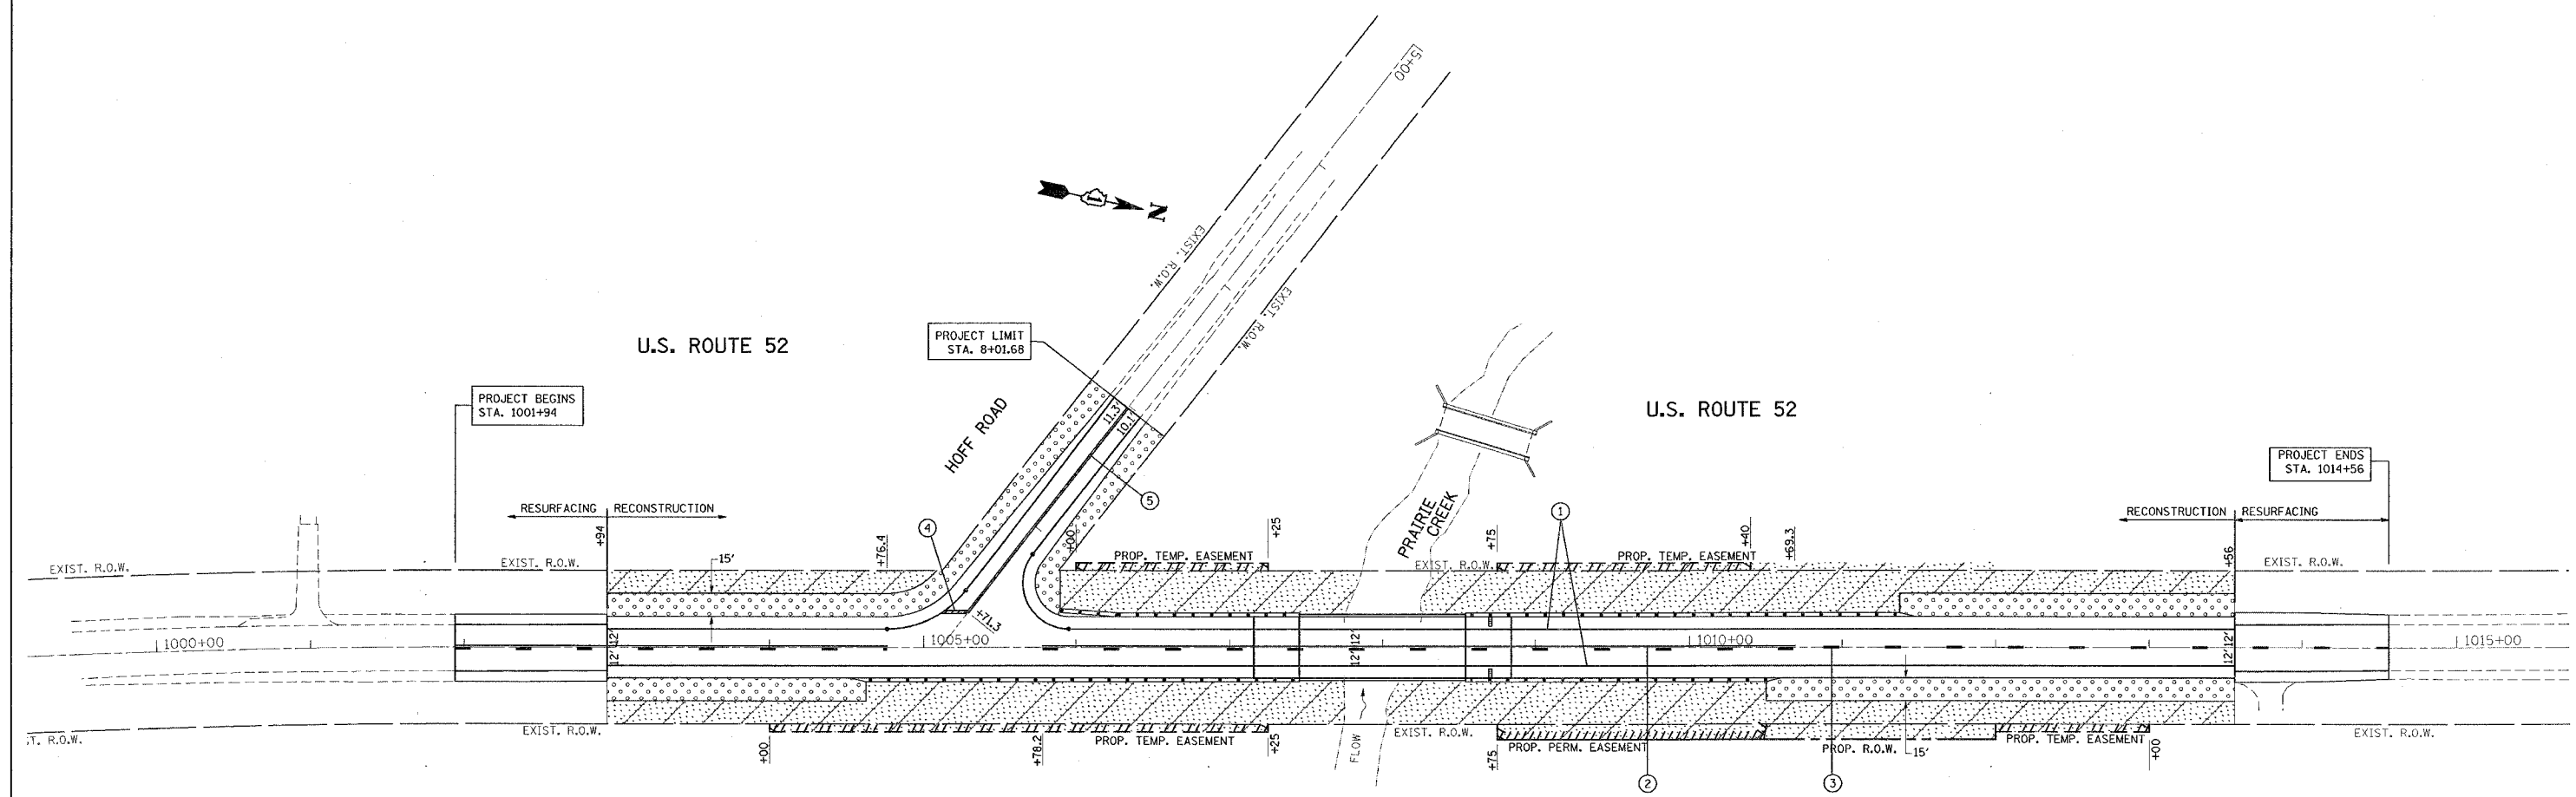


F.A.P. RTE.	SECTION	COUNTY	TOTAL SHEETS	SHEET NO.
852	18 B-5-R-2	WILL	66	24
STA.		TO STA.		
FED. ROAD DIST. NO.		ILLINOIS FED. AID PROJECT		

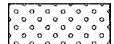
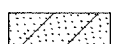
REF-pmk01



LANDSCAPING NOTES:

- 1) TOPSOIL, 4" SHOULD BE PROVIDED AT ALL AREAS OF SEEDING
- 2) SUPPLEMENTAL WATERING SHALL BE PROVIDED AT ALL SEEDING CLASS 2A AREAS
- 3) EROSION CONTROL BLANKET SHALL BE PLACED ON ALL SEEDED AREAS
- 4) TURF REINFORCEMENT MAT WILL BE PLACED AT DITCH BOTTOM ALONG AREAS WHERE THE LONGITUDINAL SLOPE IS GREATER THAN 2.8%.

LEGEND

-  TEMPORARY AND PERMANENT SEEDING CLASS 2A AREA
APPLY NITROGEN FERTILIZER NUTRIENT,
PHOSPHOROUS FERTILIZER NUTRIENT AND
POTASSIUM FERTILIZER NUTRIENT
TO ALL SEEDING CLASS 2A AREAS
-  TEMPORARY AND PERMANENT SEEDING CLASS 4A AREA

PAVEMENT MARKING NOTES:

ALL DIMENSIONS ARE TO THE EDGE OF PAVEMENT OR LANE.

ALL FINAL PAVEMENT MARKINGS ARE THERMOPLASTIC EXCEPT FOR BRIDGE DECK AND APPROACH PAVEMENT.

PAVEMENT MARKINGS FOR THE APPROACH PAVEMENT AND BRIDGE DECK SHALL BE PREFORMED PLASTIC PAVEMENT MARKING TYPE B.

ALL FINAL THERMOPLASTIC (OF THE EXTRUDED TYPE) PAVEMENT MARKINGS SHALL BE PLACED IN ACCORDANCE WITH "DISTRICT ONE TYPICAL PAVEMENT MARKINGS" DETAIL, (TC-13).

ALL RAISED REFLECTIVE PAVEMENT MARKERS SHALL BE PLACED IN ACCORDANCE WITH THE DISTRICT ONE "TYPICAL APPLICATIONS RAISED REFLECTIVE PAVEMENT MARKER" DETAIL, (TC-11).

THE RESIDENT ENGINEER SHALL VERIFY THE LOCATIONS OF ALL EXISTING PAVEMENT MARKINGS PRIOR TO MILLING OR RESURFACING.

PAVEMENT MARKING LEGEND

- ① 4" WHITE EDGE LINE
- ② 4" YELLOW NO PASSING CENTERLINE
- ③ 4" YELLOW CENTERLINE SKIP-DASH
- ④ 24" WHITE STOP BAR
- ⑤ 4" DOUBLE YELLOW CENTERLINE

TURF REINFORCEMENT AREAS

- STA. 1006+00 TO STA. 1007+45 (LT)
- STA. 1008+54 TO STA. 1008+84 (LT)
- STA. 1003+00 TO STA. 1004+00 (RT)
- STA. 1005+00 TO STA. 1005+20 (RT)
- STA. 1006+00 TO STA. 1007+00 (RT)
- STA. 1013+00 TO STA. 1013+56 (RT)

REVISIONS	
NAME	DATE

ILLINOIS DEPARTMENT OF TRANSPORTATION
U.S. RTE. 52 OVER PRAIRIE CREEK
 PROPOSED
PAVEMENT MARKING AND
LANDSCAPING PLAN

SCALE: VERT. 1"=50'
 HORIZ. 1"=50'
 DATE 8/24/2007

DRAWN BY
 CHECKED BY

PLOT DATE = 8/24/2007
 FILE NAME = c:\projects\62845\18B-5-R-2\18B-5-R-2.dwg
 USER = jrb
 PLOT SCALE = 1/4"=1'-0"