

DISTRICT ONE DETAILS

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HIGHWAY STANDARDS

000001-08	STANDARD SYMBOLS, ABBREVIATIONS AND PATTERNS
280001-07	TEMPORARY EROSION CONTROL SYSTEMS
424001-11	PERPENDICULAR CURB RAMPS FOR SIDEWALKS
424006-05	DIAGONAL CURB RAMPS FOR SIDEWALKS
424011-04	CORNER PARALLEL CURB RAMPS FOR SIDEWALKS
424016-05	MID-BLOCK CURB RAMPS FOR SIDEWALKS
424021-06	DEPRESSED CORNER FOR SIDEWALKS
424026-03	ENTRANCE / ALLEY PEDESTRIAN CROSSINGS
424031-02	MEDIAN PEDESTRIAN CROSSINGS
442201-03	CLASS C AND D PATCHES
606001-08	CONCRETE CURB TYPE B AND COMBINATION CONCRETE CURB AND GUTTER
701001-02	OFF ROAD OPERATIONS, 2L, 2W, MORE THAN 15'(4.5m) AWAY
701006-05	OFF ROAD OPERATIONS, 2L, 2W, 15'(4.5m) TO 24"(600mm) FROM PAVEMENT EDGE
701011-04	OFF ROAD MOVING OPERATIONS, 2L,2W, DAY ONLY
701101-05	OFF ROAD OPERATIONS, MULTILANE, 15' (4.5m) TO 24" (600mm) FROM PAVEMENT EDGE
701301-04	LANE CLOSURE, 2L, 2W, SHORT TIME OPERATIONS
701311-03	LANE CLOSURE, 2L, 2W, MOVING OPERATIONS - DAY ONLY
701427-05	LANE CLOSURE, MULTILANE, INTERMITTENT OR MOVING OPERATION FOR SPEEDS \leq 40 MPH
701501-06	URBAN LANE CLOSURE, 2L, 2W, UNDIVIDED
701502-09	URBAN LANE CLOSURE, 2L, 2W, WITH BIDIRECTIONAL LEFT TURN LANE
701601-09	URBAN LANE CLOSURE, MULTILANE, 1W OR 2W WITH NONTRANSVERSABLE MEDIAN
701606-10	URBAN SINGLE LANE CLOSURE, MULTILANE, 2W WITH MOUNTABLE MEDIAN
701701-10	URBAN LANE CLOSURE, MULTILANE INTERSECTION
701801-06	SIDEWALK CORNER OR CROSSWALK CLOSURE
701901-08	TRAFFIC CONTROL DEVICES
720001-01	SIGN PANEL MOUNTING DETAILS
720006-04	SIGN PANEL ERECTION DETAILS
720016-04	MAST ARM MOUNTED STREET NAME SIGNS
728001-01	TELESCOPING STEEL SIGN SUPPORT
731001-01	BASE FOR TELESCOPING STEEL SIGN SUPPORT
780001-05	TYPICAL PAVEMENT MARKINGS
782001-01	CURB REFLECTORS
814001-03	HANDHOLES
838001-01	BREAKAWAY DEVICES
857001-01	STANDARD PHASE DESIGNATION DIAGRAMS AND PHASE SEQUENCES
873001-02	TRAFFIC SIGNAL GROUNDING & BONDING
877011-10	STEEL COMB. MAST ARM ASSEMBLY & POLE 16' THROUGH 55'
880006-01	TRAFFIC SIGNAL MOUNTING DETAILS
886001-01	DETECTOR LOOP INSTALLATIONS
886006-01	TYPICAL LAYOUTS FOR DETECTION LOOPS

BD-22	PAVEMENT PATCHING FOR HMA SUP
BD-32	BUTT JOINTS AND HMA TAPER
TC-10	TRAFFIC CONTROL AND PROTECTION
TC-13	DISTRICT ONE TYPICAL PAVEMENT M
TC-14	TRAFFIC CONTROL AND PROTECTION
TC-16	SHORT TERM PAVEMENT MARKING L
TC-22	ARTERIAL ROAD INFORMATION SIGN
TC-26	DRIVEWAY ENTRANCE SIGNING
TS-05	DISTRICT ONE STANDARD TRAFFIC S
TS-07	DETECTOR LOOP INSTALLATION DET

GENERAL NOTES

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BD-

- THE PLANS SHALL BE PERFORMED AS DIRECTED BY THE ENGINEER
- 2. THE ROBINSON ENGINEERING, LTD. FIELD OFFICE (708-331-6700), AND THE PUBLIC WORKS DIRECTOR (815-886-1870), AT THE VILLAGE OF ROMEOVILLE, SHALL BE NOTIFIED TWO (2) WORKING DAYS BEFORE CONSTRUCTION BEGINS.
- 3. BEFORE STARTING ANY EXCAVATION THE CONTRACTOR SHALL CALL "J.U.L.I.E." AT (800) 892-0123 OR 811 AND (312) 744-7000 FOR FIELD LOCATIONS OF BURIED ELECTRIC, TELEPHONE AND GAS UTILITIES. (48 HOUR NOTIFICATION REQUIRED)
- 4. UTILITIES INDICATED ON THE PLANS ARE PROVIDED FOR THE CONTRACTOR'S USE AND ARE BASED UPON INFORMATION AVAILABLE AT THE TIME OF THE ADVERTISEMENT FOR BIDS. THE OWNER AND ENGINEER DO NOT GUARANTEE THE ACCURACY OF UTILITY INFORMATION.
- EXISTING IN THE FIELD PRIOR TO CONSTRUCTION AND ORDERING OF MATERIALS.
- 6. THE THICKNESS OF HMA MIXTURE STATED IN THE SPECIFICATIONS IS THE NOMINAL THICKNESS. DEVIATIONS FROM THE NOMINAL THICKNESS WILL BE PERMITTED WHEN SUCH DEVIATIONS OCCUR DUE TO IRREGULARITIES IN THE EXISTING SURFACE OR BASE ON WHICH THE HMA SURFACE IS PLACED.
- 7. ANY LOOSE MATERIAL DEPOSITED IN THE FLOW LINE OF DITCHES, GUTTERS OR OTHER DRAINAGE STRUCTURES SHALL BE REMOVED BY THE END OF EACH DAY BY THE CONTRACTOR.
- OF THE ENGINEER AFTER PAVEMENT MILLING
- 9. CONTRACTOR SHALL TAKE PRECAUTION BY PRESERVING EXISTING TREES WITHIN THE RIGHT OF WAY. IF ANY DAMAGE OCCURS, TREES SHALL BE REPLACED IN KIND PER ARTICLE 201.07 REPAIR OR REPLACEMENT OF EXISTING PLANT MATERIAL REQUIREMENTS STATED HEREIN.
- 10. NO PAVEMENT PATCHING SHALL BE PERMITTED AFTER FRIDAY AT 3:00 PM OF EACH AND EVERY WEEK AND NO HOLES WILL BE ALLOWED TO REMAIN OPEN OVERNIGHT OR OVER THE WEEKEND
- 11. ALL EQUIPMENT SHALL BE REMOVED OFF THE VILLAGE STREETS DURING ALL HOLIDAY WEEKENDS AS COORDINATED WITH THE VILLAGE.
- 12. HMA PAVING SHALL BE PERFORMED WITH HOT JOINTS.
- CONTROL SUPERVISOR, AT KALPANA.KANNAN-HOSADURGA@ILLINOIS.GOV A MINIMUM OF 72 HOURS IN ADVANCE OF BEGINNING WORK.
- 615 ANDERSON DRIVE, ROMEOVILLE, IL 60446.
- 15. PROPOSED SIGNS AND DECORATIVE SIGN POSTS SHALL BE APPROVED BY THE VILLAGE AND RESIDENT ENGINEER PRIOR TO MANUFACTURING.
- 16. KINDER MORGAN WILL REQUIRE THAT A KINDER MORGAN DAMAGE PREVENTION INSPECTOR BE ON SITE THE ENTIRE TIME ANY WORK IS BEING COMPLETED 25 FEET OR CLOSER TO THE MUST BE DONE BY SOFT TECHNIQUES, HAND OR HYDRO VACUUM. SIDEWALK REMOVAL AND NPGL ROW SHALL BE INSTALLED BY HYDROVAC AND MUST BE LOCATED 5 FEET AWAY FROM GUIDELINES FOR DESIGN AND CONSTRUCTION NEAR KINDER MORGAN OPERATED FACILITIES ARE INCLUDED IN THE BID DOCUMENTS.
- 17. ONEOK NATURAL GAS PIPELINE HAS FACILITIES AT APPROXIMATE STATION 93+00. WARNING -HIGH PRESSURE NATURAL GAS PIPELINE OR NATURAL GAS LIQUIDS LINE, CONTACT THE "EXHIBIT D - PROTECTION OF THE PIPELINES AND EASEMENTS OF ONEOK" LOCATED IN THE SPECIAL PROVISIONS.

FILE NAME = 18R1036_02-INDX-01 - P01	USER NAME =	DESIGNED - MPN	REVISED - 09-19-23			135TH STREET	F.A.U BTE	SECTION	COUNTY	TOTAL SHEET SHEETS NO
		CHECKED — WPD	REVISED —	STATE OF ILLINOIS		ROADWAY RESURFACING	0282	20-00069-00-BT	WILL	76 2
	PLOT SCALE =	DRAWN — RG	REVISED —	DEPARTMENT OF TRANSPORTATION	IN	NDEX OF SHEETS, STANDARDS & GENERAL NOTES			CONTRAC	T NO. 61J80
	PLOT DATE = 08-07-23	CHECKED — AG	REVISED —		SCALE: NONE	SHEET NO. 2 OF 76 SHEETS STA. TO STA.	FED. ROAD	DIST. NO. 1 ILLINOIS F	ED. AID PROJECT AP!	AT(993)

REACED PAVEMENT

N FOR SIDE ROADS, INTERSECTIONS AND DRIVEWAYS MARKINGS IN AT TURN BAYS (TO REMAIN OPEN TO TRAFFIC) LETTERS AND SYMBOLS

SIGNAL DESIGN DETAILS TAIL FOR ROADWAY RESURFACING

1. ITEMS OF WORK LISTED IN THE SUMMARY OF QUANTITIES NOT SPECIFICALLY CALLED OUT ON

5. IT SHALL BE THE CONTRACTOR'S RESPONSIBILITY TO VERIFY ALL DIMENSIONS AND CONDITIONS

8. CLASS D PATCHING QUANTITIES FOR THIS CONTRACT SHALL BE PERFORMED AT THE DIRECTION

13. THE CONTRACTOR SHALL CONTACT KALPANA KANNAN-HOSADURGA, THE DISTRICT ONE TRAFFIC

14. ALL SIGNS REMOVED THAT ARE NOT BEING REINSTALLED ARE THE PROPERTY OF THE VILLAGE AND SHALL BE DELIVERED TO THE VILLAGE OF ROMEOVILLE PUBLIC WORKS DEPARTMENT AT

PIPELINE OR WITHIN THE PIPELINE ROW. ANY DIGGING TWO FEET OR CLOSER TO THE PIPELINE CURB AND GUTTER REMOVAL WITHIN THE PIPELINE ROW MUST BE COMPLETE BY SAWCUT AND REMOVAL, IT MAY NOT BE PERFORMED BY JACKHAMMER OR VIBRATORY EQUIPMENT. NO VIBRATORY WORK IS ALLOWED OVER THE PIPELINE ROW. PROPOSED SIGNAGE WITHIN THE SIDE OF PIPELINE. PIPELINE CROSSINGS MUST BE AT A MINIMUM OF 24 INCHES OF CLEARANCE AND CROSSINGS NEED TO BE VERIFIED WITH A POTHOLE VIEWING WINDOW. KINDER MORGAN

STATE'S "ONE-CALL" SYSTEM AND ONEOK AT 800-562-5879 BEFORE DIGGING. ALSO REFER TO

A20200100EARTH EXCAVATIONCut voCut vo202001020REMOVE AND DEREGAL OF INSUITABLE MATERIALCut voCut voCut voCut vo202001020REMOVE AND DEREGAL OF INSUITABLE MATERIALCut voCut voCut voCut voCut vo202001020REMOVE AND DEREGAL OF INSUITABLE MATERIALFORTCut voCut vo <th></th> <th></th> <th></th> <th></th> <th>FE</th>					FE
20200100 PATTH EXCAVATION CU VD 3.90 No 202001200 REMOVAL AND DISPOSAL OF UNBUTTABLE MATERIAL CU VD 2.40 No 202001200 REMOVAL AND DISPOSAL OF UNBUTTABLE MATERIAL CU VD 2.40 No 202001200 REMOVAL AND DISPOSAL OF UNBUTTABLE MATERIAL POOT 2.50 No No 202001200 PREMATERIA ENDERINGA MATERIAL POOT 2.50 No No No 202001200 DISBAGE GRANULAR MATERIAL TYPE B 4° SO VD 1.230 No No 1.230 No 202001200 DISBAGE GRANULAR MATERIAL TYPE B 4° SO VD 1.230 No					VILL
20200100 EARTH EXCAVATION CU Y0 J30 202001200 REMOVAL AND DEPOSAL OF UNSUITABLE MATERIAL. CU Y0 240 202001200 REMOVAL AND DEPOSAL OF UNSUITABLE MATERIAL. CU Y0 240 202001200 REMOVAL AND DEPOSAL OF UNSUITABLE MATERIAL. CU Y0 240 202001200 REMOVAL AND DEPOSAL OF UNSUITABLE MATERIAL. CU Y0 240 202001200 REMOVAL AND DEPOSAL OF UNSUITABLE MATERIAL. CU Y0 240 202001200 REPOSAL GENERAL REMOVAL MATERIAL. YF # 4 S0 Y0 265 20101200 ADEREGRATE BASE COLREGE, TYPE H. 4* S0 Y0 4.897 100 2010100 REFERATION OF BASE S0 Y0 4.897 100 2010100 REFERATION OF BASE ADEREGRATE FOR TEMPORARY ACCESS TON 1.819 2010100 ADEREGRATE FOR TEMPORARY ACCESS TON 2.660 100 20101000 ADEREGRATE FOR TEMPORARY ACCESS POINTUS 3.660 100 2010100000 MATERIALS (PRIME COAT) POINTUS 3.660 100 100 2010100000 MATERIALS (PRIME COAT) POINTUS 3.660 1					RO
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Image: Second	20200100	EARTH EXCAVATION	CU YD	150	
Image: second					
Image: state	20201200	REMOVAL AND DISPOSAL OF UNSUITABLE MATERIAL	CU YD	240	
Image: state					
Image: section of the section of th	28000400	PERIMETER EROSION BARRIER	FOOT	350	
Image: state of the state of					
Image: Market Mathematical State Image: Market M	31101200	SUBBASE GRANULAR MATERIAL, TYPE B 4"	SQ YD	665	
Image: section of					
Image: Constraint of the section of	35101600	AGGREGATE BASE COURSE, TYPE B 4"	SQ YD	1,320	
Image: Constraint of the section of	25000100	DEEDADATION OF RASE		1 207	
Image: Market Mathematical Mathematical Market Mathematical Market Ma	5300100			4,097	
Image: Constraint of the section of	35800200	AGGREGATE BASE REPAIR	TON	1,616	1
Image: August					
Image:	40201000	AGGREGATE FOR TEMPORARY ACCESS	TON	175	
Image:					
Image: Construction of the second	40600275	BITUMINOUS MATERIALS (PRIME COAT)	POUND	2,600	
Image: A state of the stat					
Image: constraint of the second sec	40600290	BITUMINOUS MATERIALS (TACK COAT)	POUND	38,400	3
Image: constraint of the second sec					
Image:	40600370	LONGITUDINAL JOINT SEALANT	FOOT	33,600	3
Image:					
Image: A state of the stat	40600400	MIXTURE FOR CRACKS, JOINTS, AND FLANGEWAYS	TON	85	
Image: And the second secon					
Image:	40600982	HOT-MIX ASPHALT SURFACE REMOVAL - BUTT JOINT	SQ YD	285	
Image:	40602000		том	146	
40603085 HOT-MIX ASPHALT BINDER COURSE II-19.0 N70 TON 7.120	40603080			146	
	40603085	HOT-MIX ASPHALT BINDER COURSE, IL-19.0, N70	TON	7,120	
	+000000			,,,,,,,,,,,,,,,,,,,,,,,,,,,,,,,,,,,,,,,	

FILE NAME = 18R1036_02-QUAN-01 - P01	USER NAME =	DESIGNED — MPN	REVISED —			135TH STREE	T		F.A.U BTE	SECTION		COUNTY	TOTAL S	SHEET
		CHECKED — WD	REVISED —	STATE OF ILLINOIS		ROADWAY RESURE			0282	20-00069-00-B		WILL	76	3
	PLOT SCALE =	DRAWN — RG	REVISED —	DEPARTMENT OF TRANSPORTATION		SUMMARY OF QUA	NTITIES					CONTRACT N	IO. 61J80	
	PLOT DATE = 08-07-23	CHECKED — AG	REVISED —		SCALE: NONE	SHEET NO. 3 OF 76 SHEETS	STA.	TO STA.	FED. ROAD DI	T. NO. 1 ILLINOI	DIS FED. AID P	ROJECT APMT(9	993)	

FED 80%	FED 80%	FED 80%
VILLAGE 20%	VILLAGE 20%	VILLAGE 20%
ROADWAY	SAFETY	TRAINEES
	CONSTRUCTION TYPE CO	DE
0005	0021	0042
150		
240		
350		
220		
	665	
	1320	
4 007		
4,897		
1,616		
175		
2000		
2600		
38,400		
33,600		
85		
285		
	146	
7120		

				+	FED 80%	FED 80%	FED 80%
					VILLAGE 20%	VILLAGE 20%	VILLAGE 20%
					ROADWAY	SAFETY	TRAINEES
.I.	CODE NO.	PAY ITEM	UNIT	TOTAL QUANTITY	(CONSTRUCTION TYPE CO	DE
					0005	0021	0042
	40604060	HOT-MIX ASPHALT SURFACE COURSE, IL-9.5, MIX "D", N50	TON	97		97	
	40604062	HOT-MIX ASPHALT SURFACE COURSE, IL-9.5, MIX "D", N70	TON	5,540	5,540		
	42300400	PORTLAND CEMENT CONCRETE DRIVEWAY PAVEMENT, 8 INCH	SQ YD	308	308		
	42300400			500	500		
	42400200	PORTLAND CEMENT CONCRETE SIDEWALK 5 INCH	SQ FT	5,962		5962	
	40.000						
	42400800	DETECTABLE WARNINGS	SQ FT	730		730	
	44000100	PAVEMENT REMOVAL	SQ YD	642	642		
	44000164	HOT-MIX ASPHALT SURFACE REMOVAL, 3 3/4"	SQ YD	56,500	56,500		
	44000200	DRIVEWAY PAVEMENT REMOVAL	SQ YD	536	536		
	44000200			550	220		
	44000500	COMBINATION CURB AND GUTTER REMOVAL	FOOT	8,453	8,453		
	44201761	CLASS D PATCHES, TYPE I, 10 INCH	SQ YD	4	4		
	44201765	CLASS D PATCHES, TYPE II, 10 INCH	SQ YD	107	107		
	44201769	CLASS D PATCHES, TYPE III, 10 INCH	SQ YD	377	377		
	44001771		50.V5	4.400	4.400		
	44201771	CLASS D PATCHES, TYPE IV, 10 INCH	SQ YD	4,409	4,409		
	60600605	CONCRETE CURB, TYPE B	FOOT	53	53		
	60619600	CONCRETE MEDIAN, TYPE SB-6.12	SQ FT	120	120		

FILE NAME = 18R1036_02-QUAN-01 - P02	USER NAME =	DESIGNED - MPN	REVISED —			135TH STR
		CHECKED — WD	REVISED —	STATE OF ILLINOIS		ROADWAY RESU
	PLOT SCALE =	DRAWN — RG	REVISED —	DEPARTMENT OF TRANSPORTATION		SUMMARY OF QL
	PLOT DATE = 08-07-23	CHECKED — AG	REVISED —		SCALE: NONE	SHEET NO. 4 OF 76 SHEETS

EE			F.A.U RTE.		SECT	ION		COUNTY	TOTAL SHEETS	SHEET NO.
IRFACING		0282	20	-0006	9-00-BT		WILL	76	4	
JA	NTITIES							CONTRACT I	NO. 61J8	30
	STA.	TO STA.	FED. R	OAD DIST. NO.	1	ILLINOIS	FED. AI	D PROJECT APMT	993)	

				-	FED 80% VILLAGE 20%	FED 80% VILLAGE 20%	FED 80% VILLAGE 20%
		1			ROADWAY	SAFETY	TRAINEES
5.I.	CODE NO.	PAY ITEM	UNIT	TOTAL QUANTITY		CONSTRUCTION TYPE CO	
					0005	0021	0042
	67100100	MOBILIZATION	LSUM	1	1		
	70102620	TRAFFIC CONTROL AND PROTECTION, STANDARD 701501	LSUM	1	1		
	70102622	TRAFFIC CONTROL AND PROTECTION, STANDARD 701502	LSUM	1	1		
	,0102022			-	-		
	70102625	TRAFFIC CONTROL AND PROTECTION, STANDARD 701606	LSUM	1	1		
	70102630	TRAFFIC CONTROL AND PROTECTION, STANDARD 701601	LSUM	1	1		
	70102635	TRAFFIC CONTROL AND PROTECTION, STANDARD 701701	LSUM	1	1		
	/0102055				1		
	70102640	TRAFFIC CONTROL AND PROTECTION, STANDARD 701801	LSUM	1	1		
	70107025	CHANGEABLE MESSAGE SIGN	CAL DA	90	90		
	70300100	SHORT TERM PAVEMENT MARKING	FOOT	15,225		15,225	
	,0300100			15,225		13,223	
	70300150	SHORT TERM PAVEMENT MARKING REMOVAL	SQ FT	3,075		3,075	
*	72000100	SIGN PANEL - TYPE 1	SQ FT	455		455	
*	72000200	SIGN PANEL - TYPE 2	SQ FT	35		35	
	, 2000200						
*	72400100	REMOVE SIGN PANEL ASSEMBLY - TYPE A	EACH	18		18	
.1.				++			
*	72400200	REMOVE SIGN PANEL ASSEMBLY - TYPE B	EACH	4		4	
*	72400310	REMOVE SIGN PANEL - TYPE 1	SQ FT	80		80	

FILE NAME = 18R1036_02-QUAN-01 - P03	USER NAME =	DESIGNED - MPN	REVISED —		l	135TH STRI
		CHECKED — WD	REVISED —	STATE OF ILLINOIS	1	ROADWAY RESU
	PLOT SCALE =	DRAWN — RG	REVISED —	DEPARTMENT OF TRANSPORTATION	1	SUMMARY OF QU
	PLOT DATE = 08-07-23	CHECKED — AG	REVISED —		SCALE: NONE	SHEET NO. 5 OF 76 SHEETS

F.A.U RTE.	SECT	ION		COUNTY	TOTAL SHEETS	SHEET NO.
0282	20-0006	9-00-BT		WILL	76	5
				CONTRACT I	NO. 61J8	30
FED. RO	AD DIST. NO. 1	ILLINOIS	FED. AI	D PROJECT APMT	993)	
	RTE. 0282	RTE. SECT	RTE. SECTION 0282 20-00069-00-BT	RTE. SECTION 0282 20-00069-00-BT	RTE. SECTION COUNTY 0282 20-00069-00-BT WILL CONTRACT I	RTE. SECTION COUNTY SHEETS 0282 20:00069-00-BT WILL 76 CONTRACT NO. 61JE

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Id CODE NO. EAST DUCK OWER PERMISSION CONSTRUCT SOM PARIEL ADDUCTURE ADDUC			1			ROADWAY	SAFETY	TRAINEES
1 1	5.I.	CODE NO.	PAY ITEM	UNIT	TOTAL QUANTITY			
Image:						0005	0021	0042
Normal Normal <td>*</td> <td>72400500</td> <td>RELOCATE SIGN PANEL ASSEMBLY - TYPE A</td> <td>EACH</td> <td>1</td> <td></td> <td>1</td> <td></td>	*	72400500	RELOCATE SIGN PANEL ASSEMBLY - TYPE A	EACH	1		1	
Image: state of the state of	*	72400600	RELOCATE SIGN PANEL ASSEMBLY - TYPE B	FACH	1		1	
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Notice Interport later of the service state and out of the service state and out of the service state and out of the service state and s	*	72400710	RELOCATE SIGN PANEL - TYPE 1	SQ FT	13		13	
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IndexInterface Mathematication of the second se	*	73100100	BASE FOR TELESCOPING STEEL SIGN SUPPORT	EACH	2		2	
Answer of the second	*	78000100	THERMOPLASTIC PAVEMENT MARKING - LETTERS AND SYMBOLS	SQ FT	3,326		3,326	
IndexIndexIndexIndexIndexIndexIndexImage: Image: Image								
Image: Note of the second se	*	78000200	THERMOPLASTIC PAVEMENT MARKING - LINE 4"	FOOT	41,620		41,620	
Image: Note of the sector of	*	78000400	THERMORIASTIC PAVEMENT MARKING - LINE 6"	FOOT	4 620		4 620	
Index of the second of the s								
AccessedMarket Sint Price Market Sint PriceMarket Sint PriceMarket Sint PriceMarket Sint Price111<	*	78000500	THERMOPLASTIC PAVEMENT MARKING - LINE 8"	FOOT	520		520	
AccessedMarked Schemenster Andrease and and intervention of the action of the actionMarkedMarked interventionMarked intervention111 <td>*</td> <td>78000600</td> <td>THEDMODIASTIC DAVEMENT MARKING LINE 12"</td> <td>FOOT</td> <td>4 265</td> <td></td> <td>4 265</td> <td></td>	*	78000600	THEDMODIASTIC DAVEMENT MARKING LINE 12"	FOOT	4 265		4 265	
Normal InterferenceNormal InterferenceNormal InterferenceNormal 		/8000000			4,203		4,203	
NotesticalConstructionConstructionConstructionConstructionConstruction11<	*	78000650	THERMOPLASTIC PAVEMENT MARKING - LINE 24"	FOOT	300		300	
AccordActionActio								
Construct	*	78200020	CURB REFLECTORS	EACH	20		20	
Image: A state of the state	*	80400100	ELECTRIC SERVICE INSTALLATION	EACH	2		2	
Image: A state of the state								
Image: Constraint of the second se	*	80400200	ELECTRIC UTILITY SERVICE CONNECTION	L SUM	1		1	
Image: state of the state	*	81028200	UNDERGROUND CONDUIT, GALVANIZED STEEL, 2" DIA.	FOOT	158		158	
* 81028210 UNDERGROUND CONDUIT GALVANIZED STEEL 2 1/2" DIA EQUINATION FOOT 150 150		0						
	*	81028210	UNDERGROUND CONDUIT, GALVANIZED STEEL, 2 1/2" DIA.	FOOT	150		150	

FILE NAME = 18R1036_02-QUAN-01 - P04	USER NAME =	DESIGNED - MPN	REVISED —			135TH STR
		CHECKED — WD	REVISED —	STATE OF ILLINOIS		ROADWAY RESU
	PLOT SCALE =	DRAWN — RG	REVISED —	DEPARTMENT OF TRANSPORTATION		SUMMARY OF QU
	PLOT DATE = 08-07-23	CHECKED — AG	REVISED —		SCALE: NONE	SHEET NO. 6 OF 76 SHEETS

	F.A.U RTE.	SEC	TION		COUNTY	TOTAL SHEETS	SHEET NO.
ACING	0282	20-0006	9-00-BT		WILL	76	6
TITIES		•			CONTRACT I	NO. 61J8	30
STA. TO STA.	FED. RC	AD DIST. NO. 1	ILLINOIS	FED. A	D PROJECT APMT	(993)	

				-	FED 80% VILLAGE 20% ROADWAY	FED 80% VILLAGE 20% SAFETY	FED 80% VILLAGE 20% TRAINEES
					(CONSTRUCTION TYPE CO	DE
.I.	CODE NO.	PAY ITEM	UNIT	TOTAL QUANTITY-	0005	0021	0042
*	81028220	UNDERGROUND CONDUIT, GALVANIZED STEEL, 3" DIA.	FOOT	97		97	
k	81028240	UNDERGROUND CONDUIT, GALVANIZED STEEL, 4" DIA.	FOOT	229		229	
<	81400100	HANDHOLE	EACH	1		1	
k	81400200	HEAVY-DUTY HANDHOLE	EACH	4		4	
*	81603598	UNIT DUCT, 600V, 6-1C NO.6, 1/C NO.8 GROUND, (XLP-TYPE USE), 1 1/2" DIA. POLYETHYLENE	FOOT	200		200	
*	01702440			150		150	
	81702440	ELECTRIC CABLE IN CONDUIT, 600V (XLP-TYPE USE) 3-1/C NO. 1/0	FOOT	150		150	
k	82110007	LUMINAIRE, LED, ROADWAY, OUTPUT DESIGNATION G	EACH	4		4	
k	83600200	LIGHT POLE FOUNDATION, 24" DIAMETER	FOOT	8		8	
k	84400105	RELOCATE EXISTING LIGHTING UNIT	EACH	1		1	
k	85100500	PAINT NEW TRAFFIC SIGNAL POST	EACH	4		4	
k							
T	85100600	PAINT NEW MAST ARM AND POLE, UNDER 40 FOOT	EACH	4		4	
k	87301215	ELECTRIC CABLE IN CONDUIT, SIGNAL NO. 14 2C	FOOT	696		696	
k	87301225	ELECTRIC CABLE IN CONDUIT, SIGNAL NO. 14 3C	FOOT	992		992	
:	87301245	ELECTRIC CABLE IN CONDUIT, SIGNAL NO. 14 5C	FOOT	648		648	
<	87301255	ELECTRIC CABLE IN CONDUIT, SIGNAL NO. 14 7C	FOOT	1,420		1,420	

FILE NAME = 18R1036_02-QUAN-01 - P05	USER NAME =	DESIGNED - MPN	REVISED —			135TH STR
		CHECKED — WD	REVISED —	STATE OF ILLINOIS		ROADWAY RESU
	PLOT SCALE =	DRAWN — RG	REVISED —	DEPARTMENT OF TRANSPORTATION		SUMMARY OF QU
	PLOT DATE = 08-07-23	CHECKED — AG	REVISED —		SCALE: NONE	SHEET NO. 7 OF 76 SHEETS

F.A.U RTE.	ę	SECI	ION		COUNTY	TOTAL SHEETS	SHEET NO.
0282	20-	0006	9-00-BT		WILL	76	7
					CONTRACT I	NO. 61J8	0
FED. RC	AD DIST. NO.	1	ILLINOIS	FED. A	D PROJECT APMT	(993)	
	RTE. 0282	RTE.	RTE. SECT	RTE. SECTION 0282 20-00069-00-BT	RTE. SECTION 0282 20-00069-00-BT	RTE. SECTION COUNTY 0282 20-00069-00-BT WILL	RTE. SECTION COUNTY SHEETS 0282 20-00069-00-BT WILL 76 CONTRACT NO. 61JE

					FED 80%	FED 80%	FED 80%
				_	VILLAGE 20%	VILLAGE 20%	VILLAGE 20%
					ROADWAY	SAFETY	TRAINEES
5.I.	CODE NO.	PAY ITEM	UNIT	TOTAL QUANTITY	(CONSTRUCTION TYPE CO	DE
5					0005	0021	0042
*	87301305	ELECTRIC CABLE IN CONDUIT, LEAD-IN, NO. 14 1 PAIR	FOOT	889		889	
*	87301900	ELECTRIC CABLE IN CONDUIT, EQUIPMENT GROUNDING CONDUCTOR, NO. 6 1C	FOOT	489		489	
*	87502500	TRAFFIC SIGNAL POST, GALVANIZED STEEL 16 FT.	EACH	4		4	
*	87702830	STEEL COMBINATION MAST ARM ASSEMBLY AND POLE 20 FT.	EACH	1		1	
*	87702870	STEEL COMBINATION MAST ARM ASSEMBLY AND POLE 28 FT.	EACH	1		1	
*	87702880	STEEL COMBINATION MAST ARM ASSEMBLY AND POLE 30 FT.	EACH	1		1	
*	87702910	STEEL COMBINATION MAST ARM ASSEMBLY AND POLE 36 FT.	EACH	1		1	
*	87800100	CONCRETE FOUNDATION, TYPE A	FOOT	16		16	
*	87800415	CONCRETE FOUNDATION, TYPE E 36-INCH DIAMETER	FOOT	47		47	
*	87900200	DRILL EXISTING HANDHOLE	EACH	4		4	
*	88030020	SIGNAL HEAD, LED, 1-FACE, 3-SECTION, MAST-ARM MOUNTED	EACH	3		3	
*	88030100	SIGNAL HEAD, LED, 1-FACE, 5-SECTION, BRACKET MOUNTED	EACH	5		5	
*	88030110	SIGNAL HEAD, LED, 1-FACE, 5-SECTION, MAST-ARM MOUNTED	EACH	5		5	
*	88102717	PEDESTRIAN SIGNAL HEAD, LED, 1-FACE, BRACKET MOUNTED WITH COUNTDOWN TIMER	EACH	6		6	
*	88200410	TRAFFIC SIGNAL BACKPLATE, LOUVERED, FORMED PLASTIC	EACH	8		8	
	50200 /10						

FILE NAME = 18R1036_02-QUAN-01 - P06	USER NAME =	DESIGNED - MPN	REVISED —			135TH STR
		CHECKED — WD	REVISED —	STATE OF ILLINOIS	1	ROADWAY RESU
	PLOT SCALE =	DRAWN — RG	REVISED —	DEPARTMENT OF TRANSPORTATION	1	SUMMARY OF QU
	PLOT DATE = 08-07-23	CHECKED — AG	REVISED —		SCALE: NONE	SHEET NO. 8 OF 76 SHEETS

DRFACING 0282 20-00069-00-BT WILL 76 8 JANTITIES CONTRACT NO. 61J80	E			F.A.U RTE.		SECT	ION		COUNTY	TOTAL SHEETS	SHEET NO.
CONTRACT NO. 61380				0282	20	-0006	9-00-BT		WILL	76	8
	JA	NITTES							CONTRACT N	NO. 61J8	0
STA. TO STA. FED. ROAD DIST. NO. 1 ILLINOIS FED. AID PROJECT APMT(993)		STA.	TO STA.	FED. RO	AD DIST. NO.	1	ILLINOIS	FED. AI	D PROJECT APMT(993)	

				-	FED 80%	FED 80%	FED 80%
					VILLAGE 20%	VILLAGE 20%	VILLAGE 20%
					ROADWAY	SAFETY	TRAINEES
					(CONSTRUCTION TYPE CO	DE
.I.	CODE NO.	PAY ITEM	UNIT	TOTAL QUANTITY-	0005	0021	0042
*	88500100	INDUCTIVE LOOP DETECTOR	EACH	8		8	
*	88600100	DETECTOR LOOP, TYPE I	FOOT	779		779	
<	89000100	TEMPORARY TRAFFIC SIGNAL INSTALLATION	EACH	1		1	
<	89501400	RELOCATE EXISTING EMERGENCY VEHICLE PRIORITY SYSTEM, DETECTOR UNIT	EACH	2		2	
*	89501510	RELOCATE EXISTING FLASHING BEACON	EACH	1		1	
*	89502200	MODIFY EXISTING CONTROLLER	EACH	1		1	
k	89502375	REMOVE EXISTING TRAFFIC SIGNAL EQUIPMENT	EACH	1		1	
*	89502380	REMOVE EXISTING HANDHOLE	EACH	1		1	
ĸ	89502385	REMOVE EXISTING CONCRETE FOUNDATION	EACH	7		7	
	Z0004518	HOT-MIX ASPHALT DRIVEWAY PAVEMENT, 5"	SQ YD	208	208		
	Z0017400	DRAINAGE & UTILITY STRUCTURES TO BE ADJUSTED	EACH	140	140		
	70017700		EACH	1	1		
	Z0017700	DRAINAGE & UTILITY STRUCTURES TO BE RECONSTRUCTED	EACH	1	1		
	Z0030850	TEMPORARY INFORMATION SIGNING	SQ FT	152	152		
k	Z0073510	TEMPORARY TRAFFIC SIGNAL TIMING	EACH	1		1	
	70070000			500			F00
	Z0076600	TRAINEES	HOUR	500			500

FILE NAME = 18R1036_02-QUAN-01 - P07	USER NAME =	DESIGNED - MPN	REVISED —			135TH STR
		CHECKED — WD	REVISED —	STATE OF ILLINOIS		ROADWAY RESU
	PLOT SCALE =	DRAWN — RG	REVISED —	DEPARTMENT OF TRANSPORTATION		SUMMARY OF QU
	PLOT DATE = 08-07-23	CHECKED — AG	REVISED —		SCALE: NONE	SHEET NO. 9 OF 76 SHEETS

F.A.U RTE.	SECTION			COUNTY	TOTAL SHEETS	SHEET NO.
0282	20-0006	9-00-BT		WILL	76	9
				CONTRACT NO. 61J80		
FED. RO	FED. ROAD DIST. NO. 1 ILLINOIS FED.			FED. AID PROJECT APMT(993)		
	RTE. 0282	RTE. SECT 0282 20-0006	RTE. SECTION 0282 20-00069-00-BT	RTE. SECTION 0282 20-00069-00-BT	RTE. SECTION COUNTY 0282 20-00069-00-BT WILL CONTRACT I CONTRACT I	RTE. SECTION COUNTY SHEETS 0282 20-00069-00-BT WILL 76 CONTRACT NO. 61JE

				-	FED 80%	FED 80%	FED 80%
				-	VILLAGE 20%	VILLAGE 20%	VILLAGE 209
					ROADWAY	SAFETY CONSTRUCTION TYPE COI	TRAINEES
S.I.	CODE NO.	PAY ITEM	UNIT	TOTAL QUANTITY	0005	0021	0042
	Z0076604	TRAINESS TRAINING PROGRAM GRADUATE	HOUR	500			500
*	X0324085	EMERGENCY VEHICLE PRIORITY SYSTEM LINE SENSOR CABLE, NO. 20 3/C	FOOT	254		254	
*	X0326899	SOLAR-POWERED FLASHING BEACON ASSEMBLY (COMPLETE)	EACH	4		4	
*	X0327018	DECORATIVE SIGN POST	EACH	74		74	
	X4404700	SIDEWALK REMOVAL (SPECIAL)	SQ FT	9,847		9847	
	X6060048	COMBINATION CONCRETE CURB AND GUTTER, TYPE B-6.18 (SPECIAL)	FOOT	6,047	6,047		
	X6064200	COMBINATION CONCRETE CURB AND GUTTER, TYPE B-6.12 (SPECIAL)	FOOT	2,406	2,406		
*	X8730105	ELECTRIC CABLE IN CONDUIT, SIGNAL NO. 10 3C	FOOT	697		697	
*	X8760200	ACCESSIBLE PEDESTRIAN SIGNALS	EACH	6		6	
*	X8950090	RELOCATE EXISTING LIGHTING CONTROLLER	EACH	1		1	
	XX006343	SEEDING (COMPLETE)	SQ YD	1,780	1780		

FILE NAME = 18R1036_02-QUAN-01 - P08	USER NAME =	DESIGNED - MPN	REVISED —		135TH STREET ROADWAY RESURFACING				F.A.U BTE	SECTION	COUNTY	TOTAL SHEET
		CHECKED — WD	REVISED —	STATE OF ILLINOIS					0282	20-00069-00-BT	WILL	76 10
	PLOT SCALE =	DRAWN — RG	REVISED —	DEPARTMENT OF TRANSPORTATION	SUMMARY OF QUANTITIES					CONTRAC	CT NO. 61J80	
	PLOT DATE = 08-07-23	CHECKED — AG	REVISED —		SCALE: NONE	SHEET NO. 10 OF 76 SHEETS	STA.	TO STA.	FED. ROAD	DIST. NO. 1 ILLINOIS FE	D. AID PROJECT API	

			CL	JRB & MEDIAN		
	LOCATION		COMBINATION CONCRETE CURB AND GUTTER, TYPE B-6.18 (SPECIAL)	COMBINATION CONCRETE CURB AND GUTTER, TYPE B-6.12 (SPECIAL)	CONCRETE CURB, TYPE B	CONCRETE MEDIAN, TYPE SB-6.12
Sta. From	Sta. To	Offset	(FOOT)	(FOOT)	(FOOT)	(SQ FT)
				135th STREET		
87+97.30	88+15.74	LT	18.00			
88+60.48	88+75.15	LT	16.00			
88+60.92	88+75.23	RT	15.00			
89+08.53	89+56.77	RT	48.00			
89+34.57	89+48.52	LT	14.00			
90+57.73	90+68.39	RT	11.00			
90+90.58	91+05.10	LT	15.00			
91+78.56	91+84.56	LT				60.00
91+78.56	91+84.56	LT		10.00		
91+78.56	91+84.56	LT		10.00		
91+84.56	92+72.89	LT		88.00		
91+84.56	92+72.82 92+17.94	RT	22.00	88.00		
91+96.42		LT RT	22.00			
91+99.37 92+68.61	92+17.85 93+16.31	LT	48.00			
92+72.82	92+72.89	LT	+3.00		9.00	
92+75.02	93+01.16	RT	26.00		5.00	
93+27.47	93+39.41	LT	12.00			
93+70.89	93+70.91	LT			9.00	
93+70.89	94+29.69	LT		59.00		
93+70.91	94+29.54	LT		59.00		
93+75.88	94+49.58	LT	74.00			
94+29.54	96+95.88	LT		266.00		
94+29.69	96+95.88	LT		266.00		
95+55.83	95+68.71	RT	13.00			
96+95.88	97+01.88	LT		9.00		
96+95.88	97+01.88	LT		9.00		
96+95.88	97+01.88	LT				60.00
97+69.97	98+02.48	LT	33.00			
98+16.16	98+49.80	LT	34.00			
99+01.53	99+44.17	LT	43.00			
99+48.37	99+65.29	RT	32.00			
100+33.06	100+69.86	RT	52.00			
100+43.96	100+84.38	LT	40.00			
100+92.30	101+34.69	RT	42.00			
101+14.09	101+26.27	LT	12.00			
101+55.79	101+70.88	LT	15.00			
101+80.57	102+20.27	RT LT	40.00			
102+46.29	102+60.46	LT	14.00			
103+02.24	103+10.84	RT	62.00			
103+08.23	103+75.14	LT	16.00			
103+38.70	104+67.59	RT	49.00			
105+15.58	105+80.91	RT	65.00			
105+38.05	105+53.14	LT	15.00			
105+92.90	106+10.48	RT	38.00			
106+13.53	106+33.73	LT	20.00			
106+25.13	106+26.11	RT	10.00			
106+31.78	106+32.76	RT	10.00			
106+51.97	107+18.79	RT	103.00			
107+17.62	107+39.76	LT	22.00			
107+84.03	107+95.59	LT	12.00			
108+41.43	108+62.91	RT	21.00			
108+85.89	108+94.36	LT	8.00			
108+89.20	109+99.81	RT	111.00			
109+07.18	109+43.15	LT	36.00			
109+70.41	110+55.88	LT	85.00			
110+14.51	110+65.61	RT	51.00			
111+25.45	111+44.58	RT	19.00 36.00			
111+91.31	112+27.69	RT				

	LOCATION		COMBINATION CONCRETE CURB
Sta. From	Sta. To	Offset	GUTTER, TYPE B-6.18 (SPECIA (FOOT)
113+74.71	113+99.39	LT	25.00
		RT	
113+82.45 114+43.34	113+95.82 114+53.59	LT	13.00
114+43.34	114+97.88	LT	6.00
114+91.71	114+97.88	RT	48.00
116+46.48	116+59.59	LT	14.00
116+70.34	116+72.73	LT	14.00
117+21.88	117+50.04	RT	44.00
117+22.21	117+37.47	LT	27.00
19+93.71	120+20.78	LT	27.00
19+95.81	120+10.24	RT	14.00
21+30.62	120+10.24	BT	82.00
21+61.20	121+80.11	LT	19.00
22+65.86	122+78.86	LT	13.00
123+12.08	123+37.31	RT	25.00
123+51.44	123+80.07	LT	29.00
124+61.68	125+12.44	BT	51.00
125+34.81	125+55.37	LT	21.00
125+36.61	125+56.81	RT	20.00
125+98.80	126+11.87	RT	13.00
126+08.32	126+34.27	LT	31.00
126+58.54	126+65.54	LT	11.00
126+98.09	127+15.63	LT	18.00
127+52.56	127+64.50	RT	12.00
127+72.83	127+86.69	LT	14.00
127+79.47	127+99.19	RT	33.00
128+31.72	128+59.07	LT	27.00
128+51.99	128+60.39	RT	21.00
128+73.56	129+32.44	RT	59.00
128+91.81	129+20.73	LT	29.00
129+80.36	130+45.81	RT	65.00
129+80.93	129+93.50	LT	13.00
130+15.21	130+41.06	LT	26.00
130+68.07	130+73.73	LT	11.00
130+95.10	131+21.10	RT	26.00
130+98.41	131+16.40	LT	23.00
131+37.57	131+46.17	LT	9.00
131+70.40	131+83.77	RT	13.00
132+08.38	132+22.78	LT	14.00
132+11.02	132+23.85	RT	13.00
132+75.99	133+68.28	RT	93.00
132+91.60	132+99.58	LT	8.00
133+83.73	134+12.37	LT	38.00
133+99.09	134+12.11	RT	13.00
134+42.43	134+59.88	LT	26.00
135+12.50	135+25.97	LT	13.00
135+69.01	136+02.72	RT	34.00
135+77.41	135+97.49	LT	20.00
136+94.05	137+36.32	LT	42.00
137+07.75	137+70.82	RT	63.00
137+60.94	137+73.77	LT	13.00
138+12.17	138+52.16	RT	40.00
138+65.84	138+92.21	LT	26.00
139+12.83	139+27.85	RT	46.00
139+23.06	139+83.30	LT	60.00
139+45.09	139+45.37	RT	7.00
139+57.84	139+57.86	RT	7.00
139+74.95	139+82.16	RT	25.00
140+39.31	140+92.22	RT	53.00
140+60.85	140+77.63	LT	22.00
140+96.31	1		21.00

FILE NAME = 18R1036_02-SCHD-01 - P01	USER NAME =	DESIGNED - MPN	REVISED - 09-19-23			135TH STRE
		CHECKED — WD	REVISED —	STATE OF ILLINOIS		ROADWAY RESUR
	PLOT SCALE =	DRAWN — RG	REVISED —	DEPARTMENT OF TRANSPORTATION		SUMMARY OF SCH
	PLOT DATE = 08-07-23	CHECKED — AG	REVISED —		SCALE: NONE	SHEET NO. 11 OF 76 SHEETS


١D	COMBINATION CONCRETE CURB AND GUTTER, TYPE B-6.12 (SPECIAL) (FOOT)	CONCRETE CURB, TYPE B (FOOT)	CONCRETE MEDIAN, TYPE SB-6.12 (SQ FT)
	L35th STREET		(11 92)
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eet RFACING HEDULES		:	SECT	ΓΙΟΝ		COUNTY	TOTAL SHEETS	SHEET NO.
		20-00069-00-BT			WILL	76	11	
		CONTRACT NO. 61J80					80	
STA. TO STA.	FED. ROAD DIST. NO. 1 ILLI			ILLINOIS	FED. A	D PROJECT APMT(993)	

			CL	JRB & MEDIAN		
	LOCATION		COMBINATION CONCRETE CURB AND GUTTER, TYPE B-6.18 (SPECIAL)	COMBINATION CONCRETE CURB AND GUTTER, TYPE B-6.12 (SPECIAL)	CONCRETE CURB, TYPE B	CONCRETE MEDIAN, TYP SB-6.12
Sta. From	Sta. To	Offset	(FOOT)	(FOOT)	(FOOT)	(SQ FT)
				135th STREET		
141+89.61	142+58.44	RT	69.00			
142+24.33	142+40.61	LT	16.00			
142+53.34	142+67.92	LT	19.00			
142+91.57	143+55.14	LT	70.00			
143+18.08	143+37.34	RT	19.00			
143+74.61	144+05.63 144+43.29	RT	31.00			
144+23.74	144+43.29	LT RT	19.00 35.00			
144+64.44	145+35.85	LT	71.00			
144+95.04	145+73.20	RT	78.00			
145+56.63	145+87.01	LT	30.00			
146+64.62	147+10.86	RT	53.00			
146+90.57	147+14.48	LT	46.00			
147+45.84	147+69.03	RT	28.00			
147+48.25	147+71.17	LT	45.00			
148+20.91	148+98.50	RT	78.00			
149+70.13	149+90.87	LT	21.00			
150+32.83	150+50.43	LT	18.00			
151+26.73	151+50.50 152+10.15	RT RT	24.00			
151+75.76	152+10.15	LT	34.00 20.00			
151+87.85	152+07.67	LT	20.00			
153+16.21	153+47.43	LT	31.00			
153+79.47	153+96.53	RT	17.00			
153+92.92	154+12.35	LT	19.00			
154+85.58	155+00.33	RT	15.00			
155+44.91	155+61.03	LT	16.00			
155+89.07	156+21.18	LT	32.00			
157+07.79	157+18.71	LT	11.00			
157+41.47	157+51.13	RT	10.00			
157+42.52	157+56.22	LT	14.00			
157+51.13	157+60.79 157+65.76	RT		22.00		
157+56.22	157+65.76	LT RT		23.00		
157+93.06	158+02.31	LT		23.00		
158+02.31	158+10.44	LT	8.00	23.00		
158+53.04	158+95.28	RT		42.00		
159+03.40	159+52.81	LT	49.00			
159+28.43	159+59.68	RT		31.00		
159+51.13	160+29.44	LT	39.00			
160+21.77	161+05.28	RT		84.00		
160+55.56	163+02.35	LT	247.00			
161+30.64	162+54.15	RT		134.00		
162+80.22	163+26.66	RT		55.00		
163+67.73	164+02.65	LT	35.00			
164+56.56	164+73.42 165+08.67	LT RT	17.00	14.00		
164+94.71	165+08.67	LT	47.00	14.00		
165+01.49	165+48.26	LT	21.00			
167+51.52	167+77.98	LT	26.00			
167+60.79	167+73.85	RT		12.00		
167+79.96	167+82.26	RT		7.00		
168+08.33	168+32.42	RT		30.00		
168+63.65	168+91.91	LT	28.00			
169+74.33	170+03.11	LT	29.00			
170+23.59	170+46.17	RT		28.00		
170+35.57	170+51.63	LT	16.00			
170+72.33	170+93.88	RT		28.00		
170+93.31 172+17.06	170+99.73	LT	6.00			
	172+42.16	LT	25.00			1

			CL	JRB & MEDIAN		
Cho. Exam	LOCATION	Offeet	GUTTER, TYPE B-6.18 (SPECIAL)	COMBINATION CONCRETE CURB AND GUTTER, TYPE B-6.12 (SPECIAL)	CONCRETE CURB, TYPE B (FOOT)	CONCRETE MEDIAN, TYPE SB-6.12
Sta. From	Sta. To	Offset	(FOOT)	(FOOT)	(1001)	(SQ FT)
				135th STREET		
172+92.44	173+17.68	LT	25.00			
173+45.91	173+84.97	RT		39.00		
174+90.40	175+08.63	LT	18.00			
175+51.10	175+73.46	RT		32.00		
175+53.95	176+06.76	LT	53.00			
176+00.52	176+21.62	RT		33.00		
176+53.60	176+58.00	LT	4.00			
176+61.03	177+16.09	RT		55.00		
177+26.27	177+33.72	RT		12.00		
177+72.02	177+87.22	RT		15.00		
178+93.49	179+37.75	LT	44.00			
179+08.44	179+47.65	RT	39.00			
179+65.11	179+97.60	RT	32.00			
179+74.25	179+88.42	LT	14.00			
180+23.77	181+04.48	RT	81.00			
181+15.44	181+20.43	RT		9.00		
181+45.67	181+49.49	RT		8.00		
181+96.04	182+52.68	RT	57.00			
182+16.31	182+61.25	LT	45.00			
183+19.00	183+35.75	RT	17.00			
183+68.79	183+86.82	LT	18.00			
183+74.18	184+18.31	RT	44.00			
184+59.08	184+75.08	LT	16.00			
184+70.63	184+79.40	RT	9.00			
185+14.47	185+38.12	RT	24.00			
185+22.68	186+05.65	LT	83.00			
185+77.82	185+88.56	RT	11.00			
186+16.98	186+50.33	RT	33.00			
186+63.31	187+24.28	RT	61.00			
186+73.12	186+81.47	RT			18.00	
187+15.55	187+21.22	RT			17.00	
187+35.64	187+46.33	RT	11.00			
187+67.03	187+91.15	LT	24.00			
187+73.91	188+11.40	RT	37.00			
188+02.34	188+20.56	LT	18.00			
188+68.06	189+10.43	RT	42.00			
188+88.41	189+40.84	LT	52.00			
189+51.52	190+86.58	RT	135.00			
189+77.45	190+09.12	LT	32.00			
191+56.96	192+27.25	RT	70.00			
192+54.97	193+06.75	RT	52.00			
192+83.56	193+06.57	LT		23.00		
193+26.50	193+64.50	RT	38.00			
193+28.96	193+63.43	LT		34.00		
194+17.75	195+01.23	LT		83.00		
194+22.50	194+44.48	RT		25.00		
194+81.53	194+99.00	RT		20.00		
195+17.13	198+03.12	RT		286.00		
196+22.71	196+98.42	LT		75.00		
197+44.75	197+93.60	LT		49.00		
198+15.33	198+46.06	RT		31.00		
198+52.17	199+15.67	LT		63.00		
198+65.95	199+13.91	RT		49.00		
	TOTALS	1	6047.00	2406.00	53.00	120.00


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		CHECKED — WD	REVISED —	STATE OF ILLINOIS		ROADWAY RESURFACING	0282	20-00069-00-BT	WILL	76 12
	PLOT SCALE =	DRAWN — RG	REVISED —	DEPARTMENT OF TRANSPORTATION	SUMMARY OF SCHEDULES			CONTRACT	F NO. 61J80	
	PLOT DATE = 08-07-23	CHECKED — AG	REVISED —		SCALE: NONE	SHEET NO. 12 OF 76 SHEETS STA. TO STA.	FED. ROAD	DIST. NO. 1 ILLINOIS FEI	D. AID PROJECT APM	

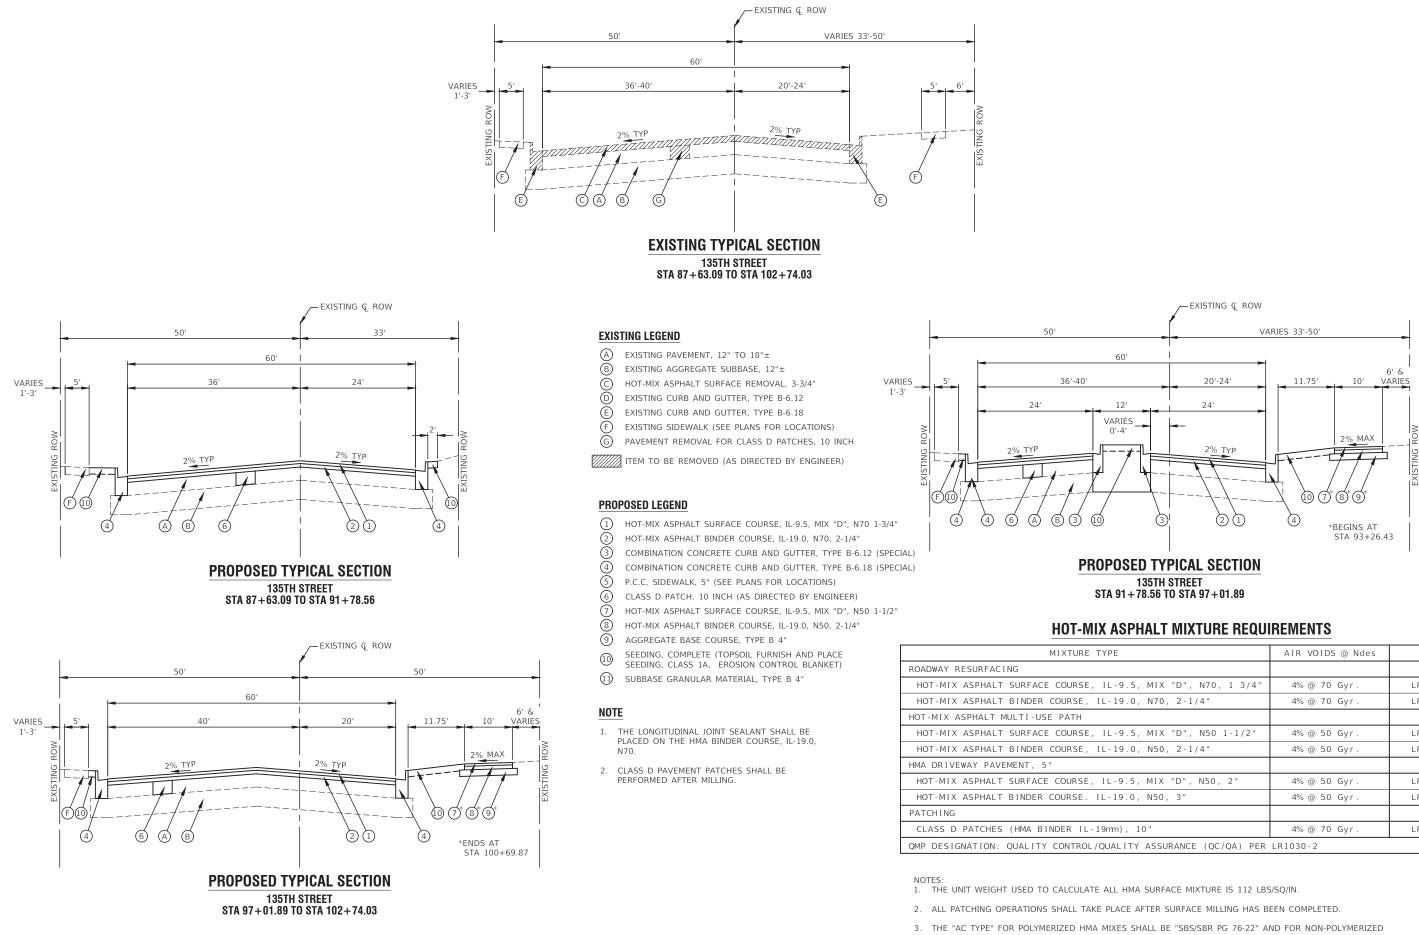


FILE NAME = 18R1036_02-TYPX-01 - IDOT P01	USER NAME =	DESIGNED — MPN	REVISED —			135TH STRE			F.A.U. RTE.	SECTION	COUNTY	TOTAL	SHEET NO.
		CHECKED — WPD	REVISED —	STATE OF ILLINOIS		ROADWAY RESUR			0282	20-00069-00-BT	WILL	76	13
	PLOT SCALE =	DRAWN — RG	REVISED —	DEPARTMENT OF TRANSPORTATION		TYPICAL CROSS S	ECTIONS				CONTRAC	T NO. 61J8	30
	PLOT DATE = 08-07-23	CHECKED — AG	REVISED —		SCALE:	SHEET NO. 13 OF 76 SHEETS	STA.	TO STA.	FED. ROAD D	IST. NO. 1 ILLINOIS FEE	AID PROJECT AP		


E TYPE	AIR VOIDS @ Ndes	QMP
E, IL-9.5, MIX "D", N70, 1 3/4"	4% @ 70 Gyr.	LR 1030-2
, IL-19.0, N70, 2-1/4"	4% @ 70 Gyr.	LR 1030-2
E, IL-9.5, MIX "D", N50 1-1/2"	4% @ 50 Gyr.	LR 1030-2
, IL-19.0, N50, 2-1/4"	4% @ 50 Gyr.	LR 1030-2
E, IL-9.5, MIX "D", N50, 2"	4% @ 50 Gyr.	LR 1030-2
. IL-19.0, N50, 3"	4% @ 50 Gyr.	LR 1030-2
L-19mm), 10"	4% @ 70 Gyr.	LR 1030-2
DL/QUALITY ASSURANCE (QC/QA) PER	LR1030-2	•


HMA THE "AC TYPE" SHALL BE "PG-64-22" UNLESS MODIFIED BY RECLAIMED MATERIALS SPECIFICATIONS.

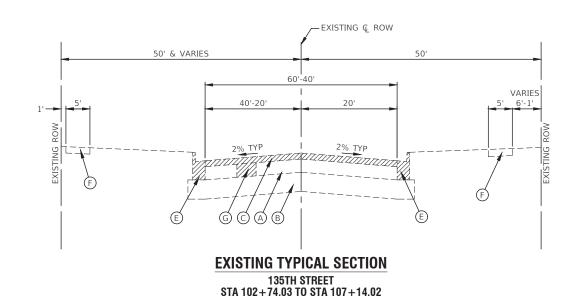

33' VARIES 11'-27' 20' 2% TYP F EXISTING G C A B Ē **EXISTING TYPICAL SECTION** 135TH STREET STA 107+14.02 TO STA 116+00

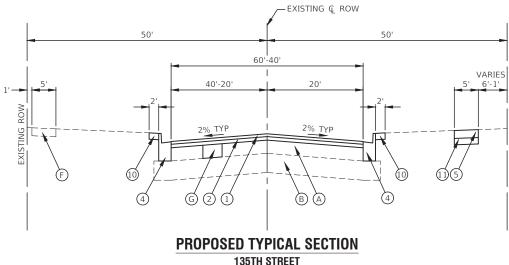

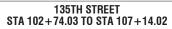

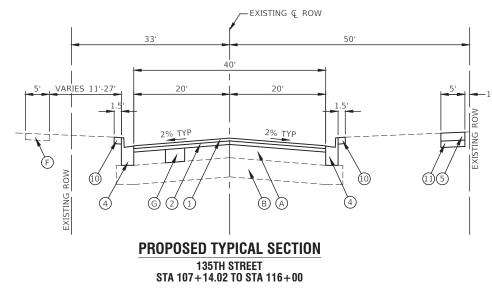

EXISTING LEGEND

(A)EXISTING PAVEMENT, 12" TO 18"±

- (B) EXISTING AGGREGATE SUBBASE, 12"±
- \bigcirc HOT-MIX ASPHALT SURFACE REMOVAL, 3-3/4"
- \bigcirc EXISTING CURB AND GUTTER, TYPE B-6.12
- E EXISTING CURB AND GUTTER, TYPE B-6.18
- (F)EXISTING SIDEWALK (SEE PLANS FOR LOCATIONS) G PAVEMENT REMOVAL FOR CLASS D PATCHES, 10 INCH

ITEM TO BE REMOVED (AS DIRECTED BY ENGINEER)

NOTE


- 1. THE LONGITUDINAL JOINT SEALANT SHALL BE PLACED ON THE HMA BINDER COURSE, IL-19.0, N70.
- 2. CLASS D PAVEMENT PATCHES SHALL BE PERFORMED AFTER MILLING.

PROPOSED LEGEND

- (1)HOT-MIX ASPHALT SURFACE COURSE, IL-9.5, MIX "D", N70 1-3/4"
- 2 HOT-MIX ASPHALT BINDER COURSE, IL-19.0, N70, 2-1/4"
- 3 COMBINATION CONCRETE CURB AND GUTTER, TYPE B-6.12 (SPECIAL)
- 4 COMBINATION CONCRETE CURB AND GUTTER, TYPE B-6.18 (SPECIAL)
- 5 P.C.C. SIDEWALK, 5" (SEE PLANS FOR LOCATIONS)
- 6 CLASS D PATCH, 10 INCH (AS DIRECTED BY ENGINEER)
- Ī HOT-MIX ASPHALT SURFACE COURSE, IL-9.5, MIX "D", N50 1-1/2"
- 8 HOT-MIX ASPHALT BINDER COURSE, IL-19.0, N50, 2-1/4"
- 9 AGGREGATE BASE COURSE, TYPE B 4"
- SEEDING, COMPLETE (TOPSOIL FURNISH AND PLACE 10
- SEEDING, CLASS 1A, EROSION CONTROL BLANKET)
- 1) SUBBASE GRANULAR MATERIAL, TYPE B 4"


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		CHECKED — WPD	REVISED —	STATE OF ILLINOIS	ROADWAY RESURFACING TYPICAL CROSS SECTIONS				0282	20-00069-00-BT	WILL	76 14
	PLOT SCALE =	DRAWN — RG	REVISED —	DEPARTMENT OF TRANSPORTATION							CONTRACT	NO. 61J80
	PLOT DATE = 08-07-23	CHECKED — AG	REVISED —		SCALE:	SHEET NO. 14 OF 76 SHEETS	STA.	TO STA.	FED. ROAD [DIST. NO. 1 ILLINOIS F	D. AID PROJECT APM	T(993)




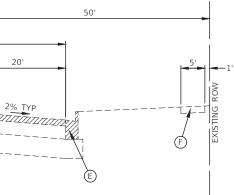






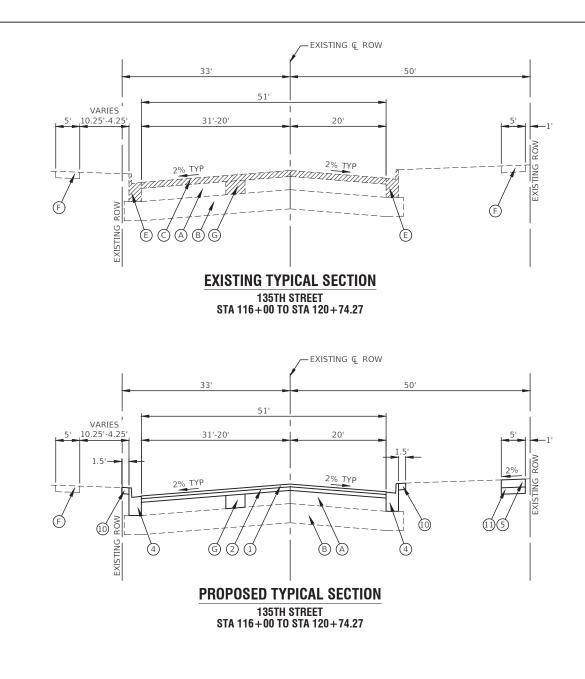


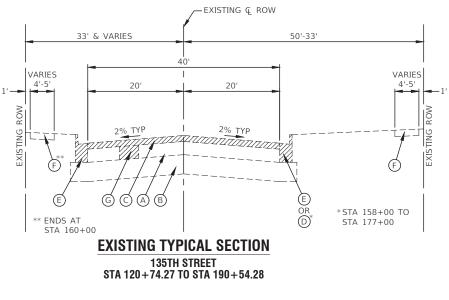

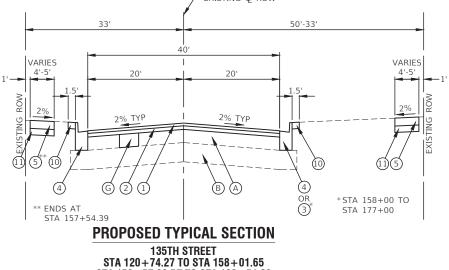

STA 159+57.03 RT TO STA 190+54.28 STA 159+64.89 LT TO STA 190+54.28

1'

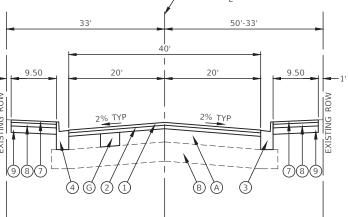

PROPOSED TYPICAL SECTION

135TH STREET STA 158+01.65 TO STA 159+57.03 RT STA 158+01.65 TO STA 159+64.89 LT

EXISTING LEGENI

- (A)EXISTING PAVEMENT, 12" TO 18"±
- B EXISTING AGGREGATE SUBBASE, 12"±
- \bigcirc HOT-MIX ASPHALT SURFACE REMOVAL, 3-3/4"
- D EXISTING CURB AND GUTTER, TYPE B-6.12
- E EXISTING CURB AND GUTTER, TYPE B-6.18
- F EXISTING SIDEWALK (SEE PLANS FOR LOCATIONS) G
- PAVEMENT REMOVAL FOR CLASS D PATCHES, 10 INCH

ITEM TO BE REMOVED (AS DIRECTED BY ENGINEER)

NOTE

- 1. THE LONGITUDINAL JOINT SEALANT SHALL BE PLACED ON THE HMA BINDER COURSE, IL-19.0, N70.
- 2. CLASS D PAVEMENT PATCHES SHALL BE PERFORMED AFTER MILLING.

PROPOSED LEGEND


- (1)HOT-MIX ASPHALT SURFACE COURSE, IL-9.5, MIX "D", N70 1-3/4"
- $\check{2}$ HOT-MIX ASPHALT BINDER COURSE, IL-19.0, N70, 2-1/4"
- 3 COMBINATION CONCRETE CURB AND GUTTER, TYPE B-6.12 (SPECIAL)
- (4)COMBINATION CONCRETE CURB AND GUTTER, TYPE B-6.18 (SPECIAL)
- 5 P.C.C. SIDEWALK, 5" (SEE PLANS FOR LOCATIONS)
- 6 CLASS D PATCH, 10 INCH (AS DIRECTED BY ENGINEER)
- 7 HOT-MIX ASPHALT SURFACE COURSE, IL-9.5, MIX "D", N50 1-1/2"
- 8 HOT-MIX ASPHALT BINDER COURSE, IL-19.0, N50, 2-1/4"
- Õ AGGREGATE BASE COURSE, TYPE B 4"
- SEEDING, COMPLETE (TOPSOIL FURNISH AND PLACE 10 SEEDING, CLASS 1A, EROSION CONTROL BLANKET)
- (11)SUBBASE GRANULAR MATERIAL, TYPE B 4"


FILE NAME = 18R1036_02-TYPX-01 - IDOT P03 REVISED USER NAME = DESIGNED - MPN 135TH STRE STATE OF ILLINOIS CHECKED - WPD REVISED ROADWAY RESU PLOT SCALE = DRAWN — RG REVISED DEPARTMENT OF TRANSPORTATION TYPICAL CROSS S SCALE: PLOT DATE = 08-07-23 CHECKED - AG REVISED SHEET NO. 15 OF 76 SHEETS


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- EXISTING & ROW


	ET		F.A.U. RTE.	SECT	ION		COUNTY	TOTAL SHEETS	SHEET NO.
				0282 20-00069-00-BT WILL				76	15
SI	SECTIONS						CONTRACT	NO. 61J8	30
	STA.	TO STA.	FED. RO	AD DIST. NO. 1	ILLINOIS	FED. AI	D PROJECT APMT	(993)	



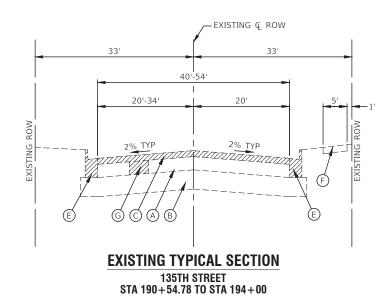

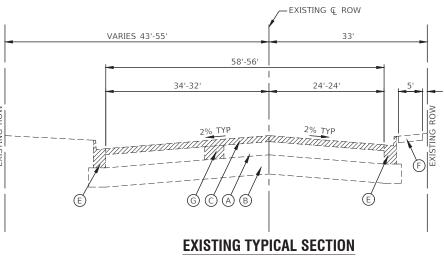

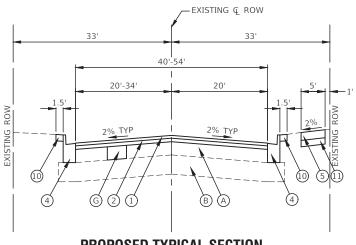PROPOSED TYPICAL SECTION 135TH STREET STA 190+54.78 TO STA 194+00

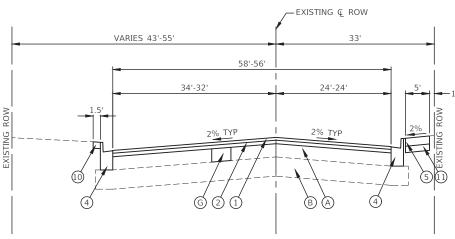

EXISTING LEGEND

(A)EXISTING PAVEMENT, 12" TO 18"±

- (B) EXISTING AGGREGATE SUBBASE, 12"±
- \bigcirc HOT-MIX ASPHALT SURFACE REMOVAL, 3-3/4"
- \bigcirc EXISTING CURB AND GUTTER, TYPE B-6.12
- E EXISTING CURB AND GUTTER, TYPE B-6.18
- (F)EXISTING SIDEWALK (SEE PLANS FOR LOCATIONS)

G PAVEMENT REMOVAL FOR CLASS D PATCHES, 10 INCH

ITEM TO BE REMOVED (AS DIRECTED BY ENGINEER)

NOTE

- 1. THE LONGITUDINAL JOINT SEALANT SHALL BE PLACED ON THE HMA BINDER COURSE, IL-19.0, N70.
- 2. CLASS D PAVEMENT PATCHES SHALL BE PERFORMED AFTER MILLING.

PROPOSED LEGEND


- 1 HOT-MIX ASPHALT SURFACE COURSE, IL-9.5, MIX "D", N70 1-3/4"
- 2 HOT-MIX ASPHALT BINDER COURSE, IL-19.0, N70, 2-1/4"
- 3 COMBINATION CONCRETE CURB AND GUTTER, TYPE B-6.12 (SPECIAL)
- 4 COMBINATION CONCRETE CURB AND GUTTER, TYPE B-6.18 (SPECIAL)
- 5 P.C.C. SIDEWALK, 5" (SEE PLANS FOR LOCATIONS)
- 6 CLASS D PATCH, 10 INCH (AS DIRECTED BY ENGINEER)
- Ī HOT-MIX ASPHALT SURFACE COURSE, IL-9.5, MIX "D", N50 1-1/2"
- 8 HOT-MIX ASPHALT BINDER COURSE, IL-19.0, N50, 2-1/4"
- 9 AGGREGATE BASE COURSE, TYPE B 4"
- SEEDING, COMPLETE (TOPSOIL FURNISH AND PLACE SEEDING, CLASS 1A, EROSION CONTROL BLANKET) (10)
- 1) SUBBASE GRANULAR MATERIAL, TYPE B 4"


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		CHECKED - WPD	REVISED —] STATE OF ILLINOIS	ROADWAY RESURFACING TYPICAL CROSS SECTIONS			0282	20-00069-00-BT	WILL	76 16
	PLOT SCALE =	DRAWN — RG	REVISED —	DEPARTMENT OF TRANSPORTATION						CONTRAC	T NO. 61J80
	PLOT DATE = 08-07-23	CHECKED — AG	REVISED —		SCALE:	SHEET NO. 16 OF 76 SHEETS STA.	TO STA.	FED. ROAD	DIST. NO. 1 ILLINOIS F	ED. AID PROJECT API	

135TH STREET STA 194+00 TO STA 199+16

PROPOSED TYPICAL SECTION


135TH STREET STA 194+00 TO STA 199+16

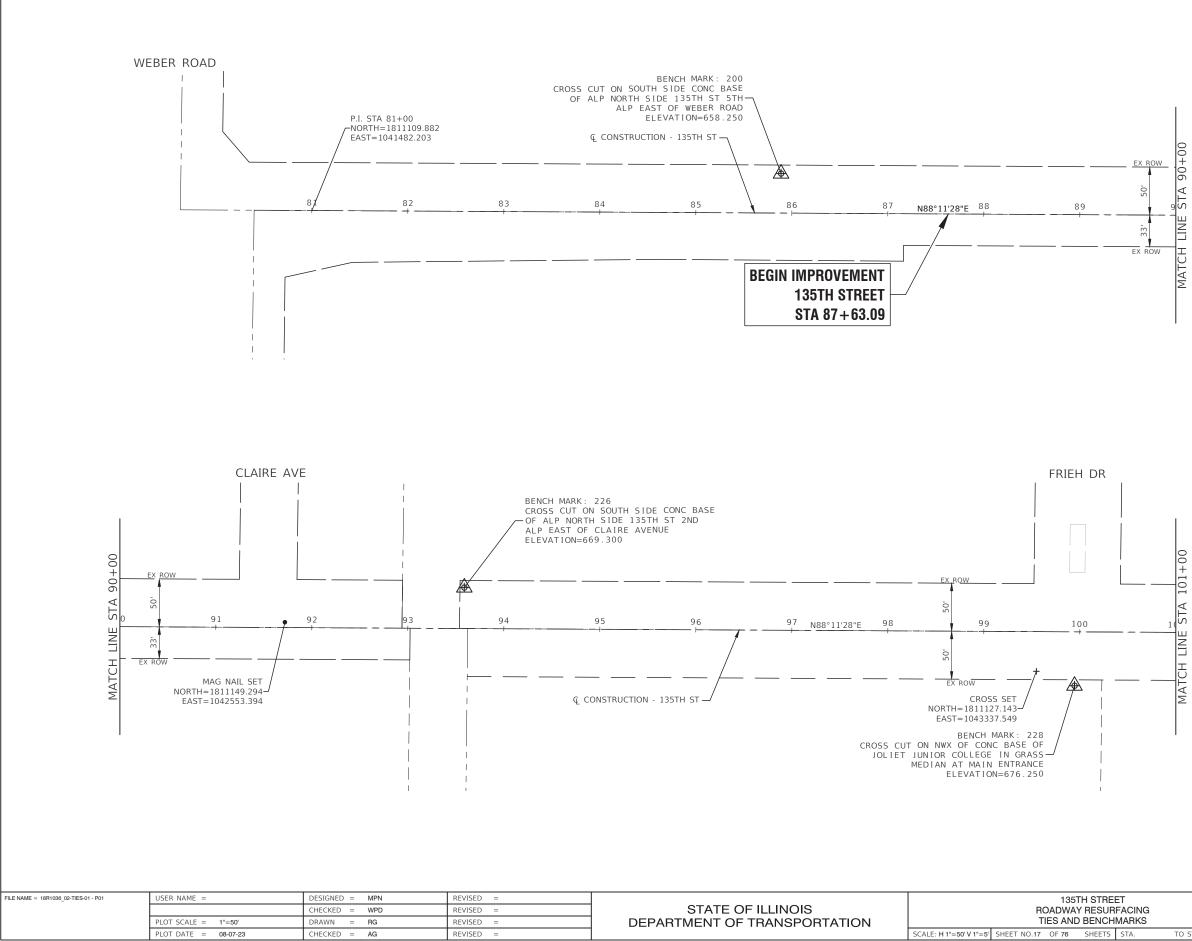

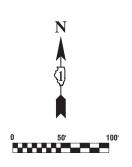

- 1. COORDINATES ARE BASED ON ILLINOIS STATE PLANE EASTERN ZONE NORTH AMERICAN DATUM 1983
- 2. SURVEY FEET UNITS WERE USED.
- 3. ALL ELEVATIONS REFER TO NAVD88 DATUM.


	EET BEACING			F.A.U. RTE.	SECT	ION		COUNTY	TOTAL SHEETS	SHEET NO.
JRFACING			0282 20-00069-00-BT				WILL	76	17	
H	CHMARKS							CONTRACT I	VO. 61J8	30
S	5 STA. TO STA.		FED. RO	AD DIST. NO. 1	ILLINOIS	FED. A	ID PROJECT APMT	993)		

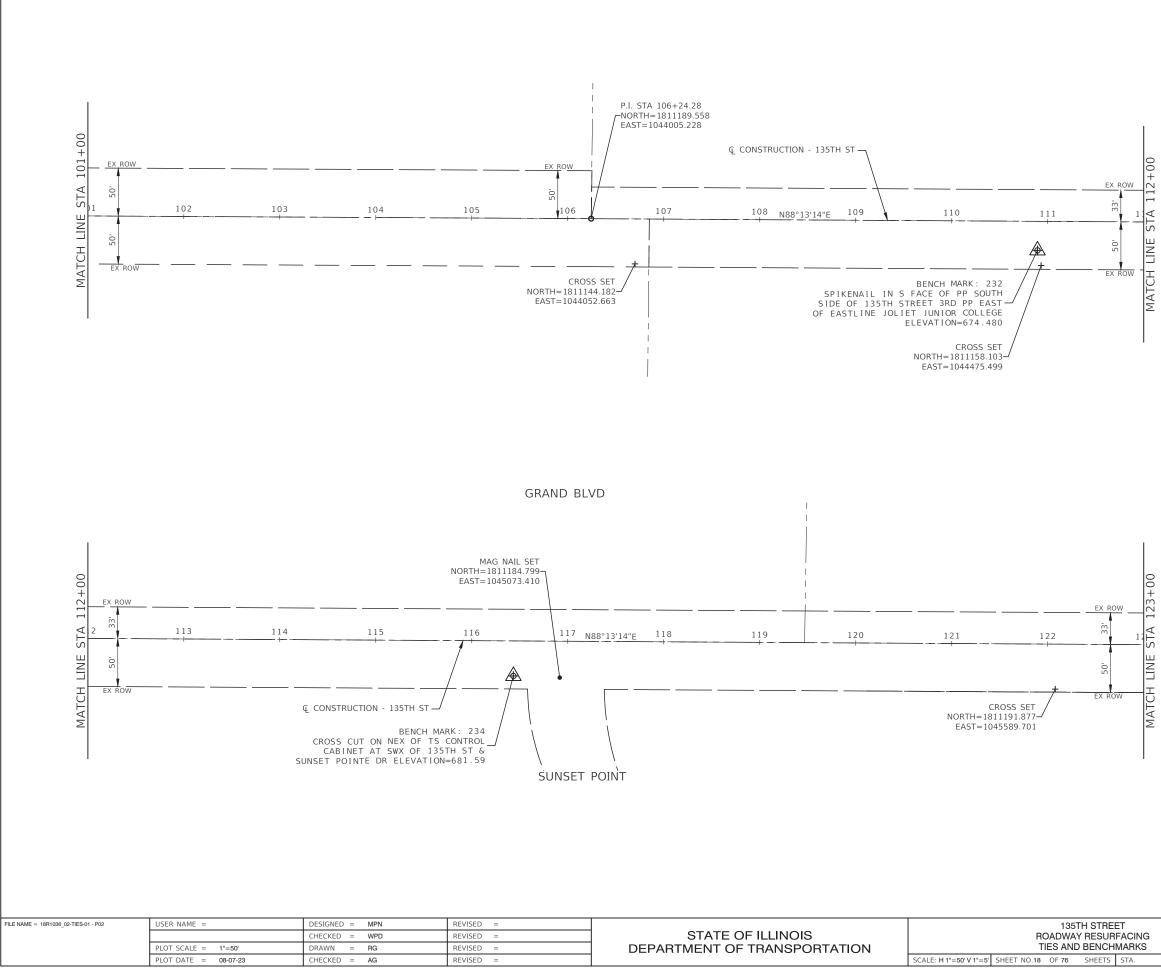

- 1. COORDINATES ARE BASED ON ILLINOIS STATE PLANE EASTERN ZONE NORTH AMERICAN DATUM 1983
- 2. SURVEY FEET UNITS WERE USED.
- 3. ALL ELEVATIONS REFER TO NAVD88 DATUM.

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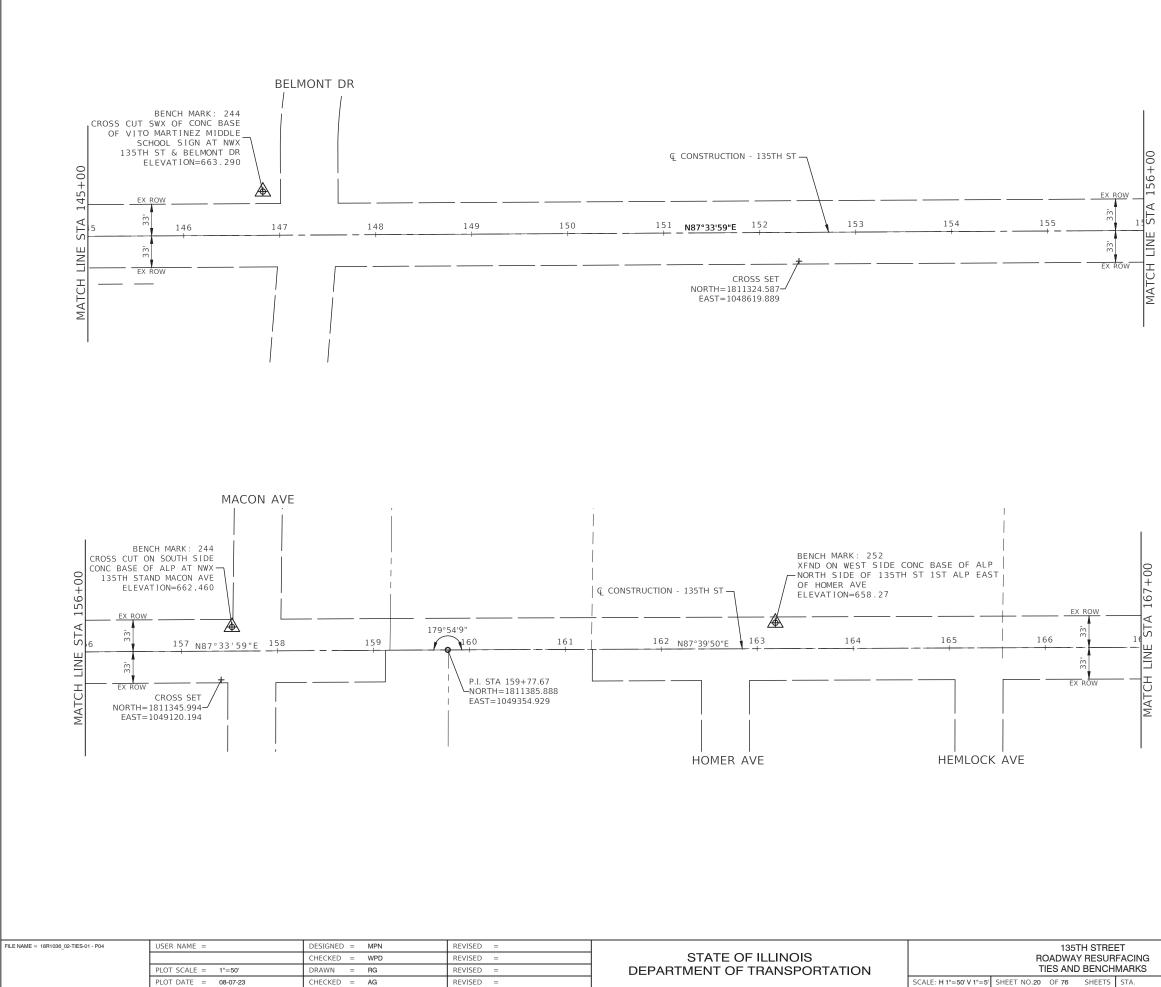
EET	F.A.U. RTE.	SECTION			COUNTY	TOTAL SHEETS	SHEET NO.	
JRFACING	0282	0282 20-00069-00-BT			WILL	76	18	
CHMARKS					CONTRACT NO. 61J80			
S STA. TO STA.	FED, RO	AD DIST. NO. 1	ILLINOIS	FED. A	ID PROJECT APMT	(993)		

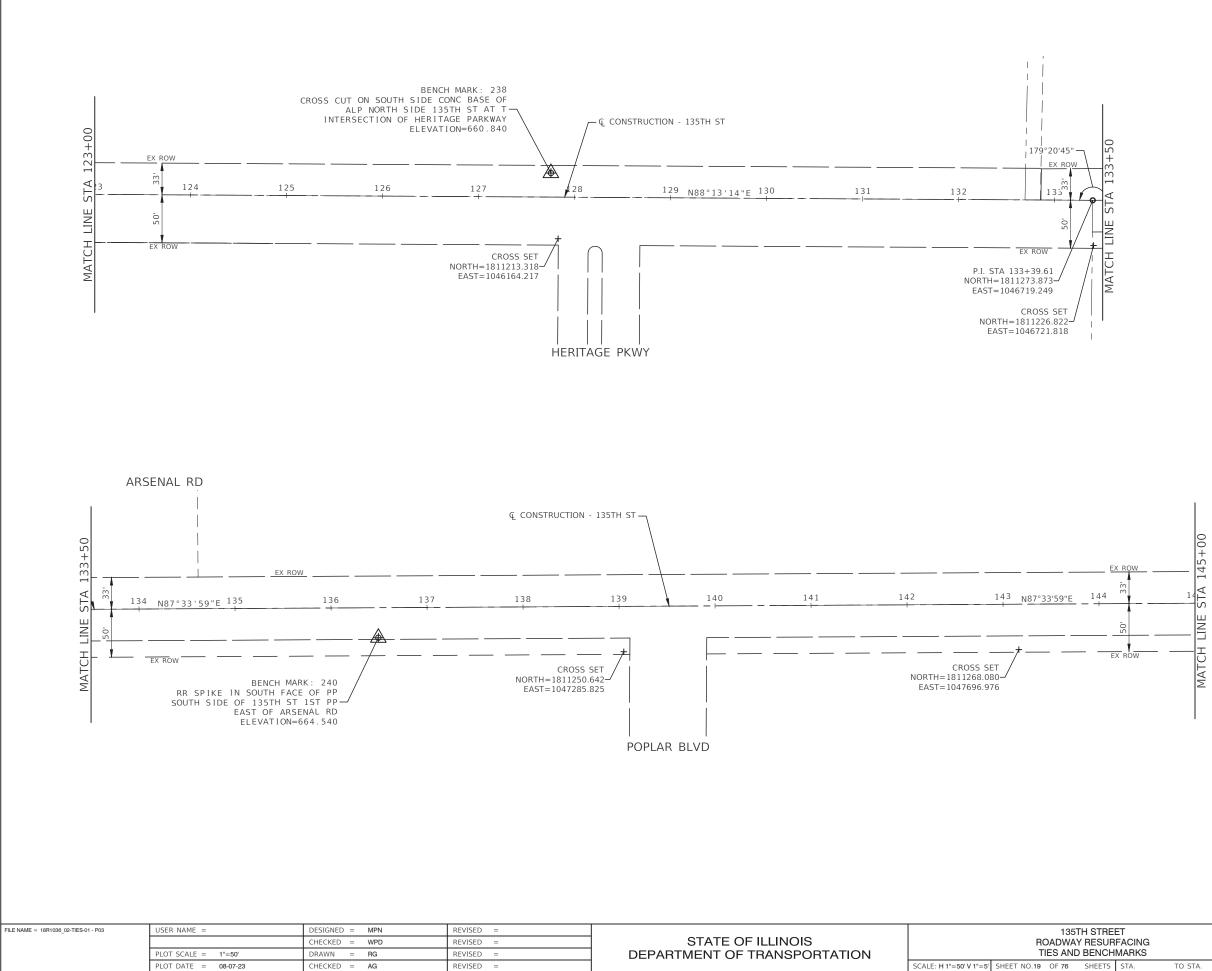


- 1. COORDINATES ARE BASED ON ILLINOIS STATE PLANE EASTERN ZONE NORTH AMERICAN DATUM 1983
- 2. SURVEY FEET UNITS WERE USED.
- 3. ALL ELEVATIONS REFER TO NAVD88 DATUM.

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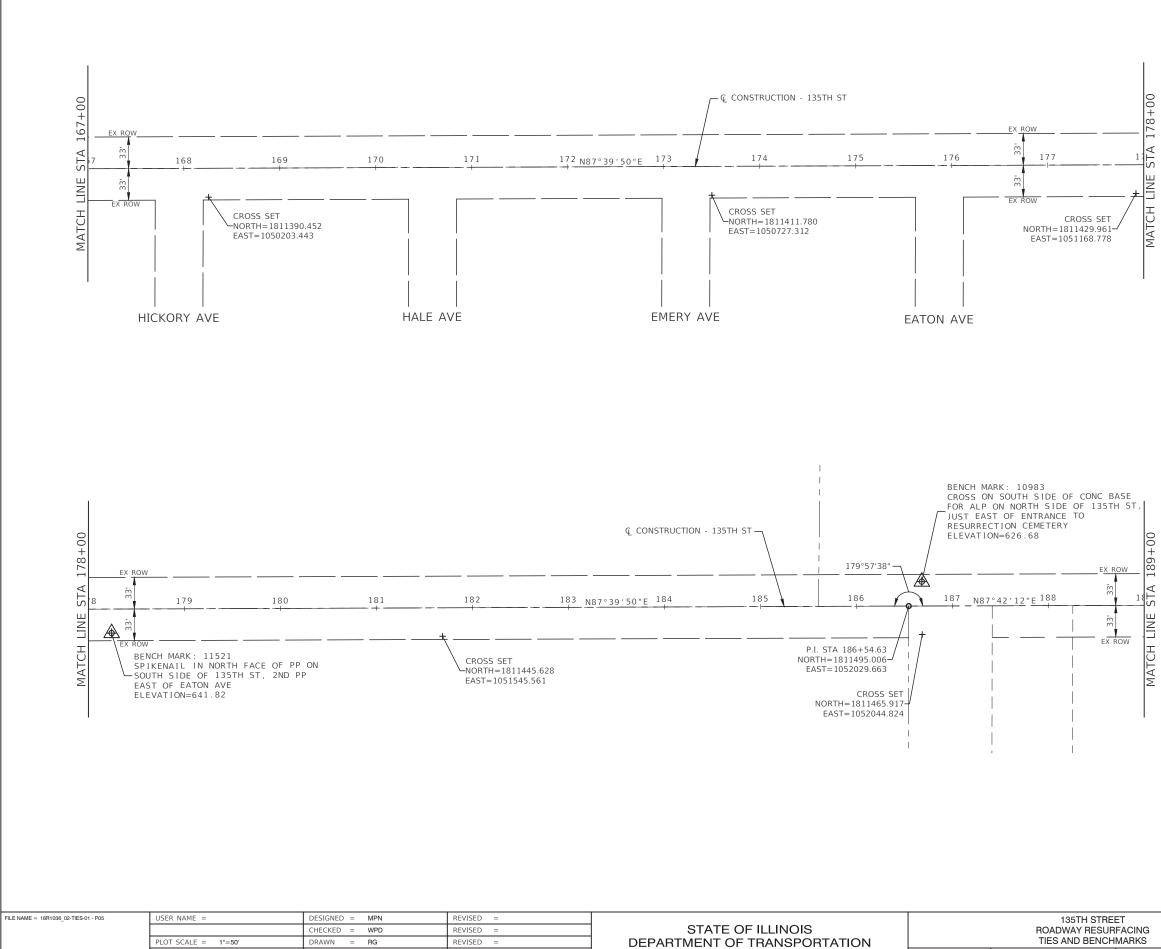
EET	F.A.U. RTE. SECTION			COUNTY	TOTAL SHEETS	SHEET NO.	
JRFACING		0282 20-00069-00-BT			WILL	76	19
HMARKS					CONTRACT I	VO. 61J8	30
S STA. TO STA.		AD DIST. NO. 1	ILLINOIS	FED. A	ID PROJECT APMT	993)	



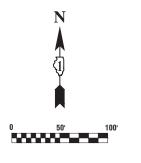

- 1. COORDINATES ARE BASED ON ILLINOIS STATE PLANE EASTERN ZONE NORTH AMERICAN DATUM 1983
- 2. SURVEY FEET UNITS WERE USED.
- 3. ALL ELEVATIONS REFER TO NAVD88 DATUM.


	EET IRFACING		F.A.U. RTE.				COUNTY	TOTAL SHEETS	SHEET NO.
			0282	0282 20-00069-00-BT			WILL	76	20
HMARKS			_				CONTRACT I	VO. 61J8	30
S	STA.	TO STA.	FED, RC	DAD DIST. NO. 1	ILLINOIS	FED. A	AID PROJECT APMT	993)	



PLOT DATE = 08-07-23


CHECKED = AG


REVISED =

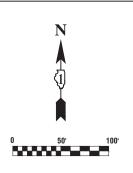

- 1. COORDINATES ARE BASED ON ILLINOIS STATE PLANE EASTERN ZONE NORTH AMERICAN DATUM 1983
- 2. SURVEY FEET UNITS WERE USED.
- 3. ALL ELEVATIONS REFER TO NAVD88 DATUM.


				F.A.U. RTE.	SECTION			COUNTY	TOTAL SHEETS	SHEET NO.
JRFACING		0282 20-00069-00-BT				WILL	76	21		
Ή	CHMARKS							CONTRACT I	NO. 61J8	30
S	STA.	TO STA.		FED, RO	AD DIST. NO. 1	ILLINOIS	FED, A	AID PROJECT APMT	993)	

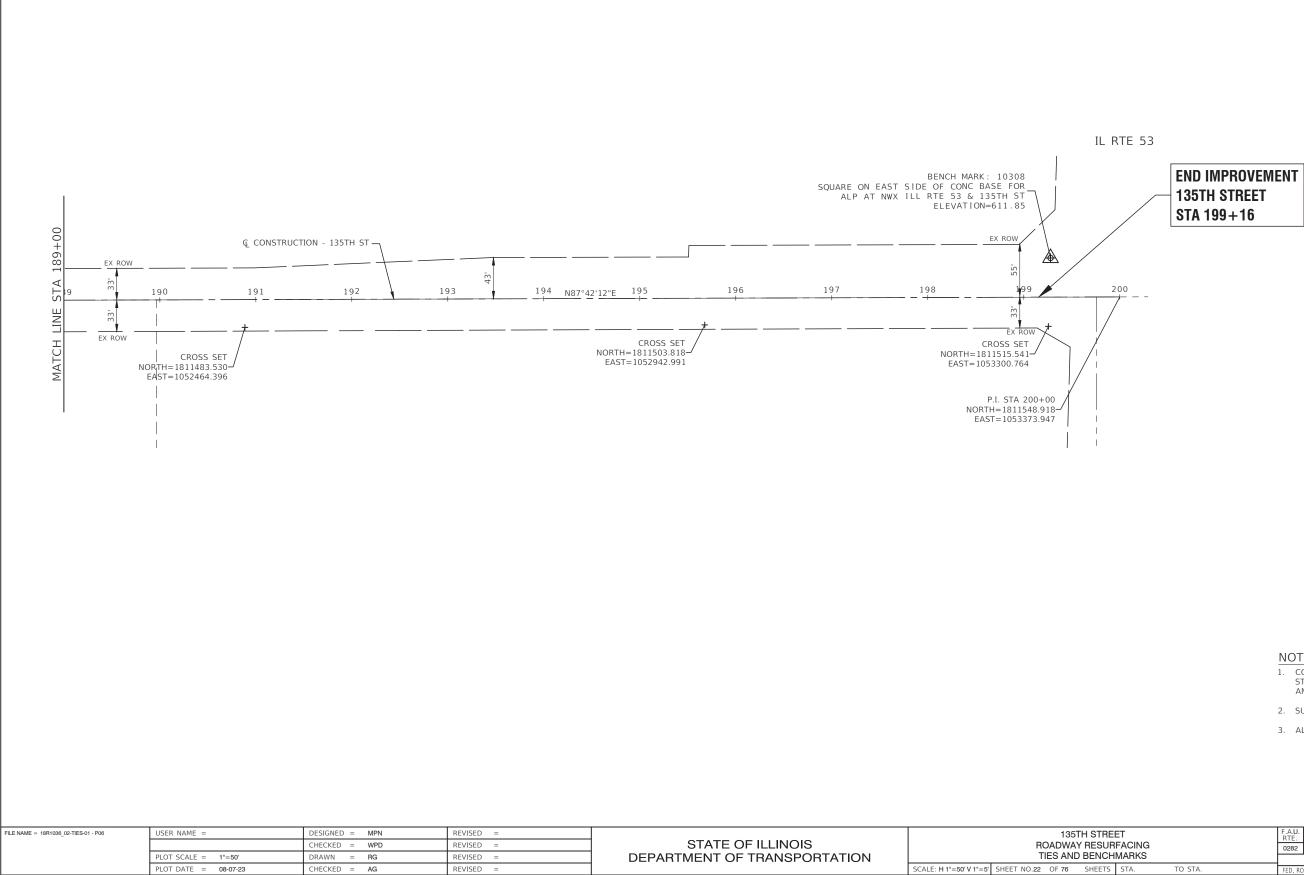

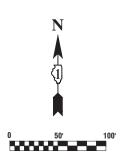


- 1. COORDINATES ARE BASED ON ILLINOIS STATE PLANE EASTERN ZONE NORTH AMERICAN DATUM 1983
- 2. SURVEY FEET UNITS WERE USED.
- 3. ALL ELEVATIONS REFER TO NAVD88 DATUM.

					SECT	ION		COUNTY	TOTAL SHEETS	SHEET NO.
JRFACING			0282	20-00069-00-BT			WILL	76	22	
CHMARKS								CONTRACT I	NO. 61J8	30
S	STA.	TO STA.		FED. RO	AD DIST. NO. 1	ILLINOIS	FED, A	ID PROJECT APMT	(993)	

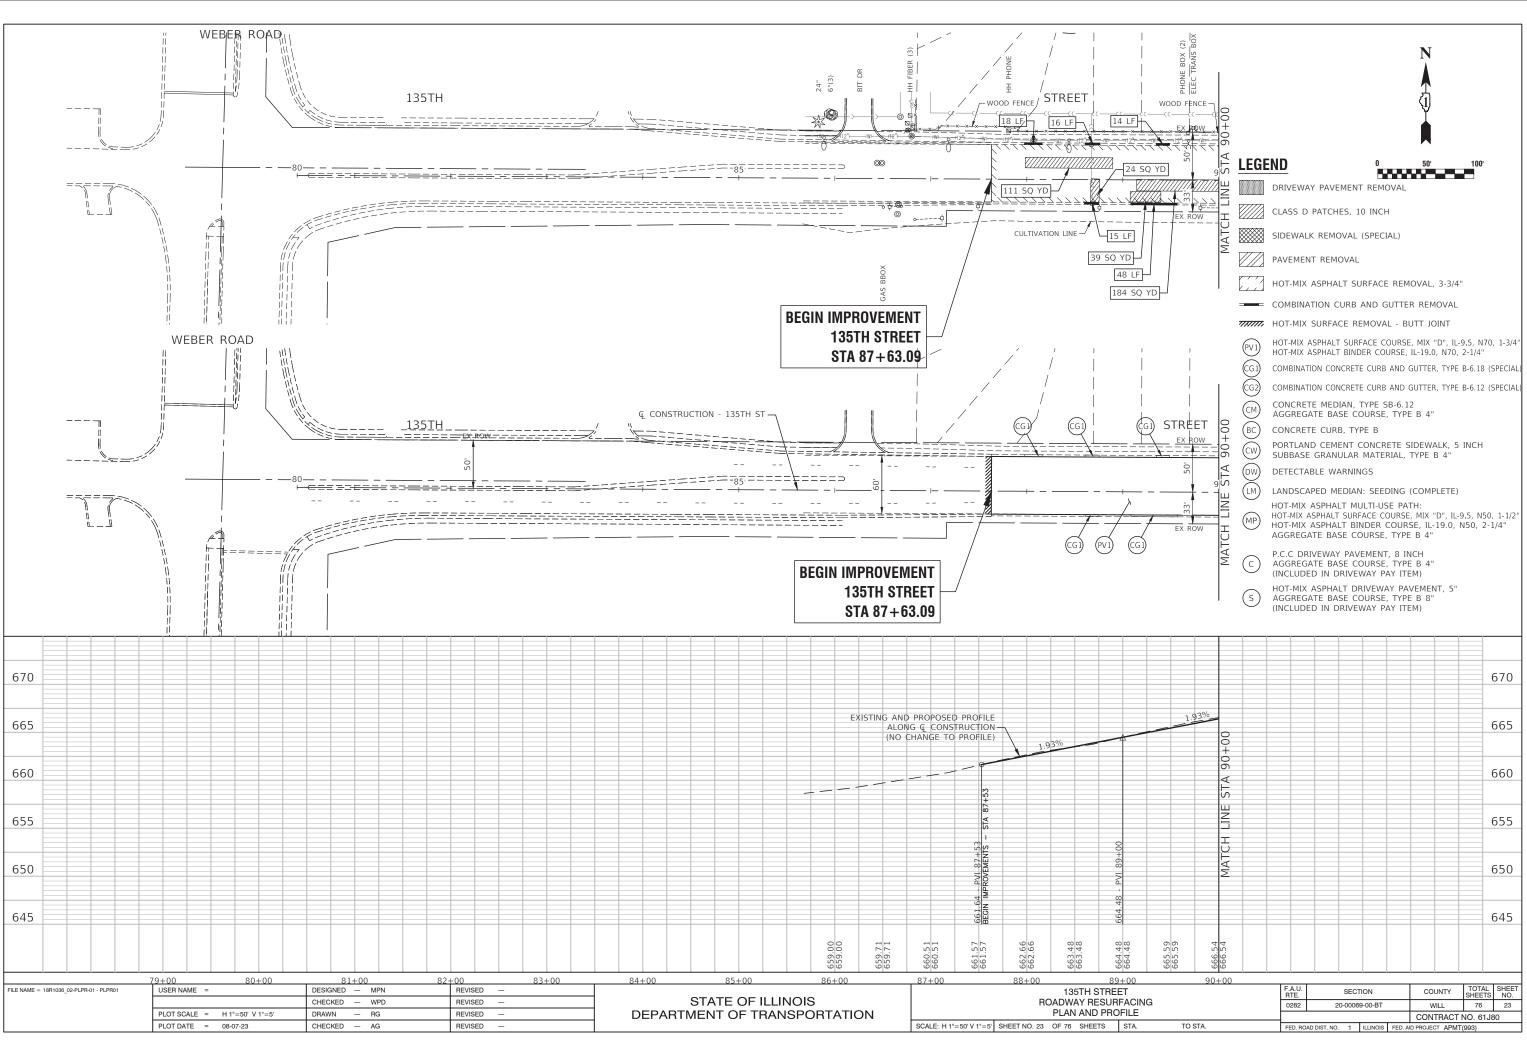

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89+00		90+00	 							
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IRFACING			0282	2	20-00069	9-00-BT	V	/ILL	76	
ROFILE							CON	TRACT I	NO. 6'	1J80

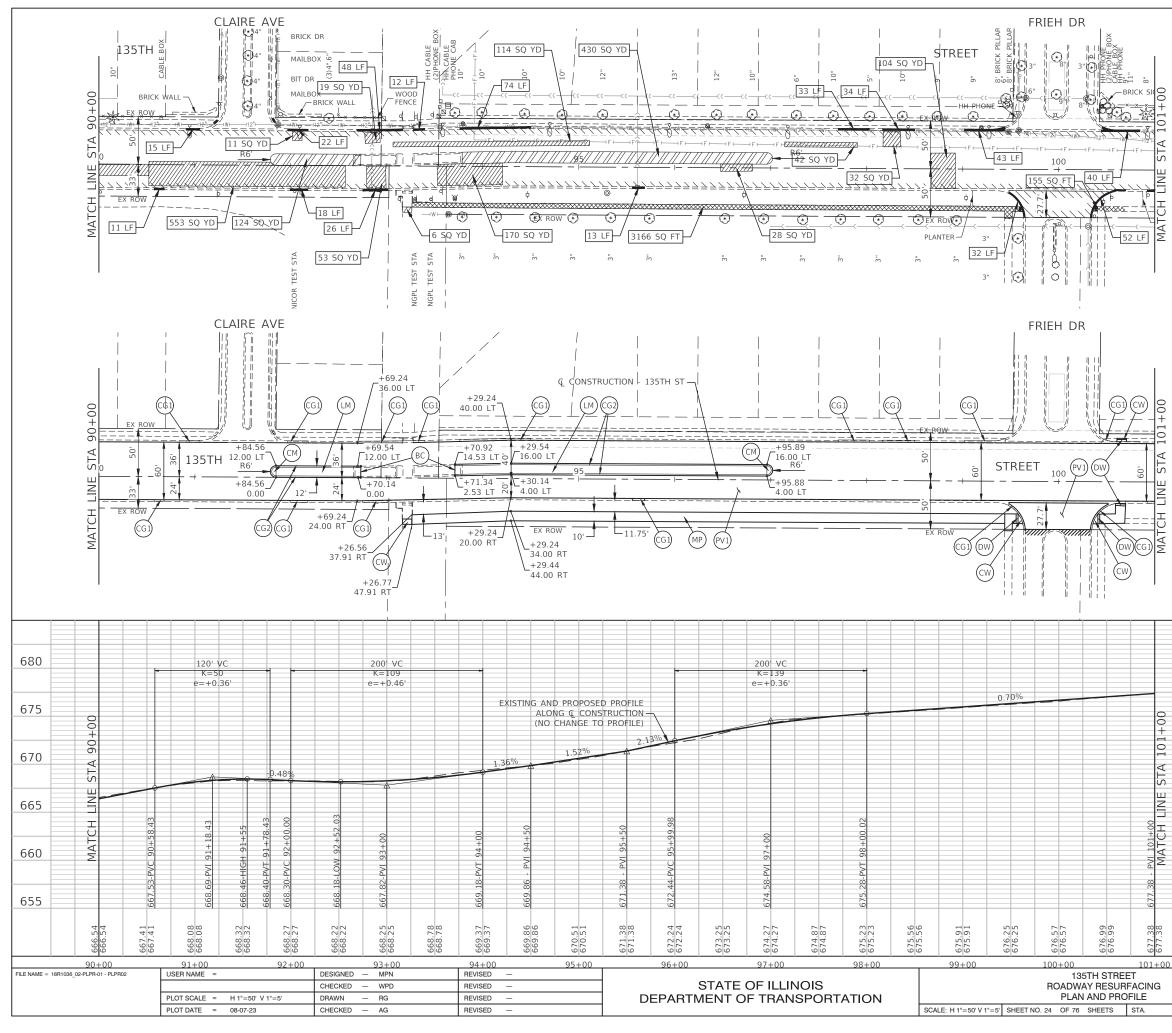




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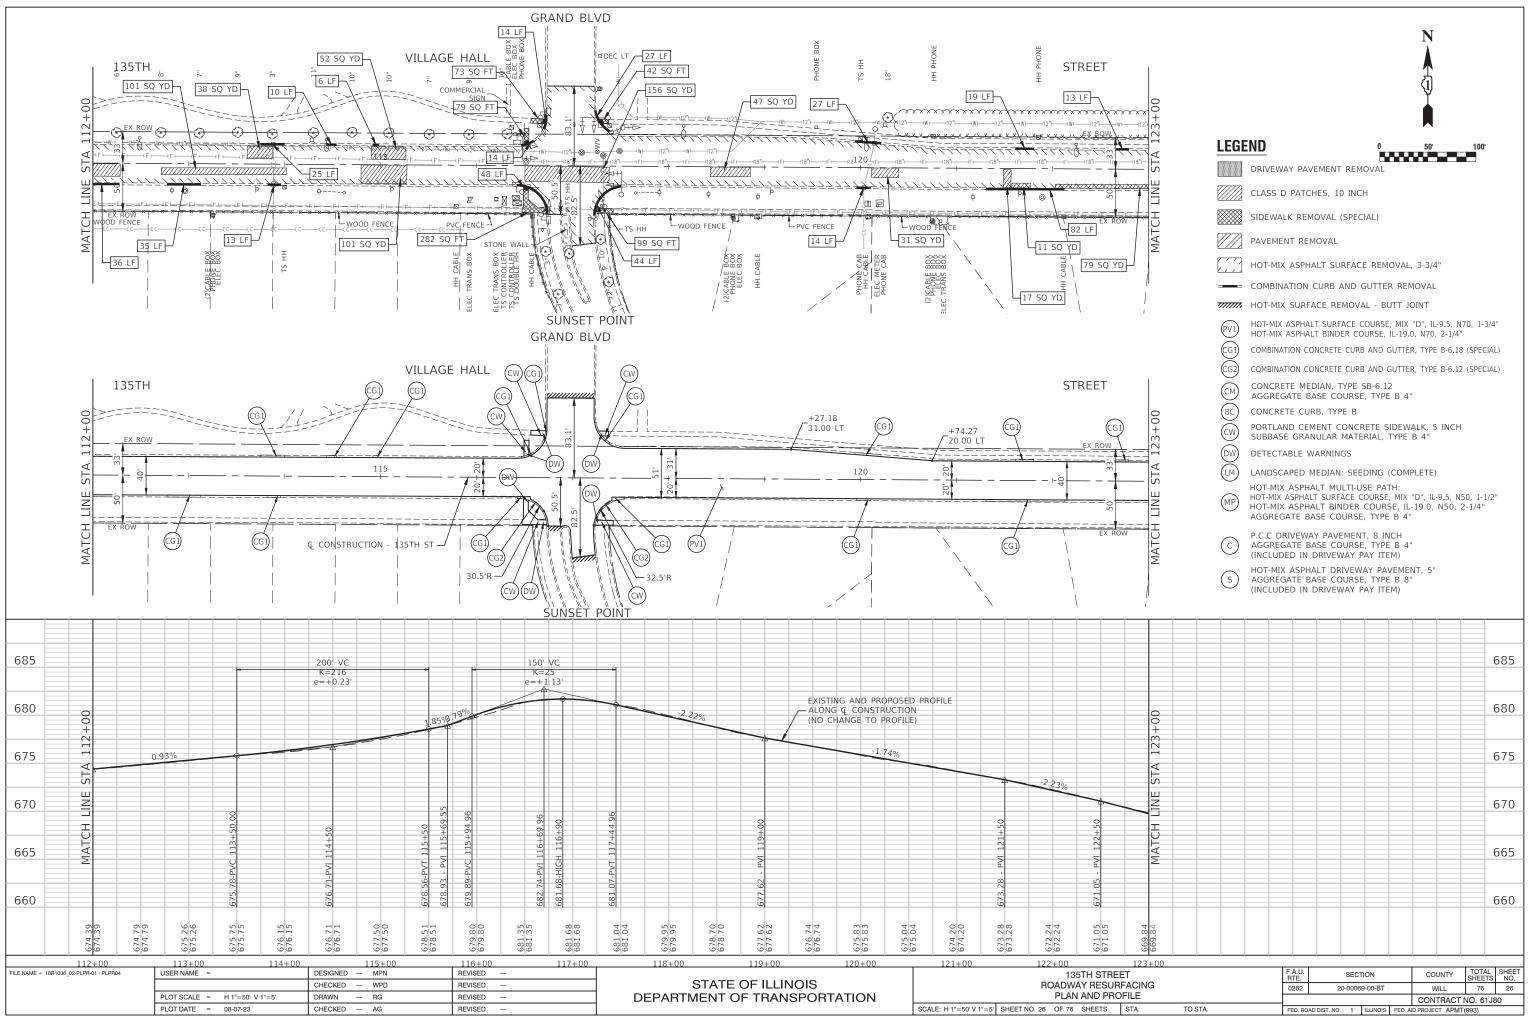
E

LEGE	ND 0 50' 100'
	DRIVEWAY PAVEMENT REMOVAL
	CLASS D PATCHES, 10 INCH
	SIDEWALK REMOVAL (SPECIAL)
	PAVEMENT REMOVAL
	HOT-MIX ASPHALT SURFACE REMOVAL, 3-3/4"
	COMBINATION CURB AND GUTTER REMOVAL
,,,,,,,,,,,,,,,,,,,,,,,,,,,,,,,,,,,,,,,	HOT-MIX SURFACE REMOVAL - BUTT JOINT
(PV1)	HOT-MIX ASPHALT SURFACE COURSE, MIX "D", IL-9.5, N70, 1-3/4" HOT-MIX ASPHALT BINDER COURSE, IL-19.0, N70, 2-1/4"
CG1	COMBINATION CONCRETE CURB AND GUTTER, TYPE B-6.18 (SPECIAL)
CG2	COMBINATION CONCRETE CURB AND GUTTER, TYPE B-6.12 (SPECIAL)
CM	CONCRETE MEDIAN, TYPE SB-6.12 AGGREGATE BASE COURSE, TYPE B 4"
BC	CONCRETE CURB, TYPE B
CW	PORTLAND CEMENT CONCRETE SIDEWALK, 5 INCH SUBBASE GRANULAR MATERIAL, TYPE B 4"
DW	DETECTABLE WARNINGS
LM	LANDSCAPED MEDIAN: SEEDING (COMPLETE)
MP	HOT-MIX ASPHALT MULTI-USE PATH: HOT-MIX ASPHALT SURFACE COURSE, MIX "D", IL-9.5, N50, 1-1/2" HOT-MIX ASPHALT BINDER COURSE, IL-19.0, N50, 2-1/4" AGGREGATE BASE COURSE, TYPE B 4"
С	P.C.C DRIVEWAY PAVEMENT, 8 INCH AGGREGATE BASE COURSE, TYPE B 4" (INCLUDED IN DRIVEWAY PAY ITEM)
5	HOT-MIX ASPHALT DRIVEWAY PAVEMENT, 5" AGGREGATE BASE COURSE, TYPE B 8" (INCLUDED IN DRIVEWAY PAY ITEM)


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	F.A.U. RTE.	SECTION		COUNTY	TOTAL SHEETS	SHEET	
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E		F.A.U. RTE.		SECT	TION		COUNTY	TOTAL SHEETS	SHEET NO.			
JRFACING				20-	0006	9-00-BT		WILL	76	25		
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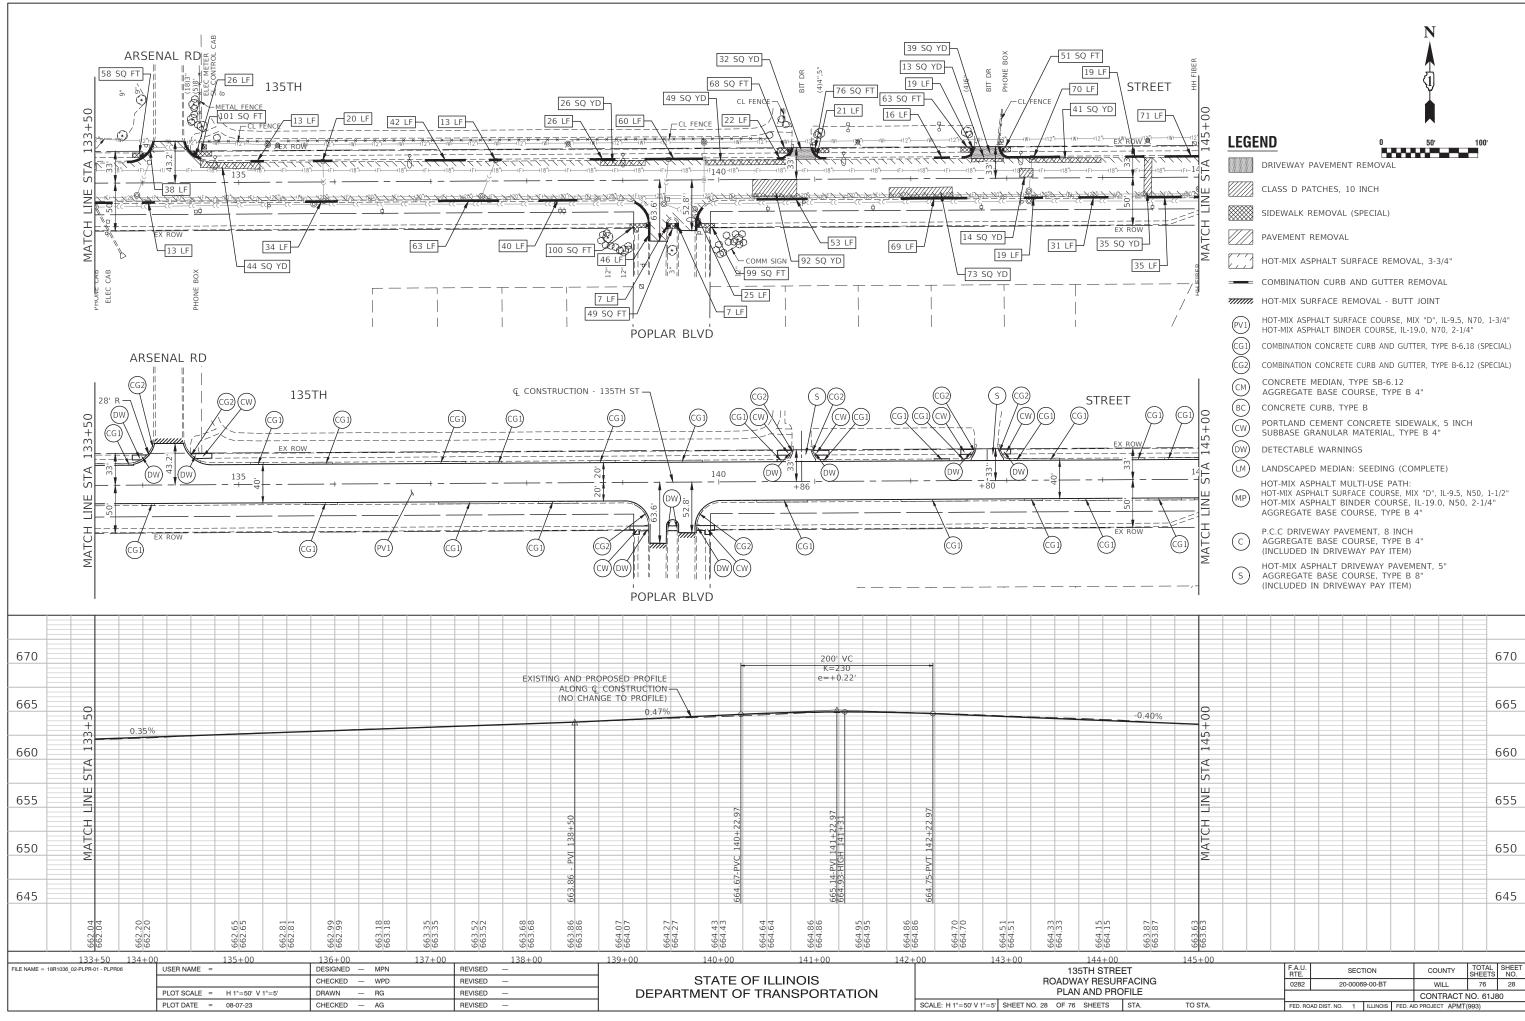
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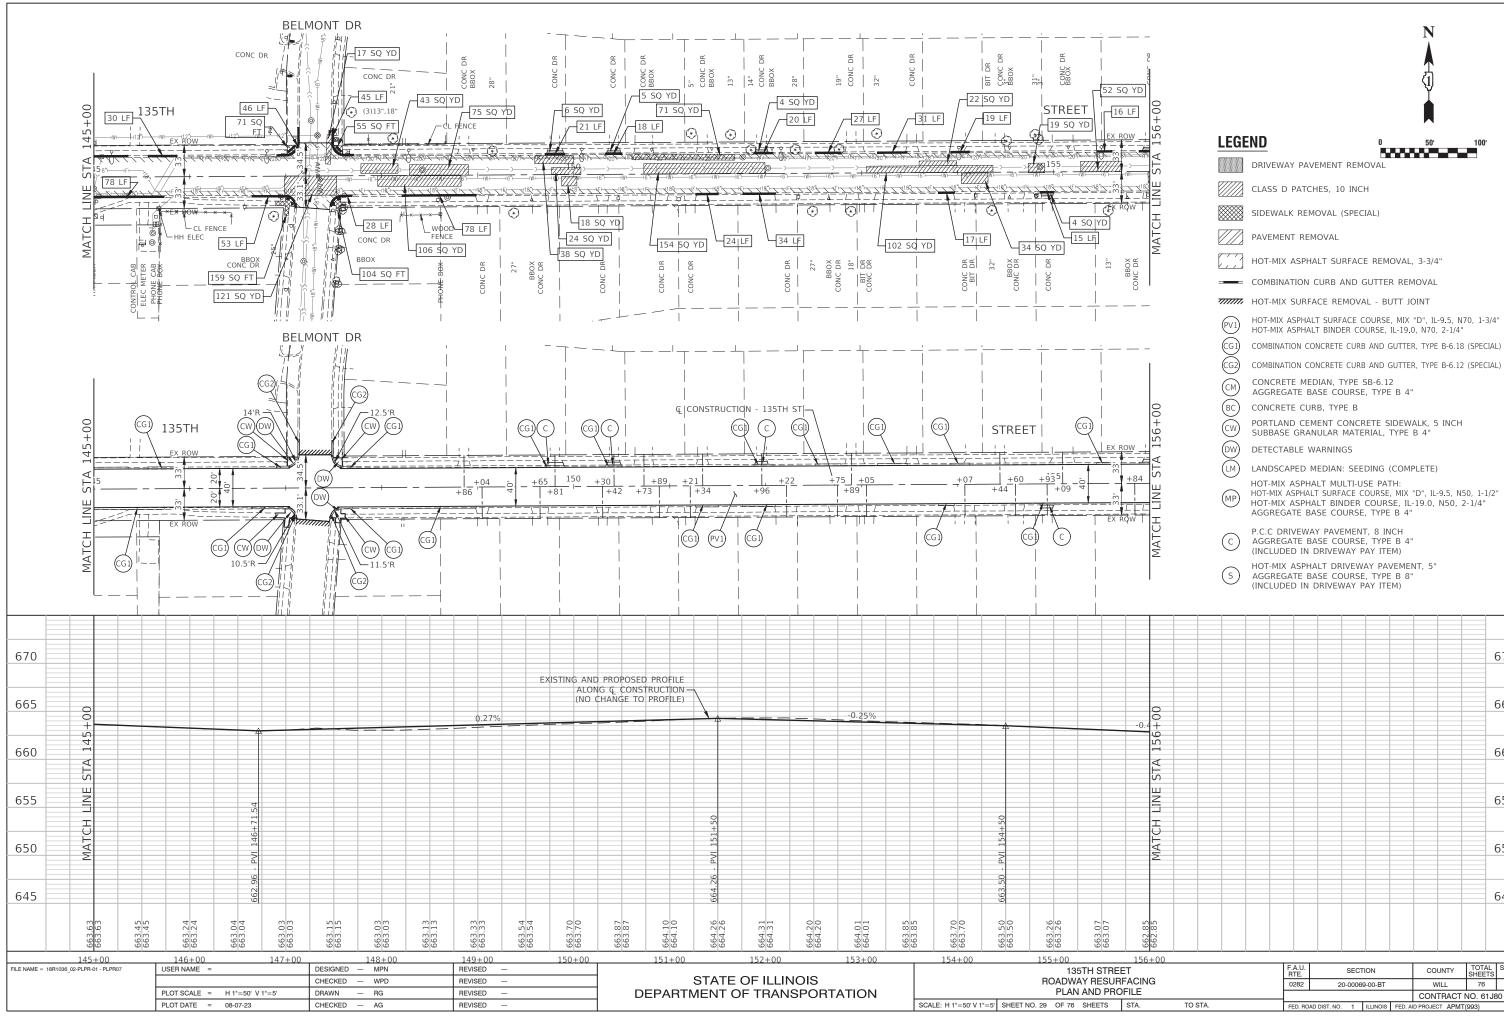
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LEGE	ND 0 50' 100'
	CLASS D PATCHES, 10 INCH
	SIDEWALK REMOVAL (SPECIAL)
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	HOT-MIX ASPHALT SURFACE REMOVAL, 3-3/4"
	COMBINATION CURB AND GUTTER REMOVAL
777777 7	HOT-MIX SURFACE REMOVAL - BUTT JOINT
(PV1)	HOT-MIX ASPHALT SURFACE COURSE, MIX "D", IL-9.5, N70, 1-3/4" HOT-MIX ASPHALT BINDER COURSE, IL-19.0, N70, 2-1/4"
CG1)	COMBINATION CONCRETE CURB AND GUTTER, TYPE B-6.18 (SPECIAL)
CG2	COMBINATION CONCRETE CURB AND GUTTER, TYPE B-6.12 (SPECIAL)
CM	CONCRETE MEDIAN, TYPE SB-6.12 AGGREGATE BASE COURSE, TYPE B 4"
BC	CONCRETE CURB, TYPE B
CW	PORTLAND CEMENT CONCRETE SIDEWALK, 5 INCH SUBBASE GRANULAR MATERIAL, TYPE B 4"
DW	DETECTABLE WARNINGS
LM	LANDSCAPED MEDIAN: SEEDING (COMPLETE)
MP	HOT-MIX ASPHALT MULTI-USE PATH: HOT-MIX ASPHALT SURFACE COURSE, MIX "D", IL-9.5, N50, 1-1/2" HOT-MIX ASPHALT BINDER COURSE, IL-19.0, N50, 2-1/4" AGGREGATE BASE COURSE, TYPE B 4"
С	P.C.C DRIVEWAY PAVEMENT, 8 INCH AGGREGATE BASE COURSE, TYPE B 4" (INCLUDED IN DRIVEWAY PAY ITEM)
S	HOT-MIX ASPHALT DRIVEWAY PAVEMENT, 5" AGGREGATE BASE COURSE, TYPE B 8" (INCLUDED IN DRIVEWAY PAY ITEM)

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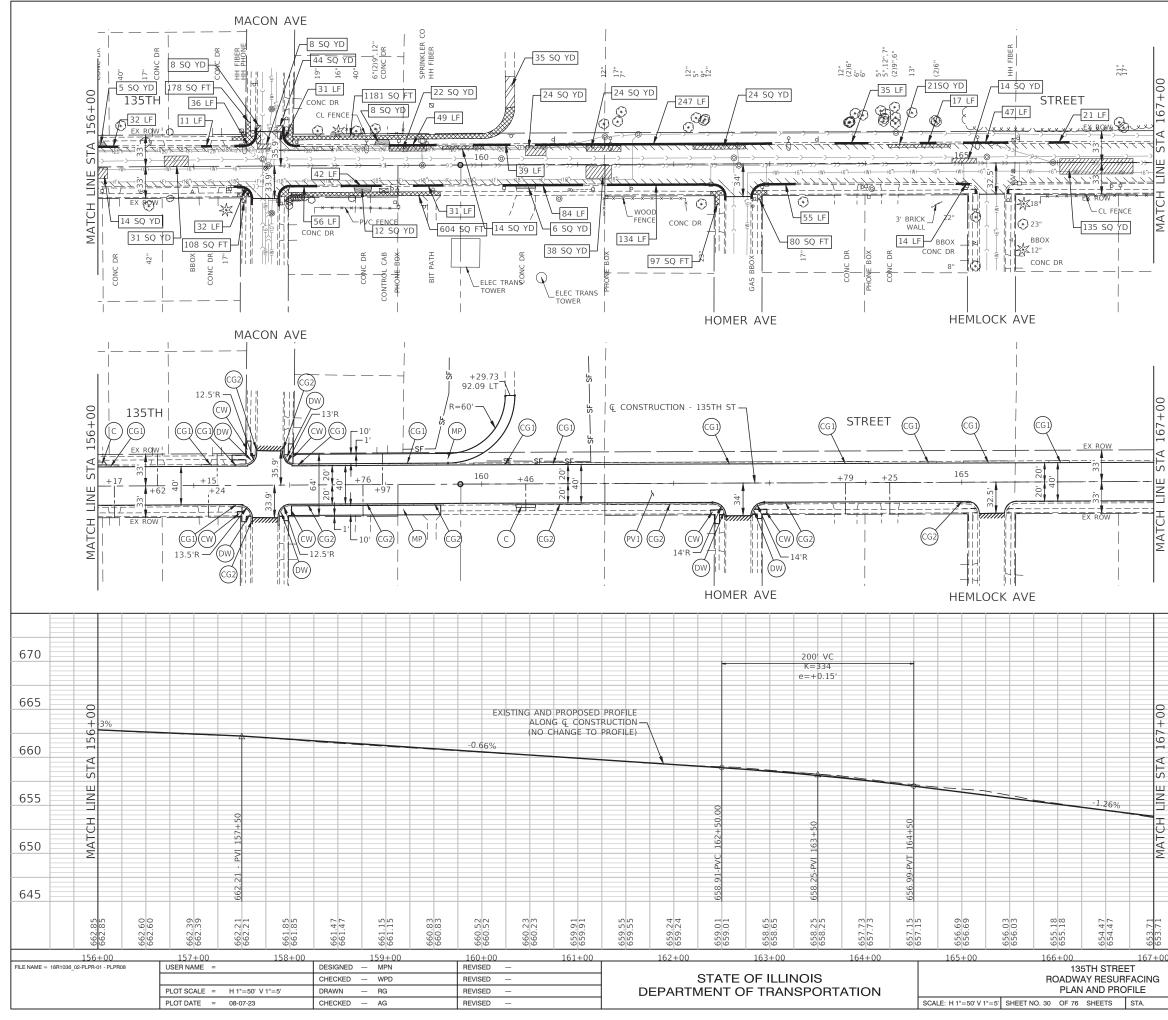

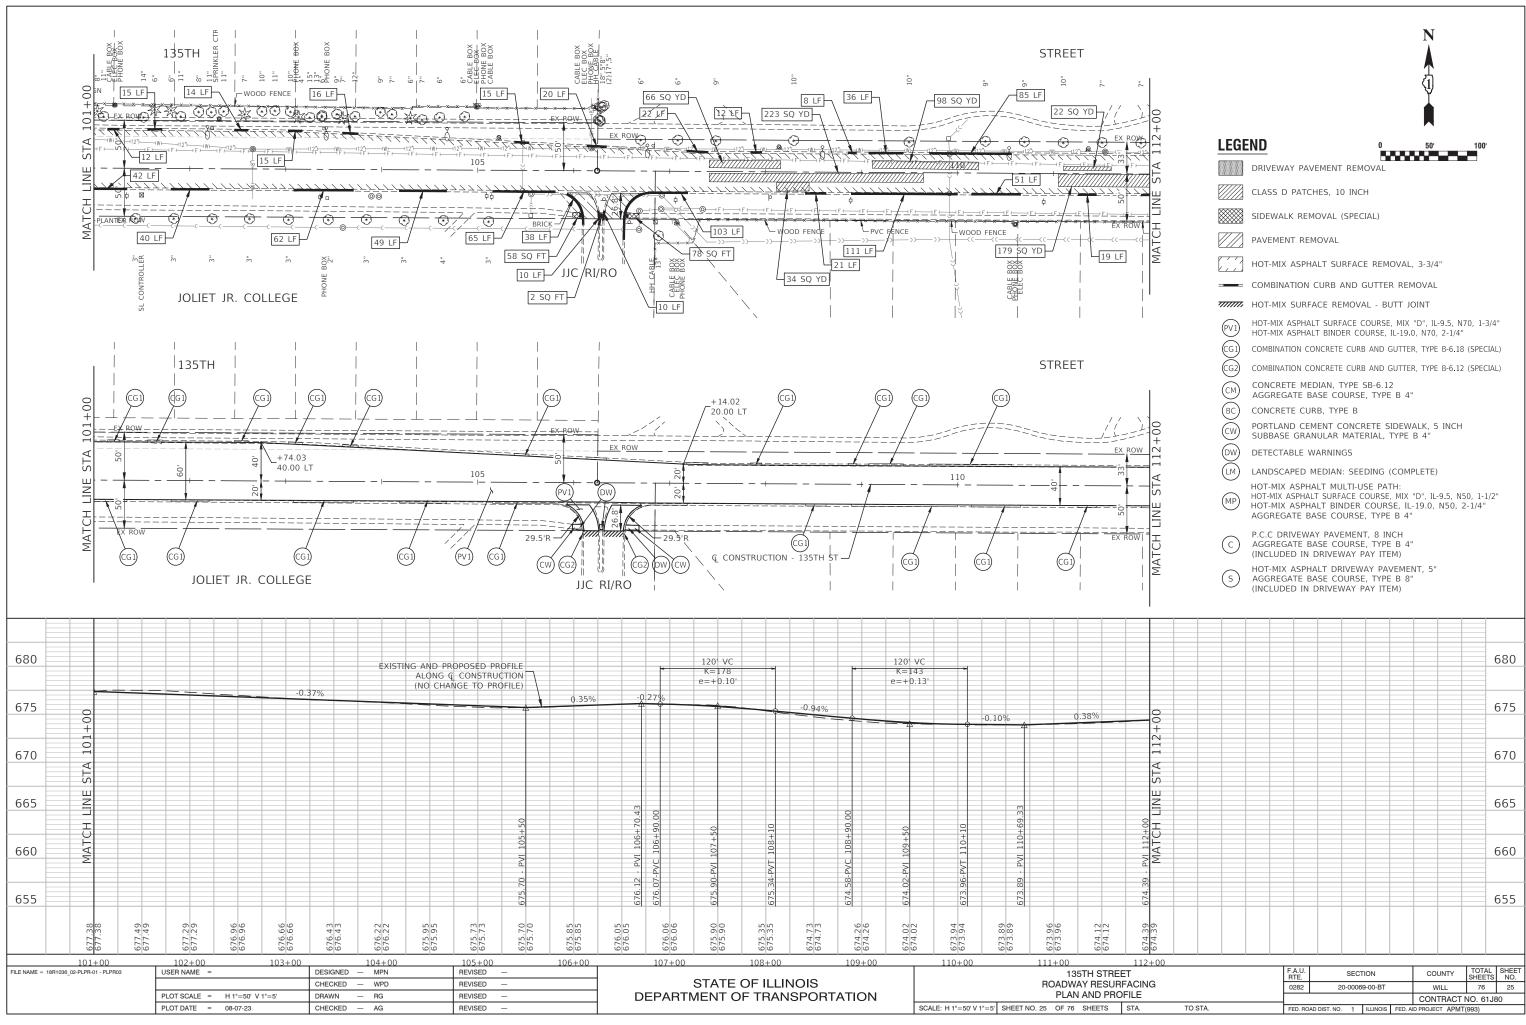
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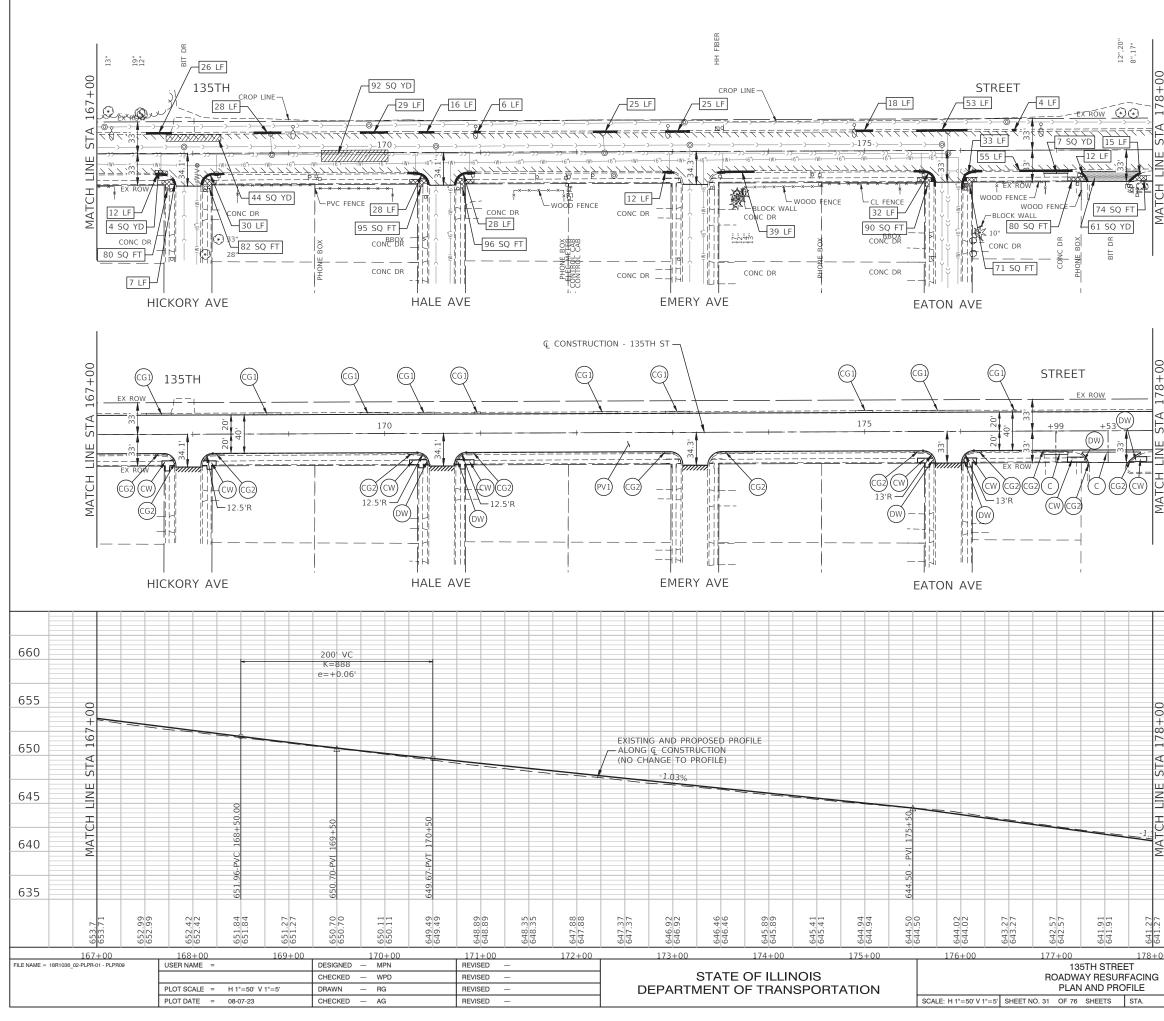
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CONTRACT NO. 61J80 FED. ROAD DIST. NO. 1 ILLINOIS FED. AID PROJECT APMT(993



LEGE	ND 0 50' 100'
	DRIVEWAY PAVEMENT REMOVAL
	CLASS D PATCHES, 10 INCH
	SIDEWALK REMOVAL (SPECIAL)
	PAVEMENT REMOVAL
	HOT-MIX ASPHALT SURFACE REMOVAL, 3-3/4"
	COMBINATION CURB AND GUTTER REMOVAL
,,,,,,,,,,,,,,,,,,,,,,,,,,,,,,,,,,,,,,,	HOT-MIX SURFACE REMOVAL - BUTT JOINT
(PV1)	HOT-MIX ASPHALT SURFACE COURSE, MIX "D", IL-9.5, N70, 1-3/4" HOT-MIX ASPHALT BINDER COURSE, IL-19.0, N70, 2-1/4"
CG1)	COMBINATION CONCRETE CURB AND GUTTER, TYPE B-6.18 (SPECIAL)
CG2	COMBINATION CONCRETE CURB AND GUTTER, TYPE B-6.12 (SPECIAL)
CM	CONCRETE MEDIAN, TYPE SB-6.12 AGGREGATE BASE COURSE, TYPE B 4"
BC	CONCRETE CURB, TYPE B
ĊW	PORTLAND CEMENT CONCRETE SIDEWALK, 5 INCH SUBBASE GRANULAR MATERIAL, TYPE B 4"
DW	DETECTABLE WARNINGS
(LM)	LANDSCAPED MEDIAN: SEEDING (COMPLETE)
MP	HOT-MIX ASPHALT MULTI-USE PATH: HOT-MIX ASPHALT SURFACE COURSE, MIX "D", IL-9.5, N50, 1-1/2" HOT-MIX ASPHALT BINDER COURSE, IL-19.0, N50, 2-1/4" AGGREGATE BASE COURSE, TYPE B 4"
С	P.C.C DRIVEWAY PAVEMENT, 8 INCH AGGREGATE BASE COURSE, TYPE B 4" (INCLUDED IN DRIVEWAY PAY ITEM)
5	HOT-MIX ASPHALT DRIVEWAY PAVEMENT, 5" AGGREGATE BASE COURSE, TYPE B 8" (INCLUDED IN DRIVEWAY PAY ITEM)

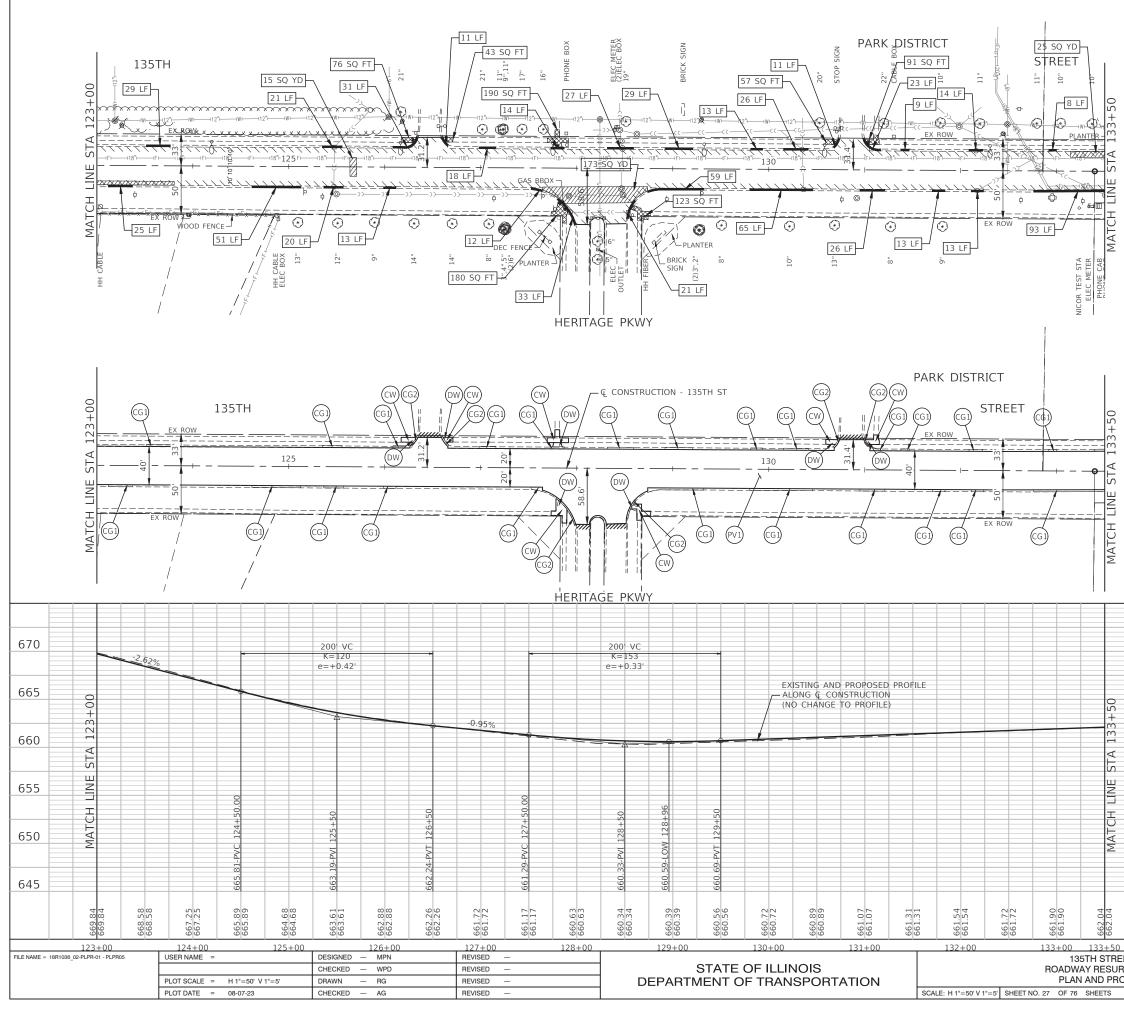
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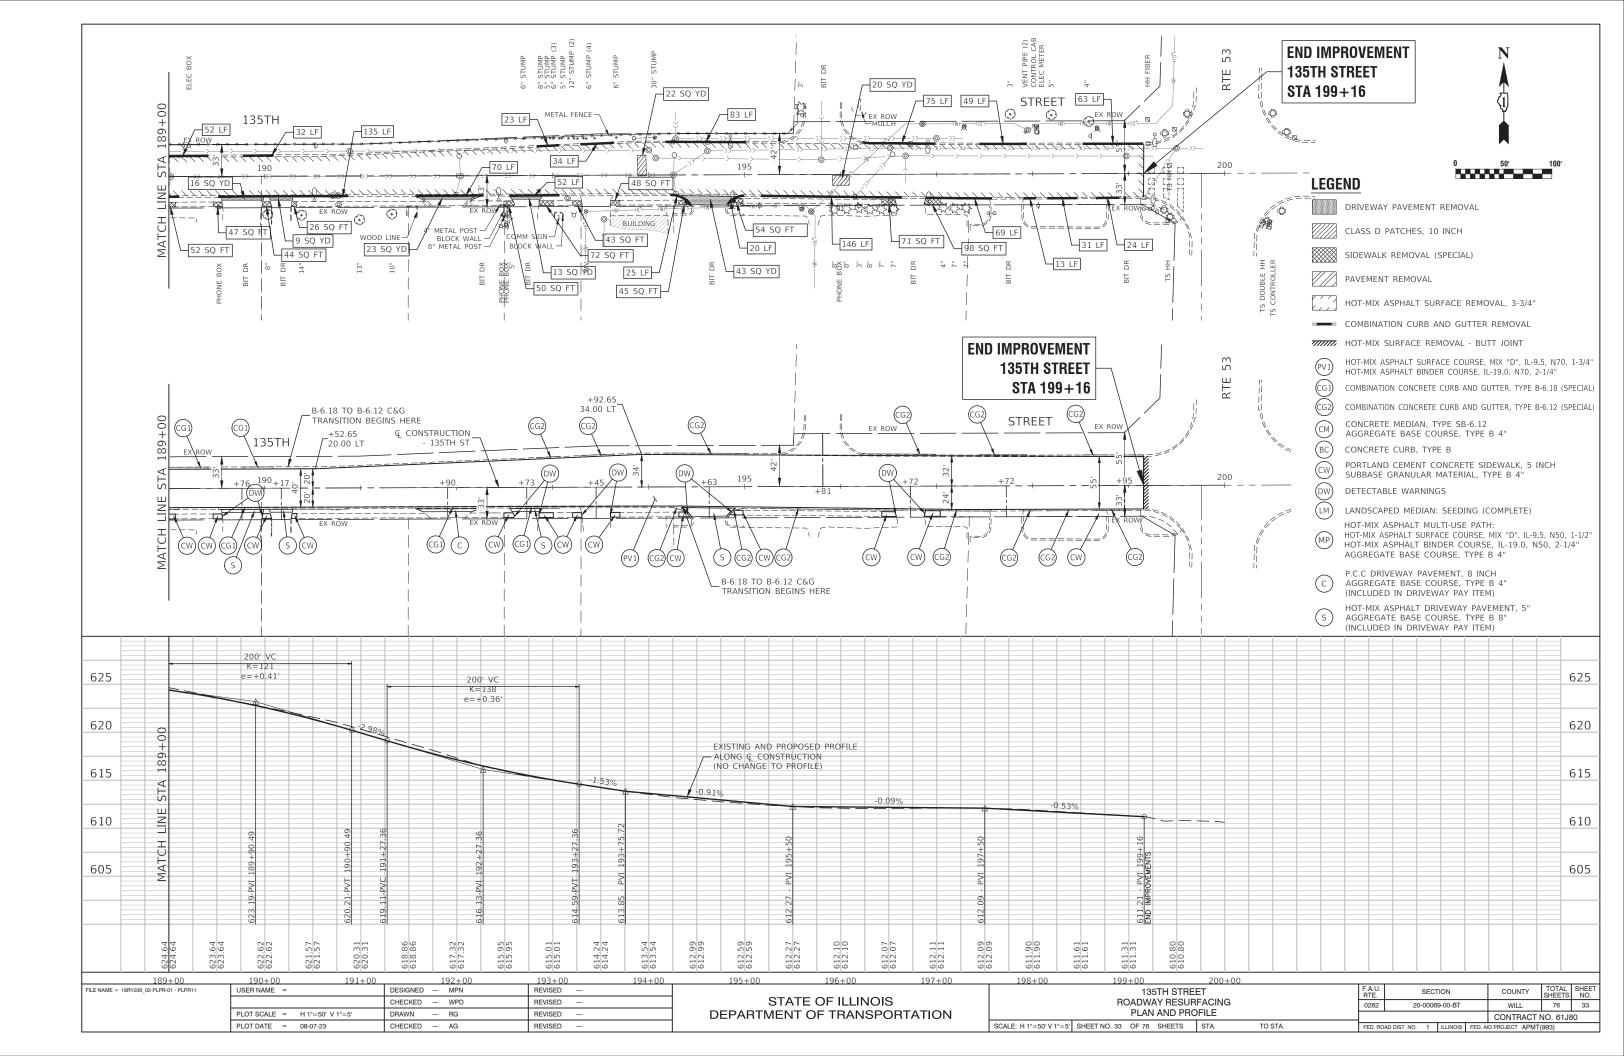
EGE	ND 0 50' 100'
	DRIVEWAY PAVEMENT REMOVAL
	CLASS D PATCHES, 10 INCH
	SIDEWALK REMOVAL (SPECIAL)
	PAVEMENT REMOVAL
	HOT-MIX ASPHALT SURFACE REMOVAL, 3-3/4"
	COMBINATION CURB AND GUTTER REMOVAL
,,,,,,,,,,,,,,,,,,,,,,,,,,,,,,,,,,,,,,,	HOT-MIX SURFACE REMOVAL - BUTT JOINT
(PV1)	HOT-MIX ASPHALT SURFACE COURSE, MIX "D", IL-9.5, N70, 1-3/4" HOT-MIX ASPHALT BINDER COURSE, IL-19.0, N70, 2-1/4"
(CG1)	COMBINATION CONCRETE CURB AND GUTTER, TYPE B-6.18 (SPECIAL)
CG2	COMBINATION CONCRETE CURB AND GUTTER, TYPE B-6.12 (SPECIAL)
(CM)	CONCRETE MEDIAN, TYPE SB-6.12 AGGREGATE BASE COURSE, TYPE B 4"
(BC)	CONCRETE CURB, TYPE B
œ	PORTLAND CEMENT CONCRETE SIDEWALK, 5 INCH SUBBASE GRANULAR MATERIAL, TYPE B 4"
DW	DETECTABLE WARNINGS
(LM)	LANDSCAPED MEDIAN: SEEDING (COMPLETE)
MP	HOT-MIX ASPHALT MULTI-USE PATH: HOT-MIX ASPHALT SURFACE COURSE, MIX "D", IL-9.5, N50, 1-1/2" HOT-MIX ASPHALT BINDER COURSE, IL-19.0, N50, 2-1/4" AGGREGATE BASE COURSE, TYPE B 4"
С	P.C.C DRIVEWAY PAVEMENT, 8 INCH AGGREGATE BASE COURSE, TYPE B 4" (INCLUDED IN DRIVEWAY PAY ITEM)
S	HOT-MIX ASPHALT DRIVEWAY PAVEMENT, 5" AGGREGATE BASE COURSE, TYPE B 8" (INCLUDED IN DRIVEWAY PAY ITEM)


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LEGE	
	DRIVEWAY PAVEMENT REMOVAL
	CLASS D PATCHES, 10 INCH
	SIDEWALK REMOVAL (SPECIAL)
	PAVEMENT REMOVAL
	HOT-MIX ASPHALT SURFACE REMOVAL, 3-3/4"
_	COMBINATION CURB AND GUTTER REMOVAL
777777 7	HOT-MIX SURFACE REMOVAL - BUTT JOINT
(PV1)	HOT-MIX ASPHALT SURFACE COURSE, MIX "D", IL-9.5, N70, 1-3/4" HOT-MIX ASPHALT BINDER COURSE, IL-19.0, N70, 2-1/4"
(CG1)	COMBINATION CONCRETE CURB AND GUTTER, TYPE B-6.18 (SPECIAL)
CG2	COMBINATION CONCRETE CURB AND GUTTER, TYPE B-6.12 (SPECIAL)
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BC	CONCRETE CURB, TYPE B
CW	PORTLAND CEMENT CONCRETE SIDEWALK, 5 INCH SUBBASE GRANULAR MATERIAL, TYPE B 4"
DW	DETECTABLE WARNINGS
LM	LANDSCAPED MEDIAN: SEEDING (COMPLETE)
MP	HOT-MIX ASPHALT MULTI-USE PATH: HOT-MIX ASPHALT SURFACE COURSE, MIX "D", IL-9.5, N50, 1-1/2" HOT-MIX ASPHALT BINDER COURSE, IL-19.0, N50, 2-1/4" AGGREGATE BASE COURSE, TYPE B 4"
С	P.C.C DRIVEWAY PAVEMENT, 8 INCH AGGREGATE BASE COURSE, TYPE B 4" (INCLUDED IN DRIVEWAY PAY ITEM)
S	HOT-MIX ASPHALT DRIVEWAY PAVEMENT, 5" AGGREGATE BASE COURSE, TYPE B 8" (INCLUDED IN DRIVEWAY PAY ITEM)

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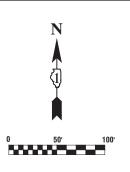





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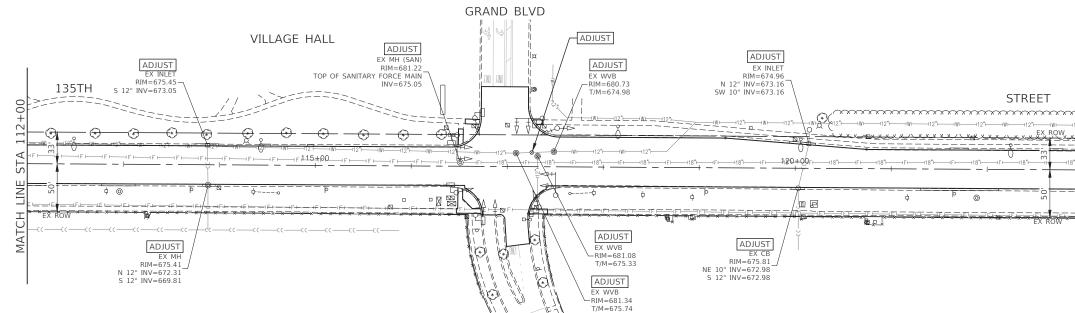
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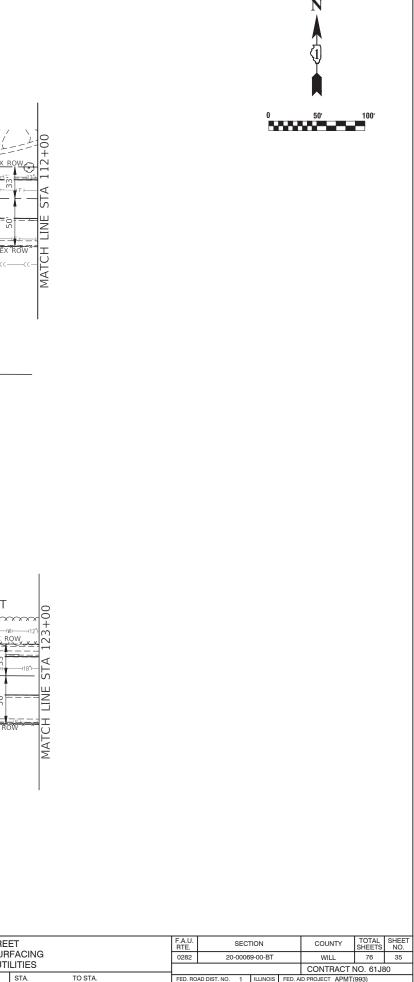


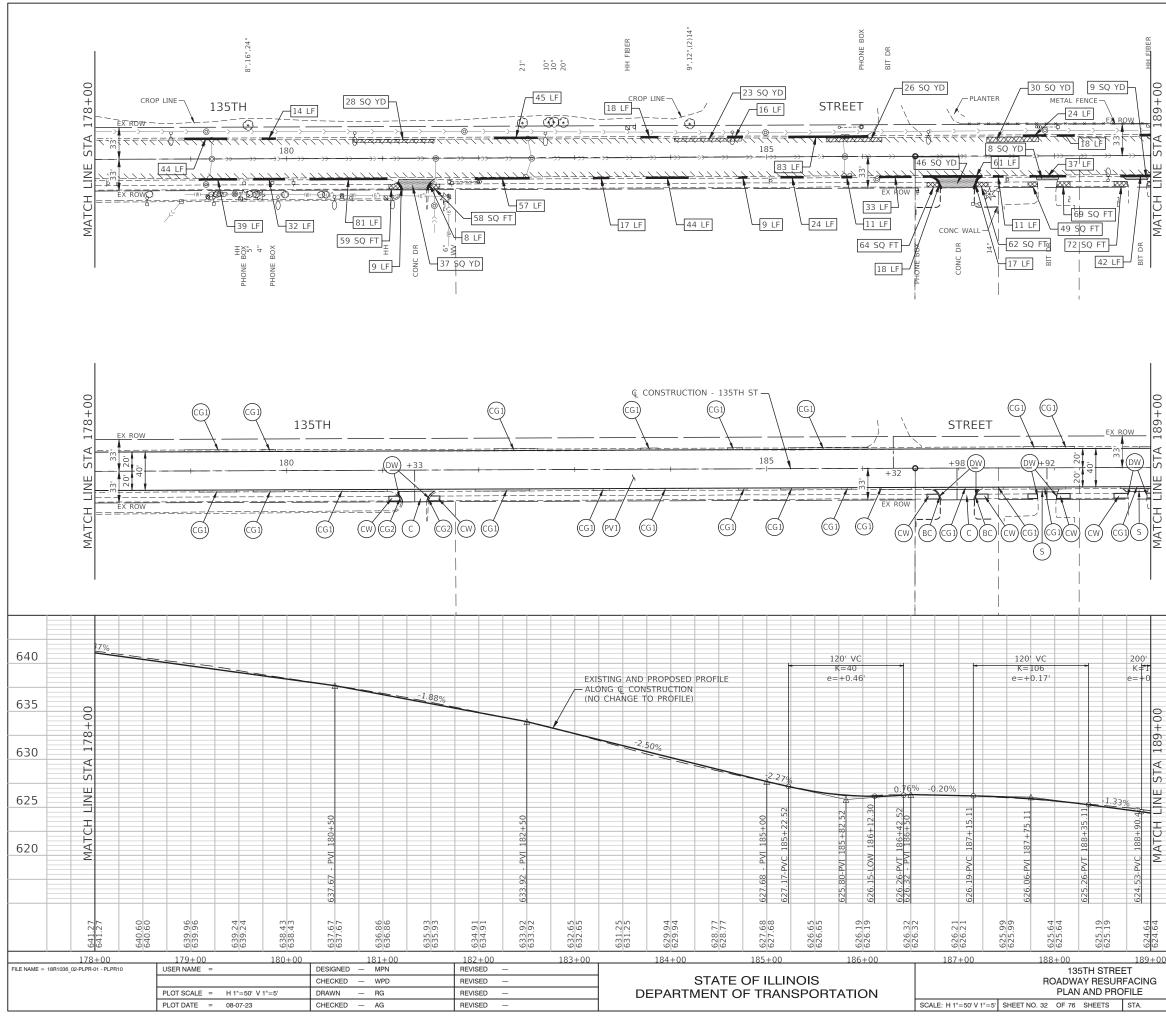
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				CONTRACT NO. 61J80			
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FILE NAME = 18R1036_02-STRM-01 - PLPR02	USER NAME =	DESIGNED - MPN	REVISED —		135TH STREET
		CHECKED — WPD	REVISED —	STATE OF ILLINOIS	ROADWAY RESURFA
	PLOT SCALE = H 1"=50' V 1"=5'	DRAWN — RG	REVISED —	DEPARTMENT OF TRANSPORTATION	DRAINAGE & UTILI
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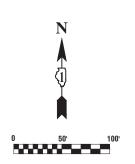


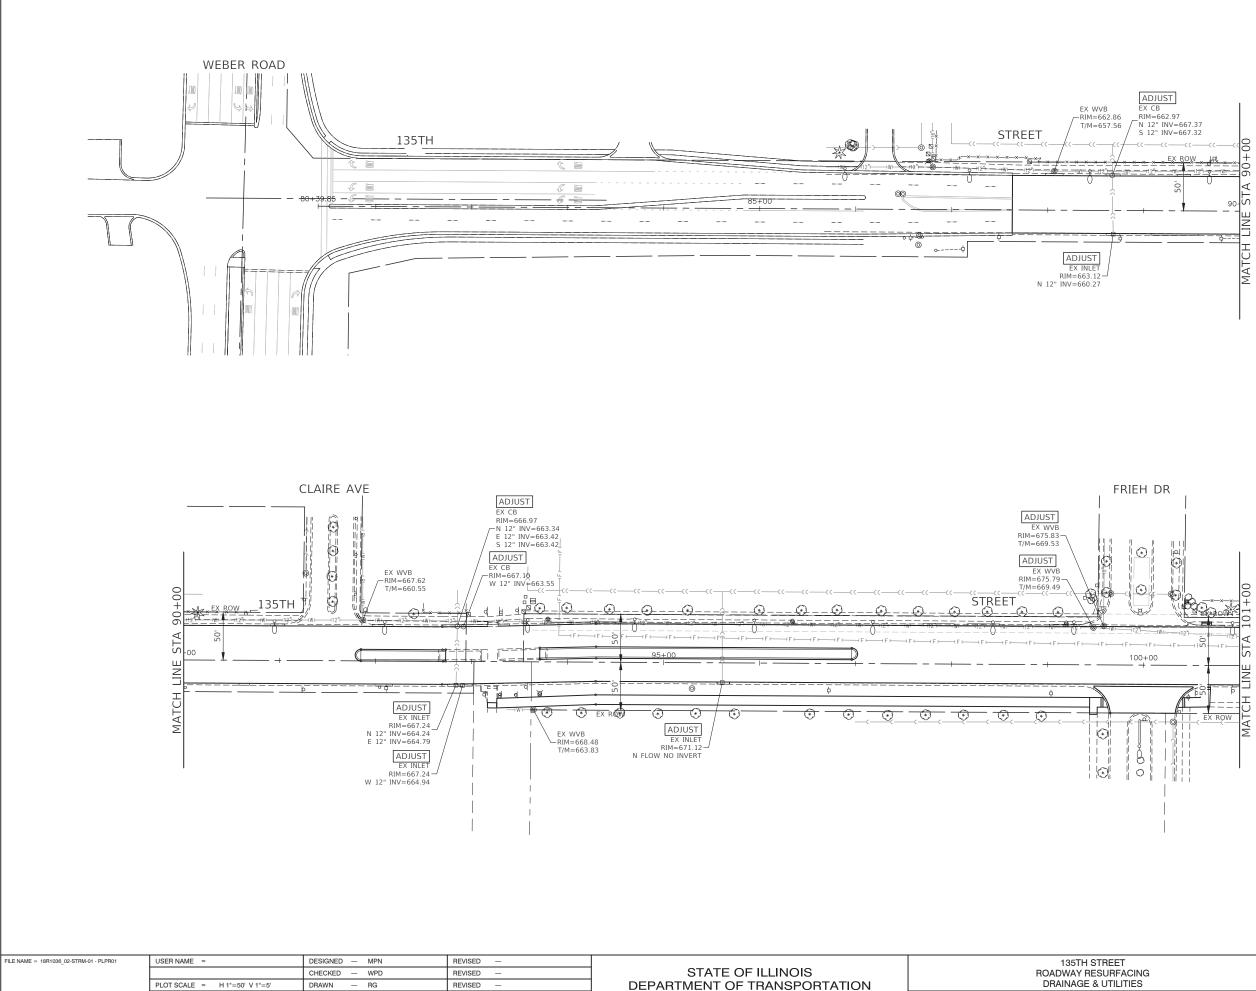
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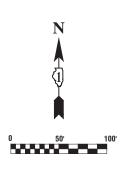
REVISED


	ст		F.A.U.	SEC	MOIT		COUNTY	TOTAL	SHEET	
REET				RTE. SECTION			COONTI	SHEETS	NO.	
JRFACING			0282	20-000	20-00069-00-BT			76	36	
JTILITIES						CONTRACT NO. 61J80				
	STA.	TO STA.	FED. R	FED. ROAD DIST. NO. 1 ILLINOIS FED. AID PROJECT APMT(993)						



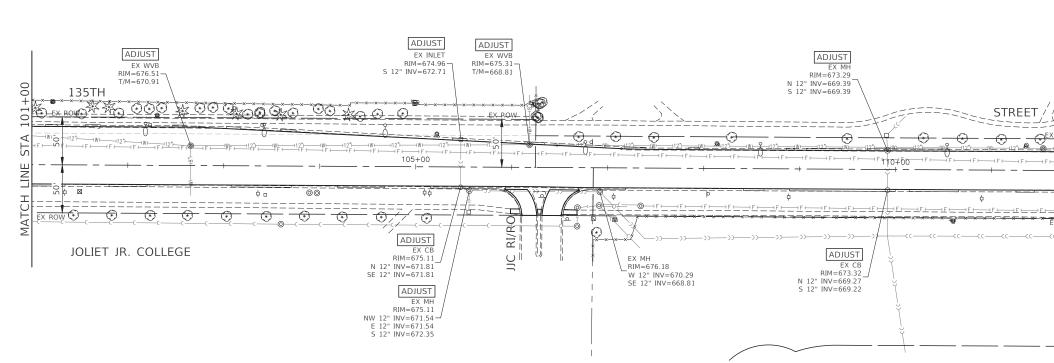


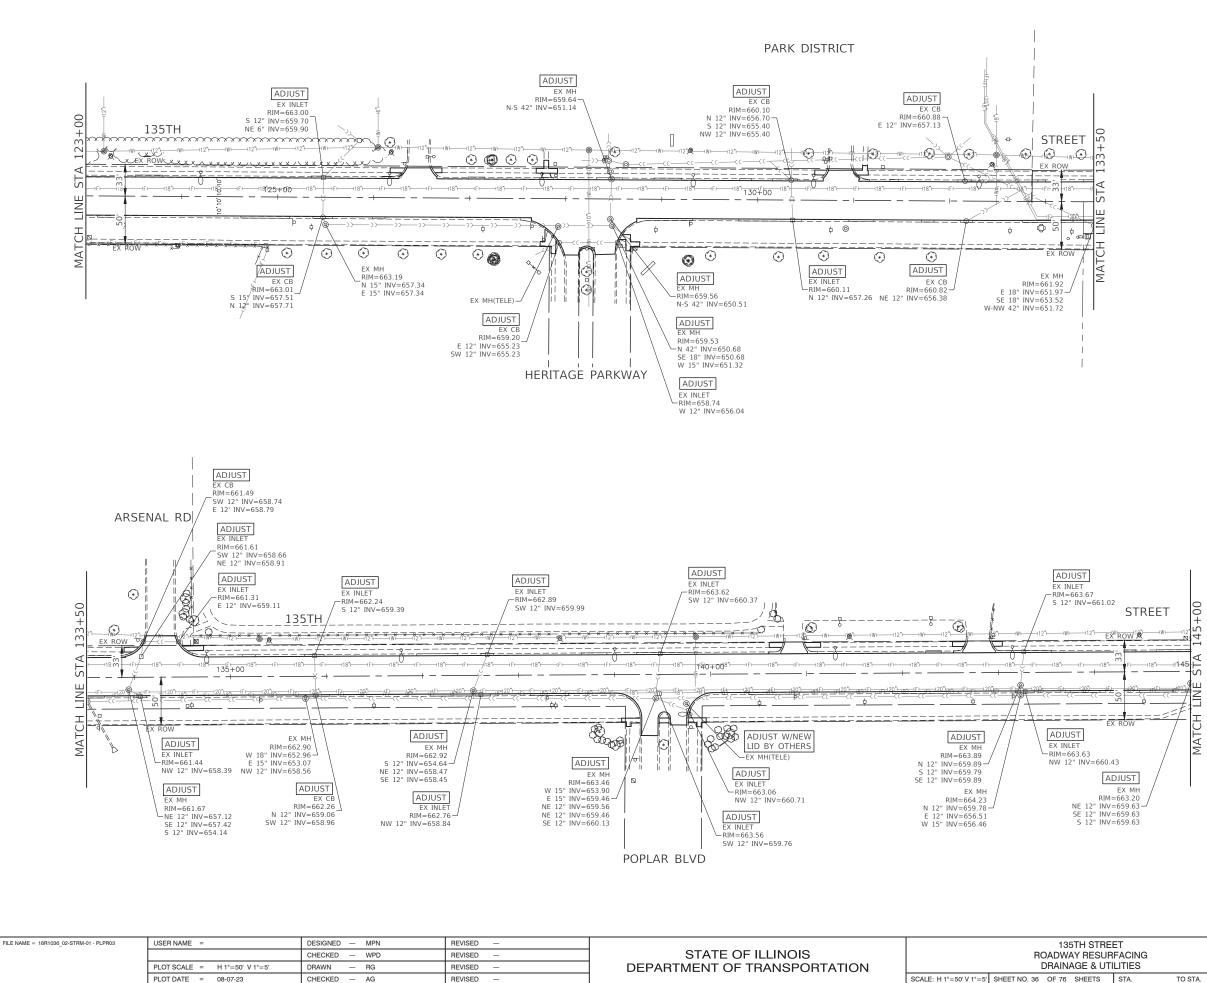
 ET		F.A.U. RTE.	SECT	ION		COUNTY	TOTAL SHEETS	SHEET NO.
 RFACING		0282	20-0006	9-00-BT		WILL	76	37
LITIES						CONTRACT	NO. 61J8	30
STA.	TO STA.	FED. RO	AD DIST. NO. 1	ILLINOIS	FED. AI	D PROJECT APMT	(993)	

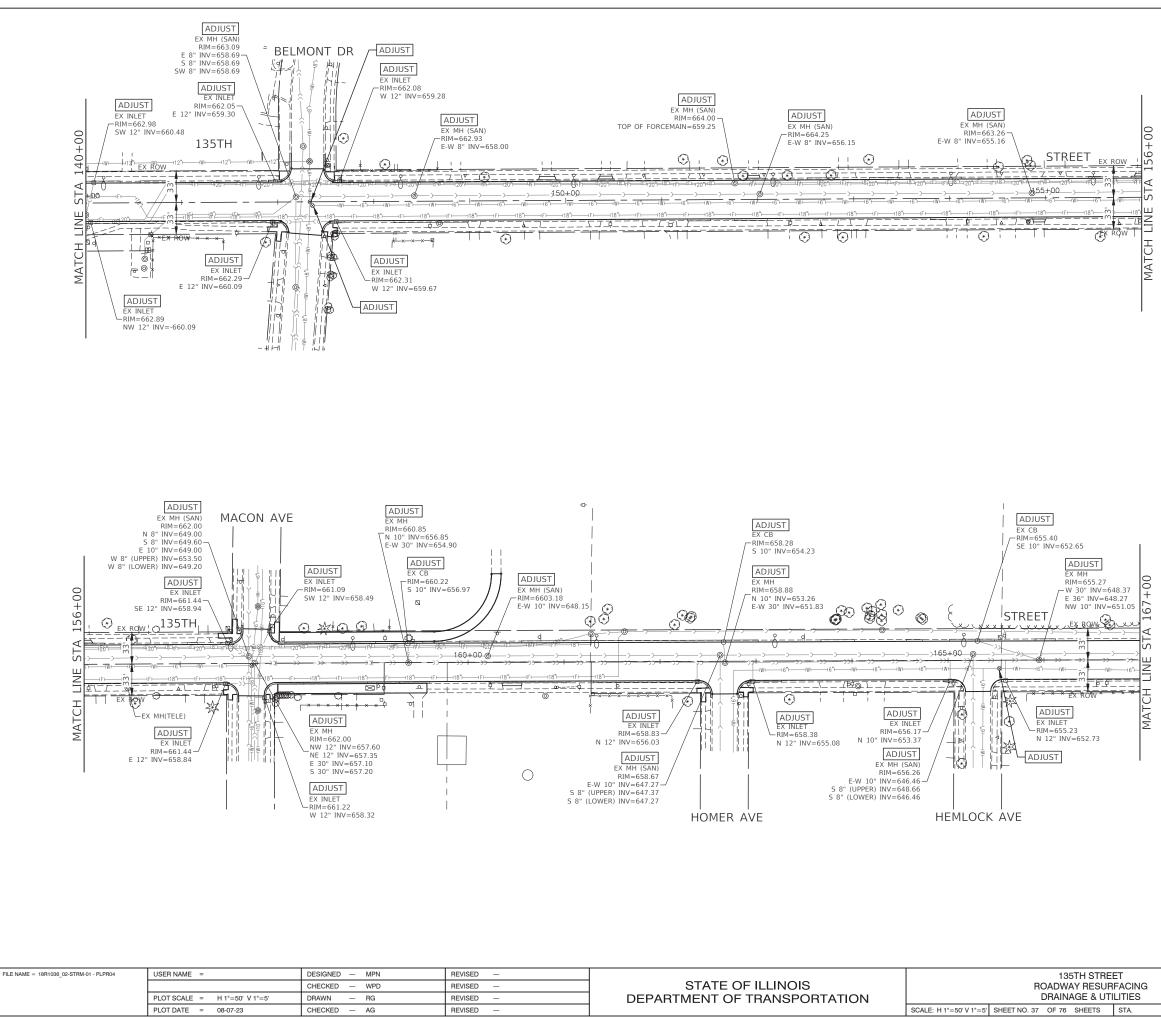

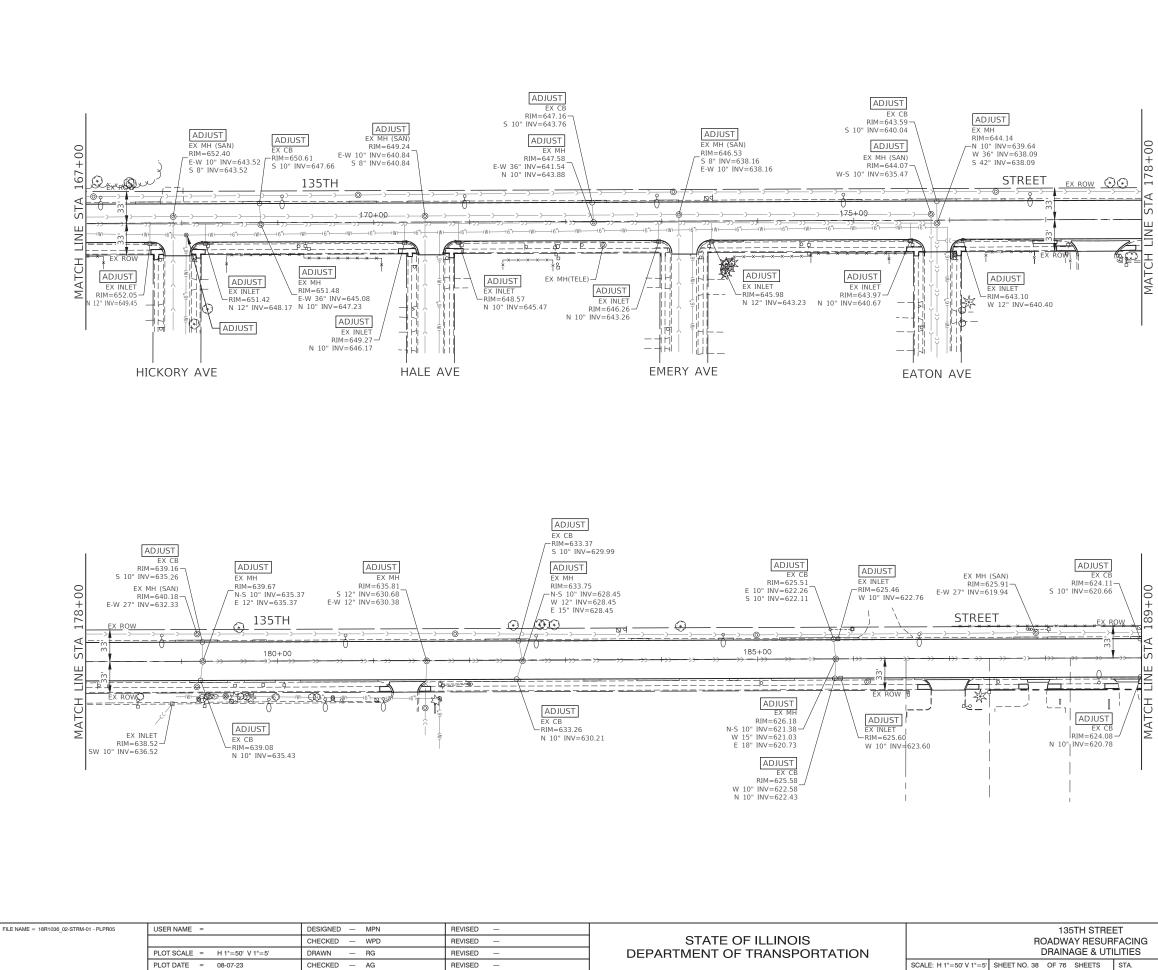

REI			F.A.U. RTE.	SECT	ION		COUNTY	TOTAL SHEETS	SHEET NO.
	RFACING			20-0006	9-00-BT		WILL	76	38
JTILITIES							CONTRACT I	NO. 61J8	30
	STA.	TO STA.	FED. RO	AD DIST. NO. 1	ILLINOIS	FED. A	D PROJECT APMT	(993)	

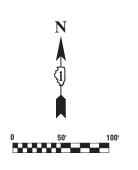


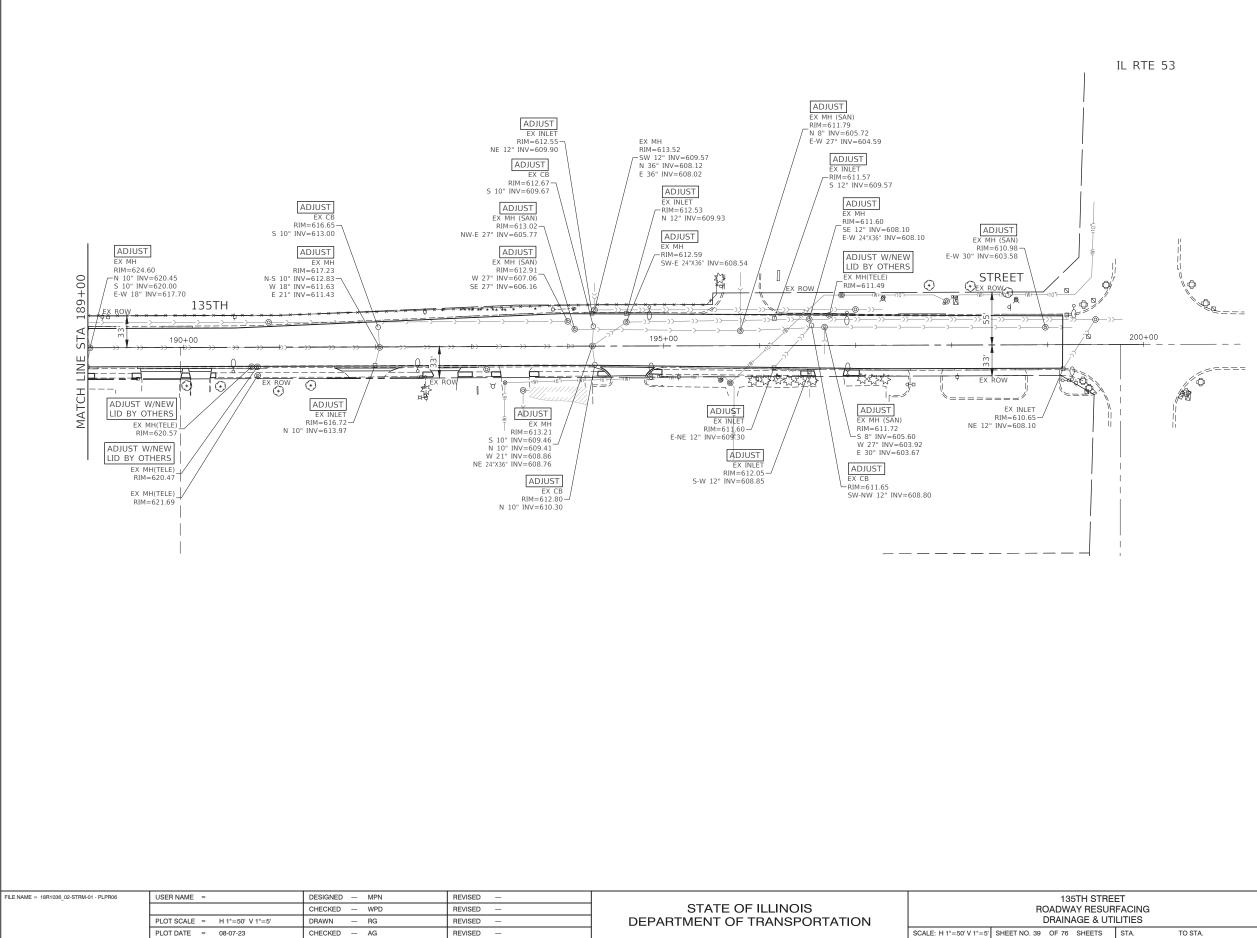


PLOT DATE = 08-07-23


CHECKED - AG

REVISED -

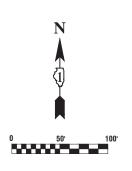

E			F.A.U. RTE.				COUNTY	TOTAL SHEETS	SHEET NO.
	RFACING		0282	20-0006	9-00-BT		WILL 76 39		
	TILITIES						CONTRACT I	NO. 61J8	30
	STA.	TO STA.	FED. RO	AD DIST. NO. 1	ILLINOIS	FED. AI	D PROJECT APMT	993)	

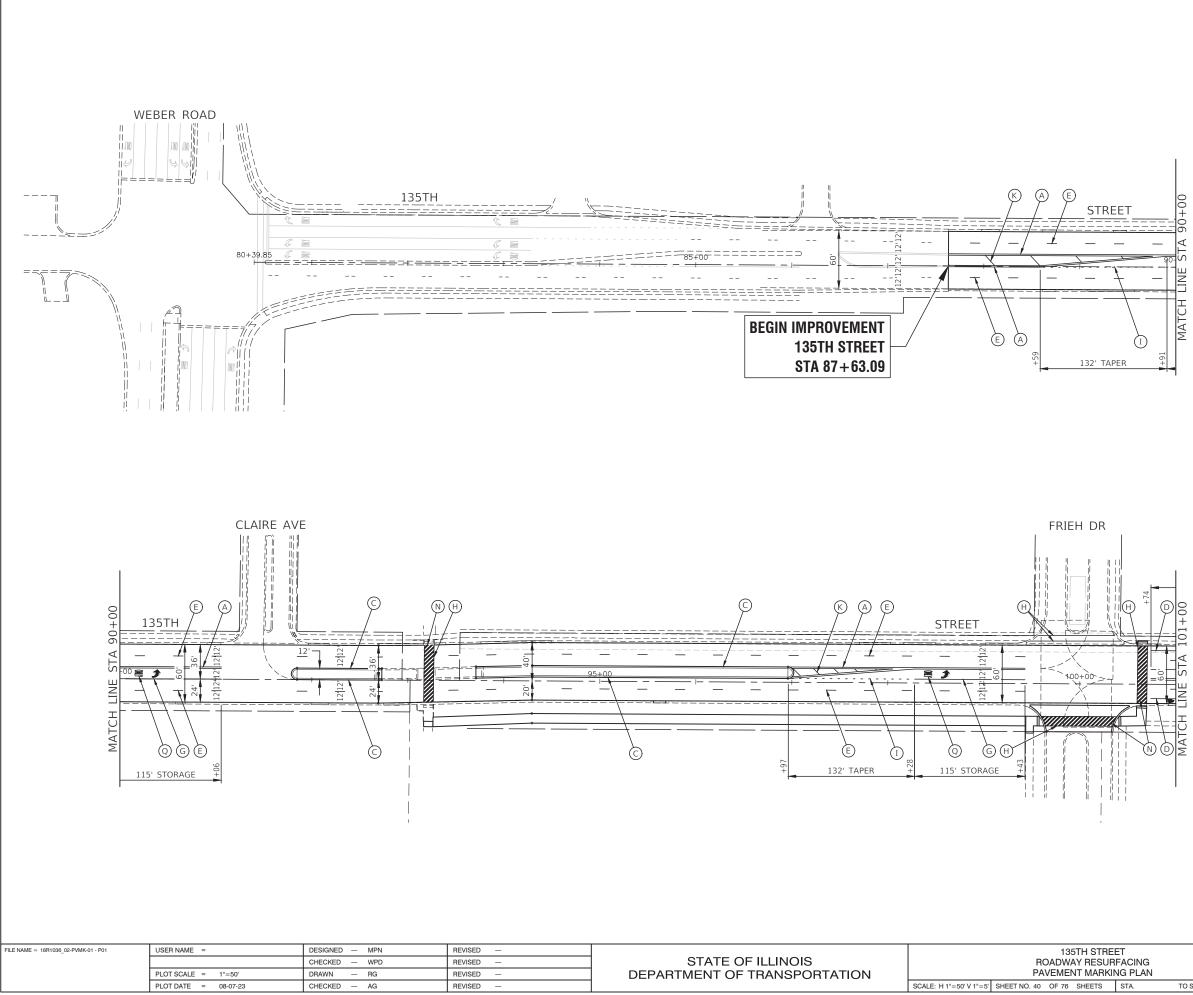

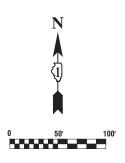



PAVEMENT MARKING LEGEND

- THERMOPLASTIC PAVEMENT MARKING 4" LINE (A)DOUBLE YELLOW (11" C-C)
- THERMOPLASTIC PAVEMENT MARKING 4" LINE B YELLOW SKIP DASH (10' LINE WITH 30' SPACE)
- THERMOPLASTIC PAVEMENT MARKING 4" LINE \bigcirc YELLOW LINE
- THERMOPLASTIC PAVEMENT MARKING 4" LINE \bigcirc WHITE LINE
- THERMOPLASTIC PAVEMENT MARKING 4" LINE E WHITE SKIP DASH (10' LINE WITH 30' SPACE)
- THERMOPLASTIC PAVEMENT MARKING 4" LINE F WHITE SKIP DASH (2' LINE-6' SPACE)
- THERMOPLASTIC PAVEMENT MARKING 6" LINE G WHITE LANE LINE
- THERMOPLASTIC PAVEMENT MARKING 6" LINE (H)
- WHITE CROSS-WALK (10' C-C / 6' C-C PER TC-13) THERMOPLASTIC PAVEMENT MARKING - 6" LINE WHITE SKIP DASH (2' LINE-6' SPACE)
- THERMOPLASTIC PAVEMENT MARKING 8" LINE \bigcirc WHITE LINE
- THERMOPLASTIC PAVEMENT MARKING 12" LINE (k)YELLOW DIAGONAL LINE (45 DEGREES SPACING PER TC-13)
- THERMOPLASTIC PAVEMENT MARKING 12" LINE WHITE DIAGONAL LINE (45 DEGREES SPACING PER TC-13)
- THERMOPLASTIC PAVEMENT MARKING 12" LINE (M)WHITE CROSS-WALK (3' C-C)
- THERMOPLASTIC PAVEMENT MARKING 12" LINE \mathbb{N} WHITE DIAGONAL (3' C-C @ 45 DEGREES)
- THERMOPLASTIC PAVEMENT MARKING 24" LINE WHITE STOP BAR LINE (P)
- THERMOPLASTIC PAVEMENT MARKING WHITE LETTERS & SYMBOLS \bigcirc


- SEE TC-13 DISTRICT ONE TYPICAL PAVEMENT MARKING FOR GUIDANCE. 1.
- 2. ALL PAVEMENT MARKINGS SHALL BE THERMOPLASTIC UNLESS OTHERWISE SHOWN.

 ET RFACING		F.A.U. RTE.		SECT	TION		COUNTY	TOTAL SHEETS	SHEET NO.
 		0282	20-00069-00-BT				WILL	76	40
ING PLAN							CONTRACT I	NO. 61J8	30
STA.	TO STA.	FED. RO	AD DIST. NO.	1	ILLINOIS	FED. AI	D PROJECT APMT	(993)	

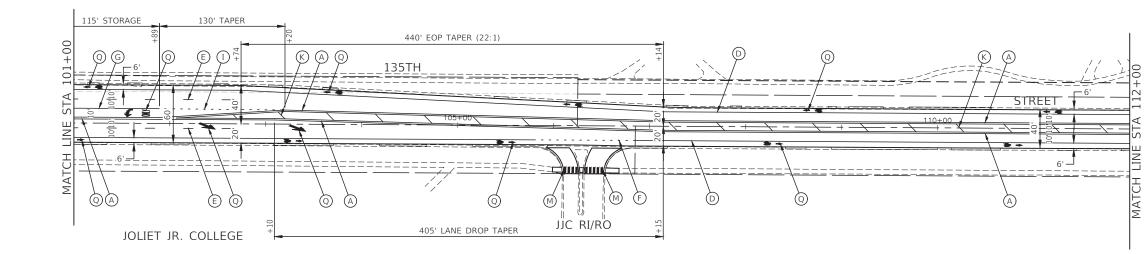

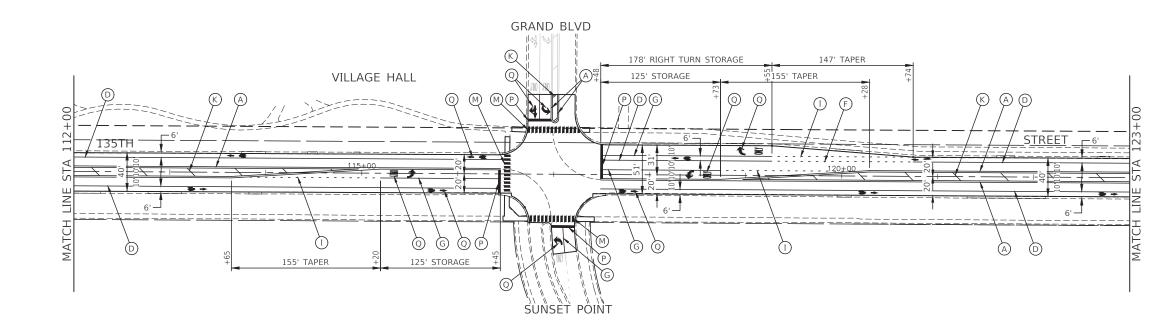


FILE NAME = 18R1036_02-PVMK-01 - P02	USER NAME =	DESIGNED — MPN	REVISED —			F.A.U. BTE	SECTION	COUNTY	TOTAL	SHEET
		CHECKED - WPD	REVISED —] STATE OF ILLINOIS		0282	20-00069-00-BT	WILL	76	41
	PLOT SCALE = 1"=50'	DRAWN — RG	REVISED —	DEPARTMENT OF TRANSPORTATION	PAVEMENT MARKING PLAN			CONTRACT	NO. 61J	180
	PLOT DATE = 08-07-23	CHECKED — AG	REVISED —		SCALE: H 1"=50' V 1"=5' SHEET NO. 41 OF 76 SHEETS STA. TO STA.	FED. ROAD D	IST. NO. 1 ILLINOIS FE	D. AID PROJECT APMT		

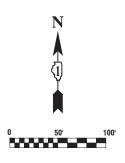


PAVEMENT MARKING LEGEND


- THERMOPLASTIC PAVEMENT MARKING 4" LINE A THERMOPLASTIC FAVE MILEN. DOUBLE YELLOW (11" C-C) THERMOPLASTIC PAVEMENT MARKING - 4" LINE B YELLOW SKIP DASH (10' LINE WITH 30' SPACE) THERMOPLASTIC PAVEMENT MARKING - 4" LINE \bigcirc YELLOW LINE
- THERMOPLASTIC PAVEMENT MARKING 4" LINE \bigcirc WHITE LINE
- THERMOPLASTIC PAVEMENT MARKING 4" LINE E WHITE SKIP DASH (10' LINE WITH 30' SPACE)
- THERMOPLASTIC PAVEMENT MARKING 4" LINE F WHITE SKIP DASH (2' LINE-6' SPACE)
- THERMOPLASTIC PAVEMENT MARKING 6" LINE G WHITE LANE LINE
- THERMOPLASTIC PAVEMENT MARKING 6" LINE (H)
- WHITE CROSS-WALK (10' C-C / 6' C-C PER TC-13) THERMOPLASTIC PAVEMENT MARKING - 6" LINE WHITE SKIP DASH (2' LINE-6' SPACE)
- THERMOPLASTIC PAVEMENT MARKING 8" LINE \bigcirc WHITE LINE
- THERMOPLASTIC PAVEMENT MARKING 12" LINE K YELLOW DIAGONAL LINE (45 DEGREES SPACING PER TC-13)
- THERMOPLASTIC PAVEMENT MARKING 12" LINE WHITE DIAGONAL LINE (45 DEGREES SPACING PER TC-13)
- THERMOPLASTIC PAVEMENT MARKING 12" LINE (M)WHITE CROSS-WALK (3' C-C)
- THERMOPLASTIC PAVEMENT MARKING 12" LINE \mathbb{N}
- WHITE DIAGONAL (3' C-C @ 45 DEGREES)
- THERMOPLASTIC PAVEMENT MARKING 24" LINE WHITE STOP BAR LINE P
- O THERMOPLASTIC PAVEMENT MARKING WHITE LETTERS & SYMBOLS

- 1. SEE TC-13 DISTRICT ONE TYPICAL PAVEMENT MARKING FOR GUIDANCE.
- 2. ALL PAVEMENT MARKINGS SHALL BE THERMOPLASTIC UNLESS OTHERWISE SHOWN.

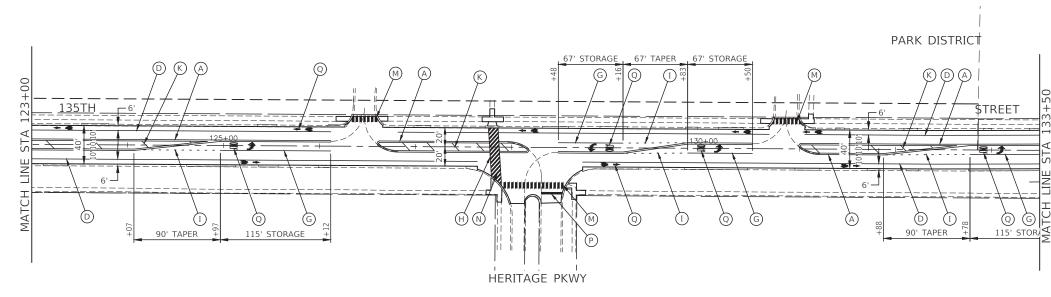

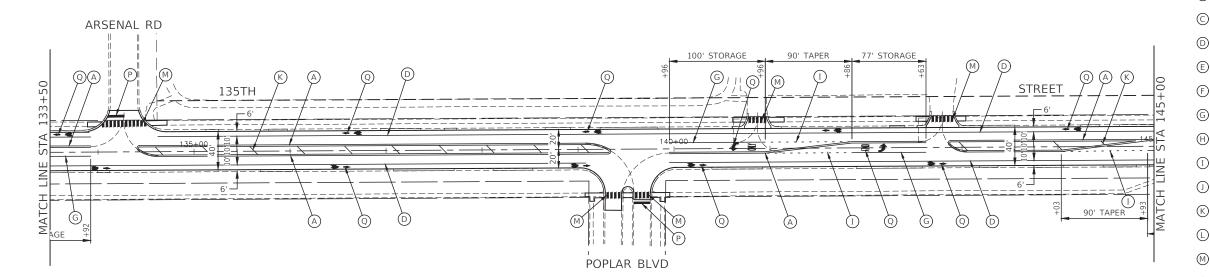


FILE NAME = 18R1036_02-PVMK-01 - P03	USER NAME =	DESIGNED — MPN	REVISED —		135TH STREET	F.A.U. BTE.	SECTION	COUNTY	TOTAL	SHEET
		CHECKED — WPD	REVISED —	STATE OF ILLINOIS	ROADWAY RESURFACING	0282	20-00069-00-BT	WILL	76	42
	PLOT SCALE = 1"=50"	DRAWN — RG	REVISED —	DEPARTMENT OF TRANSPORTATION	PAVEMENT MARKING PLAN				NO. 61J8	80
	PLOT DATE = 08-07-23	CHECKED — AG	REVISED —		SCALE: H 1"=50' V 1"=5' SHEET NO. 42 OF 76 SHEETS STA. TO STA.	FED. ROAD DIST. N	IO. 1 ILLINOIS FED	AID PROJECT APMT	T(993)	

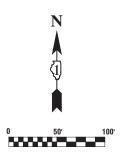


PAVEMENT MARKING LEGEND


- THERMOPLASTIC PAVEMENT MARKING 4" LINE A THERMOPLASTIC FAVE MILEN. DOUBLE YELLOW (11" C-C)
- THERMOPLASTIC PAVEMENT MARKING 4" LINE B YELLOW SKIP DASH (10' LINE WITH 30' SPACE)
- THERMOPLASTIC PAVEMENT MARKING 4" LINE \bigcirc YELLOW LINE
- THERMOPLASTIC PAVEMENT MARKING 4" LINE WHITE LINE D
- THERMOPLASTIC PAVEMENT MARKING 4" LINE E WHITE SKIP DASH (10' LINE WITH 30' SPACE)
- THERMOPLASTIC PAVEMENT MARKING 4" LINE F WHITE SKIP DASH (2' LINE-6' SPACE)
- THERMOPLASTIC PAVEMENT MARKING 6" LINE G WHITE LANE LINE
- THERMOPLASTIC PAVEMENT MARKING 6" LINE
- WHITE CROSS-WALK (10' C-C / 6' C-C PER TC-13)
- THERMOPLASTIC PAVEMENT MARKING 6" LINE WHITE SKIP DASH (2' LINE-6' SPACE)
- THERMOPLASTIC PAVEMENT MARKING 8" LINE \bigcirc WHITE LINE
- THERMOPLASTIC PAVEMENT MARKING 12" LINE K YELLOW DIAGONAL LINE (45 DEGREES SPACING PER TC-13)
- THERMOPLASTIC PAVEMENT MARKING 12" LINE WHITE DIAGONAL LINE (45 DEGREES SPACING PER TC-13)
- THERMOPLASTIC PAVEMENT MARKING 12" LINE (M)WHITE CROSS-WALK (3' C-C)
- THERMOPLASTIC PAVEMENT MARKING 12" LINE WHITE DIAGONAL (3' C-C @ 45 DEGREES) \mathbb{N}
- THERMOPLASTIC PAVEMENT MARKING 24" LINE WHITE STOP BAR LINE P
- O THERMOPLASTIC PAVEMENT MARKING WHITE LETTERS & SYMBOLS

- 1. SEE TC-13 DISTRICT ONE TYPICAL PAVEMENT MARKING FOR GUIDANCE.
- 2. ALL PAVEMENT MARKINGS SHALL BE THERMOPLASTIC UNLESS OTHERWISE SHOWN.

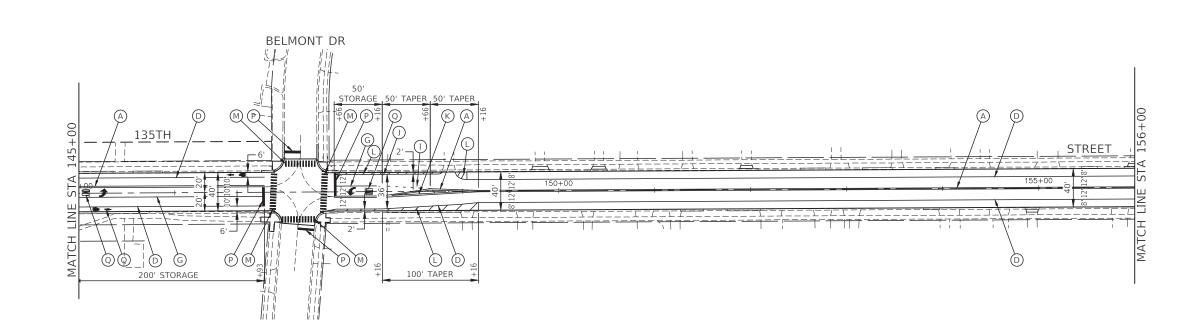

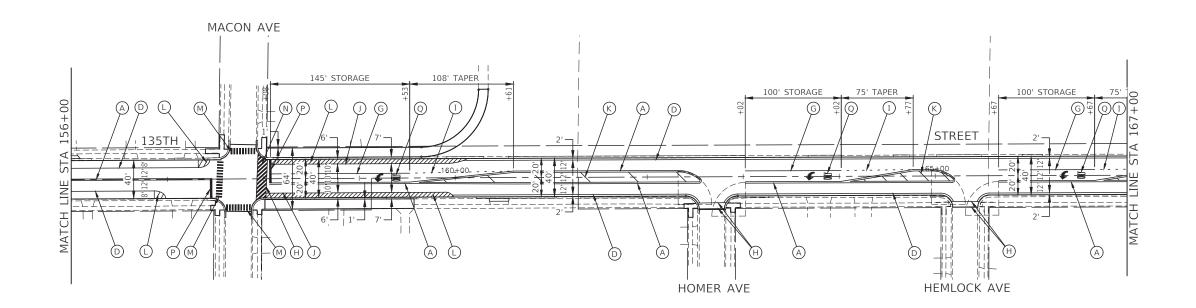

FILE NAME = 18R1036_02-PVMK-01 - P04	USER NAME =	DESIGNED - MPN	REVISED —		135TH STREE	ΞT		F.A.U. BTE	SECTION	COL		TOTAL S	SHEET
		CHECKED - WPD	REVISED —	STATE OF ILLINOIS	ROADWAY RESUR	FACING		0282	20-00069-00-B	r w		76	43
	PLOT SCALE = 1"=50"	DRAWN — RG	REVISED —	DEPARTMENT OF TRANSPORTATION	PAVEMENT MARKIN	NG PLAN					FRACT NO	. 61J80	
	PLOT DATE = 08-07-23	CHECKED — AG	REVISED —		SCALE: H 1"=50' V 1"=5' SHEET NO. 43 OF 76 SHEETS	STA. TO	STA.	FED. ROAD DI	ST. NO. 1 ILLINO	IS FED. AID PROJEC			

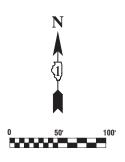








- C THERMOPLASTIC PAVEMENT MARKING 4" LINE YELLOW LINE
- THERMOPLASTIC PAVEMENT MARKING 4" LINE
 WHITE LINE
- E THERMOPLASTIC PAVEMENT MARKING 4" LINE WHITE SKIP DASH (10' LINE WITH 30' SPACE)
- (F) THERMOPLASTIC PAVEMENT MARKING 4" LINE WHITE SKIP DASH (2' LINE-6' SPACE)
- G THERMOPLASTIC PAVEMENT MARKING 6" LINE WHITE LANE LINE
- THERMOPLASTIC PAVEMENT MARKING 6" LINE
- THERMOPLASTIC PAVEMENT MARKING 6" LII
 WHITE SKIP DASH (2' LINE-6' SPACE)
- \bigoplus $% \left({{\mathbb{T}}_{{\mathbb{T}}}} \right)$. Thermoplastic pavement marking 8" line white line
- (K) THERMOPLASTIC PAVEMENT MARKING 12" LINE YELLOW DIAGONAL LINE (45 DEGREES SPACING PER TC-13)
- C THERMOPLASTIC PAVEMENT MARKING 12" LINE WHITE DIAGONAL LINE (45 DEGREES SPACING PER TC-13)
- M THERMOPLASTIC PAVEMENT MARKING 12" LINE WHITE CROSS-WALK (3' C-C)
- N THERMOPLASTIC PAVEMENT MARKING 12" LINE WHITE DIAGONAL (3' C-C @ 45 DEGREES)
- Ŋ WHITE DIAGONAL (3' C-C @ 45 DEGREES)
- $\ensuremath{\mathbb{P}}$ $\ensuremath{\mathbb{P}}$ Thermoplastic pavement marking 24" line white stop bar line
- O THERMOPLASTIC PAVEMENT MARKING WHITE LETTERS & SYMBOLS

- 1. SEE TC-13 DISTRICT ONE TYPICAL PAVEMENT MARKING FOR GUIDANCE.
- 2. ALL PAVEMENT MARKINGS SHALL BE THERMOPLASTIC UNLESS OTHERWISE SHOWN.

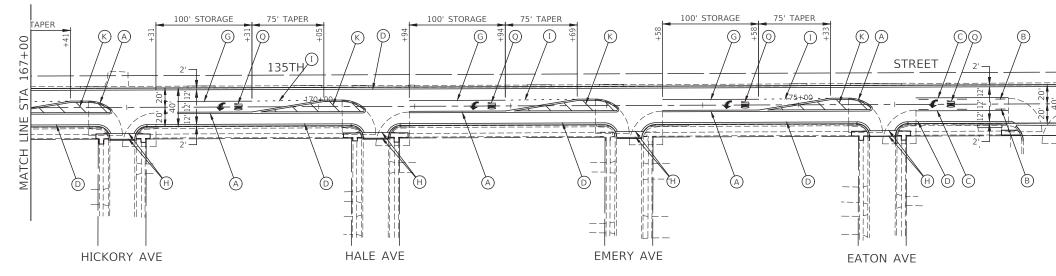

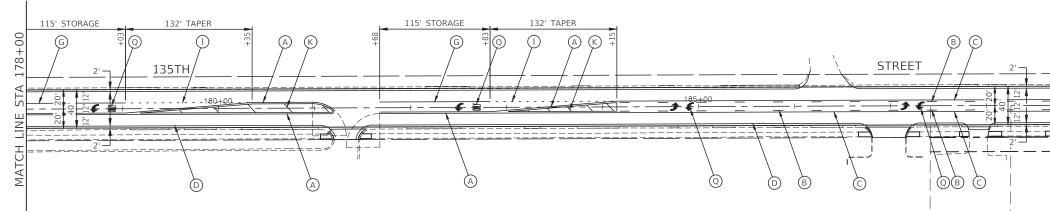

FILE NAME = 18R1036_02-PVMK-01 - P05	USER NAME =	DESIGNED — MPN	REVISED —		135TH STREET	F.A.U. BTE	SECTION	COUNTY	TOTAL	SHEET
		CHECKED - WPD	REVISED —	STATE OF ILLINOIS	ROADWAY RESURFACING	0282	20-00069-00-BT	WILL	76	44
	PLOT SCALE = 1"=50"	DRAWN — RG	REVISED —	DEPARTMENT OF TRANSPORTATION	PAVEMENT MARKING PLAN			CONTRACT	NO. 61J	180
	PLOT DATE = 08-07-23	CHECKED — AG	REVISED —		SCALE: H 1"=50' V 1"=5' SHEET NO. 44 OF 76 SHEETS STA. TO STA.	FED. ROAD D	IST. NO. 1 ILLINOIS FED.	AID PROJECT APMT		

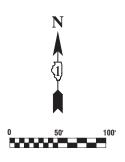








- THERMOPLASTIC PAVEMENT MARKING 4" LINE
 WHITE SKIP DASH (10' LINE WITH 30' SPACE)
- (F) THERMOPLASTIC PAVEMENT MARKING 4" LINE WHITE SKIP DASH (2' LINE-6' SPACE)
- G THERMOPLASTIC PAVEMENT MARKING 6" LINE WHITE LANE LINE
- THERMOPLASTIC PAVEMENT MARKING 6" LINE WHITE SKIP DASH (2' LINE-6' SPACE)
- THERMOPLASTIC PAVEMENT MARKING 8" LINE WHITE LINE
- (K) THERMOPLASTIC PAVEMENT MARKING 12" LINE YELLOW DIAGONAL LINE (45 DEGREES SPACING PER TC-13)
- THERMOPLASTIC PAVEMENT MARKING 12" LINE
 WHITE DIAGONAL LINE (45 DEGREES SPACING PER TC-13)
- N THERMOPLASTIC PAVEMENT MARKING 12" LINE WHITE DIAGONAL (3' C-C @ 45 DEGREES)
- ♥ WHITE DIAGONAL (3' C-C @ 45 DEGREES)
- $\ensuremath{\mathbb{P}}$ $\ensuremath{\mathbb{P}}$ Thermoplastic pavement marking 24" line white stop bar line
- $\textcircled{\sc 0}$ Thermoplastic pavement marking white letters & symbols

- 1. SEE TC-13 DISTRICT ONE TYPICAL PAVEMENT MARKING FOR GUIDANCE.
- 2. ALL PAVEMENT MARKINGS SHALL BE THERMOPLASTIC UNLESS OTHERWISE SHOWN.




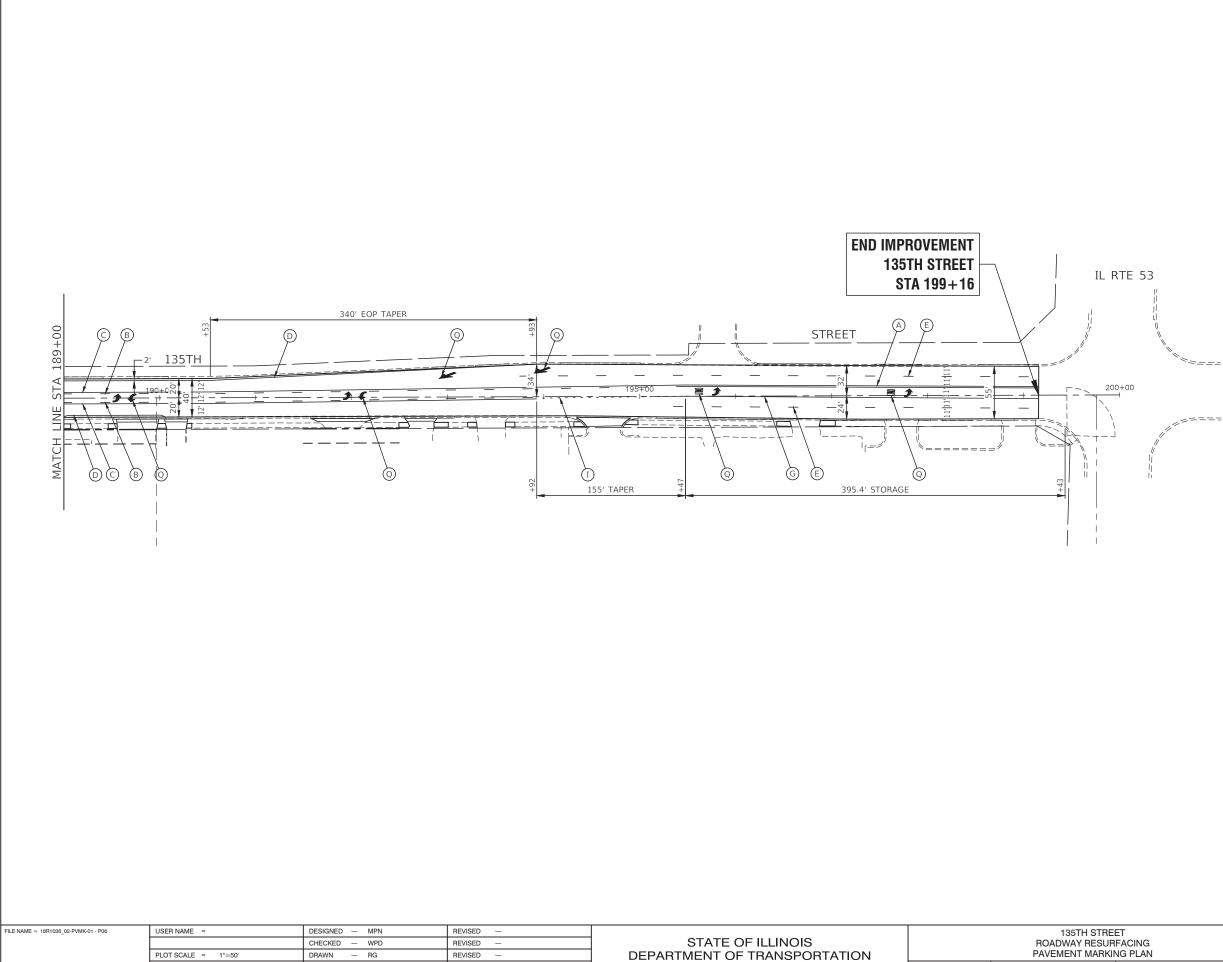

PLOT DATE = 08-07-23

CHECKED - AG

REVISED -

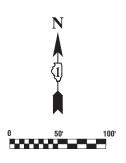


PAVEMENT MARKING LEGEND


A	THERMOPLASTIC PAVEMENT MARKING - 4" LINE DOUBLE YELLOW (11" C-C)
B	THERMOPLASTIC PAVEMENT MARKING - 4" LINE YELLOW SKIP DASH (10' LINE WITH 30' SPACE)
C	THERMOPLASTIC PAVEMENT MARKING - 4" LINE YELLOW LINE
D	THERMOPLASTIC PAVEMENT MARKING - 4" LINE WHITE LINE
Ð	THERMOPLASTIC PAVEMENT MARKING - 4" LINE WHITE SKIP DASH (10' LINE WITH 30' SPACE)
Ð	THERMOPLASTIC PAVEMENT MARKING - 4" LINE WHITE SKIP DASH (2' LINE-6' SPACE)
G	THERMOPLASTIC PAVEMENT MARKING - 6" LINE WHITE LANE LINE
H	THERMOPLASTIC PAVEMENT MARKING - 6" LINE WHITE CROSS-WALK (10' C-C / 6' C-C PER TC-13)
I	THERMOPLASTIC PAVEMENT MARKING - 6" LINE WHITE SKIP DASH (2' LINE-6' SPACE)
J	THERMOPLASTIC PAVEMENT MARKING - 8" LINE WHITE LINE
K	THERMOPLASTIC PAVEMENT MARKING - 12" LINE YELLOW DIAGONAL LINE (45 DEGREES SPACING PER TC-13)
D	THERMOPLASTIC PAVEMENT MARKING - 12" LINE WHITE DIAGONAL LINE (45 DEGREES SPACING PER TC-13)
M	THERMOPLASTIC PAVEMENT MARKING - 12" LINE WHITE CROSS-WALK (3' C-C)
N	THERMOPLASTIC PAVEMENT MARKING - 12" LINE WHITE DIAGONAL (3' C-C @ 45 DEGREES)
P	THERMOPLASTIC PAVEMENT MARKING - 24" LINE WHITE STOP BAR LINE


O THERMOPLASTIC PAVEMENT MARKING - WHITE LETTERS & SYMBOLS

- 1. SEE TC-13 DISTRICT ONE TYPICAL PAVEMENT MARKING FOR GUIDANCE.
- 2. ALL PAVEMENT MARKINGS SHALL BE THERMOPLASTIC UNLESS OTHERWISE SHOWN.


EE	FACING		F.A.U. RTE.	SECTION			COUNTY	TOTAL SHEETS	SHEET NO.
			0282 20-00069-00-BT				WILL	76	45
	NG PLAN						CONTRACT N	NO. 61J8	30
	STA.	TO STA.	FED. RO	AD DIST. NO. 1	ILLINOIS	FED. AI	D PROJECT APMT(993)	

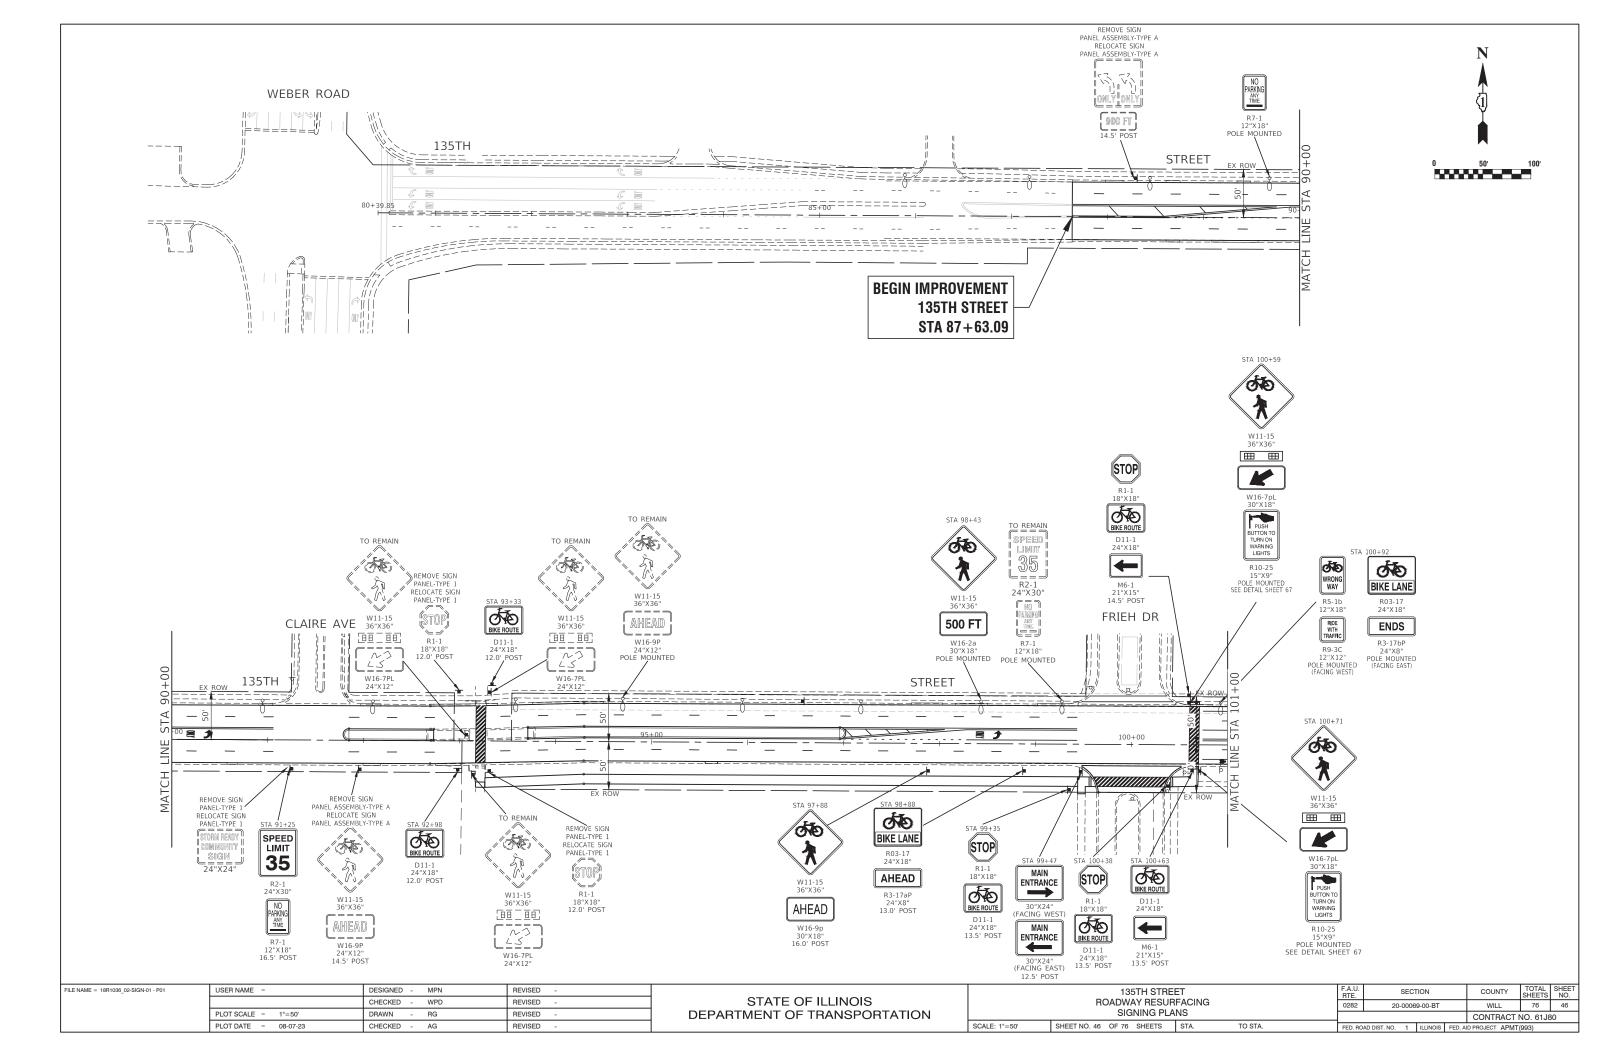

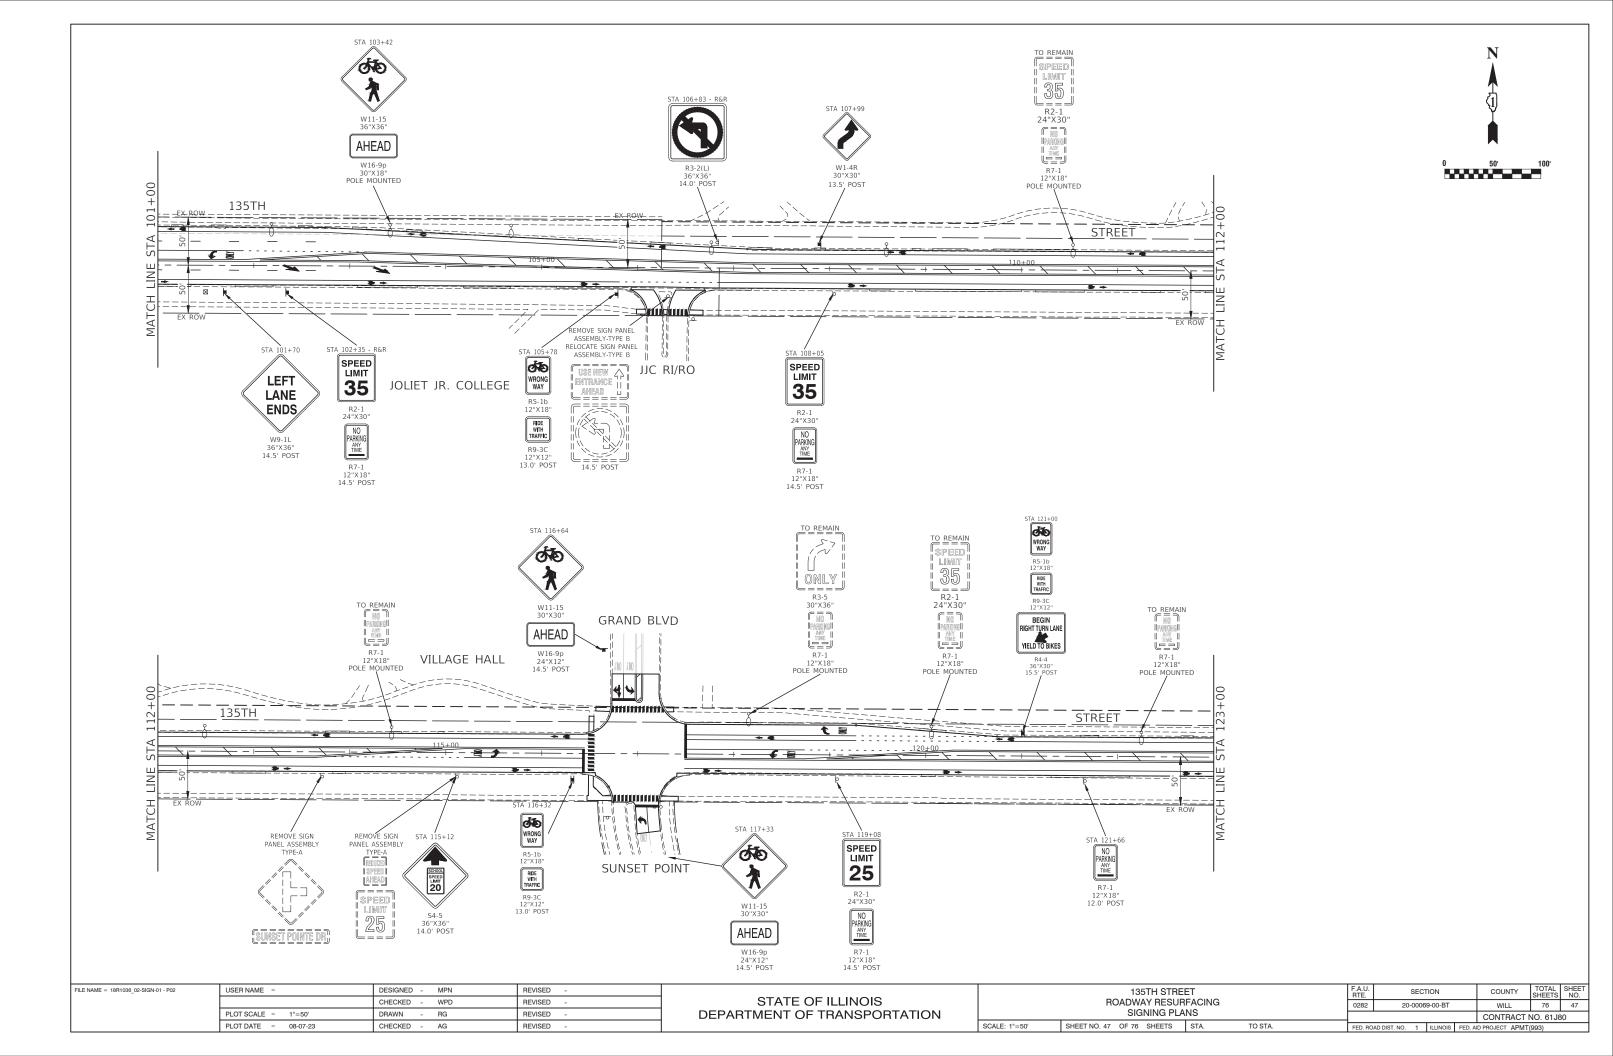

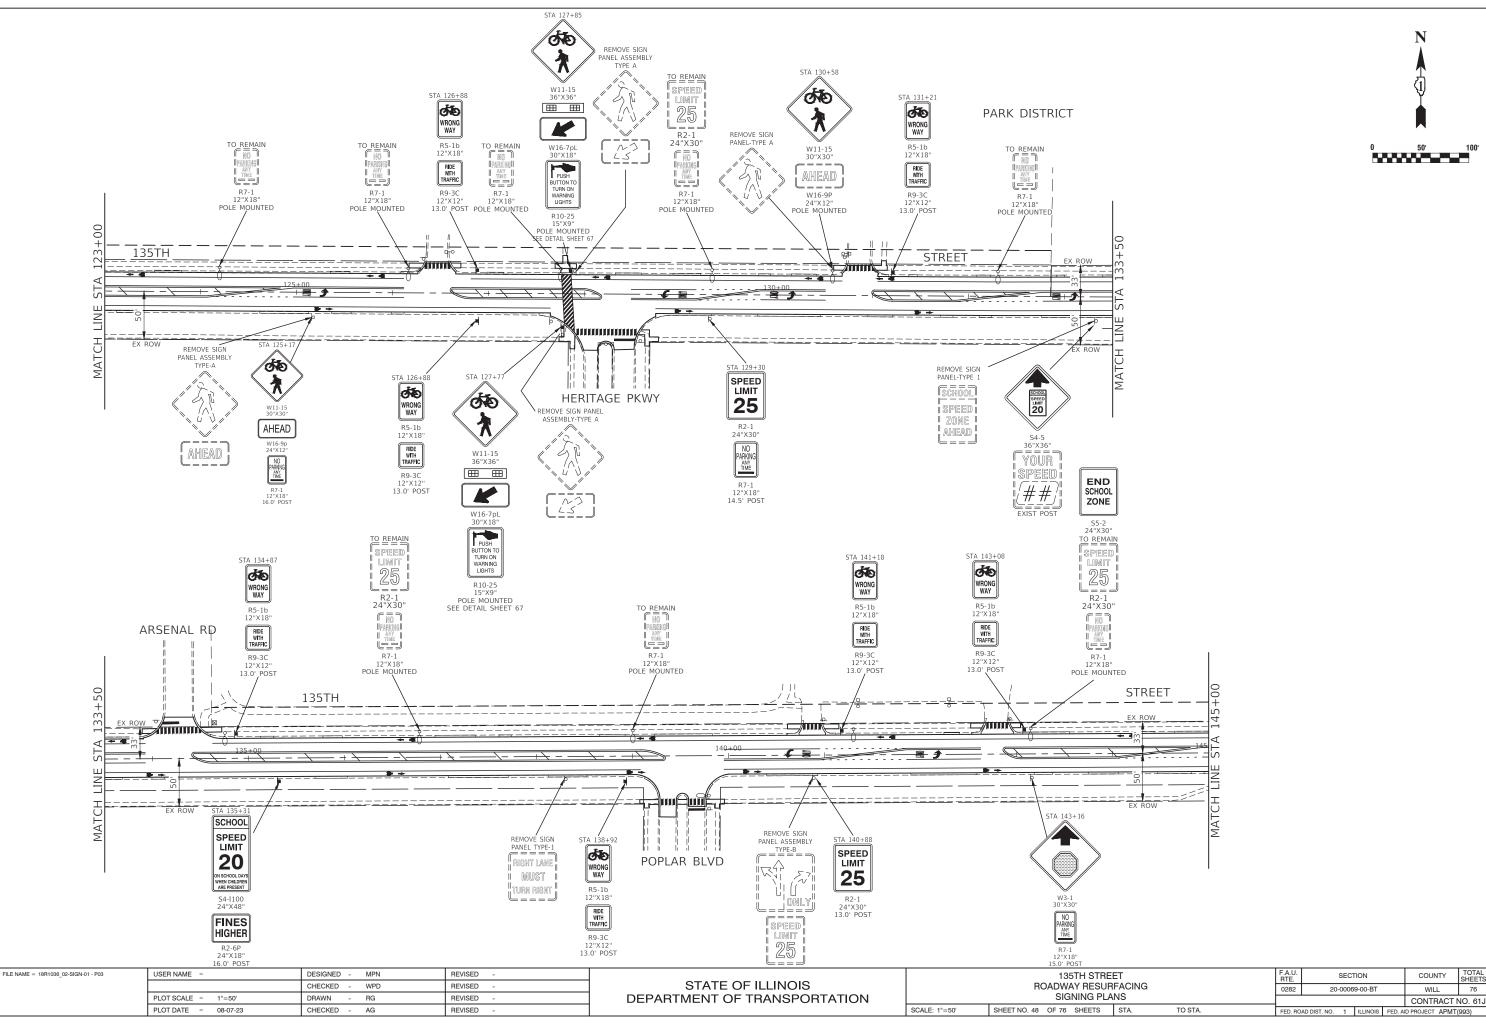


REI			F.A.U. RTE.	SECTION			COUNTY	TOTAL SHEETS	SHEET NO.
	RFACING ANS		0282	0282 20-00069-00-BT			WILL	76	48
LA	NS	IS CONTRACT NO. 61			NO. 61J8	30			
	STA.	TO STA.	FED. RC	DAD DIST. NO. 1	DIST. NO. 1 ILLINOIS FED.		D PROJECT APMT	(993)	

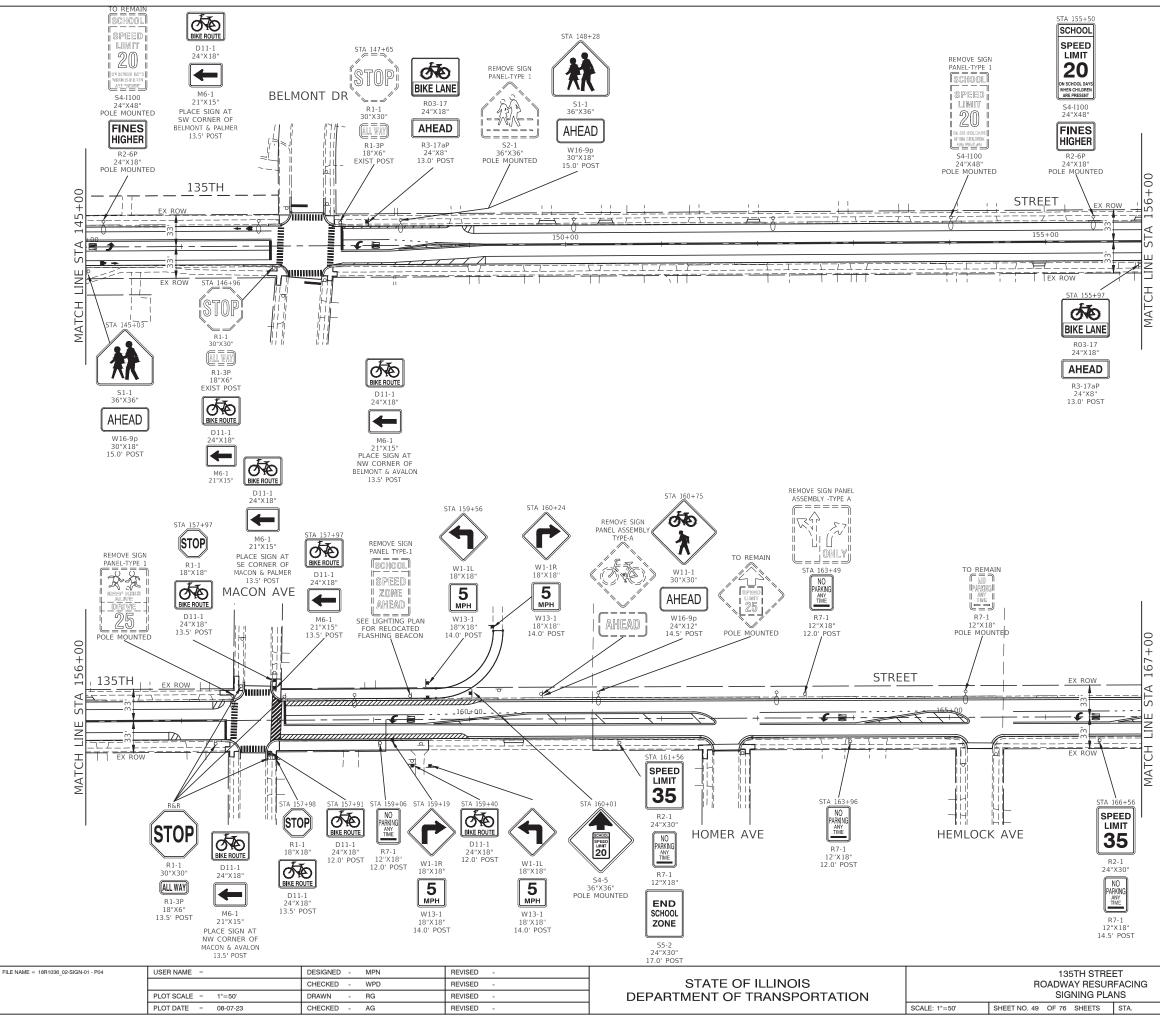





THE EXISTING STREET SIGNS AT THE TOP OF THE STOP SIGN PANEL ASSEMBLY ON THE SOUTHEAST CORNER OF 135TH STREET AND MACON AVENUE SHALL BE REUSED AND INSTALLED ON THE PROPOSED SIGN POST AND SHALL BE PAID FOR AS "RELOCATE SIGN PANEL - TYPE 1."


_	ET RFACING			F.A.U. RTE. SECTION			COUNTY	TOTAL SHEETS	SHEET NO.		
			02	282	20	-0006	9-00-BT		WILL	76	49
.A	NS								CONTRACT	NO. 61J8	0
	STA.	TO STA.	FEI	D. ROA	D DIST. NO.	1	ILLINOIS	FED. AI	D PROJECT APMT	(993)	

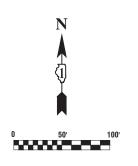


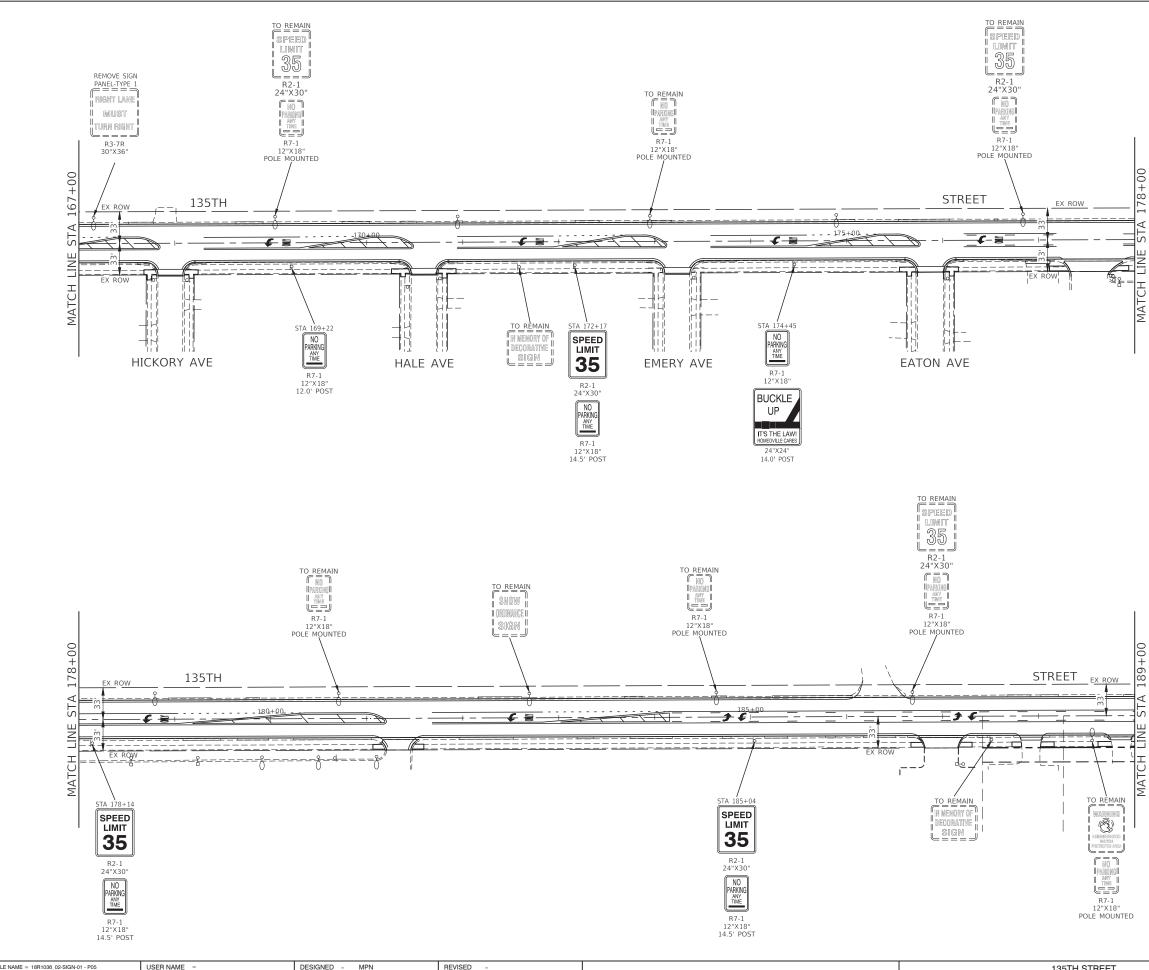


FILE NAME = 18R1036_02-SIGN-01 - P05	USER NAME =	DESIGNED - MPN	REVISED -		135TH STREET		F.A.U. BTE	SECTION	COUNTY	TOTAL SHEET
		CHECKED - WPD	REVISED -] STATE OF ILLINOIS	ROADWAY RESURFACING SIGNING PLANS			20-00069-00-BT	WILL	76 50
	PLOT SCALE = 1"=50'	DRAWN - RG	REVISED -	DEPARTMENT OF TRANSPORTATION					CONTRAC	T NO. 61J80
	PLOT DATE = 08-07-23	CHECKED - AG	REVISED -		SCALE: 1"=50'	SHEET NO. 50 OF 76 SHEETS STA. TO STA.	FED. ROAD D	IST. NO. 1 ILLINOIS FEI	D. AID PROJECT APM	MT(993)

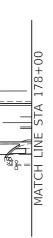

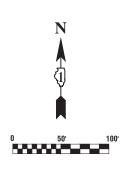

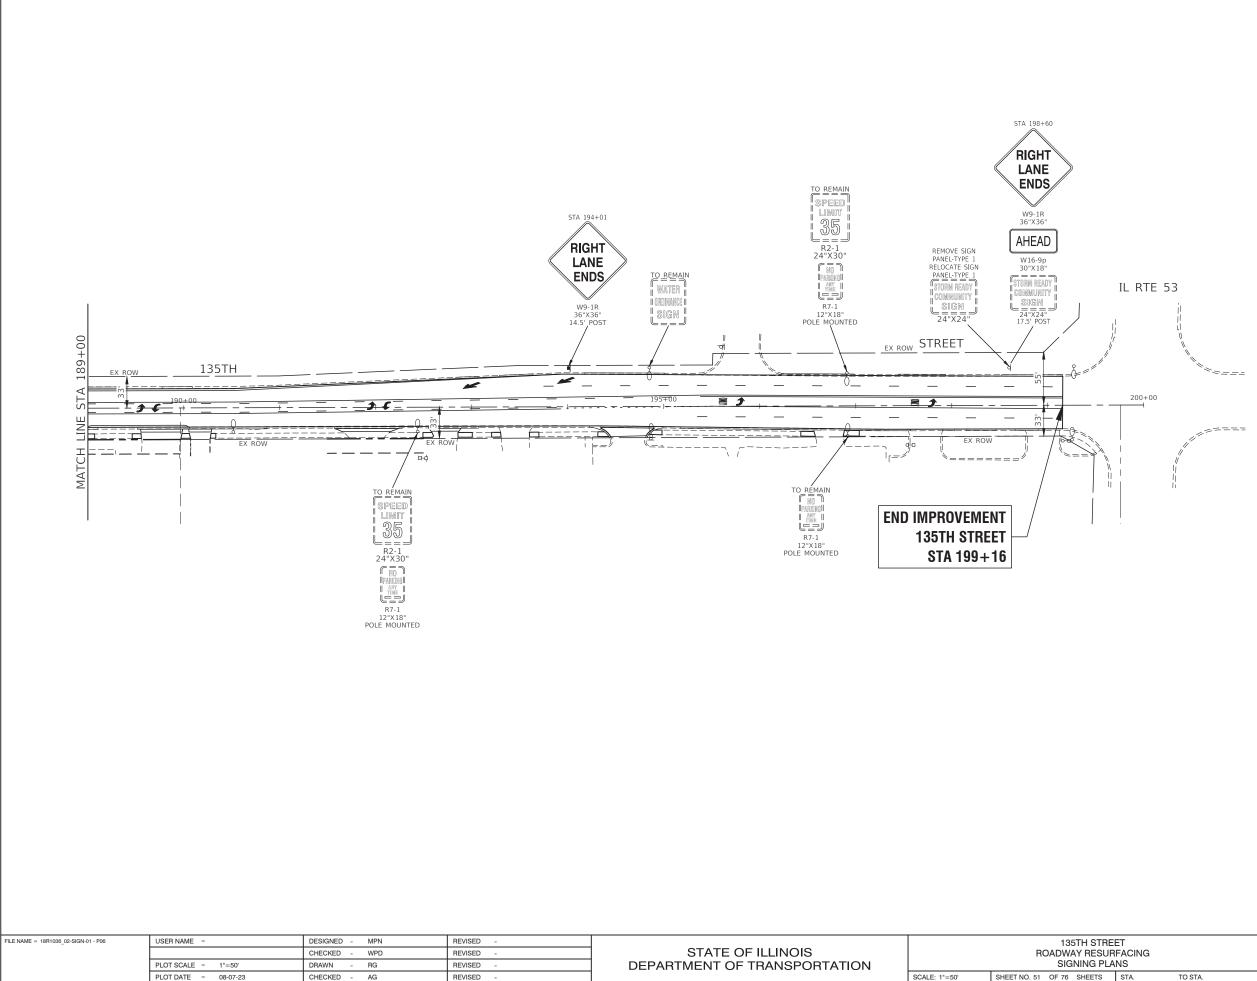

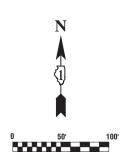

REET JRFACING LANS		F.A.U. RTE.				COUNTY	TOTAL SHEETS	SHEET NO.
		0282	20-00069-00-BT			WILL	76	51
						CONTRACT I	NO. 61J8	30
	STA.	TO STA.	FED. ROAD DIST. NO. 1 ILLINOIS FED. AID F			D PROJECT APMT	993)	

TRAFFIC SIGNAL LEGEND

TTENT	EXISTING	PROPOSED	TEM	DUSTING	TROPOSED	ITEM	EXISTING
CONTROLLER CABINET	\boxtimes	► •++++	HANDHOLE -Square			SIGNAL HEAD	R
COMMUNICATION CABINET	ECC	CC	-ROUND			-{P) programmable signal head	
MASTER CONTROLLER	EMC	MC	HEAVY DUTY HANDHOLE -SQUARE -ROUND	H (H)			
MASTER MASTER CONTROLLER	EMMC	ММС	DOUBLE HANDHOLE				F (5)
UNINTERRUPTABLE POWER SUPPLY	4	F	JUNCTION BOX	\bigcirc	•	SIGNAL HEAD WITH BACKPLATE -(P) PROGRAMMABLE SIGNAL HEAD -(RB) RETROREFLECTIVE BACKPLATE	
SERVICE INSTALLATION -(P) POLE MOUNTED	- -	- - P	RAILROAD CANTILEVER MAST ARM	X OX X X	Xex X		
SERVICE INSTALLATION			RAILROAD FLASHING SIGNAL	XoX	XeX		P
-(G) GROUND MOUNTED -(GM) GROUND MOUNTED METERED	⊠e ⊠ew	x [€] x ^{GM}	RAILROAD CROSSING GATE	X0X>	X•X-	PEDESTRIAN SIGNAL HEAD	
TELEPHONE CONNECTION	ET	Т	RAILROAD CROSSBUCK	¥	¥	AT RAILROAD INTERSECTIONS	
STEEL MAST ARM ASSEMBLY AND POLE	0	•	RAILROAD CONTROLLER CABINET			PEDESTRIAN SIGNAL HEAD	C C D
ALUMINUM MAST ARM ASSEMBLY AND POLE			UNDERGROUND CONDUIT (UC), GALVANIZED STEEL			WITH COUNTDOWN TIMER	
Steel combination mast arm Assembly and pole with luminaire	0-X	•*	TEMPORARY SPAN WIRE, TETHER WIRE, AND CABLE			ILLUMINATED SIGN "NO LEFT TURN"/"NO RIGHT TURN"	
SIGNAL POST	0	• • BM	SYSTEM ITEM	s	SP	NUMBER OF CONDUCTORS, ELECTRIC CABLE NO. 14, UNLESS NOTED OTHERWISE.	
-(BM) BARREL MOUNTED - TEMPORARY			INTERSECTION ITEM	1	IÞ	ALL DETECTOR LOOP CABLE TO BE SHIELDED) S
WOOD POLE	\otimes	Ð	REMOVE ITEM		R	GROUND CABLE IN CONDUIT, NO. 6 SOLID COPPER (GREEN)	
GUY WIRE	\succ	\succ	RELOCATE ITEM		RL	ELECTRIC CABLE IN CONDUIT, TRACER	
SIGNAL HEAD	->	-	ABANDON ITEM		Α	NO. 14 1/C	
SIGNAL HEAD WITH BACKPLATE		+► B B	CONTROLLER CABINET AND FOUNDATION TO BE REMOVED		RCF	COAXIAL CABLE	— C
SIGNAL HEAD OPTICALLY PROGRAMMED			MAST ARM POLE AND		RMF	VENDOR CABLE	—(v)-
Flasher Installation -(FS) Solar Powered	orb ^F orb ^{FS} F FS		FOUNDATION TO BE REMOVED		120-11	COPPER INTERCONNECT CABLE,	
			SIGNAL POST AND FOUNDATION TO BE REMOVED		RPF	NO. 18, 3 PAIR TWISTED, SHIELDED	0#15
PEDESTRIAN SIGNAL HEAD	-[]	-1	DETECTOR LOOP, TYPE I			FIBER OPTIC CABLE -NO. 62.5/125, MM12F	—12F
Pedestrian Push Button -(APS) Accessible Pedestrian Push Button	© © APS	© © A ps	PREFORMED DETECTOR LOOP	9 9	P (P)	-NO. 62.5/125, MM12F SM12F -NO. 62.5/125, MM12F SM24F	-24F
RADAR DETECTION SENSOR	R	R	SAMPLING (SYSTEM) DETECTOR	s (s)	s s		- <u>36F</u>
VIDEO DETECTION CAMERA		V	INTERSECTION AND SAMPLING (SYSTEM) DETECTOR	21 21	E 3		
RADAR/VIDEO DETECTION ZONE			QUEUE AND SAMPLING (SYSTEM) DETECTOR	45 (65)	45 46	GROUND ROD -(C) CONTROLLER -(M) MAST ARM	
PAN, TILT, ZOOM (PTZ) CAMERA		TT	WIRELESS DETECTOR SENSOR	 @	•	-(P) POST -(S) SERVICE	
EMERGENCY VEHICLE LIGHT DETECTOR	\bigtriangledown		WIRELESS ACCESS POINT				
CONFIMATION BEACON	00	•-(
WIRELESS INTERCONNECT	0+++++	● •+++ -					
	ERR	RR					


FILE NAME = 18R1036_02-DTLS-TS05 - P01	USER NAME = : footerni	DESIGNED — ႃ	REVISED —		DISTRICT ONE Standard traffic signal design details		F.A.U.	SECTION	COUNTY	TOTAL SHEETS	IEET	
		CHECKED — 🍱	REVISED —	STATE OF ILLINOIS			1	20-00069-00-BT	WILL	76	52	
	PLOT SCALE = 150.0000 1 / 17.	DRAWN — LP	REVISED —	DEPARTMENT OF TRANSPORTATION				TS-85	CONTRACT	NO. 61J80		
	PLOT DATE =: 3/4/2019	CHECKED - 9/29/2016	REVISED —		SCALE: NONE	SHEET NO. 52 OF 76 SHEETS	STA. TO STA.	FED. ROAL		AID PROJECT APMT		

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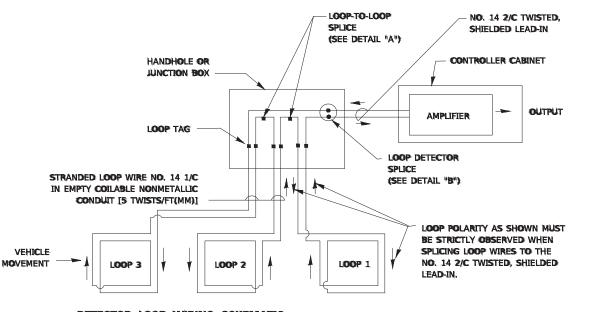
PROPOSED

LOOP DETECTOR NOTES

- 1. EACH PAIR OF LOOP WIRES SHALL BE PLACED IN A SEPARATE EMPTY COILABLE NONMETALLIC CONDUIT FROM THE EDGE OF PAVEMENT TO THE HANDHOLE. SPACING BETWEEN THE HOLES DRILLED IN THE PAVEMENT SHALL NOT BE LESS THAN 6" (150 mm). EMPTY COILABLE NONMETALLIC CONDUIT SHALL BE INCLUDED IN THE COST OF THE LOOP WIRE.
- 2. THE NUMBER OF LOOP TURNS SHALL BE AS RECOMMENDED BY THE AMPLIFIER MANUFACTURER. ALL ADJACENT SIDES OF THE LOOPS SHALL BE INSTALLED IN SUCH A WAY THAT THE CURRENT FLOW IS IN THE SAME DIRECTION TO REINFORCE ITS MAGNETIC FIELDS FOR SMALL VEHICLE DETECTION.
- 3. EACH LOOP LEAD-IN SHALL BE IDENTIFIED AND PERMANENTLY TAGGED IN THE HANDHOLE. EACH LEAD-IN CABLE TAG SHALL INDICATE THE LOCATION OF THE LOOP, LOOP ROTATION (CLOCKWISE/COUNTERCLOCKWISE), LOOP LEAD-IN DIRECTION (IN OR OUT), LOOP CABLE NUMBER AND LOCATION IN CABINET. AND NUMBER OF TURNS IN THE DETECTOR LOOPS IN WATER PROOF INK AS INDICATED ON THE DISTRICT 1 STANDARD TRAFFIC SIGNAL DESIGN DETAIL. THE CONTRACTOR SHALL MARK LOOP LOCATIONS ON RECORD DRAWINGS AND PRESENT TO THE ENGINEER AFTER FINAL INSPECTION. LOOPS SHALL BE MARKED BY LANE AND LOOP NUMBER. SEE DETAIL BELOW.
- 4. ALL LOOP CABLE SHALL BE FASTENED WITH PLASTIC TIE WRAP TO THE HANDHOLE HOOKS.
- 5. IN ASPHALT PAVEMENT, LOOPS SHOULD BE PLACED IN THE BINDER AND DIVEHOLES MARKED AT THE CURB WITH A SAW-CUT. THE SAW-CUT SHALL BE CUT IN ACCORDANCE WITH LOCAL AND E.P.A. DUST CONTROL REQUIREMENTS. DETECTOR LOOP(S) SHALL NOT BE INSTALLED IN WET CONDITIONS AND THE SAW-CUTS MUST BE FREE OF DEBRIS AND RESIDUE SUCH AS DUST AND WATER WHICH IS TO BE ACHIEVED BY THE USE OF COMPRESSED AIR, WIRE BRUSHING AND HEAT DRYING ACCORDING TO SEALANT MANUFACTURER REQUIREMENTS. THE DETECTOR WIRE SHALL BE HELD IN PLACE BY THE USE OF FORM WEDGES. WEDGES SHALL BE SPACED NO MORE THAN 18" (450 mm) APART.
- 6. LOOP SPLICES SHALL BE SOLDERED USING A SOLDERING IRON. BLOW TORCHES OR OTHER DEVICES WHICH OXIDIZE COPPER CABLE SHALL NOT BE ALLOWED FOR SOLDERING OPERATIONS. SEE DETAIL BELOW RIGHT.
- 7. PREFORMED DETECTOR LOOPS SHALL BE USED, AS SHOWN ON THE PLANS, WHERE NEW CONCRETE PAVEMENT IS PROPOSED. THE INSTALLATION OF PREFORMED LOOPS SHALL BE IN ACCORDANCE WITH THE DISTRICT 1 SPECIFICATIONS OR AS DIRECTED BY THE ENGINEER.

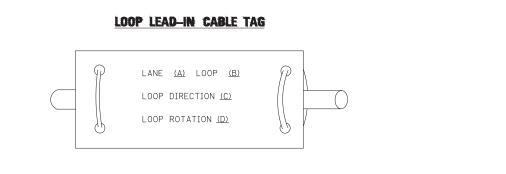


- A. LANE 1 IS THE LANE CLOSEST TO THE CENTERLINE OF THE ROADWAY
- B. LOOP #1 IS THE LOOP IN THE LANE CLOSEST TO THE INTERSECTION.
- C. LABEL LOOP CABLE "IN" OR LOOP CABLE "OUT".
- D. LABEL LOOP CABLE CLOCKWISE OR LOOP CABLE COUNTERCLOCKWISE.




DETECTOR LOOP WIRING SCHEMATIC

- LOOPS SHALL BE SPLICED IN SERIES. SAW-CUTS SHALL BE A MINIMUM WIDTH OF 5/16" (8 mm).
- = SAW-CUT DEPTHS SHALL BE 3" (75 mm). IF IN CONCRETE,
- = THE SAW-CUT DEPTH SHALL BE TO THE TOP OF THE REINFORCEMENT.
- LOOP CORNERS SHALL BE DRILLED WITH A 2" (50 mm) DIAMETER CORE.

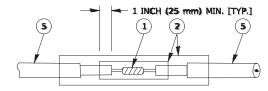


DETAIL "A" LOOP-TO-LOOP SPLICE

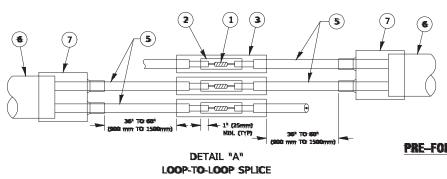


LOOP DETECTOR SPLICE

- $\fbox{(1)}$ western union splice soldered with rosin core flux. All exposed surfaces OF THE SOLDER SHALL BE SMOOTH. THE WESTERN UNION SPLICES SHALL BE STAGGERED.
- (2) WCSMW 30/100 HEAT SHRINK TUBE, MINIMUM LENGTH 3" (75 mm), UNDERWATER GRADE.
- (3) WCS 200/750 HEAT SHRINK TUBE, MINIMUM LENGHT 6" (150 mm), UNDERWATER GRADE.
- (4) NO. 14 2/C TWISTED, SHIELDED CABLE.

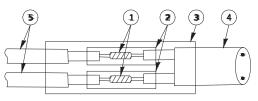

TYPE I LOOP

DETAIL "R" LOOP-TO-CONTROLLER SPLICE

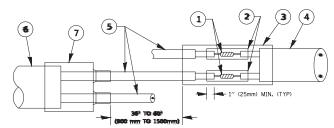

PRE-FORMED LOOP


DETAIL "B" LOOP-TO-CONTROLLER SPLICE

- PRE-FORMED LOOP **(6)** XL POLYOLEFIN 2 CONDUCTOR

(5) LOOP CONDUCTOR WITH FLEXIBLE PLASTIC TUBE.

(7) BREAKOUT SEALS. TYCO CBR-2 OR APPROVED

ONE		F.A.U. RTE.	F.A.U. SECTION			COUNTY	TOTAL SHEETS	SHEET NO.	
1	IAL DESIGN DETAILS		1	20-00069-00-BT			WILL	76	53
ar design details			TS-0	1		CONTRACT I	NO. 61J8	30	
	STA.	TO STA.	FED. RC	FED. ROAD DIST. NO. 1 ILLINOIS FED.			D PROJECT APMT	(993)	

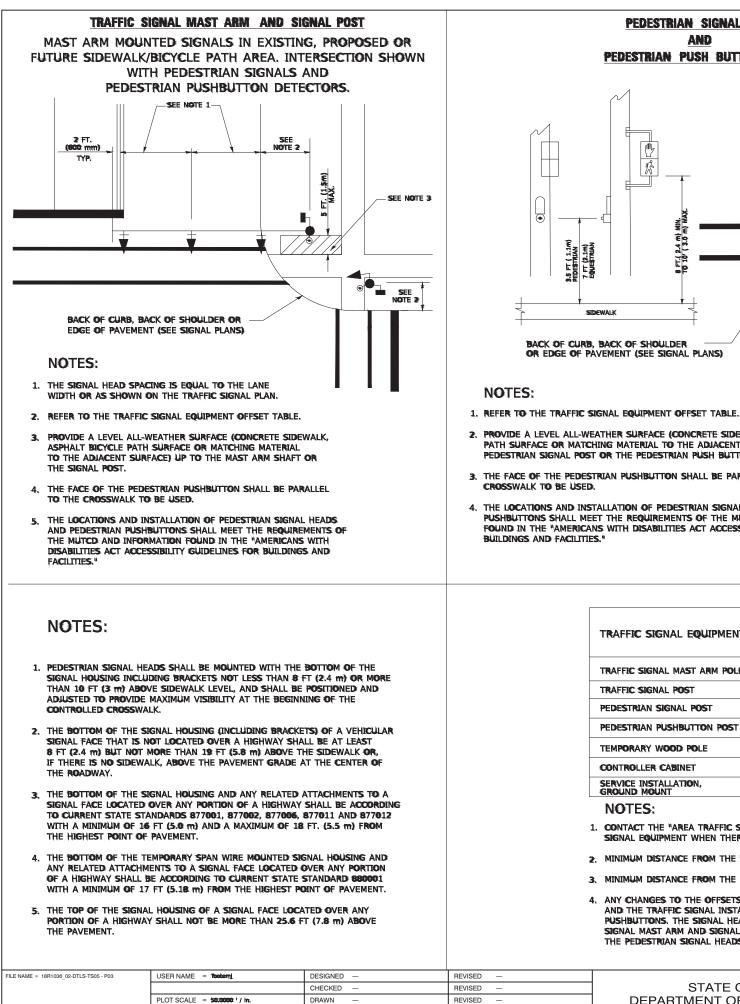


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- 2. PROVIDE A LEVEL ALL-WEATHER SURFACE (CONCRETE SIDEWALK, ASPHALT BICYCLE PATH SURFACE OR MATCHING MATERIAL TO THE ADJACENT SURFACE) UP TO THE PEDESTRIAN SIGNAL POST OR THE PEDESTRIAN PUSH BUTTON POST.
- 3. THE FACE OF THE PEDESTRIAN PUSHBUTTON SHALL BE PARALLEL TO THE CROSSWALK TO BE USED.
- 4. THE LOCATIONS AND INSTALLATION OF PEDESTRIAN SIGNAL HEADS AND PEDESTRIAN PUSHBUTTONS SHALL MEET THE REQUIREMENTS OF THE MUTCO AND INFORMATION FOUND IN THE "AMERICANS WITH DISABILITIES ACT ACCESSIBILITY GUIDELINES FOR BUILDINGS AND FACILITIES."

+FT.) MAX.	

BE PLACED CLOSER TOGETHER OR ON THE SAME POLE.

TRAFFIC SIGNAL EQUIPMENT OFFSET

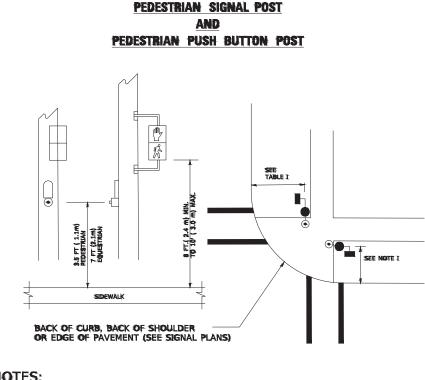5.0 (1.5 m

COMBINATION CONCRETE CURB AND GUTTER (MINIMUM DISTANCE FROM BACK OF CURB TO CENTERLINE OF FOUNDATION)	
6 FT (1.8m)	SHOU
4 FT (1.2m)	SHOU
4 FT (1.2m)	SHOU
4 FT (1.2m)	SHOU
6 FT (1.8m)	SHOU
6 FT (1.8m) MINIMUM DISTANCE SEE NOTE 2	SHOU
6 FT (1.8m) MINIMUM DISTANCE SEE NOTE 2	SHOU
	(MINIMUM DISTANCE FROM BACK OF CURB TO CENTERLINE OF FOUNDATION) 6 FT (1.8m) 4 FT (1.2m) 4 FT (1.2m) 6 FT (1.8m) 6 FT (1.8m) 6 FT (1.8m)

NOTES:


1. CONTACT THE "AREA TRAFFIC SIGNAL MAINTENANCE AND OPERATIONS ENGINEER" FOR ASSISTANCE IN LOCATING THE TRAFFIC SIGNAL EQUIPMENT WHEN THERE ARE CONFLICTS WITH DITCHES OR THE MINIMUM OFFSET DISTANCES CANNOT BE MET.


2. MINIMUM DISTANCE FROM THE BACK OF CURB TO THE ROADWAY SIDE OF THE FOUNDATION.

3. MINIMUM DISTANCE FROM THE EDGE OF PAVEMENT TOTHE ROADWAY SIDE OF THE FOUNDATION.

4. ANY CHANGES TO THE OFFSETS OF THE FOUNDATIONS, FROM THE MINIMUM DISTANCES LISTED IN THE "TRAFFIC SIGNAL EQUIPMENT OFFSET" CHART AND THE TRAFFIC SIGNAL INSTALLATION PLAN, COULD EFFECT THE PLACEMENT OF THE SIGNAL HEADS, PEDESTRIAN SIGNAL HEADS AND THE PEDESTRIAN PUSHBUTTONS. THE SIGNAL HEAD PLACEMENT ON THE MAST ARMS SHALL REMAIN AS PER THE TRAFFIC SIGNAL INSTALLATION PLAN AND THE "TRAFFIC SIGNAL MAST ARM AND SIGNAL POST" DETAIL ABOVE, THE PROPOSED MAST ARM LENGTHS MAY NEED TO BE REVISED TO MEET THE ABOVE REQUIREMENTS. THE PEDESTRIAN SIGNAL HEADS AND PEDESTRIAN PUSHBUTTONS MUST MEET THE REQUIREMENTS UNDER THE DETAILS ON THIS SHEET.

DISTRICT ONE STATE OF ILLINOIS STANDARD TRAFFIC SIGNAL DESIGN DETAILS PLOT SCALE = 50.0000 / im. DEPARTMENT OF TRANSPORTATION SCALE: NONE SHEET NO. 54 OF 76 SHEETS STA. PLOT DATE = 3/4/2019 CHECKED REVISED

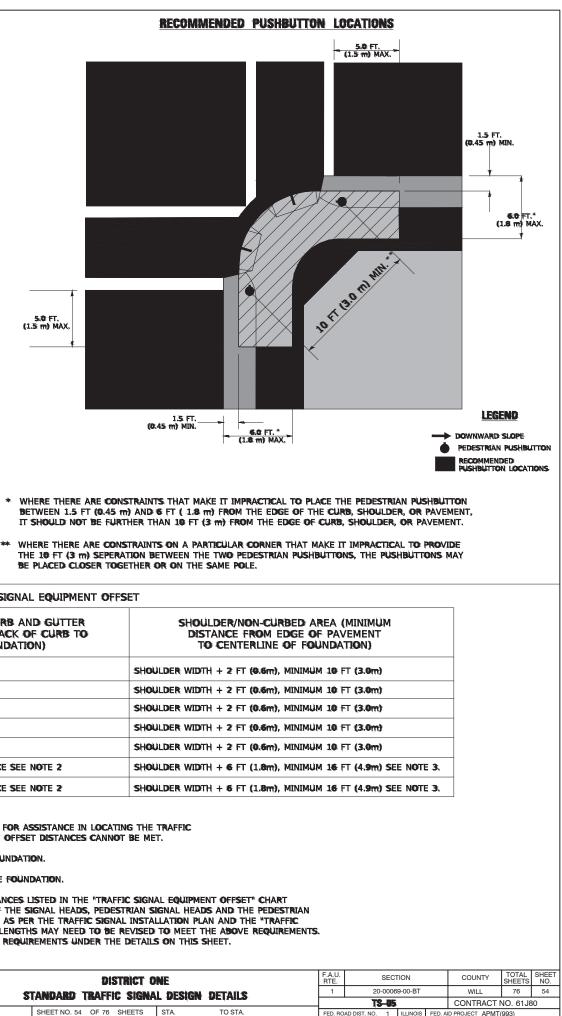

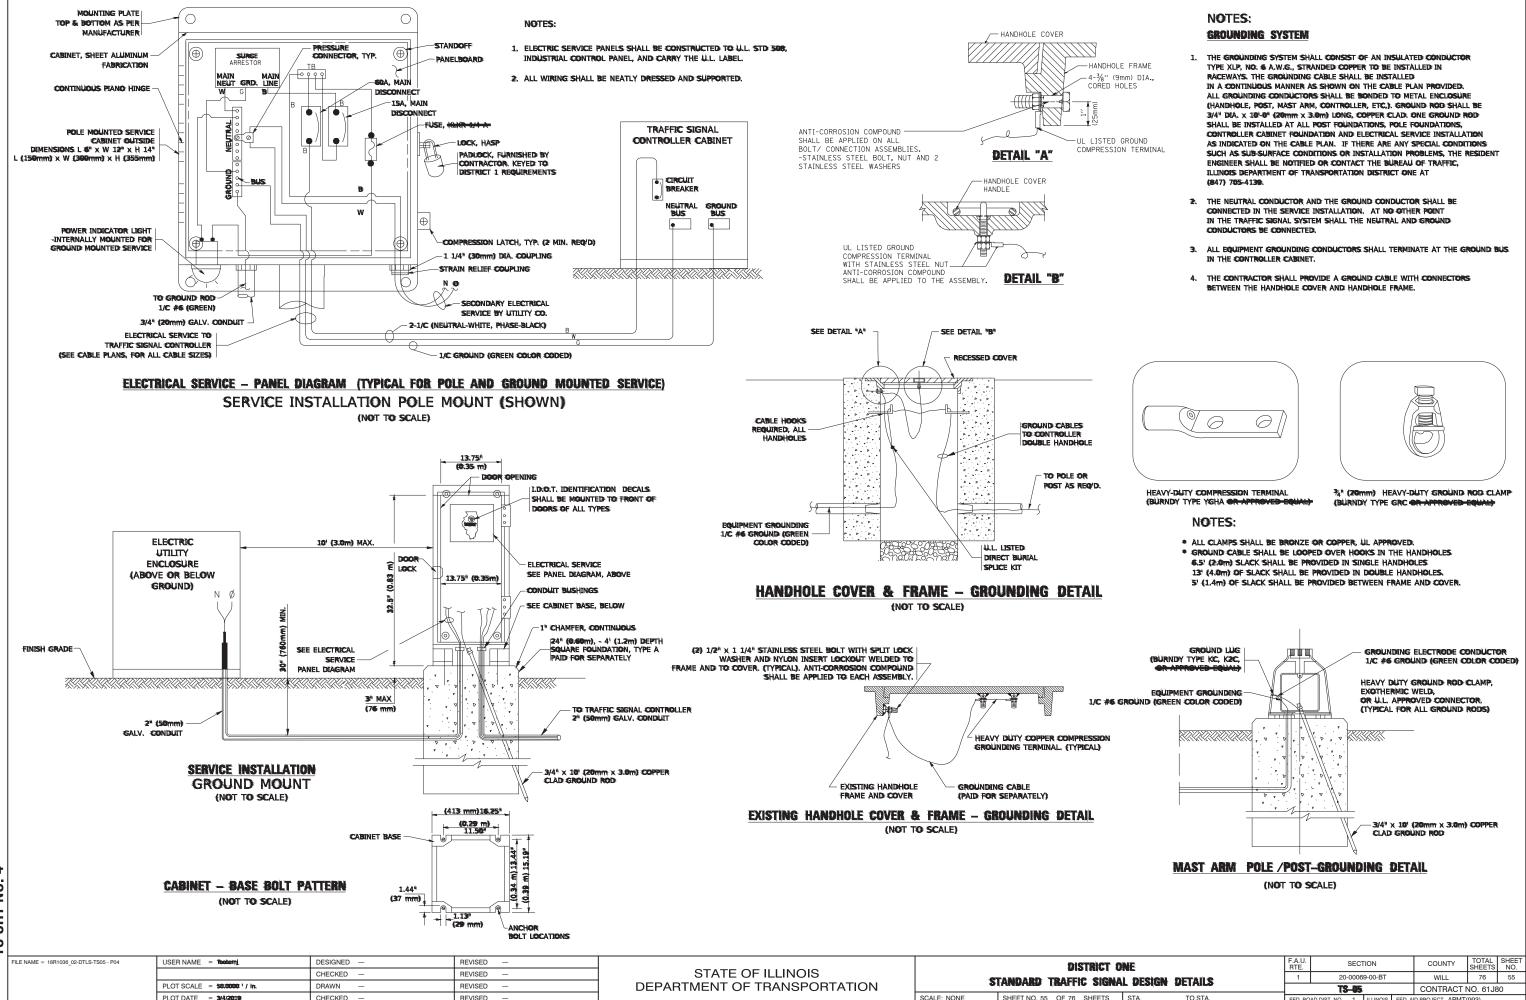


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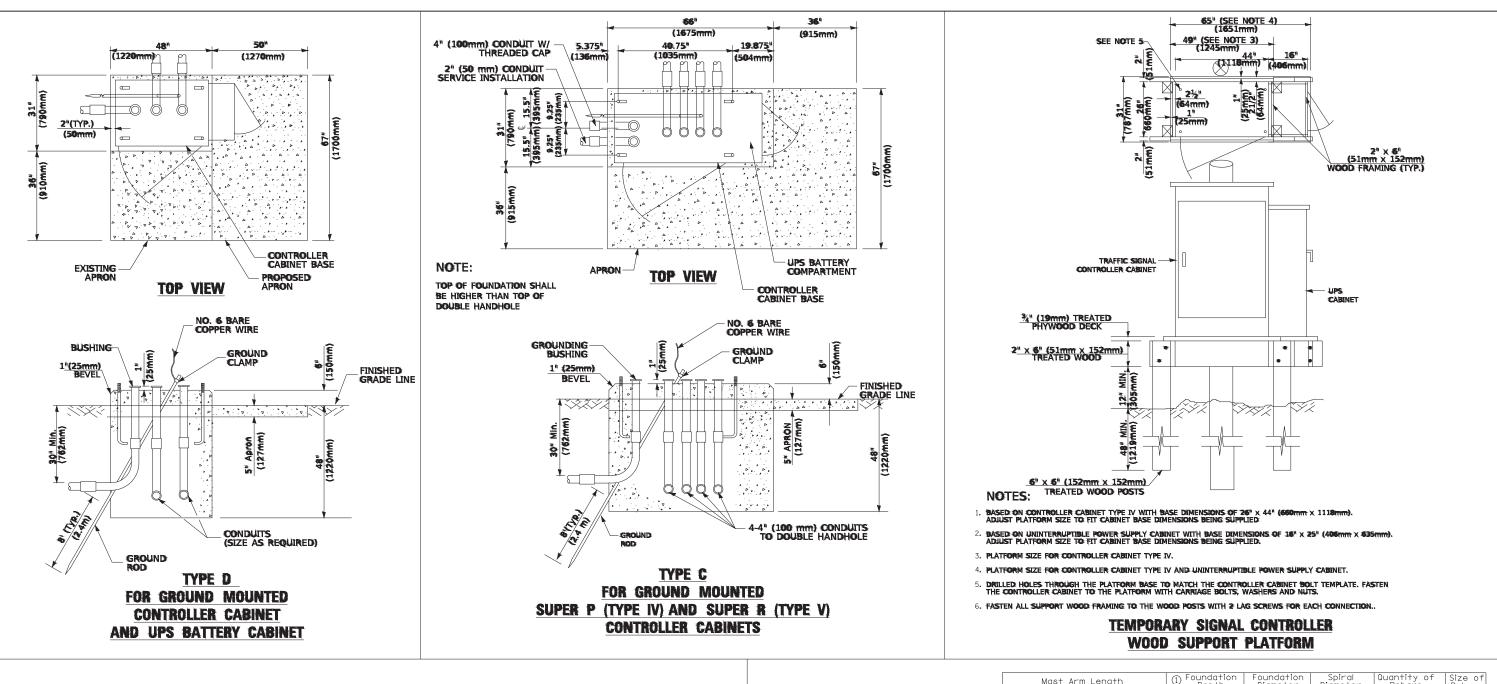
SCALE: NONE

SHEET NO. 55 OF 76 SHEETS STA.





FED. AID PROJECT APMT(993

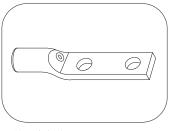

CABLE SLACK LENGTH	FEET	METER
HANDHOLE	6.5	2.0
DOUBLE HANDHOLE	13.0	4.0
SIGNAL POST	2.0	0.6
MAST ARM	2.0	9,6
CONTROLLER CABINET	1.5	0.5
FIBER OPTIC AT CABINET	13.0	4.0
electric service at (Cabinet or service location)	1.5	0.5
Ground Cable (Signal Post, Mast Arm, Cabinet)	1.5	0.5
GROUND CABLE (Between Frame and Cover)	5.0	1.6

VERTICAL CABLE LENGTH	FEET	METER
MAST ARM POLE (MAST ARM MOUNTED SIGNAL HEAD)		
(L = MAST ARM LENGTH - DISTANCE TO SIGNAL HEAD FROM END OF ARM)	20.0+L	6.0+L
BRACKET MOUNTED (MAST ARM POLE OR SIGNAL POLE)	13.0	4.0
PEDESTRIAN PUSH BUTTON	6.0	2.0
SERVICE INSTALLATION POLE MOUNT TO SERVICE DROP	13.5	4.1
SERVICE INSTALLATION POLE MOUNT TO GROUND	13.5	4.1
SERVICE INSTALLATION GROUND MOUNT	6.0	2.0
FOUNDATION (SIGNAL POST, MAST ARM POLE, CONTROLLER CABINET, SERVICE-GROUND MOUNT)	3.0	1.0

VERTICAL CABLE LENGTH

FOUNDATION	DEPTH
TYPE A - Signal Post	4'-0" (1.2m)
TYPE C - CONTROLLER W/ UPS	440" (1.2m)
TYPE D - CONTROLLER	4'-0" (1.2m)
Service Installation, Ground Mount, Type A - Square	4 '-0" (1.2m)
DEPTH OF FOUNDA	TION

Greater than or 65′ (19.8 m) and 75′ (22.9 r NOTES:

Less than 30 Greater than or 30' (9.1 m) and 1 40' (12.2 Greater than or 40' (12.2 m) and 50' (15.2 Greater than or 50' (15.2 m) an 55' (16.8

Greater than or 56' (16.8 m) and

65′ (19.8

DEPTH OF MAST ARM FOUNDATIONS, TYPE E

CABLE SLAC	K
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SHT NO. TS

FILE NAME = 18R1036_02-DTLS-TS05 - P05	USER NAME = Tooterni	DESIGNED —	REVISED —		DISTRICT ONE			F.A.U. BTE	SECTION	COUNTY	TOTAL	SHEET	
		CHECKED —	REVISED —	STATE OF ILLINOIS				CTAILE	1	20-00069-00-BT	WILL	76	56
	PLOT SCALE = 50.0000 / in.	DRAWN —	REVISED —	DEPARTMENT OF TRANSPORTATION		STANDARD TRAFFIC SIGNAL DESIGN DETAILS				TS-05	CONTRACT	NO. 61J	80
	PLOT DATE = 3/4/2019	CHECKED —	REVISED —		SCALE: NONE	SHEET NO. 56 OF 76 SHEETS	STA.	TO STA.	FED. ROAD D	DIST. NO. 1 ILLINOIS FE	D. AID PROJECT APMT		$\neg \neg$


S

ength.	① Foundation Depth	Foundation Diameter	Spiral Diameter	Quantity of Rebars	Size of Rebars
′ (9 . 1 m)	10'-0'' (3.0 m)	30" (750mm)	24" (600mm)	8	6(19)
r equal to	13'-6'' (4.1 m)	30'' (750mm)	24'' (600mm)	8	6(19)
less than m)	11'-0'' (3.4 m)	' (3.4 m) 36'' (900mm) 30'' (750mm)	12	7(22)	
r equal to less than m)	13'-0'' (4.0 m)	36″ (900mm)	30" (750mm)	12	7(22)
r equal to nd up to m)	15'-0'' (4.6 m)	36" (900mm)	30" (750mm)	12	7(22)
r equal to less than m)	21'-0'' (6.4 m)	42" (1060mm)	36" (900mm)	16	8(25)
r equal to nd up to m)	25'-0" (7.6 m)	42" (1060mm)	36″ (900mm)	16	8(25)

. These foundation depths are for sites which have cohesive soils (clayey silt, sandy clay, etc.) along the length of the shaft, with an average Unconfined Compressive Strength (Qu) > 1.0 tsf (100 kpa). This strength shall be verified by boring data prior to construction or with testing by the Engineer during foundation drilling. The Bureau of Bridges & structures should be contacted for a revised design if other conditions are encountered.

2. Combination mast arm assemblies under 55 feet (16.8 m) shall use 36" (900 mm) diameter foundations. Combination mast arm assemblies under 56 feet (16.8 m) through 75 feet (22.9 m) shall use 42" (1060 mm) diameter foundations

4. For mast arm assemblies with dual arms refer to state standard 878001 ..

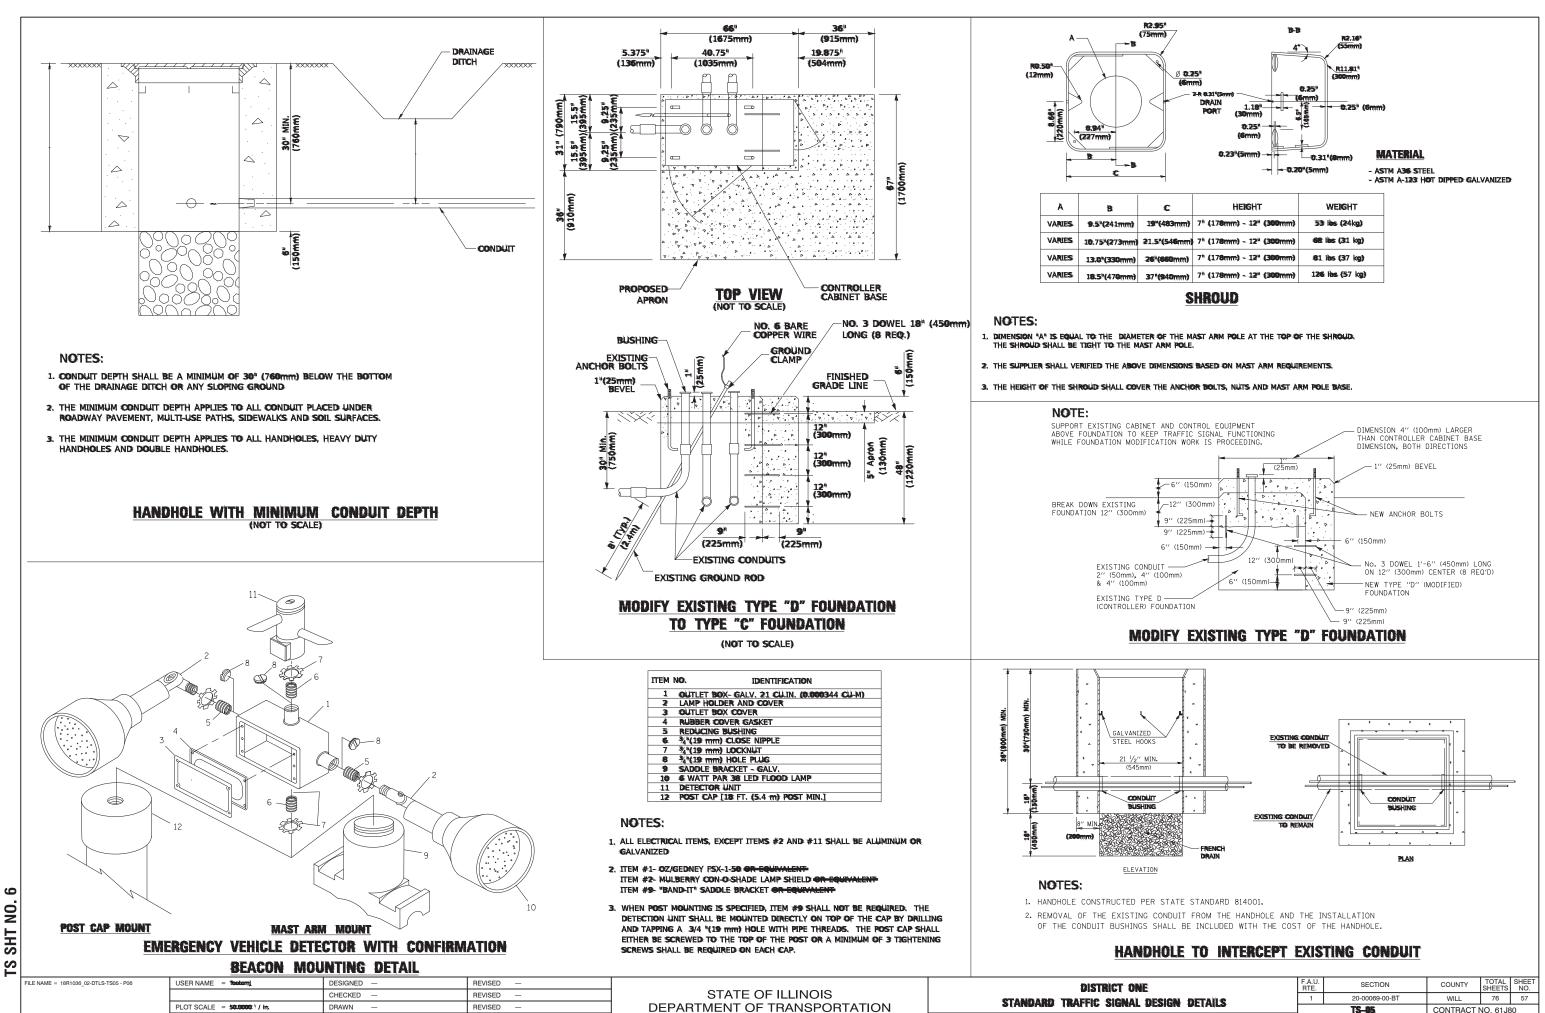

PLOT DATE = 3/4/2019


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SCALE: NONE

SHEET NO. 57 OF 76 SHEETS

ONE IAL DESIGN DETAILS		F.A.U. RTE.	SECT	CTION		COUNTY	TOTAL SHEETS	SHEET NO.
		1	20-00069-00-BT			WILL	76	57
			TS-05	CONTRACT NO. 61J80			30	
	STA. TO STA.	FED. RO	AD DIST. NO. 1	ILLINOIS	FED. AI	D PROJECT APMT	993)	



TS SHT NO.

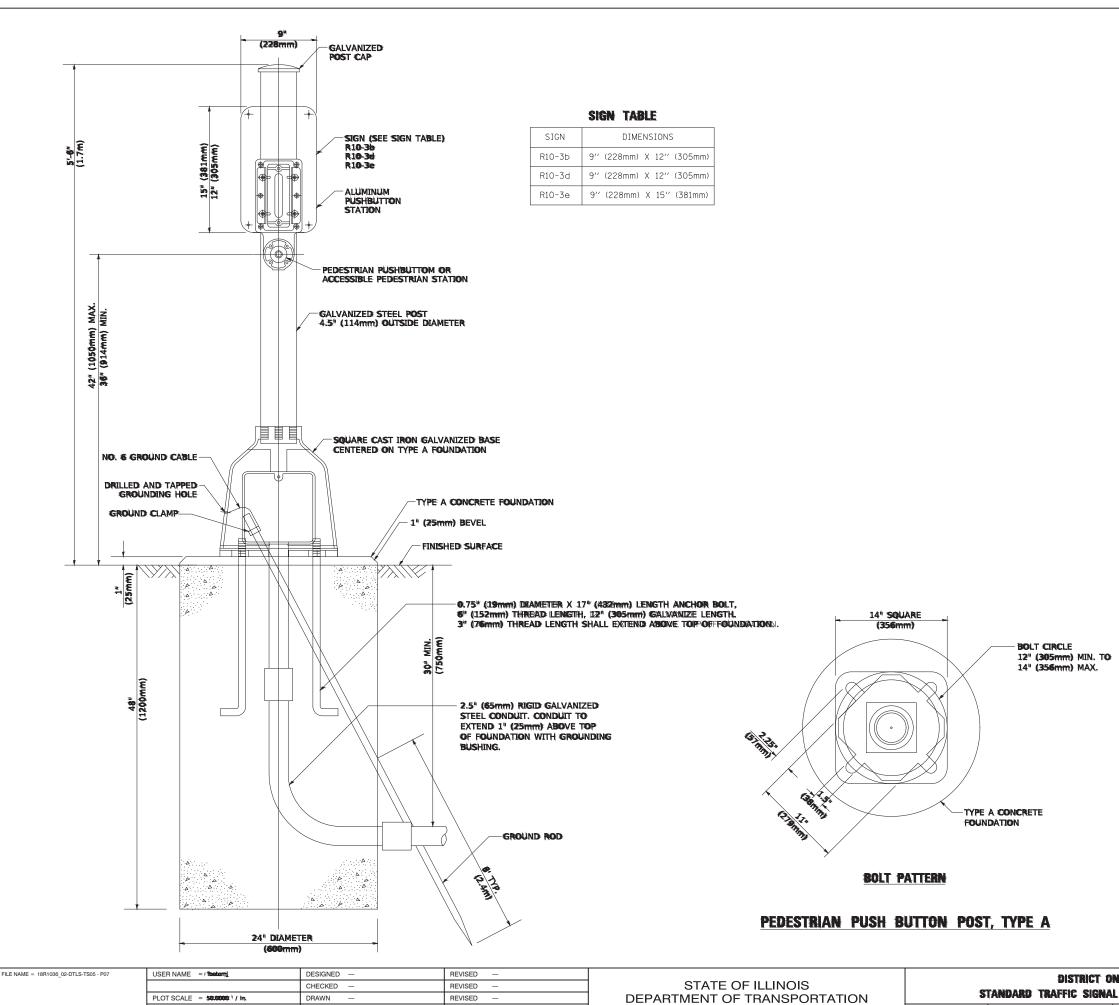PLOT DATE = 3/4/2019


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ONE IAL DESIGN DETAILS		.U. SECTION E.			COUNTY	TOTAL SHEETS	SHEET NO.	
		20-00069-00-BT				WILL	76	58
		TS-05 CONTRACT NO. 61J80					30	
STA. TO STA.	FED. ROAD DIST. NO. 1 ILLINOIS FE			FED. AI	AID PROJECT APMT(993)			

SCALE: NONE

SHEET NO. 58 OF 76 SHEETS



FILE NAME = 18R1036_02-SGNL-01 - P01	USER NAME =	DESIGNED - MPN	REVISED —			135TH STREET - ROADWAY
		CHECKED — WPD	REVISED —	STATE OF ILLINOIS DEPARTMENT OF TRANSPORTATION		IPORARY TRAFFIC SIGNAL INS
	PLOT SCALE =	DRAWN — RG/KWM	REVISED —		REN	MOVE EXISTING TRAFFIC SIGN
	PLOT DATE = 08-07-23	CHECKED — AG	REVISED —		SCALE: 1"=20'	SHEET NO. 59 OF 76 SHEETS

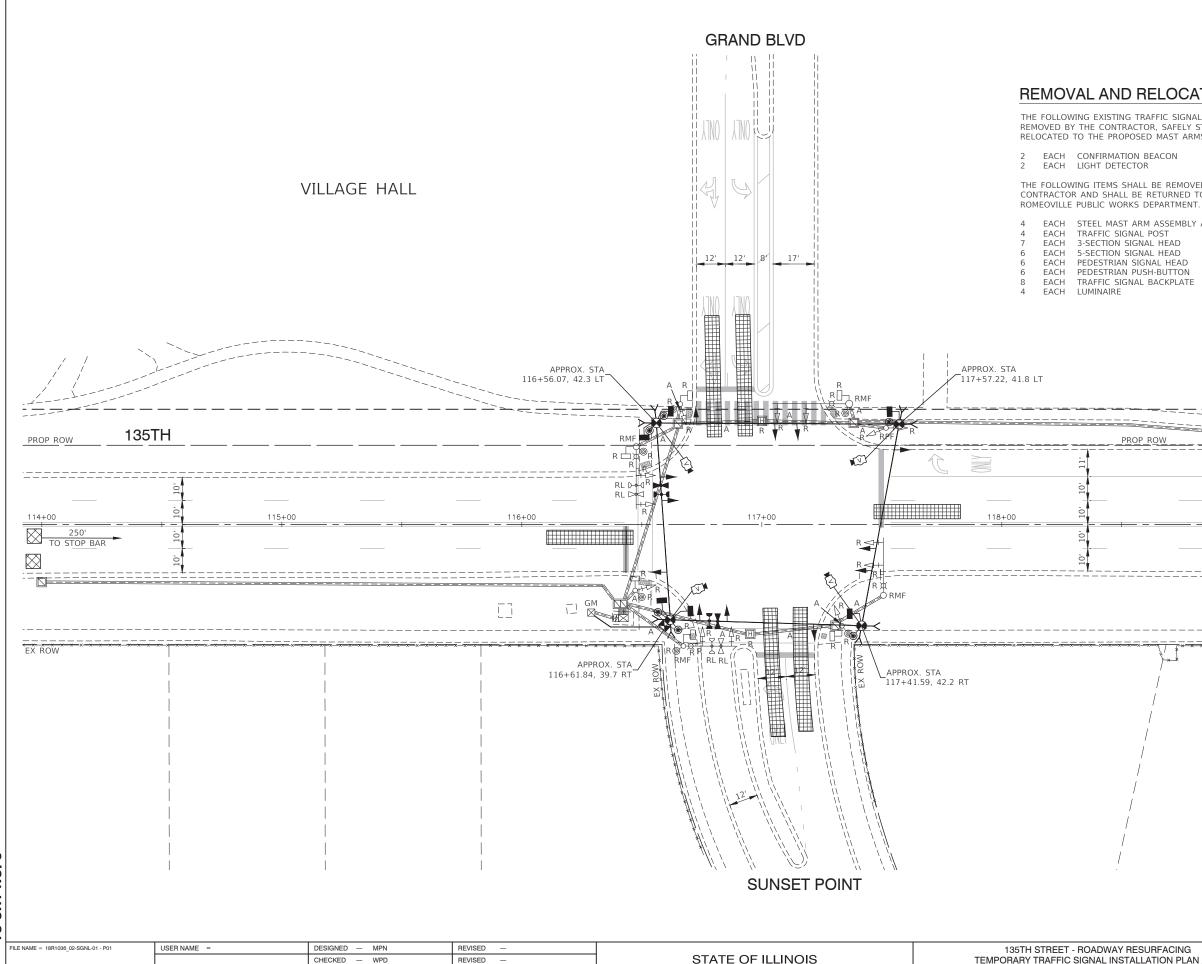
REMOVAL AND RELOCATION NOTES:

THE FOLLOWING EXISTING TRAFFIC SIGNAL EQUIPMENT SHALL BE REMOVED BY THE CONTRACTOR, SAFELY STORED, AND RELOCATED TO THE PROPOSED MAST ARMS.

THE FOLLOWING ITEMS SHALL BE REMOVED BY THE CONTRACTOR AND SHALL BE RETURNED TO THE VILLAGE OF

EACH STEEL MAST ARM ASSEMBLY AND POLE EACH TRAFFIC SIGNAL POST EACH 3-SECTION SIGNAL HEAD EACH 5-SECTION SIGNAL HEAD EACH PEDESTRIAN SIGNAL HEAD EACH PEDESTRIAN PUSH-BUTTON EACH TRAFFIC SIGNAL BACKPLATE


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AY RESURFACING NSTALLATION PLAN AND	F.A.U. RTE.	SECT			COUNTY	TOTAL SHEETS	SHEET
GNAL EQUIPMENT PLAN	0282	20-0006	9-00-BT		WILL CONTRACT	76 NO. 61J8	59 30
STA. TO STA.	FED. RC	AD DIST. NO. 1	ILLINOIS	FED. A	ID PROJECT APMT		

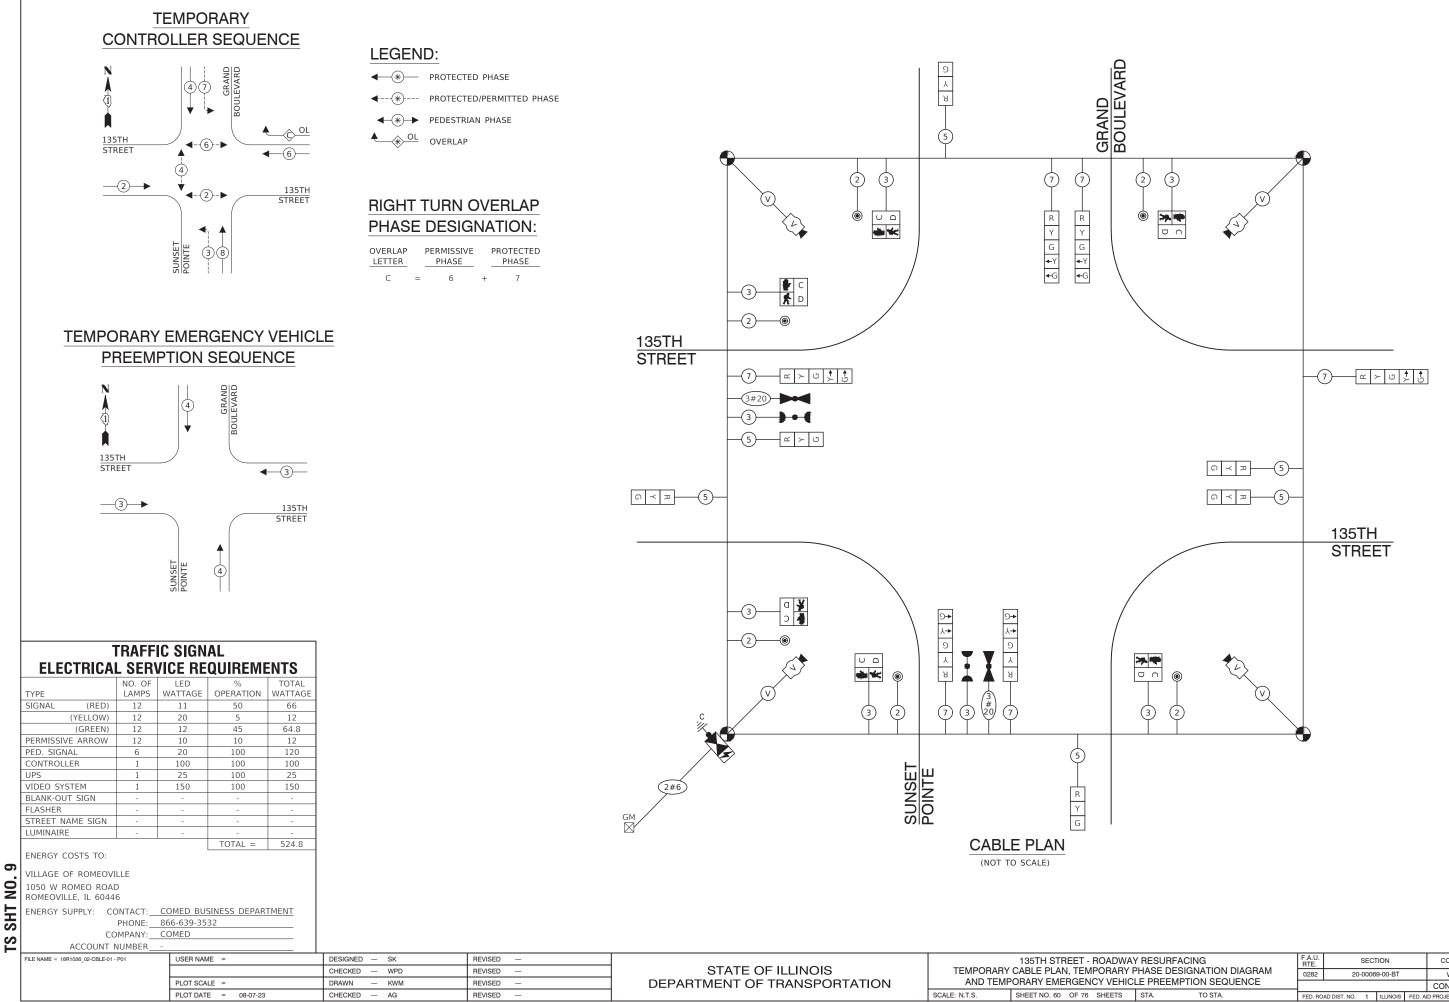


AY RESURFACING Y PHASE DESIGNATION DIAGRAM ICLE PREEMPTION SEQUENCE		F.A.U. RTE.	SECTION		COUNTY	TOTAL SHEETS	SHEET NO.		
		0282	20-00069-00-BT			WILL	76	60	
						CONTRACT	NO. 61J8	30	
	STA.	TO STA.	FED. RO	AD DIST. NO. 1	ILLINOIS	FED. AI	D PROJECT APMT	(993)	

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PLOT DATE = 08-07-23


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SCALE: N.T.S. SHEET NO. 62 OF 76 SHEETS

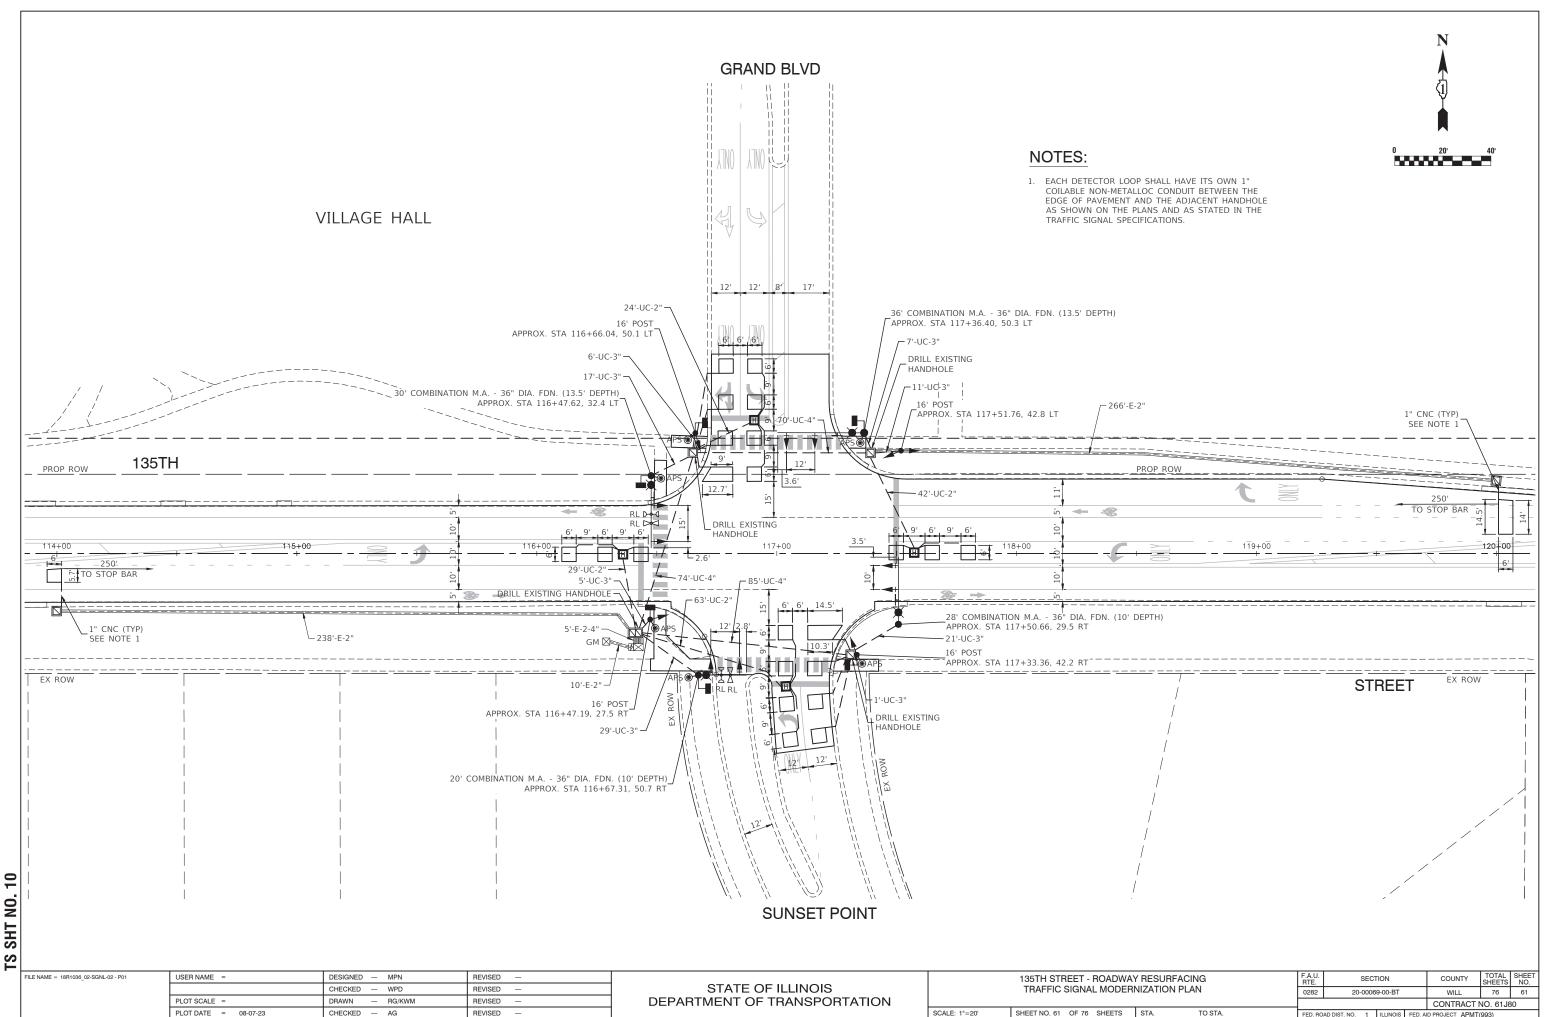

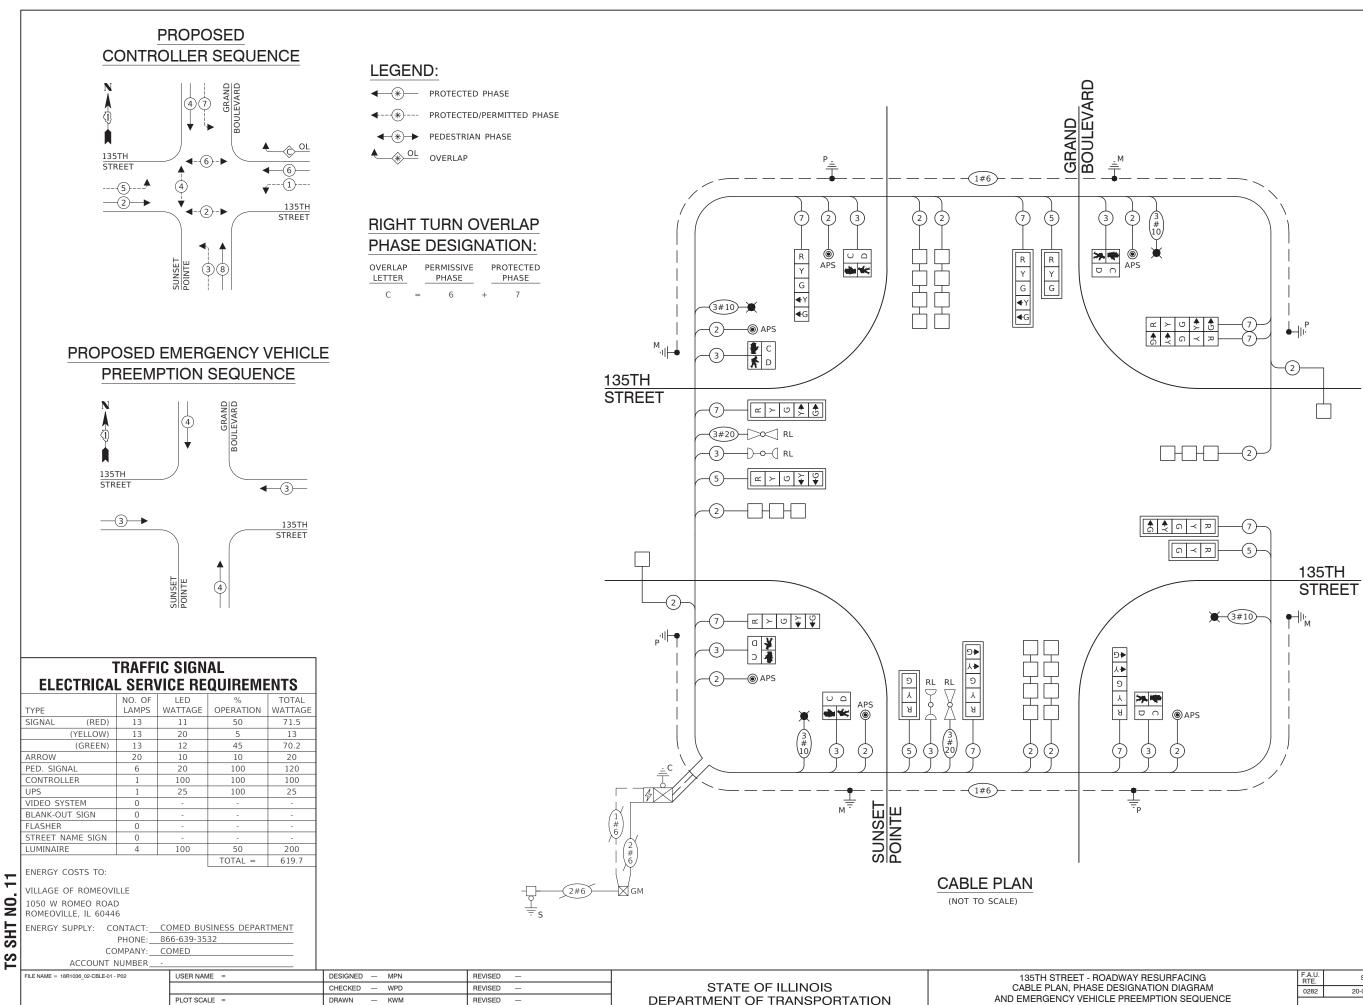F.A.U. RTE.	SECTION		COUNTY	TOTAL SHEETS	SHEET NO.		
0282	20-00069-00-BT			WILL	76	62	
				CONTRACT NO. 61J80			
FED. ROAD DIST. NO. 1 ILLINOIS FED. AID PROJECT APMT(993					(993)		
	RTE. 0282	RTE. SEC 0282 20-0006	RTE. SECTION 0282 20-00069-00-BT	RTE. SECTION 0282 20-00069-00-BT	RTE. SECTION COUNTY 0282 20-00069-00-BT WILL CONTRACT I CONTRACT I	RTE. SECTION COUNTY SHEETS 0282 20-00069-00-BT WILL 76 CONTRACT NO. 61JE	



DESIGN	AREA	SIGN PANEL	SHEETING	QTY
SERIES	(SQ FT)	TYPE	TYPE	REQUIRED
D	17.5	2	ZZ	1

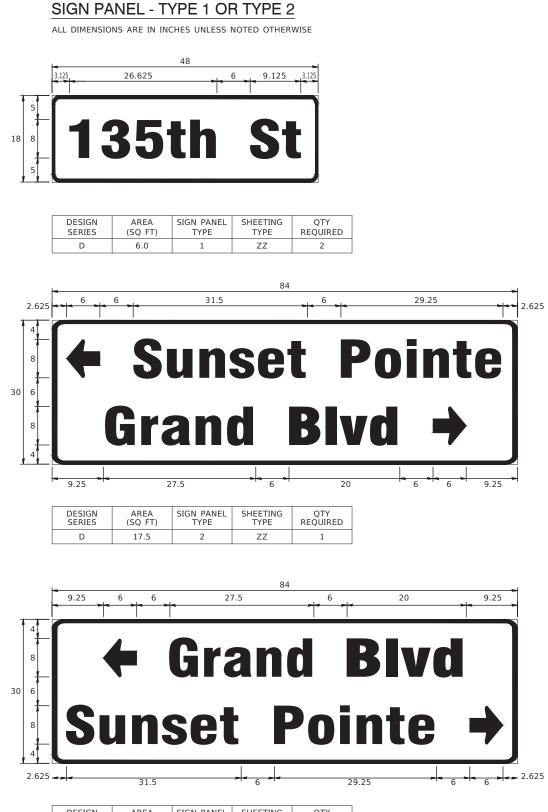NOTE: FOR ADDITIONAL DESIGN AND INSTALLATION INFORMATION PLEASE SEE DISTRICT ONE MAST ARM MOUNTED STREET NAME SIGNS DETAIL.

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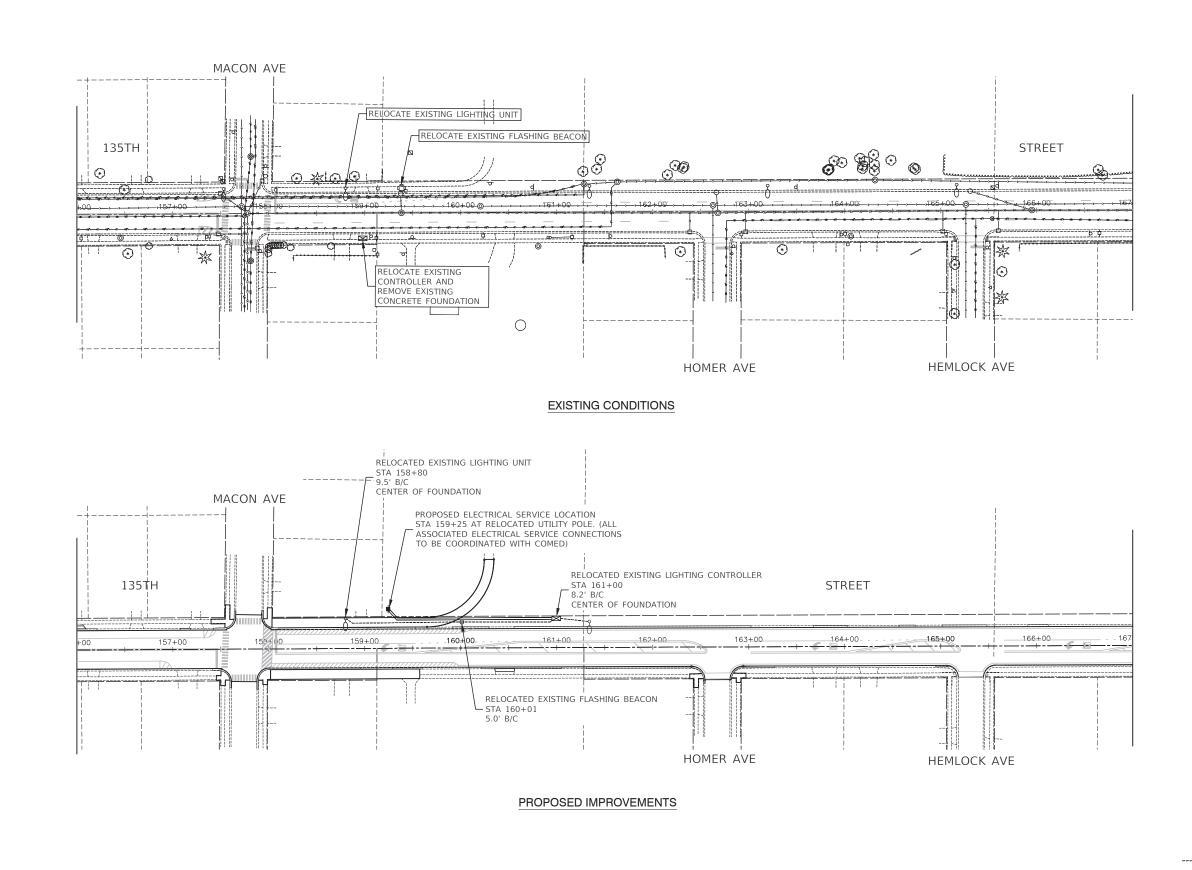
ITEM DESCRIPTION	UNITS	TOTA QTY
SIGN PANEL - TYPE 1	SQ FT	12
SIGN PANEL - TYPE 2	SQ FT	35
UNDERGROUND CONDUIT, GALVANIZED STEEL, 2" DIA.	FOOT	158
UNDERGROUND CONDUIT, GALVANIZED STEEL, 3" DIA.	FOOT	97
UNDERGROUND CONDUIT, GALVANIZED STEEL, 4" DIA.	FOOT	229
HANDHOLE	EACH	1
HEAVY-DUTY HANDHOLE	EACH	4
LUMINAIRE, LED, ROADWAY, OUTPUT DESIGNATION G	EACH	4
PAINT NEW TRAFFIC SIGNAL POST	EACH	4
PAINT NEW MAST ARM AND POLE, UNDER 40 FOOT	EACH	4
ELECTRIC CABLE IN CONDUIT, SIGNAL NO. 14 2C	FOOT	696
ELECTRIC CABLE IN CONDUIT, SIGNAL NO. 14 3C	FOOT	992
ELECTRIC CABLE IN CONDUIT, SIGNAL NO. 14 5C	FOOT	648
ELECTRIC CABLE IN CONDUIT, SIGNAL NO. 14 7C	FOOT	1420
ELECTRIC CABLE IN CONDUIT, LEAD-IN, NO. 14 1 PAIR	FOOT	889
ELECTRIC CABLE IN CONDUIT, EQUIPMENT GROUNDING CONDUCTOR, NO. 6 1C	FOOT	489
TRAFFIC SIGNAL POST, GALVANIZED STEEL 16 FT.	EACH	4
STEEL COMBINATION MAST ARM ASSEMBLY AND POLE 20 FT.	EACH	1
STEEL COMBINATION MAST ARM ASSEMBLY AND POLE 28 FT.	EACH	1
STEEL COMBINATION MAST ARM ASSEMBLY AND POLE 30 FT.	EACH	1
STEEL COMBINATION MAST ARM ASSEMBLY AND POLE 36 FT.	EACH	1
CONCRETE FOUNDATION, TYPE A	FOOT	16
CONCRETE FOUNDATION, TYPE E 36-INCH DIAMETER	FOOT	47
DRILL EXISTING HANDHOLE	EACH	4
SIGNAL HEAD, LED, 1-FACE, 3-SECTION, MAST-ARM MOUNTED	EACH	3
SIGNAL HEAD, LED, 1-FACE, 5-SECTION, BRACKET MOUNTED	EACH	5
SIGNAL HEAD, LED, 1-FACE, 5-SECTION, MAST-ARM MOUNTED	EACH	5
PEDESTRIAN SIGNAL HEAD, LED, 1-FACE, BRACKET MOUNTED WITH COUNTDOWN TIMER	EACH	6
TRAFFIC SIGNAL BACKPLATE, LOUVERED, FORMED PLASTIC	EACH	8
INDUCTIVE LOOP DETECTOR	EACH	8
DETECTOR LOOP, TYPE I	FOOT	779
TEMPORARY TRAFFIC SIGNAL INSTALLATION	EACH	1
RELOCATE EXISTING EMERGENCY VEHICLE PRIORITY SYSTEM, DETECTOR UNIT	EACH	2
RELOCATE EXISTING FLASHING BEACON	EACH	1
MODIFY EXISTING CONTROLLER	EACH	1
REMOVE EXISTING TRAFFIC SIGNAL EQUIPMENT	EACH	1
REMOVE EXISTING HANDHOLE	EACH	1
REMOVE EXISTING CONCRETE FOUNDATION	EACH	5
EMERGENCY VEHICLE PRIORITY SYSTEM LINE SENSOR CABLE, NO. 20 3/C	FOOT	254
ELECTRIC CABLE IN CONDUIT, SIGNAL NO. 10 3C	FOOT	697
ACCESSIBLE PEDESTRIAN SIGNALS	EACH	6
TEMPORARY TRAFFIC SIGNAL TIMING	EACH	1

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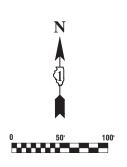
FILE NAME = 18R1036_02-SIGN-02 - P01	USER NAME =	DESIGNED - SK	REVISED —		135TH STREET - ROADWAY RESURFACING MAST ARM MOUNTED STREET NAME SIGNS		F.A.U. BTE.	SECTION	COUNTY	TOTAL	SHEET NO.
		CHECKED — WPD	REVISED —] STATE OF ILLINOIS			0282	20-00069-00-BT	WILL	76	63
	PLOT SCALE =	DRAWN — KWM	REVISED —	DEPARTMENT OF TRANSPORTATION	AND SCHEDULE OF QUANTITIES				CONTRACT	NO. 61J	30
	PLOT DATE = 08-07-23	CHECKED — AG	REVISED —		SCALE: N.T.S. SHEET NO. 63 OF 76 SHEETS STA. TO STA.		FED. ROAD	ROAD DIST. NO. 1 ILLINOIS FED. AID PROJECT APMT(993)			

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F QUANTITIES



FILE NAME = 18R1036_02-LGHT-01 - P01	USER NAME =	DESIGNED - SK	REVISED —		135TH STREET ROADWAY RESURFACING STREET LIGHTING PLANS		F.A.U. BTE	SECTION	COUNTY	TOTAL SHEET
		CHECKED — WPD	REVISED —] STATE OF ILLINOIS			0282	0282 20-00069-00-BT WILL 76		
	PLOT SCALE = 1"=50"	DRAWN — KWM	REVISED —	DEPARTMENT OF TRANSPORTATION					CONTRACT N	O. 61J80
	PLOT DATE = 08-07-23	CHECKED — AG	REVISED —		SCALE: 1"=20'	SHEET NO. 64 OF 76 SHEETS STA. TO STA.	FED. RO	DAD DIST. NO. 1 ILLINOIS FE	D. AID PROJECT APMT(9	



LEGEND:

• EXISTING ALUMINUM LIGHT POLE

- EXISTING POWER POLE
- RELOCATED STREET LIGHT-250W HPS
- RELOCATED CONTROLLER
- RELOCATED FLASHING BEACON
- PROPOSED POWER POLE


B/C BACK OF CURB

UNIT DUCT, 600V, 6-1/C, NO.6 1/C AWG NO.8 GROUND, (XLP-TYPE USE) 1-1/2" DIA. POLYETHYLENE SERVICE WIRE, 3-1/C, NO. 1/0 AWG IN 2.5" RGSC

LIGHTING GENERAL NOTES

- 2.
- 3. COORDINATED WITH COMED FOR APPROVAL
- 4. ALL CONDUIT TO BE 2 1/2" DIAMETER UNLESS OTHERWISE SPECIFIED.
- 5. THIS WORK SHALL BE CONSIDERED INCLUDED IN THE COST OF THE CONTRACT.
- OPERATIONS, AS APPLICABLE.
- 7. OF THE FOUNDATION HEIGHTS AND THE LIGHT SHALL REMAIN WITH THE CONTRACTOR
- 8.
- 9. AND SHALL TAG ALL WIRE ACCORDINGLY.

- LOCATION
- UTILITIES
- 14.
- SEPARATELY, BUT SHALL BE CONSIDERED INCLUDED IN THE COST OF THE PAY ITEM.

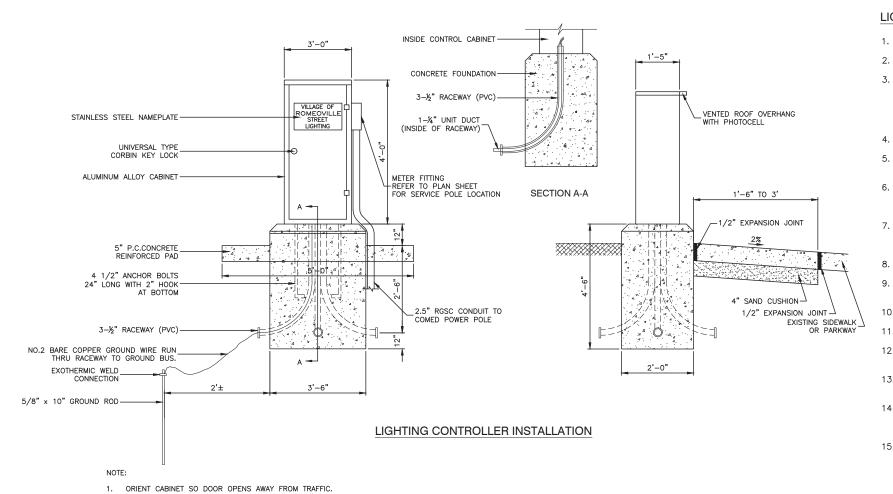

12" MAXIMUM WIDTH EXCEPT AS HEAT-SHRINKABLE 12" MAXIMUM WIDTH EXCEPT AS APPROVED BY THE ENGINEER APPLIED WATERPROOF APPROVED BY THE ENGINEER ACCOMMODATE NU SAW CUT JOINT (INCIDENTAL)--SAW CUT JOINT (INCIDENTAL) EXISTING PAVEMENT OR ELECTRIC FEEDER CABLES. SU CONCRETE SIDEWALK (SIZE AS NOTED ON CONT · · · / ELECTRIC C (SIZE AS NO -PAVEMENT AS SPECIFIED RESTORATION AS SPECIFIED MAGNETIC DETECTABLE WARNING TAPE MAGNETIC DETECTABLE WARNING TAPE "O TRENCH BACKFILL -COMPACTED EARTH BACKFILL UNIT DUCT TO BE PLACED IN GALVANIZED STEEL CONDUIT UNDER ROADWAYS - TRENCH BACKFILL -1 1/2" CABLE DUCT WITH 6-1/C #6 WIRES, AND 1/C NO.8 GROUND -1 1/2" CABLE DUCT WITH 6-1/C #6 WIRES, AND 1/C NO.8 GROUND

TRENCH DETAIL - PAVED AREAS

METER FITTING TO BE LOCATED ON THE SIDE OF THE CABINET CLOSEST TO SERVICE POLE.

TRENCH DETAIL - UNPAVED AREAS

ſ	FILE NAME = 18R1036_02-DTLS-LGHT - LGHT (2)	USER NAME =	DESIGNED — SK	REVISED —				F.A.U. BTE.	SECTION	COUNTY	TOTAL SHEF
			CHECKED — WPD	REVISED —	STATE OF ILLINOIS		ROADWAY RESURFACING	0282	20-00069-00-BT	WILL	76 65
		PLOT SCALE = N.T.S	DRAWN — KWM	REVISED —	DEPARTMENT OF TRANSPORTATION	STREET LIGHTING DETAILS		-		CONTRACT	NO 61,180
		PLOT DATE = 08-07-23	CHECKED — AG	REVISED —		SCALE: N.T.S.	SHEET NO. 65 OF 76 SHEETS STA. TO STA.	FED. ROAD I	DIST. NO. 1 ILLINOIS FED.	AID PROJECT APMT	

1. ALL WORK TO CONFORM TO THE MOST RECENT NATIONAL ELECTRICAL CODE AND ANY APPLICABLE LOCAL CODES.

CONTRACTOR TO VERIFY LOCATION OF ALL UNDERGROUND UTILITIES BEFORE TRENCHING OR AUGURING.

THE EXACT LOCATIONS OF ALL UTILITIES SHALL BE VERIFIED BY THE CONTRACTOR BEFORE THE INSTALLATION OF ANY COMPONENTS OF THE LIGHTING SYSTEM. FOR THE LOCATIONS OF THE UTILITIES, CALL JULIE TOLL FREE AT 1-800-892-0123 AT LEAST 48 HOURS BEFORE ANY EXCAVATION IS TO TAKE PLACE. IT IS THE CONTRACTOR'S RESPONSIBILITY TO LOCATE EXISTING TRAFFIC SIGNAL CABLES AND CONDUITS. PRIOR TO CONSTRUCTION, ANY OVERHEAD CLEARANCE CONFLICTS SHOULD BE

ANY TREE TRIMMING REQUIRED AS DIRECTED BY THE ENGINEER SHALL BE PERFORMED BY THE CONTRACTOR, AND THE COST OF

THE CONTRACTOR SHALL MAKE SPECIAL NOTE OF THE REQUIREMENT FOR BURIED WARNING TAPE. THE INSTALLATION OF THE TAPE SHALL BE INSPECTED AND APPROVED BY THE RESIDENT ENGINEER DURING PLOWING

THE CONTRACTOR SHALL BE RESPONSIBLE FOR THE ESTABLISHMENT OF FINISHED GRADE. THE RESIDENT ENGINEER MAY ASSIST THE CONTRACTOR, AS APPLICABLE, BUT THE RESPONSIBILITY FOR COORDINATING THE FINISHED GRADE ELEVATION WITH THE TOP

NO POLES SHALL BE ERECTED UNTIL THE RESPECTIVE FOUNDATIONS HAVE CURED, AS APPROVED BY THE ENGINEER.

THE CONTRACTOR SHALL MAKE SPECIAL NOTE OF THE REQUIREMENTS FOR WIRE MARKERS AND SHALL TAG ALL WIRE MARKERS

10. EQUIPMENT GROUND CONDUCTORS SHALL BE SPLICED AND BONDED AT EACH LIGHT POLE OR OTHER PIECE OF EQUIPMENT.

11. UNDERGROUND SPLICING OF CABLES SHALL NOT BE ALLOWED. ALL CABLE SPLICES SHALL BE CONSTRUCTED IN POLES.


12. BEFORE INSTALLING STANDARDS NEAR OVERHEAD FACILITIES CALL COMMONWEALTH EDISON COMPANY FOR APPROVAL OF

13. CONDUITS AND UNIT DUCTS MUST BE POSITIONED IN THE FIELD TO AVOID CONFLICT WITH TREES, BUSHES, DRAINS AND OTHER

UNIT DUCT SHALL BE BORED AND PULLED WHERE NEEDED TO MINIMIZE THE NEED FOR RESTORATION. IF THE CONTRACTOR CHOOSES TO TRENCH THE UNIT DUCT IN THESE AREAS, THE RESTORATION AND BACKFILL COSTS WILL NOT BE PAID FOR SEPARATELY, BUT SHALL BE CONSIDERED INCLUDED IN THE COST OF THE PAY ITEM.

15. UNDERGROUND CONDUIT SHALL BE PUSHED WHERE NEEDED TO MINIMIZE THE NEED FOR RESTORATION. IF THE CONTRACTOR CHOOSES TO TRENCH THE CONDUIT IN THESE AREAS, THE RESTORATION AND BACKFILL COSTS WILL NOT BE PAID FOR


TRIMMED CABLES CAP WITH FACTORY SEALANT. (SIZED TO MBER OF CABLES).	COMPRESSION TYPE COPPER SLEEVE. (SIZED FOR ACTUAL NUMBER OF CABLES AND MFR. SUGGESTED CRIMP TOOL USED)
UCH AS UNIT DUCT TRACT DRAWINGS).	SEALANT TAPE OR INSERT. (AROUND AND THROUGH CROTCH OF SPLICE).
ABLE TO LUMINAIRE ITED ELSEWHERE IN- THESE PLANS).	
	- EXPOSED SEALANT
SPLICING ELECTRIC C	ABLES
BASIC MATERIALS AND M	IETHODS
<u>*NOTE:</u> THAT NUMBER OF CABLES IN SPLI	CE MAY VARY.

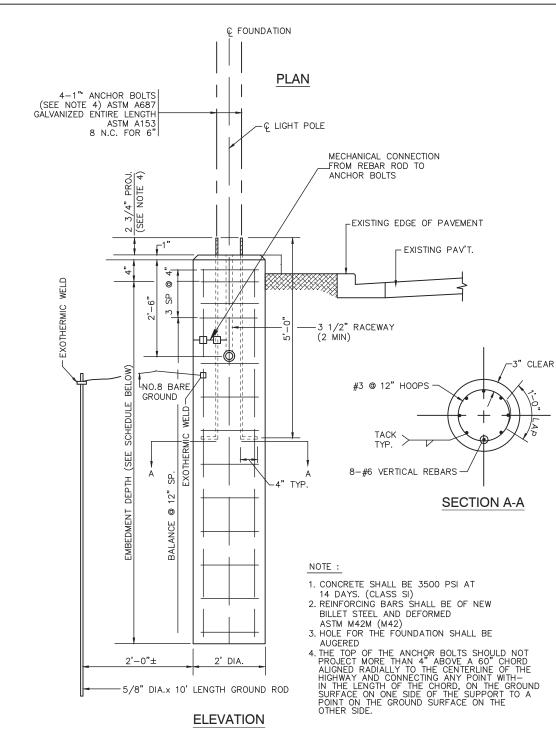


LIGHT POLE FOUNDATION (TYPICAL)

	FOUN	NDATION SC	HEDULE						
TYPE	OF SOILS		EMBEDMENT						
			MOUNTING	G HEIGHT					
DESCRIPTION	STANDARDS	≤ 30 FT.	35 FT.	40 FT.	50 FT.				
SOFT CLAY	Qu= .2550 T/FT. ²	9'-0"	9'-8"	10'-6"	14'-0"				
MEDIUM CLAY	Qu= .50-1.0 T/FT. ²	6'-6"	7'-0"	7'-6"*	10'-0"				
DENSE CLAY	Qu= 1.0-2.0 T/FT. ²	5'-6"	6'-0"	6'-6"	8'-6"				
LOOSE SAND	N= 4-10	7'-0"	7'-8"	8'-4"	11'-0"				
MEDIUM SAND	N= 10-30	6'-0"	6'-6"	7'–3"	9'-6"				
DENSE SAND	N= 30-50	5'-6"	6'-0"	6'-6"	8'-6"				

FILE NAME = 18R1036_02-DTLS-LGHT - LGHT (5)	USER NAME =	DESIGNED - SK	REVISED —			135TH ST
		CHECKED — WPD	REVISED —	STATE OF ILLINOIS		ROADWAY RES
	PLOT SCALE = N.T.S	DRAWN — KWM	REVISED —	DEPARTMENT OF TRANSPORTATION		STREET LIGHTI
	PLOT DATE = 08-07-23	CHECKED — AG	REVISED —		SCALE: N.T.S.	SHEET NO. 66 OF 76 SHEETS

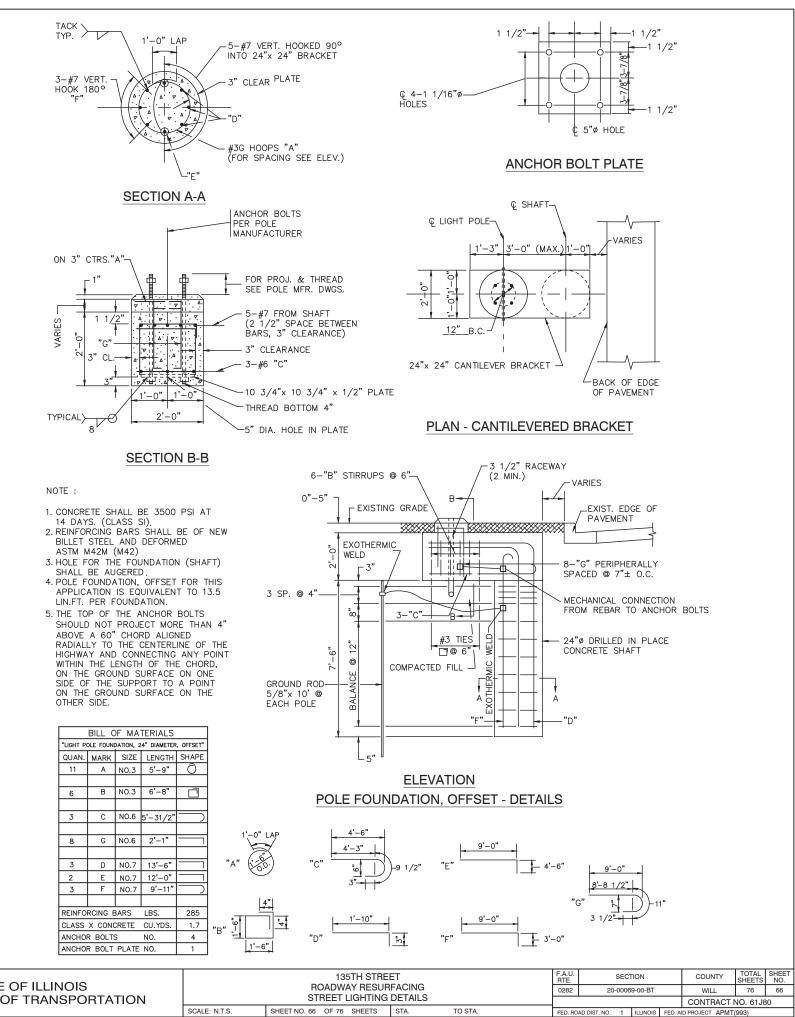

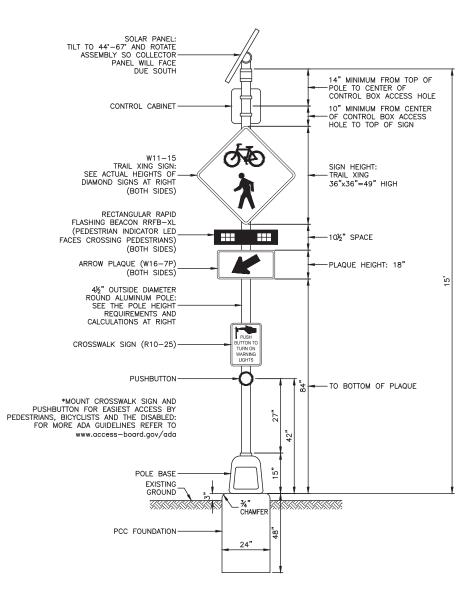

TYPICAL RECTANGULAR RAPID FLASHING BEACON CONFIGURATION

NOTES


- THE SCHEDULE OF QUANTITIES LISTS ITEMS INCLUDED FOR ONE COMPLETE ASSEMBLY.
- 2. SEE THE SPECIAL PROVISIONS FOR SOLAR POWERED FLASHING BEACON ASSEMBLY (COMPLETE) FOR FURTHER DETAILS.
- TRAIL CROSSING, ARROW PLAQUES, AND RRFB SHALL BE INSTALLED FACING BOTH DIRECTIONS OF VEHICLE TRAFFIC ON EACH SIDE OF THE TRAIL CROSSING.

FILE NAME = 18R1036_02-DTLS-02 - IDOT P01	USER NAME =	DESIGNED - MPN	REVISED —			135TH STREE			F.A.U. BTE	SECTION	COUNTY	TOTAL	SHEET NO.
		CHECKED — WPD	REVISED —	STATE OF ILLINOIS	ROADWAY RESURFACING		0282	20-00069-00-BT	WILL	76	67		
	PLOT SCALE =	DRAWN — RG	REVISED —	DEPARTMENT OF TRANSPORTATION	SOLAR-POWERED FLASHING BEACON DETAIL					CONTRACT	NO. 61J8	.0	
LAST SAVED BY: BGAMBOA ON 9/1/23 PLOTTED BY: BOB GAMBOA ON 9/1/23	PLOT DATE = 08-07-23	CHECKED — AG	REVISED —		SCALE: NONE SHEET NO. 67 OF 76 SHEETS STA. TO STA.		FED. ROAD D	FED. ROAD DIST. NO. 1 ILLINOIS FED. AID PROJECT APMT(993)					

SCHEDULE OF QUANTITIES PER ASSEMBLY

ITEM	<u>UNIT</u>	QUAN
SOLAR PANEL	EACH	1
CONTROL CABINET AND ELECTRICAL COMPONENTS	EACH	1
RRFB-XL	EACH	2
PEDESTRIAN PUSHBUTTON	EACH	1
4 1/2" DIAMETER ALUMINUM POLE	EACH	1
P.C.C. FOUNDATION	EACH	1
TRAIL CROSSING SIGN	EACH	2
ARROW PLAQUE	EACH	2
CROSSWALK SIGN	EACH	1

METHOD OF MEASUREMENT

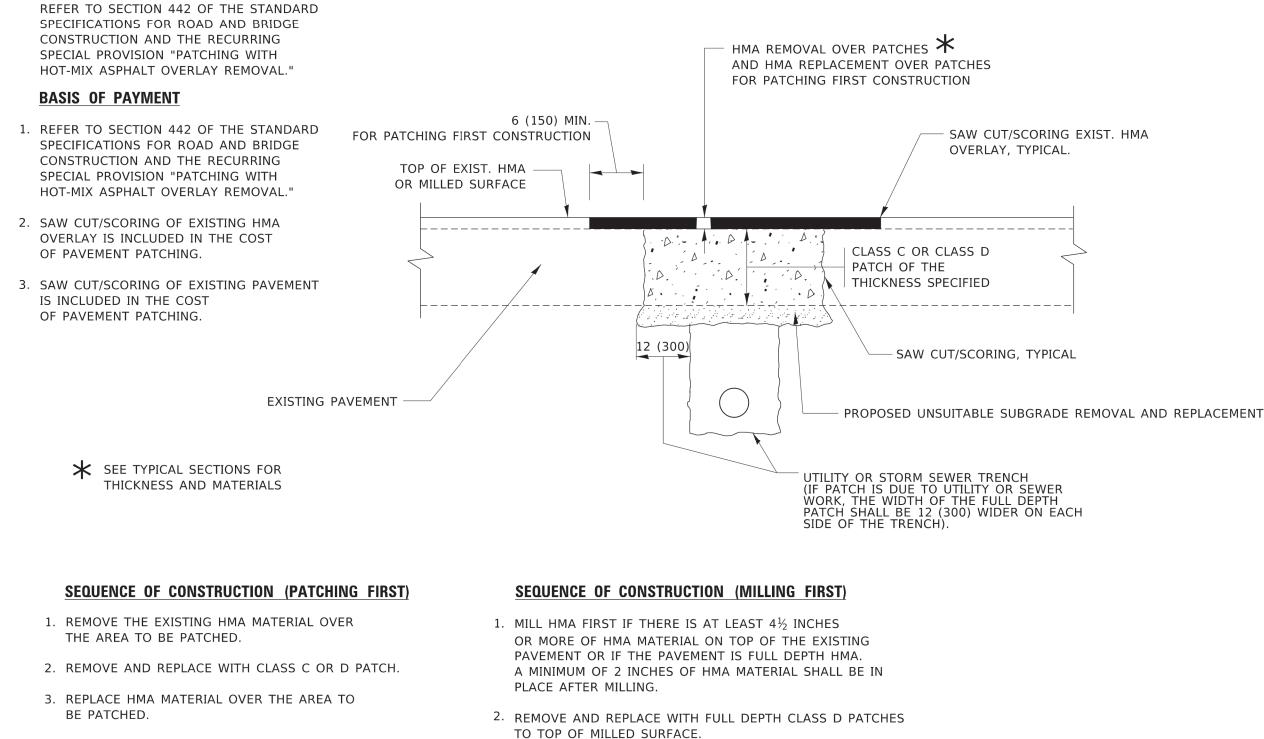


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0	Т	ŀ

:md	USER NAME = Lawrence.DeManche	DESIGNED - R. SHAH	REVISED - R. BORO 01-01-07			PAVEMENT PATC	HING FOR		F.A. BTE	SECTION	COUNTY	TOTAL SHEET
AME		DRAWN -	REVISED - R. BORO 09-04-07	STATE OF ILLINOIS				-				SHEETS NO.
Z U	PLOT SCALE = 100.0000 ' / in.	CHECKED -	REVISED - K. ENG 10-27-08	DEPARTMENT OF TRANSPORTATION		HMA SURFACED	PAVEIMENT		BD400-	-04 (BD-22)	CONTRACT	T NO.
Ē	PLOT DATE = 11/18/2022	DATE - 10-25-94	REVISED - K. SMITH 11-18-22		SCALE: NONE	SHEET 1 OF 1 SHEET	S STA.	TO STA.		ILLINOIS FED. A	ID PROJECT	

FILE NAME = 18R1036_02-DTLS-01 - BD22	USER NAME =	DESIGNED —	REVISED —				F.A.U. BTE	SECTION	COUNTY T	TOTAL SHEET	
		CHECKED —	REVISED —	STATE OF ILLINOIS	DISTRICT 1 DETAILS		0282	20-00069-00-BT	0-BT WILL 76 68		
	PLOT SCALE =	DRAWN —	REVISED —	DEPARTMENT OF TRANSPORTATION					CONTRACT NO	O. 61J80	
	PLOT DATE =	CHECKED —	REVISED —		SCALE:	SHEET NO. 68 OF 76 SHEETS STA. TO STA.	FED. ROAD DIST	. NO. 1 ILLINOIS FED	AID PROJECT APMT (99		


DIMENSIONS ARE IN INCHES (MILLIMETERS) UNLESS OTHERWISE SHOWN.

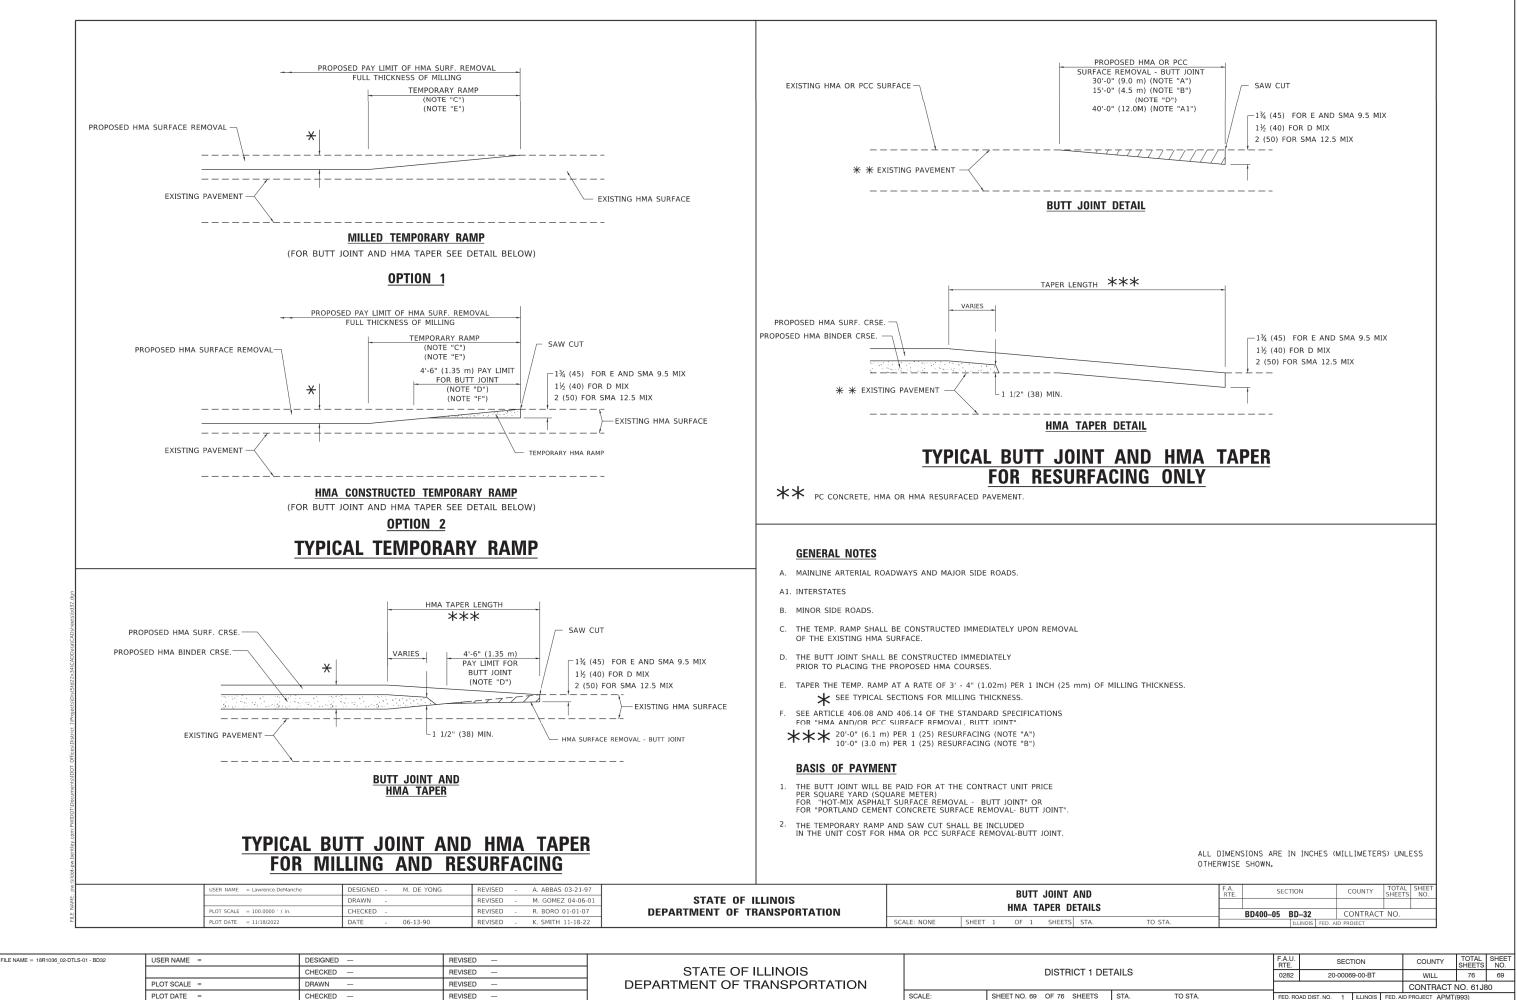


FILE NAME = 18R1036_02-DTLS-01 - BD32	USER NAME =	DESIGNED -	REVISED —	STATE OF ILLINOIS			
		CHECKED —	REVISED —	STATE OF ILLINOIS		DISTRICT 1 DET	ΓAI
	PLOT SCALE =	DRAWN —	REVISED —	DEPARTMENT OF TRANSPORTATION			
	PLOT DATE =	CHECKED —	REVISED —		SCALE:	SHEET NO. 69 OF 76 SHEETS	S

E NAME = 18R1036_02-DTLS-	S-01 - TC10	USER NAME =		DESIGNED	-	REVISED —				
FILE			PLOT DATE = 3/4/2019		DATE - 06-89		A. SCHUETZE 09-15-16			SCALE: NONE SHEET 1 OF 1 SHEETS STA.
NAME			PLOT SCALE = 50.0000 ' / in.		DRAWN - CHECKED -	REVISED -	T. RAMMACHER 01-06-0 A. SCHUETZE 07-01-13	 STATE OF II EPARTMENT OF TR		TRAFFIC CONTROL AND PROTECTION SIDE ROADS, INTERSECTIONS, AND DRIVE
pw://IL0			USER NAME = footemj		DESIGNED - L.H.A.	REVISED -	A. HOUSEH 10-15-96		<u> </u>	TRAFEIC CONTROL AND DRATECTION
084EBID1										
JINTEG. III									BE USED IN LIEU OF THE DOL	JULE HEADED ANNOW (MO-4).
linois.gov:										ETWEEN THE BEGINNING OF THE MAINLINE IE, A SINGLE HEADED ARROW (M6-1) SHALL IBLE HEADED ARROW (M6-4)
PWIDOT/E									IN HEIGHT.	
Documents/li										N. FOR BARRICADES OR DRUMS AT HALF THE TIONS. CONES SHALL BE A MINIMUM OF 28 (710)
DOT Offices/									 b) BLOCKING WITH TYPE III 	F THE MAIN ROUTE SHALL BE PROTECTED BY BARRICADES, 1/2 OF THE CROSS SECTION
Strict 1/Proj										ON AHEAD" SIGN 48 x 48 (1.2 m x 1.2 m) WITH A T APPROXIMATELY 500' (150 m) IN ADVANCE
ects/DistStd2										MIT GREATER THAN 40 MPH (60 km/h) ; AND AS DIRECTED BY THE ENGINEER:
(2x34)CADDa										F THE MAIN ROUTE SHALL BE PROTECTED BY TYPE II OR TYPE III BARRICADES, 1/3 OF THE CLOSED PORTION.
italCADsheet									MOUNTED ON IT APPROX	ON AHEAD" SIGN 36 \times 36 (900x900) WITH A FLASHER IMATELY 200' (60 m) IN ADVANCE OF THE MAIN ROUTE.
sitc10.dgn										MIT OF 40 MPH (60 km/h) OR LESS AS ID AS DIRECTED BY THE ENGINEER:
									NOTES:	
										★
										CONSTRUCTION AHEAD
										ED LIMITS
										SPEED LIMIT> 40 MPH (60 km/h)
										E III NORK AREA I
									5001 /150	LIGHTS ON EACH. (SEE NOTE 2) 200' (60 m) DRIVEWAY
									Ĩ	* TYPE III BARRICADES WITH TWO FLASHING AMBER LIGHTS ON EACH. (SEE NOTE 2)
									15 (380)	
									ROAD CONSTRUCTION AHEAD	CONSTRUCTION AHEAD
_										

FILE NAME = 18R1036_02-DTLS-01 - TC10	USER NAME =	DESIGNED -	REVISED —			
		CHECKED —	REVISED —	STATE OF ILLINOIS		DISTRICT 1 DET
	PLOT SCALE =	DRAWN —	REVISED —	DEPARTMENT OF TRANSPORTATION		
	PLOT DATE =	CHECKED —	REVISED —		SCALE:	SHEET NO. 70 OF 76 SHEETS

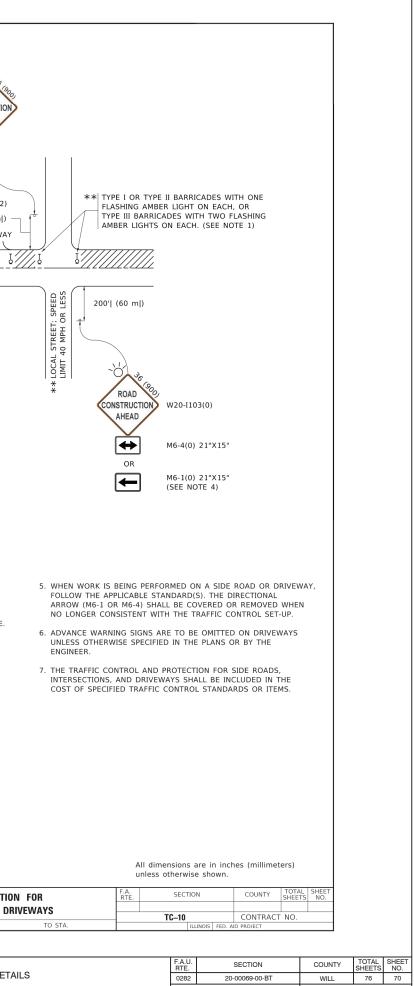

STA. TO STA. FED. ROAD DIST. NO. 1 ILLINOIS FED. AID PROJECT APMT(993)

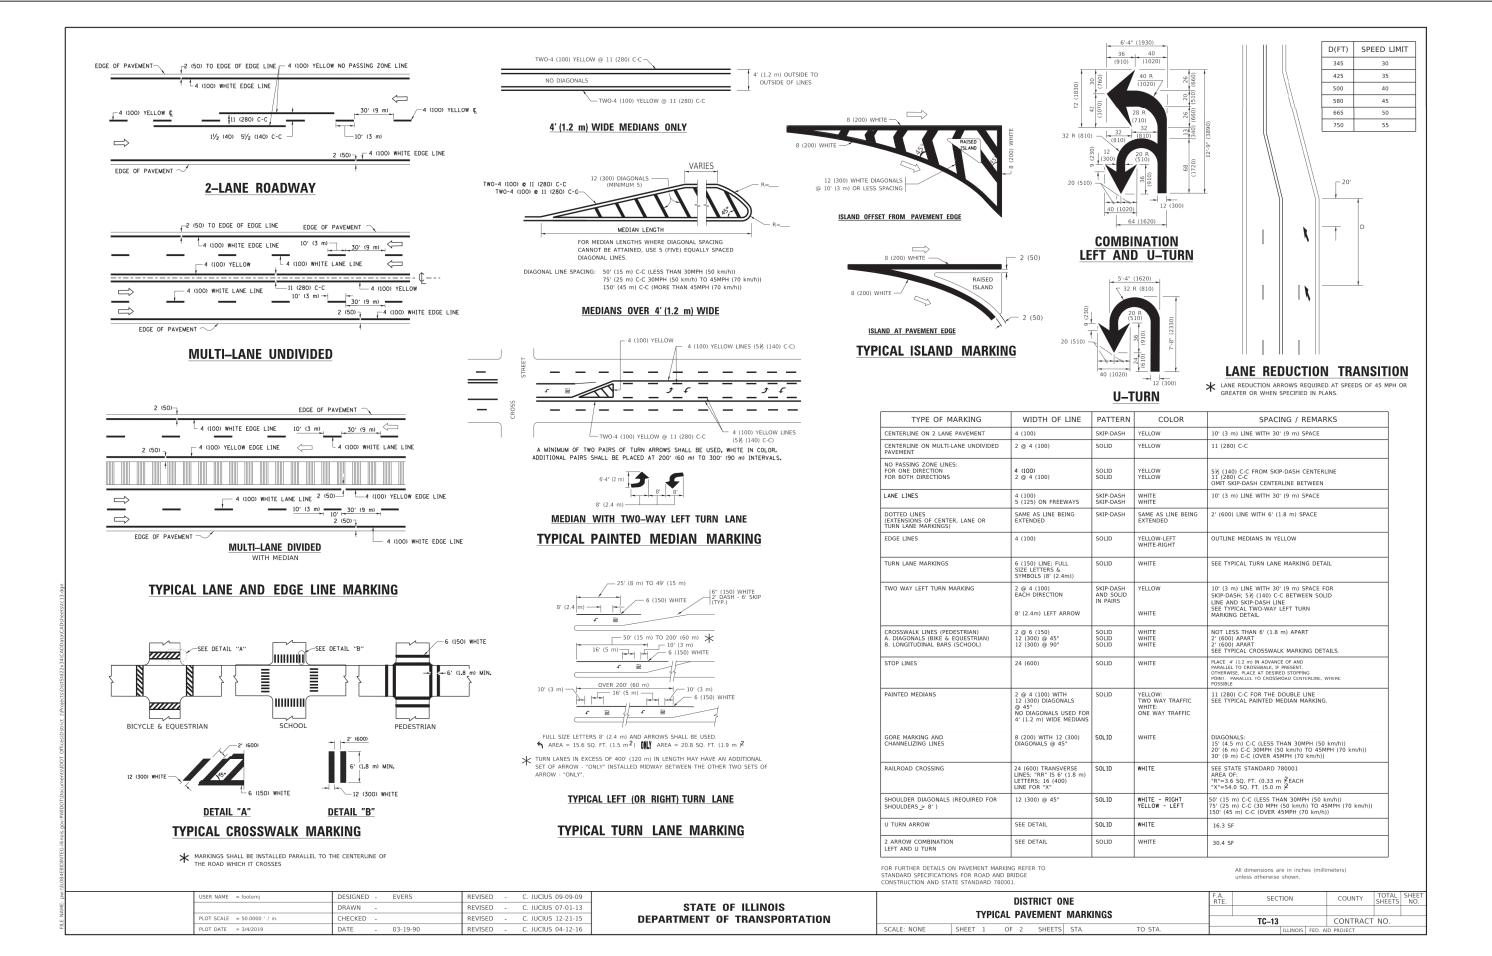

STATE OF ILLINOIS

DEPARTMENT OF TRANSPORTATION

FILE NAME = 18R1036_02-DTLS-01 - TC13

USER NAME =

PLOT SCALE =

PLOT DATE =

DESIGNED -

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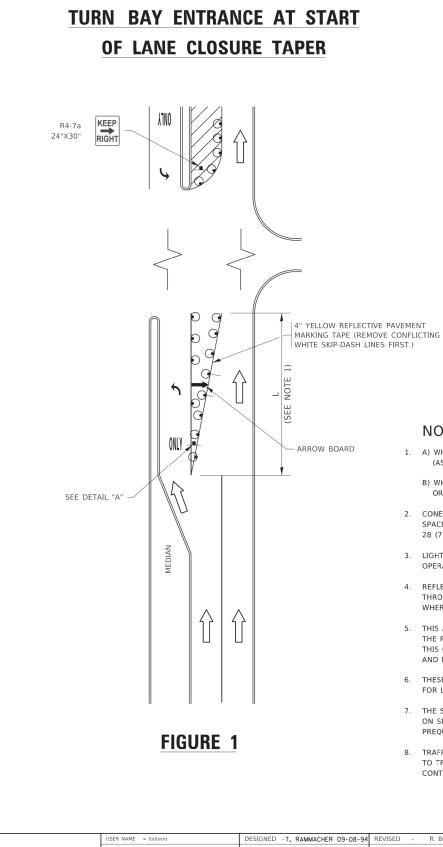
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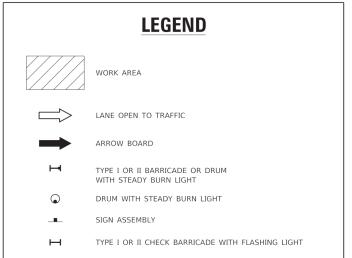
REVISED

DISTRICT 1 DETAILS				SEC	ΓΙΟΝ		COUNTY	TOTAL SHEETS	SHEET NO.
				20-0006	9-00-BT		WILL	76	71
OF 76 SHEETS STA. TO STA.							CONTRACT	NO. 61J8	30
			FED. RO	AD DIST. NO. 1	ILLINOIS	FED. A	D PROJECT APMT	(993)	

SHEET NO. 71 OF 76 SHEETS


SCALE:





NOTES:

- 1. A) WHEN "L" IS \leq THE STORAGE LENGTH OF THE TURN LANE (AS SHOWN IN FIG. 1), USE FIGURE 1.
 - B) WHEN "L" IS > THE STORAGE LENGTH OF THE TURN LANE OR THE TURN LANE IS WITHIN THE LANE CLOSURE, USE FIGURE 2.
- 2. CONES MAY BE SUBSTITUTED FOR BARRICADES OR DRUMS AT HALF THE SPACING DURING DAY OPERATIONS. CONES SHALL BE A MINIMUM OF 28 (710) IN HEIGHT.
- 3. LIGHTS WILL NOT BE REQUIRED ON BARRICADES OR DRUMS FOR DAY OPERATIONS. ALL LIGHTS SHALL BE MONODIRECTIONAL.
- 4. REFLECTIVE TEMPORARY PAVEMENT MARKINGS SHALL BE PLACED THROUGHOUT THE BARRICADED AREAS OF EACH TURN BAY AS SHOWN WHERE THE CLOSURE TIME IS GREATER THAN FOURTEEN (14) DAYS.
- 5. THIS APPLICATION ALSO APPLIES WHEN WORK IS BEING PERFORMED IN THE RIGHT LANE(S) AND THE RIGHT TURN BAY IS TO REMAIN OPEN. UNDER THIS CONDITION, "RIGHT TURN LANE" R3-1100R 24 x 24 (600 x 600) AND M6-2R 21 x 15 (530 x 380) SHALL BE USED.
- 6. THESE CONTROLS SHALL SUPPLEMENT MAINLINE TRAFFIC CONTROL FOR LANE CLOSURES.
- 7. THE SIGNS SHALL BE MOUNTED ABOVE THE BARRICADES/DRUMS ON SEPARATE SIGN SUPPORTS THAT MEET NCHRP 350 OR MASH PREQUIREMENTS.
- 8. TRAFFIC CONTROL AND PROTECTION AT TURN BAYS (TO REMAIN OPEN TO TRAFFIC) SHALL BE INCLUDED IN THE COST OF SPECIFIED TRAFFIC CONTROL STANDARDS OR ITEMS.

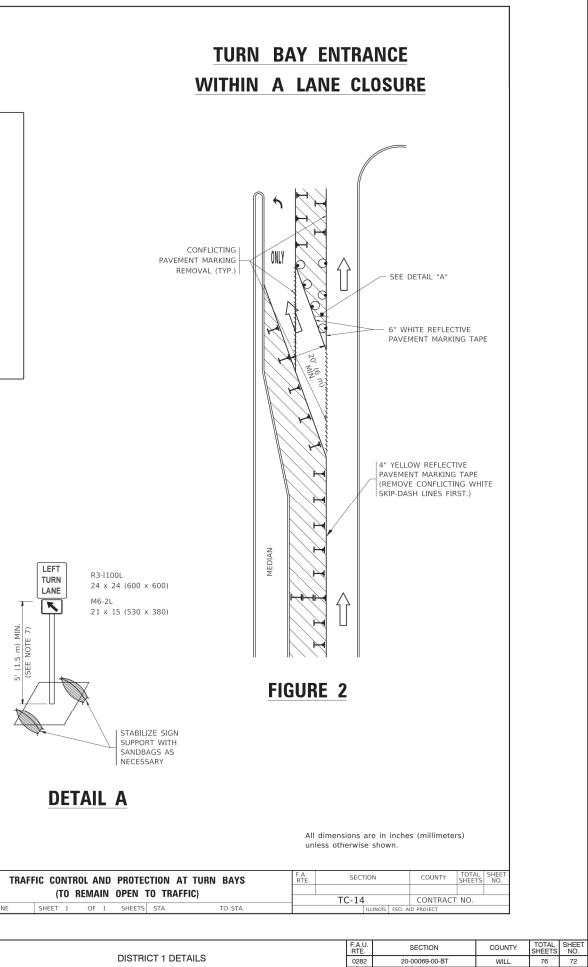


TO STA.

CONTRACT NO. 61J80

FED. ROAD DIST. NO. 1 ILLINOIS FED. AID PROJECT APMT(993)

E NAME: pw	USER NAME = footemj PLOT SCALE = 50.0000 ' / in.	DESIGNED - T. RAMMACHER 09-08-94 DRAWN - A. HOUSEH 11-07-95 CHECKED - A. HOUSEH 10-12-96	REVISED - A. SCHUETZE 07-01-13		ONTROL AN (TO REMAII		CTION AT To traff
E .	PLOT DATE = 3/4/2019	DATE -T. RAMMACHER 01-06-00	REVISED -	 SCALE: NONE SHEE	T 1 OF 1	SHEETS	STA.


PLOT SCALE = DRAWN - REVISED - DEPARTMENT OF TRANSPORTATION	FILE NAME = 18R1036_02-DTLS-01 - TC14	USER NAME =	DESIGNED —	REVISED —				
			CHECKED —	REVISED —	STATE OF ILLINOIS		DISTRICT 1 DE	ETAILS
PLOT DATE = CHECKED - BEVISED - SCALE SCALE SHEET NO. 72 OF 76 SHEET		PLOT SCALE =	DRAWN —	REVISED —	DEPARTMENT OF TRANSPORTATION			
		PLOT DATE =	CHECKED —	REVISED —		SCALE:	SHEET NO. 72 OF 76 SHEETS	STA.

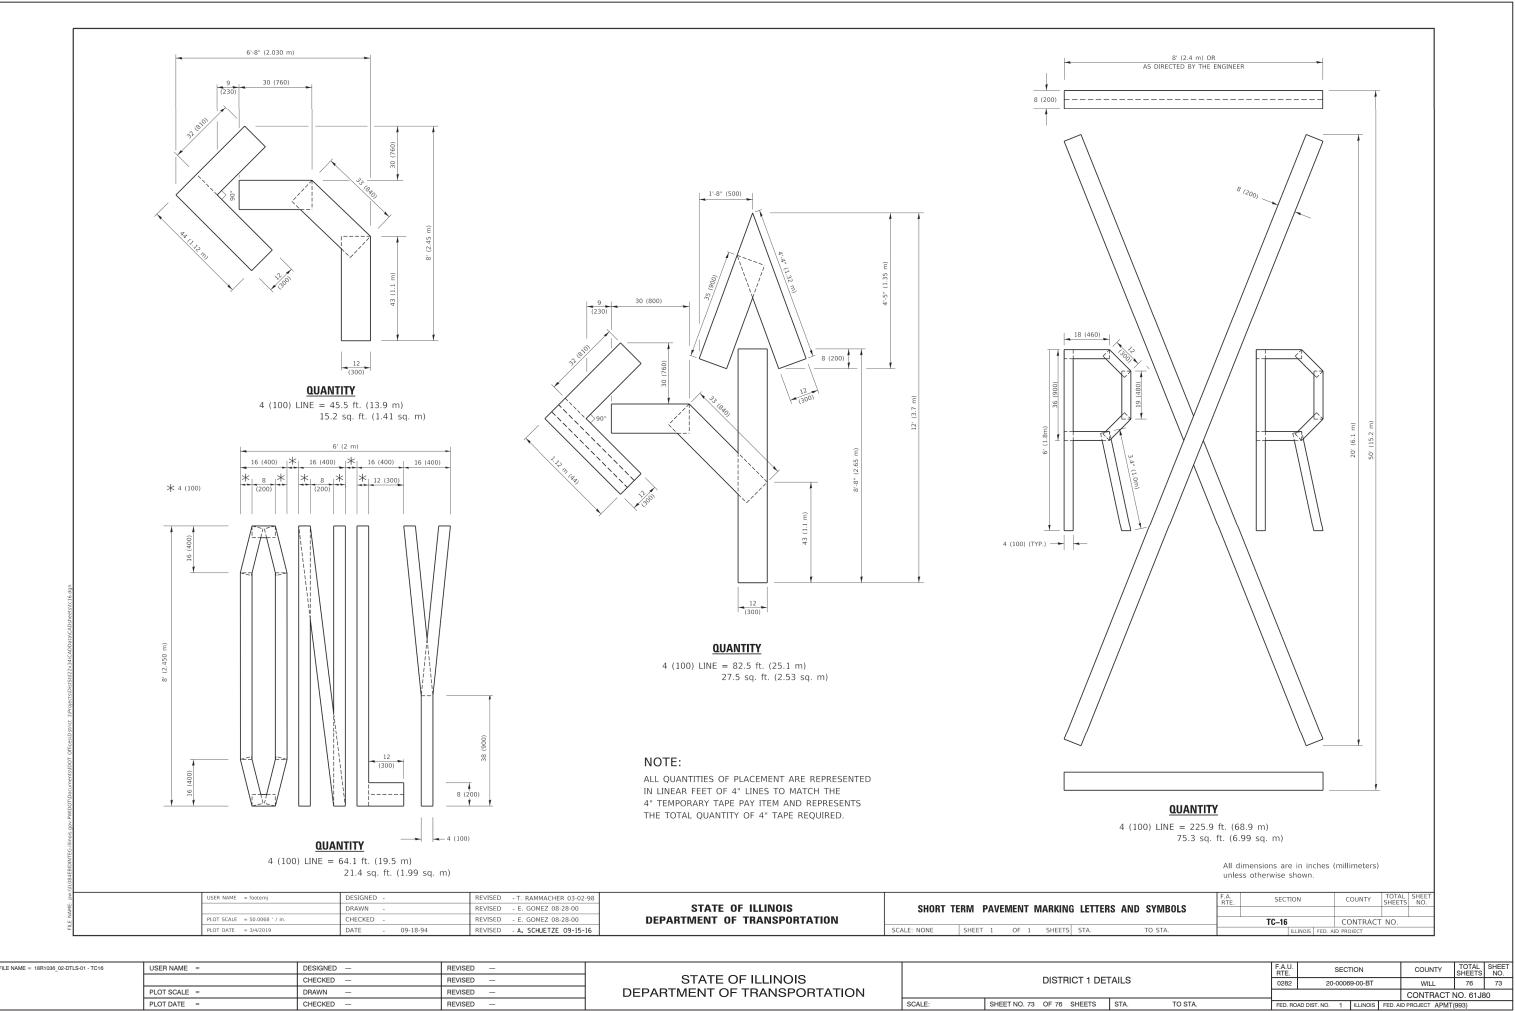


FILE NAME = 18R1036_02-DTLS-01 - TC16	USER NAME =	DESIGNED -	REVISED —				
		CHECKED —	REVISED —	STATE OF ILLINOIS		DISTRICT 1 DE	ΞTA
	PLOT SCALE =	DRAWN —	REVISED —	DEPARTMENT OF TRANSPORTATION			
	PLOT DATE =	CHECKED —	REVISED —		SCALE:	SHEET NO. 73 OF 76 SHEETS	1
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NOTES: 1. USE BLACK LETTENING ON ORANGE BACKGROUND. 2. ERECT SIGN WAVARCE OF THE LOCATION FOR THE "BOO A READ SIGN AT JOANCE OF THE LOCATION FOR THE "BOO A READ SIGN AT JOANCE OF THE LOCATION FOR THE "BOO A READ SIGN AT JOANCE OF THE LOCATION FOR THE "BOO A READ SIGN AT JOANCE OF THE LOCATION FOR THE "BOO A READ SIGN AT JOANCE OF THE LOCATION FOR THE "BOO A READ SIGN AT JOANCE OF THE LOCATION FOR THE "BOO A READ SIGN AT JOANCE OF THE LOCATION FOR THE "BOO A READ SIGN AT JOANCE OF THE LOCATION FOR THE "BOO A READ SIGN AT JOANCE OF THE LOCATION FOR THE "BOO A READ SIGN AT JOANCE OF THE LOCATION FOR THE THE START OF CONSTRUCTION 5. SEE SPECIAL PROVISION FOR "THENDRARY INFORMATION SIGNING. 6. ONE SIGN ASSEMBLY EQUALS 25.70 SO, FT. (2.3 SO, M.) 7. SHALL BE PAID FOR AS TEMPORARY INFORMATION SIGNING.	AHEAD A	FILE NAME: 5	USER NAME = rootem) PLOT SCALE = 50.0000 ° / in. PLOT DATE = 3/4/2019	DESIGNED - DRAWN - CHECKED - DATE -	REVISED - K. MIRS 09-15-97 REVISED - K. MIRS 12-11-97 REVISED - T. RAMMACHER 02-02-99 REVISED - C. JUCIUS 01-31-07	STATE OF ILLINO DEPARTMENT OF TRANSP		ARTERIAL ROAD INFORMATION SIGN SCALE: NONE SHEET 1 OF 1 SHEETS STA.	
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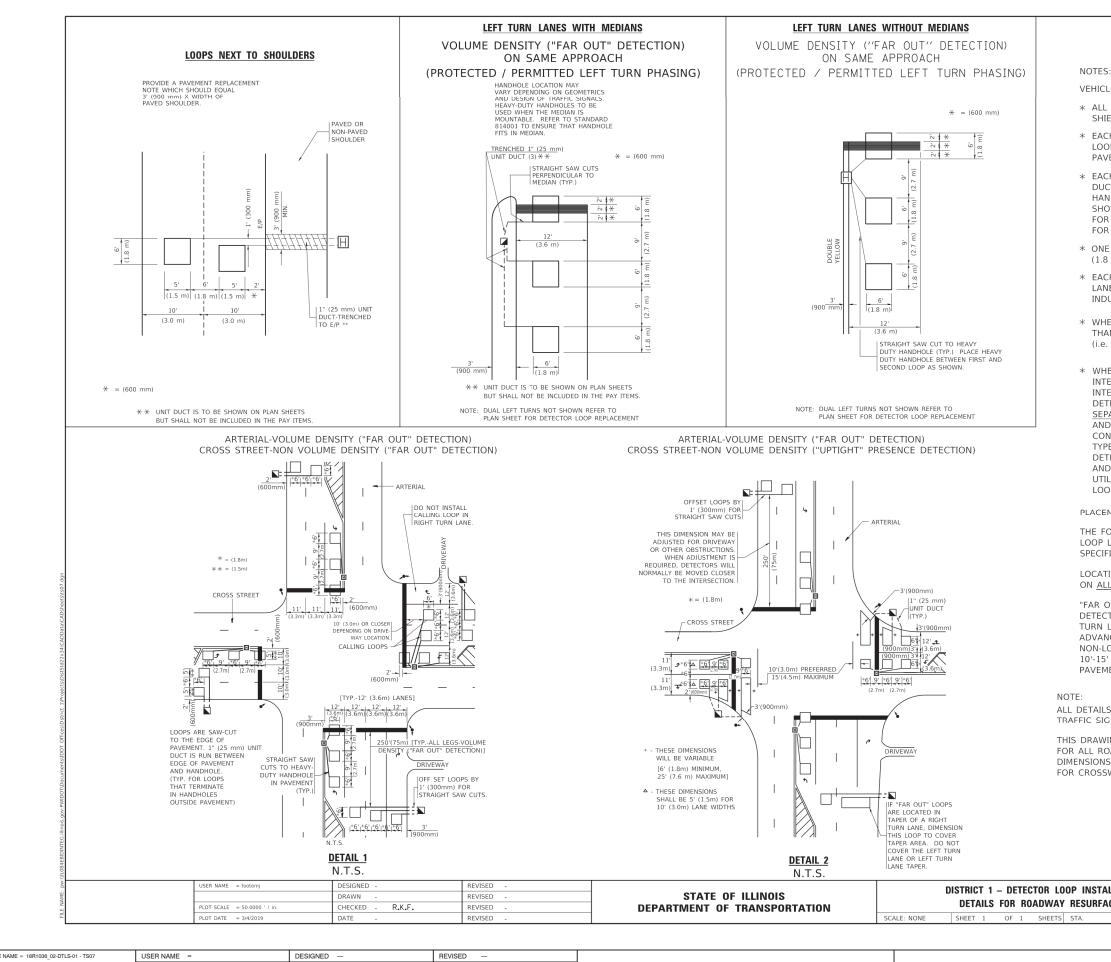
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VEHICLES LOOP DETECTORS

* ALL LEAD IN CABLE SHALL BE TWO CONDUCTOR NO. 14 TWISTED, SHIELDED

* EACH DETECTOR LOOP SHALL HAVE ITS OWN SAW CUT FROM THE LOOP TO THE EDGE OF PAVEMENT OR TO A HANDHOLE IN THE PAVEMENT.

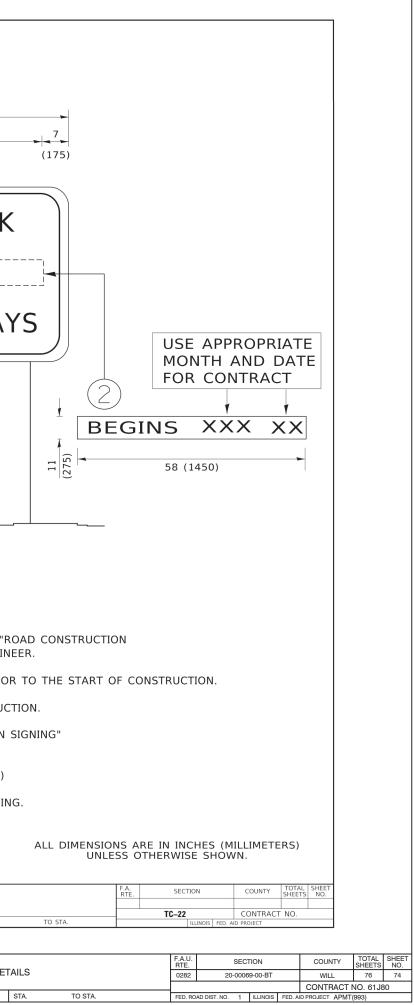* EACH DETECTOR LOOP SHALL HAVE ITS OWN ONE INCH (25 mm) UNIT DUCT BETWEEN THE EDGE OF PAVEMENT AND THE FIRST HANDHOLE OR JUNCTION BOX. EACH UNIT DUCT RUN SHALL BE SHOWN ON THE PLANS BY THE DESIGNER, BUT SHALL NOT BE PAID FOR SEPARATLY. THIS ITEM IS INCIDENTAL TO THE PAY ITEM FOR DETECTOR LOOPS.

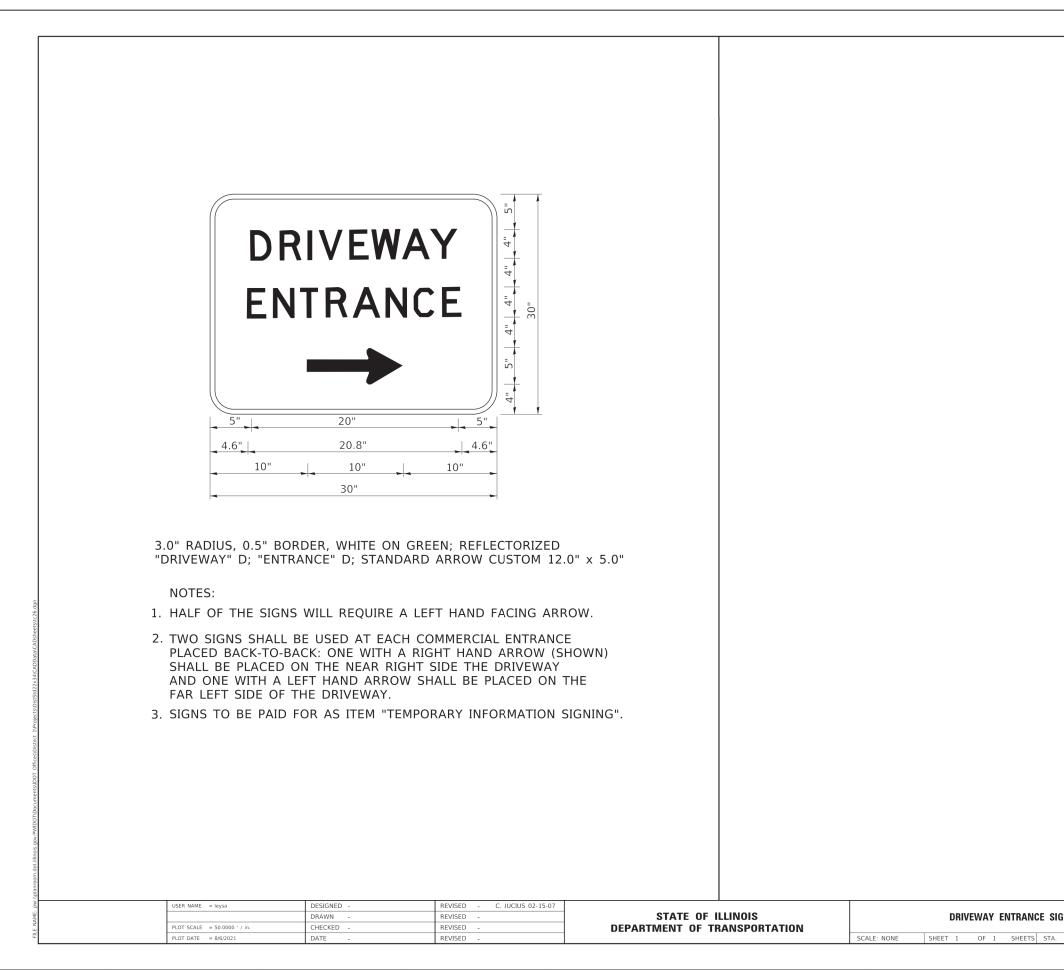* ONE DIMENSION OF ALL DETECTOR LOOPS SHALL BE SIX FEET (1.8 m)

* EACH LANE OF NON-LOCKING, PRESENCE DETECTION AND EACH LANE OF A DOUBLE LEFT TURN LANE REQUIRES A SEPARATE INDUCTIVE LOOP DETECTOR AND LEAD IN CABLE.

* WHEN NON-LOCKING, PRESENCE DETECTION IS USED, MORE THAN ONE LOOP PER LANE IS REQUIRED BEHIND THE STOP BAR (i.e. 1-1/2, 1-3/4, 2).

* WHEN SYSTEM LOOPS ARE REQUIRED ON AN APPROACH OF AN INTERSECTION, THE LOOPS USED FOR VOLUME DENSITY AND INTERSECTION TIMING SHALL ALSO BE USED AS SYSTEM DETECTORS. EACH ONE OF THESE TYPE OF LOOPS REQUIRES A SEPARATE TWO CONDUCTOR NO. 14 TWISTED SHIELDED CABLE AND A SEPARATE INDUCTIVE LOOP DETECTOR WHEN NEW CONTROLLERS ARE UTILIZED. THE DESIGNER SHALL LABEL THESE TYPES OF LOOPS AS "INTERSECTION AND SAMPLING (SYSTEM) DETECTORS" ON THE SIGNAL LAYOUT, THE INTERCONNECT PLAN AND THE SYSTEM CABLE PLAN. WHEN AN EXISTING CONTROLLER IS UTILIZED FOR THIS TYPE OF DETECTION. THE PAY ITEM "INDUCTIVE LOOP DETECTOR WITH SYSTEM OUTPUT" SHOULD BE USED.

PLACEMENT OF DETECTORS

THE FOLLOWING FIGURES REPRESENT THE MOST COMMON DETECTOR LOOP LOCATIONS AND SIZES. ADJUSTMENTS WILL BE NECESSARY FOR SPECIFIC GEOMETRIC CONSIDERATIONS.

LOCATIONS AND DEMENSIONS OF DETECTOR LOOPS ARE REQUIRED ON ALL SIGNAL LAYOUT PLAN SHEETS.

"FAR OUT" DETECTION REFERS TO LOCKING, PRESENCE TYPE DETECTION LOCATED IN THRU LANES, RIGHT TURN LANES, AND RIGHT TURN LANE TAPER AREAS (IF APPLICABLE), USUALLY 250' (75 m) IN ADVANCE OF STOP BARS. "UPTIGHT" DETECTION REFERS TO NON-LOCKING PRESENCE TYPE DETECTION LOCATED IN ALL LANES AND 10'-15' (3.0 m-4.5 m) BEHIND THE CROSSING STREET'S EDGE OF PAVEMENT EXTENDED.

ALL DETAILS AND NOTES SHOWN ARE FROM THE I.D.O.T. DISTRICT 1 TRAFFIC SIGNAL DESIGN GUIDELINES DATED JANUARY 1995

THIS DRAWING HAS BEEN PREPARED TO ASSIST THE RESIDENT ENGINEER FOR ALL ROADWAY RESURFACING OR S.M.A.R.T. PROJECTS WHERE THE DIMENSIONS ARE NOT SHOWN ON THE PLANS AND THE FINAL LOCATIONS FOR CROSSWALKS OR STOP BARS ARE NOT DETERMINED.

TALLATION	F.A. SECTION			COUNTY	TOTAL SHEETS	SHEET NO.	
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II ACING		TS-07			CONTRACT	NO.	
TO STA.			ILLINOIS	FED. AI	ID PROJECT		

		F.A.U. RTE.	SECTION		COUNTY	TOTAL SHEETS	SHEET NO.			
ETAILS			0282	20-00069-00-BT			WILL	76	76	
		CONTRACT NO. 61J80								
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